

Proposed Change Order
City of Needles Well No. 11 Treatment Plant Upgrade Project



WATERWORKS
ENGINEERS

PCO NO.: 7
SUBJECT: Generator Relocation
FROM: Water Works Engineers
AUTHOR: Joe Riess

DATE REQUESTED: 4/10/2024

TO: City of Needles
Attn: Kathy Raasch
817 Third Street, Needles, CA 92363

760-326-5700 Ext. 130

WORK CHANGE REQUESTED:

1. Relocate generator to Southwest corner of site as shown on the Drawings. Provide new buried conduit and wire to new generator location.

JUSTIFICATION OR NEED FOR THE CHANGE:

1. During project scoping, the new generator was located West of the existing building and transformer. After survey of the site was completed, it was discovered that the location of the generator would block entry to site from the existing 30-ft wide gate and be located over existing primary electrical conduit and wires. Relocating the generator to the Southwest corner of the site prevents it from obstructing access through the gate and does not interfere with the existing electrical conduit.
2. Overexcavation 5-ft horizontally and vertically around the generator foundation was recommended in the April 2023 Geotech Report. The original generator location was near the existing fire hydrant and buried power conduit. Relocating the generator to the Southwest corner of the site provides more working room around the generator pad and provides clearance between the overexcavation work area and existing buried utilities.
3. The additional distance from the generator to the automatic transfer switch required larger conductors and conduit.

PROJECT IMPACT:

COST CHANGE, \$ \$56,459.75

TIME CHANGE, days 0

CONTRACTOR
Pacific Hydrotech Corporation

ENGINEER
Water Works Engineers, LLC

By: _____

By: _____

Date: _____

Date: 04/10/2024



March 27, 2024

City of Needles
817 3rd Street
Needles, CA 92363

Project: 1307 River Road - Well 11 Improvements

Reference: Generator relocation

Dear Kathy,

Find for your review and approval the attached documents for the engineer requested upgrade relocation of the generator. Costs reflect all material, labor, tools and equipment for increase in overall length for the installations from the new ATS location to the relocated generator. Costs include excavation, saw cutting, demolition, conduit/cable installations, concrete encasement and backfill/compaction.


This proposal is based on the installation being completed concurrent with the existing contract. No additional contract time is required.

Respectfully,

Digitally signed by Eric Christensen
DN: cn=Eric Christensen,
o=Pacific Hydrotech Corporation,
ou=Construction Division,
email=eric.christensen@pachydro.com,
c=US
Reason: I am the author of this document
Date: 2024.04.10 15:59:07 -07'00'

Eric Christensen
Pacific Hydrotech, Inc

| | | | |
|-------------------------|----|----|-----------|
| Equipment Total Cost | | \$ | 3,305.08 |
| Material Total Cost | | \$ | 4,523.43 |
| Subcontracts Total Cost | | \$ | 39,659.55 |
| Labor Total Cost | | \$ | 8,971.69 |
| Subtotal | | \$ | 56,459.75 |
| Bond | 0% | \$ | - |
| Insurance | 0% | \$ | - |
| TOTAL COSTS | | \$ | 56,459.75 |

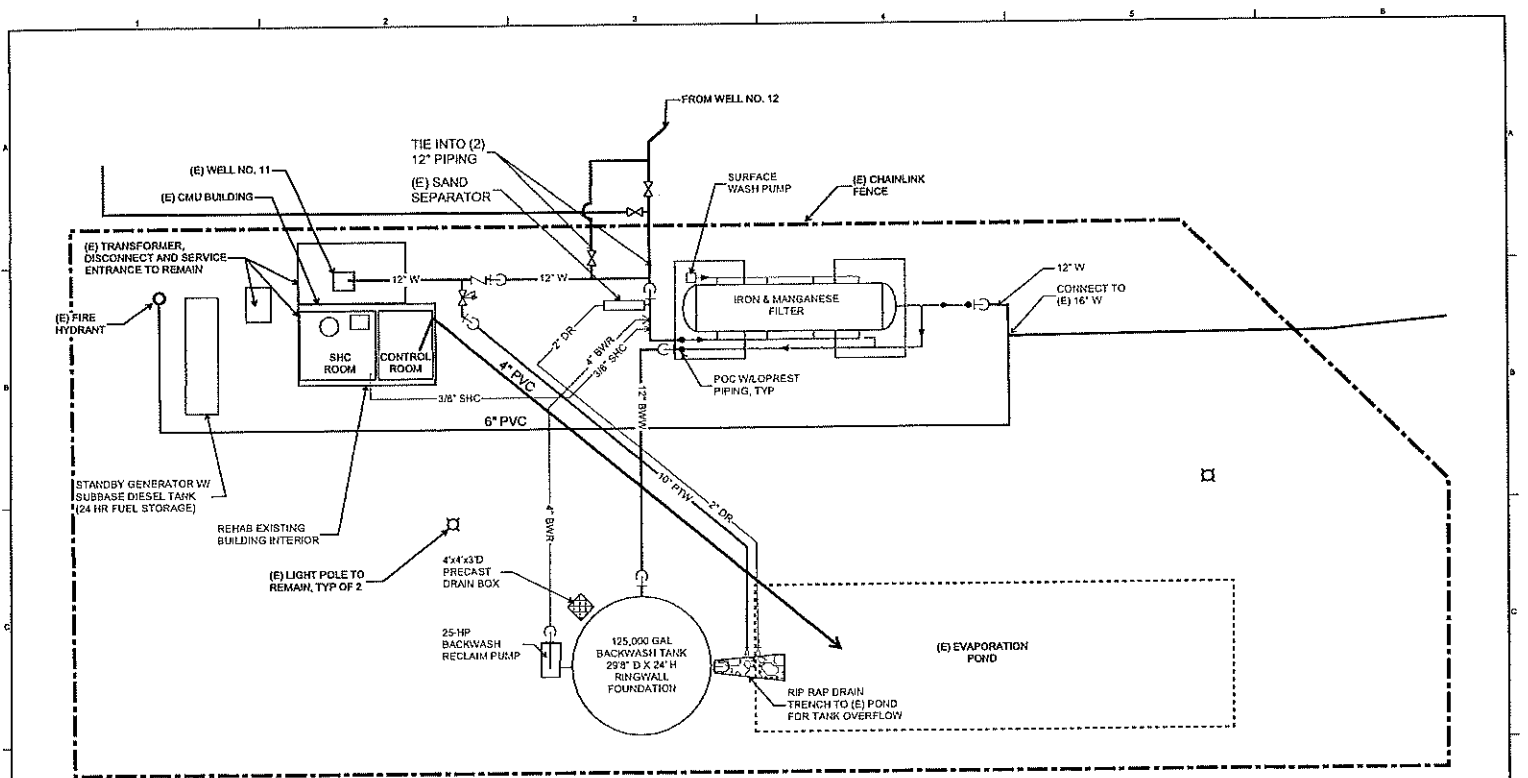

NOTES:
 1. SITE PLAN IS CONCEPTUAL AND NOT FOR BUDGETING PURPOSES ONLY. LOCATION, SIZE AND CONDITION OF EXISTING PIPING, STORAGE AND TREATMENT FACILITIES MUST BE VERIFIED.
 2. SAMPLE LINES AND ELECTRICAL CONDUIT NOT SHOWN.
 3. NOT ALL VALVES, EQUIPMENT AND INSTRUMENTS SHOWN. SEE P&IDS.

— EXISTING
 — PROPOSED (NEW)



| VERIFY SCALE | DATE | REVISION | BY | APPD |
|----------------------------------|------|----------|----|------|
| DATE AND HOW ON ORIGINAL DRAWING | | | | |
| DATE AND HOW ON THIS REVISION | | | | |
| DATE AND HOW ON THIS REVISION | | | | |
| DATE AND HOW ON THIS REVISION | | | | |

PRELIMINARY
NOT FOR
CONSTRUCTION

DESIGN
J. PEREZ
CHECK
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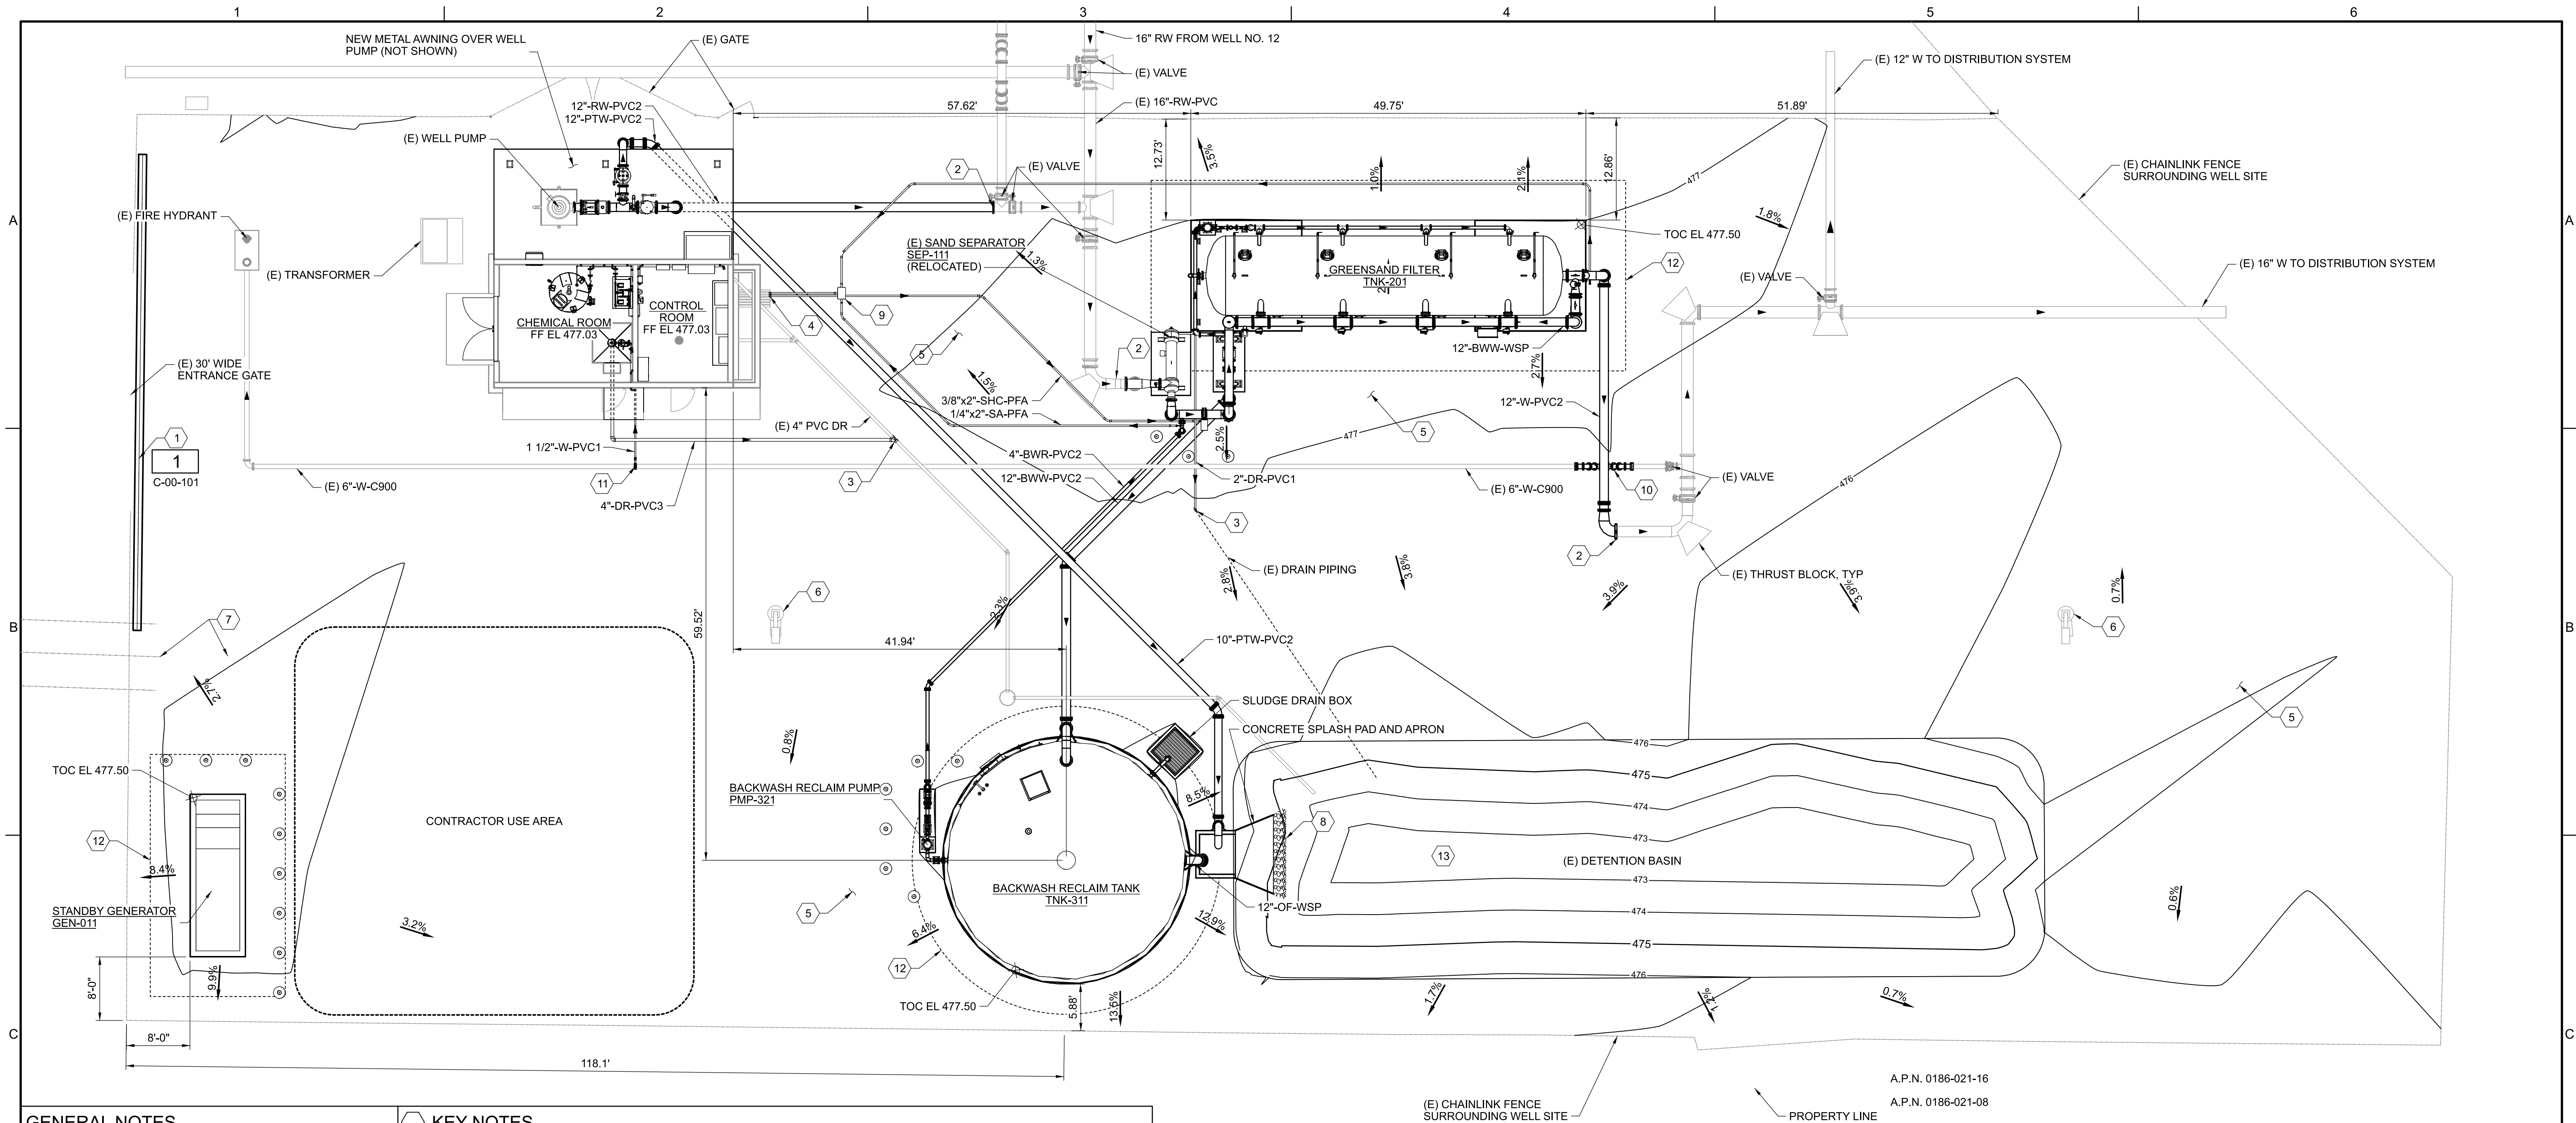
**WATERWORKS
ENGINEERS**

GARDENA, CALIFORNIA
 PHONE: 562.923.1111


CITY OF REDDICK
 WELL 11 TREATMENT PROJECT
 REDDICK, CALIFORNIA

DATE
OCTOBER 2022
 PROJECT NO.
110
 DRAWING NO.
C-002
 REVISION
X


DATE: 10/10/22
 TIME: 11:30 AM




| GENERAL NOTES | | KEY NOTES | |
|---------------|--|-----------|---|
| 1. | EXISTING SITE SHOWN WITH ITEMS TO BE DEMOLISHED REMOVED. | 1. | INSTALL V-GROOVE TRACK AND NEW METAL WHEEL ASSEMBLIES ON EXISTING 30' WIDE GATE (2 SECTIONS @ 15' EA). |
| 2. | INSTALL ALL BURIED PIPING WITH MIN 3' COVER. | 2. | CONNECT TO EXST PIPING. RESTRAIN ALL JOINTS. |
| 3. | RESTRAIN ALL JOINTS ON PRESSURIZED PIPING. | 3. | CONNECT TO EXST DRAIN PIPING. SIZE AND TYPE UNKNOWN. PROVIDE FITTINGS AND ADAPTERS AS NECESSARY TO ADAPT TO PIPE SIZE AND MATERIAL. |
| | | 4. | CONNECT TO EXST CONDUITS INTO BLDG FOR SHC AND SA PIPING SYSTEMS. |
| | | 5. | FOLLOWING DEMOLITION OF FILTER SYSTEM AND TANKS, RECONTOUR AREAS TO PROVIDE UNIFORM SURFACE. EXCAVATED MATERIALS FROM NEW FOUNDATIONS MAY BE USED TO FILL VOIDS REMAINING AFTER DEMOLITION OF EXISTING FOUNDATIONS. |
| | | 6. | PROTECT IN PLACE EXST LIGHT POLE. |
| | | 7. | PROTECT IN PLACE EXST UTILITY POLE AND GUY WIRE. |
| | | 8. | INSTALL GEOTEXTILE AND CALTRANS CLASS I (6-INCH) RIP RAP AT BASE OF CONCRETE APRON. |
| | | 9. | 12"x18" HANDHOLE BOX. |
| | | 10. | RELOCATE EXST 6" C900 W PIPING. |
| | | 11. | 1 1/2" SADDLE TAP ON (E) 6" C900 PIPING. |
| | | 12. | OVEREXCAVATE AND RECOMPACT FOR NEW STRUCTURES PER PROJECT GEOTECHNICAL REPORT. |
| | | 13. | RECONOTUR EXISTING DETENTION BASIN AFTER EXISTING LINER IS DEMOLISHED. |

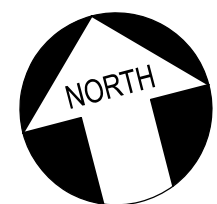

PLAN
1"=10'

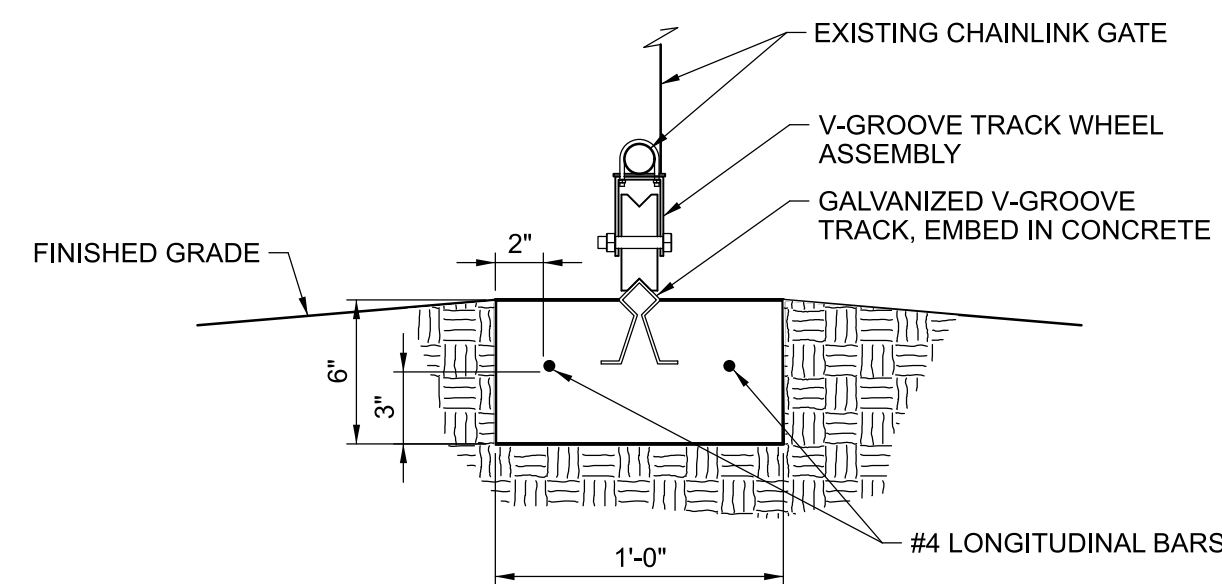

1 DETAIL
C-00-101 1 1/2"=1'-0"

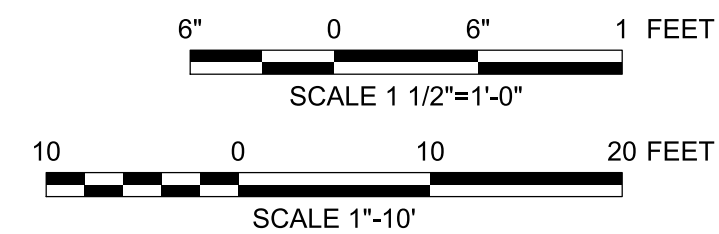

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| VERIFY SCALE | |
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Proposed Change Order

Faith Electric

1980 Orange Tree Lane, Suite 106
Redlands, California 92374

Client Address:

Pacific Hydrotech Corporation

314 E. 3rd Street
Perris, California 92570

Project Name: P2305-City of Needles Well#11

Contract #: P2305

Faith Electric Job#: P2305

Client PCO #:

Faith Electric PCO#: 6

Thursday, March 21, 2024

Work Description

CO-006 = 100% Generator Circuit Extension**Files Acknowledged:**

- Needles 100% Drawings 20230908;
- ~~Needles 100% Specifications 20230908;~~ (Omitted) Faith Electric will install per code minimum requirements;

Scope of Work:

- F&I conduit and circuiting for the generator at the revised location per the 100% drawings;
- F&I conduit and circuiting for the following conduit tags: P0011A, P011B, C002 and C011 (Approximately 120');)
- Conduit will be installed with the use of PVC underground, GRC & EMT aboveground, Nema-1 indoor, Nema-3R outdoor, as required per code minimum;
- Allowances have NOT been included in this proposal;
- Credit / Deduct:
 - (1) 600amp power circuit (2-2-1/2" PVC, 3-3/0, 1#1) to the new 800kw generator from the ATS (Approximately 82');
 - (1) Conduit and wiring for controls (1-1" PVC, 6#14, 1#14) to the new 800kw generator from the ATS (Approximately 82');

Clarifications:

- The conduit routing and grouping shown in the drawings is considered a suggestion. Faith Electric will arrange and consolidate conduits and circuits where possible, ensuring adherence to code requirements.

Exclusions:

- Contract Exclusions apply;
- Bare Copper Ground in Trench / Duct banks (ESD-001 – Detail 16030);
- Vaults or hand holes;
- Seismic Engineering;
- X-ray or core drilling;
- Any items not specifically included in the Scope of Work above.

Proposed Change Order

Faith Electric

1980 Orange Tree Lane, Suite 106
Redlands, California 92374

Client Address:

Pacific Hydrotech Corporation

314 E. 3rd Street
Perris, California 92570

Contract Name: P2305-City of Needles Well#11

Contract #: P2305

Project Name: P2305

Project #: P2305-City of Needles Well 11

Client PCO #:

Our PCO #: 6

Itemized Description

| Description | Qty | Total Mat. \$ | Total Hours |
|---|------------------|------------------|---------------|
| 1"Conduit - EMT 10' Lengths | 35.960 | 65.81 | 1.456 |
| 1"Conduit - PVC 40 10' Lengths | 155.880 | 152.44 | 6.874 |
| 2-1/2"Conduit - PVC 40 10' Lengths | -165.480 | -574.41 | -14.562 |
| 4"Conduit - PVC 40 10' Lengths | 243.310 | 1,465.04 | 33.577 |
| 1"Elbow 90 Degree - PVC 40 Bell End | 5.000 | 8.91 | 1.100 |
| 2-1/2"Elbow 90 Degree - PVC 40 Bell End | -6.000 | -46.11 | -3.120 |
| 4"Elbow 90 Degree - PVC 40 Bell End | 8.000 | 175.26 | 8.400 |
| 1"Coupling - EMT Compression Steel | 3.000 | 1.07 | 0.330 |
| 1"Coupling - PVC | 5.000 | 0.99 | 0.105 |
| 2-1/2"Coupling - PVC | -6.000 | -5.44 | -0.252 |
| 4"Coupling - PVC | 8.000 | 18.23 | 0.576 |
| 1"Connector - EMT Compression Steel | 2.000 | 0.80 | 0.312 |
| 1"Locknut - Steel | 2.000 | 0.26 | 0.065 |
| 2-1/2"Locknut - Steel | -4.000 | -3.07 | -0.340 |
| 4"Locknut - Steel | 4.000 | 58.52 | 0.504 |
| 1"LB Conduit Body - RMC Galvanized w/ Cover & Gasket | 2.000 | 80.52 | 1.360 |
| 4"LB Conduit Body - RMC Galvanized w/ Cover & Gasket | 2.000 | 1,071.58 | 3.420 |
| 1"Male Adapter - PVC Socket to Box | 2.000 | 1.52 | 0.200 |
| 2-1/2"Male Adapter - PVC Socket to Box | -4.000 | -18.76 | -0.800 |
| 4"Male Adapter - PVC Socket to Box | 4.000 | 17.21 | 1.600 |
| PVC Cement Standard (per US Oz) | 19.480 | 17.53 | 0.623 |
| #14 BlackWire THHN / T90 - Copper | 1,301.040 | 187.35 | 5.594 |
| #14 GreenWire THHN / T90 - Copper | 216.840 | 31.22 | 0.932 |
| #1 GreenWire THHN / T90 - Copper | -185.480 | -325.02 | -2.504 |
| #1/0 GreenWire THHN / T90 - Copper | 273.310 | 592.08 | 3.881 |
| #3/0 BlackWire THHN / T90 - Copper | -556.440 | -1,796.74 | -10.461 |
| #600 BlackWire THHN / T90 - Copper | 1,093.240 | 13,942.29 | 46.353 |
| 1"2-Piece Strut Clamp - Universal Steel Zinc Plated Break-Apart | 3.669 | 26.62 | 0.205 |
| 4" x 3" SpacingIntermediate Spacer - EB / DB Duct | 47.000 | 61.26 | 1.175 |
| #14Power Termination Per Wire to 600V | 14.000 | 0.00 | 0.980 |
| #1Power Termination Per Wire to 600V | -2.000 | 0.00 | -0.609 |
| #1/0Power Termination Per Wire to 600V | 4.000 | 0.00 | 1.280 |
| #3/0Power Termination Per Wire to 600V | -12.000 | 0.00 | -4.680 |
| #600Power Termination Per Wire to 600V | 16.000 | 0.00 | 11.200 |
| Conduit Label | 4.000 | 25.44 | 0.680 |
| Manual Labor Adjustment / Discount | -30.000 | 0.00 | -30.000 |
| Totals | 2,503.329 | 15,232.40 | 65.454 |

Proposed Change Order

Faith Electric

1980 Orange Tree Lane, Suite 106
Redlands, California 92374

Client Address:

Pacific Hydrotech Corporation

314 E. 3rd Street
Perris, California 92570

Contract Name: P2305-City of Needles Well#11

Contract #: P2305

Project Name: P2305

Project #: P2305-City of Needles Well 11

Client PCO #:

Our PCO #: 6

Summary

| | | | | | | | | | |
|--|----------|--------------|-----------------|------------------|--------------|------------------|-------------|--------------|------------------|
| Extension Materials | | | | | | | % | Total | |
| Database Material | | | | | | | | 15,232.40 | |
| Total Extension Material Cost | | | | | | | | 15,232.40 | |
| Material Tax | | | | | | | 7.750 | 1,180.51 | |
| Total Extension Material | | | | | | | | | 16,412.91 |
| Labor | | Hours | | Rate | | Sub Total | % | Total | |
| Field Labor | | | | | | | | | |
| 477 Foreman (Zone B) | | 32.727 | | 137.21 | | 4,490.47 | | | |
| 477 Journeyman (Zone B) | | 32.727 | | 127.93 | | 4,186.77 | | | |
| Total Field Labor | | | | | | | | 8,677.24 | |
| Indirect Labor | | | | | | | | | |
| 477 General Foreman (Zone B) | | 6.545 | | 146.49 | | 958.84 | | | |
| Total Indirect Labor | | | | | | | | 958.84 | |
| Total Labor Cost | | | | | | | | 9,636.02 | |
| Total Labor | | | | | | | | | 9,636.02 |
| General Expenses | | Qty | Duration | Cost/Unit | Tax % | OH % | MU % | Total | |
| Daily Lodging (excluding taxes) \$124 Per Day, Oct 2023-Sept 2024 | 65.45 | 0.000 | | 15.50 | 0.000 | 0.000 | 0.000 | 1,093.17 | |
| Meals and Incidentals (M&IE) \$64 Per Day | 65.45 | 0.000 | | 8.00 | 0.000 | 0.000 | 0.000 | 523.63 | |
| Small Tools and Consumables | 8,677.28 | 1.000 | | 0.01 | 0.000 | 0.000 | 0.000 | 86.77 | |
| Total General Expenses | | | | | | | | | 1,703.57 |
| Equipment | | Qty | Duration | Cost/Unit | Tax % | OH % | MU % | Total | |
| Foreman Service/Tool Truck (Per Hr.) | 65.454 | 0.500 | | 24.70 | 0.000 | 0.000 | 0.000 | 808.36 | |
| Total Equipment | | | | | | | | | 808.36 |
| Sub Total 1 | | | | | | | | | 28,560.86 |
| Global Overhead() | | | | | | | 15.000 | 4,284.13 | |
| Global Markup | | | | | | | 15.000 | 4,926.75 | |
| Total Global Overhead and Markup | | | | | | | | | 9,210.88 |
| Sub Total 2 | | | | | | | | | 37,771.74 |
| Final Adj | | | | | | | -0.002 | -0.74 | |
| Total Adjustments | | | | | | | | | -0.74 |
| Total | | | | | | | | | 37,771.00 |

Proposed Change Order

Faith Electric

1980 Orange Tree Lane, Suite 106
Redlands, California 92374

Client Address:

Pacific Hydrotech Corporation

314 E. 3rd Street
Perris, California 92570

Contract Name: P2305-City of Needles Well#11

Contract #: P2305

Project Name: P2305

Project #: P2305-City of Needles Well 11

Client PCO #:

Our PCO #: 6

Client Acceptance

PCO #: 6

Final Amount: \$ 37,771.00


Name: _____

Date: _____

Signature: _____


Change Order #: _____

I hereby accept this quotation and authorize the contractor to complete the above described work

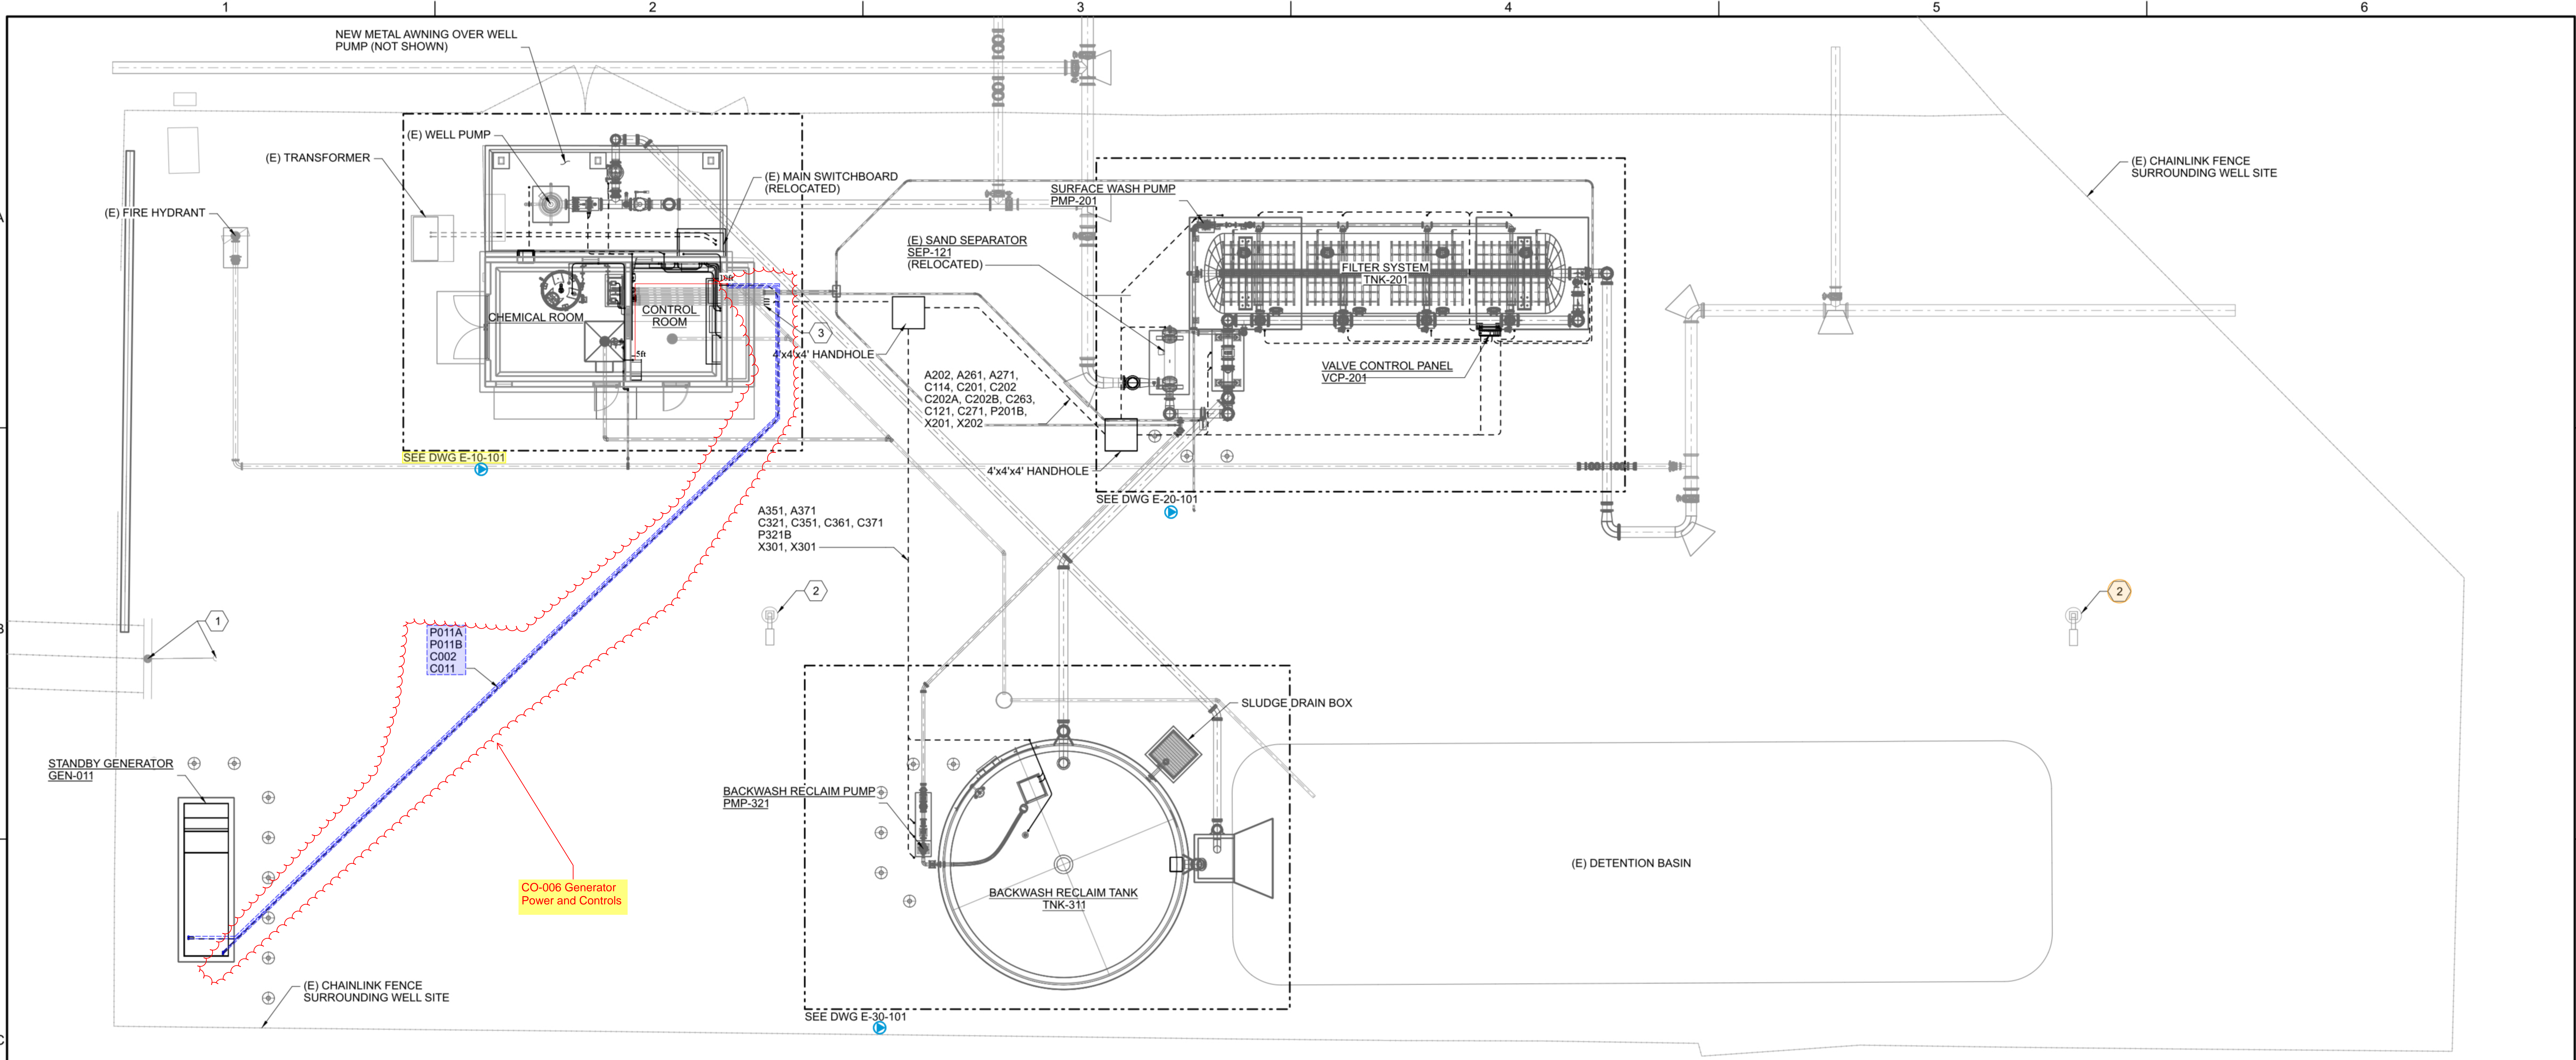


- GENERAL NOTES**
1. REUSE EXISTING CONDUITS WHERE APPLICABLE.
 2. PROVIDE NEW PULL BOXES AND CONDUITS.
 3. INDOOR CONDUITS SHALL BE SURFACE MOUNTED.

- KEY NOTES**
1. PROTECT IN PLACE EXST LIGHT POLE.
 2. PROTECT IN PLACE EXST UTILITY POLE AND GUY WIRE.
 3. EXISTING CONDUIT MAY BE REUSED WITH PRIOR APPROVAL OF ENGINEER. CONDUIT TO BE REUSED SHALL BE MANDREL TESTED PRIOR TO REUSE TO CONFIRM INTEGRITY.

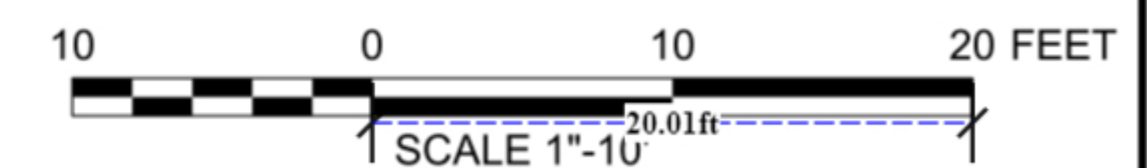



| | | | | | | | | | | | | |
|--|----|------|----------|----|------|--|----------------------|-------------------------|--|---|-----------------------------|------------------------|
| VERIFY SCALE BAR IS ONE INCH ON ORIGINAL DRAWING 0 1" IF NOT ONE INCH ON THIS SHEET, ADJUST SCALES ACCORDINGLY | NO | DATE | REVISION | BY | APVD | | DESIGN J. BOYLES | GARDENA, CALIFORNIA | | CITY OF NEEDLES WELL 11 TREATMENT PROJECT NEEDLES, CALIFORNIA | ELECTRICAL SITE PLAN | DATE SEPTEMBER 2023 |
| | | | | | | | DRAWN J. RIESS | | | | | PROJECT NO. 22-107 |
| | | | | | | | CHECKED J. RIESS | | | | | DRAWING NO. E-101 |
| | | | | | | | APPROVED J. RIESS | | | | | SHEET NO. 42 |

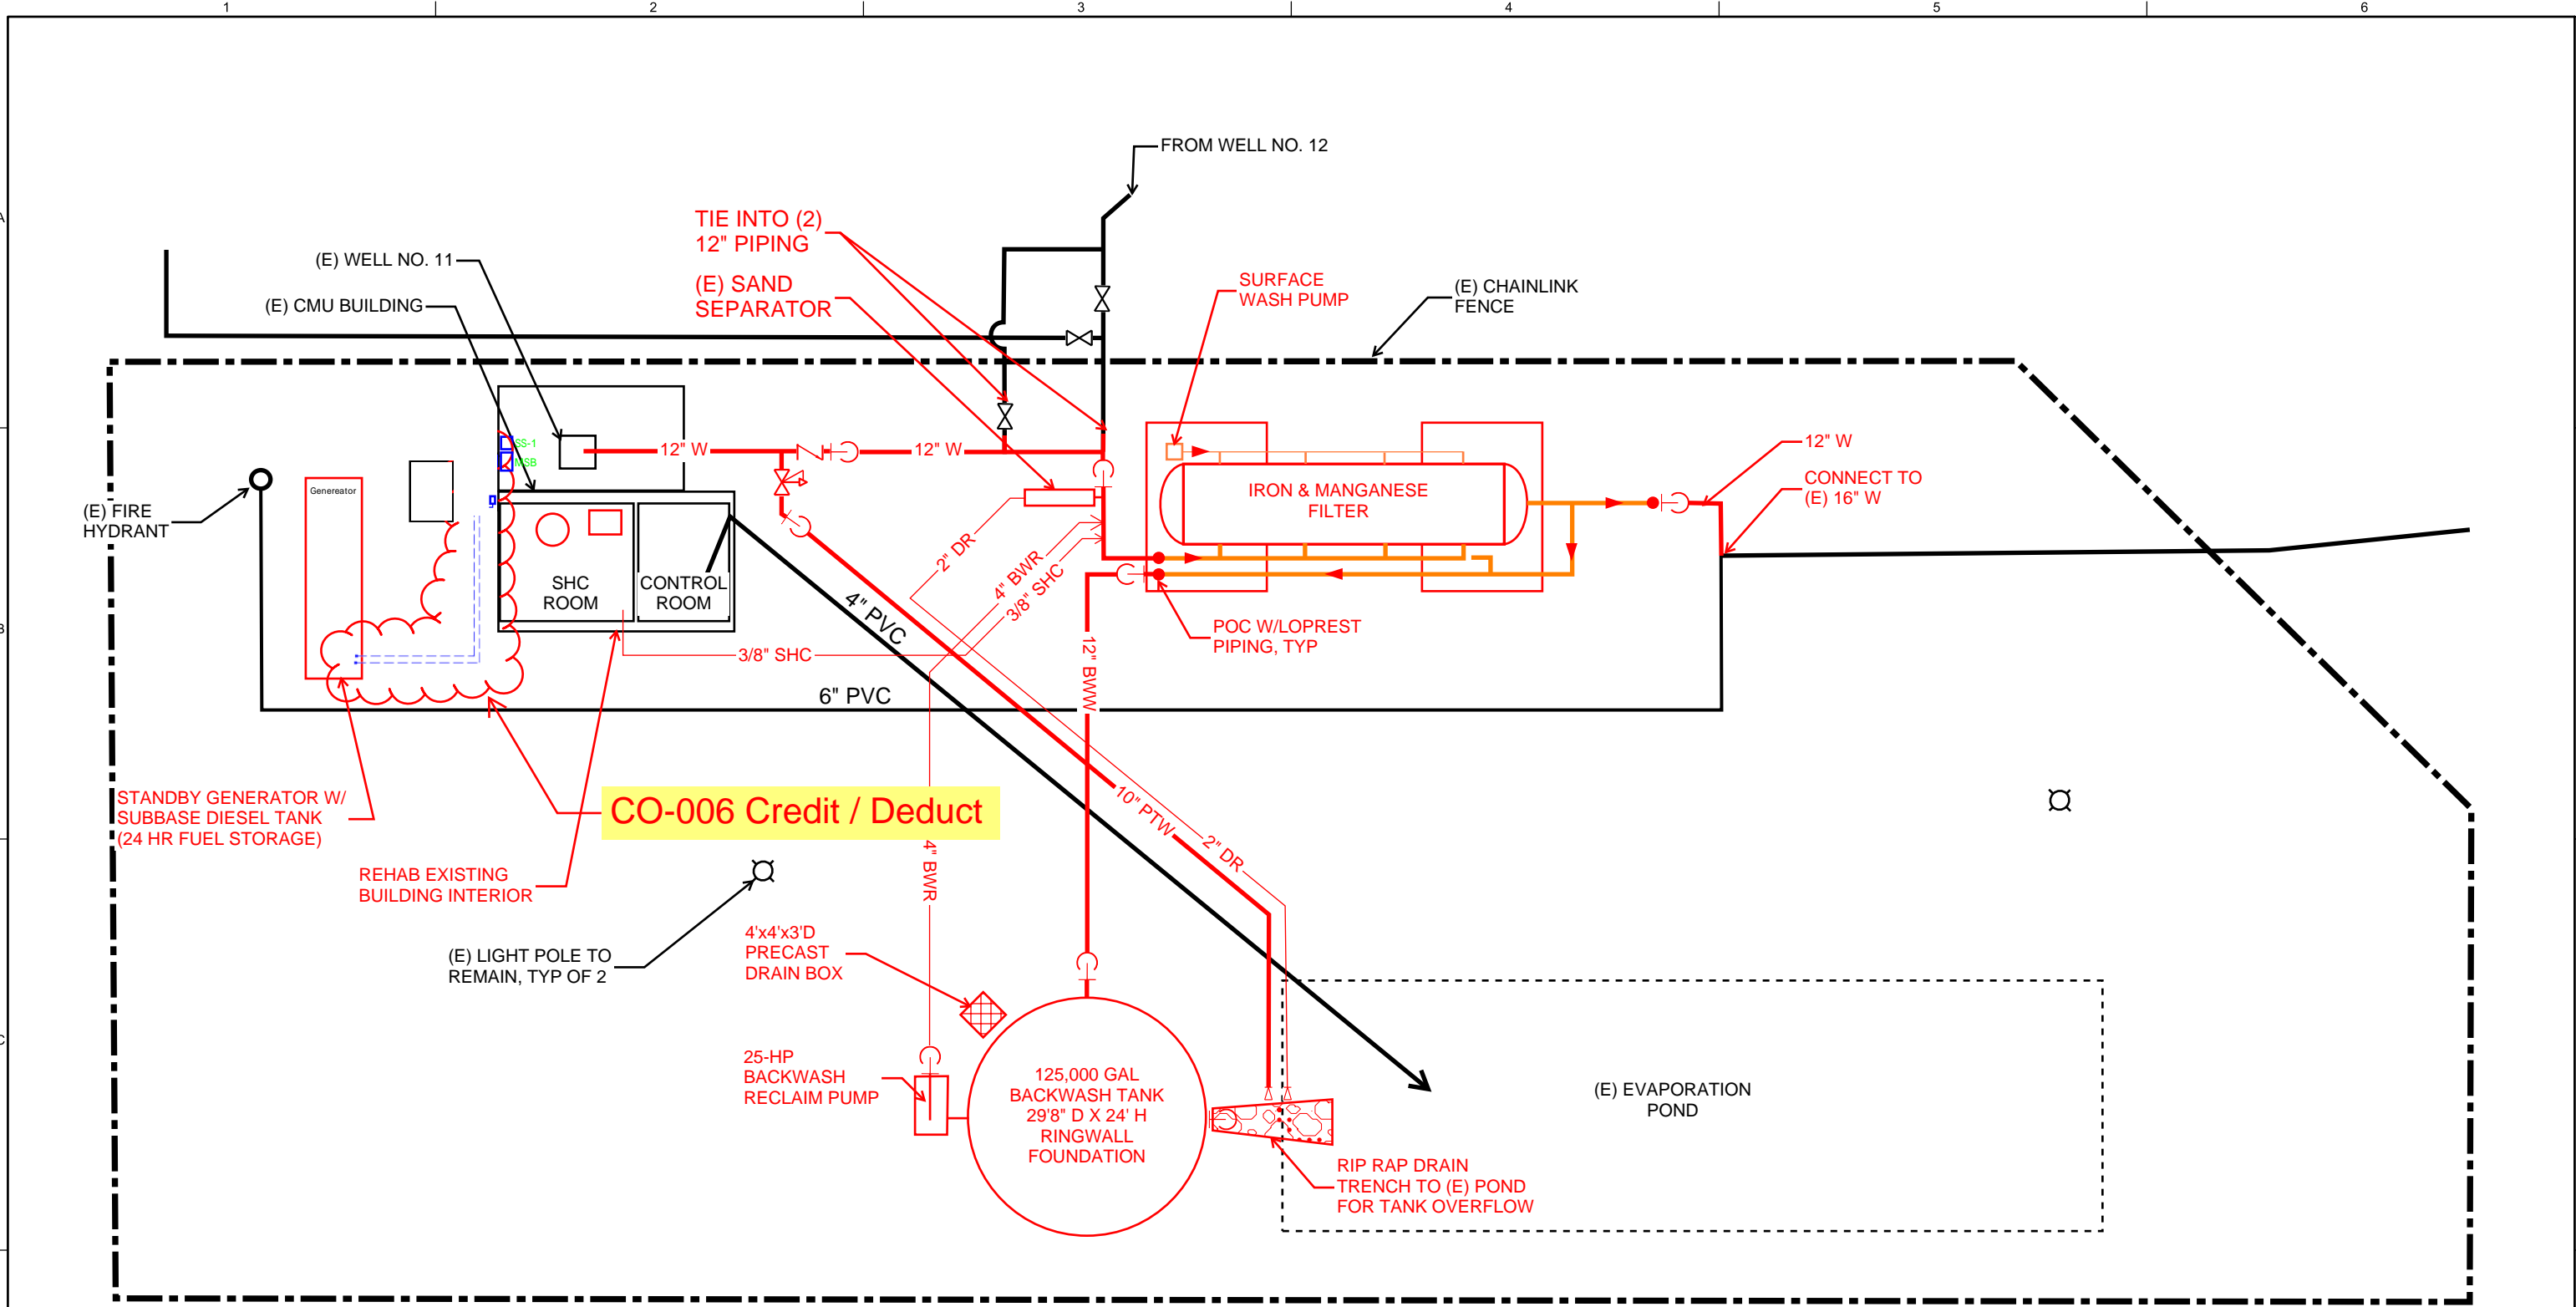

NOTES:
1. SITE PLAN IS CONCEPTUAL AND NOT FOR BUDGETING PURPOSES ONLY. LOCATION, SIZE AND CONDITION OF EXISTING PIPING, STORAGE AND TREATMENT FACILITIES MUST BE VERIFIED.
2. SAMPLE LINES AND ELECTRICAL CONDUIT NOT SHOWN.
3. NOT ALL VALVES, EQUIPMENT AND INSTRUMENTS SHOWN. SEE P&IDS.

— EXISTING
— PROPOSED (NEW)

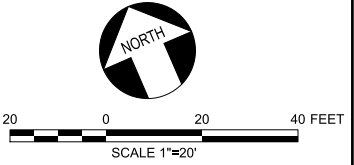

| | | | | | | | | | | |
|---|----|------|----------|----|--|--|---|---|--------------------|--|
| VERIFY SCALE BAR IS ONE INCH ON ORIGINAL DRAWING 0 1" IF NOT ONE INCH ON THIS SHEET, ADJUST SCALES ACCORDINGLY | | | | | PRELIMINARY NOT FOR CONSTRUCTION | DESIGN J. RIESS DRAWN J. RIESS CHECKED XXX APPROVED XXX |  WATERWORKS ENGINEERS GARDENA, CALIFORNIA FILENAME: \$FILES | CITY OF NEEDLES WELL 11 TREATMENT PROJECT NEEDLES, CALIFORNIA | CIVIL SITE PLAN | DATE OCTOBER 2022 PROJECT NO. TBD DRAWING NO. C-002 SHEET NO. X |
| | NO | DATE | REVISION | BY | | | | | | |
| | | | | | | | | | | |
| | | | | | | | | | | |



BRANCH N23
2250 SILVER CREEK RD
BULLHEAD CITY AZ 86442-8473
928-758-5757
928-758-6966 FAX

231939075

Job site

WELL 11
1307 RIVER RD
NEEDLES CA 92363

Office: 951-943-8803 Cell: 951-704-0526

Customer # : 657917
Quote Date : 03/27/24
Estimated Out : 04/08/24 09:00 AM
Estimated In : 04/15/24 09:00 AM
UR Job Loc : 1307 RIVER RD, NEEDL
UR Job # : 337
Customer Job ID:
P.O. # : QUOTE
Ordered By : ERIC CHRISTENSON
Written By : BRUCE ROKJER
Salesperson :

PACIFIC HYDROTECH CORP
314 E 3RD ST
PERRIS CA 92570-2225

**This is not an invoice
Please do not pay from this document**

| RENTAL ITEMS: | | | | | | | | |
|----------------------------|------------------------------|------------------------------|---------|--------|----------------------|----------|----------------|--|
| Qty | Equipment | Description | Minimum | Day | Week | 4 Week | Estimated Amt. | |
| 1 | 9021020 | BACKHOE/LOADER 60-90HP 4WD | 393.00 | 393.00 | 1,267.00 | 3,577.00 | 1,267.00 | |
| 1 | 902/5024 | BACKHOE BUCKET 24" | 1.08 | 1.08 | 3.24 | 13.00 | 3.24 | |
| 1 | 9025255 | BACKHOE 24" COMPACTION WHEEL | 123.00 | 123.00 | 335.00 | 1,174.00 | 335.00 | |
| | | | | | Rental Subtotal: | 1,605.24 | | |
| SALES/MISCELLANEOUS ITEMS: | | | | | | | | |
| Qty | Item | | Price | | Unit of Measure | | Extended Amt. | |
| 1 | ENVIRONMENTAL SERVICE CHARGE | [ENV/MCI] | 32.040 | | EACH | | 32.04 | |
| 1 | DELIVERY CHARGE | | 135.000 | | EACH | | 135.00 | |
| 1 | PICKUP CHARGE | | 135.000 | | EACH | | 135.00 | |
| | | | | | Sales/Misc Subtotal: | 302.04 | | |
| | | | | | Agreement Subtotal: | 1,907.28 | | |
| | | | | | Tax: | 137.34 | | |
| | | | | | Estimated Total: | 2,044.62 | | |

COMMENTS/NOTES:

CONTACT: ERIC CHRISTENSON
CELL#: 951-704-0526
Dlv/Pku loc selected by Map Pin Option

TO SCHEDULE EQUIPMENT FOR PICKUP, CALL 800-UR-RENTS (800-877-3687)
WE ARE AVAILABLE 24/7 TO SUPPLY YOU WITH A CONFIRMATION #
IN ORDER TO CLOSE THIS CONTRACT

This proposal may be withdrawn if not accepted within 30 days. The above referenced Rental Protection Plan, environmental, and tax charges are estimates and are subject to change.

NOTICE: This is not a rental agreement. The rental of equipment and any items listed above is subject to availability and subject to the terms and conditions of the Rental and Service Agreement, which are available at <https://www.unitedrentals.com/legal/rental-service-terms-US> and which are incorporated herein by reference. A COPY OF THE RENTAL AND SERVICE AGREEMENT TERMS ARE AVAILABLE IN PAPER FORM UPON REQUEST.

S&S CONCRETE & MATERIALS, LLC
Mailing Address: PO BOX 23283, Bullhead City, AZ 86439
Physical Address: 3000 Pass Canyon Road, Bullhead City, AZ 86442
Telephone: 928-754-1999 Fax: 928-754-1991

PROJECT QUOTE

PROJECT: City Of Needles Wastewater
ATTN: Eric Christensen
PH: 951-704-0526
Fax:
Email: echristensen@pachydro.com

CUSTOMER: Pacific Hydrotech Corp
DATE: 1/23/2024
EXPIRES: 30 Days

| Description | UNITS | UM | Unit Price | DEL/FOB |
|-------------|-------|----|------------|---------|
|-------------|-------|----|------------|---------|

300 Yards 4000psi

Ready Mix:

| | | | |
|--|-----------|----------|-----------|
| Mix Design ID # 4502CL-S4000 (4000psi) | CY | \$166.00 | DELIVERED |
| Mix ID # 3000W5.5 | CY | \$155.50 | DELIVERED |
| Delivery Fee (Needles) | PER TRUCK | \$100.00 | |

Additional Charges:

| | | |
|---|-----------|----------|
| Fuel Surcharge (Adjustable Quarterly) | PER TRUCK | \$39.50 |
| SHORT LOAD < 3 YARDS | LOAD | \$150.00 |
| SHORT LOAD 3-4 3/4 YARDS | LOAD | \$100.00 |
| Standby charges will apply after 6 minutes per yard | MINUTE | \$1.50 |
| Saturday Charge | CY | \$5.00 |
| Red dye ASTM 979 | CY | \$110.00 |

Aggregates:

| | |
|-----|-----------|
| TON | DELIVERED |
| TON | FOB |

S&S Concrete & Materials reserves the right to be included on all email chains regarding test results from the awarded job.

Prices are based on the award of all concrete and construction aggregates on the job.

Prices are good when S&S Concrete & Materials, materials and mix design are accepted by project engineer on above materials.

ANY ADDITIONAL CHARGES FROM OUR ENGINEER FOR JOB SPECIFIC, STAMPED MIX DESIGN WILL BE CHARGED AT A COST + 10%

Signature

Sales Manager Dale Abbott

Title Name

ACCEPTED

Authorized Representative Title

Name

Date

Signature