




CONCRETE GENERAL NOTES

- 1. REBAR SHALL BE LAPPED A MINIMUM 30 BAR DIAMETERS.
- 2. REBAR LAPPS (WHEN NECESSARY) SHALL BE AS FOLLOWS:
  TOP BARS: AT MID SPAN OF BEAM
  BOTTOM BARS: AT BEAM INTERSECTION
- 3. ALL CONCRETE SHALL HAVE A MIN. COMPRESSIVE STRENGTH OF f =3000 PSI @ 28 DAYS (MINIMUM 5 SACKS OF CEMENT).
- 4. ALL REINFORCING BARS SHALL BE GRADE 60.

				GINDER DESIGN 28423 FM 1097 WEST MONTGOMERY, TX 77356 (936) 449-6052	FOUNDATION PLAN	MONTGOMERY MEMORIAL CEMETERY FM 1097 MONTGOMERY, TX 77356
DWG. NO.	REFERENCE DWG.	REV DSN CK	DESCRIPTION		YEAR: <b>2021</b> W.O. SCA	LE: NTS DWG. MM-003 REV. 0

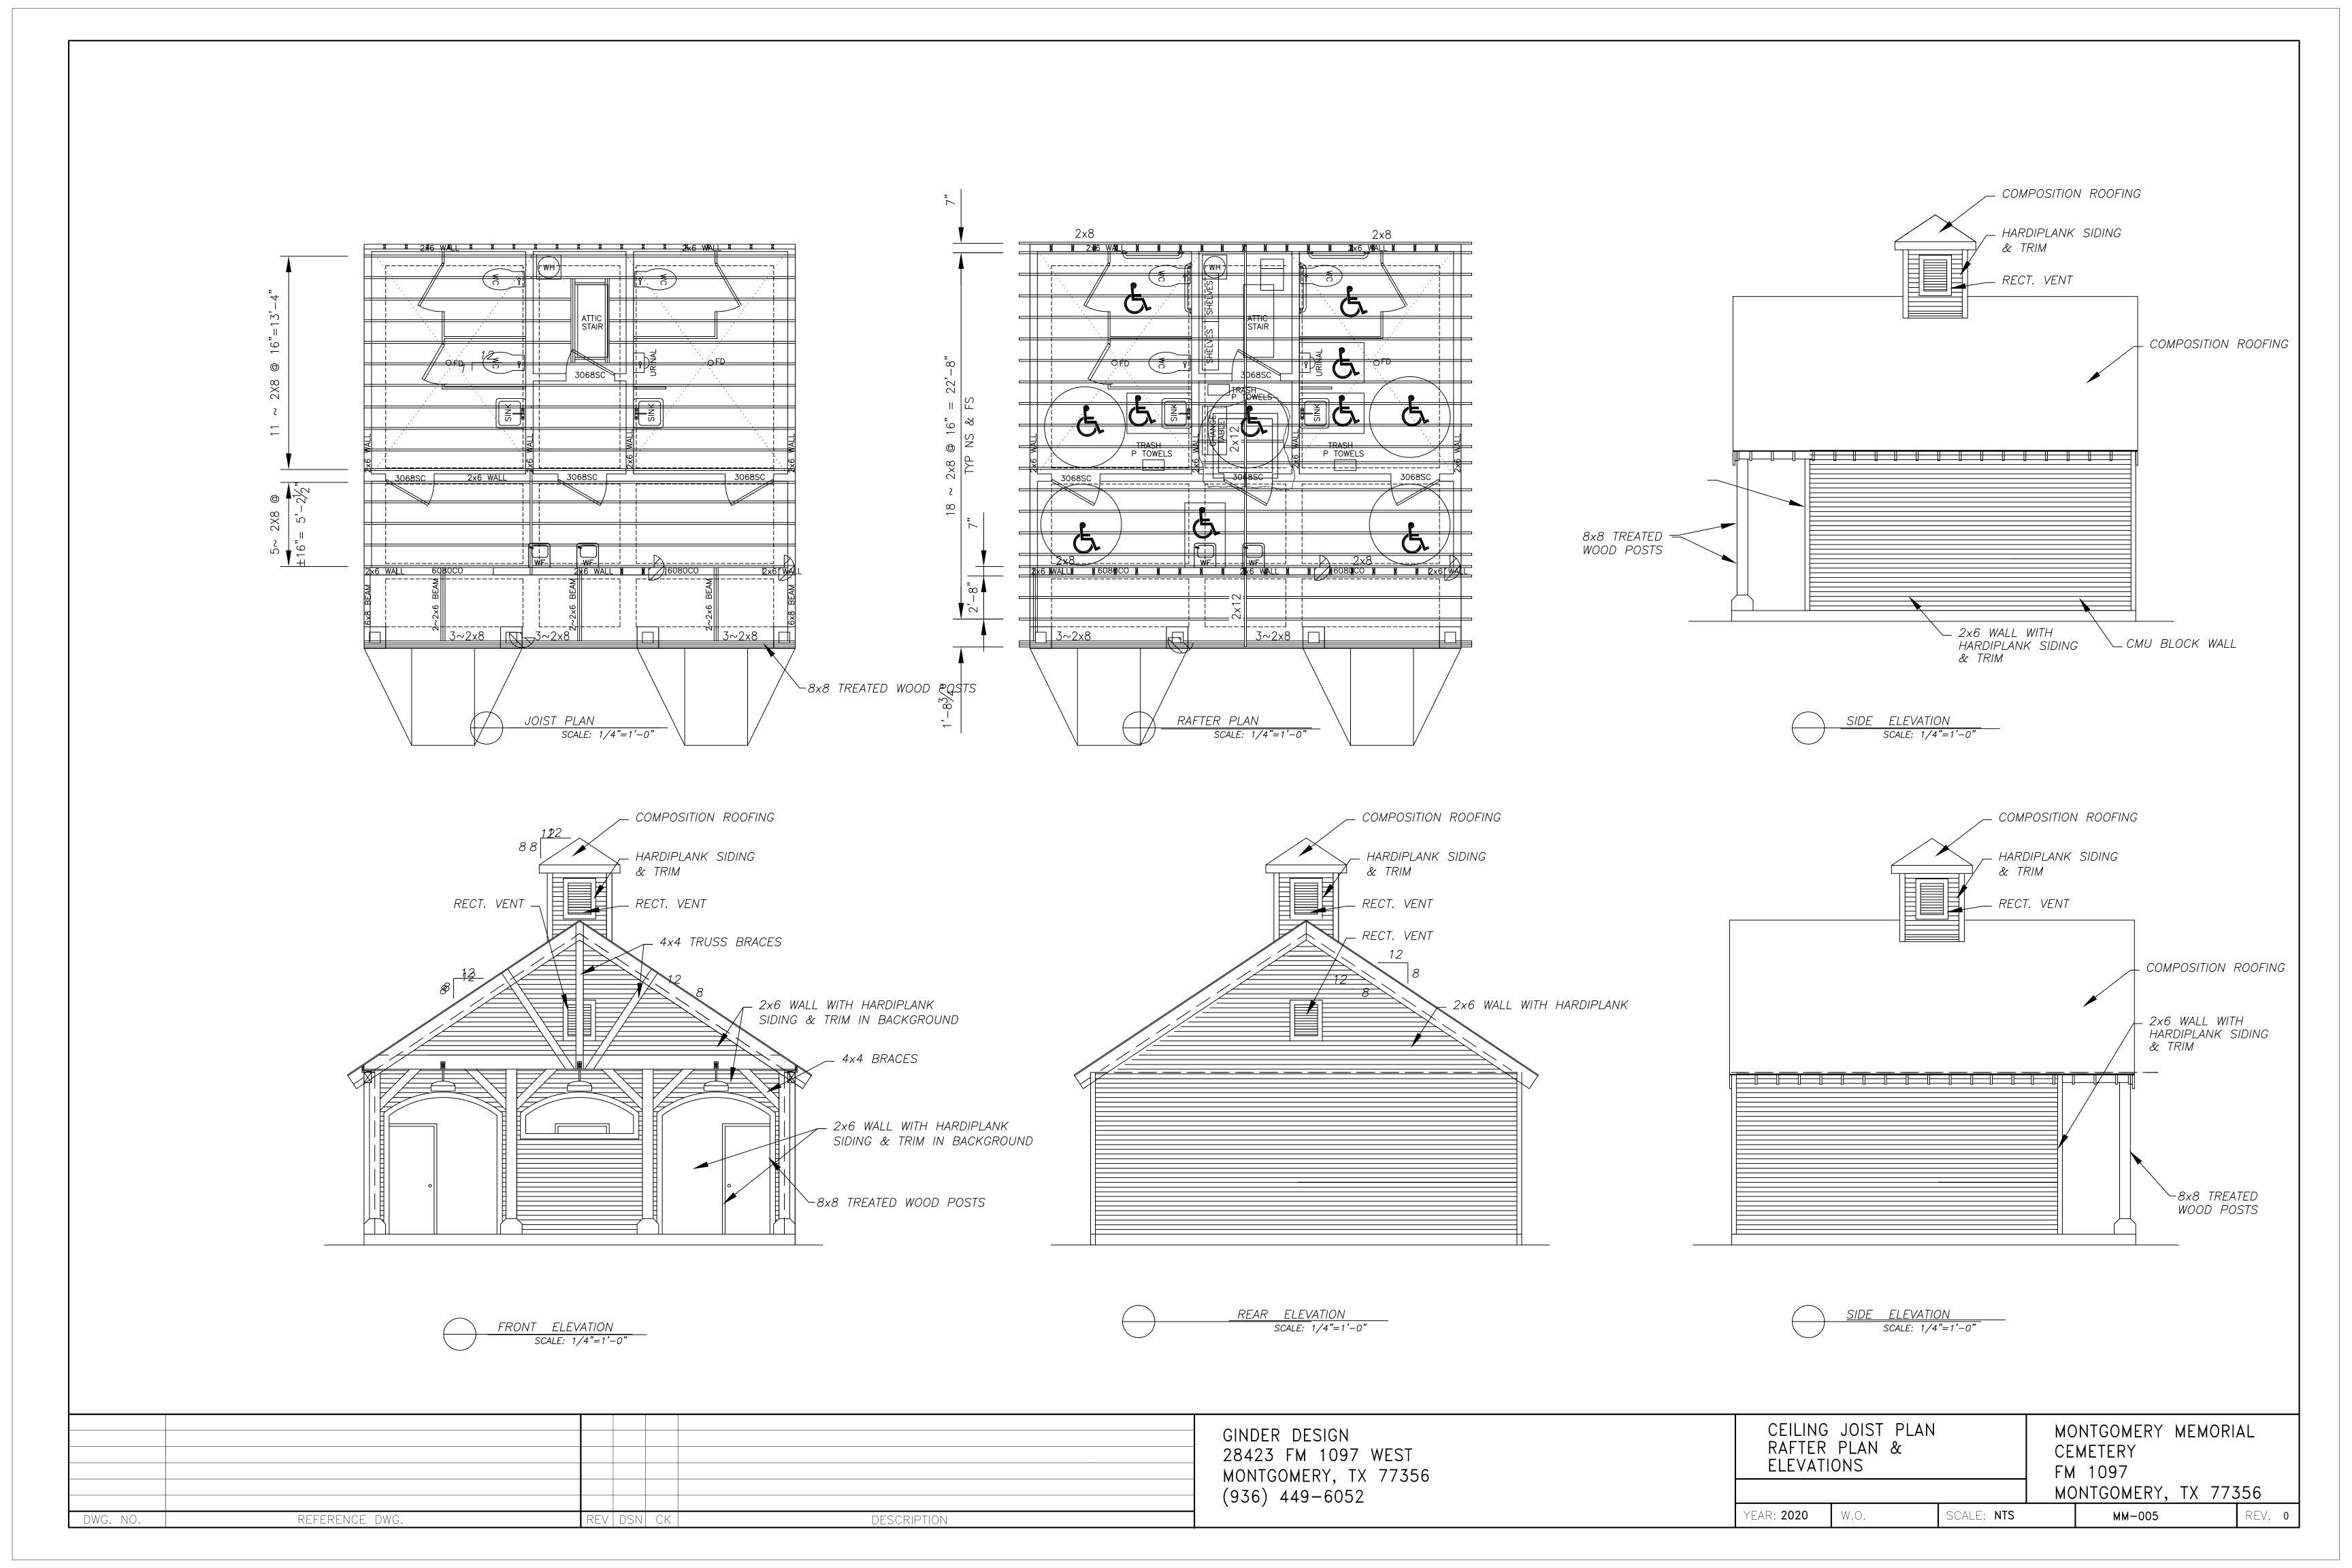

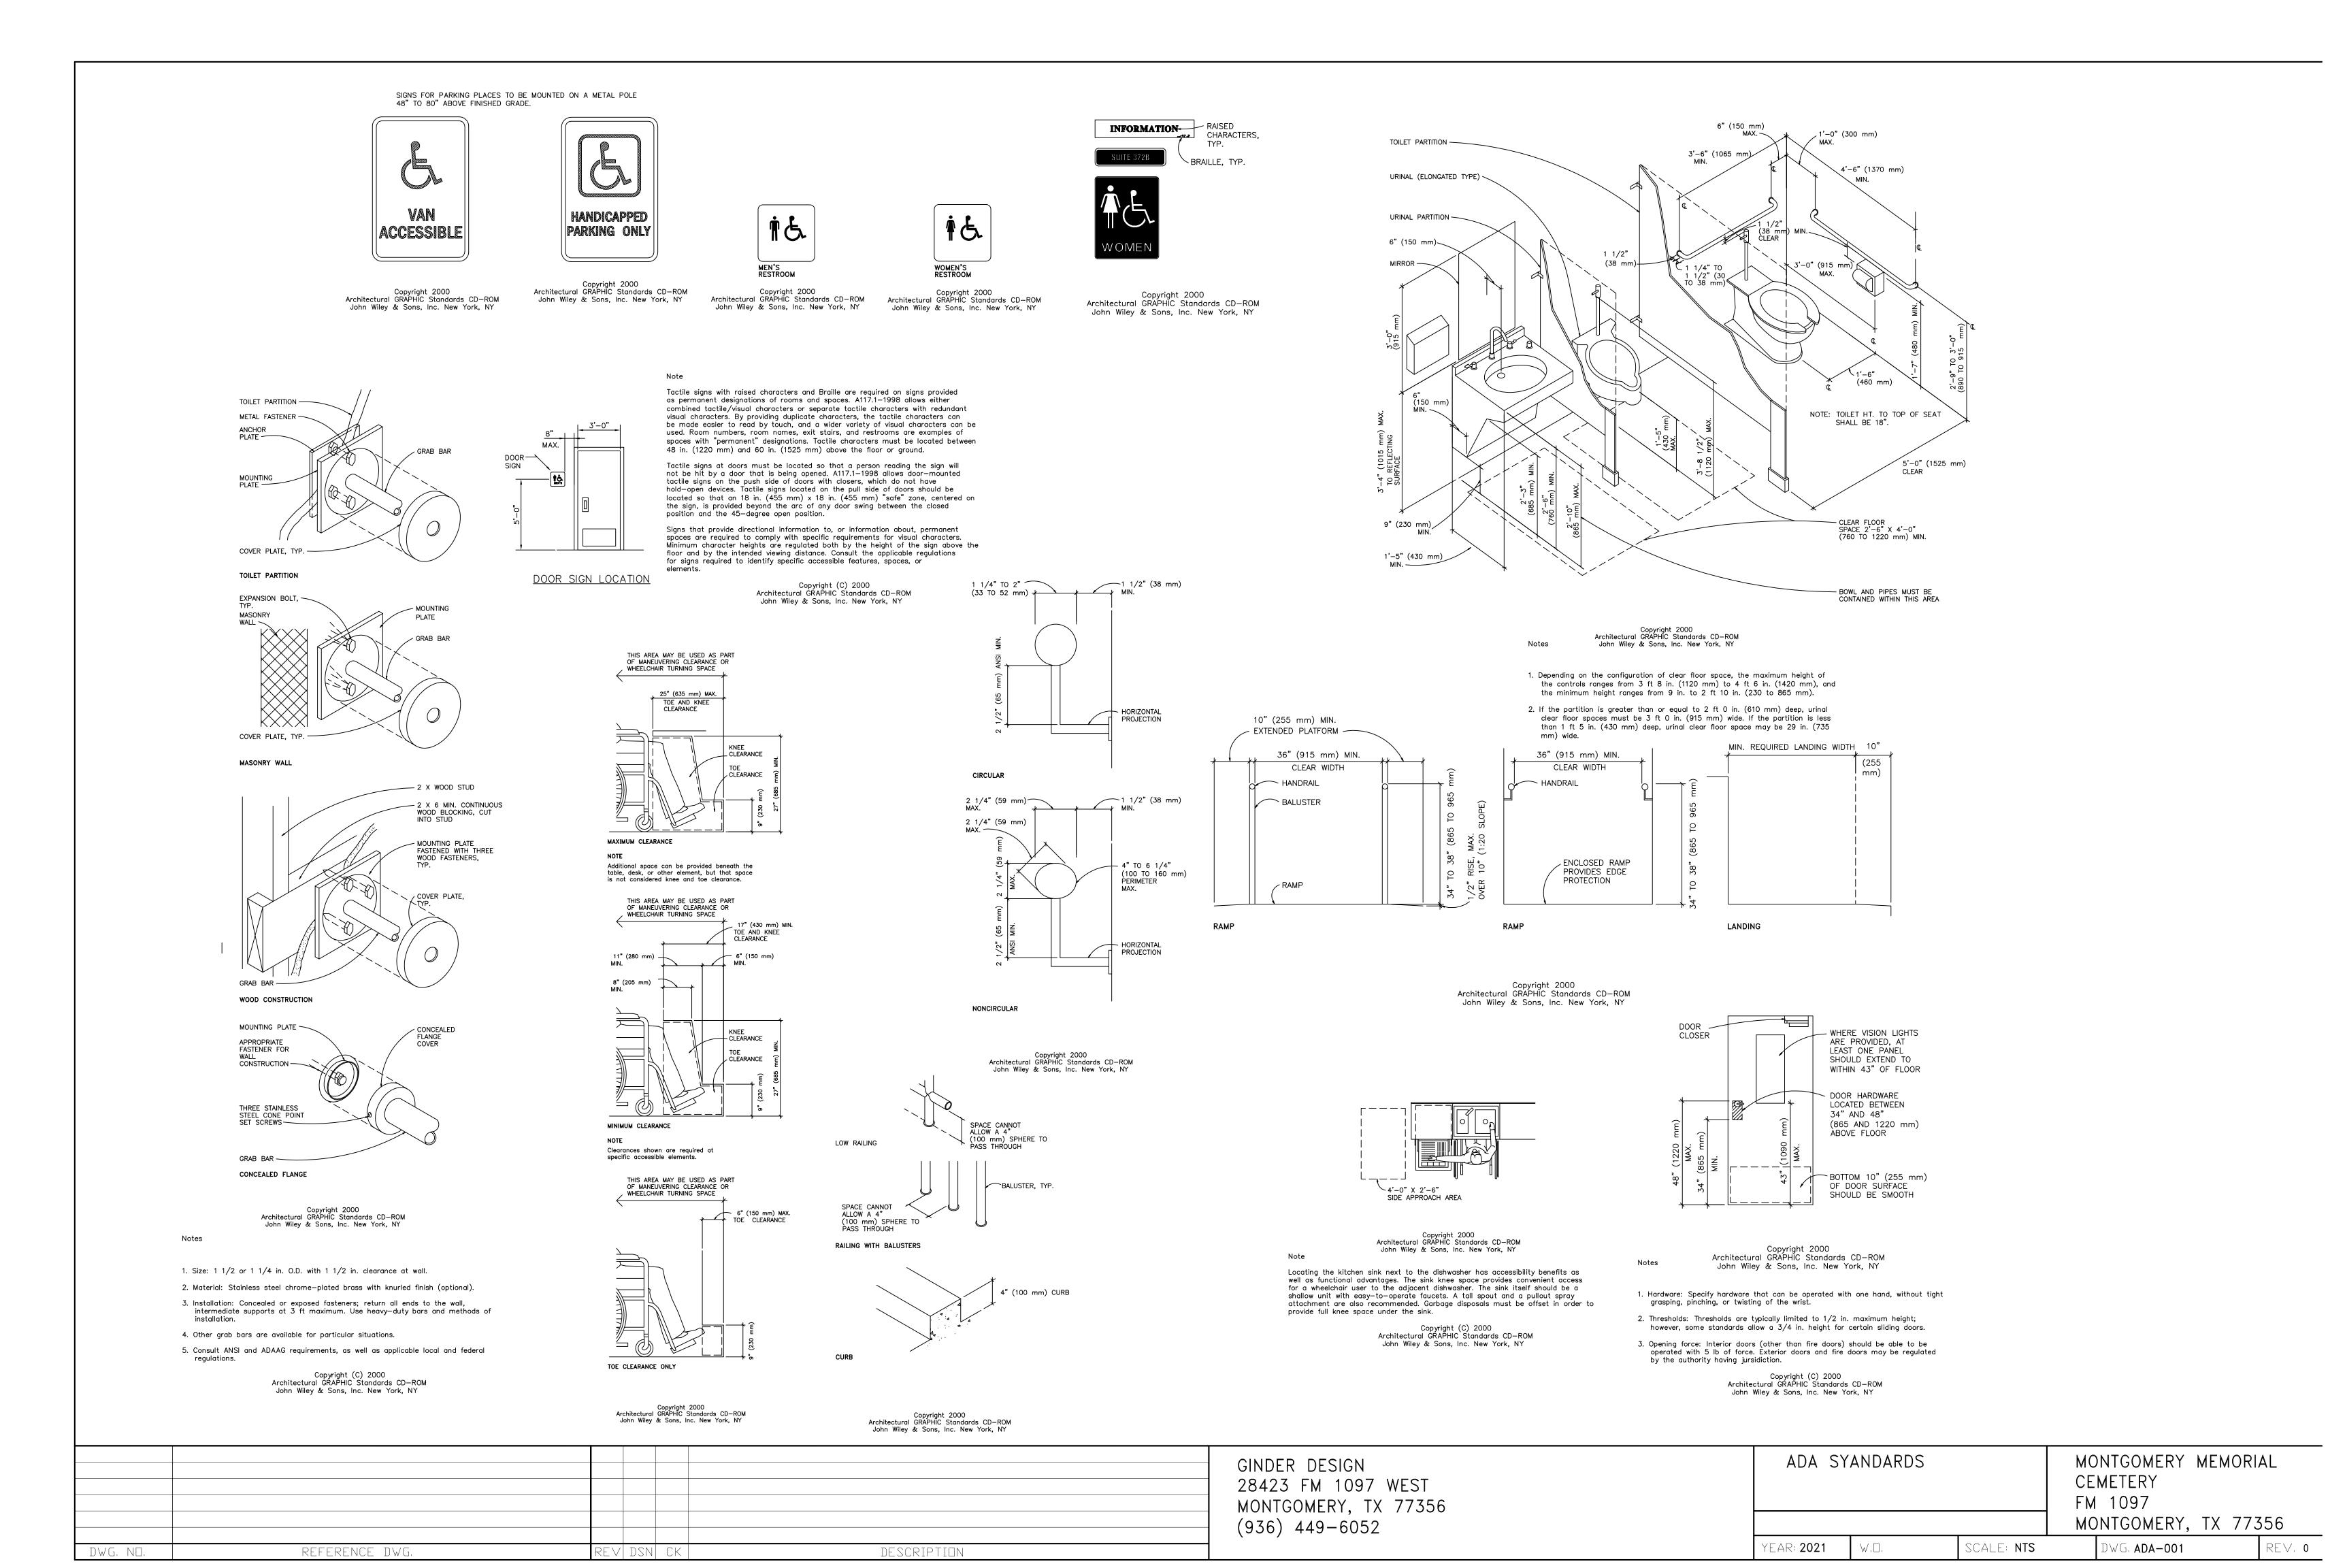

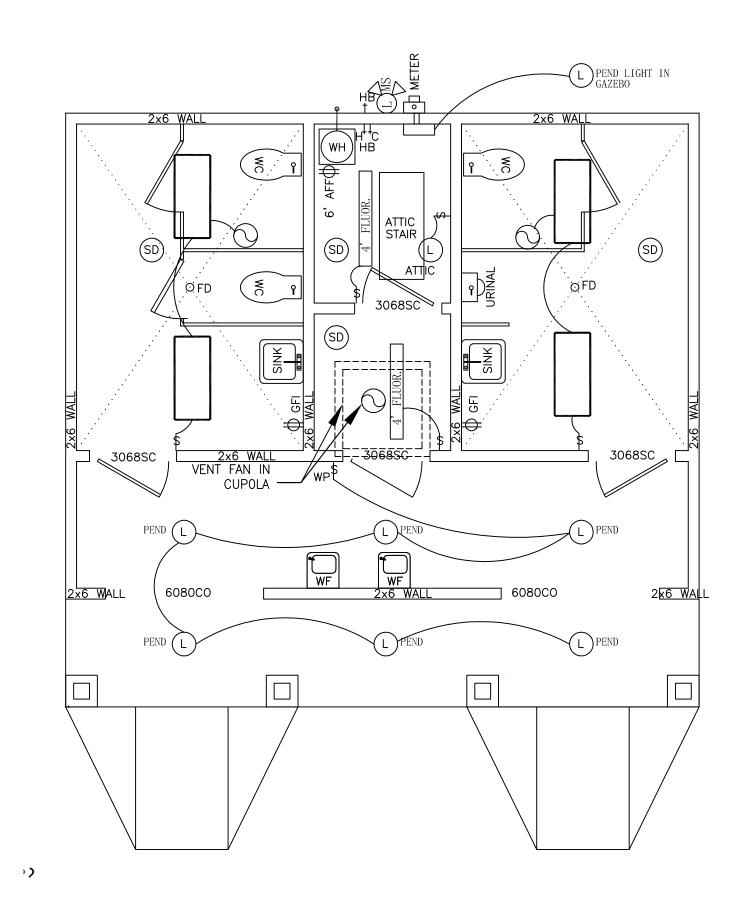

## ELECTRICAL PLAN

## ELECTRICAL LEGEND

SINGLE POLE SWITCH 3 WAY SWITCH 120V. DUPLEX OUTLET 120V. DUPLEX OUTLET W/ GROUND FAULT INDICATOR

> 220V. OUTLET VENT

EXTERIOR LIGHT W/ MOTION DETECTOR

2~TUBE 4' STRIP L.E.D. LIGHT FIXTURE W/ TUBE COVERS

2~TUBE 8' STRIP L.E.D. LIGHT FIXTURE W/ TUBE COVERS

2' x 4' L. E. D. SURFACE MOUNTED LIGHT FIXTURE W/ DIFFUSER


SURFACE MT. LT. FIXTURE

SMOKE DETECTOR

BATHROOM VENT

(L) PEND PENDANT LIGHT

**LEGEND** 

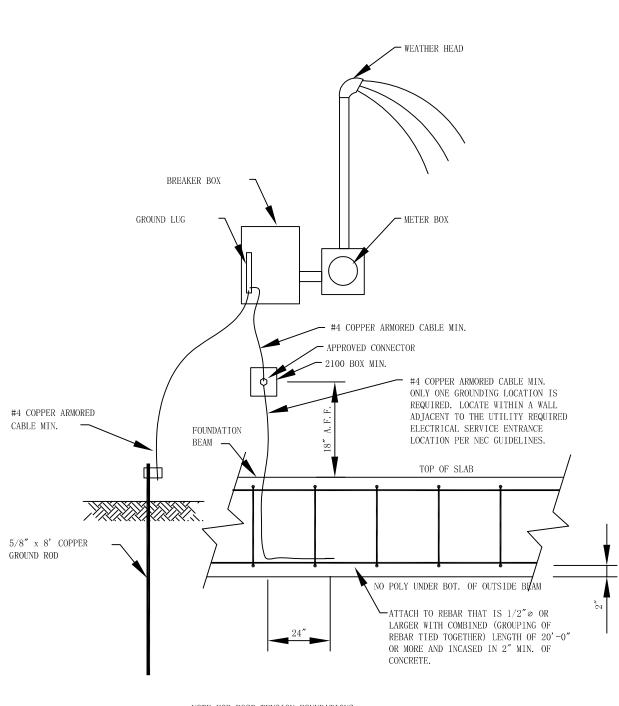

NOTE FOR POST TENSION FOUNDATIONS: DO NOT ATTACH GROUNDING SYSTEM (DIRECTLY OR INDIRECTLY) TO THE POST TENSION REINFORCEMENT IN ANY WAY. ATTACH TO REBAR THATIS 1/2"Ø OR LARGER WITH A COMBINED (GROUPINGS OF REBAR TIED TOGETHER) LENGTH OF 20'-0" OR MORE AND ENCASED IN 2" MIN. OF CONCRETE.

**SERVICE** 

REFERENCE DWG. REVIDSNICKI DESCRIPTION DWG. NO.

GINDER DESIGN 28423 FM 1097 WEST MONTGOMERY, TX 77356 (936) 449-6052

NOTES:

1. TO THE BEST OF MY KNOWLEDGE THESE PLANS ARE DRAWN TO COMPLY WITH THE OWNERS SPECIFICATION. EVERY ATTEMPT HAS BEEN MADE IN THE PREPARATION OF THESE DRAWINGS AND SPECIFICATIONS TO AVOID MISTAKES. CONTRACTOR AND/OR OWNER SHALL VERIFY ALL DIMENSION, DETAILS, AND SPECIFICATIONS. DESIGNER WILL NOT BE LIABLE FOR HUMAN ERROR AFTER CONSTRUCTION STARTS. IN NO CASE SHALL DESIGNER BE LIABLE FOR MORE THAN THE COST OF THESE PLANS.

2. DETAILS SHOWN ON THIS SET OF DRAWINGS SHOULD BE CONSIDERED AS MINIMUM. WE ASSUME NO RESPONSIBILITY FOR THE STRUCTURAL INTEGRITY OF THIS BUILDING.

3. IN ORDER TO VERIFY AND INSURE THAT THERE ARE NO ENCROACHMENTS ON PROPERTY LINES, UTILITY EASEMENTS OR BUILDING LINES, A SURVEYOR SHOULD BE EMPLOYED TO VERIFY LOCATION OF BUILDING ON PLAT PRIOR TO START OF CONSTRUCTION.

1. DESIGN IS BASED ON INFORMATION SUPPLIED BY PROPERTY REPRESENTATIVE

2. SELECT FILL SHALL CONSIST OF HOMOGENEOUS SOILS FREE OF ORGANIC MATTER AND POSSESSING AN ATTERBERG PLASTIC INDEX OF 12 PERCENT OR LESS, WITH A LIQUID LIMIT OF 30 PERCENT OR LESS. 3. THE MATERIAL SHALL BE PLACED IN THE FOLLOWING MANNER:

A. REMOVE SURFICAL VEGETATION, WASTE AND SOIL, MINIMUM EXCAVATION SHOULD BE ON THE ORDER OF ONE FOOT, EXTENDING 10 FEET OUTSIDE THE BUILDING LIMITS. IN AREAS TO BE OVER EXCAVATED REMOVE SOIL TO INDICATE DEPTH. THE EXPOSED SUB-GRADE SHOULD BE PROOF-ROLLED TO DETECT SOFT AND PUMPING SOILS.

ALL SOFT AND PUMPING SOILS SHOULD BE EXCAVATED TO STIFF SOIL. B. SCARIFY THE EXPOSED SUBGRADE TO A DEPTH OF SIX INCHES, ADJUST MOISTURE CONTENT, AND RECOMPACT TO A MINIMUM OF 95 PERCENT OF THE MAXIMUM DENSITY DEFINED IN ASTM D-698 (STANDARD PROCTOR). C. PLACE SUBSEQUENT LIFTS OF SELECT FILL IN THIN. LOOSE LAYERS NOT TO EXCEED EIGHT INCHES IN THICKNESS TO THE DESIRED ROUGH

GRADE AND COMPACT TO A MINIMUM OF 95 PERCENT OF THE MAXIMUM DENSITY DEFINED BY ASTM D-698, MAINTAIN MOISTURE WITHIN TWO PERCENT OF THEORETICAL OPTIMUM. D. PROVIDE FIELD DENSITY TESTS AT THE RATE OF ONE TEST PER

3000 SQUARE FEET FOR EVERY LIFT. E. EXTREME DILIGENCE SHOULD BE MAINTAINED DURING CONSTRUCTION TO PREVENT EXCESSIVE LOSS OF MOISTURE CONTENT.

F. FOR SELECT FILL PLACED ABOVE THE EXISTING NATURAL GRADE, EXTEND THE LATERAL LIMITS OF THE FILL 10 FEET BEYOND THE BUILDING LIMITS AND TRANSITION TO EXISTING GRADE ON A 3:1 SLOPE (HORIZ: VERT). 4. SITE PREPARATION

A. CARE SHOULD BE TAKEN TO SHAPE THE SITE SUCH THAT WATER WILL NOT POND 10 FOOT OF THE BUILDING LINES. DILIGENCE IN CONTROLLING THE MOISTURE CONTENT IN THE IMMEDIATE BUILDING AREA IS REQUIRED.

5. REBAR SHALL BE LAPPED A MINIMUM 30 BAR DIAMETERS.

6. ALL CONCRETE SHALL HAVE A MIN, COMPRESSIVE STRENGTH OF 3000 PSI @ 28 DAYS

( 5 SACK MIN.) 7. ALL REINFORCING BARS SHALL BE GRADE 60.

8. ALL CONCRETE SHALL BE PLACED IN ACCORDANCE WITH ACI CODE, LATEST EDITION. 9. CONCRETE SHALL BE PLACE TRUE AND LEVEL (U. N. O.) WITH A STEEL TROWEL FINISH. 10. SOIL REPORT NOTES ON SITE PREPARATION SHALL TAKE PRECEDENCE OVER NOTES ON

1. ALL SIDING SHALL BE HARDIPLANK OR EQUAL. 2. EXTERIOR DOORS SHALL BE METAL (SELECTED BY OWNER). INTERIOR DOORS

SHALL BE METAL. 3. DRAIN, WASTE & VENT PIPES SHALL BE SCH. 40 PVC. WATER PIPES SHALL BE COPPER LOOPED UNDER SLAB IN POLY TUBING AND HARD COPPER IN WALLS

ALL CONNECTION SHALL BE LEAD FREE.
4. CONTRACTOR SHALL POLYSEAL AROUND ALL PIPES, ELECTRIC WIRING, WINDOWS, BASEPLATES & ETC.

5. SHEETROCK SHALL HAVE A ORANGE PEEL FINISH ON CEILING WITH 2 COATS OF GLOSS LATEX PAINT.

6. ALL CONSTRUCTION SHALL BE DONE IN ACCORDANCE WITH INTERNATIONAL BUILDING CODE, LATEST EDITION & CITY OF MONTGOMERY BUILDING CODE.

7. ALL WIRING SHALL BE COPPER #12 MIN. 8. ELECTRICAL SHALL BE INSTALLED IN ACCORDANCE WITH THE NATIONAL ELECTRIC CODE, LATEST EDITION.

9. ALL INTERIOR ROOMS SHALL HAVE SMOKE/HEAT DETECTOR'S

THAT OPERATE ON 115V W/ BATTERY BACK-UP. ALL ALARMS SHALL BE WIRED SO THAT WHEN ONE ALARM IS ACTIVATED ALL ALARMS SOUND ALARM.


10. PROVIDE TERMITE PROTECTION OVER COMPACTED OR GRANDULAR FILL


11. PROVIDE ATTIC VENTILATION EQUAL TO ONE SQ. FT. PER 150 SQ. FT.

OF ATTIC OR PER LOCAL BUILDING CODE.,

**GENERAL NOTES** 

ELECTRICAL PLAN, DETAILS MONTGOMERY MEMORIAL & GENERAL NOTÉS CEMETERY FM 1097 MONTGOMERY, TX 77356 YEAR: **2021** SCALE: NTS WG. **MM-004** 

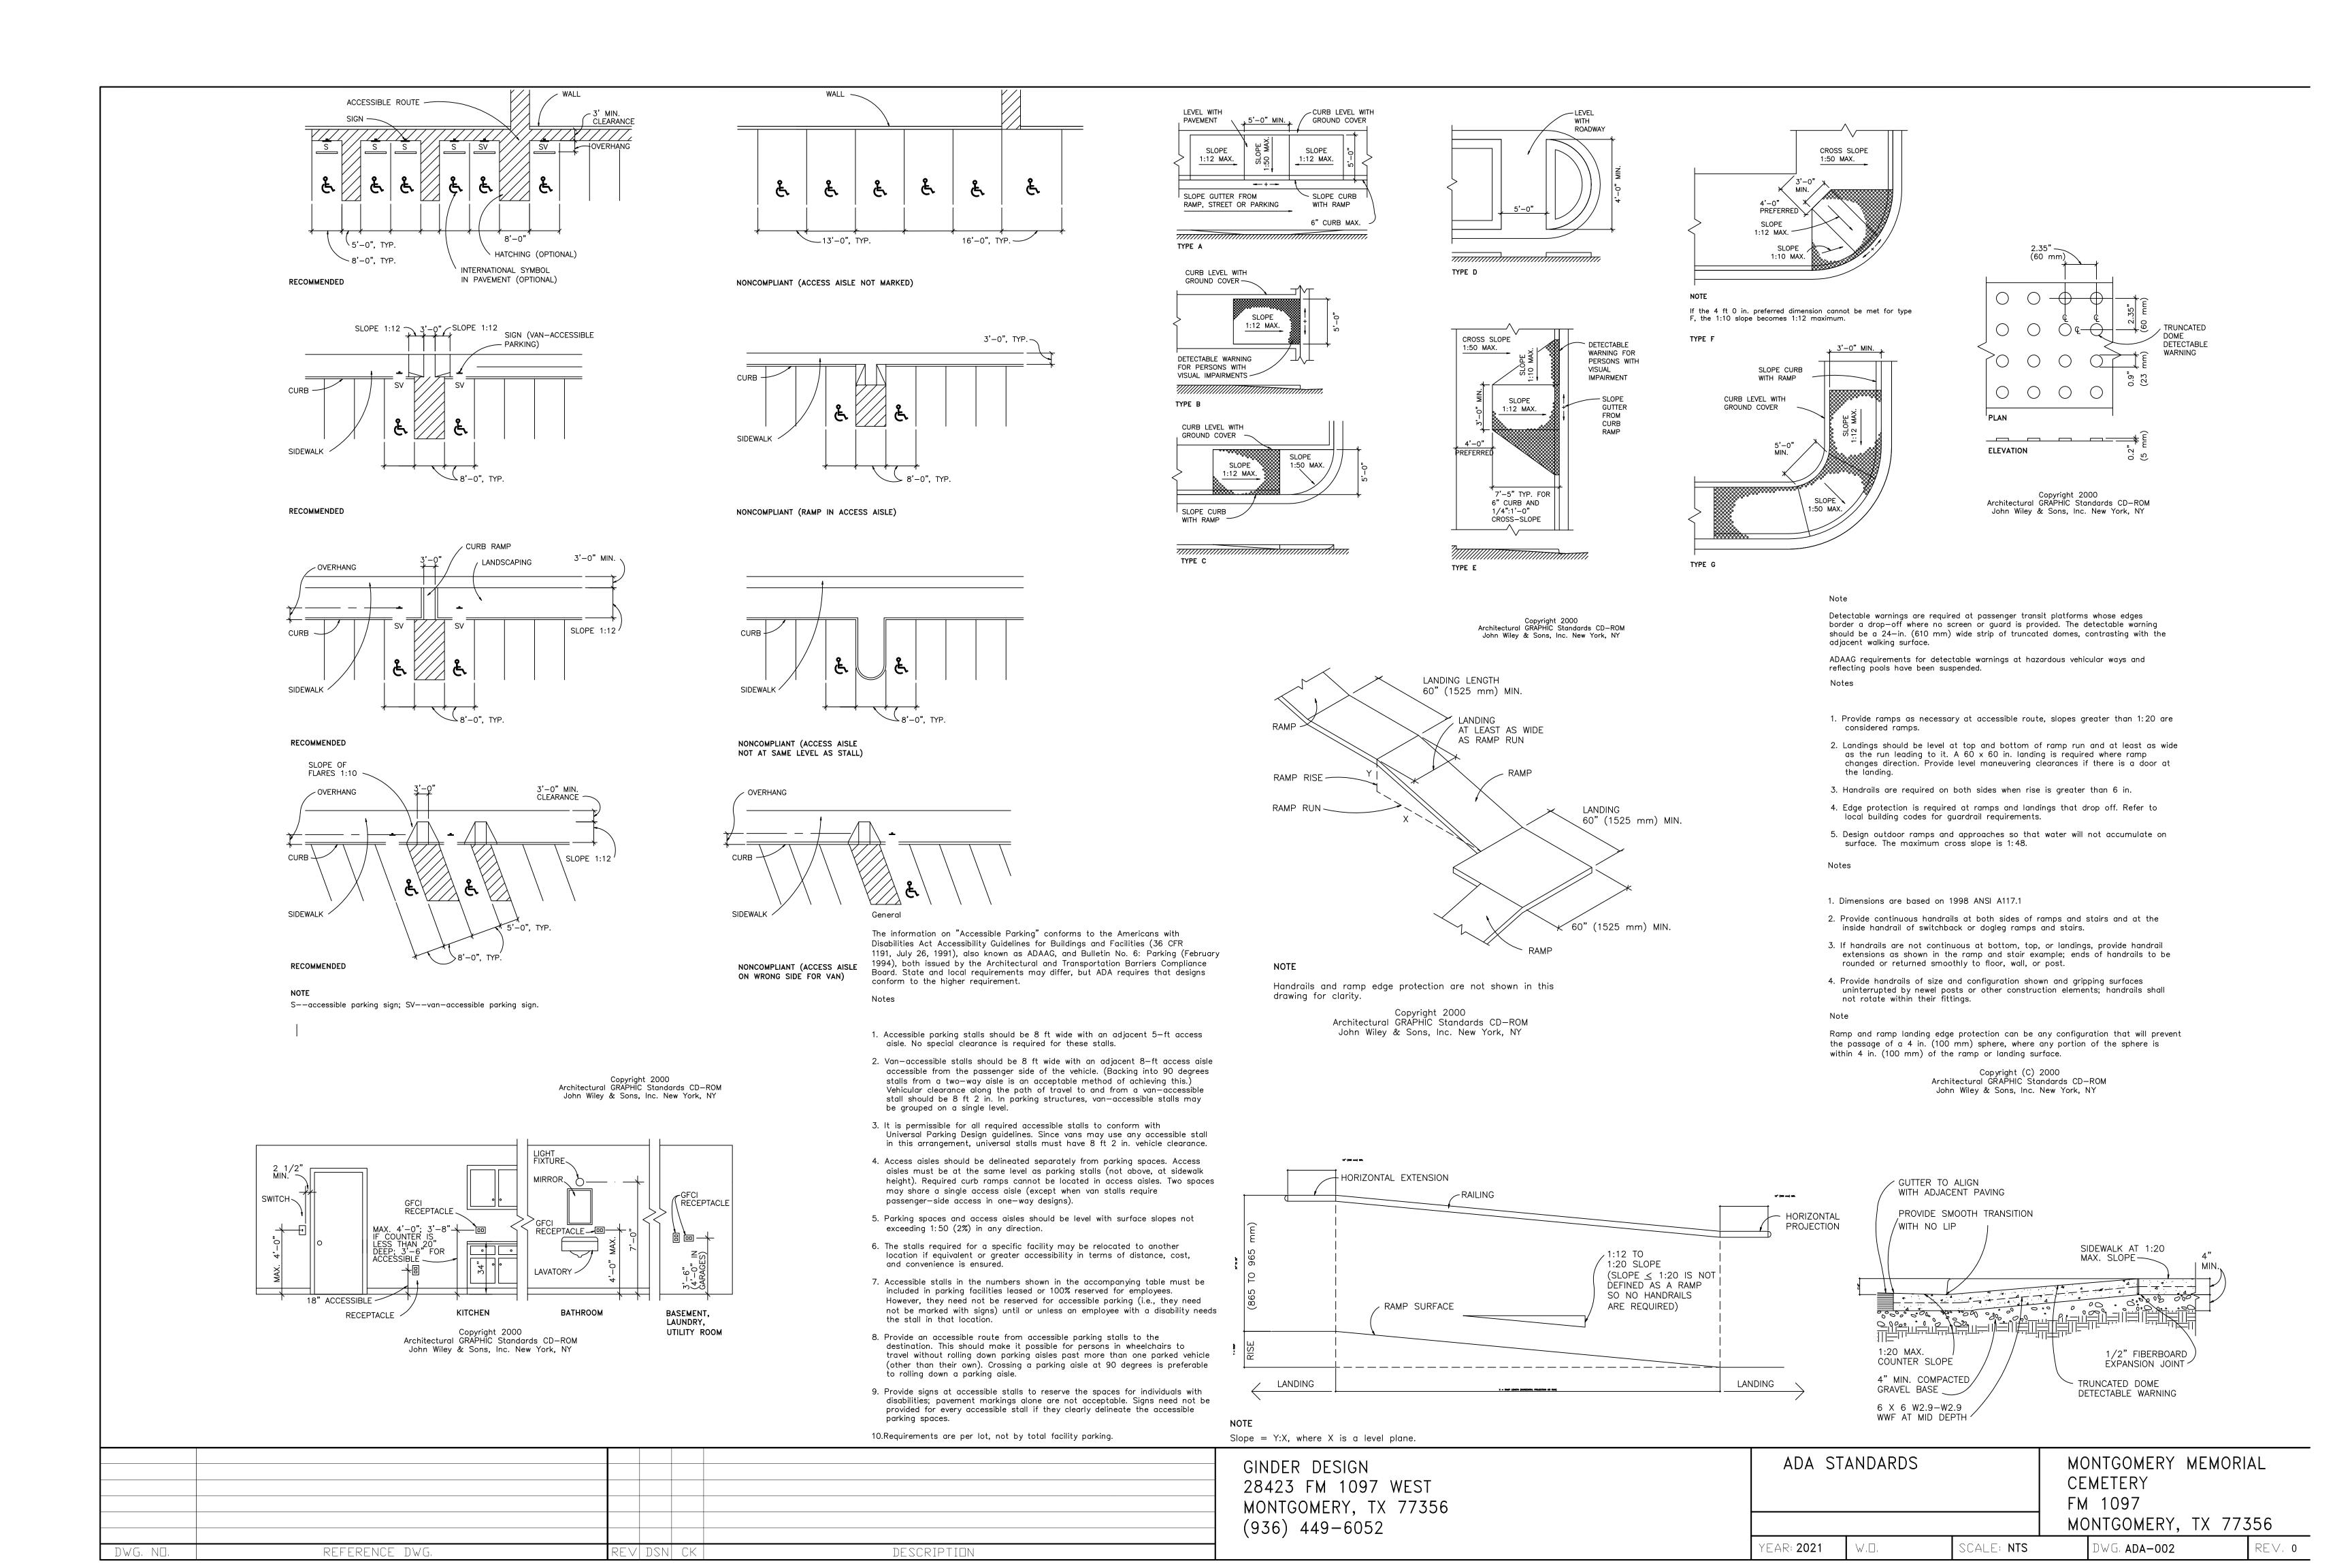

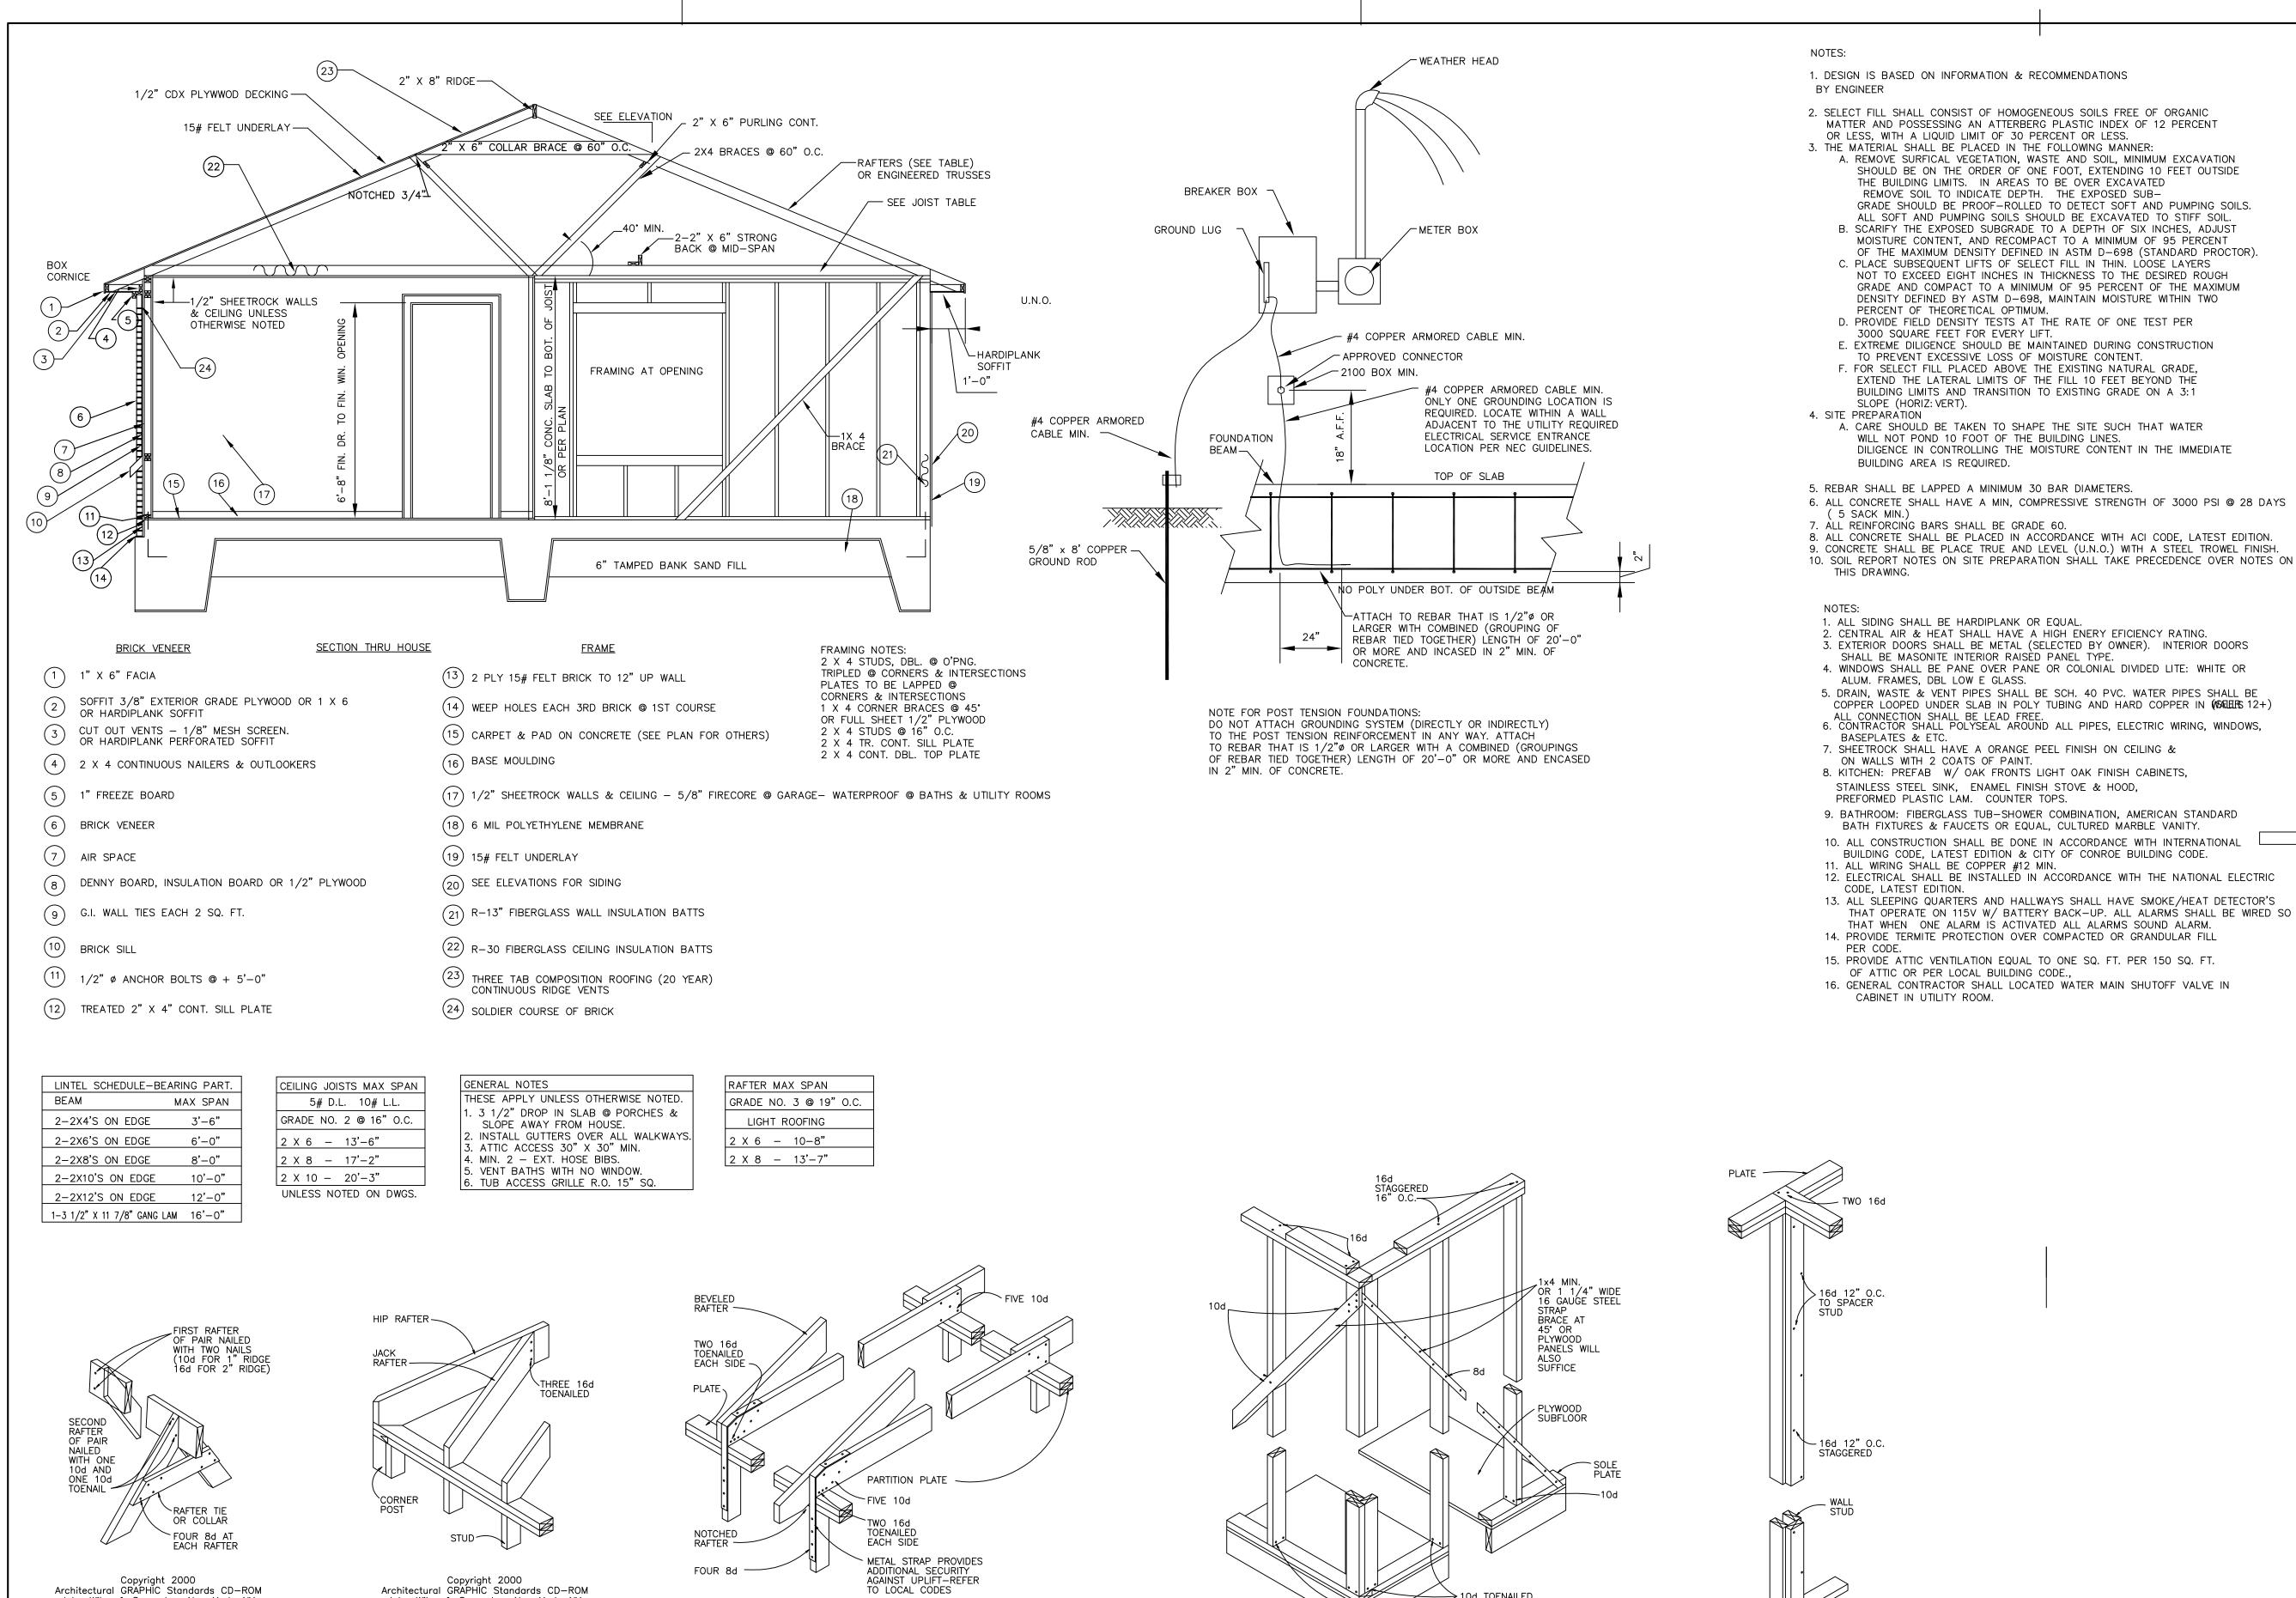

1. DESIGN IS BASED ON INFORMATION & RECOMMENDATIONS

2. SELECT FILL SHALL CONSIST OF HOMOGENEOUS SOILS FREE OF ORGANIC MATTER AND POSSESSING AN ATTERBERG PLASTIC INDEX OF 12 PERCENT

OR LESS, WITH A LIQUID LIMIT OF 30 PERCENT OR LESS. 3. THE MATERIAL SHALL BE PLACED IN THE FOLLOWING MANNER A. REMOVE SURFICAL VEGETATION, WASTE AND SOIL, MINIMUM EXCAVATION

REMOVE SOIL TO INDICATE DEPTH. THE EXPOSED SUB-GRADE SHOULD BE PROOF-ROLLED TO DETECT SOFT AND PUMPING SOILS. ALL SOFT AND PUMPING SOILS SHOULD BE EXCAVATED TO STIFF SOIL. B. SCARIFY THE EXPOSED SUBGRADE TO A DEPTH OF SIX INCHES, ADJUST MOISTURE CONTENT, AND RECOMPACT TO A MINIMUM OF 95 PERCENT

OF THE MAXIMUM DENSITY DEFINED IN ASTM D-698 (STANDARD PROCTOR). C. PLACE SUBSEQUENT LIFTS OF SELECT FILL IN THIN. LOOSE LAYERS NOT TO EXCEED EIGHT INCHES IN THICKNESS TO THE DESIRED ROUGH GRADE AND COMPACT TO A MINIMUM OF 95 PERCENT OF THE MAXIMUM DENSITY DEFINED BY ASTM D-698, MAINTAIN MOISTURE WITHIN TWO

D. PROVIDE FIELD DENSITY TESTS AT THE RATE OF ONE TEST PER

E. EXTREME DILIGENCE SHOULD BE MAINTAINED DURING CONSTRUCTION TO PREVENT EXCESSIVE LOSS OF MOISTURE CONTENT. F. FOR SELECT FILL PLACED ABOVE THE EXISTING NATURAL GRADE,

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5. REBAR SHALL BE LAPPED A MINIMUM 30 BAR DIAMETERS.

6. ALL CONCRETE SHALL HAVE A MIN, COMPRESSIVE STRENGTH OF 3000 PSI @ 28 DAYS

8. ALL CONCRETE SHALL BE PLACED IN ACCORDANCE WITH ACI CODE, LATEST EDITION. 9. CONCRETE SHALL BE PLACE TRUE AND LEVEL (U.N.O.) WITH A STEEL TROWEL FINISH.

2. CENTRAL AIR & HEAT SHALL HAVE A HIGH ENERY EFICIENCY RATING. 3. EXTERIOR DOORS SHALL BE METAL (SELECTED BY OWNER). INTERIOR DOORS SHALL BE MASONITE INTERIOR RAISED PANEL TYPE.

ALUM. FRAMES, DBL LOW E GLASS. 5. DRAIN, WASTE & VENT PIPES SHALL BE SCH. 40 PVC. WATER PIPES SHALL BE COPPER LOOPED UNDER SLAB IN POLY TUBING AND HARD COPPER IN (MALES 12+)

ALL CONNECTION SHALL BE LEAD FREE.
6. CONTRACTOR SHALL POLYSEAL AROUND ALL PIPES, ELECTRIC WIRING, WINDOWS,

7. SHEETROCK SHALL HAVE A ORANGE PEEL FINISH ON CEILING & ON WALLS WITH 2 COATS OF PAINT. 8. KITCHEN: PREFAB W/ OAK FRONTS LIGHT OAK FINISH CABINETS,

9. BATHROOM: FIBERGLASS TUB-SHOWER COMBINATION, AMERICAN STANDARD BATH FIXTURES & FAUCETS OR EQUAL, CULTURED MARBLE VANITY.

10. ALL CONSTRUCTION SHALL BE DONE IN ACCORDANCE WITH INTERNATIONAL BUILDING CODE, LATEST EDITION & CITY OF CONROE BUILDING CODE.

11. ALL WIRING SHALL BE COPPER #12 MIN. 12. ELECTRICAL SHALL BE INSTALLED IN ACCORDANCE WITH THE NATIONAL ELECTRIC

13. ALL SLEEPING QUARTERS AND HALLWAYS SHALL HAVE SMOKE/HEAT DETECTOR'S THAT OPERATE ON 115V W/ BATTERY BACK-UP. ALL ALARMS SHALL BE WIRED SO THAT WHEN ONE ALARM IS ACTIVATED ALL ALARMS SOUND ALARM.

14. PROVIDE TERMITE PROTECTION OVER COMPACTED OR GRANDULAR FILL 15. PROVIDE ATTIC VENTILATION EQUAL TO ONE SQ. FT. PER 150 SQ. FT.

OF ATTIC OR PER LOCAL BUILDING CODE.,

16. GENERAL CONTRACTOR SHALL LOCATED WATER MAIN SHUTOFF VALVE IN CABINET IN UTILITY ROOM.

(EAR: 2021

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## ELECTRICAL LEGEND

SINGLE POLE SWITCH 3 WAY SWITCH 120V. DUPLEX OUTLET 120V. DUPLEX OUTLET W/ GROUND FAULT INDICATOR

220V. OUTLET

2~TUBE 4' STRIP FLOURECENT LIGHT FIXTURE W/ TUBE COVERS

2~TUBE 8' STRIP FLOURECENT LIGHT FIXTURE W/ TUBE COVERS


2' x 4' FLOURECENT SURFACE MOUNTED MT FLUOR LIGHT FIXTURE W/ DIFFUSER

SURFACE MT. LT. FIXTURE

SMOKE DETECTOR


THERMOSTAT

GARBAGE DISPOSAL

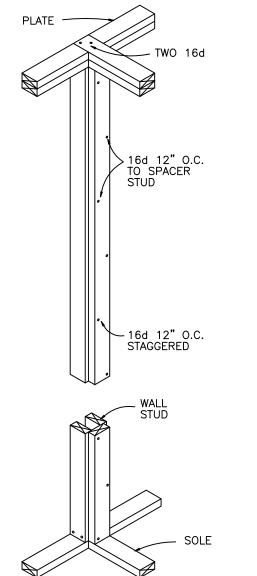

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28423 FM 1097 WEST MONTGOMERY, TX 77356 STANDARDS MONTGOMERY MEMORIAL CEMETERY FM 1097 MONTGOMERY, TX 77356

SCALE: NTS

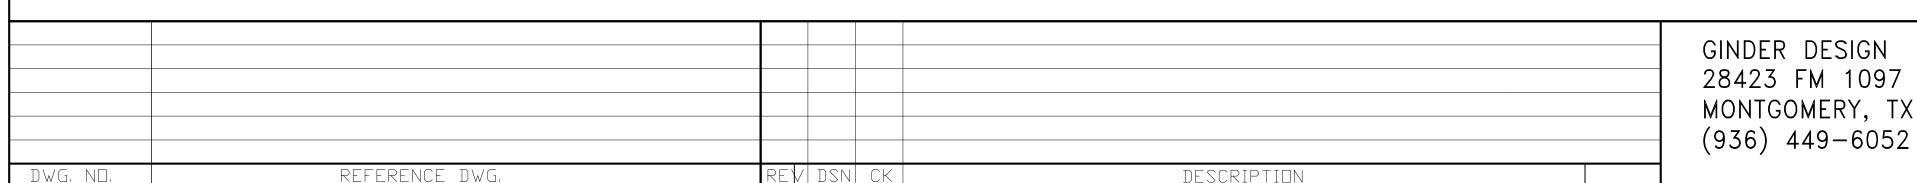WG. STD-001

REV. 0

