
BELDEN PLACE

Lot 12 - 0019 Belden Way Single Family w/ ADU Minturn, CO 81645

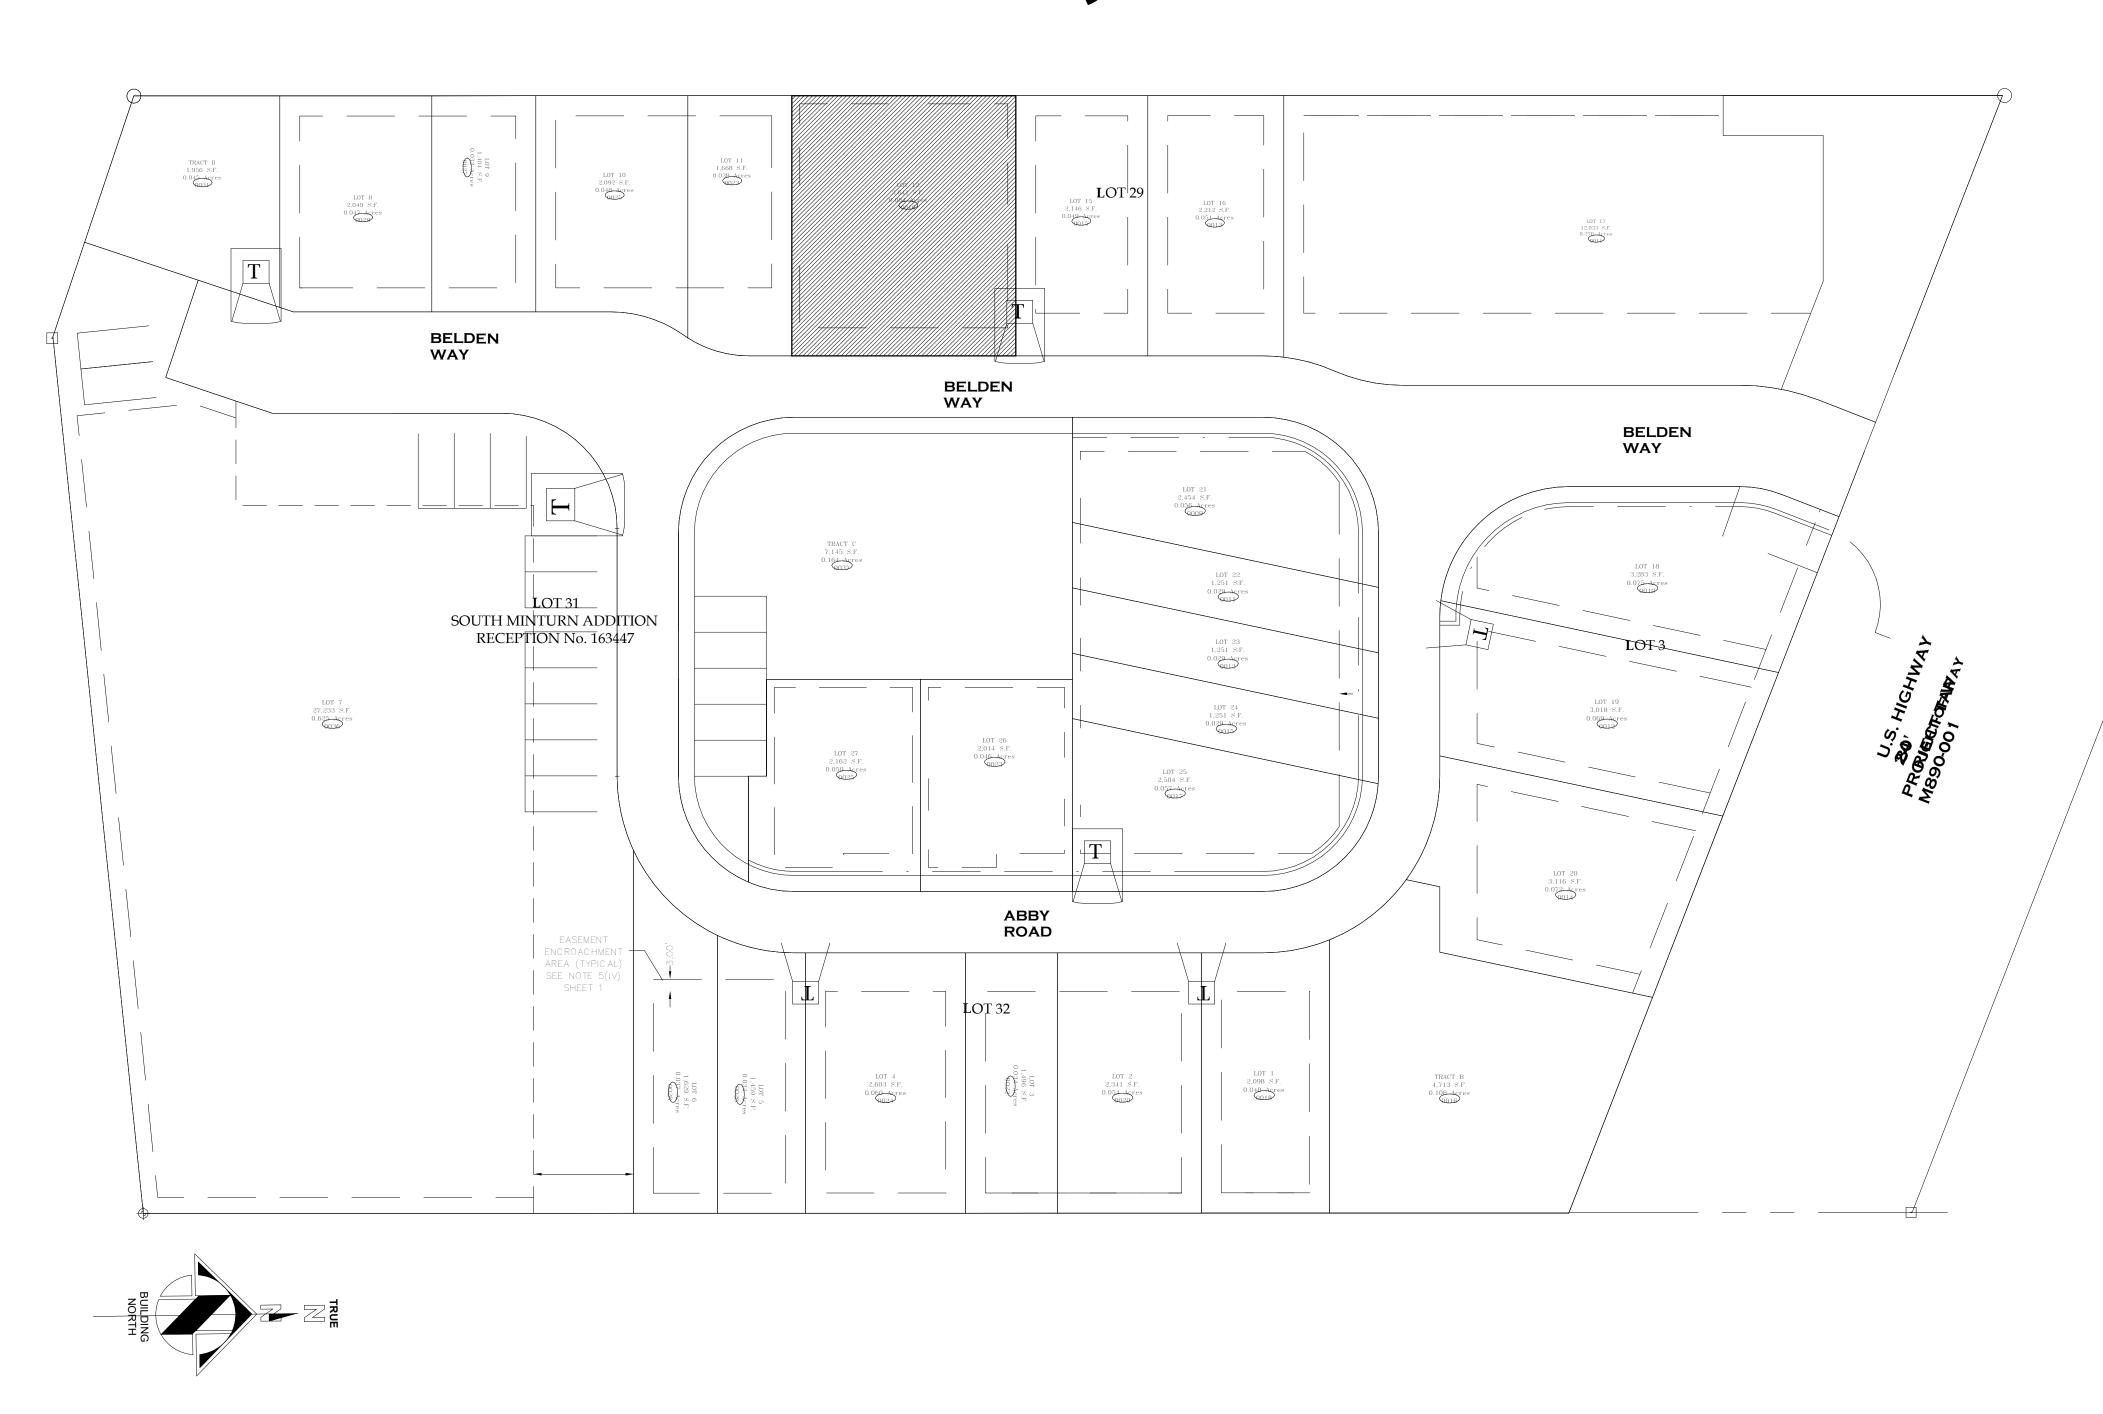

DESIGN REVIEW 12/11/2024



A0.02 PUD GUIDE P0.01 PLAT

C1.110 SURVEY C1.111 OVERALL SITE PLAN

C1 SITE DI ANI

.1 SITE PLAN

C.2 DETAILS AND CROSS SECTIONS
A1.1 LANDSCAPE PLAN AND DETAILS
A2.1 BASEMENT AND GROUND FLOOR PLANS

A2.1 BASEMENT AND GROUND LOOK FLA A2.2 MAIN AND UPPER FLOOR PLANS

A2.3 ROOF PLAN


A3.1 EXTERIOR ELEVATIONS A3.2 EXTERIOR ELEVATIONS

A3.2 EXTERIOR ELI A3.3 RENDERINGS A3.4 MATERIALS

A4.1 SECTIONS A5.01 DETAILS A5.02 DETAILS



VICINITY MAP

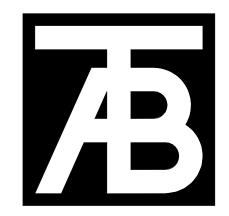

TAB Associate

Associates

The Architectural Balance

0056 Edwards Village Blvd.
Suite 210
Edwards, CO 81632

(970) 766-1470
fax: (970) 766-1471
email: tab@vail.net
www.tabassociates.com

Civil Engineer

Timberline Engineering
(970) 963-9869
Structural Engineer

KRM Consultants, Inc
(970) 949-9391

Electrical Engineer

Seal

den Place - Single Family w/ ADU Lot 12 - 0019 Belden Way

Revisions:
No Description Date

Issue Dates:
DRB-10/10/2024
DRB-12/11/2024

Sheet Title:
Cover


Project No:
2215

Sheet No:


BELDEN PLACE PUD GUIDE INFORMATION

The following is an abrieviated verision of information found in the PUD guide.

Building Height. Determining building height uses a weighted height calculation as measured from final/finished grade. Max heights - 28' for single famil and duplex, 35' for Row Houses and Flats.

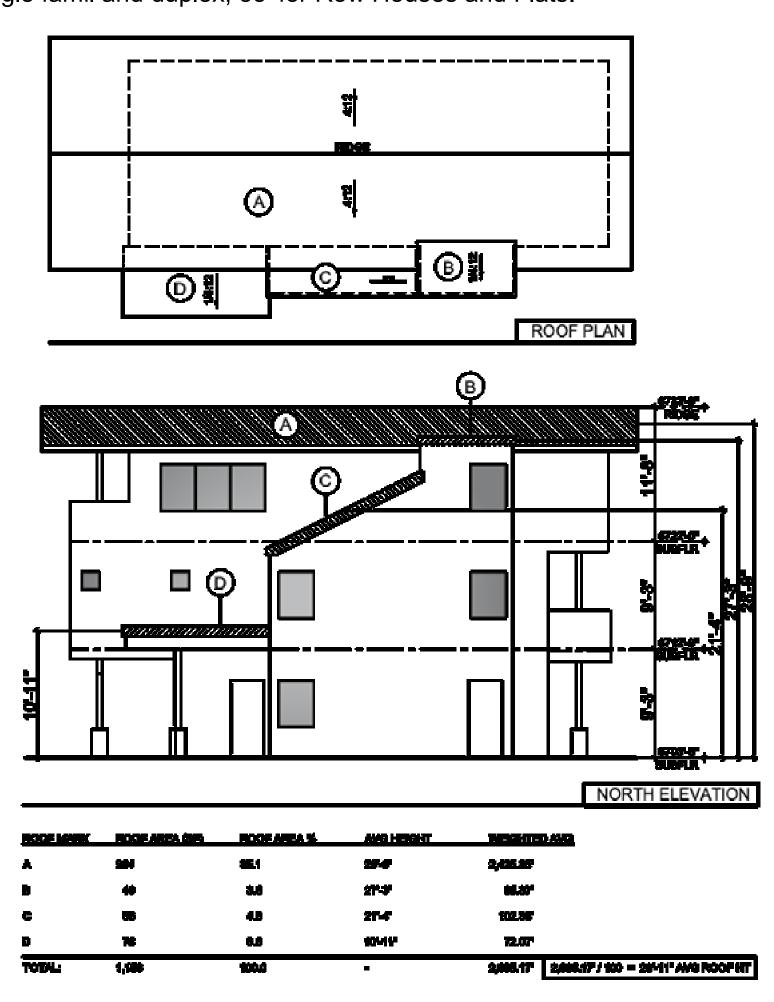

Site Coverage. Site coverage means the portion of a lot covered by materials forming any unbroken surface, impervious to water including, but not limited to: buildings, streets, slab on-grade patios, exterior fireplaces, and other hardscape materials. Site coverage excludes nonhardscape areas under eaves or similar (e.g., open-sided cantilever)

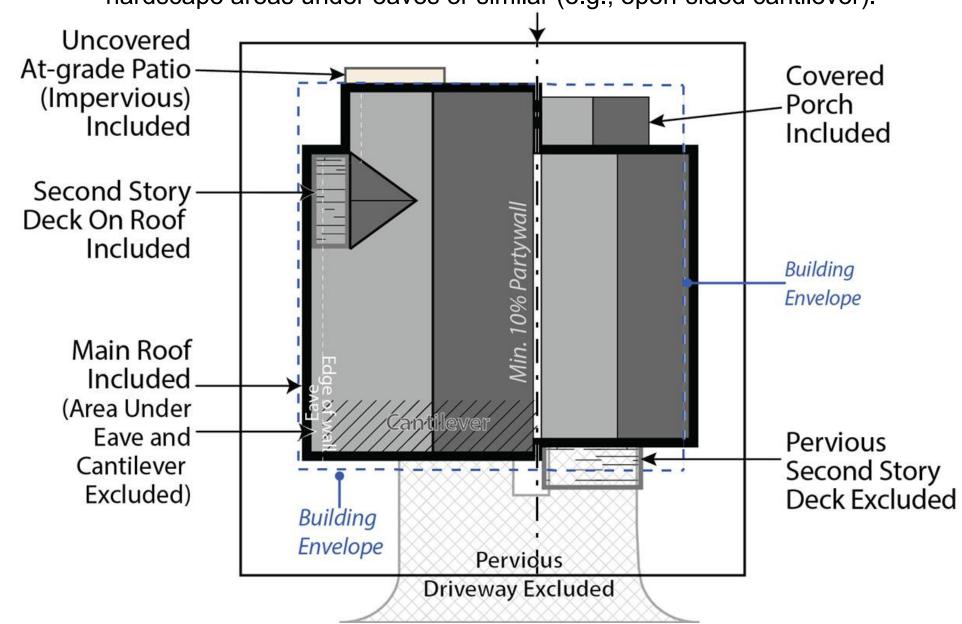

BUILDING PLACEMENT AND ENVELOPES

Residential building envelopes are necessary in order to maximize the buildability and economic viability of the lots while offering greenspace and or space between neighbors to the greatest extent possible. All portions of structure- including fireplaces, chimneys, window wells, eaves, overhangs, etc. must be contained within property lines; however, with the platted building envelope acting as building setbacks for each lot, encroachments are available for certain features.

The following encroachments are permitted beyond the platted building envelope:

Unenclosed or uncovered decks; deck supports; eaves up to 18" beyond the envelope; porches, patios and landings less than 30" above the surrounding natural or finished grade; window or light wells; heat or A/C units; residential solar alternative energy installations; fences; counterforts below grade; staircases (enclosed or otherwise); structures of less than 6" in height; landscaping and drainage features. No encroachment may be located within 24" from the property line or directly on top of in-ground utility easements. Underground parking elements and staircases may encroach within 12" of the most southern property line on Lot 7.

SINGLE-FAMILY DETACHED

a. Style

- (1) Residences with the same architectural elevations and coloring shall not be placed adjacent to each other or directly across the street from one another.
- (2) Each residential unit type shall have at least two (2) elevations to provide stylistic diversity. This may include:
- Roof forms/lines and profiles
- Varied window and door styles
- Varied entry treatments and locations including porches, columns, etc.
- iv. Two or three story homes
- Second or third story decks or balconies

b. Building Form

- (1) The mass of the residence should strongly reflect the architectural style and be scaled to provide visual interest and depth, reduce boxiness and achieve an articulated form on the front and sides of the homes.
- (2) Roofs shall be designed and pitched accordingly in consideration of solar technology and/or drainage
- (3) Roof-top decks are permitted only on certain lots as established by developer and cannot be added on buildings not constructed with this initial feature.

2. DUPLEX/TRI-PLEX or MULTIFAMILY STRUCTURES

- (1) Structures shall have at least two (2) elevations to provide stylistic diversity.
- (2) Units may be multi-stories.
- (3) Units may be divided horizontally (townhomes) or vertically
- (4) Second story decks or balconies permitted.
- (5) Units have no minimum length of connection and may be joined via shared walls of the garage, external staircases, or main living area wall(s) or floors.

b. Building Form

- (1) The mass of the residence should strongly reflect the architectural style and be scaled to provide visual interest and depth, reduce boxiness and achieve an articulated form on the front of the homes.
- (2) Roofs shall be designed and pitched accordingly in
- consideration of solar technology and/or drainage
- (3) Roof-top decks are permitted only on certain lots as established by developer and cannot be added on buildings not constructed with this initial feature.

3. MATERIALS

Roofing materials are limited to the following:

- (1) Artificial wood shingle (to mimic wood shake shingle). Treated wood shake shingles or any other combustible material is prohibited.
- (2) Standing seam metal.
- (3) Asphalt shingles.
- (4) Imitation (composite or similar); or, real slate tiles.
- (5) Non-reflective solar tiles that mimic the above-mentioned products
- (6) Any other recommended FireWise materials similar to the above-mentioned products.

Siding materials are limited to the following:

- (1) Metal
- (2) Wood
- (3) Composite siding (4) Fiber cement board (commonly known as "Hardie Board")
- (5) Stucco.
- (6) Any other recommended FireWise materials similar to the above-mentioned products.
- (7) All siding materials to have non-reflective finishes.

c. Doors and Windows:

- (1) Structures with multiple garage doors must always have identical, matching doors.
- (2) All replacement windows shall be consistent and match the aesthetic of previous windows unless otherwise approved by the design review board. Skylight or solar tubes permitted.
- (3) Screen or storm doors, in addition to typical front doors are permitted. Screen or storm doors cannot replace front doors at any time.
- Design Elements. This development may incorporate mountain appropriate design elements into the buildings, including, but not limited to, exposed heavy timber beams as accent elements or entry features, walls faced with wood, stone, faux stone or cultured stone, metal railings or accents. Stucco may only be utilized in small quantities on building facades and is not to be used as a primary material for home.
- e. Building materials for residential exteriors shall include at least two (2) types of materials as part of the building façade.

LANDSCAPING – See also PUD Landscaping Plan Shall not interfere with any drainage way, utility, pedestrian access, or entry into any structure. Landscaping shall not obscure windows, be installed under gas fireplace or dryer vents, nor shall any landscaping material overtake any yard, or spread into any common or neighboring yards.

Landscaping minimums:

- 1. At least one (1) tree per 1,200 sf of lot area and two (2) shrubs for all lots. See also official Landscaping Plan for Belden Place. 2. All landscaping proposed on the approved Landscaping Plan shall be installed initially with expectations for maintenance. 3. No exposed soil is permitted. Soil must be covered in
- groundcover that may consist of seed (includes wildflower seed), cobble, perennials, mulch, or similar.
- 4. All dead materials must be replaced during the same season death occurs.




TAB


Associates The Architectural Balan 0056 Edwards Village Blvd. Suite 210 Edwards, CO 81632

> (970) 766-1470 fax: (970) 766-1471 email: tab@vail.net Civil Engineer Timberline Engineerin (970) 963-9869 Structural Engineer KRM Consultants, Inc (970) 949-9391

Mechanical Engineer Electrical Engineer

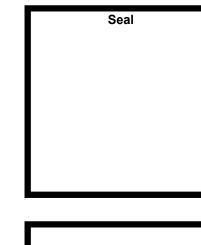

4 **≒**≥ **口**の -<u>-</u> – S . 0 Ф 0 2 <u>a</u> –

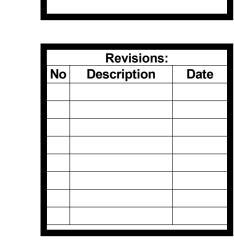


Issue Dates: DRB-10/10/2024


Sheet Title:


PUD Guide


Project No: 2215


A0.2

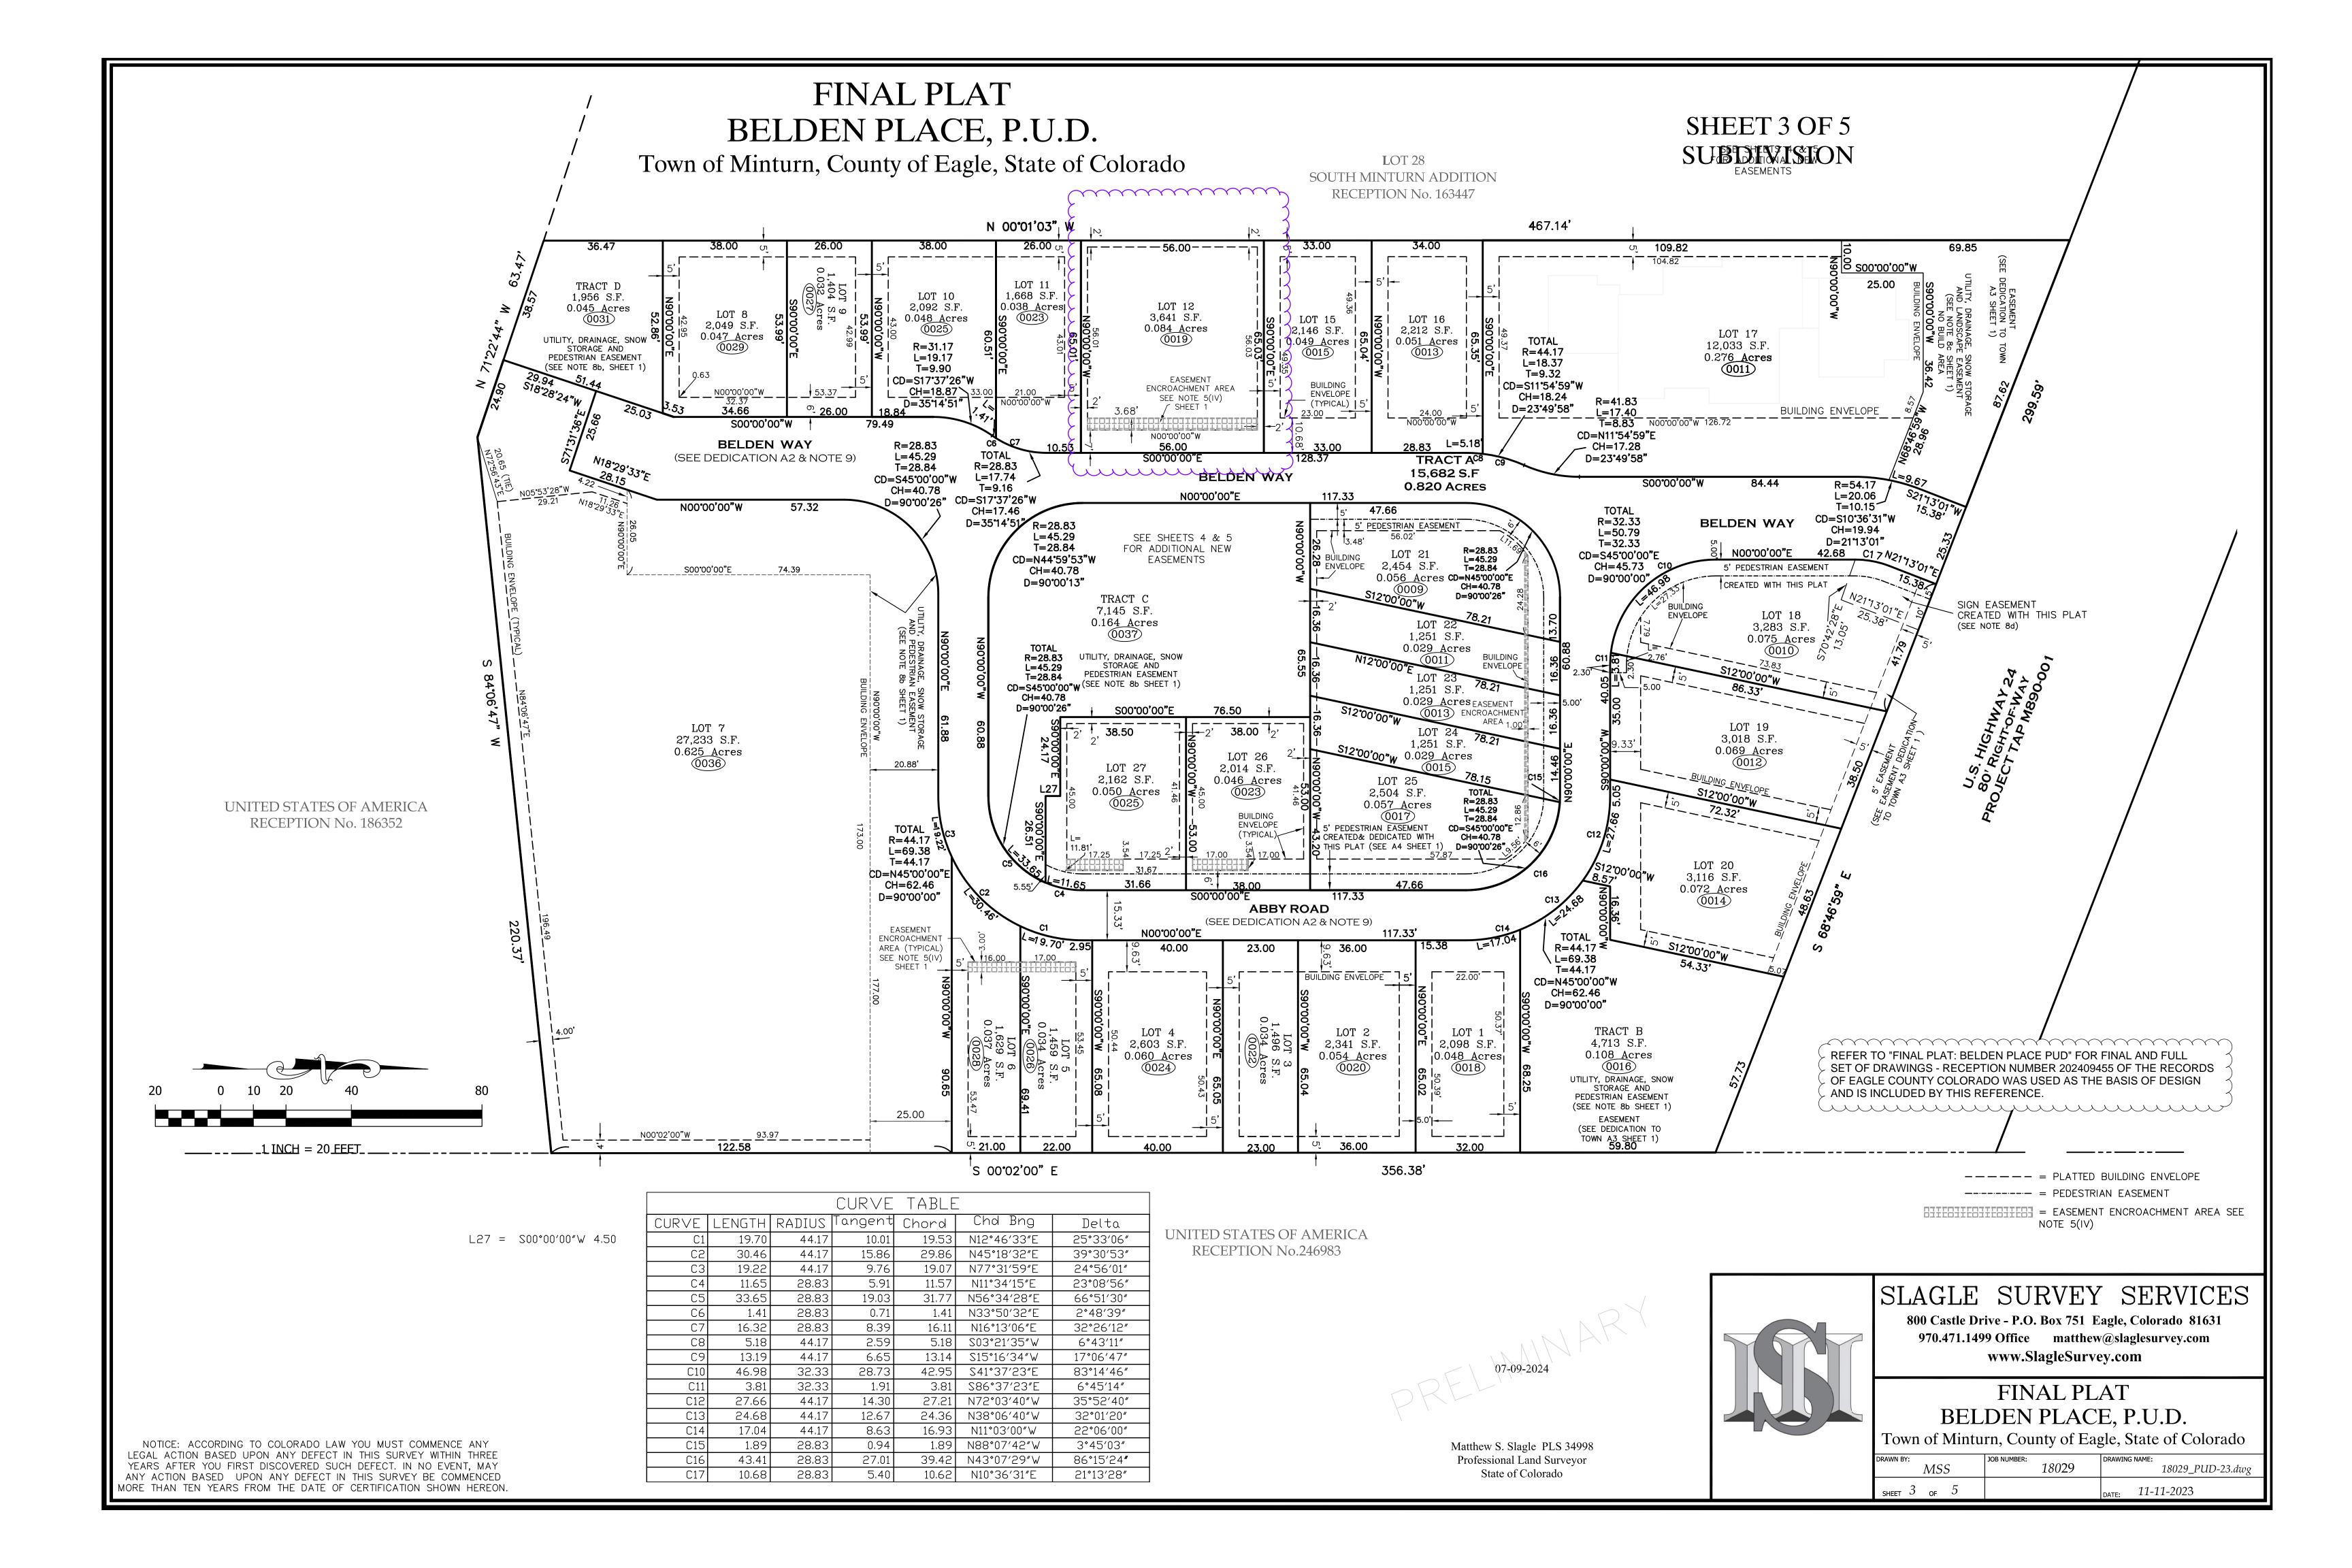


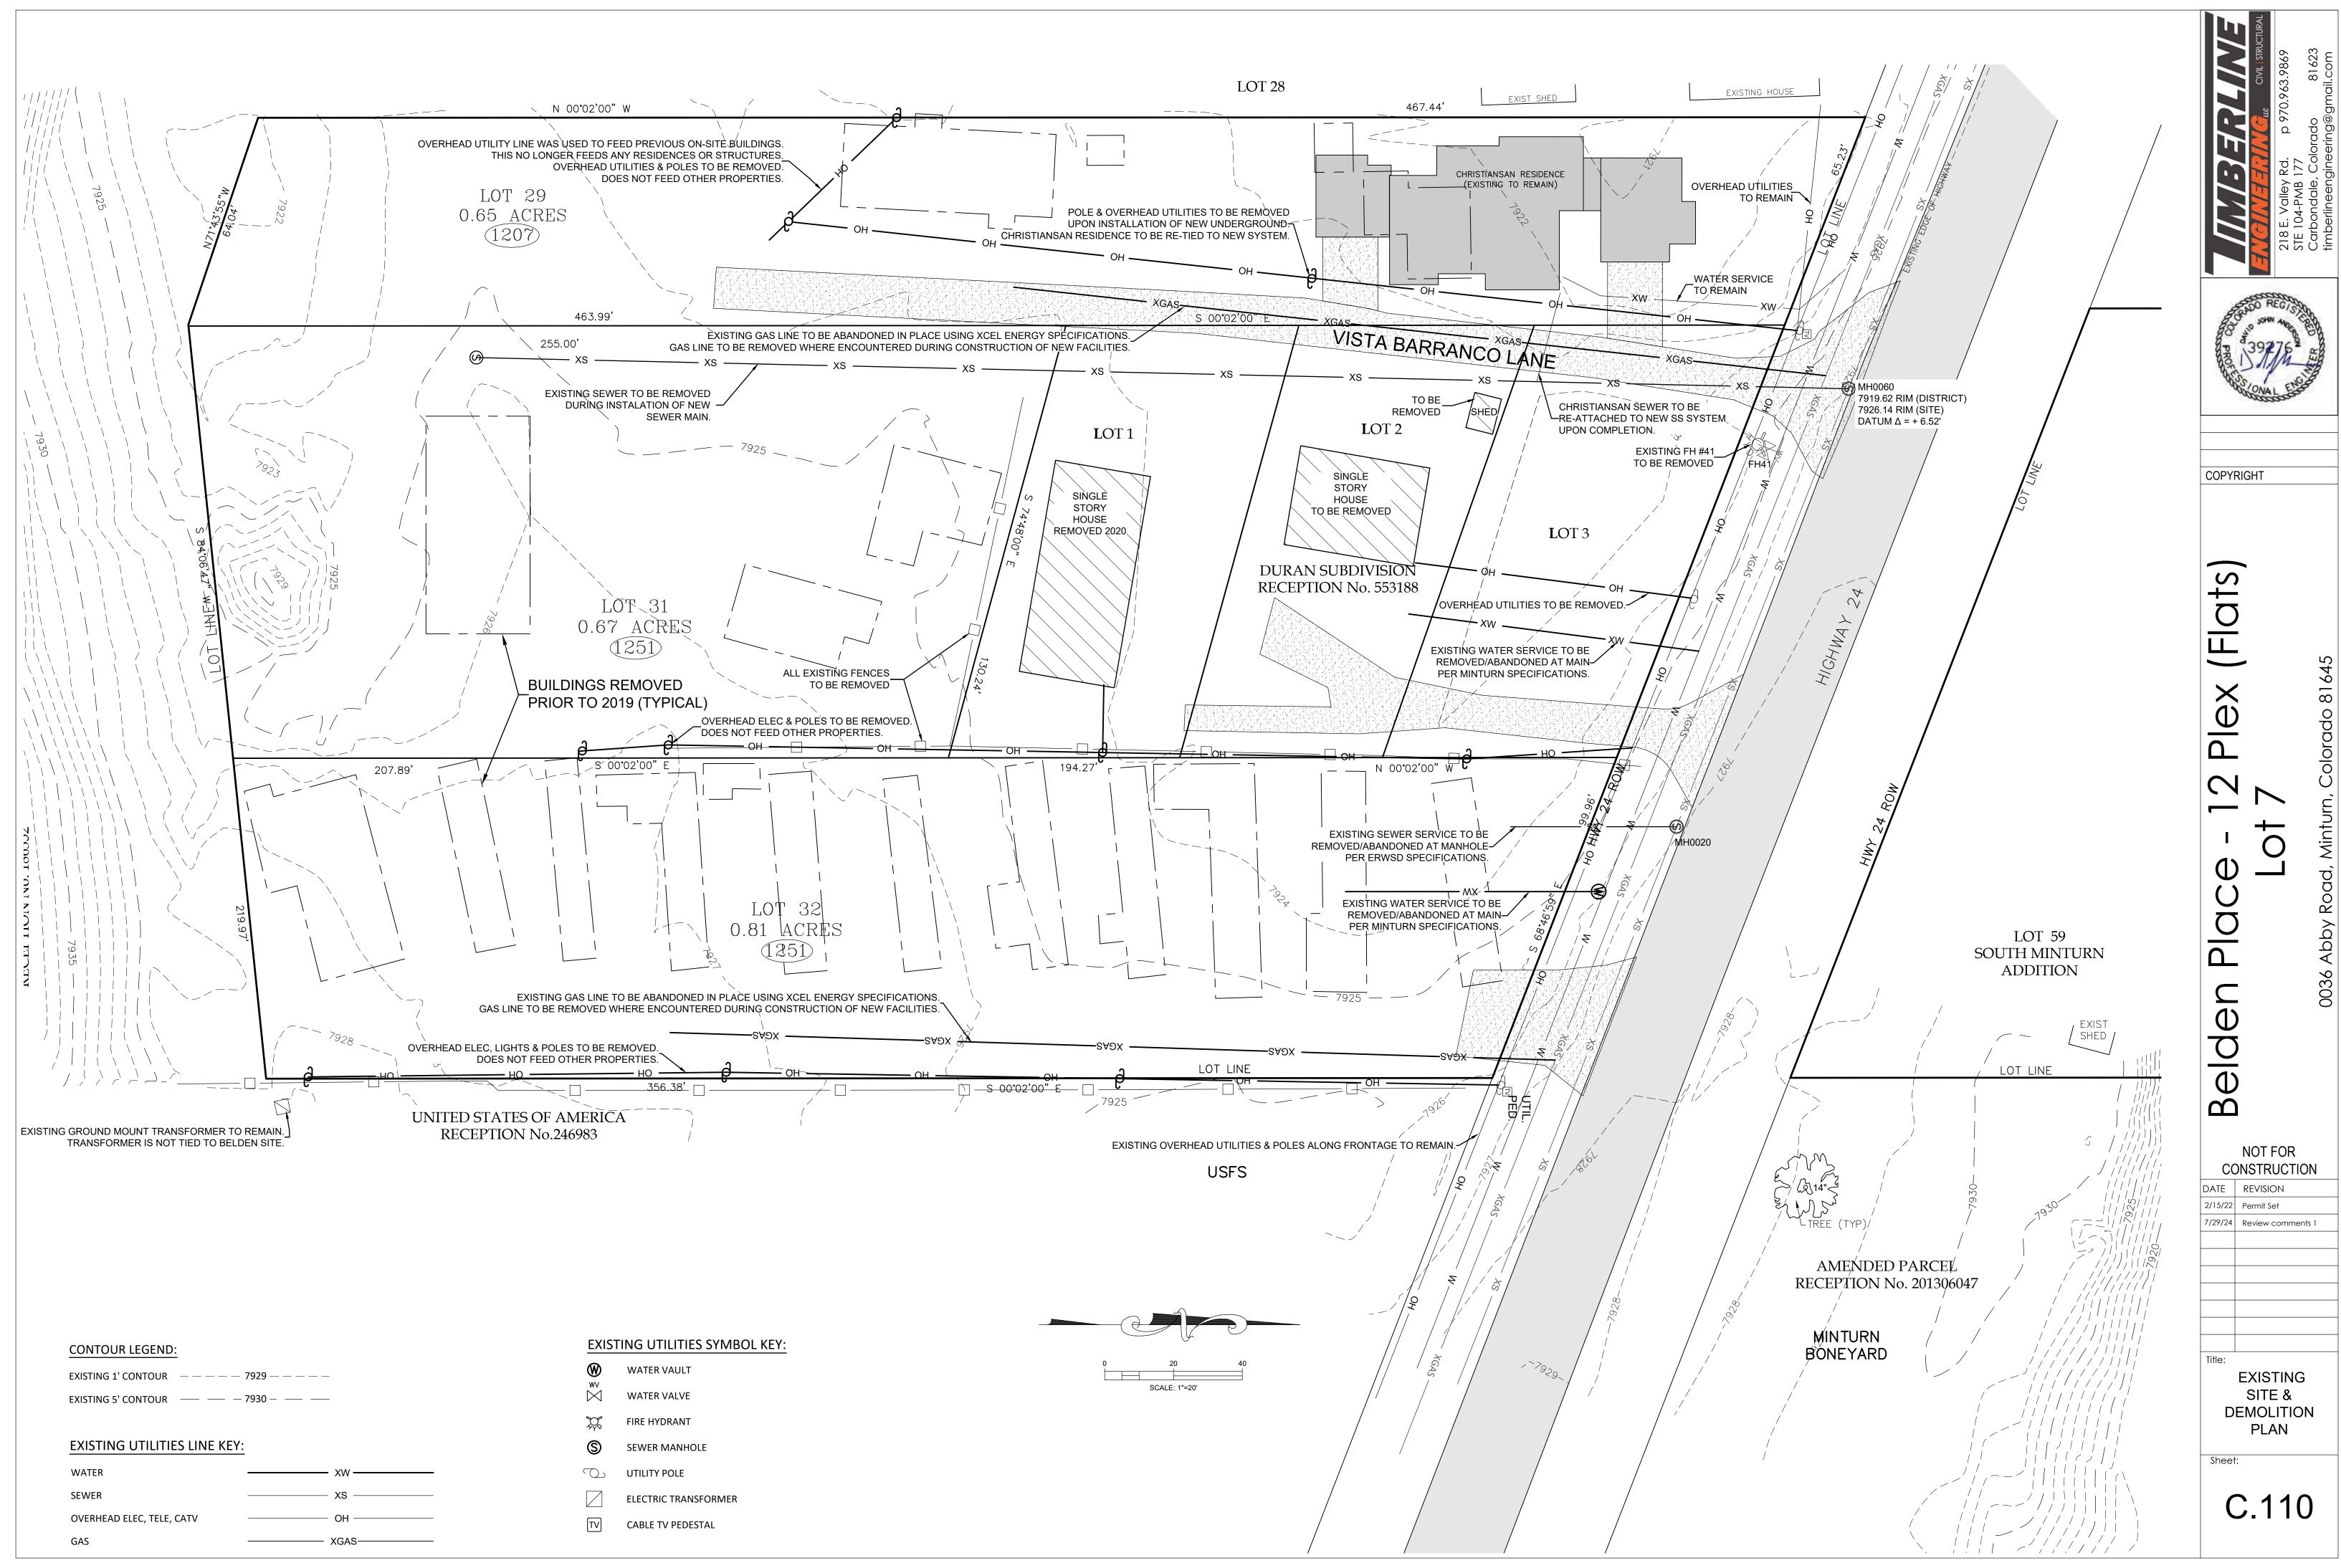


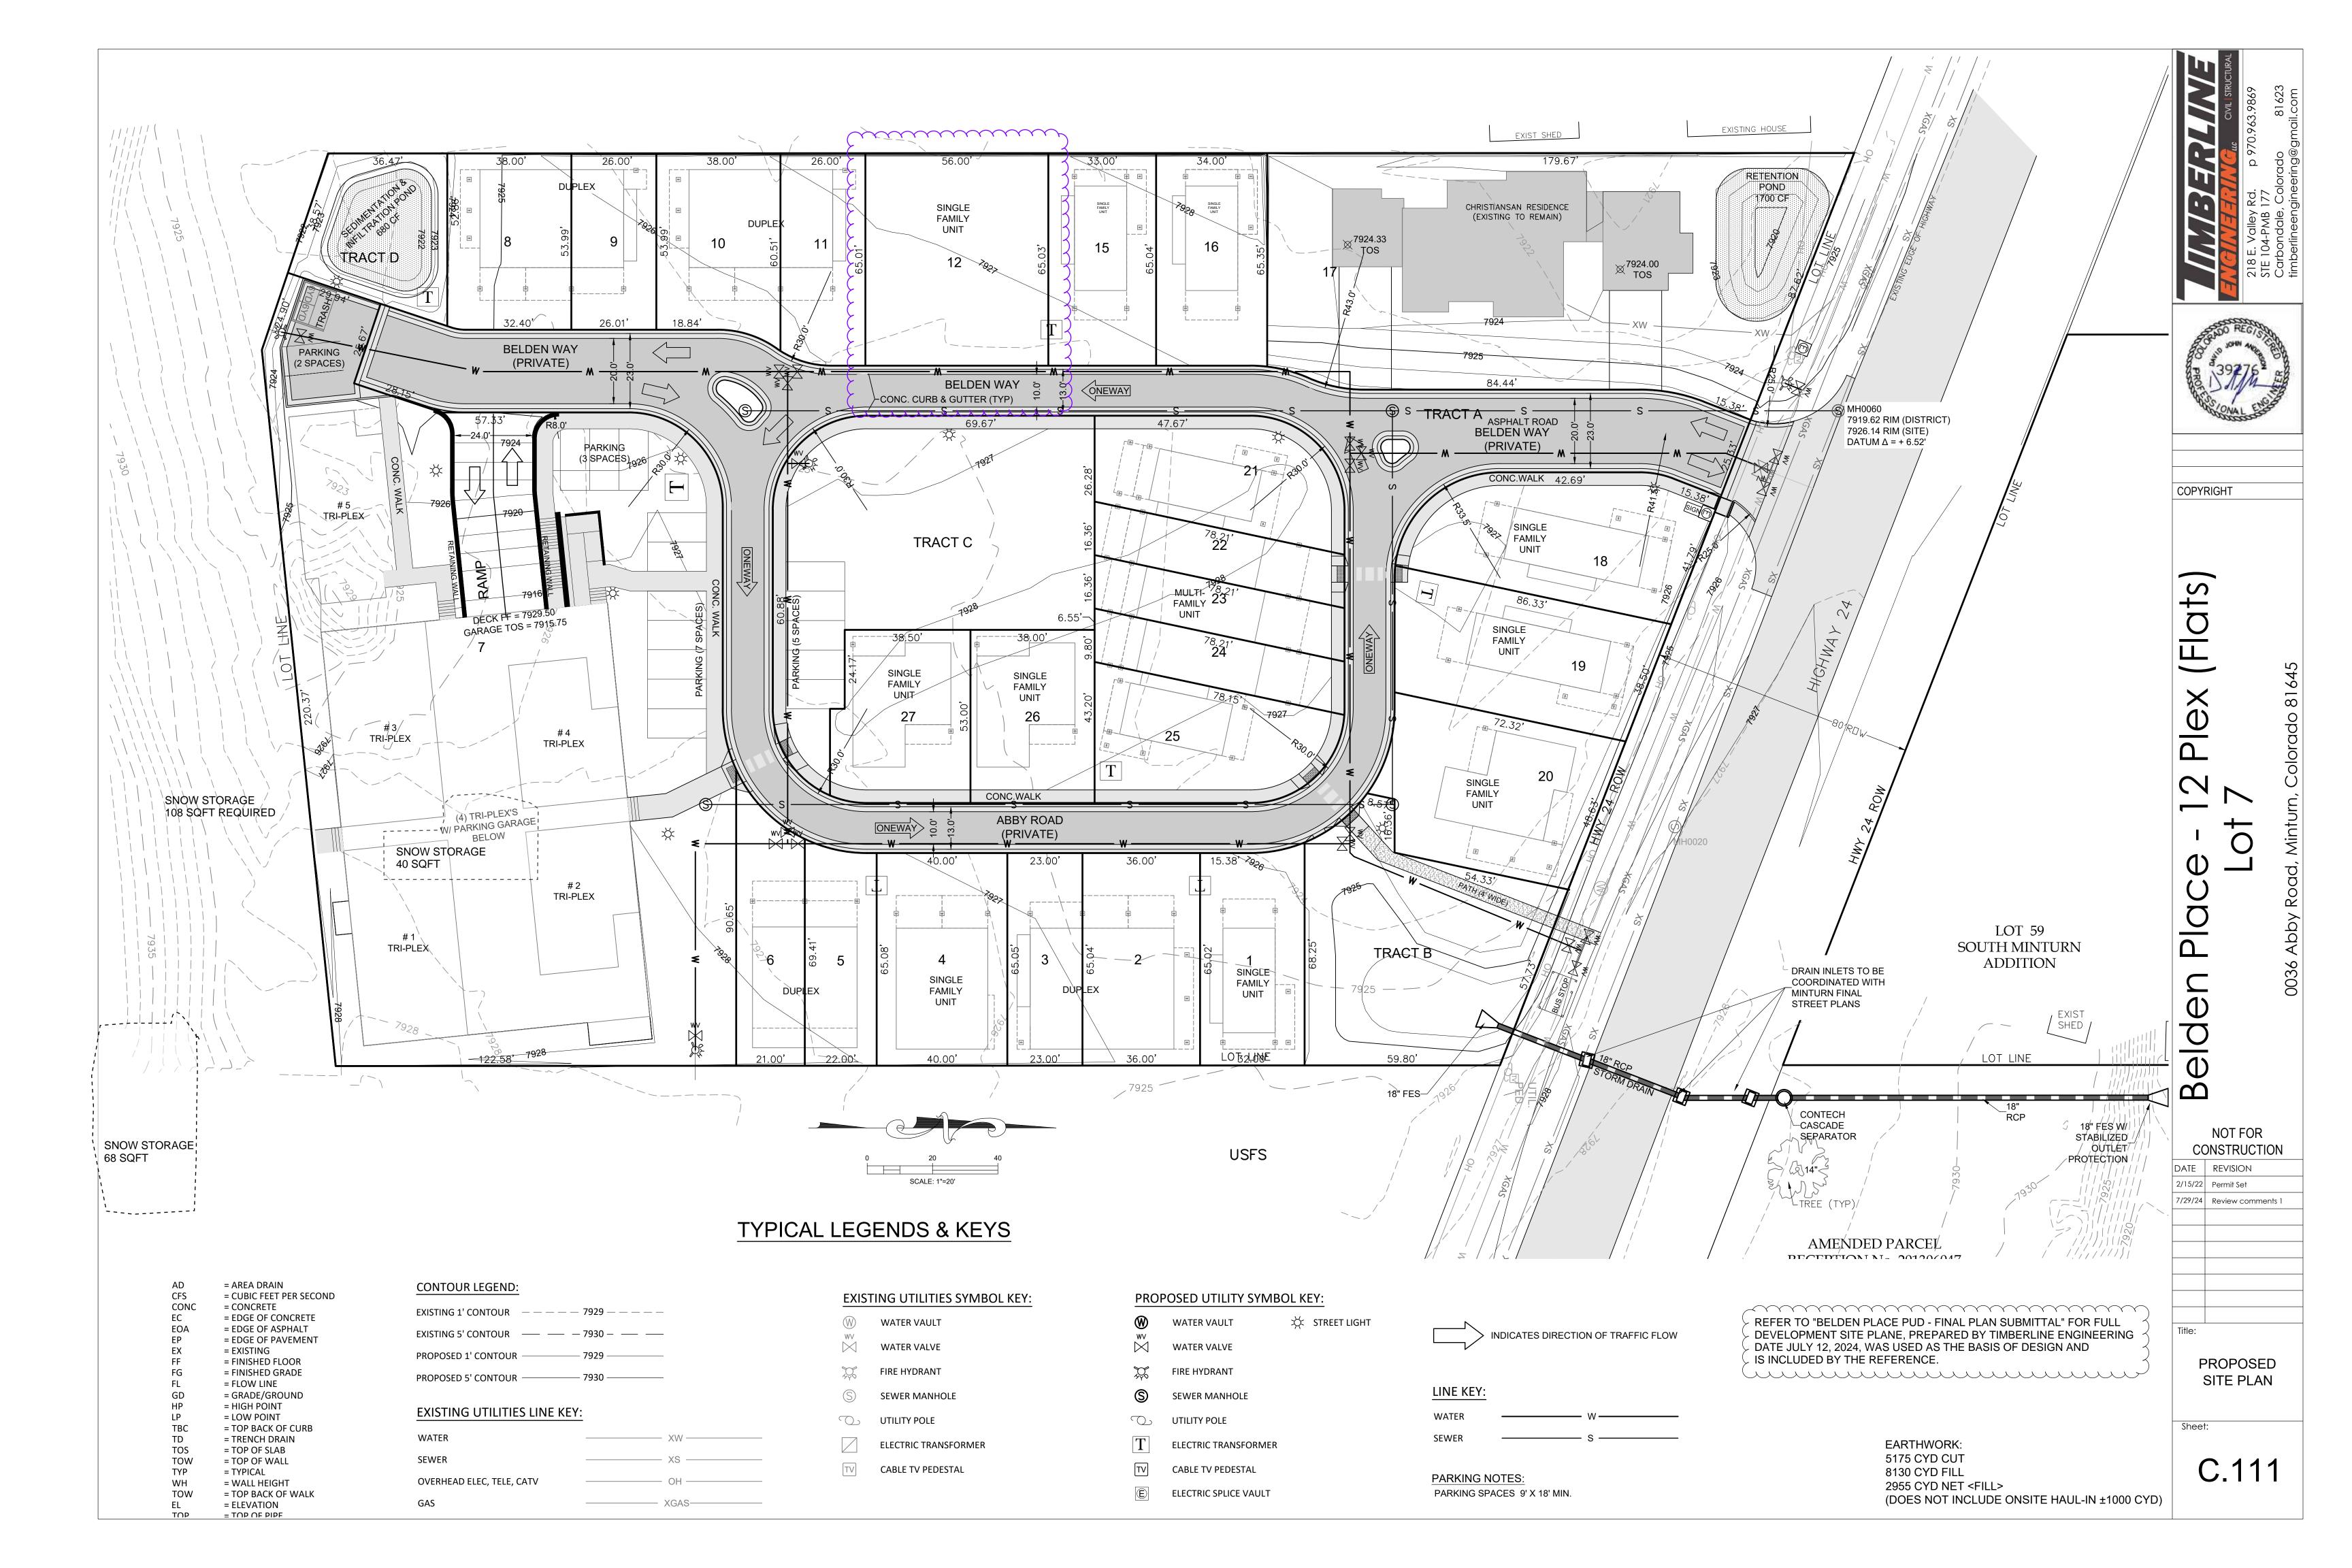


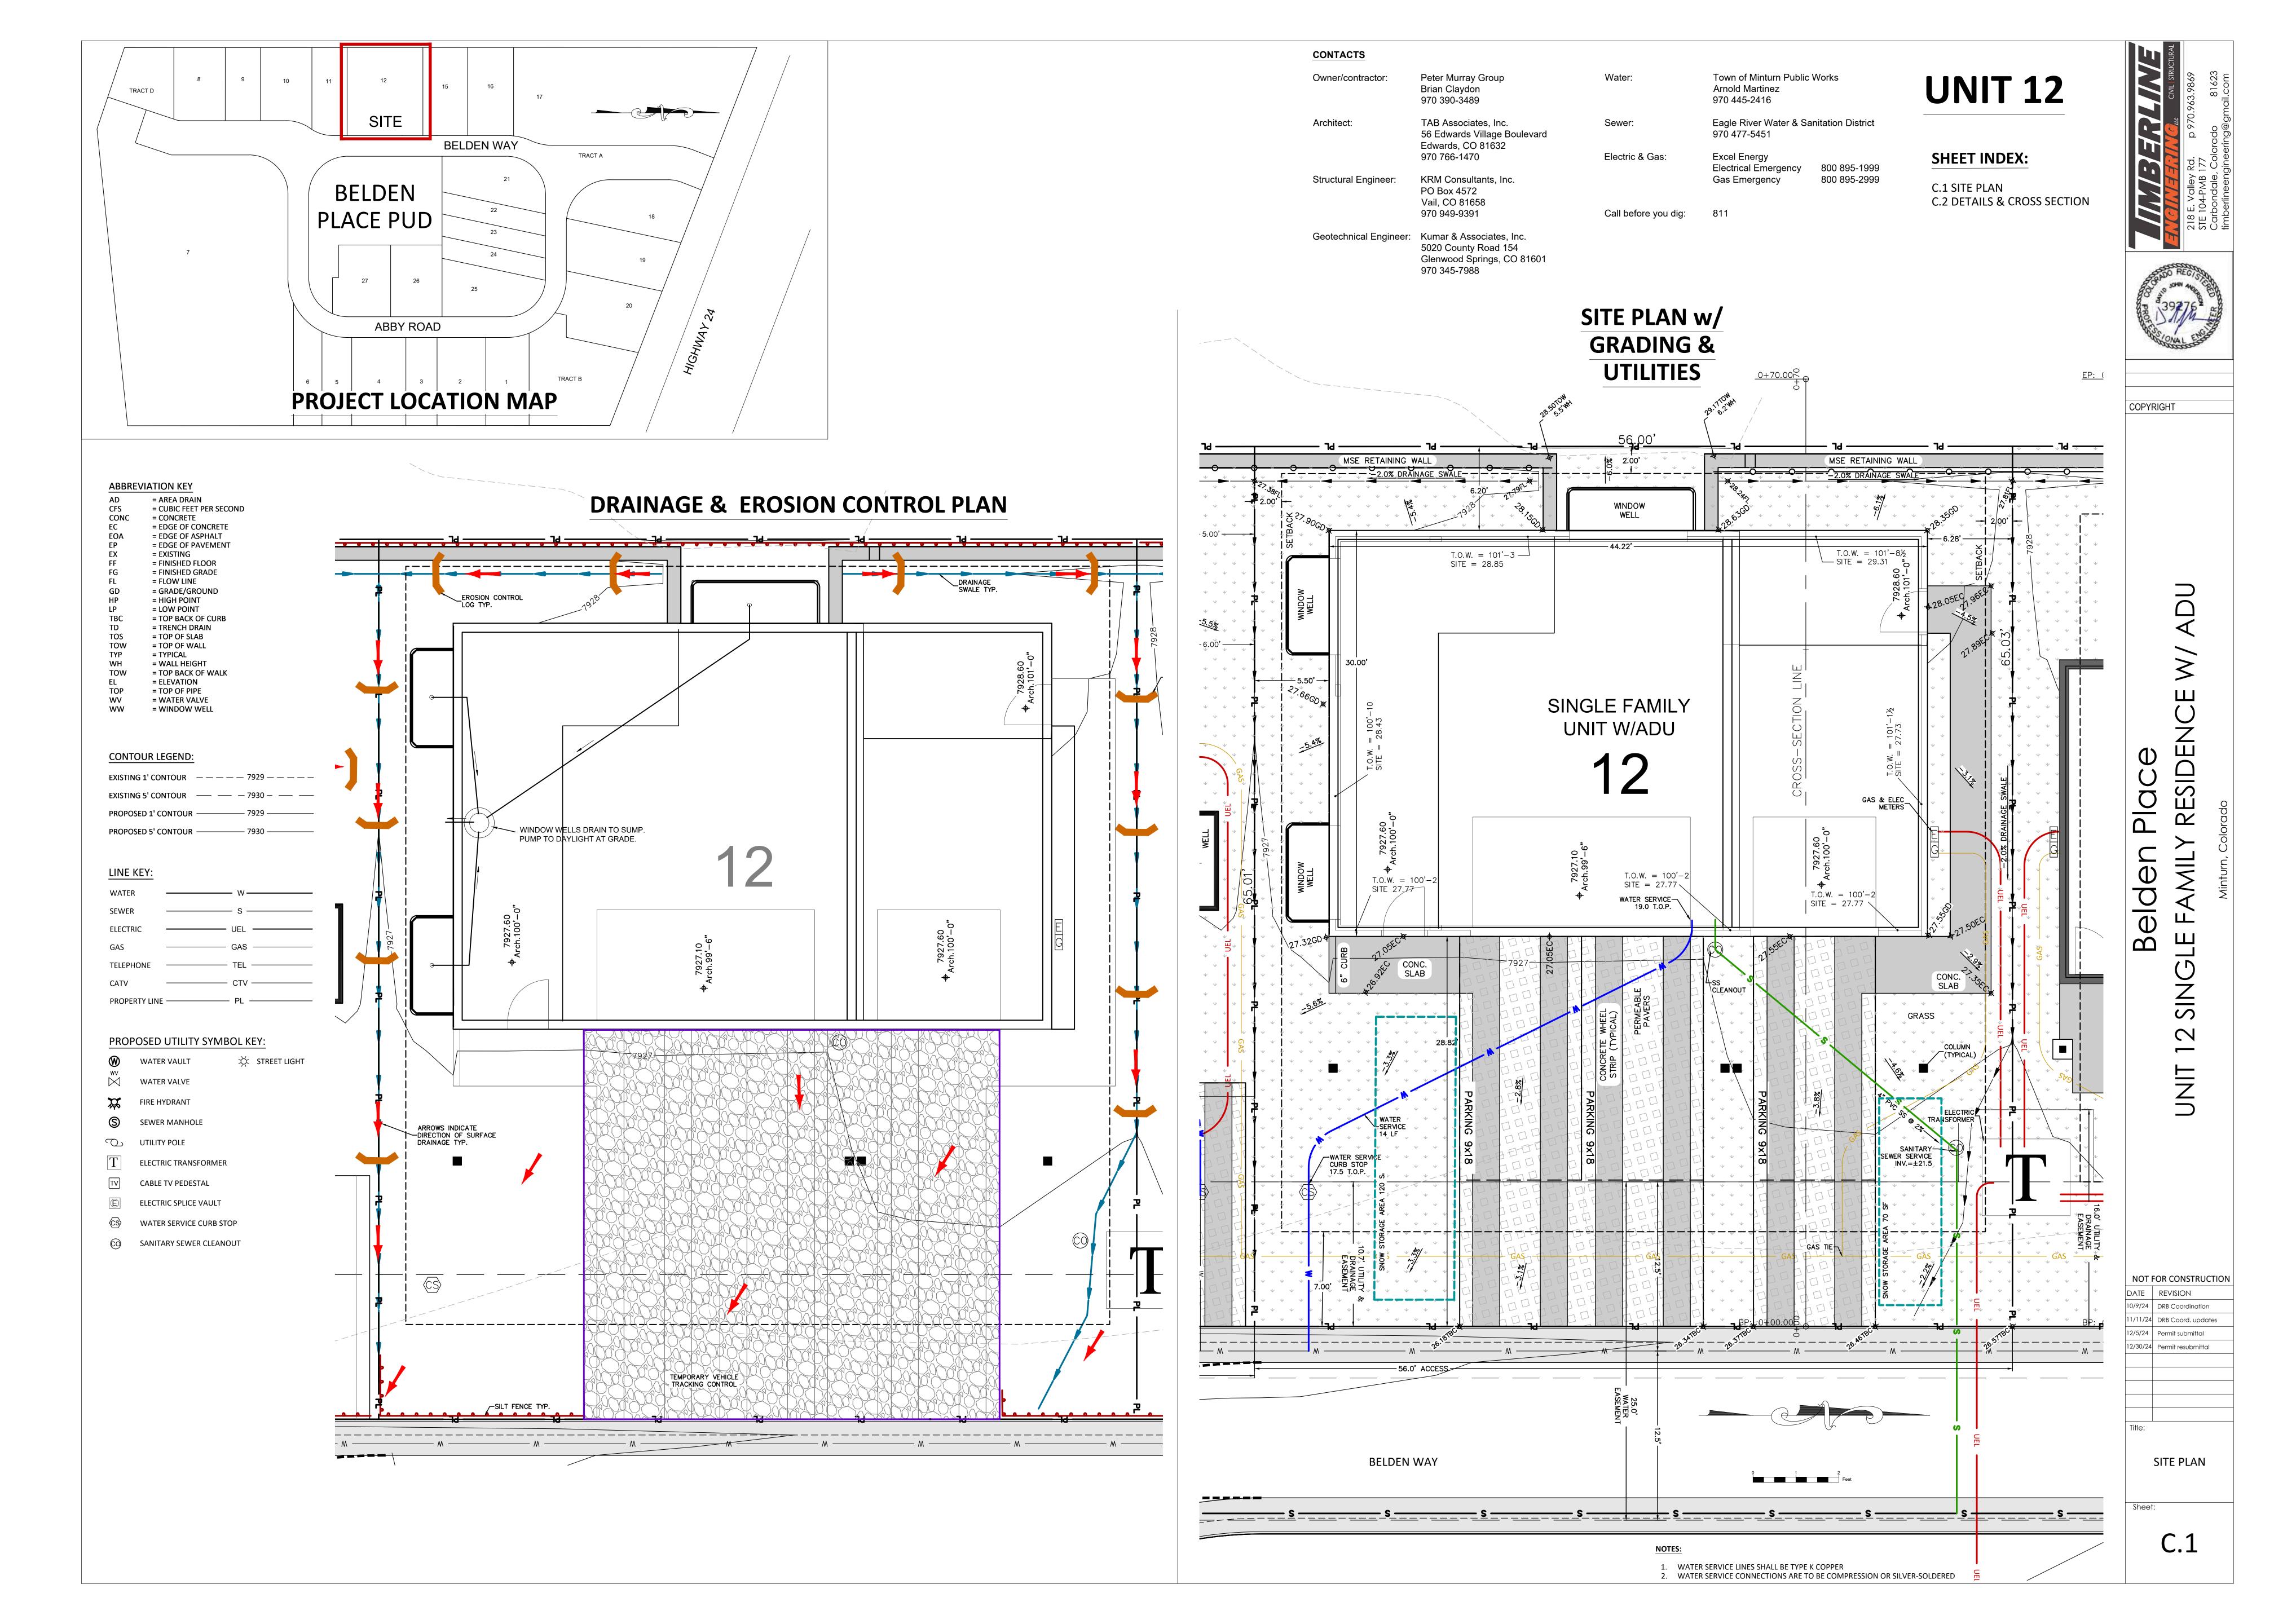


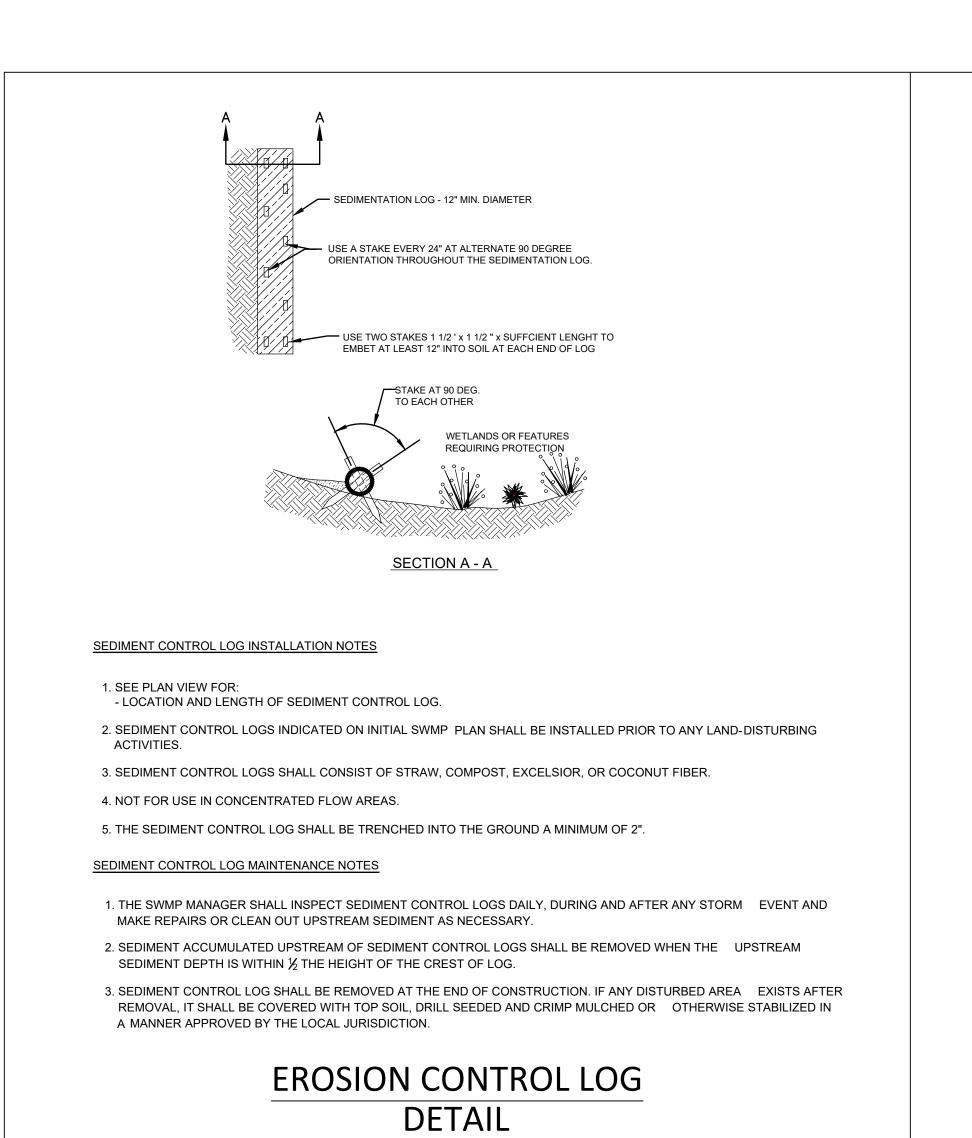


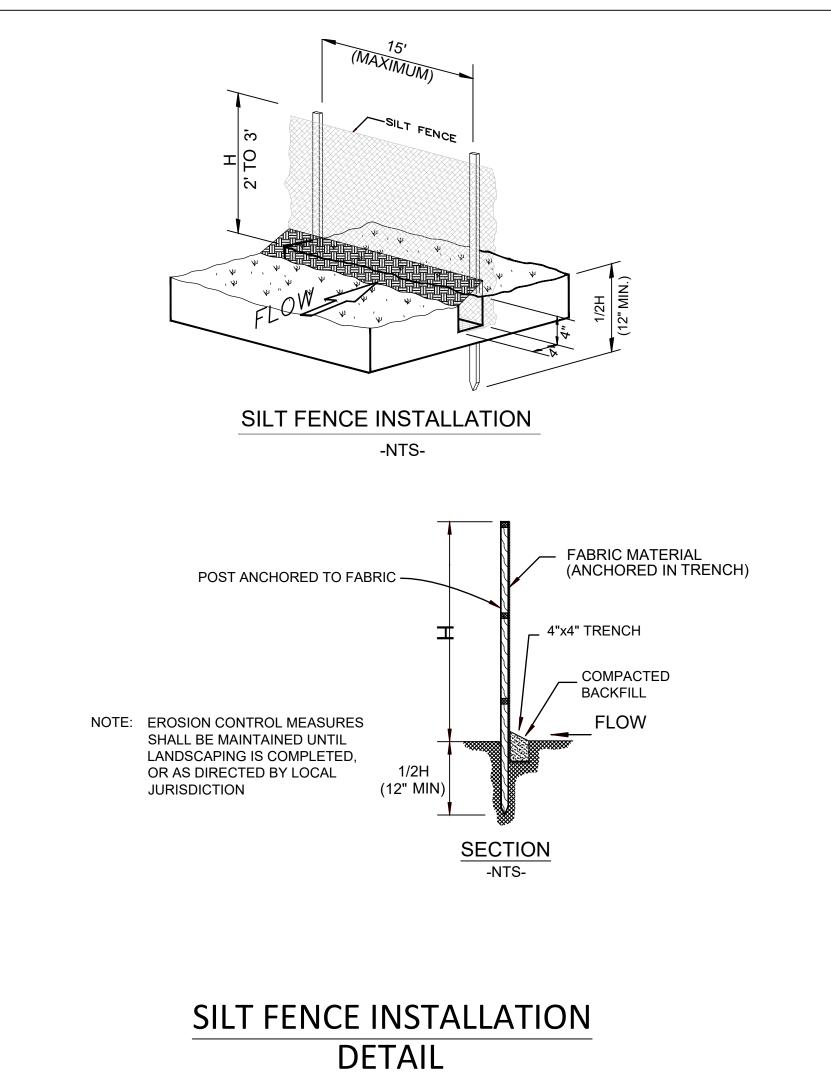


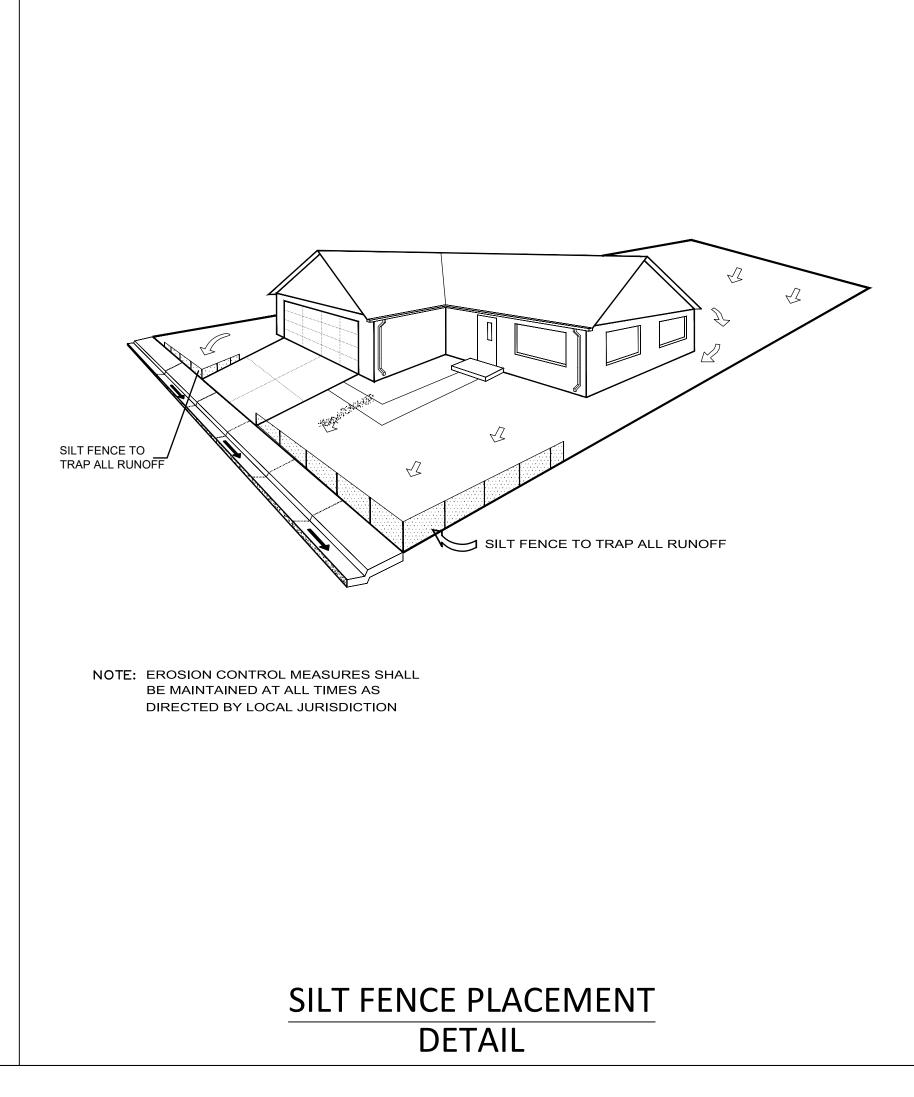

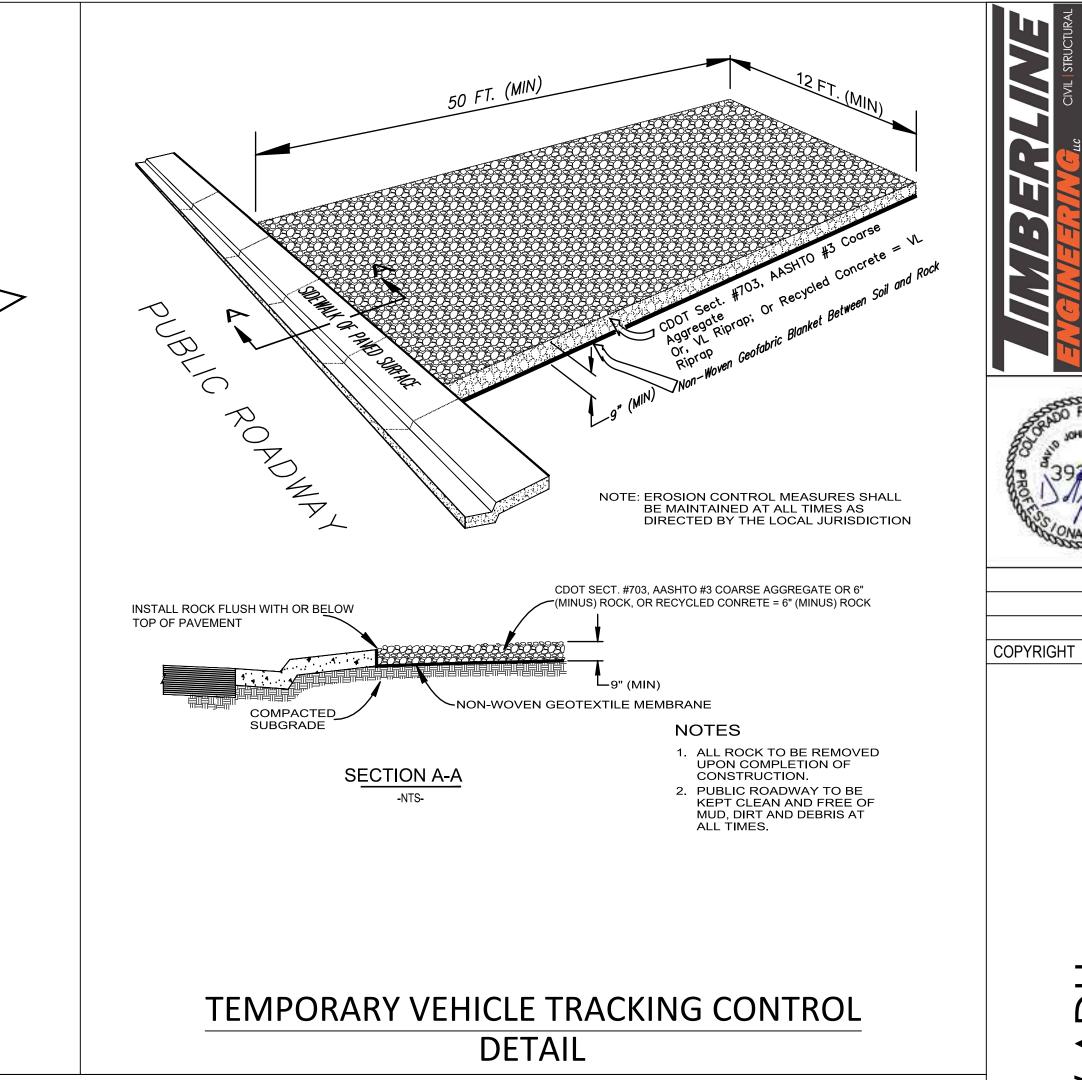


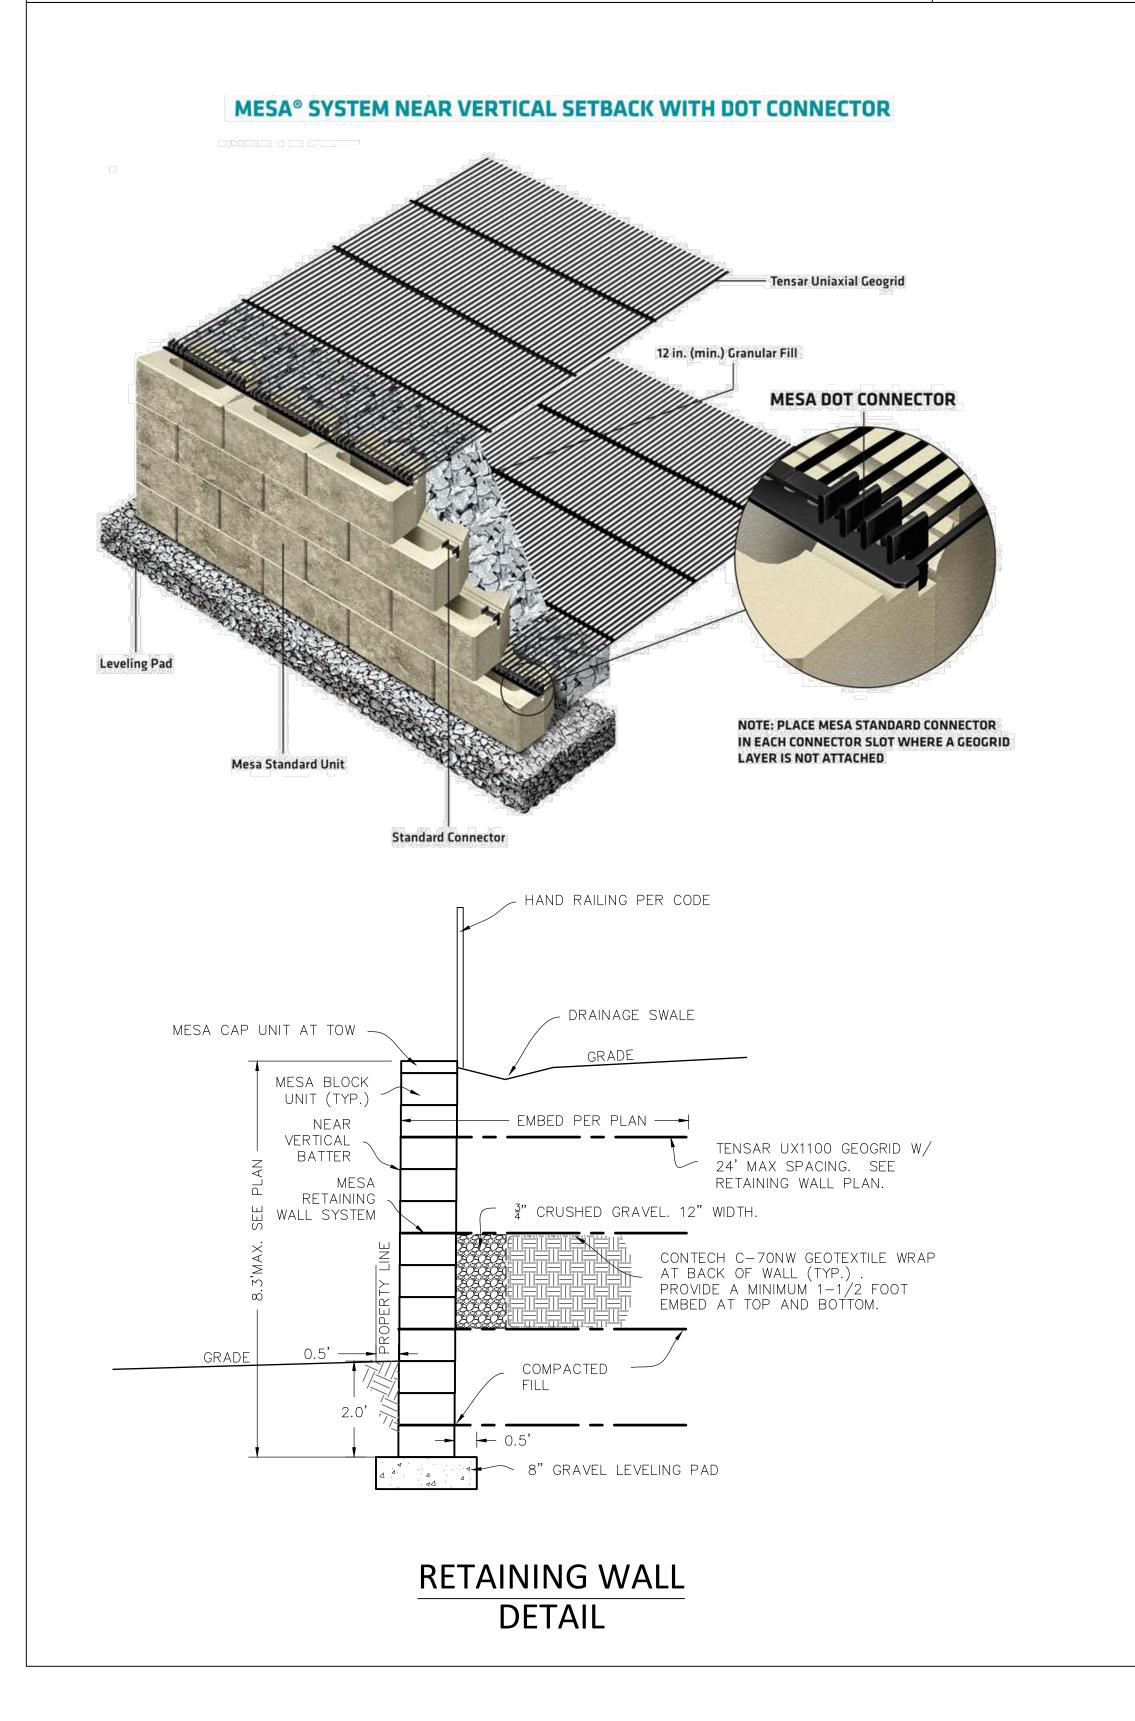

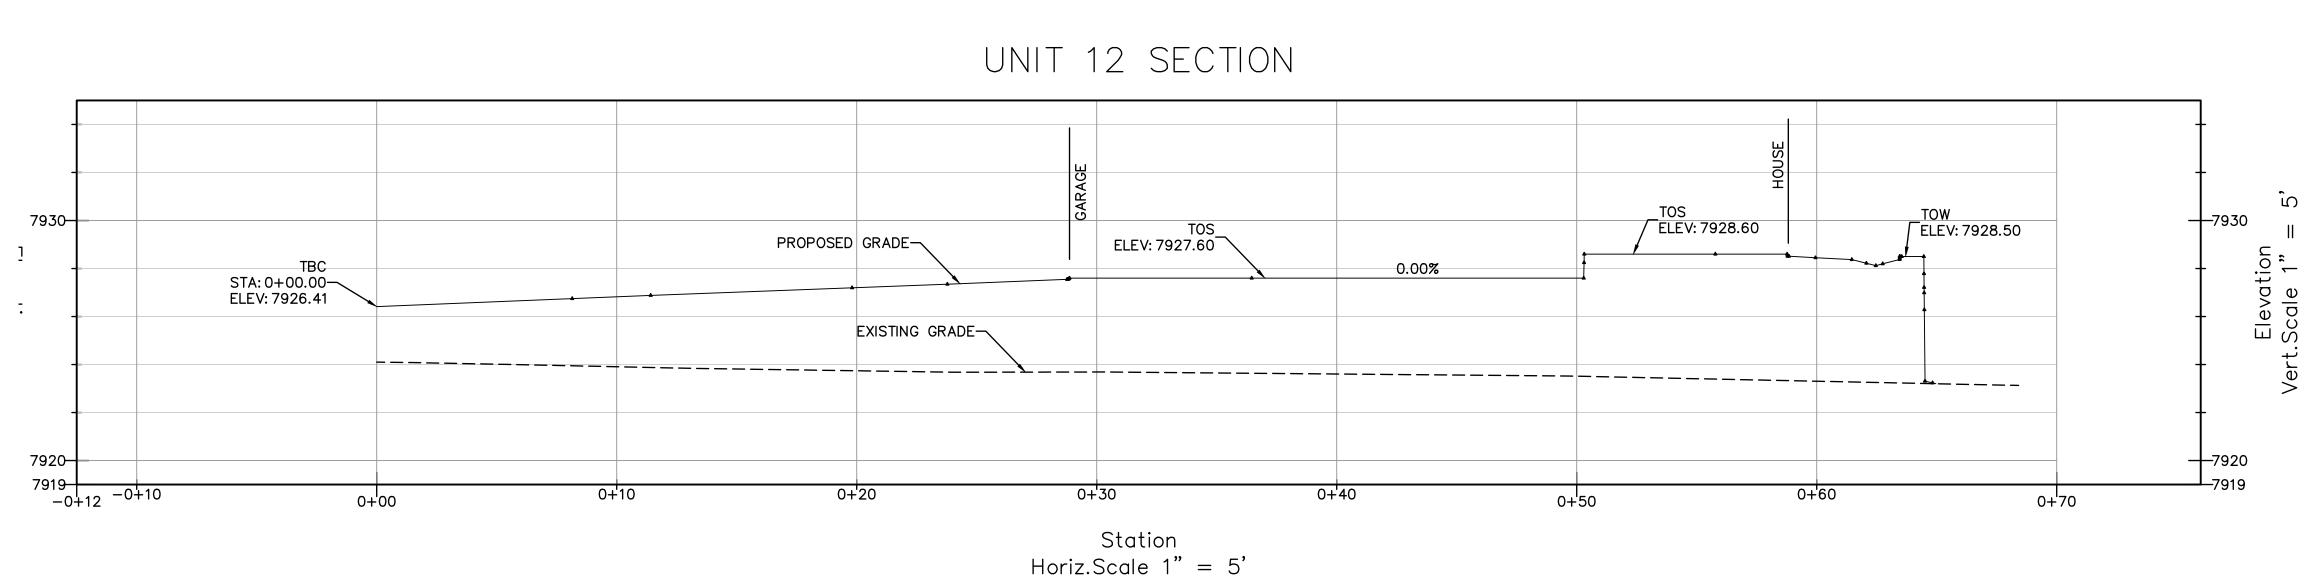

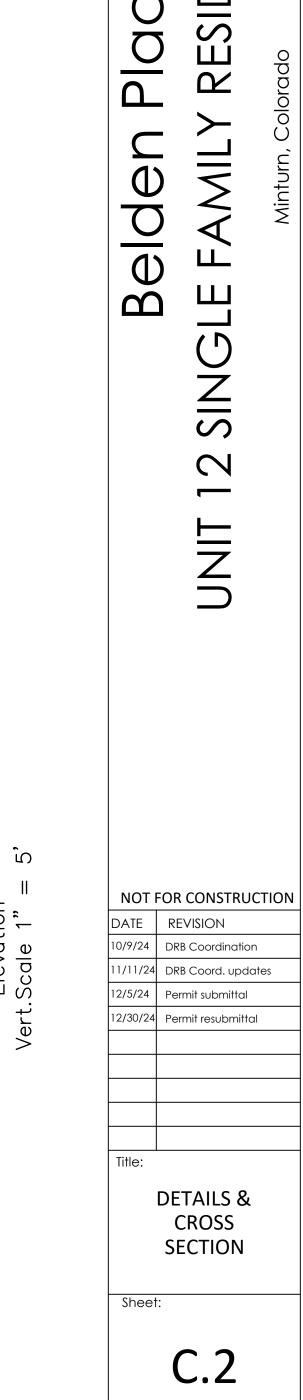

1/4 BACKFILL MIXTURE & 3/4 EXISTING SOIL SHRUB PLANTING SCALE: 3/4" = 1'-0"

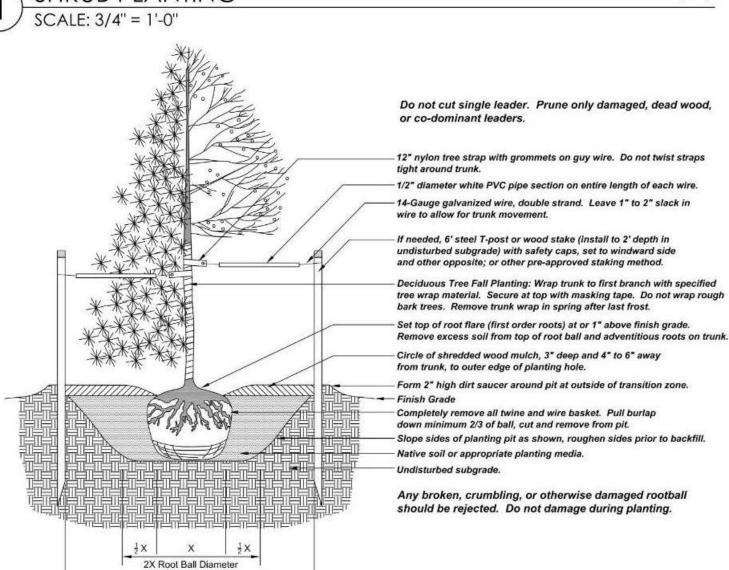

TREE PLANTING ADJACENT PERENNIAL BED OR LAWN ADJACENT PERENNIAL BED OR LAWN - STEEL EDGER METAL STAKES

1. CONTRACTOR TO SUBMIT SAMPLE PRIOR TO ORDERING MATERIAL OR DELIVERING TO SITE. 2. NO EDGER REQUIRED WHEN MULCH IS ADJACENT TO PAVEMENT, BORDER, OR WALLS.

- 3. SET ALL EDGING 1/2" ABOVE FINISH GRADE AS SHOWN. 4. EDGING SHALL ABUT ALL CONCRETE CURBS AND WALKS PERPENDICULAR, AND FLUSH W/ GRADES
- ALL JOINTS TO BE SECURELY STAKED.

3-4 X Root Ball Diameter

6. CONTRACTOR SHALL CUT TOP EDGE(S) AS NEEDED TO BE PARALLEL WITH GRADE.



GENERAL NOTES:

CONSTRUCTION SHALL CONFORM TO ALL APPLICABLE STATE AND LOCAL CODES AND REGULATIONS.

- 2. CONTRACTOR TO CONTACT THE UTILITY NOTIFICATION CENTER OF COLORADO BEFORE DIGGING, INCLUDING BUT NOT LIMITED TO, TRENCHING, SHRUB AND TREE PLANTING PITS. IF UTILITIES OCCUR WITHIN (3) THREE FEET OF PROPOSED FOOTINGS, THE CONTRACTOR SHALL REPORT SUCH CONDITIONS TO THE OWNER.
- CONTRACTOR IS RESPONSIBLE FOR FULL ON-SITE INVESTIGATIONS AS NEEDED IN ORDER TO GAIN A FULL UNDERSTANDING OF EXISTING CONDITIONS PRIOR TO CONSTRUCTION. FAILURE TO INSPECT THE SITE PRIOR TO CONSTRUCTION SHALL NOT BE CAUSE FOR REQUESTING ADDITIONAL MONIES BY THE CONTRACTOR.
- 4. THE CONTRACTOR SHALL OBTAIN, AT HIS EXPENSE, ALL PERMITS WHICH ARE NECESSARY TO PERFORM THE PROPOSED WORK.
- THE LANDSCAPE ARCHITECT IS NOT RESPONSIBLE FOR THE CONSTRUCTION MEANS, METHODS, TECHNIQUES, SEQUENCES OR FOR SAFETY PRECAUTIONS OR PROBLEMS UTILIZED IN CONNECTION WITH THE WORK, AND HE/SHE WILL NOT BE RESPONSIBLE FOR THE CONTRACTOR'S FAILURE TO CARRY OUT THE WORK IN ACCORDANCE WITH THE CONTRACT DOCUMENTS.
- VERIFY ALL CONDITIONS AT THE JOB SITE AND NOTIFY LANDSCAPE ARCHITECT AND THE OWNER'S REP. IMMEDIATELY OF ANY DIMENSIONAL ERRORS, OMISSIONS OR DISCREPANCIES PRIOR TO ANY DEMOLITION OR CONSTRUCTION.

SIGHT TRIANGLE NOTES:

PEDESTRIAN SIGHT TRIANGLES: NO ITEMS THAT ARE WIDER THAN 18" MAY BE TALLER THAN 30" WITHIN THE PEDESTRIAN SIGHT TRIANGLE.

CORNER SIGHT TRIANGLES: NO ITEMS TALLER THAN 30" MAY BE PLACED WITHIN THE CORNER SIGHT TRIANGLE, EXCEPT FOR TRAFFIC CONTROL DEVICES AND EQUIPMENT. TREES MUST BE LIMBED TO 8 FEET AT ADEQUATE MATURITY. TREES SHALL BE PLANTED A MINIMUM OF 10 FEET FROM LIGHT OR UTILITY POLES.

ROADWAY SIGHT TRIANGLES: NO ITEMS THAT ARE WIDER THAN 18" MAY BE TALLER THAN 30" WITHIN THE ROADWAY SIGHT TRIANGLE EXCEPT FOR STREET TREES AND TRAFFIC CONTROL DEVICES AND EQUIPMENT.

TREE PROTECTION ZONE (TPZ) NOTES:


- CONTRACTOR SHALL VERIFY FINAL BOUNDARIES OF TPZ PRIOR TO COMMENCEMENT OF CONSTRUCTION/DEMOLITION ACTIVITIES. EXCESSIVE BRANCH PRUNING ON EXISTING TREES FOR CONSTRUCTION CLEARANCE WILL NOT BE PERMITTED. PRUNING FOR BUILDING CLEARANCE SHALL BE MINIMIZED. DUE TO SCOPE OF CONSTRUCTION AND SIZE OF EX. ROW TREES, USE CHAIN LINK FENCING TO ESTABLISH TPZ.
- 2. THE TREE LAWN WITHIN THE BOUNDARY OF THE TREE DRIPLINE SHALL NOT BE ROTOTILLED AT ANY TIME. ROTOTILLING IS ONLY PERMITTED IN AREAS OUTSIDE OF EXISTING TREE DRIPLINE WHERE CONCRETE & HARDSCAPE ARE REMOVED.


ORNAMENTAL TREES BOTANIC COMMON SPACING SIZE Autumn Brilliance Serviceberry Amelanchier x grandiflora 8' clump Crataegus x mordenensis 'Toba' Toba Hawthorn 2" Cal 2" Cal Spring Snow Crabapple Malus 'Thunderchild' Thunderchild Crabapple 2" Cal Gambel Oak 8' clump Quercus gambelii as shown

DECIDUOUS SHRUBS BOTANIC COMMON SPACING SIZE QTY Creeping Willow Ash-leaf Spirea as shown Miss Kim Lilac as shown Western Snowberry Symphoricapos occidentalis as shown

> PLAN IS ENLARGED DETAIL AND UPDATE FROM THE PUD APPROVED PLAN. REFER TO PUD APPROVED PLAN FOR ADDITIONAL INFROMATION

V	NATIVE GRASS	SITE CALCULATIONS	
\(NATIVE GRASS	SITE CALCULATIONS	
\vee \vee		SITE SQFT	3,641 SQFT
	2' GRAVEL DRIP	BUILDING COVERAGE	1,820 SQFT
	LINE MULCH	IMPERVIOUS COVERAGE (Includes Building)	2,180 SQFT
4 4 4 4	2' GRAVEL DRIP LINE MULCH	SITE COVERAGE ALLOWE SITE COVERAGE	D 70% 59.9%
	PERMEABLE PAVERS		

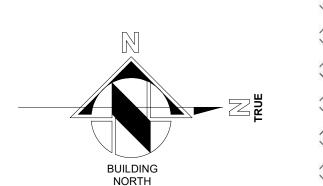

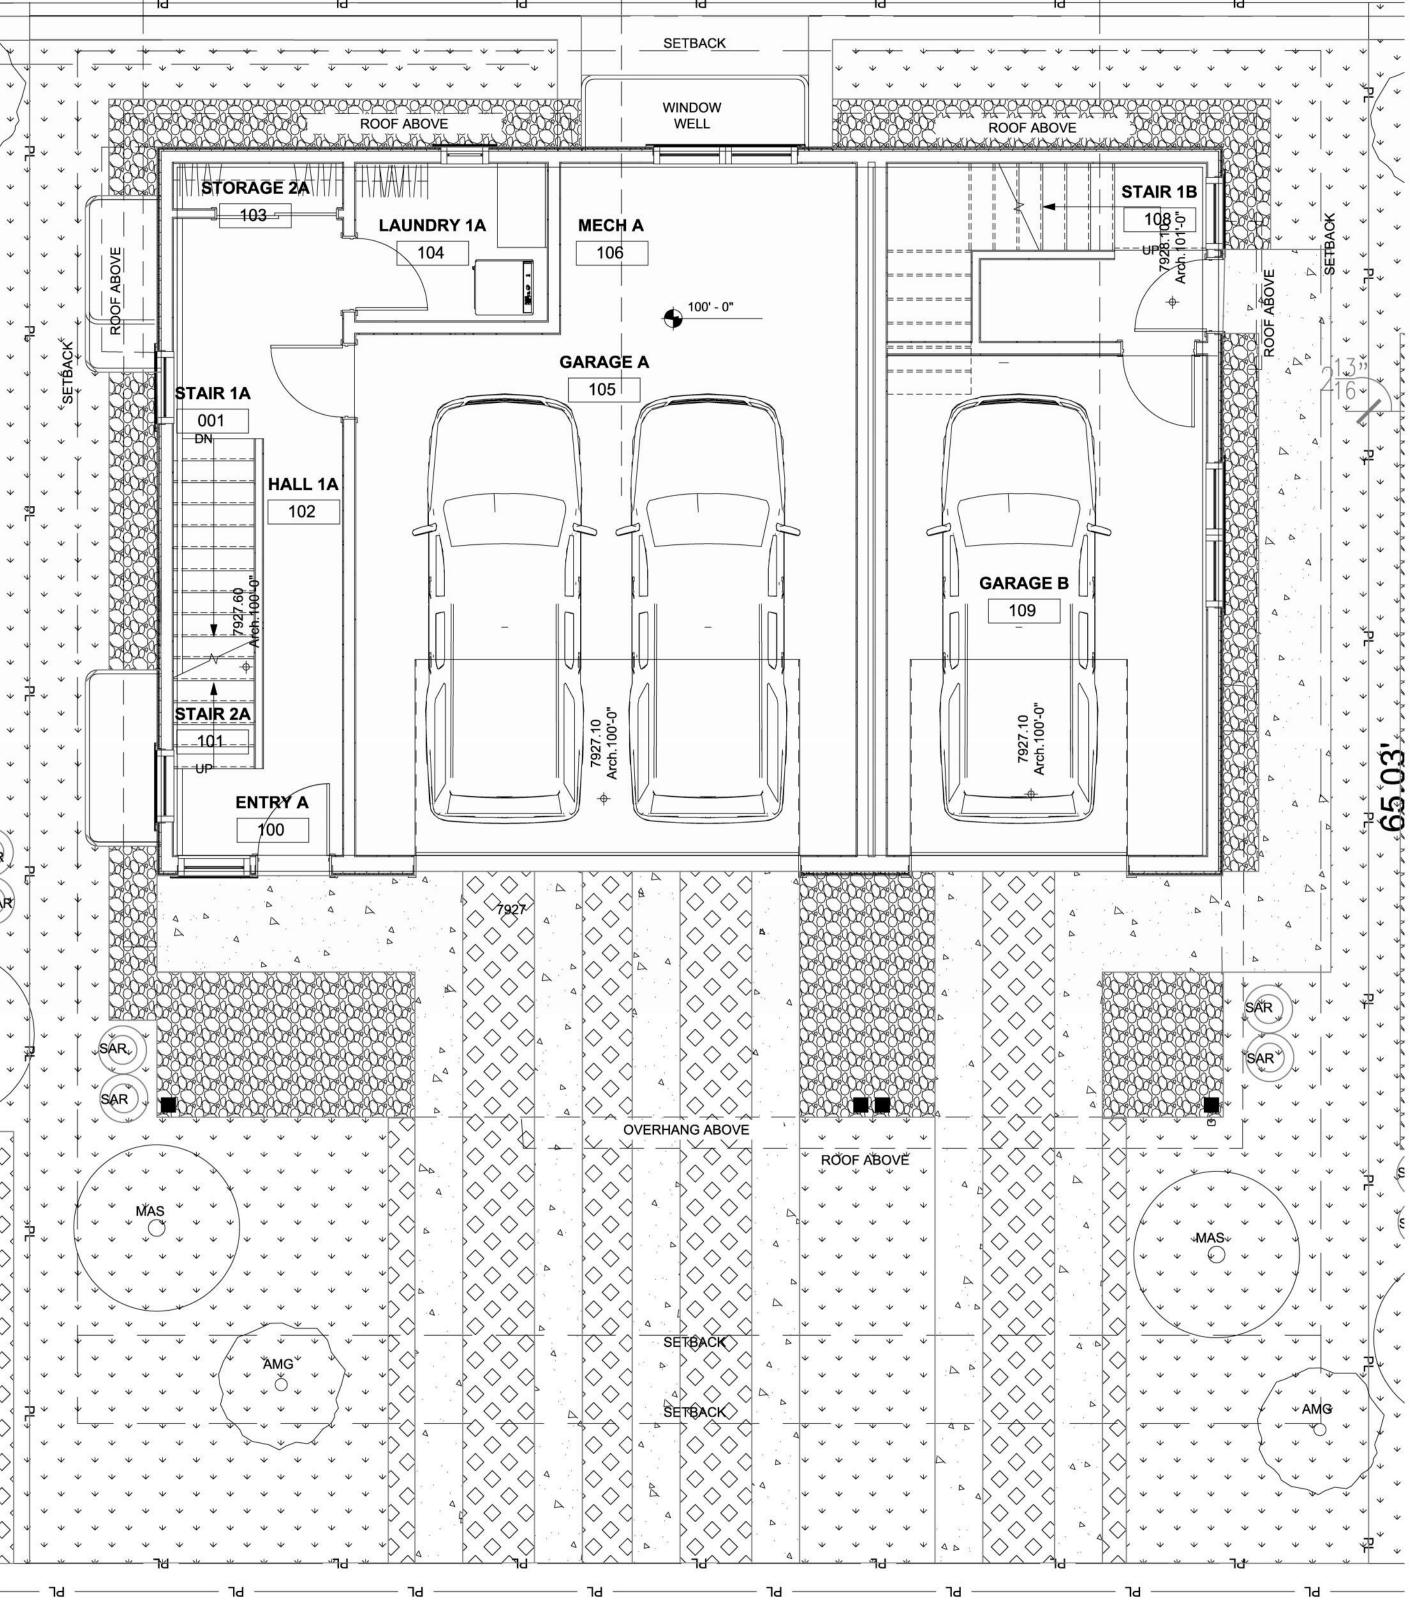

1 LANDSCAPE PLAN A1.1 1/4" = 1'-0"

LANDSCAPE NOTES:

- ALL NEW LANDSCAPE AND IRRIGATION SHALL BE UNDER WARRANTY FOR A PERIOD OF (1) ONE YEAR. THE WARRANTY PERIOD SHALL COMMENCE ONCE ALL PUNCH LIST ITEMS ARE SATISFACTORY COMPLETED AND A LETTER OF FINAL COMPLETION IS PROVIDED FROM THE OWNER'S REPRESENTATIVE. ALL LANDSCAPE AND IRRIGATION MAINTENANCE SHALL BE THE RESPONSIBILITY OF THE CONTRACTOR 1 YEAR AFTER THE FINAL COMPLETION IS PROVIDED IN WRITING.
- 2. PLANT MATERIAL AND BED LOCATIONS TO BE STAKED BY THE LANDSCAPE CONTRACTOR FOR REVIEW BY THE OWNER'S REPRESENTATIVE OR LANDSCAPE ARCHITECT. ALL ADJUSTMENTS SHALL BE MADE BY THE CONTRACTOR. THE CONTRACTOR SHALL NOT DIG PLANT PITS UNTIL LOCATIONS ARE **APPROVED**
- ROUGH GRADING TO PLUS OR MINUS ONE TENTH OF A FOOT BY GENERAL CONTRACTOR. LANDSCAPE CONTRACTOR TO PROVIDE FINISH GRADING IN ALL LANDSCAPE AREAS. LANDSCAPE CONTRACTOR TO APPROVE ROUGH GRADES PRIOR TO MOBILIZATION. MOBILIZATION ON THE PART OF THE LANDSCAPE CONTRACTOR WILL INDICATE THAT ROUGH GRADING IS ACCEPTABLE TO THE LANDSCAPE CONTRACTOR, AND THEREFORE BE RESPONSIBLE FOR PROVIDING ALL FINISHED GRADES TO MEET THE CIVIL GRADING PLANS.
- TREES AND SHRUBS WILL BE INSPECTED ON-SITE, LANDSCAPE PLANT MATERIALS MAY BE REJECTED AT ANY TIME DUE TO ISSUES OF QUALITY.
- ALL NEW LANDSCAPE AREAS SHALL BE IRRIGATED BY A COMMERCIAL GRADE, FULLY AUTOMATIC UNDERGROUND IRRIGATION SYSTEM. TREES, SHRUBS, AND DECORATIVE GRASSES SHALL BE IRRIGATED BY A SEPARATE ZONE FROM SOD/GRASS; THIS INCLUDES TREES PLANTED IN SOD/GRASS AREA. THE IRRIGATION SYSTEM IS TO HAVE A RAIN SENSOR SHUTOFF INSTALLED. IRRIGATION TO BE DESIGN/BUILD, CONTRACTOR IS RESPONSIBLE FOR COORDINATION WITH ARCHITECT, LANDSCAPE ARCHITECT, AND MECHANICAL AND FOR GENERATION OF AN IRRIGATION PLAN FOR REVIEW WITH AS BUILT PLAN AS REQUIRED.
- ALL PLANT MATERIAL SHALL MEET OR EXCEED CURRENT AMERICAN STANDARD FOR NURSERY STOCK ANSI Z60.1 AND THE COLORADO NURSERY ACT AND ACCOMPANYING RULE AND
- TRUNK-WRAP TAPE: TWO LAYERS OF CRINKLED PAPER CEMENTED TOGETHER WITH BITUMINOUS MATERIAL, 4 INCHES (102 MM) WIDE MIN.
- WRAPPING TREE TRUNKS: WRAP TREES WITH TRUNK-WRAP TAPE. START AT BASE OF TRUNK AND SPIRAL COVER TRUNK TO HEIGHT OF FIRST BRANCHES. OVERLAP WRAP, EXPOSING HALF THE WIDTH, AND SECURELY ATTACH WITHOUT CAUSING GIRDLING. DO NOT USE STAPLES. INSPECT TREE TRUNKS FOR INJURY, IMPROPER PRUNING, AND INSECT INFESTATION AND TAKE CORRECTIVE MEASURES REQUIRED BEFORE WRAPPING. DO NOT WRAP ROUGH BARK, POPULUS OR GLEDITSIA TREES. REMOVE WRAP IN SPRING.
- NO TREE SHALL BE WRAPPED AFTER MAY 21 OR BEFORE NOVEMBER 1
- ALL DECIDUOUS TREES SHALL BE WRAPPED BY NOV. 15. REMOVE TREE WRAP BY MAY 15. CONTRACTOR SHALL BE RESPONSIBLE FOR WRAPPING AND UNWRAPPING TREES DURING THE WARRANTY PERIOD.
- 9. FIBER MULCH AT PLANTING BEDS: ORGANIC MULCH FREE FROM DELETERIOUS MATERIALS AND SUITABLE AS A TOP DRESSING OF TREES AND SHRUBS, CONSISTING OF SHREDDED REDWOOD MULCH NOT LARGER THAN FOUR INCHES (4") IN LENGTH. SUBMIT 1.0 CF SAMPLE FOR APPROVAL.

SOIL PREPARATION:

SOIL SHALL BE AMENDED BASED ON THE SOIL TEST RECOMMENDATIONS (TO ADDRESS SPECIFIC DEFICIENCIES & ISSUES IN EXISTING SOIL). THE FOLLOWING INCLUDES THE SOIL TEST REQUIREMENTS AND RECOMMENDATIONS TO BE USED IN CONJUNCTION WITH THE SOIL TEST RESULTS:

- SOIL ANALYSIS, BULK DENSITY TESTING AND REMEDIATION REQUIRED. SOIL ANALYSIS FROM A LOCAL ACCREDITED SOIL ANALYSIS LABORATORY WITH EXPERIENCE IN LOCAL URBAN SOILS SHALL BE REQUIRED WHEN PLANTS ARE TO BE INSTALLED IN GREEN
- SPACE. ALL SOIL REMEDIATION SHALL BE BASED ON THE SOIL ANALYSIS. MINIMUM SOIL ANALYSIS MUST DETERMINE SOIL TEXTURE AND STRUCTURE, PH BALANCE, SOIL SALINITY, FREE LIME, ORGANIC MATTER (OM) CONTENT, PLANT
 - AVAILABLE NUTRIENTS AND COMPACTION. DEPTH OF LANDSCAPE SOIL ANALYSIS SHALL BE 24IN FOR TREES AND 8IN FOR ALL OTHER AREAS
 - SOIL REMEDIATION REQUIRED BASED ON SOIL ANALYSIS.
- 2. COMPOSTED MATERIAL SHALL CONSIST OF AGED ORGANIC MATTER, FREE OF WEED LUMPS, STONES, OR OTHER FOREIGN OR OTHER NOXIOUS PLANT SEEDS, CONTAMINANTS HARMFUL TO PLANT LIFE, AND HAVING THE FOLLOWING

CHARACTERISTICS BASED ON A NUTRIENT TEST PERFORMED NO LONGER THAN 3 MONTHS PRIOR TO ITS INCORPORATION INTO THE PROJECT

- ORGANIC MATTER: 25% MINIMUM.
- SALT CONTENT: 5.0 MMHOS/CM MAXIMUM.
- PH: 8.5 MAXIMUM.
- CARBON TO NITROGEN RATIO OF 10:1 TO 20:1. PARTICLE SIZE NO PARTICLE SMALLER THAN SILT OR CLAY SIZE, OR LARGER THAN
- 1/2" DIAMETER ACCEPTABLE COMPOST PRODUCT: CLASS I COMPOST, SUCH AS ECOGRO OR BIO-COMP, AS PROVIDED BY A1 ORGANICS, EATON, CO, OR APPROVED EQUAL.
- 2. FINISH GRADE TO BE BELOW THE EDGE OF PAVEMENT PRIOR TO SODDING OR PLANTING:
- SEEDED/SODDED AREAS: ALLOW 1 INCH FOR SOD.
- PLANTED AREAS: ALLOW 3 INCHES FOR MULCH.
- 4. AFTER APPLYING SOIL CONDITIONER AND FERTILIZER, THOROUGHLY TILL AREA TO DEPTH OF 6" MINIMUM UNTIL SOIL IS WELL PULVERIZED AND THOROUGHLY MIXED.

Associates The Architectural Balan 0056 Edwards Village Blvd. Edwards, CO 81632


(970) 766-1470 fax: (970) 766-1471 email: tab@vail.net Civil Engineer Timberline Engineerin (970) 963-9869 Structural Engineer KRM Consultants, Inc (970) 949-9391 Mechanical Engineer Electrical Engineer


≧≥ **□ 0** 50 . 0


Description

DRB-10/10/2024 Landscape Plan

2215

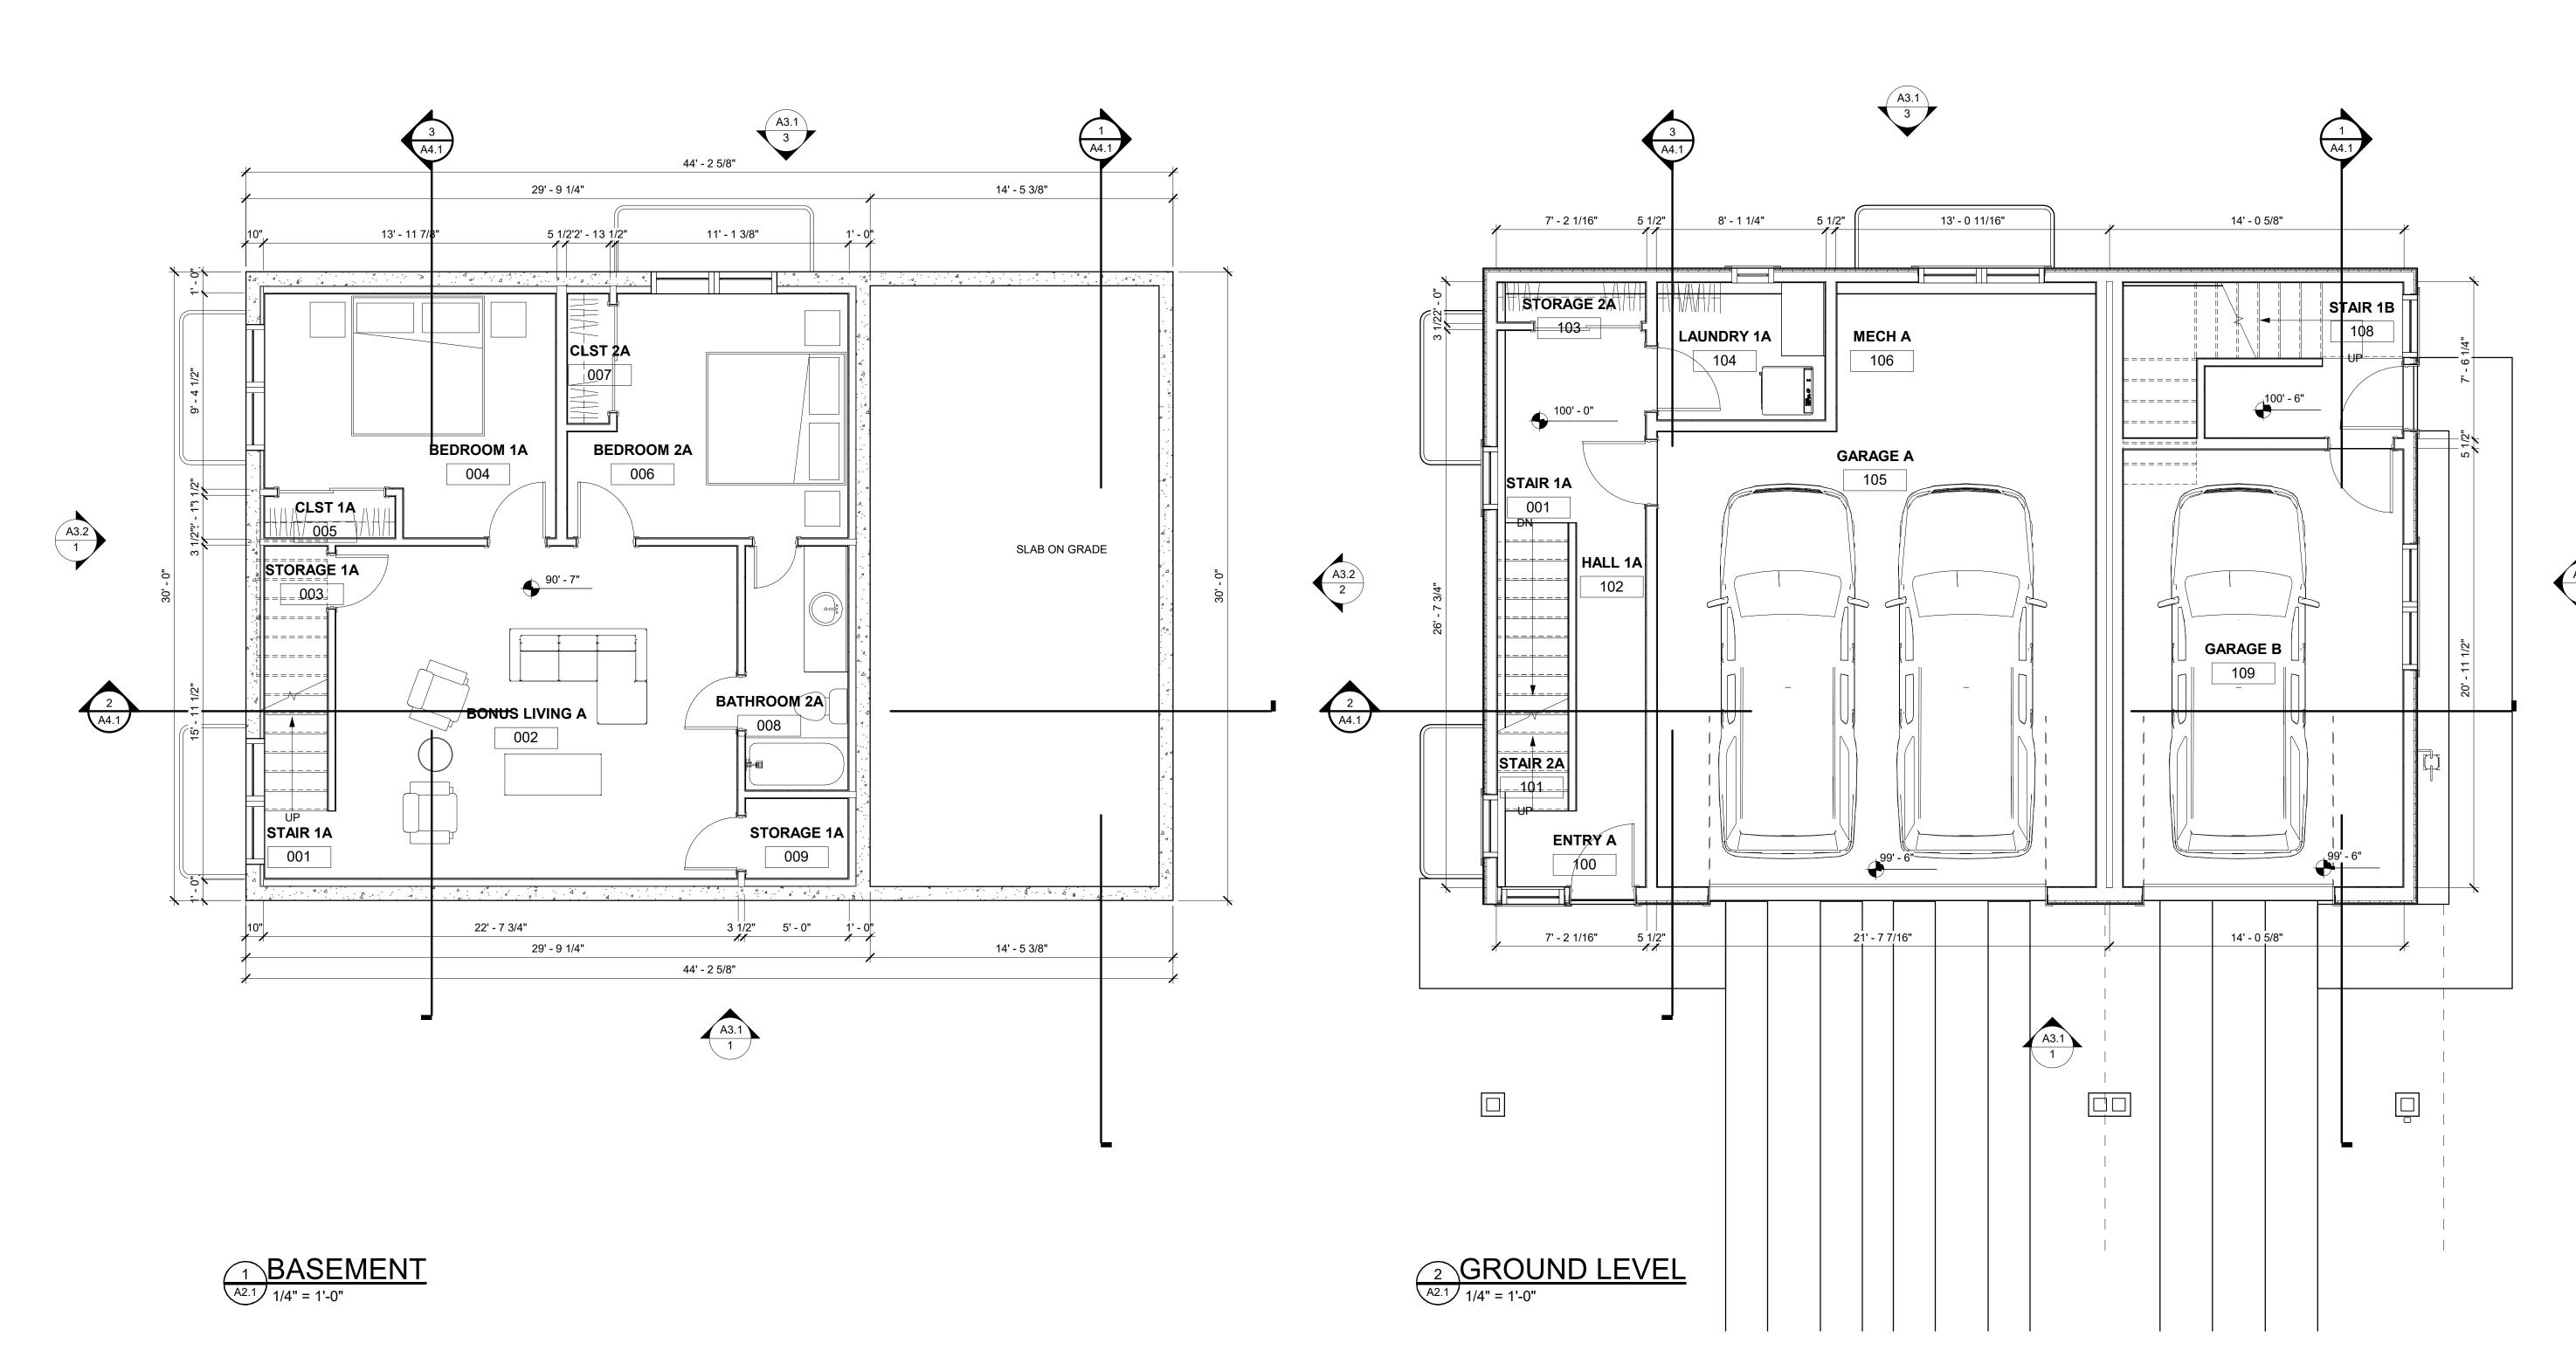

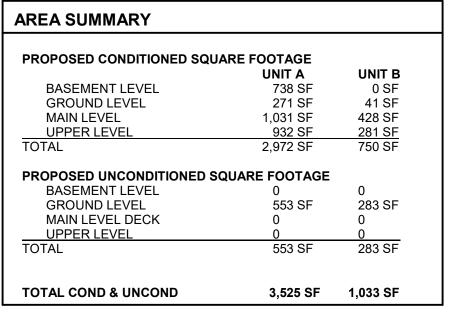

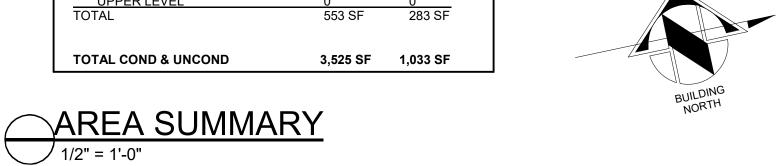



CLOSET NOTES:

- SINGLE HANGING: DESIGNATED BY SINGLE DASHED LINE IN CLOSETS TO BE: 16" SHELF @ 7'-0" AFF, 16" SHELF & ROD @ 5'-6" AFF.
- DOUBLE HANGING: DESIGNATED BY DOUBLE (2) DASHED LINE IN CLOSETS TO BE: 16" SHELF & ROD
- @ 7'-0" AFF, 12" SHELF & ROD @ 3'-6" AFF. SHELVES @ WALK-IN CLOSETS: 6 - 16" SHELVES @ $\langle 3
 angle$ 1'-2" OC, 1st SHELF @ 1'-2" AFF, SHELF WIDTH TO BE
- INDICATED. LINEN SHELVES: 6 SHELVES, WIDTH AS NOTED, @ (4) 1'-2" OC, 1st SHELF @ 1'-2" AFF, FULL CLOSET

Associates

The Architectural Balance 0056 Edwards Village Blvd. Edwards, CO 81632

(970) 766-1470

fax: (970) 766-1471 email: tab@vail.net

Civil Engineer Timberline Engineering

(970) 963-9869

Structural Engineer

KRM Consultants, Inc (970) 949-9391

Mechanical Engineer

Electrical Engineer

S

. 0

CLOSET WIDTH, LESS 4'-0" OR AS OTHERWISE

STORAGE SHELVES: 6 - 16" SHELVES @ 1'-2" OC, 1st 5 SHELF @ 1'-2" AFF, FULL CLOSET WIDTH.

GENERAL CLOSET NOTES: 1. ALL SHELVES & VERTICAL DIVIDERS TO BE AC

PLYWOOD WITH 1x2 EDGE. SPECIES TO BE SPECIFIED BY DEVELOPER. 2. CLEATS TO BE 1x2 CLEAR PINE. 3. PROVIDE ROD SUPPORTS @ 36" OC MAX.

4. ALL TO BE STAINED TO MATCH CASE & BASE.

FLOOR PLAN GENERAL NOTES:


- 1. PATCH EXISTING CONSTRUCTION SCHEDULED TO REMAIN. REPAIRED SURFACES TO BE FLUSH WITH ADJACENT FINISH SURFACES. TO SAME QUALITY AS NEW CONSTRUCTION PRIOR TO INSTALLING NEW FINISHES. REFER TO THE FINISH MANUFACTURER'S GUIDELINES FOR INSTALLATION.
- 2. PATCH EXISTING FIRE-RATED WALLS, FLOOR CEILINGS, ETC. SO AS TO MAINTAIN THE FIRE-RADIATING. ADD FIRE-SMOKE DAMPERS WHERE NEW DUCTS CROSS. ADD FIRE STOP AT ALL
- 3. PATCH WALLS AT REMOVED RECEPTACLE OPENINGS SO AS TO RECEIVE SUBSEQUENT WORK.
- 4. PATCH AND LEVEL FLOOR SUBSTRATES TO RECEIVE NEW WORK AS SCHEDULED.
- 5. COORDINATE ALL FLOOR CORE DRILLING WITH
- EXISTING.
- 6. DO NOT SCALE DRAWINGS.
- 7. IN ROOMS WITH FLOOR DRAINS, SLOPE CONCRETE SURFACE WITHIN 18" RADIUS AT 1/4" PER FOOT TOWARD FLOOR DRAIN, UNLESS OTHERWISE
- 8. ALL SPOT ELEVATIONS SHOWN ON THE FLOOR PLANS OUTSIDE THE BUILDING RELATE TO USGS ELEVATIONS. ALL SPOT ELEVATIONS INSIDE THE BUILDING REFER TO BUILDING REFERENCE ELEVATIONS. NOTIFY ARCHITECT IMMEDIATELY SHOULD CONDITIONS BE FOUND CONTRADICTORY TO THESE DRAWINGS.
- 9. ALL ANGLES SHOWN ON THE FLOOR PLANS ARE 90 DEGREES UNLESS OTHERWISE NOTED.
- 7 10 ALL DIMENSIONS ARE TO GRID LINE FACE OF CONCRETE OR MASONRY, OR FACE OF GYPSUM BOARD, UNLESS OTHERWISE NOTED.
- 11. ALL FLOOR PLAN DIMENSIONS TO MASONRY ARE NOMINAL DIMENSIONS, UNLESS NOTED AS ACTUAL.
- 12. "TB" NEW CORK TACKBOARDS OR "MB" NEW MARKERBOARDS
- 13. PROVIDE EXIT DOOR NUMBERS PER DOOR SIGNAGE SHEET AT ALL EXIT DOORS.

GENERAL NOTES:

- 1. DO NOT SCALE DRAWINGS. USE GIVEN DIMENSIONS. IMMEDIATELY NOTIFY ARCHITECT IF ADDITIONAL INFORMATION IS REQUIRED. ALL DIMENSIONS ARE GIVEN TO FACE OF WALL FRAMING. SEE WALL SECTIONS AND WALL TYPES FOR EXACT CONSTRUCTION
- 2. SEE SHEET A0.1 FOR WALL TYPES INDICATED ON FLOOR PLANS
- 3. PROVIDE ALL NECESSARY BLOCKING FOR PROPER ATTACHMENT OF WORK IN WALLS AND CEILINGS. LOCATIONS INCLUDE BUT NOT LIMITED TO, TOILET AND BATH ACCESSORIES, WALL AND CEILING MOUNTED ELECTRICAL EQUIPMENT, WINDOW TREATMENTS, CASEWORK, COUNTERTOPS, ETC.
- 4. WHERE WALL PARTITIONS ARE A CONTINUATION OF EXISTING ONES. NEW FINISH SURFACES MUST BE FLUSH AND CONTINUOUS WITH EXISTING SURFACES ON BOTH SIDES. INFILL OPENINGS IN EXISTING WALLS WITH MATERIAL TO MATCH EXISTING WALL THICKNESS, TEXTURE, AND FINISH.
- 5. REFERENCE S-SERIES DRAWINGS FOR STRUCTURAL NOTES AND DETAILS AND COORDINATE.
- 6. EXISTING BUILDING DIMENSIONS AND ELEVATIONS ARE BASED UPON EXISTING SURVEY INFORMATION. IMMEDIATELY NOTIFY ARCHITECT IF CONDITIONS ARE ENCOUNTERED THAT DO NOT AGREE WITH DIMENSIONS AND/OR ELEVATIONS SHOWN.
- 7. VERIFY ALL PITCHED FLOOR AREAS SHOWN WITH PITCH LINES WITH THE ARCHITECT. PROVIDE A SLAB DEPRESSION AT ALL FLOOR DRAINS WHERE PITCH LINES ARE NOT SHOWN ON DRAWINGS.
- 8. PROVIDE 4" RETURN FROM FACE OF ADJACENT WALL FOR ANY DOORS NOT DIMENSIONED.
- DRAWINGS FOR ITEMS NOT SHOWN ON ARCHITECTURAL DRAWINGS AND COORDINATE. 10. ALL INTERIOR WALLS SHALL EXTEND TO UNDERSIDE

9. SEE MECHANICAL, PLUMBING, AND ELECTRICAL


- OF ROOF DECK AND STEEL STRUCTURE (BEAM) UNLESS NOTED OTHERWISE. SEE PARTITION WALL TYPES ON SHEET A0.03
- 11. DATUM 100'-0" INDICATED ON ALL DRAWINGS, OTHER THAN CIVIL SERIES EQUALS XXXX.XX ON CIVIL DRAWINGS 12. ALL STEEL LOCATED BELOW AND EXPOSED TO GRADE TO BE COATED WITH BITUMINOUS DAMPROOFING.
- 13. CONTRACTOR TO COMPLY WITH ALL REQUIREMENTS FOR SPECIAL INSPECTIONS, 2015 IBC-1704.

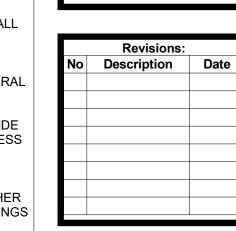


Issue Dates: DRB-10/10/2024

Sheet Title: Basement & Ground **Floor Plans**

2215

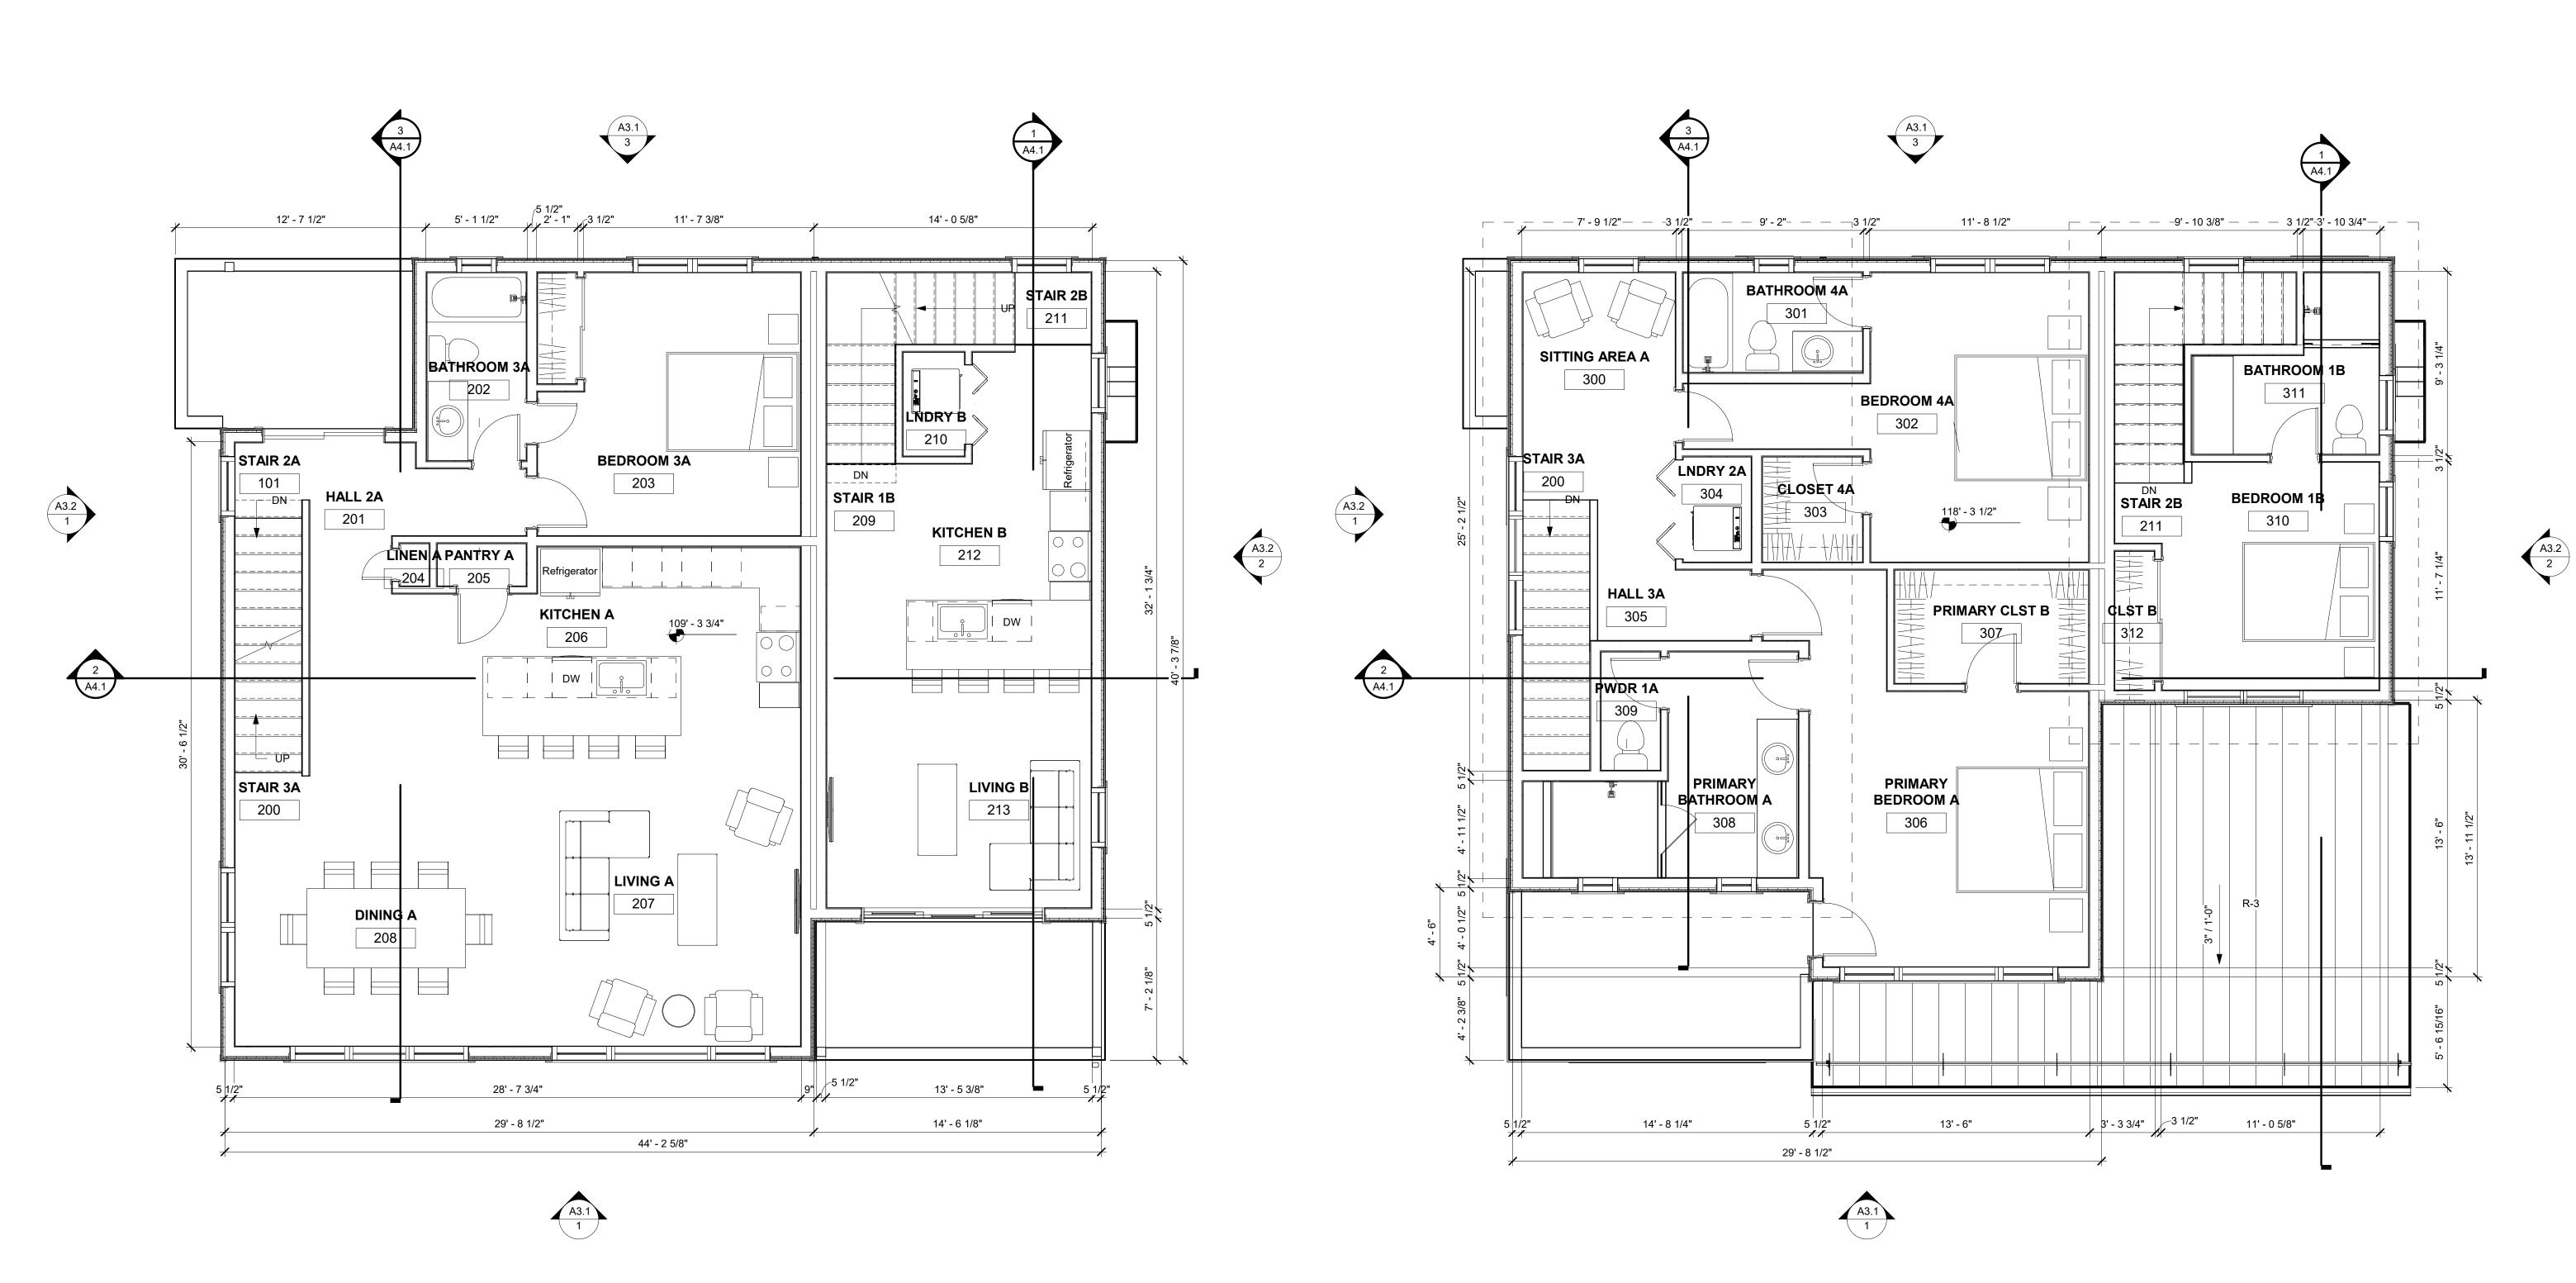

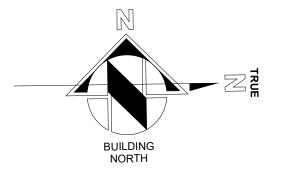

- **CLOSET NOTES:**
- SINGLE HANGING: DESIGNATED BY SINGLE DASHED LINE IN CLOSETS TO BE: 16" SHELF @ 7'-0" AFF, 16" SHELF & ROD @ 5'-6" AFF.
- DOUBLE HANGING: DESIGNATED BY DOUBLE (2) DASHED LINE IN CLOSETS TO BE: 16" SHELF & ROD @ 7'-0" AFF, 12" SHELF & ROD @ 3'-6" AFF.
- SHELVES @ WALK-IN CLOSETS: 6 16" SHELVES @ \langle 3 \rangle 1'-2" OC, 1st SHELF @ 1'-2" AFF, SHELF WIDTH TO BE CLOSET WIDTH, LESS 4'-0" OR AS OTHERWISE
- LINEN SHELVES: 6 SHELVES, WIDTH AS NOTED, @ 4 1'-2" OC, 1st SHELF @ 1'-2" AFF, FULL CLOSET
- STORAGE SHELVES: 6 16" SHELVES @ 1'-2" OC, 1st
- 5 SHELF @ 1'-2" AFF, FULL CLOSET WIDTH.
- **GENERAL CLOSET NOTES:**
- 1. ALL SHELVES & VERTICAL DIVIDERS TO BE AC PLYWOOD WITH 1x2 EDGE. SPECIES TO BE SPECIFIED BY DEVELOPER. 2. CLEATS TO BE 1x2 CLEAR PINE.

3. PROVIDE ROD SUPPORTS @ 36" OC MAX.

4. ALL TO BE STAINED TO MATCH CASE & BASE.

FLOOR PLAN GENERAL NOTES:

- 1. PATCH EXISTING CONSTRUCTION SCHEDULED TO REMAIN. REPAIRED SURFACES TO BE FLUSH WITH ADJACENT FINISH SURFACES. TO SAME QUALITY AS NEW CONSTRUCTION PRIOR TO INSTALLING NEW FINISHES. REFER TO THE FINISH MANUFACTURER'S GUIDELINES FOR INSTALLATION.
- 2. PATCH EXISTING FIRE-RATED WALLS, FLOOR CEILINGS, ETC. SO AS TO MAINTAIN THE FIRE-RADIATING. ADD FIRE-SMOKE DAMPERS WHERE NEW DUCTS CROSS. ADD FIRE STOP AT ALL
- 3. PATCH WALLS AT REMOVED RECEPTACLE OPENINGS SO AS TO RECEIVE SUBSEQUENT WORK.
- 4. PATCH AND LEVEL FLOOR SUBSTRATES TO RECEIVE NEW WORK AS SCHEDULED.
- 5. COORDINATE ALL FLOOR CORE DRILLING WITH EXISTING.

- 6. DO NOT SCALE DRAWINGS.
- 7. IN ROOMS WITH FLOOR DRAINS, SLOPE CONCRETE SURFACE WITHIN 18" RADIUS AT 1/4" PER FOOT TOWARD FLOOR DRAIN, UNLESS OTHERWISE INDICATED.
- 8. ALL SPOT ELEVATIONS SHOWN ON THE FLOOR PLANS OUTSIDE THE BUILDING RELATE TO USGS ELEVATIONS. ALL SPOT ELEVATIONS INSIDE THE BUILDING REFER TO BUILDING REFERENCE ELEVATIONS. NOTIFY ARCHITECT IMMEDIATELY SHOULD CONDITIONS BE FOUND CONTRADICTORY TO THESE DRAWINGS.
- 9. ALL ANGLES SHOWN ON THE FLOOR PLANS ARE 90 DEGREES UNLESS OTHERWISE NOTED.
- 10. ALL DIMENSIONS ARE TO GRID LINE, FACE OF CONCRETE OR MASONRY, OR FACE OF GYPSUM BOARD, UNLESS OTHERWISE NOTED.
- 11. ALL FLOOR PLAN DIMENSIONS TO MASONRY ARE NOMINAL DIMENSIONS, UNLESS NOTED AS ACTUAL.
- 12. "TB" NEW CORK TACKBOARDS OR "MB" NEW MARKERBOARDS
- 13. PROVIDE EXIT DOOR NUMBERS PER DOOR SIGNAGE SHEET AT ALL EXIT DOORS.

GENERAL NOTES:

FLOOR PLANS

1. DO NOT SCALE DRAWINGS. USE GIVEN DIMENSIONS. IMMEDIATELY NOTIFY ARCHITECT IF ADDITIONAL INFORMATION IS REQUIRED. ALL DIMENSIONS ARE GIVEN TO FACE OF WALL FRAMING. SEE WALL SECTIONS AND WALL TYPES FOR EXACT CONSTRUCTION

2. SEE SHEET A0.1 FOR WALL TYPES INDICATED ON

3. PROVIDE ALL NECESSARY BLOCKING FOR PROPER ATTACHMENT OF WORK IN WALLS AND CEILINGS. LOCATIONS INCLUDE BUT NOT LIMITED TO, TOILET AND BATH ACCESSORIES, WALL AND CEILING MOUNTED ELECTRICAL EQUIPMENT, WINDOW TREATMENTS, CASEWORK, COUNTERTOPS, ETC.

4. WHERE WALL PARTITIONS ARE A CONTINUATION OF EXISTING ONES. NEW FINISH SURFACES MUST BE FLUSH AND CONTINUOUS WITH EXISTING SURFACES ON BOTH SIDES. INFILL OPENINGS IN EXISTING WALLS WITH MATERIAL TO MATCH EXISTING WALL THICKNESS, TEXTURE, AND FINISH.

5. REFERENCE S-SERIES DRAWINGS FOR STRUCTURAL NOTES AND DETAILS AND COORDINATE.

6. EXISTING BUILDING DIMENSIONS AND ELEVATIONS ARE

IMMEDIATELY NOTIFY ARCHITECT IF CONDITIONS ARE ENCOUNTERED THAT DO NOT AGREE WITH DIMENSIONS AND/OR ELEVATIONS SHOWN. 7. VERIFY ALL PITCHED FLOOR AREAS SHOWN WITH

BASED UPON EXISTING SURVEY INFORMATION.

PITCH LINES WITH THE ARCHITECT. PROVIDE A SLAB DEPRESSION AT ALL FLOOR DRAINS WHERE PITCH LINES ARE NOT SHOWN ON DRAWINGS.

8. PROVIDE 4" RETURN FROM FACE OF ADJACENT WALL FOR ANY DOORS NOT DIMENSIONED. 9. SEE MECHANICAL, PLUMBING, AND ELECTRICAL DRAWINGS FOR ITEMS NOT SHOWN ON ARCHITECTURAL

DRAWINGS AND COORDINATE. 10. ALL INTERIOR WALLS SHALL EXTEND TO UNDERSIDE OF ROOF DECK AND STEEL STRUCTURE (BEAM) UNLESS NOTED OTHERWISE. SEE PARTITION WALL TYPES ON

SHEET A0.03 11. DATUM 100'-0" INDICATED ON ALL DRAWINGS, OTHER THAN CIVIL SERIES EQUALS XXXX.XX ON CIVIL DRAWINGS 12. ALL STEEL LOCATED BELOW AND EXPOSED TO GRADE TO BE COATED WITH BITUMINOUS DAMPROOFING. 13. CONTRACTOR TO COMPLY WITH ALL REQUIREMENTS

FOR SPECIAL INSPECTIONS, 2015 IBC-1704.



Associates

The Architectural Balance 0056 Edwards Village Blvd. Edwards, CO 81632 (970) 766-1470 fax: (970) 766-1471

email: tab@vail.net Civil Engineer Timberline Engineering (970) 963-9869 Structural Engineer KRM Consultants, Inc (970) 949-9391 Mechanical Engineer


Electrical Engineer

SO . 0


Issue Dates: DRB-10/10/2024

Sheet Title:

Main & Upper **Floor Plans**

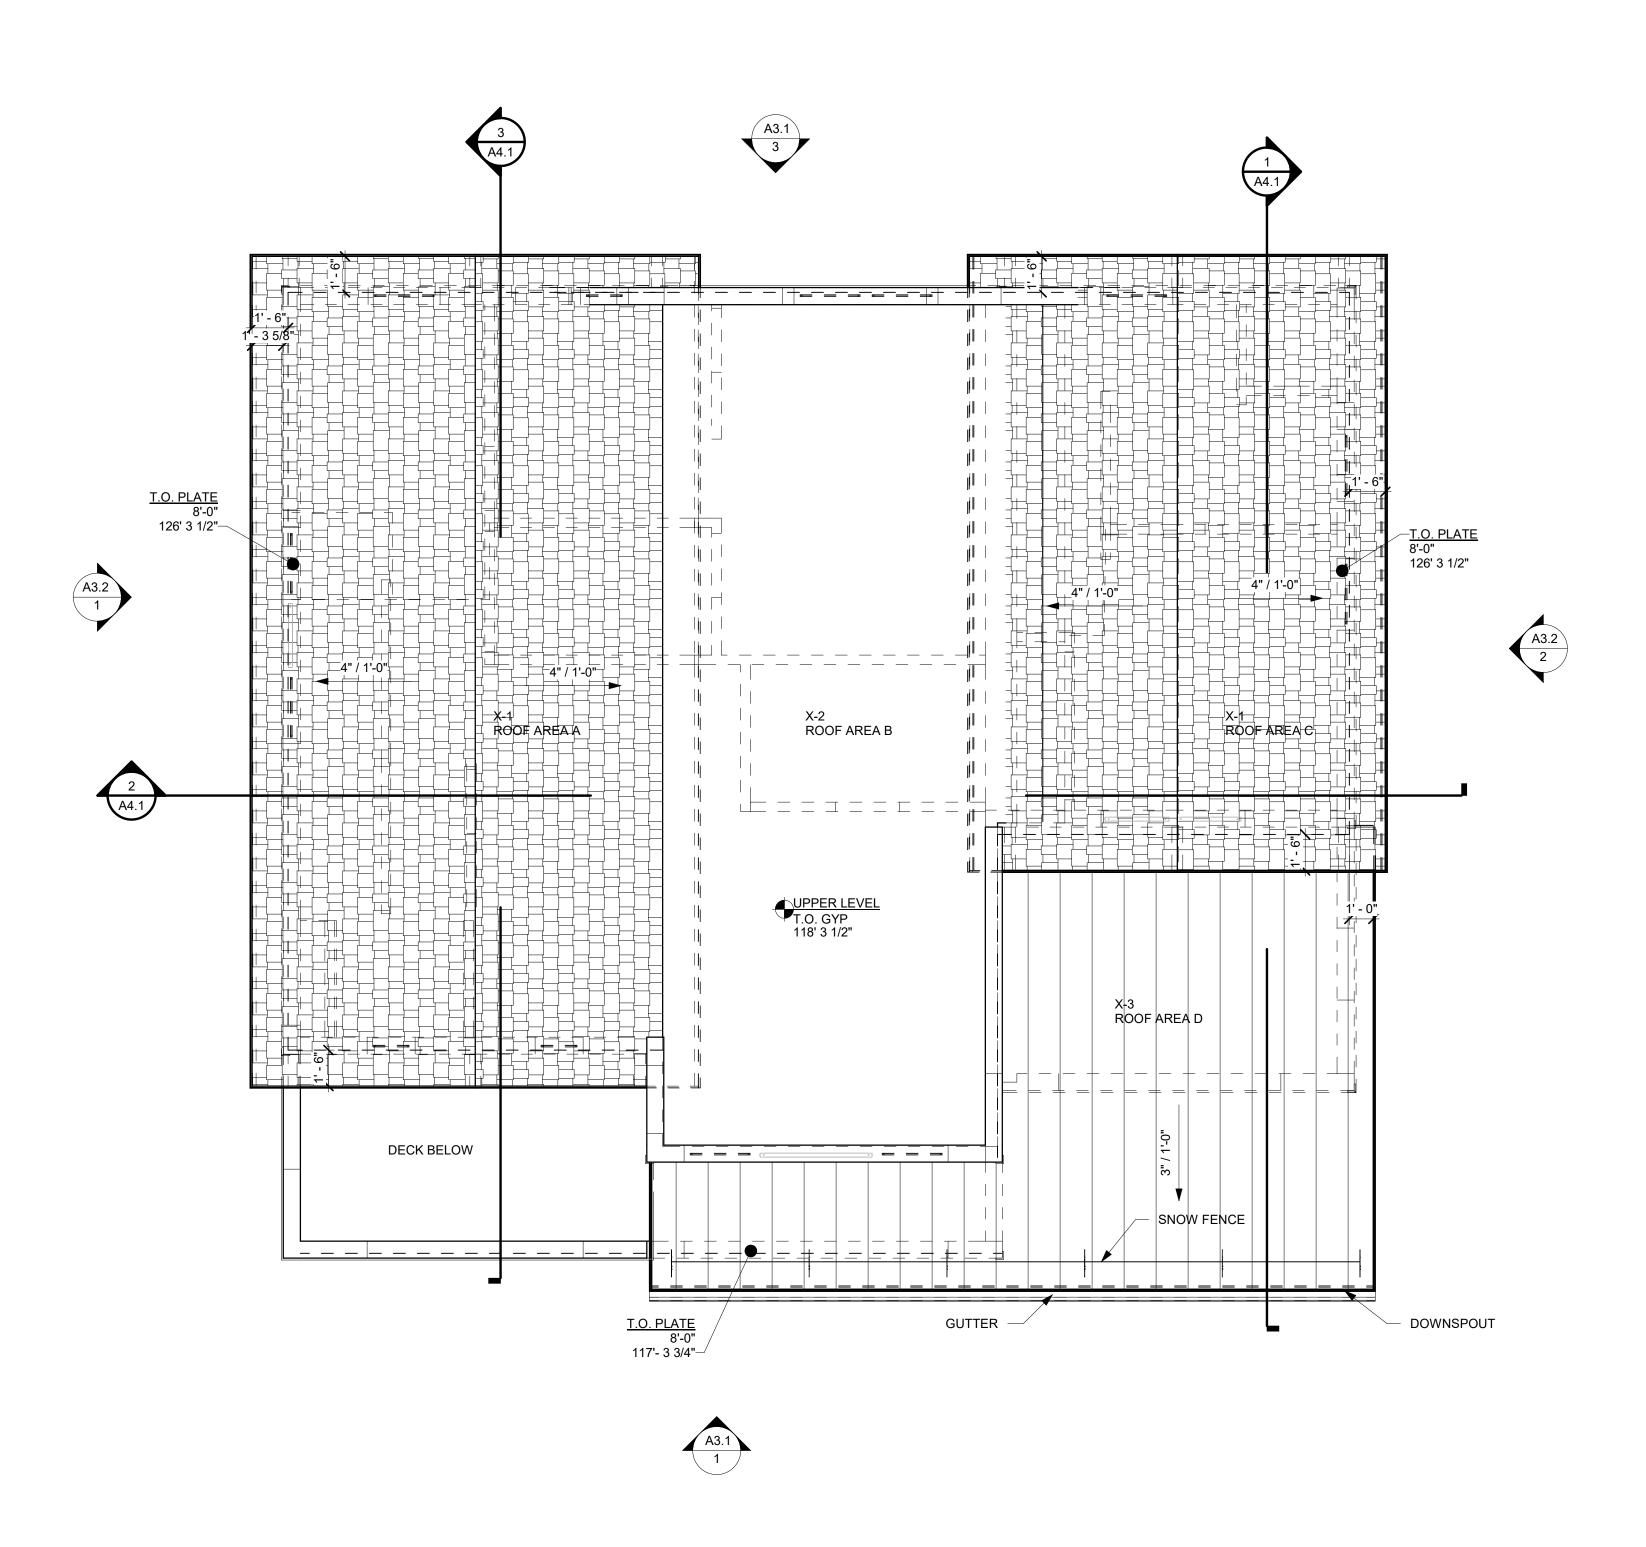

1 ROOF PLAN
A2.3 1/4" = 1'-0"

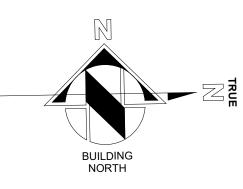

NOTES:

ROOF FINISH LEGEND

NOTES:

1. HATCHED AREAS INDICATE OVERBUILT
ROOF & CRICKETS, RE: STRUCTURAL

- 2. ALL GUTTERS & DOWNSPOUTS TO RECEIVE HEAT TAPE FOR ENTIRE LENGTH, RE: DIAGRAM ON ELECTRICAL PLANS
- 3. T.O. RIDGE ELEVATIONS GIVEN AT TOP OF ROOF SHEATHING

4. CONTRACTOR TO VERIFY CHIMNEY DIMENSIONS WITH FIREPLACE

MANUFACTURERS' REQUIREMENTS


- R-1 TAMKO ASPHALT SHINGLES, HERITAGE PREMIUM, COLOR: NATURAL TIMBER
- R-2 COIL COATED MTL STANDING SEAM
 ROOF SEE SYSTEM NOTES SHEET A0.1

COIL COATED MTL FLASHING, GUTTERS, AND DOWNSPOUTS

OVERHANGS ARE 2'-0" FROM FACE OF FRAMING TYP. U.N.O.

CHIMNEY CAP - 6" SANDSTONE CAP
ROOF BEAMS - ROUGH SAWN TIMBER

BEAMWORK LEGEND:

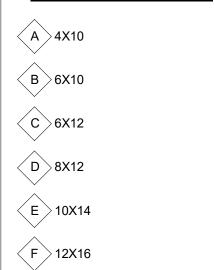

STICK RIDGE T.O. WALL PLATE

FLOOR SPOT ELEV

TRUSS RIDGE TRUSS BEARING

T.O. PLATE +10'-0" 110'-0" +16" HEEL

B.O. RIDGE +20'-2 5/8" 120'-2 5/8" (8359.22') T.O. RIDGE 8360.68' T.O. PLATE +10'-0" 110'-0" MAIN LEVEL T.O. PLYWD/CONC/GYP 100'-0" (8466.5') +20'-2 5/8" T.O. RIDGE 8360.68'

Belden Place - Single Family w/ ADI Lot 12 - 0019 Belden Way

Associates

The Architectural Balance

0056 Edwards Village Blvd. Suite 210 Edwards, CO 81632

(970) 766-1470

fax: (970) 766-1471 email: tab@vail.net www.tabassociates.com

Civil Engineer

Timberline Engineering (970) 963-9869

Structural Engineer

KRM Consultants, Inc (970) 949-9391

Mechanical Engineer

Electrical Engineer

Revisions:
No Description Date

Issue Dates:
DRB-10/10/2024

Sheet Title:
Roof Plan


Project No 2215

A2.3

Roof Area		3 A4.1	1 A4.1	
370.00	PLATE 126' - 3 1/2" UPPER LEVEL 118' - 3 1/2"	X-2 X-3 X-1 X-2	SNOV	W FENCE
	8 - 11 3/4" WAIN LEVEL AREA A AREA A	X-2 X-2 X-2 X-2 X-2 X-2 X-2	28' - 9 3/4"	WNSPOUT OR A CONTROL OF THE CONTROL
	GROUND LEVEL 100' - 0" BASEMENT			
		┇ ══╡ [╊] ╅═╋╅╅╟══┪┪╫══┪╢╫══╅╫╒═╘╅╟══┪╫╒═┪┋┇══╬┇┋╬══╅╁┇═╩		
	A*11'.0' X-1 X-1		4"/1'-0"	PLATE 126' - 3 1/2"
	X-1 3/4"	····┃┃ ┃┃┗━━━┛┃┃ ┃┃┃┃┃┃┃┃┃┃┃┃┃┃┃┃┃┃┃┃┃┃┃┃┃┃┃┃┃┃	X-2	118' - 3 1/2"
		X-4		MAIN LEVEL 109' - 3 3/4"
	-26			GROUND LEVEL 100' - 0" 7927.6
		VORTH ELEVATION		BASEMENT 90' - 7"

EXTERIOR MATERIAL LEGEND:

- X-1 DIAMOND KOTE LP SMARTSIDE LAP SIDING
 X-2 DIAMOND KOTE LP SMARTSIDE LAP SIDING
 X-3 DIAMOND KOTE LP SMARTSIDE LAP SIDING
- X-4 VERTICAL CORRUGATED METAL SIDING
- R-1 ASPHALT SHINGLE ROOF R-2 LOW SLOPE EPDM R-3 STANDING SEAM METAL ROOF

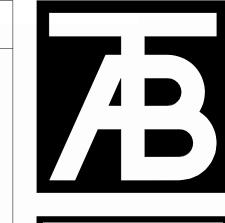

Associates

The Architectural Balance 0056 Edwards Village Blvd. Suite 210 Edwards, CO 81632 (970) 766-1470 fax: (970) 766-1471 email: tab@vail.net www.tabassociates.com

Civil Engineer Timberline Engineering (970) 963-9869 Structural Engineer KRM Consultants, Inc

(970) 949-9391 Mechanical Engineer

Electrical Engineer

EXTERIOR ELEVATION GENERAL NOTES:

1. EXTERIOR FINISHES INDICATED ON ELEVATIONS SEE "EXTERIOR MATERIAL LEGEND" FOR MATERIALS.

2. RFERENCE ROOF PLAN FOR LOCATIONS OF ROOF COMPONENETS NOT INDICATED ON EXTERIOR

3. REFER TO MEP AND STRUCTURAL DRAWINGS FOR

ANY ADDITIONAL WORK. 4. ASSUME ALL PAINTED SURFACES WILL BE REPAINTED. THIS INCLUDES BUT IS NOT LIMITED TO: DOORS, DOOR FRAMES, WINDOW FRAMES, AND HEADERS, CEILINGS,

HANDRAILS, EXPOSED MECHANICAL, CMU ACCENTS, SOFFITS, STRUCTURAL BEAMS, AND ETC. 5. PROVIDE ALLOWANCE TO SEAL AND CAULK VARIOUS WALL PENERTRATIONS ANS HOLES AROUND

EXTERIOR PERIMETER OF BUIDLING, SIMILAR AREAS SUCH AS HOSE BIBS, PIPES, ETC. 6. PROVIDE ALLOWANCE TO REVIEW ALL EXPOSED ELECTRICAL CONDUIT TO DETERMINE FEASIBILITY TO

REMOVE OR RELOCATE. INCLUDE IN ALLOWANCE LABOR AND MATERIALS TO REMOVE OR RELOCATE. 7. SEE CIVIL PLANS FOR NOTE TO RESEAL ALL HORIZONTAL CONCRETE AND ASPHALT JOINTS AT

BUILDING. 8. WHEN A PORTION OF A WALL IS PAINTED ASSUME THE ENTIRE WALL IS PAINTED TO INSIDE OR OUTSIDE

CORNERS. 9. DO NOT SCALE DRAWINGS.

10. ALL ANGLES SHOWN ON THE FLOOR PLANS ARE 90 DEGREES UNLESS NOTED OTHERWISE.

Exterior Elevations

EXTERIOR MATERIAL LEGEND:

- X-1 DIAMOND KOTE LP SMARTSIDE LAP SIDING
 X-2 DIAMOND KOTE LP SMARTSIDE LAP SIDING
 X-3 DIAMOND KOTE LP SMARTSIDE LAP SIDING
- X-4 VERTICAL CORRUGATED METAL SIDING
- R-1 ASPHALT SHINGLE ROOF R-2 LOW SLOPE EPDM R-3 STANDING SEAM METAL ROOF



Associates The Architectural Balance 0056 Edwards Village Blvd. Suite 210 Edwards, CO 81632 (970) 766-1470 fax: (970) 766-1471

Civil Engineer Timberline Engineering (970) 963-9869 Structural Engineer KRM Consultants, Inc

email: tab@vail.net www.tabassociates.com

Electrical Engineer

(970) 949-9391 Mechanical Engineer

2. RFERENCE ROOF PLAN FOR LOCATIONS OF ROOF COMPONENETS NOT INDICATED ON EXTERIOR

ELEVATIONS. 3. REFER TO MEP AND STRUCTURAL DRAWINGS FOR


- ANY ADDITIONAL WORK. 4. ASSUME ALL PAINTED SURFACES WILL BE REPAINTED. THIS INCLUDES BUT IS NOT LIMITED TO: DOORS, DOOR
- FRAMES, WINDOW FRAMES, AND HEADERS, CEILINGS, HANDRAILS, EXPOSED MECHANICAL, CMU ACCENTS, SOFFITS, STRUCTURAL BEAMS, AND ETC. 5. PROVIDE ALLOWANCE TO SEAL AND CAULK VARIOUS
- WALL PENERTRATIONS ANS HOLES AROUND EXTERIOR PERIMETER OF BUIDLING, SIMILAR AREAS SUCH AS HOSE BIBS, PIPES, ETC.
- 6. PROVIDE ALLOWANCE TO REVIEW ALL EXPOSED ELECTRICAL CONDUIT TO DETERMINE FEASIBILITY TO REMOVE OR RELOCATE. INCLUDE IN ALLOWANCE LABOR AND MATERIALS TO REMOVE OR RELOCATE.
- 7. SEE CIVIL PLANS FOR NOTE TO RESEAL ALL HORIZONTAL CONCRETE AND ASPHALT JOINTS AT
- 8. WHEN A PORTION OF A WALL IS PAINTED ASSUME THE ENTIRE WALL IS PAINTED TO INSIDE OR OUTSIDE CORNERS.
- 9. DO NOT SCALE DRAWINGS.
- 10. ALL ANGLES SHOWN ON THE FLOOR PLANS ARE 90 DEGREES UNLESS NOTED OTHERWISE.


- Single 0019 Be linturn, CO 8

DRB-10/10/2024

Sheet Title: **Exterior**

Elevations

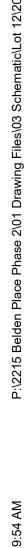

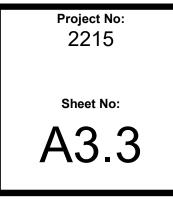

Issue Dates: DRB-10/10/2024

Sheet Title:

Renderings

The Architectural Balance
0056 Edwards Village Blvd.
Suite 210
Edwards, CO 81632

(970) 766-1470

fax: (970) 766-1471 email: tab@vail.net www.tabassociates.com

Civil Engineer Timberline Engineering (970) 963-9869

Structural Engineer
KRM Consultants, Inc
(970) 949-9391

Mechanical Engineer

Electrical Engineer

- Single Family of the state of



NORTHEAST CORNER

A3.3



SOUTHWEST CORNER


A3.3





3 NORTHWEST CORNER
A3.3



4 SOUTHEAST CORNER
A3.3

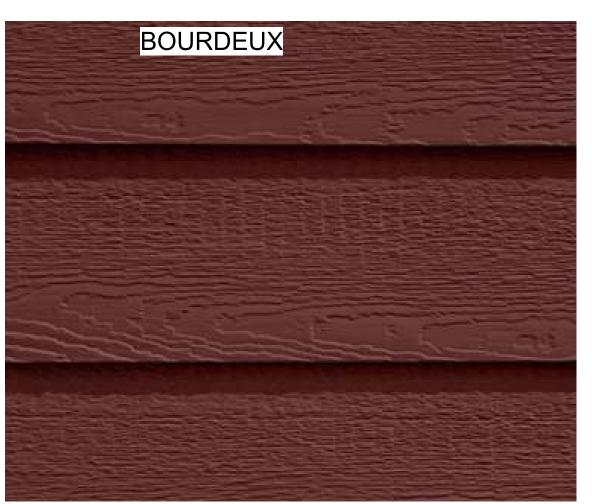

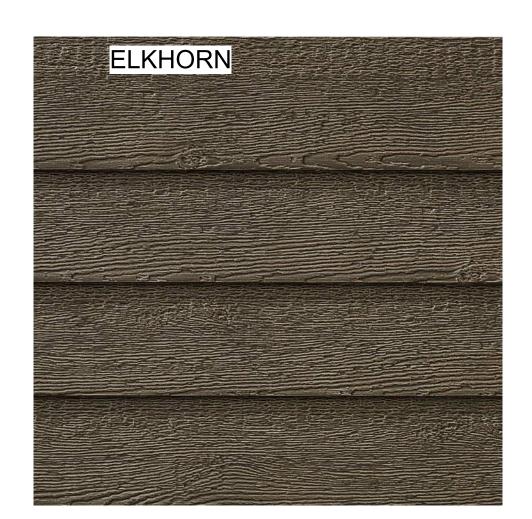

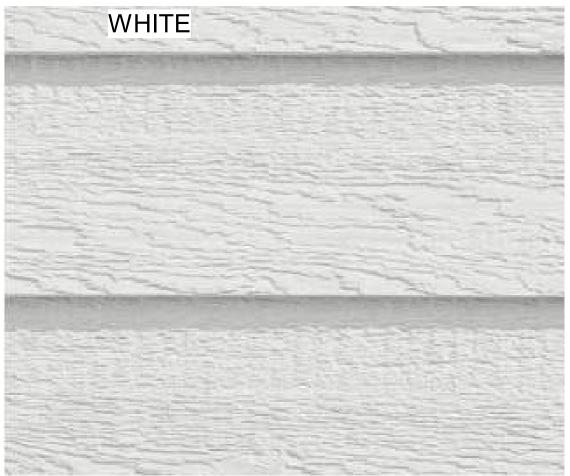

X-1 - LAP SIDING COLOR 1

X-2 - LAP SIDING COLOR 2

X-3 - LAP SIDING COLOR 2



X-4 VERTICAL CORRUGATED PANELS



COURTLAND LOW RISE

X-6 STONE VENEER SIMILAR TO GALLEGOS - #366



PAINTED ITEMS: SHERWIN WILLIAMS 7069 IRON ORE TRIM, WOOD BEAMS, GUTTERS AND OTHER METALS



GARAGE DOORS: SIMILAR TO RAYNOR - ASPEN SERIES RECESSED RANCH GROOVED PANELS COLOR: WALNUT



R-1 ROOFING SIMILAR TO GAF DEISGNER SHINGLES WOODLAN 'CASTLEWOOD GRAY'

WINDOWS: SIMILAR TO SIERRA PACIFIC "BLACK" WOOD CLAD WINDOWS



R-3 ROOFING SIMILAR OT WESTERN STATES 2" STANDING SEAM - 12" WIDTH COLOR: GALVANIZED TO MATCH CORRUGATED PANELS

GENERATION LIGHTING

8637401-12: Medium One Light Outdoor Wall Lantern Dimensions:



Connection: Mounted To Box

1 - Medium A19 75w Max. 120v - Not included

 Dark sky friendly. Designed to emit no light above the 90° horizontal plane. Photometry unavailable.
 Easily converts to LED with optional replacement lamps Leany convents to LED with optional replacement lamps
 Meets Title 24 energy efficiency standards
 Title 24 compilant if used with Joint Appendix (JA8) approved light builbs listed in the California Energy Commission Appliance database.

EXTERIOR MATERIAL LEGEND:

R-1 ASPHALT SHINGLE ROOF R-2 LOW SLOPE EPDM R-3 STANDING SEAM METAL ROOF

X-1 DIAMOND KOTE LP SMARTSIDE LAP SIDING
X-2 DIAMOND KOTE LP SMARTSIDE LAP SIDING
X-3 DIAMOND KOTE LP SMARTSIDE LAP SIDING
X-4 VERTICAL CORRUGATED METAL SIDING

Collection: Barn Light Material List: 1 Body - Aluminum - Black Featured in the decorative Barn Light collection Safety Listing: 1 A19 Medium 75 watt light buib Safety Listed for Wet Locations Dark sky friendly. Designed to emit no light above the 90° horizontal plane. Photometry unavailable. Instruction Sheets: Trilingual (English, Spanish, and French) (990W8_37401-BRL) Easily converts to LED with optional replacement lamps

Meets Title 24 energy efficiency standards UPC #:785652069352 Finish: Black (12)

Type	Height / Le	ngth	Width	Depth	Dlame	er.	Outle	t Bax Up	- 13	Outlet Box	Down
Back Plate				1 1/4	5		- 4	1/8		5 1/2	

Generation Lighting reserves the right to revise the design of components of any product due to parts availability or change in safety listing standards without assuming any obligation or liability to modify any products previously manufactured and without notice. This illustrature depicts a product design that is the sole and exclusive property of Generation Lighting. In compliance with U.S copyright and patient requirements, notification is hereby presented in this form that this illustrature, or the product it depicts, is not to be copied, altered or used in any manner without the express written content of, or contrary to the best interests of Generation Lighting, a Visual Comfort & Co brand.

Project No: 2215

Issue Dates:

DRB-10/10/2024

Sheet Title:

Materials

Associates The Architectural Balance

0056 Edwards Village Blvd. Suite 210 Edwards, CO 81632

(970) 766-1470 fax: (970) 766-1471 email: tab@vail.net

Civil Engineer Timberline Engineering (970) 963-9869 Structural Engineer KRM Consultants, Inc (970) 949-9391 Mechanical Engineer

Electrical Engineer

0

. 0



EXTERIOR MATERIAL LEGEND:


X-1 DIAMOND KOTE LP SMARTSIDE LAP SIDING
 X-2 DIAMOND KOTE LP SMARTSIDE LAP SIDING
 X-3 DIAMOND KOTE LP SMARTSIDE LAP SIDING
 X-4 VERTICAL CORRUGATED METAL SIDING

R-1 ASPHALT SHINGLE ROOF R-2 LOW SLOPE EPDM R-3 STANDING SEAM METAL ROOF

Associates The Architectural Balance 0056 Edwards Village Blvd. Suite 210 Edwards, CO 81632 (970) 766-1470

fax: (970) 766-1471 email: tab@vail.net www.tabassociates.com Civil Engineer Timberline Engineering (970) 963-9869 Structural Engineer
KRM Consultants, Inc (970) 949-9391 Mechanical Engineer Electrical Engineer


- Single Fami 0019 Belden Minturn, CO 81645 Belden Place Lot 12 -

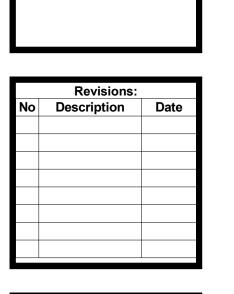

DRB-10/10/2024 Sheet Title: Building **Sections**

A4.1

BASEMENT 90' - 7"

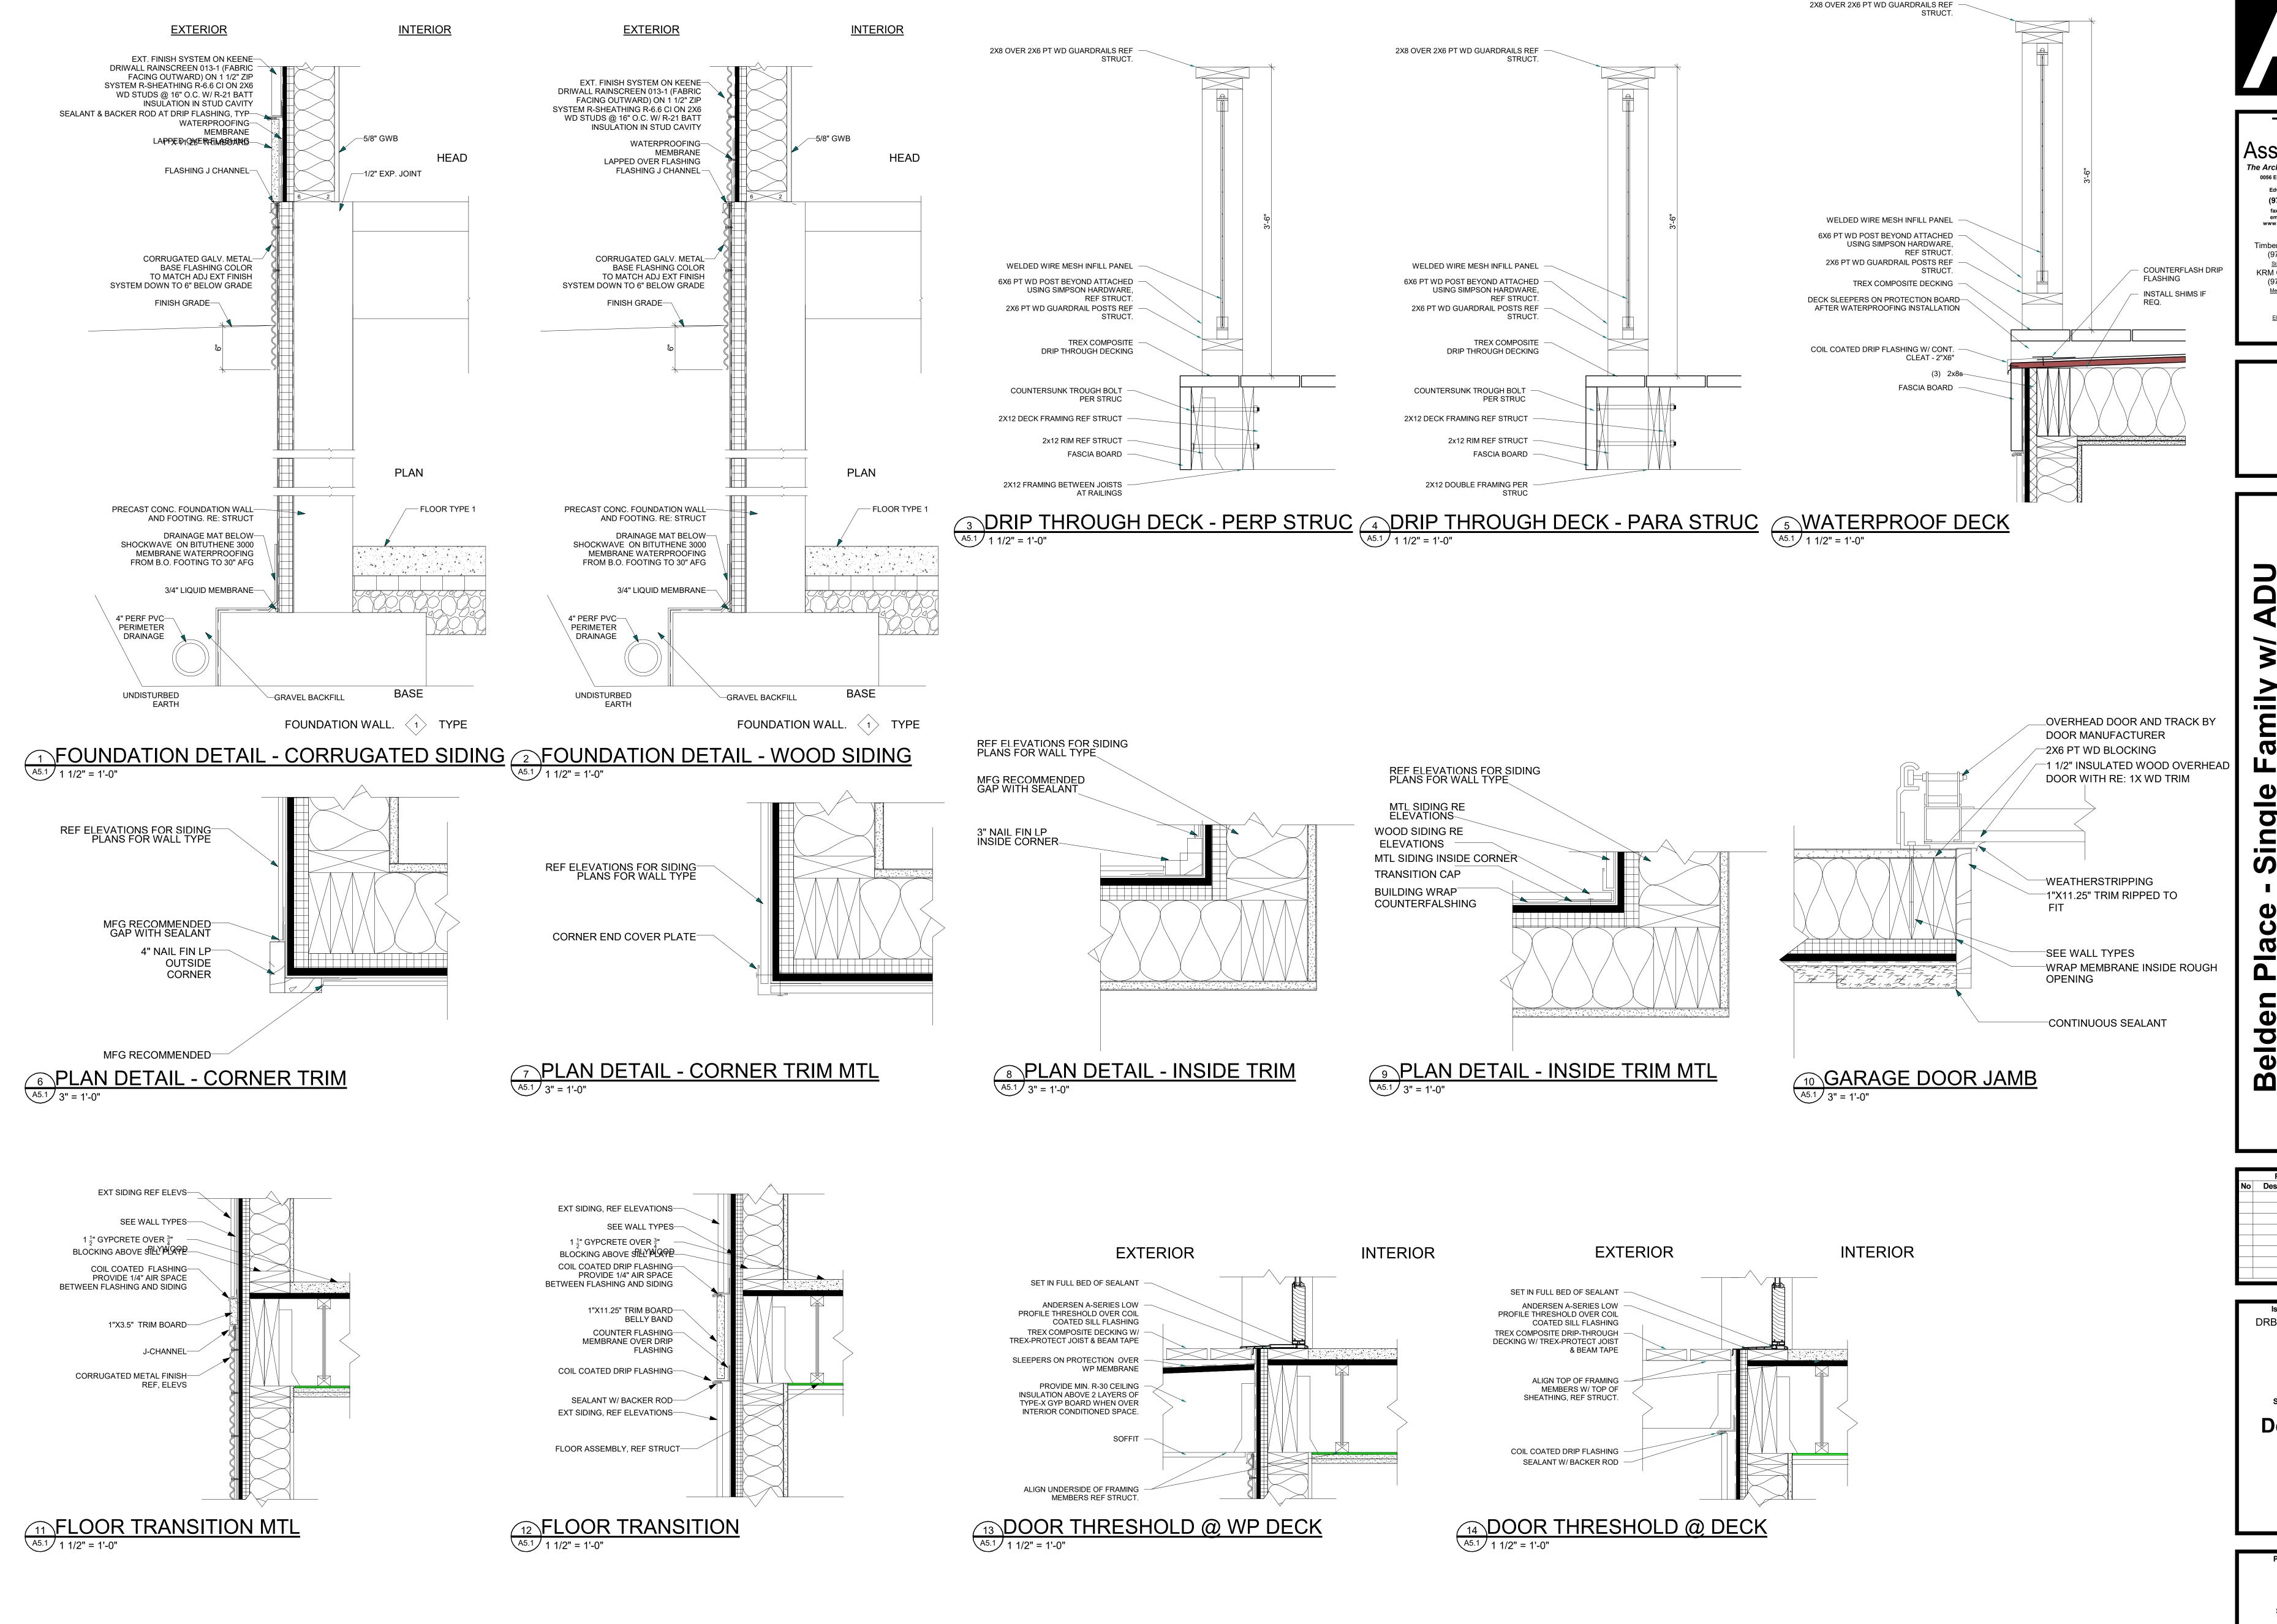


Associates The Architectural Balance 0056 Edwards Village Blvd. Suite 210 Edwards, CO 81632 (970) 766-1470 fax: (970) 766-1471 email: tab@vail.net Civil Engineer Timberline Engineering (970) 963-9869 Structural Engineer KRM Consultants, Inc (970) 949-9391 Mechanical Engineer Electrical Engineer

0 . 0 **(1)**


Description

Issue Dates: DRB-10/10/2024 Sheet Title: **Details**

Project No: 2215 A5.1

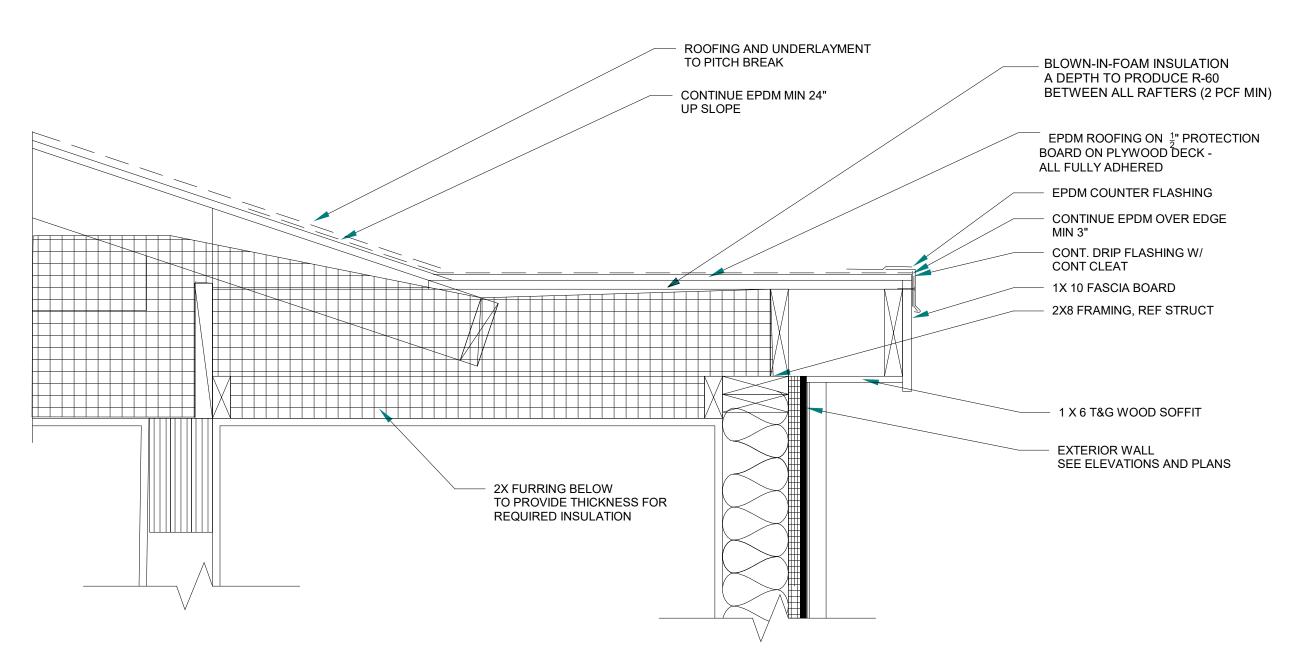

6 STAIR ROOF - LOW SLOPE TRANSITION
A5.2 1 1/2" = 1'-0"

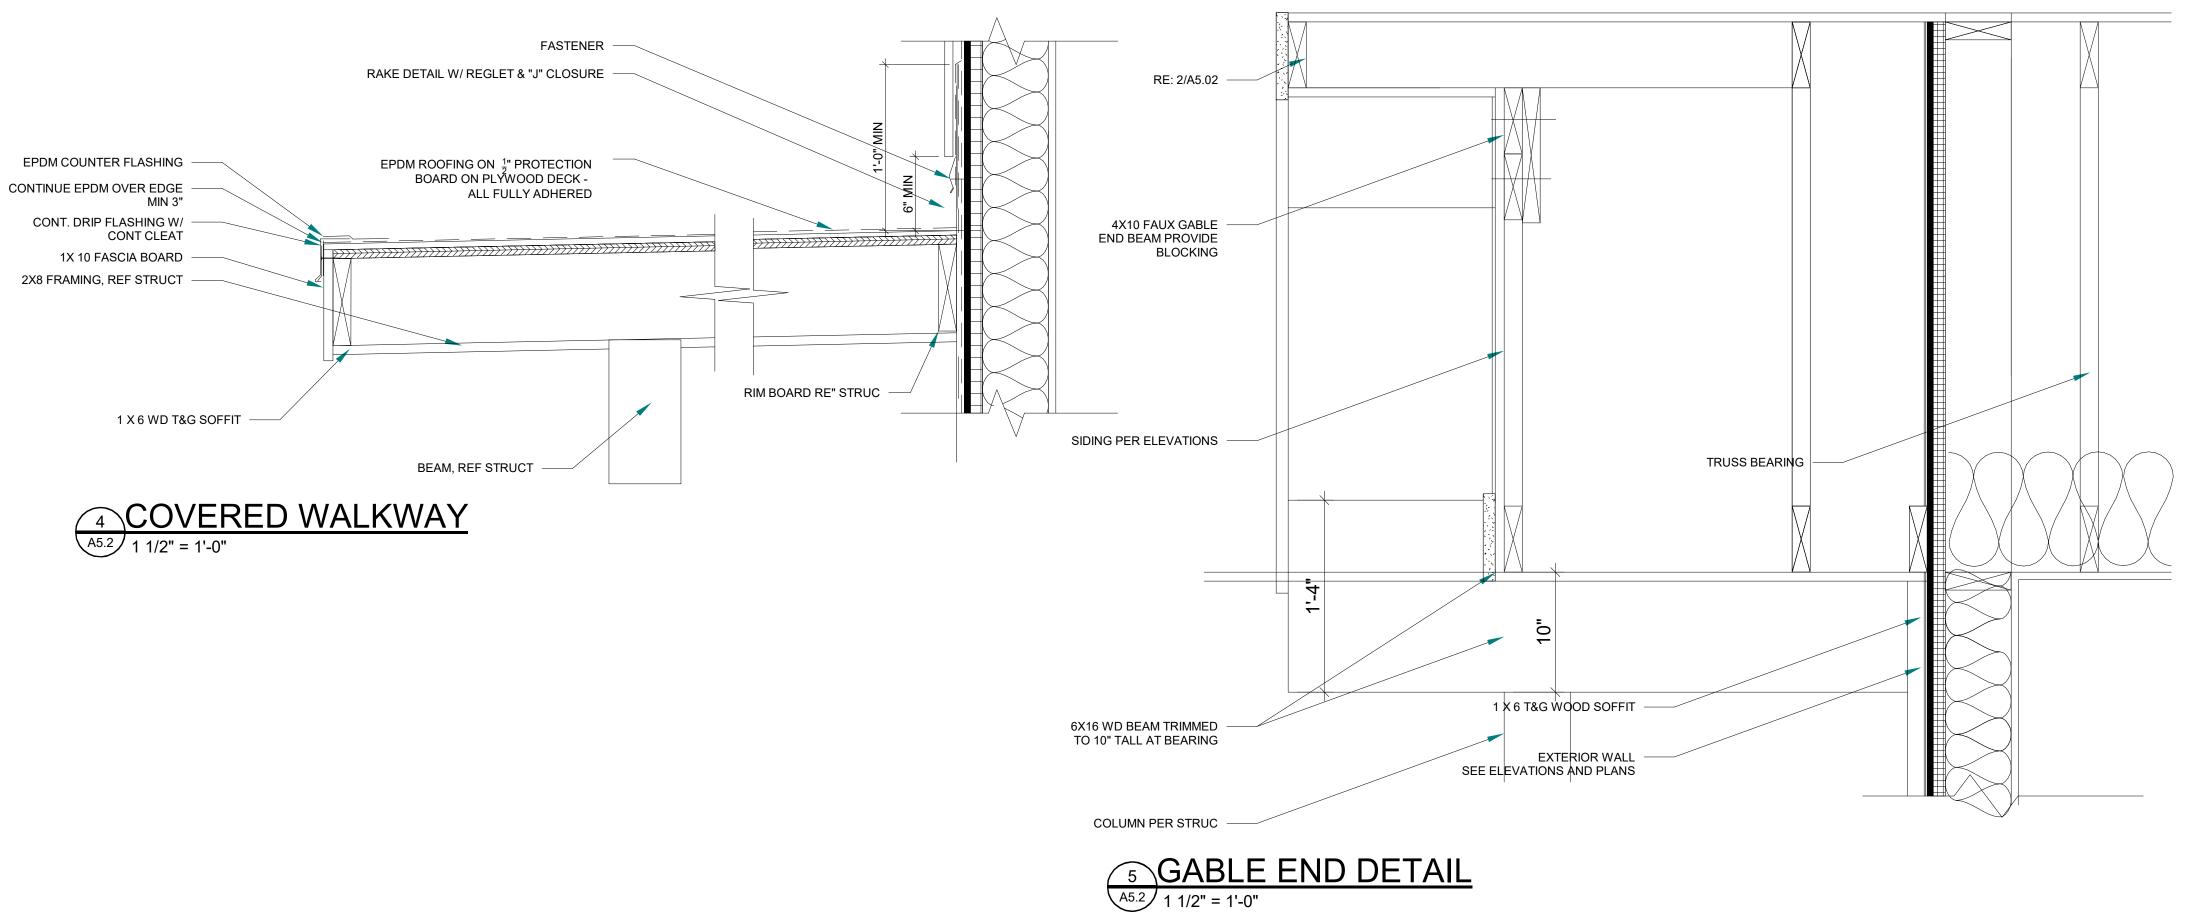

TAB
Associates
The Architectural Balance

0056 Edwards Village Blvd.
Suite 210
Edwards, CO 81632
(970) 766-1470
fax: (970) 766-1471
email: tab@vail.net
www.tabassociates.com

Civil Engineer
Timberline Engineering
(970) 963-9869
Structural Engineer
KRM Consultants, Inc
(970) 949-9391
Mechanical Engineer

Electrical Engineer

Seal

len Place - Single Family w/ AD Lot 12 - 0019 Belden Way

Revisions:
No Description Date

Issue Dates:
DRB-10/10/2024

Sheet Title:
Details


2215


Sheet No:

A5.2


A5.3 3" = 1'-0"


CASING PER

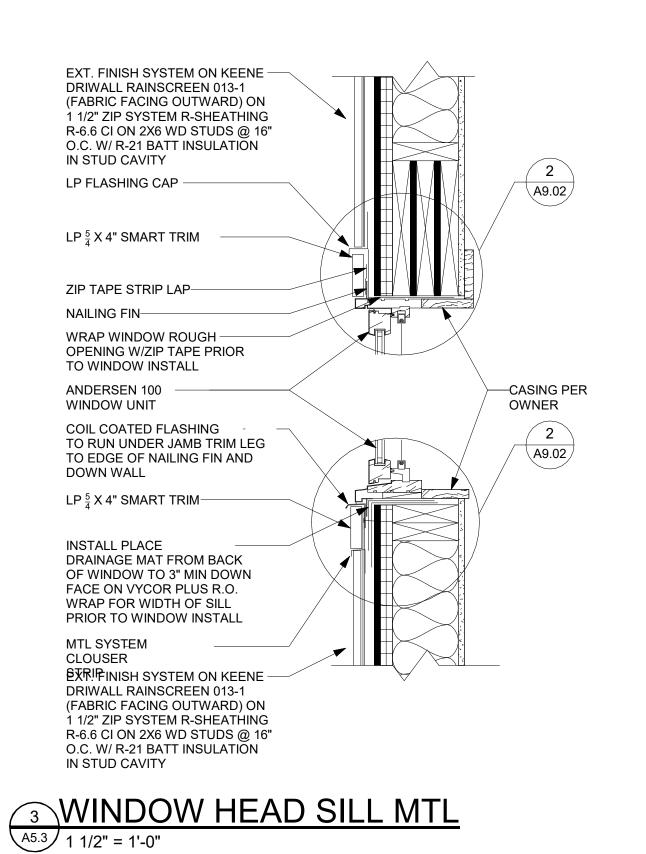


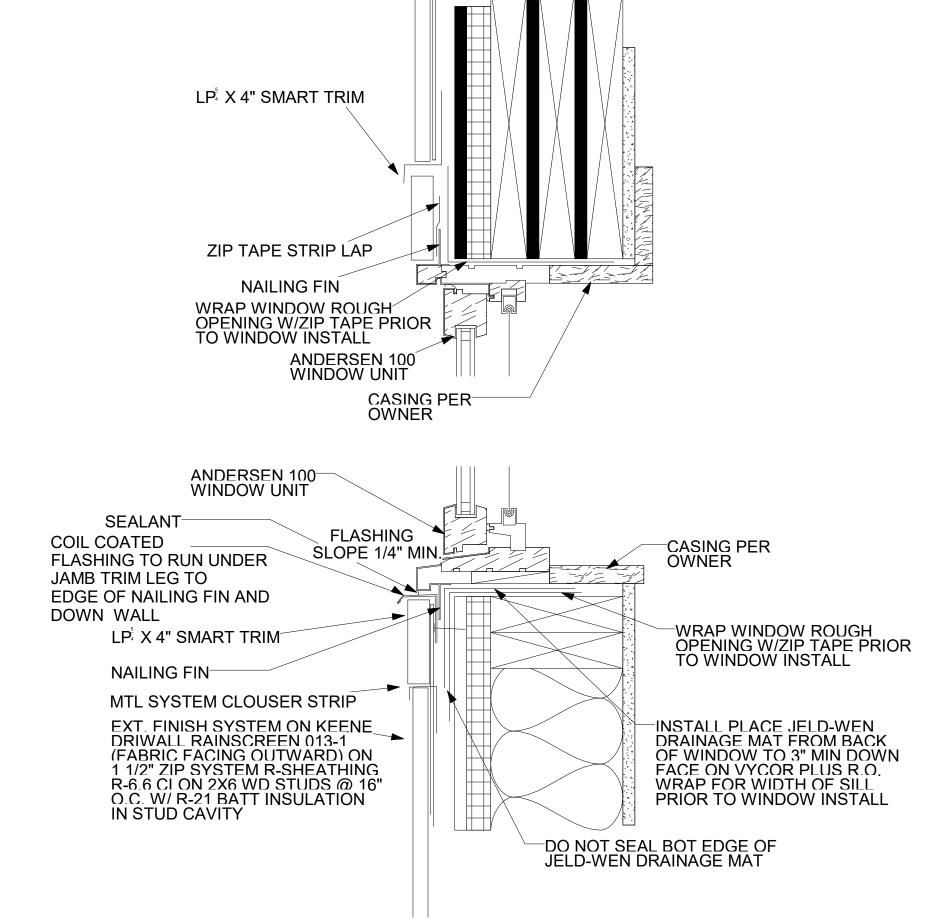



WINDOW HEAD SILL MTL - ENLARGED A5.3 3" = 1'-0"

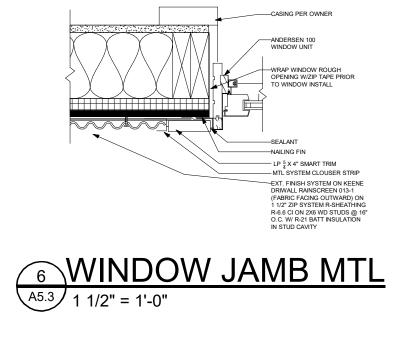


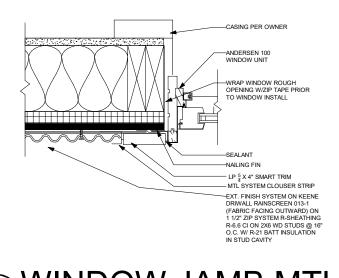


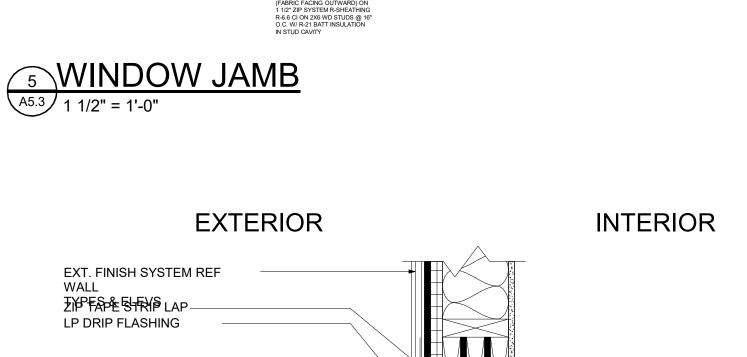


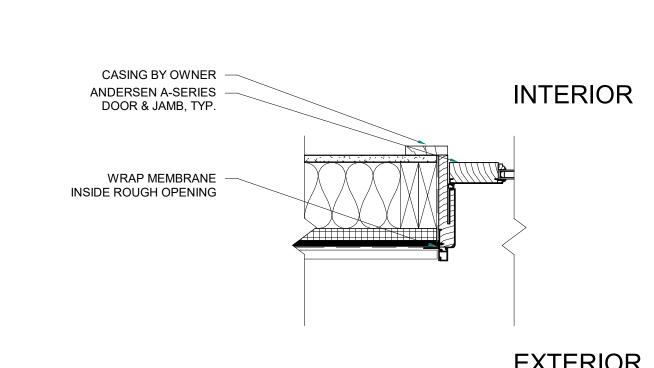

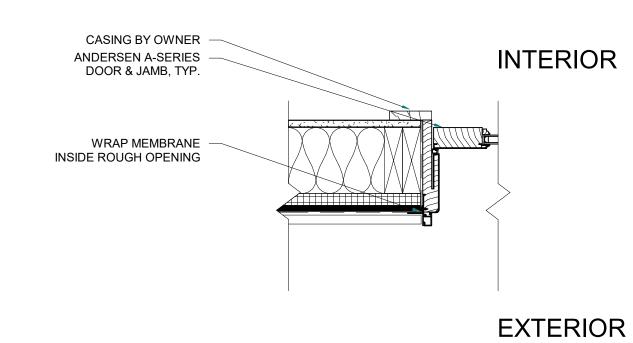

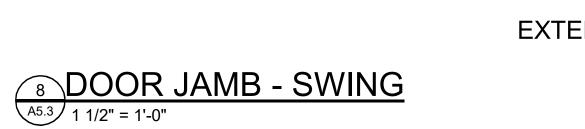

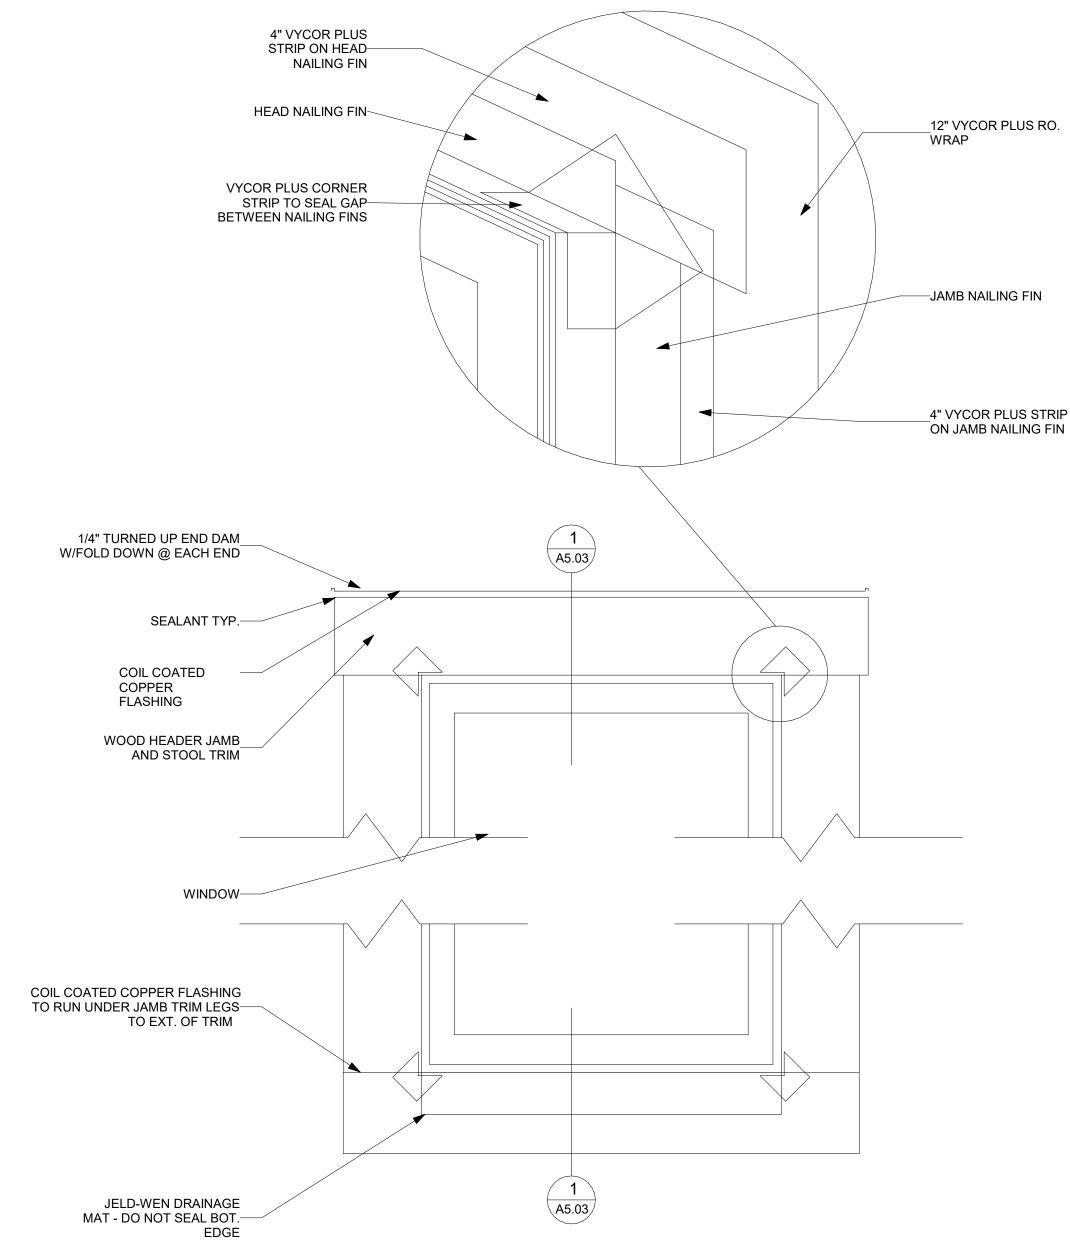

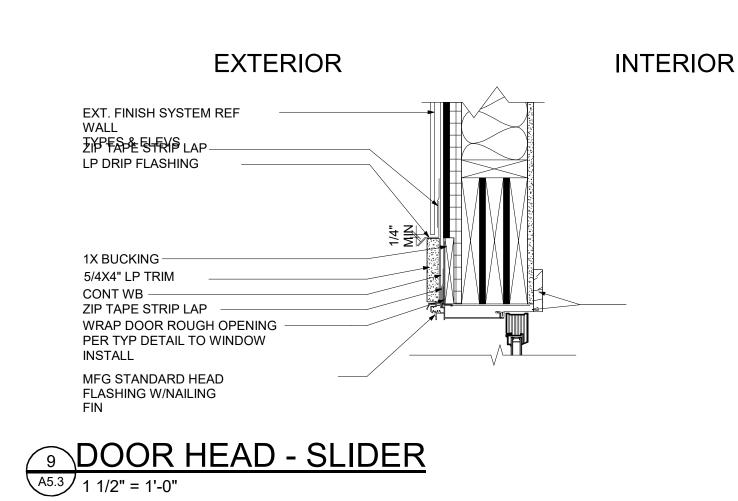

1X BUCKING -5/4X4" LP TRIM CONT WB -

INSTALL


A5.3 1 1/2" = 1'-0"


ZIP TAPE STRIP LAP

MFG STANDARD HEAD FLASHING W/NAILING

WRAP DOOR ROUGH OPENING PER TYP DETAIL TO WINDOW

7 DOOR HEAD - SWING

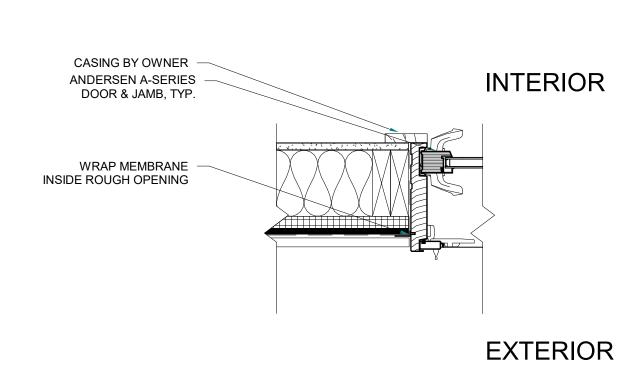

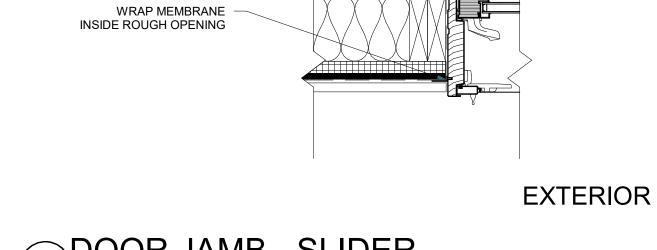

10 DOOR JAMB - SLIDER
A5.3 1 1/2" = 1'-0"

11 WINDOW FLASHING A5.3 1 1/2" = 1'-0"

A5.3

Project No: 2215

Issue Dates:

DRB-10/10/2024

Sheet Title:

Details

Associates

The Architectural Balance

0056 Edwards Village Blvd.

Suite 210 Edwards, CO 81632

(970) 766-1470

fax: (970) 766-1471

email: tab@vail.net

Civil Engineer

Timberline Engineering

(970) 963-9869

Structural Engineer

KRM Consultants, Inc

(970) 949-9391

Mechanical Engineer

Electrical Engineer

0