
Belden Place

Lot 10 - 0025 Beldan Way

Lot 11 - 0023 Beldan Way Duplex Residences

Minturn, Colorado 81645

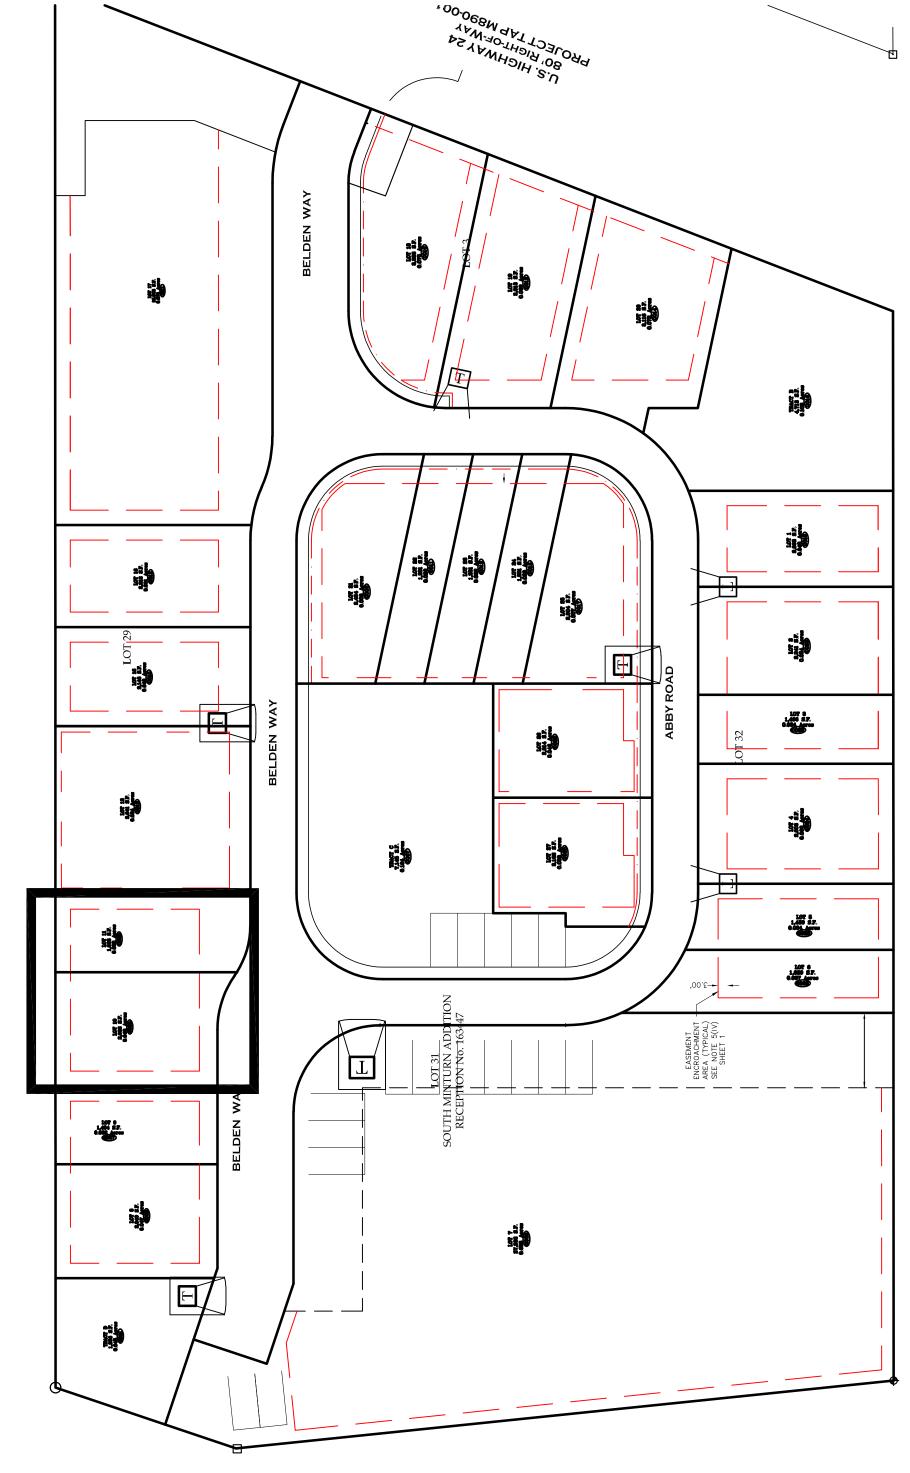

Design Review Submittal 09/20/2024

A0.00 COVER SHEET

A0.02 PUD GUIDE INFORMATION
FINAL PLAT

C1.110 SURVEY

C1.111 OVERALL DEVELOPMENT SITE PLAN

C.1 SITE PLAN & UTILITY PLAN

C.2 GRADING, DRAINAGE & EROSION CONTROL PLANS

C.2 DETAILS AND CROSS SECTION

A1.1 LANDSCAPE PLAN AND DETAILS

A1.1 LANDSCAPE PLAN AND DETAILS
A2.1 GROUND AND BASEMENT FLOOR PLANS
A2.2 MAIN AND UPPER FLOOR PLANS
A2.3 ROOF PLAN
A3.1 EXTERIOR ELEVATIONS

A3.1 EXTERIOR ELI
A3.2 MATERIALS
A3.3 RENDERINGS
A4.1 SECTIONS
A5.1 DETAILS
A5.2 DETAILS
A5.3 DETAILS




Vicinity Map



TAB
ASSOCIATES
The Architectural Balance

0056 Edwards Village Blvd.
Edwards, CO 81632
(970) 766-1470
fax: (970) 766-1471
email: tab@vail.net
www.tabassociates.com



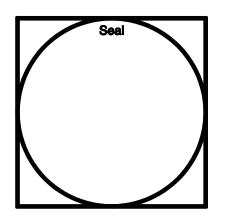

colorado 81645

Revisions:

00

6

Issue Dates: 20220509 Struct Coord DRB-09/20/2024

Sheet Title:
Cover

Project No:

2215


Sheet No:

AO.OO


BELDEN PLACE PUD GUIDE INFORMATION

The following is an abrieviated verision of information found in the PUD guide.

Building Height. Determining building height uses a weighted height calculation as measured from final/finished grade. Max heights - 28' for single famil and duplex, 35' for Row Houses and Flats.

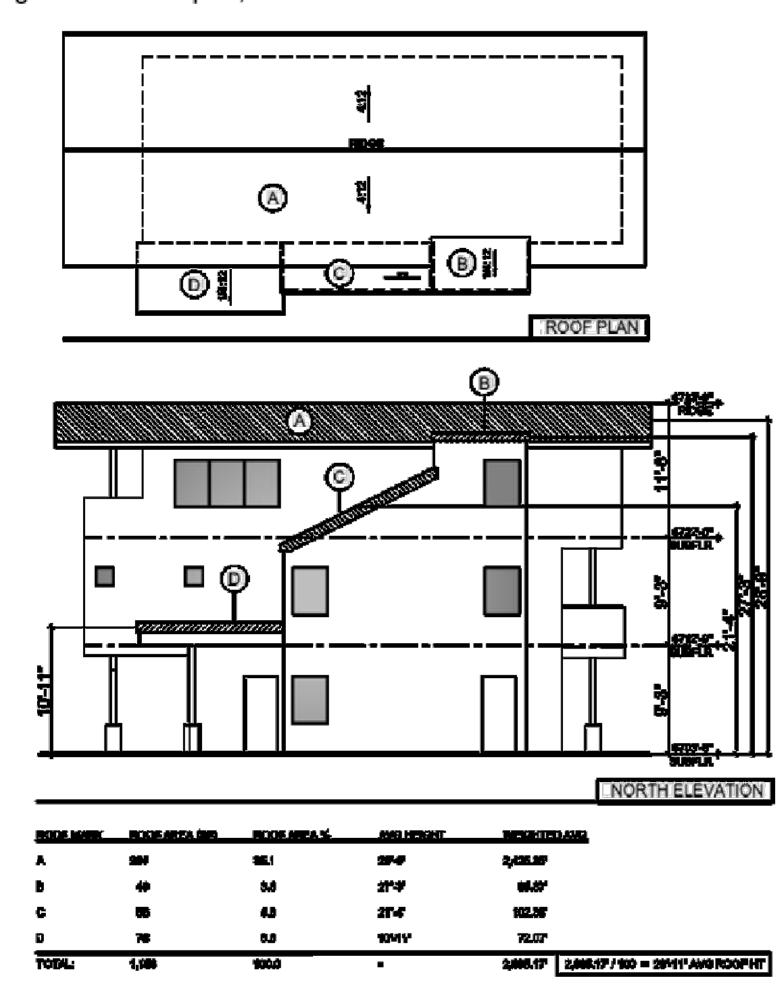

Site Coverage. Site coverage means the portion of a lot covered by materials forming any unbroken surface, impervious to water including, but not limited to: buildings, streets, slab on-grade patios, exterior fireplaces, and other hardscape materials. Site coverage excludes non-hardscape areas under eaves or similar (e.g., open-sided cantilever).

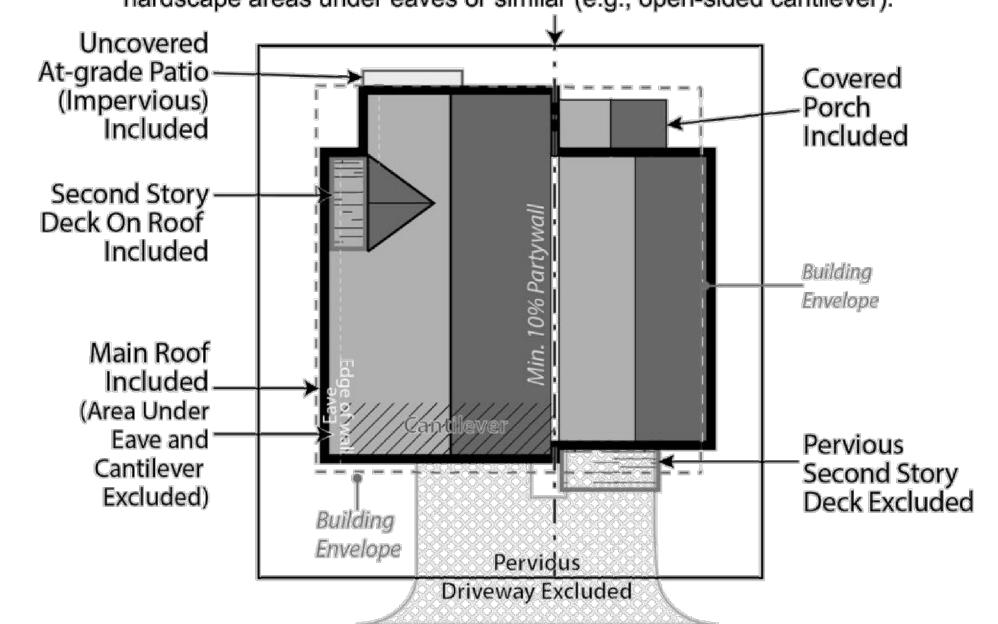

BUILDING PLACEMENT AND ENVELOPES

Residential building envelopes are necessary in order to maximize the buildability and economic viability of the lots while offering greenspace and or space between neighbors to the greatest extent possible. All portions of structure- including fireplaces, chimneys, window wells, eaves, overhangs, etc. must be contained within property lines; however, with the platted building envelope acting as building setbacks for each lot, encroachments are available for certain features.

The following encroachments are permitted beyond the platted building envelope:

Unenclosed or uncovered decks; deck supports; eaves up to 18" beyond the envelope; porches, patios and landings less than 30" above the surrounding natural or finished grade; window or light wells; heat or A/C units; residential solar alternative energy installations; fences; counterforts below grade; staircases (enclosed or otherwise); structures of less than 6" in height; landscaping and drainage features. No encroachment may be located within 24" from the property line or directly on top of in-ground utility easements. Underground parking elements and staircases may encroach within 12" of the most southern property line on Lot 7.

1. SINGLE-FAMILY DETACHED

a. Style

- (1) Residences with the same architectural elevations and coloring shall not be placed adjacent to each other or directly across the street from one another.
- (2) Each residential unit type shall have at least two (2) elevations to provide stylistic diversity. This may include:
- i. Roof forms/lines and profiles
- ii. Varied window and door styles
- iii. Varied entry treatments and locations including porches, columns, etc.
- iv. Two or three story homes
- v. Second or third story decks or balconies

Building Form

- (1) The mass of the residence should strongly reflect the architectural style and be scaled to provide visual interest and depth, reduce boxiness and achieve an articulated form on the front and sides of the homes.
- (2) Roofs shall be designed and pitched accordingly in consideration of solar technology and/or drainage.
- (3) Roof-top decks are permitted only on certain lots as established by developer and cannot be added on buildings not constructed with this initial feature.

. DUPLEX/TRI-PLEX or MULTIFAMILY STRUCTURES

a. Sty

- Structures shall have at least two (2) elevations to provide stylistic diversity.
- (2) Units may be multi-stories.
- (3) Units may be divided horizontally (townhomes) or vertically (flats).
- (4) Second story decks or balconies permitted.
- (5) Units have no minimum length of connection and may be joined via shared walls of the garage, external staircases, or main living area wall(s) or floors.

b. Building Form

- (1) The mass of the residence should strongly reflect the architectural style and be scaled to provide visual interest and depth, reduce boxiness and achieve an articulated form on the front of the homes.
- (2) Roofs shall be designed and pitched accordingly in consideration of solar technology and/or drainage.
- (3) Roof-top decks are permitted only on certain lots as established by developer and cannot be added on buildings not constructed with this initial feature.

. MATERIALS

- a. Roofing materials are limited to the following:
- (1) Artificial wood shingle (to mimic wood shake shingle). Treated wood shake shingles or any other combustible material is prohibited.
- (2) Standing seam metal.
- Asphalt shingles.
- (4) Imitation (composite or similar); or, real slate tiles.
- (5) Non-reflective solar tiles that mimic the above-mentioned products
- (6) Any other recommended FireWise materials similar to the above-mentioned products.

o. Siding materials are limited to the following:

- (1) Metal
- (2) Wood
- (3) Composite siding
- (4) Fiber cement board (commonly known as "Hardie Board")
- (5) Stucco.
- (6) Any other recommended FireWise materials similar to the above-mentioned products.
- (7) All siding materials to have non-reflective finishes.

c. Doors and Windows:

- Structures with multiple garage doors must always have identical, matching doors.
- (2) All replacement windows shall be consistent and match the aesthetic of previous windows unless otherwise approved by the design review board. Skylight or solar tubes permitted.
- (3) Screen or storm doors, in addition to typical front doors are permitted. Screen or storm doors cannot replace front doors at any time.
- Design Elements. This development may incorporate mountain appropriate design elements into the buildings, including, but not limited to, exposed heavy timber beams as accent elements or entry features, walls faced with wood, stone, faux stone or cultured stone, metal railings or accents. Stucco may only be utilized in small quantities on building facades and is not to be used as a primary material for home.
- e. Building materials for residential exteriors shall include at least two (2) types of materials as part of the building façade.

I. LANDSCAPING – See also PUD Landscaping Plan
Shall not interfere with any drainage way, utility, pedestrian access, or
entry into any structure. Landscaping shall not obscure windows, be
installed under gas fireplace or dryer vents, nor shall any landscaping
material overtake any yard, or spread into any common or
neighboring yards.

Landscaping minimums:

- 1. At least one (1) tree per 1,200 sf of lot area and two (2) shrubs for all lots. See also official Landscaping Plan for Belden Place.
- 2. All landscaping proposed on the approved Landscaping Plan shall be installed initially with expectations for maintenance.
- No exposed soil is permitted. Soil must be covered in groundcover that may consist of seed (includes wildflower seed), cobble, perennials, mulch, or similar.
- All dead materials must be replaced during the same season death occurs.



TAB
Associates
The Architectural Balance

0056 Edwards Village Blvd.
Edwards, CO 81632

(970) 766-1470
fax: (970) 766-1471
email: tab@vail.net
www.tabassociates.com


Civil Engineer:

Timberline Engineering
(970) 963 9869

Structural Engineer:

KRM Consultants, Inc,

(970) 949-9391

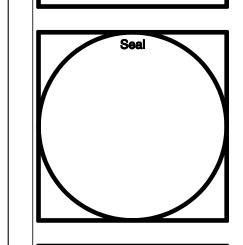

Belden Place - Duplex Units ots 10/ 0025 Beldan Way & 11 / 0023 Beldan Way

Revisions:


Issue Dates:
20220509 Struct Coord


DRB-09/20/2024


Sheet Title:
PUD
Information


Project No:


Sheet No: **A0.02**

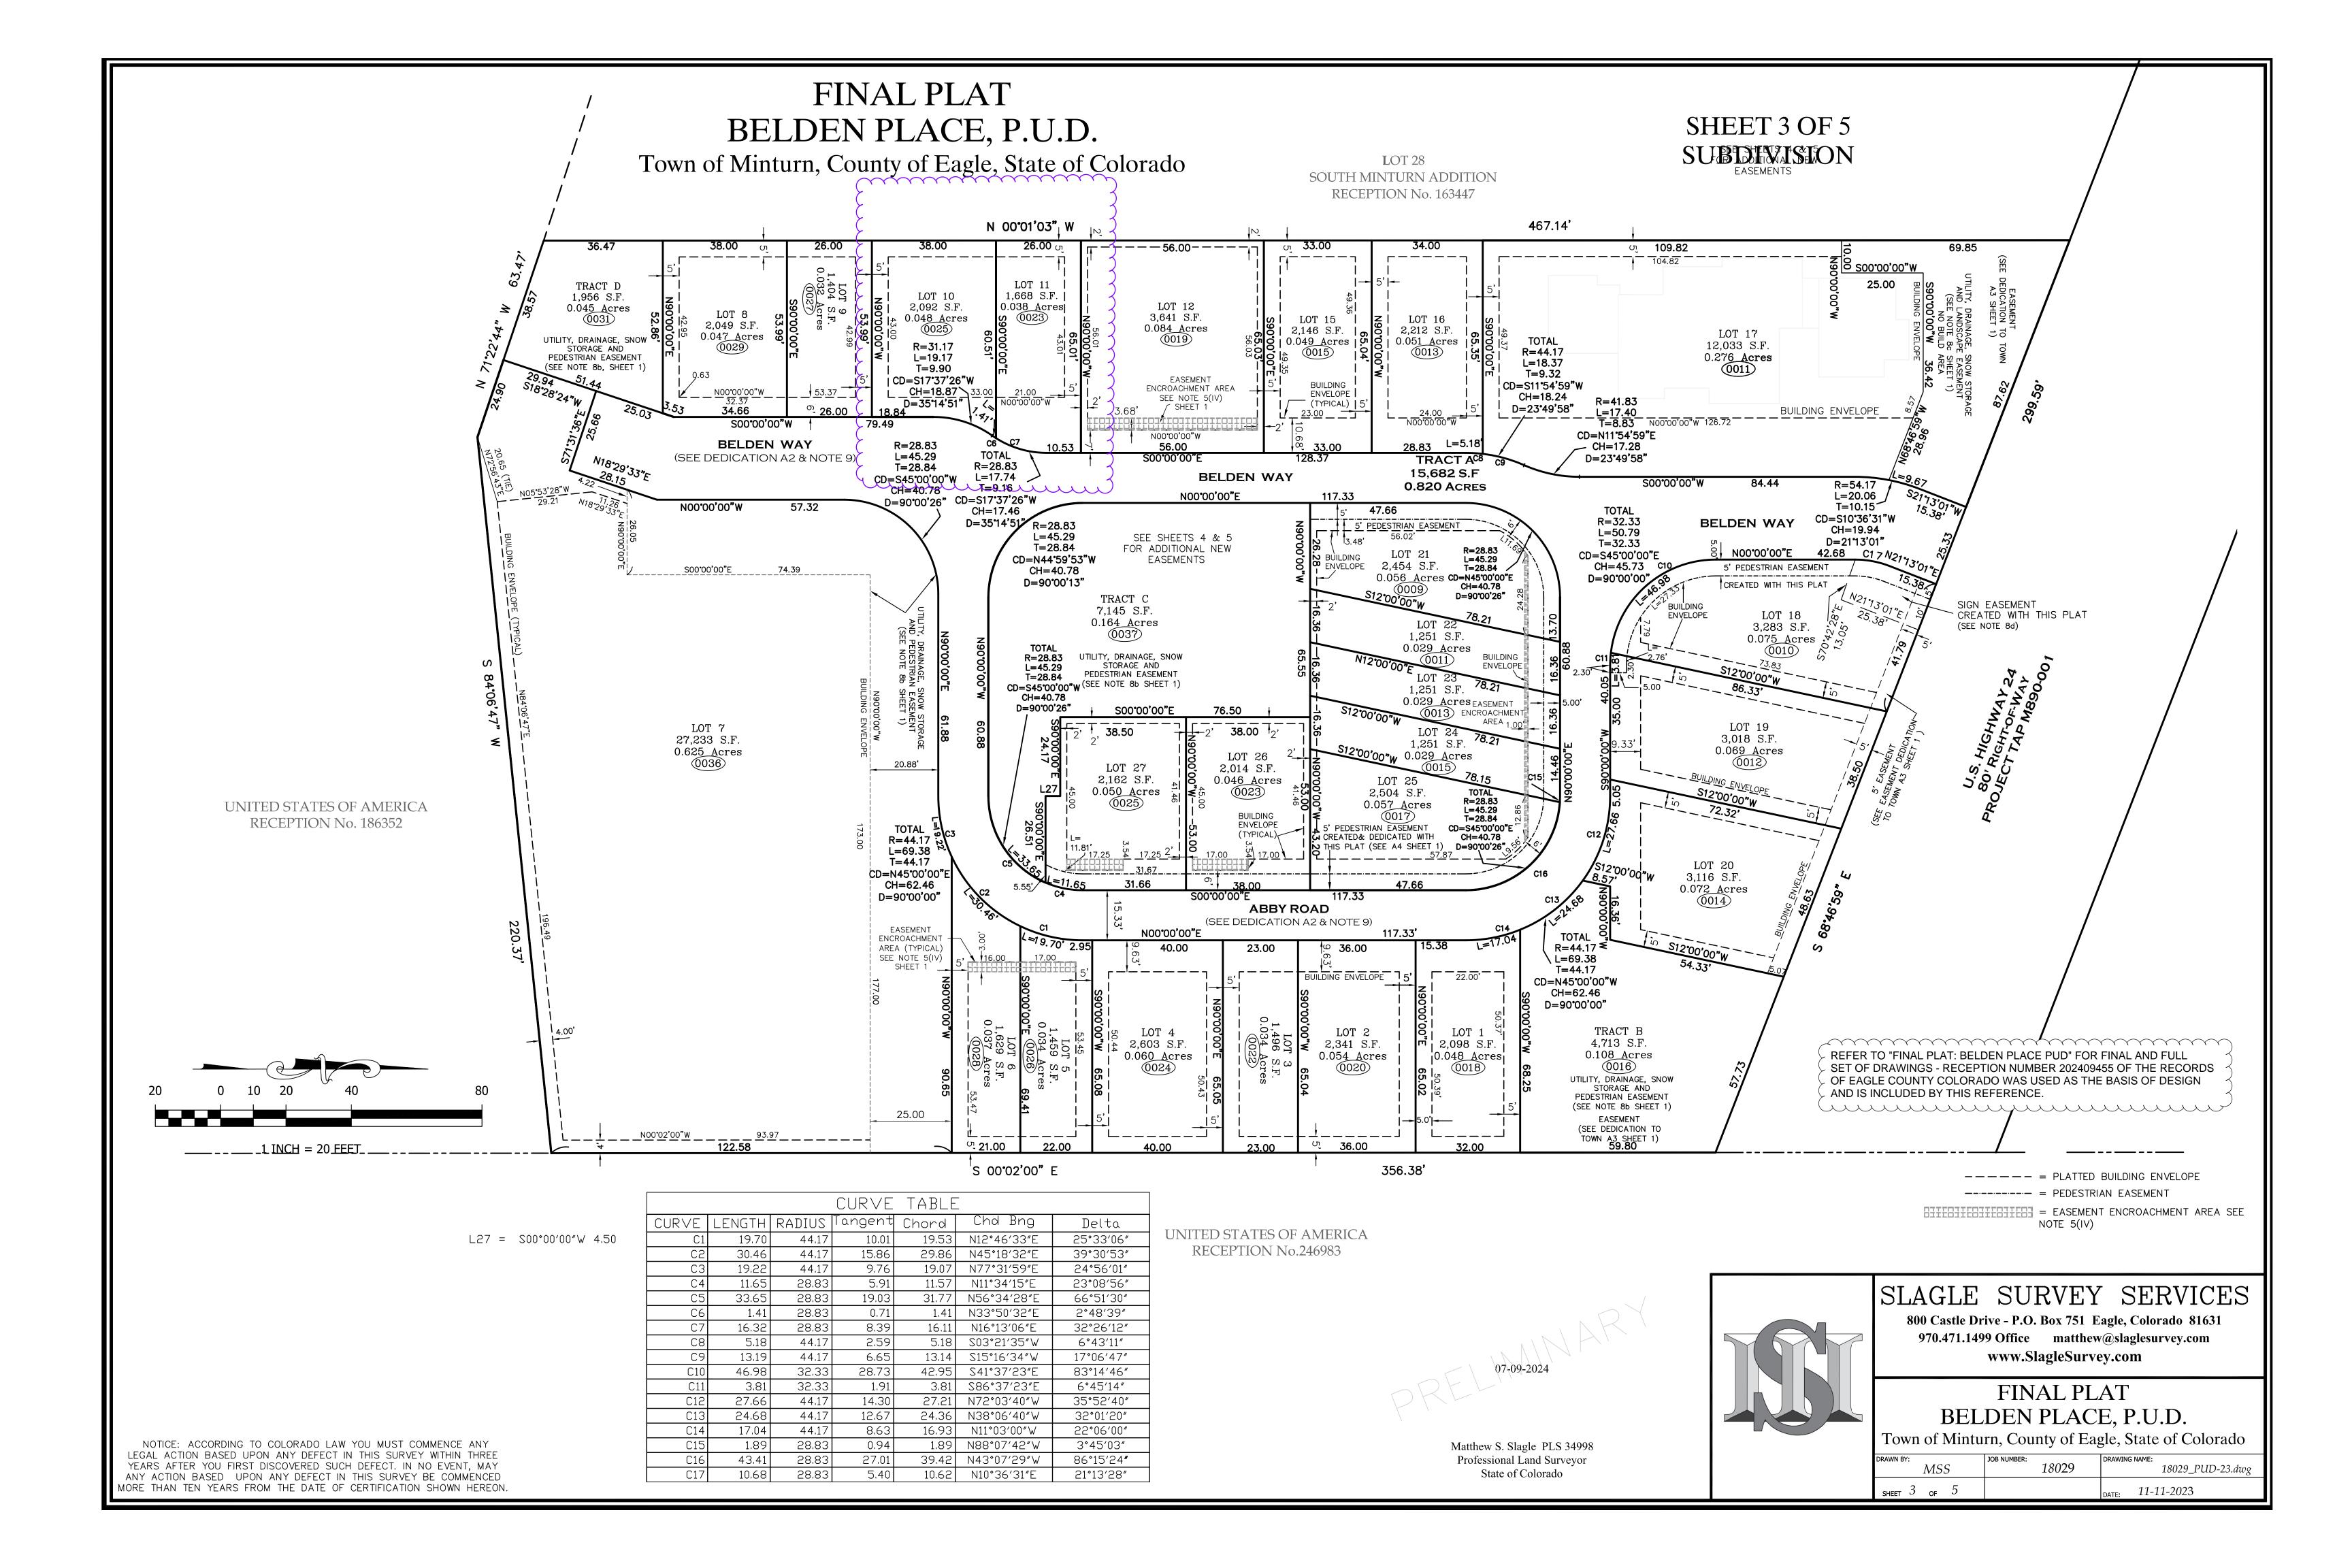


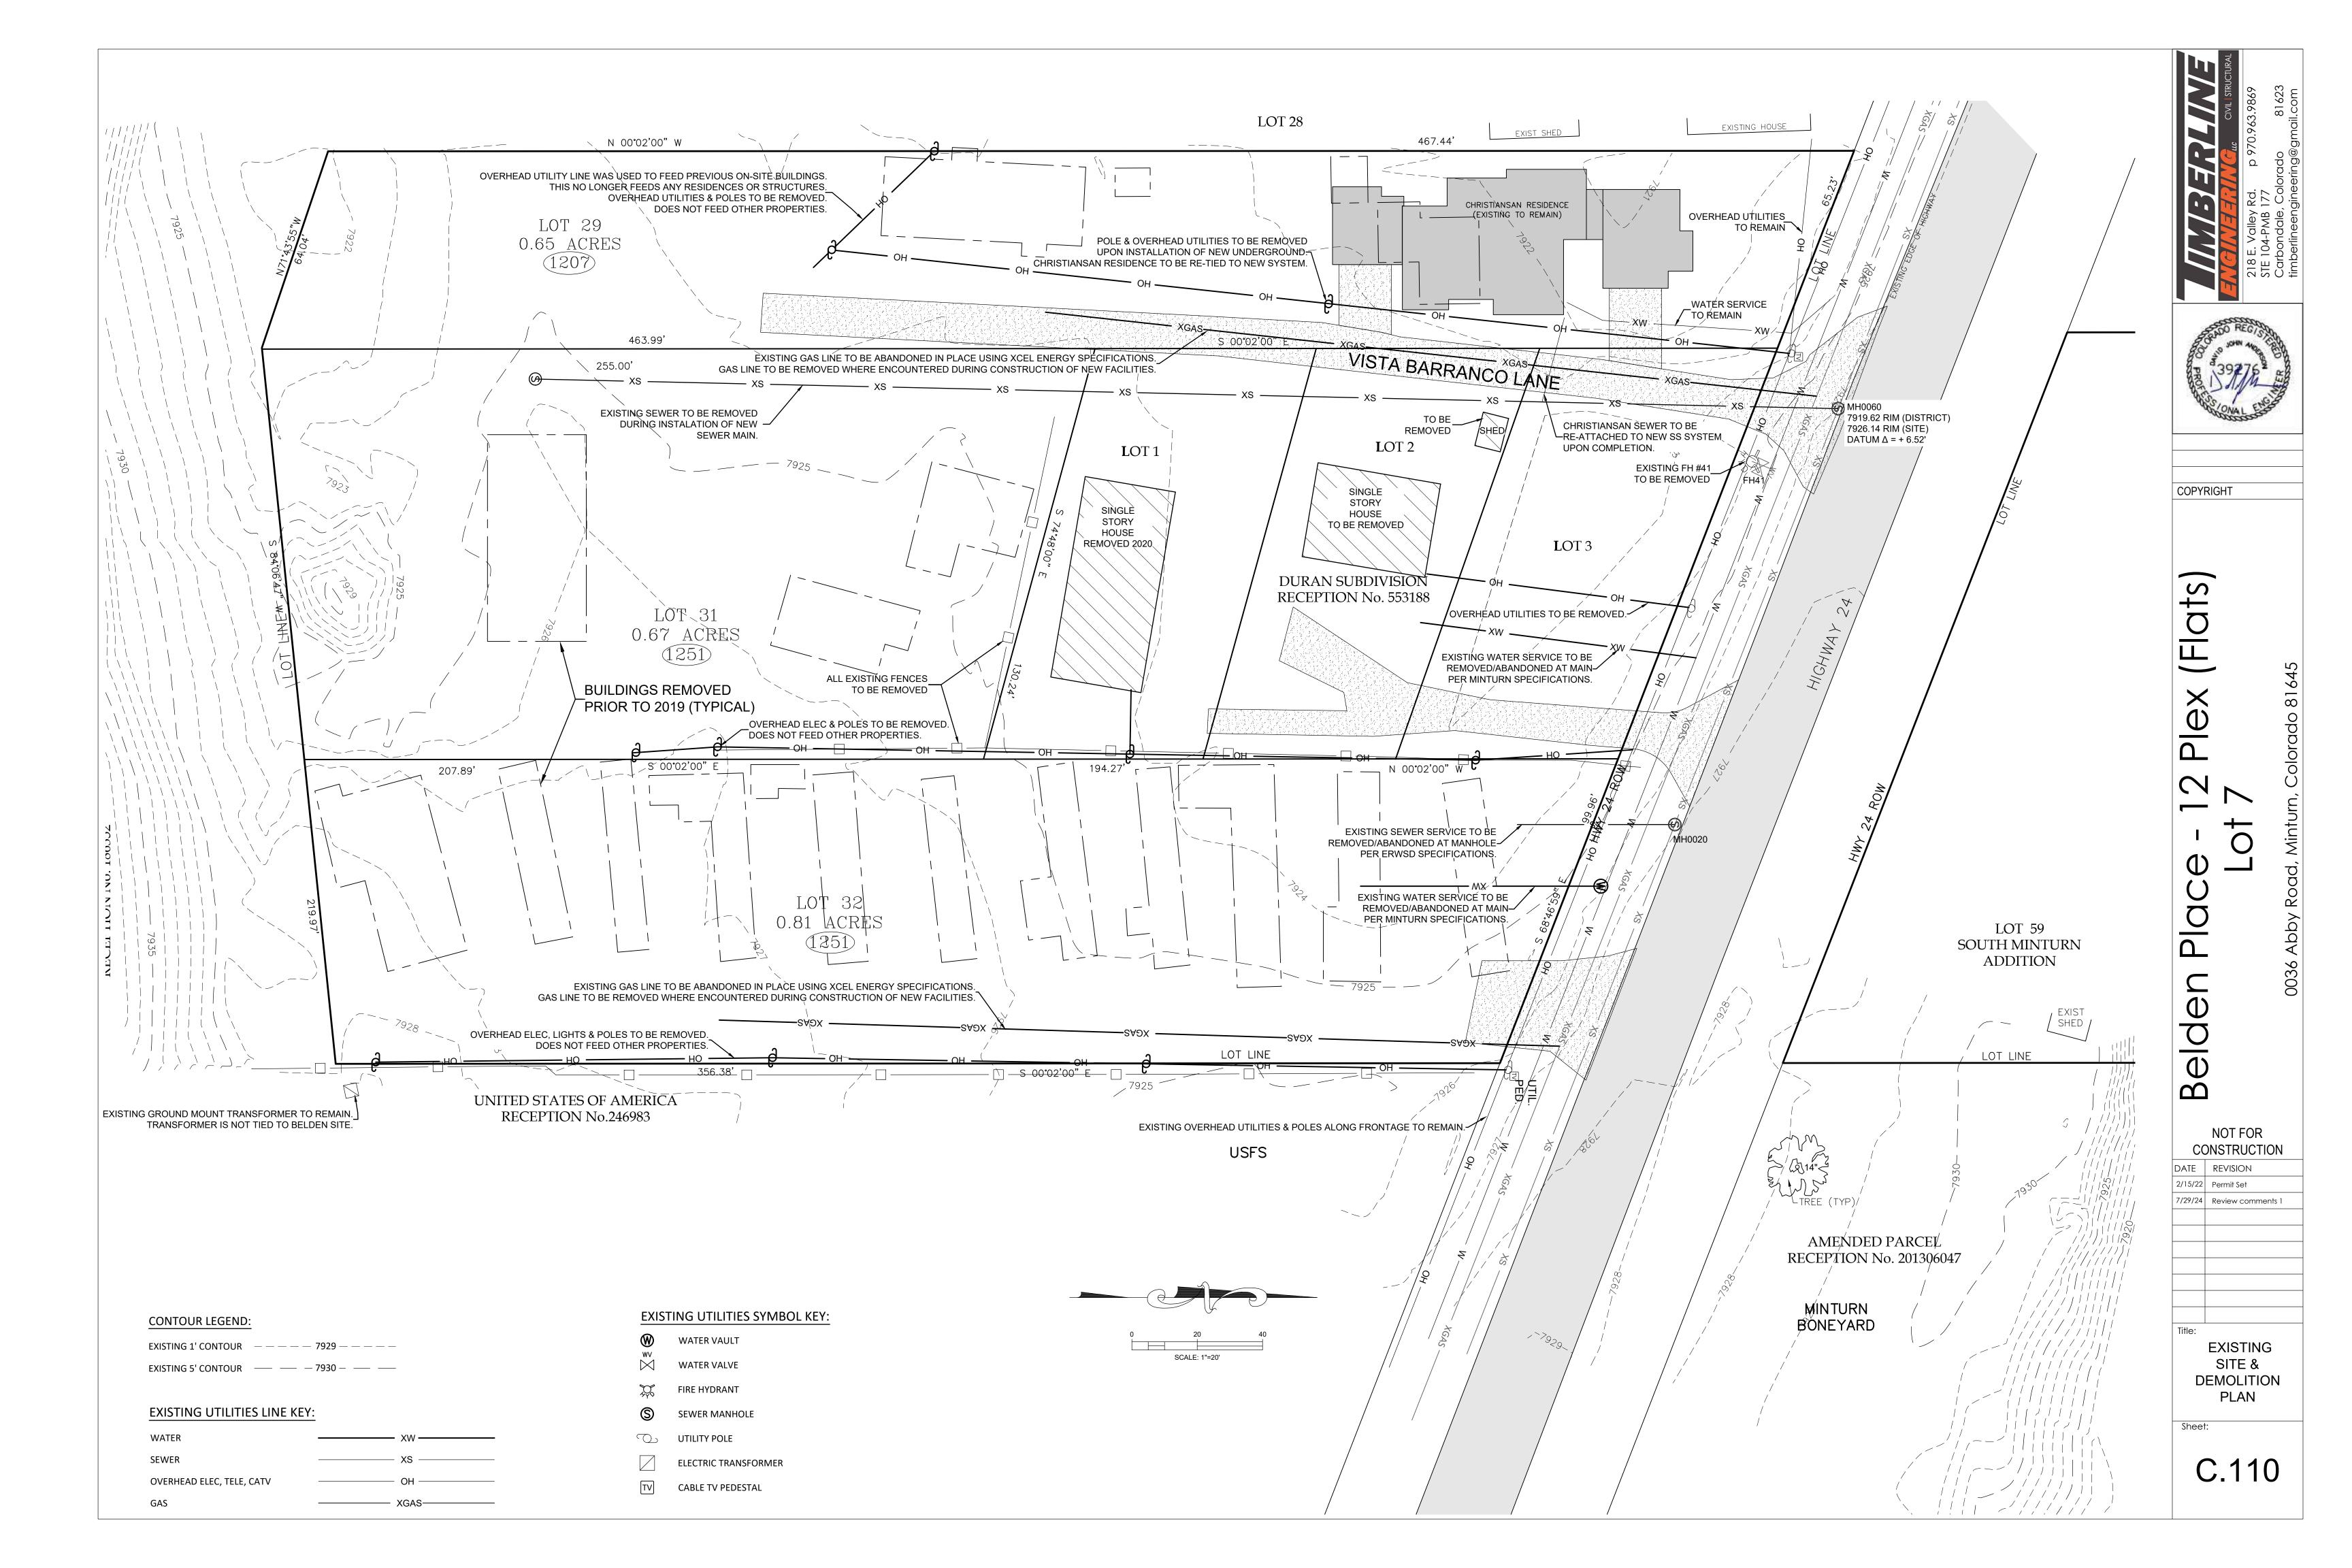


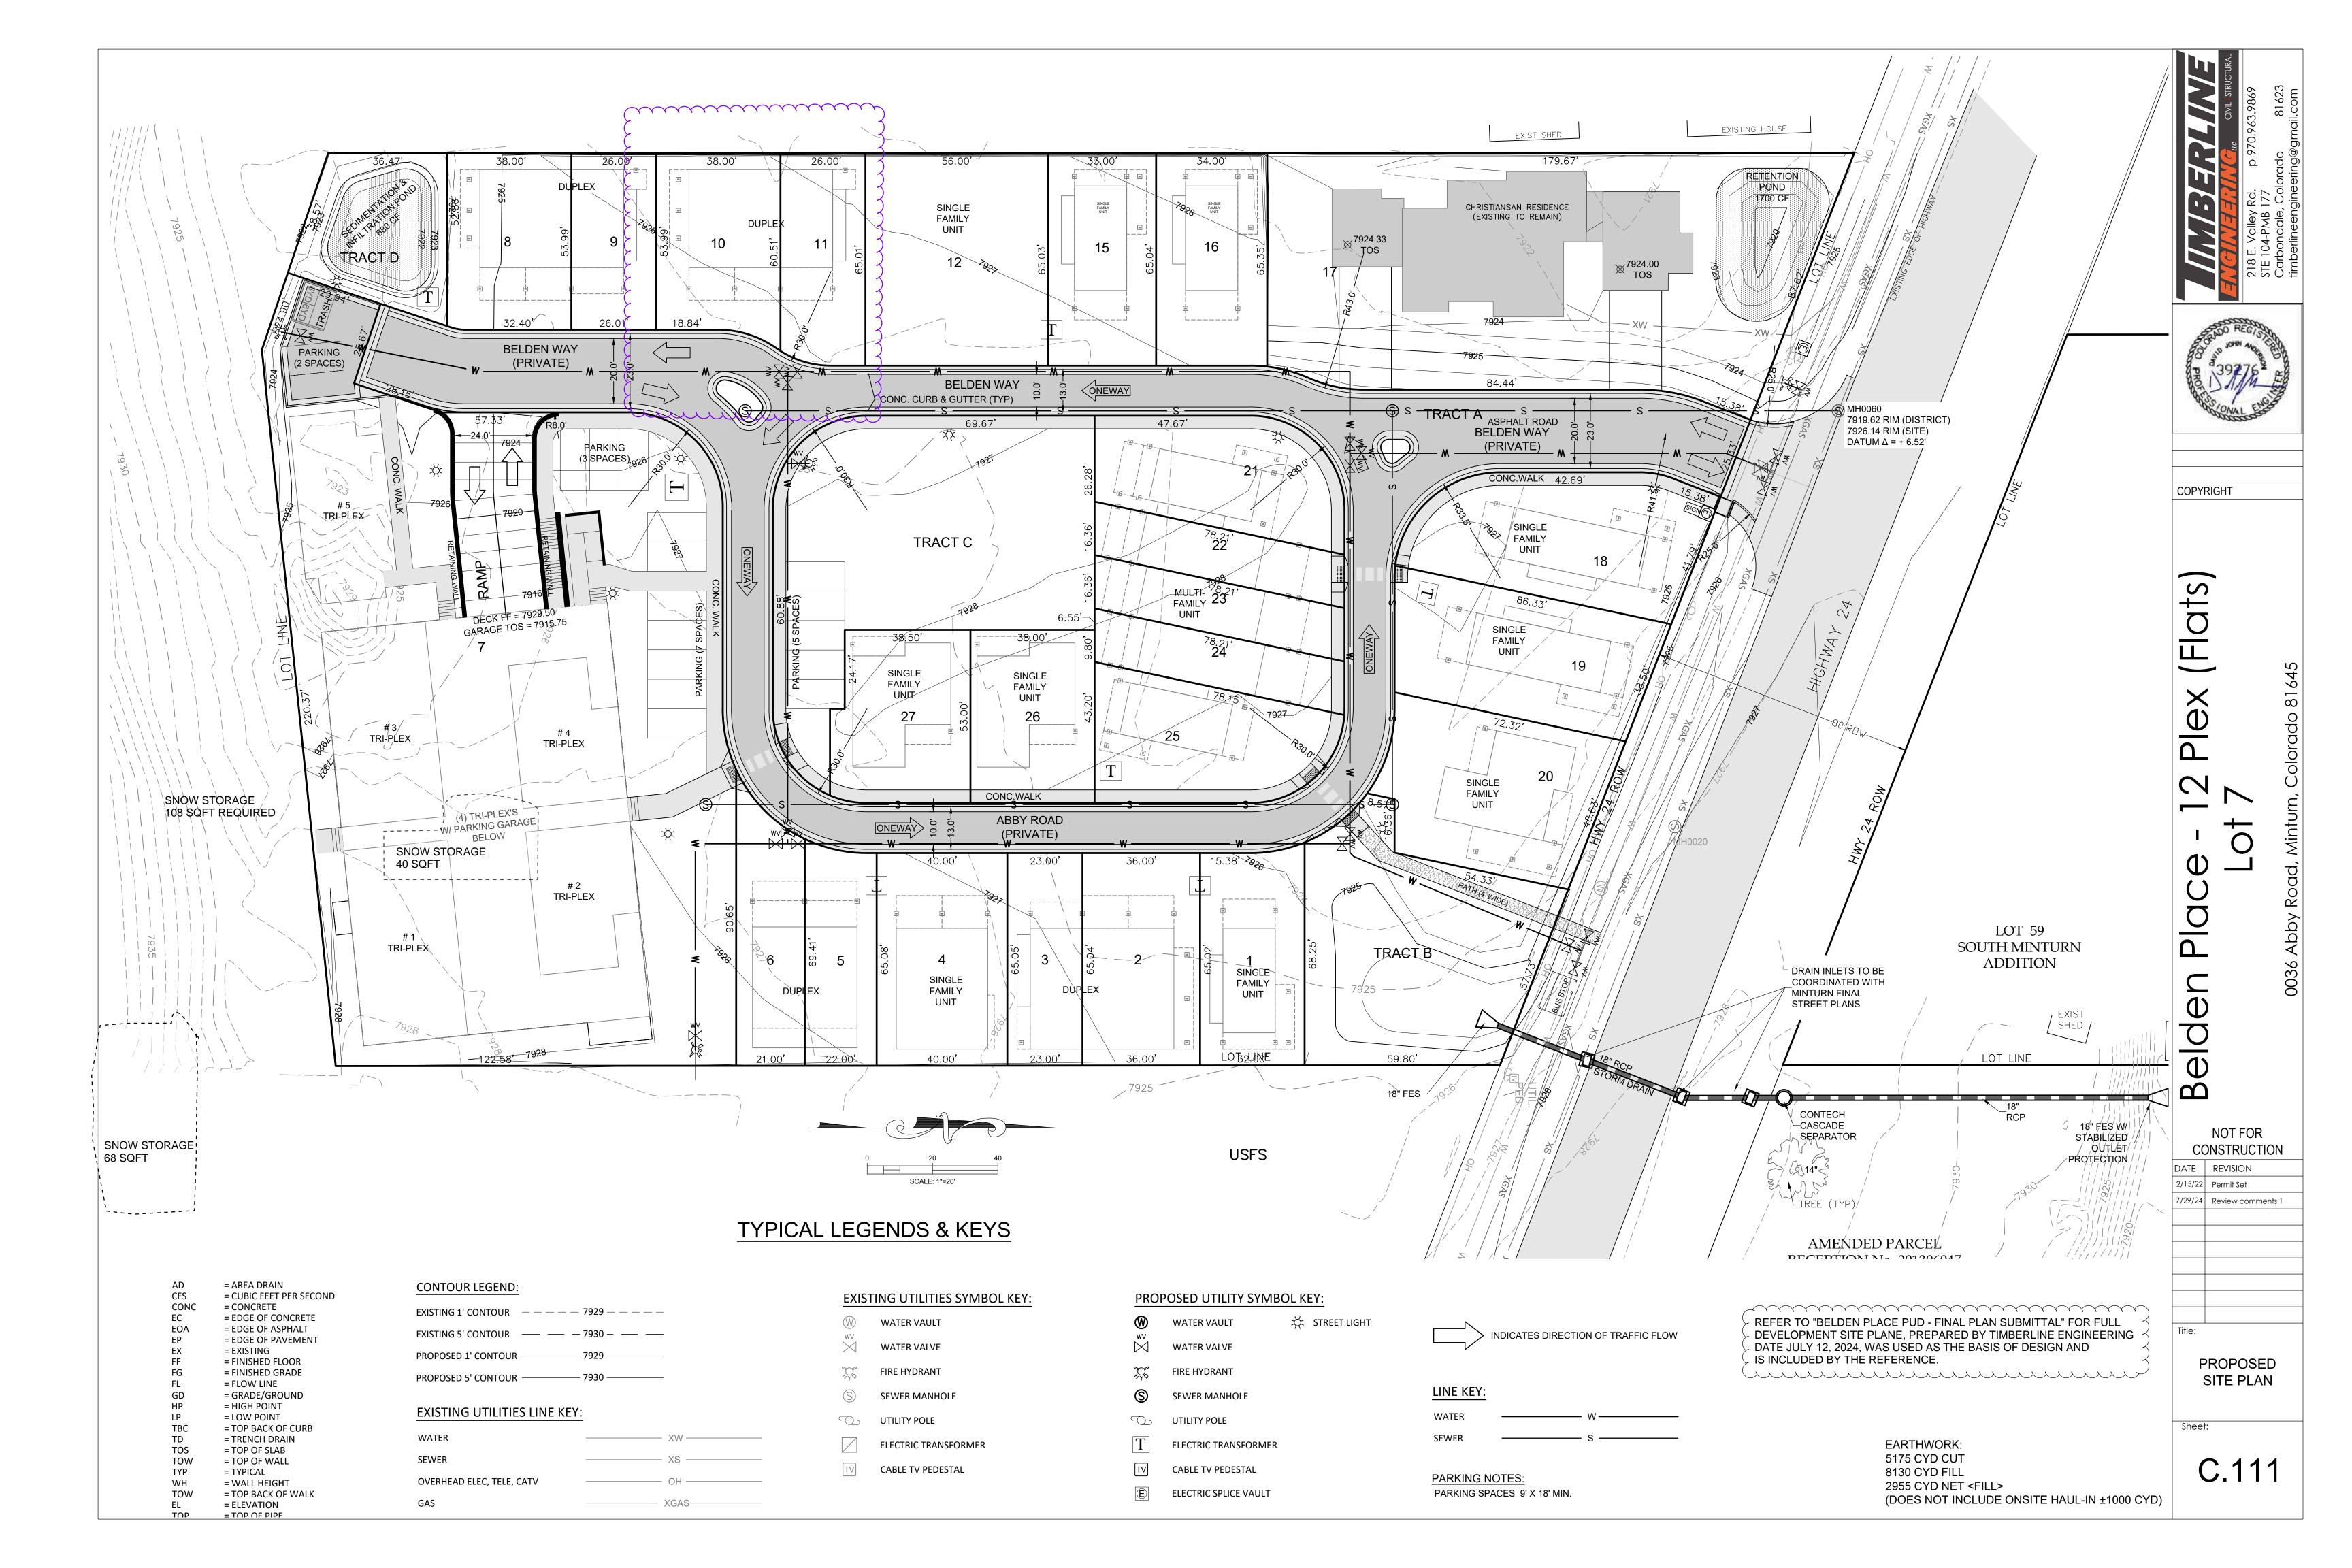

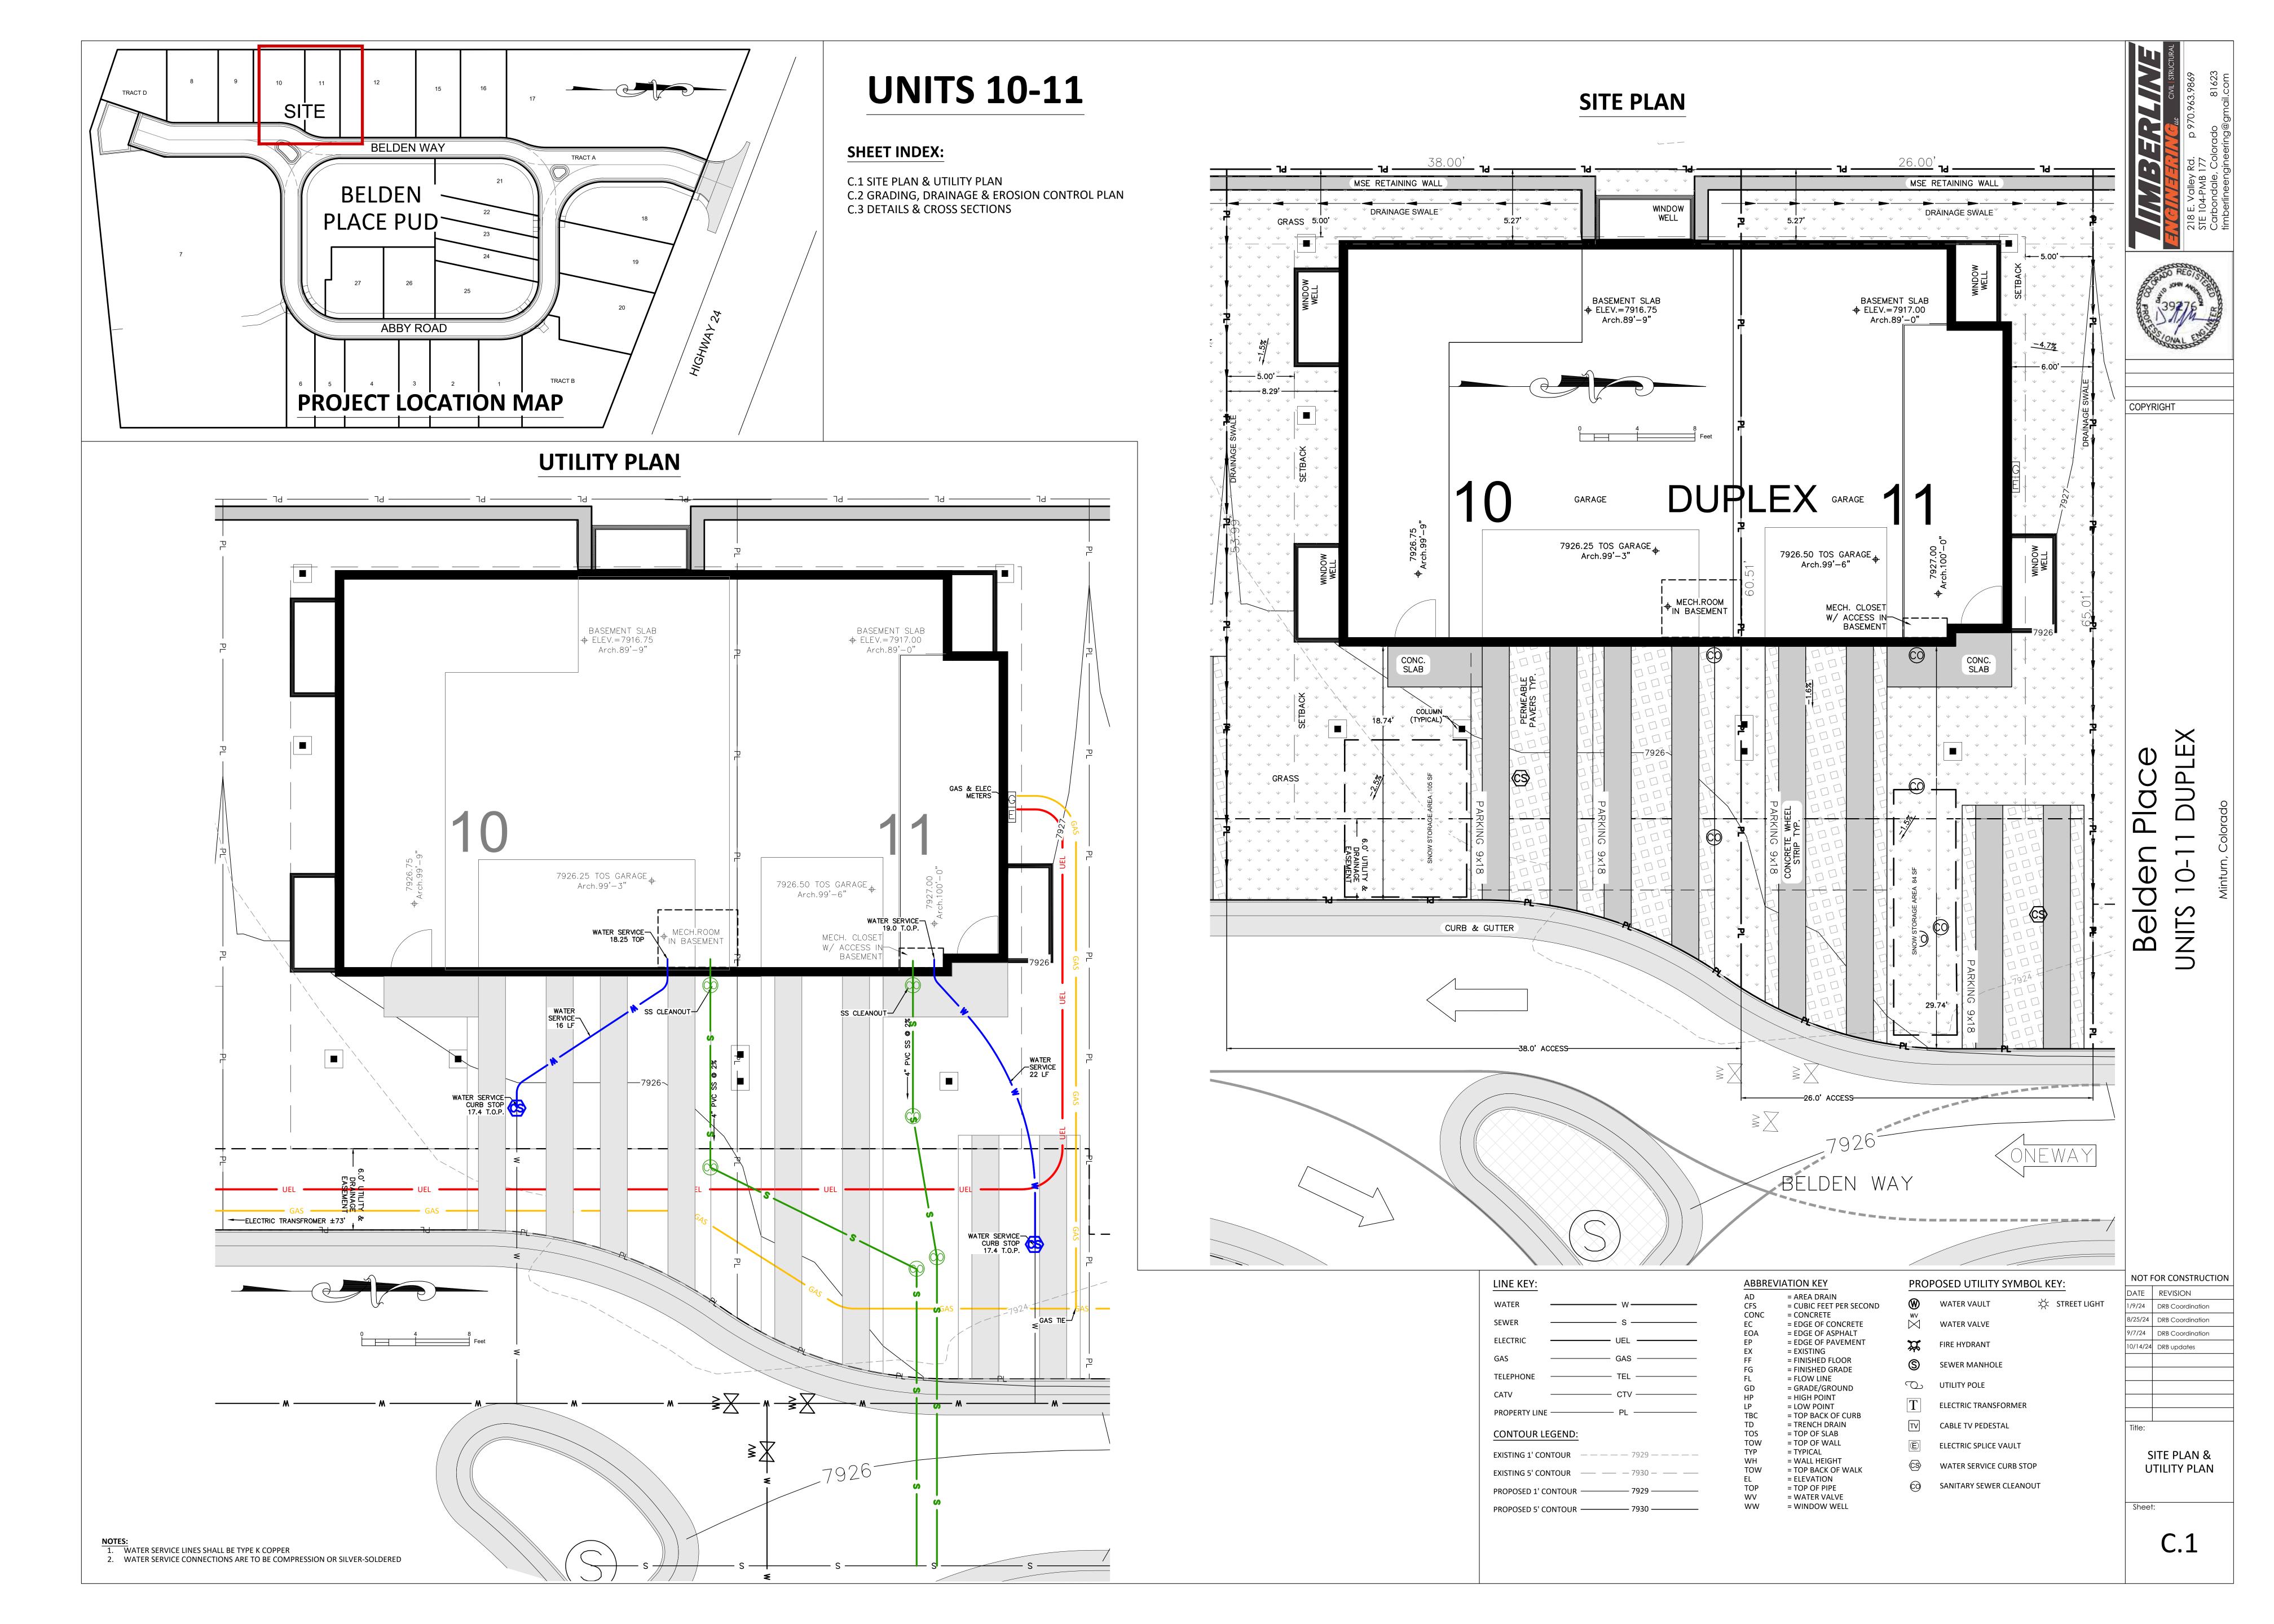

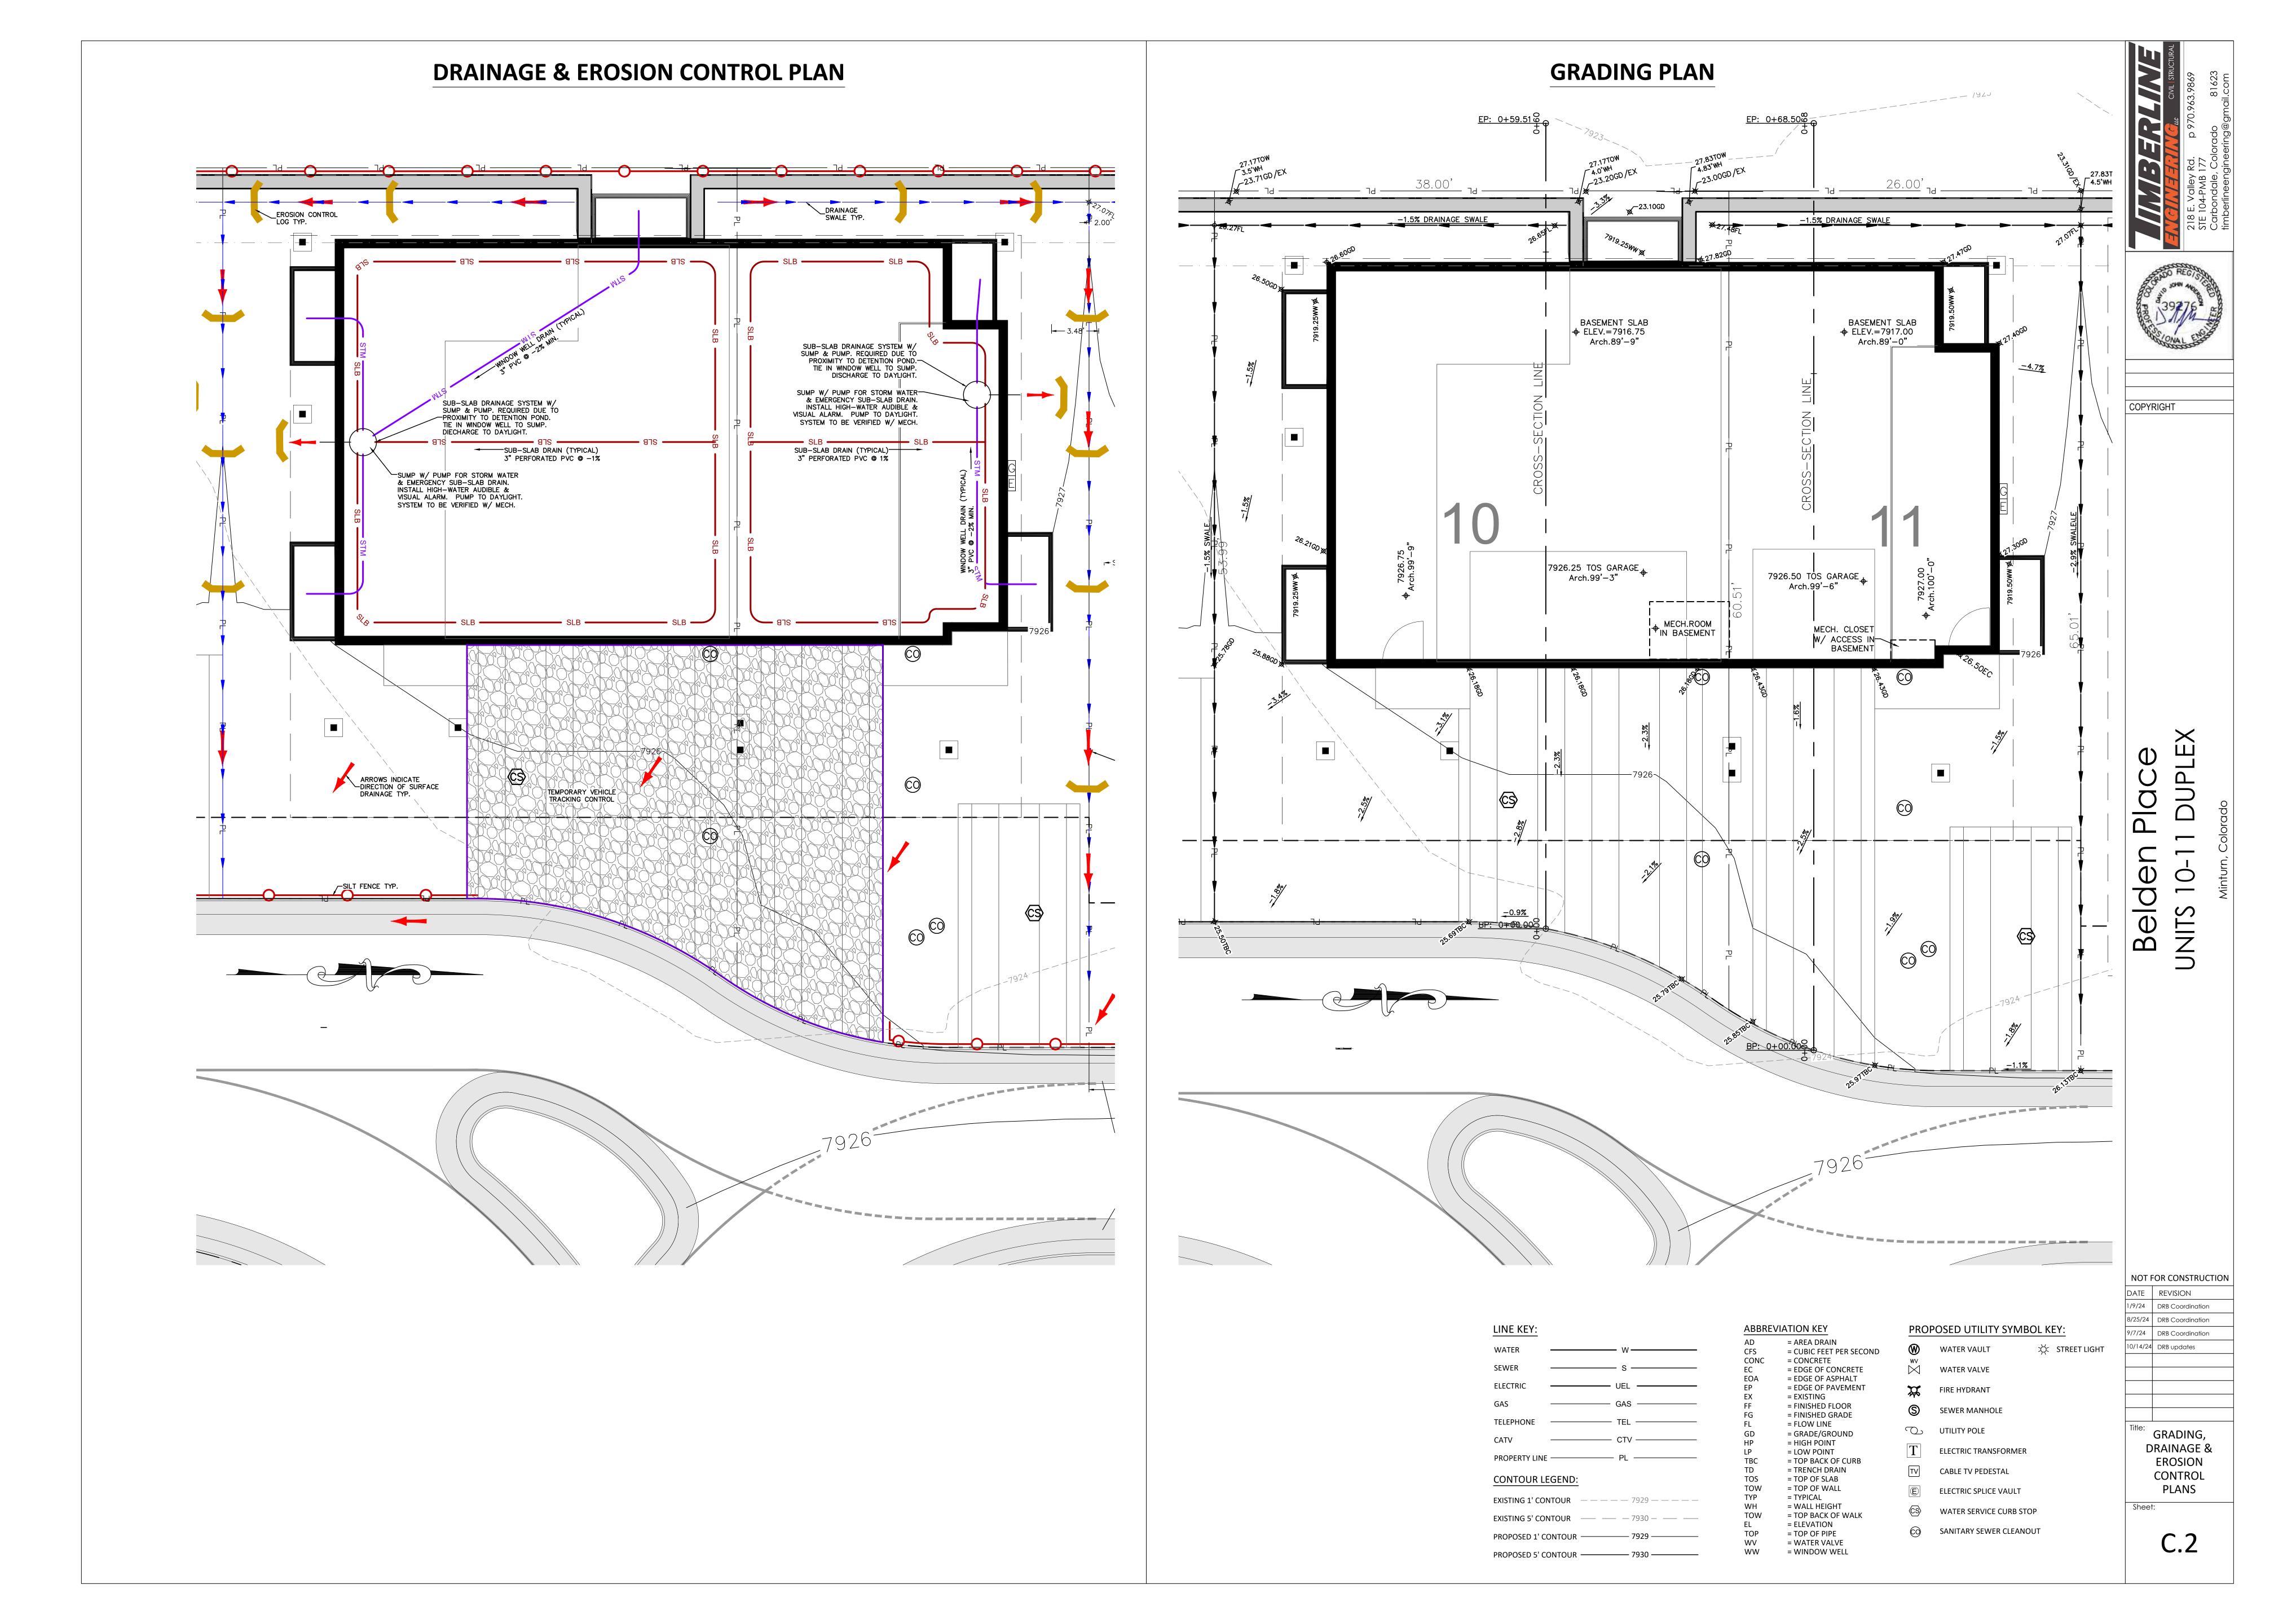

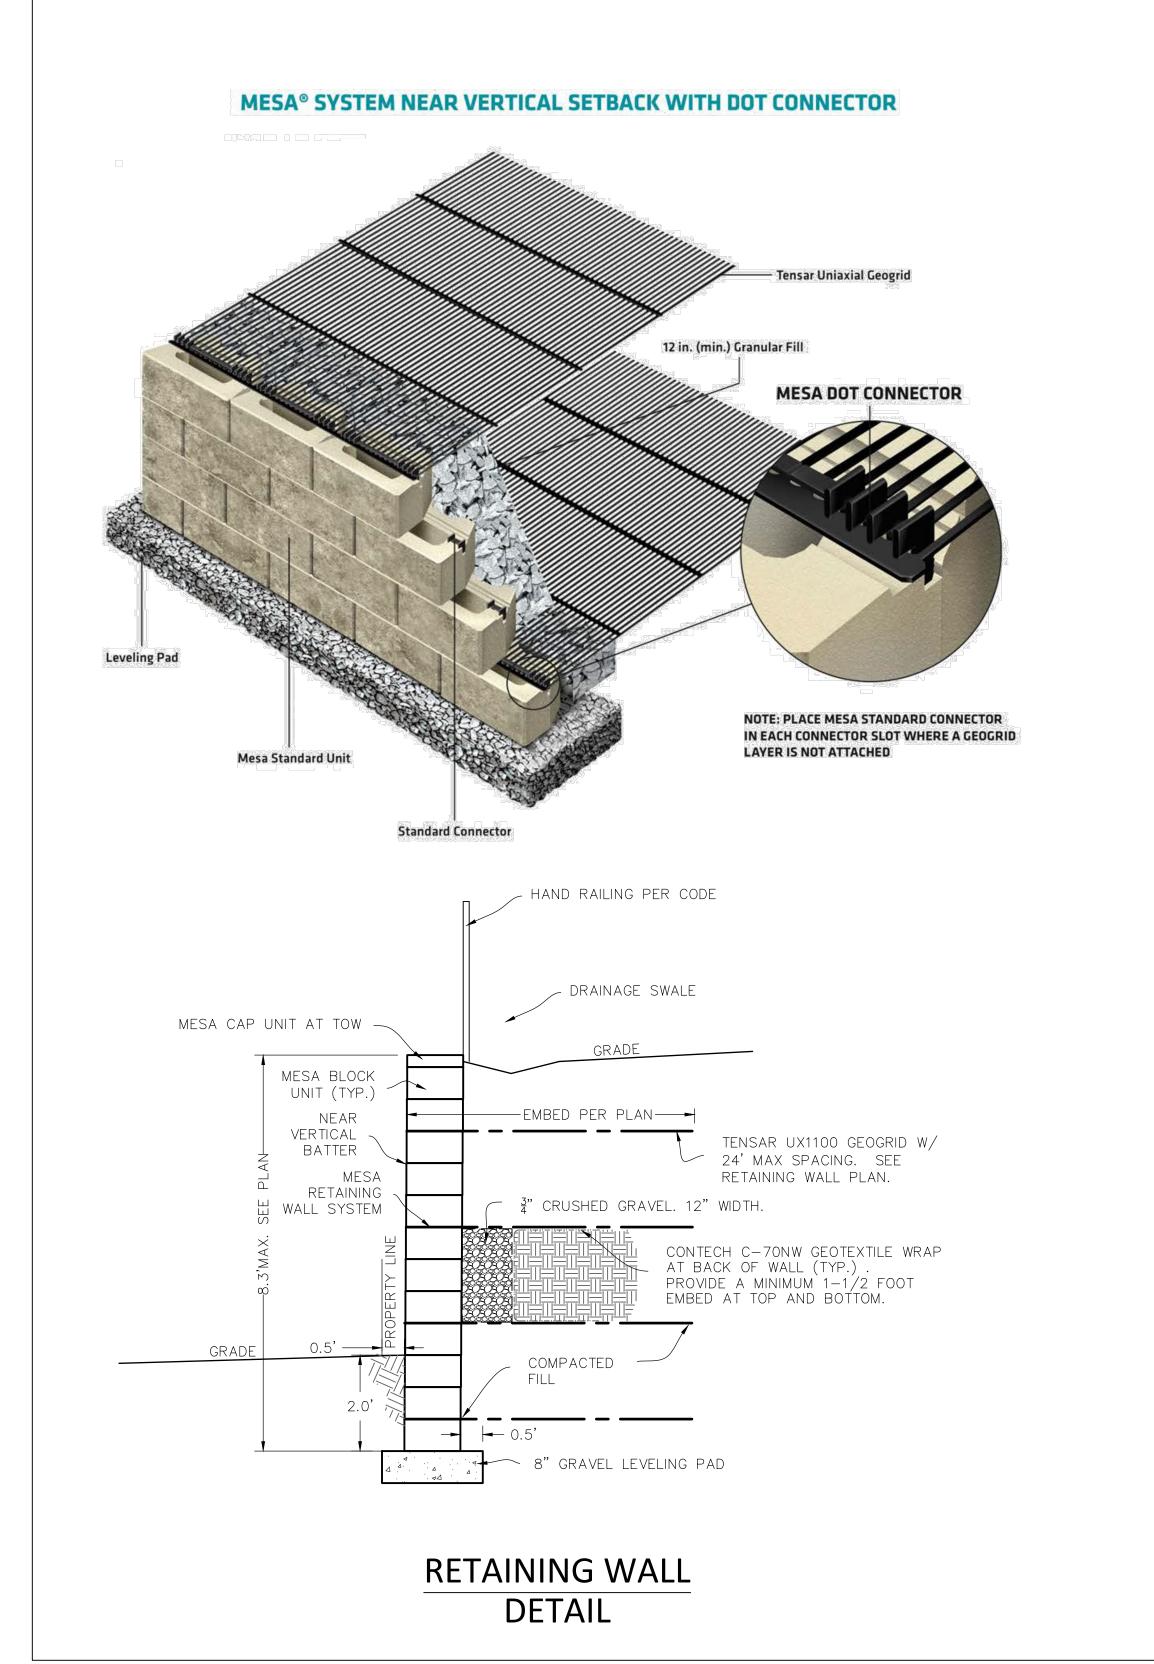

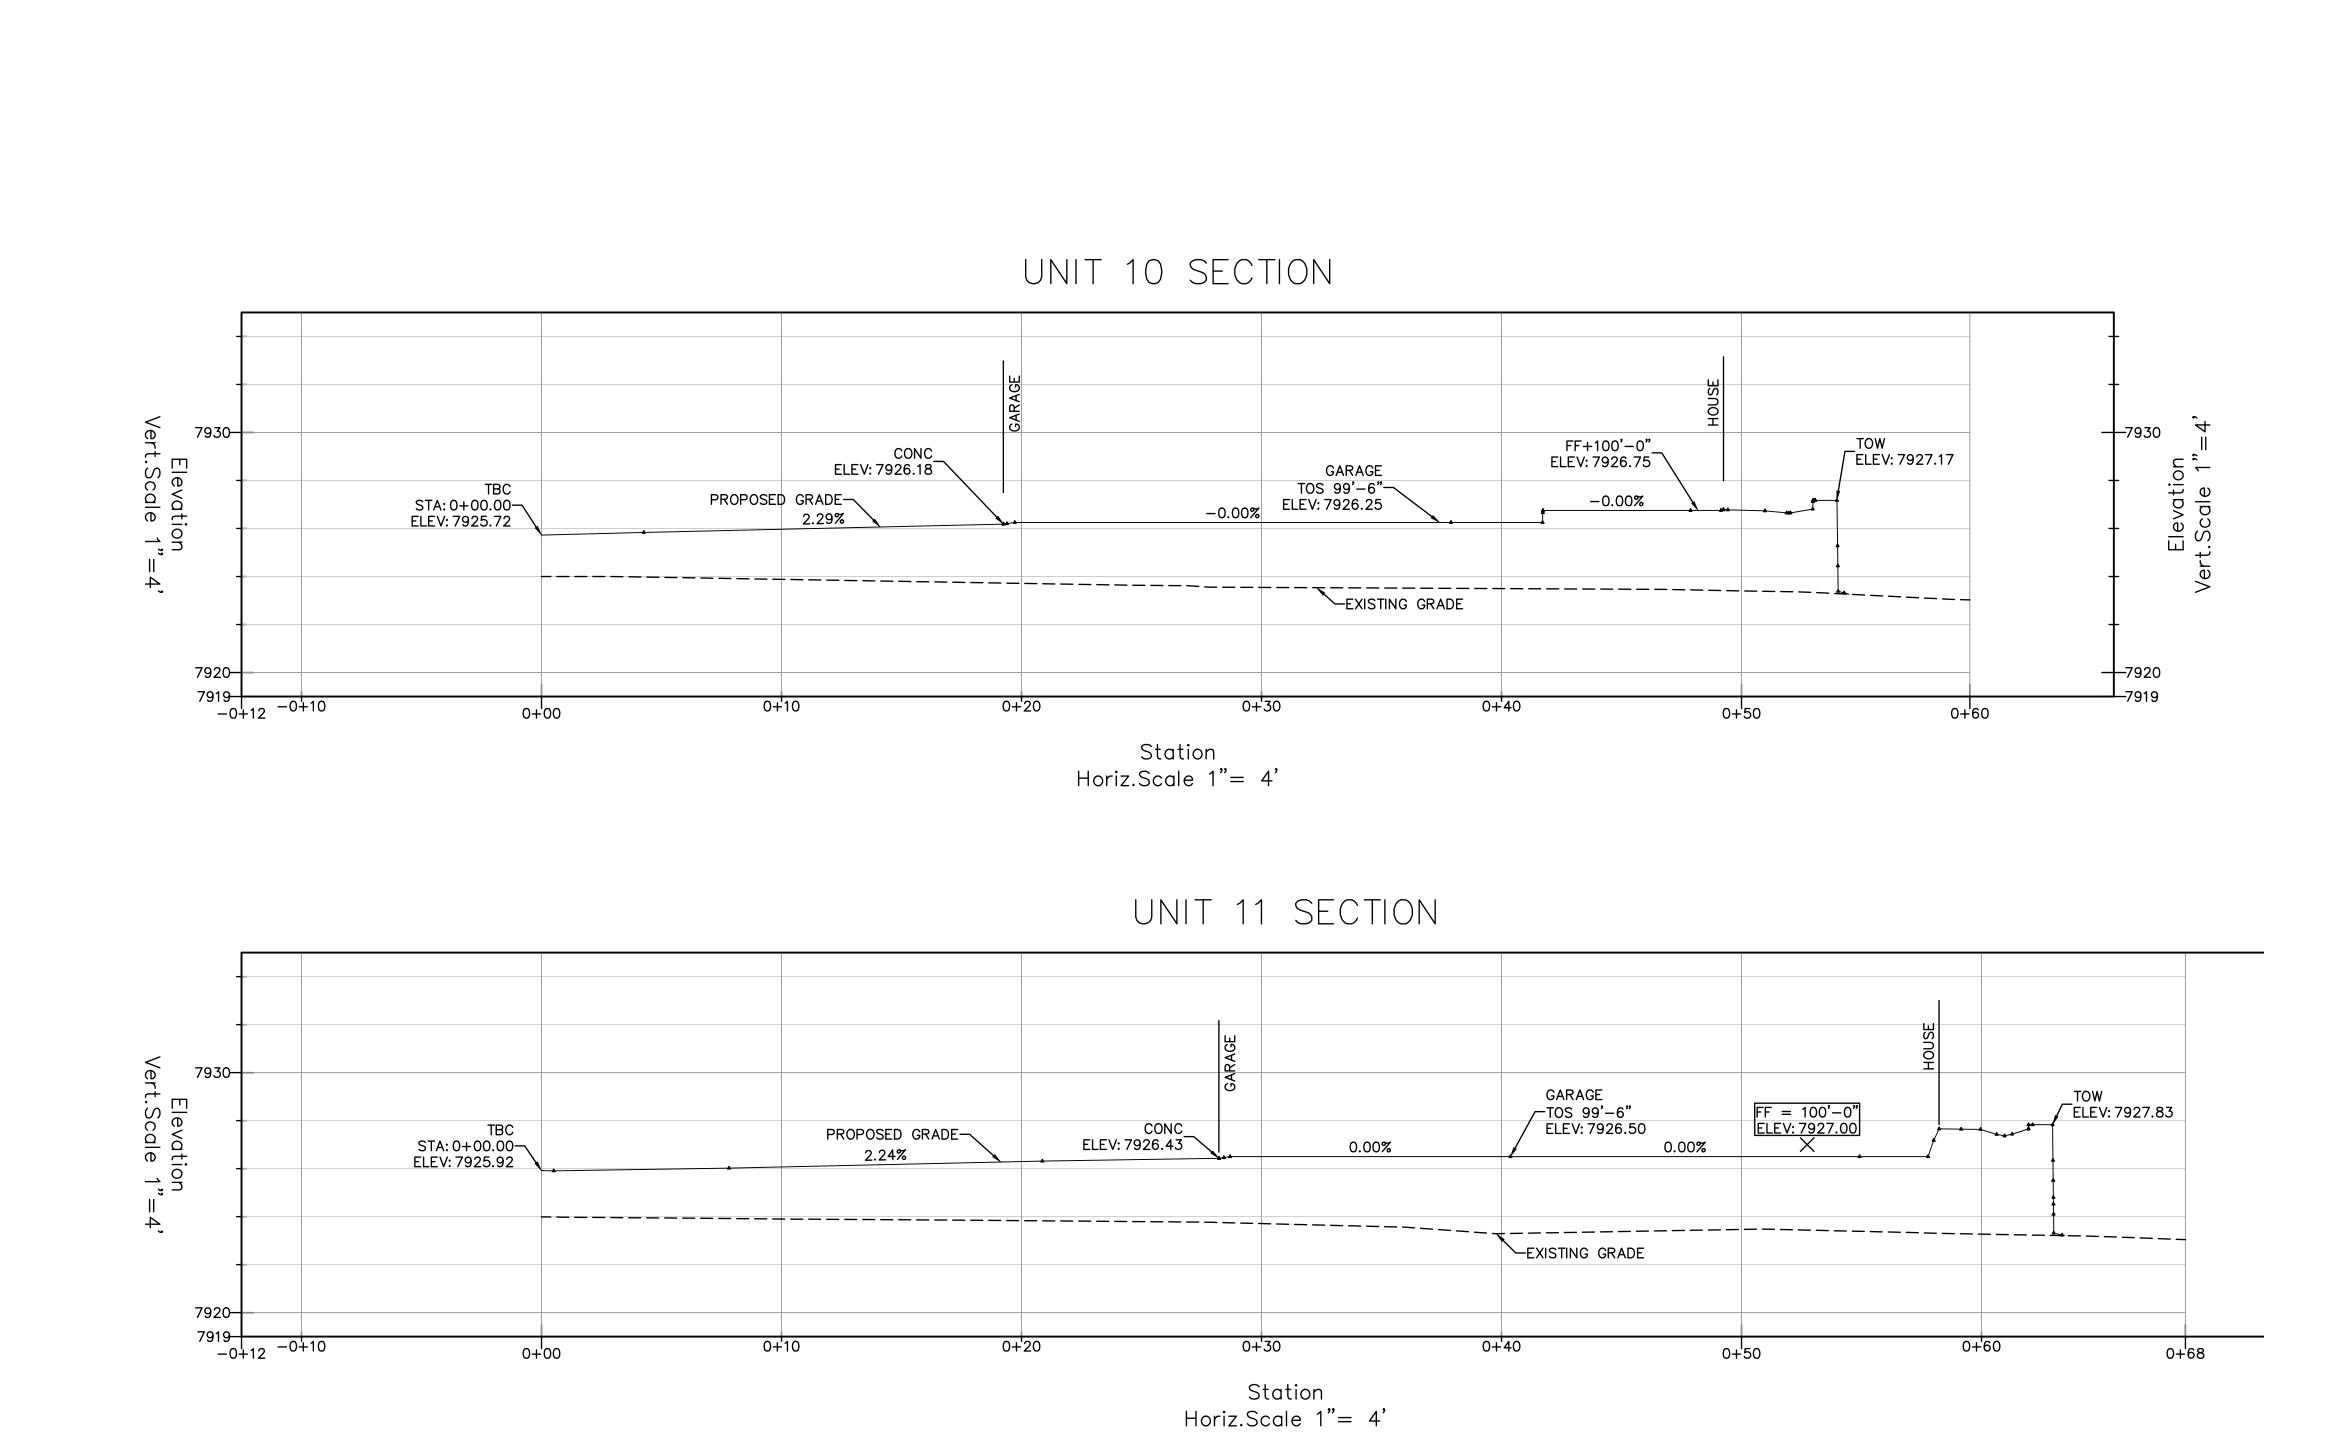

Beld

NOT FOR CONSTRUCTION

DETAILS & CROSS

SECIONS


Sheet:


DATE REVISION

1/9/24 DRB Coordination

8/25/24 DRB Coordination


9/7/24 DRB Coordination
10/14/24 DRB updates

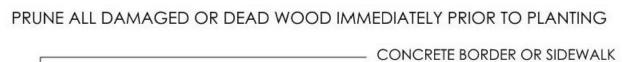


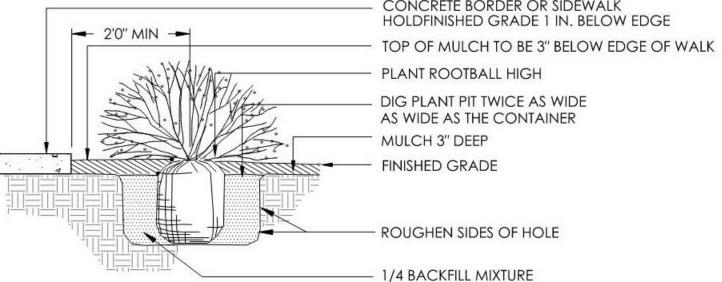


SHRUB PLANTING

SCALE: 3/4" = 1'-0"

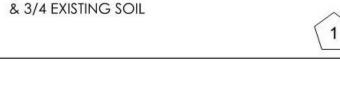

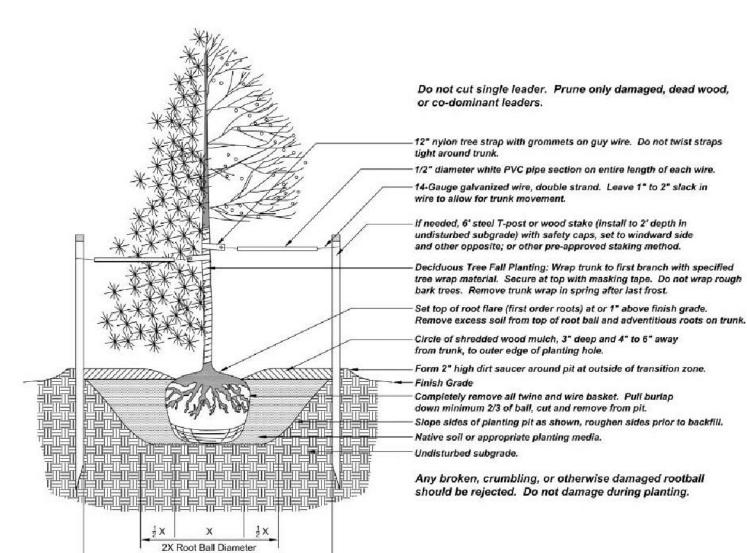

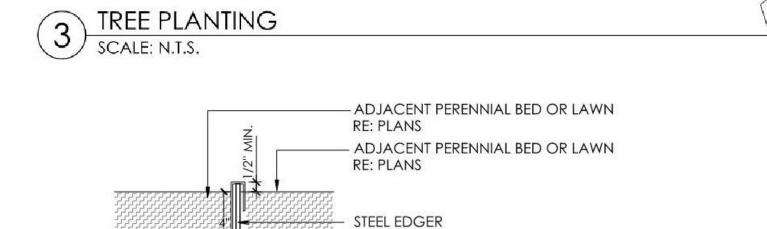

- METAL STAKES NOTES:

3-4 X Root Ball Diameter

2. NO EDGER REQUIRED WHEN MULCH IS ADJACENT TO PAVEMENT, BORDER, OR WALLS. SET ALL EDGING 1/2" ABOVE FINISH GRADE AS SHOWN.

1. CONTRACTOR TO SUBMIT SAMPLE PRIOR TO ORDERING MATERIAL OR DELIVERING TO SITE.

- 4. EDGING SHALL ABUT ALL CONCRETE CURBS AND WALKS PERPENDICULAR, AND FLUSH W/ GRADES
- ALL JOINTS TO BE SECURELY STAKED.
- 6. CONTRACTOR SHALL CUT TOP EDGE(S) AS NEEDED TO BE PARALLEL WITH GRADE.



GENERAL NOTES:

- CONSTRUCTION SHALL CONFORM TO ALL APPLICABLE STATE AND LOCAL CODES AND REGULATIONS.
- 2. CONTRACTOR TO CONTACT THE UTILITY NOTIFICATION CENTER OF COLORADO BEFORE DIGGING, INCLUDING BUT NOT LIMITED TO, TRENCHING, SHRUB AND TREE PLANTING PITS. IF UTILITIES OCCUR WITHIN (3) THREE FEET OF PROPOSED FOOTINGS, THE CONTRACTOR SHALL REPORT SUCH CONDITIONS TO THE OWNER.
- CONTRACTOR IS RESPONSIBLE FOR FULL ON-SITE INVESTIGATIONS AS NEEDED IN ORDER TO GAIN A FULL UNDERSTANDING OF EXISTING CONDITIONS PRIOR TO CONSTRUCTION. FAILURE TO INSPECT THE SITE PRIOR TO CONSTRUCTION SHALL NOT BE CAUSE FOR REQUESTING ADDITIONAL MONIES BY THE CONTRACTOR.
- 4. THE CONTRACTOR SHALL OBTAIN, AT HIS EXPENSE, ALL PERMITS WHICH ARE NECESSARY TO PERFORM THE PROPOSED WORK.
- 5. THE LANDSCAPE ARCHITECT IS NOT RESPONSIBLE FOR THE CONSTRUCTION MEANS, METHODS, TECHNIQUES, SEQUENCES OR FOR SAFETY PRECAUTIONS OR PROBLEMS UTILIZED IN CONNECTION WITH THE WORK, AND HE/SHE WILL NOT BE RESPONSIBLE FOR THE CONTRACTOR'S FAILURE TO CARRY OUT THE WORK IN ACCORDANCE WITH THE CONTRACT DOCUMENTS.
- 6. VERIFY ALL CONDITIONS AT THE JOB SITE AND NOTIFY LANDSCAPE ARCHITECT AND THE OWNER'S REP. IMMEDIATELY OF ANY DIMENSIONAL ERRORS, OMISSIONS OR DISCREPANCIES PRIOR TO ANY DEMOLITION OR CONSTRUCTION.

SIGHT TRIANGLE NOTES:

PEDESTRIAN SIGHT TRIANGLES: NO ITEMS THAT ARE WIDER THAN 18" MAY BE TALLER THAN 30" WITHIN THE PEDESTRIAN

CORNER SIGHT TRIANGLES: NO ITEMS TALLER THAN 30" MAY BE PLACED WITHIN THE CORNER SIGHT TRIANGLE, EXCEPT FOR TRAFFIC CONTROL DEVICES AND EQUIPMENT. TREES MUST BE LIMBED TO 8 FEET AT ADEQUATE MATURITY. TREES SHALL BE PLANTED A MINIMUM OF 10 FEET FROM LIGHT OR UTILITY POLES.


ROADWAY SIGHT TRIANGLES: NO ITEMS THAT ARE WIDER THAN 18" MAY BE TALLER THAN 30" WITHIN THE ROADWAY SIGHT TRIANGLE EXCEPT FOR STREET TREES AND TRAFFIC CONTROL DEVICES AND EQUIPMENT.

TREE PROTECTION ZONE (TPZ) NOTES:

- CONTRACTOR SHALL VERIFY FINAL BOUNDARIES OF TPZ PRIOR TO COMMENCEMENT OF CONSTRUCTION/DEMOLITION ACTIVITIES. EXCESSIVE BRANCH PRUNING ON EXISTING TREES FOR CONSTRUCTION CLEARANCE WILL NOT BE PERMITTED PRUNING FOR BUILDING CLEARANCE SHALL BE MINIMIZED. DUE TO SCOPE OF CONSTRUCTION AND SIZE OF EX. ROW TREES, USE CHAIN LINK FENCING TO ESTABLISH TPZ.
- 2. THE TREE LAWN WITHIN THE BOUNDARY OF THE TREE DRIPLINE SHALL NOT BE ROTOTILLED AT ANY TIME. ROTOTILLING IS ONLY PERMITTED IN AREAS OUTSIDE OF EXISTING TREE DRIPLINE WHERE CONCRETE & HARDSCAPE ARE REMOVED.



DECIDUOUS SHRUBS ABB. BOTANIC COMMON SPACING SIZE Creeping Willow Sorbaria sorbifolia Ash-leaf Spirea as shown 5 Gal. Syringa patula 'Miss Kim' Miss Kim Lilac as shown 5 Gal. Symphoricapos occidentalis Western Snowberry as shown 5 Gal.

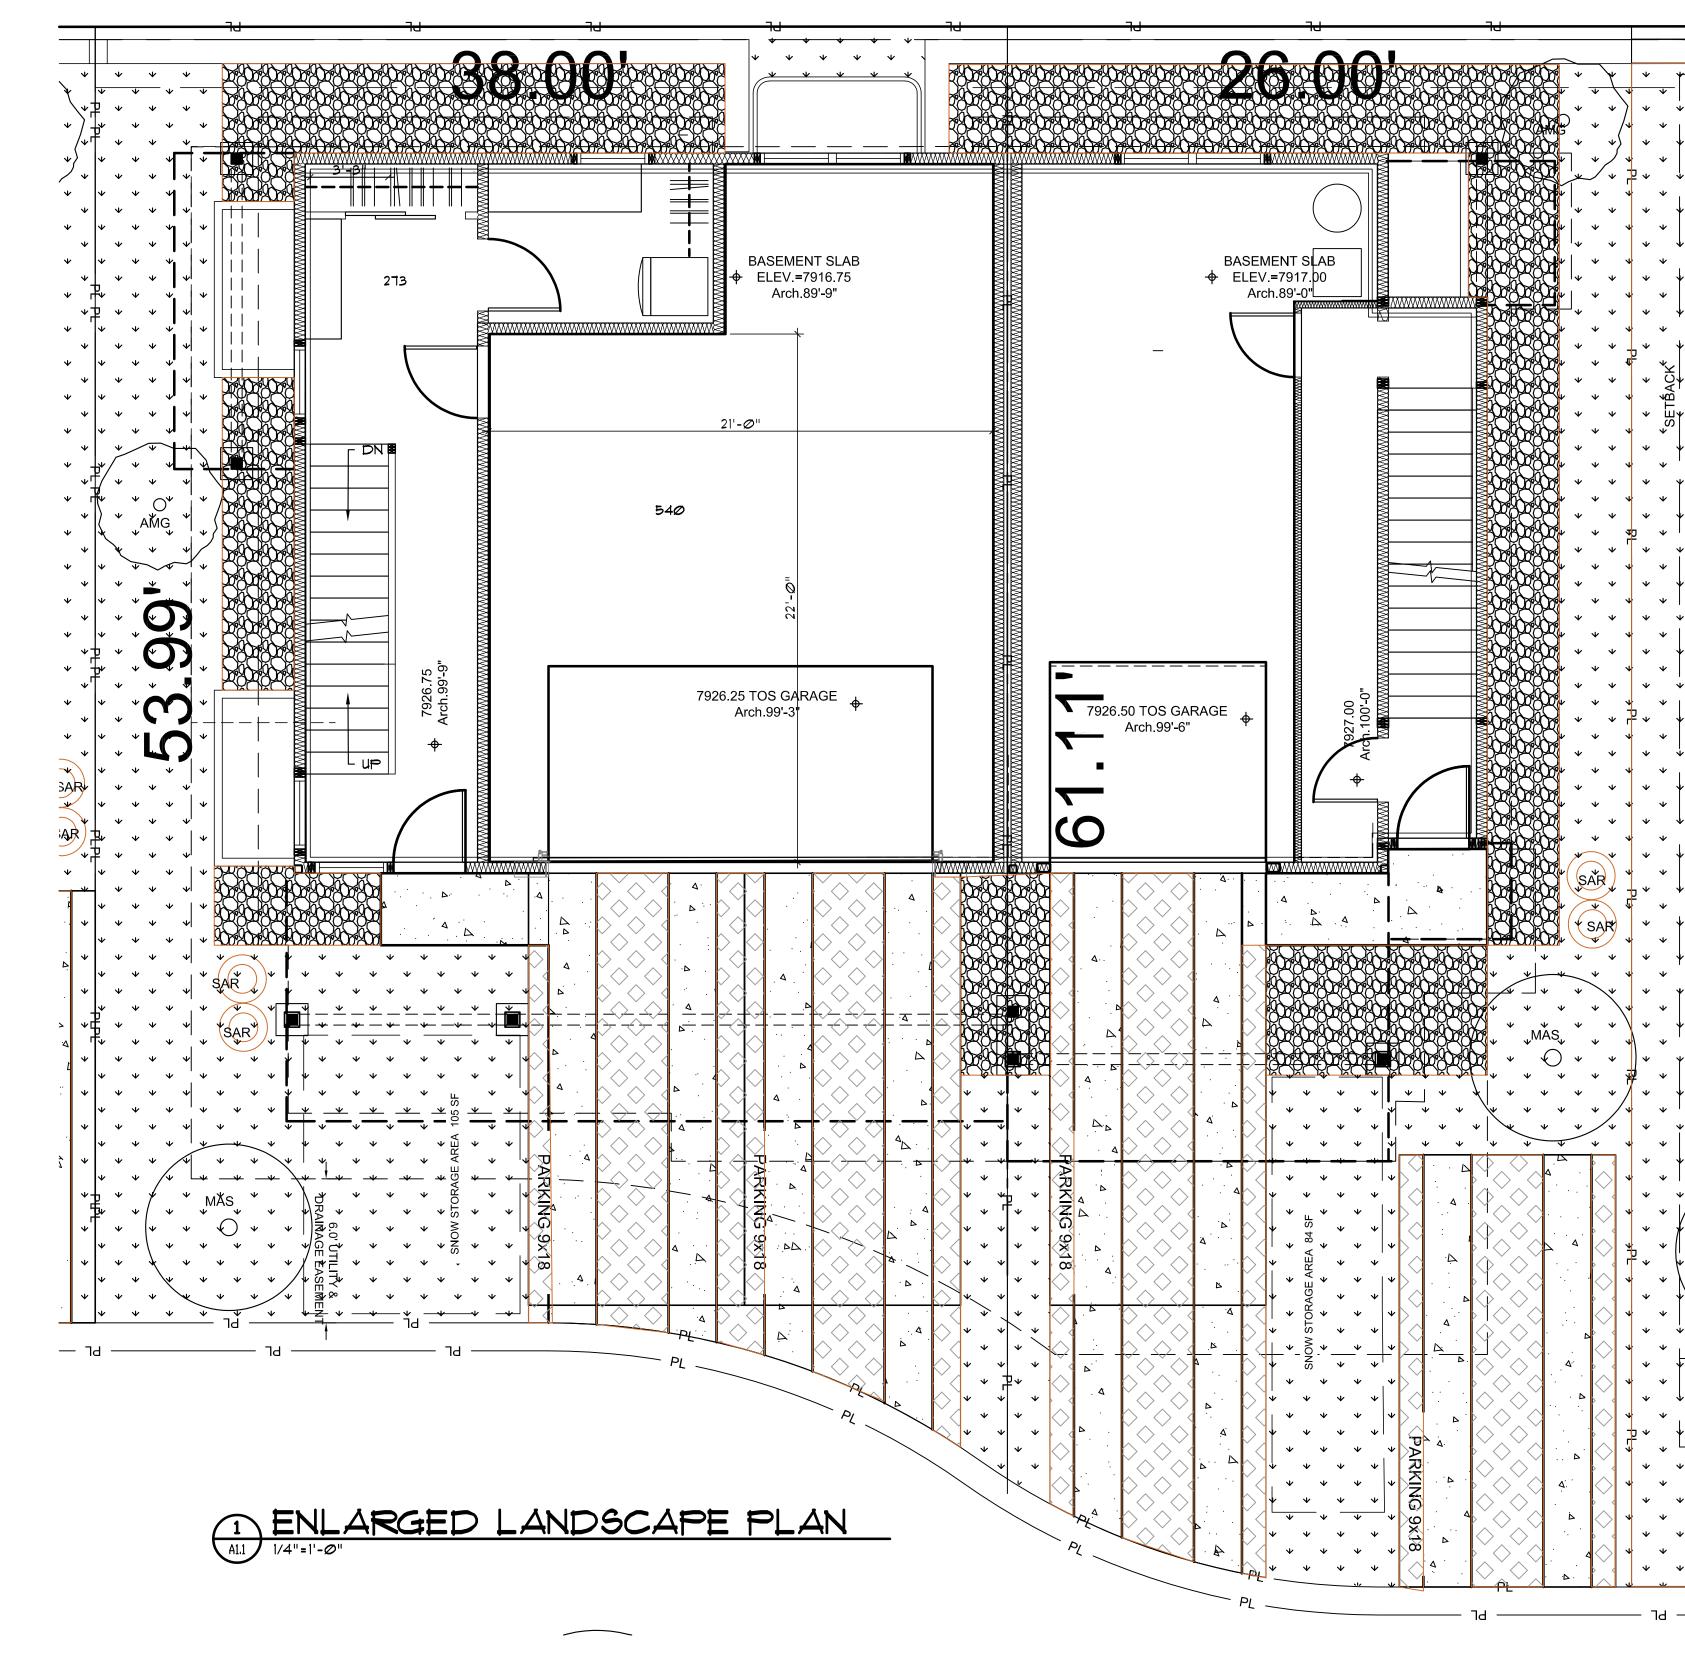

LANDSCAPE NOTES:

- ALL NEW LANDSCAPE AND IRRIGATION SHALL BE UNDER WARRANTY FOR A PERIOD OF (1) ONE YEAR. THE WARRANTY PERIOD SHALL COMMENCE ONCE ALL PUNCH LIST ITEMS ARE SATISFACTORY COMPLETED AND A LETTER OF FINAL COMPLETION IS PROVIDED FROM THE OWNER'S REPRESENTATIVE. ALL LANDSCAPE AND IRRIGATION MAINTENANCE SHALL BE THE RESPONSIBILITY OF THE CONTRACTOR 1 YEAR AFTER THE FINAL COMPLETION IS PROVIDED IN WRITING
- PLANT MATERIAL AND BED LOCATIONS TO BE STAKED BY THE LANDSCAPE CONTRACTOR FOR review by the owner's representative or landscape architect. All adjustments shall be MADE BY THE CONTRACTOR. THE CONTRACTOR SHALL NOT DIG PLANT PITS UNTIL LOCATIONS ARE APPROVED.
- ROUGH GRADING TO PLUS OR MINUS ONE TENTH OF A FOOT BY GENERAL CONTRACTOR. LANDSCAPE CONTRACTOR TO PROVIDE FINISH GRADING IN ALL LANDSCAPE AREAS. LANDSCAPE CONTRACTOR TO APPROVE ROUGH GRADES PRIOR TO MOBILIZATION. MOBILIZATION ON THE PART OF THE LANDSCAPE CONTRACTOR WILL INDICATE THAT ROUGH GRADING IS ACCEPTABLE TO THE LANDSCAPE CONTRACTOR, AND THEREFORE BE RESPONSIBLE FOR PROVIDING ALL FINISHED GRADES TO MEET THE CIVIL GRADING PLANS.
- TREES AND SHRUBS WILL BE INSPECTED ON-SITE. LANDSCAPE PLANT MATERIALS MAY BE REJECTED AT ANY TIME DUE TO ISSUES OF QUALITY.
- ALL NEW LANDSCAPE AREAS SHALL BE IRRIGATED BY A COMMERCIAL GRADE, FULLY AUTOMATIC UNDERGROUND IRRIGATION SYSTEM. TREES, SHRUBS, AND DECORATIVE GRASSES SHALL BE IRRIGATED BY A SEPARATE ZONE FROM SOD/GRASS; THIS INCLUDES TREES PLANTED IN SOD/GRASS AREA. THE IRRIGATION SYSTEM IS TO HAVE A RAIN SENSOR SHUTOFF INSTALLED. IRRIGATION TO BE DESIGN/BUILD, CONTRACTOR IS RESPONSIBLE FOR COORDINATION WITH ARCHITECT, LANDSCAPE ARCHITECT, AND MECHANICAL AND FOR GENERATION OF AN IRRIGATION PLAN FOR REVIEW WITH AS BUILT PLAN AS REQUIRED.
- ALL PLANT MATERIAL SHALL MEET OR EXCEED CURRENT AMERICAN STANDARD FOR NURSERY STOCK ANSI Z60.1 AND THE COLORADO NURSERY ACT AND ACCOMPANYING RULE AND REGULATIONS.
- TRUNK-WRAP TAPE: TWO LAYERS OF CRINKLED PAPER CEMENTED TOGETHER WITH BITUMINOUS MATERIAL, 4 INCHES (102 MM) WIDE MIN.
- WRAPPING TREE TRUNKS: WRAP TREES WITH TRUNK-WRAP TAPE. START AT BASE OF TRUNK AND SPIRAL COVER TRUNK TO HEIGHT OF FIRST BRANCHES. OVERLAP WRAP, EXPOSING HALF THE WIDTH, AND SECURELY ATTACH WITHOUT CAUSING GIRDLING. DO NOT USE STAPLES. INSPECT TREE TRUNKS FOR INJURY, IMPROPER PRUNING, AND INSECT INFESTATION AND TAKE CORRECTIVE MEASURES REQUIRED BEFORE WRAPPING. DO NOT WRAP ROUGH BARK, POPULUS OR GLEDITSIA TREES. REMOVE WRAP IN SPRING.
- NO TREE SHALL BE WRAPPED AFTER MAY 21 OR BEFORE NOVEMBER 1
- ALL DECIDUOUS TREES SHALL BE WRAPPED BY NOV. 15. REMOVE TREE WRAP BY MAY 15. CONTRACTOR SHALL BE RESPONSIBLE FOR WRAPPING AND UNWRAPPING TREES DURING THE WARRANTY PERIOD.
- FIBER MULCH AT PLANTING BEDS: ORGANIC MULCH FREE FROM DELETERIOUS MATERIALS AND SUITABLE AS A TOP DRESSING OF TREES AND SHRUBS, CONSISTING OF SHREDDED REDWOOD MULCH NOT LARGER THAN FOUR INCHES (4") IN LENGTH. SUBMIT 1.0 CF SAMPLE FOR APPROVAL.

SOIL PREPARATION:


SOIL SHALL BE AMENDED BASED ON THE SOIL TEST RECOMMENDATIONS (TO ADDRESS SPECIFIC DEFICIENCIES & ISSUES IN EXISTING SOIL). THE FOLLOWING INCLUDES THE SOIL TEST REQUIREMENTS AND RECOMMENDATIONS TO BE USED IN CONJUNCTION WITH THE SOIL TEST RESULTS:

SOIL ANALYSIS, BULK DENSITY TESTING AND REMEDIATION REQUIRED. SOIL ANALYSIS FROM A LOCAL ACCREDITED SOIL ANALYSIS LABORATORY WITH EXPERIENCE IN LOCAL URBAN SOILS SHALL BE REQUIRED WHEN PLANTS ARE TO BE INSTALLED IN GREEN SPACE. ALL SOIL REMEDIATION SHALL BE BASED ON THE SOIL ANALYSIS. 1.1. MINIMUM SOIL ANALYSIS MUST DETERMINE SOIL TEXTURE AND STRUCTURE, PH

BALANCE, SOIL SALINITY, FREE LIME, ORGANIC MATTER (OM) CONTENT, PLANT AVAILABLE NUTRIENTS AND COMPACTION.

COMPOSTED MATERIAL SHALL CONSIST OF AGED ORGANIC MATTER, FREE OF WEED


- DEPTH OF LANDSCAPE SOIL ANALYSIS SHALL BE 24IN FOR TREES AND 8IN FOR ALL OTHER AREAS
- SOIL REMEDIATION REQUIRED BASED ON SOIL ANALYSIS.
- OR OTHER NOXIOUS PLANT SEEDS, LUMPS, STONES, OR OTHER FOREIGN CONTAMINANTS HARMFUL TO PLANT LIFE, AND HAVING THE FOLLOWING CHARACTERISTICS BASED ON A NUTRIENT TEST PERFORMED NO LONGER THAN 3
- MONTHS PRIOR TO ITS INCORPORATION INTO THE PROJECT: ORGANIC MATTER: 25% MINIMUM.
- SALT CONTENT: 5.0 MMHOS/CM MAXIMUM.
- 1.3. PH: 8.5 MAXIMUM.
- 1.4. CARBON TO NITROGEN RATIO OF 10:1 TO 20:1.
- PARTICLE SIZE NO PARTICLE SMALLER THAN SILT OR CLAY SIZE, OR LARGER THAN
- ACCEPTABLE COMPOST PRODUCT: CLASS I COMPOST, SUCH AS ECOGRO OR BIO-COMP, AS PROVIDED BY A1 ORGANICS, EATON, CO, OR APPROVED
- FINISH GRADE TO BE BELOW THE EDGE OF PAVEMENT PRIOR TO SODDING OR PLANTING:
- SEEDED/SODDED AREAS: ALLOW 1 INCH FOR SOD. PLANTED AREAS: ALLOW 3 INCHES FOR MULCH.
- 4. AFTER APPLYING SOIL CONDITIONER AND FERTILIZER, THOROUGHLY TILL AREA TO DEPTH OF 6" MINIMUM UNTIL SOIL IS WELL PULVERIZED AND THOROUGHLY MIXED.

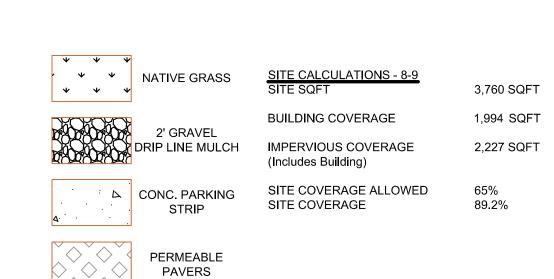

Associates

The Architectural Balanc Edwards, CO 81632 (970) 766-1470 fax: (970) 766-147 email: tab@vail.net www.tabassociates.com Timberline Engineering (970) 963 9869 Structural Engineer

> KRM Consultants, Inc. (970) 949-9391

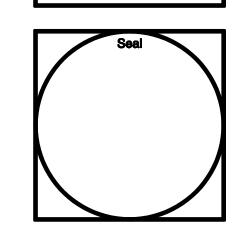


0 0 0

Revisions:


Issue Dates: 20220509 Struct Coord DRB-09/20/2024

Sheet Title: Landscape Plan

Project No: Sheet No: A1.1

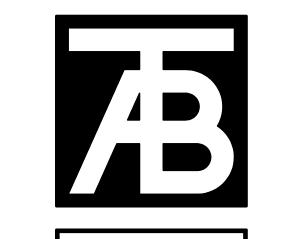

Associates The Architectural Balance 0056 Edwards Village Blvd. Edwards, CO 81632 (970) 766-1470 fax: (970) 766-1471 email: tab@vail.net www.tabassociates.com Civil Engineer:
Timberline Engineering
(970) 963 9869 Structural Engineer: KRM Consultants, Inc, (970) 949-9391

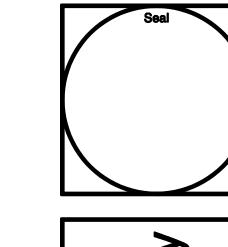


lits 3 Ba x Un 002 <u>□</u> ∞ Belden 25 Beld Beld 00 0

20220509 Struct Coord

Basement

2215

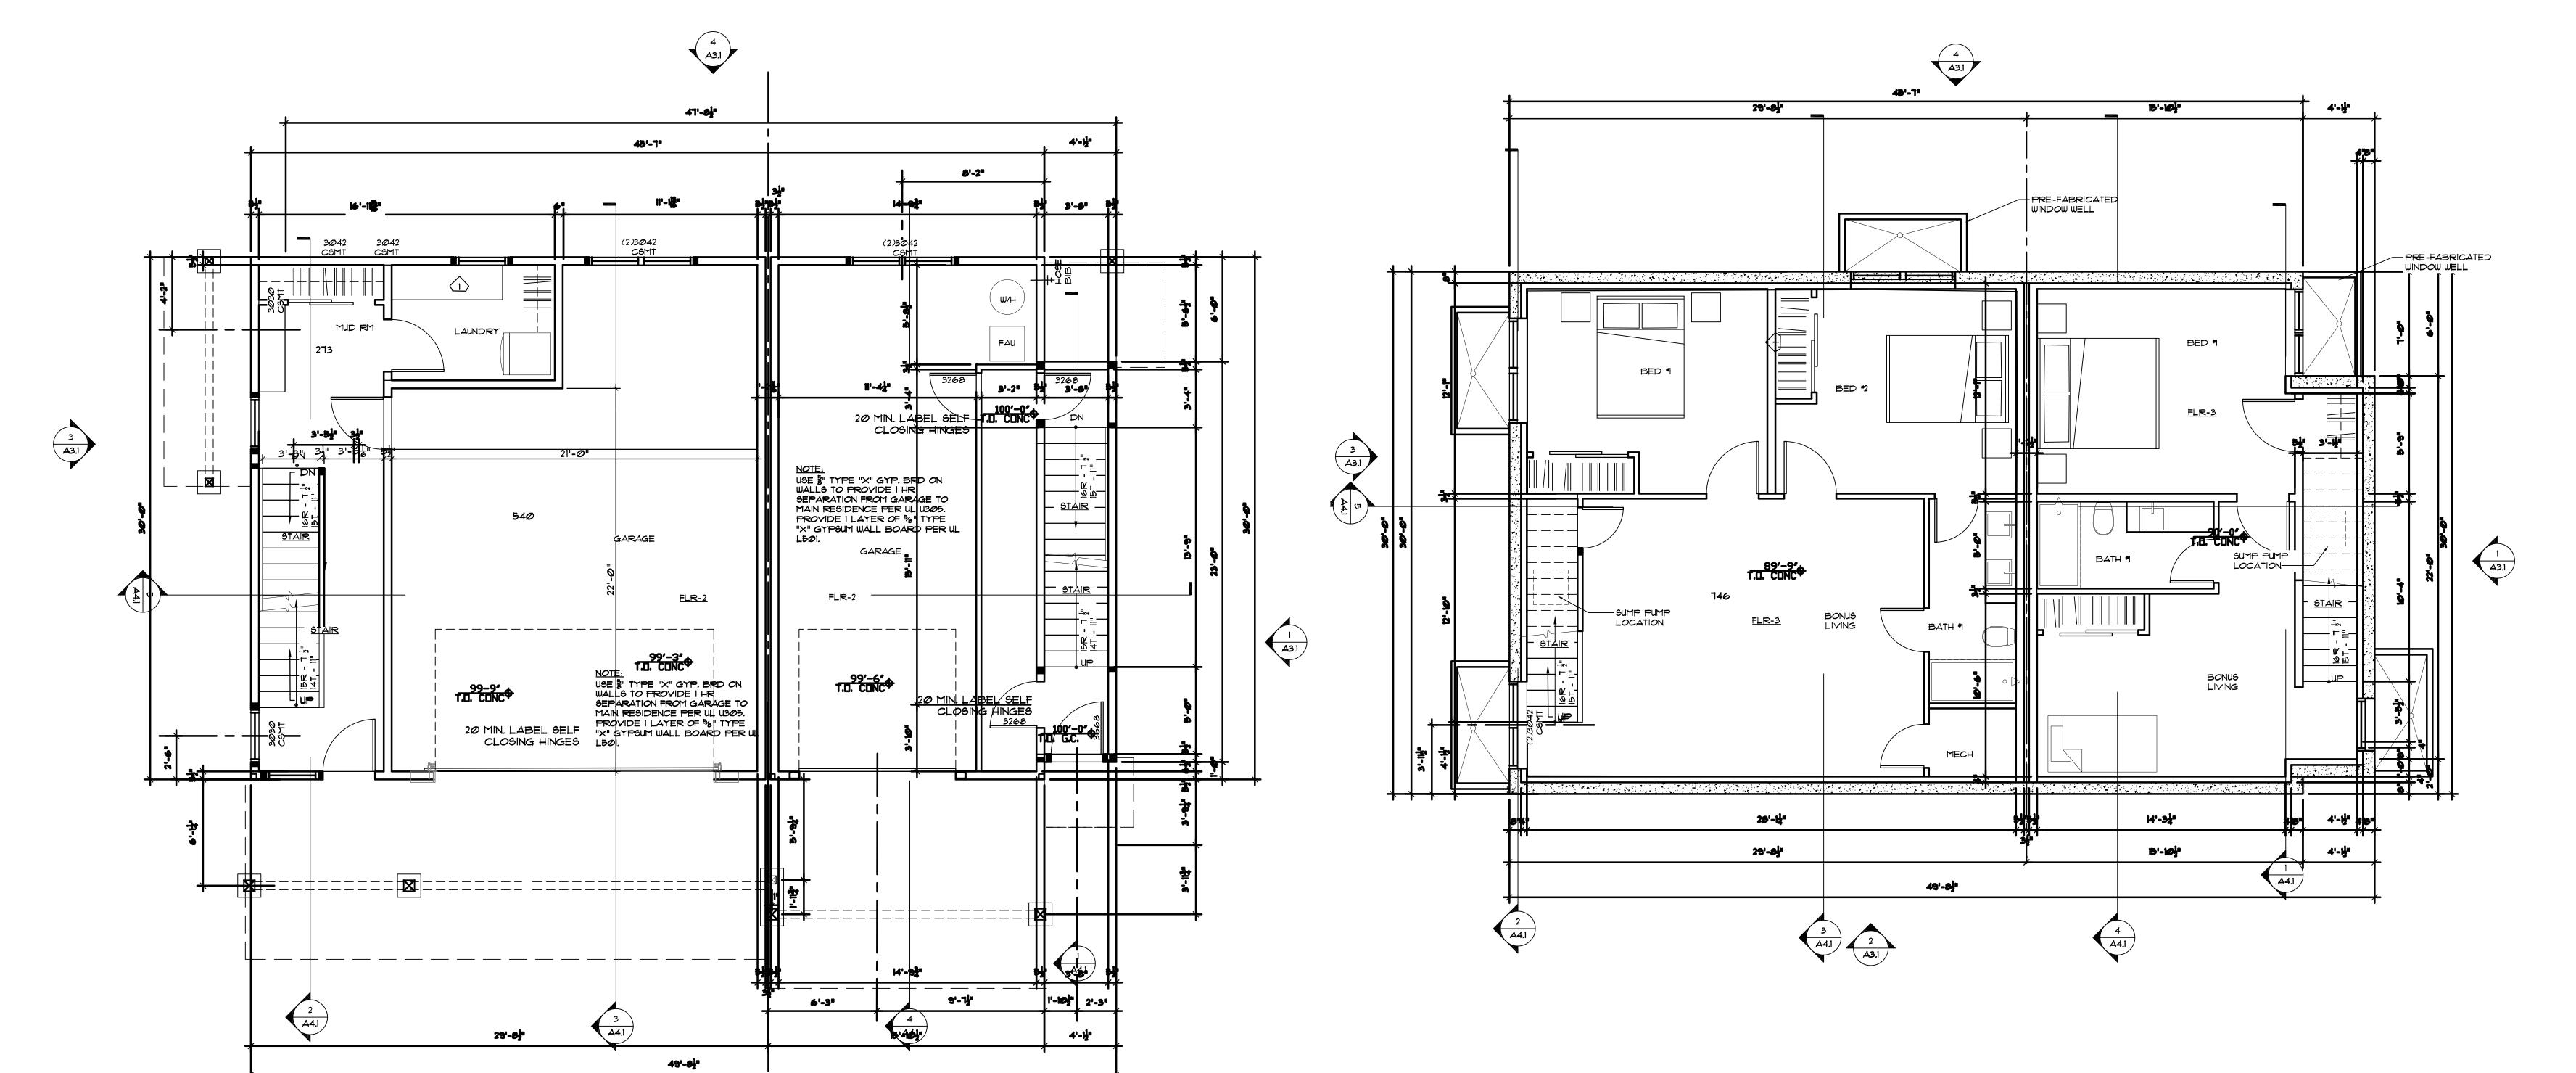


LOWER LEVEL FLOOR PLAN

| 1/4"=1'-@"

2 A3.1

1 BASEMENT FLOOR PLAN
A2.1 1/4"=1'-@"

SCALE: 1/4"=1'-0"

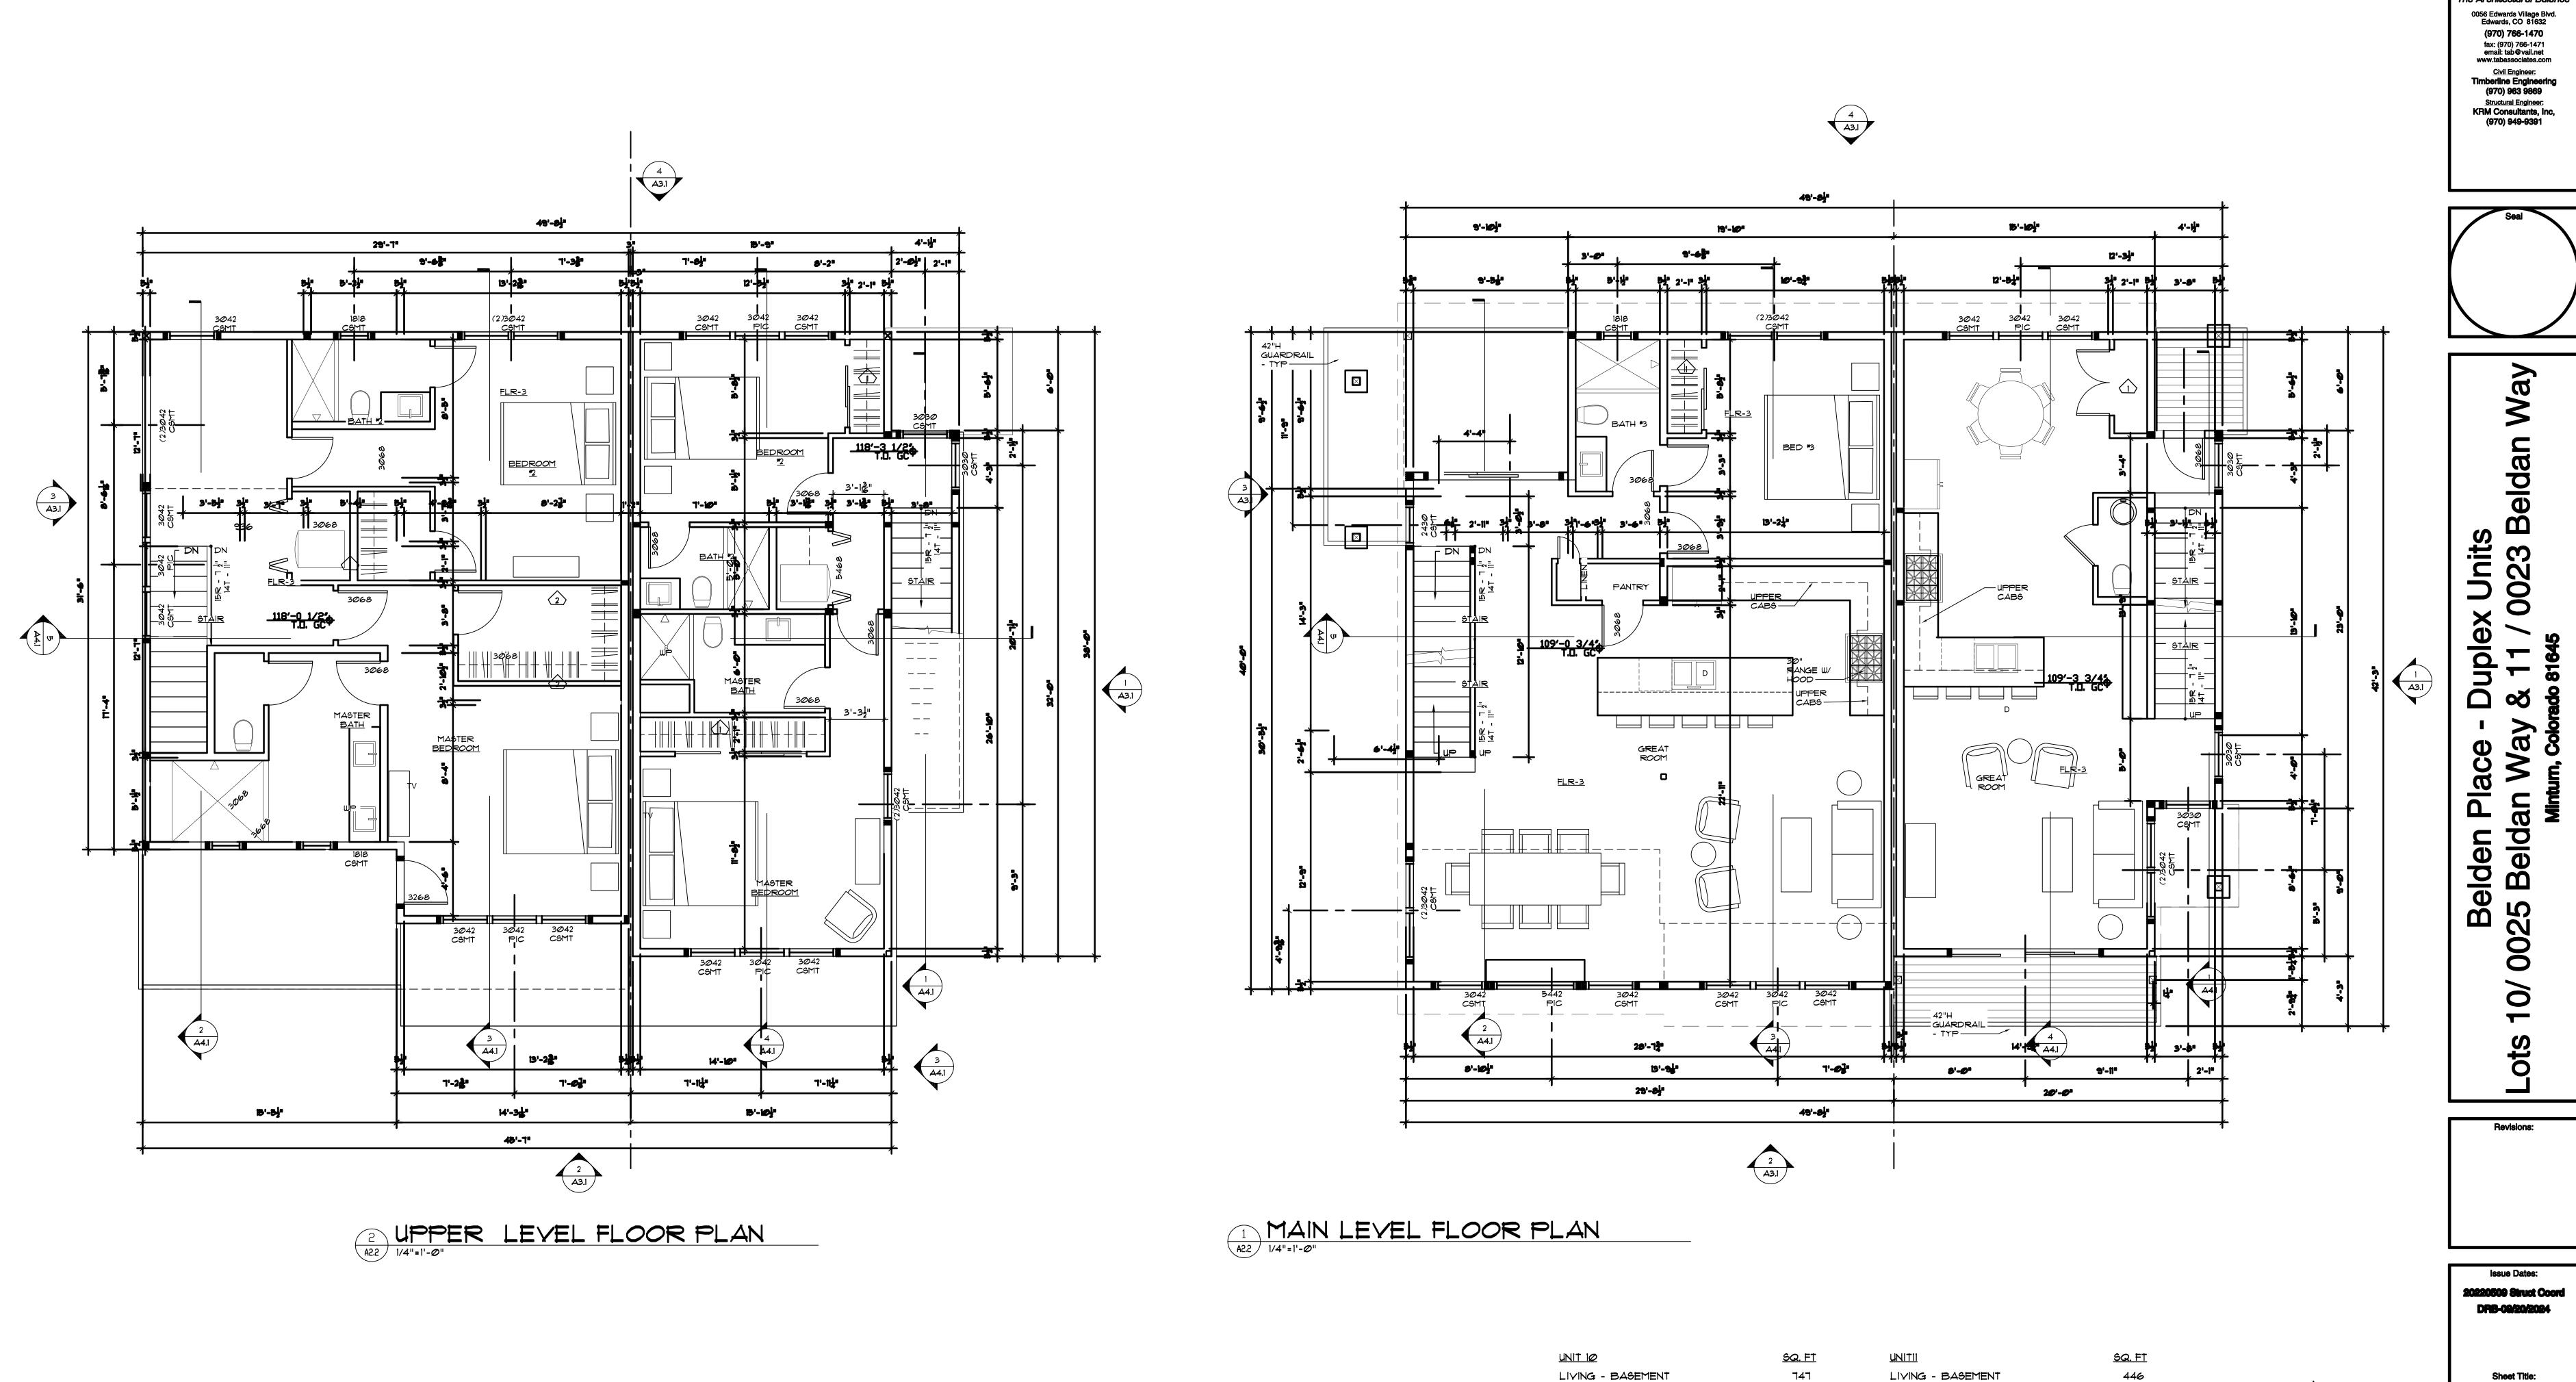

LIYING - LOWER

LIYING - MAIN

LIYING - UPPER

TOTAL LIVING

MECHANICAL

GARAGE

TOTAL

271

1,030

930

556

Ø

3,524

2,978

LIYING - LOWER

LIYING - MAIN

TOTAL LIVING

MECHANICAL

SCALE: 1/4"=1'-0"

GARAGE

TOTAL

TOTAL

LIVING - UPPER

166

629

1,845

348

Ø

2,193

דוד,5

TAB
Associates
The Architectural Balance

0056 Edwards Village Blvd.
Edwards, CO 81632
(970) 766-1470
fax: (970) 766-1471

Sheet Title:


Main and Upper Level Floor Plans

Project No:


2215

Sheet No:

A2.2

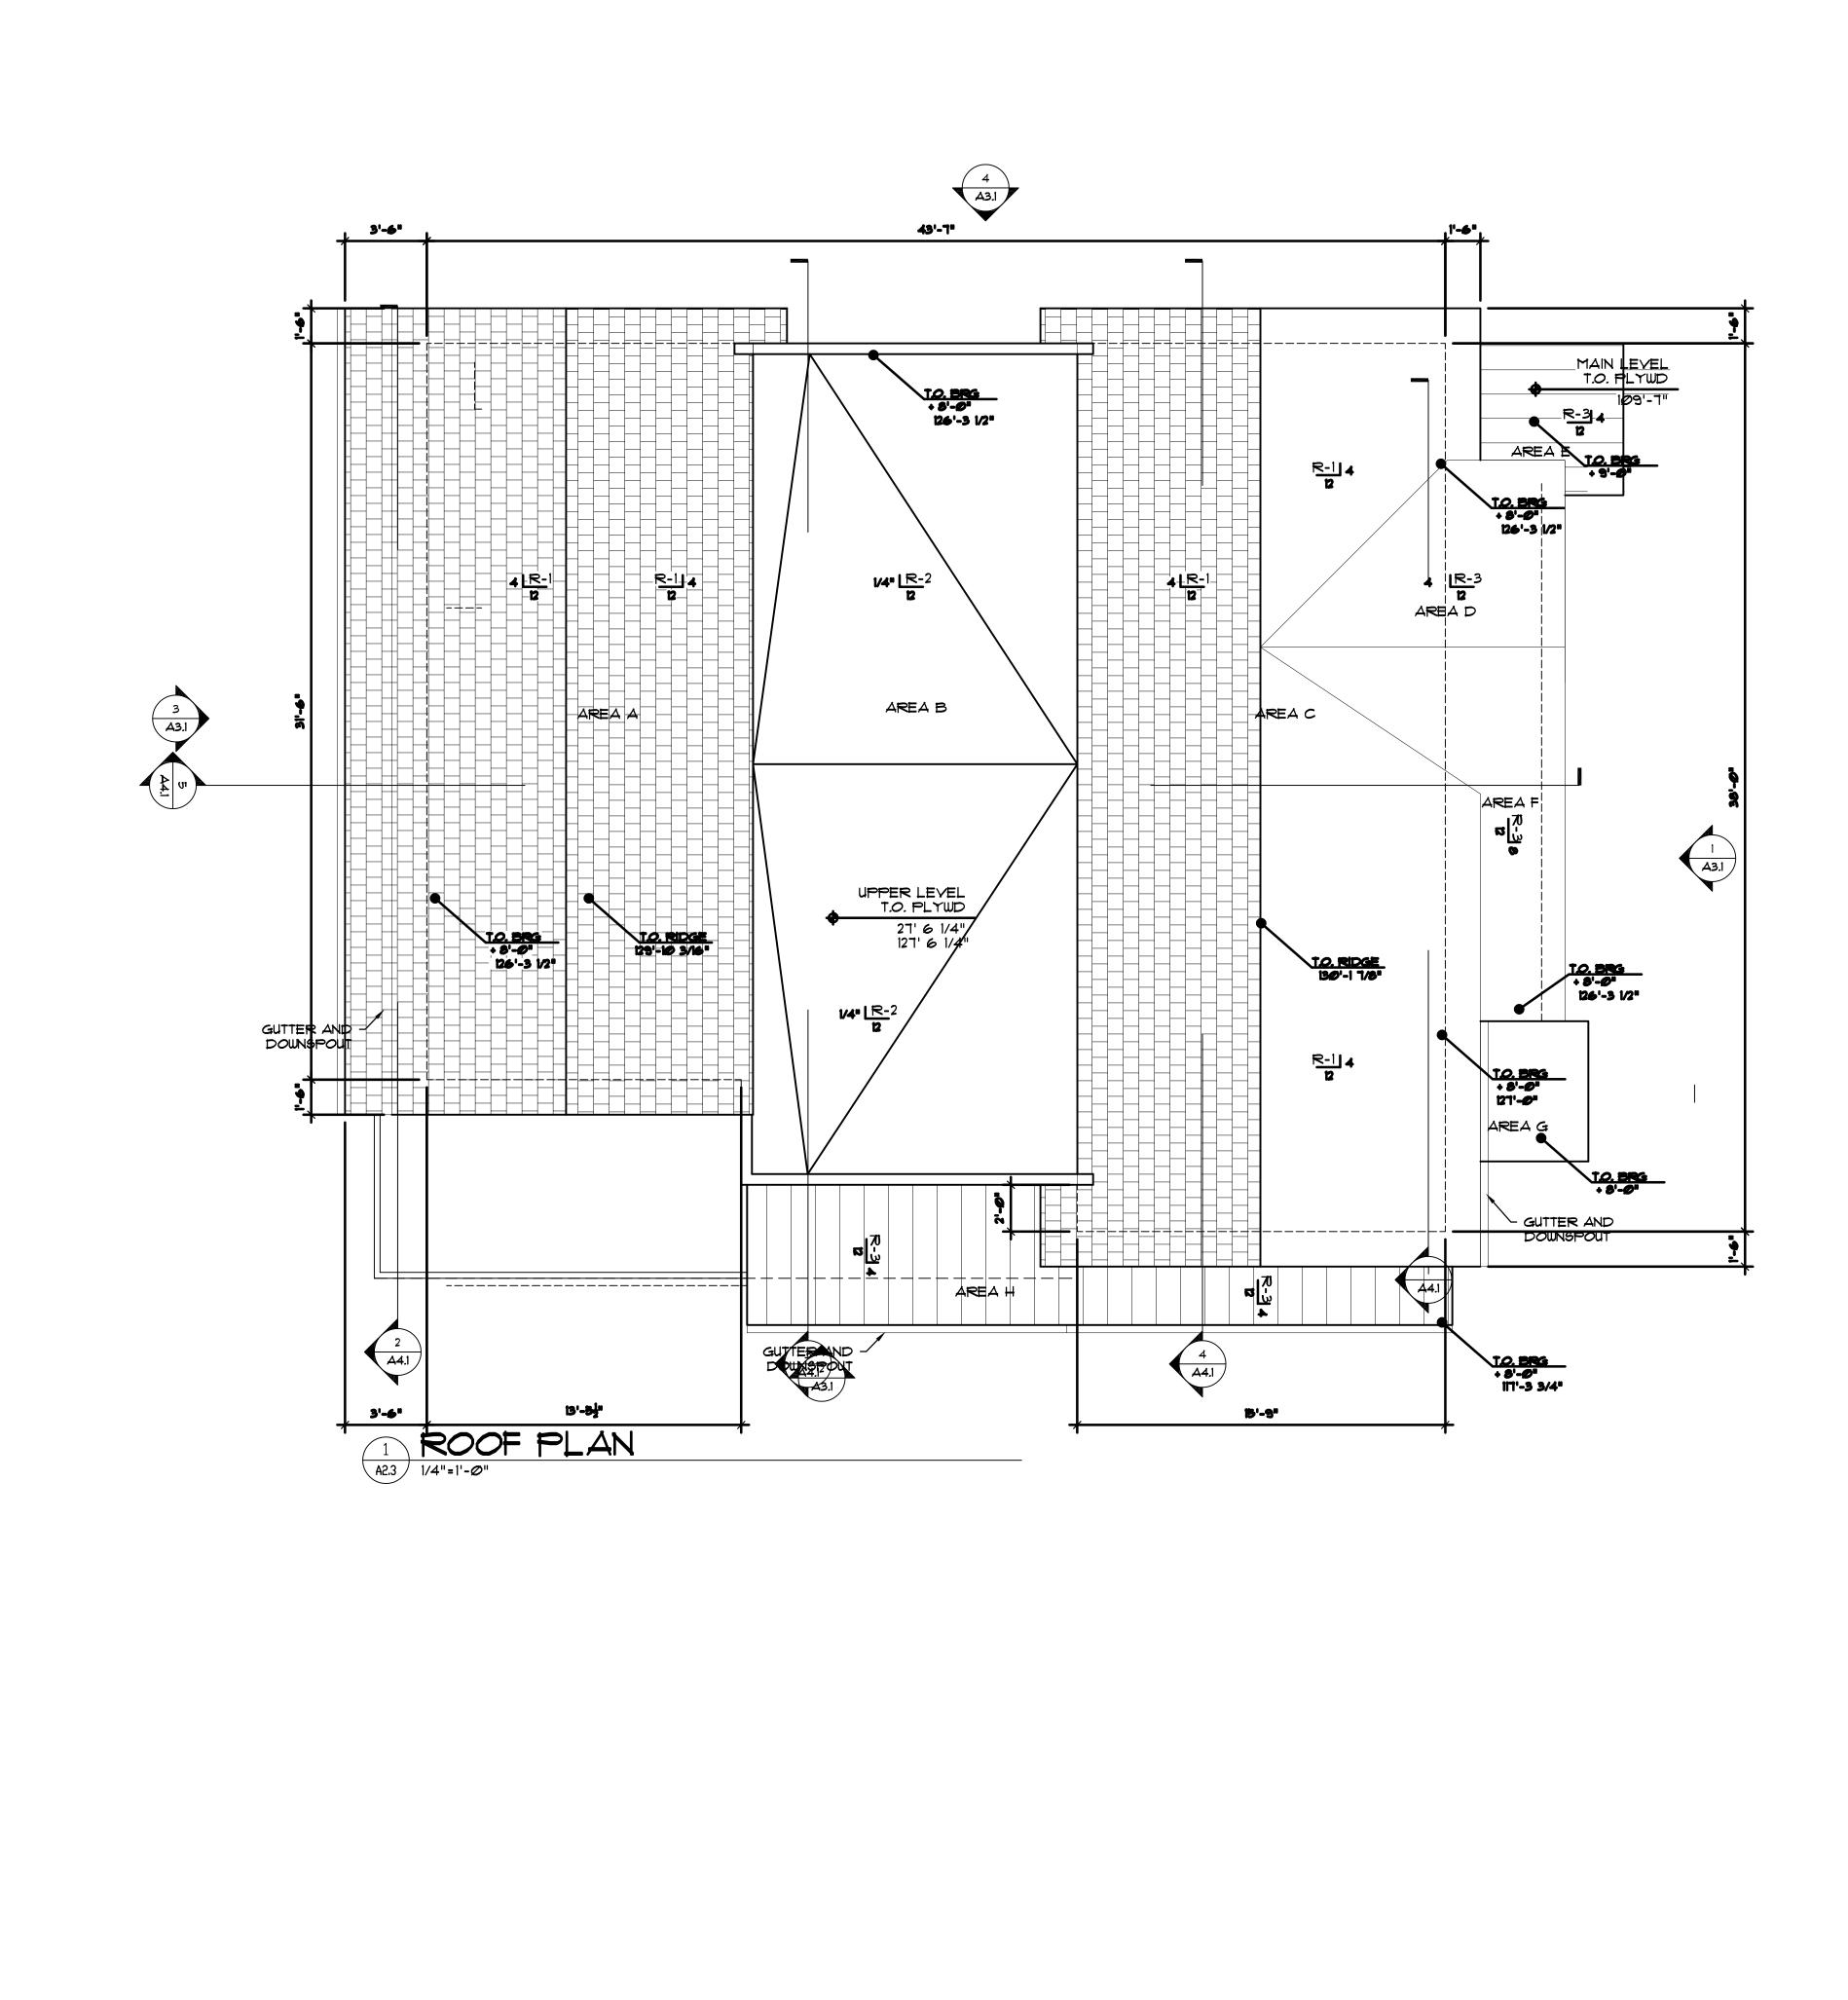

SCALE: 1/4"=1'-0"

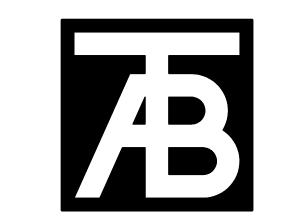

TAB Associates

The Architectural Balance

0056 Edwards Village Blvd. Edwards, CO 81632 (970) 766-1470 fax: (970) 766-1471 email: tab@vail.net www.tabassociates.com

Civil Engineer:
Timberline Engineering
(970) 963 9869
Structural Engineer:
KRM Consultants, Inc,
(970) 949-9391

iits 23 Beldan × Un Duplex Belden Place - 10025 Beldan Way 10/ Lots

Issue Dates:

Roof


Plan

2215



TAB
Associates
The Architectural Balance

0056 Edwards Village Blvd.
Edwards, CO 81632
(970) 766-1470
fax: (970) 766-1471
email: tab@vail.net
www.tabassociates.com
Civil Engineer:
Timberline Engineering
(970) 963 9869
Structural Engineer:
KRM Consultants, Inc,
(970) 949-9391

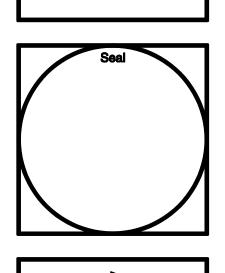

Belden Place - Duplex Units ots 10/ 0025 Beldan Way & 11 / 0023 Beldan V

Revisions:

20220509 Struct Coord
DRB-09/20/2024

Sheet Title:
Exterior
Elevations

Project No:

2215
Sheet No:

A3.1



X-1

LAP SIDING

8" LAP SIDING

COLOR: BOURDEUX





X-2 2 LAP SIDING

SIMILAR TO DIAMOND KOTE LP YERTI9CAL GROOVE COLOR: ELKHORN



SIMILAR TO DIAMOND KOTE LP

X-4 HORIZONTAL CORRUGATED PANELS

X-5 VERTICAL CORRUGATED PANELS SIMILAR TO WESTERN STATES METAL ROOFING - GALVANIZED 3" CORRUGATED PANELS




STONE VENEER - THIN VENEER

SIMILAR TO GALLEGOS - #366 COURTLAND LOW RISE

SW 7069 Iron Ore Interior / Exterior

PAINTED ITEMS: SHERWIN WILLIAMS 7069 - IRON ORE TRIM, WOOD BEAMS, GUTTERS AND OTHER METALS

WINDOWS SIMILAR TO: SIERRA PACIFIC "BLACK" WOOD CLAD WINDOWS

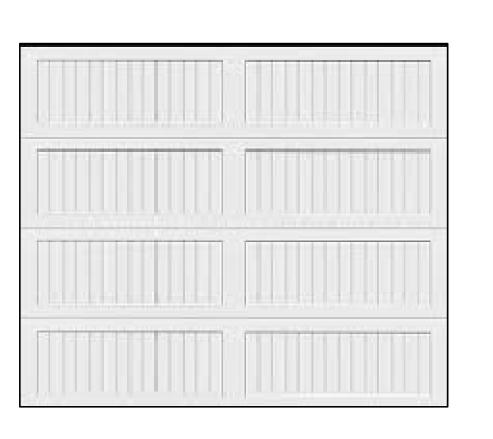

8 GARAGE DOOR
A3.1

SIMILAR RAYNOR ST AUGUSTINE (PANEL PATTERN) TEXTURED PANELS COLOR: WALNUT



SIMILAR TO DIAMOND KOTE LP

X-3 TLAP SIDING

8" LAP SIDING


COLOR: GLACIER FOG

SIMILAR GAF DESIGNER SHINGLES WOODLAND "CASTLEWOOD GRAY"

R-3 TB ROOFING

ROOFING

SIMILAR WESTERN STATES 2" STANDING SEAM - 12" WIDTH COLOR: GALYANIZED TO MATCH CORRUGATED PANELS

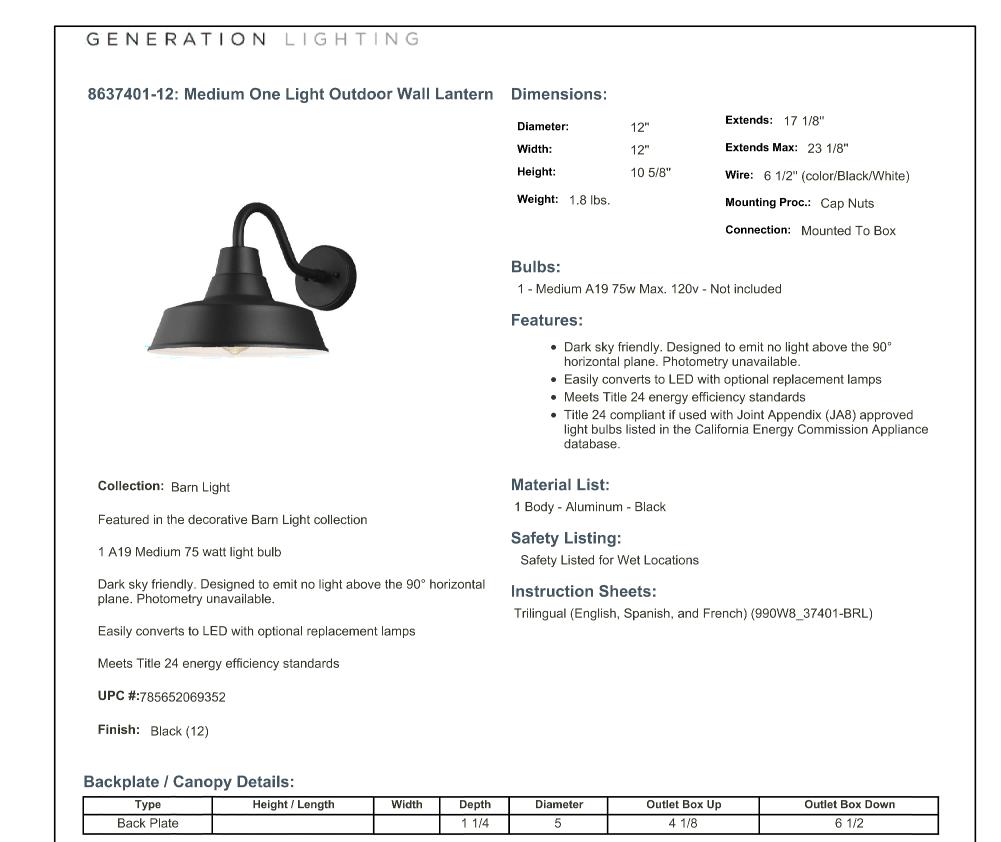





8537401EN3-12 1

Shipping Information:

Individual

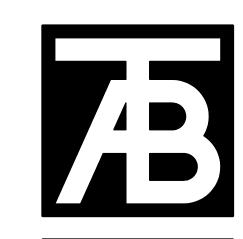

TAB Associates <u>Civil Engineer:</u>
Timberline Engineerir
(970) 963 9869

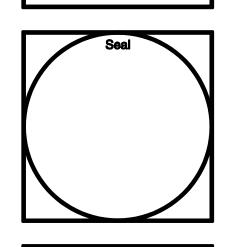

Beld 0 0

DRB-07/05/2024


Issue Dates:


20220509 Struct Coord

Materials

Sheet No:

A3.2

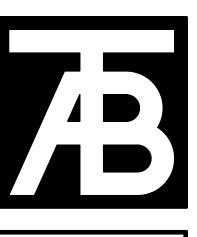

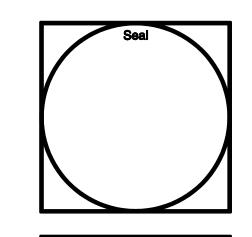

Belden Place Lots 10/ 0025 Beldan Wa

20220509 Struct Coord DRB - 11/28/2023

Renderings

2215

A3.3







<u>NE 3D</u>





<u>SE 3D</u>

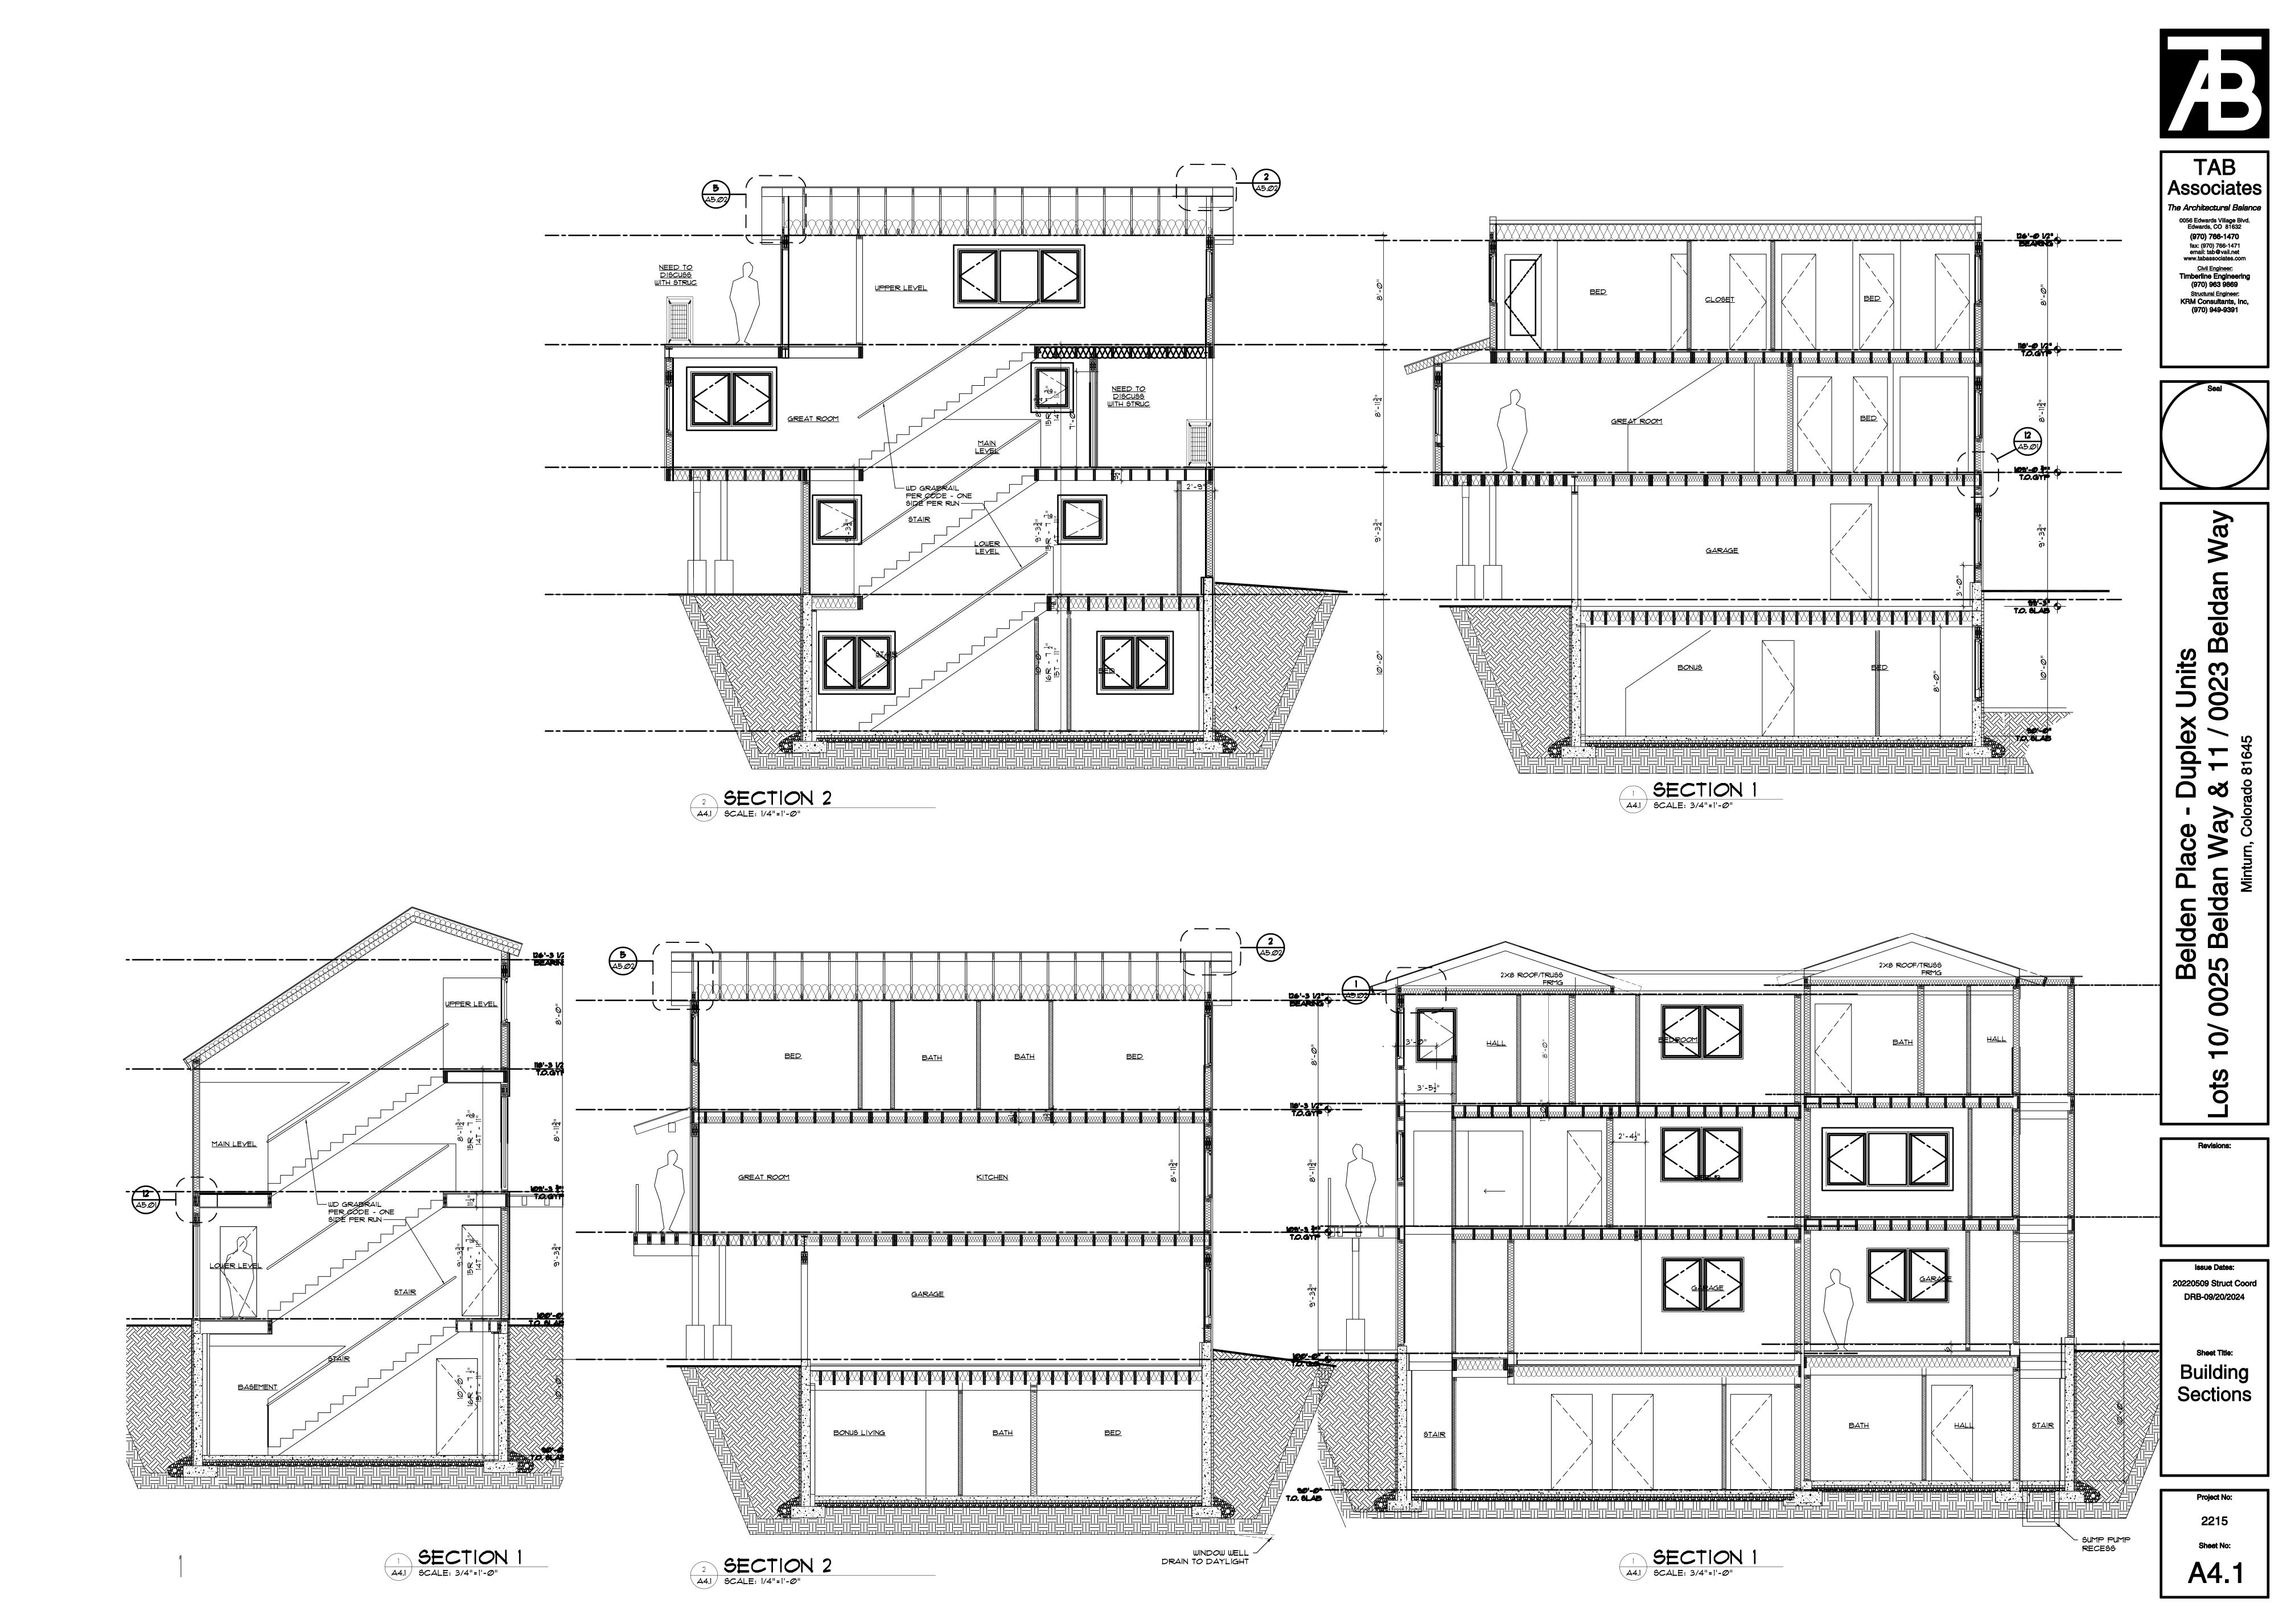

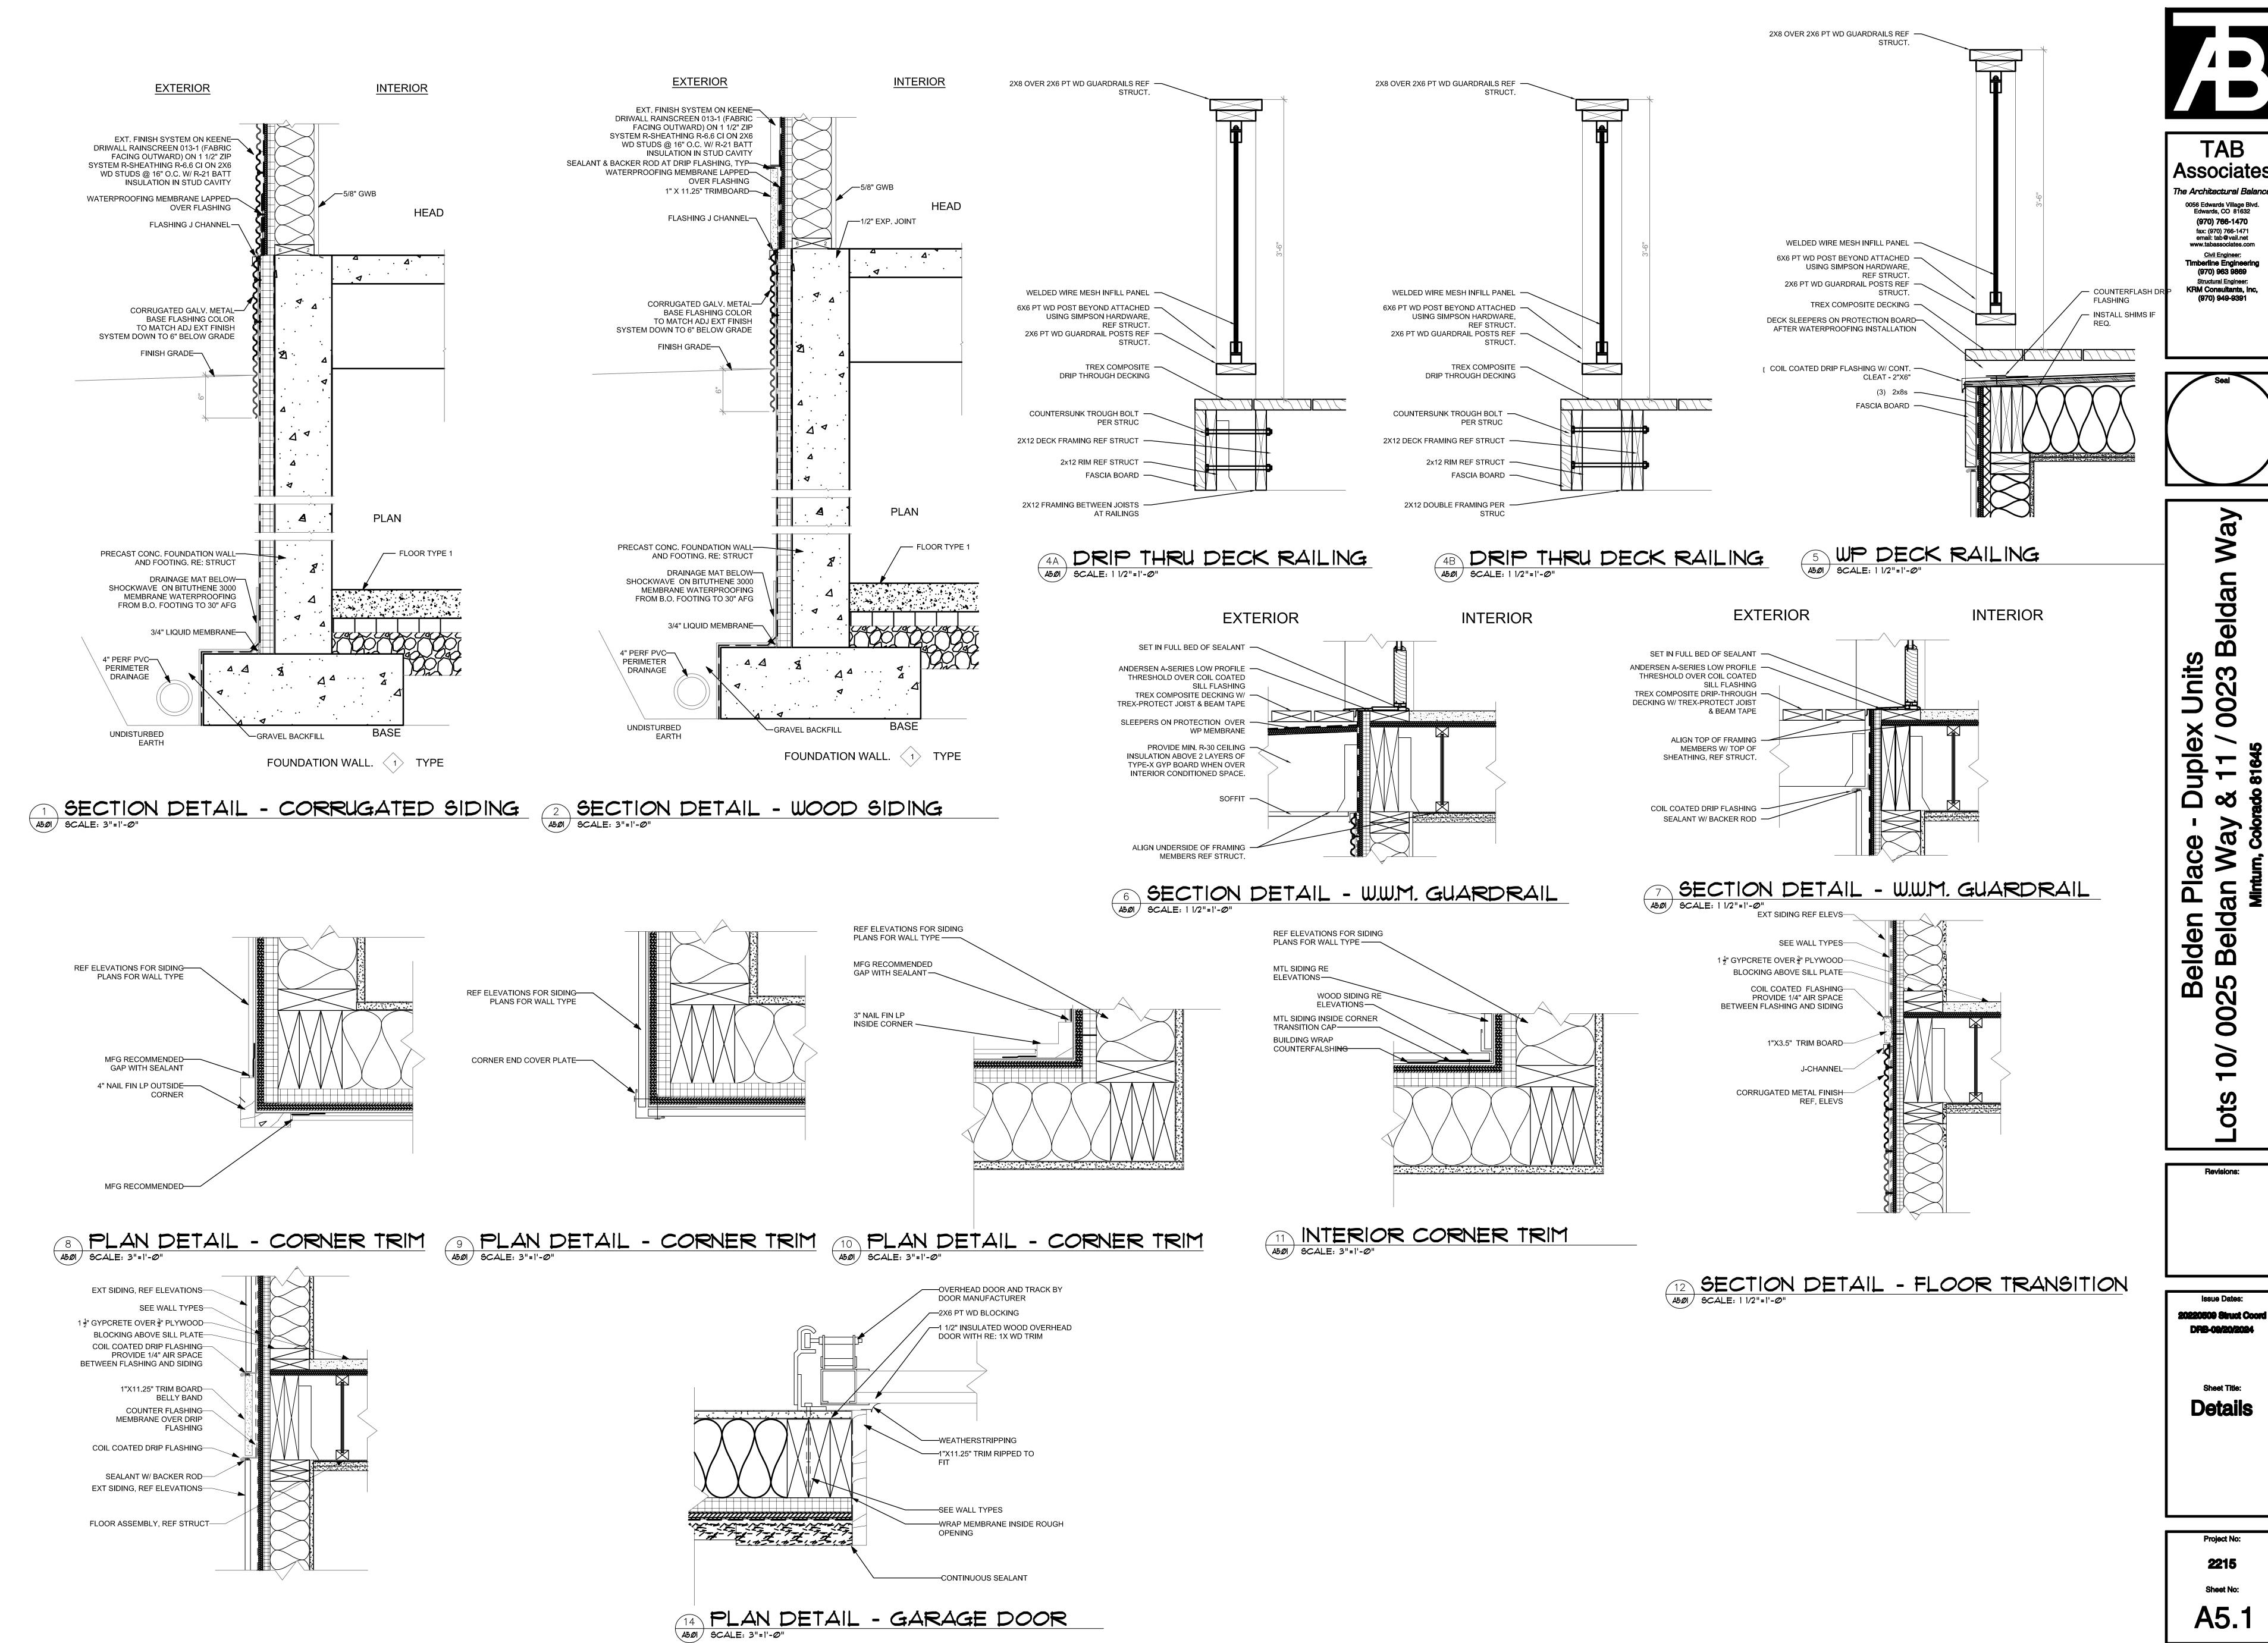



9


90


6

SECTION DETAIL - FLOOR TRANSITION A5ØI SCALE: 1 1/2"=1'-@"

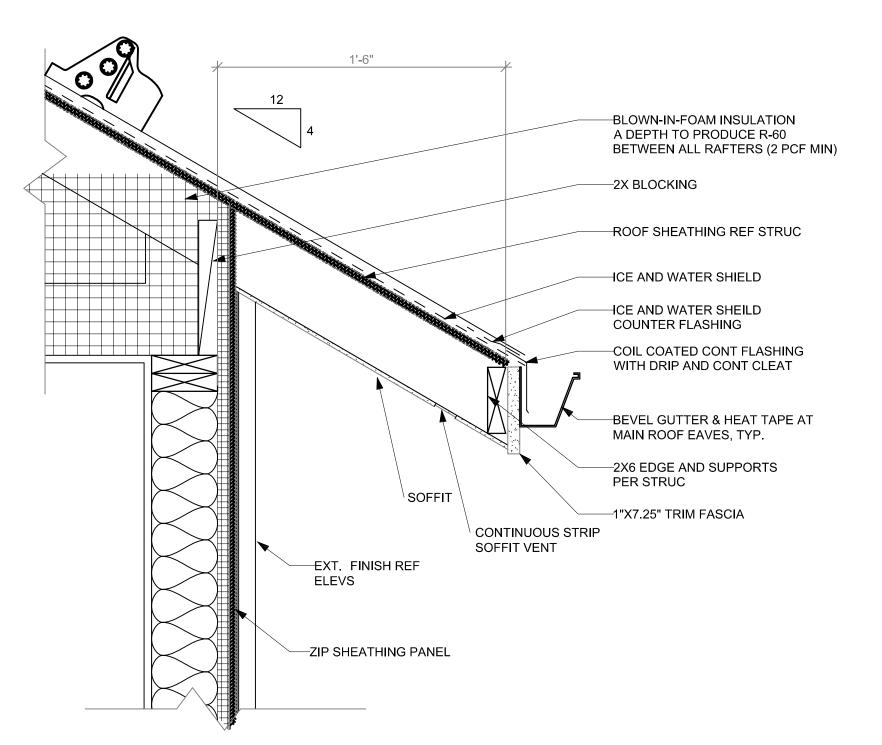


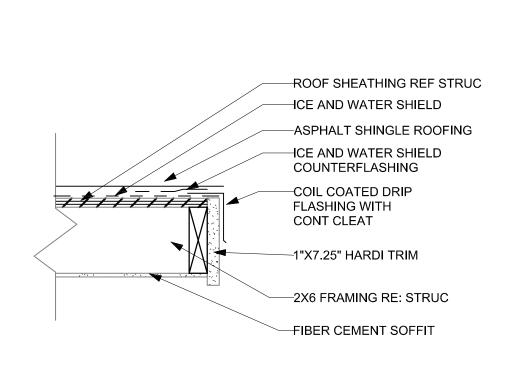

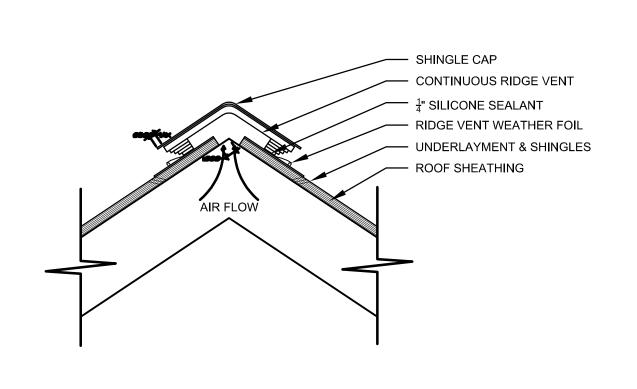

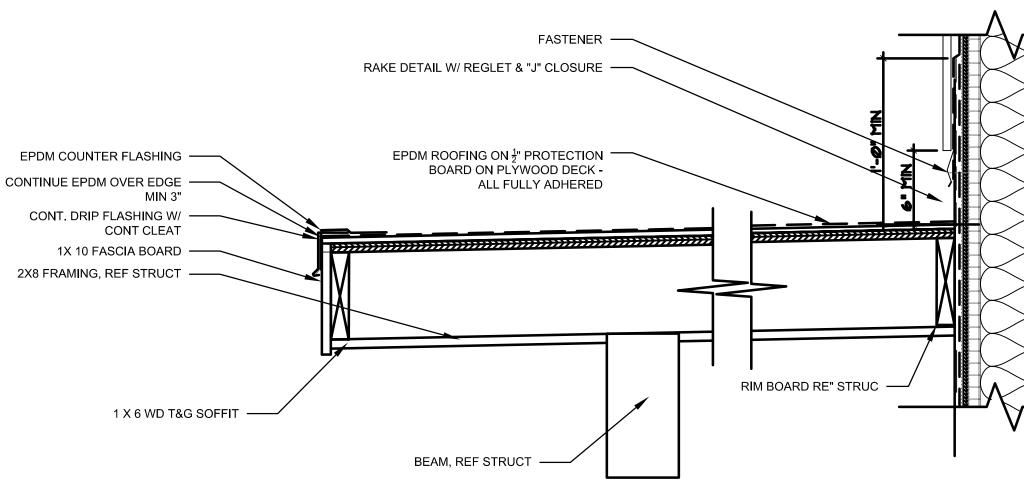



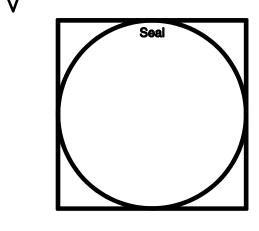

eld


8

SECTION DETAIL - COVERED WALKWAY A5@2 SCALE: 1 1/2"=1'-@"



SECTION DETAIL - EAVE A5.02 SCALE: 1 1/2"=1'-0"

3 SECTION DETAIL - RIDGE A5@2 SCALE: 1 1/2"=1'-@"

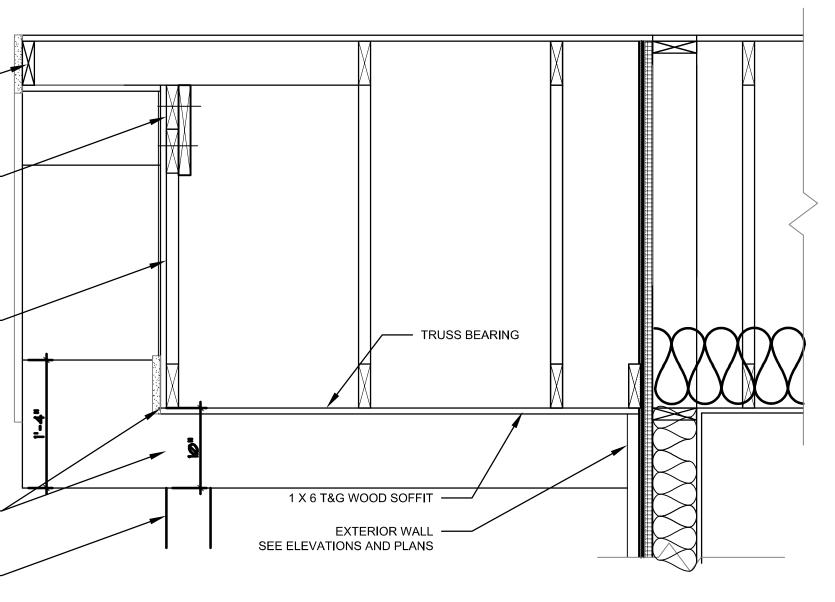



SECTION DETAIL - FASCIA

SCALE: 1 1/2"=1'-0"

RE: 2/A5.02 ——


4X10 FAUX GABLE END BEAM PROVIDE

SIDING PER ELEVATIONS -

6X16 WD BEAM TRIMMED -TO 10" TALL AT BEARING

COLUMN PER STRUC ----

BLOCKING

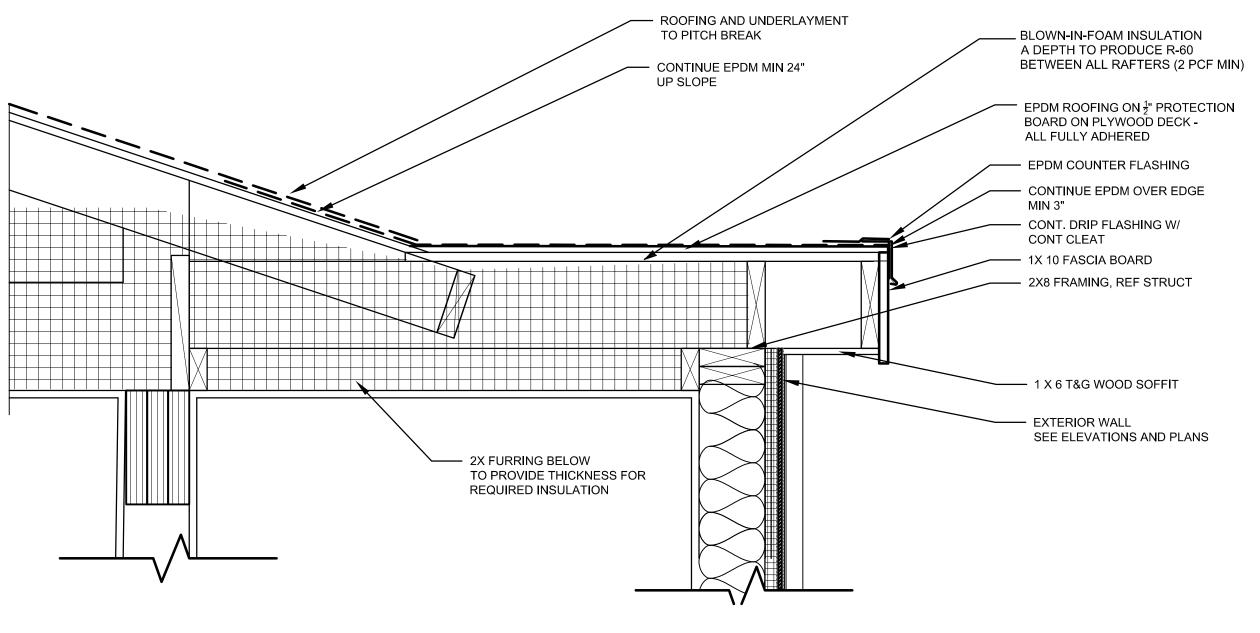


6 STAIR ROOF - LOW SLOPE A5002 SCALE: 1 1/2"=1'-0"

Duplex Belden Place -25 Beldan Way 00 0


Revisions:

Issue Dates: 20220509 Struct Coord


Details

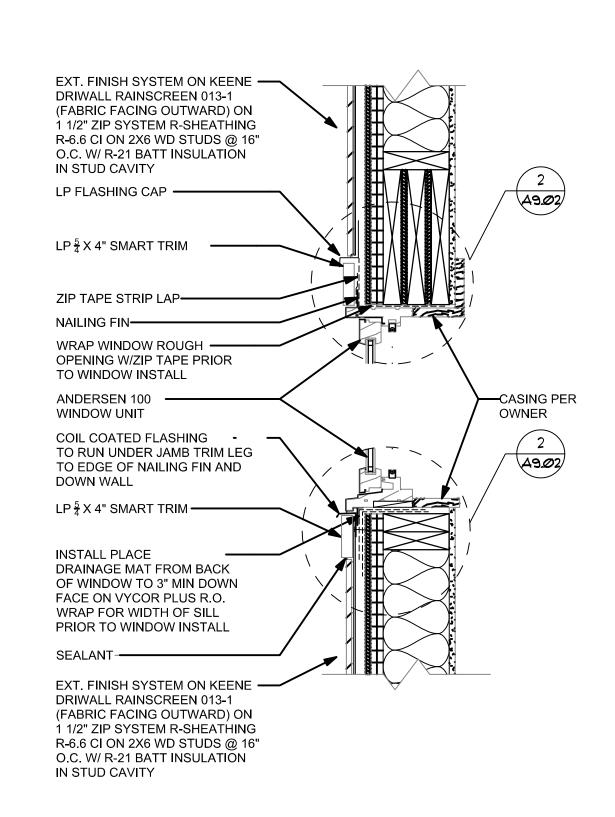


2 WINDOW DETAIL - HEAD/SILL A5Ø3 SCALE: 1 1/2"=1'-Ø"

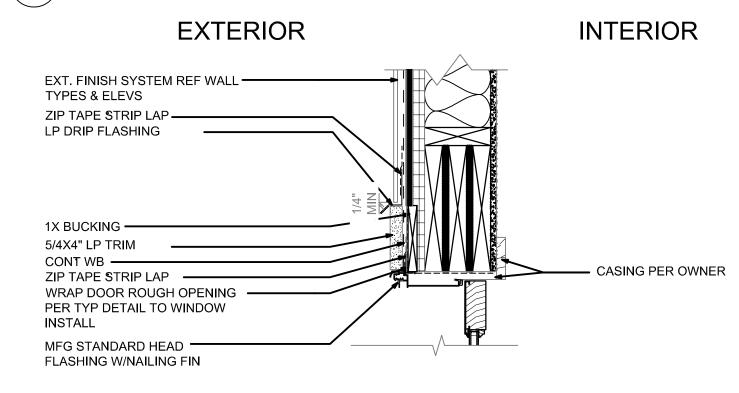


5 DOOR DETAIL - INSWING HEAD TYP. A503 SCALE: 1 1/2"=1"-0"

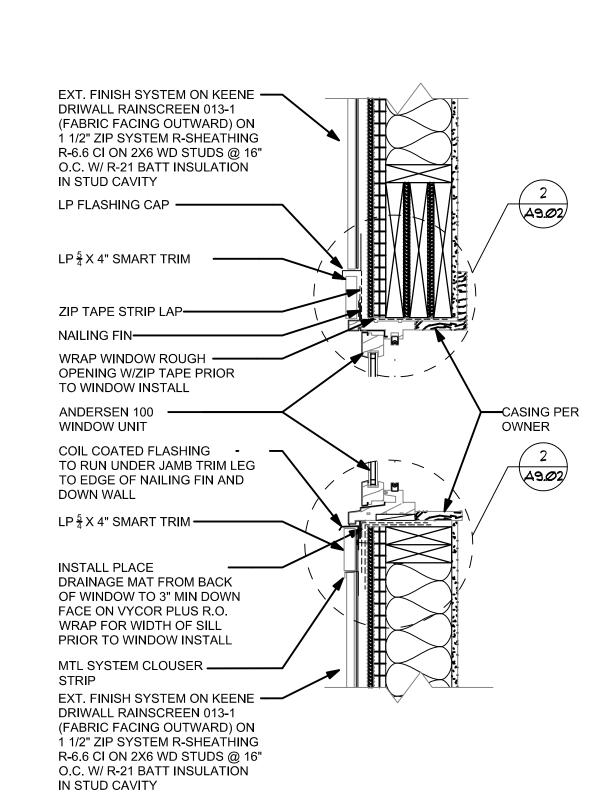


7 WINDOW DETAIL - HEAD/SILL
A5.03 SCALE: 1 1/2"=1'-0"

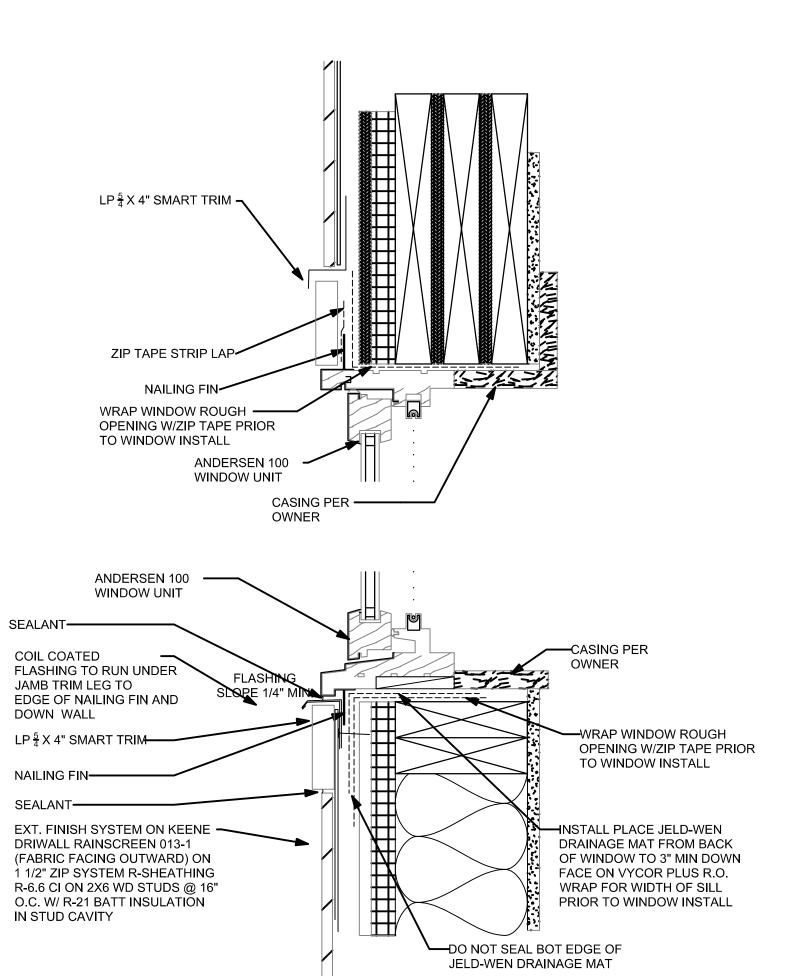


3 WINDOW DETAIL - HEAD/SILL A5Ø3 SCALE: 3"=1'-Ø"

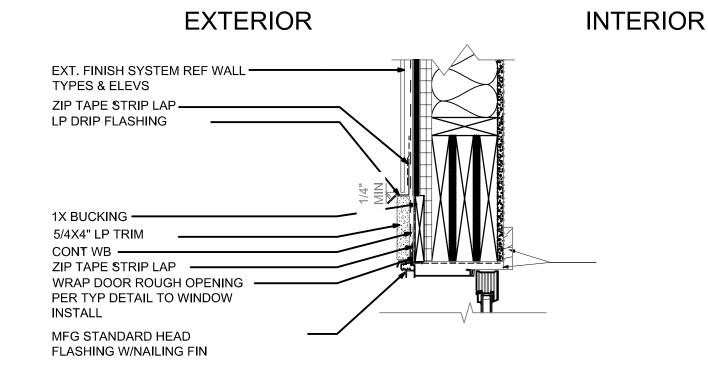


6 DOOR DETAIL - SLIDER HEAD TYP. A503 SCALE: 1 1/2"=1"-0"

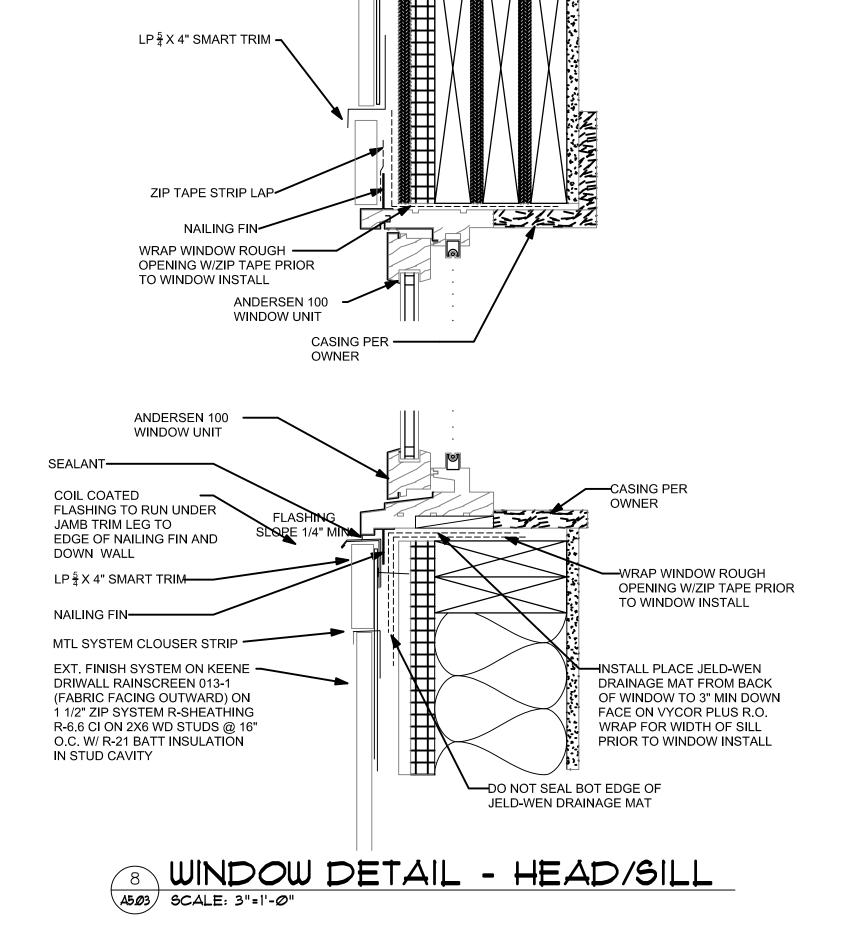


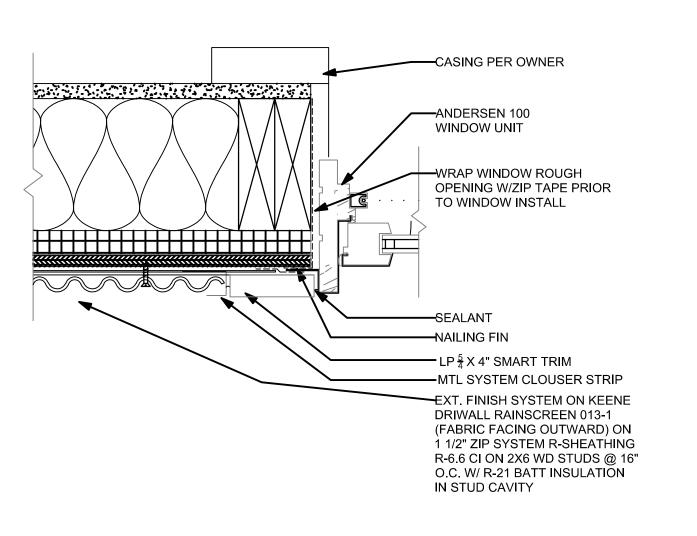


9 WINDOW DETAIL - JAMB
A503 SCALE: 3"=1'-0"

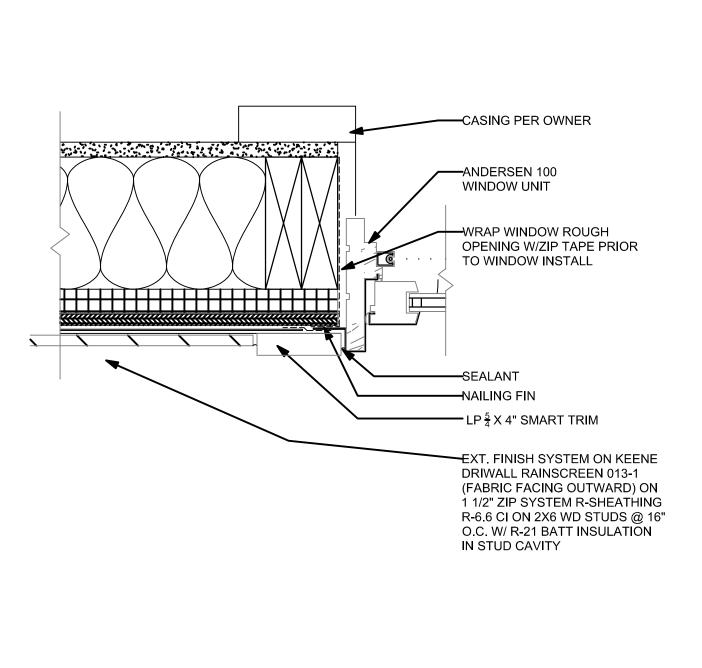



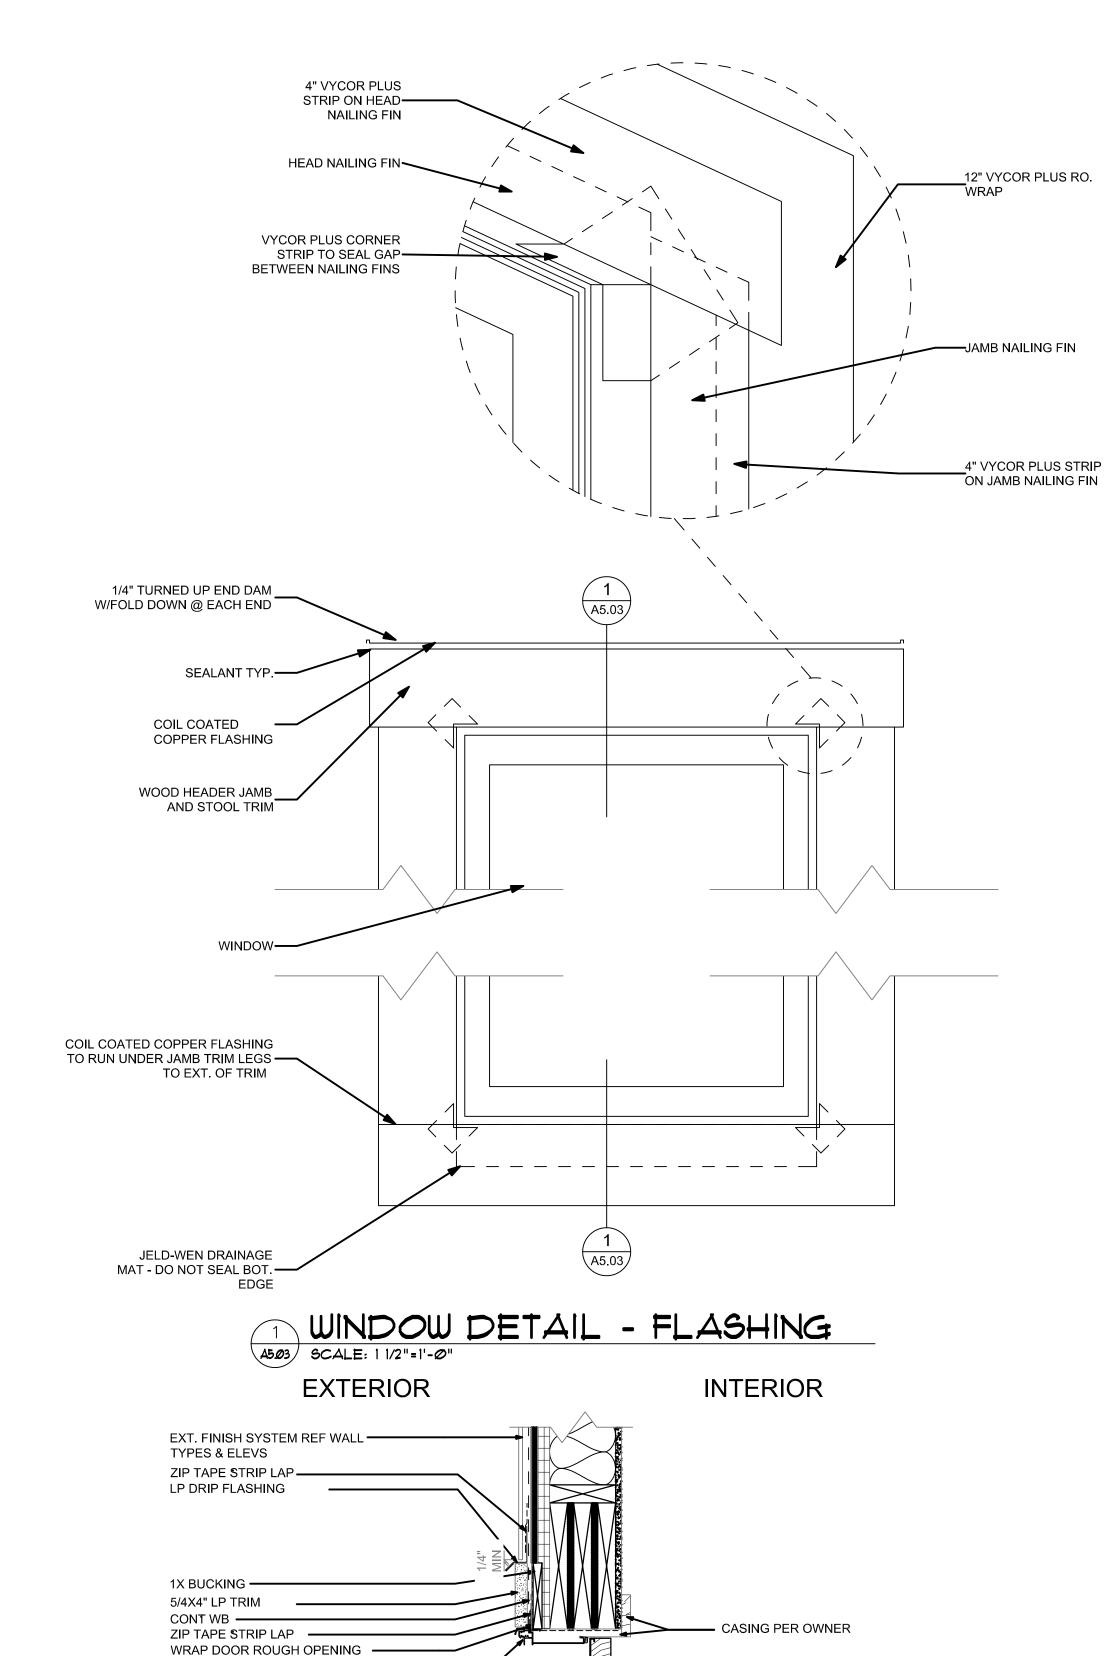

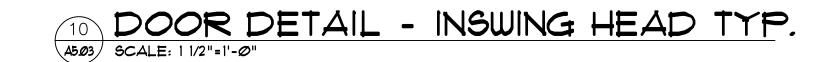


PER TYP DETAIL TO WINDOW

MFG STANDARD HEAD


FLASHING W/NAILING FIN

INSTALL

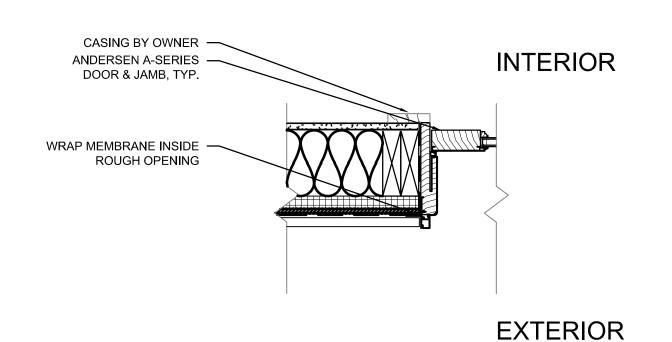

11 DOOR DETAIL - INSWING JAMB, TYP.

A5Ø3 SCALE: 1 1/2"=1'-Ø"

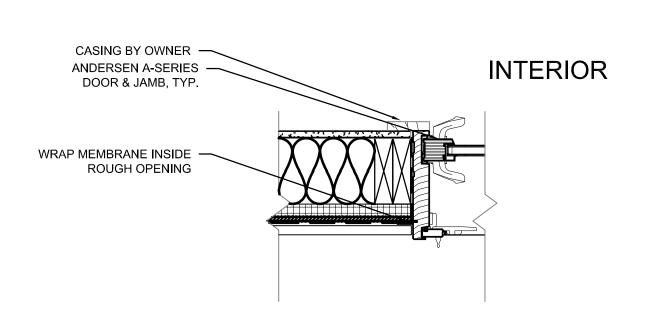


EXTERIOR

12 DOOR DETAIL - SLIDER JAMB, TYP.

A503 SCALE: 1 1/2"=1'-0"

TAB
ASSOCIATES
The Architectural Balance

0056 Edwards Village Blvd.
Edwards, CO 81632
(970) 766-1470
fax: (970) 766-1471
email: tab@vail.net
www.tabassociates.com
Civil Engineer:
Timberline Engineering
(970) 963 9869
Structural Engineer:
KRM Consultants, Inc,
(970) 949-9391

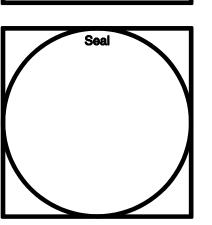

eldan Way

Belden Place - Duplex Units

Lots 10/ 0025 Beldan Way & 11 / 0023 Beldan Market State

Lots 10/ 0025 Beldan Way & 11 / 0023 Beldan Market State

Lots 10/ 0025 Beldan Way & 11 / 0023 Beldan Way & 11 / 00

Revisions:

Issue Dates: 20220509 Struct Coord DFB-09/20/2024

Sheet Title:

Details

2215
Sheet No:
A5.3