
# BELDEN PLACE

## Lot 1 - 0018 Abby Road Single Family Minturn, CO 81645

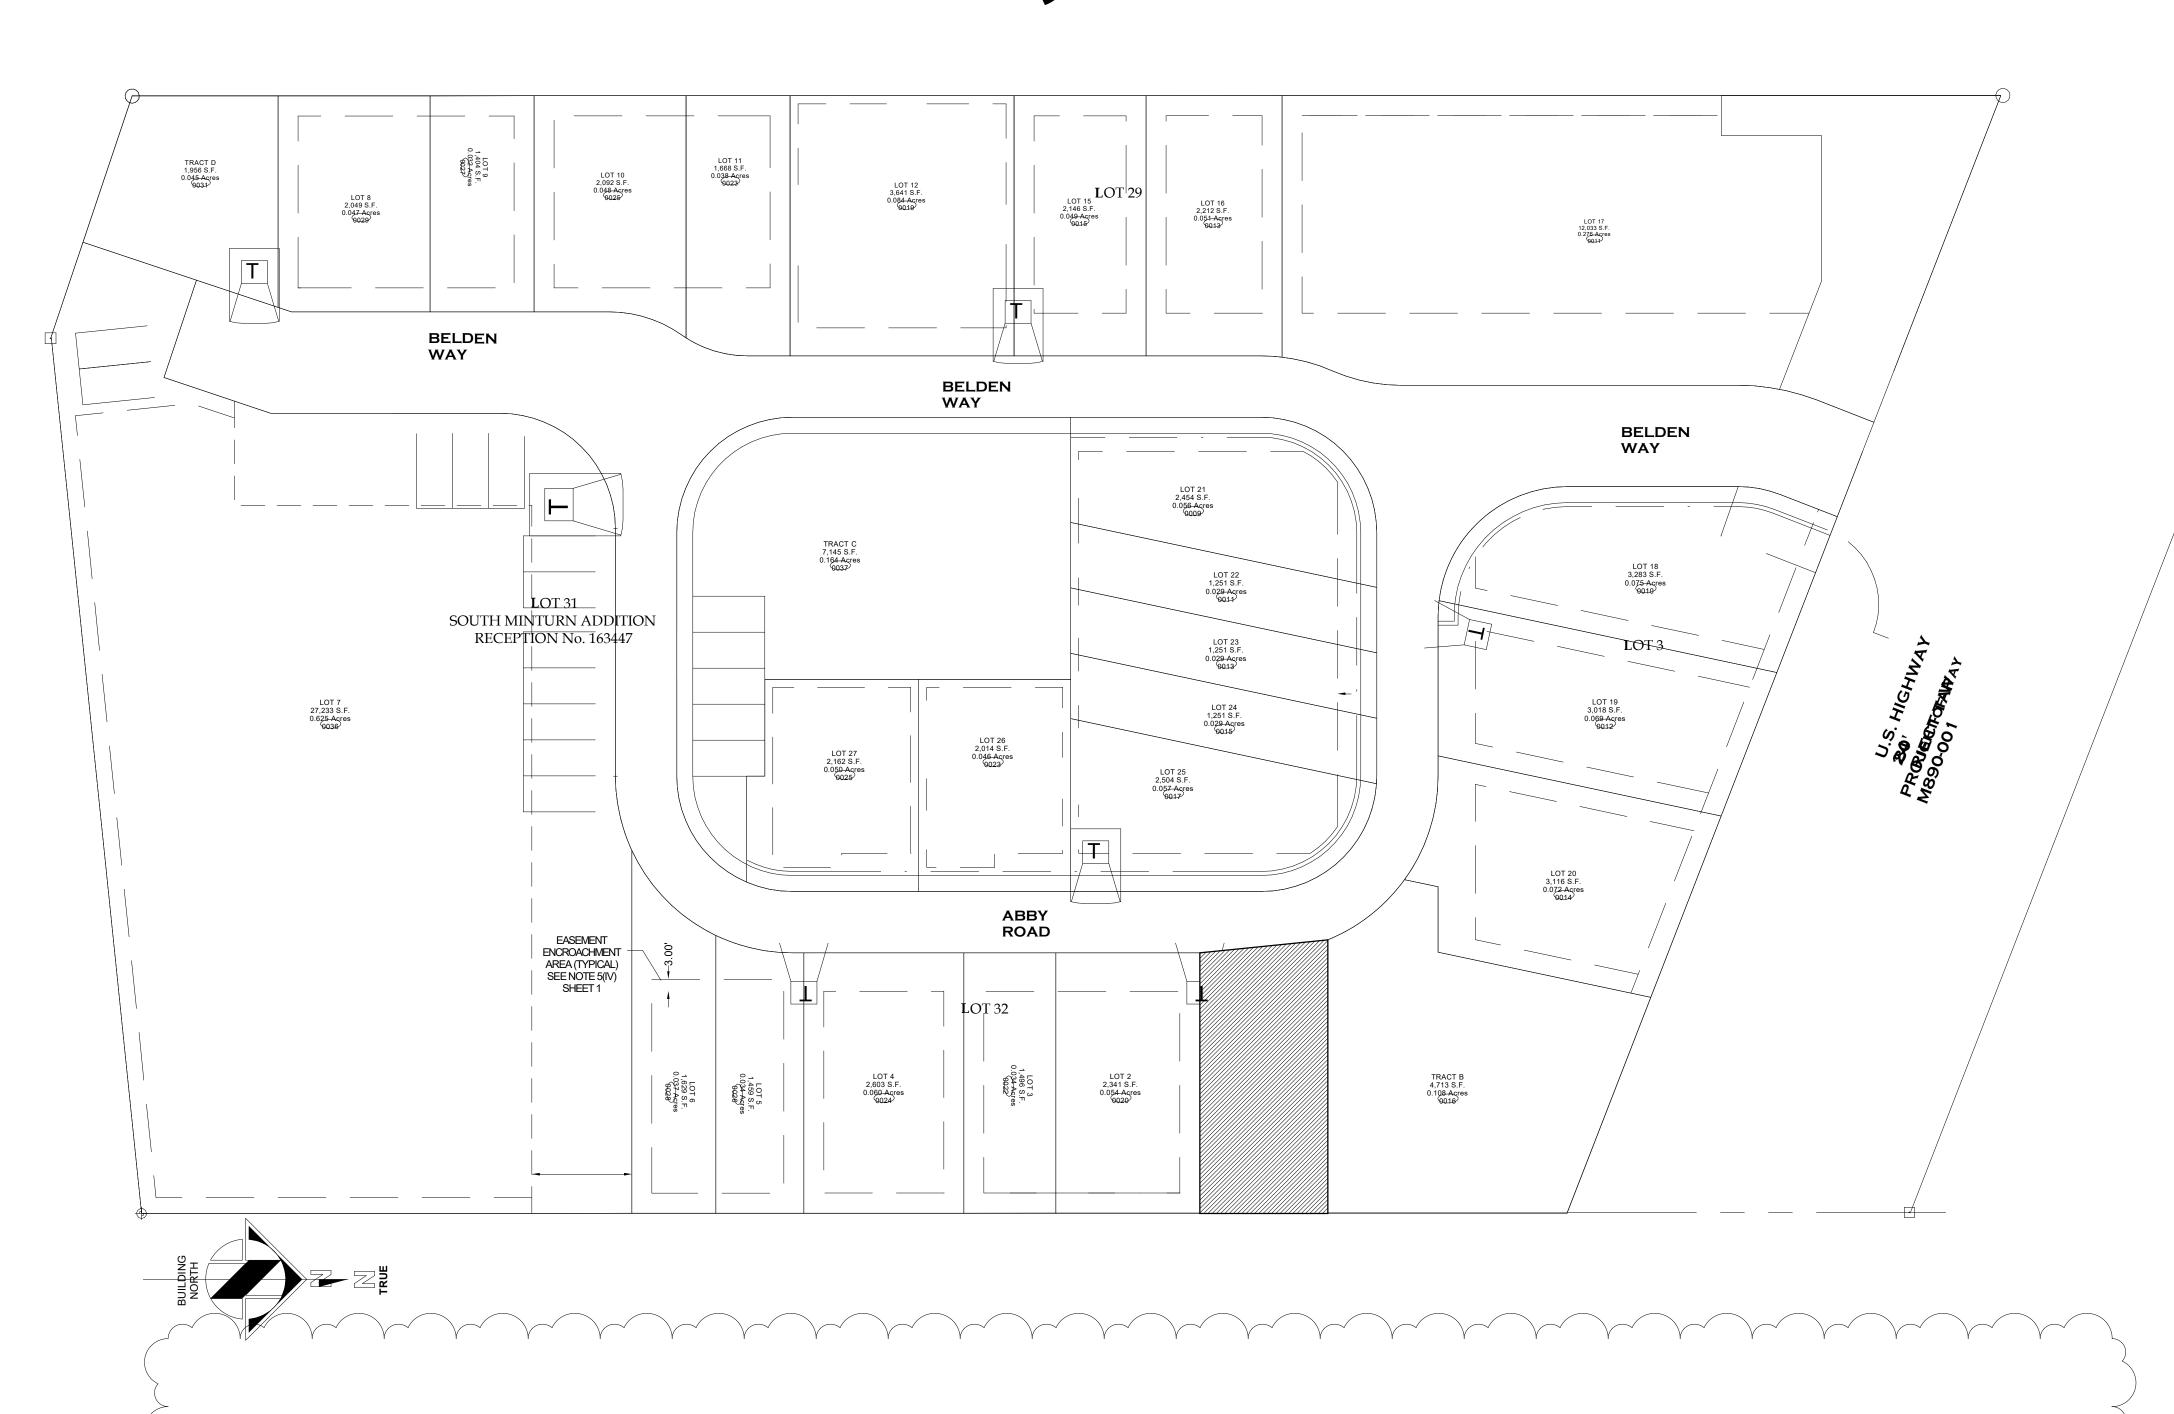

DESIGN REVIEW BOARD - REVISED 03/17/2025

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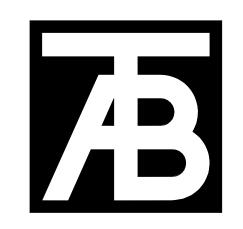
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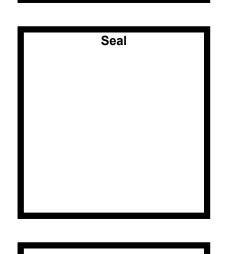


TAB
ASSOCIATES
The Architectural Balance


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Belden Place- Single Family
Lot 01 - 0018 Abby Road






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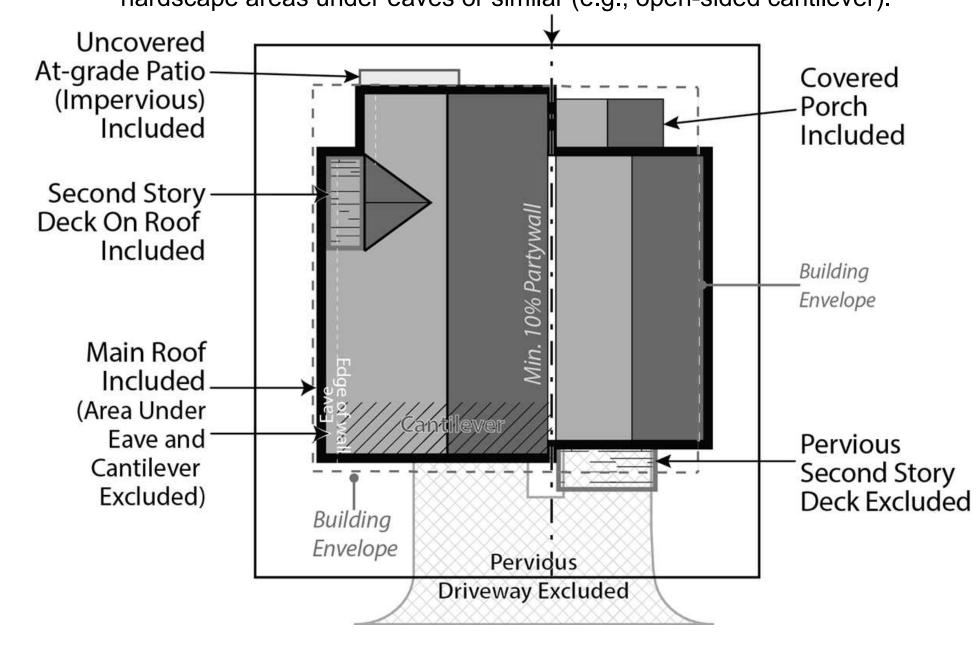
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**Building Height.** Determining building height uses a weighted height calculation as measured from final/finished grade. Max heights - 28' for single famil and duplex, 35' for Row Houses and Flats.

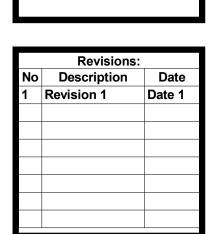

**Site Coverage.** Site coverage means the portion of a lot covered by materials forming any unbroken surface, impervious to water including, but not limited to: buildings, streets, slab on-grade patios, exterior fireplaces, and other hardscape materials. Site coverage excludes non-hardscape areas under eaves or similar (e.g., open-sided cantilever).

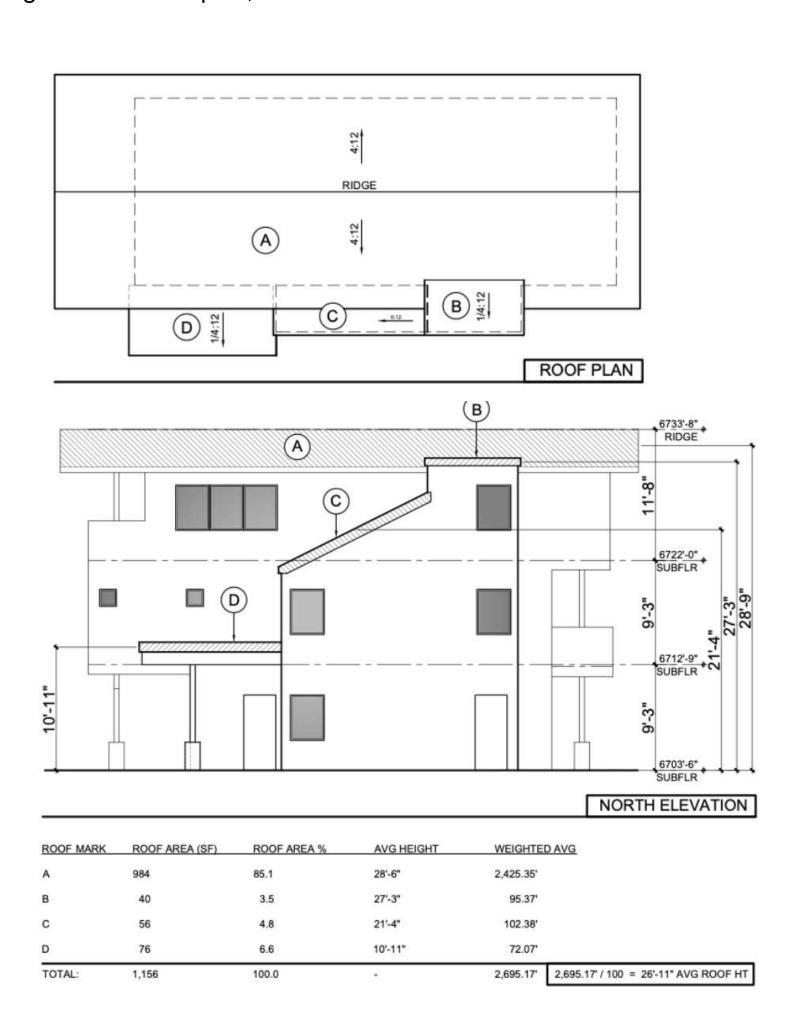

### **BUILDING PLACEMENT AND ENVELOPES**

Residential building envelopes are necessary in order to maximize the buildability and economic viability of the lots while offering greenspace and or space between neighbors to the greatest extent possible. All portions of structure- including fireplaces, chimneys, window wells, eaves, overhangs, etc. must be contained within property lines; however, with the platted building envelope acting as building setbacks for each lot, encroachments are available for certain features.

The following encroachments are permitted beyond the platted building envelope:

Unenclosed or uncovered decks; deck supports; eaves up to 18" beyond the envelope; porches, patios and landings less than 30" above the surrounding natural or finished grade; window or light wells; heat or A/C units; residential solar alternative energy installations; fences; counterforts below grade; staircases (enclosed or otherwise); structures of less than 6" in height; landscaping and drainage features. No encroachment may be located within 24" from the property line or directly on top of in-ground utility easements. Underground parking elements and staircases may encroach within 12" of the most southern property line on Lot 7.

### SINGLE-FAMILY DETACHED

### a. Style

- (1) Residences with the same architectural elevations and coloring shall not be placed adjacent to each other or directly across the street from one another.
- (2) Each residential unit type shall have at least two (2) elevations to provide stylistic diversity. This may include:
- Roof forms/lines and profiles
- . Varied window and door styles
- iii. Varied entry treatments and locations including porches, columns, etc.
- iv. Two or three story homes
- v. Second or third story decks or balconies

### b. Building Form

- (1) The mass of the residence should strongly reflect the architectural style and be scaled to provide visual interest and depth, reduce boxiness and achieve an articulated form on the front and sides of the homes.
- (2) Roofs shall be designed and pitched accordingly in consideration of solar technology and/or drainage.
- (3) Roof-top decks are permitted only on certain lots as established by developer and cannot be added on buildings not constructed with this initial feature.

### 2. DUPLEX/TRI-PLEX or MULTIFAMILY STRUCTURES

### a. Style

- (1) Structures shall have at least two (2) elevations to provide stylistic diversity.
- (2) Units may be multi-stories.
- (3) Units may be divided horizontally (townhomes) or vertically (flats).
- (4) Second story decks or balconies permitted.
- (5) Units have no minimum length of connection and may be joined via shared walls of the garage, external staircases, or main living area wall(s) or floors.

### b. Building Form

- (1) The mass of the residence should strongly reflect the architectural style and be scaled to provide visual interest and depth, reduce boxiness and achieve an articulated form on the front of the homes.
- (2) Roofs shall be designed and pitched accordingly in consideration of solar technology and/or drainage.
- (3) Roof-top decks are permitted only on certain lots as established by developer and cannot be added on buildings not constructed with this initial feature.

### 3. MATERIALS

### a. Roofing materials are limited to the following:

- (1) Artificial wood shingle (to mimic wood shake shingle). Treated wood shake shingles or any other combustible material is prohibited.
- (2) Standing seam metal.
- (3) Asphalt shingles.
- (4) Imitation (composite or similar); or, real slate tiles.
- (5) Non-reflective solar tiles that mimic the above-mentioned products
- (6) Any other recommended FireWise materials similar to the above-mentioned products.

### b. Siding materials are limited to the following:

- (1) Metal
- (2) Wood
- (3) Composite siding
- (4) Fiber cement board (commonly known as "Hardie Board")
- (5) Stucco.
- (6) Any other recommended FireWise materials similar to the above-mentioned products.
- (7) All siding materials to have non-reflective finishes.

### c. Doors and Windows:


- (1) Structures with multiple garage doors must always have identical, matching doors.
- (2) All replacement windows shall be consistent and match the aesthetic of previous windows unless otherwise approved by the design review board. Skylight or solar tubes permitted.
- (3) Screen or storm doors, in addition to typical front doors are permitted. Screen or storm doors cannot replace front doors at any time.
- d. Design Elements. This development may incorporate mountain appropriate design elements into the buildings, including, but not limited to, exposed heavy timber beams as accent elements or entry features, walls faced with wood, stone, faux stone or cultured stone, metal railings or accents. Stucco may only be utilized in small quantities on building facades and is not to be used as a primary material for home.
- e. Building materials for residential exteriors shall include at least two (2) types of materials as part of the building façade.

I. LANDSCAPING – See also PUD Landscaping Plan Shall not interfere with any drainage way, utility, pedestrian access, or entry into any structure. Landscaping shall not obscure windows, be installed under gas fireplace or dryer vents, nor shall any landscaping material overtake any yard, or spread into any common or neighboring yards.

### Landscaping minimums:

- At least one (1) tree per 1,200 sf of lot area and two (2) shrubs for all lots. See also official Landscaping Plan for Belden Place.
   All landscaping proposed on the approved Landscaping Plan
- shall be installed initially with expectations for maintenance.

  3. No exposed soil is permitted. Soil must be covered in groundcover that may consist of seed (includes wildflower seed), cobble, perennials, mulch, or similar.
- 4. All dead materials must be replaced during the same season death occurs.

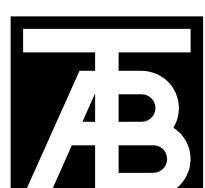

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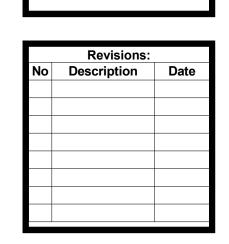
Structural Engineer

(970) 963-9869 <u>Structural Engineer</u> KRM Consultants, Inc (970) 949-9391 <u>Mechanical Engineer</u>

Electrical Engineer

Seal

Belden Place- Single Family
Lot 01 - 0018 Abby Road





Issue Dates: DESIGN REVIEW 02/10/25


> PUD GUIDE


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A0.2



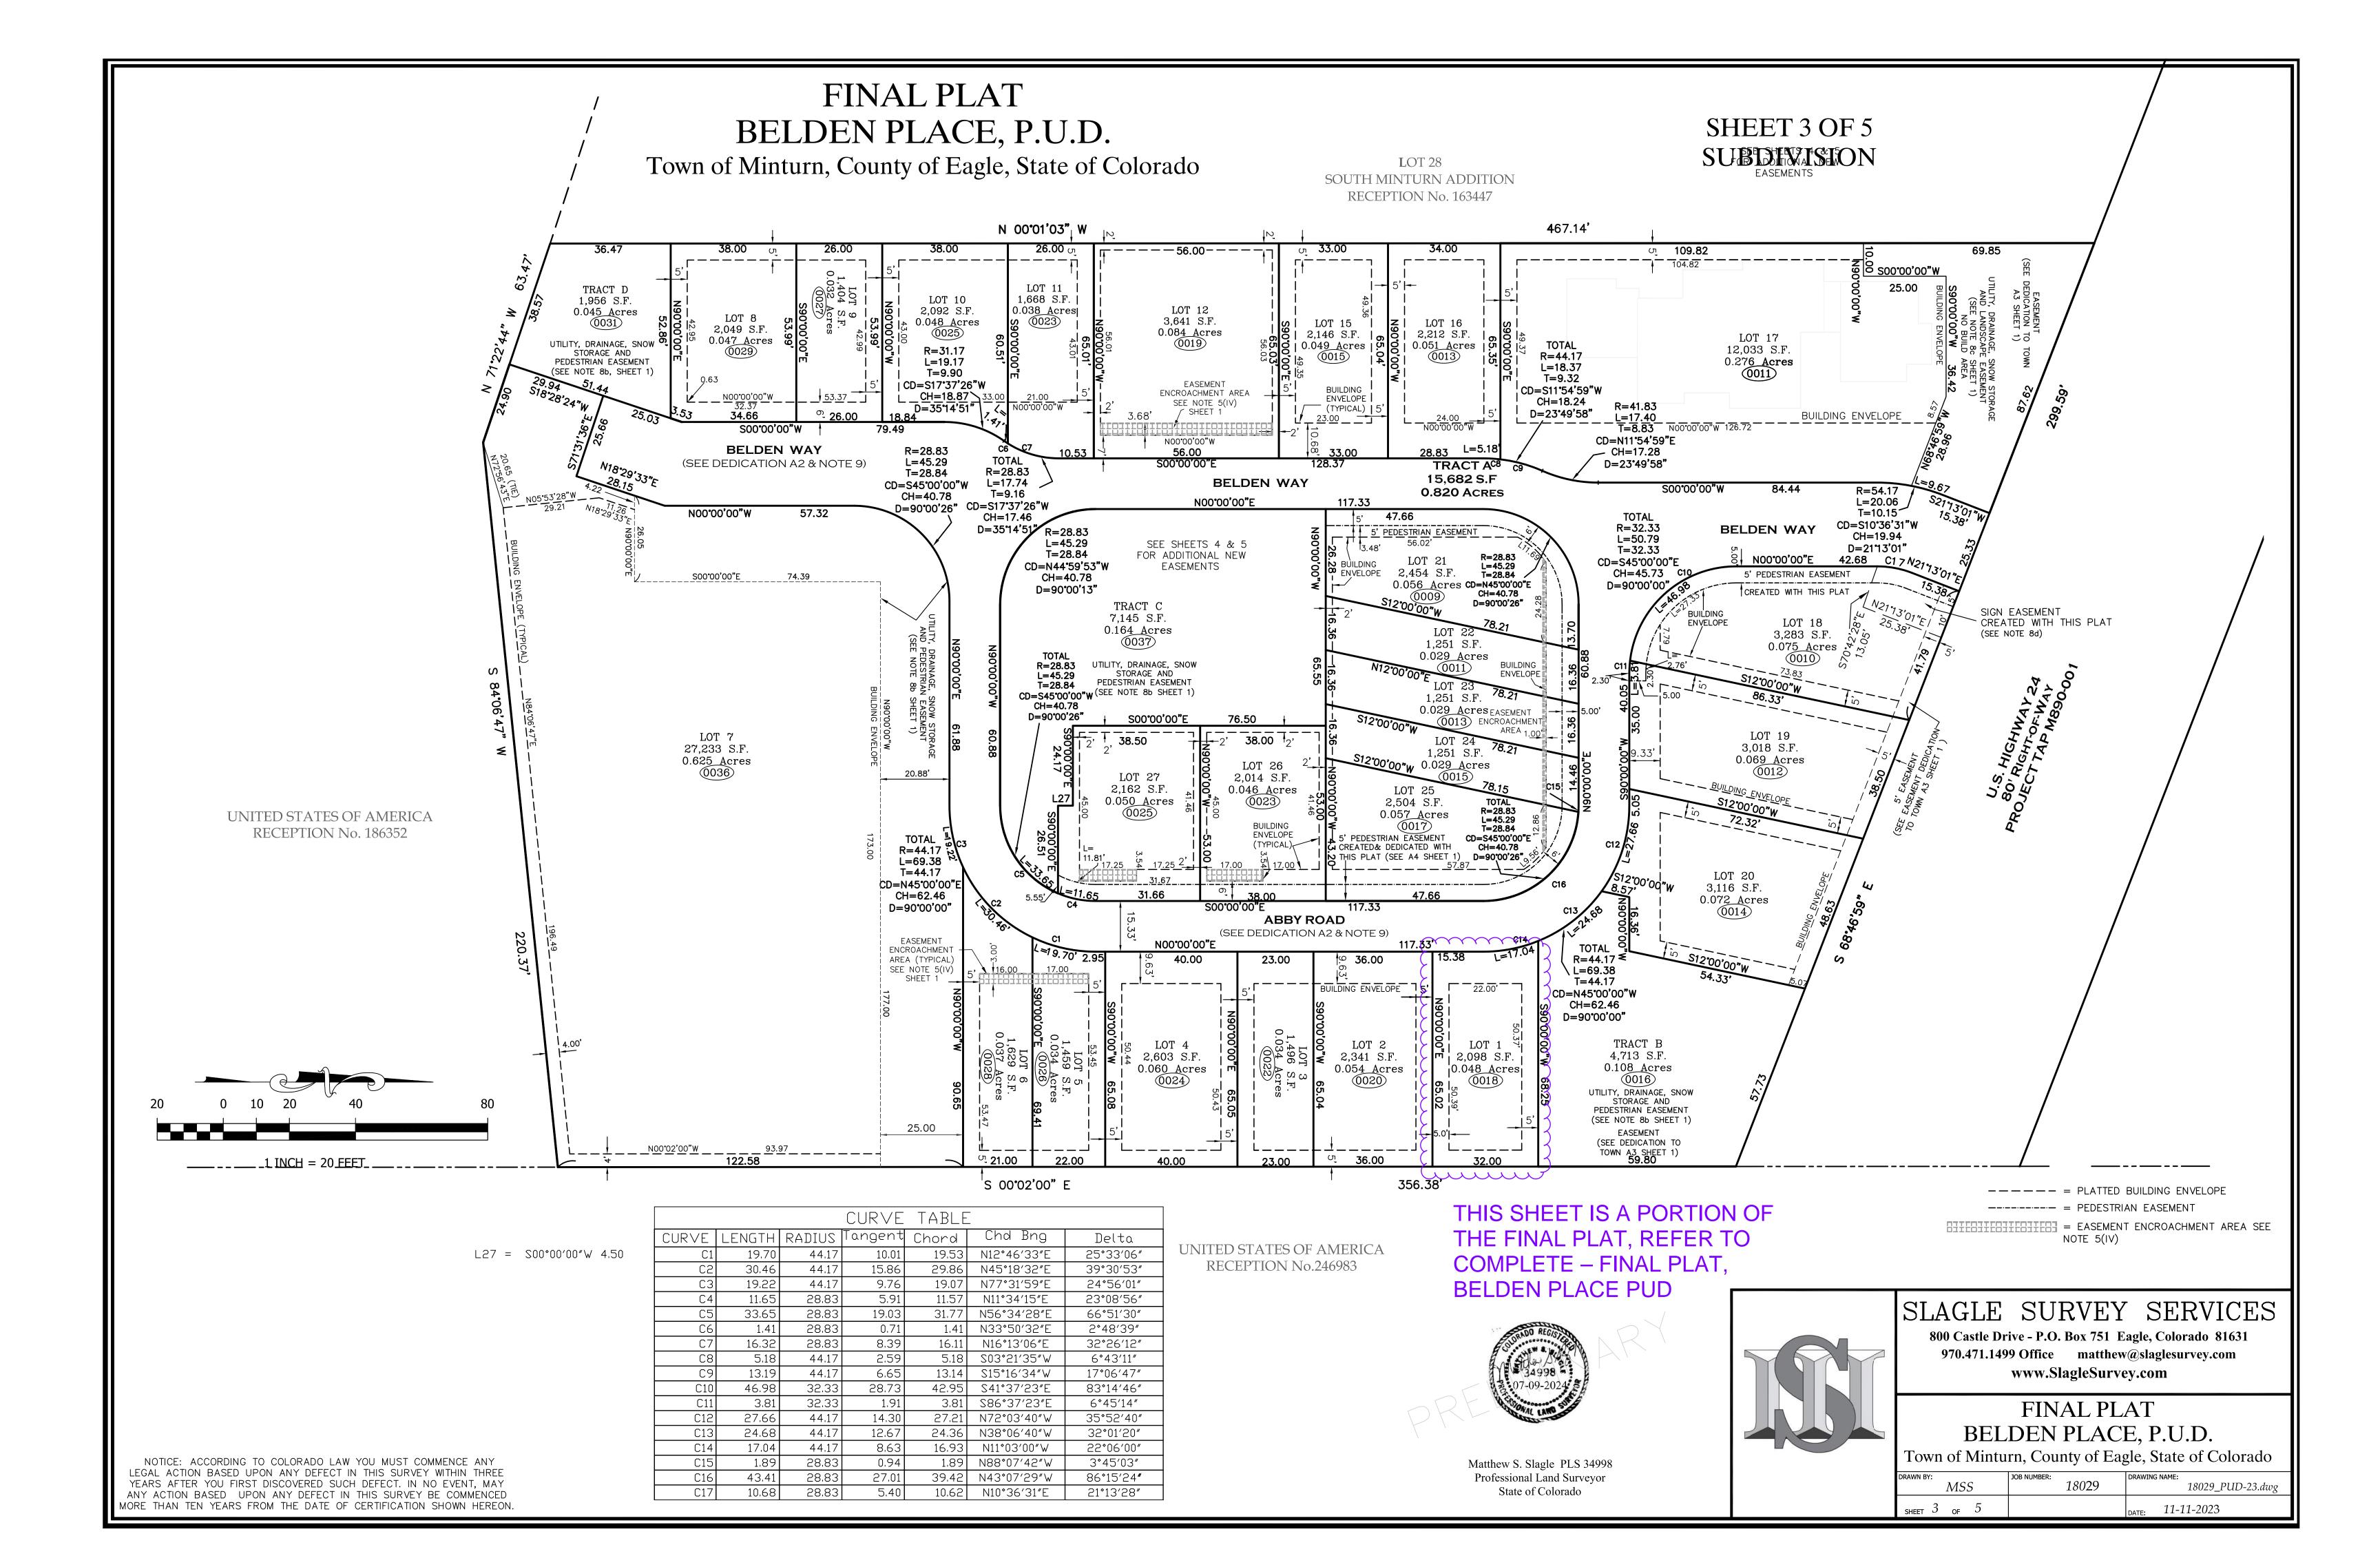

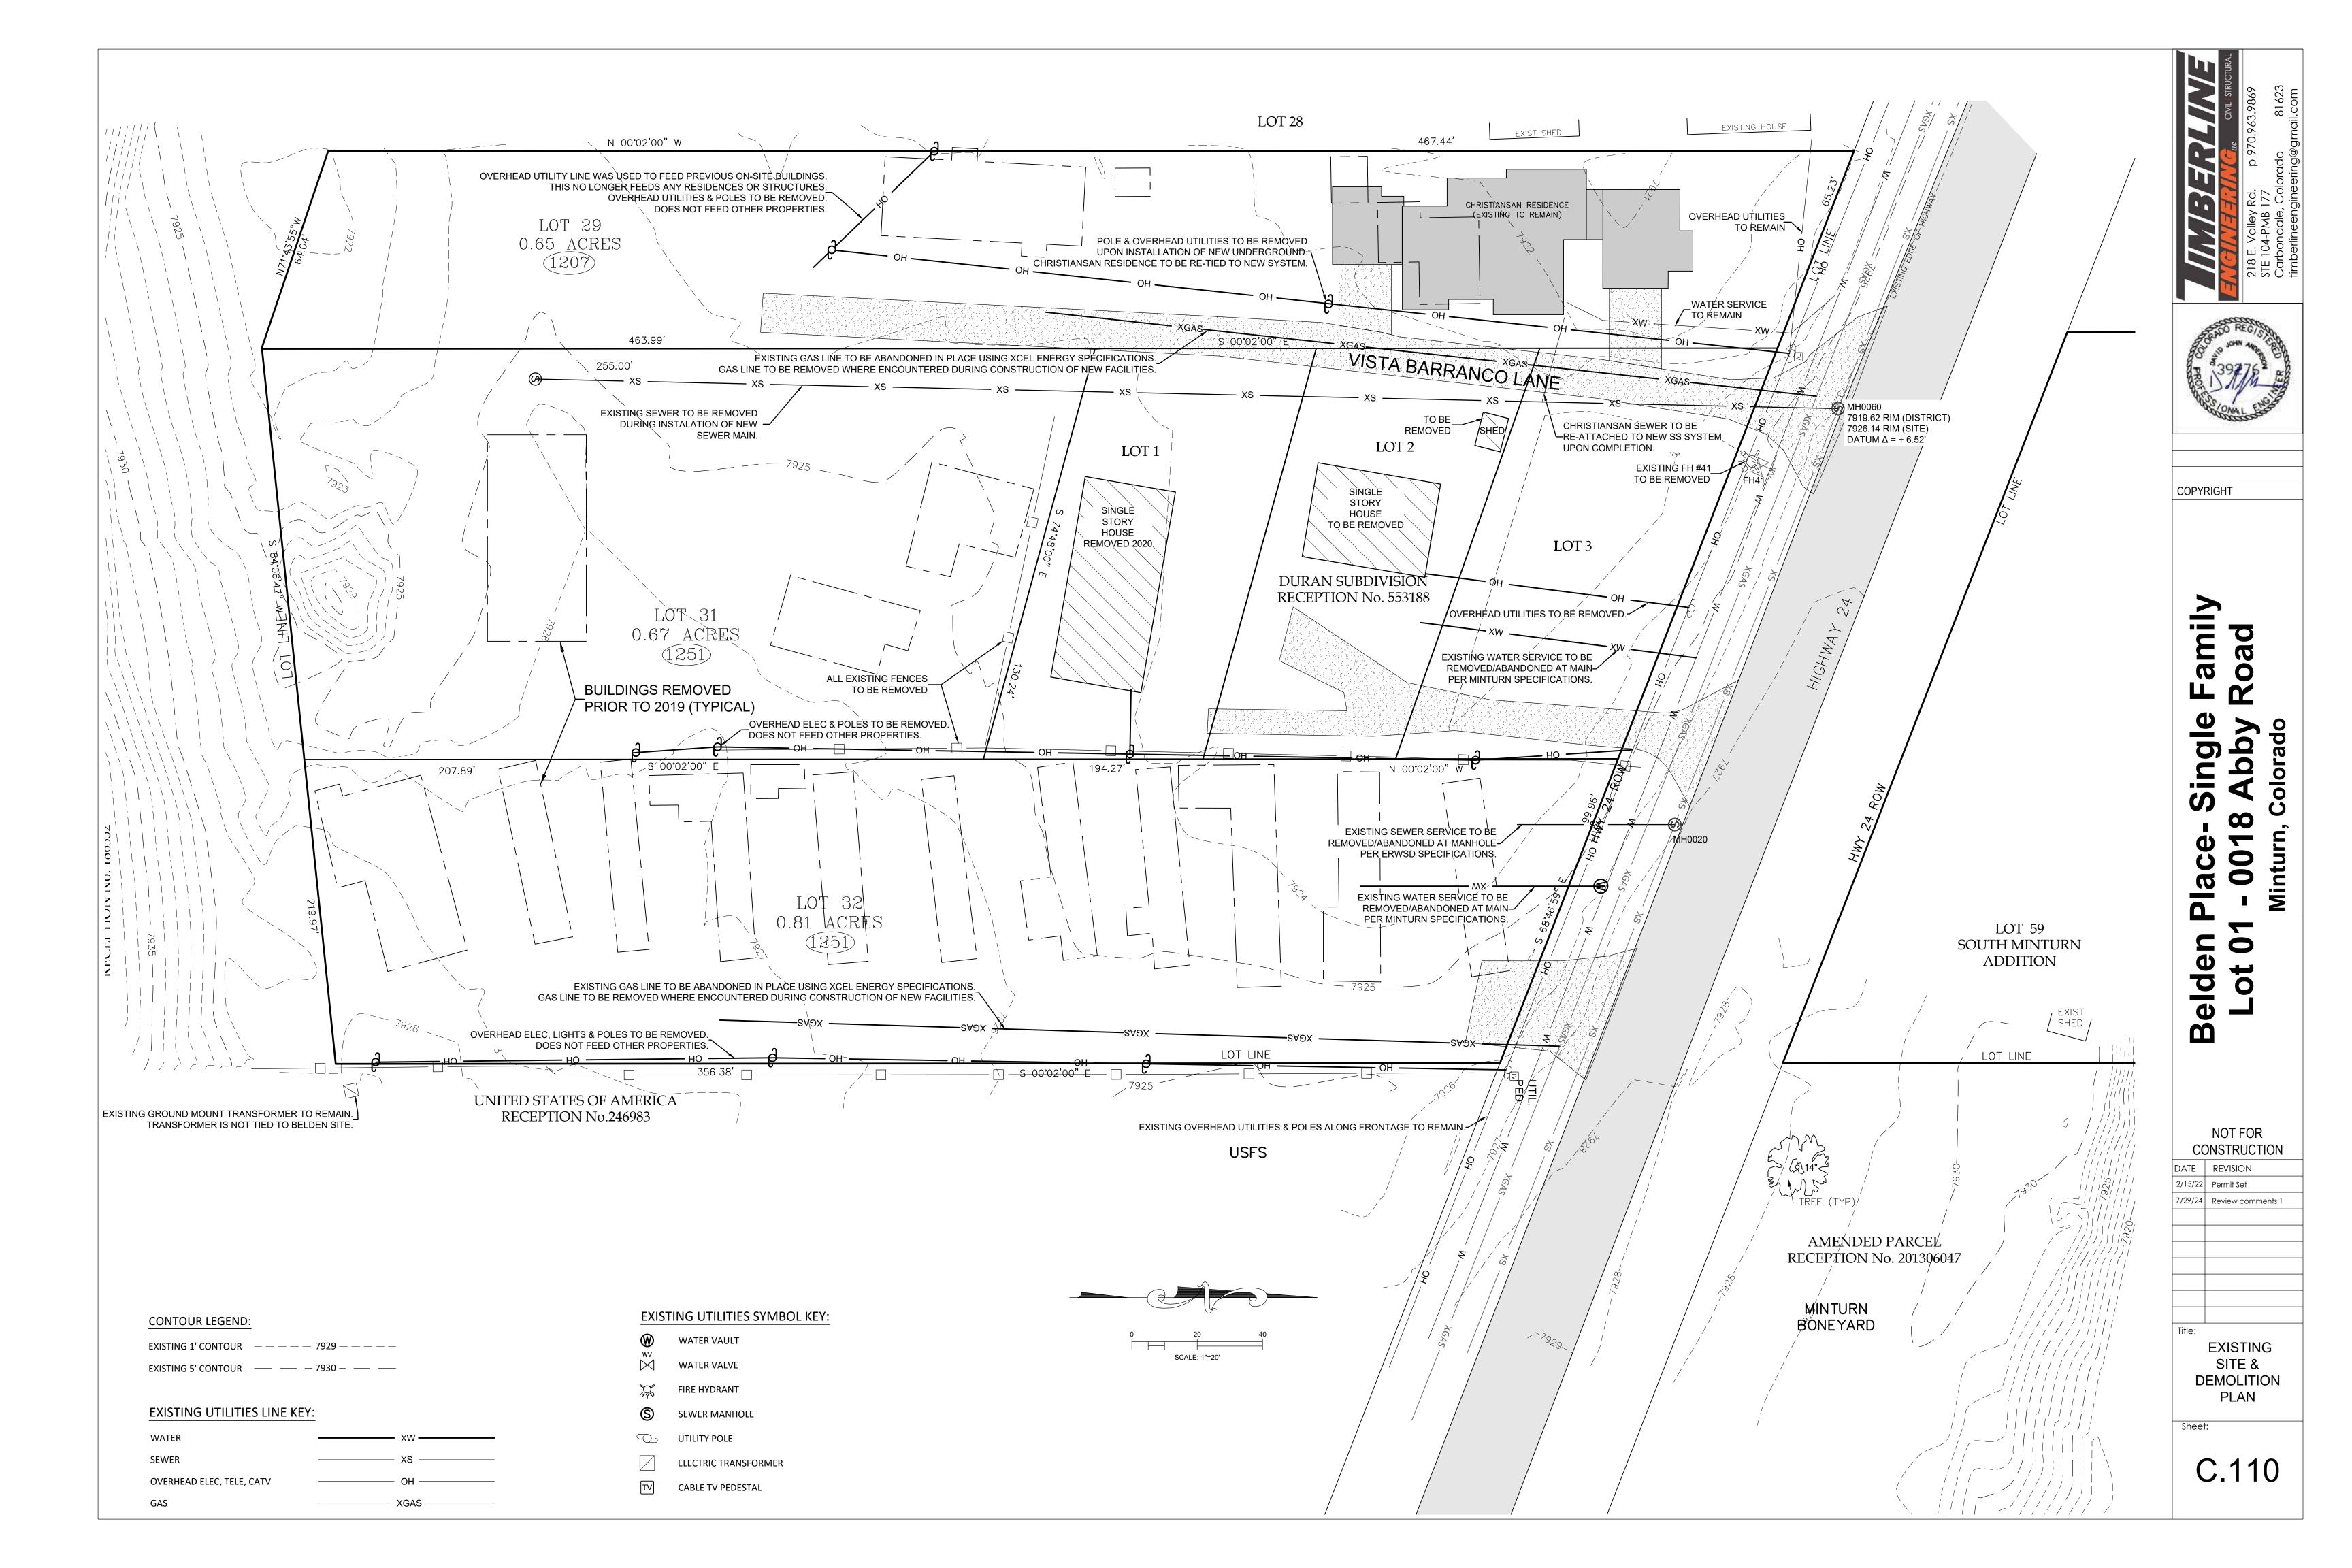

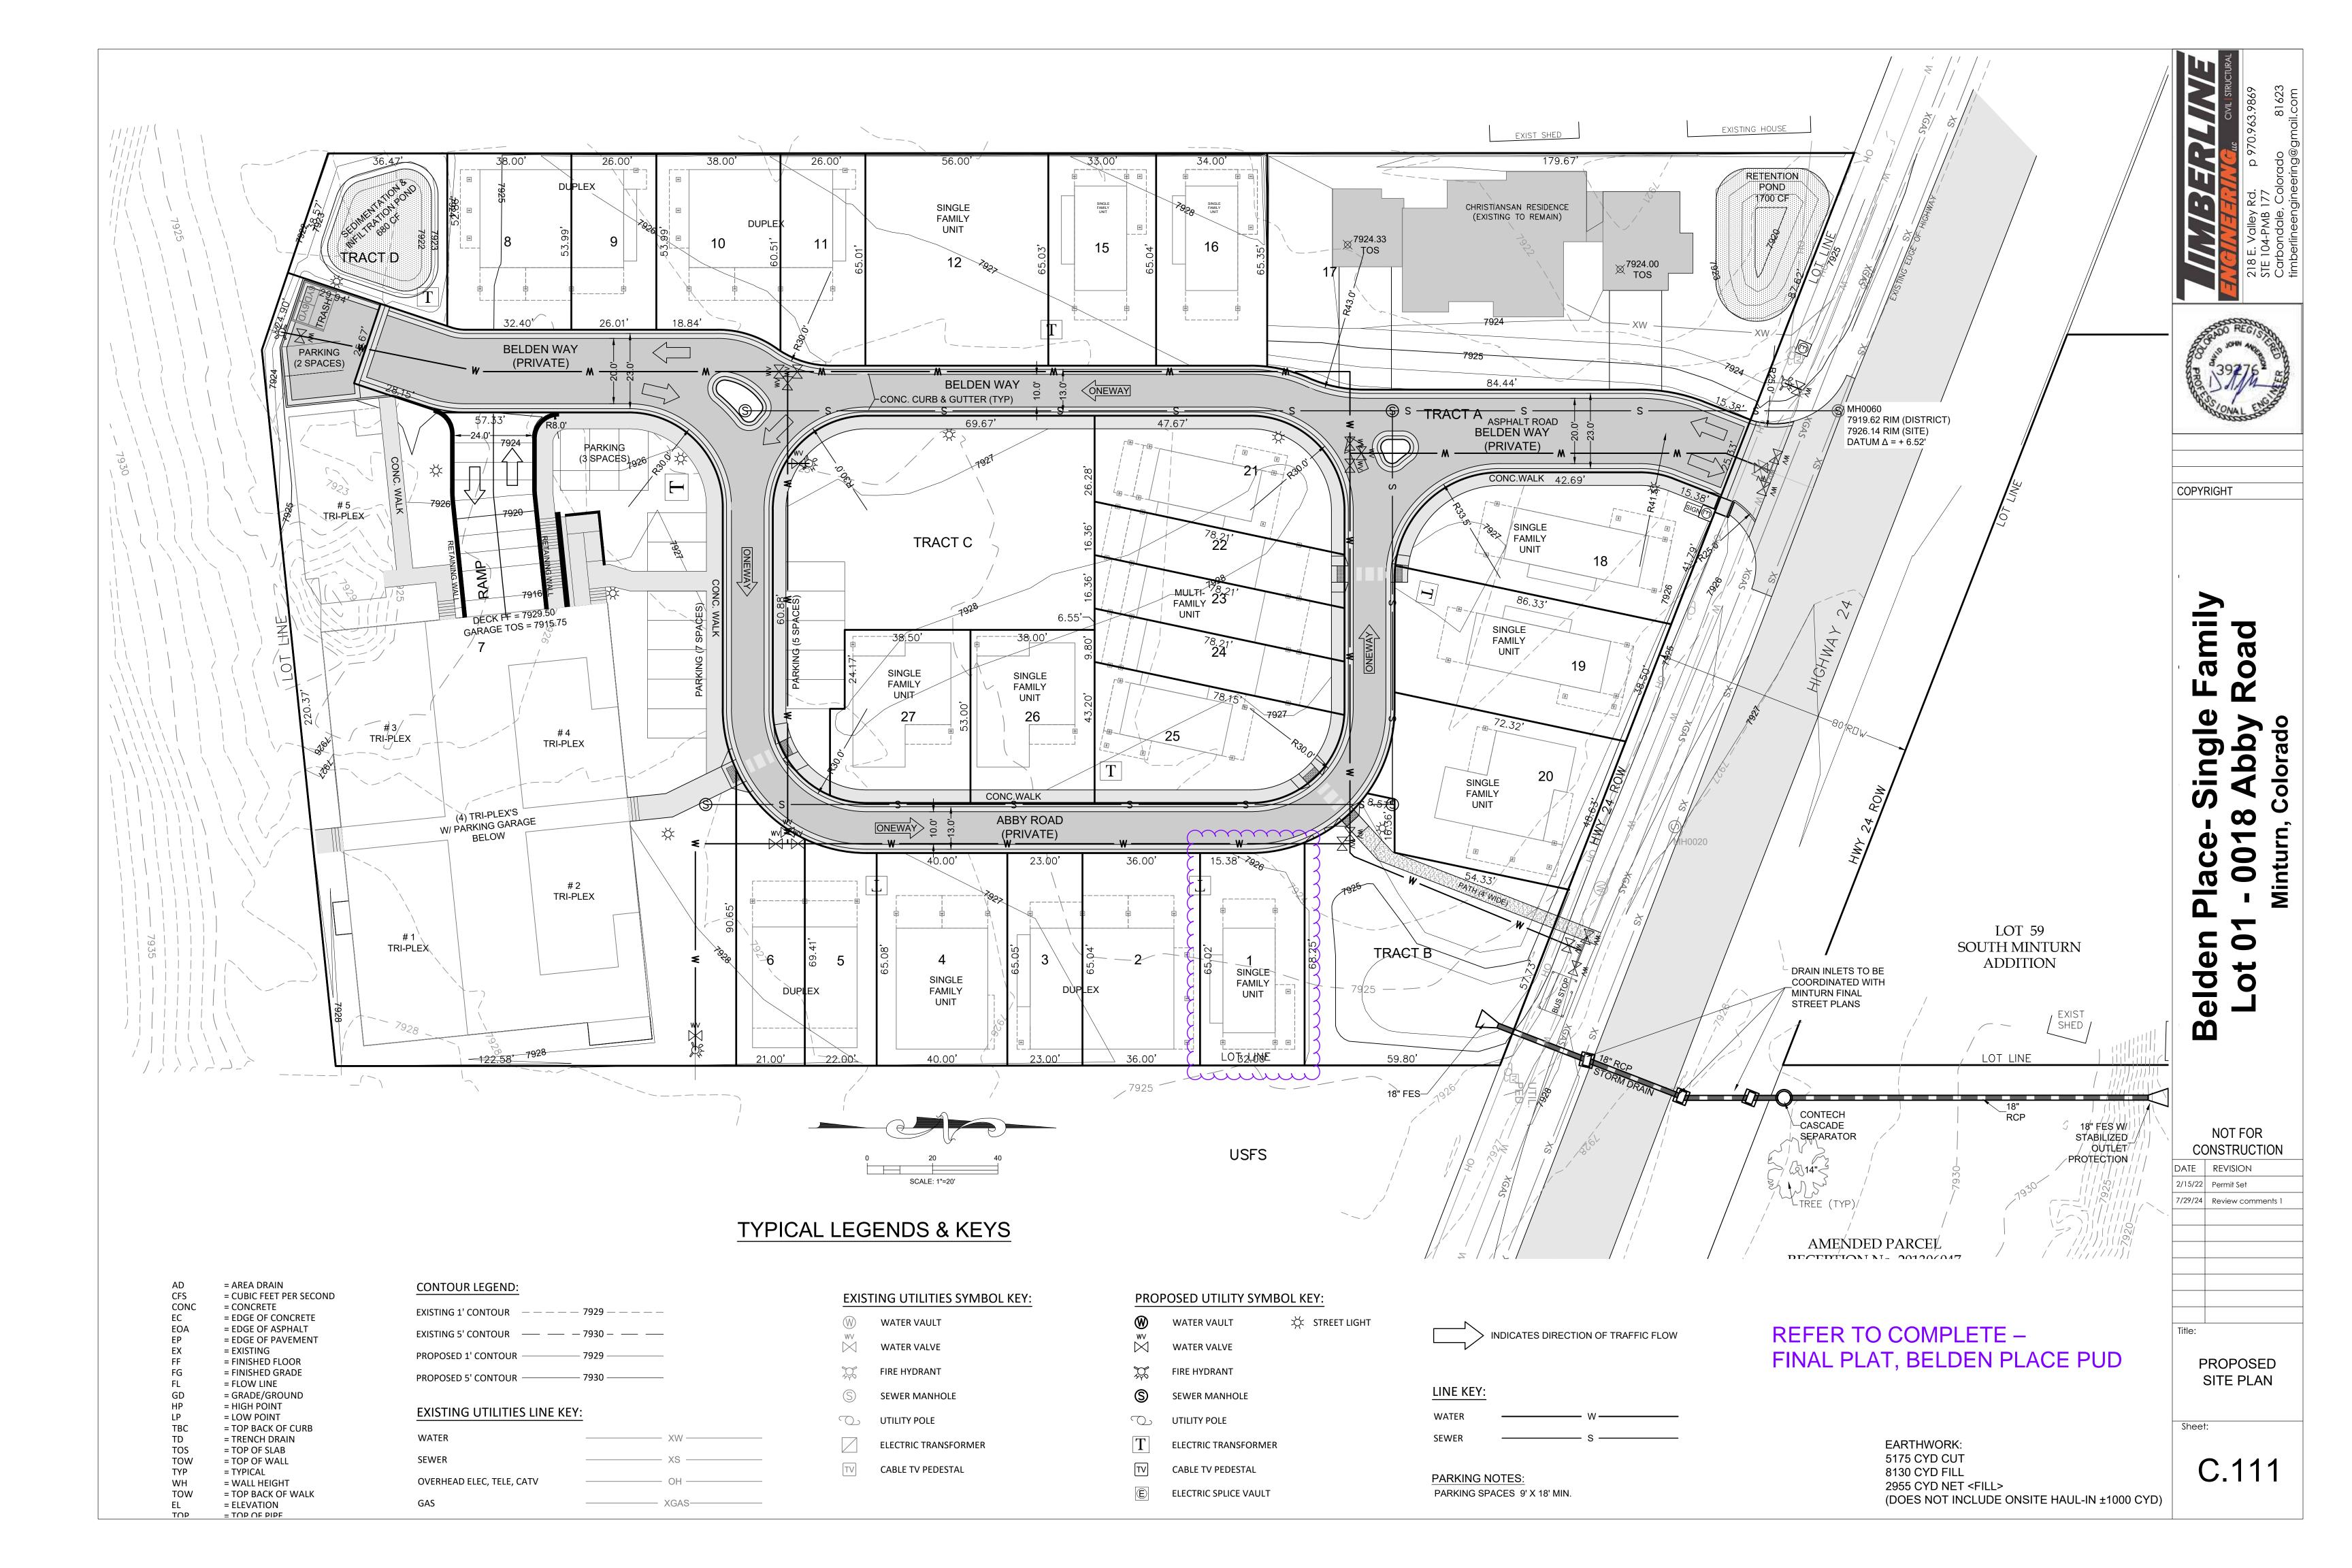

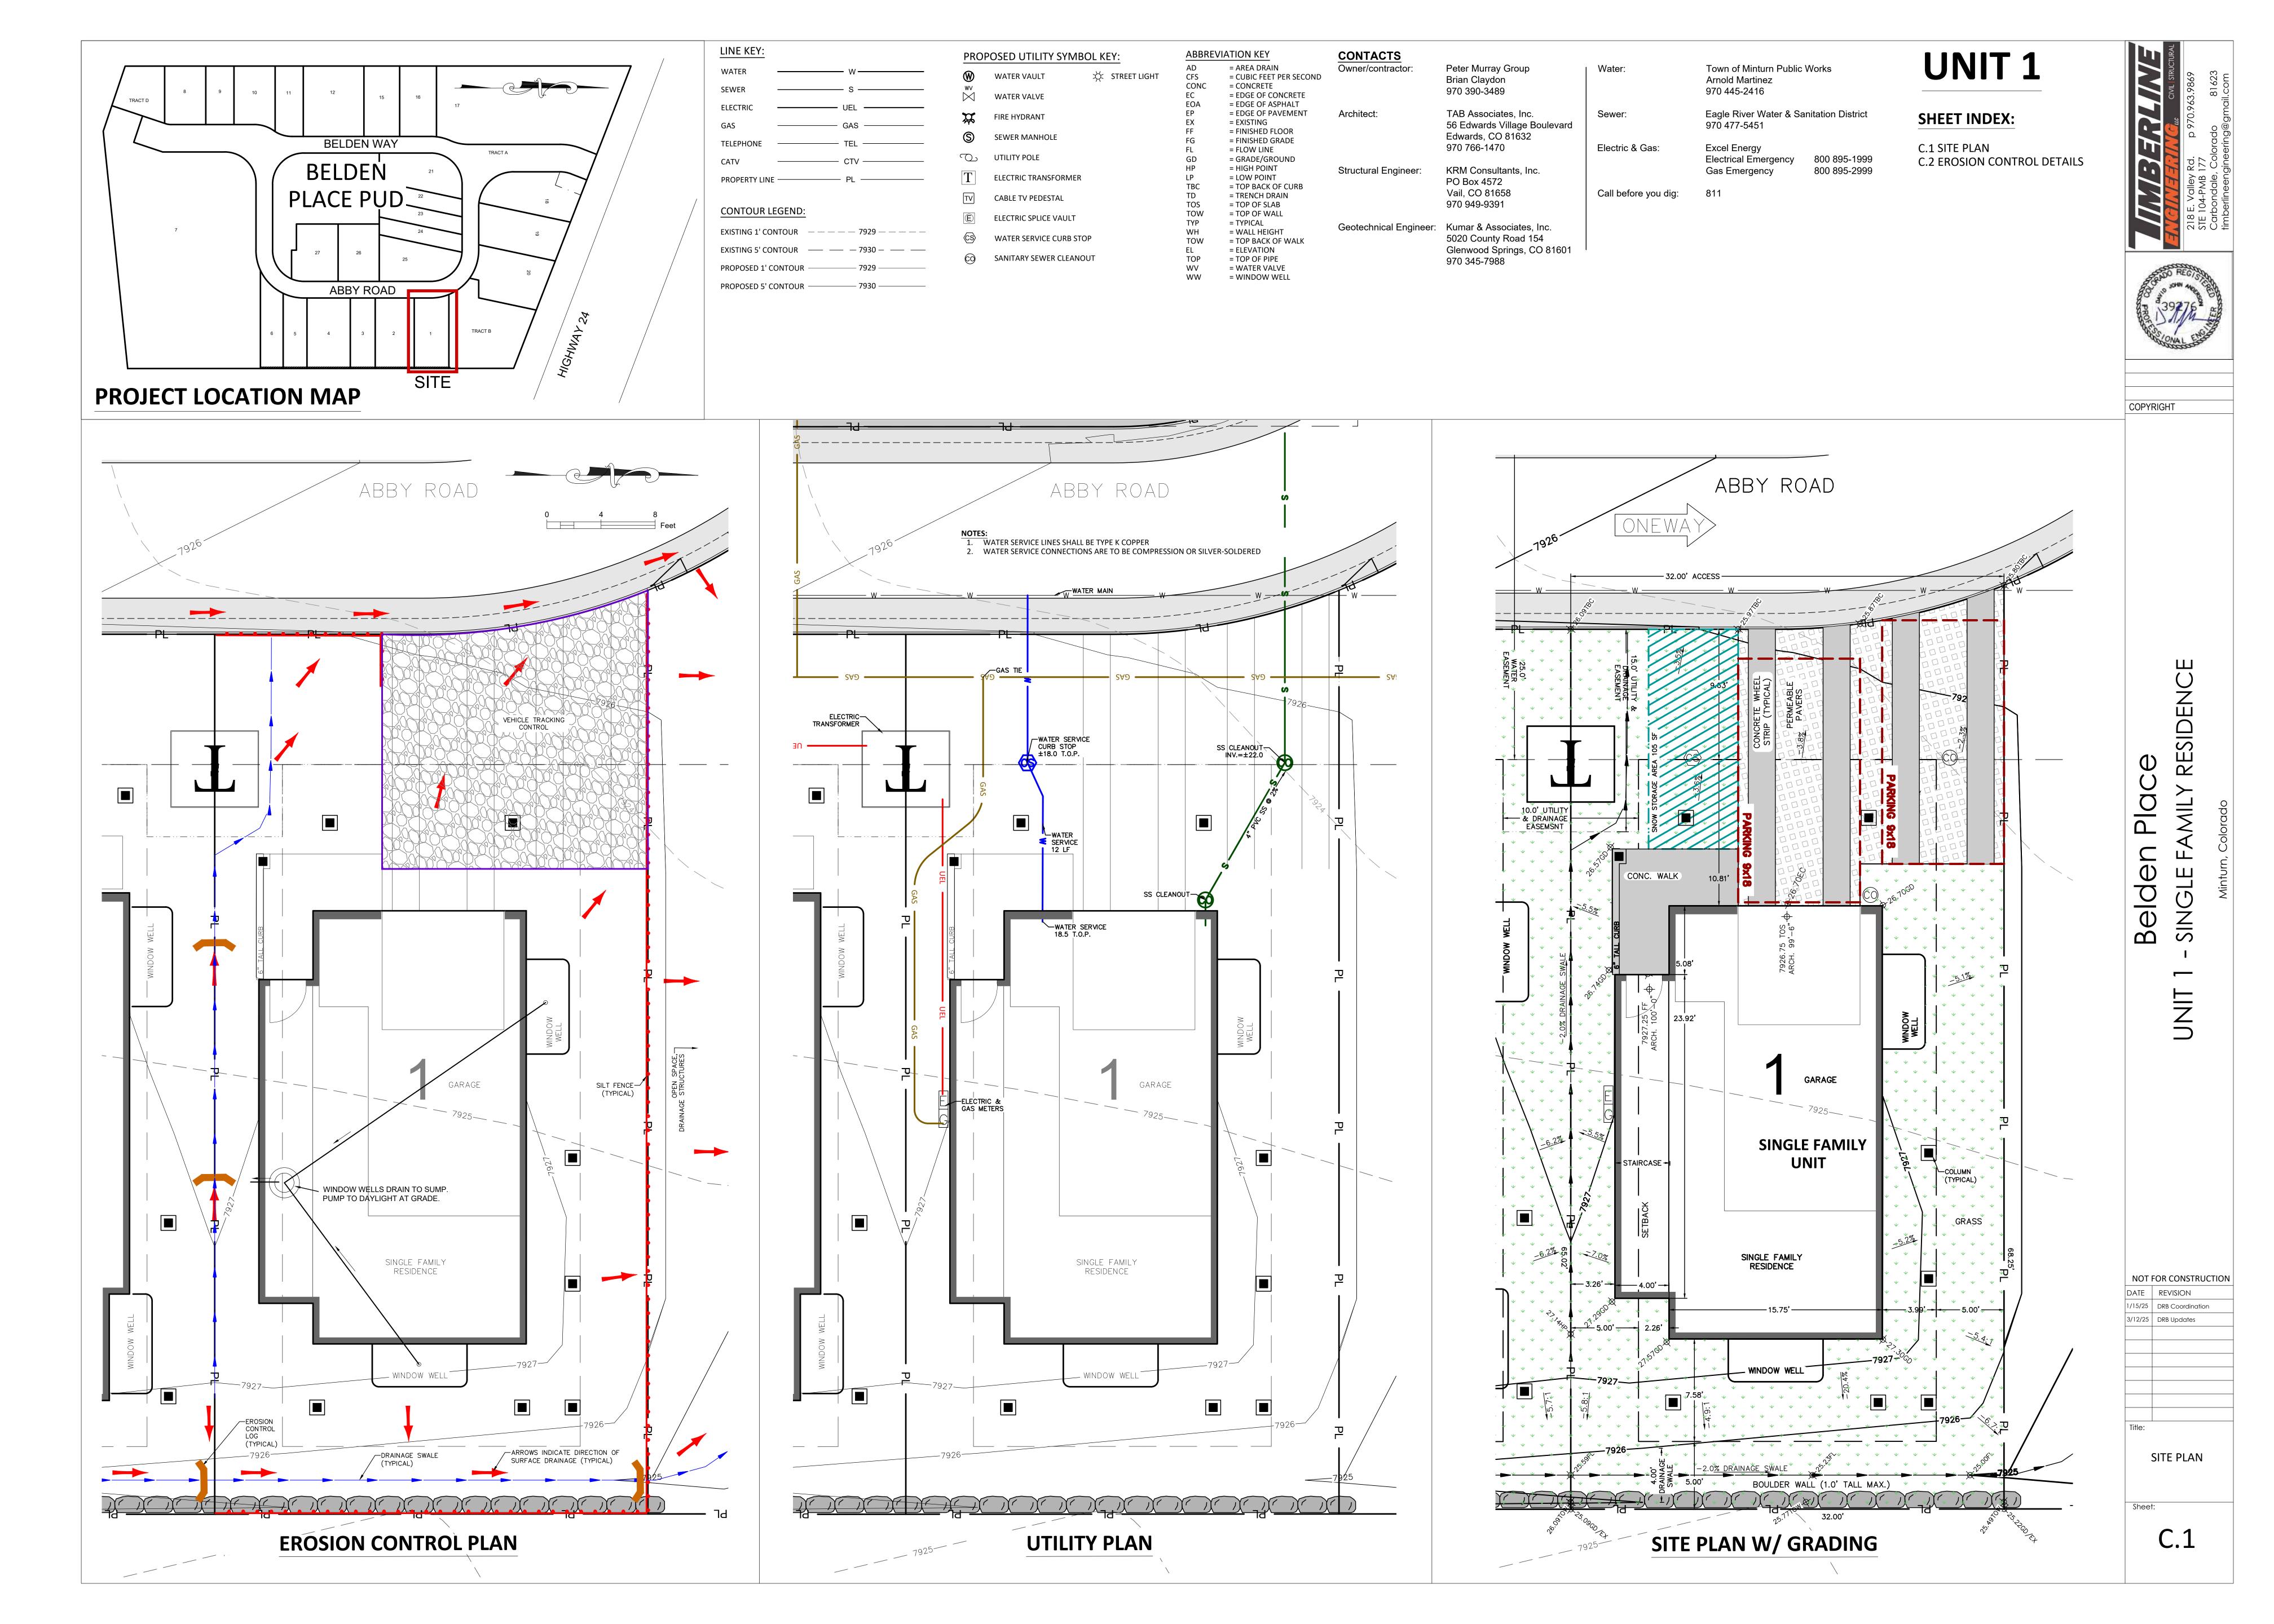
### SEDIMENT CONTROL LOG INSTALLATION NOTES

- SEE PLAN VIEW FOR:
   LOCATION AND LENGTH OF SEDIMENT CONTROL LOG.
- 2. SEDIMENT CONTROL LOGS INDICATED ON INITIAL SWMP PLAN SHALL BE INSTALLED PRIOR TO ANY LAND-DISTURBING
- 3. SEDIMENT CONTROL LOGS SHALL CONSIST OF STRAW, COMPOST, EXCELSIOR, OR COCONUT FIBER.
- 4. NOT FOR USE IN CONCENTRATED FLOW AREAS. 5. THE SEDIMENT CONTROL LOG SHALL BE TRENCHED INTO THE GROUND A MINIMUM OF 2".


### SEDIMENT CONTROL LOG MAINTENANCE NOTES

- 1. THE SWMP MANAGER SHALL INSPECT SEDIMENT CONTROL LOGS DAILY, DURING AND AFTER ANY STORM EVENT AND MAKE REPAIRS OR CLEAN OUT UPSTREAM SEDIMENT AS NECESSARY.
- 2. SEDIMENT ACCUMULATED UPSTREAM OF SEDIMENT CONTROL LOGS SHALL BE REMOVED WHEN THE UPSTREAM SEDIMENT DEPTH IS WITHIN  $rac{1}{2}$  THE HEIGHT OF THE CREST OF LOG.
- 3. SEDIMENT CONTROL LOG SHALL BE REMOVED AT THE END OF CONSTRUCTION. IF ANY DISTURBED AREA EXISTS AFTER REMOVAL, IT SHALL BE COVERED WITH TOP SOIL, DRILL SEEDED AND CRIMP MULCHED OR OTHERWISE STABILIZED IN A MANNER APPROVED BY THE LOCAL JURISDICTION.


EROSION CONTROL LOG DETAIL

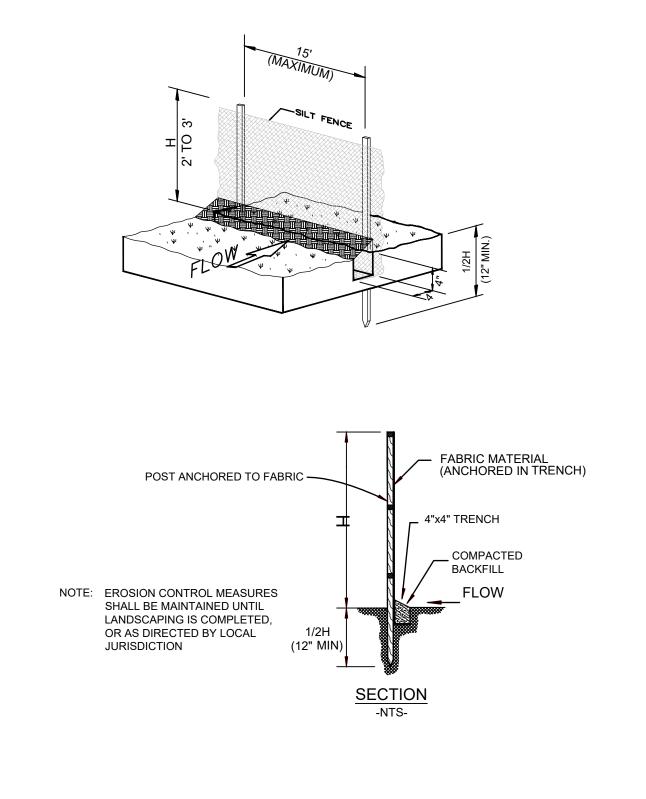


SILT FENCE INSTALLATION DETAIL

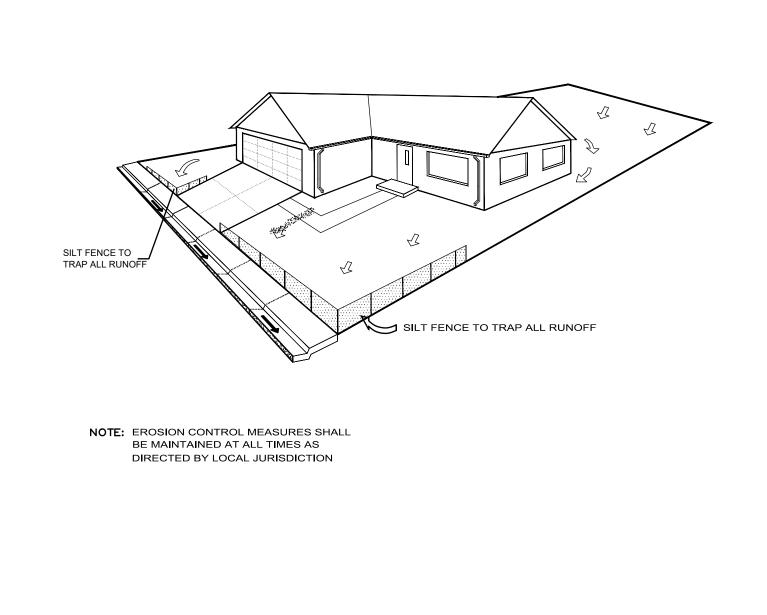

SILT FENCE PLACEMENT DETAIL

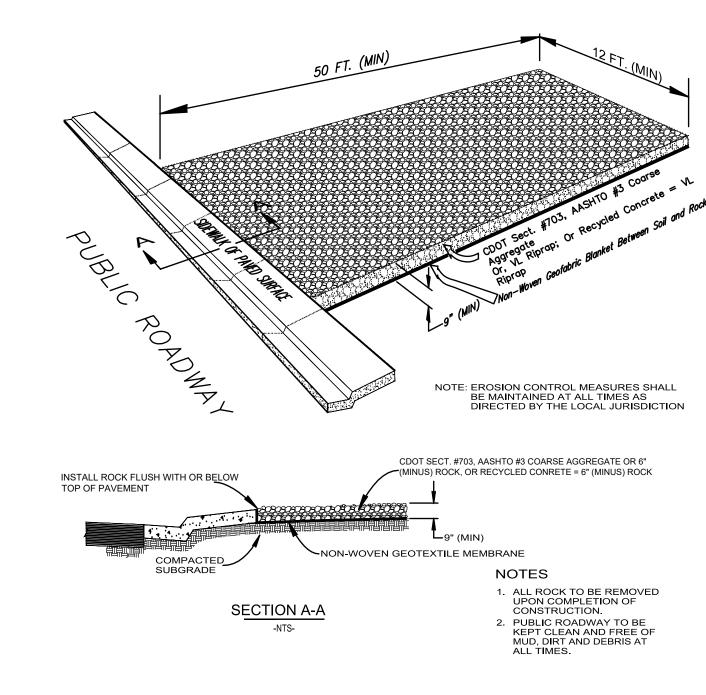

TEMPORARY VEHICLE TRACKING CONTROL DETAIL

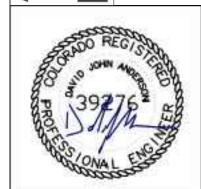

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Belden

NOT FOR CONSTRUCTION

DATE REVISION

1/15/25 DRB Coordination 3/12/25 DRB Updates

**EROSION** CONTROL **DETAILS** 

**C.2** 

1/4 BACKFILL MIXTURE & 3/4 EXISTING SOIL SHRUB PLANTING SCALE: 3/4" = 1'-0' Do not cut single leader. Prune only damaged, dead wood, or co-dominant leaders

12" nylon tree strap with grommets on guy wire. Do not twist straps tight around trunk. 1/2" diameter white PVC pipe section on entire length of each wire -14-Gauge galvanized wire, double strand. Leave 1" to 2" slack in wire to allow for trunk movement. If needed, 6' steel T-post or wood stake (install to 2' depth in indisturbed subgrade) with safety caps, set to windward side and other opposite; or other pre-approved staking method. eciduous Tree Fall Planting: Wrap trunk to first branch with specified ree wrap material. Secure at top with masking tape. Do not wrap rough bark trees. Remove trunk wrap in spring after last frost. Set top of root flare (first order roots) at or 1" above finish grade. emove excess soil from top of root ball and adventitious roots on truni Circle of shredded wood mulch, 3" deep and 4" to 6" away from trunk, to outer edge of planting hole. - Form 2" high dirt saucer around pit at outside of transition zone Completely remove all twine and wire basket. Pull burlay down minimum 2/3 of ball, cut and remove from pit. Slope sides of planting pit as shown, roughen sides prior to backfill Native soil or appropriate planting media. Any broken, crumbling, or otherwise damaged rootball should be rejected. Do not damage during planting. 2X Root Ball Diameter

TREE PLANTING - ADJACENT PERENNIAL BED OR LAWN ADJACENT PERENNIAL BED OR LAWN RE: PLANS STEEL EDGER METAL STAKES

1. CONTRACTOR TO SUBMIT SAMPLE PRIOR TO ORDERING MATERIAL OR DELIVERING TO SITE. 2. NO EDGER REQUIRED WHEN MULCH IS ADJACENT TO PAVEMENT, BORDER, OR WALLS.

3. SET ALL EDGING 1/2" ABOVE FINISH GRADE AS SHOWN. 4. EDGING SHALL ABUT ALL CONCRETE CURBS AND WALKS PERPENDICULAR, AND FLUSH W/ GRADES

5. ALL JOINTS TO BE SECURELY STAKED.

6. CONTRACTOR SHALL CUT TOP EDGE(S) AS NEEDED TO BE PARALLEL WITH GRADE.

8 METAL EDGER SCALE: 3/4" = 1'-0"

3-4 X Root Ball Diameter

### **GENERAL NOTES:**

CONSTRUCTION SHALL CONFORM TO ALL APPLICABLE STATE AND LOCAL CODES AND REGULATIONS

2. CONTRACTOR TO CONTACT THE UTILITY NOTIFICATION CENTER OF COLORADO BEFORE DIGGING, INCLUDING BUT NOT LIMITED TO, TRENCHING, SHRUB AND TREE PLANTING PITS. IF UTILITIES OCCUR WITHIN (3) THREE FEET OF PROPOSED FOOTINGS, THE CONTRACTOR SHALL REPORT SUCH CONDITIONS TO THE OWNER.

CONTRACTOR IS RESPONSIBLE FOR FULL ON-SITE INVESTIGATIONS AS NEEDED IN ORDER TO GAIN A FULL UNDERSTANDING OF EXISTING CONDITIONS PRIOR TO CONSTRUCTION FAILURE TO INSPECT THE SITE PRIOR TO CONSTRUCTION SHALL NOT BE CAUSE FOR REQUESTING ADDITIONAL MONIES BY THE CONTRACTOR.

4. THE CONTRACTOR SHALL OBTAIN, AT HIS EXPENSE, ALL PERMITS WHICH ARE NECESSARY TO PERFORM THE PROPOSED WORK.

THE LANDSCAPE ARCHITECT IS NOT RESPONSIBLE FOR THE CONSTRUCTION MEANS, METHODS, TECHNIQUES, SEQUENCES OR FOR SAFETY PRECAUTIONS OR PROBLEMS UTILIZED IN CONNECTION WITH THE WORK, AND HE/SHE WILL NOT BE RESPONSIBLE FOR THE CONTRACTOR'S FAILURE TO CARRY OUT THE WORK IN ACCORDANCE WITH THE CONTRACT DOCUMENTS.

VERIFY ALL CONDITIONS AT THE JOB SITE AND NOTIFY LANDSCAPE ARCHITECT AND THE OWNER'S REP. IMMEDIATELY OF ANY DIMENSIONAL ERRORS, OMISSIONS OR DISCREPANCIES PRIOR TO ANY DEMOLITION OR CONSTRUCTION.

### SIGHT TRIANGLE NOTES:

PEDESTRIAN SIGHT TRIANGLES: NO ITEMS THAT ARE WIDER THAN 18" MAY BE TALLER THAN 30" WITHIN THE PEDESTRIAN SIGHT TRIANGLE.

CORNER SIGHT TRIANGLES: NO ITEMS TALLER THAN 30" MAY BE PLACED WITHIN THE CORNER SIGHT TRIANGLE, EXCEPT FOR TRAFFIC CONTROL DEVICES AND EQUIPMENT. TREES MUST BE LIMBED TO 8 FEET AT ADEQUATE MATURITY. TREES SHALL BE PLANTED A MINIMUM OF 10 FEET FROM LIGHT OR UTILITY POLES.

ROADWAY SIGHT TRIANGLES: NO ITEMS THAT ARE WIDER THAN 18" MAY BE TALLER THAN 30" WITHIN THE ROADWAY SIGHT TRIANGLE EXCEPT FOR STREET TREES AND TRAFFIC CONTROL DEVICES AND EQUIPMENT.

## TREE PROTECTION ZONE (TPZ) NOTES:

CONTRACTOR SHALL VERIFY FINAL BOUNDARIES OF TPZ PRIOR TO COMMENCEMENT OF CONSTRUCTION/DEMOLITION ACTIVITIES. EXCESSIVE BRANCH PRUNING ON EXISTING TREES FOR CONSTRUCTION CLEARANCE WILL NOT BE PERMITTED. PRUNING FOR BUILDING CLEARANCE SHALL BE MINIMIZED. DUE TO SCOPE OF CONSTRUCTION AND SIZE OF EX. ROW TREES, USE CHAIN LINK FENCING TO ESTABLISH TPZ.

2. THE TREE LAWN WITHIN THE BOUNDARY OF THE TREE DRIPLINE SHALL NOT BE ROTOTILLED AT ANY TIME. ROTOTILLING IS ONLY PERMITTED IN AREAS OUTSIDE OF EXISTING TREE DRIPLINE WHERE CONCRETE & HARDSCAPE ARE REMOVED.


ORNAMENTAL TREES BOTANIC COMMON SPACING Autumn Brilliance Serviceberry Amelanchier x grandiflora


SIZE 8' clump Crataegus x mordenensis 'Toba' Toba Hawthorn 2" Cal Spring Snow Crabapple 2" Cal Malus 'Thunderchild' Thunderchild Crabapple 2" Cal Gambel Oak Quercus gambelii 8' clump


**DECIDUOUS SHRUBS** 

ABB.	BOTANIC	COMMON	SPACING	SIZE	QTY
SAR	Salix repens	Creeping Willow	as shown	5 Gal.	9
sos	Sorbaria sorbifolia	Ash-leaf Spirea	as shown	5 Gal.	6
SOS SPM	Syringa patula 'Miss Kim'	Miss Kim Lilac	as shown	5 Gal.	9
SYO	Symphoricapos occidentalis	Western Snowberry	as shown	5 Gal.	4

PLAN IS ENLARGED DETAIL AND UPDATE FROM THE PUD APPROVED PLAN. REFER TO PUD APPROVED PLAN FOR ADDITIONAL INFORMATION

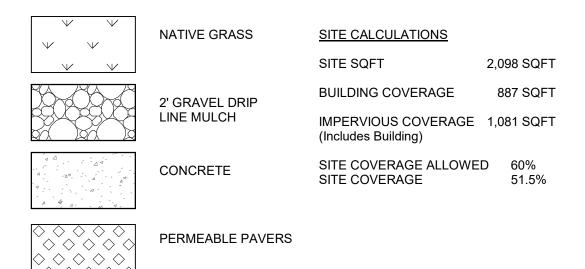

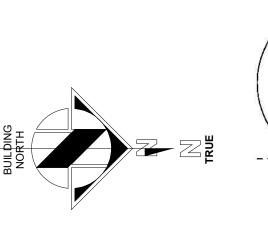

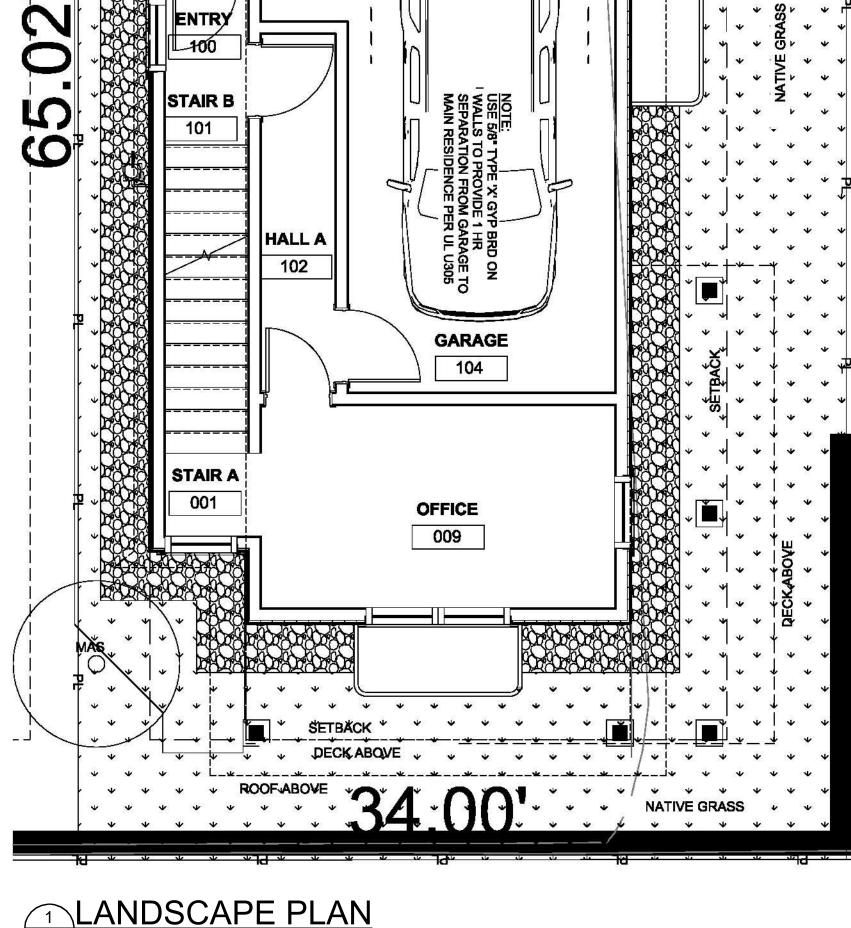

### **1 LANDSCAPE PLAN** A1.1 1/4" = 1'-0"

### LANDSCAPE NOTES:

- ALL NEW LANDSCAPE AND IRRIGATION SHALL BE UNDER WARRANTY FOR A PERIOD OF (1) ONE YEAR. THE WARRANTY PERIOD SHALL COMMENCE ONCE ALL PUNCH LIST ITEMS ARE SATISFACTORY COMPLETED AND A LETTER OF FINAL COMPLETION IS PROVIDED FROM THE OWNER'S REPRESENTATIVE. ALL LANDSCAPE AND IRRIGATION MAINTENANCE SHALL BE THE RESPONSIBILITY
- 2. PLANT MATERIAL AND BED LOCATIONS TO BE STAKED BY THE LANDSCAPE CONTRACTOR FOR REVIEW BY THE OWNER'S REPRESENTATIVE OR LANDSCAPE ARCHITECT. ALL ADJUSTMENTS SHALL BE MADE BY THE CONTRACTOR. THE CONTRACTOR SHALL NOT DIG PLANT PITS UNTIL LOCATIONS ARE **APPROVED**

OF THE CONTRACTOR 1 YEAR AFTER THE FINAL COMPLETION IS PROVIDED IN WRITING.

- ROUGH GRADING TO PLUS OR MINUS ONE TENTH OF A FOOT BY GENERAL CONTRACTOR. LANDSCAPE CONTRACTOR TO PROVIDE FINISH GRADING IN ALL LANDSCAPE AREAS. LANDSCAPE CONTRACTOR TO APPROVE ROUGH GRADES PRIOR TO MOBILIZATION. MOBILIZATION ON THE PART OF THE LANDSCAPE CONTRACTOR WILL INDICATE THAT ROUGH GRADING IS ACCEPTABLE TO THE LANDSCAPE CONTRACTOR, AND THEREFORE BE RESPONSIBLE FOR PROVIDING ALL FINISHED GRADES TO MEET THE CIVIL GRADING PLANS.
- TREES AND SHRUBS WILL BE INSPECTED ON-SITE. LANDSCAPE PLANT MATERIALS MAY BE REJECTED AT ANY TIME DUE TO ISSUES OF QUALITY.
- ALL NEW LANDSCAPE AREAS SHALL BE IRRIGATED BY A COMMERCIAL GRADE, FULLY AUTOMATIC UNDERGROUND IRRIGATION SYSTEM. TREES, SHRUBS, AND DECORATIVE GRASSES SHALL BE IRRIGATED BY A SEPARATE ZONE FROM SOD/GRASS; THIS INCLUDES TREES PLANTED IN SOD/GRASS AREA. THE IRRIGATION SYSTEM IS TO HAVE A RAIN SENSOR SHUTOFF INSTALLED. IRRIGATION TO BE DESIGN/BUILD, CONTRACTOR IS RESPONSIBLE FOR COORDINATION WITH ARCHITECT, LANDSCAPE ARCHITECT, AND MECHANICAL AND FOR GENERATION OF AN IRRIGATION PLAN FOR REVIEW WITH AS BUILT PLAN AS REQUIRED.
- ALL PLANT MATERIAL SHALL MEET OR EXCEED CURRENT AMERICAN STANDARD FOR NURSERY STOCK ANSI Z60.1 AND THE COLORADO NURSERY ACT AND ACCOMPANYING RULE AND
- TRUNK-WRAP TAPE: TWO LAYERS OF CRINKLED PAPER CEMENTED TOGETHER WITH BITUMINOUS MATERIAL, 4 INCHES (102 MM) WIDE MIN.
- WRAPPING TREE TRUNKS: WRAP TREES WITH TRUNK-WRAP TAPE. START AT BASE OF TRUNK AND SPIRAL COVER TRUNK TO HEIGHT OF FIRST BRANCHES. OVERLAP WRAP, EXPOSING HALF THE WIDTH, AND SECURELY ATTACH WITHOUT CAUSING GIRDLING. DO NOT USE STAPLES. INSPECT TREE TRUNKS FOR INJURY, IMPROPER PRUNING, AND INSECT INFESTATION AND TAKE CORRECTIVE MEASURES REQUIRED BEFORE WRAPPING. DO NOT WRAP ROUGH BARK, POPULUS OR GLEDITSIA TREES. REMOVE WRAP IN SPRING.
- NO TREE SHALL BE WRAPPED AFTER MAY 21 OR BEFORE NOVEMBER 1
- ALL DECIDUOUS TREES SHALL BE WRAPPED BY NOV. 15. REMOVE TREE WRAP BY MAY 15. CONTRACTOR SHALL BE RESPONSIBLE FOR WRAPPING AND UNWRAPPING TREES DURING THE WARRANTY PERIOD.
- 9. FIBER MULCH AT PLANTING BEDS: ORGANIC MULCH FREE FROM DELETERIOUS MATERIALS AND SUITABLE AS A TOP DRESSING OF TREES AND SHRUBS, CONSISTING OF SHREDDED REDWOOD MULCH NOT LARGER THAN FOUR INCHES (4") IN LENGTH. SUBMIT 1.0 CF SAMPLE FOR APPROVAL.

### **SOIL PREPARATION:**

SOIL SHALL BE AMENDED BASED ON THE SOIL TEST RECOMMENDATIONS (TO ADDRESS SPECIFIC DEFICIENCIES & ISSUES IN EXISTING SOIL). THE FOLLOWING INCLUDES THE SOIL TEST REQUIREMENTS AND RECOMMENDATIONS TO BE USED IN CONJUNCTION WITH THE SOIL TEST RESULTS:

- SOIL ANALYSIS, BULK DENSITY TESTING AND REMEDIATION REQUIRED. SOIL ANALYSIS FROM A LOCAL ACCREDITED SOIL ANALYSIS LABORATORY WITH EXPERIENCE IN LOCAL URBAN SOILS SHALL BE REQUIRED WHEN PLANTS ARE TO BE INSTALLED IN GREEN
- SPACE. ALL SOIL REMEDIATION SHALL BE BASED ON THE SOIL ANALYSIS. MINIMUM SOIL ANALYSIS MUST DETERMINE SOIL TEXTURE AND STRUCTURE, PH BALANCE, SOIL SALINITY, FREE LIME, ORGANIC MATTER (OM) CONTENT, PLANT
- DEPTH OF LANDSCAPE SOIL ANALYSIS SHALL BE 24IN FOR TREES AND 8IN FOR ALL OTHER AREAS
- SOIL REMEDIATION REQUIRED BASED ON SOIL ANALYSIS.

AVAILABLE NUTRIENTS AND COMPACTION.

2. COMPOSTED MATERIAL SHALL CONSIST OF AGED ORGANIC MATTER, FREE OF WEED OR OTHER NOXIOUS PLANT SEEDS, LUMPS, STONES, OR OTHER FOREIGN CONTAMINANTS HARMFUL TO PLANT LIFE, AND HAVING THE FOLLOWING

CHARACTERISTICS BASED ON A NUTRIENT TEST PERFORMED NO LONGER THAN 3 MONTHS PRIOR TO ITS INCORPORATION INTO THE PROJECT

- ORGANIC MATTER: 25% MINIMUM. SALT CONTENT: 5.0 MMHOS/CM MAXIMUM
- PH: 8.5 MAXIMUM
- CARBON TO NITROGEN RATIO OF 10:1 TO 20:1.
- PARTICLE SIZE NO PARTICLE SMALLER THAN SILT OR CLAY SIZE, OR LARGER THAN 1/2" DIAMETER
- ACCEPTABLE COMPOST PRODUCT: CLASS I COMPOST, SUCH AS ECOGRO OR BIO-COMP, AS PROVIDED BY A1 ORGANICS, EATON, CO., OR APPROVED EQUAL.
- 2. FINISH GRADE TO BE BELOW THE EDGE OF PAVEMENT PRIOR TO SODDING OR PLANTING:
- SEEDED/SODDED AREAS: ALLOW 1 INCH FOR SOD. 1.2. PLANTED AREAS: ALLOW 3 INCHES FOR MULCH.
- 4. AFTER APPLYING SOIL CONDITIONER AND FERTILIZER, THOROUGHLY TILL AREA TO DEPTH OF 6" MINIMUM UNTIL SOIL IS WELL PULVERIZED AND THOROUGHLY MIXED.

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Civil Engineer Timberline Engineerin (970) 963-9869 Structural Engineer KRM Consultants, Inc (970) 949-9391 Mechanical Engineer

Electrical Engineer


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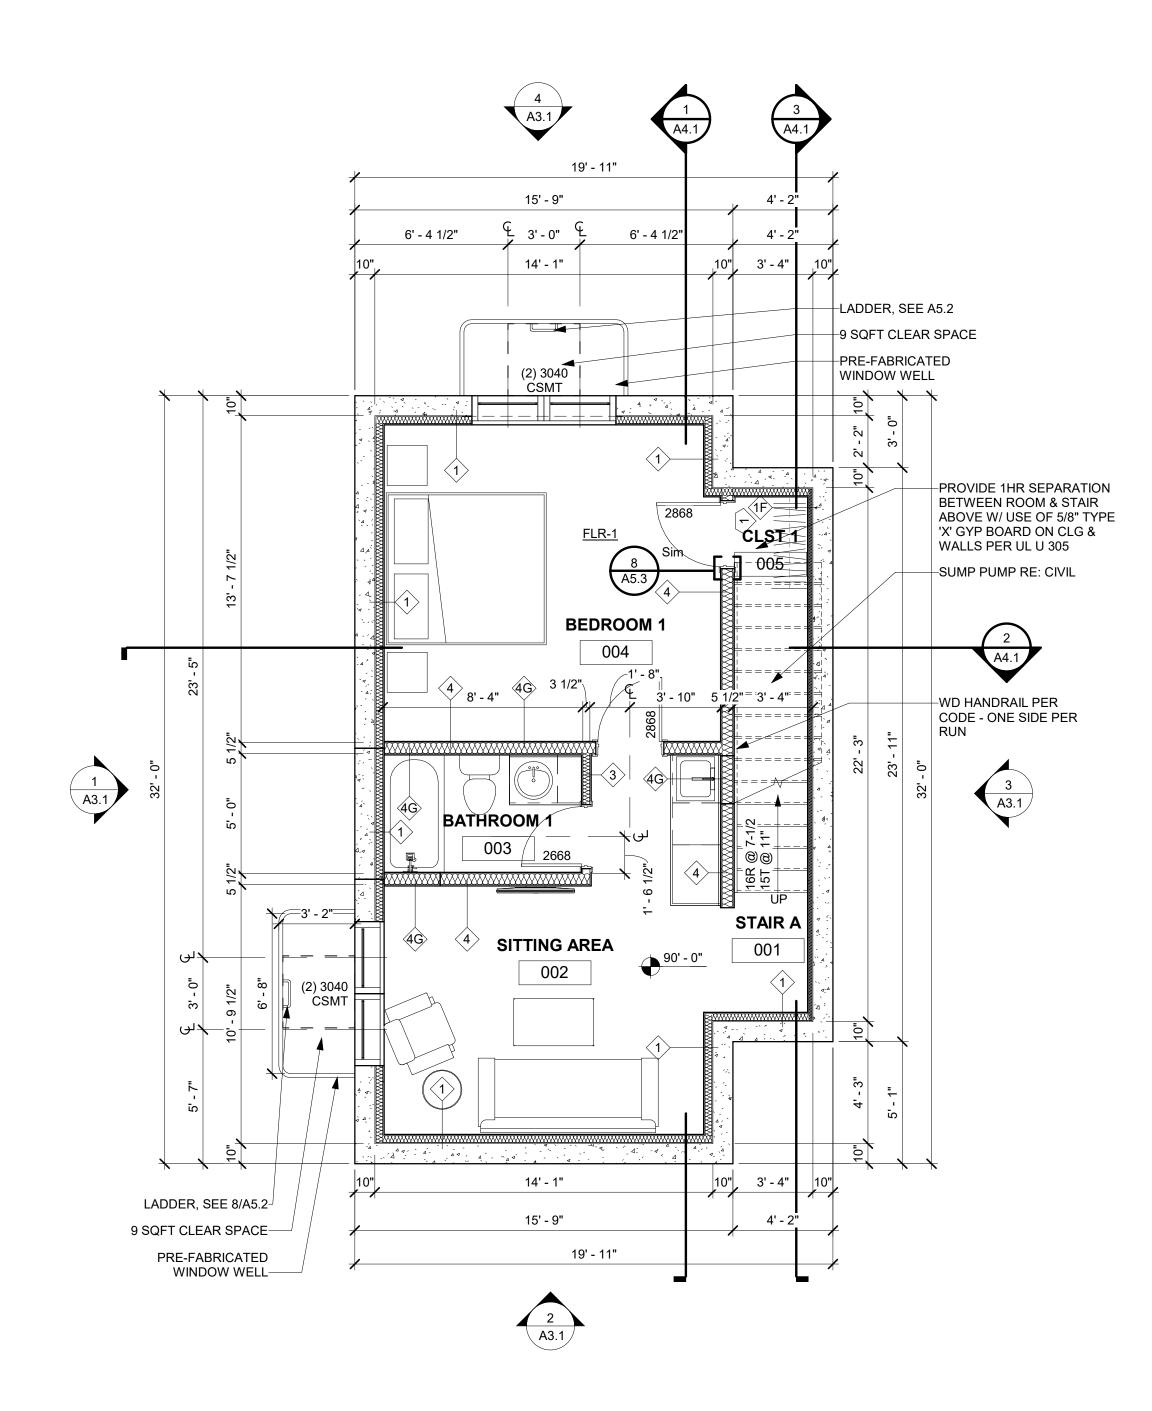
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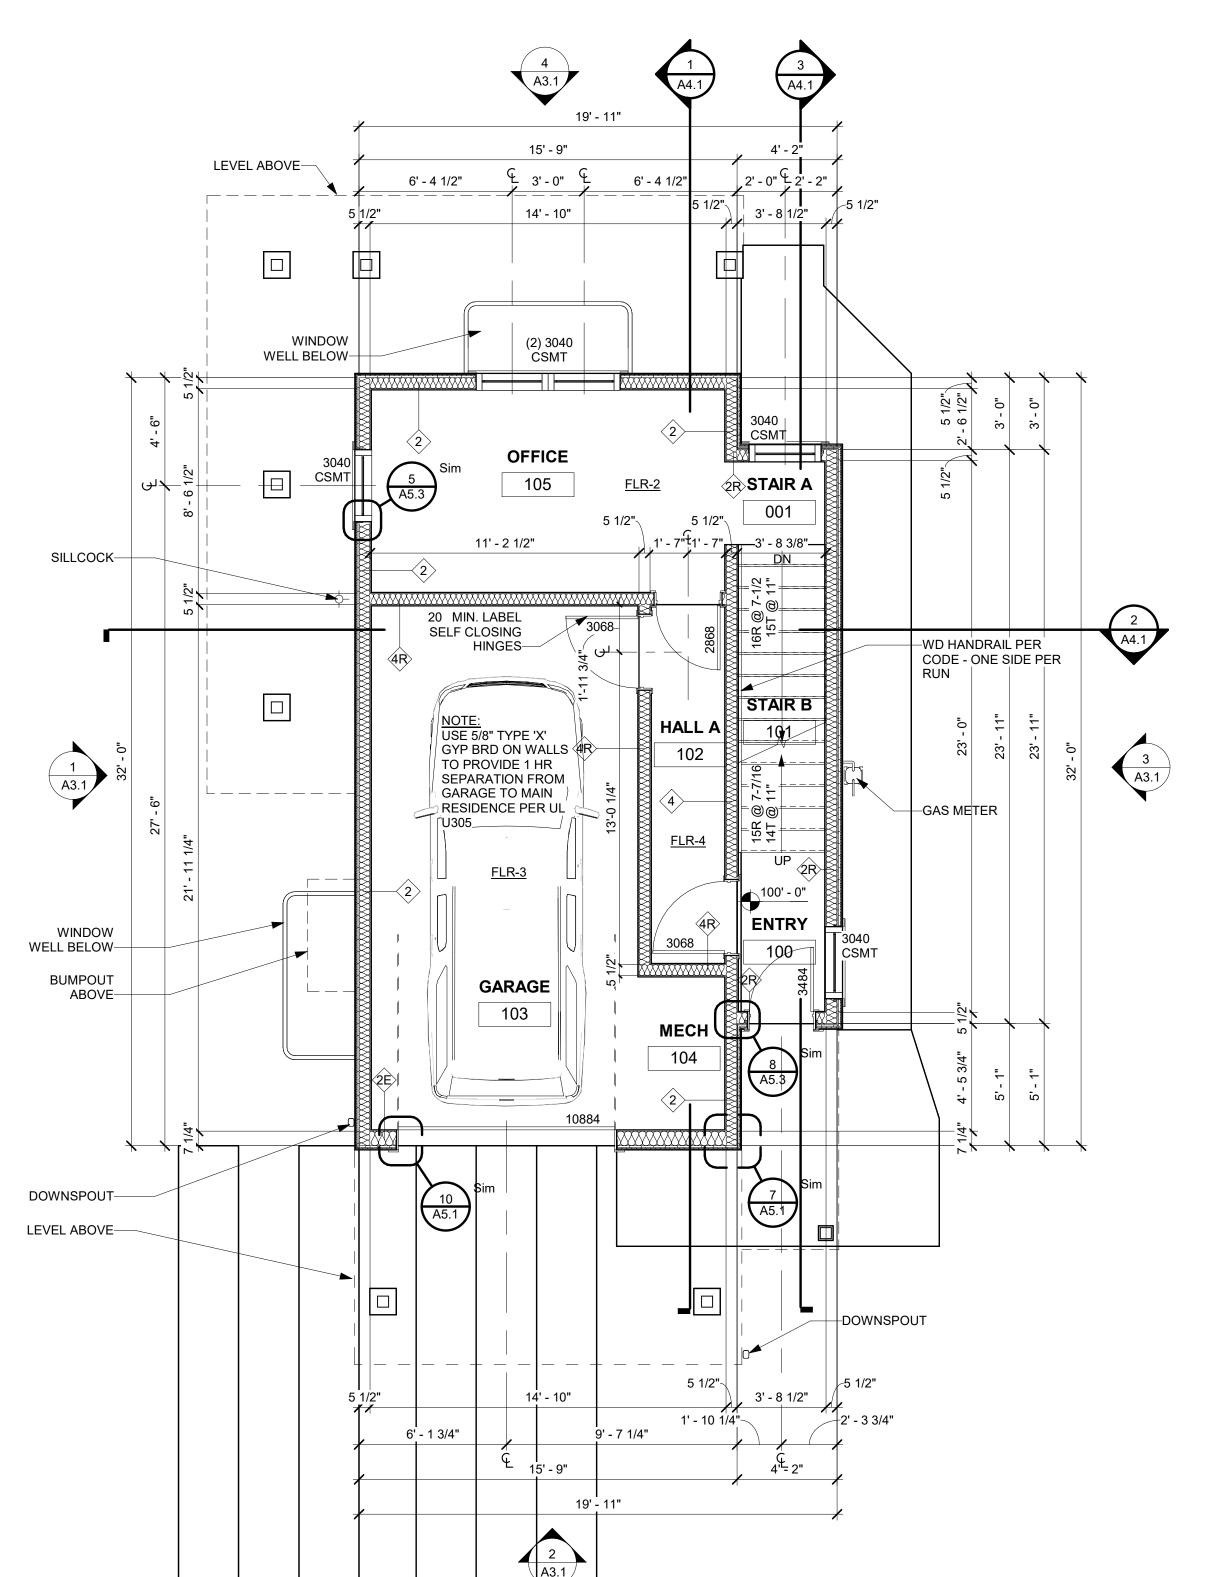
DRB - 02/14/2025 Landscape Plan

Project No: 2215





1 BASEMENT A2.1 1/4" = 1'-0"

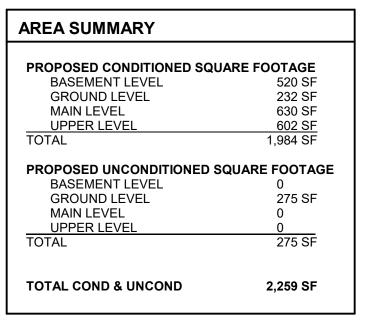

2 GROUND LEVEL
A2.1 1/4" = 1'-0"

CONTRACTOR TO PROVIDE THE FOLLOWING AS DEFFERED SUBMITTALS FOR BUILDING PERMIT

MECHANICAL M1. PLEASE PROVIDE THE REQUIRED MANUAL J AND S. M1401.2 M2. PLEASE PROVIDE THE REQUIRED MANUAL D. M1601.1

M3. PLEASE PROVIDE THE CONSTRUCTION DETAILS FOR THE PROPOSED WHOLE HOUSE VENTILATION SYSTEM. M1505.4 M4. SHEET A2.1: IF ALL THE GAS FIRED APPLIANCES ARE NOT SEALED COMBUSTION AND THE KITCHEN EXHAUST HOOD IS GREATER THAN 400 CFM A

PLUMBING
P1. SHEET A2.1: LOWER FLOOR. PLEASE INDICATE HOW THE WATER HEATER AND ASSOCIATED PIPING WILL BE PROTECTED FROM FREEZING. P2603.5 PLEASE INDICATE THE REQUIRED 3' X 3' X 7' HIGH CLEAR SPACE AT THE WATER HEATER, R403,5.4 AS AMENDED. B. INDICATE THE REQUIRED CONDENSATE DRAIN AT THE WATER HEATER THAT WILL ALLOW NATURAL DRAINAGE. R403.5.4 AS AMENDED PLEASE NOTE THAT THAT THESE TWO COMMENTS ARE INTENDED TO PROVIDE SPACE AND DRAINAGE FOR A HEAT PUMP WATER HEATER. WE ARE NOT AWARE THAT HEAT PUMP WATER HEATERS CAN BE INSTALLED IN AN UNCONDITIONED OR CONDITIONED GARAGE.


MAKEUP AIR SYSTEM WILL BE REQUIRED. PLEASE PROVIDE THE CONSTRUCTION DETAILS FOR THE PROPOSED MAKEUP AIR SYSTEM IF NEEDED.

CONTRACTOR TO PROVIDE THE FOLLOWING FOR IECC REQUIREMENTS AND COMPLETION

REQUIRED BLOWER DOOR TEST AT 3-ACH50. R402.4.1.3 A. REQUIRED DUCT TIGHTNESS TEST. R403.3.5

IV. REQUIRED DOMESTIC HOT WATER PING INSULATION. R403.5.2 VI. THE REQUIRED ITEMS THAT ARE TO BE LISTED ON THE COMPLIANCE CERTIFICATE. R401.3 AS AMENDED

CONTRACTOR TO COORDINATE DUCTING FROM THE FURNACE (IF PENETRATING THE GARAGE/HOUSE SEPARATION) WILL BE A MINIMUM OF 26 GAUGE AND THAT THE FURNACE HAS NO OPENINGS INTO THE GARAGE. R302.5. NOTE THAT WE ARE NOT AWARE OF ANY FURNACE THAT IS AIRTIGHT. HAVING THE FURNACE AND THE WATER HEATER WITHIN THE GARAGE SPACE CAN BE

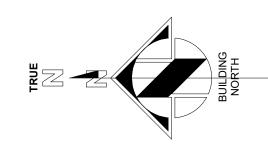

### NOTES:

### **CLOSET NOTES:**

SINGLE HANGING: DESIGNATED BY SINGLE DASHED LINE IN CLOSETS TO BE: 16" SHELF @ 7'-0"

AFF, 16" SHELF & ROD @ 5'-6" AFF.

- DOUBLE HANGING: DESIGNATED BY DOUBLE 2 DASHED LINE IN CLOSETS TO BE: 16" SHELF & ROD
- @ 7'-0" AFF, 12" SHELF & ROD @ 3'-6" AFF. SHELVES @ WALK-IN CLOSETS: 6 - 16" SHELVES @  $\langle 3 
  angle$  1'-2" OC, 1st shelf @ 1'-2" AFF, shelf width to be
- INDICATED. LINEN SHELVES: 6 SHELVES, WIDTH AS NOTED, @ 4 1'-2" OC, 1st SHELF @ 1'-2" AFF, FULL CLOSET

CLOSET WIDTH, LESS 4'-0" OR AS OTHERWISE

- STORAGE SHELVES: 6 16" SHELVES @ 1'-2" OC, 1st SHELF @ 1'-2" AFF, FULL CLOSET WIDTH.

### GENERAL CLOSET NOTES: 1. ALL SHELVES & VERTICAL DIVIDERS TO BE AC

PLYWOOD WITH 1x2 EDGE. SPECIES TO BE SPECIFIED BY DEVELOPER. 2. CLEATS TO BE 1x2 CLEAR PINE. 3. PROVIDE ROD SUPPORTS @ 36" OC MAX.

4. ALL TO BE STAINED TO MATCH CASE & BASE.

### **FLOOR PLAN GENERAL NOTES:**

- 1. PATCH EXISTING CONSTRUCTION SCHEDULED TO REMAIN. REPAIRED SURFACES TO BE FLUSH WITH ADJACENT FINISH SURFACES. TO SAME QUALITY AS NEW CONSTRUCTION PRIOR TO INSTALLING NEW FINISHES. REFER TO THE FINISH MANUFACTURER'S GUIDELINES FOR INSTALLATION.
- 2. PATCH EXISTING FIRE-RATED WALLS, FLOOR CEILINGS, ETC. SO AS TO MAINTAIN THE FIRE-RADIATING. ADD FIRE-SMOKE DAMPERS WHERE NEW DUCTS CROSS. ADD FIRE STOP AT ALL
- 3. PATCH WALLS AT REMOVED RECEPTACLE OPENINGS SO AS TO RECEIVE SUBSEQUENT WORK.
- 4. PATCH AND LEVEL FLOOR SUBSTRATES TO RECEIVE NEW WORK AS SCHEDULED.
- 5. COORDINATE ALL FLOOR CORE DRILLING WITH EXISTING.
- 6. DO NOT SCALE DRAWINGS.
- 7. IN ROOMS WITH FLOOR DRAINS, SLOPE CONCRETE SURFACE WITHIN 18" RADIUS AT 1/4" PER FOOT TOWARD FLOOR DRAIN, UNLESS OTHERWISE
- 8. ALL SPOT ELEVATIONS SHOWN ON THE FLOOR PLANS OUTSIDE THE BUILDING RELATE TO USGS ELEVATIONS. ALL SPOT ELEVATIONS INSIDE THE BUILDING REFER TO BUILDING REFERENCE ELEVATIONS. NOTIFY ARCHITECT IMMEDIATELY SHOULD CONDITIONS BE FOUND CONTRADICTORY TO THESE DRAWINGS.
- 9. ALL ANGLES SHOWN ON THE FLOOR PLANS ARE 90 DEGREES UNLESS OTHERWISE NOTED.
- 10. ALL DIMENSIONS ARE TO GRID LINE, FACE OF CONCRETE OR MASONRY, OR FACE OF GYPSUM BOARD, UNLESS OTHERWISE NOTED.
- 11. ALL FLOOR PLAN DIMENSIONS TO MASONRY ARE NOMINAL DIMENSIONS, UNLESS NOTED AS ACTUAL.

### **GENERAL NOTES:**

1. DO NOT SCALE DRAWINGS. USE GIVEN DIMENSIONS. IMMEDIATELY NOTIFY ARCHITECT IF ADDITIONAL INFORMATION IS REQUIRED. ALL DIMENSIONS ARE GIVEN TO FACE OF WALL FRAMING. SEE WALL SECTIONS AND WALL TYPES FOR EXACT CONSTRUCTION

2. SEE SHEET A0.1 FOR WALL TYPES INDICATED ON FLOOR PLANS

3. PROVIDE ALL NECESSARY BLOCKING FOR PROPER ATTACHMENT OF WORK IN WALLS AND CEILINGS. LOCATIONS INCLUDE BUT NOT LIMITED TO, TOILET AND BATH ACCESSORIES, WALL AND CEILING MOUNTED ELECTRICAL EQUIPMENT, WINDOW TREATMENTS, CASEWORK, COUNTERTOPS, ETC.

4. WHERE WALL PARTITIONS ARE A CONTINUATION OF EXISTING ONES. NEW FINISH SURFACES MUST BE FLUSH AND CONTINUOUS WITH EXISTING SURFACES ON BOTH SIDES. INFILL OPENINGS IN EXISTING WALLS WITH MATERIAL TO MATCH EXISTING WALL THICKNESS, TEXTURE, AND FINISH.

5. REFERENCE S-SERIES DRAWINGS FOR STRUCTURAL NOTES AND DETAILS AND COORDINATE.

6. EXISTING BUILDING DIMENSIONS AND ELEVATIONS ARE BASED UPON EXISTING SURVEY INFORMATION. IMMEDIATELY NOTIFY ARCHITECT IF CONDITIONS ARE ENCOUNTERED THAT DO NOT AGREE WITH DIMENSIONS

AND/OR ELEVATIONS SHOWN. 7. VERIFY ALL PITCHED FLOOR AREAS SHOWN WITH PITCH LINES WITH THE ARCHITECT. PROVIDE A SLAB DEPRESSION AT ALL FLOOR DRAINS WHERE PITCH LINES ARE NOT SHOWN ON DRAWINGS.

8. PROVIDE 4" RETURN FROM FACE OF ADJACENT WALL

FOR ANY DOORS NOT DIMENSIONED.

9. SEE MECHANICAL, PLUMBING, AND ELECTRICAL DRAWINGS FOR ITEMS NOT SHOWN ON ARCHITECTURAL DRAWINGS AND COORDINATE.

10. ALL INTERIOR WALLS SHALL EXTEND TO UNDERSIDE OF ROOF DECK AND STEEL STRUCTURE (BEAM) UNLESS NOTED OTHERWISE. SEE PARTITION WALL TYPES ON SHEET A0.03

11. DATUM 100'-0" INDICATED ON ALL DRAWINGS, OTHER THAN CIVIL SERIES EQUALS XXXX.XX ON CIVIL DRAWINGS 12. ALL STEEL LOCATED BELOW AND EXPOSED TO GRADE TO BE COATED WITH BITUMINOUS DAMPROOFING. 13. CONTRACTOR TO COMPLY WITH ALL REQUIREMENTS

FOR SPECIAL INSPECTIONS, 2015 IBC-1704.

Associates

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(970) 949-9391 Mechanical Engineer

Electrical Engineer

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DRB - 02/14/2025

**Sheet Title:** Basement & Ground

2 A3.1

2 UPPER LEVEL
A2.2 1/4" = 1'-0"

CONTRACTOR TO PROVIDE THE FOLLOWING AS DEFFERED SUBMITTALS FOR BUILDING PERMIT

1 MAIN LEVEL A2.2 1/4" = 1'-0"

MECHANICAL M1. PLEASE PROVIDE THE REQUIRED MANUAL J AND S. M1401.2

M2. PLEASE PROVIDE THE REQUIRED MANUAL D. M1601.1

M3. PLEASE PROVIDE THE CONSTRUCTION DETAILS FOR THE PROPOSED WHOLE HOUSE VENTILATION SYSTEM. M1505.4 M4. SHEET A2.1: IF ALL THE GAS FIRED APPLIANCES ARE NOT SEALED COMBUSTION AND THE KITCHEN EXHAUST HOOD IS GREATER THAN 400 CFM A MAKEUP AIR SYSTEM WILL BE REQUIRED. PLEASE PROVIDE THE CONSTRUCTION DETAILS FOR THE PROPOSED MAKEUP AIR SYSTEM IF NEEDED.

19' - 11"

A3.1

PLUMBING
P1. SHEET A2.1: LOWER FLOOR. PLEASE INDICATE HOW THE WATER HEATER AND ASSOCIATED PIPING WILL BE PROTECTED FROM FREEZING. P2603.5 PLEASE INDICATE THE REQUIRED 3' X 3' X 7' HIGH CLEAR SPACE AT THE WATER HEATER. R403.5.4 AS AMENDED. B. INDICATE THE REQUIRED CONDENSATE DRAIN AT THE WATER HEATER THAT WILL ALLOW NATURAL DRAINAGE. R403.5.4 AS AMENDED PLEASE NOTE THAT THAT THESE TWO COMMENTS ARE INTENDED TO PROVIDE SPACE AND DRAINAGE FOR A HEAT PUMP WATER HEATER. WE ARE NOT AWARE THAT HEAT PUMP WATER HEATERS CAN BE INSTALLED IN AN UNCONDITIONED OR CONDITIONED GARAGE.

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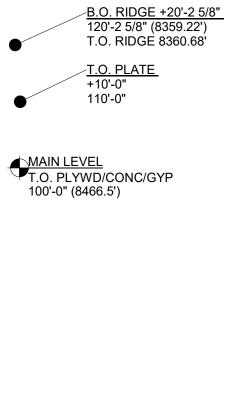
**FLOOR** SPOT ELEV


**TRUSS** 

**RIDGE** 

T.O. WALL

PLATE



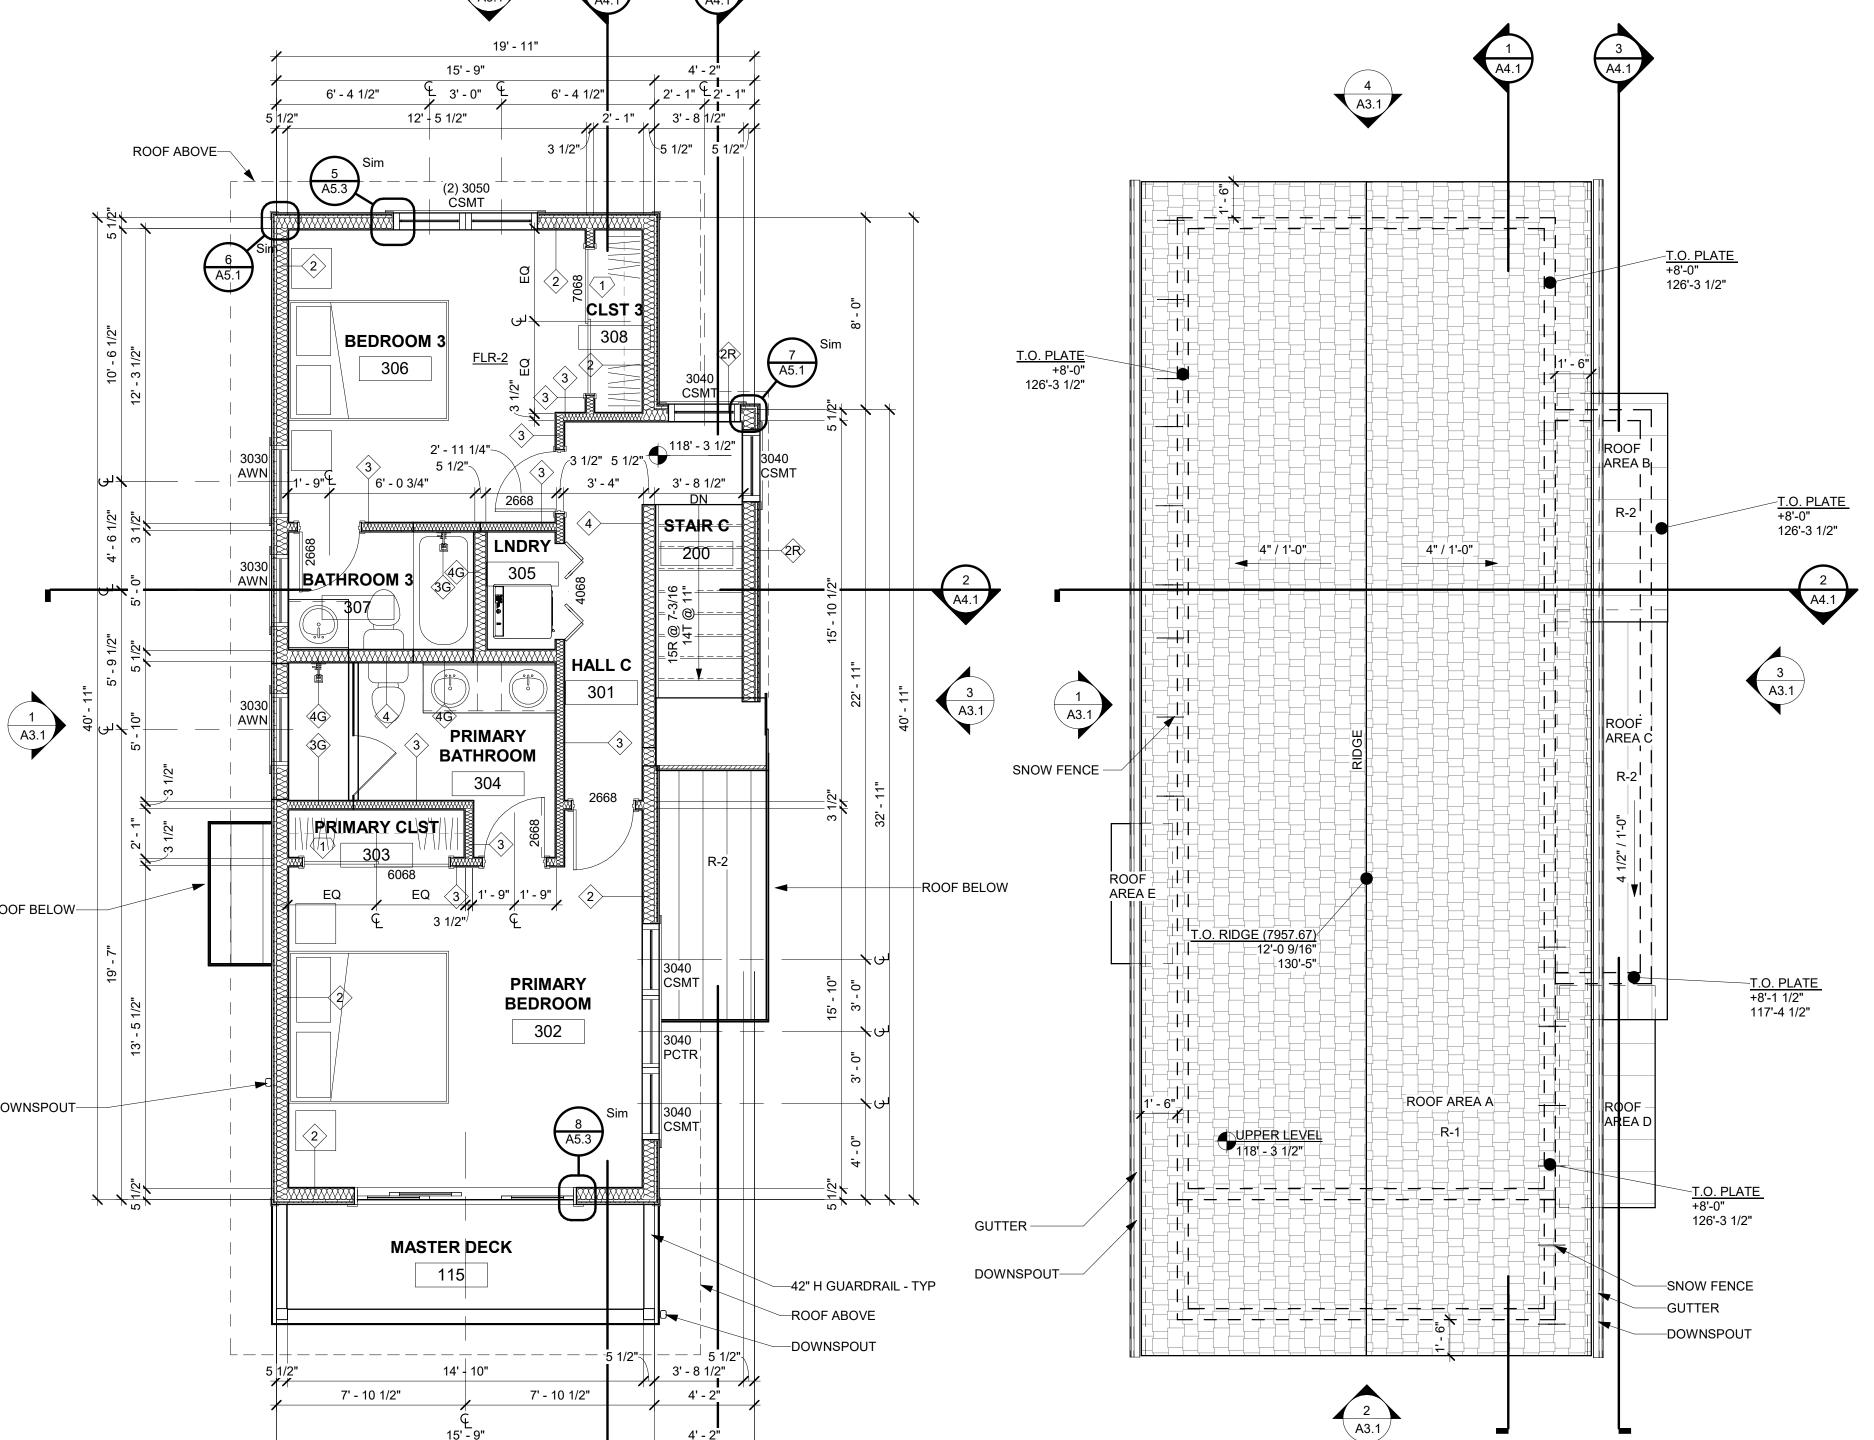

3 ROOF PLAN

PROVIDE ROUGH IN FOR ROOF MOUNTED SOLAR PV

CLOSET NOTES:

STORAGE SHELVES: 6 - 16" SHELVES @ 1'-2" OC, 1st 5 SHELF @ 1'-2" AFF, FULL CLOSET WIDTH.

LINEN SHELVES: 6 SHELVES, WIDTH AS NOTED, @

1'-2" OC, 1st SHELF @ 1'-2" AFF, FULL CLOSET

NOTES:

SINGLE HANGING: DESIGNATED BY SINGLE

DOUBLE HANGING: DESIGNATED BY DOUBLE

2 DASHED LINE IN CLOSETS TO BE: 16" SHELF & ROD @ 7'-0" AFF, 12" SHELF & ROD @ 3'-6" AFF.

SHELVES @ WALK-IN CLOSETS: 6 - 16" SHELVES @  $|3\rangle$  1'-2" OC, 1st SHELF @ 1'-2" AFF, SHELF WIDTH TO B CLOSET WIDTH, LESS 4'-0" OR AS OTHERWISE

AFF, 16" SHELF & ROD @ 5'-6" AFF.

DASHED LINE IN CLOSETS TO BE: 16" SHELF @ 7'-0"

**GENERAL CLOSET NOTES:** 

1. ALL SHELVES & VERTICAL DIVIDERS TO BE AC

2. CLEATS TO BE 1x2 CLEAR PINE. 3. PROVIDE ROD SUPPORTS @ 36" OC MAX. 4. ALL TO BE STAINED TO MATCH CASE & BASE.

PLYWOOD WITH 1x2 EDGE. SPECIES TO BE

### **FLOOR PLAN GENERAL NOTES:**

SPECIFIED BY DEVELOPER.

1. PATCH EXISTING CONSTRUCTION SCHEDULED TO REMAIN. REPAIRED SURFACES TO BE FLUSH WITH ADJACENT FINISH SURFACES. TO SAME QUALITY AS NEW CONSTRUCTION PRIOR TO INSTALLING NEW FINISHES. REFER TO THE FINISH MANUFACTURER'S GUIDELINES FOR INSTALLATION.

2. PATCH EXISTING FIRE-RATED WALLS, FLOOR CEILINGS, ETC. SO AS TO MAINTAIN THE FIRE-RADIATING. ADD FIRE-SMOKE DAMPERS WHERE NEW DUCTS CROSS. ADD FIRE STOP AT ALL

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4. PATCH AND LEVEL FLOOR SUBSTRATES TO RECEIVE NEW WORK AS SCHEDULED.

5. COORDINATE ALL FLOOR CORE DRILLING WITH EXISTING.

6. DO NOT SCALE DRAWINGS.

7. IN ROOMS WITH FLOOR DRAINS, SLOPE CONCRETE SURFACE WITHIN 18" RADIUS AT 1/4" PER FOOT TOWARD FLOOR DRAIN, UNLESS OTHERWISE

8. ALL SPOT ELEVATIONS SHOWN ON THE FLOOR PLANS OUTSIDE THE BUILDING RELATE TO USGS ELEVATIONS. ALL SPOT ELEVATIONS INSIDE THE BUILDING REFER TO BUILDING REFERENCE ELEVATIONS. NOTIFY ARCHITECT IMMEDIATELY SHOULD CONDITIONS BE FOUND CONTRADICTORY TO THESE DRAWINGS.

9. ALL ANGLES SHOWN ON THE FLOOR PLANS ARE 90 DEGREES UNLESS OTHERWISE NOTED.

CONCRETE OR MASONRY, OR FACE OF GYPSUM BOARD, UNLESS OTHERWISE NOTED.

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### **GENERAL NOTES:**

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FLOOR PLANS 3. PROVIDE ALL NECESSARY BLOCKING FOR PROPER

2. SEE SHEET A0.1 FOR WALL TYPES INDICATED ON

ATTACHMENT OF WORK IN WALLS AND CEILINGS. LOCATIONS INCLUDE BUT NOT LIMITED TO, TOILET AND BATH ACCESSORIES, WALL AND CEILING MOUNTED ELECTRICAL EQUIPMENT, WINDOW TREATMENTS, CASEWORK, COUNTERTOPS, ETC.

4. WHERE WALL PARTITIONS ARE A CONTINUATION OF EXISTING ONES. NEW FINISH SURFACES MUST BE FLUSH AND CONTINUOUS WITH EXISTING SURFACES ON BOTH SIDES. INFILL OPENINGS IN EXISTING WALLS WITH MATERIAL TO MATCH EXISTING WALL THICKNESS, TEXTURE, AND FINISH.

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PITCH LINES WITH THE ARCHITECT. PROVIDE A SLAB DEPRESSION AT ALL FLOOR DRAINS WHERE PITCH LINES ARE NOT SHOWN ON DRAWINGS.

8. PROVIDE 4" RETURN FROM FACE OF ADJACENT WALL FOR ANY DOORS NOT DIMENSIONED. 9. SEE MECHANICAL, PLUMBING, AND ELECTRICAL

DRAWINGS FOR ITEMS NOT SHOWN ON ARCHITECTURAL DRAWINGS AND COORDINATE. 10. ALL INTERIOR WALLS SHALL EXTEND TO UNDERSIDE OF ROOF DECK AND STEEL STRUCTURE (BEAM) UNLESS NOTED OTHERWISE. SEE PARTITION WALL TYPES ON SHEET A0.03

11. DATUM 100'-0" INDICATED ON ALL DRAWINGS, OTHER THAN CIVIL SERIES EQUALS XXXX.XX ON CIVIL DRAWINGS 12. ALL STEEL LOCATED BELOW AND EXPOSED TO GRADE TO BE COATED WITH BITUMINOUS DAMPROOFING. 13. CONTRACTOR TO COMPLY WITH ALL REQUIREMENTS

### FOR SPECIAL INSPECTIONS, 2015 IBC-1704. ROOF FINISH LEGEND

NOTES:

1. HATCHED AREAS INDICATE OVERBUILT ROOF & CRICKETS, RE: STRUCTURAL

2. ALL GUTTERS & DOWNSPOUTS TO RECEIVE HEAT TAPE FOR ENTIRE LENGTH,

RE: DIAGRAM ON ELECTRICAL PLANS 3. T.O. RIDGE ELEVATIONS GIVEN AT TOP OF ROOF SHEATHING

4. CONTRACTOR TO VERIFY CHIMNEY DIMENSIONS WITH FIREPLACE MANUFACTURERS' REQUIREMENTS

R-1 RANDOM ASPHALT SHINGLES, SEE

SYSTEM NOTES SHEET A0.1 R-2 60 MIL EPDM ROOF SEE SYSTEM

NOTES SHEET A0.1 R-3 COIL COATED MTL STANDING SEAM

ROOF SEE SYTEM NOTES SHEET A0.1 COIL COATED MTL FLASHING, GUTTERS, AND DOWNSPOUTS

OVERHANGS ARE 1'-6" FROM FACE OF FRAMING TYP. U.N.O. ROOF BEAMS - ROUGH SAWN TIMBER

Associates

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Electrical Engineer


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DRB - 02/14/2025

Sheet Title:

Upper, & Roof **Plans** 



### NOTES:
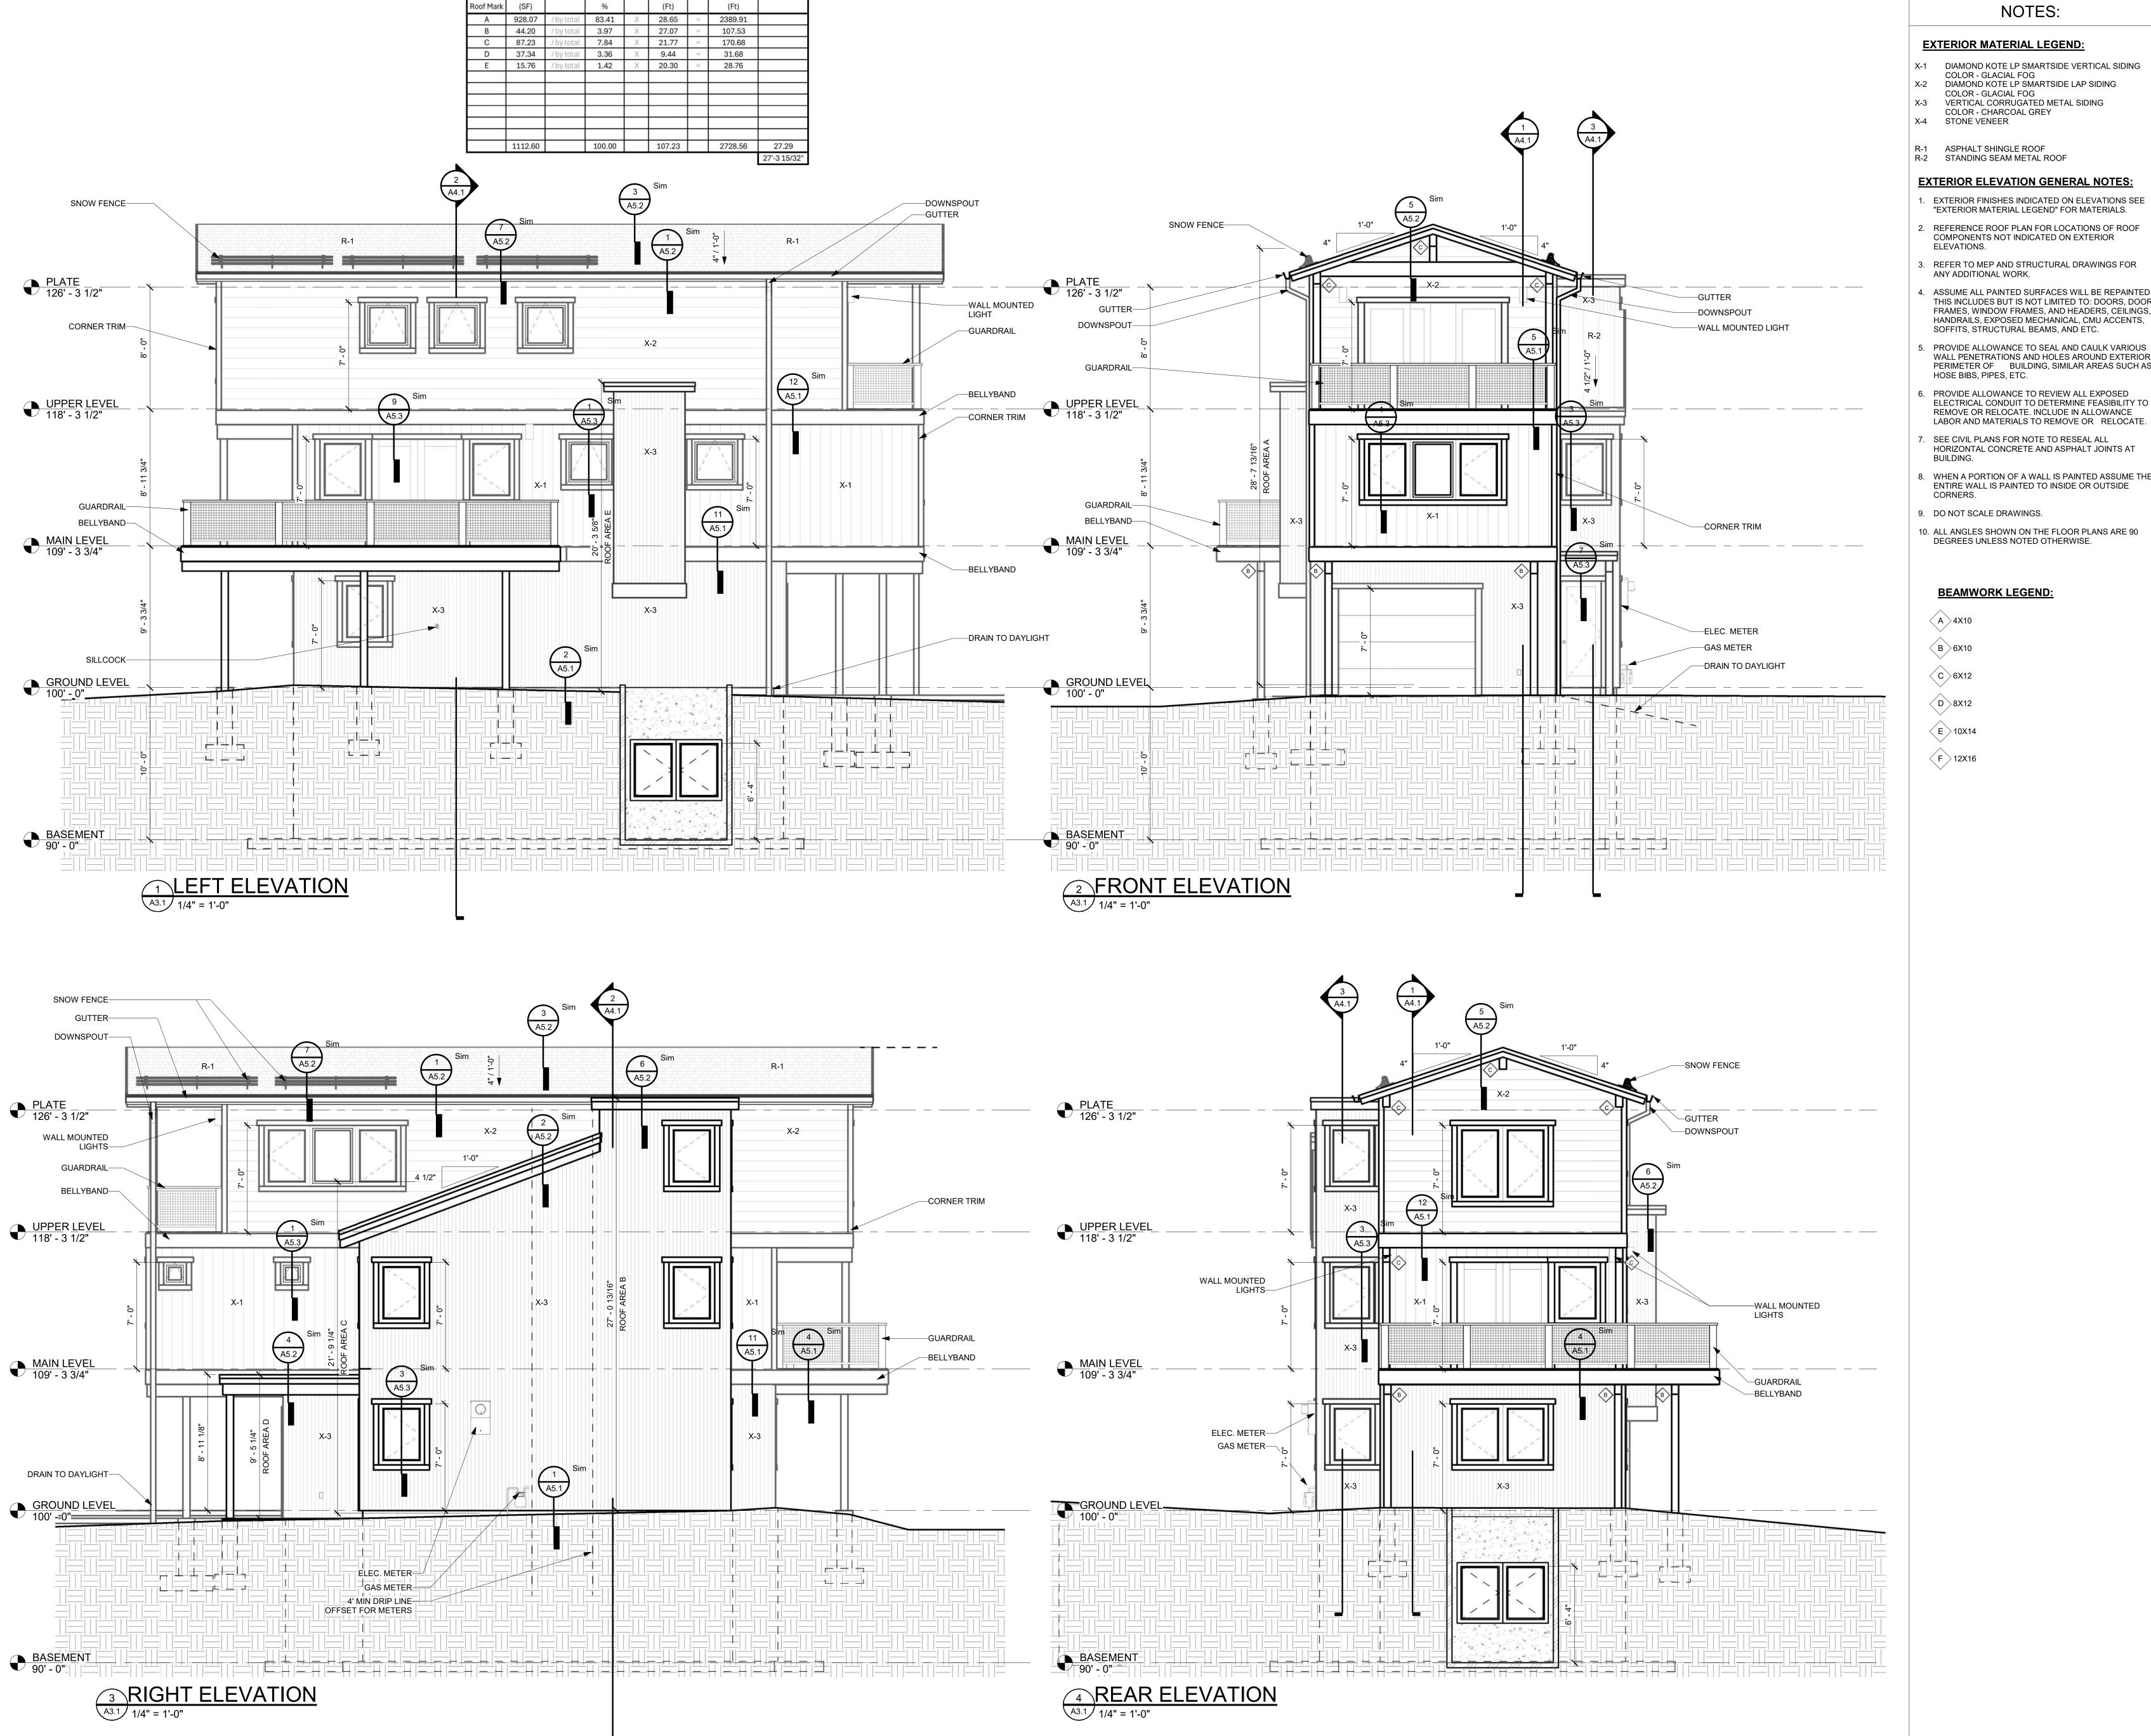
### **EXTERIOR MATERIAL LEGEND:**

- X-1 DIAMOND KOTE LP SMARTSIDE VERTICAL SIDING COLOR GLACIAL FOG
  X-2 DIAMOND KOTE LP SMARTSIDE LAP SIDING
- COLOR GLACIAL FOG X-3 VERTICAL CORRUGATED METAL SIDING
- COLOR CHARCOAL GREY X-4 STONE VENEER
- R-1 ASPHALT SHINGLE ROOF R-2 STANDING SEAM METAL ROOF

### **EXTERIOR ELEVATION GENERAL NOTES:**

- 1. EXTERIOR FINISHES INDICATED ON ELEVATIONS SEE "EXTERIOR MATERIAL LEGEND" FOR MATERIALS.
- 2. REFERENCE ROOF PLAN FOR LOCATIONS OF ROOF COMPONENTS NOT INDICATED ON EXTERIOR ELEVATIONS.
- 3. REFER TO MEP AND STRUCTURAL DRAWINGS FOR
- 4. ASSUME ALL PAINTED SURFACES WILL BE REPAINTED. THIS INCLUDES BUT IS NOT LIMITED TO: DOORS, DOOR FRAMES, WINDOW FRAMES, AND HEADERS, CEILINGS,
- 5. PROVIDE ALLOWANCE TO SEAL AND CAULK VARIOUS WALL PENETRATIONS AND HOLES AROUND EXTERIOR PERIMETER OF BUILDING, SIMILAR AREAS SUCH AS HOSE BIBS, PIPES, ETC.
- 6. PROVIDE ALLOWANCE TO REVIEW ALL EXPOSED ELECTRICAL CONDUIT TO DETERMINE FEASIBILITY TO REMOVE OR RELOCATE. INCLUDE IN ALLOWANCE LABOR AND MATERIALS TO REMOVE OR RELOCATE.
- 7. SEE CIVIL PLANS FOR NOTE TO RESEAL ALL HORIZONTAL CONCRETE AND ASPHALT JOINTS AT
- 8. WHEN A PORTION OF A WALL IS PAINTED ASSUME THE ENTIRE WALL IS PAINTED TO INSIDE OR OUTSIDE
- 9. DO NOT SCALE DRAWINGS.
- 10. ALL ANGLES SHOWN ON THE FLOOR PLANS ARE 90 DEGREES UNLESS NOTED OTHERWISE.

### **BEAMWORK LEGEND:**

- (B)6X10
- D 8X12
- E 10X14 F 12X16

Associates


The Architectural Balance 0056 Edwards Village Blvd. Suite 210 Edwards, CO 81632 (970) 766-1470

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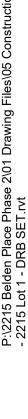
Fan Roa Single S Abby Colorado Place-1 - 001 selden Lot 0'  $\mathbf{\Omega}$ 




DRB - 02/14/2025 Sheet Title:

**Exterior** Elevations

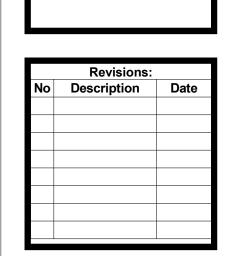Project No: 2215



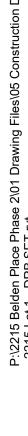




GLACIAL FOG



X-2 - LAP SIDING COLOR



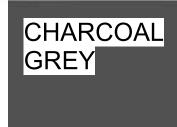



X-4 STONE VENEER SIMILAR TO GALLEGOS - #366 COURTLAND LOW RISE






PAINTED ITEMS: SHERWIN WILLIAMS 7069 IRON ORE TRIM, CORNER TRIM, WINDOW AND DOOR TRIM, WOOD BEAMS, GUTTERS AND OTHER METALS



**GARAGE DOORS:** SIMILAR TO RAYNOR - ASPEN SERIES RECESSED RANCH GROOVED PANELS COLOR: WALNUT

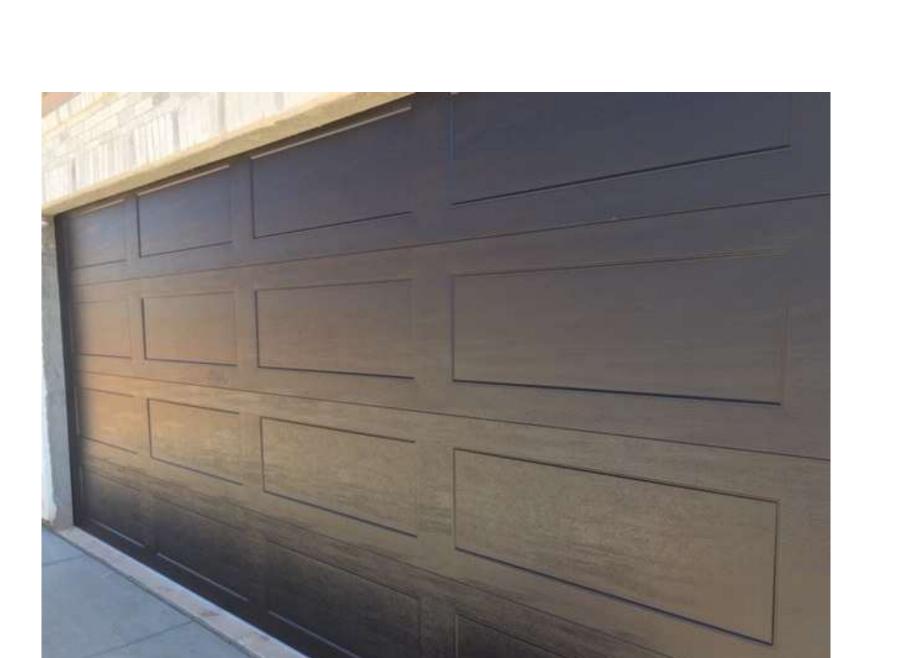

**EXTERIOR MATERIAL LEGEND:** 

COLOR - CHARCOAL GREY

X-4 STONE VENEER

WINDOWS:

R-1 ASPHALT SHINGLE ROOF R-2 STANDING SEAM METAL ROOF

WOOD CLAD WINDOWS

X-1 DIAMOND KOTE LP SMARTSIDE VERTICAL SIDING COLOR - GLACIAL FOG

SIMILAR TO SIERRA PACIFIC "BLACK"

X-2 DIAMOND KOTE LP SMARTSIDE LAP SIDING COLOR - GLACIAL FOG

X-3 VERTICAL CORRUGATED METAL SIDING



R-1 ROOFING SIMILAR TO GAF DESIGNER SHINGLES WOODLAN 'CASTLEWOOD GRAY'



R-2 ROOFING SIMILAR TO WESTERN STATES 2" STANDING SEAM - 12" WIDTH COLOR: GALVANIZED TO MATCH GALVALUME PANELS

### GENERATION LIGHTING

8637401-12: Medium One Light Outdoor Wall Lantern Dimensions:



1 A19 Medium 75 watt light bulb

Mounting Proc.: Cap Nuts Connection: Mounted To Box

1 - Medium A19 75w Max. 120v - Not included Dark sky friendly. Designed to emit no light above the 90° horizontal plane. Photometry unavailable.
 Easily converts to LED with optional replacement lamps

 Meets Title 24 energy efficiency standards Title 24 compliant if used with Joint Appendix (JA8) approved light bulbs listed in the California Energy Commission Appliance Material List: Collection: Barn Light 1 Body - Aluminum - Black Featured in the decorative Barn Light collection

Safety Listing:

Safety Listed for Wet Locations

Dark sky friendly. Designed to emit no light above the 90° horizontal plane. Photometry unavailable. Instruction Sheets: Trilingual (English, Spanish, and French) (990W8\_37401-BRL) Easily converts to LED with optional replacement lamps Meets Title 24 energy efficiency standards

UPC #:785652069352 Finish: Black (12) Backplate / Canopy Details:

Type	Height / I	ength.	Width Depth	Diameter		Outlet Box Up			Outlet Box Down	
Back Plate	)			5		4 1/8			6 1/2	
Chinning Inf										
	ormation: Product#	Quantity	UPC	Length	Width	Height	Cube	Weight	Frt. Class	UPS Ship
Package Type		Quantity	UPC 785652069352	Length 16.75	<b>Width</b> 14.58	Height 13.25	<b>Cube</b> 1.873	Weight 4.1	Frt. Class 250	UPS Ship
Package Type Individual NJ Pallet	Product#	Quantity 1 45			NO DATESTICAL		A CONTRACTOR OF THE PARTY OF TH	100000000000000000000000000000000000000		VPS Ship Yes No

Project No: 2215

DRB - 02/14/2025

Sheet Title:

**Materials** 

Associates

The Architectural Balance

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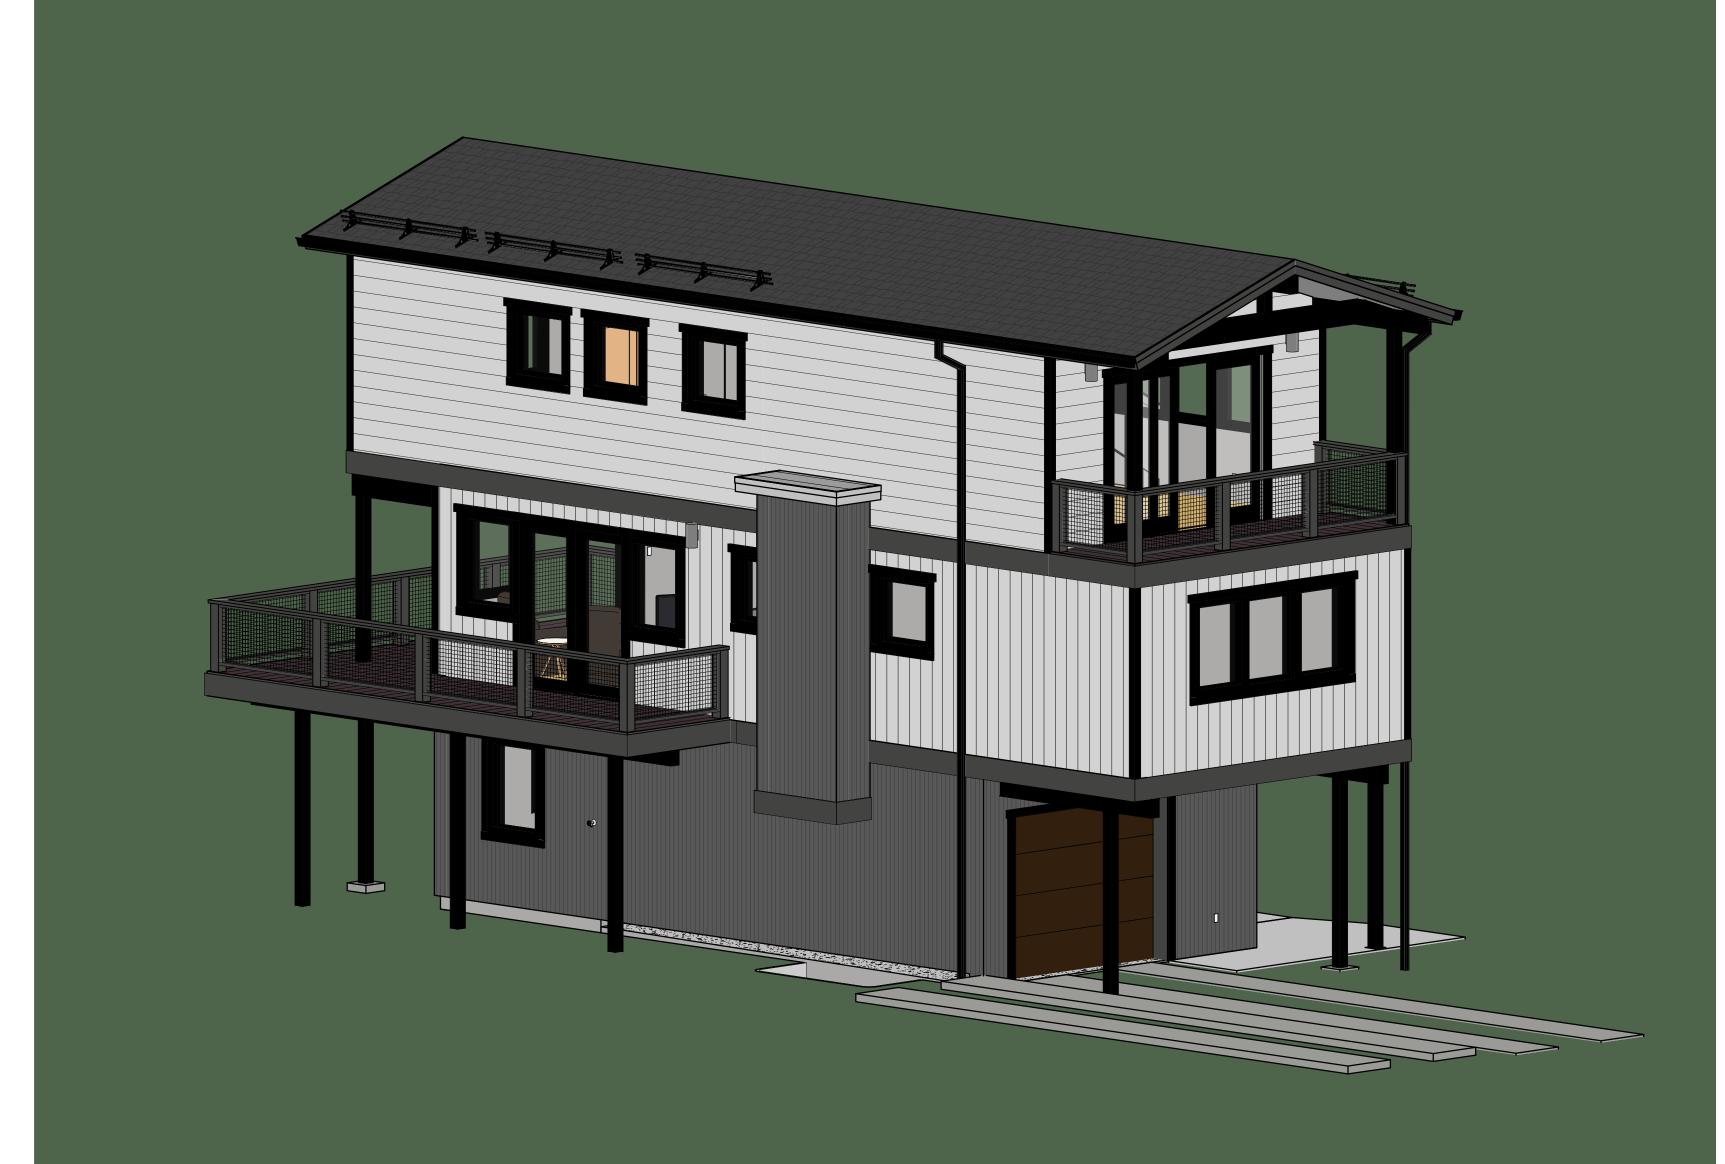
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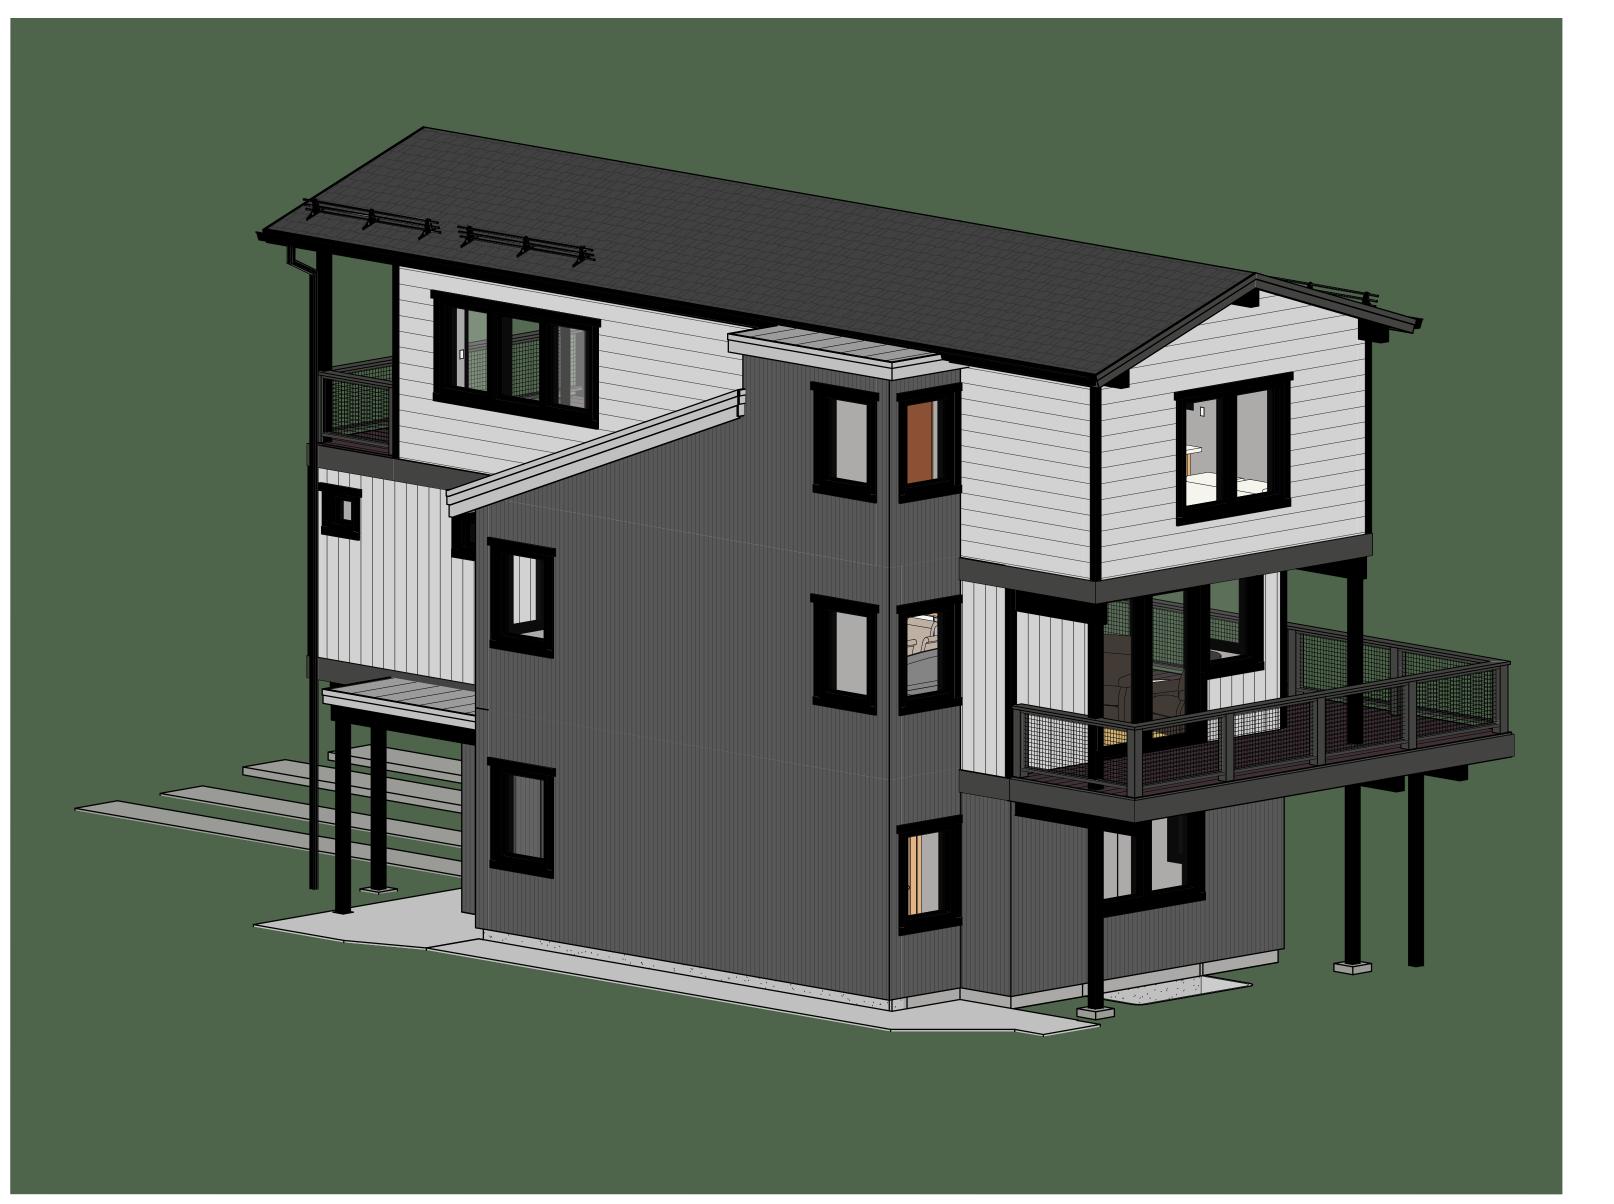
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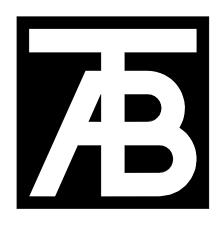
SOUTH WEST ELEVATION

A3.3



4 SOUTH EAST ELEVATION

A3.3



Associates The Architectural Balance

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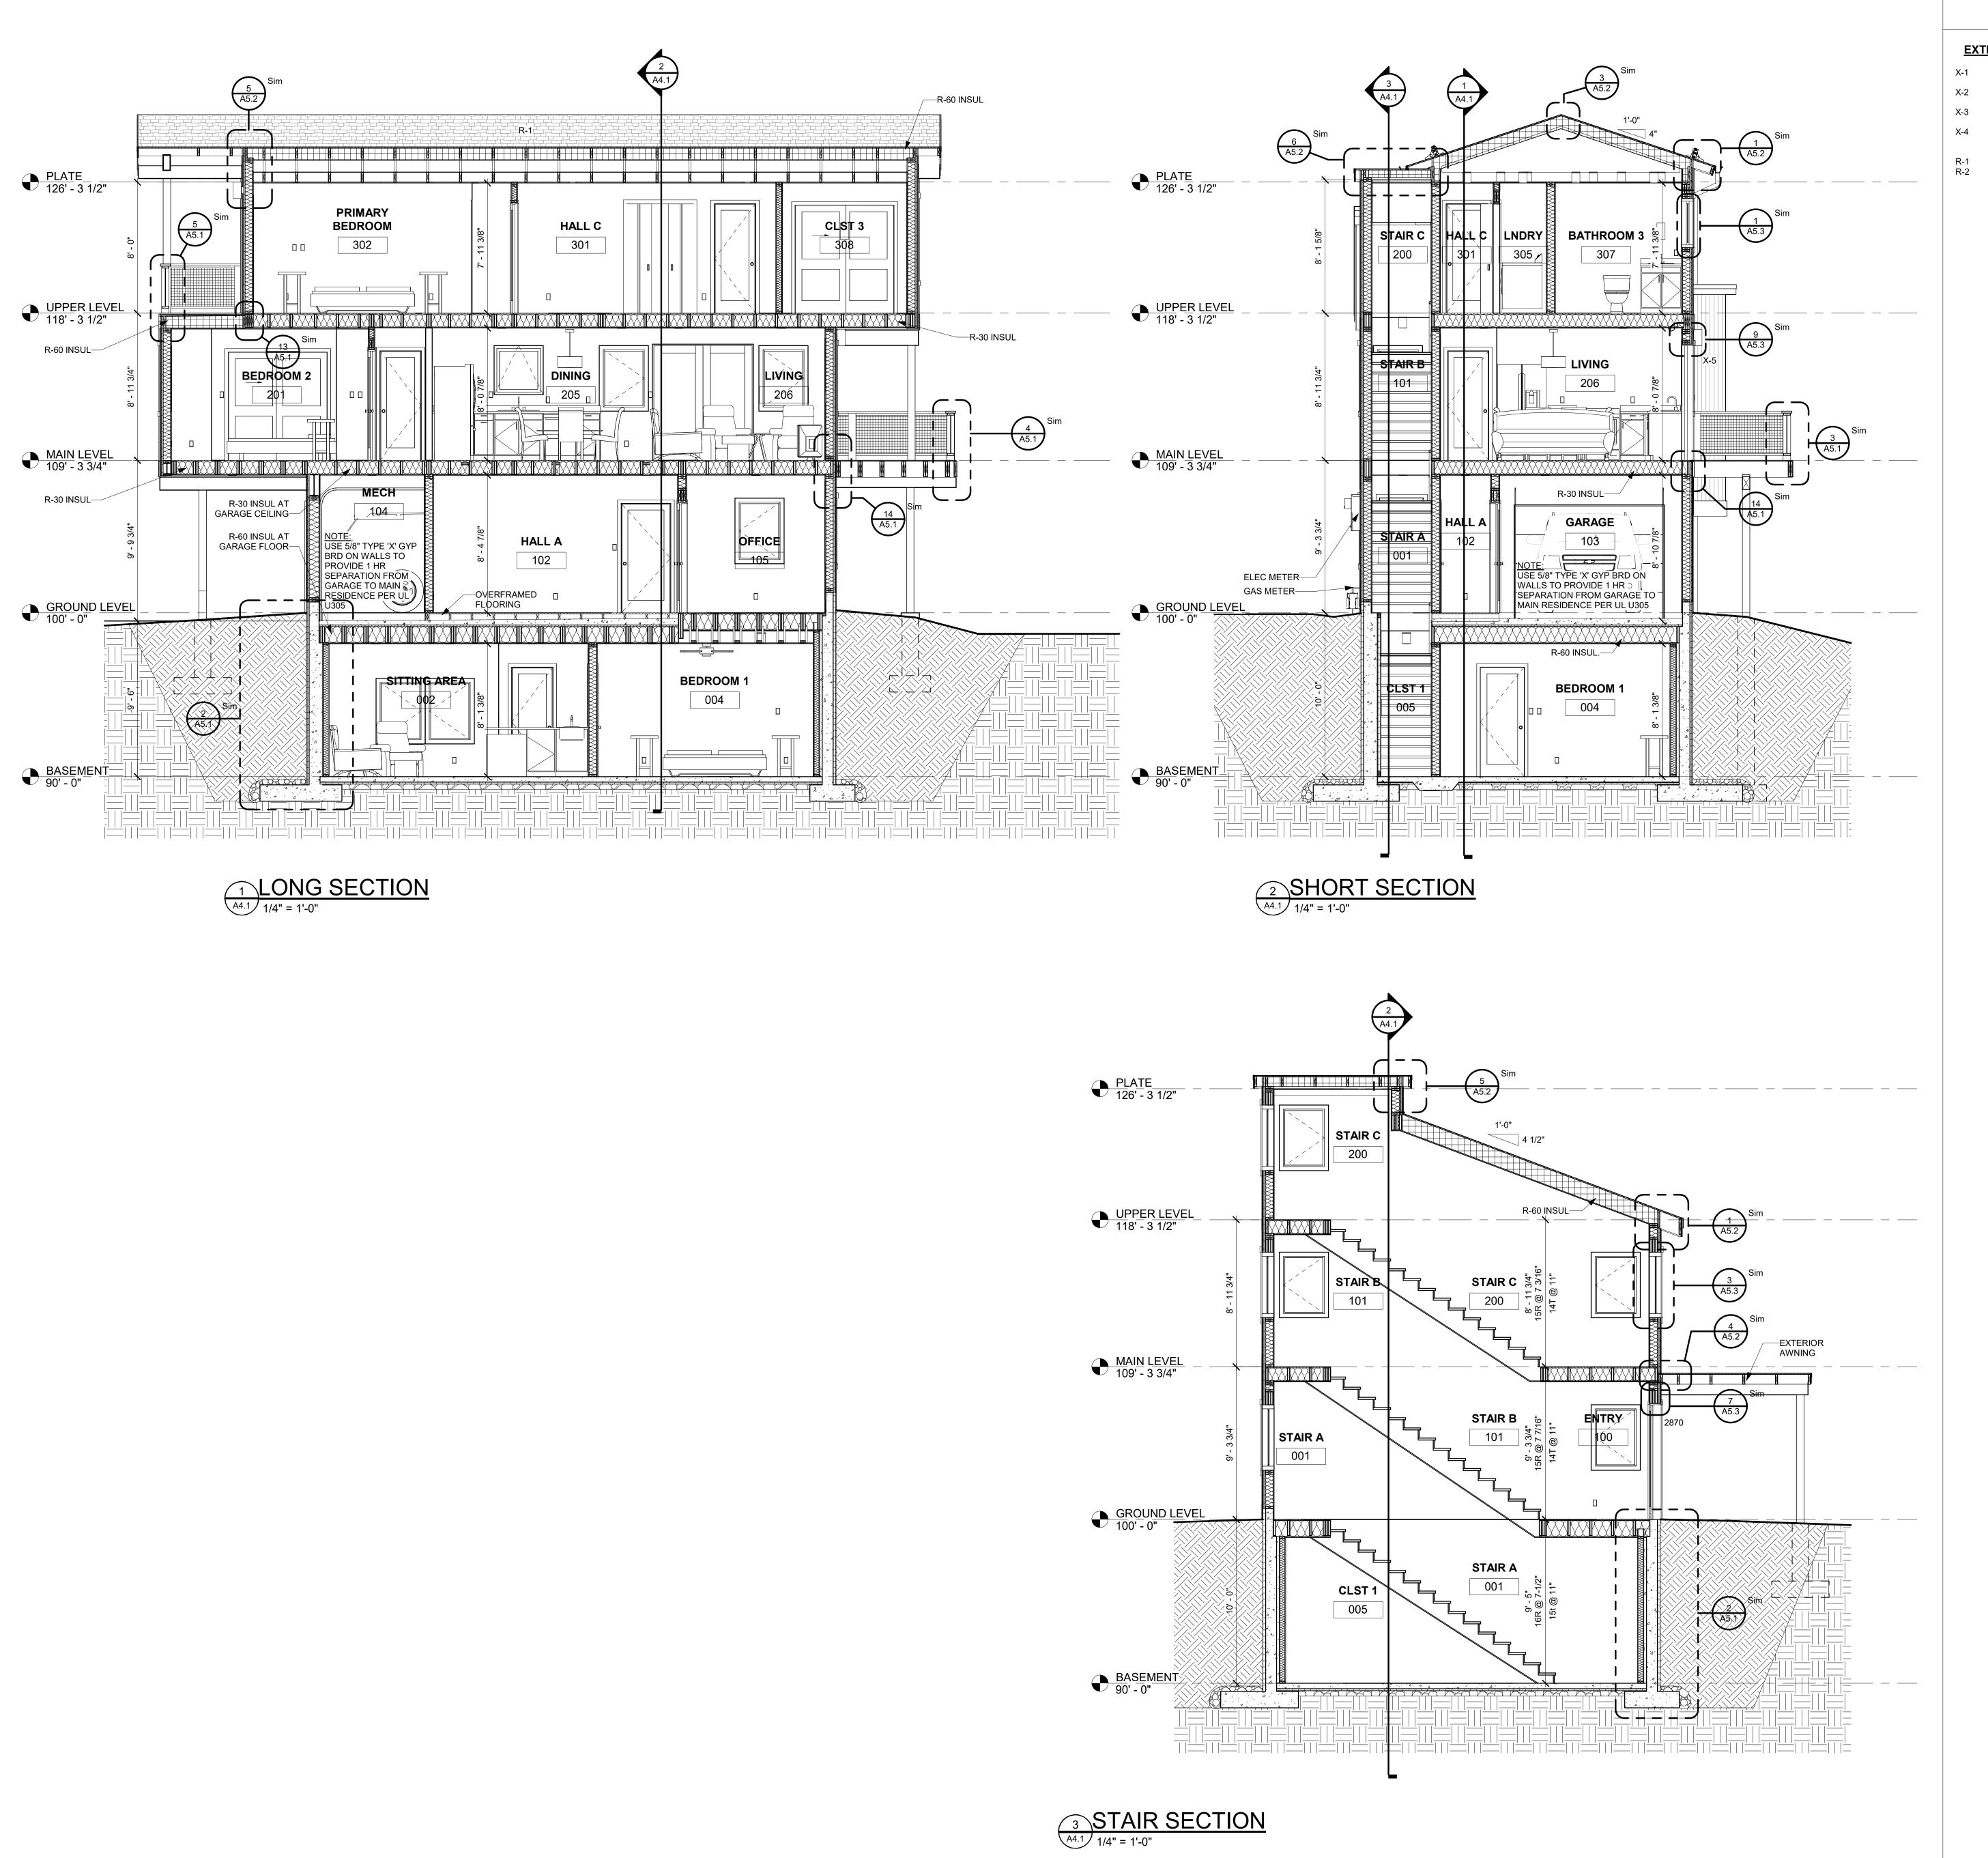
Place- 5 Belden Lot 01

Issue Dates: DRB - 02/14/2025 **Exterior** Color Elevations & 3D

Project No: 2215

NORTH EAST ELEVATION

A3.3



NOTES:

### **EXTERIOR MATERIAL LEGEND:**

- X-1 DIAMOND KOTE LP SMARTSIDE VERTICAL SIDING
  COLOR GLACIAL FOG

  X-2 DIAMOND KOTE LP SMARTSIDE LAP SIDING
  COLOR GLACIAL FOG

  X-3 VERTICAL CORRUGATED METAL SIDING
  COLOR CHARCOAL GREY

  X-4 STONE VENEER


- R-1 ASPHALT SHINGLE ROOF R-2 STANDING SEAM METAL ROOF

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email: tab@vail.net www.tabassociates.com Civil Engineer Timberline Engineering (970) 963-9869 Structural Engineer KRM Consultants, Inc (970) 949-9391 Mechanical Engineer

Electrical Engineer

Far Roa Place-Minturn elden Lot 0'  $\mathbf{m}$ 

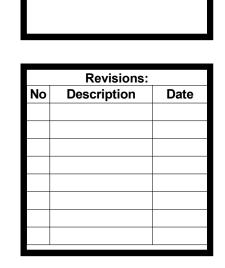


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Sheet Title: Building **Sections** 

Project No: 2215

A4.1

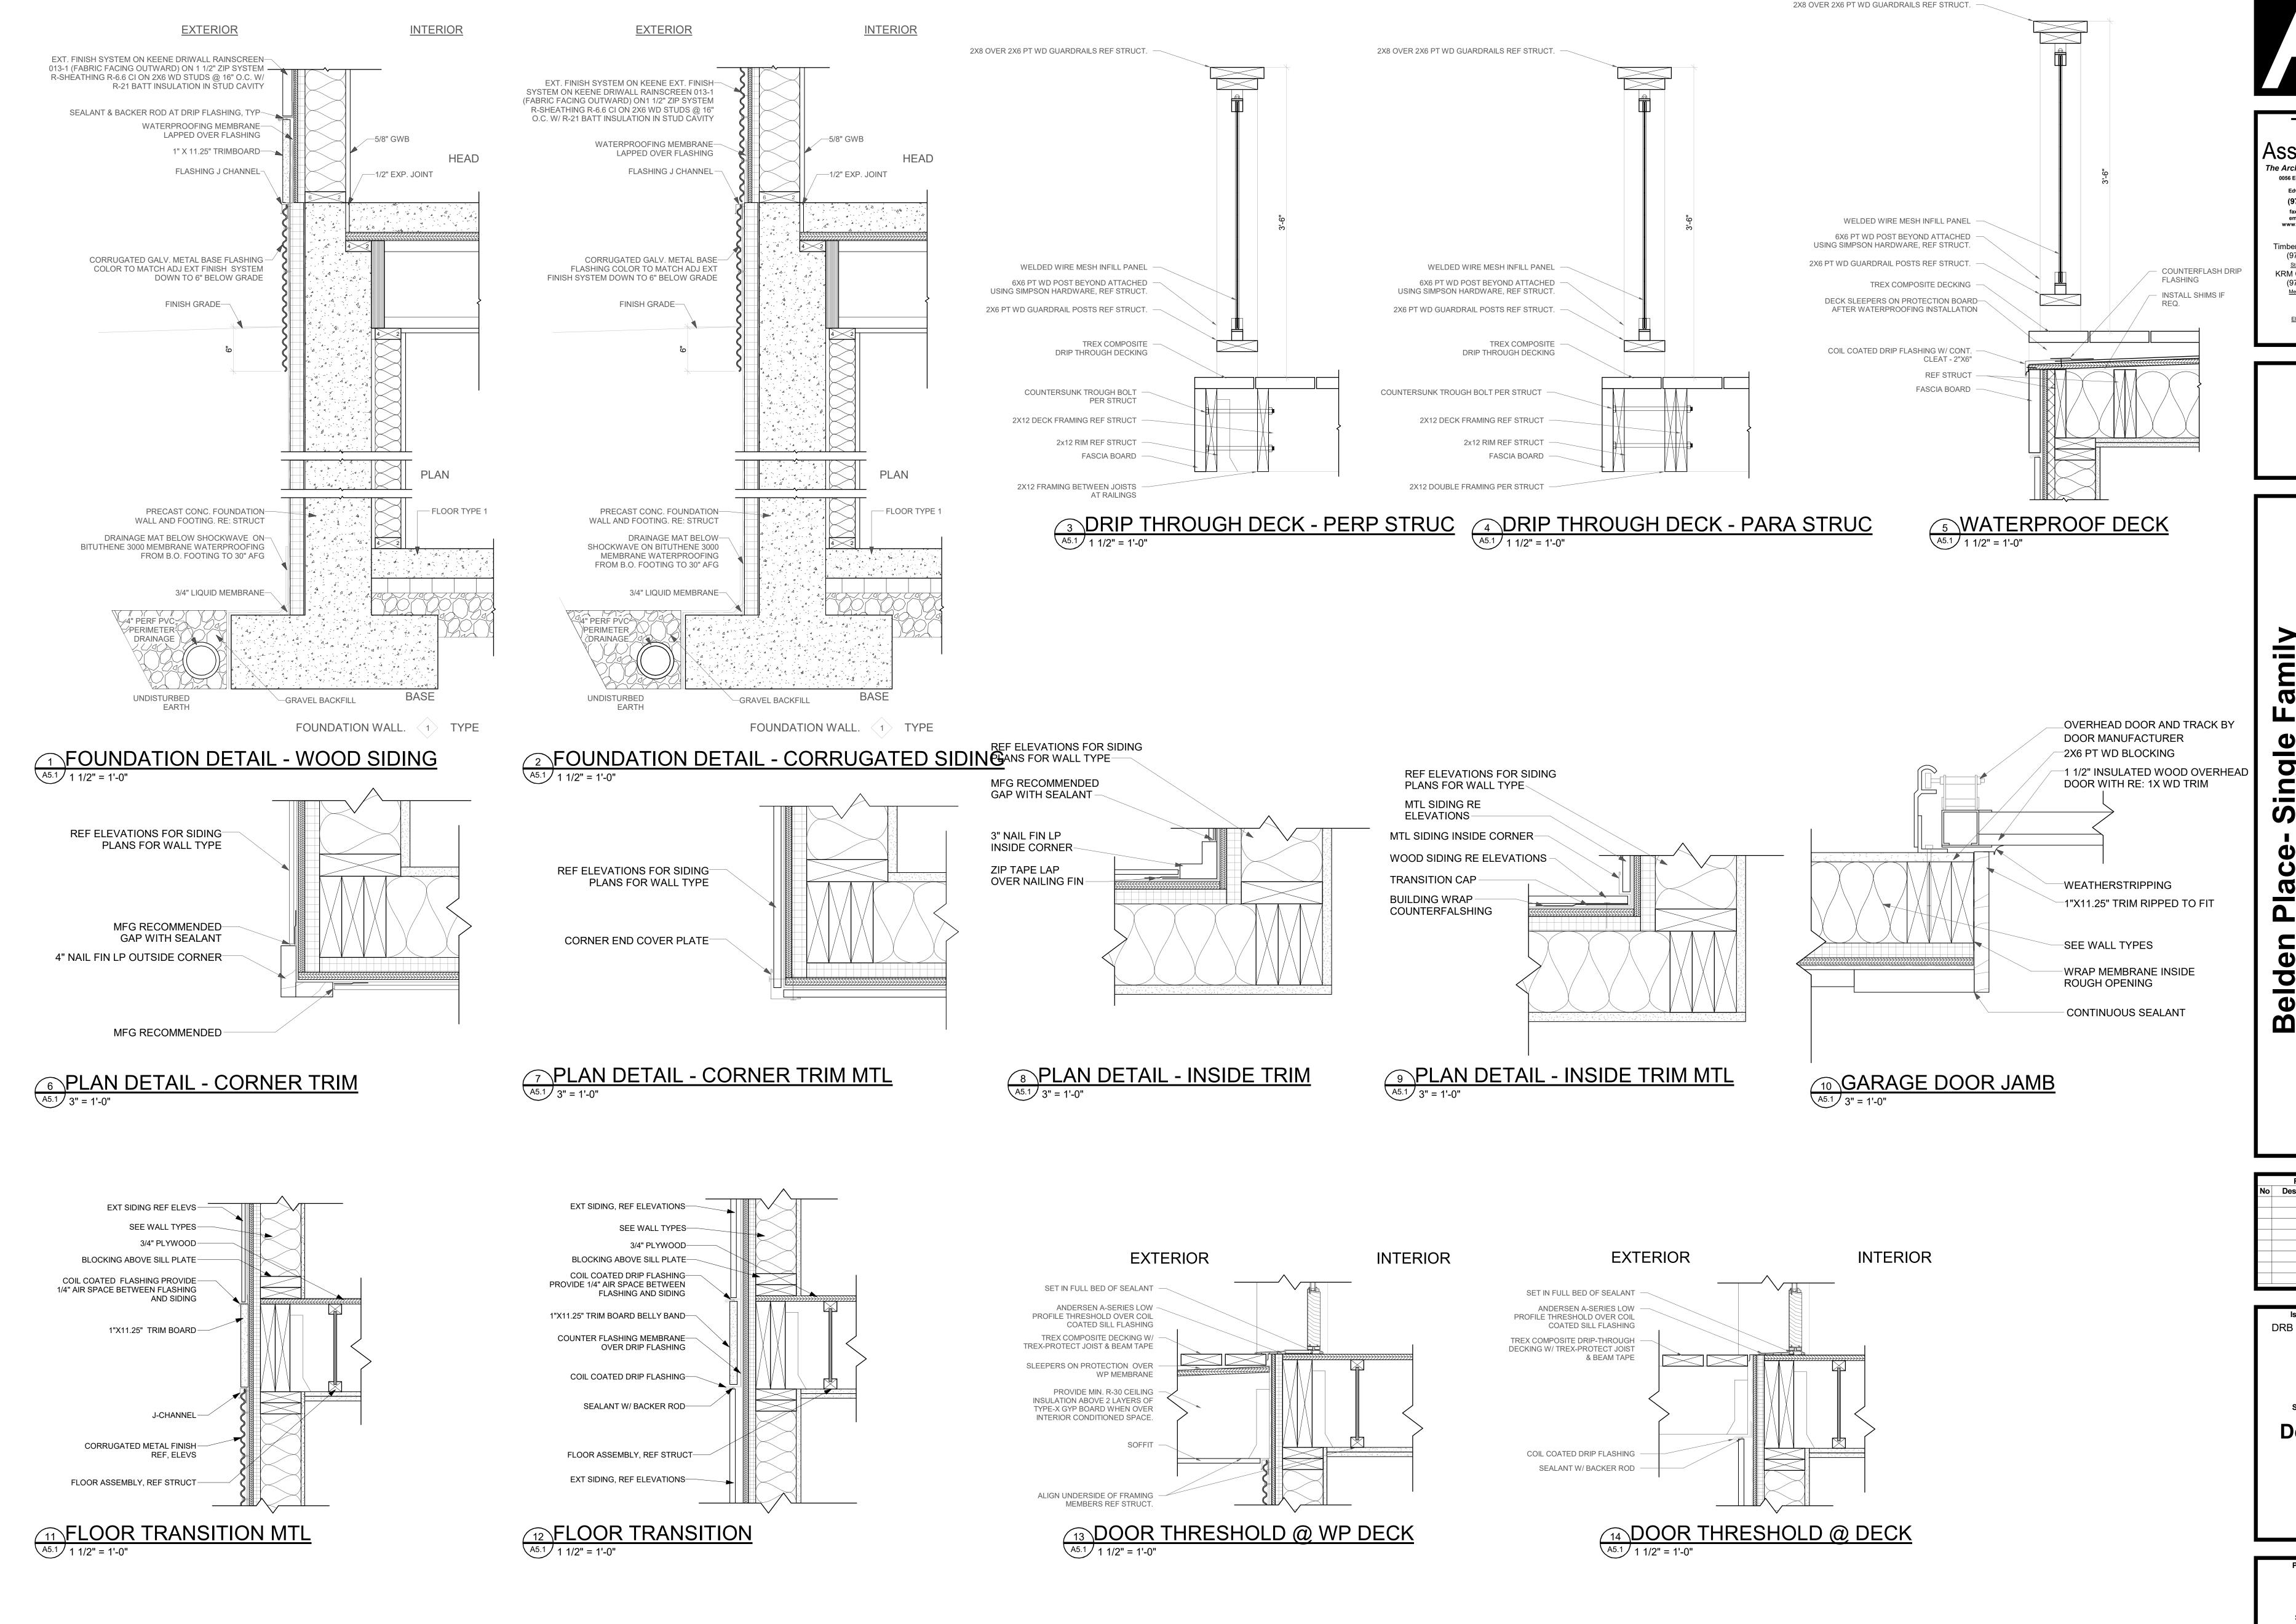

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Seal

Belden Place- Single Family Lot 01 - 0018 Abby Road


Revisions:
No Description Date

Issue Dates:
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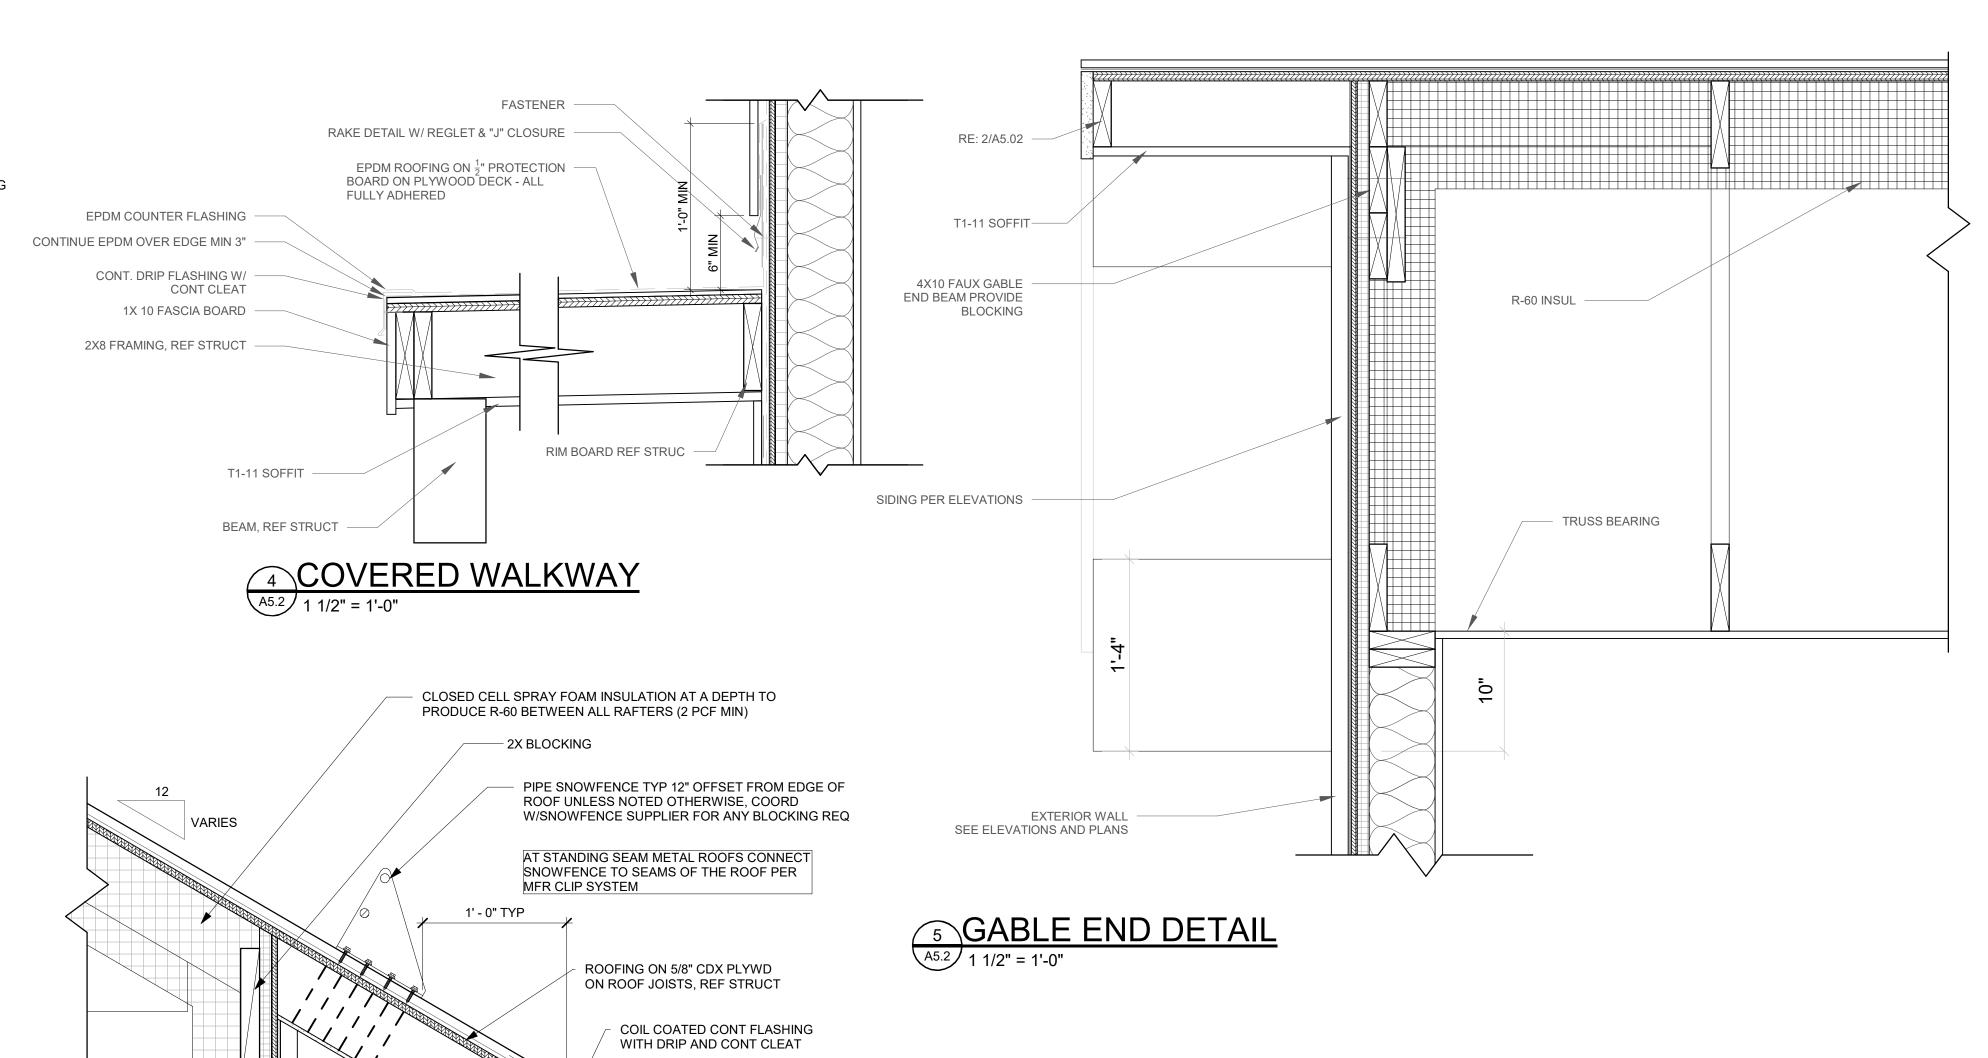
Sheet Title:
Details

Project No: 2215


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6 STAIR ROOF - LOW SLOPE TRANSITION
A5.2 1 1/2" = 1'-0"



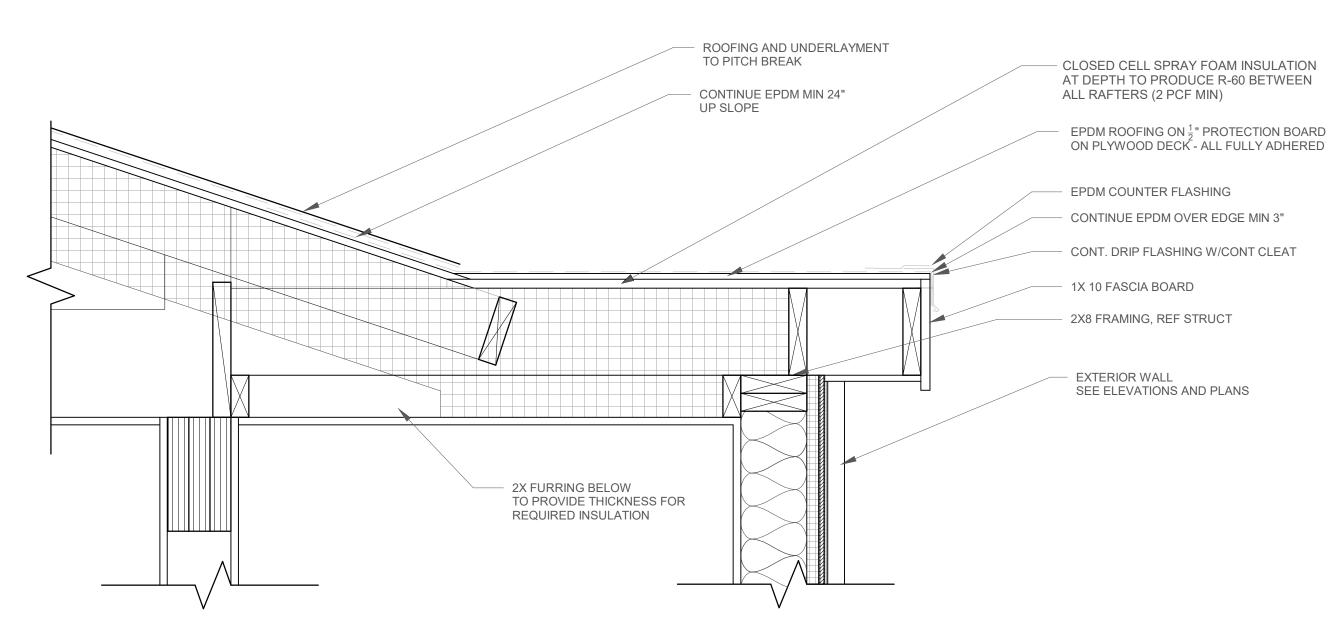




1"X7.25" TRIM FASCIA

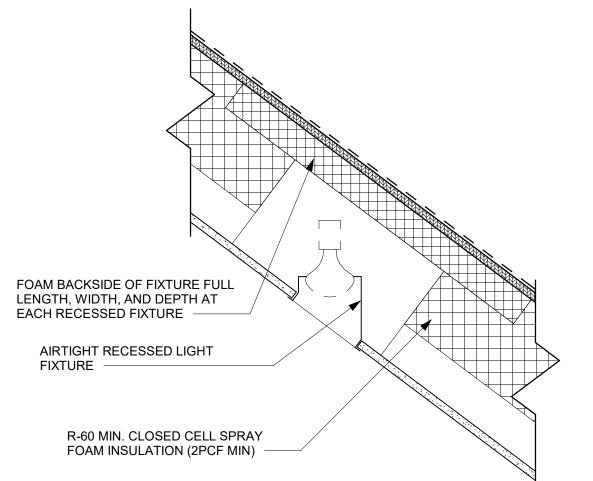EXT. FINISH REF ELEVS

9 RECESSED LIGHT FIXTURE
A5.2 1 1/2" = 1'-0"



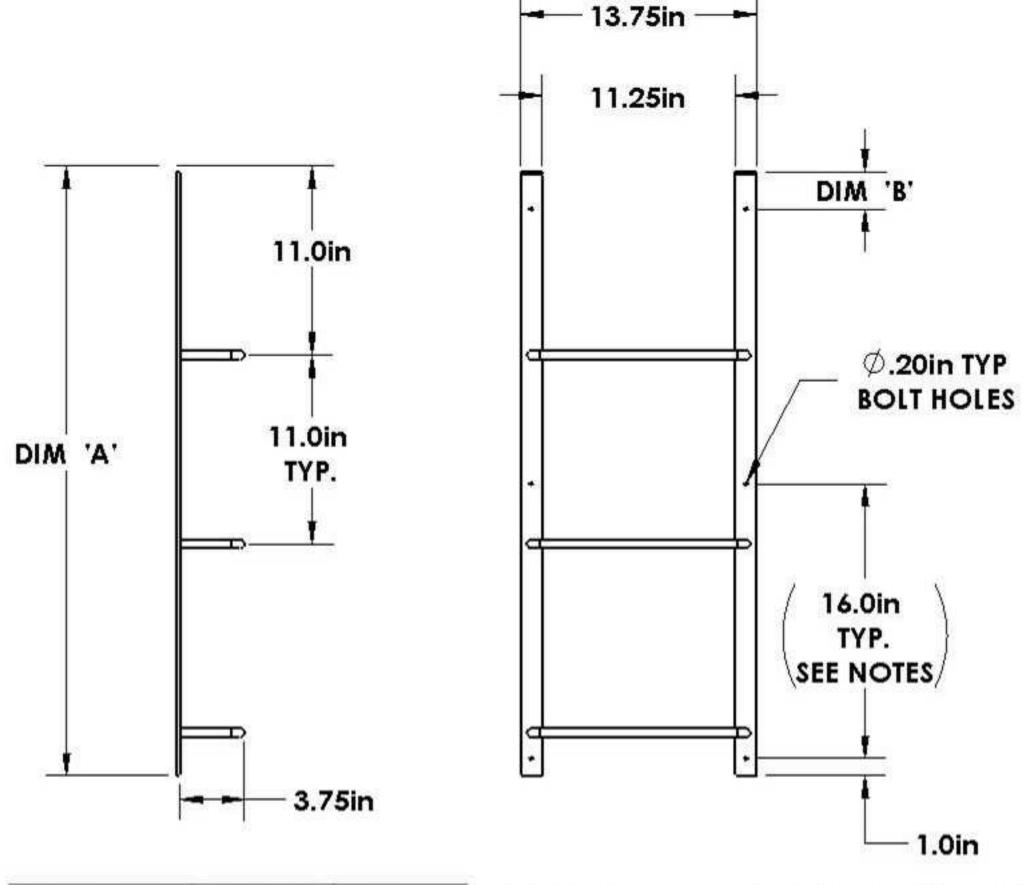

	Ladder Size	Dim 'A' [in]	Dim 'B' [in]	Material: Rung Spacing:	Powder-coated Steel 11.0in
	3 Rung	35.0	2.0	Hole Spacing:	16.0in, hole spacing
	4 Rung	46.0	1.0		may vary
	5 Rung	57.0	8.0	Hole Diameter: Screw Size*:	0.20in
	6 Rung	68.0	3.0		#10 (3/16in)
	7 Rung	79.0	1.0	TYPICAL LADDER LENGTH	
	PERMANENTLY FIXED LAD	DER			REV A

EGRESS LADDER
71/4" = 1'-0"

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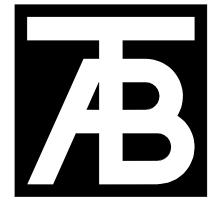
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A5.2



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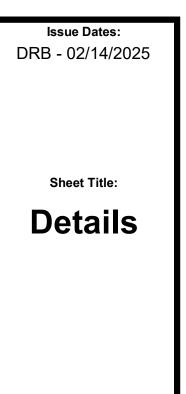
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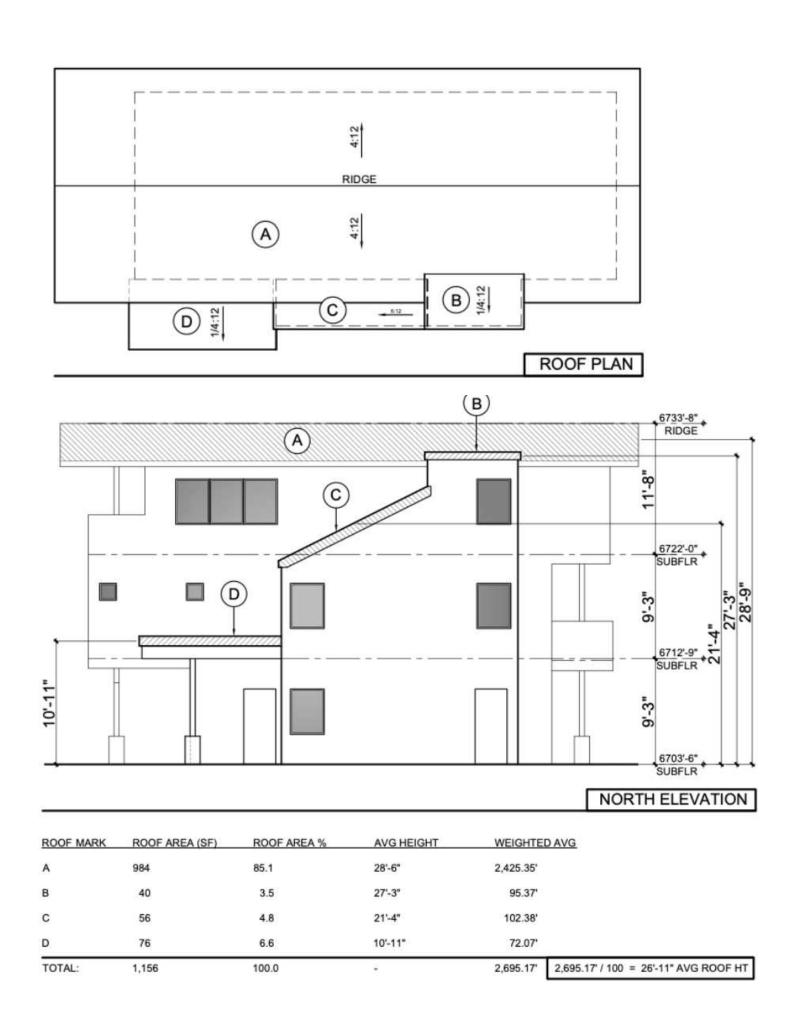
Belden Place- Single Family Lot 01 - 0018 Abby Road






2215
Sheet No:

A5.3



**Site Coverage.** Site coverage means the portion of a lot covered by materials forming any unbroken surface, impervious to water including, but not limited to: buildings, streets, slab on-grade patios, exterior fireplaces, and other hardscape materials. Site coverage excludes non-hardscape areas under eaves or similar (e.g., open-sided cantilever).

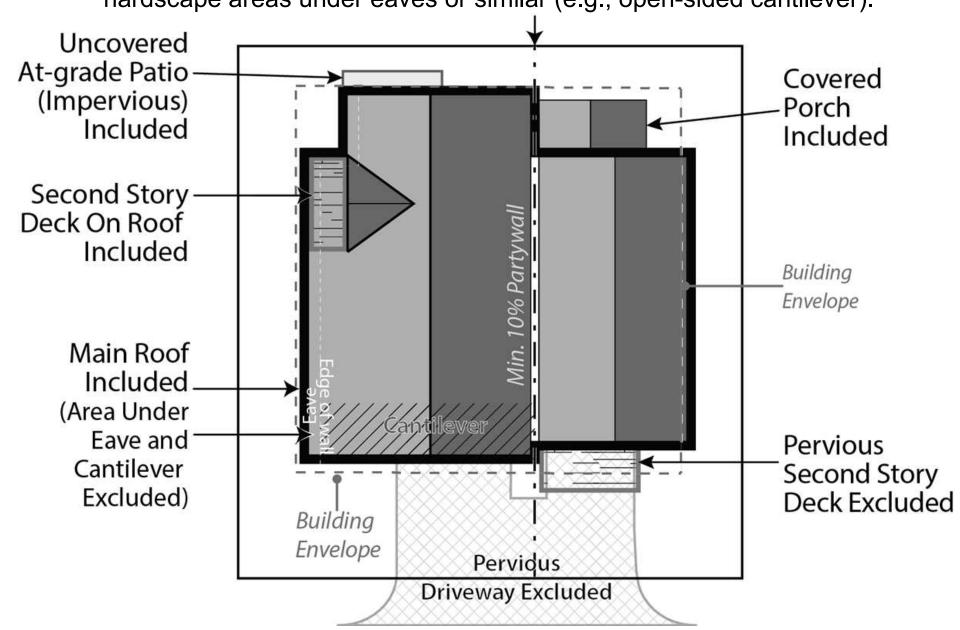

### **BUILDING PLACEMENT AND ENVELOPES**

Residential building envelopes are necessary in order to maximize the buildability and economic viability of the lots while offering greenspace and or space between neighbors to the greatest extent possible. All portions of structure- including fireplaces, chimneys, window wells, eaves, overhangs, etc. must be contained within property lines; however, with the platted building envelope acting as building setbacks for each lot, encroachments are available for certain features.

The following encroachments are permitted beyond the platted building envelope:

Unenclosed or uncovered decks; deck supports; eaves up to 18" beyond the envelope; porches, patios and landings less than 30" above the surrounding natural or finished grade; window or light wells; heat or A/C units; residential solar alternative energy installations; fences; counterforts below grade; staircases (enclosed or otherwise); structures of less than 6" in height; landscaping and drainage features. No encroachment may be located within 24" from the property line or directly on top of in-ground utility easements. Underground parking elements and staircases may encroach within 12" of the most southern property line on Lot 7.

### SINGLE-FAMILY DETACHED

### a. Style

- (1) Residences with the same architectural elevations and coloring shall not be placed adjacent to each other or directly across the street from one another.
- (2) Each residential unit type shall have at least two (2) elevations to provide stylistic diversity. This may include:
- . Roof forms/lines and profiles
- i. Varied window and door styles
- iii. Varied entry treatments and locations including porches, columns, etc.
- iv. Two or three story homes
- v. Second or third story decks or balconies
- b. Building Form
- (1) The mass of the residence should strongly reflect the architectural style and be scaled to provide visual interest and depth, reduce boxiness and achieve an articulated form on the front and sides of the homes.
- (2) Roofs shall be designed and pitched accordingly in consideration of solar technology and/or drainage.
- (3) Roof-top decks are permitted only on certain lots as established by developer and cannot be added on buildings not constructed with this initial feature.

### 2. DUPLEX/TRI-PLEX or MULTIFAMILY STRUCTURES

### a. Style

- (1) Structures shall have at least two (2) elevations to provide stylistic diversity.
- (2) Units may be multi-stories.
- (3) Units may be divided horizontally (townhomes) or vertically (flats).
- (4) Second story decks or balconies permitted.
- (5) Units have no minimum length of connection and may be joined via shared walls of the garage, external staircases, or main living area wall(s) or floors.

### b. Building Form

- (1) The mass of the residence should strongly reflect the architectural style and be scaled to provide visual interest and depth, reduce boxiness and achieve an articulated form on the front of the homes.
- (2) Roofs shall be designed and pitched accordingly in consideration of solar technology and/or drainage.
- (3) Roof-top decks are permitted only on certain lots as established by developer and cannot be added on buildings not constructed with this initial feature.

### . MATERIALS

### a. Roofing materials are limited to the following:

- (1) Artificial wood shingle (to mimic wood shake shingle). Treated wood shake shingles or any other combustible material is prohibited.
- (2) Standing seam metal.
- (3) Asphalt shingles.
- (4) Imitation (composite or similar); or, real slate tiles.
- (5) Non-reflective solar tiles that mimic the above-mentioned products
- (6) Any other recommended FireWise materials similar to the above-mentioned products.

### b. Siding materials are limited to the following:

- (1) Metal
- (2) Wood
- (3) Composite siding(4) Fiber cement board (commonly known as "Hardie Board")
- (5) Stucco.
- (6) Any other recommended FireWise materials similar to the above-mentioned products.
- (7) All siding materials to have non-reflective finishes.

### c. Doors and Windows:

- (1) Structures with multiple garage doors must always have identical, matching doors.
- (2) All replacement windows shall be consistent and match the aesthetic of previous windows unless otherwise approved by the design review board. Skylight or solar tubes permitted.
- (3) Screen or storm doors, in addition to typical front doors are permitted. Screen or storm doors cannot replace front doors at any time.
- d. Design Elements. This development may incorporate mountain appropriate design elements into the buildings, including, but not limited to, exposed heavy timber beams as accent elements or entry features, walls faced with wood, stone, faux stone or cultured stone, metal railings or accents. Stucco may only be utilized in small quantities on building facades and is not to be used as a primary material for home.
- e. Building materials for residential exteriors shall include at least two (2) types of materials as part of the building façade.

I. LANDSCAPING – See also PUD Landscaping Plan
Shall not interfere with any drainage way, utility, pedestrian access, or
entry into any structure. Landscaping shall not obscure windows, be
installed under gas fireplace or dryer vents, nor shall any landscaping
material overtake any yard, or spread into any common or
neighboring yards.

### Landscaping minimums:

- At least one (1) tree per 1,200 sf of lot area and two (2) shrubs for all lots. See also official Landscaping Plan for Belden Place.
   All landscaping proposed on the approved Landscaping Plan
- shall be installed initially with expectations for maintenance.

  3. No exposed soil is permitted. Soil must be covered in groundcover that may consist of seed (includes wildflower seed), cobble, perennials, mulch, or similar.
- 4. All dead materials must be replaced during the same season death occurs.

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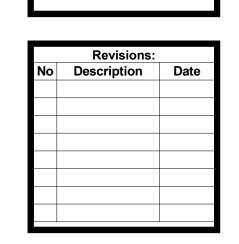
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Belden Place- Single Family
Lot 01 - 0018 Abby Road



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PUD GUIDE

> Project No: 2215

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