
Lot 18 - 0010 Abby Road

Single Family Minturn, CO 81645

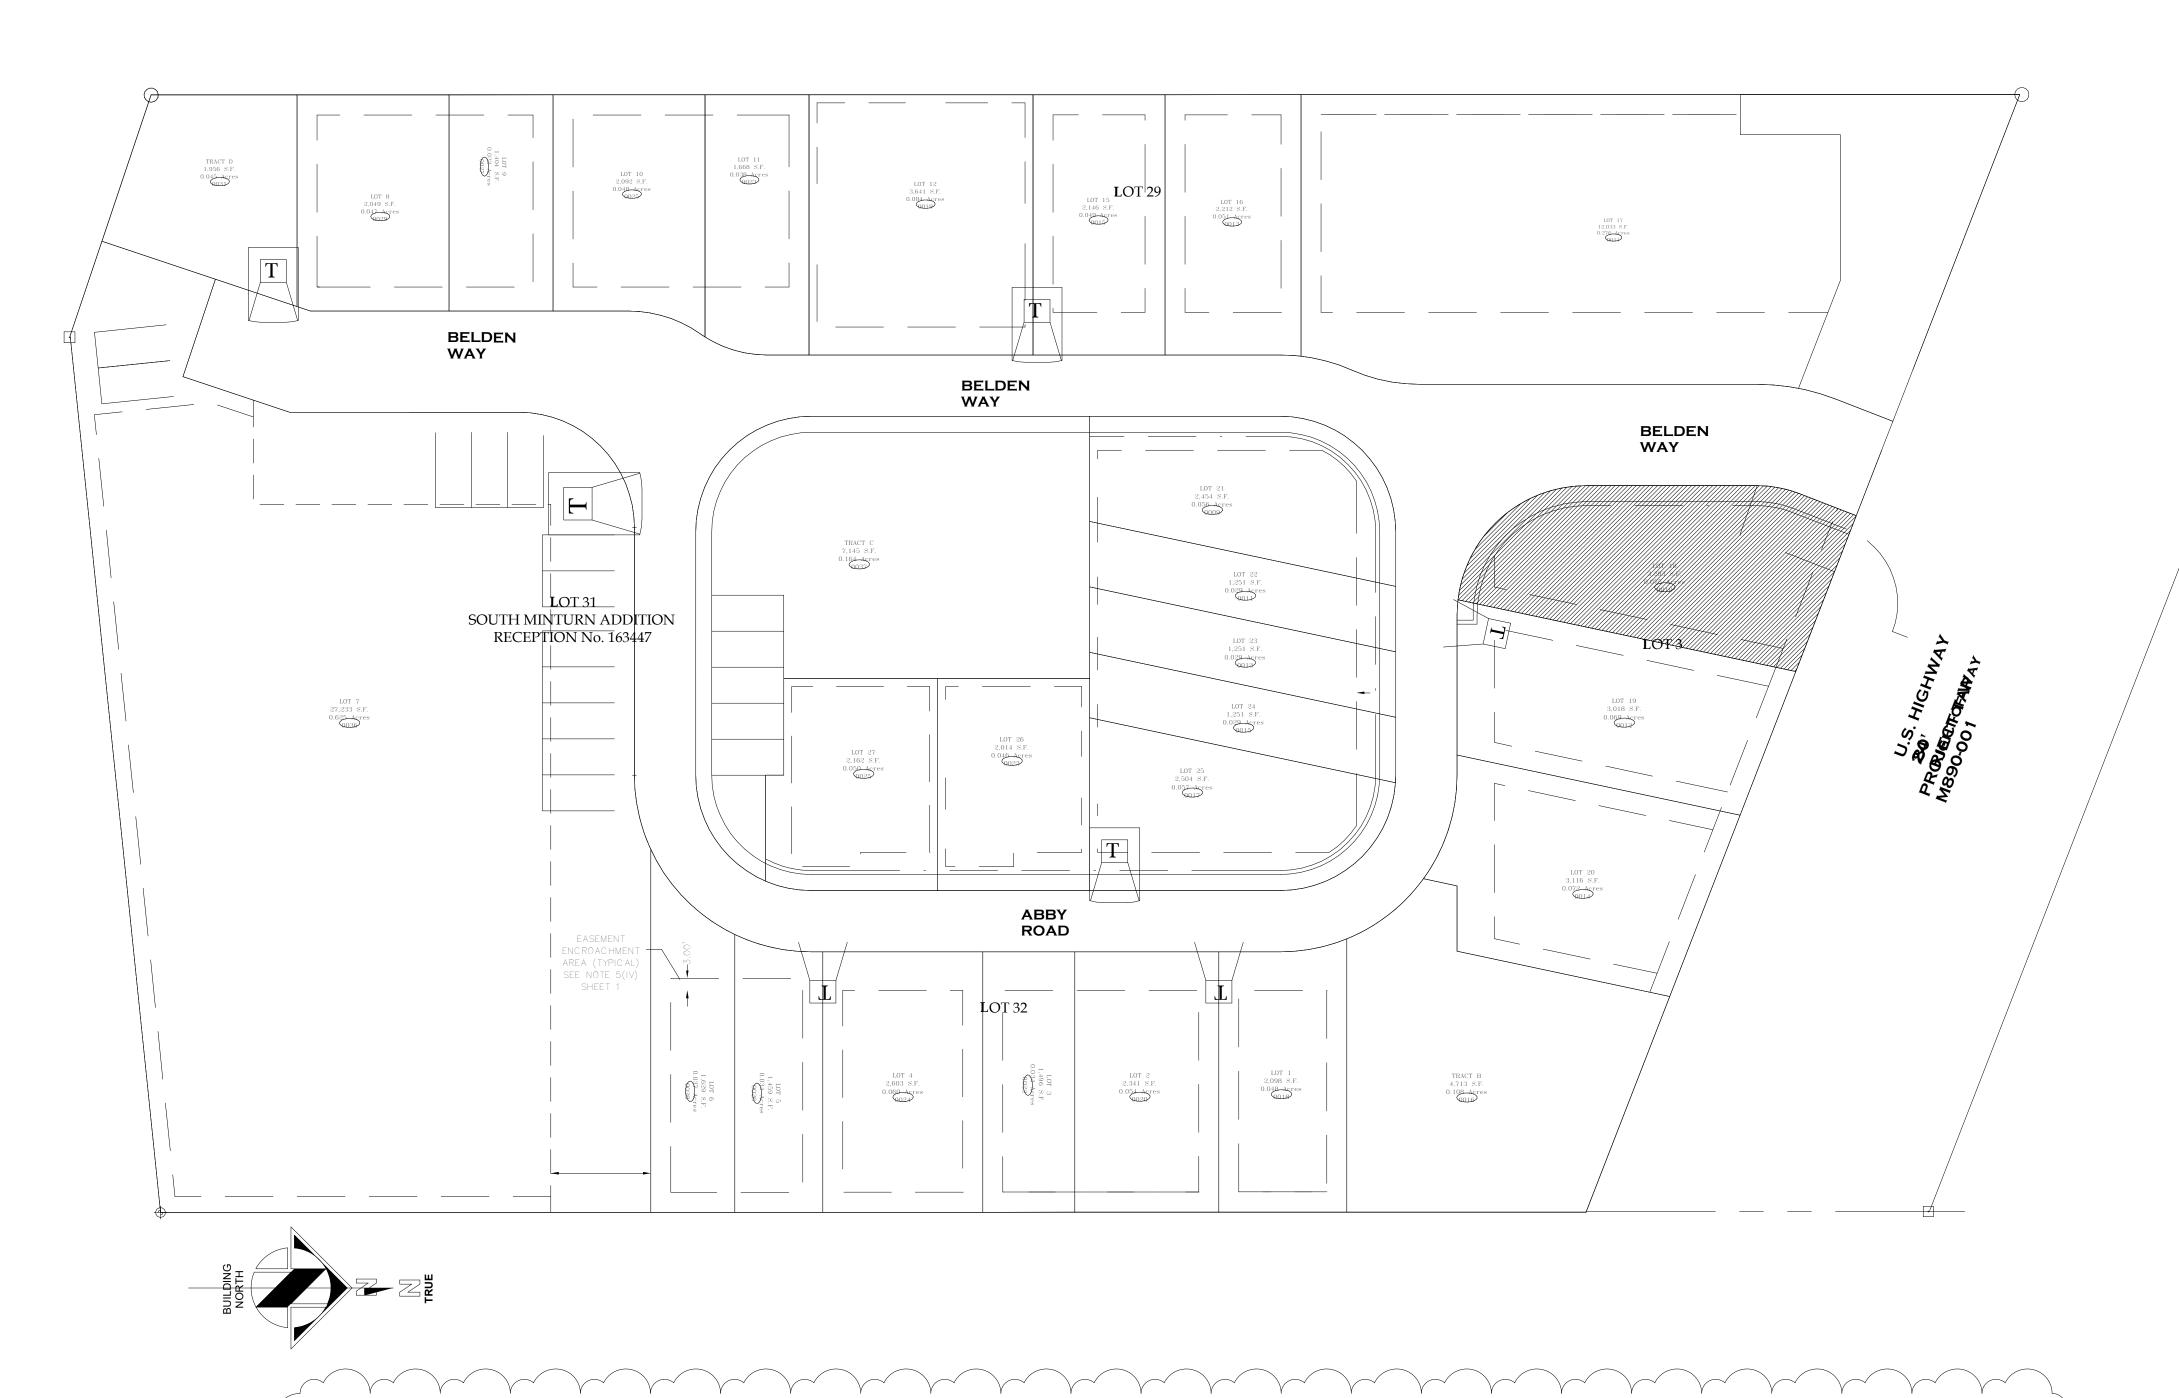

DESIGN REVIEW BOARD REVISED 03/12/2025

TAB
ASSOCIATES
The Architectural Balance

0056 Edwards Village Blvd.
Suite 210
Edwards, CO 81632
(970) 766-1470
fax: (970) 766-1471

Edwards, CO 81632

(970) 766-1470

fax: (970) 766-1471

email: tab@vail.net

www.tabassociates.com

Civil Engineer

Timberline Engineering

(970) 963-9869

Structural Engineer

KRM Consultants, Inc

(970) 949-9391

Mechanical Engineer

Electrical Engineer

Seal

te - Singel Family 010 Abby Road

Revisions:

No Description Date

1 DRB Rev 3/12/25

elde I ot

Issue Dates:
DRB - 02/14/2025

Sheet Title:
Cover

Project No:
2215

Sheet No:

AO.O

TABLE OF CONTENTS
A0.0 COVER SHEET
A0.02 PUD GUIDE

P0.01 PLAT
C1.110 SURVEY
C1.111 SITE PLAN

C1 SITE PLAN
C2 UTILITY PLAN & EROSION CONTOL PLAN

C3 EROSION CONTROL DETAILS
A1.1 LANDSCAPE PLAN

A1.1 LANDSCAPE PLAN
A2.1 BASEMENT & GROU

A2.1 BASEMENT & GROUND PLANS A2.2 MAIN, UPPER, & ROOF PLANS A3.1 EXTERIOR ELEVATIONS

A3.2 MATERIALS A3.3 RENDERINGS

A4.1 BUILDING SECTIONS

A5.1 DETAILS A5.2 DETAILS A5.3 DETAILS




VICINITY MAP


BELDEN PLACE PUD GUIDE INFORMATION

The following is an abrieviated verision of information found in the PUD guide.

Building Height. Determining building height uses a weighted height calculation as measured from final/finished grade. Max heights - 28' for single famil and duplex, 35' for Row Houses and Flats.

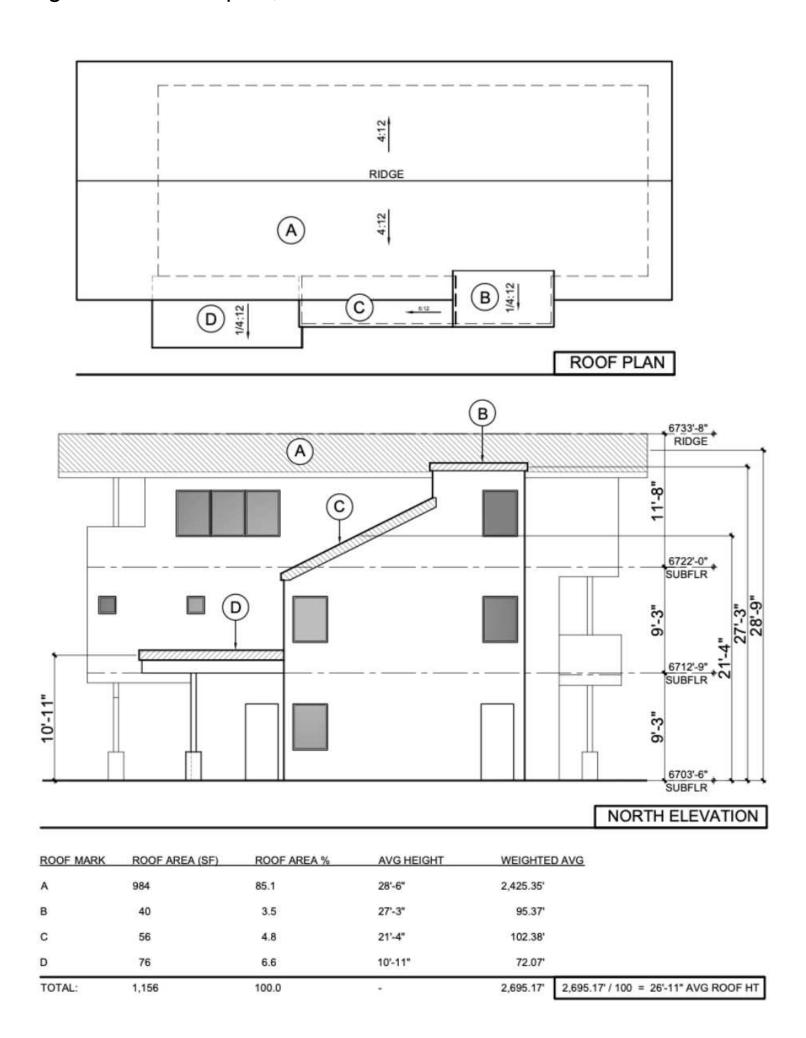

Site Coverage. Site coverage means the portion of a lot covered by materials forming any unbroken surface, impervious to water including, but not limited to: buildings, streets, slab on-grade patios, exterior fireplaces, and other hardscape materials. Site coverage excludes nonhardscape areas under eaves or similar (e.g., open-sided cantilever).

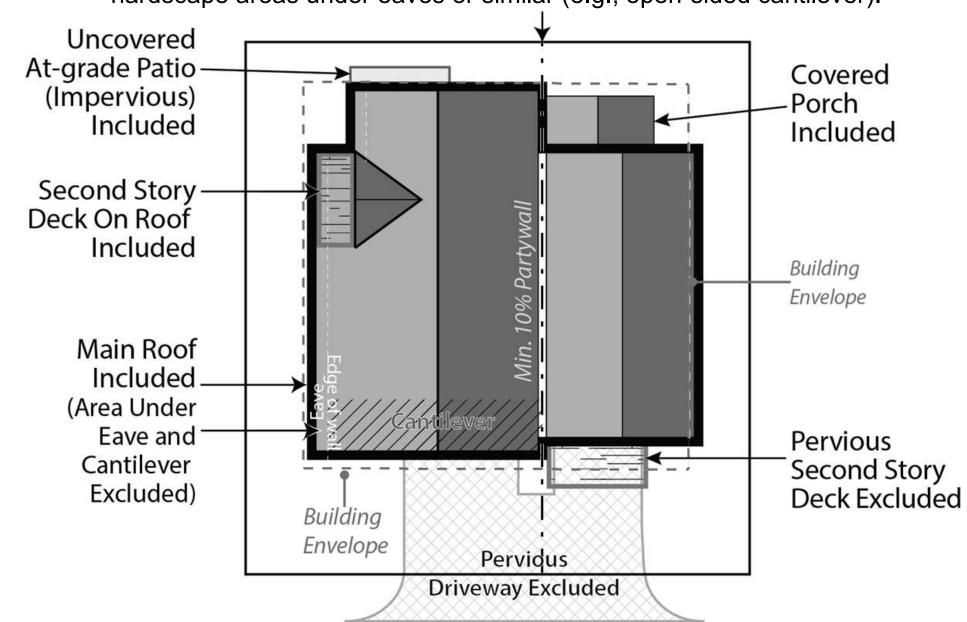

BUILDING PLACEMENT AND ENVELOPES

Residential building envelopes are necessary in order to maximize the buildability and economic viability of the lots while offering greenspace and or space between neighbors to the greatest extent possible. All portions of structure- including fireplaces, chimneys, window wells, eaves, overhangs, etc. must be contained within property lines; however, with the platted building envelope acting as building setbacks for each lot, encroachments are available for certain features.

The following encroachments are permitted beyond the platted building envelope:

Unenclosed or uncovered decks; deck supports; eaves up to 18" beyond the envelope; porches, patios and landings less than 30" above the surrounding natural or finished grade; window or light wells; heat or A/C units; residential solar alternative energy installations; fences; counterforts below grade; staircases (enclosed or otherwise); structures of less than 6" in height; landscaping and drainage features. No encroachment may be located within 24" from the property line or directly on top of in-ground utility easements. Underground parking elements and staircases may encroach within 12" of the most southern property line on Lot 7.

SINGLE-FAMILY DETACHED

Style

- (1) Residences with the same architectural elevations and coloring shall not be placed adjacent to each other or directly across the street from one another.
- (2) Each residential unit type shall have at least two (2) elevations to provide stylistic diversity. This may include:
- Roof forms/lines and profiles
- Varied window and door styles
- Varied entry treatments and locations including porches, columns, etc.
- iv. Two or three story homes
- Second or third story decks or balconies

b. Building Form

- (1) The mass of the residence should strongly reflect the architectural style and be scaled to provide visual interest and depth, reduce boxiness and achieve an articulated form on the front and sides of the homes.
- (2) Roofs shall be designed and pitched accordingly in consideration of solar technology and/or drainage
- (3) Roof-top decks are permitted only on certain lots as established by developer and cannot be added on buildings not constructed with this initial feature.

2. DUPLEX/TRI-PLEX or MULTIFAMILY STRUCTURES

- (1) Structures shall have at least two (2) elevations to provide stylistic diversity.
- (2) Units may be multi-stories.
- (3) Units may be divided horizontally (townhomes) or vertically (flats).
- (4) Second story decks or balconies permitted.
- (5) Units have no minimum length of connection and may be joined via shared walls of the garage, external staircases, or main living area wall(s) or floors.

b. Building Form

- (1) The mass of the residence should strongly reflect the architectural style and be scaled to provide visual interest and depth, reduce boxiness and achieve an articulated form on the front of the homes.
- (2) Roofs shall be designed and pitched accordingly in
- consideration of solar technology and/or drainage
- (3) Roof-top decks are permitted only on certain lots as established by developer and cannot be added on buildings not constructed with this initial feature.

3. MATERIALS

Roofing materials are limited to the following:

- (1) Artificial wood shingle (to mimic wood shake shingle). Treated wood shake shingles or any other combustible material is prohibited.
- (2) Standing seam metal.
- (3) Asphalt shingles
- (4) Imitation (composite or similar); or, real slate tiles.
- (5) Non-reflective solar tiles that mimic the above-mentioned products
- (6) Any other recommended FireWise materials similar to the above-mentioned products.

Siding materials are limited to the following:

- (1) Metal
- (2) Wood (3) Composite siding
- (4) Fiber cement board (commonly known as "Hardie Board")
- (5) Stucco.
- (6) Any other recommended FireWise materials similar to the above-mentioned products.
- (7) All siding materials to have non-reflective finishes.


c. Doors and Windows:

- (1) Structures with multiple garage doors must always have identical, matching doors.
- (2) All replacement windows shall be consistent and match the aesthetic of previous windows unless otherwise approved by the design review board. Skylight or solar tubes permitted.
- (3) Screen or storm doors, in addition to typical front doors are permitted. Screen or storm doors cannot replace front doors at any time.
- Design Elements. This development may incorporate mountain appropriate design elements into the buildings, including, but not limited to, exposed heavy timber beams as accent elements or entry features, walls faced with wood, stone, faux stone or cultured stone, metal railings or accents. Stucco may only be utilized in small quantities on building facades and is not to be used as a primary material for home.
- e. Building materials for residential exteriors shall include at least two (2) types of materials as part of the building façade.

LANDSCAPING – See also PUD Landscaping Plan Shall not interfere with any drainage way, utility, pedestrian access, or entry into any structure. Landscaping shall not obscure windows, be installed under gas fireplace or dryer vents, nor shall any landscaping material overtake any yard, or spread into any common or neighboring yards.

Landscaping minimums:

- 1. At least one (1) tree per 1,200 sf of lot area and two (2) shrubs for all lots. See also official Landscaping Plan for Belden Place. 2. All landscaping proposed on the approved Landscaping Plan shall be installed initially with expectations for maintenance. 3. No exposed soil is permitted. Soil must be covered in
- groundcover that may consist of seed (includes wildflower seed), cobble, perennials, mulch, or similar.
- 4. All dead materials must be replaced during the same season death occurs.

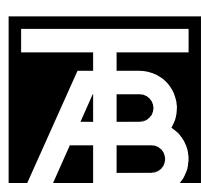


TAB Associates

The Architectural Balan 0056 Edwards Village Blvd. Suite 210 Edwards, CO 81632 (970) 766-1470 fax: (970) 766-1471 email: tab@vail.net

Civil Engineer Timberline Engineering (970) 963-9869 Structural Engineer KRM Consultants, Inc (970) 949-9391 Mechanical Engineer

Electrical Engineer

a ge| bv Sin 00 4 eld

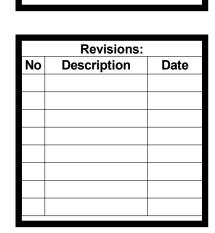



Issue Dates: DRB - 02/14/2025


> **Sheet Title:** PUD GUIDE


> > Project No: 2215


A0.2

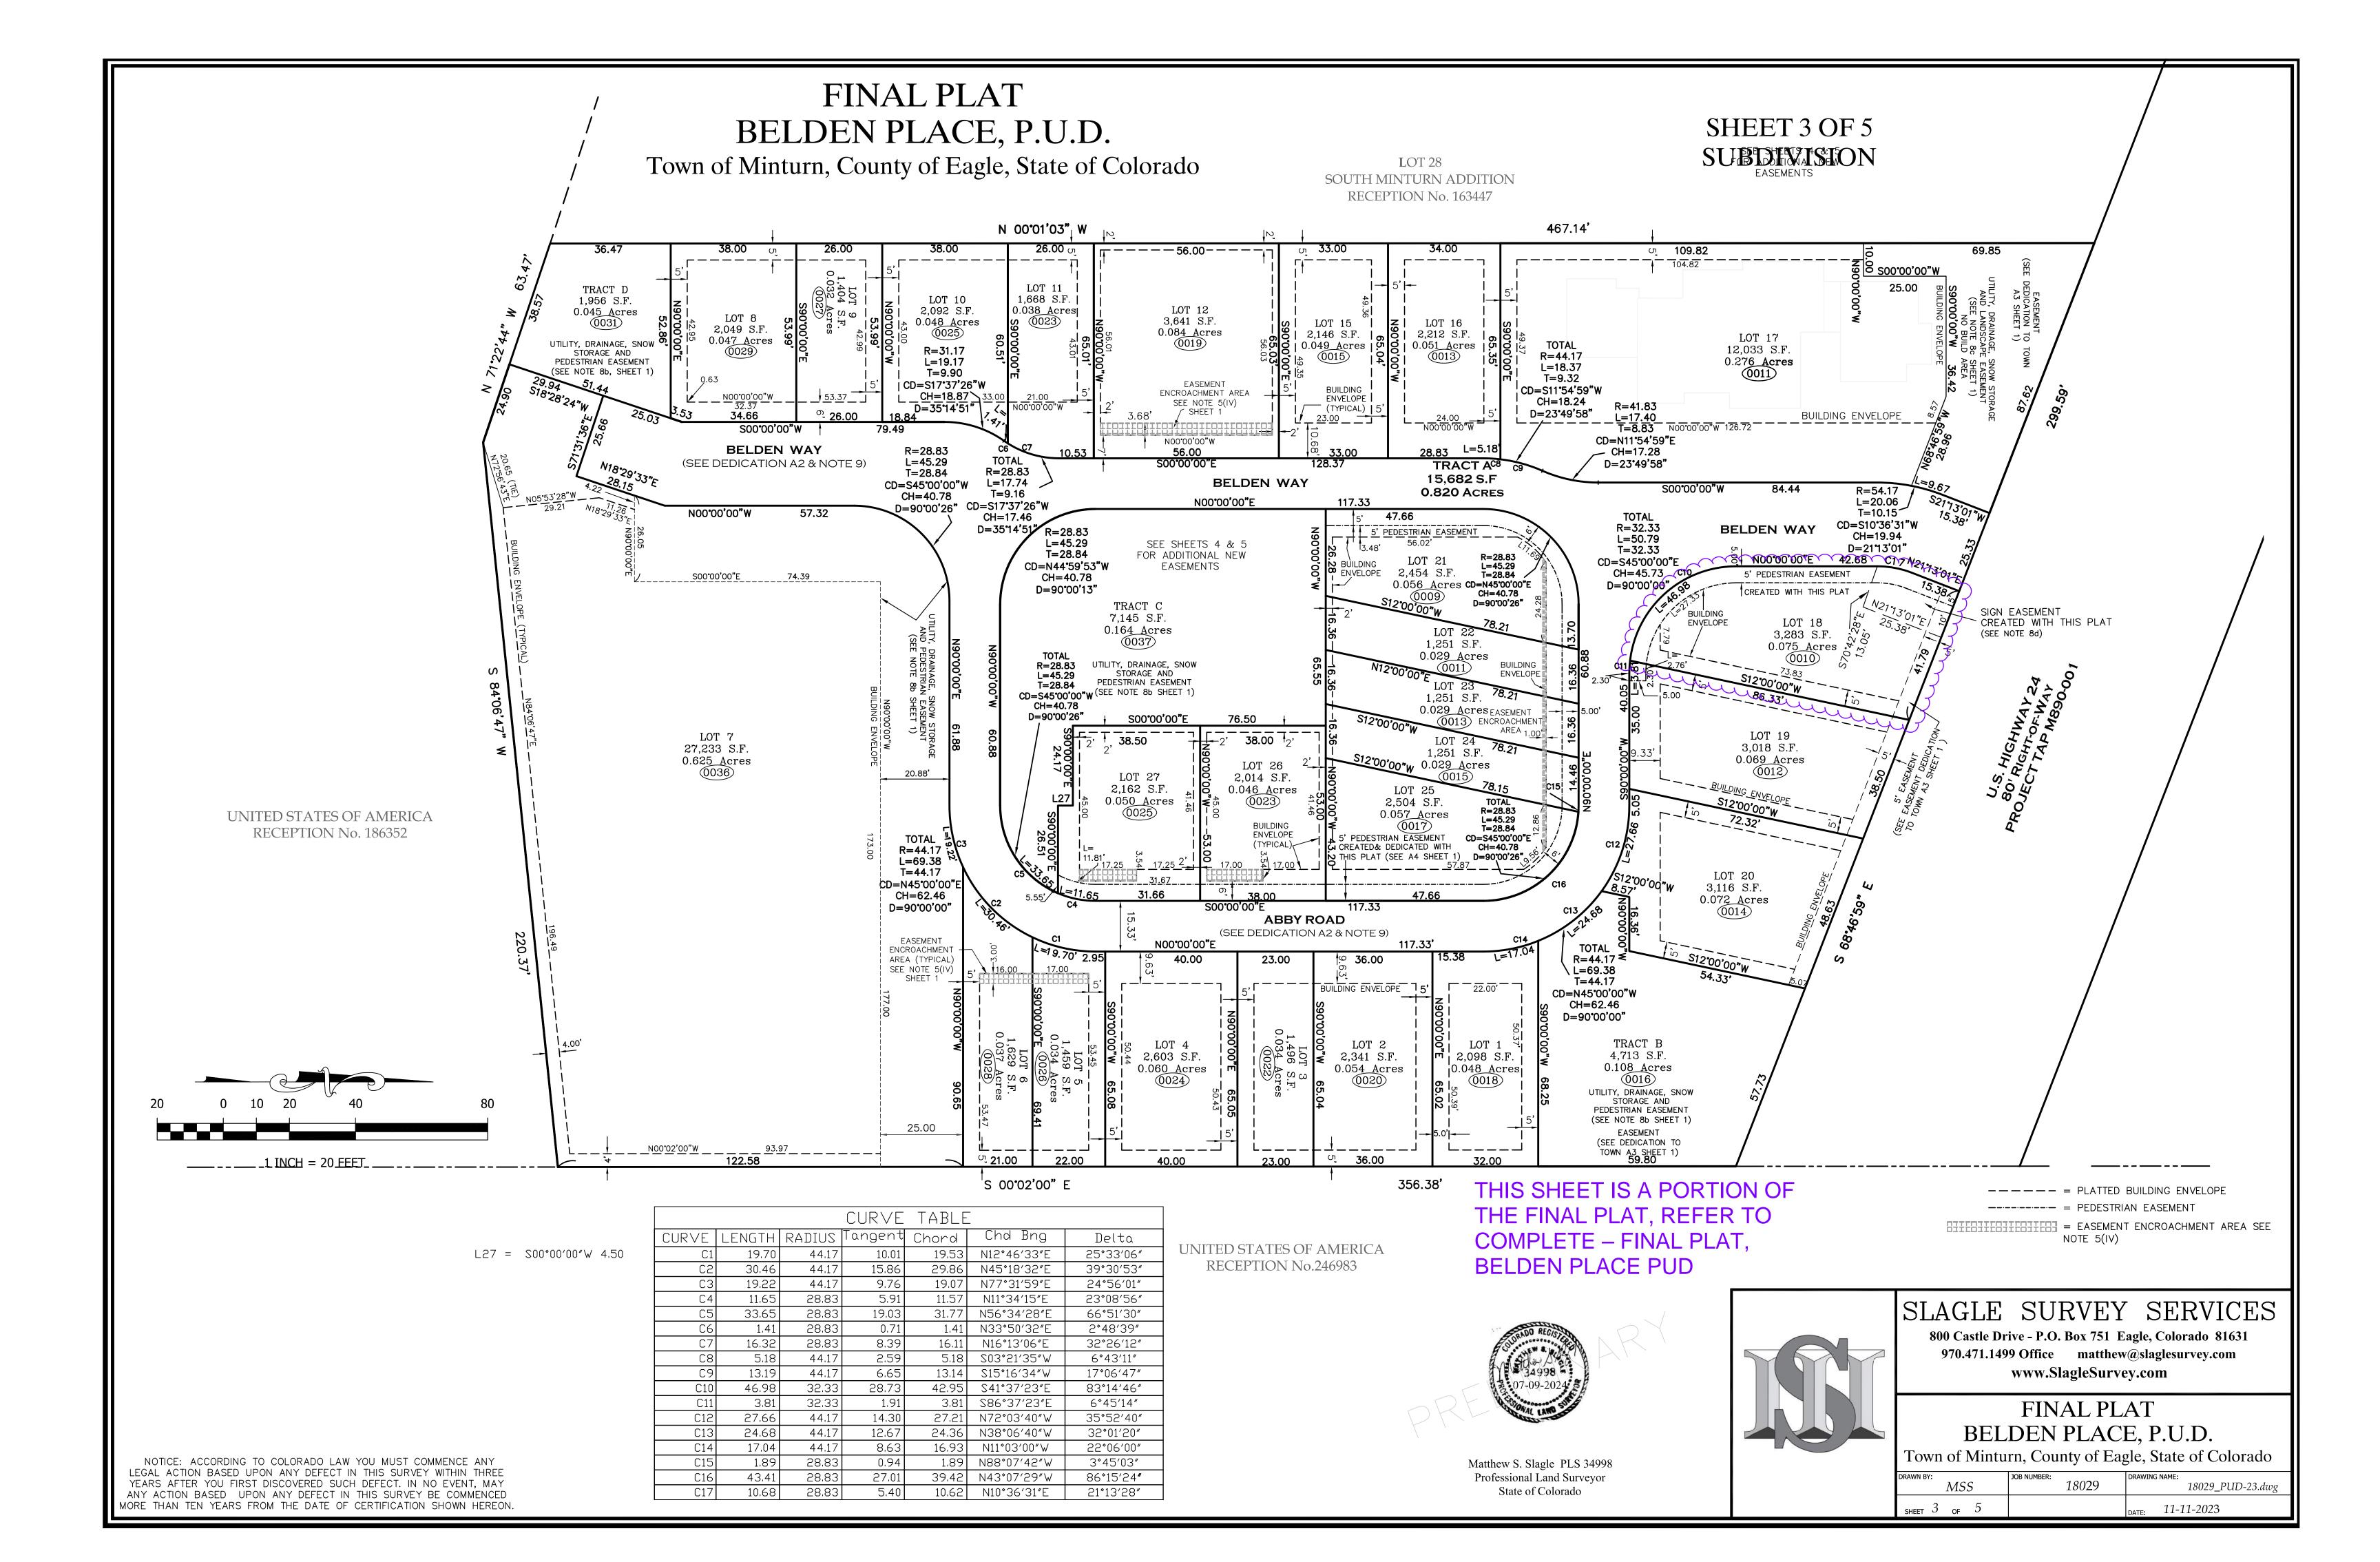

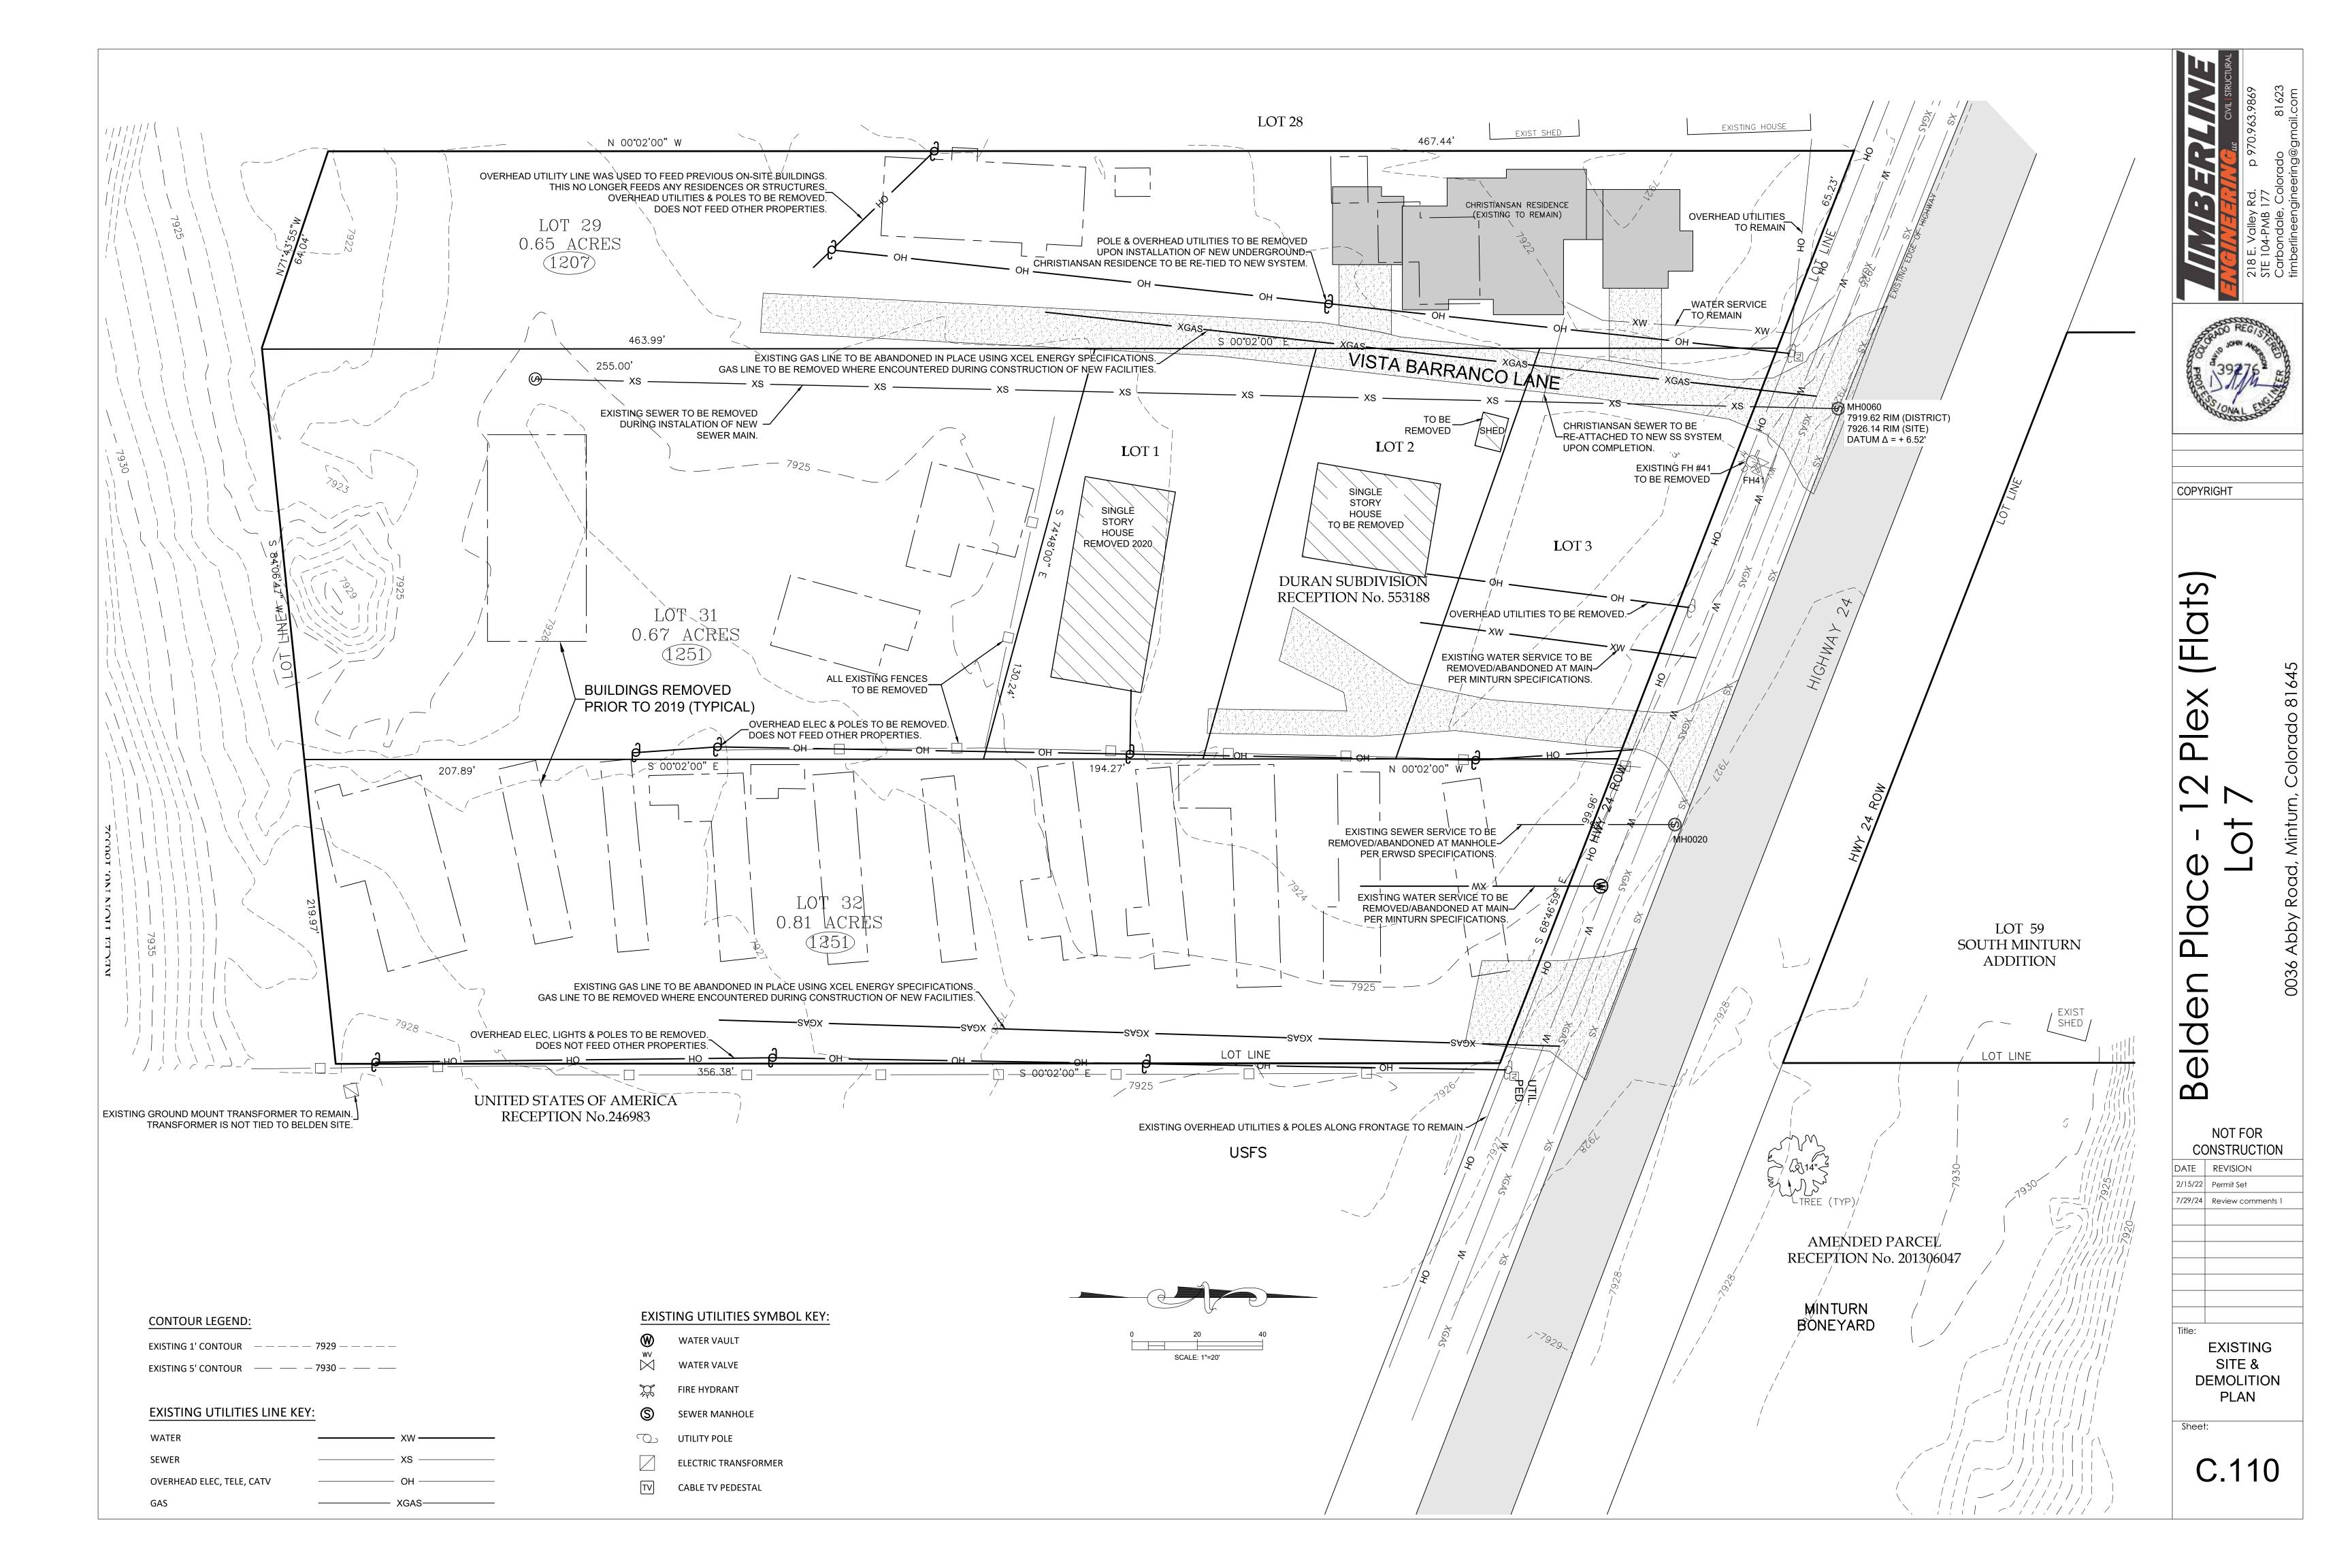

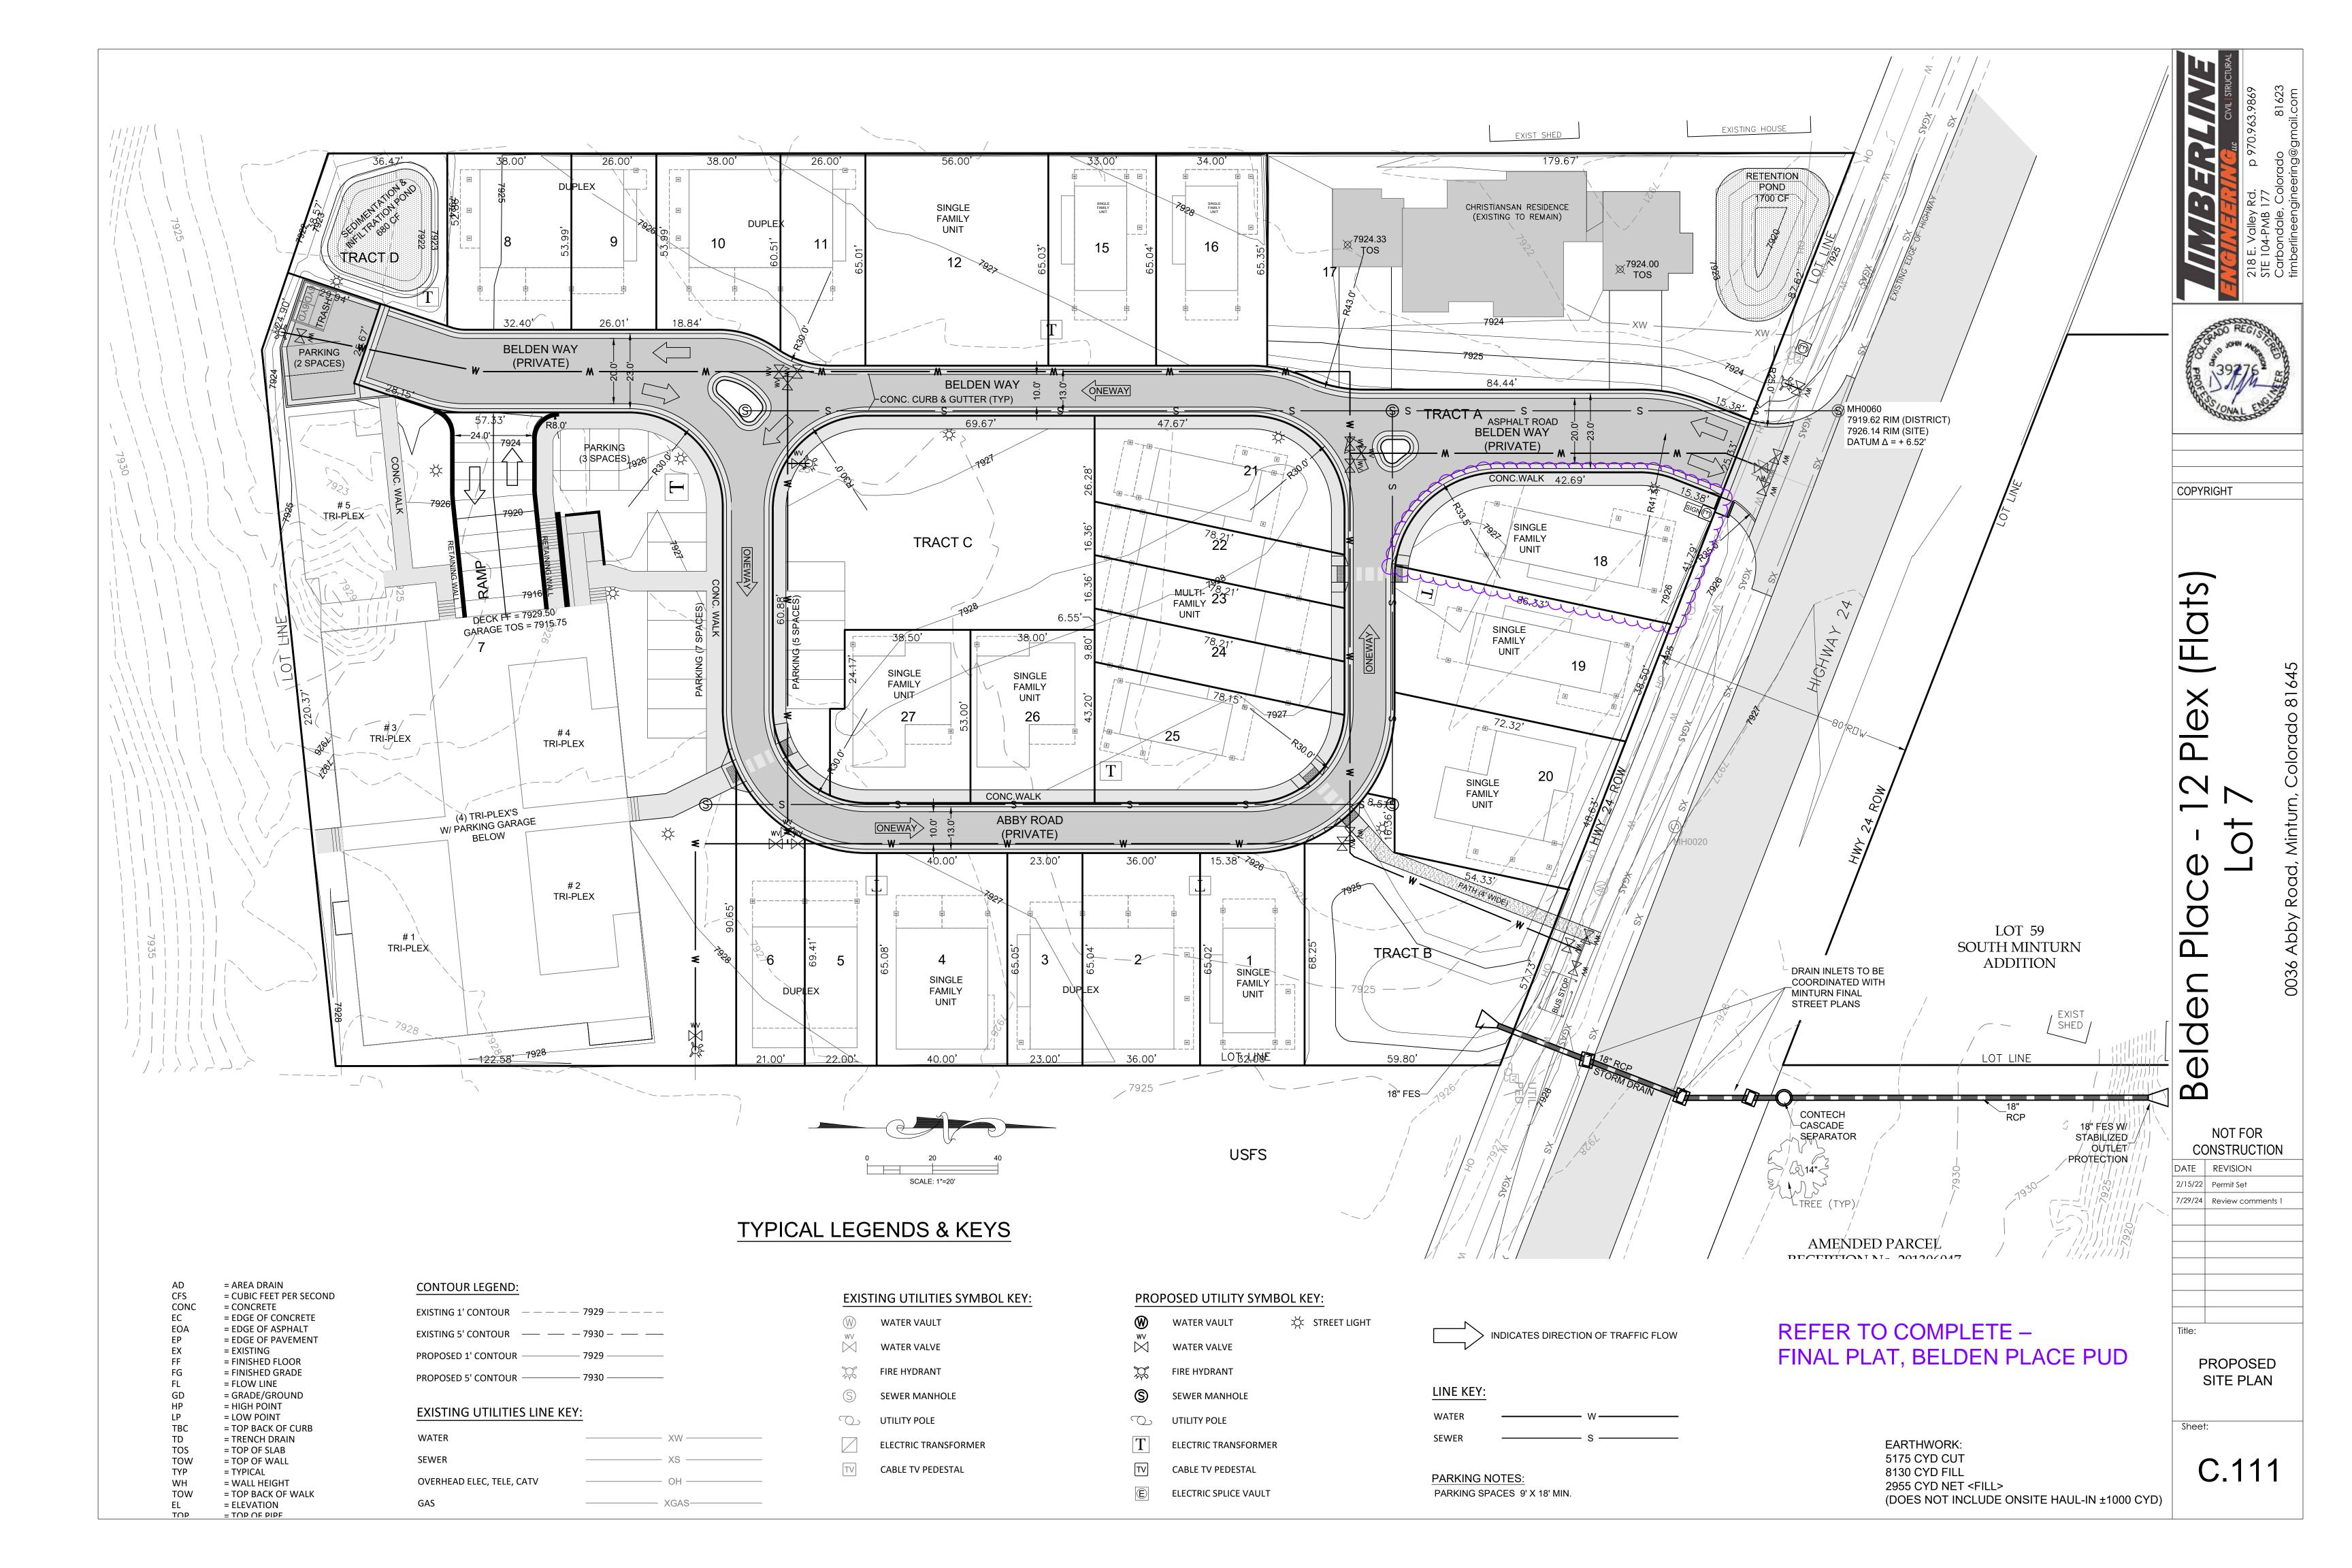

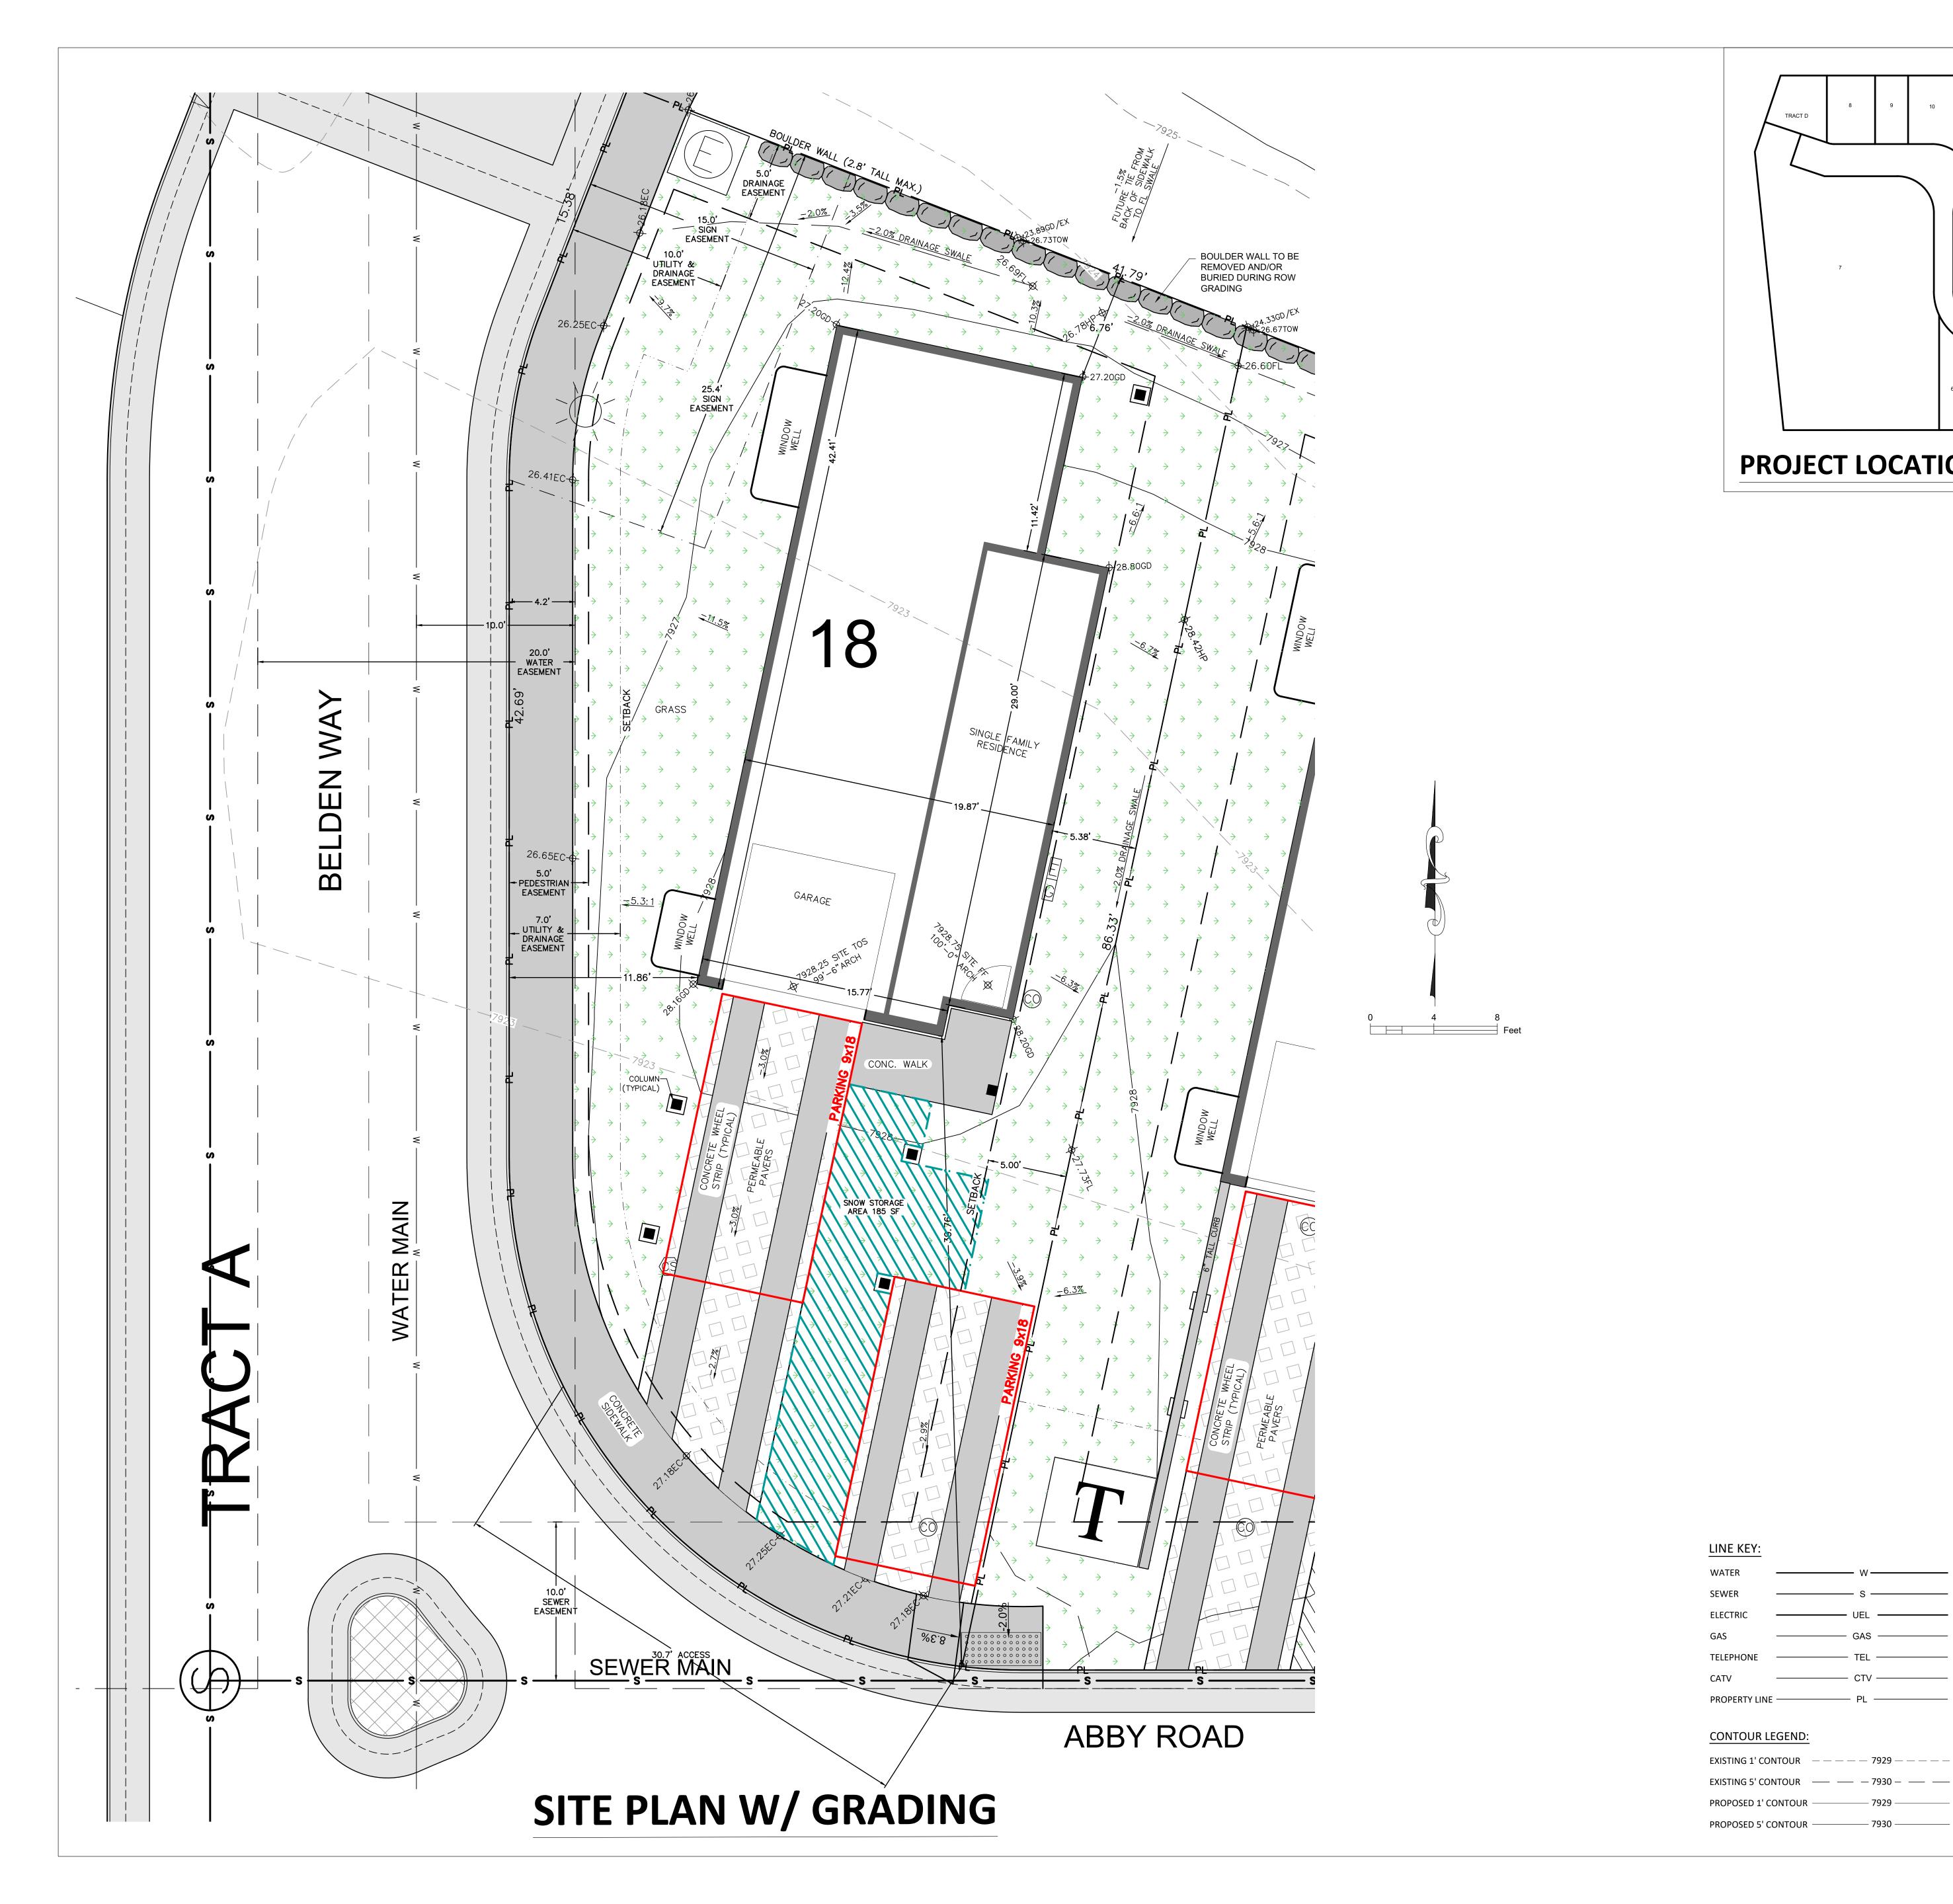

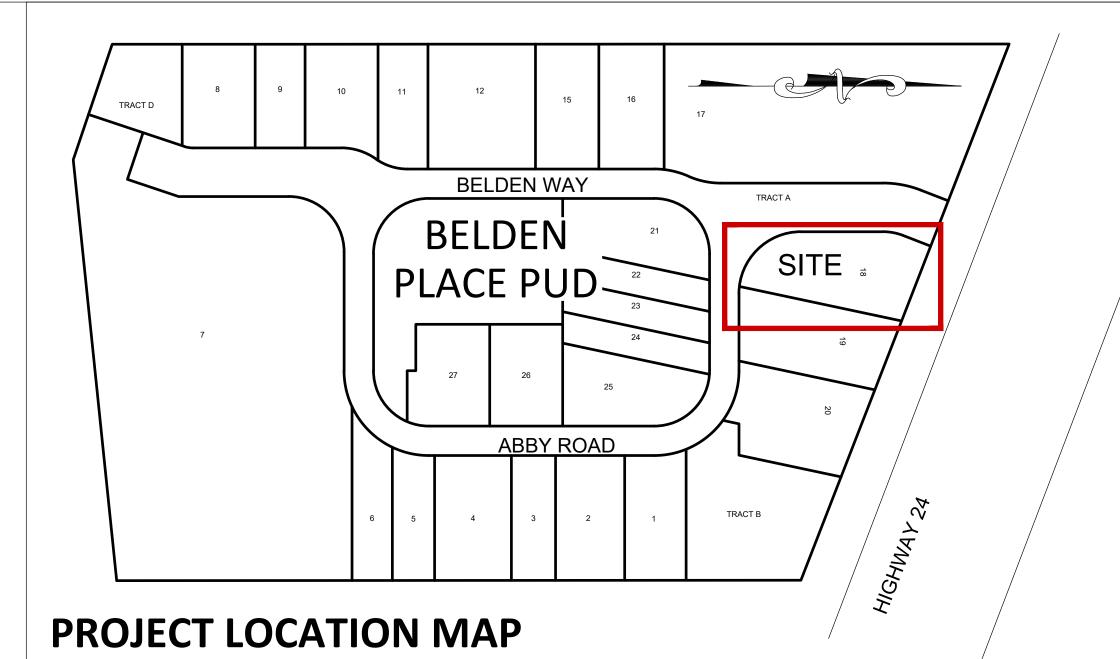

UNIT 18

SHEET INDEX:

C.1 SITE PLAN W/ GRADING

C.2 UTILITY PLAN & EROSION CONTROL PLAN

C.3 EROSION CONTROL DETAILS

CONTACTS Owner/contractor:

Architect:

Peter Murray Group Brian Claydon

970 390-3489

56 Edwards Village Boulevard Edwards, CO 81632

970 766-1470

TAB Associates, Inc.

KRM Consultants, Inc. Structural Engineer:

PO Box 4572 Vail, CO 81658 970 949-9391

Geotechnical Engineer: Kumar & Associates, Inc.

5020 County Road 154 Glenwood Springs, CO 81601

970 345-7988

Town of Minturn Public Works Arnold Martinez

970 445-2416

Eagle River Water & Sanitation District 970 477-5451

Electric & Gas:

Excel Energy

Electrical Emergency 800 895-1999 Gas Emergency 800 895-2999

Call before you dig:


ABBREVIATION KEY PROPOSED UTILITY SYMBOL KEY: AD = AREA DRAIN = CUBIC FEET PER SECOND = CONCRETE = EDGE OF CONCRETE = EDGE OF ASPHALT WATER VALVE = EDGE OF PAVEMENT = EXISTING = FINISHED FLOOR SEWER MANHOLE = FINISHED GRADE = FLOW LINE = GRADE/GROUND = HIGH POINT ELECTRIC TRANSFORMER = LOW POINT = TOP BACK OF CURB = TRENCH DRAIN CABLE TV PEDESTAL = TOP OF SLAB = TOP OF WALL ELECTRIC SPLICE VAULT WATER SERVICE CURB STOP = TOP BACK OF WALK = ELEVATION SANITARY SEWER CLEANOUT = TOP OF PIPE

= WATER VALVE = WINDOW WELL COPYRIGHT

<u>e</u> $\mathbf{\Omega}$

NOT FOR CONSTRUCTION DATE REVISION 2/4/25 DRB Coordination 4/17/25 DRB Updates 2

SITE PLAN

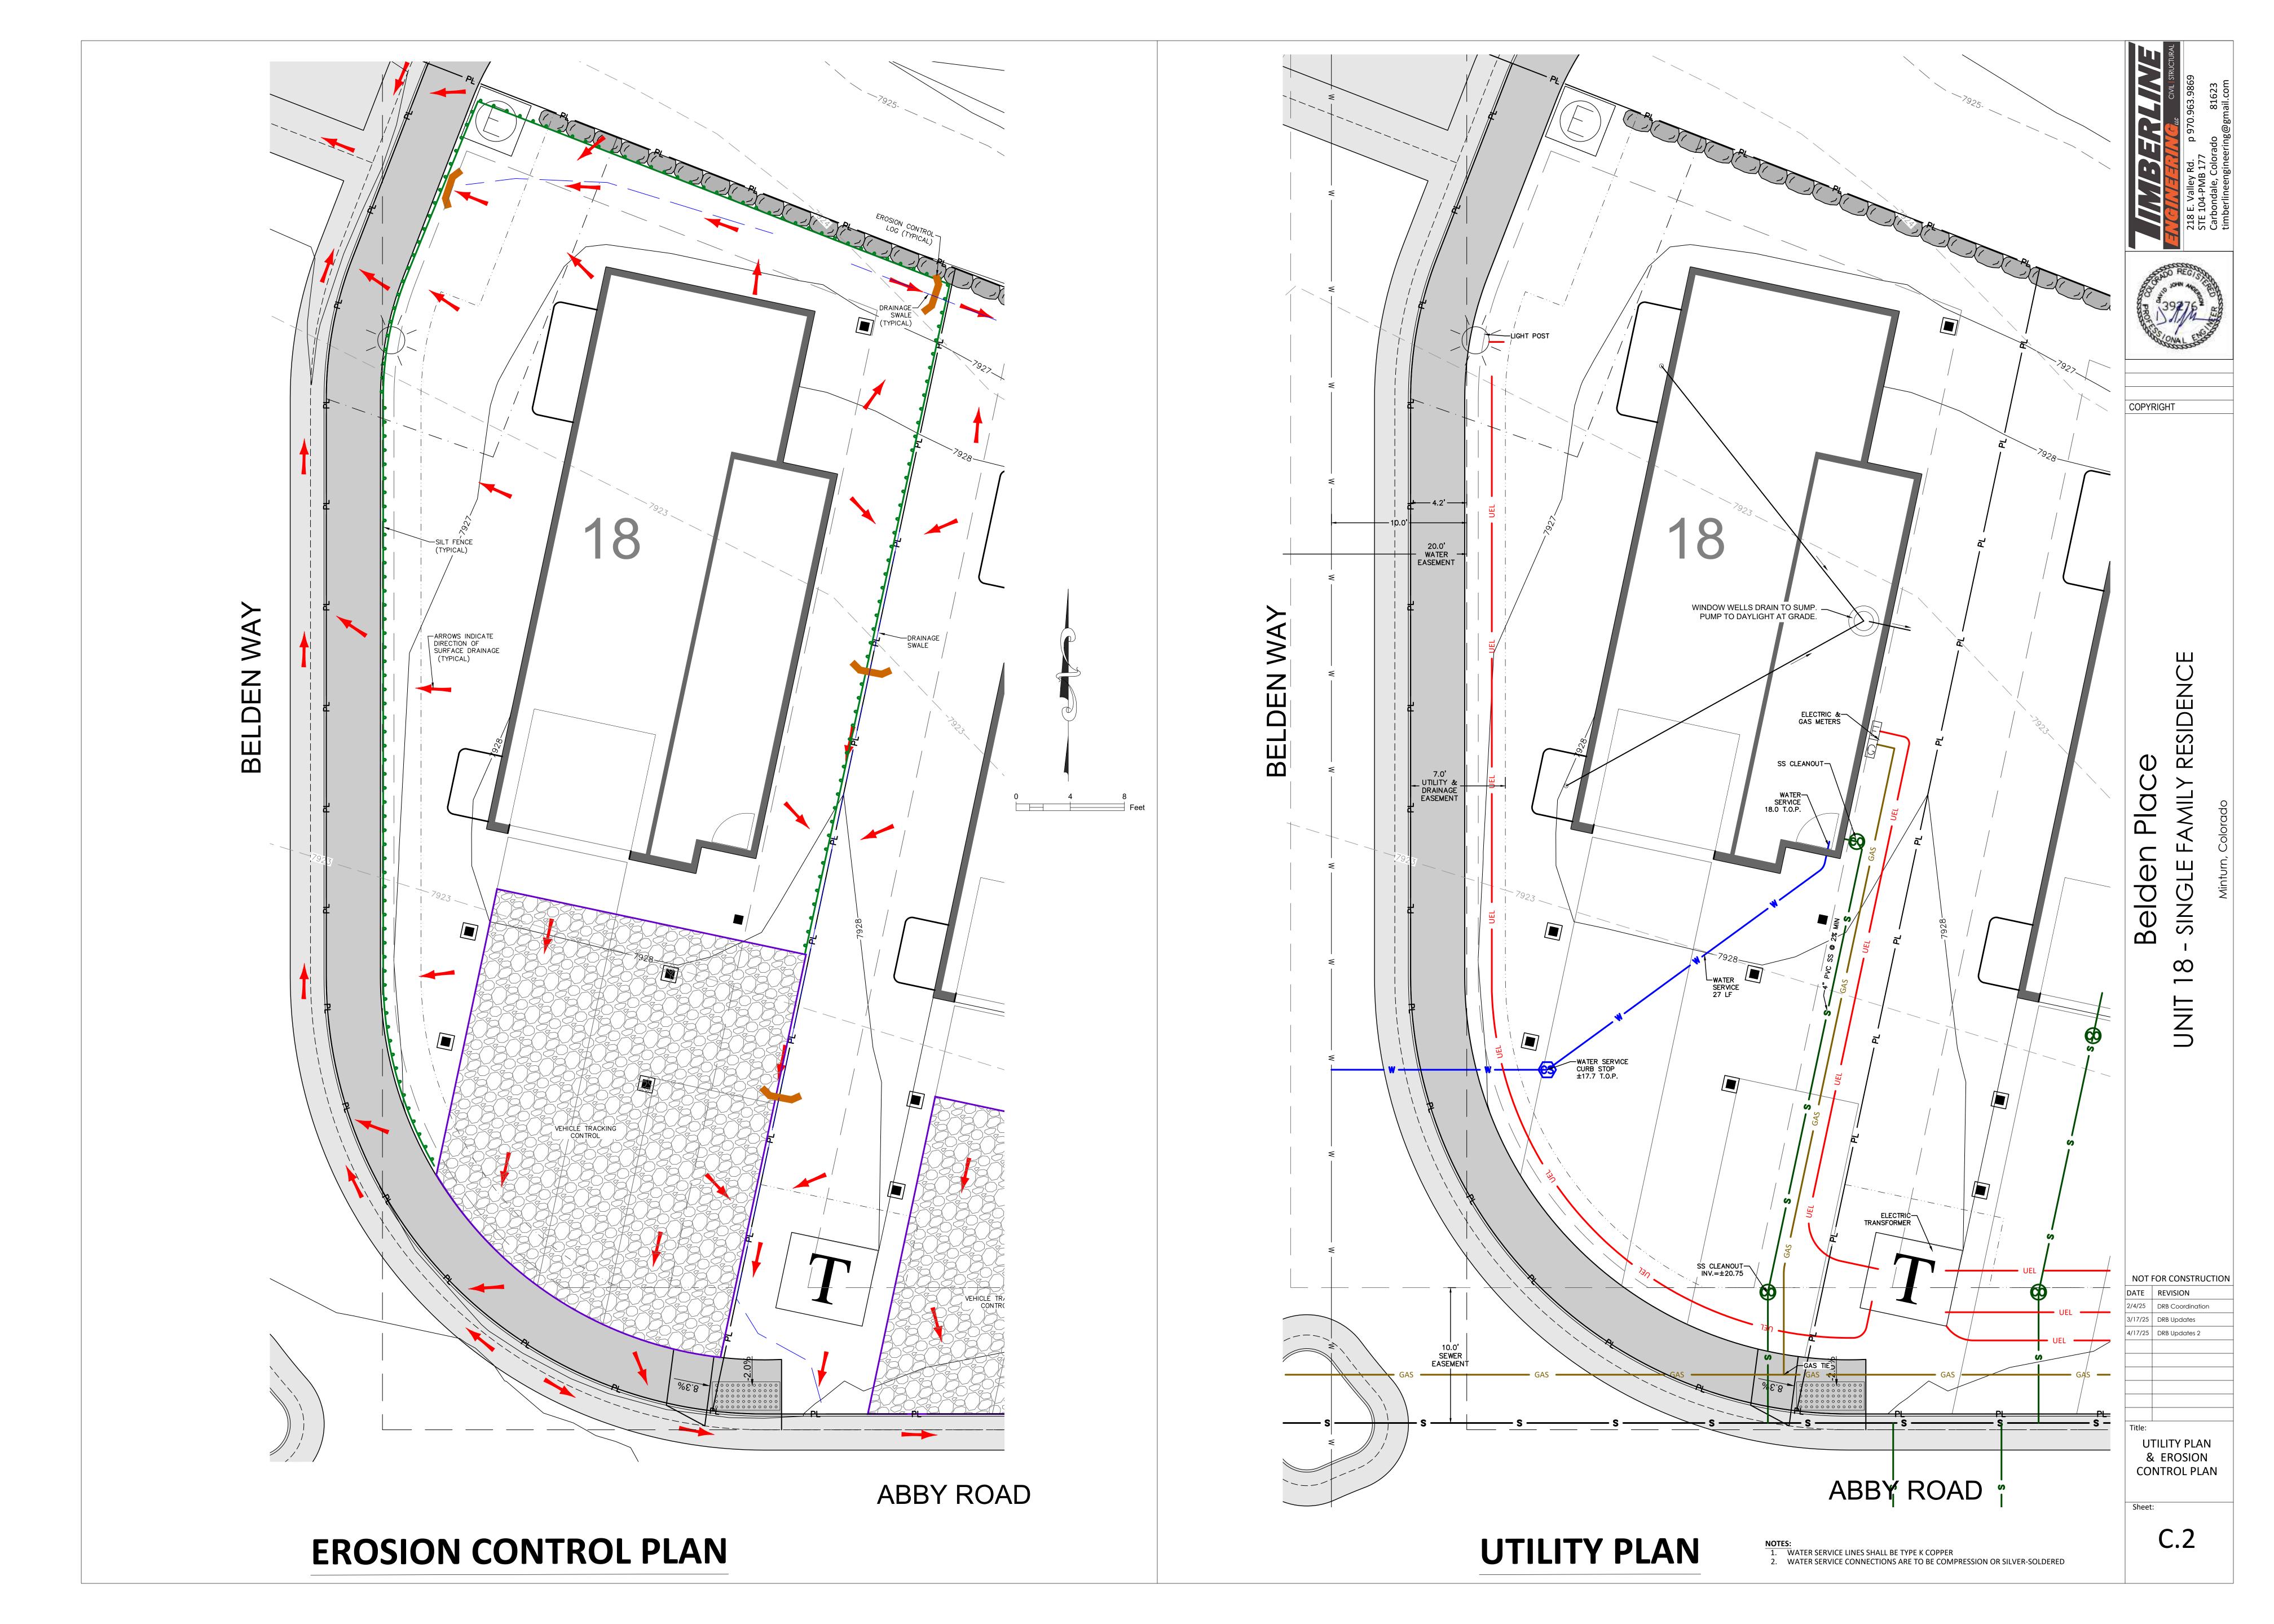


SEDIMENT CONTROL LOG INSTALLATION NOTES

- 1. SEE PLAN VIEW FOR: - LOCATION AND LENGTH OF SEDIMENT CONTROL LOG.
- 2. SEDIMENT CONTROL LOGS INDICATED ON INITIAL SWMP PLAN SHALL BE INSTALLED PRIOR TO ANY LAND-DISTURBING
- 3. SEDIMENT CONTROL LOGS SHALL CONSIST OF STRAW, COMPOST, EXCELSIOR, OR COCONUT FIBER.
- 4. NOT FOR USE IN CONCENTRATED FLOW AREAS. 5. THE SEDIMENT CONTROL LOG SHALL BE TRENCHED INTO THE GROUND A MINIMUM OF 2".


SEDIMENT CONTROL LOG MAINTENANCE NOTES

- 1. THE SWMP MANAGER SHALL INSPECT SEDIMENT CONTROL LOGS DAILY, DURING AND AFTER ANY STORM EVENT AND MAKE REPAIRS OR CLEAN OUT UPSTREAM SEDIMENT AS NECESSARY.
- 2. SEDIMENT ACCUMULATED UPSTREAM OF SEDIMENT CONTROL LOGS SHALL BE REMOVED WHEN THE UPSTREAM SEDIMENT DEPTH IS WITHIN $rac{1}{2}$ THE HEIGHT OF THE CREST OF LOG.
- 3. SEDIMENT CONTROL LOG SHALL BE REMOVED AT THE END OF CONSTRUCTION. IF ANY DISTURBED AREA EXISTS AFTER REMOVAL, IT SHALL BE COVERED WITH TOP SOIL, DRILL SEEDED AND CRIMP MULCHED OR OTHERWISE STABILIZED IN A MANNER APPROVED BY THE LOCAL JURISDICTION.


EROSION CONTROL LOG DETAIL

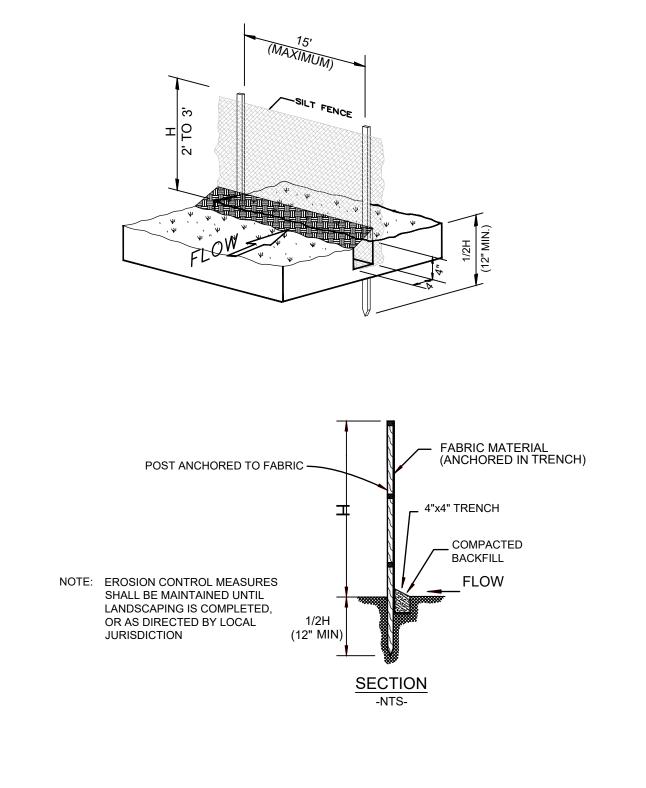

SILT FENCE INSTALLATION DETAIL

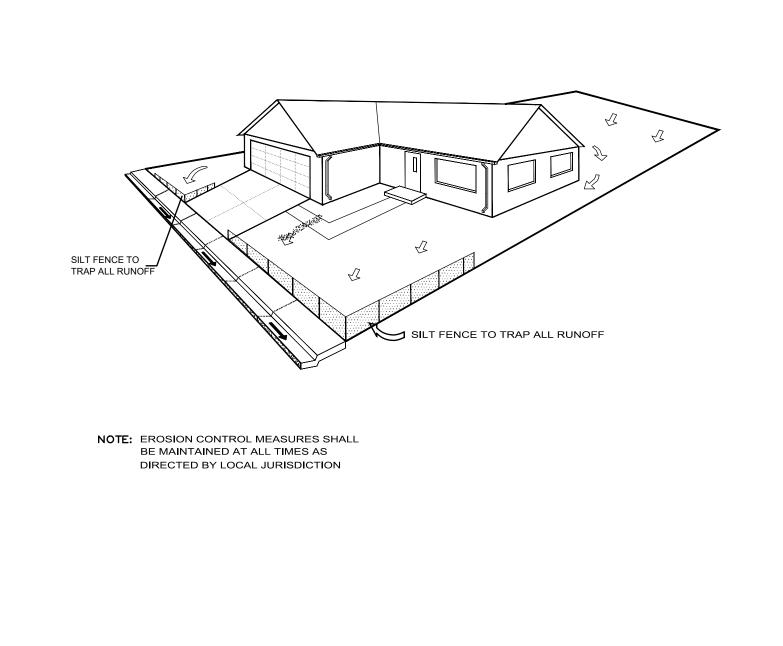

SILT FENCE PLACEMENT DETAIL

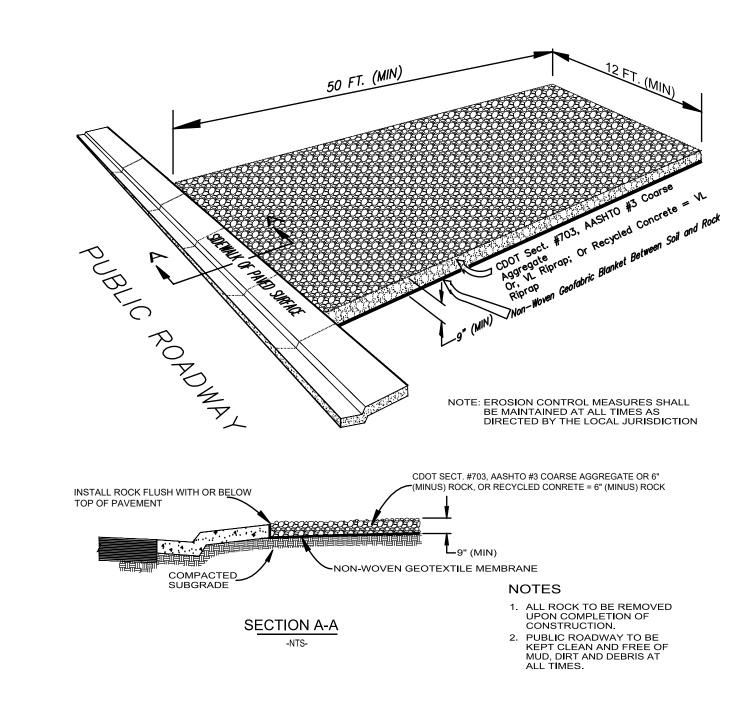

TEMPORARY VEHICLE TRACKING CONTROL DETAIL



COPYRIGHT

Belden

NOT FOR CONSTRUCTION

2/4/25 DRB Coordination 3/17/25 DRB Updates

4/17/25 DRB Updates 2


EROSION CONTROL **DETAILS**

C.3

1/4 BACKFILL MIXTURE

& 3/4 EXISTING SOIL

SHRUB PLANTING SCALE: 3/4" = 1'-0" Do not cut single leader. Prune only damaged, dead wood, or co-dominant leaders 12" nylon tree strap with grommets on guy wire. Do not twist straps tight around trunk. -1/2" diameter white PVC pipe section on entire length of each wire. -14-Gauge galvanized wire, double strand. Leave 1" to 2" slack in wire to allow for trunk movement. If needed, 6' steel T-post or wood stake (install to 2' depth in undisturbed subgrade) with safety caps, set to windward side and other opposite; or other pre-approved staking method. eciduous Tree Fall Planting: Wrap trunk to first branch with specified ree wrap material. Secure at top with masking tape. Do not wrap rough bark trees. Remove trunk wrap in spring after last frost. Set top of root flare (first order roots) at or 1" above finish grade. Remove excess soil from top of root ball and adventitious roots on trunk Circle of shredded wood mulch, 3" deep and 4" to 6" away Form 2" high dirt saucer around pit at outside of transition zone. Completely remove all twine and wire basket. Pull burlag down minimum 2/3 of ball, cut and remove from pit. Slope sides of planting pit as shown, roughen sides prior to backfill. Native soil or appropriate planting media. Undisturbed subgrade. Any broken, crumbling, or otherwise damaged rootball should be rejected. Do not damage during planting.

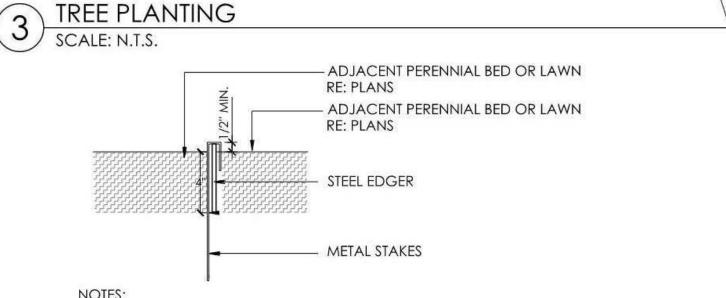

- CONTRACTOR TO SUBMIT SAMPLE PRIOR TO ORDERING MATERIAL OR DELIVERING TO SIT
 NO EDGER REQUIRED WHEN MULCH IS ADJACENT TO PAVEMENT, BORDER, OR WALLS.
- SET ALL EDGING 1/2" ABOVE FINISH GRADE AS SHOWN.
 EDGING SHALL ABUT ALL CONCRETE CURBS AND WALKS PERPENDICULAR, AND FLUSH W/ GRADES
- OF CONCRETE.

 5. ALL JOINTS TO BE SECURELY STAKED.

2X Root Ball Diameter

3-4 X Root Ball Diameter

6. CONTRACTOR SHALL CUT TOP EDGE(S) AS NEEDED TO BE PARALLEL WITH GRADE.



GENERAL NOTES:

- CONSTRUCTION SHALL CONFORM TO ALL APPLICABLE STATE AND LOCAL CODES AND REGULATIONS.
- CONTRACTOR TO CONTACT THE UTILITY NOTIFICATION CENTER OF COLORADO BEFORE DIGGING, INCLUDING BUT NOT LIMITED TO, TRENCHING, SHRUB AND TREE PLANTING PITS. IF UTILITIES OCCUR WITHIN (3) THREE FEET OF PROPOSED FOOTINGS, THE CONTRACTOR SHALL REPORT SUCH CONDITIONS TO THE OWNER.
- 3. CONTRACTOR IS RESPONSIBLE FOR FULL ON-SITE INVESTIGATIONS AS NEEDED IN ORDER TO GAIN A FULL UNDERSTANDING OF EXISTING CONDITIONS PRIOR TO CONSTRUCTION FAILURE TO INSPECT THE SITE PRIOR TO CONSTRUCTION SHALL NOT BE CAUSE FOR REQUESTING ADDITIONAL MONIES BY THE CONTRACTOR.
- 4. THE CONTRACTOR SHALL OBTAIN, AT HIS EXPENSE, ALL PERMITS WHICH ARE NECESSARY TO PERFORM THE PROPOSED WORK.
- 5. THE LANDSCAPE ARCHITECT IS NOT RESPONSIBLE FOR THE CONSTRUCTION MEANS, METHODS, TECHNIQUES, SEQUENCES OR FOR SAFETY PRECAUTIONS OR PROBLEMS UTILIZED IN CONNECTION WITH THE WORK, AND HE/SHE WILL NOT BE RESPONSIBLE FOR THE CONTRACTOR'S FAILURE TO CARRY OUT THE WORK IN ACCORDANCE WITH THE CONTRACT DOCUMENTS.
- 6. VERIFY ALL CONDITIONS AT THE JOB SITE AND NOTIFY LANDSCAPE ARCHITECT AND THE OWNER'S REP. IMMEDIATELY OF ANY DIMENSIONAL ERRORS, OMISSIONS OR DISCREPANCIES PRIOR TO ANY DEMOLITION OR CONSTRUCTION.

SIGHT TRIANGLE NOTES:

PEDESTRIAN SIGHT TRIANGLES: NO ITEMS THAT ARE WIDER THAN 18" MAY BE TALLER THAN 30" WITHIN THE PEDESTRIAN SIGHT TRIANGLE.

CORNER SIGHT TRIANGLES: NO ITEMS TALLER THAN 30" MAY BE PLACED WITHIN THE CORNER SIGHT TRIANGLE, EXCEPT FOR TRAFFIC CONTROL DEVICES AND EQUIPMENT. TREES MUST BE LIMBED TO 8 FEET AT ADEQUATE MATURITY. TREES SHALL BE PLANTED A MINIMUM OF 10 FEET FROM LIGHT OR UTILITY POLES.

ROADWAY SIGHT TRIANGLES: NO ITEMS THAT ARE WIDER THAN 18" MAY BE TALLER THAN 30" WITHIN THE ROADWAY SIGHT TRIANGLE EXCEPT FOR STREET TREES AND TRAFFIC CONTROL DEVICES AND EQUIPMENT.

TREE PROTECTION ZONE (TPZ) NOTES:

- 1. CONTRACTOR SHALL VERIFY FINAL BOUNDARIES OF TPZ PRIOR TO COMMENCEMENT OF CONSTRUCTION/DEMOLITION ACTIVITIES. EXCESSIVE BRANCH PRUNING ON EXISTING TREES FOR CONSTRUCTION CLEARANCE WILL NOT BE PERMITTED. PRUNING FOR BUILDING CLEARANCE SHALL BE MINIMIZED. DUE TO SCOPE OF CONSTRUCTION AND SIZE OF EX. ROW TREES, USE CHAIN LINK FENCING TO ESTABLISH TPZ.
- THE TREE LAWN WITHIN THE BOUNDARY OF THE TREE DRIPLINE SHALL NOT BE ROTOTILLED AT ANY TIME. ROTOTILLING IS ONLY
 PERMITTED IN AREAS OUTSIDE OF EXISTING TREE DRIPLINE WHERE CONCRETE & HARDSCAPE ARE REMOVED.

ORNAMENTAL TREES


BOTANIC COMMON SIZE QTY Amelanchier x grandiflora Autumn Brilliance Serviceberry 8' clump Crataegus x mordenensis 'Toba' 2" Cal Toba Hawthorn as shown Malus x 'Spring Snow' 2" Cal Spring Snow Crabapple as shown Malus 'Thunderchild' Thunderchild Crabapple 2" Cal as shown Quercus gambelii Gambel Oak 8' clump

DECIDUOUS SHRUBS

ABB. BOTANIC COMMON SPACING SIZE QTY *
SAR Salix repens Creeping Willow as shown 5 Gal. 9
SOS Sorbaria sorbifolia Ash-leaf Spirea as shown 5 Gal. 6

PLAN IS ENLARGED DETAIL AND UPDATE FROM THE PUD APPROVED PLAN. REFER TO PUD APPROVED PLAN FOR ADDITIONAL INFROMATION

\(\frac{\frac}}}}}}}{\frac{\frac{\frac{\frac{\frac{\frac{\frac{\frac{\frac{\frac}\frac{\frac{\frac{\frac{\frac{\frac{\frac{\frac{\frac{\frac{\frac}}}}}}}{\frac{\frac{\frac{\frac{\frac{\frac{\frac{\frac{\frac}}}}}}}{\frac{\frac{\frac{\frac{\frac{\frac{\frac{\frac{\frac{\frac{\frac{\frac{\frac{\frac{\frac{\frac}}}}}}}}{\frac}}}}}}}}{\frac{\frac{\frac{\frac{\frac{\frac{\frac{\frac{\frac{\frac{\frac{\frac}}}}}}}}{\frac{\frac{\frac{\frac{\frac{\frac{\frac{\frac}}}}}}}{\frac{\frac{\frac{	NATIVE GRASS	SITE CALCULATIONS	
		SITE SQFT	3,283 SQFT
	2' GRAVEL DRIP	BUILDING COVERAGE	1,161 SQFT
	LINE MULCH	IMPERVIOUS COVERAGE (Includes Building)	1,340 SQFT
4 4 4 4	CONC. PARKING STRIP	SITE COVERAGE ALLOWE SITE COVERAGE	D 45% 40.8%

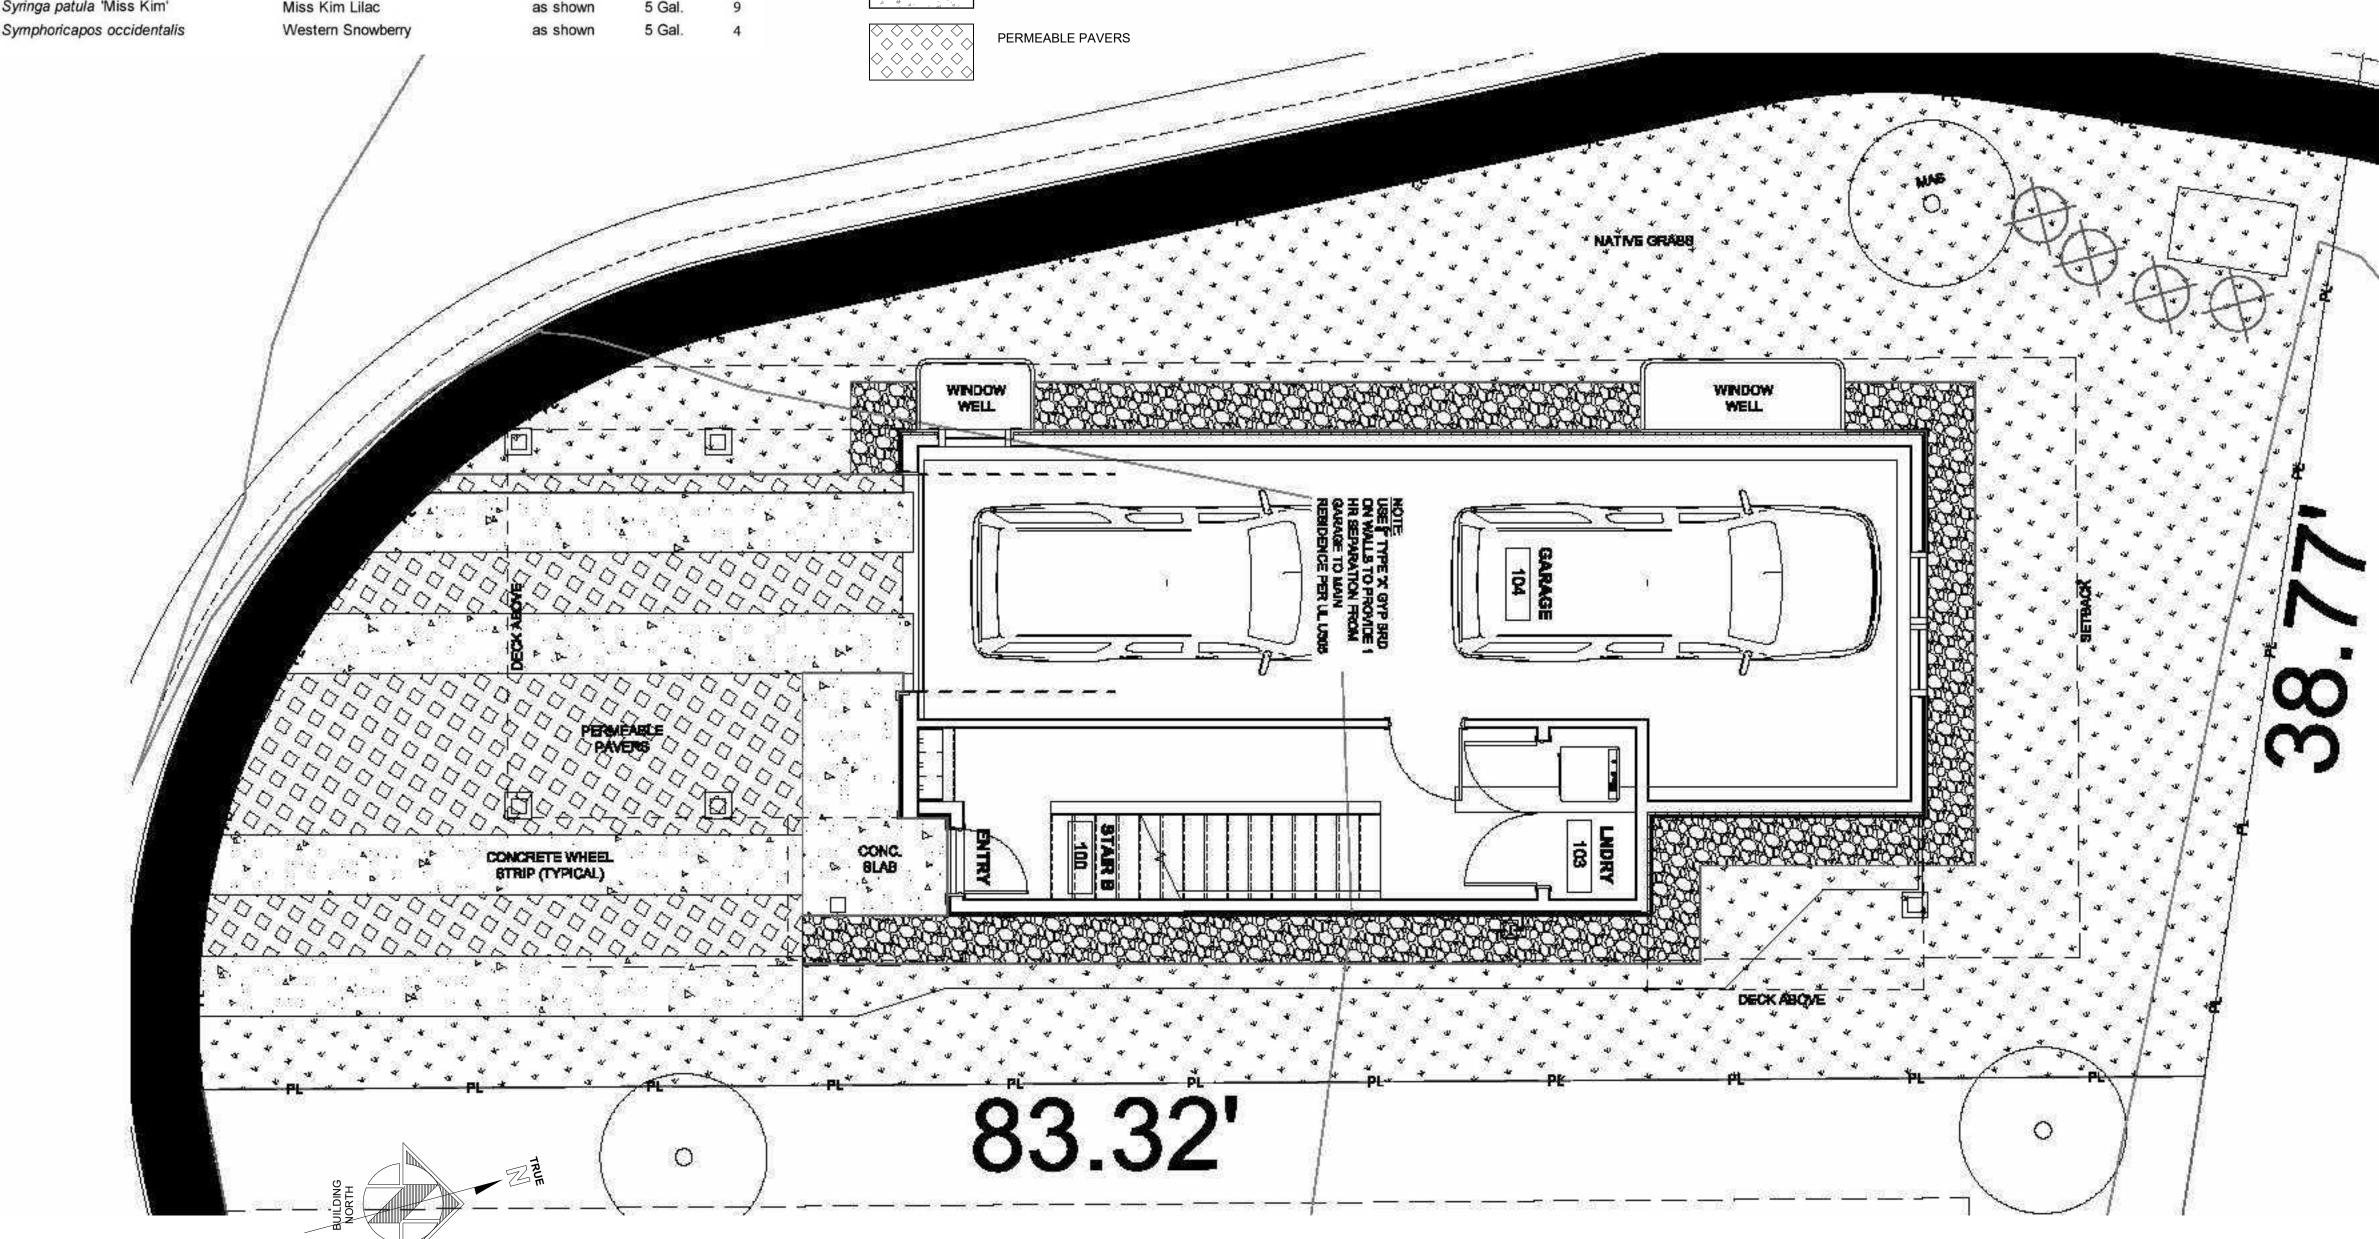

LANDSCAPE NOTES:

- ALL NEW LANDSCAPE AND IRRIGATION SHALL BE UNDER WARRANTY FOR A PERIOD OF (1) ONE YEAR. THE WARRANTY PERIOD SHALL COMMENCE ONCE ALL PUNCH LIST ITEMS ARE SATISFACTORY COMPLETED AND A LETTER OF FINAL COMPLETION IS PROVIDED FROM THE OWNER'S REPRESENTATIVE. ALL LANDSCAPE AND IRRIGATION MAINTENANCE SHALL BE THE RESPONSIBILITY OF THE CONTRACTOR 1 YEAR AFTER THE FINAL COMPLETION IS PROVIDED IN WRITING.
- PLANT MATERIAL AND BED LOCATIONS TO BE STAKED BY THE LANDSCAPE CONTRACTOR FOR
 REVIEW BY THE OWNER'S REPRESENTATIVE OR LANDSCAPE ARCHITECT. ALL ADJUSTMENTS SHALL BE
 MADE BY THE CONTRACTOR. THE CONTRACTOR SHALL NOT DIG PLANT PITS UNTIL LOCATIONS ARE
 APPROVED.
- 3. ROUGH GRADING TO PLUS OR MINUS ONE TENTH OF A FOOT BY GENERAL CONTRACTOR.

 LANDSCAPE CONTRACTOR TO PROVIDE FINISH GRADING IN ALL LANDSCAPE AREAS. LANDSCAPE
 CONTRACTOR TO APPROVE ROUGH GRADES PRIOR TO MOBILIZATION. MOBILIZATION ON THE
 PART OF THE LANDSCAPE CONTRACTOR WILL INDICATE THAT ROUGH GRADING IS ACCEPTABLE TO
 THE LANDSCAPE CONTRACTOR, AND THEREFORE BE RESPONSIBLE FOR PROVIDING ALL FINISHED
 GRADES TO MEET THE CIVIL GRADING PLANS.
- 4. TREES AND SHRUBS WILL BE INSPECTED ON-SITE. LANDSCAPE PLANT MATERIALS MAY BE REJECTED AT ANY TIME DUE TO ISSUES OF QUALITY.
- 5. ALL NEW LANDSCAPE AREAS SHALL BE IRRIGATED BY A COMMERCIAL GRADE, FULLY AUTOMATIC UNDERGROUND IRRIGATION SYSTEM. TREES, SHRUBS, AND DECORATIVE GRASSES SHALL BE IRRIGATED BY A SEPARATE ZONE FROM SOD/GRASS; THIS INCLUDES TREES PLANTED IN SOD/GRASS AREA. THE IRRIGATION SYSTEM IS TO HAVE A RAIN SENSOR SHUTOFF INSTALLED. IRRIGATION TO BE DESIGN/BUILD, CONTRACTOR IS RESPONSIBLE FOR COORDINATION WITH ARCHITECT, LANDSCAPE ARCHITECT, AND MECHANICAL AND FOR GENERATION OF AN IRRIGATION PLAN FOR REVIEW WITH AS BUILT PLAN AS REQUIRED.
- S. ALL PLANT MATERIAL SHALL MEET OR EXCEED CURRENT AMERICAN STANDARD FOR NURSERY STOCK ANSI Z60.1 AND THE COLORADO NURSERY ACT AND ACCOMPANYING RULE AND REGULATIONS
- 7. TRUNK-WRAP TAPE: TWO LAYERS OF CRINKLED PAPER CEMENTED TOGETHER WITH BITUMINOUS MATERIAL, 4 INCHES (102 MM) WIDE MIN.
- WRAPPING TREE TRUNKS: WRAP TREES WITH TRUNK-WRAP TAPE. START AT BASE OF TRUNK AND SPIRAL COVER TRUNK TO HEIGHT OF FIRST BRANCHES. OVERLAP WRAP, EXPOSING HALF THE WIDTH, AND SECURELY ATTACH WITHOUT CAUSING GIRDLING. DO NOT USE STAPLES. INSPECT TREE TRUNKS FOR INJURY, IMPROPER PRUNING, AND INSECT INFESTATION AND TAKE CORRECTIVE MEASURES REQUIRED BEFORE WRAPPING. DO NOT WRAP ROUGH BARK, POPULUS OR GLEDITSIA TREES. REMOVE WRAP IN SPRING.
- 8.1. NO TREE SHALL BE WRAPPED AFTER MAY 21 OR BEFORE NOVEMBER 1
- 8.2. ALL DECIDUOUS TREES SHALL BE WRAPPED BY NOV. 15. REMOVE TREE WRAP BY MAY 15.
 8.3. CONTRACTOR SHALL BE RESPONSIBLE FOR WRAPPING AND UNWRAPPING TREES DURING THE WARRANTY PERIOD.
- 9. FIBER MULCH AT PLANTING BEDS: ORGANIC MULCH FREE FROM DELETERIOUS MATERIALS AND SUITABLE AS A TOP DRESSING OF TREES AND SHRUBS, CONSISTING OF SHREDDED REDWOOD MULCH NOT LARGER THAN FOUR INCHES (4") IN LENGTH. SUBMIT 1.0 CF SAMPLE FOR APPROVAL.

SOIL PREPARATION:

SOIL SHALL BE AMENDED BASED ON THE SOIL TEST RECOMMENDATIONS (TO ADDRESS SPECIFIC DEFICIENCIES & ISSUES IN EXISTING SOIL). THE FOLLOWING INCLUDES THE SOIL TEST REQUIREMENTS AND RECOMMENDATIONS TO BE USED IN CONJUNCTION WITH THE SOIL TEST RESULTS:

- 1. SOIL ANALYSIS, BULK DENSITY TESTING AND REMEDIATION REQUIRED. SOIL ANALYSIS FROM A LOCAL ACCREDITED SOIL ANALYSIS LABORATORY WITH EXPERIENCE IN LOCAL URBAN SOILS SHALL BE REQUIRED WHEN PLANTS ARE TO BE INSTALLED. IN GREEN SPACE, ALL SOIL REMEDIATION SHALL BE BASED ON THE SOIL ANALYSIS.
- SPACE. ALL SOIL REMEDIATION SHALL BE BASED ON THE SOIL ANALYSIS.

 1.1. MINIMUM SOIL ANALYSIS MUST DETERMINE SOIL TEXTURE AND STRUCTURE, PH
 BALANCE, SOIL SALINITY, FREE LIME, ORGANIC MATTER (OM) CONTENT, PLANT
- AVAILABLE NUTRIENTS AND COMPACTION.

 1.2. DEPTH OF LANDSCAPE SOIL ANALYSIS SHALL BE 24IN FOR TREES AND 8IN FOR ALL OTHER AREAS
- 1.3. SOIL REMEDIATION REQUIRED BASED ON SOIL ANALYSIS.
- 2. COMPOSTED MATERIAL SHALL CONSIST OF AGED ORGANIC MATTER, FREE OF WEED OR OTHER NOXIOUS PLANT SEEDS, LUMPS, STONES, OR OTHER FOREIGN CONTAMINANTS HARMFUL TO PLANT LIFE, AND HAVING THE FOLLOWING

CHARACTERISTICS BASED ON A NUTRIENT TEST PERFORMED NO LONGER THAN 3 MONTHS PRIOR TO ITS INCORPORATION INTO THE PROJECT:

- 1.1. ORGANIC MATTER: 25% MINIMUM.
- 2. SALT CONTENT: 5.0 MMHOS/CM MAXIMUM.
- 1.3. PH: 8.5 MAXIMUM
- CARBON TO NITROGEN RATIO OF 10:1 TO 20:1.
- 1.5. PARTICLE SIZE NO PARTICLE SMALLER THAN SILT OR CLAY SIZE, OR LARGER THAN ½" DIAMETER
- ACCEPTABLE COMPOST PRODUCT: CLASS I COMPOST, SUCH AS ECOGRO OR BIO-COMP, AS PROVIDED BY A1 ORGANICS, EATON, CO, OR APPROVED EQUAL.
- 2. FINISH GRADE TO BE BELOW THE EDGE OF PAVEMENT PRIOR TO SODDING OR PLANTING:
- 1.1. SEEDED/SODDED AREAS: ALLOW 1 INCH FOR SOD.1.2. PLANTED AREAS: ALLOW 3 INCHES FOR MULCH.
- 4. AFTER APPLYING SOIL CONDITIONER AND FERTILIZER, THOROUGHLY TILL AREA TO DEPTH OF 6" MINIMUM UNTIL SOIL IS WELL PULVERIZED AND THOROUGHLY MIXED.

TAB ssociates

TAB
Associates
The Architectural Balance
0056 Edwards Village Blvd.
Suite 210
Edwards, CO 81632
(970) 766-1470

fax: (970) 766-1471

email: tab@vail.net
www.tabassociates.com

Civil Engineer

Timberline Engineerin
(970) 963-9869

Structural Engineer

KRM Consultants, Inc.
(970) 949-9391

Mechanical Engineer

Electrical Engineer

Seal

Belden Place - Singel Family
Lot 18 - 0010 Abby Road

Revisions:
No Description Date


Issue Dates:
DRB - 02/14/2025
Sheet Title:

Landscape Plan

Project No:
2215
Sheet No:

Sheet No:

REA SUMMARY	
PROPOSED CONDITIONED SQUA BASEMENT LEVEL GROUND LEVEL MAIN LEVEL	678 SF 156 SF 792 SF
<u>UPPER LEVEL</u> TOTAL	727 SF 2,353 SF
PROPOSED UNCONDITIONED SQ BASEMENT LEVEL GROUND LEVEL MAIN LEVEL UPPER LEVEL	0 513 SF 0 0
TOTAL	513 SF

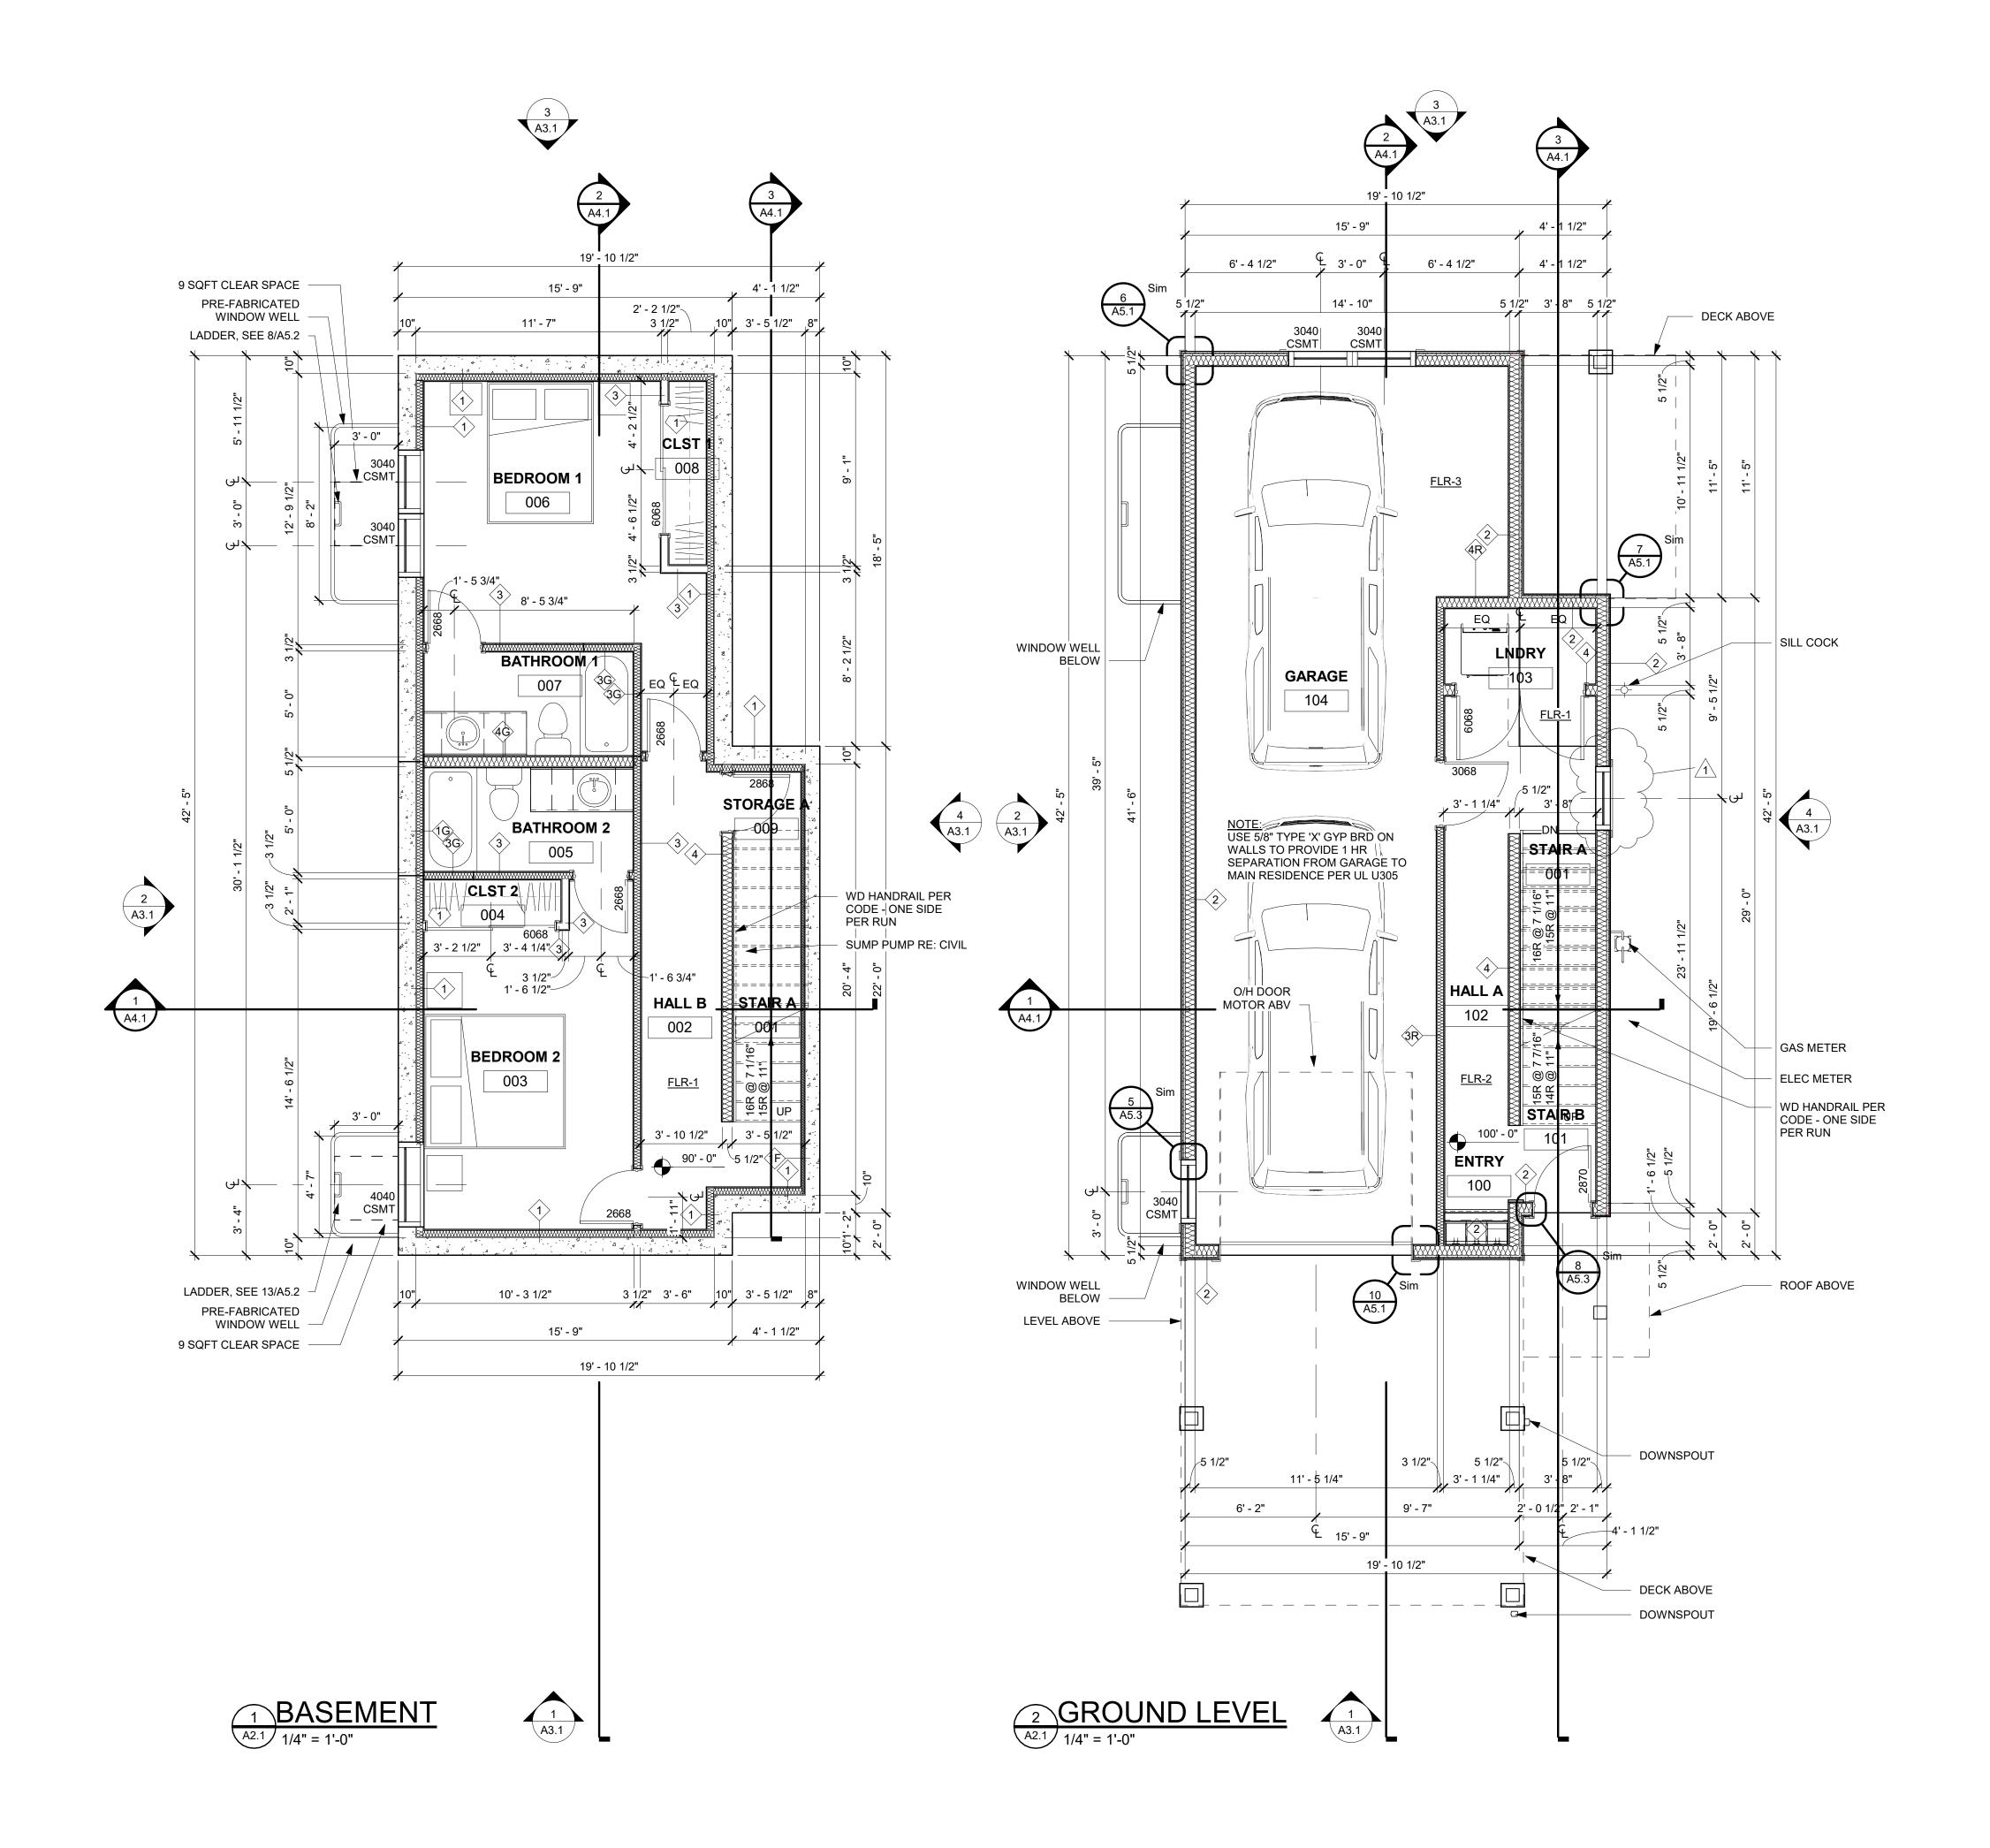

NOTES:

- **CLOSET NOTES:**
- SINGLE HANGING: DESIGNATED BY SINGLE DASHED LINE IN CLOSETS TO BE: 16" SHELF @ 7'-0" AFF, 16" SHELF & ROD @ 5'-6" AFF.
- DOUBLE HANGING: DESIGNATED BY DOUBLE 2 DASHED LINE IN CLOSETS TO BE: 16" SHELF & ROD @ 7'-0" AFF, 12" SHELF & ROD @ 3'-6" AFF.
- SHELVES @ WALK-IN CLOSETS: 6 16" SHELVES @ (3) 1'-2" OC, 1st SHELF @ 1'-2" AFF, SHELF WIDTH TO BE CLOSET WIDTH, LESS 4'-0" OR AS OTHERWISE
- LINEN SHELVES: 6 SHELVES, WIDTH AS NOTED, @ 4 1'-2" OC, 1st SHELF @ 1'-2" AFF, FULL CLOSET
- STORAGE SHELVES: 6 16" SHELVES @ 1'-2" OC, 1st 5 SHELF @ 1'-2" AFF, FULL CLOSET WIDTH.
- **GENERAL CLOSET NOTES:**
- 1. ALL SHELVES & VERTICAL DIVIDERS TO BE AC PLYWOOD WITH 1x2 EDGE. SPECIES TO BE SPECIFIED BY DEVELOPER. 2. CLEATS TO BE 1x2 CLEAR PINE.
- 3. PROVIDE ROD SUPPORTS @ 36" OC MAX. 4. ALL TO BE STAINED TO MATCH CASE & BASE.

FLOOR PLAN GENERAL NOTES:

- 1. PATCH EXISTING CONSTRUCTION SCHEDULED TO REMAIN. REPAIRED SURFACES TO BE FLUSH WITH ADJACENT FINISH SURFACES. TO SAME QUALITY AS NEW CONSTRUCTION PRIOR TO INSTALLING NEW FINISHES. REFER TO THE FINISH MANUFACTURER'S GUIDELINES FOR INSTALLATION.
- 2. PATCH EXISTING FIRE-RATED WALLS, FLOOR CEILINGS, ETC. SO AS TO MAINTAIN THE FIRE-RADIATING. ADD FIRE-SMOKE DAMPERS WHERE NEW DUCTS CROSS. ADD FIRE STOP AT ALL
- 3. PATCH WALLS AT REMOVED RECEPTACLE OPENINGS SO AS TO RECEIVE SUBSEQUENT WORK.
- 4. PATCH AND LEVEL FLOOR SUBSTRATES TO RECEIVE NEW WORK AS SCHEDULED.
- 5. COORDINATE ALL FLOOR CORE DRILLING WITH EXISTING.
- 6. DO NOT SCALE DRAWINGS.
- 7. IN ROOMS WITH FLOOR DRAINS, SLOPE CONCRETE SURFACE WITHIN 18" RADIUS AT 1/4" PER FOOT TOWARD FLOOR DRAIN, UNLESS OTHERWISE INDICATED.
- 8. ALL SPOT ELEVATIONS SHOWN ON THE FLOOR PLANS OUTSIDE THE BUILDING RELATE TO USGS ELEVATIONS. ALL SPOT ELEVATIONS INSIDE THE BUILDING REFER TO BUILDING REFERENCE ELEVATIONS. NOTIFY ARCHITECT IMMEDIATELY SHOULD CONDITIONS BE FOUND CONTRADICTORY TO THESE DRAWINGS.
- 9. ALL ANGLES SHOWN ON THE FLOOR PLANS ARE 90 DEGREES UNLESS OTHERWISE NOTED.
- 10. ALL DIMENSIONS ARE TO GRID LINE, FACE OF CONCRETE OR MASONRY, OR FACE OF GYPSUM BOARD, UNLESS OTHERWISE NOTED.
- 11. ALL FLOOR PLAN DIMENSIONS TO MASONRY ARE NOMINAL DIMENSIONS, UNLESS NOTED AS ACTUAL.

GENERAL NOTES:

1. DO NOT SCALE DRAWINGS. USE GIVEN DIMENSIONS. IMMEDIATELY NOTIFY ARCHITECT IF ADDITIONAL INFORMATION IS REQUIRED. ALL DIMENSIONS ARE GIVEN TO FACE OF WALL FRAMING. SEE WALL SECTIONS AND WALL TYPES FOR EXACT CONSTRUCTION

2. SEE SHEET A0.1 FOR WALL TYPES INDICATED ON FLOOR PLANS

3. PROVIDE ALL NECESSARY BLOCKING FOR PROPER ATTACHMENT OF WORK IN WALLS AND CEILINGS. LOCATIONS INCLUDE BUT NOT LIMITED TO, TOILET AND BATH ACCESSORIES, WALL AND CEILING MOUNTED ELECTRICAL EQUIPMENT, WINDOW TREATMENTS, CASEWORK, COUNTERTOPS, ETC.

4. WHERE WALL PARTITIONS ARE A CONTINUATION OF EXISTING ONES. NEW FINISH SURFACES MUST BE FLUSH AND CONTINUOUS WITH EXISTING SURFACES ON BOTH SIDES. INFILL OPENINGS IN EXISTING WALLS WITH MATERIAL TO MATCH EXISTING WALL THICKNESS, TEXTURE, AND FINISH.

6. EXISTING BUILDING DIMENSIONS AND ELEVATIONS ARE

5. REFERENCE S-SERIES DRAWINGS FOR STRUCTURAL NOTES AND DETAILS AND COORDINATE.

BASED UPON EXISTING SURVEY INFORMATION.

IMMEDIATELY NOTIFY ARCHITECT IF CONDITIONS ARE ENCOUNTERED THAT DO NOT AGREE WITH DIMENSIONS AND/OR ELEVATIONS SHOWN.

7. VERIFY ALL PITCHED FLOOR AREAS SHOWN WITH PITCH LINES WITH THE ARCHITECT. PROVIDE A SLAB DEPRESSION AT ALL FLOOR DRAINS WHERE PITCH LINES ARE NOT SHOWN ON DRAWINGS.

8. PROVIDE 4" RETURN FROM FACE OF ADJACENT WALL FOR ANY DOORS NOT DIMENSIONED.

9. SEE MECHANICAL, PLUMBING, AND ELECTRICAL DRAWINGS FOR ITEMS NOT SHOWN ON ARCHITECTURAL DRAWINGS AND COORDINATE.

10. ALL INTERIOR WALLS SHALL EXTEND TO UNDERSIDE OF ROOF DECK AND STEEL STRUCTURE (BEAM) UNLESS NOTED OTHERWISE. SEE PARTITION WALL TYPES ON SHEET A0.03

11. DATUM 100'-0" INDICATED ON ALL DRAWINGS, OTHER THAN CIVIL SERIES EQUALS XXXX.XX ON CIVIL DRAWINGS 12. ALL STEEL LOCATED BELOW AND EXPOSED TO GRADE TO BE COATED WITH BITUMINOUS DAMPROOFING. 13. CONTRACTOR TO COMPLY WITH ALL REQUIREMENTS FOR SPECIAL INSPECTIONS, 2015 IBC-1704.




Associates The Architectural Balance 0056 Edwards Village Blvd. Edwards, CO 81632 (970) 766-1470

fax: (970) 766-1471 email: tab@vail.net Civil Engineer Timberline Engineering (970) 963-9869 Structural Engineer KRM Consultants, Inc (970) 949-9391

Mechanical Engineer

Electrical Engineer

a 0 00

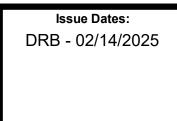


Basement & Ground Floor **Plans**

Project No: 2215

A2.1



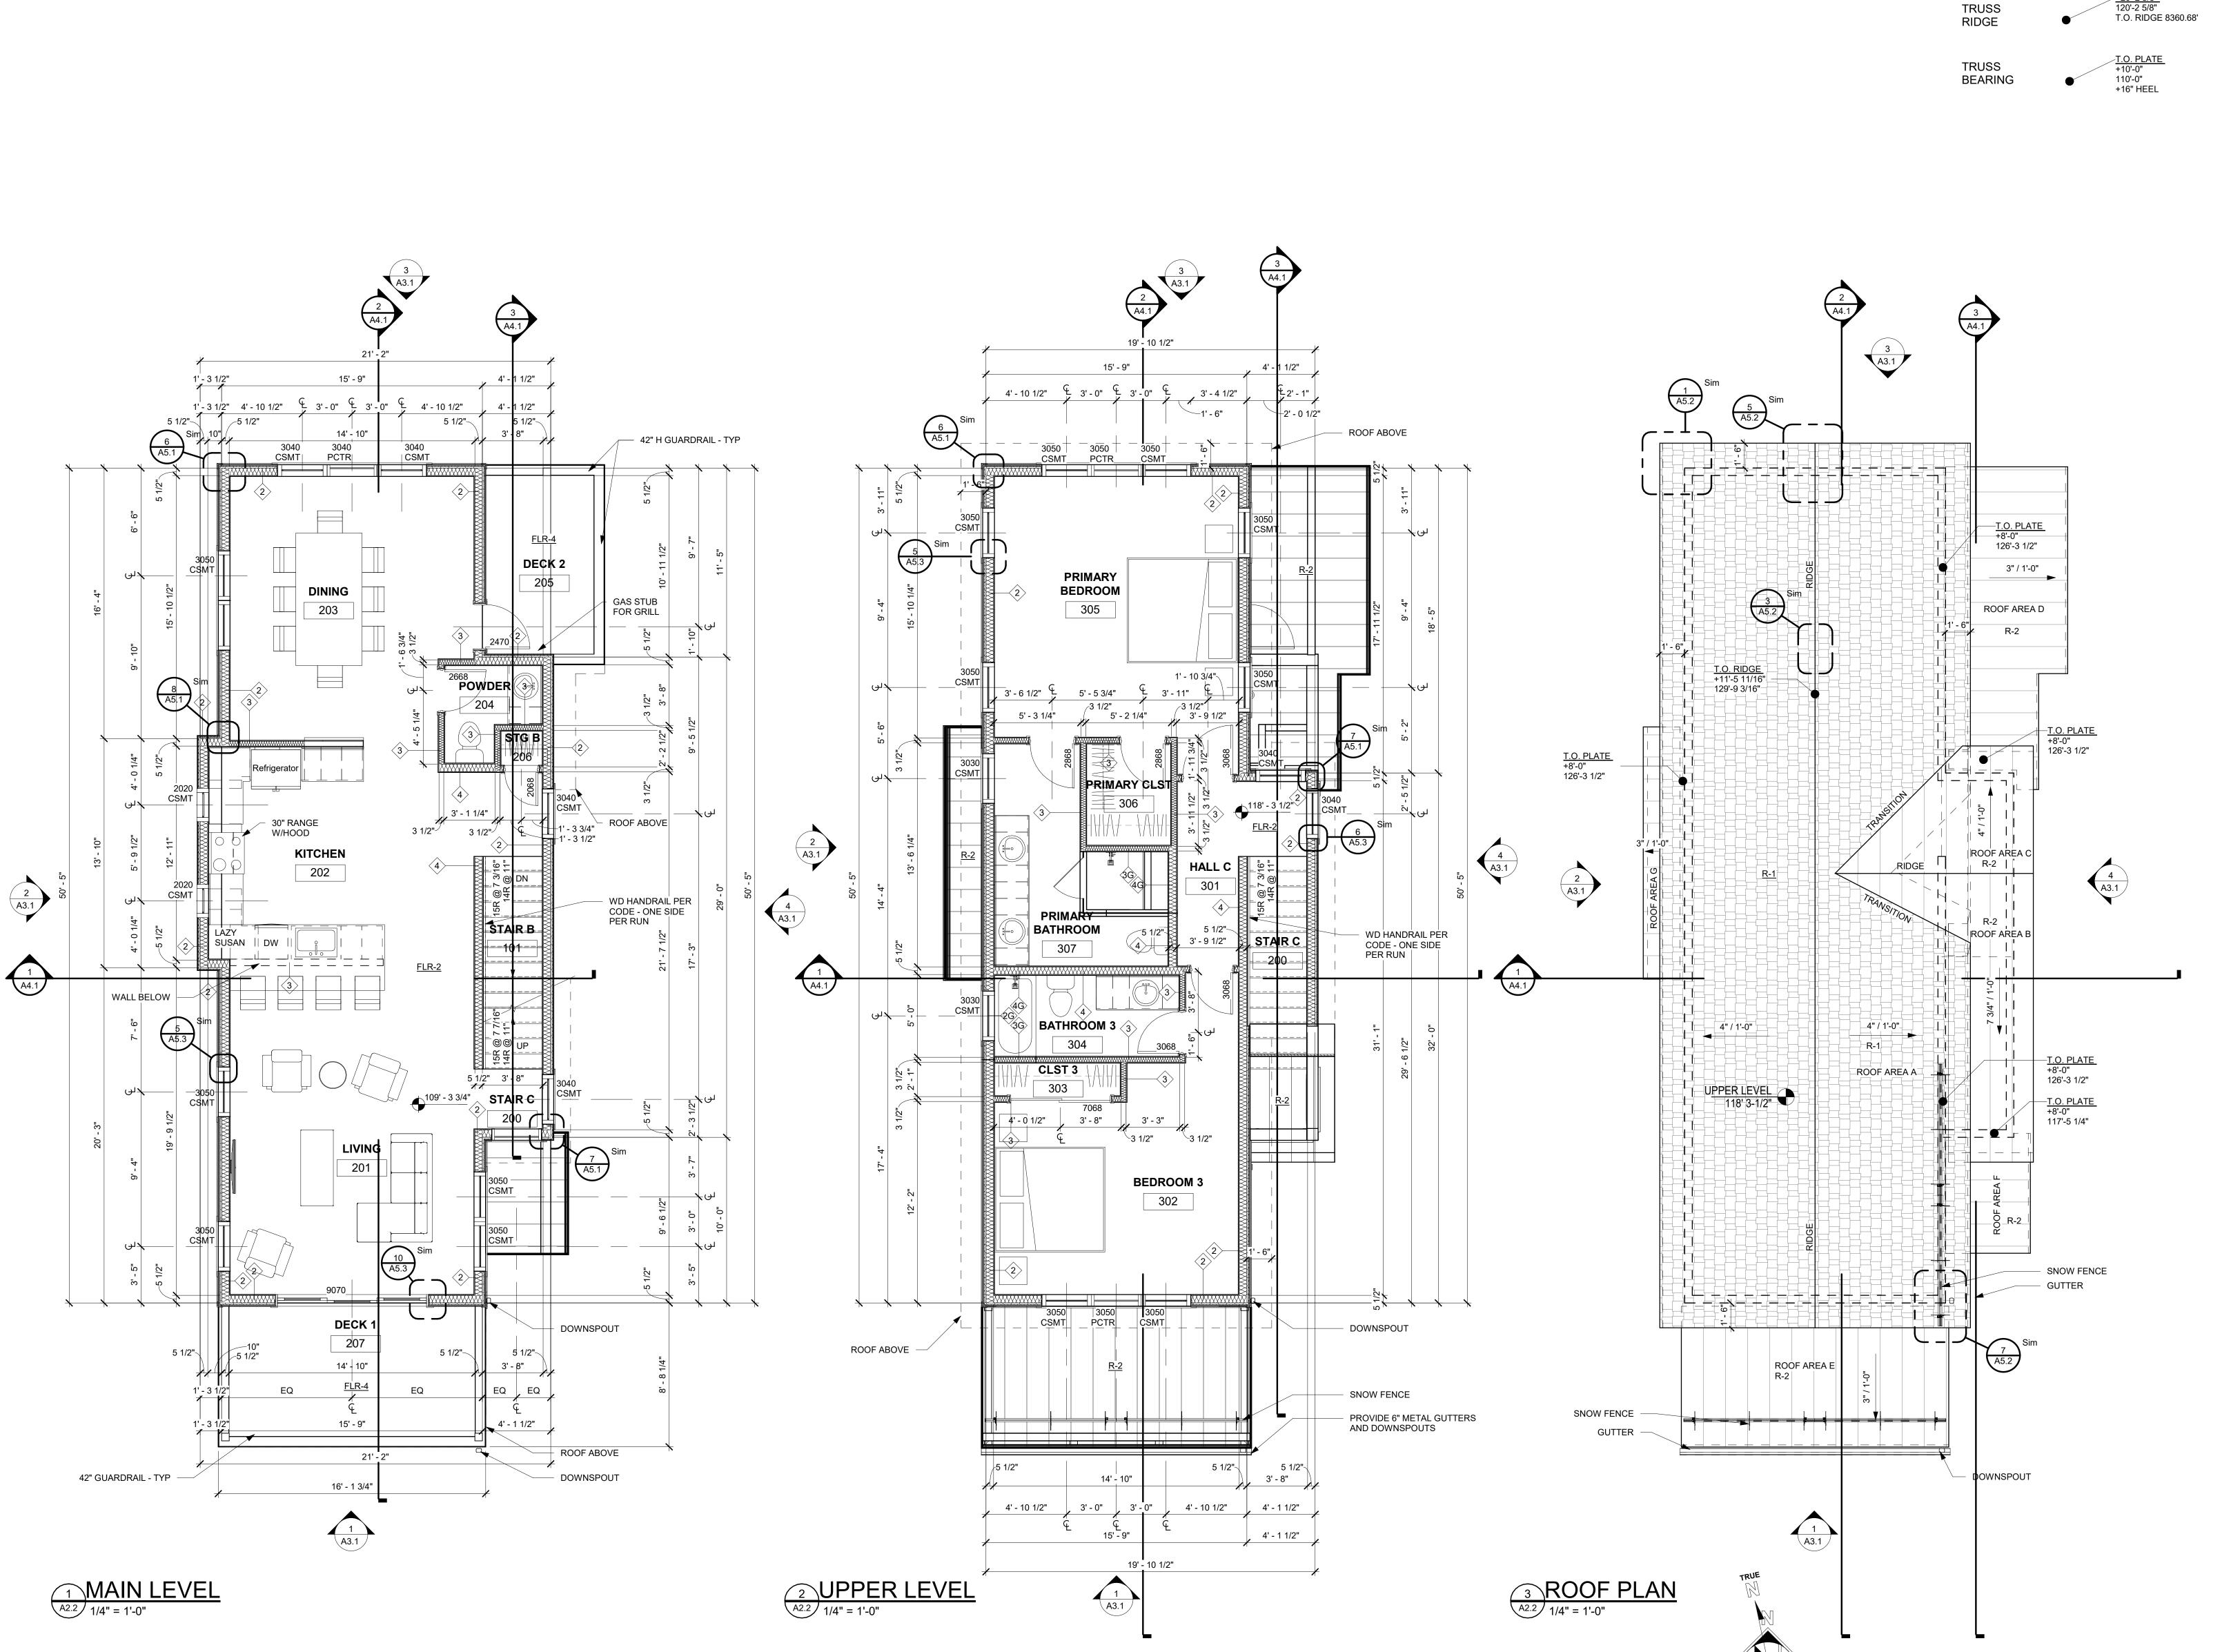

NOTES:

ROOF FINISH LEGEND

B.O. RIDGE +20'-2 5/8"

120'-2 5/8" (8359.22') T.O. RIDGE 8360.68'

T.O. PLYWD/CONC/GYP

100'-0" (8466.5')


STICK

RIDGE

T.O. WALL PLATE

FLOOR

SPOT ELEV

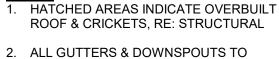

RECEIVE HEAT TAPE FOR ENTIRE LENGTH, RE: DIAGRAM ON ELECTRICAL PLANS 3. T.O. RIDGE ELEVATIONS GIVEN AT TOP OF

ROOF SHEATHING 4. CONTRACTOR TO VERIFY CHIMNEY DIMENSIONS WITH FIREPLACE

R-1 TAMKO ASPHALT SHINGLES, HERITAGE PREMIUM, COLOR: NATURAL TIMBER

MANUFACTURERS' REQUIREMENTS

R-2 COIL COATED MTL STANDING SEAM ROOF SEE SYSTEM NOTES SHEET A0.1

COIL COATED MTL FLASHING, GUTTERS, AND DOWNSPOUTS

OVERHANGS ARE 2'-0" FROM FACE OF

FRAMING TYP. U.N.O.

CHIMNEY CAP - 6" SANDSTONE CAP ROOF BEAMS - ROUGH SAWN TIMBER

GENERAL NOTES:

1. DO NOT SCALE DRAWINGS. USE GIVEN DIMENSIONS. IMMEDIATELY NOTIFY ARCHITECT IF ADDITIONAL INFORMATION IS REQUIRED. ALL DIMENSIONS ARE GIVEN TO FACE OF WALL FRAMING. SEE WALL SECTIONS AND WALL TYPES FOR EXACT CONSTRUCTION

2. SEE SHEET A0.1 FOR WALL TYPES INDICATED ON FLOOR PLANS

3. PROVIDE ALL NECESSARY BLOCKING FOR PROPER ATTACHMENT OF WORK IN WALLS AND CEILINGS. LOCATIONS INCLUDE BUT NOT LIMITED TO, TOILET AND BATH ACCESSORIES, WALL AND CEILING MOUNTED ELECTRICAL EQUIPMENT, WINDOW TREATMENTS,

CASEWORK, COUNTERTOPS, ETC.

4. WHERE WALL PARTITIONS ARE A CONTINUATION OF EXISTING ONES. NEW FINISH SURFACES MUST BE FLUSH AND CONTINUOUS WITH EXISTING SURFACES ON BOTH SIDES. INFILL OPENINGS IN EXISTING WALLS WITH MATERIAL TO MATCH EXISTING WALL THICKNESS, TEXTURE, AND FINISH.

5. REFERENCE S-SERIES DRAWINGS FOR STRUCTURAL NOTES AND DETAILS AND COORDINATE.

6. EXISTING BUILDING DIMENSIONS AND ELEVATIONS ARE BASED UPON EXISTING SURVEY INFORMATION. IMMEDIATELY NOTIFY ARCHITECT IF CONDITIONS ARE ENCOUNTERED THAT DO NOT AGREE WITH DIMENSIONS AND/OR ELEVATIONS SHOWN.

PITCH LINES WITH THE ARCHITECT, PROVIDE A SLAB DEPRESSION AT ALL FLOOR DRAINS WHERE PITCH LINES ARE NOT SHOWN ON DRAWINGS.

7. VERIFY ALL PITCHED FLOOR AREAS SHOWN WITH

8. PROVIDE 4" RETURN FROM FACE OF ADJACENT WALL FOR ANY DOORS NOT DIMENSIONED.

9. SEE MECHANICAL, PLUMBING, AND ELECTRICAL DRAWINGS FOR ITEMS NOT SHOWN ON ARCHITECTURAL DRAWINGS AND COORDINATE. 10. ALL INTERIOR WALLS SHALL EXTEND TO UNDERSIDE

NOTED OTHERWISE. SEE PARTITION WALL TYPES ON SHEET A0.03 11. DATUM 100'-0" INDICATED ON ALL DRAWINGS, OTHER THAN CIVIL SERIES EQUALS XXXX.XX ON CIVIL DRAWINGS

OF ROOF DECK AND STEEL STRUCTURE (BEAM) UNLESS

TO BE COATED WITH BITUMINOUS DAMPROOFING. 13. CONTRACTOR TO COMPLY WITH ALL REQUIREMENTS

12. ALL STEEL LOCATED BELOW AND EXPOSED TO GRADE

CLOSET NOTES:

SINGLE HANGING: DESIGNATED BY SINGLE DASHED LINE IN CLOSETS TO BE: 16" SHELF @ 7'-0"

FOR SPECIAL INSPECTIONS, 2015 IBC-1704.

AFF, 16" SHELF & ROD @ 5'-6" AFF.

DOUBLE HANGING: DESIGNATED BY DOUBLE

DASHED LINE IN CLOSETS TO BE: 16" SHELF & ROD @ 7'-0" AFF, 12" SHELF & ROD @ 3'-6" AFF.

SHELVES @ WALK-IN CLOSETS: 6 - 16" SHELVES @ 3 1'-2" OC, 1st SHELF @ 1'-2" AFF, SHELF WIDTH TO BE CLOSET WIDTH, LESS 4'-0" OR AS OTHERWISE

INDICATED. LINEN SHELVES: 6 SHELVES, WIDTH AS NOTED, @ 4 1'-2" OC, 1st SHELF @ 1'-2" AFF, FULL CLOSET

STORAGE SHELVES: 6 - 16" SHELVES @ 1'-2" OC, 1st SHELF @ 1'-2" AFF, FULL CLOSET WIDTH.

GENERAL CLOSET NOTES: 1. ALL SHELVES & VERTICAL DIVIDERS TO BE AC

PLYWOOD WITH 1x2 EDGE. SPECIES TO BE SPECIFIED BY DEVELOPER.
2. CLEATS TO BE 1x2 CLEAR PINE. 3. PROVIDE ROD SUPPORTS @ 36" OC MAX. 4. ALL TO BE STAINED TO MATCH CASE & BASE.

FLOOR PLAN GENERAL NOTES:

1. PATCH EXISTING CONSTRUCTION SCHEDULED TO REMAIN. REPAIRED SURFACES TO BE FLUSH WITH ADJACENT FINISH SURFACES. TO SAME QUALITY AS NEW CONSTRUCTION PRIOR TO INSTALLING NEW FINISHES. REFER TO THE FINISH MANUFACTURER'S GUIDELINES FOR INSTALLATION.

2. PATCH EXISTING FIRE-RATED WALLS, FLOOR CEILINGS, ETC. SO AS TO MAINTAIN THE FIRE-RADIATING. ADD FIRE-SMOKE DAMPERS WHERE NEW DUCTS CROSS. ADD FIRE STOP AT ALL

B. PATCH WALLS AT REMOVED RECEPTACLE OPENINGS SO AS TO RECEIVE SUBSEQUENT WORK. 4. PATCH AND LEVEL FLOOR SUBSTRATES TO RECEIVE

NEW WORK AS SCHEDULED. 5. COORDINATE ALL FLOOR CORE DRILLING WITH EXISTING.

6. DO NOT SCALE DRAWINGS.

7. IN ROOMS WITH FLOOR DRAINS, SLOPE CONCRETE SURFACE WITHIN 18" RADIUS AT 1/4" PER FOOT TOWARD FLOOR DRAIN, UNLESS OTHERWISE INDICATED.

8. ALL SPOT ELEVATIONS SHOWN ON THE FLOOR PLANS OUTSIDE THE BUILDING RELATE TO USGS ELEVATIONS. ALL SPOT ELEVATIONS INSIDE THE BUILDING REFER TO BUILDING REFERENCE ELEVATIONS. NOTIFY ARCHITECT IMMEDIATELY SHOULD CONDITIONS BE FOUND CONTRADICTORY TO THESE DRAWINGS.

9. ALL ANGLES SHOWN ON THE FLOOR PLANS ARE 90 DEGREES UNLESS OTHERWISE NOTED.

10. ALL DIMENSIONS ARE TO GRID LINE, FACE OF CONCRETE OR MASONRY, OR FACE OF GYPSUM BOARD, UNLESS OTHERWISE NOTED.

11. ALL FLOOR PLAN DIMENSIONS TO MASONRY ARE NOMINAL DIMENSIONS, UNLESS NOTED AS ACTUAL.

Associates The Architectural Balance 0056 Edwards Village Blvd.

Edwards, CO 81632 (970) 766-1470 fax: (970) 766-1471 email: tab@vail.net Civil Engineer Timberline Engineering (970) 963-9869 Structural Engineer


KRM Consultants, Inc (970) 949-9391 Mechanical Engineer Electrical Engineer

0 00

DRB - 02/14/2025

Sheet Title: Main,

Upper, & Roof **Plans**

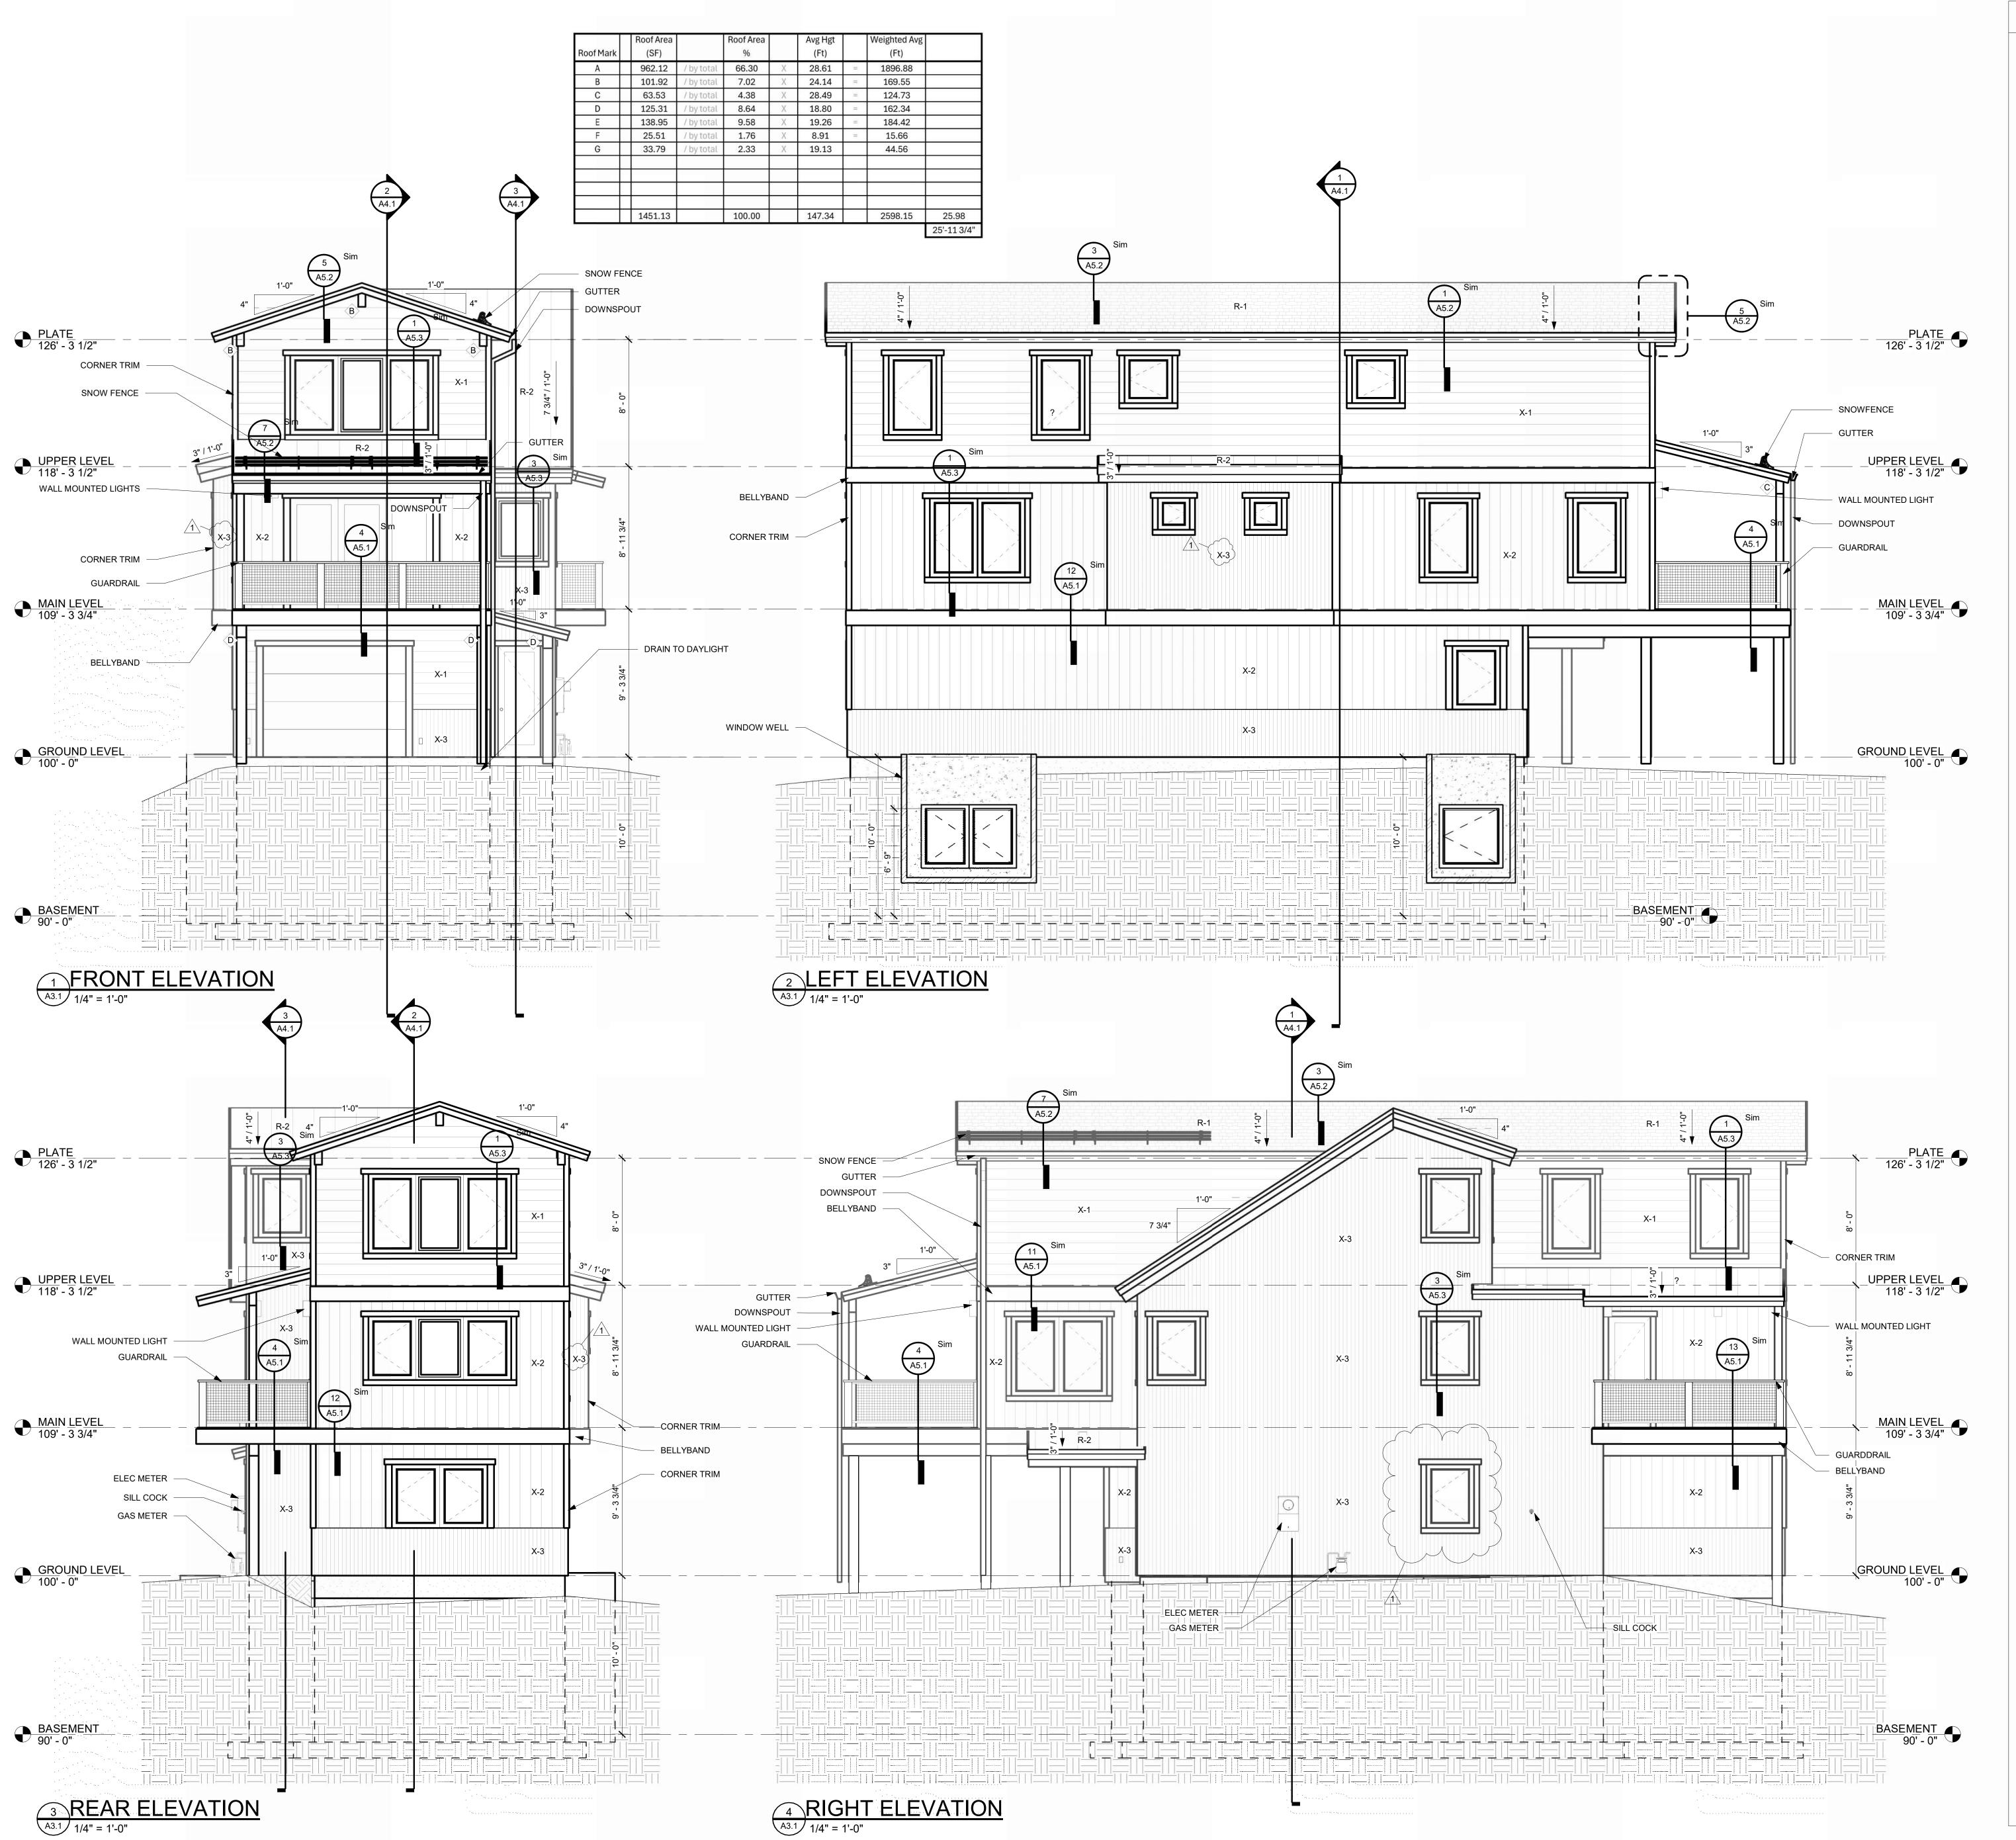

NOTES:

EXTERIOR MATERIAL LEGEND:

- X-1 DIAMOND KOTE LP SMARTSIDE LAP SIDING
- COLOR WHITE
- X-2 DIAMOND KOTE LP SMARTSIDE VERTICAL SIDING COLOR - WHITE
- X-3 VERTICAL CORRUGATED METAL SIDING COLOR - GALVALUME
- R-1 ASPHALT SHINGLE ROOF R-2 STANDING SEAM METAL ROOF

EXTERIOR ELEVATION GENERAL NOTES:

- 1. EXTERIOR FINISHES INDICATED ON ELEVATIONS SEE "EXTERIOR MATERIAL LEGEND" FOR MATERIALS.
- 2. RFERENCE ROOF PLAN FOR LOCATIONS OF ROOF COMPONENETS NOT INDICATED ON EXTERIOR ELEVATIONS.

SOFFITS, STRUCTURAL BEAMS, AND ETC.

- 3. REFER TO MEP AND STRUCTURAL DRAWINGS FOR ANY ADDITIONAL WORK.
- 4. ASSUME ALL PAINTED SURFACES WILL BE REPAINTED. THIS INCLUDES BUT IS NOT LIMITED TO: DOORS, DOOR FRAMES, WINDOW FRAMES, AND HEADERS, CEILINGS, HANDRAILS, EXPOSED MECHANICAL, CMU ACCENTS,
- 5. PROVIDE ALLOWANCE TO SEAL AND CAULK VARIOUS WALL PENERTRATIONS ANS HOLES AROUND EXTERIOR PERIMETER OF BUIDLING, SIMILAR AREAS SUCH AS HOSE BIBS, PIPES, ETC.

LABOR AND MATERIALS TO REMOVE OR RELOCATE.

- 6. PROVIDE ALLOWANCE TO REVIEW ALL EXPOSED ELECTRICAL CONDUIT TO DETERMINE FEASIBILITY TO REMOVE OR RELOCATE. INCLUDE IN ALLOWANCE
- 7. SEE CIVIL PLANS FOR NOTE TO RESEAL ALL HORIZONTAL CONCRETE AND ASPHALT JOINTS AT
- 8. WHEN A PORTION OF A WALL IS PAINTED ASSUME THE ENTIRE WALL IS PAINTED TO INSIDE OR OUTSIDE CORNERS.
- 9. DO NOT SCALE DRAWINGS.
- 10. ALL ANGLES SHOWN ON THE FLOOR PLANS ARE 90 DEGREES UNLESS NOTED OTHERWISE.

BEAMWORK LEGEND:

- (A) 4X10
- B 6X10
- (C) 6X12

a 0 elde

Associates

The Architectural Balance

0056 Edwards Village Blvd. Suite 210 Edwards, CO 81632

(970) 766-1470

fax: (970) 766-1471

email: tab@vail.net

Civil Engineer

Timberline Engineering

(970) 963-9869

Structural Engineer

KRM Consultants, Inc

(970) 949-9391


Mechanical Engineer

Electrical Engineer


DRB - 02/14/2025 Sheet Title:

Exterior Elevations



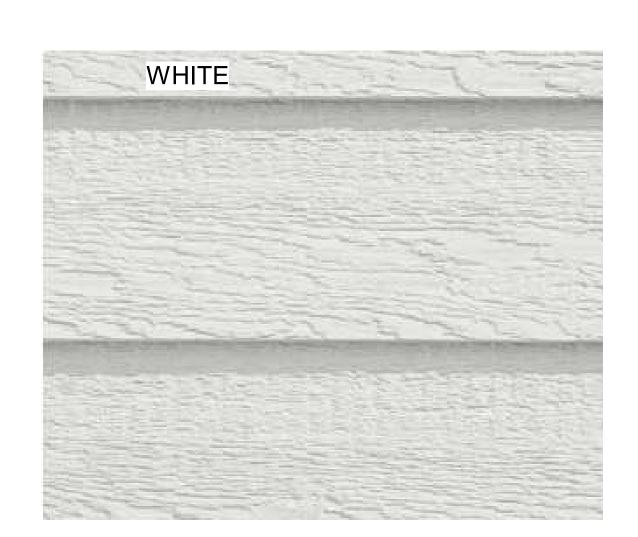


X-1 - LAP SIDING COLOR 1

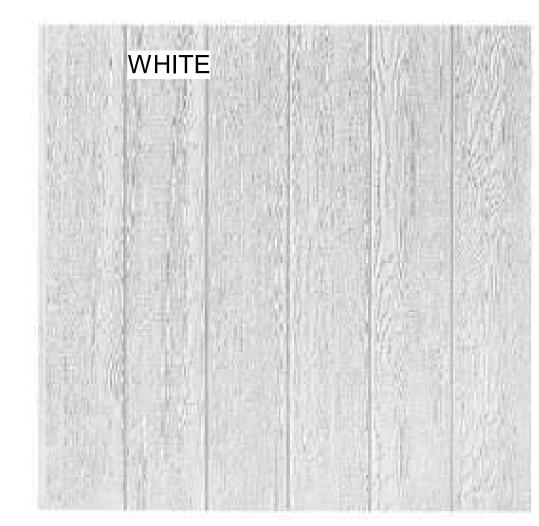

X-2 - VERTICAL SIDING COLOR 1



X-3 GALVALUME CORRUGATED PANELS

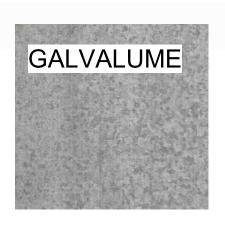

SW 7069 Iron Ore Interior / Exterior



PAINTED ITEMS: SHERWIN WILLIAMS 7069 IRON ORE TRIM, CORNER TRIM, WINDOW TRIM, WOOD BEAMS, GUTTERS AND OTHER METALS




GARAGE DOORS: SIMILAR TO RAYNOR - ASPEN SERIES RECESSED RANCH GROOVED PANELS COLOR: WALNUT



EXTERIOR MATERIAL LEGEND:

- X-2 DIAMOND KOTE LP SMARTSIDE VERTICAL SIDING COLOR - WHITE
- X-3 VERTICAL CORRUGATED METAL SIDING COLOR GALVALUME
- R-1 ASPHALT SHINGLE ROOF

WINDOWS: SIMILAR TO SIERRA PACIFIC "BLACK" WOOD CLAD WINDOWS

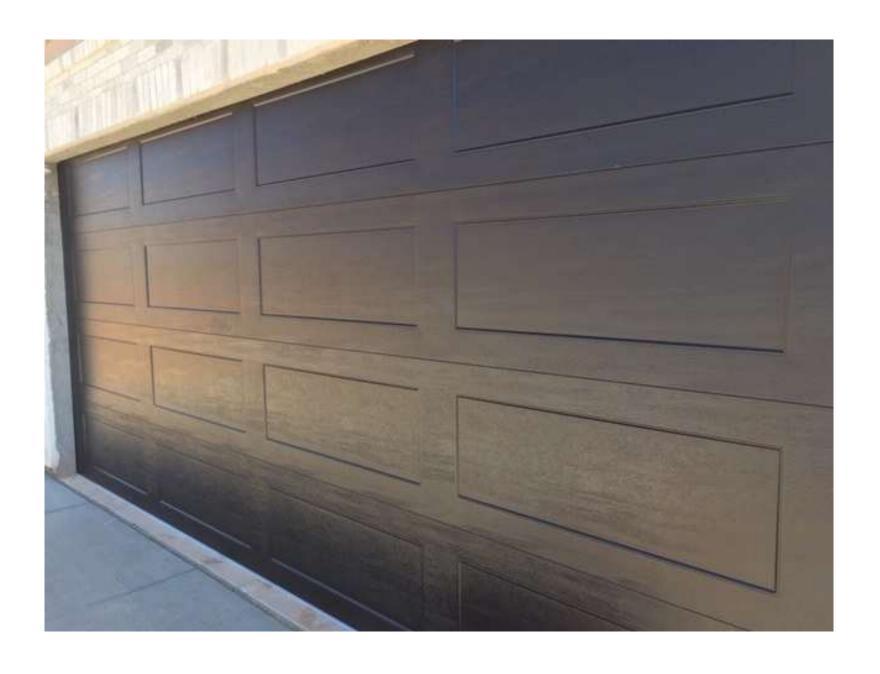



R-1 ROOFING SIMILAR TO GAF DEISGNER SHINGLES WOODLAN 'CASTLEWOOD GRAY'



R-2 ROOFING SIMILAR OT WESTERN STATES 2" STANDING SEAM - 12" WIDTH COLOR: GALVANIZED TO MATCH GALVALUME METAL PANELS

GENERATION LIGHTING

8637401-12: Medium One Light Outdoor Wall Lantern Dimensions:



Wire: 6 1/2" (color/Black/White) Mounting Proc.: Cap Nuts Connection: Mounted To Box

Material List:

1 Body - Aluminum - Black

Safety Listed for Wet Locations

1 - Medium A19 75w Max. 120v - Not included Features:

 Dark sky friendly. Designed to emit no light above the 90° horizontal plane. Photometry unavailable. Easily converts to LED with optional replacement lamps Meets Title 24 energy efficiency standards Title 24 compliant if used with Joint Appendix (JA8) approved light bulbs listed in the California Energy Commission Appliance

Trilingual (English, Spanish, and French) (990W8_37401-BRL)

Extends Max: 23 1/8"

Featured in the decorative Barn Light collection Safety Listing: 1 A19 Medium 75 watt light bulb Dark sky friendly. Designed to emit no light above the 90° horizontal plane. Photometry unavailable. Instruction Sheets:

Easily converts to LED with optional replacement lamps Meets Title 24 energy efficiency standards

UPC #:785652069352 Finish: Black (12)

Collection: Barn Light

Backplate /	Canopy	Detail

Type	Height / Le	ngth	Width	Depth	Diameter 5		Outlet Box Up 4 1/8			Outlet Box Down 6 1/2		
Back Plate)			1 1/4								
Shipping Inf	ormation:	Quantity	TUPC		Length	Width	Height	Cube	Weight	Frt. Class	UPS Ship	
rackage IVDe												
Individual	8537401EN3-12	1	7856520	069352	16.75	14.58	13.25	1.873	4.1	250	Yes	
	(Telephone Contract)	1 45	(minute)	069352		NO DISTRIBUTION		A TOUR DESIGNATION		150102302103000001	Section Services	

Generation Lighting reserves the right to revise the design of components of any product due to parts availability or change in safety listing standards without assuming any obligation or liability to modify any products previously manufactured and without notice. This literature depicts a product design that is the sole and exclusive property of Generation Lighting. In compliance with U.S copyright and patent requirements, notification is hereby presented in this form that this literature, or the product it depicts, is not to be copied, altered or used in any manner without the express written consent of, or contrary to the best interests of Generation Lighting, a Visual Comfort & Co brand.

Associates The Architectural Balance

0056 Edwards Village Blvd. Suite 210 Edwards, CO 81632 (970) 766-1470 fax: (970) 766-1471 email: tab@vail.net www.tabassociates.com Civil Engineer

Timberline Engineering (970) 963-9869 Structural Engineer KRM Consultants, Inc (970) 949-9391 Mechanical Engineer

Electrical Engineer

a 0

DRB - 02/14/2025 Sheet Title:

Materials





SOUTHWEST ELEVATION

A3.3





SOUTHEAST ELEVATION

A3.3








4 NORTHEAST ELEVATION

A3.3

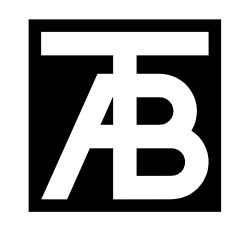

The Architectural Balance

0056 Edwards Village Blvd.
Suite 210
Edwards, CO 81632 fax: (970) 766-1471 email: tab@vail.net www.tabassociates.com

Timberline Engineering (970) 963-9869 Structural Engineer
KRM Consultants, Inc (970) 949-9391

Electrical Engineer

Fai Place - 8

Issue Dates: DRB - 02/14/2025 **Exterior** Color Elevations & 3D

3 STAIR SECTION
A4.1 1/4" = 1'-0"

NOTES:

EXTERIOR MATERIAL LEGEND:

- X-1 DIAMOND KOTE LP SMARTSIDE LAP SIDING
 COLOR WHITE
 X-2 DIAMOND KOTE LP SMARTSIDE VERTICAL SIDING
 COLOR WHITE
 X-3 VERTICAL CORRUGATED METAL SIDING
 COLOR GALVALUME


- R-1 ASPHALT SHINGLE ROOF R-2 STANDING SEAM METAL ROOF

Associates The Architectural Balanc

0056 Edwards Village Blvd. Suite 210 Edwards, CO 81632 (970) 766-1470 fax: (970) 766-1471 email: tab@vail.net www.tabassociates.com Civil Engineer Timberline Engineering (970) 963-9869 Structural Engineer KRM Consultants, Inc (970) 949-9391 Mechanical Engineer

Electrical Engineer


mily ad Ros <u>a</u> Singel
Abby I 0 Place 8 - 001 Minturn elde Lot \mathbf{M}

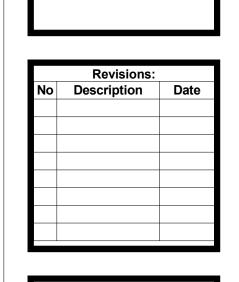

DRB - 02/14/2025 Sheet Title:

Building **Sections**


Project No: 2215 A4.1

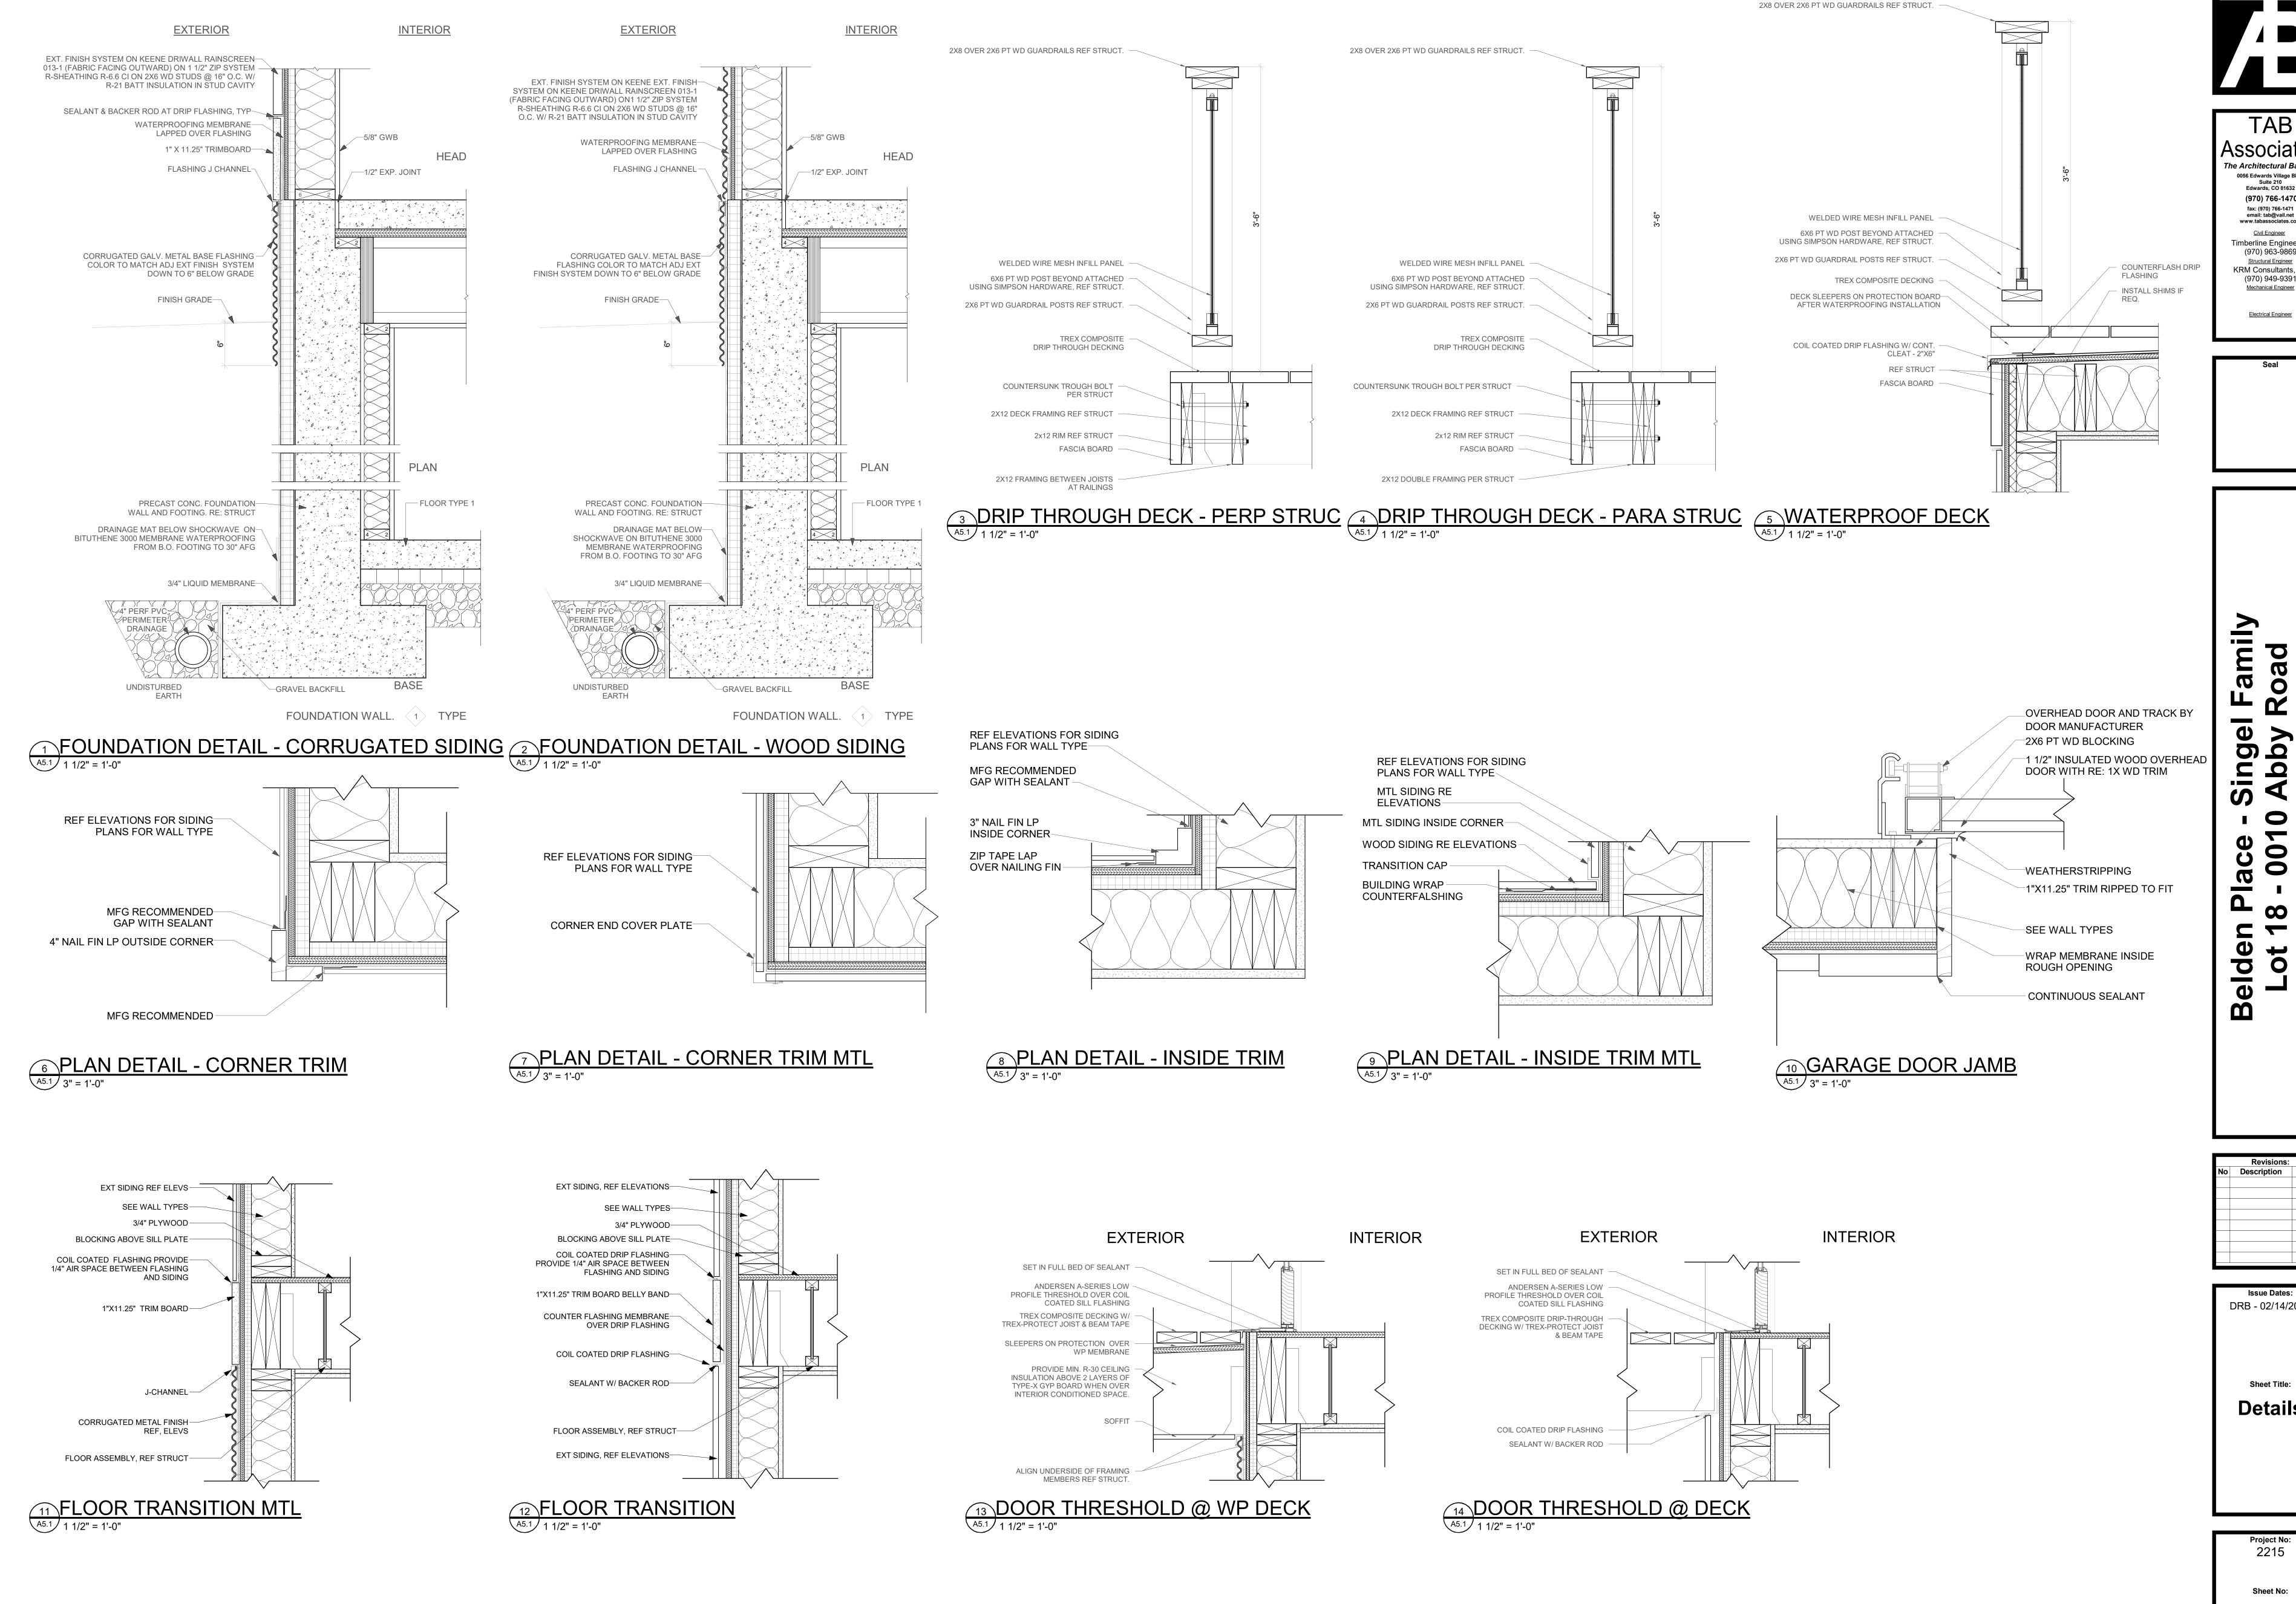


Associates The Architectural Balance 0056 Edwards Village Blvd. Suite 210 Edwards, CO 81632 (970) 766-1470 fax: (970) 766-1471 email: tab@vail.net Civil Engineer Timberline Engineering (970) 963-9869 Structural Engineer KRM Consultants, Inc (970) 949-9391 Mechanical Engineer


Issue Dates: DRB - 02/14/2025 Sheet Title: **Details**

1 FASCIA AT TRUSS
1 1/2" = 1'-0"

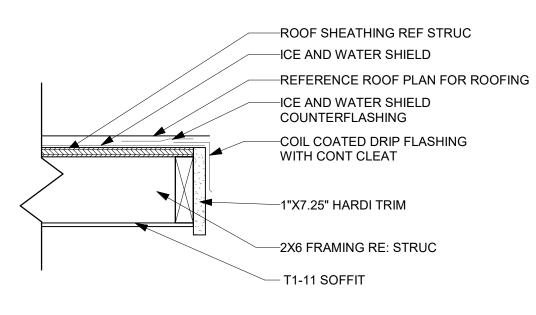




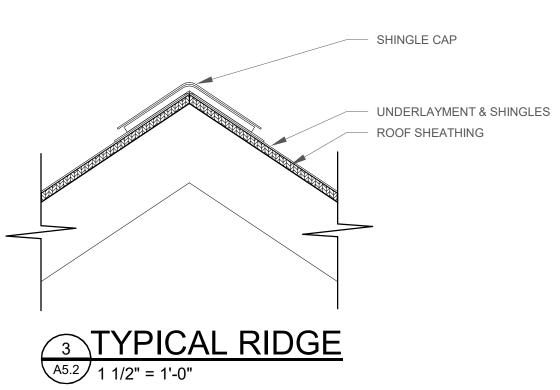


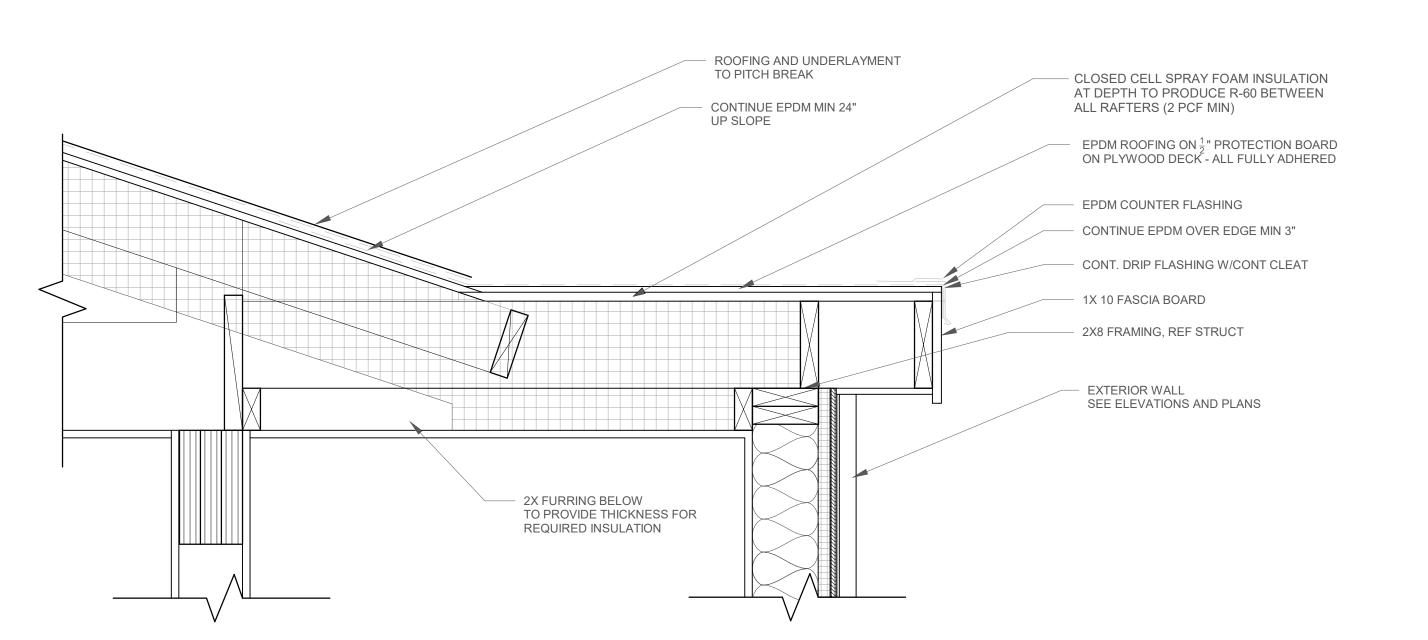


6 STAIR ROOF - LOW SLOPE TRANSITION
A5.2 1 1/2" = 1'-0"

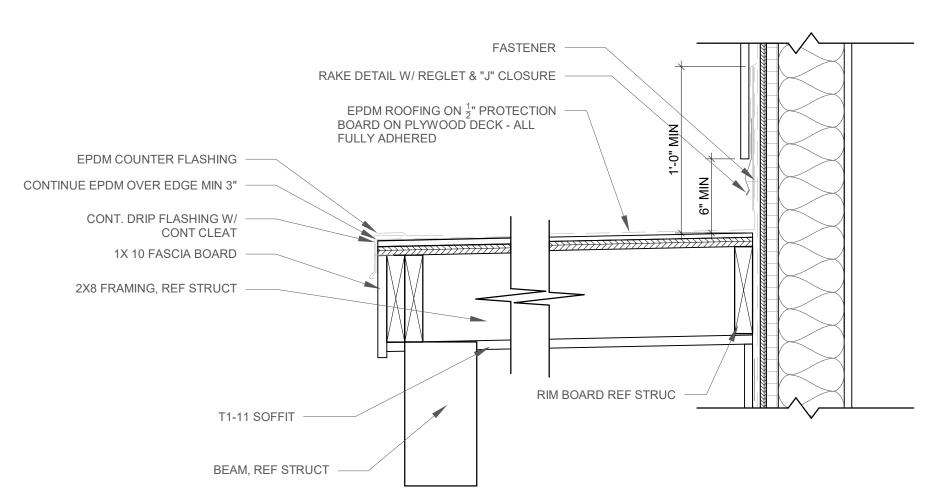


4 COVERED WALKWAY A5.2 1 1/2" = 1'-0"

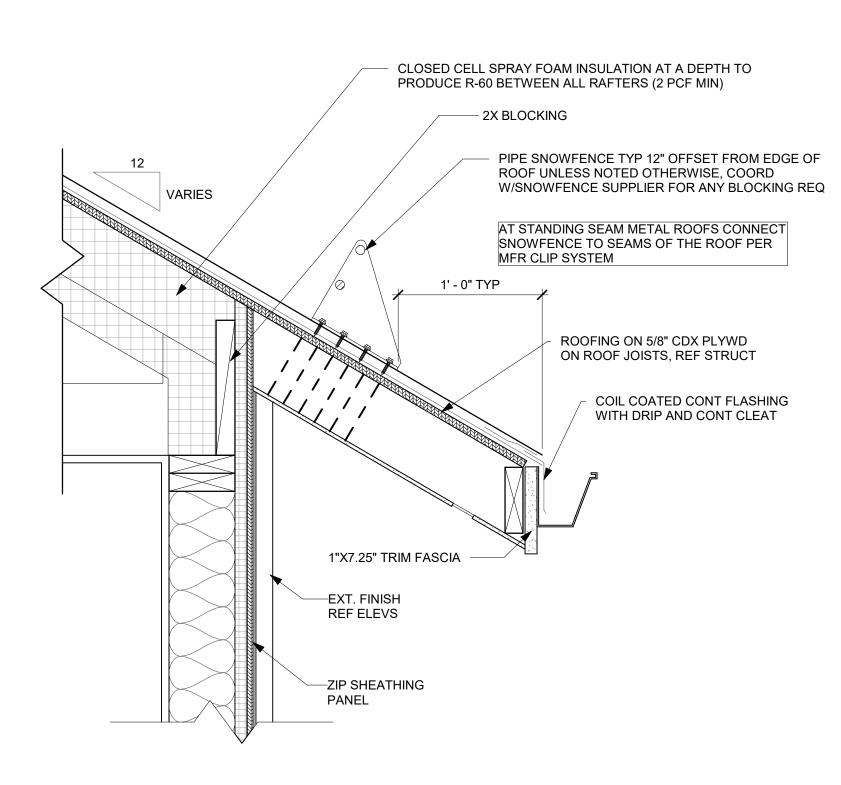


7 ROOF SNOWFENCE
A5.2 1 1/2" = 1'-0"

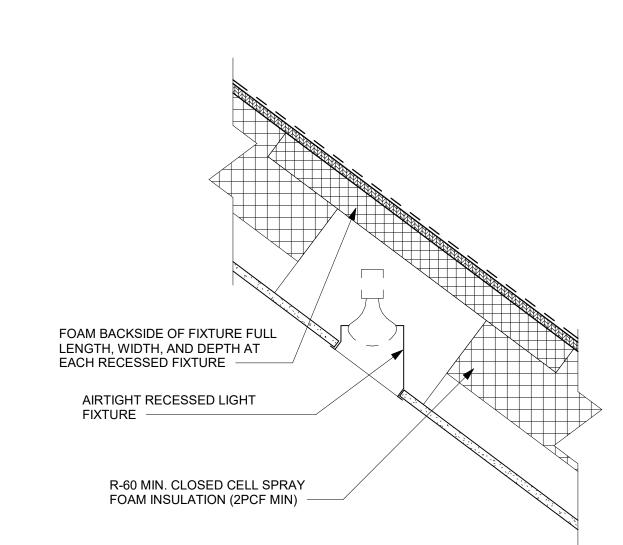


9 RECESSED LIGHT FIXTURE
A5.2 1 1/2" = 1'-0"

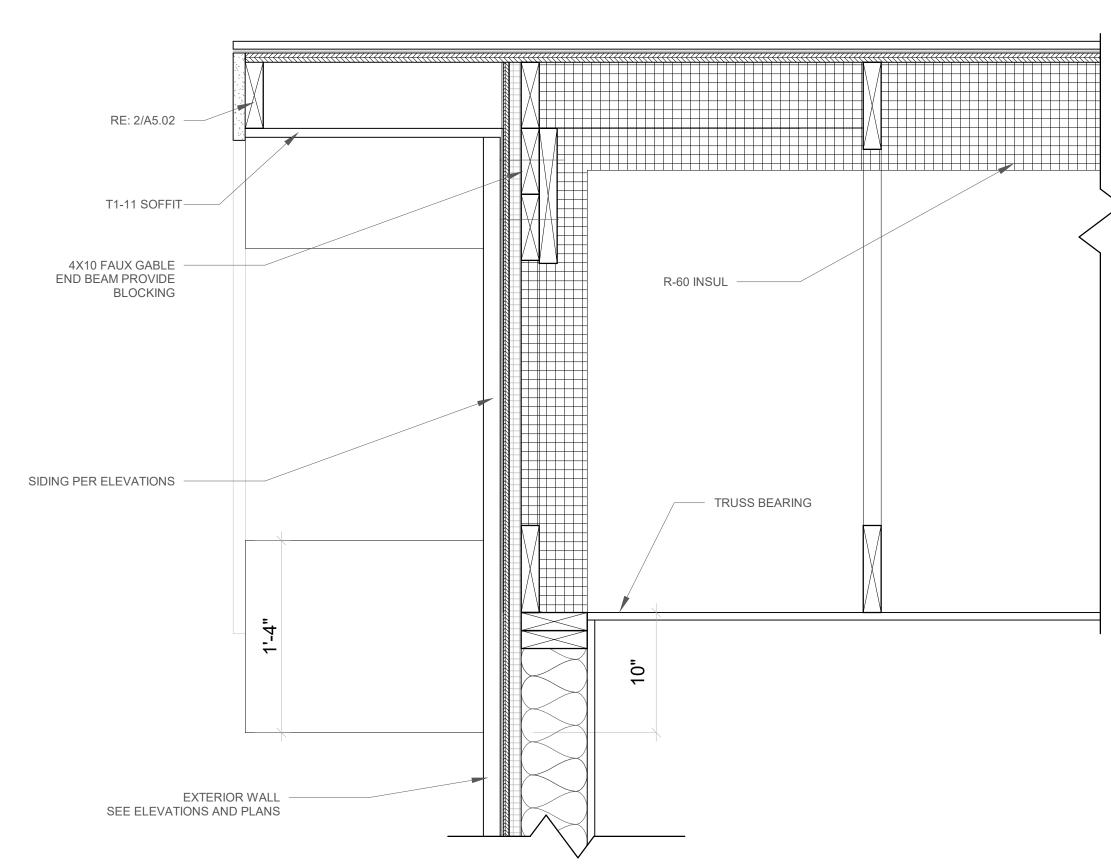

5 GABLE END DETAIL
A5.2 1 1/2" = 1'-0"

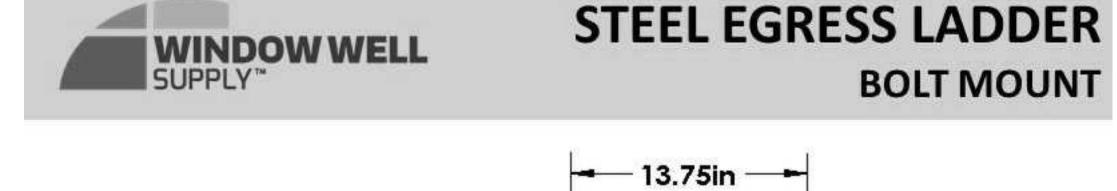

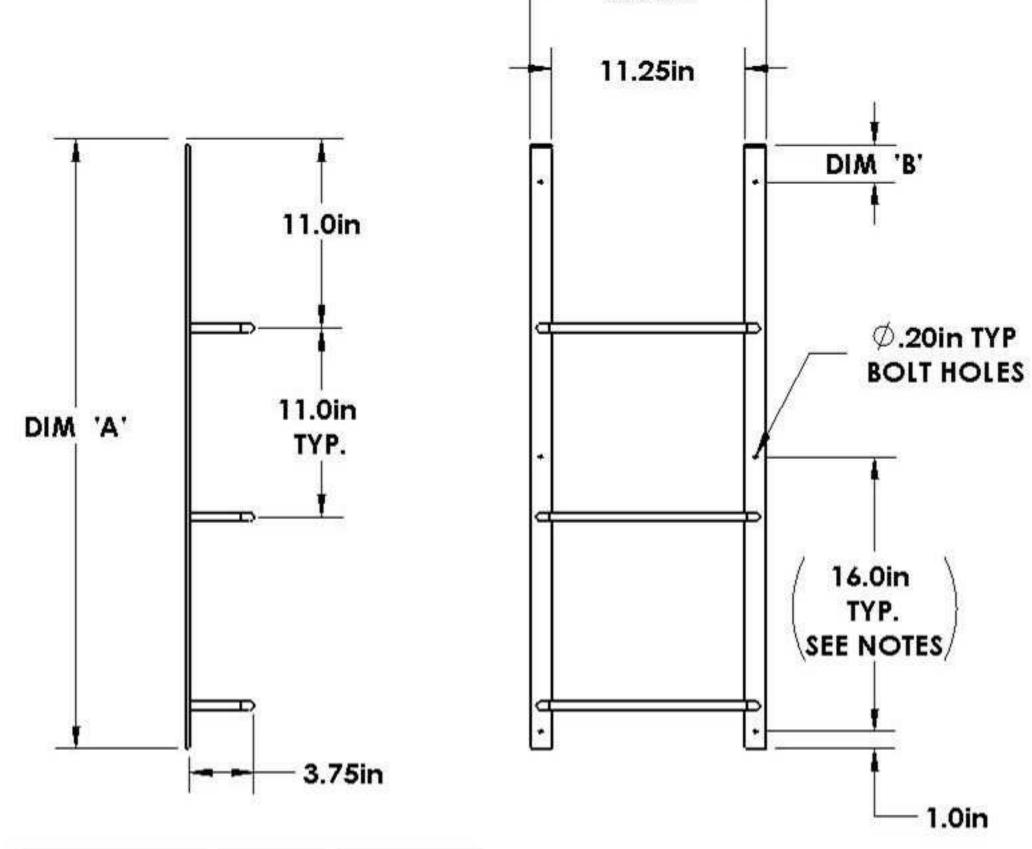

Ladder Size	Dim 'A' [in]	Dim 'B' [in]	TOTAL STREET
3 Rung	35.0	2.0	0000
4 Rung	46.0	1.0	
5 Rung	57.0	8.0	7,000
6 Rung	68.0	3.0	
7 Rung	79.0	1.0	•

Powder-coated Steel Material: 11.0in Rung Spacing: 16.0in, hole spacing Hole Spacing: may vary

Hole Diameter: 0.20in Screw Size*:

TYPICAL LADDER LENGTH


#10 (3/16in)

REVA

BOLT MOUNT

8 EGRESS LADDER A5.2 1/4" = 1'-0"

PERMANENTLY FIXED LADDER

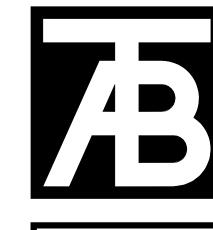


Associates The Architectural Balance 0056 Edwards Village Blvd. Suite 210 Edwards, CO 81632 (970) 766-1470 fax: (970) 766-1471 email: tab@vail.net Civil Engineer Timberline Engineering (970) 963-9869 Structural Engineer KRM Consultants, Inc (970) 949-9391 Mechanical Engineer

Electrical Engineer

Roa <u>a</u> Singel
Abby I . 0 Place 8 - 001 Belder Lot

DRB - 02/14/2025 Sheet Title: **Details**

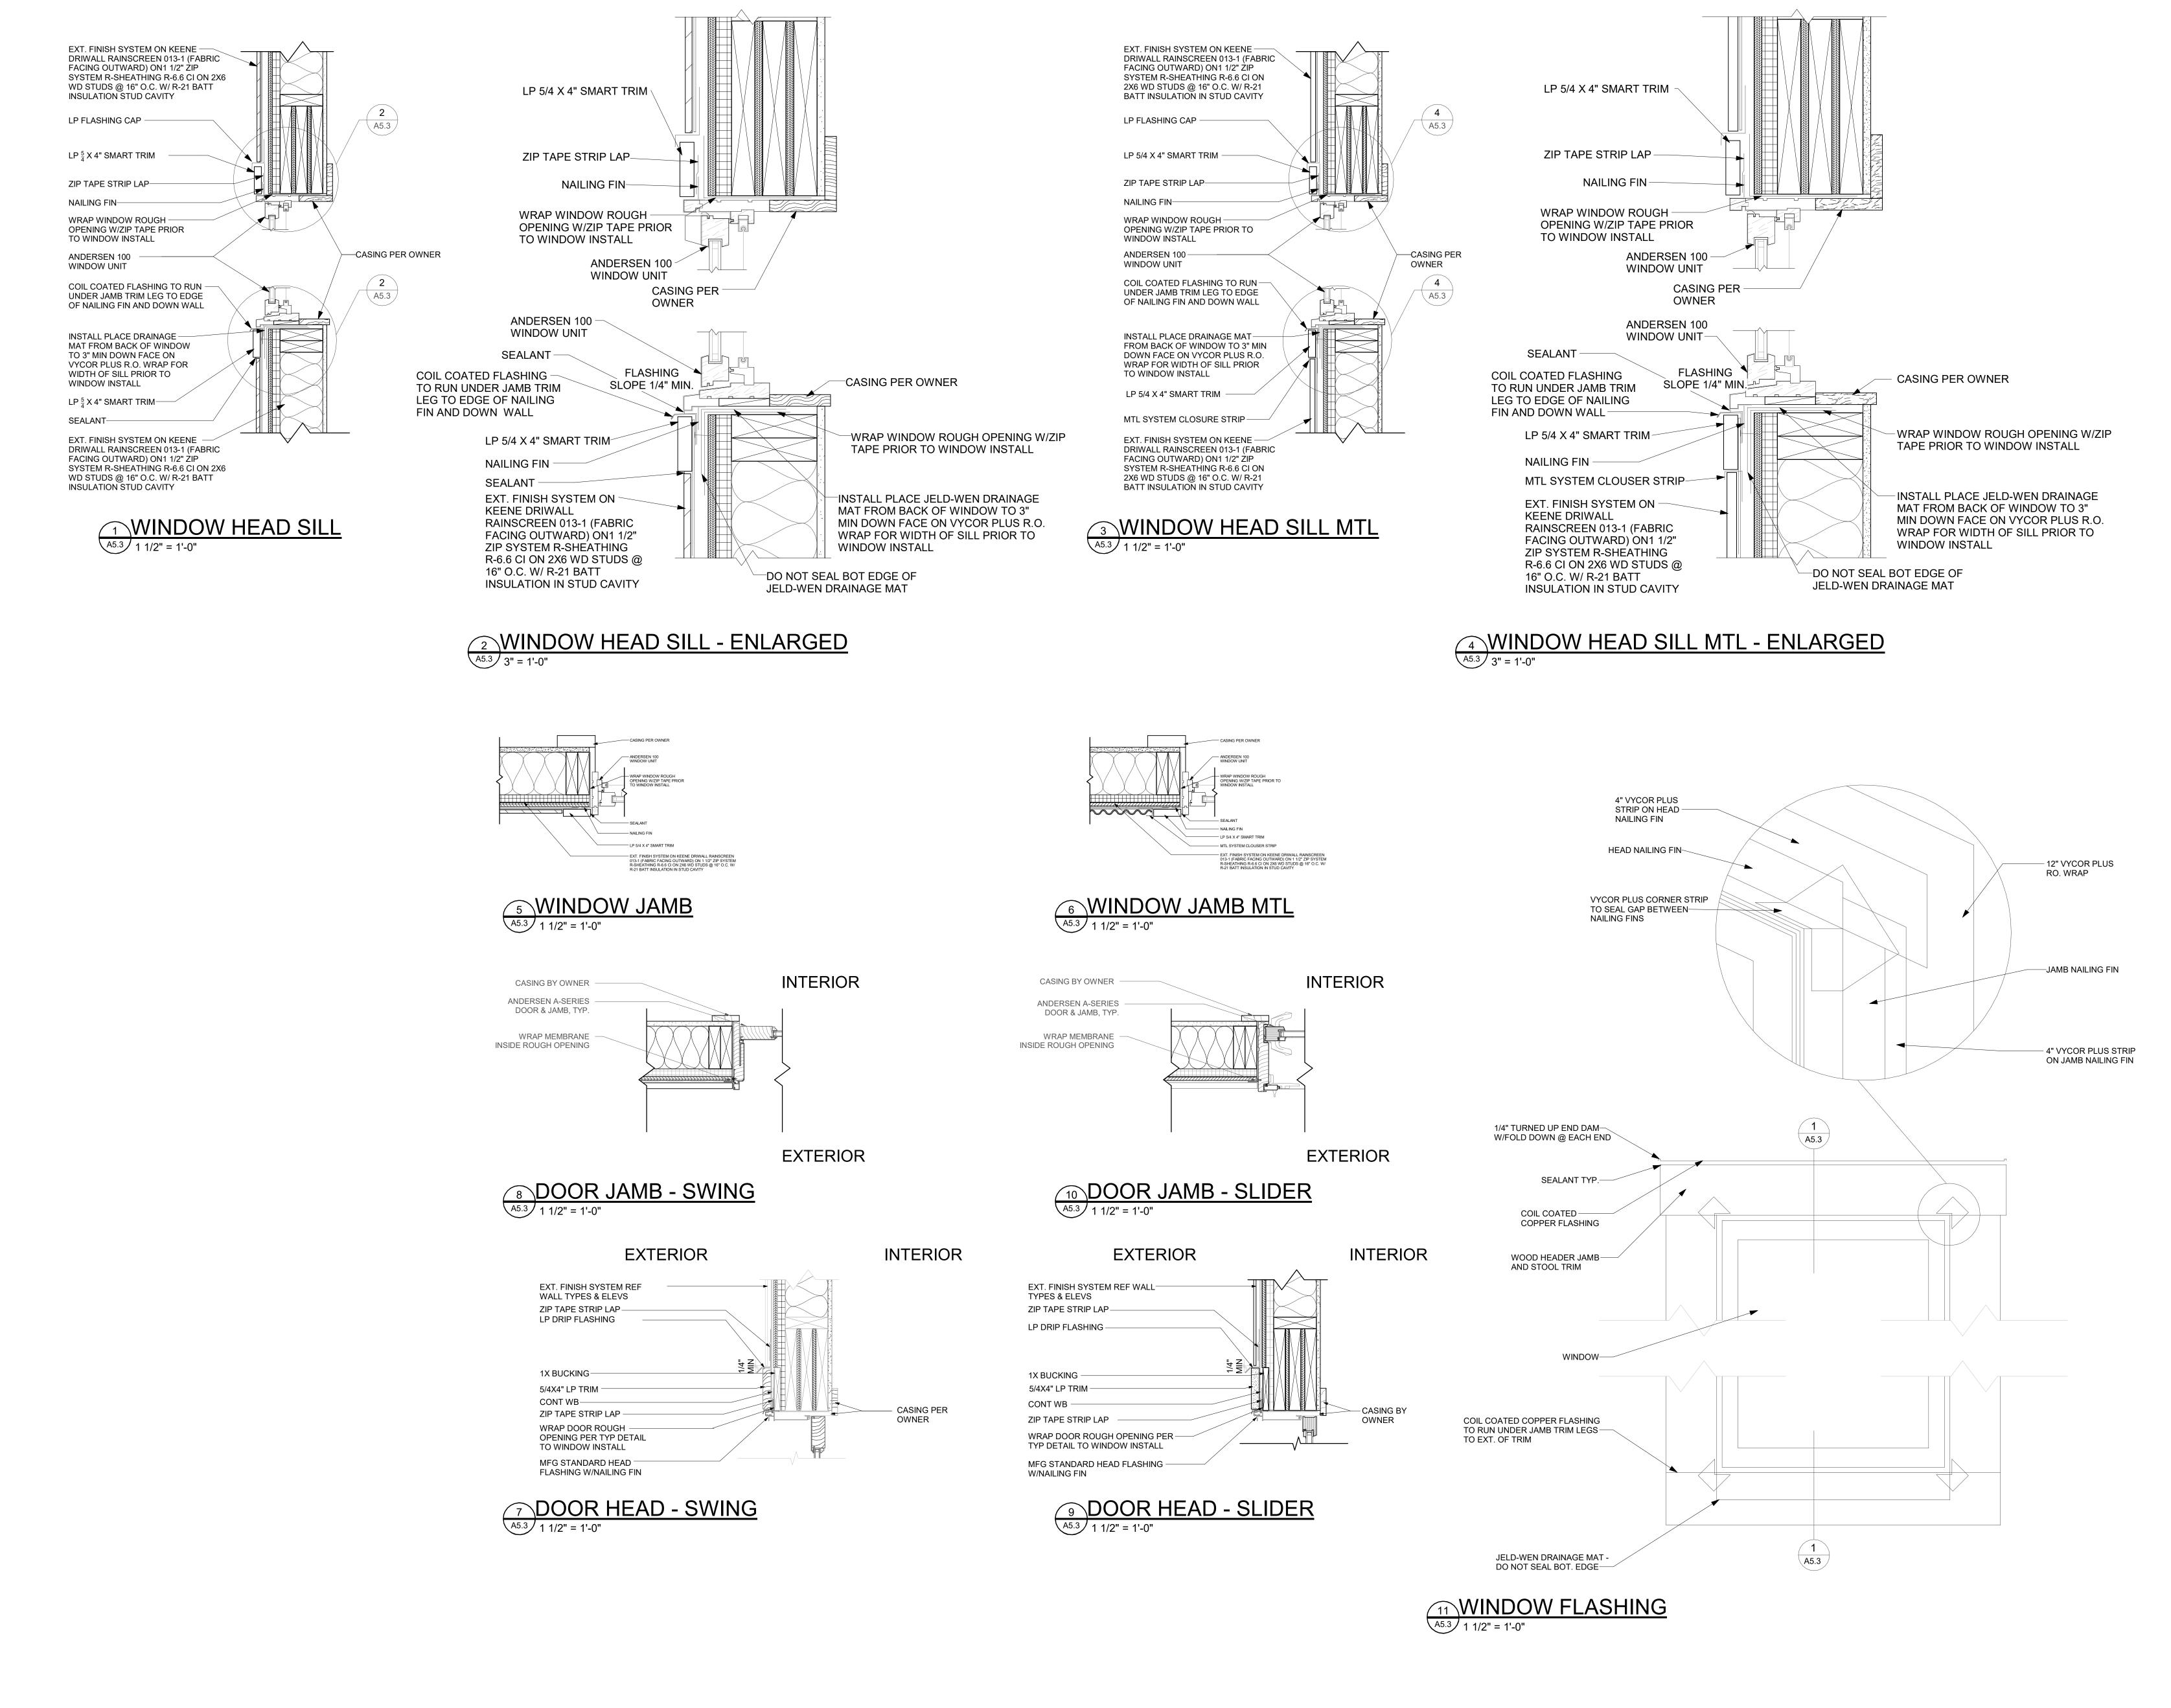

TAB
Associates
The Architectural Balance

0056 Edwards Village Blvd.
Suite 210
Edwards, CO 81632
(970) 766-1470
fax: (970) 766-1471
email: tab@vail.net
www.tabassociates.com

Civil Engineer
Timberline Engineering
(970) 963-9869
Structural Engineer
KRM Consultants, Inc
(970) 949-9391
Mechanical Engineer

Seal

Electrical Engineer

Belden Place - Singel Family Lot 18 - 0010 Abby Road

Revisions:
No Description Date



Project No:
2215

Sheet No:

A5.3