BELDEN PLACE LOT 20 - 0014 ABBY ROAD Single Family Minturn, CO 81645




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VICINITY MAP



CP-08/14/2024 DRB-2/14/2025

Cover

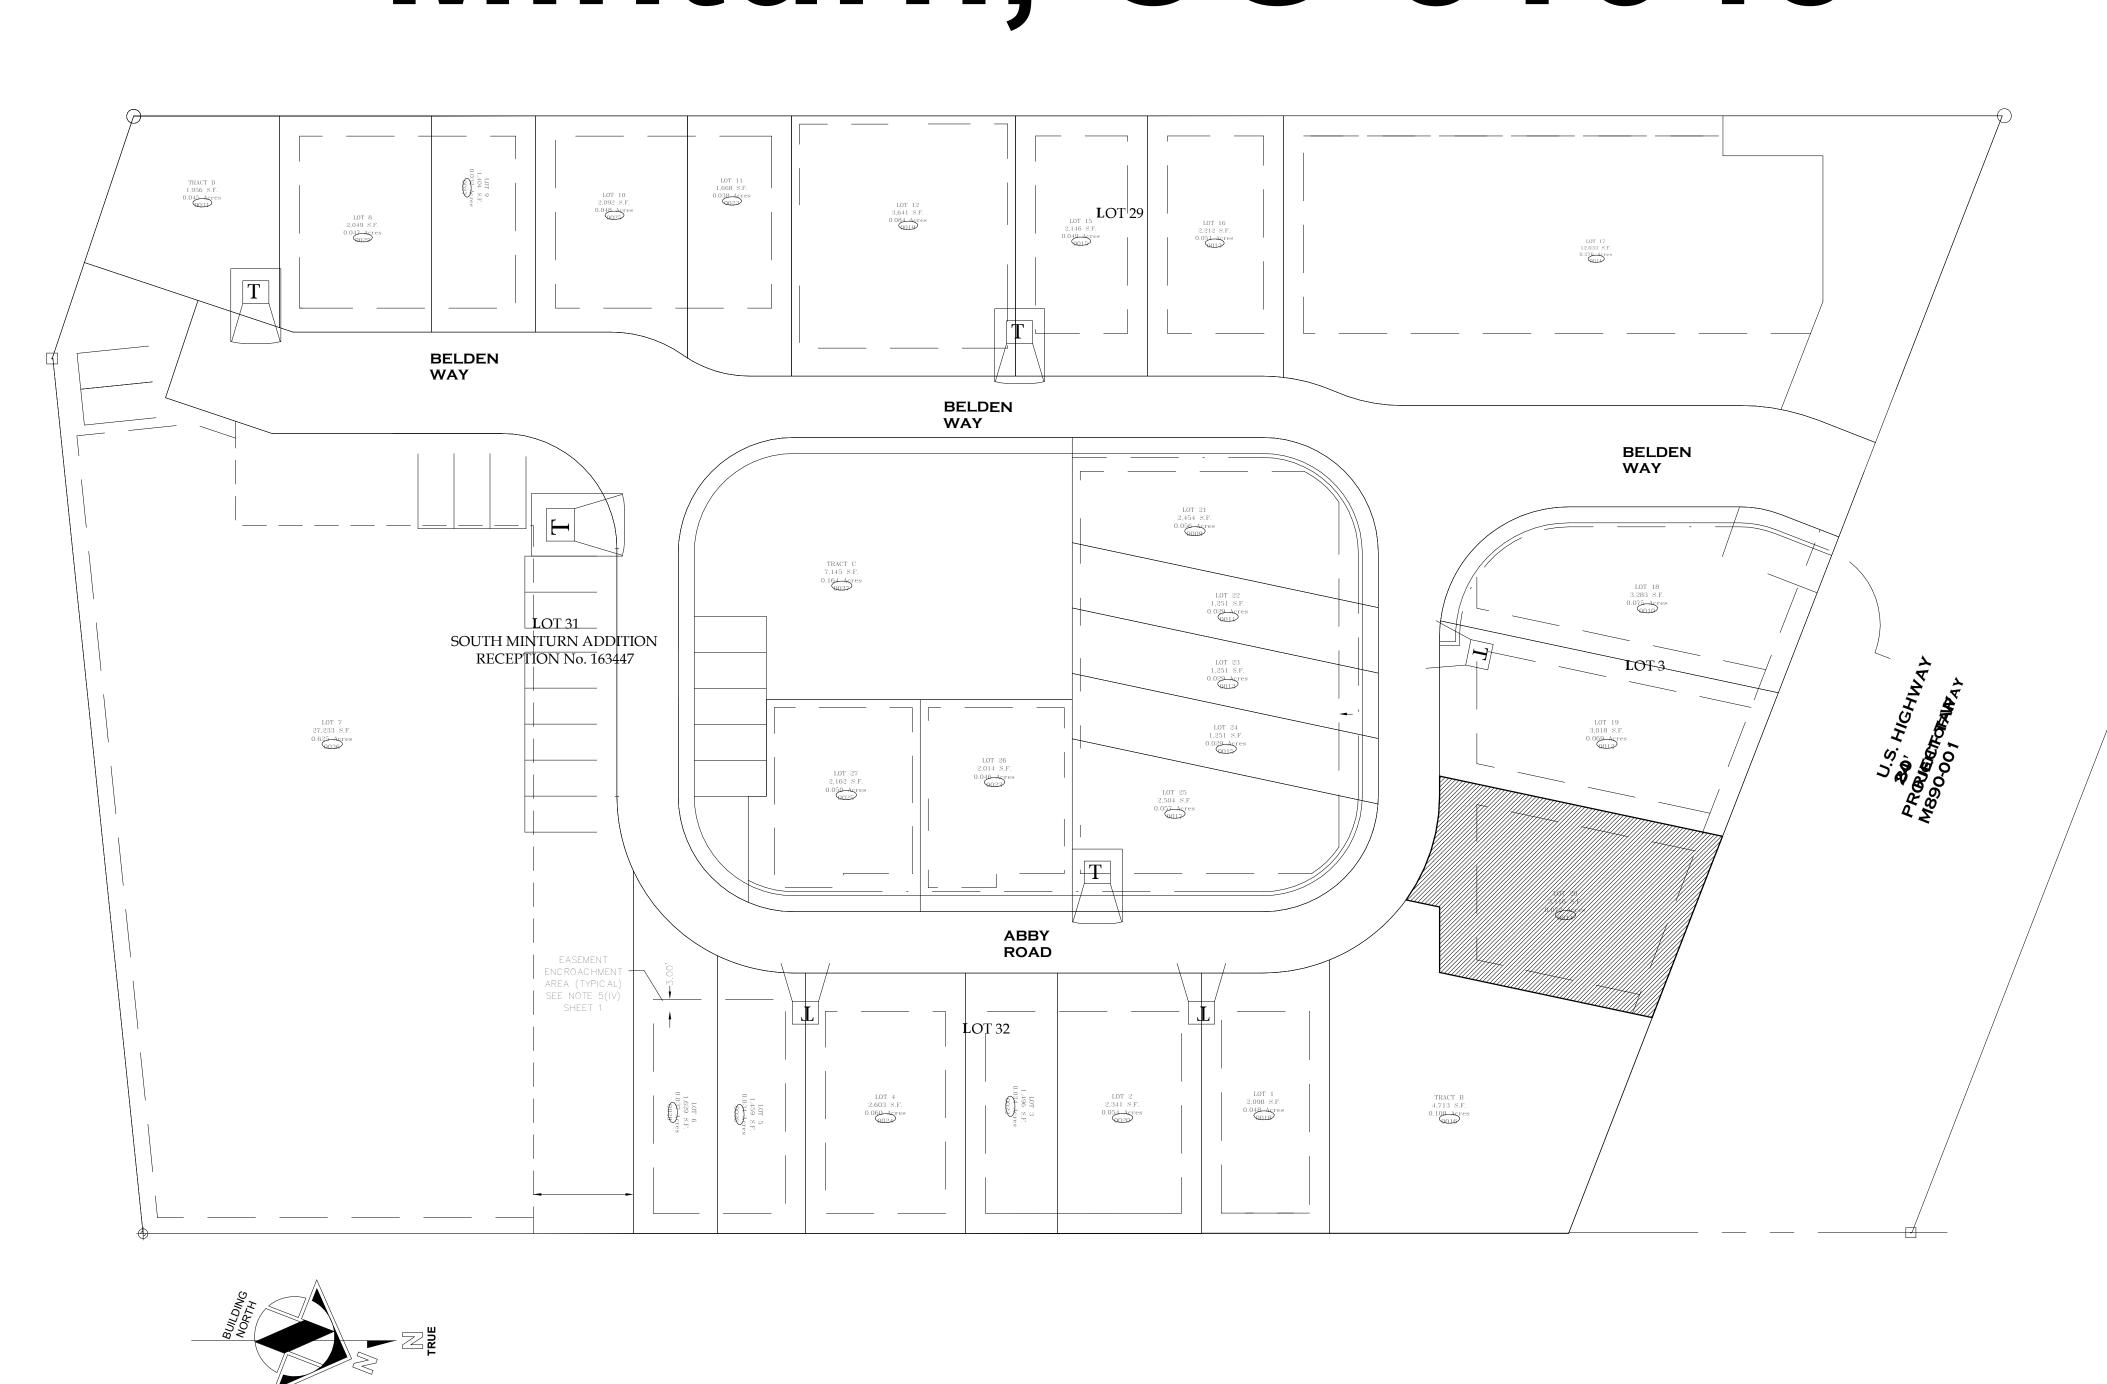
KRM Consultants, Inc (970) 949-9391

DESIGN REVIEW BOARD REVISED 3/12/2025

BELDEN PLACE PUD GUIDE INFORMATION


The following is an abrieviated verision of information found in the PUD guide.

Building Height. Determining building height uses a weighted height calculation as measured from final/finished grade. Max heights - 28' for single famil and duplex, 35' for Row Houses and Flats.

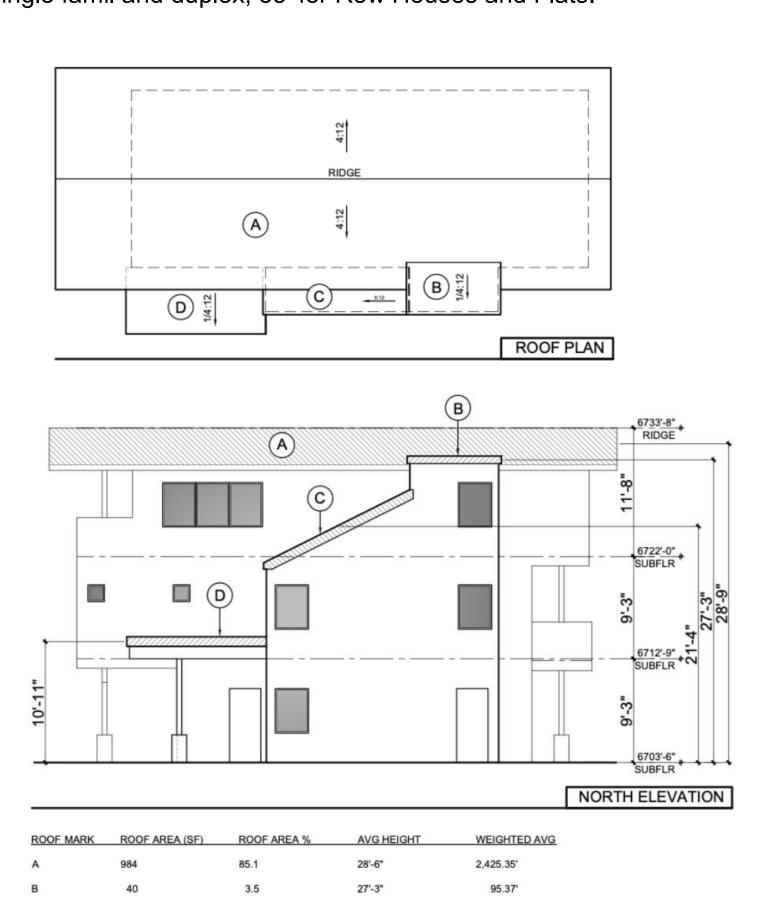

Site Coverage. Site coverage means the portion of a lot covered by materials forming any unbroken surface, impervious to water including, but not limited to: buildings, streets, slab on-grade patios, exterior fireplaces, and other hardscape materials. Site coverage excludes nonhardscape areas under eaves or similar (e.g., open-sided cantilever)

2,695.17' 2,695.17' / 100 = 26'-11" AVG ROOF H

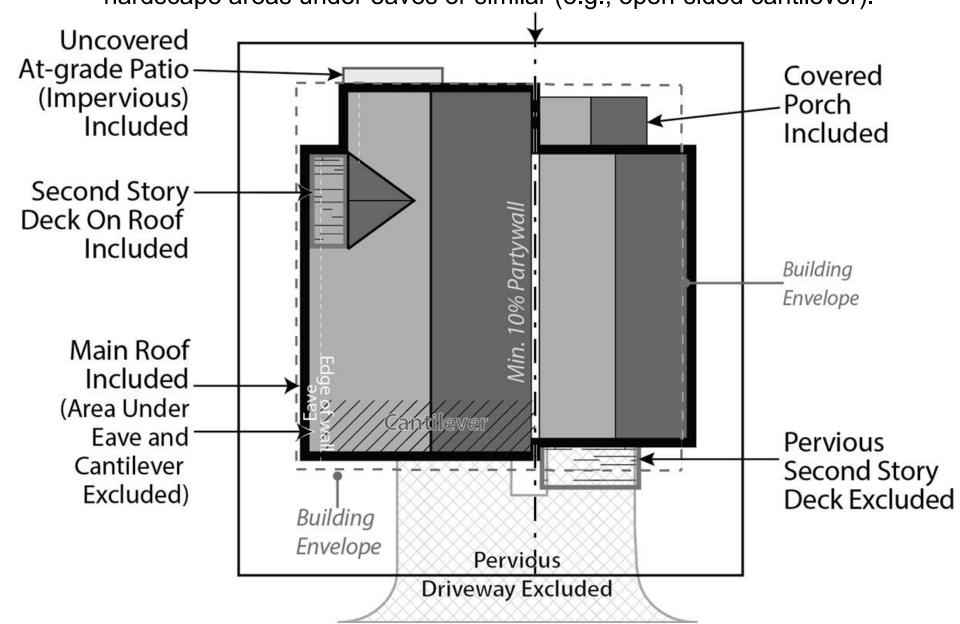

BUILDING PLACEMENT AND ENVELOPES

Residential building envelopes are necessary in order to maximize the buildability and economic viability of the lots while offering greenspace and or space between neighbors to the greatest extent possible. All portions of structure- including fireplaces, chimneys, window wells, eaves, overhangs, etc. must be contained within property lines; however, with the platted building envelope acting as building setbacks for each lot, encroachments are available for certain features.

The following encroachments are permitted beyond the platted building envelope:

Unenclosed or uncovered decks; deck supports; eaves up to 18" beyond the envelope; porches, patios and landings less than 30" above the surrounding natural or finished grade; window or light wells; heat or A/C units; residential solar alternative energy installations; fences; counterforts below grade; staircases (enclosed or otherwise); structures of less than 6" in height; landscaping and drainage features. No encroachment may be located within 24" from the property line or directly on top of in-ground utility easements. Underground parking elements and staircases may encroach within 12" of the most southern property line on Lot 7.

SINGLE-FAMILY DETACHED

a. Style

- (1) Residences with the same architectural elevations and coloring shall not be placed adjacent to each other or directly across the street from one another.
- (2) Each residential unit type shall have at least two (2) elevations to provide stylistic diversity. This may include:
- Roof forms/lines and profiles
- Varied window and door styles
- iii. Varied entry treatments and locations including porches, columns, etc.
- iv. Two or three story homes
- Second or third story decks or balconies

b. Building Form

- (1) The mass of the residence should strongly reflect the architectural style and be scaled to provide visual interest and depth, reduce boxiness and achieve an articulated form on the front and sides of the homes.
- (2) Roofs shall be designed and pitched accordingly in consideration of solar technology and/or drainage
- (3) Roof-top decks are permitted only on certain lots as established by developer and cannot be added on buildings not constructed with this initial feature.

2. DUPLEX/TRI-PLEX or MULTIFAMILY STRUCTURES

- (1) Structures shall have at least two (2) elevations to provide stylistic diversity.
- (2) Units may be multi-stories.
- (3) Units may be divided horizontally (townhomes) or vertically
- (4) Second story decks or balconies permitted.
- (5) Units have no minimum length of connection and may be joined via shared walls of the garage, external staircases, or main living area wall(s) or floors.

b. Building Form

- (1) The mass of the residence should strongly reflect the architectural style and be scaled to provide visual interest and depth, reduce boxiness and achieve an articulated form on the front of the homes.
- (2) Roofs shall be designed and pitched accordingly in
- consideration of solar technology and/or drainage
- (3) Roof-top decks are permitted only on certain lots as established by developer and cannot be added on buildings not constructed with this initial feature.

3. MATERIALS

Roofing materials are limited to the following:

- (1) Artificial wood shingle (to mimic wood shake shingle). Treated wood shake shingles or any other combustible material is prohibited.
- (2) Standing seam metal.
- (3) Asphalt shingles.
- (4) Imitation (composite or similar); or, real slate tiles.
- (5) Non-reflective solar tiles that mimic the above-mentioned products
- (6) Any other recommended FireWise materials similar to the above-mentioned products.

Siding materials are limited to the following:

- (1) Metal
- (2) Wood (3) Composite siding
- (4) Fiber cement board (commonly known as "Hardie Board")
- (5) Stucco.
- (6) Any other recommended FireWise materials similar to the above-mentioned products.
- (7) All siding materials to have non-reflective finishes.


c. Doors and Windows:

- (1) Structures with multiple garage doors must always have identical, matching doors.
- (2) All replacement windows shall be consistent and match the aesthetic of previous windows unless otherwise approved by the design review board. Skylight or solar tubes permitted.
- (3) Screen or storm doors, in addition to typical front doors are permitted. Screen or storm doors cannot replace front doors at any time.
- Design Elements. This development may incorporate mountain appropriate design elements into the buildings, including, but not limited to, exposed heavy timber beams as accent elements or entry features, walls faced with wood, stone, faux stone or cultured stone, metal railings or accents. Stucco may only be utilized in small quantities on building facades and is not to be used as a primary material for home.
- e. Building materials for residential exteriors shall include at least two (2) types of materials as part of the building façade.

LANDSCAPING – See also PUD Landscaping Plan Shall not interfere with any drainage way, utility, pedestrian access, or entry into any structure. Landscaping shall not obscure windows, be installed under gas fireplace or dryer vents, nor shall any landscaping material overtake any yard, or spread into any common or neighboring yards.

Landscaping minimums:

- 1. At least one (1) tree per 1,200 sf of lot area and two (2) shrubs for all lots. See also official Landscaping Plan for Belden Place. 2. All landscaping proposed on the approved Landscaping Plan shall be installed initially with expectations for maintenance. 3. No exposed soil is permitted. Soil must be covered in
- groundcover that may consist of seed (includes wildflower seed), cobble, perennials, mulch, or similar.
- 4. All dead materials must be replaced during the same season death occurs.

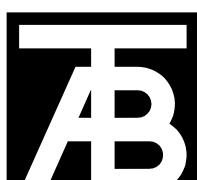

TAB Associates


The Architectural Balan 0056 Edwards Village Blvd. Suite 210 Edwards, CO 81632 (970) 766-1470 fax: (970) 766-1471 email: tab@vail.net

> Structural Engineer Mechanical Engineer

Civil Engineer

Electrical Engineer

eld

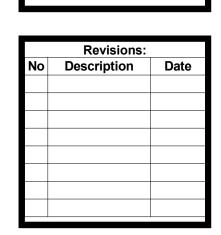


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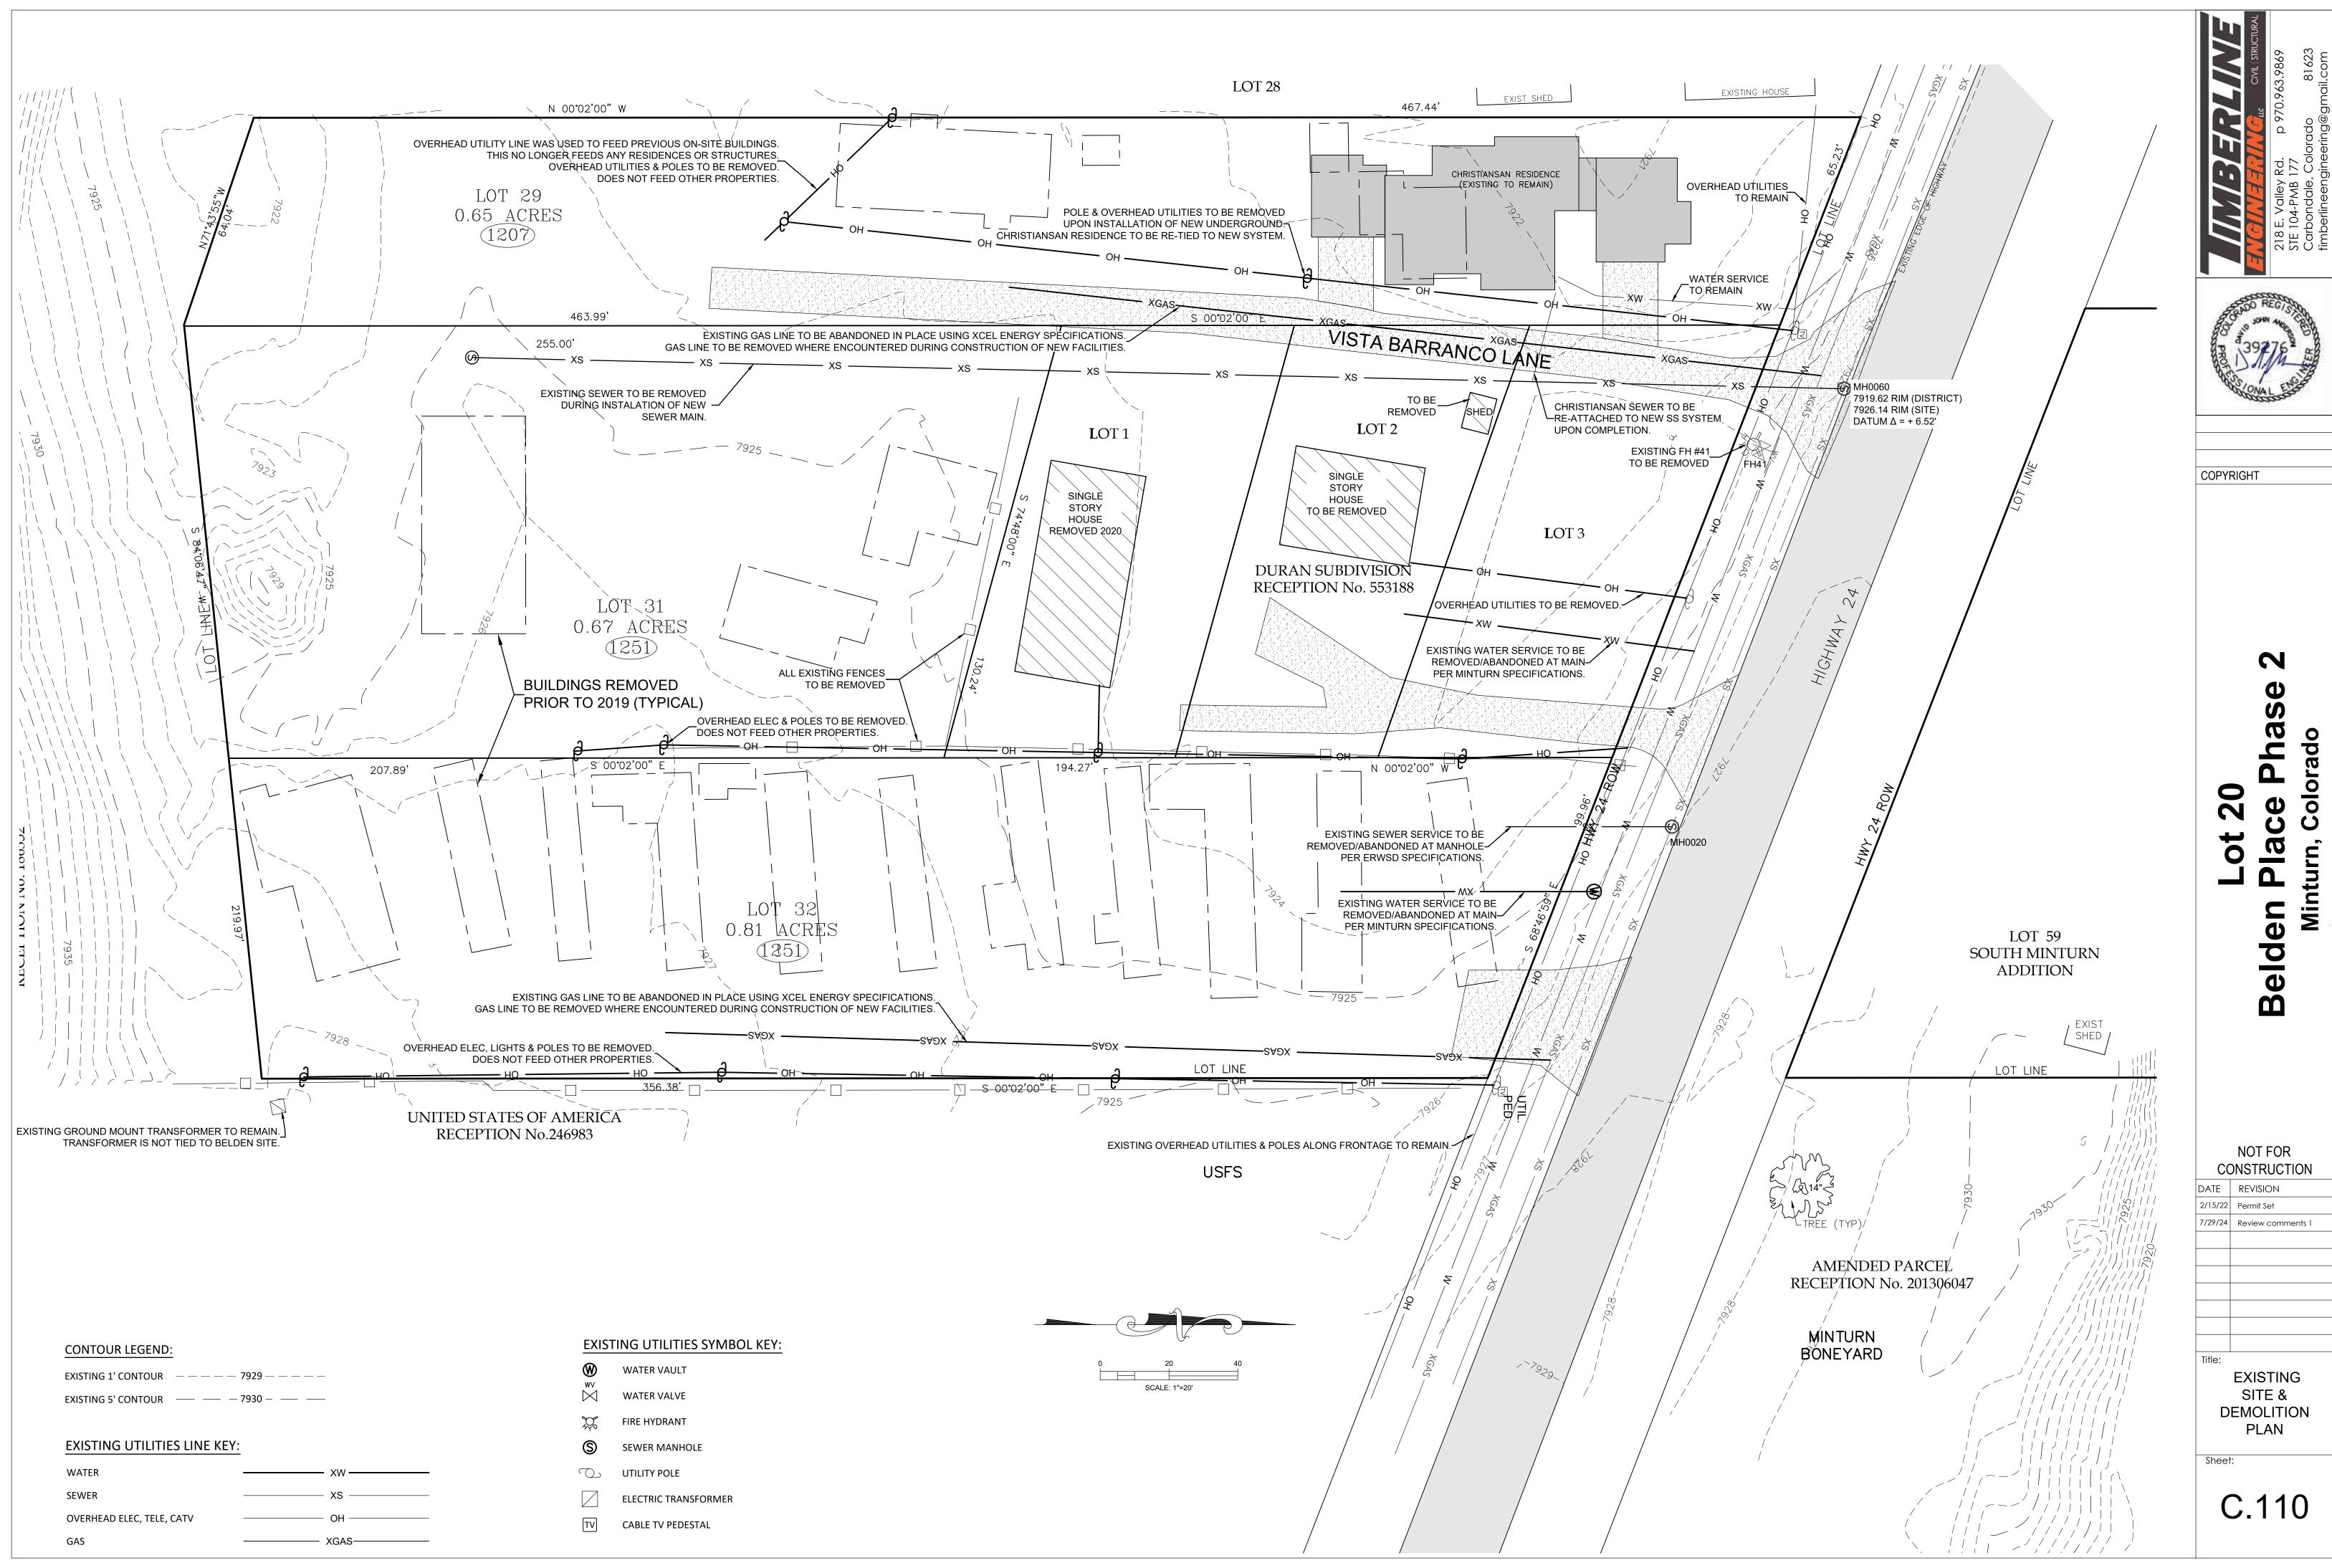
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PUD Guide


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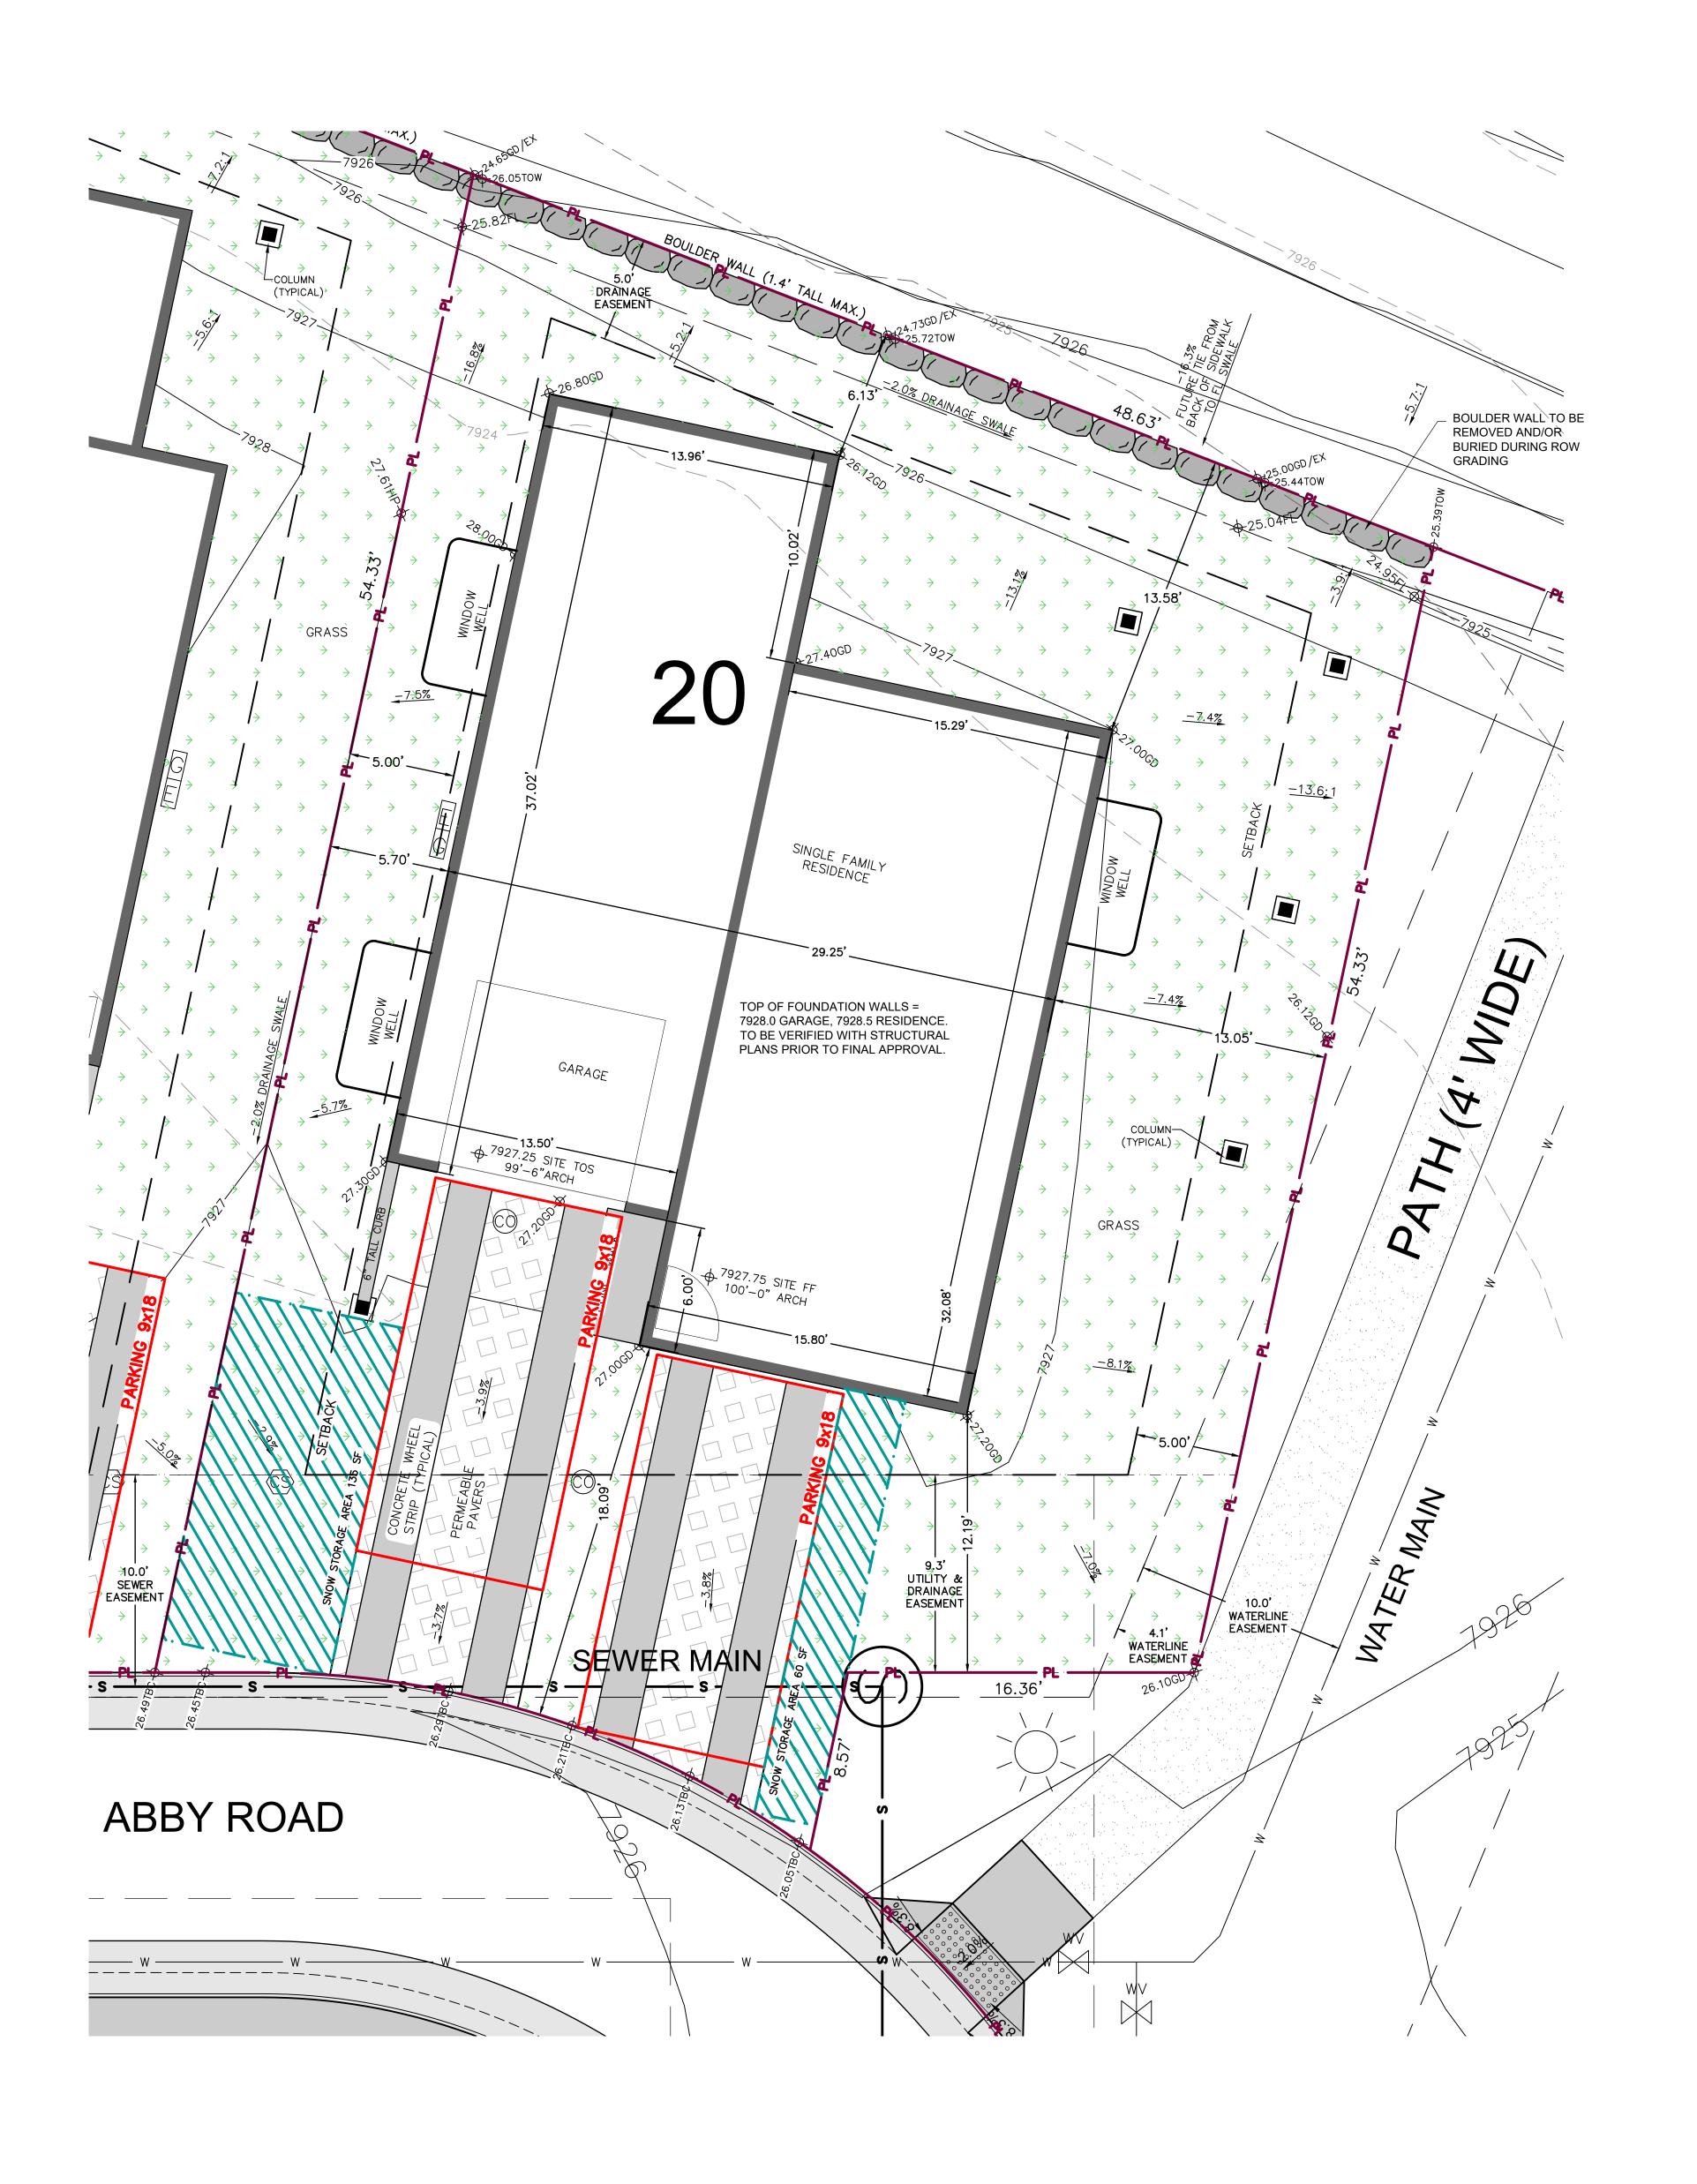
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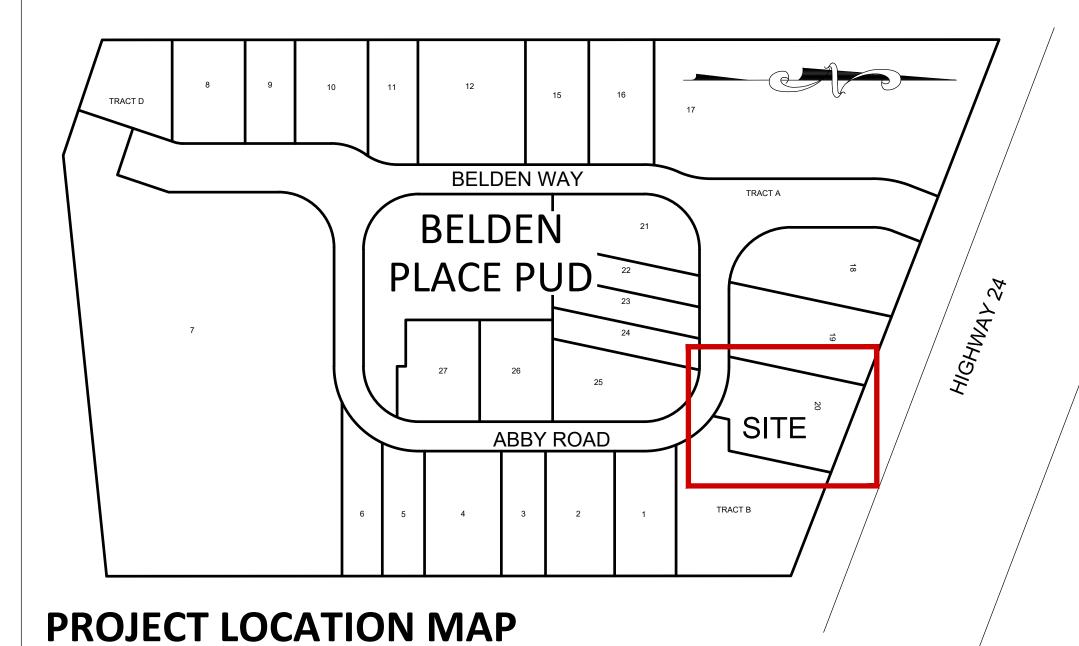






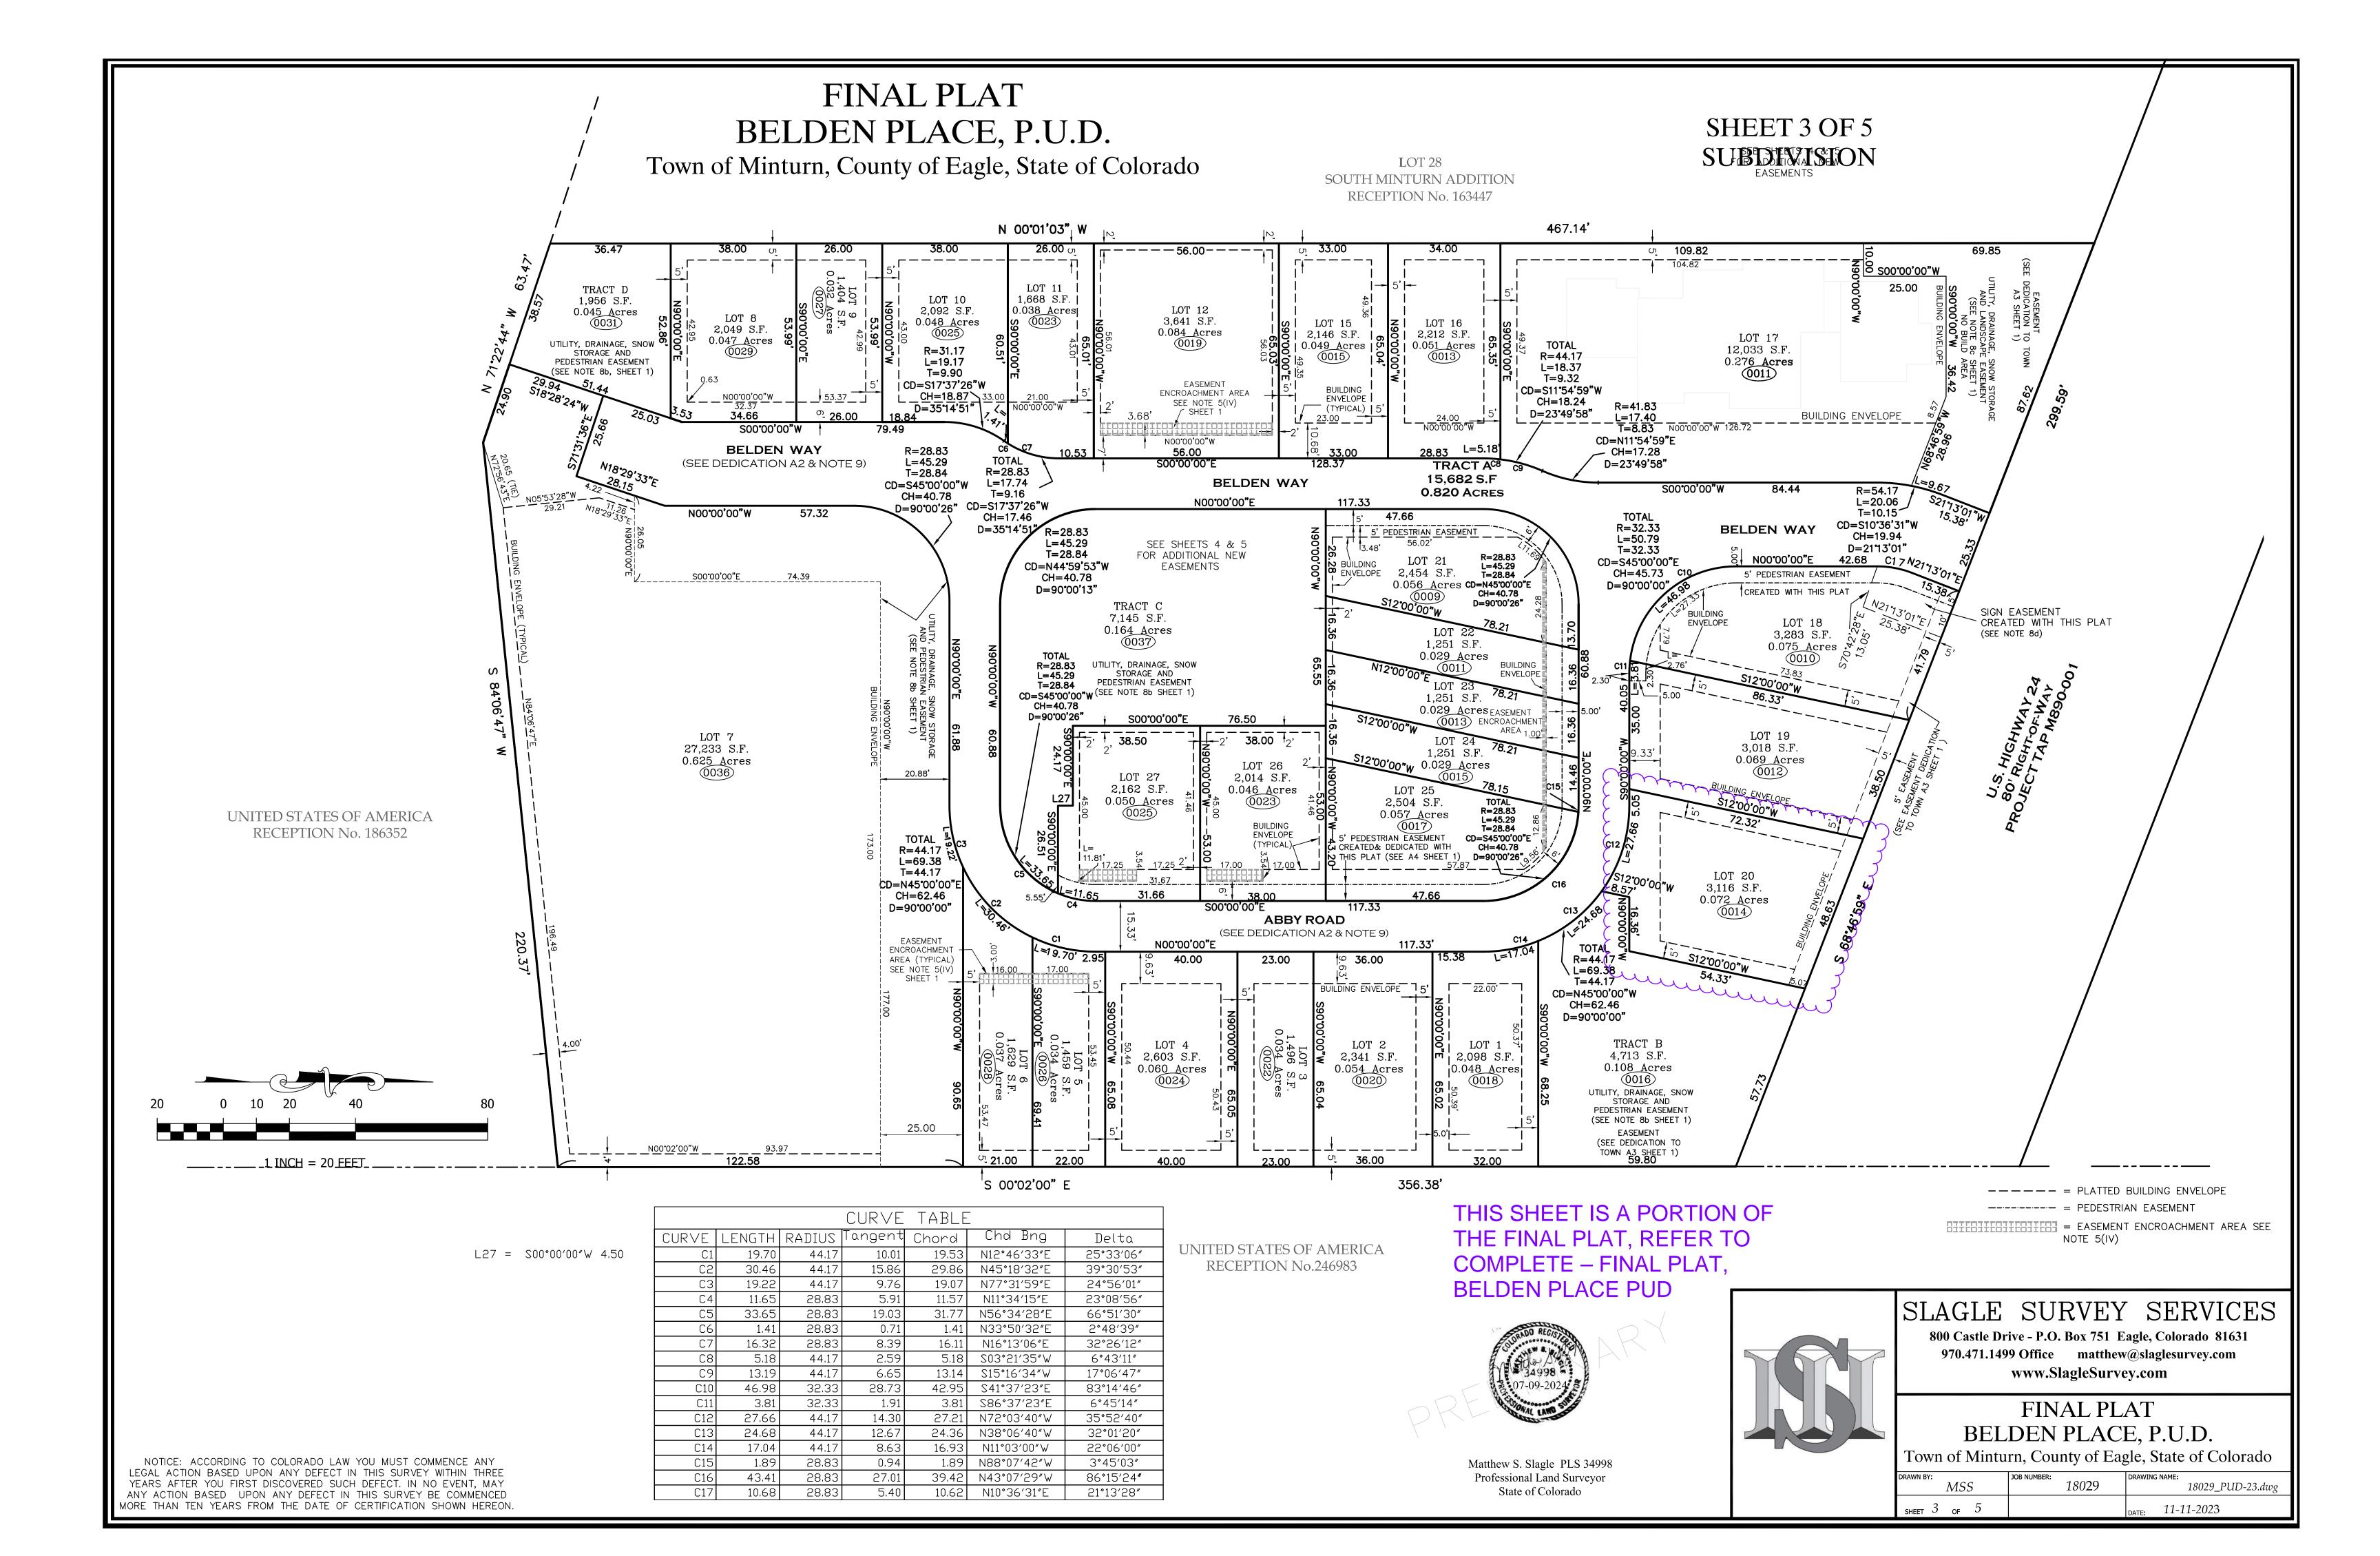

SITE PLAN W/ GRADING

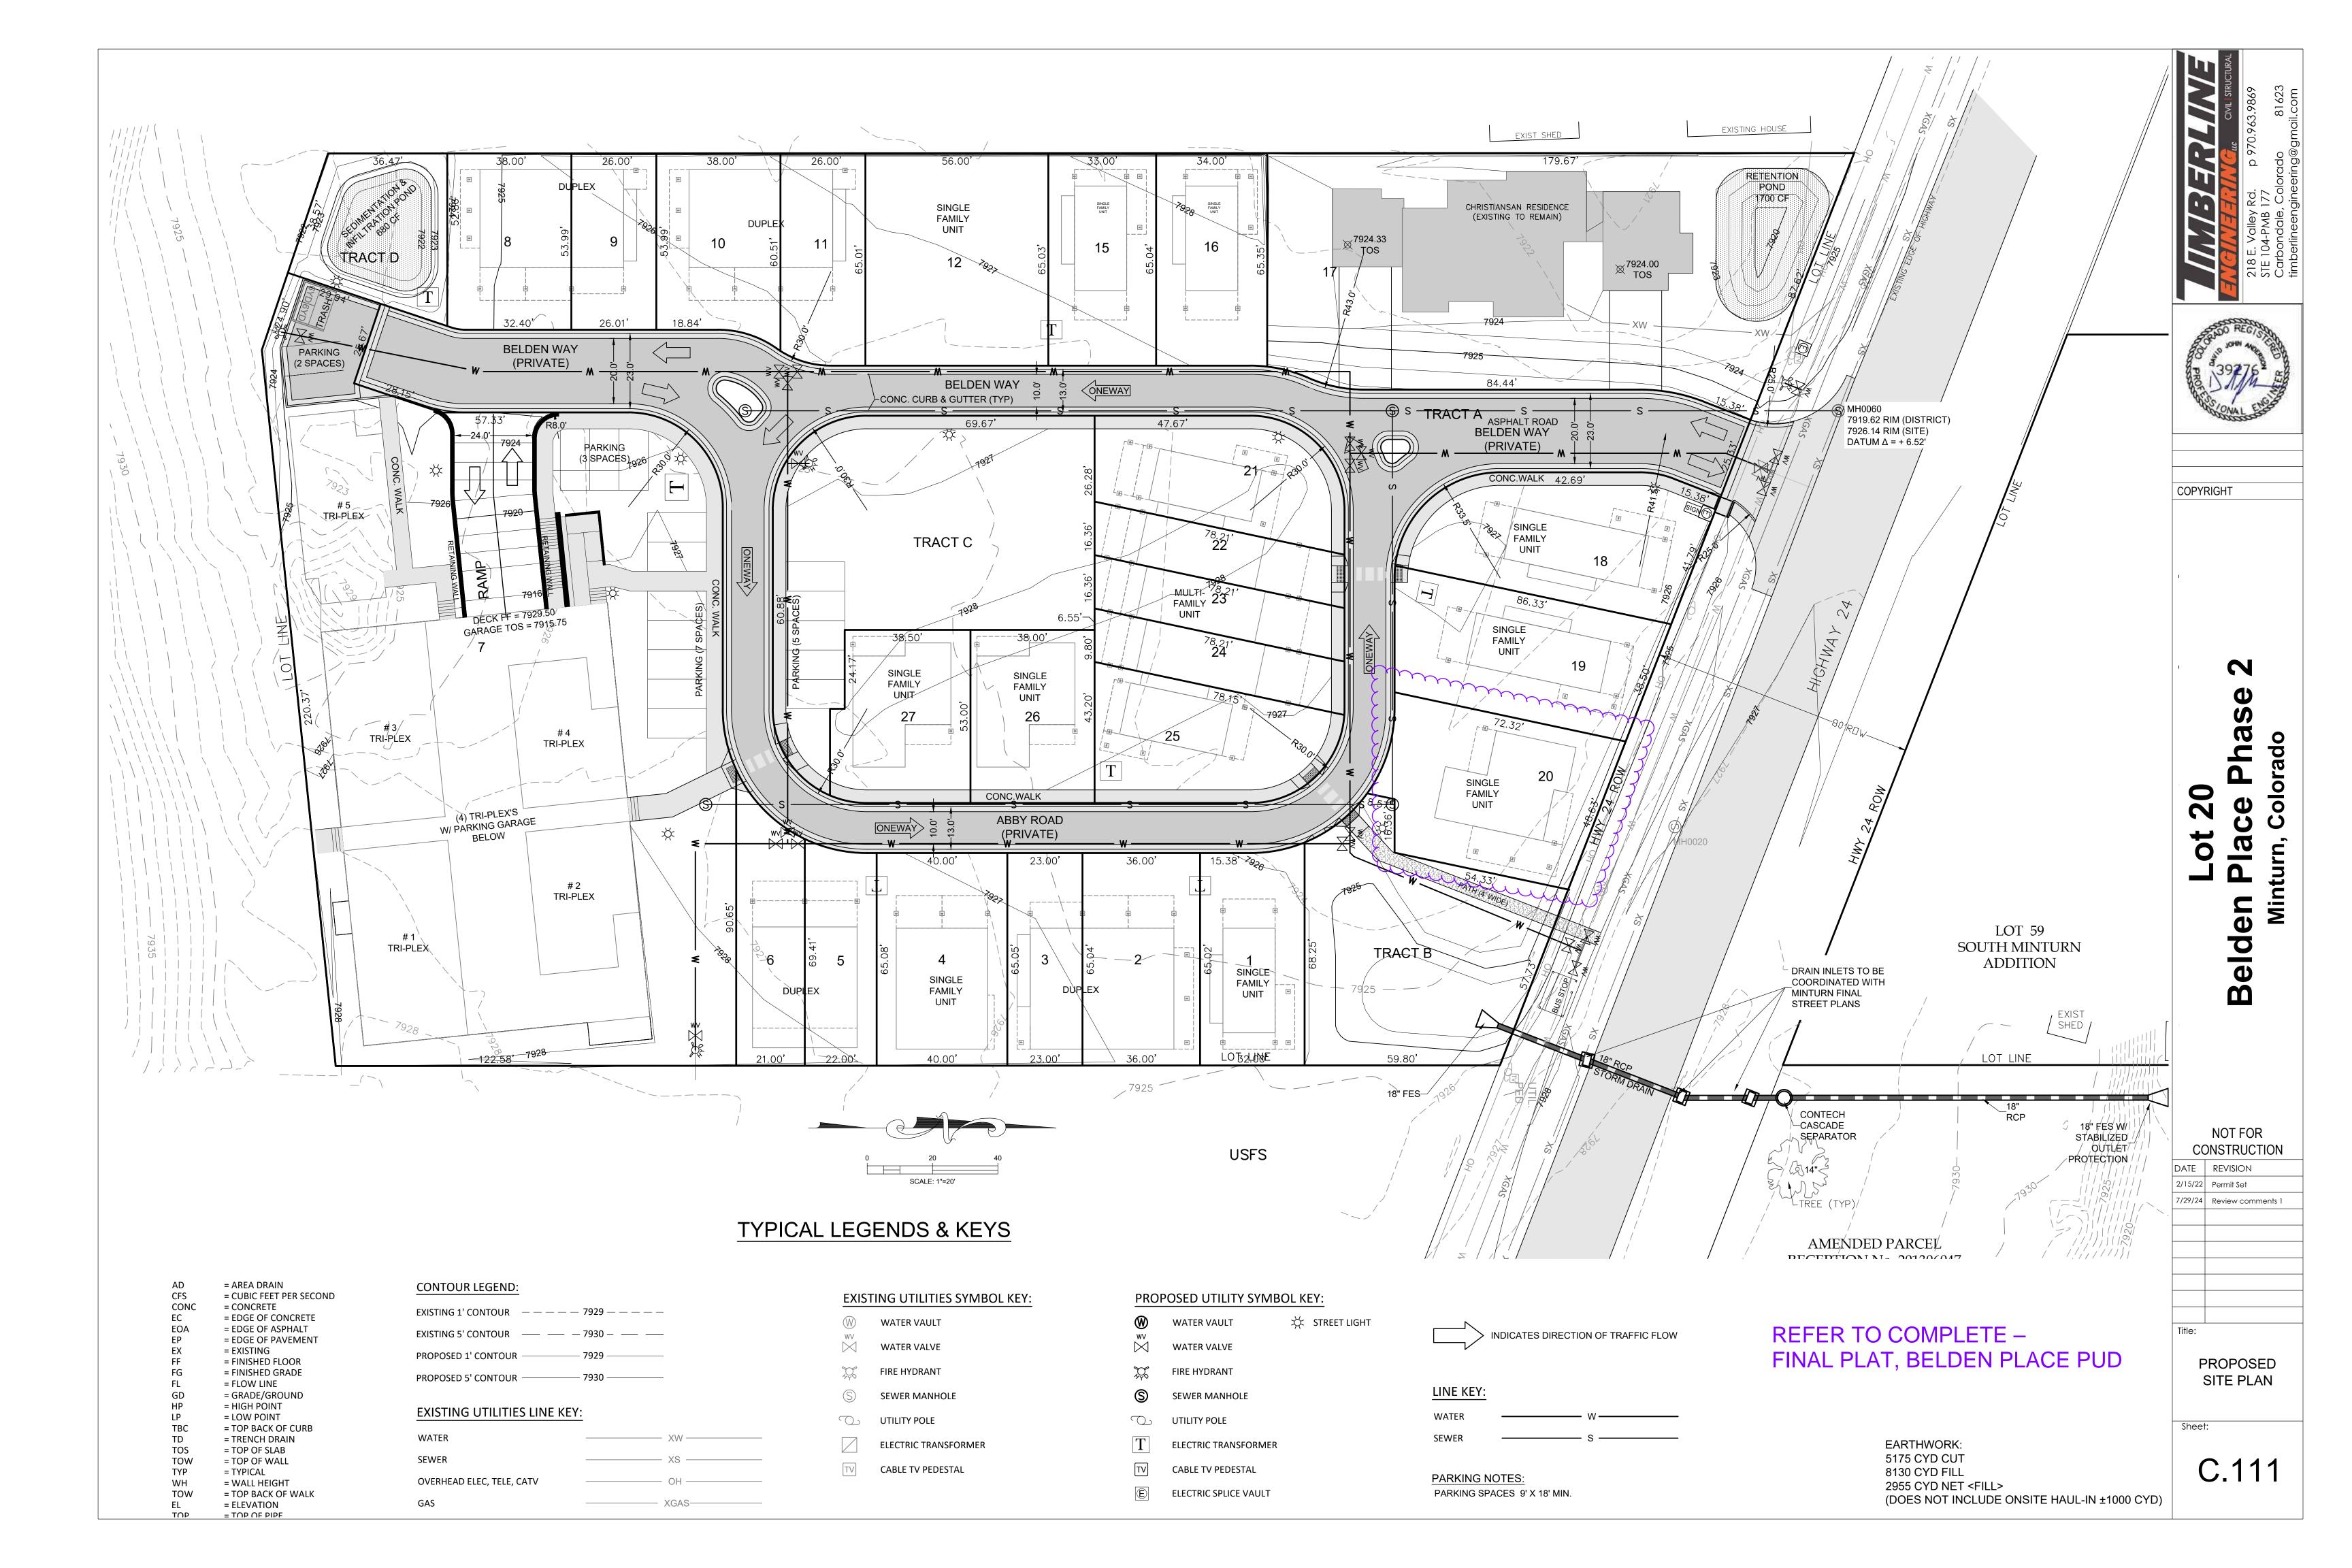

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UNIT 20

SHEET INDEX:

C.1 SITE PLAN W/ GRADING

C.2 UTILITY PLAN & EROSION CONTROL PLAN

C.3 EROSION CONTROL DETAILS

CONTACTS Owner/contractor:

Architect:

Peter Murray Group Brian Claydon

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Glenwood Springs, CO 81601 970 345-7988

Town of Minturn Public Works

Arnold Martinez 970 445-2416

Eagle River Water & Sanitation District 970 477-5451

Excel Energy

Electrical Emergency 800 895-1999

ABBREVIATION KEY

= AREA DRAIN

= CONCRETE

= EXISTING

= EDGE OF CONCRETE = EDGE OF ASPHALT

= EDGE OF PAVEMENT

= FINISHED FLOOR

= WINDOW WELL

Gas Emergency 800 895-2999

Call before you dig:

Electric & Gas:

Beld

LINE KEY:				PROF	POSED UTIL
WATER		— w——			WATER VAU
SEWER		— s ——		wv 	WATER VALV
ELECTRIC		- UEL			
GAS		- GAS		*	FIRE HYDRAI
TELEPHONE		- TEL		S	SEWER MAN
CATV		- CTV		\bigcirc	UTILITY POLI
PROPERTY LINE	Ī	— PL ———		T	ELECTRIC TR
				TV	CABLE TV PE
CONTOUR L	EGEND:			E	ELECTRIC SP
EXISTING 1' CO	NTOUR ———	—— 7929 —	- — — —	(cs)	WATER SER\
EXISTING 5' CO	NTOUR — —	— — 7930 —	· ——	<u>_</u>	SANITARY SE
PROPOSED 1' C	ONTOUR —	——— 7929 —		9	5/111/1/11/15

— 7930 ———

0 4 8 Feet

PROPOSED 5' CONTOUR -

ROP	OSED UTILITY SYMBO	DL KI	EY:
Ø	WATER VAULT	*	STREET LIGHT
v <	WATER VALVE		
Z	FIRE HYDRANT		
3	SEWER MANHOLE		
ک	UTILITY POLE		
Γ	ELECTRIC TRANSFORMER		
V	CABLE TV PEDESTAL		
_	ELECTRIC CRITICE MALILE		

SEWER MANHOLE	FG	= FINISHED GRADE
	FL	= FLOW LINE
UTILITY POLE	GD	= GRADE/GROUND
	HP	= HIGH POINT
ELECTRIC TRANSFORMER	LP	= LOW POINT
	TBC	= TOP BACK OF CURB
CABLE TV PEDESTAL	TD	= TRENCH DRAIN
	TOS	= TOP OF SLAB
ELECTRIC SPLICE VAULT	TOW	= TOP OF WALL
ELECTRIC SPEICE VAOLI	TYP	= TYPICAL
WATER CERVICE CURR CTOR	WH	= WALL HEIGHT
WATER SERVICE CURB STOP	TOW	= TOP BACK OF WALK
	EL	= ELEVATION
SANITARY SEWER CLEANOUT	TOP	= TOP OF PIPE
	WV	= WATER VALVE

DATE REVISION 2/6/25 | DRB Coordination 3/17/25 DRB Updates 4/17/25 | DRB Updates 2 = CUBIC FEET PER SECOND

NOT FOR CONSTRUCTION

Sheet:

SITE PLAN




SEDIMENT CONTROL LOG INSTALLATION NOTES

- 1. SEE PLAN VIEW FOR: - LOCATION AND LENGTH OF SEDIMENT CONTROL LOG.
- 2. SEDIMENT CONTROL LOGS INDICATED ON INITIAL SWMP PLAN SHALL BE INSTALLED PRIOR TO ANY LAND-DISTURBING
- 3. SEDIMENT CONTROL LOGS SHALL CONSIST OF STRAW, COMPOST, EXCELSIOR, OR COCONUT FIBER.
- 4. NOT FOR USE IN CONCENTRATED FLOW AREAS. 5. THE SEDIMENT CONTROL LOG SHALL BE TRENCHED INTO THE GROUND A MINIMUM OF 2".


SEDIMENT CONTROL LOG MAINTENANCE NOTES

- 1. THE SWMP MANAGER SHALL INSPECT SEDIMENT CONTROL LOGS DAILY, DURING AND AFTER ANY STORM EVENT AND MAKE REPAIRS OR CLEAN OUT UPSTREAM SEDIMENT AS NECESSARY.
- 2. SEDIMENT ACCUMULATED UPSTREAM OF SEDIMENT CONTROL LOGS SHALL BE REMOVED WHEN THE UPSTREAM SEDIMENT DEPTH IS WITHIN $rac{1}{2}$ THE HEIGHT OF THE CREST OF LOG.
- 3. SEDIMENT CONTROL LOG SHALL BE REMOVED AT THE END OF CONSTRUCTION. IF ANY DISTURBED AREA EXISTS AFTER REMOVAL, IT SHALL BE COVERED WITH TOP SOIL, DRILL SEEDED AND CRIMP MULCHED OR OTHERWISE STABILIZED IN A MANNER APPROVED BY THE LOCAL JURISDICTION.


EROSION CONTROL LOG DETAIL

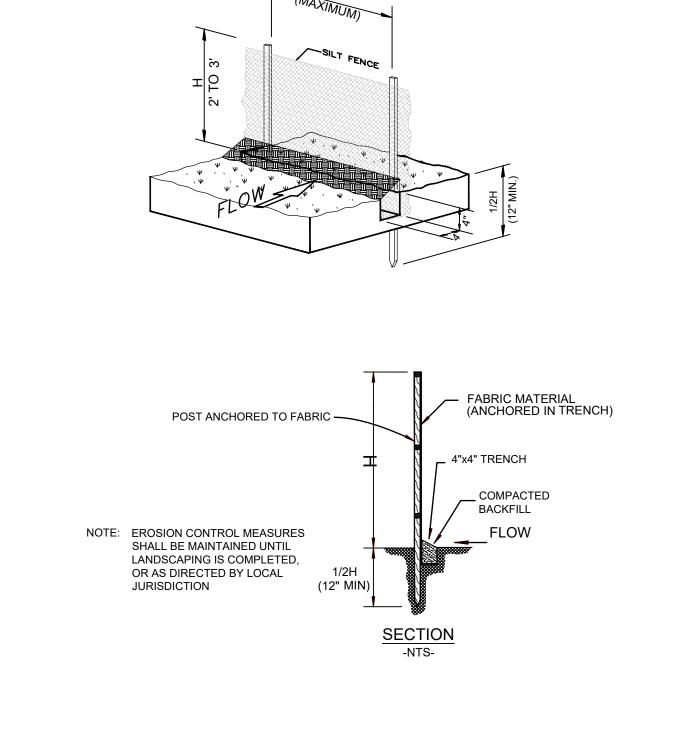


SILT FENCE INSTALLATION DETAIL

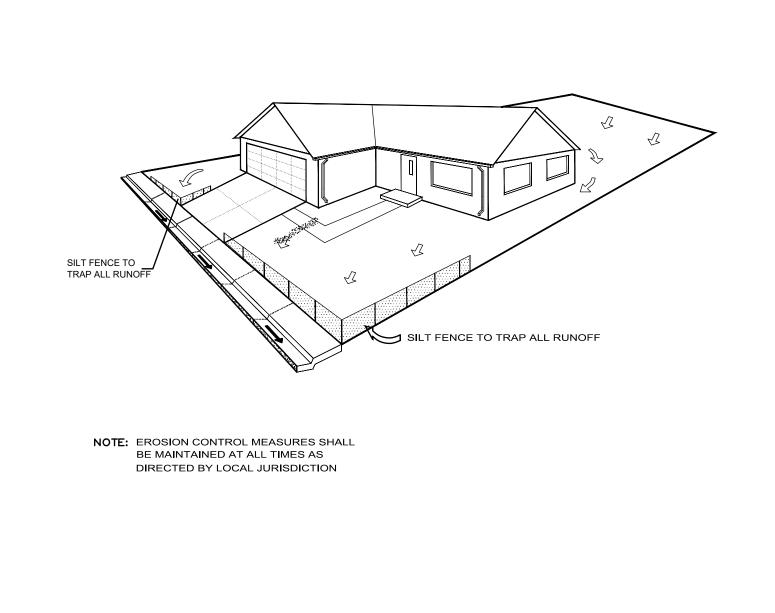

SILT FENCE PLACEMENT DETAIL

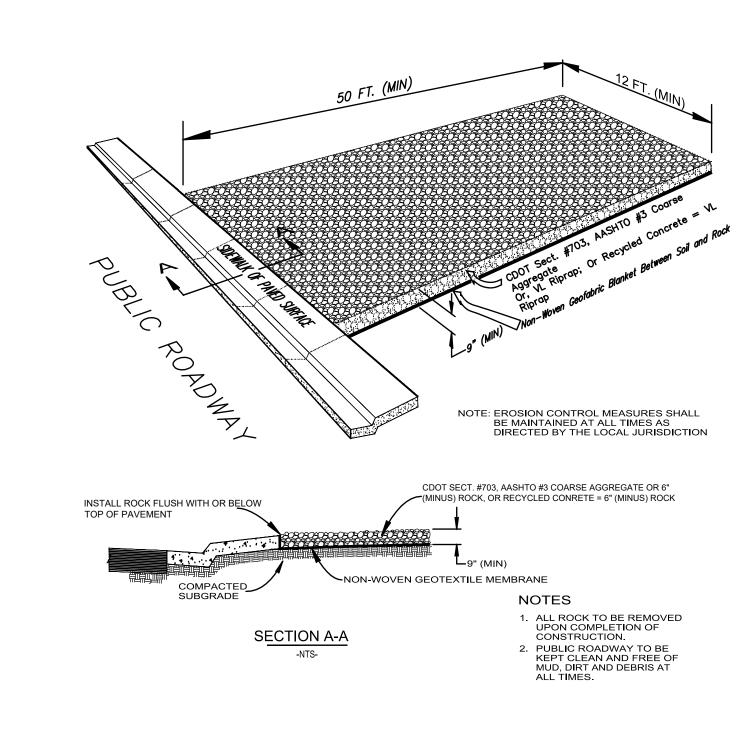

TEMPORARY VEHICLE TRACKING CONTROL DETAIL

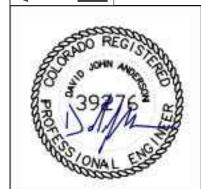

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Belden 20

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2/6/25 DRB Coordination 3/17/25 DRB Updates 4/17/25 DRB Updates 2

EROSION

CONTROL **DETAILS**

C.3

& 3/4 EXISTING SOIL SHRUB PLANTING SCALE: 3/4" = 1'-0" Do not cut single leader. Prune only damaged, dead wood, or co-dominant leaders. -12" nylon tree strap with grommets on guy wire. Do not twist straps tight around trunk. 1/2" diameter white PVC pipe section on entire length of each wire -14-Gauge galvanized wire, double strand. Leave 1" to 2" slack in wire to allow for trunk movement. If needed, 6' steel T-post or wood stake (install to 2' depth in ındisturbed subgrade) with safety caps, set to windward side and other opposite; or other pre-approved staking method. eciduous Tree Fall Planting: Wrap trunk to first branch with specified tree wrap material. Secure at top with masking tape. Do not wrap rough bark trees. Remove trunk wrap in spring after last frost. Set top of root flare (first order roots) at or 1" above finish grade. Remove excess soil from top of root ball and adventitious roots on trunk Circle of shredded wood mulch, 3" deep and 4" to 6" away from trunk, to outer edge of planting hole. Form 2" high dirt saucer around pit at outside of transition zone.

1/4 BACKFILL MIXTURE

Completely remove all twine and wire basket. Pull burlap

Slope sides of planting pit as shown, roughen sides prior to backfill.

Any broken, crumbling, or otherwise damaged rootball should be rejected. Do not damage during planting.

down minimum 2/3 of ball, cut and remove from pit.

Native soil or appropriate planting media.

Undisturbed subgrade.

3-4 X Root Ball Diameter TREE PLANTING ADJACENT PERENNIAL BED OR LAWN ADJACENT PERENNIAL BED OR LAWN

STEEL EDGER METAL STAKES

1. CONTRACTOR TO SUBMIT SAMPLE PRIOR TO ORDERING MATERIAL OR DELIVERING TO SITE 2. NO EDGER REQUIRED WHEN MULCH IS ADJACENT TO PAVEMENT, BORDER, OR WALLS.

3. SET ALL EDGING 1/2" ABOVE FINISH GRADE AS SHOWN. 4. EDGING SHALL ABUT ALL CONCRETE CURBS AND WALKS PERPENDICULAR, AND FLUSH W/ GRADES

ALL JOINTS TO BE SECURELY STAKED.

2X Root Ball Diameter

6. CONTRACTOR SHALL CUT TOP EDGE(S) AS NEEDED TO BE PARALLEL WITH GRADE.



GENERAL NOTES:

CONSTRUCTION SHALL CONFORM TO ALL APPLICABLE STATE AND LOCAL CODES AND REGULATIONS

CONTRACTOR TO CONTACT THE UTILITY NOTIFICATION CENTER OF COLORADO BEFORE DIGGING, INCLUDING BUT NOT LIMITED TO, TRENCHING, SHRUB AND TREE PLANTING PITS. IF UTILITIES OCCUR WITHIN (3) THREE FEET OF PROPOSED FOOTINGS, THE CONTRACTOR SHALL REPORT SUCH CONDITIONS TO THE OWNER.

CONTRACTOR IS RESPONSIBLE FOR FULL ON-SITE INVESTIGATIONS AS NEEDED IN ORDER TO GAIN A FULL UNDERSTANDING OF EXISTING CONDITIONS PRIOR TO CONSTRUCTION FAILURE TO INSPECT THE SITE PRIOR TO CONSTRUCTION SHALL NOT BE CAUSE FOR REQUESTING ADDITIONAL MONIES BY THE CONTRACTOR.

4. THE CONTRACTOR SHALL OBTAIN, AT HIS EXPENSE, ALL PERMITS WHICH ARE NECESSARY TO PERFORM THE PROPOSED WORK.

5. THE LANDSCAPE ARCHITECT IS NOT RESPONSIBLE FOR THE CONSTRUCTION MEANS, METHODS, TECHNIQUES, SEQUENCES OR FOR SAFETY PRECAUTIONS OR PROBLEMS UTILIZED IN CONNECTION WITH THE WORK, AND HE/SHE WILL NOT BE RESPONSIBLE FOR THE CONTRACTOR'S FAILURE TO CARRY OUT THE WORK IN ACCORDANCE WITH THE CONTRACT DOCUMENTS.

VERIFY ALL CONDITIONS AT THE JOB SITE AND NOTIFY LANDSCAPE ARCHITECT AND THE OWNER'S REP. IMMEDIATELY OF ANY DIMENSIONAL ERRORS, OMISSIONS OR DISCREPANCIES PRIOR TO ANY DEMOLITION OR CONSTRUCTION.

SIGHT TRIANGLE NOTES:

PEDESTRIAN SIGHT TRIANGLES: NO ITEMS THAT ARE WIDER THAN 18" MAY BE TALLER THAN 30" WITHIN THE PEDESTRIAN SIGHT TRIANGLE.

CORNER SIGHT TRIANGLES: NO ITEMS TALLER THAN 30" MAY BE PLACED WITHIN THE CORNER SIGHT TRIANGLE, EXCEPT FOR TRAFFIC CONTROL DEVICES AND EQUIPMENT. TREES MUST BE LIMBED TO 8 FEET AT ADEQUATE MATURITY. TREES SHALL BE PLANTED A MINIMUM OF 10 FEET FROM LIGHT OR UTILITY POLES.

ROADWAY SIGHT TRIANGLES: NO ITEMS THAT ARE WIDER THAN 18" MAY BE TALLER THAN 30" WITHIN THE ROADWAY SIGHT TRIANGLE EXCEPT FOR STREET TREES AND TRAFFIC CONTROL DEVICES AND EQUIPMENT.


TREE PROTECTION ZONE (TPZ) NOTES:


- CONTRACTOR SHALL VERIFY FINAL BOUNDARIES OF TPZ PRIOR TO COMMENCEMENT OF CONSTRUCTION/DEMOLITION ACTIVITIES. EXCESSIVE BRANCH PRUNING ON EXISTING TREES FOR CONSTRUCTION CLEARANCE WILL NOT BE PERMITTED. PRUNING FOR BUILDING CLEARANCE SHALL BE MINIMIZED. DUE TO SCOPE OF CONSTRUCTION AND SIZE OF EX. ROW TREES, USE CHAIN LINK FENCING TO ESTABLISH TPZ.
- 2. THE TREE LAWN WITHIN THE BOUNDARY OF THE TREE DRIPLINE SHALL NOT BE ROTOTILLED AT ANY TIME. ROTOTILLING IS ONLY PERMITTED IN AREAS OUTSIDE OF EXISTING TREE DRIPLINE WHERE CONCRETE & HARDSCAPE ARE REMOVED.

ORNAMENTAL TREES BOTANIC COMMON SIZE Autumn Brilliance Serviceberry Amelanchier x grandiflora 8' clump Crataegus x mordenensis 'Toba' Toba Hawthorn 2" Cal Spring Snow Crabapple 2" Cal Malus 'Thunderchild' Thunderchild Crabapple 2" Cal Gambel Oak 8' clump Quercus gambelii

DECIDUOUS SHRUBS SIZE QTY BOTANIC Creeping Willow Ash-leaf Spirea as shown Miss Kim Lilac as shown Western Snowberry as shown

> PLAN IS ENLARGED DETAIL AND UPDATE FROM THE PUD APPROVED PLAN. REFER TO PUD APPROVED PLAN FOR ADDITIONAL INFORMATION

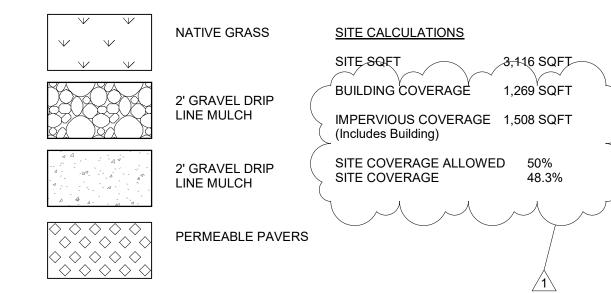

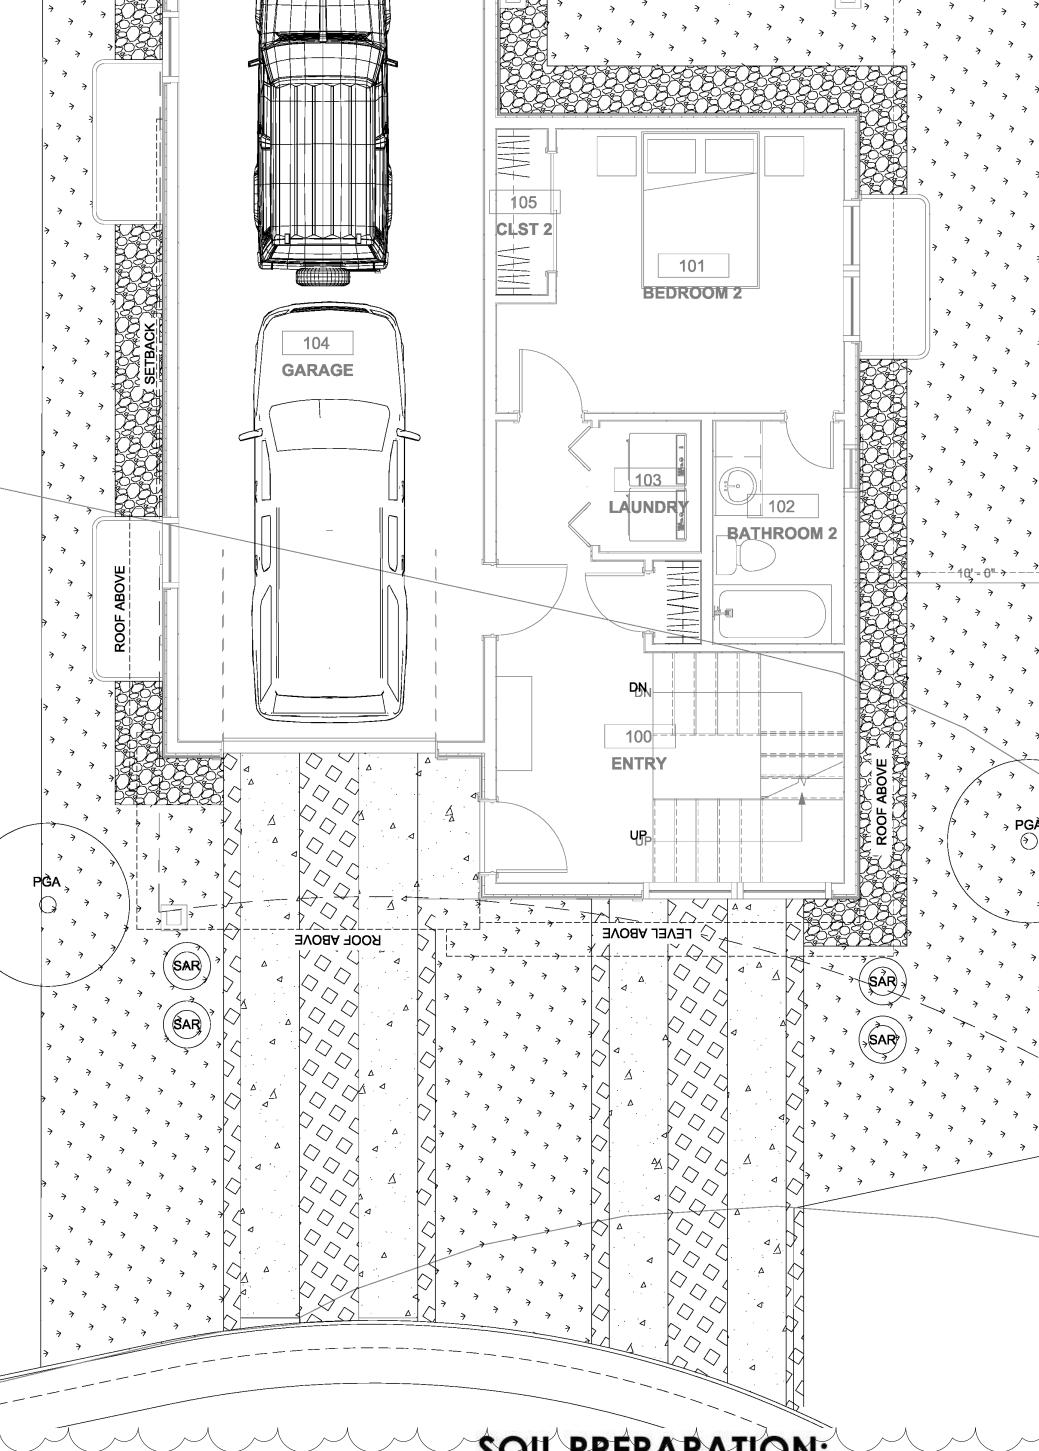

🖄 ROOF ABOVE 😸

LANDSCAPE NOTES:

- ALL NEW LANDSCAPE AND IRRIGATION SHALL BE UNDER WARRANTY FOR A PERIOD OF (1) ONE YEAR. THE WARRANTY PERIOD SHALL COMMENCE ONCE ALL PUNCH LIST ITEMS ARE SATISFACTORY COMPLETED AND A LETTER OF FINAL COMPLETION IS PROVIDED FROM THE OWNER'S REPRESENTATIVE. ALL LANDSCAPE AND IRRIGATION MAINTENANCE SHALL BE THE RESPONSIBILITY OF THE CONTRACTOR 1 YEAR AFTER THE FINAL COMPLETION IS PROVIDED IN WRITING.
- PLANT MATERIAL AND BED LOCATIONS TO BE STAKED BY THE LANDSCAPE CONTRACTOR FOR REVIEW BY THE OWNER'S REPRESENTATIVE OR LANDSCAPE ARCHITECT. ALL ADJUSTMENTS SHALL BE MADE BY THE CONTRACTOR. THE CONTRACTOR SHALL NOT DIG PLANT PITS UNTIL LOCATIONS ARE **APPROVED**
- ROUGH GRADING TO PLUS OR MINUS ONE TENTH OF A FOOT BY GENERAL CONTRACTOR. LANDSCAPE CONTRACTOR TO PROVIDE FINISH GRADING IN ALL LANDSCAPE AREAS. LANDSCAPE CONTRACTOR TO APPROVE ROUGH GRADES PRIOR TO MOBILIZATION. MOBILIZATION ON THE PART OF THE LANDSCAPE CONTRACTOR WILL INDICATE THAT ROUGH GRADING IS ACCEPTABLE TO THE LANDSCAPE CONTRACTOR, AND THEREFORE BE RESPONSIBLE FOR PROVIDING ALL FINISHED GRADES TO MEET THE CIVIL GRADING PLANS.
- TREES AND SHRUBS WILL BE INSPECTED ON-SITE. LANDSCAPE PLANT MATERIALS MAY BE REJECTED AT ANY TIME DUE TO ISSUES OF QUALITY.
- ALL NEW LANDSCAPE AREAS SHALL BE IRRIGATED BY A COMMERCIAL GRADE, FULLY AUTOMATIC UNDERGROUND IRRIGATION SYSTEM. TREES, SHRUBS, AND DECORATIVE GRASSES SHALL BE IRRIGATED BY A SEPARATE ZONE FROM SOD/GRASS; THIS INCLUDES TREES PLANTED IN SOD/GRASS AREA. THE IRRIGATION SYSTEM IS TO HAVE A RAIN SENSOR SHUTOFF INSTALLED. IRRIGATION TO BE DESIGN/BUILD, CONTRACTOR IS RESPONSIBLE FOR COORDINATION WITH ARCHITECT, LANDSCAPE ARCHITECT, AND MECHANICAL AND FOR GENERATION OF AN IRRIGATION PLAN FOR REVIEW WITH AS BUILT PLAN AS REQUIRED.
- ALL PLANT MATERIAL SHALL MEET OR EXCEED CURRENT AMERICAN STANDARD FOR NURSERY STOCK ANSI Z60.1 AND THE COLORADO NURSERY ACT AND ACCOMPANYING RULE AND REGULATIONS.
- TRUNK-WRAP TAPE: TWO LAYERS OF CRINKLED PAPER CEMENTED TOGETHER WITH BITUMINOUS MATERIAL, 4 INCHES (102 MM) WIDE MIN.
- WRAPPING TREE TRUNKS: WRAP TREES WITH TRUNK-WRAP TAPE. START AT BASE OF TRUNK AND SPIRAL COVER TRUNK TO HEIGHT OF FIRST BRANCHES. OVERLAP WRAP, EXPOSING HALF THE WIDTH, AND SECURELY ATTACH WITHOUT CAUSING GIRDLING. DO NOT USE STAPLES. INSPECT TREE TRUNKS FOR INJURY, IMPROPER PRUNING, AND INSECT INFESTATION AND TAKE CORRECTIVE MEASURES REQUIRED BEFORE WRAPPING. DO NOT WRAP ROUGH BARK, POPULUS OR GLEDITSIA TREES. REMOVE WRAP IN SPRING.
- NO TREE SHALL BE WRAPPED AFTER MAY 21 OR BEFORE NOVEMBER 1
- ALL DECIDUOUS TREES SHALL BE WRAPPED BY NOV. 15. REMOVE TREE WRAP BY MAY 15. CONTRACTOR SHALL BE RESPONSIBLE FOR WRAPPING AND UNWRAPPING TREES DURING THE WARRANTY PERIOD.
- 9. FIBER MULCH AT PLANTING BEDS: ORGANIC MULCH FREE FROM DELETERIOUS MATERIALS AND SUITABLE AS A TOP DRESSING OF TREES AND SHRUBS, CONSISTING OF SHREDDED REDWOOD MULCH NOT LARGER THAN FOUR INCHES (4") IN LENGTH. SUBMIT 1.0 CF SAMPLE FOR APPROVAL.

SOIL PREPARATION:

SOIL SHALL BE AMENDED BASED ON THE SOIL TEST RECOMMENDATIONS (TO ADDRESS SPECIFIC DEFICIENCIES & ISSUES IN EXISTING SOIL). THE FOLLOWING INCLUDES THE SOIL TEST REQUIREMENTS AND RECOMMENDATIONS TO BE USED IN CONJUNCTION WITH THE SOIL TEST RESULTS:

SOIL ANALYSIS, BULK DENSITY TESTING AND REMEDIATION REQUIRED. SOIL ANALYSIS FROM A LOCAL ACCREDITED SOIL ANALYSIS LABORATORY WITH EXPERIENCE IN LOCAL URBAN SOILS SHALL BE REQUIRED WHEN PLANTS ARE TO BE INSTALLED IN GREEN SPACE. ALL SOIL REMEDIATION SHALL BE BASED ON THE SOIL ANALYSIS

- MINIMUM SOIL ANALYSIS MUST DETERMINE SOIL TEXTURE AND STRUCTURE, PH BALANCE, SOIL SALINITY, FREE LIME, ORGANIC MATTER (OM) CONTENT, PLANT
- AVAILABLE NUTRIENTS AND COMPACTION. DEPTH OF LANDSCAPE SOIL ANALYSIS SHALL BE 24IN FOR TREES AND 8IN FOR ALL OTHER AREAS
- SOIL REMEDIATION REQUIRED BASED ON SOIL ANALYSIS.
- 2. COMPOSTED MATERIAL SHALL CONSIST OF AGED ORGANIC MATTER, FREE OF WEED OR OTHER NOXIOUS PLANT SEEDS, LUMPS, STONES, OR OTHER FOREIGN CONTAMINANTS HARMFUL TO PLANT LIFE, AND HAVING THE FOLLOWING CHARACTERISTICS BASED ON A NUTRIENT TEST PERFORMED NO LONGER THAN 3

MONTHS PRIOR TO ITS INCORPORATION INTO THE PROJECT:

- ORGANIC MATTER: 25% MINIMUM.
- SALT CONTENT: 5.0 MMHOS/CM MAXIMUM.
- 1.3. PH: 8.5 MAXIMUM.
- CARBON TO NITROGEN RATIO OF 10:1 TO 20:1. PARTICLE SIZE NO PARTICLE SMALLER THAN SILT OR CLAY SIZE, OR LARGER THAN
- 1/2" DIAMETER ACCEPTABLE COMPOST PRODUCT: CLASS I COMPOST, SUCH AS ECOGRO OR

BIO-COMP. AS PROVIDED BY A1 ORGANICS, EATON, CO, OR APPROVED

- 2. FINISH GRADE TO BE BELOW THE EDGE OF PAVEMENT PRIOR TO SODDING OR
- PLANTING:
- SEEDED/SODDED AREAS: ALLOW 1 INCH FOR SOD. PLANTED AREAS: ALLOW 3 INCHES FOR MULCH.
- 4. AFTER APPLYING SOIL CONDITIONER AND FERTILIZER, THOROUGHLY TILL AREA TO DEPTH OF 6" MINIMUM UNTIL SOIL IS WELL PULVERIZED AND THOROUGHLY MIXED.

Associates

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> Mechanical Engineer Electrical Engineer

(970) 949-9391

(1)


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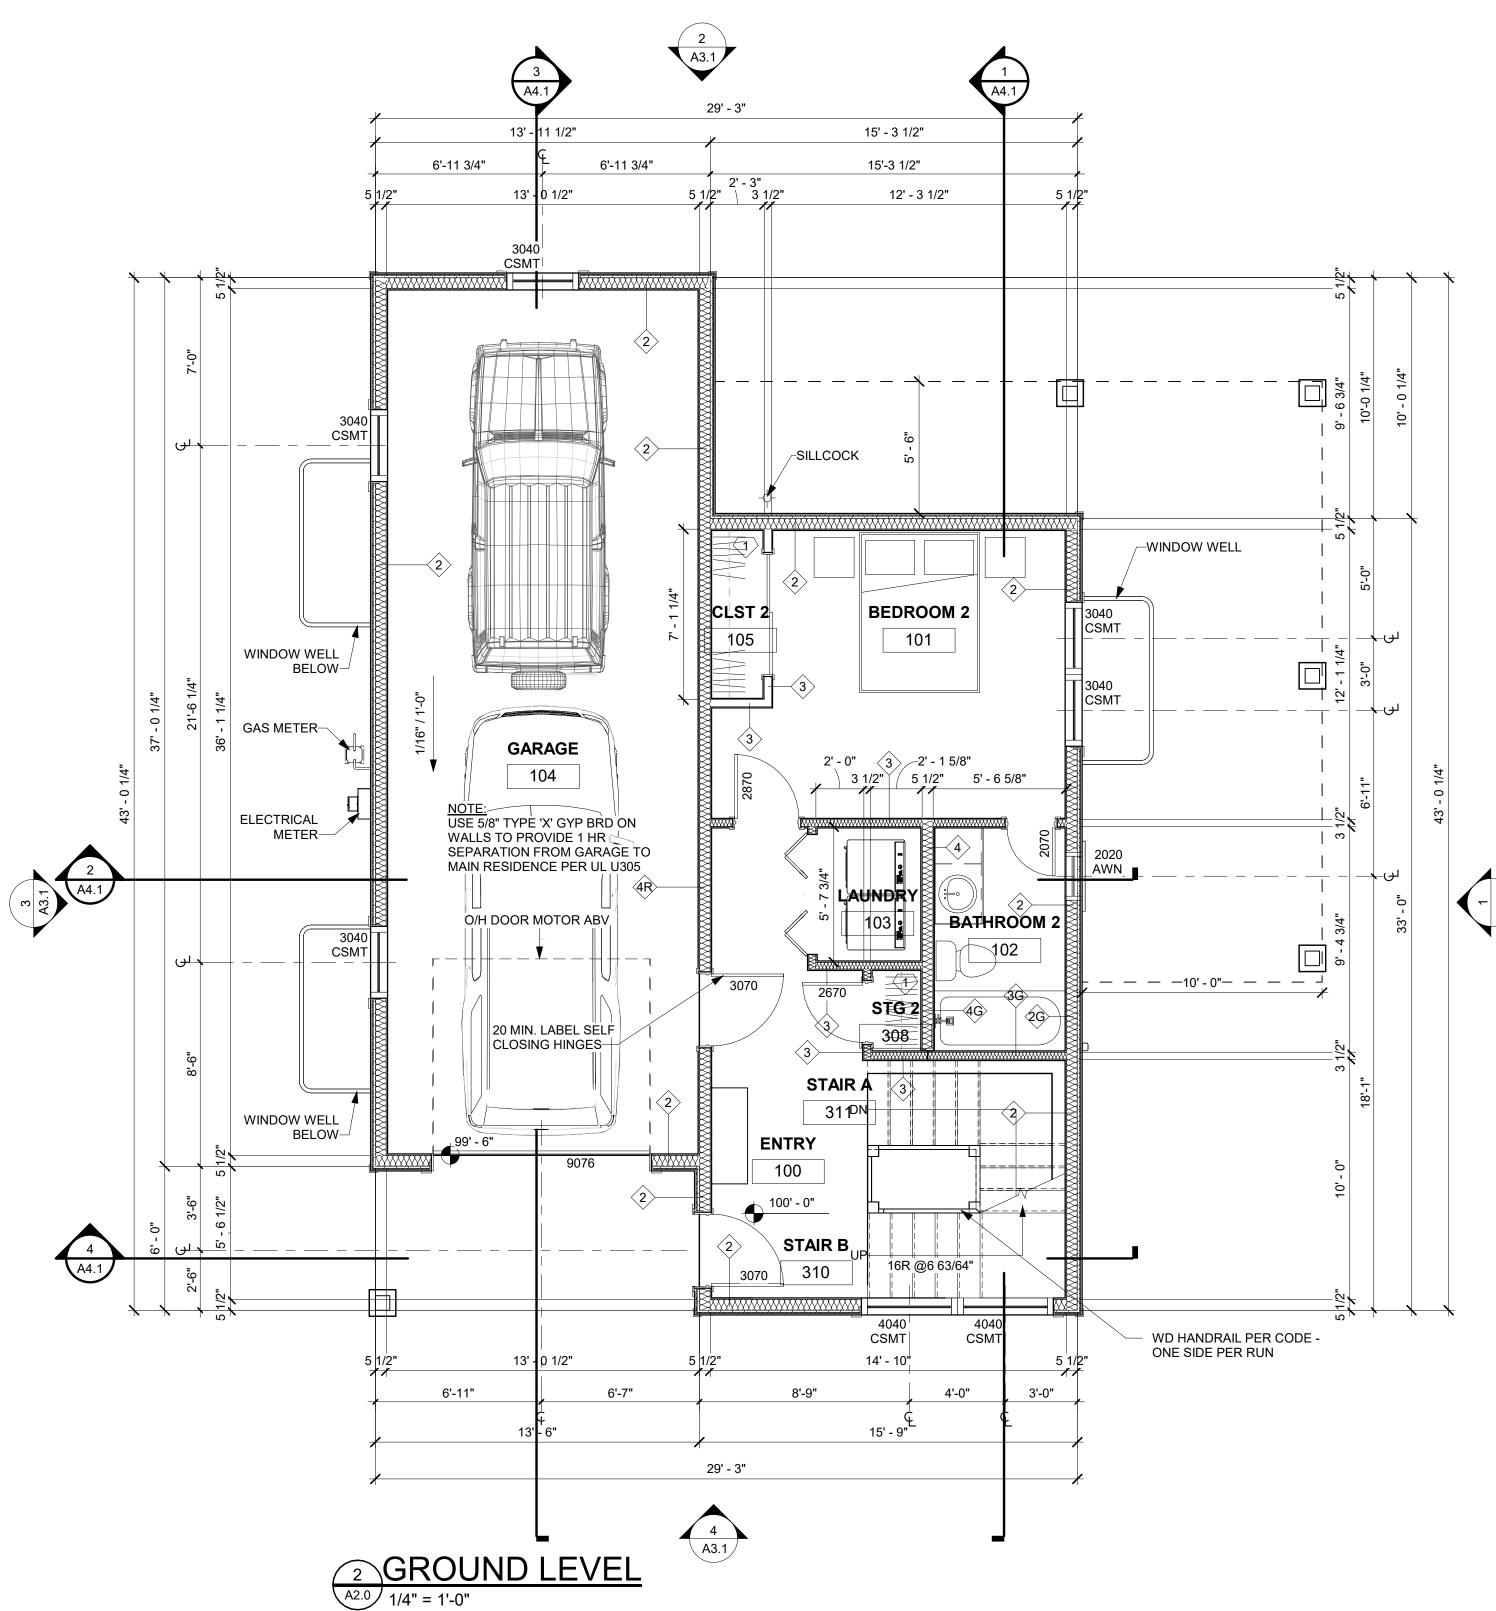
Issue Dates: CP-08/14/2024 DRB-2/14/2025

Landscape Plan

Project No: 2215

Sheet No:



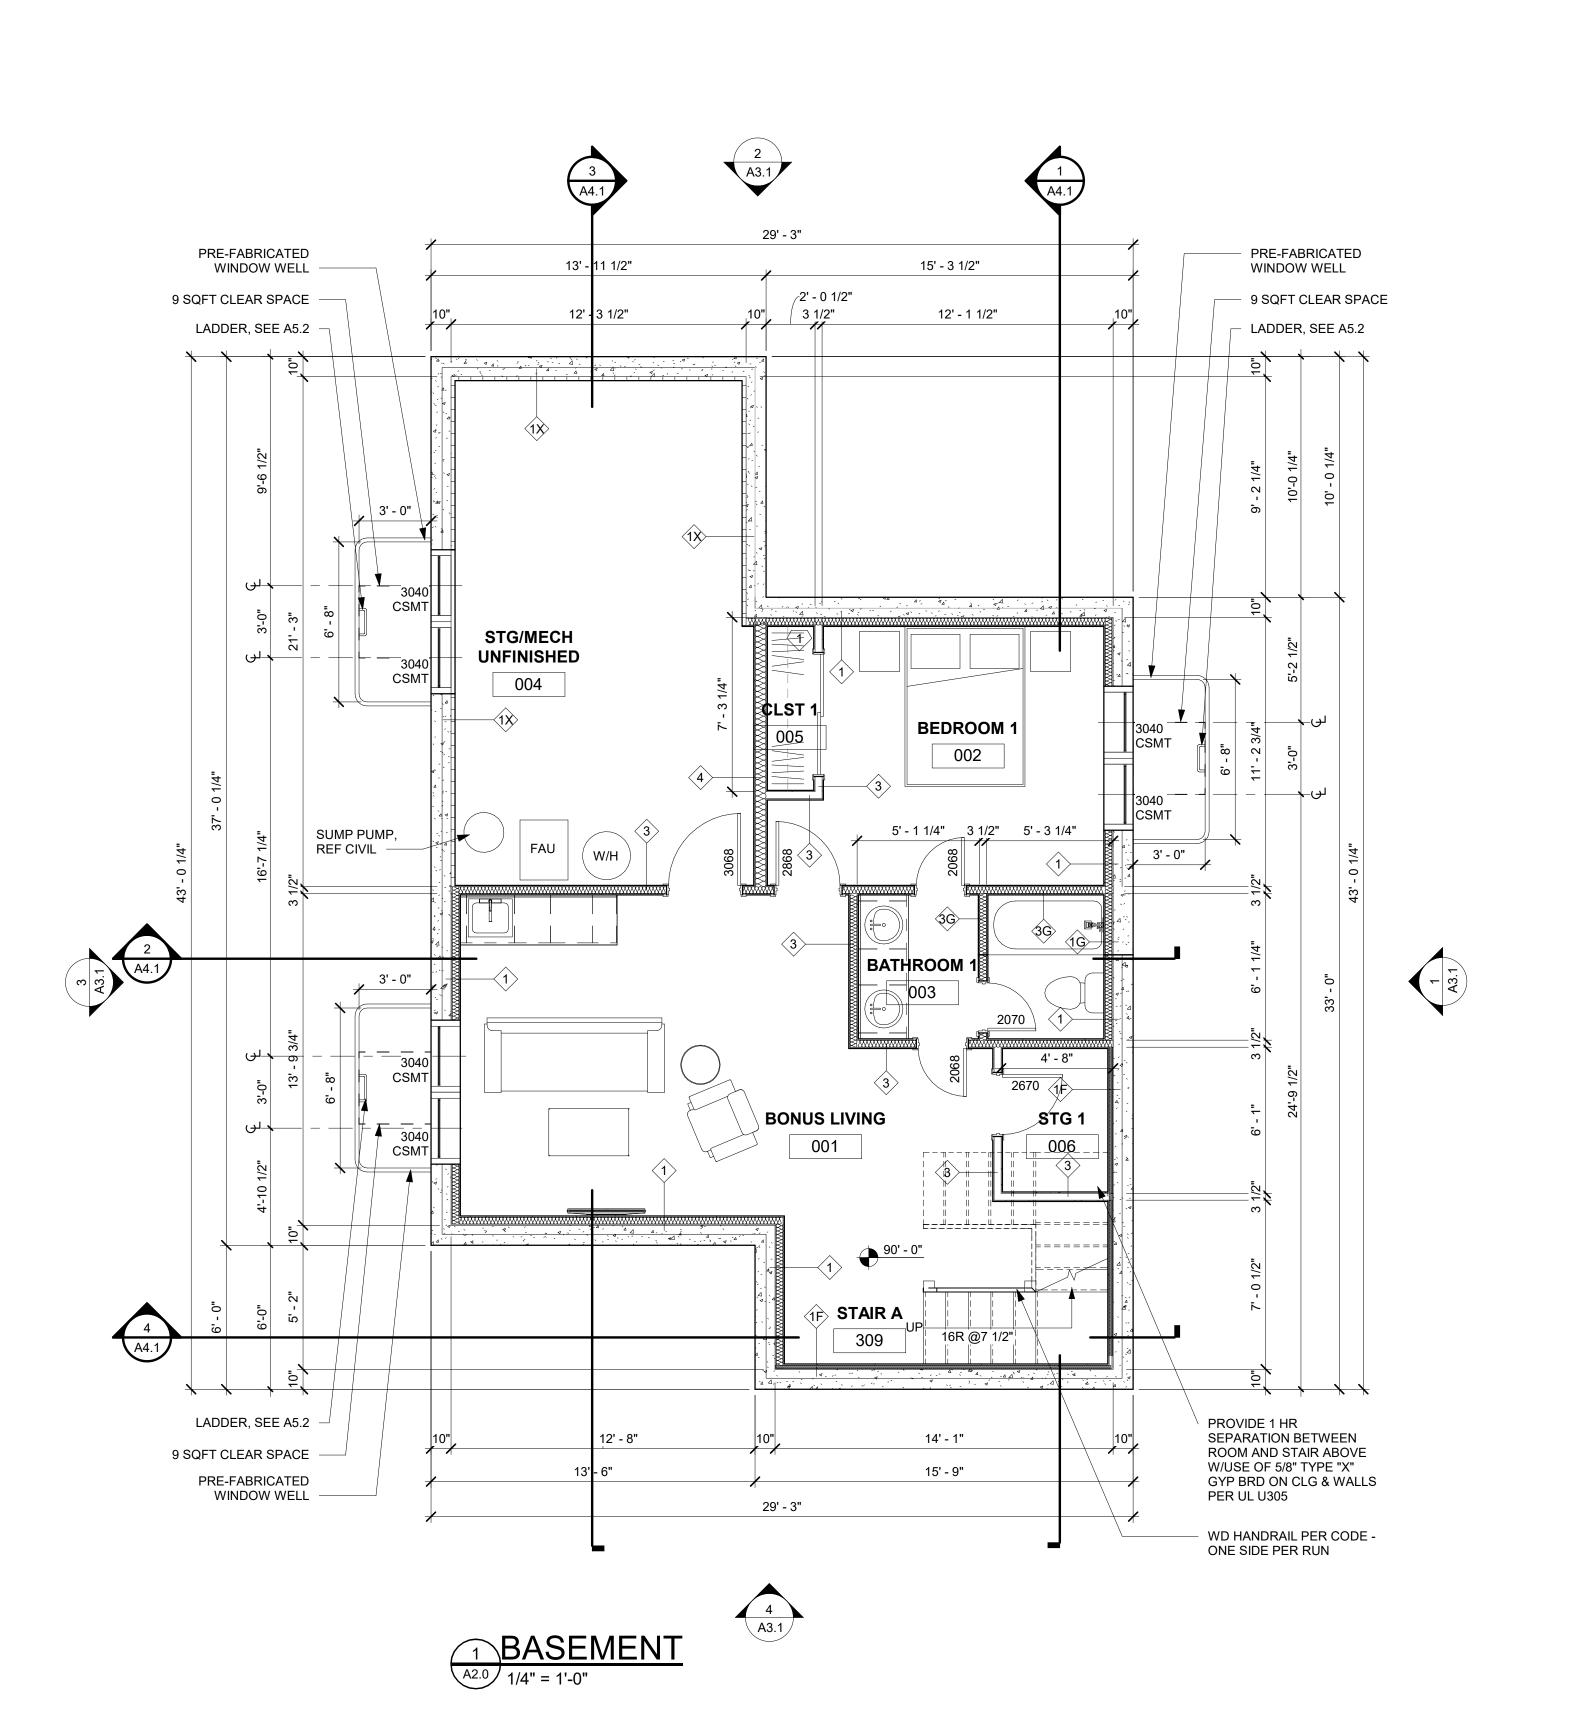

CONTRACTOR TO PROVIDE THE FOLLOWING AS DEFFERED SUBMITTALS FOR BUILDING PERMIT

- MECHANICAL
 M1. PLEASE PROVIDE THE REQUIRED MANUAL J AND S. M1401.2 M2. PLEASE PROVIDE THE REQUIRED MANUAL D. M1601.1
- M3. PLEASE PROVIDE THE CONSTRUCTION DETAILS FOR THE PROPOSED WHOLE HOUSE VENTILATION SYSTEM. M1505.4 M4. SHEET A2.1: IF ALL THE GAS FIRED APPLIANCES ARE NOT SEALED COMBUSTION AND THE KITCHEN EXHAUST HOOD IS GREATER THAN 400 CFM A MAKEUP AIR SYSTEM WILL BE REQUIRED. PLEASE PROVIDE THE CONSTRUCTION DETAILS FOR THE PROPOSED MAKEUP AIR SYSTEM IF NEEDED.


PLUMBING
P1. SHEET A2.1: LOWER FLOOR. PLEASE INDICATE HOW THE WATER HEATER AND ASSOCIATED PIPING WILL BE PROTECTED FROM FREEZING. P2603.5
PLEASE INDICATE THE REQUIRED 3' X 3' X 7' HIGH CLEAR SPACE AT THE WATER HEATER. R403.5.4 AS AMENDED. B. INDICATE THE REQUIRED CONDENSATE DRAIN AT THE WATER HEATER THAT WILL ALLOW NATURAL DRAINAGE. R403.5.4 AS AMENDED PLEASE NOTE THAT THAT THESE TWO COMMENTS ARE INTENDED TO PROVIDE SPACE AND DRAINAGE FOR A HEAT PUMP WATER HEATER. WE ARE NOT AWARE THAT HEAT PUMP WATER HEATERS CAN BE INSTALLED IN AN UNCONDITIONED OR CONDITIONED GARAGE.

CONTRACTOR TO PROVIDE THE FOLLOWING FOR IECC REQUIREMENTS AND COMPLETION

REQUIRED BLOWER DOOR TEST AT 3-ACH50. R402.4.1.3 A. REQUIRED DUCT TIGHTNESS TEST. R403.3.5

IV. REQUIRED DOMESTIC HOT WATER PING INSULATION. R403.5.2 VI. THE REQUIRED ITEMS THAT ARE TO BE LISTED ON THE COMPLIANCE CERTIFICATE. R401.3 AS AMENDED PROVIDE ROUGH IN FOR ROOF MOUNTED SOLAR PV

CONTRACTOR TO COORDINATE DUCTING FROM THE FURNACE (IF PENETRATING THE GARAGE/HOUSE SEPARATION) WILL BE A MINIMUM OF 26 GAUGE AND THAT THE FURNACE HAS NO OPENINGS INTO THE GARAGE. R302.5.2. NOTE THAT WE ARE NOT AWARE OF ANY FURNACE THAT IS AIRTIGHT. HAVING THE FURNACE AND THE WATER HEATER WITHIN THE GARAGE SPACE CAN BE

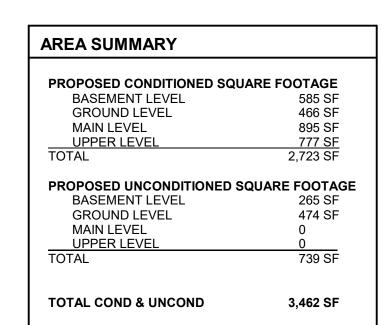

NOTES:

CLOSET NOTES:

- SINGLE HANGING: DESIGNATED BY SINGLE DASHED LINE IN CLOSETS TO BE: 16" SHELF @ 7'-0"
- AFF, 16" SHELF & ROD @ 5'-6" AFF. DOUBLE HANGING: DESIGNATED BY DOUBLE
- 2 DASHED LINE IN CLOSETS TO BE: 16" SHELF & ROD @ 7'-0" AFF, 12" SHELF & ROD @ 3'-6" AFF. SHELVES @ WALK-IN CLOSETS: 6 - 16" SHELVES @ 3 1'-2" OC, 1st SHELF @ 1'-2" AFF, SHELF WIDTH TO BE
- INDICATED. LINEN SHELVES: 6 SHELVES, WIDTH AS NOTED, @ 4 1'-2" OC, 1st SHELF @ 1'-2" AFF, FULL CLOSET

Associates

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Civil Engineer

Structural Engineer

Mechanical Engineer

Electrical Engineer

0

(1)

CLOSET WIDTH, LESS 4'-0" OR AS OTHERWISE

STORAGE SHELVES: 6 - 16" SHELVES @ 1'-2" OC, 1st SHELF @ 1'-2" AFF, FULL CLOSET WIDTH.

1. ALL SHELVES & VERTICAL DIVIDERS TO BE AC PLYWOOD WITH 1x2 EDGE. SPECIES TO BE SPECIFIED BY DEVELOPER.

2. CLEATS TO BE 1x2 CLEAR PINE. 3. PROVIDE ROD SUPPORTS @ 36" OC MAX. 4. ALL TO BE STAINED TO MATCH CASE & BASE.

FLOOR PLAN GENERAL NOTES:

GENERAL CLOSET NOTES:

- 1. PATCH EXISTING CONSTRUCTION SCHEDULED TO REMAIN. REPAIRED SURFACES TO BE FLUSH WITH ADJACENT FINISH SURFACES. TO SAME QUALITY AS NEW CONSTRUCTION PRIOR TO INSTALLING NEW FINISHES. REFER TO THE FINISH MANUFACTURER'S GUIDELINES FOR INSTALLATION.
- 2. PATCH EXISTING FIRE-RATED WALLS, FLOOR CEILINGS, ETC. SO AS TO MAINTAIN THE FIRE-RADIATING. ADD FIRE-SMOKE DAMPERS WHERE NEW
- DUCTS CROSS. ADD FIRE STOP AT ALL 3. PATCH WALLS AT REMOVED RECEPTACLE OPENINGS
- 4. PATCH AND LEVEL FLOOR SUBSTRATES TO RECEIVE NEW WORK AS SCHEDULED.

SO AS TO RECEIVE SUBSEQUENT WORK.

- 5. COORDINATE ALL FLOOR CORE DRILLING WITH EXISTING.
- 6. DO NOT SCALE DRAWINGS.
- 7. IN ROOMS WITH FLOOR DRAINS, SLOPE CONCRETE SURFACE WITHIN 18" RADIUS AT 1/4" PER FOOT TOWARD FLOOR DRAIN, UNLESS OTHERWISE
- 8. ALL SPOT ELEVATIONS SHOWN ON THE FLOOR PLANS OUTSIDE THE BUILDING RELATE TO USGS ELEVATIONS. ALL SPOT ELEVATIONS INSIDE THE BUILDING REFER TO BUILDING REFERENCE ELEVATIONS. NOTIFY ARCHITECT IMMEDIATELY SHOULD CONDITIONS BE FOUND CONTRADICTORY TO THESE DRAWINGS.
- 9. ALL ANGLES SHOWN ON THE FLOOR PLANS ARE 90 DEGREES UNLESS OTHERWISE NOTED.
- 10. ALL DIMENSIONS ARE TO GRID LINE, FACE OF CONCRETE OR MASONRY, OR FACE OF GYPSUM BOARD, UNLESS OTHERWISE NOTED.
- 11. ALL FLOOR PLAN DIMENSIONS TO MASONRY ARE NOMINAL DIMENSIONS, UNLESS NOTED AS ACTUAL. 12. "TB" NEW CORK TACKBOARDS OR "MB" NEW
- MARKERBOARDS 13. PROVIDE EXIT DOOR NUMBERS PER DOOR SIGNAGE SHEET AT ALL EXIT DOORS.

GENERAL NOTES:

TEXTURE, AND FINISH.

1. DO NOT SCALE DRAWINGS. USE GIVEN DIMENSIONS. IMMEDIATELY NOTIFY ARCHITECT IF ADDITIONAL INFORMATION IS REQUIRED. ALL DIMENSIONS ARE GIVEN TO FACE OF WALL FRAMING. SEE WALL SECTIONS AND WALL TYPES FOR EXACT CONSTRUCTION

2. SEE SHEET A0.1 FOR WALL TYPES INDICATED ON FLOOR PLANS

3. PROVIDE ALL NECESSARY BLOCKING FOR PROPER ATTACHMENT OF WORK IN WALLS AND CEILINGS. LOCATIONS INCLUDE BUT NOT LIMITED TO, TOILET AND BATH ACCESSORIES, WALL AND CEILING MOUNTED ELECTRICAL EQUIPMENT, WINDOW TREATMENTS, CASEWORK, COUNTERTOPS, ETC.

4. WHERE WALL PARTITIONS ARE A CONTINUATION OF EXISTING ONES. NEW FINISH SURFACES MUST BE FLUSH AND CONTINUOUS WITH EXISTING SURFACES ON BOTH SIDES. INFILL OPENINGS IN EXISTING WALLS WITH MATERIAL TO MATCH EXISTING WALL THICKNESS,

5. REFERENCE S-SERIES DRAWINGS FOR STRUCTURAL NOTES AND DETAILS AND COORDINATE.

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AND/OR ELEVATIONS SHOWN. 7. VERIFY ALL PITCHED FLOOR AREAS SHOWN WITH PITCH LINES WITH THE ARCHITECT. PROVIDE A SLAB DEPRESSION AT ALL FLOOR DRAINS WHERE PITCH LINES ARE NOT SHOWN ON DRAWINGS.

8. PROVIDE 4" RETURN FROM FACE OF ADJACENT WALL

FOR ANY DOORS NOT DIMENSIONED.

DRAWINGS FOR ITEMS NOT SHOWN ON ARCHITECTURAL DRAWINGS AND COORDINATE.

9. SEE MECHANICAL, PLUMBING, AND ELECTRICAL

10. ALL INTERIOR WALLS SHALL EXTEND TO UNDERSIDE OF ROOF DECK AND STEEL STRUCTURE (BEAM) UNLESS NOTED OTHERWISE. SEE PARTITION WALL TYPES ON SHEET A0.03

> 11. DATUM 100'-0" INDICATED ON ALL DRAWINGS, OTHER THAN CIVIL SERIES EQUALS XXXX.XX ON CIVIL DRAWINGS 12. ALL STEEL LOCATED BELOW AND EXPOSED TO GRADE TO BE COATED WITH BITUMINOUS DAMPROOFING. 13. CONTRACTOR TO COMPLY WITH ALL REQUIREMENTS

FOR SPECIAL INSPECTIONS, 2015 IBC-1704.


Level Floor **Plans**

Issue Dates:

CP-08/14/2024

DRB-2/14/2025

Sheet Title:

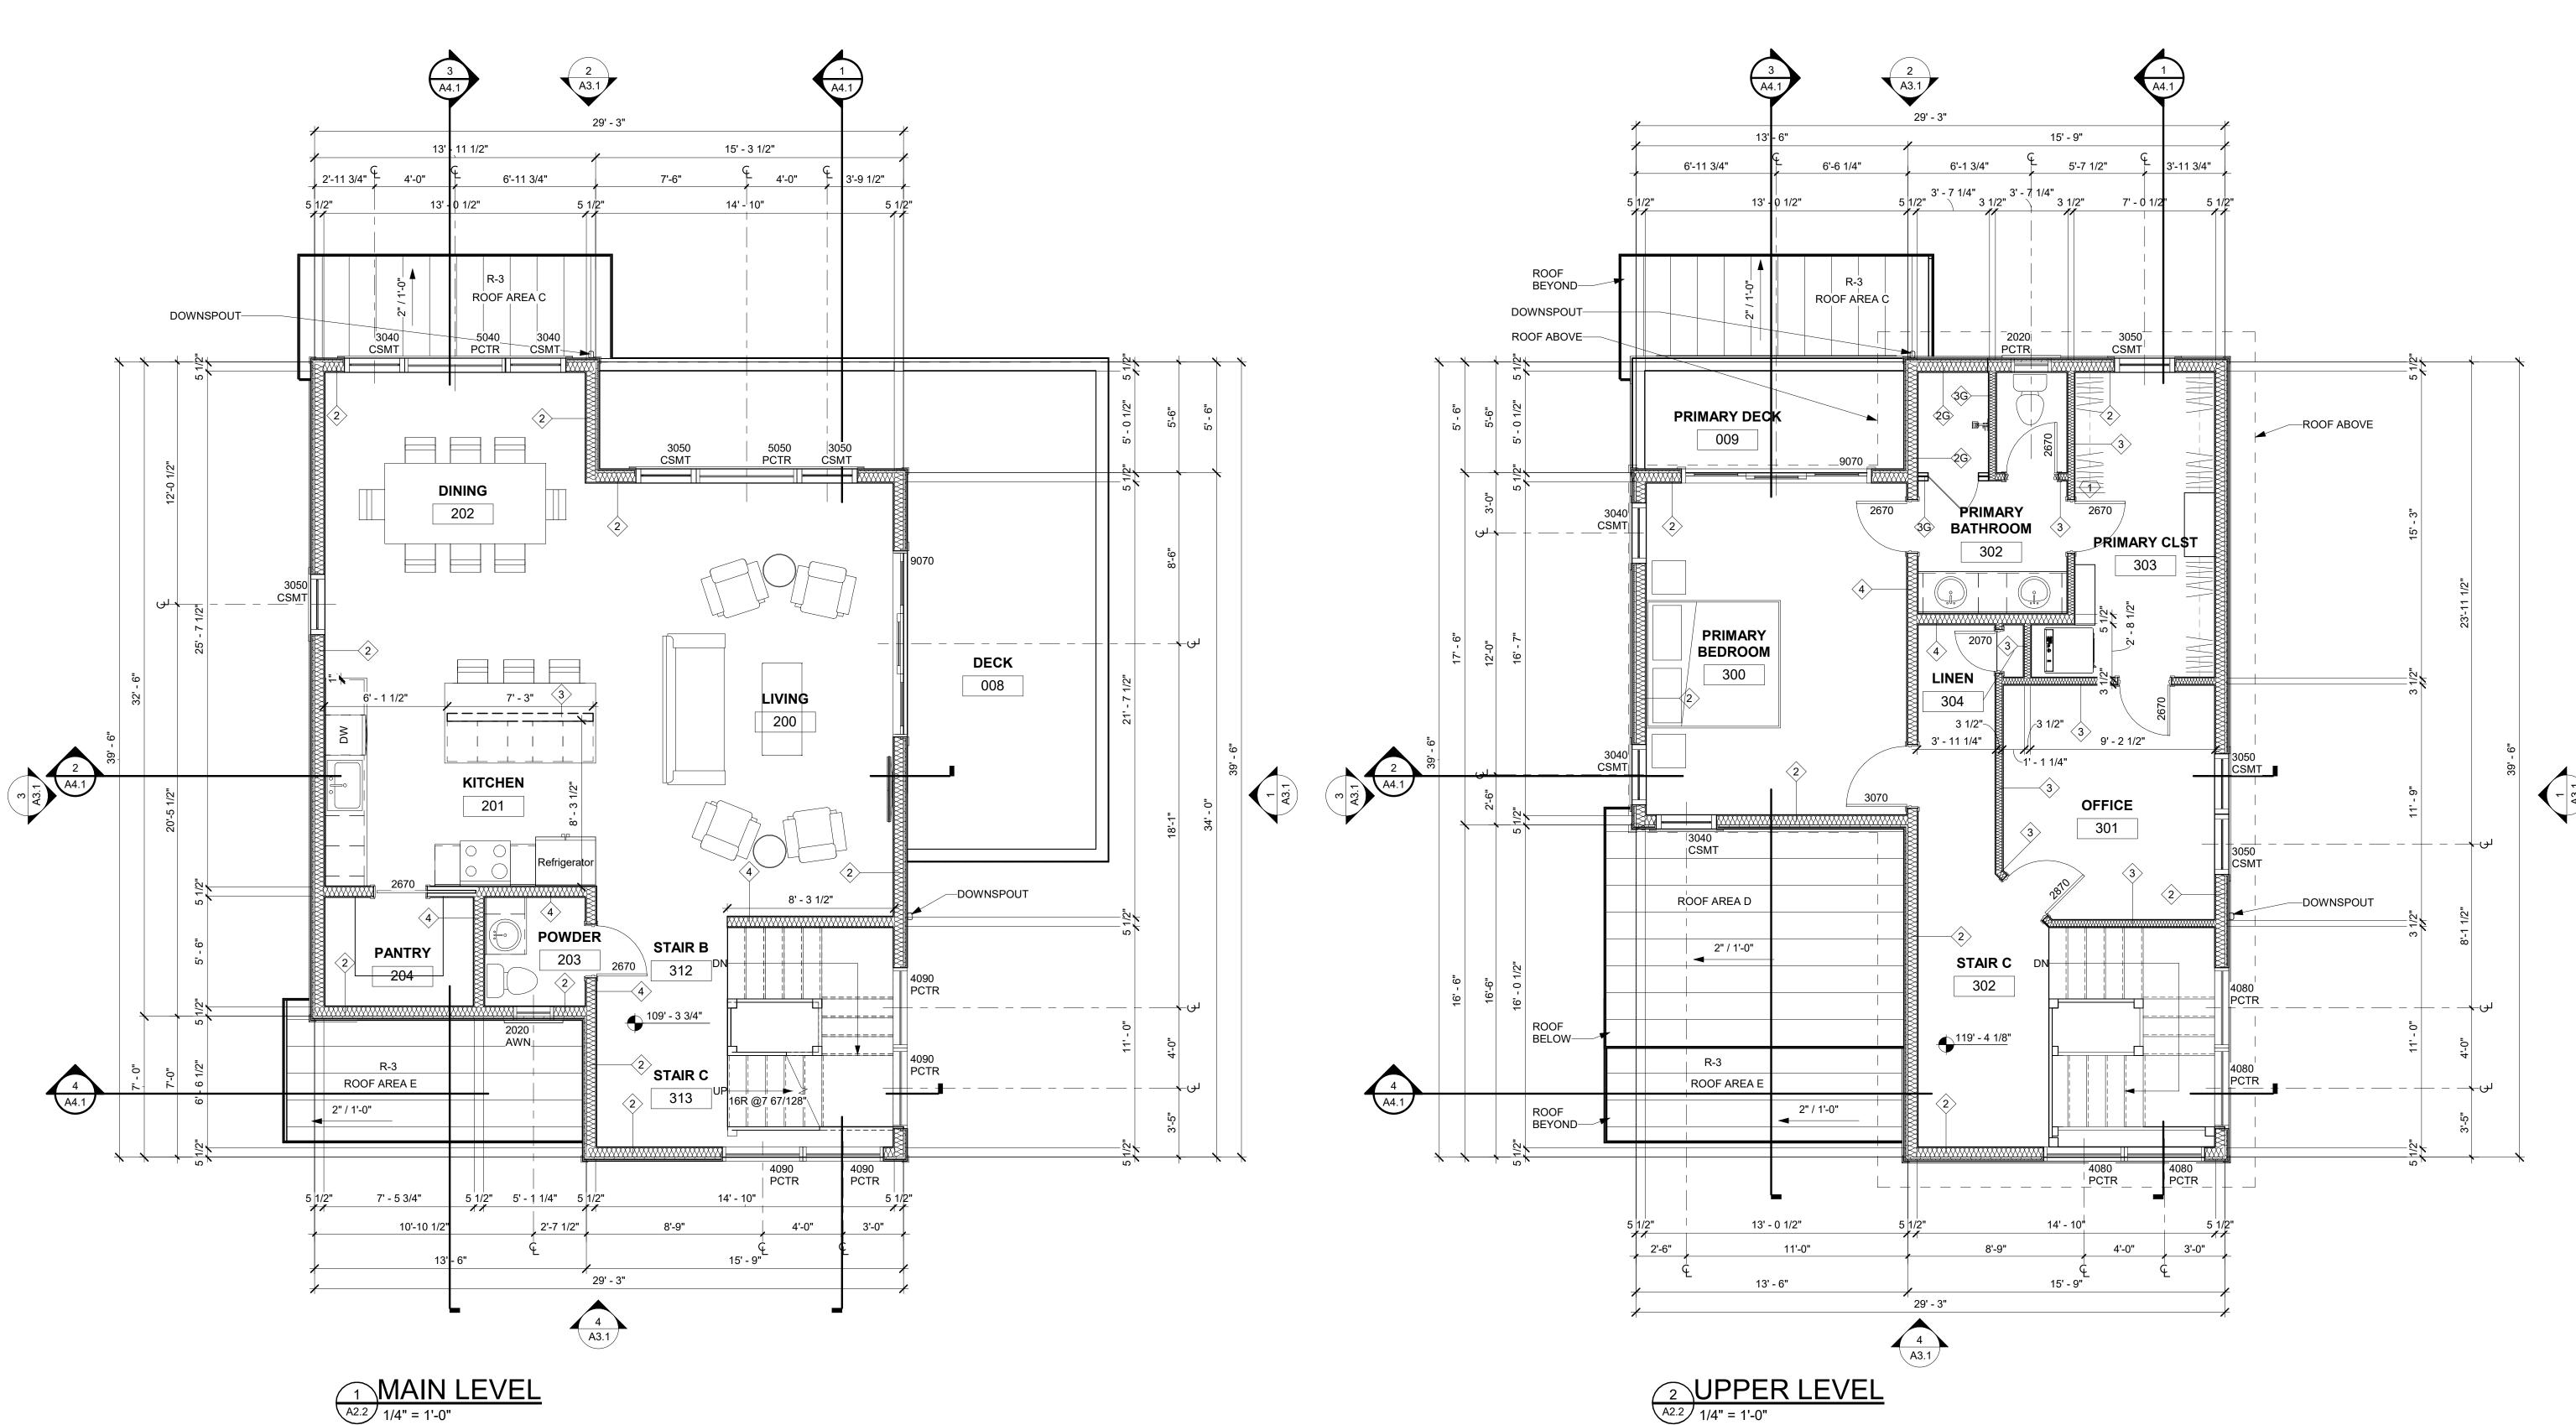

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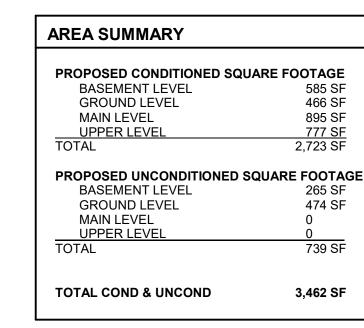
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- SHELVES @ WALK-IN CLOSETS: 6 16" SHELVES @ $\langle 3 \rangle$ 1'-2" OC, 1st SHELF @ 1'-2" AFF, SHELF WIDTH TO B CLOSET WIDTH, LESS 4'-0" OR AS OTHERWISE
- LINEN SHELVES: 6 SHELVES, WIDTH AS NOTED, @ 1'-2" OC, 1st SHELF @ 1'-2" AFF, FULL CLOSET

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FOR SPECIAL INSPECTIONS, 2015 IBC-1704.


Issue Dates: CP-08/14/2024 DRB-2/14/2025 **Sheet Title:**


Level

Floor


Plans

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PROVIDE ROUGH IN FOR ROOF MOUNTED SOLAR PV

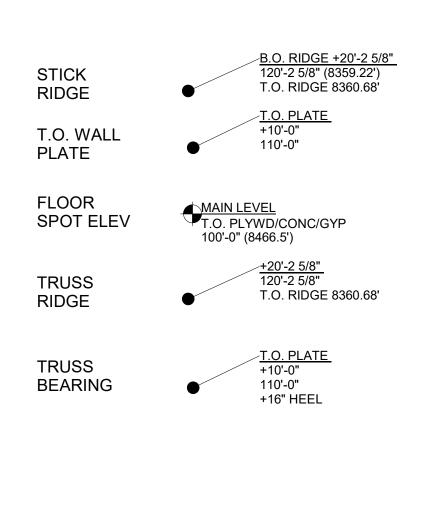

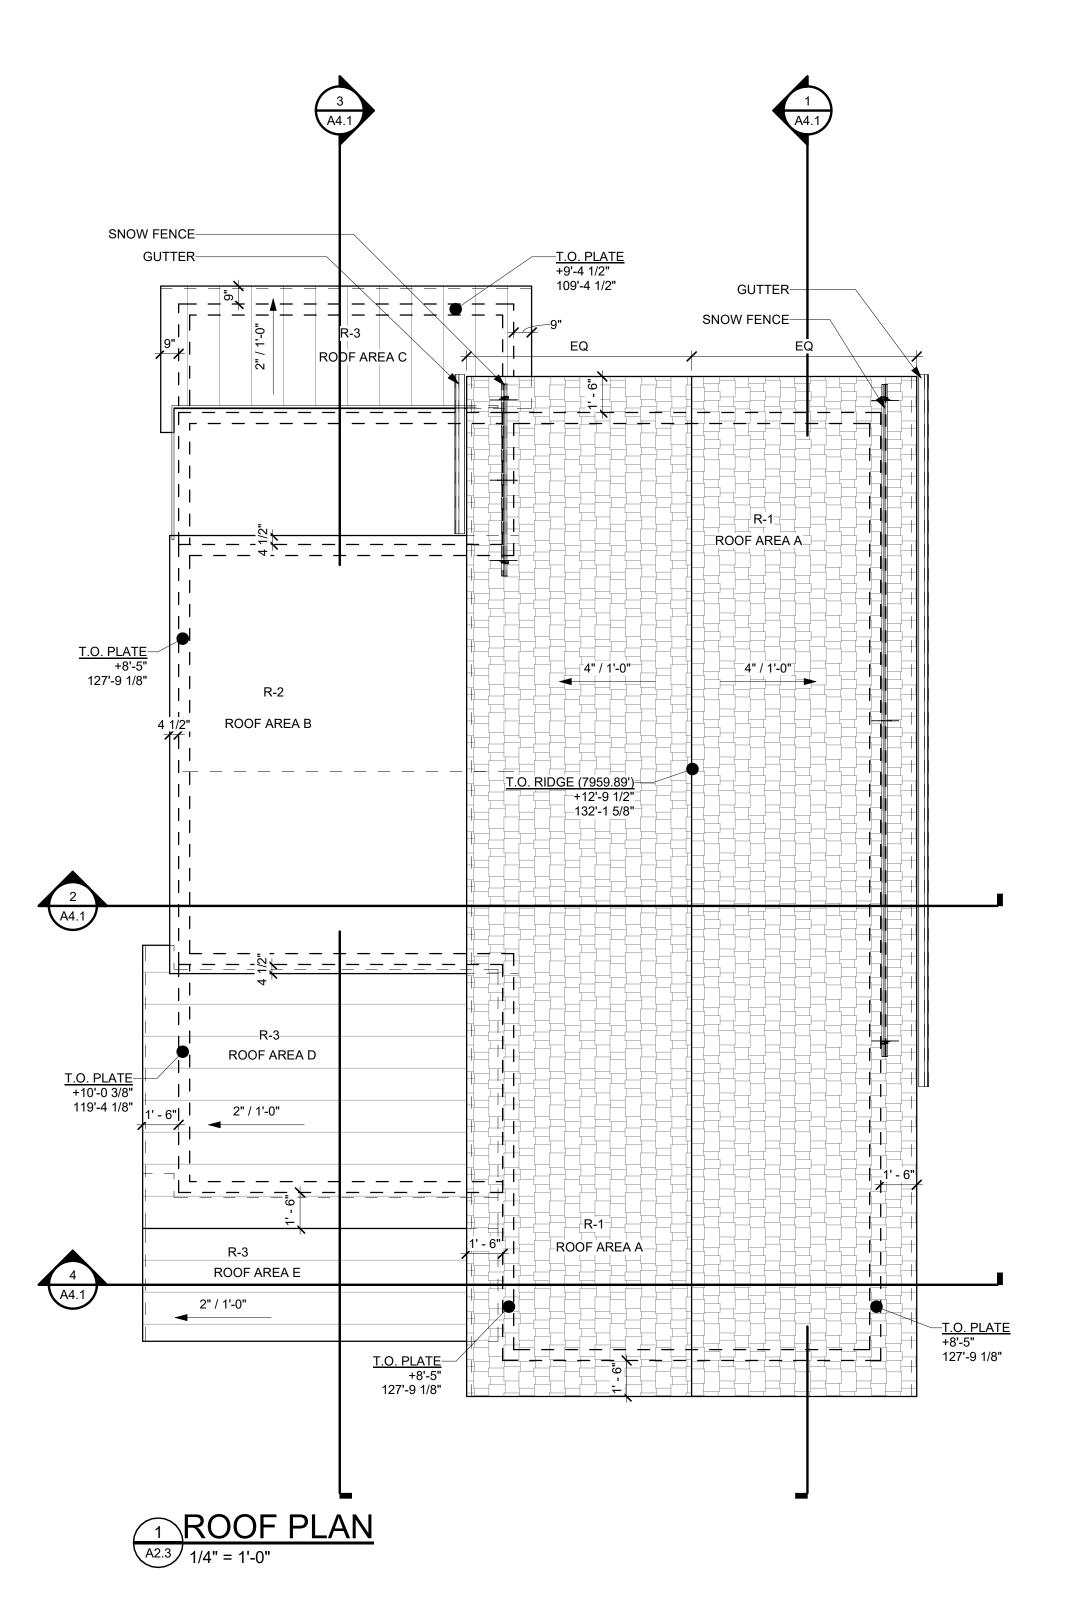

NOTES:

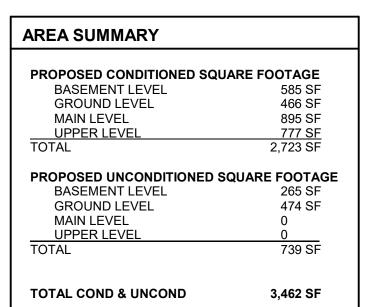GENERAL NOTES:

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8. PROVIDE 4" RETURN FROM FACE OF ADJACENT WALL FOR ANY DOORS NOT DIMENSIONED.

9. SEE MECHANICAL, PLUMBING, AND ELECTRICAL DRAWINGS FOR ITEMS NOT SHOWN ON ARCHITECTURAL DRAWINGS AND COORDINATE.

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11. DATUM 100'-0" INDICATED ON ALL DRAWINGS, OTHER THAN CIVIL SERIES EQUALS XXXX.XX ON CIVIL DRAWINGS

12. ALL STEEL LOCATED BELOW AND EXPOSED TO GRADE TO BE COATED WITH BITUMINOUS DAMPROOFING.

13. CONTRACTOR TO COMPLY WITH ALL REQUIREMENTS FOR SPECIAL INSPECTIONS, 2015 IBC-1704.

ROOF FINISH LEGEND

NOTES:

1. HATCHED AREAS INDICATE OVERBUILT ROOF & CRICKETS, RE: STRUCTURAL

- 2. ALL GUTTERS & DOWNSPOUTS TO RECEIVE HEAT TAPE FOR ENTIRE LENGTH, RE: DIAGRAM ON ELECTRICAL PLANS
- 3. T.O. RIDGE ELEVATIONS GIVEN AT TOP OF ROOF SHEATHING

 4. CONTRACTOR TO VERIFY CHIMNEY DIMENSIONS
- WITH FIREPLACE MANUFACTURERS' REQUIREMENTS
- R-1 RANDOM ASPHALT SHINGLES, SEE SYSTEM NOTES SHEET A0.1
- R-2 60 MIL EPDM ROOF SEE SYSTEM NOTES SHEET A0.1
- R-3 COIL COATED MTL STANDING SEAM ROOF SEE SYSTEM NOTES SHEET A0.1

COIL COATED MTL FLASHING, GUTTERS, AND DOWNSPOUTS

OVERHANGS ARE 1'-6" FROM FACE OF FRAMING

ROOF BEAMS - ROUGH SAWN TIMBER

Lot 20
Belden Place Phase 2
Minturn, Colorado

Associates

The Architectural Balance

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Civil Engineer

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Mechanical Engineer

Electrical Engineer

Revisions:
No Description Date


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Sheet Title:

Roof Plan

Project No: 2215

Sheet No:

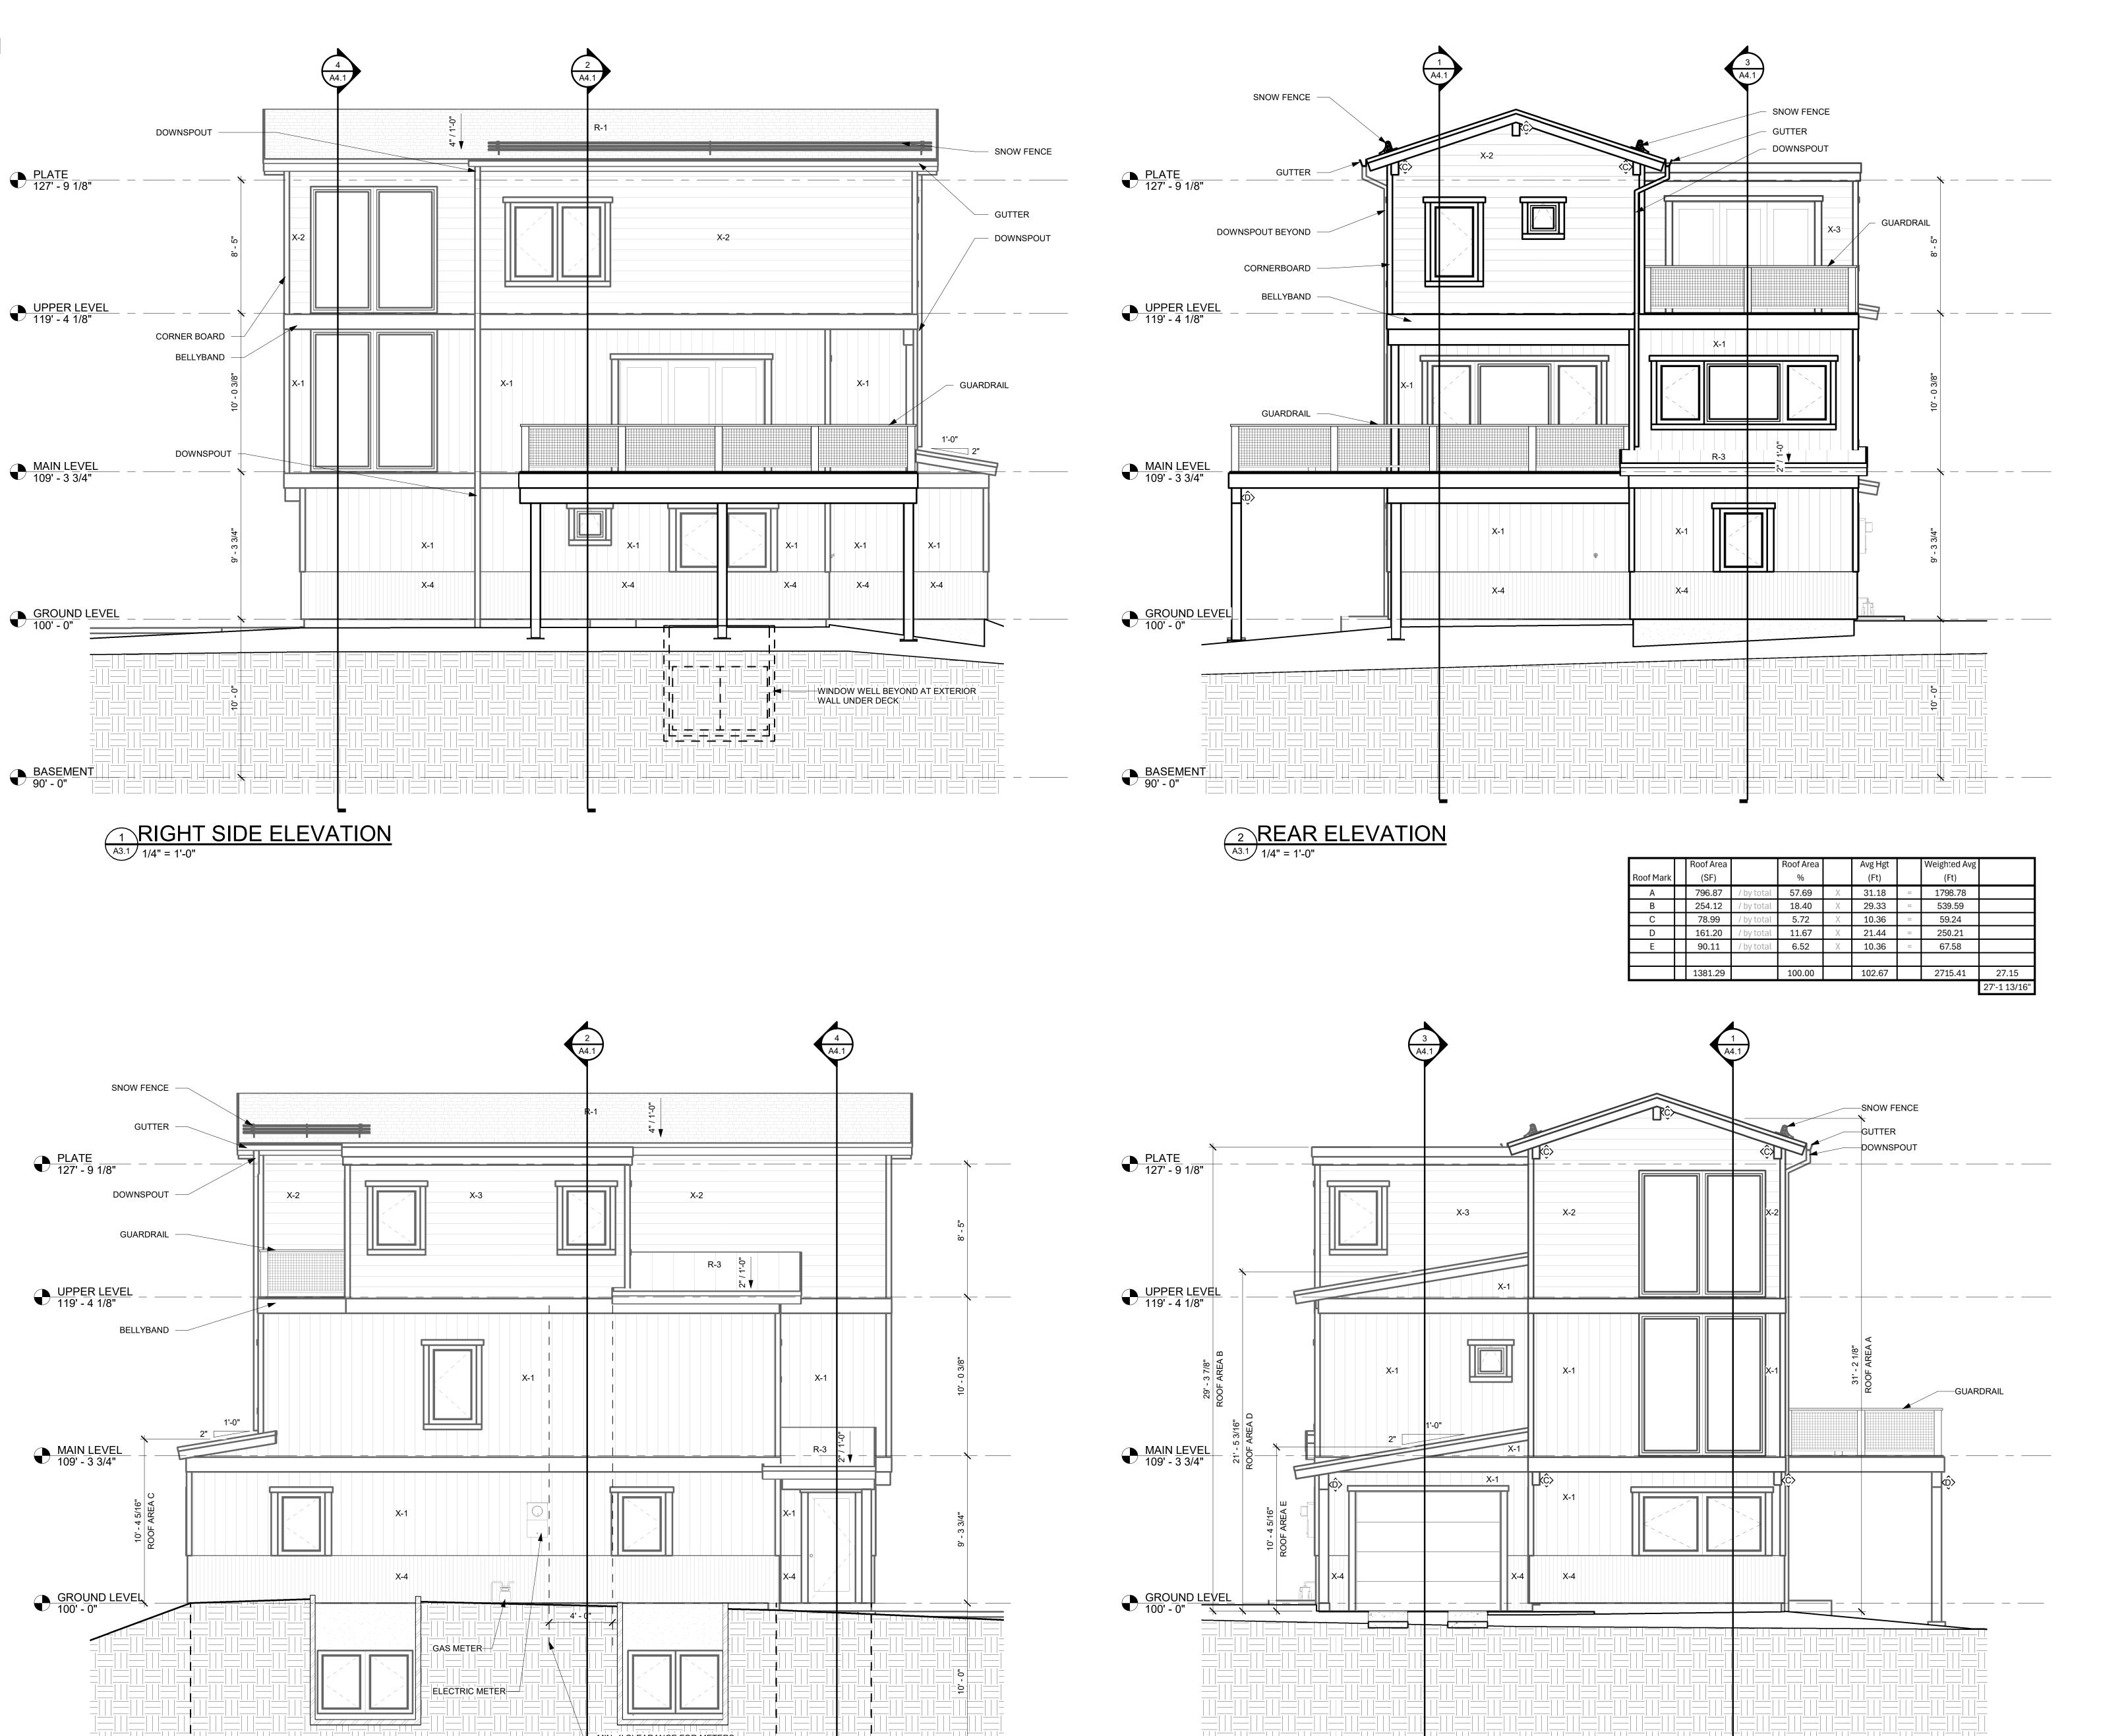

FRONT ELEVATION

A3.1 1/4" = 1'-0"

90' - 0"_||

3 LEFT SIDE ELEVATION
A3.1 1/4" = 1'-0"

NOTES:

EXTERIOR MATERIAL LEGEND:

- X-1 DIAMOND KOTE LP SMARTSIDE VERTICAL SIDING COLOR PELICAN
- X-2 DIAMOND KOTE LP SMARTSIDE LAP SIDING COLOR - PELICAN
- X-3 DIAMOND KOTE LP SMARTSIDE LAP SIDING COLOR - CASCADE X-4 VERTICAL CORRUGATED METAL SIDING
- COLOR BURNISHED SLATE
- R-1 ASPHALT SHINGLE ROOF
 R-2 LOW SLOPE EPDM
 R-3 STANDING SEAM METAL ROOF

EXTERIOR ELEVATION GENERAL NOTES:

- 1. EXTERIOR FINISHES INDICATED ON ELEVATIONS SEE "EXTERIOR MATERIAL LEGEND" FOR MATERIALS.
- 2. RFERENCE ROOF PLAN FOR LOCATIONS OF ROOF COMPONENETS NOT INDICATED ON EXTERIOR
- ELEVATIONS. 3. REFER TO MEP AND STRUCTURAL DRAWINGS FOR
- ANY ADDITIONAL WORK. 4. ASSUME ALL PAINTED SURFACES WILL BE REPAINTED.
- THIS INCLUDES BUT IS NOT LIMITED TO: DOORS, DOOR FRAMES, WINDOW FRAMES, AND HEADERS, CEILINGS, HANDRAILS, EXPOSED MECHANICAL, CMU ACCENTS, SOFFITS, STRUCTURAL BEAMS, AND ETC.
- 5. PROVIDE ALLOWANCE TO SEAL AND CAULK VARIOUS WALL PENERTRATIONS ANS HOLES AROUND EXTERIOR PERIMETER OF BUIDLING, SIMILAR AREAS SUCH AS HOSE BIBS, PIPES, ETC.
- 6. PROVIDE ALLOWANCE TO REVIEW ALL EXPOSED ELECTRICAL CONDUIT TO DETERMINE FEASIBILITY TO REMOVE OR RELOCATE. INCLUDE IN ALLOWANCE LABOR AND MATERIALS TO REMOVE OR RELOCATE.
- 7. SEE CIVIL PLANS FOR NOTE TO RESEAL ALL HORIZONTAL CONCRETE AND ASPHALT JOINTS AT
- 8. WHEN A PORTION OF A WALL IS PAINTED ASSUME THE ENTIRE WALL IS PAINTED TO INSIDE OR OUTSIDE
- 9. DO NOT SCALE DRAWINGS. 10. ALL ANGLES SHOWN ON THE FLOOR PLANS ARE 90
- DEGREES UNLESS NOTED OTHERWISE.

BEAMWORK LEGEND:

A 4X10

B 6X10

C 6X12 D 8X12

E 10X14

F 12X16

Associates The Architectural Balance 0056 Edwards Village Blvd.

Suite 210 Edwards, CO 81632 (970) 766-1470 fax: (970) 766-1471 email: tab@vail.net Civil Engineer

Structural Engineer

Mechanical Engineer Electrical Engineer

Phas: orado Belden Plac Minturn, (

DRB-2/14/2025 Sheet Title: **Exterior Elevations**


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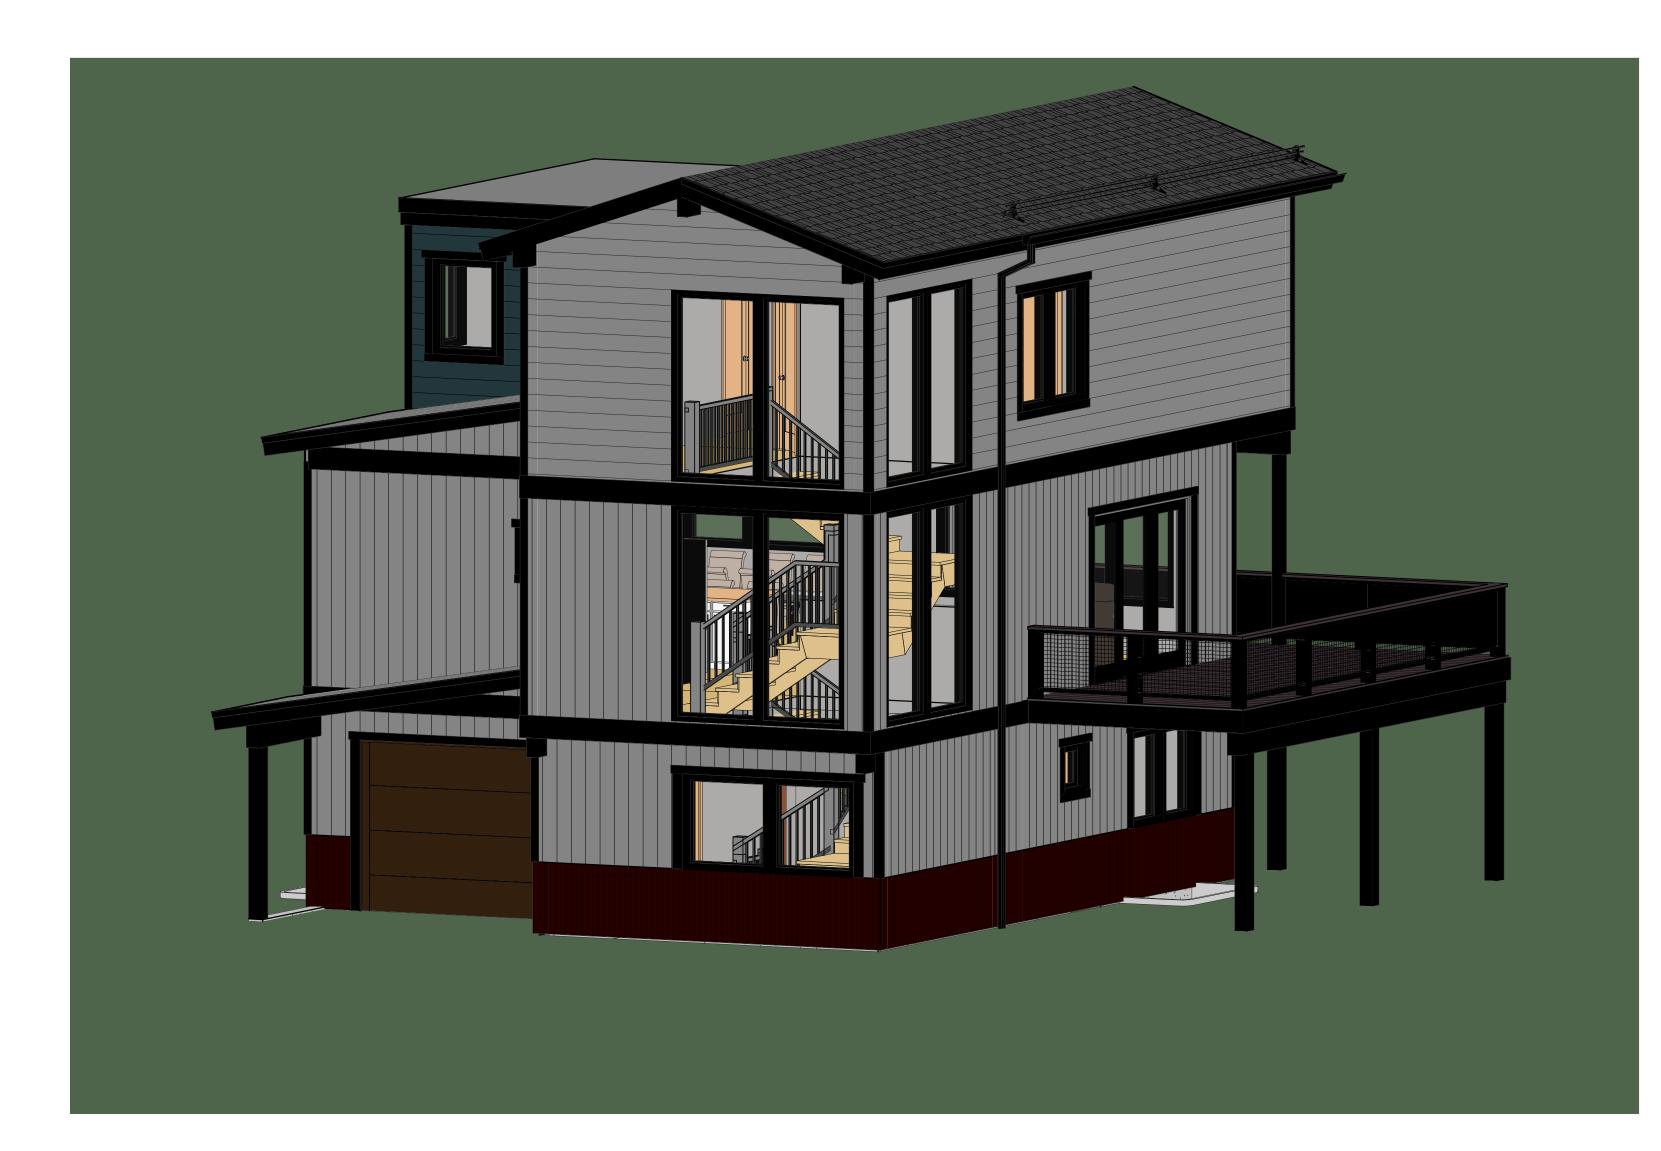





3D FRONT - GARAGE




3 3D BACK - MASTER

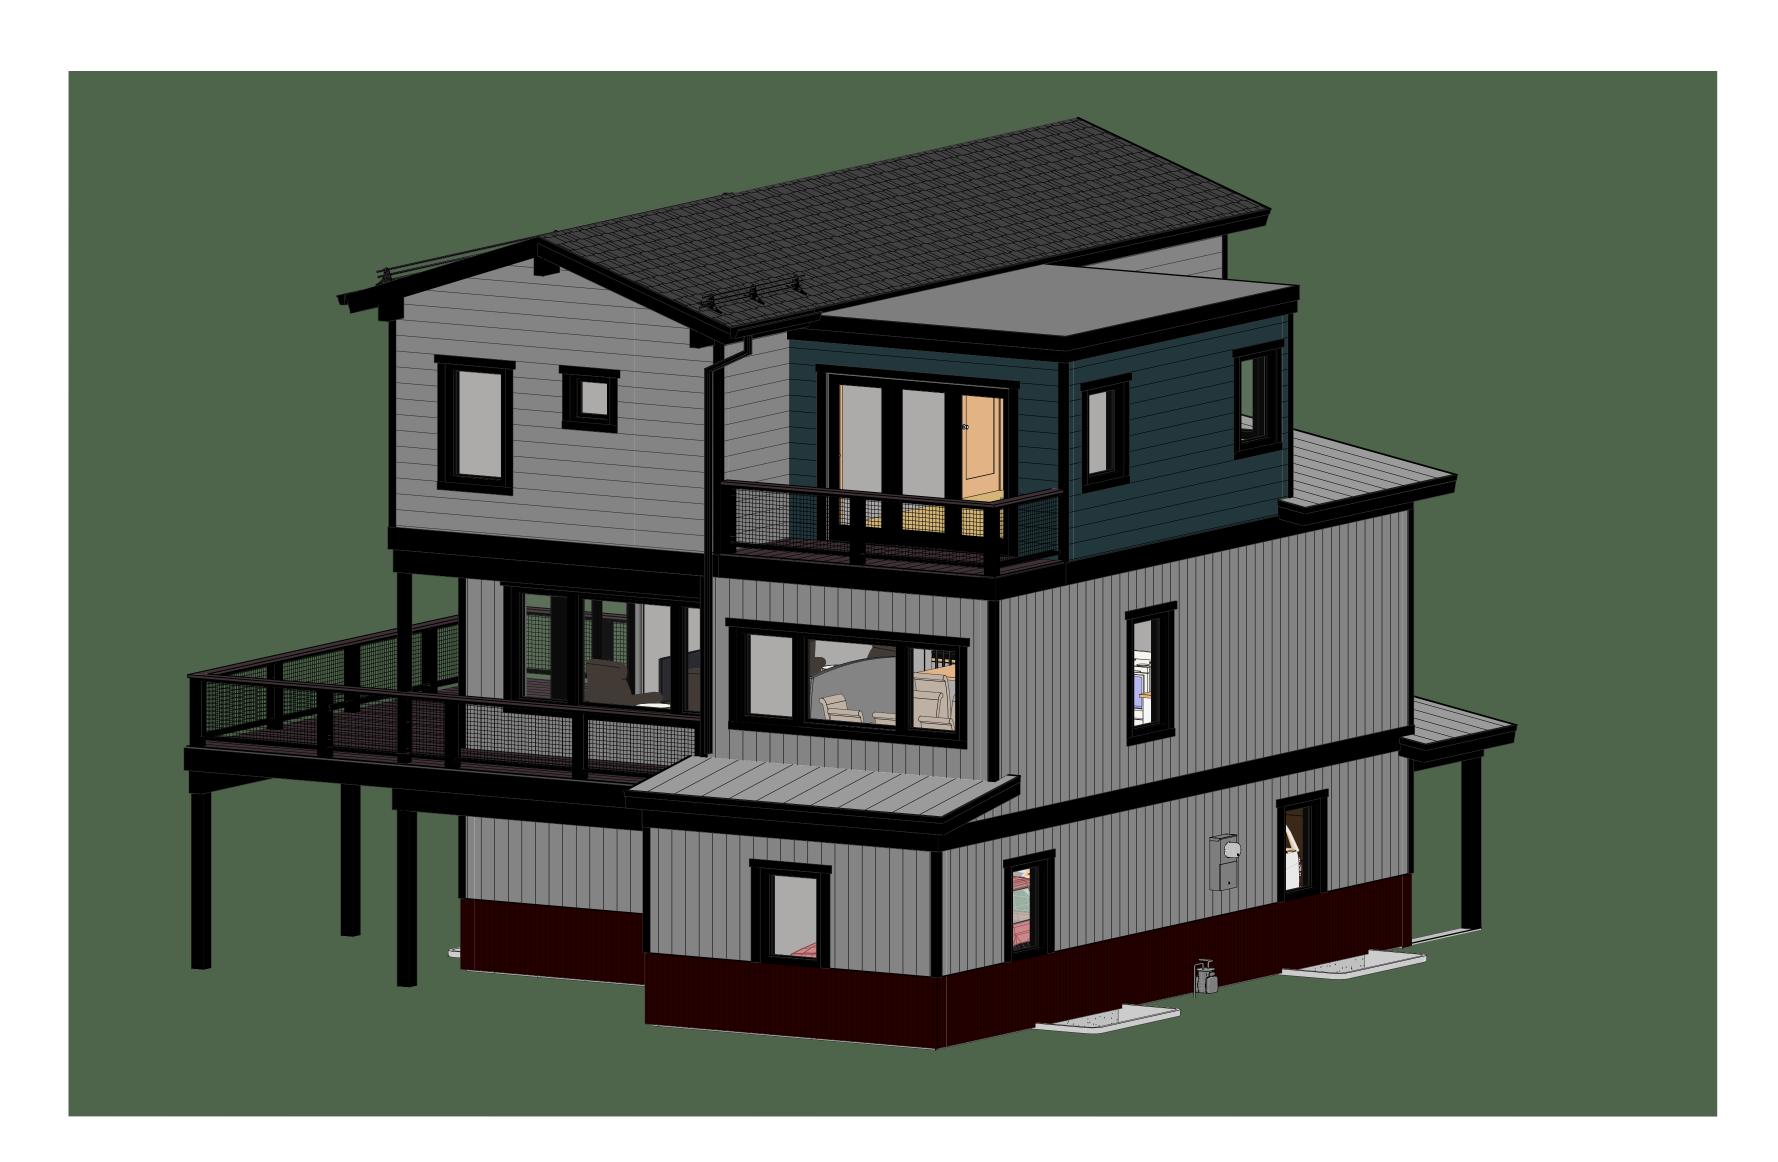

2 3D FRONT- DECK
A3.2

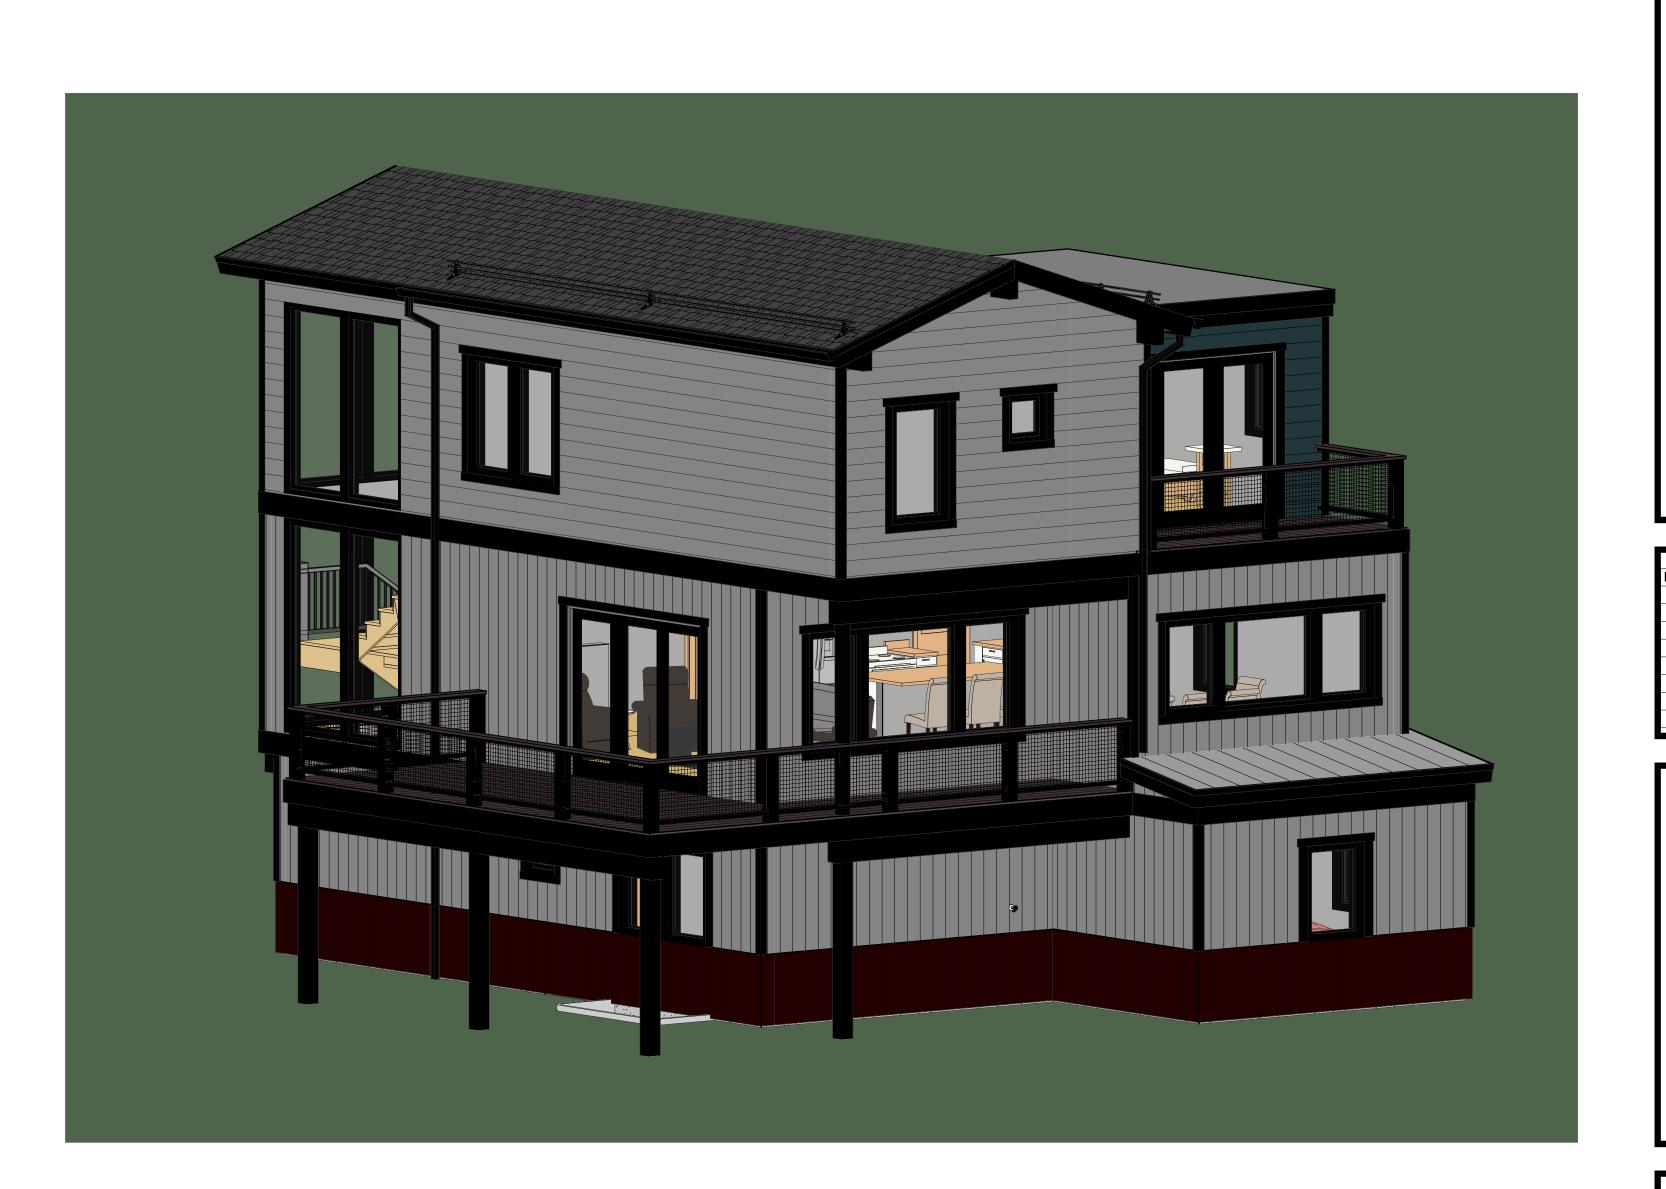

4 3D BACK - DECK
A3.2

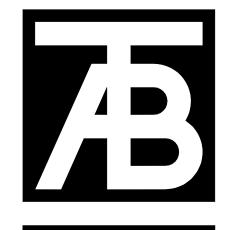

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> Structural Engineer Mechanical Engineer

Electrical Engineer

Belden Plac Minturn, (

Issue Dates: CP-08/14/2024 DRB-2/14/2025 **Exterior** Color Elevations & 3D

Project No: 2215



X-1 - VERTICAL SIDING COLOR 1



X-2 - LAP SIDING COLOR 1



X-3 - LAP SIDING COLOR 2



R-1 ROOFING SIMILAR TO GAF DESIGNER SHINGLES WOODLAN 'CASTLEWOOD GRAY'



X-4 VERTICAL CORRUGATED PANELS





SIMILAR TO GALLEGOS - #366

COURTLAND LOW RISE

#366 Courtland Low Rise TV X-6 STONE VENEER



EXTERIOR MATERIAL LEGEND:

WINDOWS: SIMILAR TO SIERRA PACIFIC "BLACK" WOOD CLAD WINDOWS



R-3 ROOFING SIMILAR TO WESTERN STATES 2" STANDING SEAM - 12" WIDTH COLOR: GALVANIZED TO MATCH **GALVALUME PANELS**

GENERATION LIGHTING

8637401-12: Medium One Light Outdoor Wall Lantern Dimensions:



Wire: 6 1/2" (color/Black/White) Mounting Proc.: Cap Nuts Connection: Mounted To Box

1 - Medium A19 75w Max. 120v - Not included Dark sky friendly. Designed to emit no light above the 90° horizontal plane. Photometry unavailable. Easily converts to LED with optional replacement lamps Meets Title 24 energy efficiency standards Title 24 compliant if used with Joint Appendix (JA8) approved light bulbs listed in the California Energy Commission Appliance database.

Material List: Collection: Barn Light 1 Body - Aluminum - Black Featured in the decorative Barn Light collection Safety Listing: 1 A19 Medium 75 watt light bulb Safety Listed for Wet Locations Dark sky friendly. Designed to emit no light above the 90° horizontal plane. Photometry unavailable.

Instruction Sheets: Trilingual (English, Spanish, and French) (990W8_37401-BRL) Easily converts to LED with optional replacement lamps

Meets Title 24 energy efficiency standards UPC #:785652069352

Finish: Black (12)

Backplate / 0	Canopy Details:											
Туре	Height / L	ength.	Width	Depth	Diame	ter	Outle	t Box Up		Outlet Box	Down	
Back Plate	İ			1 1/4			4 1/8			6 1/2		
Shipping Info Package Type	ormation: Product#	Quantity	UPC		Length	Width	Height	Cube	Weight	Frt. Class		
Individual											UPS Sh	
maividuai	8537401EN3-12	1	785652	069352	16.75	14.58	13.25	1.873	4.1	250	Yes	
NJ Pallet	8537401EN3-12	1 45	785652	069352	16.75 48	14.58 40	13.25 77	1.873 85.556	4.1 184	250		


SW 7069 Iron Ore Interior / Exterior

PAINTED ITEMS: SHERWIN WILLIAMS 7069 IRON ORE TRIM, WOOD BEAMS, GUTTERS AND OTHER METALS

INCLUDING: CORNER TRIM AND WINDOW/DOOR TRIM



GARAGE DOORS: SIMILAR TO RAYNOR - ASPEN SERIES RECESSED RANCH GROOVED PANELS COLOR: WALNUT

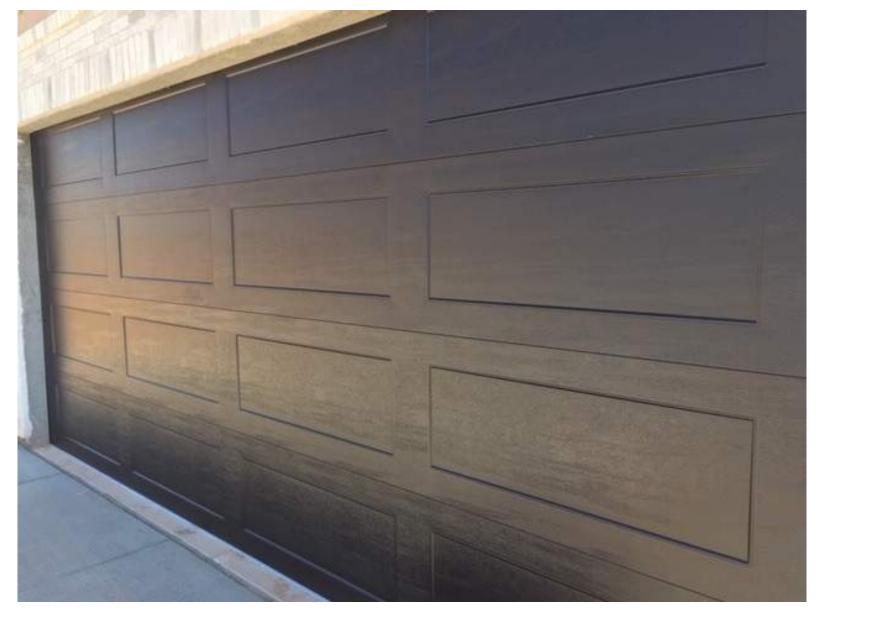

Type	Height / Le	ngth	Width	Depth	Diame	er	Outle	t Box Up		Outlet Box	Down
Back Plate)			1 1/4	5	5		4 1/8		6 1/2	
Shipping Int	ormation:										
		Quantity	LIPC		Length	Width	Height	Cube	Weight	Frt Class	IIPS Shin
Package Type	Product #	Quantity	UPC 785652	069352	Length	Width 14 58	Height	Cube 1.873	Weight	Frt. Class	UPS Ship
Package Type Individual		1	UPC 785652	069352	16.75	14.58	13.25	1.873	4.1	Frt. Class 250	Yes
Shipping Inf Package Type Individual NJ Pallet	Product #	Quantity 1 45		069352							

Generation Lighting reserves the right to revise the design of components of any product due to parts availability or change in safety listing standards without assuming any obligation or liability to modify any products previously manufactured and without notice. This literature depicts a product design that is the sole and exclusive property of Generation Lighting. In compliance with U.S copyright and patent requirements, notification is hereby presented in this form that this literature, or the product it depicts, is not to be copied, altered or used in any manner without the express written consent of, or contrary to the best interests of Generation Lighting, a Visual Comfort & Co brand.

Associates The Architectural Balanc 0056 Edwards Village Blvd. Suite 210 Edwards, CO 81632 (970) 766-1470 fax: (970) 766-1471 email: tab@vail.net www.tabassociates.com

Civil Engineer Structural Engineer

Mechanical Engineer Electrical Engineer


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DRB-2/14/2025 Sheet Title: **Materials**

Issue Dates:

CP-08/14/2024

Project No: 2215



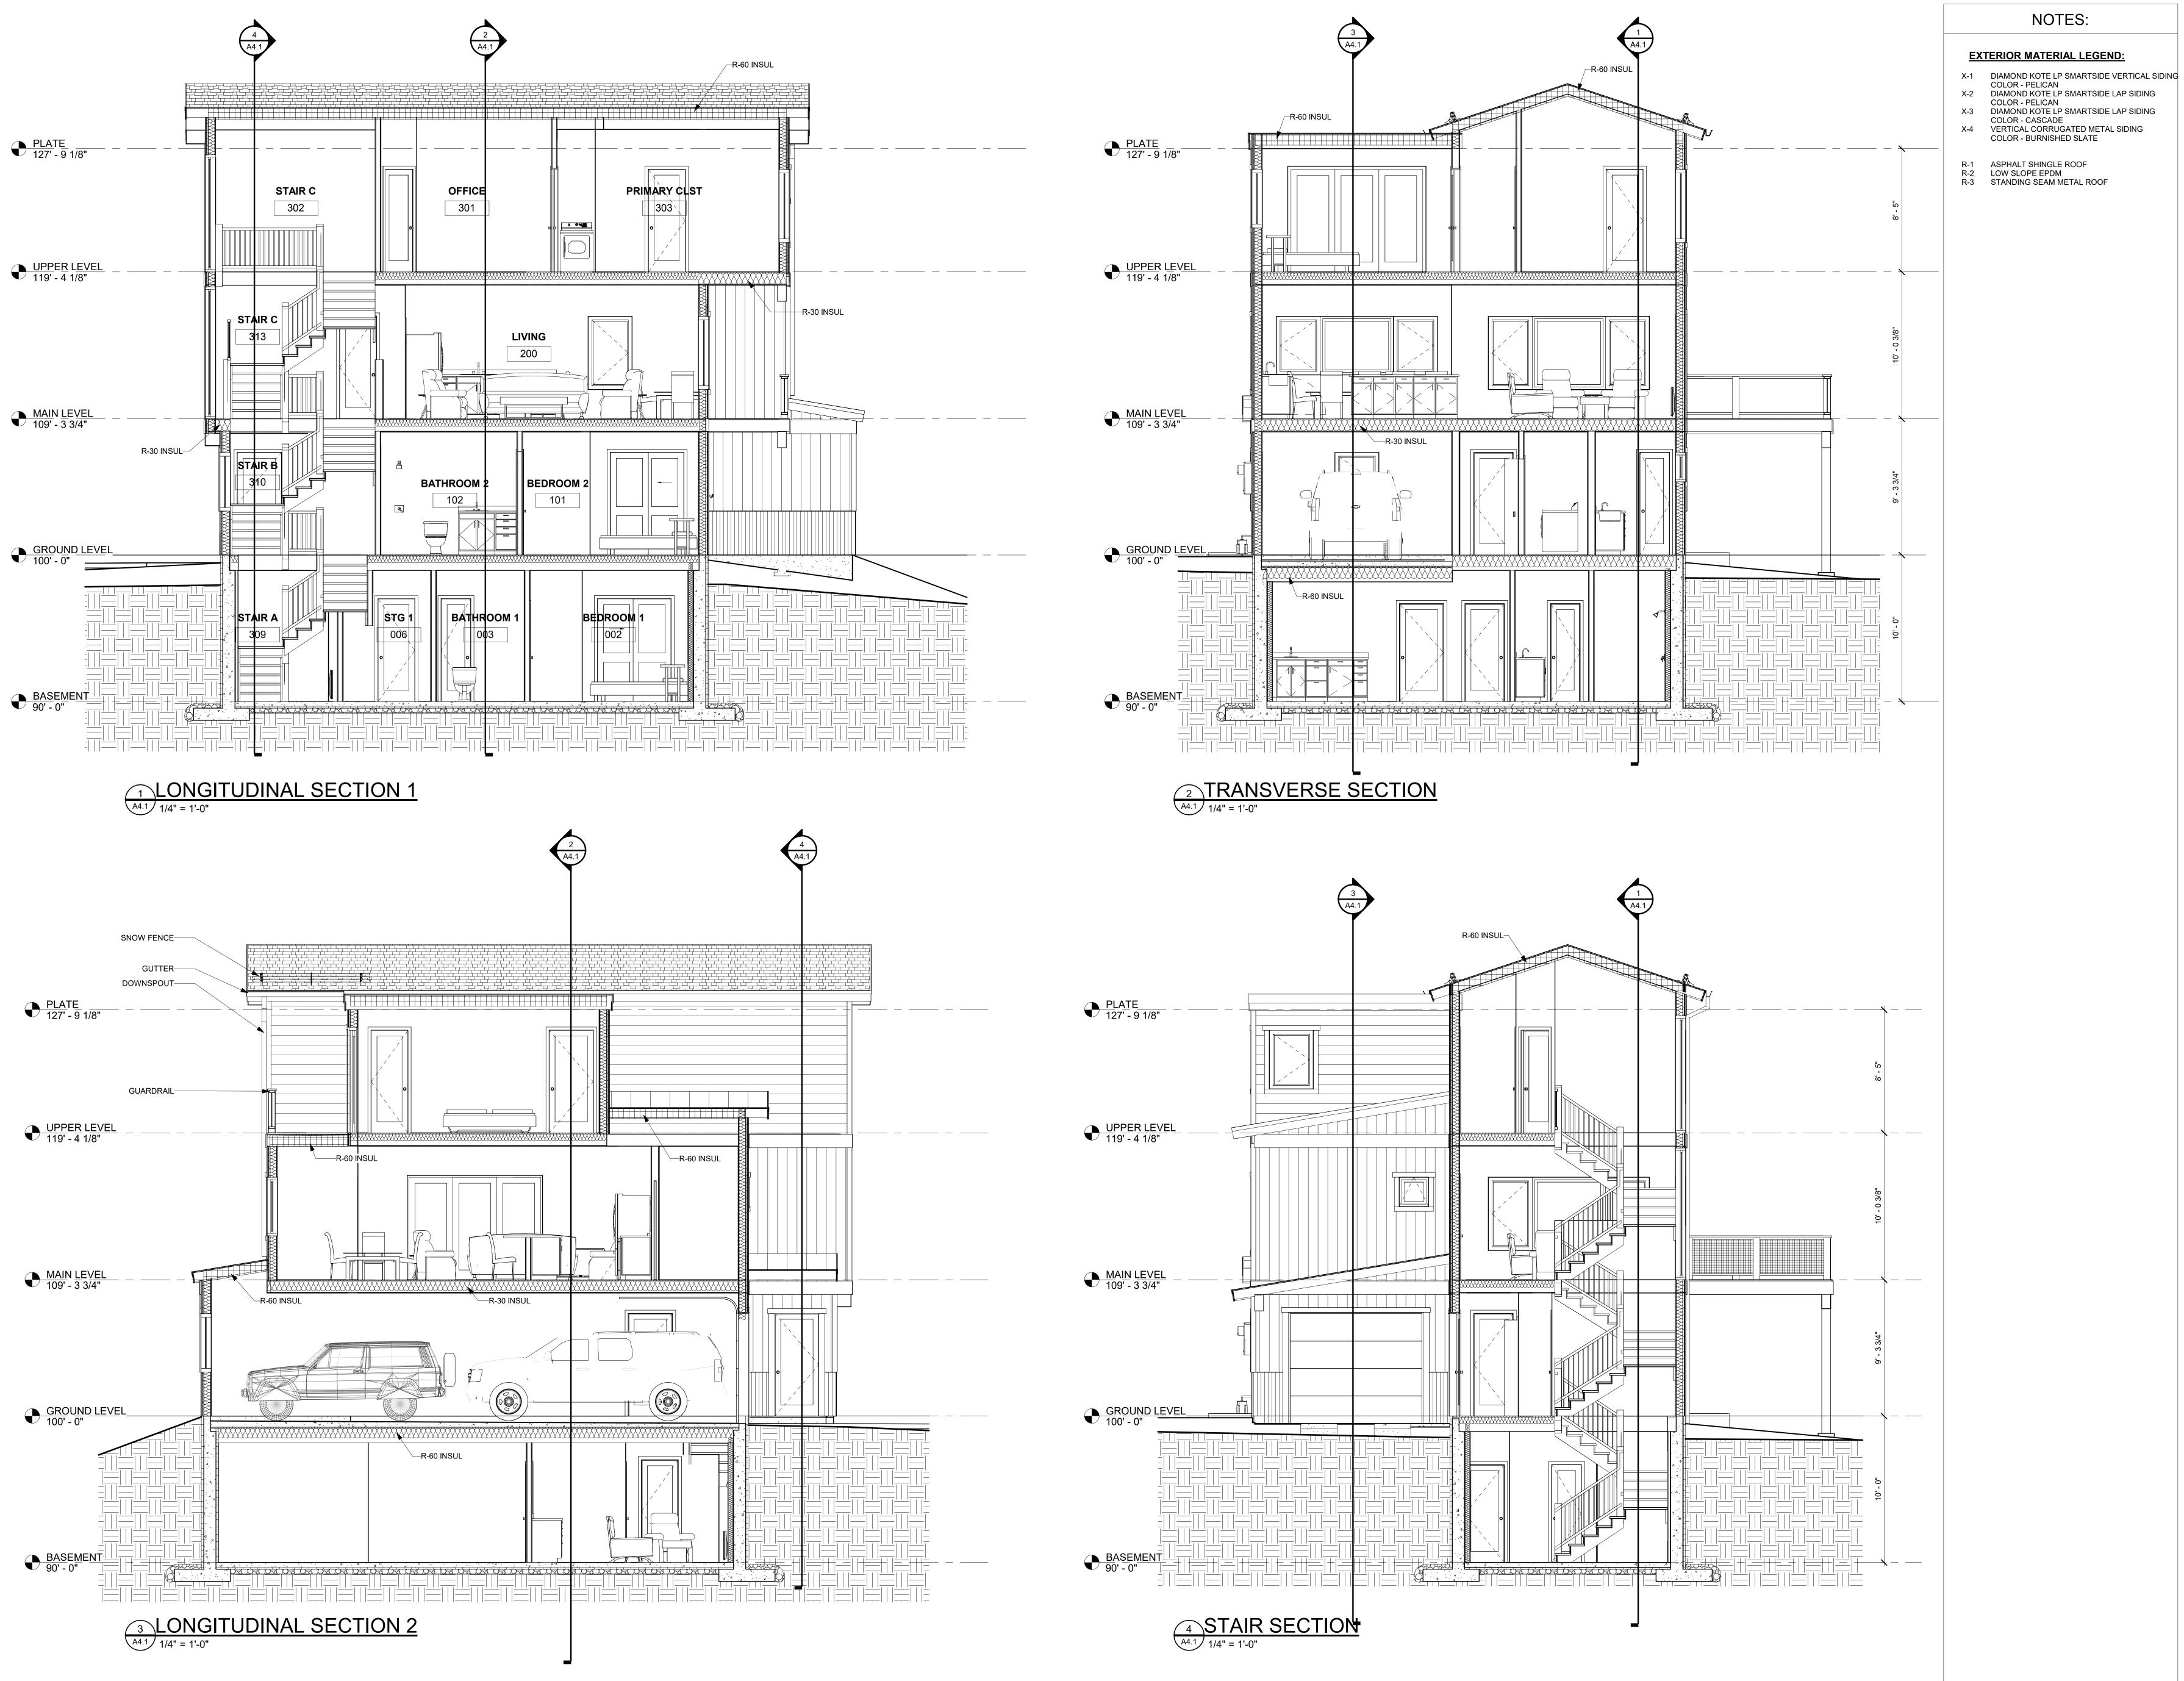

Associates

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> Civil Engineer Structural Engineer


Mechanical Engineer Electrical Engineer

Belden Plac Minturn, (

CP-08/14/2024 DRB-2/14/2025

Building Sections

Project No: 2215 A4.1

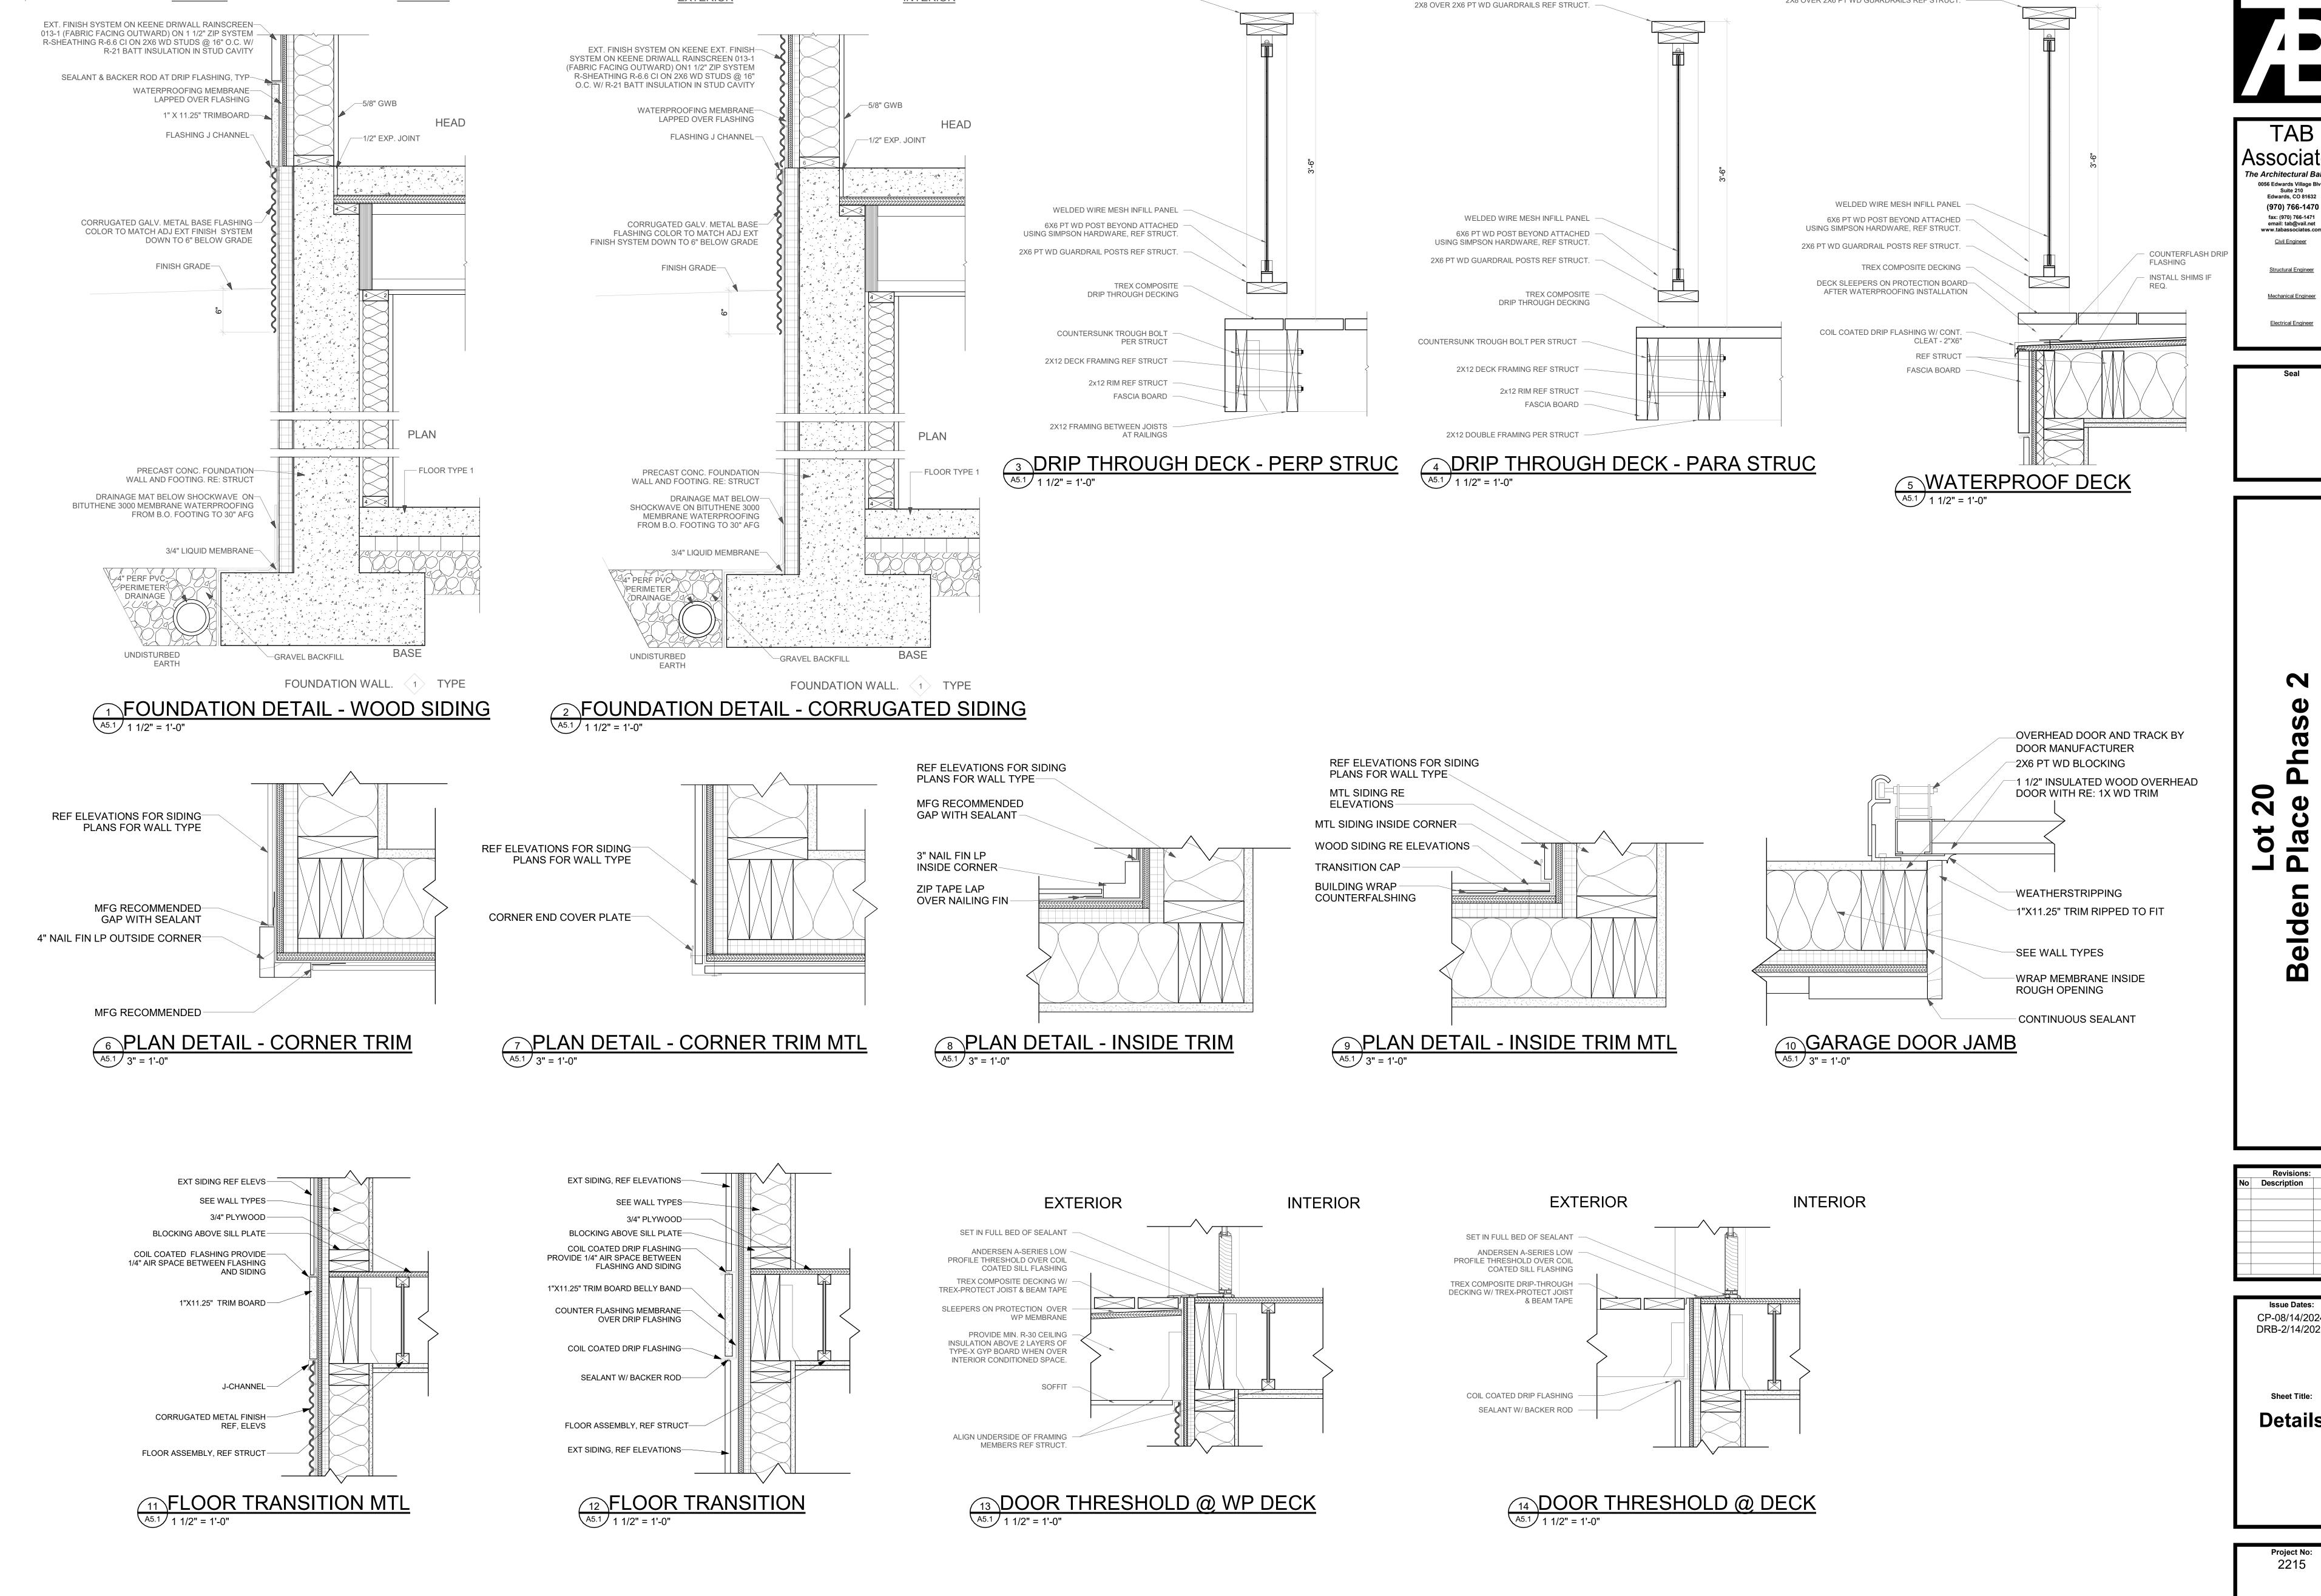

2X8 OVER 2X6 PT WD GUARDRAILS REF STRUCT.

EXTERIOR

<u>INTERIOR</u>

EXTERIOR


2X8 OVER 2X6 PT WD GUARDRAILS REF STRUCT. -

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Electrical Engineer


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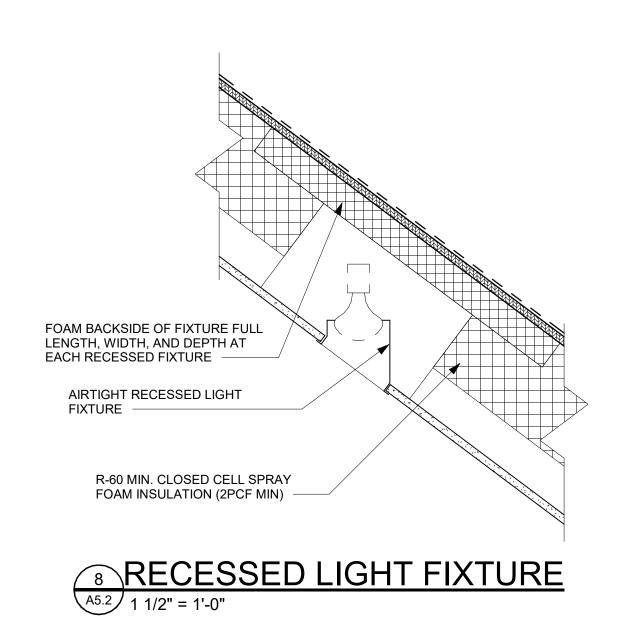
CP-08/14/2024 DRB-2/14/2025 Sheet Title: **Details**





CLOSED CELL SPRAY FOAM INSULATION AT A DEPTH TO PRODUCE R-60 BETWEEN ALL RAFTERS (2 PCF MIN) - 2X BLOCKING PIPE SNOWFENCE TYP 12" OFFSET FROM EDGE OF ROOF UNLESS NOTED OTHERWISE, COORD W/SNOWFENCE SUPPLIER FOR ANY BLOCKING REQ VARIES AT STANDING SEAM METAL ROOFS CONNECT SNOWFENCE TO SEAMS OF THE ROOF PER MFR CLIP SYSTEM 1' - 0" TYP ROOFING ON 5/8" CDX PLYWD ON ROOF JOISTS, REF STRUCT 1"X9.25" TRIM FASCIA EXT. FINISH **REF ELEVS** —ZIP SHEATHING 7 ROOF SNOWFENCE A5.2 1 1/2" = 1'-0"

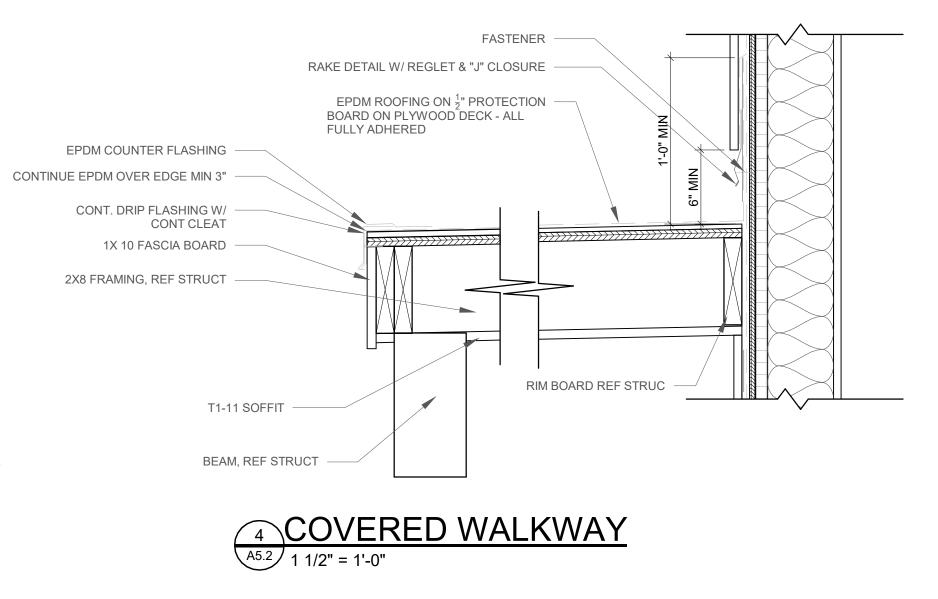
COIL COATED CONT FLASHING WITH DRIP AND CONT CLEAT




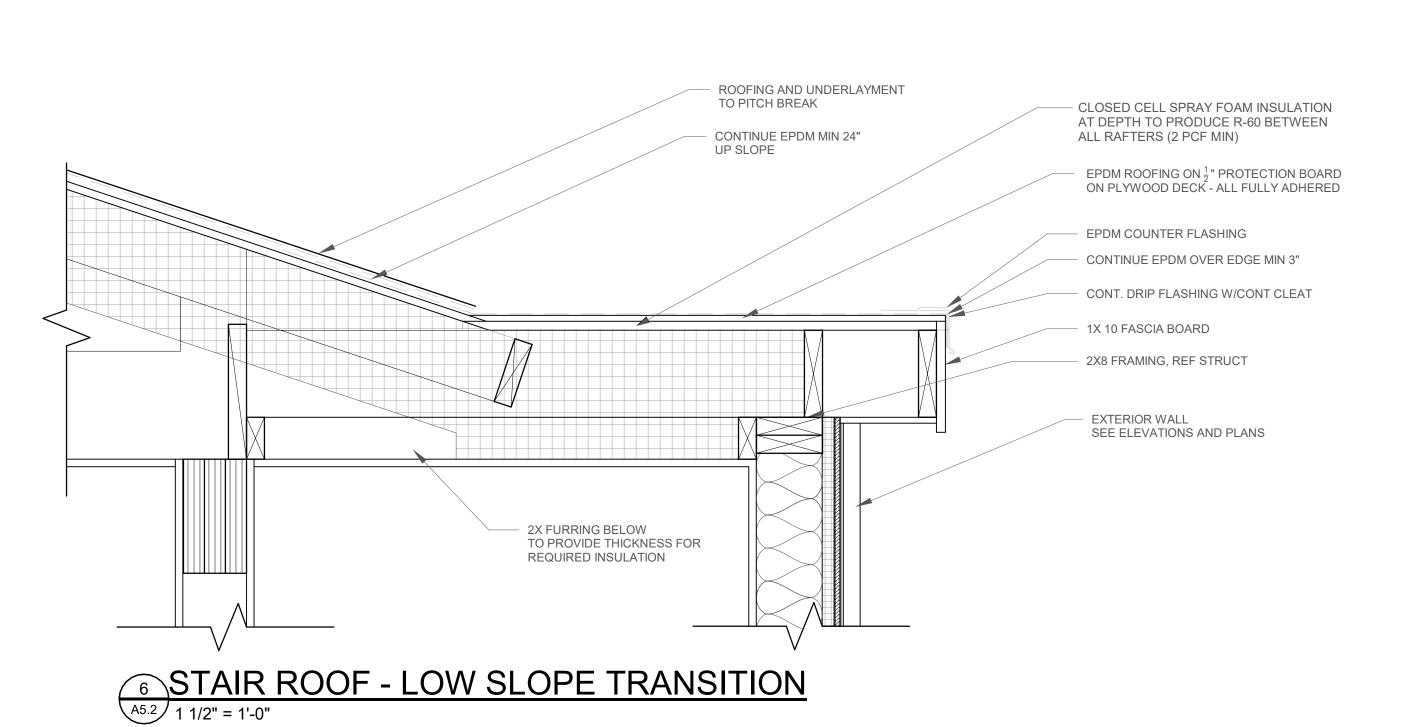

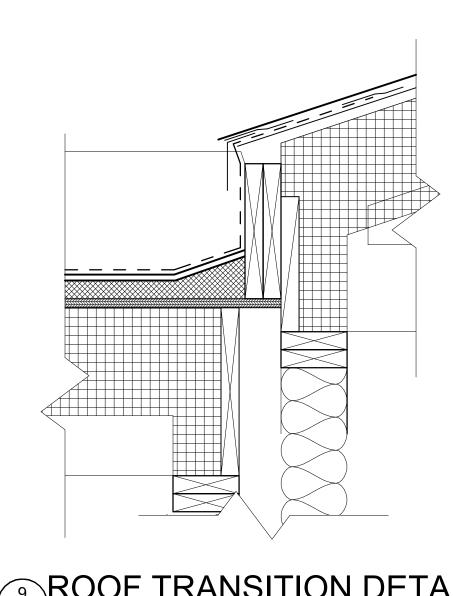

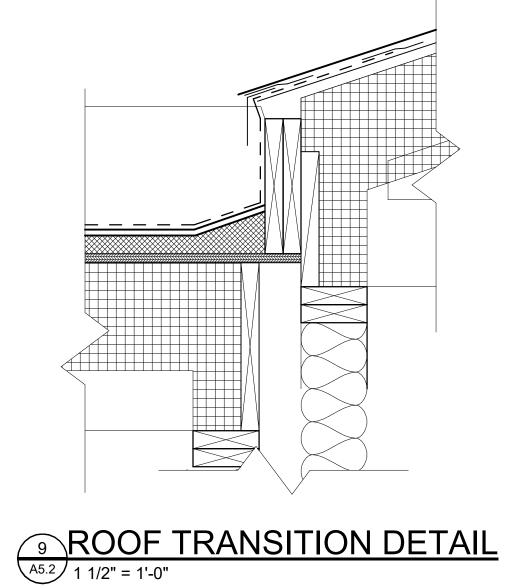

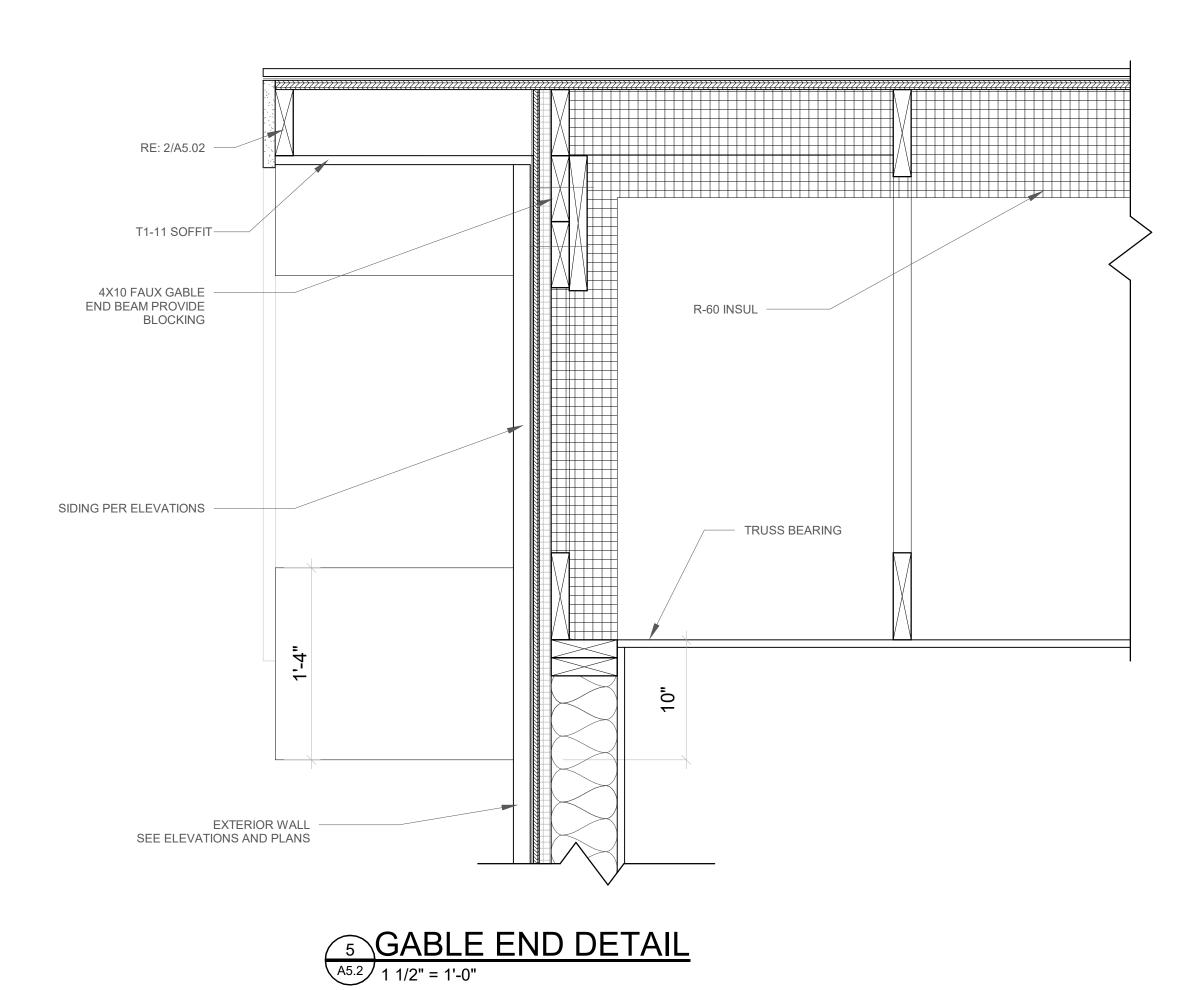

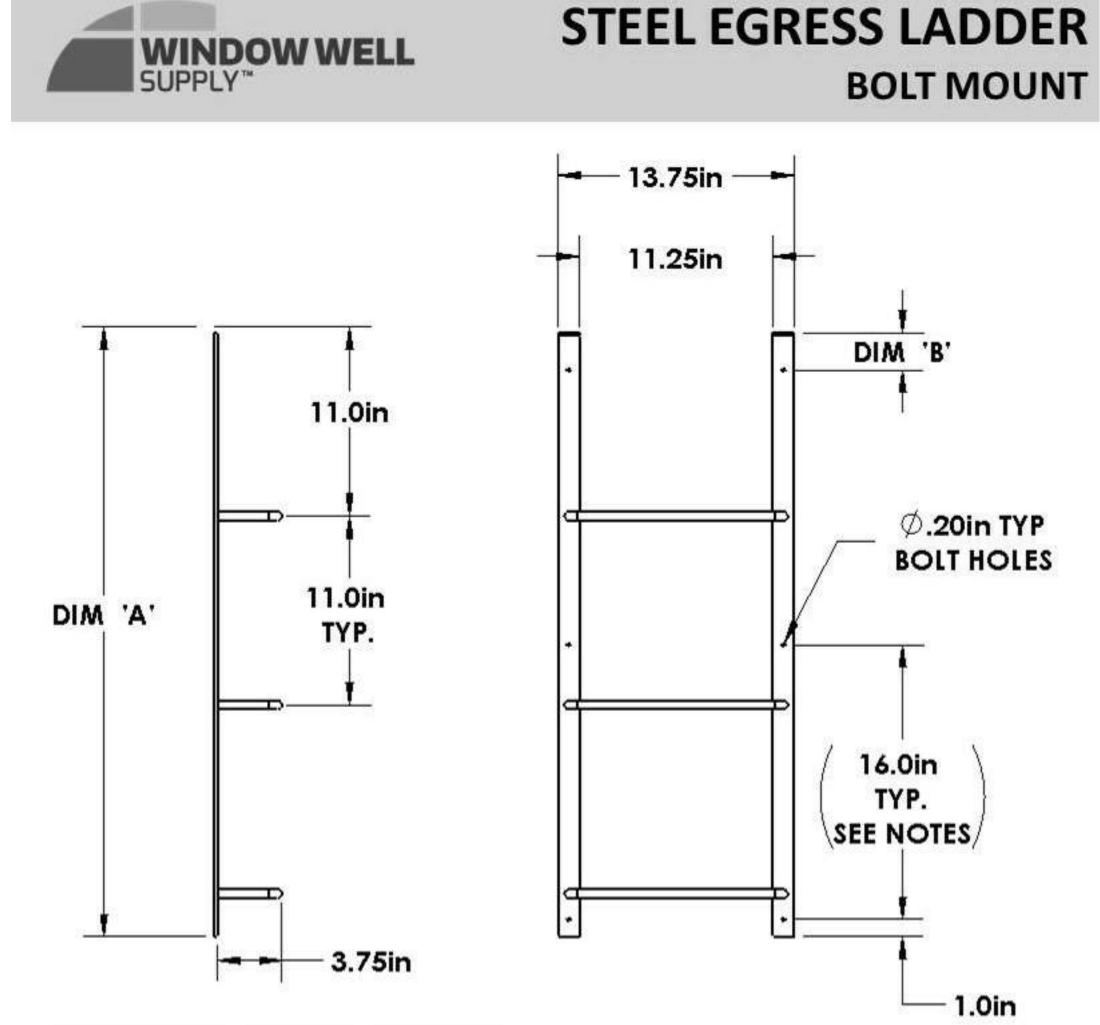

	Ladder Size	Dim 'A' [in]	Dim 'B' [in]	Material: Rung Spacing:	Powder-coated Steel 11.0in		
Ī	3 Rung	35.0	2.0	Hole Spacing:	16.0in, hole spacing		
	4 Rung	46.0	1.0		may vary		
	5 Rung	57.0	8.0	Hole Diameter:	0.20in		
	6 Rung	68.0	3.0	Screw Size*:	#10 (3/16in)		
	7 Rung	79.0	1.0	TYPICAL LADDER LENGTH			

PERMANENTLY FIXED LADDER

REVA

Project No: 2215

Issue Dates:

CP-08/14/2024 DRB-2/14/2025

Sheet Title:

Details

Associates

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Civil Engineer


Structural Engineer


Mechanical Engineer

Electrical Engineer


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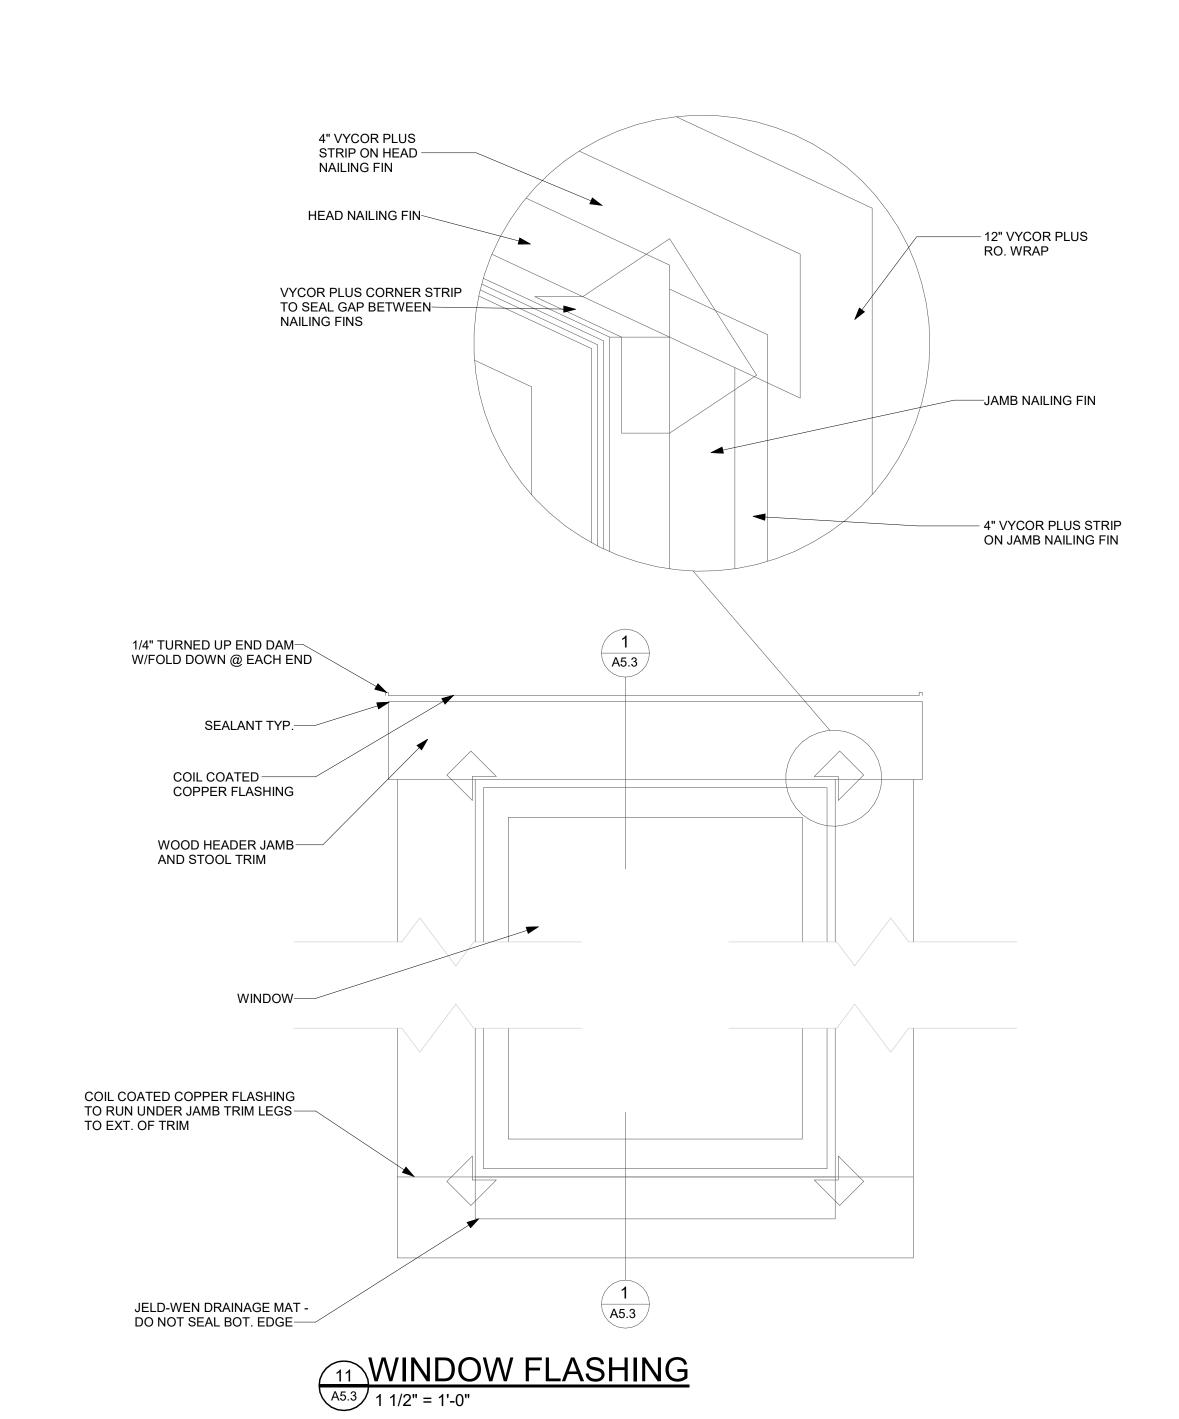
Belde



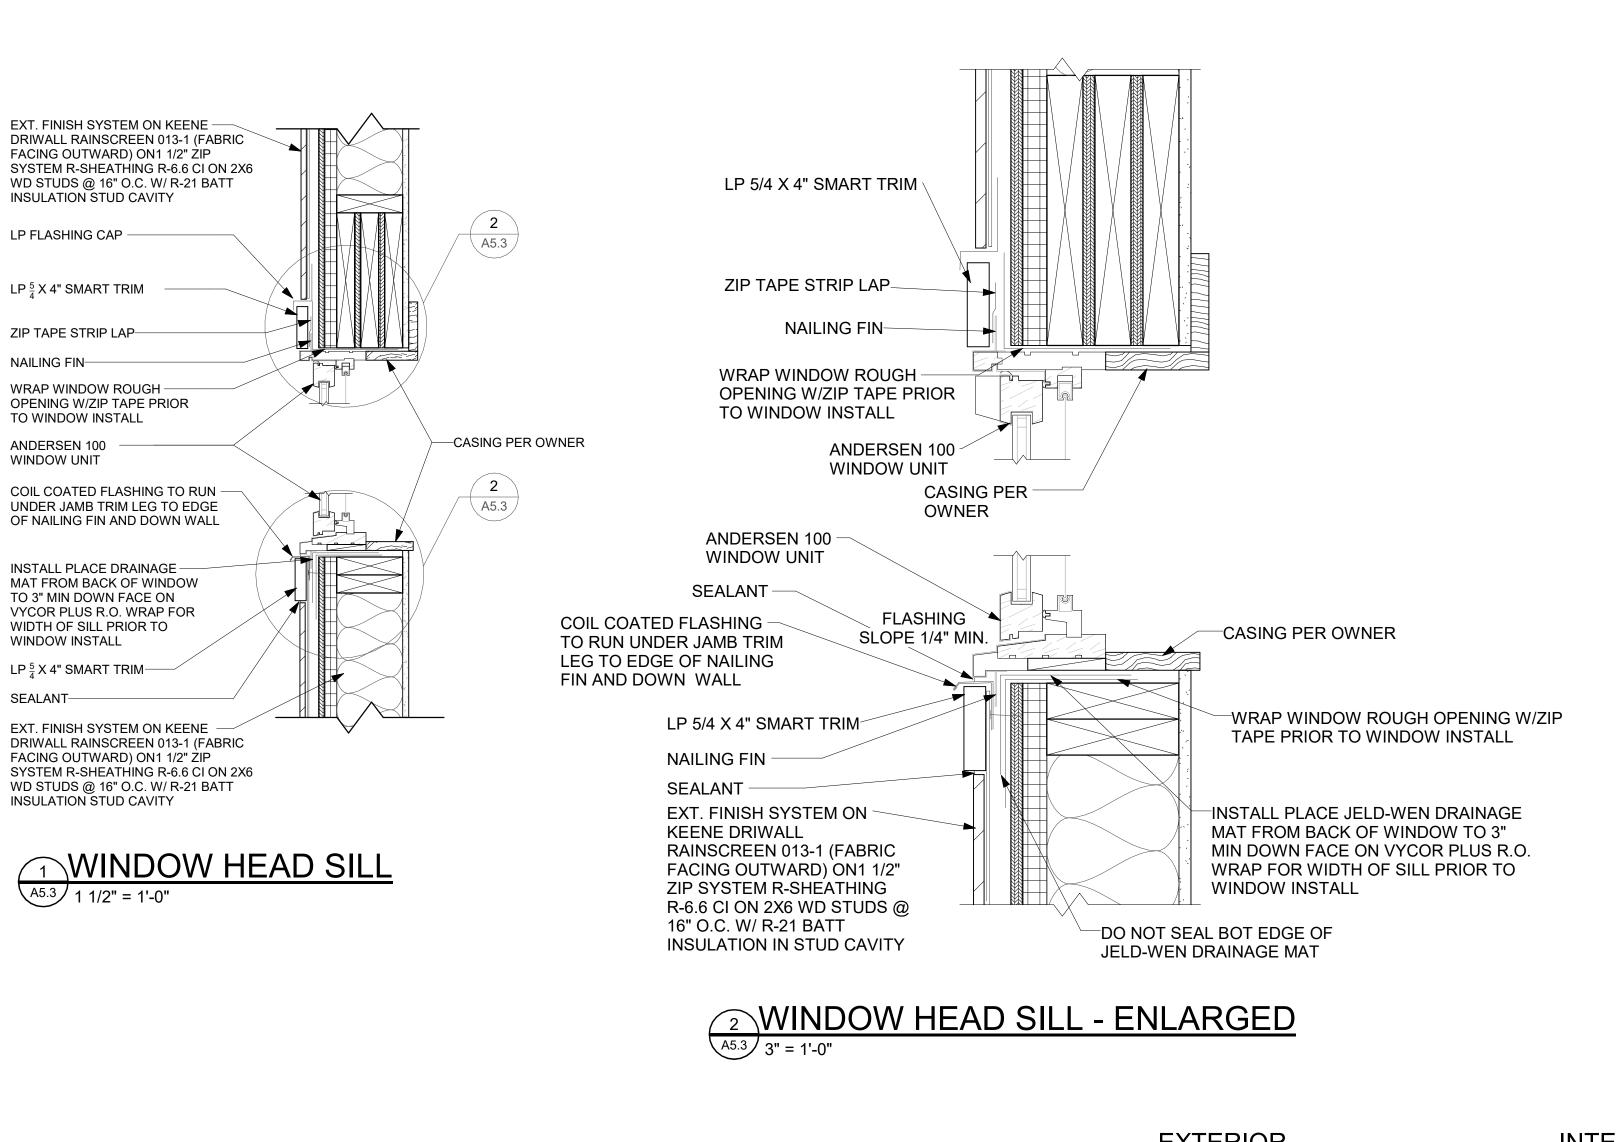

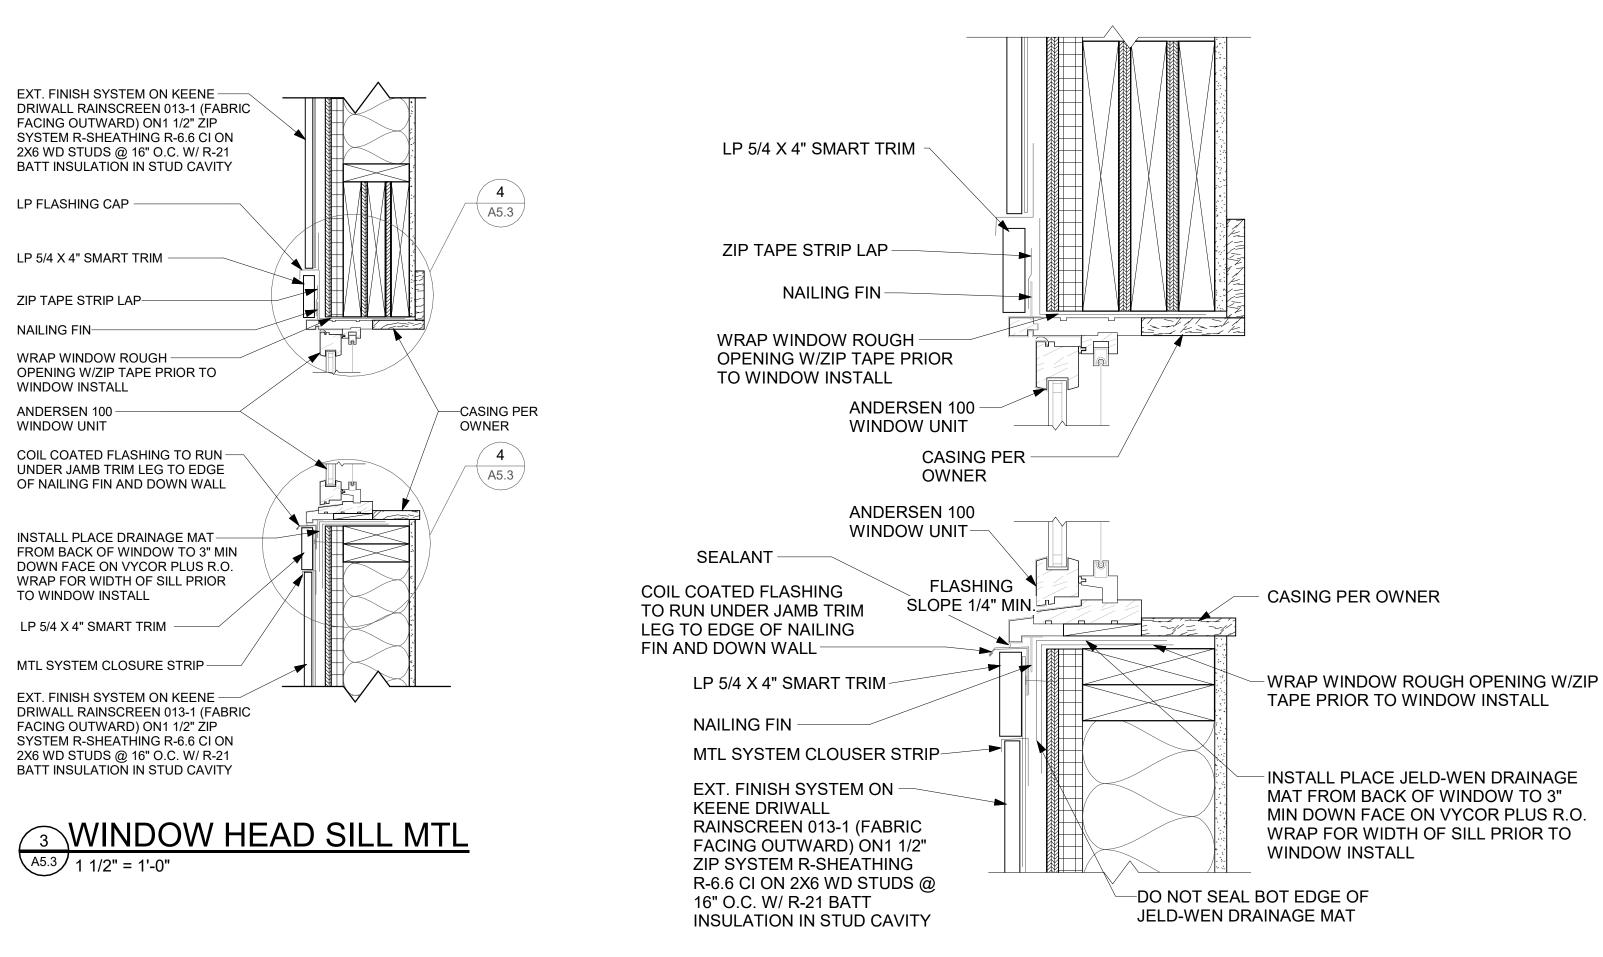WINDOW HEAD SILL MTL - ENLARGED A5.3 3" = 1'-0"



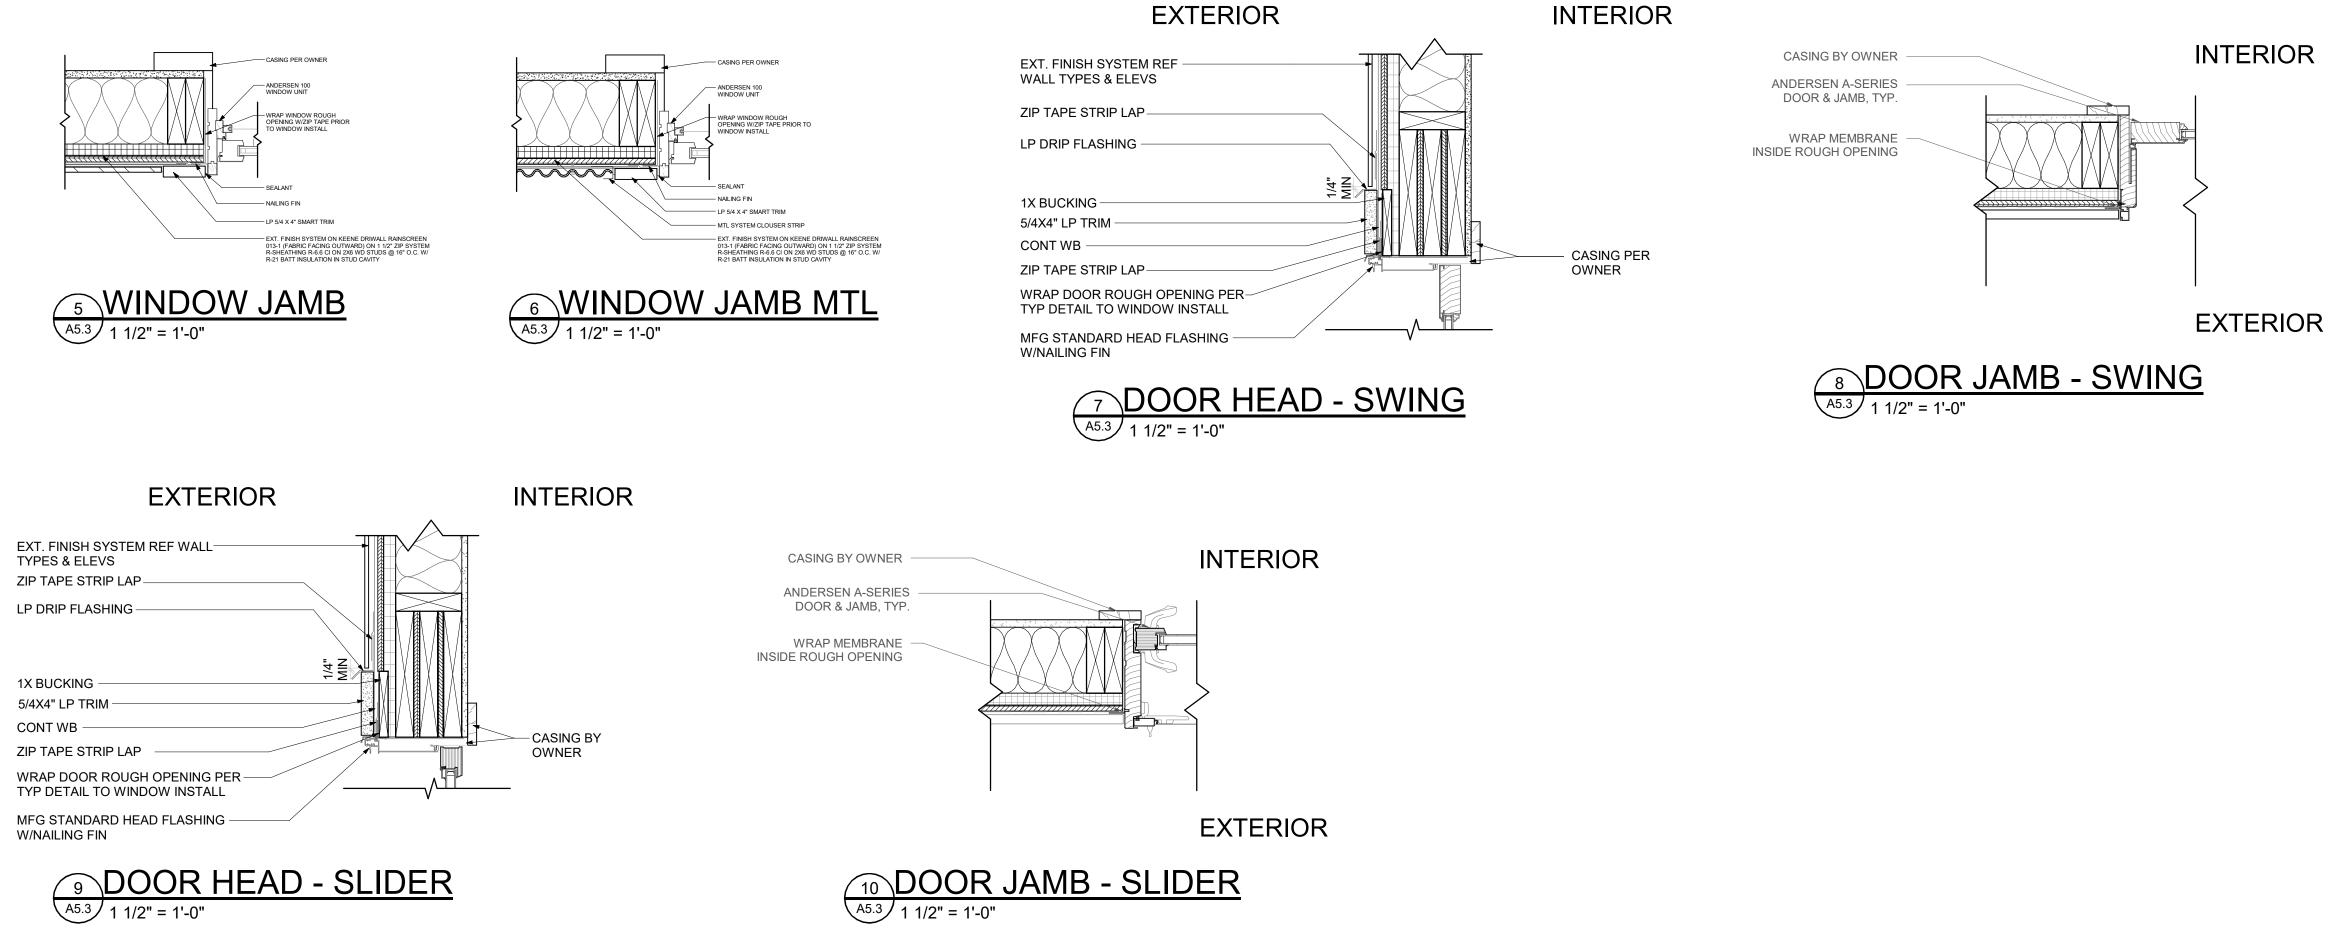

Electrical Engineer

Issue Dates:
CP-08/14/2024
DRB-2/14/2025

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Details

Project No:
2215

Sheet No: