




NORTH 15 FEET OF LOT 10 AND ALL OF LOT 11, TURNER BELL ADDITION, ACCORDING TO THE PLAT THEREOF RECORDED IN VOLUME 40 OF PLATS, PAGE 19, RECORDS OF KING COUNTY, WASHINGTON.

TEBALDI ENGINEERING, LLC DOES NOT WARRANT THAT THE TOPOGRAPHY SHOWN ON THESE DRAWINGS IS REPRESENTATIVE OF WHAT IS CONSTRUCTED. IT IS THE CONTRACTOR'S RESPONSIBILITY TO COORDINATE WITH THE OWNER TO HAVE ALL IMPROVEMENTS FIELD VERIFIED PRIOR TO CONSTRUCTION. DISCREPANCIES SHALL BE BROUGHT TO THE ATTENTION OF THE ENGINEER PRIOR TO WORK.

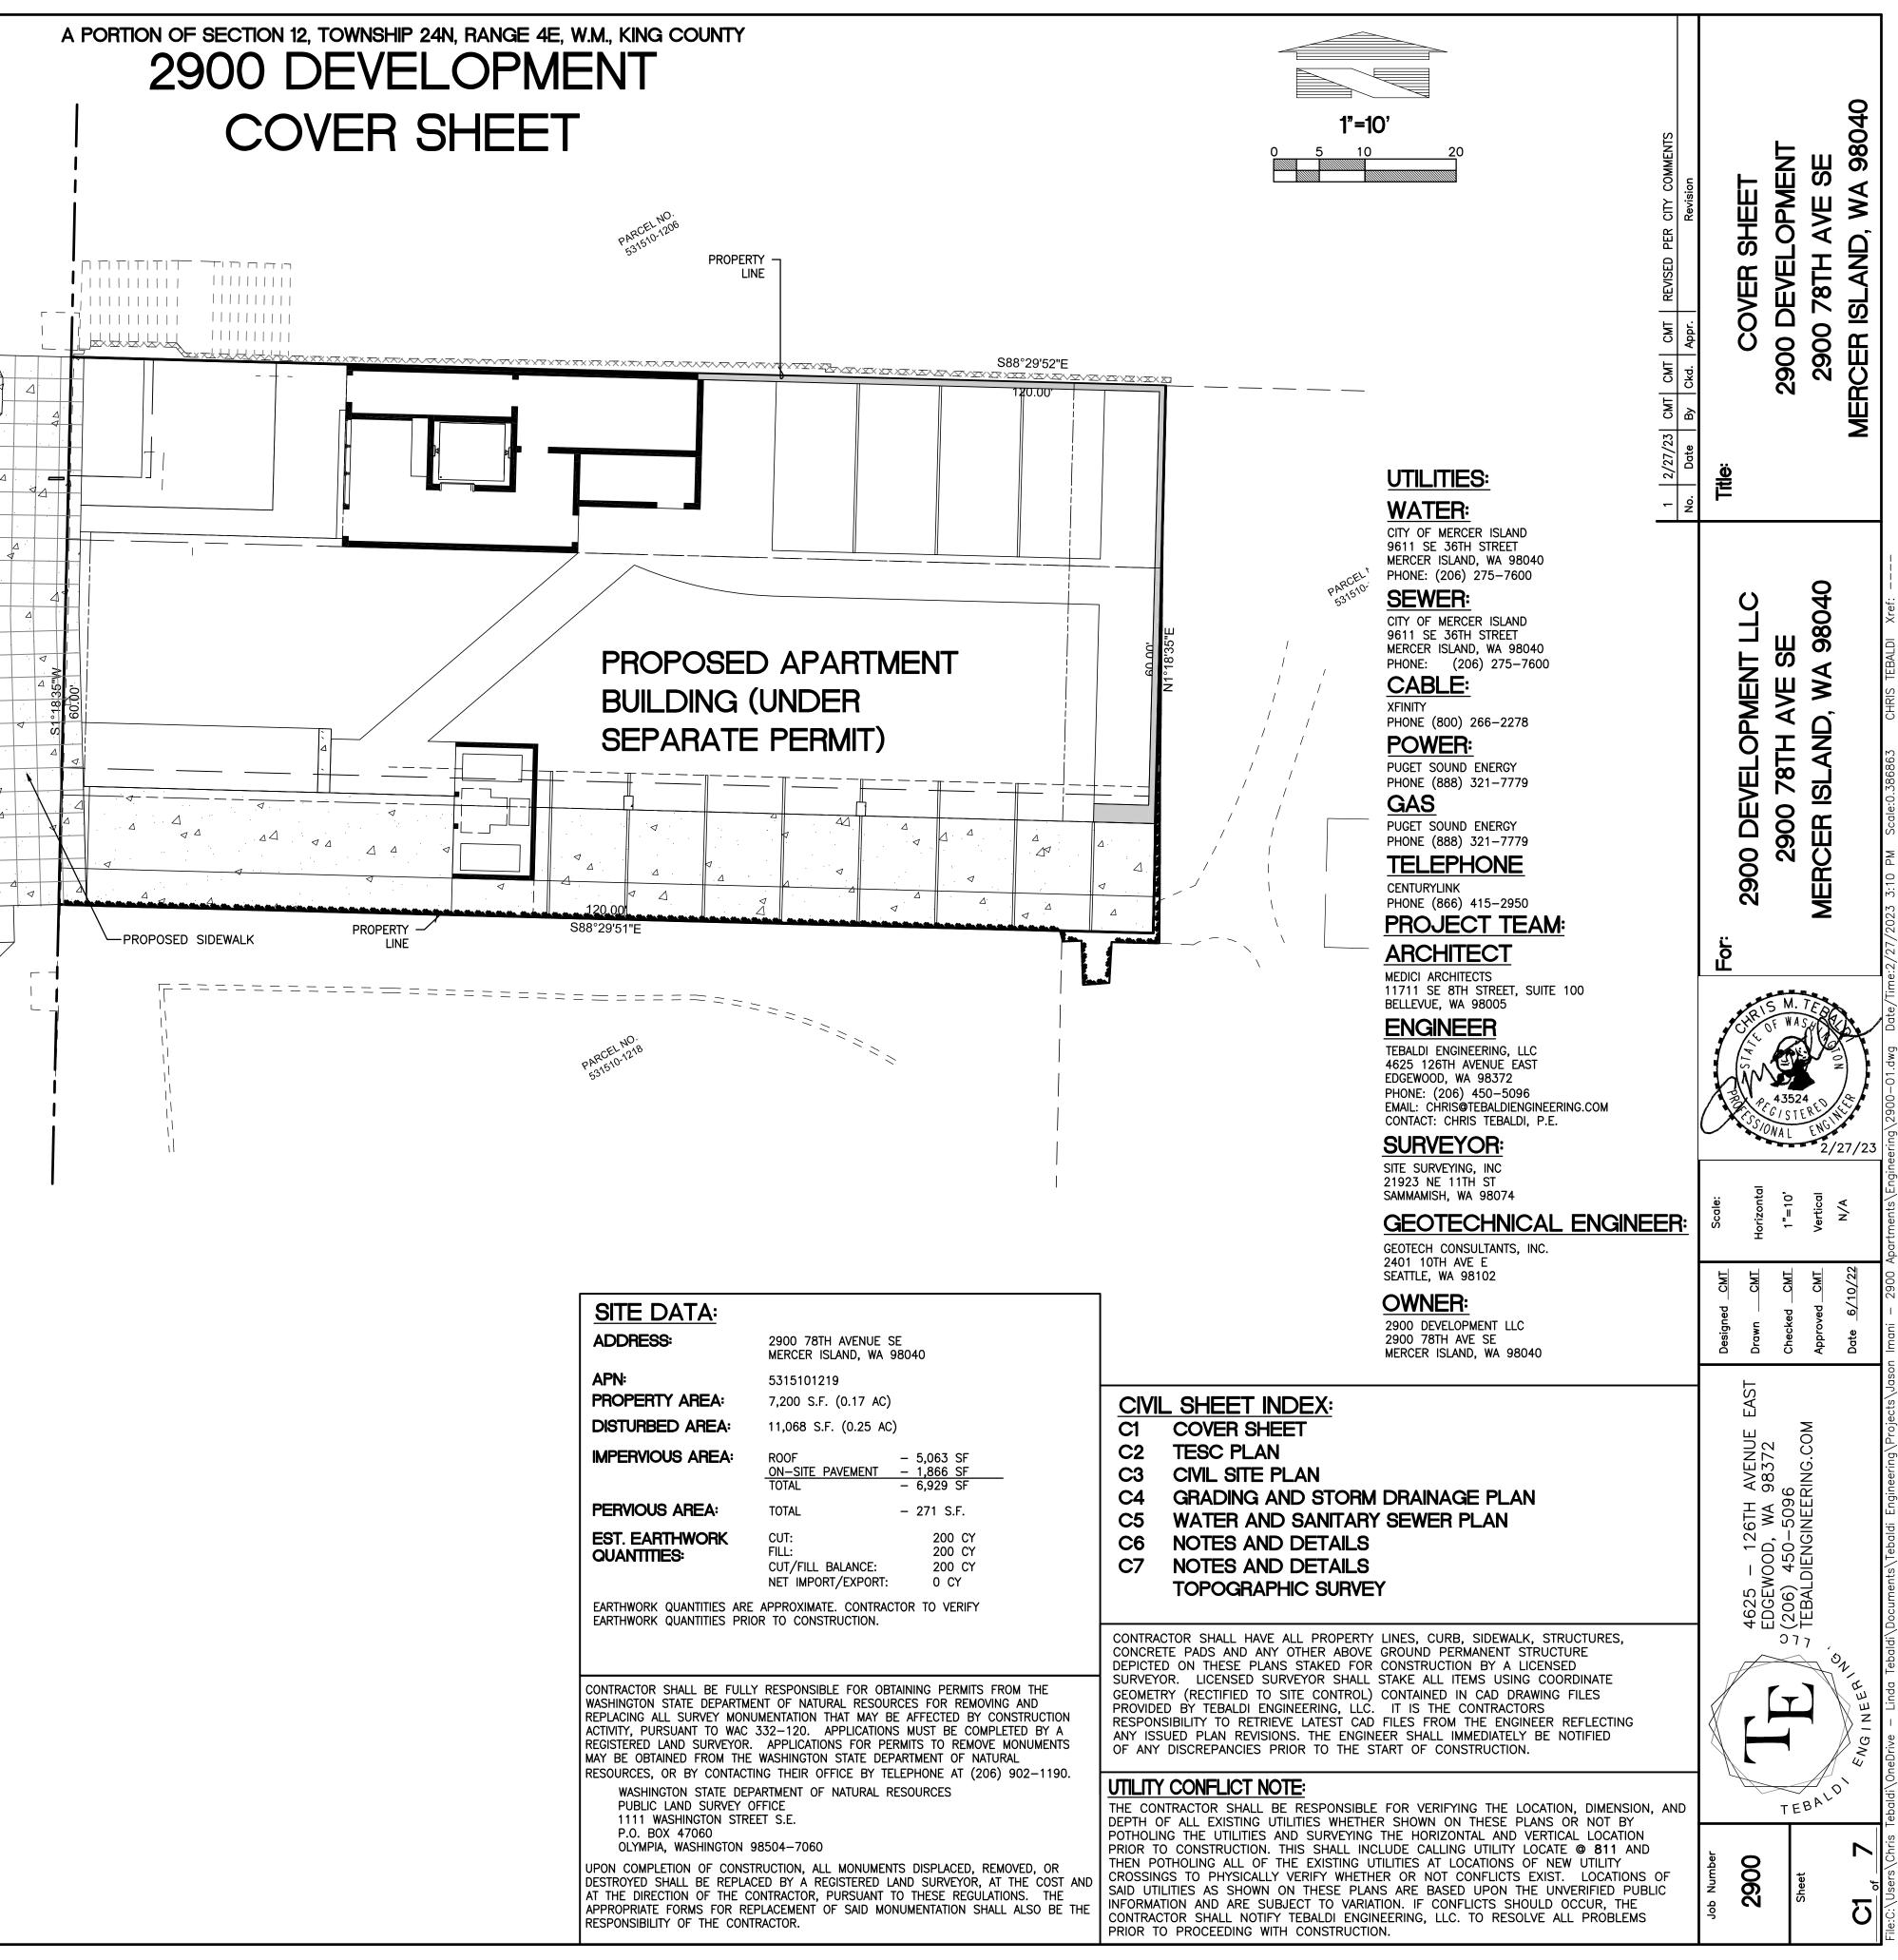

<u>SITE DATA:</u>			
ADDRESS:	2900 78TH AVENUE SE MERCER ISLAND, WA 98040		
APN:	5315101219		
PROPERTY AREA:	7,200 S.F. (0.17 AC)		
DISTURBED AREA:	11,068 S.F. (0.25 AC)		
IMPERVIOUS AREA:	ROOF - 5,063 SF ON-SITE PAVEMENT - 1,866 SF TOTAL - 6,929 SF		
PERVIOUS AREA:	TOTAL – 271 S.F.		
EST. EARTHWORK QUANTITIES:	CUT:200 CYFILL:200 CYCUT/FILL BALANCE:200 CYNET IMPORT/EXPORT:0 CY		
	APPROXIMATE. CONTRACTOR TO VERIFY		
EARTHWORK QUANTITIES PRIOR TO CONSTRUCTION.			
	RESPONSIBLE FOR OBTAINING PERMITS FROM THE		
WASHINGTON STATE DEPARTMENT OF NATURAL RESOURCES FOR REMOVING AND REPLACING ALL SURVEY MONUMENTATION THAT MAY BE AFFECTED BY CONSTRUCTION			
ACTIVITY, PURSUANT TO WAC 332–120. APPLICATIONS MUST BE COMPLETED BY A REGISTERED LAND SURVEYOR. APPLICATIONS FOR PERMITS TO REMOVE MONUMENTS MAY BE OBTAINED FROM THE WASHINGTON STATE DEPARTMENT OF NATURAL			
	IG THEIR OFFICE BY TELEPHONE AT (206) 902-1190.	-	
WASHINGTON STATE DEPARTMENT OF NATURAL RESOURCES PUBLIC LAND SURVEY OFFICE			
1111 WASHINGTON STREET S.E. P.O. BOX 47060			
OLYMPIA, WASHINGTON 98504-7060			
	UCTION, ALL MONUMENTS DISPLACED, REMOVED, OR ED BY A REGISTERED LAND SURVEYOR, AT THE COST AND		
AT THE DIRECTION OF THE CO	NTRACTOR, PURSUANT TO THESE REGULATIONS. THE		
APPROPRIATE FORMS FOR REPLACEMENT OF SAID MONUMENTATION SHALL ALSO BE THE RESPONSIBILITY OF THE CONTRACTOR.			
		F	

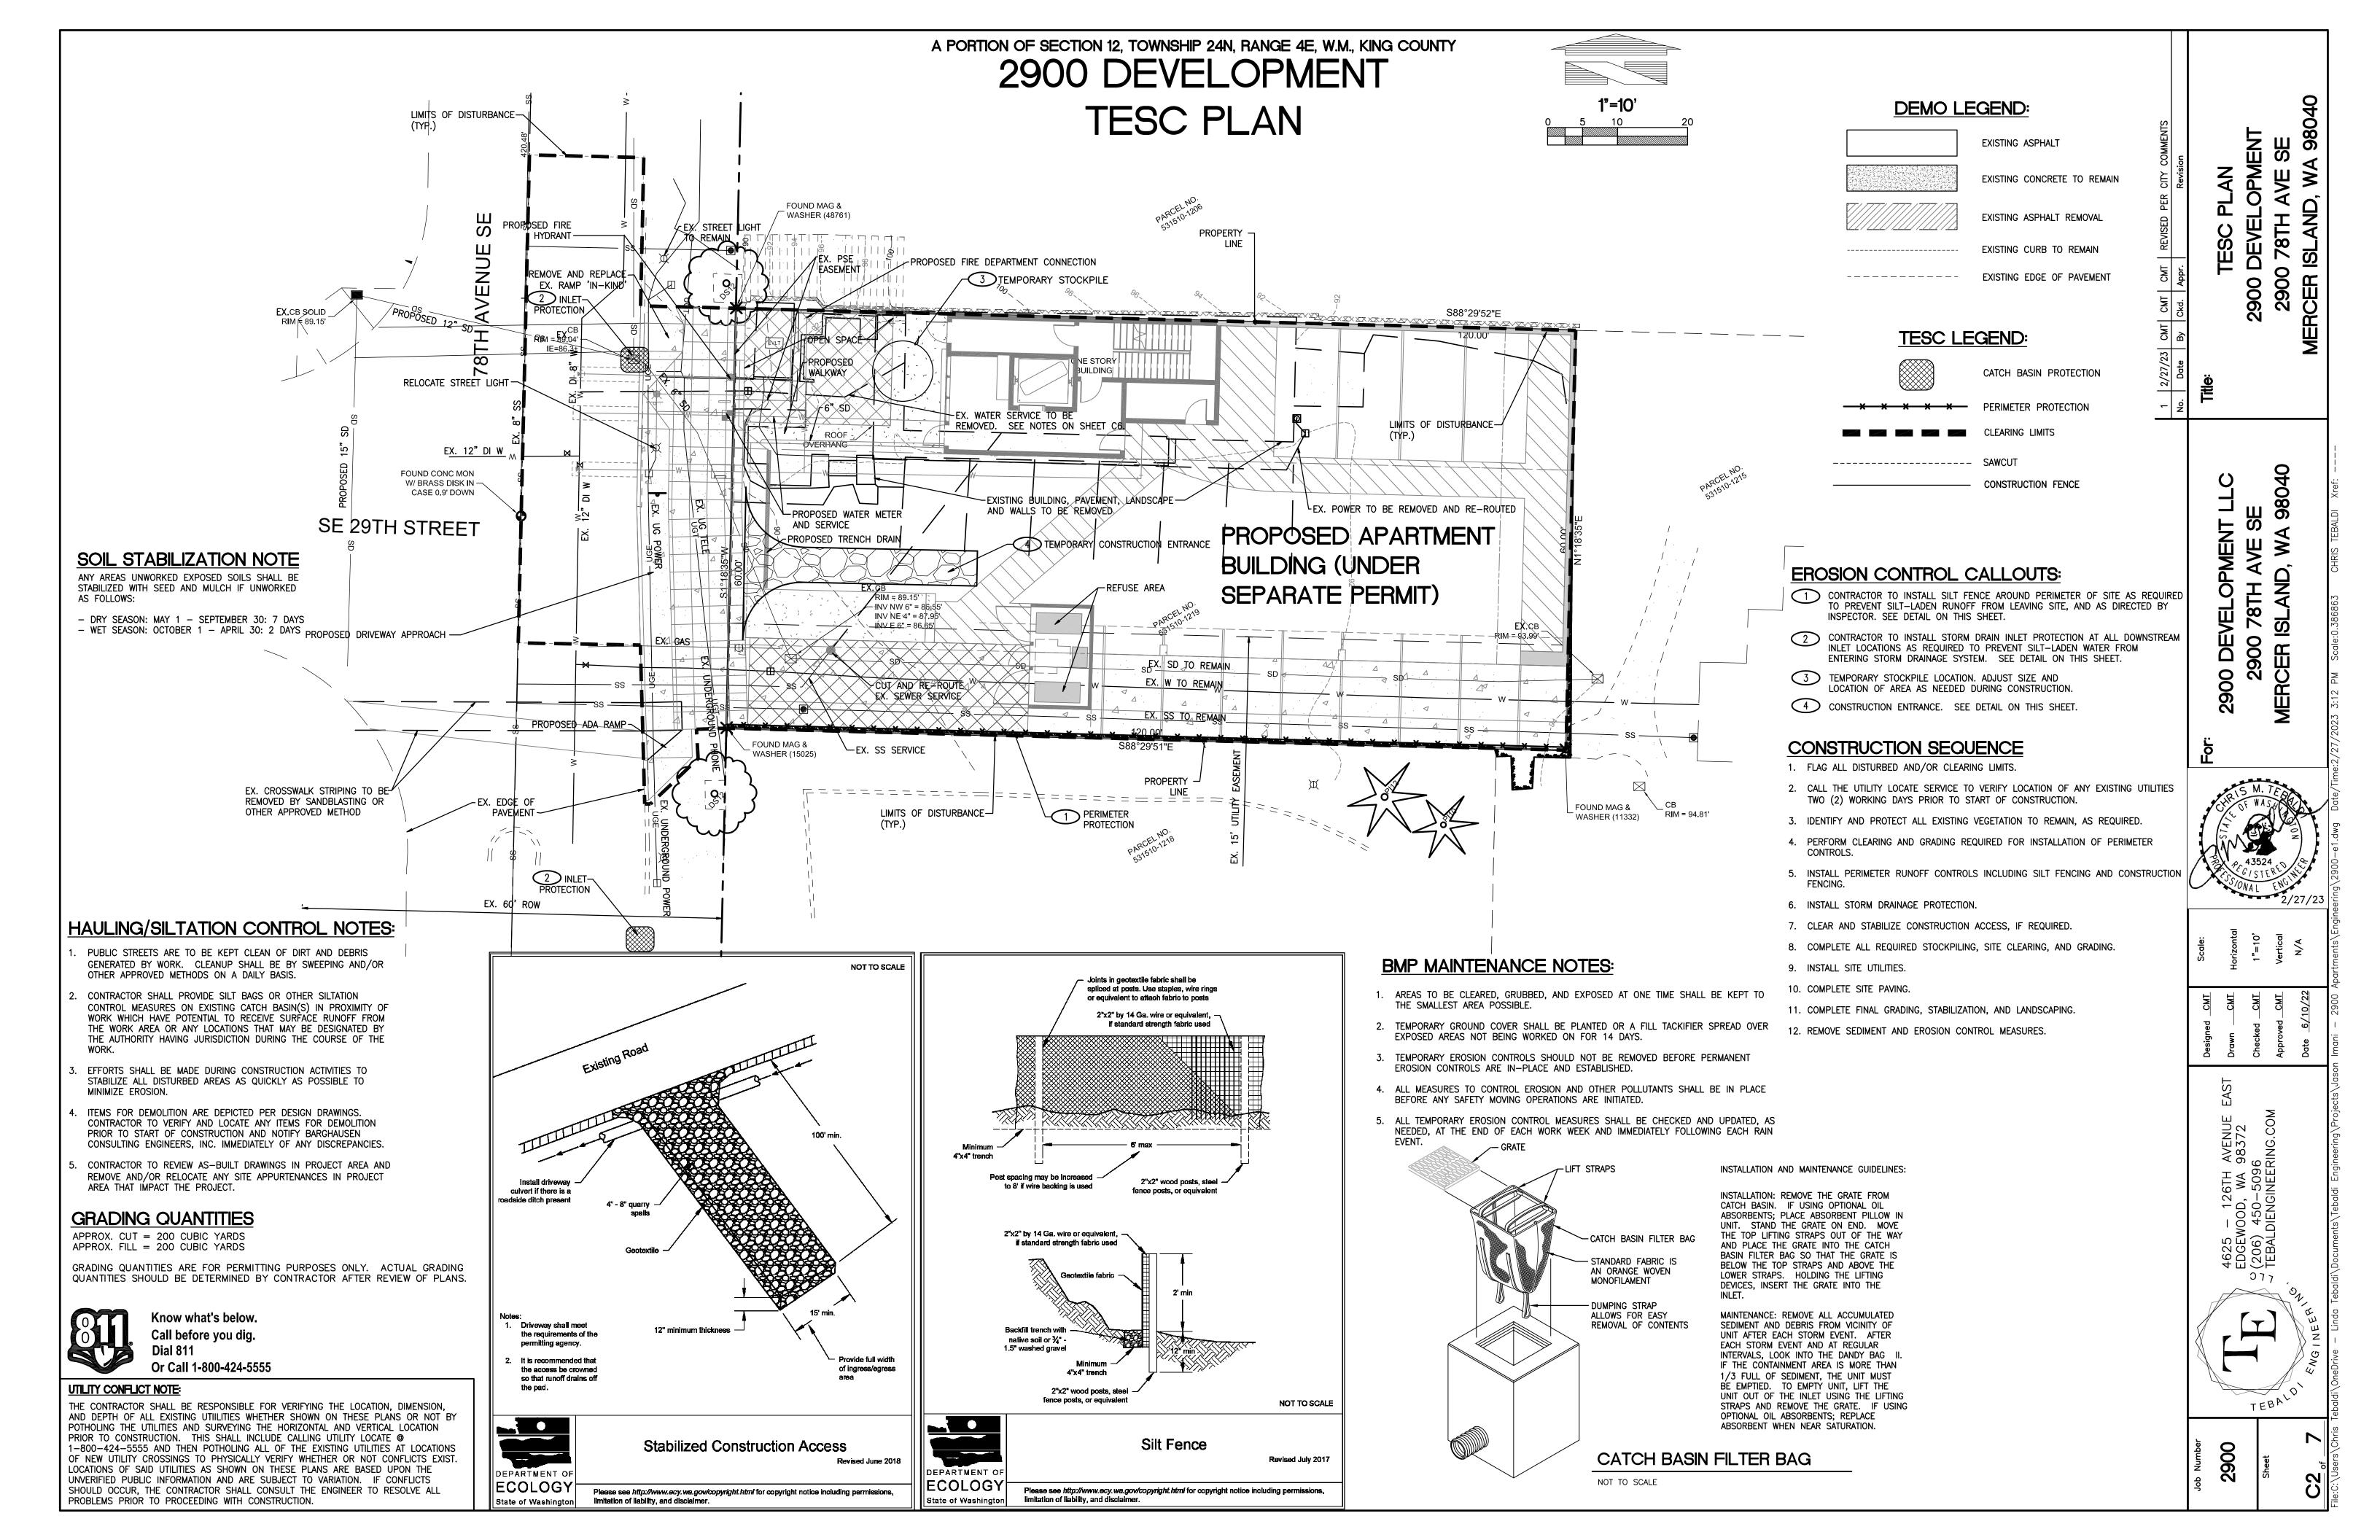

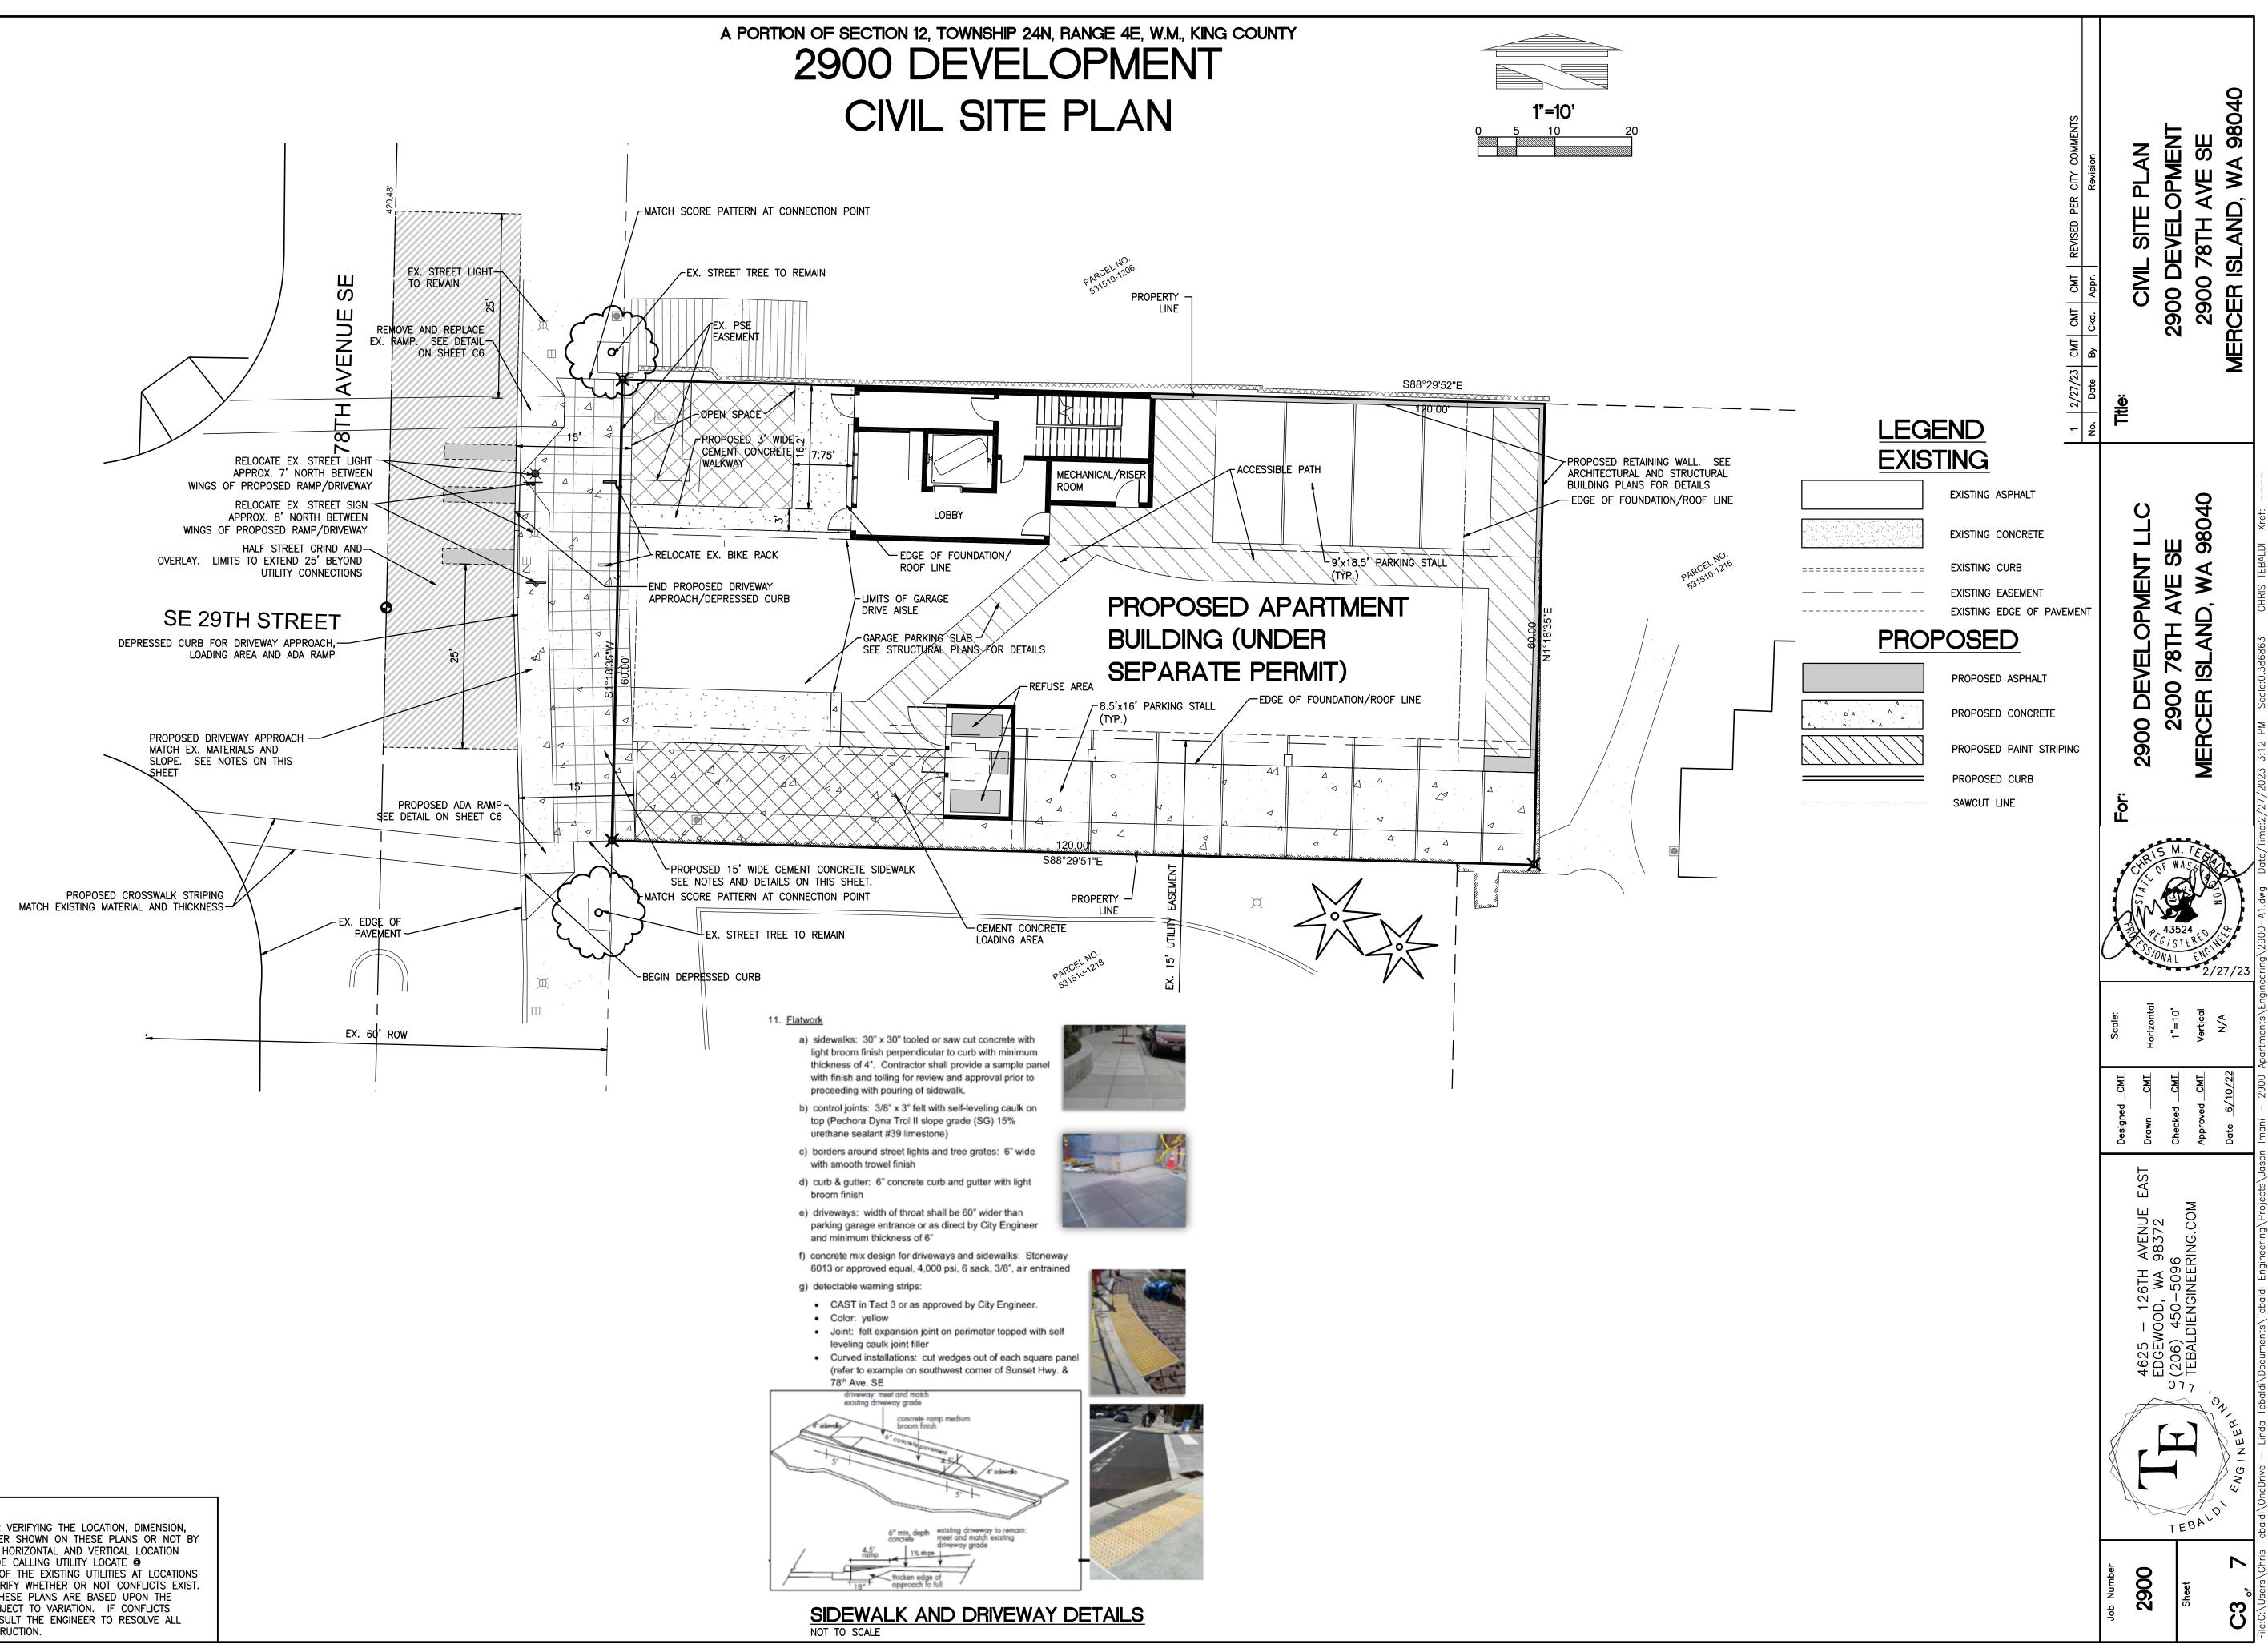





Know what's below. Call before you dig. Dial 811 Or Call 1-800-424-5555

UTILITY CONFLICT NOTE:

THE CONTRACTOR SHALL BE RESPONSIBLE FOR VERIFYING THE LOCATION, DIMENSION, AND DEPTH OF ALL EXISTING UTIILITIES WHETHER SHOWN ON THESE PLANS OR NOT BY POTHOLING THE UTILITIES AND SURVEYING THE HORIZONTAL AND VERTICAL LOCATION PRIOR TO CONSTRUCTION. THIS SHALL INCLUDE CALLING UTILITY LOCATE @ 1-800-424-5555 AND THEN POTHOLING ALL OF THE EXISTING UTILITIES AT LOCATIONS OF NEW UTILITY CROSSINGS TO PHYSICALLY VERIFY WHETHER OR NOT CONFLICTS EXIST. LOCATIONS OF SAID UTILITIES AS SHOWN ON THESE PLANS ARE BASED UPON THE UNVERIFIED PUBLIC INFORMATION AND ARE SUBJECT TO VARIATION. IF CONFLICTS SHOULD OCCUR, THE CONTRACTOR SHALL CONSULT THE ENGINEER TO RESOLVE ALL PROBLEMS PRIOR TO PROCEEDING WITH CONSTRUCTION.

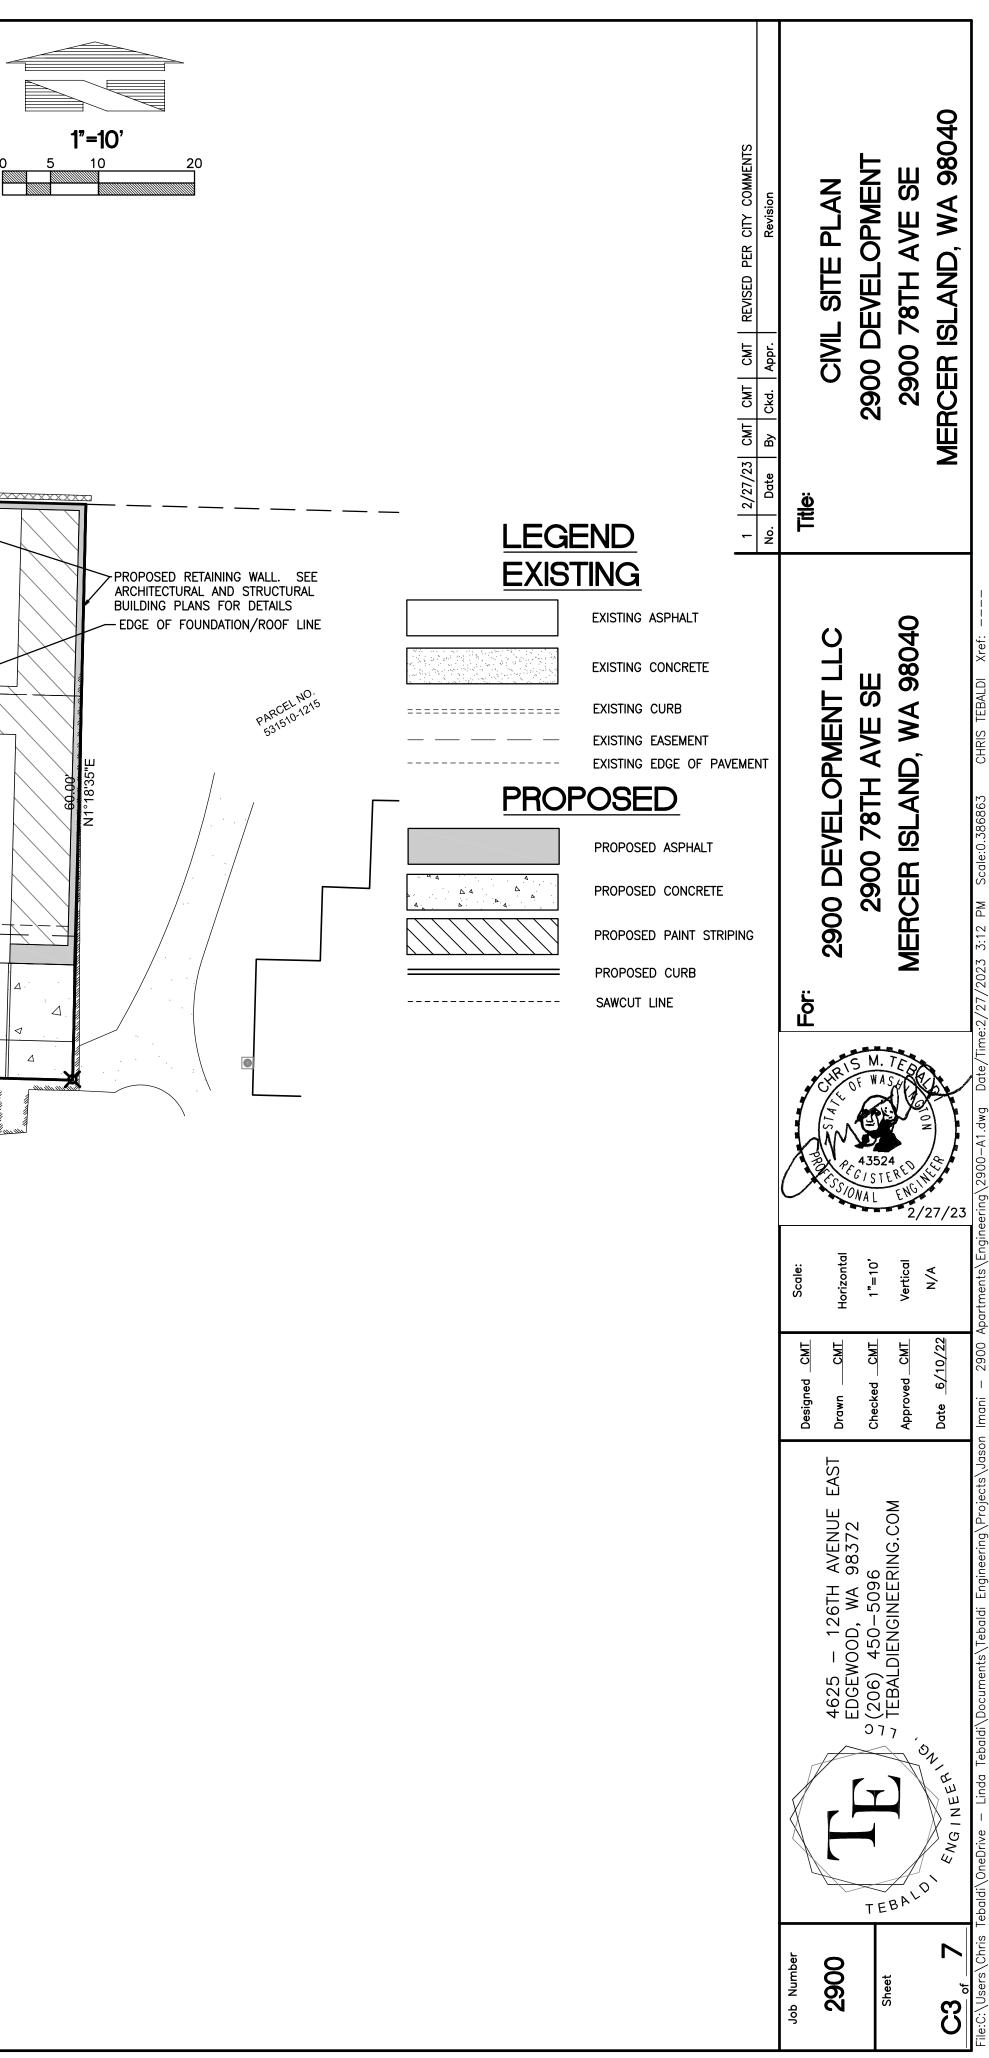

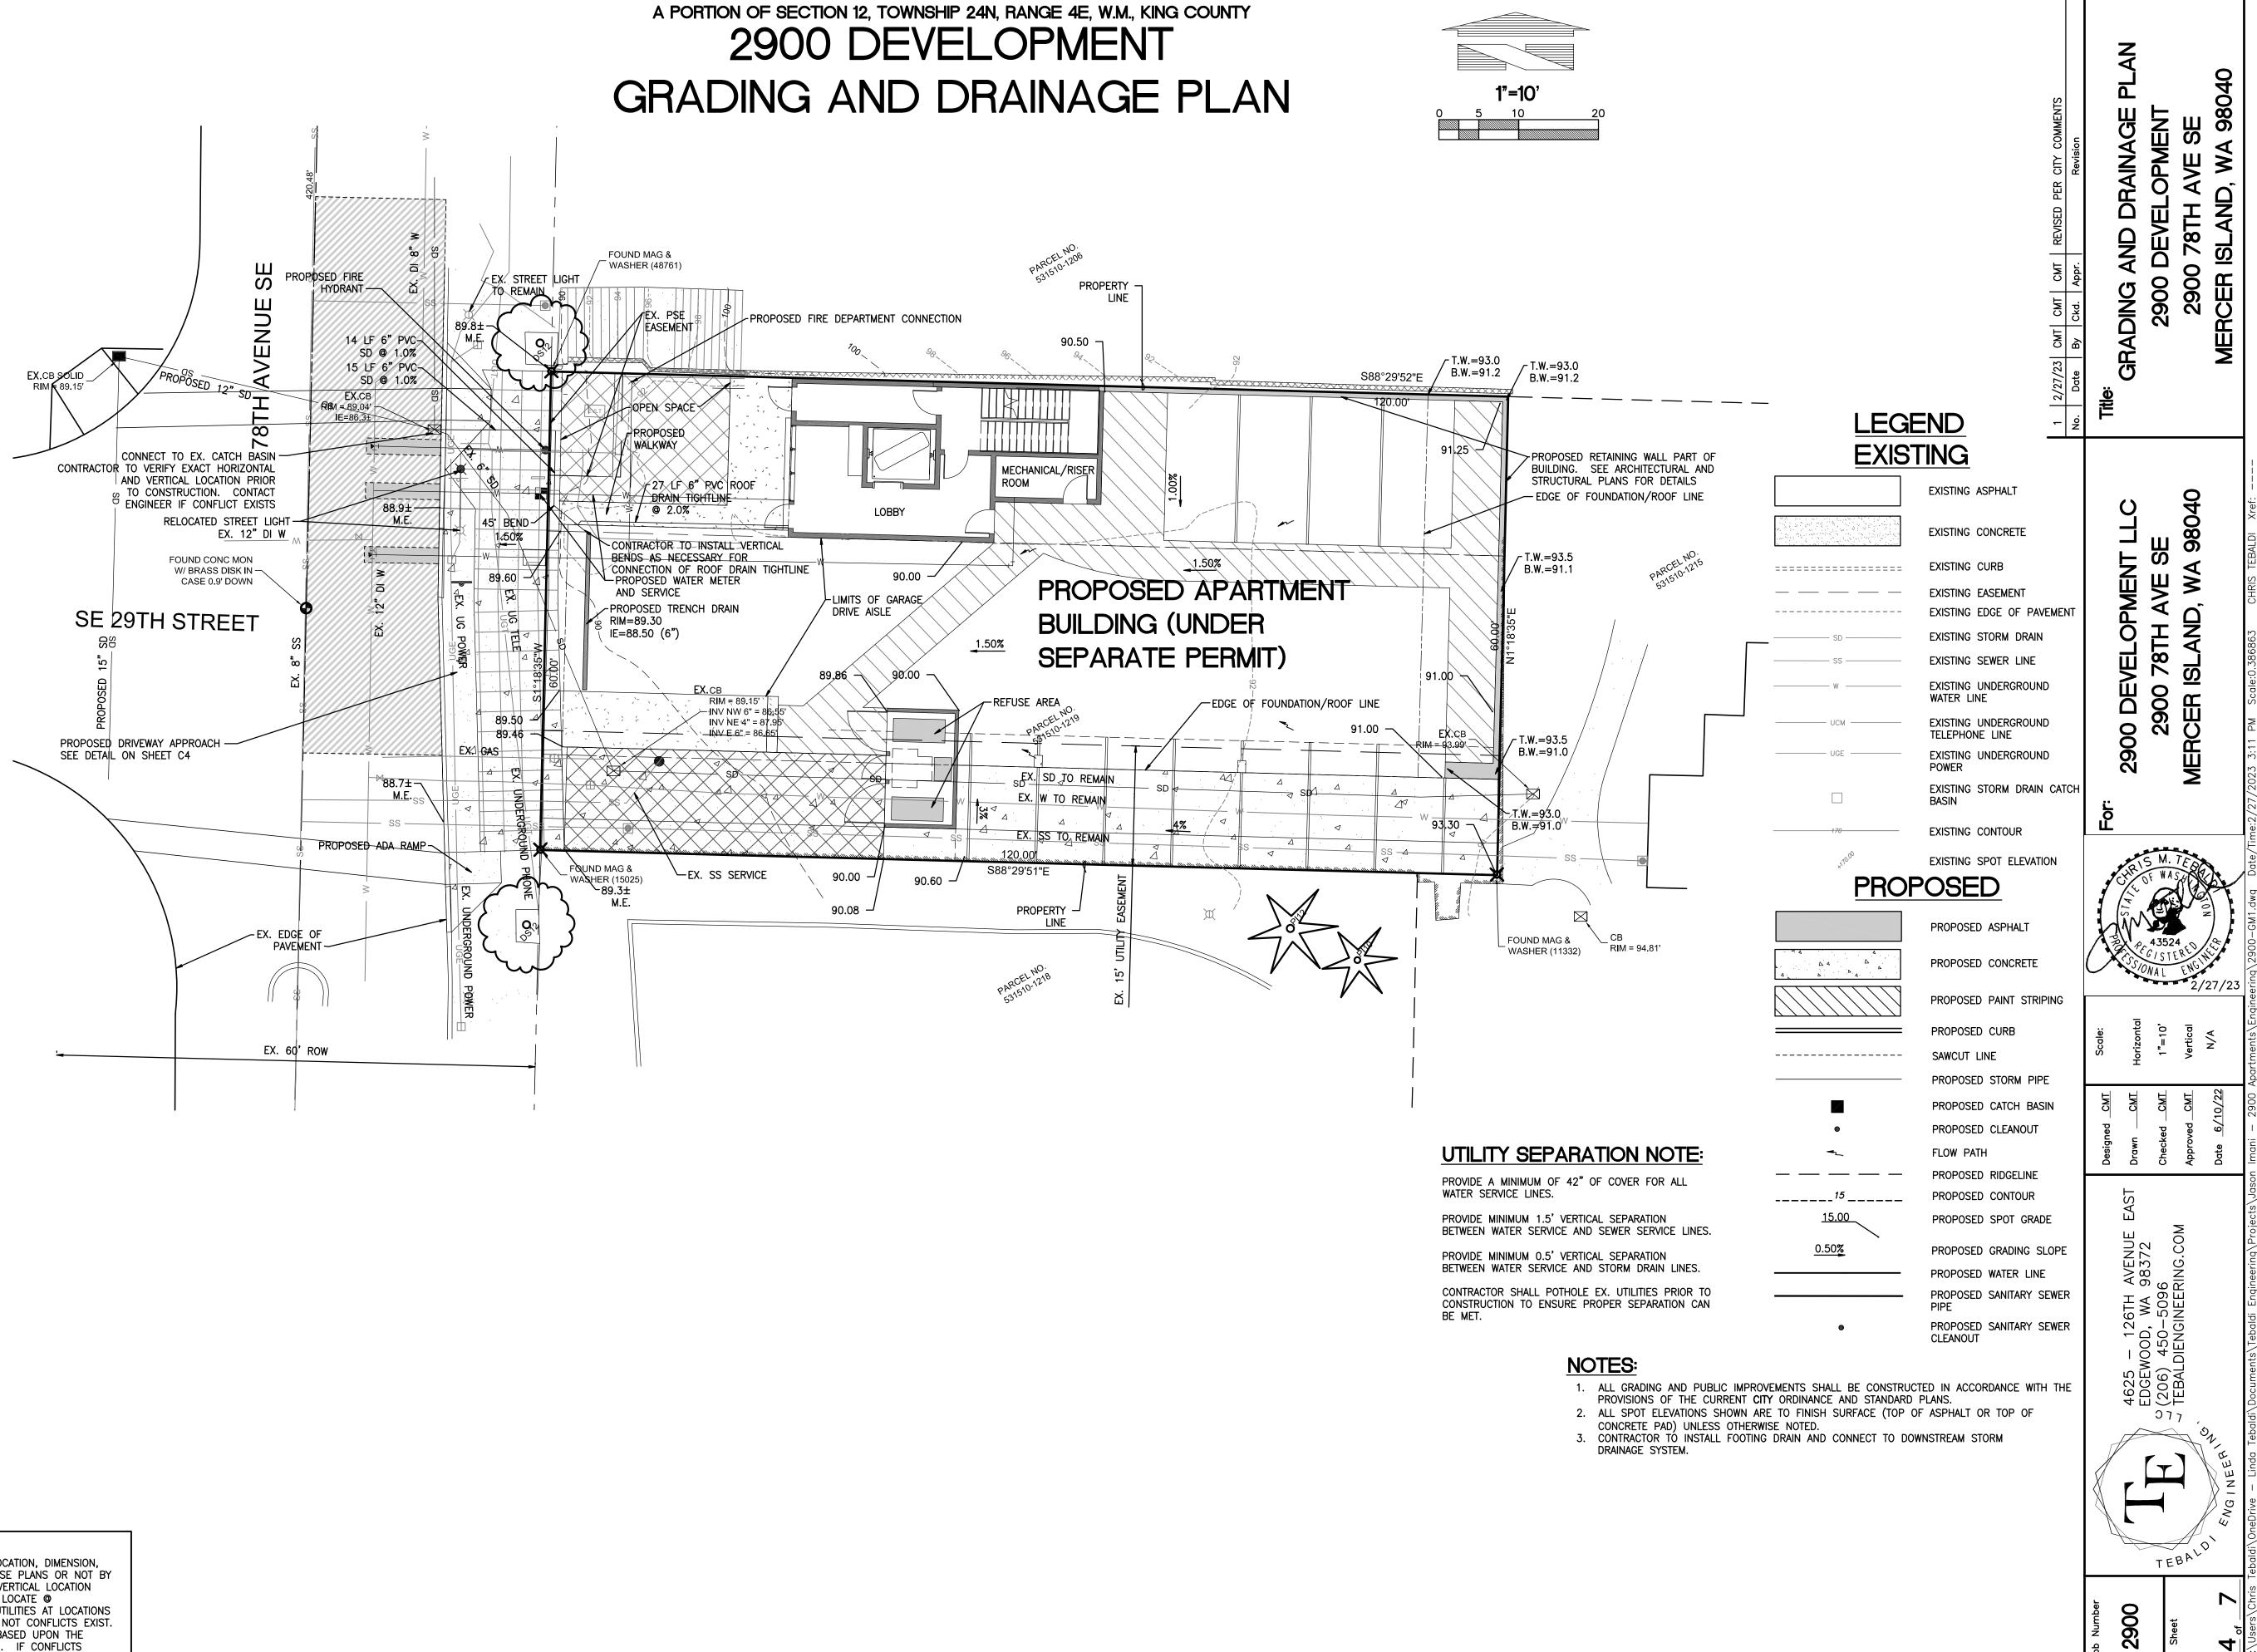





Know what's below. Call before you dig. Dial 811 Or Call 1-800-424-5555


UTILITY CONFLICT NOTE:


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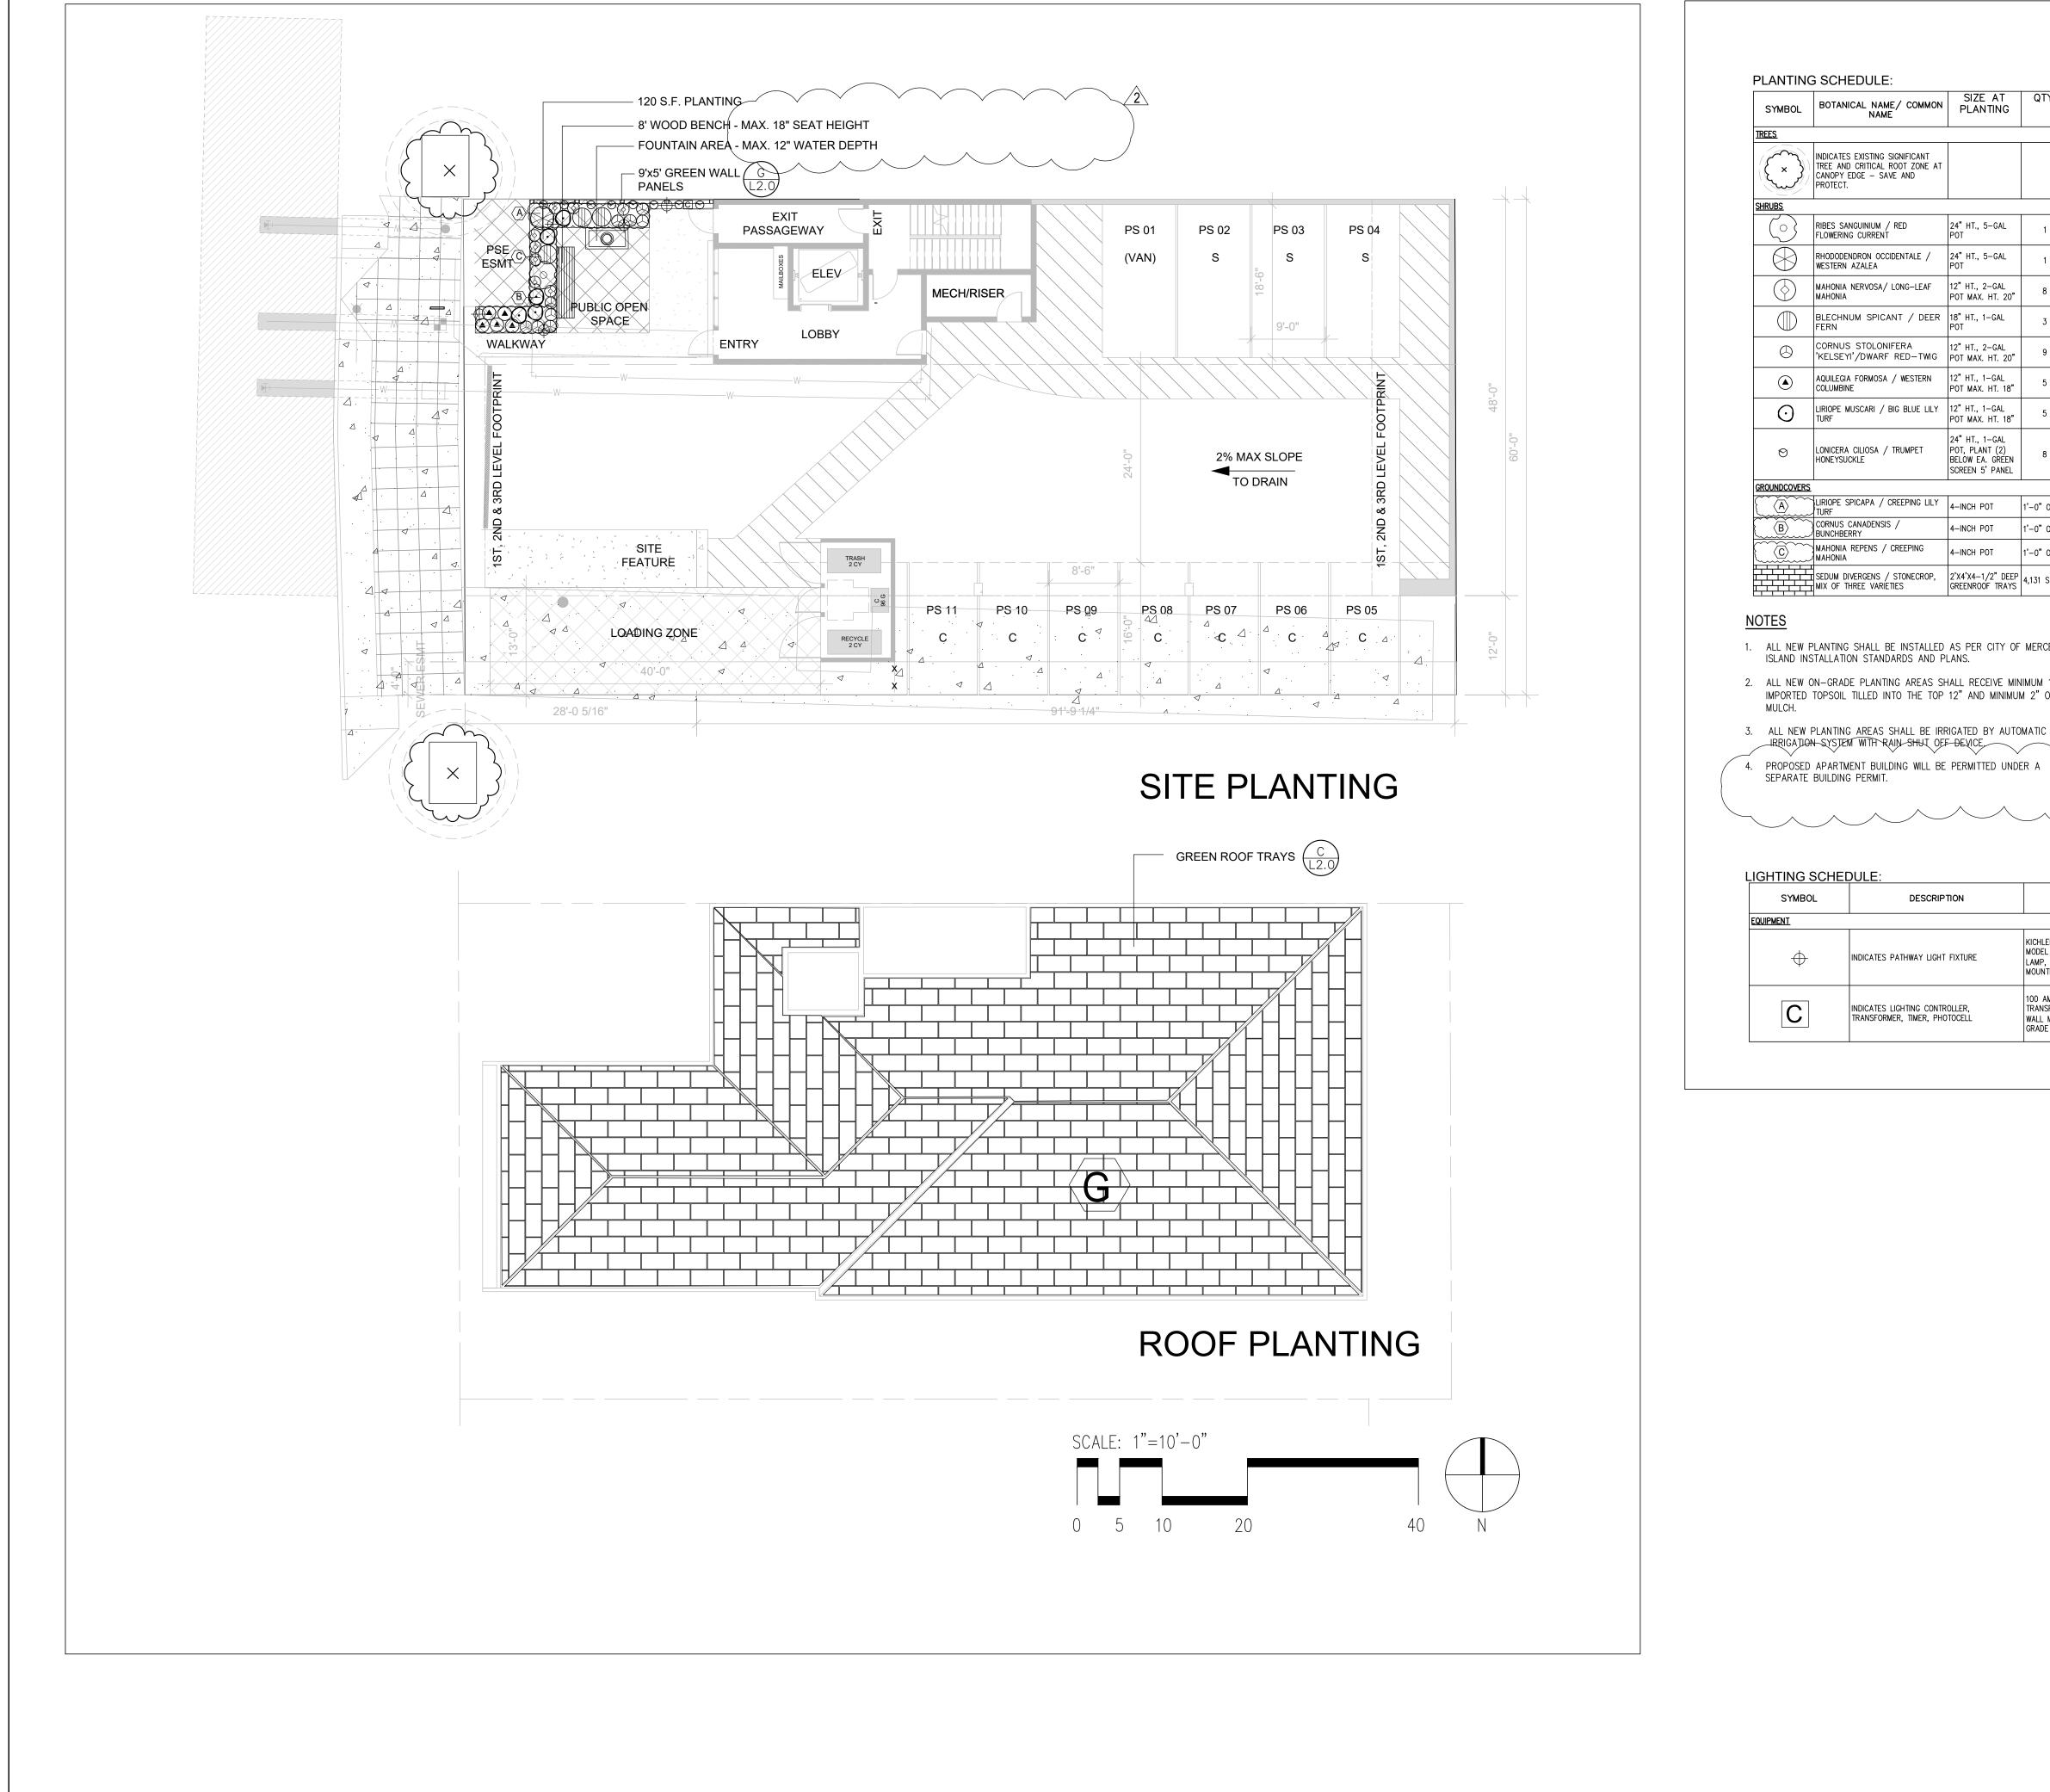


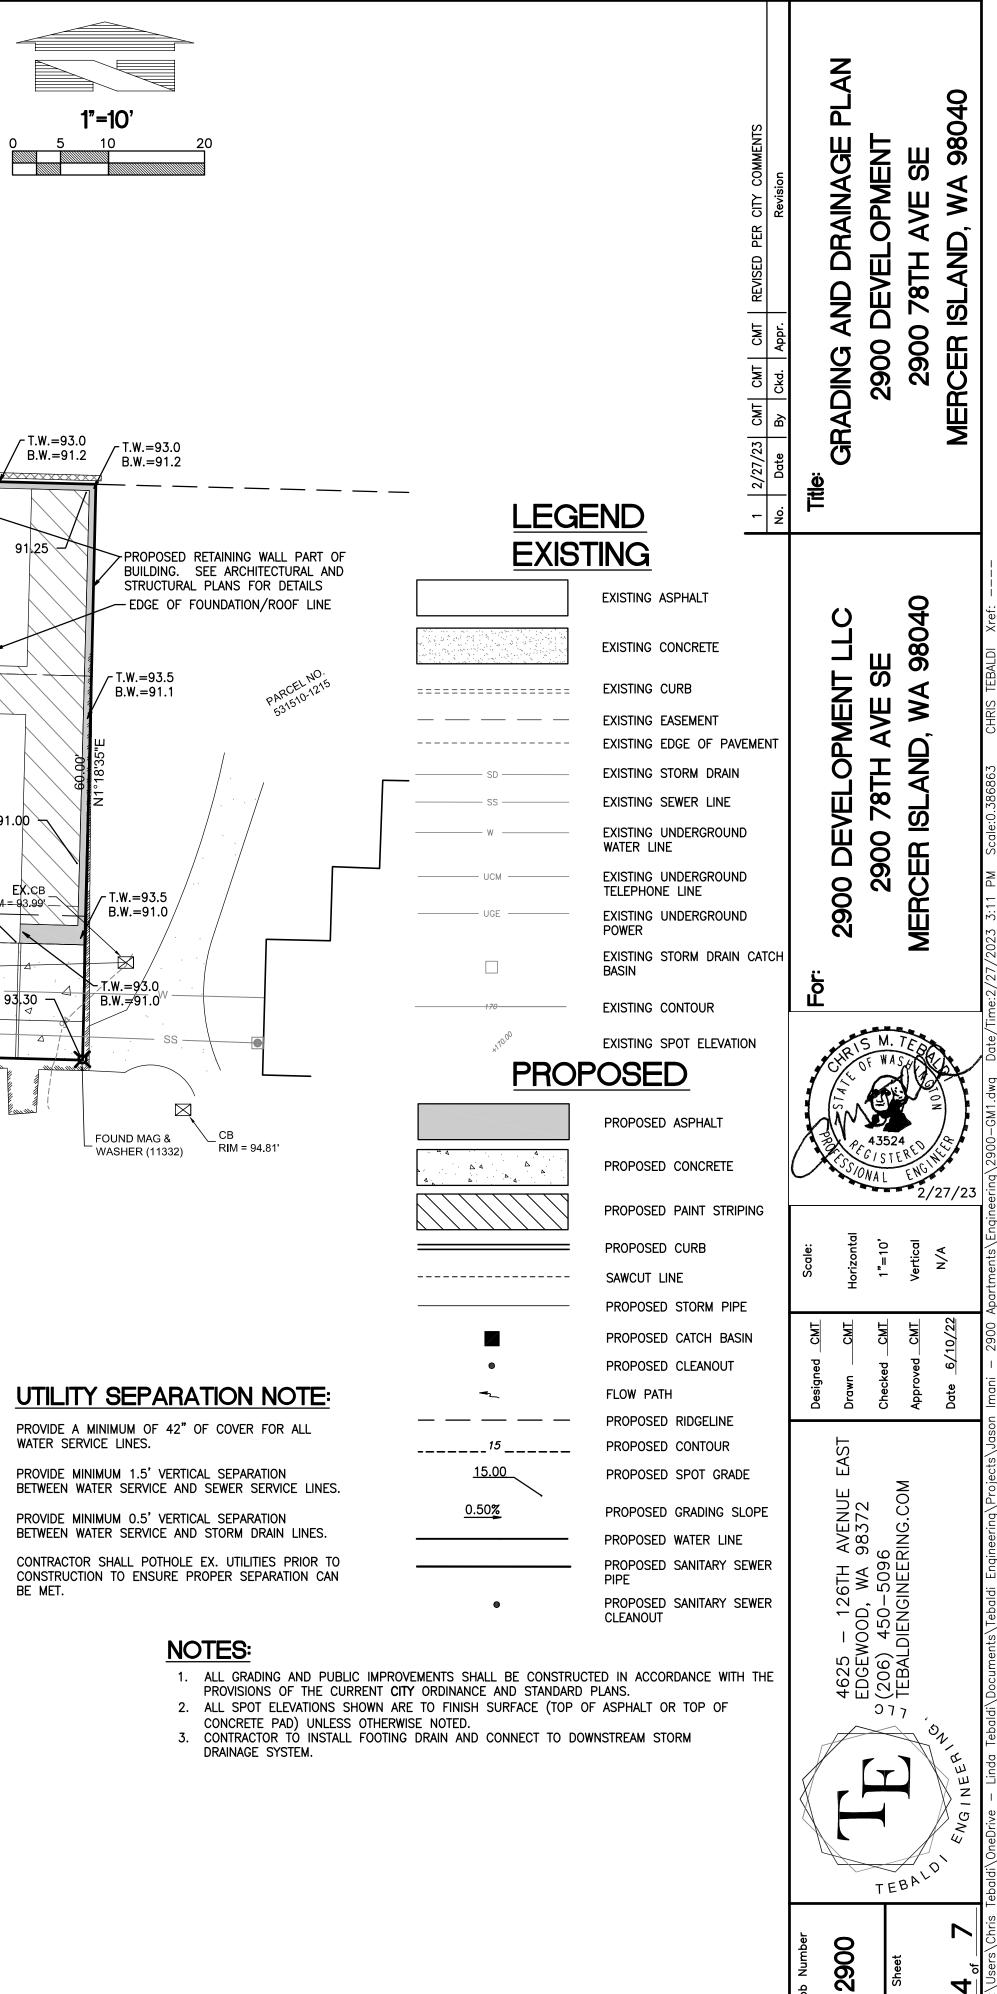

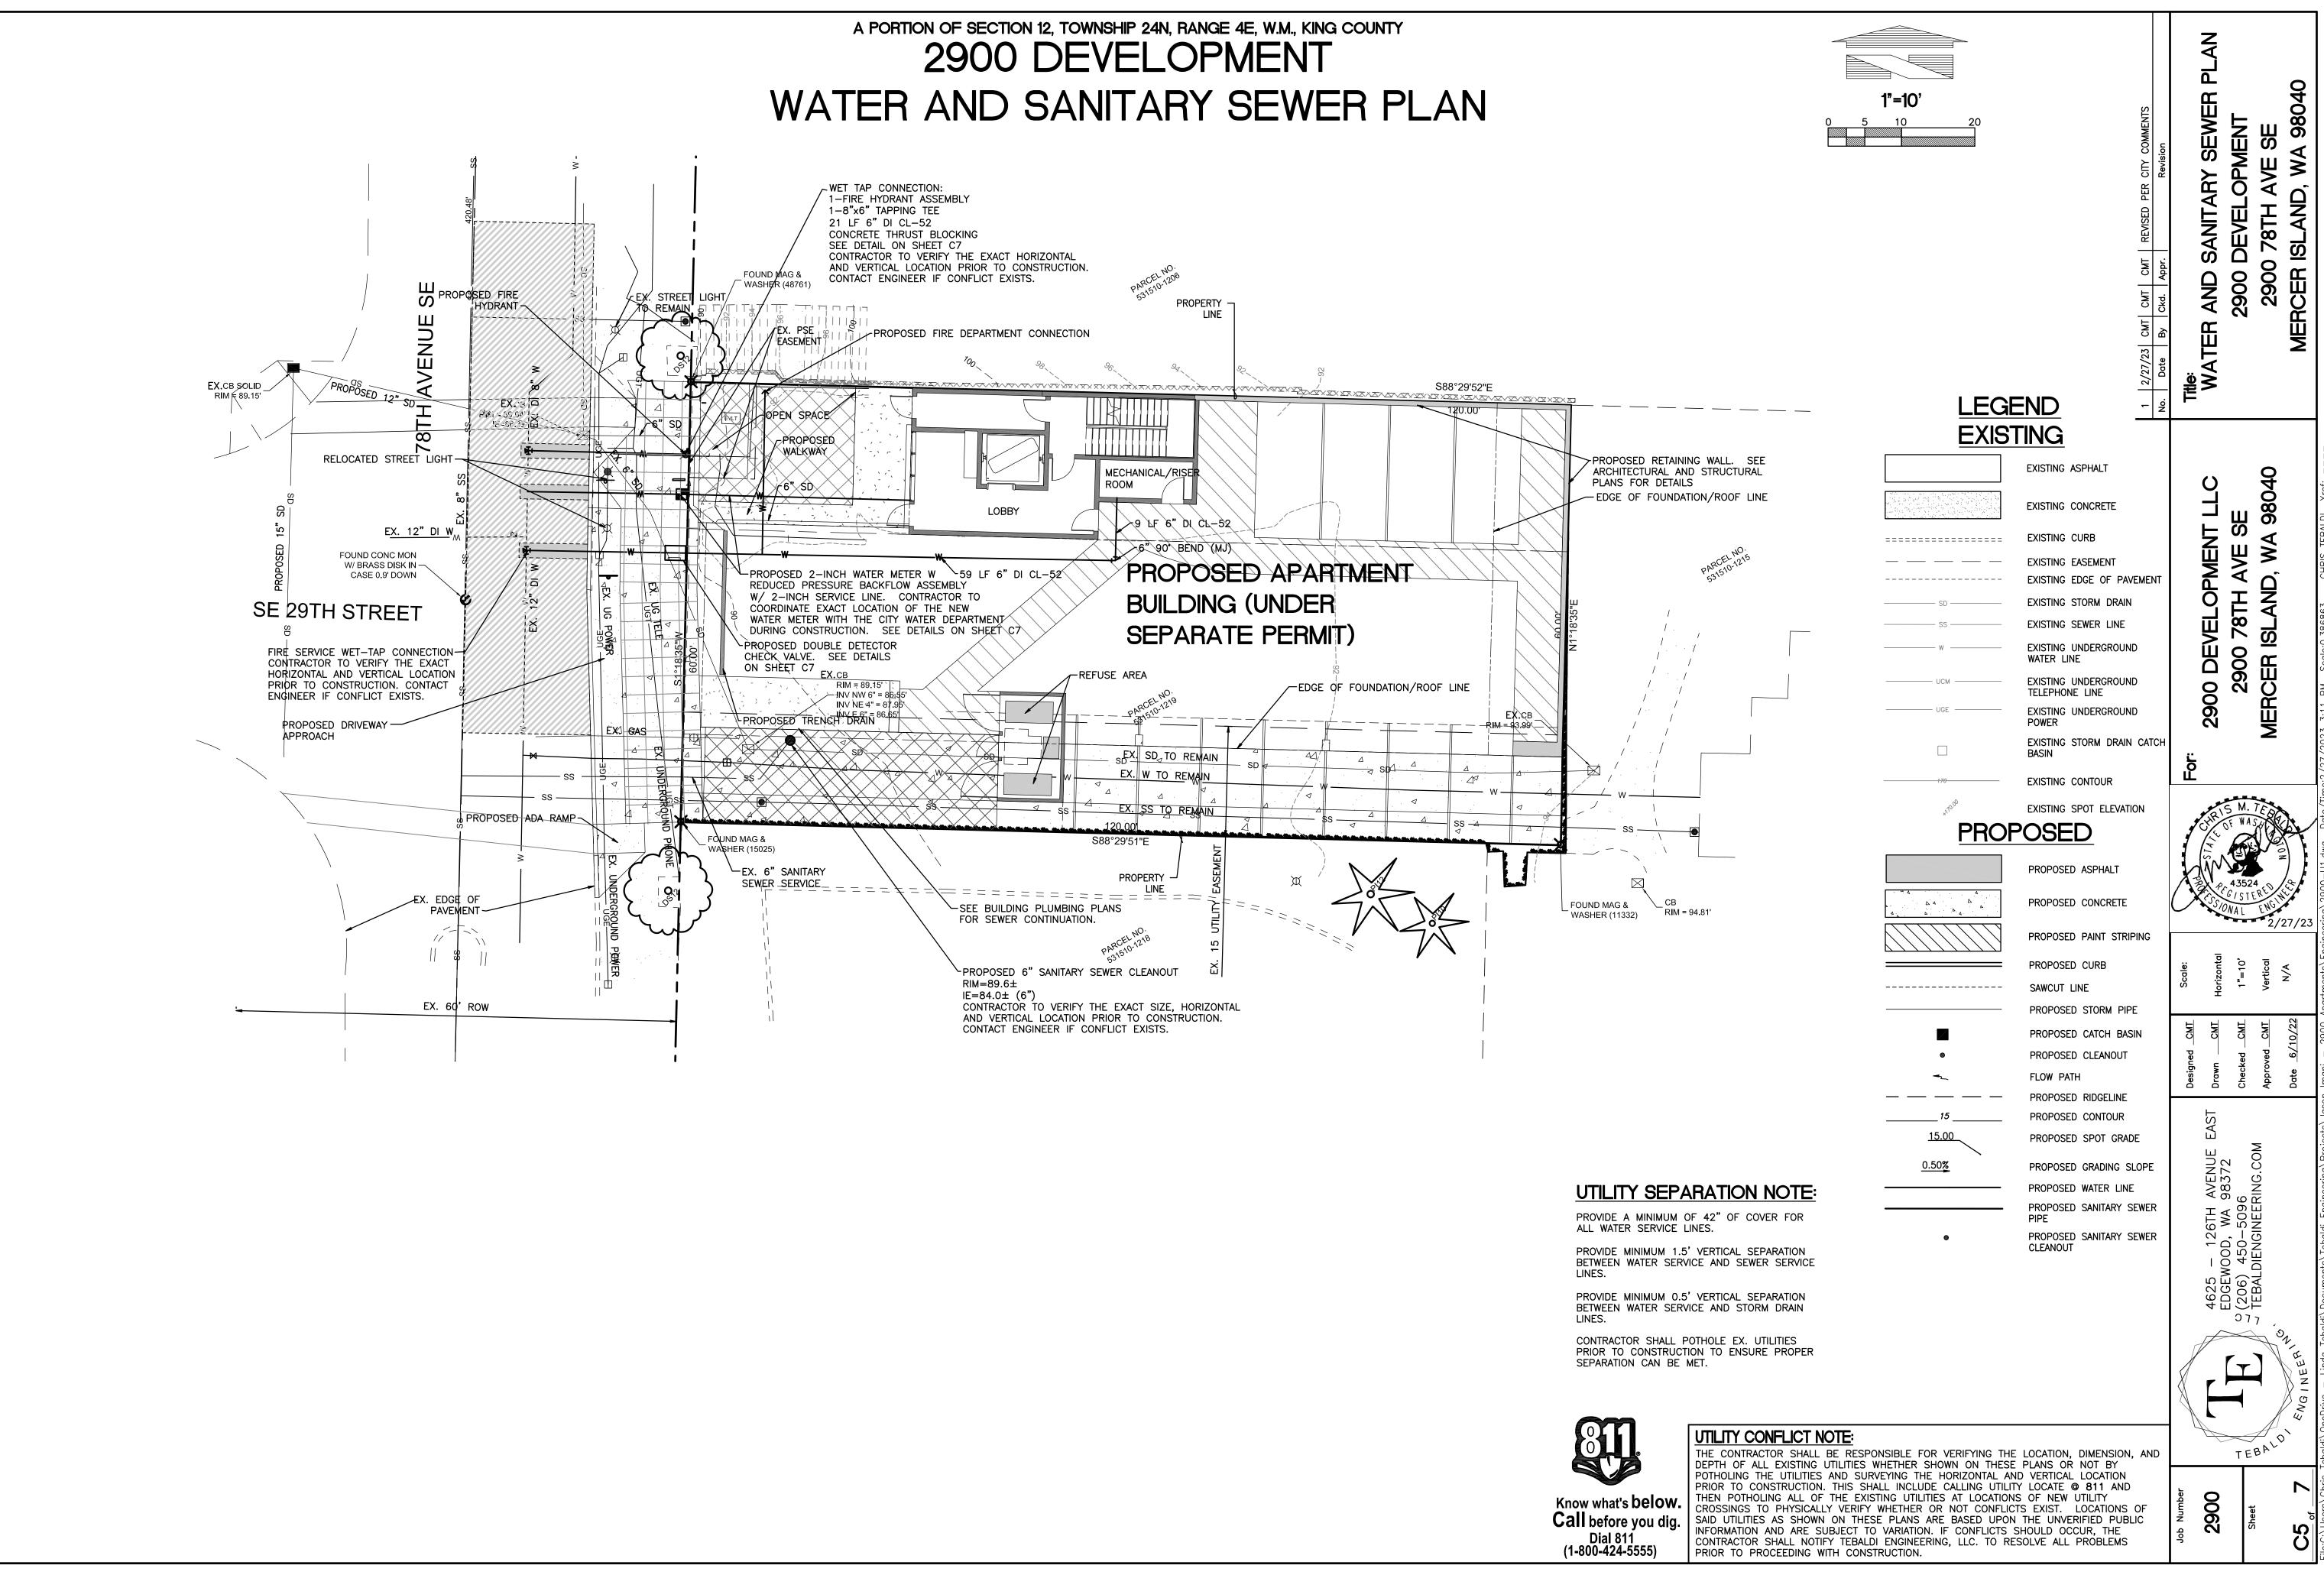





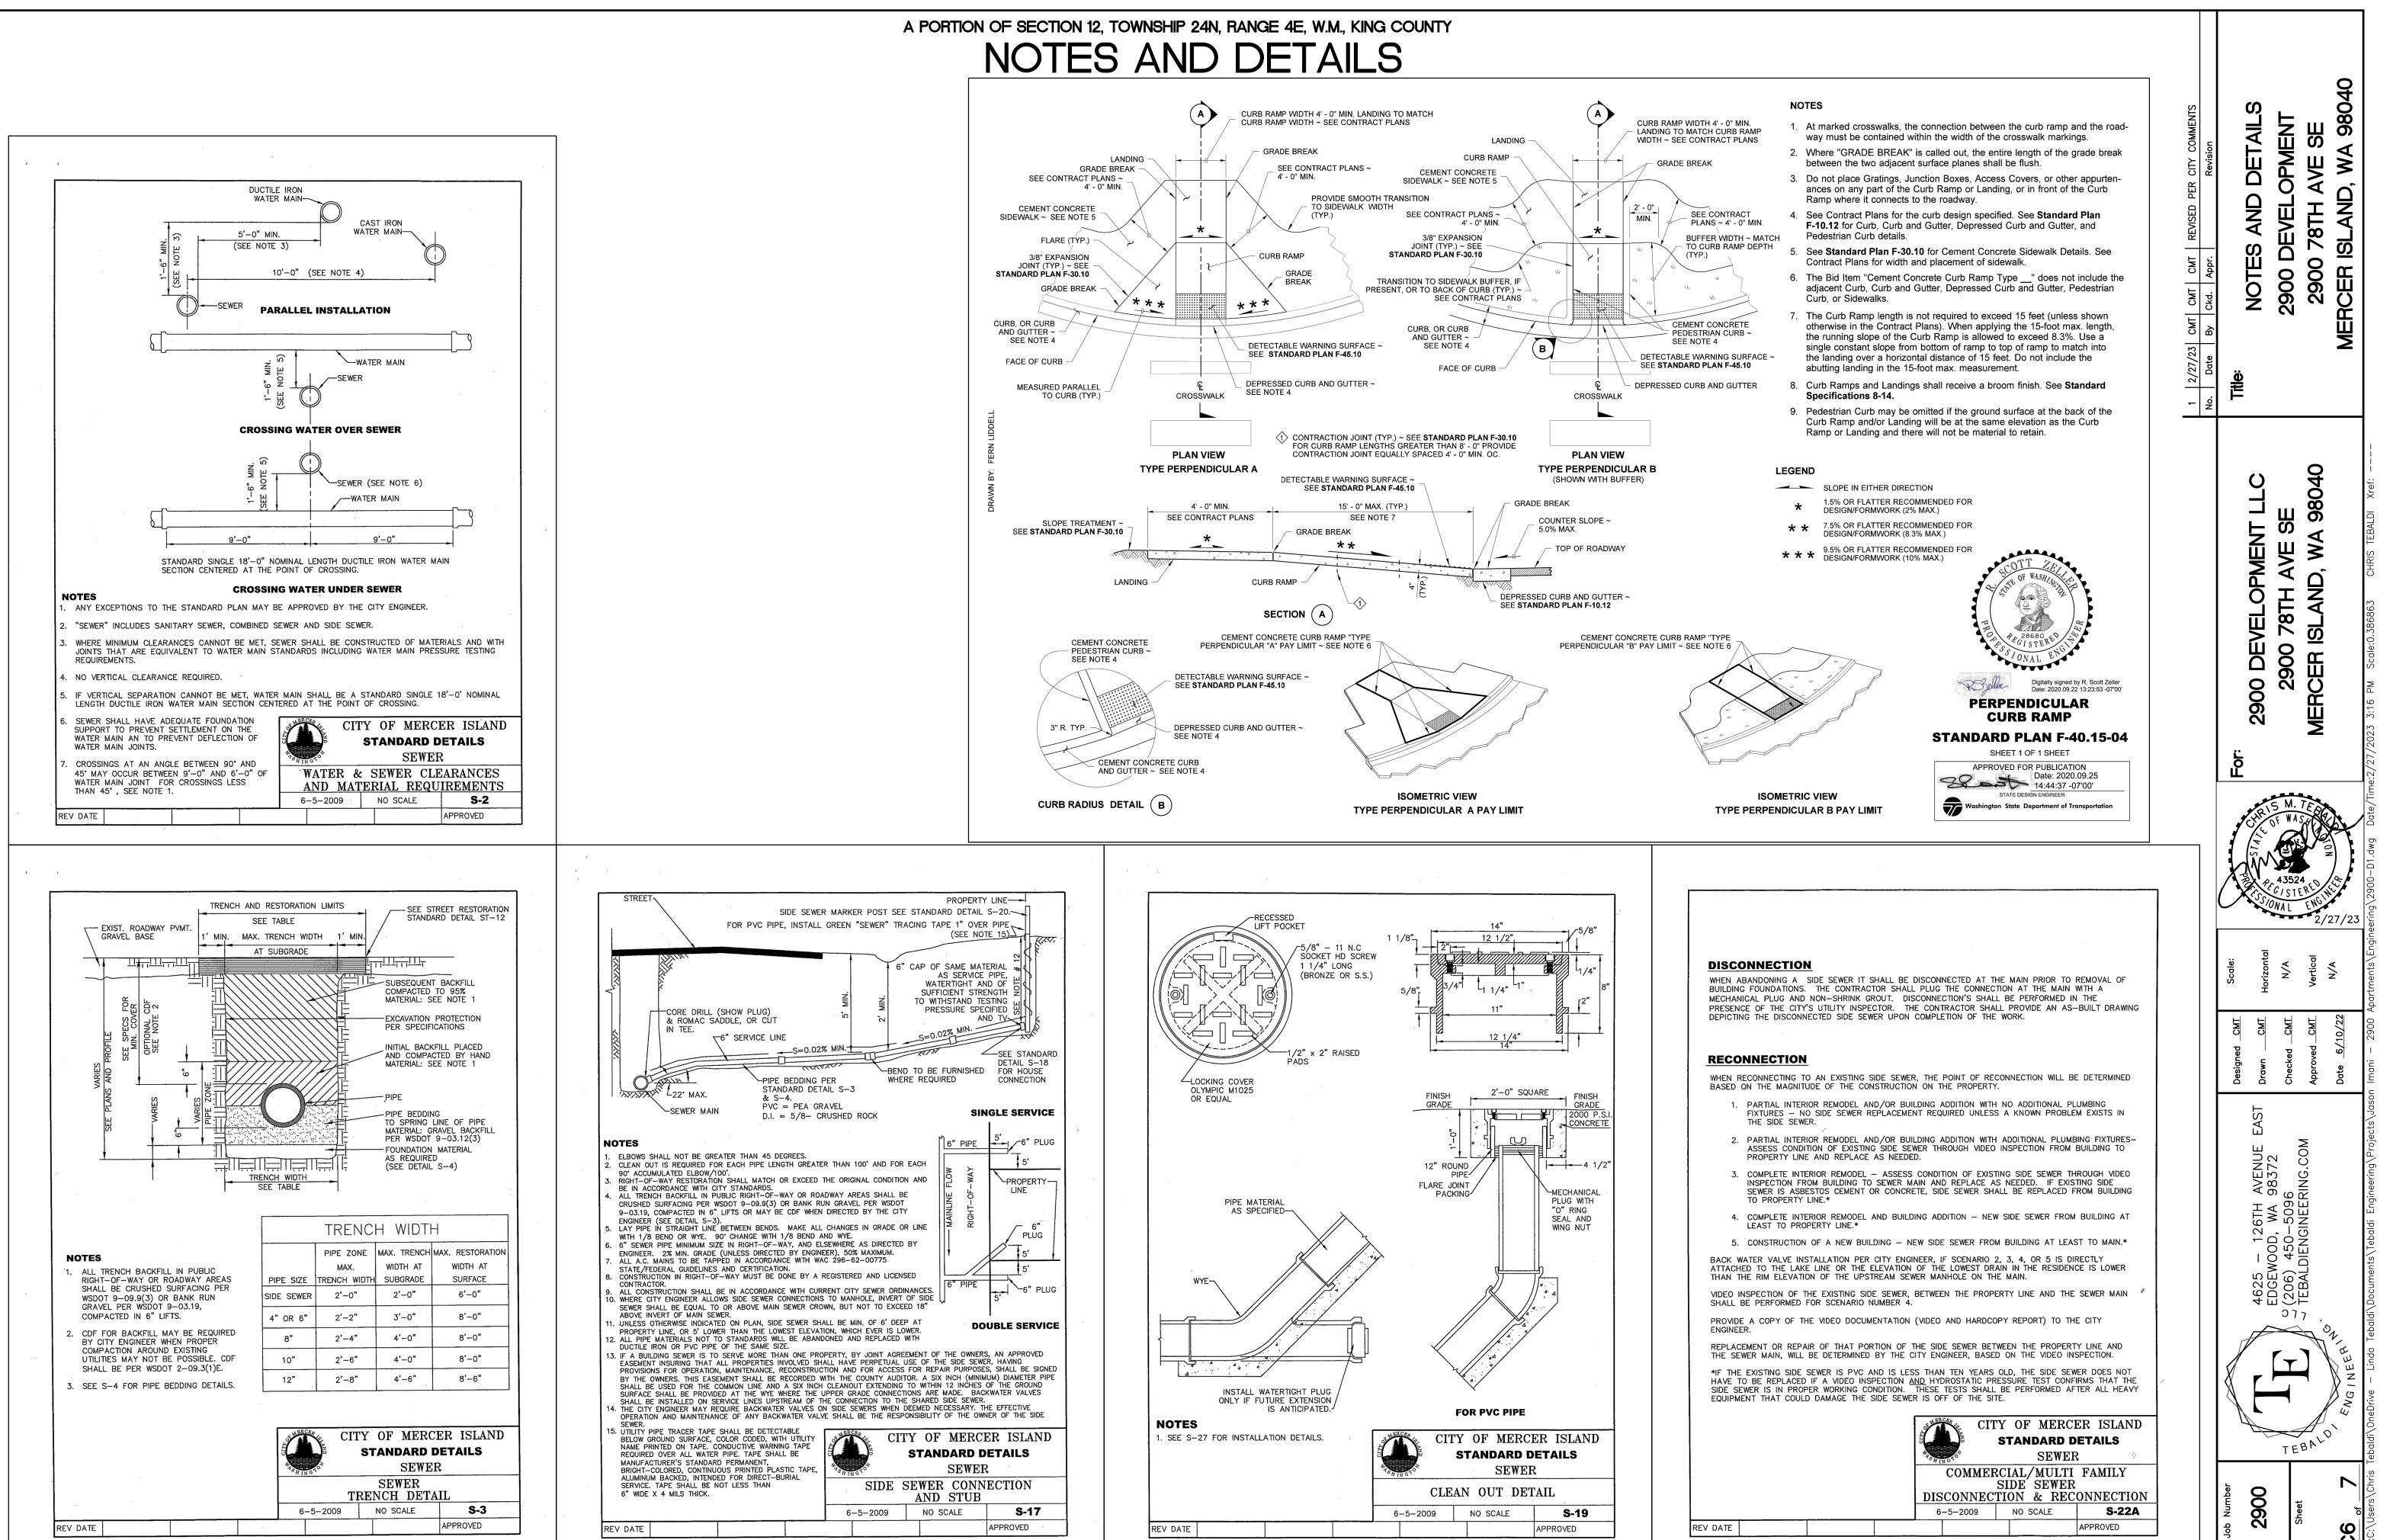

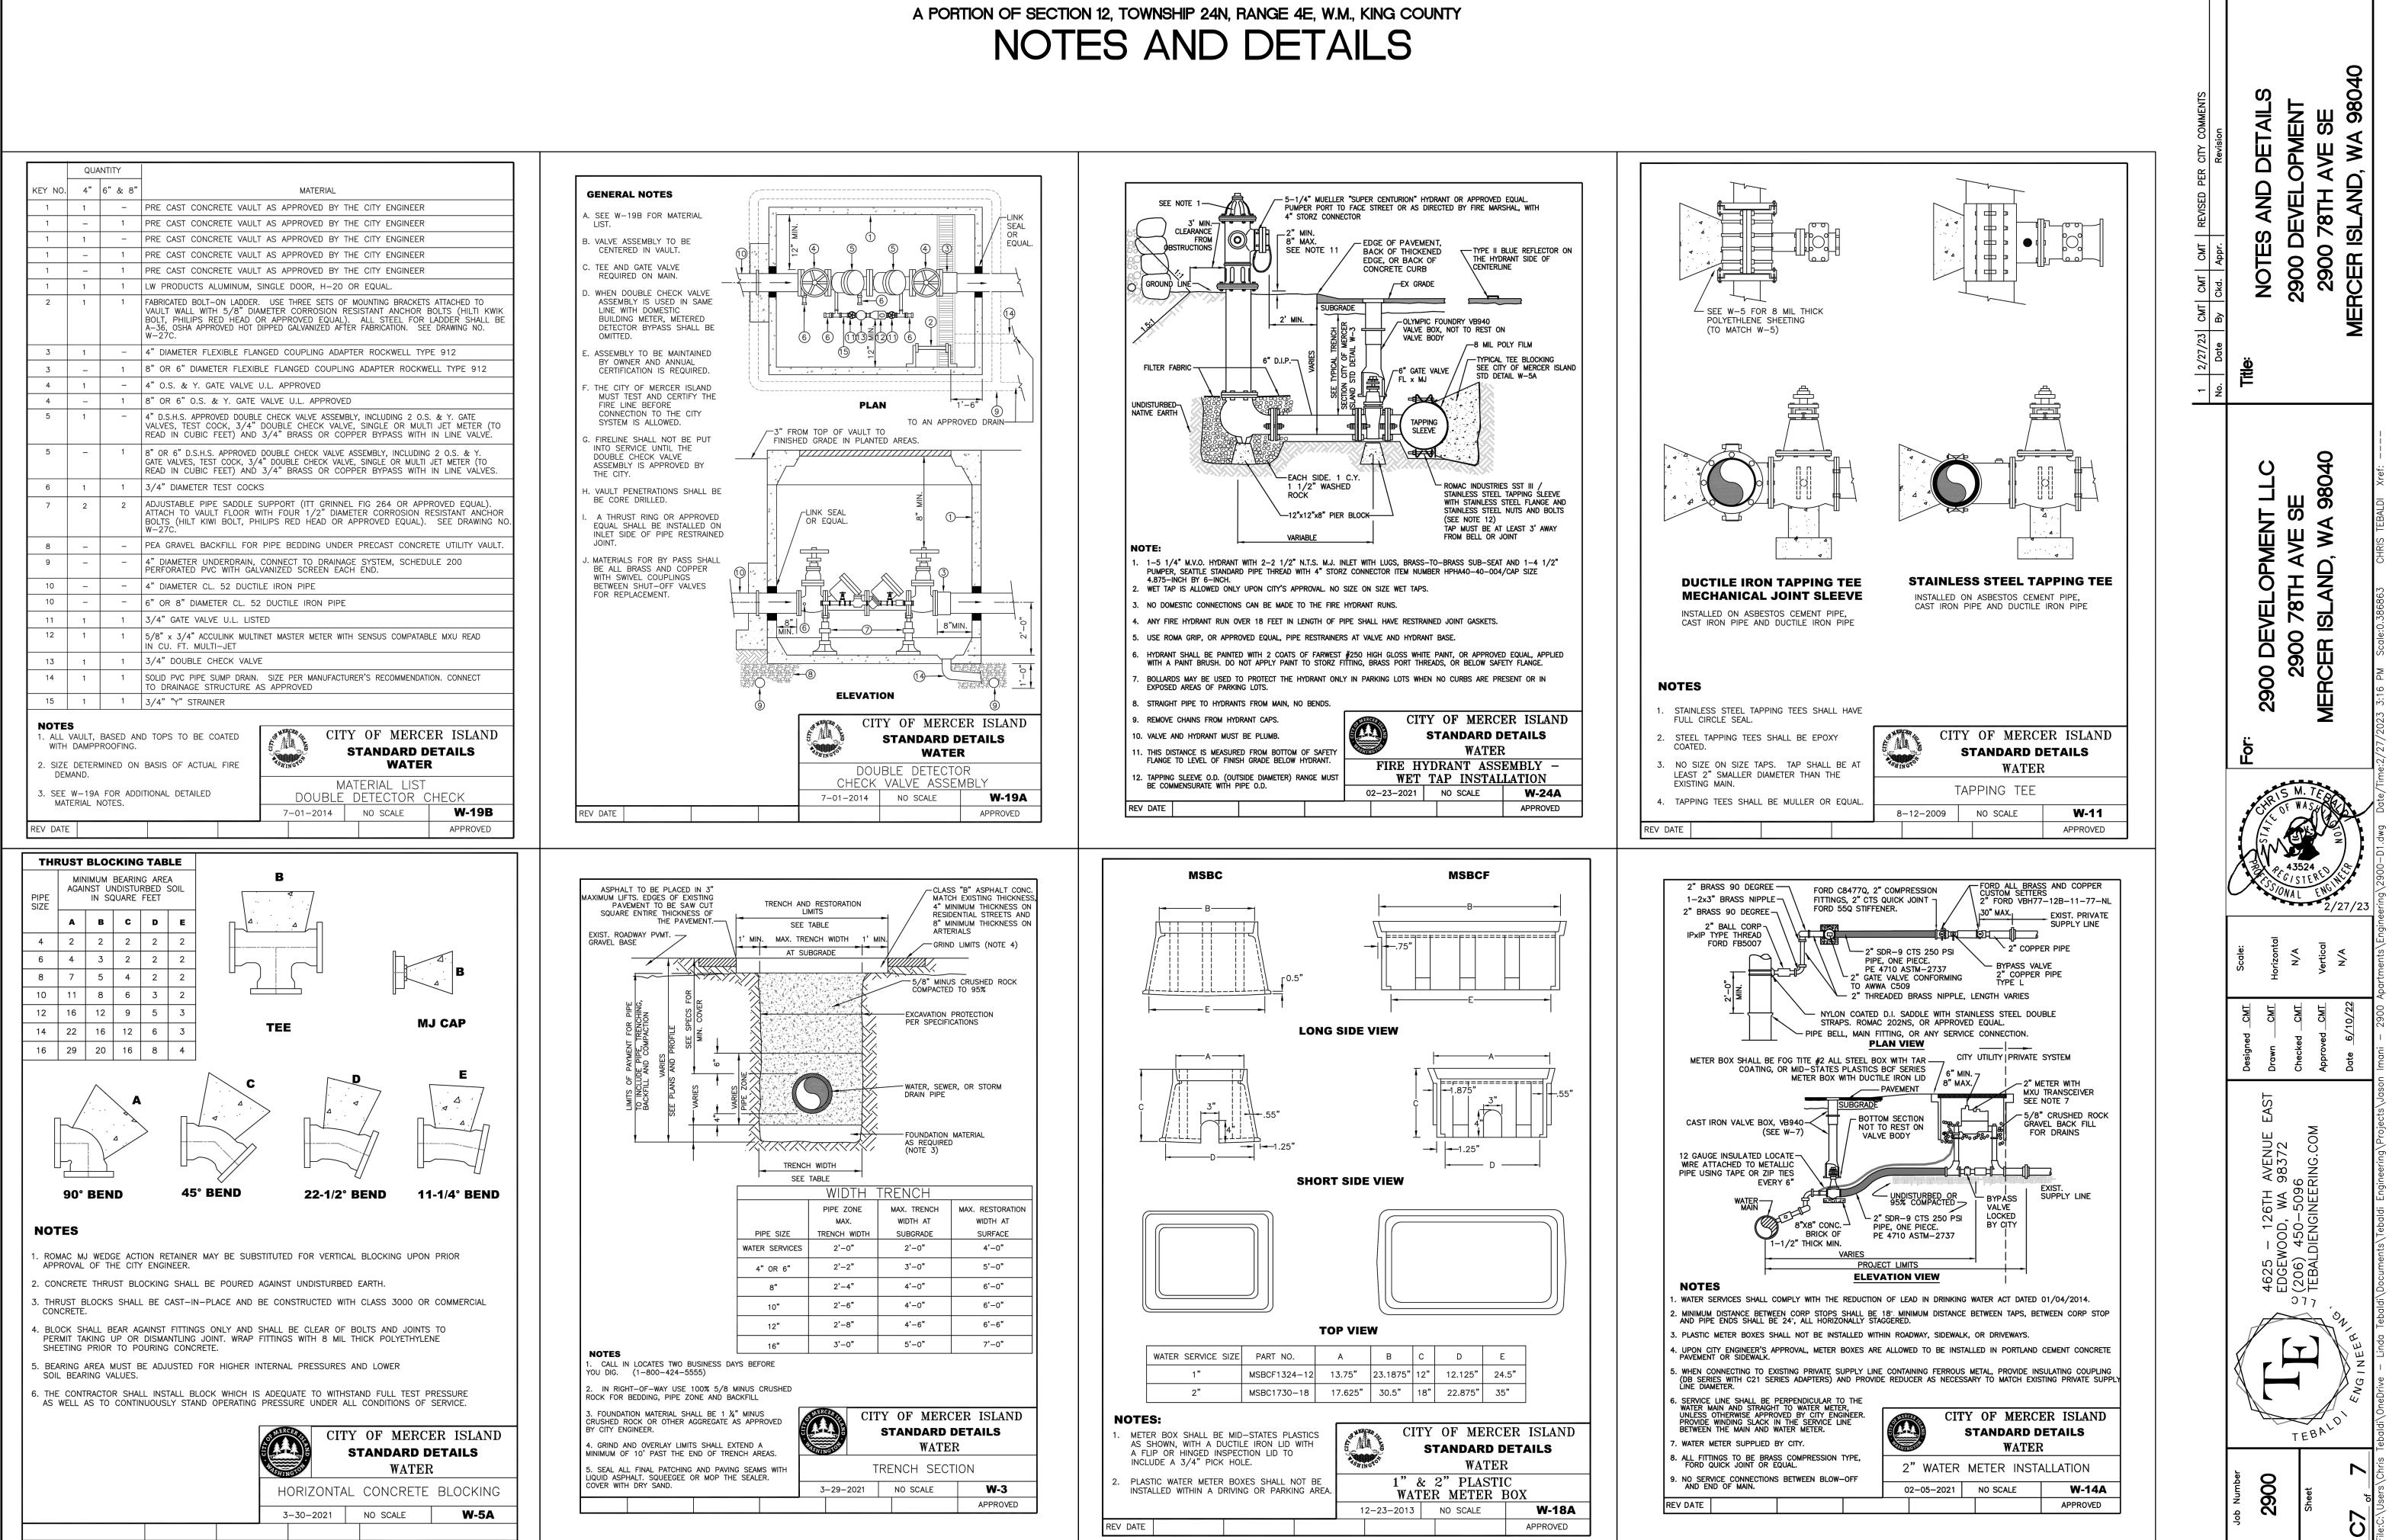

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WASHINGTON REGISTERED LANDSCAPE ARCHITE UNIT A. WU VERTIFICATE NO. 44 DATE: 6-10-2022 LAST UPDATE: CAD FILE: DRAWING TITLE PLANTING PL SHEET NUMBER	JUNT AT 4' HT. FROM FINISH	
WASHINGTON REGISTERED LANDSCAPE ARCHITE UNIT A. WU VERTIFICATE NO. 44 DATE: 6-10-2022 LAST UPDATE: CAD FILE: DRAWING TITLE PLANTING PL SHEET NUMBER	R LED SHALLOW SHADE-SMALL 15805-BKT-4W 12 VOLT LED 23" HT. WITH GROUND STAKE NG; TEXTURED BLACK COLOR P CONTROLLER 120 TO 12 VOLT ORMER, PHOTOCELL, TIMER - OUNT AT 4' HT. FROM FINISH	
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REGISTERED LANDSCAPE ARCHITEC Wing A. W.U CERTIFICATE NO. 44 DATE: 6-10-2022 LAST UPDATE: CAD FILE: DRAWING TITLE PLANTING PL SHEET NUMBER		
LAST UPDATE: CAD FILE: DRAWING TITLE PLANTING PL SHEET NUMBER		
DRAWING TITLE PLANTING PL SHEET NUMBER		
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SSMH

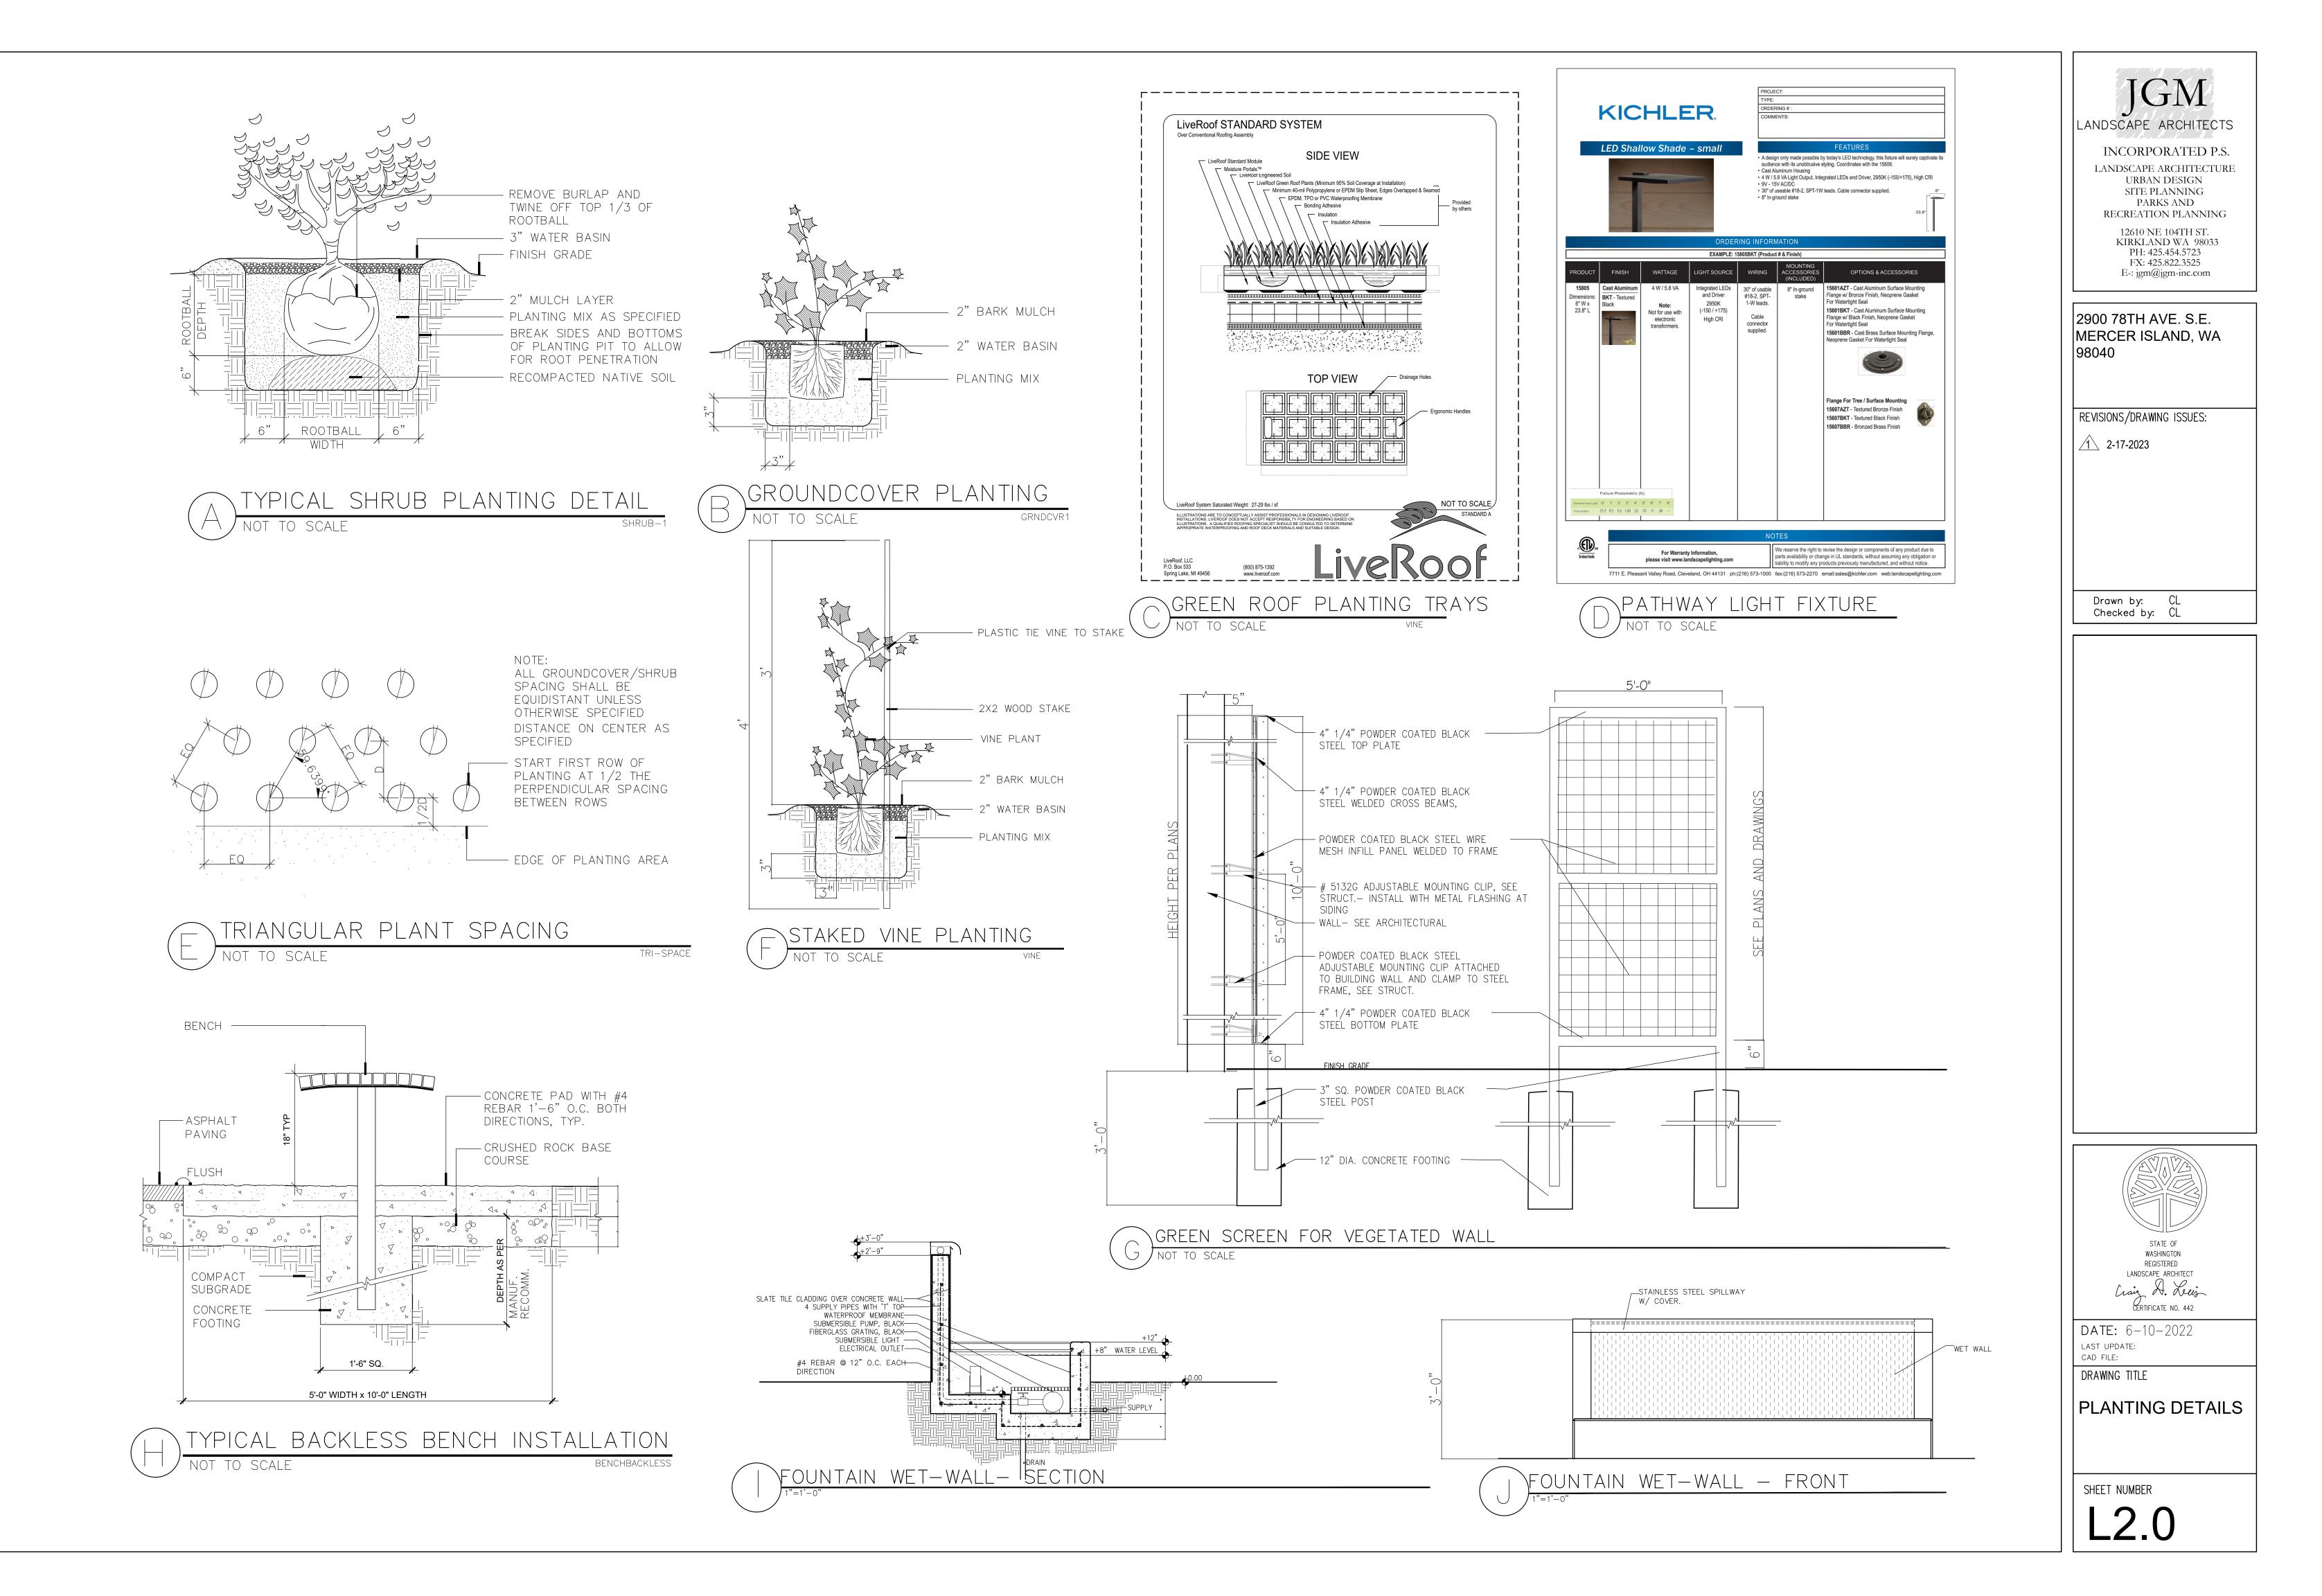FOUND CONC MON W/ BRASS DISK IN -CASE 0.9' DOWN

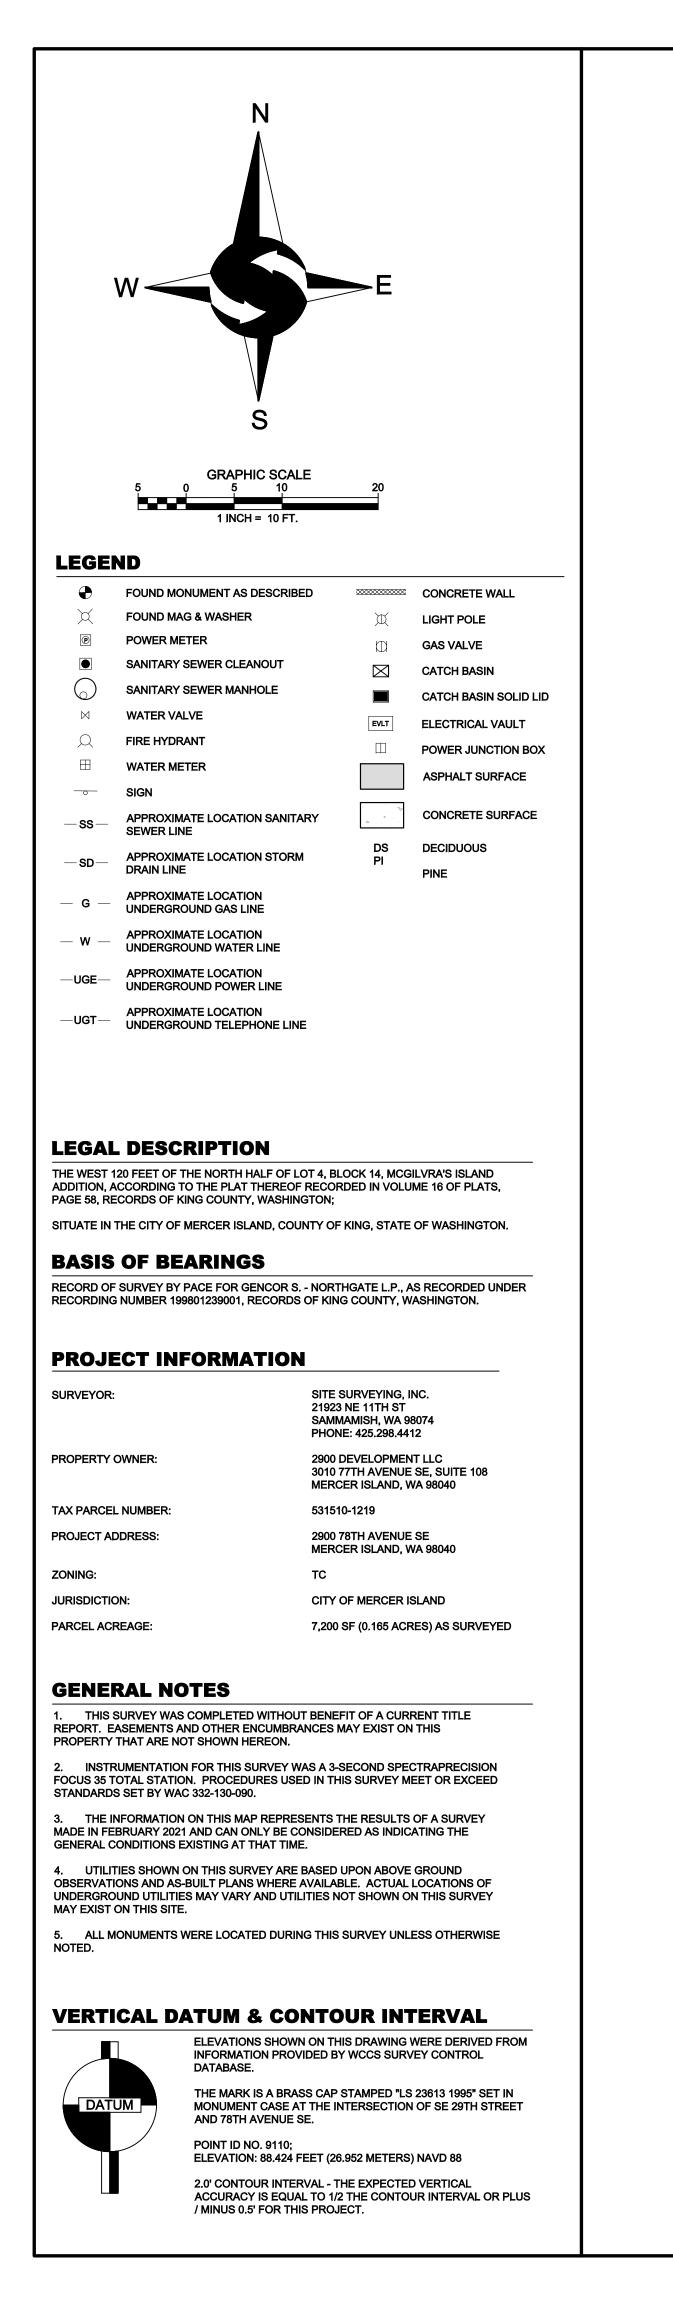
SE 29TH STREET


CB SOLID

RIM = 89.15'

FOUND CONC MON W/ BRASS PLUG IN -CASE 1.2' DOWN

> SSMH RIM = 89.88'

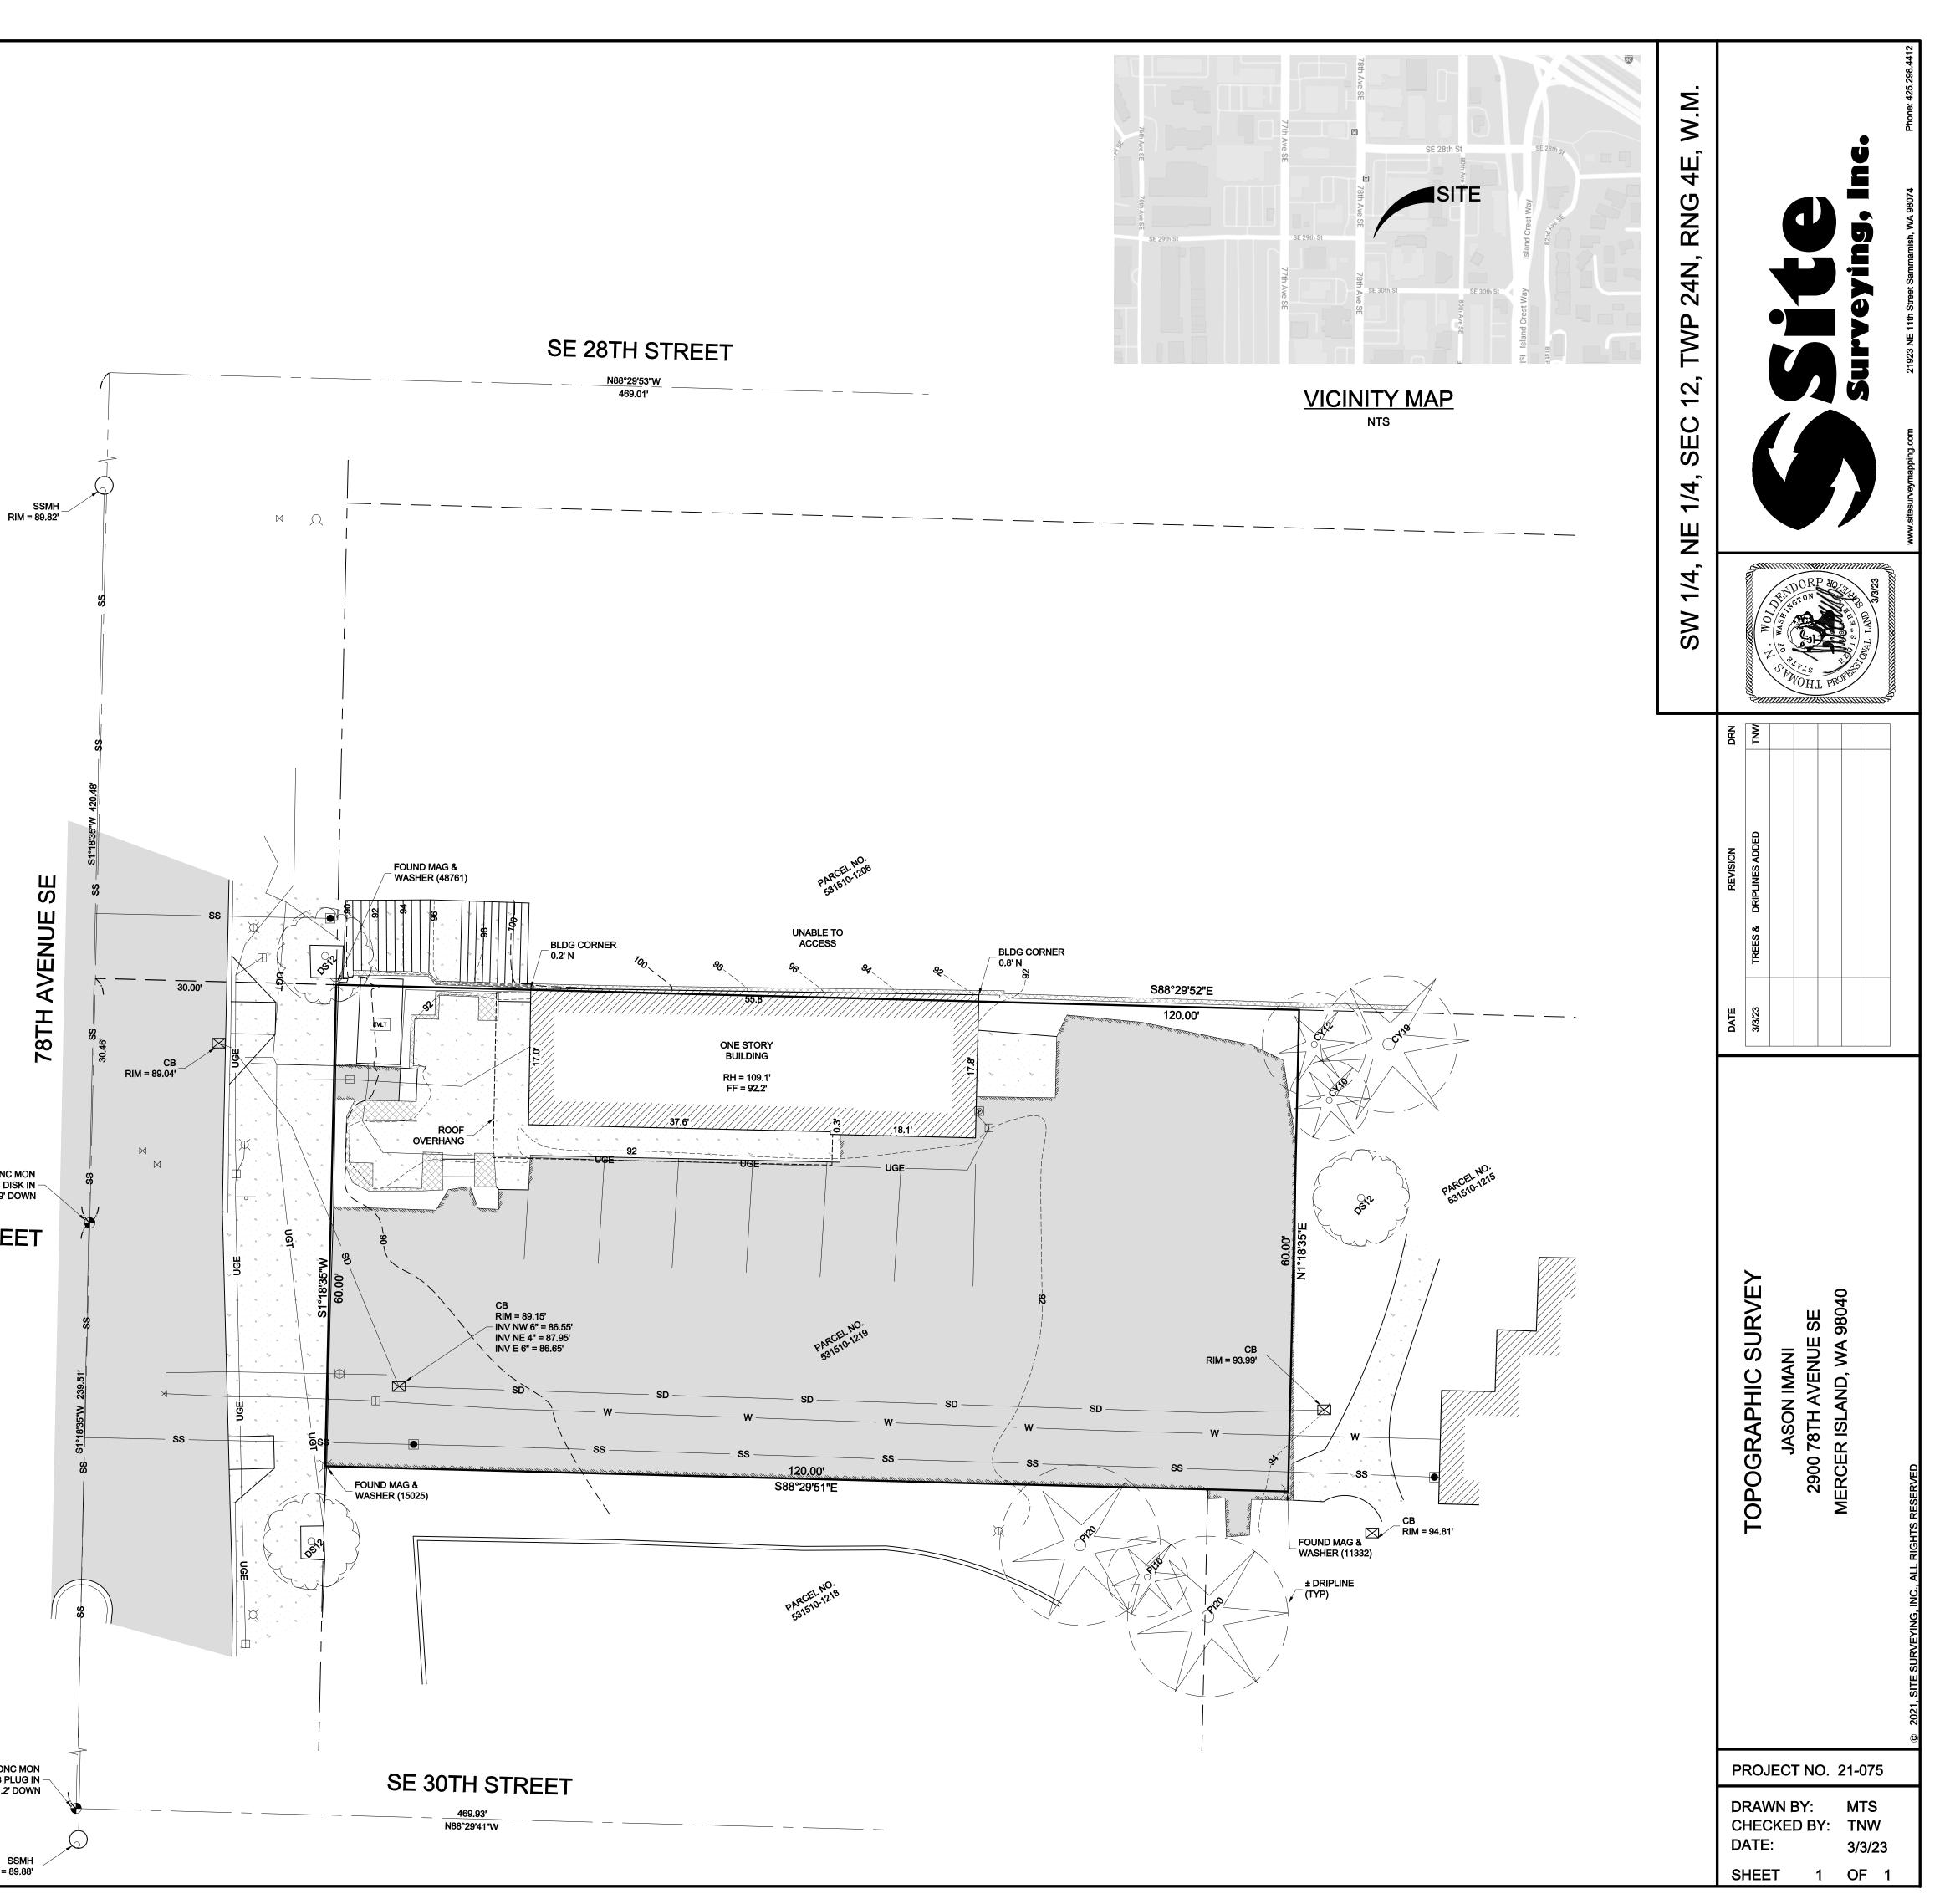

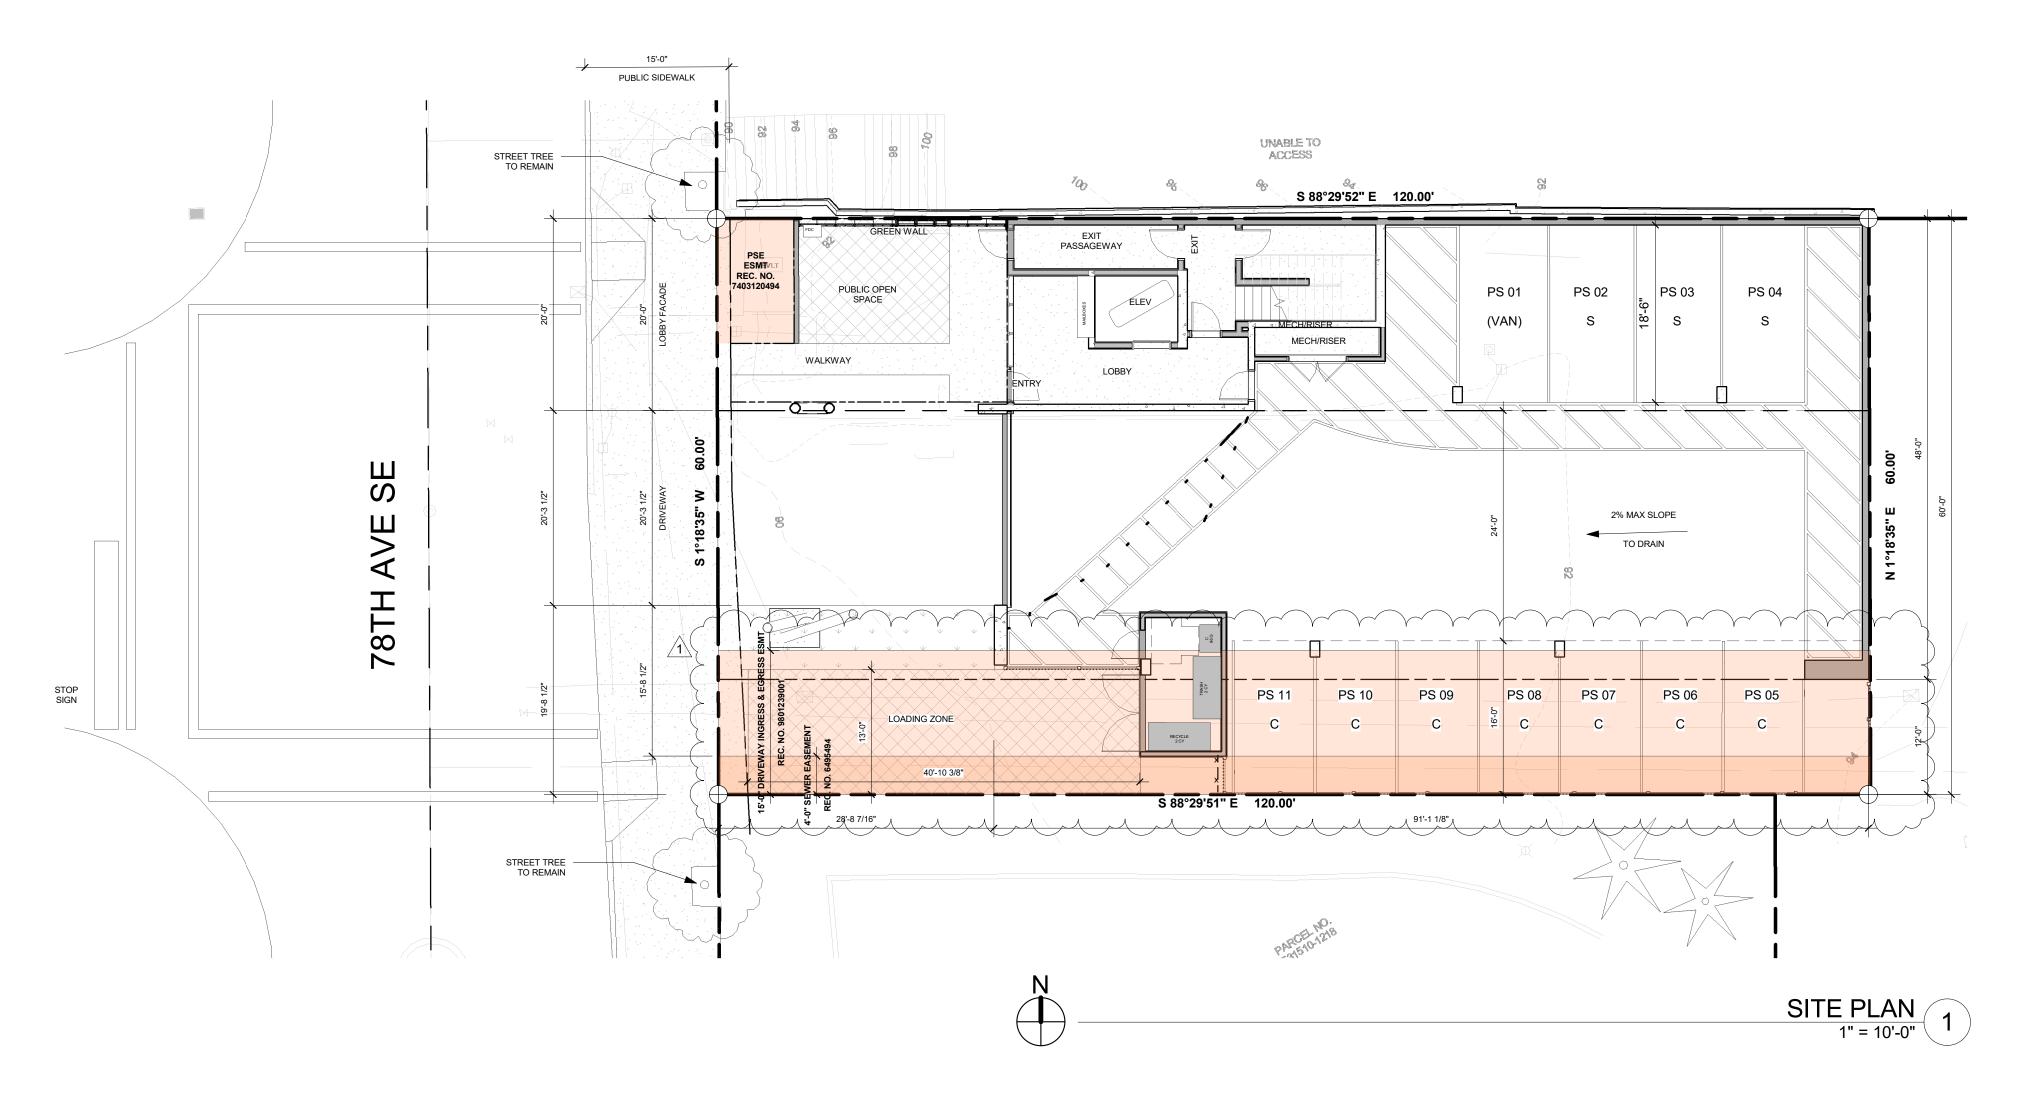

LEGEND

LOCATION OF EXISTING EASEMENTS IDENTIFIED IN TITLE REPORT

ZONING REQUIREMENTS

JURISDICTION: ZONING: PARCEL ASSESSOR'S #: LOT SIZE:

CITY OF MERCER ISLAND TC-4 531510-1219 7200 SF = 0.17 ACRE

<u>LEGAL DESCRIPTION:</u> THE WEST 120 FEET OF THE NORTH HALF OF LOT 4, BLOCK 14, MCGILVRA'S ISLAND ADDITION, ACCORDING TO THE PLAT THEREOF RECORDED IN VOLUME 16 OF PLATS, PAGE 58, RECORDS OF KING COUNTY, WASHINGTON.

SITUATE IN THE CITY OF MERCER ISLAND, COUNTY OF KING, STATE OF WASHINGTON.

MAXIMUMS:

MAX. FAR:	2.3 (X SF) MUST MEET THE STANDARDS OF SUBSECTION
	23.45.530, GREEN BUILDING STANDARDS
MAX. HEIGHT:	27' BASE HEIGHT
	51' MAX HEIGHT (REQUIRES MIN. 10% AFFORDABLE
	HOUSING)
MAX. STORIES:	2 BASE STORIES
	4 MAX STORIES (REQUIRES MIN. 10% AFFORDABLE
	HOUSING)
GROUND FLOOR HEIGHT:	15' MINIMUM / 27' MAXIMUM
CETDACKO.	

SETBACKS: TOWN CENTER - TC-4 SUBAREA, PER MICC 19.11.030 **REQUIRED FRONT:** PROVIDED: SEE SIDEWALK REQ'T PROVIDED: 0' NORTH, 12' SOUTH MIN. O' MIN REQUIRED SIDE: MIN. O' MIN REQUIRED REAR: PROVIDED: 0' MIN. O' MIN

SIDEWALK: MICC 19.11.030(A)(6)

ALONG 78TH AVE SE, ALL STRUCTURES SHALL BE SET BACK SO THAT SPACE IS PROVIDED FOR AT LEAST 15 FEET OF SIDEWALK BETWEEN THE STRUCTURE AND THE FACE OF THE STREET CURB.

DAYLIGHT PLANE: MICC 19.11.030(A)(7)


BLOCK FRONTAGES ALONG STREETS MUST INTEGRATE AVERAGE MINIMUM UPPER BUILDING SETBACK. FROM A HEIGHT OF 25 FEET AT THE FRONT PROPERTY LINE, BUILDINGS SHALL STEP BACK AT A 45-DEGREE ANGLE UP TO THE MAXIMUM HEIGHT LIMIT.

SINCE THE DAYLIGHT PLANE STANDARDS APPLY A MINIMUM AVERAGE, PORTIONS OF BLOCK FRONTAGES MAY PROJECT BEYOND THE DAYLIGHT PLANE CONCEPT DESCRIBED IN SUBSECTION (A)(7)(a) OF THIS SECTION, PROVIDED THE APPLICABLE BLOCK FRONTAGE AS A WHOLE COMPLIES WITH THE MINIMUM AVERAGE.

VEHICULAR PARKING: MICC 19.11.130

REQUIRED: PROVIDED:


1 TO 1.4 STALLS PER	R UNIT ((10 UNITS = MIN. 10 STALLS
VAN ACCESSIBLE:	1	
STANDARD:	3	(22.2%)
COMPACT:	7	(66.7%)
TOTAL:	11	

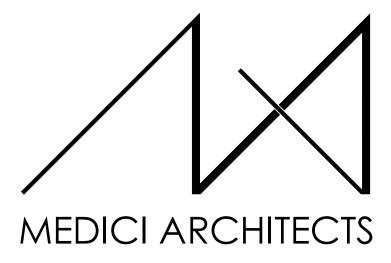

11711 SE 8TH STREET SUITE 100 BELLEVUE, WA 98005 KETCHUM, ID 83340 TEL: (425) 453-9298 TEL: (208) 726-0194

200 W. RIVER ST. SUITE 301

REGISTRATION:

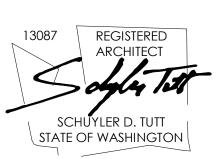

INTAKE DATE:

12/13/22

REVISIONS:		DATE:	
1	CORRECTIONS	4/19/2023	

PROJECT / CLIENT:

2900 78TH AVE SE

2900 Development LLC

JOB ADDRESS: 2900 78TH AVE SE MERCER ISLAND, 98040

DRAWING NAME:

SITE PLAN

Drawn By: KH Checked By: ST Owner Approval:

PHASE:


DESIGN REVIEW


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A0.1a

APPROVED FOR CONSTRUCTION:


PROJECT No.: A21 021 DATE: 4/29/2023



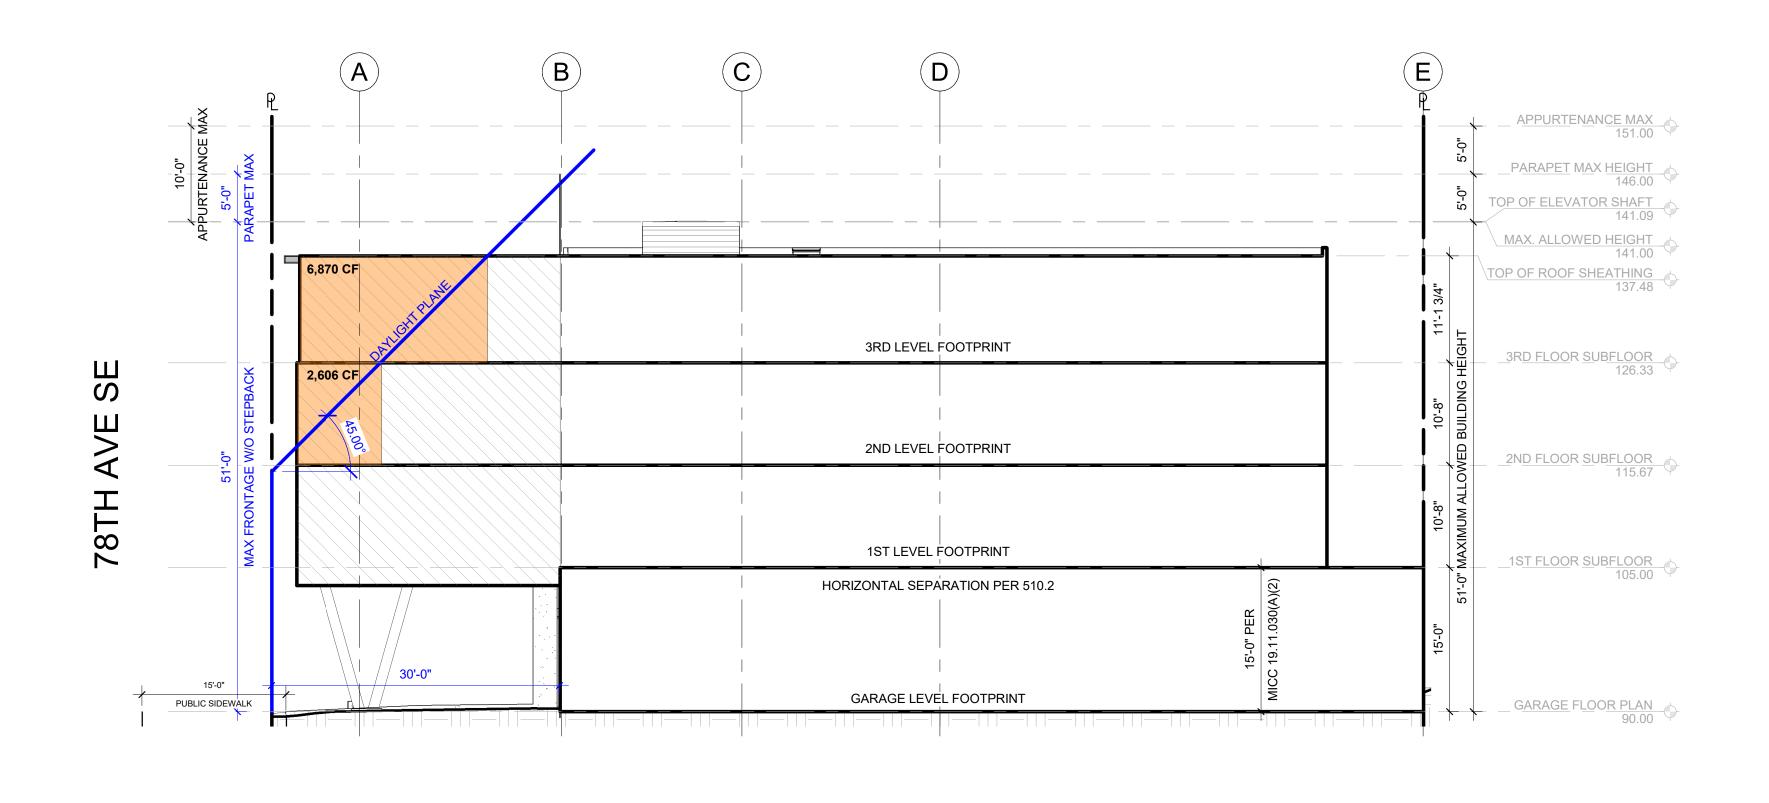

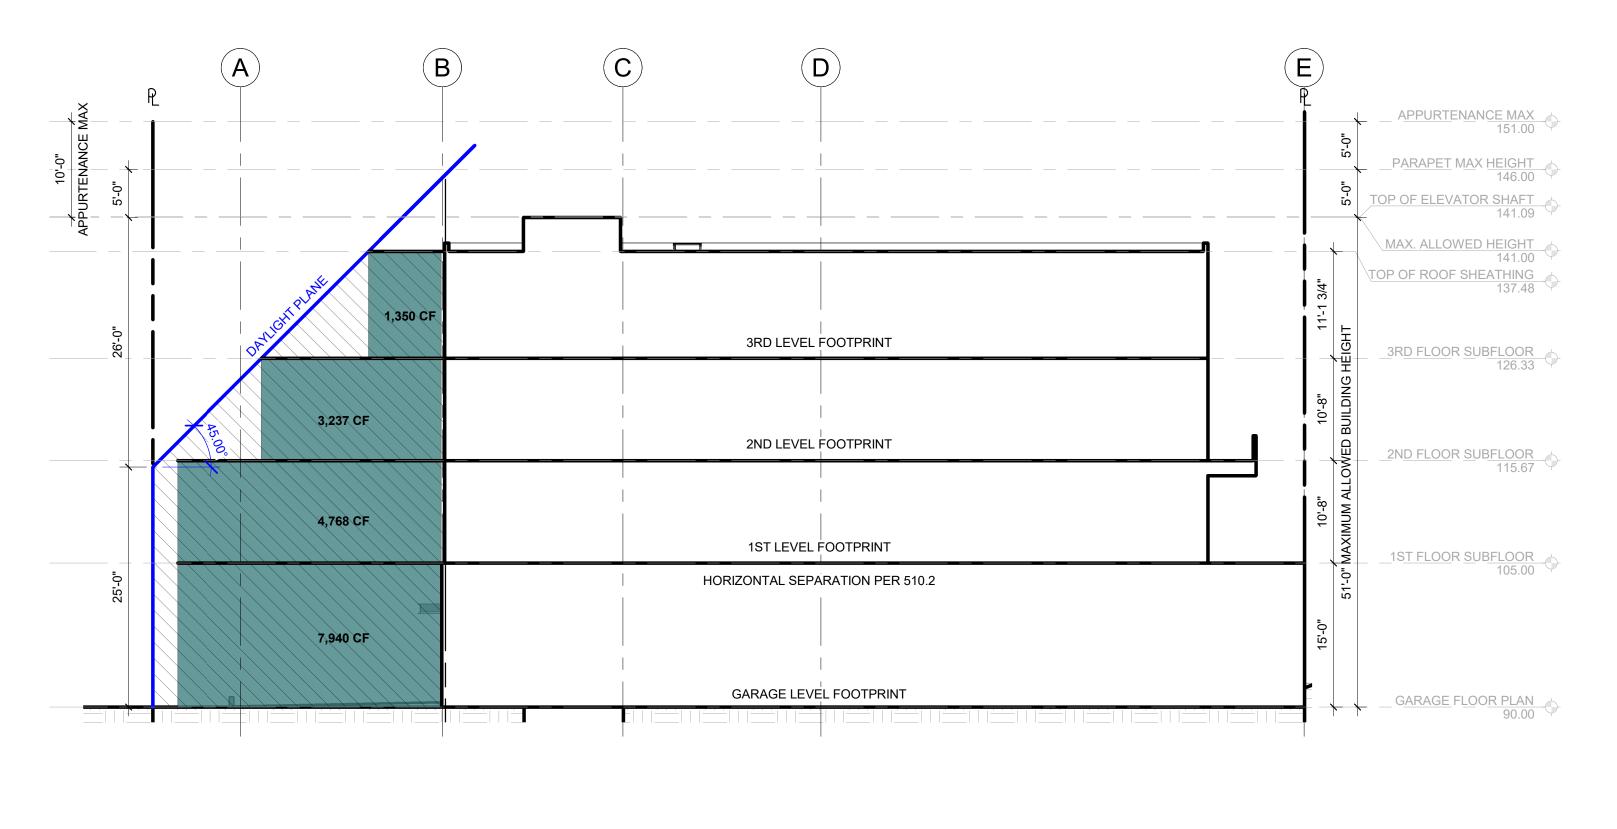
DAYLIGHT PLANE - DEBIT VOLUME 1" = 10'-0" 2

DAYLIGHT PLANE - CREDIT VOLUME 1" = 10'-0" 3

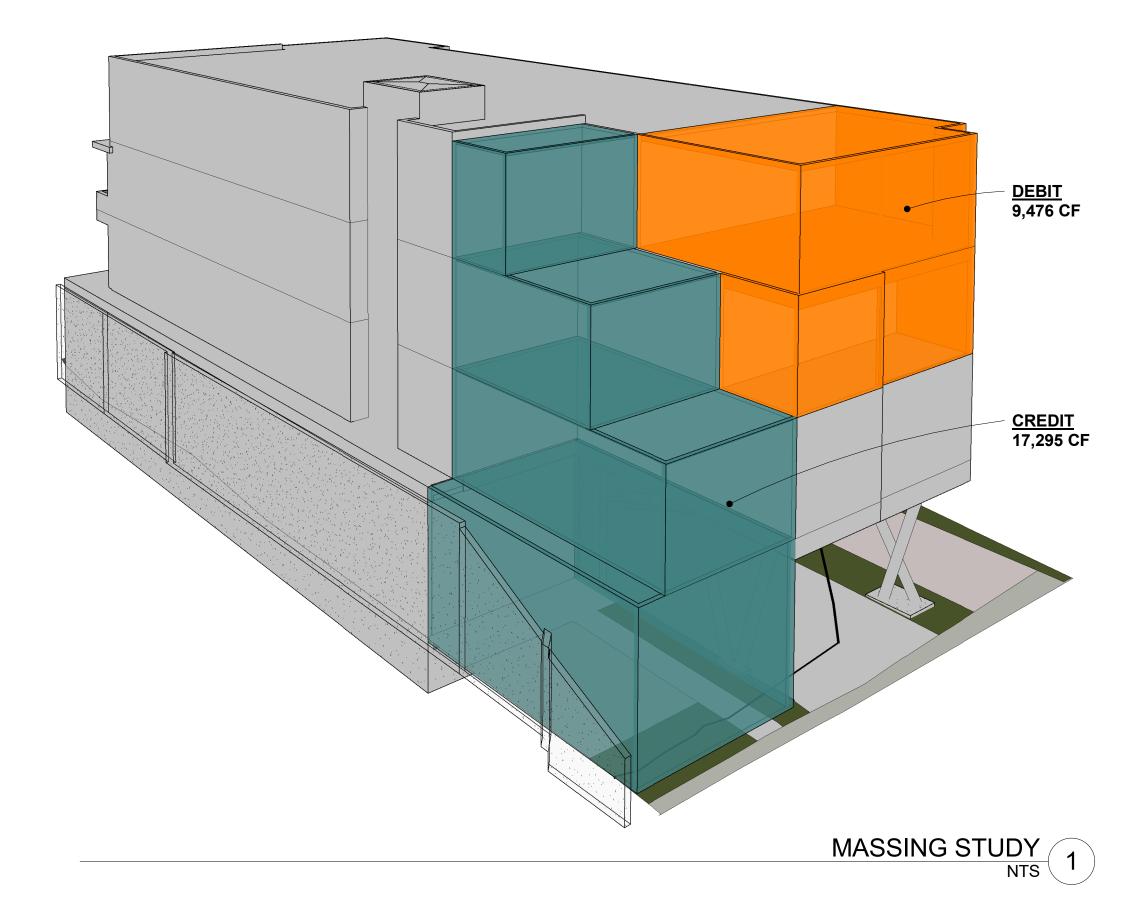


AVERAGE DAYLIGHT PLANE CALCULATION

DEBIT VOLUME	
2ND FLOOR: <u>3RD FLOOR:</u>	2,606 6,870
DEBIT TOTAL:	9,476 CF
CREDIT VOLUME	
GARAGE LEVEL: 1ST FLOOR: 2ND FLOOR: <u>3RD FLOOR:</u>	7,940 4,768 3,237 1,350
CREDIT TOTAL:	17,295 CF
DIFFERENCE	17,295 - 9,476
TOTAL CREDIT VOLUME:	7,819 CF

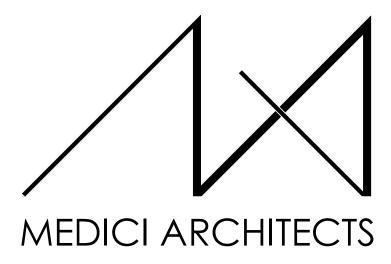

11711 SE 8TH STREET200 W. RIVER ST.SUITE 100SUITE 301BELLEVUE, WA 98005KETCHUM, ID 83340TEL: (425) 453-9298TEL: (208) 726-0194

REGISTRATION:

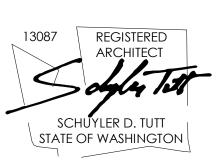

INTAKE DATE:

12/13/22

REVISIONS:		[DATE:	

PROJECT / CLIENT:

2900 78TH AVE SE

2900 Development LLC

JOB ADDRESS: 2900 78TH AVE SE MERCER ISLAND, 98040

DRAWING NAME:

ZONING DIAGRAMS

Drawn By: KH Checked By: ST Owner Approval:


PHASE:

DESIGN REVIEW

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APPROVED FOR CONSTRUCTION:

PROJECT No.: A21 021 DATE: 4/29/2023

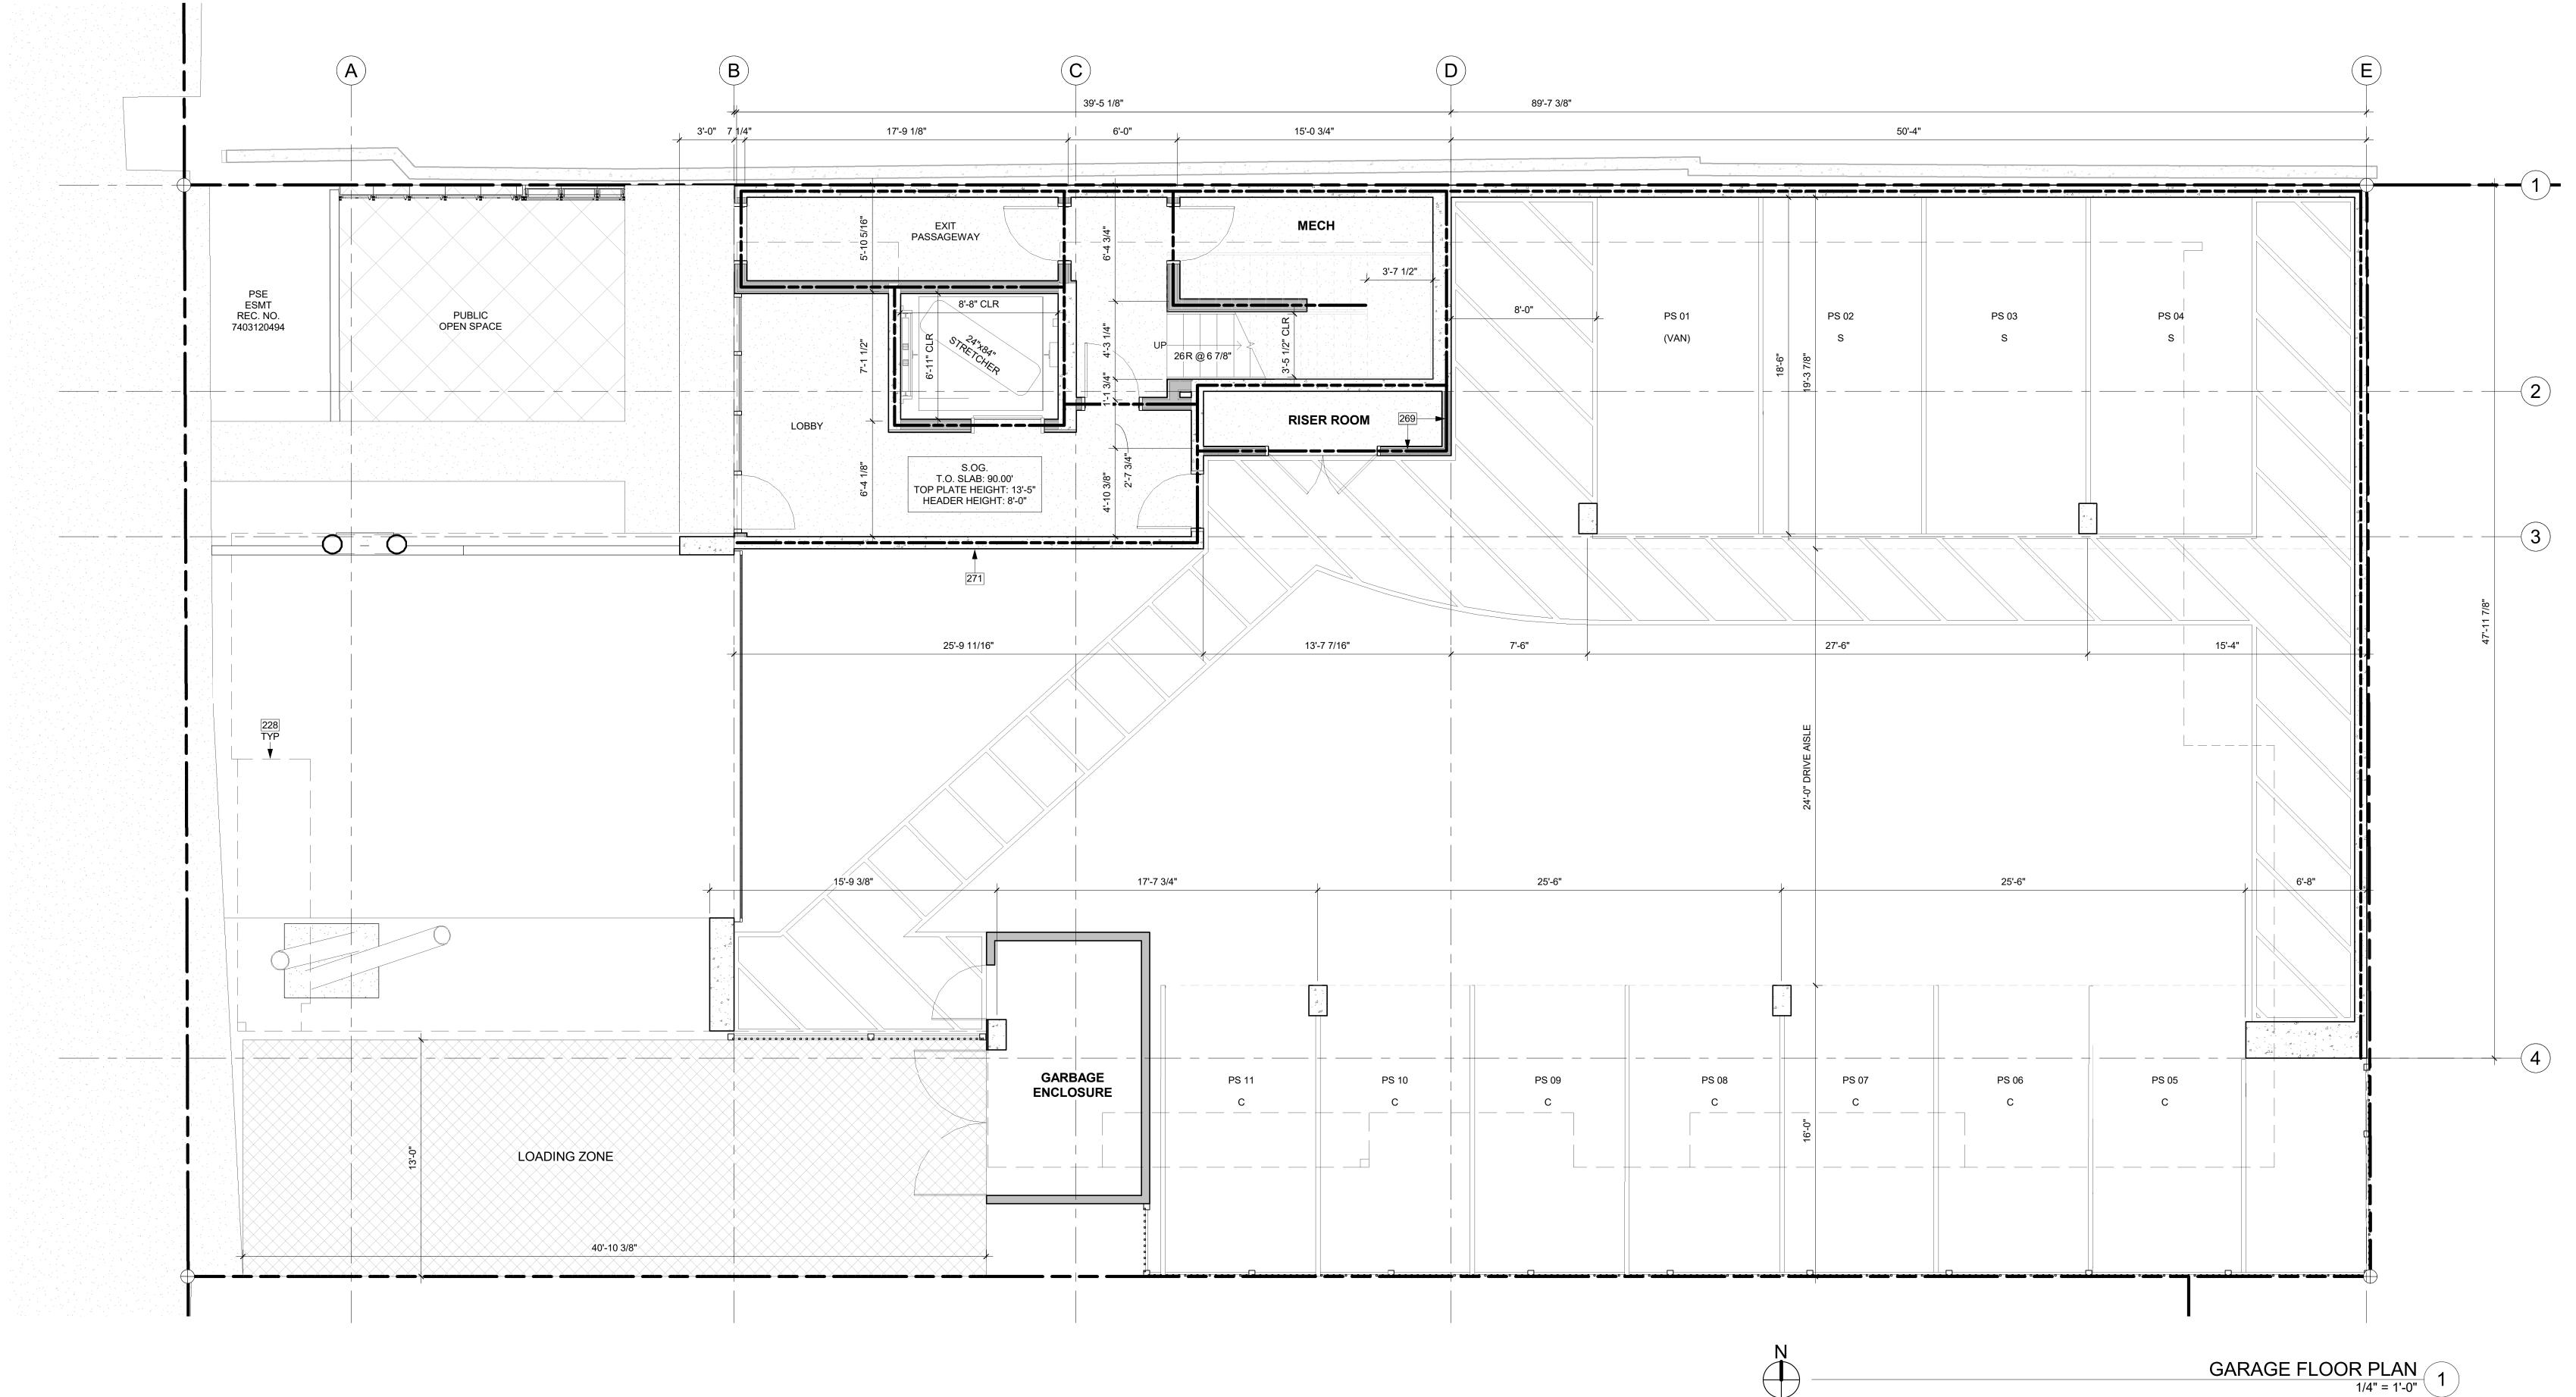

228LONG DASHED LINE OF BUILDING ABOVE.2692-HOUR RATED NON-COMBUSTIBLE WALL; WP 1522. 3 5/8" STEEL STUDS. SEE ASSEMBLY DETAIL ON A0.5a

271 3-HOUR RATED CONCRETE COLUMN PER STRUCTURAL.



FLOOR PLAN NOTES

- CONTRACTOR SHALL VERIFY ALL NOTES, DIMENSIONS & CONDITIONS PRIOR TO CONSTRUCTION. 1
- SEE STRUCTURAL DRAWINGS FOR ALL POSTS, BEAMS AND HEADERS. PROVIDE SOLID BLOCKING OVER SUPPORTS. PROVIDE FIRE BLOCKING @ ALL PLUMBING PENETRATIONS.
- WINDOWS & DOORS ARE SHOWN & NOTED AS NOMINAL SIZES.
- DOOR JAMB 4.5" FROM CORNER TYP., U.N.O. SEE SHEETS A0.3, A4.0 & A4.1 FOR WINDOW & DOOR HEADER HEIGHTS ABOVE FINISHED FLOOR.
- ALL WOOD IN CONTACT WITH CONCRETE TO BE PRESSURE TREATED. EXTERIOR WALLS TO BE 2x6 STUDS @ 16" O.C., U.N.O. INSTALL SIMPSON CONC. TO WOOD HOLDOWNS PER STRUCTURAL 10 DRAWINGS, ALSO SEE MANUFACTURER'S SPECS.
- 11. SMOKE & CARBON MONOXIDE DETECTORS: • SHALL BE 110V INTERCONNECTED W/ BATTERY BACKUP. • SHALL SOUND AN ALARM AUDIBLE IN ALL SLEEPING ROOMS. • SHALL BE INSTALLED ON EACH FLOOR AND IN ALL BEDROOMS. • SHALL BE INSTALLED IN EACH LOCATION WHERE THERE IS A CEILING CHANGE OF GREATER THAN 24"
- 12. FRESH AIR PROVIDED BY WHOLE-HOUSE EXHAUST FAN WITH FRESH AIR PORT (NET 4 SF IN MIN. OPENING) AT EACH HABITABLE ROOM. A TIMER OPERATES AN EXHAUST FAN WHICH PULLS OUTSIDE AIR THROUGH AIR INLETS LOCATED IN EACH HABITABLE ROOM.
- 13. LIMITING DEVICE FOR TUBS TO PROVIDE MAX. 120°F HOT WATER TEMPERATURE. 14. FOOTINGS SHALL BEAR ON SOLID UNDISTURBED EARTH (CONTROLLED, COMPACTED STRUCTURAL FILL OR BOTH). DEPTH OF FOOTINGS TO BE DETERMINED BY STRUCTURAL ENGINEER. FOUNDATION EXCAVATION, BACKFILL AND COMPACTION SHALL CONFORM TO SPECIFICATION REQUIREMENTS. THIS CONSTRUCTION WORK, INCLUDING DRAINAGE, SHORING AND SUCH OTHER RELATED WORK AS REQUIRED, SHALL BE CONDUCTED BY THE CONTRACTOR. STOP WORK IF RECOMMENDED
- EXCAVATION CUT OR BEARING SOIL CHANGES OCCUR IN EITHER HORIZONTAL OR VERTICAL DIRECTION AND NOTIFY IMMEDIATELY THE GEOTECHNICAL ENGINEER AND STRUCTURAL ENGINEER. AT WHICH POINT THE ENGINEERS SHALL DETERMINE CAUSE OF DISPLACEMENT AND DEVELOP AND IMPLEMENT REMEDIAL MEASURES.

FIRE-RESISTANCE ASSEMBLIES

— · — · —	1-HOUR RATED WALL ASSEMBLY
	2-HOUR RATED WALL ASSEMBLY

3-HOUR RATED WALL ASSEMBLY

SYMBOL LEGEND

SEE TITLE SHEET A0.0 FOR COMPLETE SYMBOL INDEX.

HOUSE VENTILATION

2018 IRC - PROVIDE WHOLE HOUSE VENTILATION PER M1505.4, INTERMITTENT WHOLE HOUSE VENTILATION USING EXHAUST FAN PER 1505.4.1.2 (WA) AND TABLE 1505.4.3(1) & (3) (WA); PROVIDE CONTROLS PER 1505.4.2. COMPLY WITH WSEC R403.		
SYMBOL		MINIMUM FAN REQUIREMENTS
	BATH & POWDER	MIN. 50 CFM (INTERMITTENT) @ 0.25" WG (TABLE M1505.4.4)
	KITCHEN	MIN. 100 CFM (INTERMITTENT) @ 0.25" WG (TABLE M1505.4.4) RANGE HOOD OR DOWN DRAFT EXHAUST FAN RATED AT MIN. 100 CFM AT 0.10" WG MAY BE USED FOR EXHAUST FAN REQUIREMENT. IF OVER 400 CFM, MAKEUP AIR IS REQUITED IN THE SAME ROOM PER M1503.6.
	LAUNDRY ROOM	MIN. 210 A. (INTERMITTENT) @ 0.25" WG - TO FUNCTIE AND UP ABELED AS WHOLE HOUSE FAN (4-5 BED A IS 4501<6000 SF) TO OPERATE 50% OF TIME IN EAUP HOUR SEGMENT.
** MAKEUP AIR IS NOT REQUIRED IF ALL GAS APPLIANCES IN THE HOUSE HAVE A		


** MAKEUP AIR IS NOT REQUIRED IF ALL GAS APPLIANCES IN THE HOUSE HAVE A DIRECT VENT OR MECHANICAL DRAFT VENT SYSTEM, PER MODIFICATION M1503.6.



11711 SE 8TH STREET SUITE 100 BELLEVUE, WA 98005 KETCHUM, ID 83340 TEL: (425) 453-9298 TEL: (208) 726-0194

200 W. RIVER ST. SUITE 301

REGISTRATION:

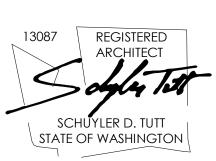

INTAKE DATE:

12/13/22

REVISIONS:		DATE:

PROJECT / CLIENT:

2900 78TH AVE SE

2900 Development LLC

JOB ADDRESS: 2900 78TH AVE SE MERCER ISLAND, 98040

DRAWING NAME:

GARAGE PLAN

Drawn By: KH Checked By: ST Owner Approval:

PHASE:


DESIGN REVIEW

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A2.0

APPROVED FOR CONSTRUCTION:

PROJECT No.: A21 021 DATE: 4/29/2023

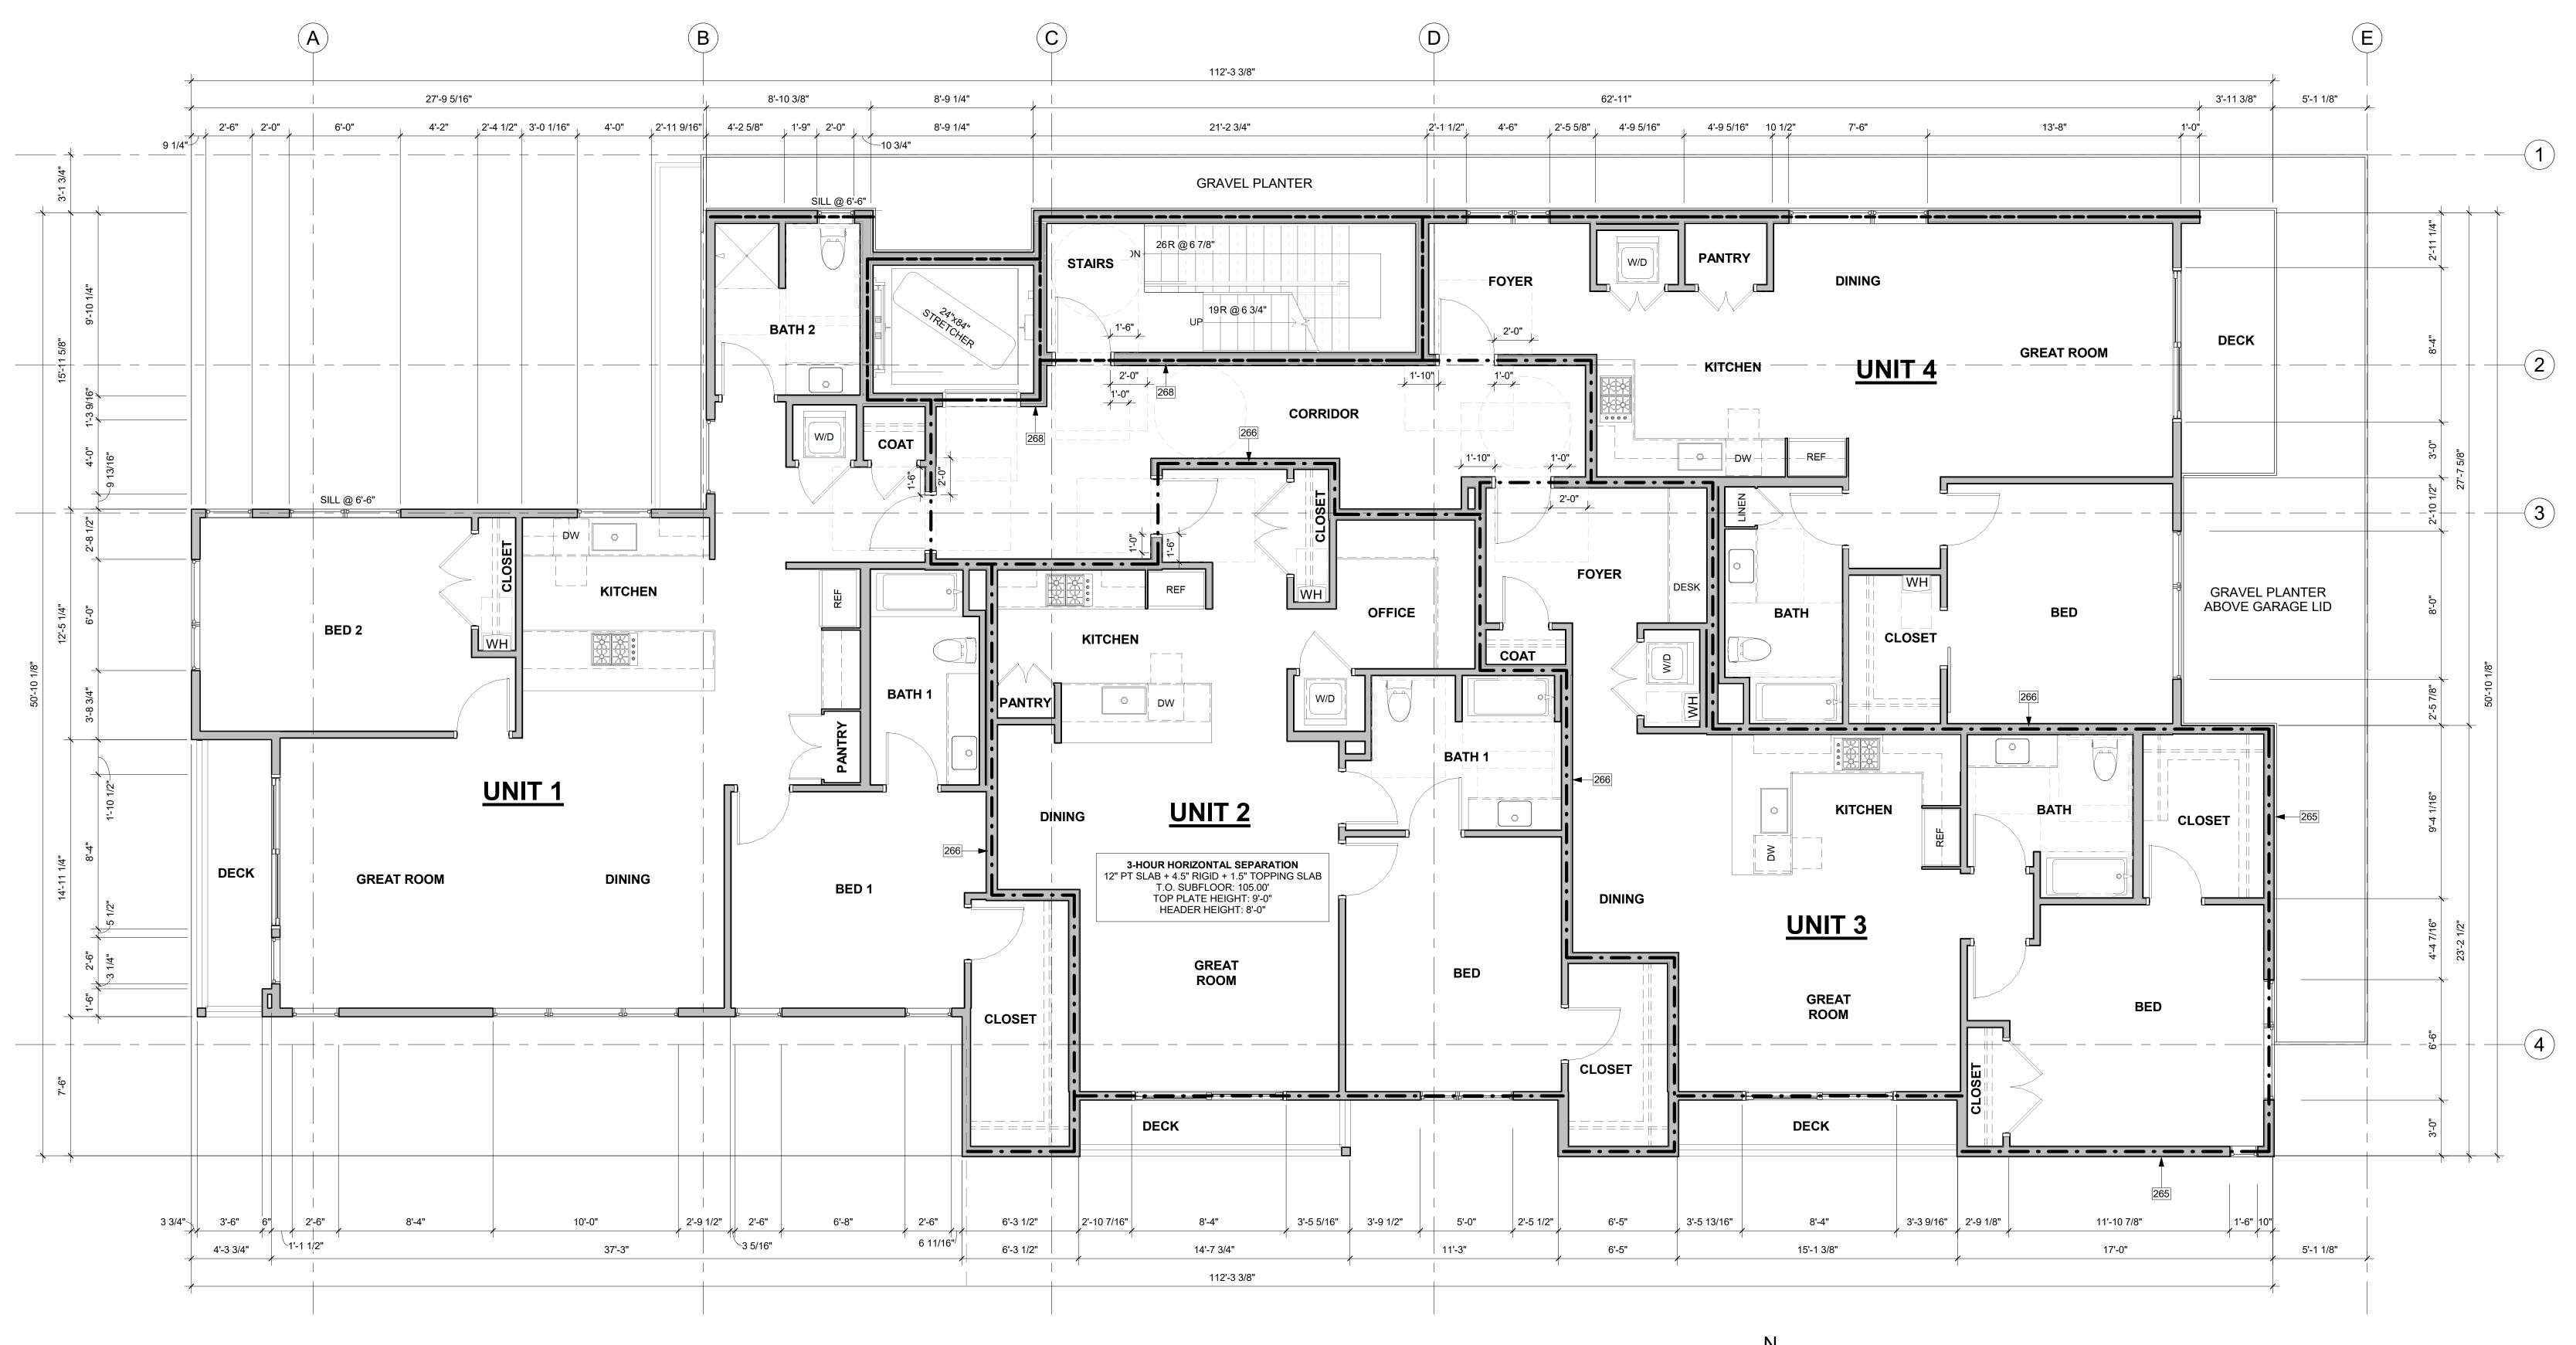

- 2651-HOUR RATED EXTERIOR WALL; WP 8105. SEE ASSEMBLY DETAIL ON A0.5a.2661-HOUR RATED FIRE PARTITION; WP 3242. STC RATING OF 50-54. SEE
- ASSEMBLY DETAIL ON A0.5a 268 2-HOUR RATED ELEVATOR SHAFT; WP 3825. STC RATING OF 55-59. SEE
- ASSEMBLY DETAIL ON A0.5a.

1ST FLOOR PLAN 1/4" = 1'-0" 1

FLOOR PLAN NOTES

- CONTRACTOR SHALL VERIFY ALL NOTES, DIMENSIONS & CONDITIONS PRIOR TO CONSTRUCTION. 1
- SEE STRUCTURAL DRAWINGS FOR ALL POSTS, BEAMS AND HEADERS. PROVIDE SOLID BLOCKING OVER SUPPORTS. PROVIDE FIRE BLOCKING @ ALL PLUMBING PENETRATIONS.
- WINDOWS & DOORS ARE SHOWN & NOTED AS NOMINAL SIZES.
- DOOR JAMB 4.5" FROM CORNER TYP., U.N.O. SEE SHEETS A0.3, A4.0 & A4.1 FOR WINDOW & DOOR HEADER HEIGHTS ABOVE FINISHED FLOOR. ALL WOOD IN CONTACT WITH CONCRETE TO BE PRESSURE TREATED.
- EXTERIOR WALLS TO BE 2x6 STUDS @ 16" O.C., U.N.O. INSTALL SIMPSON CONC. TO WOOD HOLDOWNS PER STRUCTURAL 10 DRAWINGS, ALSO SEE MANUFACTURER'S SPECS.
- 11. SMOKE & CARBON MONOXIDE DETECTORS: • SHALL BE 110V INTERCONNECTED W/ BATTERY BACKUP. • SHALL SOUND AN ALARM AUDIBLE IN ALL SLEEPING ROOMS. • SHALL BE INSTALLED ON EACH FLOOR AND IN ALL BEDROOMS. • SHALL BE INSTALLED IN EACH LOCATION WHERE THERE IS A CEILING CHANGE OF GREATER THAN 24"
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- DEVELOP AND IMPLEMENT REMEDIAL MEASURES.

FIRE-RESISTANCE ASSEMBLIES

— · — · —	1-HOUR RATED WALL ASSEMBLY
	2-HOUR RATED WALL ASSEMBLY
	3-HOUR RATED WALL ASSEMBLY

3-HOUR RATED WALL ASSEMBLY


SYMBOL LEGEND

SEE TITLE SHEET A0.0 FOR COMPLETE SYMBOL INDEX.

HOUSE VENTILATION

2018 IRC - PROVIDE WHOLE HOUSE VENTILATION PER M1505.4, INTERMITTENT			
WHOLE HO	USE VENTILA	TION USING EXHAUST FAN PER 1505.4.1.2 (WA) AND TABLE	
		ROVIDE CONTROLS PER 1505.4.2. COMPLY WITH WSEC R403.	
SYMBOL	LOCATION	MINIMUM FAN REQUIREMENTS	
A	BATH &	MIN. 50 CFM (INTERMITTENT) @ 0.25" WG (TABLE M1505.4.4)	
	POWDER		
B B	KITCHEN	MIN. 100 CFM (INTERMITTENT) @ 0.25" WG (TABLE	
		M1505.4.4) RANGE HOOD OR DOWN DRAFT EXHAUST FAN	
		RATED AT MIN. 100 CFM AT 0.10" WG MAY BE USED FOR	
		EXHAUST FAN REQUIREMENT. IF OVER 400 CFM, MAKEUP	
		AIR IS REQUISED IN THE SAME ROOM PER M1503.6.	
L_C	LAUNDRY	MIN. 210 A. (INTERMITTENT) @ 0.25" WG - TO FUNCT F AND UP ABELED AS WHOLE HOUSE FAN (4-5 BED A. IS 4501<6000 SF) TO OPERATE 50% OF TIME IN EAUP HOUR	
	ROOM	AND THE ABELED AS WHOLE HOUSE FAN (4-5 BED A 45	
		SEGMENT.	


** MAKEUP AIR IS NOT REQUIRED IF ALL GAS APPLIANCES IN THE HOUSE HAVE A DIRECT VENT OR MECHANICAL DRAFT VENT SYSTEM, PER MODIFICATION M1503.6.

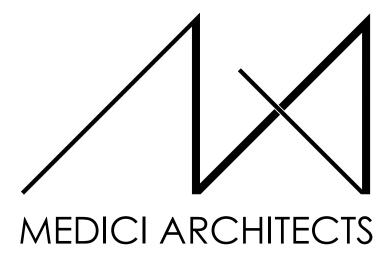

11711 SE 8TH STREET SUITE 100 BELLEVUE, WA 98005 KETCHUM, ID 83340 TEL: (425) 453-9298

200 W. RIVER ST. SUITE 301 TEL: (208) 726-0194

REGISTRATION:

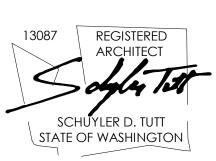

INTAKE DATE:

12/13/22

REVISIONS:		[DATE:	

PROJECT / CLIENT:

2900 78TH AVE SE

2900 Development LLC

JOB ADDRESS: 2900 78TH AVE SE MERCER ISLAND, 98040

DRAWING NAME:

1ST FLOOR PLAN

Drawn By: KH

Checked By: ST Owner Approval:


PHASE:

DESIGN REVIEW

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APPROVED FOR CONSTRUCTION:

PROJECT No.: A21 021 DATE: 4/29/2023

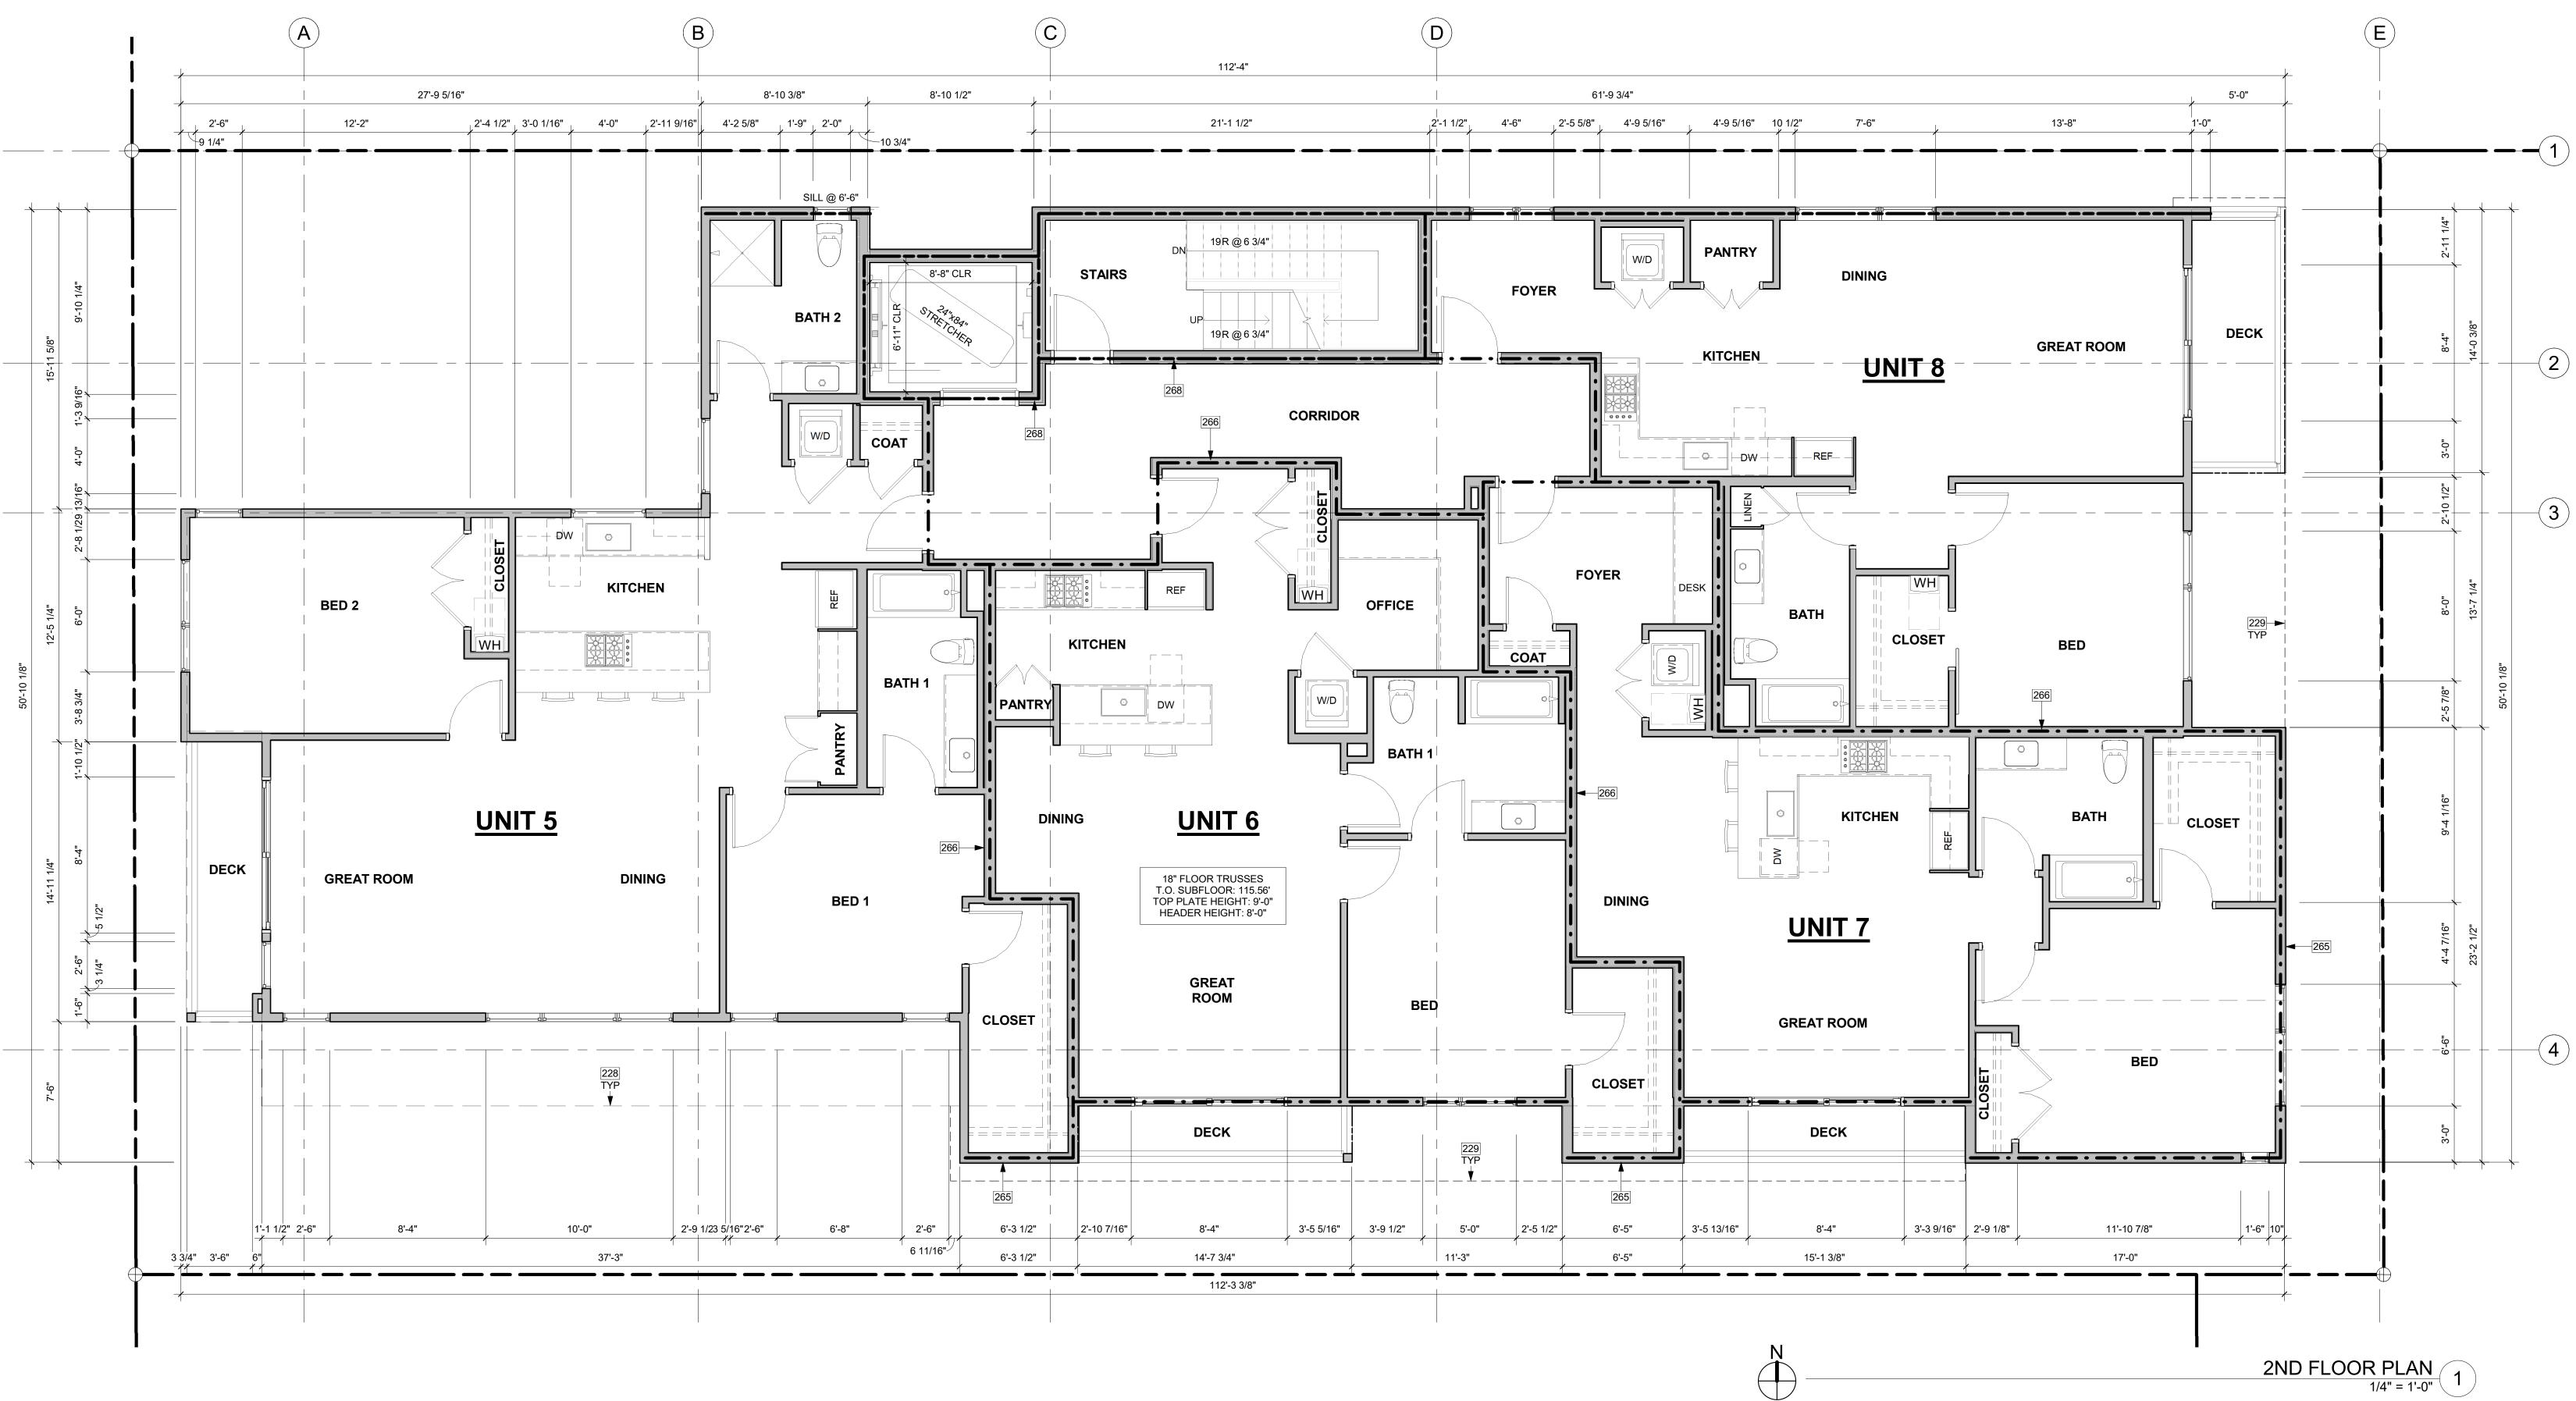

228	LONG DASHED LINE OF BUILDING ABOVE.
229	LONG DASHED LINE OF ROOF ABOVE.
265	1-HOUR RATED EXTERIOR WALL; WP 8105. SEE ASSEMBLY DETAIL ON A0.5a.
266	1-HOUR RATED FIRE PARTITION; WP 3242. STC RATING OF 50-54. SEE ASSEMBLY DETAIL ON A0.5a
268	2-HOUR RATED ELEVATOR SHAFT; WP 3825. STC RATING OF 55-59. SEE ASSEMBLY DETAIL ON A0.5a.

FLOOR PLAN NOTES

- CONTRACTOR SHALL VERIFY ALL NOTES, DIMENSIONS & CONDITIONS PRIOR TO CONSTRUCTION. 1
- SEE STRUCTURAL DRAWINGS FOR ALL POSTS, BEAMS AND HEADERS. PROVIDE SOLID BLOCKING @ ALL PLUMBING PENETRATIONS.
- WINDOWS & DOORS ARE SHOWN & NOTED AS NOMINAL SIZES.
- DOOR JAMB 4.5" FROM CORNER TYP., U.N.O. SEE SHEETS A0.3, A4.0 & A4.1 FOR WINDOW & DOOR HEADER HEIGHTS ABOVE FINISHED FLOOR.
- ALL WOOD IN CONTACT WITH CONCRETE TO BE PRESSURE TREATED. EXTERIOR WALLS TO BE 2x6 STUDS @ 16" O.C., U.N.O. INSTALL SIMPSON CONC. TO WOOD HOLDOWNS PER STRUCTURAL 10
- DRAWINGS, ALSO SEE MANUFACTURER'S SPECS. 11. SMOKE & CARBON MONOXIDE DETECTORS: • SHALL BE 110V INTERCONNECTED W/ BATTERY BACKUP. • SHALL SOUND AN ALARM AUDIBLE IN ALL SLEEPING ROOMS. • SHALL BE INSTALLED ON EACH FLOOR AND IN ALL BEDROOMS. • SHALL BE INSTALLED IN EACH LOCATION WHERE THERE IS A CEILING CHANGE OF GREATER THAN 24"
- 12. FRESH AIR PROVIDED BY WHOLE-HOUSE EXHAUST FAN WITH FRESH AIR PORT (NET 4 SF IN MIN. OPENING) AT EACH HABITABLE ROOM. A TIMER OPERÀTES AN EXHAUST FAN WHICH PULLS OUTSIDE AIR THROUGH AIR INLETS LOCATED IN EACH HABITABLE ROOM.
- 13. LIMITING DEVICE FOR TUBS TO PROVIDE MAX. 120°F HOT WATER TEMPERATURE. 14. FOOTINGS SHALL BEAR ON SOLID UNDISTURBED EARTH (CONTROLLED, COMPACTED STRUCTURAL FILL OR BOTH). DEPTH OF FOOTINGS TO BE DETERMINED BY STRUCTURAL ENGINEER. FOUNDATION EXCAVATION, BACKFILL AND COMPACTION SHALL CONFORM TO SPECIFICATION REQUIREMENTS. THIS CONSTRUCTION WORK, INCLUDING DRAINAGE, SHORING AND SUCH OTHER RELATED WORK AS REQUIRED, SHALL BE CONDUCTED BY THE CONTRACTOR. STOP WORK IF RECOMMENDED EXCAVATION CUT OR BEARING SOIL CHANGES OCCUR IN EITHER HORIZONTAL OR VERTICAL DIRECTION AND NOTIFY IMMEDIATELY THE
- GEOTECHNICAL ENGINEER AND STRUCTURAL ENGINEER. AT WHICH POINT THE ENGINEERS SHALL DETERMINE CAUSE OF DISPLACEMENT AND DEVELOP AND IMPLEMENT REMEDIAL MEASURES.

FIRE-RESISTANCE ASSEMBLIES

— · — · —	1-HOUR RATED WALL ASSEMBLY
	2-HOUR RATED WALL ASSEMBLY

3-HOUR RATED WALL ASSEMBLY

SYMBOL LEGEND

SEE TITLE SHEET A0.0 FOR COMPLETE SYMBOL INDEX.

HOUSE VENTILATION

WHOLE HO	2018 IRC - PROVIDE WHOLE HOUSE VENTILATION PER M1505.4, INTERMITTENT WHOLE HOUSE VENTILATION USING EXHAUST FAN PER 1505.4.1.2 (WA) AND TABLE 1505.4.3(1) & (3) (WA); PROVIDE CONTROLS PER 1505.4.2. COMPLY WITH WSEC R403.		
SYMBOL	LOCATION	MINIMUM FAN REQUIREMENTS	
	BATH & POWDER	MIN. 50 CFM (INTERMITTENT) @ 0.25" WG (TABLE M1505.4.4)	
- C	KITCHEN	MIN. 100 CFM (INTERMITTENT) @ 0.25" WG (TABLE M1505.4.4) RANGE HOOD OR DOWN DRAFT EXHAUST FAN RATED AT MIN. 100 CFM AT 0.10" WG MAY BE USED FOR EXHAUST FAN REQUIREMENT. IF OVER 400 CFM, MAKEUP AIR IS REQUITED IN THE SAME ROOM PER M1503.6.	
- C	LAUNDRY ROOM	MIN. 210 A (INTERMITTENT) @ 0.25" WG - TO FUNCT F AND UP ABELED AS WHOLE HOUSE FAN (4-5 BED A VIS 4501<6000 SF) TO OPERATE 50% OF TIME IN EAUP HOUR SEGMENT.	


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200 W. RIVER ST. SUITE 301 TEL: (208) 726-0194

REGISTRATION:



INTAKE DATE:

12/13/22

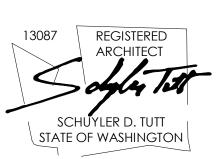REVISIONS:		DATE:

PROJECT / CLIENT:

2900 78TH AVE SE

2900 Development LLC

JOB ADDRESS: 2900 78TH AVE SE MERCER ISLAND, 98040

DRAWING NAME:

2ND FLOOR PLAN

Drawn By: KH Checked By: ST Owner Approval:


PHASE:

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APPROVED FOR CONSTRUCTION:

PROJECT No.: A21 021 DATE: 4/29/2023



227	SHORT DASHED LINE OF BUILDING BELOW.
229	LONG DASHED LINE OF ROOF ABOVE.
265	1-HOUR RATED EXTERIOR WALL; WP 8105. SEE ASSEMBLY DETAIL ON A0.5a.
266	1-HOUR RATED FIRE PARTITION; WP 3242. STC RATING OF 50-54. SEE ASSEMBLY DETAIL ON A0.5a
268	2-HOUR RATED ELEVATOR SHAFT; WP 3825. STC RATING OF 55-59. SEE ASSEMBLY DETAIL ON A0.5a.

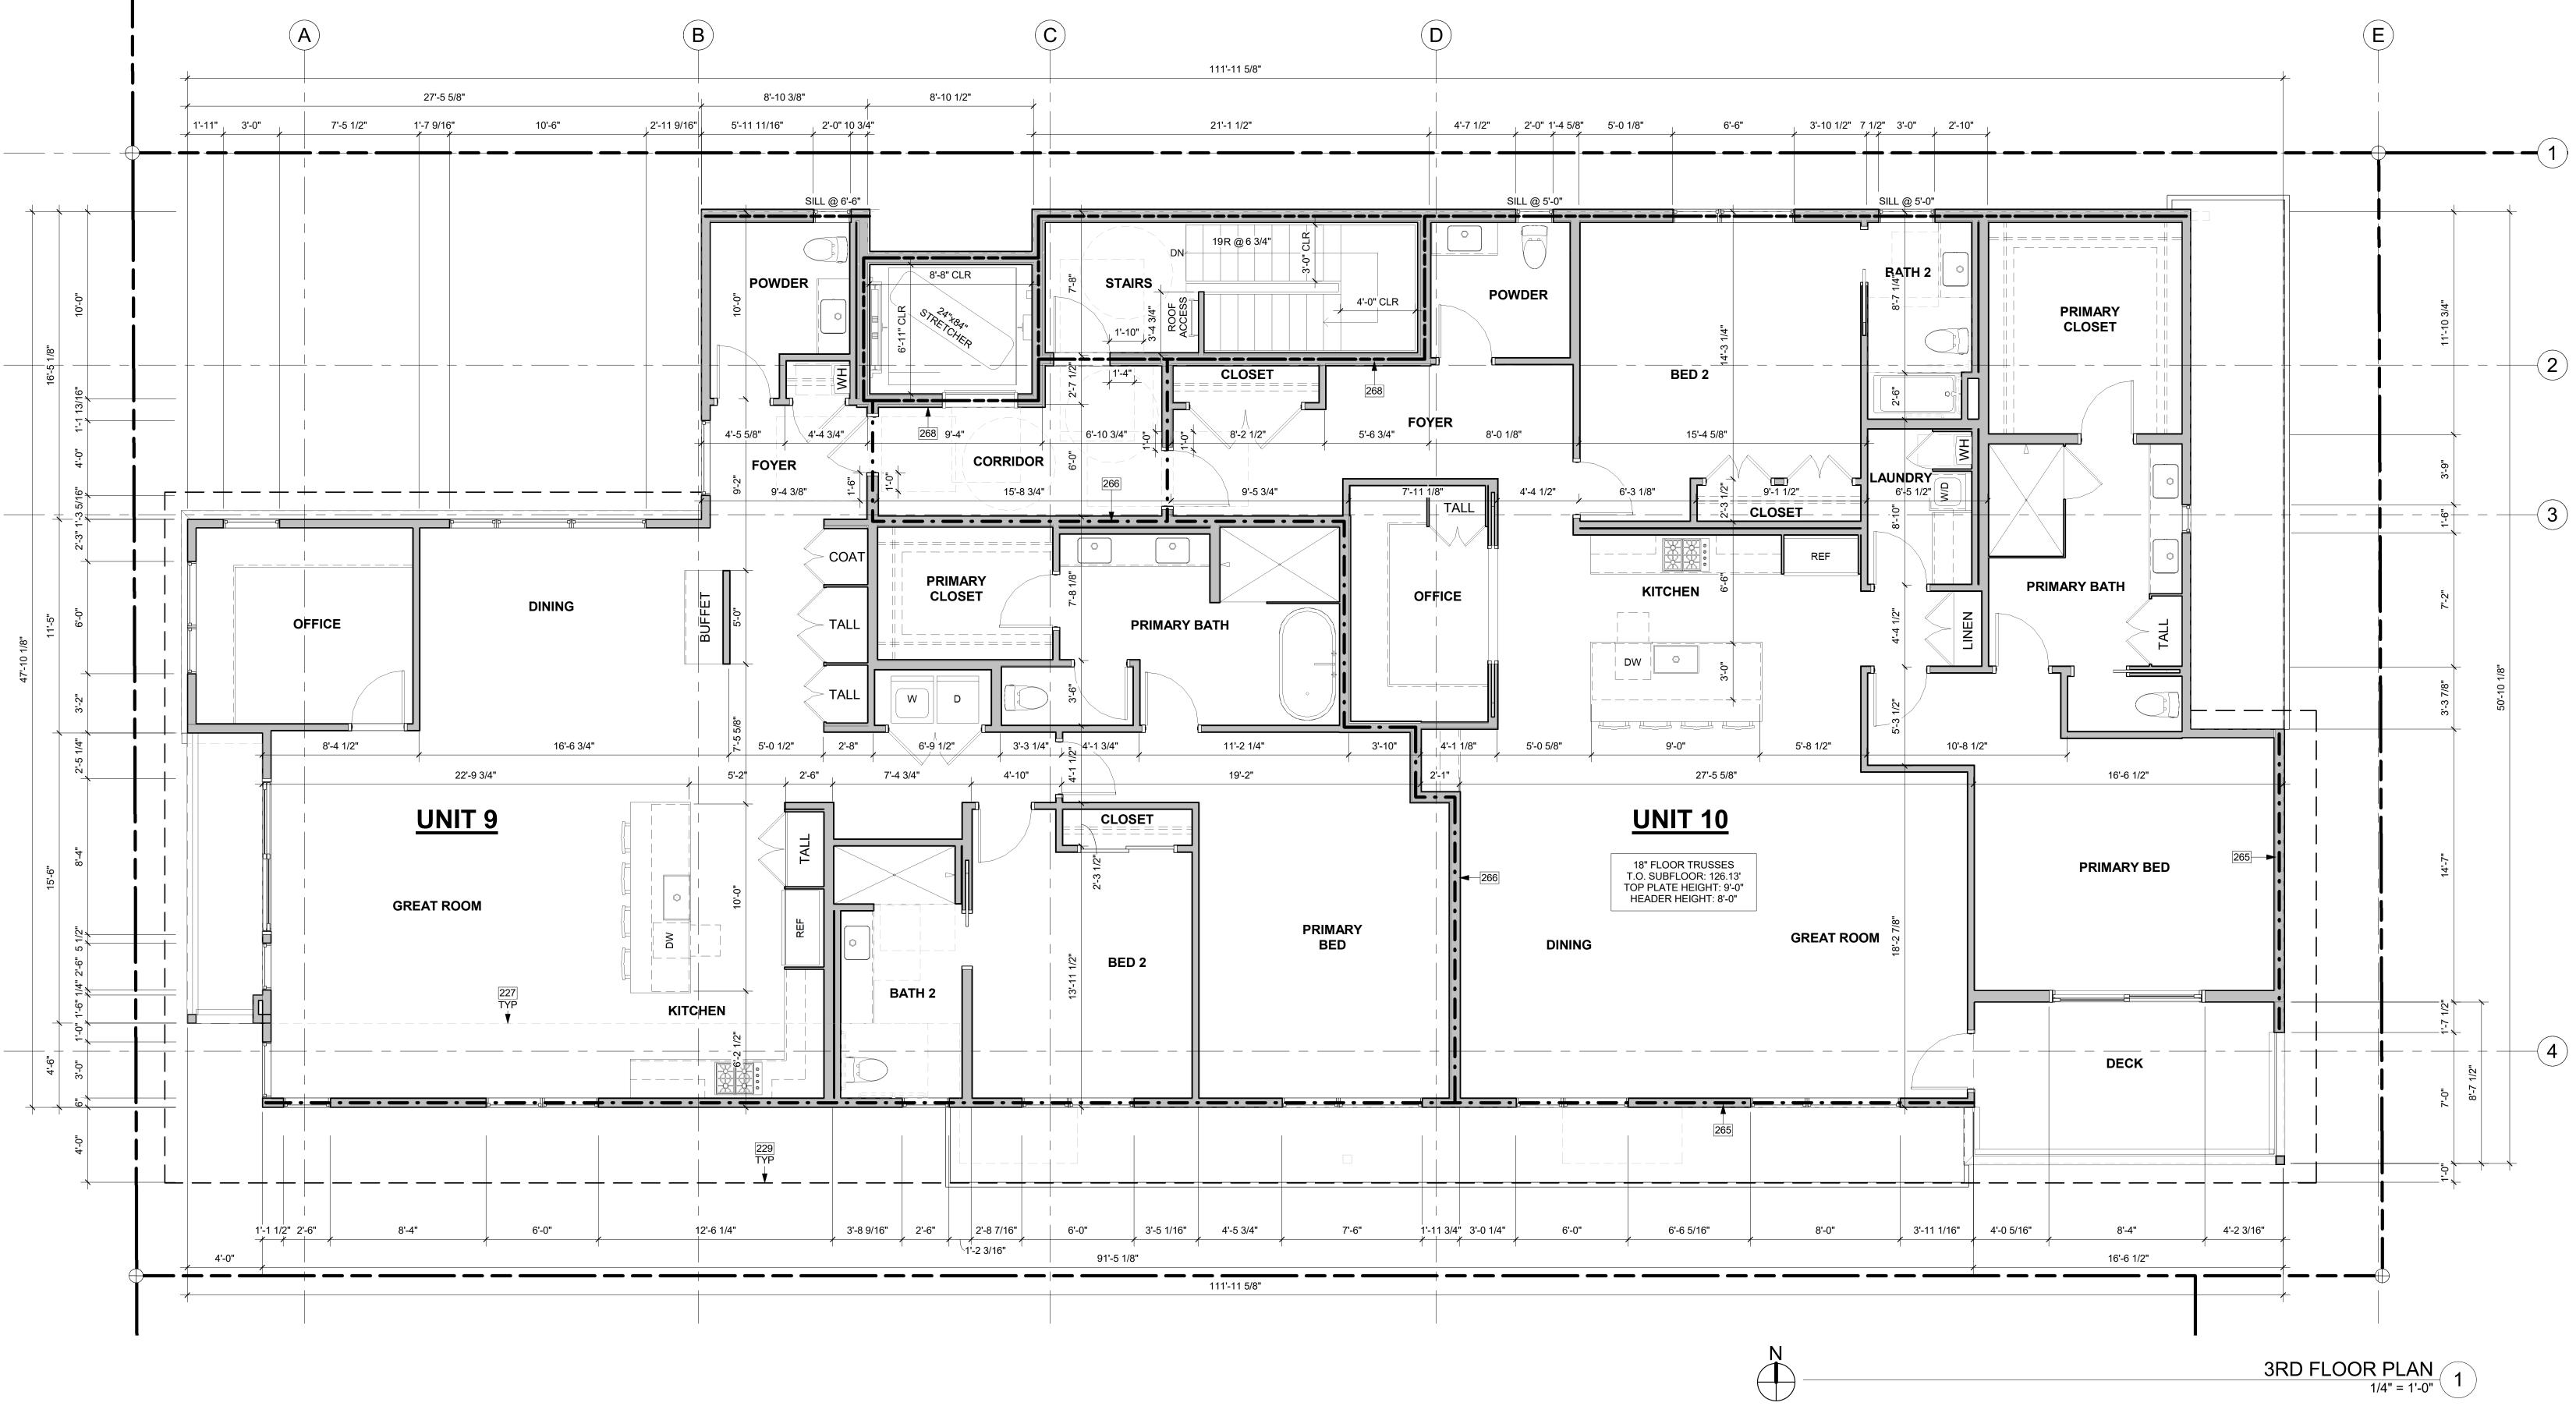FLOOR PLAN NOTES

- CONTRACTOR SHALL VERIFY ALL NOTES, DIMENSIONS & CONDITIONS PRIOR TO CONSTRUCTION. 1
- SEE STRUCTURAL DRAWINGS FOR ALL POSTS, BEAMS AND HEADERS. PROVIDE SOLID BLOCKING OVER SUPPORTS. PROVIDE FIRE BLOCKING @ ALL PLUMBING PENETRATIONS.
- WINDOWS & DOORS ARE SHOWN & NOTED AS NOMINAL SIZES.
- DOOR JAMB 4.5" FROM CORNER TYP., U.N.O. SEE SHEETS A0.3, A4.0 & A4.1 FOR WINDOW & DOOR HEADER HEIGHTS ABOVE FINISHED FLOOR.
- ALL WOOD IN CONTACT WITH CONCRETE TO BE PRESSURE TREATED. EXTERIOR WALLS TO BE 2x6 STUDS @ 16" O.C., U.N.O. INSTALL SIMPSON CONC. TO WOOD HOLDOWNS PER STRUCTURAL 10.
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- 12. FRESH AIR PROVIDED BY WHOLE-HOUSE EXHAUST FAN WITH FRESH AIR PORT (NET 4 SF IN MIN. OPENING) AT EACH HABITABLE ROOM. A TIMER OPERATES AN EXHAUST FAN WHICH PULLS OUTSIDE AIR THROUGH AIR INLETS LOCATED IN EACH HABITABLE ROOM.
- 13. LIMITING DEVICE FOR TUBS TO PROVIDE MAX. 120°F HOT WATER TEMPERATURE. 14. FOOTINGS SHALL BEAR ON SOLID UNDISTURBED EARTH (CONTROLLED, COMPACTED STRUCTURAL FILL OR BOTH). DEPTH OF FOOTINGS TO BE DETERMINED BY STRUCTURAL ENGINEER. FOUNDATION EXCAVATION, BACKFILL AND COMPACTION SHALL CONFORM TO SPECIFICATION REQUIREMENTS. THIS CONSTRUCTION WORK, INCLUDING DRAINAGE, SHORING AND SUCH OTHER RELATED WORK AS REQUIRED, SHALL BE CONDUCTED BY THE CONTRACTOR. STOP WORK IF RECOMMENDED
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FIRE-RESISTANCE ASSEMBLIES

— · — · —	1-HOUR RATED WALL ASSEMBLY
	2-HOUR RATED WALL ASSEMBLY
	3-HOUR RATED WALL ASSEMBLY

3-HOUR RATED WALL ASSEMBLY

SYMBOL LEGEND

SEE TITLE SHEET A0.0 FOR COMPLETE SYMBOL INDEX.

HOUSE VENTILATION

WHOLE HO	2018 IRC - PROVIDE WHOLE HOUSE VENTILATION PER M1505.4, INTERMITTENT WHOLE HOUSE VENTILATION USING EXHAUST FAN PER 1505.4.1.2 (WA) AND TABLE 1505.4.3(1) & (3) (WA); PROVIDE CONTROLS PER 1505.4.2. COMPLY WITH WSEC R403.		
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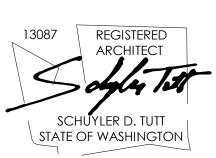
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11711 SE 8TH STREET SUITE 100 BELLEVUE, WA 98005 KETCHUM, ID 83340 TEL: (425) 453-9298

200 W. RIVER ST. SUITE 301 TEL: (208) 726-0194

REGISTRATION:



INTAKE DATE:

12/13/22

REVISIONS:		[DATE:	

PROJECT / CLIENT:

2900 78TH AVE SE

2900 Development LLC

JOB ADDRESS: 2900 78TH AVE SE MERCER ISLAND, 98040

DRAWING NAME:

3RD FLOOR PLAN

Drawn By: KH Checked By: ST Owner Approval:

PHASE:


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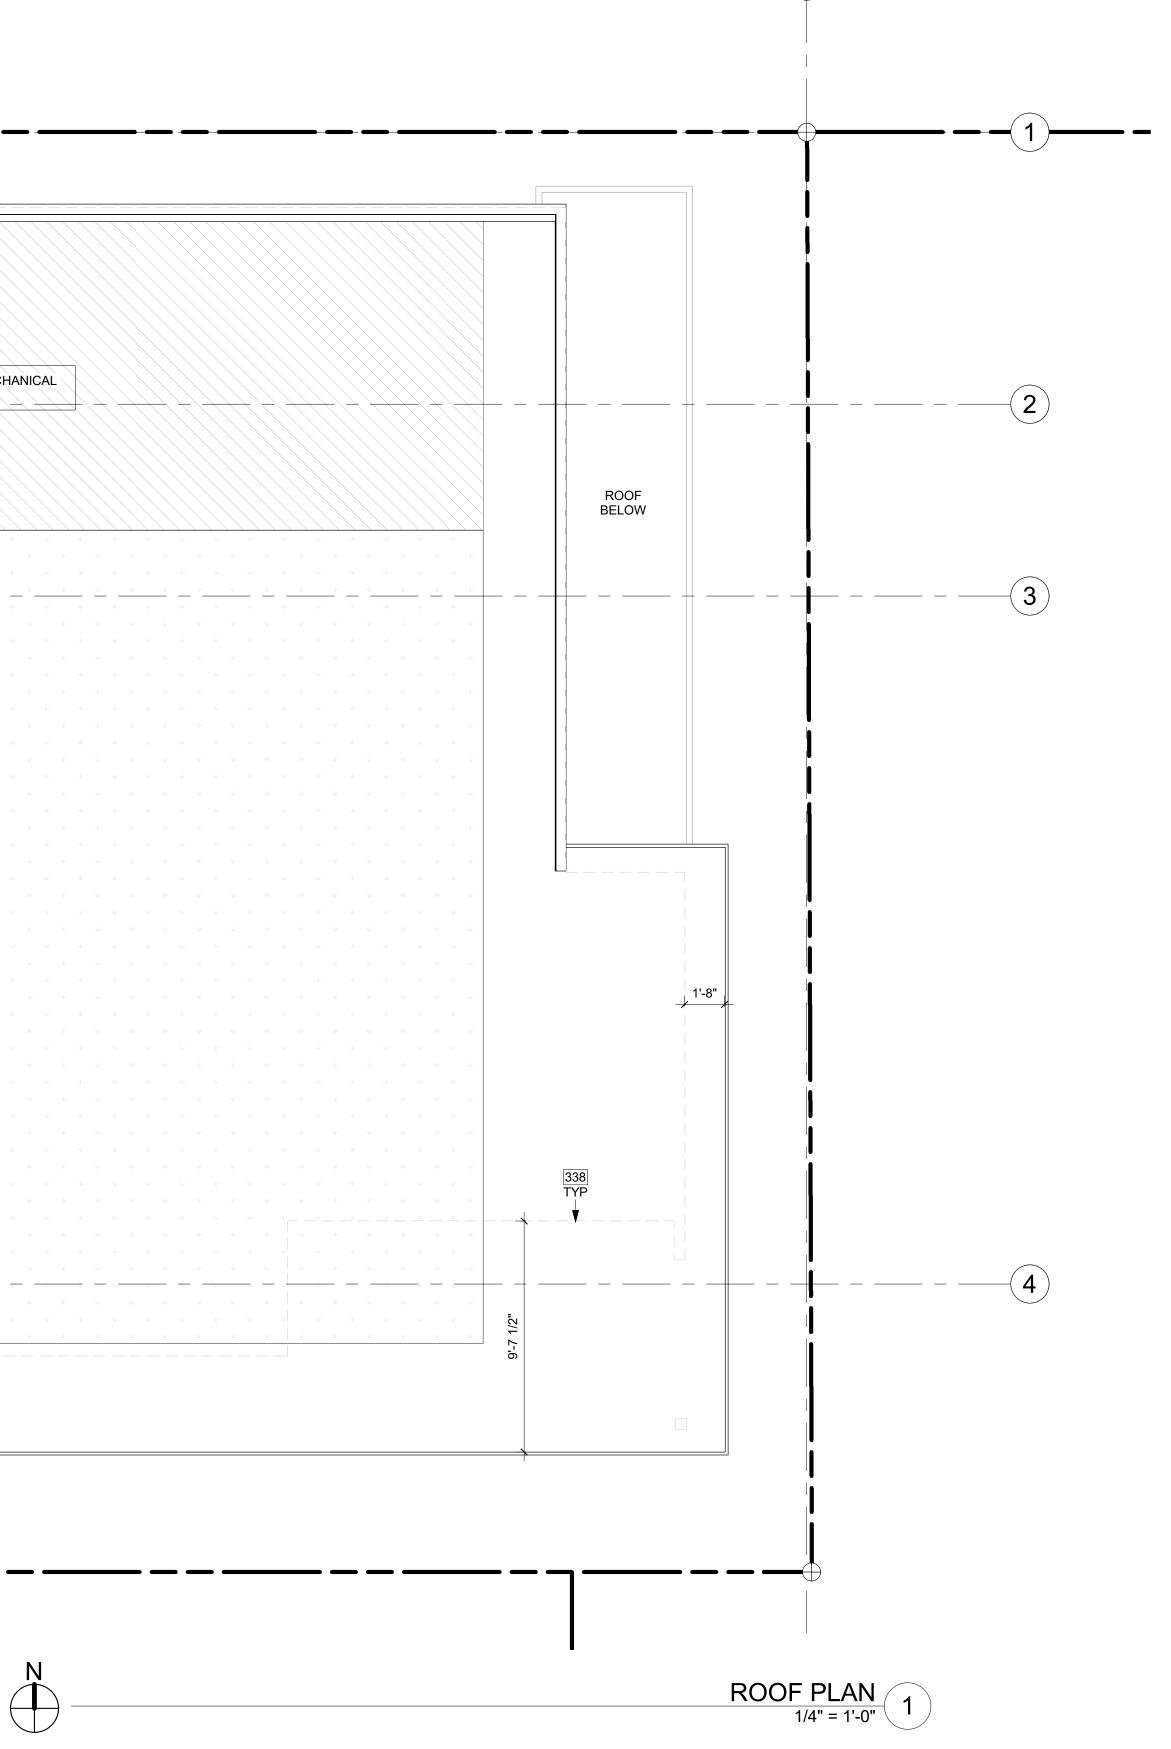
A2.3


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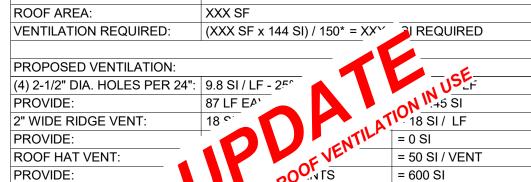
PROJECT No.: A21 021 DATE: 4/29/2023



338 DASHED LINE OF BUILDING BELOW.
339 1-HOUR RATED ROOF ASSEMBLY; RC 2604. SEE ASSEMBLY DETAIL ON A0.5a
340 2-HOUR RATED ROOF ASSEMBLY AT STAIRS AND ELEVATOR SHAFT; RC 2751. SEE ASSEMBLY DETAIL ON A0.5a.



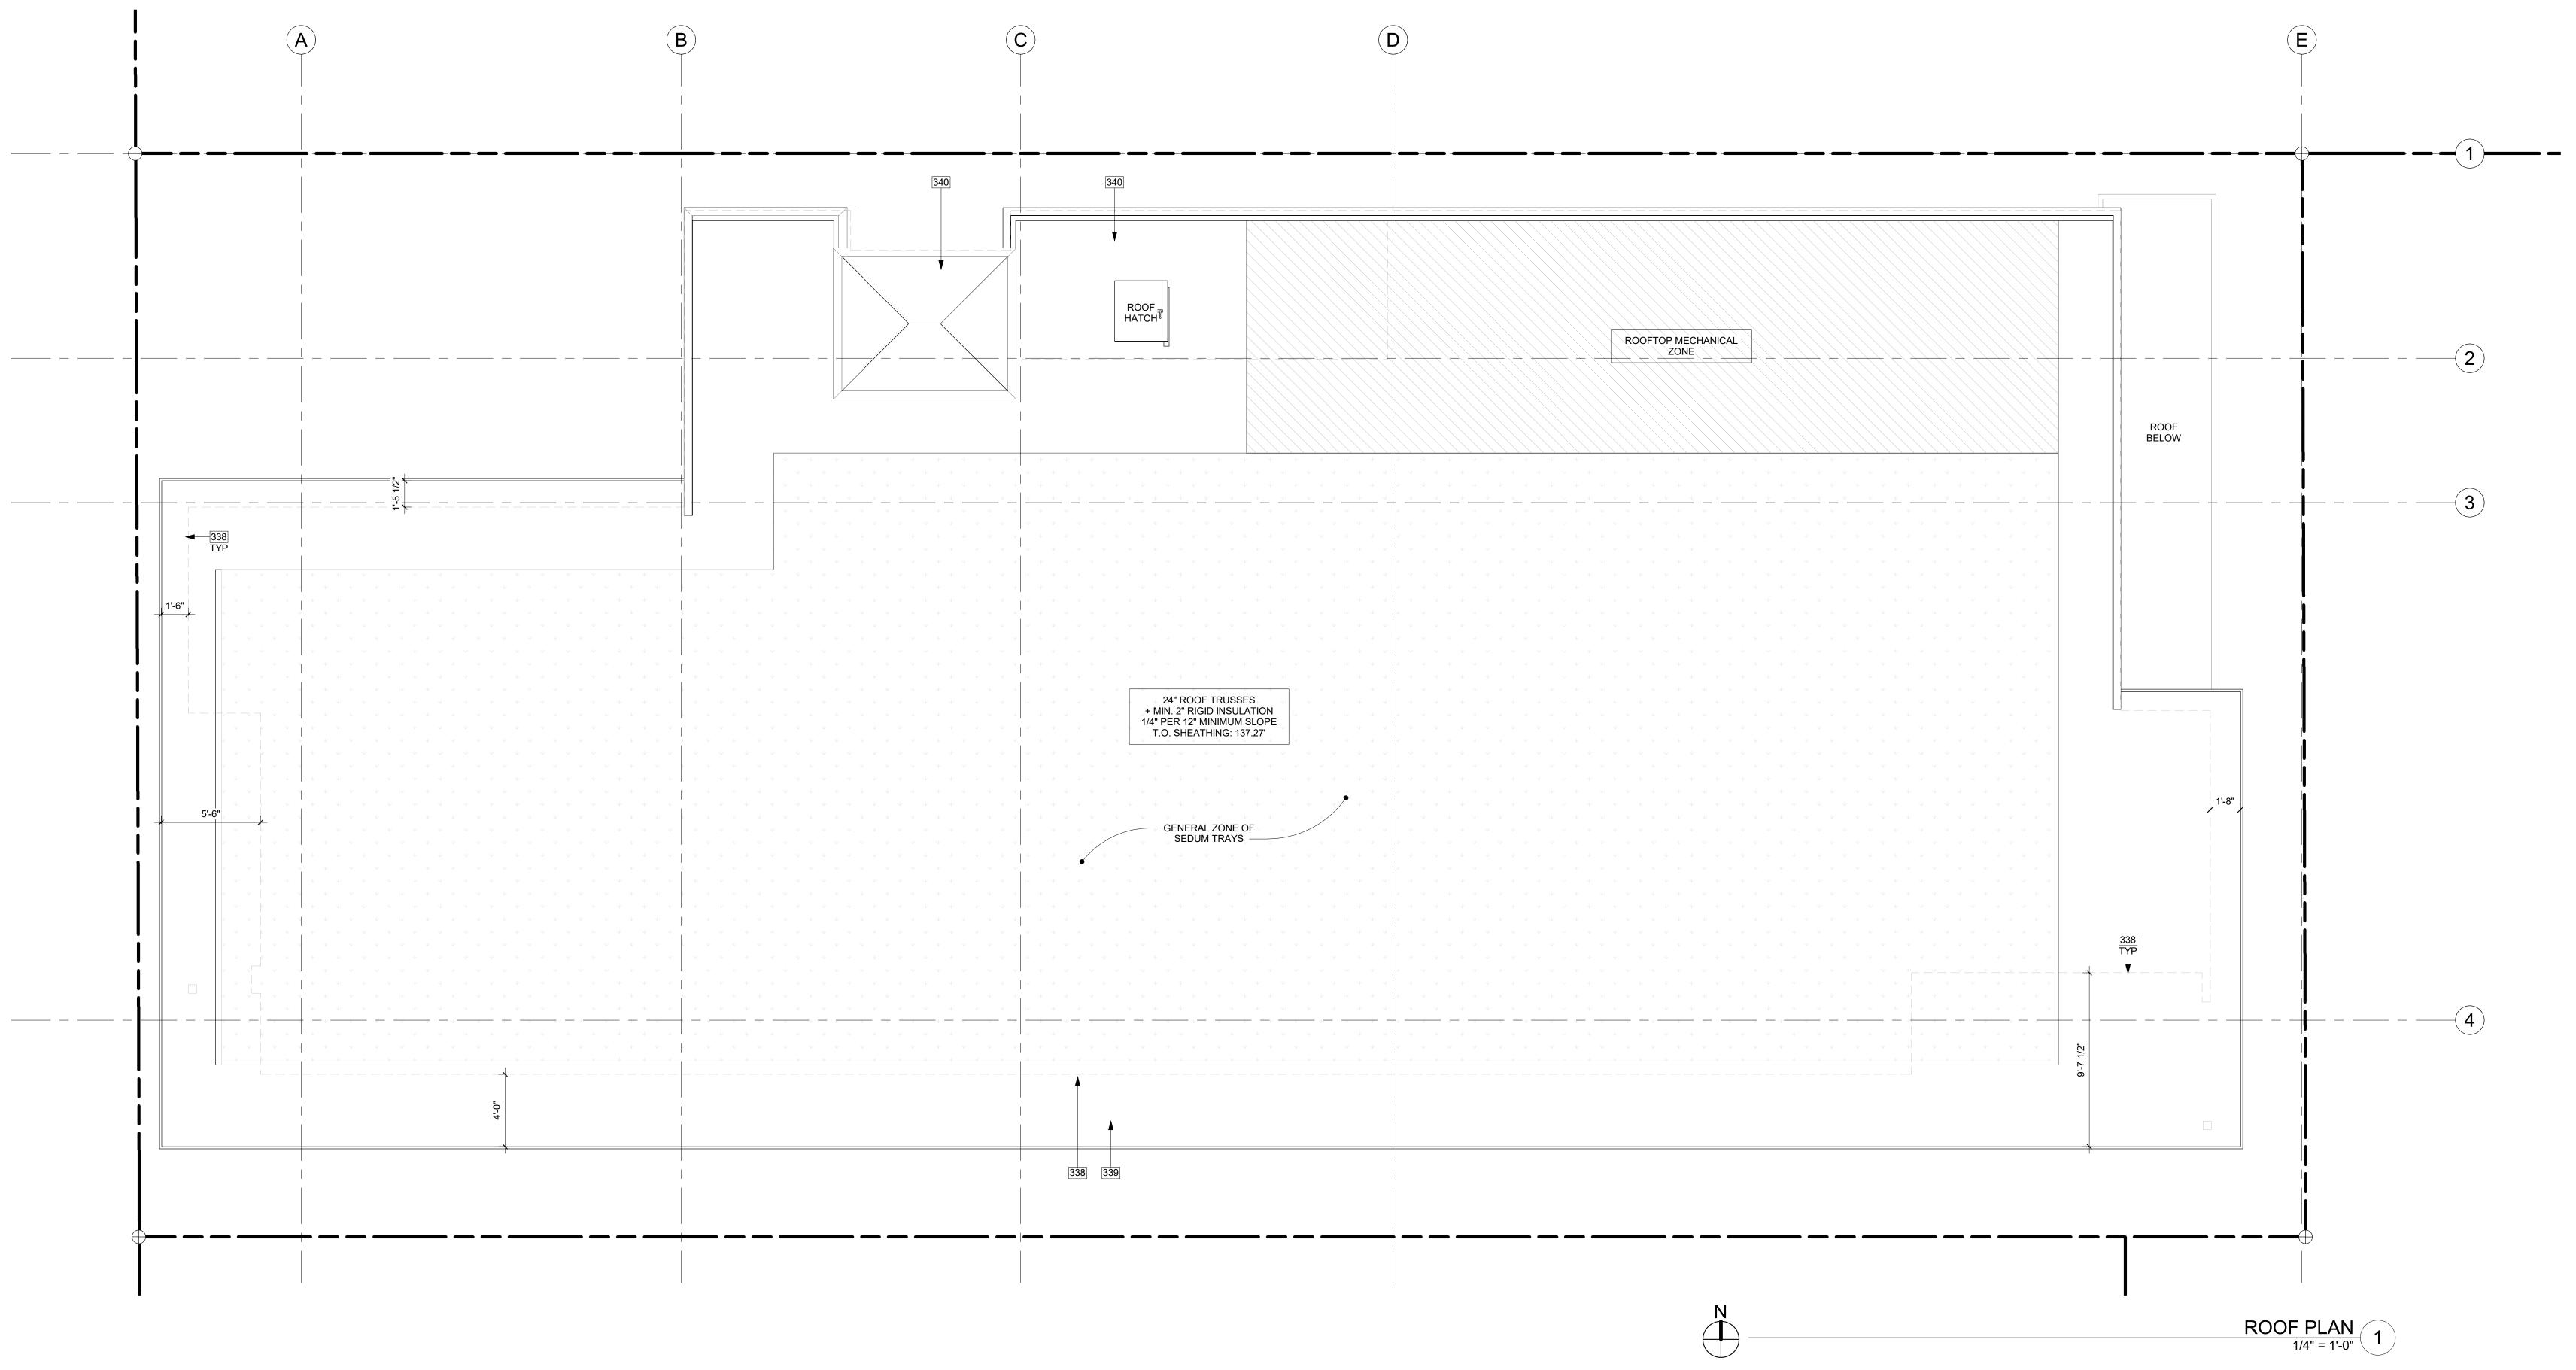


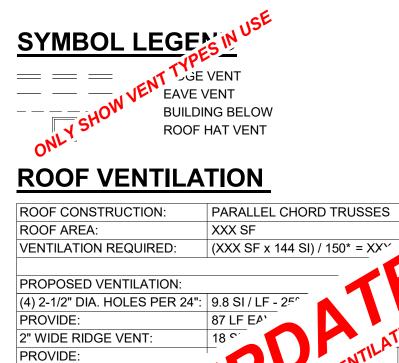

J.45 SI IS GREATER THAN 1237.9 REQ.


* PER IRC R806.2, MINIMUM NAREA SHALL BE 1/150 OF THE AREA. AS AN ALTERNATIVE AVERT FREE CROSS VENTILATION AREA MAY BE REDUCED TO 1/300 WHEN LOW WEEN 40-50% OF REQUIRED VENTILATION AREA IS LOCATED IN THE UPPER PORTION OF ROOF, PER IRC SECTION R806.2.2

TOTAL MIN. VENTILATION

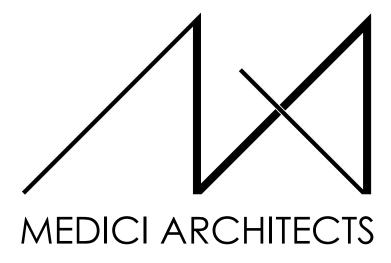

11711 SE 8TH STREET200 W. RIVER ST.SUITE 100SUITE 301BELLEVUE, WA 98005KETCHUM, ID 83340TEL: (425) 453-9298TEL: (208) 726-0194

REGISTRATION:

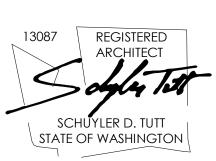

INTAKE DATE:

12/13/22

REVISIONS: D		DATE:	

PROJECT / CLIENT:

2900 78TH AVE SE

2900 Development LLC

JOB ADDRESS: 2900 78TH AVE SE MERCER ISLAND, 98040

DRAWING NAME:

ROOF PLAN

Drawn By: KH Checked By: ST Owner Approval:

PHASE:

DESIGN REVIEW

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PROJECT No.: A21 021 DATE: 4/29/2023



MATERIALS NTS


- WEATHER PROTECTION. EXTERIOR WALLS SHALL PROVIDE THE BUILDING WITH A WEATHER-RESISTANT EXTERIOR WALL ENVELOPE. THE EXTERIOR WALL ENVELOPE SHALL INCLUDE FLASHING AND BE CONSTRUCTED IN SUCH A MANNER AS TO PREVENT THE ACCUMULATION OF WATER WITHIN THE WALL ASSEMBLY BY PROVIDING A WATER-RESISTIVE BARRIER BEHIND THE EXTERIOR VENEER AND A MEANS FOR DRAINING WATER THAT
- CONDENSATION IN THE EXTERIOR WALL ASSEMBLY SHALL BE PROVIDED. PER IRC R703.8. FLASHING AT WALLS. FLASHING SHALL BE INSTALLED IN SUCH A MANNER SO AS TO PREVENT MOISTURE FROM ENTERING THE WALL OR TO REDIRECT THAT MOISTURE TO THE EXTERIOR. FLASHING SHALL BE INSTALLED AT THE PERIMETERS OF EXTERIOR DOOR AND WINDOW ASSEMBLIES, PENETRATIONS AND TERMINATIONS OF EXTERIOR WALL ASSEMBLIES, EXTERIOR WALL INTERSECTIONS WITH ROOFS, CHIMNEYS, PORCHES, DECKS, BALCONIES AND SIMILAR PROJECTIONS AND AT BUILT-IN GUTTERS AND SIMILAR LOCATIONS WHERE MOISTURE COULD ENTER THE WALL. FLASHING WITH PROJECTING FLANGES SHALL BE
- INSTALLED ON BOTH SIDES AND THE ENDS OF COPINGS, UNDER SILLS AND CONTINUOUSLY ABOVE PROJECTING TRIM. PROVIDE FLASHING AT ROOF PENETRATIONS PER IRC R903.2.1. FLASHING 5. SHALL BE INSTALLED AT WALL AND ROOF INTERSECTIONS, AT GUTTERS, WHEREVER THERE IS A CHANGE IN ROOF SLOPE OR DIRECTION AND AROUND ROOF OPENINGS. WHERE FLASHING IS OF METAL, THE METAL
- SHALL BE CORROSION RESISTANT. PROVIDE CONTINUOUS GUTTERS & DOWNSPOUTS AT EAVES PER PLANS, 6. TVP
- PROVIDE WEATHER STRIPPING AT ALL EXTERIOR & GARAGE DOORS. 7. CAULK ALL EXTERIOR JOINTS & PENETRATIONS. WINDOWS AND DOORS SHALL BE INSTALLED IN ACCORDANCE WITH 8. APPROVED MANUFACTURER'S INSTRUCTIONS.
- SEE GENERAL NOTES SHEET A0.3 FOR ADDITIONAL NOTES. 9.



11711 SE 8TH STREET SUITE 100SUITE 301BELLEVUE, WA 98005KETCHUM, ID 83340TEL: (425) 453-9298TEL: (208) 726-0194

200 W. RIVER ST.

REGISTRATION:

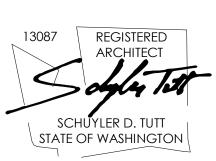

INTAKE DATE:

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REVISIONS:		[DATE:

PROJECT / CLIENT:

2900 78TH AVE SE

2900 Development LLC

JOB ADDRESS: 2900 78TH AVE SE MERCER ISLAND, 98040

DRAWING NAME:

ELEVATIONS

Drawn By: KH Checked By: ST Owner Approval:

PHASE:


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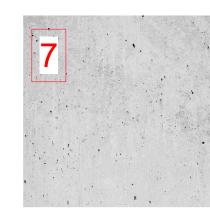






SHERWIN WILLIAMS SW 6258 - TRICORN BLACK MATERIAL: INFILL PANELS FASCIA SOFFITS

FIBER CEMENT PANEL SW 7067- CITYSCAPE MATERIAL: NORTH FACADE EAST FACADE

FIBER CEMENT V-GROOVE SIDING SW 7048 - URBANE BRONZE MATERIAL: RECESSED FACADES ELEVATOR SHAFT

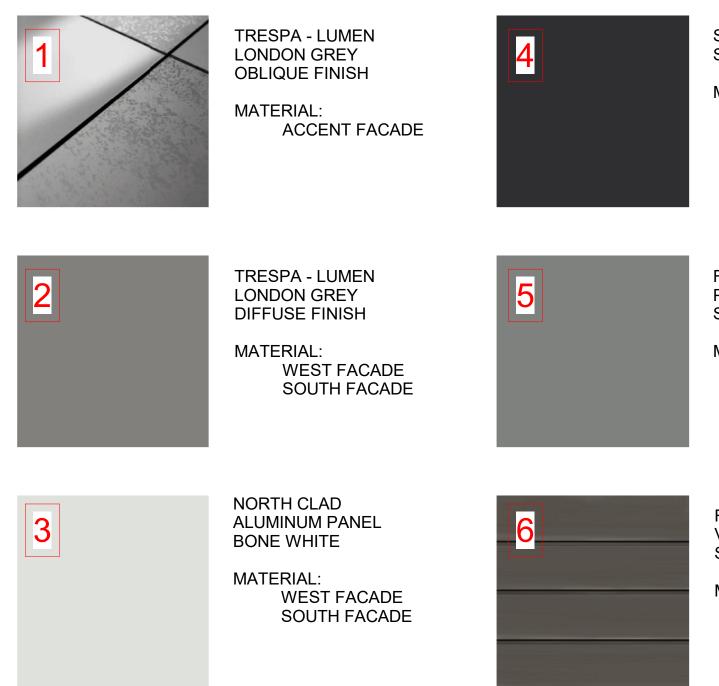

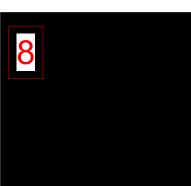

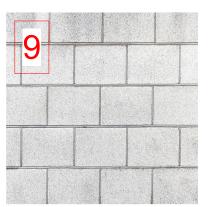

CONCRETE

MATERIAL: PARKING GARAGE WALLS STRUCTURAL COLUMNS

BLACK

MATERIAL: STRUCTURAL STEEL COLUMNS WINDOW AND DOOR FRAMES RAILING METAL AWNING EXIT DOOR STEEL PLATES LIGHT FIXTURES

GUTTERS / DOWNSPOUTS FLASHING

CMU BLOCK MATERIAL: TRASH ENCLOSURE

> MATERIALS NTS

10



ELEVATION NOTES

2.


- VERIFY SHEAR WALL NAILING & HOLDOWNS PER STRUCTURAL PLAN & SCHEDULE PRIOR TO INSTALLING SIDING. WOOD SIDING - SEAL & STAIN ALL SIDES BEFORE INSTALLING AND @ ALL
- CUTS. WEATHER PROTECTION. EXTERIOR WALLS SHALL PROVIDE THE BUILDING WITH A WEATHER-RESISTANT EXTERIOR WALL ENVELOPE. THE EXTERIOR WALL ENVELOPE SHALL INCLUDE FLASHING AND BE CONSTRUCTED IN SUCH A MANNER AS TO PREVENT THE ACCUMULATION OF WATER WITHIN THE WALL ASSEMBLY BY PROVIDING A WATER-RESISTIVE BARRIER BEHIND THE EXTERIOR VENEER AND A MEANS FOR DRAINING WATER THAT
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- TYP PROVIDE WEATHER STRIPPING AT ALL EXTERIOR & GARAGE DOORS. 7. CAULK ALL EXTERIOR JOINTS & PENETRATIONS.
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11711 SE 8TH STREET SUITE 100SUITE 301BELLEVUE, WA 98005KETCHUM, ID 83340TEL: (425) 453-9298TEL: (208) 726-0194

200 W. RIVER ST.

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PROJECT / CLIENT:

2900 78TH AVE SE

2900 Development LLC

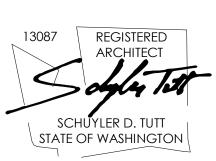JOB ADDRESS: 2900 78TH AVE SE MERCER ISLAND, 98040

DRAWING NAME:

ELEVATIONS

Drawn By: KH Checked By: ST Owner Approval:

PHASE:


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A4.

APPROVED FOR CONSTRUCTION:

PROJECT No.: A21 021 DATE: 4/29/2023




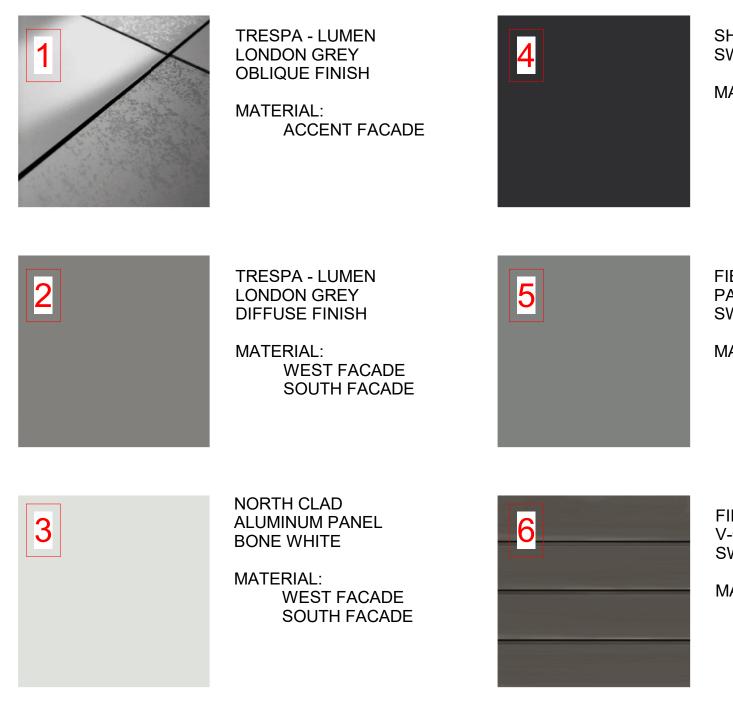


SHERWIN WILLIAMS SW 6258 - TRICORN BLACK MATERIAL: INFILL PANELS FASCIA SOFFITS

FIBER CEMENT PANEL SW 7067- CITYSCAPE MATERIAL: NORTH FACADE EAST FACADE

FIBER CEMENT V-GROOVE SIDING SW 7048 - URBANE BRONZE MATERIAL: RECESSED FACADES ELEVATOR SHAFT

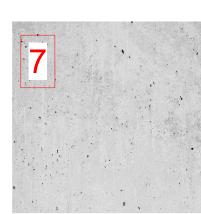



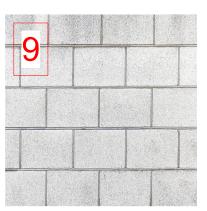

CONCRETE

MATERIAL: PARKING GARAGE WALLS STRUCTURAL COLUMNS

10



GRAY MATERIAL: TRASH ENCLOSURE DOORS FLASHING

BLACK MATERIAL: STRUCTURAL STEEL COLUMNS

WINDOW AND DOOR FRAMES RAILING METAL AWNING EXIT DOOR STEEL PLATES LIGHT FIXTURES **GUTTERS / DOWNSPOUTS** FLASHING

CMU BLOCK

MATERIAL: TRASH ENCLOSURE

MATERIALS NTS

ELEVATION NOTES

2


- VERIFY SHEAR WALL NAILING & HOLDOWNS PER STRUCTURAL PLAN & SCHEDULE PRIOR TO INSTALLING SIDING. WOOD SIDING - SEAL & STAIN ALL SIDES BEFORE INSTALLING AND @ ALL
- CUTS. WEATHER PROTECTION. EXTERIOR WALLS SHALL PROVIDE THE BUILDING WITH A WEATHER-RESISTANT EXTERIOR WALL ENVELOPE. THE EXTERIOR WALL ENVELOPE SHALL INCLUDE FLASHING AND BE CONSTRUCTED IN SUCH A MANNER AS TO PREVENT THE ACCUMULATION OF WATER WITHIN THE WALL ASSEMBLY BY PROVIDING A WATER-RESISTIVE BARRIER BEHIND THE EXTERIOR VENEER AND A MEANS FOR DRAINING WATER THAT
- ENTERS THE ASSEMBLY TO THE EXTERIOR. PROTECTION AGAINST CONDENSATION IN THE EXTERIOR WALL ASSEMBLY SHALL BE PROVIDED. 4. PER IRC R703.8. FLASHING AT WALLS. FLASHING SHALL BE INSTALLED IN SUCH A MANNER SO AS TO PREVENT MOISTURE FROM ENTERING THE WALL OR TO REDIRECT THAT MOISTURE TO THE EXTERIOR. FLASHING SHALL BE INSTALLED AT THE PERIMETERS OF EXTERIOR DOOR AND WINDOW ASSEMBLIES, PENETRATIONS AND TERMINATIONS OF EXTERIOR WALL ASSEMBLIES, EXTERIOR WALL INTERSECTIONS WITH ROOFS,
- CHIMNEYS, PORCHES, DECKS, BALCONIES AND SIMILAR PROJECTIONS AND AT BUILT-IN GUTTERS AND SIMILAR LOCATIONS WHERE MOISTURE COULD ENTER THE WALL. FLASHING WITH PROJECTING FLANGES SHALL BE INSTALLED ON BOTH SIDES AND THE ENDS OF COPINGS, UNDER SILLS AND CONTINUOUSLY ABOVE PROJECTING TRIM. PROVIDE FLASHING AT ROOF PENETRATIONS PER IRC R903.2.1. FLASHING 5.
- SHALL BE INSTALLED AT WALL AND ROOF INTERSECTIONS, AT GUTTERS, WHEREVER THERE IS A CHANGE IN ROOF SLOPE OR DIRECTION AND AROUND ROOF OPENINGS. WHERE FLASHING IS OF METAL, THE METAL SHALL BE CORROSION RESISTANT. PROVIDE CONTINUOUS GUTTERS & DOWNSPOUTS AT EAVES PER PLANS, 6.
- TYP PROVIDE WEATHER STRIPPING AT ALL EXTERIOR & GARAGE DOORS. 7. CAULK ALL EXTERIOR JOINTS & PENETRATIONS.
- WINDOWS AND DOORS SHALL BE INSTALLED IN ACCORDANCE WITH 8. APPROVED MANUFACTURER'S INSTRUCTIONS.
- SEE GENERAL NOTES SHEET A0.3 FOR ADDITIONAL NOTES. 9.



11711 SE 8TH STREET SUITE 100SUITE 301BELLEVUE, WA 98005KETCHUM, ID 83340TEL: (425) 453-9298TEL: (208) 726-0194

200 W. RIVER ST.

REGISTRATION:

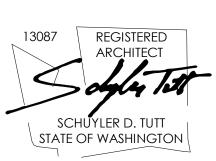

INTAKE DATE:

12/13/22

REVISIONS:		DATE:	

PROJECT / CLIENT:

2900 78TH AVE SE

2900 Development LLC

JOB ADDRESS: 2900 78TH AVE SE MERCER ISLAND, 98040

DRAWING NAME:

ELEVATIONS

Drawn By: KH Checked By: ST Owner Approval:


PHASE:

DESIGN REVIEW

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APPROVED FOR CONSTRUCTION:

PROJECT No.: A21 021 DATE: 4/29/2023



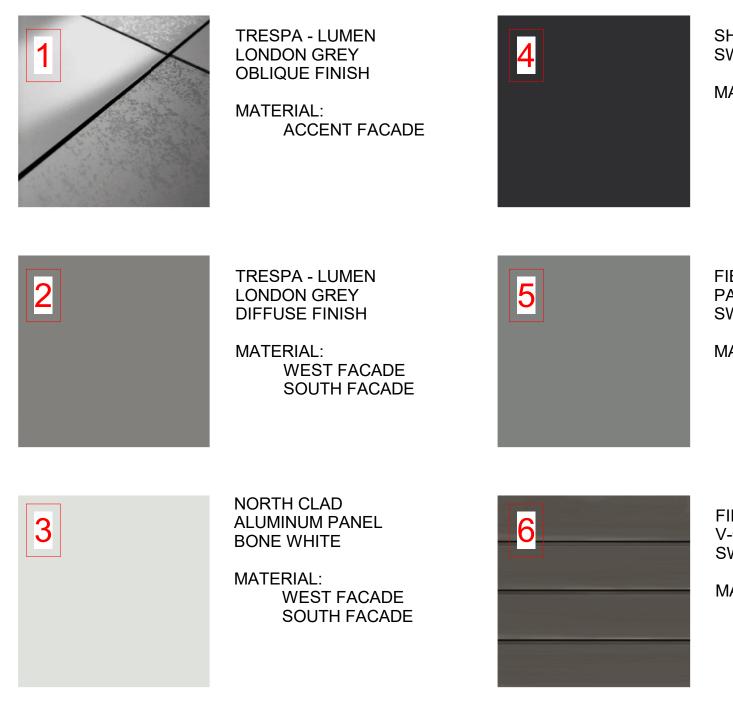


SHERWIN WILLIAMS SW 6258 - TRICORN BLACK MATERIAL: INFILL PANELS FASCIA SOFFITS

FIBER CEMENT PANEL SW 7067- CITYSCAPE MATERIAL: NORTH FACADE EAST FACADE

FIBER CEMENT V-GROOVE SIDING SW 7048 - URBANE BRONZE MATERIAL: RECESSED FACADES ELEVATOR SHAFT





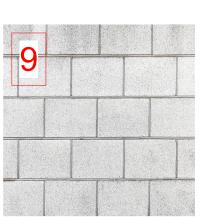

CONCRETE

MATERIAL: PARKING GARAGE WALLS STRUCTURAL COLUMNS

BLACK

MATERIAL: STRUCTURAL STEEL COLUMNS WINDOW AND DOOR FRAMES RAILING METAL AWNING EXIT DOOR STEEL PLATES LIGHT FIXTURES **GUTTERS / DOWNSPOUTS**

CMU BLOCK MATERIAL: TRASH ENCLOSURE

FLASHING

MATERIALS NTS

10

GRAY MATERIAL: TRASH ENCLOSURE DOORS FLASHING EAST ELEVATION 1/4" = 1'-0" 1

ELEVATION NOTES


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REVISIONS:		[DATE:	

PROJECT / CLIENT:

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2900 Development LLC

JOB ADDRESS: 2900 78TH AVE SE MERCER ISLAND, 98040

DRAWING NAME:

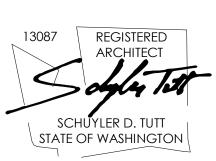ELEVATIONS

Drawn By: KH Checked By: ST Owner Approval:

PHASE:

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A4.3

APPROVED FOR CONSTRUCTION:

PROJECT No.: A21 021 DATE: 4/29/2023







SE PERSPECTIVE NTS

NW PERSPECTIVE NTS



NOTE: 3D RENDERINGS ARE FOR ILLUSTRATIVE PURPOSES ONLY. NOT TO BE USED FOR CONSTRUCTION.

PLOT	SCALE:	1:1

PROJECT No.: A21 021 DATE: 4/29/2023

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DESIGN REVIEW

PHASE:

Owner Approval:

Drawn By: KH Checked By: ST

PERSPECTIVES

DRAWING NAME:

2900 78TH AVE SE MERCER ISLAND, 98040

PROJECT / CLIENT: 2900 78TH AVE SE

2900 Development LLC

JOB ADDRESS:

INTAKE DATE: **REVISIONS**:

SCHUYLER D. TUTT STATE OF WASHINGTON

REGISTRATION:

11711 SE 8TH STREET200 W. RIVER ST.SUITE 100SUITE 301BELLEVUE, WA 98005KETCHUM, ID 83340TEL: (425) 453-9298TEL: (208) 726-0194

12/13/22

DATE:

