Proposed Building Plans for

Mauston, Wisconsin

these documents. All code required work to be included in contract sum.

All work to be constructed per governing codes/ordinances, as amended by local authorities. Said codes/ordinances are herein incorporated into



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Structural Notes

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S1.0

S1.2

S2 0

PROJECT DIRECTORY

OWNER

Don Slama

608-489-2275

ARCHITECT

Hillsboro Equipment

Hillsboro WI 54634

E 18898 Hwy 33 East

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608-588-7484

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715-384-3184

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Equipment Retail Store, Wisconsin

sboro

Mauston F Mauston, \

4-15-2024 Title Sheet

H85040

T1.0

Hillsboro Equipment Mauston **GENERAL NOTES ABBREVIATIONS**

Adherence to Code Requirements of the New and Remodeled construction shall be the strict responsibility of the Owner/ Builder. The Architect shall not be held liable for any such unauthorized deviations or violations of any applicable Building, Plumbing, HVAC, or Electrical codes or the ADA (Americans with Disabilities Act.) General notes are intended to clarify or emphasize the requirements of the drawings and specifications. In the event of a conflict between the drawings or specifications and these notes, the contractor shall comply with the more stringent requirement. All work to be performed in a manner so as to have a minimum of disruption and disturbance with existing operations and local environment. Noise Do not scale drawings. Permit and approvals are to be kept on-site at all times. Details and notes of similar conditions are typical whether or not called out at all places. references to any detail is for convenience only and does not limit the application of such detail or drawing Systems shown on drawings are intended to be furnished, installed, and turned over to the owner in proper functioning condition. All work to be Contractor shall check and verify all field conditions and dimensions with the construction drawings at the project site prior to construction, erection, and/or fabrication. Contractor shall inspect related work and adjacent surfaces. Contractor shall report any discrepancies between the contract documents and the existing conditions which shall prevent proper execution of this work to the architect before proceeding with the work. Contractor is responsible for dimensions, quantities, and coordination of other trades Special finish materials, carpet/ flooring, bases, doors, etc. are not shown on all details for clarity purposes. refer to plans, sections, other details, specifications, and schedules for additional information. Installation of all materials and systems shall be in accordance with manufacturer's written instructions This project is being constructed using a design-bid-build construction methodology. All contractors are responsible for complying with all applicable codes and ordinances related to their design and construction and integration with other systems and components. All concerns or conflicts related to such shall be brought to the attention of the general contractor prior to the start of construction All products are to be selected for the intended use and installed per manufacturer's specifications SUMMARY BUILDING CODE REQUIREMENTS Applicable code provisions include, but are not limited to the following: All through penetrations and membrane penetrations in fire resistance rated assemblies shall comply with IBC Section 714 362.0715 - Opening Protective's All doors in fire resistance rated assemblies shall comply with IBC section 716. 362.0716 - Duct and Air Transfer Openings All ducts and air transfer openings in fire resistance rated assemblies shall comply with IBC section 717. 362.0719 - Thermal and Sound Insulating Materials

Internally lit exit signs with battery backup shall be provided to mark approved exits from any direction of egress travel

Fasteners for preservative treated wood shall be hot-dipped, zinc coated, galvanized, or stainless steel

code provisions are complied with. Review the full Wisconsin Building Code for complete requirements

362,2304.9.5 - Fasteners in preservative treated wood

Provide Safety Glazing per IBC section 2406.

362.2406 - Safety Glazing

The means of egress, including the exit discharge, shall be illuminated to a minimum of 1 foot-candle at the floor level at all times the building space is

In the event of power supply failure, an emergency system shall automatically illuminate to and average of 1 foot-candle and minimum of 0.1 foot-candle at

the floor level at all corridors, stairways, and the portion of the exterior exit discharge immediately adjacent to exit discharge doorways, exterior walk or stoops

The General Contractor and sub contractors are responsible for coordinating with product manufacturers, suppliers, and installers to ensure that all applicable

CONTROL JOINT CEILING CENTER LINE COLUMN CONCRETE CONCRETE MASONRY UNIT CARPET CARPET
CERAMIC TILE
DIMENSION
DOWNSPOUT
EXPANSION JOINT EQUAL EXTERIOR FLOOR DRAIN FIBERGLASS REINFORCED PLASTIC FIRE EXTINGUISHER FINISHED FLOOR FLOOR REINFORC (ED) (ING) GYPSUM WALLBOARD GENERAL CONTRACTOR INSULATION INTERIOR
JOINT
METAL
MOISTURE RESISTANT
NOT TO SCALE
OUTSIDE DIMENSION
PLATE
QUANTITY
RADIUS
ROOM ROUGH OPENING SOUND ATTENUATION BATT SUSPENDED CEILING STAINI ESS STEEL STEEL
TEMPERED
TOP AND BOTTOM
TOP OF CONCRETE
TOP OF FOOTING
TOP OF SLAB
TOP OF WALL

TYPICAL UNLESS OTHERWISE NOTED

VINYL FACED WALL COVERING

ELEVATION

DETAIL

DOOR

WINDOW

WALL TYPE

A101

(i)

(101)

BUILDING SECTION

VAPOR BARRIER VINYL COMPOSITE TILE

MAP ARCHITECTURAL SYMBOLS

PROJECT ADDRESS Kennedy Street Mauston, WI 53948

CODE SUMMARY

OCCUPANCY

AREA

CONSTRUCTION

FIRE PROTECTION

PROJECT DESCRIPTION: Construction of a new showroom and shop

S-1 Moderate Hazard Storage

IIB Metal Frame Unprotected

Fully Sprinklered NFPA13

TAX PARCEL NUMBER:

ZONING REVIEW INFORMATION PROJECTED NUMBER OF OPERATIONAL OCCUPANCY

HOURS OF OPERATION: 7am- 5 pm

100 daily customers (nonconcurrent), 20 employees (concurrent)

NON-RESIDENTIAL USES (A) Min. Zoning District Area (B) Min Lot Area 20 000 s f (C) Max. Princ. bldg. coverage (D) Max. acc. bldg. coverage 10% (E) Max. coverage of all bldgs

4F:0.50 FAR (G) Max. gross density/intensity (H) Min. landscaping surface ratio (J) Min. lot width 100 feet (K) Min. street frontage 50 feet 25 ft/40ft 25 ft/40ft

(M) Front setback to acc. bldg. (N) Side setback to princ, bldg (S) Min. paved surface setback


20 ft


5 ft. from side/rear;10 ft from street


(V) Max. princ. bldg. height


(T) Min. separation of princ. bldgs

292510265

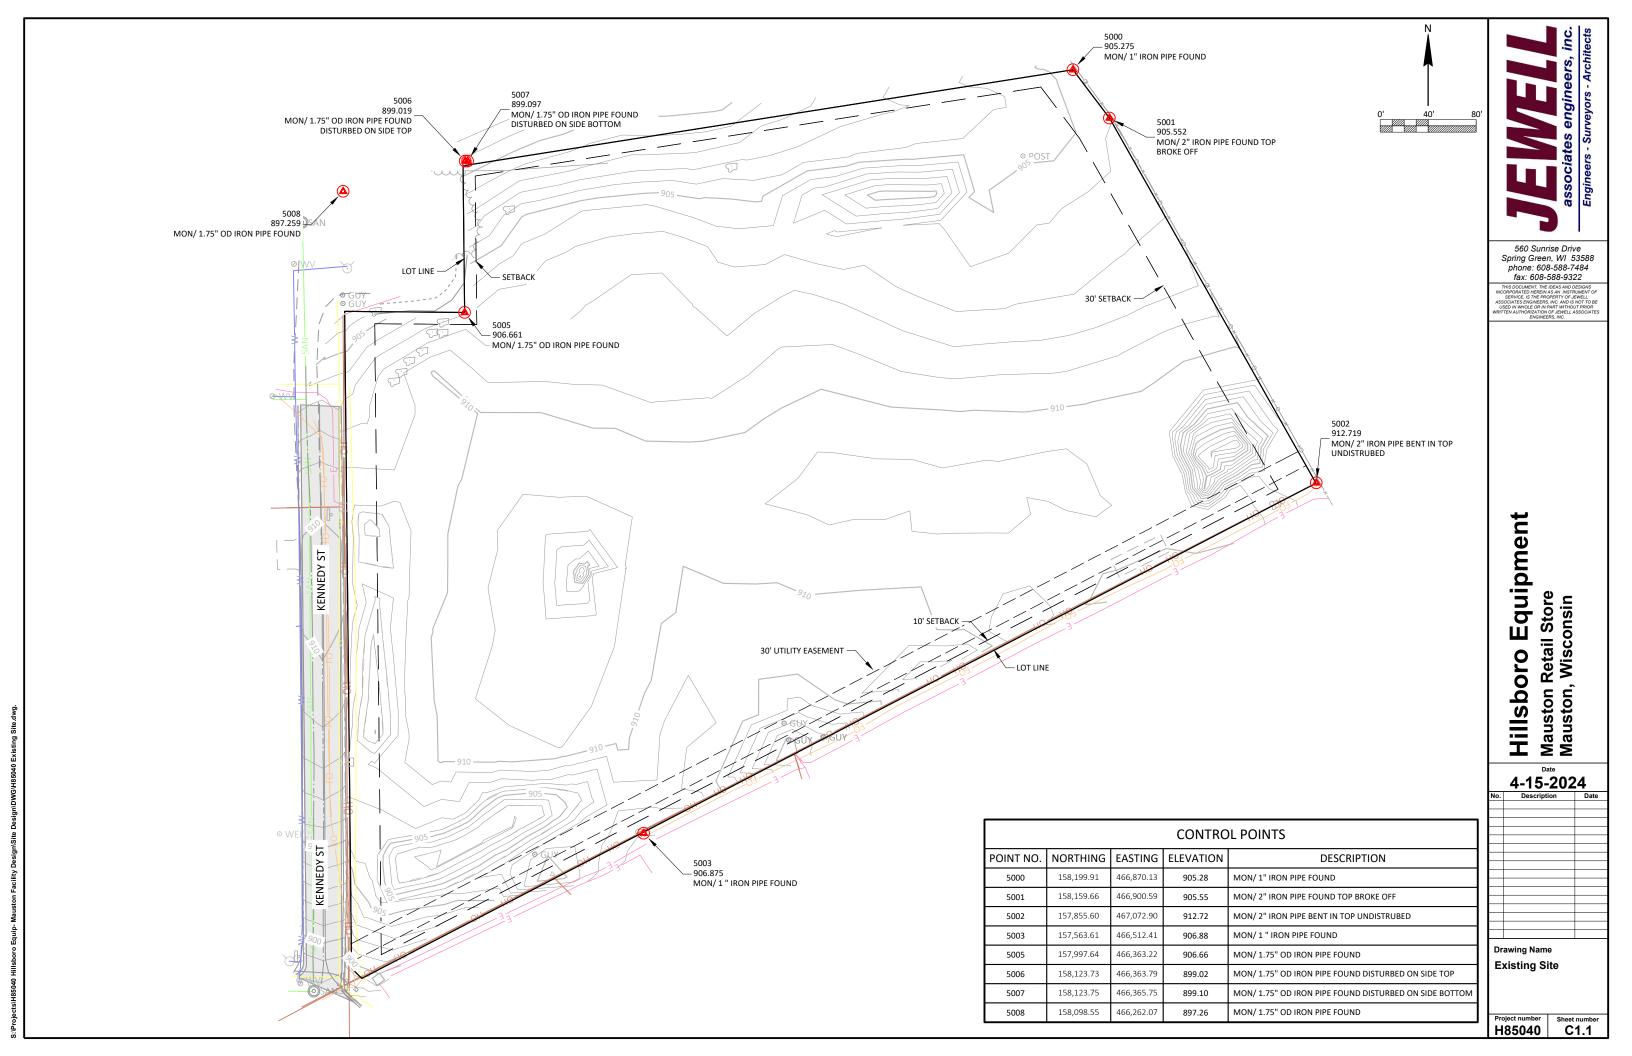

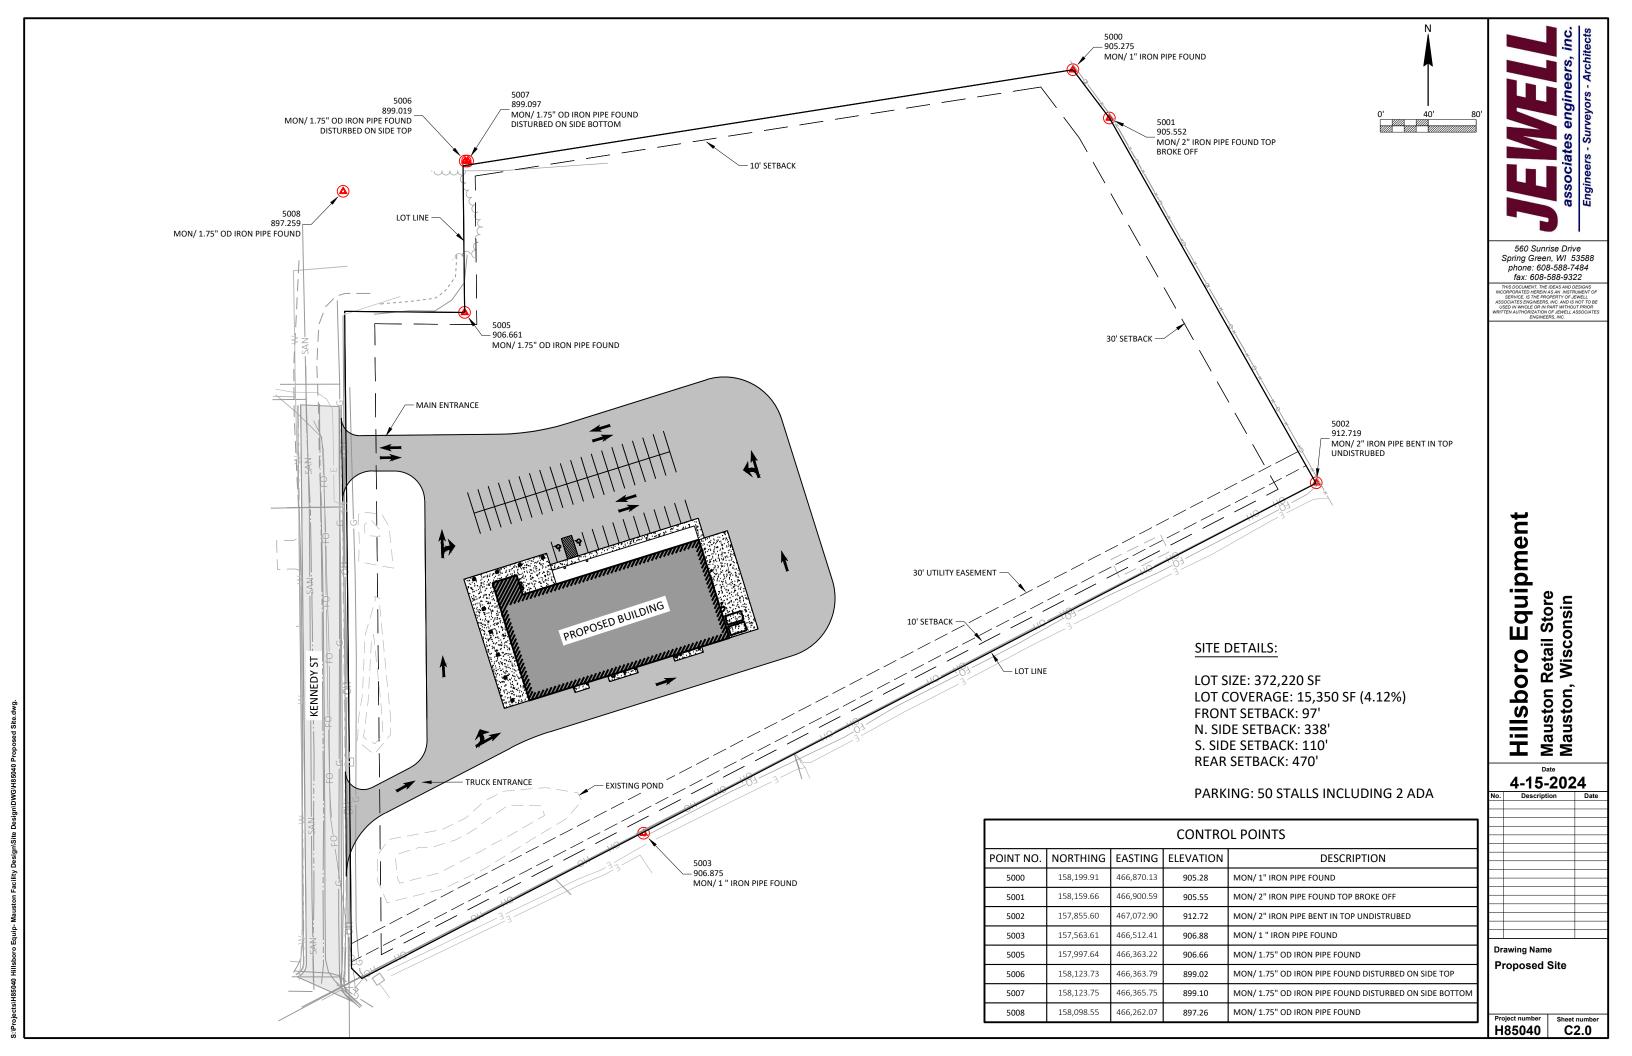

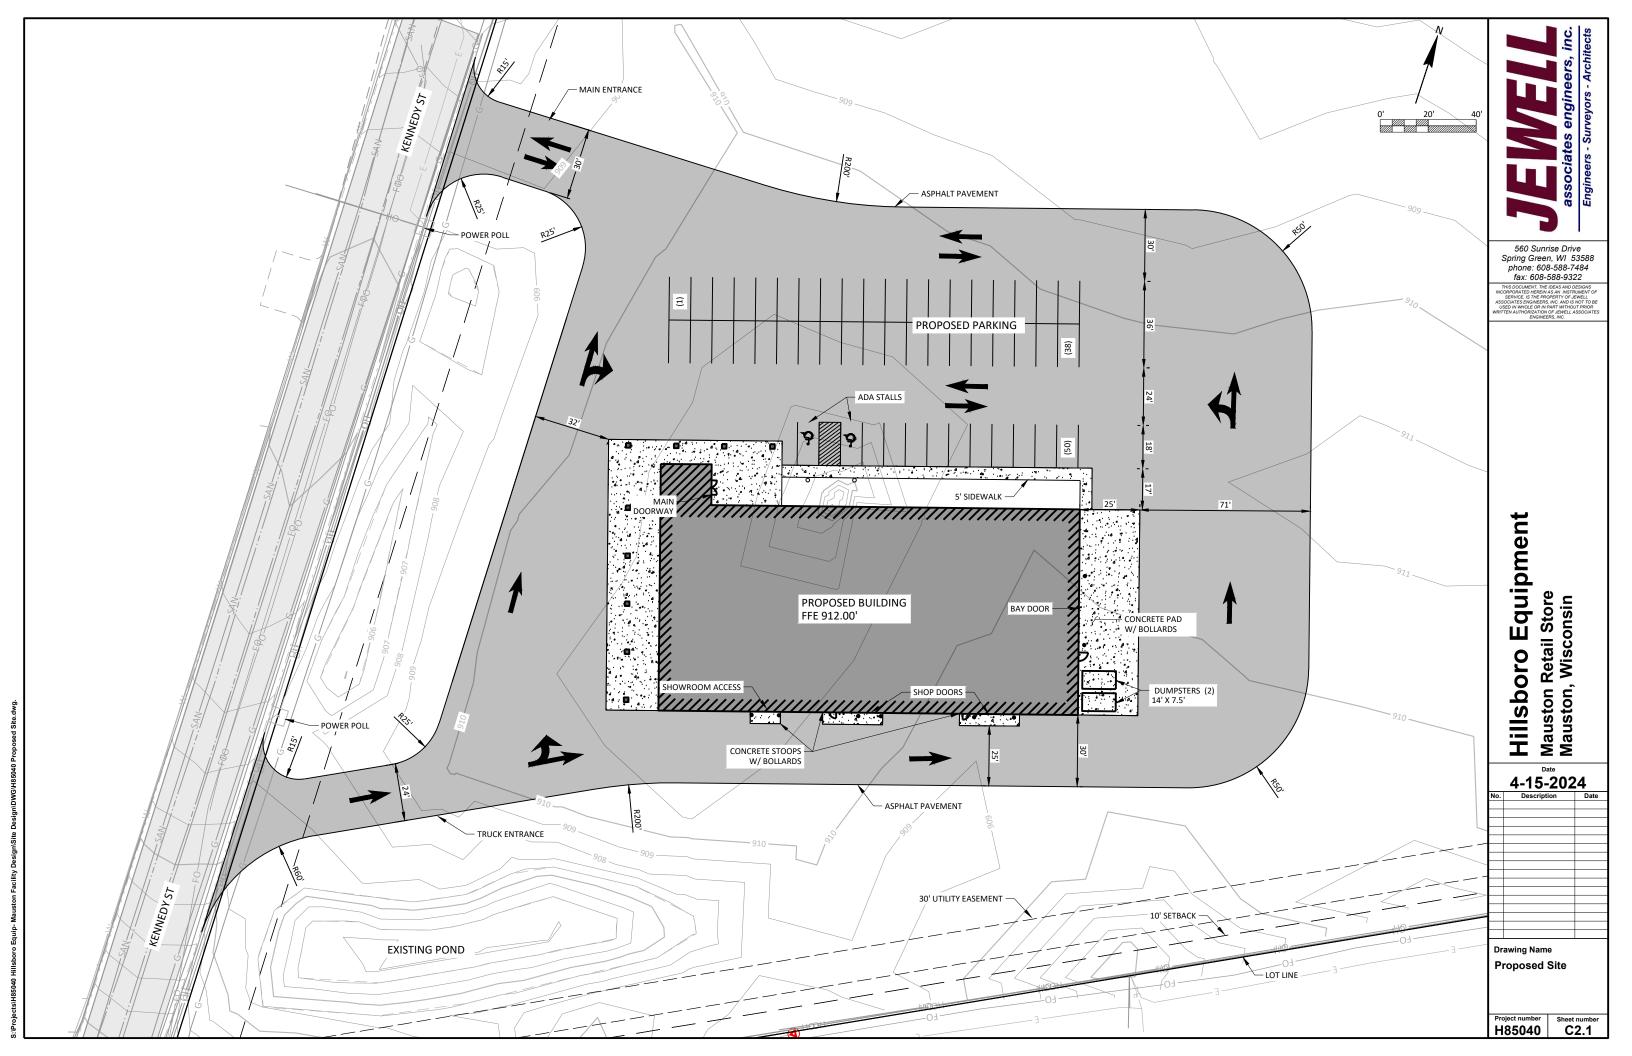

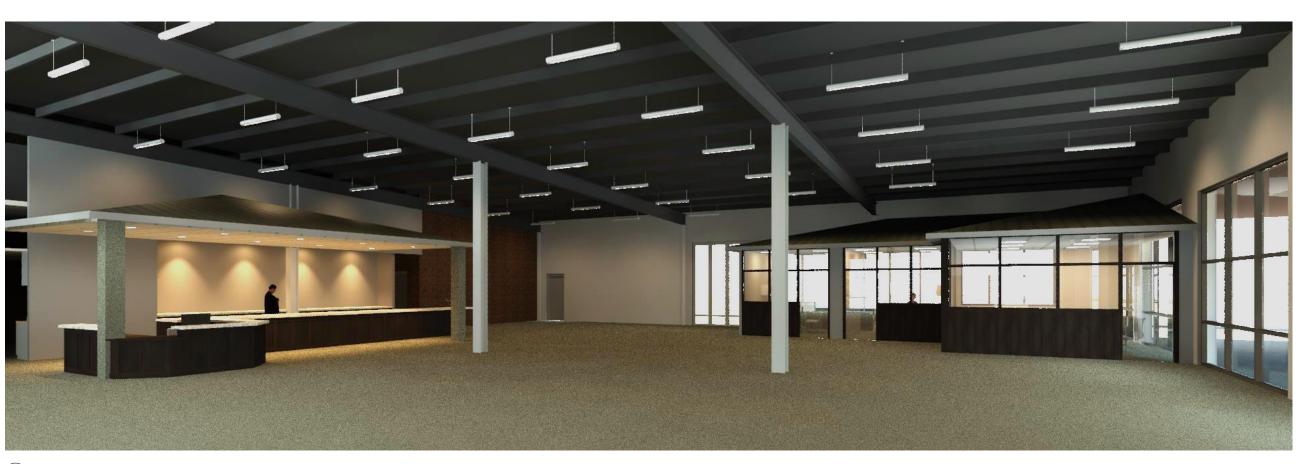

1 3D office View A0.1 NOT TO SCALE



2 Exterior Day Rendering A0.1 NOT TO SCALE

560 Sunrise Drive Spring Green, WI 53588 phone: 608-588-7484 fax: 608-588-9322



Hillsboro Equipment Mauston Retail Store Mauston, Wisconsin

4-15-2024			
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Drawing Name Rendered Views

Project number Sheet number A0.1



1 Exterior Night Rendering
A0.2 1" = 20'-0"



2 Highway Night Rendering A0.2 1" = 30'-0"

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fax: 608-588-9322
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Drawing Name Rendered Views

Project number Sheet number A0.2



Northeast Rendering
A0.3 1" = 100'-0"



Front Night Rendering
3/64" = 1'-0"


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4-15-2024				
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Drawing Name Rendered Views

Project number Sheet number A0.3



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Hillsboro Equipment Mauston Retail Store Mauston, Wisconsin

4-15-2024 **Drawing Name** Floor Plan

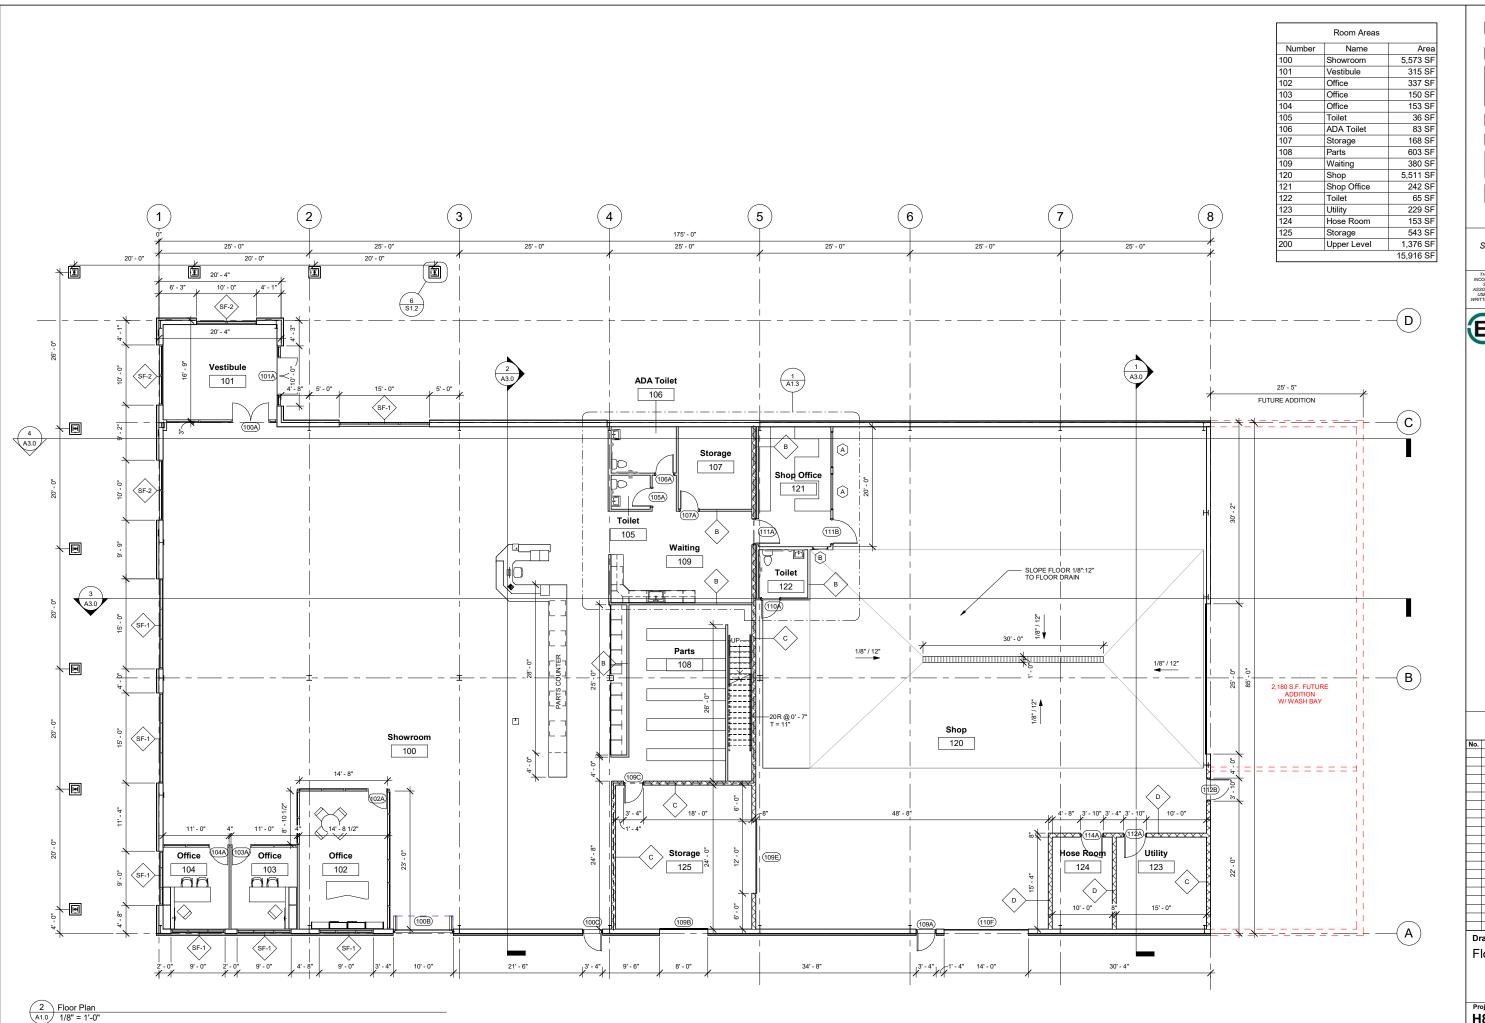Project number Sheet number A1.0



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Hillsboro Equipment Mauston Retail Store Mauston, Wisconsin

Date					
4-15-2024					
No.					
NO.	Description	Date			
_					
Drawing Name					

Proposed Elevations

Project number Sheet number A2.0