Proposed Building Plans for

Hillsboro Equipment Mauston

Mauston, Wisconsin



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S1.0

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PROJECT DIRECTORY

OWNER

Don Slama

608-489-2275

ARCHITECT

Hillsboro Equipment

Hillshoro WI 54634

E 18898 Hwy 33 East

Andrea Ring, Architect

CIVIL ENGINEERING

STRUCTURAL ENGINEERING

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Spring Green, WI 53588

GENERAL CONTRACTOR

2613 W. Veterans Parkway

Marshfield, WI 54449

560 Sunrise Drive Spring Green, WI 53588 fax: 608-588-9322

Equipment Retail Store, Wisconsin sboro Mauston F Mauston, \ 4-15-2024 Title Sheet

GENERAL NOTES ABBREVIATIONS All work to be constructed per governing codes/ordinances, as amended by local authorities. Said codes/ordinances are herein incorporated into these documents. All code required work to be included in contract sum. Adherence to Code Requirements of the New and Remodeled construction shall be the strict responsibility of the Owner/ Builder. The Architect shall not be held liable for any such unauthorized deviations or violations of any applicable Building, Plumbing, HVAC, or Electrical codes or the ADA (Americans with Disabilities Act.) General notes are intended to clarify or emphasize the requirements of the drawings and specifications. In the event of a conflict between the drawings or specifications and these notes, the contractor shall comply with the more stringent requirement. All work to be performed in a manner so as to have a minimum of disruption and disturbance with existing operations and local environment. Noise Do not scale drawings. Permit and approvals are to be kept on-site at all times. Details and notes of similar conditions are typical whether or not called out at all places. references to any detail is for convenience only and does not limit the application of such detail or drawing Systems shown on drawings are intended to be furnished, installed, and turned over to the owner in proper functioning condition. All work to be

- specifications, and schedules for additional information. Installation of all materials and systems shall be in accordance with manufacturer's written instructions This project is being constructed using a design-bid-build construction methodology. All contractors are responsible for complying with all applicable codes and ordinances related to their design and construction and integration with other systems and components. All concerns or conflicts related to
- such shall be brought to the attention of the general contractor prior to the start of construction All products are to be selected for the intended use and installed per manufacturer's specifications

All through penetrations and membrane penetrations in fire resistance rated assemblies shall comply with IBC Section 714

Internally lit exit signs with battery backup shall be provided to mark approved exits from any direction of egress travel

responsible for dimensions, quantities, and coordination of other trades

SUMMARY BUILDING CODE REQUIREMENTS

Applicable code provisions include, but are not limited to the following:

All doors in fire resistance rated assemblies shall comply with IBC section 716.

CONTROL JOINT CEILING CENTER LINE COLUMN CONCRETE CONCRETE MASONRY UNIT CARPET CARPET CERAMIC TILE DIMENSION DOWNSPOUT EXPANSION JOINT EQUAL EXTERIOR FLOOR DRAIN FIBERGLASS REINFORCED PLASTIC FIRE EXTINGUISHER FINISHED FLOOR FLOOR REINFORC (ED) (ING) Contractor shall check and verify all field conditions and dimensions with the construction drawings at the project site prior to construction, erection, and/or fabrication. Contractor shall inspect related work and adjacent surfaces. Contractor shall report any discrepancies between the contract GYPSUM WALLBOARD documents and the existing conditions which shall prevent proper execution of this work to the architect before proceeding with the work. Contractor is GENERAL CONTRACTOR INSULATION INTERIOR JOINT METAL MOISTURE RESISTANT NOT TO SCALE OUTSIDE DIMENSION PLATE QUANTITY RADIUS ROOM Special finish materials, carpet/ flooring, bases, doors, etc. are not shown on all details for clarity purposes. refer to plans, sections, other details, ROUGH OPENING SOUND ATTENUATION BATT SUSPENDED CEILING STAINI ESS STEEL

STEEL TEMPERED TOP AND BOTTOM TOP OF CONCRETE TOP OF FOOTING TOP OF SLAB TOP OF WALL TYPICAL UNLESS OTHERWISE NOTED VAPOR BARRIER VINYL COMPOSITE TILE VINYL FACED WALL COVERING ARCHITECTURAL SYMBOLS

(1) (A101)

(i)

(101)

ELEVATION

DETAIL

DOOR

WINDOW

WALL TYPE

BUILDING SECTION

MAP

PROJECT ADDRESS Kennedy Street Mauston, WI 53948

CODE SUMMARY

OCCUPANCY

AREA

CONSTRUCTION

FIRE PROTECTION

PROJECT DESCRIPTION: Construction of a new showroom and shop

S-1 Moderate Hazard Storage

IIB Metal Frame Unprotected

New Construction = 17.550 S.F

Fully Sprinklered NFPA13

TAX PARCEL NUMBER: 292510265

> 20 000 s f 10% 4F:0.50 FAR

100 feet 50 feet 25 ft/40ft 25 ft/40ft

20 ft

5 ft. from side/rear;10 ft from street

362,2304,9.5 - Fasteners in preservative treated wood

Fasteners for preservative treated wood shall be hot-dipped, zinc coated, galvanized, or stainless steel

All ducts and air transfer openings in fire resistance rated assemblies shall comply with IBC section 717.

362,2406 - Safety Glazing

362.0715 - Opening Protective's

362.0716 - Duct and Air Transfer Openings

362.0719 - Thermal and Sound Insulating Materials

Provide Safety Glazing per IBC section 2406.

362.1006 - Illumination Emergency Power

The General Contractor and sub contractors are responsible for coordinating with product manufacturers, suppliers, and installers to ensure that all applicable code provisions are complied with. Review the full Wisconsin Building Code for complete requirements

The means of egress, including the exit discharge, shall be illuminated to a minimum of 1 foot-candle at the floor level at all times the building space is

In the event of power supply failure, an emergency system shall automatically illuminate to and average of 1 foot-candle and minimum of 0.1 foot-candle at

the floor level at all corridors, stairways, and the portion of the exterior exit discharge immediately adjacent to exit discharge doorways, exterior walk or stoops

PROJECTED NUMBER OF OPERATIONAL OCCUPANCY

ZONING REVIEW INFORMATION

HOURS OF OPERATION: 7am- 5 pm

NON-RESIDENTIAL USES (A) Min. Zoning District Area (B) Min Lot Area


(C) Max. Princ. bldg. coverage (D) Max. acc. bldg. coverage (E) Max. coverage of all bldgs (G) Max. gross density/intensity (H) Min. landscaping surface ratio (J) Min. lot width (K) Min. street frontage


(M) Front setback to acc. bldg. (N) Side setback to princ. bldg.


(S) Min. paved surface setback (T) Min. separation of princ. bldgs (V) Max. princ. bldg. height

H85040

T1.0

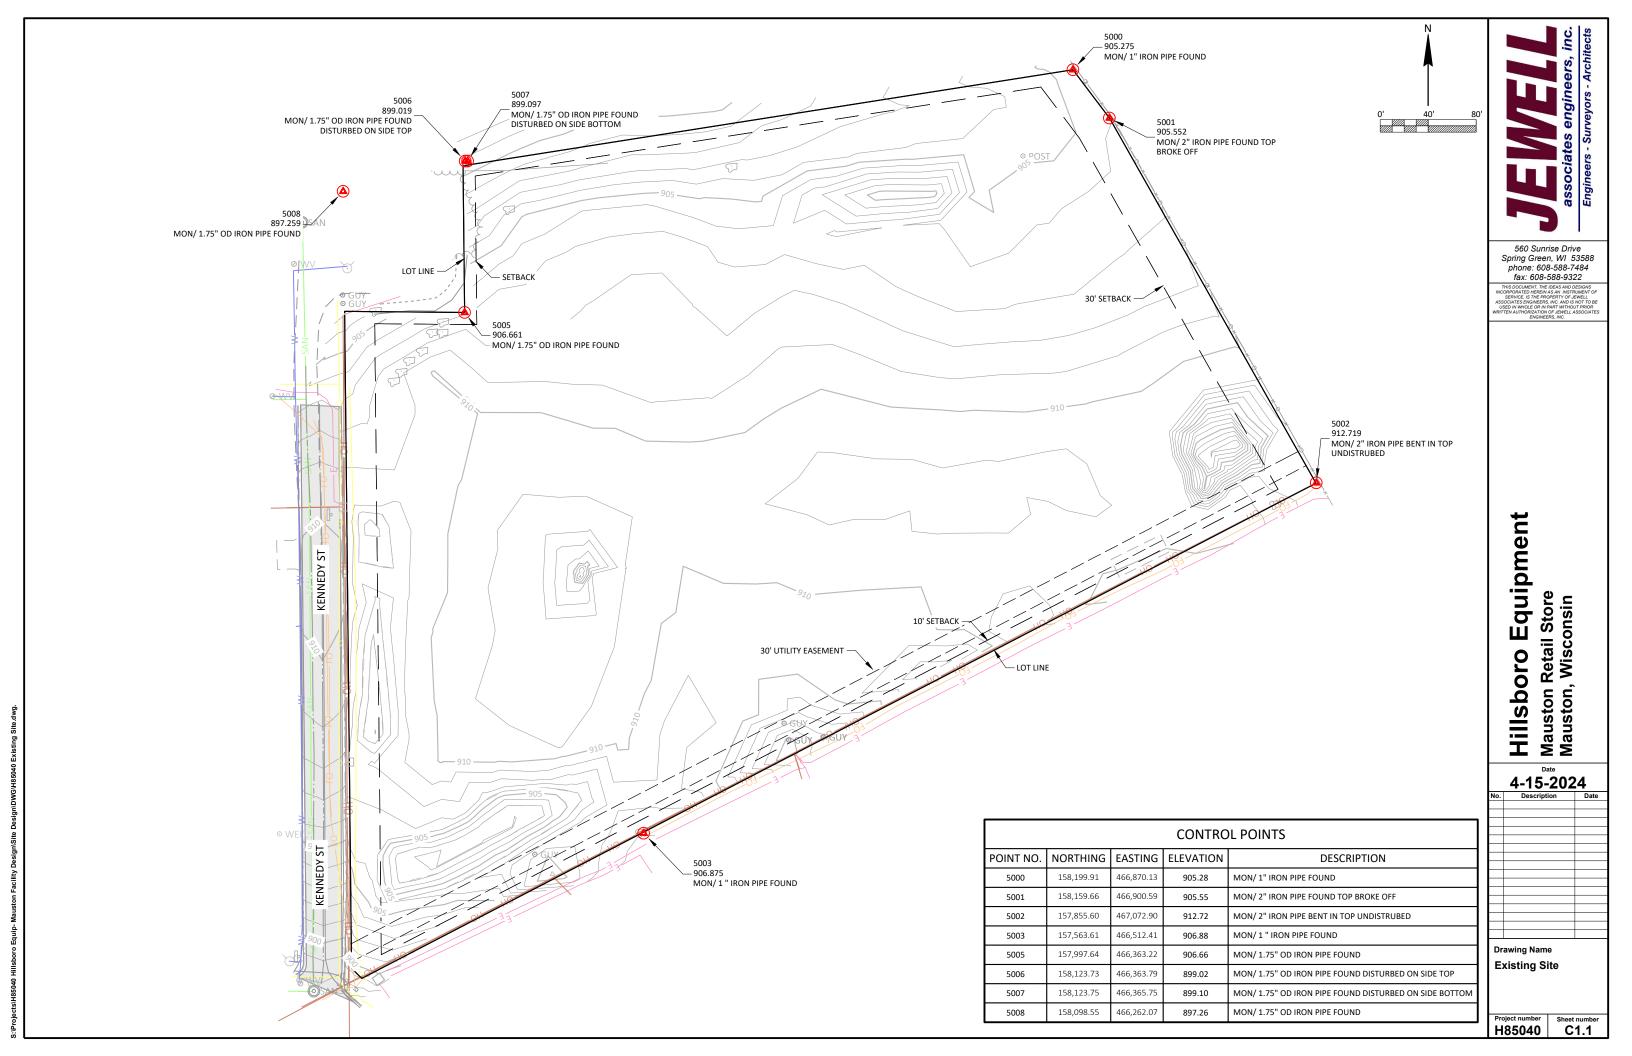

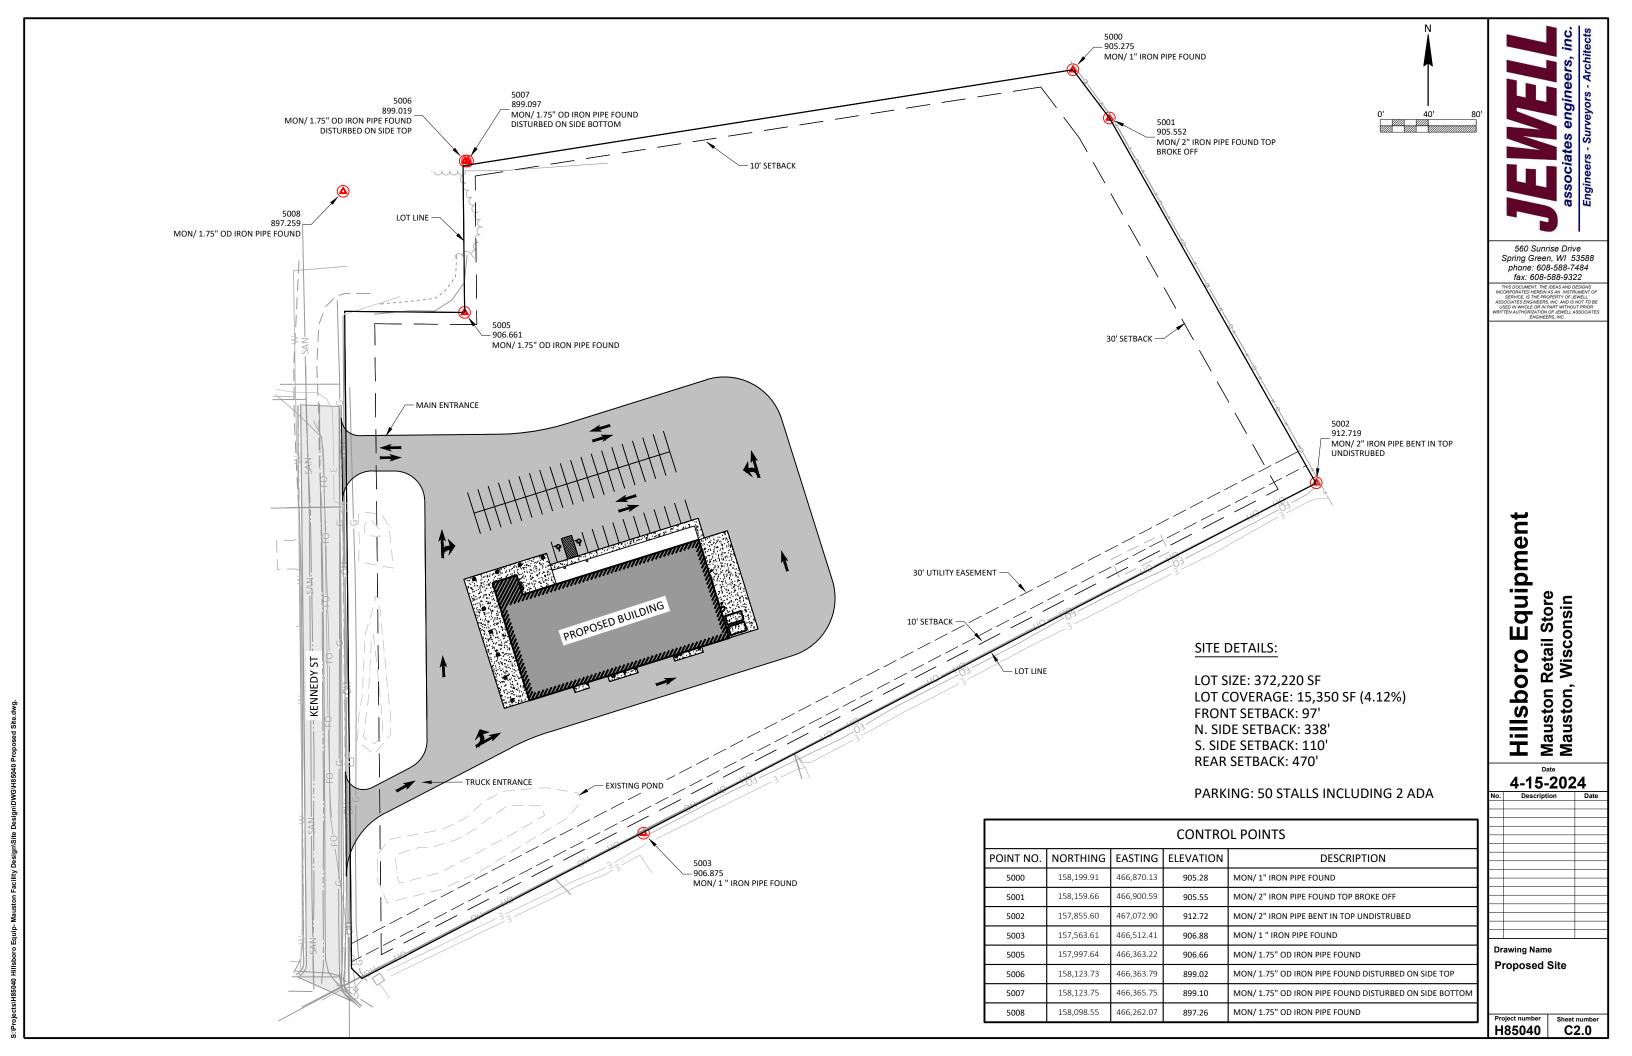

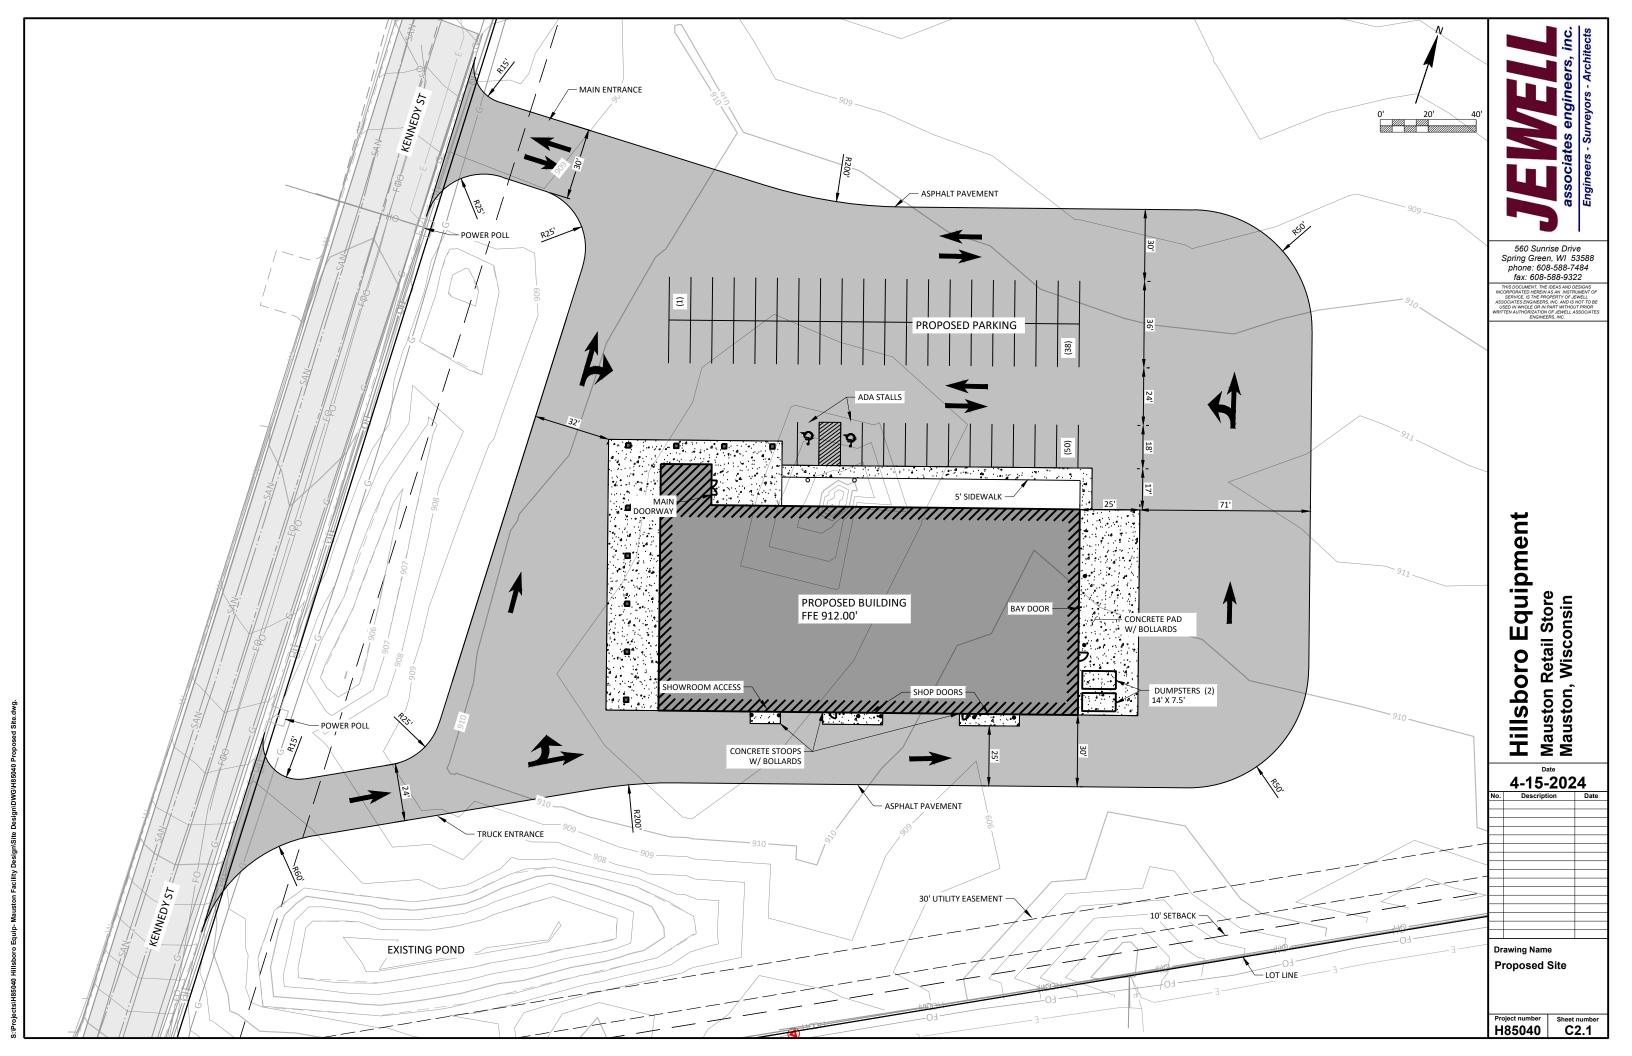



1 3D office View A0.1 NOT TO SCALE



2 Exterior Day Rendering NOT TO SCALE

560 Sunrise Drive Spring Green, WI 53588 phone: 608-588-7484 fax: 608-588-9322



Hillsboro Equipment Mauston Retail Store Mauston, Wisconsin

4-15-2024

U.	Description	ט

Drawing Name Rendered Views

Project number Sheet number A0.1



1 Exterior Night Rendering
A0.2 1" = 20'-0"



2 Highway Night Rendering A0.2 1" = 30'-0"

Hillsboro Equipment

Mauston Retail Store Mauston, Wisconsin

4-15-2024

Drawing Name Rendered Views

Project number Sheet number A0.2

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Spring Green, WI 53588
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fax: 608-588-9322
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Northeast Rendering
A0.3 1" = 100'-0"



Front Night Rendering
3/64" = 1'-0"


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	Date			
4-15-2024				
No.	Description	Date		
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-				

Drawing Name Rendered Views

Project number Sheet number A0.3



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Hillsboro Equipment Mauston Retail Store Mauston, Wisconsin

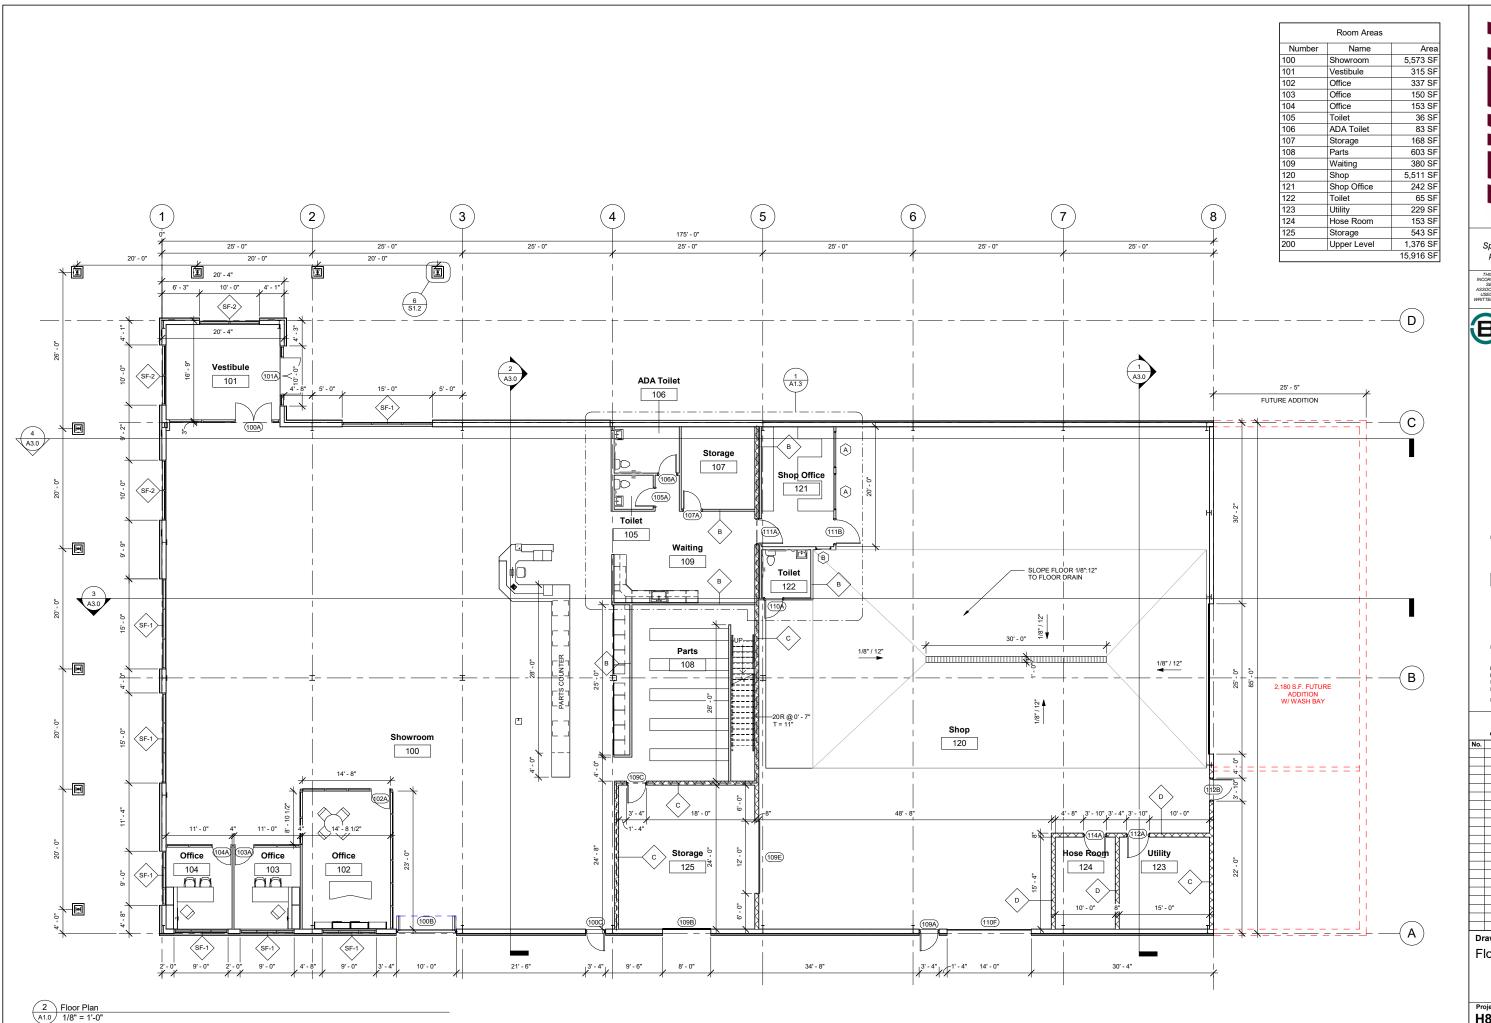4-15-2024 **Drawing Name** Floor Plan

Project number Sheet number A1.0



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Hillsboro Equipment Mauston Retail Store Mauston, Wisconsin

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4-15-2024				
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Drawing Name				

Project number H85040 A2.0