
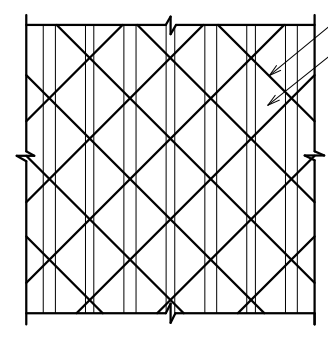
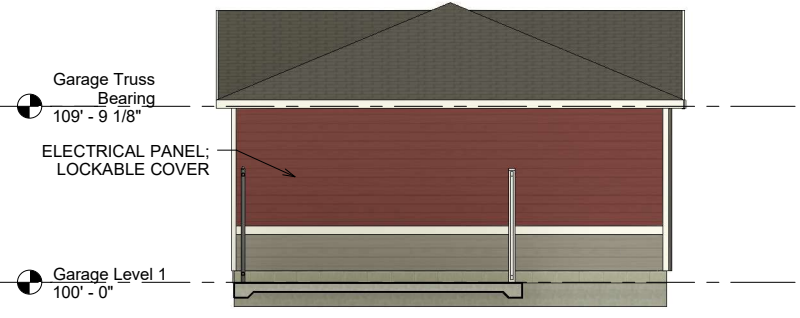


① Garage 1 - Front Elevation
3/16" = 1'-0"

- GENERAL NOTES:
- GARAGE OCCUPANCY GROUP: U OCCUPANCY
 - GARAGE CONSTRUCTION TYPE: VB

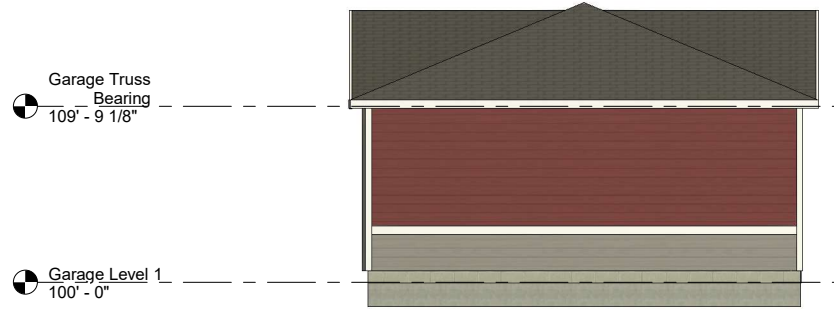

CHAIN LINK MESH SIZE = 2-3/8"
1-1/4" WIDE VINYL SLATS (GREY)

THIS DETAIL ILLUSTRATES A TYPICAL 1' X 1' SECTION OF THE CHAIN LINK FENCE AREA AT THE FRONT (GATE) SIDE OF THE REFUSE ENCLOSURE.

GALVANIZED METAL CHAIN LINK FENCE TO HAVE 2-3/8" MESH SIZE.

1-1/4" WIDE VINYL SLATS INSTALLED AT APPROX. 1-3/4" O.C.


VINYL SLATS PROVIDE 107 INCHES OF OPACITY PER 144 SQUARE INCHES OF AREA = 74% OPACITY

CALCULATION DOES NOT FACTOR IN THE CHAIN LINK GAUGE SIZE OR SUPPORT STRUCTURE.

② Garage 1 - Side 1 Elevation
3/16" = 1'-0"

③ Garage 1 - Side 2 Elevation
3/16" = 1'-0"

○ Refuse Enclosure Detail
3" = 1'-0"

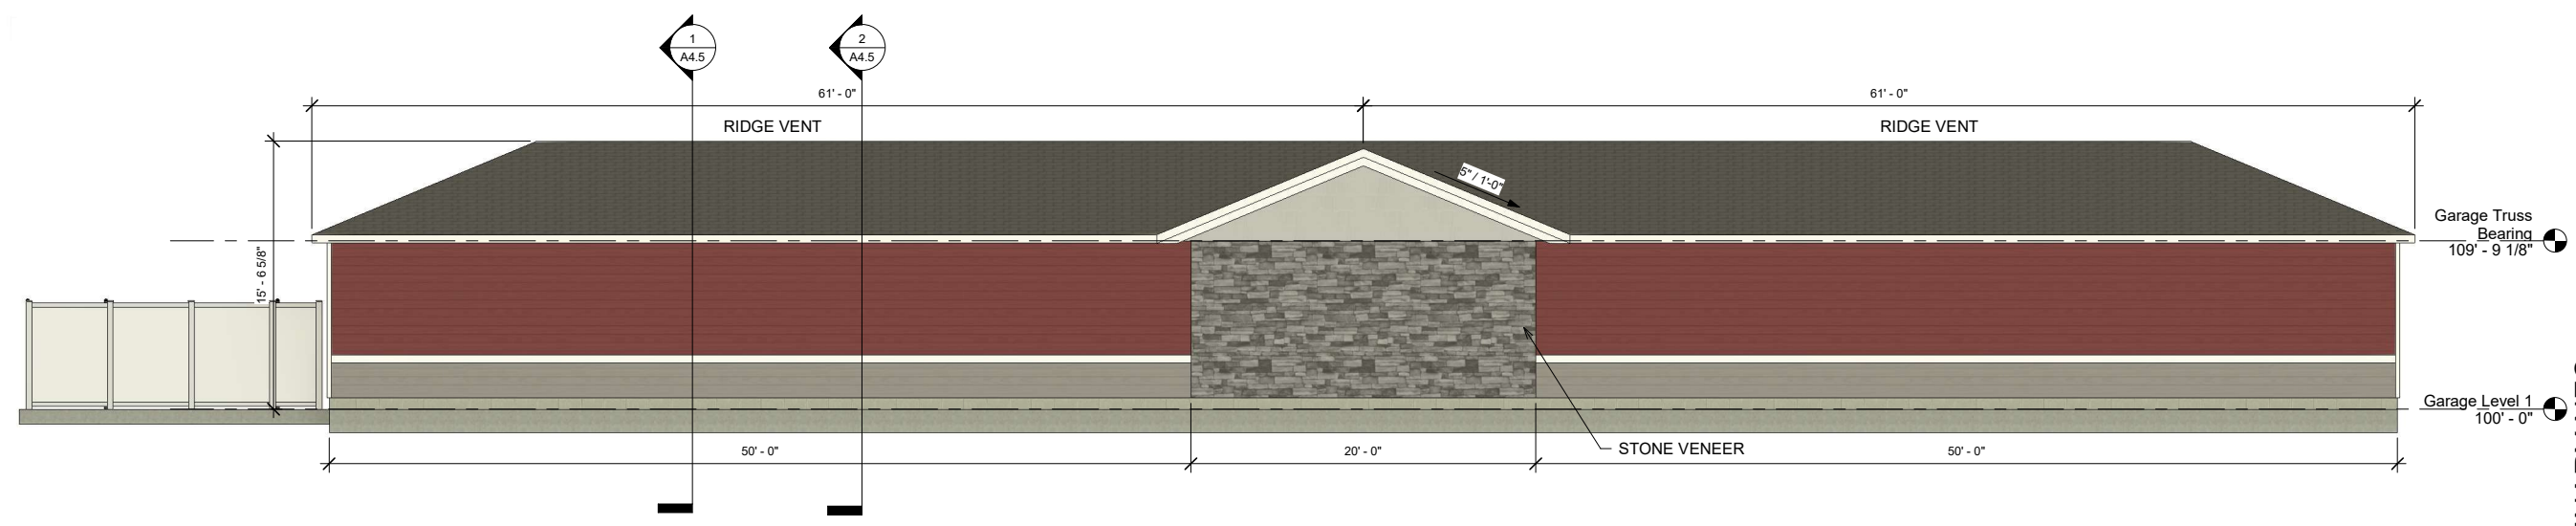

④ Garage 1 - Rear Elevation
3/16" = 1'-0"

No.	Description	Date

I hereby certify that this plan, specification, or report was prepared by me or under my direct supervision and that I am a duly Licensed Architect under the laws of the State of Minnesota. Name: Christopher J. Raimann, AIA Signed:

Date: 08-15-2022 License #: 46319

KUJEPERS^{INC}
ARCHITECTS & BUILDERS
BRAINERD/BAXTER, MN 218-829-0707

Stone Meadow Apartments - Building A

PRELIMINARY NFC

Kuepers Inc. Building A	
Project number XX-XX-XXXX	Date 09-01-2023
Drawn by RET	Checked by CJR

A3.2
Garage 1 Elevations
Scale As indicated

