ROUTE 1100 EVENT CENTER



3 D VISUALIZATION

OUTLINE SPECIFICATIONS FOR OFFICE BUILDING MANOR, TEXAS

DIVISION I - GENERAL REQUIREMENTS

.I General:

.01 This project shall be constructed of carefully selected materials to provide low maintenance cost, initial low construction cost and

.02 All provisions for the handicapped are to be part of the

.2 Insurance: General Contractor shall furnish and pay for the following insurance policies indemnifying himself, the Owner and the

DIVISION 2 - SITE WORK:

.1 Soil Treatment: Termite control is to be provided under entire

.2 Sidewalks: To be 4" thick Concrete over 2" compacted sandfill. Reinforced with welded wire mesh.

.3 Finish Grading: To be hand graded approximately 20' from the building and all improvements.

.4 Landscaping: Included as a part of this contract.

DIVISION 3 - CONCRETE:

.I Foundation: Reinforced concrete monolithic beam and slab on 6" compacted selected fill. Concrete slab shall be trowel finish. All concrete shall be minimum 3,000 PSI Test at 28 days.

.2 Vapor Barrier: 6 mil polyethelene

DIVISION 4 - MASONRY:

.1 Portland Cement Plaster system over hot dipped galv. paper backed self furring metal lath over 8" cmu with cavity wall foam

.2 Interior Stud Walls: 4" studs and gypsum drywall partitions.

DIVISION 6 - CARPENTRY:

.I Architectural wood work.

.1 Roofing: METAL Roofing system .2 Insulation: 6" building insulation. Batt insulation above SAC.

DIVISION 8 - DOORS, WINDOWS, AND GLASS:

.I Doors and Frames: All interior doors shall be I-3/4" solid core flush veneer doors. Frames shall be hollow metal frames.

.2 Storefront Doors and Frames: All exterior storefront system shall be aluminum.

.3 Glass: All glass shall be I/4" tempered glass.

DIVISION 9 - FINISHES:

.I Floors: All central traffic areas shall be vinyl composition tile

01 Offices to be 1/8" vinyl composition tile. 02 Base shall be rubber base.

.2 Walls

01 All gypsum walls shall be painted.

.3 Ceilings: Areas where shown shall be suspended acoustical grid system with square edge fissured mineral fiber board panels. and/or painted gypsum board DIVISION 10 - SPECIALTIES:

.I None Required.

DIVISION I I - EQUIPMENT:

DIVISION 12 - FURNISHINGS:

.I None Required.

.I None Required.

DIVISION 13 - SPECIAL CONSTRUCTION: .I None Required

2018 International Building Code 2018 International Mechanical Code 2018 International Fire Code

> 1. USE AND OCCUPANCY CLASSIFICATION: **EVENT CENTER**

2018 International Plumbing Code

2. BUILDING HEIGHT:

Actual Height (stories/height) 1 story / 22'-6"

2018 International Energy Conservation Code

2018 NPPA Life Safety Code





PROJECT INFORMATION

3. BUILDING AREA: Building Floor Area (Fire Area) ______5,865 2018 National Electric Code ADA Accessibility Guidelines

4. Fire Protection Systems: A. Fire Smoke Detection Required <u>Yes</u> Provided <u>Yes</u> B. Portable fire Exinguisher Required Yes Provided Yes
C. Fire Sprinkler System Required NO Provided NO

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EVENT CENTER DESIGN FOR

ROUTE 1100 EVENT CENTER

BEING 3.478 ACRE TRACT OF LAND OUT OF THE LEMUEL KIMBRO SURVEY


TRAVIS COUNTY , TEXAS 78526

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B & B DESIGN FIRM LLC 1175 W. Price Road Ste. 6 Brownsville, Tx. 78521 **OFFICE** 956 . 801 . 9417

_	DATE:	4.12.25
∽ ⋅ Ⅱ		
	DRAWING NAME:	COVE
	PROJECT#	DT24-096

SHEET **COVER**

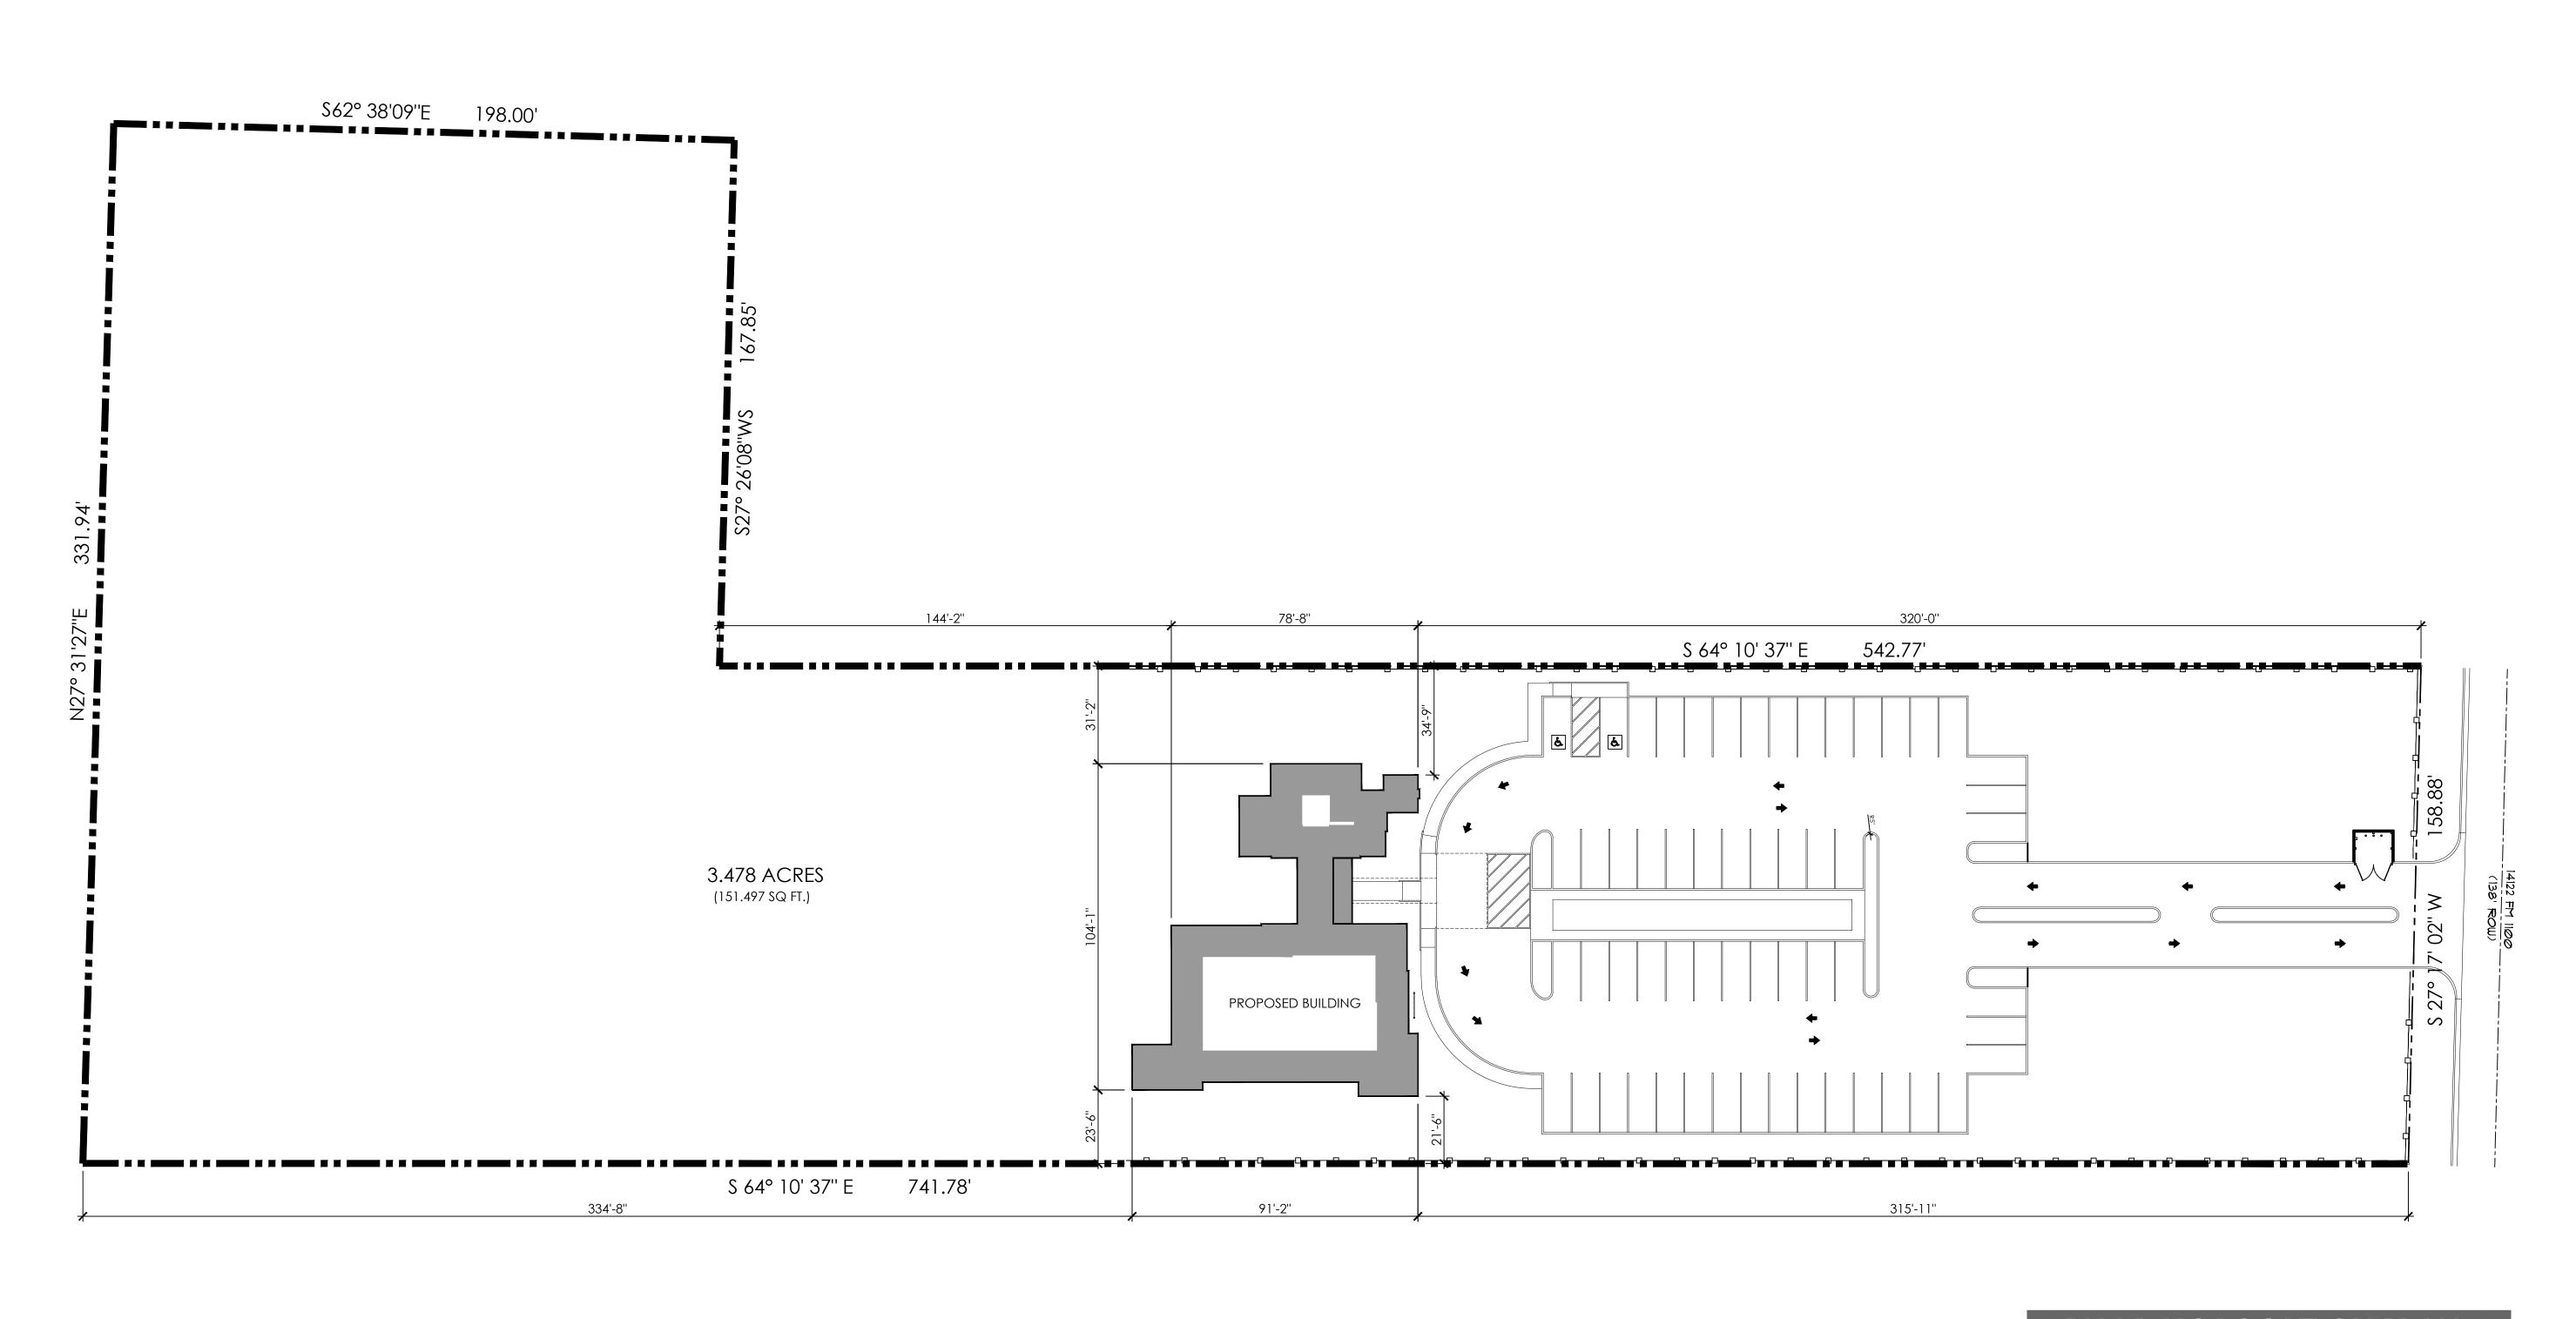

BUILDING LOCATION PLAN

SCALE: 1" = 20'-0"

SITE NOTES:

1. FINISH GRADE TO BE 6" BELOW FINISH FLOOR ELEVATION SLOPE AWAY FROM ALL IMPROVEMENTS AT A RATE OF 1/4" PER FOOT FOR THE FIRST 10'-0"; THEN AT A RATE OF 1/8" PER FOOT FOR THE NEXT 20'-0"

2. SIDE WALK SLOPE IS NOT TO EXCEED 1:20 WITH A CROSS SLOPE OF 1:50 AT ANY INSTANCE.

3. REFERENCE SHEET MEP1 FOR SITE IMPROVEMENTS AND MECHANICAL, ELECTRICAL, AND PLUMBING SITE NOTES

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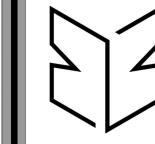
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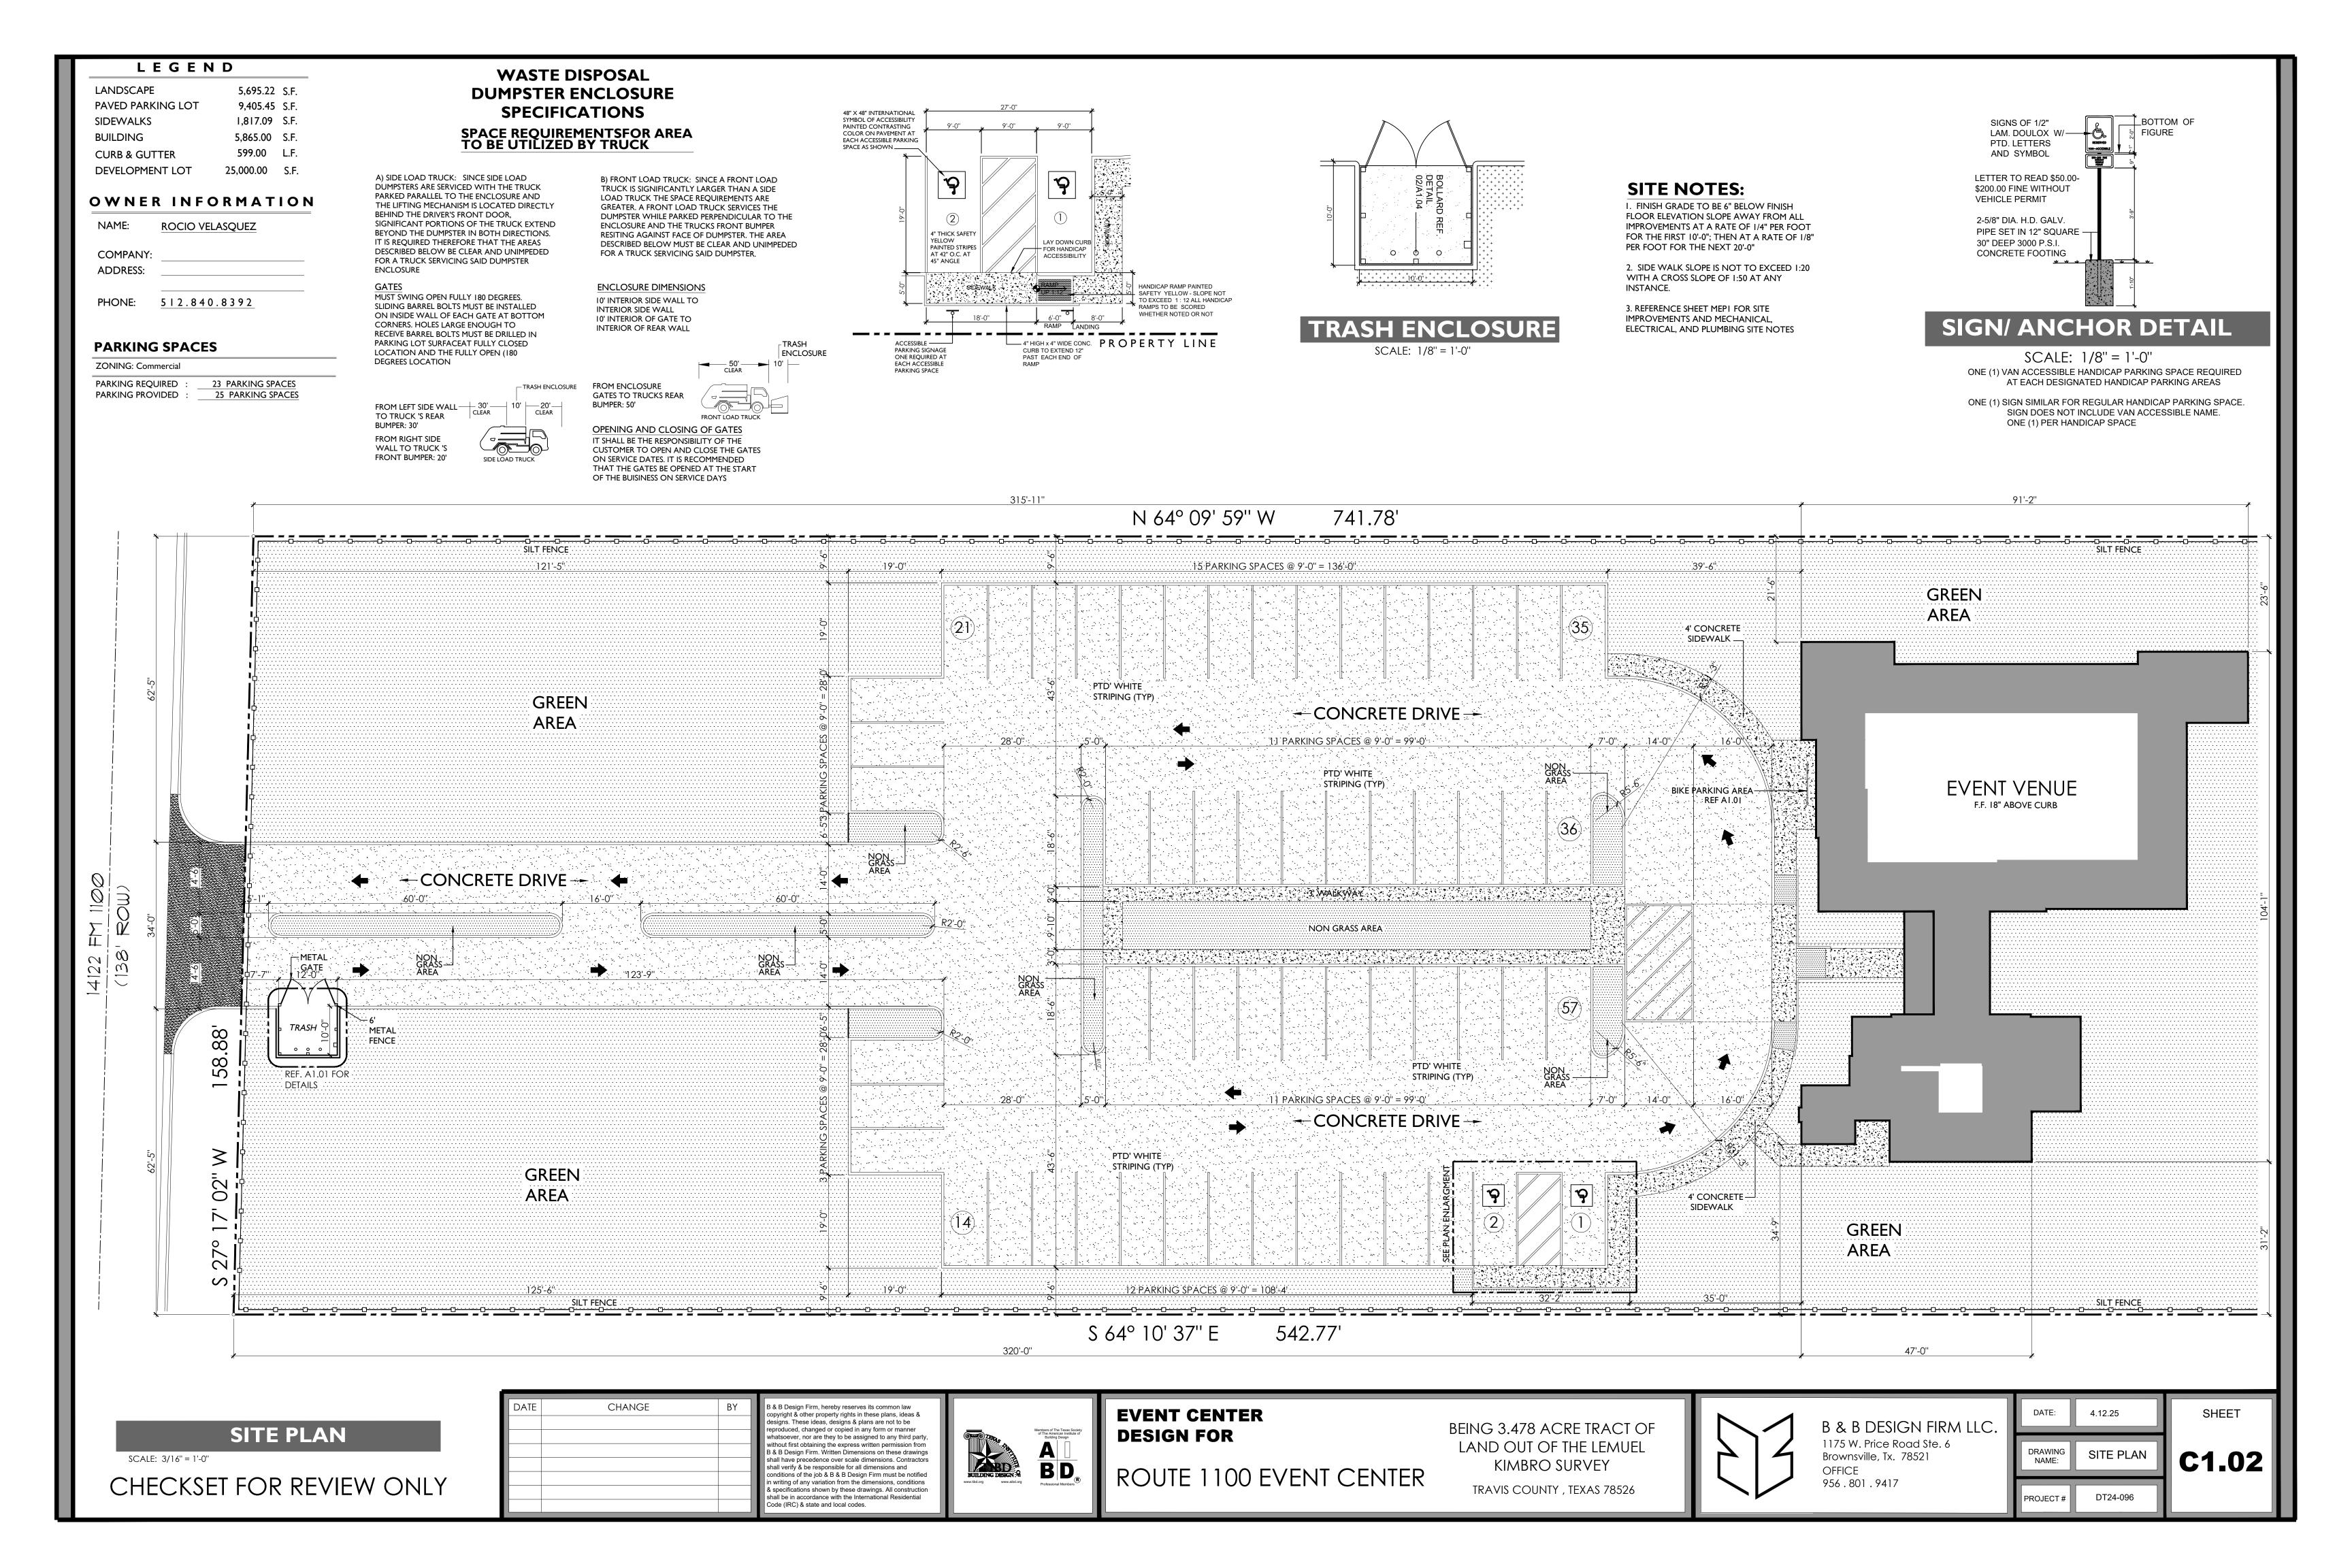
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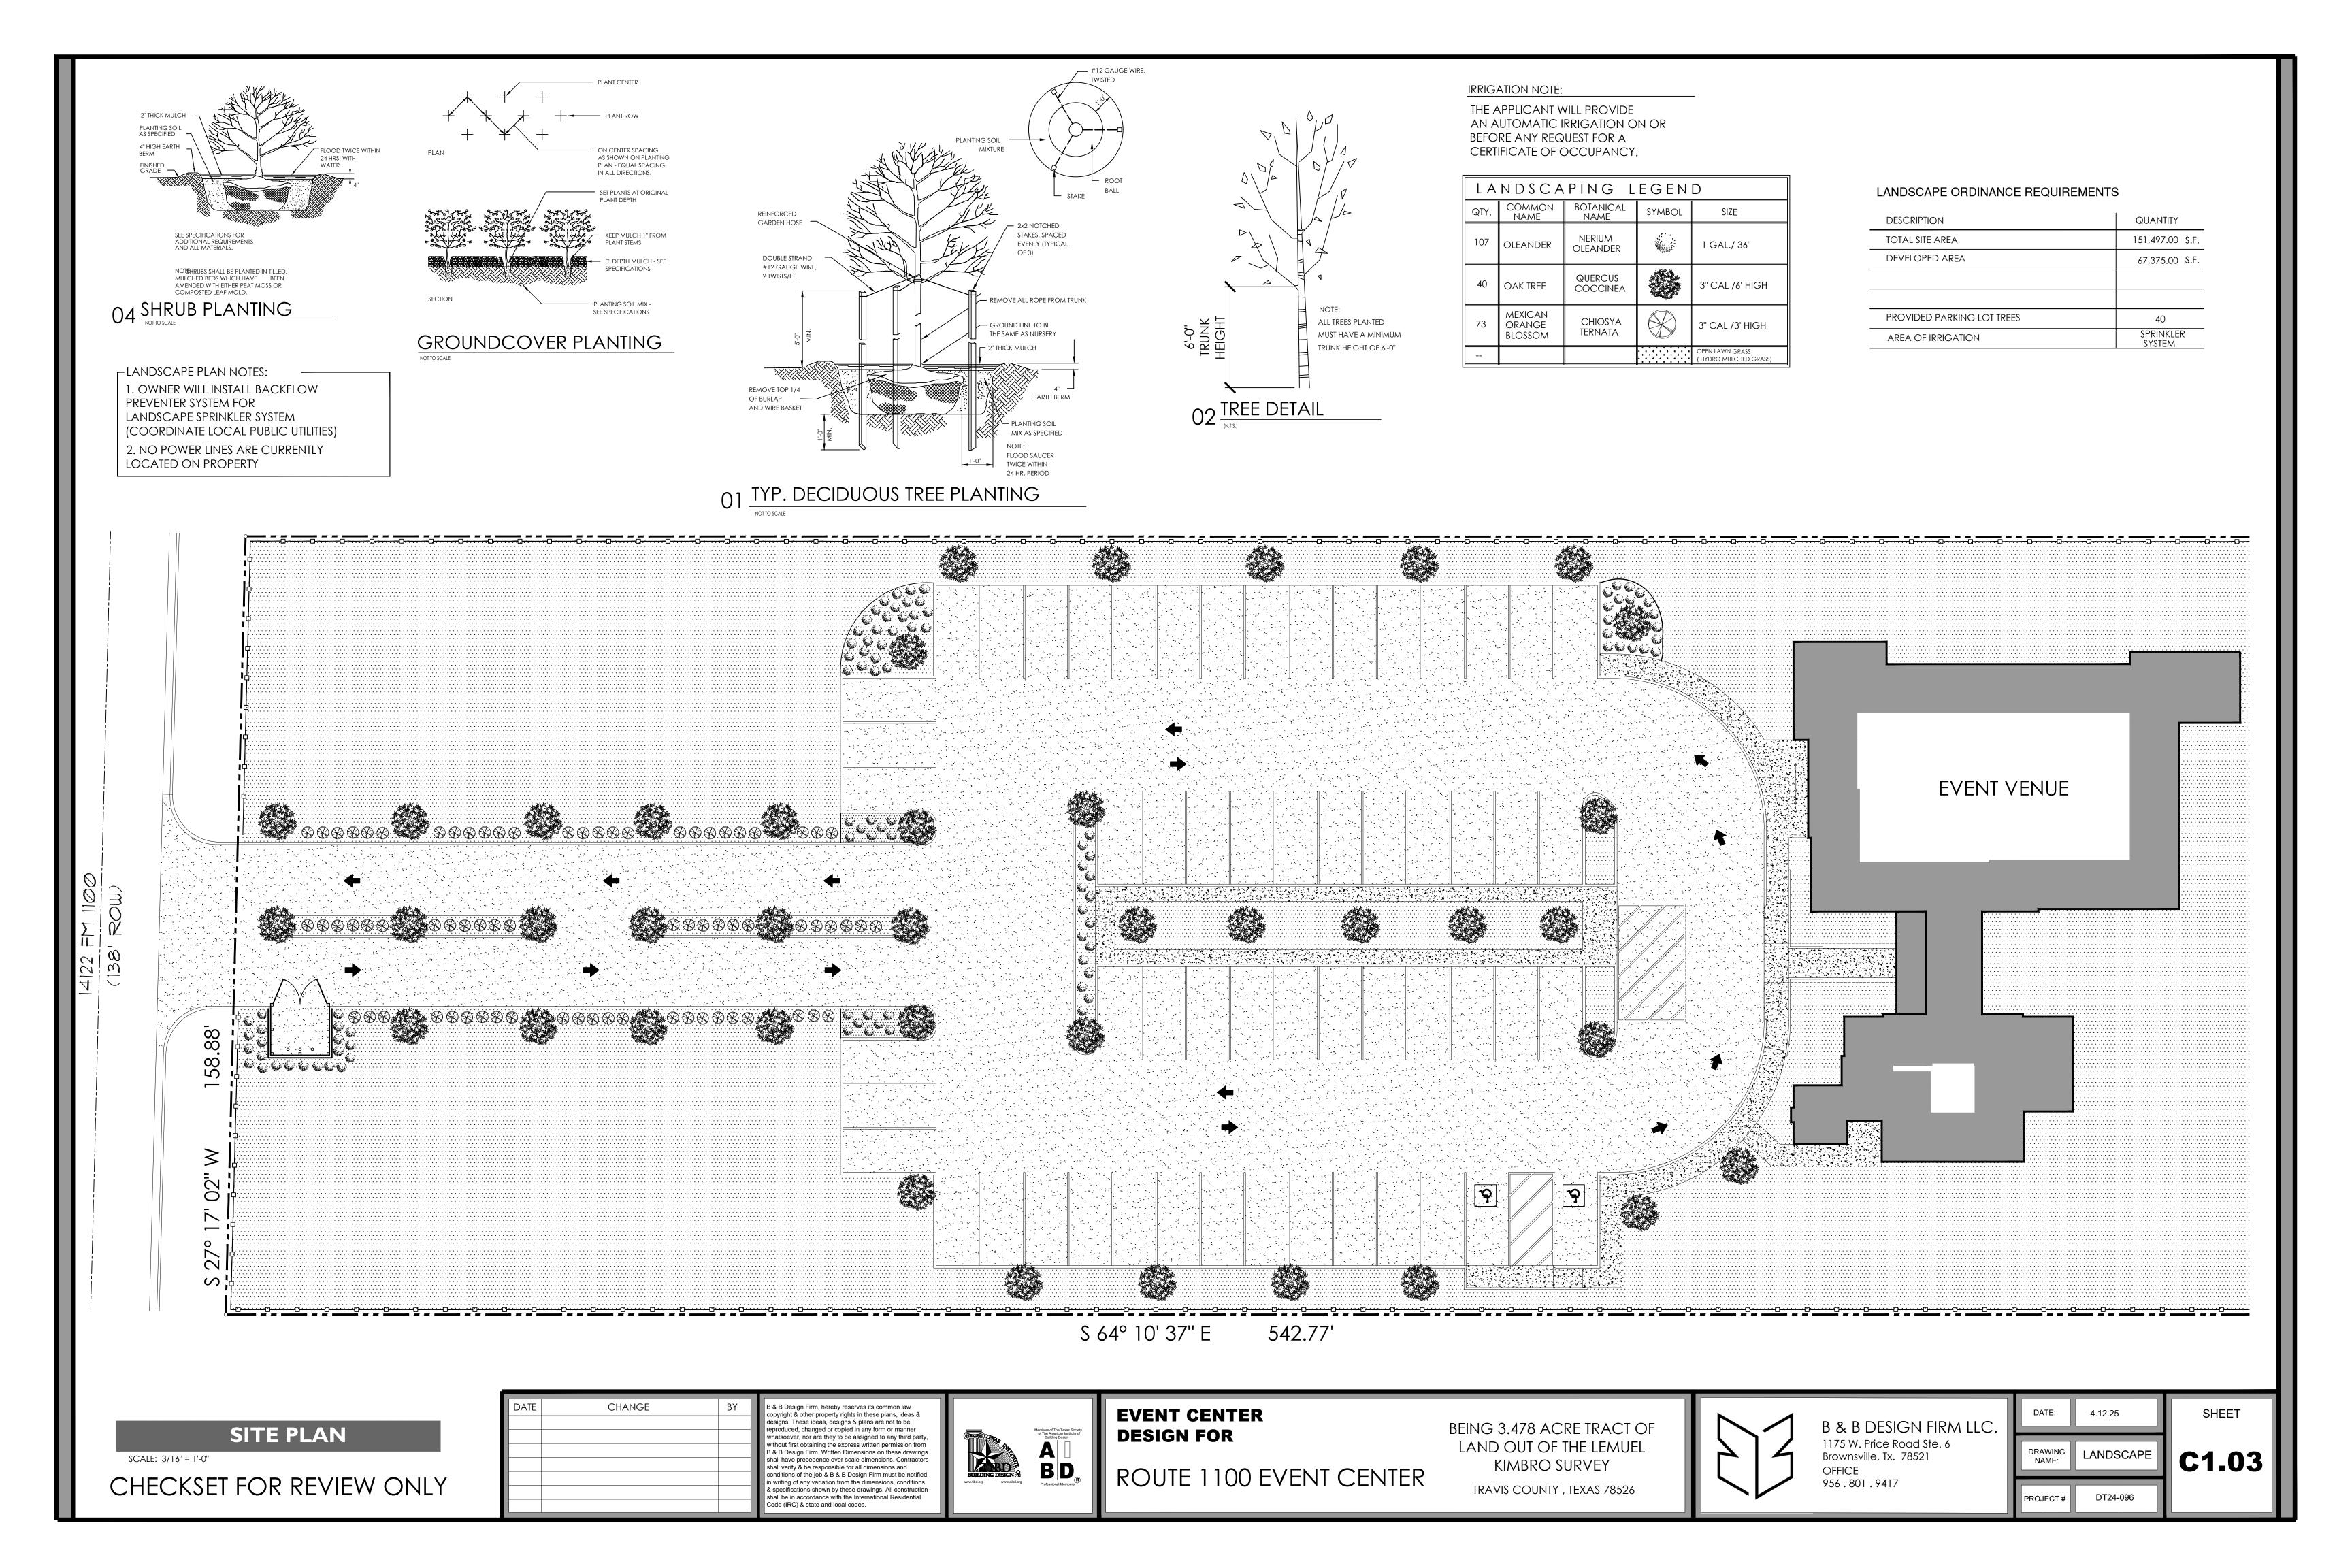



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<u>:</u>	4.12.25	
ING E:	SITE PLAN	


SHEET **C1.01**






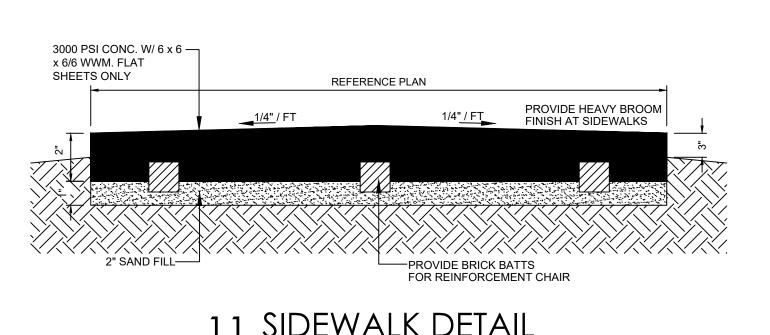


SIDEWALK DETAIL SCALE: 1-1/2" = 1'-0"

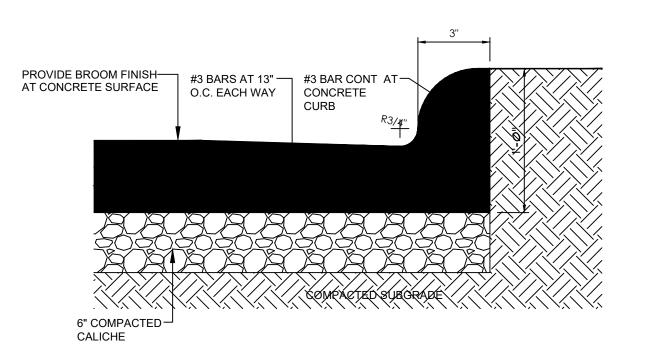


10 CURB & GUTTER DETAIL SCALE 1 1/2" = 1'-0"

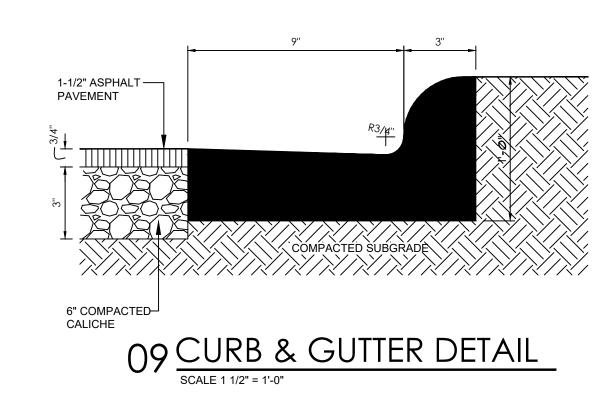

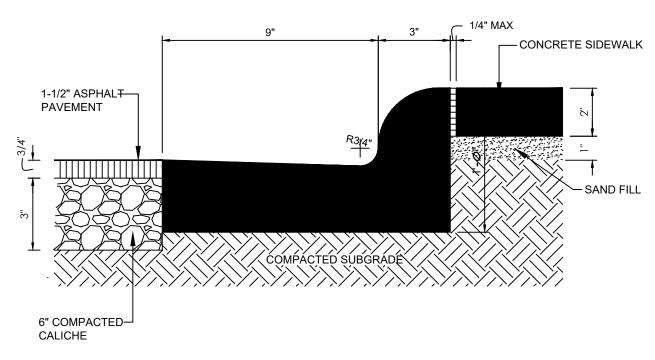


08 CURB & GUTTER DETAIL

SCALE 1 1/2" = 1'-0" @ SIDEWALK CONDITION

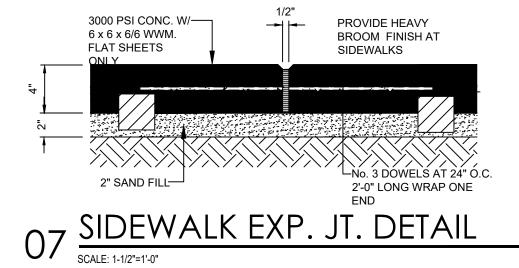




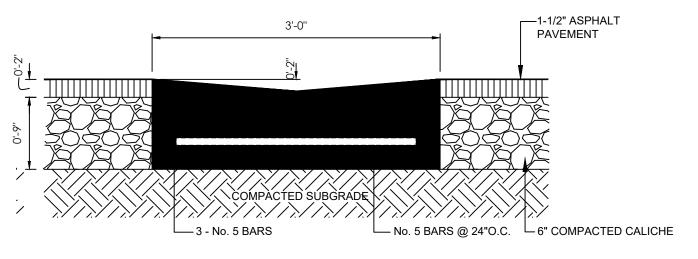


06 VALLEY GUTTER DETAIL

SCALE: 1-1/2"=1'-0"

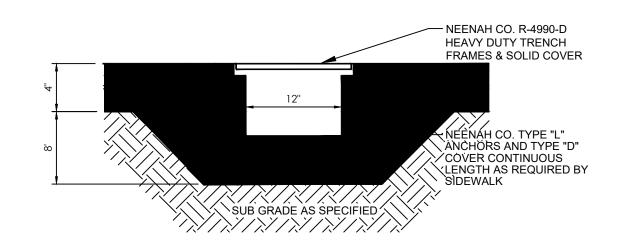


05 TRENCH DETAIL
SCALE 1 1/2" = 1'-0" NOTE: PROVIDE FOR FIFTEEN (25) UNITS TO BE LOCATED BY ARCHITECT'S OFFICE

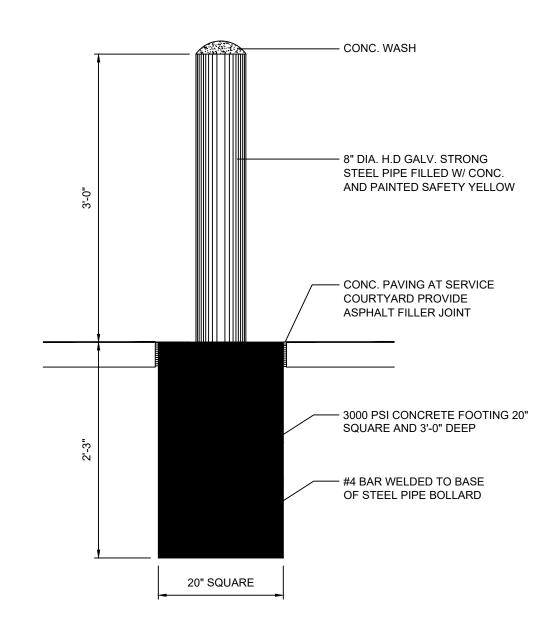


04 PIPE BULLARD DETAIL


SCALE 3/8" = 1'-0" SEE SITE PLAN FOR LOCATION

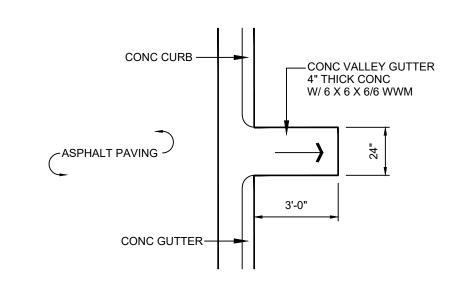

03 CURB BREAK DETAIL

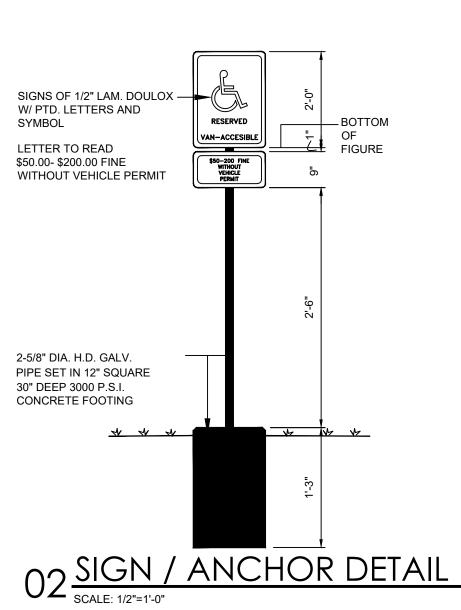

ONE (1) VAN ACCESSIBLE HANDICAP PARKING SPACE REQUIRED AT EACH DESIGNATED HANDICAP PARKING AREAS ONE (1) SIGN SIMILAR FOR REGULAR HANDICAP PARKING SPACE. SIGN DOES NOT INCLUDE VAN ACCESSIBLE NAME. ONE (1) PER HANDICAP SPACE

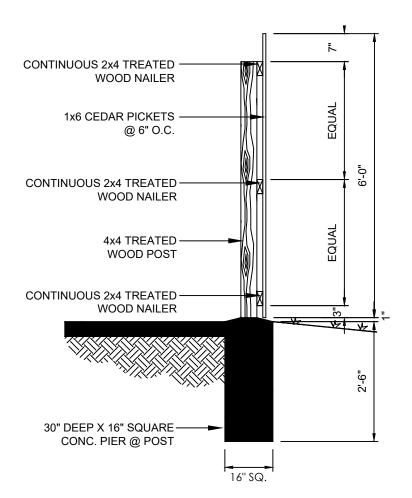

01 CEDAR FENCE SECTION

DATE	CHANGE	BY
DATE	CHAINGE	

PROVIDE HEAVY BROOM FINISH AT SIDEWALKS

PROVIDE BRICK BATTS FOR REINFORCEMENT SUPPORT

— FILL 1/4" JOINT WITH

AT 24" O.C.

13 CONC. PAVING CONST. JNT.

SCALE: 3/4" = 1'-0"

12 SIDEWALK CONTROL JT.

SCALE: 1-1/2"=1'-0"

COMP. FILLER JOINT


PROVIDE BROOM FINISH AT CONCRETE SURFACE

3000 PSI CONC. W/—— 6 x 6 x 6/6 WWM.

3 BARS AT 13"

O.C. EACH WAY

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EVENT CENTER DESIGN FOR

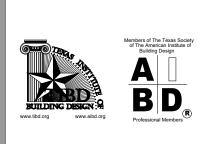
ROUTE 1100 EVENT CENTER


BEING 3.478 ACRE TRACT OF LAND OUT OF THE LEMUEL KIMBRO SURVEY

TRAVIS COUNTY, TEXAS 78526

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SHEET SITE PLAN DRAWING DETAILS **A2.03** DT24-096



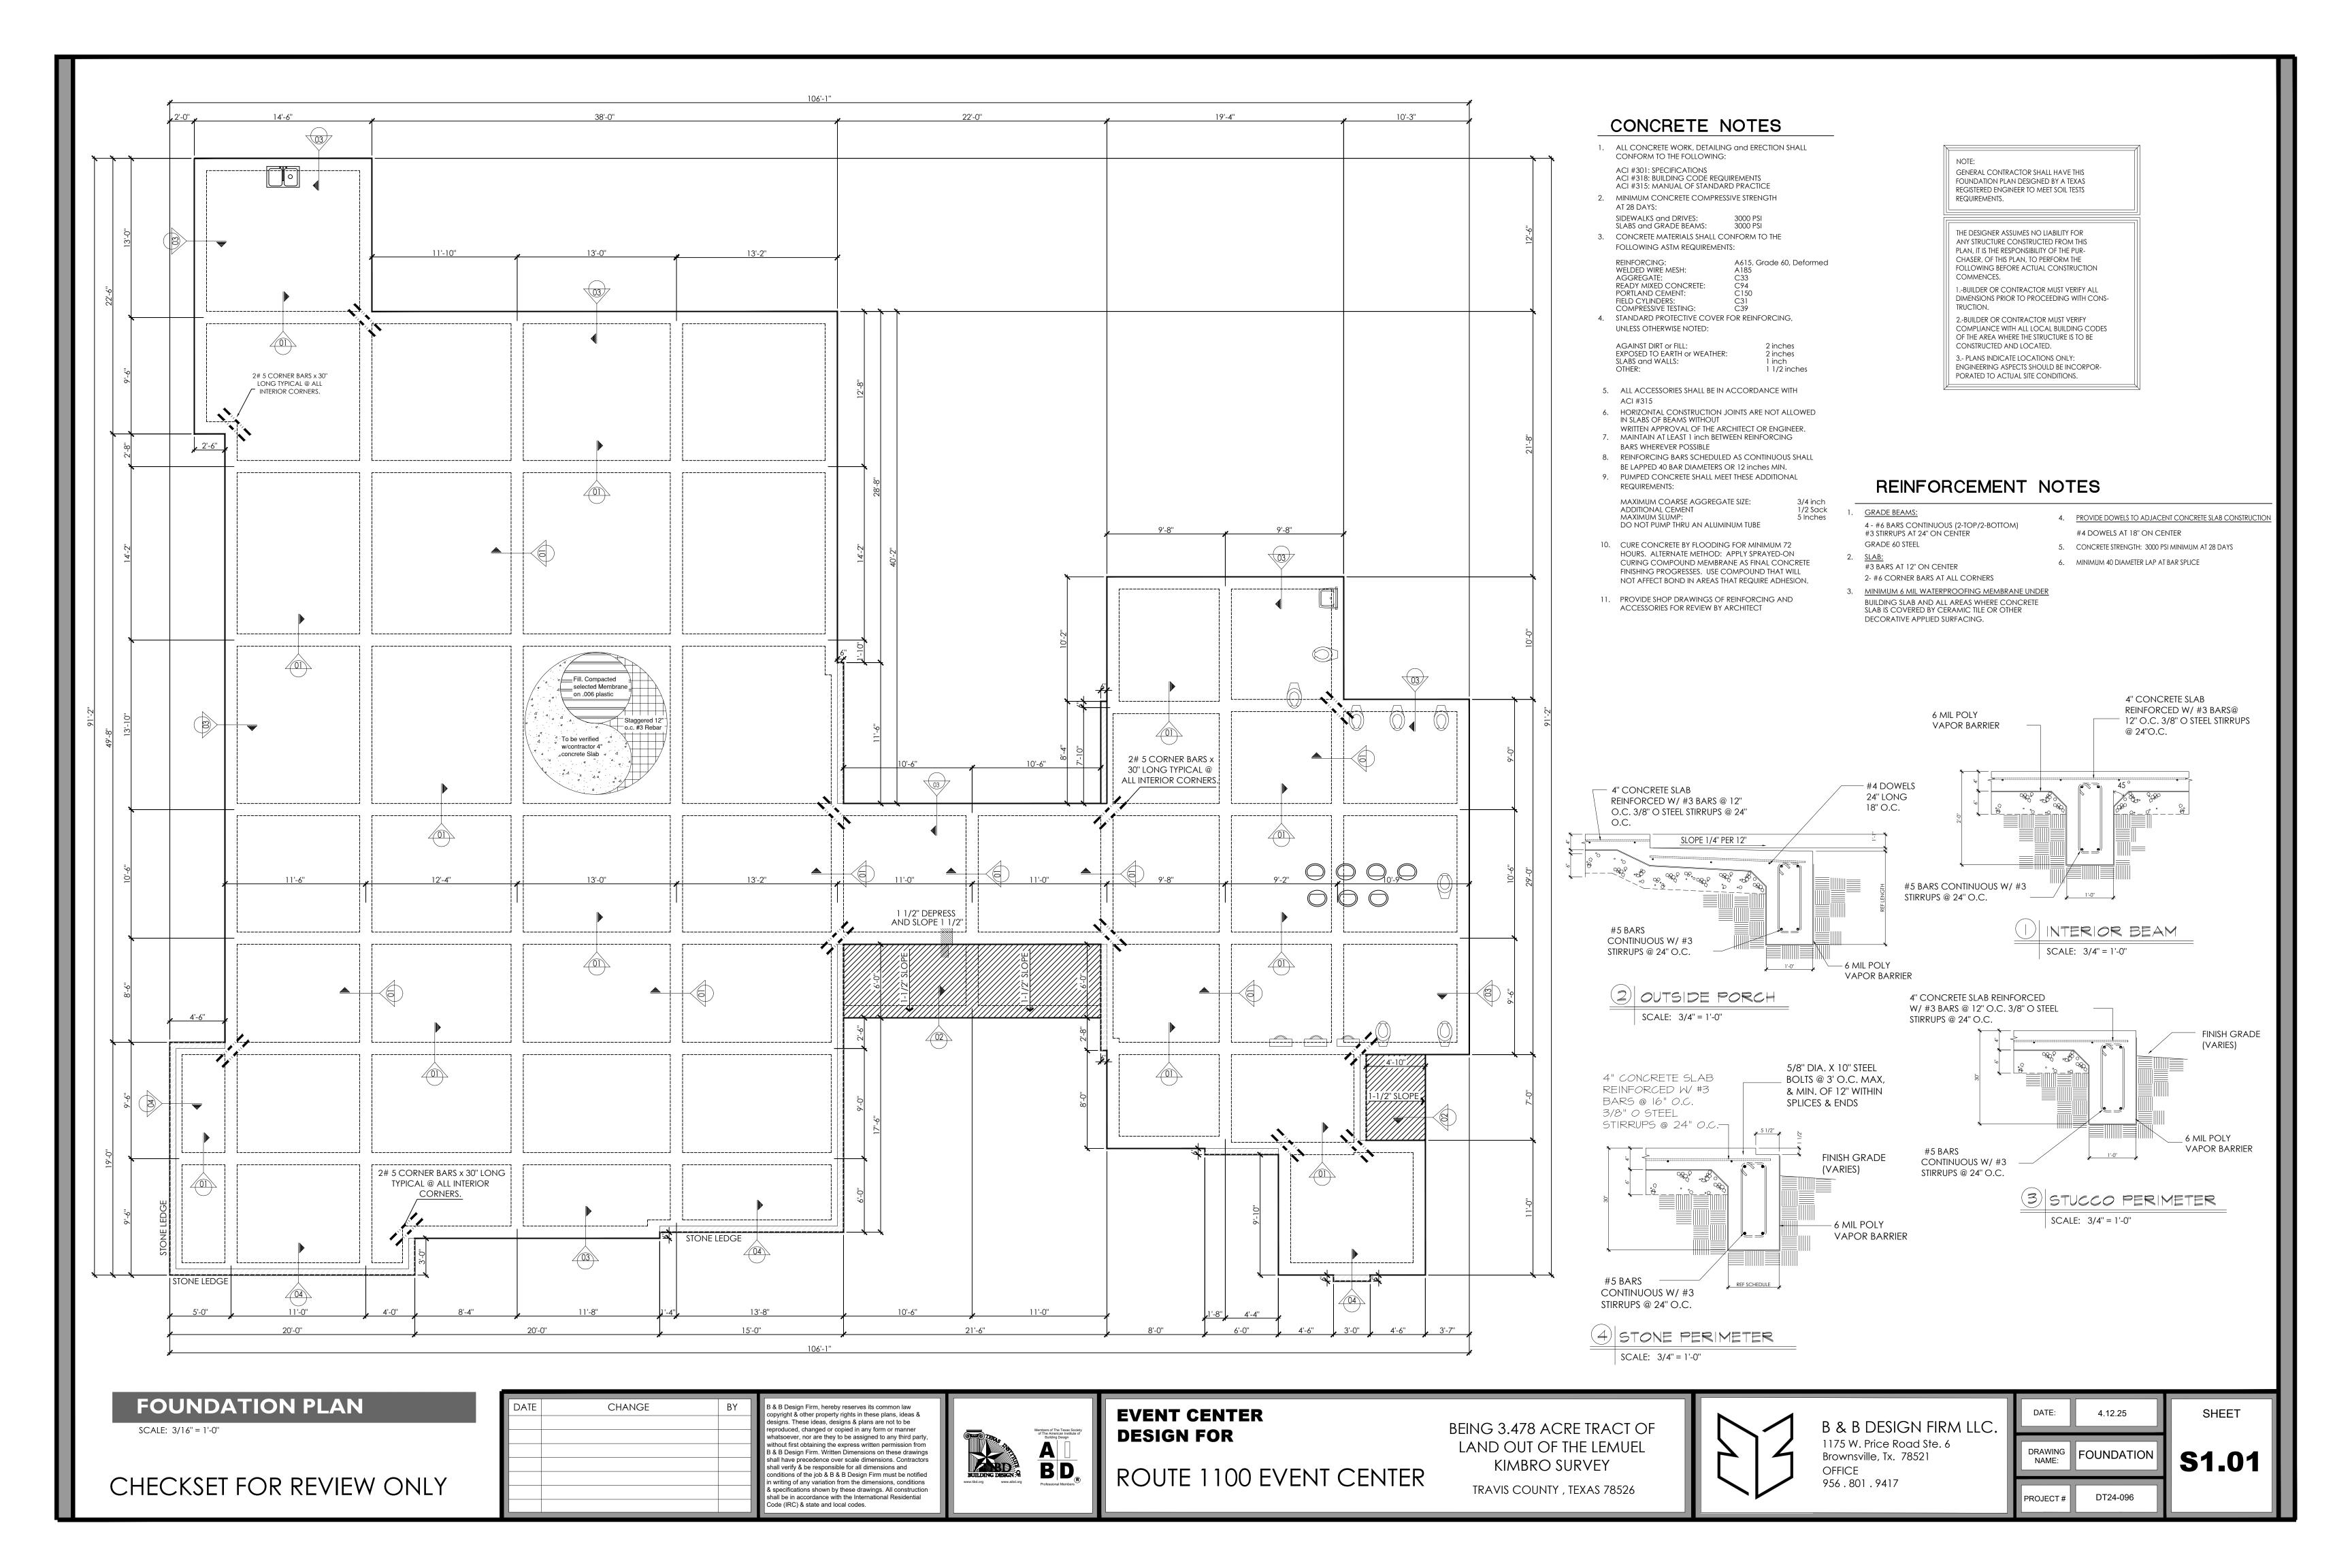

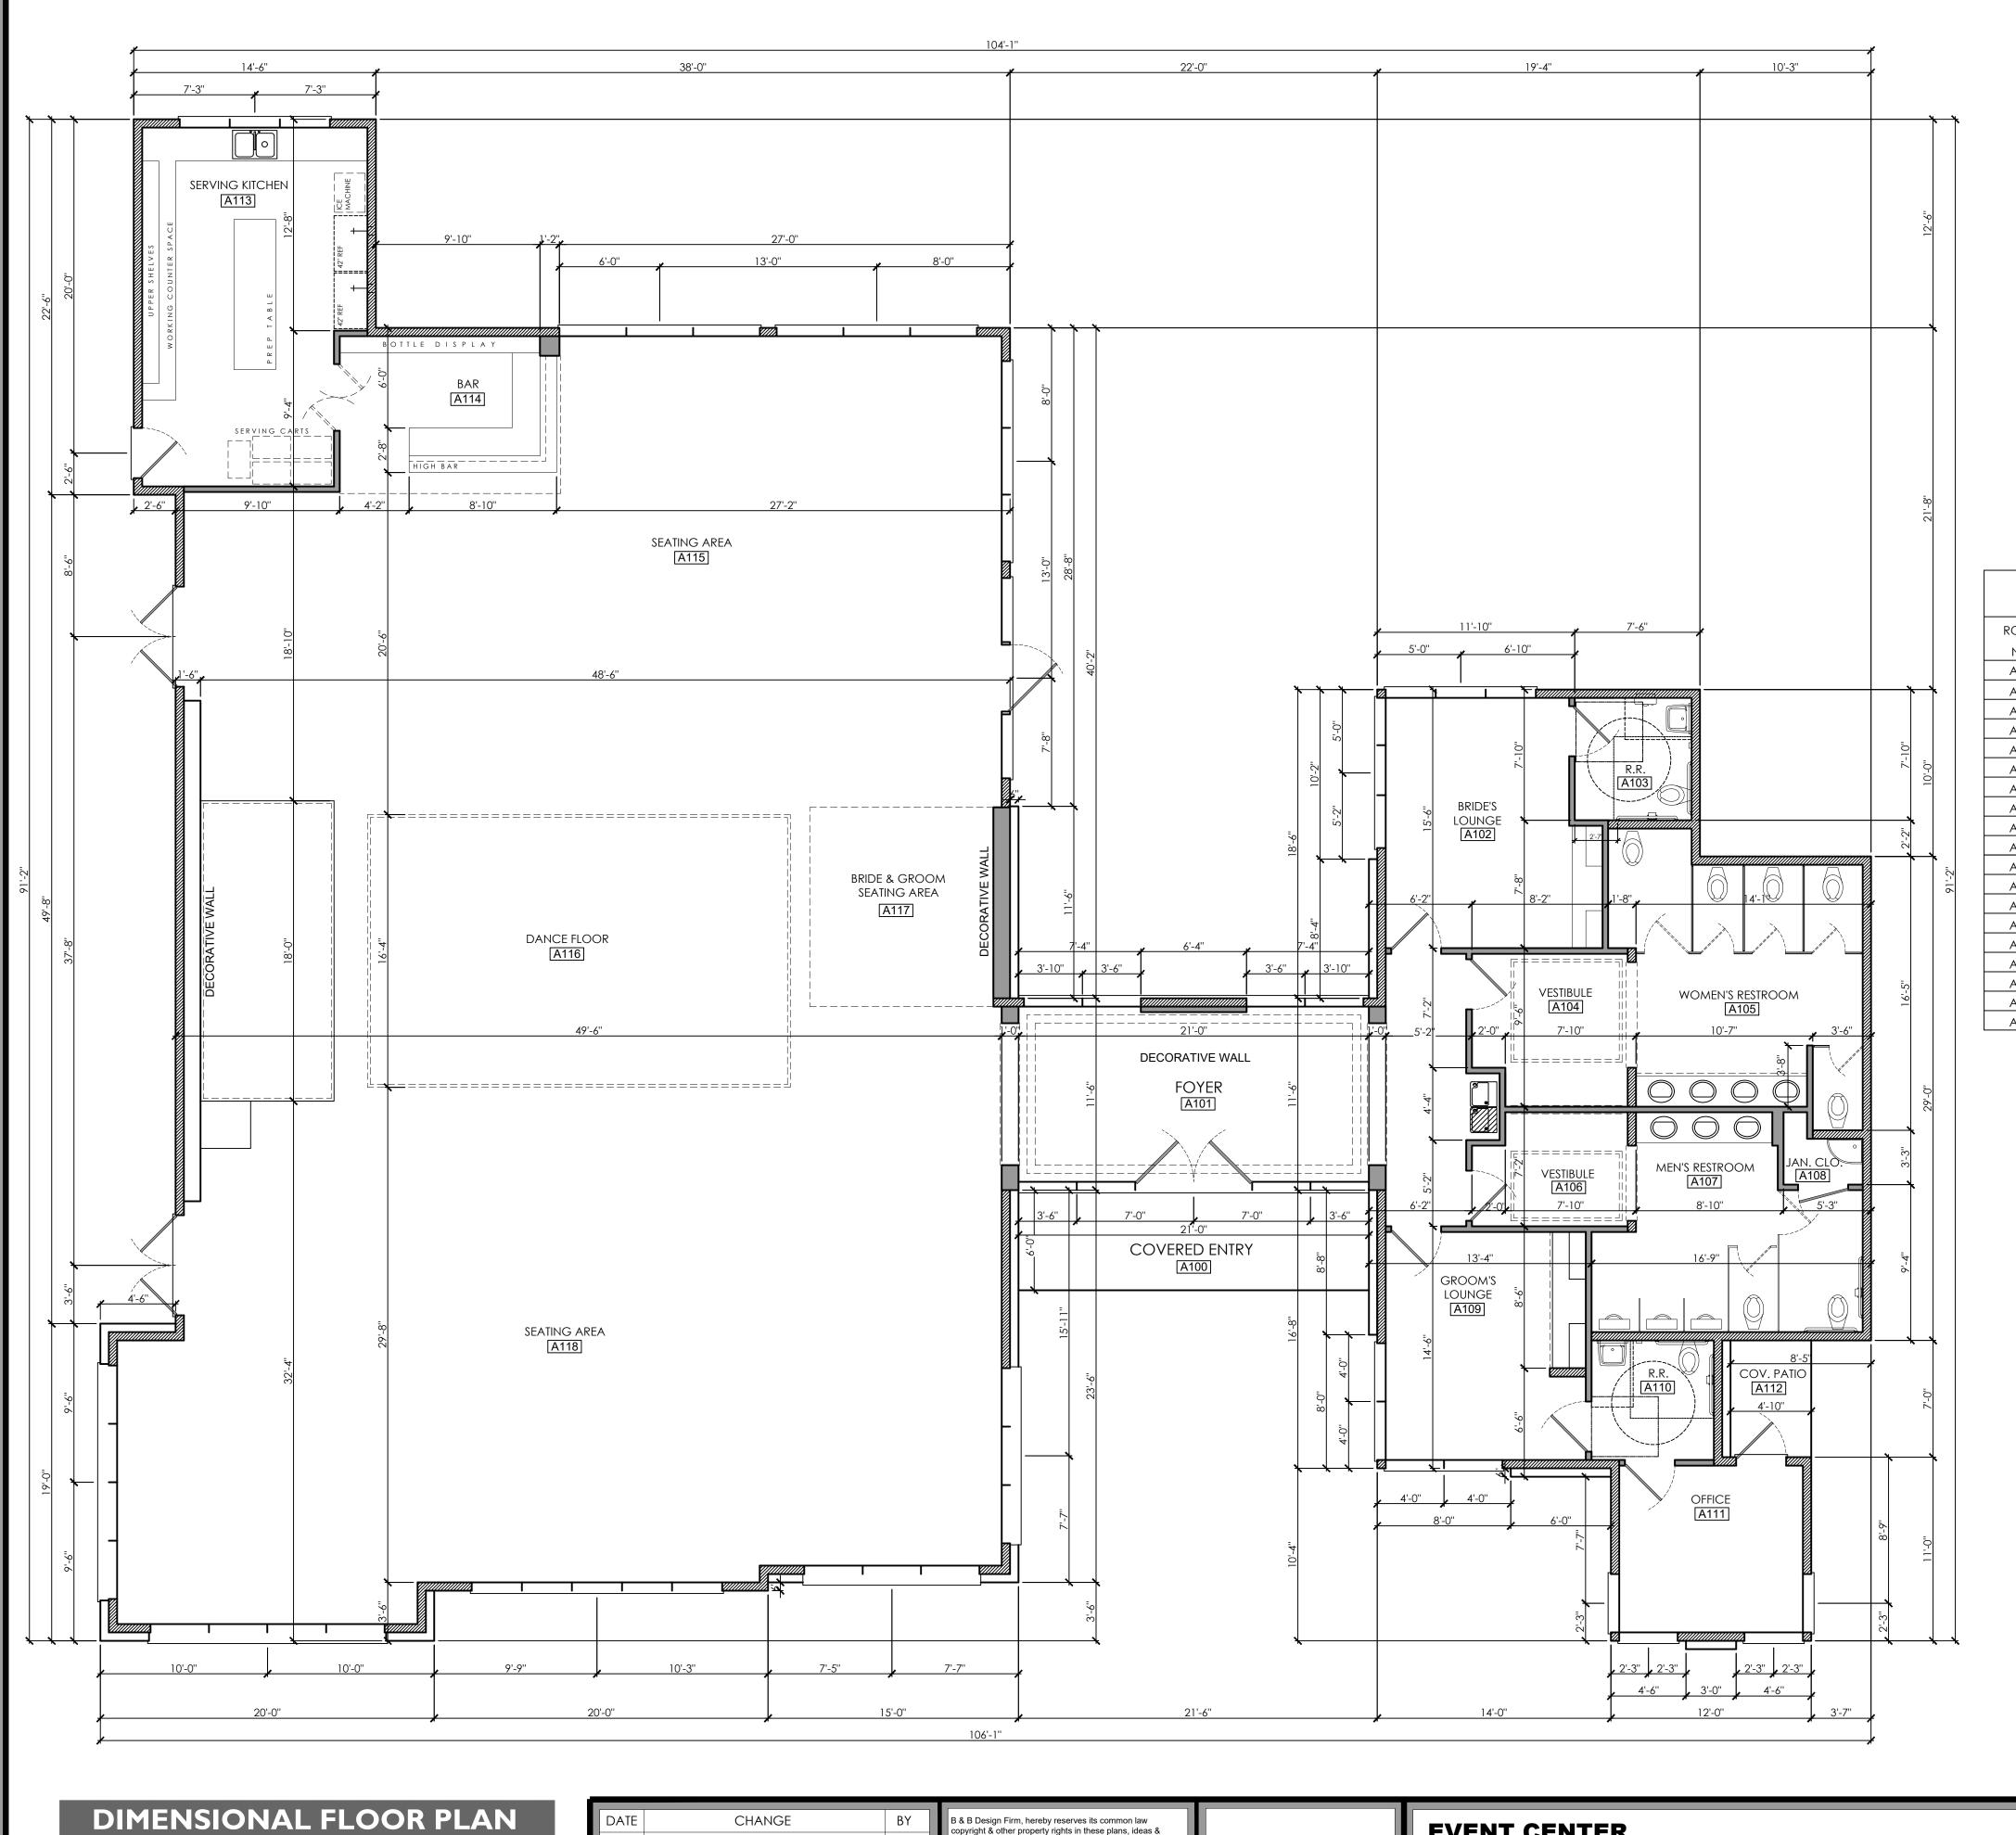OCCUPANCY CHART

DESCRIPTION	SQ. FT. / CAPACITY
RECEPTION AREA DJ/TABLES & CHAIRS/BRIDE GROOM	2,850 SQ. FT. / 15 190
DANCE FLOOR	680 SQ. FT. / 5 135
FOYER	220 SQ. FT. / 5 44
BRIDE'S LOUNGE	163 SQ. FT. / 15 11
GROOM'S LOUNGE	150 SQ. FT. / 15 10
SERVING KITCHEN	70 SQ. FT. / 15 15
OFFICE	70 SQ. FT. / 15 5
TOTAL BUILDING CAPACITY	410 OCCUPANTS

THE DESIGNER ASSUMES NO LIABILITY FOR ANY STRUCTURE CONSTRUCTED FROM THIS PLAN, IT IS THE RESPONSIBILITY OF THE PURCHASER, OF THIS PLAN, TO PERFORM THE FOLLOWING BEFORE ACTUAL CONSTRUCTION COMMENCES.

1.-BUILDER OR CONTRACTOR MUST VERIFY ALL DIMENSIONS PRIOR TO PROCEEDING WITH CONSTRUCTION.

2.-BUILDER OR CONTRACTOR MUST VERIFY COMPLIANCE WITH ALL LOCAL BUILDING CODES OF THE AREA WHERE THE STRUCTURE IS TO BE

CONSTRUCTED AND LOCATED.

3.- PLANS INDICATE LOCATIONS ONLY:
ENGINEERING ASPECTS SHOULD BE INCORPORPORATED TO ACTUAL SITE CONDITIONS.

WALL LEGEND

2" x 4" FRAMED WALL

2" x 6" FRAMED WALL


SQUARE FOOTAGE

BUILDING AREA	5, 7 3 9 SQ.FT.
COVERED ENTRY	1 2 6 SQ. FT.
TOTAL LIVING AREA	5, 8 6 5 SQ. FT.

ROOM FINISH SCHEDULE										
ROOM					W	ALLS			CLG.	
NO.	ROOM NAME	BASE	FLR	N	S	E	W	CLG.	HEIGHTS	REMARKS
A100	COV. ENTRY		CONC.		P.C.P.					
A101	FOYER	RUBBER	C.T.	GYP/PTD	GYP/PTD	GYP/PTD	GYP/PTD	S.A.C. 1	12'-0''	
A102	BRIDE'S LOUNGE	RUBBER	C.T.	GYP/PTD	GYP/PTD	GYP/PTD	GYP/PTD	S.A.C. 1	12'-0''	
A103	RESTROOM	C.T.	C.T.	GYP/PTD	GYP/PTD	GYP/PTD	GYP/PTD	S.A.C. 1	12'-0''	6'-0" HIGH C.T. WAINSCOT
A104	VESTIBULE	RUBBER	C.T.	GYP/PTD	GYP/PTD	GYP/PTD	GYP/PTD	S.A.C. 1	10'-0''	
A105	WOMEN'S R.R.	C.T.	C.T.	GYP/PTD	GYP/PTD	GYP/PTD	GYP/PTD	S.A.C. 1	10'-0''	6'-0" HIGH C.T. WAINSCOT
A106	VESTIBULE	RUBBER	C.T.	GYP/PTD	GYP/PTD	GYP/PTD	GYP/PTD	S.A.C. 1	12'-0''	
A107	MEN'S R.R.	C.T.	C.T.	GYP/PTD	GYP/PTD	GYP/PTD	GYP/PTD	S.A.C. 1	12'-0''	6'-0" HIGH C.T. WAINSCOT
A108	JANITORS	C.T.	C.T.	GYP/PTD	GYP/PTD	GYP/PTD	GYP/PTD	S.A.C. 1	12'-0''	
A109	GROOM'S LOUNGE	RUBBER	C.T.	GYP/PTD	GYP/PTD	GYP/PTD	GYP/PTD	S.A.C. 1	12'-0''	
A110	RESTROOM	C.T.	C.T.	GYP/PTD	GYP/PTD	GYP/PTD	GYP/PTD	S.A.C. 1	10'-0''	6'-0" HIGH C.T. WAINSCOT
A111	OFFICE	RUBBER	C.T.	GYP/PTD	GYP/PTD	GYP/PTD	GYP/PTD	S.A.C. 1	12'-0''	
A112	COV. PATIO		CONC.	GYP/PTD	GYP/PTD	GYP/PTD	GYP/PTD	S.A.C. 1	12'-0''	
A113	SERVING KITCHEN	C.T.	C.T.	GYP/PTD	GYP/PTD	GYP/PTD	GYP/PTD	S.A.C. 1	12'-0''	POURED EPOXY
A114	BAR	C.T.	C.T.	GYP/PTD	GYP/PTD	GYP/PTD	GYP/PTD	S.A.C. 1	10'-0''	6'-0" HIGH C.T. WAINSCOT
A115	SEATING AREA	C.T.	C.T.	GYP/PTD	GYP/PTD	GYP/PTD	GYP/PTD	S.A.C. 1	10'-0''	6'-0" HIGH C.T. WAINSCOT
A116	DANCE FLOOR	C.T.	C.T.	GYP/PTD	GYP/PTD	GYP/PTD	GYP/PTD	S.A.C. 1	12'-0''	POURED EPOXY
A117	B & G SEATING AREA	C.T.	C.T.	GYP/PTD	GYP/PTD	GYP/PTD	GYP/PTD	S.A.C. 1	12'-0''	
A118	SEATING AREA	C.T.	C.T.	GYP/PTD	GYP/PTD	GYP/PTD	GYP/PTD	S.A.C. 1	12'-0''	POURED EPOXY

SCALE: 3/16" = 1'-0"

CHECKSET FOR REVIEW ONLY

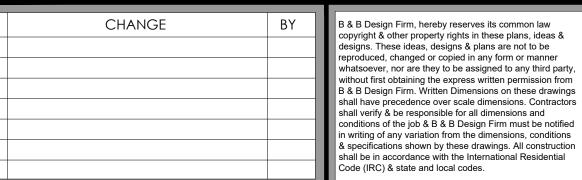




EVENT CENTER DESIGN FOR

ROUTE 1100 EVENT CENTER

BEING 3.478 ACRE TRACT OF LAND OUT OF THE LEMUEL KIMBRO SURVEY


KIMBRO SURVEY
TRAVIS COUNTY , TEXAS 78526

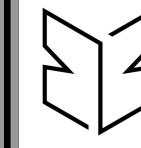



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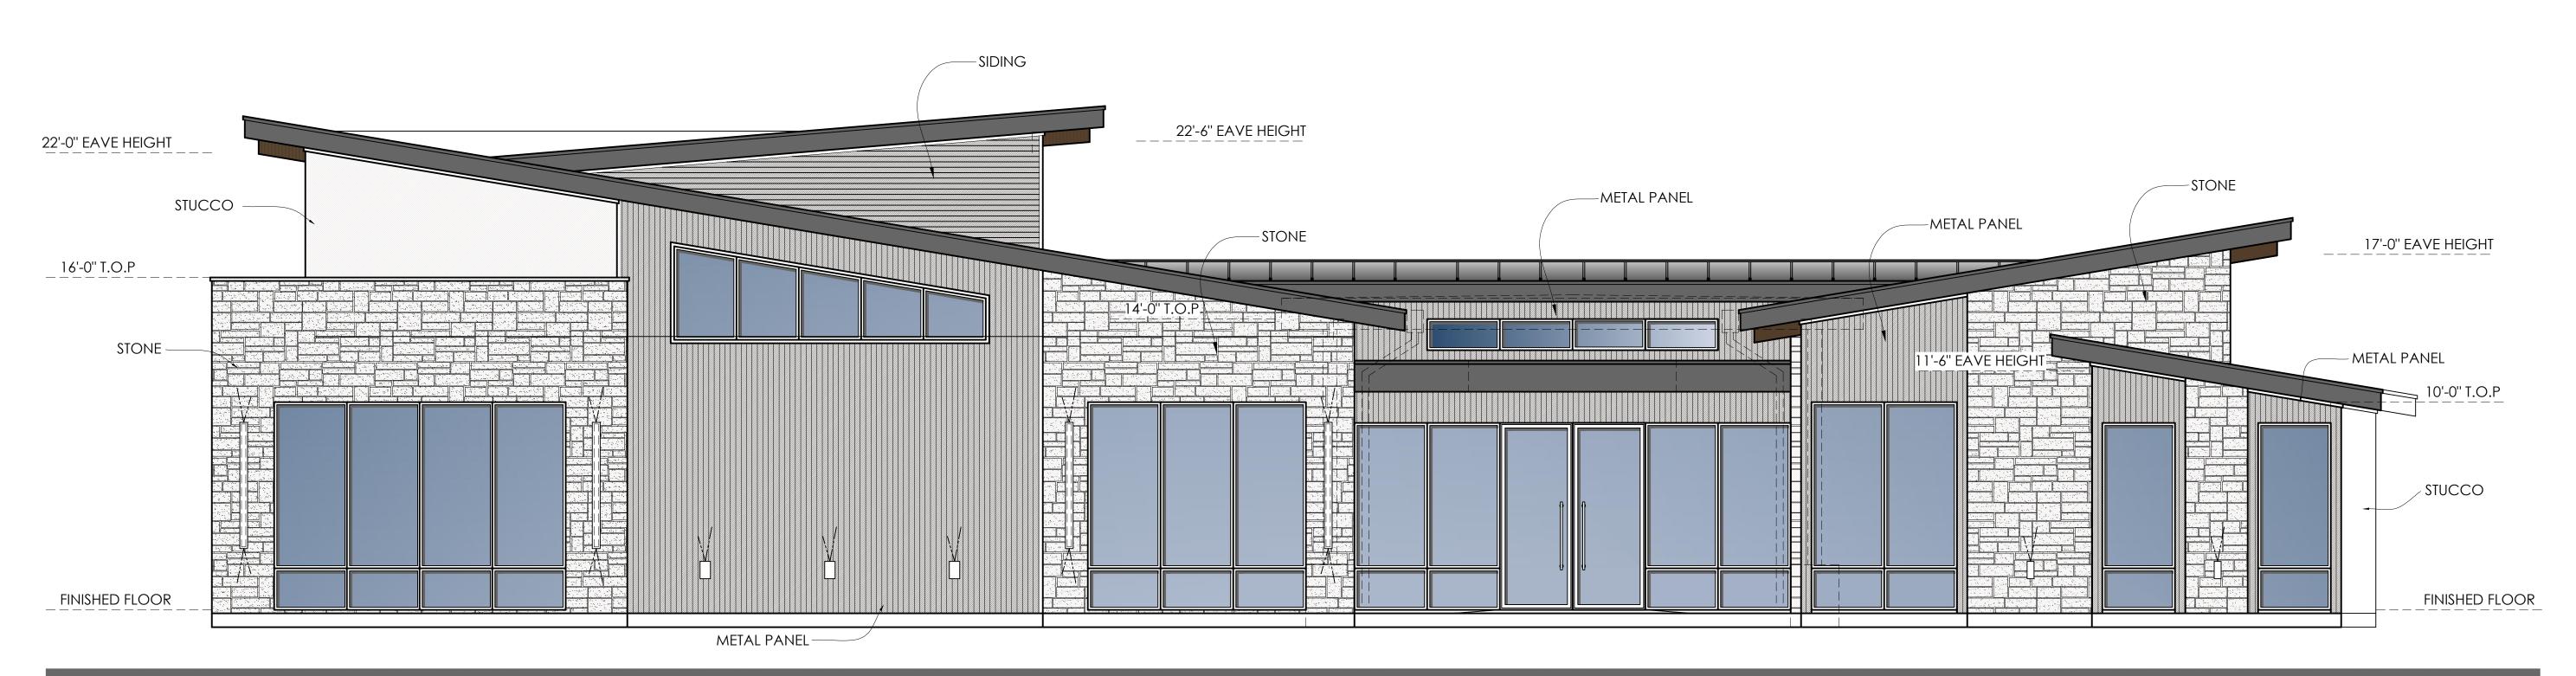
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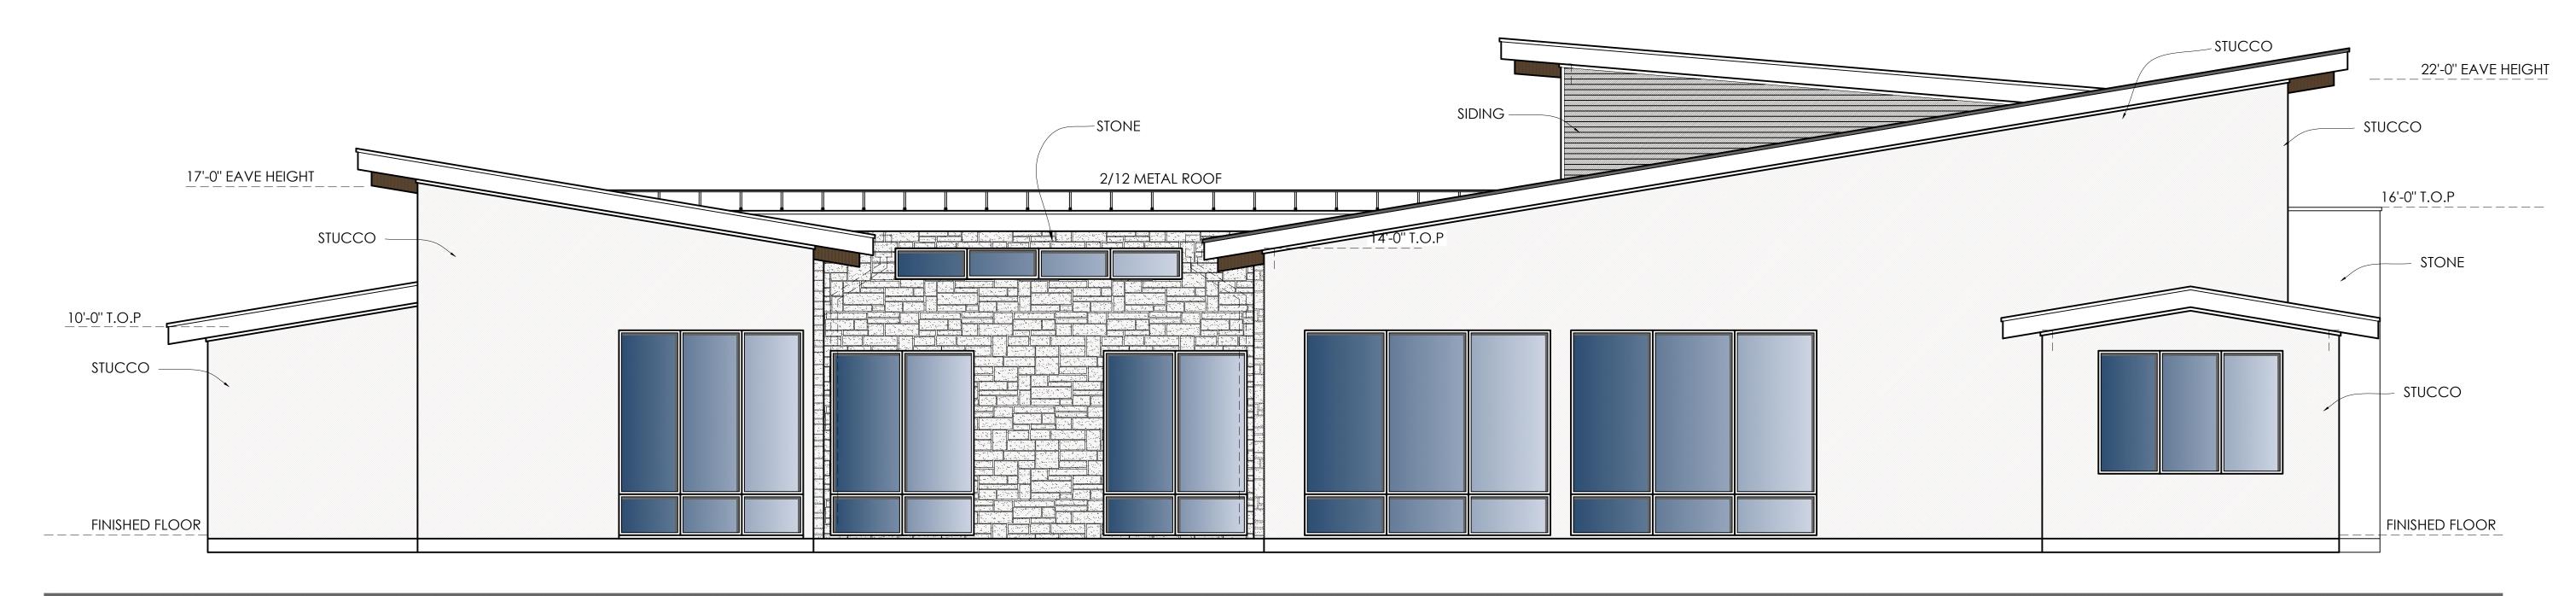




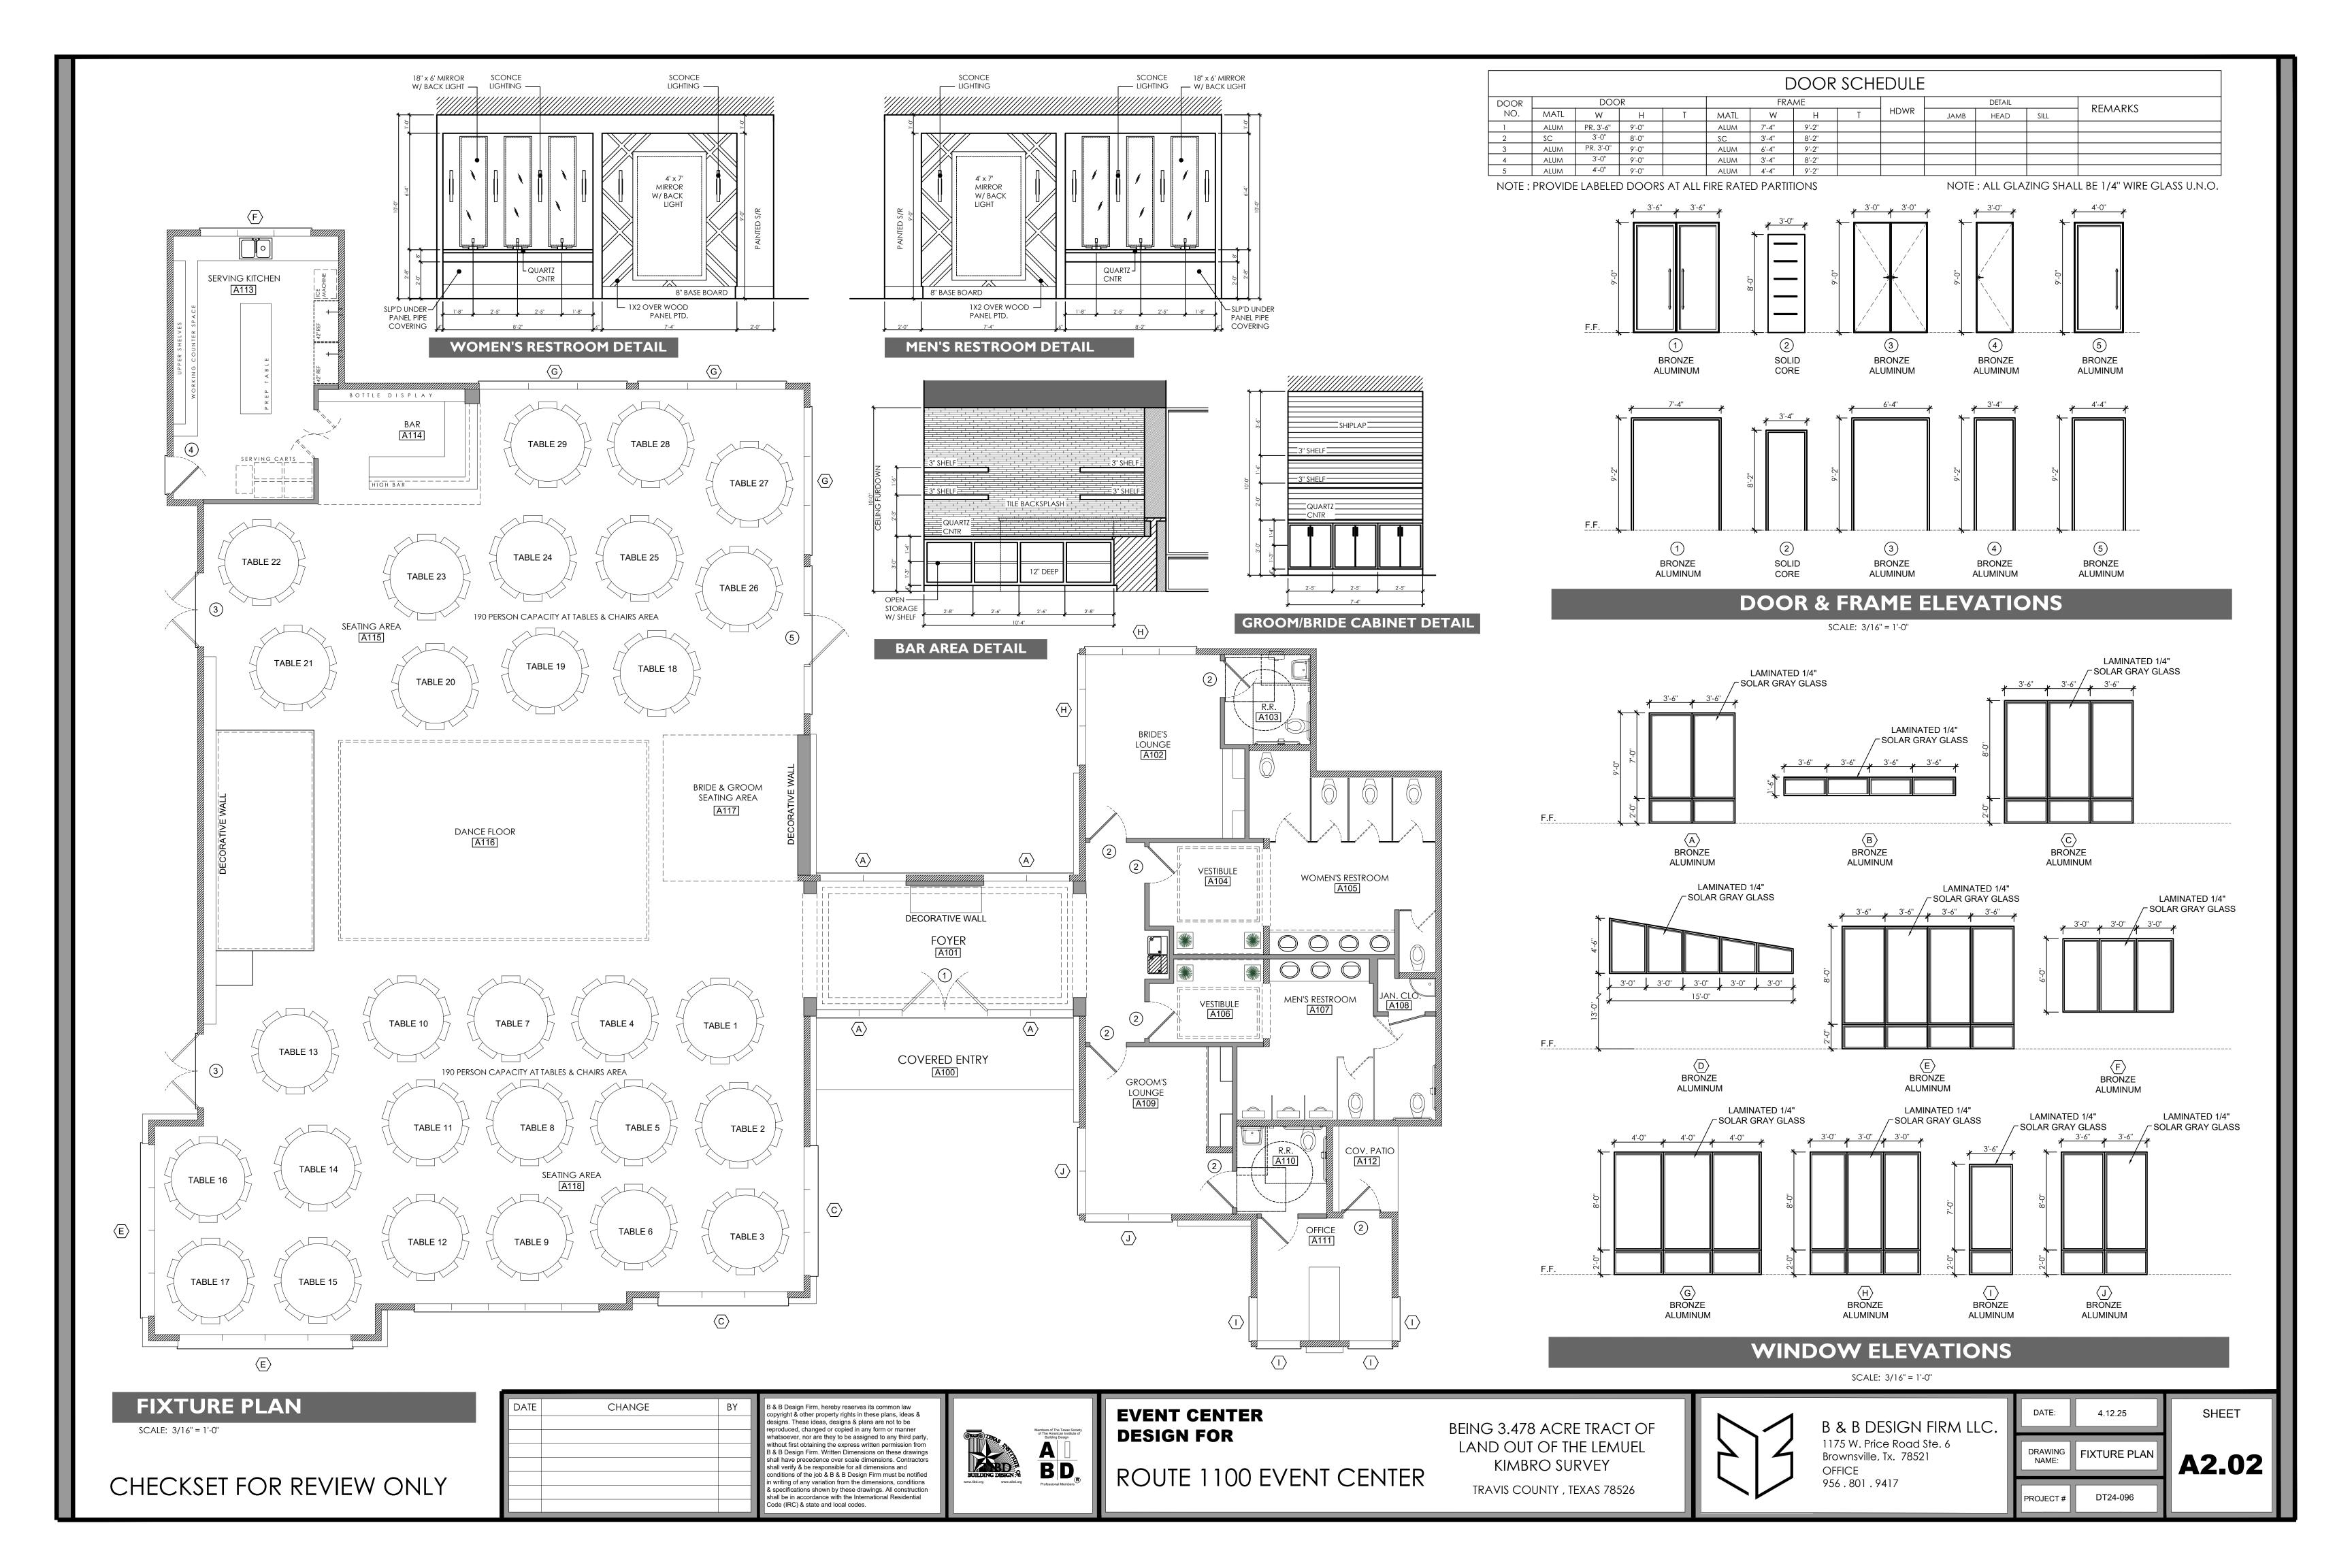

FRONT ELEVATION

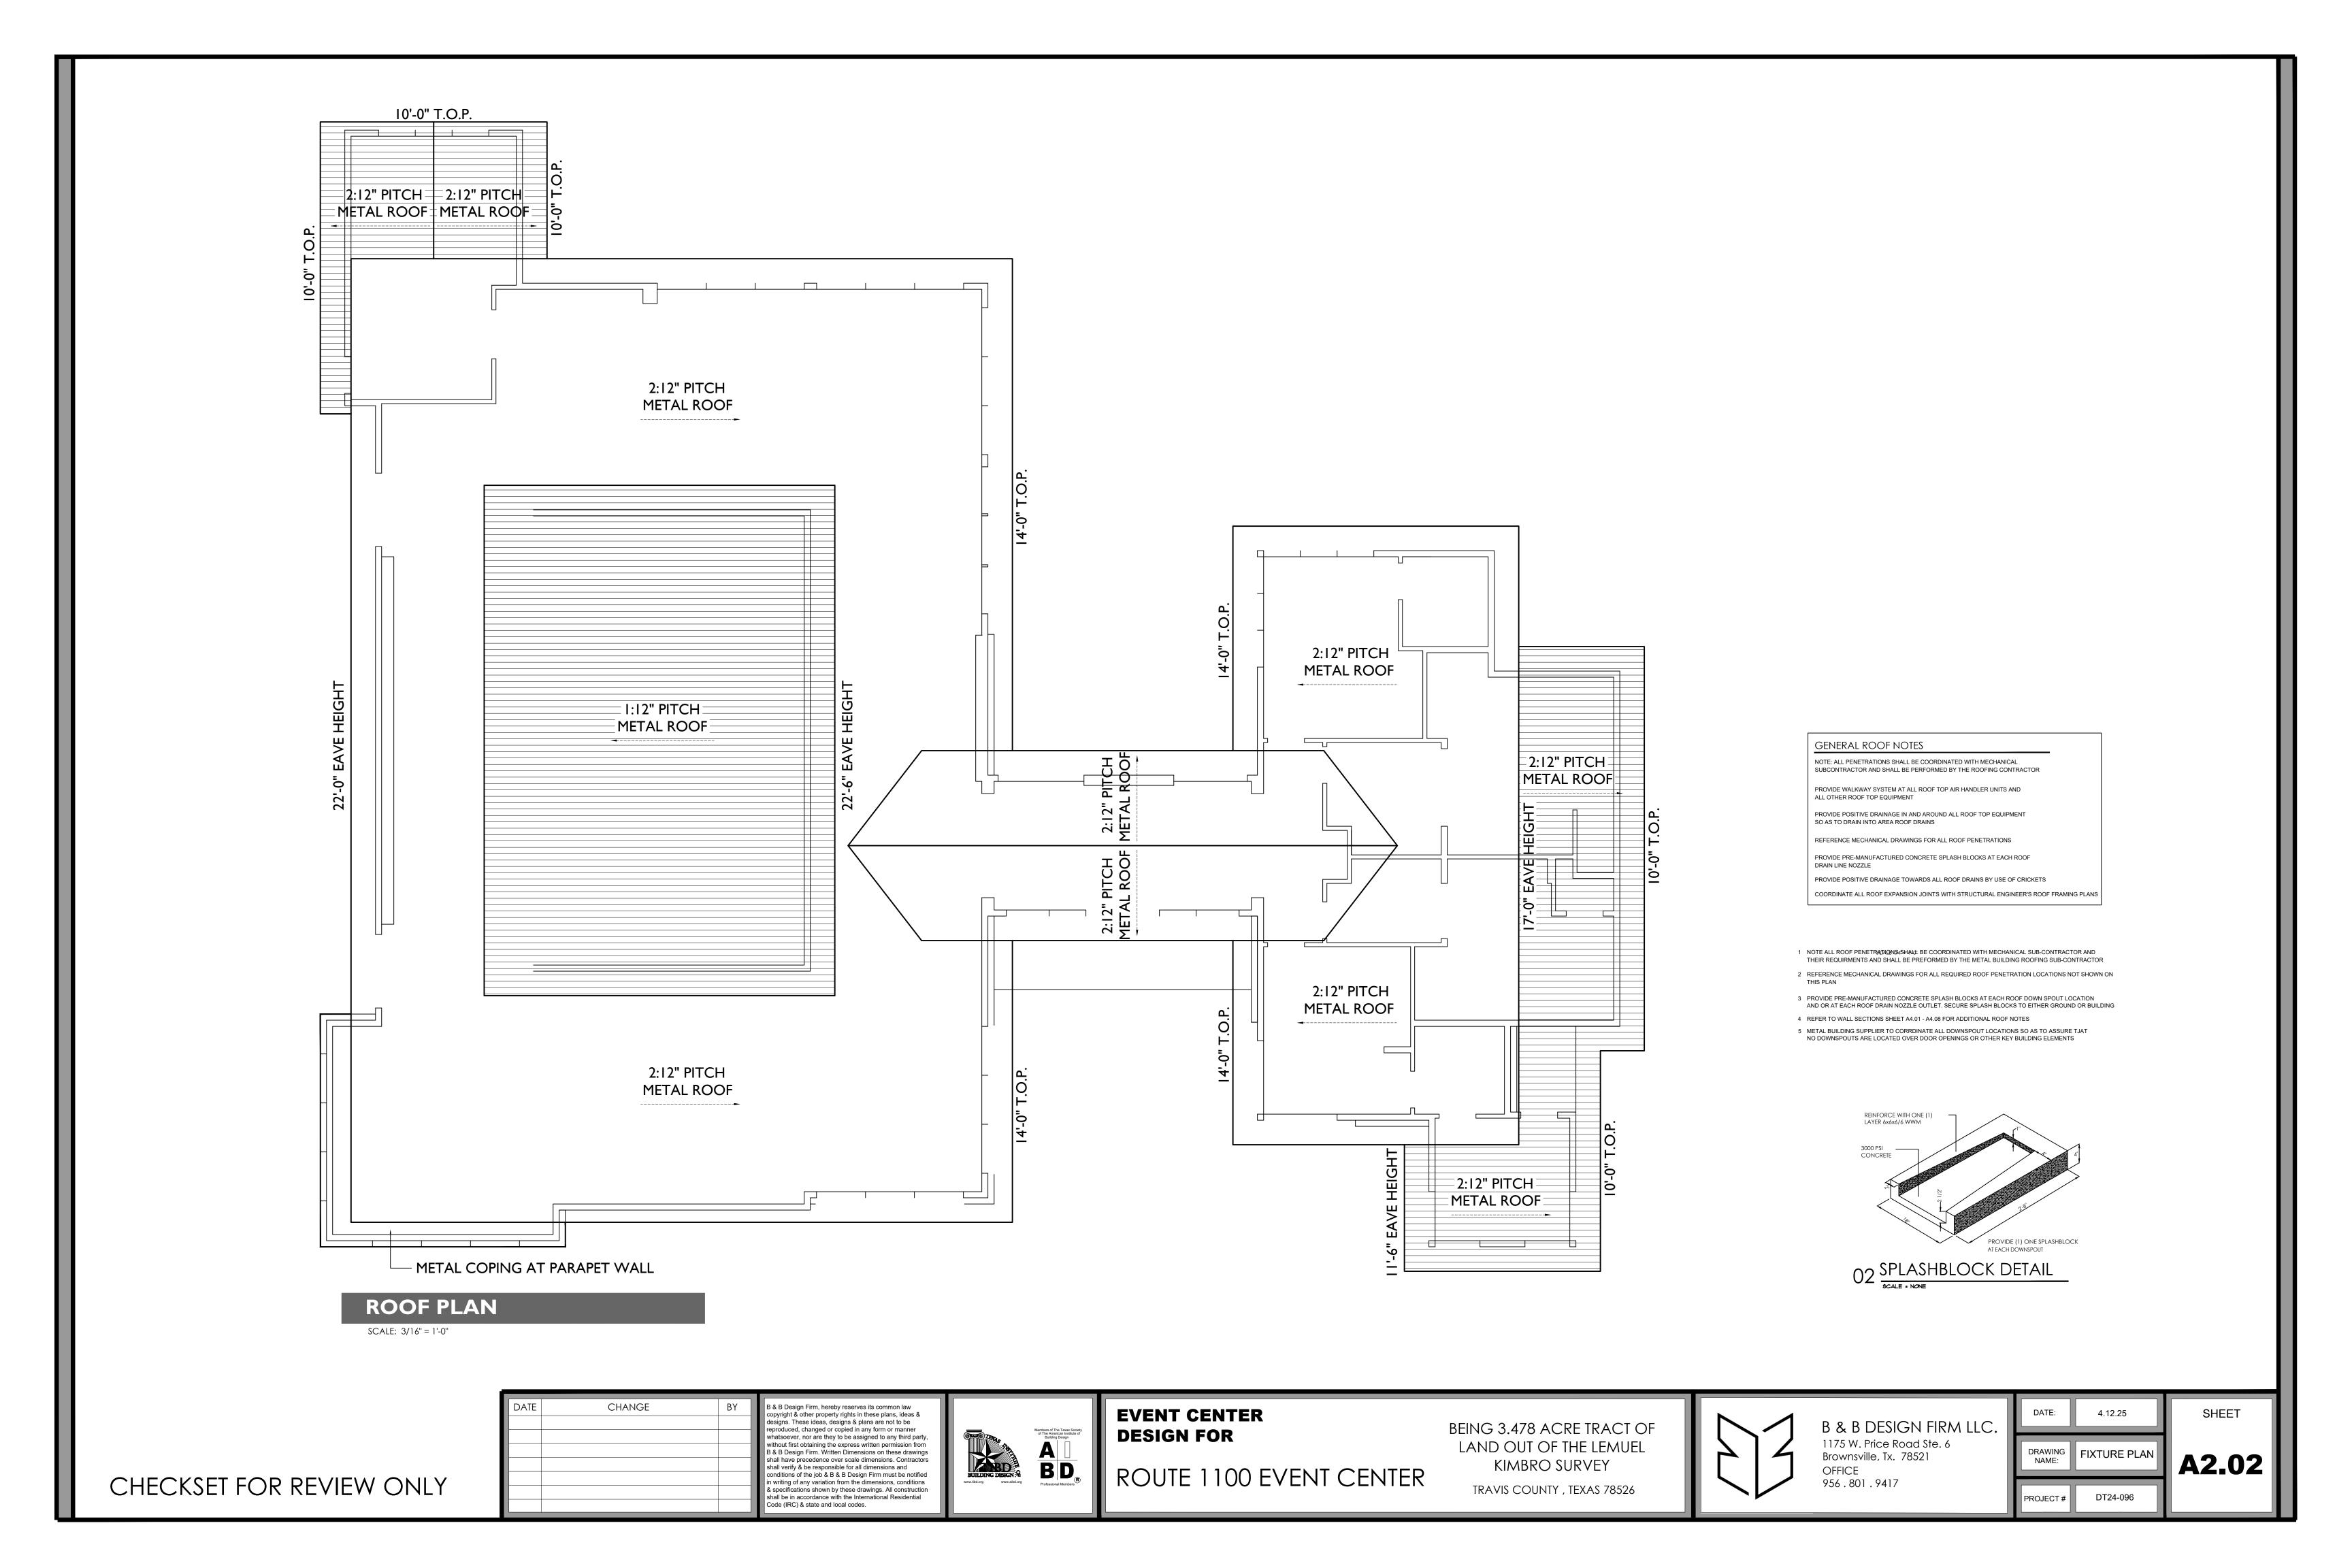SCALE: 3/16" = 1'-0"

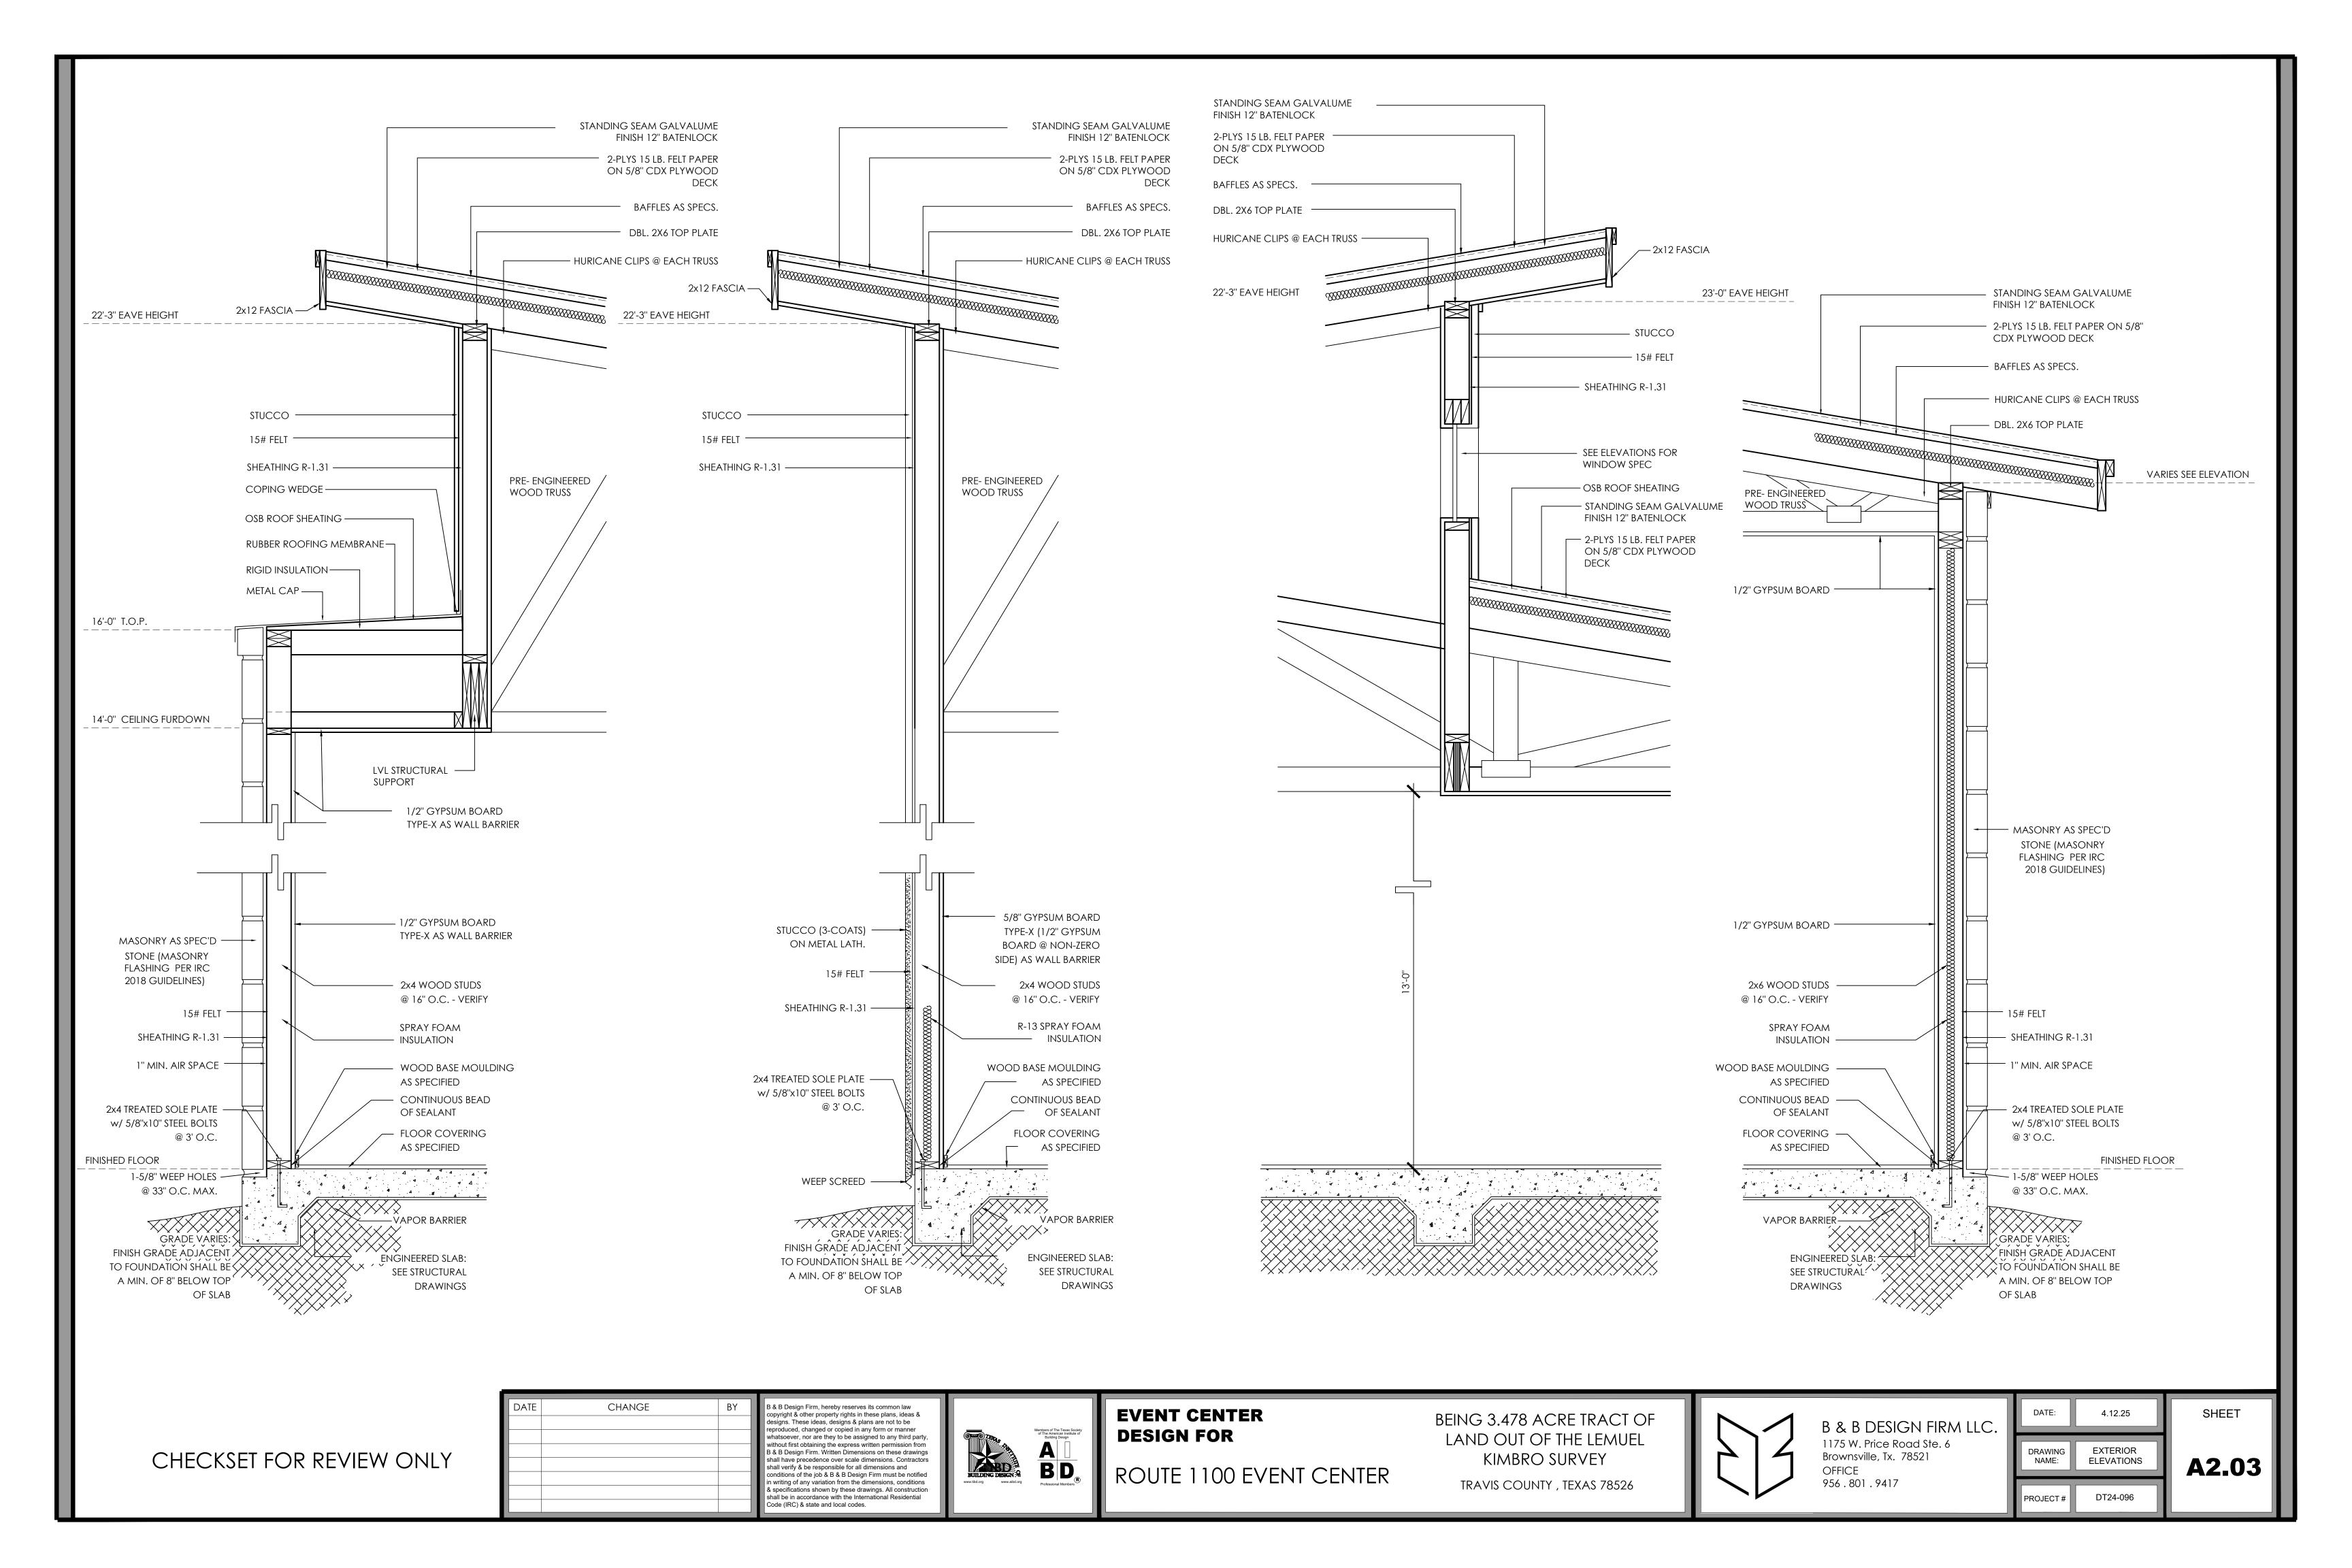


REAR ELEVATION

SCALE: 1/4" = 1'-0"

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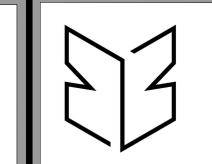


EVENT CENTER
DESIGN FOR

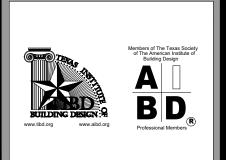ROUTE 1100 EVENT CENTER

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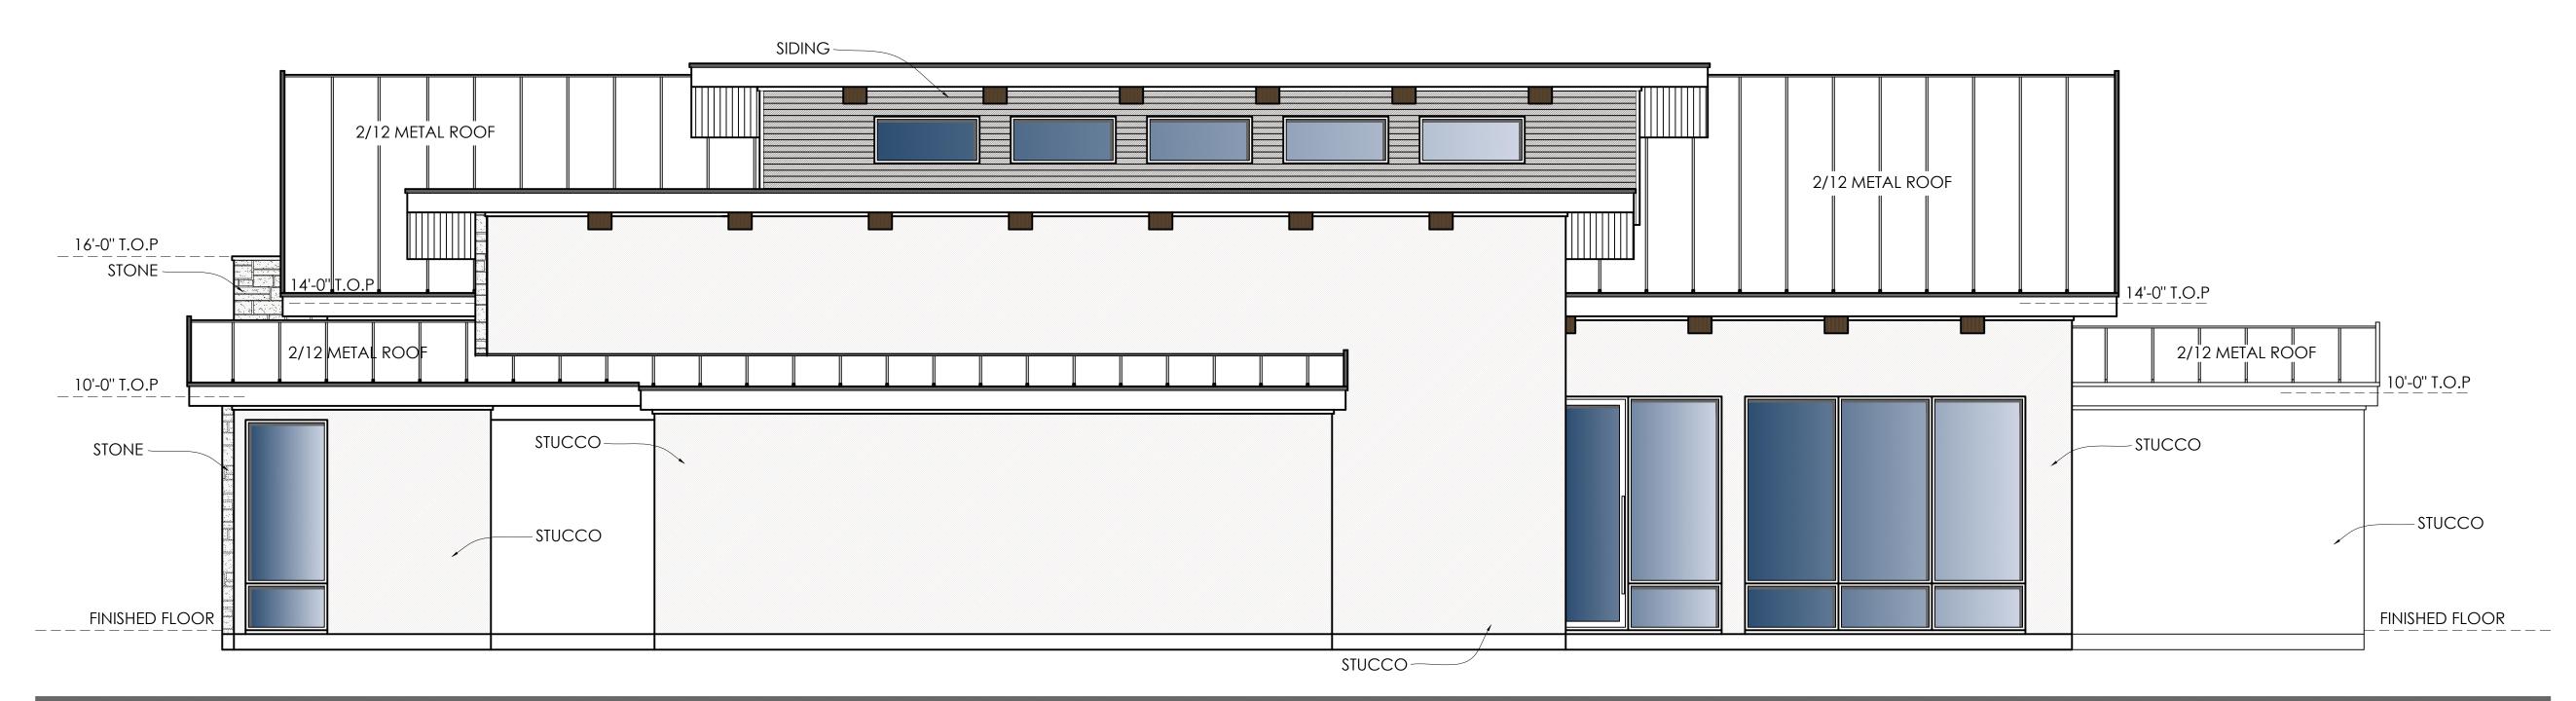
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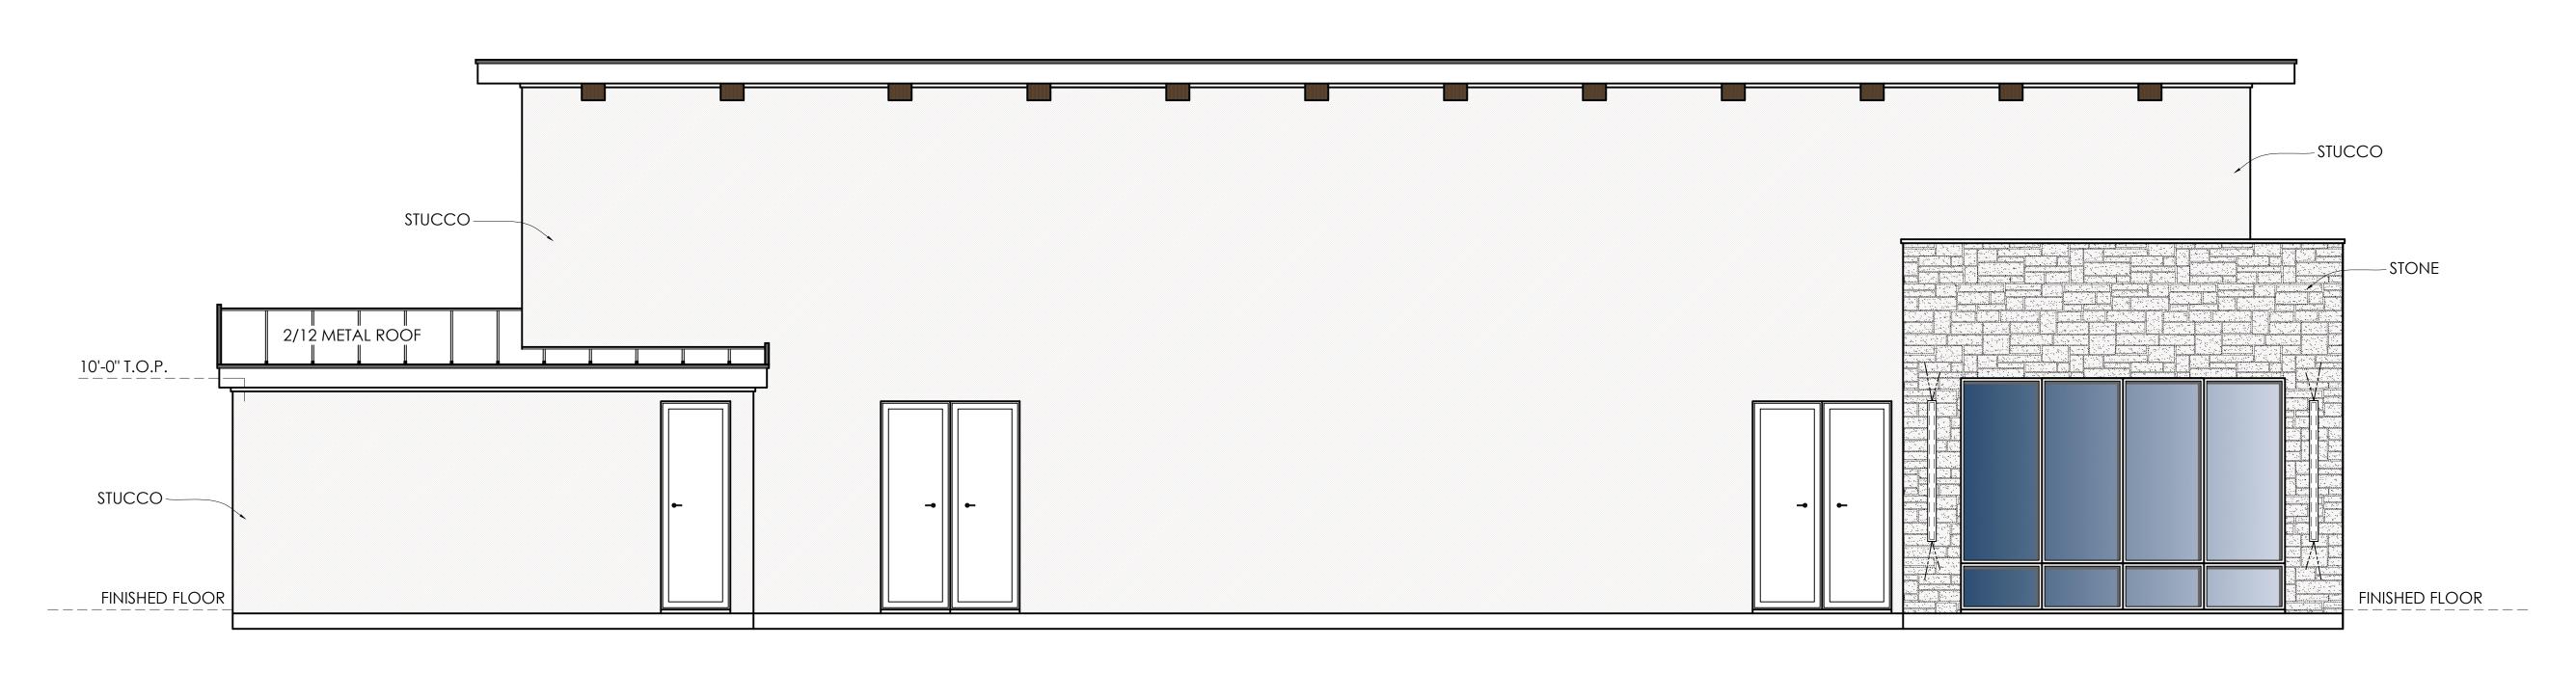
DATE:	4.12.25
DRAWING NAME:	EXTERIOR ELEVATIONS
PROJECT#	DT24-096

SHEET **A2.03**



RIGHT ELEVATION

SCALE: 3/16" = 1'-0"



LEFT ELEVATION

SCALE: 3/16" = 1'-0"

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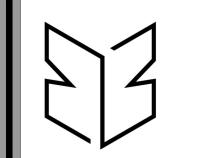
EVENT CENTER
DESIGN FOR

ROUTE 1100 EVENT CENTER

KIMBRO SURVEY

TRAVIS COUNTY . TEXAS 78

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TRAVIS COUNTY, TEXAS 78526




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PROJECT#	DT24-096

A2.04




CROSS SECTION 1-1

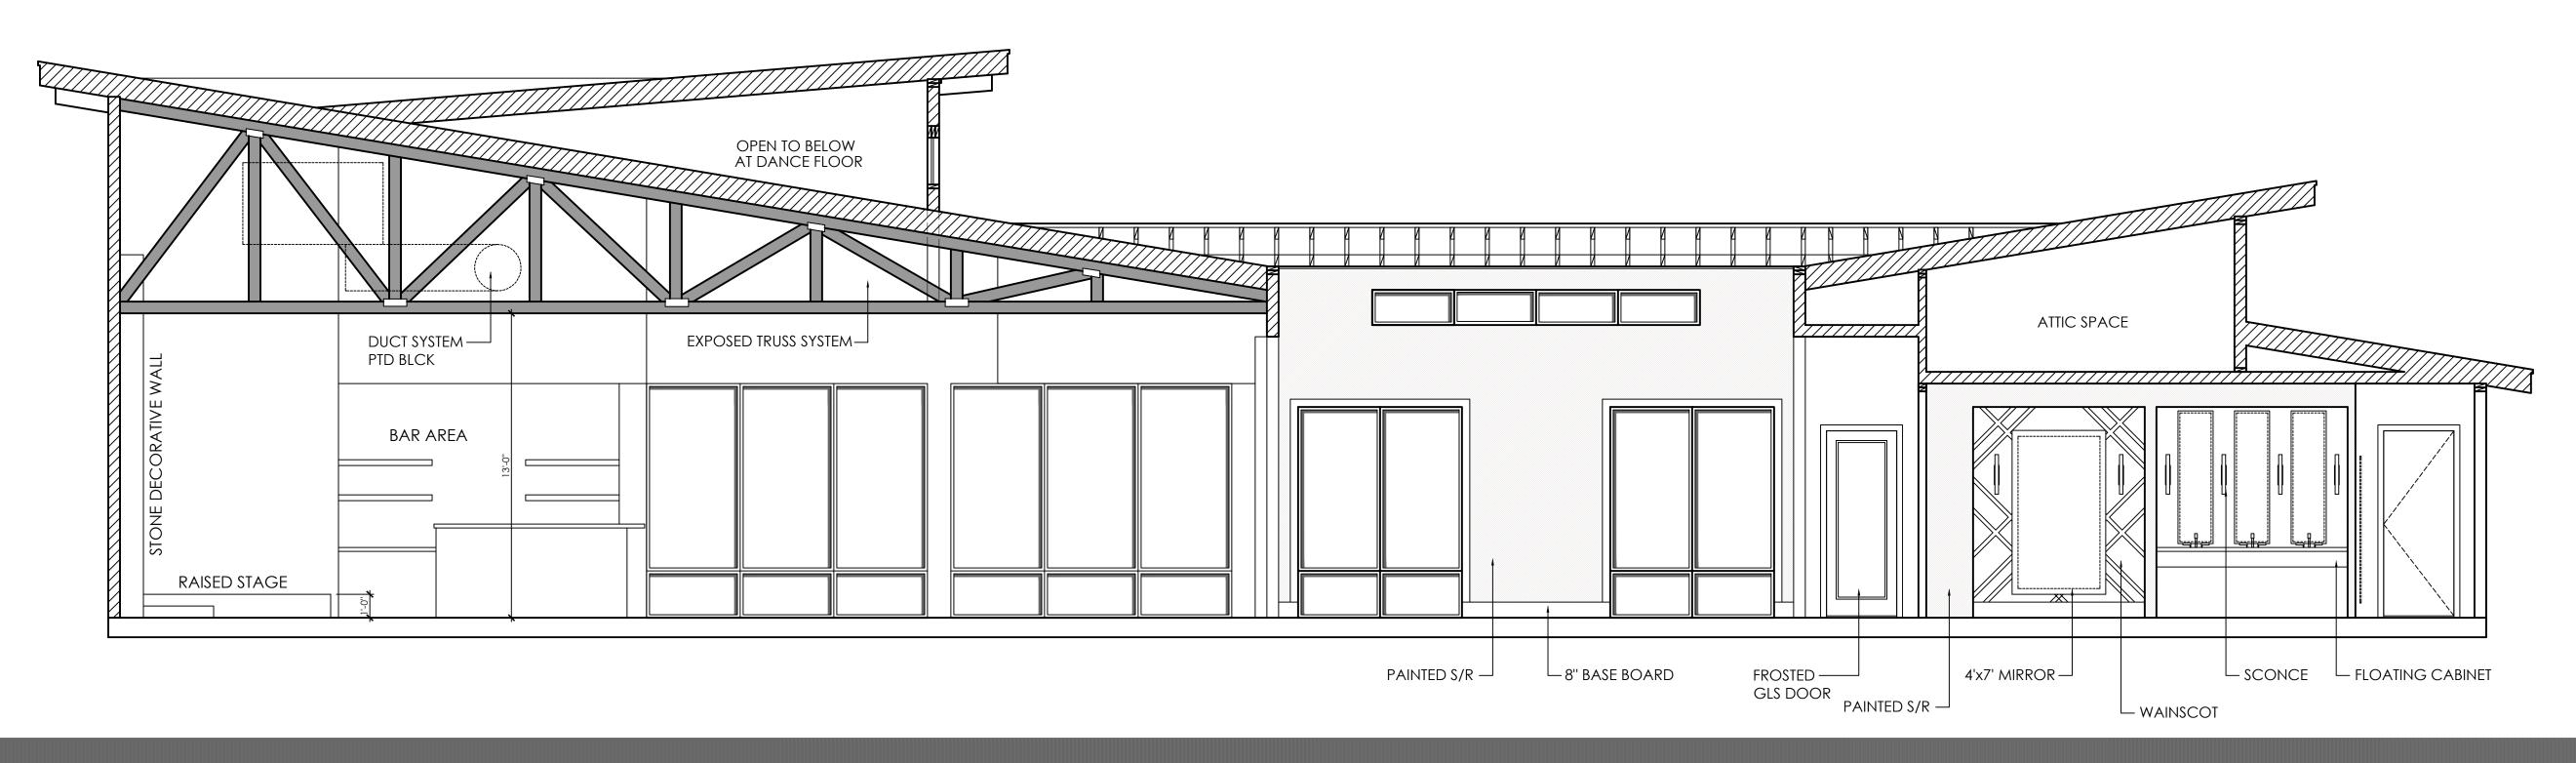

CROSS SECTION 2-2

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EVENT CENTER
DESIGN FOR

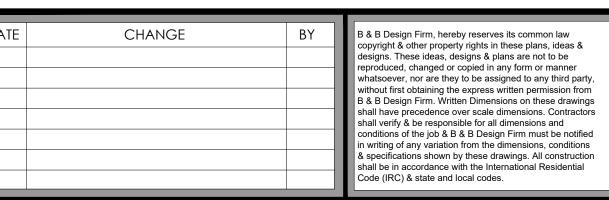ROUTE 1100 EVENT CENTER

BEING 3.478 ACRE TRACT OF LAND OUT OF THE LEMUEL KIMBRO SURVEY

TRAVIS COUNTY, TEXAS 78526




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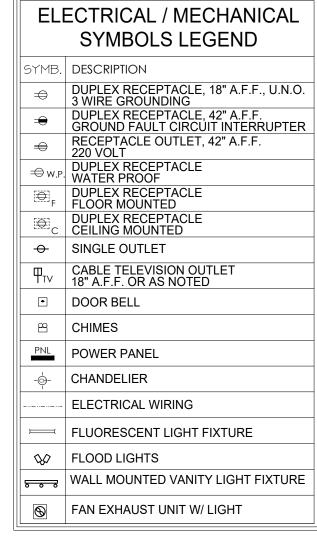
DRAWING NAME: CROSS SECTIONS

PROJECT # DT24-096

A2.05

SHEET



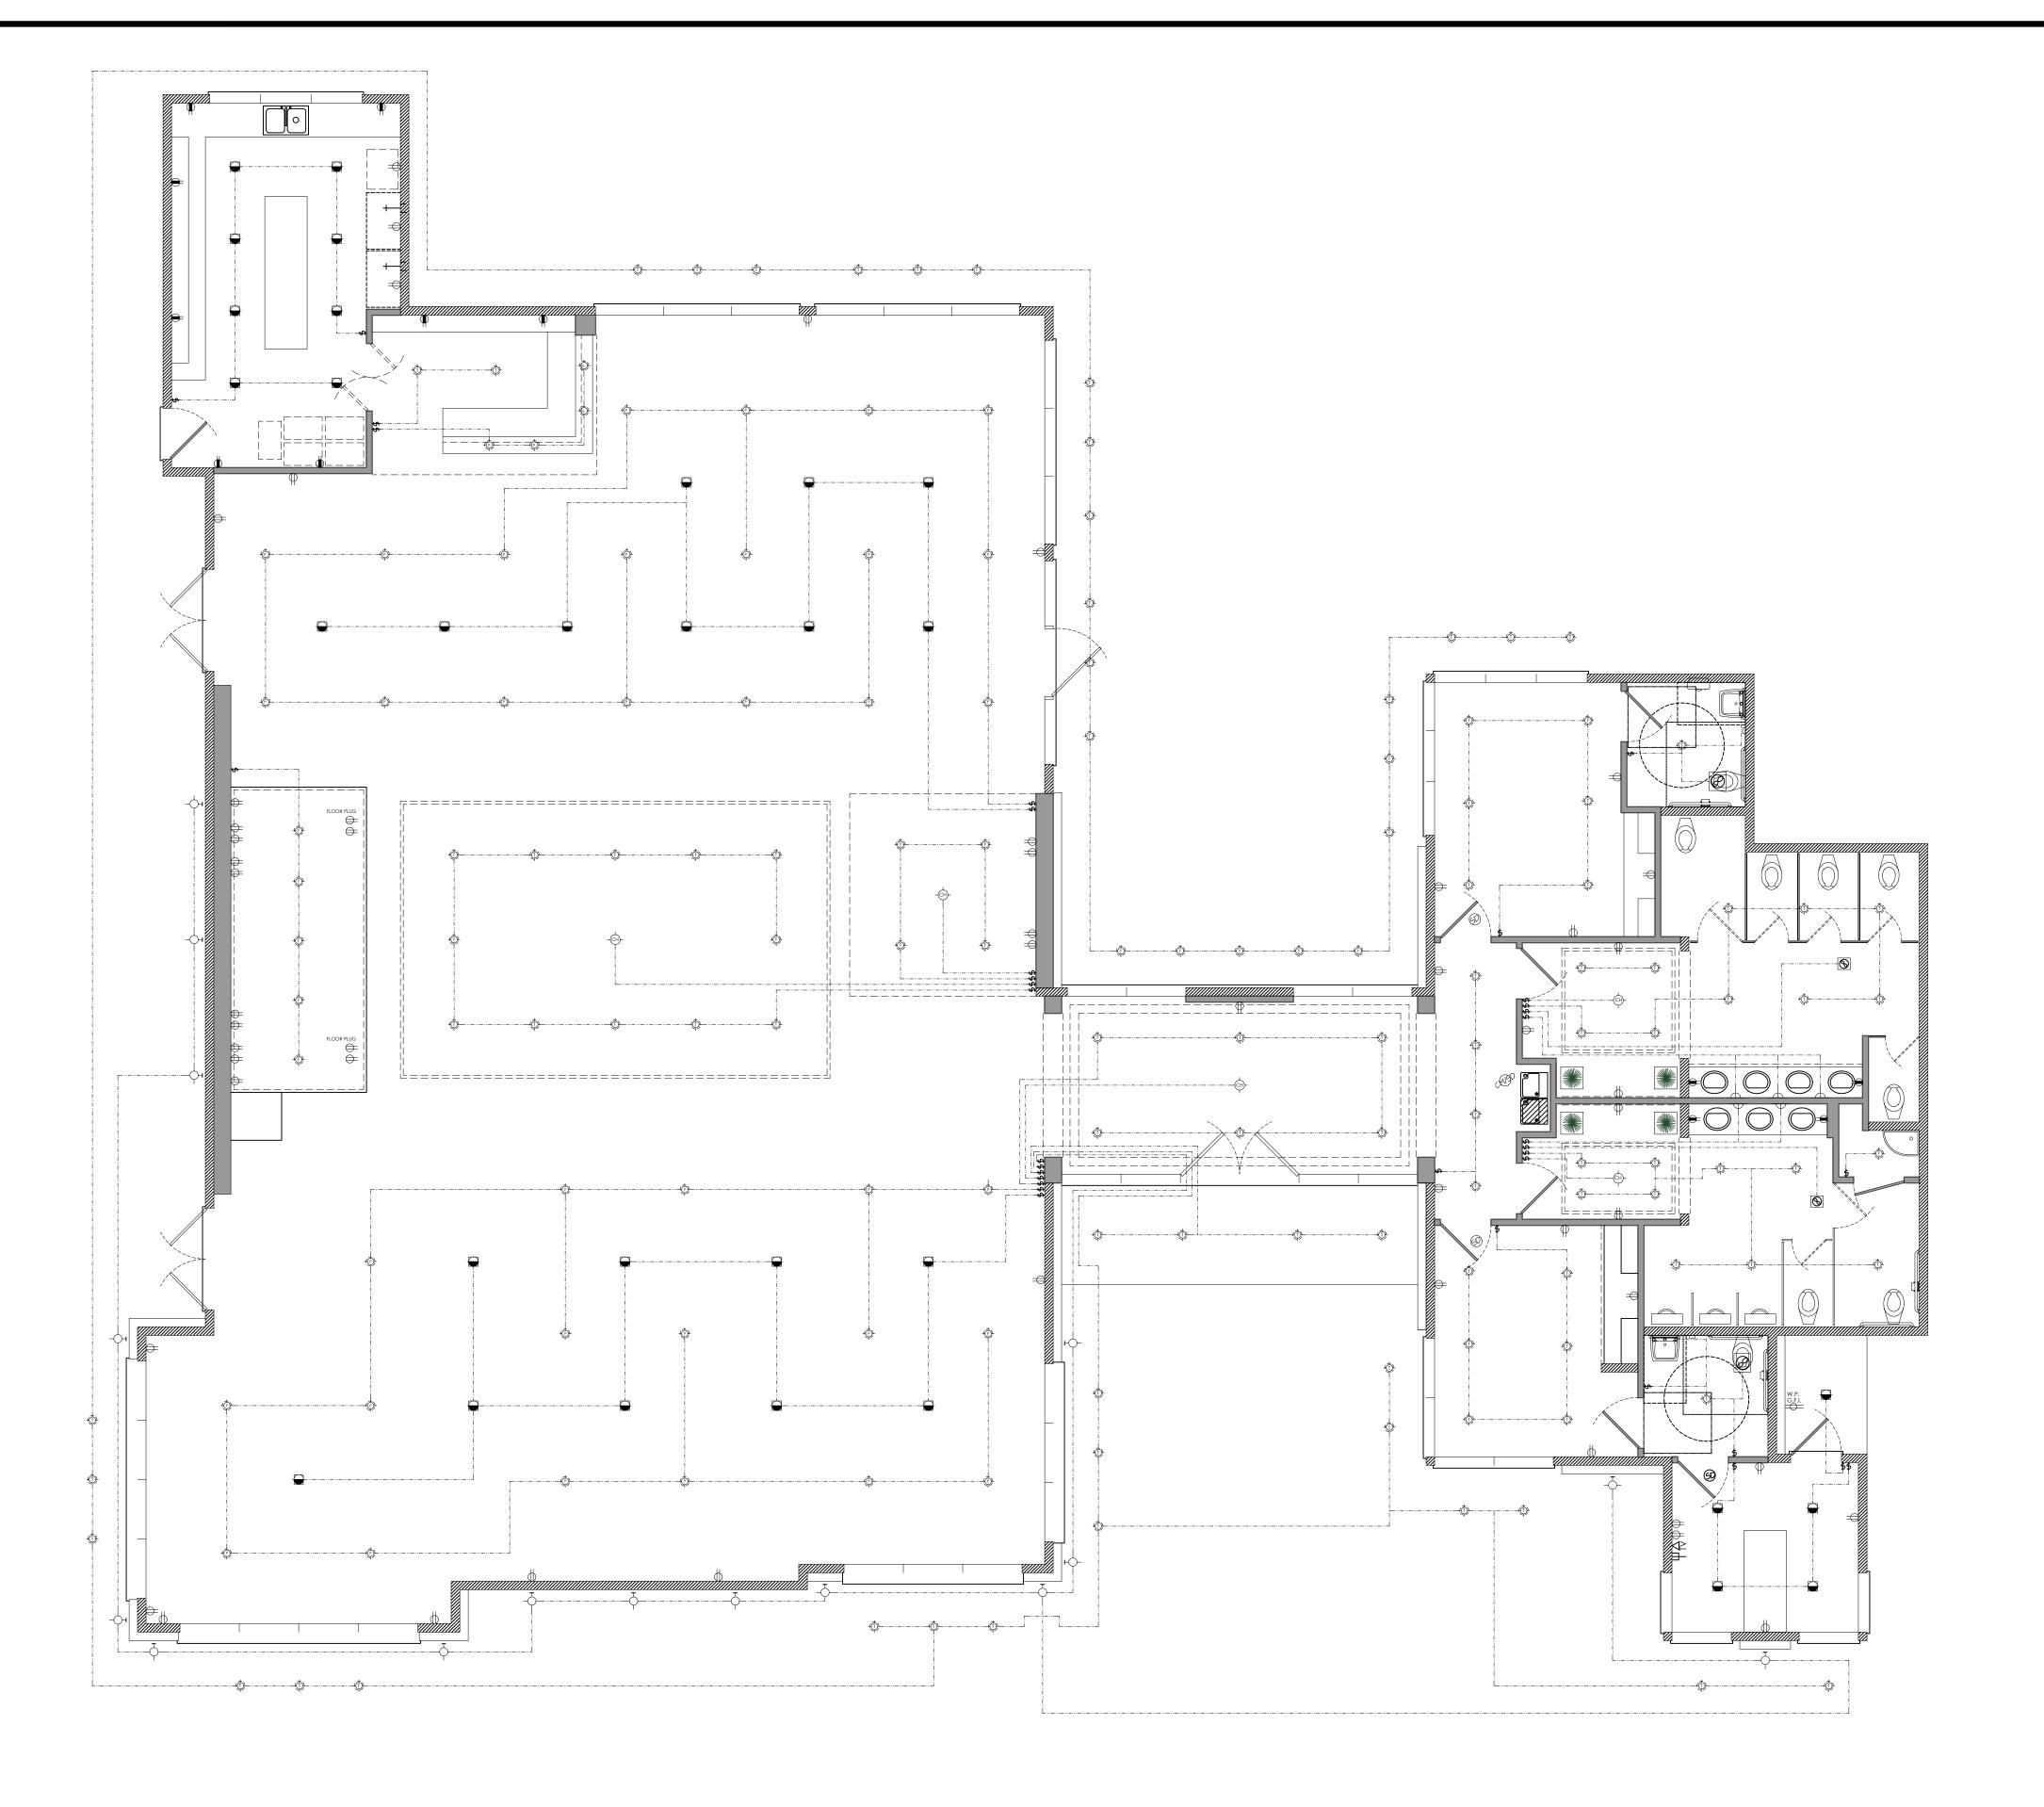

ELECTRICAL / MECHANICAL SYMBOLS LEGEND SMOKE DETECTOR SMOKE DETECTOR / CARBON MONOXIDE LOW VOLTAGE TASK LIGHT RECESSED POWER PANEL WALL MOUNTED SCONCE LIGHT FIXTURE A.C. TOGGLE SWITCH, SINGLE POLE 120-277 VAC, 48" A.F.F. INCANDESCENT DIMMER SWITCH 1500W, 48" A.F.F. DUPLEX OUTLET, WEATHERPROOF W/GROUND FAULT INDICATOR FAN W/ LIGHT FIXTURE CEILING SURFACE MOUNT INCANDESCENT LIGHT FIXTURE CEILING SURFACE MOUNT INCANDESCENT LIGHT FIXTURE WALL MOUNT INCANDESCENT "CAN" LIGHT FIXTURE RECESSED JUNCTION BOX DISCONNECT SWITCH

ELECT. SERVICE NOTES

- 1. RECEPTACLES SHALL BE SPACED SO THAT NO POINT ALONG THE FLOOR LINE IS MORE THAN 6'0" FROM AN OUTLET, AND OVER ANY COUNTER SPACE WIDER THAN 12"
- 2. RECEPTACLES IN BATHROOMS., GARAGES OR LOCATED OUTDOORS SHALL BE PROTECTED BY A GROUND FAULT INTERRUPTION SYSTEM., (G.F.I., W.P.)
- 3. SMOKE DETECTORS SHALL BE PLACE NO MORE THAN 12 FROM DUCT OPENINGS SMOKE DETECTORS SHALL BE PERMANENTLY WIRED AND INTERCONNECTED. PROTECTING ALL SLEEPING
- 4. OUTLET BOXES IN WALL BETWEEN THE DWELLING AND THE GARAGE SHALL BE METAL OR U.L. APPROVED PLASTIC.
- 5. SWITCH PLATES AT 42" A.F.F. TO CENTER TYPICAL
- 6. ALL LIGHTING FIXTURES IN CLOSETS SHALL BE LOCATED MINIMUM 18" FROM ALL SHELVES
- 7. TWO OR MORE 20 AMP SMALL APPLIANCE CIRCUITS SHALL BE PROVIDED TO SERE THE KITCHEN, BREAKFAST, AND OUTLETS. NEG. ART 220-3 (C)

ELECT. GROUNDING NOTES


- 1. CONSULT LOCAL UTILITY AND LOCAL CODE FOR PROPER SYSTEM GROUNDING.
- 2. ALL INTERIOR METALLIC WATER PIPING WHICH MAY BECOME ENERGIZED SHALL BE BONDED TOGETHER AND MADE ELECTRICALLY CONTINUOUS A BOND BARE COPPER WIRE #4) SHALL BE MADE BETWEEN THE BONDED PIPING SYSTEM AND THE GROUNDING ELECTRODE CONDUCTOR AT THE SERVICE DISCONNECTING MEANS.
- 3. THE INTERIOR METAL COLD WATER PIPING SYSTEM SHALL BE BONDED THE THE SERVICE EQUIPMENT ENCLOSURE. THE GROUNDING CONDUCTOR AT THE SERVE, THE GROUNDING ELECTRODE, OR TO ONE OR MORE GROUNDING ELECTRODES USED.

ELECTRICAL PLAN

SCALE: 3/16" = 1'-0"

CHECKSET FOR REVIEW ONLY

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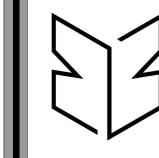


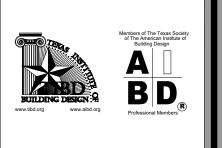EVENT CENTER DESIGN FOR

ROUTE 1100 EVENT CENTER

BEING 3.478 ACRE TRACT OF LAND OUT OF THE LEMUEL KIMBRO SURVEY

TRAVIS COUNTY, TEXAS 78526



B & B DESIGN FIRM LLC. 1175 W. Price Road Ste. 6 Brownsville, Tx. 78521 OFFICE 956 . 801 . 9417

A LLC.


4.12.25 SHEET

ELECTRICAL

E1.0

DT24-096

E1.01

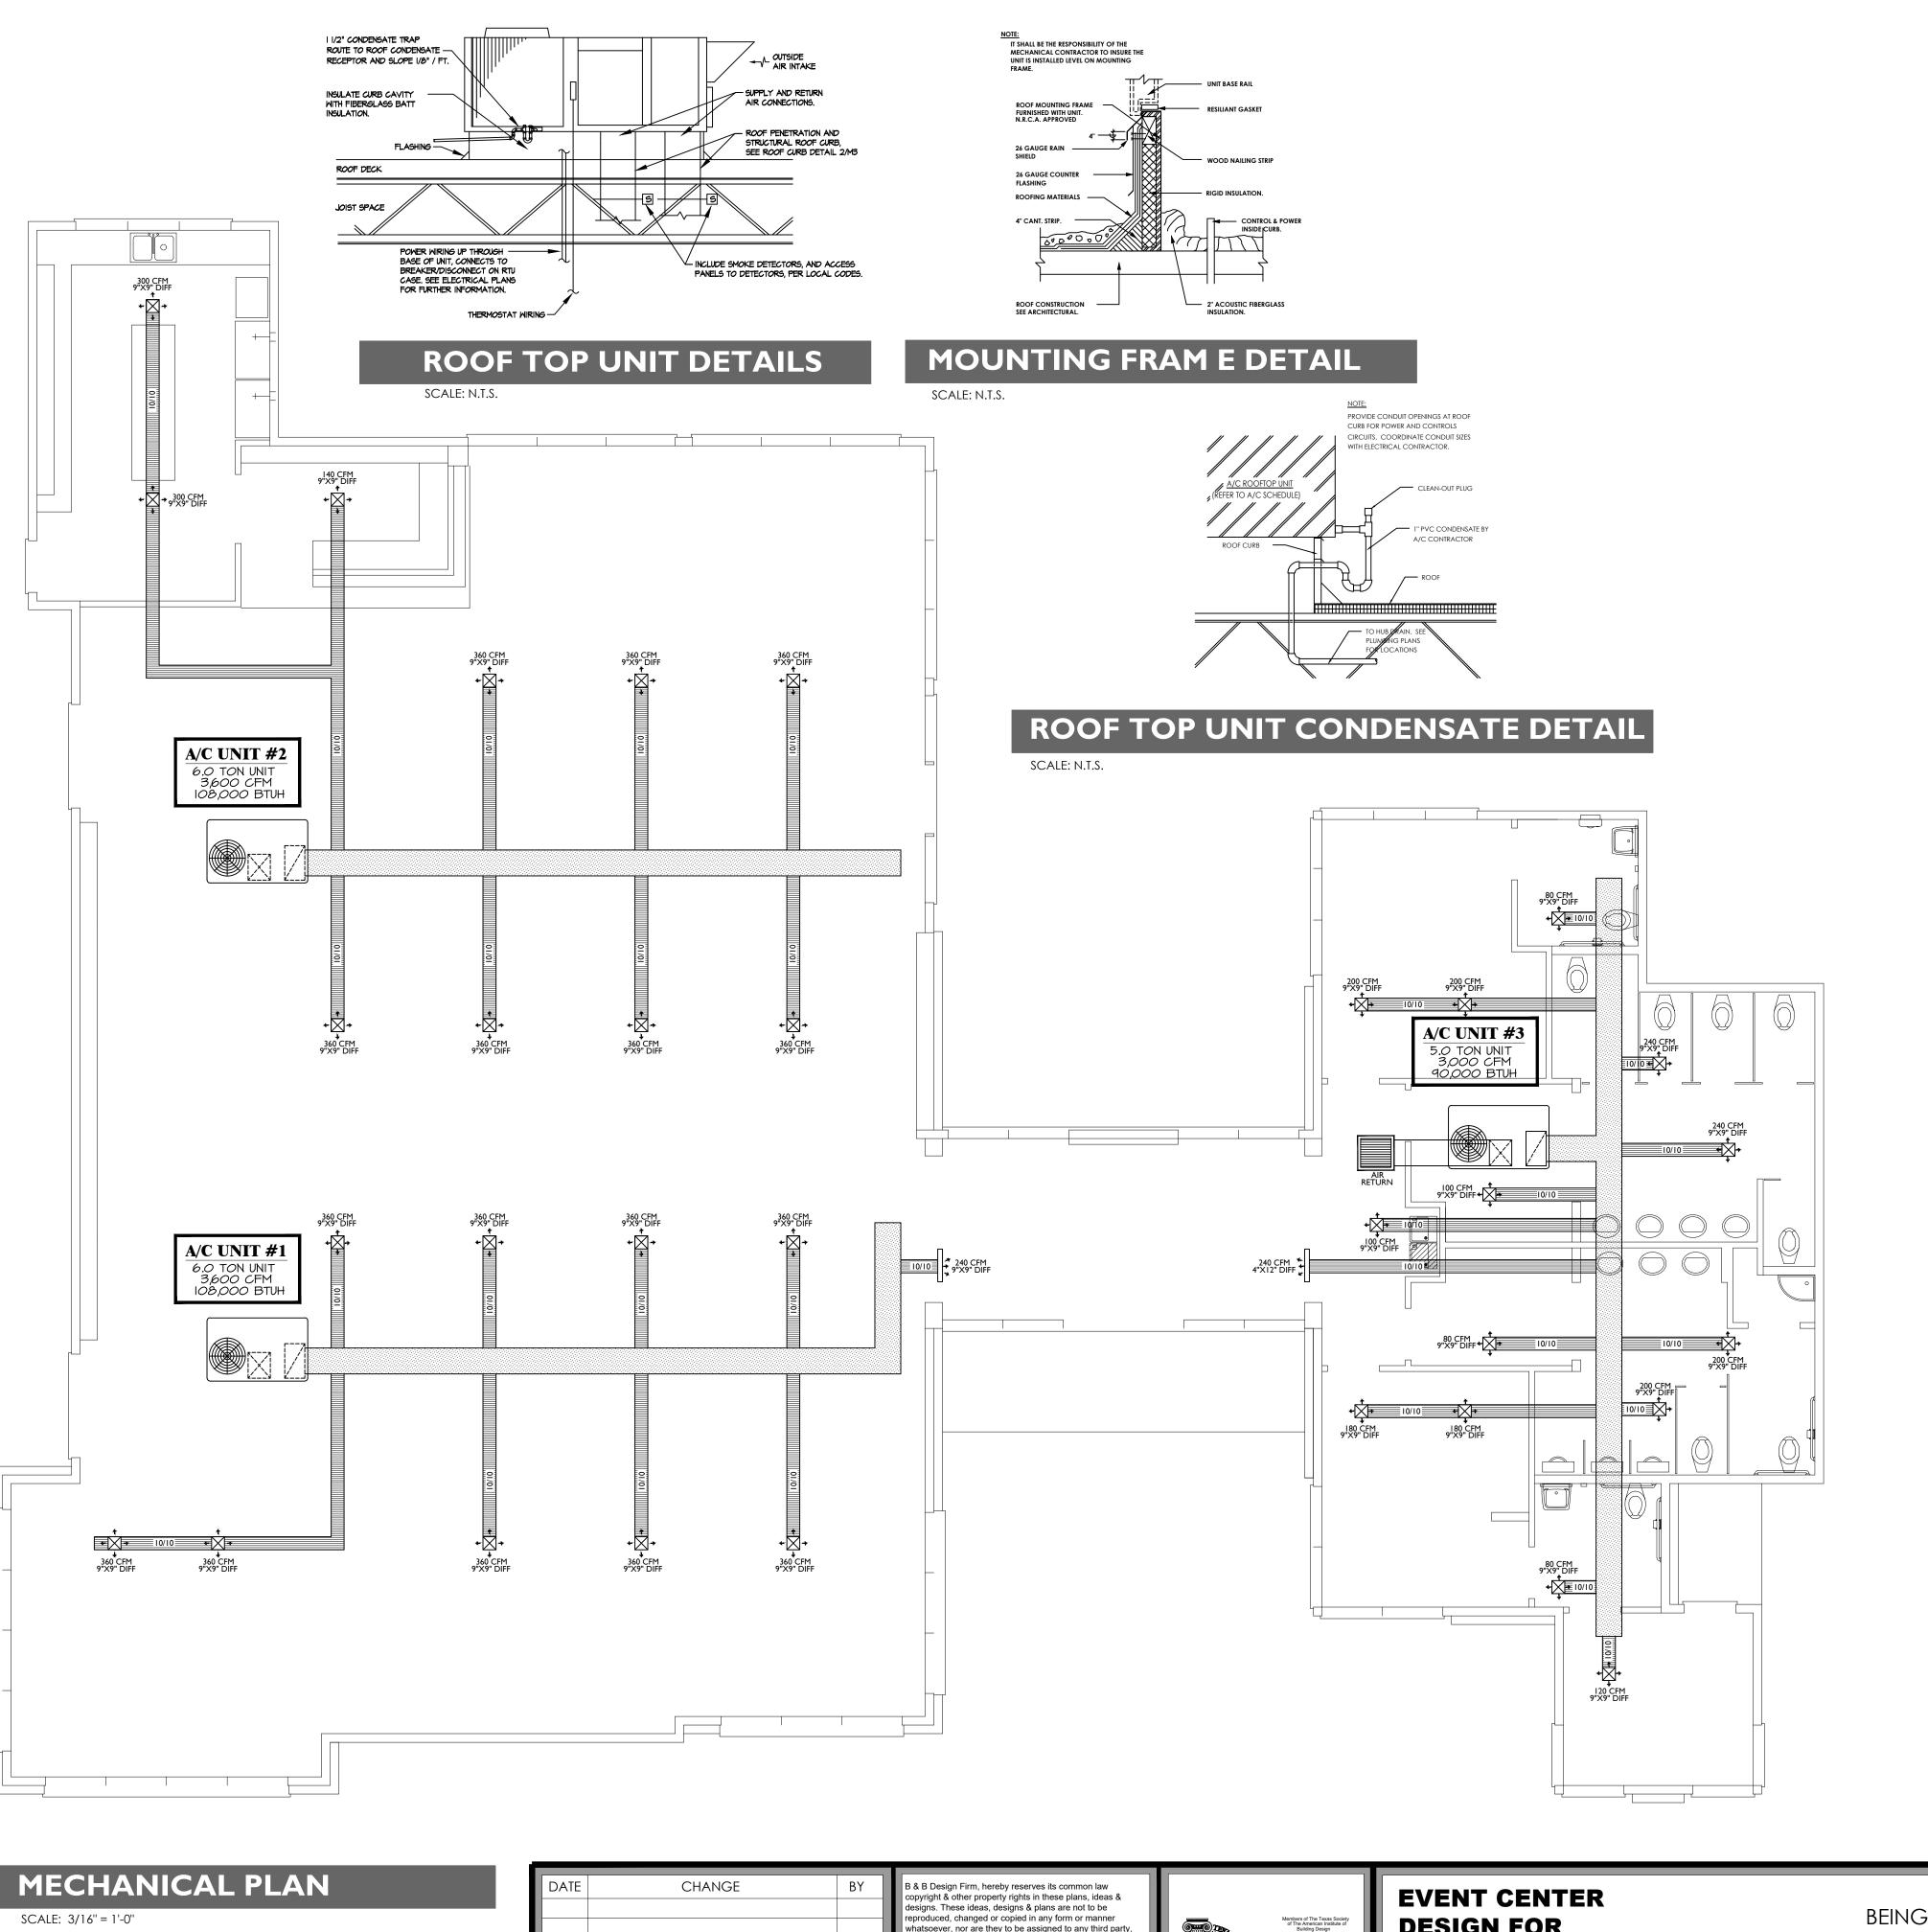

TYP. HEAT LOAD SUMMARY FOR AC FOR UNIT A 301-306

		· · · · · · · · · · · · · · · · · · ·					
ROOM NAME	SQUARE FT.	HEATING LOSS BTUH	HYDRONIX HEAT LINEAR FT.	LATENT / SENSIBLE GAIN BTUH	COOLING GAIN BTUH	COOLING TONS	COOLING CFM
RECEPTION							
FOYER							
SERVING KITCHEN							
BRIDES LOUNGE							
GROOMS LOUNGE							
WOMEN'S RR							
MEN'S RR							
OFFICE							
TOTALS							

SYN	MBOL LEGE	ND		
MK.	SYMBOL	SPECIFICATIONS	MOUNTING HT.	NOTES
	•			•
N/A	← \(\frac{\dagger}{\dagger} \) →	LAY-IN HVAC SUPPLY REGISTER PROVIDED BY HVAC CONTRACTOR	MOUNT TO SCHEDULED ACOUSTICAL CEILING	PAINTED REFER TO PAINT SCHEDULE SHEET A.4
N/A		LAY-IN HVAC RETURN REGISTER PROVIDED BY HVAC CONTRACTOR	MOUNT TO SCHEDULED ACOUSTICAL CEILING	PAINTED REFER TO PAINT SCHEDULE SHEET A.4
EF	Θ	RESTROOM EXHAUST FAN: BROAN #HD80 80CFM SUPPLIER: MELETIO ELECTRICAL SUPPLY	MOUNT TO SCHEDULED ACOUSTICAL CEILING	STANDARD WHITE COVER

1. DUCTWORK:

DIFFUSERS 5' OR LESS IN LENGTH

- A. SUPPLY AND RETURN AIR DUCTWORK UNDER 36" DIMENSION IN EITHER DIRECTION SHALL BE 1" RECTANGULAR FIBERGLASS REINFORCED ROUND FLEX DUCT MAY BE USED FOR RUN-OUTS TO
- B. SUPPLY AND RETURN AIR DUCTWORK OVER 36" DIMENSION IN EITHER DIRECTION SHALL BE 1" INSULATED GI METAL DUCTWORK

TOGETHER TO MINIMIZE PENETRATIONS IN WALLS AND ROOFS.

- C. EXHAUST DUCTWORK SHALL BE GI METAL. TIE ALL DUCTS
- D. OUTSIDE AIR SUPPLY DUCTWORK SHALL BE GI METAL. PROVIDE POSSIBLE 10% OUTSIDE AIR DUCTED TO AIR-HANDLING UNITS FROM FILTERED GRILLES IN EXTERIOR WALL. TIE ALL DUCTS TOGETHER TO MINIMIZE PENETRATIONS IN WALLS AND ROOFS.

2. EXHAUST FANS:

- A. ALL EXHAUST FANS IN OCCUPIED AREAS SHALL BE INDIVIDUAL FANS LOCATED AT CEILINGS AND SWITCHED WITH LIGHTS.
- B. PROVIDE 22" UP-TURNED LEADERS AT ALL GUEST BATH AND RESTROOM EXHAUSTS AND JOIN TO COMMON EXHAUST RISERS PER CODE. COMBINE AND/OR TIE DUCTS TOGETHER TO MINIMIMIZE PENETRATIONS IN WALLS AND ROOFS.

3. AIR DEVICES:

- A. SUPPLY GRILLES LOCATED IN LAY-IN ACOUSTICAL CEILINGS SHALL BE 24" X 24" LAY-IN TYPED PAINTED WHITE GRILLES WITH AIR FLOW ADJUSTMENT AT THROAT TYPICAL. PROVIDE 12" X 12" GRILLES IN RESTROOMS AND STORAGE ROOMS AS INDICATED
- B. ALL SUPPLY AIR GRILLES LOCATED IN GYPSUM BOARD CEILINGS SHALL BE SQUARE PAINTED WHITE GRILLES WITH ADJUSTABLE AIR FLOW. GRILLES SHALL BE CONFIGURED AS 1-WAY, 2-WAY, 3-WAY, OR 4-WAY THROW PATTERN(S) AS APPROPRIATE FOR THE LOCATION OF THE GRILLE AND THE AREA(S) TO BE SERVED
- C. ALL SUPPLY AIR GRILLES LOCATED IN WALLS SHALL BE WHITE PAINTED ALUMINUM GRILLES WITH ADJUSTABLE AIR FLOW AND 2-WAY ADJUSTABLE FACE LOUVERS. NO STAMPED GRILLES SHALL BE ACCEPTABLE
- D. ALL RETURN AIR GRILLES SHALL BE ANODIZED ALUMINUM SWING-DOWN/OUT TYPE FILTER GRILLES CONFIGURED TO ACCEPT 1" DISPOSABLE FILTERS
- E. ALL TRANSFER GRILLES OR CEILING PLENUM GRILLES SHALL BE ANODIZED ALUMINUM GRILLES

4. CONTROLS:

- A. SPLIT SYSTEM SHALL HAVE WALL-MOUNTED PROGRAMMABLE THERMOSTATS WITH ON/OFF, TEMPERATURE, HEAT/COOL, FAN ONLY SELECTIONS
- B. INSTALL REMOTE TEMPERATURE SENSORS WHERE INDICATED AND/OR REQUIRED

PROVIDE LOCKING COVERS AT ALL THERMOSTATS

5. GENERAL


- A. PROVIDE MINIMUM 24" X 24" PAINTED ACCESS PANELS FOR ALL UNITS MOUNTED ABOVE CEILINGS WHICH ARE NOT ACCESSIBLE
- B. DRAIN ALL UNITS TO THE BUILDING SANITARY SEWER SYSTEM.
- C. PROVIDE TRAPS AT ALL DRAIN LINES
- D. PROVIDE SECONDARY DRAIN PANS UNDER FAN/COIL UNITS AS PER CODE. PIPE SECONDARY DRAINS TO "TELL TALE" DRAINS THRU CEILING ABOVE NEAREST SINK; CUT FLUSH AND TRIM WITH ESCUTCHEON. PROVIDE FLOAT SWITCHES TO SHUT TO SHUT DOWN UNIT IF DRAIN PAN BECOMES FULL AND "TELL TALE" RED LIGHT AT CEILING UNDER FAN/COIL (AIR-HANDLING) UNIT TO INDICATE THAT FLOAT SWITCH HAS SHUT DOWN UNIT.
- E. COMPLY WITH ALL LOCAL CODES & ORDINANCES

- 1. SUPPLY SIDE SMOKE DETECTORS SHALL BE ADDED FOR SYSTEMS SUPPLYING AIR IN EXCESS OF 2000 CFM TO ENCLOSED SPACES WITHIN BUILDINGS
- 2. NO FLEX DUCT SHALL BE USED IN THIS INSTALLATION
- 3. EXISTING ROOF ACCESS ALREADY INSTALLED AT BUILDING LOCATION

HVAC SHEDULE							
Brand	UNITY	MODEL	BTU	TON	CFM	ELECTRIC	
						HEAT	
RHEEM	2		180,000	6	3600	20 KW	
RHEEM	1		150,000	5	3000	15 KW	

Or approved equal

pending ENGINEER SEAL

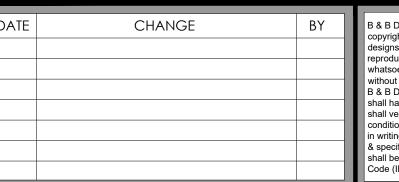

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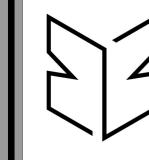


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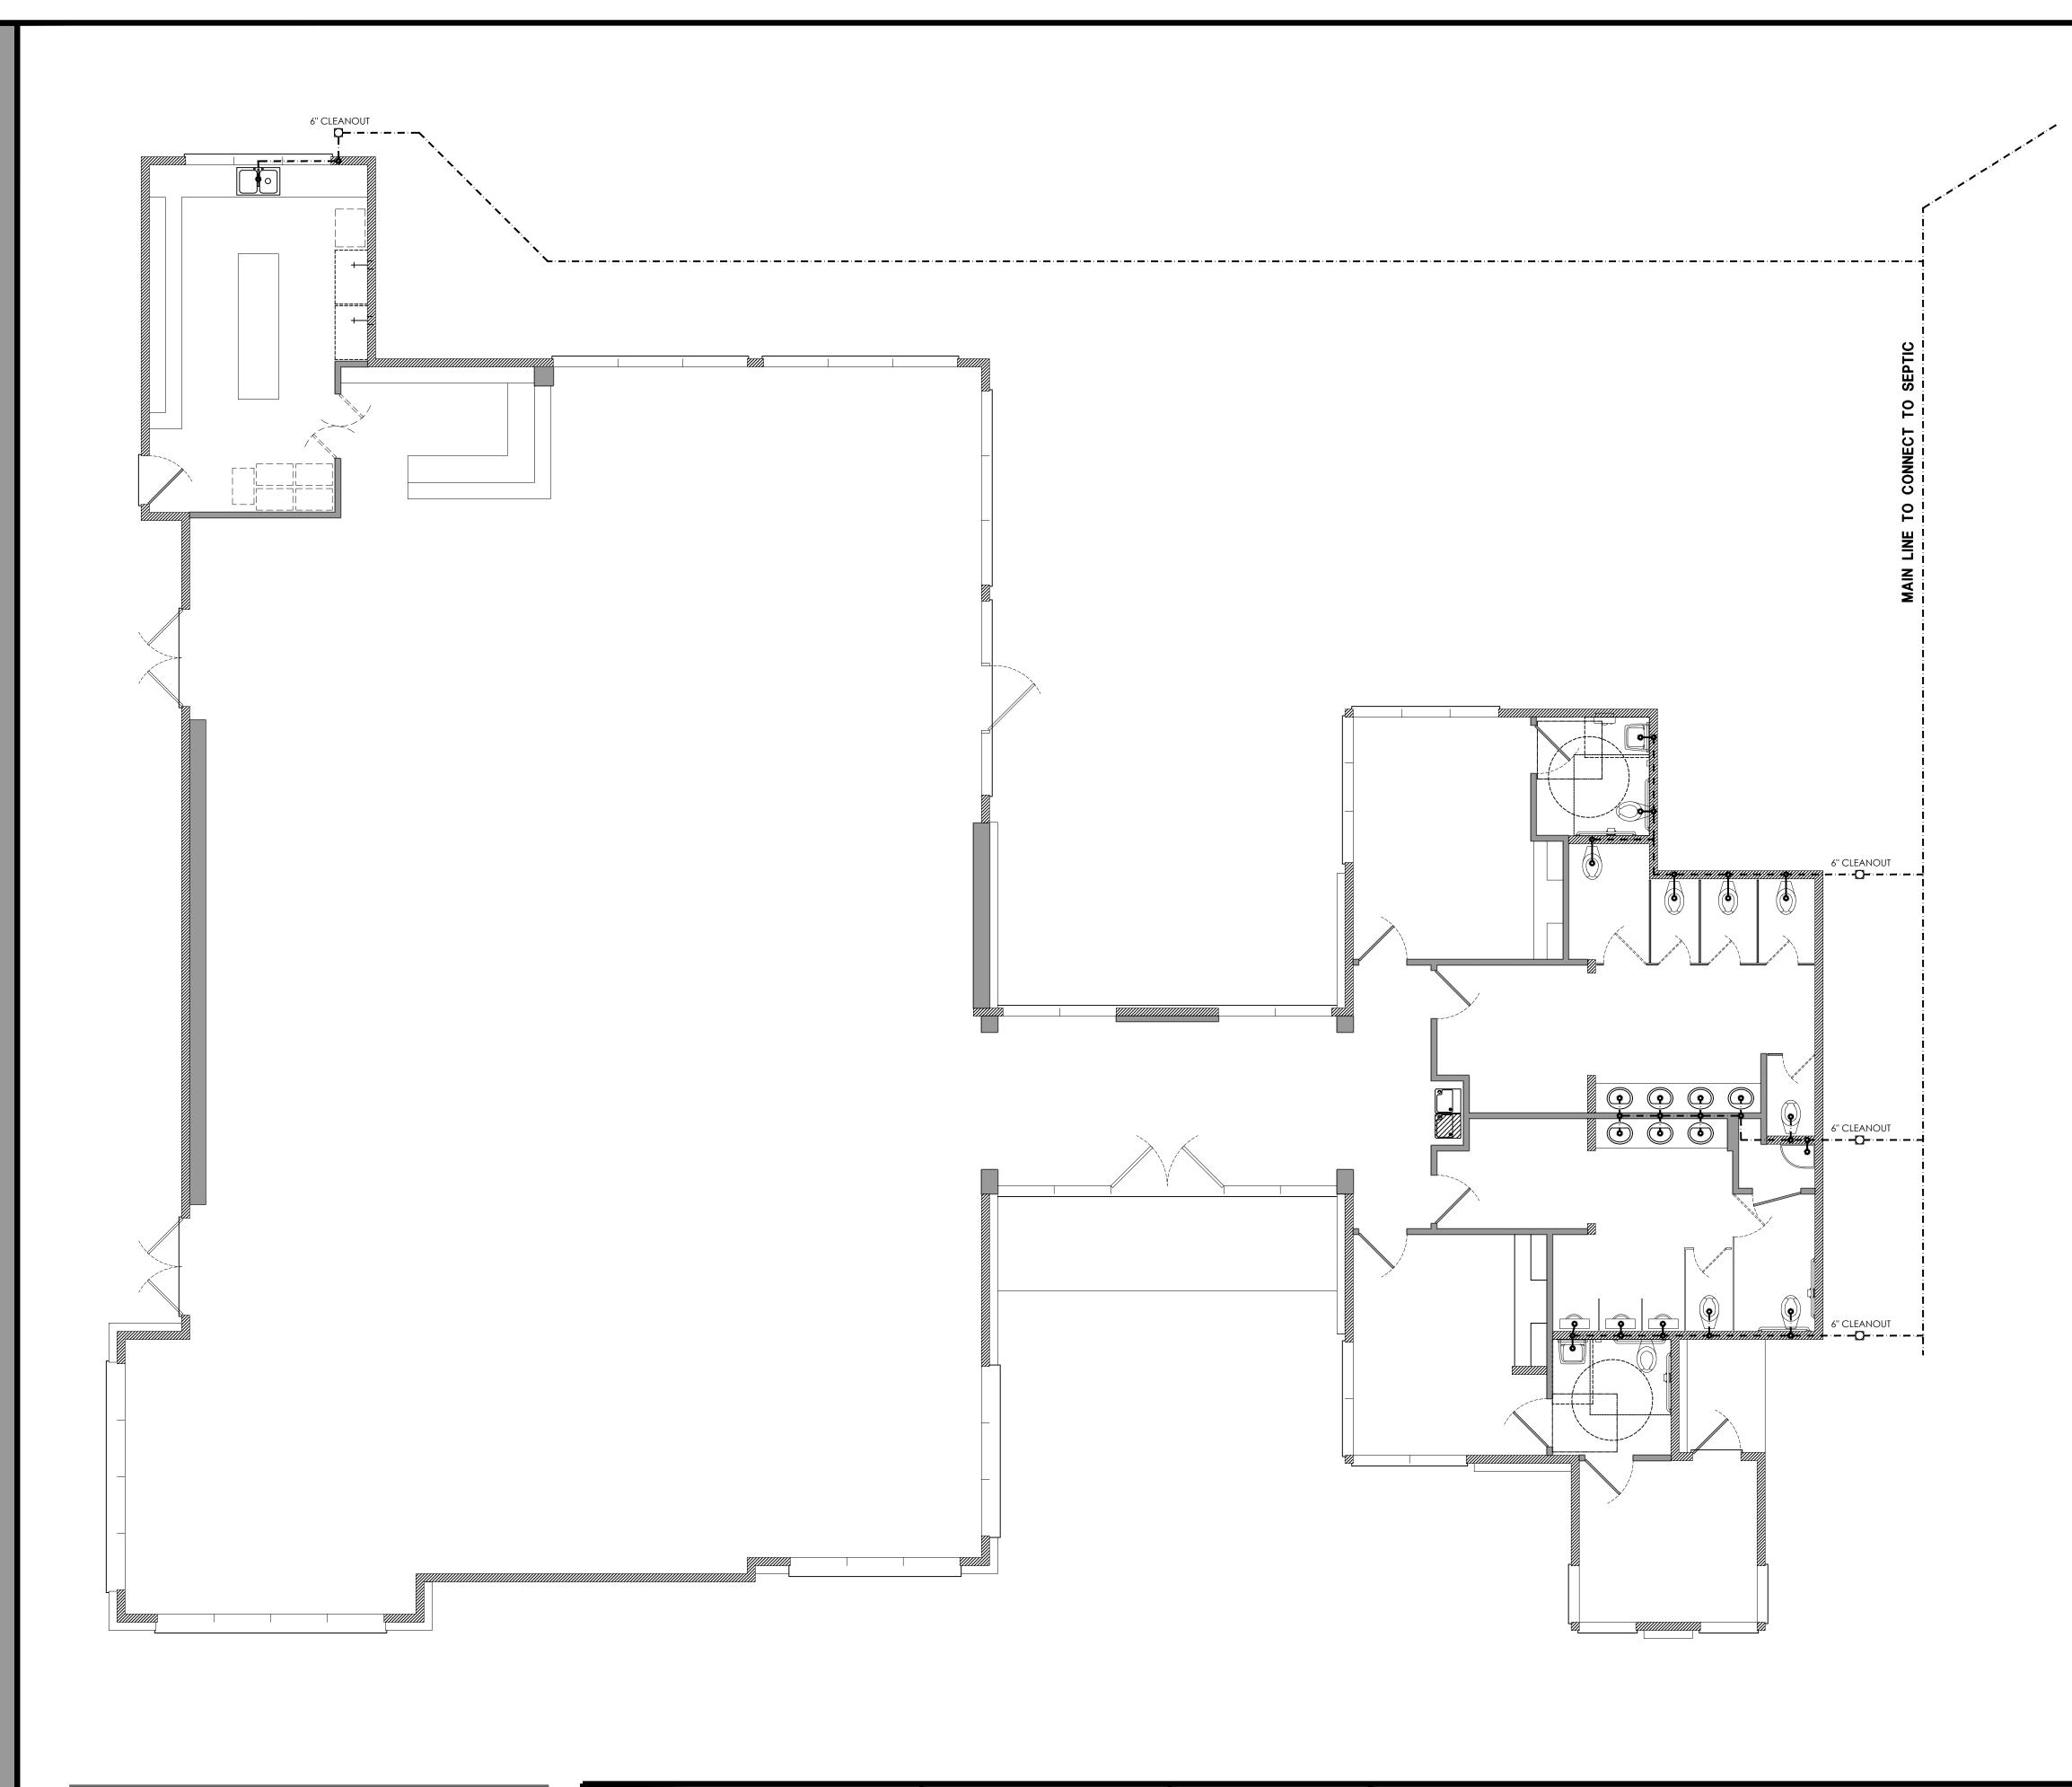
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	DATE:	4.12.25
	DRAWING NAME:	MECHANI
ı	PROJECT#	DT24-096

SHEET M1.01



PLUMBING FIXTURE SCHEDULE					
SYMBOL	DESCRIPTION	MANUFACTURER (OR EQUAL)			
WC-1	WATER CLOSET - TANK TYPE "WELLWORTH", VITREOUS CHINA, CLOSE COUPLED DESIGN, ELONGATED BONL, SIPHON JET FLUSHING, LEFT HAND TRIP LEVER, BOLT CAPS, BRASS FLOOR FLANGE, BOL-WAX SEAL, AND PLASTIC OPEN FRONT SEAT WITH COVER.	KOHLER #K-3420-EB KOHLER #D-4650			
LAV-1	ACCESSIBLE WALL MOUNTED LAVATORY "KINGSTON", VITREOUS CHINA, &" FAUCET CENTERS, CONCEALED CHAIR CARRIER, A.D.A. COMPLIANT TWO BLADE FAUCET FOR HOT AND COLD WATER, AERATOR, ANGLE STOPS, FLEXIBLE RISERS AND OFFSET LAVATORY DRAIN WITH PERFORATED STRAINER. NOTE: P-TRAP AND ANGLE VALVES SHALL BE COVERED WITH A.D.A. APPROVED PROTECTIVE PIPE COVERS SECURED WITH SNAP-CLIP FLUSH RE-USABLE FASTENERS AND ANGLE STOPS SHALL HAVE LOCK-LID LOCKING ACCESS COVERS.	KOHLER #K-2006 KOHLER #K-I3805 CHICAGO #404A-3IT-EI2-CP ZURN #ZR-I23I TRUEBRO PIPING INSULATION AT ALL EXPOSED PIPING			
WS-1	HEAVY DUTY COMMERCIAL WASHER REFER TO CLIENT FOR SPECS AND INFORMATION REGARDING ALL WASHERS USED IN THIS BUILDING	REFER TO OWNER			
DR-1	COMMERCIAL DRYER REFER TO CLIENT FOR SPECS AND INFORMATION REGARDING ALL WASHERS USED IN THIS BUILDING	REFER TO OWNER			
9K-1	CORNER FLOOR SINK "WHITBY", 26" X 26" X 13", ACID RESISTANT, COATED WIRE RIM GUARD, 3" PERFORATED STRAINER, WALL MOUNTED TWO (2) LEVER CHROME PLATED FAUCET WITH VACUUM BREAKER, HOSE FITTING CONNECTION, AND GARDEN HOSE ATTACHMENT.	KOHLER #K-6710 KOHLER #K-8940 KOHLER #K-9146 KOHLER #K-8928			
WH-1	ELECTRIC WATER HEATER 40 GALLON TANK CAPACITY, 4500 WATT ELEMENT, 240 VOLT, SINGLE PHASE, LOW BOY MODEL. FURNISH WITH DRAIN PAN AND TEMPERATURE & PRESSURE RELIEF VALVE WITH RELIEF PIPING STUBBED TO BUILDING EXTERIOR. HEATER SHALL MEET ASHRAE STANDARD 90A-FOR ENERGY EFFICIENCIES AND THE MINIMUM ENERGY FACTOR REQUIRED BY THE FEDERAL NATIONAL APPLIANCE ENERGY CONSERVATION ACT AND LISTED BY UNDERWRITERS LABORATORIES.	GE #4056A/487-672			
WS-2	COMMERCIAL WASHER REFER TO CLIENT FOR SPECS AND INFORMATION REGARDING ALL WASHERS USED IN THIS BUILDING	REFER TO OWNER			

<u>Plumbing Notes:</u>

- ALL SOIL, WASTE, AND VENT PIPES FITTING BENEATH THE BUILDING AND WITH IN THE BUILDING SHALL BE SCHEDULED 40 DWC PVC PIPE W/ SOLVENT WELDED FITTINGS.
- EXTERIOR UNDERGROUND DOMESTIC WATER PIPING SHALL BE' PYC PRESSURE PIPE CLASS 100 - C900 W/ RUBBERIZING TYPE JOINTS.
- 3. DOMESTICS WATER LINES WITHIN THE BUILDING SHALL BE CPVC WITH A MIN. DESIGN PRESSURE OF 100 PSI. @ 180°F OR AS PER CITY CODE.
- 4. ALL HOT & COLD WATER SHALL HAVE WATER HAMMER ARRESTERS OR 24" AIR CHAMBERS, LOCATED ON FIXTURES ON KITCHEN SINK, WASHERS, WATER CLOSET AND LAVATORY.
- 5. WATER SUPPLY TO UNIT SHALL BE MIN. 3/4" TO WATER HEATER.
- 6. 3/4" FROM WATER HEATER TO WASHER, BOTH HOT AND
- 7. ALL OTHERS SHALL BE A MIN. OF 1/2".
- 8. ALL FLOOR DRAINS SHALL BE PRIMED FROM NEAREST LAV.
 - PROVIDE COMMERCIAL GRADE FIXTURES. LAY, WC, MIR, FTC.

PLUMBING PLAN

SCALE: 3/16" = 1'-0"

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DATE

CHANGE

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DRAWING NAME: FOUNDATION

PROJECT # DT24-096

A2.02

SHEET