






Plotted By: Cuplin, Warren Date: October 30, 2024 01:33:21pm File Path: K:\vms\_civil\069255700\_sky\_village\_south\069255700\_preliminary\_phases\_4\_5\plan\_sheets\PRELIMINARY\_PLAN\_SHEET.dwg This document, together with the concepts and designs presented herein, is intended only for the specific purpose and client for which it was prepared. Reuse of and improper reliance on this document without written authorization and adaptation by Kimley-Horn and Associates, Inc. shall be without liability to Kimley-Horn and Associates, Inc.

ADJACENT PROPERTY OWNERS MAILING ADDRESSES

BLOCK	LOT	TAX ID @ PARCEL @ PROPERTY ID	GEO ID	PROPERTY OWNER NAME	PROPERTY ADDRESS	CITY/STATE/ZIP	MAILING ADDRESS (IF DIFFERENT THAN THE PROPERTY ADDRESS)	MAILING CITY/STATE/ZIP
ABS 154	SUR 52	248124	0242800215	PARENT TONY ENTERPRISES INC	13550 OLD KIMBRO RD BLDG 1	MANOR TX 78653	13350 OLD KIMBRO RD BLDG 1	MANOR, TX 78653
ABS 154	SUR 52	705863	0242800277	SCHNEIDER BRIAN S	13550 OLD KIMBRO RD BLDG 2	MANOR, TX 78653	PO BOX 1303	ELGIN, TX 78621-8303
ABS 154	SUR 52	704715	0242800275	PEREZ DANIEL	13550 OLD KIMBRO RD BLDG 3	MANOR, TX 78653	12200 JOHNSON RD	MANOR, TX 78653
ABS 154	SUR 52	704712	0242800274	DUQUE STATES LLC	13550 OLD KIMBRO RD BLDG 4	MANOR, TX 78653	4868 E YAGER LN	MANOR, TX 78653
NAGLE J	LOT 1	248121	0242800212	FORESTAR USA REAL ESTATE GROUP	13354 OLD KIMBRO RD	MANOR, TX 78653	2221 E LAMAR BLVD STE 790	ARLINGTON, TX 76006
BLK A	LOT 2	500922	0242800265	JOHNSON CRAIG & TAMMY	BOIS D ARC LN	MANOR, TX 78653	13034 PARTRIDGE BEND DR	AUSTIN, TX 78729
ABS 456	SUR 64	442769	0242700310	DE LA LUZ EDUVIGES	14211 BOIS D ARC LN	MANOR, TX 78653	14211 BOIS DARC LANE	MANOR, TX 78653
ABS 456	SUR 64	460355	0242800254	RIOJAS MARIA	14217 BOIS D ARC LN	MANOR, TX 78613	14217 BOIS D ARC LN	MANOR, TX 78653-3814
ABS 456	SUR 64	460356	0242800255	SUAREZ ERNESTO	14121 BOIS D ARC LN	MANOR, TX 78653	14121 BOIS D ARC LN	MANOR, TX 78653
ABS 456	SUR 64	460357	0242800256	LANDEROS LETICIA C & JOSE J REVOCABLE TRUST	14315 BOIS D ARC LN	MANOR, TX 78653	14315 BOIS D ARC LN	MANOR, TX 78653
ABS 456	SUR 64	460358	0242800257	TELLO TIMOTHY & JESSICA ANDERSON	14409 BOIS D ARC LN	MANOR, TX 78653	900 BRISTOL CREEK BND	LAKEWAY, TX 78738
ABS 456	SUR 64	442776	0242800249	WHEAT PHILIP A & LILLIAN T	14425 BOIS D ARC LN	MANOR, TX 78653	14425 BOIS D ARC LN	MANOR, TX 78653
ABS 456	SUR 64	460351	0242800250	PHILIPS TAMMIE C	14515 BOIS D ARC RD	MANOR, TX 78653	14515 BOIS D ARC LN	MANOR, TX 78653
	LOT 5	500927	0242800270	PATRICK JOSHUA DAVID	14813 BOIS D ARC LN	MANOR, TX 78653	14809 BOIS D ARC LN	MANOR, TX 78653
ABS 456	SUR 64	248126	0242800217	PATRICK DAVID LEE	14817 BOIS D ARC LN	MANOR, TX 78653	14805 BOIS D ARC LN	MANOR, TX 78653
ABS 456	SUR 64	248145	0242800233	RODRIGUEZ ERNEST LEE	BOIS D ARC LN	MANOR, TX 78653	238 BEVERLY DRIVE	SAN ANTONIO, TX 78228-5141
ABS 456	SUR 64	248152	0242800239	UGARTE JOSE V & EVA BENITEZ	14831 BOIS D ARC LN 2	MANOR, TX 78653	14831 BOIS D ARC LN	MANOR, TX 78653
ABS 456	SUR 64	248149	0242800237	FRANCISCO DOMINGUEZ JAIMES	14831 BOIS D ARC LN 4	MANOR, TX 78754	11606 AUS TEX ACRES LN	MANOR, TX 78753
NAGLE J F ESTATES	LOT 3	477400	0242800263	FORESTAR USA REAL ESTATE GROUP	13354 OLD KIMBRO RD	MANOR, TX 78653	2221 E LAMAR BLVD STE 790	ARLINGTON, TX 76006-7458
ABS 456	SUR 64	460349	0241700317	NGUYEN TUAN & NHIEU NGUYEN	BOIS D ARC LN	MANOR, TX 78613	124 SNOWFLAKE DR	ROUND ROCK, TX 78664-4063
BLK A	LOT 100	952002	0241790137	FORESTAR REAL ESTATE GROUP INC	ALLEN SHIVERS STREET	MANOR, TX 78653	2221 E LAMAR BLVD STE 790	ARLINGTON, TX 76006-7458


BUILDING SETBACK DETAIL

SCALE: 1"=60'

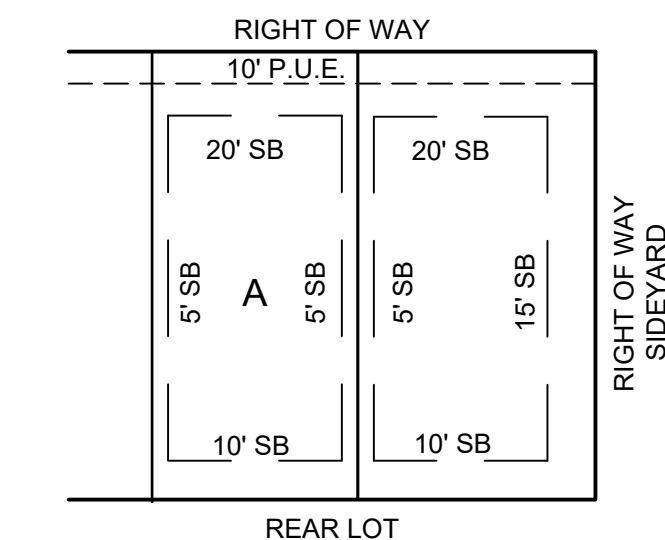


GENERAL NOTES


1. AN AERIAL PHOTOGRAPH MAY BE SUBMITTED AT THE PRELIMINARY PLAT STAGE RATHER THAN A TREE SURVEY.
2. AN INVENTORY OF SIGNIFICANT TREES THAT IDENTIFIES THE NUMBER OF SIGNIFICANT TREES BY CATEGORY (TREES 18 INCHES IN CALIPER OR LARGER AND TREES BETWEEN 8 AND 18 INCHES IN CALIPER) TO REMAIN DURING CONSTRUCTION AND THE NUMBER OF SIGNIFICANT TREES IN EACH CATEGORY DESIGNATED TO BE REMOVED DURING CONSTRUCTION SHALL BE SUBMITTED WITH CONSTRUCTION PLANS.
3. THE NUMBER OF REPLACEMENT TREES THAT WILL BE INSTALLED, WITHOUT THE IDENTIFICATION OF THE PARTICULAR LOCATION AT WHICH THE REPLACEMENT TREES SHALL BE INSTALLED, WILL BE SUBMITTED WITH FOR REVIEW WITH THE CONSTRUCTION PLANS, ON A PER PHASE BASIS.
4. SIGNIFICANT COTTONWOOD, HACKBERRY OR MESQUITE TREES REMOVED SHALL BE REPLACED AT A RATE OF 50% PER CALIPER INCH WITH AN APPROVED HARDWOOD TREE. ALL OTHER SIGNIFICANT TREES MUST BE REPLACED AT THE RATIOS DEFINED IN THE CITY'S SUBDIVISION ORDINANCE.
5. THE MINIMUM LOT AREA AND LOT WIDTH REQUIREMENTS (INCLUDING THE PERCENTAGE OF TOTAL LOTS WITHIN THE LAND PLAN THAT ARE PERMITTED TO BE OF SUCH MINIMUM LOT AREA AND LOT WIDTH CATEGORY), HEIGHT AND SETBACK REQUIREMENTS, LOT COVERAGE REQUIREMENTS, PARKING REQUIREMENTS, AND LANDSCAPING REQUIREMENTS FOR EACH LOT SHALL BE AS SET FORTH IN THE MINIMUM DEVELOPMENT STANDARDS FOR LOTS WITHIN THE LAND PLAN AND OUTSIDE THE CORPORATE BOUNDARIES OF THE CITY OR AS SET FORTH IN THE PUD VARIANCES FOR LOTS WITHIN THE PUD AND THE CORPORATE BOUNDARIES OF THE CITY.
6. LOTS SHALL NOT BE REQUIRED TO FACE A SIMILAR LOT ACROSS THE STREET.
7. SIDE LOT LINES SHALL NOT BE REQUIRED TO PROJECT AWAY FROM THE FRONT LOT LINE AT APPROXIMATELY RIGHT ANGLES TO STREET LINES AND RADIAL TO CURVED STREET LINES.
8. THE CONSTRUCTION OF SIDEWALKS IN RESIDENTIAL AND COMMERCIAL AREAS NEED NOT BE COMPLETED PRIOR TO FINAL APPROVAL AND ACCEPTANCE OF A FINAL PLAT, BUT MUST BE COMPLETED PRIOR TO THE ISSUANCE OF A CERTIFICATE OF OCCUPANCY OR WITHIN 2 YEARS FROM THE APPROVAL OF THE FINAL PLAT. A COST ESTIMATE FOR THE CONSTRUCTION OF ANY SIDEWALKS IN RESIDENTIAL AREAS NOT CONSTRUCTED PRIOR TO THE FINAL APPROVAL AND ACCEPTANCE OF THE FINAL PLAT SHALL BE PREPARED AND A BOND FOR 110% OF SUCH COSTS SHALL BE POSTED WITH THE CITY. EACH YEAR THE DEVELOPER AND CITY MAY AGREE TO THE ADDITIONAL SIDEWALKS IN RESIDENTIAL AREAS THAT WERE COMPLETED DURING THE PREVIOUS YEAR AND REDUCE THE AMOUNT OF THE BOND TO REFLECT THE CONSTRUCTION COSTS OF THE SIDEWALKS THAT HAVE BEEN COMPLETED. SIDEWALKS IN RESIDENTIAL AREAS NOT COMPLETED PRIOR TO THE END OF THE 2-YEAR PERIOD SHALL BE COMPLETED BY THE DEVELOPER OR BY THE CITY WITH THE BOND FUNDS. FAILURE TO PROVIDE SUFFICIENT BONDS OR COMPLETE THE SIDEWALKS IN RESIDENTIAL AREAS SHALL NOT OBLIGATE THE CITY TO BUILD SIDEWALKS. THE CONSTRUCTION OF SIDEWALKS IN NON-RESIDENTIAL AREAS SHALL BE COMPLETED DURING SUBDIVISION CONSTRUCTION.
9. THE MINIMUM SINGLE-FAMILY RESIDENTIAL LOT SHALL BE 6,250 SQUARE FEET WITHIN PUD-SF-1, AND 3300 SQUARE FEET WITHIN PUD-MEDIUM DENSITY.
10. LOT FRONTAGE WIDTHS OF PUD SF-1 SHALL BE AS FOLLOWS:
  - 10.1. ALL LOTS EXCEPT THOSE IN CUL-DE-SACS OR ALONG A CURVED ROADWAY TO HAVE A MINIMUM FRONTAGE OF NO LESS THAN 50 FEET.
  - 10.2. LOTS ALONG CUL-DE-SACS AND CURVED ROADWAY TO HAVE A MINIMUM FRONTAGE OF NO LESS THAN 30 FEET AT THE RIGHT OF WAY, AND 50' WIDE FRONTAGE MEASURED AT THE PROPERTY SETBACK LINE.
11. SINGLE-FAMILY RESIDENTIAL LOTS HAVE A MINIMUM SIDE SET BACK OF FIVE (5) FEET FOR EACH LOT.
12. SINGLE-FAMILY RESIDENTIAL LOTS HAVE A MINIMUM REAR SET BACK OF TEN (10) FEET FOR EACH LOT.
13. OFF-STREET PARKING SPACES AND LOADING FACILITIES FOR THE COMMERCIAL TRACTS HAVE BEEN CONTEMPLATED AND WILL MEET CITY OF MANOR'S PARKING CALCULATION TABLES REQUIREMENTS.
14. EXISTING SITE TOPOGRAPHY CONTAINS RELATIVELY FLAT SLOPES RANGING FROM 1% TO 5%. PROPOSED ROADWAY GRADES WILL BE SUITABLE FOR EMERGENCY ACCESS AND WILL MEET CITY OF AUSTIN TRANSPORTATION CRITERIA MANUAL AND EMERGENCY SERVICE DISTRICT 12 REQUIREMENTS.
15. LANDSCAPING AND SCREENING WILL BE INTEGRATED INTO THE FINAL OVERALL SITE DESIGN AND WILL BE PROVIDED TO CREATE ADEQUATE BUFFERS TO SHIELD LIGHTS, NOISE, MOVEMENT OR ACTIVITIES FROM ADJACENT PROPERTIES.
16. NO DUPLEXES ARE ALLOWED IN THIS PUD.
17. THE DEVELOPMENT WILL BE IN ACCORDANCE WITH THE ENVIRONMENTAL ASSESSMENT FOR THE SITE.
18. MINIMUM ON-SITE PARKING REQUIREMENTS FOR PUD MEDIUM DENSITIES SHALL BE TWO SPACES FOR EACH LIVING UNIT AND ONE-HALF SPACE FOR EACH ADDITIONAL BEDROOM ABOVE TWO PLUS 10% ADDITIONAL SPACES FOR VISITOR PARKING. TANDEM SPACES ARE ALLOWABLE. OFF-SITE PARKING TO MEET THIS PARKING REQUIREMENT IS SUBJECT TO APPROVAL BY THE CITY DEVELOPMENT SERVICES DEPARTMENT.
19. ALL RESIDENTIAL HOMES WITHIN THIS PUD WILL FOLLOW THE DESIGN STANDARDS THAT ARE AGREED UPON BETWEEN THE DEVELOPER AND CITY OF MANOR.
20. THERE WILL BE A (4) FOUR HOUR MAXIMUM TIME LIMIT FOR THE PARKING ON RESIDENTIAL STREETS.
21. PUBLIC TRAILS SHOWN ALONG FLOODPLAIN, CITY PARKLAND, AND OPEN SPACE SHALL BE A MINIMUM OF 8' WIDE AND SHALL BE COMPOSED OF A COMBINATION OF DECOMPOSED GRANITE AND CONCRETE DEPENDING ON SITE CONDITIONS AT TRAIL LOCATIONS.
22. REQUIRED MINIMUM MASONRY REQUIREMENTS ARE PER THE DEVELOPMENT AGREEMENT DATED NOVEMBER 7, 2018, AS MAY BE AMENDED.
23. HOUSE PLANS SUBMITTED TO THE CITY SHALL BE STAMPED OR INDICATED BY LETTER OF TRANSMITTAL (OR SIMILAR LANGUAGE) THAT THE ARCHITECTURAL REVIEW COMMITTEE (ARC) HAS REVIEWED AND APPROVED THE HOUSE PLANS AS COMPLYING WITH THE PUD ARCHITECTURAL DESIGN REQUIREMENTS FOR CITY REVIEW.
24. LOTS UNDER THE PUD MEDIUM DENSITY CATEGORY SHALL BE ALLEY LOADED WHEN THE PROPOSED FRONT YARD SETBACK IS 10 FEET.

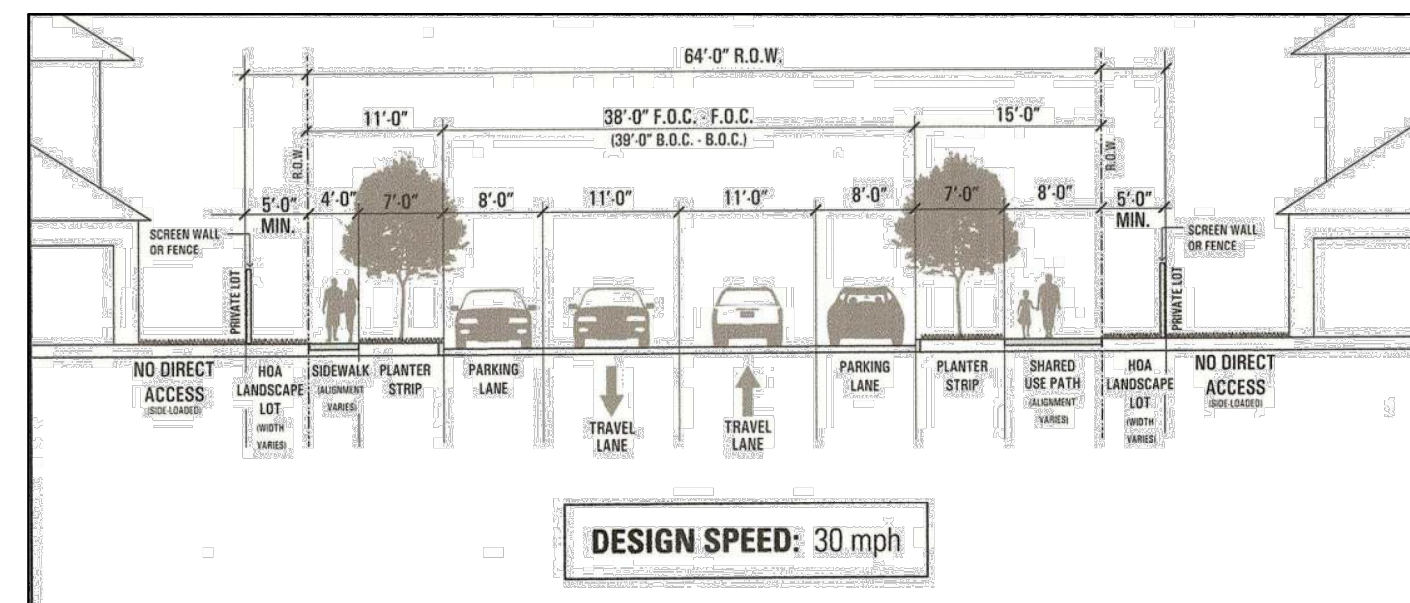


PRIMARY COLLECTOR (WITH SF-1 FRONTAGE)

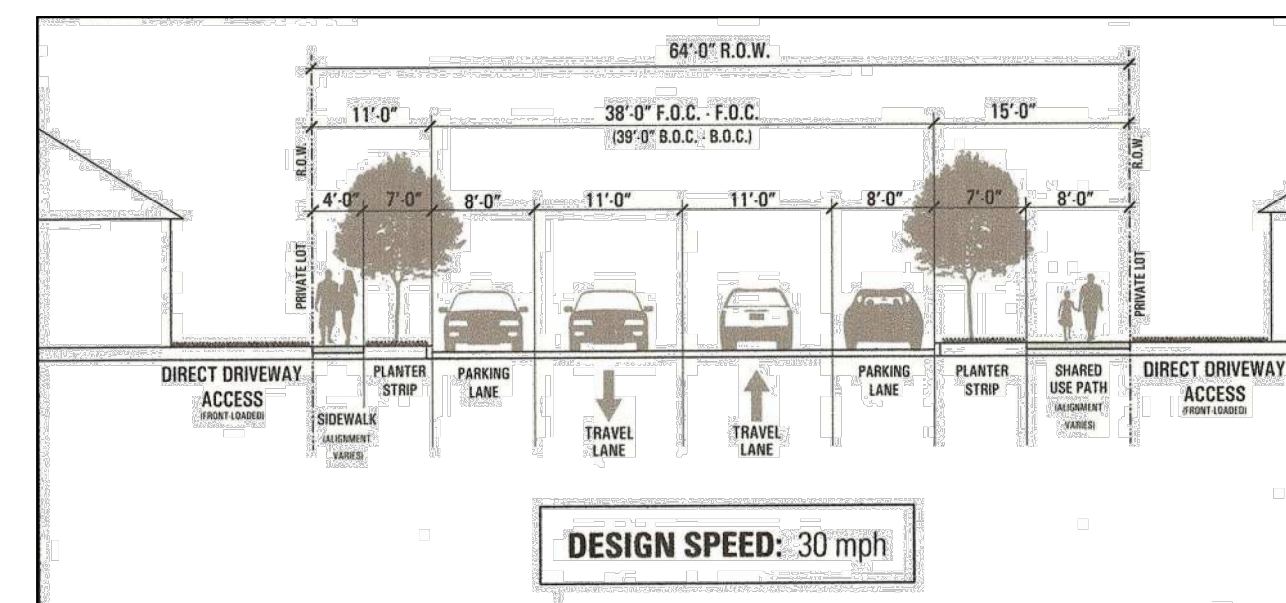

PRIMARY COLLECTOR (WITH SF-1 FRONTAGE)

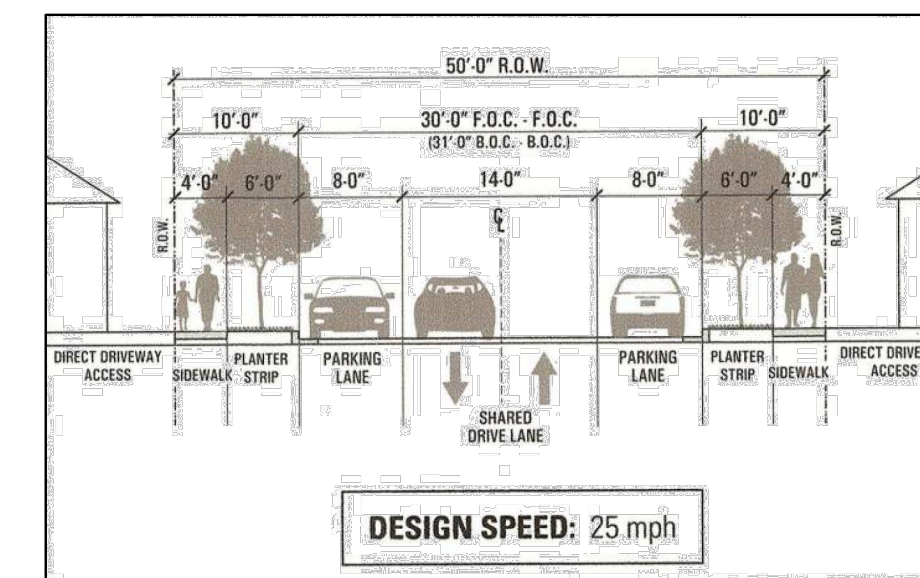

STANDARD RESIDENTIAL ROADWAY SECTION

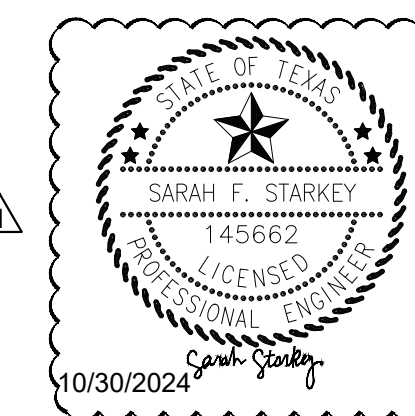

NO.	REVISIONS	DATE	BY



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 WWW.KIMLEY-HORN.COM  
 TEXAS REGISTERED ENGINEERING FIRM F-928

6/23/2021  
 KHA PROJECT 069255700  
 DATE JUNE 2021  
 SCALE AS SHOWN  
 DESIGNED BY: CBM  
 DRAWN BY: RJ  
 CHECKED BY: JR

PRELIMINARY PLAN (SHEET 1 OF 5)



MANOR HEIGHTS PHASES 4 & 5  
 CITY OF MANOR  
 TRAVIS COUNTY, TEXAS

Plotted By: Cuplin, Warren Date: October 30, 2024 01:33:43pm File Path: \\nas-civil\069255700-sky\_village\_south\069255700-preliminary\069255700-preliminary-plan-sheet.dwg  
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**LEGEND**

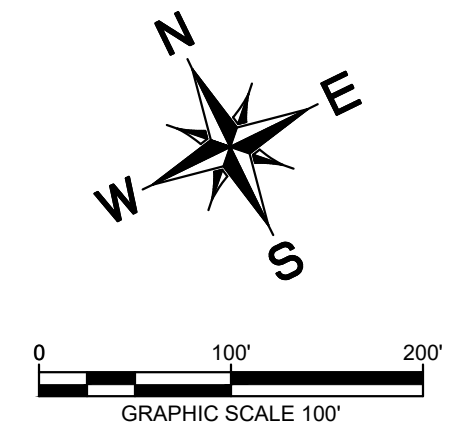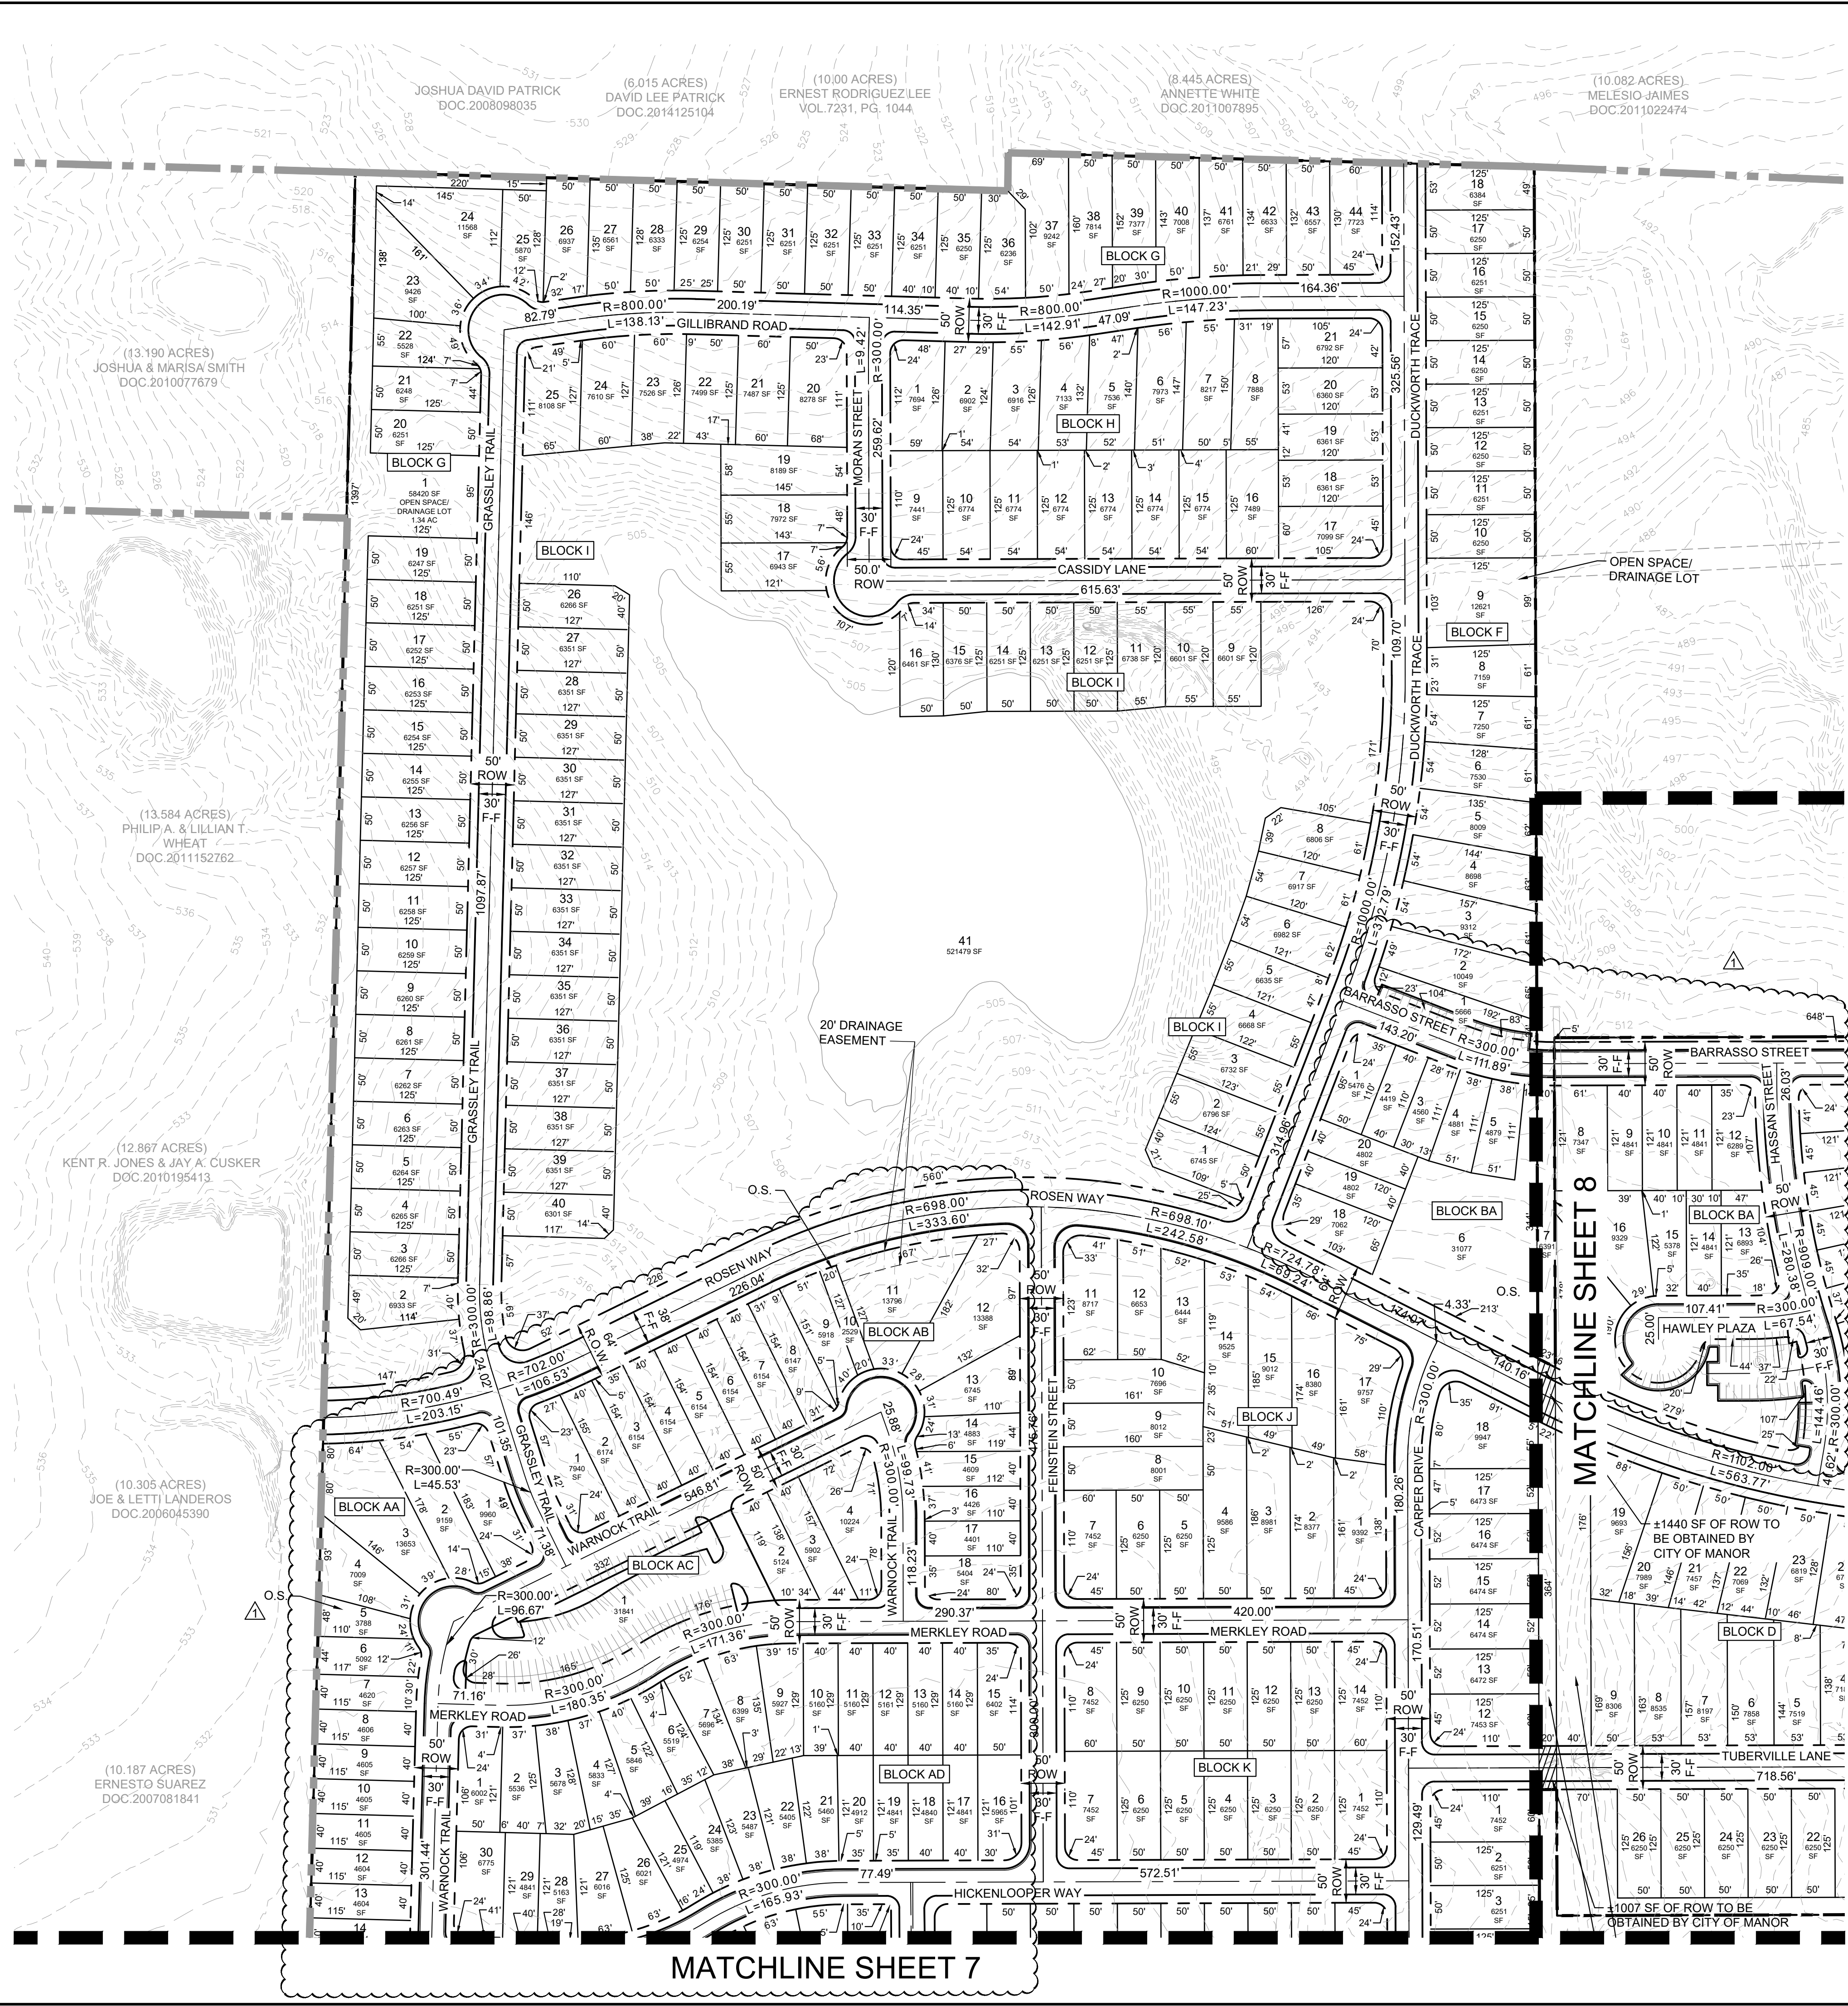- EXISTING PROPERTY BOUNDARY
- PROPOSED PROPERTY BOUNDARY
- PHASE LINE
- PROPOSED SIDEWALK
- EXISTING 100-YEAR FLOODPLAIN
- PROPOSED 100-YEAR FLOODPLAIN
- PROPOSED EASEMENT
- OFFSITE EASEMENT
- PROPOSED ROAD CENTERLINE
- EXISTING CONTOUR
- ROW TO BE OBTAINED BY THE CITY OF MANOR



- NOTES:**
1. SEE SHEET 4 FOR LINE AND CURVE TABLES.
  2. ALL PAVEMENT DIMENSIONS ARE TO THE FACE OF CURB.

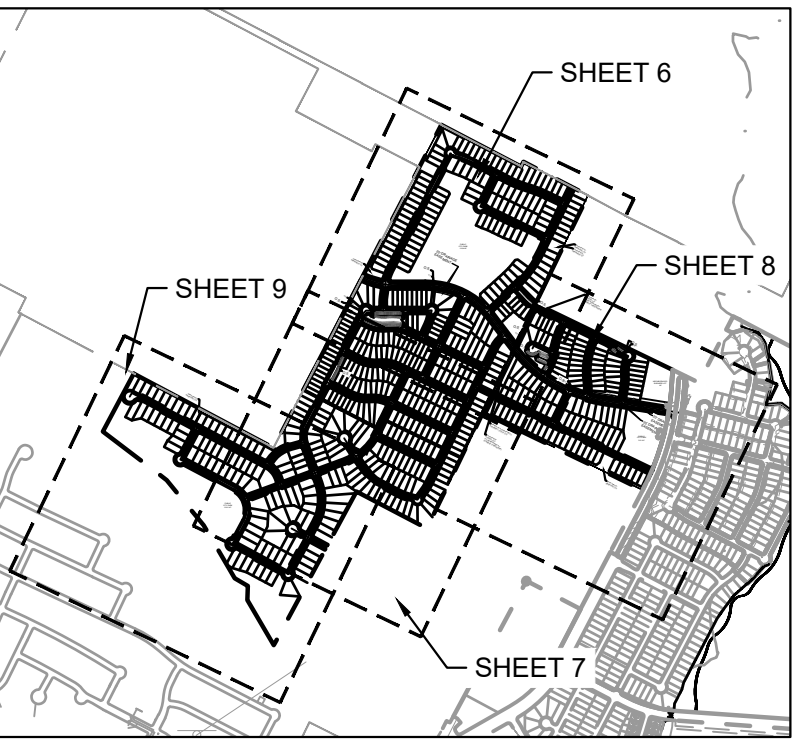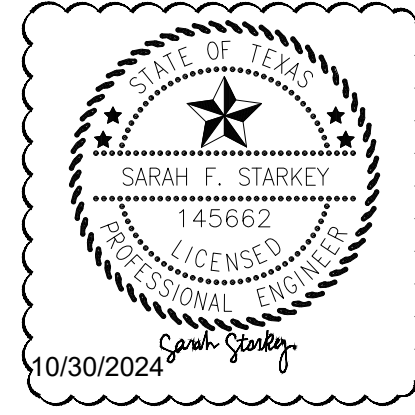NO.	REVISIONS	DATE

**Kimley-Horn**

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TEXAS REGISTERED ENGINEERING FIRM F-928

KHA PROJECT	069255700
DATE	JUNE 2021
SCALE	AS SHOWN
DESIGNED BY	CEM
DRAWN BY	RJ
CHECKED BY	JR

**PRELIMINARY PLAN**  
**(SHEET 2 OF 5)**


**MANOR HEIGHTS**  
**PHASES 4 & 5**  
 CITY OF MANOR  
 TRAVIS COUNTY, TEXAS

Plotted By: Cuplin, Warren Date: October 30, 2024 01:33:53pm File Path: \\nas-civil\069255700-sky\_village\_south\Cad\preliminary\_phases\_4-5\plan\preliminary\_Plan\_SHEET.dwg  
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MATCHLINE SHEET 9





MATCHLINE SHEET 8

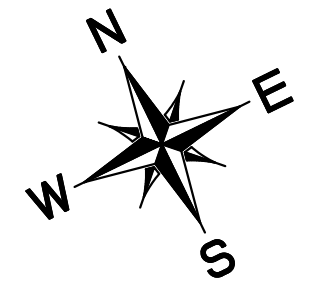

0 100' 200'  
GRAPHIC SCALE 100'

LEGEND

	EXISTING PROPERTY BOUNDARY
	PROPOSED PROPERTY BOUNDARY
	PHASE LINE
	PROPOSED SIDEWALK
	EXISTING 100-YEAR FLOODPLAIN
	PROPOSED 100-YEAR FLOODPLAIN
	PROPOSED EASEMENT
	OFFSITE EASEMENT
	PROPOSED ROAD CENTERLINE
	EXISTING CONTOUR
	ROW TO BE OBTAINED BY THE CITY OF MANOR

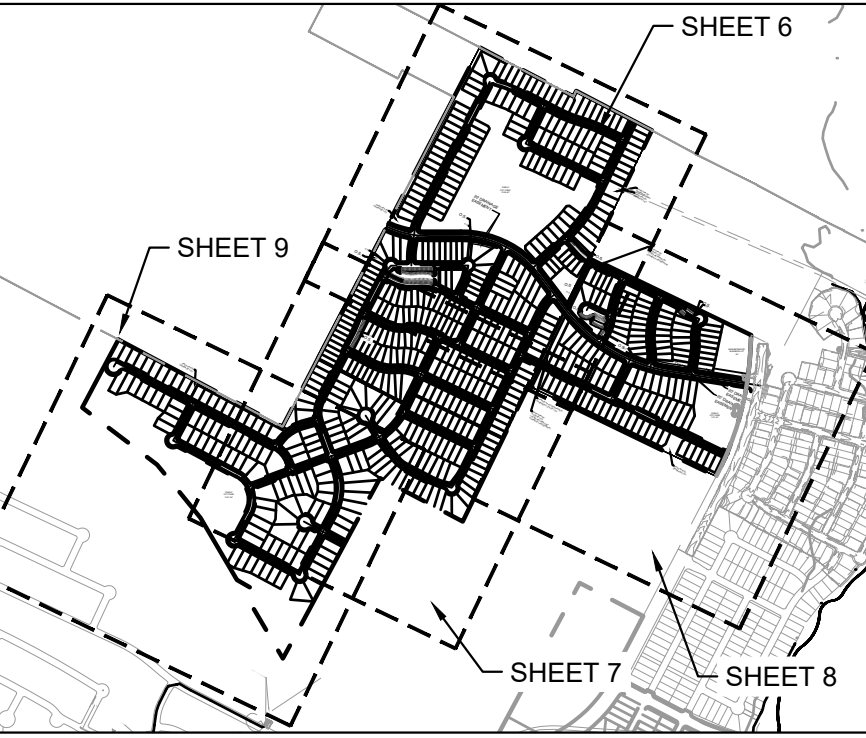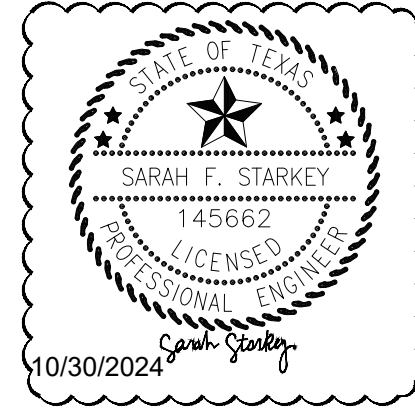

- NOTES:
- SEE SHEET 4 FOR LINE AND CURVE TABLES.
  - ALL PAVEMENT DIMENSIONS ARE TO THE FACE OF CURB.

NO.	REVISIONS	DATE	BY
1	ADDED MEDIUM DENSITY LOTS	10/30/2024	JS/S

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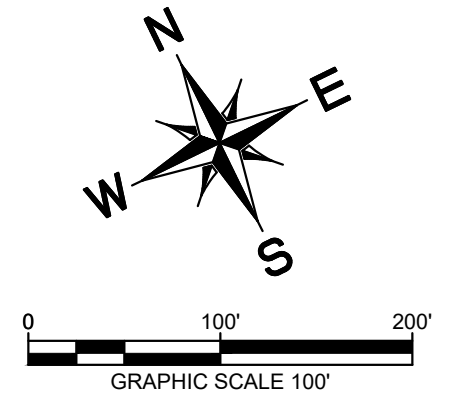
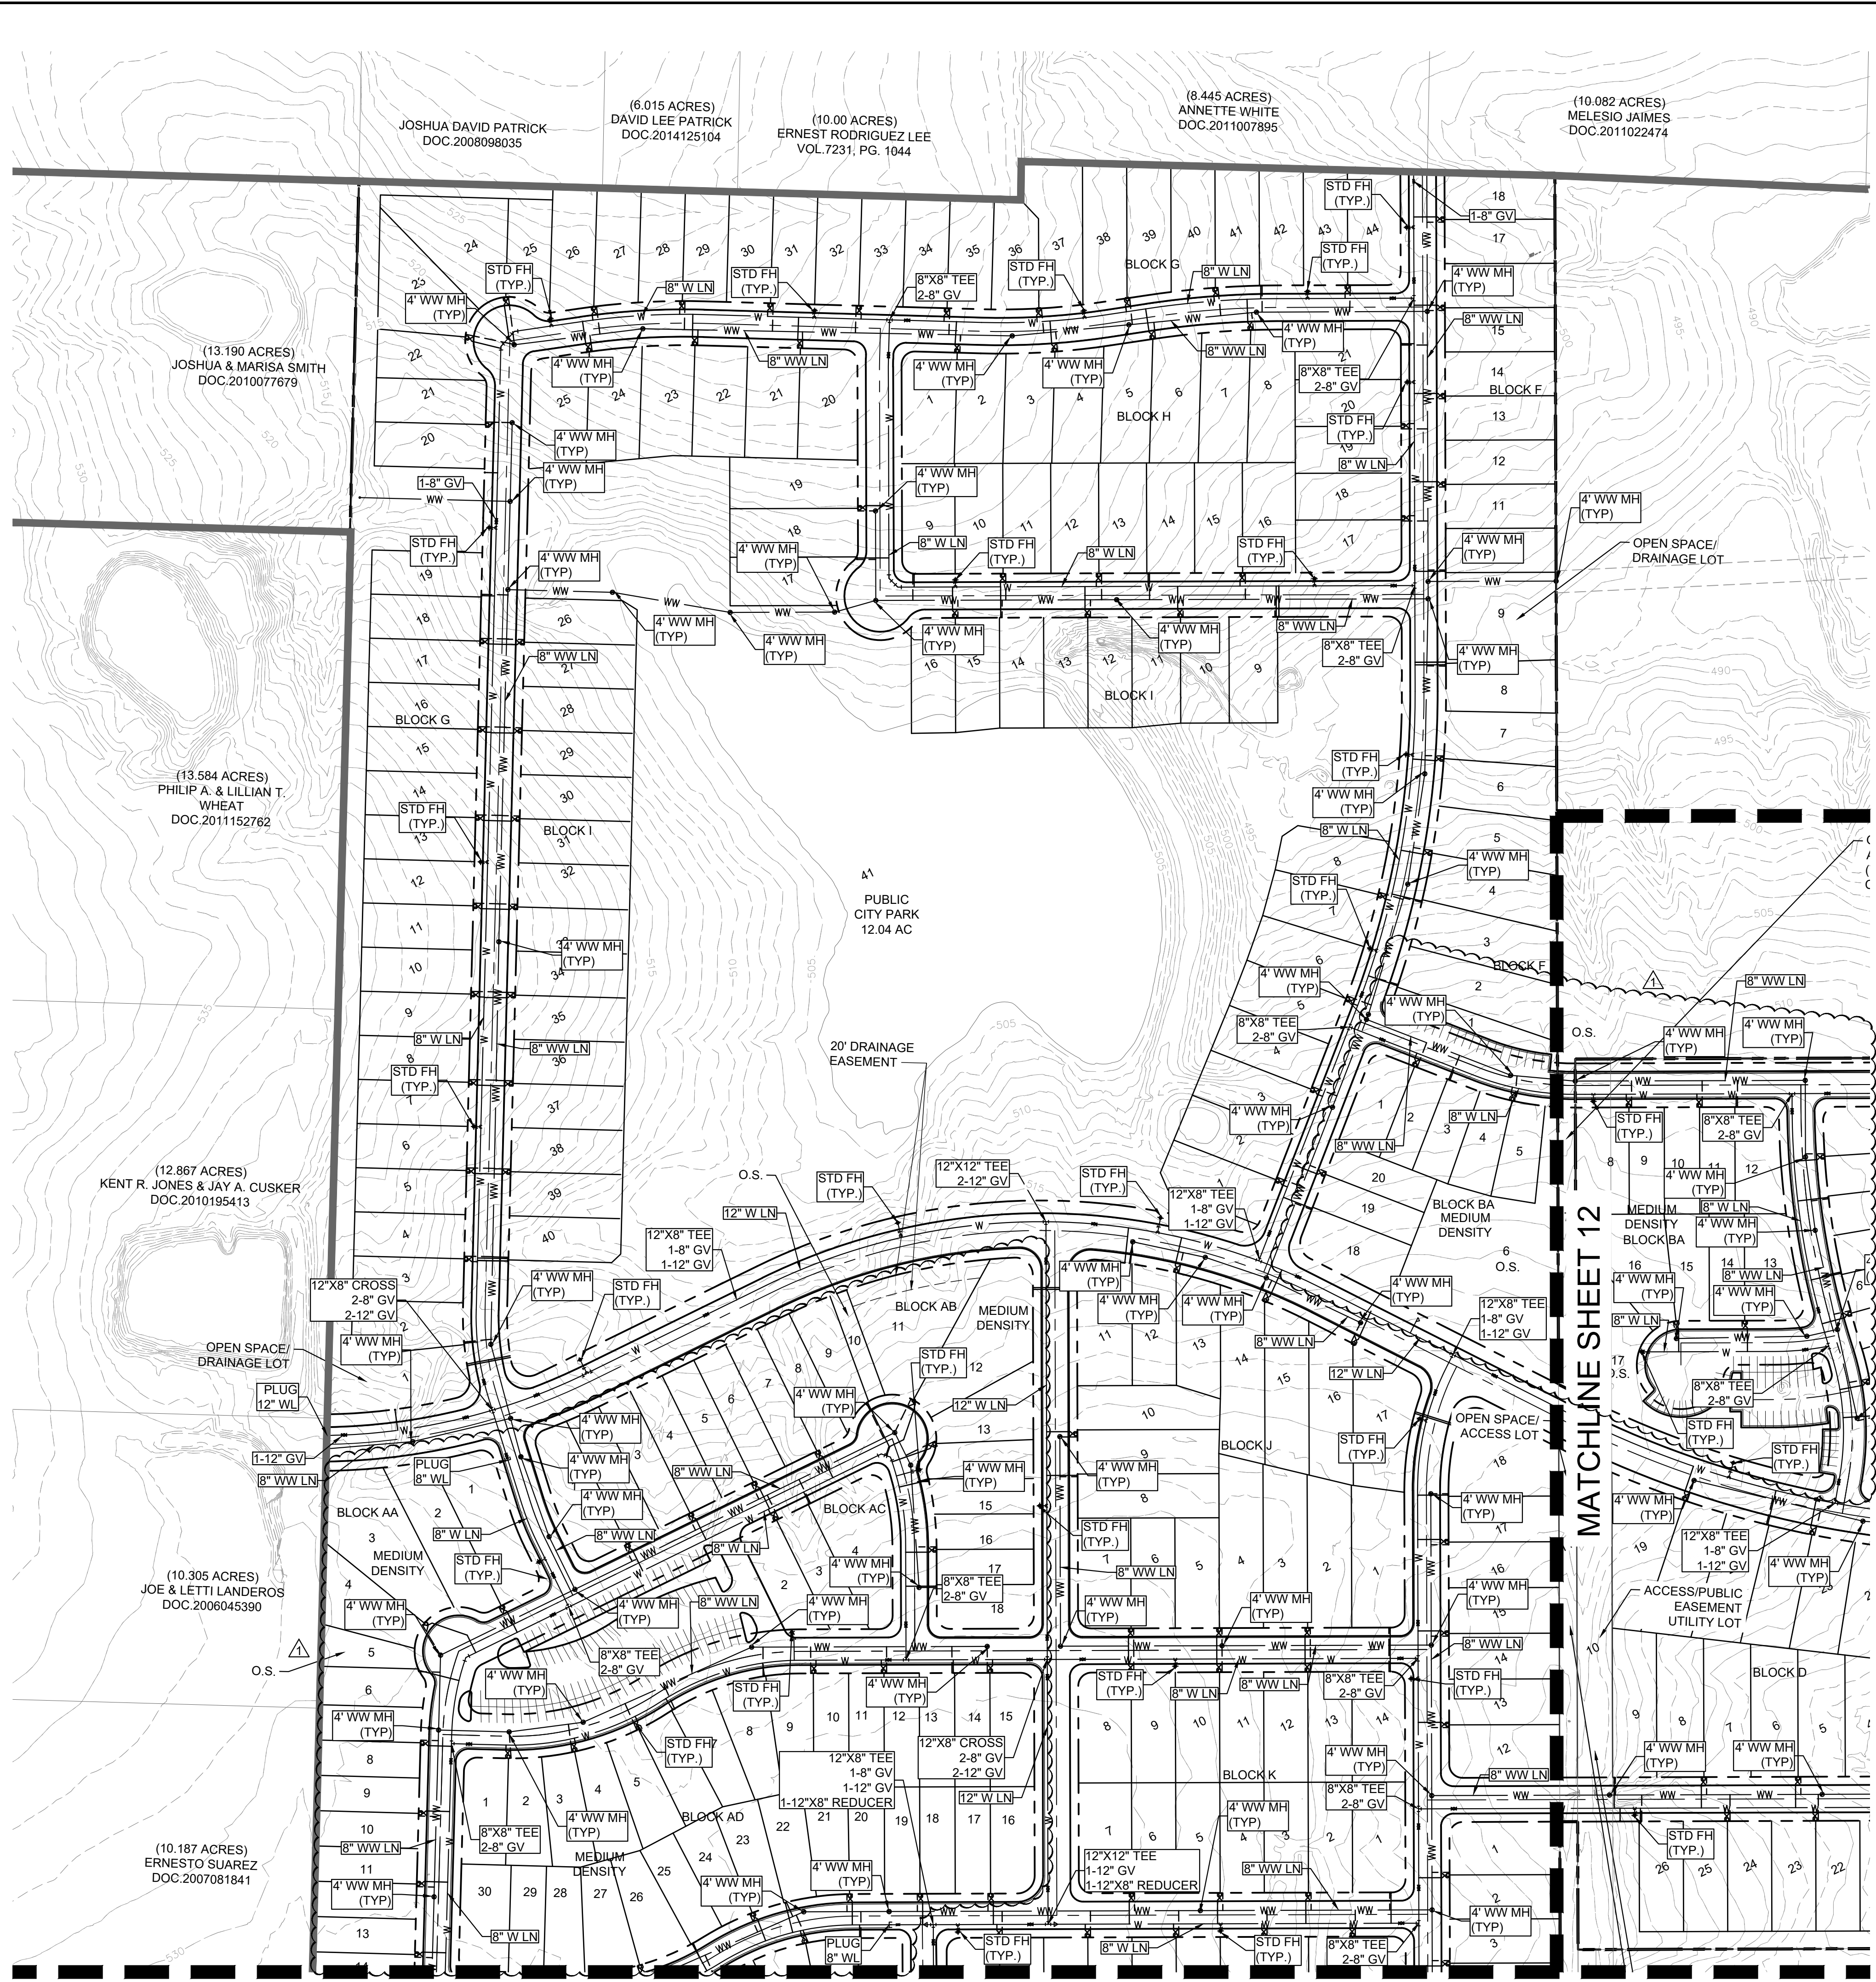
6/23/2021  
 KHA PROJECT 069255700  
 DATE JUNE 2021  
 SCALE: AS SHOWN  
 DESIGNED BY: CBM  
 DRAWN BY: RJ  
 CHECKED BY: JR

PRELIMINARY PLAN  
(SHEET 3 OF 5)

MANOR HEIGHTS  
PHASES 4 & 5  
CITY OF MANOR  
TRAVIS COUNTY, TEXAS




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UTILITY LEGEND	
	PROPERTY LINE
	PROPOSED WASTE WATER LINE
	PROPOSED WATER LINE
	PROPOSED WASTE WATER MANHOLE
	PROPOSED WASTE WATER CLEANOUT
	WASTE WATER FLOW DIRECTION
	PROPOSED FIRE HYDRANT
	PROPOSED TAPPING SLLEEVE & VALVE
	IRRIGATION SLEEVE
	EXISTING OVERHEAD POWER LINE
	EXISTING WATER LINE
	EXISTING WASTE WATER LINE
	EXISTING STORM SEWER LINE
	EXISTING POWER POLE
	EXISTING FIRE HYDRANT
	EXISTING WATER METER
	EXISTING WASTE WATER MANHOLE

LUE TABLE			
Phase	Type	LUE	Area (Acres)
Phases 4-5	SF	456	172.14
	Medium Density	170	
	NB	20.62	
	Irrigation	3	
Total Water		649.62	
Total Wastewater		646.62	
*Irrigation LUE not included in wastewater demand			



**MANOR HEIGHTS PHASES 4 AND 5  
WASTEWATER CAPACITY CALCULATIONS**

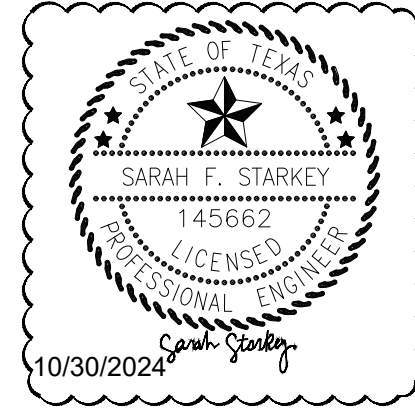**Design Criteria**

**Project Data**  
 Development Size = 172.14 Acres  
 Units = Units  
 LUE/Unit =

**Population:**

	LUE's	People per LUE	Total Pop.
MD	456	3.5	1,596.0
SF-1	170.00	3.5	595.00
<b>Total</b>	<b>691.19</b>		<b>2,191.00</b>

**Data from City of Austin Utility Criteria Manual**  
 Wastewater Generation = 70 Gal/Person/Day  
 Inflow and Infiltration = 750 Gal/Acre/Day

**Calculations**  
 Total Avg Dry Weather Flow (F) = 153,370 Gal/day or 106.51 gpm  
 Peaking Factor (Mp) = 3.55 Unitless  

$$Mp = \frac{18 + (0.0206 * F)^{0.5}}{4 + (0.0206 * F)^{0.5}}$$
  
 Min. Flow Factor (Mm) = 0.22 Unitless  

$$Mm = 0.2 * (0.0144 * F)^{0.158}$$

**Minimum Dry Weather Flow** - 33,384.66 Gal/day or 23.18 gpm = 0.05 cfs  
**Peak Dry Weather Flow** - 545,103 Gal/day or 378.54 gpm = 0.84 cfs  
**I&I Contribution** - 129,105 Gal/Day or 89.66 gpm = 0.20 cfs  
**Total Peak Wet Weather Flow** - 674,208 Gal/Day or 468.20 gpm = 1.04 cfs  
**8" PVC Max flow at 0.5%** - 652,635 Gal/Day or 453.22 gpm = 1.01 cfs

**MANOR HEIGHTS PHASES 4 AND 5  
WATER CAPACITY CALCULATIONS**

**Population:**

	LUE's	People per LUE	Total Pop.
SF-1	626.00	3.5	2,191.00
<b>Total</b>			<b>2,191.00</b>


**Data from City of Austin Utility Criteria Manual**  
 Peak hour demand = 900 Gal/Person/Day = 0.00139 cfs

**Calculations**  
 Total Peak Hour Demand = 1,971,900 Gal/Day or 1,369.38 gpm = 3.051 cfs

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**UTILITY PLAN  
(SHEET 1 OF 4)**

**MANOR HEIGHTS  
PHASES 4 & 5  
CITY OF MANOR  
TRAVIS COUNTY, TEXAS**


MATCHLINE SHEET 11

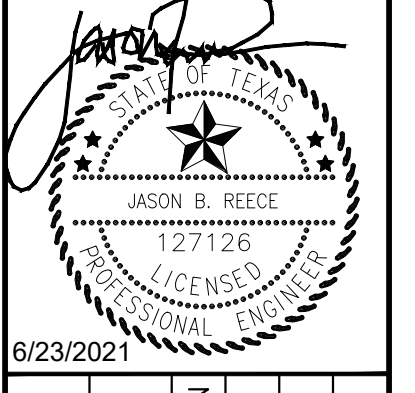MATCHLINE SHEET 12





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	EXISTING WASTE WATER LINE
	EXISTING STORM SEWER LINE
	EXISTING POWER POLE
	EXISTING FIRE HYDRANT
	EXISTING WATER METER
	EXISTING WASTE WATER MANHOLE

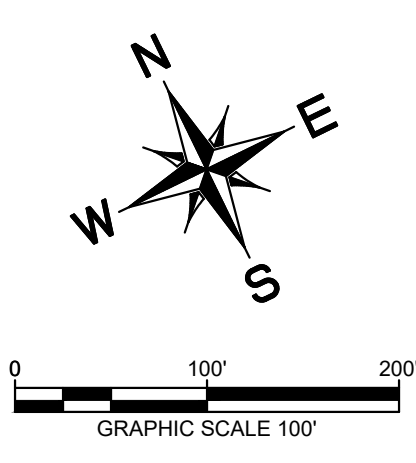

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 TEXAS REGISTERED ENGINEERING FIRM F-928

KHA PROJECT	069255700
DATE	JUNE 2021
SCALE	AS SHOWN
DESIGNED BY	CBM
DRAWN BY	RJ
CHECKED BY	JR

**UTILITY PLAN  
(SHEET 3 OF 4)**


**MANOR HEIGHTS  
PHASES 4 & 5**  
 CITY OF MANOR  
 TRAVIS COUNTY, TEXAS

SHEET NUMBER  
**12**




Plotted By: Cuplin, Warren Date: October 30, 2024 01:40:59pm File Path: \\nas-civil\069255700-sky\_village\_south\069255700-preliminary-phases\_4-5\stormwater\inlet\drainage\_area\map.dwg  
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MATCHLINE SHEET 18

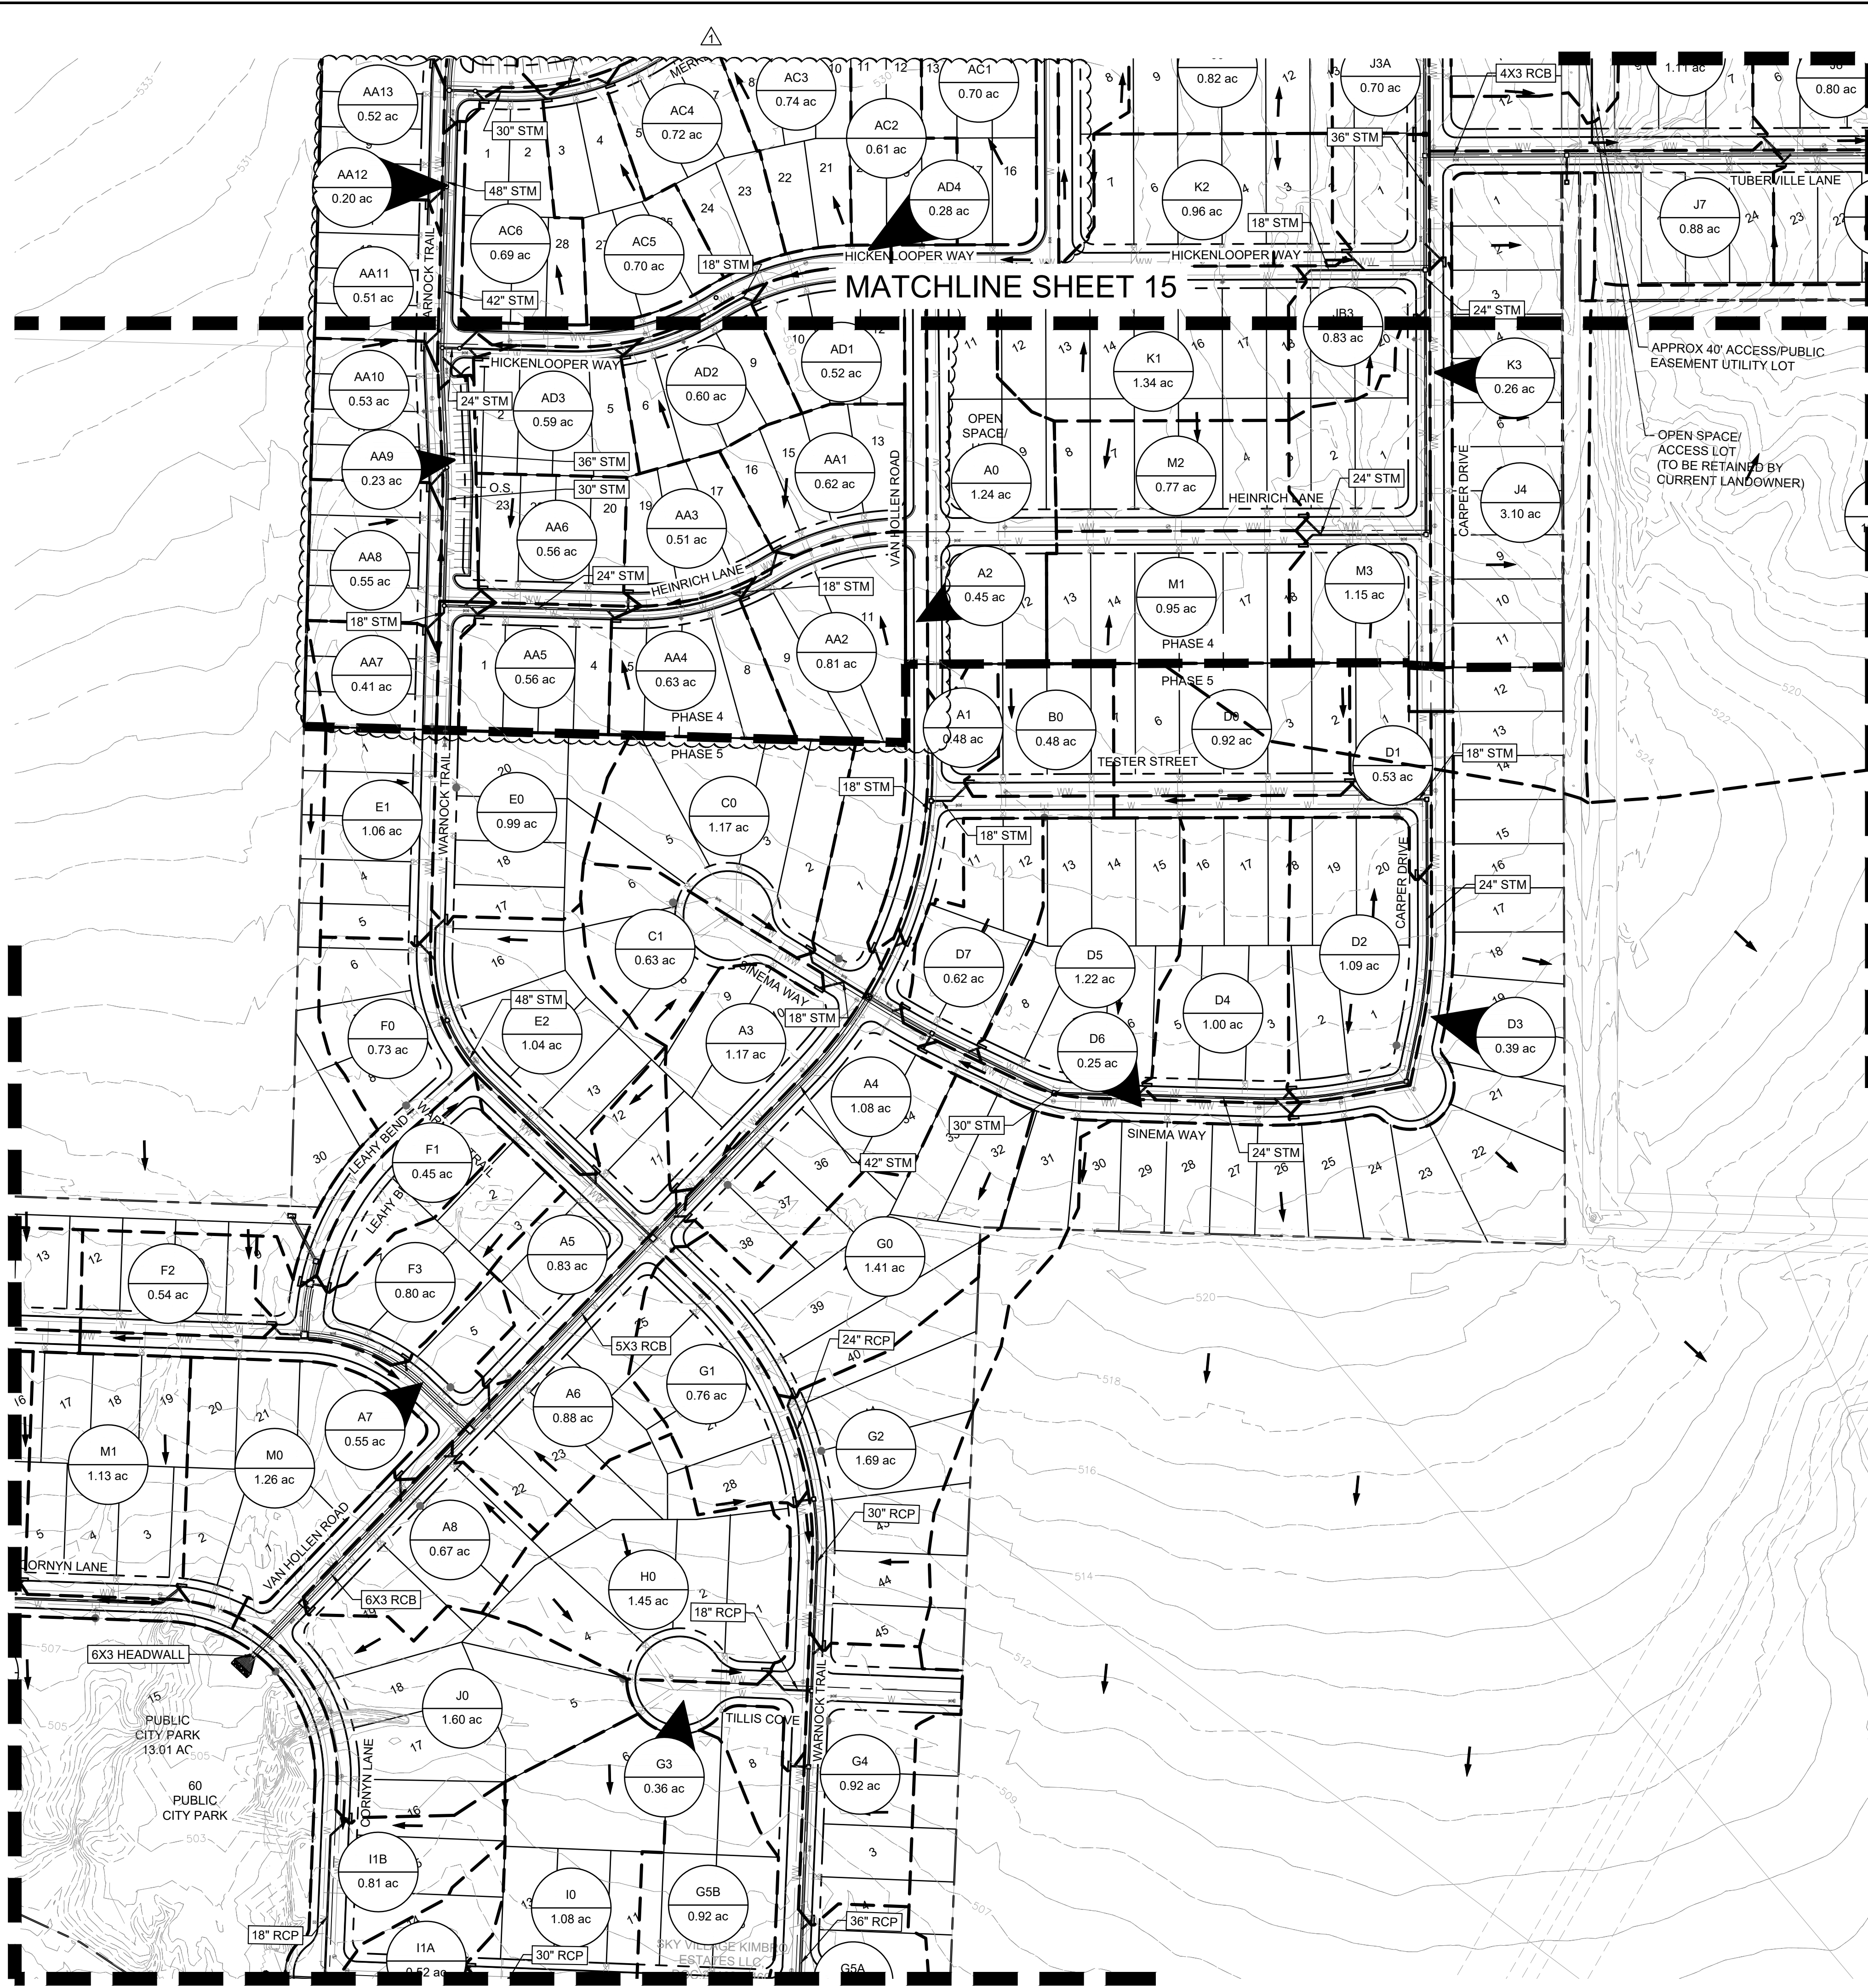


MATCHLINE SHEET 17

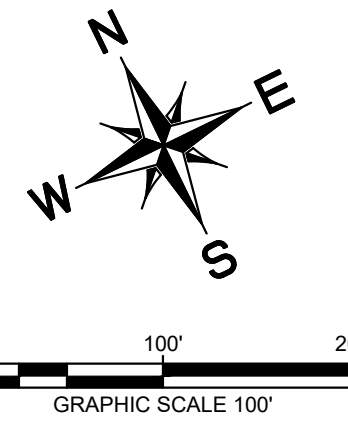

**LEGEND**


- X-1  
9.9 ac AREA DESIGNATOR  
AREA IN ACRES
- PROPERTY LINE
- PROPOSED STORM DRAIN LINE
- - - EXISTING STORM DRAIN LINE
- - - PROPOSED DRAINAGE DIVIDE
- PROPOSED STORM DRAIN INLET
- PROPOSED STORM DRAIN MANHOLE
- PROPOSED FLOW DIRECTION
- PROPOSED STORM DRAIN HEADWALL
- PROPOSED FLOW DIRECTION
- EXISTING CONTOUR
- EXISTING CONTOUR
- To FLOWPATH

NOTE: REFER TO DRAINAGE CALCULATIONS SHEET 19 FOR CALCULATIONS.

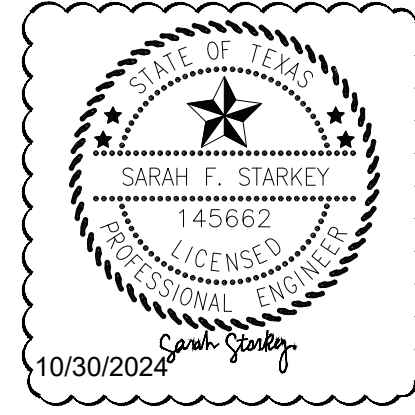

NO.	REVISIONS	DATE	BY

**Kimley-Horn**  
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 10814 JOLLYVILLE ROAD, AVALLON IV, SUITE 200, AUSTIN, TX 78759  
 PHONE: 512-418-1771 FAX: 512-418-1791  
 WWW.KIMLEY-HORN.COM  
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**INLET DRAINAGE AREA  
 MAP (SHEET 2 OF 4)**

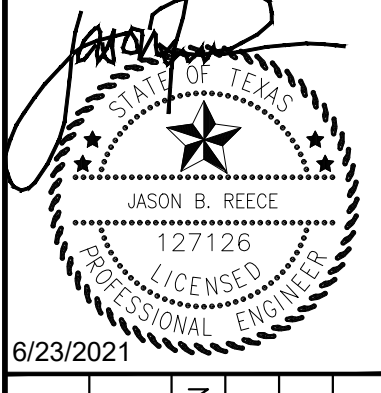**MANOR HEIGHTS  
 PHASES 4 & 5  
 CITY OF MANOR  
 TRAVIS COUNTY, TEXAS**



