

## TOWN OF LOS GATOS HISTORIC PRESERVATION COMMITTEE REPORT

MEETING DATE: 03/26/2024

ITEM NO: 3

DATE: March 21, 2025

TO: Historic Preservation Committee

FROM: Joel Paulson, Community Development Director

SUBJECT: Consider a Request for Approval to Modify Planned Development Ordinance

2025 to Allow Modifications to Building E, an Architecture and Site

Application for Exterior Modifications to an Existing Commercial Building in the University/Edelen Historic District, and a Conditional Use Permit for Formula Retail over 10,000 square feet and for a Restaurant with Alcohol Service on a Property Zoned C-2:LHP:PD. Located at 31 University Avenue. APN 529-02-044. Planned Development Modification PD-25-001, Architecture

and Site Application S-25-004, and Conditional Use Permit U-25-001. Categorically Exempt Pursuant to CEQA Guidelines Section 15301: Existing Facilities. Property Owner: SRI Old Town, LLC. Applicant: Rick Nelson, MBH

Architects. Project Planner: Erin Walters.

#### **RECOMMENDATION:**

Consider a request for approval for exterior modifications to an existing commercial building, Building E in the Old Town Los Gatos Shopping Center in the University/Edelen Historic District on property zoned C-2:LHP:PD, located at 31 University Avenue.

#### **BACKGROUND:**

On February 26, 2025, the Committee considered the request, discussed the item, and continued the item to a meeting date certain with the following feedback (Attachment 5):

- Although the proposed design is a Mediterranean style, it is not as compatible with the
  existing Old Town buildings; and not consistent with the Planned Development or the
  character of the University/Edelen Historic District;
- The design should convey a collective of individual structures rather than one consistent and symmetrical mass;
- Consider the addition of tile roofing material; and
- Consider the visual impact of the skylight from all elevations.

PREPARED BY: Erin M. Walters

Senior Planner

110 E. Main Street Los Gatos, CA 95030 ● 408-354-6874

www.losgatosca.gov EXHIBIT 12

PAGE 2 OF 4

SUBJECT: 31 University Avenue/PD-25-001, S-25-004 and U-25-001

DATE: March 21, 2025

#### **DISCUSSION:**

The applicant considered the Committee's direction and has decided to not modify the proposed exterior modifications and has provided a response letter (Attachment 6).

The applicant proposes to modify the exterior of Building E to establish more cohesive architecture for the future single tenant of the building (Attachment 7). Exterior modifications would be made to all four elevations and include:

- Roof alterations creating consistent and symmetrical massing;
- Changes to window and door shapes, integrating arched, and rectangular fenestration;
- New fabric awnings and metal and glass canopy awnings;
- A new skylight; and
- New stucco siding.

A color and materials sheet showing the proposed finishes of the new exterior materials is included on A406 in the Development Plans included as Attachment 7.

#### **CONCLUSION:**

The applicant is seeking a recommendation from the Committee for exterior modifications to Building E. (Attachment 7). Should the Committee find merit in the request, the Committee should forward a recommendation of approval for the request to the Planning Commission. The application package would continue through the discretionary review process and would not return to the Committee.

#### **CONSIDERATIONS:**

A. Considerations Required with Recommendation

In evaluating applications, the deciding body shall consider the architectural style, design, arrangement, texture, materials and color, and any other pertinent factors. Applications shall not be granted unless:

In historic districts, the proposed work will neither adversely affect the exterior architectural characteristics or other features of the property which is the subject of the application, nor adversely affect its relationship, in terms of harmony and appropriateness, with its surroundings, including neighboring structures, nor adversely affect the character, or the historical, architectural or aesthetic interest or value of the district.

#### PAGE **3** OF **4**

SUBJECT: 31 University Avenue/PD-25-001, S-25-004 and U-25-001

DATE: March 21, 2025

#### **ATTACHMENTS**:

#### Previously distributed with the February 26, 2025, Staff Report:

- 1. Planned Development Ordinance 2025
- 2. Applicant's Request and Letter of Justification
- 3. Development Plans

#### Previously received with the February 26, 2025, Desk Item Report:

4. Existing and Proposed Building Elevations

#### **Received with this Staff Report:**

- 5. HPC Action Letter, February 26, 2025
- 6. Response Letter
- 7. Development Plans

This Page Intentionally Left Blank



#### **TOWN OF LOS GATOS**

COMMUNITY DEVELOPMENT DEPARTMENT PLANNING DIVISION (408) 354-6872 Fax (408) 354-7593

CIVIC CENTER 110 E. MAIN STREET LOS GATOS, CA 95030

February 26, 2025

Rick Nelson, MBH Architects Via email

RE: 31 University Avenue

Planned Development Modification PD-25-001 Architecture and Site Application S-25-004 Conditional Use Permit U-25-001

Requesting Approval for Modification of Planned Development Ordinance to Allow Modifications to Building E, an Architecture and Site Application for Exterior Modifications to an Existing Commercial Building in the University/Edelen Historic District, and a Conditional Permit for Formula Retail over 10,000 square feet and for a Restaurant with Alcohol Service on a Property Zoned C-2:LHP:PD. APN 529-02-044. Categorically Exempt Pursuant to CEQA Guidelines Section 15301: Existing Facilities.

Property Owner: SRI Old Town, LLC. Applicant: Rick Nelson, MBH Architects.

Project Planner: Erin Walters.

On February 26, 2025, the Los Gatos Historic Preservation Committee considered the request, discussed the item, and continued the application to a meeting date certain of March 26, 2025, with the following feedback:

- Although the proposed design is a Mediterranean style, it is not as compatible with the existing Old Town buildings; it is not consistent with the Planned Development; or the character of the University/Edelen Historic District;
- The design should convey a collective of individual structures rather than one consistent and symmetrical massing;
- Consider the addition of tile roofing material; and
- Consider the impact of the skylight from all elevations.

If you have any questions, I can be contacted by phone at (408) 354-6867or by email at <a href="mailto:ewalters@losgatosca.gov">ewalters@losgatosca.gov</a>.

Sincerely,

Erin M. Walters, Senior Planner

cc: Lindsey Laird, RH, via email

This Page Intentionally Left Blank



March 14, 2025

Historic Preservation Committee 110 E. Main Street Los Gatos, CA 95030

Project: RH Los Gatos - PD-25-001, S-25-004 and U-25-001

Location: 31 University Ave

Dear Members of the Historic Preservation Committee:

I would like to first thank you for your time on February 26, 2025. We appreciated your feedback but after careful consideration, we have chosen to maintain our current design.

When developing our Proposal, we closely studied the existing Mediterranean components of the building and the Old Town Shopping Center, its proportions, window types and architectural details. We also considered the buildings immediately adjacent and incorporated their unified design into our building, both in color and articulation, with the goal of creating a harmonious façade design that assimilates into, rather than competes with the larger Historic District.

At RH, we strive to obtain balance, symmetry and perfect proportions with our architectural approach and believe our design does exactly that. With respect, we would like to maintain our Proposal. I hope the explanation above provides you with an understanding of our position.

Thank you,

Stuart Wagner

**STUART WAGNER** 

SENIOR DIRECTOR, PRE-DEVELOPMENT

RH | GALLERY DEVELOPMENT

C: 919.621.0741

This Page Intentionally Left Blank



31 UNIVERSITY AVE, LOS GATOS, CA 95030

## **ABBREVIATIONS**

AIR CONDITIONING

ACOUSTICAL CEILING TILE

ADA	AMERICAN'S W/ DISABILITIES ACT	LBS	POUNDS
AFF	ABOVE FINISH FLOOR	LF	LINEAR FOOT
ADJ	ADJUSTABLE	LH	LEFT-HANDED
AHU	AIR HANDLING UNIT	LL	LANDLORD
ALUM/AL	ALUMINUM		
APPROX	APPROXIMATE	MAT	MATERIAL
ARCH	ARCHITECTURAL	MAX	MAXIMUM
		MECH	MECHANICAL
BD	BOARD	MFR	MANUFACTURER
BLDG	BUILDING	MIN	MINIMUM
BLKG	BLOCKING	MISC	MISCELLANEOUS
BM	BEAM	MTD	MOUNTED
ВО	BOTTOM OF	MTL	METAL
ВОТ	BOTTOM		
BSMT	BASEMENT	NAT	NATURAL
		NIC	NOT IN CONTRACT
CJ	CONTROL JOINT	NOM	NOMINAL
CL	CENTER LINE	NTS	NOT TO SCALE
CLG	CEILING		
CLG HGT	CEILING HEIGHT	O/	OVER
CLR	CLEAR	OC	ON CENTER
CMU	CONCRETE MASONRY UNIT	OD	OUTSIDE DIAMETER
CNTR	COUNTER	OPP	OPPOSITE
CO	CASED OPENING	OPNG	OPENING
CONC	CONCRETE		
CONSTR	CONSTRUCTION	PLAM	PLASTIC LAMINATE
CONT	CONTINUOUS	PLYWD	PLYWOOD
CPT	CARPET	PR	PAIR
CSK	COUNTERSINK	Р	PAINT
CT	CERAMIC TILE	PT	PORCELAIN TILE
CTR	CENTER	PTD	PAINTED
		P.T.	PRESSURE TREATED
DBL	DOUBLE	PTN	PARTITION

LONG (LENGTH)

LAVATORY

LAMINATE

DIAMETER RISER DIMENSION RADIUS REFLECTED CEILING PLAN DOWN DOOR RECESSED DR OPNG DOOR OPENING REQD REQUIRED DWG DRAWING REFERENCE RESILIENT EACH **REVISION** ELECTRICAL RIGHT HAND FI FVATION **EMERGENCY** ROUGH OPENING EQUAL RAIN WATER LEADER EOUIPMENT EXISTING TO REMAIN SOLID CORE ELECTRIC WATER COOLER SMOKE DETECTOR SECTION EXH EXP **FXHAUST SQUARE FOOT (FEET) EXPOSED** EXTERIOR

STRUCT. INSULATED PANEL FIRE ALARM SOUND INSULATION FLOOR DRAIN SPECIFICATION FIRE EXTINGUISHER FIRE EXTINGUISHER CABINET STAINLESS STEEL FINISH FACE STANDARD STEEL FIXTURE FLOOR SYSTEM FLUORESCENT LIGHTING FACE OF CONCRETE TREAD FACE OF FINISH **TONGUE & GROOVE** FACE OF STUD THICKNESS FIRE RETARDANT TREATED THRESHOLD FOOT (FEET) TOP OF BEAM TOP OF CONCRETE TOP OF JOIST TOP OF MASONRY GALVANIZED TOP OF SLAB GENERAL CONTRACTOR TOP OF STEEL GLASS or GLAZING TOP OF WALL TOILET PAPER DISPENSER GYPSUM WALLBOARD TYPICAL GYPSUM

UNDERCUT **HOLLOW CORE** UNLESS NOTED OTHERWISE UNO HOLLOW CORE WOOD DOOR HARDWOOD HARDWARE VINYL COMPOSITION TILE **HOLLOW METAL** VERTICAL HEATING, VENTILATION & COOLING VERIFY IN FIELD HORIZONTAL VENEER PLASTER HEIGHT HEATING VENTILATION AIR CONDITION HOT WATER WITHOUT

WALL ANCHOR WATER CLOSET INSULATION WIDE FLANGE WATER HEATER **WORKING POINT** WATER RESISTANT WSCT WAINSCOT

## PROJECT TEAM

PROPER	RTY OWNER:
<b>FEDERA</b>	IL REALTY
356 SAI	NTANA ROW SUITE 1005
SAN JO	SE CA 95128
PHONE:	(408) 551-2254
CONTA	CT: ROBERT AGUIRRE, SR.
PROJEC	T MANAGER
EMAIL:	RAGUIRRE@FEDERALREALTY.COM

15 KOCH RD,

CORTE MADERA, CA 94925

EMAIL: SWAGNER@RH.COM

**GARDINER & THEOBALD** 

NEW YORK, NY 10017

PHONE: 212-661-6624

PROJECT MANAGER

STRUCTURAL:

535 5TH AVENUE, FLOOR 3

MURPHY BURR CURRY, INC.

85 2ND STREET, SUITE 501

PHONE: 415-669-5382

FOOD SERVICE DESIGN:

ANNAPOLIS, MD 21401

PHONE: 410-263-1200

LOS ANGELES, CA 90017

CONTACT: CHRIS JONES

EMAIL: CHRIS.JONES@KPFF.COM

PHONE: 213-266-5260

CONTACT: ERIC MCCONNELL

EMAIL: EMCCONNELL@NEXTSTEPDESIGN.COM

NEXT STEP DESIGN

913 WEST STREET,

CIVIL ENGINEER:

PRINCIPAL

SAN FRANCISCO, CA 94105

CONTACT: ZACK C. KARDON

CONSULTING STRUCTURAL ENGINEERS

CONSTRUCTION PROJECT MANAGER:

**CONTACT: LAUREN WEINGARTNER** 

EMAIL: L.WEINGARTNER@GARDINERUSA.COM

PHONE: 415-924-1005 **CONTACT: STU WAGNER** 

ARCHITECT: MBH ARCHITECTS 960 ATLANTIC AVENUE ALAMEDA, CA, 94501 PHONE: 510-865-8663 PROJECT MANAGER EMAIL: RIX@MBHARCH.COM CONTACT: BRENDA BARAJAS DESIGNER EMAIL: BRENDAB@MBHARCH.COM

MECH/ELEC/PLUMB: MECHANICAL ELECTRICAL ENGINEERING CONSULTANTS, MEEC 14496 N. SHELDON RD., SUITE 260, PLYMOUTH, MI 48170 PHONE: 734-454-5516 EXT. 751 CONTACT: WILLIAM E. VERNIER III DIRECTOR OF MECHANICAL ENGINEERING EMAIL: ZKARDON@MBCSE.COM EMAIL: WVERNIER@MEECI.COM LIGHTING DESIGN **RKV DESIGN** 

MALIBU, CA PHONE: 310-924-2185 CONTACT: REBECCA HIDALGO EMAIL: REBECCA@RVK-DESIGN.COM PLANNING DEPARTMENT:

TOWN OF LOS GATOS COMMUNITY DEVELOPMENT DEPARTMENT 700 S. FLOWER STREET, SUITE 2100 ADDRESS:110 E. MAIN STREET, LOS GATOS, CA 95030 PHONE: 408-354-6823 **CONTACT: SEAN MULLIN** PLANNING MANAGER EMAIL: SMULLIN@LOSGATOSCA.GOV

**BUILDING DEPARTMENT:** TOWN OF LOS GATOS BUILDING DIVISION ADDRESS:110 E. MAIN STREET, LOS GATOS, CA 95030 PHONE: 408-354-6815 **CONTACT: ROBERT GRAY** CHIEF BUILDING OFFICIAL/ ADA COORDINATOR EMAIL: RGRAY@LOSGATOSCA.GOV

## **GENERAL NOTES**

2. VERIFY FIELD CONDITIONS PRIOR TO COMMENCEMENT OF EACH PORTION OF THE 3. THE ARCHITECT ASSUMES NO RESPONSIBILITY FOR ANY PORTION OF THE WORK WHICH IS PERFORMED WITHOUT A PERMIT ISSUED BY A REGULATORY AUTHORITY OF THE MUNICIPALITY IN WHICH THE PROJECT IS LOCATED. 4. THROUGHOUT THIS SET OF DRAWINGS, THE TERM "SDB" REFERS TO THE

CLIENT/TENANT. THE TERM "LANDLORD" REFERS TO THE PROPERTY OWNER. 5. THE CONTRACTOR SHALL MAKE NO REVISIONS, ALTERATIONS OR CHANGES TO THE WORK AS SHOWN IN THE CONTRACT DOCUMENTS WITHOUT THE PRIOR WRITTEN APPROVAL OF THE ARCHITECT AND/OR SDB REPRESENTATIVE. NO ADDITIONAL COSTS FROM THE GENERAL CONTRACTOR SHALL BE CONSIDERED AND THE WORK MAY E REQUIRED TO BE REMOVED WITHOUT SUCH APPROVAL BY ARCHITECT. 6. SEE SPECIFICATIONS FOR ADDITIONAL CRITERIA AND CONSTRUCTION

7. DIMENSIONS SHOWN AS 'VIF' SHALL BE VERIFIED BY THE CONTRACTOR IN THE FIELD BY LAYING OUT THE PARTITIONS. NOTIFY ARCHITECT OF ANY DISCREPANCIES IN. DIMENSIONS PRIOR TO PROCEEDING WITH WORK. 8. DIMENSIONS SHOWN AS 'CLEAR' OR 'HOLD' SHALL BE MAINTAINED AND ALLOW FOR THICKNESS OF FINISHES; INCLUDING FLOOR FINISHES. NOTIFY ARCHITECT OF ANY DISCREPANCIES IN DIMENSIONS PRIOR TO PROCEEDING WITH WORK. 9. DIMENSIONS ARE TO THE STRUCTURAL GRID OR TO FINISH SURFACES, UNLESS

OTHERWISE INDICATED. 10. ELEVATIONS REFERENCED ARE ABOVE SDB FINISH FLOOR FOR EACH ROOM THROUGHOUT TENANT SPACE, UNLESS OTHERWISE NOTED. FINISH FLOOR ELEVATIONS MAY VARY FROM ROOM TO ROOM DEPENDING UPON FLOOR FINISHES. 11. GENERAL CONTRACTOR SHALL PROVIDE THE BUILDING OFFICIAL WITH A CERTIFICATE OF CONSTRUCTION COMPLIANCE WITH ENERGY CONSERVATION STANDARDS UPON FINAL BUILDING DEPARTMENT INSPECTIONS (WHERE REQUIRED)

12. GENERAL CONTRACTOR SHALL PREPARE THE FLOOR LEVEL AND SMOOTH AND PROVIDE FOR THE FILLING OF ALL FLOOR DRAINS, FLOOR SINKS OR OTHER SUCH DEPRESSIONS, CRACKS OR IRREGULARITIES IN FLOOR SLAB. 13. PROVIDE BLOCKING AT WALLS TO MEET CODE MINIMUM WHERE REQUIRED FOR SUPPORT OF FIXTURES/ACCESSORIES.

14. GENERAL CONTRACTOR SHALL PROVIDE ACCESS PANELS FOR ALL TRADES AS REQUIRED BY CODE. LOCATIONS TO BE APPROVED BY ARCHITECT AND/OR SBD REPRESENTATIVE PRIOR TO EXECUTION OF WORK. 15 FIRE EXTINGUISHERS AND CABINETS AS REQUIRED BY LOCAL GOVERNMENT AGENCY SHALL BE PROVIDED BY GENERAL CONTRACTOR AND INCLUDED IN CONTRACT.

16. STORAGE IN STOCK/STORAGE ROOMS SHALL BE MAINTAINED 18 INCHES OR MORE BELOW SPRINKLER HEAD DEFLECTORS, A 3-INCH RED STRIPE SHALL BE MARKED ALONG ALL WALLS WITHIN STOCK/STORAGE AT THE MAXIMUM STORAGE HEIGHT, AND STRIPE SHALL BE LABELED " NO STORAGE ABOVE THIS LINE" IN WHITE LETTERS A MINIMUM OF ONCE ON EACH WALL

## PROJECT DATA

APN:
EXISTING E31 BUILDING AREA (GROSS)
EXISTING E35 BUILDING AREA (GROSS)
(NO CHANGE TO EXISTING GROSS AREA)

OCCUPANCY GROUP: M & A-2 S-2 (GARAGE) 2- STORY CONSTRUCTION TYPE: OCCUPANT LOAD: A-2 - 100 OCC

TENANT IMPROVEMENT OF TWO GROUND FLOOR TENANT SPACES. THE TWO SPACES WILL HAVE THE INTERIOR DEMOLISHED AND RE-CONFIRMED INTO ONE SPACE. THE NEW USE WILL BE A RETAIL SHOWROOM INCLUDING A RESTAURANT. THERE IS NO CHANGE IN GROSS BUILDING AREA OR PROPOSED USE. SCOPE TO INCLUDE COMPLETE BUILD-OUT WITH ASSOCIATED PLUMBING,

MECHANICAL, ELECTRICAL, KITCHEN EQUIPMENT AND FINISHES THROUGHOUT.

529 02 044

7,233 SF

8,724 SF

## **CODE INFORMATION**


AUTHORITY HAVING JURIS	DICTION:	TOWN OF LOS G	ATOS
BUILDING CODE:	CALIFORNIA BUI	LDING CODE	2022
GREEN BUILDING CODE:	CALIFORNIA GRE STANDARDS CO		2022
ACCESSIBILITY CODE:	CALIFORNIA BUI	LDING CODE	2022
ENERGY CORE.	CALIFORNIA ENI	DCV CODE	2022

CALIFORNIA ENERGY CODE ENERGY CODE: MECHANICAL CODE: CALIFORNIA MECHANICAL CODE 2022 PLUMBING CODE: CALIFORNIA PLUMBING CODE 2022 ELECTRICAL CODE: CALIFORNIA ELECTRICAL CODE 2022 CALIFORNIA FIRE CODE HEALTH CODE: CALIFORNIA RETAIL FOOD CODE 2022

## **VICINITY MAP**




RH - LOS GATOS 31 UNIVERSITY AVE, LOS GATOS, CA 95030

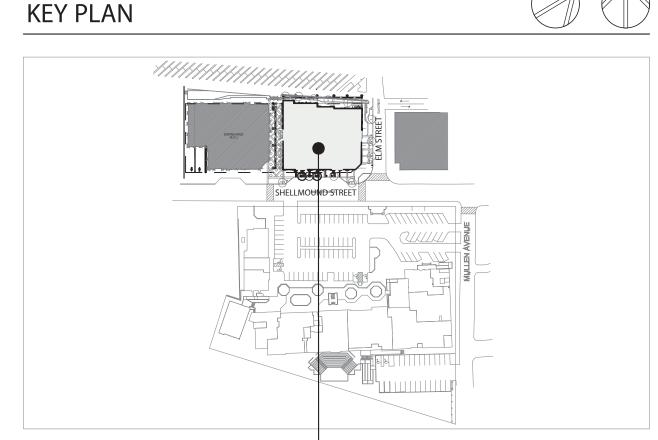

## SYMBOLS LEGEND

	EXISTING WALL		STRUCT GRII
	NEW WALL		LEASE LINE
<u></u>	NEW PARTIAL HT WALL	· ·	CENTERLINE
	COOLER/FREEZER WALL	XX	WALL TYPE

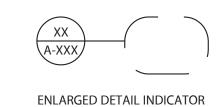








☐ RH - LOS GATOS

STRUCTURAL/EXISTING COLUMN INTERIOR ELEVATION INDICATOR GRIDLINE INDICATOR

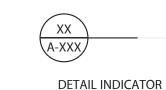

## DRAWING INDEX

		CKAGE					
SHEET NO	SHEET NAME	10/18/2024 PRE-APPLICATION PACKAGE	11/06/2024 PLANNING SUBMITTAL	11/22/2024 100% SCHEMATIC DESIGN	01/09/2025 PLANNING SUBMITTAL 2		
	ARCHITECTURAL	'					
A001	COVER SHEET	•	•	•	•		
AS101	SITE PLAN	•	•	•	•		
AD101	EXISTING FLOOR PLAN	•	•	•	•		
A100	EXISTING BASEMENT PLAN	•	•	•	•		
A101	FLOOR PLAN	•	•	•	•		
A104	ROOF PLAN	•	•	•	•		
A201	EXTERIOR ELEVATIONS	•	•	•	•		
A202	EXTERIOR ELEVATIONS	•	•	•	•		
A203	EXISTING EXTERIOR ELEVATIONS				•		
A204	EXISTING EXTERIOR ELEVATIONS				•		
A301	BUILDING SECTIONS	•	•	•	•		
A400	EXISTING BUILDING PHOTOS	•	•	•	•		
A401	EXISTING BUILDING PHOTOS	•	•	•	•		
A402	EXTERIOR BUILDING RENDERS	•	•	•	•		
A403	EXTERIOR BUILDING RENDERS	•	•	•	•		
A404	INTERIOR BUILDING RENDERS	•	•	•	•		
A405	INTERIOR BUILDING RENDERS	•	•	•	•		
A406	MATERIAL FINISHES		•	•	•		
A500	EXTERIOR SIGNAGE (FOR REFERENCE ONLY)	•	•	•	•		

LT-1.0 LIGHTING LAYOUT LT-2.0 EXTERIOR LIGHTING ELEVATIONS



## PLUMBING CALCULATIONS

FIXED BOOTH SEATING

OCCUPANCY LOAD PER 2022 CBC TABLE 1004.5					
FUNCTION OF SPACE	OCCUPANCY LOAD FACTOR (SQUARE FEET)	SQUARE FOOTAGE	TOTAL OCCUP		
MERCANTILE	1 PER 60	11073 SF	185 OCC		
ASSEMBLY (WITHOUT FIXED SEATS) UNCONCENTRATED	1 PER 15	900 SF	60 OCC		

1 PER 24"

1 PER 200

\*PER TABLE CPC 4-1 FOOTNOTE - ACCESSORY AREAS SUCH AS, BUT NOT LIMITED TO HALLWAYS/CORRIDORS, STAIRWAYS, RAMPS, TOILET ROOMS, MECHANICAL ROOMS, CLOSETS AND FIXED EQUIPMENT MAY BE EXCLUDED. \*PER TABLE CPC 422.1 - RESULT IN FRACTIONAL NUMBERS, SUCH NUMBER SHALL BE ROUNDED TO THE NEXT WHOLE NUMBER. FOR MULTIPLE OCCUPANCIES, FRACTIONAL NUMBER SHALL BE FIRST SUMMED AND THEN ROUNDED TO THE NEXT WHOLE NUMBER.

M OCCUPANCY (PER OCC. LOAD) @ GROUND FLR 185 OCCUPANTS I 93 MALE & 93 FEMALE i. WATER CLOSET (M): 93 OCCUPANTS X 1/100 = .93

FRACTIONAL

METHOD

TOTAL

REQUIRED

100 OCCUPANTS I 50 MALE & 50 FEMALE i. WATER CLOSET (M): 50 OCCUPANTS X 1/50 = 1ii. WATER CLOSET (F): 93 OCCUPANTS X 1/100 = .93 ii. WATER CLOSET (F): 50 OCCUPANTS X 1/25 = 2 iii. URINAL (M): 93 OCCUPANTS X 1/200 = .47 iii. URINAL (M): 50 OCCUPANTS X 1/200 = .25 iv. LAVATORY (M): 93 OCCUPANTS X 1/200 = .47 iv. LAVATORY (M): 50 OCCUPANTS X 1/150 = .34v. LAVATORY (F): 93 OCCUPANTS X 1/200 = .47

WATER CLOSETS

M

TOTAL:

v. LAVATORY (F): 50 OCCUPANTS X 1/150 = .34 LAVATORIES

12,776 SF

A-2 OCCUPANCY (PER OCC. LOAD) @ GROUND FLR

36 OCC

4 OCC

286 OCC

PROVIDED \*POTTY PARITY - PER CPC 422.1 NOTE 3 - THE TOTAL NUMBER OF REQUIRED WATER CLOSETS FOR FEMALES SHALL BE NOT LESS THAN THE TOTAL NUMBER OF REQUIRED WATER CLOSETS AND URINALS FOR MALES.

3\*

SUM UP ALL REQUIRED FIXTURES i. WATER CLOSET (M): .93 + 1 = 1.93 -> 2ii. WATER CLOSET (F): .93 + 2 = 2.93 -> 3iii. URINAL (M): .47 + .25 = .72 -> 1iv. LAVATORY (M): .47 + .34 = .81 -> 1v. LAVATORY (F): .47 + .34 = .81 -> 1

**COVER SHEET** 

RH - LOS GATOS

Architect

Consultant

No. Date

31 UNIVERSITY AVE,

LOS GATOS, CA 95030

Drawing No.

Issued/Revised

01 10/18/2024 PRE-APPLICATION PACKAGE

02 11/06/2024 PLANNING SUBMITTAL

03 11/22/2024 100% SCHEMATIC DESIGN

04 01/09/2025 PLANNING SUBMITTAL 2

Drawings and written material appearing herein constitute

originaland unpublished work of the Architect and may not

be duplicated, used or disclosed without written consent

© MBH ARCHITECTS-2024

Brenda B

Project No. 59485

Reviewed By: Rick N

Drawn By:

Drawing Title

FIN

FIXT

FLR

FOF

FOS FRT

FTG

HDWD

**HDWR** 


HORIZ


INCLUDED

INTERIOR

JOINT

JOIST

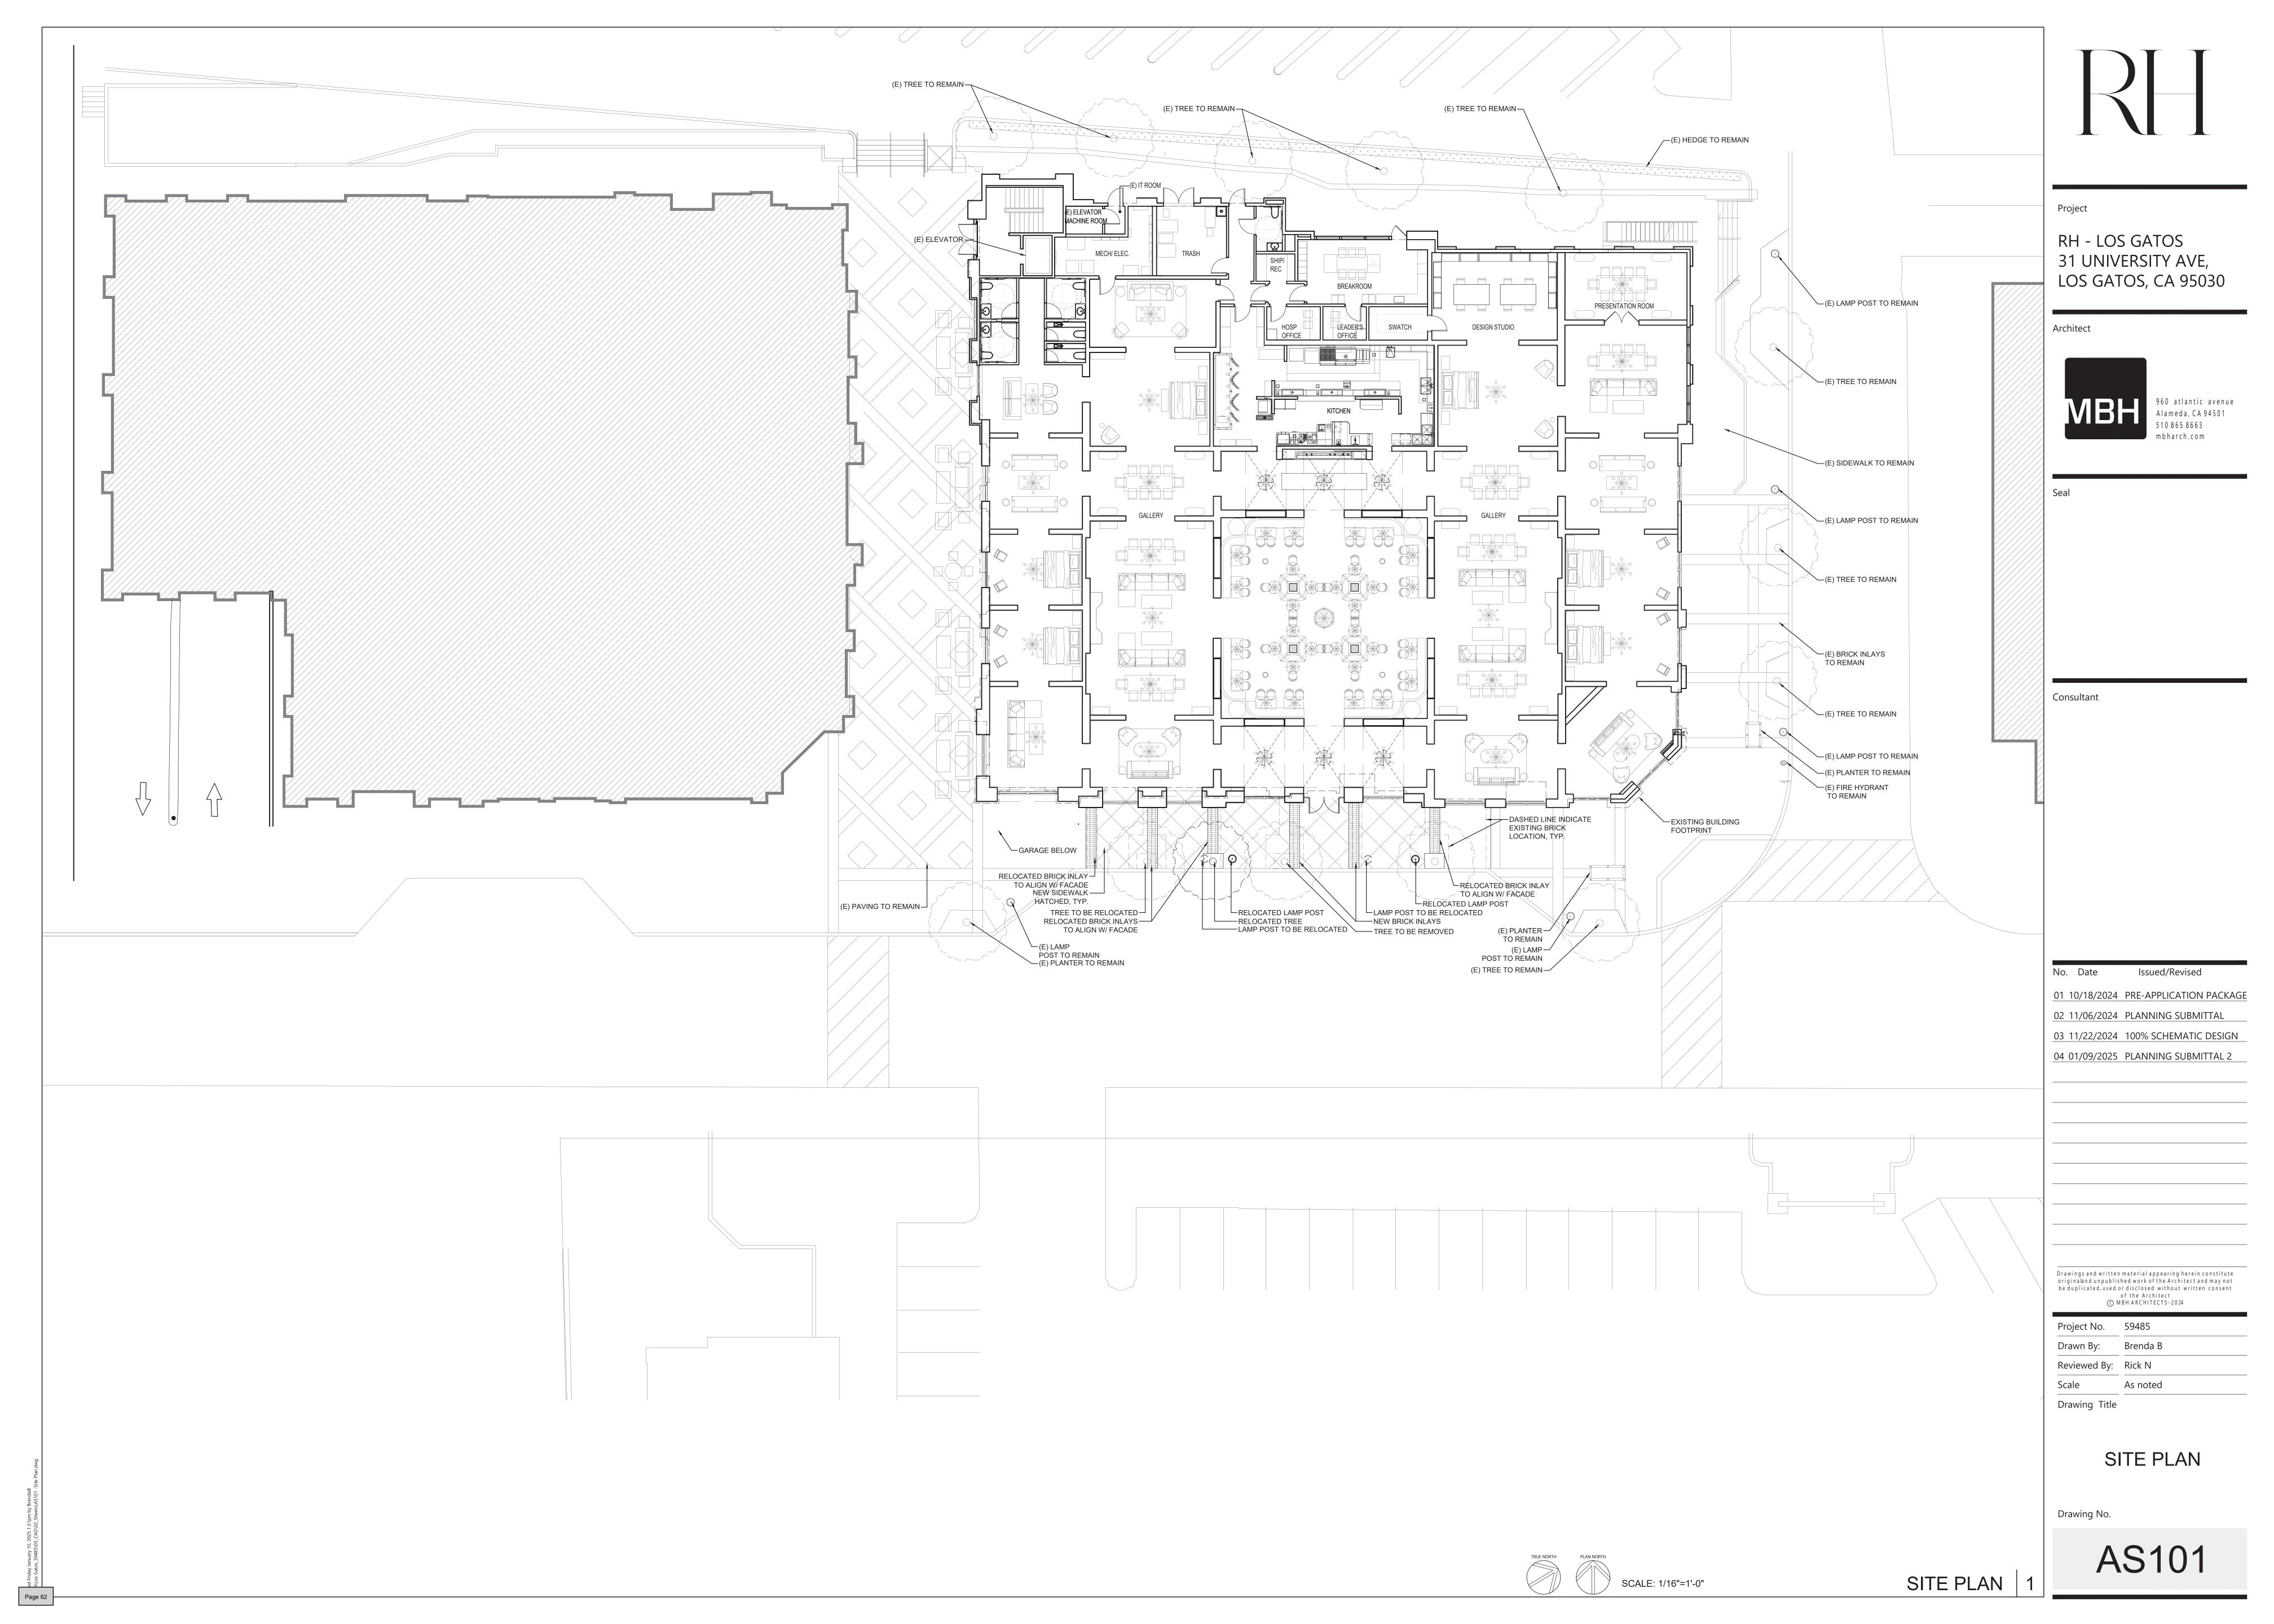

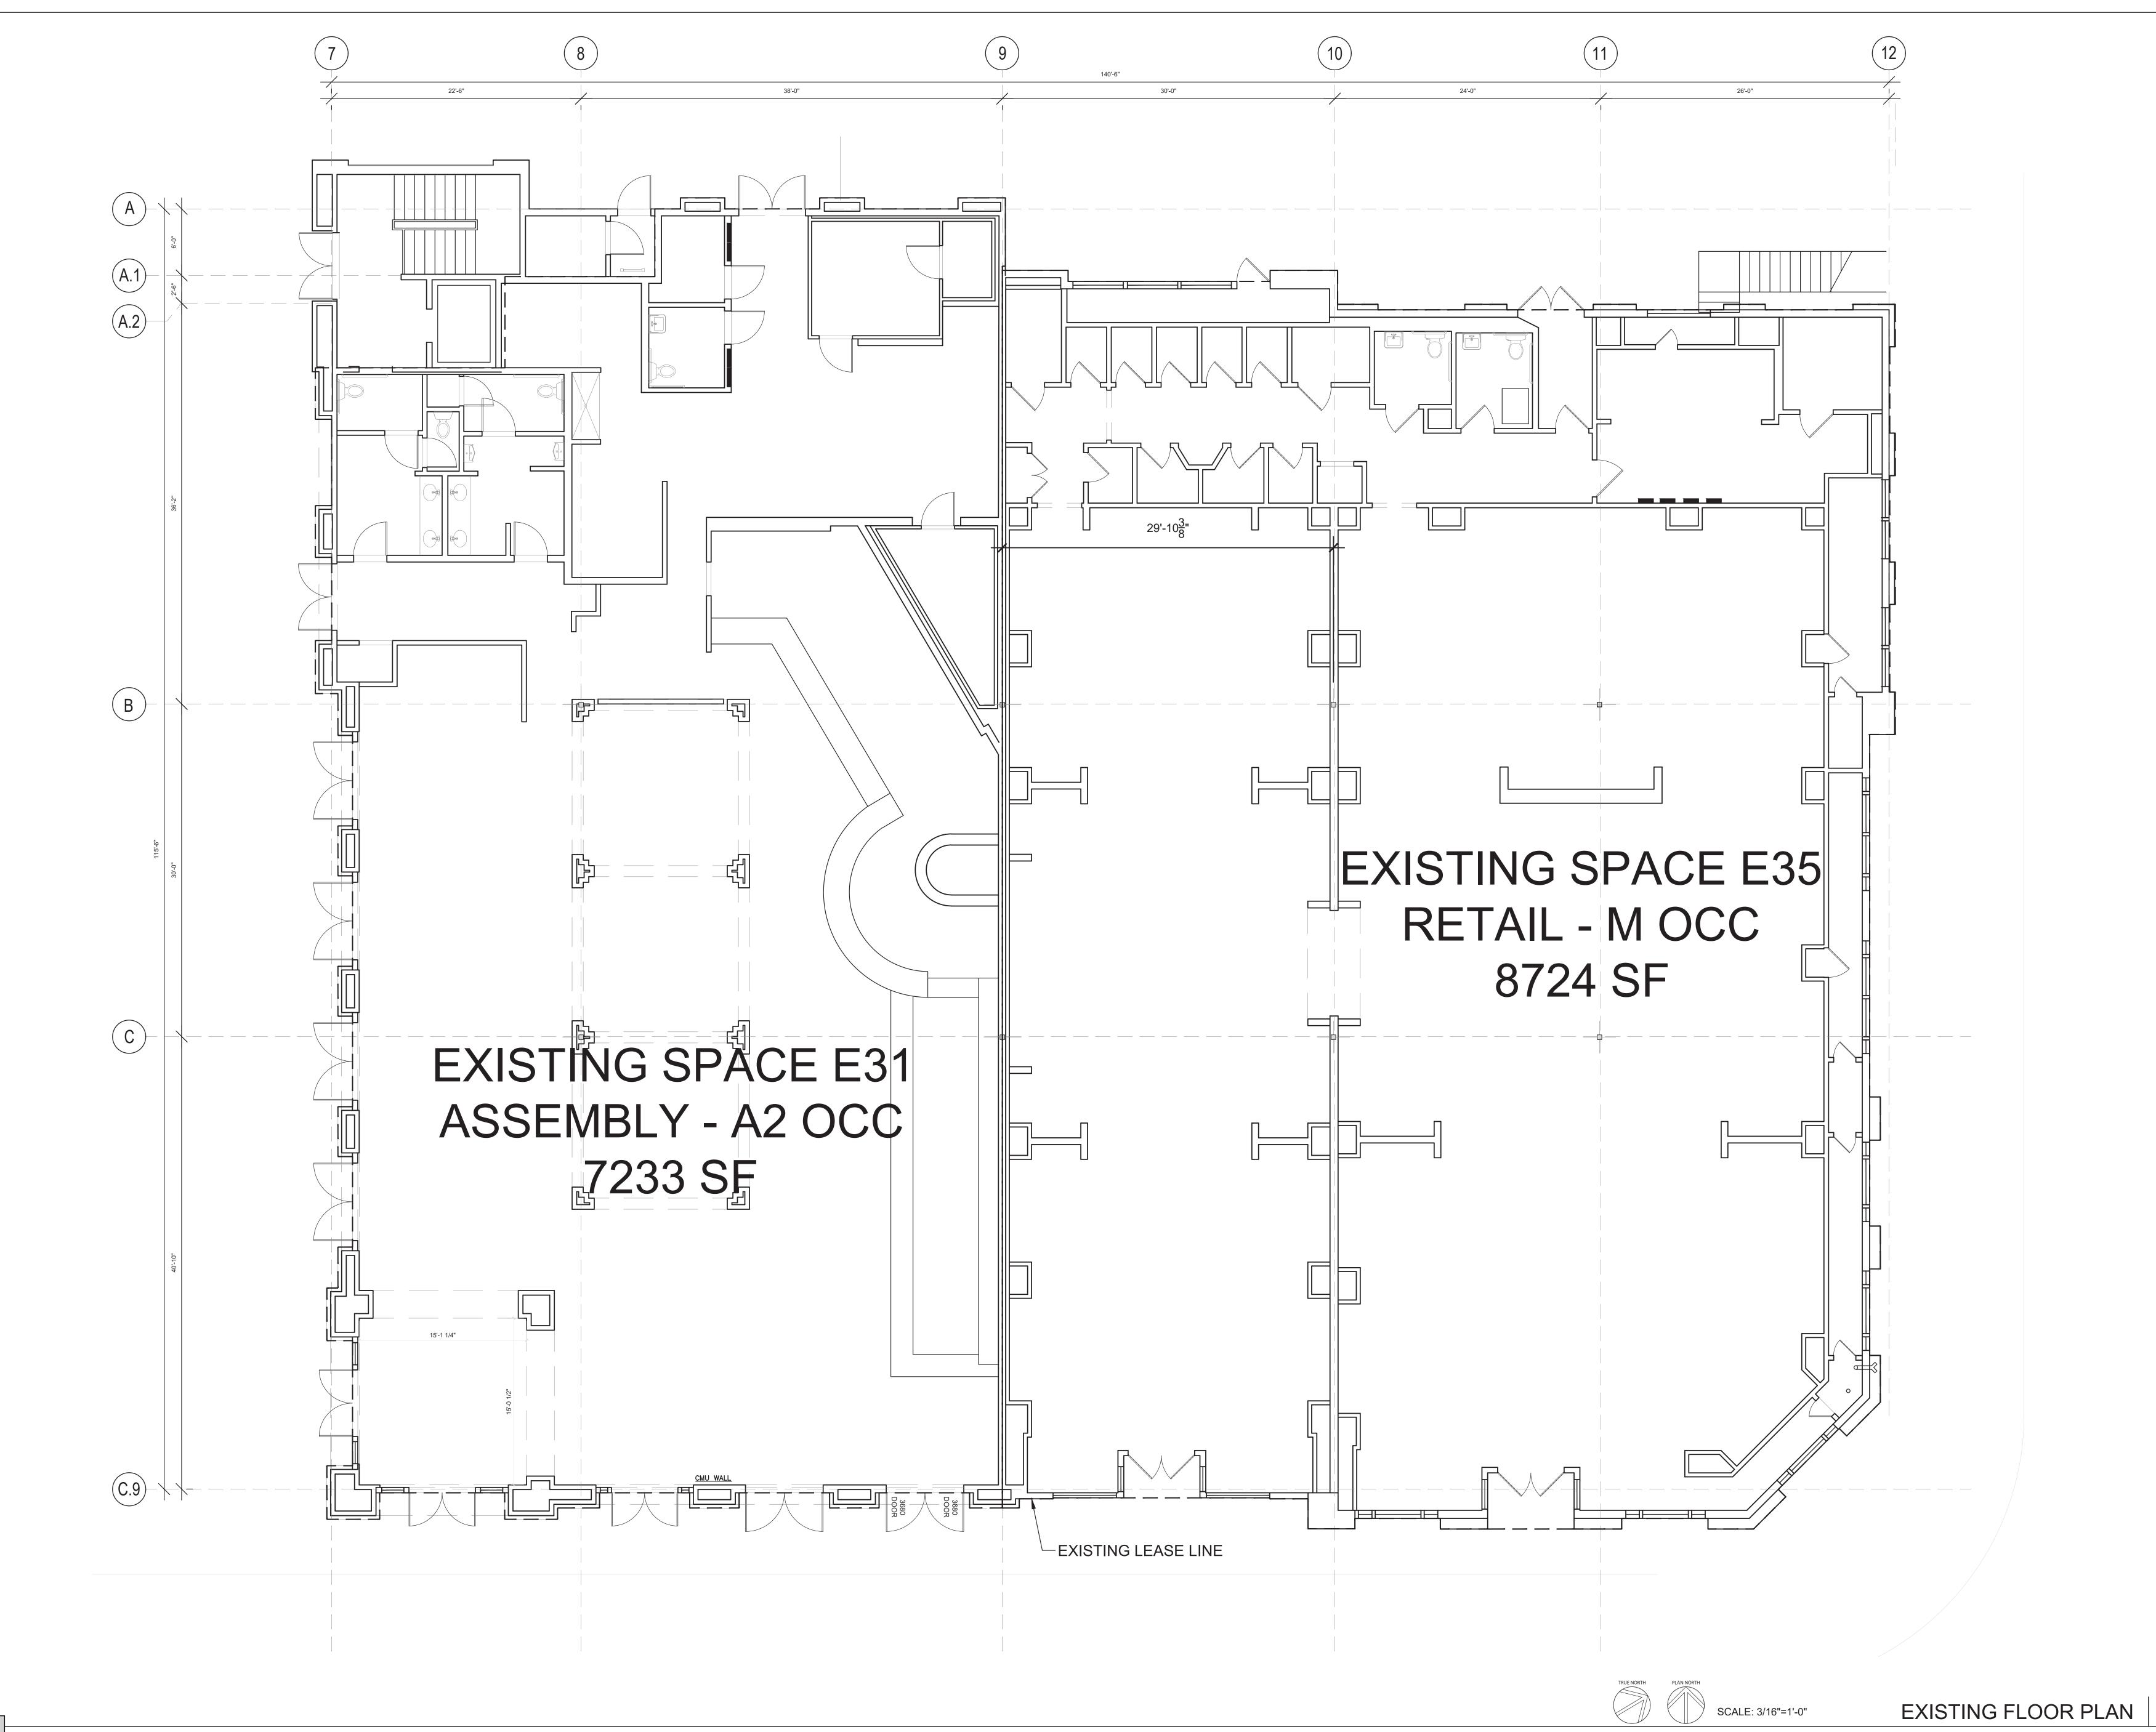





02 11/06/2024 PLANNING SUBMITTAL

03 11/22/2024 100% SCHEMATIC DESIGN 04 01/09/2025 PLANNING SUBMITTAL 2


Reviewed By: Rick N

Drawing Title


EXISTING FLOOR PLAN

Drawing No.

AD101

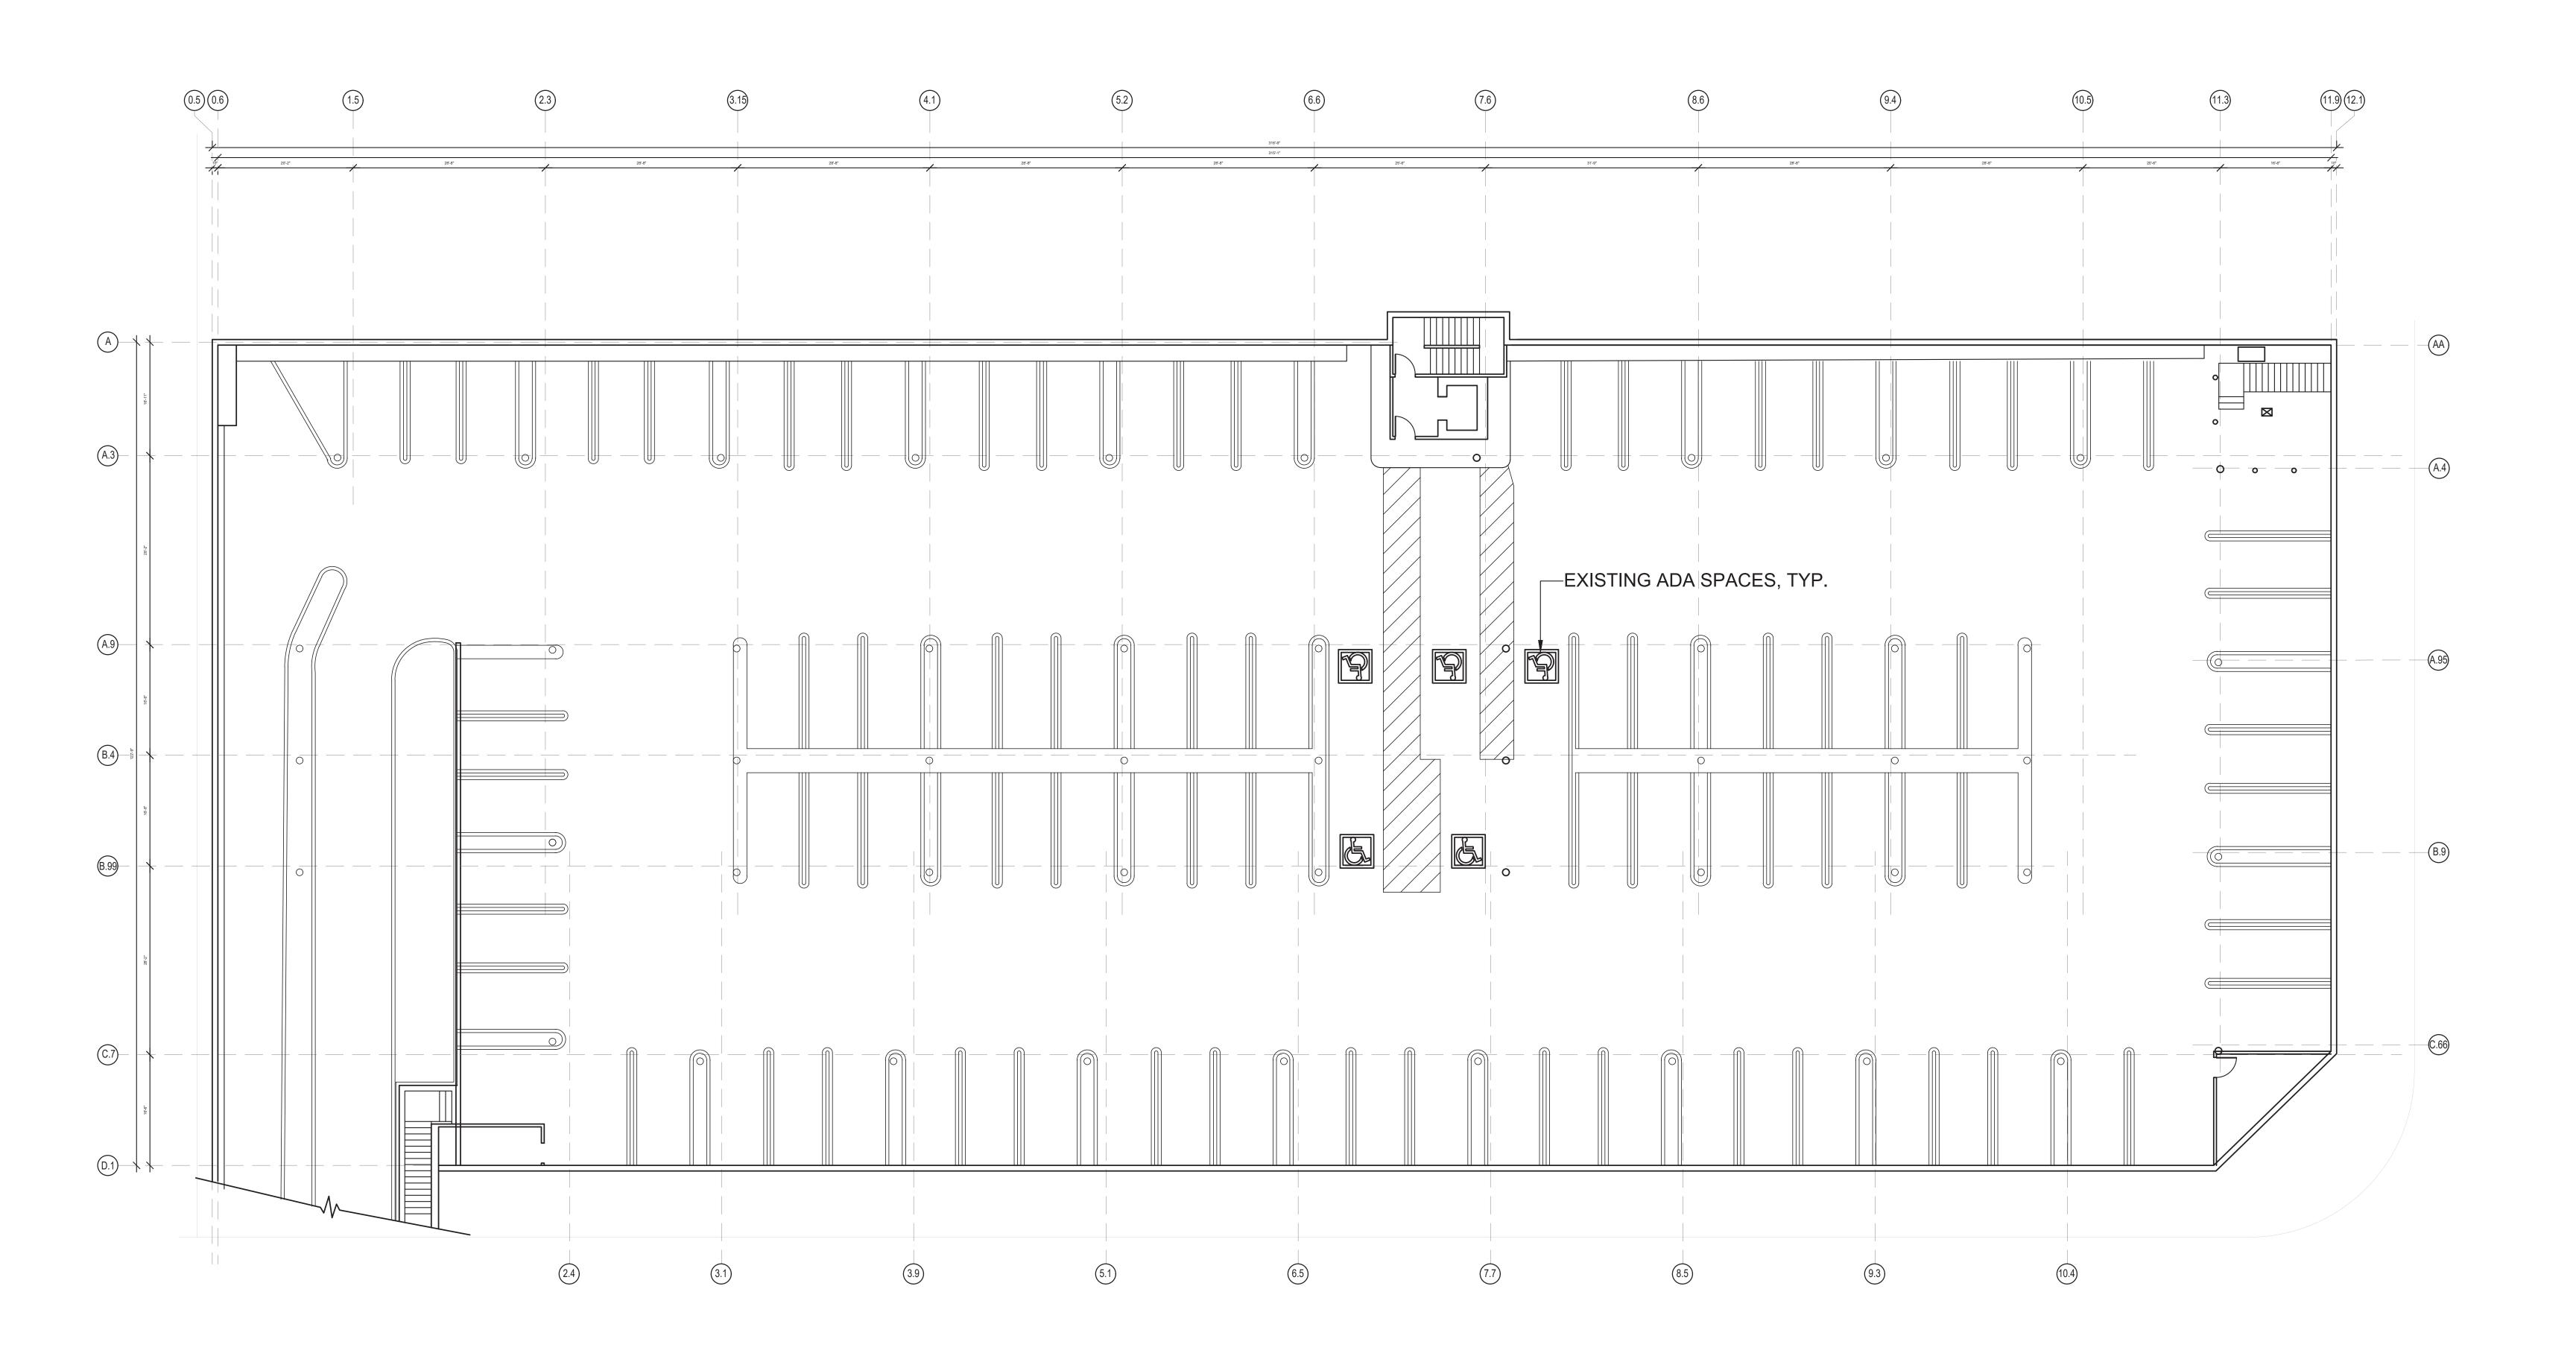

FOR REFERENCE ONLY

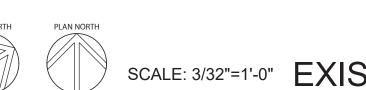

Project

RH - LOS GATOS 31 UNIVERSITY AVE, LOS GATOS, CA 95030

Architect



Sea

Consultant

 No.
 Date
 Issued/Revised

 01
 10/18/2024
 PRE-APPLICATION PACKAGE

 02
 11/06/2024
 PLANNING SUBMITTAL

 03
 11/22/2024
 100% SCHEMATIC DESIGN

 04
 01/09/2025
 PLANNING SUBMITTAL 2

Drawings and written material appearing herein constitute originaland unpublished work of the Architect and may not be duplicated, used or disclosed without written consent of the Architect

© MBH ARCHITECTS-2024

Project No. 59485


Drawn By: Brenda B


Reviewed By: Rick N

Scale A
Drawing Title

EXISTING BASEMENT PLAN

Drawing No.

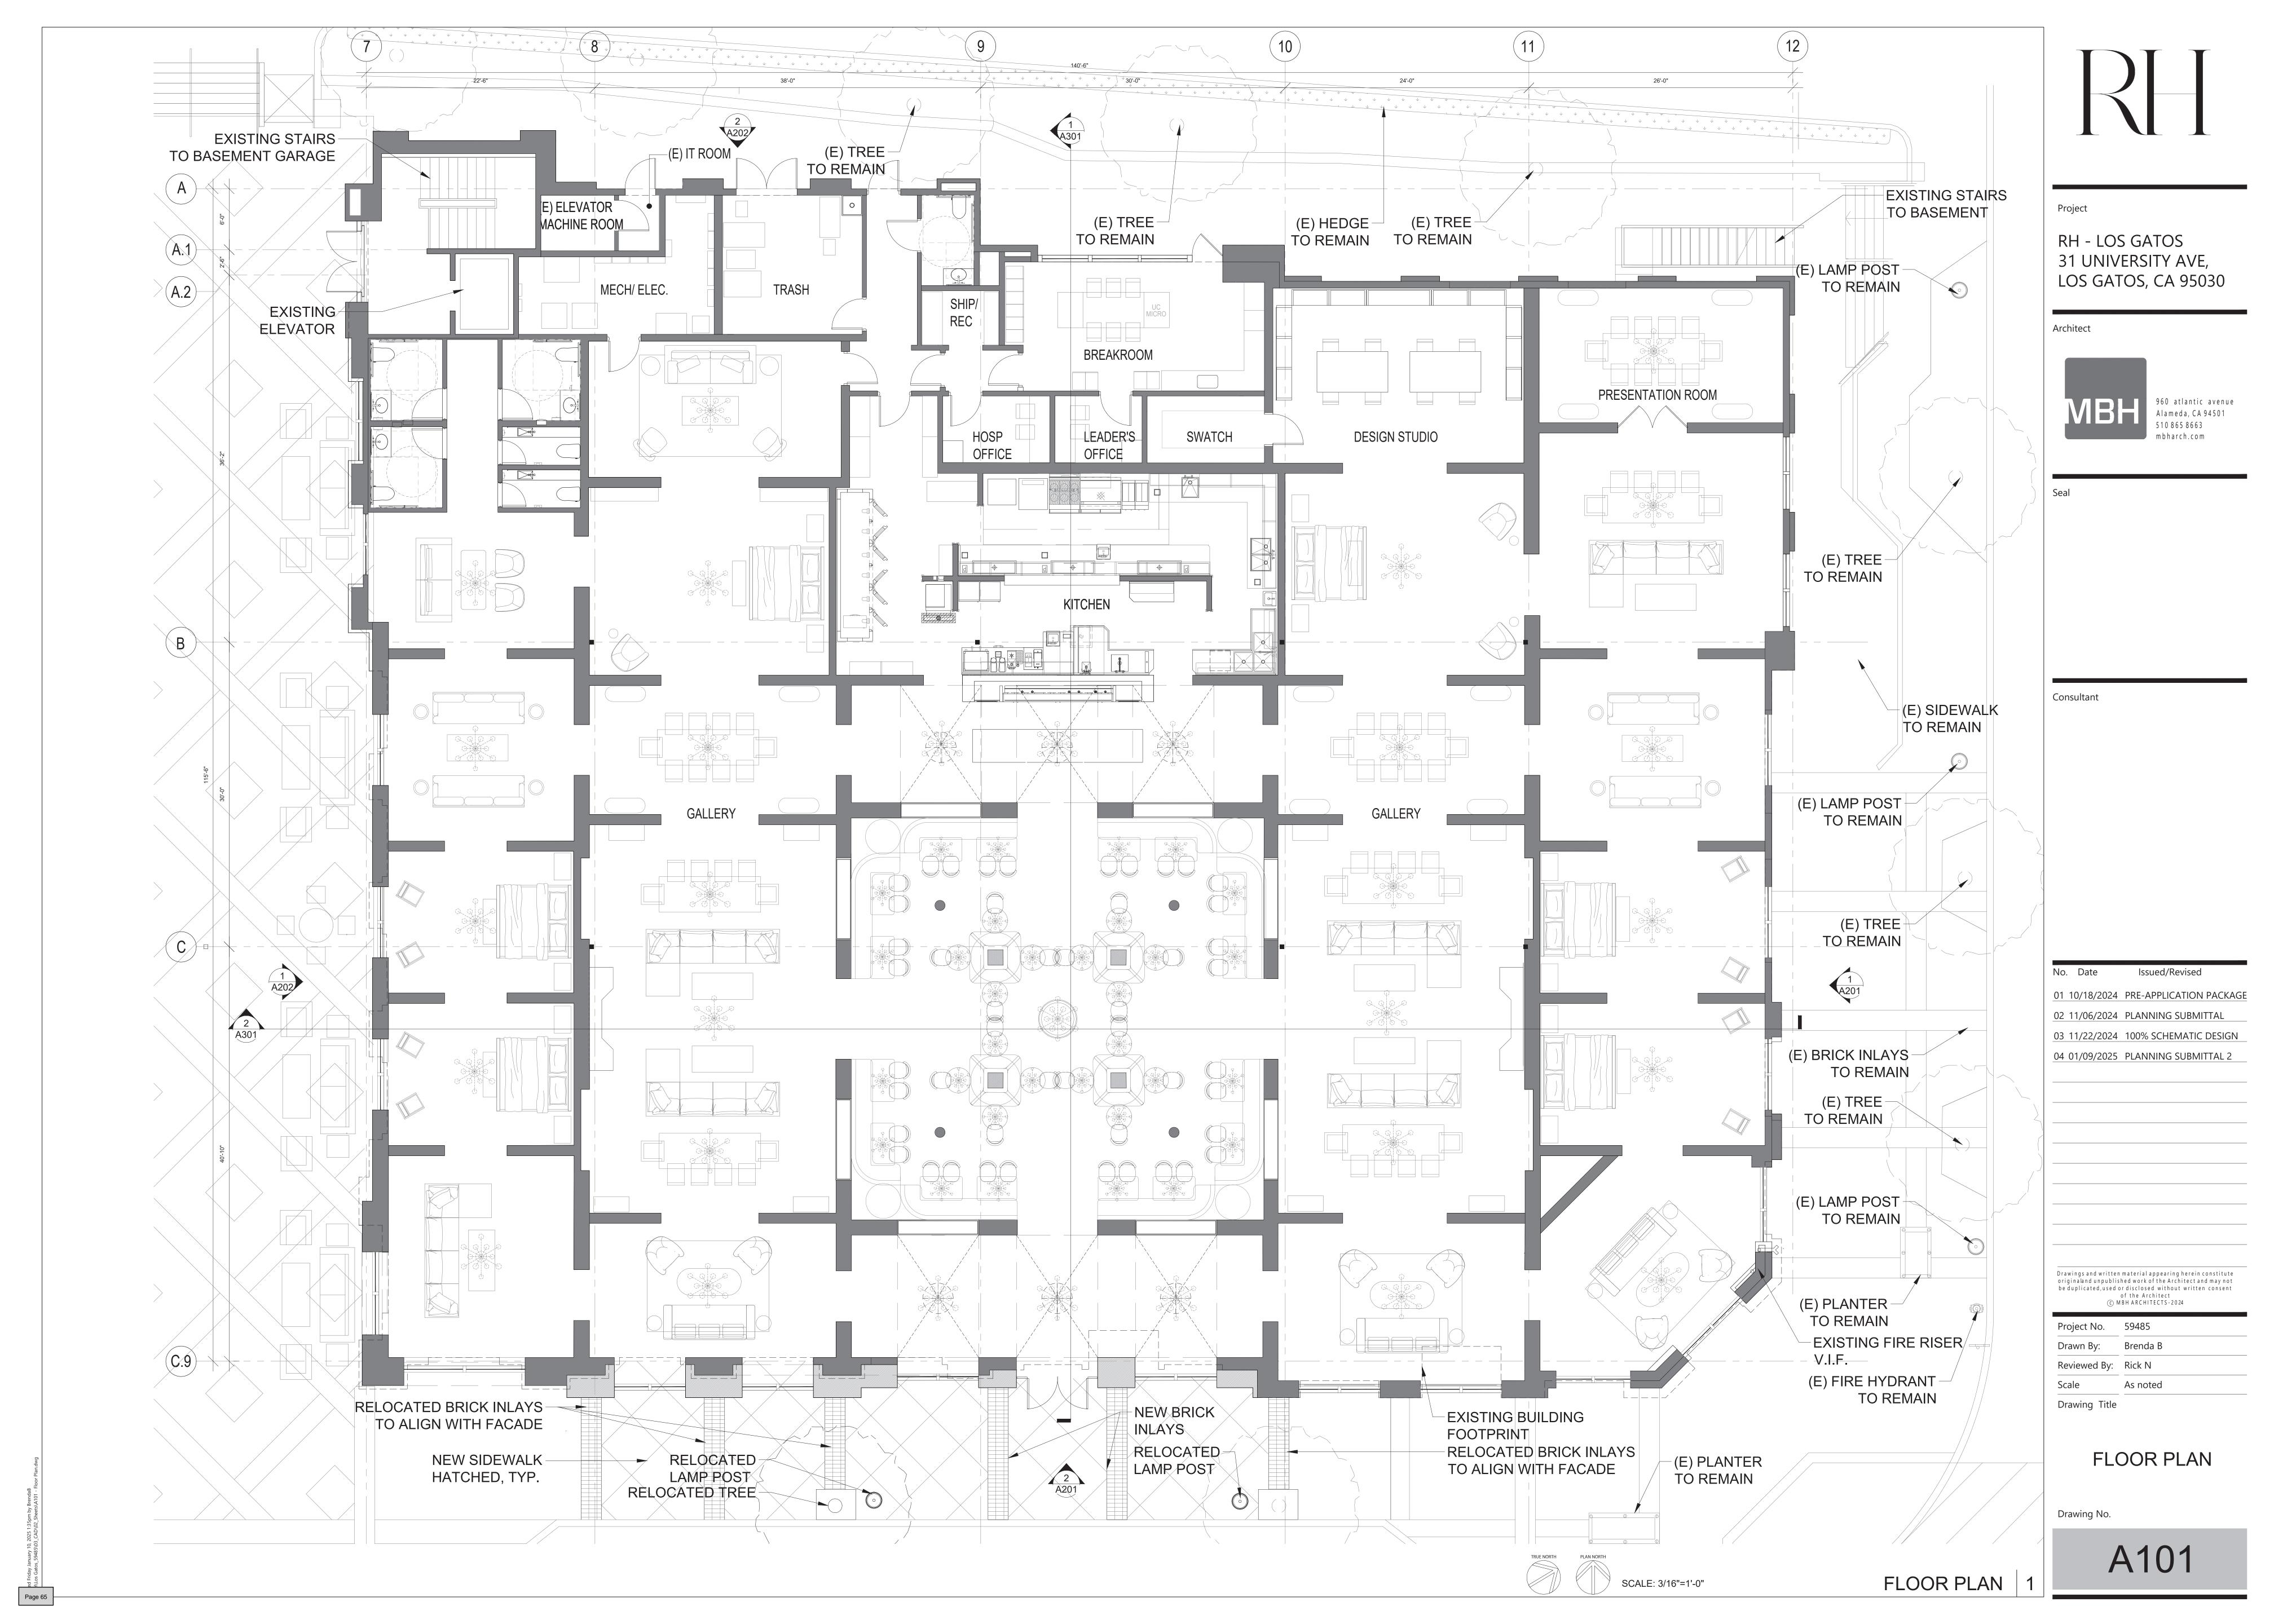

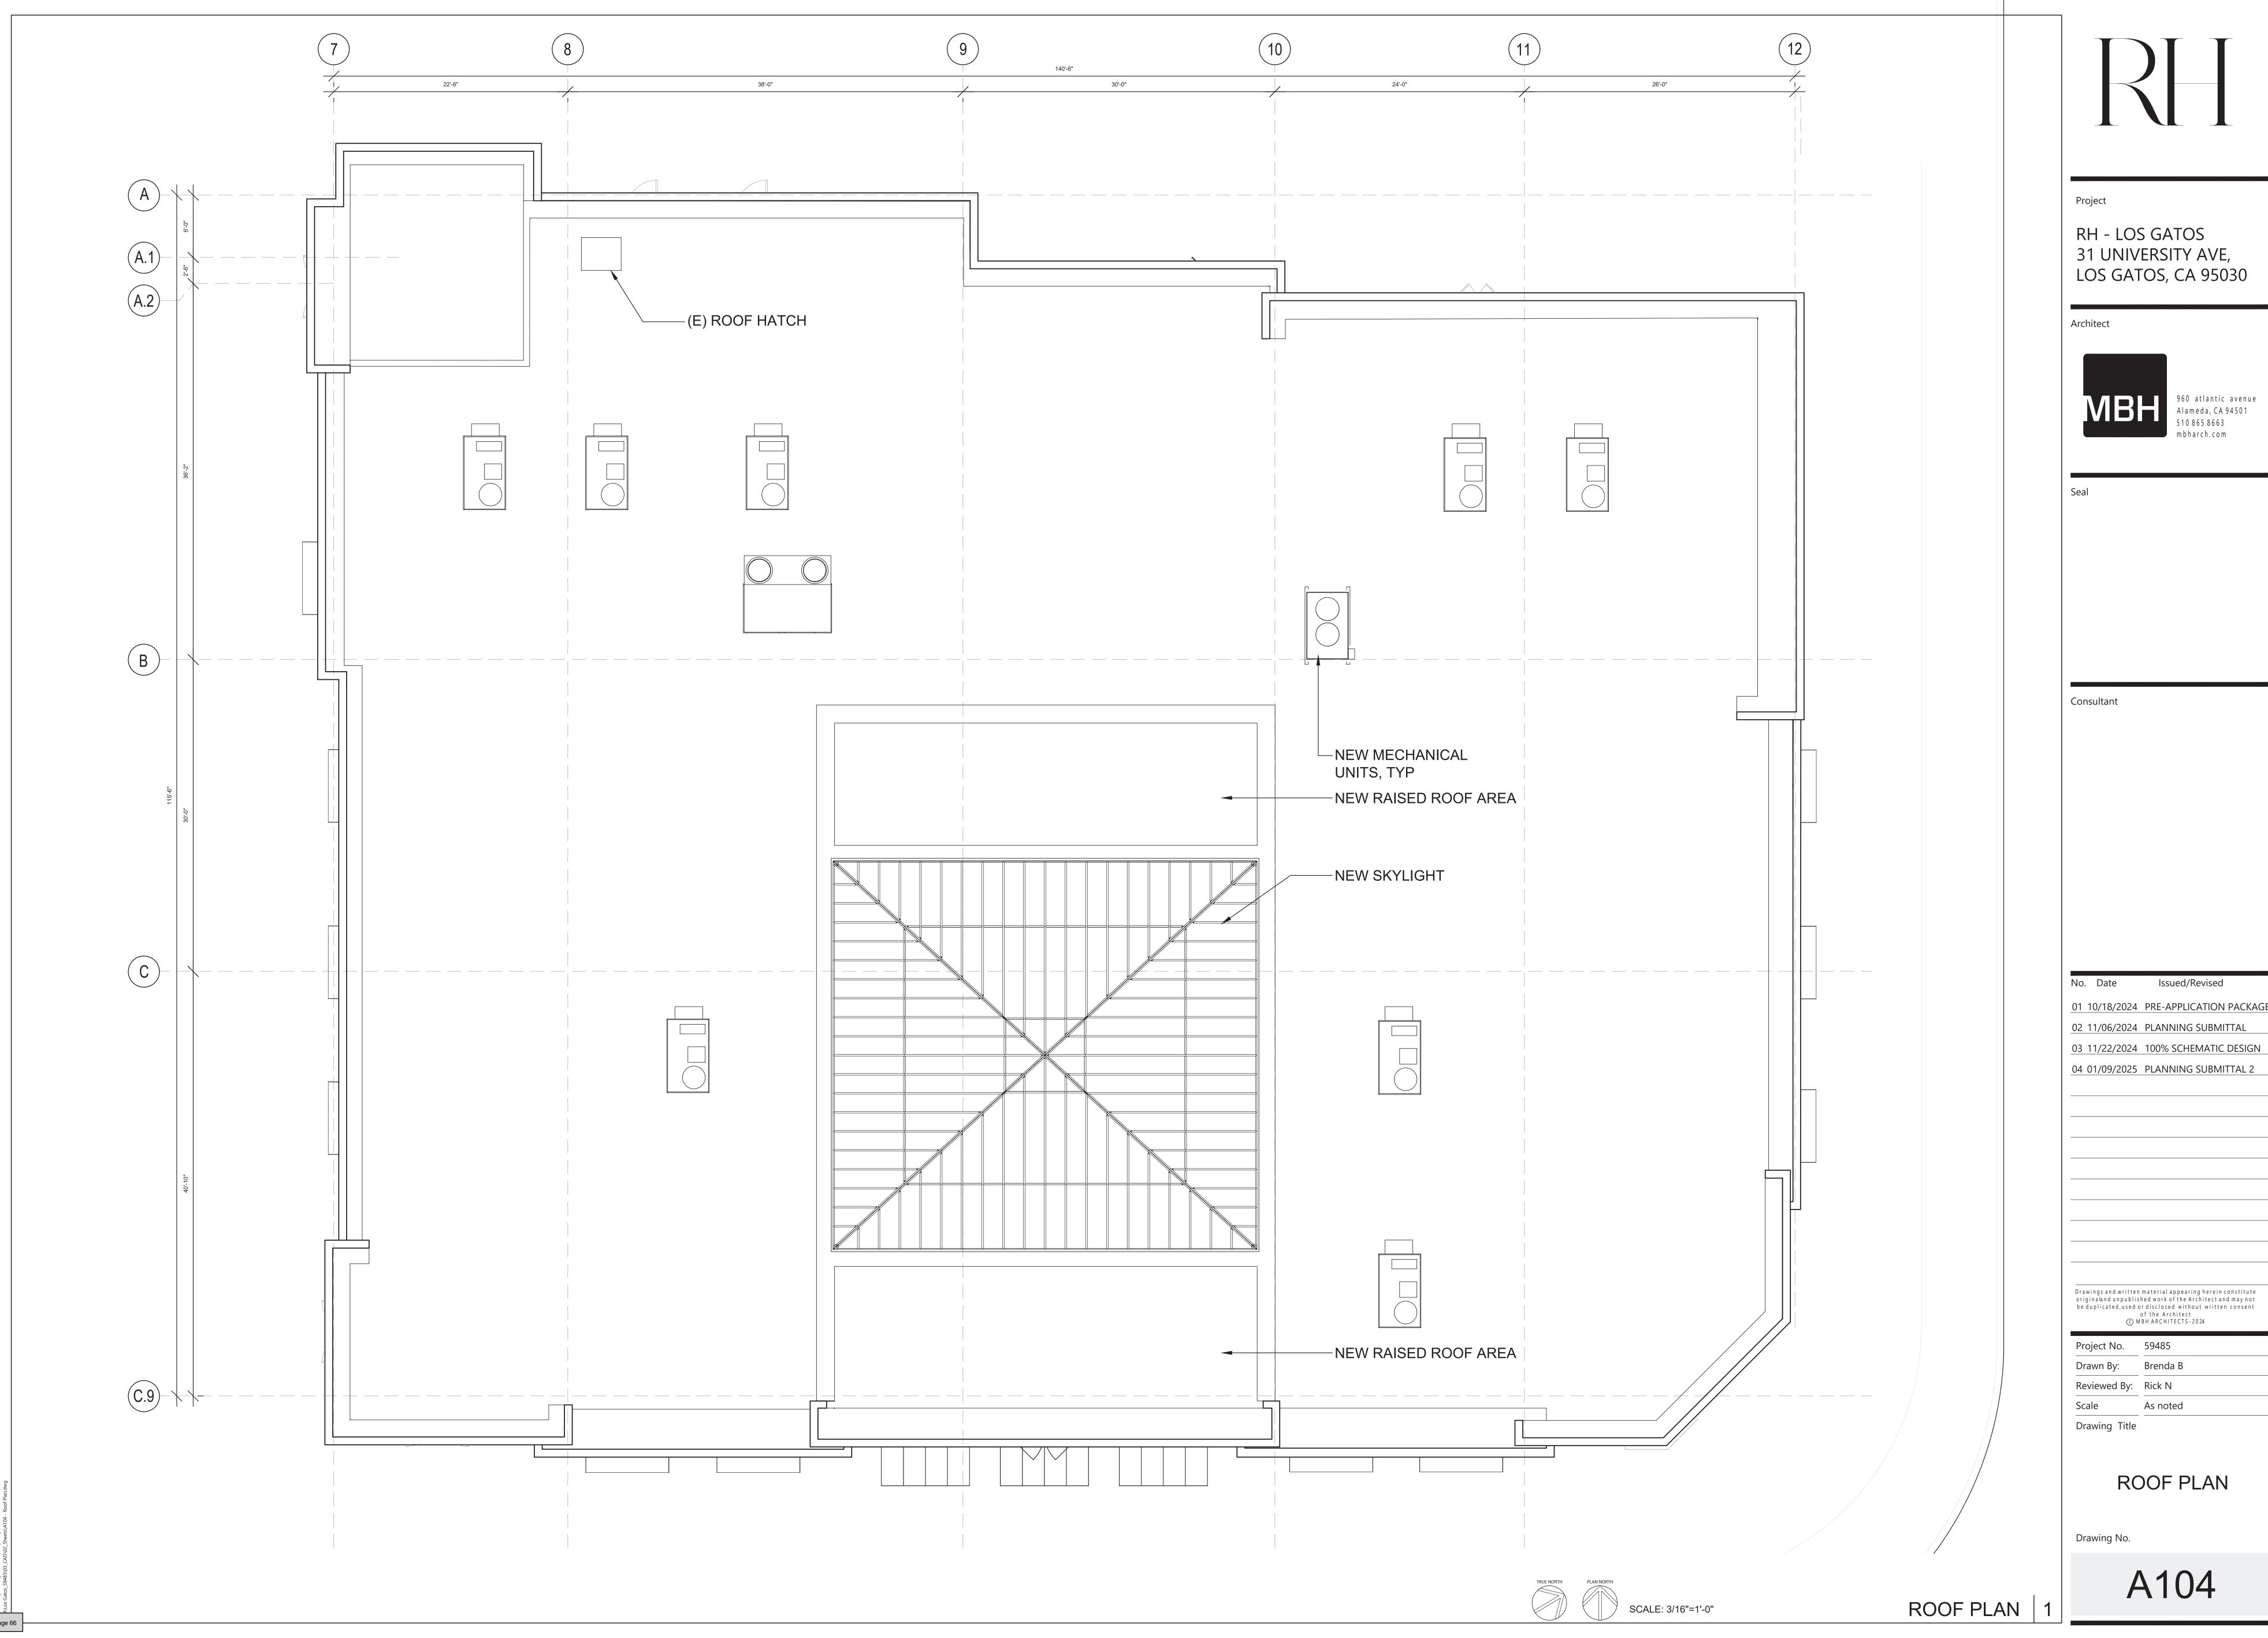

31 UNIVERSITY AVE,



01 10/18/2024 PRE-APPLICATION PACKAGE 02 11/06/2024 PLANNING SUBMITTAL 03 11/22/2024 100% SCHEMATIC DESIGN 04 01/09/2025 PLANNING SUBMITTAL 2



Project

RH - LOS GATOS 31 UNIVERSITY AVE, LOS GATOS, CA 95030

Architect



Seal

Consultant

No. Date Issued/Revised

01 10/18/2024 PRE-APPLICATION PACKAGE

02 11/06/2024 PLANNING SUBMITTAL

03 11/22/2024 100% SCHEMATIC DESIGN 04 01/09/2025 PLANNING SUBMITTAL 2

Drawings and written material appearing herein constitute originaland unpublished work of the Architect and may not be duplicated, used or disclosed without written consent of the Architect

© MBH ARCHITECTS - 2024

Project No. 59485

Drawn By: Brenda B

Reviewed By:

Scale

Drawing Title

Rick N


As noted

EXTERIOR

Drawing No.

A201

**ELEVATIONS** 

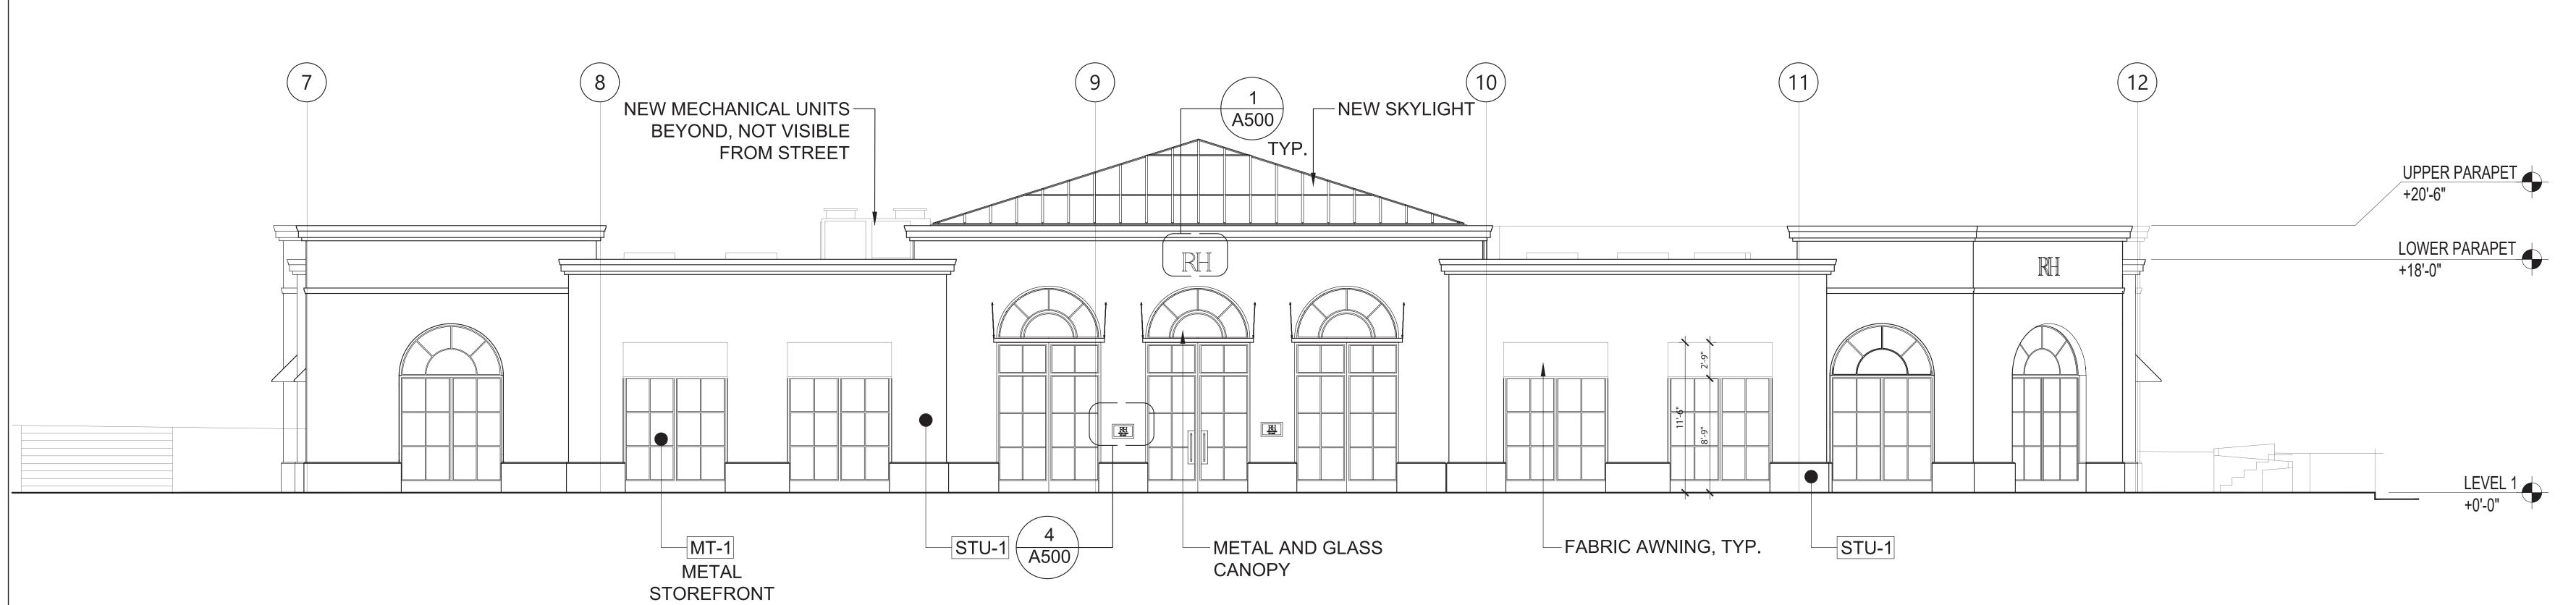


SCALE: 3/16"=1'-0" PROPO

PROPOSED SOUTH EXTERIOR ELEVATION 2

NOTE: FOR FINISH SPECS


SEE SHEETA406

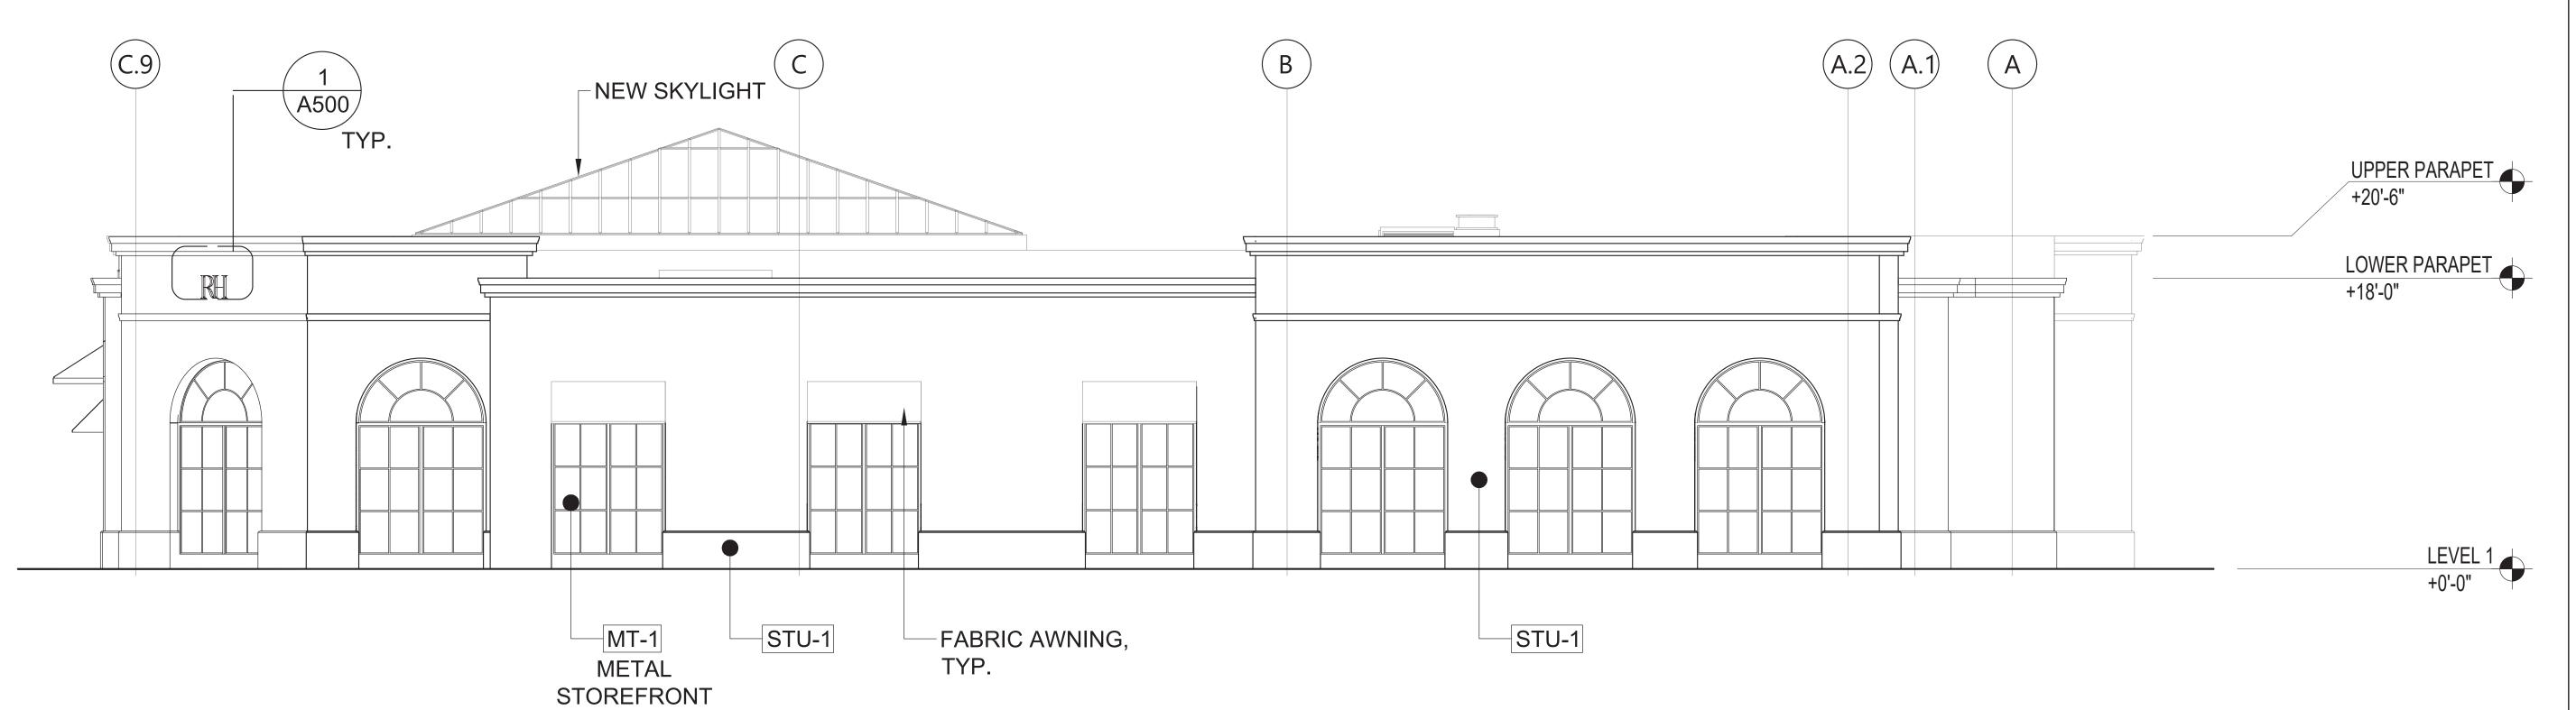

SCALE: 3/16"=1'-0"

PROPOSED EAST EXTERIOR ELEVATION

ed Friday January 10, 2025 1:32pn I\Los Gatos\_59485\03\_CAD\02\_SI

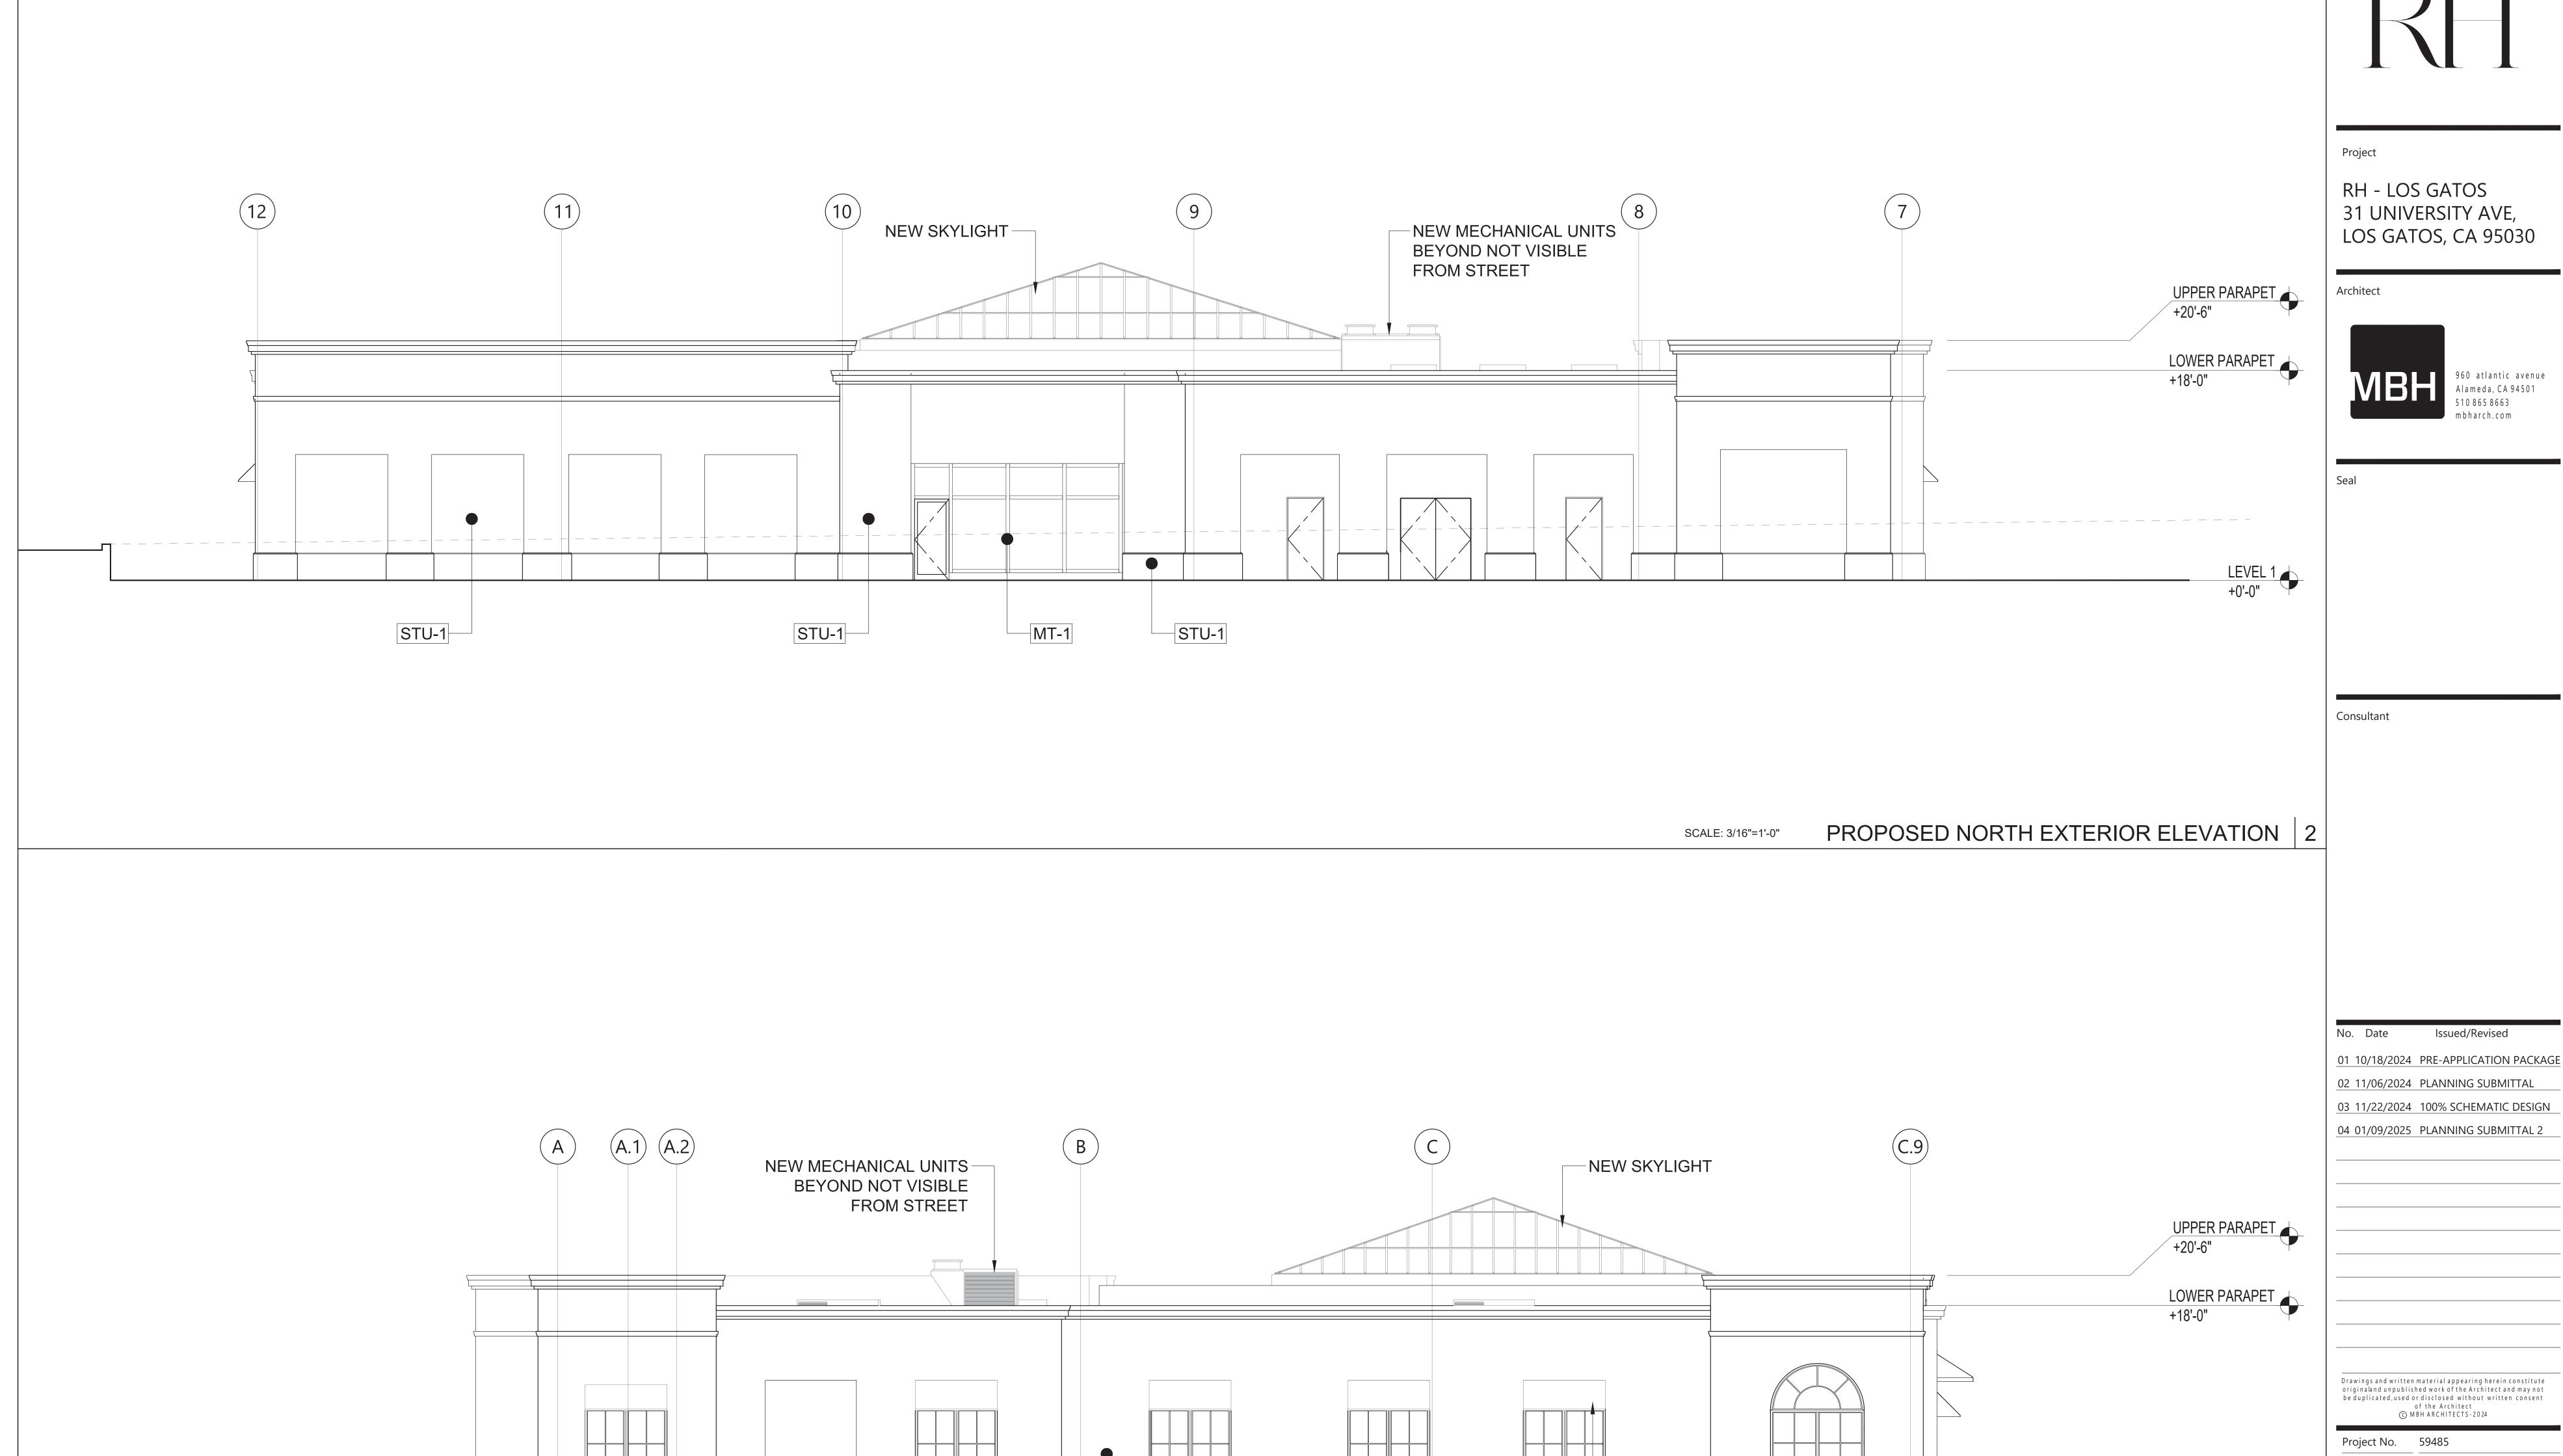

STU-1

(E) STAIR/ ELEVATOR TO

PARKING BASEMENT

STU-1

MT-1

METAL

STOREFRONT

FABRIC AWNING,

TYP.

31 UNIVERSITY AVE,



03 11/22/2024 100% SCHEMATIC DESIGN 04 01/09/2025 PLANNING SUBMITTAL 2


Drawn By: Brenda B Reviewed By: Rick N

Drawing Title

**EXTERIOR ELEVATIONS** 

Drawing No.

LEVEL 1 +0'-0"

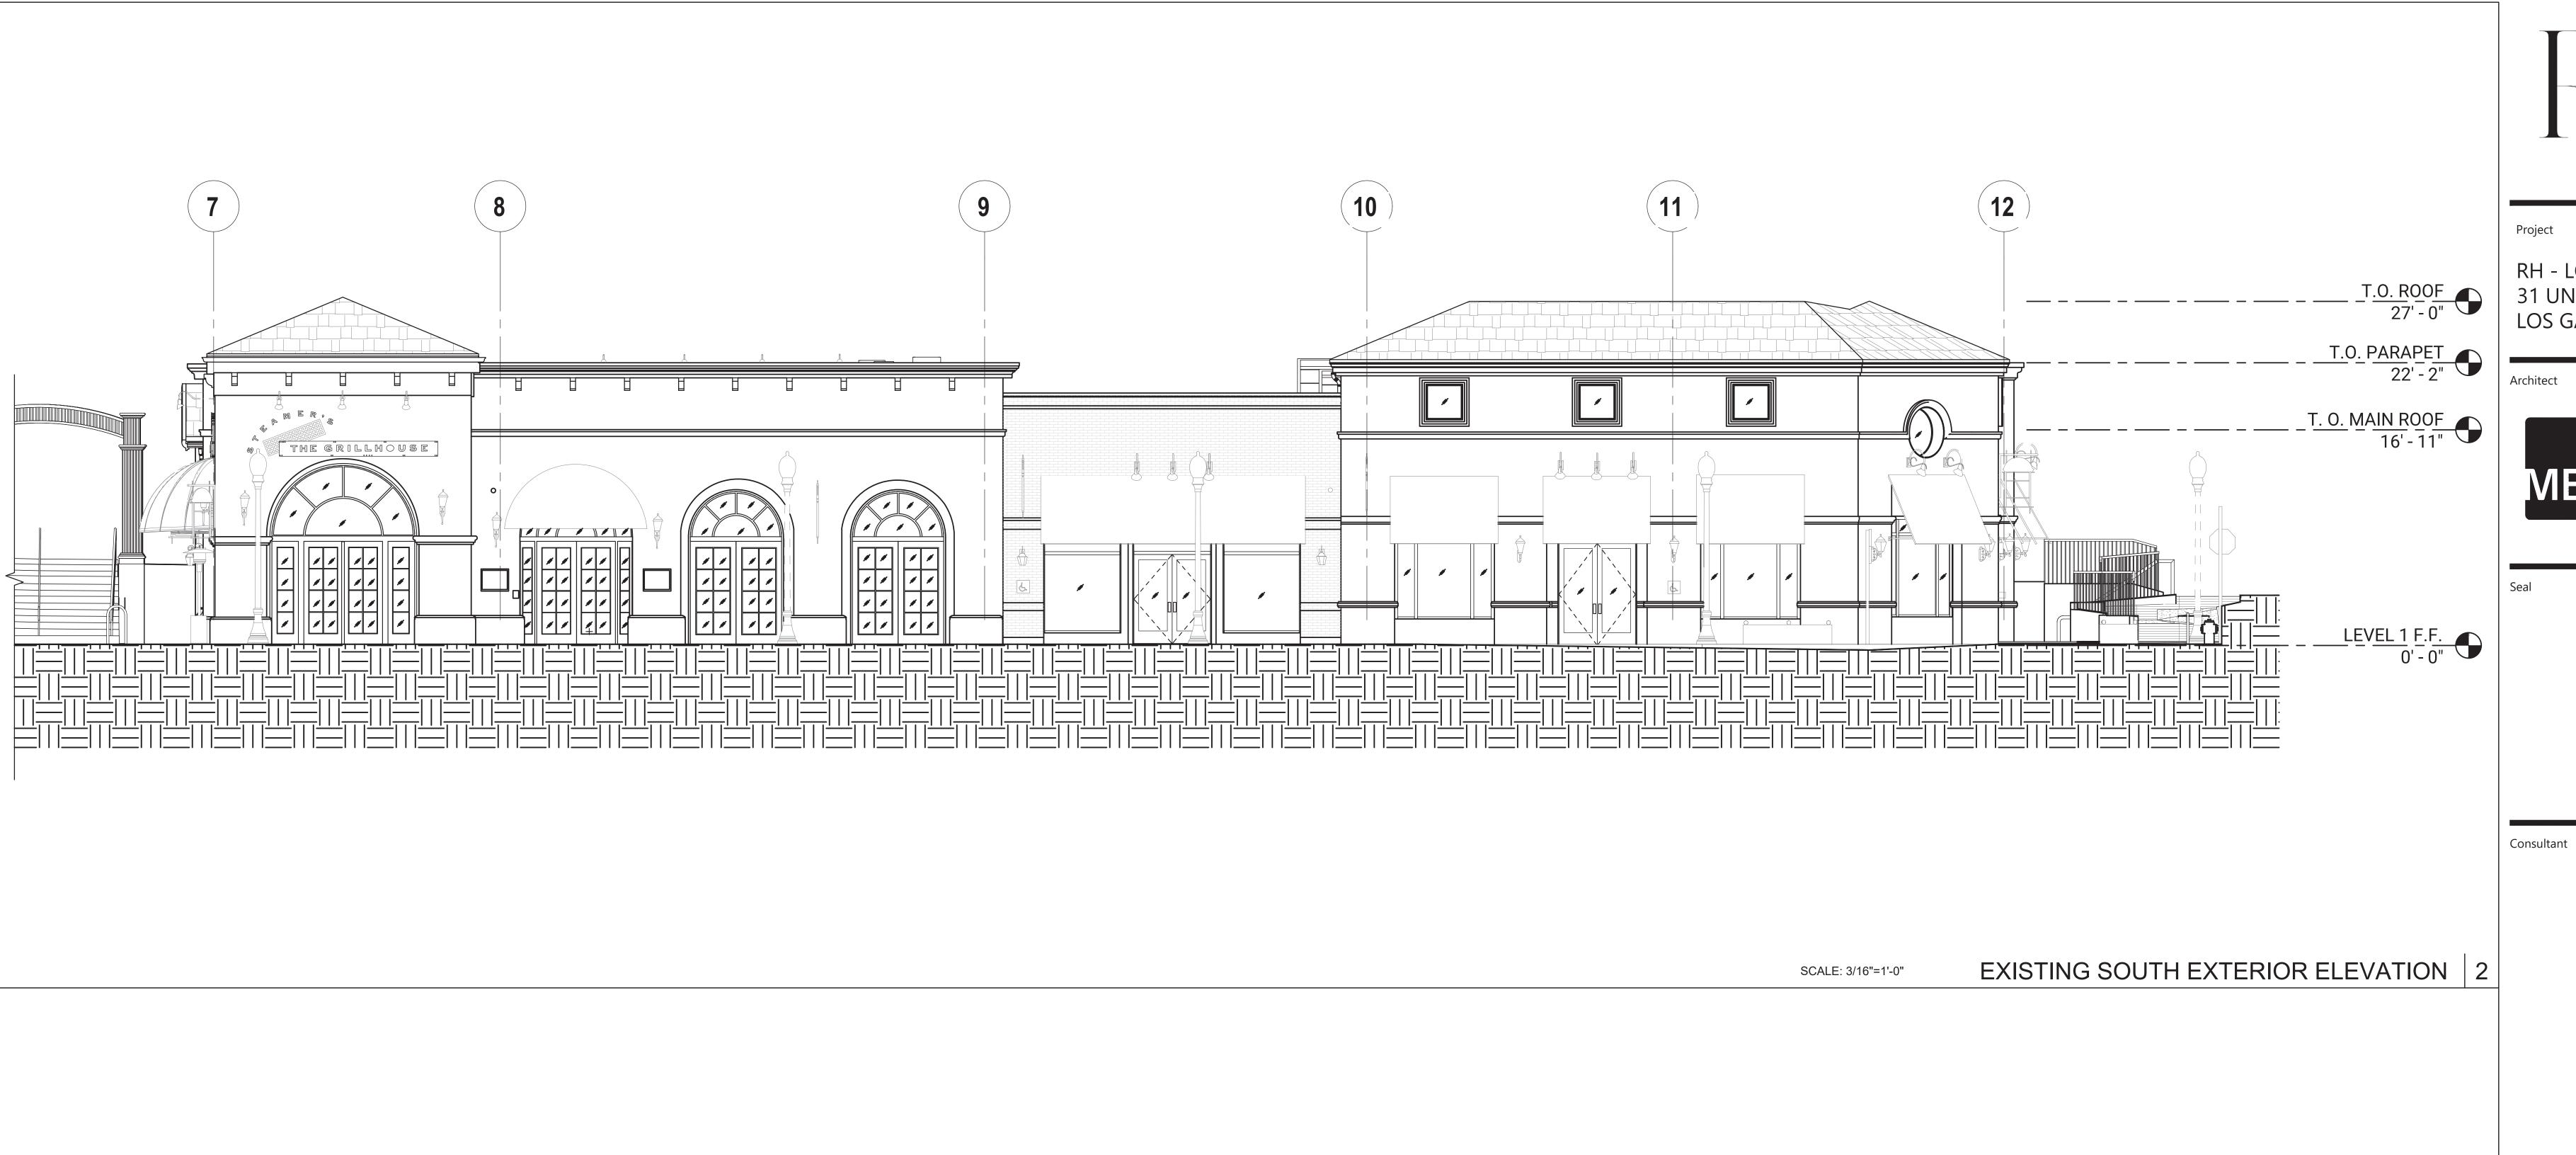



No. Date Issued/Revised

01 10/18/2024 PRE-APPLICATION PACKAGE

02 11/06/2024 PLANNING SUBMITTAL

03 11/22/2024 100% SCHEMATIC DESIGN

04 01/09/2025 PLANNING SUBMITTAL 2

Drawings and written material appearing herein constitute originaland unpublished work of the Architect and may not be duplicated, used or disclosed without written consent of the Architect

© MBH ARCHITECTS - 2024

Project No. 59485

Drawn By: Brenda B

Reviewed By: Rick N

Scale As r


Drawing Title


EXISTING EXTERIOR ELEVATIONS

Drawing No.

EXISTING EAST EXTERIOR ELEVATION

SCALE: 3/16"=1'-0"

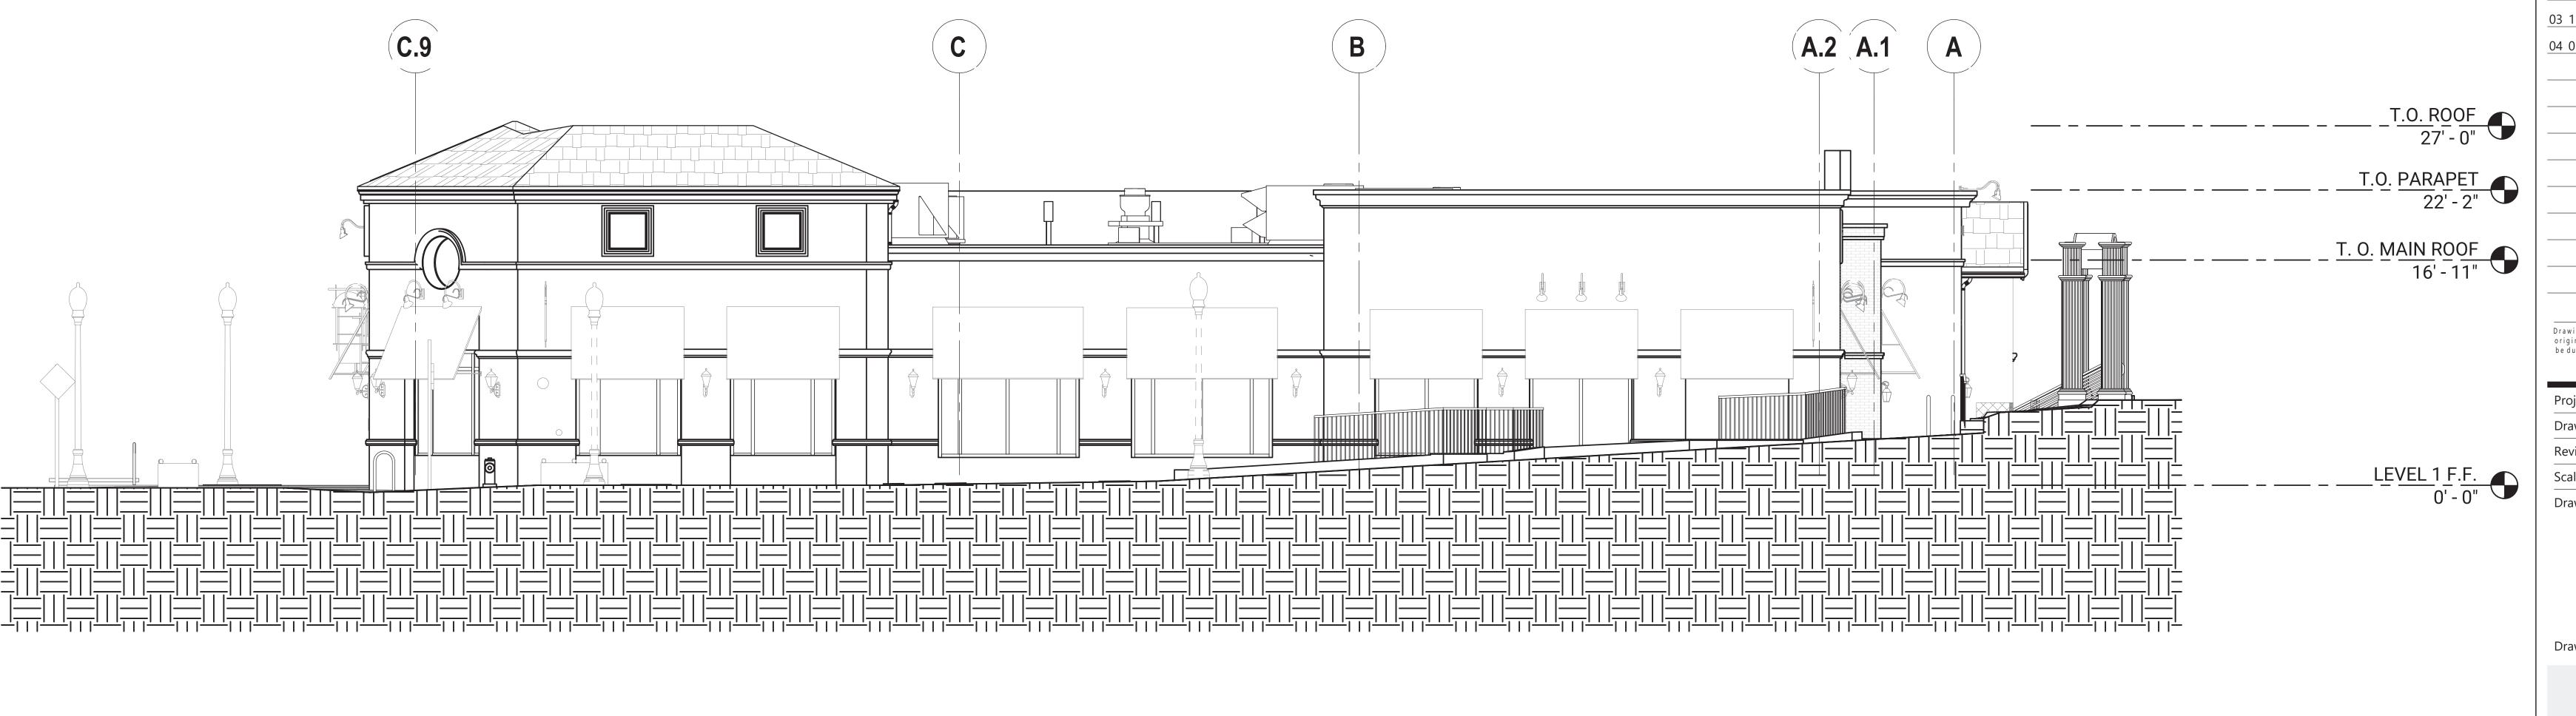

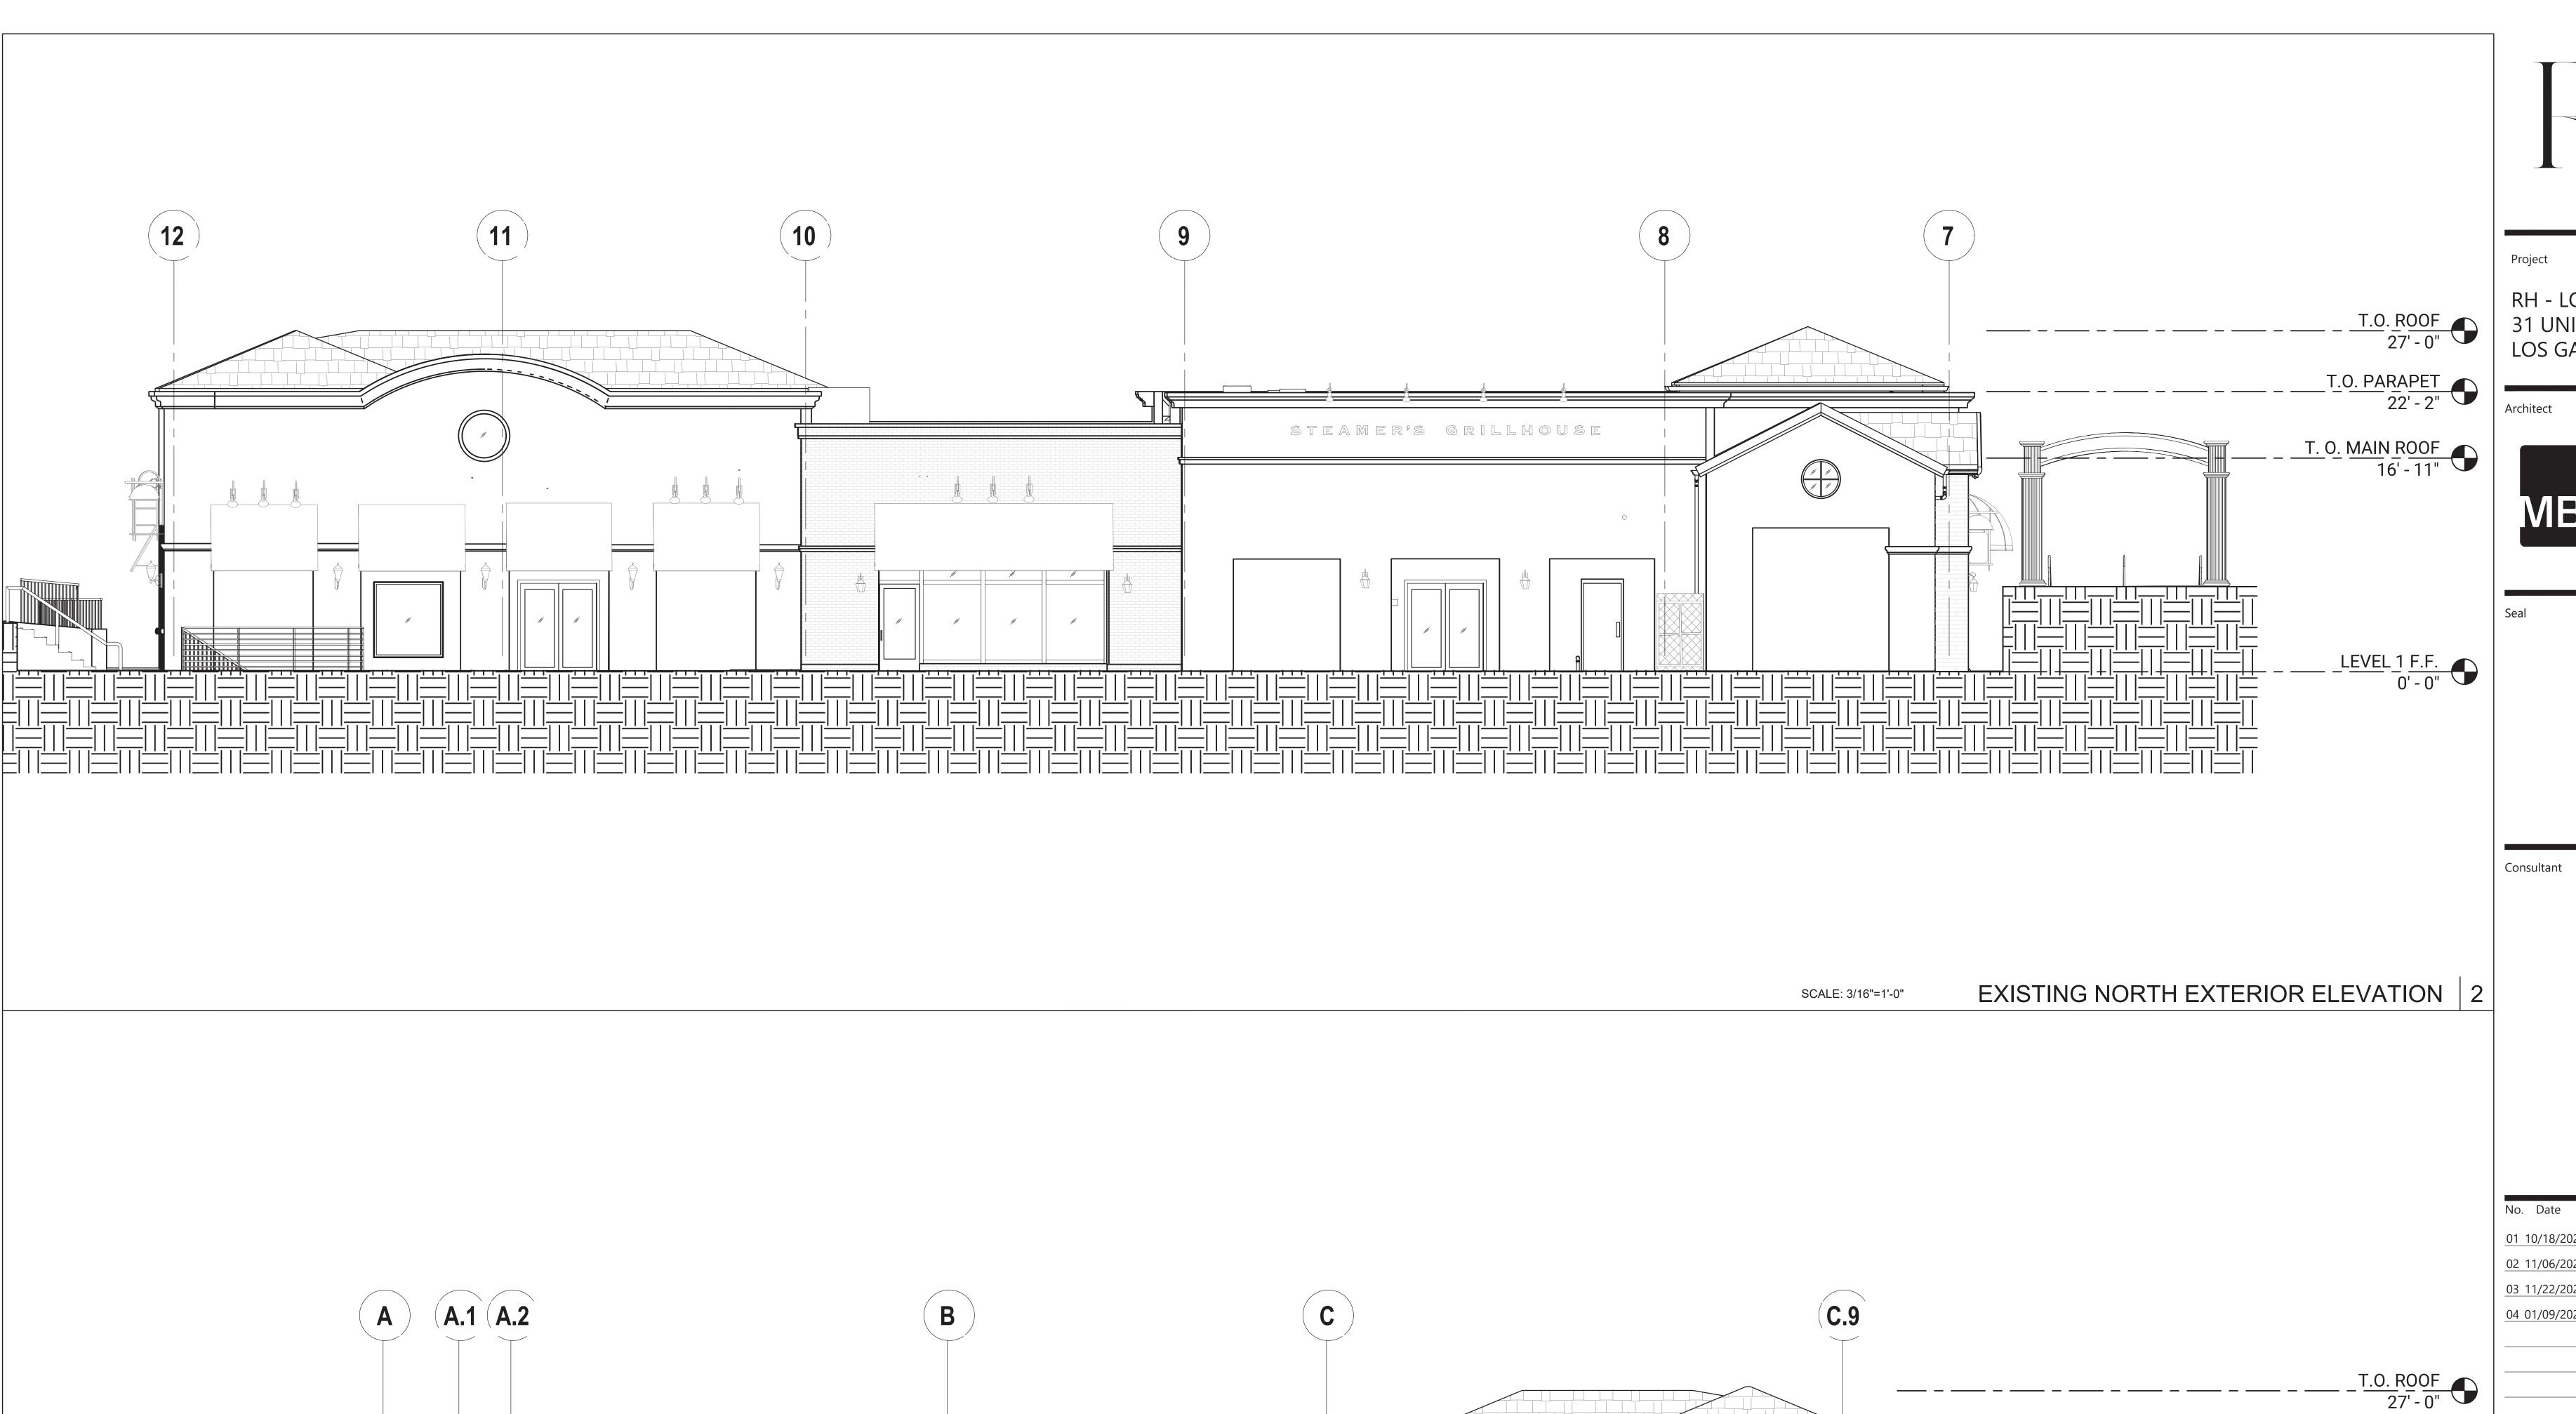



 No.
 Date
 Issued/Revised

 01
 10/18/2024
 PRE-APPLICATION PACKAGE

 02
 11/06/2024
 PLANNING SUBMITTAL

 03
 11/22/2024
 100% SCHEMATIC DESIGN

 04
 01/09/2025
 PLANNING SUBMITTAL 2

Drawings and written material appearing herein constitute originaland unpublished work of the Architect and may not be duplicated, used or disclosed without written consent of the Architect

© MBH ARCHITECTS - 2024

Project No. 59485

Drawn By: Brenda B

Reviewed By: Rick N

Scale As note Drawing Title

EXISTING EXTERIOR ELEVATIONS

Drawing No.

T.O. PARAPET 22' - 2"


T. O. MAIN ROOF 16' - 11"

> LEVEL 1 F.F. 0' - 0"

> > A204

SCALE: 3/16"=1'-0" EXISTING WEST EXTERIOR ELEVATION

THE GRILLHOUSE

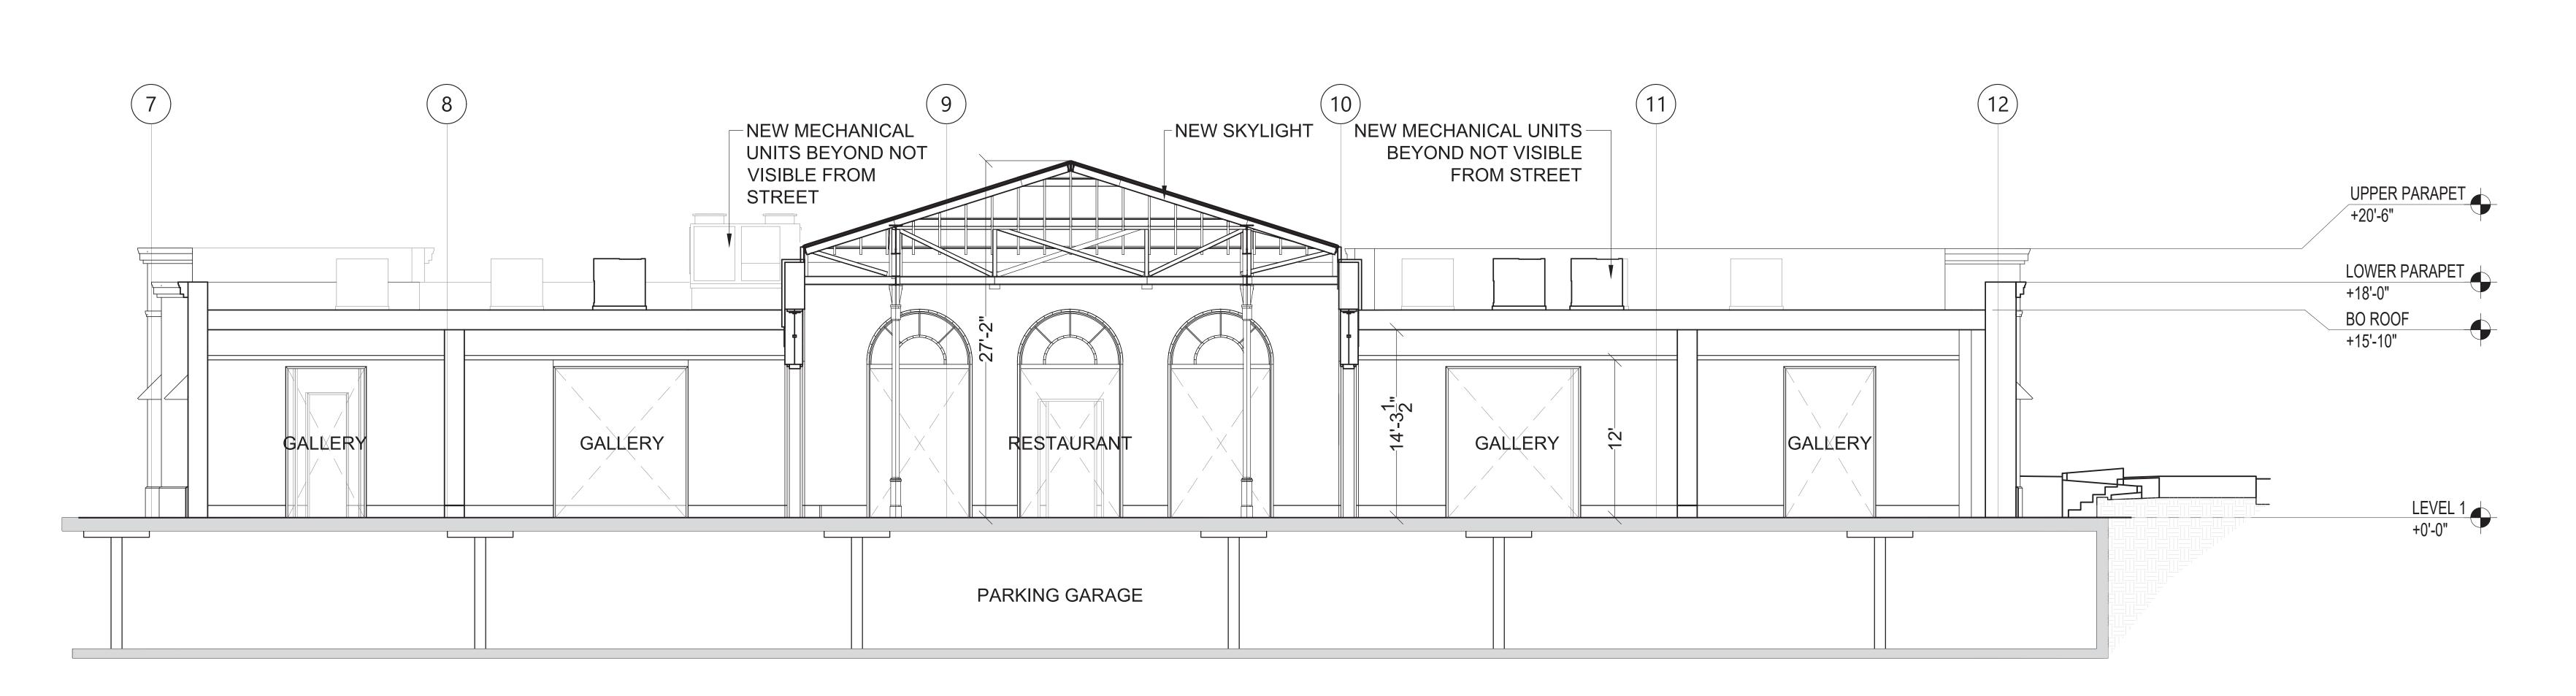

Project

RH - LOS GATOS 31 UNIVERSITY AVE, LOS GATOS, CA 95030

Architect



Coal

Consultant

PROPOSED BUILDING SECTION 2

NEW SKYLIGHT

RESTAURANT

PARKING GARAGE

RESTAURANT

 No.
 Date
 Issued/Revised

 01
 10/18/2024
 PRE-APPLICATION PACKAGE

 02
 11/06/2024
 PLANNING SUBMITTAL

 03
 11/22/2024
 100% SCHEMATIC DESIGN

 04
 01/09/2025
 PLANNING SUBMITTAL 2

Drawings and written material appearing herein constitute originaland unpublished work of the Architect and may not be duplicated, used or disclosed without written consent of the Architect

© MBH ARCHITECTS - 2024

Project No. 59485

Drawn By: Brenda B

Reviewed By: Rick N

Scale As noted

Drawing Title

BUILDING

Drawing No.

A301

SECTIONS

SCALE: 3/16"=1'-0"







Consultant

No. Date Issued/Revised 01 10/18/2024 PRE-APPLICATION PACKAGE 02 11/06/2024 PLANNING SUBMITTAL 03 11/22/2024 100% SCHEMATIC DESIGN 04 01/09/2025 PLANNING SUBMITTAL 2

Drawn By:


Reviewed By: Rick N

Drawing Title

**EXISTING** BUILDING PHOTOS

Drawing No.



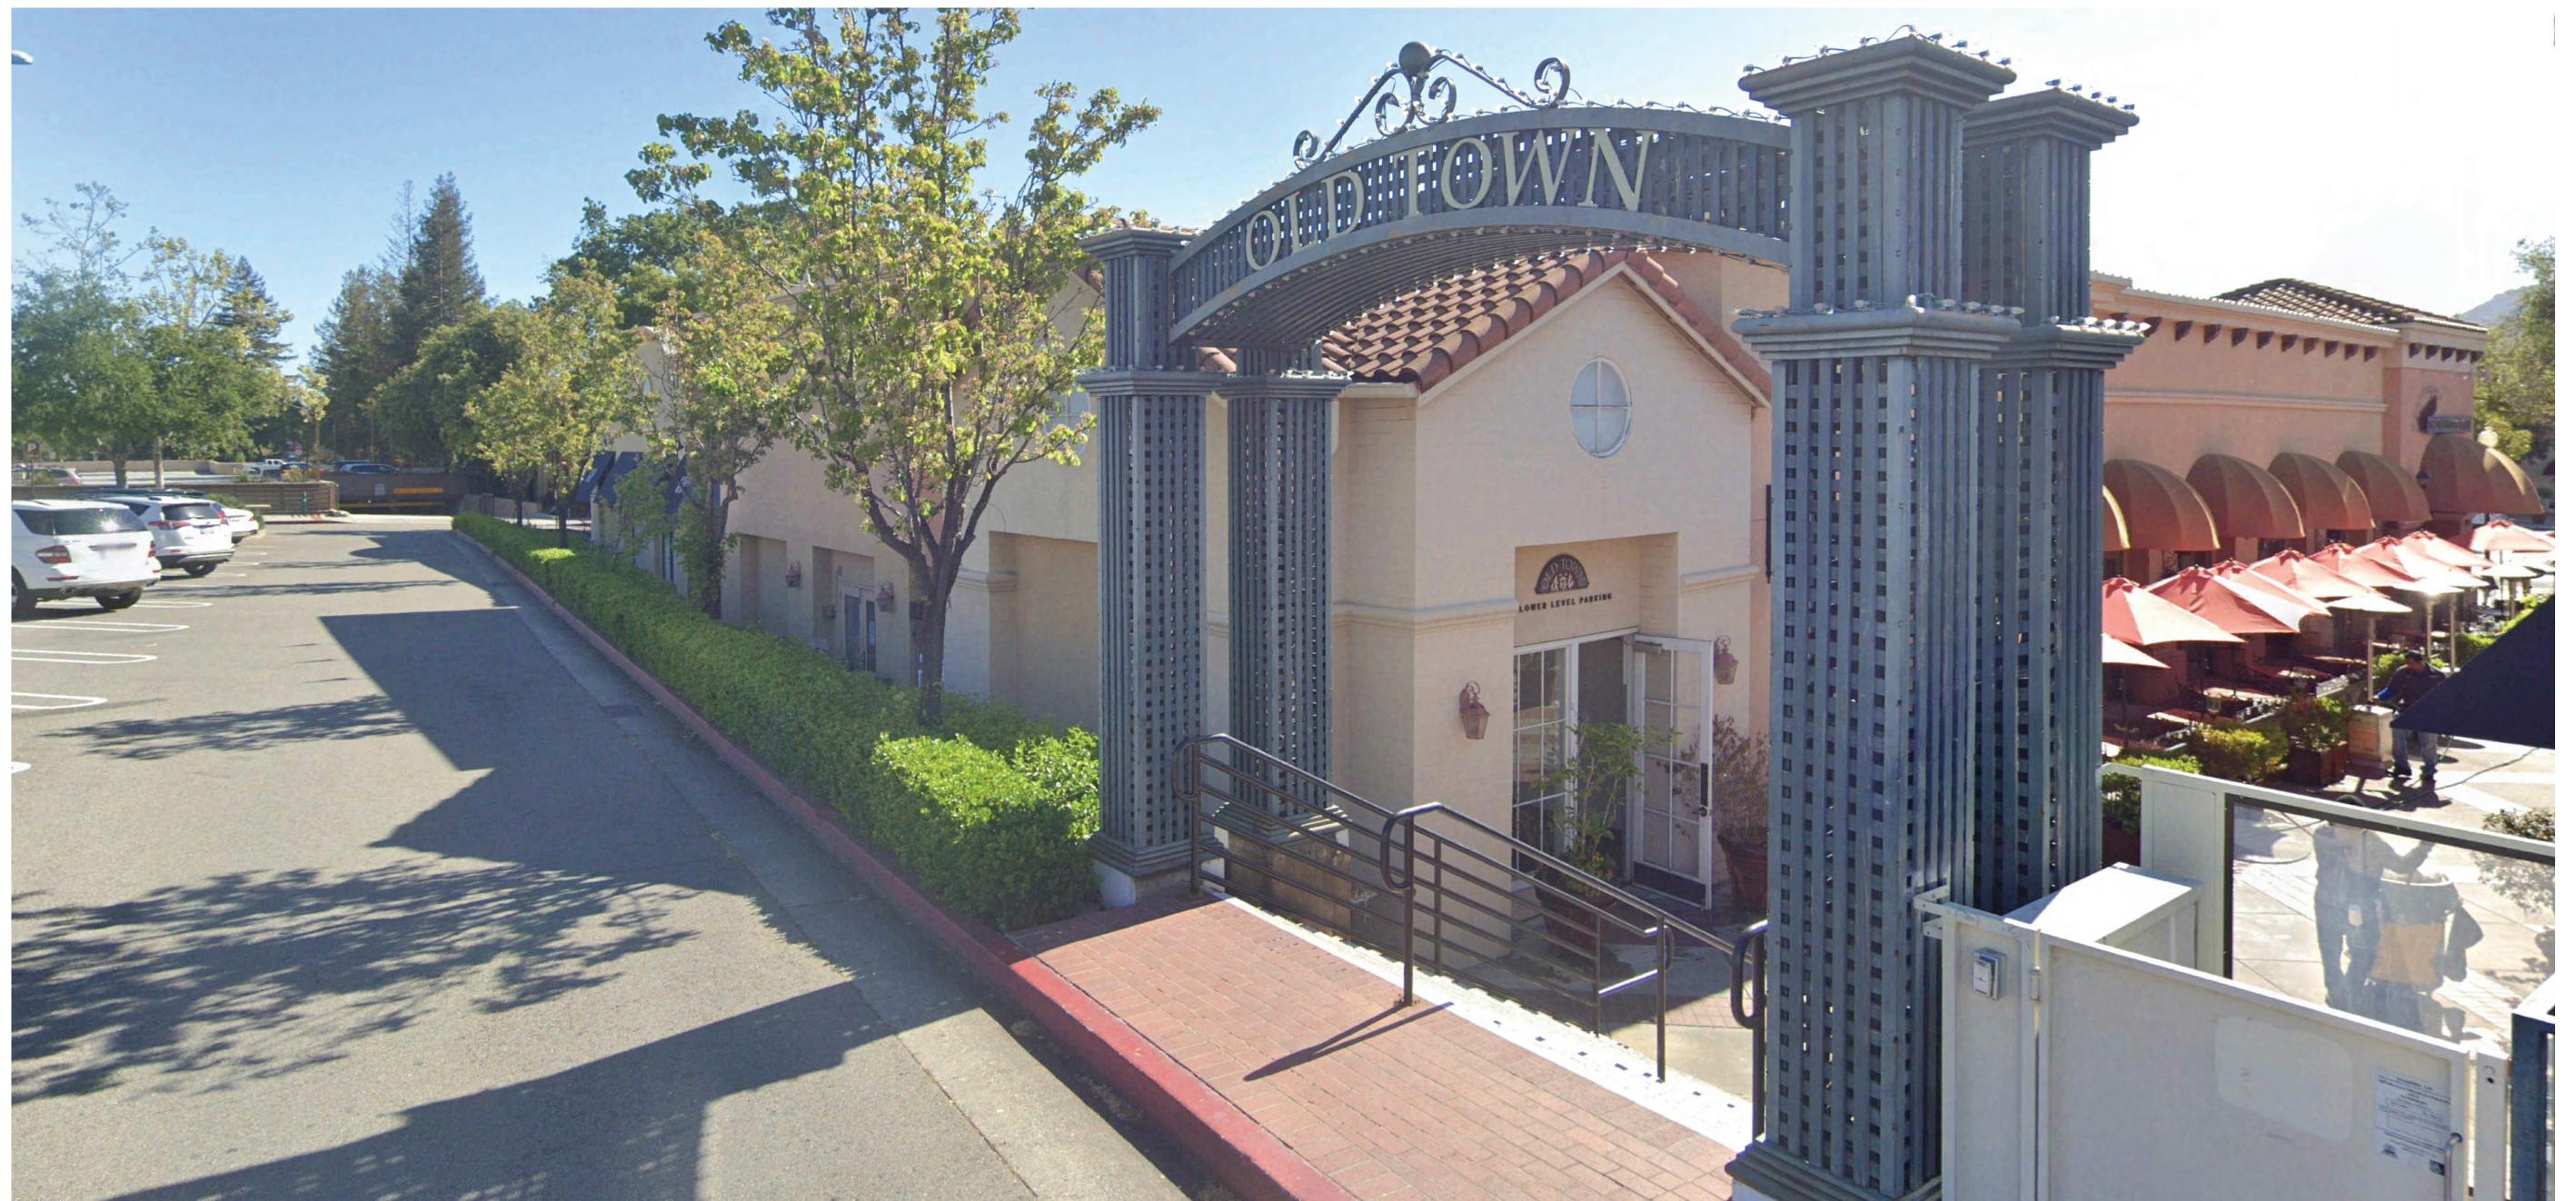

Architect



Consultant

No. Date Issued/Revised 01 10/18/2024 PRE-APPLICATION PACKAGE 02 11/06/2024 PLANNING SUBMITTAL 03 11/22/2024 100% SCHEMATIC DESIGN 04 01/09/2025 PLANNING SUBMITTAL 2

Drawings and written material appearing herein constitute originaland unpublished work of the Architect and may not be duplicated, used or disclosed without written consent of the Architect

© MBH ARCHITECTS-2024

Drawn By: Brenda B Reviewed By: Rick N

Drawing Title

**EXISTING** BUILDING PHOTOS

Drawing No.





Proj

RH - LOS GATOS 31 UNIVERSITY AVE, LOS GATOS, CA 95030

Architect



Seal

Consultant

No. Date Issued/Revised

01 10/18/2024 PRE-APPLICATION PACKAGE

02 11/06/2024 PLANNING SUBMITTAL

03 11/22/2024 100% SCHEMATIC DESIGN

04 01/09/2025 PLANNING SUBMITTAL 2

Drawings and written material appearing herein constitute originaland unpublished work of the Architect and may not be duplicated, used or disclosed without written consent of the Architect

© MBH ARCHITECTS-2024

Project No. 59485

Drawn By: Brenda B

Reviewed By: Rick N
Scale As noted

Scale As no Drawing Title

EXTERIOR BUILDING RENDERS

Drawing No.







Consultant

No. Date Issued/Revised 01 10/18/2024 PRE-APPLICATION PACKAGE 02 11/06/2024 PLANNING SUBMITTAL 03 11/22/2024 100% SCHEMATIC DESIGN 04 01/09/2025 PLANNING SUBMITTAL 2

Drawn By: Brenda B

Reviewed By: Rick N

Drawing Title

**EXTERIOR** BUILDING RENDERS

Drawing No.







Proje

RH - LOS GATOS 31 UNIVERSITY AVE, LOS GATOS, CA 95030

Architect



Se

Consultant

 No.
 Date
 Issued/Revised

 01
 10/18/2024
 PRE-APPLICATION PACKAGE

 02
 11/06/2024
 PLANNING SUBMITTAL

 03
 11/22/2024
 100% SCHEMATIC DESIGN

 04
 01/09/2025
 PLANNING SUBMITTAL 2

Drawings and written material appearing herein constitute originaland unpublished work of the Architect and may not be duplicated, used or disclosed without written consent of the Architect

© MBH ARCHITECTS-2024

Project No. 59485

Drawn By: Brenda B

Reviewed By: Rick N

Scale As
Drawing Title

INTERIOR BUILDING RENDERS

Drawing No.





Consultant

No. Date Issued/Revised 01 10/18/2024 PRE-APPLICATION PACKAGE 02 11/06/2024 PLANNING SUBMITTAL 03 11/22/2024 100% SCHEMATIC DESIGN 04 01/09/2025 PLANNING SUBMITTAL 2

Drawings and written material appearing herein constitute originaland unpublished work of the Architect and may not be duplicated, used or disclosed without written consent of the Architect

© MBH ARCHITECTS-2024

Drawn By: Brenda B Reviewed By: Rick N


Drawing Title

INTERIOR BUILDING RENDERS

Drawing No.



## MATERIAL FINISHES

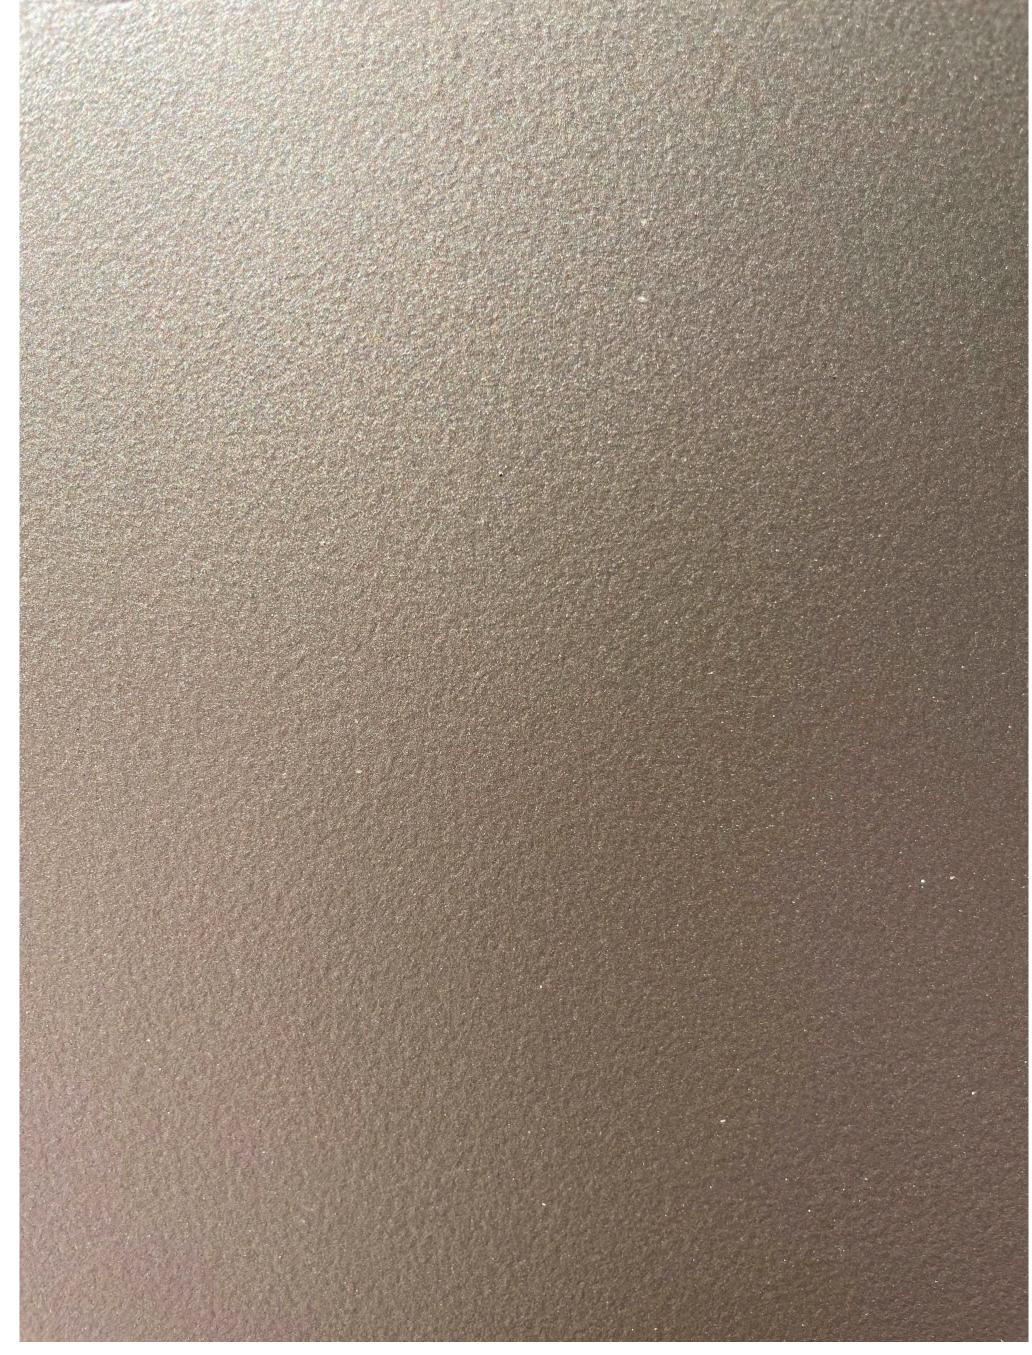

<u>MT-1</u>

METAL FINISH MFR: CREATIVE PAINTS SAN FRANCISCO PAINTED METAL CUSTOM METALLIC PLAINT




STU-1

STUCCO SYSTEM
MFR: RICK MARS
EXTERIOR CLADDING
LIGHT CREAM PROPRIETARY 5 COAT VENETIAN PLASTER
CUSTOM FINISH PER OWNER REQUIREMENTS



FABRIC AWNING

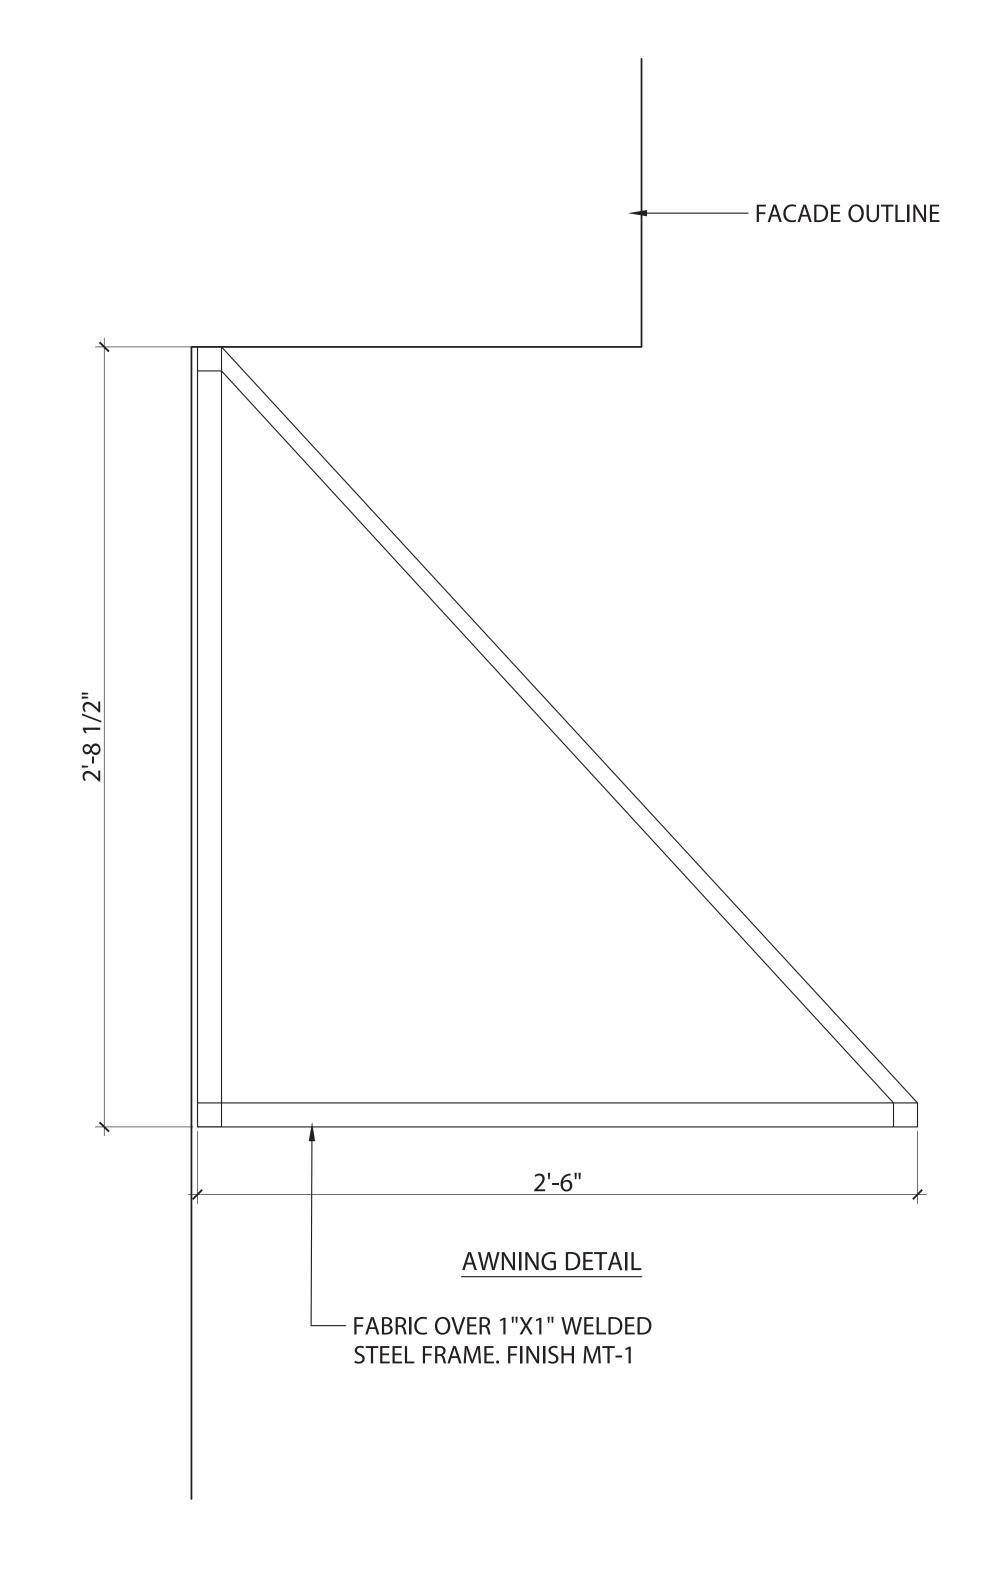



Proje

RH - LOS GATOS 31 UNIVERSITY AVE, LOS GATOS, CA 95030

Architect



Seal

Consultant

No. Date Issued/Revised

01 10/18/2024 PRE-APPLICATION PACKAGE

02 11/06/2024 PLANNING SUBMITTAL

03 11/22/2024 100% SCHEMATIC DESIGN

04 01/09/2025 PLANNING SUBMITTAL 2

Project No. 59485

Drawn By: Brenda B

Reviewed By: Rick N


Scale As no Drawing Title

MATERIAL FINISHES


Drawing No.

A406

ed Friday January 10, 2025 1.33pm by BrendaB A\Los Gatos\_59485\03\_CAD\02\_Sheets\A406 - Material Finishes.dwg

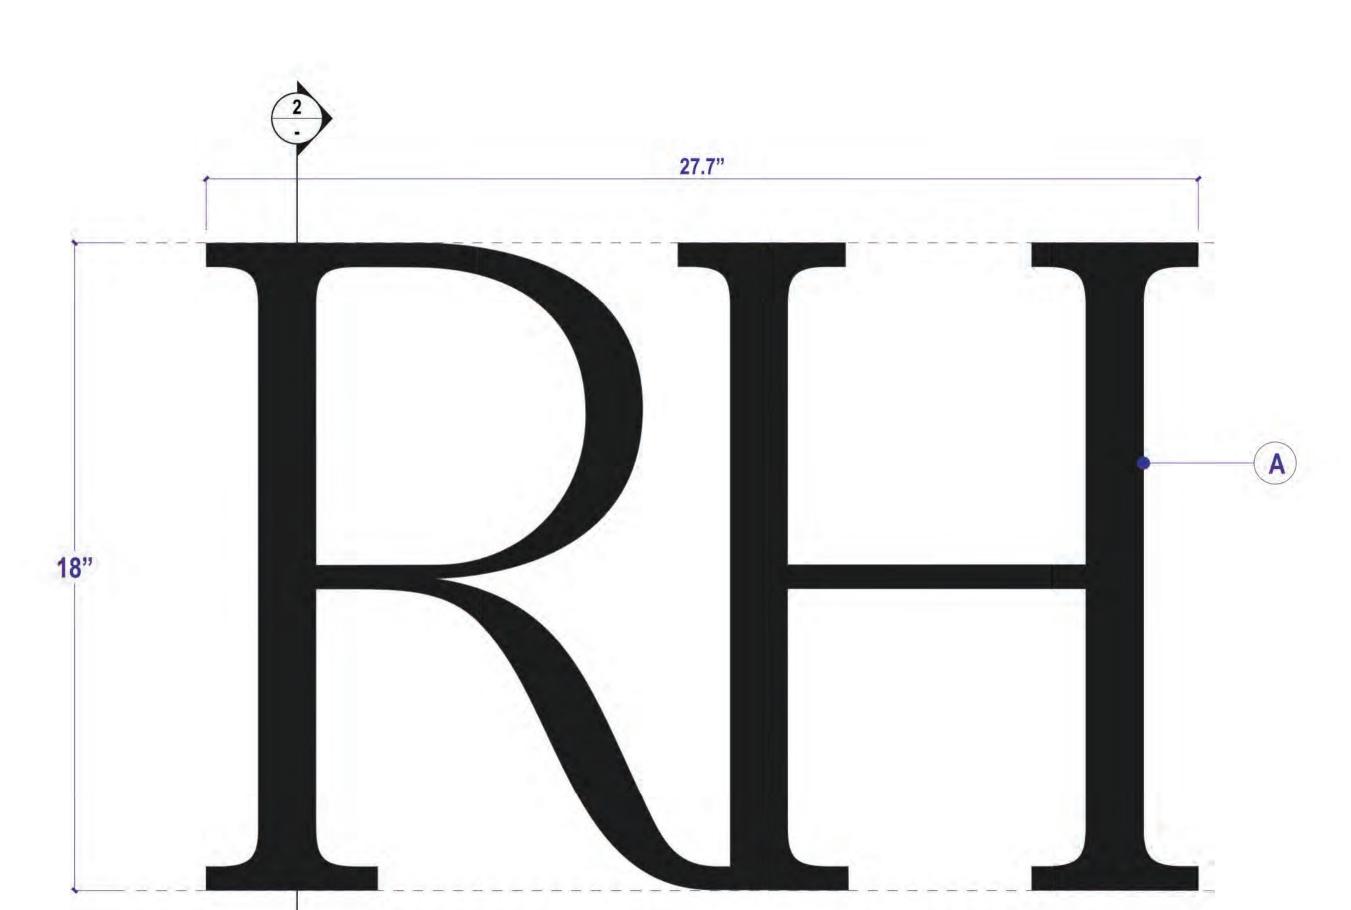

17-IN RH LOGO HALO-LIT - DETAIL

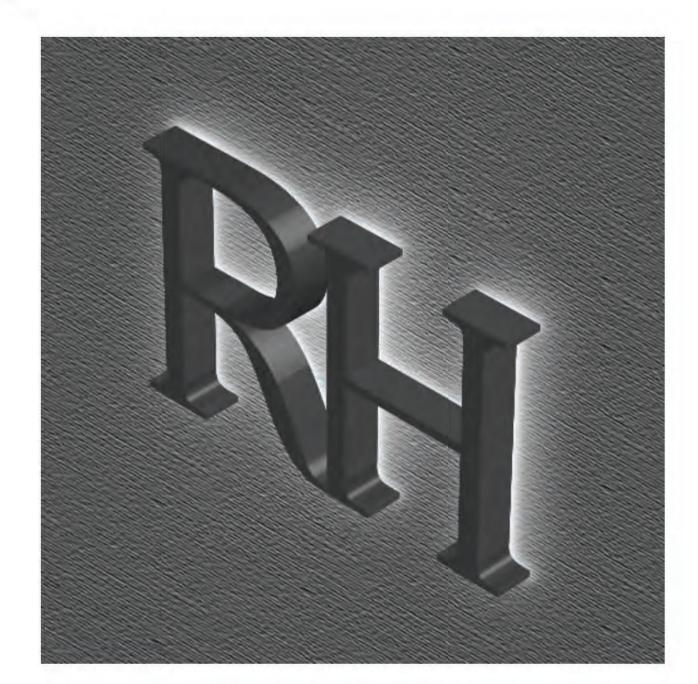

**ILLUMINATION SAMPLE** 



THOMAS-SWAN SIGN COMPANY, INC. 2717 GOODRICK AVENUE, RICHMOND, CA 94801

© 2021 THOMAS SWAN SIGN COMPANY, INC. All rights reserved. This drawing and the concepts, ideas and design development expressed herein are intended for use on this project only, and remain the sole property of Thomas Swan Sign Company, Inc. Original design concepts installation of these designs. Items are at scale 510-232-9610 • CALIFORNIA LICENSE #269069 noted when this page is printed at 11" x 17".

PROJECT NAME & ADDRESS

RESTORATION HARDWARE

RH HALO-LIT BUILDING LOGO FILE NAME 18IN\_LOS GATOS APPROVED FOR CONSTRUCTION - INCLUDE NAME & DATE

B

C

E

SECTION

DATE / REVISIONS

REMOTE

POWER

SUPPLY

**Restoration Hardware** SALES Ryan Goss DRAWN BY

8258 SHEET NUMBER QUANTITY

1.00

JOB NUMBER

SPECIFICATIONS:

A. 1/8" THICK ALUMINUM FACE PAINT TO MATCH AWNINGS/WINDOW FRAMES

NOTE: SOME STROKE ADJUSTED TO ACCOMODATE LED LIGHT LAYOUT REQUIREMENTS

**B.** .050" THICK ALUMINUM RETURNS PAINTED RAL 9005 JET BLACK SATIN (MP923) MOUNTED TO "C" VIA ANGLE BRACKETS AND SCREWS

C. 3/16" POLYCARBONATE BACK WITH SINGLE LAYER OF WHITE FROSTED CRYSTAL 7725E-324 DIFFUSER RIVETED TO ALUMINUM ANGLE BRACKETS MOUNTED TO FINISH WALL VIA 1/4"-20 SCREWS AND ANCHOR **IN 7 PLACES** 

D. 1/2" DIA. ALUMINUM SPACERS

E. AGI LIGHT 3000K

**F.** MAGNITUDE M150L12DC-AR LED DRIVER



NOT 100% SCALE 20" X 30" FRAME MATCHES RENDERING

ENTRY PLAQUE SIGN DETAIL



Drawings and written material appearing herein constitute originaland unpublished work of the Architect and may not be duplicated, used or disclosed without written consent of the Architect

© MBH ARCHITECTS-2024

> Drawn By: Brenda B Reviewed By: Rick N

> > Drawing Title

RH - LOS GATOS

Architect

Consultant

No. Date

31 UNIVERSITY AVE,

LOS GATOS, CA 95030

**EXTERIOR** 

SIGNAGE

Issued/Revised

01 10/18/2024 PRE-APPLICATION PACKAGE

02 11/06/2024 PLANNING SUBMITTAL

03 11/22/2024 100% SCHEMATIC DESIGN

04 01/09/2025 PLANNING SUBMITTAL 2


Drawing No.

A500

FOR REFERENCE ONLY

SCALE: N.T.S.

**EXTERIOR SIGNAGE** 

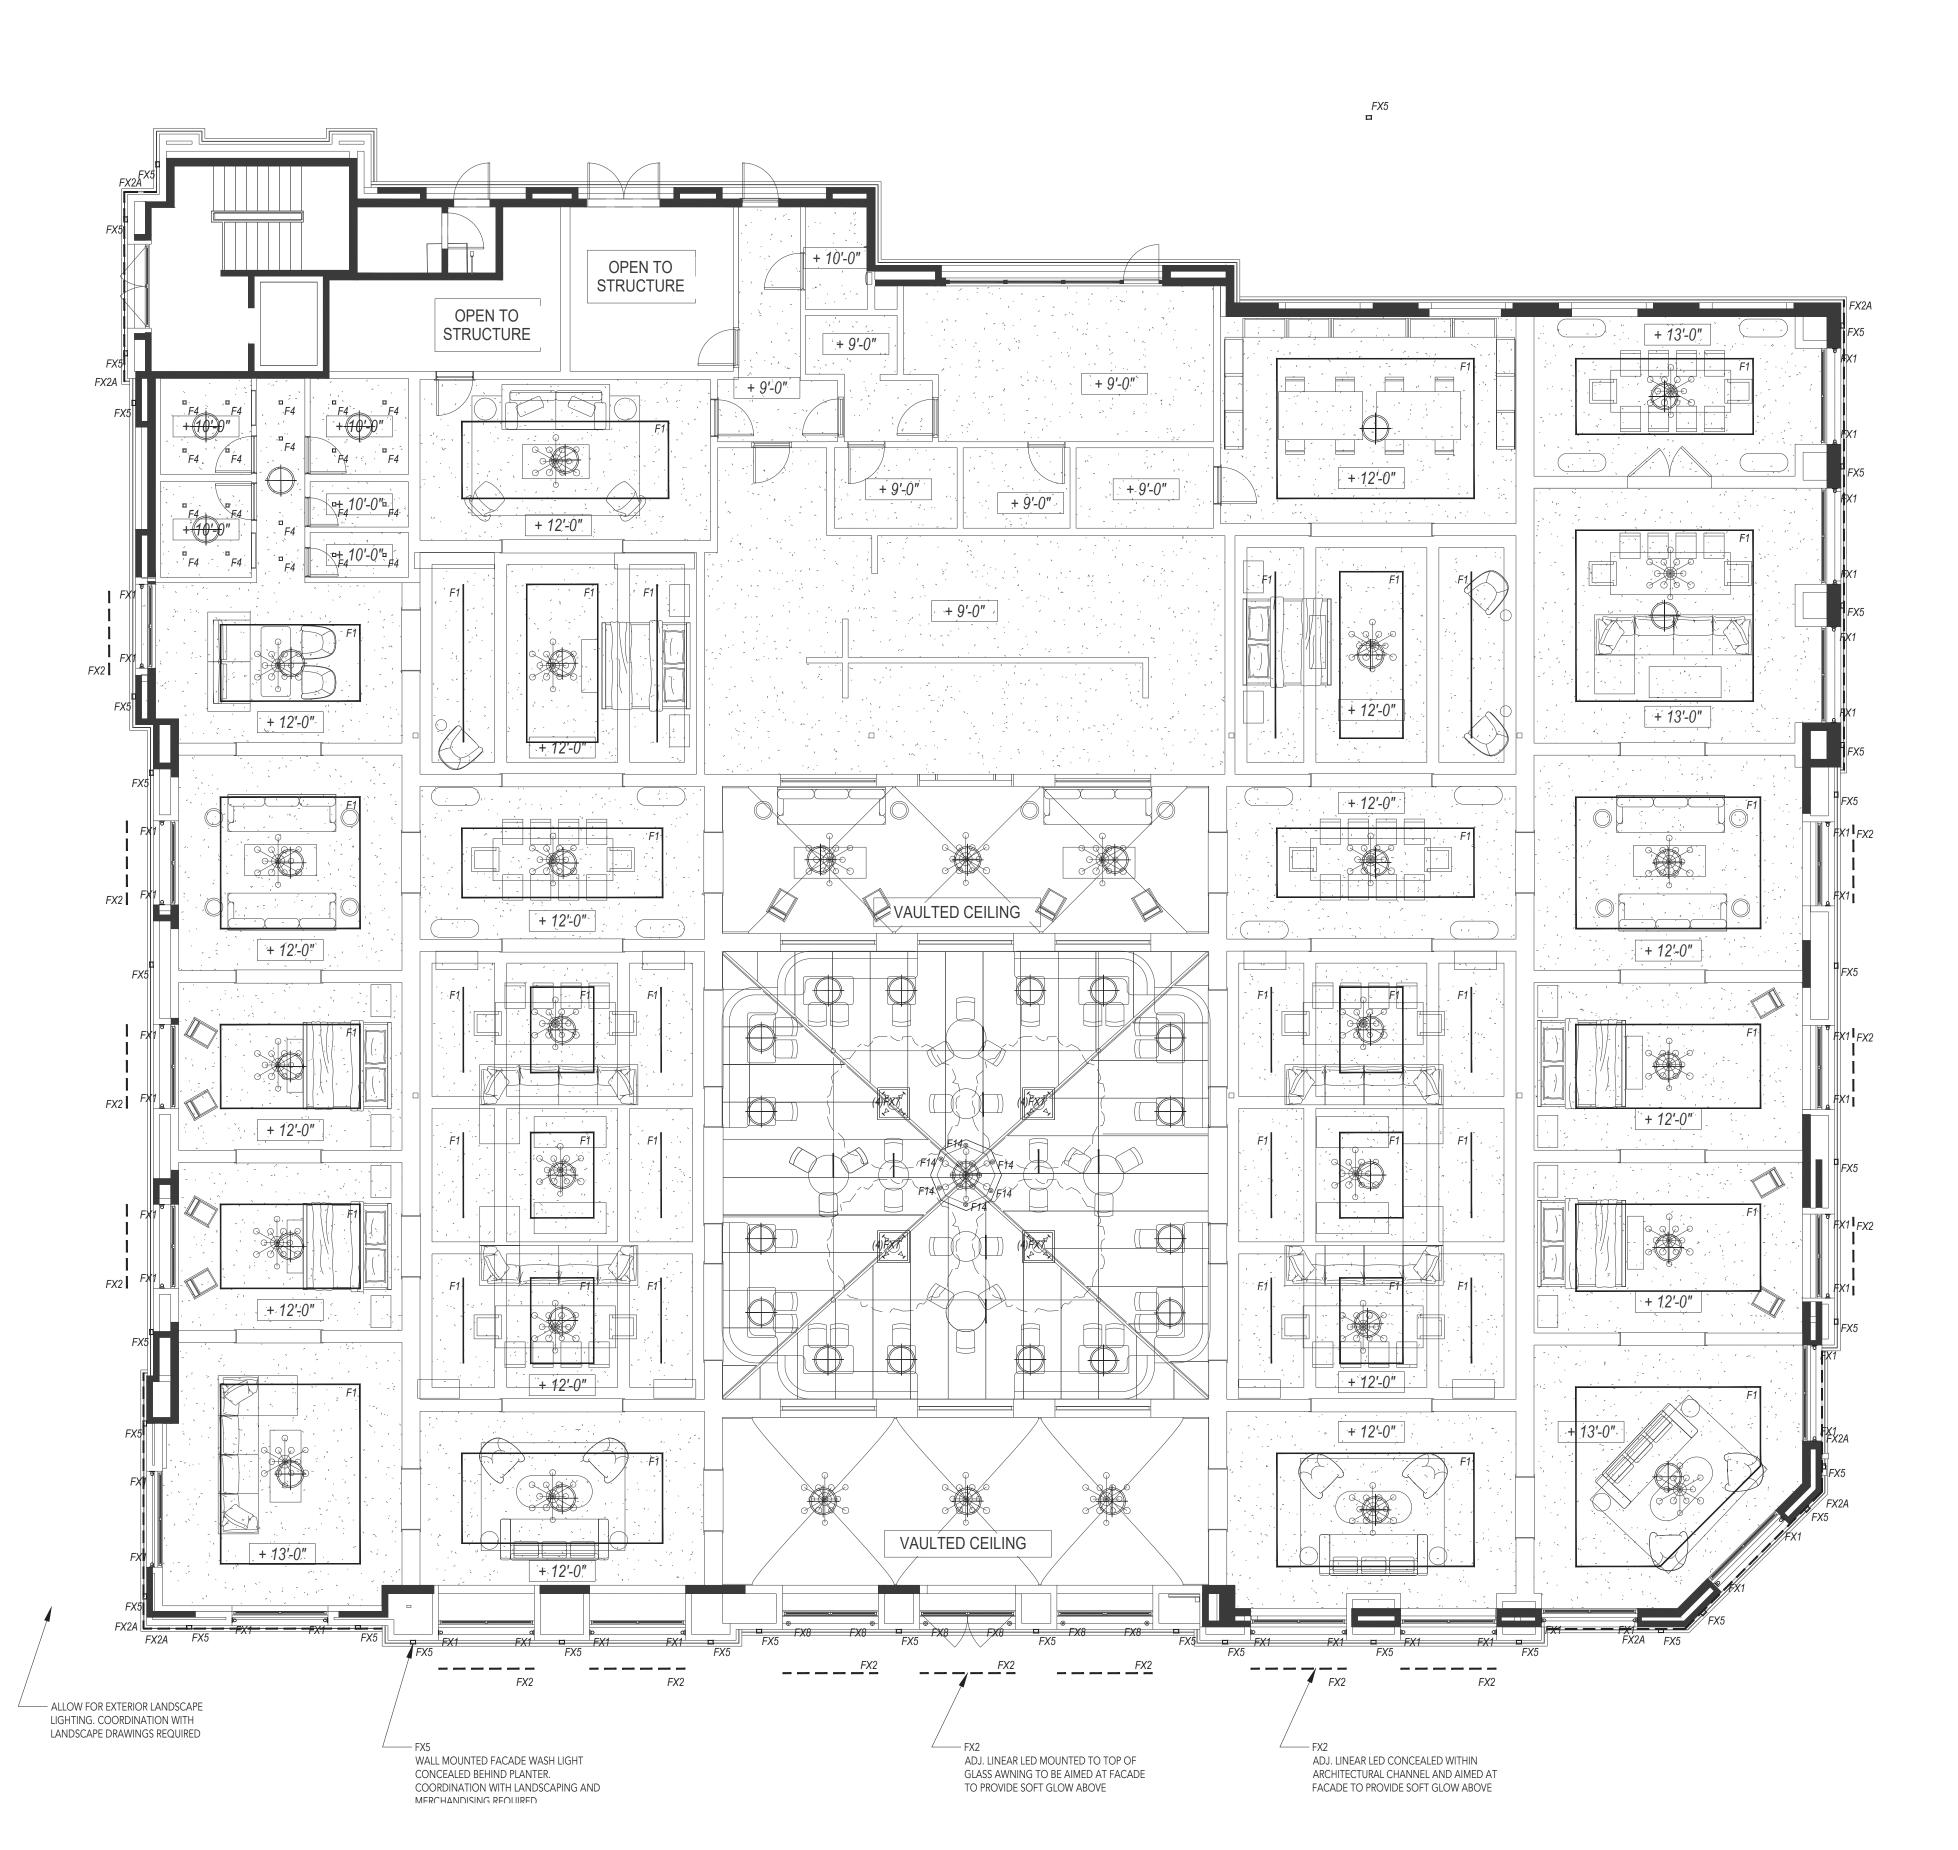

rkv DESIGN

> 23823 MALIBU ROAD SUITE 50 - 212 MALIBU, CA 90265

www.rkv-design.com +1 310 924 2185

NOTES FOR GENERAL CONTRACTOR:

 General Contractor (GC) and Electrical Contractor (EC) will be responsible for verification of all dimensions, specifications and coordination with related trades and subcontractors.

GC to paint downlight trims to match ceiling per architects direction. Ensure trims can be removed after painting and do not stick.
 GC to furnish and install adequare drainage around all direct burial transformers and recessed in-grade light fixtures.

4. GC to notify designer of any conflict with mechanical, electrical, plumbing, HVAC or structural presence or any conflicting dimensions or site conditions prior to commencement of work.

5. GC is responsible for notifying designer of any inconsistencies between design drawings and other documents.6. Do not scale drawings.

#### **GENERAL NOTES:**

Lighting Design drawings and dimensions are for design intent only. Coordination with Architectural Drawings required.
 Fixture types and specifications available in accompanying Specification packet.
 Calculations for code compliance to be provided by Electrical Engineer.
 Emergency lighting requirements to be completed by Electrical Engineer.

REV. DATE. DESCRIPTION

10.23.2024 FOR REVIEW 11.22.2024 100% SCHEMATIC DESIGN 01.10.2025 PLANNING REVIEW

### LIGHTING CONTROL SYSTEM SEQUENCE OF OPERATION:

ALL BUILDING LIGHTING AT RH LOS GATOS IS CONTROLLED BY PRESET SCENES ON A TIME CLOCK SCHEDULE.

BUILDING WIDE SCENE DESCRIPTIONS

SCENE 1: RETAIL DAY ACTIVATES AT 7:00AM DAILY, 15 SECOND FADE TIME. INTERIOR LIGHTING TURNS ON AT PRESET, DIMMED LEVELS DETERMINED BY LIGHTING DESIGNER AND APPROVED BY RH. EXTERIOR LIGHTING TURNS OFF

SCENE 2: RETAIL NIGHT ACTIVATES 15 MINUTES BEFORE SUNSET, 15 SECOND FADE TIME. EXTERIOR LIGHTING TURNS ON AT PRESET, DIMMED LEVELS DETERMINED BY LIGHTING DESIGNER AND APPROVED BY RH.

SCENE 3: OVERNIGHT ACTIVATES AT 11PM. MOST INTERIOR LIGHTING TURNS OFF, LIGHTING DESIGNER TO DETERMINE OVERNIGHT SETTING ON SITE AHEAD OF GALLERY OPENING.

SCENE 4: EVENT ACTIVATES ON-DEMAND DURING OPENING EVENT. LIGHTING DESIGNER WILL DETERMINE CUSTOM SETTING APPROVED BY RH.

## NOTES FOR ZONING AND LIGHTING CONTROLS:

ALL BUILDING LIGHTING TO BE DIMMABLE, INCLUDING ARCHITECTURAL AND DECORATIVE (MERCHANDISE) LIGHTING.
 ONE ZONE PER "F" TYPE, PER INSTALLATION LOCATION OR CONDITION (UNLESS OTHERWISE NOTED ON DRAWINGS).

LIGHTING LEGEND				
TYPE	SYMBOL	DESCRIPTION	LOCATION	
F1		SURFACE MOUNTED SINGLE CIRCUIT TRACK	RETAIL, THROUGHOUT	
F2	Þ	ADJUSTABLE TRACK HEAD	RETAIL, THROUGHOUT	
F4	п	3" SQUARE RECESSED DOWNLIGHT	RESTROOMS, PASSAGES	
F14	0	WEIGHTED BASE UNDERWATER ACCENT LIGHT	CAFE CENTRAL FOUNTAIN	
FX1	₫	JAMB MOUNTED ACCENT LIGHT	FACADE, DOOR AND WINDOW JAMBS	
FX2		SURFACE MOUNTED LINEAR LED UPLIGHT	FACADE AWNINGS	
FX2A		SURFACE MOUNTED LINEAR LED UPLIGHT	FACADE, CORNICE	
FX5	п	WALL MOUNTED FACADE WASH LIGHT	FACADE	
FX7	4	STAKE MOUNTED TREE UPLIGHT	CAFE TREES	
FX8	0	GRADE RECESSED UPLIGHT	MAIN ENTRY DOOR JAMBS	

PROJECT:

RH LOS GATOS

35 UNIVERSITY BLVD, LOS GATOS, CA 95030


DRAWING TITLE:

LIGHTING LAYOUT


SHEET:

LT-1.0

1/8" = 1'-(

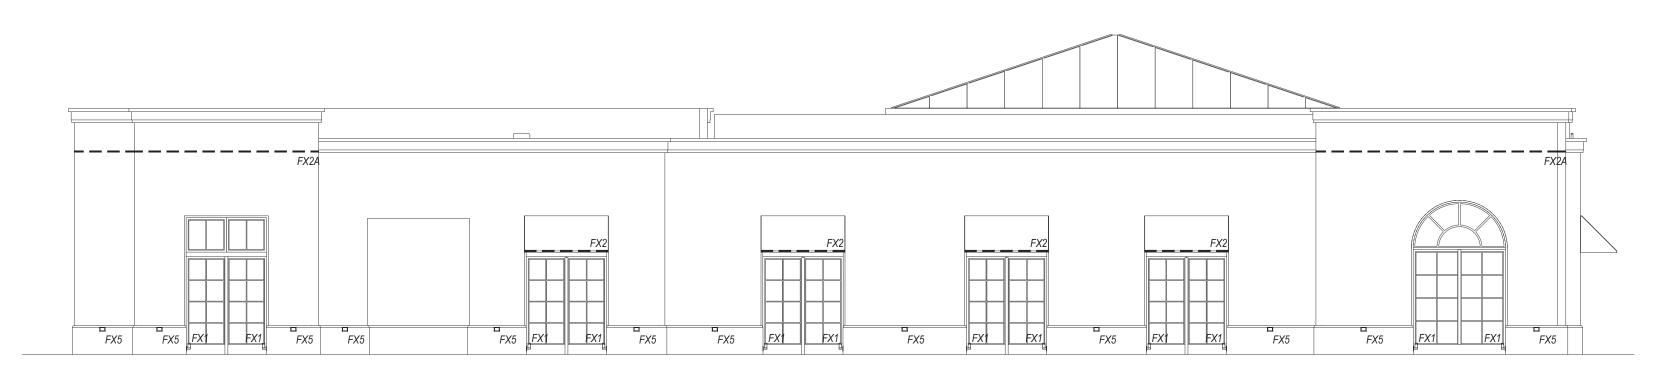

1 WEST ELEVATION
1/8" = 1'-0"

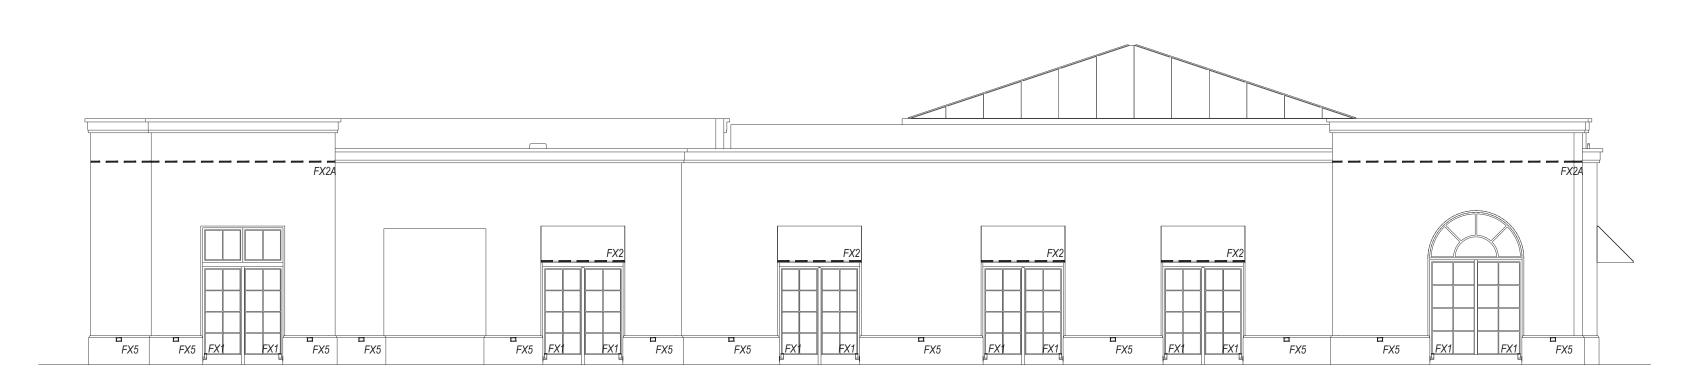

2 EAST ELEVATION 1/8" = 1'-0"



3 SOUTH ELEVATION 1/8" = 1'-0"

# rkv DESIGN

23823 MALIBU ROAD SUITE 50 - 212 MALIBU, CA 90265

www.rkv-design.com

+1 310 924 2185

NOTES FOR GENERAL CONTRACTOR:

General Contractor (GC) and Electrical
 Contractor (EC) will be responsible for
 verification of all dimensions, specifications and
 coordination with related trades and
 subcontractors.

 GC to paint downlight trims to match ceiling per architects direction. Ensure trims can be removed after painting and do not stick.
 GC to furnish and install adequare drainage around all direct burial transformers and recessed in-grade light fixtures.

4. GC to notify designer of any conflict with mechanical, electrical, plumbing, HVAC or structural presence or any conflicting dimensions or site conditions prior to commencement of work.

5. GC is responsible for notifying designer of any

inconsistencies between design drawings and other documents.6. Do not scale drawings.

GENERAL NOTES:

Lighting Design drawings and dimensions are for design intent only. Coordination with Architectural Drawings required.
 Fixture types and specifications available in accompanying Specification packet.
 Calculations for code compliance to be provided by Electrical Engineer.
 Emergency lighting requirements to be completed by Electrical Engineer.

REV. DATE. DESCRIPTION

10.23.2024 FOR REVIEW 11.22.2024 100% SCHEMATIC DESIGN 01.10.2025 PLANNING REVIEW

## LIGHTING CONTROL SYSTEM SEQUENCE OF OPERATION:

ALL BUILDING LIGHTING AT RH LOS GATOS IS CONTROLLED BY PRESET SCENES ON A TIME CLOCK SCHEDULE.

BUILDING WIDE SCENE DESCRIPTIONS

SCENE 1: RETAIL DAY ACTIVATES AT 7:00AM DAILY, 15 SECOND FADE TIME. INTERIOR LIGHTING TURNS ON AT PRESET, DIMMED LEVELS DETERMINED BY LIGHTING DESIGNER AND APPROVED BY RH. EXTERIOR LIGHTING TURNS OFF

SCENE 2: RETAIL NIGHT ACTIVATES 15 MINUTES BEFORE SUNSET, 15 SECOND FADE TIME. EXTERIOR LIGHTING TURNS ON AT PRESET, DIMMED LEVELS DETERMINED BY LIGHTING DESIGNER AND APPROVED BY RH.

SCENE 3: OVERNIGHT ACTIVATES AT 11PM. MOST INTERIOR LIGHTING TURNS OFF, LIGHTING DESIGNER TO DETERMINE OVERNIGHT SETTING ON SITE AHEAD OF GALLERY OPENING.

SCENE 4: EVENT ACTIVATES ON-DEMAND DURING OPENING EVENT. LIGHTING DESIGNER WILL DETERMINE CUSTOM SETTING APPROVED BY RH.

### NOTES FOR ZONING AND LIGHTING CONTROLS:

ALL BUILDING LIGHTING TO BE DIMMABLE, INCLUDING ARCHITECTURAL AND DECORATIVE (MERCHANDISE) LIGHTING.
 ONE ZONE PER "F" TYPE, PER INSTALLATION LOCATION OR CONDITION (UNLESS OTHERWISE NOTED ON DRAWINGS).

LIGHTING LEGEND					
TYPE	SYMBOL	DESCRIPTION	LOCATION		
F1		SURFACE MOUNTED SINGLE CIRCUIT TRACK	RETAIL, THROUGHOUT		
F2	Þ	ADJUSTABLE TRACK HEAD	RETAIL, THROUGHOUT		
F4		3" SQUARE RECESSED DOWNLIGHT	RESTROOMS, PASSAGES		
F14	0	WEIGHTED BASE UNDERWATER ACCENT LIGHT	CAFE CENTRAL FOUNTAIN		
FX1	lo lo	JAMB MOUNTED ACCENT LIGHT	FACADE, DOOR AND WINDOW JAMBS		
FX2		SURFACE MOUNTED LINEAR LED UPLIGHT	FACADE AWNINGS		
FX2A		SURFACE MOUNTED LINEAR LED UPLIGHT	FACADE, CORNICE		
FX5	п	WALL MOUNTED FACADE WASH LIGHT	FACADE		
FX7	4	STAKE MOUNTED TREE UPLIGHT	CAFE TREES		
FX8	•	GRADE RECESSED UPLIGHT	MAIN ENTRY DOOR JAMBS		

PROJECT:

RH LOS GATOS

35 UNIVERSITY BLVD, LOS GATOS, CA 95030

DRAWING TITLE:

EXTERIOR LIGHTING ELEVATIONS

SHEET

LT-2.0

This Page Intentionally Left Blank