

TOWN OF LOS GATOS HISTORIC PRESERVATION COMMITTEE REPORT

MEETING DATE: 02/26/2025

ITEM NO: 5

DESK ITEM

DATE: February 26, 2025

TO: Historic Preservation Committee

FROM: Joel Paulson, Community Development Director

SUBJECT Requesting Approval for Modification of Planned Development Ordinance to

Allow Modifications to Building E, an Architecture and Site Application for

Exterior Modifications to an Existing Commercial Building in the

University/Edelen Historic District, and a Conditional Permit for Formula Retail over 10,000 square feet and for a Restaurant with Alcohol Service on a Property Zoned C-2:LHP:PD. **Located at 31 University Avenue.** APN 529-02-044. Planned Development Modification PD-25-001, Architecture and Site Application S-25-004 and Conditional Use Permit U-25-001. Categorically Exempt Pursuant to CEQA Guidelines Section 15301: Existing Facilities. Property Owner: SRI Old Town, LLC. Applicant: Rick Nelson, MBH Architects.

Project Planner: Erin Walters.

REMARKS:

Attachment 4 includes existing and proposed building and streetscape elevations.

ATTACHMENTS:

Previously Received with the February 26, 2025, Staff Report:

- 1. Planned Development Ordinance 2025
- 2. Applicant's Request and Letter of Justification
- 3. Development Plans

Received with this Desk Item Report:

4. Existing and Proposed Building Elevations

PREPARED BY: Erin M. Walters

Senior Planner

This Page Intentionally Left Blank

1 PROPOSED SOUTH ELEVATION - VIEW FROM UNIVERSITY AVE SCALE: 3/16" = 1'-0"



2 EXISTING SOUTH ELEVATION - VIEW FROM UNIVERSITY AVE

SCALE: 3/16" = 1'-0"



RH - LOS GATOS

Project Address

31 UNIVERSITY AVE, LOS GATOS, CA 95030

Architect



Seal

Consultant

Drawings and written material appearing herein constitute original and unpublished work of the Architect and may not be duplicated, used, or disclosed without written consent of the Architect.
© MBH ARCHITECTS - 2024

No. Date Issue/ Revised

02/26/2025 HISTORICAL REVIEW

5049F

33403

Reviewed By: RN


Drawn By: BD

Scale 3/16" = 1'-0"

.

Drawing T

EXTERIOR ELEVATIONS COMPARISON

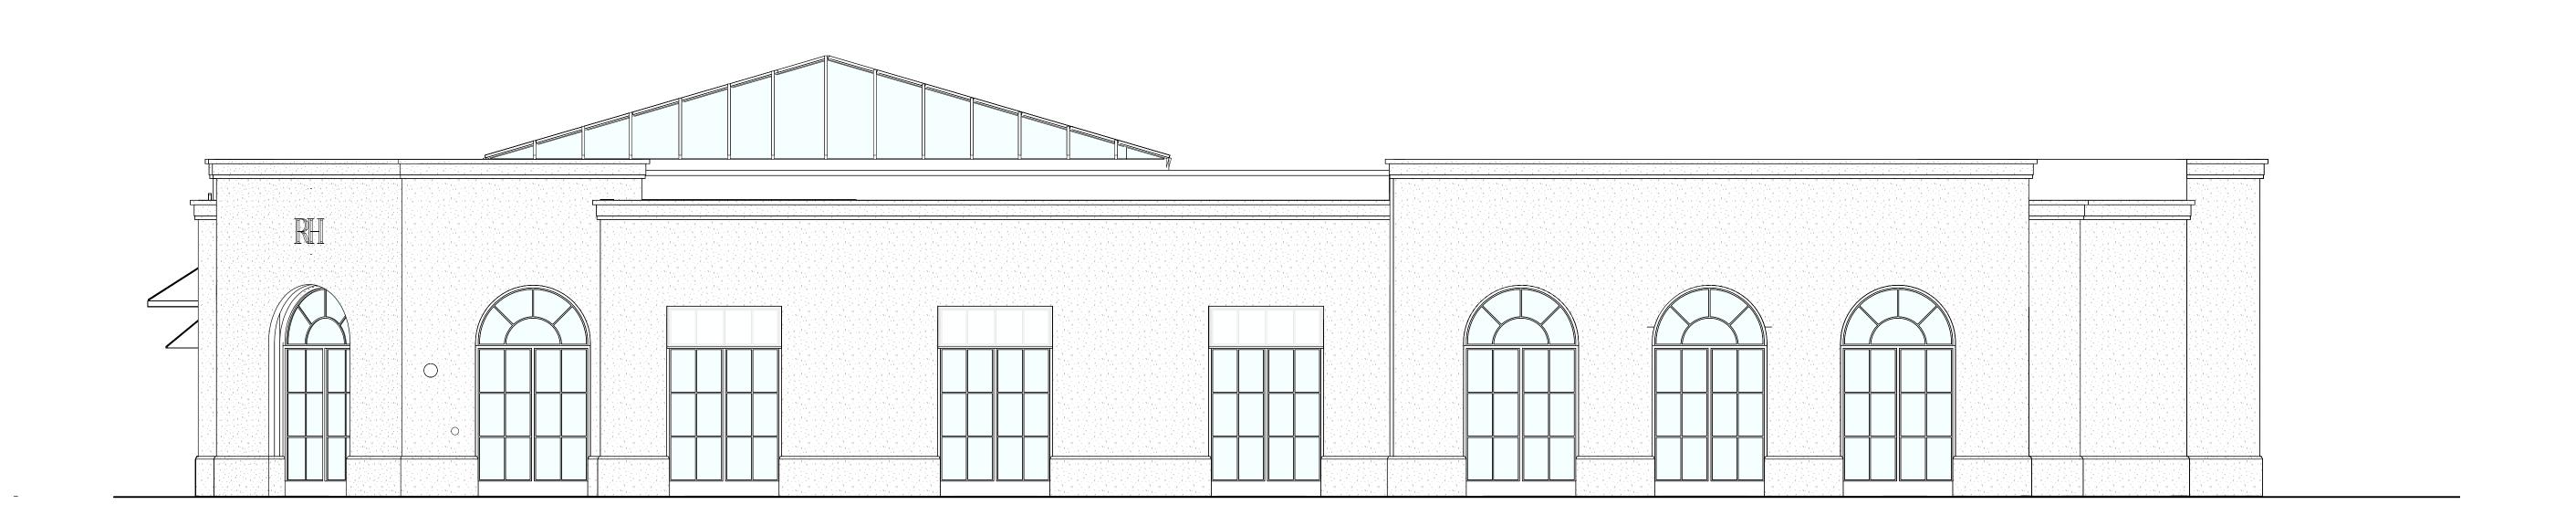

PROPOSED EAST ELEVATION - VIEW FROM ELM ST

SCALE: 3/16" = 1'-0"



2 EXISTING EAST ELEVATION - VIEW FROM ELM ST SCALE: 3/16" = 1'-0"



RH - LOS GATOS

Project Address

31 UNIVERSITY AVE, LOS GATOS, CA 95030

Architect



Seal

Consulta

Drawings and written material appearing herein constitute original and unpublished work of the Architect and may not be duplicated, used, or disclosed without written consent of the Architect.
© MBH ARCHITECTS - 2024

o. Date Issue/ Revised

02/26/2025 HISTORICAL REVIEW

Project 59485


Drawn By: BD

Reviewed By: RN


Scale 3/16" = 1'-0"

Drawing

EXTERIOR ELEVATIONS COMPARISON

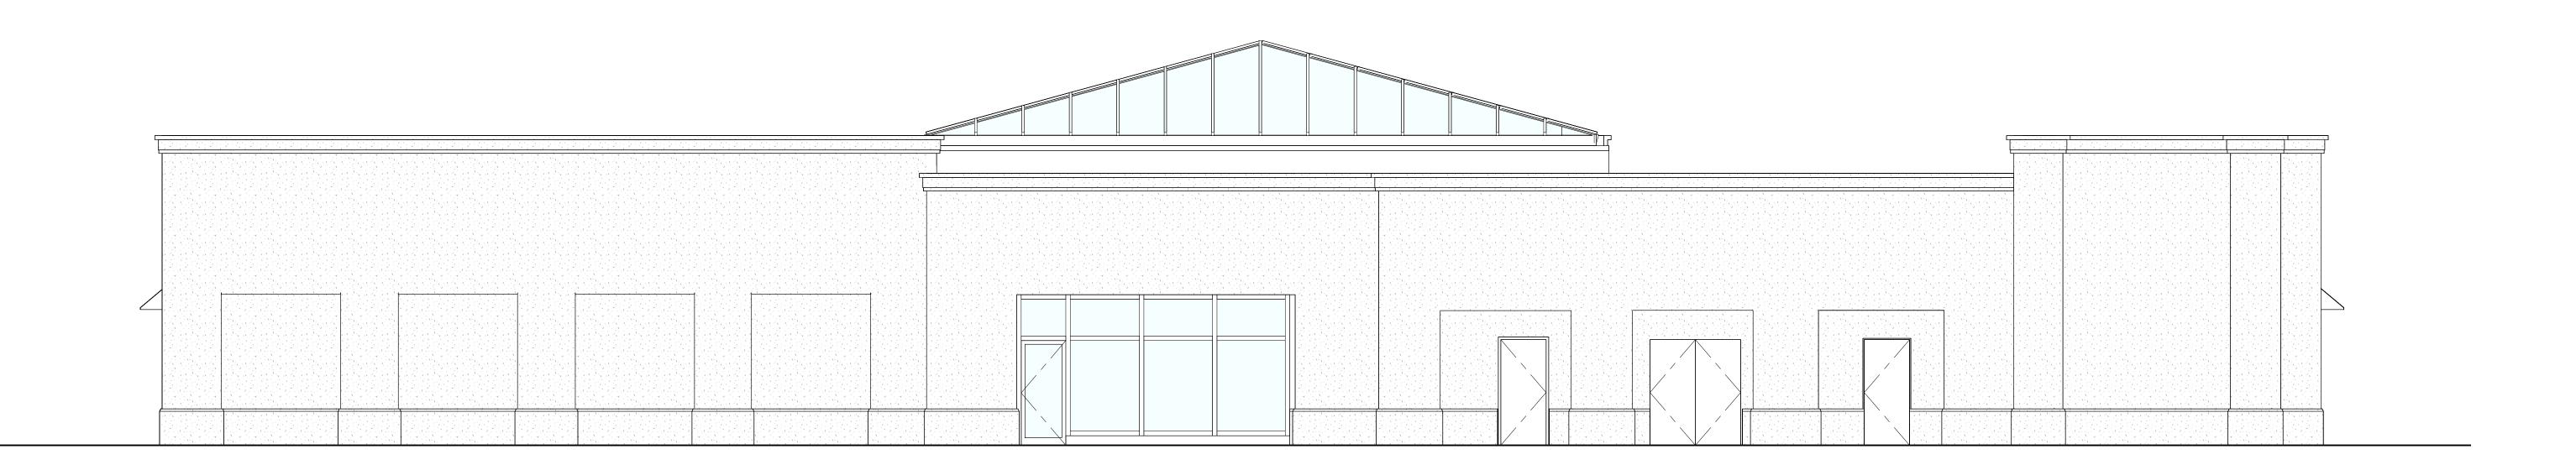

PROPOSED NORTH ELEVATION - VIEW FROM REAR PARKING LOT SCALE: 3/16" = 1'-0"

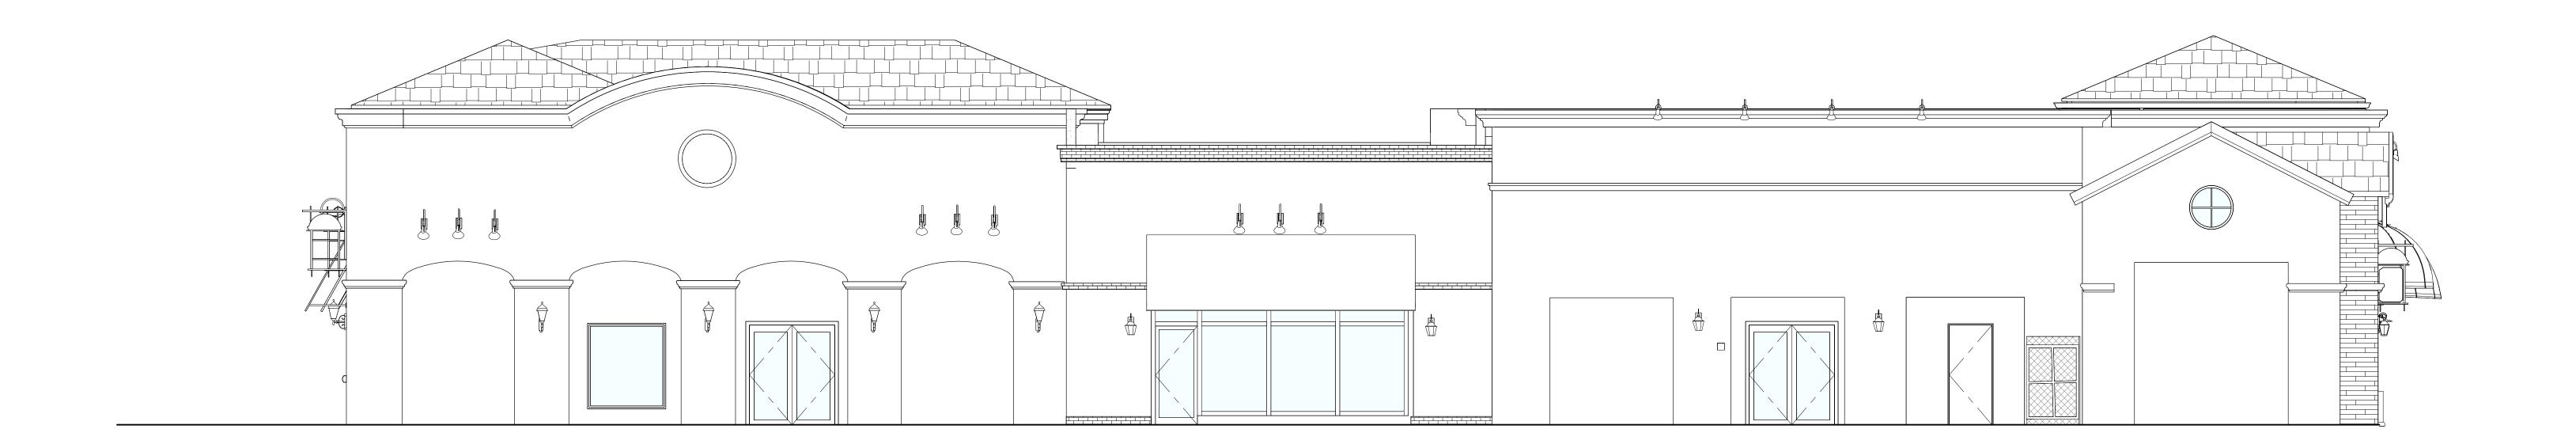

2 EXISTING NORTH ELEVATION - VIEW FROM REAR PARKING LOT SCALE: 3/16" = 1'-0"



RH - LOS GATOS

Project Address

31 UNIVERSITY AVE, LOS GATOS, CA 95030

Archited



Consulta

Drawings and written material appearing herein constitute original and unpublished work of the Architect and may not be duplicated, used, or disclosed without written consent of the Architect.

© MBH ARCHITECTS - 2024

o. Date Issue/ Revised

02/26/2025 HISTORICAL REVIEW

Project 59485


Drawn By: BD

Reviewed By: RN

Scale 3/16" = 1'-0"


Drawing Title

EXTERIOR ELEVATIONS COMPARISON

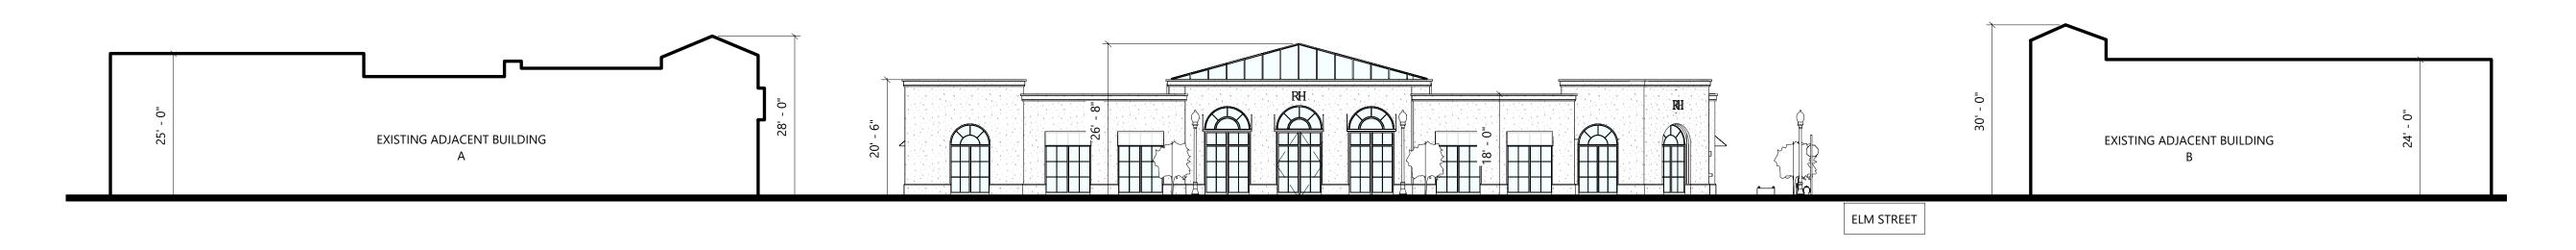


PROPOSED BUILDING VIEW FROM UNIVERSITY AVE

SCALE: 1/16" = 1'-0"

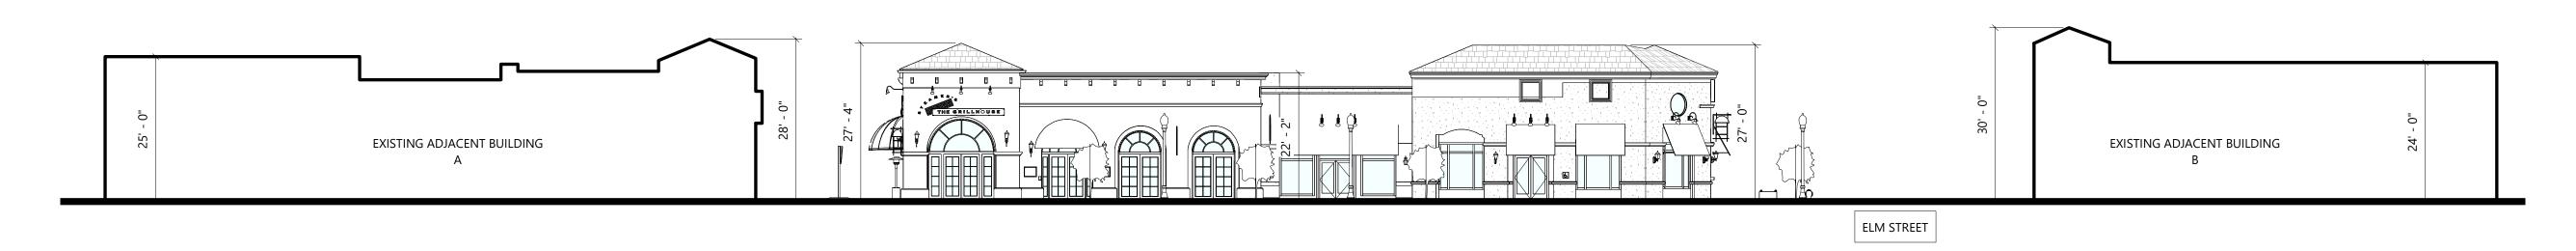

2 EXISTING BUILDING VIEW FROM UNIVERSITY AVE

SCALE: 1/16" = 1'-0"

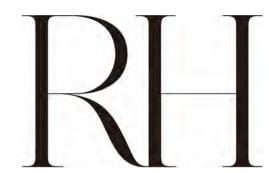


RH - LOS GATOS

Project Address

31 UNIVERSITY AVE, LOS GATOS, CA 95030

Archited

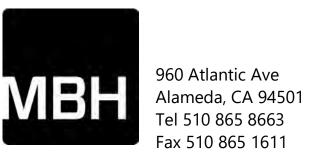

Seal

Consultant

Drawings and written material appearing herein constitute original and unpublished work of the Architect and may not be duplicated, used, or disclosed without written consent of the Architect.

© MBH ARCHITECTS - 2024

No. Date Issue/Revised
02/26/2025 HISTORICAL REVIEW

niect 5048

Drawn By: BD

Reviewed By: RN

Scale 1/16" = 1'-0"

Drawing Title

MASSING ELEVATIONS