# ABBREVIATIONS

& @ A/C ADA AFF ADJ AHU ALUM/AL APPROX ARCH	AND AT AIR CONDITIONING ACOUSTICAL CEILING TILE AMERICAN'S W/ DISABILITIES ACT ABOVE FINISH FLOOR ADJUSTABLE AIR HANDLING UNIT ALUMINUM APPROXIMATE ARCHITECTURAL
BD	BOARD
BLDG	BUILDING
BLKG	BLOCKING
BM	BEAM
BO	BOTTOM OF
BOT	BOTTOM
BSMT	BASEMENT
CJ CL CLG HGT CLR CMU CNTR CO CONC CONSTR CONT CONT CONT CSK CT	CONTROL JOINT CENTER LINE CEILING CEILING HEIGHT CLEAR CONCRETE MASONRY UNIT COUNTER CASED OPENING CONCRETE CONSTRUCTION CONTINUOUS CARPET COUNTERSINK CERAMIC TILE CENTER
DBL	DOUBLE
DET	DETAIL
DIA	DIAMETER
DIM	DIMENSION
DN	DOWN
DN	DOOR
DR	DOOR
DR OPNG	DOOR OPENING
DWG	DRAWING
ea	EACH
Elec	ELECTRICAL
Elev	ELEVATION
Equip	EMERGENCY
Equip	EQUAL
Etr	EQUIPMENT
Ewc	EXISTING TO REMAIN
Exist / (e)	ELECTRIC WATER COOLER
Exh	EXISTING
Exp	EXHAUST
Exp	EXPOSED
Ext	EXTERIOR
FA	FIRE ALARM
FD	FLOOR DRAIN
FE	FIRE EXTINGUISHER
FEC	FIRE EXTINGUISHER CABINET
FF	FINISH FACE
FIN	FINISH
FIXT	FIXTURE
FLR	FLOOR
FLUOR	FLUORESCENT LIGHTING
FOC	FACE OF CONCRETE
FOF	FACE OF FINISH
FOS	FACE OF STUD
FRT	FIRE RETARDANT TREATED
FT	FOOT (FEET)
FTG	FOOTING
GA	GAGE
GALV	GALVANIZED
GC	GENERAL CONTRACTOR
GL	GLASS or GLAZING
GR	GRADE
GWB	GYPSUM WALLBOARD
GYP	GYPSUM
HC	HOLLOW CORE
HCWD	HOLLOW CORE WOOD DOOR
HDWD	HARDWOOD
HDWR	HARDWARE
HM	HOLLOW METAL
HMF	HEATING, VENTILATION & COOLING
HORIZ	HORIZONTAL
HT	HEIGHT
HVAC	HEATING VENTILATION AIR CONDITION
HW	HOT WATER
IN	INCH
INCL	INCLUDED
INSUL	INSULATION
INT	INTERIOR
JAN	JANITOR
JT	JOINT

AV AM W BS F H L	LONG (LENGTH) LAVATORY LAMINATE LIGHTWEIGHT POUNDS LINEAR FOOT LEFT-HANDED LANDLORD
MAT	MATERIAL
MAX	MAXIMUM
MECH	MECHANICAL
MFR	MANUFACTURER
MIN	MINIMUM
MISC	MISCELLANEOUS
MTD	MOUNTED
MTL	METAL
IAT	NATURAL
IIC	NOT IN CONTRACT
IOM	NOMINAL
ITS	NOT TO SCALE
D/	OVER
DC	ON CENTER
DD	OUTSIDE DIAMETER
DPP	OPPOSITE
DPNG	OPENING
PLAM PLYWD PR PT PTD PTD PTN	PLASTIC LAMINATE PLYWOOD PAIR PAINT PORCELAIN TILE PAINTED PRESSURE TREATED PARTITION
R	RISER
RD	RADIUS
RCP	REFLECTED CEILING PLAN
REC	RECESSED
REQD	REQUIRED
REF	REFERENCE
RESIL	RESILIENT
REV	REVISION
RH	RIGHT HAND
RM	ROOM
RO	ROUGH OPENING
RWL	RAIN WATER LEADER
SF SHT SIM SIPS	SOLID CORE SMOKE DETECTOR SECTION SQUARE FOOT (FEET) SHEET SIMILAR STRUCT. INSULATED PANEL SOUND INSULATION SPECIFICATION SQUARE STAINLESS STEEL STANDARD STEEL STAIN SYSTEM
TAG THK THR TOB TOC TOJ TOM TOS TOS TOS TOW TPD TYP	TREAD TONGUE & GROOVE THICKNESS THRESHOLD TOP OF BEAM TOP OF CONCRETE TOP OF JOIST TOP OF MASONRY TOP OF SLAB TOP OF SLAB TOP OF STEEL TOP OF WALL TOILET PAPER DISPENSER TYPICAL
JC	UNDERCUT
JNO	UNLESS NOTED OTHERWISE
/AR	VARIES
/CT	VINYL COMPOSITION TILE
/ERT	VERTICAL
/IF	VERIFY IN FIELD
/P	VENEER PLASTER
N/ V/O VA VC VD VF	WITH WITHOUT WALL ANCHOR WATER CLOSET WOOD WIDE FLANGE WATER HEATER

WATER HEATER

WAINSCOT

WEIGHT

WR

WT

WSCT

WORKING POINT

WATER RESISTANT

# **PROJECT TEAM**

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CIVIL ENGINEER:

KPFF

PRINCIPAL

SAN FRANCISCO, CA 94105

CONTACT: ZACK C. KARDON

CONSULTING STRUCTURAL ENGINEERS

RH

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# GENERAL NOTES

- 1. DO NOT SCALE THE DRAWINGS. 2. VERIFY FIELD CONDITIONS PRIOR TO COMMENCEMENT OF EACH PORTION OF THE WORK.
- 3. THE ARCHITECT ASSUMES NO RESPONSIBILITY FOR ANY PORTION OF THE WORK WHICH IS PERFORMED WITHOUT A PERMIT ISSUED BY A REGULATORY AUTHORITY OF THE MUNICIPALITY IN WHICH THE PROJECT IS LOCATED.
- 4. THROUGHOUT THIS SET OF DRAWINGS, THE TERM "SDB" REFERS TO THE CLIENT/TENANT. THE TERM "LANDLORD" REFERS TO THE PROPERTY OWNER. 5. THE CONTRACTOR SHALL MAKE NO REVISIONS, ALTERATIONS OR CHANGES TO THE WORK AS SHOWN IN THE CONTRACT DOCUMENTS WITHOUT THE PRIOR WRITTEN APPROVAL OF THE ARCHITECT AND/OR SDB REPRESENTATIVE. NO ADDITIONAL COSTS FROM THE GENERAL CONTRACTOR SHALL BE CONSIDERED AND THE WORK MAY E REQUIRED TO BE REMOVED WITHOUT SUCH APPROVAL BY ARCHITECT. 6. SEE SPECIFICATIONS FOR ADDITIONAL CRITERIA AND CONSTRUCTION
- REQUIREMENTS. 7. DIMENSIONS SHOWN AS 'VIF' SHALL BE VERIFIED BY THE CONTRACTOR IN THE FIELD BY LAYING OUT THE PARTITIONS. NOTIFY ARCHITECT OF ANY DISCREPANCIES IN. DIMENSIONS PRIOR TO PROCEEDING WITH WORK. 8. DIMENSIONS SHOWN AS 'CLEAR' OR 'HOLD' SHALL BE MAINTAINED AND ALLOW FOR
- THICKNESS OF FINISHES; INCLUDING FLOOR FINISHES. NOTIFY ARCHITECT OF ANY DISCREPANCIES IN DIMENSIONS PRIOR TO PROCEEDING WITH WORK. 9. DIMENSIONS ARE TO THE STRUCTURAL GRID OR TO FINISH SURFACES, UNLESS OTHERWISE INDICATED.
- 10. ELEVATIONS REFERENCED ARE ABOVE SDB FINISH FLOOR FOR EACH ROOM THROUGHOUT TENANT SPACE, UNLESS OTHERWISE NOTED. FINISH FLOOR ELEVATIONS MAY VARY FROM ROOM TO ROOM DEPENDING UPON FLOOR FINISHES.
- 11. GENERAL CONTRACTOR SHALL PROVIDE THE BUILDING OFFICIAL WITH A CERTIFICATE OF CONSTRUCTION COMPLIANCE WITH ENERGY CONSERVATION STANDARDS UPON FINAL BUILDING DEPARTMENT INSPECTIONS (WHERE REQUIRED). 12. GENERAL CONTRACTOR SHALL PREPARE THE FLOOR LEVEL AND SMOOTH AND PROVIDE FOR THE FILLING OF ALL FLOOR DRAINS, FLOOR SINKS OR OTHER SUCH
- DEPRESSIONS, CRACKS OR IRREGULARITIES IN FLOOR SLAB. 13. PROVIDE BLOCKING AT WALLS TO MEET CODE MINIMUM WHERE REQUIRED FOR SUPPORT OF FIXTURES/ACCESSORIES.
- 14. GENERAL CONTRACTOR SHALL PROVIDE ACCESS PANELS FOR ALL TRADES AS REQUIRED BY CODE. LOCATIONS TO BE APPROVED BY ARCHITECT AND/OR SBD REPRESENTATIVE PRIOR TO EXECUTION OF WORK.
- 15 FIRE EXTINGUISHERS AND CABINETS AS REQUIRED BY LOCAL GOVERNMENT AGENCY SHALL BE PROVIDED BY GENERAL CONTRACTOR AND INCLUDED IN CONTRACT. 16. STORAGE IN STOCK/STORAGE ROOMS SHALL BE MAINTAINED 18 INCHES OR MORE BELOW SPRINKLER HEAD DEFLECTORS, A 3-INCH RED STRIPE SHALL BE MARKED ALONG ALL WALLS WITHIN STOCK/STORAGE AT THE MAXIMUM STORAGE HEIGHT, AND STRIPE SHALL BE LABELED " NO STORAGE ABOVE THIS LINE" IN WHITE LETTERS A MINIMUM OF ONCE ON EACH WALL

JST

JOIST

# RH - LOS GATOS 31 UNIVERSITY AVE, LOS GATOS, CA 95030

# PROJECT DATA

APN:

EXISTING E31 BUILDING AREA (GROSS) EXISTING E35 BUILDING AREA (GROSS) (NO CHANGE TO EXISTING GROSS AREA)

OCCUPANCY GROUP: STORIES: CONSTRUCTION TYPE: OCCUPANT LOAD: SPRINKLERED (YES/NO): 529 02 044 7,233 SF 8,724 SF

M & A-2 S-2 (GARAGE) 2- STORY IIB, VB M - 185 OCC A-2 - 100 OCC YES (EXISTING)


VICINITY MAP

KEY PLAN




PROJECT SITE -RH - LOS GATOS 31 UNIVERSITY AVE,

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SYMBOLS LEGEND

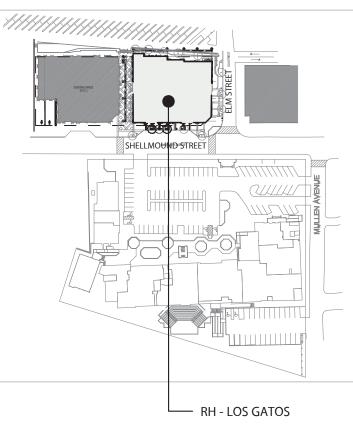

SCOPE DESCRIPTION

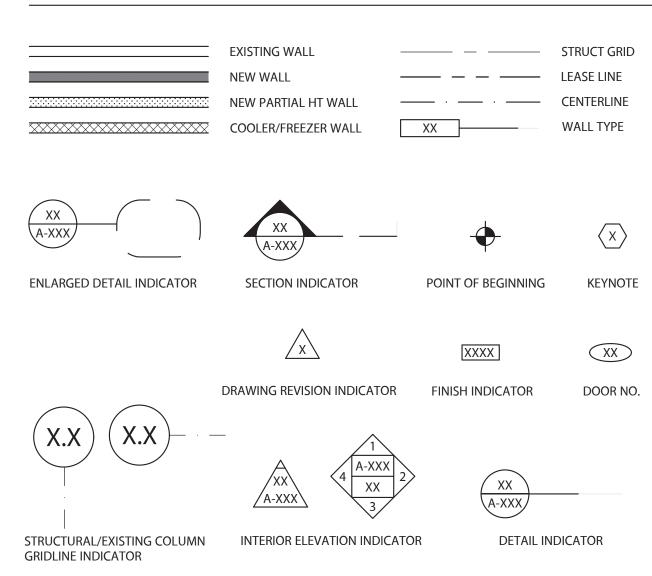TENANT IMPROVEMENT OF TWO GROUND FLOOR TENANT SPACES. THE TWO SPACES WILL HAVE THE INTERIOR DEMOLISHED AND RE-CONFIRMED INTO ONE SPACE. THE NEW USE WILL BE A RETAIL SHOWROOM INCLUDING A RESTAURANT. THERE IS NO CHANGE IN GROSS BUILDING AREA OR PROPOSED USE.

SCOPE TO INCLUDE COMPLETE BUILD-OUT WITH ASSOCIATED PLUMBING, MECHANICAL, ELECTRICAL, KITCHEN EQUIPMENT AND FINISHES THROUGHOUT.

# CODE INFORMATION

AUTHORITY HAVING JURIS	DICTION:	TOWN OF LOS G	ATOS
BUILDING CODE:	CALIFORNIA BUIL	DING CODE	2022
GREEN BUILDING CODE:	CALIFORNIA GRE STANDARDS COE		2022
ACCESSIBILITY CODE:	CALIFORNIA BUIL	DING CODE	2022
ENERGY CODE:	CALIFORNIA ENE	RGY CODE	2022
MECHANICAL CODE:	CALIFORNIA MEC	HANICAL CODE	2022
PLUMBING CODE:	CALIFORNIA PLU	MBING CODE	2022
ELECTRICAL CODE:	CALIFORNIA ELEC	CTRICAL CODE	2022
FIRE CODE:	CALIFORNIA FIRE	CODE	2022
HEALTH CODE:	CALIFORNIA RET	AIL FOOD CODE	2022

PLUMBING CALCULATIONS	
OCCUPANCY LOAD PER 2022 CBC TABLE 1004.5	

OCCOPANCE LOAD PER 2022 CBC TABLE	1004.5		
FUNCTION OF SPACE	OCCUPANCY LOAD FACTOR (SQUARE FEET)	SQUARE FOOTAGE	TOTAL OCCUPANTS
MERCANTILE	1 PER 60	11073 SF	185 OCC
ASSEMBLY (WITHOUT FIXED SEATS) UNCONCENTRATED	1 PER 15	900 SF	60 OCC
FIXED BOOTH SEATING	1 PER 24"		36 OCC
KITCHEN	1 PER 200	800 SF	4 OCC
ΤΟΤΑΙ	_:	12,776 SF	286 OCC

\*PER TABLE CPC 4-1 FOOTNOTE - ACCESSORY AREAS SUCH AS, BUT NOT LIMITED TO HALLWAYS/CORRIDORS, STAIRWAYS, RAMPS, TOILET ROOMS, MECHANICAL ROOMS, CLOSETS AND FIXED EQUIPMENT MAY BE EXCLUDED. \*PER TABLE CPC 422.1 - RESULT IN FRACTIONAL NUMBERS, SUCH NUMBER SHALL BE ROUNDED TO THE NEXT WHOLE NUMBER. FOR MULTIPLE OCCUPANCIES, FRACTIONAL NUMBER SHALL BE FIRST SUMMED AND THEN ROUNDED TO THE NEXT WHOLE NUMBER.

M OCCUPANCY (PER OCC. LOAD) @ GROUND FLR	
185 OCCUPANTS I 93 MALE & 93 FEMALE	

i. WATER CLOSET (M): 93 OCCUPANTS X 1/100 = .93 ii. WATER CLOSET (F): 93 OCCUPANTS X 1/100 = .93 iii. URINAL (M): 93 OCCUPANTS X 1/200 = .47 iv LAVATORY (M)  $\cdot$  93 OCCUPANTS X 1/200 = 47

100 OCCUPANTS I 50 MALE & 50 FEMALE i. WATER CLOSET (M): 50 OCCUPANTS X 1/50 = 1 ii. WATER CLOSET (F): 50 OCCUPANTS X 1/25 = 2 iii. URINAL (M): 50 OCCUPANTS X 1/200 = .25

A-2 OCCUPANCY (PER OCC. LOAD) @ GROUND FLR

iv. LAVATORY (M): 93 C v. LAVATORY (F): 93 OC				TORY (M): 50 OCC TORY (F): 50 OCCL		
FRACTIONAL	WATER (	CLOSETS	URINALS	LAVAT	ORIES	
METHOD	М	F	UNINALS	М	F	
TOTAL	2	3*	1	1	1	
REQUIRED	5	5	1	2	2	
PROVIDED	6	5	1 WC	6	5	


INSTEAD OF URINAL (INCLUDED IN COUNT 6) \*POTTY PARITY - PER CPC 422.1 NOTE 3 - THE TOTAL NUMBER OF REQUIRED WATER CLOSETS FOR FEMALES

SHALL BE NOT LESS THAN THE TOTAL NUMBER OF REQUIRED WATER CLOSETS AND URINALS FOR MALES.

iii. URINAL (M): .47 + .25 = .72 -> 1 iv. LAVATORY (M): .47 + .34 = .81 -> 1

v. LAVATORY (F): .47 + .34 = .81 -> 1

SUM UP ALL REQUIRED FIXTURES i. WATER CLOSET (M): .93 + 1 = 1.93 -> 2 ii. WATER CLOSET (F): .93 + 2 = 2.93 -> 3

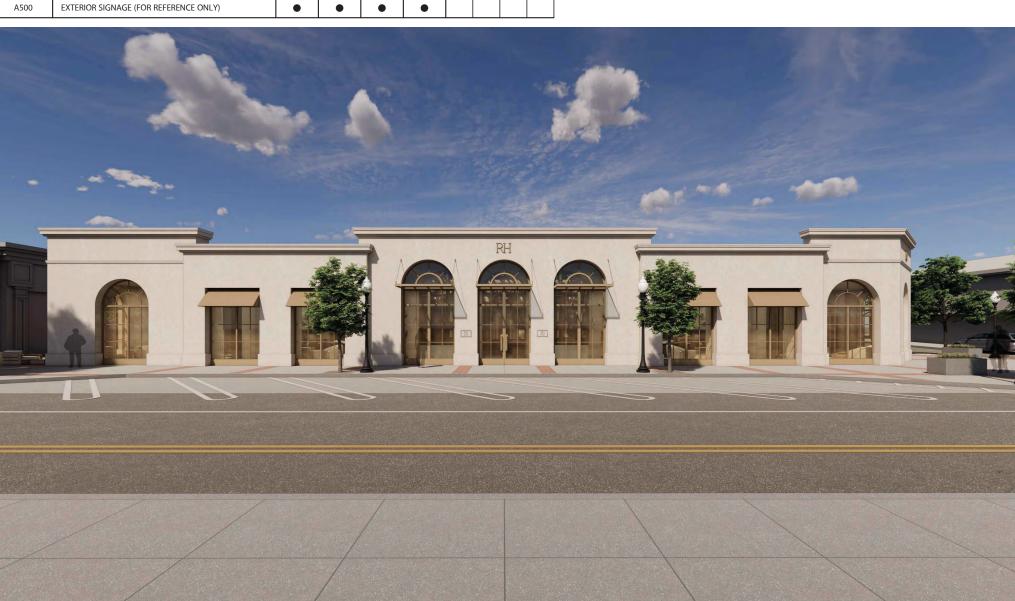


SHEET NO	SHEET NAME	10/18/2024 PRE-APPLICATION PACKAGE	11/06/2024 PLANNING SUBMITTAL	11/22/2024 100% SCHEMATIC DESIGN	01/09/2025 PLANNING SUBMITTAL 2		
	ARCHITECTURAL						
A001	COVER SHEET	•	•	•	•		
AS101	SITE PLAN	•	•	•	•		
AD101	EXISTING FLOOR PLAN	•	•	•	•		
A100	EXISTING BASEMENT PLAN	•	•	•	•		
A101	FLOOR PLAN	•	•	•	•		
A104	ROOF PLAN	•	•	•	•		
A201	EXTERIOR ELEVATIONS	•	•	•	•		
A202	EXTERIOR ELEVATIONS	•	•	•	•		
A203	EXISTING EXTERIOR ELEVATIONS				•		
A204	EXISTING EXTERIOR ELEVATIONS				•		
A301	BUILDING SECTIONS	•	•	•	•		
A400	EXISTING BUILDING PHOTOS	•	•	•	•		
A401	EXISTING BUILDING PHOTOS	•	•	•	•		
A402	EXTERIOR BUILDING RENDERS	•	•	•	•		
A403	EXTERIOR BUILDING RENDERS	•	•	•	•		
A404	INTERIOR BUILDING RENDERS	•	•	•	•		
A405	INTERIOR BUILDING RENDERS	•	•	•	•		
A406	MATERIAL FINISHES		•	•	•		
1500							

**DRAWING INDEX** 

		LIGHTING					
	LT-1.0	LIGHTING LAYOUT	•	•	•		
	LT-2.0	EXTERIOR LIGHTING ELEVATIONS	•	•	•		
l							



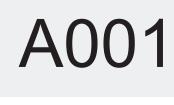

Drawing No.

Project No.	59485
Drawn By:	Brenda B
Reviewed By:	Rick N
Scale	As noted

**COVER SHEET** 

Drawings and written material appearing herein constitute

No.	Date	Issued/Revised
01	10/18/2024	PRE-APPLICATION PACKAGE
02	11/06/2024	PLANNING SUBMITTAL
03	11/22/2024	100% SCHEMATIC DESIGN
04	01/09/2025	PLANNING SUBMITTAL 2

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Project

Architect

Seal




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2 11/06/2024	PLANNING SUBMITTAL
	100% SCHEMATIC DESIGN PLANNING SUBMITTAL 2
3 11/22/2024 4 01/09/2025	
4 01/09/2025	PLANNING SUBMITTAL 2
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4 01/09/2025	PLANNING SUBMITTAL 2
4 01/09/2025	PLANNING SUBMITTAL 2         material appearing herein constitute         hed work of the Architect and may not         or disclosed without written consent         of the Architect         IBH ARCHITECTS-2024         59485         Brenda B
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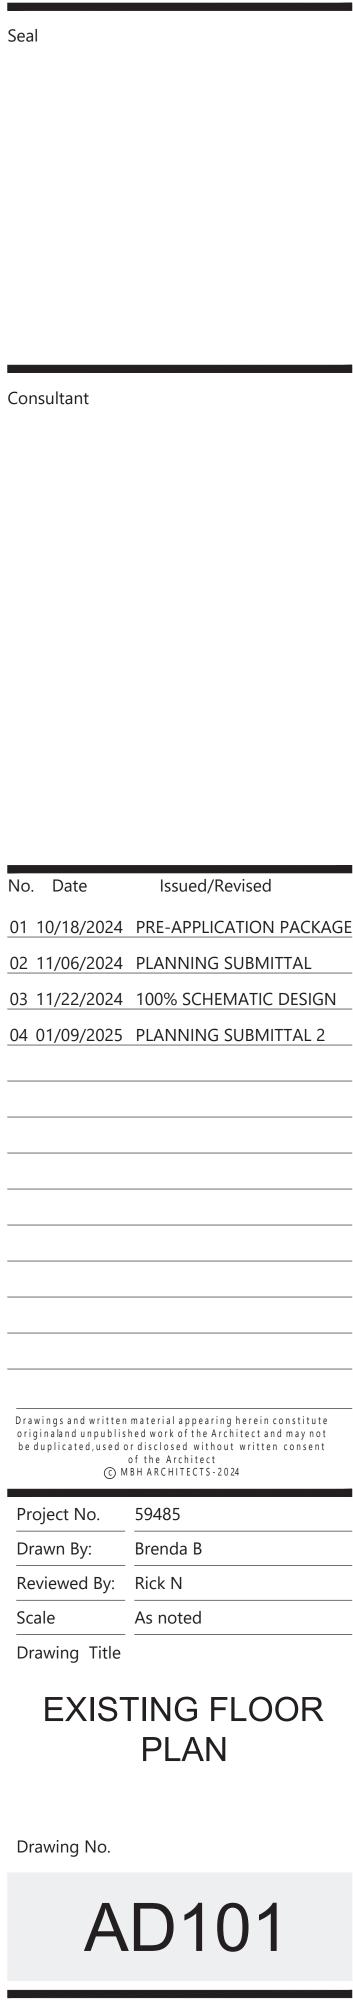


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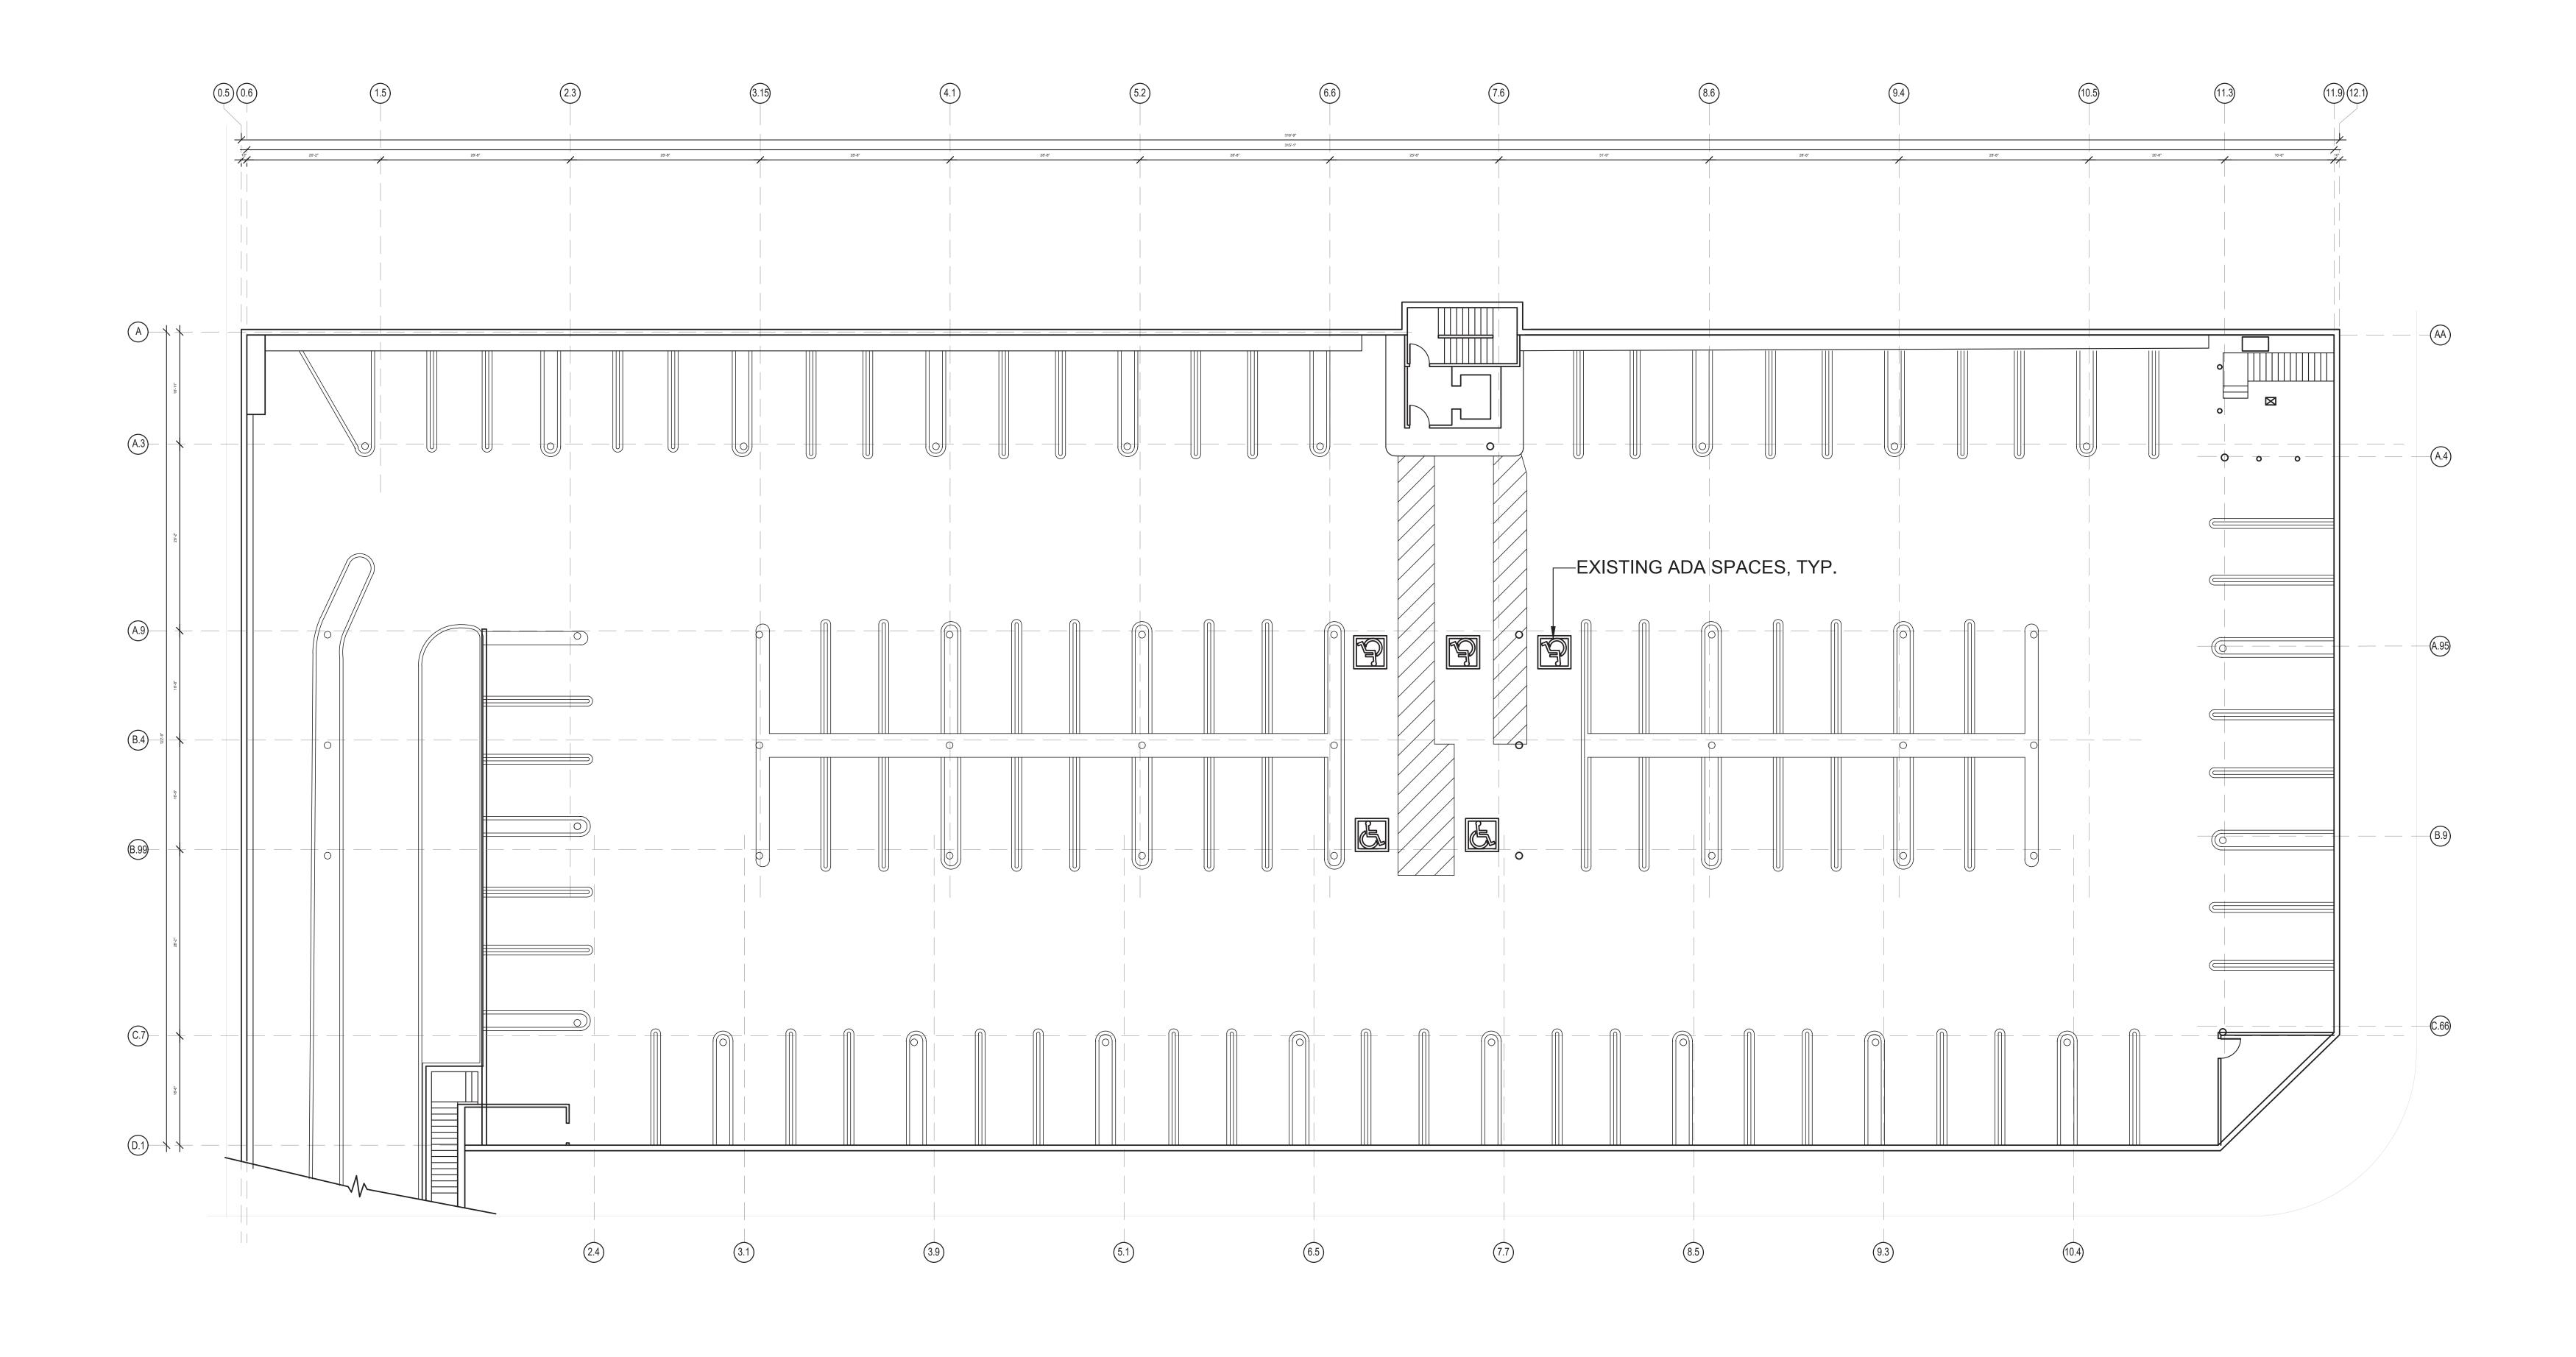
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TRUE NORTH

PLAN NORTH

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BASE	EMENT PLAN
Drawing No.	
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F	A100

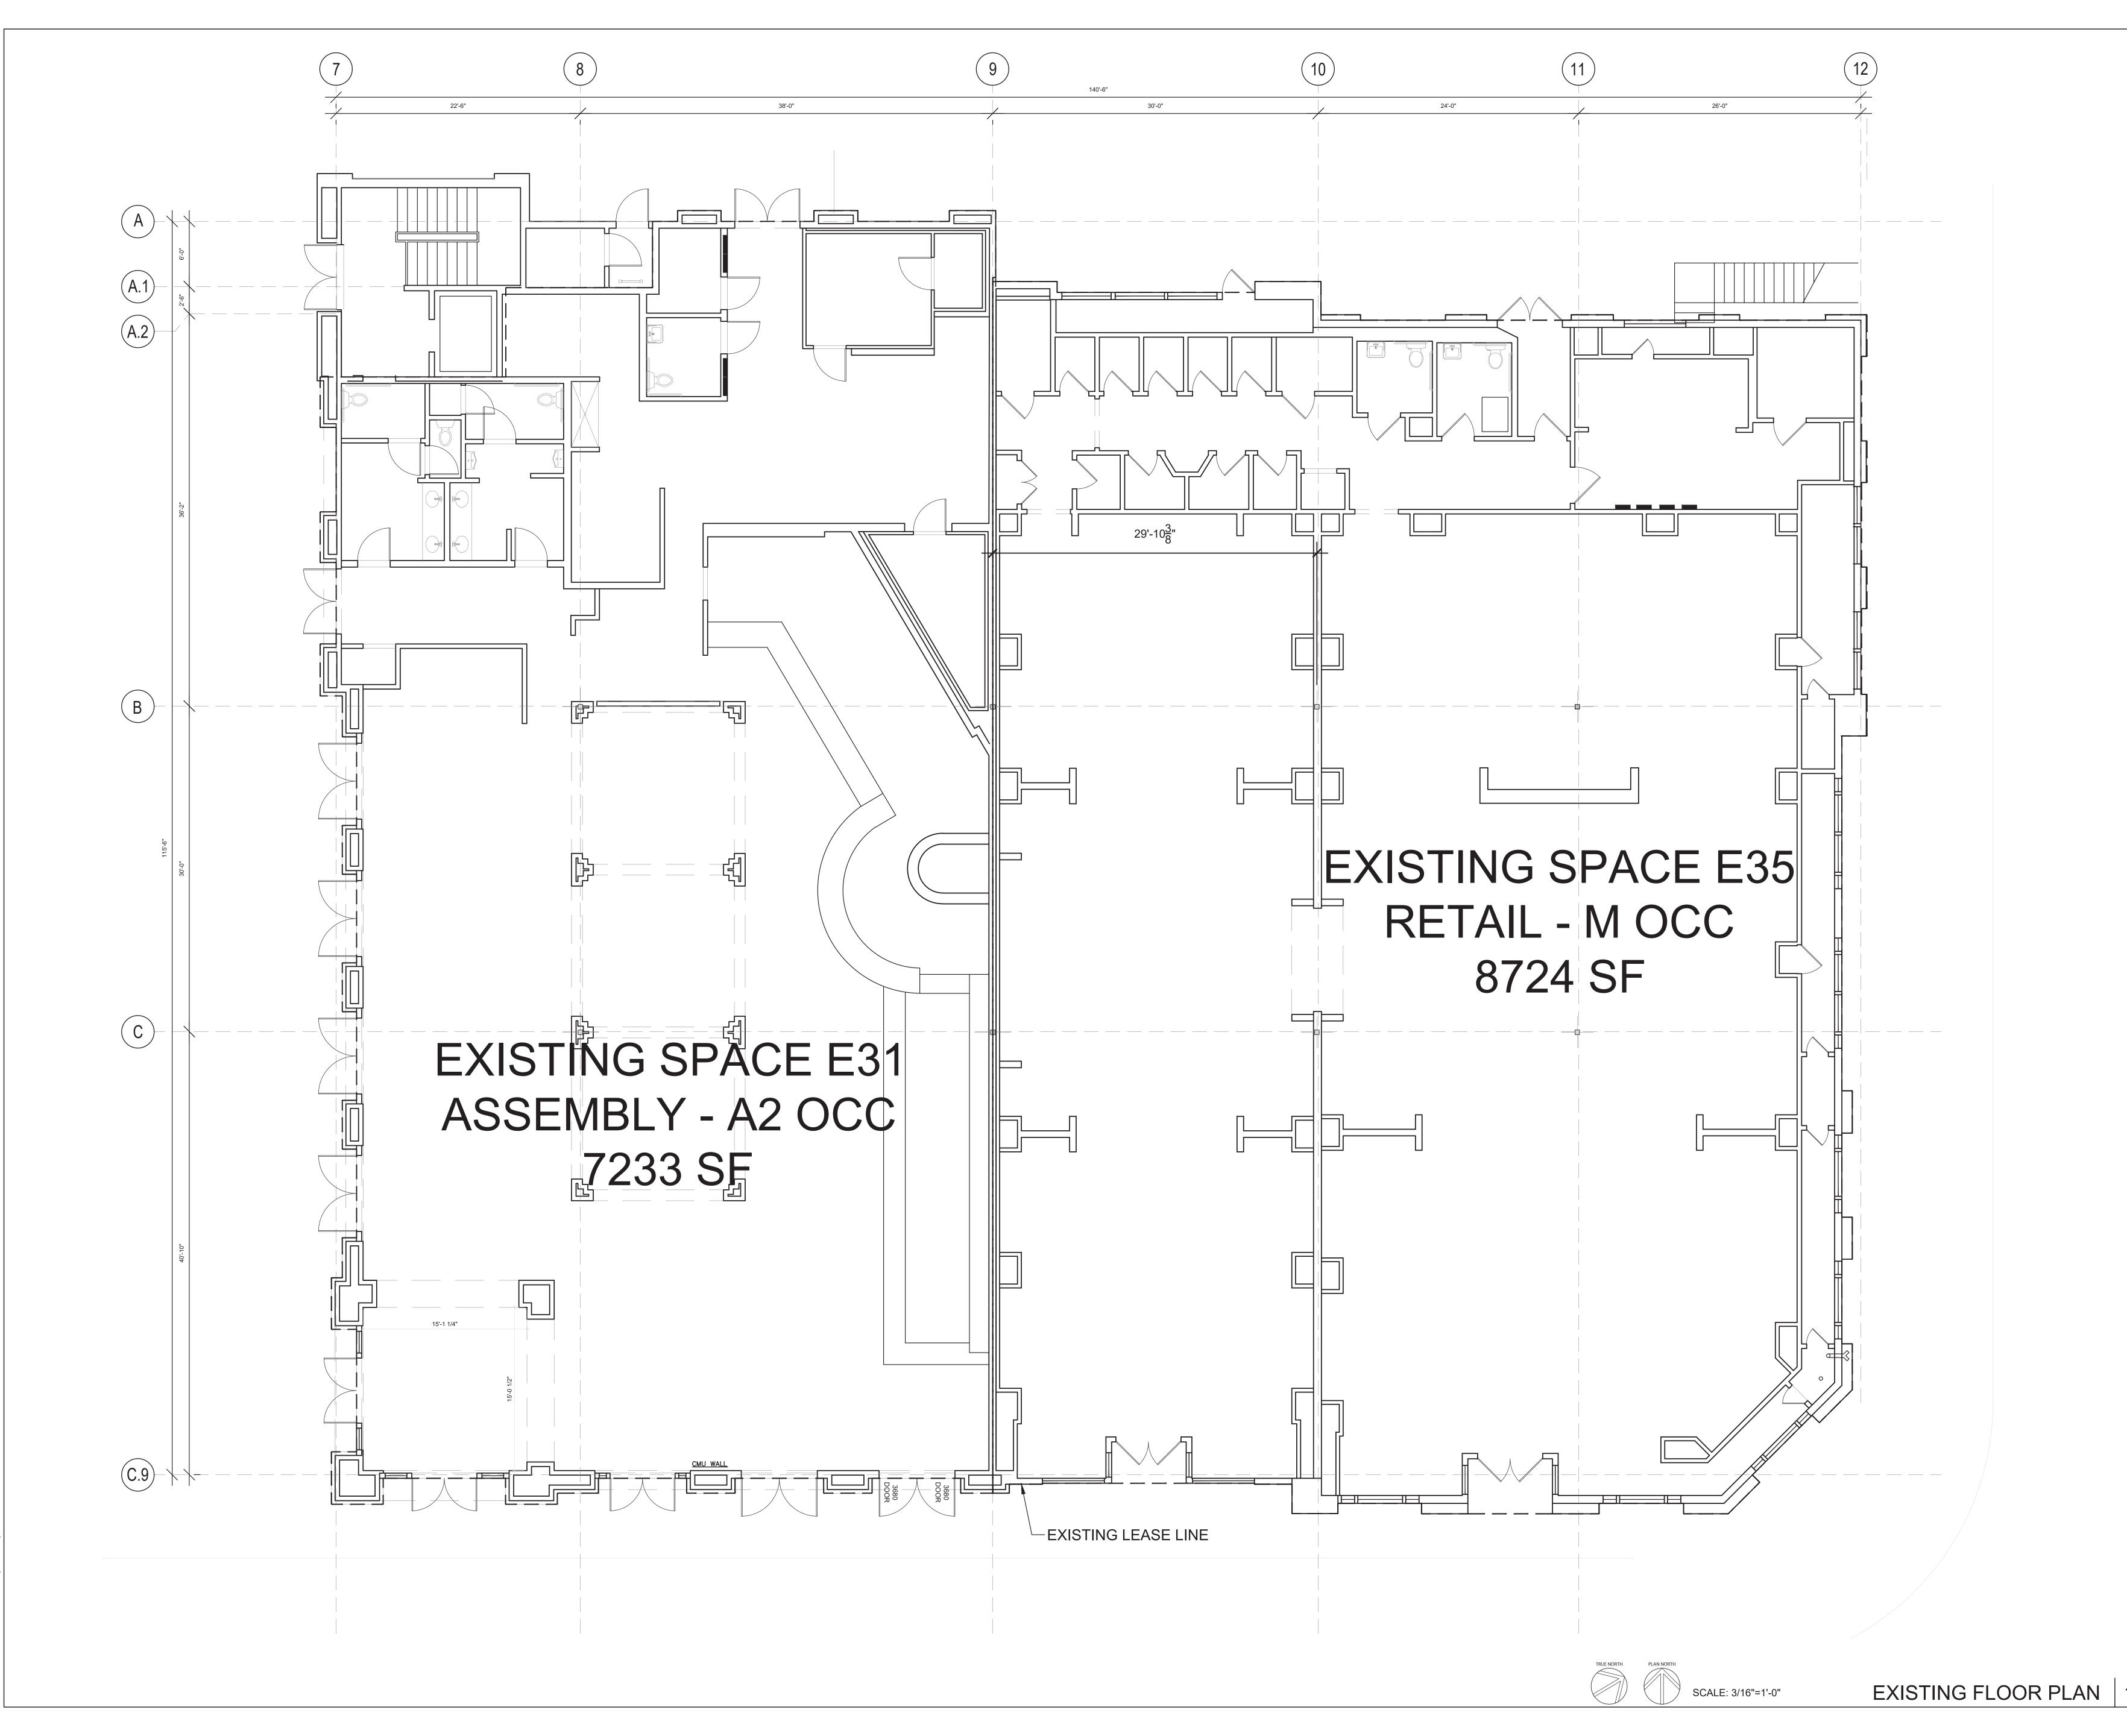


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FLOOR PLAN


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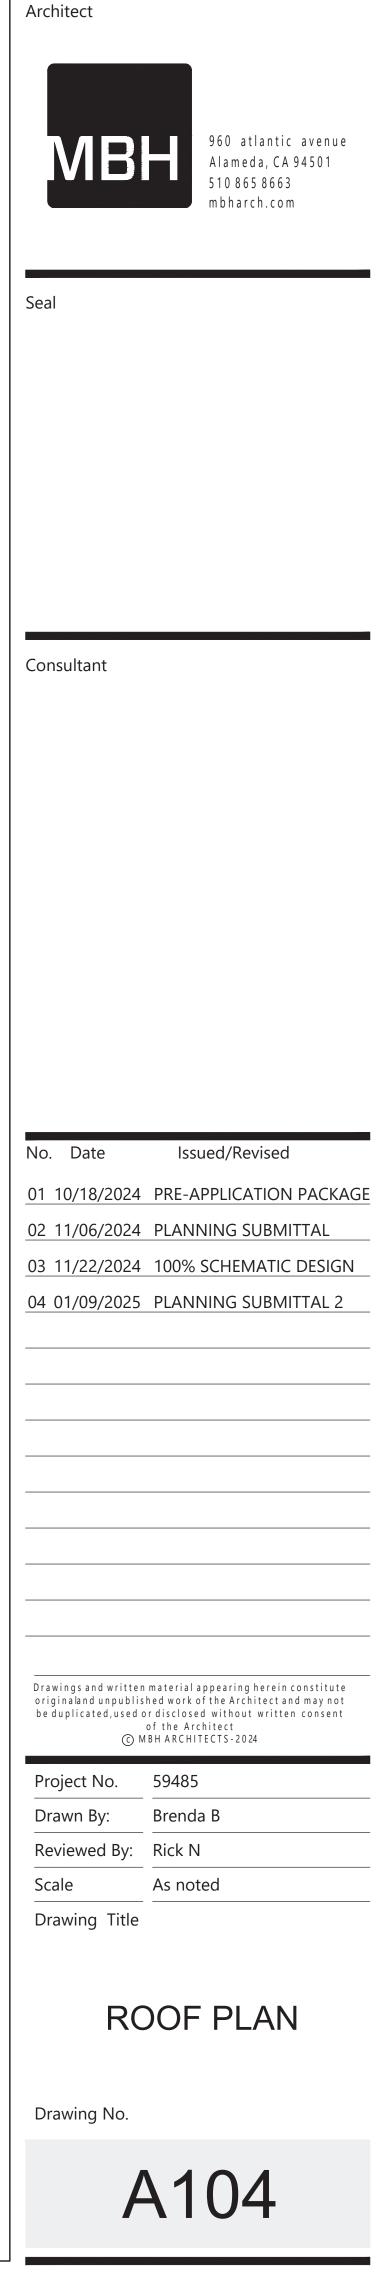
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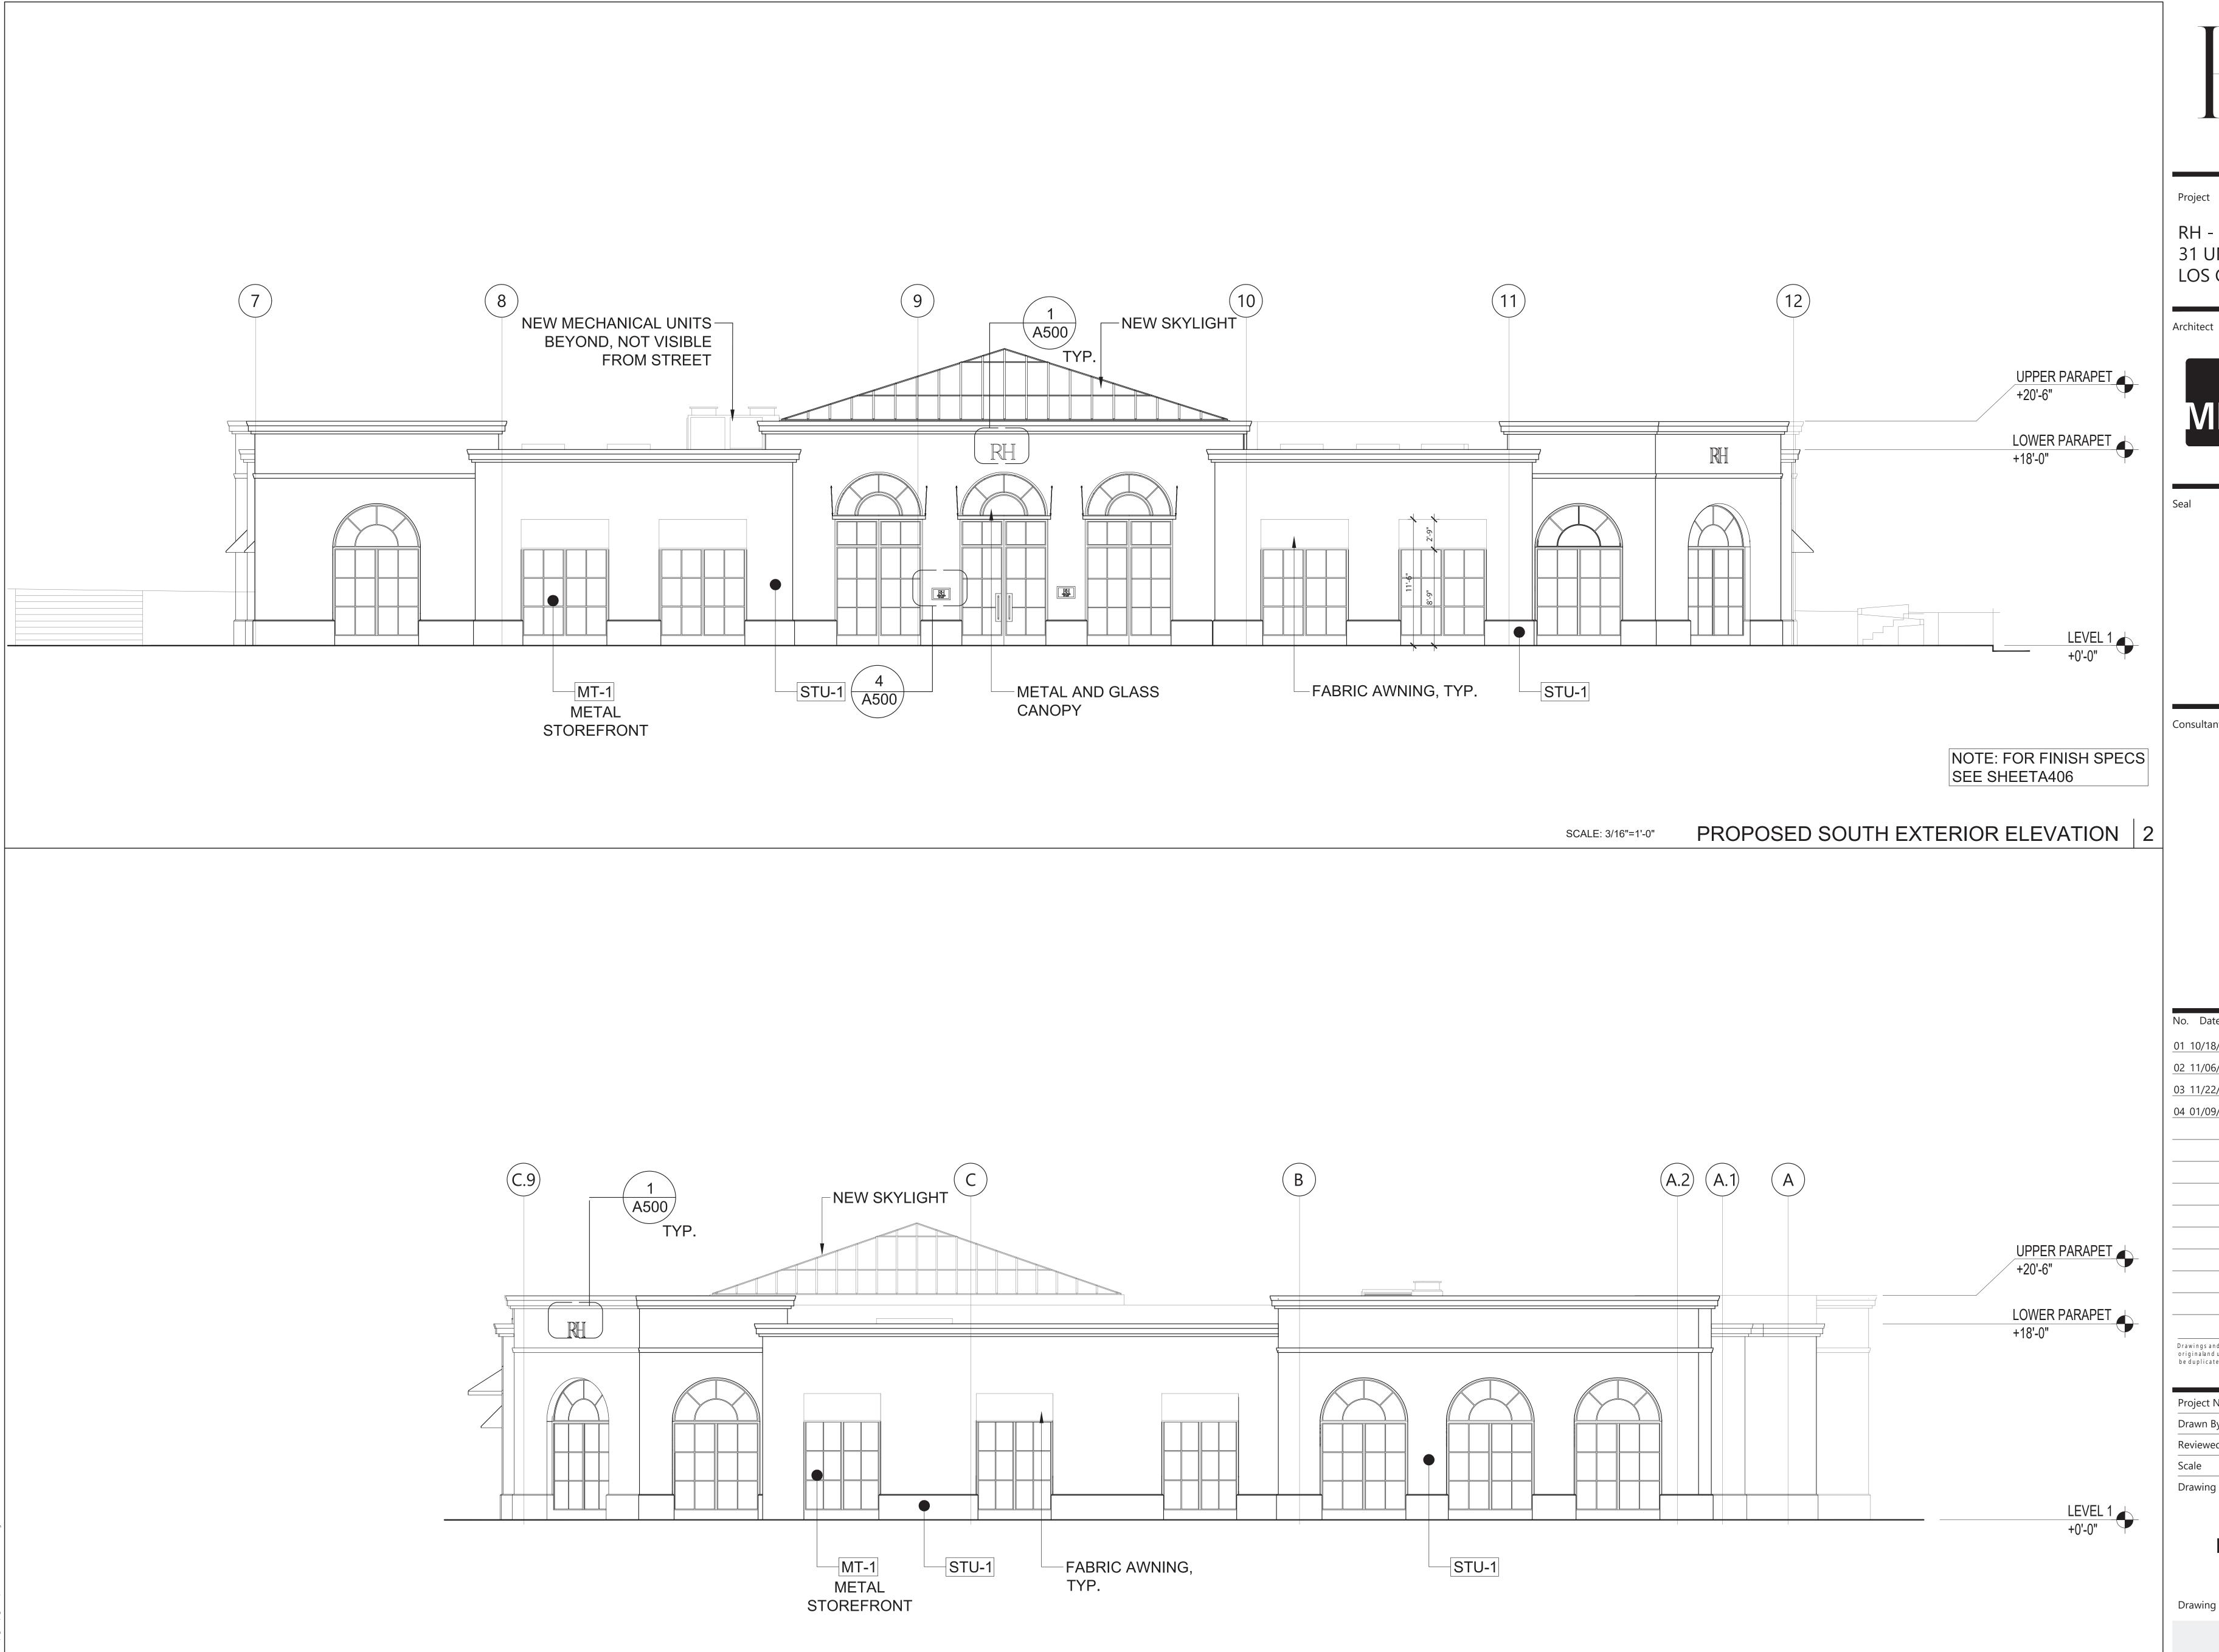


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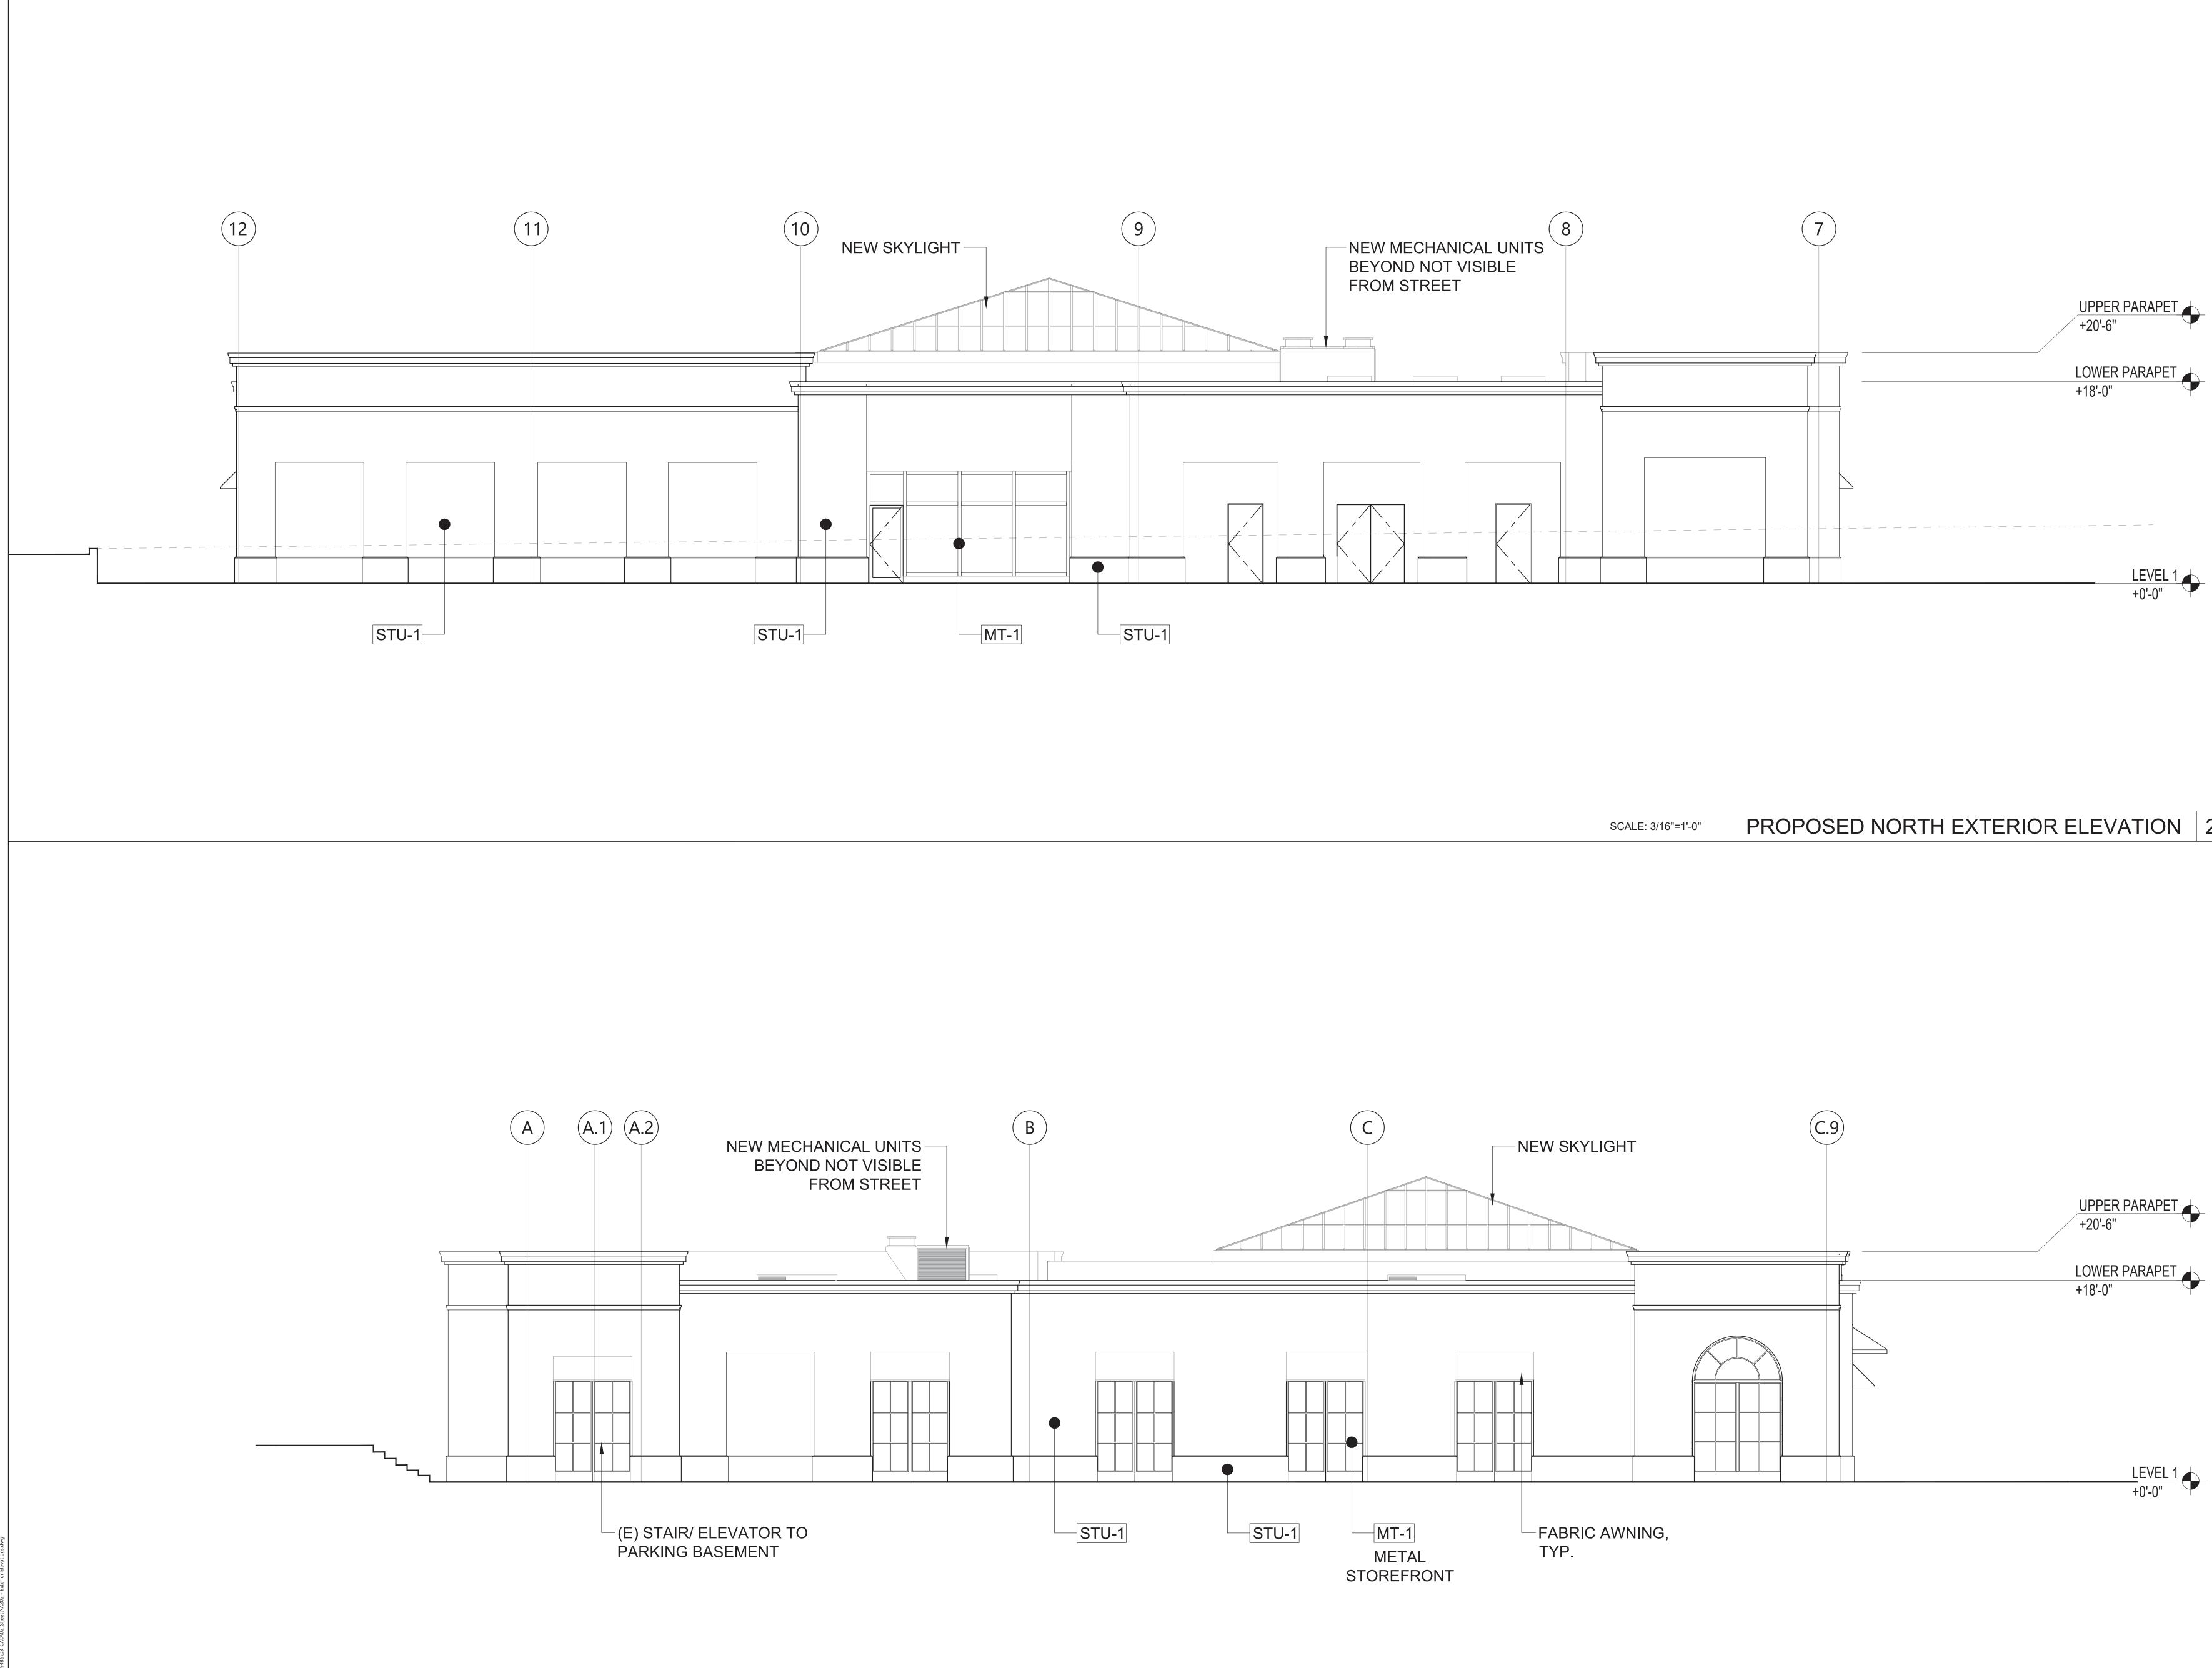


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Drawing Title
EXTERIOR ELEVATIONS
Drawing No.
A201

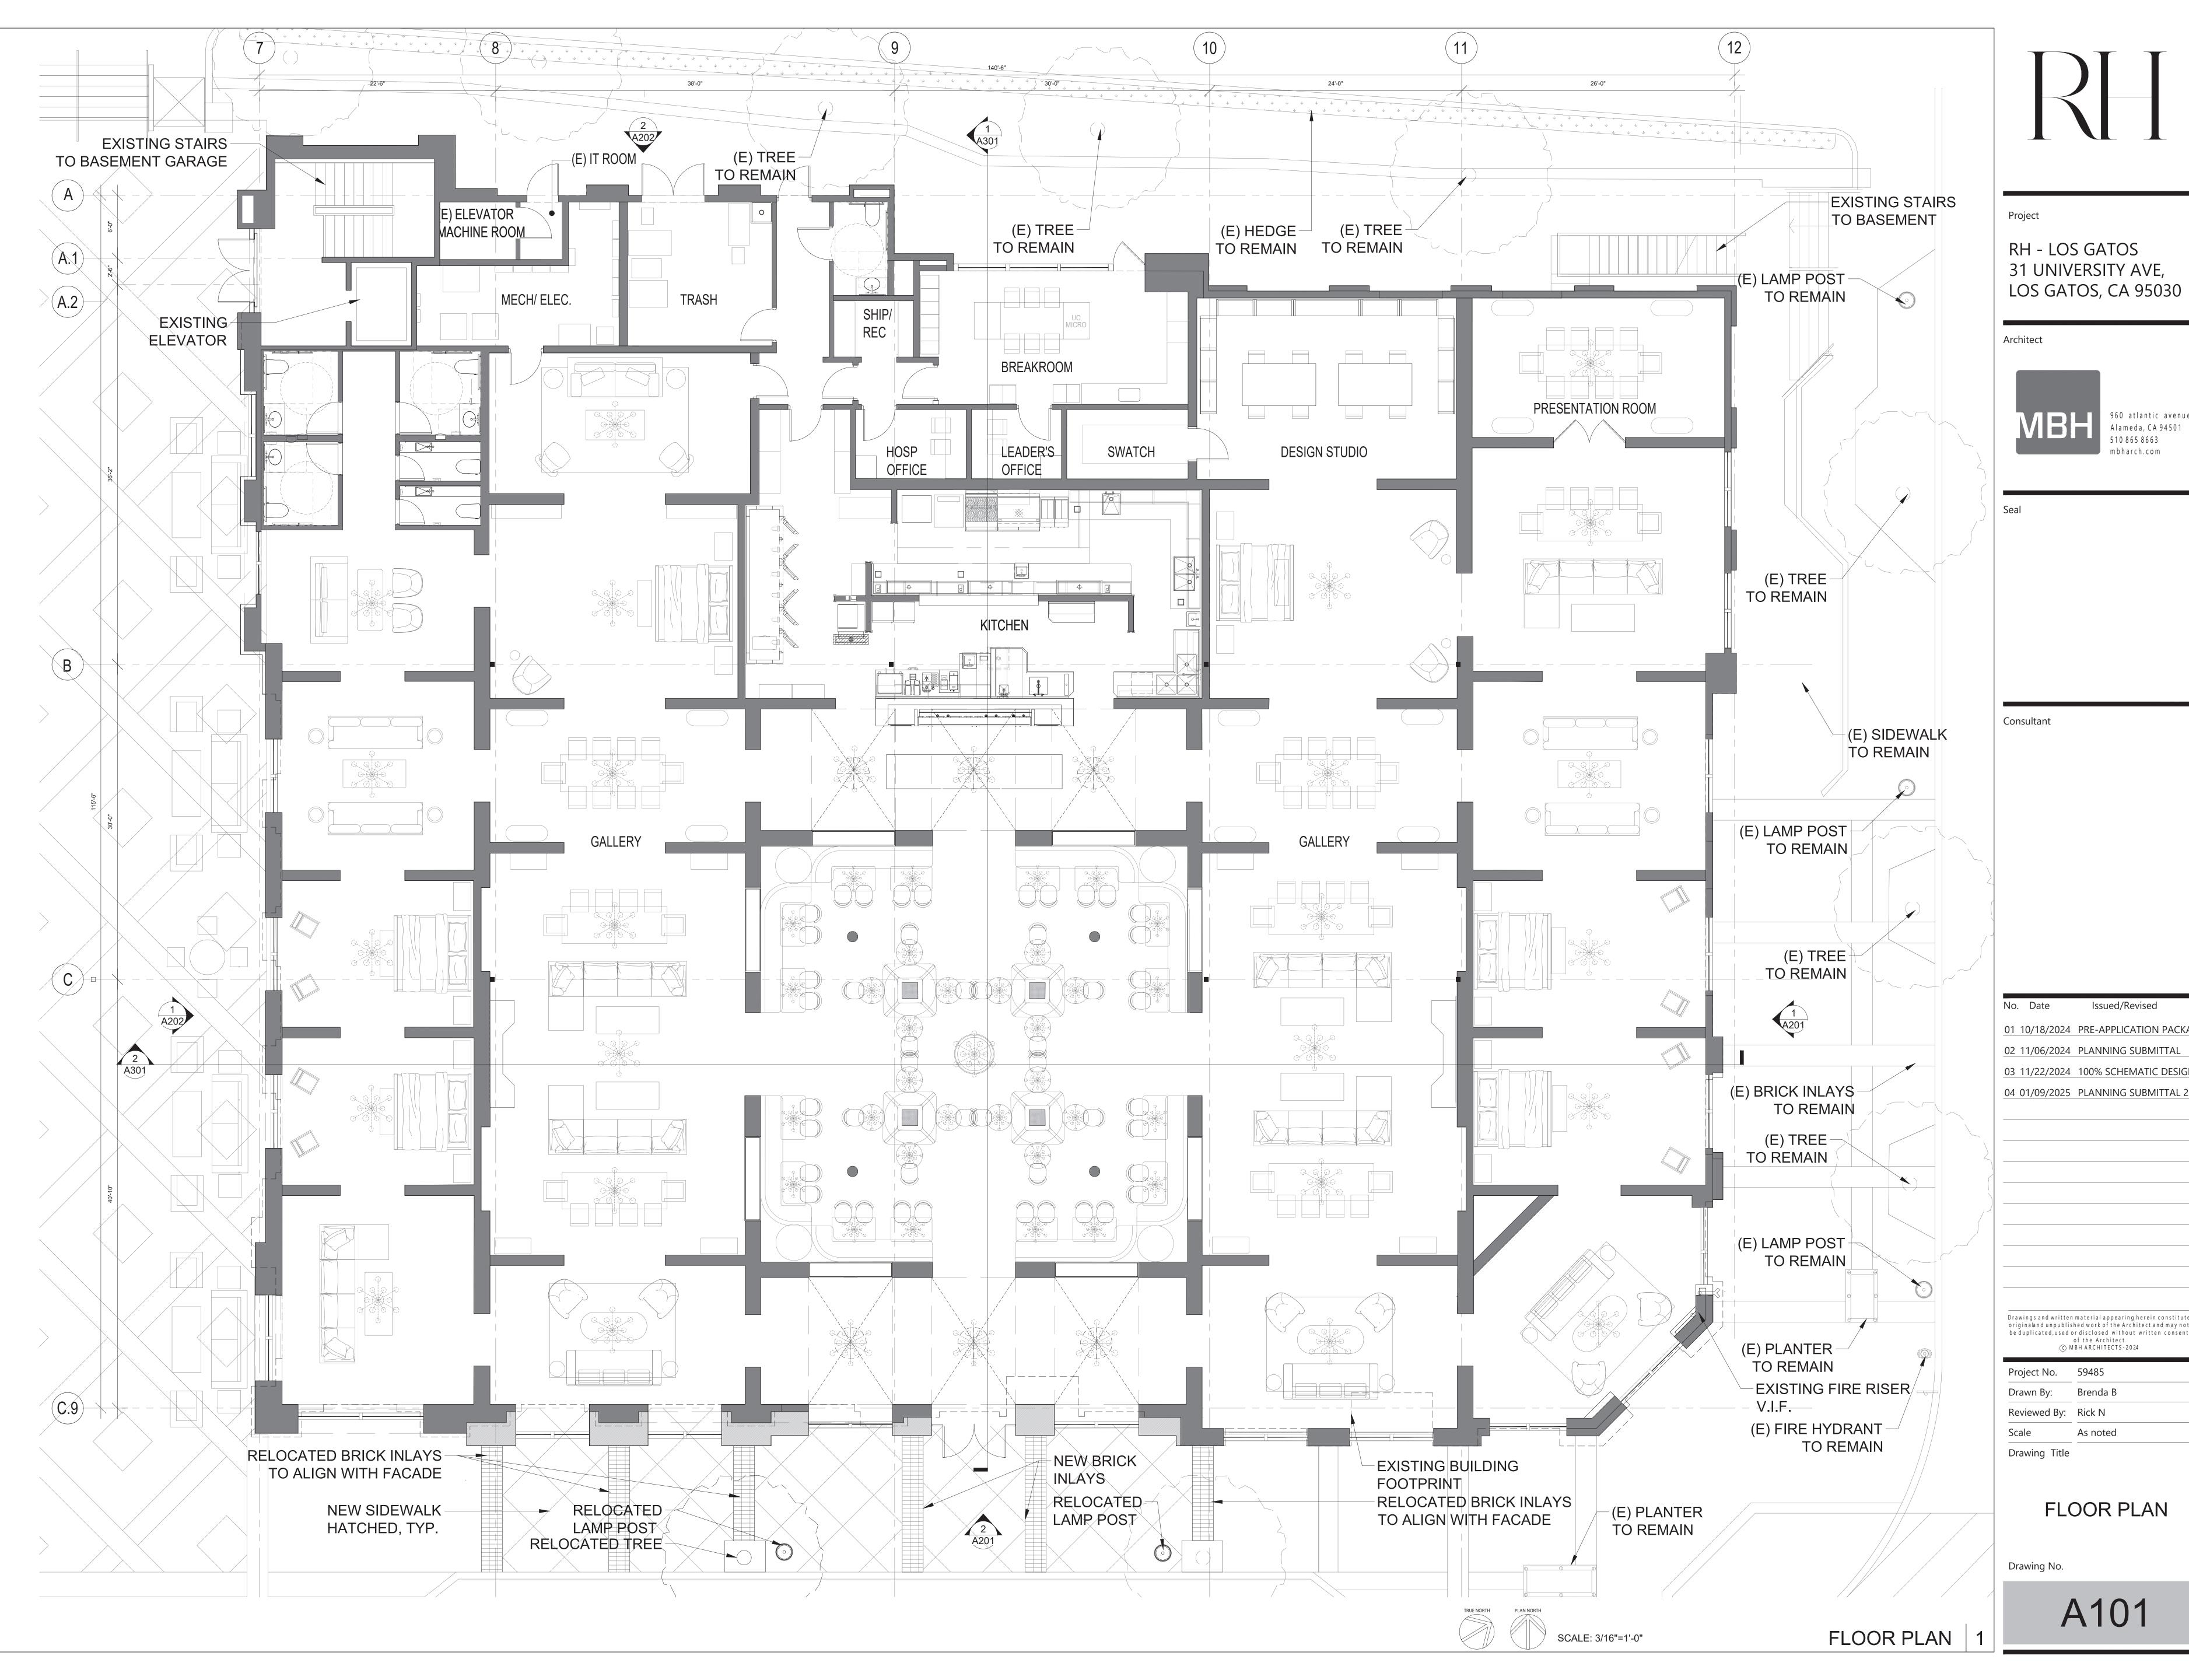

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PROPOSED NORTH EXTERIOR ELEVATION 2
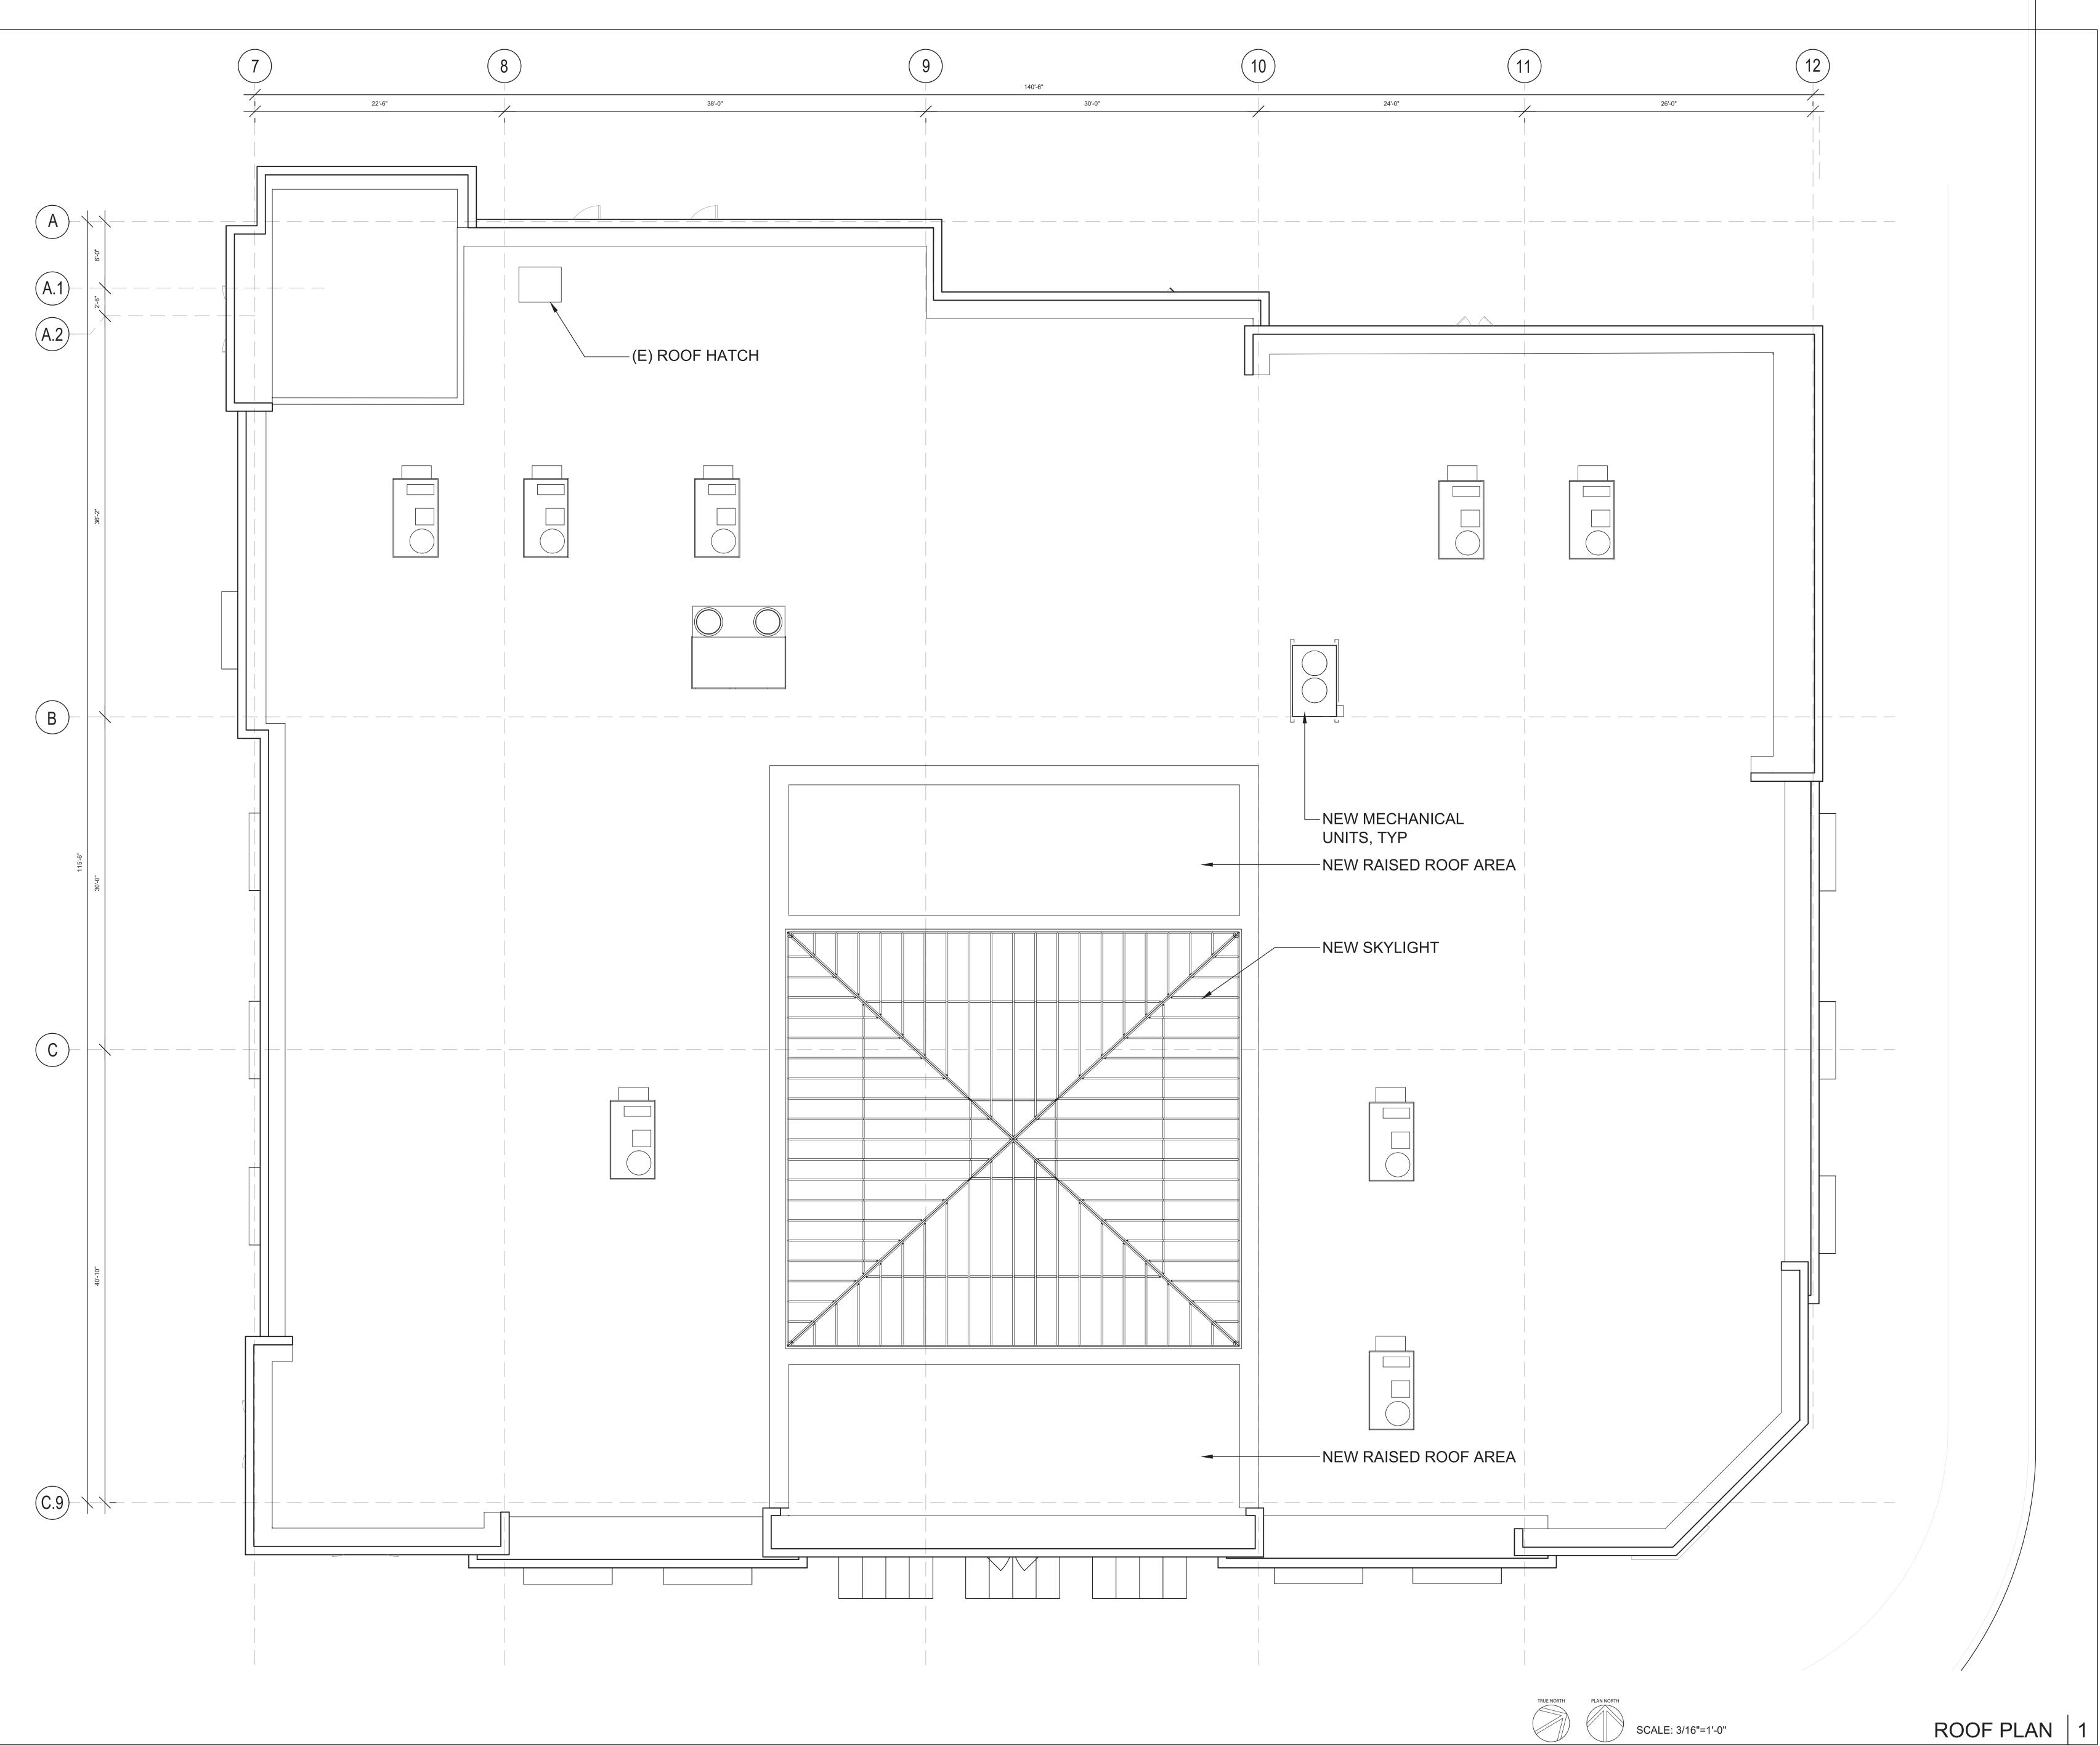
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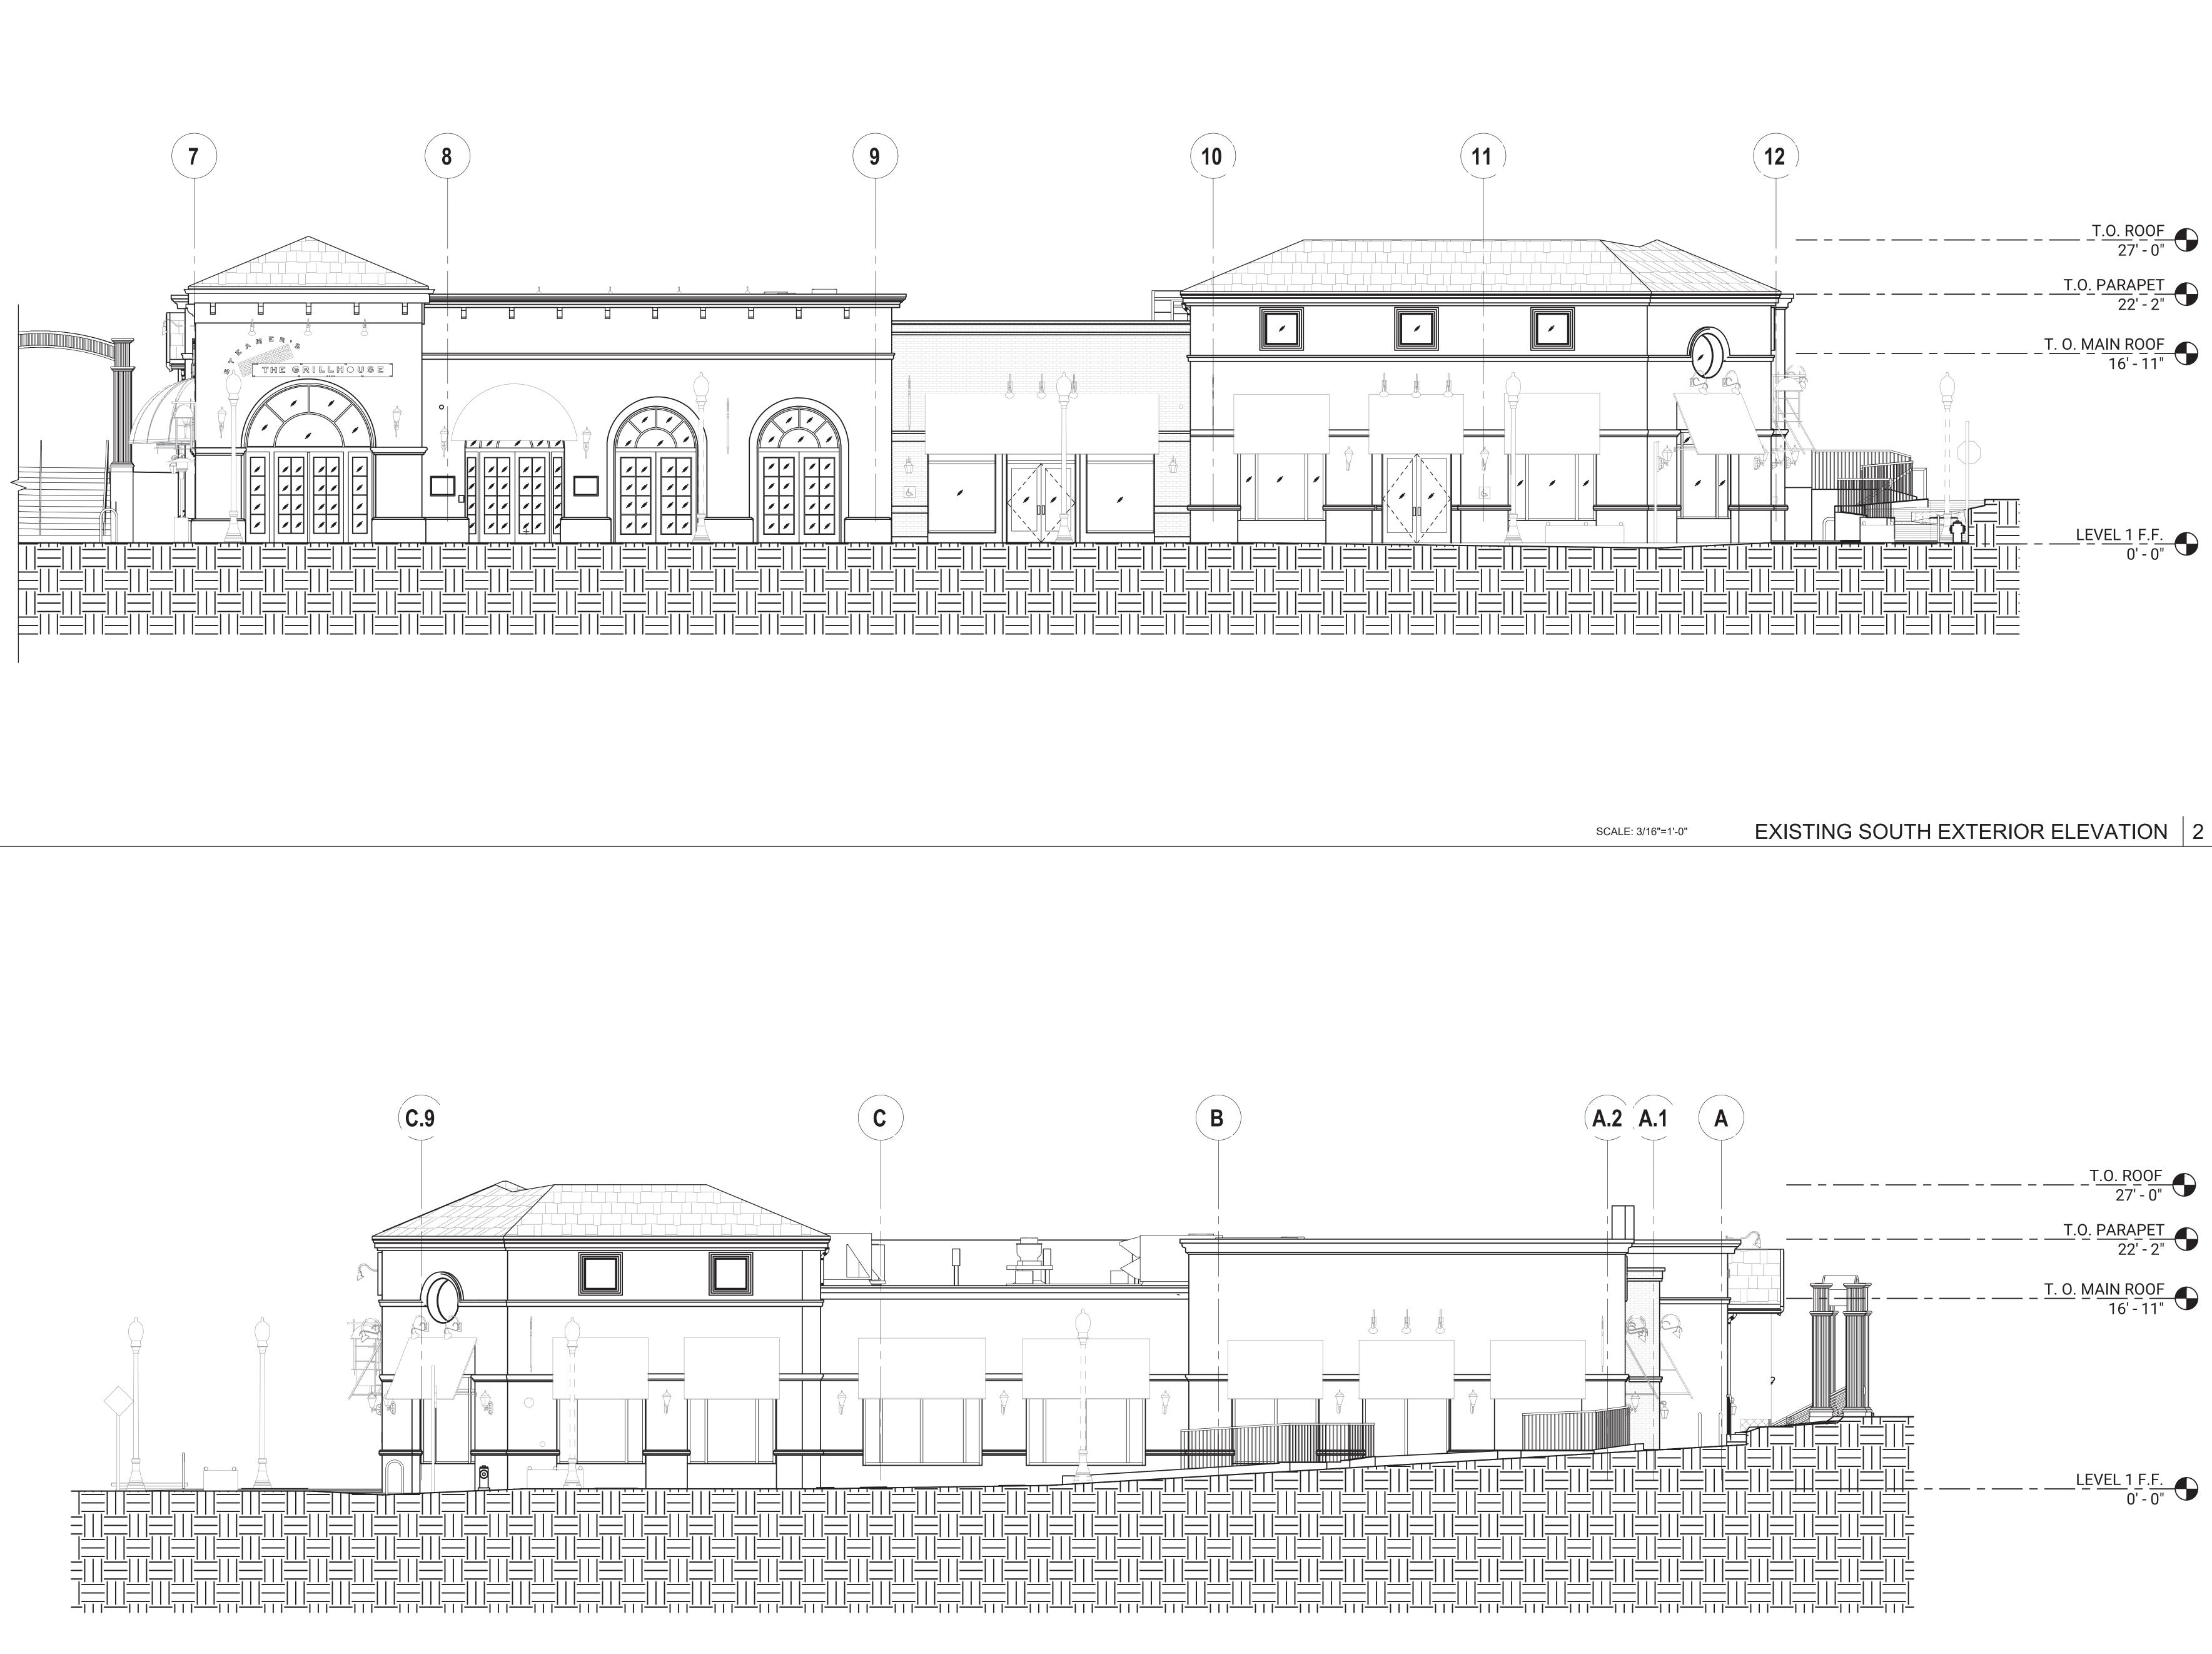



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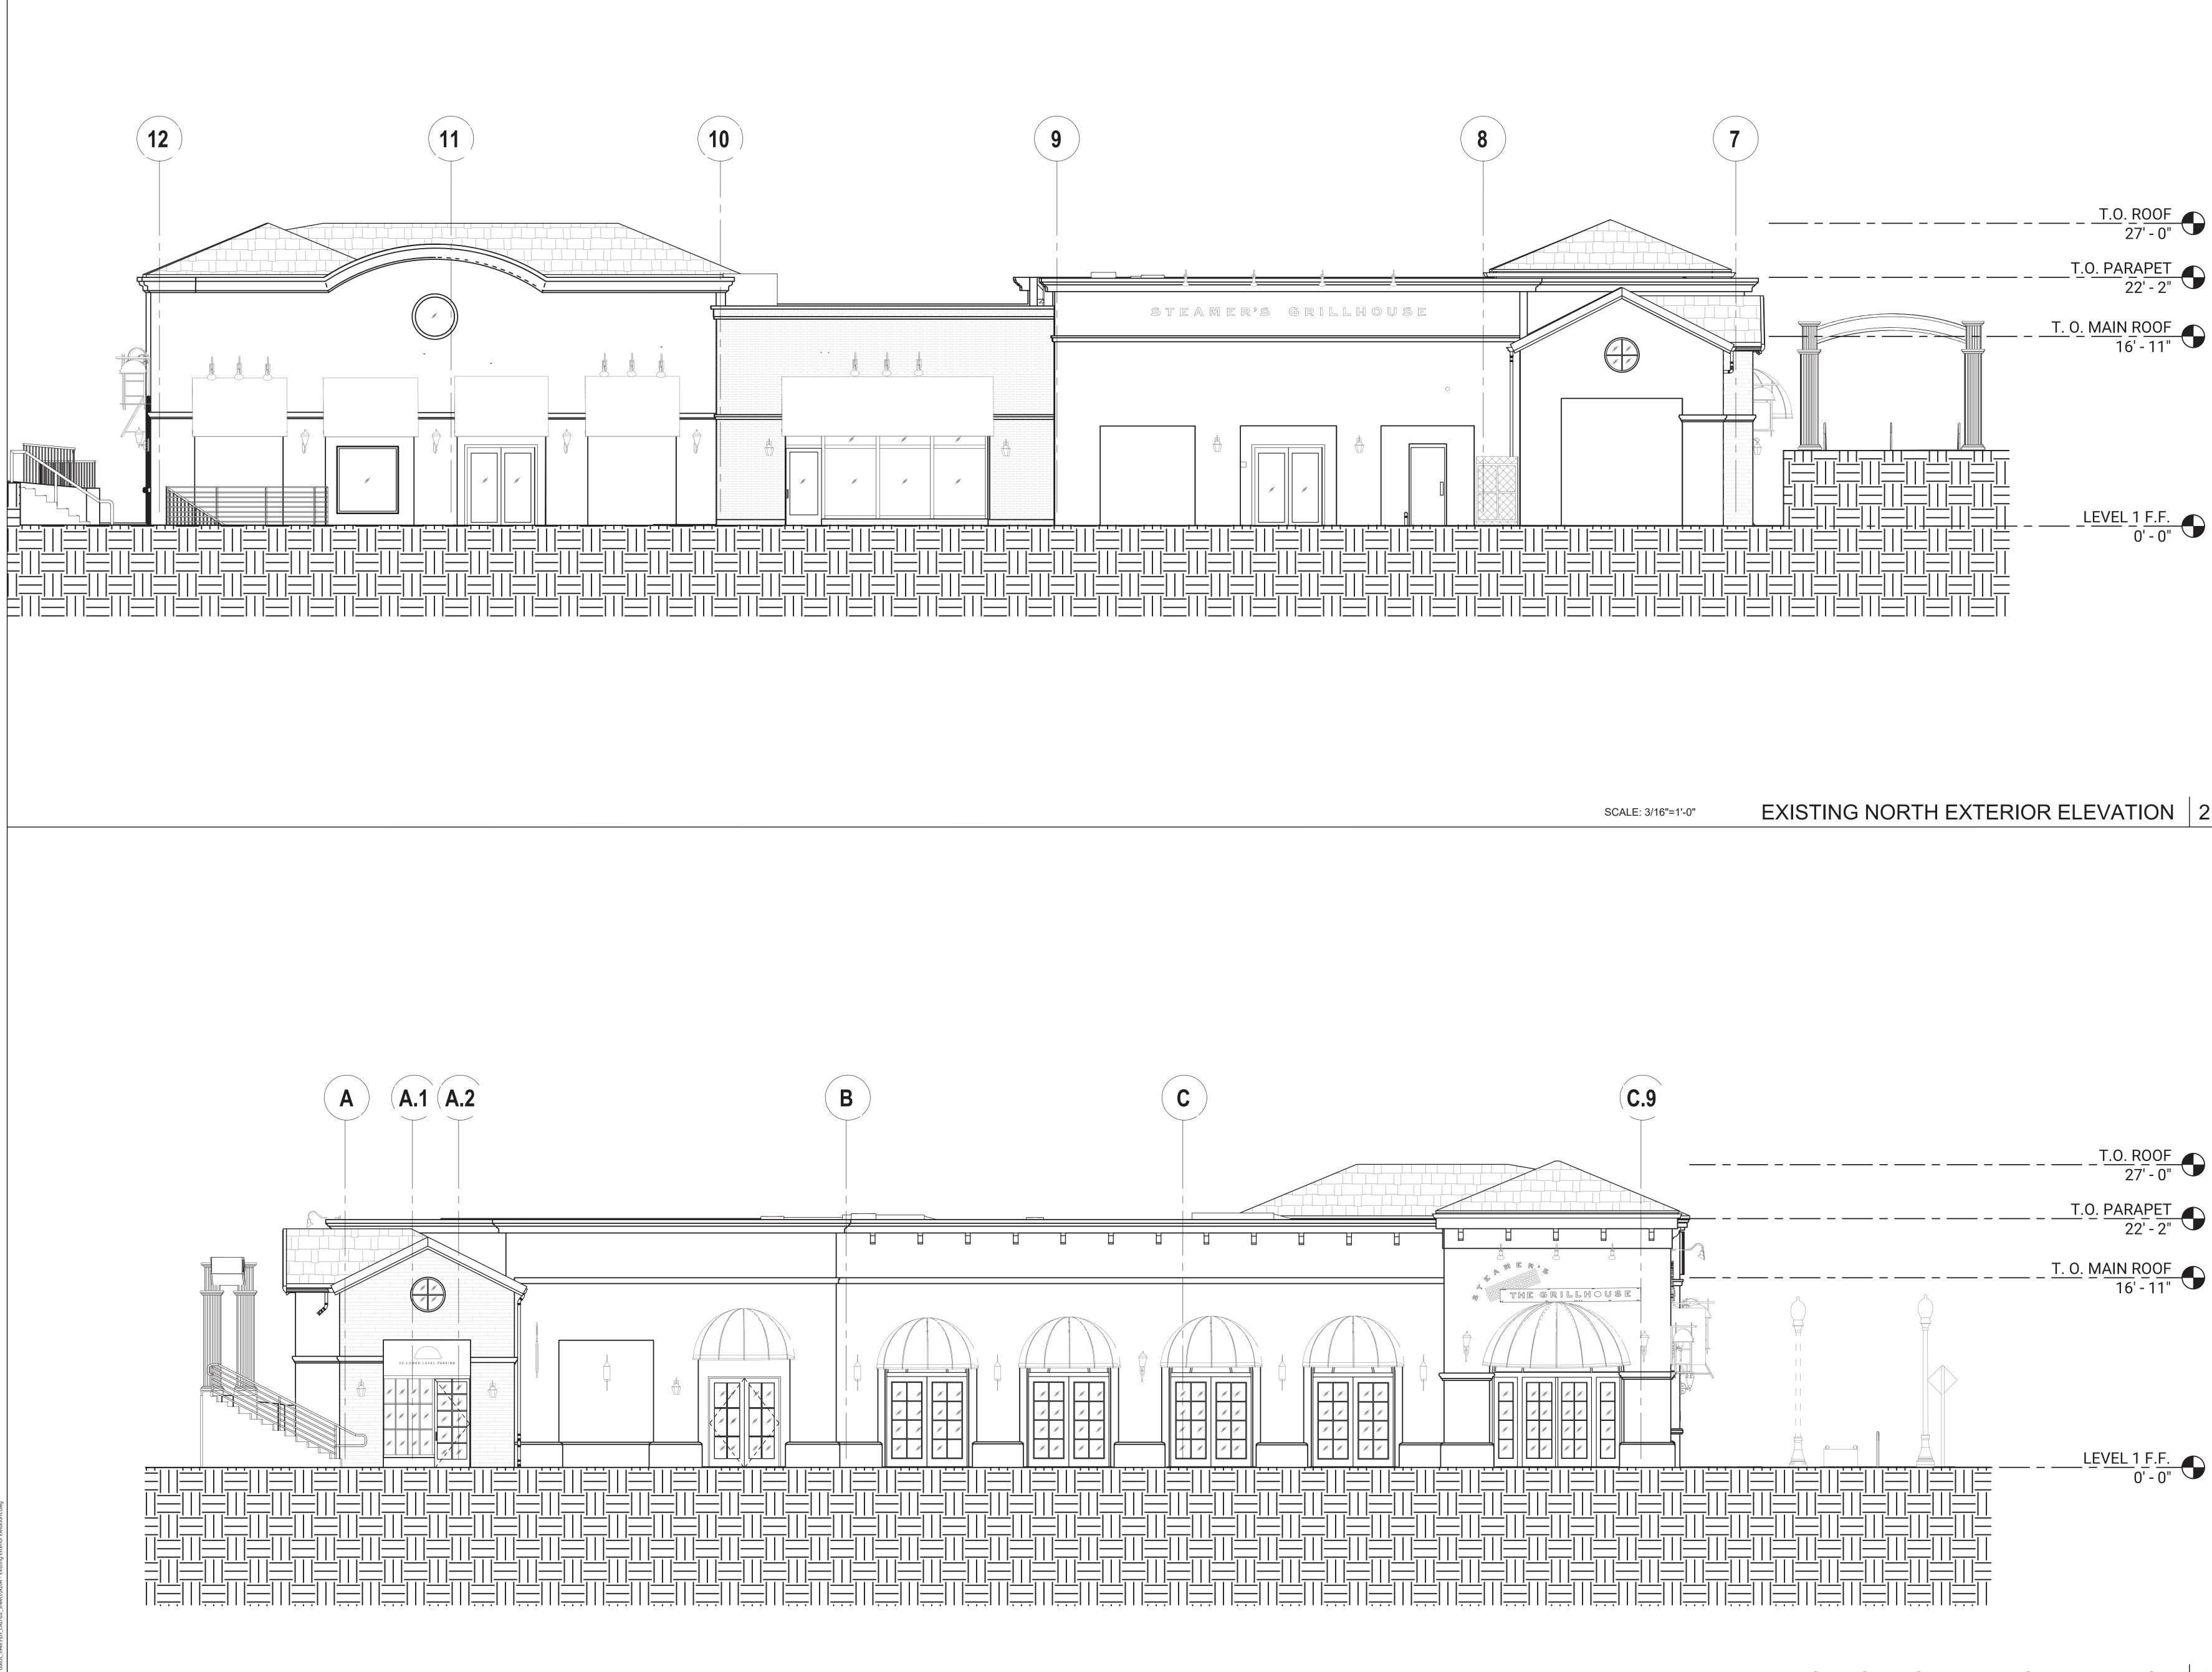
Seal






31 UNIVERSITY AVE, LOS GATOS, CA 95030

RH - LOS GATOS

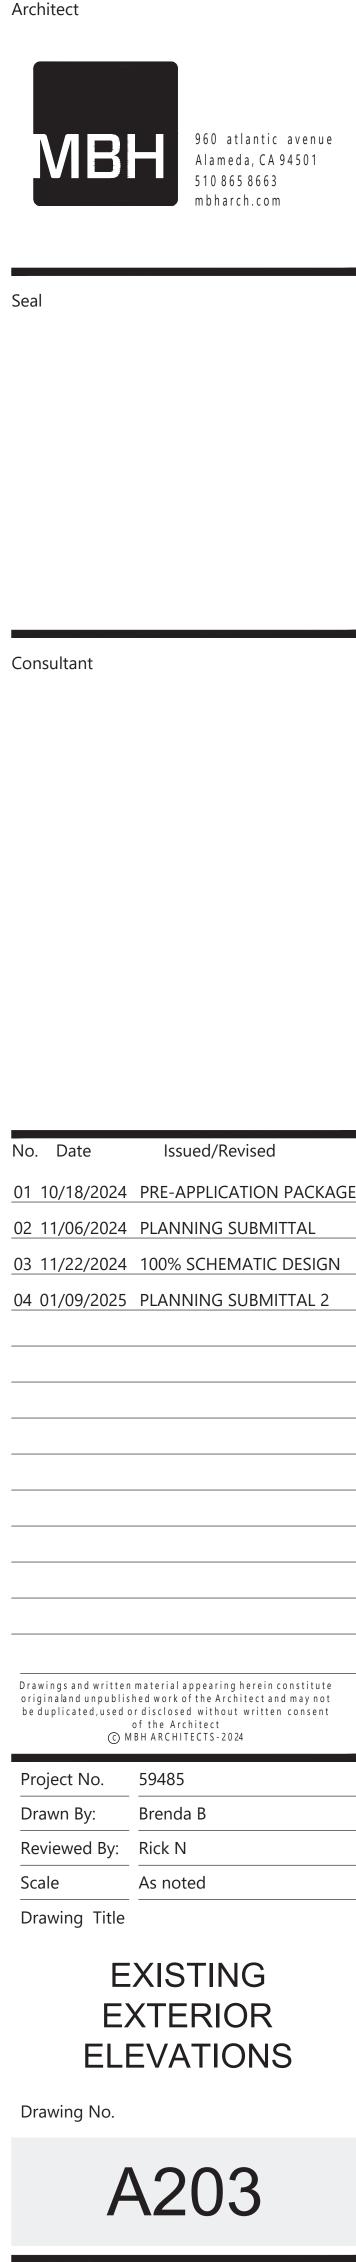

EXISTING NORTH EXTERIOR ELEVATION 2

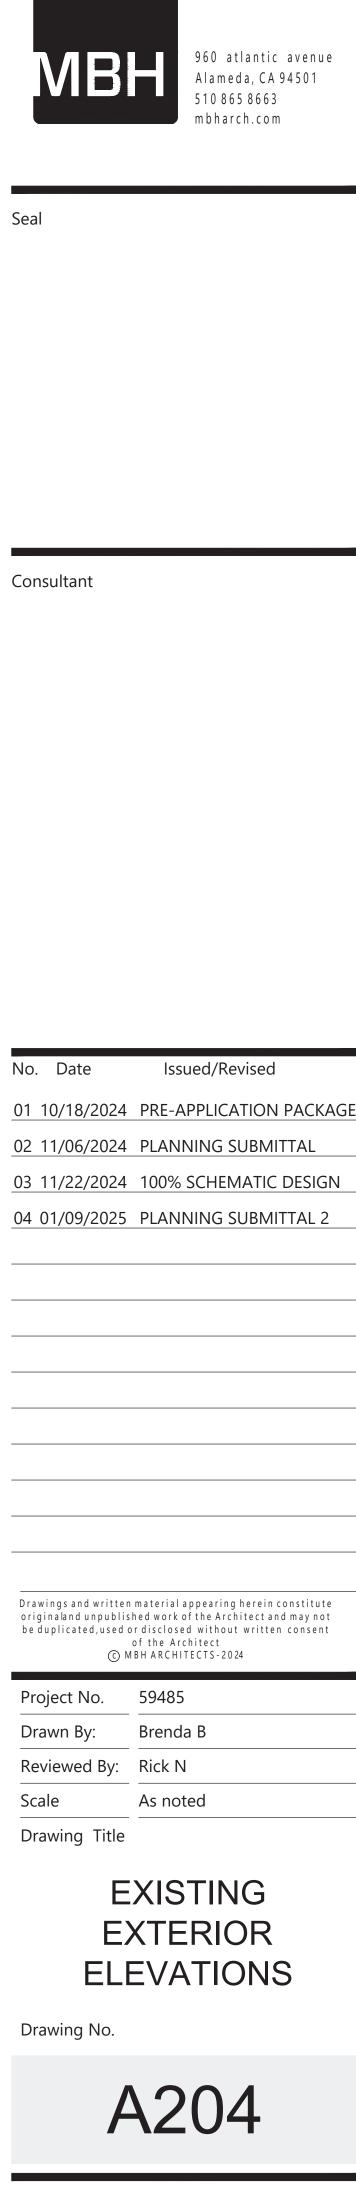


RH - LOS GATOS


31 UNIVERSITY AVE,

LOS GATOS, CA 95030



Architect

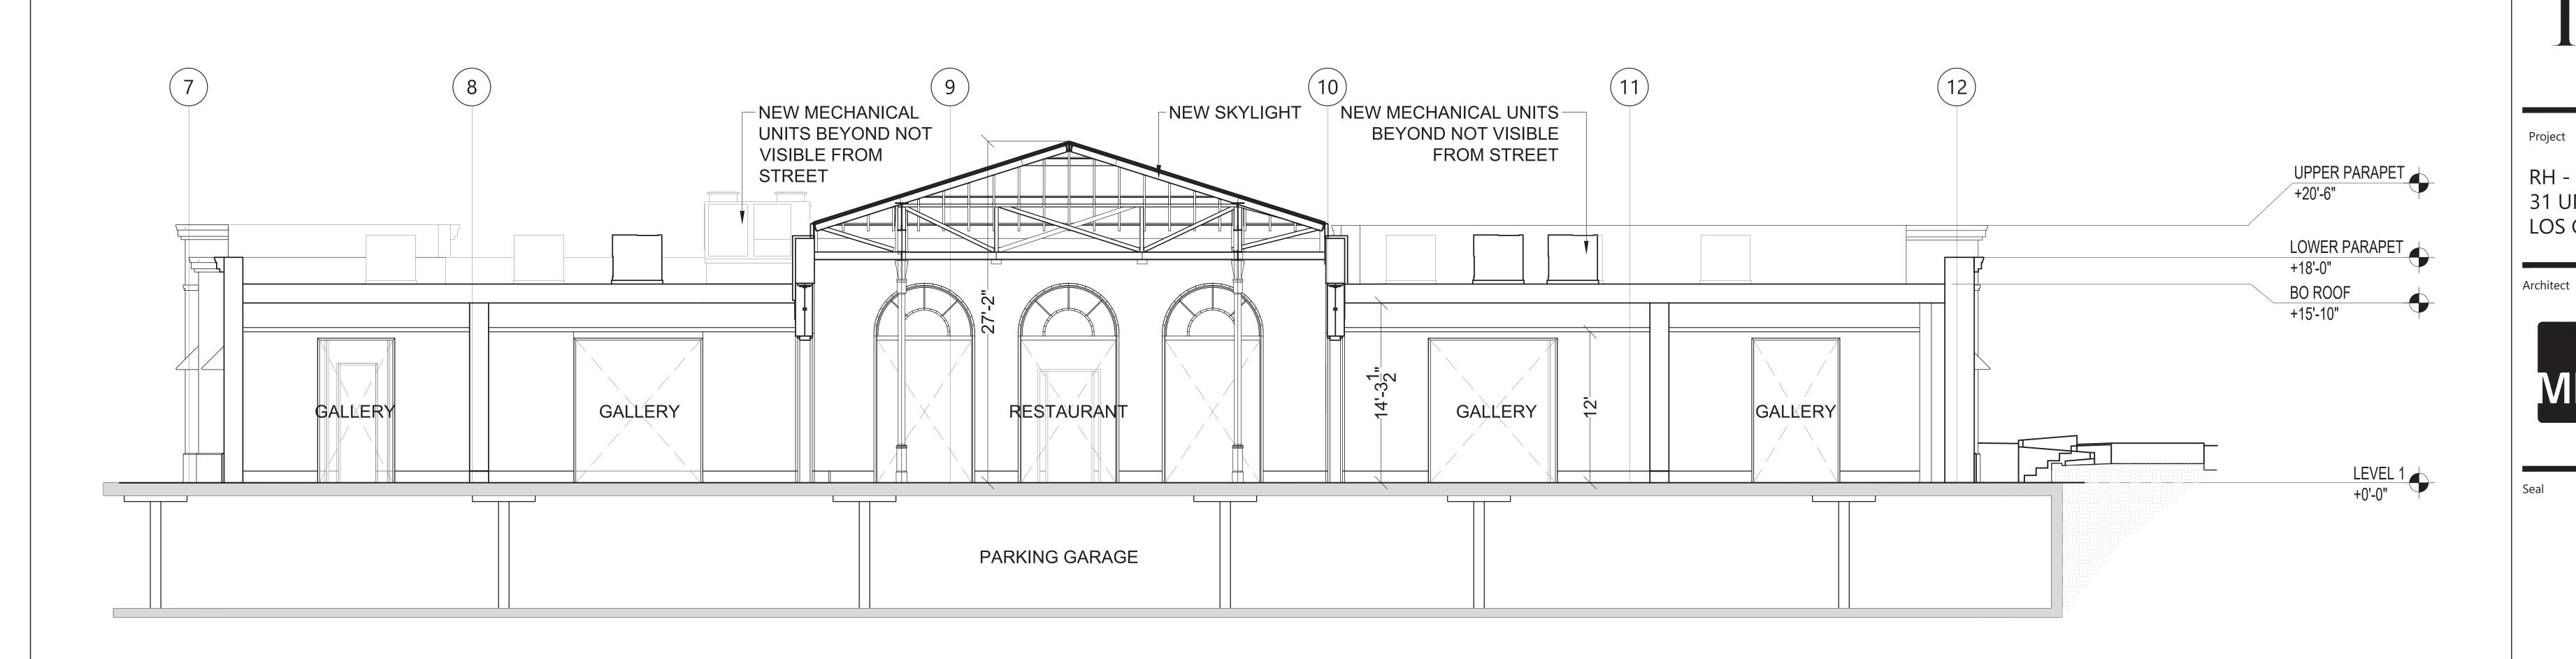

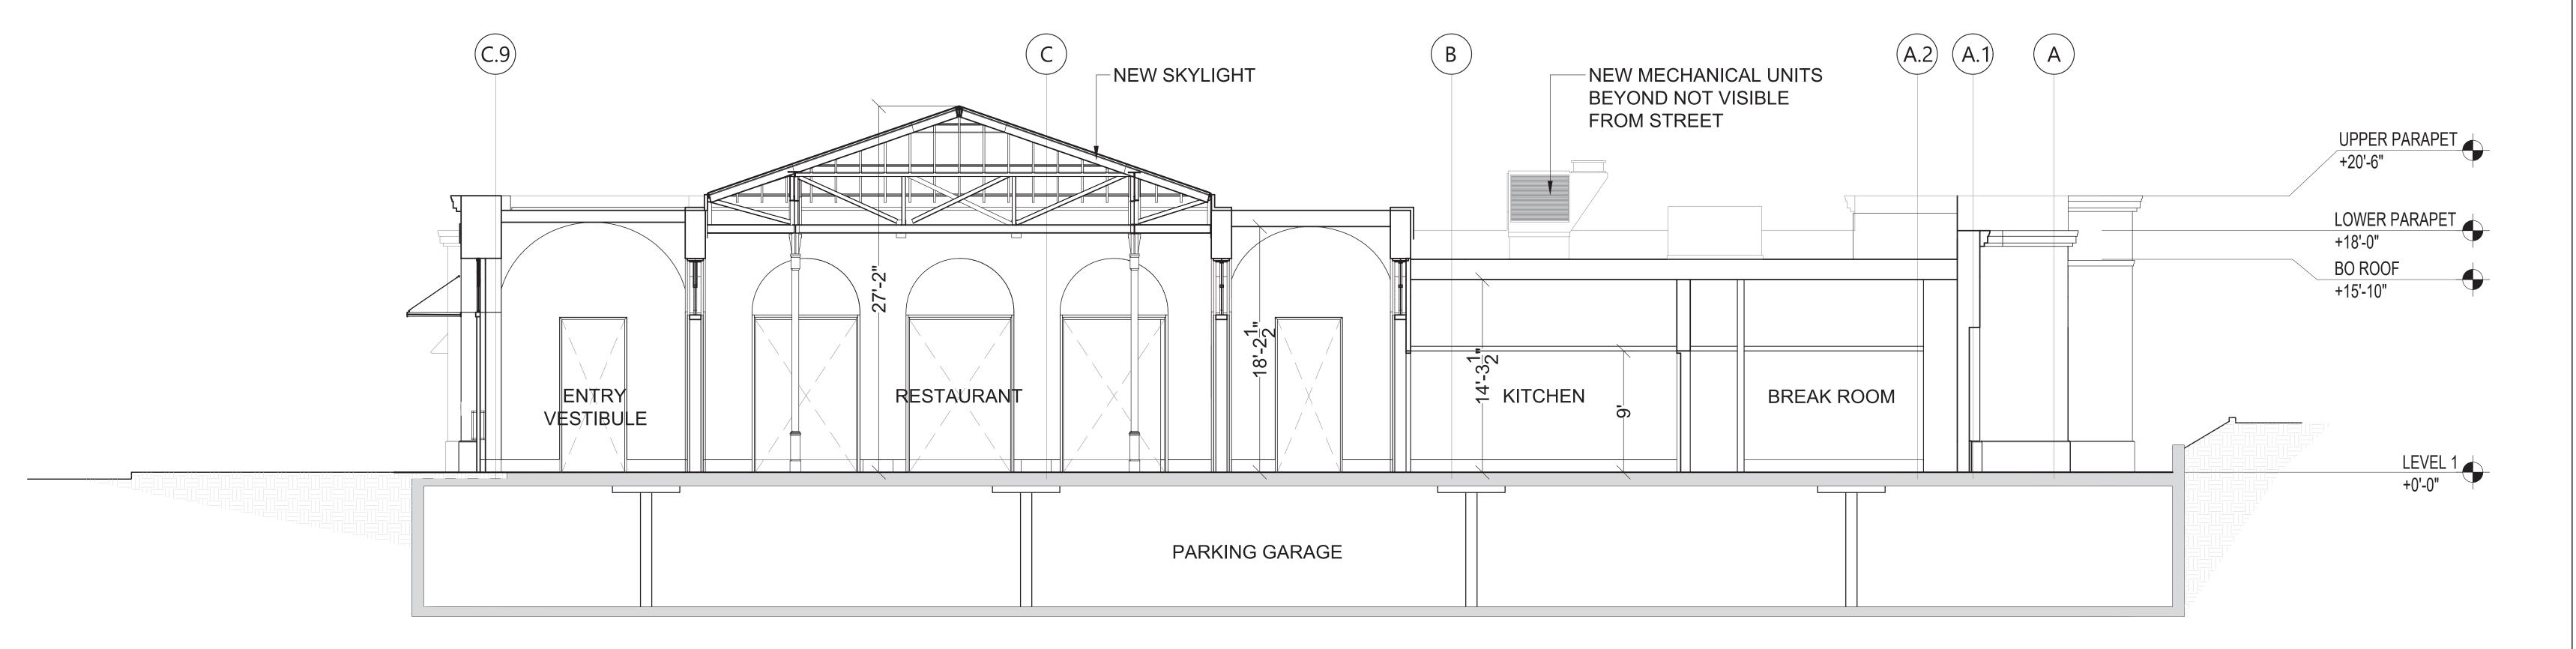

SCALE: 3/16"=1'-0"

PROPOSED BUILDING SECTION 2

Consultant	
No. Date	Issued/Revised
01 10/18/2024	PRE-APPLICATION PACKAGE
02 11/06/2024	PLANNING SUBMITTAL
03 11/22/2024	100% SCHEMATIC DESIGN
04 01/09/2025	PLANNING SUBMITTAL 2
originaland unpublis	n material appearing herein constitute hed work of the Architect and may not
be duplicated, used o	or disclosed without written consent of the Architect IBH ARCHITECTS-2024
Project No.	59485
	Brenda B
Reviewed By:	Rick N
Scale	As noted
Drawing Title	
R	UILDING
3	ECTIONS
Drawing No.	
Ļ	1301




960 atlantic avenue Alameda, CA 94501 5108658663 mbharch.com





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Seal

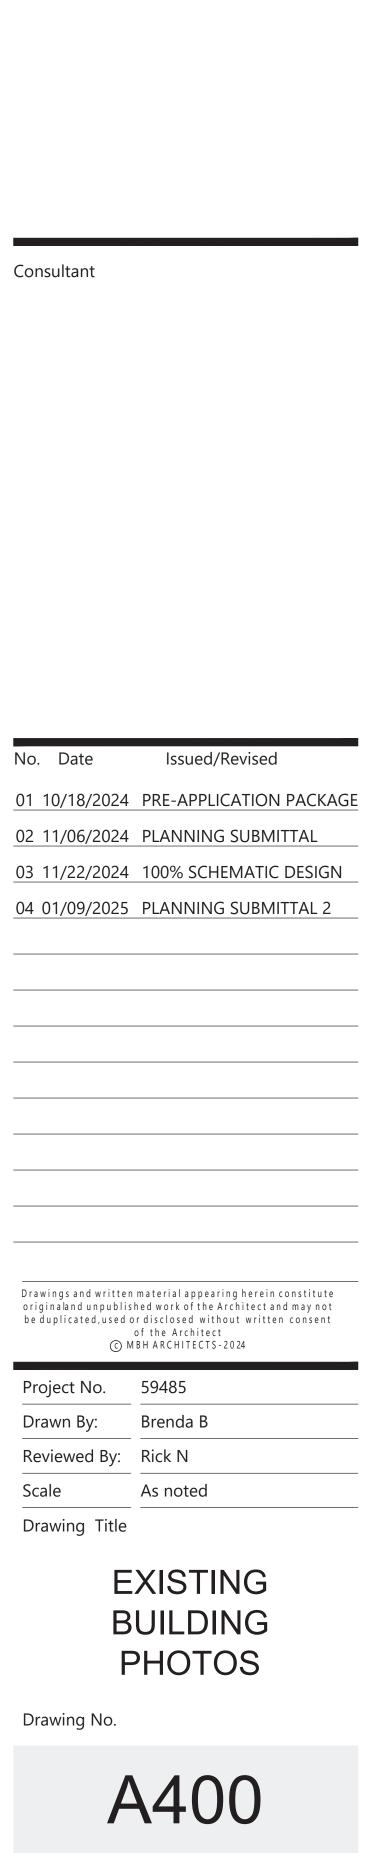
Architect







1

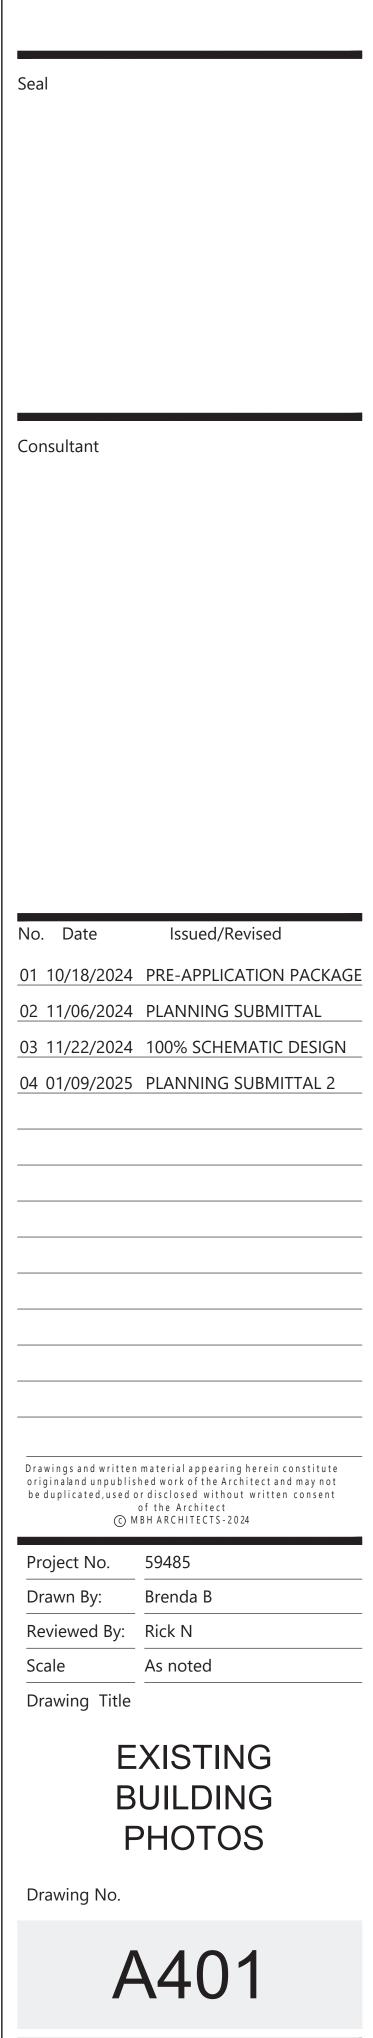



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Project

Architect




SCALE: N.T.S.

PROPOSED EXTERIOR RENDERS






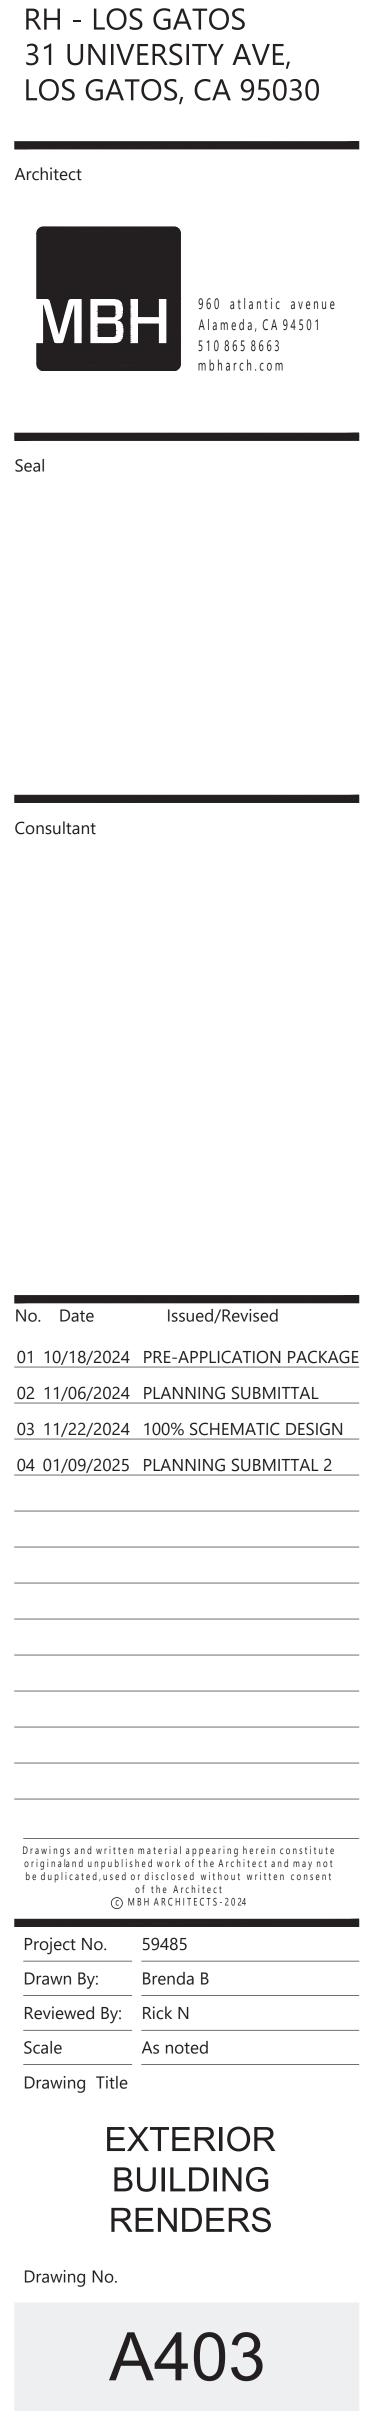


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1




LOS GATOS, CA 95030 Architect

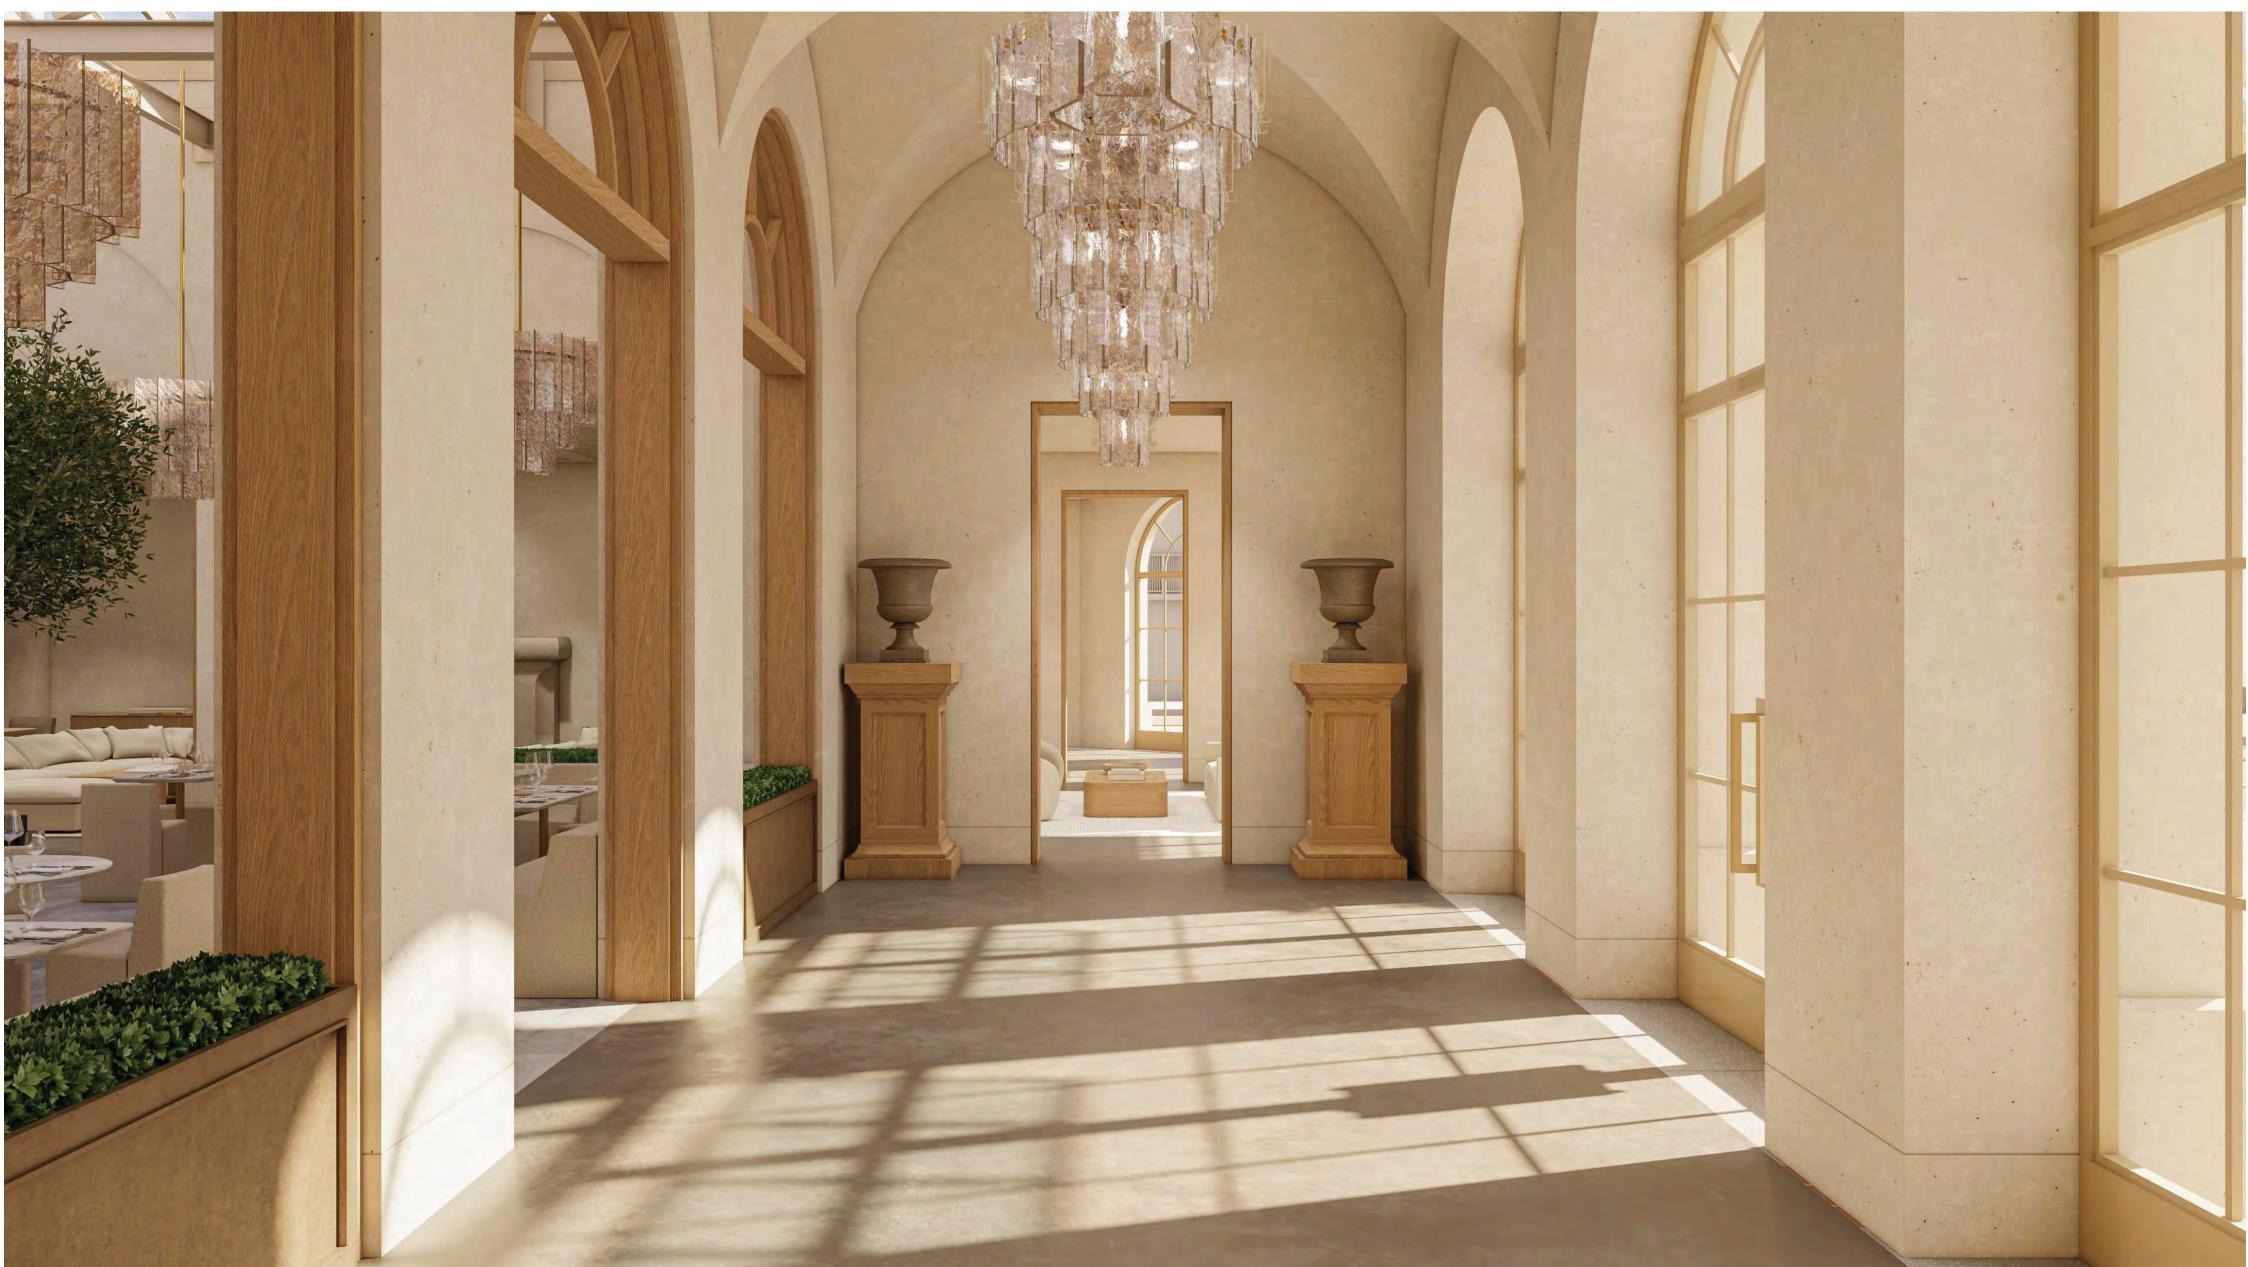31 UNIVERSITY AVE,

RH - LOS GATOS

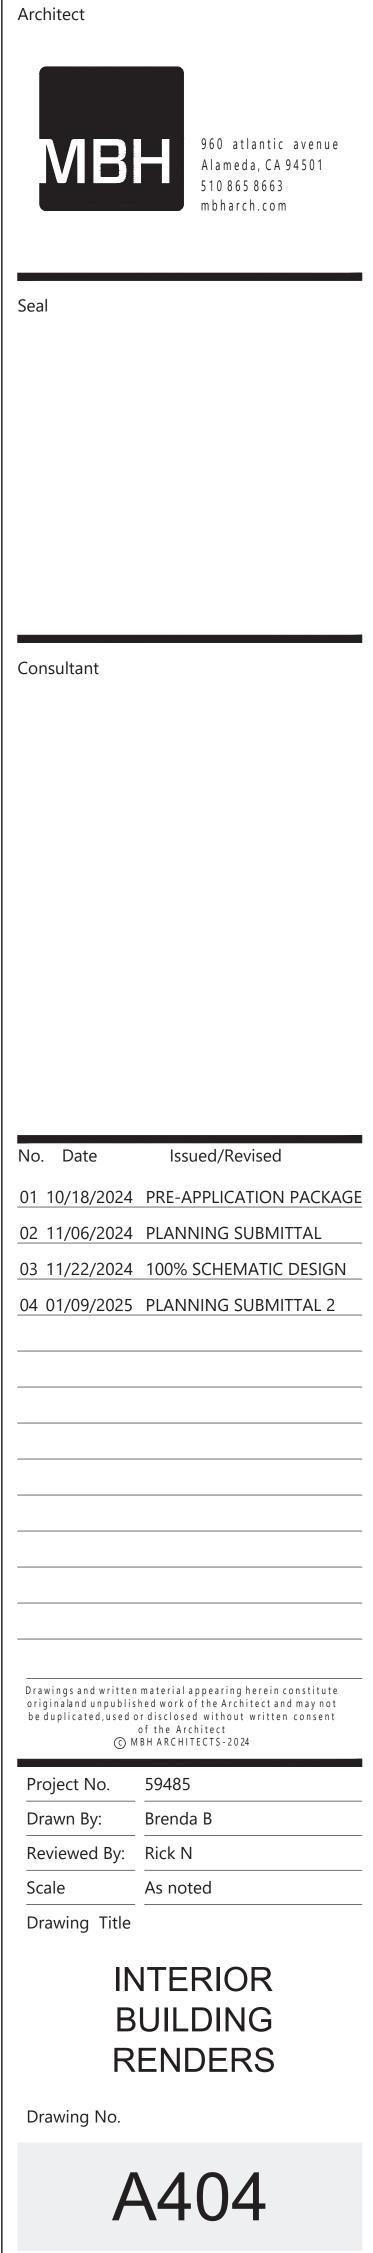
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RH - LOS GATOS 31 UNIVERSITY AVE,


# MATERIAL FINISHES

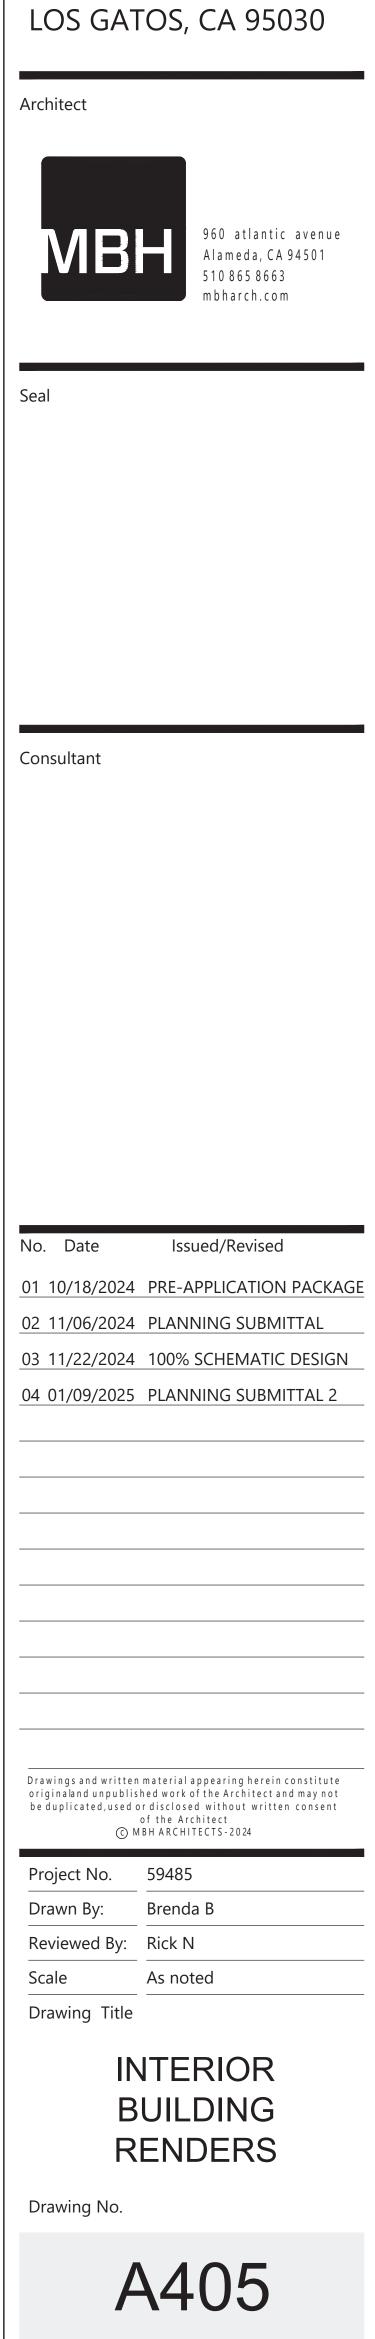

<u>MT-1</u>

METAL FINISH MFR: CREATIVE PAINTS SAN FRANCISCO PAINTED METAL CUSTOM METALLIC PLAINT

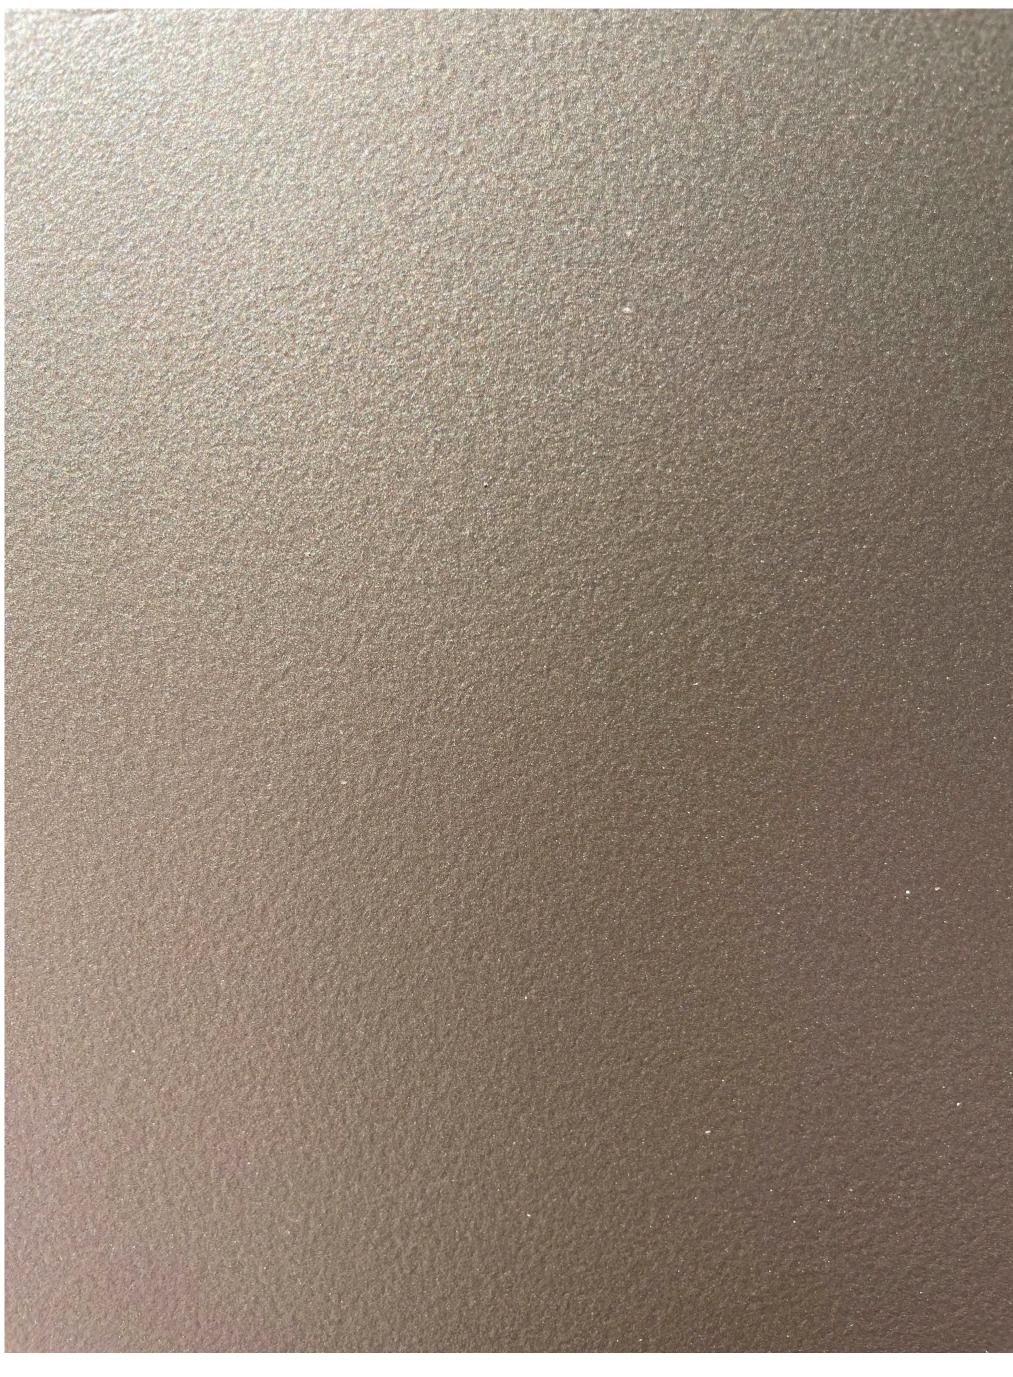


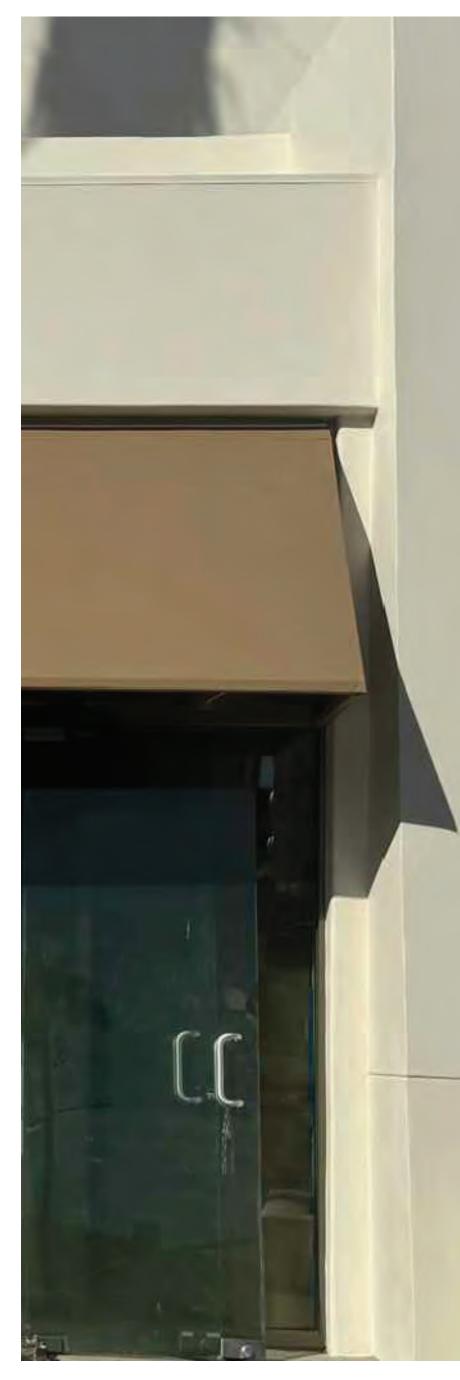


STU-1

FABRIC AWNING

STUCCO SYSTEM MFR: RICK MARS EXTERIOR CLADDING LIGHT CREAM PROPRIETARY 5 COAT VENETIAN PLASTER CUSTOM FINISH PER OWNER REQUIREMENTS

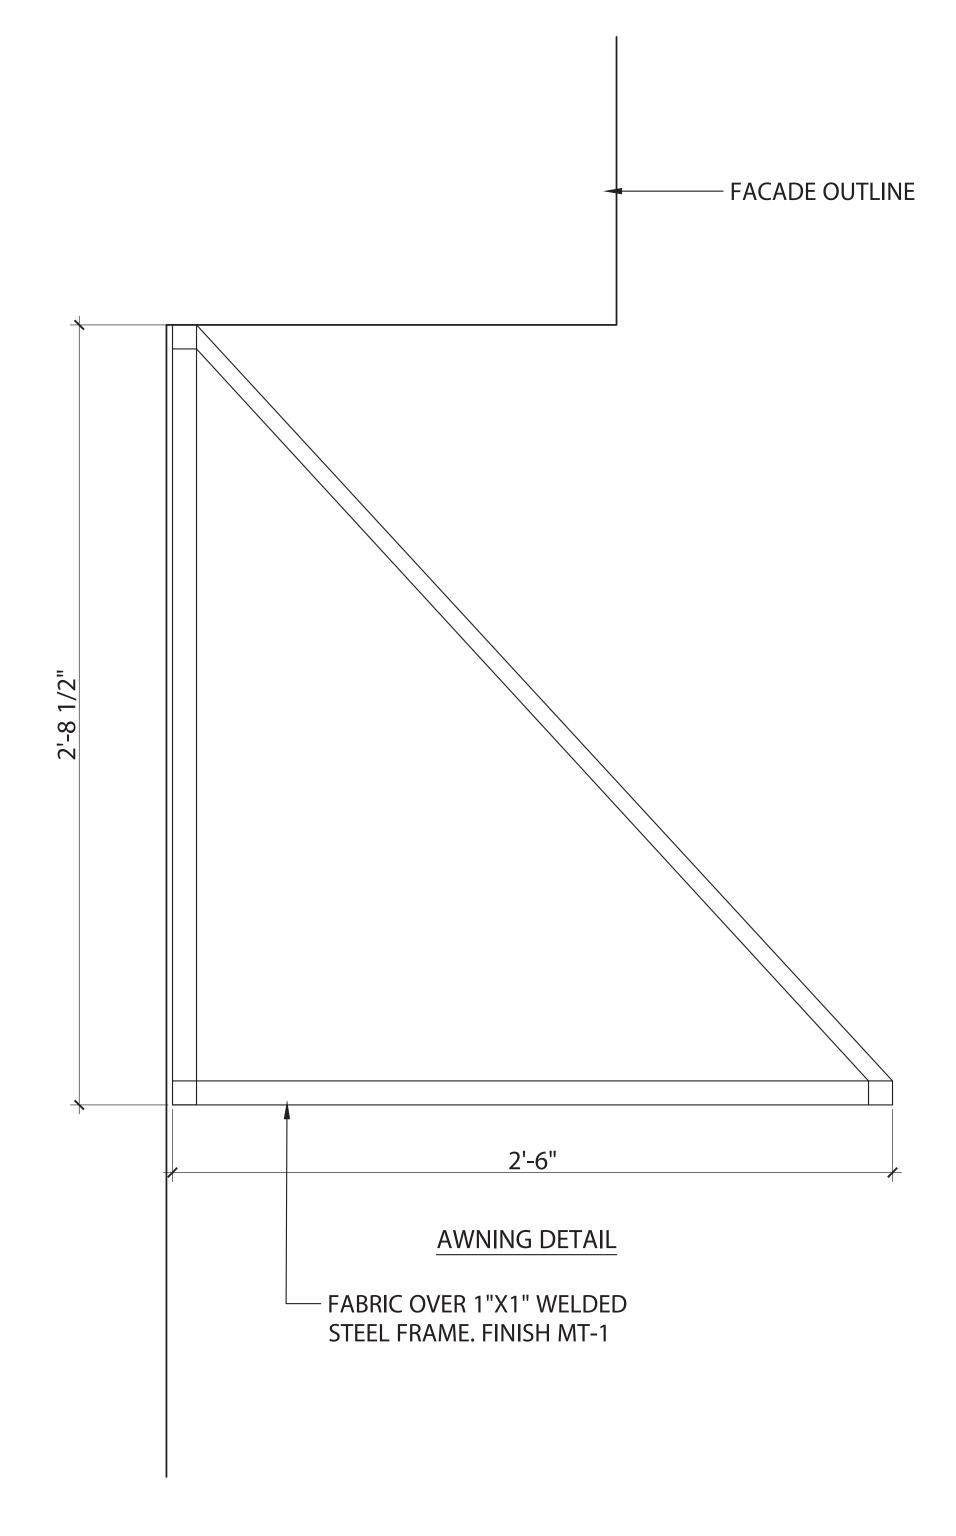

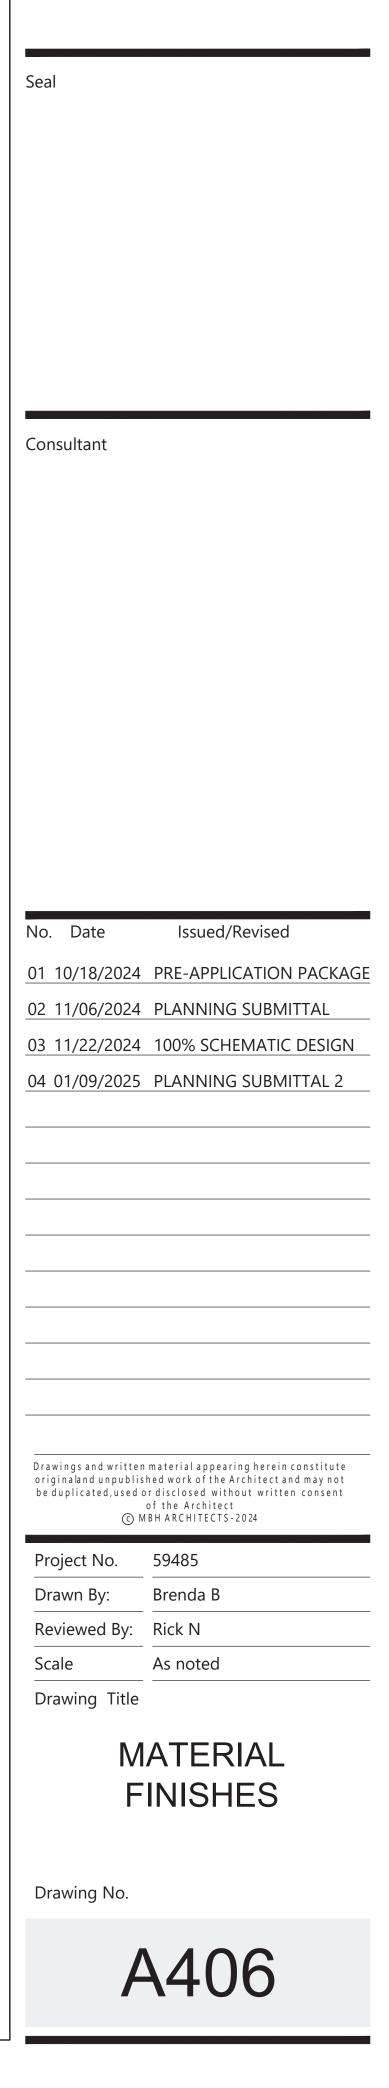





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Project

Architect





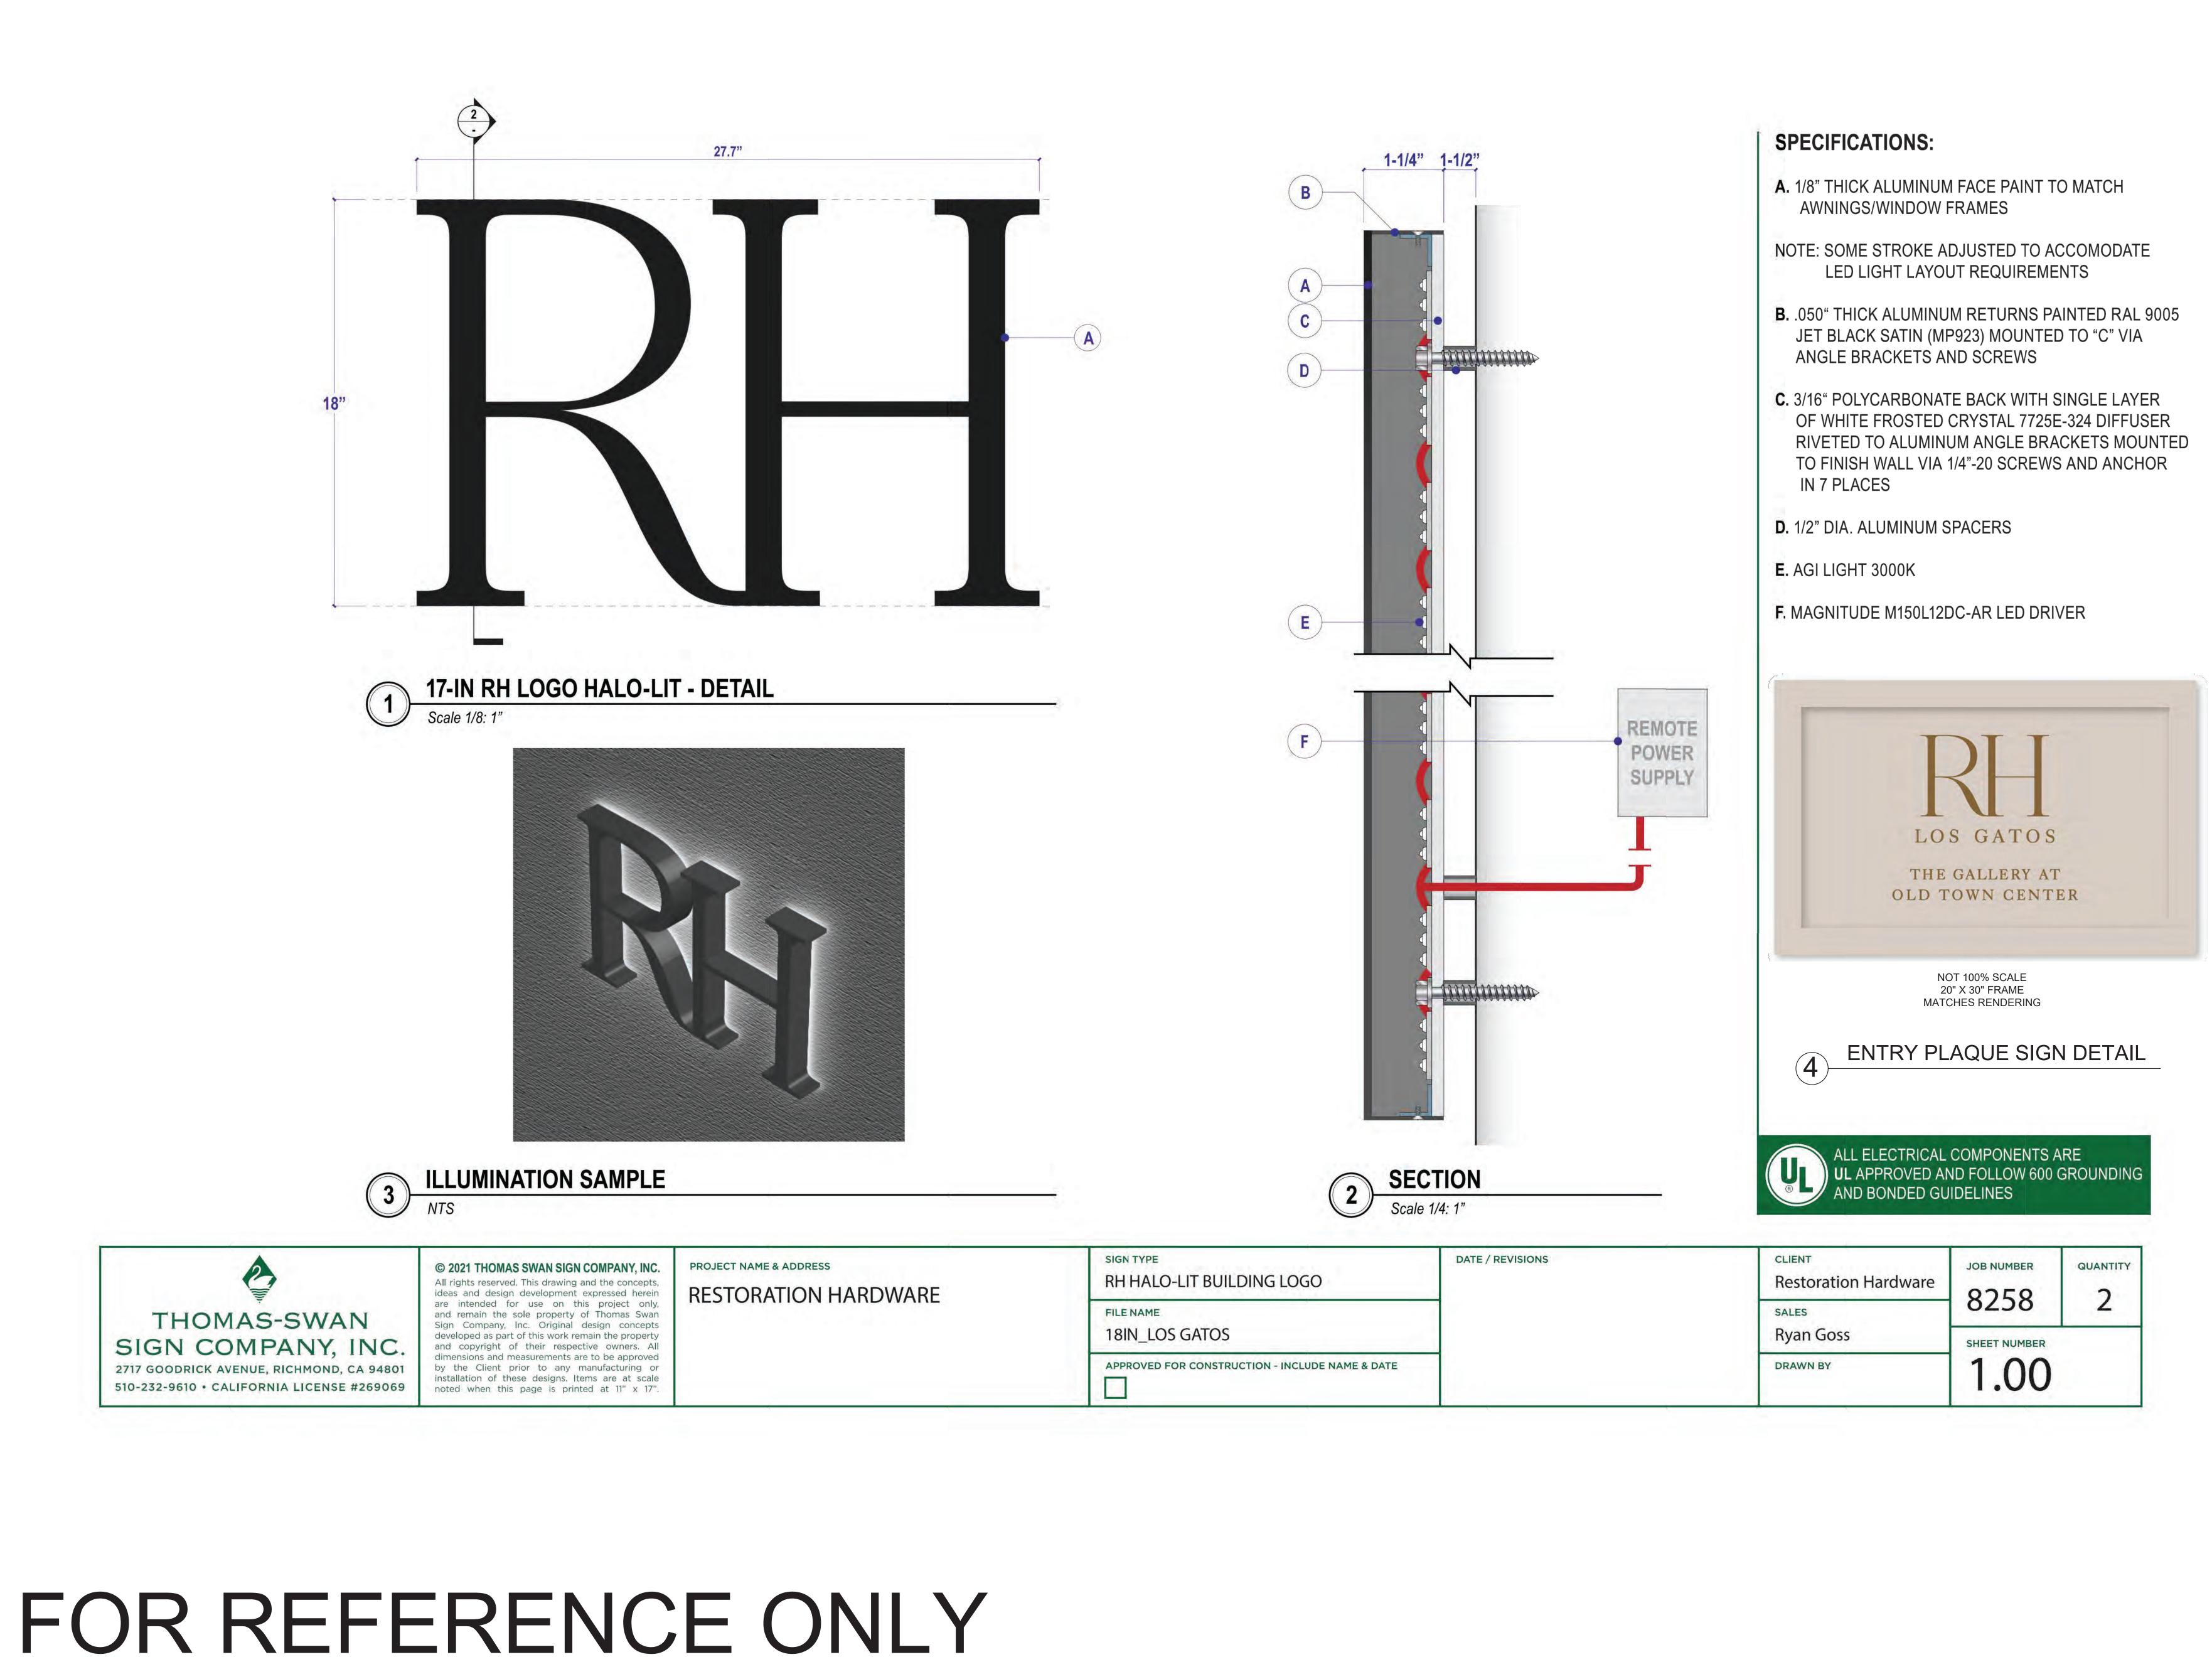

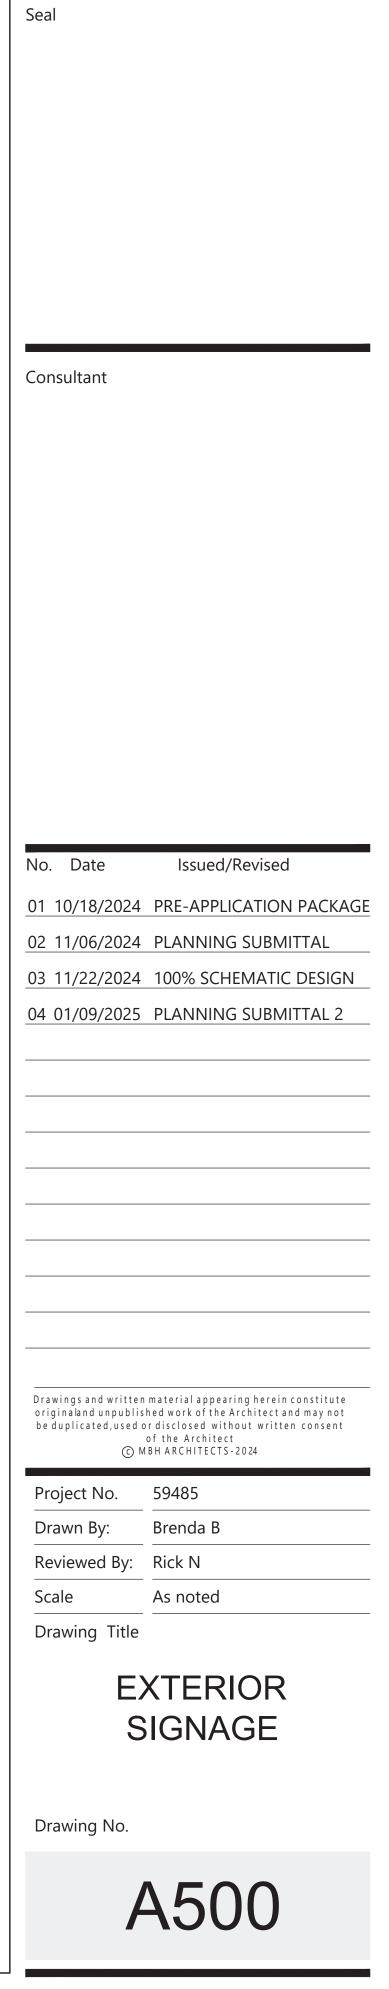


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Project

Architect



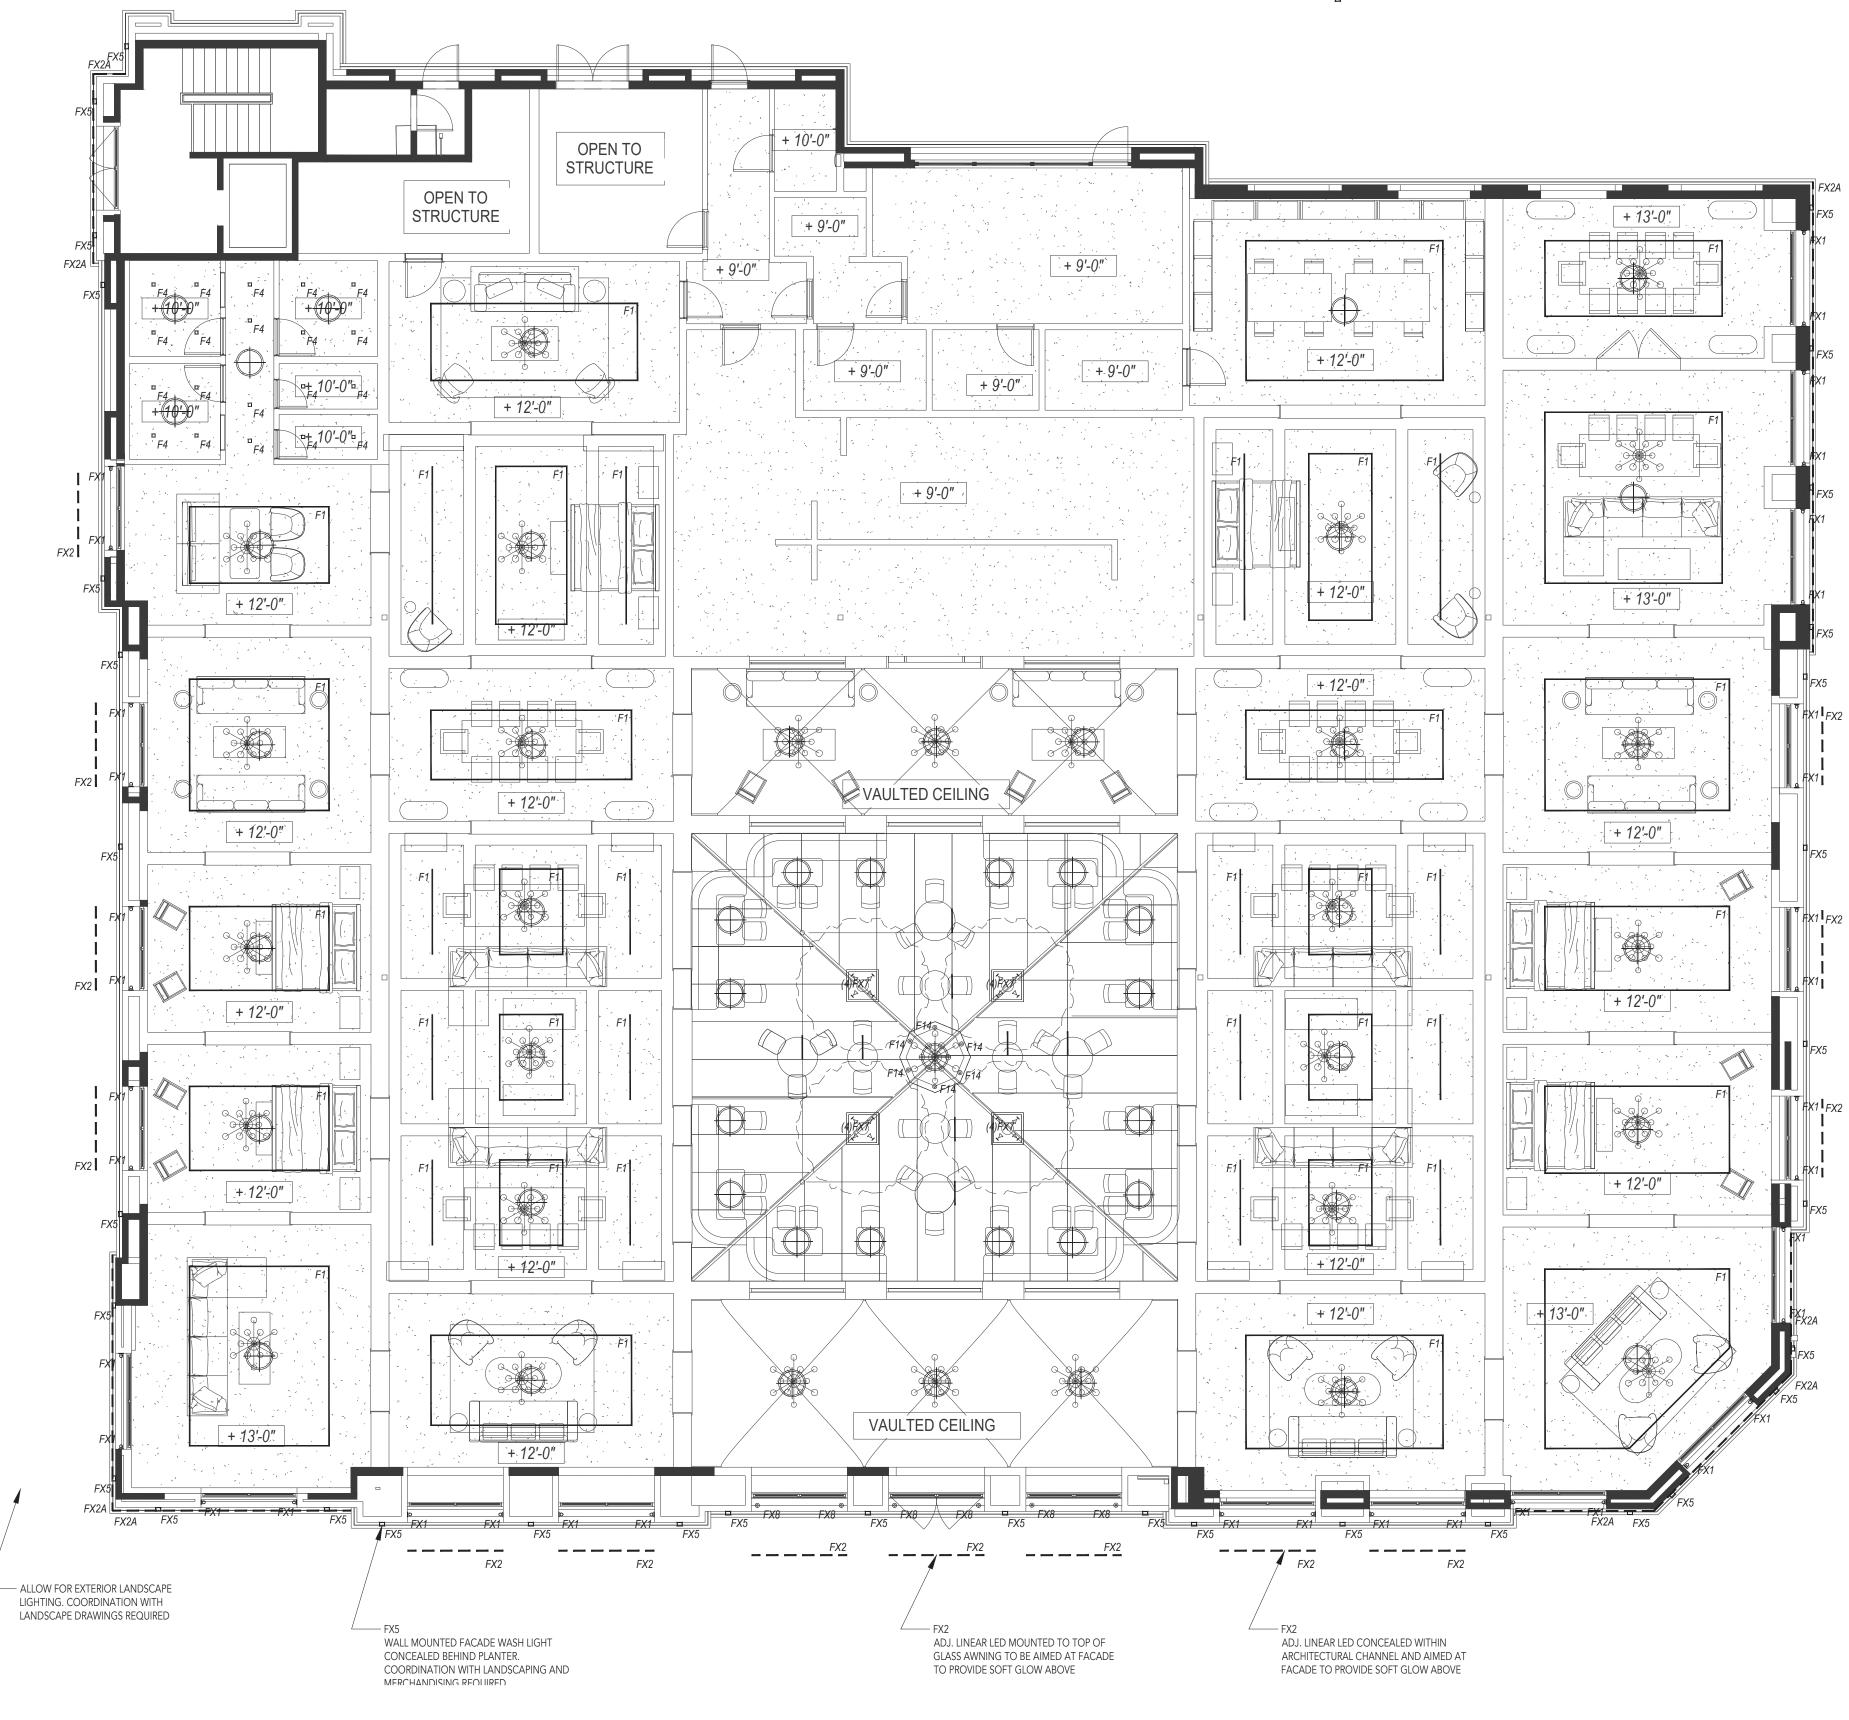


1 EXTERIOR LIGHTING LAYOUT1/8" = 1'-0"


FX5


				rkv
				DESIGN
				23823 MALIBU ROAD SUITE 50 - 212 MALIBU, CA 90265
				www.rkv-design.com
				+1 310 924 2185
				NOTES FOR GENERAL CONTRACTOR:
				<ol> <li>General Contractor (GC) and Electrical Contractor (EC) will be responsible for verification of all dimensions, specifications and coordination with related trades and</li> </ol>
				<ul> <li>subcontractors.</li> <li>2. GC to paint downlight trims to match ceiling per architects direction. Ensure trims can be removed after painting and do not stick.</li> </ul>
				<ul> <li>3. GC to furnish and install adequare drainage around all direct burial transformers and recessed in-grade light fixtures.</li> <li>4. GC to notify designer of any conflict with mechanical electrical plumbing HVAC or</li> </ul>
				mechanical, electrical, plumbing, HVAC or structural presence or any conflicting dimensions or site conditions prior to
				<ul> <li>commencement of work.</li> <li>5. GC is responsible for notifying designer of any inconsistencies between design drawings and other documents.</li> <li>6. Do not scale drawings.</li> </ul>
				GENERAL NOTES:
				1.Lighting Design drawings and dimensions are     for design intent only. Coordination with
				Architectural Drawings required. 2.Fixture types and specifications available in
				accompanying Specification packet. 3.Calculations for code compliance to be provided by Electrical Engineer.
				4.Emergency lighting requirements to be completed by Electrical Engineer.
				REV. DATE. DESCRIPTION
				10.23.2024 FOR REVIEW 11.22.2024 100% SCHEMATIC DESIGN
				01.10.2025 PLANNING REVIEW
LIGH	ITING CON	FROL SYSTEM SEQUENCE OF OPERAT	FION:	
	JILDING LIGHTING	G AT RH LOS GATOS IS CONTROLLED BY PRESET SCENE	S ON A TIME CLOCK SCHEDULE.	
SCENE	E 1: RETAIL DAY A	CTIVATES AT 7:00AM DAILY, 15 SECOND FADE TIME. IN / LIGHTING DESIGNER AND APPROVED BY RH. EXTERIO		
		ACTIVATES 15 MINUTES BEFORE SUNSET, 15 SECOND MINED BY LIGHTING DESIGNER AND APPROVED BY RH.	FADE TIME. EXTERIOR LIGHTING TURNS ON AT PRESET,	PROJECT:
SETTIN	NG ON SITE AHEA	D OF GALLERY OPENING.	OFF, LIGHTING DESIGNER TO DETERMINE OVERNIGHT	RH LOS GATOS
	2 4: EVENTACTIVA DVED BY RH.	ATES ON-DEMAND DURING OPENING EVENT. LIGHTING	DESIGNER WILL DETERMINE CUSTOM SETTING	
<ol> <li>ALL BUILDING LIGHTING TO BE DIMMABLE, INCLUDING ARCHITECTURAL AND DECORATIVE (MERCHANDISE) LIGHTING.</li> <li>ONE ZONE PER "F" TYPE, PER INSTALLATION LOCATION OR CONDITION (UNLESS OTHERWISE NOTED ON DRAWINGS).</li> </ol>		35 UNIVERSITY BLVD, LOS GATOS, CA 95030		
		LIGHTING LEGEN	ID	
TYPE F1	SYMBOL	DESCRIPTION SURFACE MOUNTED SINGLE CIRCUIT TRACK	LOCATION RETAIL, THROUGHOUT	DRAWING TITLE:
F2 F4	Þ	ADJUSTABLE TRACK HEAD 3" SQUARE RECESSED DOWNLIGHT	RETAIL, THROUGHOUT RESTROOMS, PASSAGES	
F14	۲	WEIGHTED BASE UNDERWATER ACCENT LIGHT	CAFE CENTRAL FOUNTAIN	
FX1 FX2	aj	JAMB MOUNTED ACCENT LIGHT SURFACE MOUNTED LINEAR LED UPLIGHT	FACADE, DOOR AND WINDOW JAMBS FACADE AWNINGS	SHEET:
FX2A				
FX5	 _	SURFACE MOUNTED LINEAR LED UPLIGHT WALL MOUNTED FACADE WASH LIGHT	FACADE, CORNICE FACADE	
FX5 FX7 FX8				LT-1.0




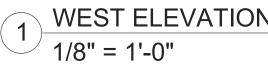



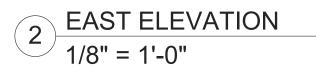

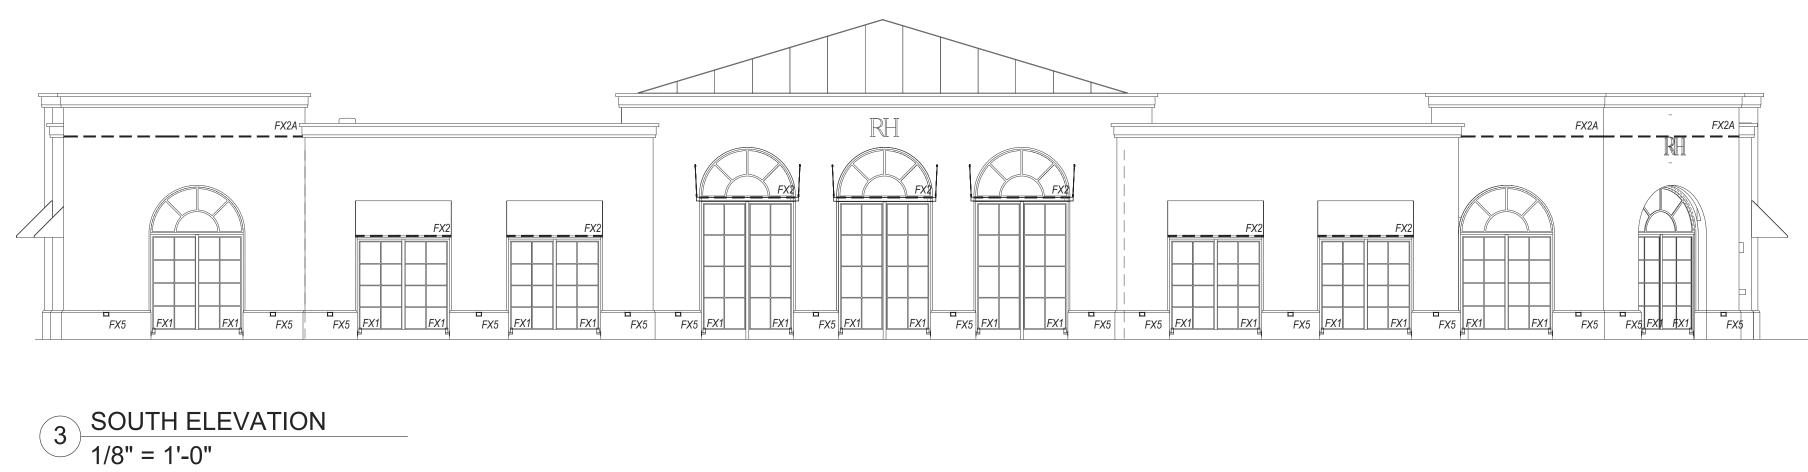

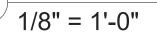

	DESIGN
	23823 MALIBU ROAD SUITE 50 - 212
	MALIBU, CA 90265
	www.rkv-design.com
	+1 310 924 2185
	NOTES FOR GENERAL CONTRACTOR:
	1. General Contractor (GC) and Electrical Contractor (EC) will be responsible for
	verification of all dimensions, specifications and coordination with related trades and
	subcontractors. 2. GC to paint downlight trims to match ceiling
	per architects direction. Ensure trims can be removed after painting and do not stick.
	3. GC to furnish and install adequare drainage around all direct burial transformers and
	recessed in-grade light fixtures. 4. GC to notify designer of any conflict with
	mechanical, electrical, plumbing, HVAC or structural presence or any conflicting
	dimensions or site conditions prior to commencement of work.
	5. GC is responsible for notifying designer of any inconsistencies between design drawings and
	other documents. 6. Do not scale drawings.
	GENERAL NOTES:
	1.Lighting Design drawings and dimensions are for design intent only. Coordination with
	Architectural Drawings required. 2.Fixture types and specifications available in
	accompanying Specification packet. 3. Calculations for code compliance to be provided
	by Electrical Engineer. 4.Emergency lighting requirements to be completed by Electrical Engineer.
	REV. DATE. DESCRIPTION
	10.23.2024 FOR REVIEW
	11.22.2024 100% SCHEMATIC DESIGN 01.10.2025 PLANNING REVIEW
1	
ME CLOCK SCHEDULE.	
SHTING TURNS ON AT PRESET, DIMMED	
G TURNS OFF E. EXTERIOR LIGHTING TURNS ON AT PRESET,	PROJECT:
ING DESIGNER TO DETERMINE OVERNIGHT	
R WILL DETERMINE CUSTOM SETTING	RH LOS GATOS
	35 UNIVERSITY BLVD,
	LOS GATOS, CA 95030
CORATIVE (MERCHANDISE) LIGHTING. S OTHERWISE NOTED ON DRAWINGS).	
	DRAWING TITLE:
LOCATION	EXTERIOR
THROUGHOUT	LIGHTING
	ELEVATIONS
, DOOR AND WINDOW JAMBS	SHEET:
AWNINGS	
, CORNICE	LT-2.0
EES	
ITRY DOOR JAMBS	

LIGHTING CONTROL SYSTEM SEQUENCE OF OPERATION:

ALL BUILDING LIGHTING AT RH LOS GATOS IS CONTROLLED BY PRESET SCENES ON A TIME CLOCK

BUILDING WIDE SCENE DESCRIPTIONS SCENE 1: RETAIL DAY ACTIVATES AT 7:00AM DAILY, 15 SECOND FADE TIME. INTERIOR LIGHTING TU LEVELS DETERMINED BY LIGHTING DESIGNER AND APPROVED BY RH. EXTERIOR LIGHTING TURNS C

SCENE 2: RETAIL NIGHT ACTIVATES 15 MINUTES BEFORE SUNSET, 15 SECOND FADE TIME. EXTERIOR DIMMED LEVELS DETERMINED BY LIGHTING DESIGNER AND APPROVED BY RH. SCENE 3: OVERNIGHT ACTIVATES AT 11PM. MOST INTERIOR LIGHTING TURNS OFF, LIGHTING DESIG SETTING ON SITE AHEAD OF GALLERY OPENING.

SCENE 4: EVENT ACTIVATES ON-DEMAND DURING OPENING EVENT. LIGHTING DESIGNER WILL DE APPROVED BY RH.

NOTES FOR ZONING AND LIGHTING CONTROLS:

1. ALL BUILDING LIGHTING TO BE DIMMABLE, INCLUDING ARCHITECTURAL AND DECORATIV 2. ONE ZONE PER "F" TYPE, PER INSTALLATION LOCATION OR CONDITION (UNLESS OTHERV

### LIGHTING LEGEND

TYPE	SYMBOL	DESCRIPTION	
F1		SURFACE MOUNTED SINGLE CIRCUIT TRACK	RETAIL, THROUGHC
F2	⊳	ADJUSTABLE TRACK HEAD	RETAIL, THROUGHC
F4	п	3" SQUARE RECESSED DOWNLIGHT	RESTROOMS, PASSA
F14	۵	WEIGHTED BASE UNDERWATER ACCENT LIGHT	CAFE CENTRAL FOU
FX1	a	JAMB MOUNTED ACCENT LIGHT	FACADE, DOOR AN
FX2		SURFACE MOUNTED LINEAR LED UPLIGHT	FACADE AWNINGS
FX2A		SURFACE MOUNTED LINEAR LED UPLIGHT	FACADE, CORNICE
FX5		WALL MOUNTED FACADE WASH LIGHT	FACADE
FX7	4	STAKE MOUNTED TREE UPLIGHT	CAFE TREES
FX8	۵	GRADE RECESSED UPLIGHT	MAIN ENTRY DOOR
	•	·	

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