# GORINI RESIDENCE

## 249 LOS GATOS, LOS GATOS, CA, 95030

ABBREVIATIONS	GENERAL NOTES	PROJECT DATA	SHEET INDEX
A.B. ANCHOR BOLT GA. GAUGE R. ABV. ABOVE GALV. GALVANIZED RAD. A/C AIR CONDITIONING G.B. GYPSUM BOARD R.A.G. ACOUS. ACOUSTICAL G.D. GARBAGE DISPOSAL RECPT. ADJ. ADJACENT G.D.O. GARAGE DOOR REF. ADJ. ADJUSTABLE OPERATOR REFER. AL. ALUMINUM G.F.I. GROUND-FAULT REINF. ALT. ALTERNATE CIRCUIT-INTERRUPTER RE/S AMP. AMPERAGE G.I. GALVANIZED IRON REQ'D	RISER RADIAL/RADIUS RETURN AIR GRILLE RECEPTACLE REFERENCE REFRIGERATOR REINFORCING RE-SAWN REQUIRED RECURDED RECURDED RECURDED RECURDED RESAWN REQUIRED RESAWN REQUIREMENTS:  1. ALL WORK AND MATERIALS SHALL COMPLY WITH ALL REQUIREMENTS OF ALL APPLICABLE FEDERAL, STATE, AND LOCAL CODES, LAWS AND REGULATIONS GOVERNING CONSTRUCTION, BUILDING ACCESS, AND THE USE OF FACILITIES. THIS INCLUDES THE 2019 CALIFORNIA BUILDING CODE & ALL CODES, ORDINANCES AND LAWS ADOPTED BY THE CITY OF LOS GATOS, CA.  2. THE "GENERAL CONDITIONS OF THE CONTRACT FOR CONSTRUCTION" AIA DOCUMENT A201 2007 EDITION, GOVERNS THIS WORK U.O.N.  3. THE CONTRACTOR IS RESPONSIBLE FOR EXAMINING ALL CONTRACT DOCUMENTS AND FIELD CONDITIONS AND SHALL BASE HIS BID ON EXISTING CONDITIONS. SUBMIT WRITTEN EXCEPTIONS OR OBJECTIONS, WITH ANALYSIS	ACCESSOR'S PARCEL NUMBER: 529-24-022  LOCAL JURISDICTION: CITY OF LOS GATOS, CA  PROJECT ADDRESS: 249 LOS GATOS, LOS GATOS, CA, 95030	BE BE
AVG. AVERAGE GL. GLASS REV.  BD. BOARD GRND. GROUND R.J.  BLDG. BUILDING GYP. GYPSUM RO-IN  BLK'G. BLOCKING G.L.B. GLUED-LAMINATED R.O.  BLT-IN BUILT-IN BEAM RO/S  BM. BEAM G.T. GIRDER TRUSS R.R.	REVERSE REVISION/REVISE ROOF JOIST ROUGH-IN ROUGH OPENING ROUGH SAWN ROOF RAFTER  AND RECOMMENDATIONS TO THE OWNER PRIOR TO SUBMITTING BID COSTS.  4. ALL MECHANICAL CONSTRUCTION SHALL BE IN ACCORDANCE WITH THE 2022 CALIFORNIA MECHANICAL CODE OR OVERRIDING LOCAL MECHANICAL CODES.  5. ALL PLUMBING CONSTRUCTION SHALL BE IN ACCORDANCE WITH THE 2022 CALIFORNIA PLUMBING CODE OR OVERRIDING LOCAL PLUMBING CODES.  6. ALL ELECTRICAL CONSTRUCTION SHALL BE IN ACCORDANCE WITH THE 2022 CALIFORNIA ELECTRICAL CODE OR OVERRIDING LOCAL ELECTRICAL CODES.	BUILDING OCCPANCY: R-1-8  CONSTRUCTION TYPE: VB  FIRE SPRINKLERS (AUTOMATIC): NO  ACTUAL STORIES: 2 STORIES	SHEET NAME
B.N. BOUNDARY NAILING BRG. BEARING B.S. BAR SINK  CABT. CABINET CALC. CALCULATION CMBR. CAMBER C.H.C. HOLLOW CORE H.D. HOLD DOWN ANCHOR HDR. HEADER S.C. SCH. SCH. SCRND. SCRND. SCRND. SCRND. SCRND. SEC. SCI. INSUL. INSULATION SEC. SECT.	OVERRIDING LOCAL ELECTRICAL CODES. 7. ALL SHEET METAL WORK AND FLASHING SHALL CONFORM TO S.M.A.C.N.A. STANDARDS.  SINK SOLID CORE SCHEDULE SCREENED SECOND SECTION  OVERRIDING LOCAL ELECTRICAL CODES. 7. ALL SHEET METAL WORK AND FLASHING SHALL CONFORM TO S.M.A.C.N.A. STANDARDS. 8. CITY AMENDMENTS: CITY OF LOS GATOS CODE, IF APPLICABLE. 9. ALL BUILDING STANDARD CONSTRUCTION, MATERIALS AND PRODUCTS SHALL CONFORM TO THE MOST CURRENT STANDARDS AND DETAILS AS OUTLINED IN THE SPECIFICATIONS, EXCEPT AS EXPLICITLY SUPERSEDED HEREIN.  SUBSTITUTIONS:	SITE AREA: 7950 SF  BUILDING AREA: EXISTING HOUSE: 1438 SF  EXISTING ATTACHED ADU: 793 SF PROPOSED: 20 SF TO ATTACHED ADU	ARCHITECTURAL  A0.1 PROJECT INFORMATION  A0.2 BLUEPRINT FOR A CLEAN BAY  A0.3 GREEN BUILDING REQUIREMENTS
CHANGE C.I. CAST IRON LAV. LAVATORY C.J. CEILING JOIST LAM. LAMINATED SER. C.L. CENTER LINE L.F. LINEAL FEET/FOOT S.H.	SELECT SELECT STRUCTURAL SERVICE SINGLE HUNG  1. REQUEST FOR SUBSTITUTION WILL BE RECEIVED FROM THE GENERAL CONTRACTOR ONLY. 2. PRODUCTS IN THE CONSTRUCTION DOCUMENTS IDENTIFIED BY NAME, BRAND OR MODEL OF A MANUFACTURER'S ARTICLE SHALL BE PROVIDED UNLESS A WRITTEN REQUEST FOR SUBSTITUTION IS ACCEPTED BY THE ARCHITECT. IN THE EVENT THAT THE CONTRACTOR MAKES A SUBSTITUTION WITHOUT PRIOR APPROVAL FROM THE ARCHITECT,	AREA COVERAGE: EXISTING: 26% PROPOSED: 26%  CODE REFERENCE	A0.4 GREEN BUILDING REQUIREMENTS  A1.1 EXISTING SITE PLAN  A1.2 EXISTING GROUND FLOOR PLAN
CLG. CEILING CLR. CLEAR CNTR. COUNTER CNTRTP. COUNTER TOP C.O. CASED OPENING CONC. CONCRETE  LLL. LOG LIGHTER SHT. SHTHG. SHTHG. SHTHG. SHUR. SHWR. SH	SHEET SHEATHING SHOWER SLIDING SPLASH SILL PLATE NAILING SHEATHING SHOWER SLIDING SPLASH SILL PLATE NAILING SHOWER SHEATHING SHOWER SHEATHING SHOWER	ALL CONSTRUCTION SHALL COMPLY WITH THE MINIMUM REQUIREMENTS OF THE FOLLOWING 2022 CALIFORNIA BUILDING STANDARDS CODE, CCR TITLE 24:  APPLICABLE BUILDING CODES:	A1.3 EXISTING SECOND FLOOR PLAN A1.4 EXISTING REFLECTED CEILING PLANS A1.5 EXISTING ROOF PLAN
CONT. CONTINUOUS MAX. MAXIMUM S & P CPT. CARPET M.B. MACHINE BOLT S.S. C.R. CURTAIN ROD M.C. MEDICINE CABINET STD. CSMT.WDW. CASEMENT WINDOW MFR. MANUFACTURER S.V. C.T. CERAMIC TILE MIN. MINIMUM STRUCT. CULT. CULTURED MIR. MIRROR SW.	SHELF & POLE SERVICE SINK STANDARD SHEET VINYL STRUCTURAL SWITCH  4. THE REQUEST SHALL INCLUDE ANY CHANGE REQUIRED IN OTHER ELEMENTS OF THE WORK DUE TO THE SUBSTITUTION.  5. UBMITTALS: SUBMITTALS: 1. SCHEDULE SUBMITTALS TO EXPEDITE PROJECT, AS TO CAUSE NO DELAY IN THE WORK OR IN THE WORK OF THE	2022 CALIFORNIA BUILDING CODE (CBC) 2022 CALIFORNIA MECHANICAL CODE (CMC) 2022 CALIFORNIA PLUMBING CODE (CPC) 2022 CALIFORNIA ELECTRICAL CODE (CEC)	A1.6 EXISTING BUILDING ELEVATIONS  A2.1 DEMOLITION FLOOR PLANS  A3.1 PROPOSED SITE PLAN  A3.2 PROPOSED GROUND FLOOR PLAN
D. DRYER DBL. DOUBLE D.F. DOUGLAS FIR DIA. OR Ø DIAMETER DIAG. DIAGONAL DIM. DIMENSION DIAG. DIAGONAL DIM. DIMENSION DIAG. DIAGONAL DIMENSION DIME	OWNER OR ANY SEPARATE CONTRACTOR. SUBMITTALS NOT SPECIFICALLY REQUESTED SHALL BE RETURNED WITHOUT REVIEW. 2. SHOP DRAWINGS SHALL BE DRAWN AT A SCALE SUFFICIENT FOR CLARITY AND COORDINATION AND SHALL SHOW NECESSARY WORKING AND ERECTION DIMENSIONS. 3. CIRCLE ALL DEVIATIONS FROM THE CONSTRUCTION DOCUMENTS AND PROVIDE A BRIEF WRITTEN EXPLANATION TO CLARIFY AND SUPPORT REASONS FOR PROPOSED DEVIATION.	2022 CALIFORNIA ENERGY CODE 2022 CALIFORNIA FIRE CODE 2022 CALIFORNIA GREEN BUILDING CODE	A3.3 PROPOSED SECOND FLOOR PLAN A3.4 PROPOSED GROUND FLOOR REFLECTED CEILING PLAN A3.5 PROPOSED SECOND FLOOR REFLECTED CEILING PLAN A4.1 PROPOSED ROOF PLAN
DISP. DISPOSAL DP. DEEP DR. DOOR DRP. DROP D.S. DOWNSPOUT D.S. DOW	TRUSS JOIST TOP OF CURB TOP OF MASONRY TOP OF SLAB TOP OF WALL TELEVISION  4. THE CONTRACTOR SHALL PROVIDE THE OWNER A PROJECT SCHEDULE OUTLINING THE WORK TO OCCUR, AND THE MATERIALS BEING ORDERED ON A WEEKLY BASIS PRIOR TO BEGINNING THE PROJECT.  5. CONTRACTOR SHALL ALLOW 5 DAYS FOR ARCHITECT AND OWNER TO REVIEW SUBMITTALS.  6. ALL SUBMITTALS SHALL HAVE CONTRACTORS STAMP INDICATING SUBMITTAL HAS BEEN REVIEWED AND APPROVED BY GENERAL CONTRACTOR PRIOR TO BEING SEND TO ARCHITECT AND OWNER FOR REVIEW.  7. SUBMITTALS SENT FOR ARCHITECT AND OWNER REVIEW THAT DO NOT HAVE THE STAMP OF THE GENERAL	2022 CALIFORNIA STANDARDS CODE  CITY AMENDMENTS: CITY OF LOS GATOS CODE  DEFERRED SUBMITTALS	A5.1 PROPOSED BUILDING ELEVATIONS A5.2 PROPOSED BUILDING SECTIONS A5.3 PROPOSED INTERIOR ELEVATIONS A6.1 PROPOSED FINISH PLAN
D.W. DISHWASHER DWG. DRAWING DWR. DRAWER EA. EACH ELECT. ELECTRICAL  DWS. OBSCURE O.C. OR O/C ON CENTER O.H. OVERHEAD OPG. OPENING U.N.O. U.N.O. VAN.	UNFINISHED URINAL UNLESS NOTED OTHERWISE VANITY  CONTRACTOR WILL BE RETURNED WITHOUT REVIEW.  CONTRACTOR WILL BE RETURNED WITHOUT REVIEW.  PROTECTIONS:  1. BY ACCEPTING THESE DRAWINGS THE CONTRACTOR AGREES THAT HE SHALL ASSUME SOLE AND COMPLETE DESPONSIBILITY FOR JOB SITE SAFETY CONDITIONS FOR ALL DEPSONS AND PROPERTY CONTINUIDUS Y DURING.	1. DEFERRED SUBMITTALS SHALL BE SUBMITTED TO THE DESIGN PROFESSIONAL IN RESPONSIBLE CHARGE WHO SHALL REVIEW THEM AND FORWARD THEM TO THE BUILDING OFFICIAL WITH A NOTATION INDICATING THAT THE DEFERRED SUBMITTAL DOCUMENTS HAVE BEEN REVIEWED AND FOUND TO BE IN GENERAL CONFORMANCE TO	A6.1 PROPOSED FINISH PLAN  A6.2 ROOFING DETAILS  A7.1 PROPOSED INTERIOR STAIR PLAN AND DETAILS  A7.2 DOOR SCHEDULE, HARDWARE, & DETAILS
ELEV. ELEVATION BOARD VEN. E.N. EDGE NAILING EQ. EQUAL P.B. PUSH BUTTON V.G. EXH. EXHAUST P.C. PORTLAND CEMENT V.B. EXT. EXTERIOR P.C. PULL CHAIN V.P. E.W. EACH WAY PCE. PIECE	VERTICAL VERTICAL VERTICAL GRAIN VAPOR BARRIER VAPORPROOF  CONSTRUCTION OF THIS PROJECT, AND NOT LIMITED TO NORMAL WORKING HOURS.  2. THE CONTRACTOR SHALL PROTECT NEW AND EXISTING WORK, EQUIPMENT, MATERIALS AND FINISHES. DAMAGED ITEMS SHALL BE REPAIRED OR REPLACED AT THE EXPENSE OF THE GENERAL CONTRACTOR.  3. THE CONTRACTOR SHALL AT ALL TIMES DURING THE COURSE OF THE CONTRACT KEEP THE BUILDING, THE OWNER'S PREMISES AND THE ADJOINING PREMISES, INCLUDING STREETS AND OTHER AREAS ASSIGNED TO, OR	THE DESIGN OF THE BUILDING WITHOUT ANY CORRECTIONS.  2. CONTACT THE BUILDING DIVISION FOR DIRECTION CONCERNING SUBMITTAL REQUIREMENTS FOR ALL DEFERRED ITEMS. DEFERRED ITEMS SHALL NOT BE CONSTRUCTED, INSTALLED OR ERECTED UNTIL UNLESS APPROVED PLANS ARE PROVIDED BY THE BUILDING DIVISION FOR SUCH DEFERRED TEM(S).	A7.3 TYPICAL DOOR FLASHING A7.4 WINDOW SCHEDULE & DETAILS A7.5 TYPICAL WINDOW FLASHING
FAU FORCED AIR UNIT PLT. PLATE W/ F.G. FINISH GRADE PLAS. PLASTER W.C. F.G. FIXED GLASS PLYWD. PLYWOOD WD. F.G. FUEL GAS PR. PAIR WDW. FIN. FINISH PSF POUNDS/SQUARE FOOT W.H.	WASHER WITH WATER CLOSET WOOD WINDOW WATER HEATER  USED BY THE CONTRACTOR, FROM ACCUMULATIONS OF WASTE MATERIALS AND RUBBISH CAUSED BY HIS EMPLOYEES, SUBCONTRACTORS OR THEIR WORK.  4. CONTRACTOR SHALL VERIFY LOCATION OF TRANSFORMERS AND UNDERGROUND UTILITIES WITH APPLICABLE UTILITY COMPANIES.  5. CONTRACTOR SHALL PROTECT FROM DAMAGE AND KEEP CLEAN ALL COMMON AREAS OF THE PROJECT.	3. SEPARATE PERMITS REQUIRE COMPLETE CONSTRUCTION DOCUMENTS FOR REVIEW AND APPROVAL BY ALL CITY DIVISIONS AND DEPARTMENTS.  4. NO FINAL INSPECTION CAN BE GRANTED OR PROVIDED UNTIL ALL DEFERRED ITEMS ARE REVIEWED AND APPROVED BY THE CITY. IN ADDITION, THE DEFERRED ITEM MUST BE INSTALLED, INSPECTED AND APPROVED BY THE CITY INSPECTOR.	STRUCTURAL S-1 FOUNDATION PLAN S-2 CEILING FRAMING PLAN
FIN.FLR. FINISH FLOOR F.J. FLOOR JOIST FL. FLUSH FLUOR. FLUORESCENT  PSI POUNDS/SQUARE INCH W/O P=L PARALLAM W.P. PT.D.F. PRESSURE TREATED W/R DOUGLAS FIR WT.	WITHOUT WEATHER PROOF WARDROBE WEIGHT  PERFORMANCE REQUIREMENTS:  1. DO NOT SCALE DRAWINGS.  2. ALL DIMENSIONS AND CONDITIONS SHALL BE VERIFIED AND CHECKED BY THE GENERAL CONTRACTOR AND THE SUBCONTRACTORS PRIOR TO BEGINNING WORK AND PRIOR TO ORDERING ANY MATERIALS. ANY ERRORS,	SCOPE OF WORK	S-3 ROOF FRAMING PLAN AND SHEAR WALL PLAN  SD-0 GENERAL NOTES AND SPECIFICATIONS  SD-1 TYPICAL FOUNDATION DETAILS
F.M.C. FLOOR MATERIAL PVC POLY VINYL CHLORIDE CHANGE F.N. FIELD NAILING FND. FOUNDATION F.O.C. FACE OF CURB F.O.M. FACE OF MASONRY F.O.S. FACE OF STUDS	OMISSIONS OR DISCREPANCIES SHALL BE BROUGHT TO THE ATTENTION OF THE ARCHITECT AND THE GENERAL CONTRACTOR. SHOULD THERE BE ANY DISCREPANCIES, ERRORS OR OMISSIONS IN THESE DRAWINGS OR SPECIFICATIONS, THE CONTRACTOR SHALL NOTIFY THE OWNER AND WAIT TO RECEIVE WRITTEN INSTRUCTIONS BEFORE PROCEEDING WITH THAT PORTION OF THE WORK.  3. THESE DRAWINGS AND SPECIFICATIONS ARE DIVIDED INTO SECTIONS FOR CONVENIENCE ONLY. CONTRACTORS, SUBCONTRACTORS, AND MATERIAL SUPPLIERS SHALL REFER TO ALL RELEVANT SECTIONS IN BIDDING AND PERFORMING THEIR WORK, AND SHALL BE RESPONSIBLE FOR ALL ASPECTS OF THEIR WORK REGARDLESS OF	REMODEL OF SINGLE FAMILY RESIDENCE AND ATTACHED ADU. ADDITION OF NEW STAIRS TO CONNECT THE HOUSE AND ADU.	SD-2 TYPICAL FRAMING DETAILS SD-3 TYPICAL ROOF FRAMING DETAILS SD-4 TYPICAL FOUNDATION DETAILS SD-5 TYPICAL FLOOR FRAMING DETAILS WSWH1 STRONG-WALL WSWH ANCHORING DETAILS
FR.DR. FRENCH DOOR FTG. FOOTING	WHERE THE INFORMATION OCCURS ON THE DRAWINGS.  4. SUBCONTRACTORS SHALL BE RESPONSIBLE FOR COORDINATION OF THEIR WORK WITH THE WORK OF OTHERS. SUBCONTRACTORS SHALL VERIFY THAT ANY WORK RELATED TO THEM, WHICH MUST BE PROVIDED BY OTHERS, HAS BEEN COMPLETED AND IS ADEQUATE PRIOR TO COMMENCING THEIR WORK.  5. PROVIDE STRUCTURAL BACKING FOR ALL WALL MOUNTED EQUIPMENT.  6. CONTRACTOR SHALL BE RESPONSIBLE FOR THE DESIGN, COORDINATION, AND EXECUTION OF CONSTRUCTION		WSWH2 STRONG-WALL WSWH FRAMING DETAILS  MECHANICAL, ELECTRICAL & PLUMBING  MEP1.1 PROPOSED GROUND FLOOR MEP PLAN
JOB SITE CONDITIONS	MEANS, METHODS AND PROCEDURES. 7. PATCH AND REPAIR ALL DISTURBED AREAS TO MATCH ADJACENT SYSTEMS, MATERIALS, AND FINISHES, UNLESS OTHERWISE NOTED.	PROJECT SYMBOL LEGEND	MEP1.1 PROPOSED GROUND PLOOR MEP PLAN MEP1.2 MECHANICAL, ELECTRICAL AND PLUMBING NOTES
SAFETY, THE GENERAL CONTRACTOR IS RESPONSIBLE FOR ALL SAFETY PRECAUTIONS OR SAFET TO PROVIDE A SAFE WORKING ENVIRONMENT ON THE JOB SITE.  CONSTRUCTION EXECUTION, EACH CONTRACTOR SHALL FURNISH ALL LABOR, MATERIALS, TOOLS AND EQUIPMENT NECESSARY TO PERFORM ALL WORK UNDER HIS TRADE IN FULL ACCORDANCE WITH DRAWINGS, SPECIFICATIONS AND CONTRACTS.	11. DETAILS SHOWN ARE TYPICAL. SIMILAR DETAILS APPLY IN SIMILAR CONDITIONS.  12. ALL GLAZING SUBJECT TO HUMAN IMPACT SHALL BE 1/4" TEMPERED GLASS UNLESS OTHERWISE NOTED.  13. CONTRACTOR SHALL FURNISH AND INSTALL ALL DOORS COMPLETE WITH ALL HARDWARE AS REQUIRED BY CODE AND/OR SPECIFIC INSTALLATION.  14. FIRE EXTINGUISHERS SHALL BE LOCATED ACCORDING TO CODE REQUIREMENTS AND MEET ALL APPLICABLE CODES.	DETAIL REFERENCE  1  DETAIL NUMBER SHEET NUMBER  REVISION	TITLE-24 CALCULATIONS  T-24.1 TITLE-24 CALCULATIONS  T-24.2 TITLE-24 CALCULATIONS  T-24.3 TITLE-24 CALCULATIONS  T-24.4 TITLE-24 CALCULATIONS
JOB SITE CONDITIONS, EACH CONTRACTOR SHALL CLEAN UP AND REMOVE ALL DEBRIS RESULTIN PRIOR TO SUBMITTING REQUEST FOR PROGRESS PAYMENT. IN NO CASE WILL FINAL PAYMENT BE EITHER THE PRIME CONTRACTOR OR ANY SUB-CONTRACTOR UNTIL ALL DEBRIS AND EQUIPMENT (CONTRACTOR'S HAS BEEN DEMOVED EDOM THIS PROJECT SITE OR LINTH, OWNER APPROVAL HAS	15. WHERE NEW WALLS ALIGN WITH EXISTING WALLS, RESULTANT WALL SURFACES SHALL FORM A SMOOTH AND CONTINUOUS PLANE.  16. AT THE COMPLETION OF THE WORK THE CONTRACTOR SHALL REMOVE FROM THE BUILDING AND THE PREMISES	SECTION REFERENCE  SECTION REFERENCE  CENTERLINE	T-24.5 TITLE-24 CALCULATIONS T-24.6 TITLE-24 CALCULATIONS

\ A6.1 / ← SHEET NUMBER

- SHEET NUMBER

ROOM NAME AND

NUMBER

\A1.1.1 / → SHEET NUMBER

**ELEVATION NUMBER** 

INTERIOR ELEVATION REFERENCE

DETAIL OR PLAN ENLARGEMENT

COLUMN LINES

EXISTING FULL HEIGHT

DEMISING WALL

NEW FULL HEIGHT

DEMISING WALL

ALL SURPLUS MATERIALS AND DEBRIS, AND CLEAN ALL NEW WORK TO THE OWNERS SATISFACTION. INCLUDING BUT

NOT LIMITED TO CLEANING INTERIOR GLASS, CLEANING ALL MILLWORK, INSIDE AND OUTSIDE OF CABINETRY, AND

17. ALL BUILDING MATERIALS SHALL BE THE MOST NONTOXIC AND THE LOWEST POLLUTING AVAILABLE. THE

JACKS, TV, LIGHT FIXTURES AND SWITCHES W/ OWNER PRIOR TO WIRING.

SPECIAL WIRING REQUIREMENTS SUCH AS ALARMS AND STEREO SYSTEMS.

BUILDING SHALL BE VENTILATED DURING CONSTRUCTION AND THOROUGHLY AIRED OUT BEFORE OCCUPANCY.

18. NAIL UP ALL J-BOXES FOR REVIEW PRIOR TO WIRING. VERIFY ALL LOCATIONS OF POWER OUTLETS, PHONE

19. CONTRACTOR SHALL PROVIDE SAMPLES OF ALL MATERIALS (INCLUDING BUT NOT LIMITED TO: TILE, TILE TRIM, PAINT, ROOFING, SIDING, WOOD TRIM, WOOD BASE, COUNTERTOPS AND HARDWARE.)TO THE OWNER FOR

20. THE CONTRACTOR SHALL VERIFY WITH THE OWNER MINIMALLY THREE WEEKS PRIOR TO COVER-UP OF THE

22. ALL ELECTRICAL, HVAC, AND PLUMBING SHALL BE DESIGN BUILD BASED ON INFORMATION PROVIDED BY

CLEANING AND WAXING ALL FLOORING.

APPROVAL PRIOR TO ORDERING MATERIALS.

OF CONTRASTING COLOR TO BACKGROUND COLOR.

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PROJECT **INFORMATION** 

ATTACHMENT 7

### THE CONSTRUCTION DOCUMENTS. MATERIALS, ALL MATERIALS, SUPPLIES AND EQUIPMENT SHALL BE INSTALLED PER MANUFACTURERS 22. A MINIMUM OF 65 PERCENT OF THE CONSTRUCTION WASTE GENERATED AT THE SITE IS DIVERTED TO RECYCLE RECOMMENDATIONS AND PER APPLICABLE CODES AND REQUIREMENTS. THE DESIGNER SHALL HAVE NO CONTROL OR SALVAGE. OR CHARGE OF AND SHALL NOT BE RESPONSIBLE FOR CONSTRUCTION MEANS, METHODS, TECHNIQUES, 23. AN OPERATION AND MAINTENANCE MANUAL SHALL BE PROVIDED TO THE BUILDING OCCUPANT OR OWNER. SEQUENCES, OR PROCEDURES IN CONNECTION WITH THE WORK, FOR THE ACTS OR OMISSIONS OF THE DEFINITIONS: "TYPICAL" MEANS IDENTICAL FOR ALL SIMILAR CONDITIONS, U.O.N. "SIMILAR" MEANS COMPARABLE CONTRACTOR, SUB-CONTRACTOR, OR ANY OTHER PERSON PERFORMING ANY OF THE WORK, OR FOR THE FAILURE CHARACTERISTICS FOR THE CONDITIONS NOTED. "ALIGN" MEANS TO ACCURATELY LOCATE FINISHES IN THE SAME OF ANY OF THEM TO CARRY OUT THE WORK IN ACCORDANCE WITH THE CONTRACT DOCUMENTS. 24. BUILDING ADDRESS: TO BE POSTED IN A CONSPICUOUS PLACE AND LIGHTED EXTERNALLY. NUMBERS SHALL BE

CONTRACTOR'S, HAS BEEN REMOVED FROM THIS PROJECT SITE OR UNTIL OWNER APPROVAL HAS BE GRANTED.

**STORAGE**, MATERIALS STORED ON SITE SHALL BE PROTECTED FROM DAMAGE BY MOISTURE, WIND, SUN, ABUSE OR

CHANGES, ANY MINOR OR REQUIRED CHANGES OR MODIFICATIONS TO THIS PLAN DO NOT REDUCE OR VOID THE

COPYRIGHTS COVERING THIS SET OF PLANS IN ANY WAY. MODIFICATIONS TO THIS PLAN, FOR ANY REASON, SHOULD


BE ATTEMPTED BY AND ARCHITECT OR ENGINEER ONLY. DESIGNER ACCEPTS NO RESPONSIBILITY FOR THE QUALITY


THE RESPONSIBLE PARTY, EITHER THE PROJECT OWNER OR THIS SIGNED DESIGNER, SHALL BE NOTIFIED OF

ERRORS OR OMISSIONS FOR CORRECTIONS BEFORE PROCEEDING WITH THE WORK.

ANY OTHER HARMFUL AFFECTS.

AND COMPLETENESS OF ANY CHANGES ATTEMPTED.

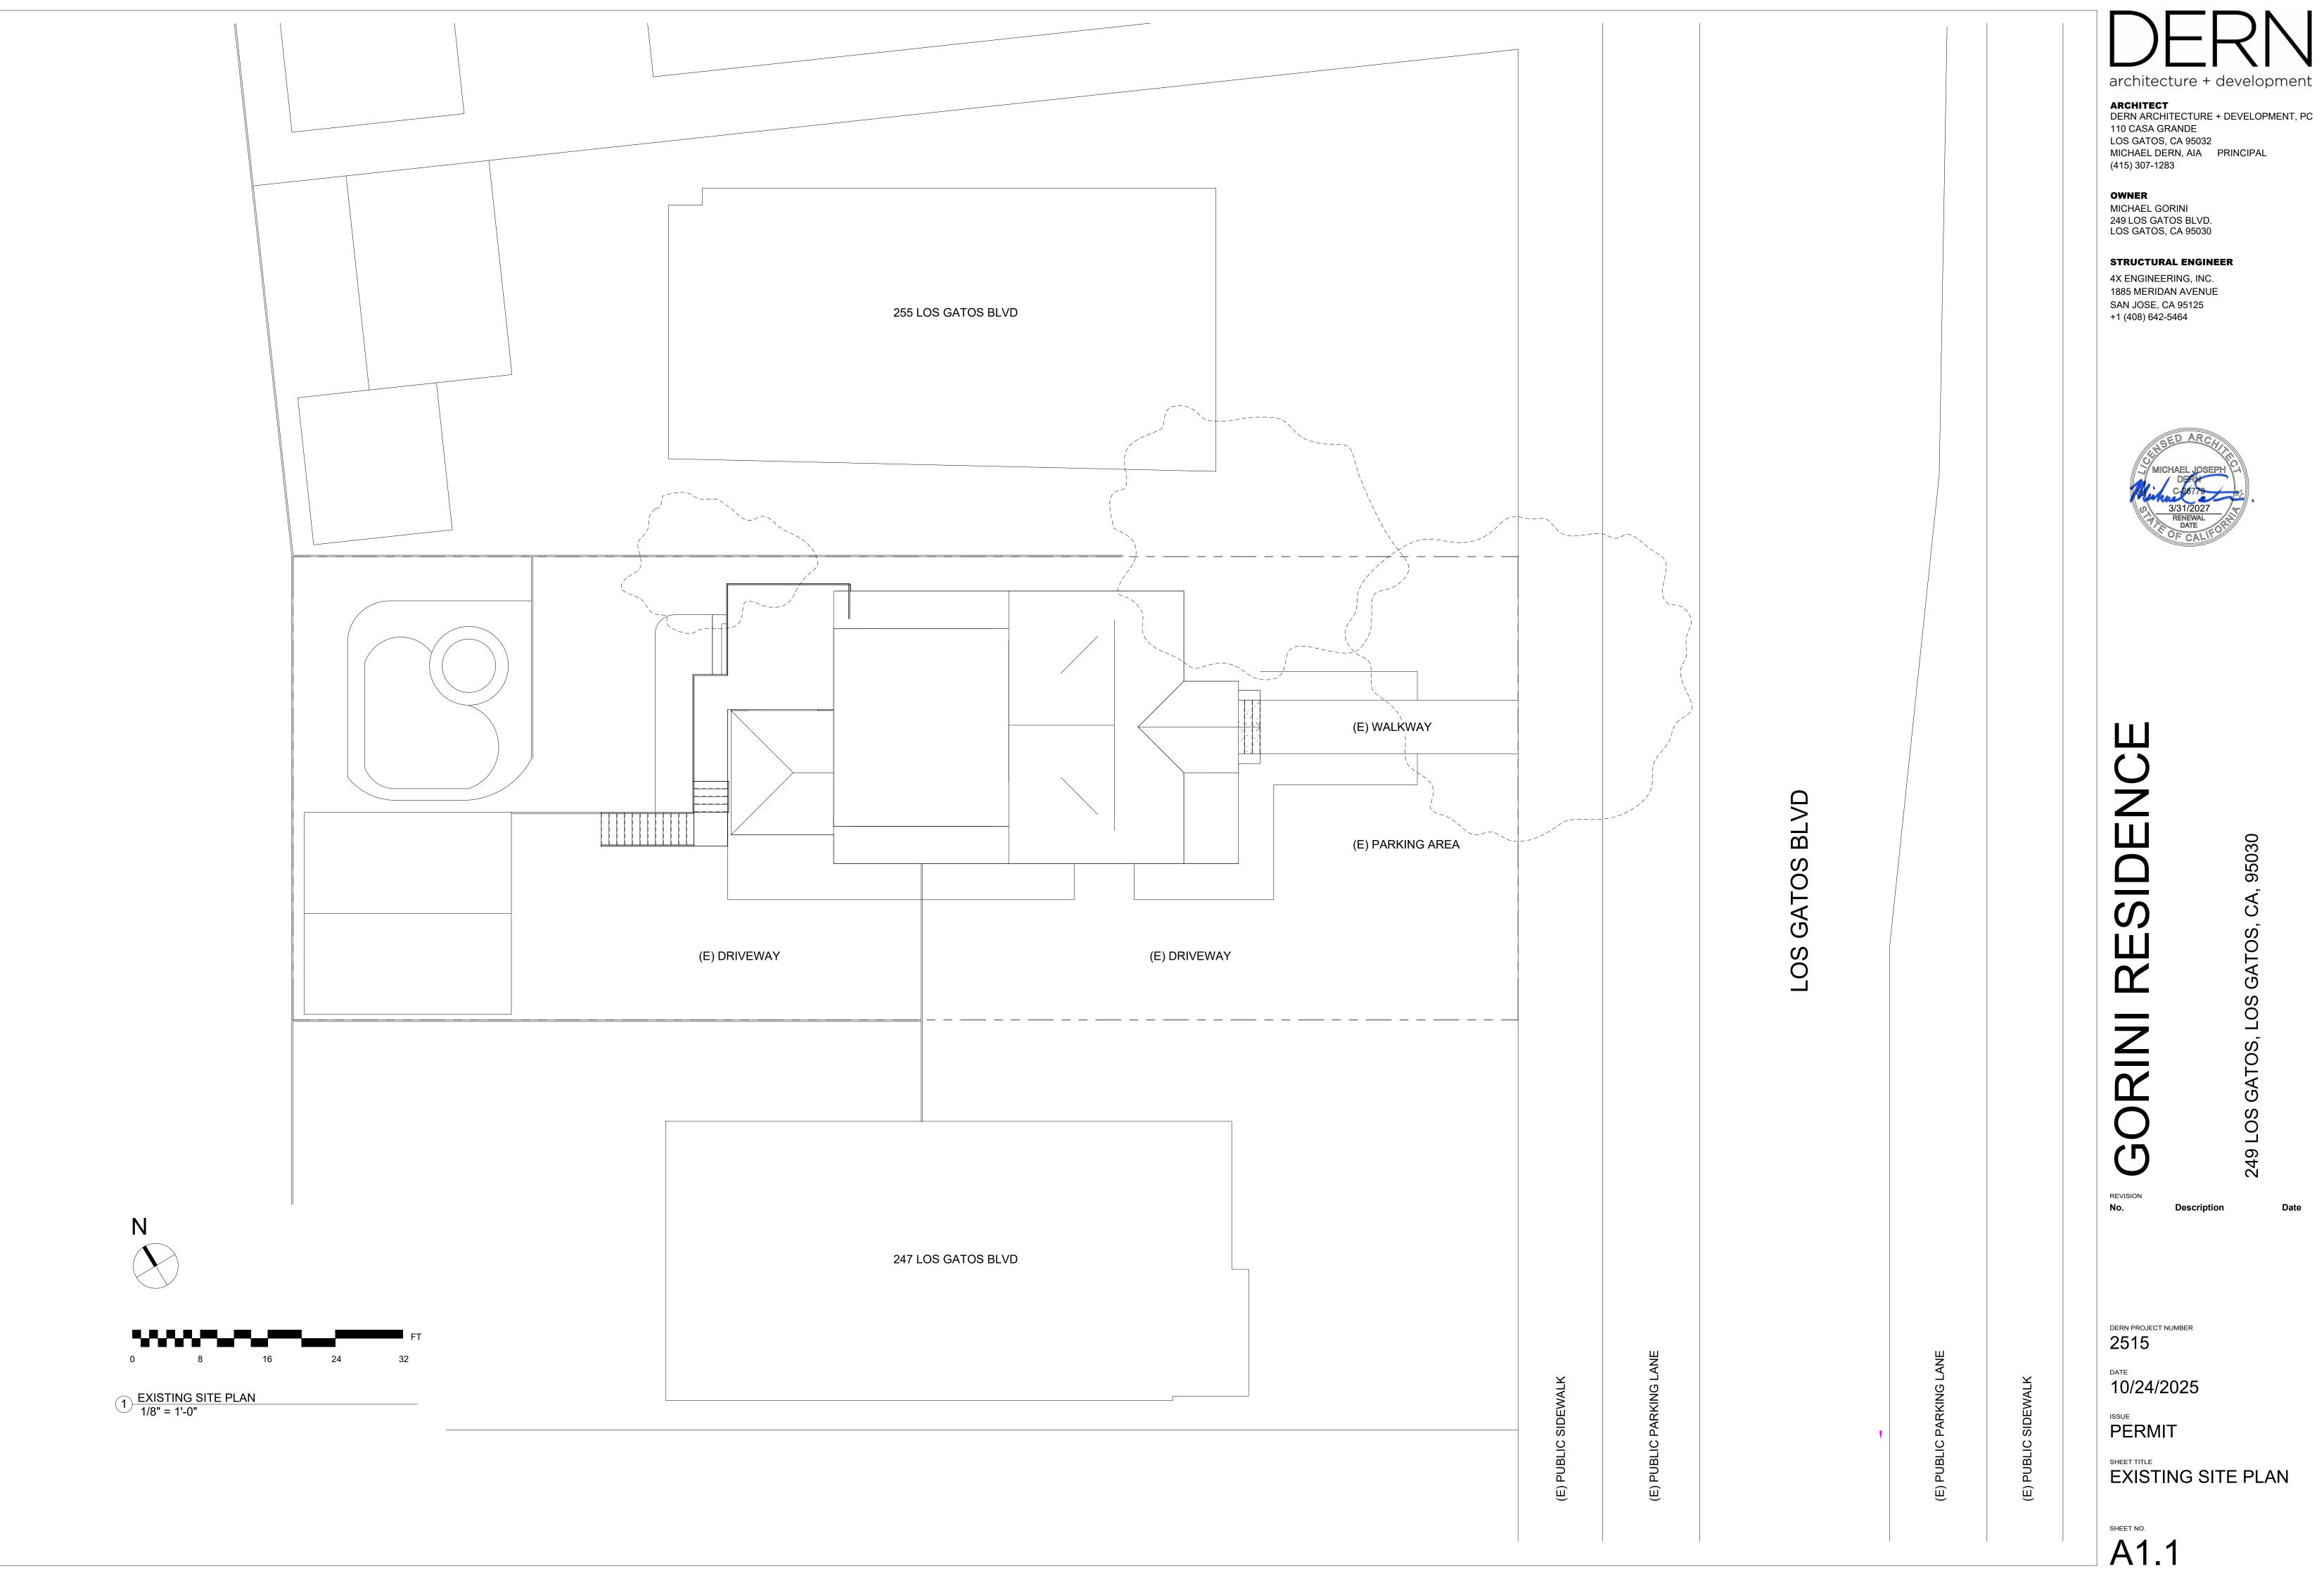

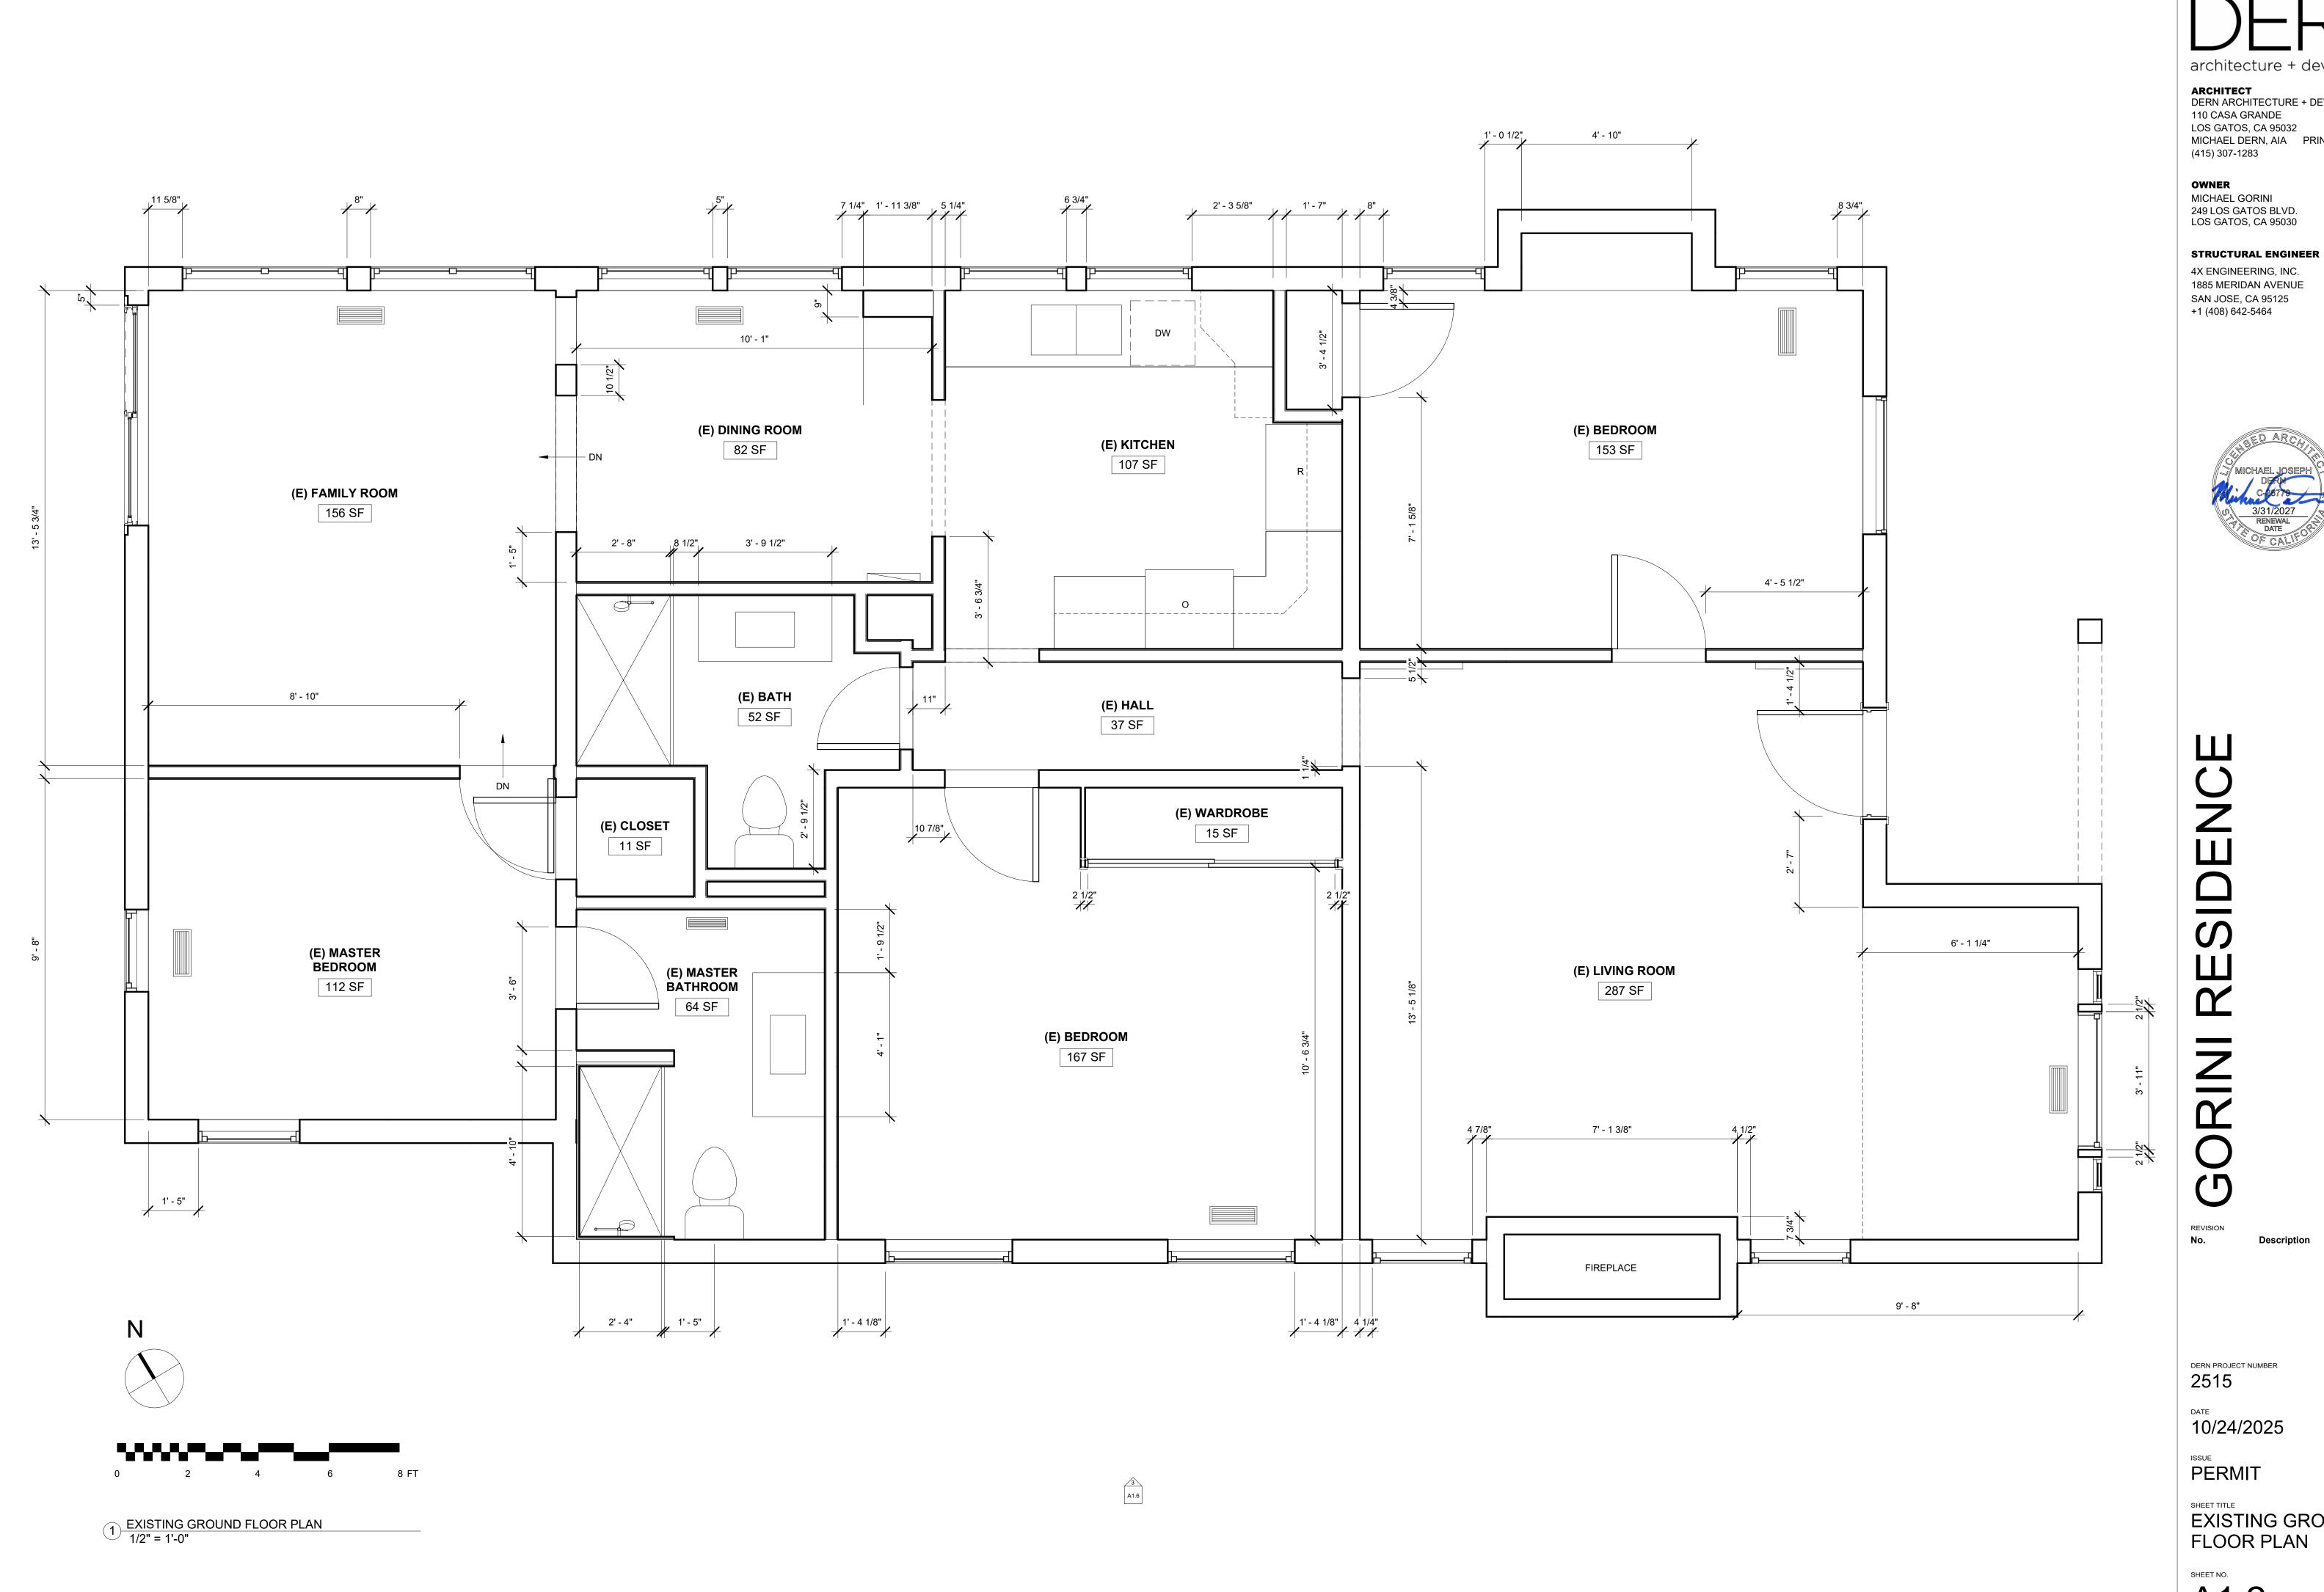

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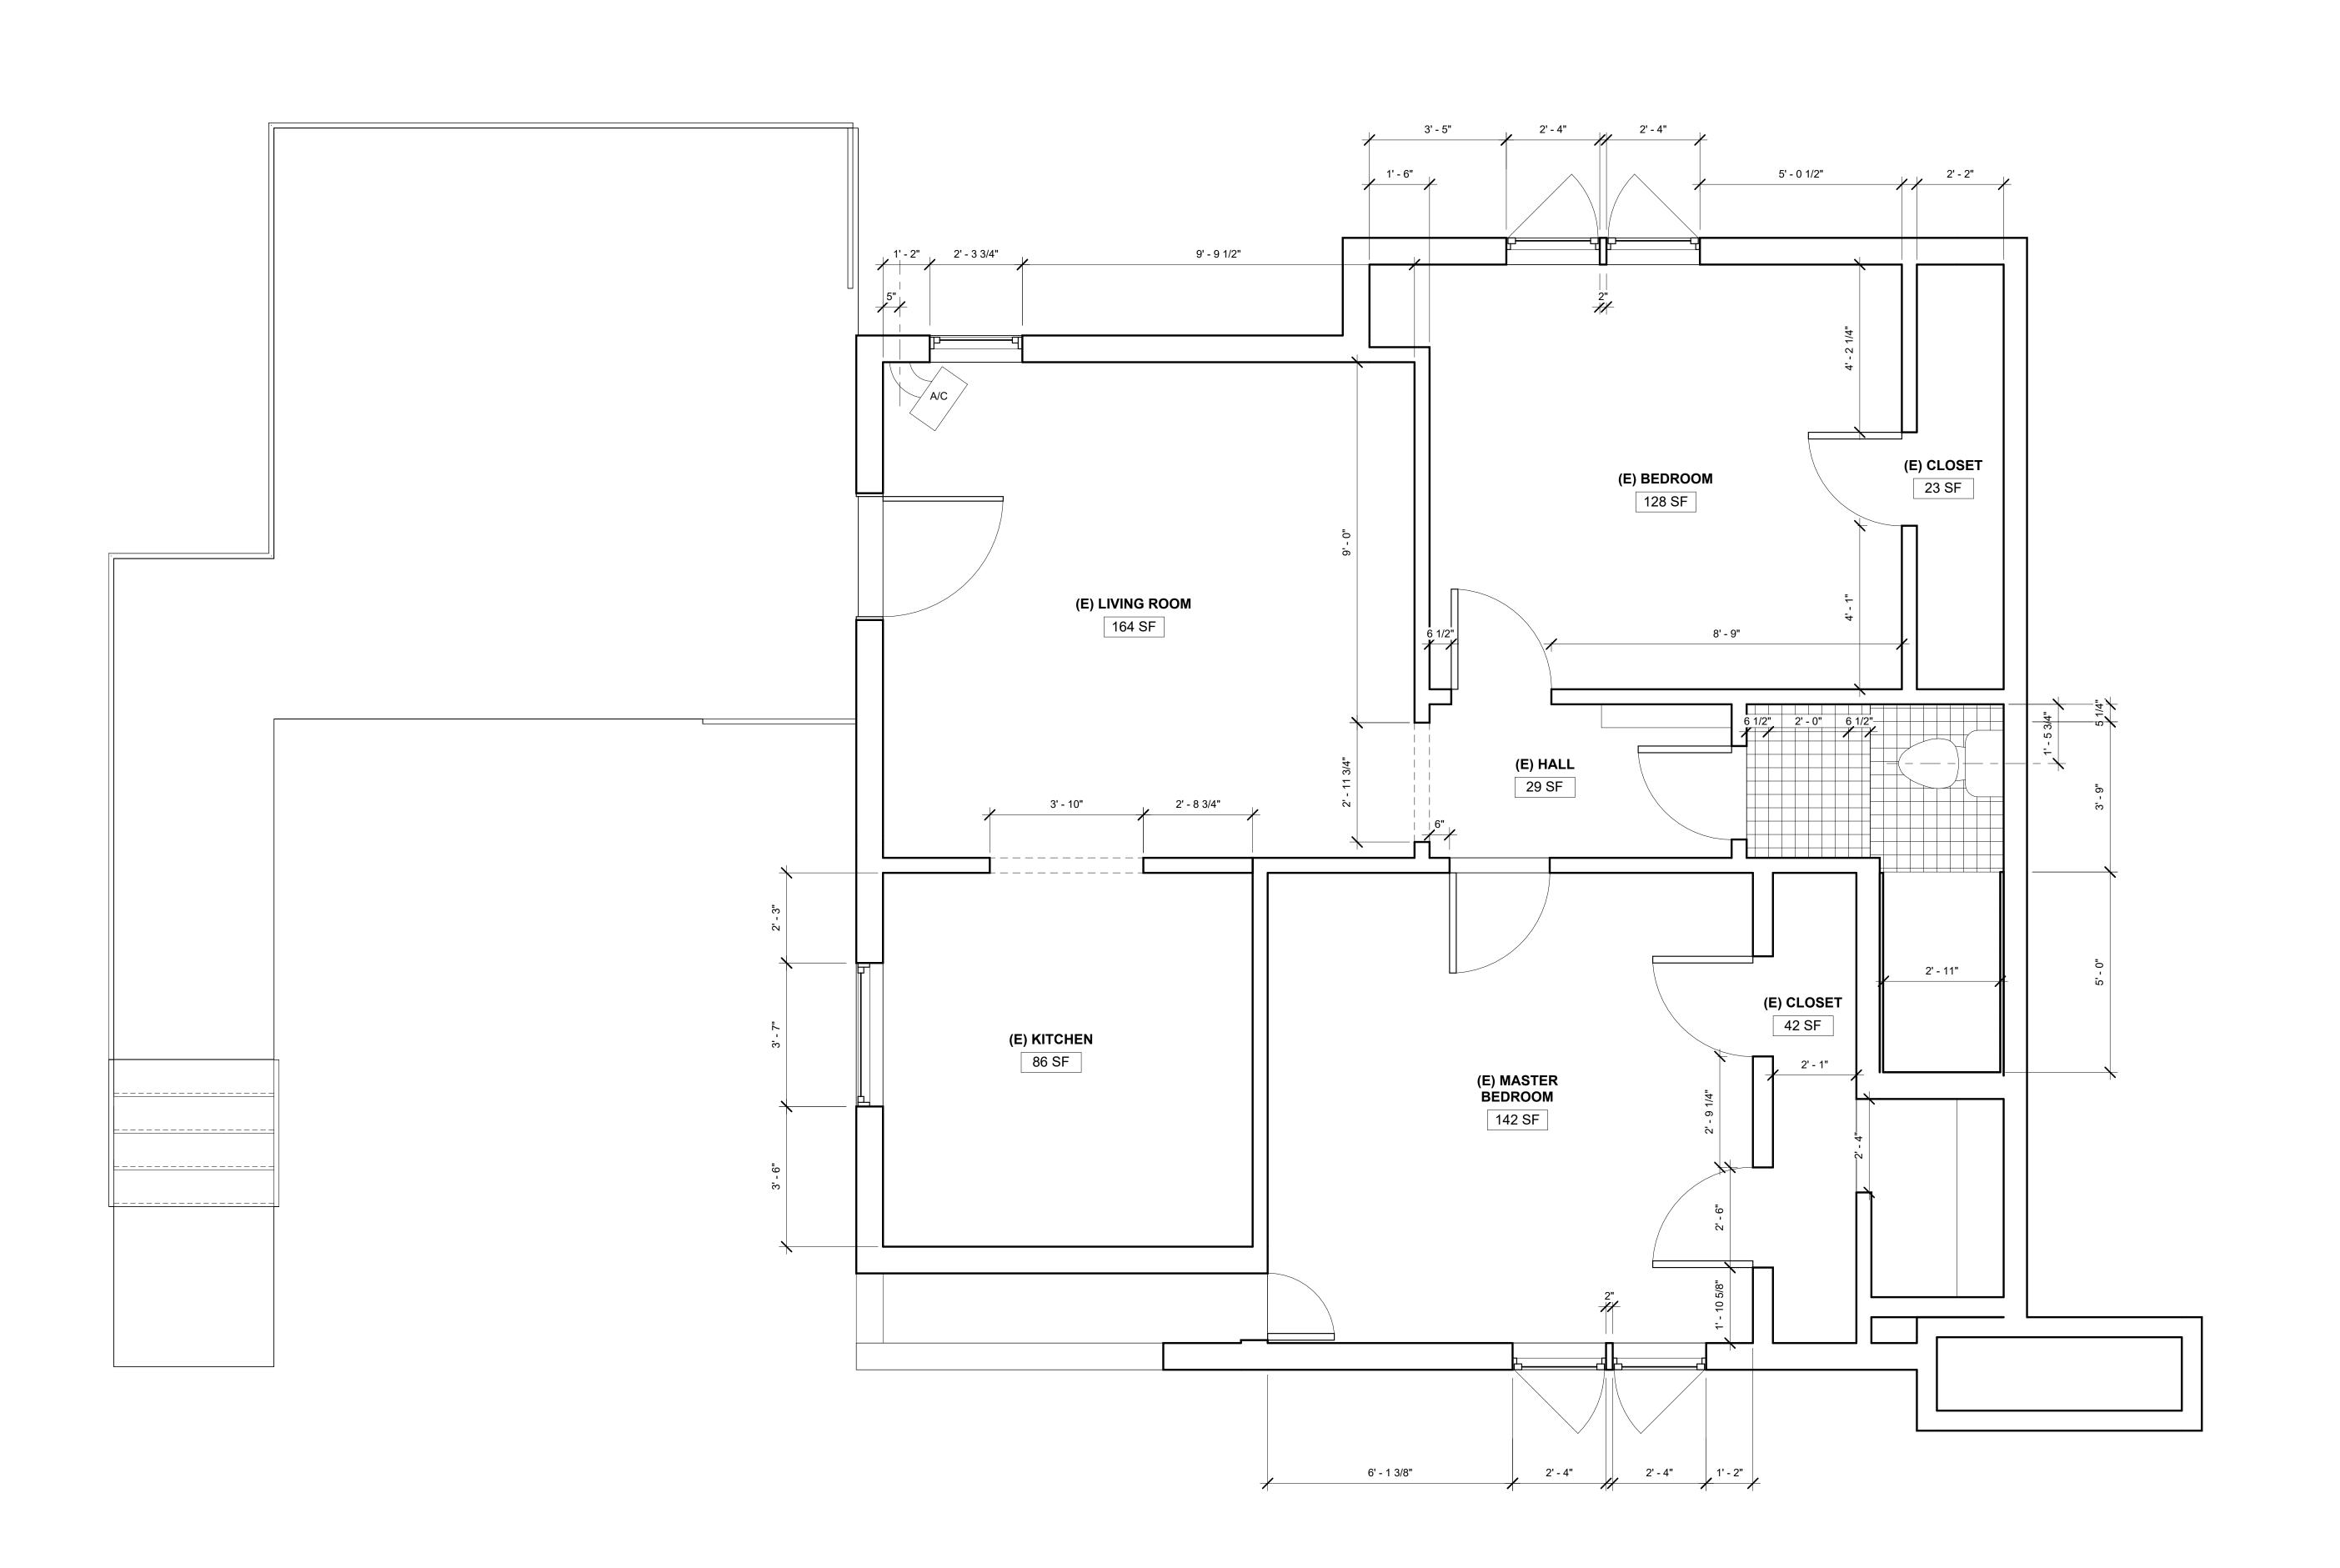
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EXISTING GROUND

A1.2



1 EXISTING SECOND FLOOR 1/2" = 1'-0"

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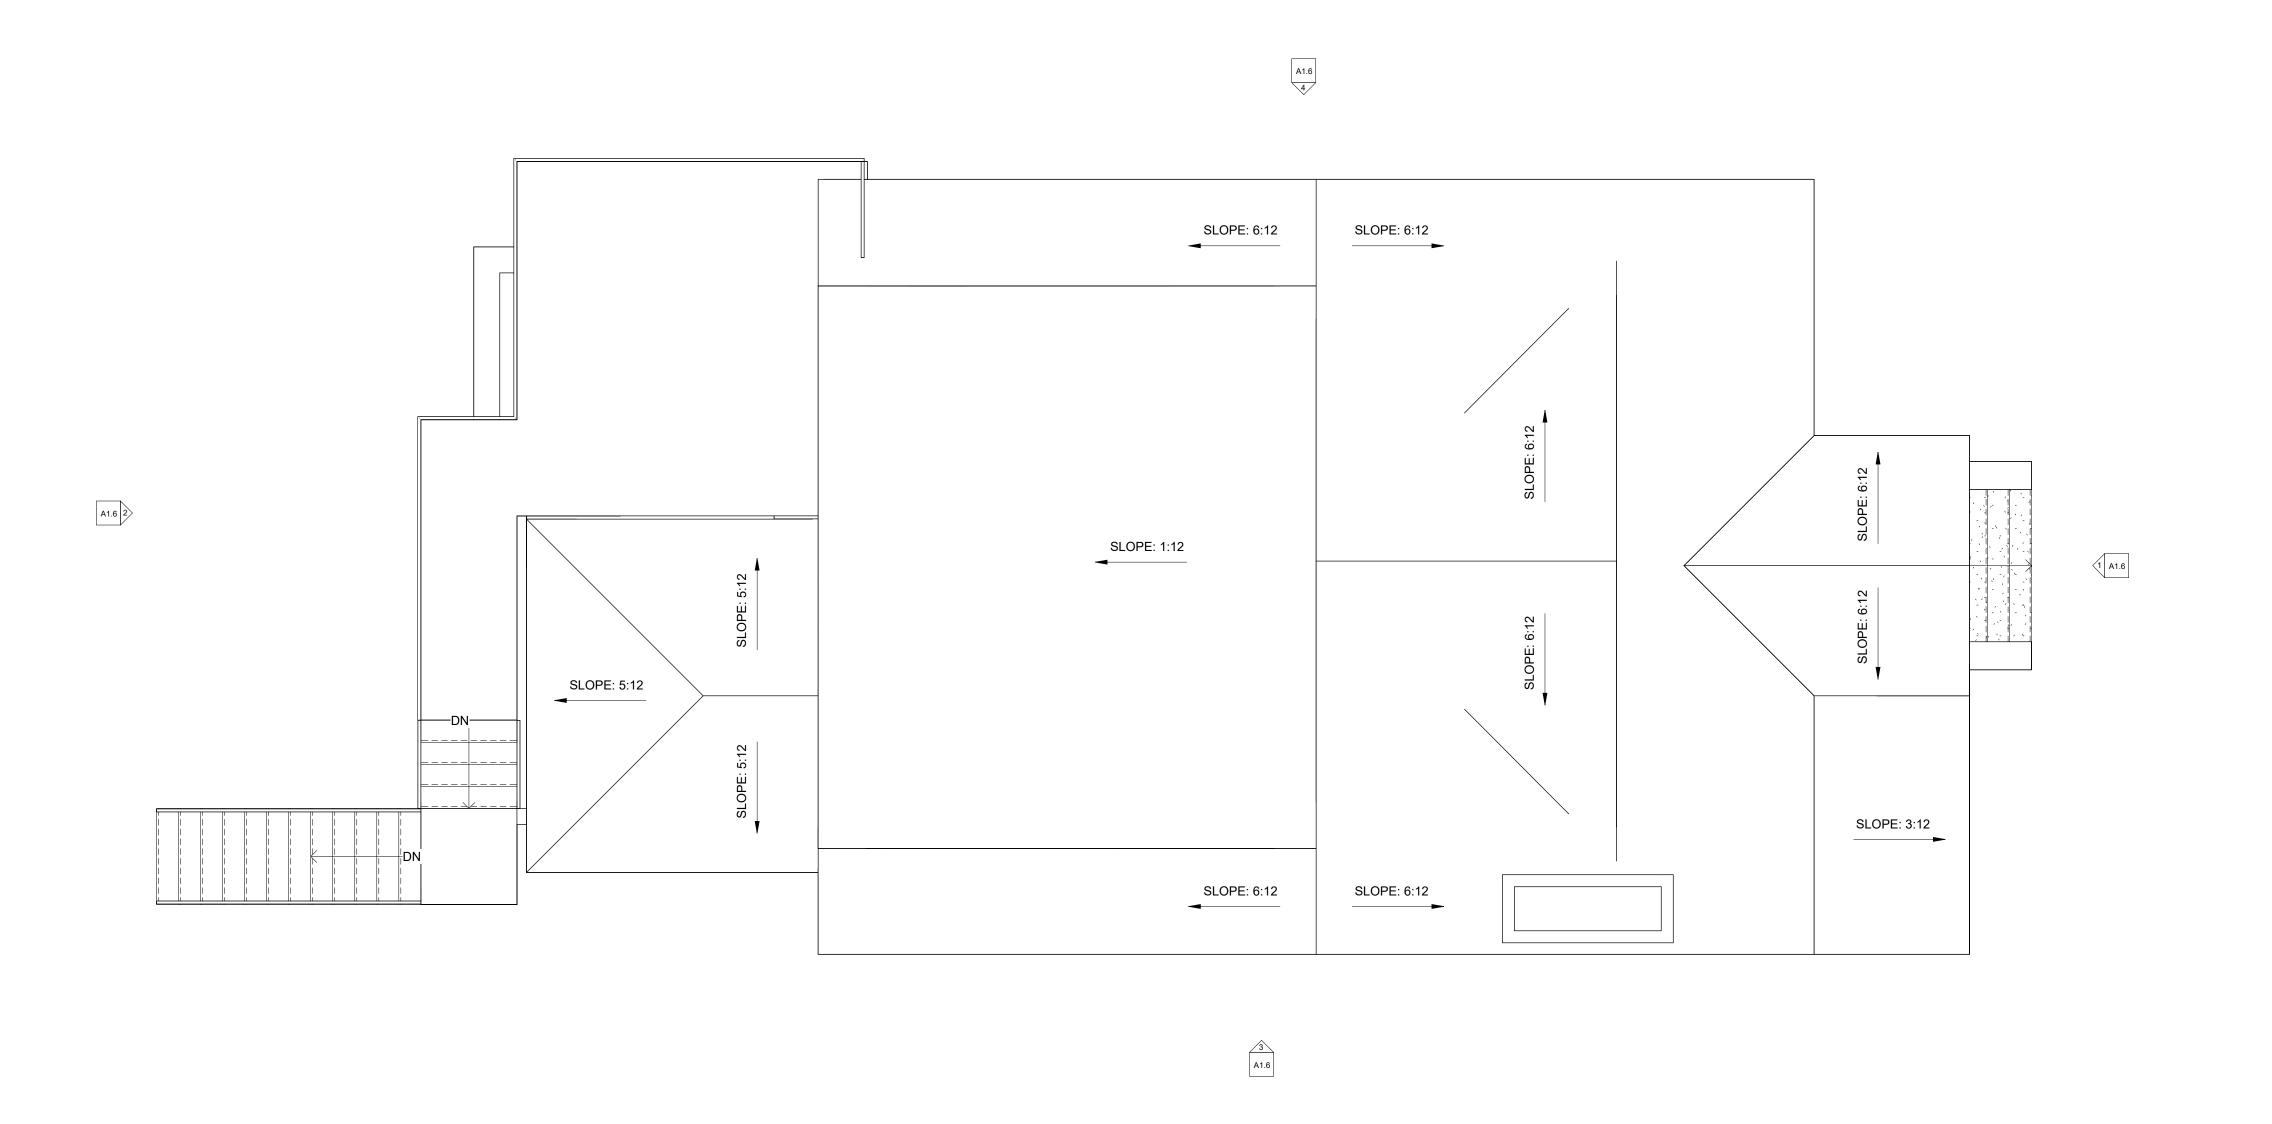
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EXISTING SECOND FLOOR PLAN

A1.3



1) EXISTING ROOF PLAN 1/4" = 1'-0" DERN

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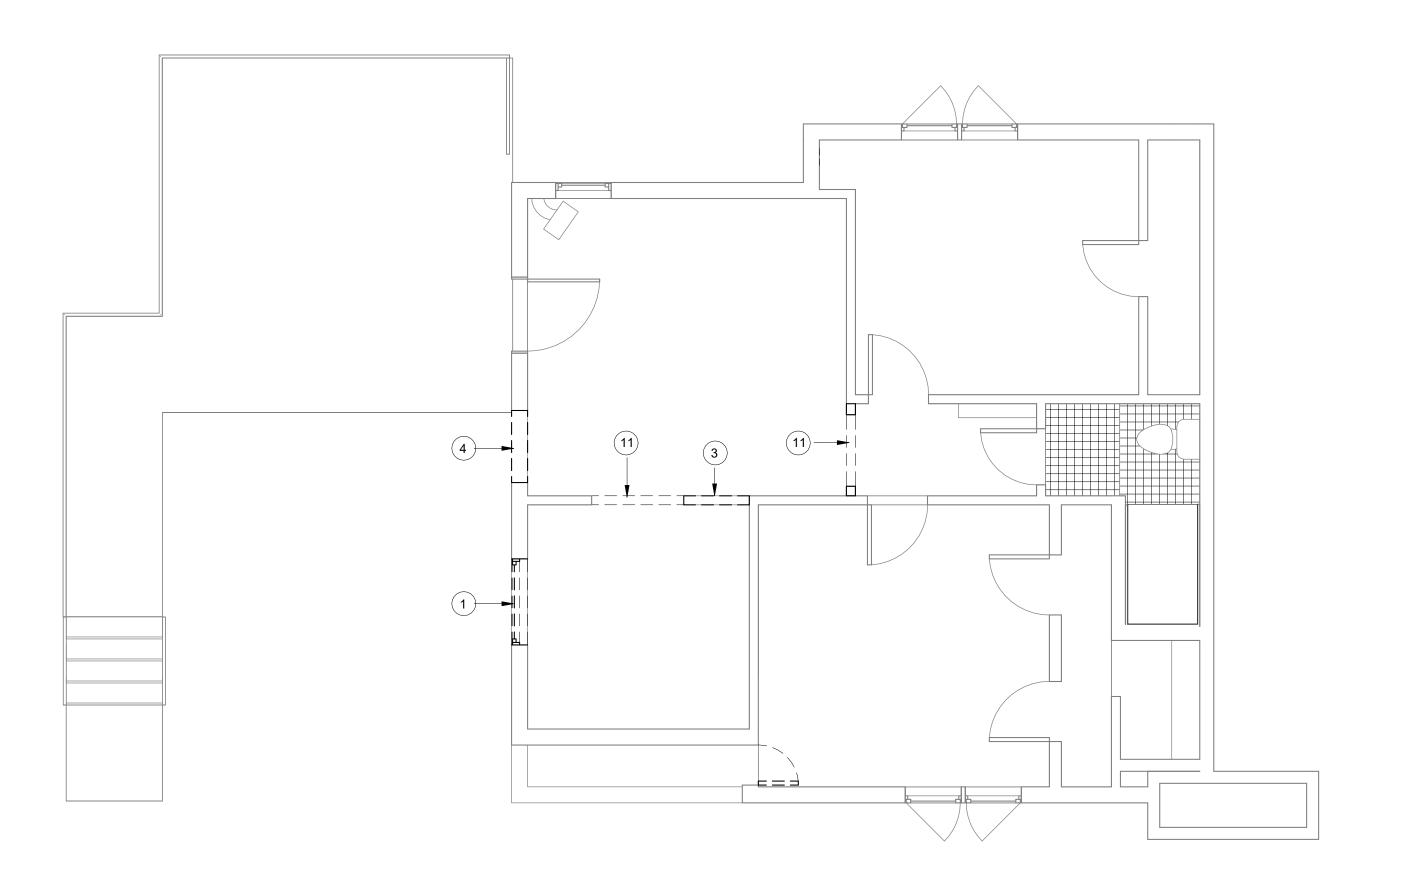
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EXISTING ROOF PLAN

A1.5






2 DEMOLITION SECOND FLOOR PLAN 1/4" = 1'-0"

### **DEMOLITION KEYNOTES**

- 1 REMOVE (E) WINDOW, KEEP FOR RELOCATION
- 2 REMOVE (E) DOORS AND FRAMES, TYP.
- 3 REMOVE (E) WALL FRAMING & FINISHES, SEE (N) FLOOR PLAN
- 4 REMOVE (E) WALL SEGMENT FOR (N) WINDOW OR DOOR FRAMING, SEE (N) FLOOR PLAN
- 5 REMOVE (E) FLOORING
- 6 REMOVE (E) COUNTER & CABINETRY BELOW
- 7 REMOVE (E) CABINETRY
- 8 REMOVE (E) APPLIANCE, KEEP FOR RELOCATION
- 9 REMOVE (E) FIXTURES
- 10 REMOVE (E) COLUMN
- REMOVE (E) PASS-THROUGH FRAMING AND WIDEN ENTRY TO THE HALLWAY. PREPARE TRANSITIONS TO HAVE ALIGNED CEILING FINISHES WITH HEADER ABOVE

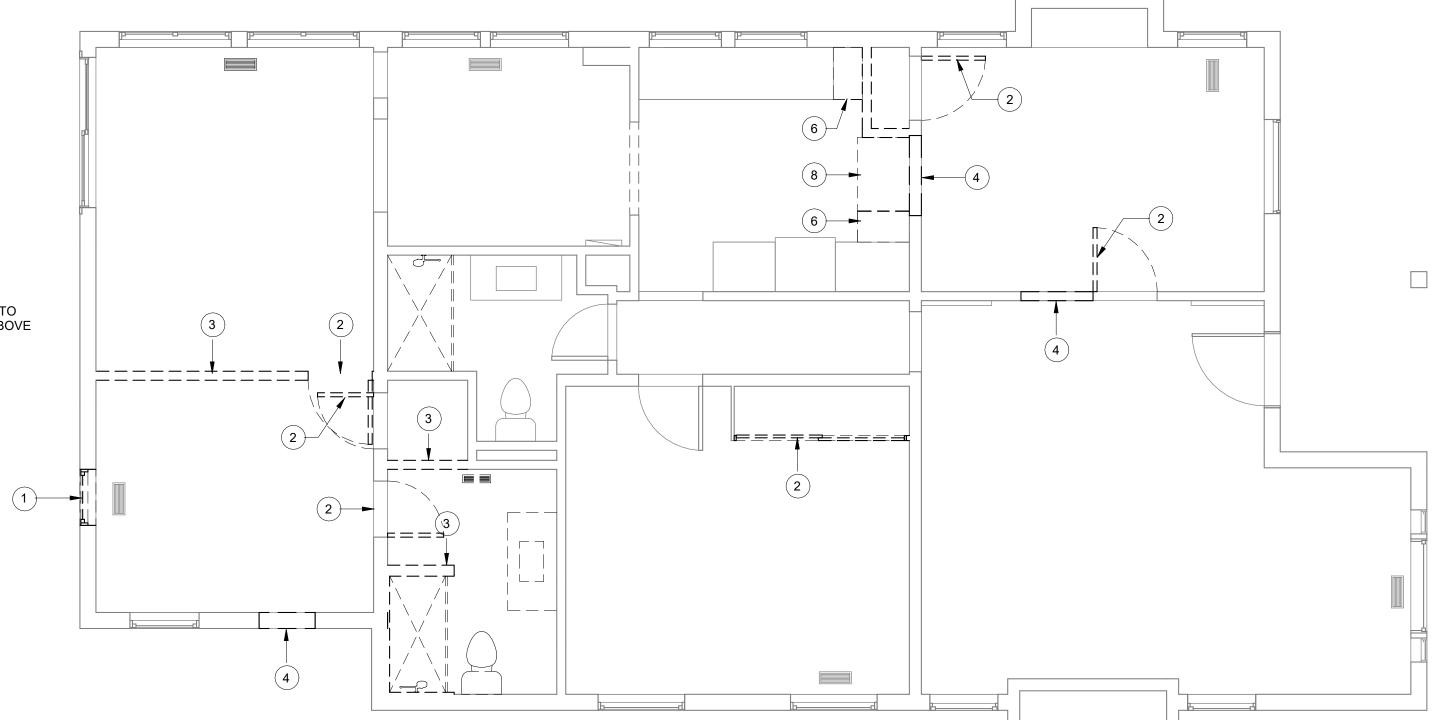

1 DEMOLITION GROUND FLOOR PLAN 1/4" = 1'-0"

# DERN

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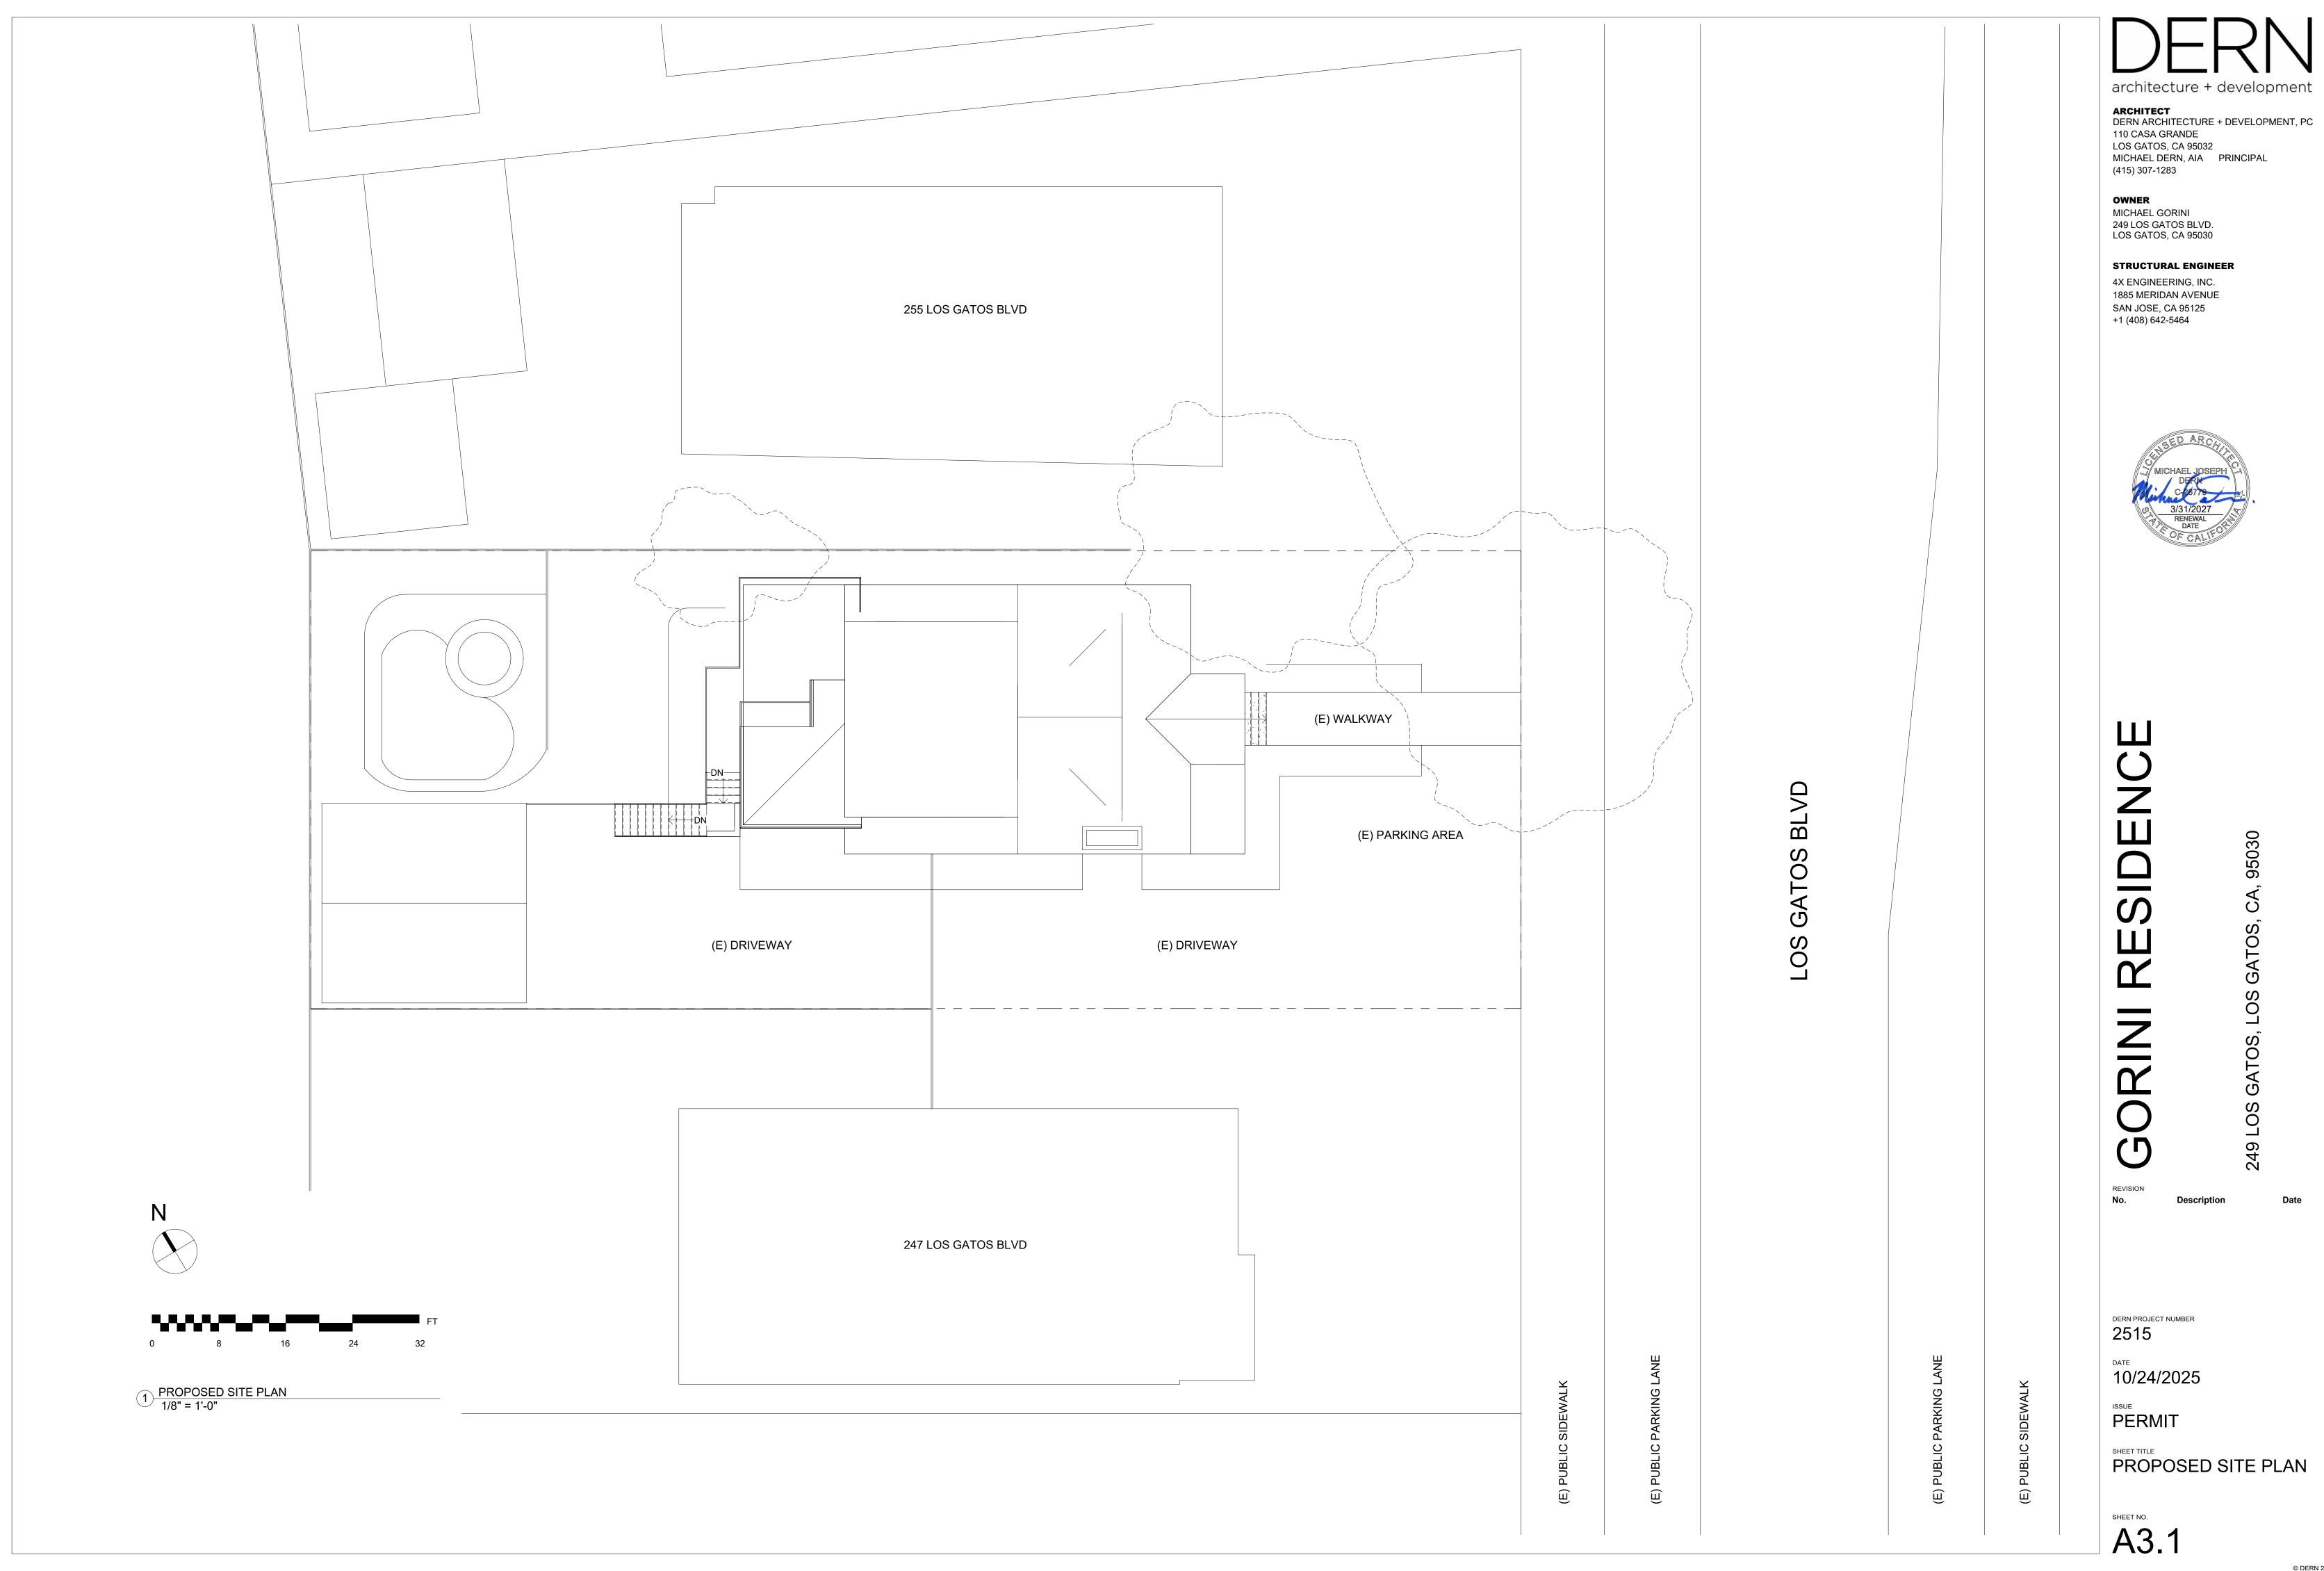
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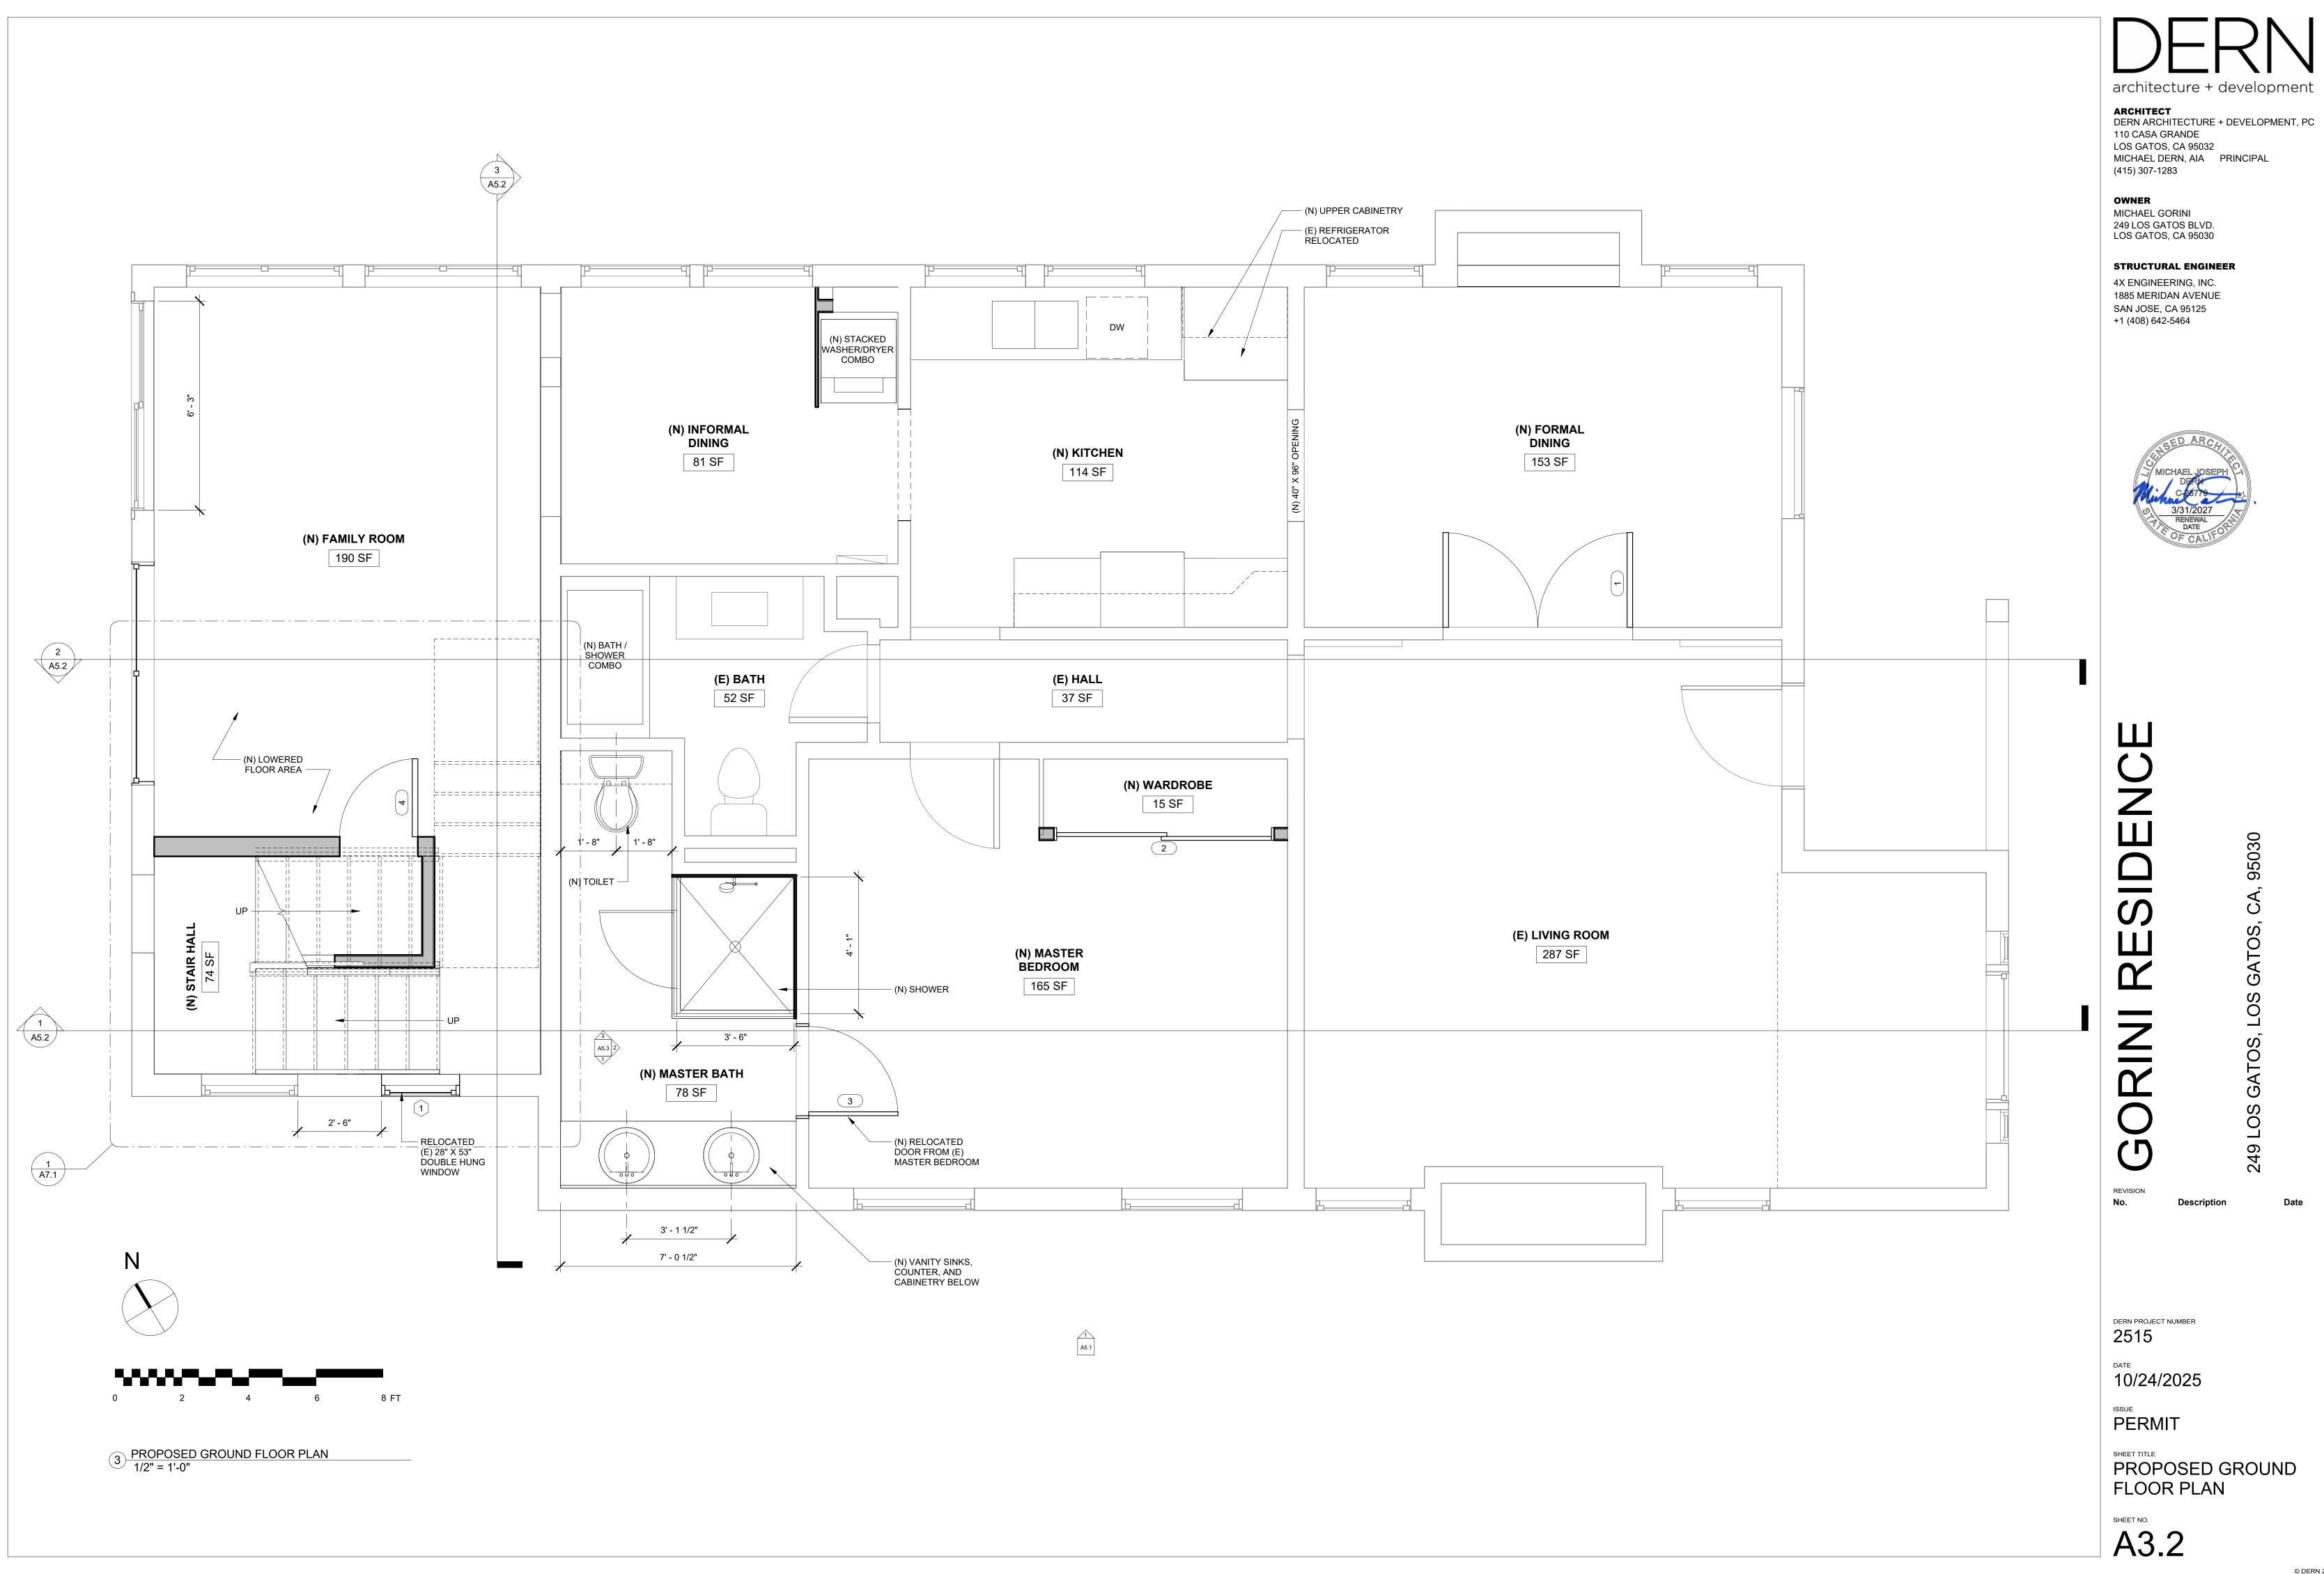
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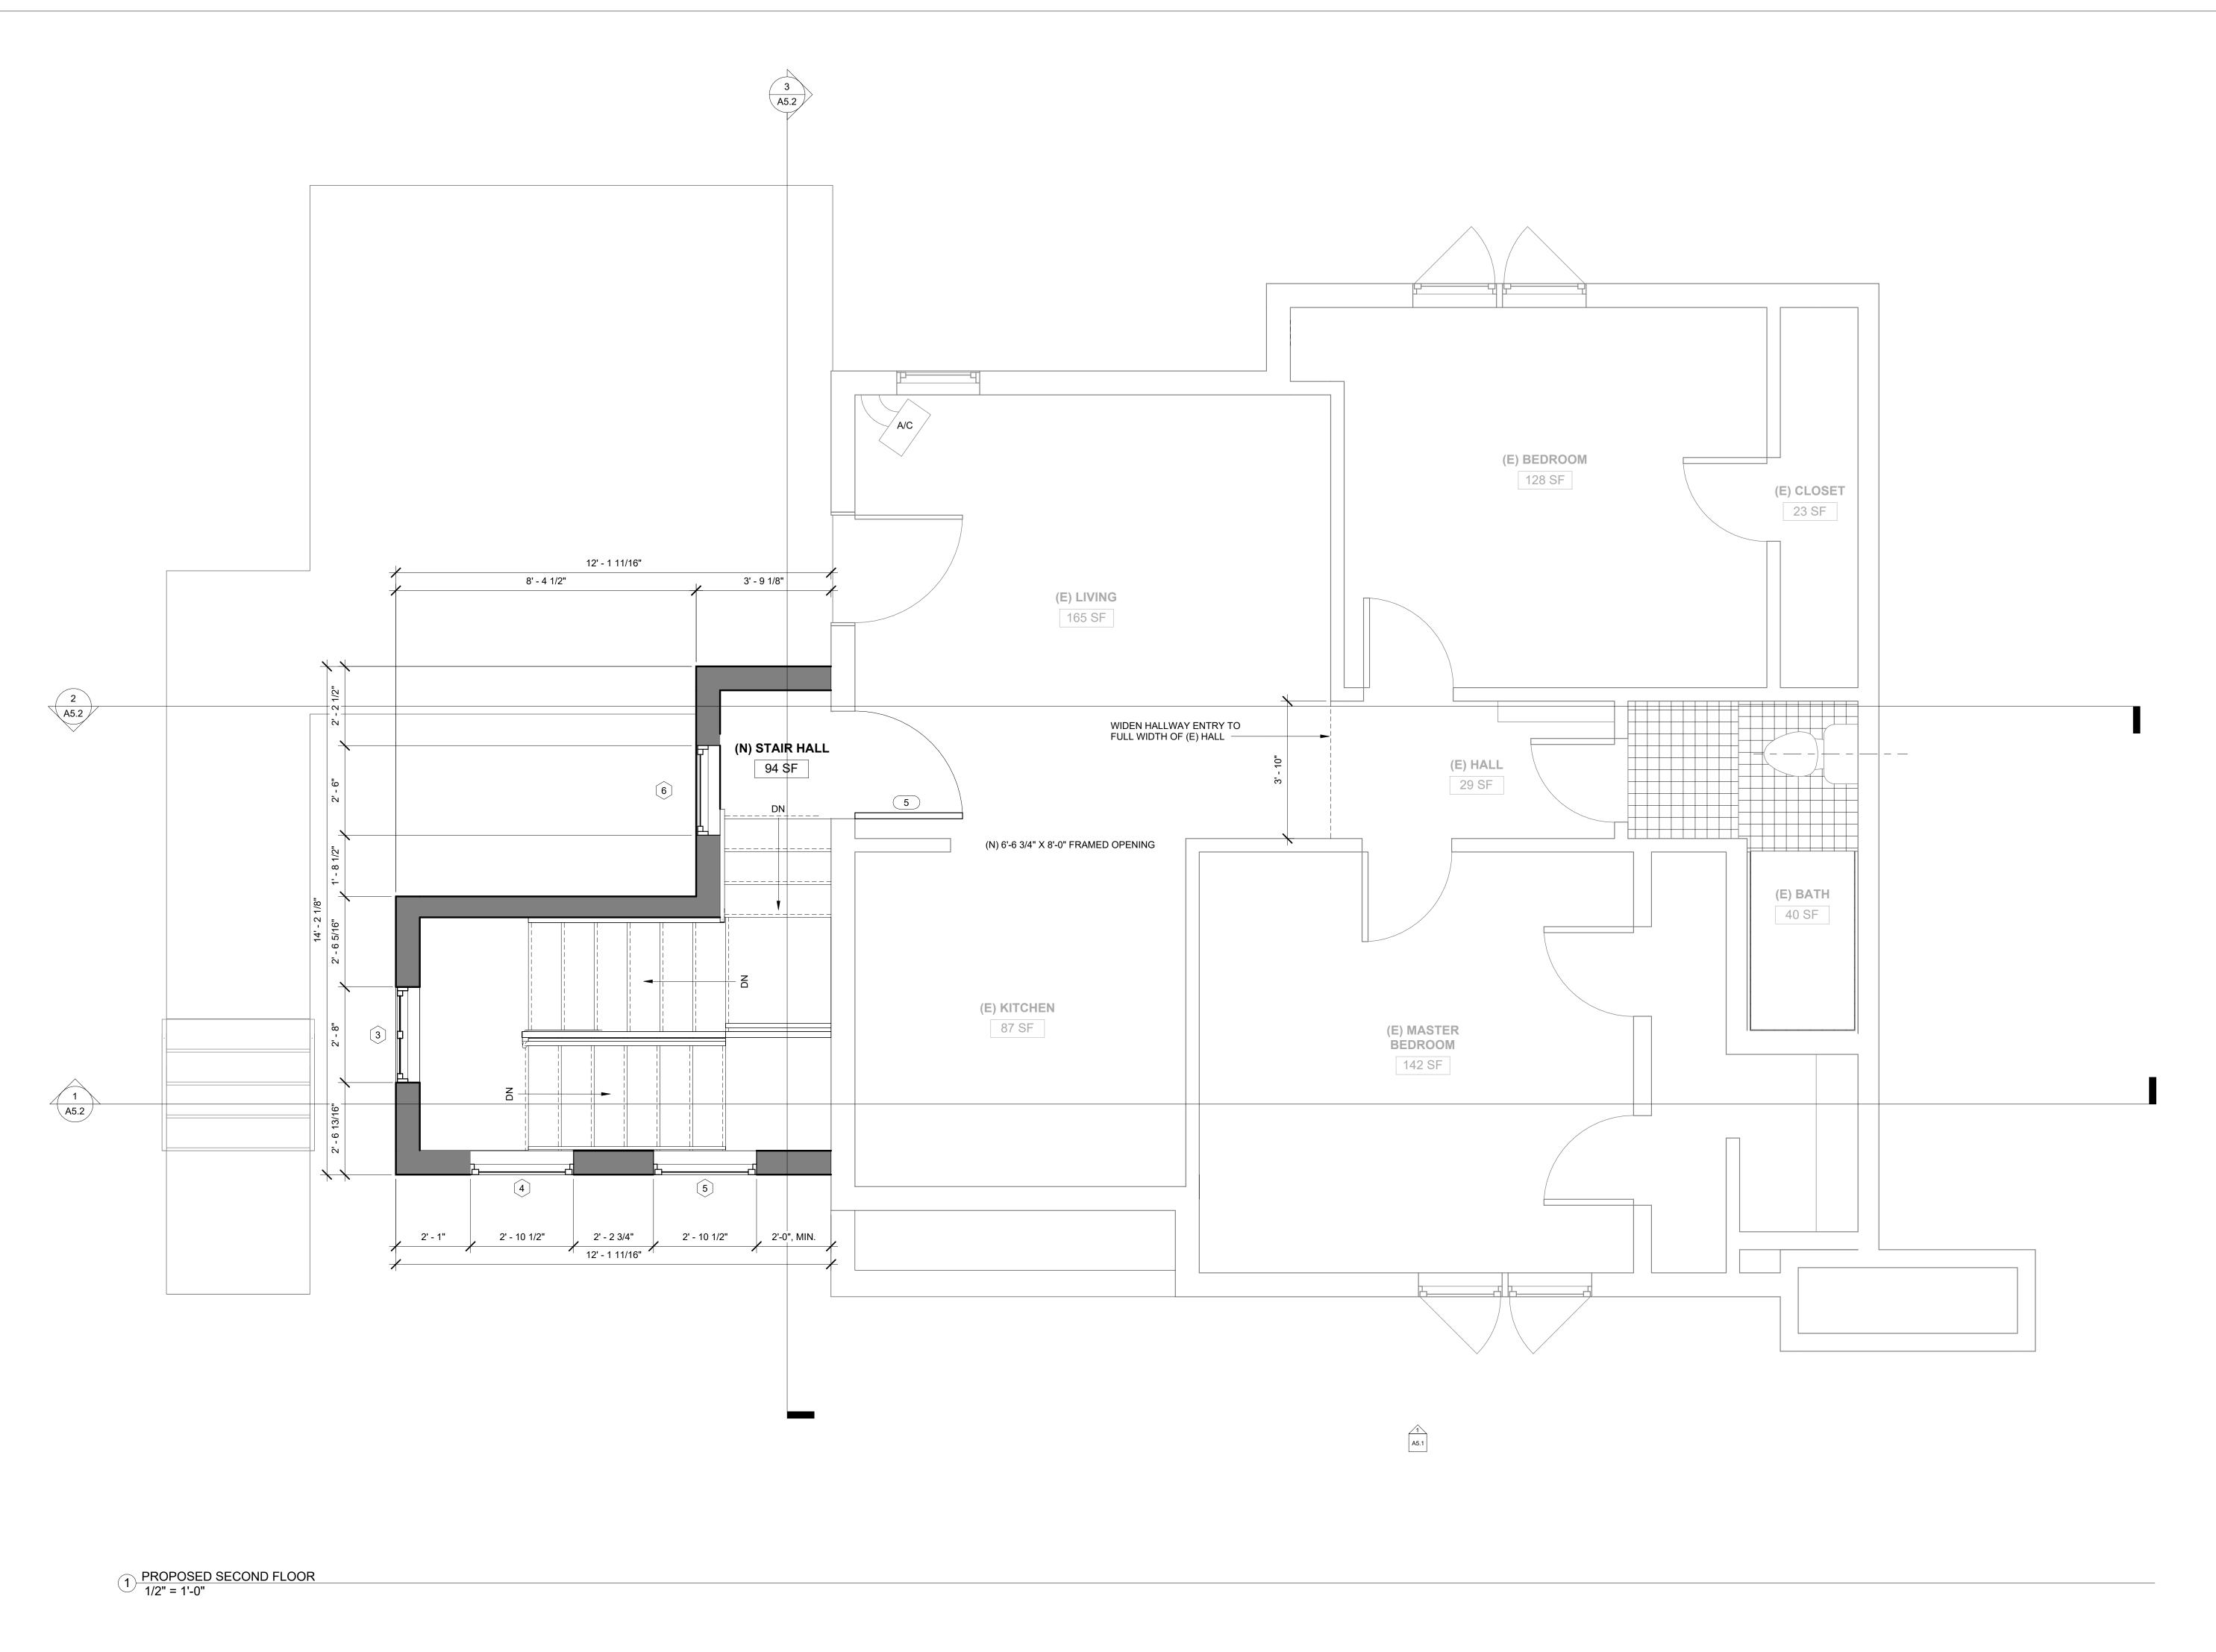
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DEMOLITION FLOOR
PLANS

A2.1







architecture + development


**ARCHITECT** DERN ARCHITECTURE + DEVELOPMENT, PC 110 CASA GRANDE LOS GATOS, CA 95032 MICHAEL DERN, AIA PRINCIPAL

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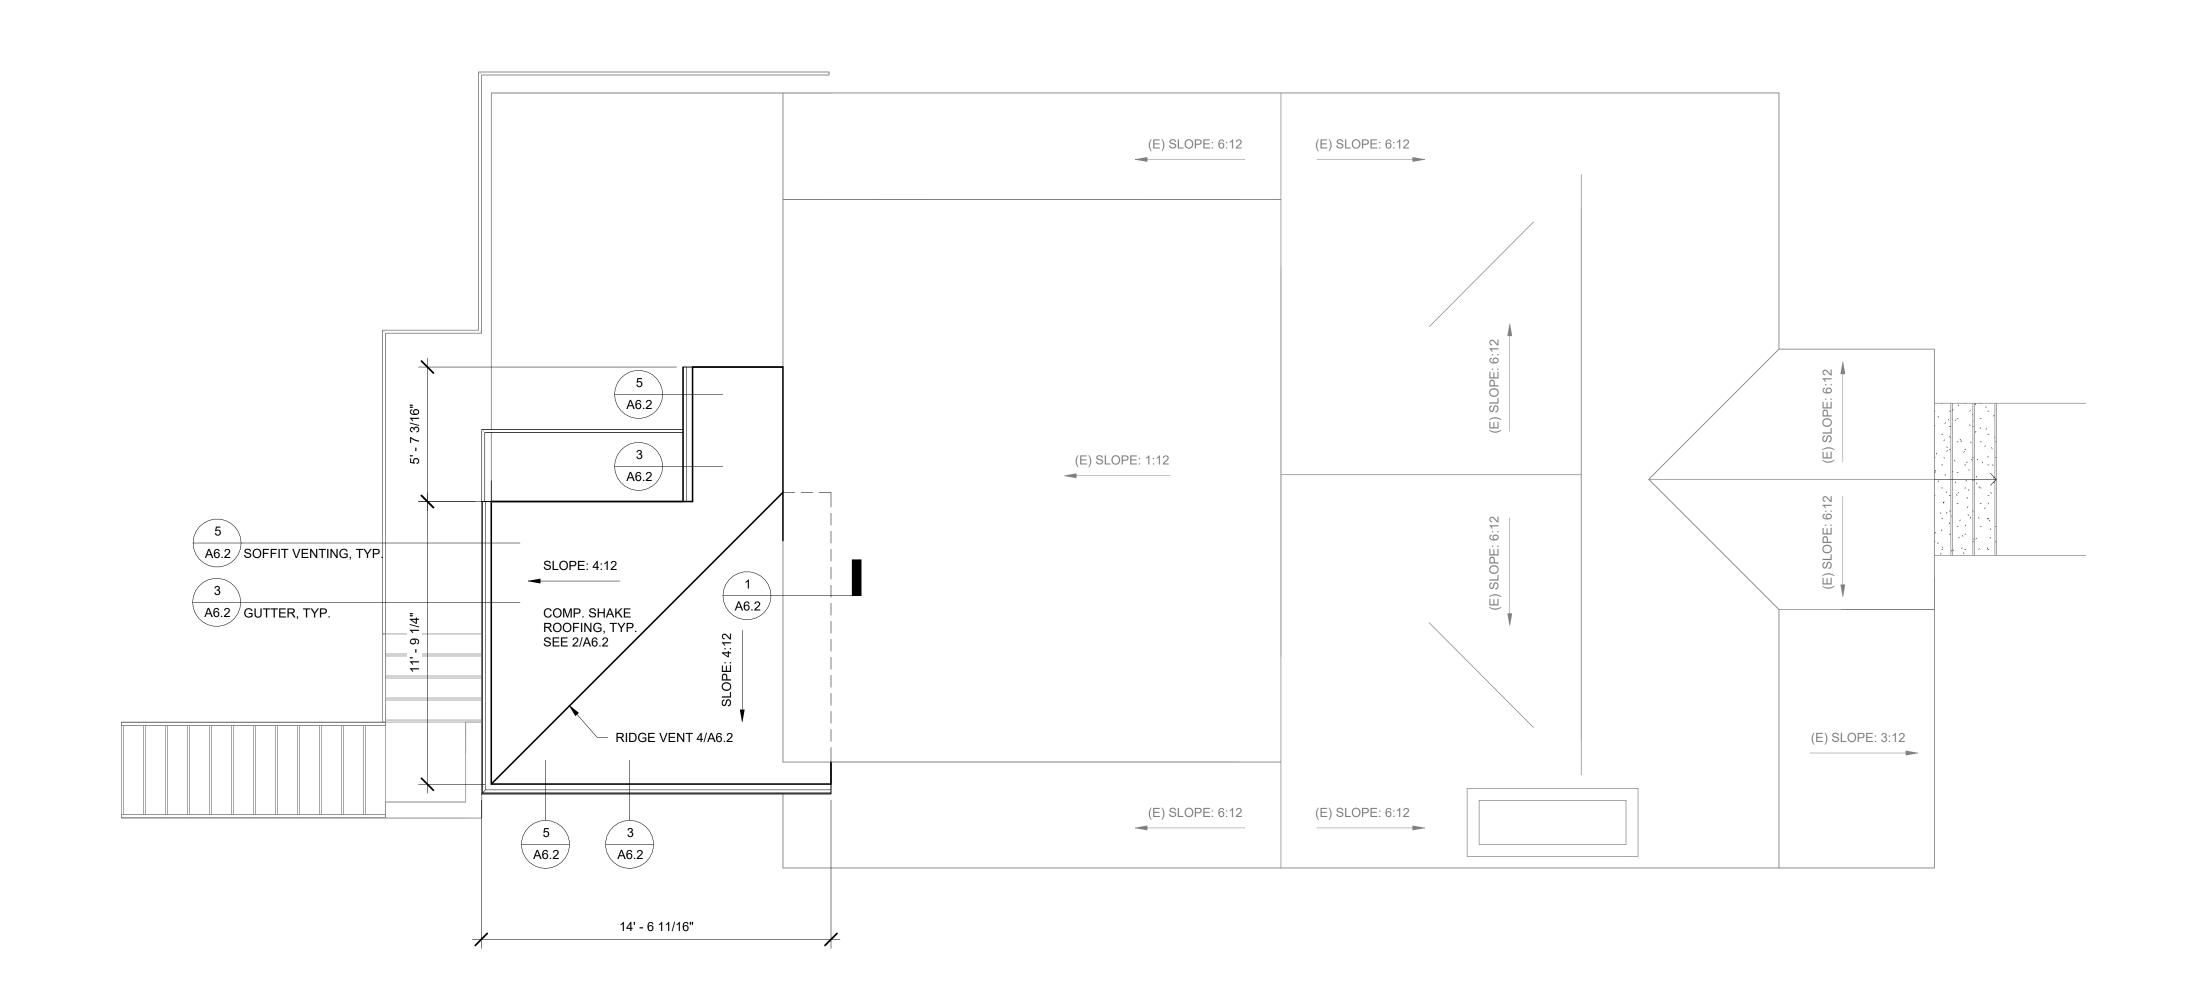
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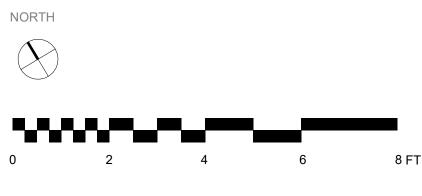
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PROPOSED SECOND FLOOR PLAN

A3.3



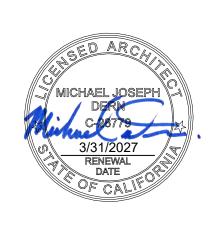

1) PROPOSED ROOF PLAN 1/4" = 1'-0"

## (N) ATTIC VENTING CALCULATIONS

THE MINIMUM NET FREE VENTILATING AREA (NFVA) SHALL BE 1 SF / 150SF OF THE AREA OF THE VENTED SPACE.

REQUIRED: 95 SF OF (N) ATTIC AREA

USING 95 SF / 150 SF = 0.634 SF ATTIC VENTILATION OPENINGS

0.634 SF X 144 SQ. IN. = 91.2 SQ. IN. FOR EACH INTAKE AND EXHAUST NFVA

EAVE VENT OF 91.2 SQ. IN. 2" x 45 LINEAR INCHES EAVE VENT = 766 SQ. IN. PROVIDED

X 40 EINEAN INGITES EAVE VENT - 700 5Q. IN. 1 NOVIE

RIDGE VENT OF 91.2 SQ. IN. 20 SQ. IN. PER LINEAR FT. ~ 4.46" MIN.

PROVIDING FULL LENGTH OF RIDGE LINE OF 31'-11"

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ARCHITECT

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# GORINI RESIDENCE

Description

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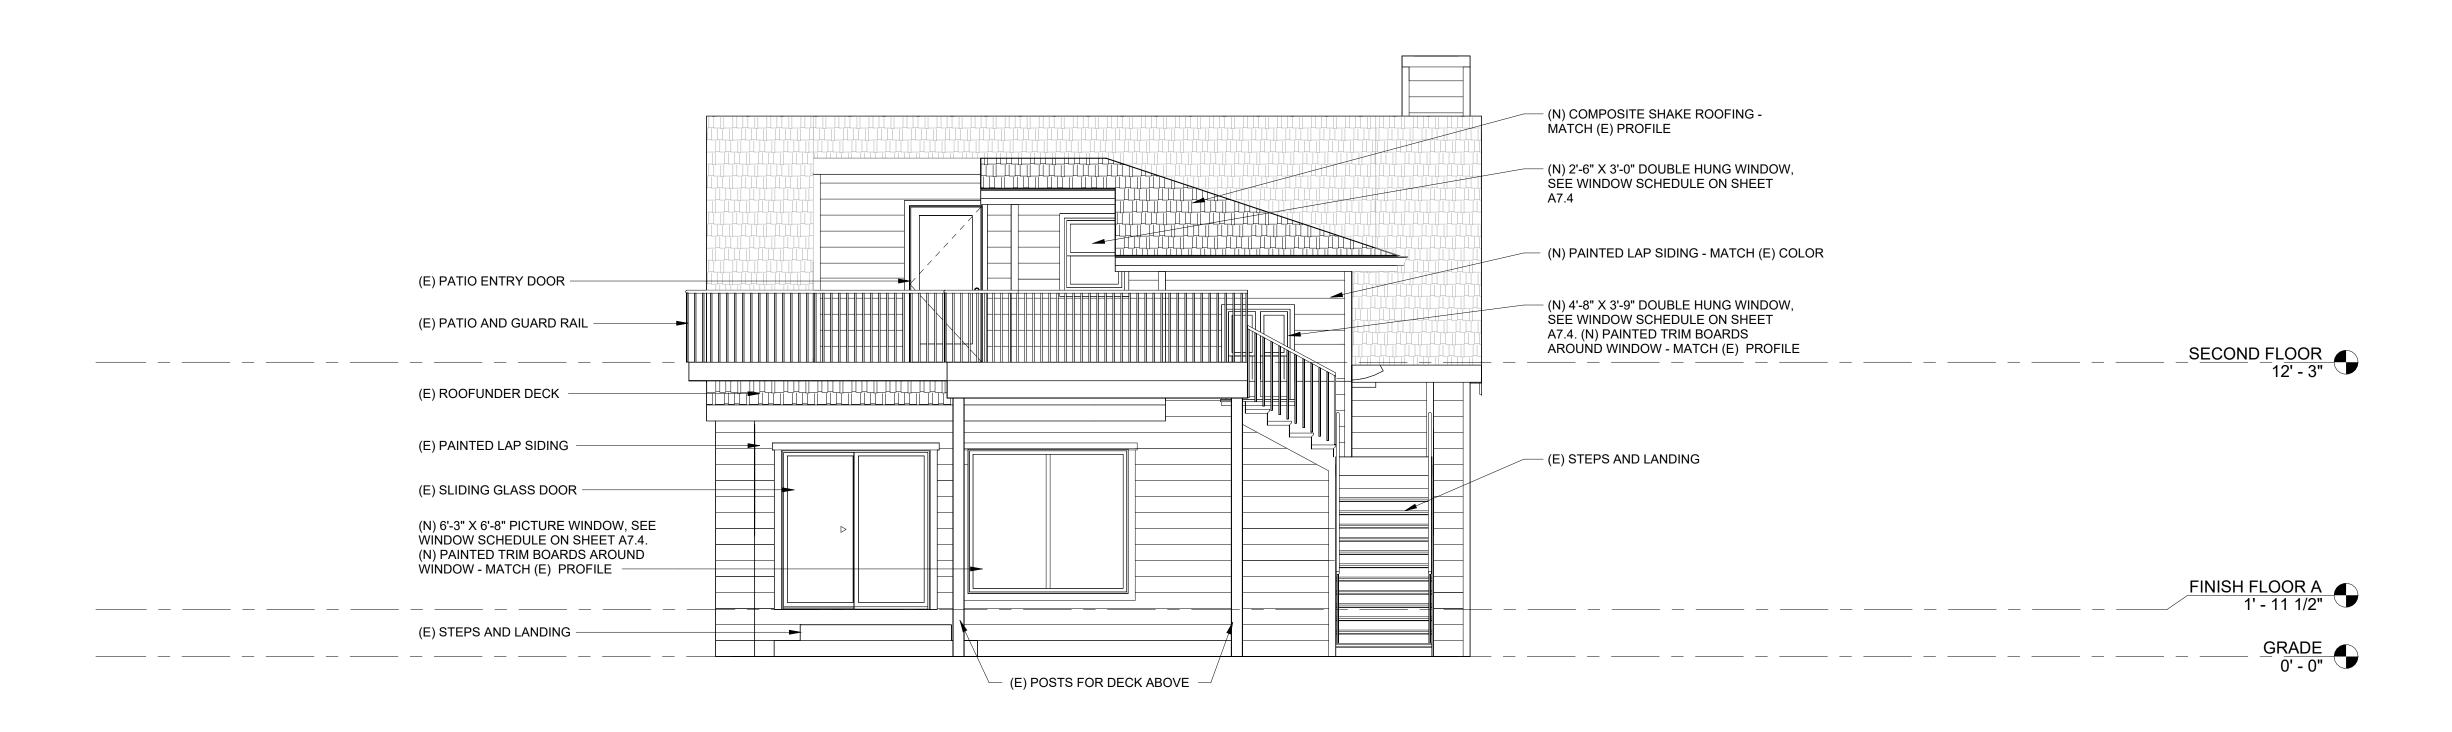
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PROPOSED ROOF PLAN

HEET NO.

**\4.1** 



PROPOSED ELEVATION - BACK OF

3 HOUSE 1/4" = 1'-0"



1 PROPOSED NORTHWEST ELEVATION 1/4" = 1'-0"

DERN

ARCHITECT
DERN ARCHITECTURE + DEVELOPMENT, PC

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# BOUNT REVISION

DERN PROJECT NUMBER 2515


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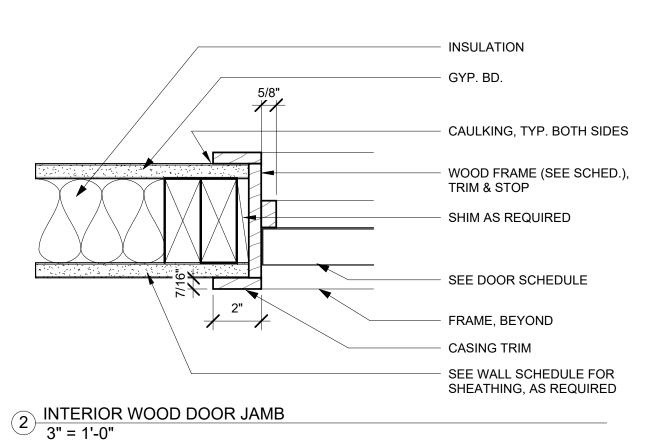
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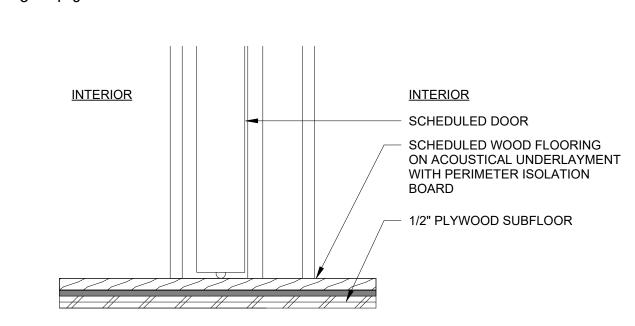
PROPOSED BUILDING ELEVATIONS

A5.1








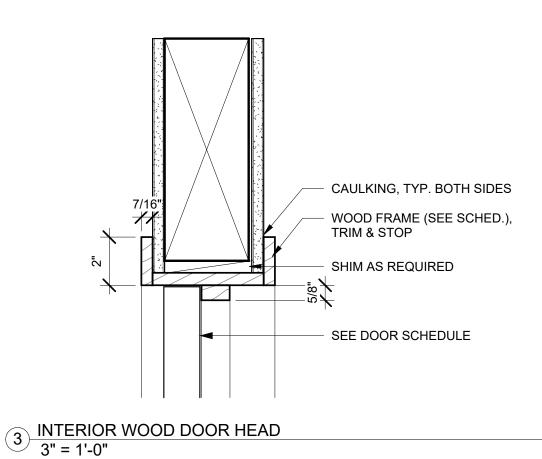

1 INTERIOR WOOD DOOR THRESHOLD 3" = 1'-0"

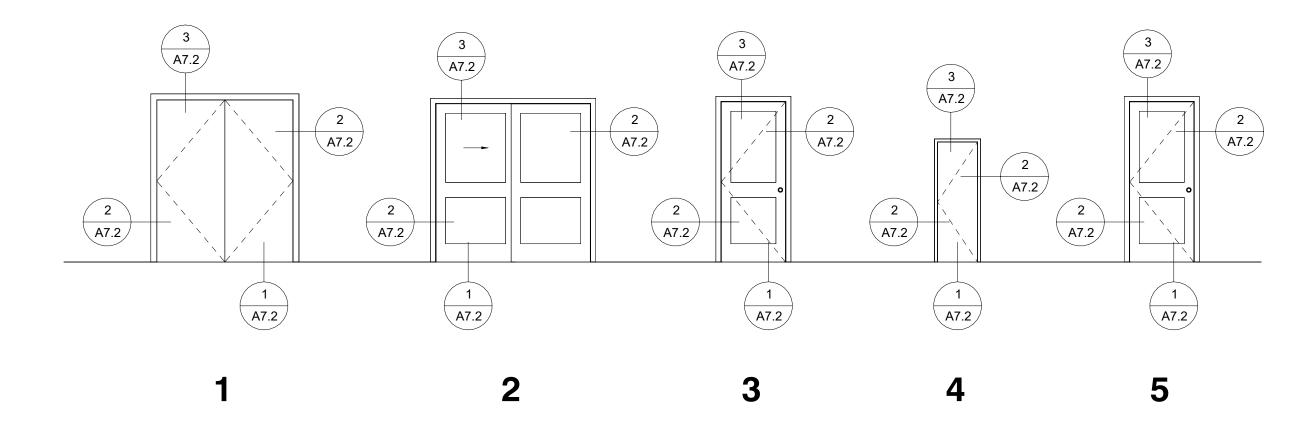

DOO	DOOR									
SCHI	<u>DU</u>	MATERIAL	WIDTH & HEIGHT	<u>THICKNESS</u>	FINISH <u>MATERIAL</u>	FRAME MATERIAL	<u>THICKNESS</u>	FINISH	HARDWARE GROUP	NOTES
1	1	(N) WOOD	5'-8" X 6'-9"	1-3/4"	PAINT	WOOD	1 1/2"	PAINT	2	(N) INTERIOR DOUBLE DOOR SET
2	2	(N) WOOD	6'-6" X 6'-8"	1-3/4"	PAINT	WOOD	1 1/2"	PAINT	2	(N) SLIDING CLOSET DOOR SET
3	3	(E) WOOD	2'-8" X 6'-8"	(E)	PAINT	WOOD	1 1/2"	PAINT	(E)	(N) INTERIOR PASSAGE DOOR
4	4	(N) WOOD	2'-4" X 5'-0"	1-3/4"	PAINT	WOOD	1 1/2"	PAINT	3	(N) UNDER-STAIR CLOSET DOOR
5	5	(E) WOOD	2'-8" X 6'-8"	1-3/4"	PAINT	WOOD	1 1/2"	PAINT	2	(N) STAIR HALL PASSAGE DOOR

**GENERAL NOTES** 

### HARDWARE GROUPS

<b>GROUP 1</b>	(ENTRY DOOR)
HINGS	
LOCKSET	

PRE-HUNG DOORSET, PER MFG. PER MFG. LOCKSET PER MFG. CYLINDER CORE STRIKE PER MFG.

GROUP 2 (INTERIOR PASSAGE DOOR )
BARN DOOR TOP RAIL & HARDWARE LOCKSET

PRE-HUNG DOORSET, PER MFG. PER MFG.

GROUP 3 (CLOSET DOOR) HINGS LOCKSET

DOORSET, SATIN NICKEL 10LAT625

GROUP 4 (BATHROOM DOOR) HINGS LOCKSET

PER MFG. PER MFG. CYLINDER CORE PER MFG. STRIKE

PRE-HUNG DOORSET, PER MFG. SCHLAGE LATITUDE PASSAGE/DUMMY

PRE-HUNG DOORSET, PER MFG.

USE OF A KEY OR ANY SPECIAL KNOWLEDGE OR EFFORT.

U.O.N.

2. THRESHOLDS SHALL NOT EXCEED ½" IN HEIGHT.

3. BOTH SIDES OF DOORS SHALL BE FINISHED THE SAME,

1. DOORS TO BE OPENABLE FROM THE INSIDE WITHOUT

4. DOORS WITH GLASS HAVE TEMPERED GLASS, TYP.

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5030

DERN PROJECT NUMBER 2515

10/24/2025

**PERMIT** 

DOOR SCHEDULE, HARDWARE, & DETAILS

SHEET NO. A7.2

110 CASA GRANDE LOS GATOS, CA 95032 MICHAEL DERN, AIA PRINCIPAL (415) 307-1283

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2515

DERN PROJECT NUMBER

10/24/2025

PERMIT TYPICAL DOOR


**FLASHING** 

A7.3

### STEPS 2 AND 3

- ENSURE ROUGH OPENING CAPABLE OF ACCOMMODATING FLASHING AND ALL APPLICABLE WATERPROOFING ELEMENTS.
- INSTALL G.S.M. BASE FLASHING
- 1a. SET FLASHING IN BED OF SEALANT


SEE DETAIL 2/- FOR DOOR SILL PAN AT PODIUM OR BALCONY CONDITION STEP 1 & 2 TO BE 1 PIECE OR BOTH INSTALLED PRIOR TO WATERPROOFING.

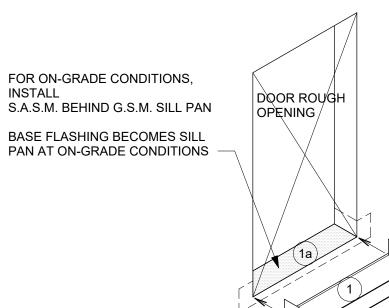

- 2. INSTALL UNCURED NEOPRENE FLASHING OVER BASE FLASHING
- WRAP NEOPRENE INTO ROUGH OPENING
- ATTACH MINIMUM 9" WIDE JAMB S.A.S.M. TO FACE
- 3a. EXTEND G.S.M. BASE FLASHING JAMB FLANGES
- WRAP 2" ONTO INSIDE OF ROUGH OPENING JAMBS
- 3c. EXTEND 4" ABOVE LOWER EDGE OF ROUGH OPENING HEAD. INSTALL WITHOUT WRINKLES & INSTALL WITH ROLLER


STEP 1 & 2 TO BE 1 PIECE OR BOTH INSTALLED PRIOR TO WATERPROOFING

- 4. ATTACH MINIMUM 9" WIDE HEAD STRIP
- 4a. WRAP BOTTOM EDGE 2" INTO ROUGH OPENING
- 4b. EXTEND BEYOND EDGE OF ROUGH OPENING HEAD MINIMUM 9"
- SECURE PER MFR. SPECIFICATIONS ACROSS CONT. SUBSTRATE

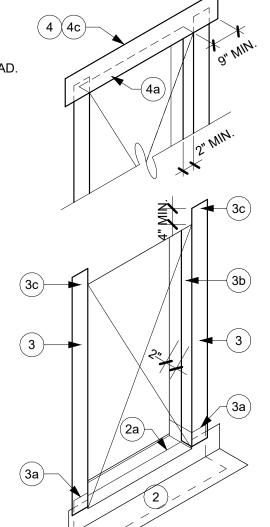

### STEP 5 AND 6

- INSTALL DOOR AND DRAME
- ATTACH FINISH MATERIAL TERMINATION (J-MOLD OR ANGLE
- FLASHING, ETC.) OVER FIRST LAYER OF MEMBRANE FLASHING LEAVE 1/2" GAP FROM FRAME OVER FIRST LAYER OF FLASHING
- INSTALL ADDITIONAL 9" WIDE S.A.S.M. OVER FINISH MATERIAL
- TERMINATION FLANGE INSTALL STRIP OVER WEEP SCREED AT CEMENT PLASTER
- 6d. EXTEND JAMB STRIPS FROM SILL TO 4" ABOVE BOTTOM OF

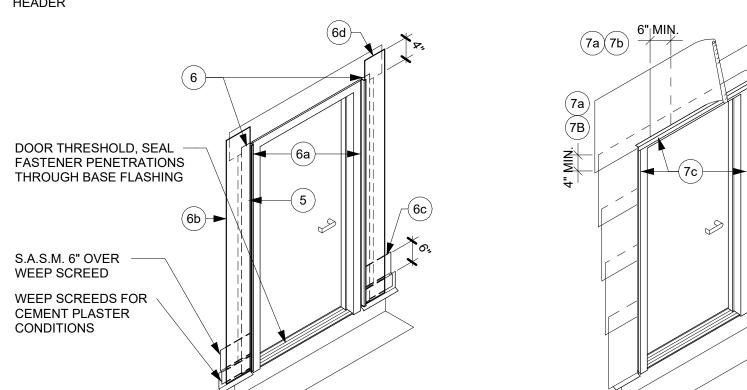

- 7. COMMENCING AT THE BOTTOM (SILL PLATE) OF THE WALL, LAY BUILDING PAPER (FIRST AND SECOND LAYERS)
- 7a. MINIMUM 4" VERTICAL LAP AND MINIMUM 6" HORIZONTAL LAP
- INTERWEAVE INDIVIDUAL BUILDING PAPER SHEETS
- 7c. INSTALL BACKER ROD AND SEALANT ALONG DOOR FRAME

### STEPS 8 AND 9


8. INSTALL G.S.M. HEAD FLASHING, 24 GA. MIN.


CONTINUE INSTALL W.R.B. ABOVE HEAD

- SET HEAD FLASHING IN BEAD OF SEALANT AT DOOR FRAME TO PROVIDE AIR SEAL
- END CAPS AT HEAD FLASHING OVER PLASTER J-MOLD AND SEALANT JOINT AT JAMBS
- INSTALL HEAD DRIP SCREED OVER HEAD FLASHING AT CEMENT PLASTER CONDITIONS


INSTALL ADDITIONAL 9" STRIP OF S.A.S.M. OVER DRIP SCREED AND HEAD FLASHING FLANGE

APPLY THIRD LAYER OF BUILDING PAPER OVER ENTIRE ASSEMBLY.

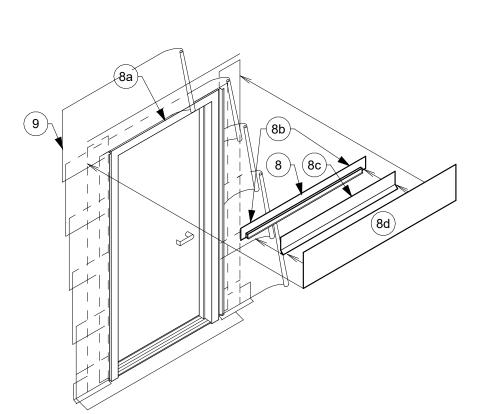


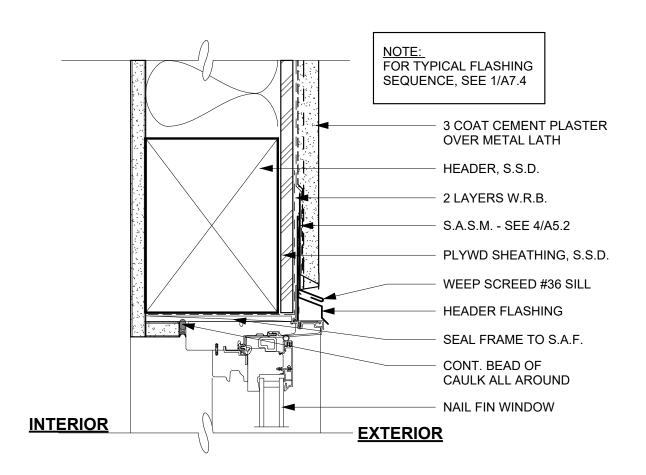


### 7 FIXED GLASS HEADER 3" = 1'-0"

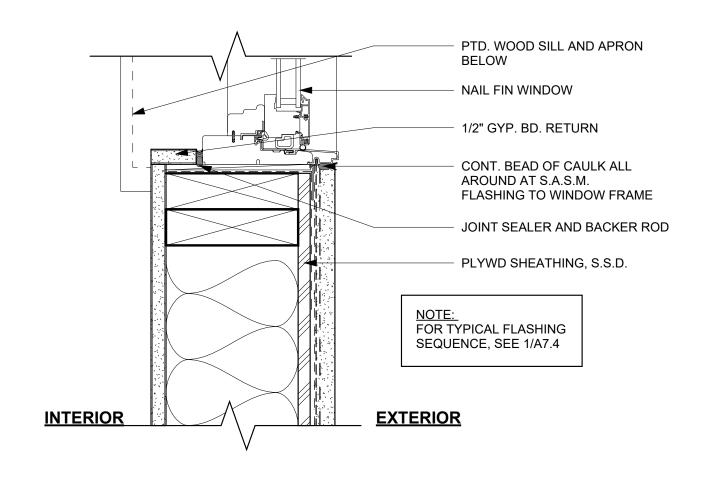


6 FIXED GLASS JAMB 3" = 1'-0"

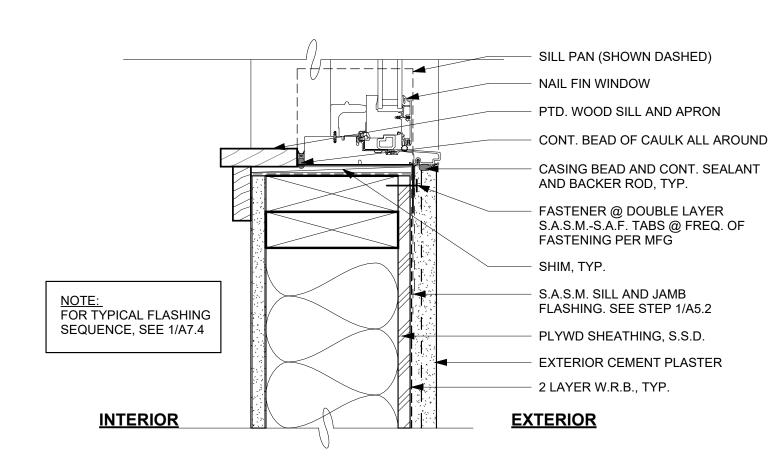


5 FIXED GLASS SILL 3" = 1'-0"

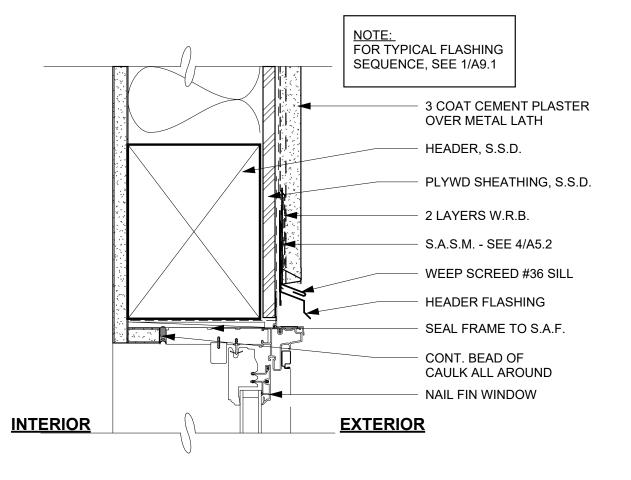





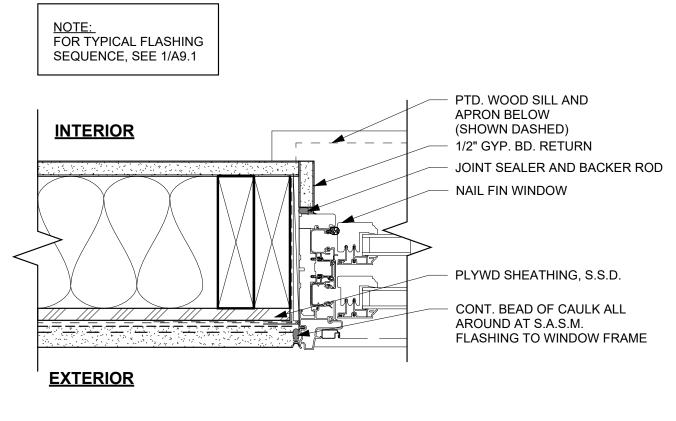




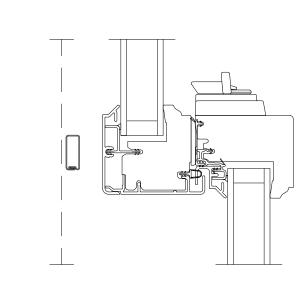

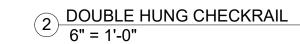

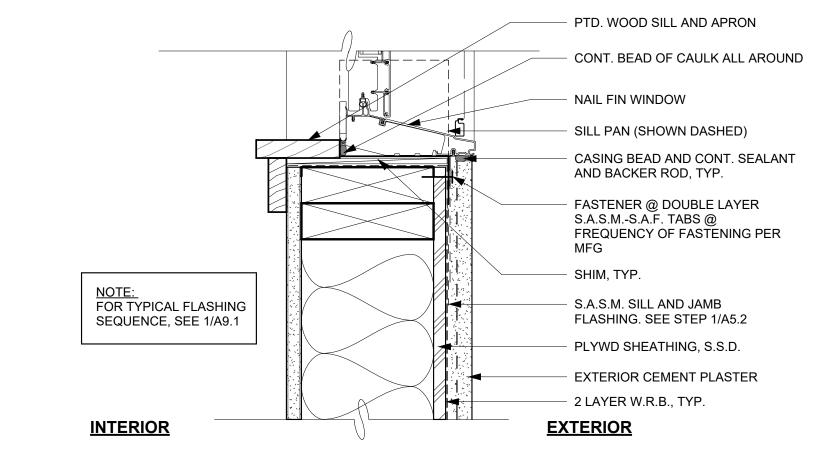

1 DOUBLE HUNG WINDOW SILL 3" = 1'-0"

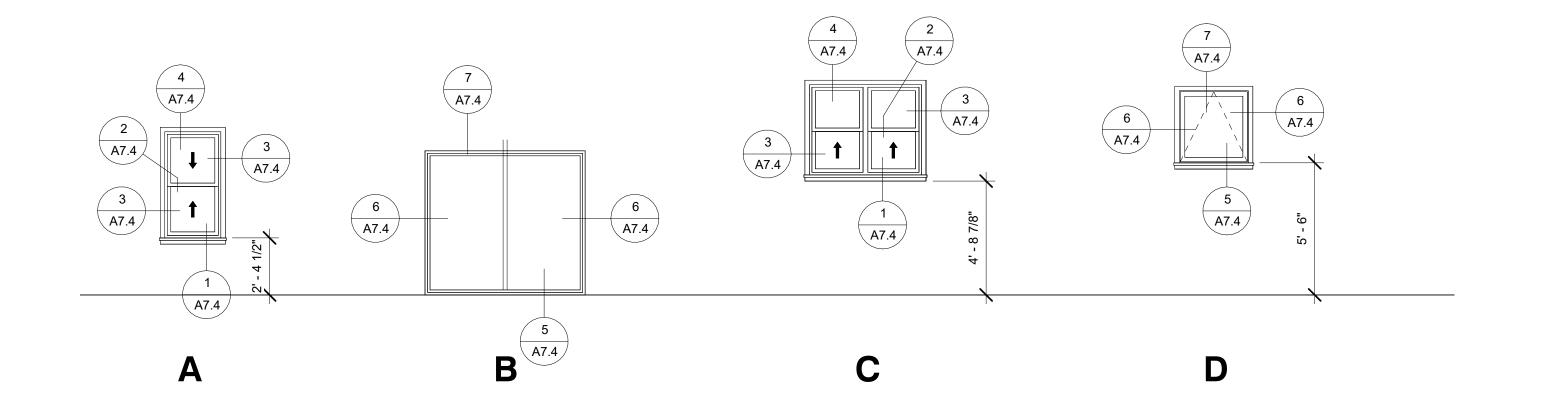

### **WINDOW** COMEDINE.

NUMBI	MEDUL Er <u>Type</u>	MATERIAL	WIDTH & HEIGHT	FRAME THICKNESS	<u>MATERIAL</u>	<u>FINISH</u>	NOTES
1	Α	(E)	2'-4" X 4'-5"	(E)	(E)	(E)	(E) DBL HUNG WINDOW RELOCATED
2	В	TEMPERED GLASS	6'-3" X 6'-8"	1"	VINYL	WHITE	(N) PICTURE WINDOW
3	С	GLASS	4'-8" X 3'-9"	1"	VINYL	WHITE	(N) DBL HUNG WINDOW
4	D	GLASS	2'-10 1/2" X 3'-0"	1"	VINYL	WHITE	(N) PICTURE WINDOW
5	D	GLASS	2'-10 1/2" X 3'-0"	1"	VINYL	WHITE	(N) AWNING WINDOW
6	Α	GLASS	2'-6" X 3'-0"	1"	VINYL	WHITE	(N) DBL HUNG WINDOW

**ARCHITECT** 

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DERN PROJECT NUMBER 2515

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WINDOW SCHEDULE & **DETAILS** 

SHEET NO. A7.4

### STEP 1 - SILL, JAMB & HEAD FLASHING


1-A
CONSTRUCT ROUGH OPENING PER WINDOW MANUFACTURER
INSTRUCTIONS. VERIFY SHEATHING CUT FLUSH WITH ROUGH
OPENING AT ALL EDGES.

1-B
INSTALL BUILDING PAPER AT SILL, CUT IT SUFFICIENTLY LONG
TO PROJECT BEYOND THE VERTICAL SELF ADHESIVE SHEET
MEMBRANE TO BE APPLIED AT STEP 1-D. NOTCH BUILDING
PAPER TO ACCOMMODATE WINDOW.

1-C/1-CA
INSTALL SELF ADHERING SHEET MEMBRANE (S.A.S.M.) AT SILL
WITH 9" BELOW AND 3" BEYOND INTO THE ROUGH OPENING.
EXTEND SELF ADHERING SHEET MEMBRANE 3" BEYOND
VERTICAL SELF ADHERING SHEET MEMBRANE TO BE APPLIED
AT STEP 1-D. SEE DIAGRAM 1-CA FOR ADDITIONAL INFO.

1-D
APPLY SELF ADHERING SHEET MEMBRANE AT JAMBS SIMILAR
TO STEP 1-C. CUT SUFFICIENTLY LONG TO PROJECT 4" BEYOND
VERTICAL SELF ADHERING SHEET MEMBRANE TO BE APPLIED
AT STEP 1-E.

1-E APPLY SELF ADHERING SHEET MEMBRANE AY HEAD SIMILAR TO STEP 1-C.

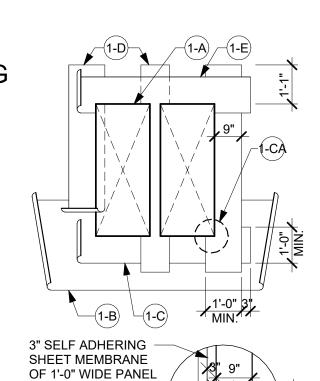

FOLDED INTO ROUGH
OPENING
CONTINUOUS BEAD
OF SEALANT
(DIAGRAM N.T.S.)

CUT, SEALED AND

EXTEND S.A.S.M. AT ROUGH
OPENING INTO RECESS, SEE STEP

## STEP 0 - HEAD AND SILL CORNER FLASHING - AT RECESSED WINDOW ONLY

ENSURE ROUGH OPENING CAPABLE OF ACCOMMODATING FLASHING AND ALL RELATED WATERPROOFING ELEMENTS.

<u>0-A</u> ADD 3 BEADS OF SEALANT IN EACH RECESSED CORNER.

0-B
APPLY PRE-FORMED CORNER SHIELD FLASHING PIECE WITH
GALVANIZED
SHEET METAL OR MEMBRANE SILL PLAN PER FIELD CONDITIONS
INTO
EACH CORNER, FASTEN WITH STAPLES.

<u>0-C</u>
INSTALL BUILDING PAPER AND S.A.S.M. AT SILL, JAMBS AND HEAD
AS NOTED IN STEPS 1B, C, D AND E. CUT SEAL AND FOLD S.A.S.M.

INCREASE S.A.S.M. WIDTH BY 12" TO APPLY ONE PIECE INTO ROUGH
OPENING, FRAMING RECESS AND REQUIRED PROJECTIONS PER STEPS
1B, C, D AND E. SHEET META

GENERAL NOTE:
WINDOW INSTALLATION TO MEET THE
REQUIREMENTS OF AAMA 2400-02
(FORMERLY CAWM 400-95) "STANDARD
PRACTICE FOR INSTALLATION OF
WINDOWS WITH A MOUNTING FLANGE
IN STUD FRAME CONSTRUCTION", METHOD B

### STEP 5 - BUILDING PAPER APPLICATION

4-A
INSTALL BUILDING PAPER. OVERLAP WEATHERBOARD FASHION
FROM BOTTOM TO TOP OF WALL PER MANUFACTURER'S
INSTRUCTIONS.

NOTES: DO NOT PENETRATE THE WINDOW NAIL FINS WITH FASTENERS FOR SIDING OR TRIM.

WHERE JAMB AND SILL SECTIONS ARE EXPOSED AT THE BOTTOM OF THE WINDOW, COVER SASM WITH AN ADDITIONAL LAYER OF BUILDING PAPER.

# DN (5-A)

## STEP 4 - SECOND SELF ADHERING SHEET MEMBRANE APPLICATION

4-A
CONTINUE INSTALLING 6" WIDE SELF ADHERING SHEET
MEMBRANE AT JAMBS TO OVERLAP NAIL FIN AND EXTEND
3" BEYOND SILL SELF ADHERING SHEET MEMBRANE.

4-B
INSTALL FLUID APPLIED MEMBRANE OR 6" SELF ADHERING SHEET
MEMBRANE AT JAMB TO OVERLAP HEAD AND SILL FLASHING.
EXTEND 3" BEYOND EDGE OF SELF ADHERING SHEET MEMBRANE
AT HEAD AND SILL.

4-C
INSTALL 6" SELF ADHERING SHEET MEMBRANE AT HEAD TO
OVERLAP SHEET METAL HEAD FLASHING. EXTEND 3" BEYOND
EDGE OF SELF ADHERING SHEET MEMBRANE AT JAMB.


### STEP 3 - HEAD AND POST FLASHING

3-A
APPLY VERTICAL STRIP OF S.A.S.M. TO MULLIONS BETWEEN
ADJACENT WINDOWS. OVERLAP JAMB FLANGES COMPLETELY.
EXTEND 6" BEYOND TOP OF HEAD FLANGE AND 6" BEYOND
BOTTOM OF SILL FLANGE.

3-B
WHERE HEAD TRIM OCCURS, INSTALL SHEET METAL HEAD
FLASHING WITH SOLDERED END CAPS, TYP. SEE DIAGRAM 3-C.
INSTALL SHEET METAL FLASHING ABOVE TRIM EXTENDING
1" BEYOND EDGE OF ROUGH OPENING. SHEET METAL FLASHING
TO HAVE A 2" MIN. VERTICAL LEG, A HORIZONTAL LEG 1/8"
DEEPER THAN HEAD TRIM, AND A VERTICAL 1/4" HEMMED
BOTTOM EDGE. INSTALL SELF ADHERING SHEET MEMBRANE OVER
VERTICAL LEG OF SHEET METAL FLASHING. EXTEND SHEET METAL
FLASHING 6" BEYOND JAMB ROUGH OPENING.

3-C SOLDERED END CAPS AT SHEET METAL HEAD FLASHING.

# 4-B 4-A 3-C) SEE BELO

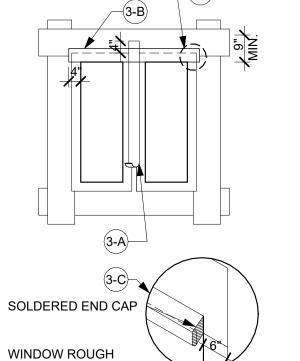


### STEP 2 - WINDOW INSTALLATION

2-A
APPLY CONTINUOUS SEALANT BEAD TO INTERIOR
SIDE OF WINDOW NAIL-FINS. APPLY ADDITIONAL SEALANT AT
MITER CORNERS OF WINDOW FRAME (BACK SIDE). INSPECT
WINDOW FINS FOR DAMAGE. INSTALL WINDOW PER
MANUFACTURER'S INSTRUCTIONS. UNLESS OTHERWISE
NOTED
BY MANUFACTURER, INSTALL AS FOLLOWS:

2-B
FASTEN AT HEAD FIN PER MANUFACTURER'S
RECOMMENDATIONS.
ATTACH AS RECOMMENDED. ALLOW FOR MOVEMENT. TAP
DOWN
SHARP EDGES AT NAIL HEAD TO AVOID DAMAGE TO FLASHING
PAPER.

2-C MIN. 3 FASTENERS EACH SIDE AT 16" O.C. MAX. TYP. OR MORE FREQUENTLY PER MANUFACTURE

2-D NO FASTENERS TO BE WITH 3" OF OUTSIDE CORNER OF FINS.

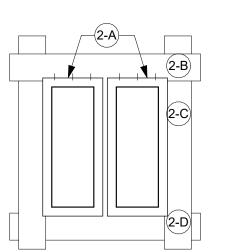

OPENING AT JAMB

## DEKIN

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# ORINI RESIDENCE

on **Doscri**i

Description

DERN PROJECT NUMBER

10/24/2025

PERMIT

TYPICAL WINDOW FLASHING

SHEET NO.

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