



ARCHITECTURE-PLANNING-INTERIORS

AMPBELL, CA 95008 408)871-1071 phone (408)871-1072 fax www.metroarchitects.com

The plans, deas and design on this The plans, dess and design on this drawing are the property of the designer, divised solely for this contract. "Plans shall not be used, in whole or in part, for any purpose for which they were not intended without the written permission of VETRO DESIGN GROUP.

PROJECT NAME

### COREY **RESIDENCE**

26 ALPINE AVE LOS GATOS, CA 95030 APN# 529-37-042

A PC1	10-27-16	D.Z.
2 PC2	1-17-17	D.Z.
₫ PC2	6-06-17	T.S.
A PC2	6-26-17	D.Z.

### 1. STTE AREA - PER HILLSIDE DEVELOPMENT STANDARDS AND GUIDELINES ALL WORK AND MATERIALS SHALL BE IN ACCORDANCE WITH THE FOLLOWING TOBY AND SUSAN COREY POLLAK ENGINEERING, INC. 20,000 SF 8,000 SF (AFTER 60% SLOPE REDUCTION) CONTACT : TOM SLOAN A.L.A. CODES, AS WELL AS ALL APPLICABLE STATE CODES & LOCAL CITY ORDINANCES, 2013 CALIFORNIA BUILDING CODE (C.B.C.) 555 SANTA CRUZ AVE 1475 S. BASCOM AVE. # 208 (408) 219-8222 LOS GATOS, CA 95030 (408) 354-0420 PHONE (I) (L) S = 0.0023 x 2 x 4,111.35 = 41.20 % AVERAGE SITE SLOPE CAMPBELL, CALIFORNIA 95008 (408) 871-1071 PHONE (408) 871-1072 FAX 122 8th AVENUE 2013 CALIFORNIA ELECTRICAL CODE (C.E.C.) CONSULTING ARBORIST SANTA CRUZ, CA 95062 2013 CALIFORNIA ELECTRICAL CODE (C.E.C.) 2013 CALIFORNIA PLUMBINS CODE (C.P.C.) 2013 CALIFORNIA MEGIANICAL CODE (C.M.C.) 2013 CALIFORNIA FERE CODE (C.F.C.) 2013 CALIFORNIA FIRE CODE (C.E.C.) 2013 CALIFORNIA GREED CODE (C.E.C.) 2013 CALIFORNIA GREED CODE (C.E.C.) 2013 CALIFORNIA GREED CODE (C.G.C.) ARTISAN LANDSCAPES CIVIL ENGINEER ANTIDAM LANGINEER SANDIS CIVIL ENGINEERS SURVEYORS, PLANNERS GARETH JONES, CERTIFIED ARBORIST PROJECT 26 ALPINE AVENUE AVERAGE SLOPE OF THE AREA PROPOSED FOR DEVELOPMENT IS 55.19% (1) (L) S = 0.0023 x 2 x 1,001.80 0.08349 = 55.19 % AVERAGE SITE SLOPE OF THE AREA PROPOSED FOR DEVELOPMENT CONTACT : CHAD J. BROWNING 1700 WINCHESTER BLVD, SUITE 200 20,000 SQ. FT. (0.459 AC) 12150 HWY 9, SITE AREA BOULDER CREEK, CA 95006 CONFORMING TO THESE COIDES & REGULATIONS. 529-37-042 A.P.N. CAMPBELL, CALIFORNIA 95008 GENERAL CONTRACTOR AND SUBCONTRACTORS SHALL EXAMINE THOROUGHLY THE . SITE VERIFICATION (40B) 636-0900 PHONE SLOPE AT LANDING AREAS: ZONING R1-20 STEE AND STRETTY THEMSELVES AS TO THE CONDITIONS TO WHICH THE WORK IS TO STRETCH AND STRETTY THEMSELVES AS TO THE CONDITIONS TO WHICH THE WORK IS TO WHICH THE CONTRACTOR SHALL VERLIFY AT THE STRETCH AND THE CONTRACTOR SHALL VERLIFY AT THE STRETCH AND THE CONTRACTOR SHALL VERLIFY AT THE STRETCH AND THE CONTRACTNESS OF THE SAME. NO EXTRA COST TO THE OWNER WILL BE ALLOWED RESULTING FROM HIS MESIL GENORE TO EXAMINE OR FAILLINE TO DISCOVER SLOPE AT PAVED AREAS: 2% MIN. AWAY FROM THE STRUCTURE LOCATED WITHIN DESIGNATED YES - STATE MANDATED LRA (VHFHA) PO SURVEY & BOUNDARIES SLOPE AT LANDSCAPE AREAS: 5% MIN, AWAY FROM THE STRUCTURE WESTFALL ENGINEERS, INC. 2. FLOOR AREA GROSS FLOOR AREA - CELLAR\* = FLOOR AREA PER DEF REQUIRED FRONT: SIDE: REAR: LOWER FLOOR 1,195.66 - 848.58 = CONTRACTOR SHALL VERIFY ALL DIMENSIONS SHOWN ON THE DRAWINGS BY MEASUREMENTS (408) 857-0244 PHONE .289.96 - 643.93 = CONTINATION SHIPLY REPETY ALL DIMENSIONS SHOWN ON THE DRAWINGS BY TAKING FILE DRAWESTS; FOR PROPER FIT AND ATTRAHMENT OF ALL PARTS IS REQUIRED. SHOULD THERE BE ANY DISCREPANCIES, IMMEDIATELY REPORT TO THE ARCHITECT IN WRITING PRIOR TO COMMENCEMENT OF ANY RELATED WORK. IN THE EVENT OF THE CONTRACTOR SHALL BE FULLY AND SOLE Y RESPONSIBLE FOR THE CORRECTION OR ADJUSTMENT OF ANY SUCH RELATED WORK OR ERRORS. -1,492.51 = PROJECT DESCRIPTION \* CELLAR IS NOT INCLUDED IN FLOOR AREA RATIO (F.A.R.) NEW SINGLE FAMILY RESIDENCE WITH ATTACHED TWO CAR GARAGE GARAGE TOTAL FLOOR AREA PROPOSED he site is located within the R-1-20 zoning district with step topographic conditions with a I. MAXIMUM FLOOR AREA - FAR awarege slope of 14%. The constraints of the site such as the existing Trees and a Riparian setback limit the options for siting a small house. The project has been designed to meet the "intant" of the Hillside Development Standards and Guidelines by siting the house in such a way that there is no grading outside of the LRDA. PROJECT SITE DO NOT SCALE THESE DRAWINGS. WRITTEN DIMENSIONS SHALL TAKE DIMENSIONS PER RESIDENTIAL DESIGN GUIDELINES PRECEDENCE OVER SCALED DRAWINGS. **SHEET INDEX** FAR = (.35)\_(8-5) X.20 = 0.326 FAR 0.326 X 8,000 = 2,608 SQUARE FEET MAX HEIGHT awy that their is no grading outside of the IRDN as an inparien water course, steep grades, multiple motive is no grading outside of the IRDN as an inparien water course, steep grades, multiple motive is no grading outside of the IRDN as an inparien water course, steep grades, multiple motive trees and 2 steep frontages on Alphe Ave. as well as abclison St. Resulting from a Constraints Analysis, there is only one piece that is acceptable to locate a residence for proposed from a Constraints Analysis, there is only one piece that is acceptable to locate a residence and the southerly building sebbeck. The 2 car Garage was located on Alphe Ave. utilitizing portion of the existing driveway aprons and in an area that inhimitates grading, preserves existing the results and the standard of the contract of the following traffic patterns and uses no retaining walls or iff. The design of the horizon these and the following the standard several the residence of the contract of storm water. Downsippe, the building elevations are briden into 3 individual elements and deep overhange that provide shadows and articulation on the two-stary valies. These betchings provide an articulated fagade that blands into the shaded environment and diminishes the mass and height of the building while providing privacy screening arrongs the adjacent residences. The new building has been sitted and designed to eliminate any perceptible grading outside of the building envelope. This technique will result in a residence that seeming the into the earth. MINOR DISCREPANCIES BETWEEN THE DRAWINGS AND ACTUAL CONDITIONS ARE TO BE EXPECTED, CONDITIONS REQUIRING CLARIFICATION SHALL BE BROUGHT THE ATTENTION OF THE ARCHITECT IMMEDIATELY. GAR = (.10)-(8-5) x .07 = 0.0916 GAR 0.0916 X 8,000 = 732.80 SQUARE FEET ALLOWABLE / PROPOSED PROPOSED 26'-3" SHEET INDEX, PROJECT DESCRIPTION, VICINITY MAP, CONSULTANTS, GENERAL NOTES AND TABULATIONS A- 0.1 BUILD IT GREEN CHECKLIST CONTRACTOR AND ALL SUBCONTRACTORS SHALL INSTALL OR APPLY, AND PROTECT MANUFACTURER'S CONSTRUCTION TYPE CONTROL TOR MAN JESUSCIANTING THE AND ASSESSED, WETHOUS, COATINGS, EQUIPMENT, APPL LANCES, HARDWARE, SOFTWARE, ETC. IN STRICT ACCORDANCE WITH THE MANUFACTURES'S SPECIFICATIONS, DETAILS & INSTRUCTIONS, TYPICAL. ALL MANUALS OR INSTRUCTIONS PROVIDED BY THESE MANUFACTURES'S FOR PROPER CORPAZIONAL MANU C-1.0 TOWN NOTES, PROJECT DATA AND LEGEND R-3/U C-1.1 CONSTRUCTION NOTES TOPOGRAPHIC SURVEY OPERATION AND MAINTENANCE OF THE ABOVE ARE TO BE DELIVERED. TO THE OWNER AT THE COMPLETION AND FINAL INSPECTION OF THE PROJECT. STORIES C-3.0 GRADING AND DRAINAGE PLAN UTILITY PLAN REQUIRED (NFPA-13D) FIRE SPRINKLERS C-5.0 EROSTON CONTROL PLAN TOTAL AREA (LIVING AREA & GARAGE) ALLOWABLE CONTRACTOR SHALL VERIFY THE QUANTITY, ROUGH OPENINGS AND TYPES OF DOORS AND WINDOW AND DOOR SCHEDULES IN RELATION TO FRANING PER FIELD PRICE TO PORENING. ANY DISCREPANCIES SHALL BE BROUGHT TO THE ATTENTION OF THE ARCHITECT IMMEDIATELY. WINDOWS AND 3,340.80 LOW DENSITY RESIDENTIAL - VACANT, URBAN EROSION CONTROL DETAILS EXISTING USE PROPOSED BLUEPRINT FOR A CLEAN BAY CONSTRUCTION DETAILS . BUILDING COVERAGE The project will retain and enhance the surrounding natural features of the site and CONSTRUCTION DET AILS ALL ADHESIVES, SEALANTS, CALLKS, PAINTS, COATINGS, AND AEROSOL PAINT CONTAINERS MUST REMAIN ON THE SITE FOR FIELD VERIFICATION BY THE BUILDING INSPECTOR. PER CGBSC SEC. 4.504.2.4 proposes in a template with reason and enhance me sourcounding beautier seatures of me size and proposes no other landscape feebures. The existing frees will provide ample screening of the new residence from the adjacent neighbor located along the northerly property line. 80% of the existing frees on size will be retained with a few trees in close proximity to the structure between the provided as safe, defensible area and remove fire hazards as required for Fire Safety. 8,000.00 SQ. FT. 40.00 % 3,114.91 SQ. FT. 15.57 % A- 1.0 STTE PLAN A- 4.0 EXTERIOR ELEVATIONS A- 4.1 EXTERIOR ELEVATIONS A- 1.1 SITE DIAGRAMS, SITE CROSS SECTION 2,851.86 A- 1.2 STREET PROFILES A- 4.2 EXTERIOR ELEVATIONS PRIOR TO FINAL INSPECTION, A LETTER SIGNED BY THE GENERAL CONTRACTOR OR ORCHES 263.05 3,114.91 A- 1.3 SHADOW STUDY DIAGRAM A- 5.0 CROSS SECTIONS 'A' & 'B' Fire Safety. The design for this project steps with the natural topography where setback trequirements allow the adjacency of multiple tooms or spaces. Rather than visibly stepping the exterior appearance with added floor area sited up hill, the design chose a lower profile that integrates with the site and provides a lower visible height and mass. The Garage doors are strought of stude and corresponding horizontal wood sliding and concealed within a creative use of building forms. The driveway will be reconstructed with a new precast concrete pawer system capable of absorbing 10096 of the storm water. The "historic" gate columns located along the street at the driveway entrance will remain and be restored. THE OWNER/BUILDER (FOR ANY OWNER/BUILDER) PROJECTS MUST BE PROVIDED TO THE CITY OF SAN JOSE BUILDING OFFICIAL CERTIFYING THAT ALL ADHESIVES, SEALANTS, CAURKS, PAINTS, COATINGS, ARBOOKO, PAINTS, AEROSCI. COATINGS, CAPET SYSTEMS (INCLUDING CAPPETING, CUSHION AND ADHESIVE), RESILIENT FLOORING. A- 1.4 EXTERIOR LIGHTING PLAN A- 2.0 LOWER FLOOR PLAN A- 5.1 CROSS SECTION 'C' 5. PARKING SPACE TS- 0.1 TREE SURVEY A- 2.1 UPPER FLOOR PLAN TP- 0.1 TREE PROTECTION PLAN 2 COVERED AT GARAGE A- 3.0 ROOF PLAN L- 1.0 TREE PLAN

SYSTEMS, AND COMPOSITE WOOD PRODUCTS INSTALLED ON THIS PROJECT ARE WITHIN THE EMISSION LIMITS SPECIFIED IN COSSC SECTION 4.504.

### **COVER SHEET**

PROJECT INFORMATION AREA TABULATIONS PROJECT DESCRIPTION SHEET INDEX CONSULTANT DIRECTORY

GENERAL NOTES

DATE: 1-17-17

SCALE: AS-NOTED

DRAWN BY: TS

CHECKED BY: TS

ARCHITECT: TOM SLOAN

PROJECT NO: 16621

SHEET NUMBER

A-0

**EXHIBIT 5** 

	NEW HOME RATING SYSTEM, VERSION 6.0							
GreenPoint	HATED SINGLE FAMILY CHECKLIST	8						
		-	Palma A	Achieved		58		
						Certify		
			24900	SO DUS L'OYS	11.	Cartis	EGI	
Build it Green is not a ser	www.buildingreen.org/greenpointraped		P	ETHIO	REQUI	RED		Process Com-
				2.0				Brown Co.
A Porter to only GreenPole	R Rated Fighthatines are verified by a Centified GreenPoint Rater through Eulin It Green.  - Version 6.0.2	0 137		II	-	-	-	man.
COREY RE		Special Control of the Control of th	Samuel S	Size.	Orkeath	acom.	Spier	
	MEASURES		_32	- 51	ossible *e	170	-	NOTES
CAL Green	ON Green Res IPS SURED)		O STATE OF	Name and		No. of Lot,		
A SITE	[A1, Construction Factorint	CO COLUMN	-		Name and	CONT.	NO INC.	Commission of the control of the con
755	82. Job Size Construction Waxte Diversion							
42	But have been a been been been been been been b					2		
153	A2. Reputed Compre Base Material					1		
744	A4. Year Island Effect Reduction Non-Roof) A4. Concrusion Environmental Quality Narragement Plan Installing Fluids-Out	1						
Yes	A6. Storoneplan Control: Prescriptive Path	1	ŧ.				-	
You	Mad The Country Tables							
150	4715 act ones by large	1350	4					
8 FOUNDATION	A7. Stormwoter Control: Performance Pace	-	-	-	-	-	-	
LONG AND	81. Ply Ash ancion Blog in Constraint Re Radon-Restaurant Constrainting							
Tax 192	B3. Foundation Drainage System	127				2		
.45	B4, Molonare Controlled Crowlepace B6. Structural Post Controls	1		-				
- 2 y <sub>12</sub>	B. Servine Share and S. Carlotte St. Carlott							
C LANDICHTE		<b>CONTRACT</b>	CORNEL CO	SESTION	eron.	USE DE	22000	THE RESERVE THE PARTY OF THE PA
727	C1 Plants Grouped by Water Needs (Hydrozotting)	2060						
*57	C2. Titree Inches of Molch in Planning Beds C3. Resource Efficient Landocases							
190	CST Selection Space memory Selection Se							
Y.,	CS Repolare Bill client Landscapes  CS Ship scape (See Long Long Long Long Long Long Long Long							
	Page no and Sancar	-					ŧ	
	C4 Minimal Tierl in Landauspe							
150 150	4 Plan Lar on Japan Tennang Piri, and Pia Connection of the American Tennas (Fig. 18 - American Tennas							
32	C3. Trees to Miccorate Budding Temperature		3.					
- dC -10	CR, High-Efficiency; trigation System CR. One leab of Compant in the Top Six to Twelve lackes of Soil							
720	C3, Rabresser Harvestrig System C3, Racceled Waslesster Impalson System						-7-	
100	610: Submeer or Dedicated Meter for Landscape Images on C11: Landscape Meets Witter Eudget	1000						
- 40	G52. Environmentally Preferable Motorials for She							
.22	A Krassin street we min Mercia a 45% Box Size \$ 1 miles							
Line.	C13 Recharged Light Profilerion C14. Large Strikers Tree(s)		1					
53	C15 Thad Party Landscape 6 high an Card mation	200	,					
D STRUCTURAL FRAN	G16. Maintenance Contract with Service Professional  ANALYSIS ENVISIONS	A Company	-				-	-
	Dit. Optional Value (Ingine eding							
183	D' l'est tres Contra Discours Discours November 1997					1		
	DZ. Construction Material Effortunate						-	
	DJ. Engineered turnber	1						
Yes	19.4 Engineers Serve and	1						
137	DOSE - a lagar						-	
- 3	Differ on Tayon of the Control of th					26		
	and the state of t		-				_	

Sana Family Blad Street	Version 5.0.2	
A SULA L A SUL D TAKAN I Y MIG	25 FSG-CardRed Wasd	
780	T St. American Lance	
64.1	C5. Solid Wall Systems	
780	DO SONG YARD SYSTEMS	
	CEST Los Species	
785	DE 1 Lon Street a	
BU 767	27. Emergy Heels on Roof Trosses 58 Overhands and Gazers	
	DB Reduced Pollupus Entering the Home from the Garage	
PEJ	1N the or have	
100	C19. Structural Past and Pat Controls	
755	all desired to a Admir Change and Admir Sur	
750	The River range business of inflormation and in increase and	
- 90	Metanic street transfer of	
No.	D1). Marybure-Resistant Materials in Wet Areas leach as Kricher, Bathrooms, Unite Rooms, and Transporter	
EXTERNOR	STREET, STREET	THE RESIDENCE OF THE PARTY OF T
. 10	51 Exelectmentally Profession Decomp	
10	E2. Fleshing Installation Third-Party Verified E3. Rain Ranner Wall System	
70	E3. Natr Norwe, 47at System  E4. Durable and Nort-Combestible Cladding Mote hats.	
40	E5. Durable Roofing Mosesale	
	Total Service February Avenue Avenue	
125%	68 Vegeteted Roof	Political Control of the Control of
INSULATION :	MARKET THE RESIDENCE OF THE PERSON.	the same of the sa
700	P1, fresulation with 36% Pest-Consumer or 38% Post-Industrial Recycled Contest	
780	1.20 a.s	
	P2. Insulation that Breets the CDPH Standard Method Residential for	1 1
	Low Emissions	
4U	2 Charles and annual	
	F3. Insultation Titul Does Not Contain Fire Returdants	
141	The state of the s	
- 00 - 00	Aldren entre	
ATTIMITIES 80	Address automotion	District
Carlotte Control	31. Efficient Fishribution of Comestic Not Water	THE RESIDENCE OF THE PERSON NAMED IN COLUMN 2 IS NOT THE PERSON NA
Yee	C11 second father-free	
100 100	LECTION AND ADDRESS OF THE STATE OF THE STAT	
100	GG, tracall Water Efficient Potences	
35	There are a face for every Manager of the contract	
TID		
	C. DW and the same from the Van Yaw Town and the T. Town or the U.	1
TRO	And the second section is the second section of the second section sec	
787	G3. Pre-Plumping for Grannistar System	
767	G.C. Operational Daysester System	
HEATING VENTEATION	AND AIR CONDITIONING	
Yes	#1. Seeded Comparation Units	
30	H2. High Performing Zened Hydronic Radiant Heating Systems	
100	H2. High Pertorming Zoned Hydronic Radiant Heating System id3. Effective Dustayet	
46	NJ. High Parlorming Zoned Hydronic Acdizet Heading Systems All. Effective Dustancet 151. 154. M	
46	22. High Performing Zoned Hydronic Rodiant Housing Systems 43. Embedies Dustainett 1971   12. Mg   1. Mg   1. Mg   1. Mg   1. Mg   1. Mg   1972   12. Mg   1. Mg   1. Mg   1. Mg   1. Mg   1. Mg   1. Mg   1973   12. Mg   1. Mg   1. Mg   1. Mg   1. Mg   1. Mg   1. Mg   1974   12. Mg   12. Mg   1. Mg   1. Mg   1. Mg   1. Mg   1975   12. Mg   1. Mg   1. Mg   1. Mg   1. Mg   1975   12. Mg   1. Mg   1. Mg   1. Mg   1975   12. Mg   1. Mg   1. Mg   1975   12. Mg   1. Mg   1975   12. Mg   1. Mg   1975   12. Mg   19	1 1
701 V (6.)	2. High Perstorming Zenod Hydroxic Rodizer Hieratog Systems (5. Elisables Districtors 1913) - M. High Perstorming Zenod Hydroxic Rodizer 1913) - M. High Perstorming Zenod Hydroxic Rodizer M. EMERICO STARON Systems For M. Standards with Air Plant Vertiled (6. Elizabened Perstorming Sec Zooling)  M. EMERICO STARON Systems For M. Standards with Air Plant Vertiled (6. Elizabened Perstorming Sec Zooling)  M. EMERICO STARON Systems  M. EMERICO STARON SYS	- 1.1
46	22. Legit National Parameter (Asset Heading Systems 18.1. Legit National Parameter (Asset Heading Syst	
7001 7001 Val. 182	23 High Federating 20 mark hydronic fordard Heading Signions 21. Effective Description (1997) and the Signions 21. Effective Description (1997) and the Signions 21. Effective Signions (1997) and the	
TOTAL	To By A service of the Control of the Control of Spiriter (Spiriter) and Control of Spiriter) and Control of Spiriter (Spiriter) and Control of Spiriter) and Control of Spiriter (Spiriter) and Control of Spiriter) and Control of Spiriter (Spiriter) and Control of Spiriter) and Control of Spiriter (Spiriter) and Control of Spiriter) and Control of Spiriter (Spiriter) and Control of Spiriter) and Control of Spiriter (Spiriter) and Control of Spiriter) and Control of Spiriter (Spiriter) and Control of Spiriter) and Control of Spiriter (Spiriter) and Control of Spiriter) and Control of Spiriter (Spiriter) and Control of Spiriter) and Control of Spiriter (Spiriter) and Control of Spiriter) and Control of Spiriter (Spiriter) and Control of Spiriter) and Control of Spiriter (Spiriter) and Control of Spiriter) and Control of Spiriter (Spiriter) and Control of Spiriter) and Control of Spiriter (Spiriter) and Control of Spiriter) and Control of Spiriter (Spiriter) and Control of Spiriter) and Control of Spiriter (Spiriter) and Control of Spiriter (Spiriter) and Control of Spiriter) and Control of Spiriter (Spiriter) and Control of Spiriter) and Control of Spiriter (Spiriter) and Control of Spiriter) and Control of Spiriter (Spiriter) and Control of Spiriter (Sp	
7001 7001 Val. 182	2. Life the Venorina State Application for all register for the Control of Systems (A. Elissishon Society (A. Elissishon Artificial Society (A. Elissi	
100 100 100 100 100	To the Processing Security of Security Secu	
100 100 100 100 100 100	To the process of the control of the	
707 707 V IA 142 241 260 861	2. Egy h Manness around Nyamon Salami Hondre Sprawa  2. Egy h Manness around Nyamon Salami Hondre Sprawa  2. Elys h Salami Salami Salami Salami Hondre Sprawa  2. Elys h Salami	
700 100 100 100 100 100 100 100	To the processing of the proce	
100 mm	2. Egy have made at the property of the prope	
750 760 760 760 760 80 80 760 760 760 760 760 760 760 760 760 76	To the processing of the proce	
750 760 760 760 760 760 760 760 760 760 76	1. Eight Mexicology (1997) 1. Eight Mexicology	
Verification of the control of the c	2. Egy Parkinson Maria Maria Maria Maria Mandra Ma	
750 760 760 760 760 760 760 760 760 760 76	To depth Management (American Statistics) in the Control of Statistics (American Statistics) in the Con	
No.	2. Egy have meaning the property of the prope	
Verification of the control of the c	2. Light Version State 1. A played to the state of the s	

e Familia New Man	MANCE AND TESTING	_	_	_			-	_	
III DI NG HERMON III J	MANGE AND TEST INS JJ. Tierd Party Yerification of Quelty of Insulation Equal abon JJ. Supply and Refer in Air Flow Teeting		1	-			1		
TES TES	J2. Supply and Return Air Flow Testing J3. Mechanical Vestillation Testing and Low Leakage			1					
155	All Comburtion Appliance Relate Tection	1111	-	+	1	-			
2013				-					
	Tide 28.4 Proposed and Service State De Carl     Tide 28.4 Proposed and Service State Dip of Chebral Energy Analysis     Tide 28.4 Proposed and Service State Dip of Chebral Energy Analysis     Tide 28.4 Proposed and Service State Dip of Chebral     Tide 28.4 Proposed and Service State Dip of Chebral     Tide 28.4 Proposed and Service State Dip of Chebral     Tide 28.4 Proposed and Service State Dip of Chebral     Tide 28.4 Proposed and Service State Dip of Chebral     Tide 28.4 Proposed and Service State Dip of Chebral     Tide 28.4 Proposed and Service State Dip of Chebral     Tide 28.4 Proposed and Service State Dip of Chebral     Tide 28.4 Proposed and Service State Dip of Chebral     Tide 28.4 Proposed and Service State Dip of Chebral     Tide 28.4 Proposed and Service State Dip of Chebral     Tide 28.4 Proposed and Service State Dip of Chebral     Tide 28.4 Proposed and Service State Dip of Chebral     Tide 28.4 Proposed Analysis State Dip of Chebral     Tide 28	- 1	-	1	1				
16.2	JT Participation in Listley Program with Third-Party Floir Review  JR. ENERGY STAP for Hanses			-					
No.	JR. 6PA trobay air Plus Certification	- 0		1					
TED	310. Blower Coxy Texas				1.2				
NISHES	K1. Expressed to Reduce Trackettic Contaminants		1000		100	Section 1	STATE OF THE PARTY.		
West TI/O	M2. Zero//CC Incerior Wall and Co ling Paints	100							
11/2	K3 Law-VDC Caulics and Safteshoop	1			1				
16.7	and the second of the second o			-	-	1			
78.7	511 S.m 44 Dec								
783	vil 8 Days vil a Lagragiana			-	-				
	KS. Farmaldenville Emissions in Imprior Pinish Expend CARB			-					
16.0	1 Show a section of the section of t		-	-	1100	-			
W.7	A waste and as				1.3				
TB2	K6. Products That Cosephy With the freight Product Deplaration Open Standard								
No.	KT. Indicor Air Pormaldehyde Level Less Than 27 Parts For Sillian K6. Genorehansive Inclusion of Level Emitting Plansters	0		+					
OORING		- Black	Name of	SCHOOL SECTION	-	-	Section 1	1000	
Th.	1.1. Andromentally Protein ble Flooring 1.2 Lew Embing Flooring Steen COPH 2010 Standard Method —Replántial					1			
7 14	L3. Ourable Flooring	1			-				
TEC	L4. Thermal Mass Figoring	- Harin		1.					
PINLANCE S AND	M1 BIERSY STARICEITHANNE	or Street, or other	-	Name and Address of the Owner, where	-	_	1		
CULT-7	IAIZ CEE-Bated Clother Worder	1					12.77		
CE reply fast	MD. Size-Etitisest ENERGY STAR Retriguistion 664. Permanter Content for Waste Recutsion Strategies		-	-					
160	WESS - Company of								
T85	MS. Lighting Efficiency		-						
V <sub>int</sub>		160							
	Marie de la companie	4	-	-		-			
160	Care Land Control of the Control of	1200		1 2					
HAMUNITY	81. Simont Developer ent	-				1511			
TEC .	William Son	- 0	-						
	II.2 Congressed in material Sec.	Jane 1999		-	37	-			
165	NI Constitution of the state of			_		-			
	MECHANICA Republicana				1				
			-						
The	N2. Home a Co-velopment Located Witten 1/2 M/v of a Major Trumen Step N3. Pediescram and Biografe Access		-1						
	YE Personal Arts of Services After the Services of the service		10						
	Francisco Confra de								
167	San Annyan Charles or NACC sheeter Falsange			T					
760			-						
16.1	File Outdoor Gathering Places		-			-			
TE2	H. Pass of Service Grant Service County of Service Ser	44501							
	85 Social Invention			-	-	-	-	-	
110	Wi Branch Emma and America and								
74.	Villenment Vista in a Congruent One	-1							
162	Not Sugar Ferrage on Season								
703	NS. PREDVE Selar Design	-			7.1	-	-		
763	W. Laure and								
TI.	NT. Assemble Building						-		
1943	Will have the large room because	C1291							
HER		I STANK		300	1949 515	100	Constitution in	The State of the	
R-5	C1. GrassFord Rose Checklist in Busprints C2. Pre-Construction Solvett Marcing with Reservand Subsenstances	1		12	-		35		
97		200		22	(0)	14.5	11.5		
TB2	O4. Builder's or Devaloper's Management Staff are Certified Grown Building			- 33					
TEO	Professionals OS. Hoese System Marators			1		***			
105	Os. Green Building Education								
165	17 a · · · C · a · ? · · · · · · · · · · · · · · · ·			3.1					
Y	OT. Screen Appreciate Address and Trind-Purer verification of Plan Institution	Y				-1			
		1000	- 9		W3.7				1000
	Summary	1					No.	1000	100000
	Minimum Points Required in Specific Calegorie	1,12		14	St.	0	- 4		
	minimum roints kequired in Specific Calegore		7	7.1	-				
AND DESCRIPTION OF THE PARTY OF	Total Points Achieved	1000							

M E T R O D E S I G N G R O U P

1475 S 3ASCOM AVE SUITE 208
CAMPBELL, CA 95008
(408)971-1071 phone
(408)971-1072 fax
www.metroarditects.com

The plare, deas and design on this
drawing are the property of the
designer fakeds solely for this
contract. Plans shall not be used,
n whole or in part, for any purpose
for which they were not intended
without the written serrinsor of
VETRO DESIGN GROUP. (3)

PROJECT NAME

# **COREY RESIDENCE**

26 ALPINE AVE LOS GATOS, CA 95030 APN# 529-37-042


REVISIONS

**BUILD IT GREEN** CHECKLIST

DATE : 1 -17 -17 SCALE : N.T.S. DRAWN BY: DZ CHECKED BY: TS ARCHITECT: TOM SLOAN PROJECT NO: 16621

SHEET NUMBER

A-0.1

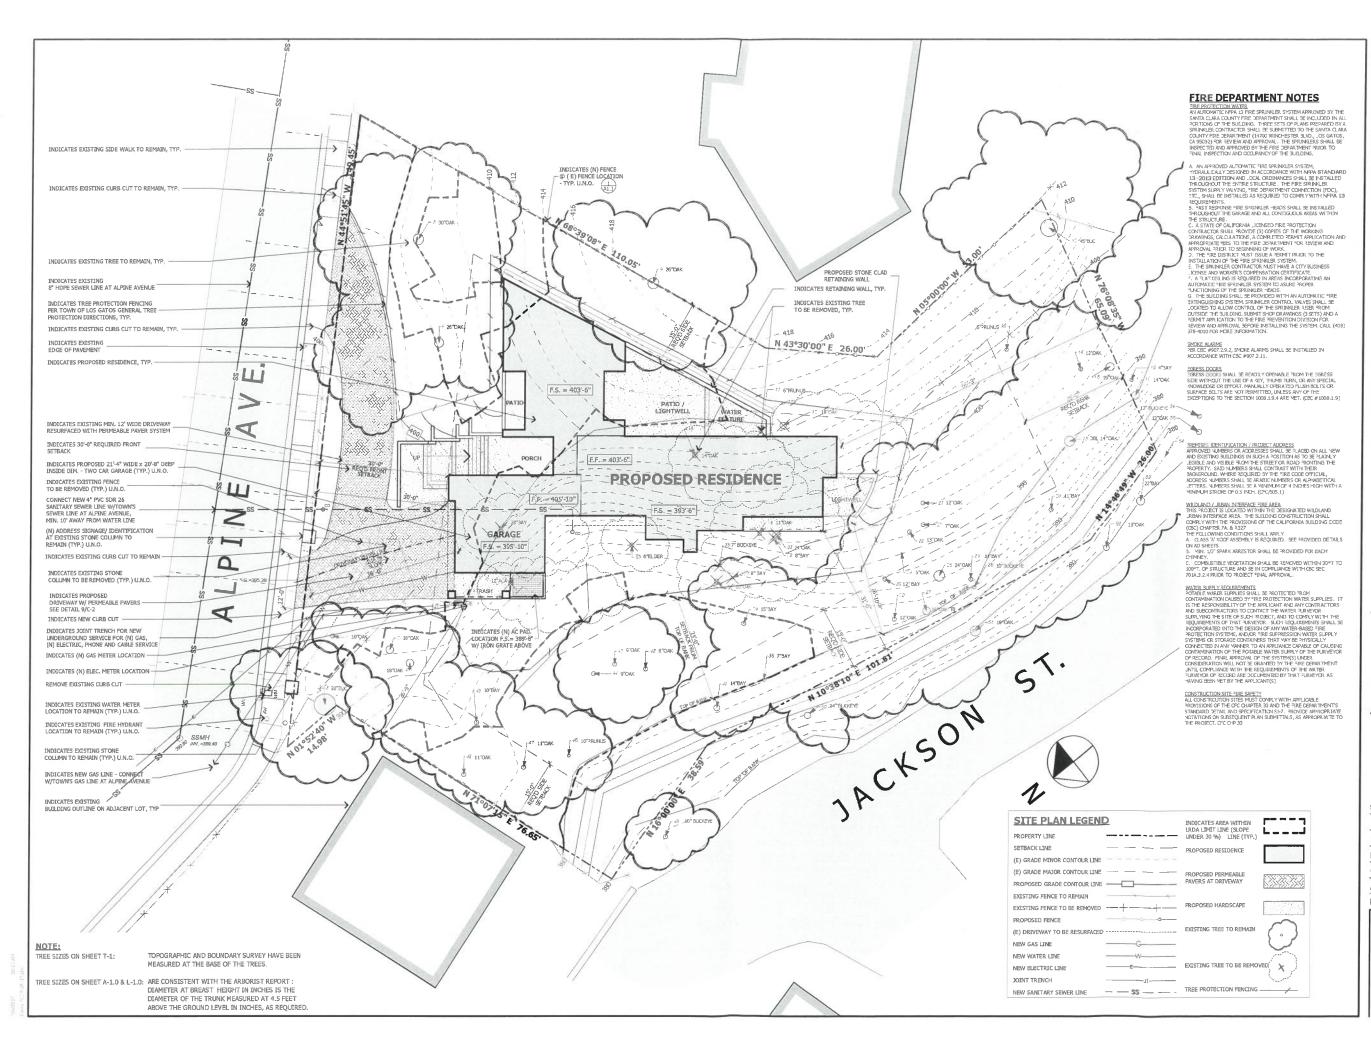



CHITECTURE-PLANNING-INTERIOR

1475 S BASCOM AVE SUITE 208 CAMPBELL, CA 95008 (408)871-1071 phone (408)871-1072 fax

The plans, deas and design on this drawing are the property of the designer, divised solely for this contract. Plans shall not be used, in whole or in part, for any purpose for which they were not intended without the written permission of VETRO DESIGN GROUP.

PROJECT NAME

### COREY RESIDENCE

26 ALPINE AVE LOS GATOS, CA 95030 APN# 529-37-042

A PC2 1-17-17	
A	D.Z.
A PC2 6-26-17	D.Z.

# PROPOSED SITE PLAN

SITE LEGEND

DATE : 1-17-17


SCALE : 1" = 10'-0"

DRAWN BY : TS / DZ

CHECKED BY : TS

ARCHITECT : TOM SLOAN
PROJECT NO : 16621

SHEET NUMBER

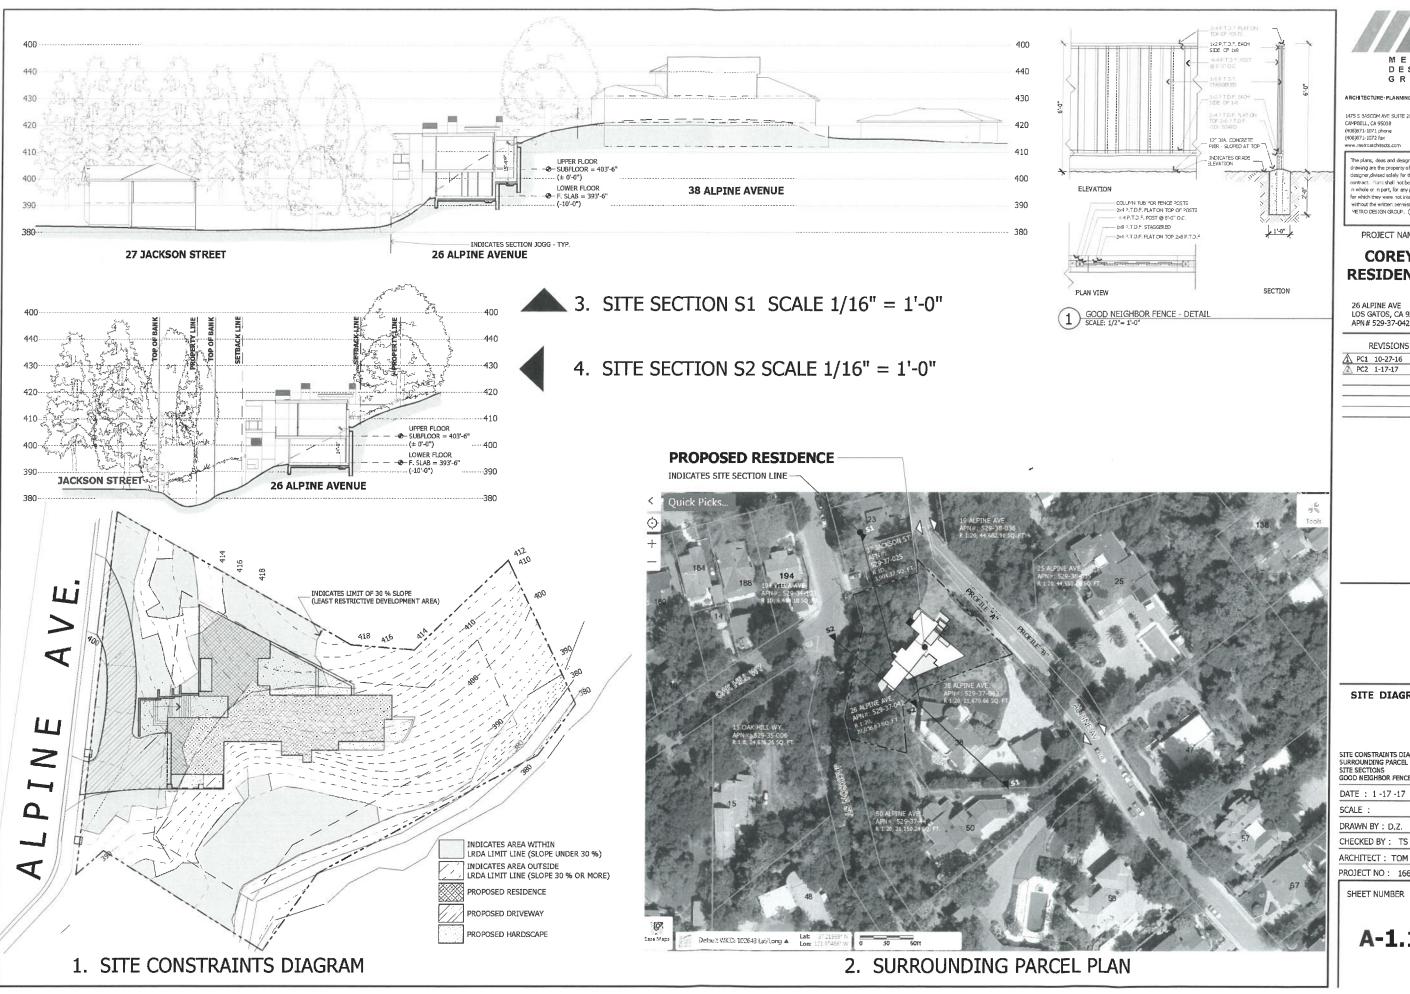

DESIGN GROUP

ARCHITECTURE PLANNING INTERIORS

The plans, deas and design on this drawing are the property of the designer divised solely for this contract. Plant shall not be used, in whole or in part, for any purpose for which they were not intended without the witten permission of METRO DESIGN GROUP.

PROJECT NAME

# COREY RESIDENCE

26 ALPINE AVE LOS GATOS, CA 95030 APN# 529-37-042

REVISIONS A PC1 10-27-16 A PC2 1-17-17

### SITE DIAGRAMS

SITE CONSTRAINTS DIAGRAM SURROUNDING PARCEL PLAN SITE SECTIONS GOOD NEIGHBOR FENCE DETAIL


DATE: 1-17-17

DRAWN BY: D.Z.


ARCHITECT: TOM SLOAN

PROJECT NO: 16621

SHEET NUMBER

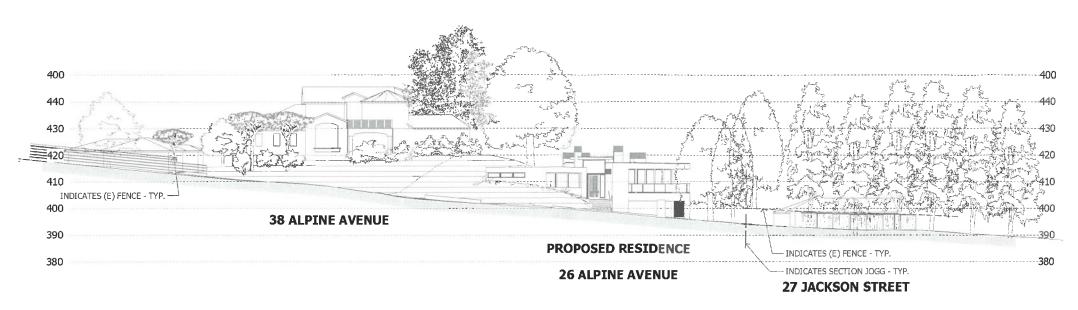

STREET PROFILE 'A' SCALE: 1/16" = 1'-0"

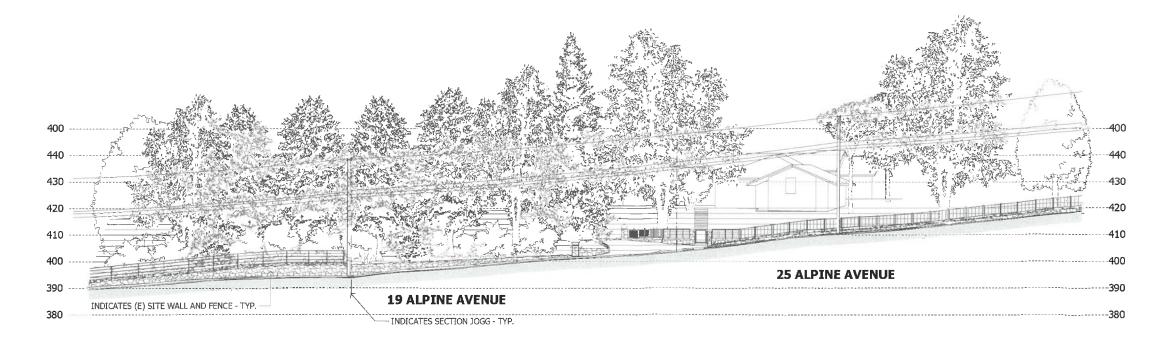

STREET PROFILE 'B' SCALE: 1/16" = 1'-0"



RCHITECTURE PLANNING INTERIORS

1475 S BASCOM AVE SUITE 208 CAMPBELL, CA 95008 (408)871-1071 phone (408)871-1072 fax www.metroarchitects.com

The plans, deas and design on this drawing are the property of the designer divised solely for this contract. Than shall not be used, in whole or in part, for any purpose for which they were not intended without the written permission of METRO DESIGN GROUP.

PROJECT NAME

# COREY RESIDENCE

26 ALPINE AVE LOS GATOS, CA 95030 APN# 529-37-042

REVISIONS

STREET PROFILES

STREET PROFILE 'A' STREET PROFILE 'B'

DATE: 1-17-17
SCALE: AS NOTED


DRAWN BY: DZ


CHECKED BY: TS

ARCHITECT: TOM SLOAN

PROJECT NO: 16621

SHEET NUMBER

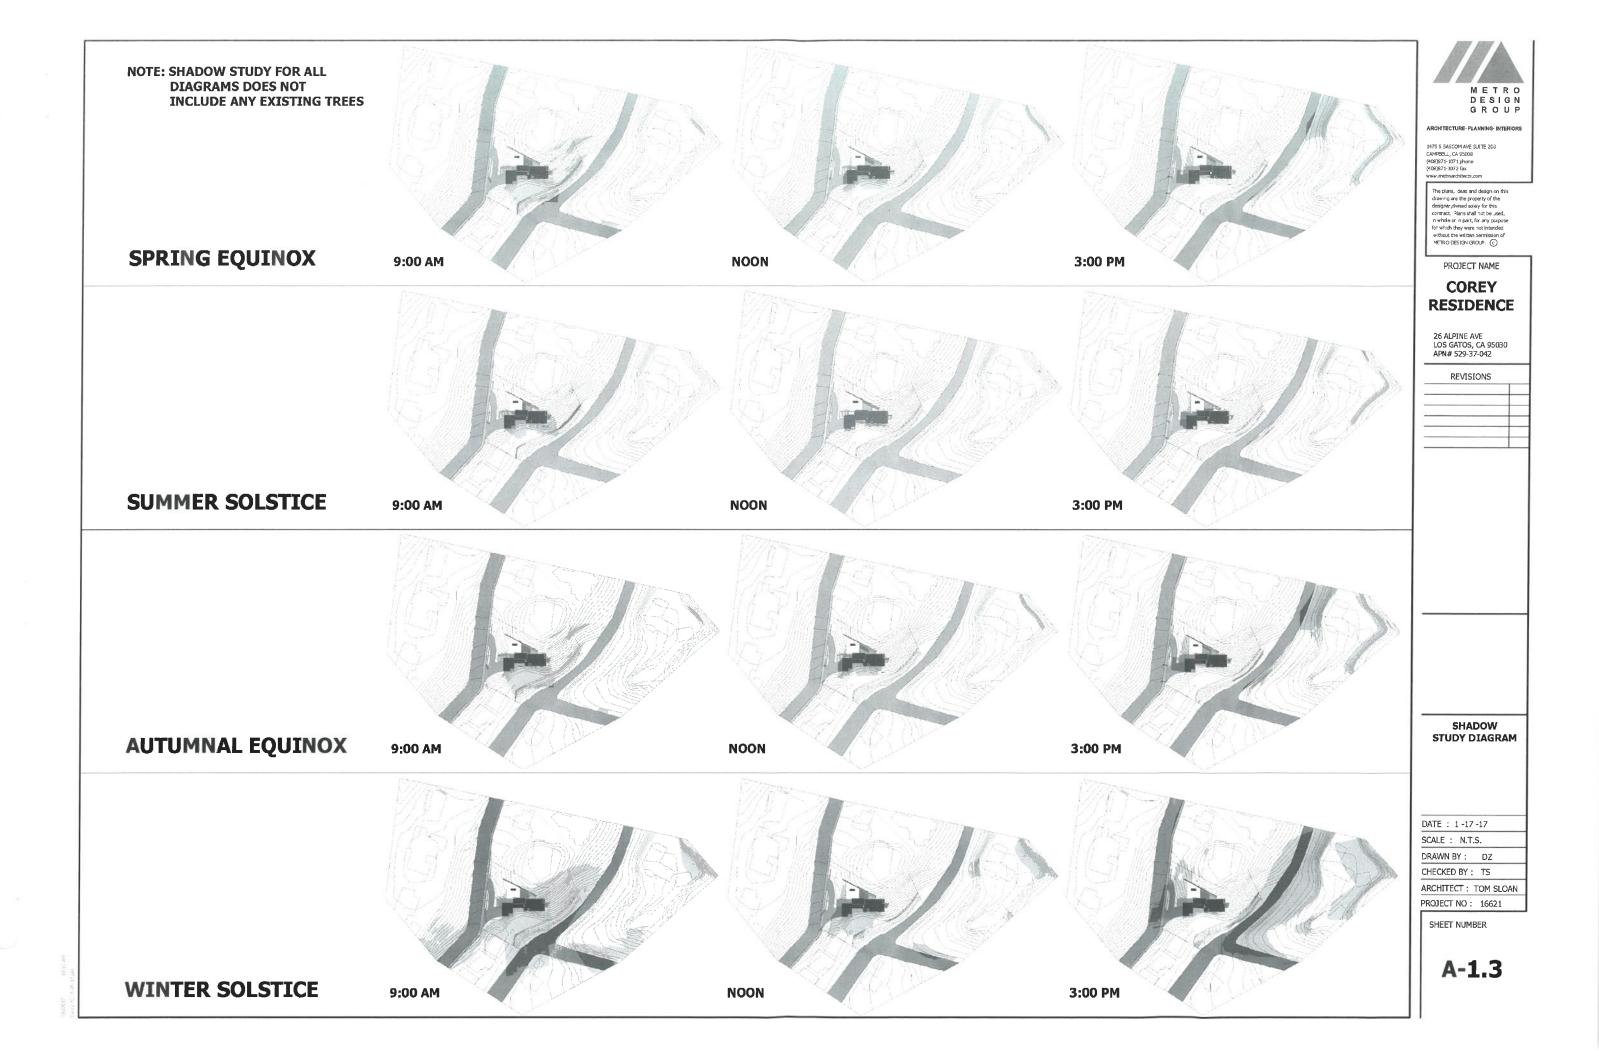

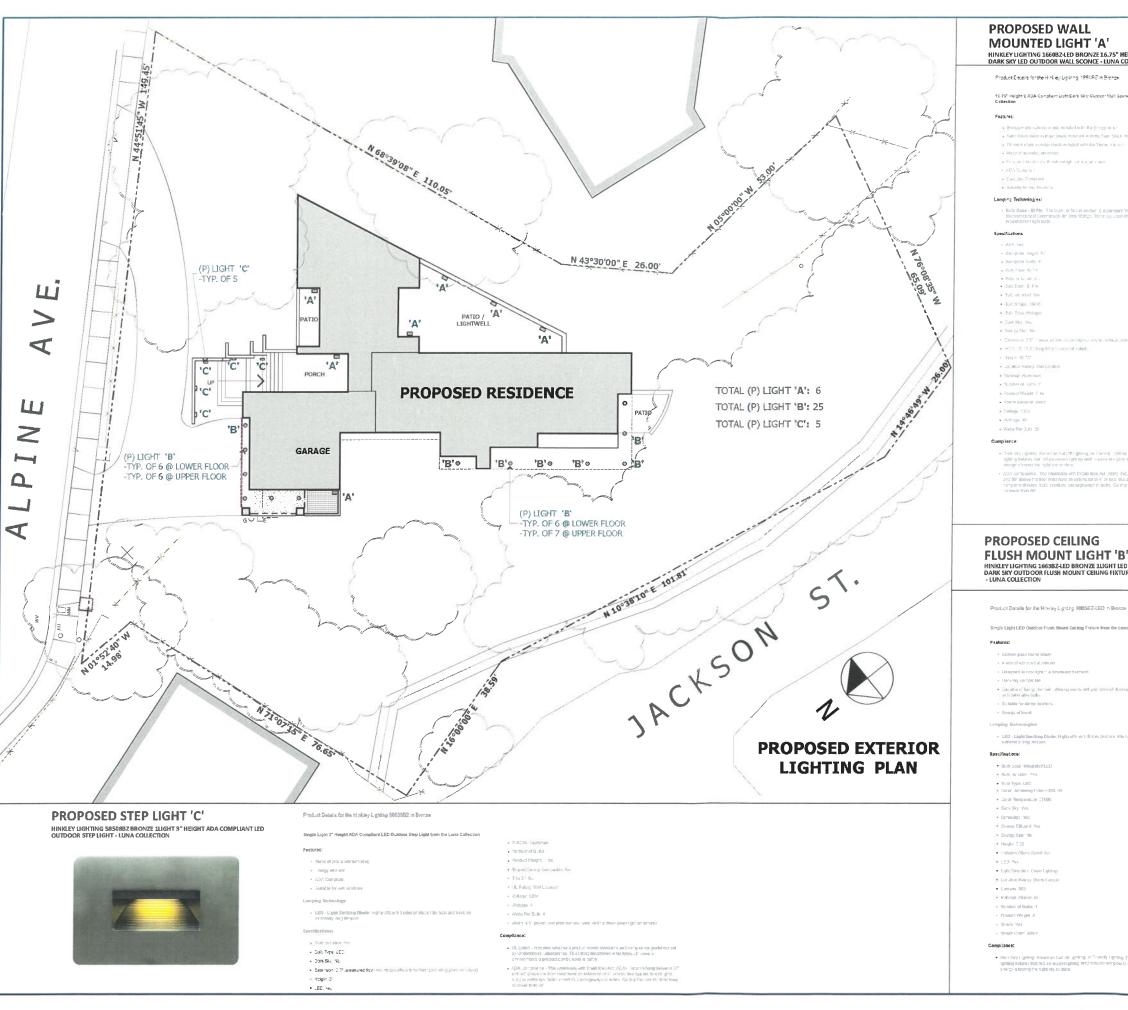

### **PROPOSED WALL MOUNTED LIGHT 'A'**

HINKLEY LIGHTING 1660BZ-LED BRONZE 16.75" HEIGHT ADA COMPLIANT DARK SKY LED OUTDOOR WALL SCONCE - LUNA COLLECTION

Product Catalis for the Hinkley Lighting 1890BZ in Bronze.

# Lamping Technologies:

- Sub-Shape MRR

- +00 10 1501(significance) relief
- Litcator Kating Well Locator Statemal Alicement
- Number of Rubs 2
   Product Weight 7 bs
- Shade Minter all stetch
   Costagle 1209

### Compitance:

HINKLEY LIGHTING 1663BZ-LED BRONZE 1LIGHT LED DARK SKY OUTD OOR FLUSH MOUNT CEILING FIXTURE - LUNA COLLECTION

Product Datails for the Hinkley Lighting 1683EZ-LED in Bronze

- Catable of being chined as in deviced place.
- Suitable for damp location

### amping Technologies:

### Specifications:

- Bublicase Integraled LED 14 Buth included Yes
- · Color Temperature 2700K
- Girmabic, Yes
   Energy Efficient Yes Energy Star No
- \* Height 7.35
- Industria Ottoria Council \* LED Yes
- Light Direction Cown Lighting
- · Maral Alamin in
- + Craders Weight 5
- Shade Cotor Worl

### Compliance:



ARCHITECTURE-PLANNING-INTERIORS

1475 S BASCOM AVE SUITE 208

The plans, deas and design on this drawing are the property of the designer divised solely for this contract. Plans shall not be used, n whole or in part, for any purpose for which they were not intended without the written permission of VETRO DESIGN GROUP.

PROJECT NAME

### **COREY RESIDENCE**

26 ALPINE AVE LOS GATOS, CA 95030 APN# 529-37-042

REVISIONS

PROPOSED EXTERIOR LIGHTING PLAN


SETE LEGEND

DATE: 1-17-17 SCALE : 1/8" = 1'-0"

DRAWN BY: DZ CHECKED BY: TS

ARCHITECT: TOM SLOAN PROJECT NO: 16621

SHEET NUMBER

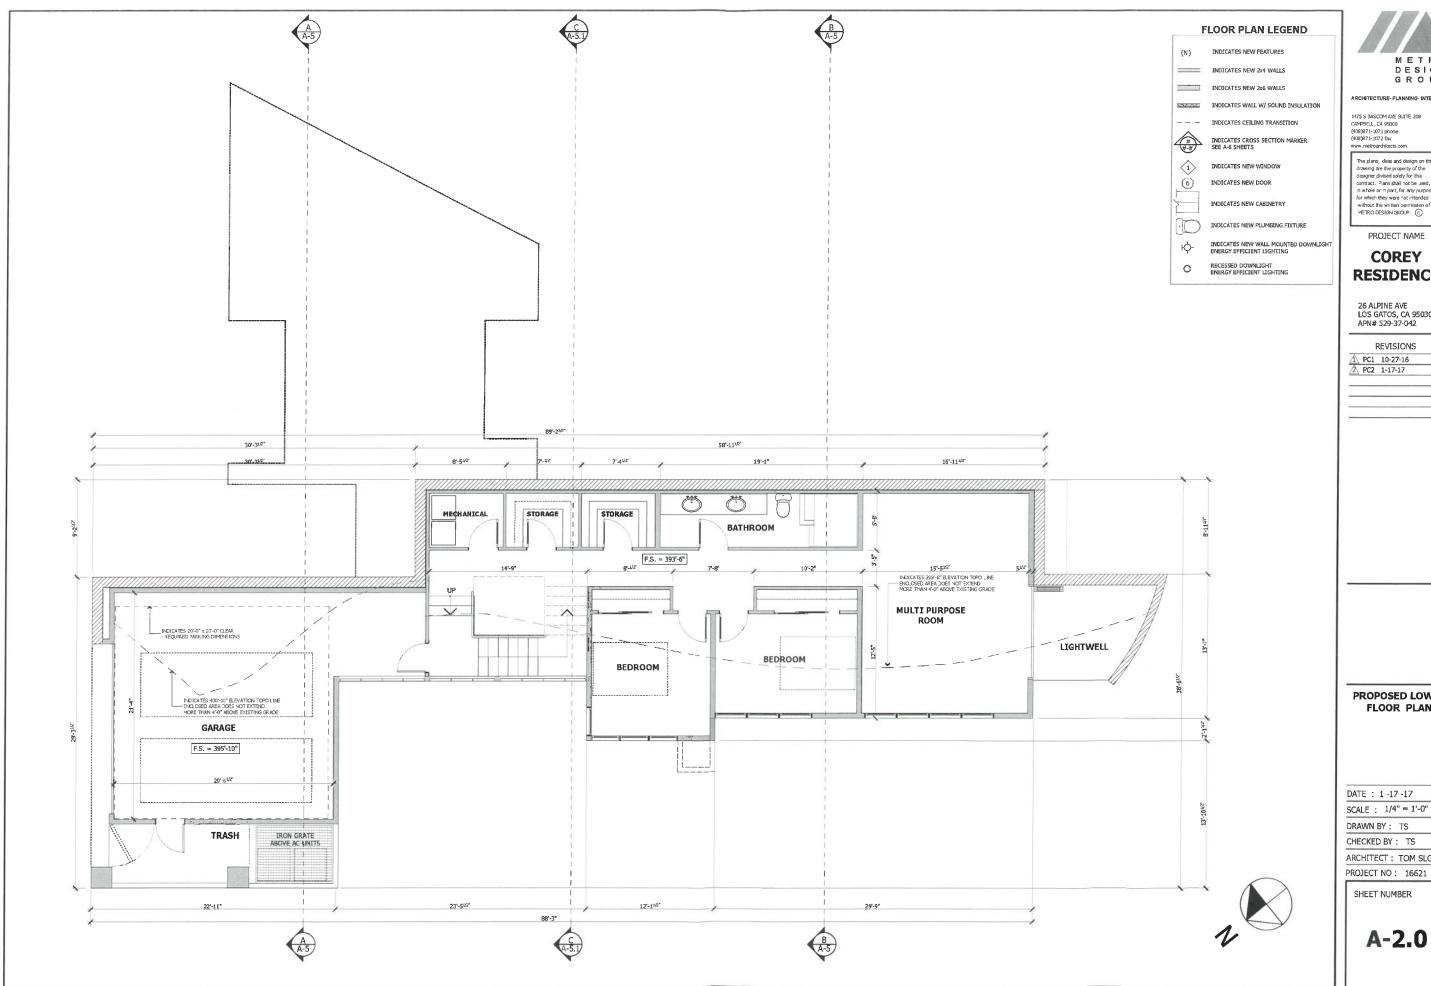



1475 S 3ASCOM AVE SUITE 208 CAMPBELL, CA 95008 (408)871-1071 phone (408)871-1072 fax www.metroarchitects.com

The plans, deas and design on this drawing are the property of the designer divised solely for this contract. Fains shall not be used, in whole or in part, for any purpose for which they were not intended without the written permission of VETRO DESIGN GROUP.

PROJECT NAME

# COREY RESIDENCE

26 ALPINE AVE LOS GATOS, CA 95030 APN# 529-37-042


A	 10-27-16	D.Z.
À	1-17-17	D.Z.
_		-
_		_

PROPOSED LOWER FLOOR PLAN

DATE : 1-17-17 SCALE : 1/4" = 1'-0" DRAWN BY: TS CHECKED BY: TS ARCHITECT: TOM SLOAN

SHEET NUMBER

A-2.0

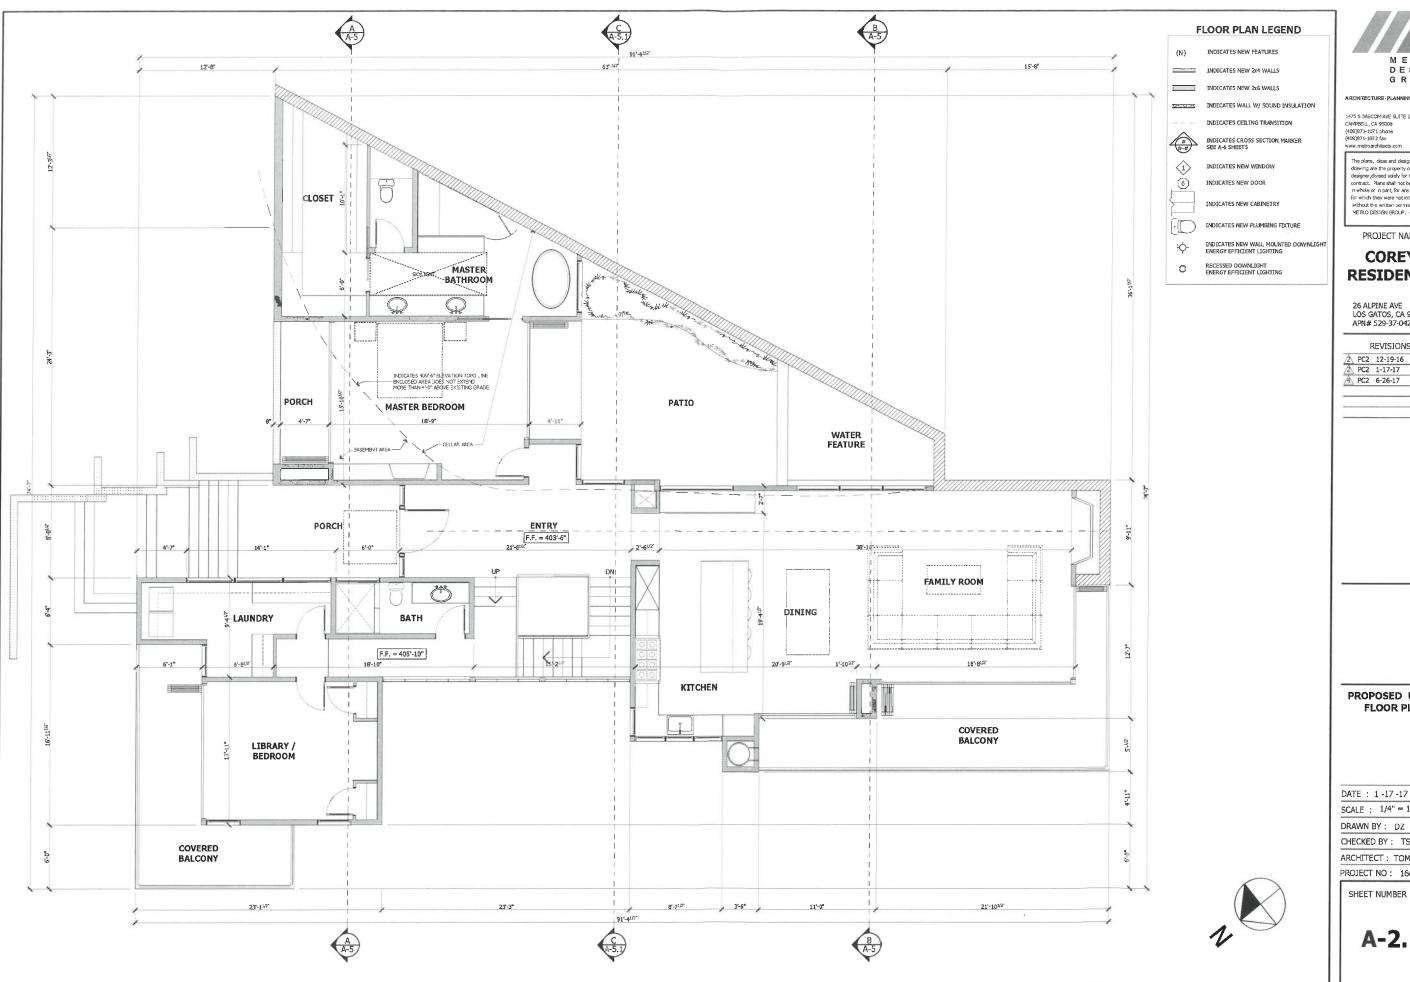

M E T R O D E S I G N

1475 S 3ASCOM AVE SUITE 208 CAMPBELL, CA 95008 (408)871-1071 phone (408)871-1072 fax www.metroarchitects.com

The plans, deas and design on this drawing are the property of the designer divised solely for this contract. Than shall not be used, in whole or in part, for any purpose for which they were not intended without the written permission of METRO DESIGN GROUP.

PROJECT NAME

# COREY RESIDENCE

26 ALPINE AVE LOS GATOS, CA 95030 APN# 529-37-042

2	PC2	12-19-16	D.Z
2	PC2	1-17-17	D.Z.
4	PC2	6-26-17	D.Z.

PROPOSED UPPER FLOOR PLAN


DATE : 1-17-17 SCALE : 1/4" = 1'-0"

CHECKED BY: TS

ARCHITECT: TOM SLOAN PROJECT NO: 16621

SHEET NUMBER

A-2.1

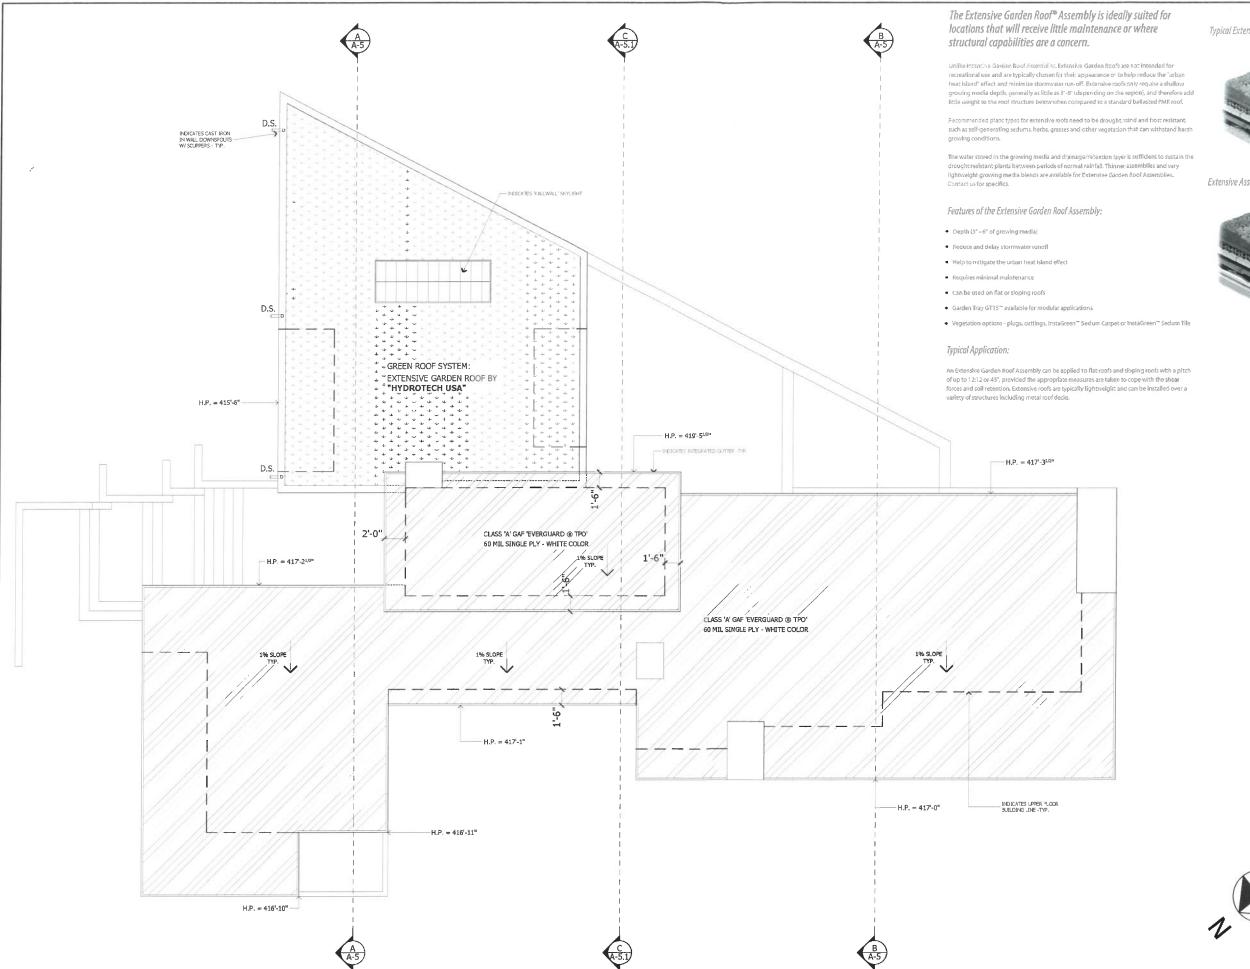





Extensive Assembly over metal deck



CTURE-PLANNING-INTERIOR

METRO

1475 S BASCOM AVE SUITE 208 CAMPBELL, CA 95008 (409)871-1071 phone (408)871-1072 fax www.metroarchitects.com

The plans, deas and design on this drawing are the property of the designer, divised sciely for this contract. Plans shall not be used, in whole or in part, for any purpose for which they were not intended without the written permission of YETRO DESIGN GROUP.

PROJECT NAME

# COREY RESIDENCE

26 ALPINE AVE LOS GATOS, CA 95030 APN# 529-37-042

REVISIONS

PC2	1-17-17	
		$\overline{}$

PROPOSED ROOF PLAN

DATE : 1-17-17

SCALE : 1/4" = 1'-0"

DRAWN BY : DZ


CHECKED BY : TS

ARCHITECT : TOM SLOAN

PROJECT NO: 16621

SHEET NUMBER

A-3.0

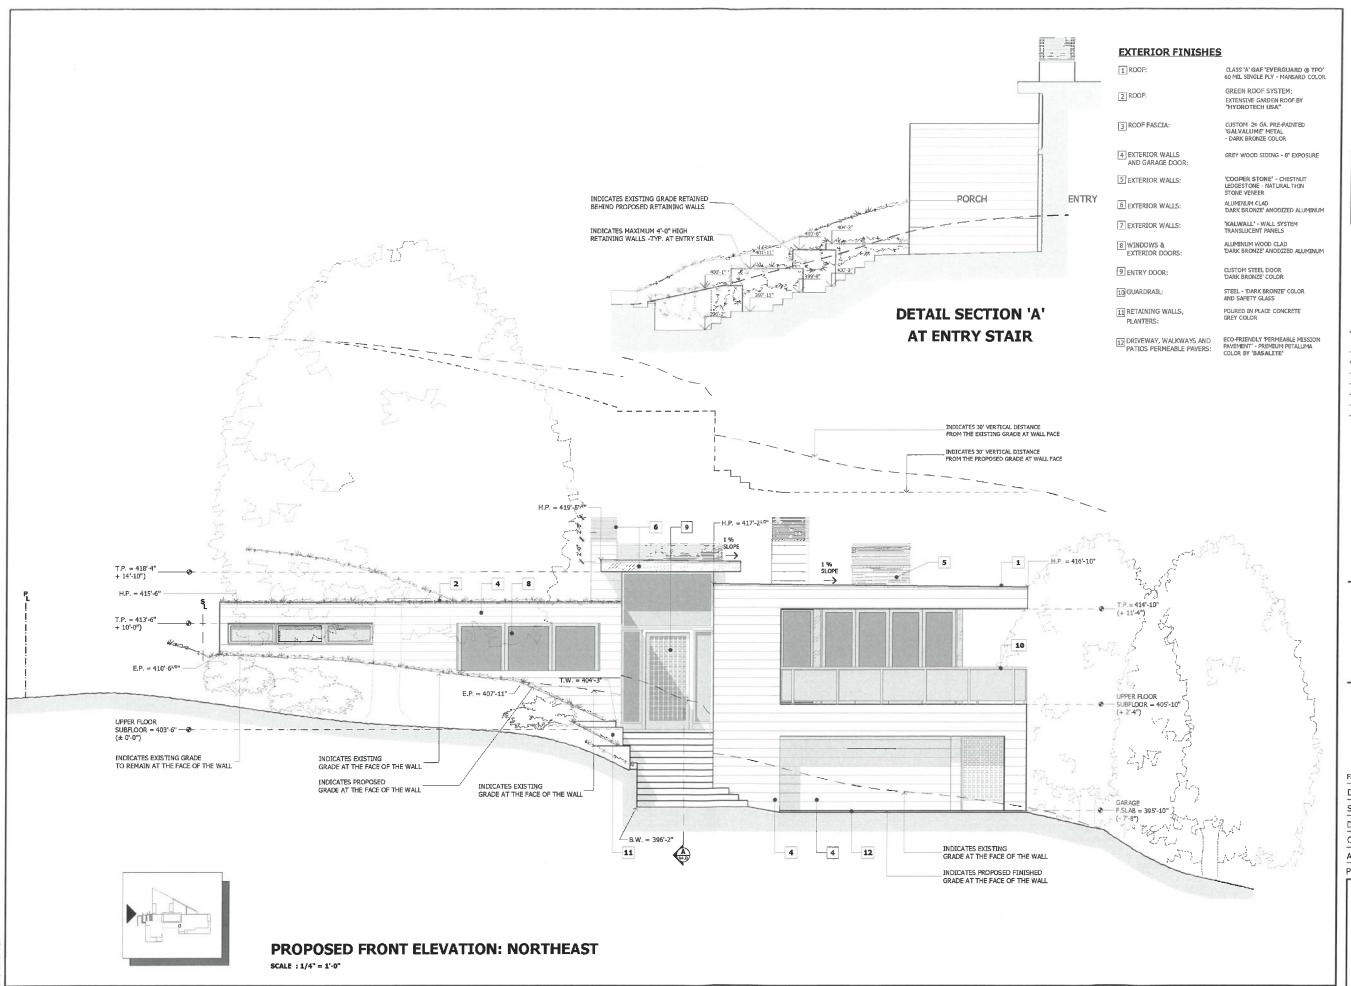



ARCHITECTURE- PLANNING- INTERIO

1475 S 3ASCOM AVE SUITE 208 CAMPBELL, CA 95008 (408)871-1071 phone (408)871-1072 fax www.metroarchitects.com

The plans, deas and design on this drawing are the property of the designer plysted solely for this contract. Plans still not be used, in whole or in part, for any purpose for which they were not intended without the written permission of METRO DESIGN GROUP.

PROJECT NAME

# COREY RESIDENCE

26 ALPINE AVE LOS GATOS, CA 95030 APN# 529-37-042

REVISIONS

2 PC2 1-17-17 [

PROPOSED EXTERIOR ELEVATIONS

FRONT ELEVATION, NE


DATE : 1-17-17 SCALE : 1/4" = 1'-0"


DRAWN BY: DZ
CHECKED BY: TS

ARCHITECT : TOM SLOAN PROJECT NO : 16621

SHEET NUMBER

A-4.0

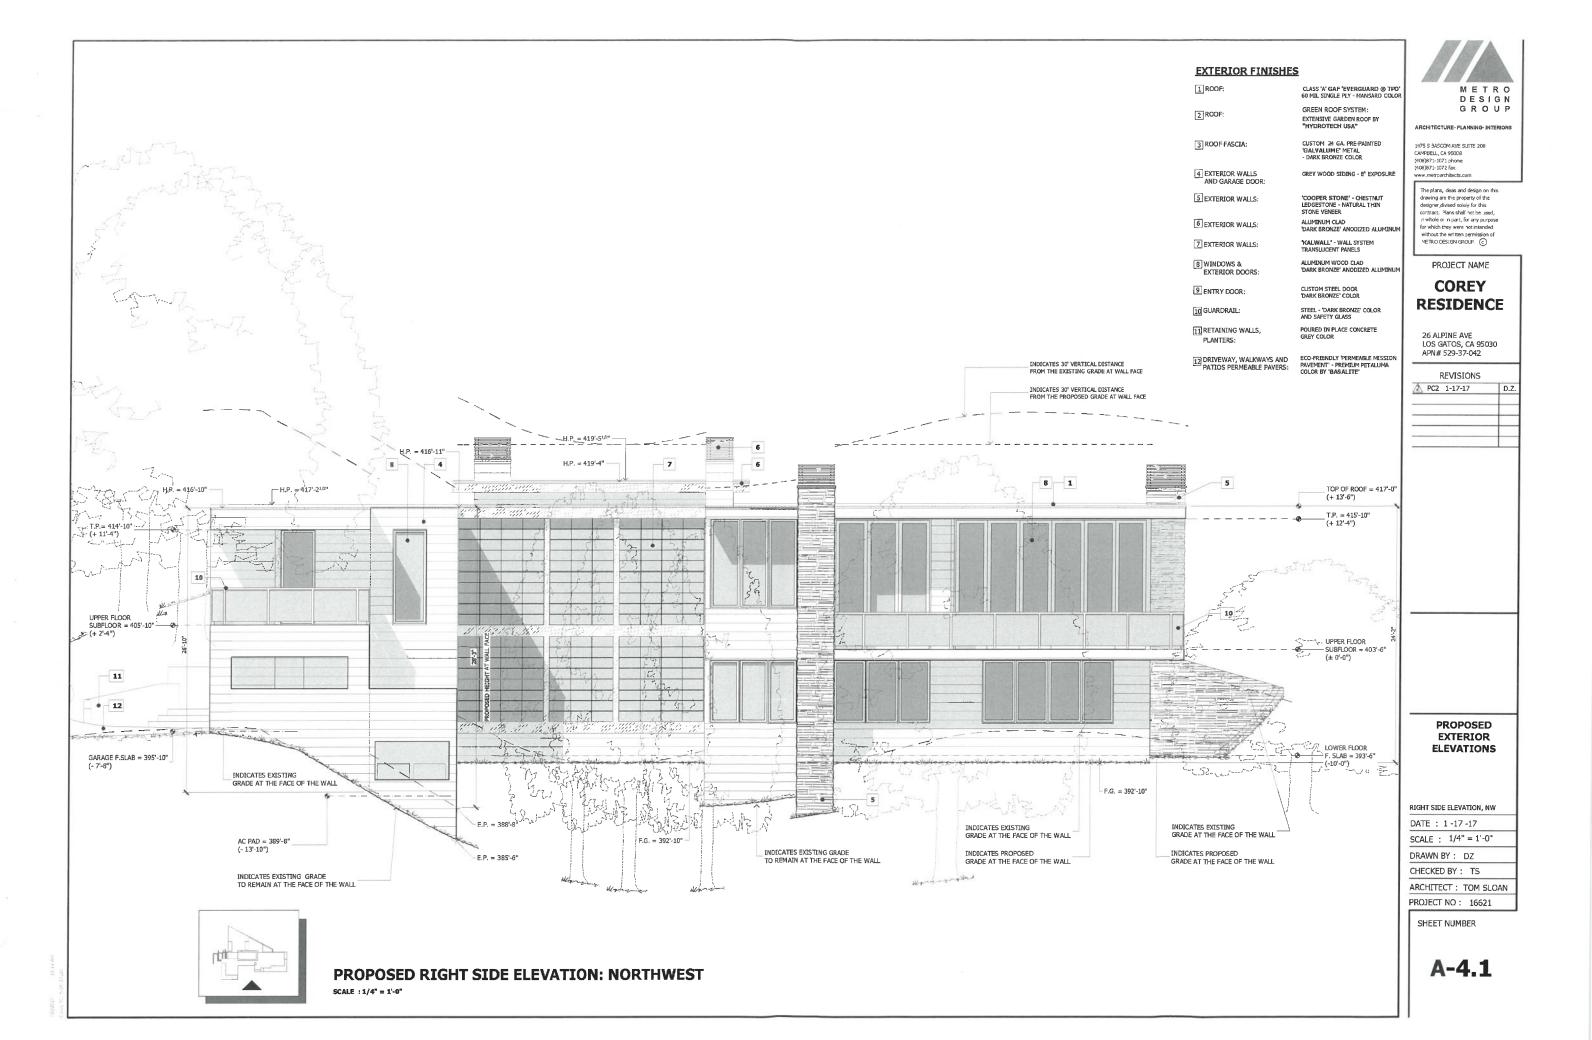

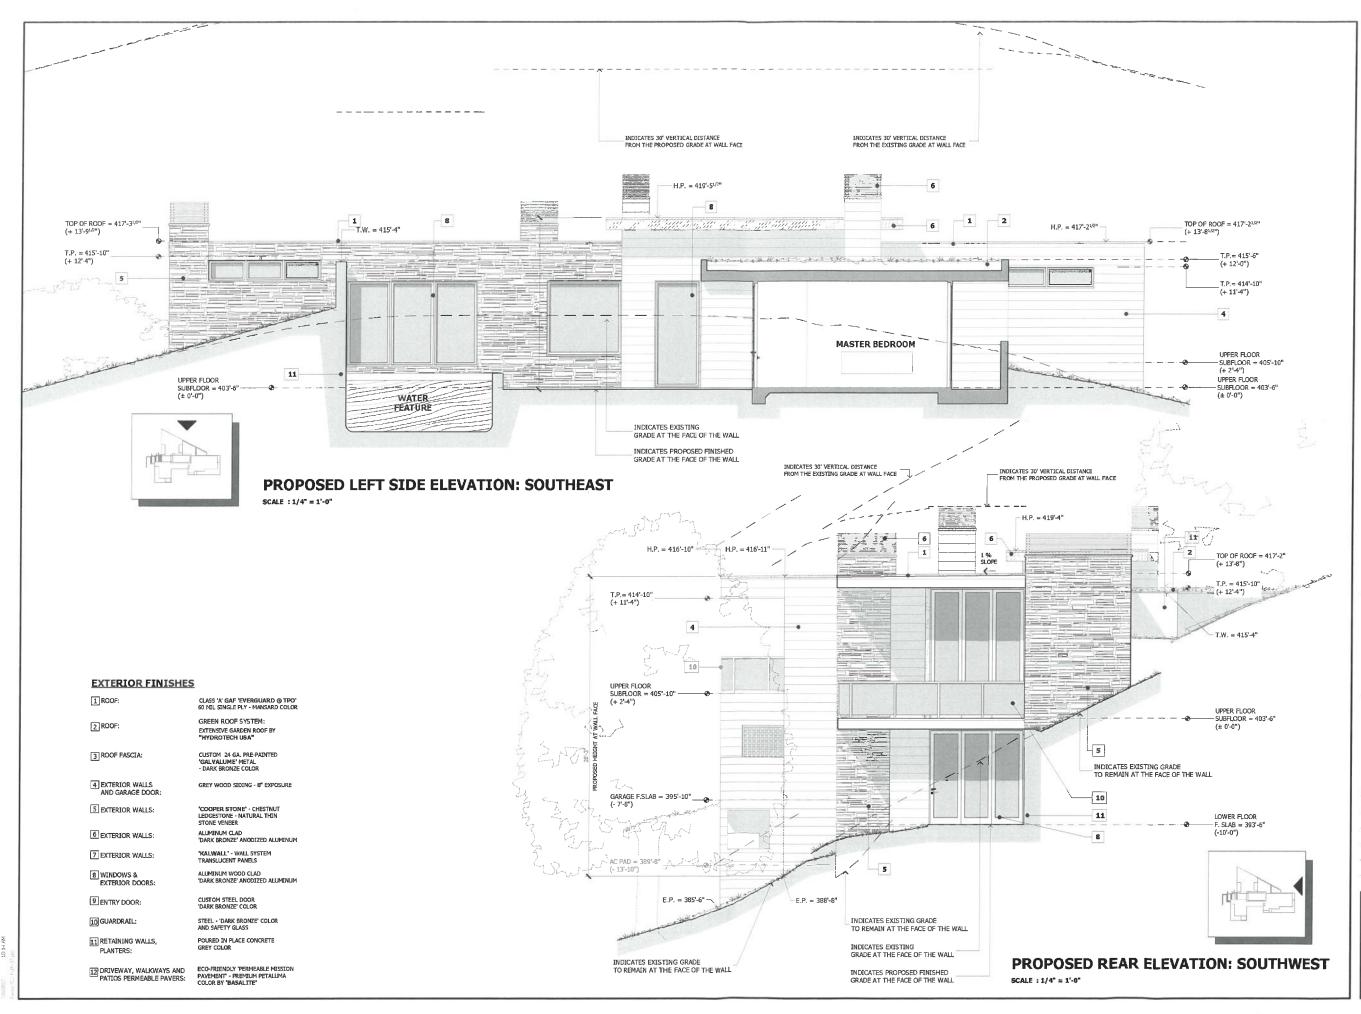

METRO DESIGN GROUP

ARCHITECTURE · PLANNING · INTERIORS

1475 S 3ASCOM AVE SUITE 208 CAMPBELL, CA 95008 (408)871-1071 phone (408)871-1072 fax www.metroarchitects.com

The plans, deas and design on this drawing are the property of the designer divised solely for this contract. Plans shall not be used, in whole or in part, for any purpose for which they were not intended without the written permission of METRO DESIGN GROUP.

PROJECT NAME

### COREY RESIDENCE

26 ALPINE AVE LOS GATOS, CA 95030 APN# 529-37-042

REVISIONS

A PC2 1-17-17 D.Z.

LEFT SIDE ELEVATION, SE REAR ELEVATION, SW

DATE : 1 -17 -17 SCALE :

DRAWN BY:


CHECKED BY: TS

ARCHITECT: TOM SLOAN

PROJECT NO: 16621

SHEET NUMBER

A-4.2

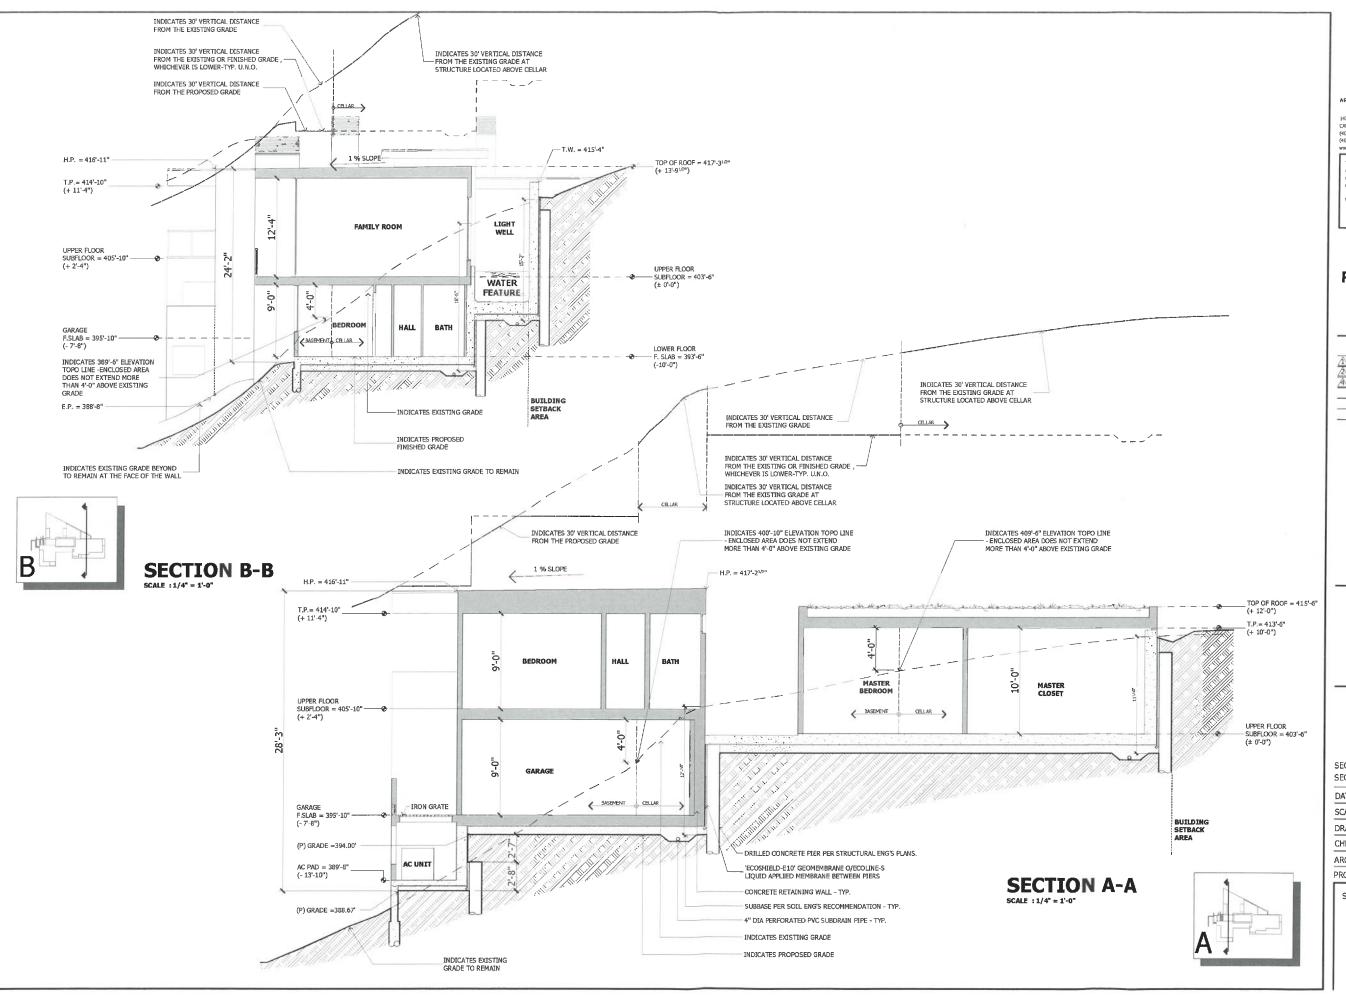

METRO DESIGN GROUP

CHITECTURE PLANNING INTERIOR

1475 5 BASCOM AVE SUITE 208 CAMPBELL, CA 95008 (408)871-1071 phone (408)871-1072 fax www.metroarchitects.com

The plans, deas and design on this drawing are the property of the designer, divised solely for this contract. Plans stall not be used, in which coin part, for any purpose for which they were not intended without the written permission of METRO DESIGN GROUP.

PROJECT NAME

# COREY RESIDENCE

26 ALPINE AVE LOS GATOS, CA 95030 APN# 529-37-042

REVISIONS

↑ PC1 10-27-16 D.Z.
↑ PC2 1-17-17 D.Z.
↑ PC2 6-26-17 D.Z.

PROPOSED SECTIONS

SECTION 'A' SECTION 'B'


DATE : 1-17-17 SCALE : 1/4" = 1'-0"

DRAWN BY: TS
CHECKED BY: TS

ARCHITECT: TOM SLOAN
PROJECT NO: 16621

SHEET NUMBER

A-5.0

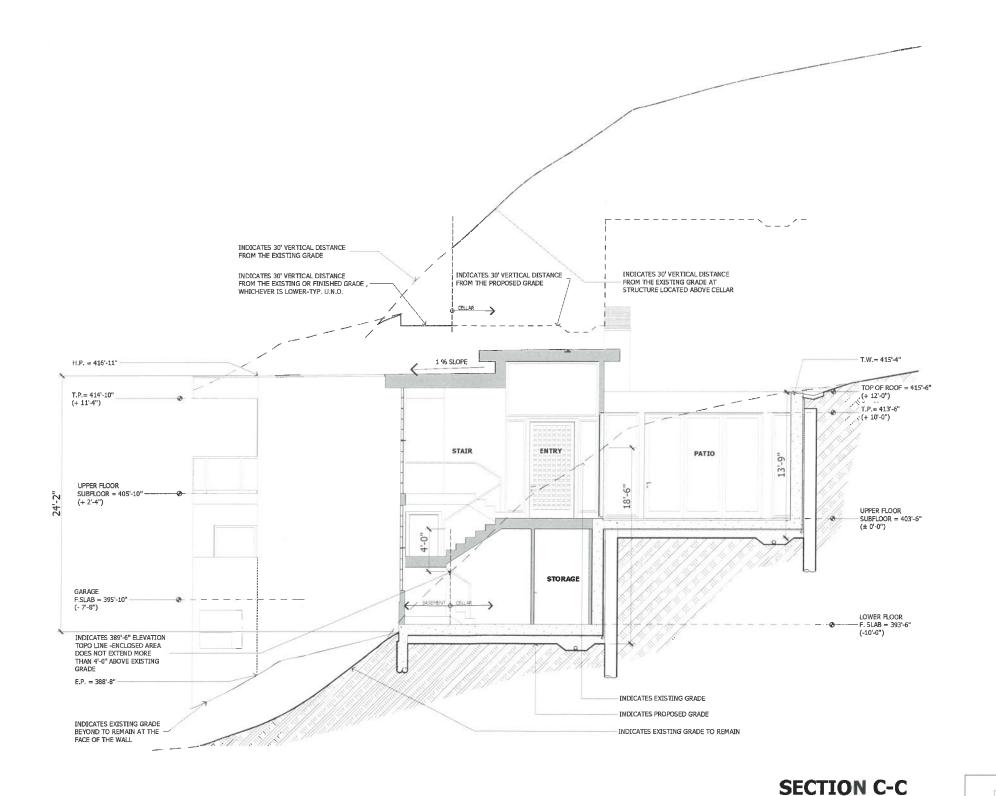



ARCHITECTURE-PLANNING-INTERIO

1475 \$ BASCOM AVE SUITE 208 CAMPBELL, CA 95008 (408)871-1071 phone (408)871-1072 fax www.metroarchitects.com

The plans, deas and design on this drawing are the property of the designer divised saidly for this contract. Plans stall not be used, in whole or in part, for any purpose for which they were not intended without the written permission of METRO DESIGN GROUP.

PROJECT NAME

# COREY RESIDENCE

26 ALPINE AVE LOS GATOS, CA 95030 APN# 529-37-042

REVISIONS

A PC2 1-17-17 D.

PROPOSED SECTIONS

SECTION 'C'

DATE : 1-17-17 SCALE : 1/4" = 1'-0"


DRAWN BY: TS
CHECKED BY: TS

ARCHITECT : TOM SLOAN PROJECT NO : 16621

SHEET NUMBER

SCALE : 1/4" = 1'-0"

A-5.1

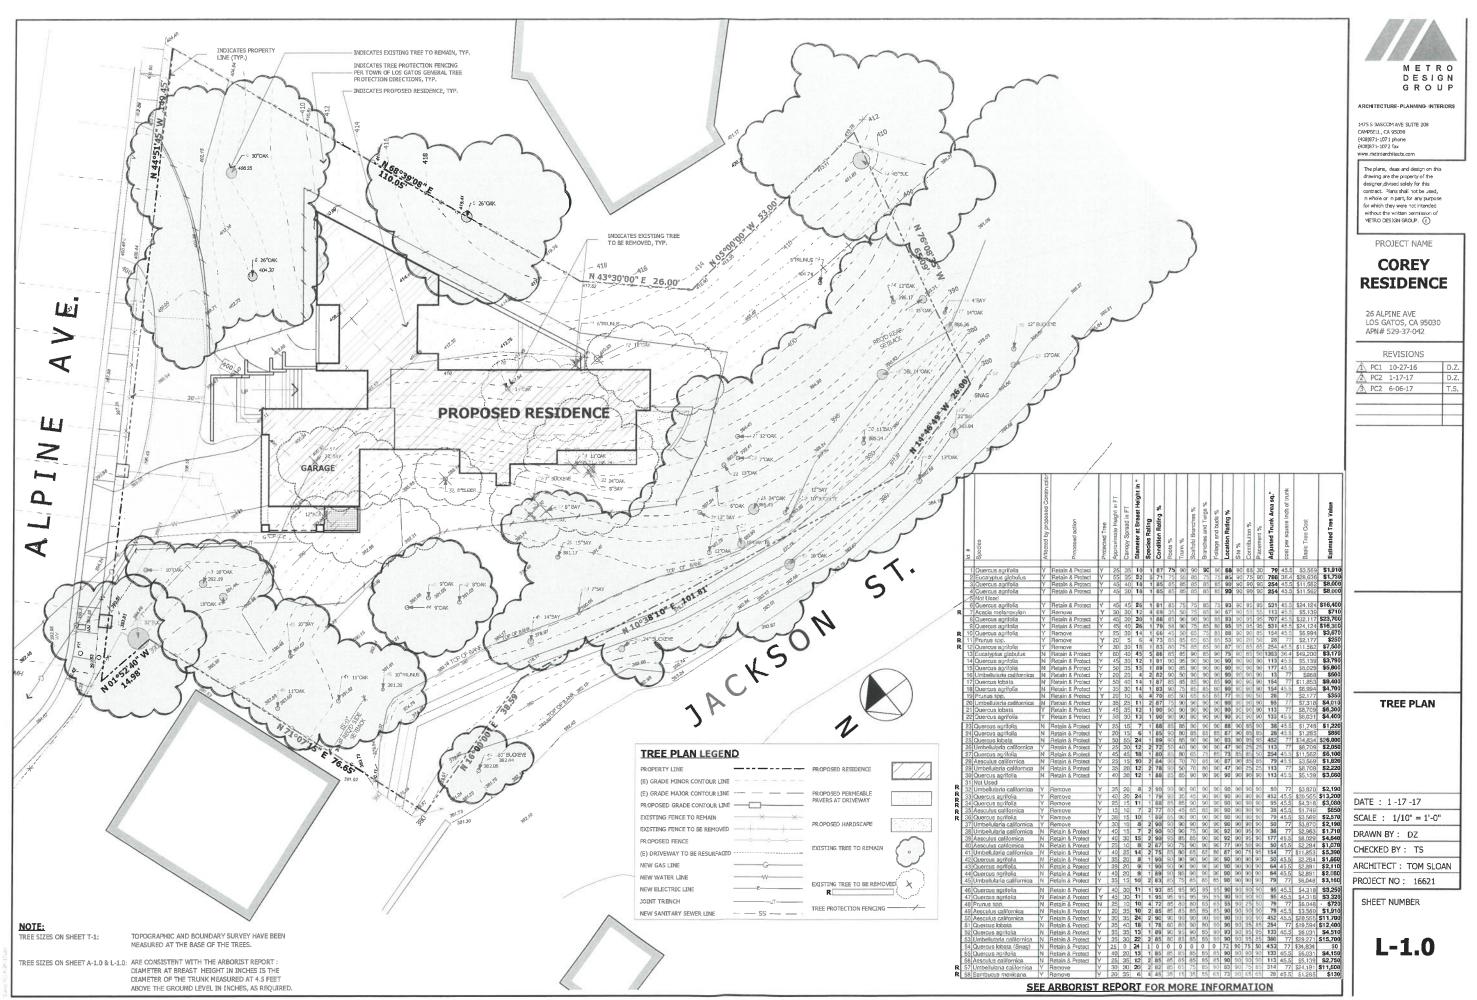

10:14 AM