BUSCHER SINGLE FAMILY RESIDENCE 707 BENVENUE AVENUE LOS ALTOS, CALIFORNIA 94024



FLOOR AREA EXCEPTIONS:

CITY OF LOS ALTOS MUNICIPAL CODE - 1 2 2 LAMC SECTION 14.15.060 EXCEPTION WILL BE APPLIED TO ACCESSORY
 STRUCTURE - ARBOR LOCATED AT THE REAR OF
 THE BUILDING FOR THE FOLLOWING CONDITION:
 1. OPEN ON ALL SIDES
 2. AREA IS LESS THAN 200 SQUARE FEET



LOS ALTOS, CA 94024

GEORG AND LING BUSCHER

PROPERTY OWNERS

ASSESSOR PARCEL NO.

REV.# DATE COMMENT BY:

TITLE PAGE

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CONSULTANTS							
SOILS ENGINEER:	ELECT/PLUMBING / MECHANICAL ENGINEER:						
ROMIG ENGINEERS COLEMAN K NG, P.E. 1390 EL CAMINO REAL, SECOND FLOOR SAN CARLOS, CA. 94020 650-591-5224 - www.romigengineers.com							
SURVEYOR:							
LEA and BRAZE Engineering, Inc 2495 Industrial Parkway West Hayward, Ca. 94545 510-887-4086 www.leabraze.com							
CIVIL ENGINEER:	STRUCTURAL ENGINEER						
Jing Deng jing_d2004@yahoo.com							
LANDSCAPE ARCHITECT:	TITLE 24						
ANYI LANDSCAPE STUDIO anyilandscape.com 650-533-0107							
ARBORIST:	GREEN RATER:						
BO FIRESTONE TREES & GARDENS 2150 LACEY DR., MILPITAS, CA 95035 E: INFO@BOFIRESTONE.COM C: (618) 698-3051 WWW.BOFIRESTONE.COM							

University Menlo Park 280 Stanford Pearson-Arastradero Mountain 85 237 Preserve Los Altos Los Altos Hills Sunnyv Foothills Park en Space

THE DEMOLITION OF AN EXISTING ONE STORY RESIDENTIAL STRUCTURE AND THE CONSTRUCTION OF

PROJECT ADDRESS:

OWNER'S NAME(S):

A.P.N.: 193-38-019

PROJECT SITE INFORMATION:

707 BENVENUE AVENUE

LOS ALTOS, CALIFORNIA

GEORG AND LING BUSCHER

A NEW TWO STORY RESIDENCE THAT WILL HOUSE 4 BEDROOMS, 4 FULL BATHS, 1 FULL BATH FOR

POOL, POWDER ROOM, 2 HOME OFFICE, LIVING, DINING, KITCHEN, PANTRY, LAUNDRY AND AN

ATTACHED ACCESSORY DWELLING UNIT THAT WILL HAVE ONE BEDROOM, ONE WORKSPACE,

KITCHEN, LIVING, DINING AND LAUNDRY CLOSET, THE STRUCTURE EXTERIOR FINISH SHALL BE

STUCCO WALLS ACCENTED WITH STONE VENEER AND CONCRETE TILE ROOF.

AREA MAP

SCOPE OF WORK

CODE COMPLIANCE:

2022 CA. ENERGY EFFICIENCY STANDARDS

2022 CA. GREEN BUILDING STANDARDS CODES

CITY OF LOS ALTOS MUNICIPAL CODE

2022 CA. RESIDENTIAL CODE


2022 CA. ELECTRICAL CODE

2022 CA. MECHANICAL CODE

2022 CA. PLUMBING CODE

2022 CA. FIRE CODE

2022 CA. BUILDING CODE

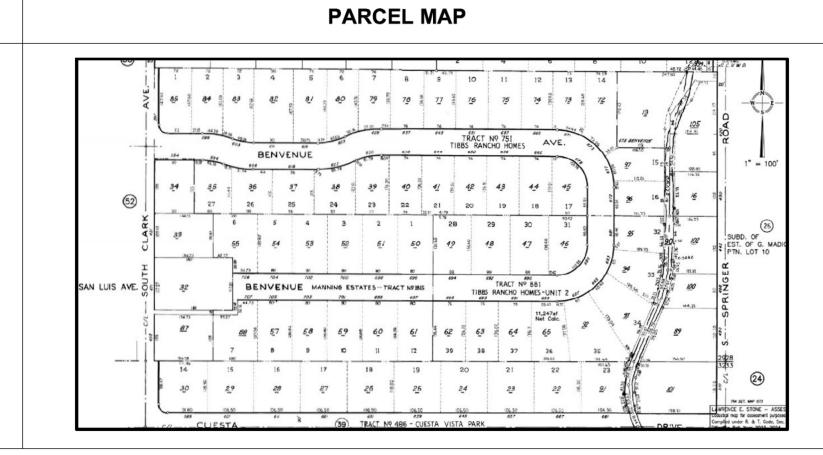

BUILDING DATA SUMMARY:

SPRINKLER SYSTEM: DEFERRED SUBMITTAL

SINGLE FAMILY DISTRICT

ZONING DISTRICT: R1-10

TYPE OF CONSTRUCTION: V-B

NUMBER OF STORIES: TWO

FLOOD ZONE: NO

LOT AREA: 11,935.0 SQUARE FEET

BUILDING OCCUPANCY GROUP: R3/U

CITY OF LOS ALTOS MUNICIPAL CODE **EXCEPTIONS:**

CITY OF LOS ALTOS MUNICIPAL CODE -LAMC SECTION 14.15.060 EXCEPTION WILL BE APPLIED TO ACCESSORY STRUCTURE - ARBOR LOCATED AT THE REAR OF

THE BUILDING.

CITY OF LOS ALTOS MUNICIPAL CODE -LAMC SECTION 14.06.120 EXCEPTION WILL BE APPLIED TO ACCESSORY STRUCTURE - POOL EQUIPMENT SHED

COUNTY OF SANTA CLARA FIRE **DEPARTMENT REQUIREMENTS:**

1

1. ADDRESS IDENTIFICATION: NEW AND EXISTING BUILDINGS SHALL HAVE APPROVED ADDRESS NUMBERS, BUILDING NUMBERS OR APPROVED BUILDING IDENTIFICATION PLACED IN A POSITION THAT IS PLAINLY LEGIBLE AND VISIBLE FROM THE STREET OR ROAD FRONT THE PROPERTY. THESE NUMBERS SHALL CONTRAST WITH THEIR BACKGROUND, WHERE REQUIRED BY THE FIRE CODE OFFICIAL, ADDRESS NUMBERS SHALL BE PROVIDED IN ADDITIONAL APPROVED LOCATIONS TO FACILITATE EMERGENCY RESPONSE. ADDRESS NUMBERS SHALL BE ARABIC NUMBERS OR ALPHABETICAL LETTERS. NUMBERS SHALL BE A MINIMUM OF 6 INCHES (101.6 MM) HIGH WITH A MINIMUM STROKE WIDTH OF 0.5 (12.7 MM). WHERE ACCESS IS BY

NUMBERS SHALL BE MAINTAINED. CFC Sec.505.1 2. CONSTRUCTION SITE FIRE SAFETY: ALL CONSTRUCTION SITES MUST COMPLY WITH APPLICABLE PROVISIONS OF THE CFC CHAPTER 33 AND OUR STANDARD DETAIL AND SPECIFICATION S1-7. PROVIDE APPROPRIATE NOTATIONS ON SUBSEQUENT PLAN SUBMITTALS, AS

MEANS OF A PRIVATE ROAD AND THE BUILDILNG CANNOT BE VIEWED

FROM THE PUBLIC WAY, A MONUMENT, POLE OR OTHER SIGN OR MANS SHALL BE USED TO IDENTIFY THE STRUCTURE. ADDRESS

APPROPRIATE TO THE PROJECT. CFC Chp.33, 3. WATER SUPPLY REQUIREMENTS: POTABLE WATER SUPPLIES SHALL BE PROTECTED FROM CONTAMINATION CAUSED BY FIRE PROTECTION WATER SUPPLIES. IT IS THE RESPONSIBILITY OF THE APPLICANT AND ANY CONTRACTORS AND SUBCONTRACTORS TO CONTACT THE WATER PURVEYOR SUPPLYING THE SITE OF SUCH PROJECT, AND TO COMPLY WITH THE REQUIREMENTS OF THAT PURVEYOR. SUCH REQUIREMENTS SHALL BE INCORPORATED INTO THE DESIGN OF ANY SYSTEMS OR STORAGE CONTAINERS THAT MAY BE PHYSICALLY CONNECTED IN ANY MANNER TO AN APPLIANCE CAPABLE OF CAUSING CONTAMINATION OF THE POTABLE WATER SUPPLY OF THE PURVEYOR OF RECORD. FINAL APPROVAL OF THE SYSTEM(S) UNDER CONSIDERATION WILL NOT BE GRANTED BY THIS OFFICE UNTIL COMPLIANCE WITH THE REQUIREMENTS OF THE WATER PURVEYOR OF RECORD ARE DOCUMENTED BY THAT PURVEYOR AS HAVING BEEN MET BY THE APPLICANT(S) 2022 CFC Sec. 903.3.5 AND HEALTH AND SAFETY CODE 13114.7

	Existing	Proposed	Allowed/Required	
Lot Coverage: Land area covered by all structures that are over 6 feet in height	2874.17 square feet (24.08 %)	3453.54 (MAIN) + 856.90 (ADU) 4310.44 SF square feet (36.11 %)	3580.5 square feet	
FLOOR AREA: Measured to the outside surfaces of exterior walls	1st Flr:2874.17 _ sq ft 2 nd Flr: sq ft Total:2874.17 _ sq ft (_24.08%)	3941.22 (MAIN) + 841.80 (ADU) 1st Flr: 3415.29 sq ft 2nd Flr: 1367.73 sq ft Total: 4783.91 sq ft (40.0 %)	3943.5 square fee (33 %)	
SETBACKS:				
Front Rear Right side (1st/2nd) Left side (1st/2nd)	feet feet feet feet feet feet	36'-10" feet 39'-5" feet 12'-6" feet/20'-1" feet 10'-2" feet/22'-6" feet	feet feet feet feet feet feet feet	
Неіснт:	14.5feet	feet	feet	
SQUA	RE FOOTAGE B	REAKDOWN		
	Existing	Change in	Total Proposed	
HABITABLE LIVING AREA: Includes habitable basement areas	2414.52square feet	_1836.49square feet	3410.10 (MAIN) + 840.91 (ADU 4251.01 square fee	
NON- HABITABLE AREA: Does not include covered porches or open structures	459.65 square feet	square feet	square fee	
	LOT CALCULA	TIONS		
NET LOT AREA:		11,935.0square feet square feet (_49_%)		
FRONT YARD HARDSCAPE AF Hardscape area in the front yard setback				
Total hardscape area (existing and proposed): 6567.39 sq ft Existing softscape (undisturbed) area: 4562.62 sq ft New softscape (new or replaced landscaping) area: 804.89 sq ft				

Sum of all three should equal the site's net lot area



MAbad ELECTRONIC SIGNATURE 08-28-24

WEBSITE 650-353-0273 MINERVA-ABAD PROJECTS@SQUARESPACE.COM ADDRESS 4255 PACIFIC AVE., STE 2-B, STOCKTON, CA 95207 msd.deslgn0821@gmal.com

> PROPERTY ADDRESS 707 BENVENUE AVENUE LOS ALTOS, CA 94024

PROPERTY OWNERS

GEORG AND LING BUSCHER

ASSESSOR PARCEL NO.

REVISIONS BY: REV.# DATE | COMMENT BY: 06-26-24 PLANNING-C1 09-08-24 PLANNING-C2

JOB NO. SCALE: DRAWN BY:

CHECKED BY:

PROJECT DATA

SHEET NUMBER

COMMUNITY OUTREACH: 650-353-0273 ADDRESS 4255 PACIFIC AVE., STE 2-B, STOCKTON, CA 95207 msd.design0821@gmail.com 706 BENVENUE AVE. ONE STORY MATERIAL: STUCCO WALL AND STANDING SEAM METAL ROOF GARAGE: 2 CAR / FACING SIDE PROPERTY ADDRESS 702 BENVENUE AVE. ONE STORY MATERIAL: STUCCO AND CONCRETE TILE ROOF GARAGE: 2 CAR / PROJECTING FROM FRONT OF HOUSE FACE 700 BENVENUE AVE. MATERIAL: BOARD AND BATTEN WALL AND COMPOSITION SHINGLE ROOF GARAGE: 2 CAR / PROJECTING FROM FRONT OF HOUSE FACE MATERIAL: SHINGLE WALL AND COMPOSITION SHINGLE ROOF GARAGE; 2 CAR / PROJECTING FROM FRONT OF HOUSE FACE GEORG AND LING BUSCHER Community Outreach: For projects that require a public hearing, provide documentation of neighborhood outreach. A letter shall be provided outlining the community outreach conducted with neighbors to distribute the project proposal, solicit input, and resolve neighbor concern. Community outreach shall occur with REVISIONS BY: neighbors in the immediate neighborhood context, which is the two contiguous houses on either side of the project site, and directly behind the project site, and the five to six houses directly across the street from the project site. Information and/or documentation to confirm outreach with neighbors may include: 1) copies of letters and emails to neighbors inviting them to the outreach meeting; 2) correspondence with neighbors confirming outreach with neighbors; or 3) any other information that confirms outreach to the above listed BENVENUE AVE. MATERIAL:STUCCO, WD SIDING WALL AND STANDING METAL SEAM ROOF GARAGE - 2 CAR / RECESSED FROM HOUSE FRONT FACE JOB NO. SCALE: CHECKED BY: 703 BENVENUE AVE. ONE STORY MATERIAL:WD SIDING, BOARD AND BATTEN, STONE VENEER WALL / CONC. TILE ROOF GARAGE: 2 CAR / ALIGNED WITH FRONT OF HOUSE FACE 701 BENVENUE AVE. ONE STORY MATERIAL:WD SIDING, STONE VENEER WALL AND 699 BENVENUE AVE. TWO STORY MATERIAL:WD SIDING, STONE VENEER WALL AND COMPOSITION SHINGLE ROOF GARAGE: 2 CAR / PROJECTING FROM FRONT OF HOUSE FACE MATERIAL:STUCCO WALL AND COMPOSITION SHINGLE ROOF GARAGE: 2 CAR / PROJECTING FROM FRONT OF HOUSE FACE GARAGE: 2 CAR / ALIGNED TO FRONT OF HOUSE FACE 585 CUESTA DRIVE 611 CUESTA DRIVE **CUESTA DRIVE CONTEXTUAL SITE PLAN** SCALE: $\frac{1}{32}$ " = 1'-0" 585 CUESTA DRIVE ONE STORY MATERIAL:STUCCO WALL AND COMPOSITION SHINGLE ROOF HORSESHOE DRIVEWAY - NO COVERED GARAGE 601 CUESTA DRIVE ONE STORY MATERIAL:STUCCO WALL AND COMPOSITION SHINGLE ROOF GARAGE - 2 CAR / RECESSED FROM HOUSE FRONT FACE GARAGE - 2 CAR / RECESSED FROM HOUSE FRONT FACE APPROVAL STAMP

MINERVA-ABAD PROJECTS@SQUARESPACE.COM

707 BENVENUE AVENUE

LOS ALTOS, CA 94024


PROPERTY OWNERS


ASSESSOR PARCEL NO.

REV.# DATE COMMENT BY: 06-26-24 PLANNING-C1 09-08-24 PLANNING-C2

CONTEXTUAL SITE

A-2.1

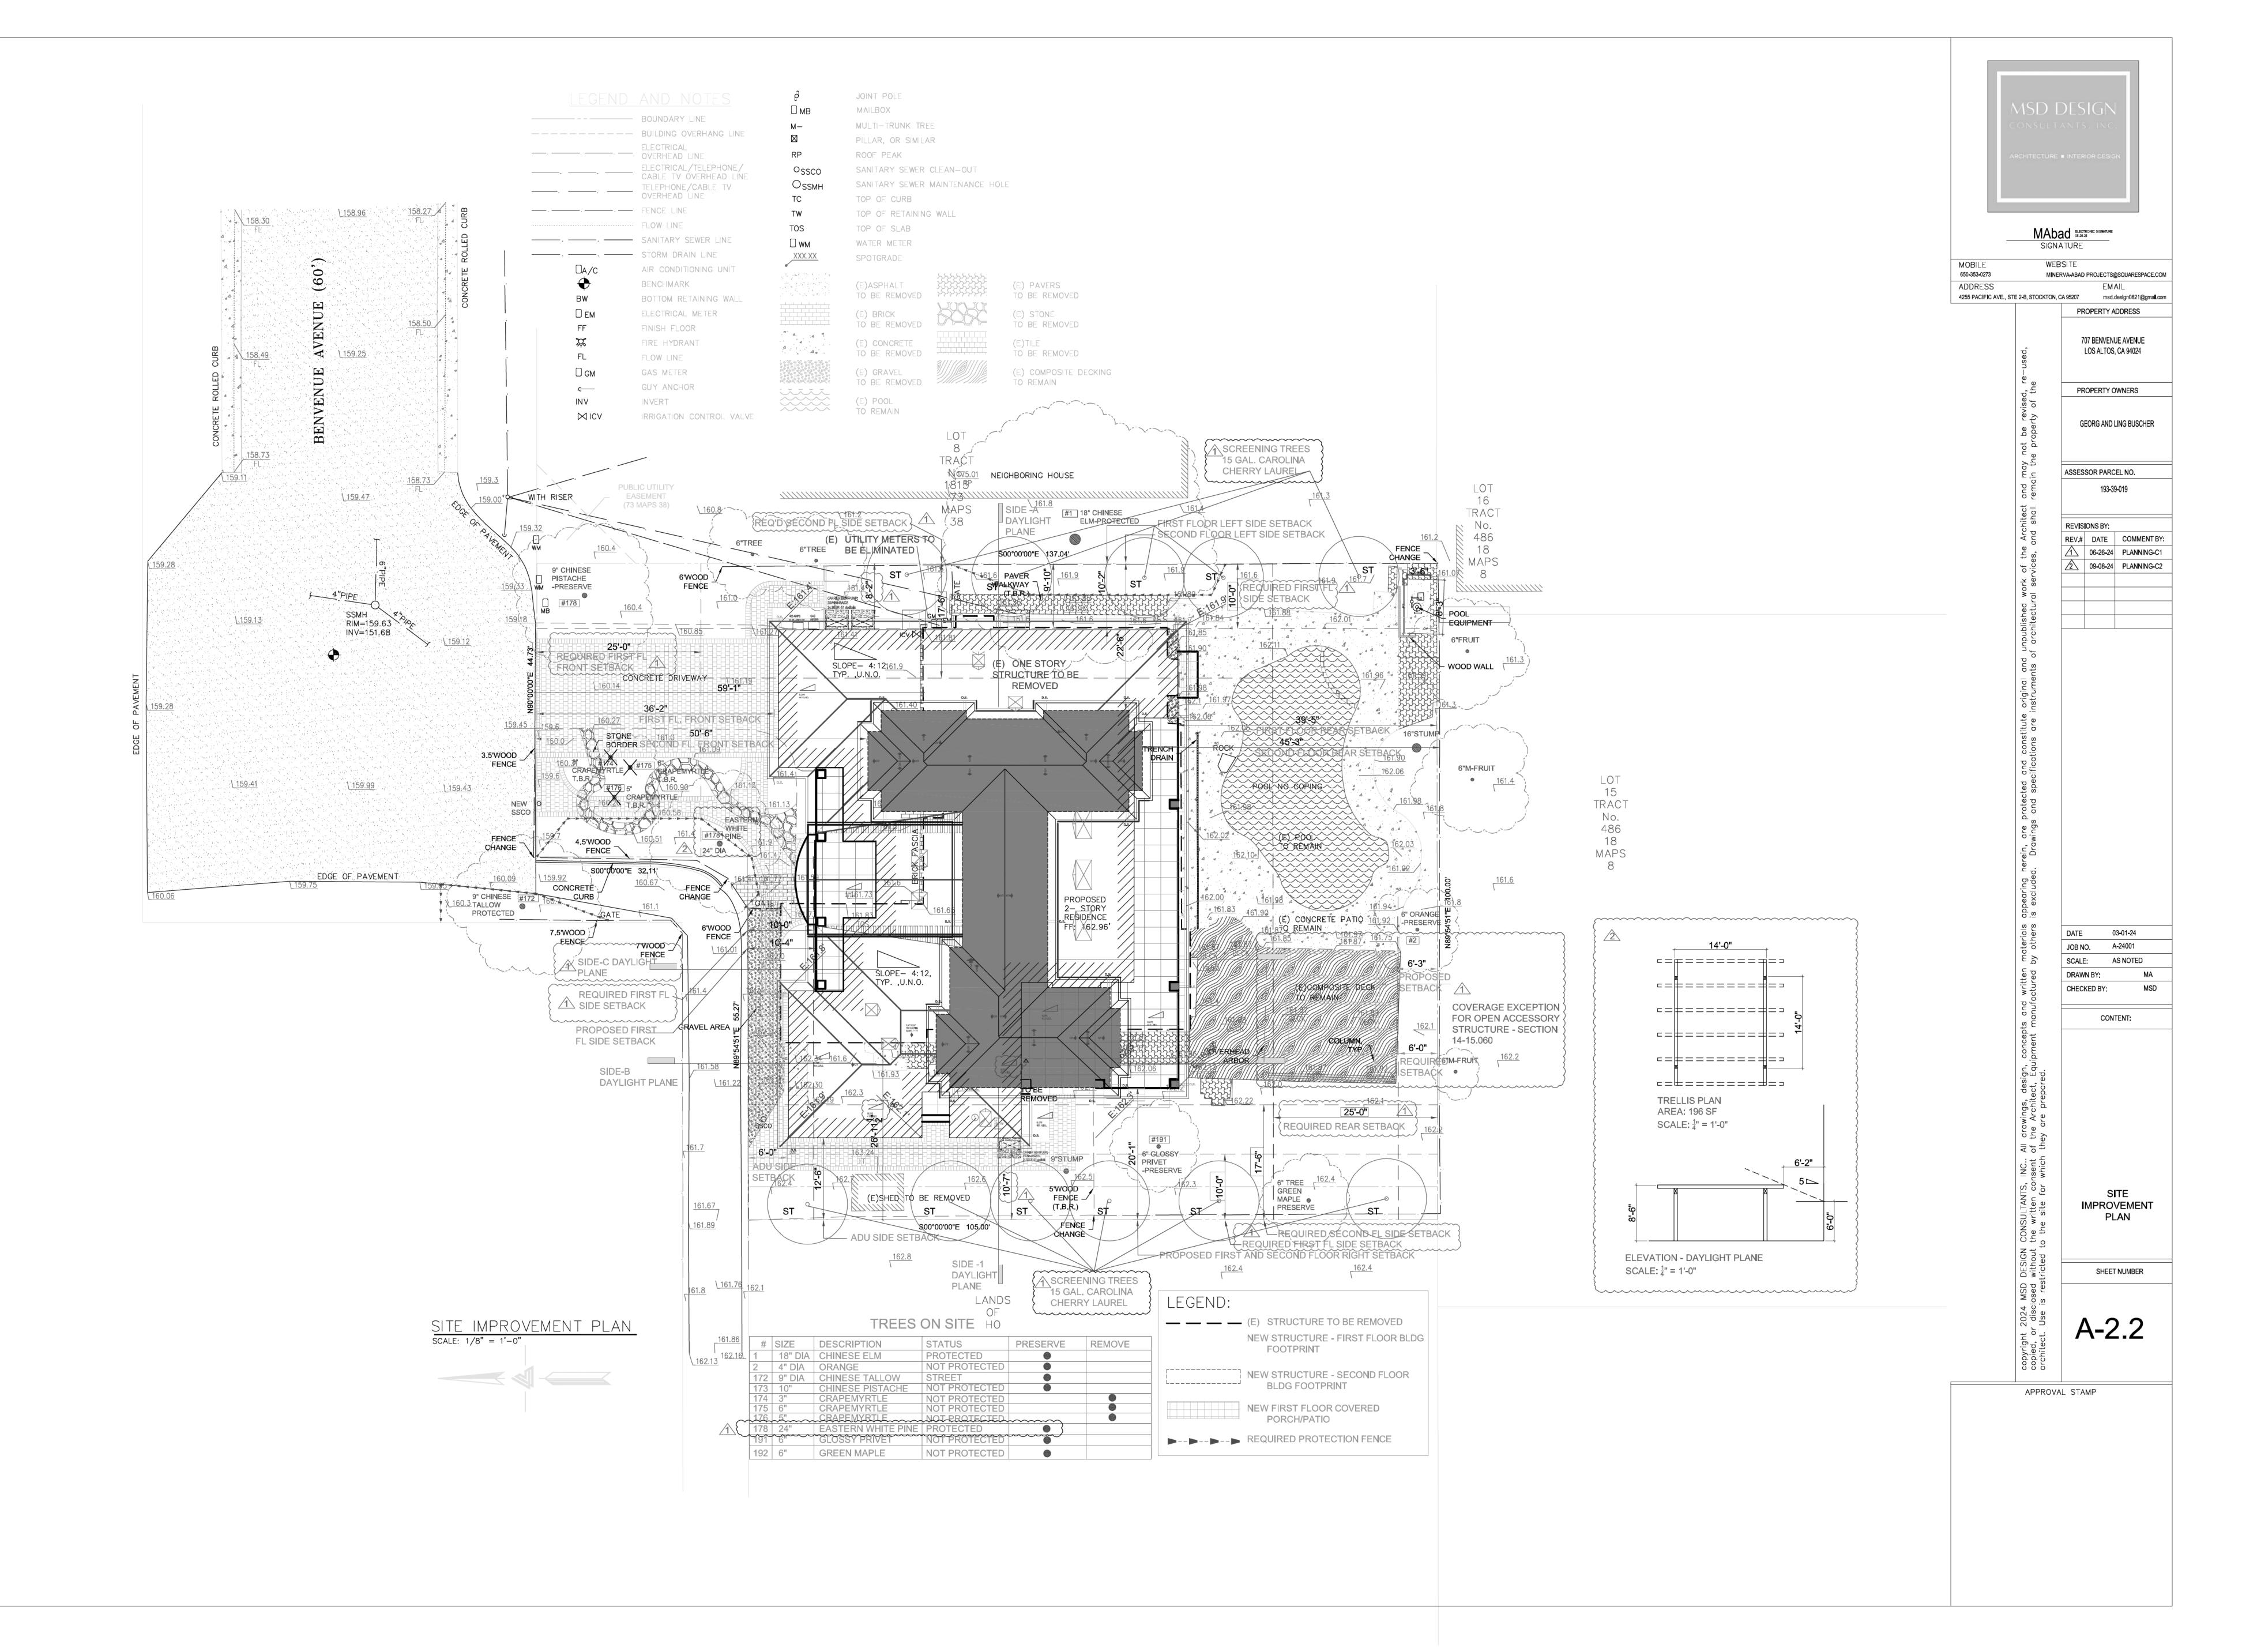

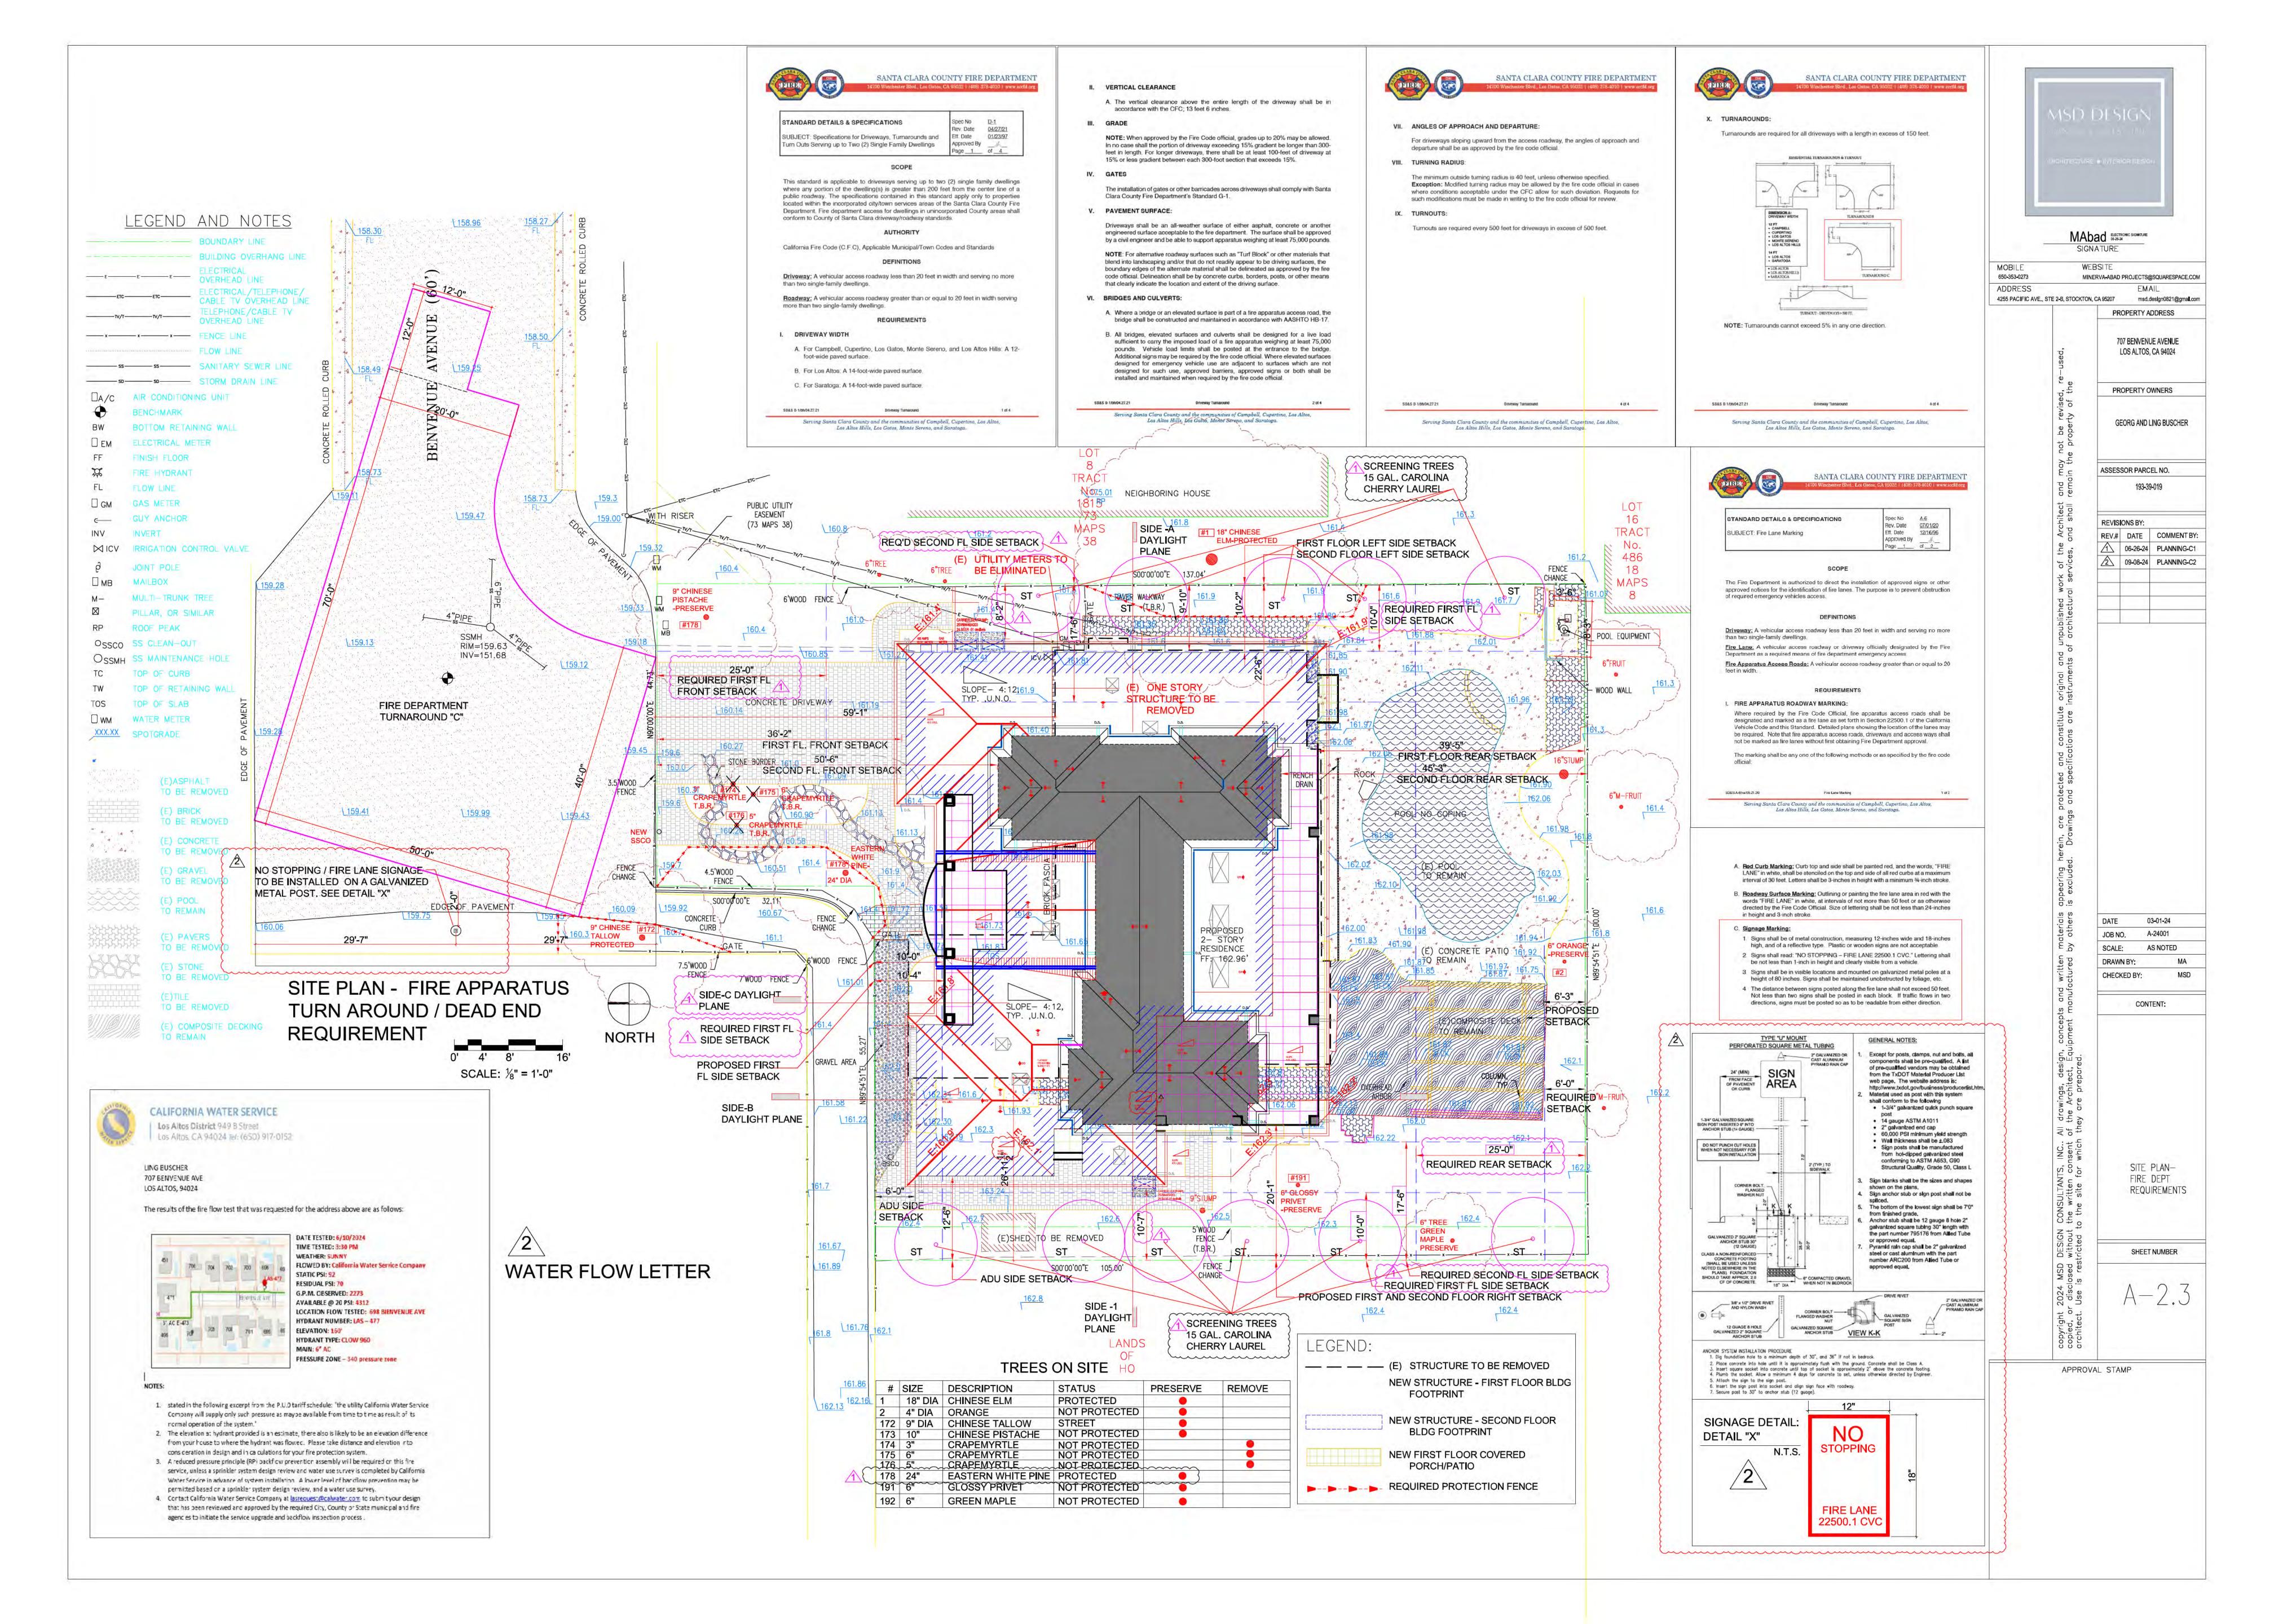





12/17/02

STANDARD DETAILS & SPECIFICATIONS

SI-7 Rev. Date 04/30/09 Eff. Date **SUBJECT**: Construction Site Fire Safety Approved By Page __1__ of <u>9</u>

SCOPE

This Standard is intended to prescribe minimum safeguards for new building construction, demolition or significant building alteration projects in order to provide a reasonable degree of safety to life and property from fire. This Standard is based on the provisions for fire safety during building construction or demolitions as set forth in the 2007 California Fire Code Chapter 14 and National Fire Protection Association Standard 241. This Standard shall not be construed to be in lieu of other applicable State or Federal laws and regulations related to construction site safety. The general contractor (or other designee of the building owner) shall be responsible for compliance with the provisions of this Standard. When the term "shall" is used in this Standard, it means a mandatory requirement.

REQUIREMENTS

I. Fire Protection Plan

A written Fire Protection Plan shall be developed for significant or complex construction projects at the discretion of the fire department. The plan shall be approved by the fire department prior to proceeding past foundation work for new buildings or commencement of demolition work in alteration projects. The written plan shall be consistent with the fire safety precautions as specified in this Standard. The general contractor is responsible for carrying out the provisions of the Fire Protection Plan and communicating it to all subcontractors. Additionally, the Fire Marshal shall be notified of any change affecting the utilization of information contained in the Fire Protection plan. The Fire Protection Plan shall include the following:

- A. Procedures for reporting emergencies to the Fire department. B. Procedures for emergency notification, evacuation and/or relocation of all
- persons in the building under construction and on the site. C. Procedures for hot work operations, management of hazardous materials and
- removal of combustible debris and maintenance of emergency access roads. D. Floor plans identifying the locations of exits, exit stairs, exit routes and portable
- fire extinguishers. E. Site plans identifying the designated exterior assembly areas for each evacuation
- F. Site plans identifying required fire apparatus access roadways and on-site fire hydrants.

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G. The name and contact phone number of the person(s) responsible for compliance with the Fire Protection Plan.

II. General Safety Requirements

A. Fire Department Access Roadways: All construction sites shall be accessible by fire department apparatus by means of roadways having an all-weather driving service of not less than 20ft. of unobstructed width. The roads shall have the ability to withstand the live loads of fire apparatus, and have a minimum 13ft. 6 in. of vertical clearance. Dead end fire access roads in excess of 150 ft. in length shall be provided with approved turnarounds.

When approved by the Chief, temporary access roadways may be utilized until such time that the permanent roadways are installed. As a minimum, the roadway shall consist of a compacted sub base and six (6) inches of road base material (Class 2 aggregate base rock) both compacted to a minimum 95%. The perimeter edges of the roadway shall be contained and delineated by curb and gutter or other approved method. The use of geotextile reinforcing fabric underlayment or soils lime-treatment may be required if so determined by the project civil engineer. Provisions for surface drainage shall also be provided where necessary. The integrity of the roadway shall be maintained at all times.

Key boxes: Key boxes and/or approved padlocks shall be required when necessary for access through locked gates or structures.

- B. <u>Fire hydrants:</u> Where underground water mains and hydrants are required for the building(s) under construction, they shall be installed, completed, and in service prior to combustible construction materials accumulating on
- C. <u>Telephone service</u>: Provisions shall be provided at the construction site for emergency notification of the fire department via telephone. The street address of the construction site shall be posted adjacent to the telephone, along with the number for the public safety answering point.
- D. Premises identification: The address numbers of the property or project location shall be plainly visible and legible from the street or road fronting the property at the fire apparatus access point or as otherwise approved.
- E. Combustible debris: Wood, cardboard, packing material, form lumber and similar combustible debris shall not be accumulated within buildings. Such debris, rubbish and waste material shall be removed from buildings on a daily basis.

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F. Oily rags: Oily rags and similar material shall be stored in metal or other approved containers equipped with tight-fitting covers.

G. Temporary heating equipment: Temporary heaters, such as those that are LPG fueled, shall be listed and shall be installed, used, and maintained in accordance with the manufacturer's instructions (See LPG storage and use requirements below). Heating devices shall be secured properly and kept clear from combustible materials. Refueling operations shall be conducted in an approved manner.

H. <u>Smoking</u>: Smoking is prohibited anywhere inside or on the roof of new buildings under construction or in the project work area of buildings undergoing alteration. A suitable number of 'No Smoking' signs shall be posted to ensure that smoking is controlled.

I. Vehicle parking: All vehicles shall be parked a minimum of 20 feet from new buildings under construction.

Exceptions: 1. Vehicles that are temporarily parked for loading/unloading or other construction related operations. Such vehicles shall not be left unattended.

- 2. Private vehicles may be parked in parking garages of Type I construction if the automatic fire sprinkler system is in service and vertical openings are protected.
- Combustible material storage: Combustible construction materials shall be stored a minimum of 20 feet from buildings under construction or undergoing remodel.

Exceptions: 1. Materials that are staged for installation on a floor level.

2. When approved by the Fire Department, materials may be stored in parking garages of Type I construction if the automatic fire sprinkler system is in service and vertical openings are protected.

III. Fire Protection Systems

A. <u>Fire Sprinkler Systems:</u> Where automatic fire sprinkler systems are required to be installed in new buildings, the system shall be placed in service as soon possible. Immediately upon the completion of sprinkler pipe installation on each floor level, the piping shall be hydrostatically tested and inspected. After inspection approval from the Fire department, each floor level of sprinkler piping shall be connected to the system supply riser and placed into service with all sprinkler heads uncovered. Protective caps may be

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installed on the active sprinklers during the installation of drywall, texturing and painting, but shall be removed immediately after this work is completed. For system activation notification, an exterior alarm bell can be installed and connected to the sprinkler waterflow device prior to installation of the monitoring system.

For buildings equipped with fire sprinkler systems that are undergoing alterations, the sprinkler system(s) shall remain in service at all times except when system modifications are necessary. Fire sprinkler systems undergoing modifications shall be returned to service at the end of each workday unless otherwise approved by the fire department. The General contractor or his/her designee shall check the sprinkler control valve(s) at the end of each workday to confirm that the system has been restored to

- B. Standpipes: Where standpipes are required, the standpipes shall be installed when the progress of construction is not more than 35 ft. in height above the lowest level of the fire department access. Standpipes shall be provided with fire department hose connections and outlets at accessible locations adjacent to usable stairs. The standpipe system shall be extended as construction progresses to within one floor of the highest point of construction having secured decking or flooring. Each floor shall be provided a 21/2-inch valve outlet for fire department use. Where construction height requires installation of a Class III standpipe, fire pumps and water main connections shall be provided to serve the standpipe.
- C. <u>Fire Extinguishers: Portable</u> fire extinguishers shall be provided and shall be mounted on a wall or post at each usable stairway and such that the travel distance to any extinguisher does not exceed 75 ft. Mounting height to the top of the extinguisher shall not exceed 5 feet. Extinguishers shall not have less than a 2A10BC rating or as otherwise directed by the fire department. The general contractor shall ensure that an adequate number of individuals are trained in the proper use of portable fire extinguishers. Fire extinguishers shall also be located in storage sheds and contractor trailers.
- D. <u>Fire Alarm Systems:</u> Fire alarm systems shall be maintained operational at all times during building alterations. When an alteration requires modification to a portion of the fire alarm system, the portion of the system requiring work shall be isolated and the remainder of the system shall be kept in service whenever practical. When it is necessary to shut down an entire fire alarm system a fire watch or other mitigation approved by the fire department shall be implemented by the general contractor until the system is returned to full service.

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IV. Means of Egress Requirements

- A. Minimum number of Exits: All new buildings under construction shall have a least one unobstructed exit. All exits shall be identified on the Fire Protection Plan.
- B. <u>Multi-Story Buildings:</u> Each level above the first story in new multi-story buildings shall be provided with at least two usable exit stairs after the floor decking is installed. The stairways shall be continuous and discharge to grade level. Stairways serving more than two floor levels shall be enclosed (with openings adequately protected) after exterior walls/windows are in stairs in new and in existing, occupied buildings shall be lighted and maintained clear of debris and construction materials at all times.

Exception: For new multi-story buildings, one of the required exit stairs may be obstructed on not more than two contiguous floor levels for the purposes of stairway construction (i.e., installation of gypsum board, painting, flooring, etc.).

C. Assembly Points: Designated exterior assembly points shall be established for all construction personnel to relocate to upon evacuation. The assembly points shall also be identified in the Fire Protection Plan.

V. Area Separation Walls

When area separation walls are required, the wall construction shall be completed (with all openings protected) immediately after the building is sufficiently weatherprotected at the location of the wall(s).

VI. Special Operation Requirements

A. Hot Work: Hot work includes any work involving operations capable of initiating fires or explosions, including cutting, welding, brazing, soldering, grinding, thermal spraying, thawing pipe, torch applied roofing, or any other similar activity. The use of hot work equipment shall be in accordance with the following guidelines, including a pre-site inspection, fire watch and post inspection procedures.

1. <u>Pre-site Inspection</u>: An inspection of the hot work site shall be conducted by the General Contractor or his/her designee prior to hot work operations to ensure:

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(a) the hot work site is clear of combustibles or that combustibles are

(b) exposed construction is of noncombustible materials or that combustible materials are protected; (c) openings are protected;

(d) there are no exposed combustibles on the opposite side of partitions, walls, ceilings, floors, etc.; (e) fire extinguishers are available, fully charged and operable; and (f) fire watch personnel are assigned, equipped and trained.

- 2. <u>Fire Watch:</u> The sole duty of fire watch personnel shall be to watch for the occurrence of fire during and after hot work operations. Individuals designated to fire watch duty shall have fire extinguishing equipment readily available and shall be trained in the use of such equipment. Personnel assigned to fire watch shall be responsible for extinguishing spot fires and communicating an alarm. Fire watch personnel shall be provided with at least one means for notification of the fire department. Hot work conducted in areas with vertical and horizontal fire exposures that cannot be observed by a single individual shall have additional personnel assigned to fire watches to ensure that all exposed areas are monitored.
- 3. <u>Post-inspection:</u> The fire watch shall be maintained a minimum of 30 minutes after the conclusion of the work to look out for leftover sparks, slag or smoldering combustibles.
- B. Asphalt and tar kettles: Asphalt kettles shall not be located within 20 feet of any combustible material, combustible building surface or building opening. With the exception of thermostatically controlled kettles, an attendant shall be within 100 feet of a kettle when the heat source is operating. Ladders or similar obstacles shall not form a part of the route between the attendance and the kettle. Kettles shall be equipped with tight-fitting covers. A minimum 3A 40-B:C rated portable fire extinguisher shall be located within 30 feet of each asphalt kettle when the heat source is operating. Minimum 3A 40-B:C rated portable fire extinguishers also shall be located on roofs during asphalt coating operations.
- C. Motor Equipment: Motorized equipment including internal-combustionpowered construction equipment shall be used in accordance with the
 - 1) Equipment shall be located so that exhausts do not discharge against combustible materials. 2) When possible, exhausts should be piped to the outside of the

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3) Equipment shall not be refueled while in operation. 4) Fuel for equipment shall be stored in an approved area outside of the

(Ref: CFC Articles 87 & 13 – also 49, 79 and 11)

VII. Hazardous Materials

- A. Liquefied Petroleum Gas (LP-Gas) Storage and use shall comply with
- 1. Propane containers may be used in buildings under construction or undergoing major renovation as a fuel source for temporary heating for curing concrete, drying plaster and similar applications in accordance with the following:
- (a) Heating elements (other than integral heater-container units) shall be located at least 6 feet from any LP-Gas container.
- (b) Integral heater-container units specifically designed for the attachment of the heater to the container, or to a supporting standard attached to the container, may be used provided they are designed and installed so as to prevent direct or radiant heat application to the LP-Gas container.
- (c) Blower and radiant type units shall not be directed toward any LP-Gas container within 20 feet.
- (d) Heat producing equipment shall be installed with clearance to the combustibles in accordance with the manufacturer's installation instructions.
- (e) Cylinders shall comply with DOT cylinder specifications and shall be secured in an upright position.
- (f) Regulators shall be approved for use with LP-Gas. Fittings shall be designed for at least 250 psig service pressure.
- (g) Hose shall be designed for a working pressure of at least 350 psig (unless limited to 5 psig) and shall be a maximum of 6 feet in length.
- (h) Portable heaters shall be equipped with an approved automatic device to shut off the flow of gas to the main burner and to the pilot in the event of flame extinguishment or combustion failure. Portable heaters with an input of more than 50,000 B.u/hr shall be equipped with either a pilot that must be proved before the main burner can be turned on or an approved electronic ignition system.

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2. In addition to the above, for LPG storage/use in buildings undergoing alteration and that are fully or partially occupied, the following shall also

(a) Specific approval must be obtained from the fire department prior to bringing LP-Gas containers on-site.

(b) The maximum water capacity of individual containers shall be 5gallon water capacity and the number of containers in the building shall not exceed the number of workers assigned to using the LP-Gas. (c) Containers having a water capacity greater than 2 1/2 lb. [1 quart] shall not be left unattended.

B. Storage, Use and Dispensing of Flammable and Combustible Liquids

- 1. Storage areas for flammable and combustible liquids shall be kept free of weeds and extraneous combustible material. Open flames and smoking
- are prohibited in flammable or combustible liquid storage areas. 2. Tanks and containers shall be marked with the name of the product and FLAMMABLE-KEEP FIRE AND FLAME AWAY. Tanks (containers in excess of 60 gallons) shall also be labeled KEEP 50 FEET FROM
- BUILDINGS. 3. Metal containers for Class I or II liquids shall be in accordance with DOT requirements or shall be of an approved design. Discharge devices shall not cause an internal pressure on the container. Individual containers shall not be interconnected and shall be kept closed when not in use.
- 4. Secondary containment or a means of spill control, drainage control, and diking is required for large containers (such as 55 gallon drums) and tanks as approved by the fire department.
- 5. Plans for the installation/use of any aboveground storage tank (containers greater than 60 gallons) shall be submitted to the fire department for review and permit prior to the proposed tank arriving at the site.

C. Compressed Gases

- Gas cylinders shall be marked with the name of the contents. Gas cylinders shall be stored upright and secured to prevent falling.
- . When not in use, valve protective caps shall be in place.
- 4. Gas cylinders shall be protected against physical damage.
- 5. When stored, gas cylinders shall be separated from each other based on their hazard classes. 6. Combustible materials shall be kept a minimum of 10 feet from gas
- 7. Gas cylinders shall not be placed near elevators, unprotected platform edges or other areas where they would drop more than 2 feet.

Los Altos Hills, Los Gatos, Monte Sereno, Morgan Hill, and Saratoga

Organized as the Santa Clara County Central Fire Protection District Serving Santa Clara County and the communities of Campbell, Cupertino, Los Altos,

MAbad ELECTRONIC SIGNATURE 08-28-24

WEBSITE 650-353-0273 MINERVA-ABAD PROJECTS@SQUARESPACE.COM **ADDRESS** 4255 PACIFIC AVE., STE 2-B, STOCKTON, CA 95207 msd.deslgn0821@gmall.com PROPERTY ADDRESS

> LOS ALTOS, CA 94024 PROPERTY OWNERS

707 BENVENUE AVENUE

GEORG AND LING BUSCHER


ASSESSOR PARCEL NO REVISIONS BY: REV.# DATE COMMENT BY: 06-26-24 PLANNING-C1

03-01-24 DATE A-24001 JOB NO.

SCALE: AS NOTED DRAWN BY: CHECKED BY: CONTENT:

FIRE DEPT STANDARD DETAILS AND **SPECIFICATIONS**

SHEET NUMBER

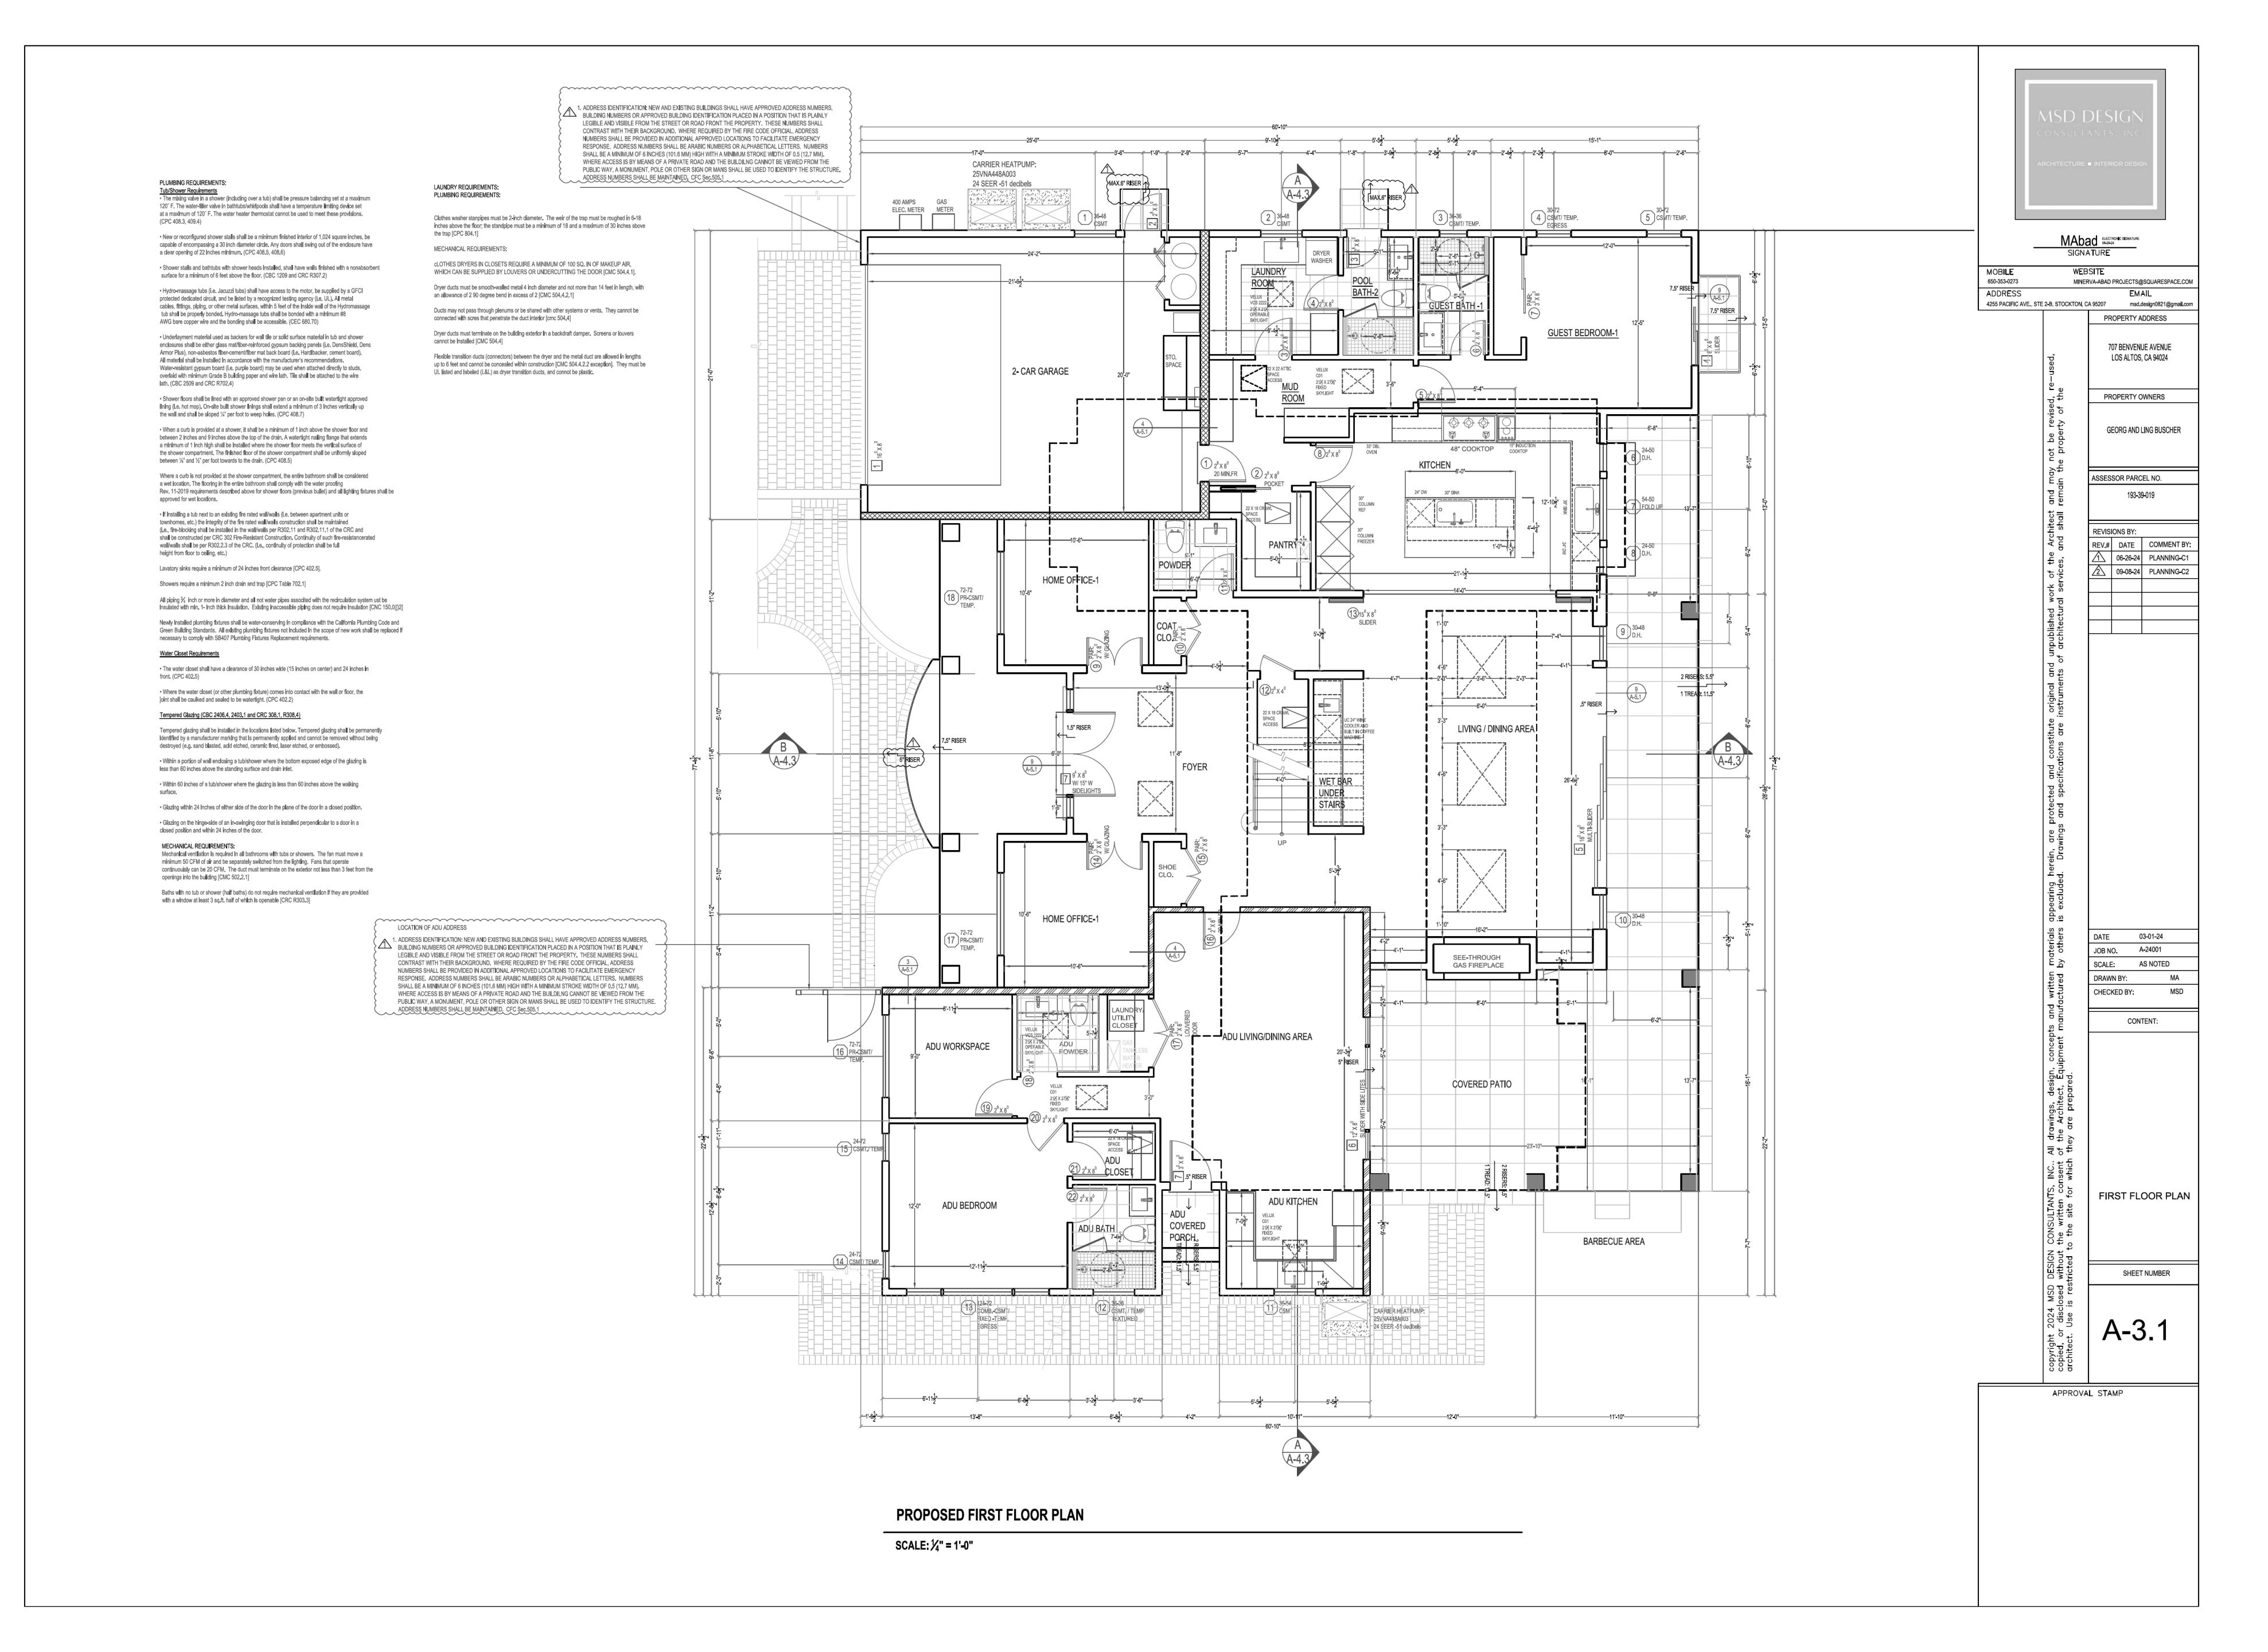

GENERAL NOTES: PLUMBING REQUIREMENTS:

Tub/Shower Requirements

• The mixing valve in a shower (including over a tub) shall be pressure ballancing set at a maximum 120° F. The water-filler valve in bathtubs/whirlpools shall have a temperature limiting device set at a maximum of 120° F. The water heater thermostat cannot be used to meet these provisions. (CPC 408.3, 409.4)

 New or reconfigured shower stalls shall be a minimum finished interior of 1,024 square inches, be capable of encompassing a 30 inch diameter circle. Any doors shall swing out of the enclosure have a clear opening of 22 inches minimum. (CPC 408.5, 408.6)

 Shower stalls and bathtubs with shower heads Installed, shall have walls finished with a nonabsorbent surface for a minimum of 6 feet above the floor. (CBC 1209 and CRC R307.2)

Hydro-massage tubs (i.e. Jacuzzi tubs) shall have access to the motor, be supplied by a GFCI protected dedicated circuit, and be listed by a recognized testing agency (i.e. UL). All metal cables, fittings, piping, or other metal surfaces, within 5 feet of the inside wall of the Hydromassage tub shall be properly bonded. Hydro-massage tubs shall be bonded with a minimum #8 AWG bare copper wire and the bonding shall be accessible. (CEC 680.70)

Underlayment material used as backers for wall tile or solid surface material in tub and shower enclosures shall be either glass mat/fiber-reinforced gypsum backing panels (i.e. DensShield, Dens Armor Plus), non-asbestos fiber-cement/fiber mat back board (i.e. Hardlbacker, cement board). All material shall be Installed in accordance with the manufacturer's recommendations. Water-resistant gypsum board (i.e. purple board) may be used when attached directly to studs, overlaid with minimum Grade B building paper and wire lath. Tile shall be attached to the wire lath. (CBC 2509 and CRC R702.4)

 Shower floors shall be lined with an approved shower pan or an on-site built watertight approved lining (i.e. hot mop). On-site built shower linings shall extend a minimum of 3 inches vertically up the wall and shall be sloped ¼" per foot to weep holes. (CPC 408.7)

 When a curb Is provided at a shower, it shall be a minimum of 1 inch above the shower floor and between 2 inches and 9 inches above the top of the drain. A watertight nailing flange that extends a minimum of 1 inch high shall be installed where the shower floor meets the vertical surface of the shower compartment. The finished floor of the shower compartment shall be uniformly sloped between ½" and ½" per foot towards to the drain. (CPC 408.5)

Where a curb is not provided at the shower compartment, the entire bathroom shall be considered a wet location. The flooring in the entire bathroom shall comply with the water proofing Rev. 11-2019 requirements described above for shower floors (previous bullet) and all lighting fixtures shall be approved for wet locations.

 If Installing a tub next to an existing fire rated wall/walls (Le, between apartment units or townhomes, etc.) the Integrity of the fire rated wall/walls construction shall be maintained (i.e., fire-blocking shall be installed in the wall/walls per R302.11 and R302.11.1 of the CRC and shall be constructed per CRC 302 Fire-Resistant Construction. Continuity of such fire-resistancerated wall/walls shall be per R302.2.3 of the CRC. (i.e., continuity of protection shall be full height from floor to celling, etc.)

Lavatory slnks require a minimum of 24 Inches front clearance [CPC 402.5].

Showers require a minimum 2 inch drain and trap [CPC Table 702.1]

All piping $\frac{3}{4}$ Inch or more in diameter and all not water pipes associated with the recirculation system ust be insulated with min. 1- inch thick insulation. Existing inaccessible piping does not require insulation [CNC 150.0(j)2]

Newly installed plumbing fixtures shall be water-conserving in compliance with the California Plumbing Code and Green Bullding Standards. All existing plumbing fixtures not included in the scope of new work shall be replaced if necessary to comply with SB407 Plumbing Fixtures Replacement requirements.

Dryer ducts must terminate on the cannot be installed [CMC 504.4]

Flexible transition ducts (connectors)

Water Efficient Plumbing Fixtures (CalGreen 301.1.1, 4.303)
All plumbing fixtures (based on water efficiency) throughout the house shall meet the following

table :	
Plumbing Fixture	Fixture Required Water-Conserving Plumbing
	Fixture (maximum flow-rates)
Water Closet (Toilet)	1.28 gallons/flush
Showerhead	1,8 gallons/minute at 80 psi
Faucet -Bathroom	1.2 gallons/mlnute at 60 psl
Faucet - Kitchen	1.8 gallons/minute at 60 psi (average)

Smoke and Carbon Monoxide Alarms (CBC 907.2.10, CRC 314 and 315)

Smoke alarms shall be installed on the ceiling or wall (between 4" and 12" of the ceiling) in all sleeping rooms, each area/hallway adjacent to sleeping rooms, each story of the building, and in any basement. Smoke alarms shall be replaced 10 years after the date of manufacture listed on the alarm (If no date is listed the alarm shall be replaced). Newly installed smoke alarms shall have a 10-year battery. Carbon monoxide (CO) alarms shall be installed on the ceiling or wall (above the door header) in each area/hallway adjacent to sleeping rooms, each occupiable story, and within a bedroom if the bedroom or attached bathroom contains a fuel-burning appliance. CO alarms are not required if there is no fuelburning appliance or fireplace in the house and where the garage is detached from the house.

Tempered Glazing (CBC 2406.4, 2403.1 and CRC 308.1, R308.4)

Tempered glazing shall be installed in the locations listed below. Tempered glazing shall be permanently identified by a manufacturer marking that is permanently applied and cannot be removed without being destroyed (e.g. sand blasted, acid etched, ceramic fired, laser etched, or embossed).

 Within a portion of wall enclosing a tub/shower where the bottom exposed edge of the glazing is less than 60 Inches above the standing surface and drain inlet.

Within 60 Inches of a tub/shower where the glazing is less than 60 Inches above the walking surface.

Glazing within 24 inches of either side of the door in the plane of the door in a closed position.
Glazing on the hinge-side of an in-swinging door that is installed perpendicular to a door in a closed position and within 24 inches of the door.

MECHANICAL REQUIREMENTS:

Mechanical ventilation is required in all bathrooms with tubs or showers. The fan must move a minimum 50 CFM of air and be separately switched from the lighting. Fans that operate continuouisly can be 20 CFM. The duct must terminate on the exterior not less than 3 feet from the openings into the building [CMC 502.2.1]

Baths with no tub or shower (half baths) do not require mechanical ventilation if they are provided with a window at least 3 sq.ft. half of which is openable [CRC R303.3]

Water Closet Requirements

• The water closet shall have a clearance of 30 inches wide (15 inches on center) and 24 inches in front. (CPC 402.5)

 Where the water closet (or other plumbing fixture) comes into contact with the wall or floor, the joint shall be caulked and sealed to be watertight. (CPC 402.2)

LAUNDRY REQUIREMENTS: PLUMBING REQUIREMENTS:

Clothes washer stanpipes must be 2-inch diameter. The weir of the trap must be roughed in 6-18 inches above the floor; the standpipe must be a minimum of 18 and a maximum of 30 inches above

MECHANICAL REQUIREMENTS:

CLOTHES DRYERS IN CLOSETS REQUIRE A MINIMUM OF 100 SQ. IN OF MAKEUP AIR, WHICH CAN BE SUPPLIED BY LOUVERS OR UNDERCUTTING THE DOOR [CMC 504.4.1].

Dryer ducts must be smooth-walled metal 4 inch diameter and not more than 14 feet in length, with

Ducts may not pass through plenums or be shared with other systems or vents. They cannot be connected with scres that penetrate the duct Interior [cmc 504.4]

an allowance of 2 90 degree bend in excess of 2 [CMC 504.4.2.1]


Dryer ducts must terminate on the building exterior in a backdraft damper. Screens or louvers cannot be installed [CMC 504.4]

Flexible transition ducts (connectors) between the dryer and the metal duct are allowed in lengths up to 6 feet and cannot be concealed within construction [CMC 504.4.2.2 exception]. They must be UL listed and labeled (L&L) as dryer transition ducts, and connot be plastic.

FIRE PROTECTION NOTES:

Smoke and Carbon Monoxide Alarms (CBC 907.2.10, CRC 314 and 315)

Smoke alarms shall be installed on the ceiling or wall (between 4" and 12" of the ceiling) in all sleeping rooms, each area/hallway adjacent to sleeping rooms, each story of the building, and in any basement. Smoke alarms shall be replaced 10 years after the date of manufacture listed on the alarm (If no date is listed the alarm shall be replaced). Newly installed smoke alarms shall have a 10-year battery. Carbon monoxide (CO) alarms shall be installed on the ceiling or wall (above the door header) in each area/hallway adjacent to sleeping rooms, each occupiable story, and within a bedroom if the bedroom or attached bathroom contains a fuel-burning appliance. CO alarms are not required if there is no fuelburning appliance or fireplace in the house and where the garage is detached from the house.

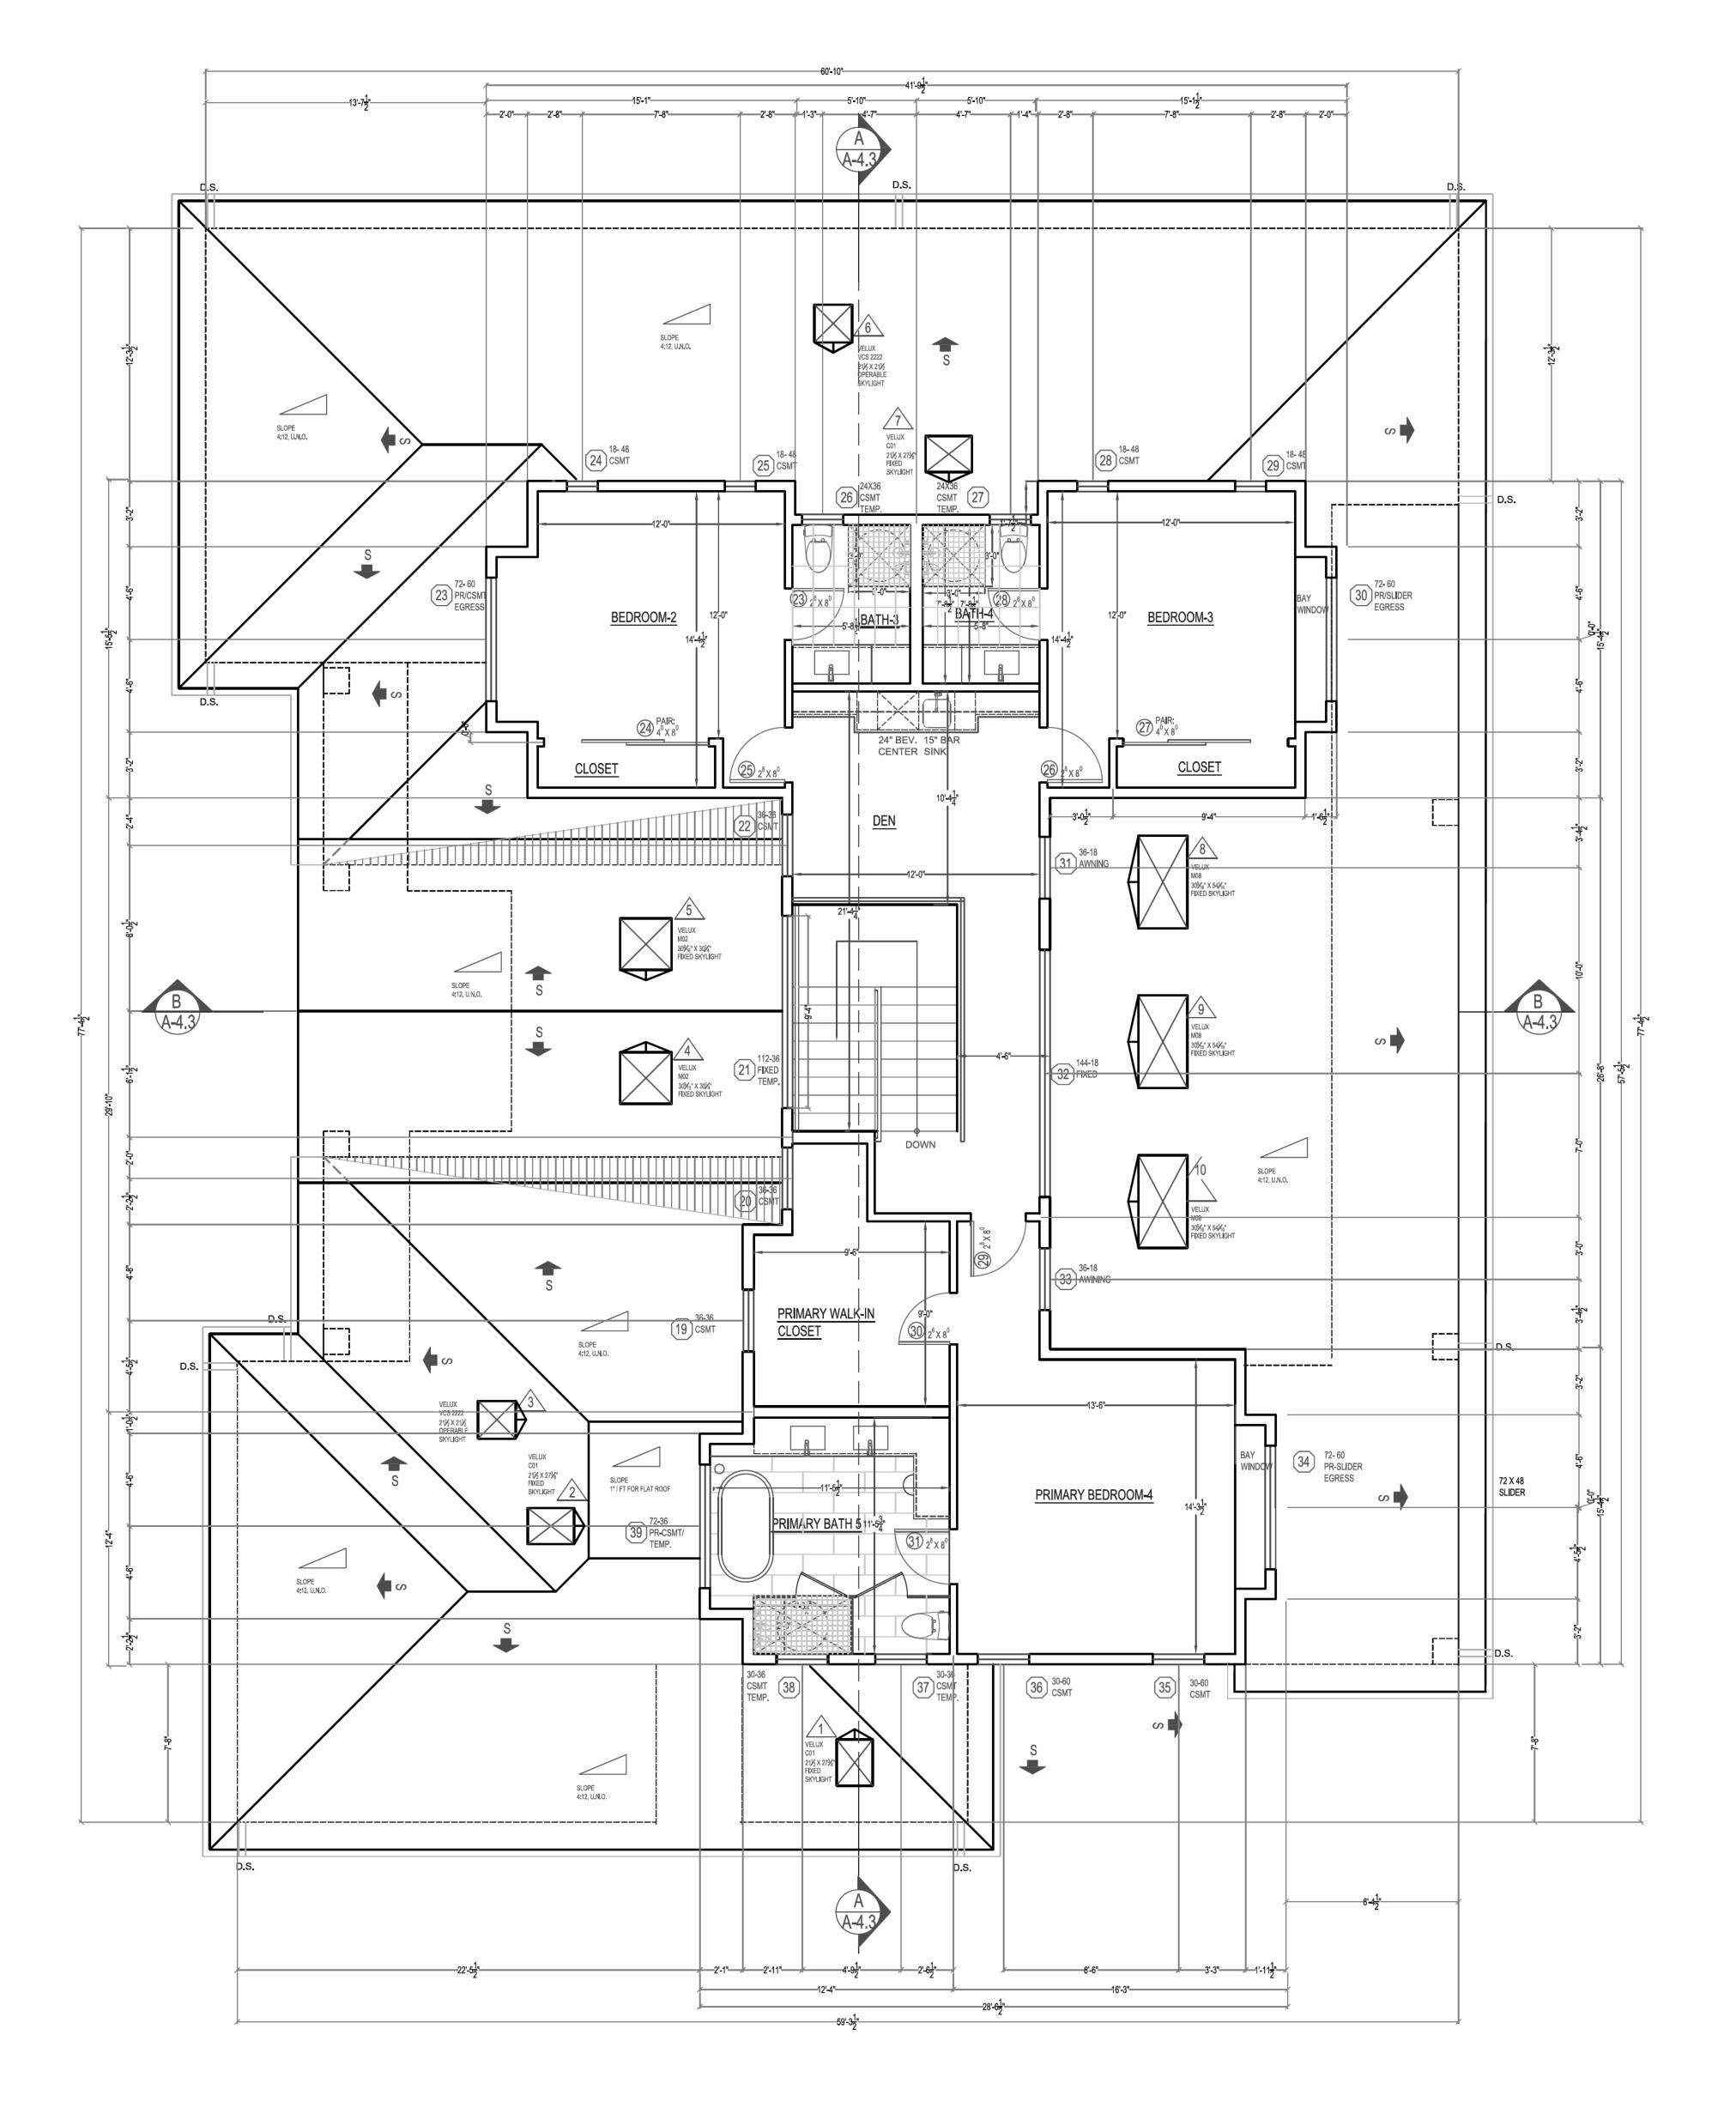

PROPOSED FIRST FLOOR ROOF PLAN / SECOND FLOOR PLAN

SCALE: 1/4" = 1'-0"



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PROPERTY ADDRESS

PROPERTY OWNERS

GEORG AND LING BUSCHER

ASSESSOR PARCEL NO.
193-39-019

REVISIONS BY:

REV.# DATE COMMENT BY:

1 06-26-24 PLANNING-C1

2 09-08-24 PLANNING-C2

DATE 03-01-24

JOB NO. A-24001

SCALE: AS NOTED


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DRAWN BY: CHECKED BY:

SECOND FLOOR PLAN AND FIRST FLOOR ROOF PLAN

SHEET NUMBER

A-3.2

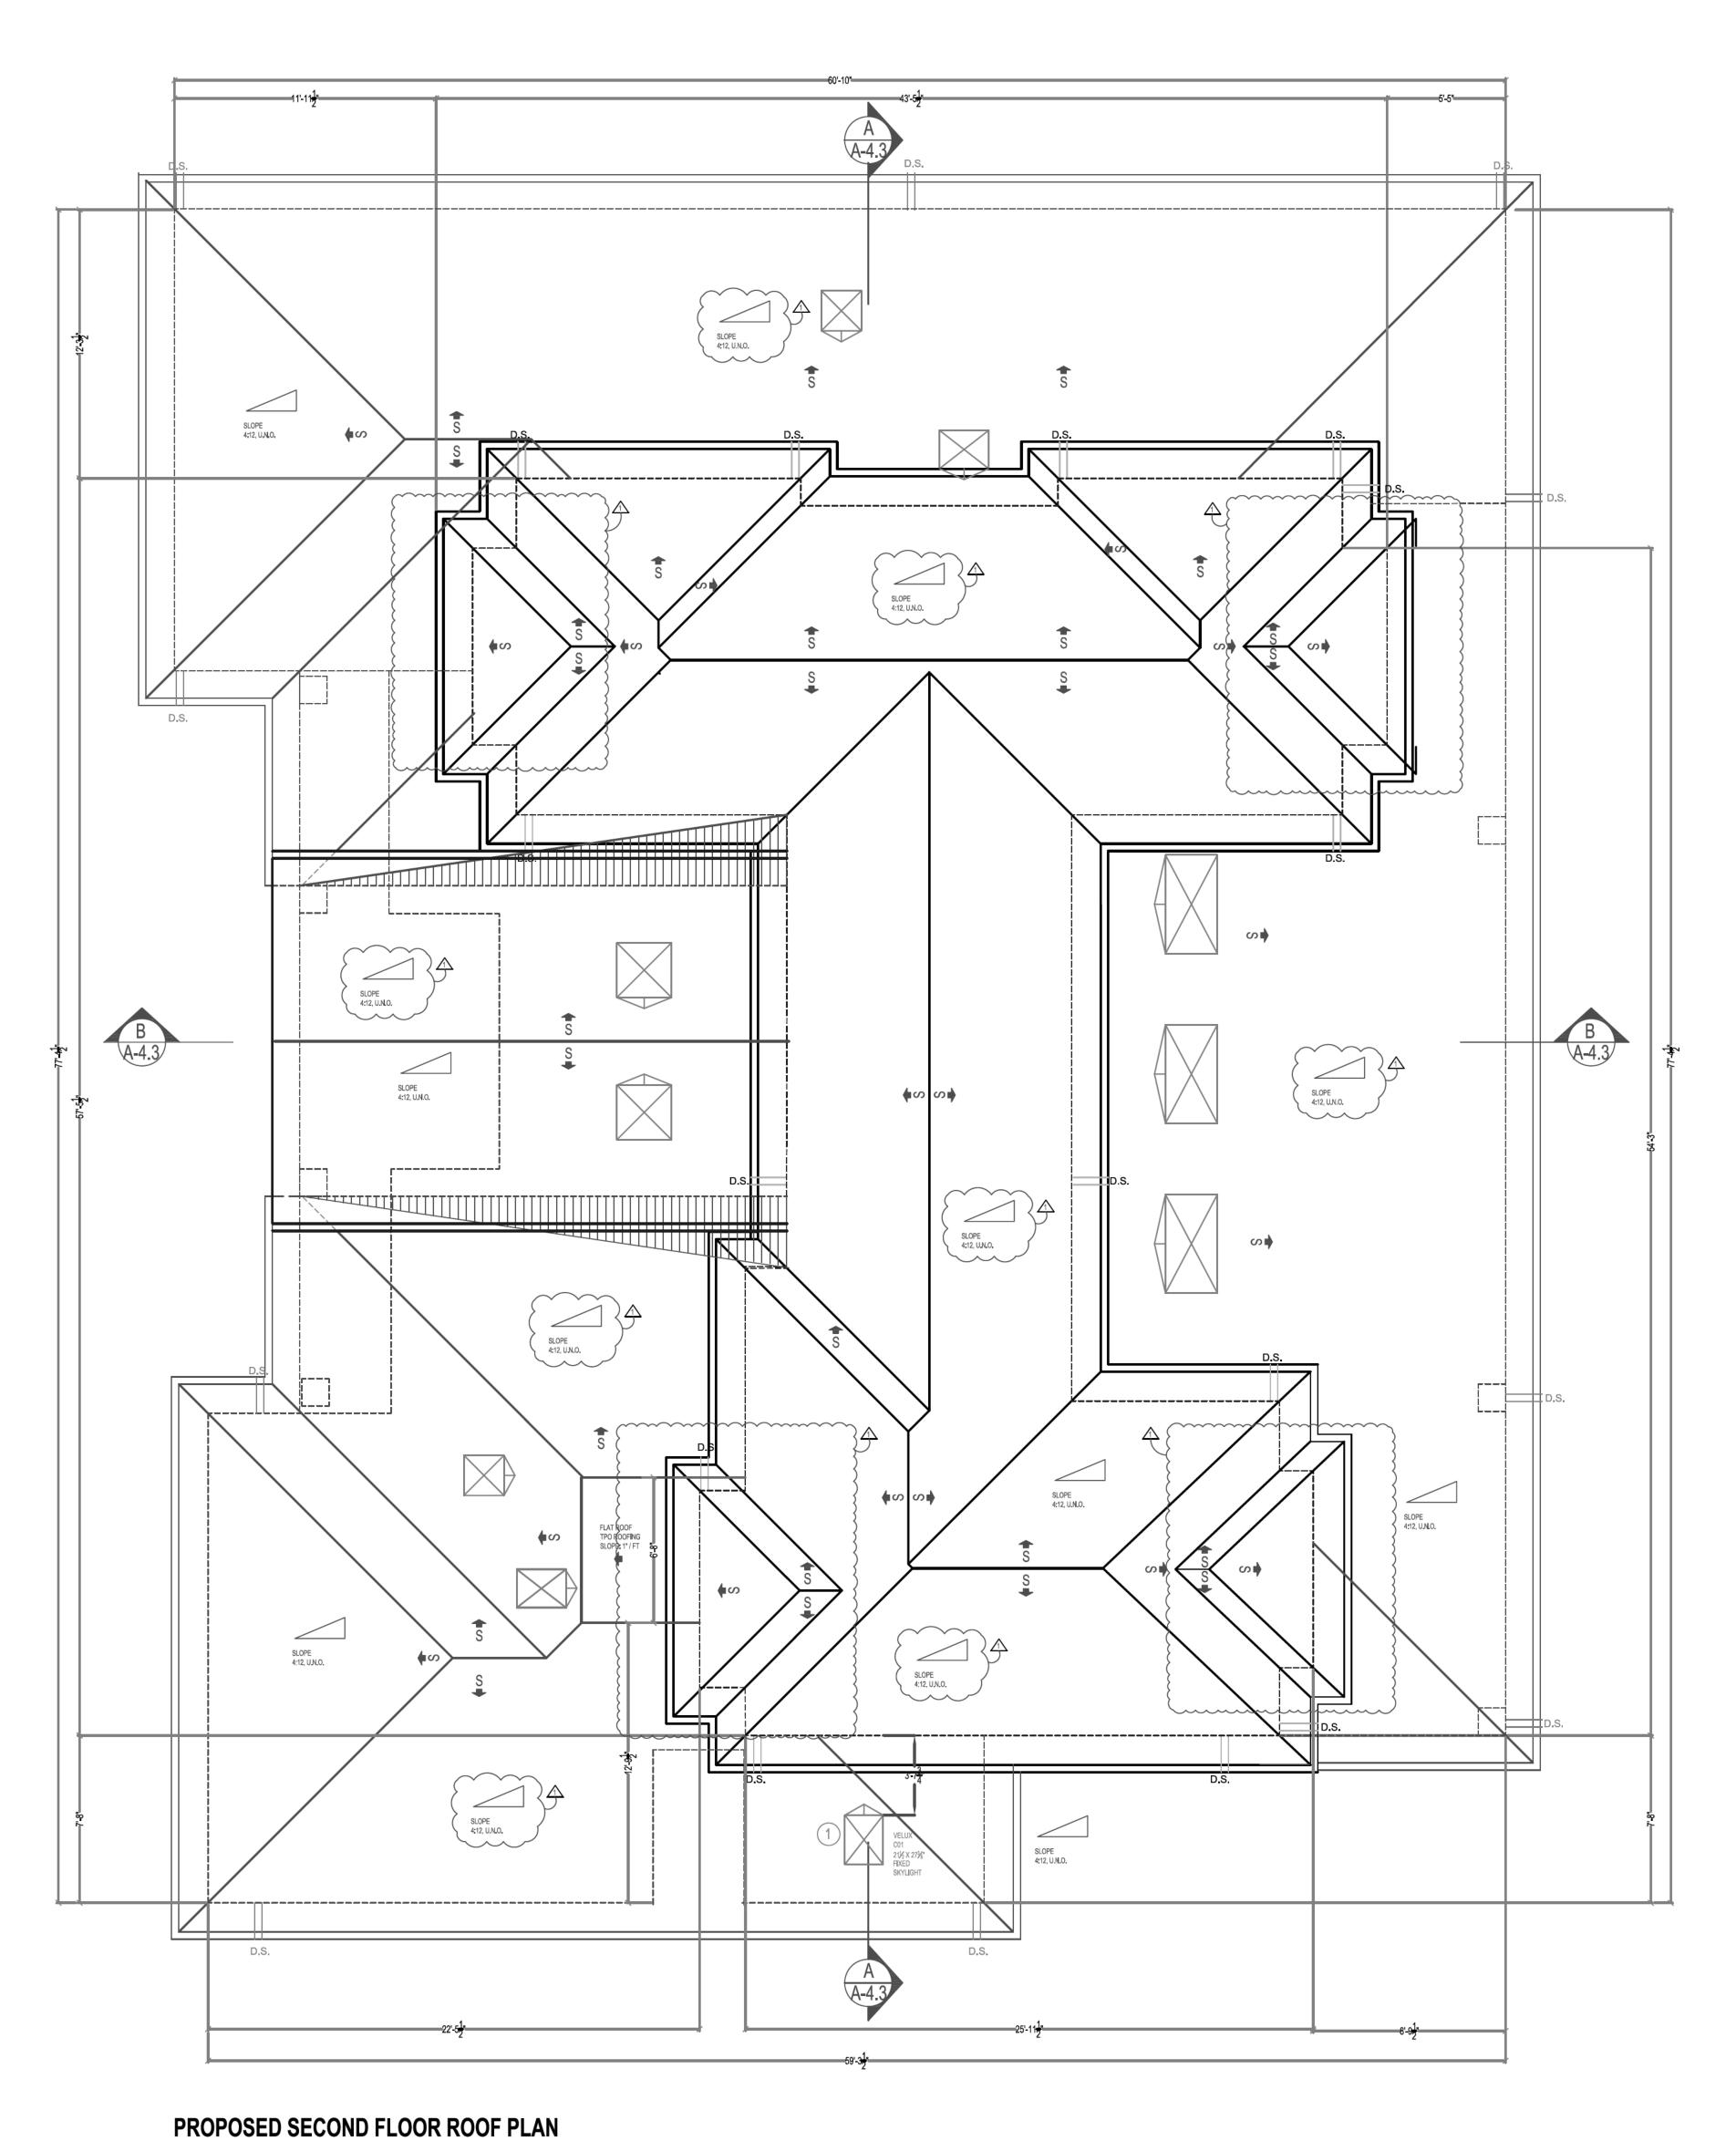

ELEVATION NOTES:

ROOF MATERIAL: CLASS 'A' CONCRETE TILE ROOF BY EAGLE ROOFING OR EQUAL.
INSTALLATION OF ROOF MATERIAL PER CODE AND MANUFACTURER
REQUIREMENTS AND INSTALLATION INSTRUCTIONS.
ROOF PITCH - 4:12, u.n.o.

ATTIC VENT:
LOW PROFILE AND EAVE VENT COMBINATION

DOWNSPOUT:
2X4 RECT. PAINTED ALUMINUM

GUTTER:
5" 26 GA G.I. PROFILE CUTTER OVER 2X4 SPRUCE FASCIA BOARD.

SKYLIGHT:
CURB MOUNT BY VELUX OR EQUAL. TYPE OF UNIT PER PLAN.

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REVISIONS BY: REV.# DATE COMMENT BY: 06-26-24 PLANNING-C1 09-08-24 PLANNING-C2

> JOB NO. A-24001 SCALE: AS NOTED DRAWN BY:

> > CONTENT:

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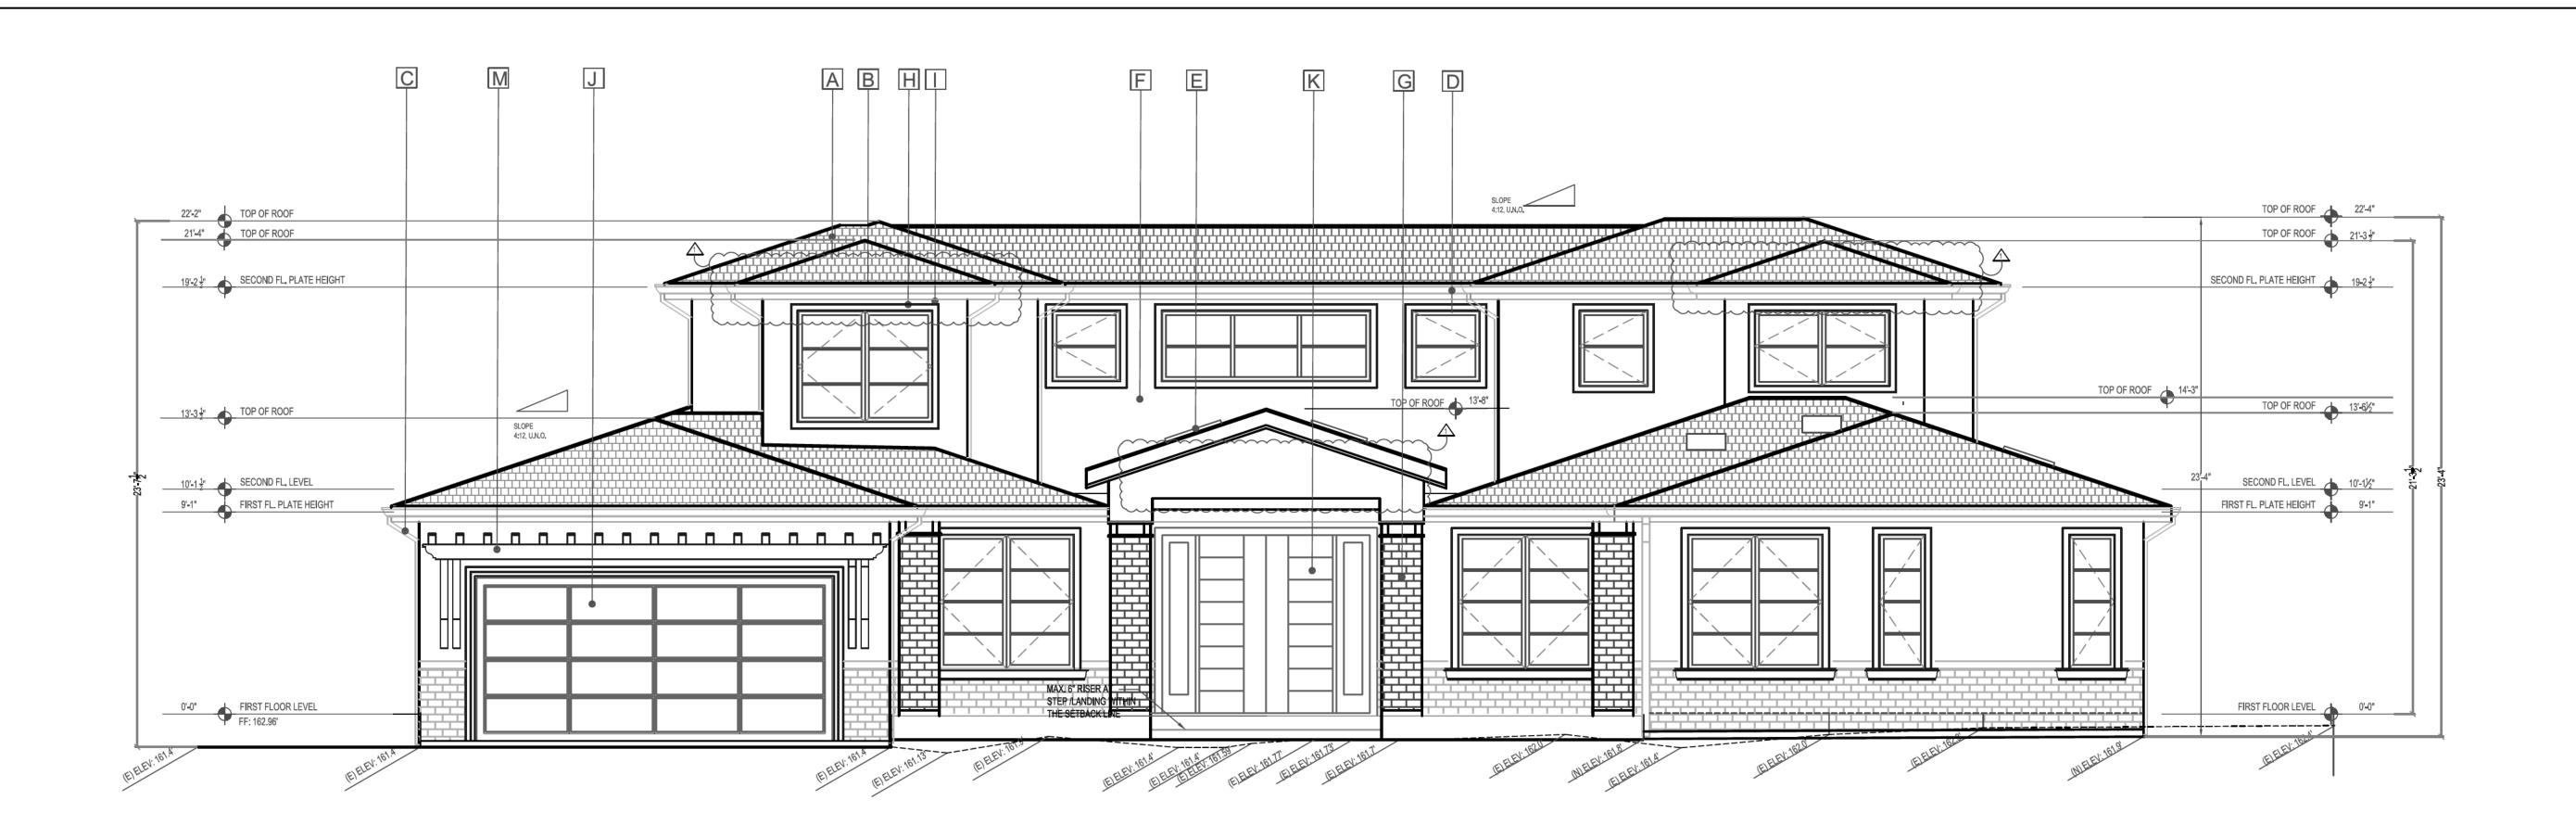
SECOND FLOOR **ROOF PLAN**

SHEET NUMBER


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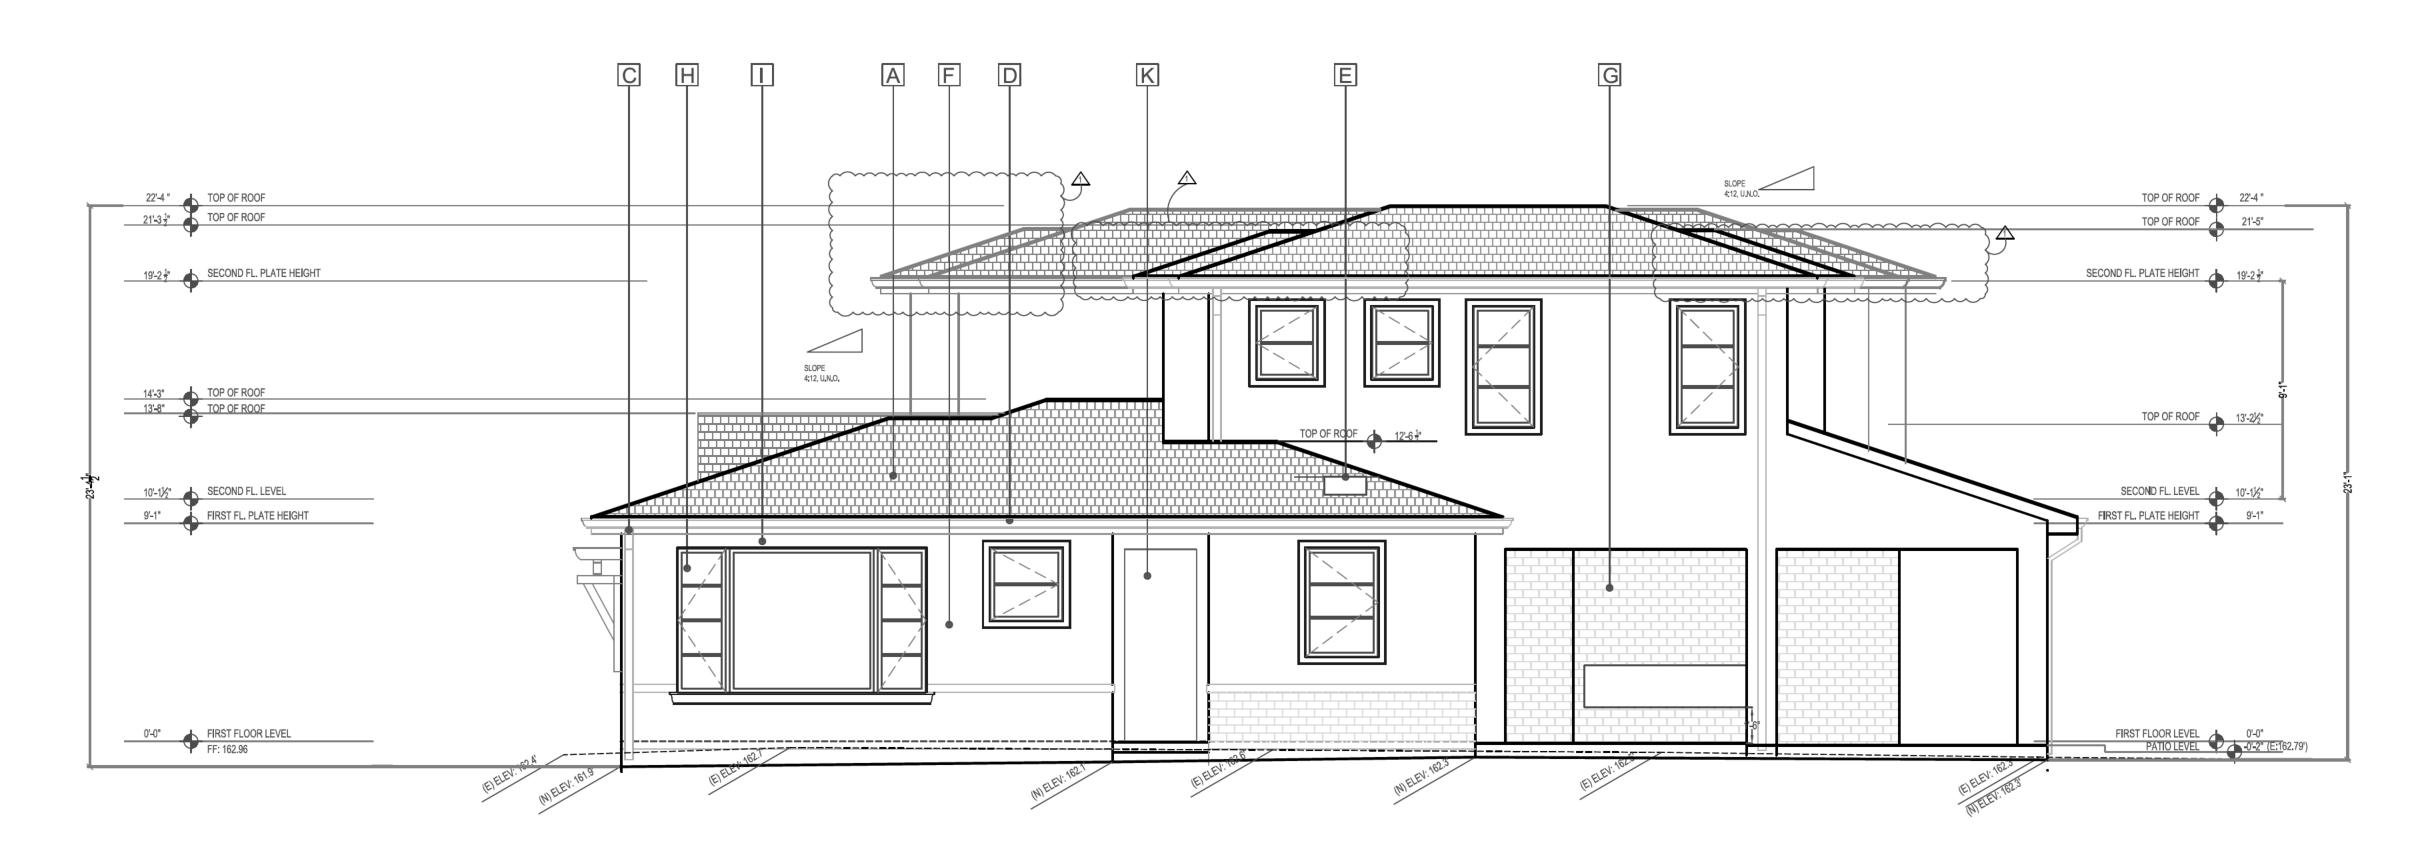
APPROVAL STAMP

SCALE: 1/4" = 1'-0"




PROPOSED FRONT - NORTH ELEVATION SCALE: $\frac{1}{4}$ "= 1'-0"



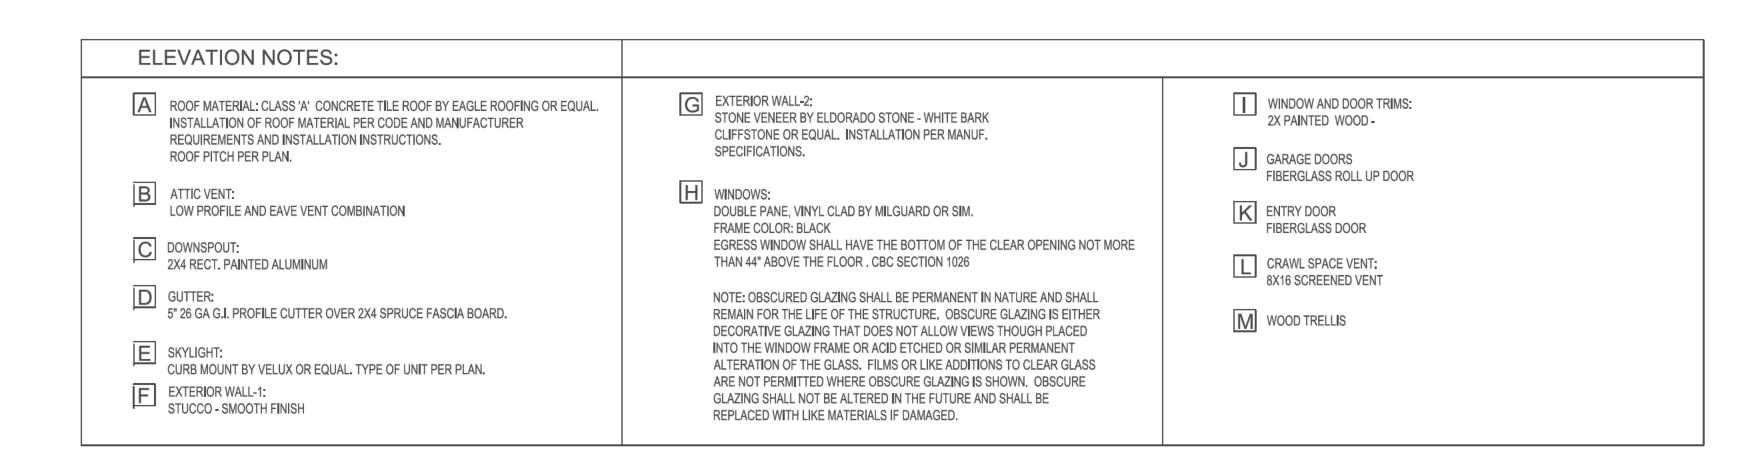

PROPOSED RIGHT SIDE - WEST ELEVATION SCALE: $\frac{1}{4}$ "= 1'-0"

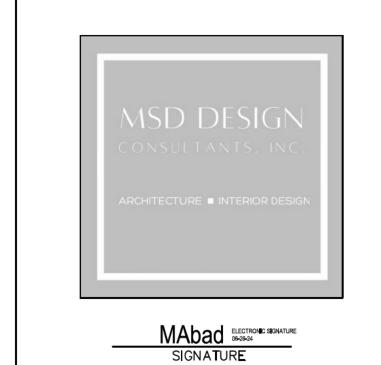

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1 06-26-24 PLANNING-C1

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DATE 03-01-24

JOB NO. A-24001

SCALE: AS NOTED

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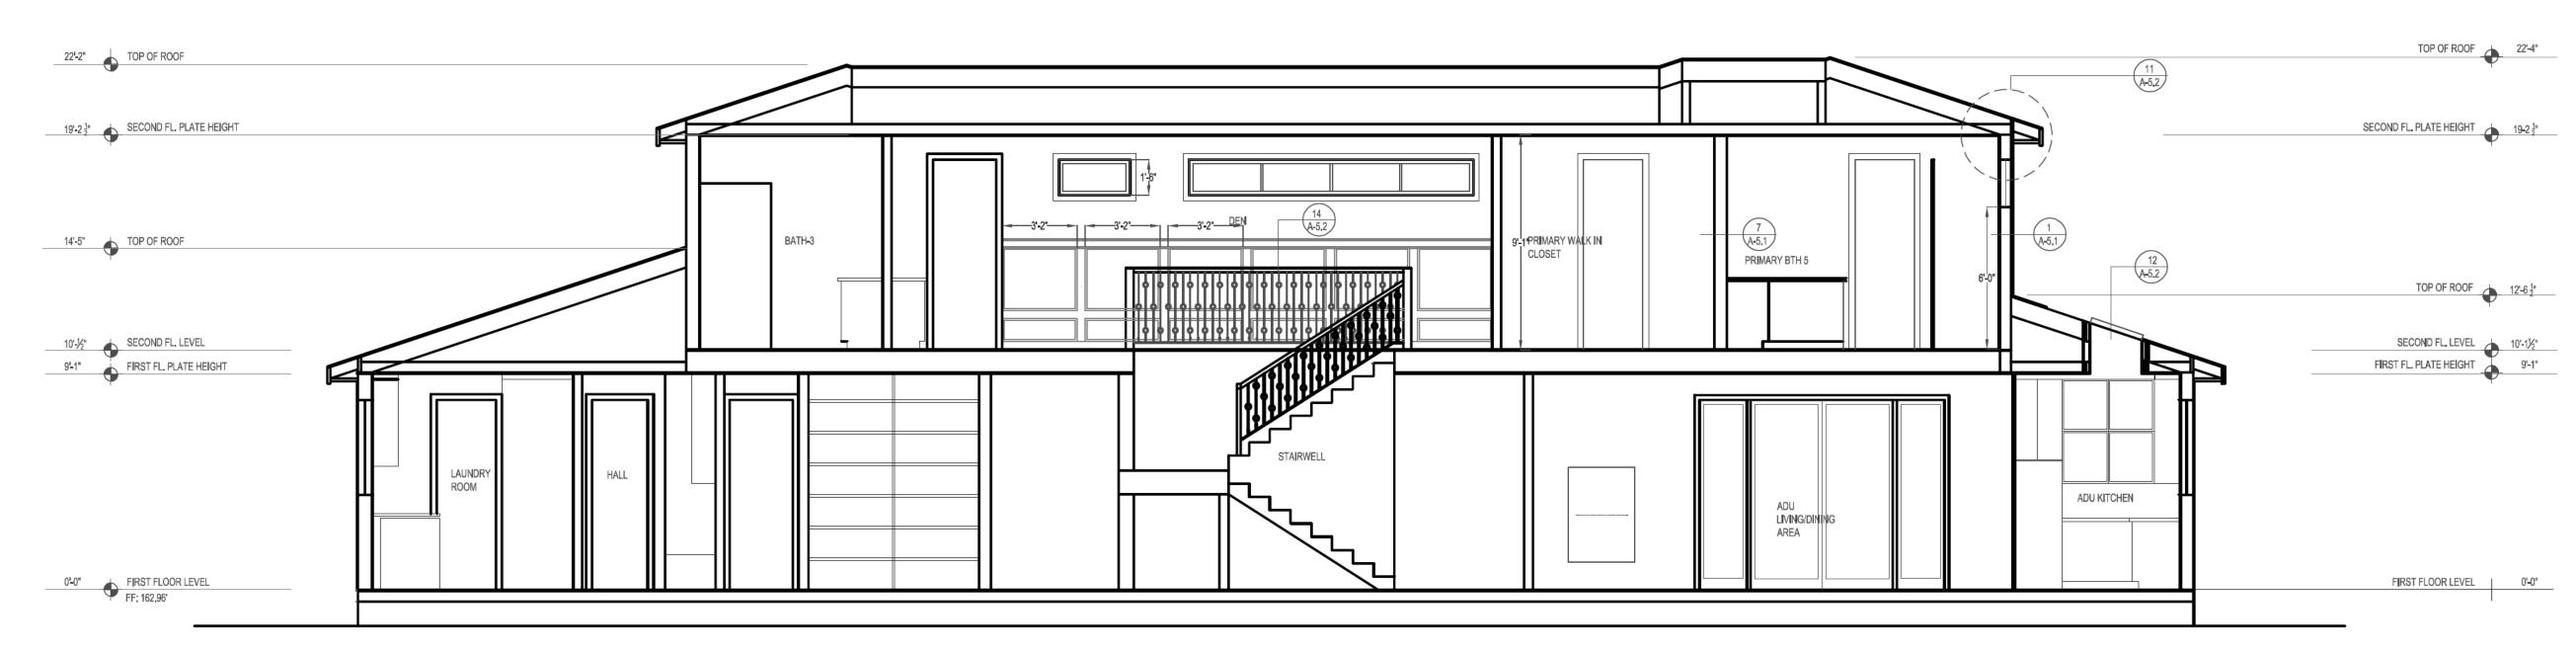
FRONT/ NORTH ELEVATION AND RIGHT SIDE/ WEST

SHEET NUMBER

ELEVATION

A-4.1





BUILDING SECTION A-A SCALE: $\frac{1}{4}$ "= 1'-0"



BUILDING SECTION B-B SCALE: $\frac{1}{4}$ "= 1'-0"



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DATE 03-01-24

JOB NO. A-24001

SCALE: AS NOTED


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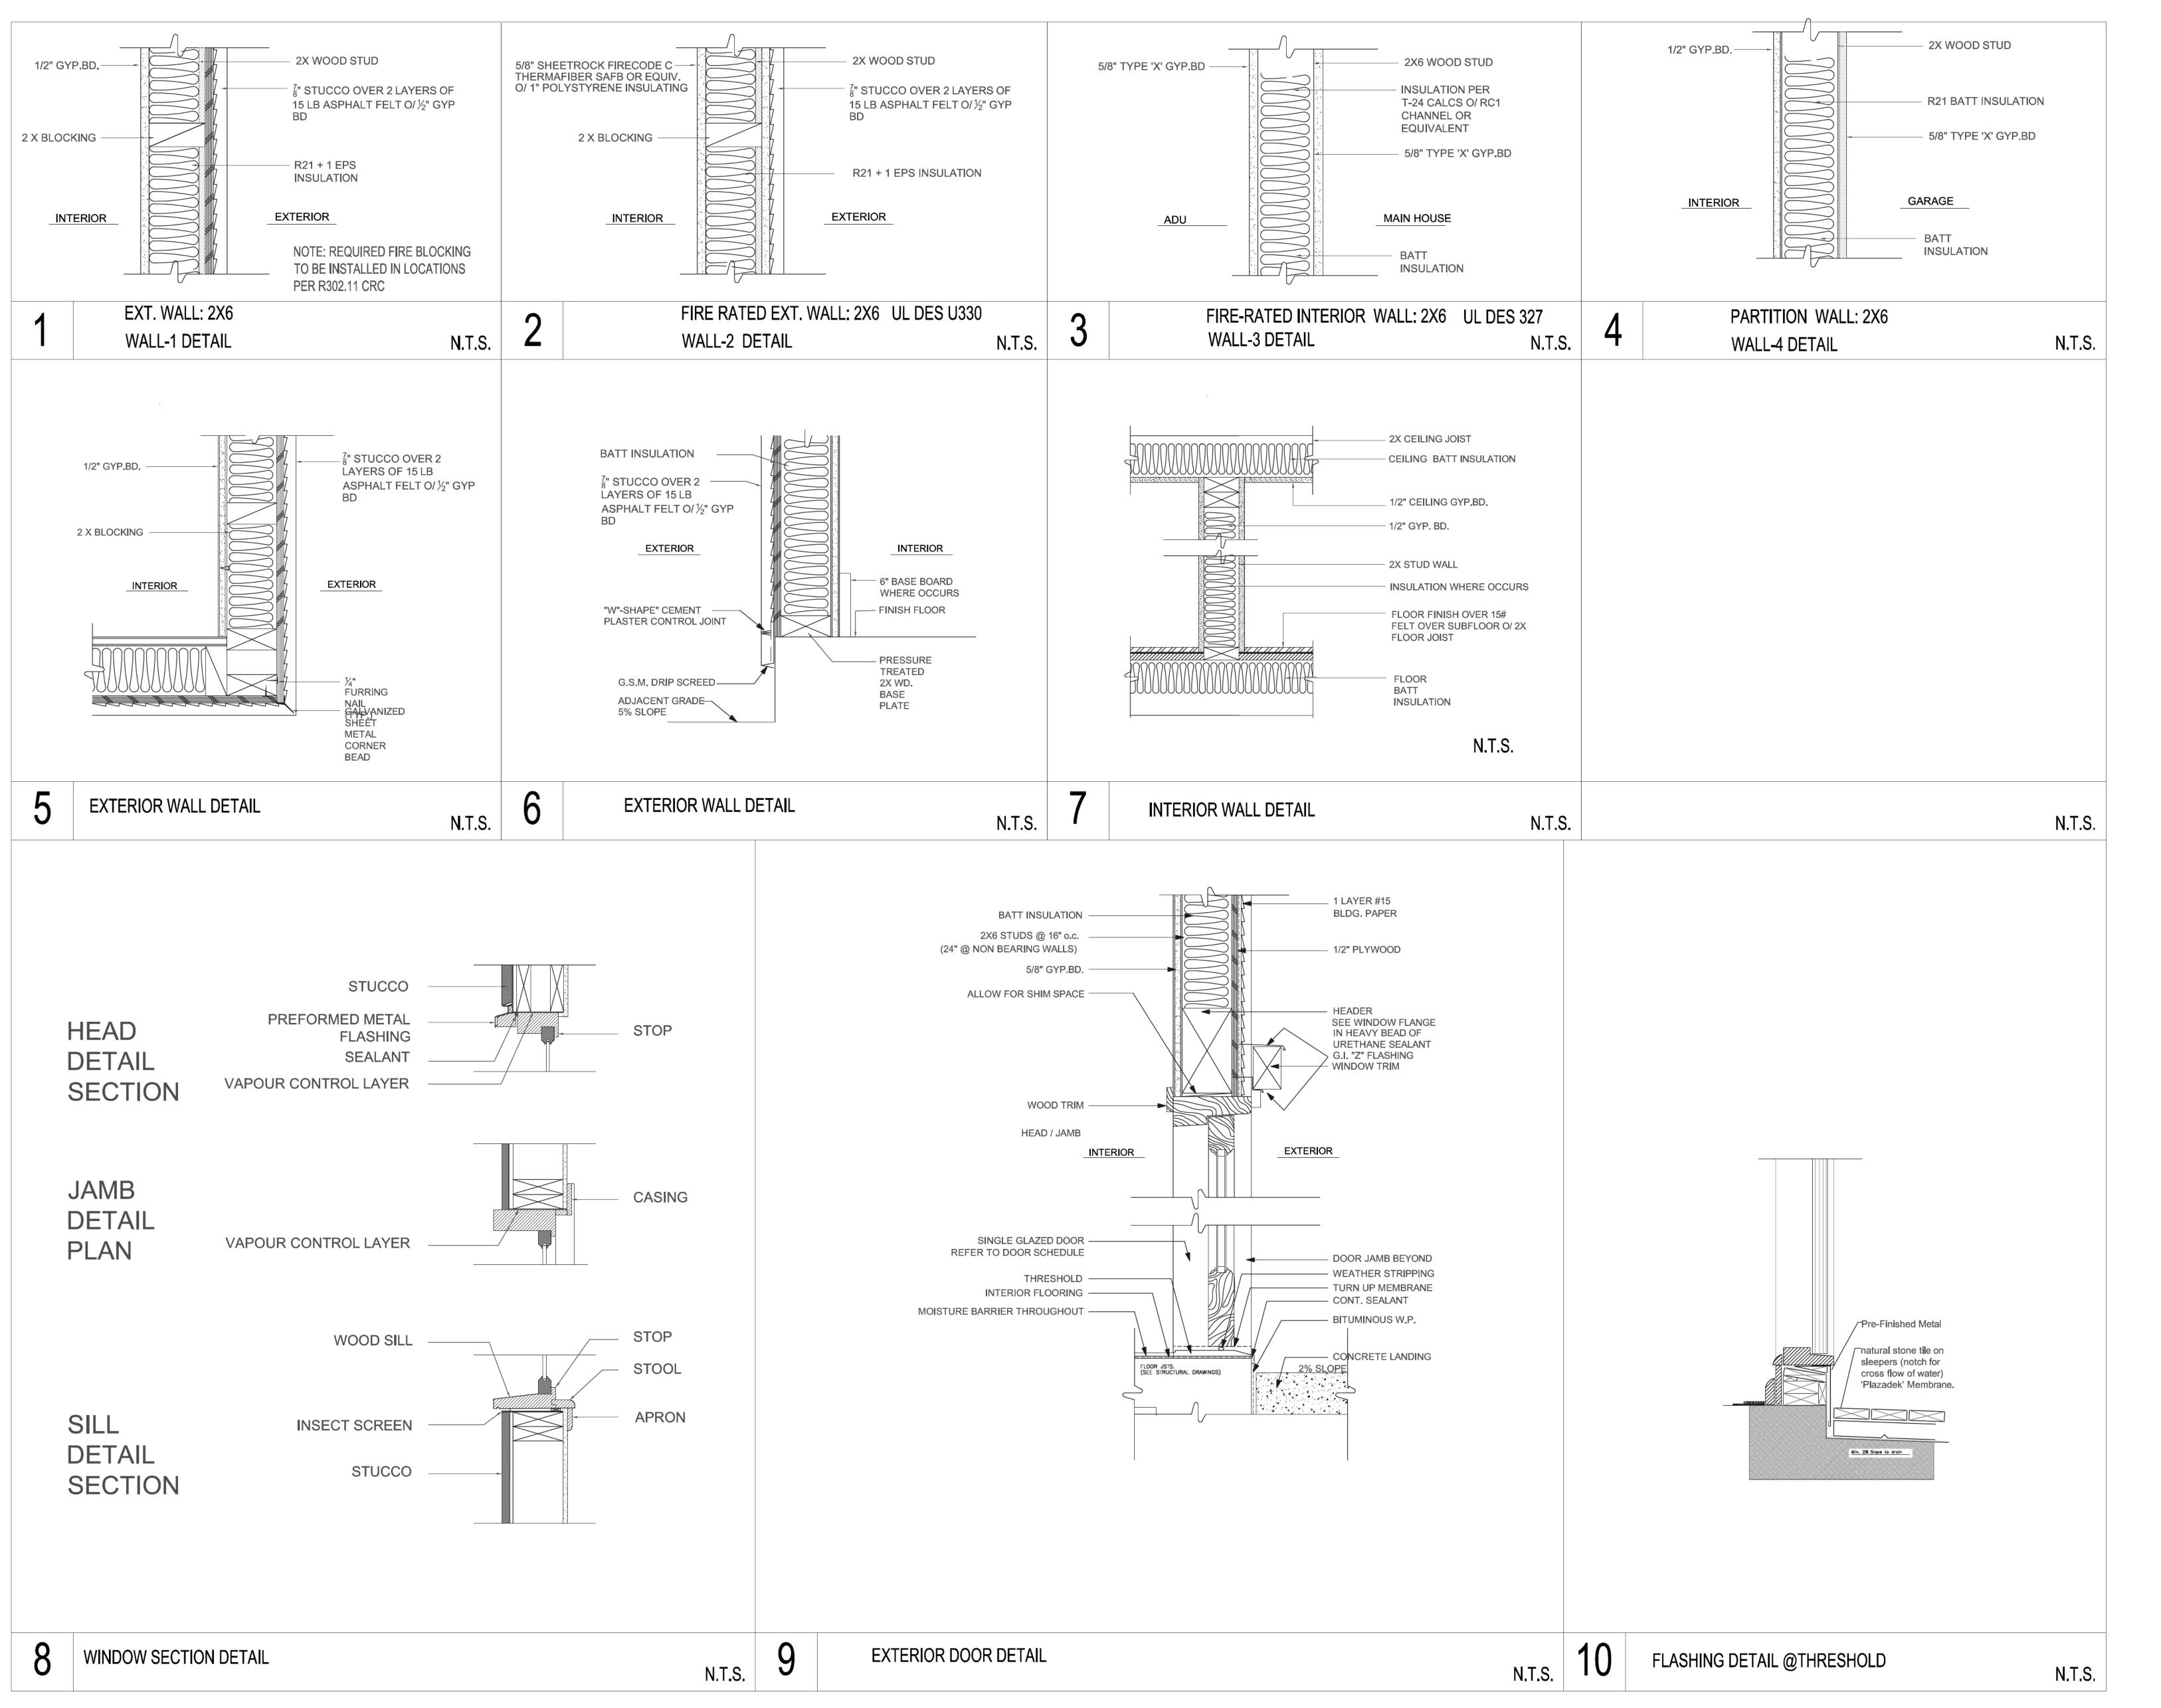
BUILDING SECTIONS

SHEET NUMBER

A-4.3



06-26-24 PLANNING-C1

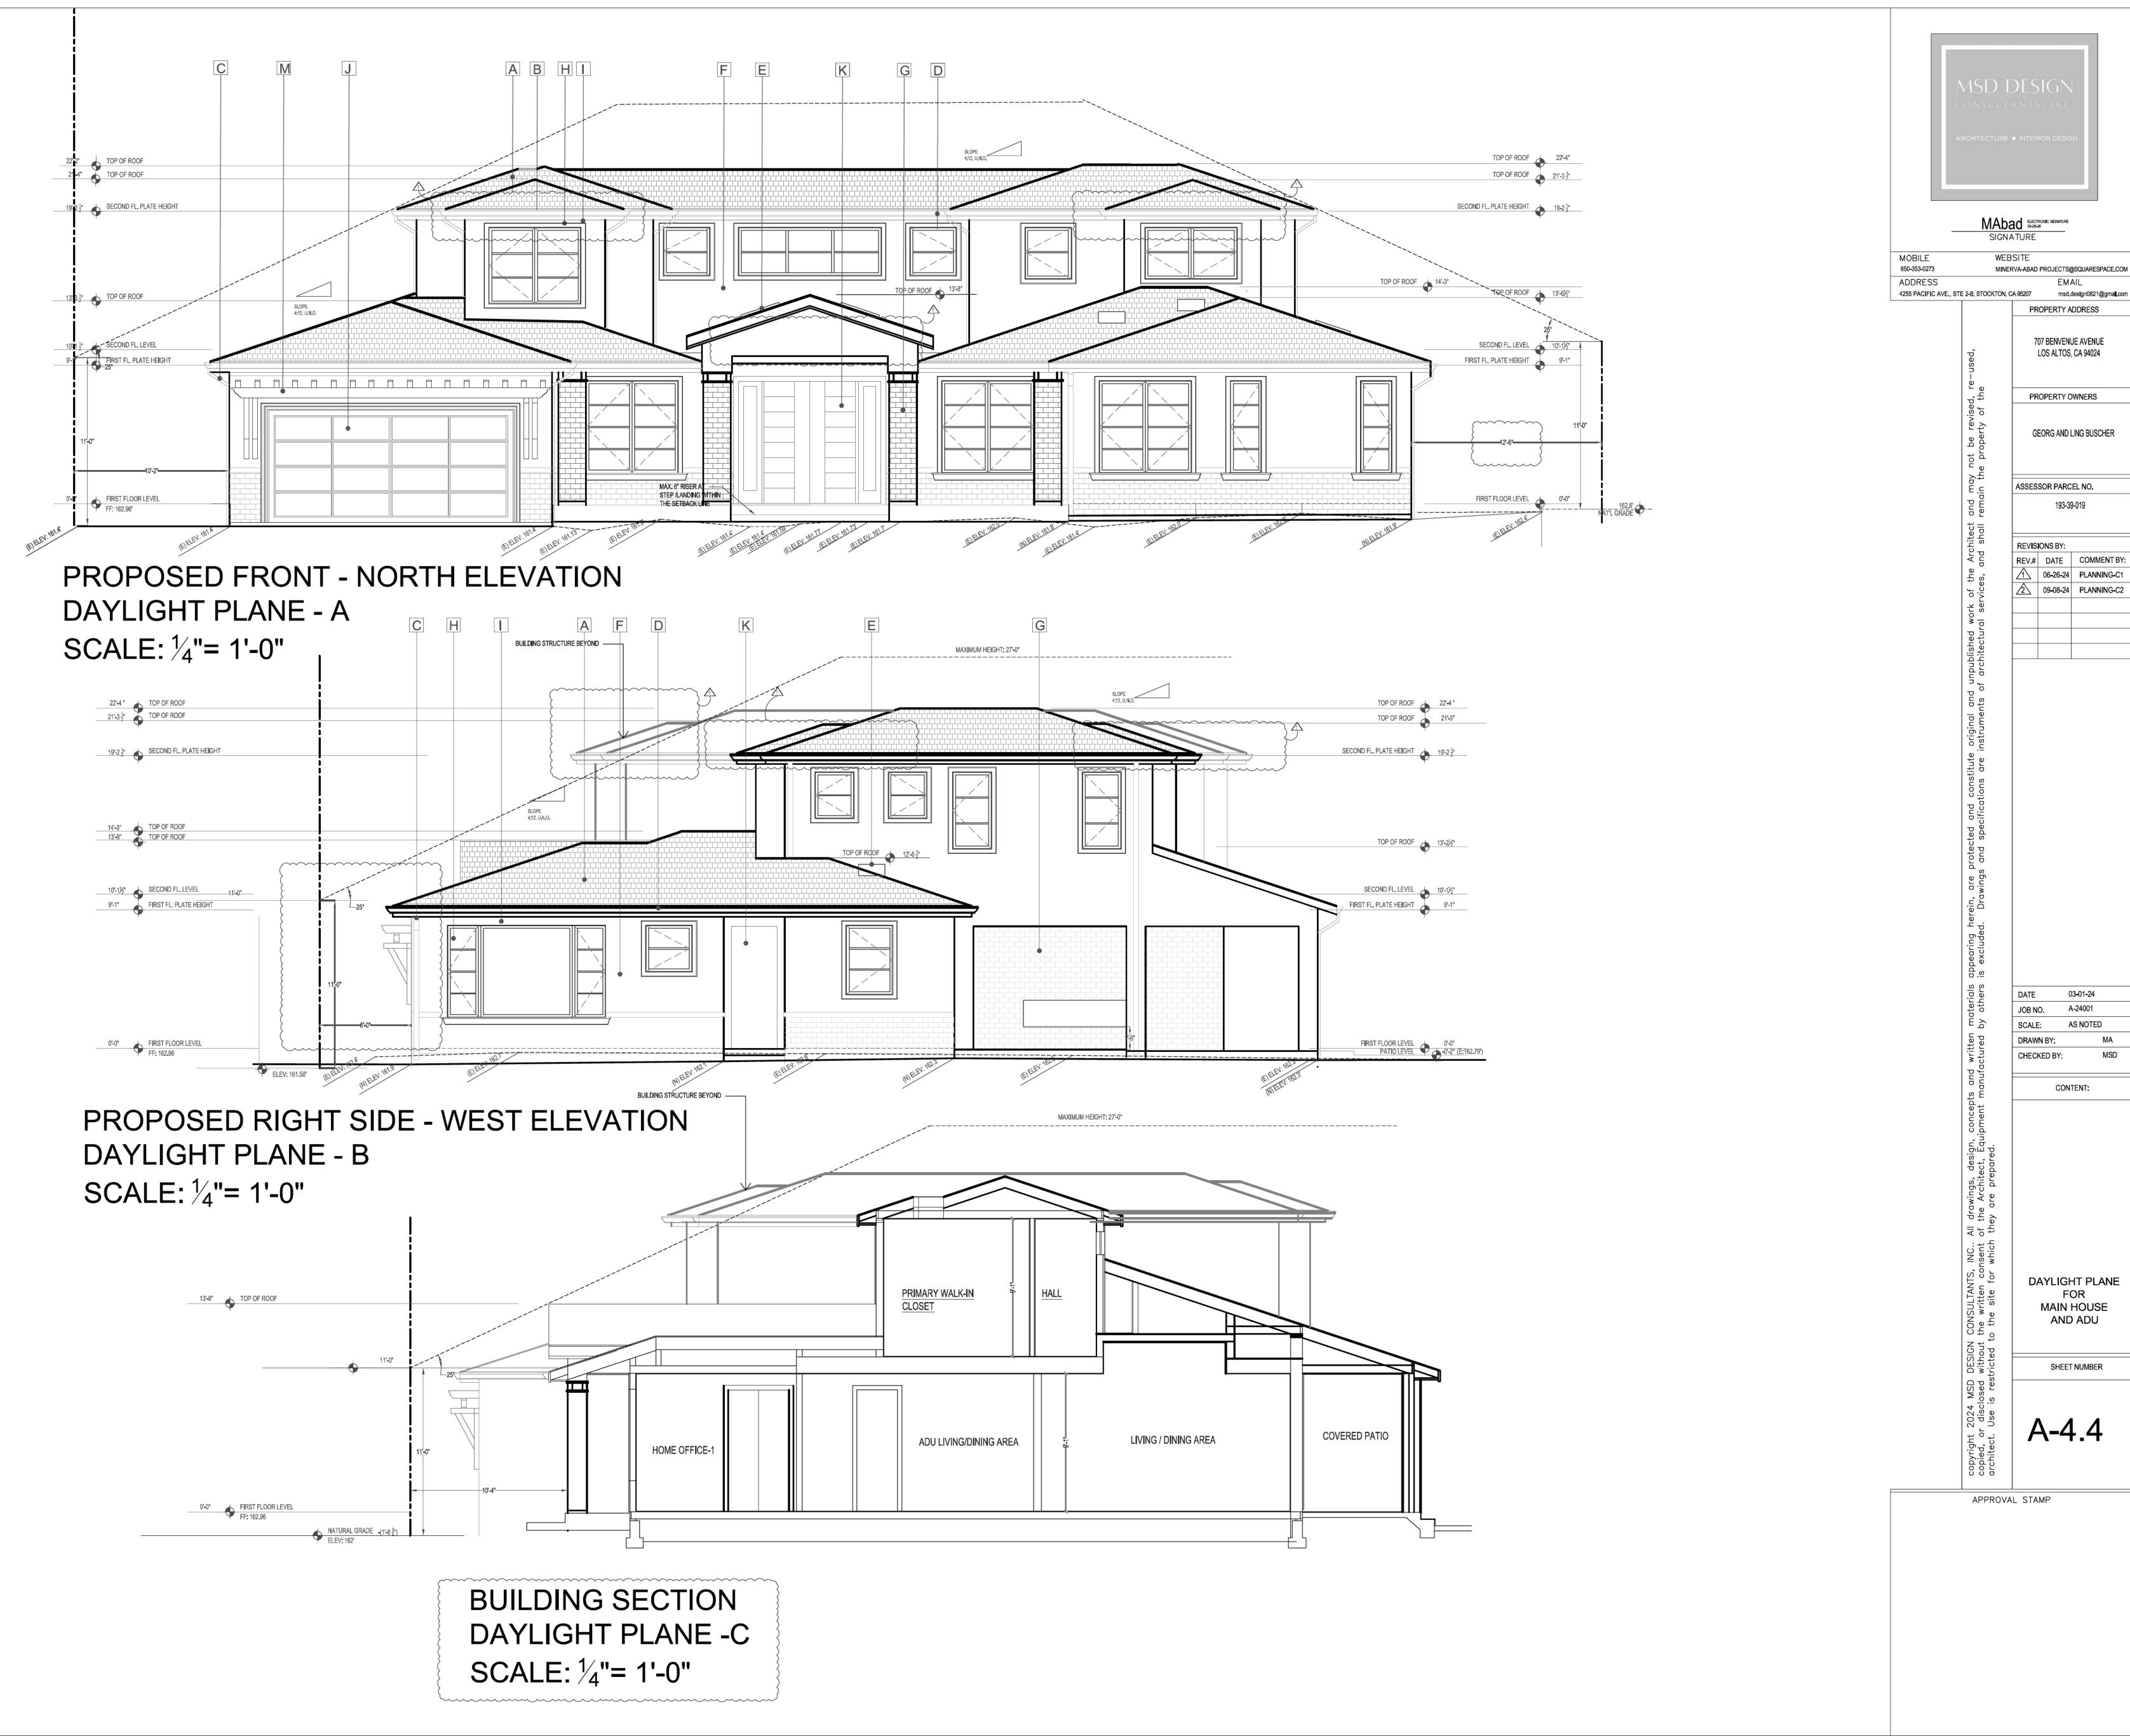



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A-24001 JOB NO. AS NOTED SCALE:


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ARCHITECTURAL DETAILS

SHEET NUMBER

A-5.1



MSD DESIGN
CONSULTANTS, INC.

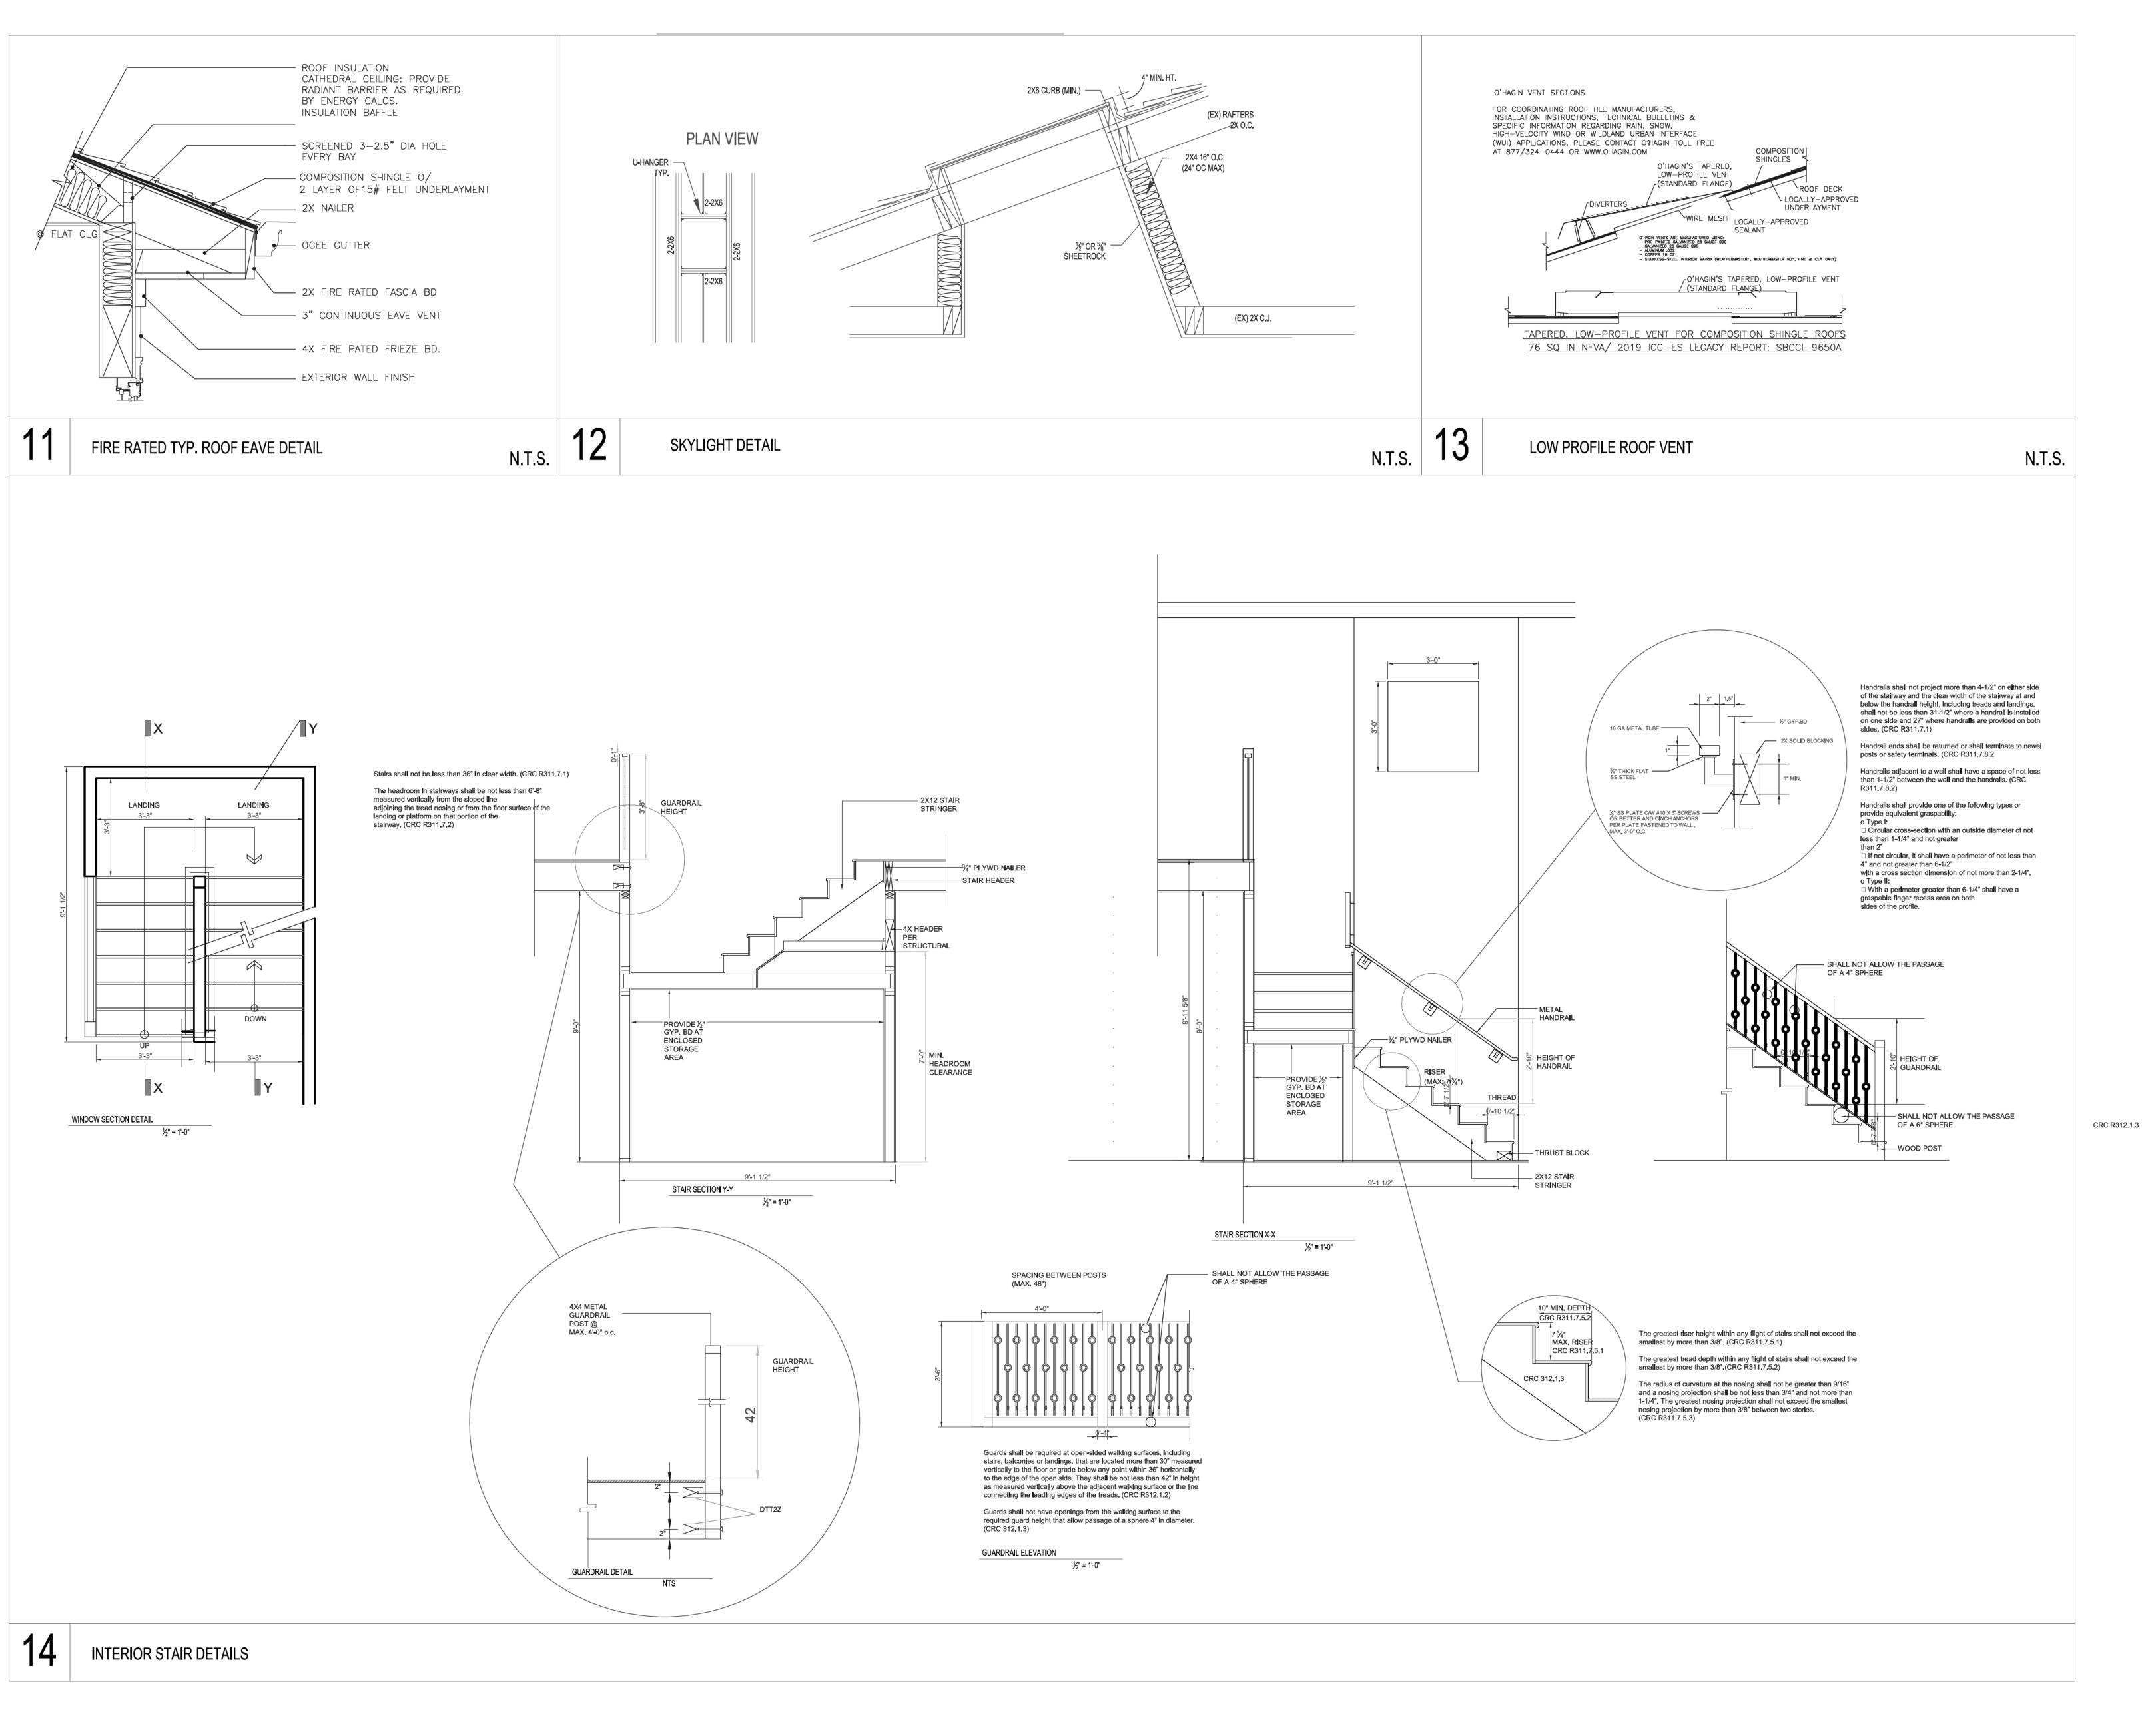ARCHITECTURE • INTERIOR DESIGN

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JOB NO. A-24001

SCALE: AS NOTED

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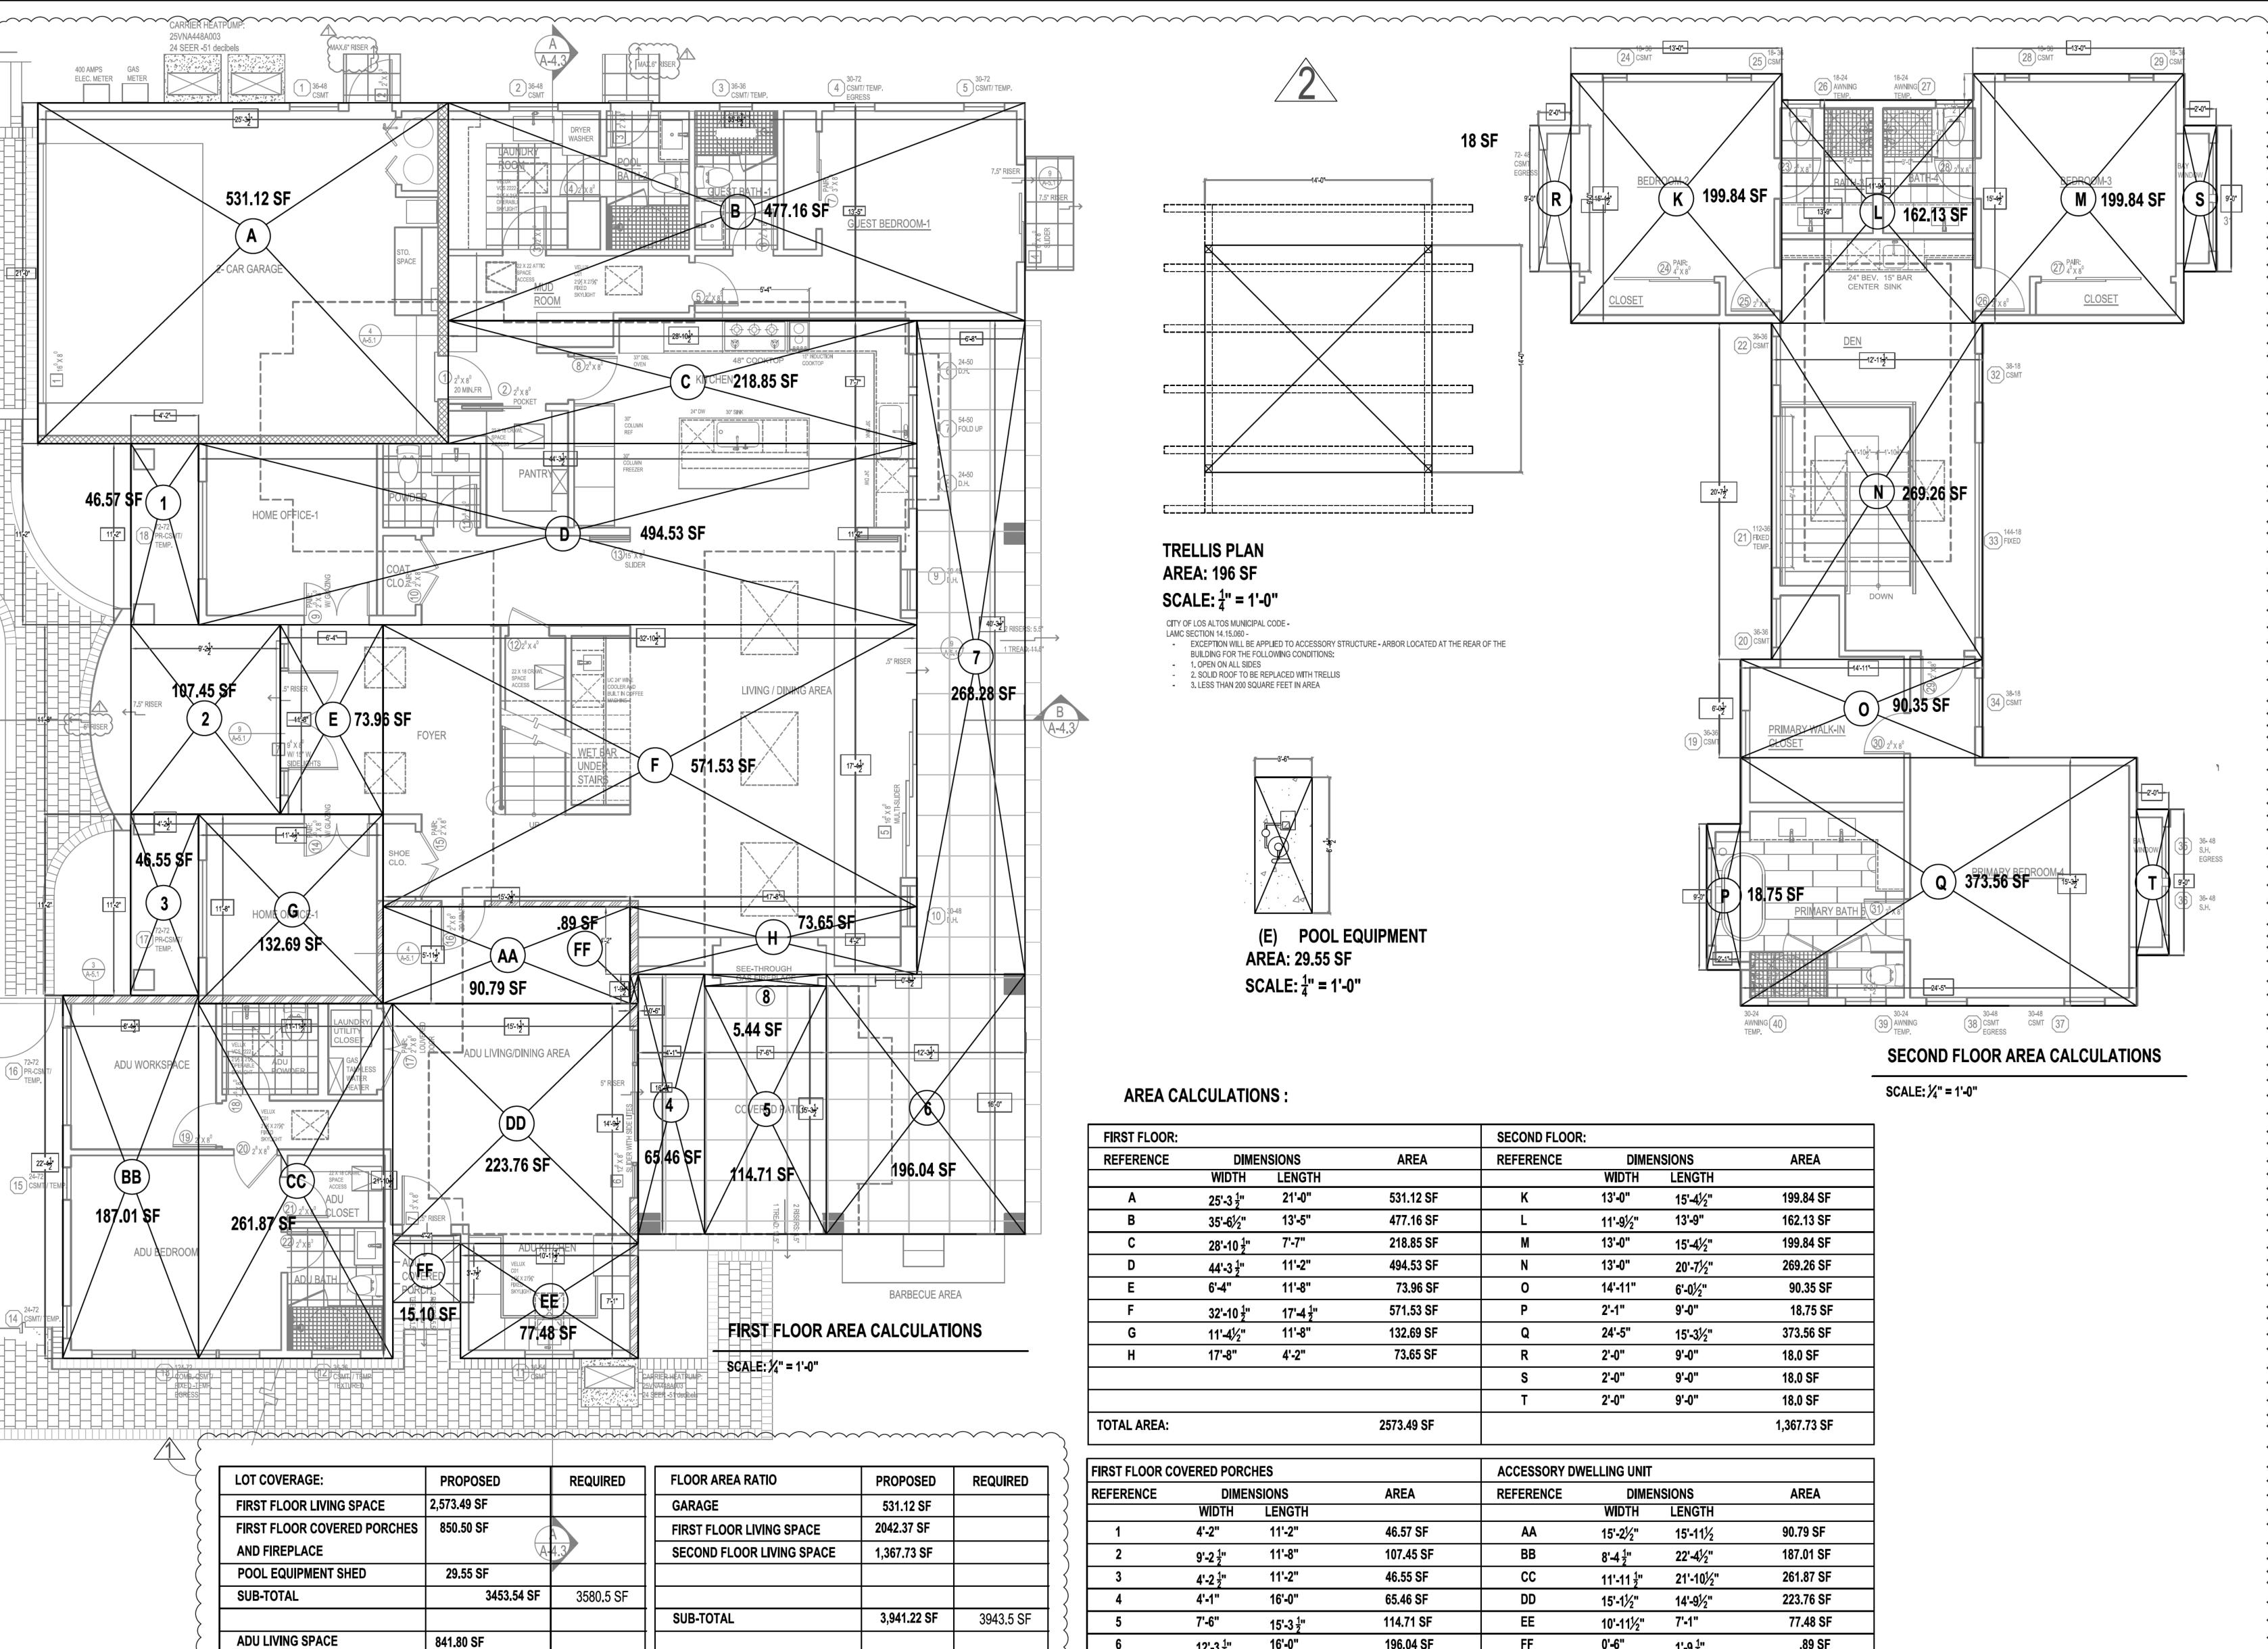
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CONTENT

ARCHITECTURAL DETAILS

SHEET NUMBER

A-5.2



ADU COVERED PORCH

SUB-TOTAL

15.10 SF

856.90 SF


4310.44 SF

ADU LIVING SPACE

TOTAL

841.80 SF

4783.02 SF

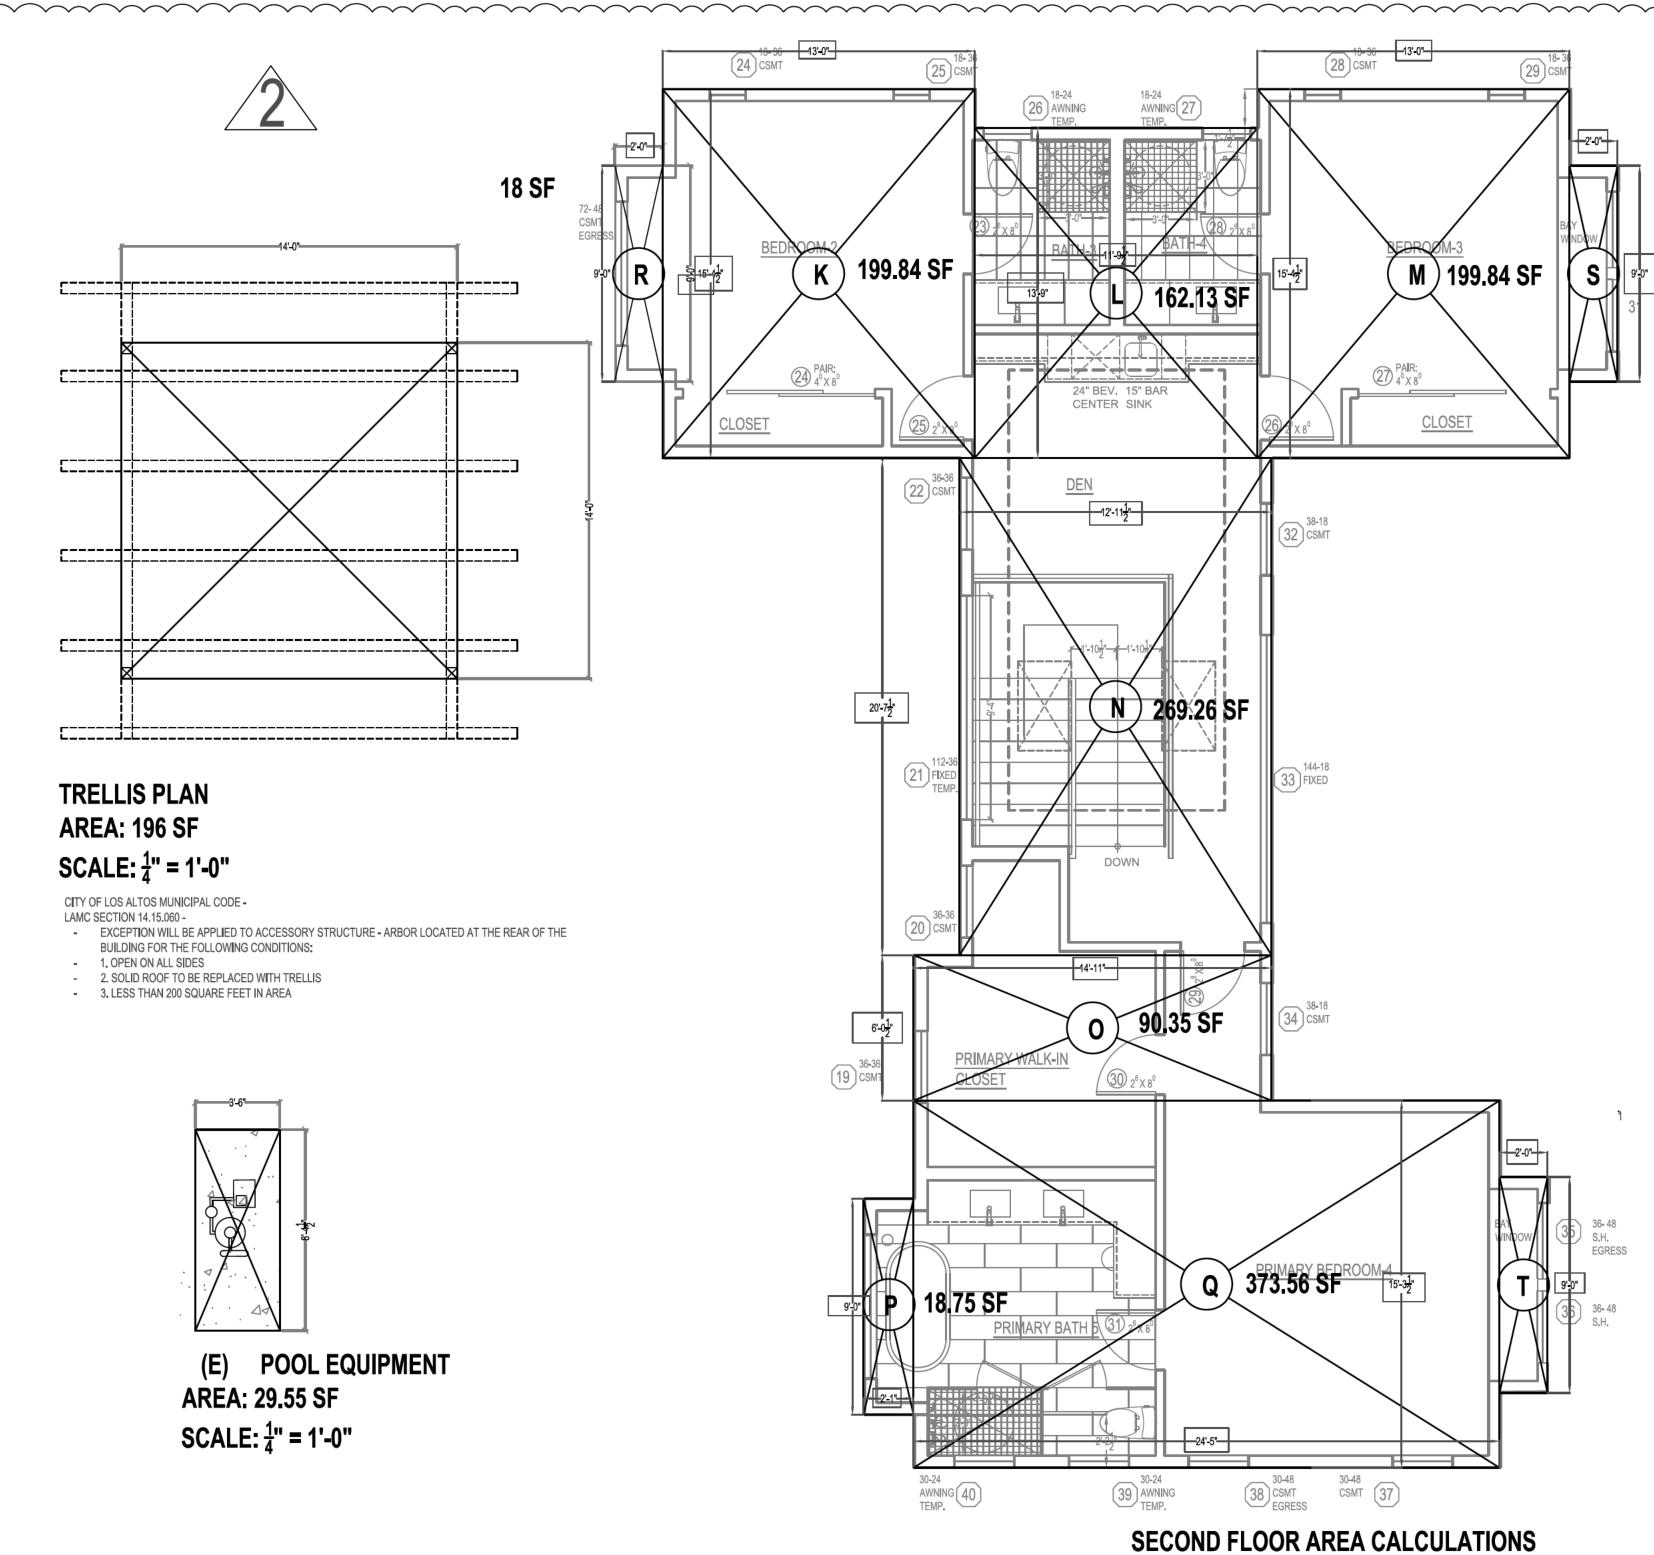

SCALE: 1/4" = 1'-0"

AREA CALCULATIONS:

FIRST FLOOR:				SECOND FLOOR	:		
REFERENCE	DIME	NSIONS	AREA	REFERENCE	DIME	NSIONS	AREA
	WIDTH	LENGTH			WIDTH	LENGTH	
Α	25'-3 ½"	21'-0"	531.12 SF	K	13'-0"	15'-4½"	199.84 SF
В	35'-6½"	13'-5"	477.16 SF	L	11'-9½"	13' - 9"	162.13 SF
С	28'-10 ¹ / ₂ "	7'-7"	218.85 SF	М	13'-0"	15'-4½"	199.84 SF
D	44'-3 ¹ / ₂ "	11'-2"	494.53 SF	N	13'-0"	20'-7½"	269.26 SF
E	6'-4"	11'-8"	73.96 SF	0	14'-11"	6'-01/2"	90.35 SF
F	32'-10 ¹ / ₂ "	17'-4 ½"	571.53 SF	Р	2'-1"	9'-0"	18.75 SF
G	11'-4½"	11'-8"	132.69 SF	Q	24'-5"	15'-3½"	373.56 SF
Н	17'-8"	4'-2"	73.65 SF	R	2'-0"	9'-0"	18.0 SF
				S	2'-0"	9'-0"	18.0 SF
				Т	2'-0"	9'-0"	18.0 SF
TOTAL AREA:			2573.49 SF				1,367.73 SF

FIRST FLOOR CO	OVERED PORCHE	S		ACCESSORY DWELLING UNIT			
REFERENCE	DIMENSIONS		AREA	REFERENCE	DIME	DIMENSIONS	
	WIDTH I	LENGTH			WIDTH	LENGTH	
1	4'-2"	11'-2"	46.57 SF	AA	15'-2½"	15'-11½	90.79 SF
2	9'-2 1 "	11'-8"	107.45 SF	BB	8'-4 ½"	22'-4½"	187.01 SF
3	4'-2 ½"	11'-2"	46.55 SF	CC	11'-11 ½"	21'-10½"	261.87 SF
4	4'-1"	16'-0"	65.46 SF	DD	15'-1½"	14'-9½"	223.76 SF
5	7'-6"	15'-3 ½"	114.71 SF	EE	10'-11½"	7'-1"	77.48 SF
6	12'-3 ½"	16'-0"	196.04 SF	FF	0'-6"	1'-9 ½"	.89 SF
7	6'-8"	40'-3 ½"	268.28 SF	TOTAL			841.80 SF
8	7'-6"	0'-8 ½"	5.44 SF				
		_		ADU COVERE	D PORCH		
				FF	4'-2"	3'-7 ½"	15.10 SF
			850.50 SF				



)			
{		MOBILE	WEBSITE	
<	1	650-353-0273	MINERVA-ABAD	PROJECTS@SQUARESPACE.COM
<		ADDRESS		EMAIL
,)	4255 PACIFIC AVE	STE 2-B STOCKTON CA 05207	med decian0821@amail.com

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PROPERTY ADDRESS

GEORG AND LING BUSCHER

PROPERTY OWNERS


ASSESSOR PARCEL NO.

REV.# DATE COMMENT BY: 06-26-24 PLANNING-C1 09-08-24 PLANNING-C2


CHECKED BY:

FIRST AND SECOND CALCULATIONS

A-6.

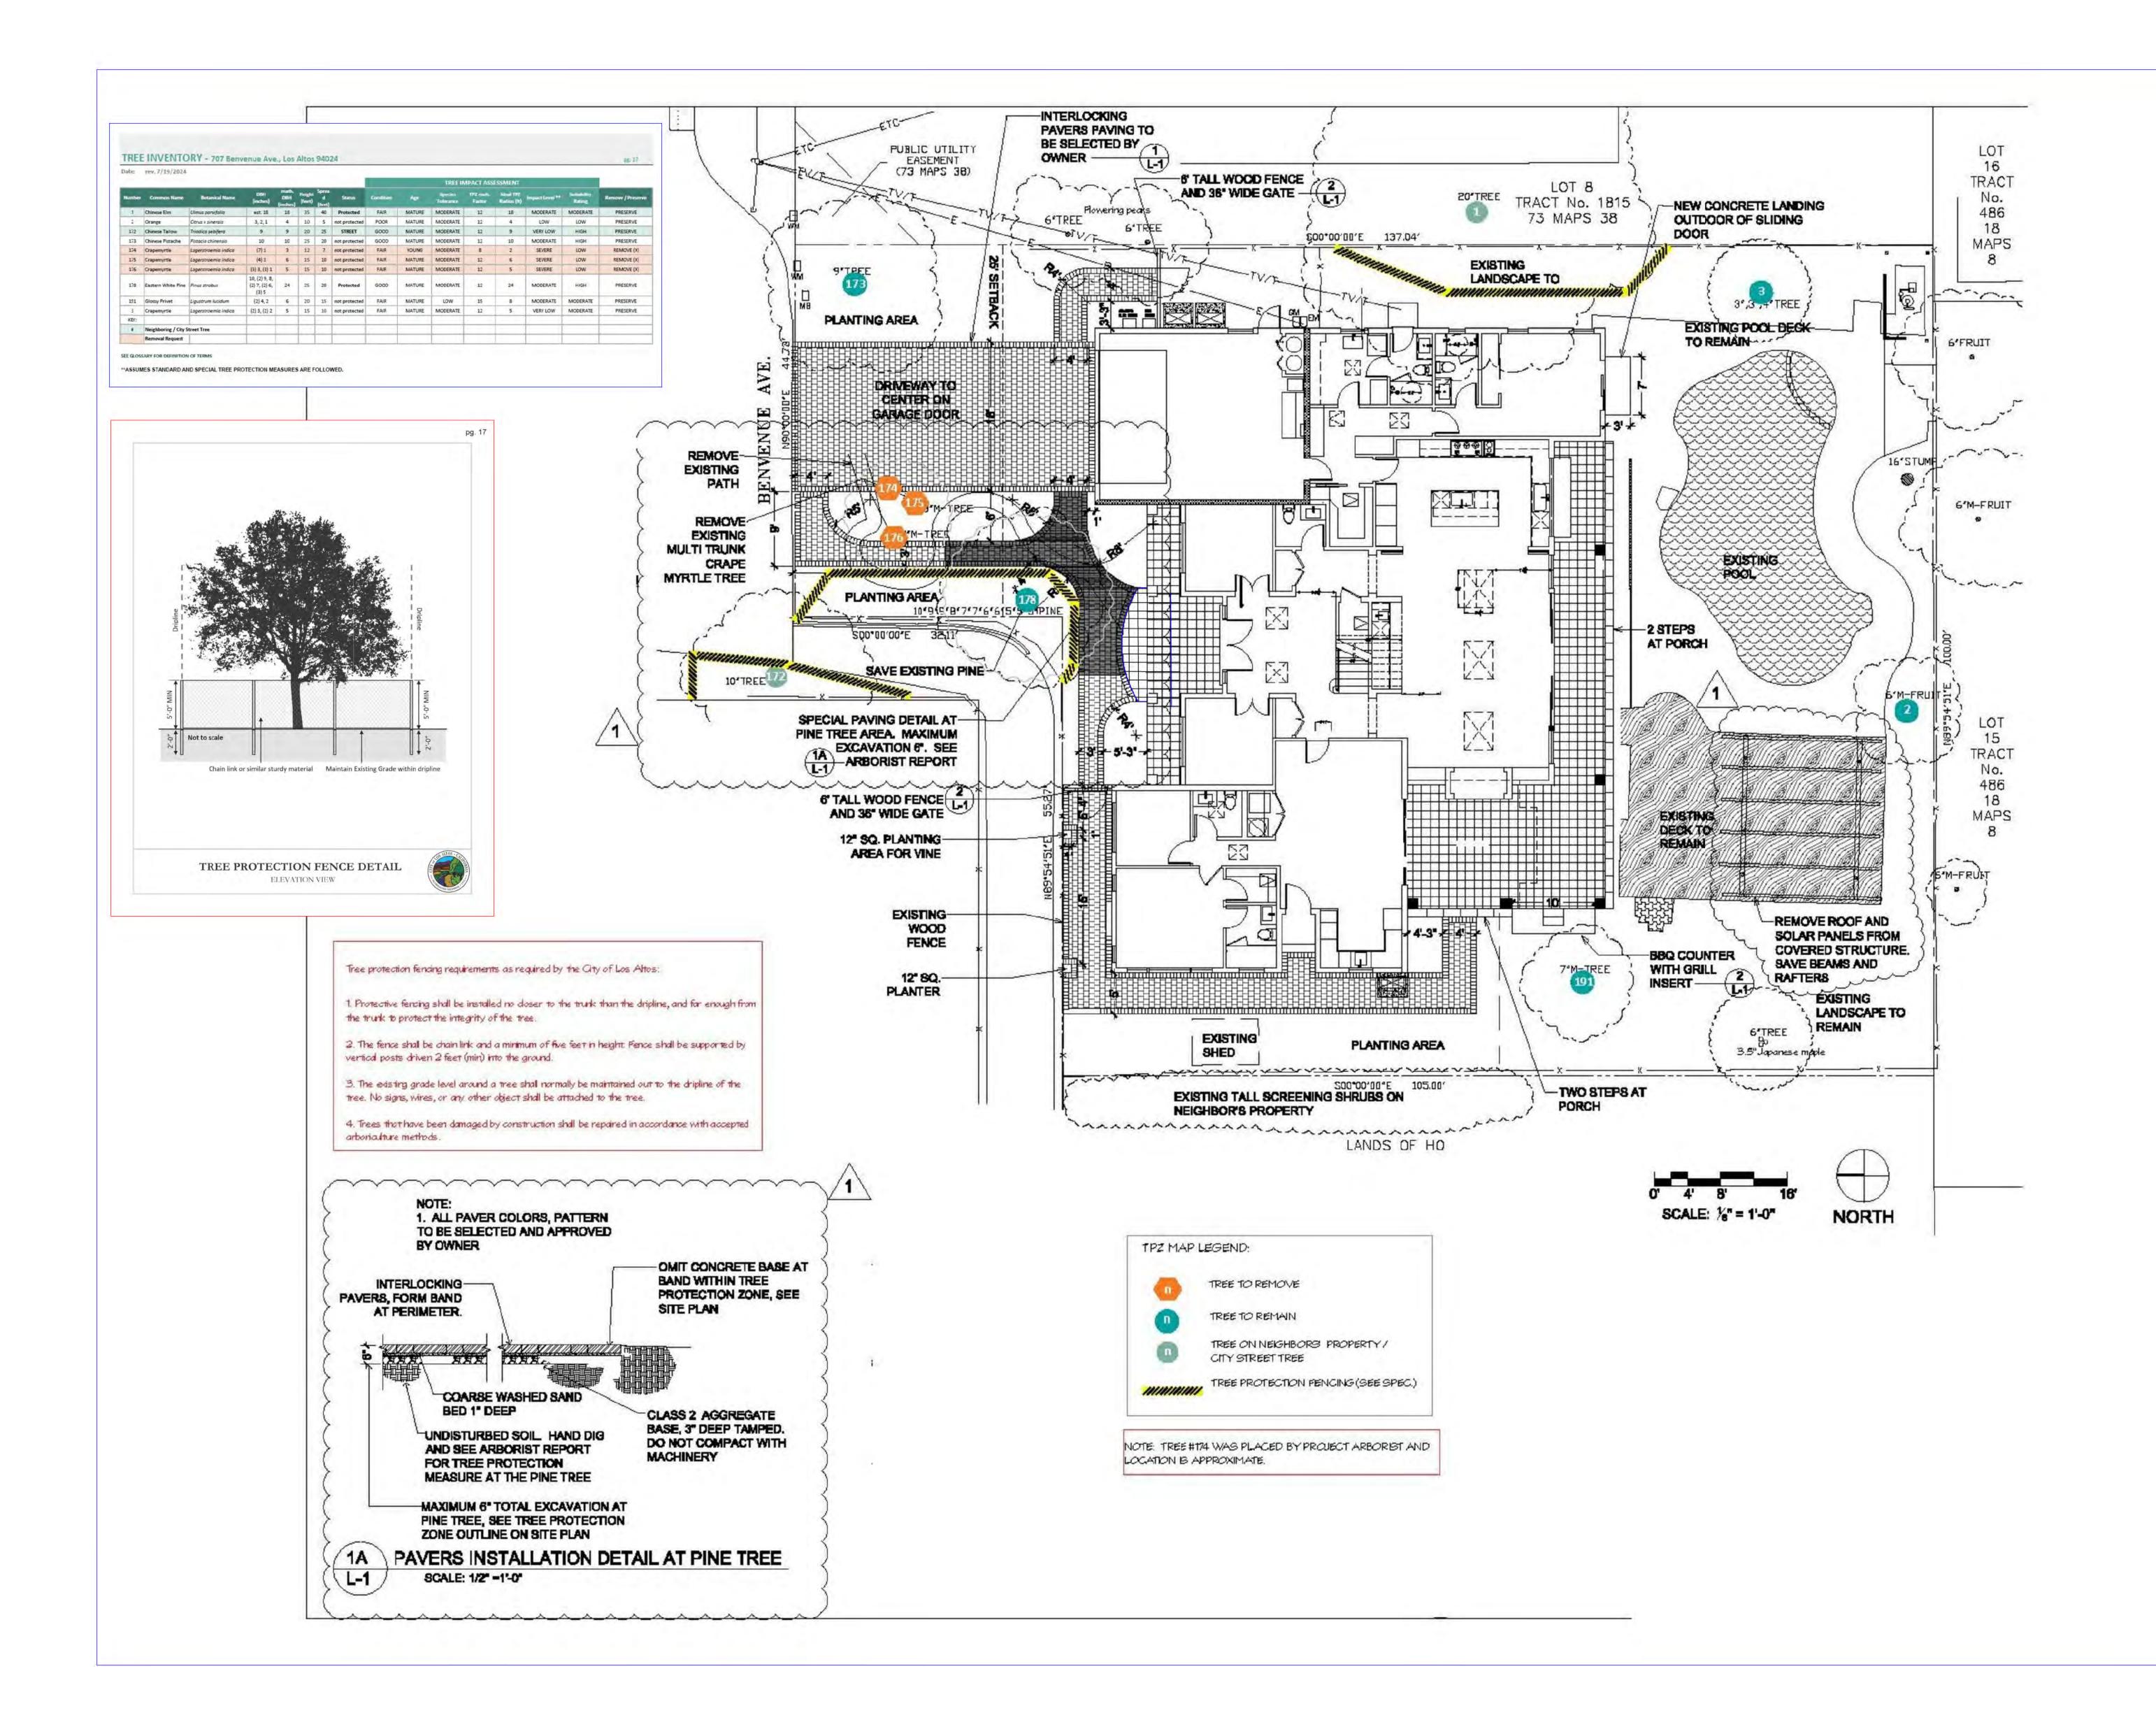

TREE PROTECTION YOUR MAP

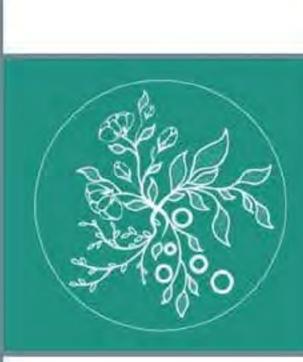


DATE: rev. 07/19/24

TPZ ELEMENTS DRAWN: K. MEYER ISA-CERTIFIED ARBORIST #WE-14992A

BASE MAP: SITE PLAN L-1.0 by ANYI LANDSCAPE STUDIO (07/15/2024)

> ARBORIST REPORT pg. 18

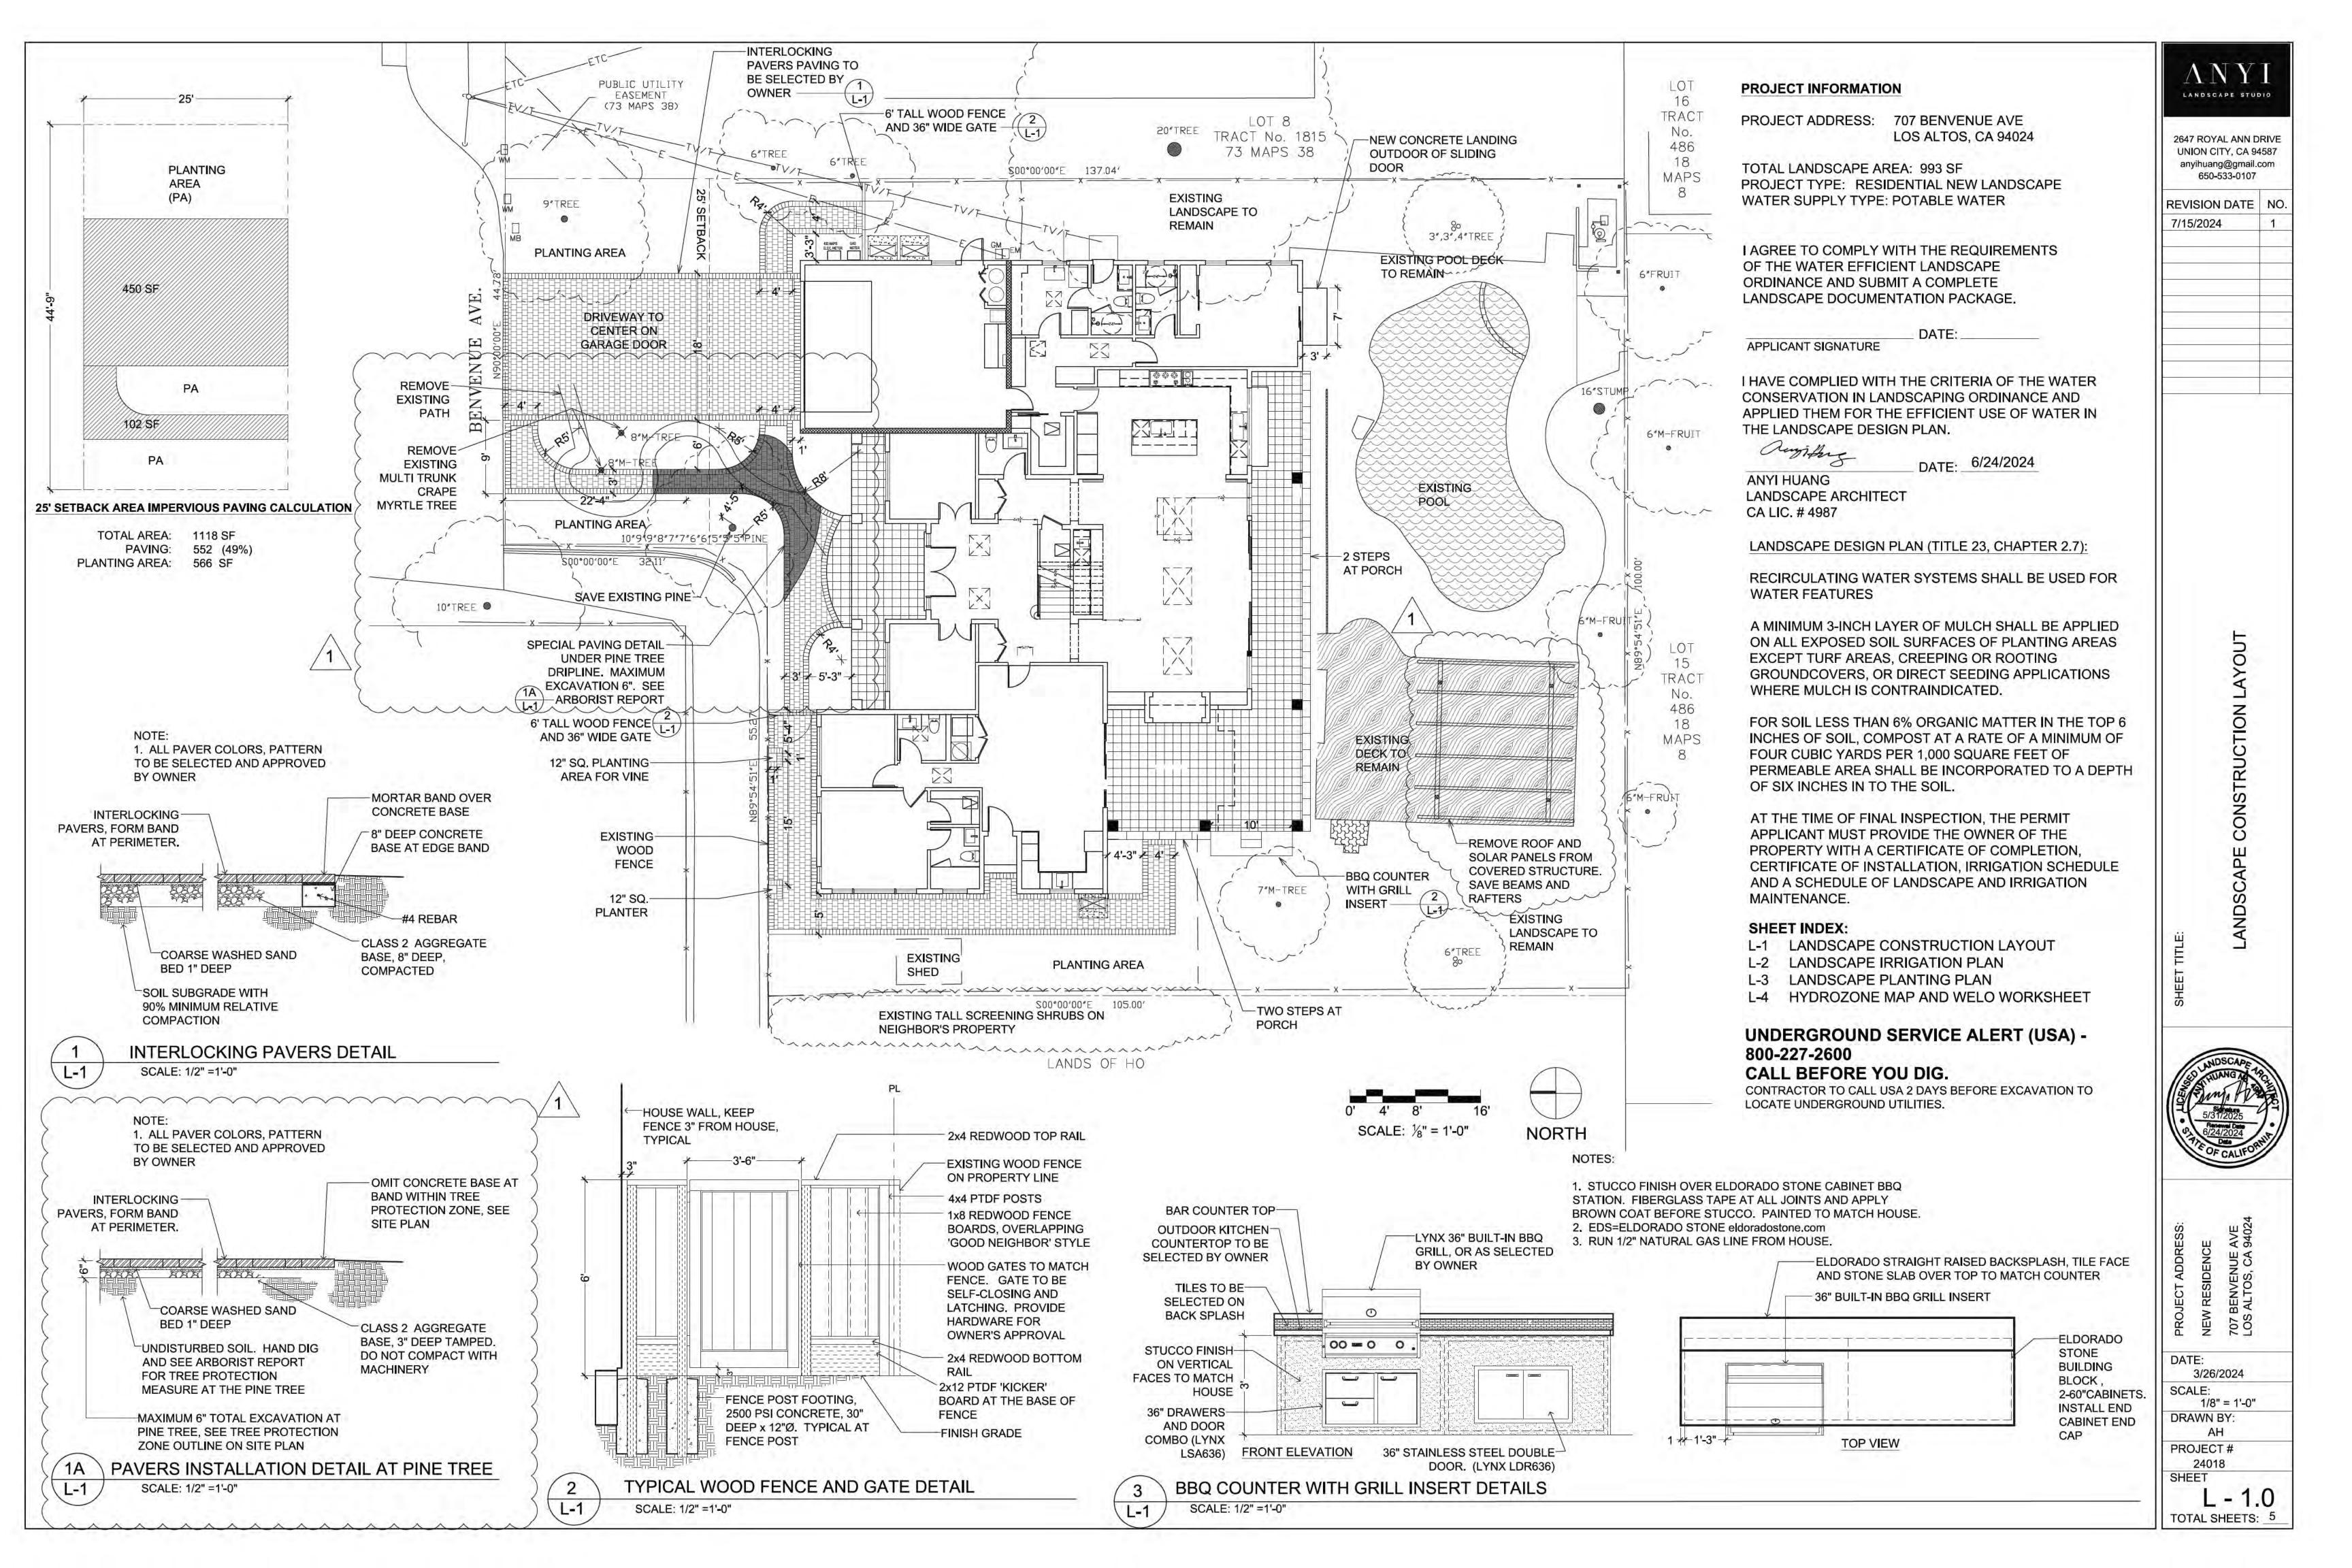

2647 ROYAL ANN DRIVE UNION CITY, CA 94587 anyihuang@gmail.com 650-533-0107

REVISION DATE NO.

7/15/2024

DATE: 3/26/2024 SCALE:

1/8" = 1'-0"


DRAWN BY:

AH

PROJECT #

PROJECT # 24018 SHEET

L - 2
TOTAL SHEETS: 5

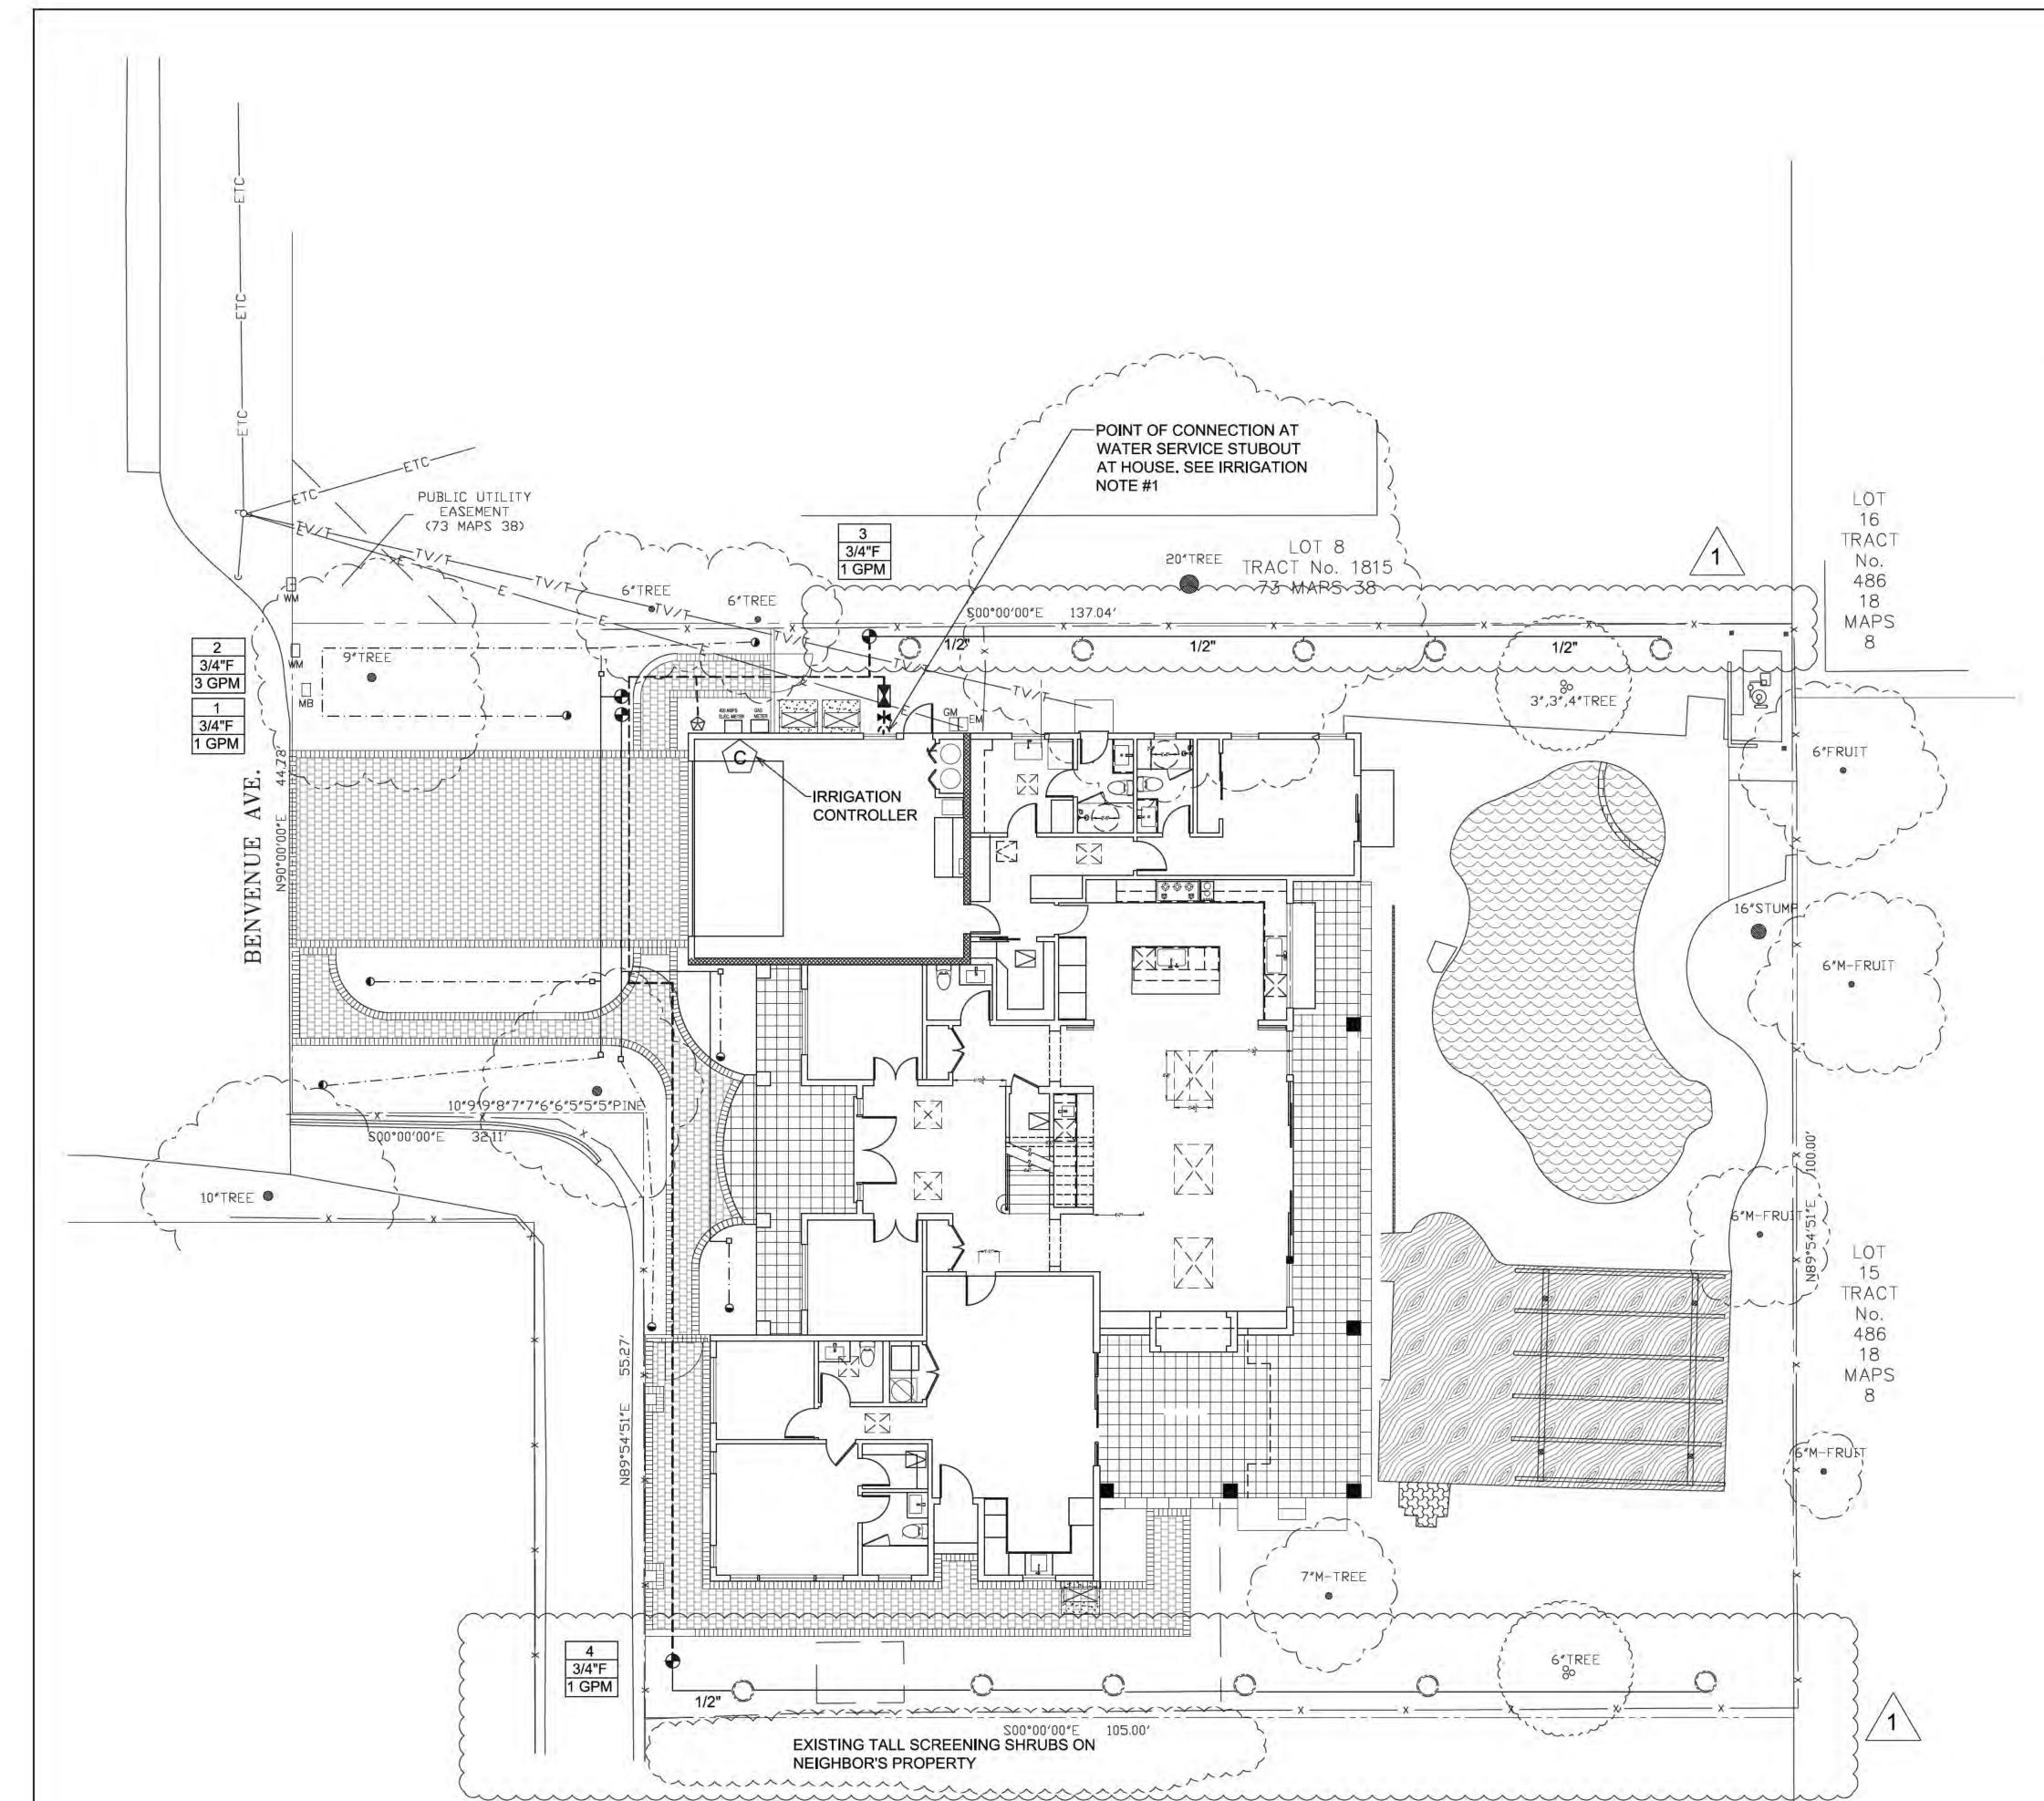

SCALE: 1/8" = 1'-0"

NORTH

IRRIGATION LEGEND

SYMBOL	DESCRIPTION
•	½" POLYETHYLENE DISTRIBUTION TUBING (RAINBIRD XT-700). SECURE IN PLACE WITH GALVANIZED TIE-DOWN STAKE EVERY 4', UNDER MULCH. USE RAINBIRD XERI-BUG EMITTERS XB-05PC (0.5 GPH) FOR 1 GALLONG PLANTS, XB-10PC (1 GPH) FOR 5 GALLON PLANTS, AND 2-XB-10PC FOR EACH 15 GALLON PLANT. INSTALL ¼" TUBING WITH STAKE AND DIFFUSER BUG CAP TO EACH PLANT. INSTALL FLUSH CAP (RAINBIRD MDCFCAP) AT THE END OF XT-700 TUBING.
0	RAINBIRD XFD ON SURFACE DRIPLINE, 0.9 GPH, 12" SPACE (XFD-09-12). 24"Ø CIRCLE AROUND TREE TRUNK (ALLOW 3 EMITTERS PER RING). SECURE DRIPLINE WITH LANDSCAPE STAPLES
	1" DIAMETER SCHEDULE 40 PVC IRRIGATION MAIN LINE, BURY 18" DEEP.
	CLASS 200 PVC LATERAL LINE, 1/2" PIPE UNLESS NOTED OTHERWISE. BURY 12" MINIMUM.
	FEBCO 765 PRESSURE VACUUM BREAKER INSTALLED ON COPPER RISER 12" ABOVE GRADE.
•	RAINBIRD XCZ-075 (VALVE FOR DRIP SYSTEM INSTALL 3/4" PR RBY FILTER AFTER VALVE). LOCATE IN VALVE BOX BELOW GRADE.
2 3/4"F 4 GPM	INDICATES IRRIGATION CONTROLLER AND STATION NUMBER INDICATES VALVE SIZE, F = HY-FILTER INDICATES FLOW RATE (GALLON PER MINUTE)
\otimes	3/4" BRASS HOSE BIB ON COPPER RISER. MOUNT ON WALL
(C)	RACHIO 3 SMART CONTROLLER, 8 ZONES. INSTALL INSIDE GARAGE.
н	MANUAL SHUT OFF VALVE

IRRIGATION NOTES:

- CONTRACTOR TO LOCATE WATER SERVICE STUB OUT FROM HOUSE. TEST WATER SUPPLY FOR AVAILABILITY OF 35 GPM AND MINIMUM STATIC WATER PRESSURE OF 55 PSI AT POINT OF CONNECTION. INSTALL PRESSURE REGULATOR IF WATER PRESSURE IS ABOVE OR BELOW SYSTEM DESIGN
- 2. TEST PIPES FOR LEAKS BEFORE BACKFILL.
- 3. INSTALL 4" PVC SLEEVE UNDER PAVING, COORDINATE WITH OTHER CONTRACTORS.
- 4. INSTALL PRESSURE REGULATING DEVICES ARE REQUIRED IF WATER PRESSURE IS BELOW OR EXCEEDS THE RECOMMENDED PRESSURE OF THE SPECIFIED IRRIGATION DEVICES.
- 5. MAINLINE IS SHOWN DIAGRAMMATICALLY AND SHALL BE PLACED IN PLANTING AREAS WHENEVER POSSIBLE.
- LOCATE ALL VALVES IN CLOSE PROXIMITY TO THE LOCATION SHOWN ON THE PLAN IN A PLANTED AREA.
- 7. PVC LATERALS AND FLEX RISERS FOR DRIP IRRIGATION ARE SHOWN DIAGRAMMATICALLY AND SHOULD ALWAYS BE LOCATED IN A PLANTING AREA WHENEVER POSSIBLE.

IRRIGATION STATIONS INFORMATION

HYDROZONE VALVE#	VALVE SIZE	FLOW RATE (GPM)	APPLICATION TYPE / RATE (IN/HR)	DESIGN OPERATION PRESSURE (PSI)	HYDROZONE / PLANT TYPES
138	3/4"F	11	DRIP/ N/A	30 PSI	Moderate / shrubs
2	3/4"F	3	DRIP/ N/A	30 PSI	Low / shrubs
3	3/4"F	1	DRIP/ N/A	30 PSI	Low / trees
4	3/4"F	110	DRIP/ N/A	30 PSI	Low / trees

* F = 'WYE' FILTER, INSTALL AFTER VALVE

I HAVE COMPLIED WITH THE CRITERIA OF THE ORDINANCE AND APPLIED THEM FOR THE EFFICIENT USE OF WATER IN THE LANDSCAPE DESIGN PLANS.

UNDERGROUND SERVICE
ALERT (USA) 800-227-2600
CALL BEFORE YOU DIG.
CONTRACTOR TO CALL USA 2 DAYS
BEFORE EXCAVATION TO LOCATE

UNDERGROUND UTILITIES.

LANDSCAPE STUDIO

2647 ROYAL ANN DRIVE UNION CITY, CA 94587 anyihuang@gmail.com 650-533-0107

REVISION DATE NO.

7/15/2024

DATE: 3/26/2024 SCALE: 1/8" = 1'-0"

DRAWN BY: PROJECT#

UNDERGROUND SERVICE

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ALERT (USA) -

UNDERGROUND UTILITIES.

800-227-2600

24018 SHEET

TOTAL SHEETS: 5

PLANTING LIST

SYMBOL	BOTANICAL NAME - COMMAN NAME	QTY	SIZE	WUCOLS	Mature Size (HxW)
TREE	S				
T1	Prunus caroliniana - Carolina Cherry Laurel (standard form)	11	15 gallon	L	30' x 15'
SHRU	IBS / PERENNIALS				
Aa Ac	Agave attenuata - Fox Tail Agave Acacia cognata 'Cousin Itt' - Cousin Itt Acacia	8	5 gallon 5 gallon	L	4'x5' 2'x4'
AH Ak	Arctostaphyllus 'Howard McMinn' - Manzanita Anigozanthos 'Big Red' - Red kangaroo paw	2 12	5 gallon 1 gallon	L	4'x5' 3'x2'
cm CY	Clivia Miniata - Clivia (by owner) Camellia 'japonica' - to be selected by owner	9	1 gallon 5 ga l lon	M M	2'x2' 5'x4'
ir Ls	Iris - Bearded irises Leucadendron salignum 'Jester' - Conebush	5 10	1 gallon 5 gallon	M L	2'x2' 4'x4'
Os Sm	Osmanthus fragrans - Sweet Osmanthus Salvia microphylla 'Hot Lips' - Salvia	2 2	5 gallon 1 gallon	M L	8'x6' 3'x4'
Sv	Santolina chamaecyparissus - Lavender Cotton	10	1 gallon	L	2'x3'
Succu	lents				
ec sa	Echeveria 'After Glow' - After Glow Echeveria Sedum 'Autumn Joy' - Autumn Joy Sedum	5 19	1 gallon 1 gallon	L	1' x 1' 1' x 2'
S	Sedum reflexum 'Blue Spruce' - Jenny's Stonecrop	9	1 gallon	L	6" x 1'
Vine					
V1 V2	Lonicera Semperirens - Honeysuckle Wisteria Sinensis - Chinese Wisteria	2 2	5 gallon 5 gallon	M M	

* Plant matured size sourced from Sunset Western Garden Book, Monrovia Plant Caterlog, www.selectree.calpoly.edu

** WUCOLS rating: H= Hign water use, M = Moderate water use, L= low water use, VL = very low water use


PLANTING NOTES


- 1. Before planting till the following materials into the top 6" of soil (for each 1,000 S.F.):
 - a. 4 cubic nitrogen fortified organic yards compost
 - 10 LB fertilizer (N16/P6/K8) w/ 2% iron
 - c. 5 LB sulfate of ammonia
- 2. Areas within the drip line of existing trees and shrubs to remain shall be prepared by hand digging to prevent damage to any roots.
- 3. Mulch all planted areas with a 3" thick layer of medium recycled wood chips, color 'Dark Brown'.
- 4. The Landscape Architect and the Owner reserve the right to reject any or all plant material, if such material does not meet the American Standards for Nursery Stock (ANSI). Plant materials shall be guaranteed against latent defects, injuries, pests, diseases or death of plants due to improper planting. Trees missing central leader will be rejected. The Contractor shall promptly replace plants that have died or are not in a vigorous, healthy condition with plants of the same kind and size as originally specified at no expense to the Owner.
- 5. Plant locations are diagrammatic, and are subject to change in the field by the Landscape Architect. The Landscape Architect and the Owner reserve the right to make substitutions, additions and deletions in planting schedule while the work is in progress. Such changes shall be accompanied by equitable adjustments in the contract price, if and when necessary.
- 6. Landscape Architect to approve plant locations prior to planting.
- 7. The Contractor shall be responsible for the adequate protection of the improvements during construction. Damaged areas, such as sprinkler heads or plant materials, shall be replaced or repaired at no additional expense to the

I HAVE COMPLIED WITH THE CRITERIA OF THE WATER CONSERVATION IN LANDSCAPING ORDINANCE AND APPLIED THEM FOR THE EFFICIENT USE OF WATER IN THE LANDSCAPE DESIGN PLAN.

A MINIMUM 3-INCH LAYER OF MULCH SHALL BE APPLIED ON ALL EXPOSED SOIL SURFACES OF PLANTING AREAS EXCEPT TURF AREAS, CREEPING OR ROOTING GROUNDCOVERS, OR DIRECT SEEDING APPLICATIONS WHERE MULCH IS CONTRAINDICATED.

PUBLIC UTILITY LOT EASEMENT (73 MAPS 38) TRACT LOT 8 20"TREE TRACT No. 1815 4 No. 486 73-MARS 38 18 137.04 \$00°00′09/E MAPS o T1 oT1 o T1 o T1 3",3",4"TRE 6"FRUIT BENVENUE 16"STUMP 6"M-FRUIT 10"TREE ● 6"M-FRUIT 15 TRACT No. 486 18 MAPS 7"M-TREE 6"TREE o T1 o T1 EXISTING TALL SCREENING SHRUBS ON **NEIGHBOR'S PROPERTY** SCALE: 1/8" = 1'-0" **NORTH**

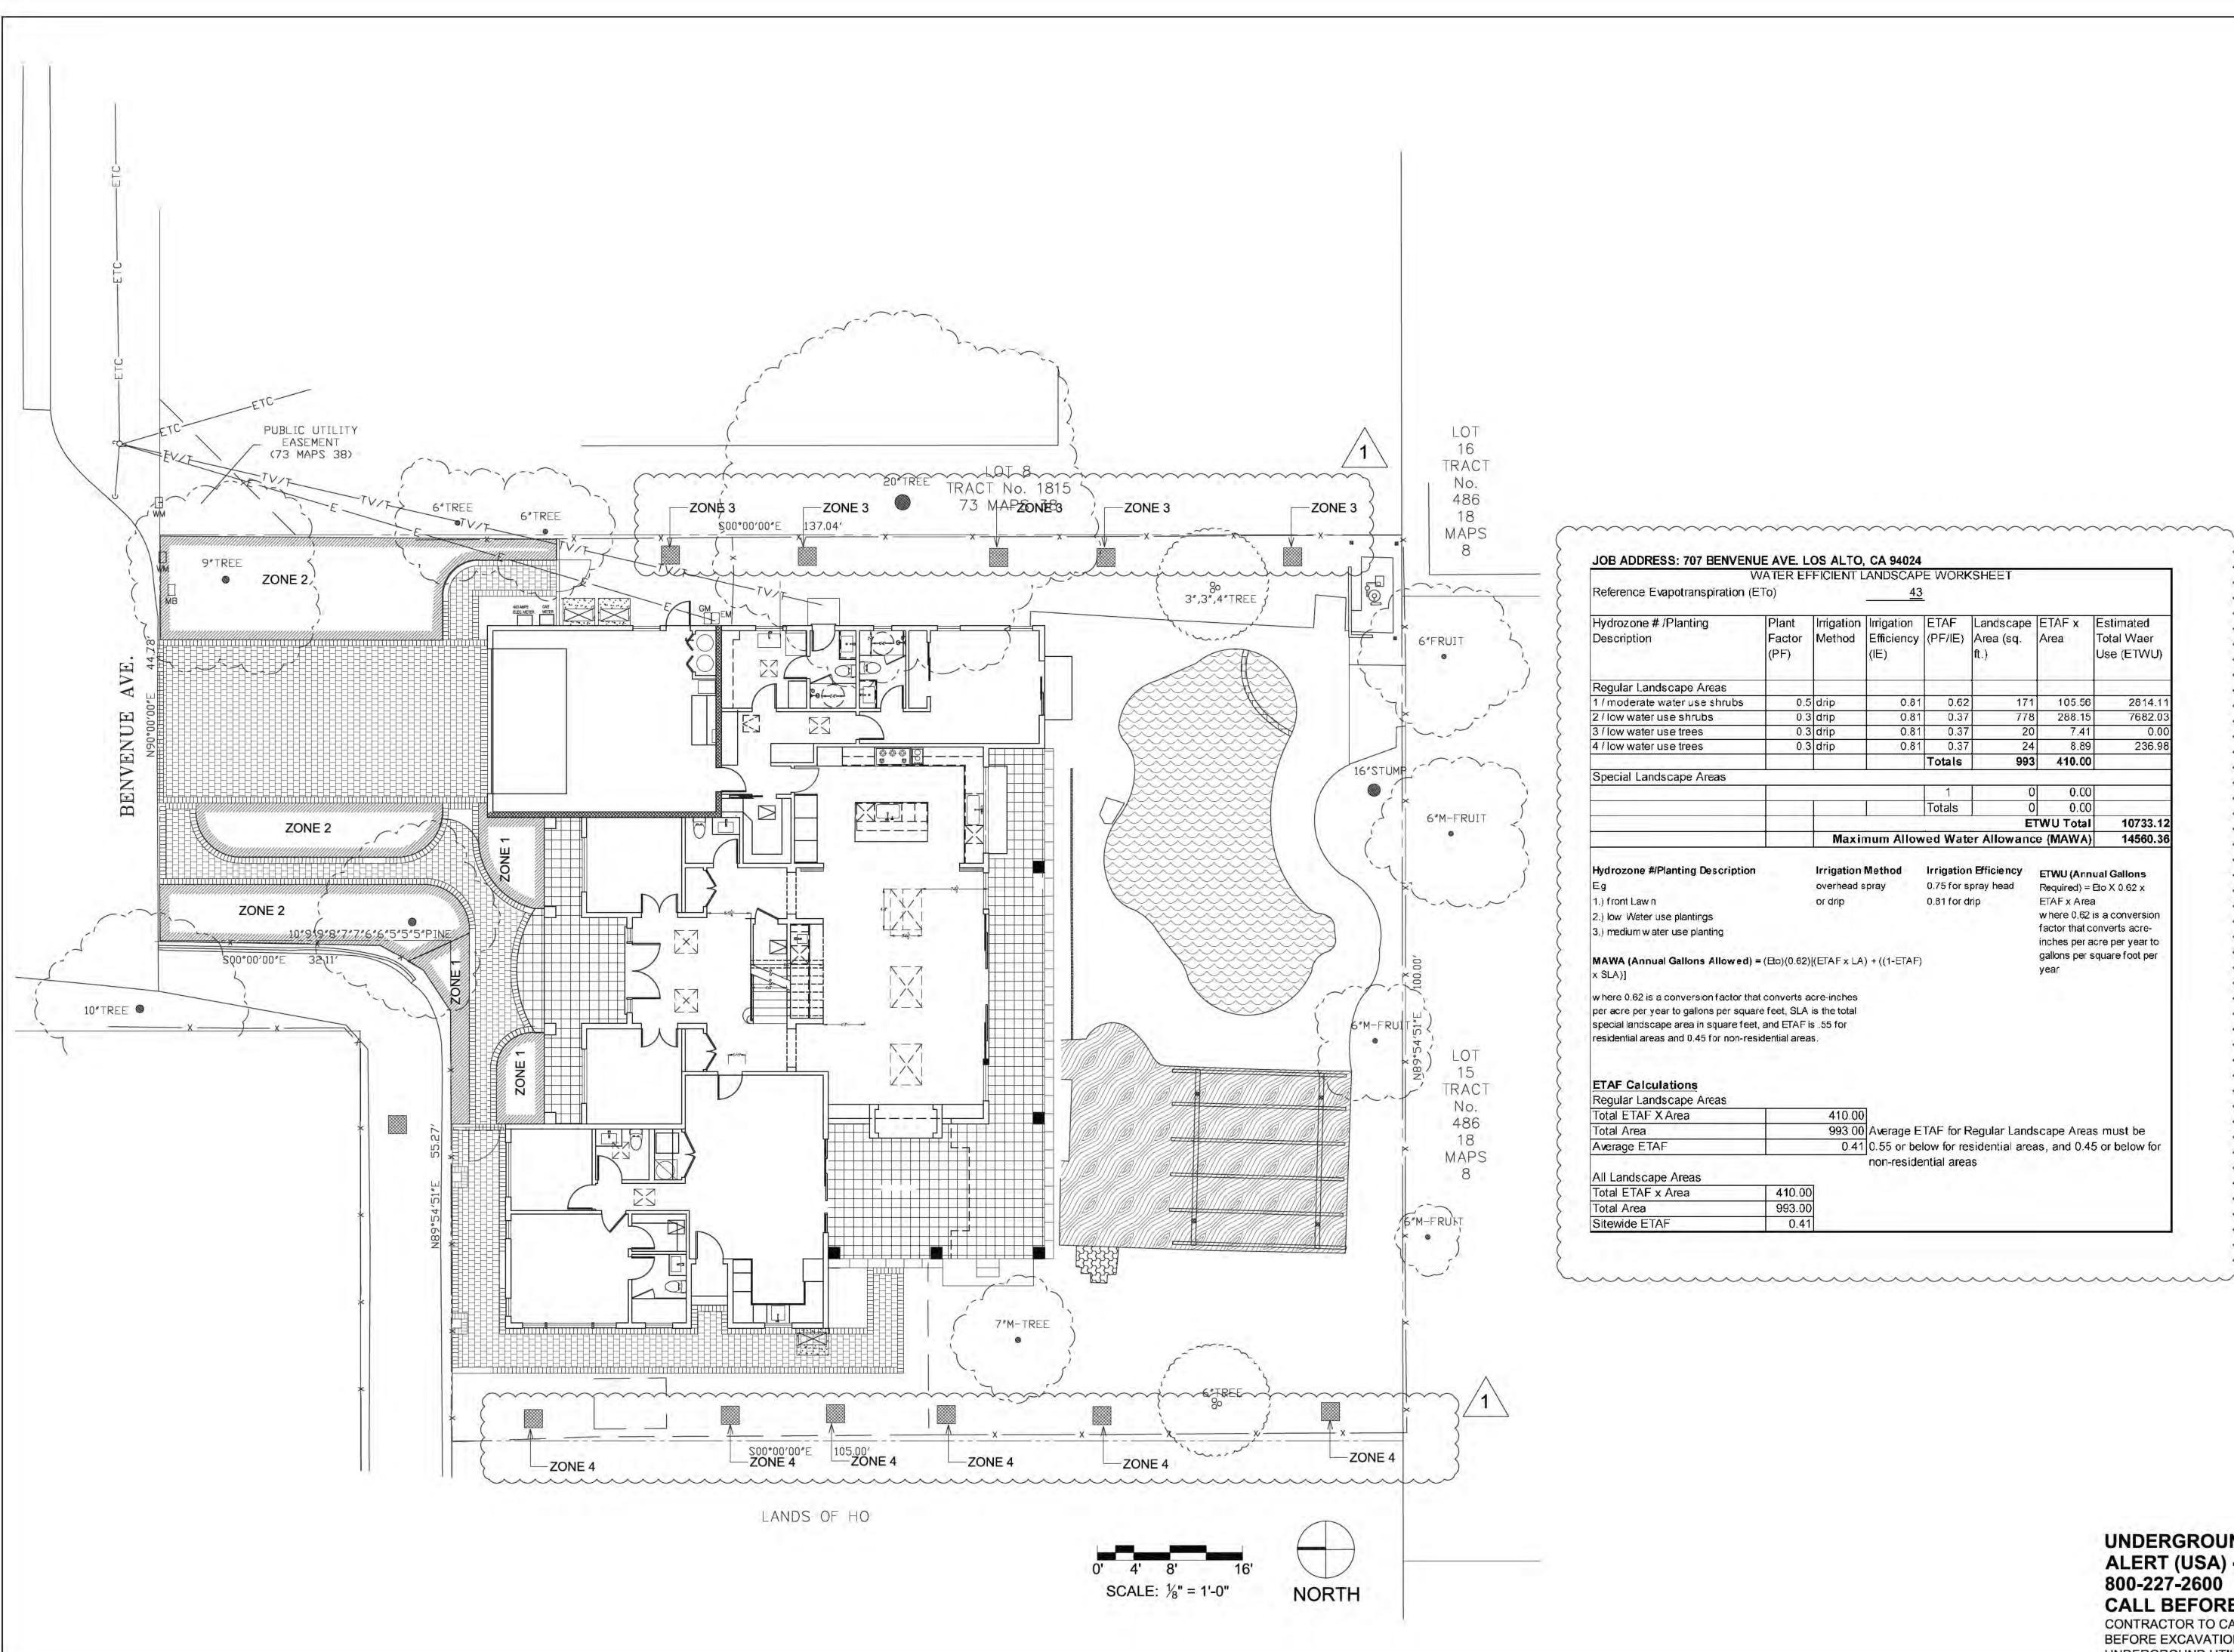

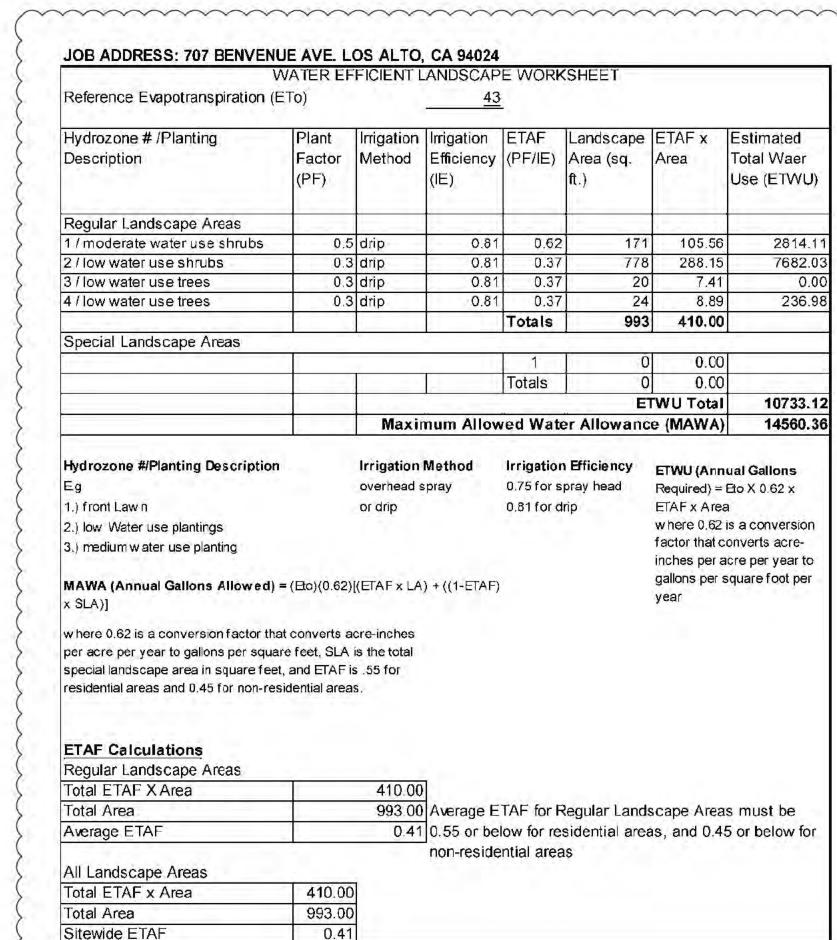

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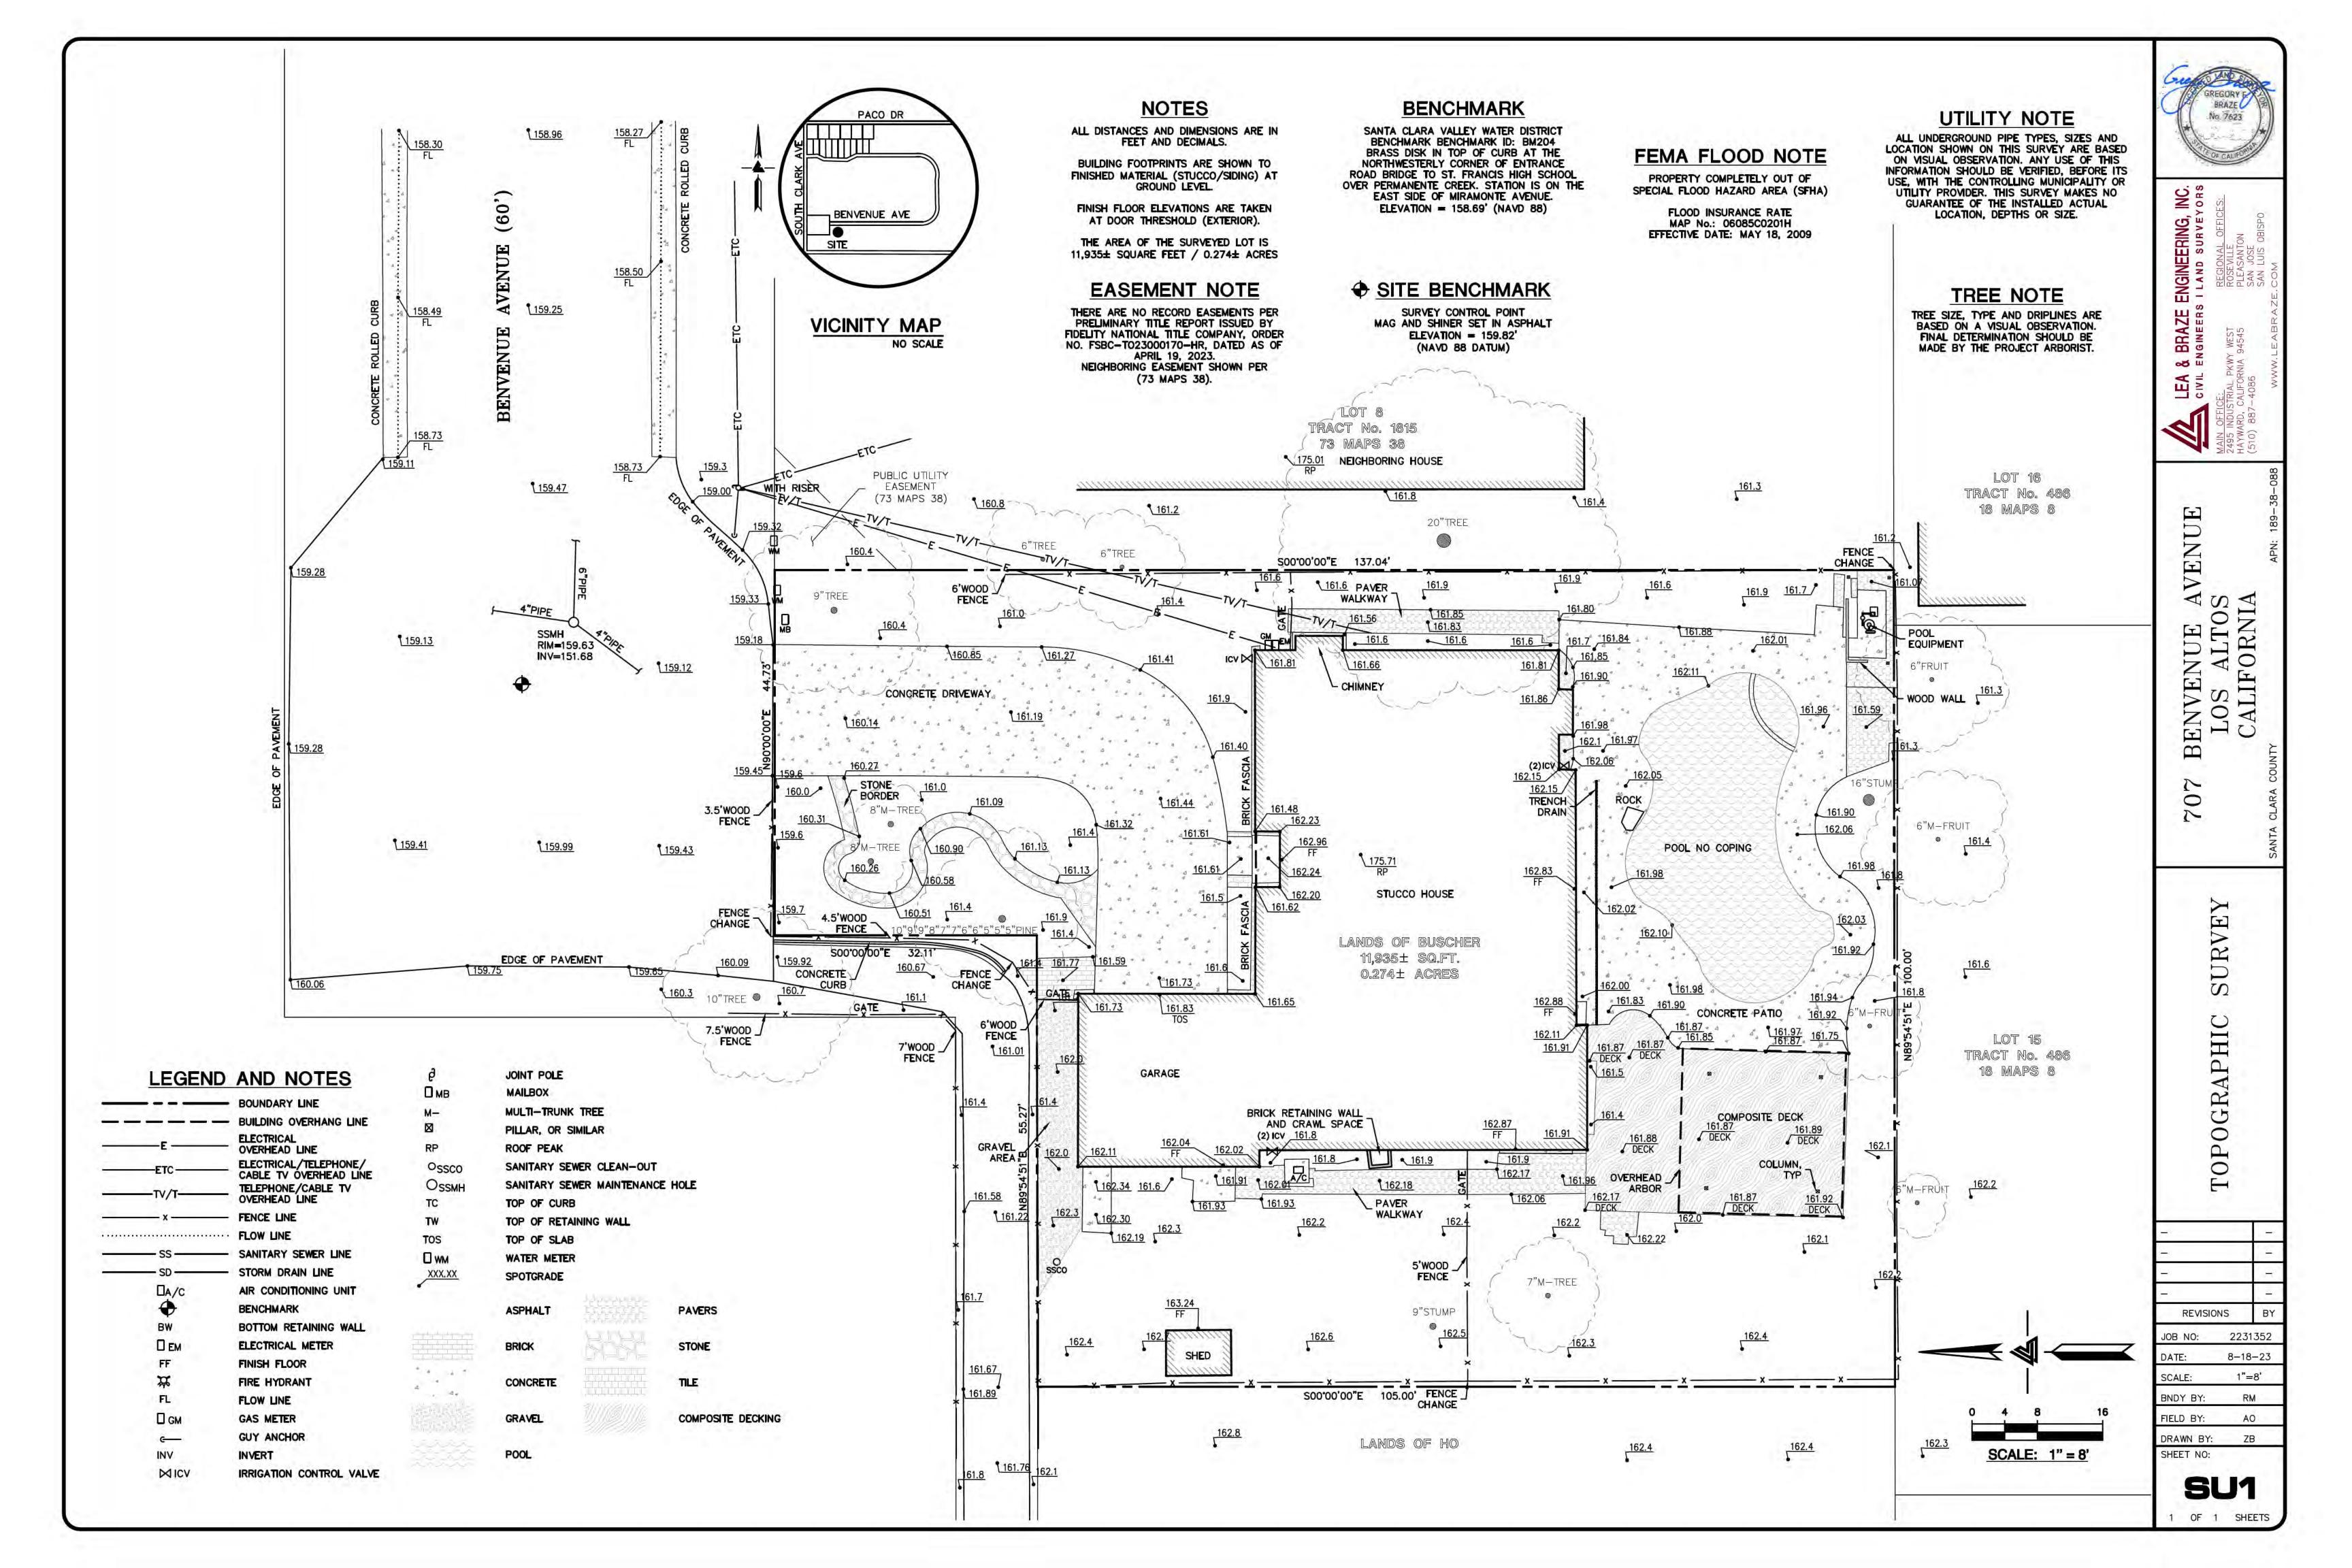
REVISION DATE NO. 7/15/2024


DATE: 3/26/2024 SCALE: 1/8" = 1'-0"

DRAWN BY: AH PROJECT#

24018 SHEET

TOTAL SHEETS: 5



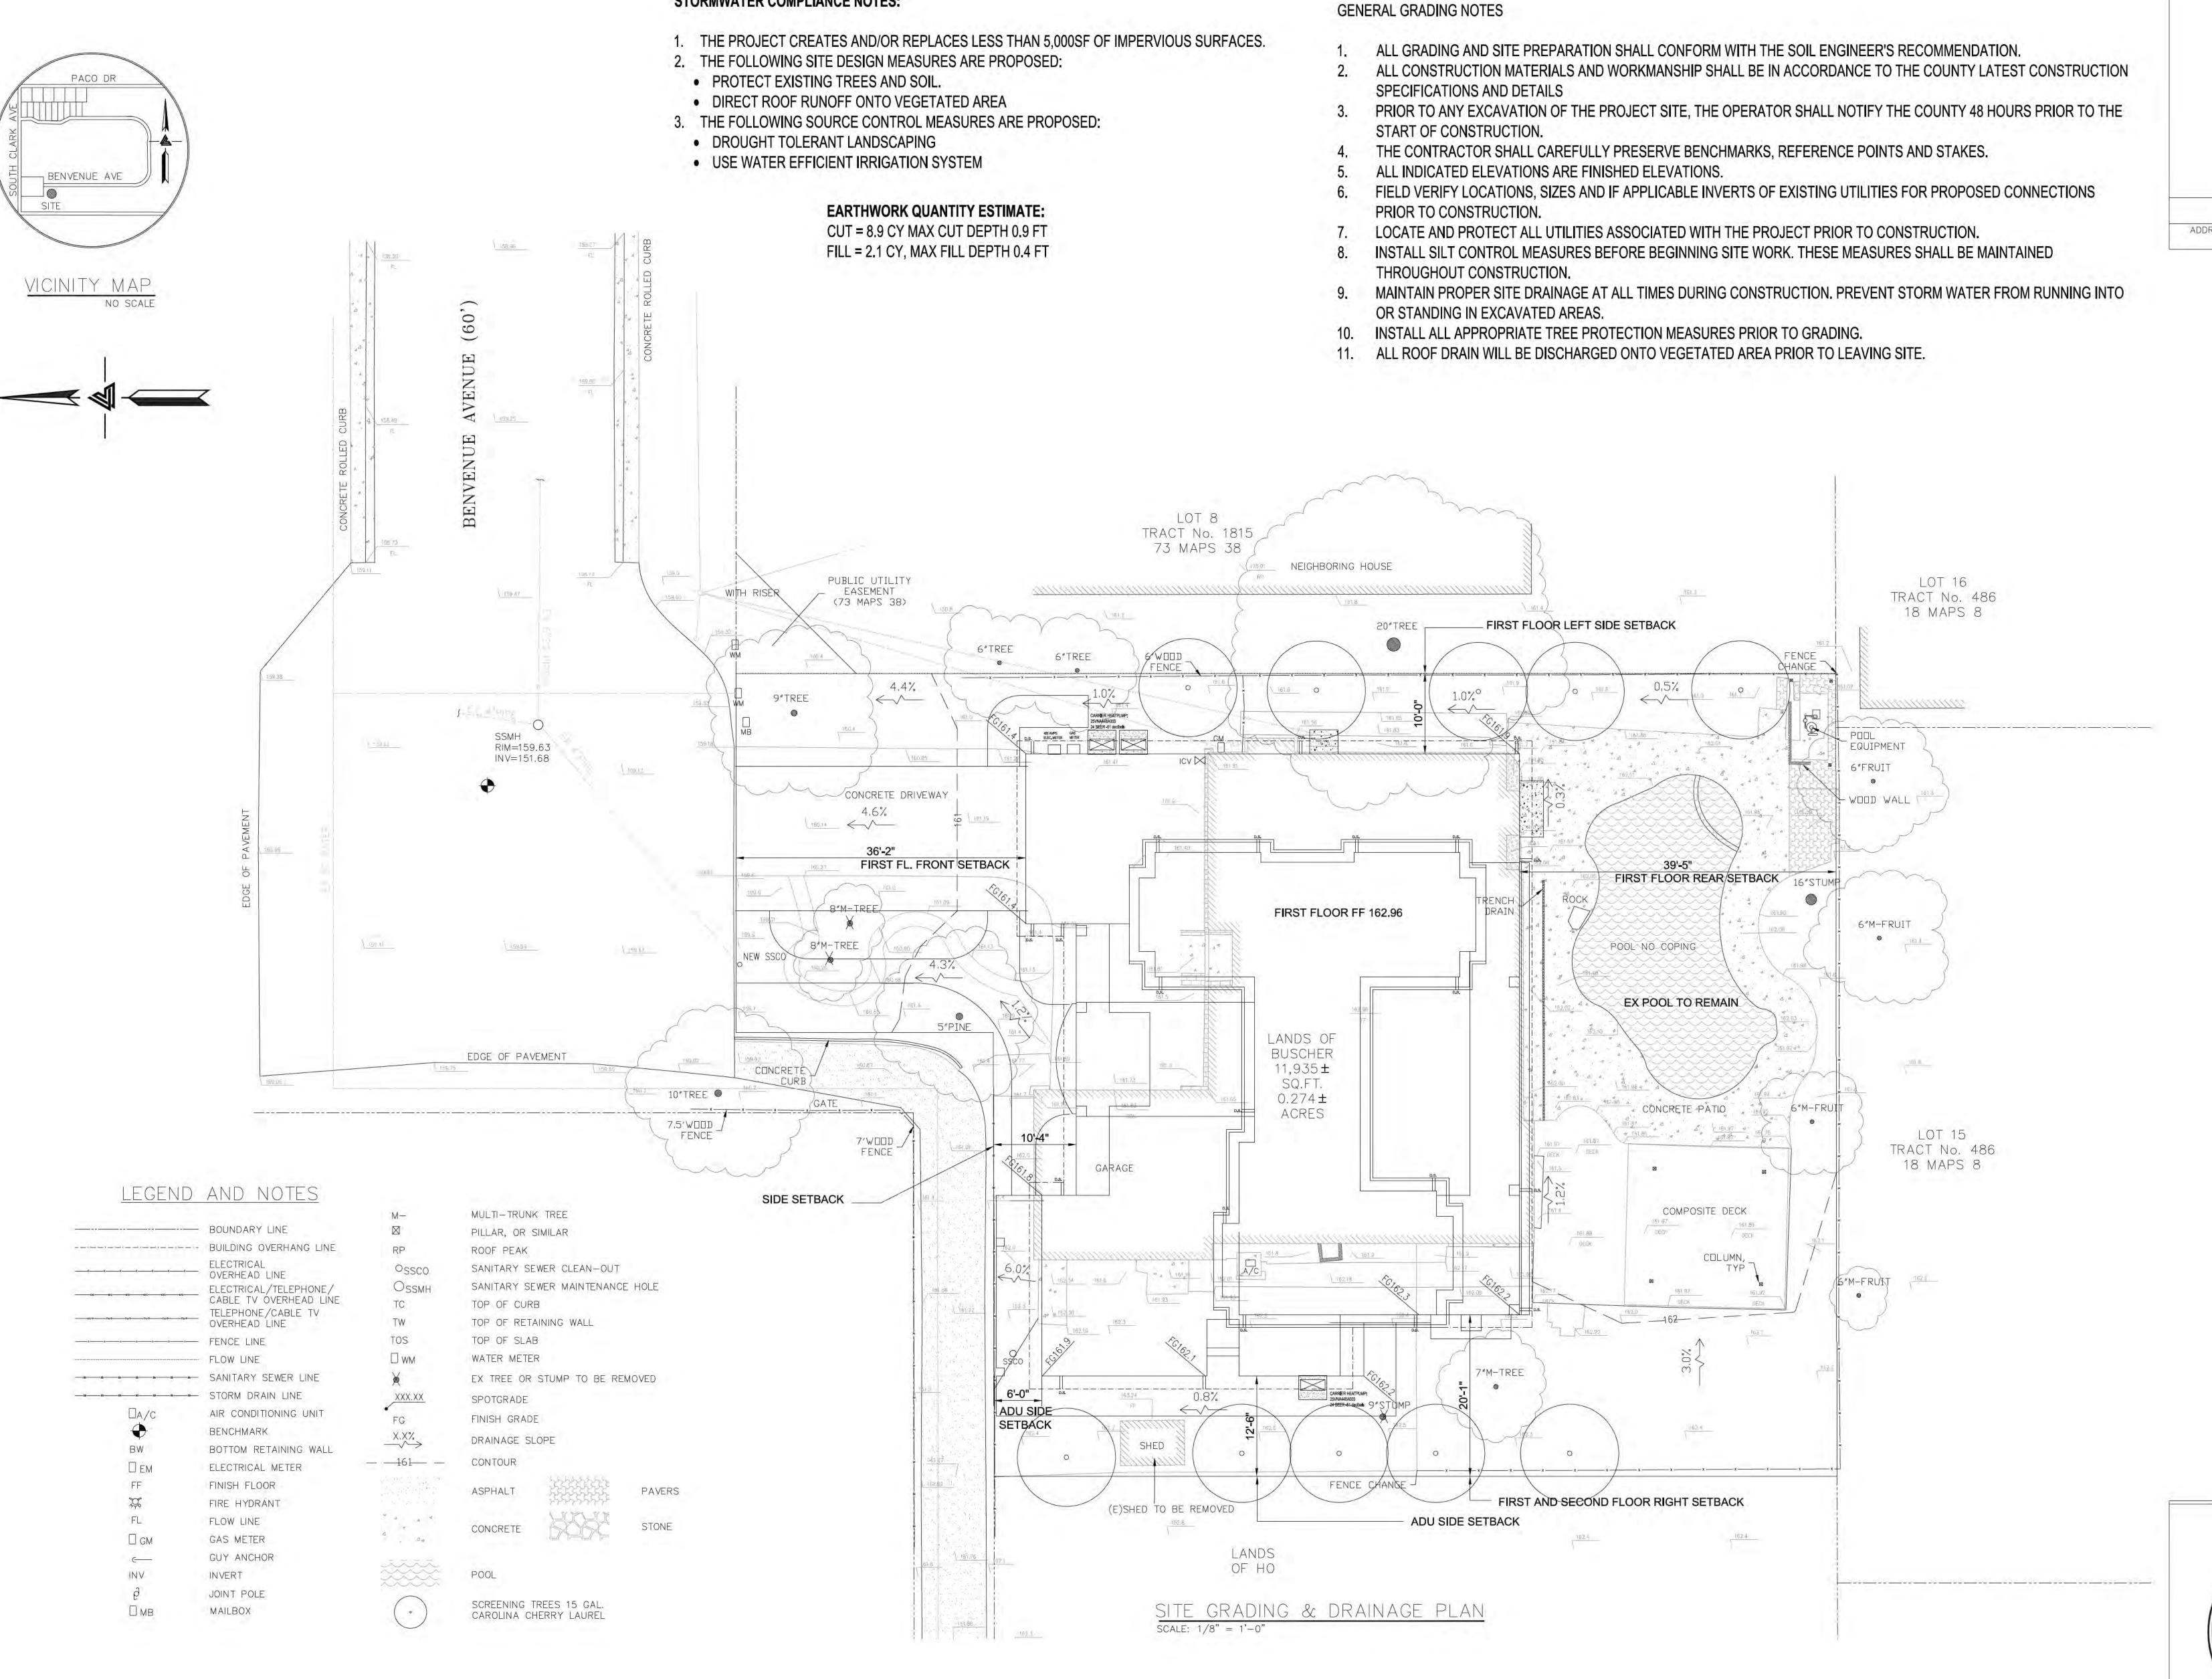

STORMWATER COMPLIANCE NOTES:

PROPERTY ADDRESS

707 BENVENUE AVENUE LOS ALTOS, CA 94024

GEORG AND LING
BUSCHER

ASSESSOR PARCEL NO.

189-38-088

REVISIONS BY: JD
REVISION DATE #

8/1/24 1

DATE 07-29-24


JOB NO.

SCALE: AS NOTED

DRAWN BY: JD

CHECKED BY: JD

APPLIES TO ALL PLANS

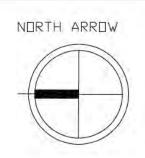

CONTENT:

CONCEPTUAL
GRADING
& DRAINAGE PLAN

SHEET NUMBER

C-1.0

