

# Attachment G

## Original Plans - 11/17/21 DRC Meeting



### THE ALON RESIDENCE

2256 DEODARA DR.  
LOS ALTOS, CALIFORNIA


#### CONSULTANTS

**DESIGN BY:**  
KHADIV DESIGN  
4657 TAMPICO WAY  
SAN JOSE, CA 95118  
Phone (408) 888-6662  
Email Address: INFO@KHADIVDESIGN.COM

**CIVIL DRAWING**  
DILIP KISHNANI, PE  
STERLING CONSULTANTS  
46560 FREMONT  
BOULEVARD, SUITE 205  
FREMONT, CA 44530  
425-105-3633 CELL

ZONING COMPLIANCE			
	Existing	Proposed	Allowed/Required
<b>LOT COVERAGE:</b> <i>Land area covered by all structures that are over 6 feet in height</i>	1,832.16 square feet (16.1%)	2,761.99 square feet (24.2%)	3,412.5 square feet (30.0%) <b>TWO STORY</b>
<b>FLOOR AREA:</b> <i>Measured to the outside surfaces of exterior walls</i>	1st Flr: 1,709.16 sq ft 2nd Flr: 699.16 sq ft Total: 2,378.16 sq ft (20.9%)	1st Flr: 2,299.98 sq ft 2nd Flr: 1,579.73 sq ft Total: 3,879.71 sq ft (34.1%)	3,887.5 square feet (34.1%)
<b>SETBACKS:</b>			
Front	25'-3" feet	25'-0" feet	25 feet
Rear	33'-0" feet	25'-0" feet	25 feet
Right side (1st/2nd)	19'-7" feet/89'-8" feet	13'-3" feet/40'-8" feet	10 feet/17.5 feet
Left side (1st/2nd)	23'-7" feet/23'-7" feet	23'-7" feet/23'-7" feet	20 feet/17.5 feet
<b>HEIGHT:</b>	21'-4" feet (+/-)	24'-8" feet	27 feet
SQUARE FOOTAGE BREAKDOWN			
	Existing	Change in	Total Proposed
<b>HABITABLE LIVING AREA:</b> <i>Includes habitable basement areas</i>	1,890.66 square feet	2,451.06 square feet	4,341.72 square feet
<b>NON-HABITABLE AREA:</b> <i>Does not include covered porches or open structures</i>	487.5 square feet <b>GARAGE</b>	0 square feet	487.5 square feet <b>GARAGE</b>
LOT CALCULATIONS			
<b>NET LOT AREA:</b>	11,375 square feet		
<b>FRONT YARD HARDSCAPE AREA:</b> <i>Hardscape area in the front yard setback shall not exceed 50%</i>	1,400 square feet (49%)		
<b>LANDSCAPING BREAKDOWN:</b>	Total hardscape area (existing and proposed): 6,053.5 sq ft Existing softscape (undisturbed) area: 5,321.5 sq ft New softscape (new or replaced landscaping) area: 0 sq ft <i>Sum of all three should equal the site's net lot area</i>		

#### VICINITY MAP

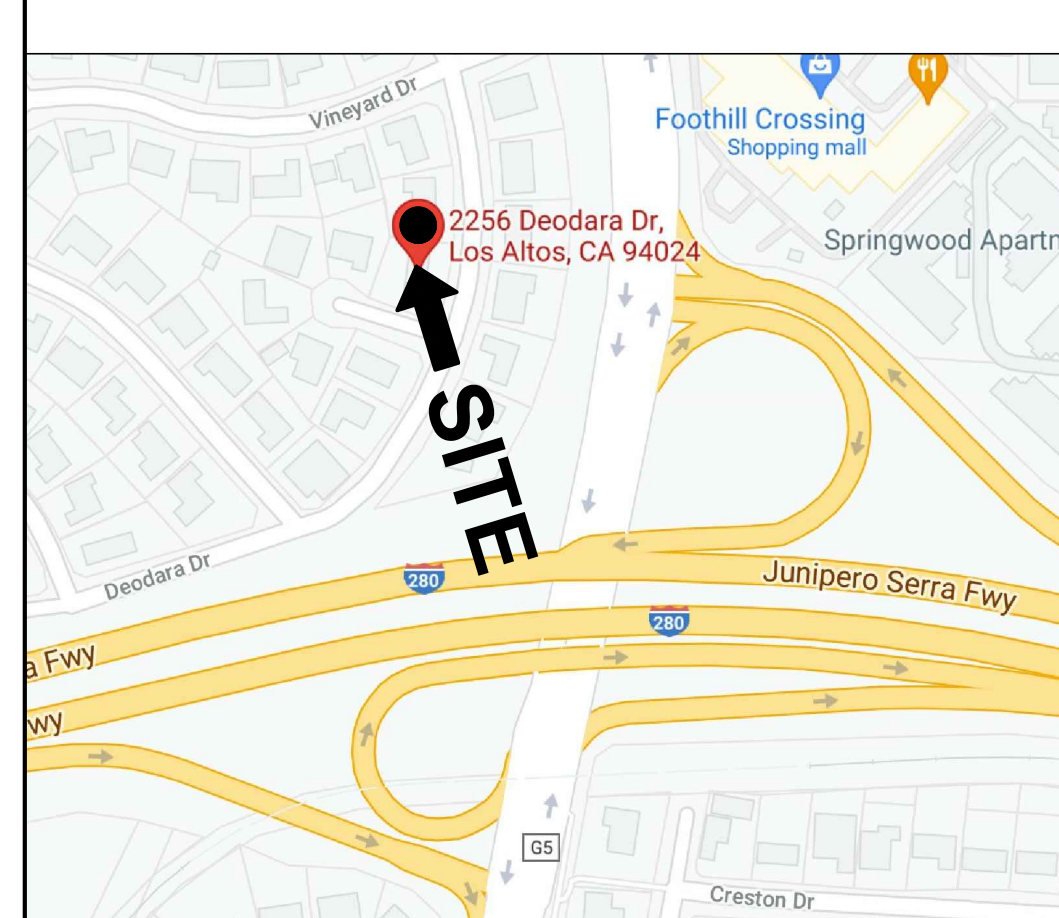

#### BUILDING CODE DATA

**OCCUPANCY:**  
R-3 / U  
SINGLE FAMILY RESIDENCE  
WITH ATTACHED GARAGE.

**CONSTRUCTION TYPE:** V-B

**FIRE SPRINKLER:** NO

**BUILDING CODE:**  
ALL APPLICABLE CURRENT CODES  
TO THE COUNTY OF SANTA CLARA  
AND THE STATE OF CALIFORNIA  
2019 CALIFORNIA BLD'G CODE (CBC)  
2019 CALIFORNIA PLUMBING CODE (CPC)  
2019 CALIFORNIA MECHANICAL CODE (CMC)  
2019 CALIFORNIA ELECTRICAL CODE (CEC)  
2019 CALIFORNIA GREEN BUILDING CODE (CALGREEN)  
2019 CALIFORNIA RESIDENTIAL CODE  
2019 CALIFORNIA ENERGY CODE

#### PROJECT DESCRIPTION

ADDITION AND REMODEL TO EXISTING TWO STORY RESIDENCE

**PROJECT ADDRESS:** 2256 DEODARA DR.  
LOS ALTOS, CA

**ZONING DISTRICT:** RI-10

#### TABULATION

#### F.A.R

THE MAXIMUM FLOOR AREA IS 3,850 SQUARE FEET PLUS 10% OF THE REMAINING LOT AREA.

LOT AREA = 11,375  
11,375 - 11,000 = 375  
F.A.R = 3,850 + 37.5 = 3,887.5 SQ. FT.

#### LOT COVERAGE

11,375 X 30% = 3,412.5

#### SHEET INDEX.

A-00 COVER SHEET/ PLANNING DATA  
CB-10 BLUEPRINT FOR CLEAN BAY  
CG-1 CALGreen MANDATORY CHECKLIST

#### ARCHITECTURAL

A-10 EXISTING SITE PLAN  
A-11 PROPOSED SITE PLAN  
A-12 EXISTING AREA CALCULATION DIAGRAM  
A-13 PROPOSED AREA CALCULATION DIAGRAM  
NC-10 NEIGHBORHOOD COMPATIBILITY WORKSHEET  
NC-11 NEIGHBORHOOD COMPATIBILITY WORKSHEET  
NC-12 NEIGHBORHOOD COMPATIBILITY WORKSHEET  
NC-13 NEIGHBORHOOD COMPATIBILITY WORKSHEET  
A-20 EXISTING FIRST FLOOR PLAN / DEMO PLAN  
A-21 EXISTING SECOND FLOOR PLAN / DEMO PLAN  
A-22 PROPOSED FIRST FLOOR PLAN  
A-23 PROPOSED SECOND FLOOR PLAN  
A-30 EXISTING ROOF PLAN / DEMO PLAN  
A-31 PROPOSED ROOF PLAN  
A-40 EXISTING & PROPOSED FRONT ELEVATION  
A-41 EXISTING & PROPOSED RIGHT SIDE ELEVATION  
A-42 EXISTING & PROPOSED REAR ELEVATION  
A-43 EXISTING & PROPOSED LEFT SIDE ELEVATION  
A-50 BUILDING CROSS SECTIONS  
A-51 BUILDING CROSS SECTIONS  
LD-10 CONCEPTUAL LANDSCAPE PLAN

#### CIVIL

C-1 EXISTING AND DEMOLITION  
C-2 GRADING AND DRAINAGE PLAN

No. Date Description

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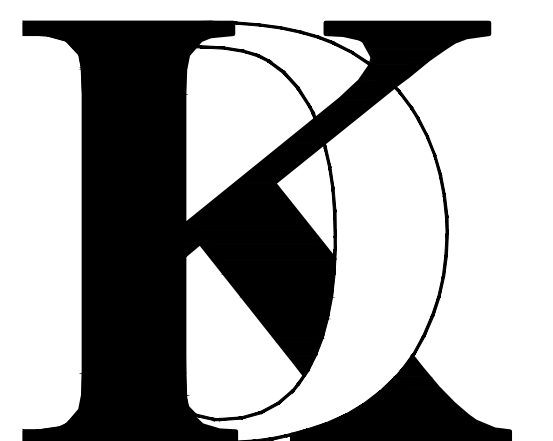
THE USE OF THESE PLANS AND SPECIFICATION SHALL BE RESTRICTED TO THE SPECIFIC SITE FOR WHICH THEY WERE PREPARED AND PUBLICATION THEREOF SHALL BE EXPRESSLY LIMITED TO SUCH USE. REUSE, REPRODUCTION OR PUBLICATION BY ANY METHOD, IN WHOLE OR IN PART, IS PROHIBITED. TITLE TO THE PLANS AND SPECIFICATIONS REMAINS WITH KHADIV-DESIGN. WITHOUT PREJUDICE VISUAL CONTACT WITH THESE PLANS AND SPECIFICATIONS SHALL INSTITUTE PRIMA FACIE EVIDENCE OF THE ACCEPTANCE OF THE RESTRICTIONS.

Client :

Mr. and Mrs. Alon  
2256 DEODARA DR.  
LOS ALTOS, CA

Project :

Mr. and Mrs. Alon  
2256 DEODARA DR.  
LOS ALTOS, CA



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#### KHADIV-DESIGN

Date: 12-07-20

Scale: N.T.S

Drawn By : FK

Job No: 2020.11

Signature :

Sheet Title :

COVER SHEET  
PLANNING DATA


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# Original Plans - 11/17/21 DRC Meeting

## Heavy Equipment Operation



**Best Management Practices for the Construction Industry**

- Vehicle and equipment operators
- Site supervisors
- General contractors
- Home builders
- Developers
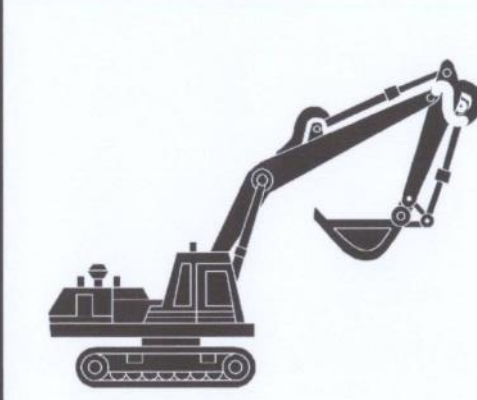
### Doing the Job Right

#### Site Planning and Preventive Vehicle Maintenance

- Inspect all vehicles and heavy equipment. Maintain frequently for and repair leaks.
- Perform major maintenance, repair jobs, and vehicle and equipment washing off site where cleanup is easier.
- If you must drain and replace motor oil, radiator coolant, or other fluids on site, use drip pans or drop cloths to catch drips and spills. Collect all spent fluids, store in separate containers, and properly dispose as hazardous waste (recycle whenever possible).
- Do not use diesel oil to lubricate equipment parts, or clean equipment. Use only water for any onsite cleaning.
- Cover exposed fifth wheel hitches and other oily or greasy equipment during rain events.

#### Storm Drain Pollution from Heavy Equipment on Construction Sites

Poorly maintained vehicles and heavy equipment that leak fuel, oil, antifreeze or other fluids on the construction site are common sources of storm drain pollution. Prevent spills and leaks by inspecting equipment from runoff channels, and by watching for leaks and other maintenance problems. Remove construction equipment from the site as soon as possible.

## Roadwork and Paving

**Best Management Practices for the Construction Industry**



**Best Management Practices for the Construction Industry**

- Road crews
- Driveways/sidewalk/parking lot construction crews
- Seal coat contractors
- Operators of grading equipment, paving machines, dump trucks, concrete mixers
- Construction inspectors
- General contractors
- Home builders
- Developers

### Doing The Job Right

#### General Business Practices

- Develop and implement erosion/sediment control plans for roadway embankments.
- Schedule excavation and grading work during dry weather.
- Check for and repair leaking equipment.
- Perform major equipment repairs at designated areas in your maintenance yard, where cleanup is easier. Avoid performing equipment repairs at construction sites.
- When refueling or when vehicle/equipment maintenance must be done on site, designate a location away from storm drains and creeks.
- Do not use diesel oil to lubricate equipment parts or clean equipment.
- Recycle used oil, concrete, broken asphalt, etc. whenever possible, or dispose of properly.

#### During Construction

- Avoid paving and seal coating in wet weather, or when rain is forecast, to prevent fresh materials from contacting stormwater runoff.
- Cover and seal catch basins and manholes when applying seal coat, slurry seal, fog seal, or similar materials.
- Protect drainage ways by using earth dikes, sand bags, or other controls to divert or trap and filter runoff.

#### Storm Drain Pollution from Roadwork

Road paving, surfacing, and pavement removal happen right in the treated dirt. Use a street sweeper or vacuum truck, or excavated material to illegally enter storm drains. Extra planning is required to store and dispose of materials properly and guard against pollution of storm drains, creeks, and the Bay.

### Doing The Job Right

#### General Business Practices

- Never wash excess material from exposed aggregate concrete or similar treatments into a street or storm drain. Collect and recycle, or dispose to dirt area.
- Cover stockpiles (asphalt, sand, etc.) and other construction materials with plastic tarps. Protect from rainfall and prevent runoff with temporary roofs or plastic sheets and berms.
- Park paving materials over drip pans or absorbent material (rags, etc.) to catch drips when not in use.
- Clean up all spills and leaks using "dry" methods with absorbent materials (and/or rags), or dig up, remove, and properly dispose of contaminated soil.
- Collect and recycle or appropriately dispose of excess abrasive gravel or sand.
- Avoid over-application by water trucks for dust control.

#### Asphalt/Concrete Removal

- Avoid creating excess dust when breaking asphalt or concrete.
- After breaking up old pavement, be sure to remove all chunks and pieces. Make sure broken pavement does not come in contact with rainfall or runoff.
- When making saw cuts, use as little water as possible. Show or vacuum saw-cut slurry and remove from the site. Cover or protect storm drain inlets with saw-cutting. Sweep up, and properly dispose of, all residues.
- Sweep, never hose down streets to clean up. Use a street sweeper or vacuum truck. Do not dump vacuumed liquid in storm drains.

## Fresh Concrete and Mortar Application

**Best Management Practices for the Construction Industry**



**Best Management Practices for the Construction Industry**

- Masons and bricklayers
- Sidewalk construction crews
- Patio construction workers
- Construction inspectors
- General contractors
- Home builders
- Developers
- Concrete delivery/pumping workers

### Doing The Job Right

#### General Business Practices

- Wash out concrete mixers only in designated wash-out areas in your yard, away from storm drains and waterways, where the water will flow into a temporary waste pit in a dirt area. Let water percolate through soil and dispose of settled, hardened concrete as garbage. Whenever possible, recycle washout by pumping back into mixers for reuse.
- Wash out chutes onto dirt areas at site that do not flow to streets or drains.
- Always store both dry and wet materials under cover, protected from rainfall and runoff and away from storm drains or waterways. Protect dry materials from wind.
- Secure bags of cement after they are open. Be sure to keep wind-blown cement powder away from streets, gutters, storm drains, rainfall, and runoff.
- Do not use diesel fuel as a lubricant on concrete forms, tools, or trailers.

#### Storm Drain Pollution from Fresh Concrete and Mortar Applications

Fresh concrete and cement-related mortars that wash into lakes, streams, or estuaries are toxic to fish and the aquatic environment. Disposing of these materials to the storm drains or creeks can block storm drains, cause serious problems, and is prohibited by law.

## Landscaping, Gardening, and Pool Maintenance

**Best Management Practices for the Construction Industry**



**Best Management Practices for the Construction Industry**

- Landscapers
- Gardeners
- Swimming pool/pas service and repair workers
- General contractors
- Home builders
- Developers
- Homeowners

### Doing The Job Right

#### General Business Practices

- Protect stockpiles and landscaping materials from wind and rain by storing them under tarps or secured plastic sheeting.
- Store pesticides, fertilizers, and other chemicals indoors or in a shed or storage cabinet.
- In San Jose, leave yard waste for curbside recycling pickup in piles in the street, 18 inches from the curb and completely out of the street to any storm drain.
- In San Jose, leave yard waste for curbside recycling pickup in piles in the street, 18 inches from the curb and completely out of the street to any storm drain.
- Use temporary check dams or ditches to divert runoff away from storm drains.
- Protect storm drains with sandbags or other sediment controls.
- Re-vegetation is an excellent form of erosion control for any site.

#### Landscaping/Garden Maintenance

- Use pesticides sparingly, according to instructions on the label. Rinse empty containers, and use rinse water as product. Dispose of rinsed, empty containers in the trash. Dispose of unused pesticides as hazardous waste.
- Collect lawn and garden clippings, pruning waste, and tree trimmings. Chip if necessary, and compost.
- In communities with curbside pick-up of yard waste, place clippings and pruning waste at the curb in approved bags or containers. Or, take to a landfill that composts yard waste. No curbside pick-up of yard waste is available for commercial properties.

#### Storm Drain Pollution from Landscaping and Swimming Pool Maintenance

Many landscaping activities expose soils and increase the likelihood that earth and garden chemicals will run off into the storm drains during irrigation or when it rains. Swimming pool water containing chlorine and copper-based algicides should never be discharged to storm drains. These chemicals are toxic to aquatic life.

### Doing The Job Right

#### General Business Practices

- Do not blow or rake leaves, etc. into the street, or place yard waste in gutters or on dirt shoulders, unless you are piling them for recycling (followed by San Jose and unincorporated County only). Sweep up any leaves, litter or residue in gutters or on dirt shoulders.
- In San Jose, leave yard waste for curbside recycling pickup in piles in the street, 18 inches from the curb and completely out of the street to any storm drain.

#### Pool/Fountain/Spa Maintenance

- When it's time to drain a pool, spa, or fountain, please be sure to call your local wastewater treatment plant before you start for further instructions on flow rate restrictions, backflow prevention, and handling special cleaning waste (such as acid wash). Discharge flows shall not exceed 100 gallons per minute.
- Never discharge pool or spa water to a street or storm drain; discharge to a sanitary sewer cleanout.
- If possible, when emptying a pool or spa, let chlorine dissipate for a few days and then recirculate water by draining it gradually into a landscaped area.
- Do not use copper-based algicides. Control algae with chlorine or bromine. Other chemicals such as sodium bromide.

#### Filter Cleaning

- Never clean a filter in the street or near a storm drain. Rinse cartridge and diatomaceous earth filters onto a dirt area, and space filter residue into soil. Dispose of spent diatomaceous earth in the garbage.
- If there is no suitable dirt area, call your local wastewater treatment plant for instructions on discharging filter backwash or rinse water to the sanitary sewer.

## Painting and Application of Solvents and Adhesives

**Best Management Practices for the Construction Industry**



**Best Management Practices for the Construction Industry**

- Homeowners
- Painters
- Paperhangers
- Plasterers
- Graphic artists
- Dry wall crews
- Floor covering installers
- General contractors
- Home builders
- Developers

### Doing The Job Right

#### Handling Paint Products

- Keep all liquid paint products and waste away from the gutter, street, and storm drains. Liquid residues from paints, thinners, solvents, glues, and cleaning fluids are hazardous wastes and must be disposed of at a hazardous waste collection facility (contact your local stormwater program listed on the back of this brochure).
- When thoroughly dry, empty paint cans, used brushes, and other drop items may be disposed of as garbage in a sanitary landfill. Empty, dry paint cans also may be recycled as metal.
- Wash water from painted buildings constructed before 1978 to contain high amounts of lead, even if paint chips are not present. Before you begin stripping paint or cleaning pre-1978 buildings with water under high pressure, test paint for lead by taking paint scrapings to a local laboratory. See Yellow Pages for a state-certified laboratory.
- If there is loose paint on the building, or if the paint tests positive for lead, block storm drains. Check with the wastewater treatment plant to determine whether you may discharge water to find and you can collect (map or vacuum) building cleaning water and dispose to the sanitary sewer. Sampling of the water may be required to assist in the wastewater treatment authority in making its decision.

#### Paint Removal

- Wash water from non-hazardous dry stripping and sand blasting may be swept up or collected in plastic drop cloths and disposed of as trash.
- Chemical paint stripping residue and chips and dust from marine paints or paints containing lead, mercury or tributyl tin must be disposed of as hazardous wastes. Lead based paint removal requires a state-certified contractor.
- When stripping or cleaning building exteriors with high-pressure water, block storm drains. Direct wash water onto a dirt area and spade into soil. Or, check with the local wastewater treatment authority to find out if you can collect (map or vacuum) building cleaning water and dispose to the sanitary sewer. Sampling of the water may be required to assist in the wastewater treatment authority in making its decision.

#### Recycle/Reuse Leftover Paints Whenever Possible

- Recycle or donate excess water-based (latex) paint, or return to supplier.
- Reuse leftover oil-based paint. Dispose of non-recyclable thinners, sludge and unwanted paint, as hazardous waste.
- Unopened cans of paint may be able to be returned to the paint vendor. Check with the vendor regarding its "buy-back" policy.

### Doing The Job Right

#### Painting Cleanup

- Never clean brushes or rinse paint containers into a street, gutter, storm drain, French drain, or stream.
- For water-based paints, paint out brushes to the extent possible, and rinse into a drain that goes to the sanitary sewer. Never pour paint down a storm drain.
- For oil-based paints, paint out brushes to the extent possible and clean with thinner or solvent in a proper container. Filter and reuse thinners and solvents. Dispose of excess liquids and residue as hazardous waste.

#### Paint Removal

- Wash water from non-hazardous dry stripping and sand blasting may be swept up or collected in plastic drop cloths and disposed of as trash.
- Chemical paint stripping residue and chips and dust from marine paints or paints containing lead, mercury or tributyl tin must be disposed of as hazardous wastes. Lead based paint removal requires a state-certified contractor.
- When stripping or cleaning building exteriors with high-pressure water, block storm drains. Direct wash water onto a dirt area and spade into soil. Or, check with the local wastewater treatment authority to find out if you can collect (map or vacuum) building cleaning water and dispose to the sanitary sewer. Sampling of the water may be required to assist in the wastewater treatment authority in making its decision.

## Los Altos Municipal Code Requirements

**Los Altos Municipal Code Chapter 10.08.390 Non-storm water discharges**

- A. Unlawful discharges. It shall be unlawful to discharge any domestic waste or industrial waste into storm drains, gutters, creeks, or San Francisco Bay. Unlawful discharges to storm drains shall include, but not be limited to, discharge from toilets; sinks; industrial processes; cooling systems; boilers; fabric cleaning; equipment cleaning; construction activities, including, but not limited to, painting, paving, concrete placement, saw cutting and grading; swimming pools; spas; and fountains, unless specifically permitted by a discharge permit or unless exempted by guidelines published by the superintendent.
- B. Threatened discharges. It shall be unlawful to cause hazardous materials, domestic waste, or industrial waste to be deposited in such a manner or location as to constitute a threatened discharge into storm drains, gutters, creeks or San Francisco Bay. A "threatened discharge" is a condition creating a substantial probability of harm, when the probability and potential extent of harm make it reasonably necessary to take immediate action to prevent, reduce or mitigate damages to persons, property or natural resources. Domestic or industrial wastes that are no longer contained in a pipe, tank or other container are considered to be threatened discharges unless they are actively being cleaned up.


#### Los Altos Municipal Code Section 10.08.430 Requirements for construction operations.

- A. A spill response plan for hazardous waste, hazardous materials and uncontained construction materials shall be prepared and available at the construction sites for all projects where the proposed construction site is equal to or greater than one acre of disturbed soil and for any other projects for which the city engineer determines it is necessary to protect surface waters. Preparation of the plan shall be in accordance with guidelines published by the city engineer.
- B. A storm water pollution prevention plan shall be prepared and available at the construction sites for all projects greater than one acre of disturbed soil and for any other projects for which the city engineer determines that a storm water management plan is necessary to protect surface waters. Preparation of the plan shall be in accordance with guidelines published by the city engineer.
- C. Prior approval shall be obtained from the city engineer or designee to discharge water pumped from construction sites to the storm drain. The city engineer or designee may require gravity settling and filtration upon a determination that either or both would improve the water quality of the discharge. Contaminated groundwater or water that exceeds state or federal requirements for discharge to navigable waters may not be discharged to the storm drain. Such water may be discharged to the sewer, provided that the requirements of Section 10.08.240 are met and the approval of the superintendent is obtained prior to discharge.
- D. No cleanup of construction debris from the streets shall result in the discharge of water to the storm drain system; nor shall any construction debris be deposited or allowed to be deposited in the storm drain system. (Prior code § 5-5.643)

#### Criminal and judicial penalties can be assessed for non-compliance.

## Earth-Moving and Dewatering Activities

**Best Management Practices for the Construction Industry**

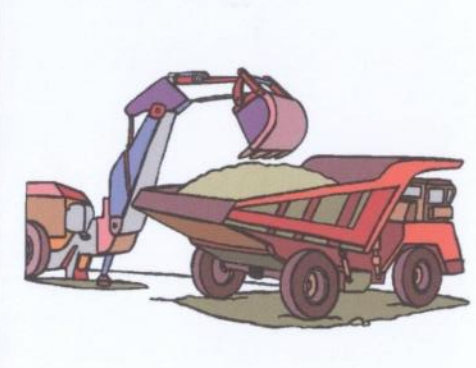

**Best Management Practices for the Construction Industry**

- Bulldozer, back hoe, and grading machine operators
- Dump truck drivers
- Site supervisors
- General contractors
- Home builders
- Developers

### Doing The Job Right

#### General Business Practices

- Schedule excavation and grading work during dry weather.
- Perform major equipment repairs away from the job site.
- When refueling or vehicle/equipment maintenance must be done on site, designate a location away from storm drains.
- Do not use diesel oil to lubricate equipment parts, or clean equipment.

#### Practices During Construction

- Remove existing vegetation only when absolutely necessary. Plant temporary vegetation for erosion control on slopes or where construction is not immediately planned.
- Protect down slope drainage courses, streams, and storm drains with wattles, or temporary drainage swales. Use check dams or ditches to divert runoff around excavations. Refer to the Regional Water Quality Control Board's Erosion and Sediment Control Field Manual for measures.

#### Storm Drain Pollution from Earth-Moving Activities and Dewatering

Soil excavation and grading operations loosen large amounts of soil that can flow or blow into storm drains when handled improperly. Sediments in runoff can clog storm drains, smother aquatic life, and destroy habitats in creeks and the Bay. Effective erosion control practices reduce the amount of runoff crossing a site and slow the flow with check dams or roughened ground surfaces. Contaminated groundwater is a common problem in the Santa Clara Valley. Depending on soil types and site history, groundwater pumped from construction sites may be contaminated with toxics (such as oil or solvents) or laden with sediments. Any of these pollutants can harm wildlife in creeks or the Bay, or interfere with wastewater treatment plant operation. Discharging sediment-laden water from a dewatering site into any water of the state without treatment is prohibited.

## General Construction And Site Supervision

**Best Management Practices For Construction**



**Best Management Practices for the Construction Industry**

- General contractors
- Site supervisors
- Inspectors
- Home builders
- Developers

### Doing The Job Right

#### General Principles

- Keep an orderly site and ensure good housekeeping practices are used.
- Maintain equipment properly.
- Cover materials when they are not in use.
- Keep materials away from streets, storm drains and drainage channels.
- Ensure dust control water doesn't leave site or discharge to storm drains.
- Advance Planning To Prevent Pollution
- Schedule excavation and grading activities for dry weather periods. To reduce soil erosion, plant temporary vegetation or place other erosion controls before rain begins. Use the Erosion and Sediment Control Manual, available from the Regional Water Quality Control Board, as a reference.
- Control the amount of runoff crossing your site (especially during excavation) by using berms or temporary or permanent drainage ditches to divert water flow around the site. Reduce storm water runoff velocities by constructing temporary check dams or berms where appropriate.
- Train your employees and subcontractors. Make these best management practices available to everyone who works on the construction site. Inform subcontractors about the storm water requirements and their own responsibilities.

#### Good Housekeeping Practices

- Designate one area of the site for auto parking, vehicle refueling, and routine equipment maintenance. The designated area should be well away from streams or storm drain inlets, berms if necessary. Make major repairs off site.
- Keep materials out of the rain - prevent runoff contamination at the source. Cover exposed piles of soil or construction materials with plastic sheeting or temporary roofs. Before it rains, sweep and remove materials from surfaces that drain to storm drains, creeks, or channels.
- Keep pollutants off exposed surfaces. Place tarps and recycling receptacles around the site to minimize litter.

#### Storm Drain Pollution from Construction Activities

Construction sites are common sources of storm water pollution. Materials and wastes that blow wash into a storm drain, gutter, or street have a direct impact on local creeks and the Bay. As a contractor, or site supervisor, owner or operator of a site, you may be responsible for any environmental damage caused by your subcontractors or employees.

## Preventing Pollution: It's Up to Us

In the Santa Clara Valley, storm drains transport water directly to local creeks and San Francisco Bay without treatment. Storm water pollution is a serious problem for wildlife dependent on our waterways and for the people who live near polluted streams or bay lands. Some common sources of this pollution include spilled oil, fuel, and fluids from vehicles and heavy equipment; construction debris; sediment created by erosion; landscaping runoff containing pesticides or weed killers; and materials such as used motor oil, antifreeze, and paint products that people pour or spill into a street or storm drain.

Thirteen valley municipalities have joined together with Santa Clara County and the Santa Clara Valley Water District to educate local residents and businesses and fight storm water pollution. To comply with this program, contractors must comply with the practices described in this drawing sheet.

### Spill Response Agencies

DIAL 9-1-1  
State Office of Emergency Services Warning Center (24 hours): 800-852-7550  
Santa Clara County Environmental Health Services: (408) 299-6930

### Local Pollution Control Agencies

County of Santa Clara Pollution Prevention Program: (408) 441-1195  
County of Santa Clara Integrated Waste Management Program: (408) 441-1198  
County of Santa Clara District Attorney Environmental Crimes Hotline: (408) 299-TIPS  
Santa Clara County Recycling Hotline: 1-800-533-8414  
Santa Clara Valley Water District: (408) 265-2600  
Santa Clara Valley Water District Pollution Hotline: 1-888-510-5151  
Regional Water Quality Control Board San Francisco Bay Region: (510) 622-2300  
Palo Alto Regional Water Quality Control Plant: (650) 329-2598  
Serving East Palo Alto Sanitary District, Los Altos, Los Altos Hills, Mountain View, Palo Alto, Stanford  
City of Los Altos  
Building Department: (650) 947-2752  
Engineering Department: (650) 947-2780

# Blueprint for a Clean Bay

Remember: The property owner and the contractor share ultimate responsibility for the activities that occur on a construction site. You may be held responsible for any environmental damage caused by your subcontractors or employees.

## Best Management Practices for the Construction Industry

### Santa Clara Urban Runoff Pollution Prevention Program


DESIGNED BY: LARRY LIND	APPROVED BY: 	CITY OF LOS ALTOS	DATE: OCTOBER, 2003
DRAWN BY: VICTOR CHEN	CITY ENGINEER	48056 R.C.E.	SCALE: N.T.S.
CHECKED BY: JIM GUSTAFSON	SHEET	OF SHEETS	DRAWING NO.:

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**Client:**  
Mr. and Mrs. Alon  
2256 DEODARA DR.  
LOS ALTOS, CA

**Project:**  
Mr. and Mrs. Alon  
2256 DEODARA DR.  
LOS ALTOS, CA



4657 TAMPICO WAY  
SAN JOSE, CA. 95118  
Phone (408) 888-6662  
farnaz@khadivdesign.com
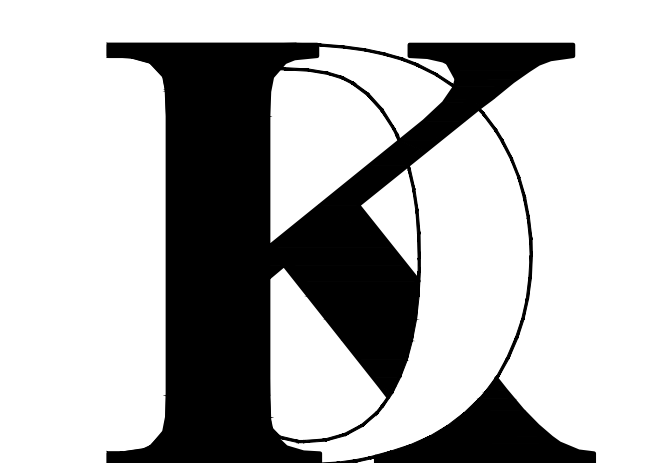
## KHADIV-DESIGN

Date: 12-07-20  
Scale: N.T.S.  
Drawn By: FK

Job No: 2020.11

Signature:


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BLUEPRINT  
FOR  
A CLEAN BAY

Sheet No.:

# CB-1.0



# Original Plans - 11/17/21 DRC Meeting

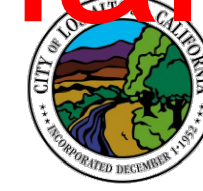

**2019 CALGREEN RESIDENTIAL CHECKLIST**  
**MANDATORY ITEMS - Version 1.01.20**  
 COMMUNITY DEVELOPMENT DEPARTMENT – BUILDING DIVISION  
 KIRK BALLARD, BUILDING OFFICIAL  
 ONE NORTH SAN ANTONIO ROAD • LOS ALTOS, CA 94022-3088  
 (650) 947-2752 • FAX/EMAIL: BUILDING@LOSALTOSCA.GOV • WWW.LOSALTOSCA.GOV

**PURPOSE:**

The 2019 CALGreen Code applies to all newly constructed hotels, motels, lodging houses, dwellings, dormitories, condominiums, shelters, congregated residences, employee housing, factory-built housing and other types of dwellings with sleeping accommodations and new accessory buildings associated with such uses. This section also applies to additions and alterations where there is an increase in conditioned space and specifies that these requirements only apply to the specific area of the addition or alteration. Existing site and landscaping improvements that are not otherwise disturbed are not subject to the requirements of CALGreen.

Project Name: ALON RESIDENCE

Project Address: 2256 DEODARA DR.

Project Description: ADDITION AND REMODEL TO EXISTING TWO STORY HOUSE

**Instructions (for projects of 300 sq. ft. or more):**

- The owner or owner's agent shall employ a licensed qualified green-point rater ([www.buildgreen.org](http://www.buildgreen.org)) experienced with the 2019 California Green Building Standards Codes to verify and assure that all required work described herein is properly planned and implemented in the project.
- The green-point rater, in collaboration with the design professional shall review Column 2 of this checklist, and initial all applicable measures, sign and date Section 1 - Design Verification at the end of this checklist, prior to submittal. Applicant to include these pages into the construction plans as well as provide (2) separate 8-1/2" x 11" signed copies.
- PRIOR TO FINAL INSPECTION BY THE BUILDING DEPARTMENT**, the Green-Point Rater shall complete Column 3 and sign and date Section 2 - Implementation Verification at the end of this checklist and submit the completed form to the Building Department.

MANDATORY FEATURE OR MEASURE	COLUMN 2 Project Requirements Rater to initial applicable measures prior to submitting forms	COLUMN 3 Verification Rater to verify during construction as applicable to project
<b>Planning and Design – Site Development</b>		
4.106.2 A plan is developed and implemented to manage storm water drainage during construction		
4.106.3 Construction plans shall indicate how site grading or a drainage system will manage all surface water flows to keep water from entering buildings.		
4.106.4 Provide capability for electric vehicle charging for one- and two-family dwellings; townhouses with attached private garages; multifamily dwellings; and hotels/motels in accordance with Section 4.106.4.1, 4.106.4.2 or 4.106.4.3 as applicable.		

<b>Environmental Comfort</b>		
4.507.2 Duct systems are sized, designed, and equipment is selected using the following methods: 1. Establish heat loss and heat gain values according to ANSI/ACCA 2 Manual J-2016 or equivalent. 2. Size duct systems according to ANSI/ACCA 1 Manual D-2016 or equivalent. 3. Select heating and cooling equipment according to ANSI/ACCA 3 Manual S-2014 or equivalent.		
<b>Installer and Special Inspector Qualifications</b>		
<b>Qualifications</b>		
702.1 HVAC system installers are trained and certified in the proper installation of HVAC systems.		
702.2 Special inspectors employed by the enforcing agency must be qualified and able to demonstrate competence in the discipline they are inspecting.		
<b>Verifications</b>		
703.1 Verification of compliance with this code may include construction documents, plans, specifications builder or installer certification, inspection reports, or other methods acceptable to the enforcing agency which show substantial conformance. 1. Green building measures listed in this table may be mandatory if adopted by a city, county, or city and county as specified in Section 101.7 2. Required prerequisite for this Tier. 3. These measures are currently required elsewhere in statute or in regulation		

**Energy Efficiency**

**General**

4.201.1 Building meets or exceeds the requirements of the California Building Energy Efficiency Standards<sup>3</sup>.

**Water Efficiency and Conservation –**

**Indoor Water Use**

4.303.1 Plumbing fixtures (water closets and urinals) and fittings (faucets and showerheads) installed in residential buildings shall comply with the prescriptive requirements of Sections 4.303.1.1 through 4.303.1.4.4.

4.303.2 Plumbing fixtures and fittings required in Section 4.303.1 shall be installed in accordance with the California Plumbing Code, and shall meet the applicable referenced standards.

4.303.1.4.3 Metering faucets in residential buildings shall not deliver more than 0.2 gallons per cycle.

**Outdoor Water Use**

4.304.1 Residential developments shall comply with a local water efficient landscape ordinance or the current California Department of Water Resources' Model Water Efficient Landscape Ordinance (MWELO), whichever is more stringent.

**Material Conservation and Resource Efficiency –**

**Enhanced Durability and Reduced Maintenance**

4.406.1 Annular spaces around pipes, electric cables, conduits or other openings in plates at exterior walls shall be protected against the passage of rodents by closing such openings with cement mortar, concrete masonry or similar method acceptable to the enforcing agency.

**Construction Waste Reduction, Disposal and Recycling**

4.408.1 Recycle and/or salvage for reuse a minimum of 65 percent of the non-hazardous construction and demolition waste in accordance with one of the following:

- Comply with a more stringent local construction and demolition waste management ordinance; or
- A construction waste management plan per Section 4.408.2; or
- A waste management company per Section 4.408.3; or
- The waste stream reduction alternative per Section 4.408.4.

**Building Maintenance and Operation**

4.410.1 An operation and maintenance manual shall be provided to the building occupant or owner.

4.410.2 Where 5 or more multifamily dwelling units are constructed on a building site, provide readily accessible areas that serve the entire building and are identified for the depositing, storage and collection of non-hazardous materials for recycling, including (at a minimum) paper, corrugated cardboard, glass, plastics, organic waste, and metals or meet a lawfully enacted local recycling ordinance, if more restrictive. See exception for rural jurisdictions

**ENVIRONMENTAL QUALITY**

**Fireplaces**

4.503.1 Any installed gas fireplace shall be a direct-vent sealed-combustion type. Any installed woodstove or pellet stove shall comply with US EPA New Source Performance Standards (NSPS) emission limits as applicable, and shall have a permanent label indicating they are certified to meet the emission limits. Woodstoves, pellet stoves and fireplaces shall also comply with applicable local ordinances.

**Pollutant Control**

4.504.1 Duct openings and other related air distribution component openings shall be covered during construction.

4.504.2.1 Adhesives, sealants and caulks shall be compliant with VOC and other toxic compound limits.

4.504.2.2 Paints, stains and other coatings shall be compliant with VOC limits.

4.504.2.3 Aerosol paints and coatings shall be compliant with product weighted MIR limits for ROC and other toxic compounds.

4.504.2.4 Documentation shall be provided to verify that compliant VOC limit finish materials have been used.

4.504.3 Carpet and carpet systems shall be compliant with VOC limits.

4.504.4 80 percent of floor area receiving resilient flooring shall comply with specified VOC criteria.

4.504.5 Particleboard, medium density fiberboard (MDF) and hardwood plywood used in interior finish systems shall comply with low formaldehyde emission standards.

**Interior Moisture Control**

4.505.2 Vapor retarder and capillary break is installed at slab-on-grade foundations.

4.505.3 Moisture content of building materials used in wall and floor framing is checked before enclosure.

**Indoor Air Quality and Exhaust**

4506.1 Each bathroom shall be provided with the following:  
 1. ENERGY STAR fans ducted to terminate outside of the building.  
 2. Fans must be controlled by a humidity control (separate or built-in); OR functioning as a component of a whole-house ventilation system.  
 3. Humidity controls with manual or automatic means of adjustment, capable of adjustment between a relative humidity range of  $\leq 50$  percent to a maximum of 80 percent

No. Date Description

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**KHADIV-DESIGN**

Date: 12-07-20

Scale: N.T.S

Drawn By : FK

Job No: 2020.11


Signature :

Sheet Title :

CALGreen  
 MANDATORY  
 MEASURES

Sheet No. :

**CG-1.0**

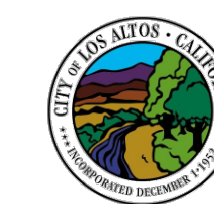

**CALGREEN SIGNATURE DECLARATIONS**

Project Name: ALON RESIDENCE

Project Address: 2256 DEODARA DR.

Project Description: ADDITION AND REMODEL TO EXISTING TWO STORY HOUSE

**SECTION 1 – DESIGN VERIFICATION**

Complete all lines of Section 1 – "Design Verification" and SUBMIT THE ENTIRE CHECKLIST (COLUMNS 2 AND 3) WITH THE PLANS AND BUILDING PERMIT APPLICATION TO THE BUILDING DEPARTMENT.

The design professional responsible for compliance with CalGreen Standards has reviewed the plans and certifies that the items checked above are hereby incorporated into the project plans and will be implemented into the project in accordance with the requirements set forth in the 2019 California Green Building Standards Code as adopted by the City of Los Altos.

Design Professional's Signature \_\_\_\_\_ Date \_\_\_\_\_

Design Professional's Name (Please Print) \_\_\_\_\_

Signature of Green Point Rater/Certified ICC CalGreen Special Inspector/Consulting Group \_\_\_\_\_ Date \_\_\_\_\_

Name of Green Point Rater/Inspector (Please Print) \_\_\_\_\_ Phone No. \_\_\_\_\_

Email Address \_\_\_\_\_ License No. \_\_\_\_\_

**SECTION 2 – IMPLEMENTATION VERIFICATION**

Complete, sign and submit the completed checklist, including column 3, together with all original signatures on Section 2 to the Building Department **PRIOR TO BUILDING DEPARTMENT FINAL INSPECTION.**

I have inspected the work and have received sufficient documentation to verify and certify that the project identified above was constructed in accordance with this Green Building Checklist and in accordance with the requirements of the 2019 California Green Building Standards Code as adopted by the City of Los Altos.


Signature of Licensed Green Point Rater/Certified ICC CalGreen Special Inspector/Consulting Group \_\_\_\_\_ Date \_\_\_\_\_

Name of Green Point Rater/Inspector (Please Print) \_\_\_\_\_ Phone No. \_\_\_\_\_

Email address \_\_\_\_\_ License No. \_\_\_\_\_



# Original Plans - 11/17/21 DRC Meeting

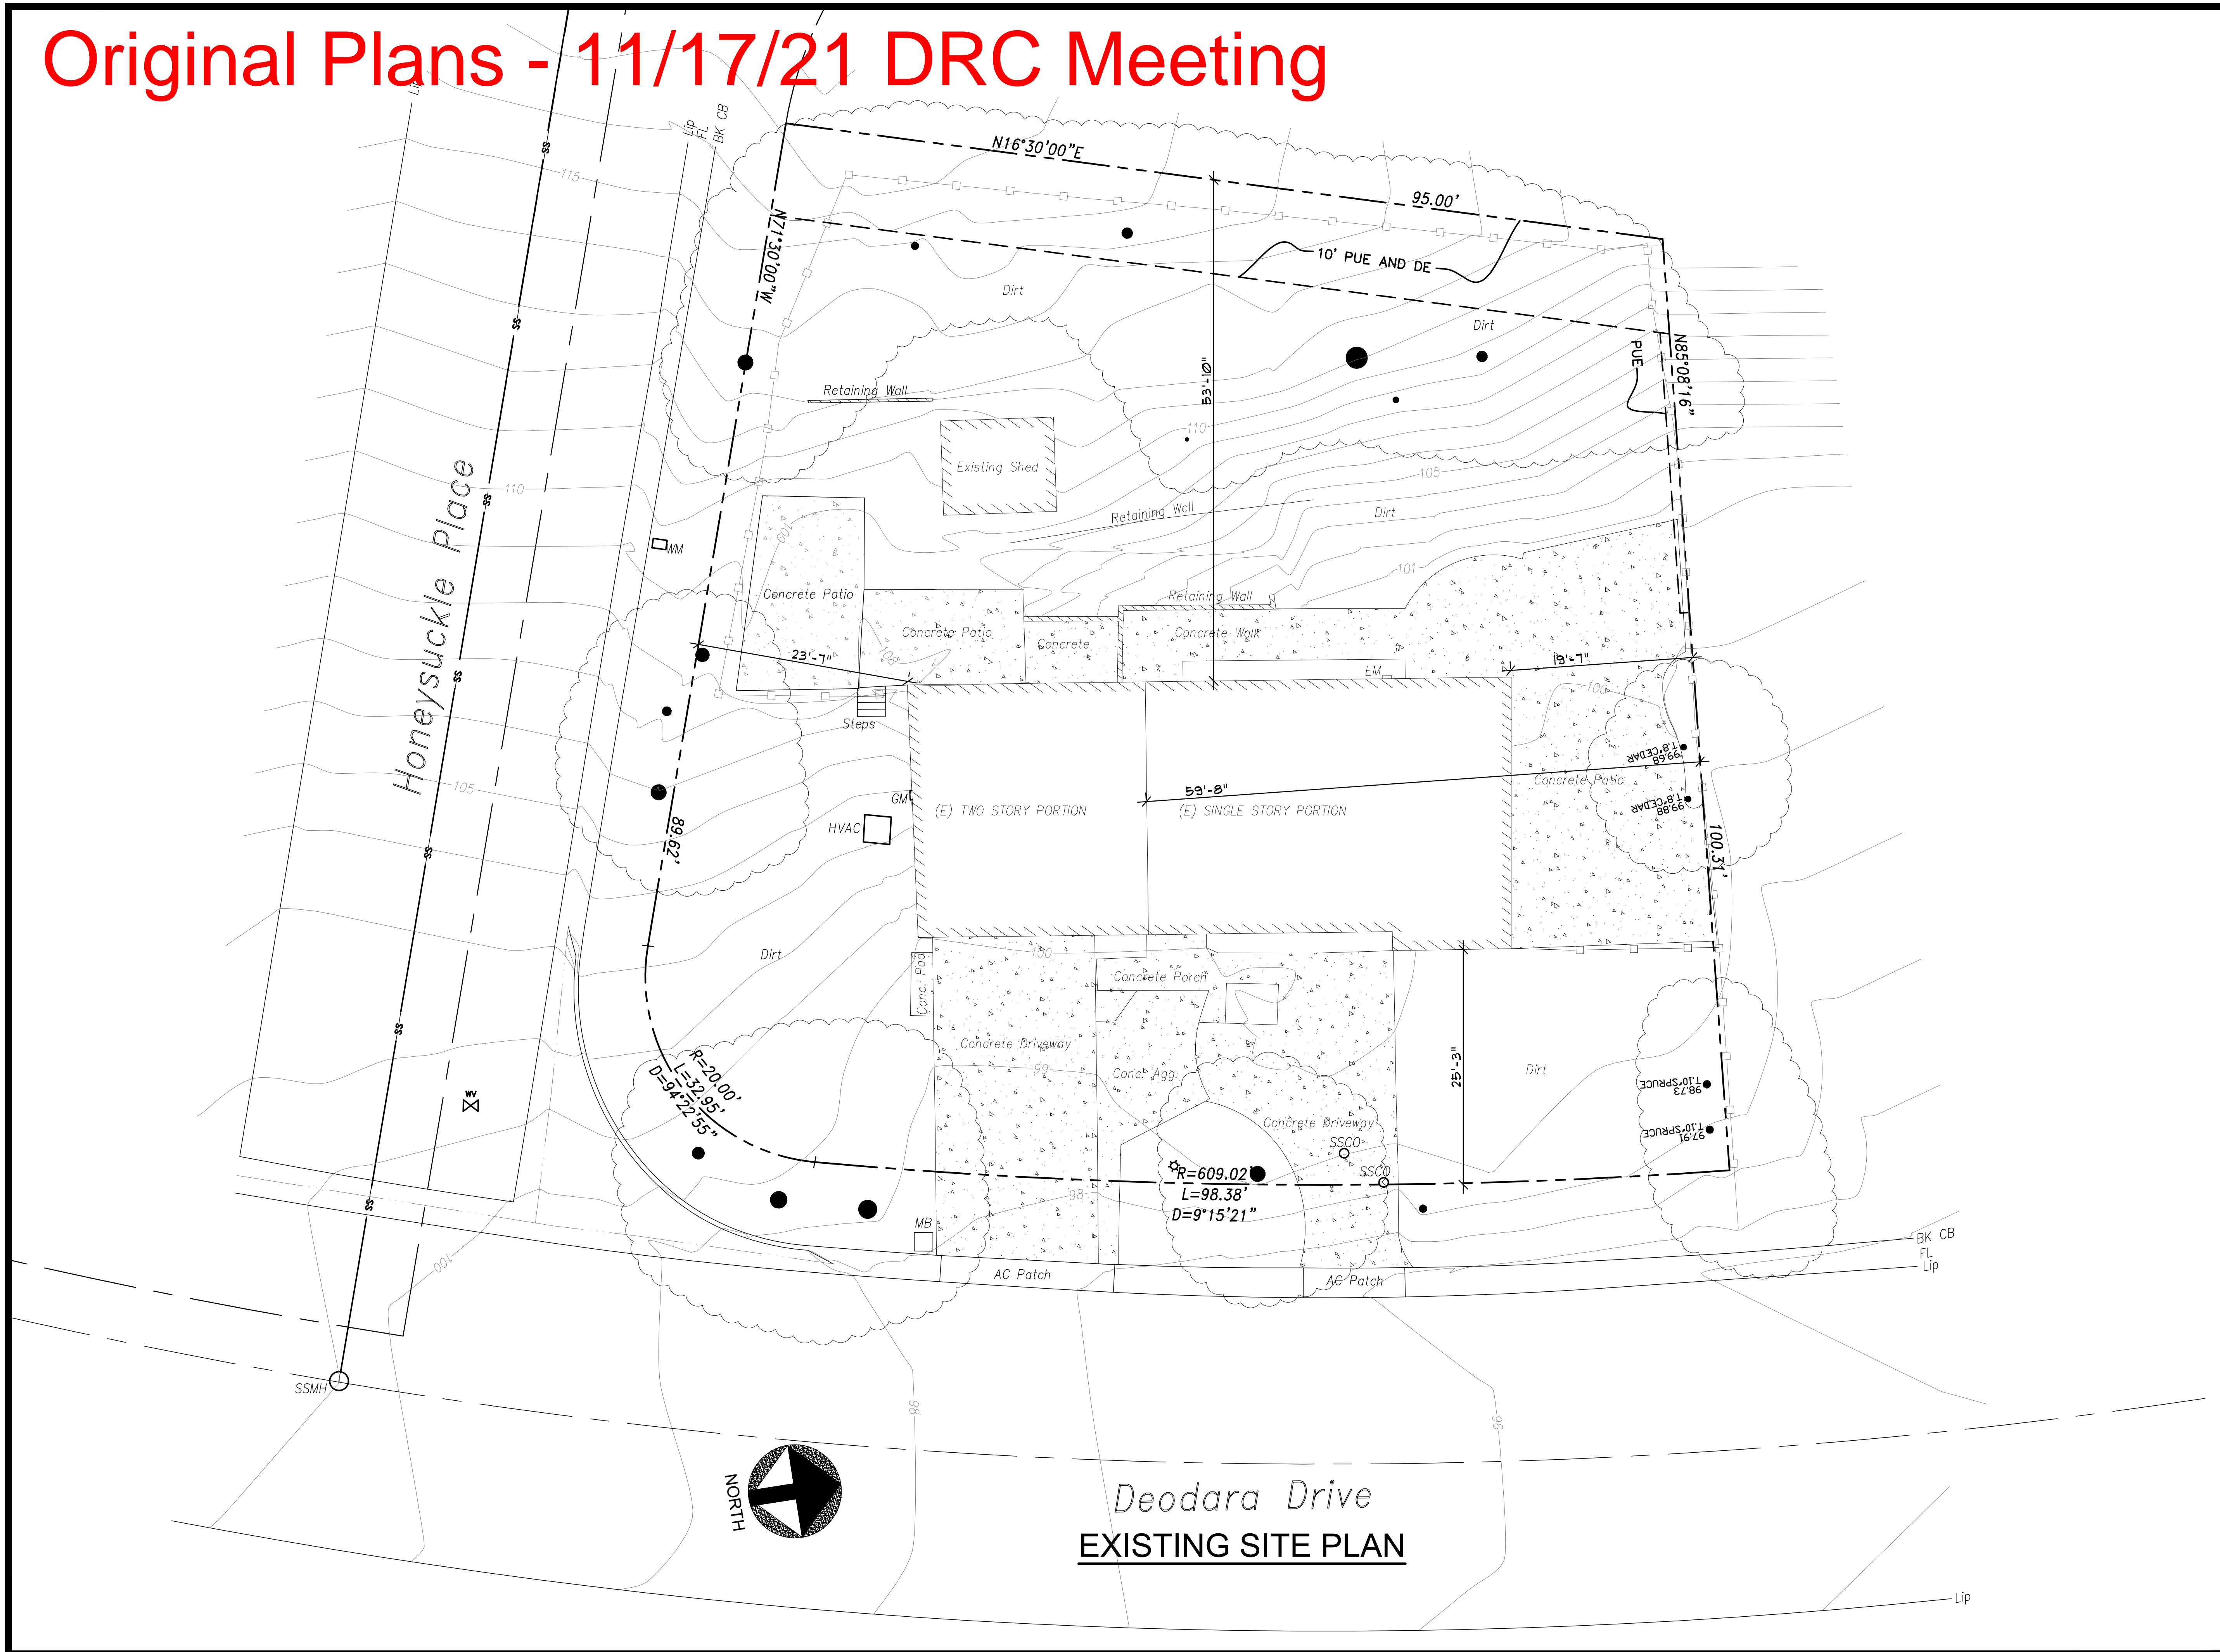


No.	Date	Description
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## KHADIV-DESIGN

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Signature :


Sheet Title :  
 EXISTING  
 SITE PLAN

Sheet No. :  
**A-1.0**

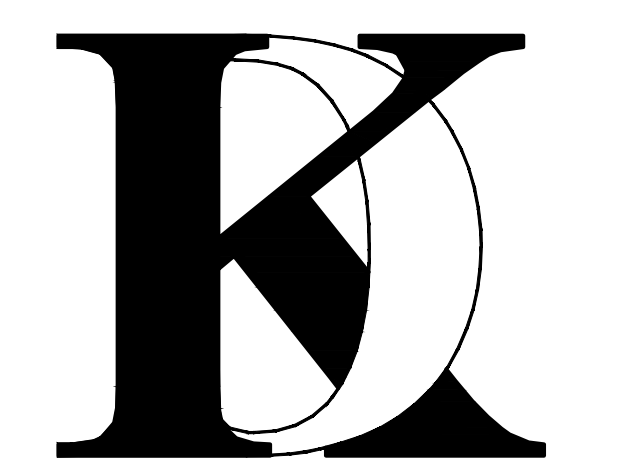Deodara Drive  
 EXISTING SITE PLAN



# Original Plans - 11/17/21 DRC Meeting

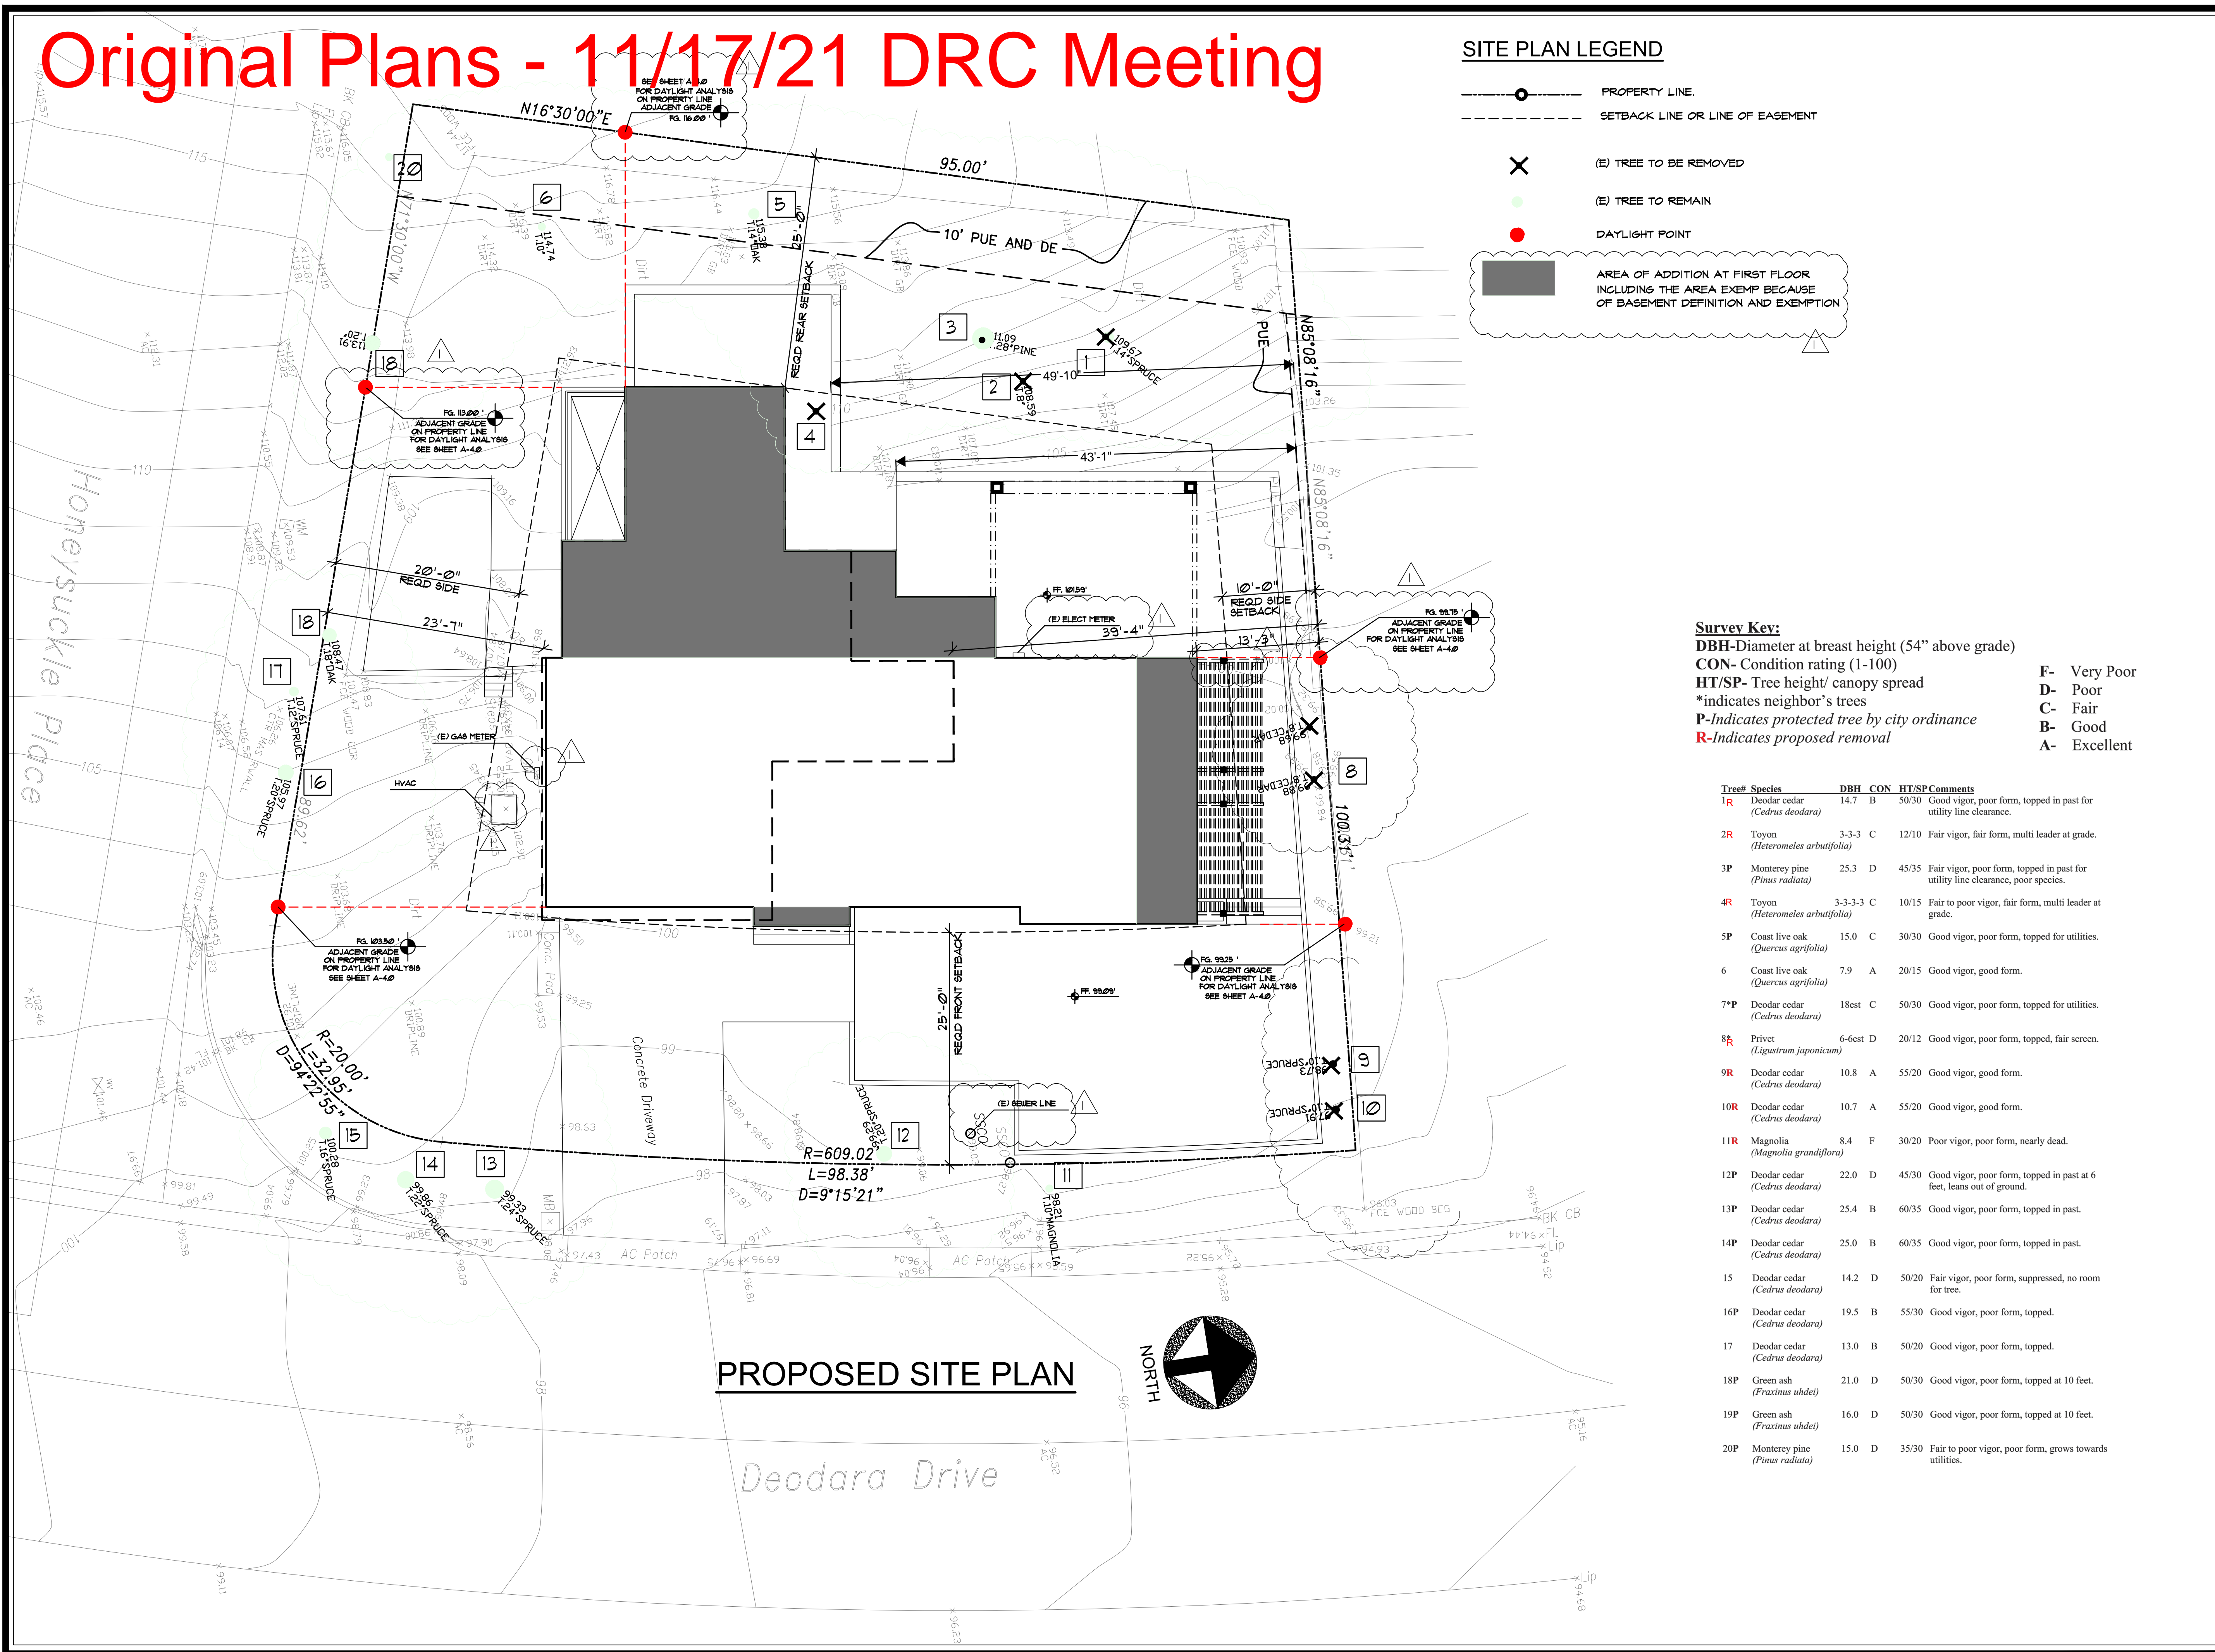

### SITE PLAN LEGEND

- PROPERTY LINE.
- SETBACK LINE OR LINE OF EASEMENT
- (E) TREE TO BE REMOVED
- (E) TREE TO REMAIN
- DAYLIGHT POINT
- AREA OF ADDITION AT FIRST FLOOR INCLUDING THE AREA EXEMP BECAUSE OF BASEMENT DEFINITION AND EXEMPTION

### Survey Key:

- DBH- Diameter at breast height (54" above grade)
- CON- Condition rating (1-100)
- HT/SP- Tree height/ canopy spread
- \*indicates neighbor's trees
- P- Indicates protected tree by city ordinance
- R- Indicates proposed removal
- F- Very Poor
- D- Poor
- C- Fair
- B- Good
- A- Excellent

Tree#	Species	DBH	CON	HT/SP	Comments
1R	Deodar cedar ( <i>Cedrus deodara</i> )	14.7	B	50/30	Good vigor, poor form, topped in past for utility line clearance.
2R	Toyon ( <i>Heteromeles arbutifolia</i> )	3-3-3	C	12/10	Fair vigor, fair form, multi leader at grade.
3P	Monterey pine ( <i>Pinus radiata</i> )	25.3	D	45/35	Fair vigor, poor form, topped in past for utility line clearance, poor species.
4R	Toyon ( <i>Heteromeles arbutifolia</i> )	3-3-3-3	C	10/15	Fair to poor vigor, fair form, multi leader at grade.
5P	Coast live oak ( <i>Quercus agrifolia</i> )	15.0	C	30/30	Good vigor, poor form, topped for utilities.
6	Coast live oak ( <i>Quercus agrifolia</i> )	7.9	A	20/15	Good vigor, good form.
7*P	Deodar cedar ( <i>Cedrus deodara</i> )	18est	C	50/30	Good vigor, poor form, topped for utilities.
8R	Privet ( <i>Ligustrum japonicum</i> )	6-6est	D	20/12	Good vigor, poor form, topped, fair screen.
9R	Deodar cedar ( <i>Cedrus deodara</i> )	10.8	A	55/20	Good vigor, good form.
10R	Deodar cedar ( <i>Cedrus deodara</i> )	10.7	A	55/20	Good vigor, good form.
11R	Magnolia ( <i>Magnolia grandiflora</i> )	8.4	F	30/20	Poor vigor, poor form, nearly dead.
12P	Deodar cedar ( <i>Cedrus deodara</i> )	22.0	D	45/30	Good vigor, poor form, topped in past at 6 feet, leans out of ground.
13P	Deodar cedar ( <i>Cedrus deodara</i> )	25.4	B	60/35	Good vigor, poor form, topped in past.
14P	Deodar cedar ( <i>Cedrus deodara</i> )	25.0	B	60/35	Good vigor, poor form, topped in past.
15	Deodar cedar ( <i>Cedrus deodara</i> )	14.2	D	50/20	Fair vigor, poor form, suppressed, no room for tree.
16P	Deodar cedar ( <i>Cedrus deodara</i> )	19.5	B	55/30	Good vigor, poor form, topped.
17	Deodar cedar ( <i>Cedrus deodara</i> )	13.0	B	50/20	Good vigor, poor form, topped.
18P	Green ash ( <i>Fraxinus uhdei</i> )	21.0	D	50/30	Good vigor, poor form, topped at 10 feet.
19P	Green ash ( <i>Fraxinus uhdei</i> )	16.0	D	50/30	Good vigor, poor form, topped at 10 feet.
20P	Monterey pine ( <i>Pinus radiata</i> )	15.0	D	35/30	Fair to poor vigor, poor form, grows towards utilities.

No. Date Description

- 7/25/21 Planning Comments


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### KHADIV-DESIGN

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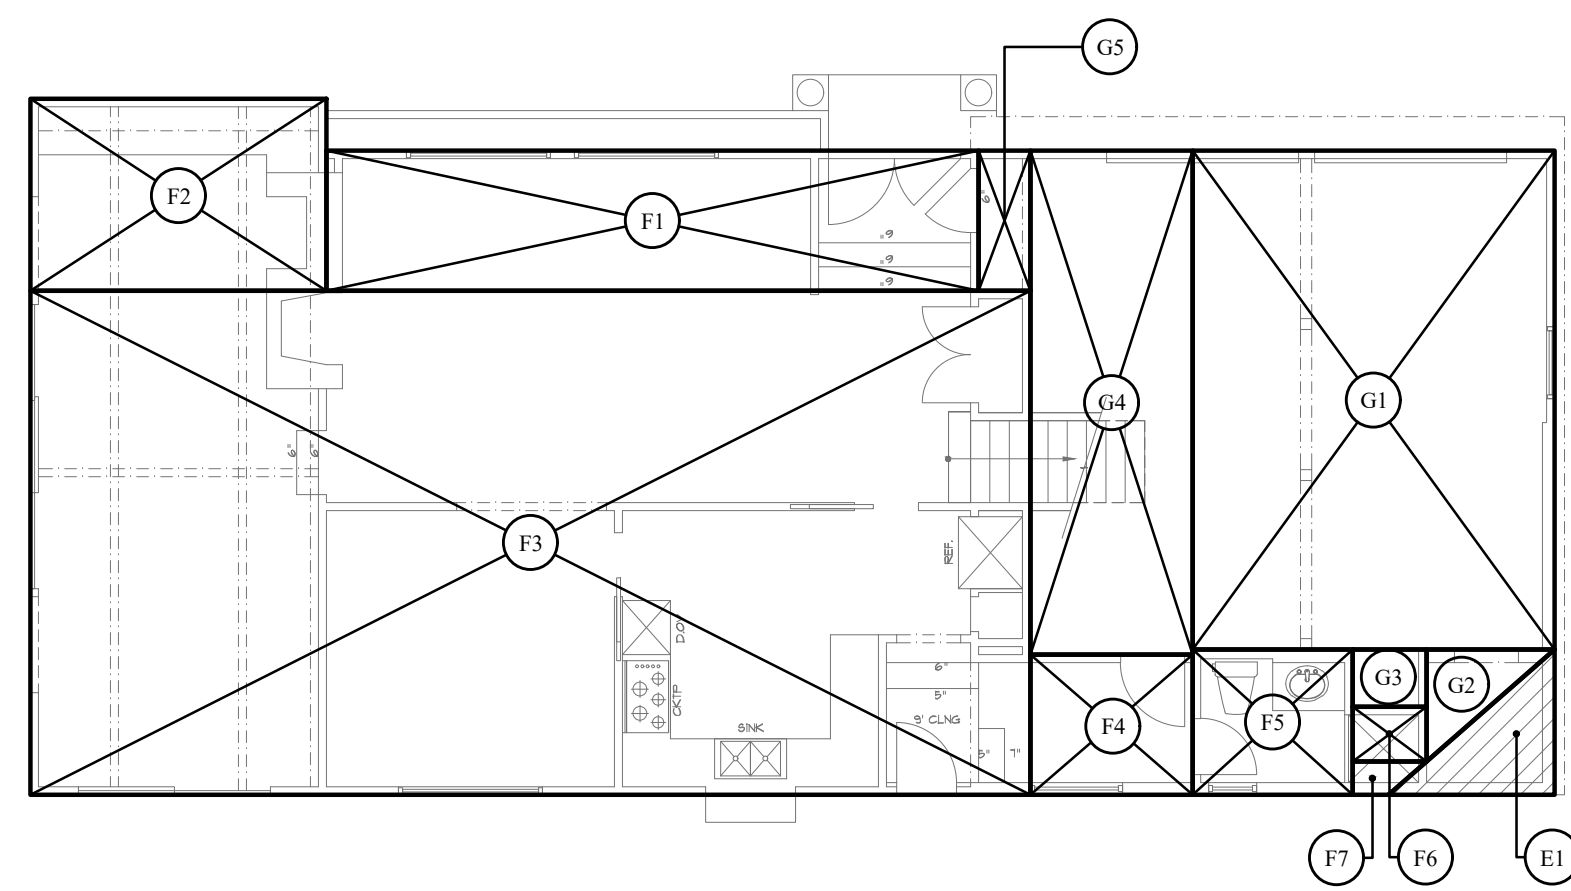
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Sheet Title :  
PROPOSED  
SITE PLAN

Sheet No. :  
**A-1.1**



# Original Plans - 11/17/21 DRC Meeting

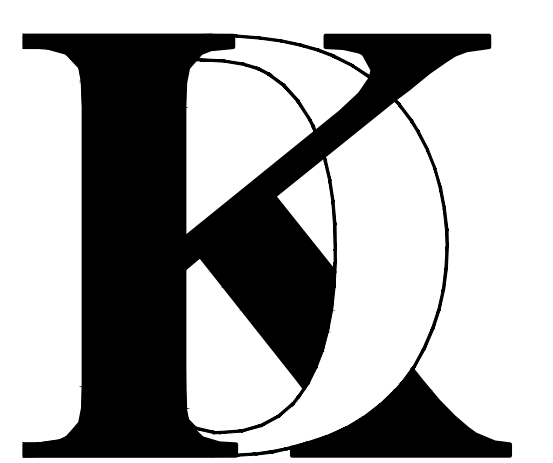

AREA EXEMPT FROM FLOOR AREA CALCULATION MEETING THE DEFINITION OF BASEMENT


## (E) FIRST FLOOR (INCLUDING GARAGE)

(E) GARAGE	DIMENSIONS	AREA	SQ. FT.
G1	15'-1" x 20'-10"	313.6	SQ. FT.
G2	(5'-4" x 4'-8") / 2	12.4	SQ. FT.
G3	3'-1" x 2'-5"	7.3	SQ. FT.
G4	6'-9" x 21'-0"	141.75	SQ. FT.
G5	2'-2" x 5'-10"	12.65	

(E) GARAGE	DIMENSIONS	AREA	SQ. FT.
EXEMPT		487.5	SQ. FT.
E1	(7'-0" x 6'-0") / 2	21.00	SQ. FT.


(E) FIRST FLOOR	DIMENSIONS	AREA	SQ. FT.
F1	27'-2" x 5'-10"	158.5	SQ. FT.
F2	12'-4" x 8'-0"	98.66	SQ. FT.
F3	41'-8" x 21'-0"	875.00	SQ. FT.
F4	6'-9" x 5'-10"	39.40	SQ. FT.
F5	6'-8" x 6'-0"	40.00	SQ. FT.
F6	3'-1" x 2'-4"	7.00	SQ. FT.
F7	$\frac{(3'-1" + 1'-6")}{2} \times 1'-4"$	3.1	SQ. FT.

(E) FIRST FLOOR	1,221.66	SQ. FT.
-----------------	----------	---------

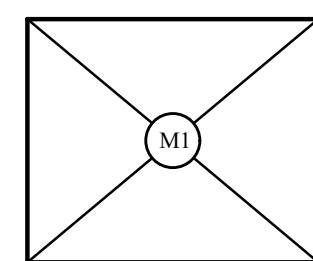

## (E) SHED TO BE REMOVED

SECOND FLOOR	DIMENSIONS	AREA	SQ. FT.
M1	12'-2" x 10'-2"	123	SQ. FT.

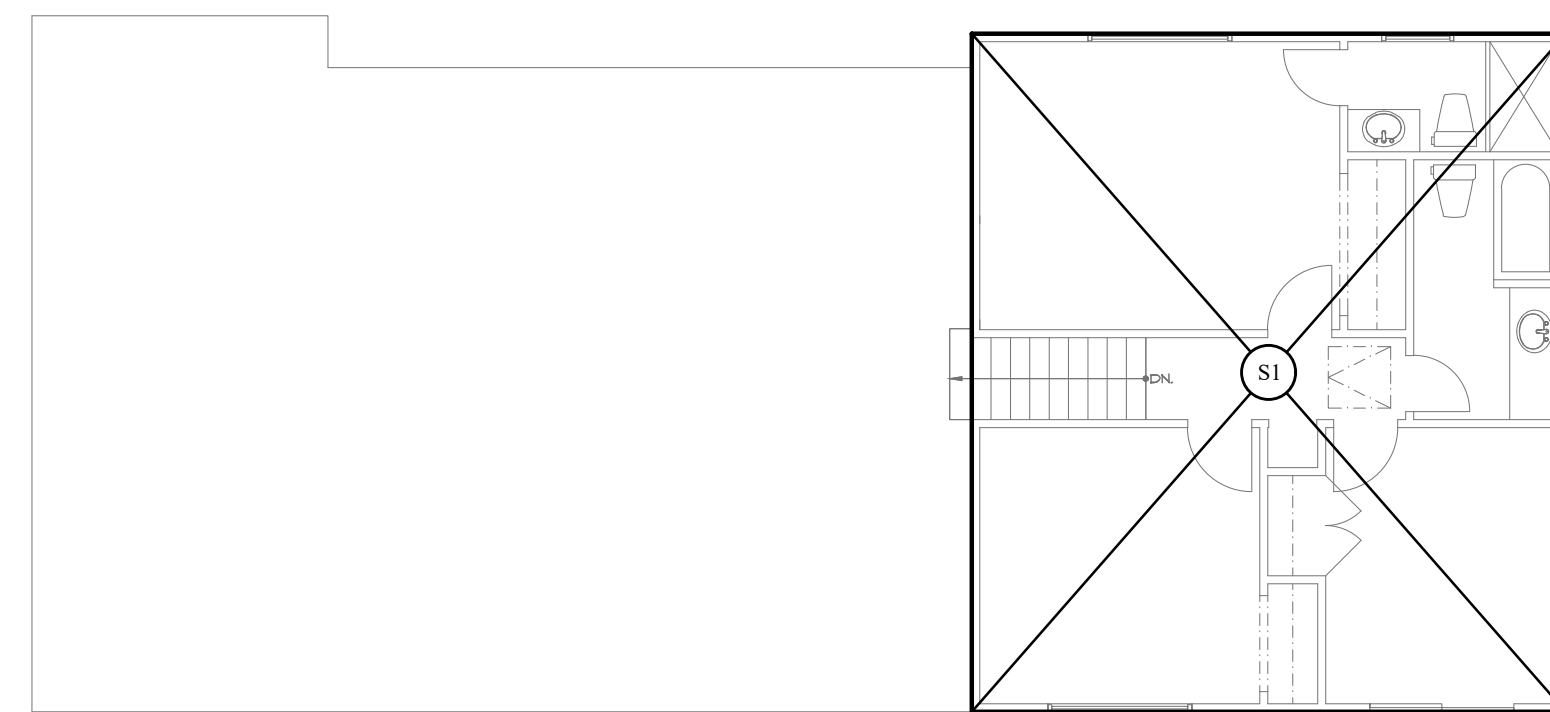

## (E) SECOND FLOOR


SECOND FLOOR	DIMENSIONS	AREA	SQ. FT.
S1	24'-9" x 28'-3"	699.00	SQ. FT.
SUB TOTAL AREA		699.00	SQ. FT.

## (E) F.A.R

(E) FIRST FLOOR (INCLD. GARAGE)	1709.16	SQ. FT.
(E) SECOND FLOOR	669.00	SQ. FT.
TOTAL F.A.R	2,378.16	SQ. FT.

## (E) LOT COVERAGE

(E) FIRST FLOOR (INCLD. GARAGE)	1709.16	SQ. FT.
(E) SHED	123	SQ. FT.
TOTAL LOT COVERAGE	1,832.16	SQ. FT.

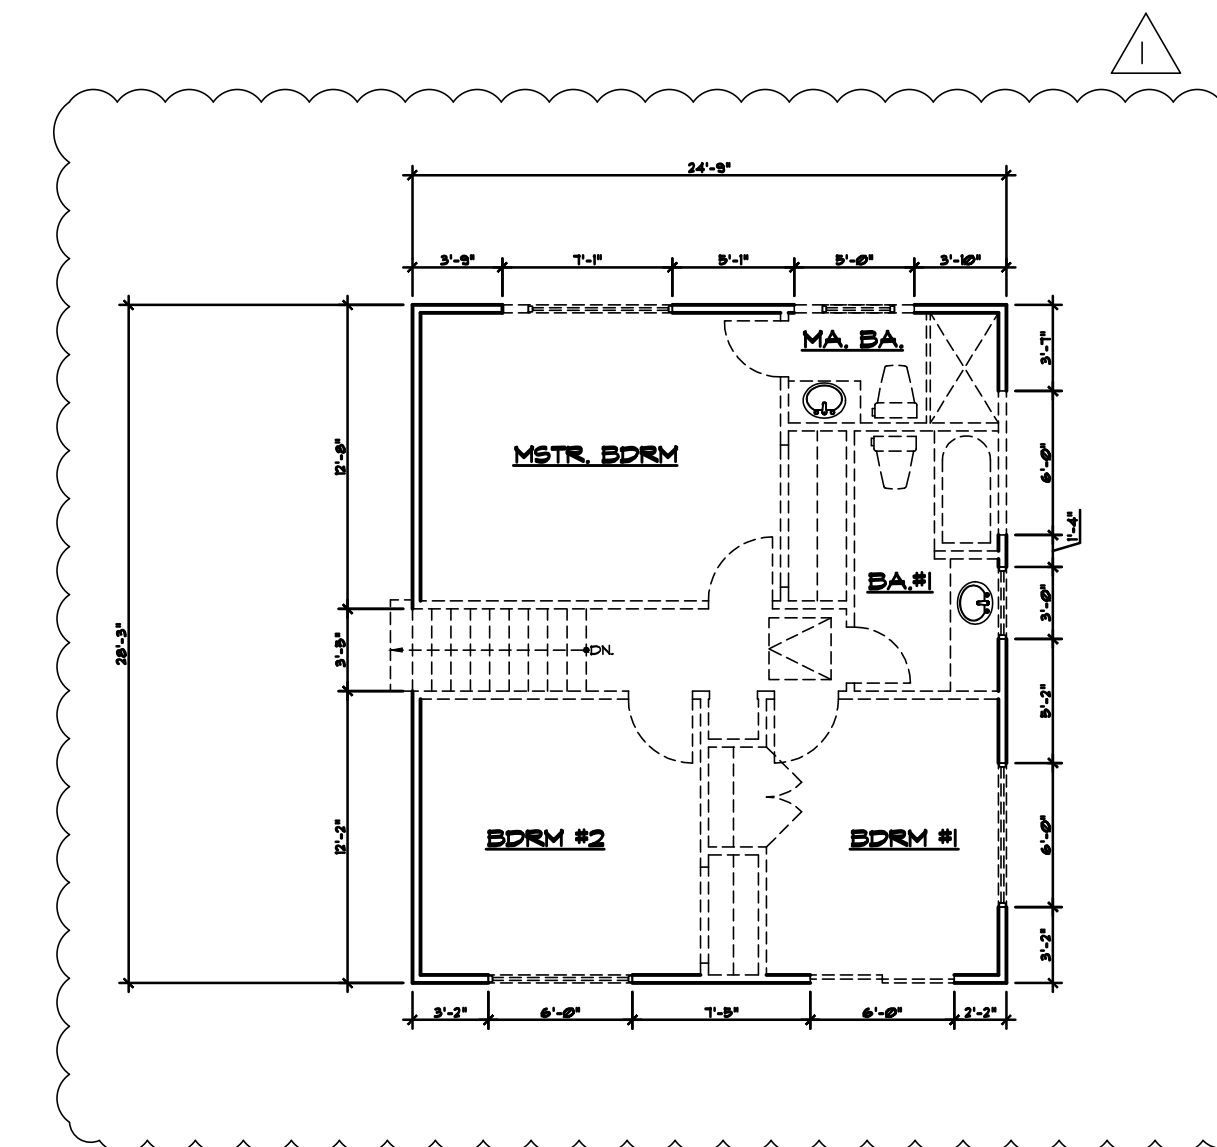

## (E) SECOND FLOOR DEMOLITION ANALYSIS

### (E) WALL TO REMAIN

12'-8"  
3'-9"  
5'-1"  
3'-10"  
3'-7"  
1'-4"  
5'-2"  
3'-2"  
2'-2"  
7'-5"  
3'-2"  
12'-2"

TOTAL LENGTH 63'-6"

### (E) WALL TO BE REMOVED

6'-0"  
3'-5"  
7'-1"  
5'-0"  
6'-0"  
3'-0"  
6'-0"

TOTAL LENGTH 36'-6"

TOTAL PERIMETER = 106'-0"  
TOTAL WALL TO BE REMOVED = 36'-6" = 35%

No. Date Description

7/25/21 Planning Comments


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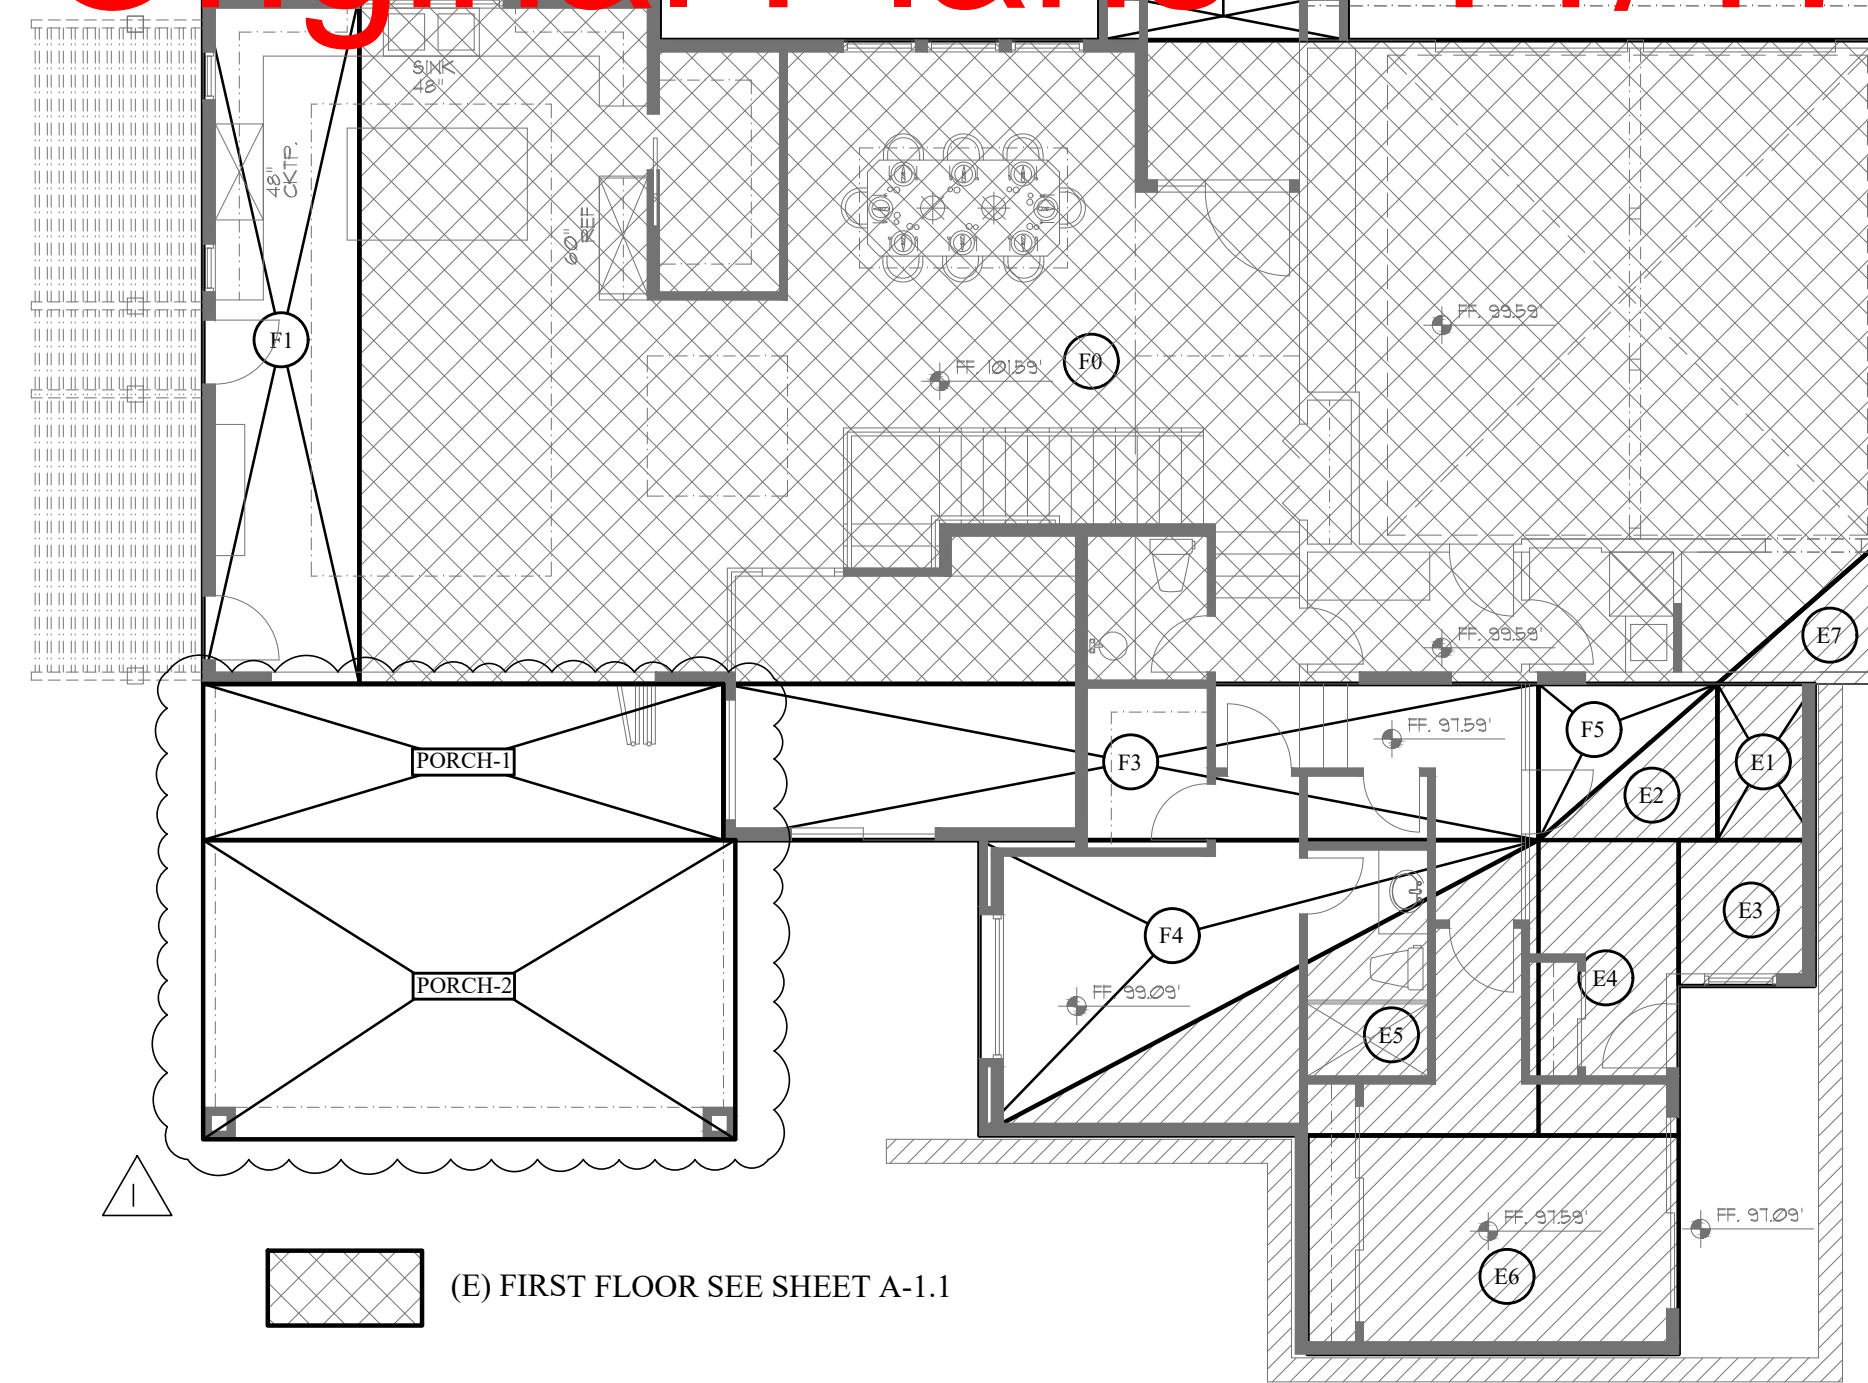
EXISTING AREA  
CALCULATION  
DIAGRAM

Sheet No. :

A-1.2





# Original Plans - 11/17/21 DRC Meeting

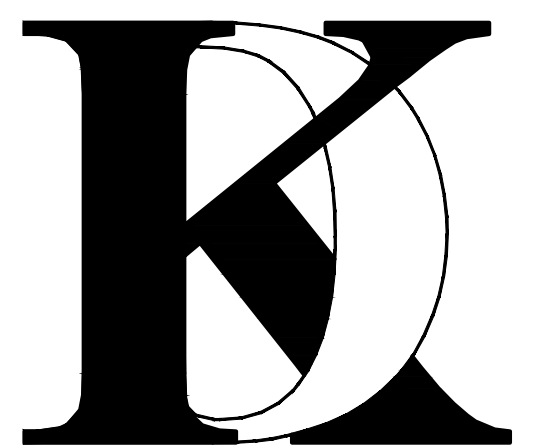

## (N) FIRST FLOOR (INCLUDING GARAGE)

(N) FIRST FLOOR	DIMENSIONS	AREA	SQ. FT.
F0	EXISTING (SEE SHT. A-1.1)	1709.16	SQ. FT.
F1	6'-6" x 28'-8"	186.3	SQ. FT.
F2	10'-4" x 2'-0"	20.66	SQ. FT.
F3	33'-11" x 6'-6"	220.78	SQ. FT.
F4	(23'-4" x 12'-4") / 2	143.38	SQ. FT.
F5	(7'-3" x 6'-6") / 2	23.5	SQ. FT.
F6	0'-2" x 1'-10"	0.3	SQ. FT.
F7 (This area is demolition)	12'-4" x 0'-4"	-4.1	SQ. FT.
(N) FIRST FLOOR		2,299.98	SQ. FT.

(N) BASEMENT	DIMENSIONS	AREA	SQ. FT.
E1	4'-1" x 6'-6"	26.34	SQ. FT.
E2	(7'-6" x 6'-6") / 2	24.2	SQ. FT.
E3	5'-8" x 6'-1"	34.5	SQ. FT.
E4	5'-10" x 12'-4"	71.7	SQ. FT.
E5	(23'-4" x 12'-4") / 2	143.38	SQ. FT.
E6	15'-6" x 9'-2"	140.89	SQ. FT.
E7	(7'-0" x 6'-0") / 2	21.00	SQ. FT.
(N) FIRST FLOOR		462.01	SQ. FT.

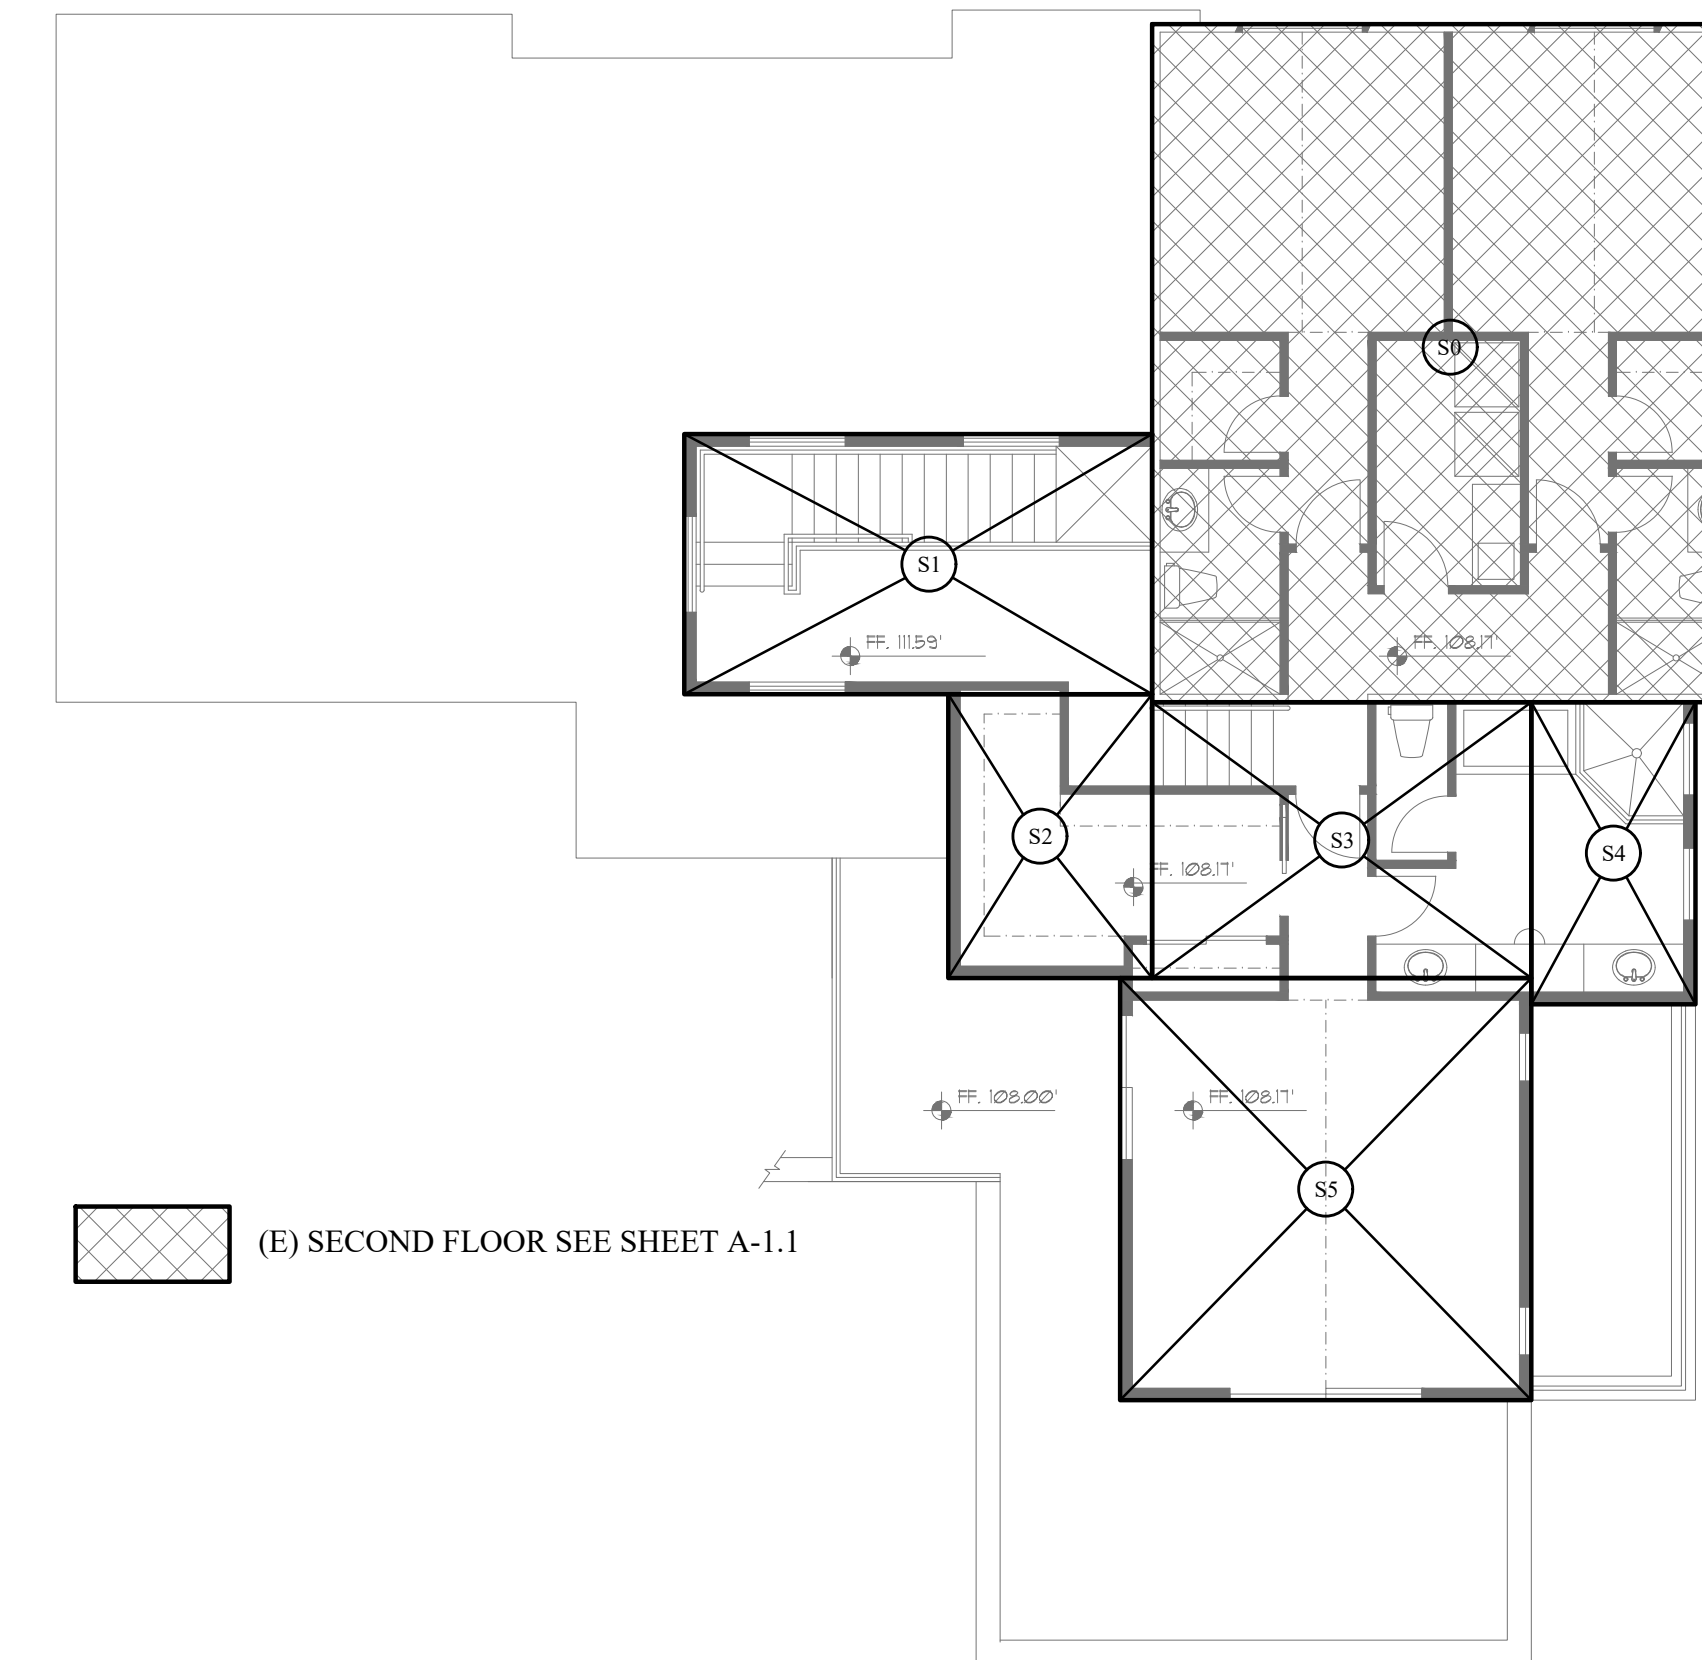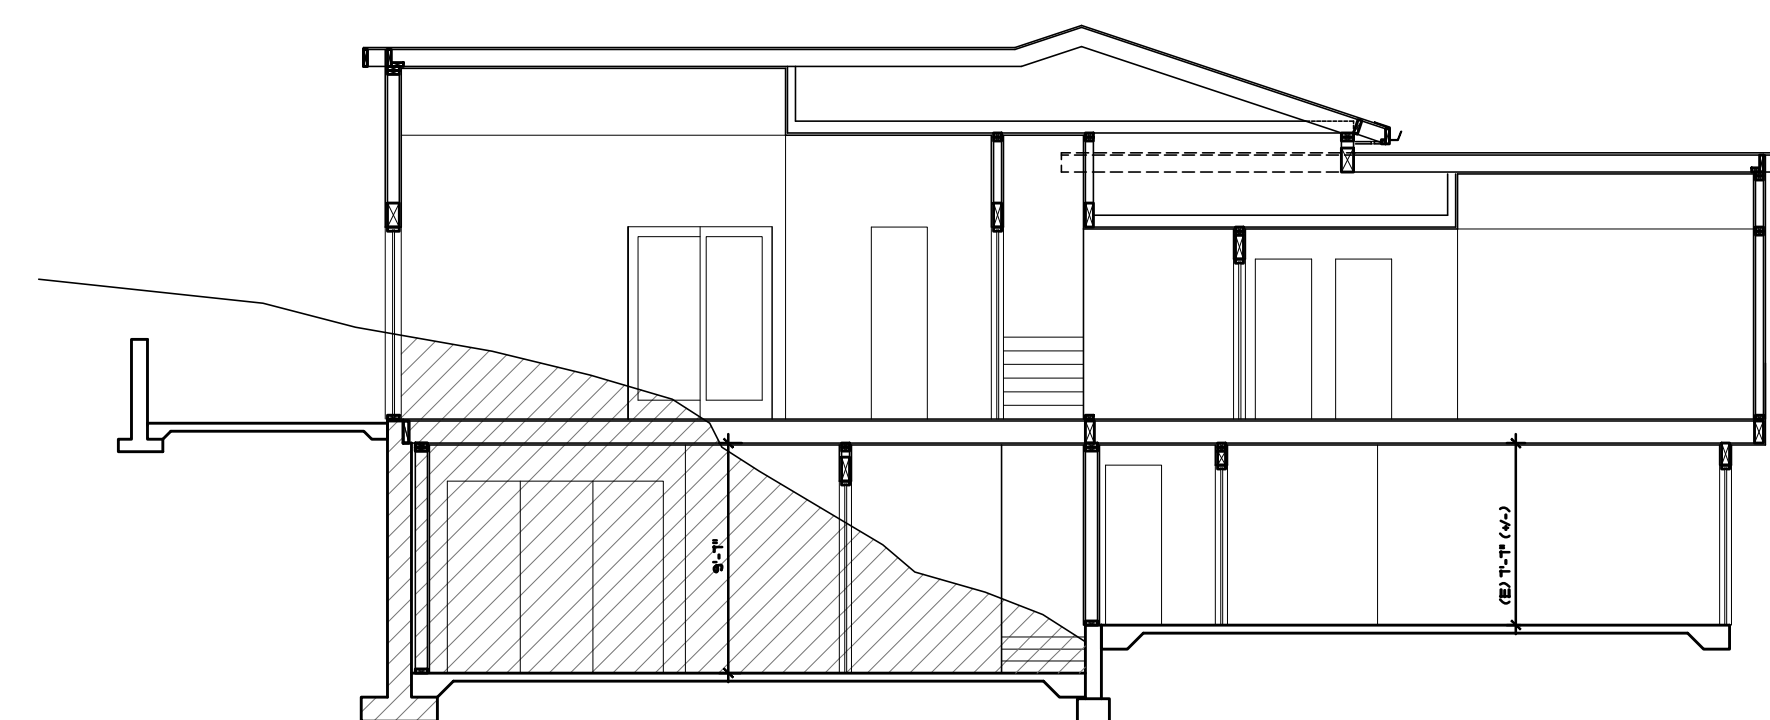

## (N) SECOND FLOOR

(N) SECOND FLOOR	DIMENSIONS	AREA	SQ. FT.
S0	EXISTING (SEE SHT. A-1.1)	699.00	SQ. FT.
S1	19'-6" x 10'-10"	211.3	SQ. FT.
S2	8'-6" x 11'-10"	100.50	SQ. FT.
S3	15'-10" x 11'-6"	181.68	SQ. FT.
S4	6'-10" x 12'-7"	86.00	SQ. FT.
S5	17'-2" x 17'-7"	301.25	SQ. FT.
(N) SECOND FLOOR		1,579.73	SQ. FT.

## (N) F.A.R

(N) FIRST FLOOR (INCLD. GARAGE)	2299.98	SQ. FT.
(N) SECOND FLOOR	1579.73	SQ. FT.
<b>TOTAL F.A.R</b>	<b>3,879.71</b>	<b>SQ. FT.</b>

## (N) LOT COVERAGE

(N) FIRST FLOOR (INCLD. GARAGE)	2299.98	SQ. FT.
(N) BASEMENT (FIRST FLOOR WITH DEFINITION OF BASEMENT EXEMPT FROM AREA CALCULATION FROM LOT COVERAGE)	462.01	SQ. FT.
PORCH-1	141	SQ. FT.
PORCH-2	276	SQ. FT.
<b>TOTAL LOT COVERAGE</b>	<b>3,178.99</b>	<b>SQ. FT.</b>

No. Date Description

7/25/21 Planning Comments


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LOS ALTOS, CA

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farnaz@khadivdesign.com

**KHADIV-DESIGN**

Date: 12-07-20

Scale: 1/8"=1'-0"

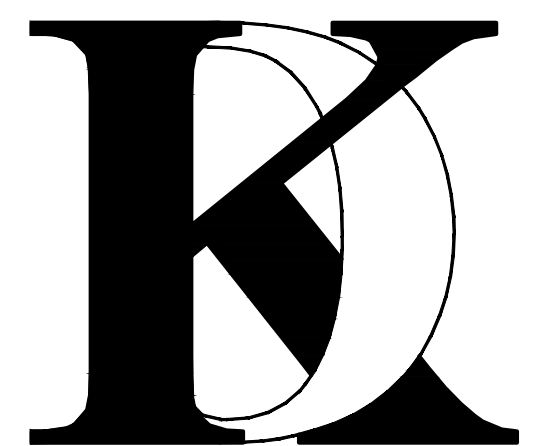Drawn By: FK

Job No: 2020.11

Signature :

Sheet Title :


**PROPOSED AREA  
CALCULATION  
DIAGRAM**

Sheet No. :

**A-1.3**



# Original Plans - 11/17/21 DRC Meeting

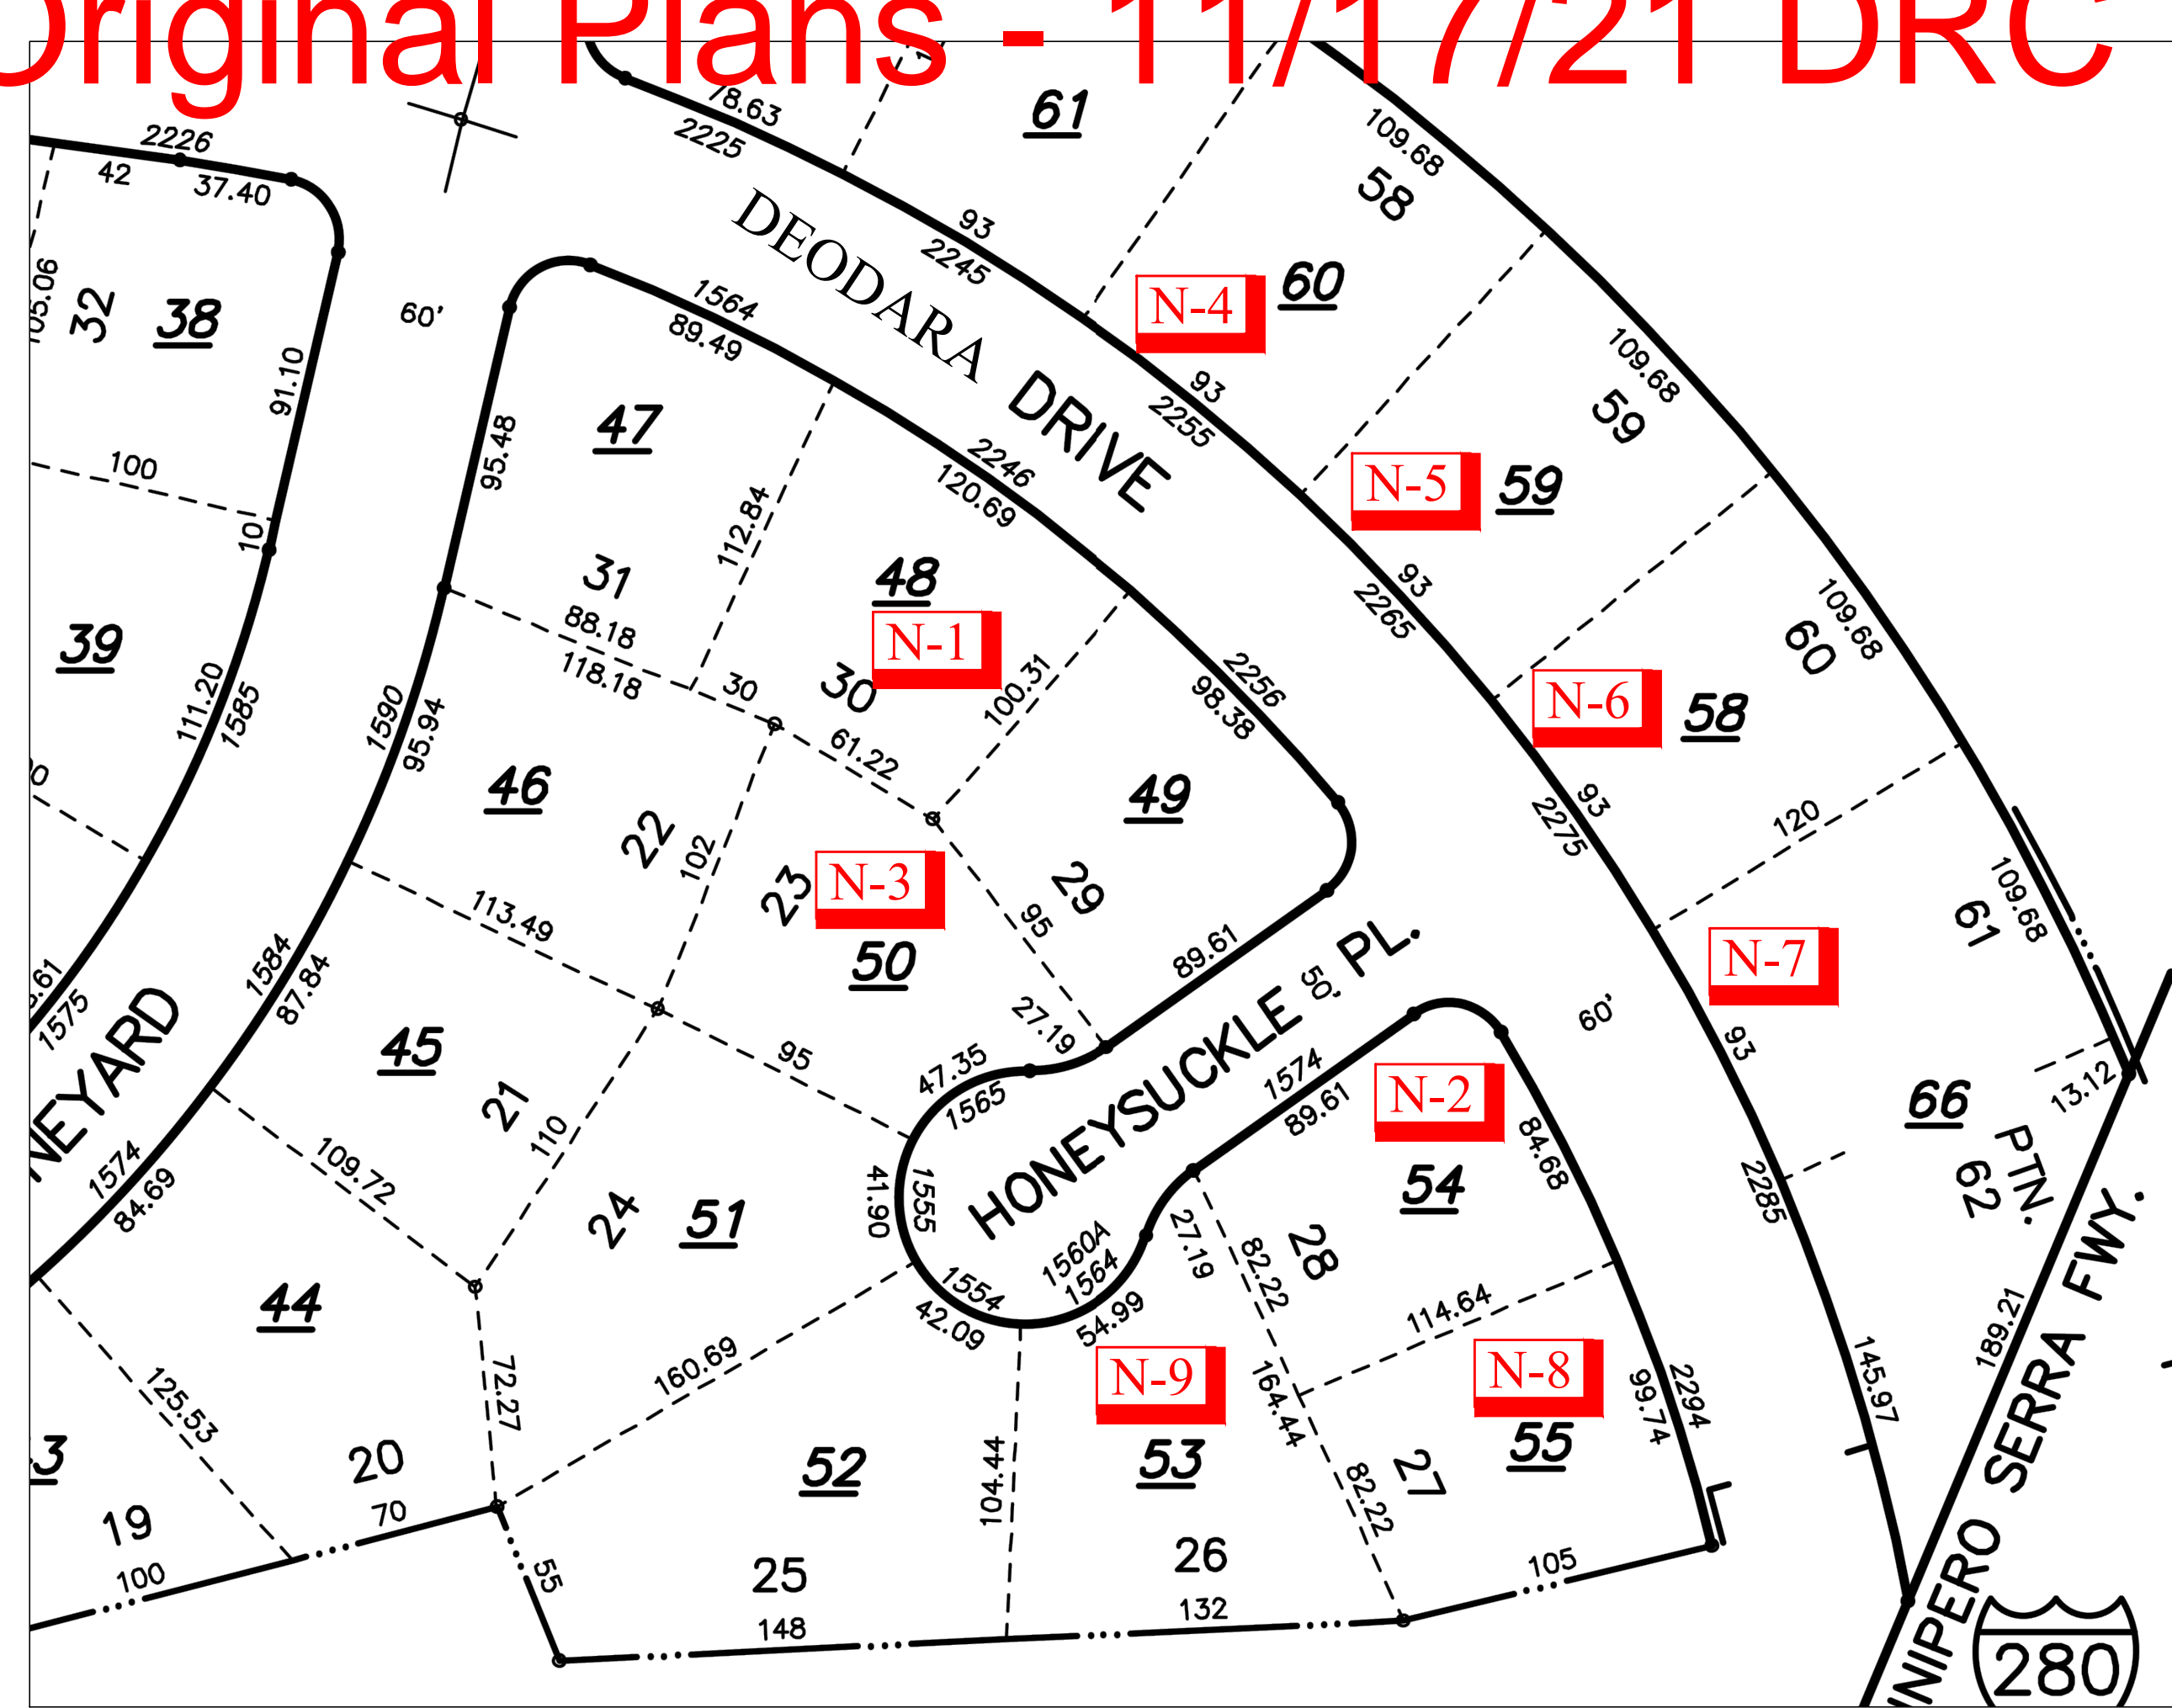

No.	Date	Description
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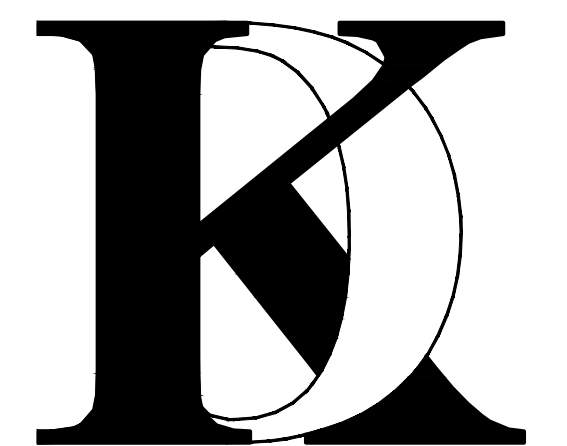
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Drawn By : FK






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Signature :

Sheet Title :  
NEIGHBORHOOD  
COMPATIBILITY  
WORKSHEET

Sheet No. :

# NC-1.0



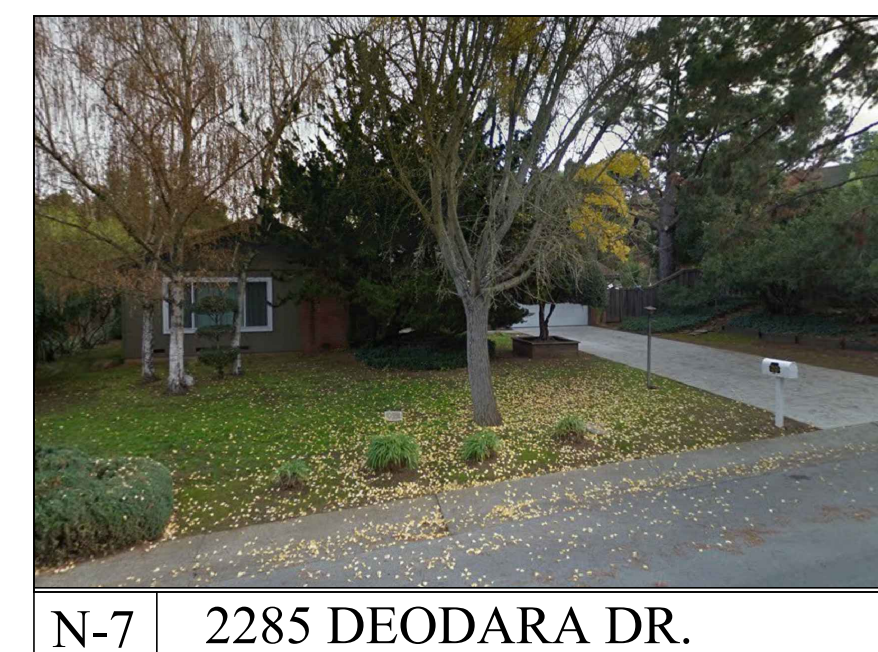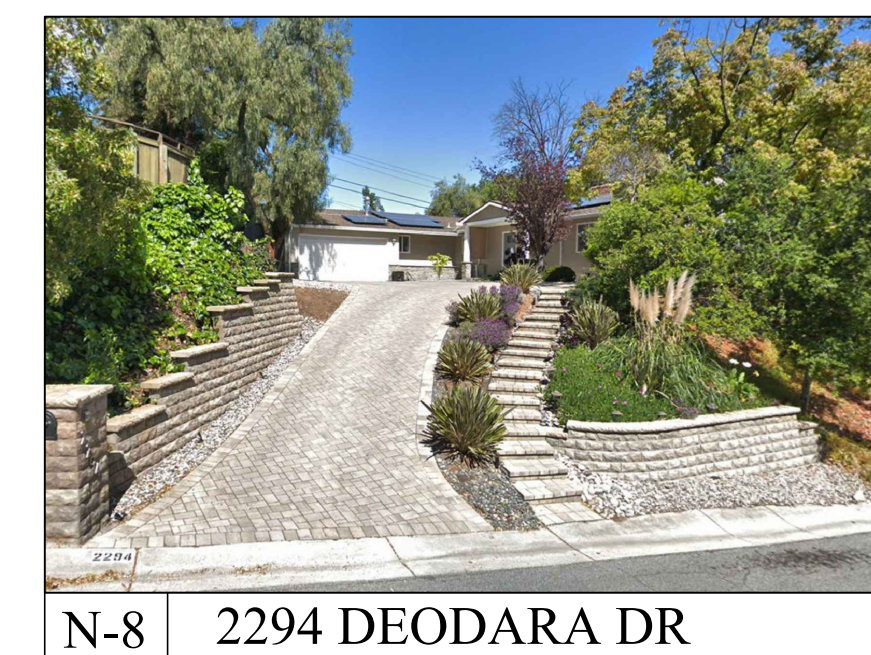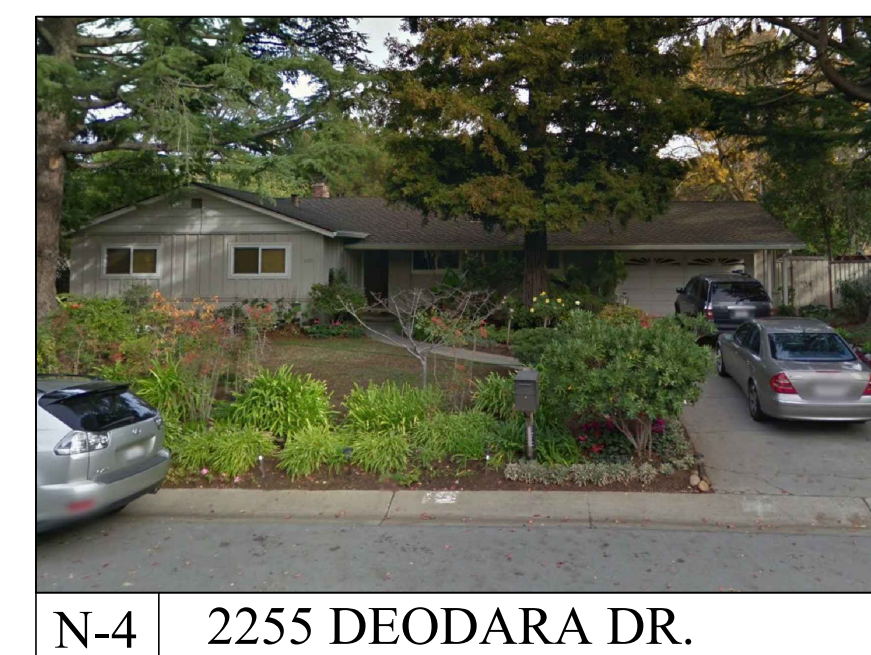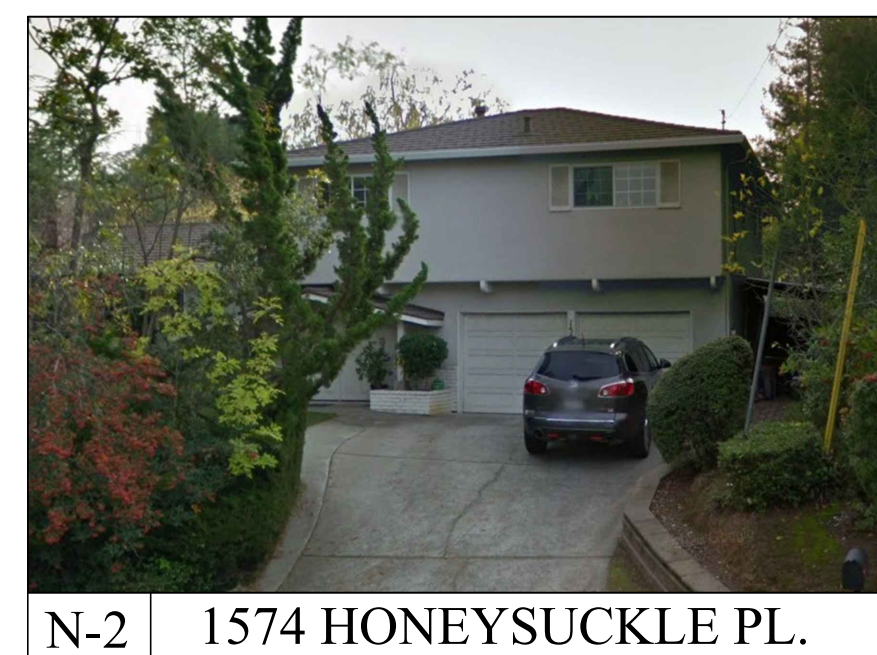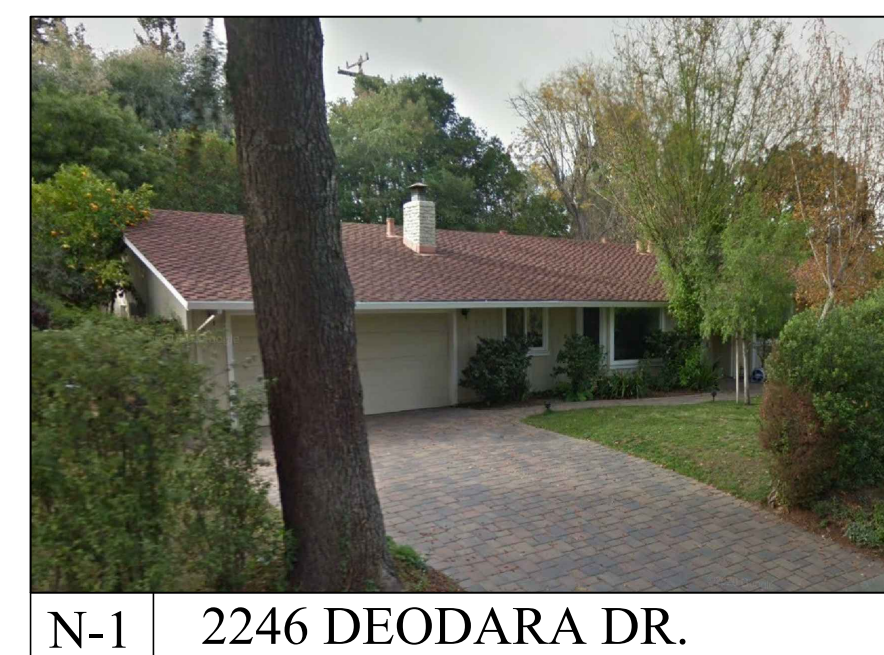

# Original Plans - 11/17/21 DRC Meeting

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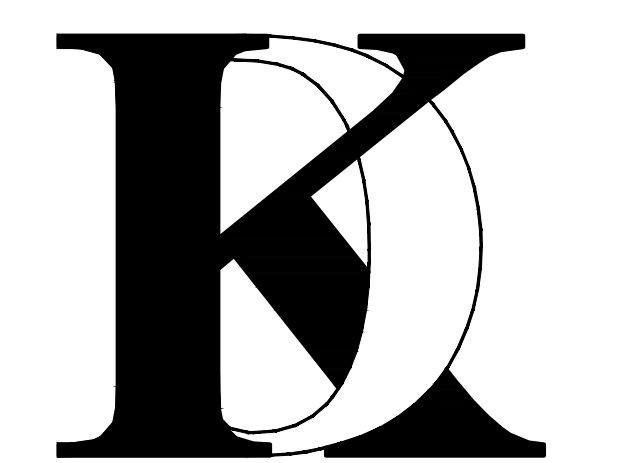
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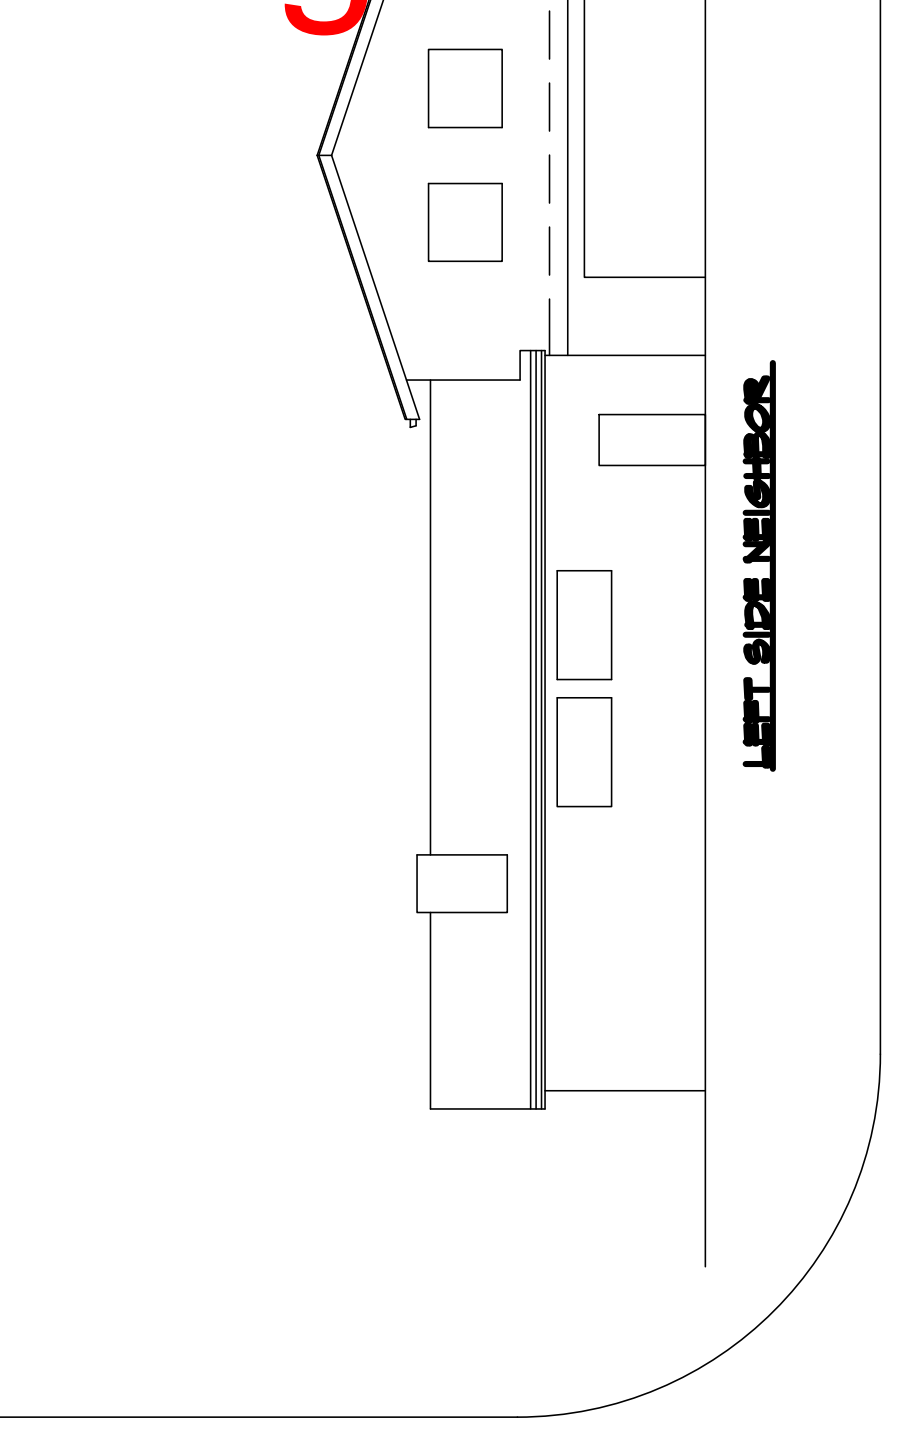
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Drawn By: FK  
Job No: 2020.11

Signature :



Sheet Title :  
NEIGHBORHOOD  
COMPATIBILITY  
WORKSHEET

Sheet No. :


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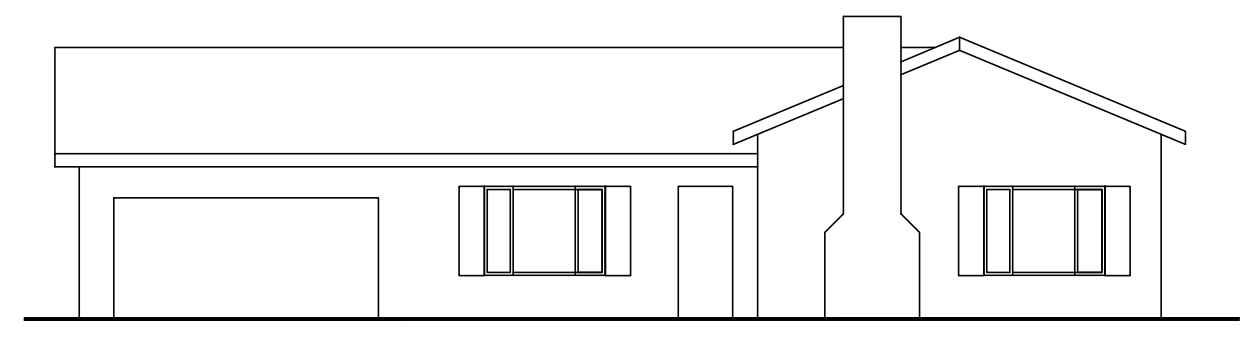
PROPOSED FRONT ELEVATION



EXISTING FRONT ELEVATION

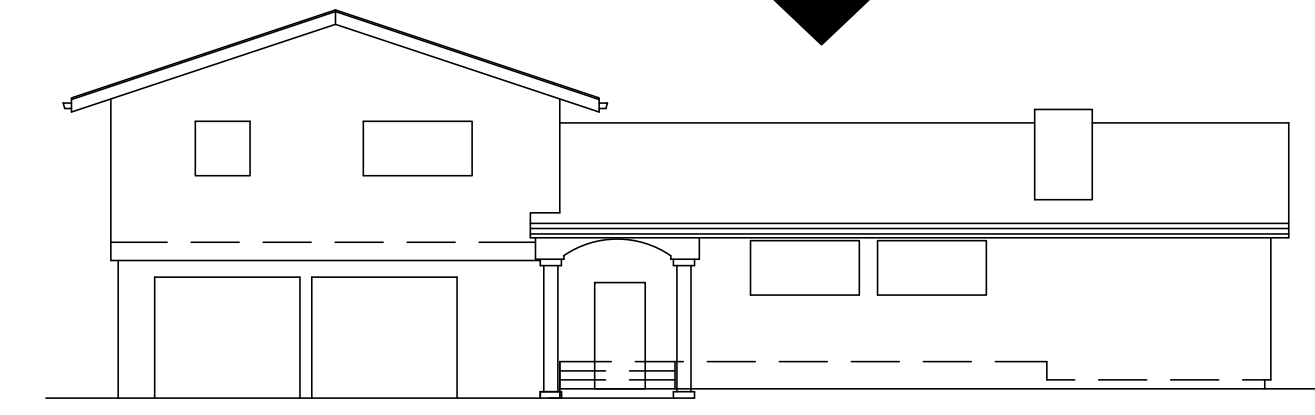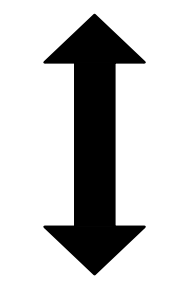


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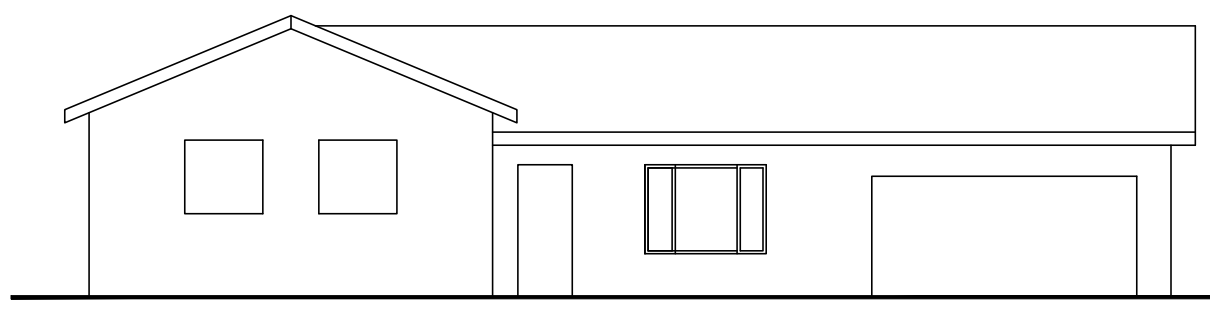
RIGHT SIDE NEIGHBOR

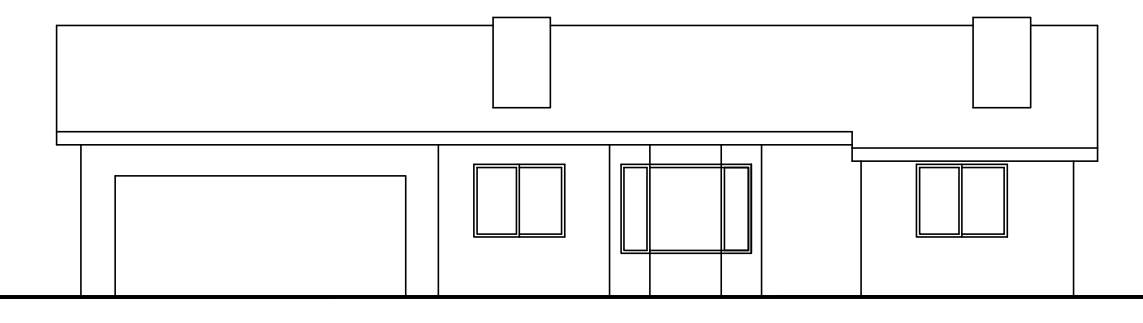DEODARA DR




DEODARA DR



FRONT OPPOSITE SIDE NEIGHBOR

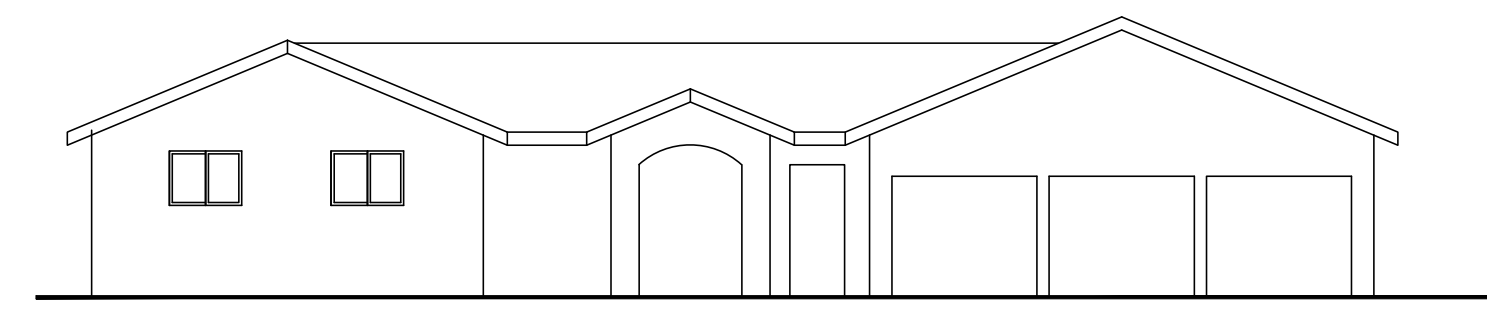


FRONT/RIGHT OPPOSITE SIDE NEIGHBOR

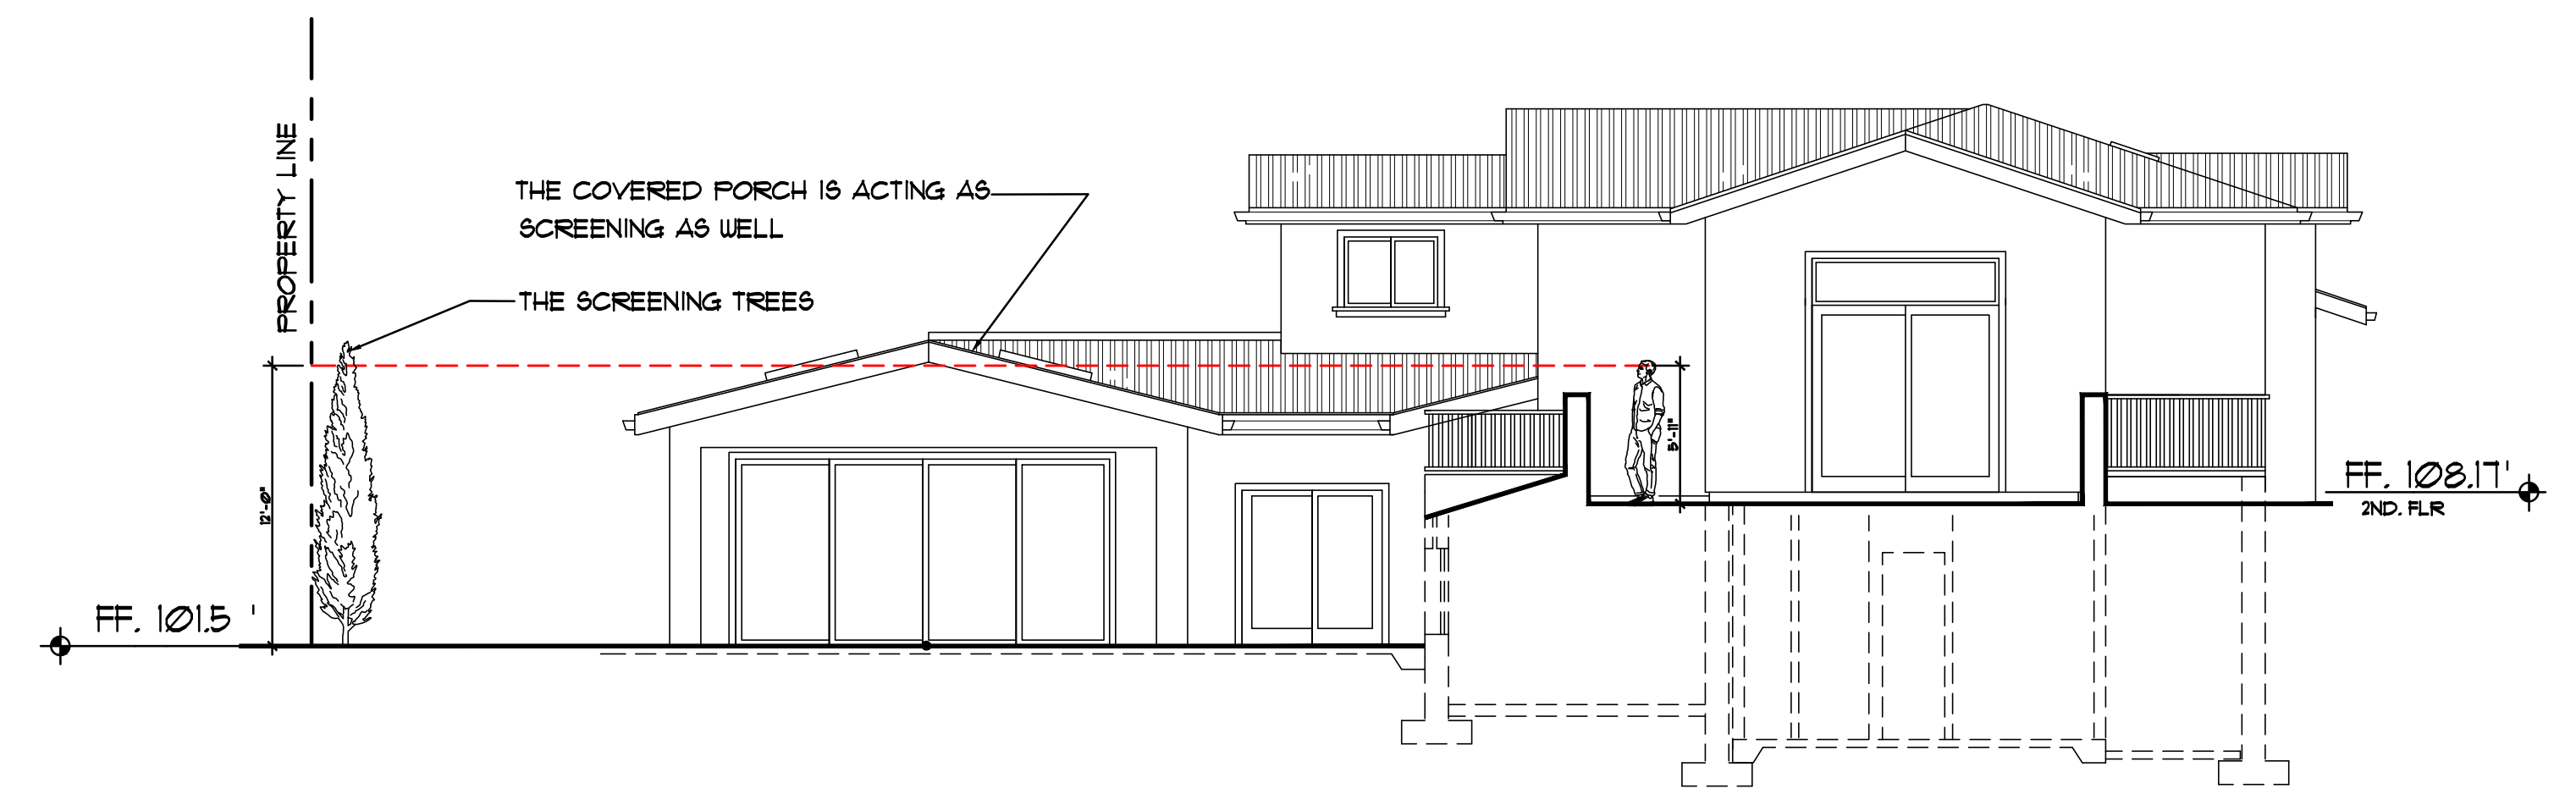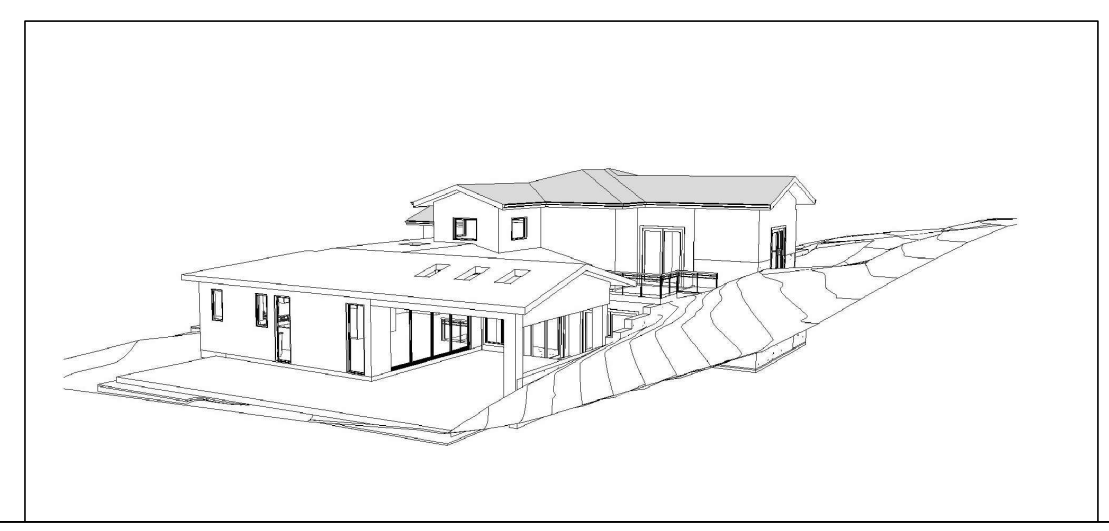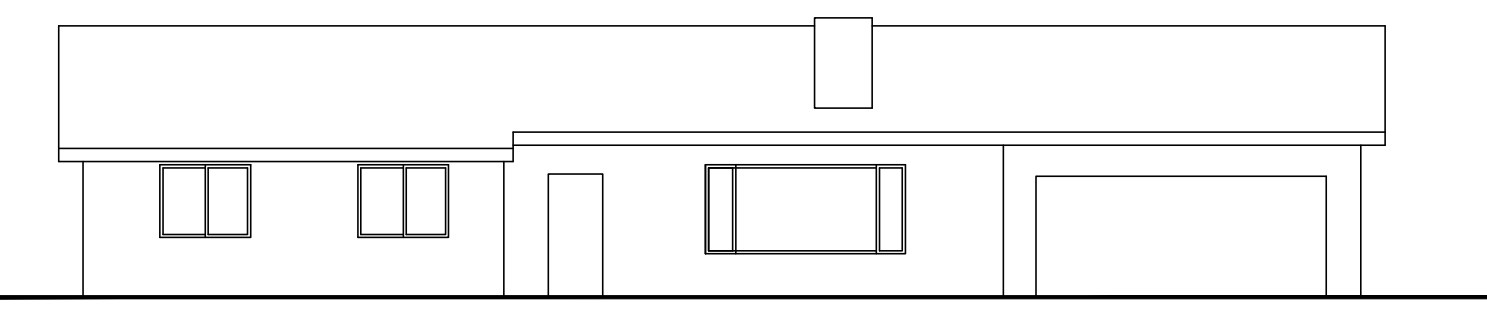


BALCONY AND PRIVACY ANALYSIS



# Original Plans - 11/17/21 DRC Meeting

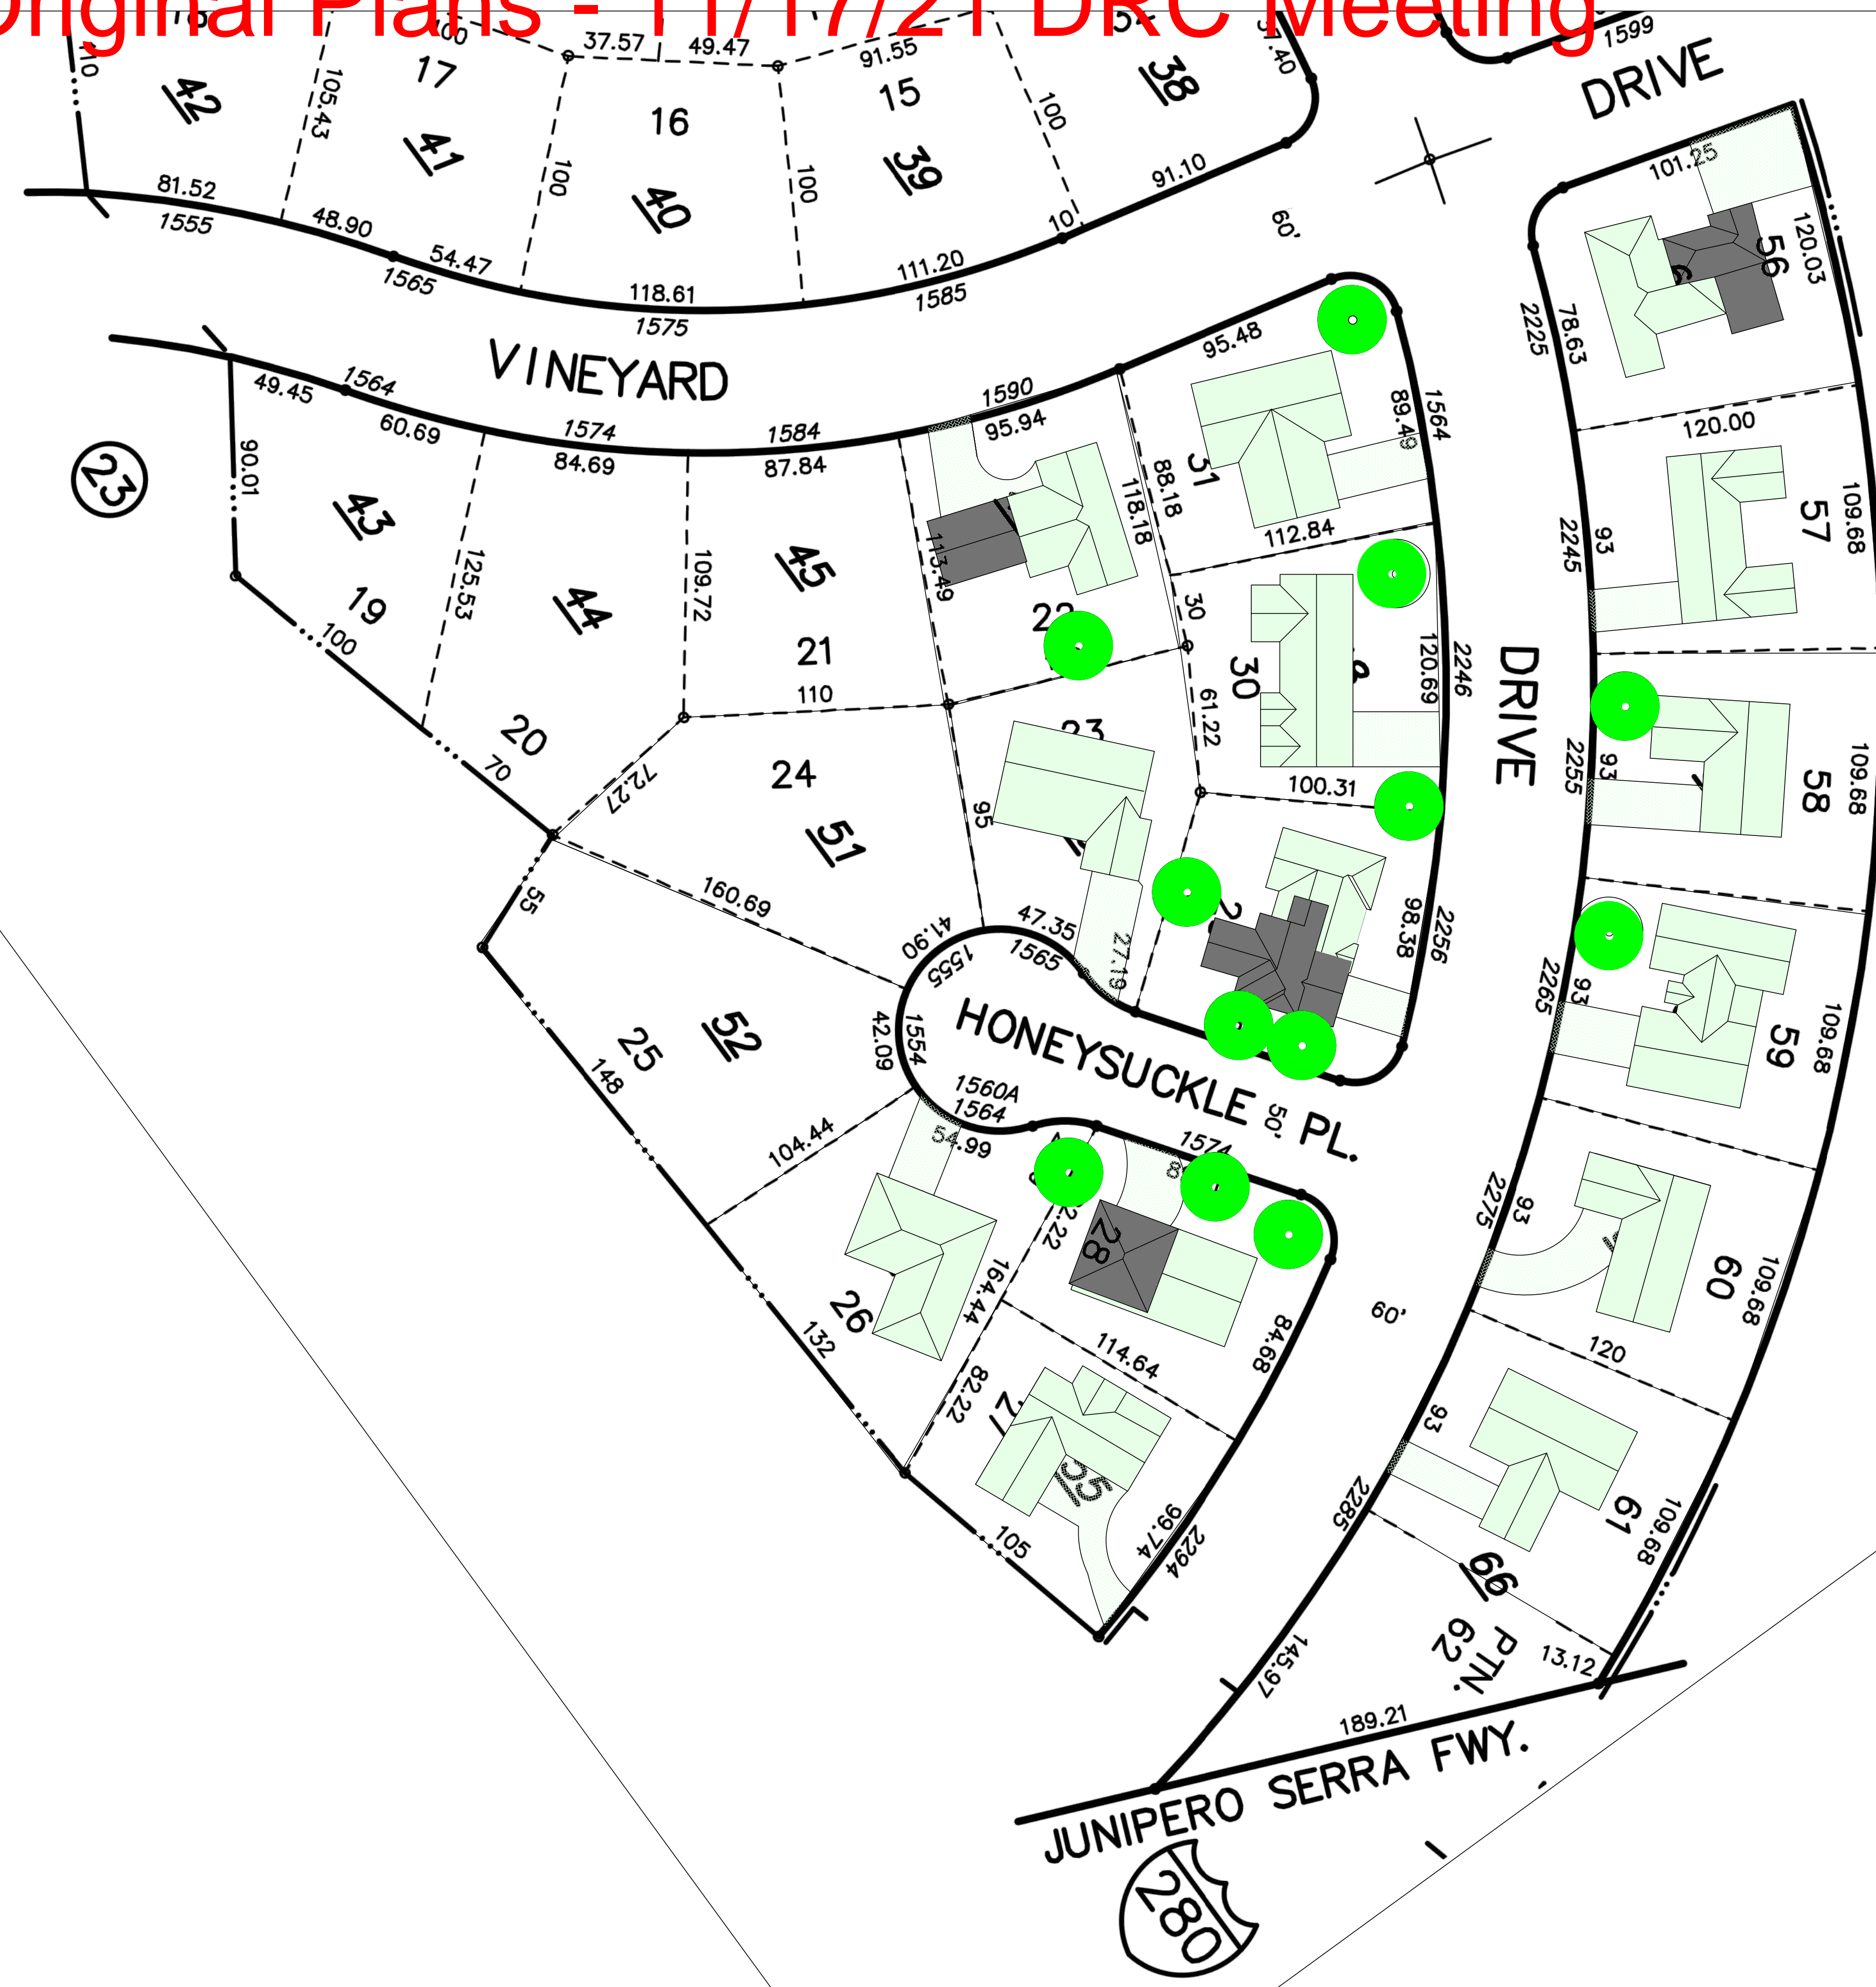

- SINGLE STORY
- TWO STORY
- MAJOR TREE

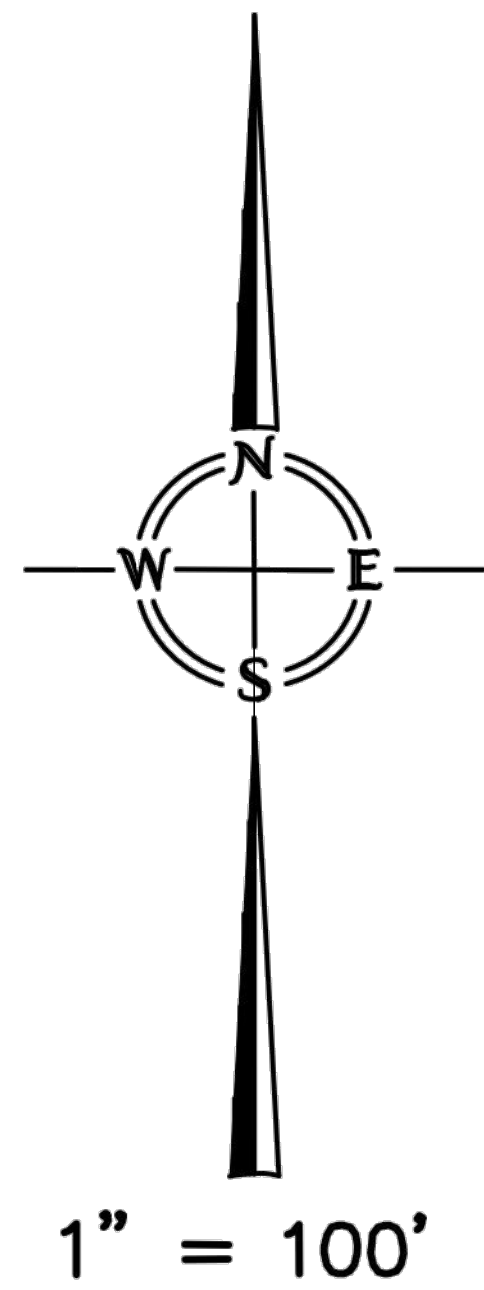


LA 15000  
 Cadastral  
 Effective Roll

No.	Date	Description
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 LOS ALTOS, CA

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## ***KHADIV-DESIGN***

Date: 12-07-20  
 Scale: 1" = 40'  
 Drawn By: FK  
 Job No: 2020.11  
 Signature:

**Sheet Title :**  
 NEIGHBORHOOD  
 COMPATIBILITY  
 WORKSHEET

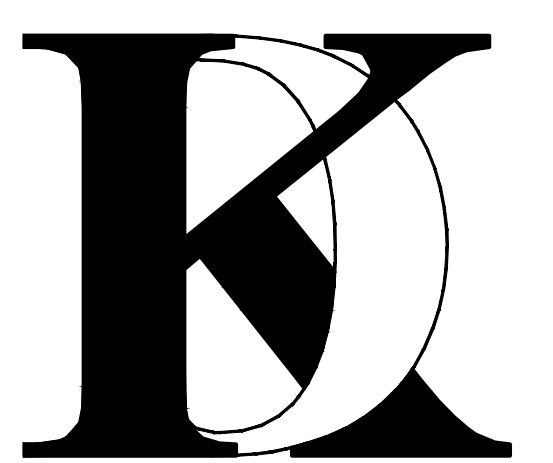**Sheet No. :**  
NC-1.2





# Original Plans 11/17/21 DRC Meeting

City of Los Altos  
Planning Division  
(650) 947-2755  
Planning@losaltosca.gov

## NEIGHBORHOOD COMPATIBILITY WORKSHEET

In order for your design review application for single-family residential remodel/addition or new construction to be successful, it is important that you consider your property, the neighborhood's special characteristics that surround that property and the compatibility of your proposal with that neighborhood. **The purpose is to help you understand your neighborhood before you begin the design process with your architect/designer/builder or begin any formal process with the City of Los Altos.** Please note that this worksheet must be submitted with your 1<sup>st</sup> application.

The Residential Design Guidelines encourage neighborhood compatibility without necessarily forsaking individual taste. Various factors contribute to a design that is considered compatible with a surrounding neighborhood. The factors that City officials will be considering in your design could include, but are not limited to: design theme, scale, bulk, size, roof line, lot coverage, slope of lot, setbacks, daylight plane, one or two-story, exterior materials, landscaping et cetera.

It will be helpful to have a site plan to use in conjunction with this worksheet. Your site plan should accurately depict your property boundaries. The best source for this is the legal description in your deed.

Photographs of your property and its relationship to your neighborhood (see below) will be a necessary part of your first submittal. Taking photographs before you start your project will allow you to see and appreciate that your property could be within an area that has a strong neighborhood pattern. The photographs should be taken from across the street with a standard 35mm camera and organized by address, one row for each side of the street. Photographs should also be taken of the properties on either side and behind your property from on your property.

This worksheet/check list is meant to help you as well as to help the City planners and Planning Commission understand your proposal. Reasonable guesses to your answers are acceptable. The City is not looking for precise measurements on this worksheet.

Project Address 2256 DEODARA DR. LOS ALTOS  
Scope of Project: Addition or Remodel  or New Home   
Age of existing home if this project is to be an addition or remodel? 60  
Is the existing house listed on the City's Historic Resources Inventory? No

Neighborhood Compatibility Worksheet Page 1  
\* See "What constitutes your neighborhood" on page 2.

Address: 2256 DEODARA DR.  
Date: 6/4/2021

8. Lot Slope: (Pg. 25 Design Guidelines)  
Does your property have a noticeable slope? Yes

What is the direction of your slope? (relative to the street)  
From rear yard to front yard.

Is your slope higher  lower  same  in relationship to the neighboring properties? Is there a noticeable difference in grade between your property/house and the one across the street or directly behind?

9. Landscaping:  
Are there any frequently used or typical landscaping features on your street (i.e. big trees, front lawns, sidewalks, curbs, landscape to street edge, etc.)?  
Front Lawn, Trees in front, no side walk, landscape to street edge

How visible are your house and other houses from the street or back neighbor's property?  
The house is visible from street. The project is located on a corner lot.

Are there any major existing landscaping features on your property and how is the unimproved public right-of-way developed in front of your property (gravel, dirt, asphalt, landscape)?  
No major landscape.

10. Width of Street:  
What is the width of the roadway paving on your street in feet?  
Is there a parking area on the street or in the shoulder area? Yes  
Is the shoulder area (unimproved public right-of-way) paved, unpaved, gravel, landscaped, and/or defined with a curb/gutter?

Neighborhood Compatibility Worksheet Page 4  
\* See "What constitutes your neighborhood", (page 2).

# 11/17/21 DRC Meeting

Address: 2256 DEODARA DR.  
Date: 6/4/2021

What constitutes your neighborhood?

There is no clear answer to this question. For the purpose of this worksheet, consider first your street, the two contiguous homes on either side of, and directly behind, your property and the five to six homes directly across the street (eight to nine homes). At the minimum, these are the houses that you should photograph. If there is any question in your mind about your neighborhood boundaries, consider a radius of approximately 200 to 300 feet around your property and consider that your neighborhood.

## Streetscape

1. Typical neighborhood lot size\*:  
Lot area: 10000 to 13000 square feet  
Lot dimensions: Length See NC-1.0 feet  
Width See NC-1.0 feet  
If your lot is significantly different than those in your neighborhood, then note its: area, length, and width.

2. Setback of homes to front property line: (Pgs. 8-11 Design Guidelines)  
Existing front setback if home is a remodel? Yes  
What % of the front facing walls of the neighborhood homes are at the front setback 100 %  
Existing front setback for house on left 25(+/-) ft./on right 25(+/-) ft.  
Do the front setbacks of adjacent houses line up? Yes

3. Garage Location Pattern: (Pg. 19 Design Guidelines)  
Indicate the relationship of garage locations in your neighborhood\* only on your street (count for each type)  
Garage facing front projecting from front of house face 7  
Garage facing front recessed from front of house face 0  
Garage in back yard 0  
Garage facing the side 1  
Number of 1-car garages 0; 2-car garages 7; 3-car garages 0

Neighborhood Compatibility Worksheet Page 2  
\* See "What constitutes your neighborhood", (page 2).

11. What characteristics make this neighborhood\* cohesive?  
Such as roof material and type (hip, gable, flat), siding (board and batten, cement plaster, horizontal wood, brick), deep front yard setbacks, horizontal feel, landscape approach etc.:  
Stucco and roof material and form as well as landscape approach

General Study  
A. Have major visible streetscape changes occurred in your neighborhood?  
B. Do you think that most (~80%) of the homes were originally built at the same time?  
C. Do the lots in your neighborhood appear to be the same size?  
D. Do the lot widths appear to be consistent in the neighborhood?  
E. Are the front setbacks of homes on your street consistent (~80% within 5 feet)?  
F. Do you have active CCR's in your neighborhood? (p.36 Building Guide)  
G. Do the houses appear to be of similar size as viewed from the street?  
H. Does the new exterior remodel or new construction design you are planning relate in most ways to the prevailing style(s) in your existing neighborhood?

Neighborhood Compatibility Worksheet Page 5  
\* See "What constitutes your neighborhood", (page 2).

Address: 2256 DEODARA DR.  
Date: 6/4/2021

4. Single or Two-Story Homes:  
What % of the homes in your neighborhood\* are:  
One-story 80  
Two-story 20

5. Roof heights and shapes:  
Is the overall height of house ridgelines generally the same in your neighborhood\*? Yes  
Are there mostly hip, gable style, or other style roofs\*?  
Do the roof forms appear simple or complex?  
Do the houses share generally the same eave height Yes?

6. Exterior Materials: (Pg. 22 Design Guidelines)  
What siding materials are frequently used in your neighborhood\*?  
wood shingle, stucco, board & batten, clapboard, tile, stone, brick, combination of one or more materials (if so, describe) Stucco and wood siding combo

What roofing materials (wood shake/shingle, asphalt shingle, flat tile, rounded tile, cement tile, slate) are consistently (about 80%) used?  
If no consistency then explain: Asphalt Shingles and Shingle

7. Architectural Style: (Appendix C, Design Guidelines)  
Does your neighborhood\* have a consistent identifiable architectural style?  
Type? Ranch, Shingle, Tudor, Mediterranean/Spanish, Contemporary, Colonial, Bungalow, Other

Neighborhood Compatibility Worksheet Page 3  
\* See "What constitutes your neighborhood", (page 2).

Address: 2256 DEODARA DR.  
Date: 6/4/2021

Summary Table  
Please use this table to summarize the characteristics of the houses in your immediate neighborhood (two homes on either side, directly behind and the five to six homes directly across the street).

Address	Front setback	Rear setback	Garage location	One or two stories	Height	Materials	Architecture (simple or complex)
N-1: 2246 DEODARA DR.	25'	25'	FRONT	ONE STORY	17 FEET	WOODSIDE	SIMPLE
N-2: 1574 HONEYSUCKLE PL	25'	25'	FRONT	TWO STORY	20 FEET	STUCCO	SIMPLE
N-3: 1565 HONEYSUCKLE PL.	25'	25'	FRONT	ONE STORY	18 FEET	WOOD SIDING	SIMPLE
N-4: 2255 DEODARA DR.	25'	25'	FRONT	ONE STORY	16 FEET	WOOD SIDING	SIMPLE
N-5: 2265 DEODARA DR.	25'	25'	FRONT	ONE STORY	17 FEET	STUCCO	SIMPLE
N-6: 2275 DEODARA DR.	25'	25'	SIDE	ONE STORY	15 FEET	WOOD SIDING	SIMPLE
N-7: 2285 DEODARA DR.	25'	25'	FRONT	ONE STORY	17 FEET	STUCCO	SIMPLE

Neighborhood Compatibility Worksheet Page 6  
\* See "What constitutes your neighborhood", (page 2).

REFER TO SHEET NC-1.0 FOR PICTURES AND SITE PLAN

No.	Date	Description
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Drawn By : FK  
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Signature :


Sheet Title :  
NEIGHBORHOOD  
COMPATIBILITY  
WORKSHEET

Sheet No. :

# NC-1.3


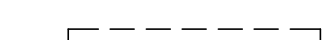
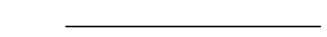


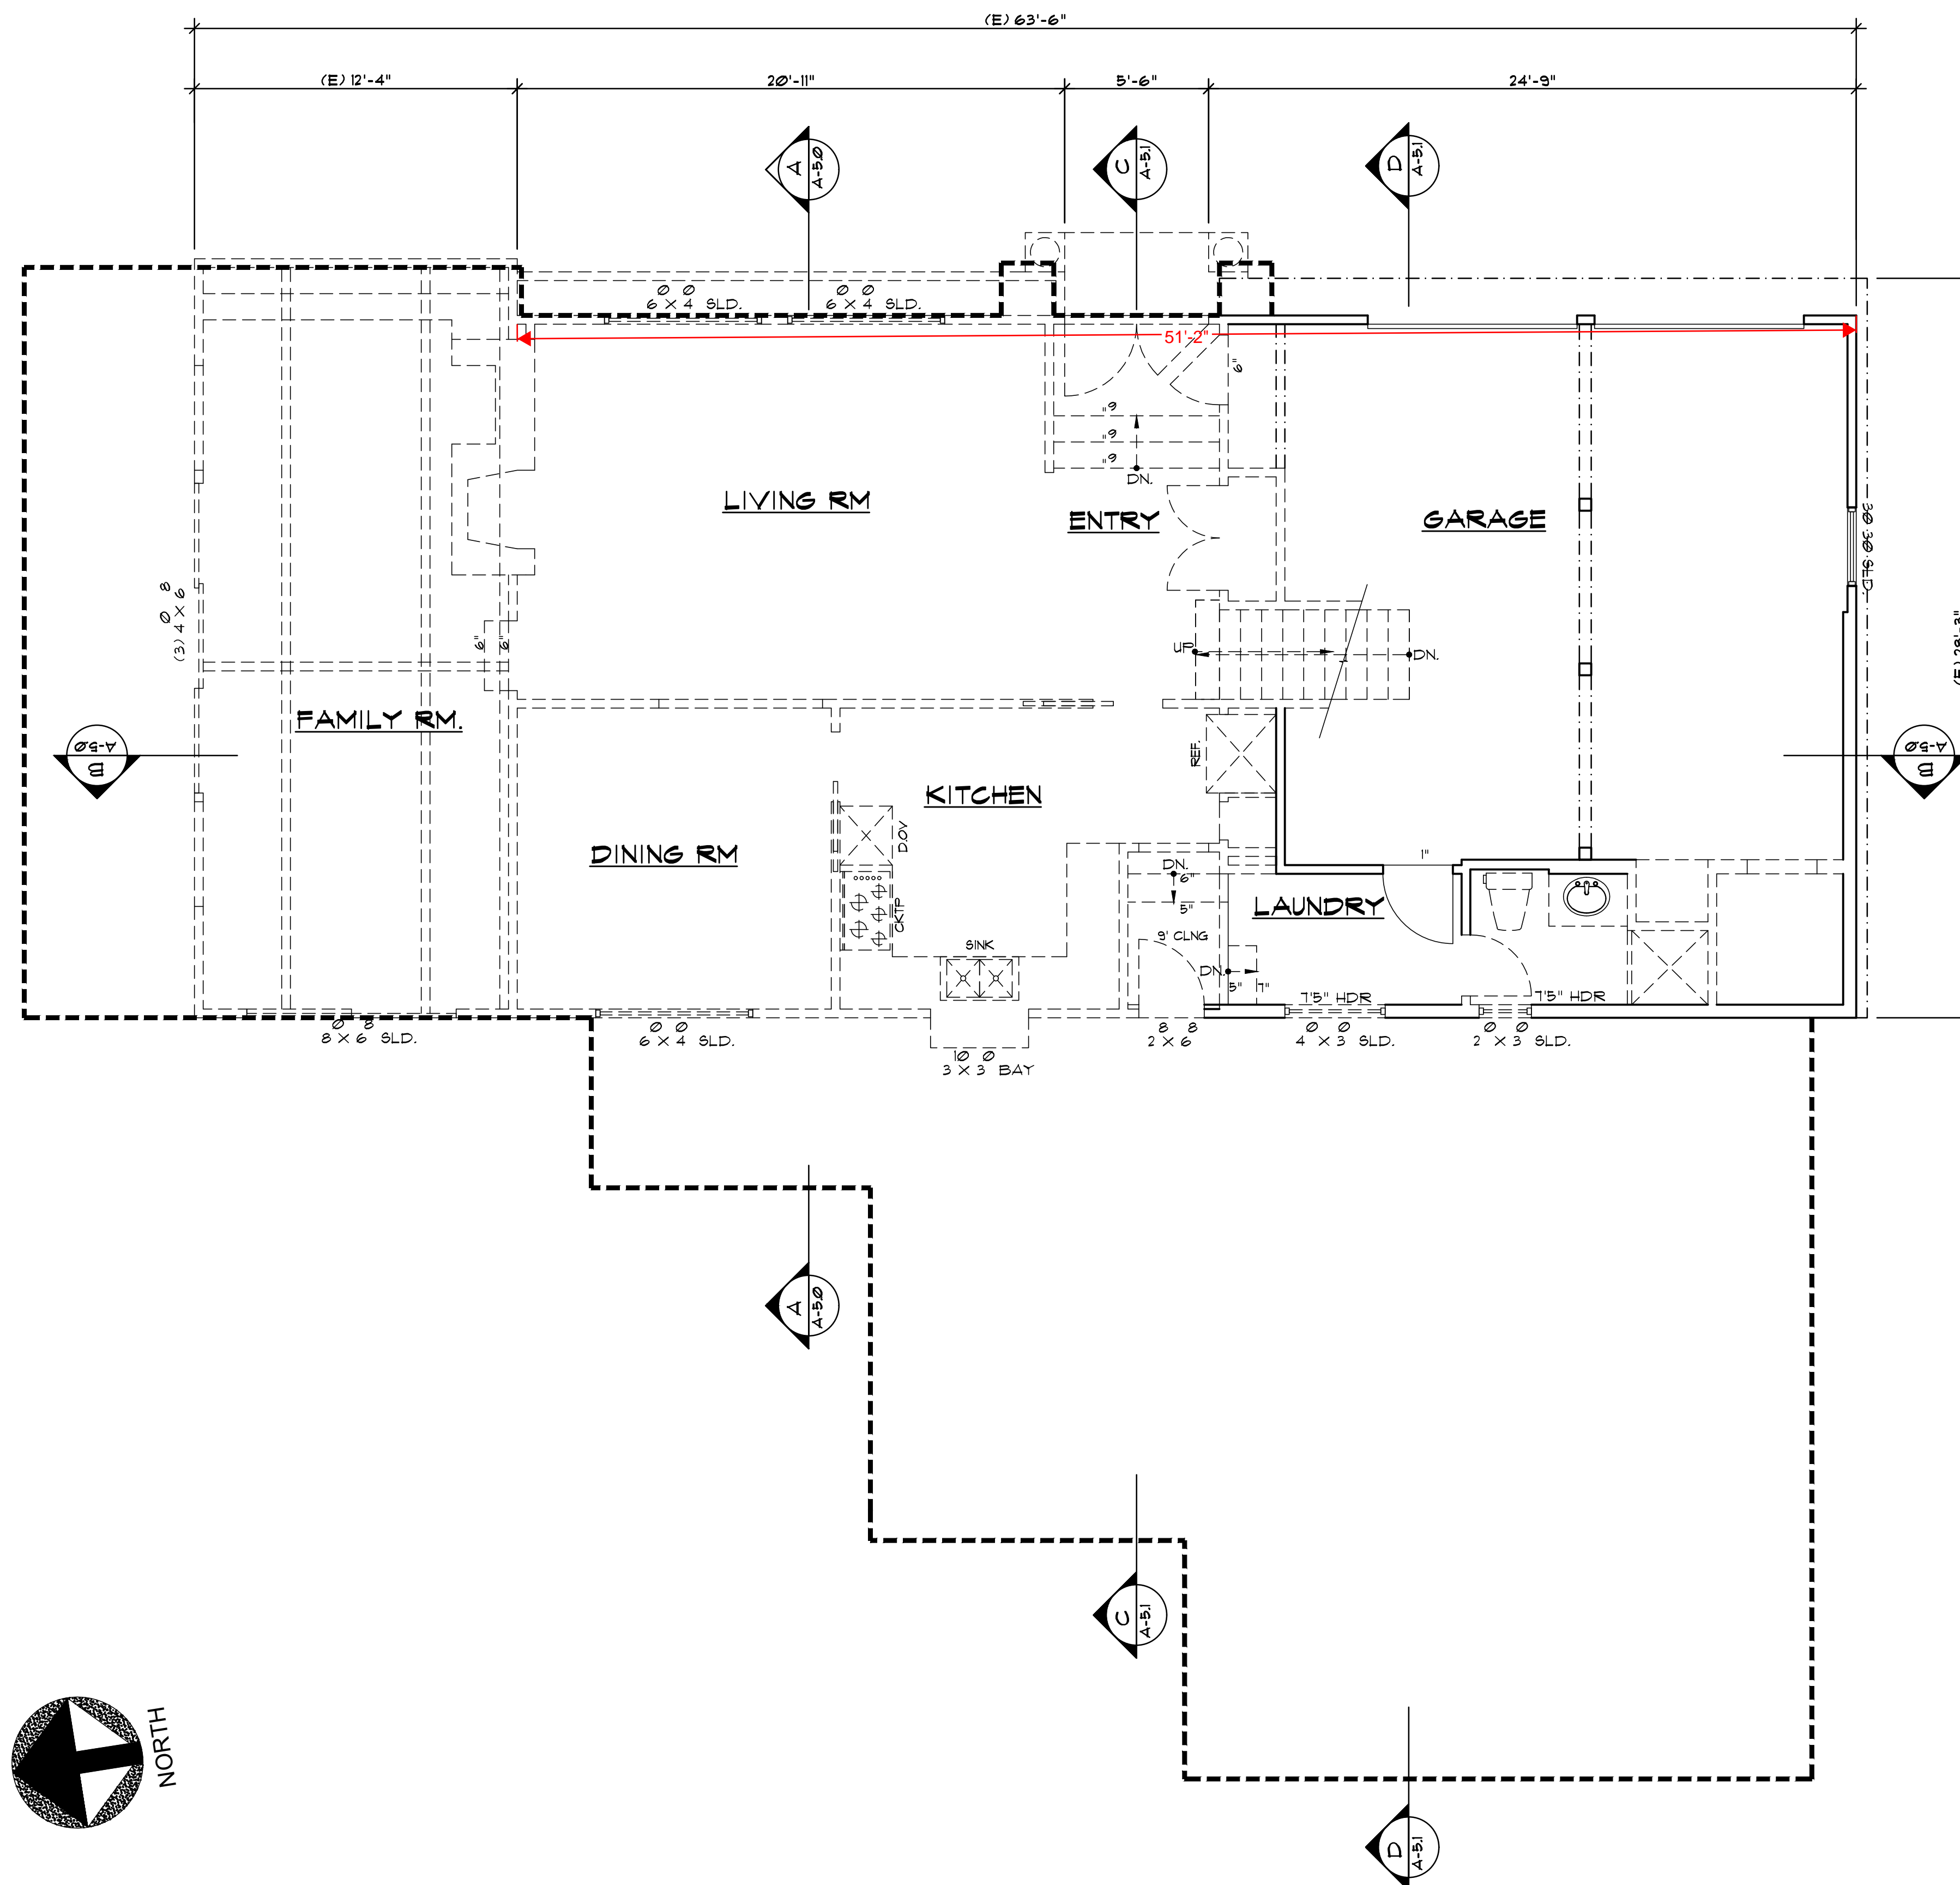

# Original Plans - 11/17/21 DRC Meeting






**EXISTING FIRST FLOOR PLAN / DEMO PLAN**

## LEGEND

-  EXISTING WALL TO REMAIN.
-  EXISTING WALL TO BE REMOVED.
-  ITEMS TO REMAIN.
-  ITEMS TO BE REMOVED.
-  NEW FOOT PRINT

No. Date Description

-  \_\_\_\_\_
-  \_\_\_\_\_
-  \_\_\_\_\_


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Drawn By : FK

Job No: 2020.11

Signature :


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PLAN / DEMO PLAN

Sheet No. :
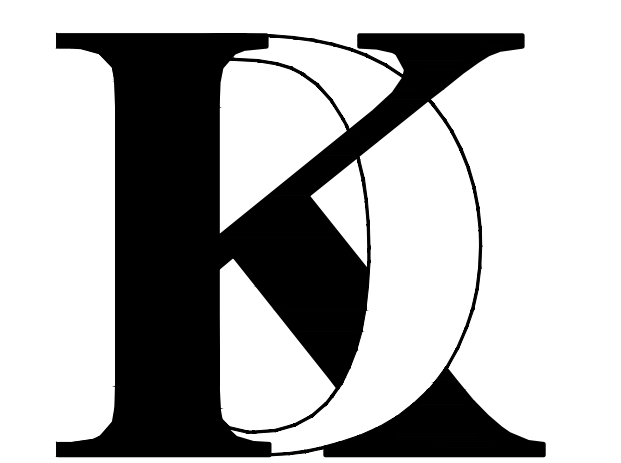
# A-2.0


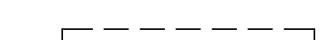
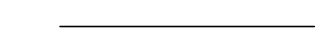
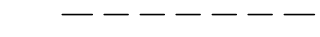



# Original Plans - 11/17/21 DRC Meeting

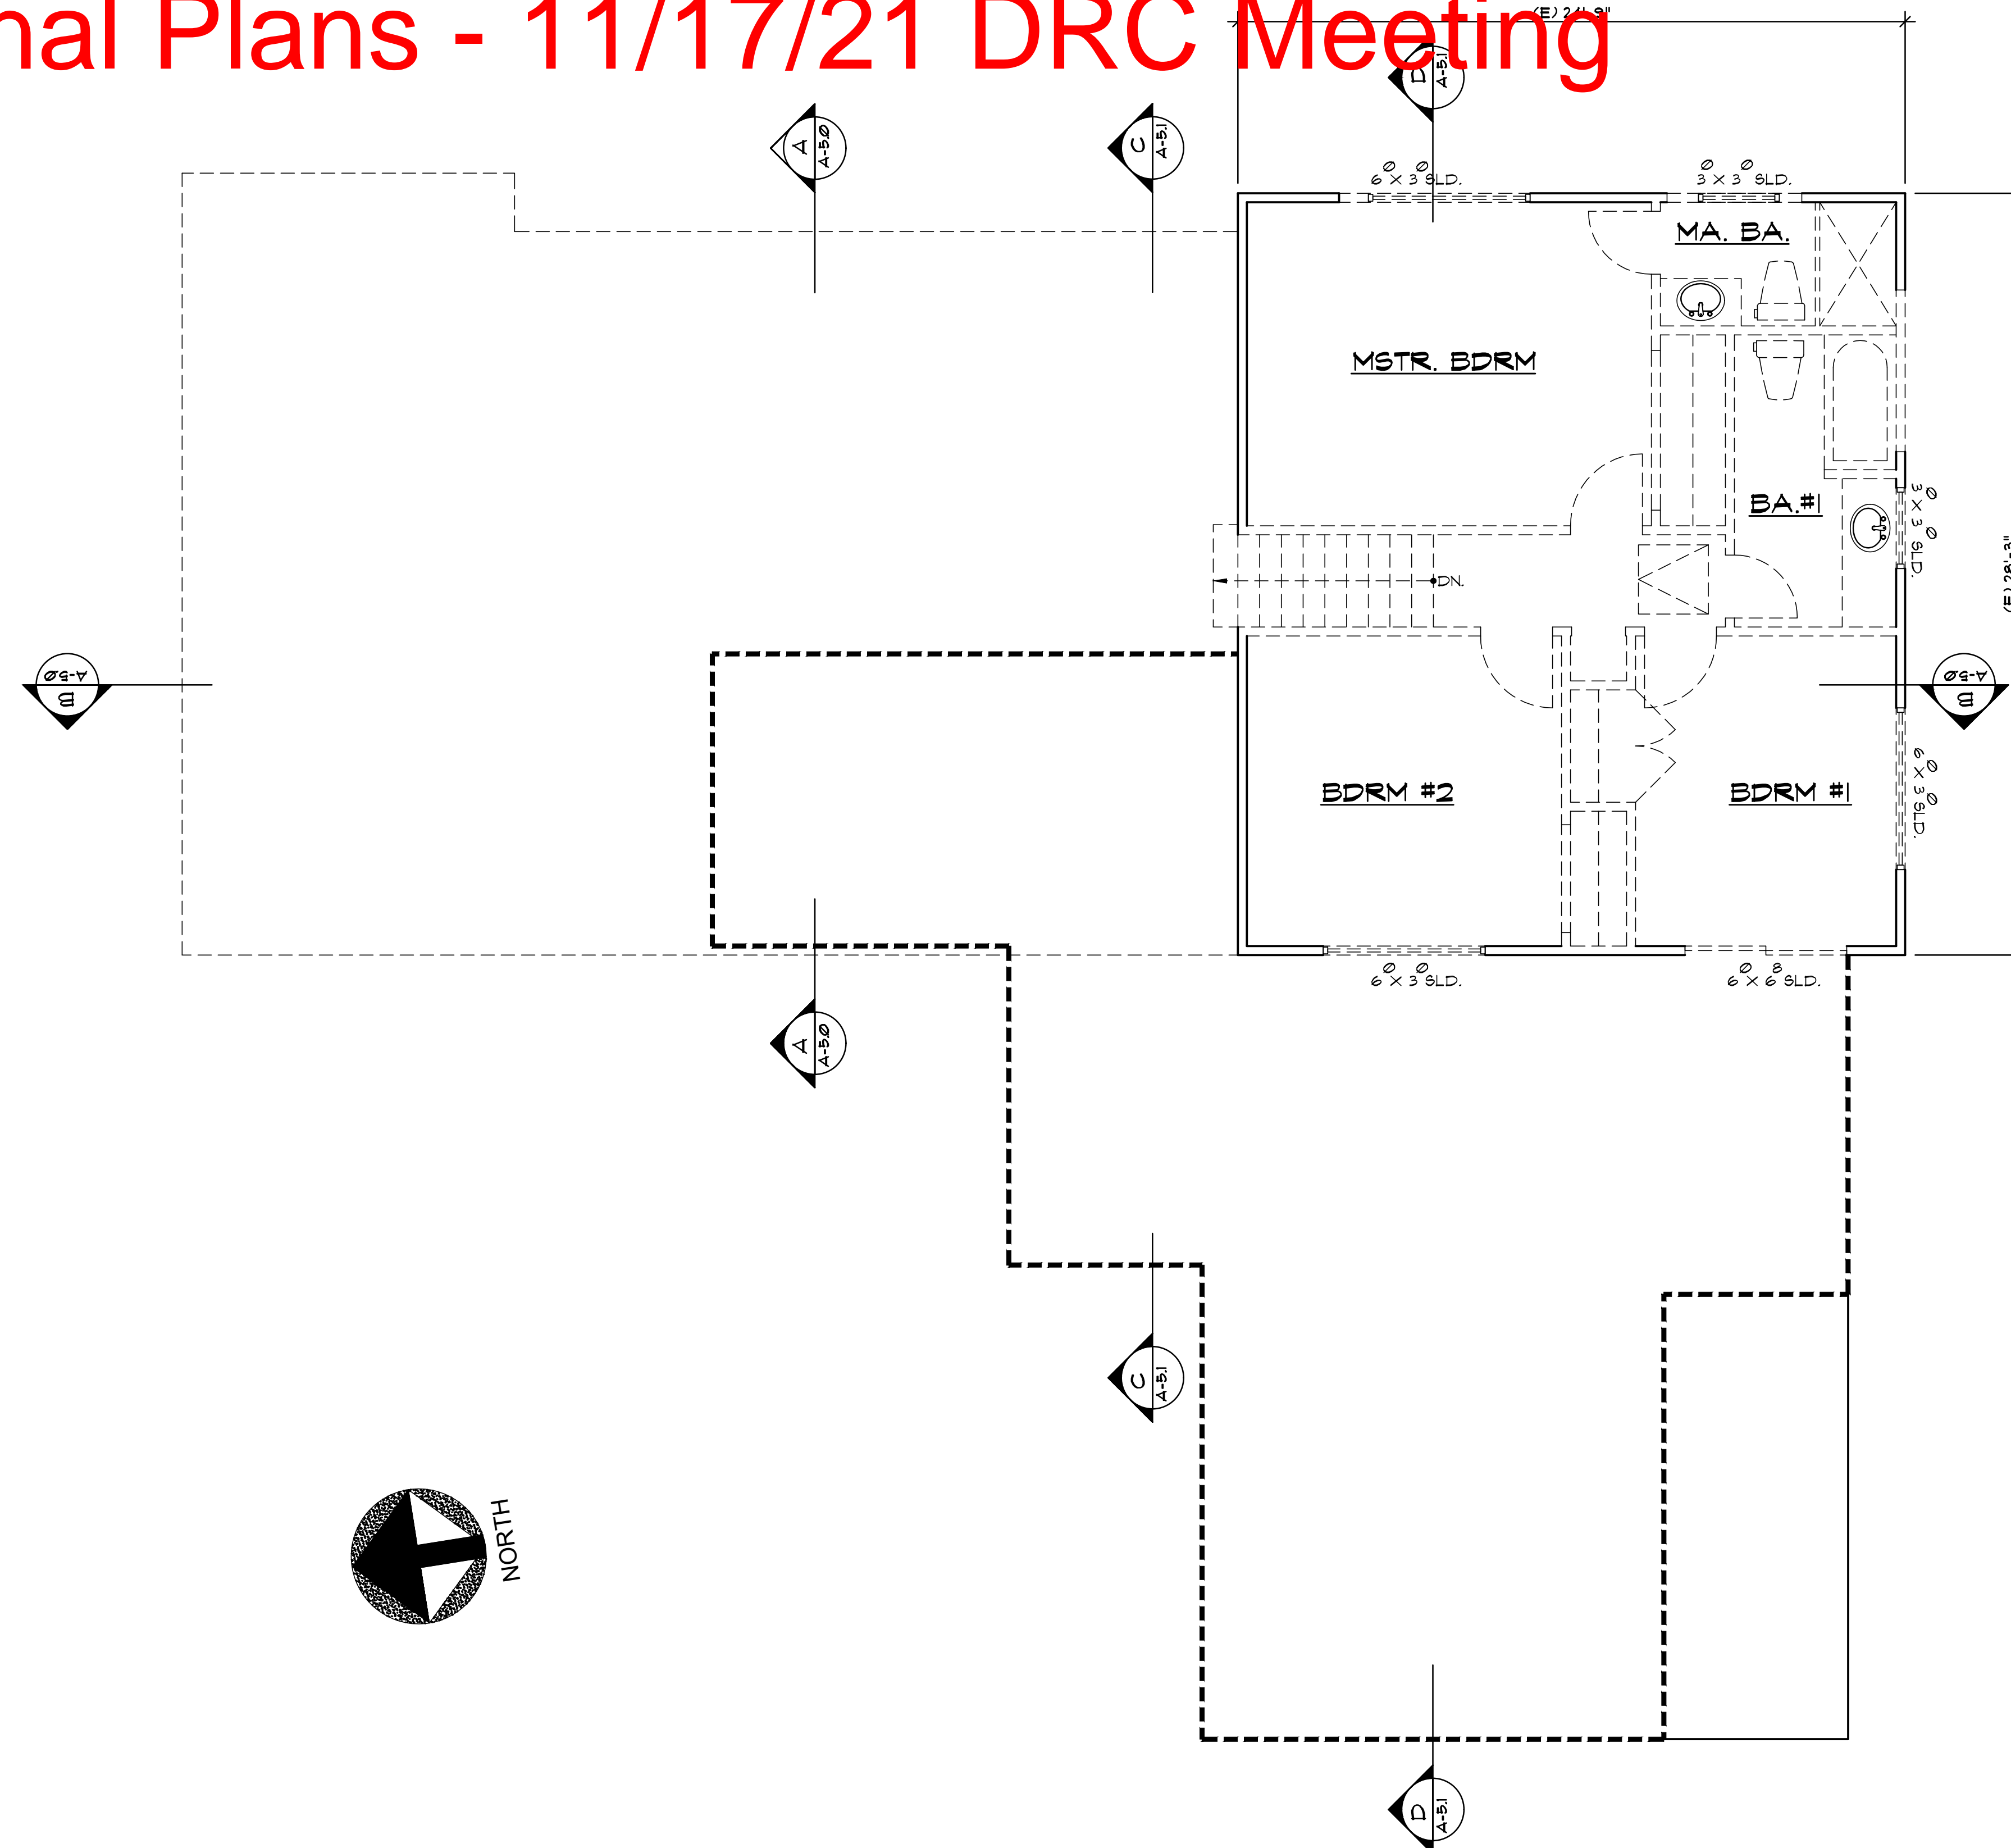

**EXISTING SECOND FLOOR PLAN / DEMO PLAN**

## LEGEND

-  EXISTING WALL TO REMAIN.
-  EXISTING WALL TO BE REMOVED.
-  ITEMS TO REMAIN.
-  ITEMS TO BE REMOVED.
-  NEW FOOT PRINT

No. Date Description

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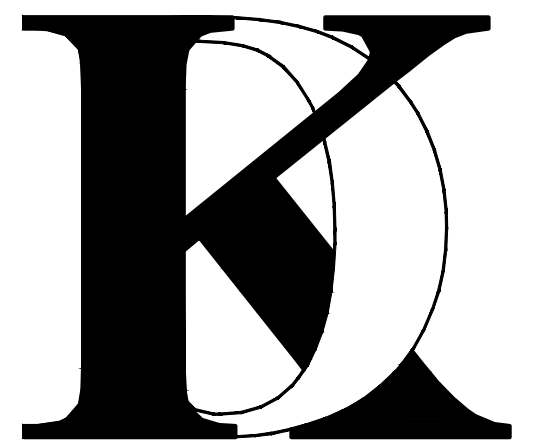
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## ***KHADIV-DESIGN***

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Job No: 2020.11

Signature :

Sheet Title :


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PLAN / DEMO PLAN

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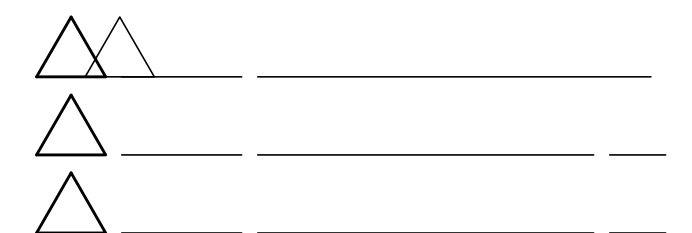
# Original Plans - 11/17/21 DRC Meeting



## LEGEND

- (N) 2 X STUD WALL
- (E) 2 X STUD WALL
- SOFFIT, UPPER CABINET, BEAM ABOVE
- EXTERIOR ELEVATION
- BUILDING SECTION
- DETAIL REFERENCE

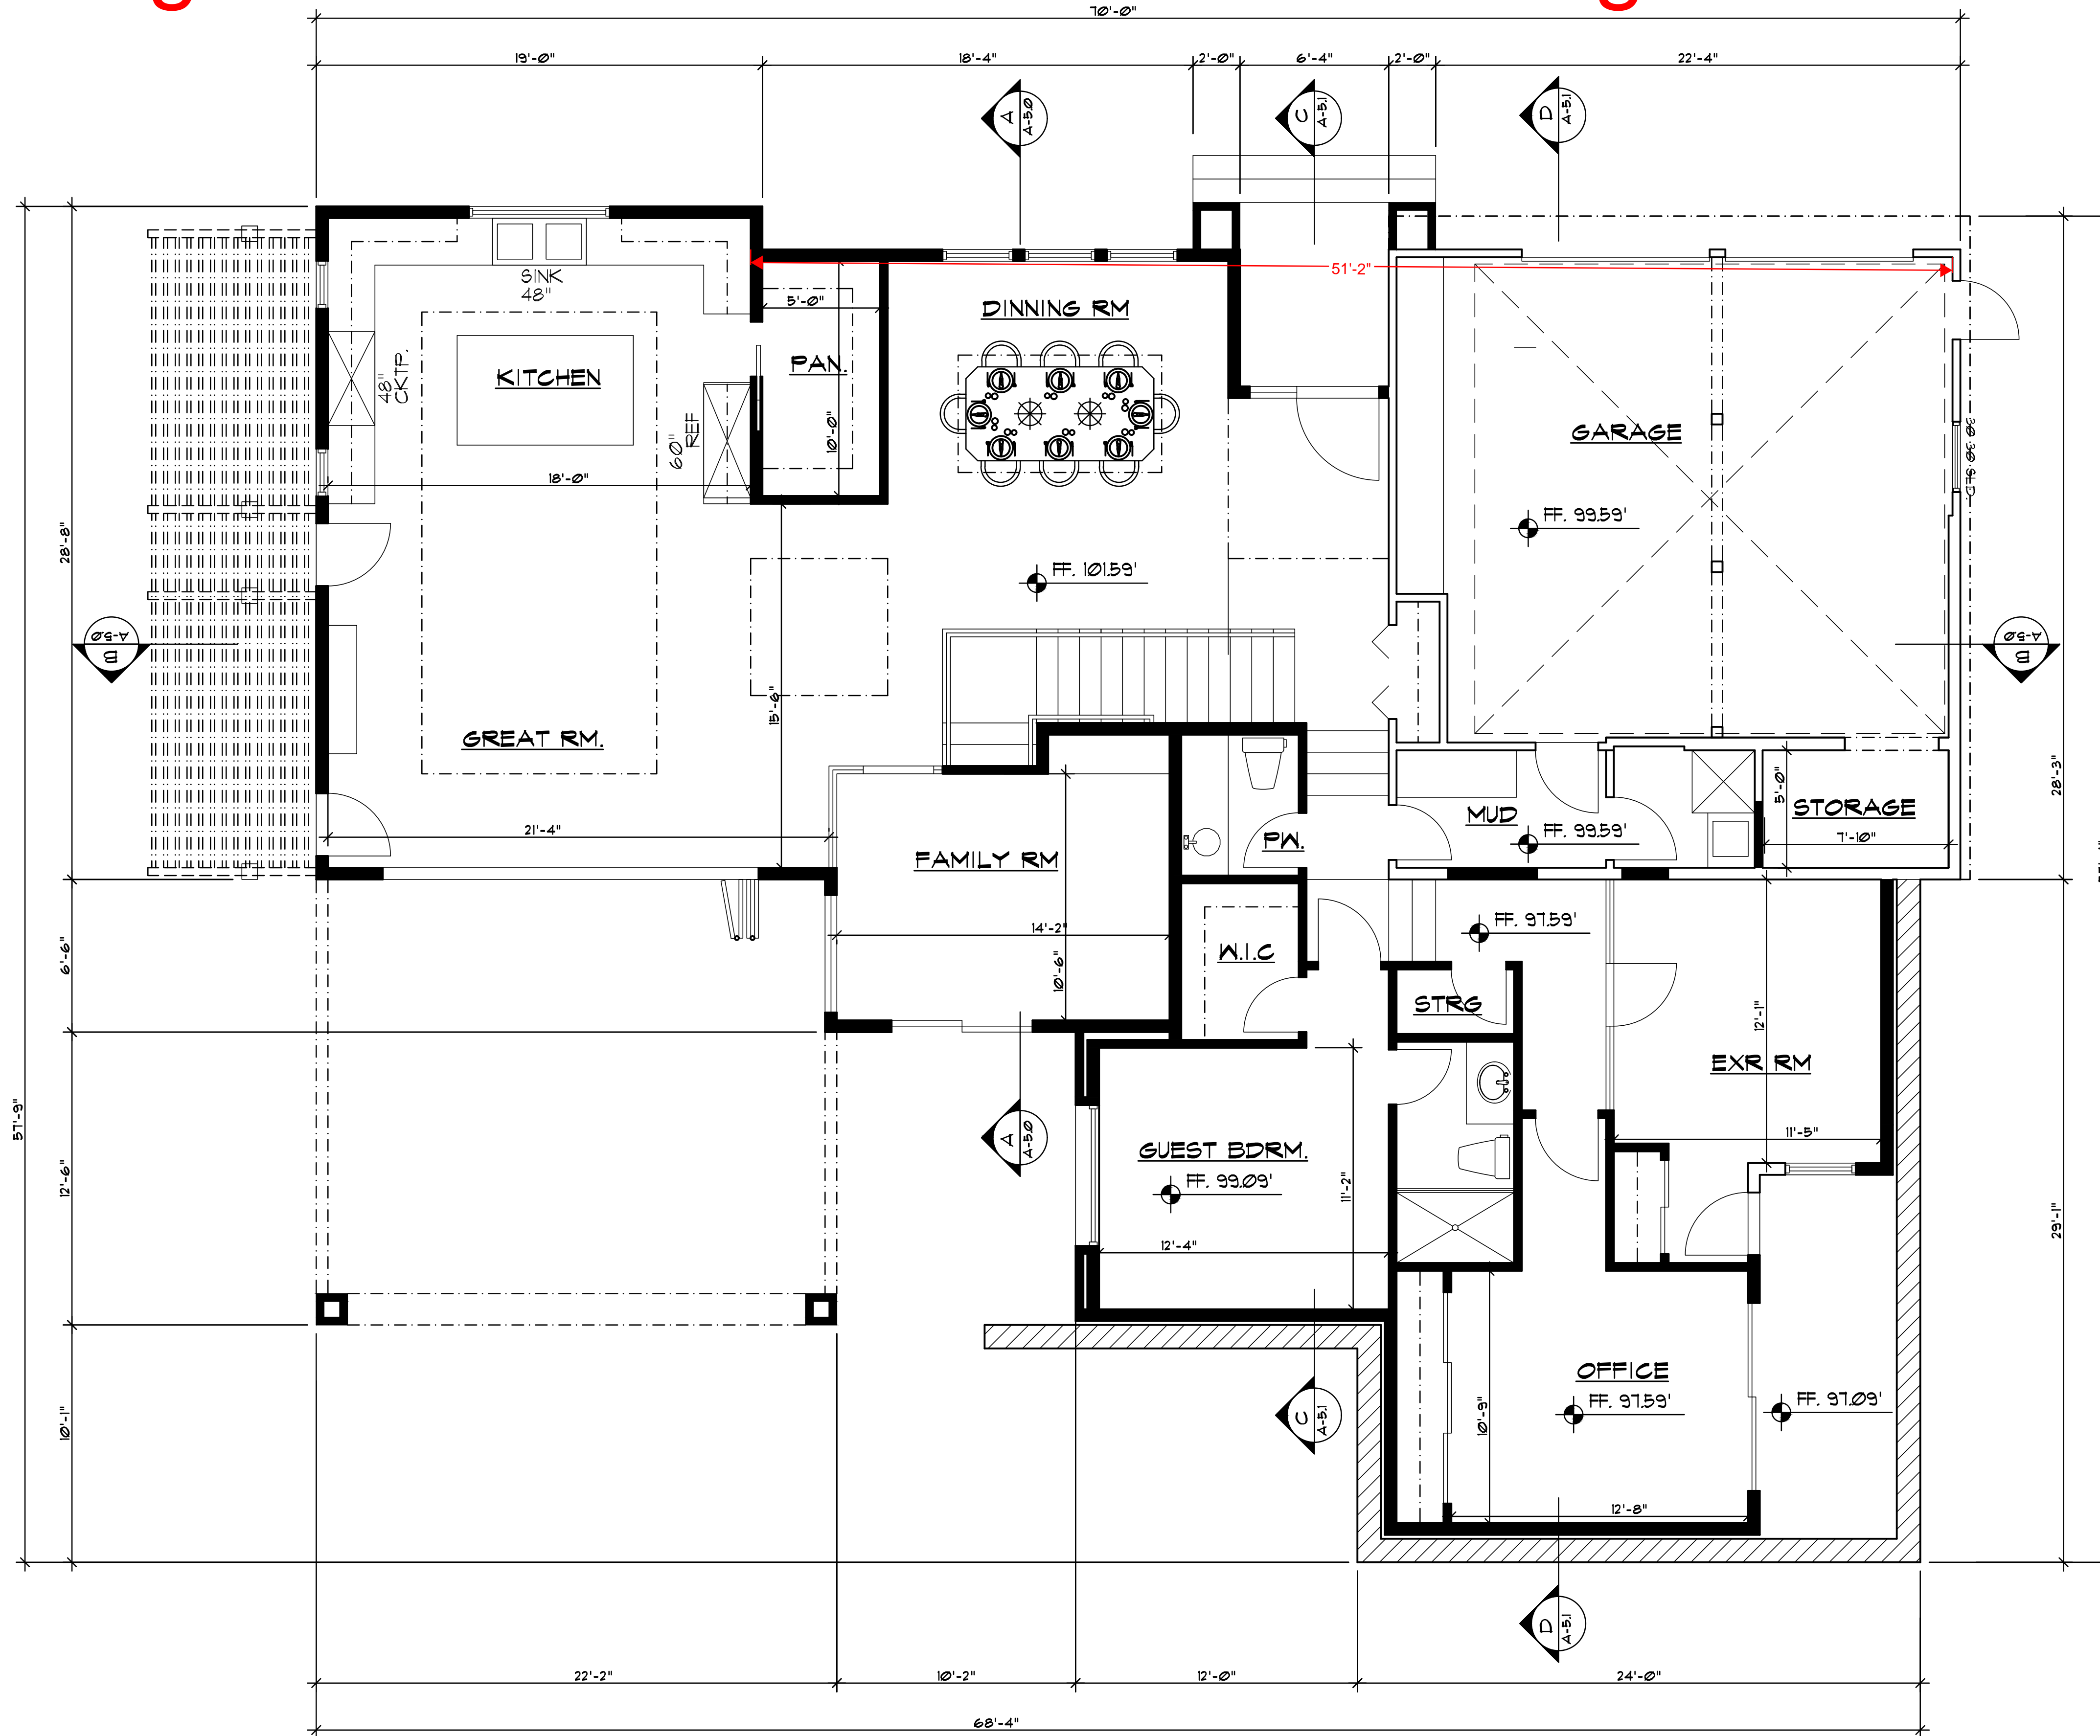No. Date Description




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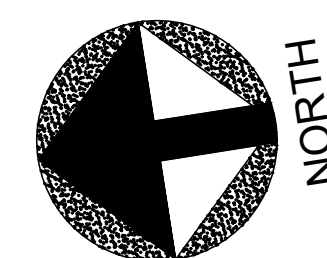
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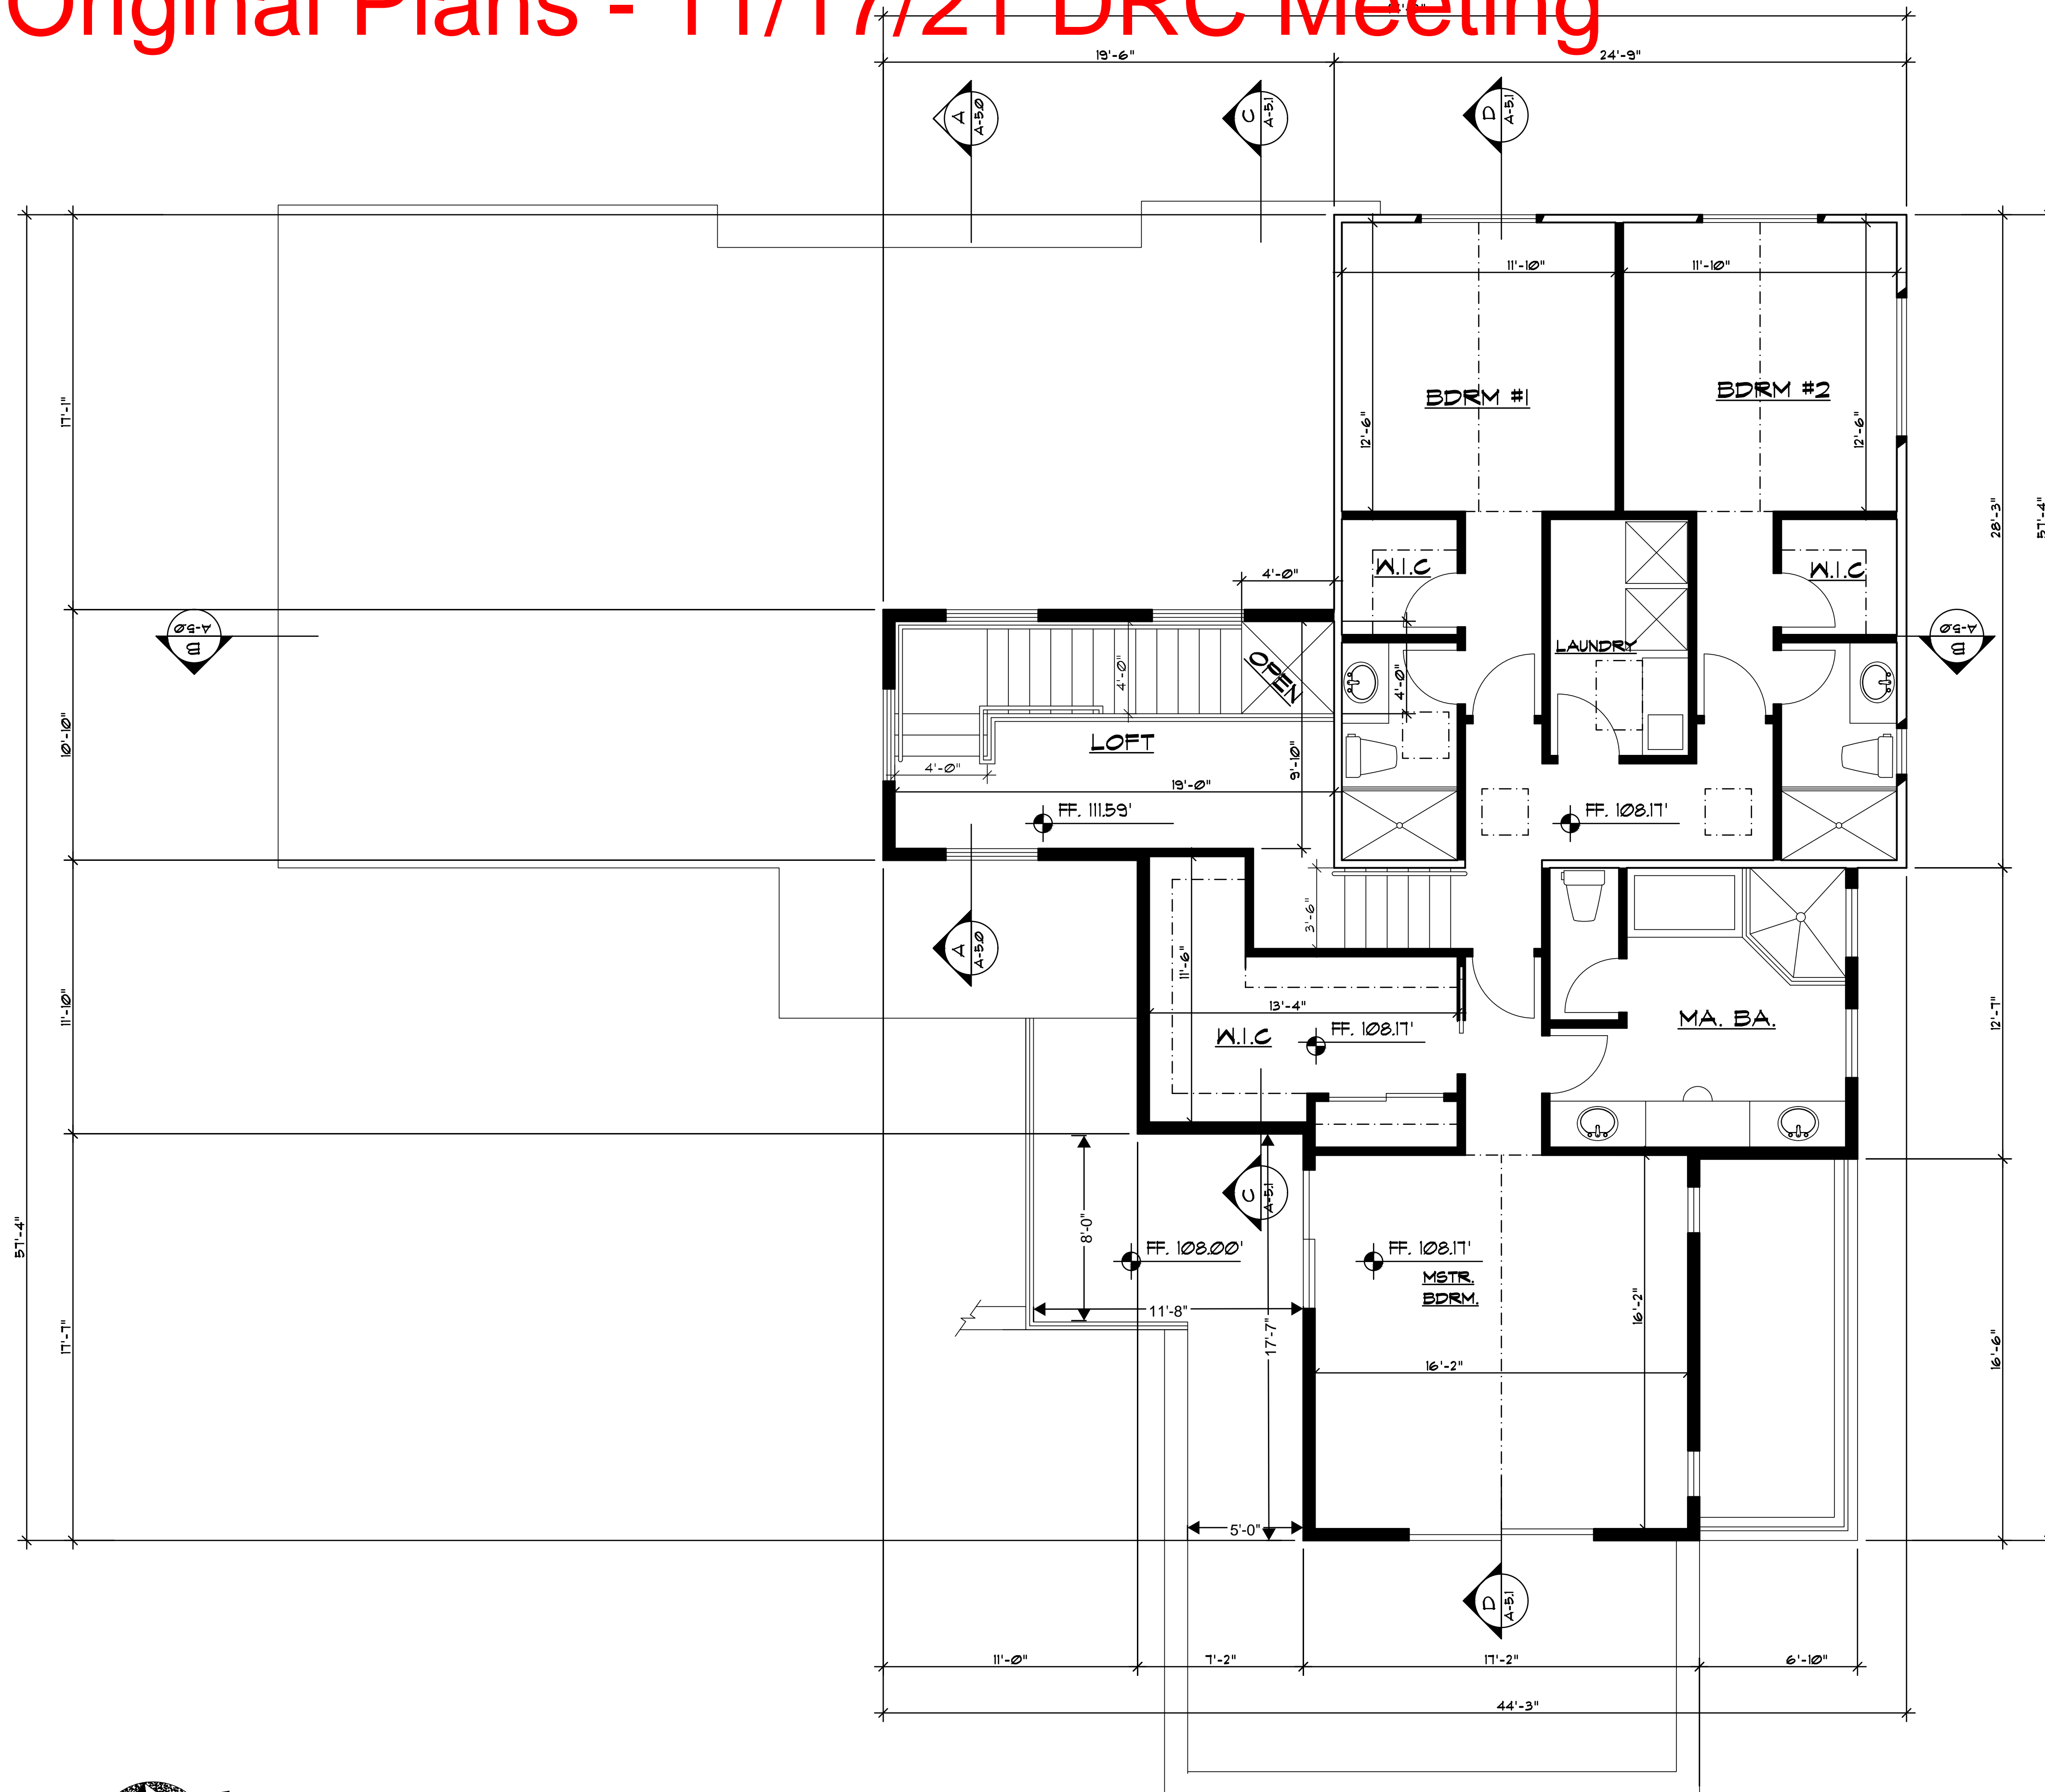
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## PROPOSED FIRST FLOOR PLAN



# Original Plans - 11/17/21 DRC Meeting



## LEGEND

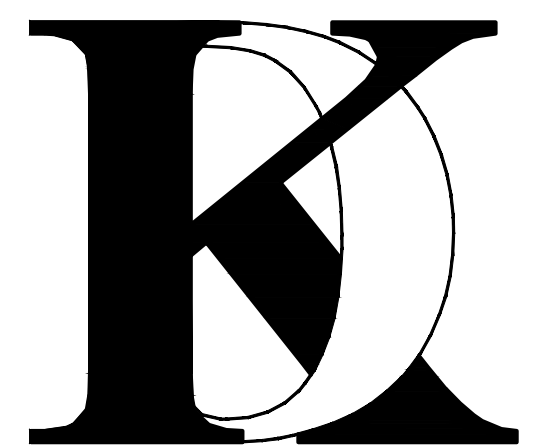- (N) 2 X STUD WALL
- (E) 2 X STUD WALL
- SOFFIT, UPPER CABINET, BEAM ABOVE
- EXTERIOR ELEVATION
- BUILDING SECTION
- DETAIL REFERENCE

No. Date Description



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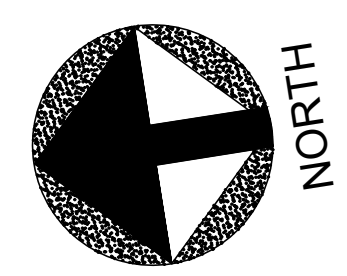
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PROPOSED SECOND FLOOR

Sheet No. :

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
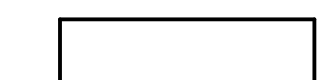
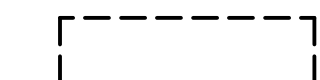


## PROPOSED SECOND FLOOR PLAN

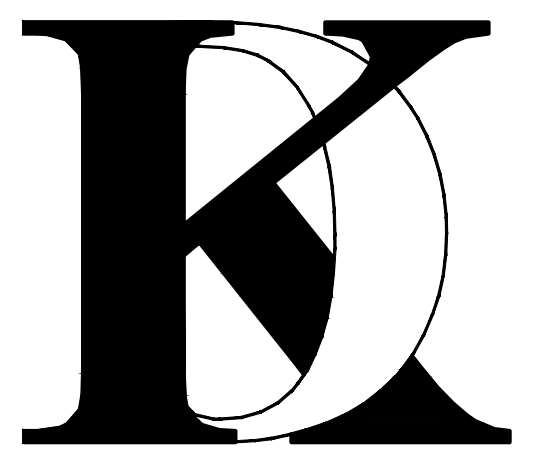

# Original Plans - 11/17/21 DRC Meeting

## LEGEND

-  EXISTING ROOF TO BE DEMOLISHED
-  EXISTING ROOF TO REMAIN
-  FOOTPRINT OF EXISTING BUILDING

No. Date Description

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△	_____	_____
△	_____	_____

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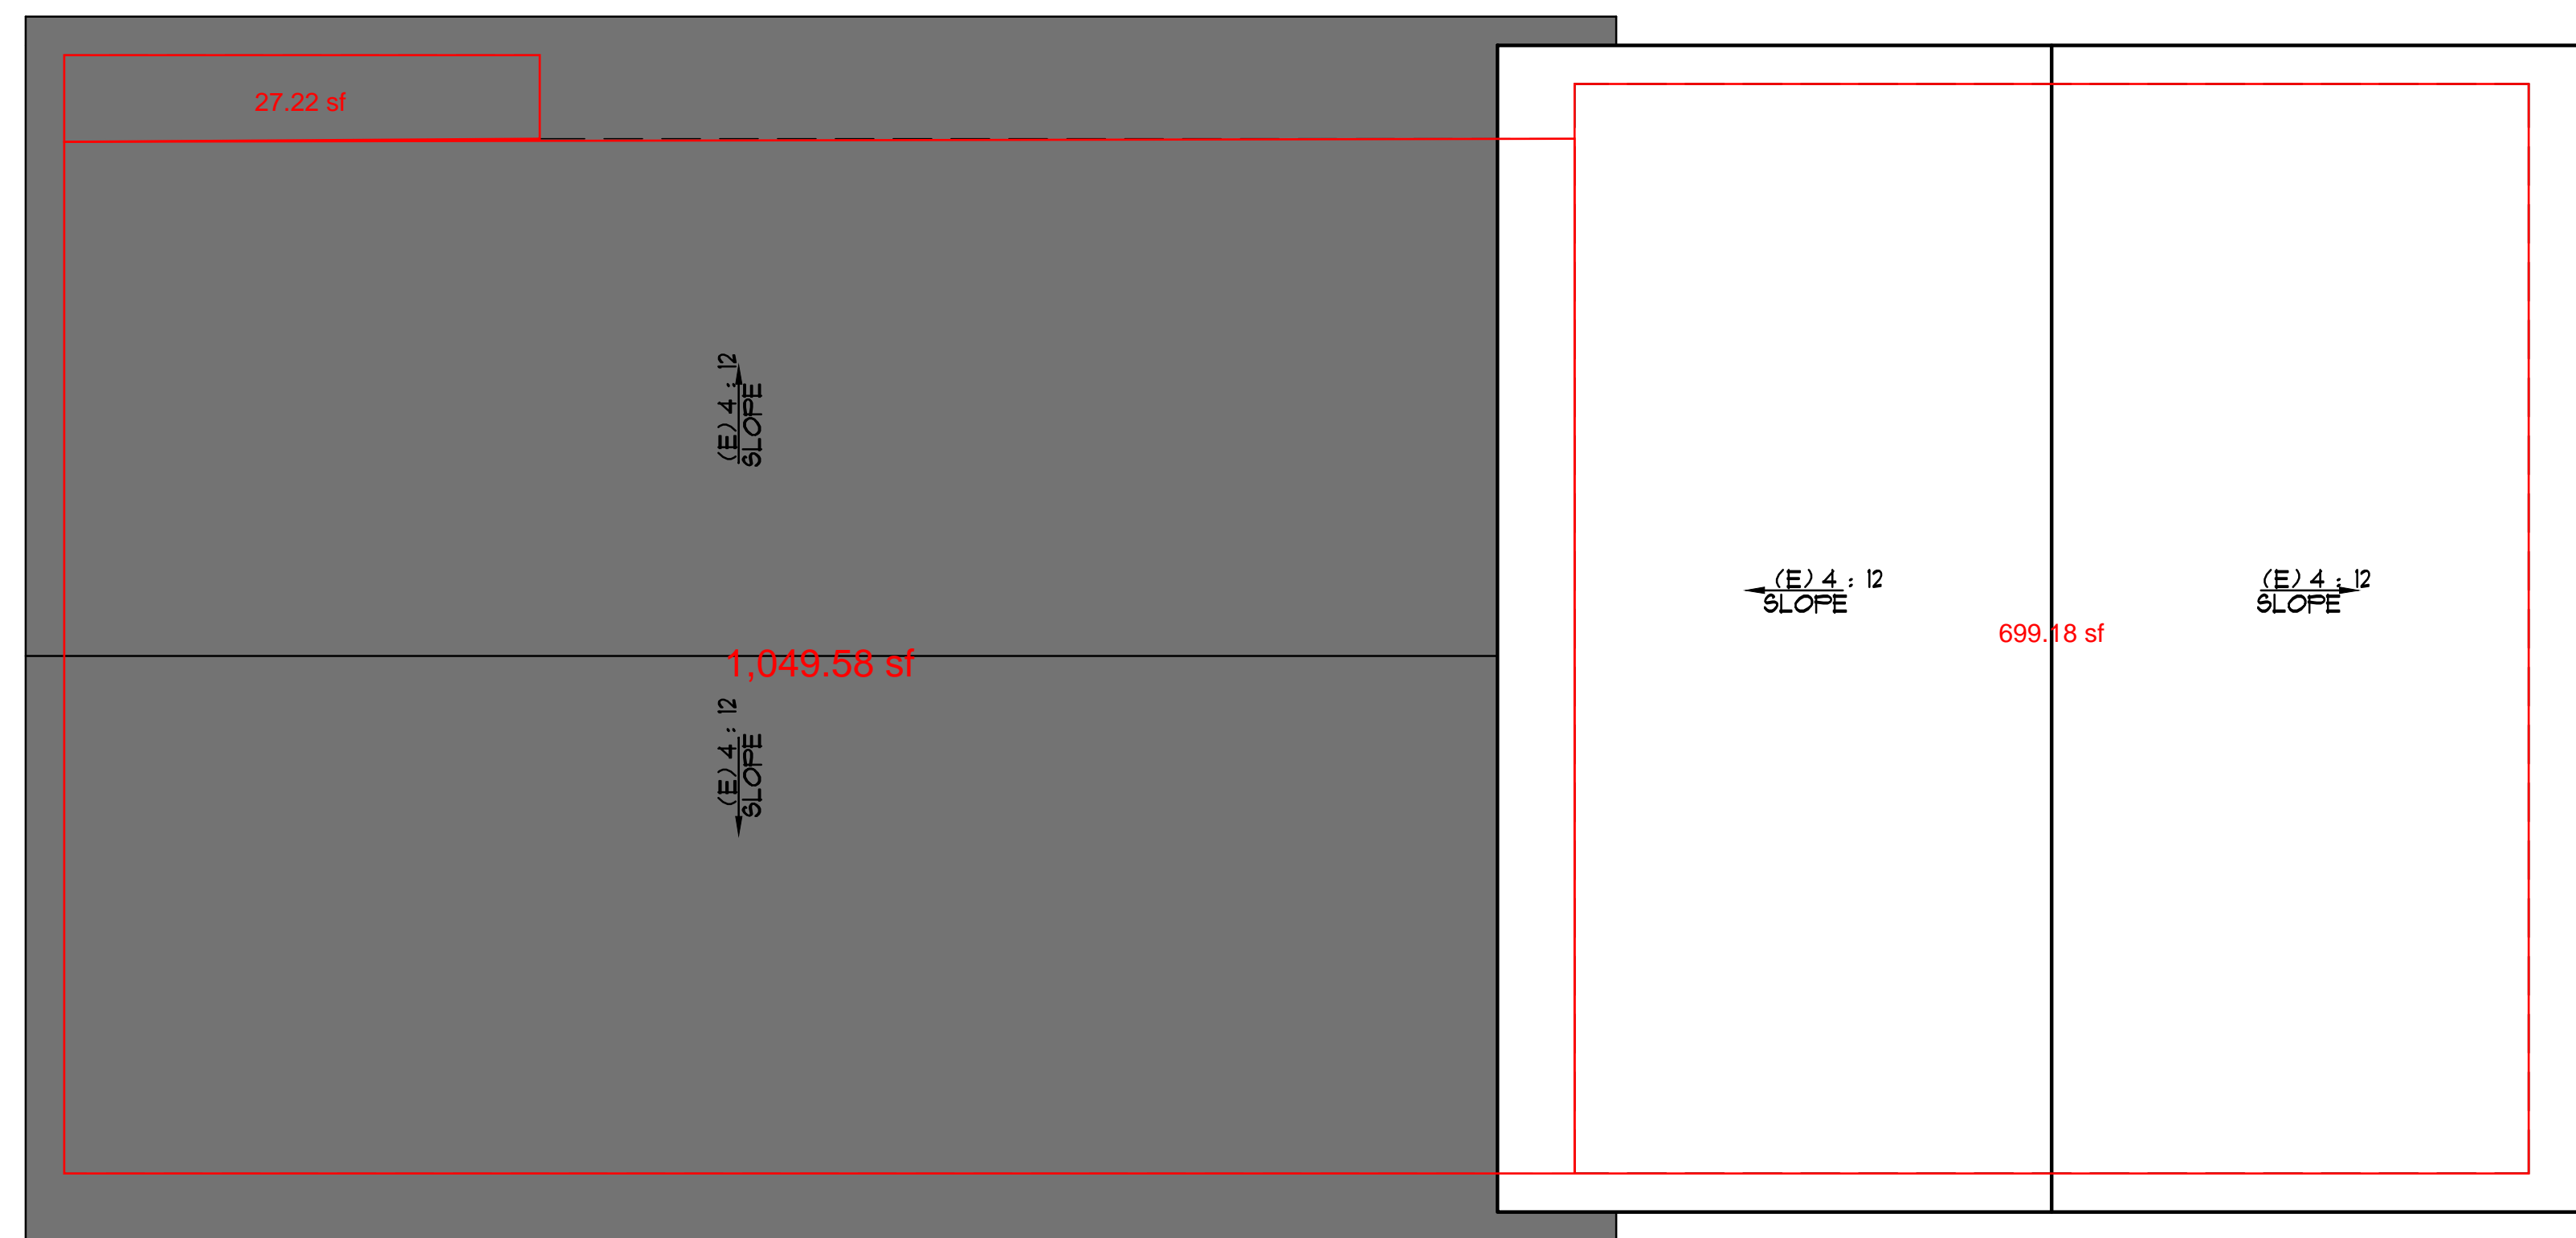
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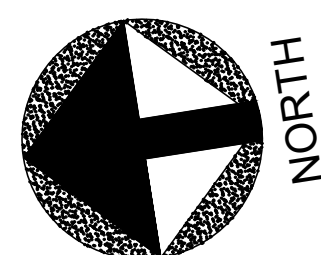
EXISTING ROOF PLAN  
PLAN / DEMO PLAN

Sheet No. :

# A-3.0





**EXISTING ROOF PLAN / DEMO PLAN**





# Original Plans - 11/17/21 DRC Meeting

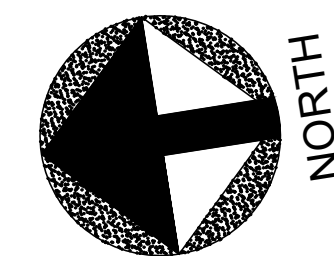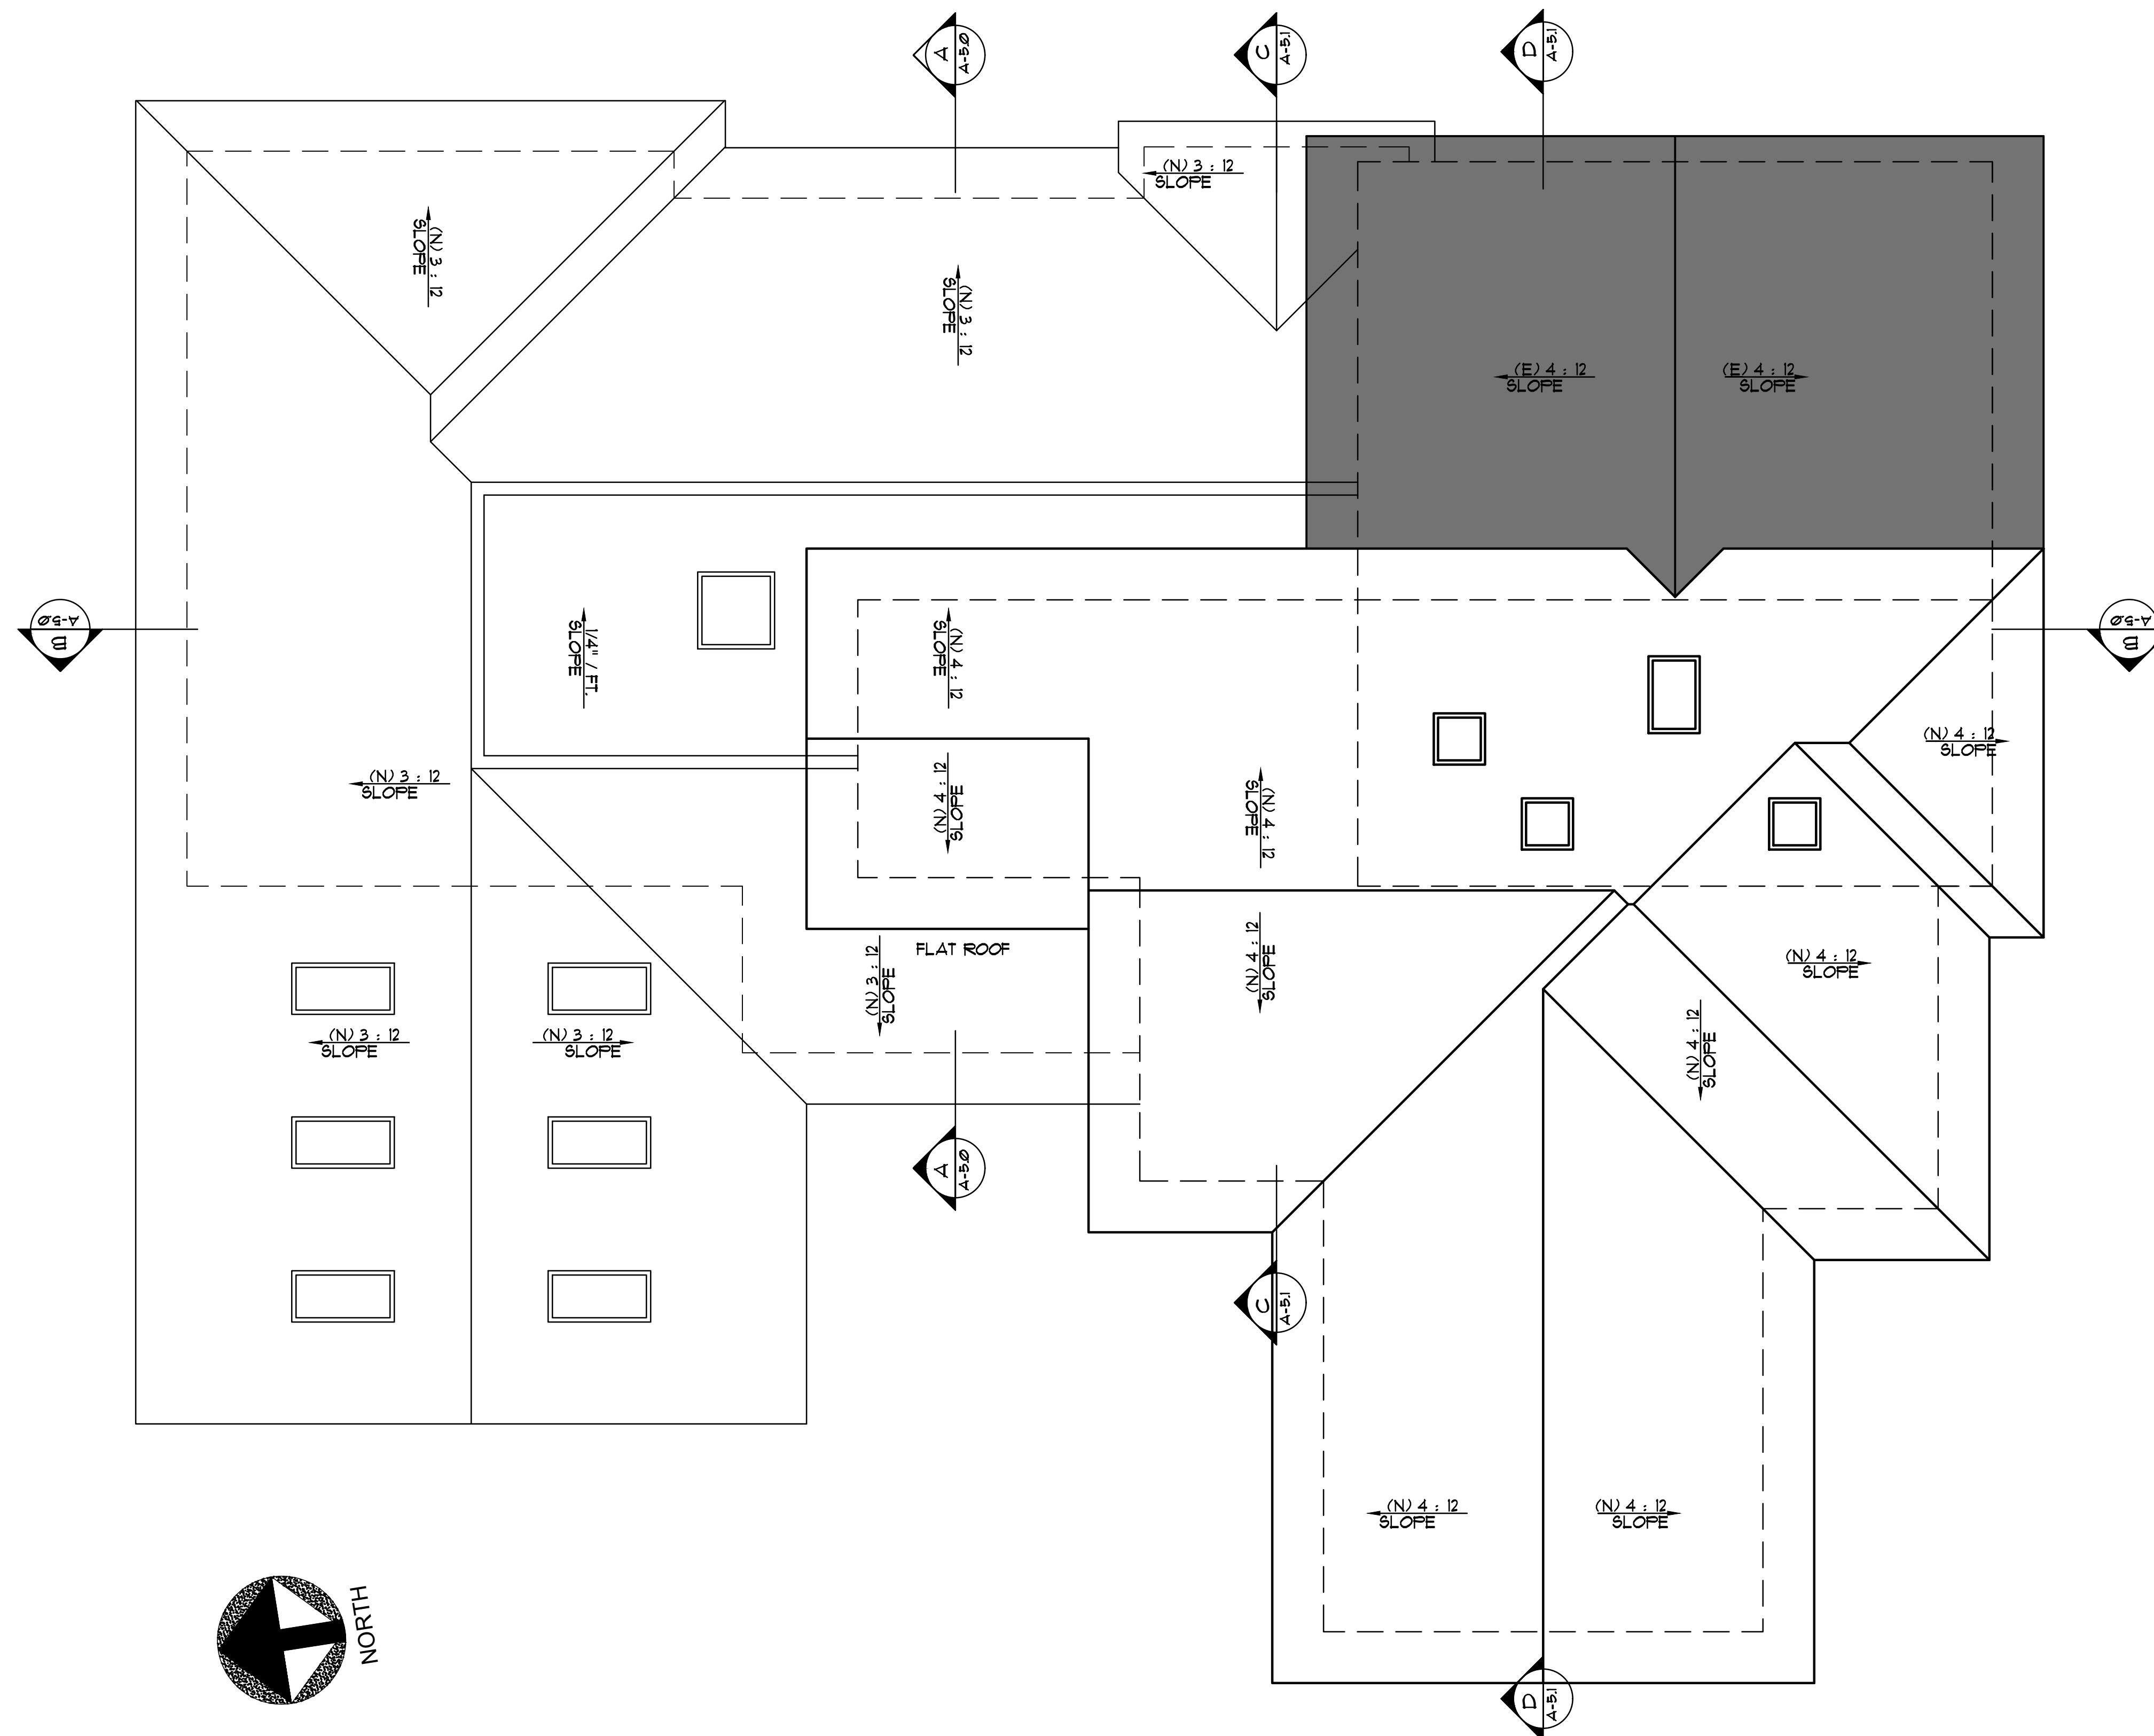

**PROPOSED ROOF PLAN**

## LEGEND

- EXISTING ROOF TO REMAIN
- NEW ROOF
- FOOTPRINT OF BUILDING

No. Date Description

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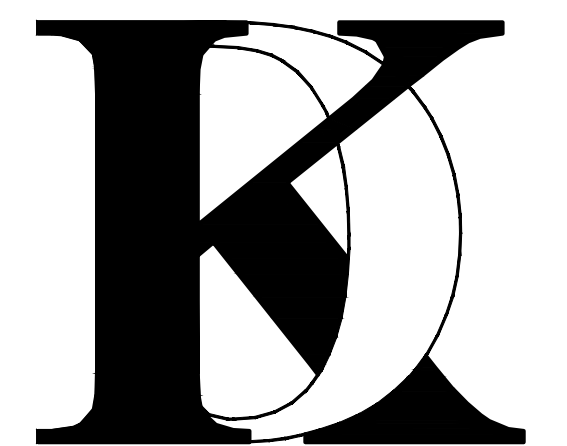
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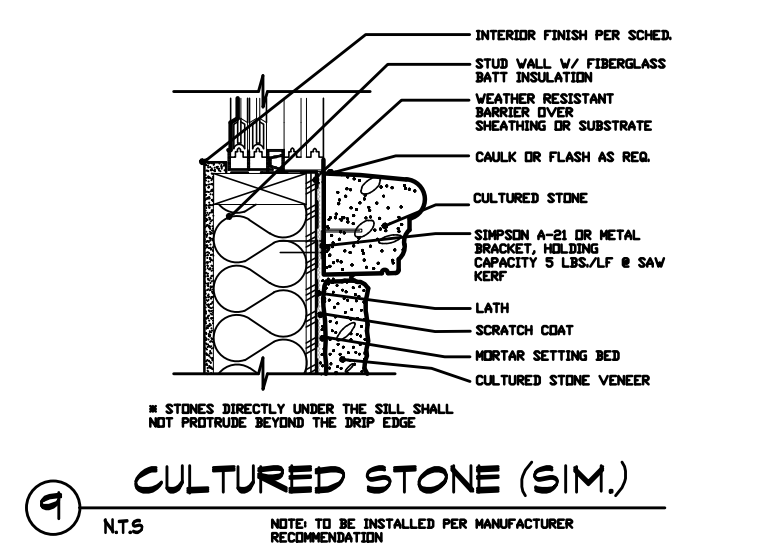
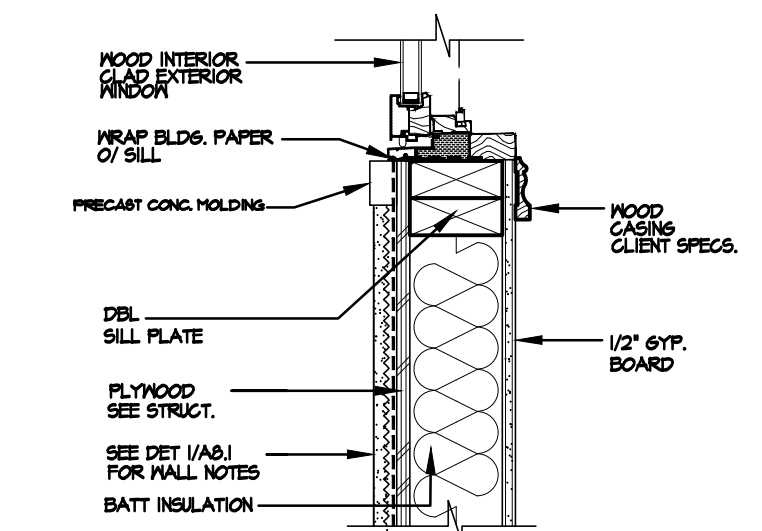
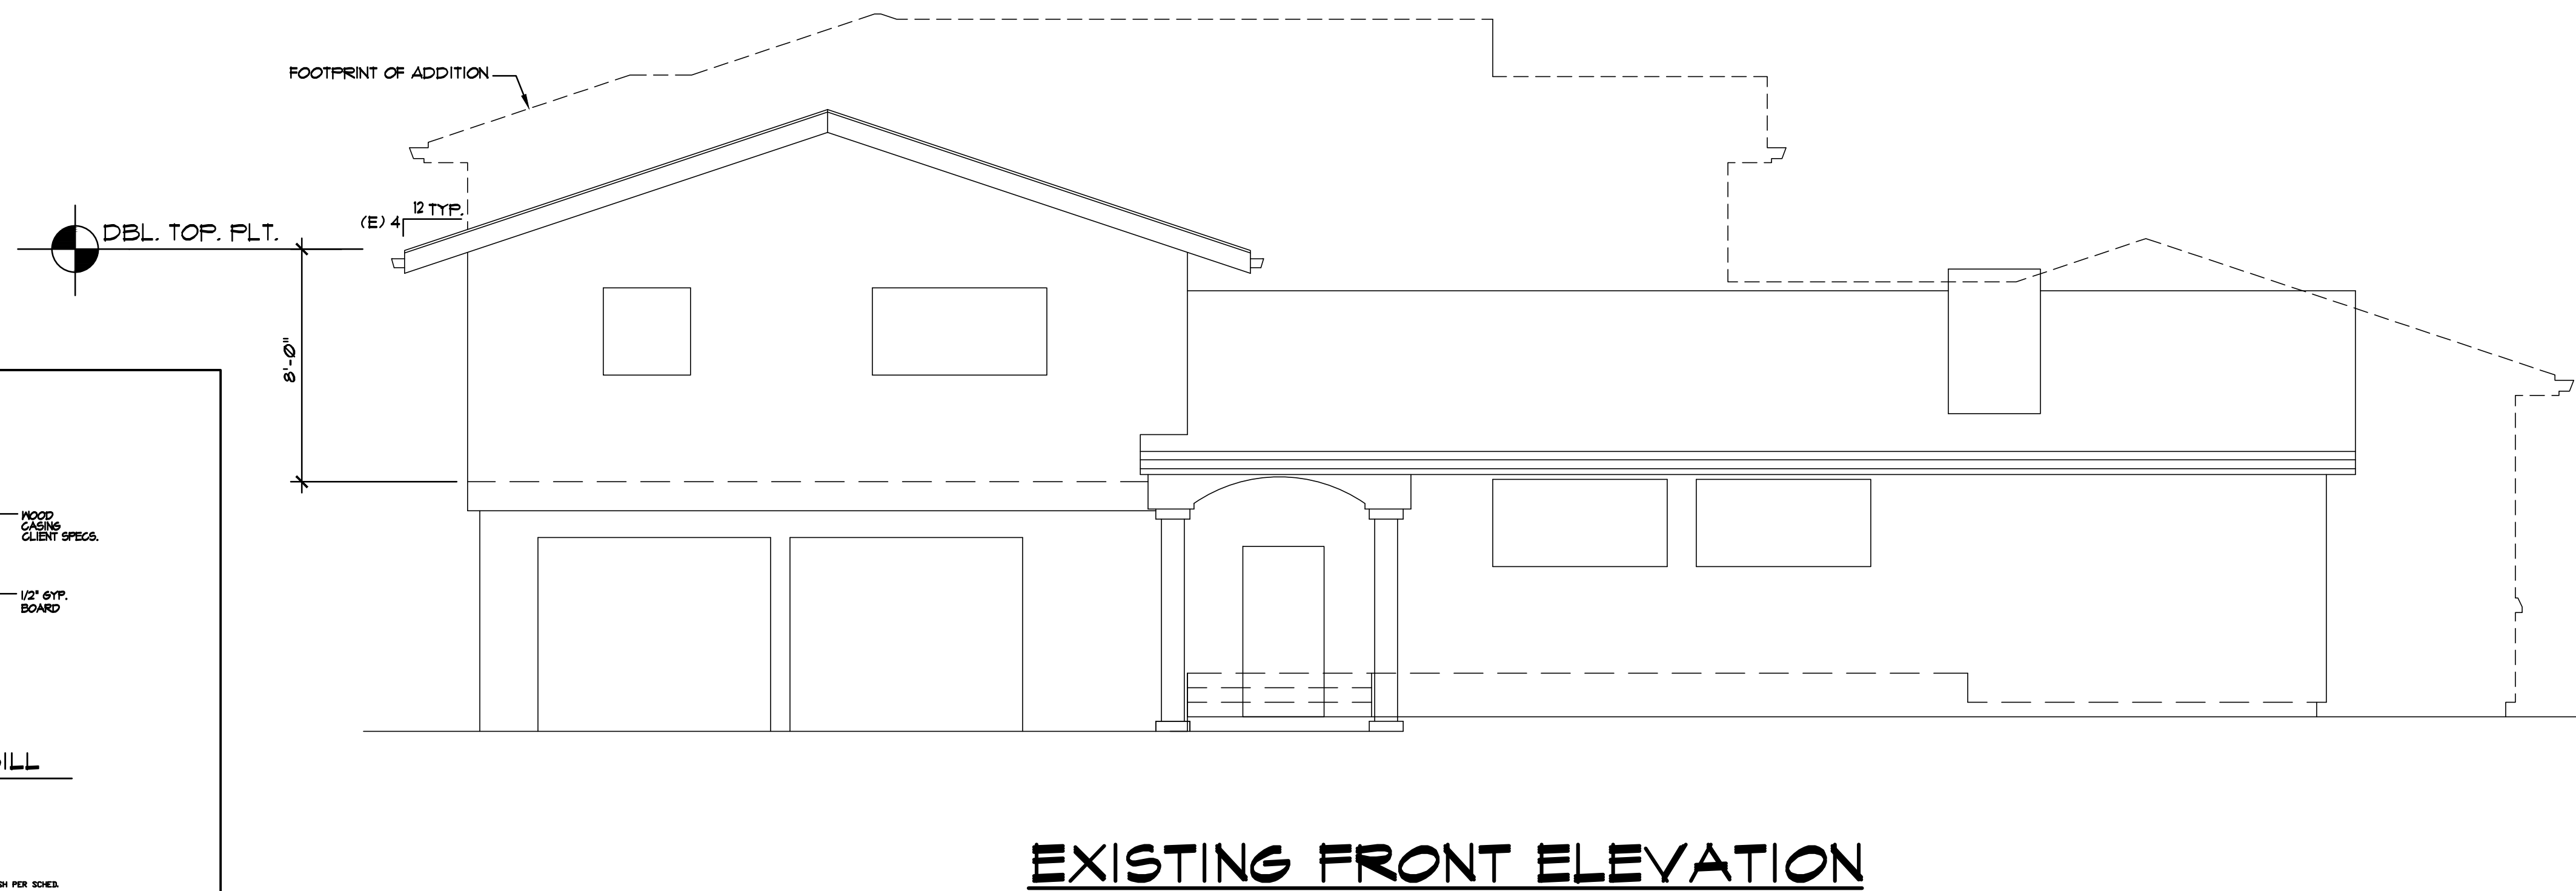
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PROPOSED ROOF PLAN

Sheet No. :

**A-3.1**



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No.	Date	Description
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**KHADIV-DESIGN**


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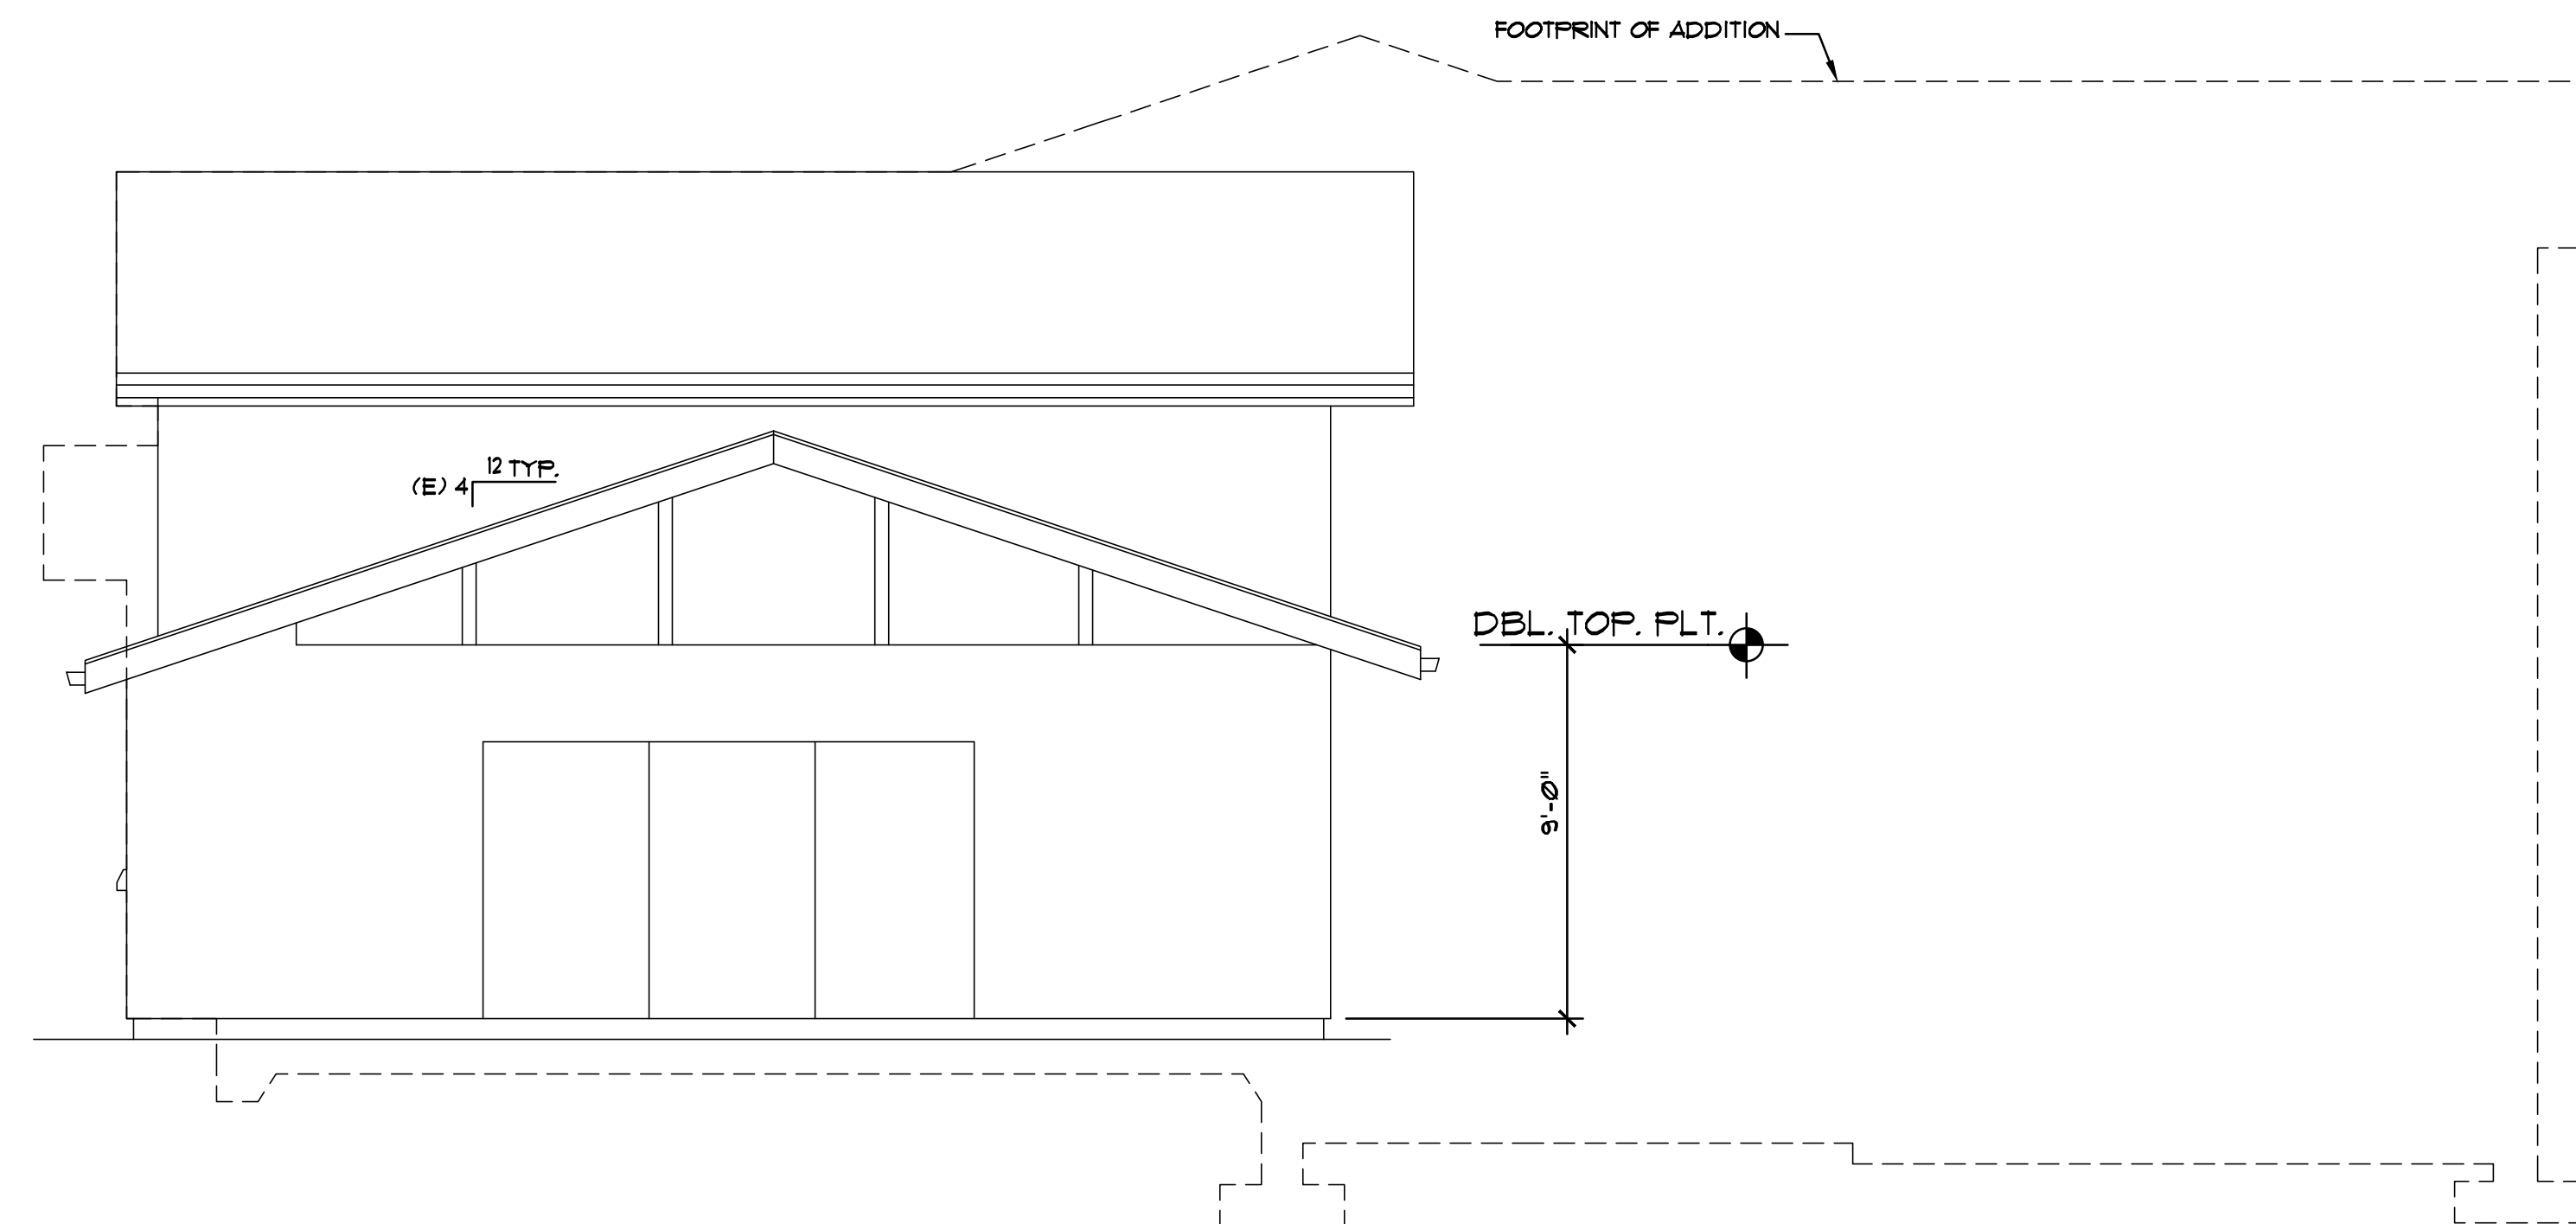
Sheet No. :  
**A-4.0**



# Original Plans - 11/17/21 DRC Meeting



**PROPOSED RIGHT SIDE ELEVATION**

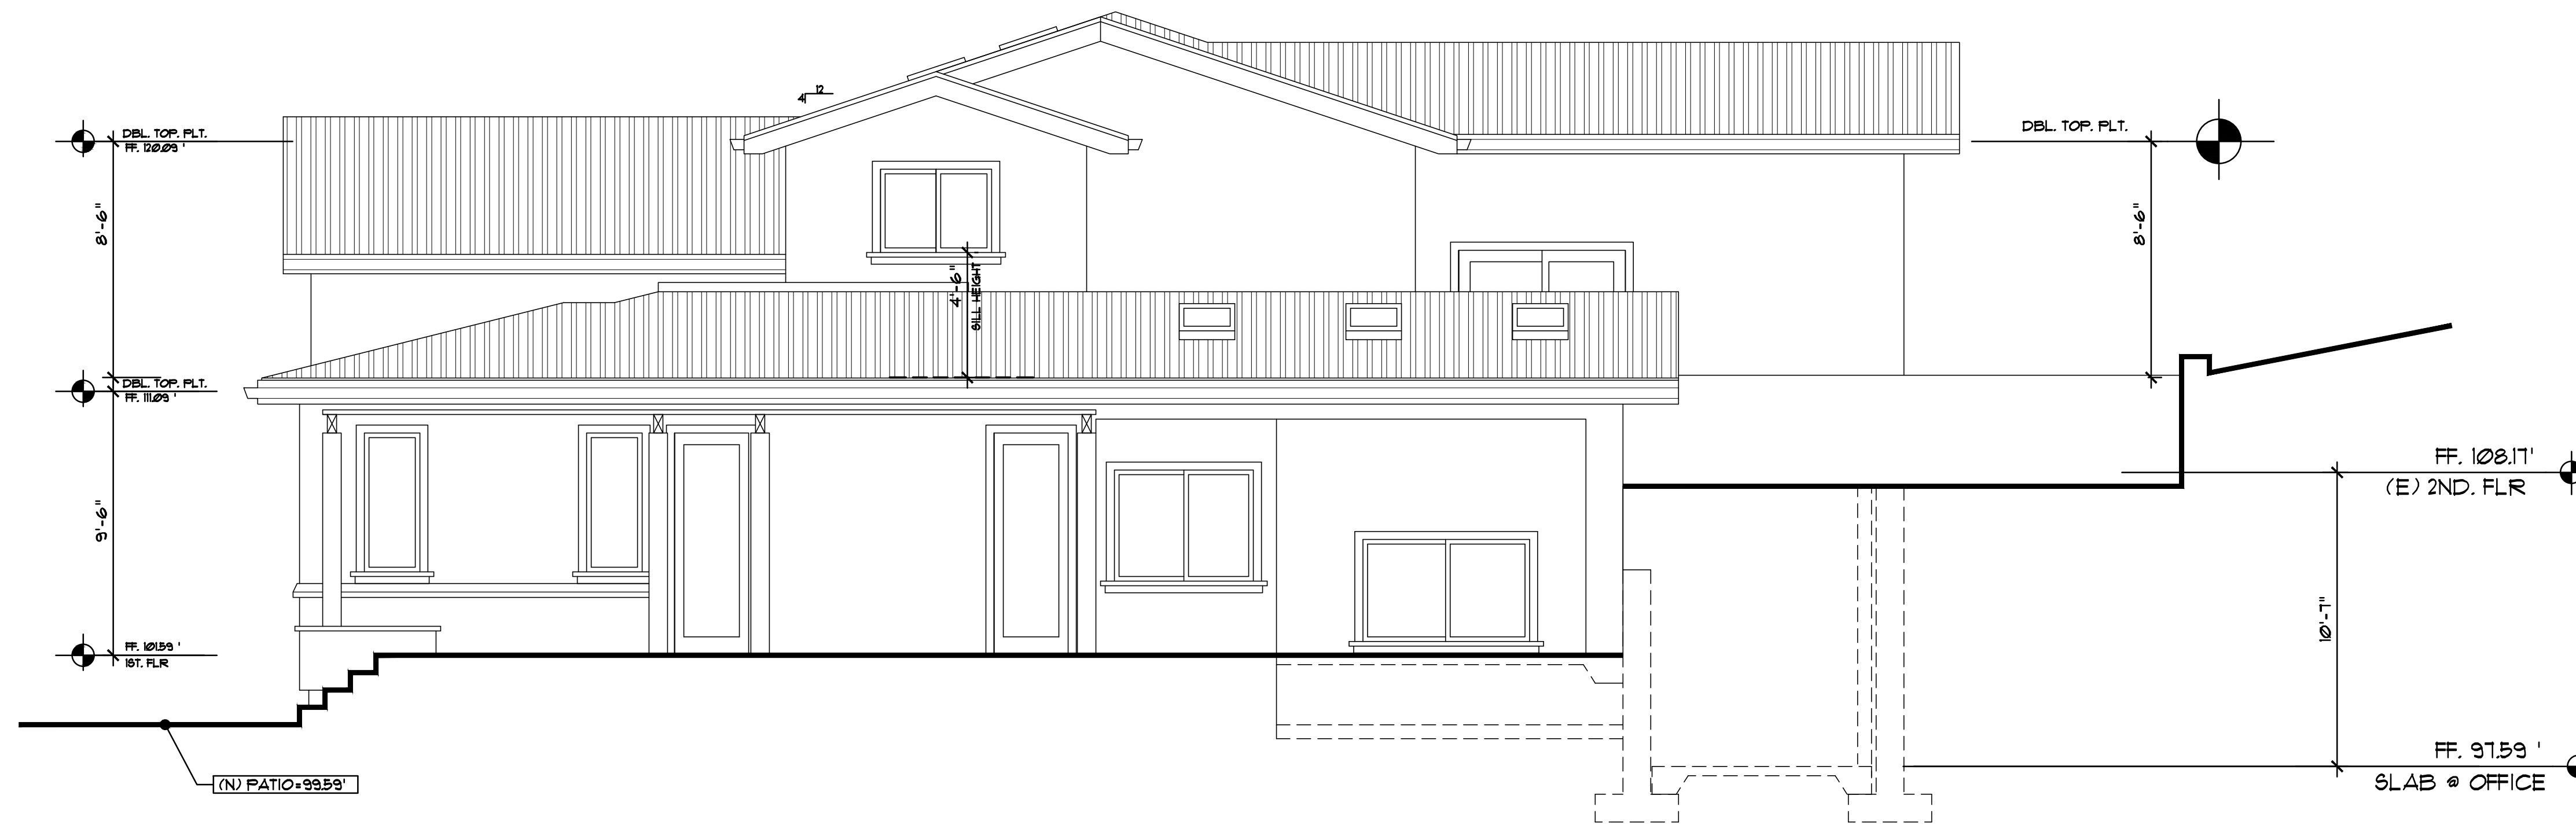

**EXISTING RIGHT SIDE ELEVATION**

No. Date Description

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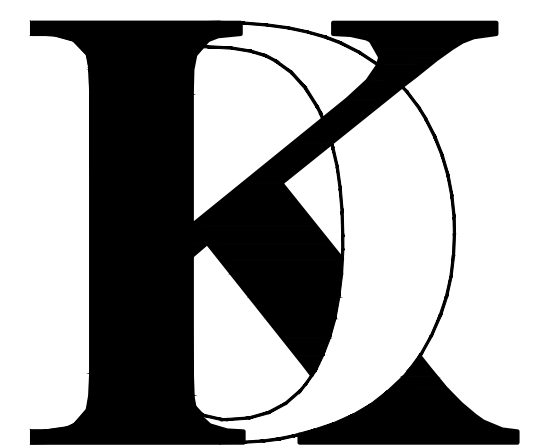
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Drawn By : FK

Job No: 2020.11

Signature :

Sheet Title :

EXTERIOR  
ELEVATION

Sheet No. :


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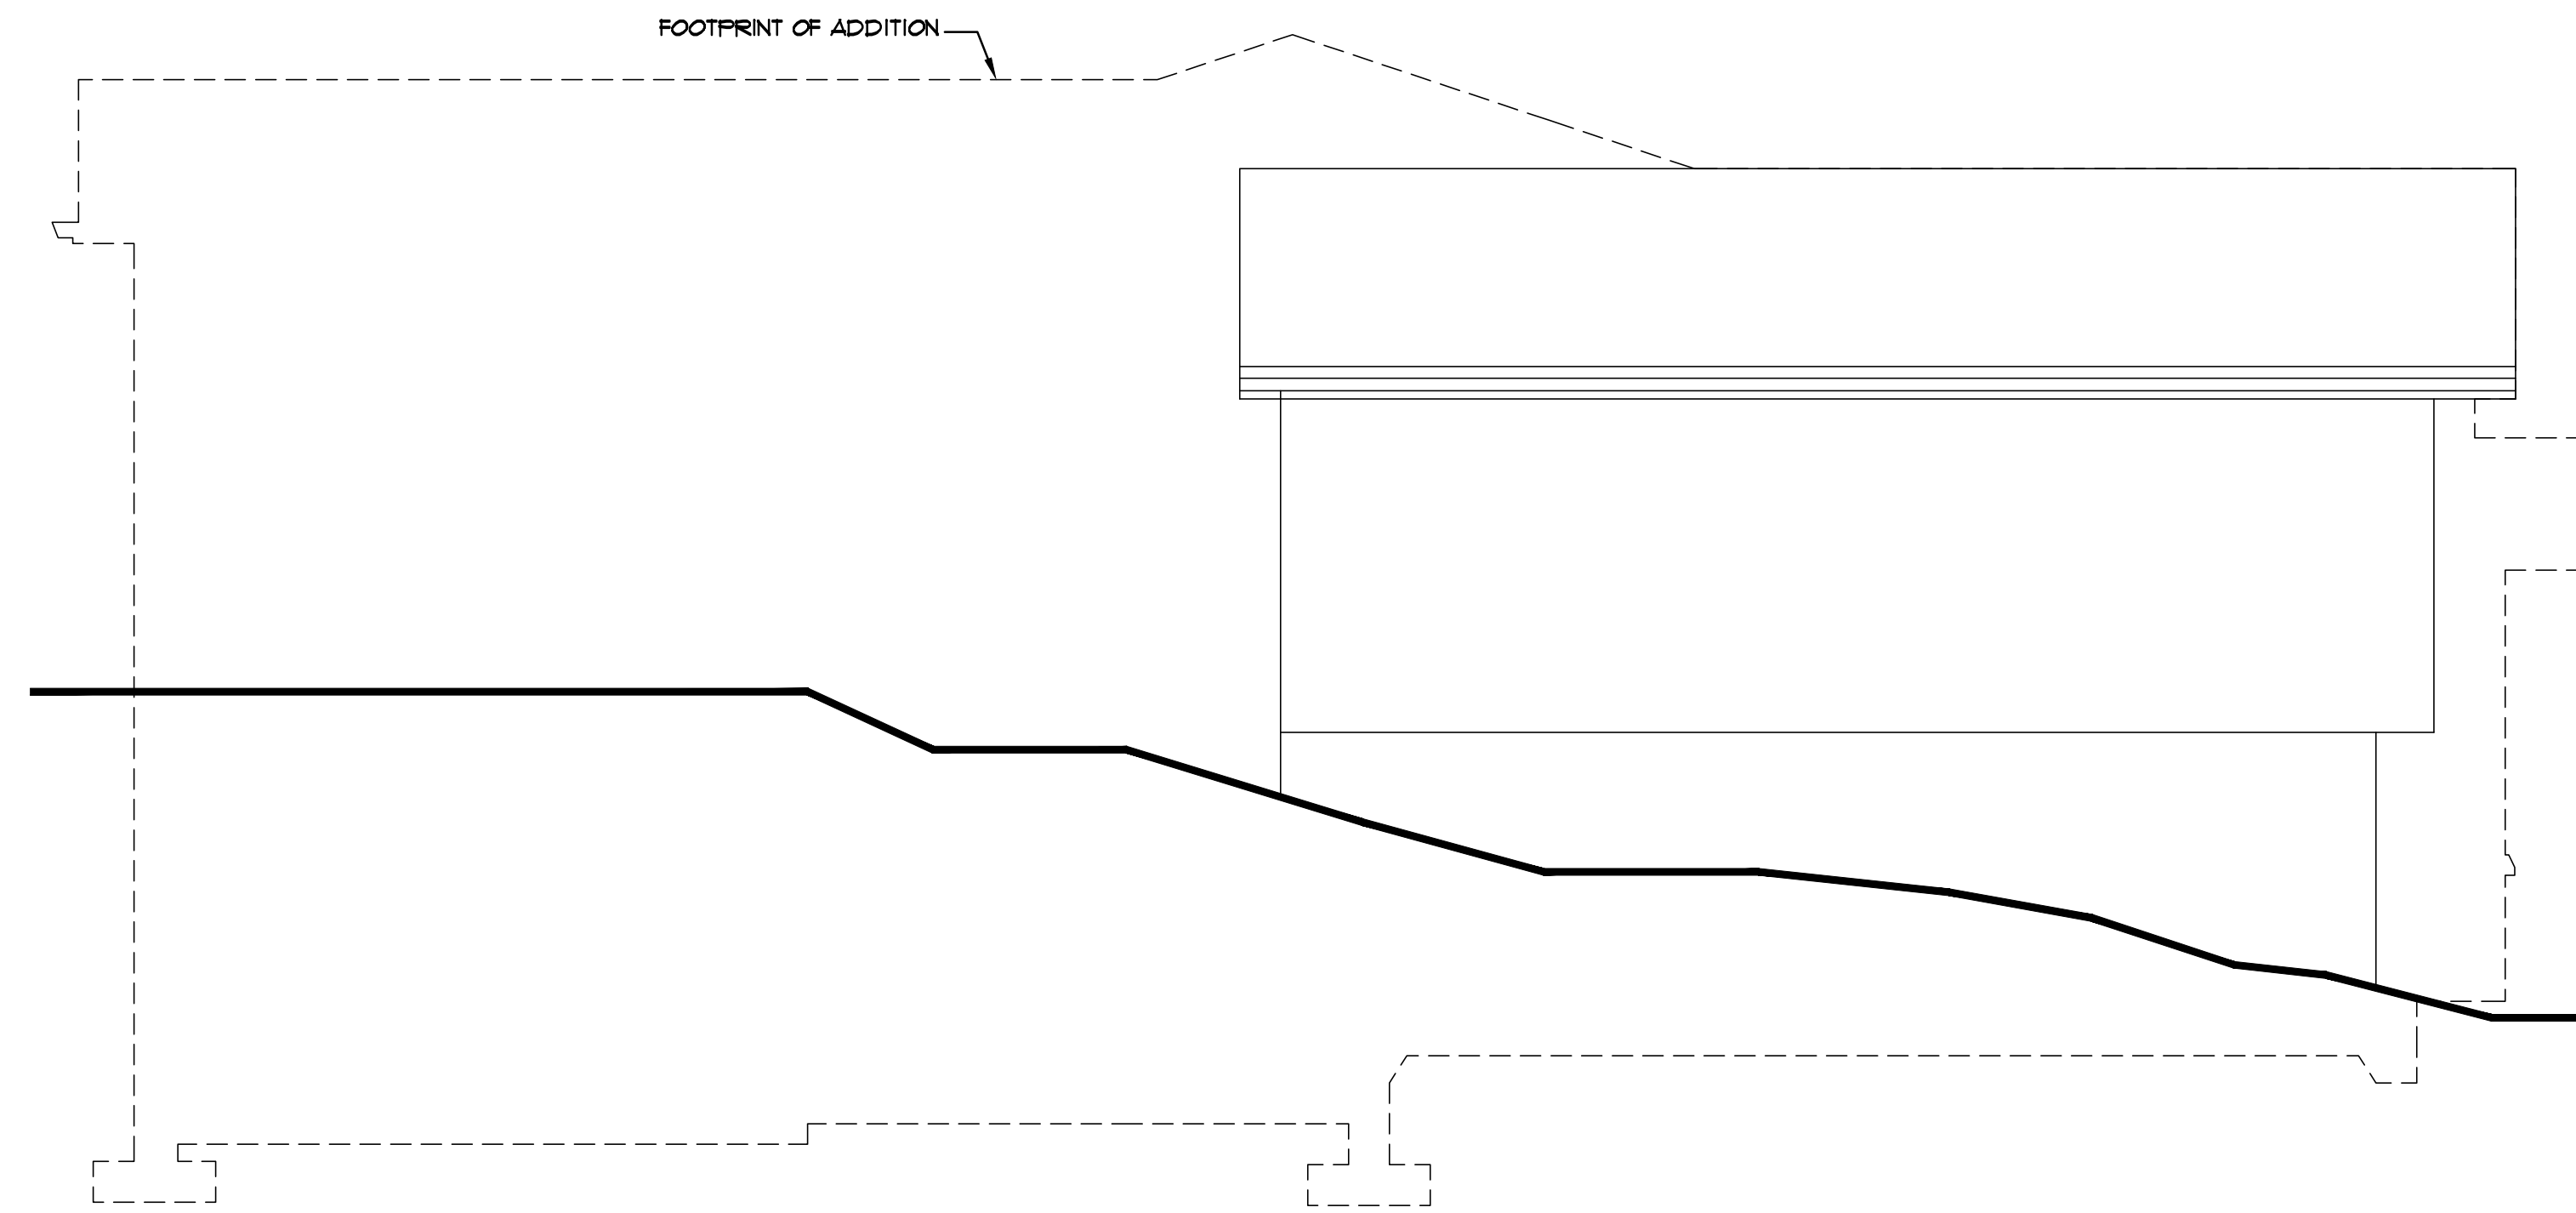




# Original Plans - 11/17/21 DRC Meeting



**PROPOSED LEFT SIDE ELEVATION**

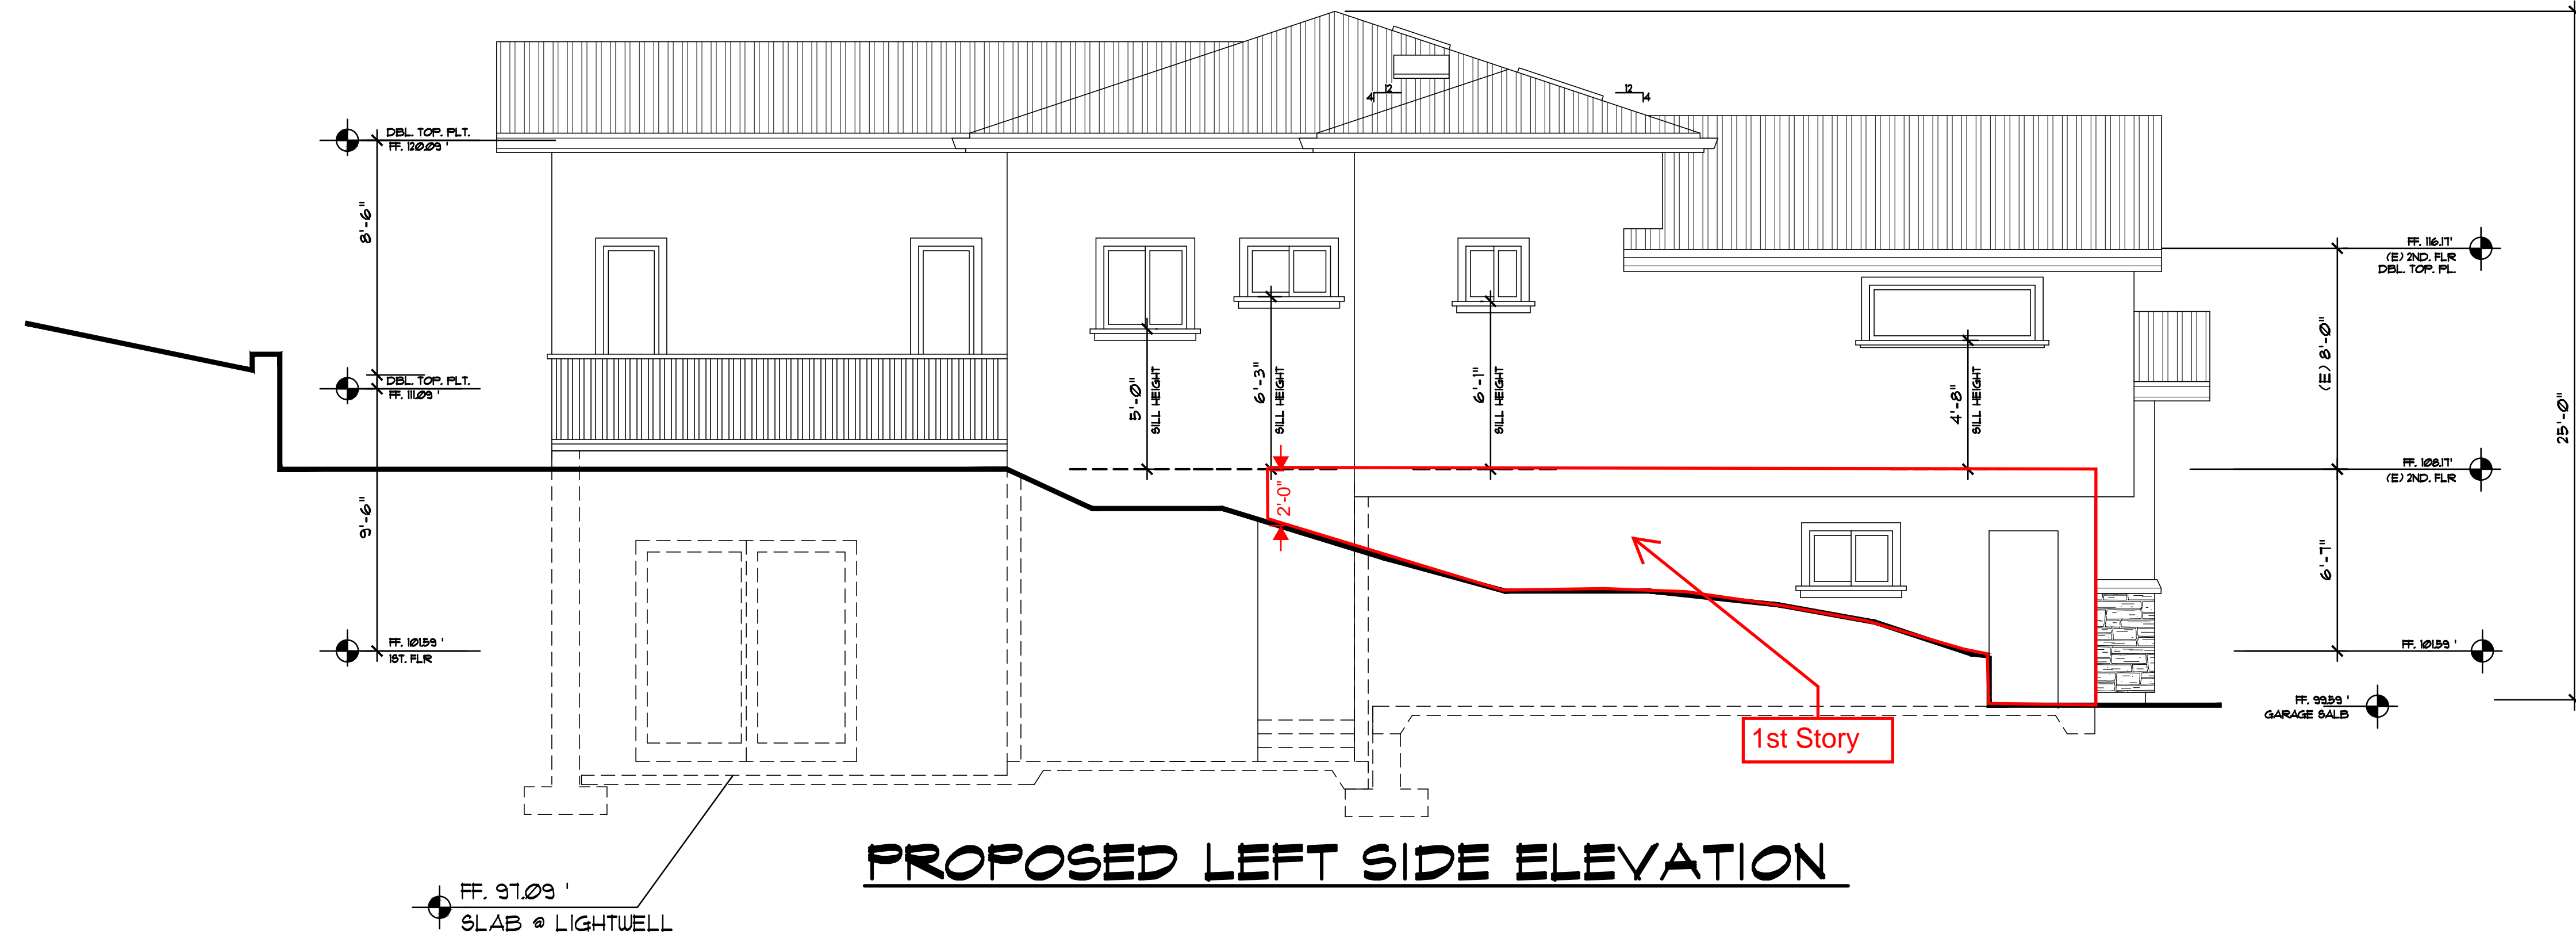

**EXISTING LEFT SIDE ELEVATION**

No. Date Description

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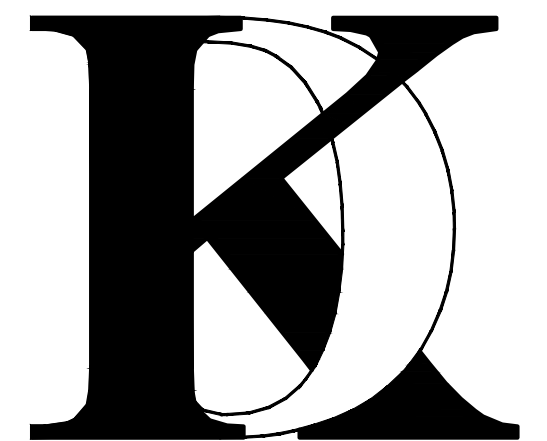
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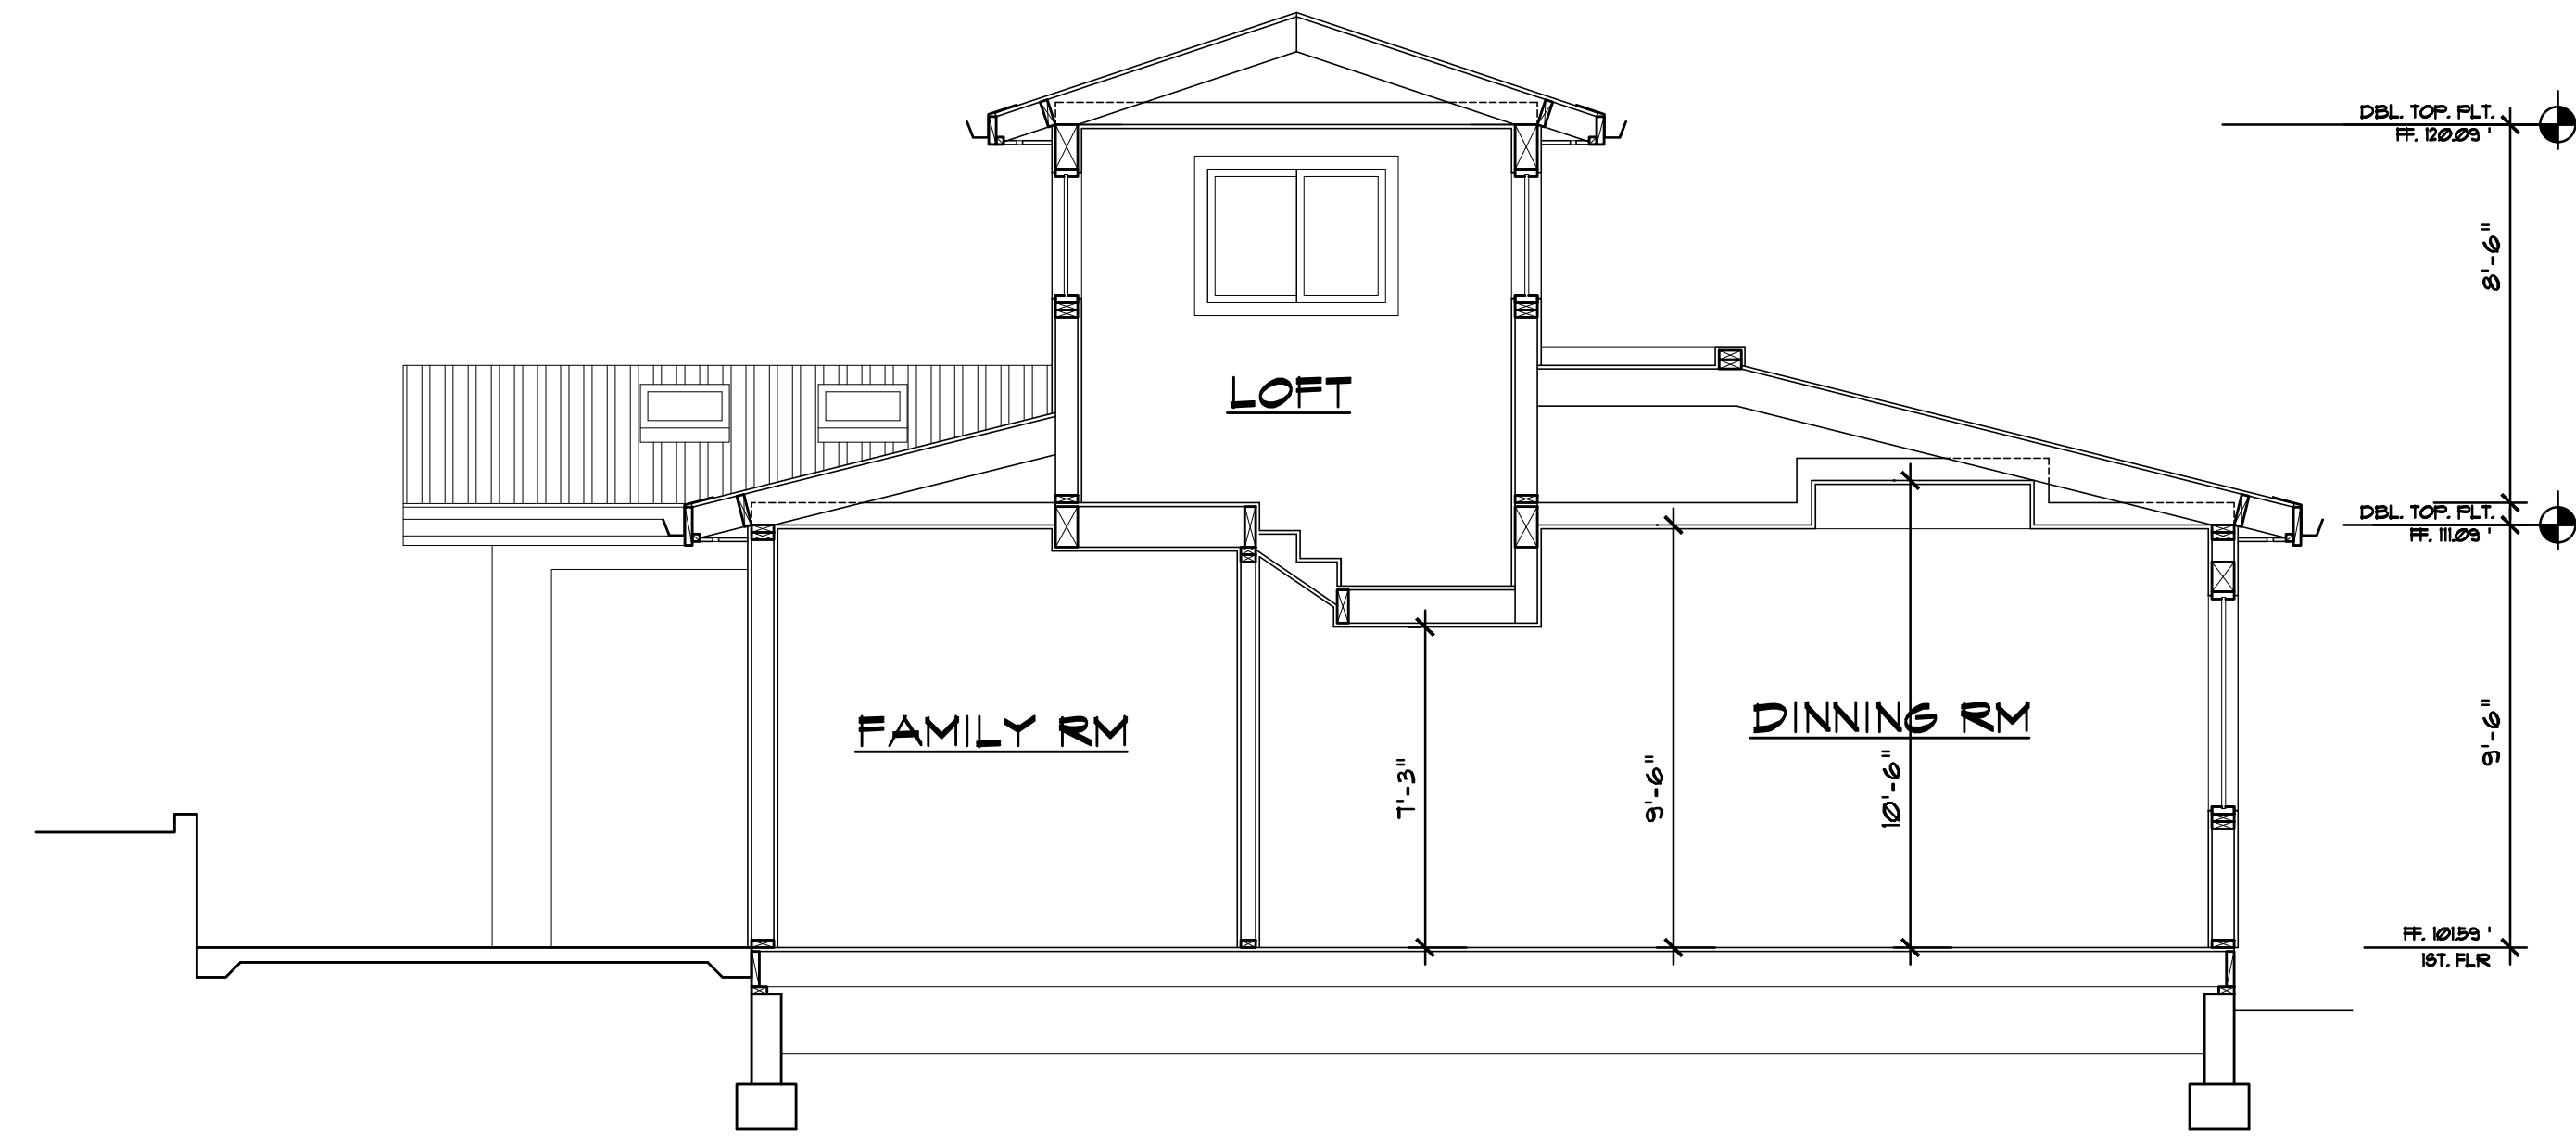
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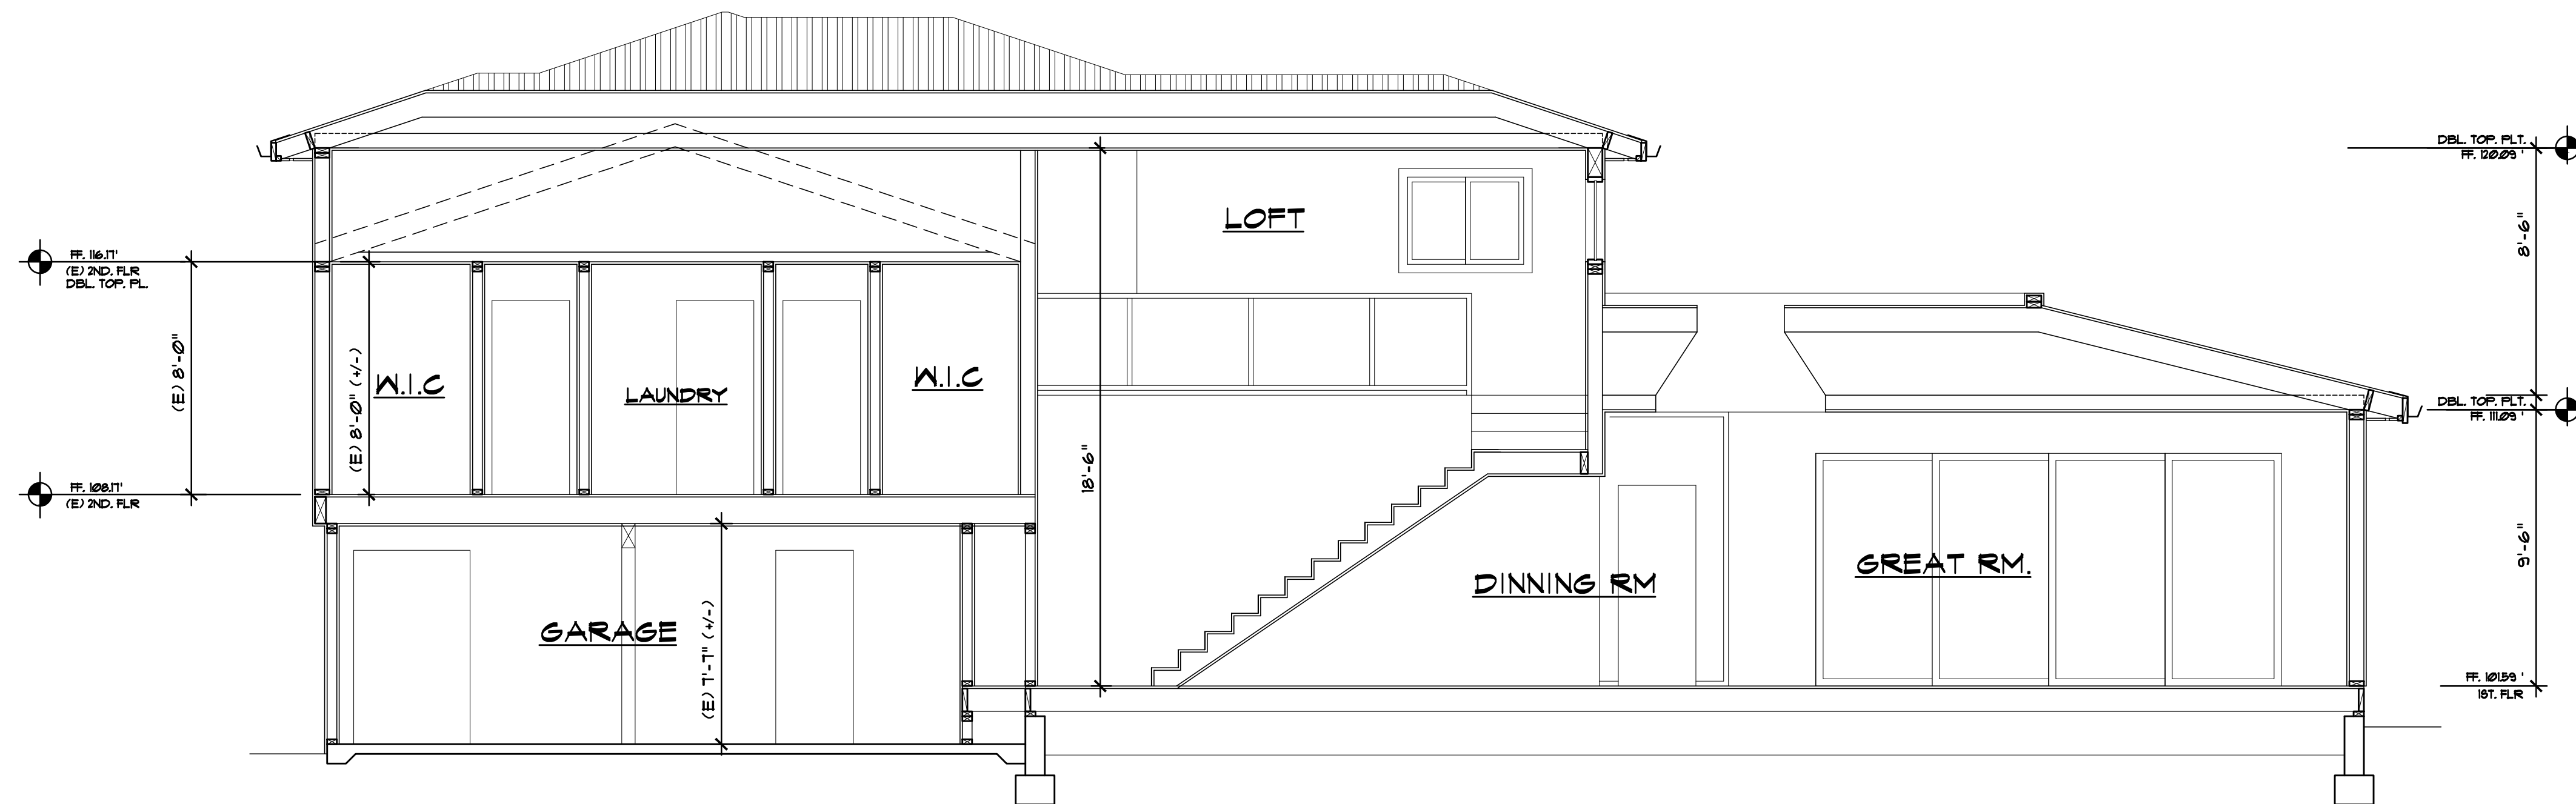
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# Original Plans - 11/17/21 DRC Meeting



**SECTION A-A**



**SECTION B-B**

No.	Date	Description
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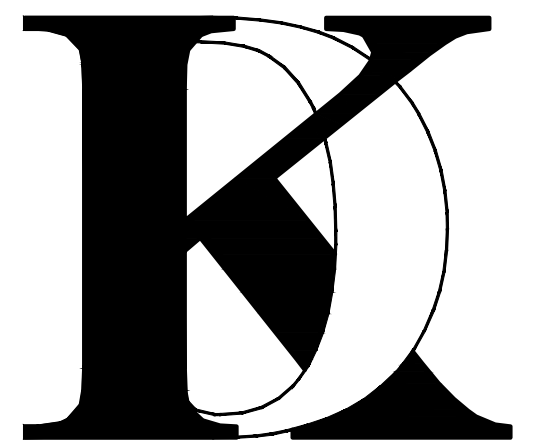
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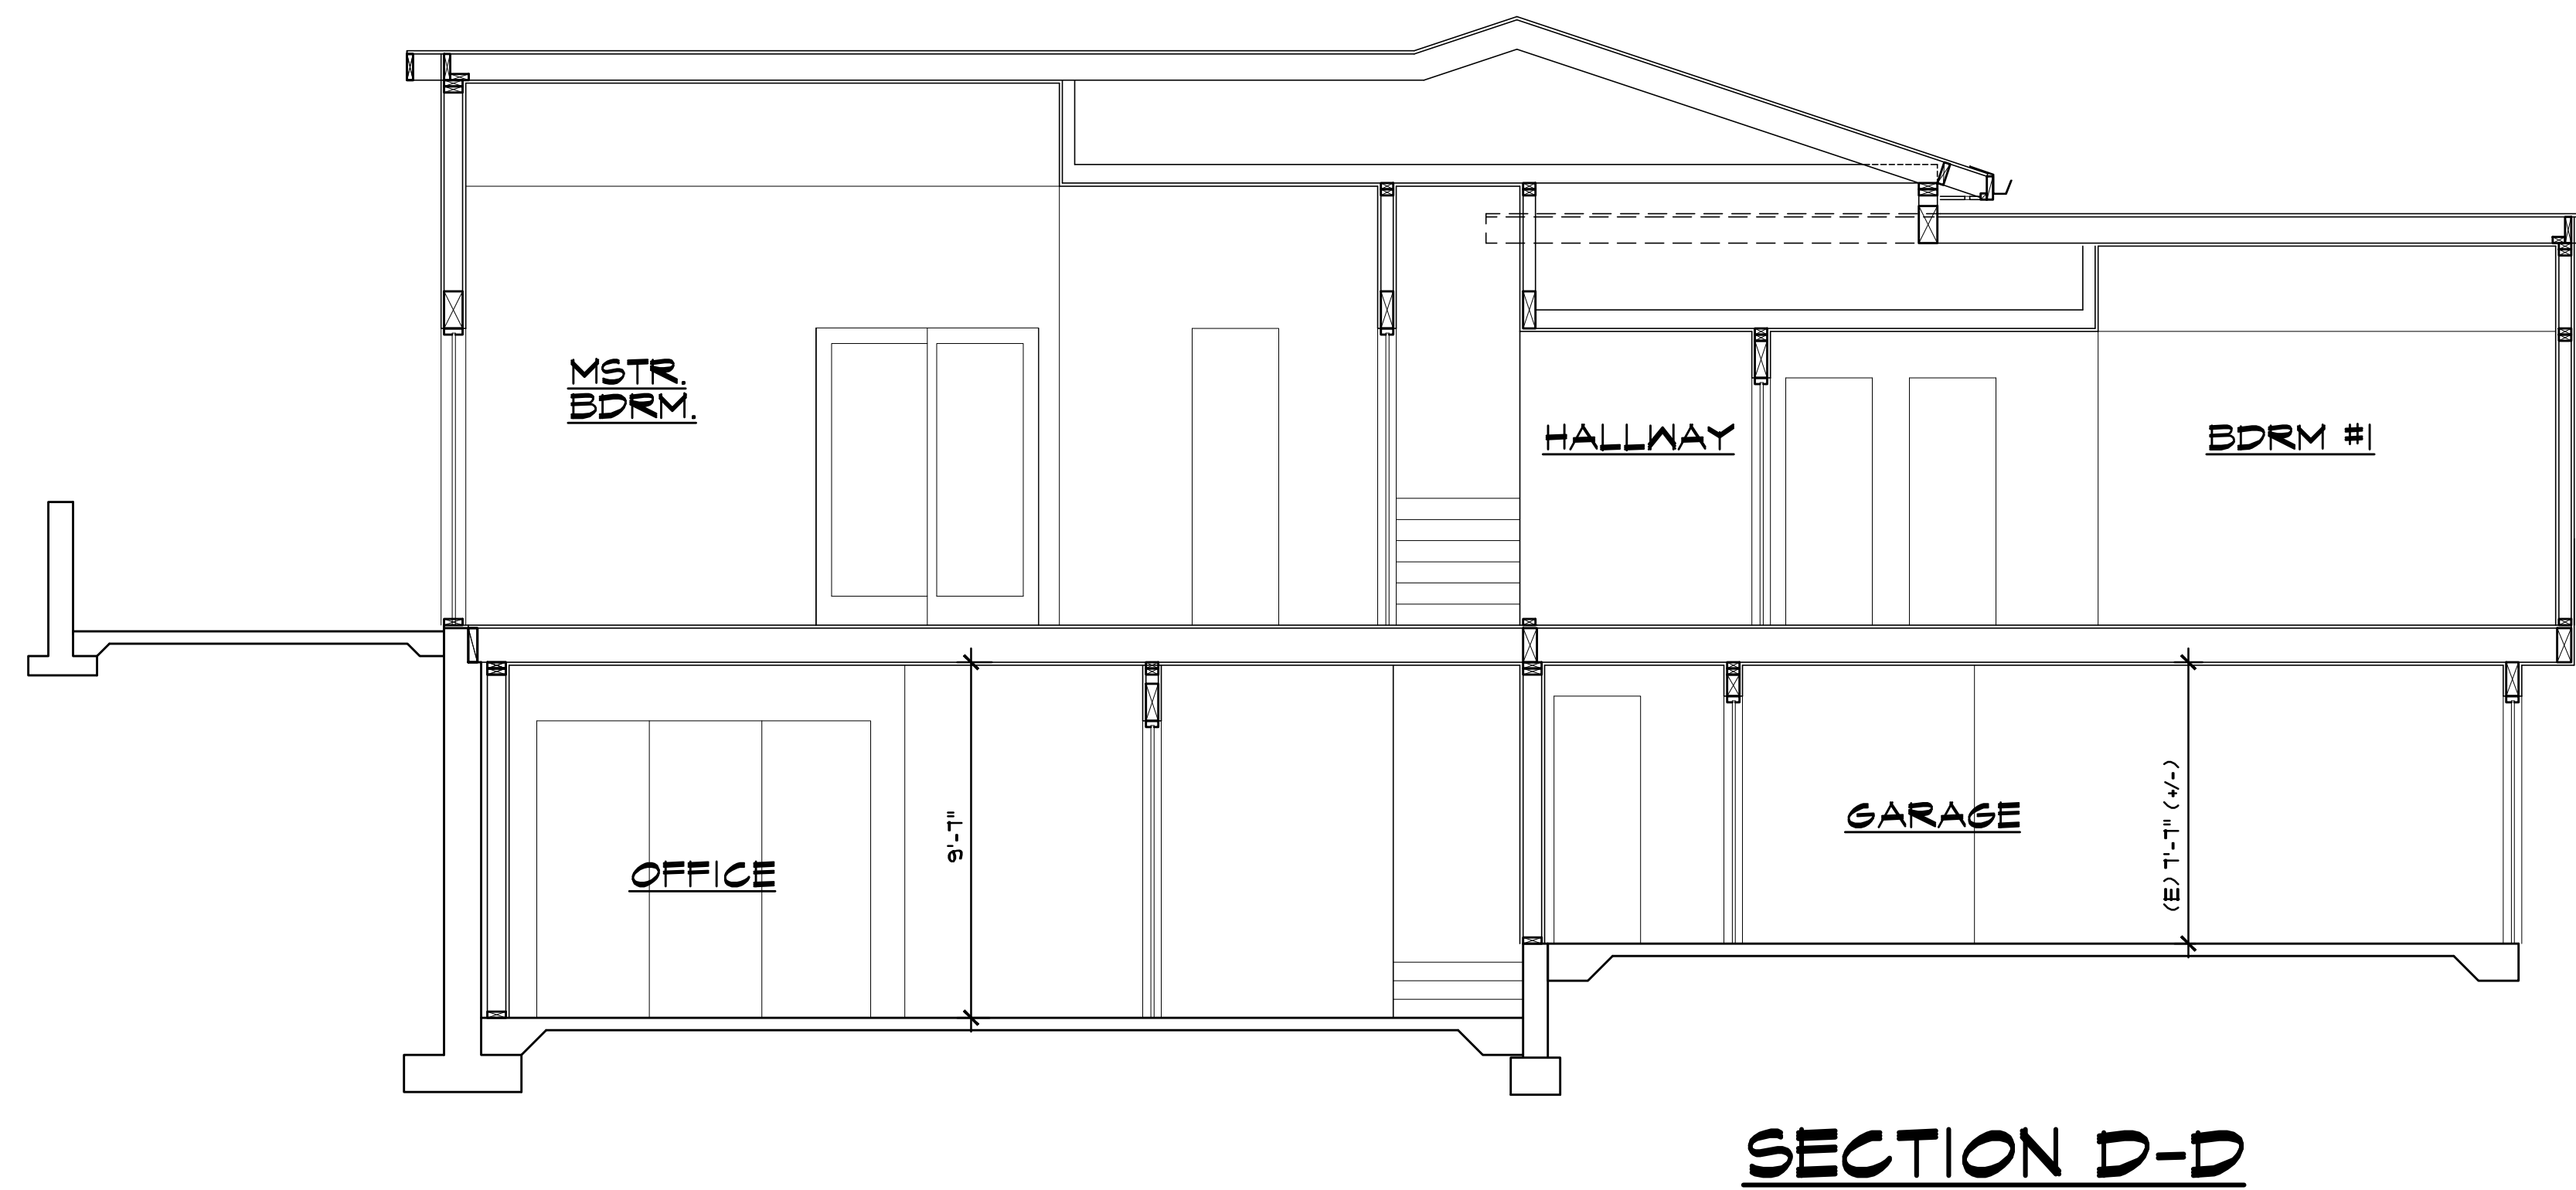
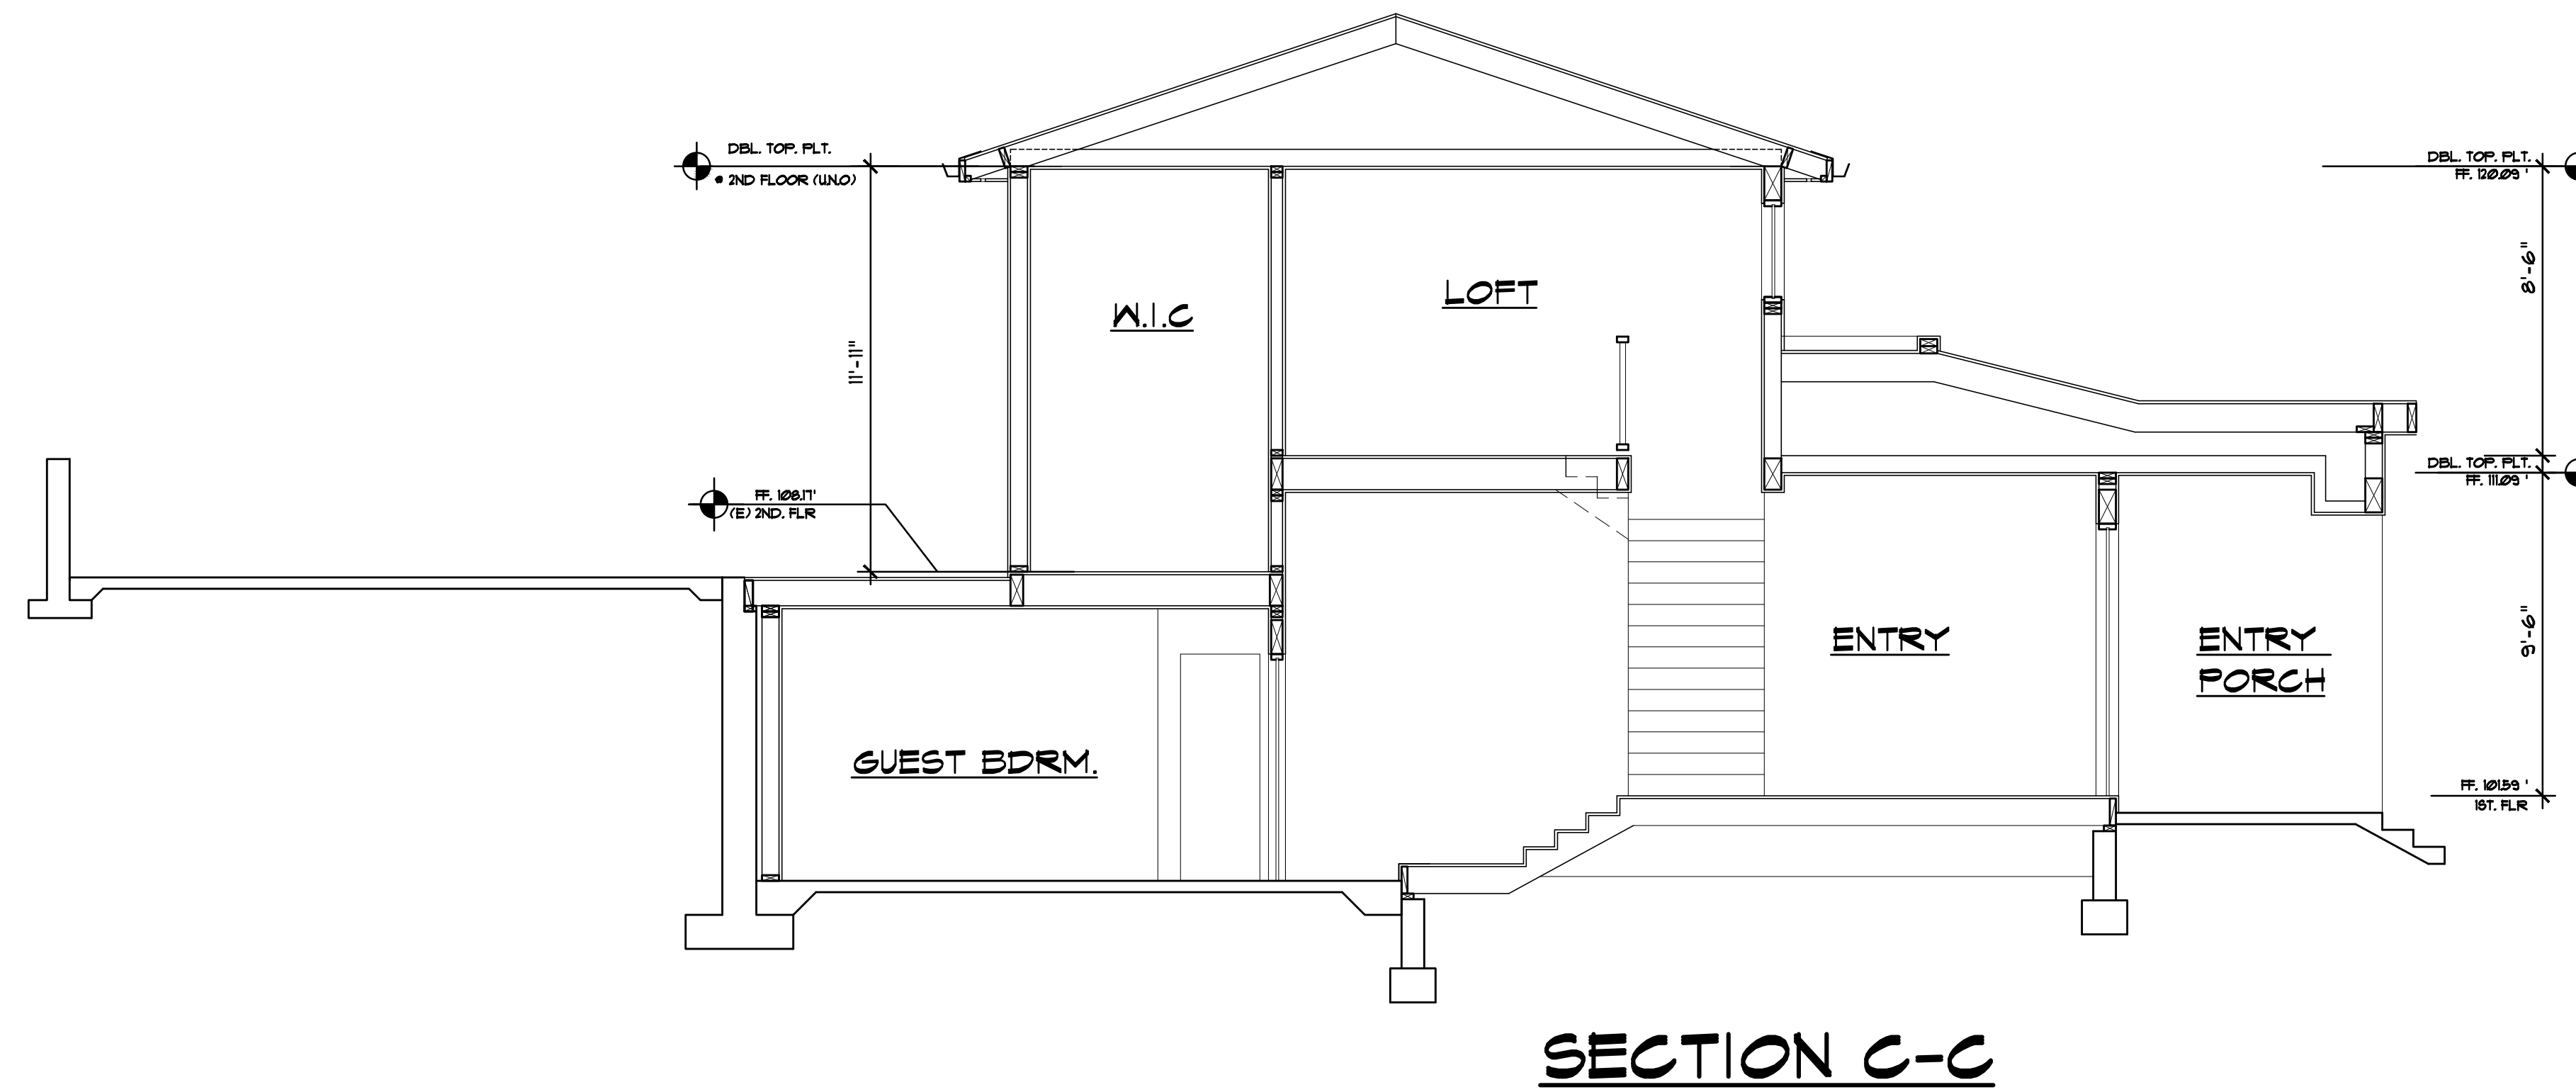
**BUILDING  
SECTIONS**

Sheet No. :

**A-5.0**



# Original Plans - 11/17/21 DRC Meeting



No.	Date	Description
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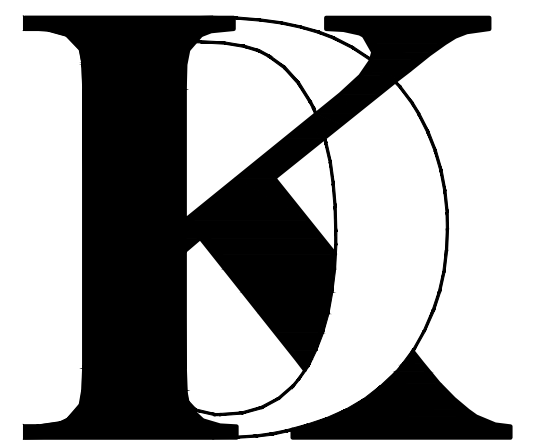
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Drawn By : FK

Job No: 2020.11

Signature :

Sheet Title :

**BUILDING  
SECTIONS**

Sheet No. :




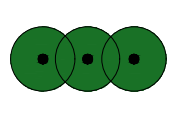
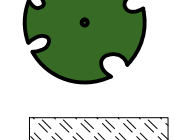
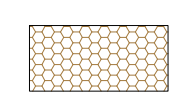

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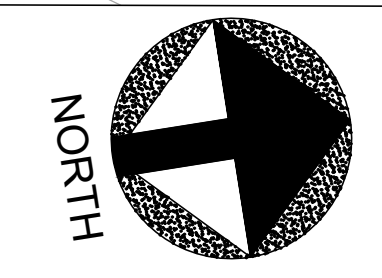
# Original Plans - 11/17/21 DRC Meeting



### LANDSCAPE LEGEND

-  (E) TREE TO REMAIN
-  (E) TREE TO BE REMOVED
-  NEW TREE
-  NEW SHRUB
-  NEW SCREENING TREE
-  TURF
-  MULCH

**PROPOSED CONCEPTUAL LANDSCAPE PLAN**

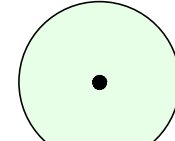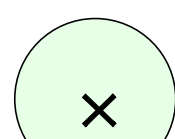

No.	Date	Description
1	7/25/21	Planning Comments


THE USE OF THESE PLANS AND SPECIFICATION SHALL BE RESTRICTED TO THE SPECIFIC SITE FOR WHICH THEY WERE PREPARED AND PUBLICATION THEREOF SHALL BE EXPRESSLY LIMITED TO SUCH USE. REUSE, REPRODUCTION OR PUBLICATION BY ANY METHOD, IN WHOLE OR IN PART, IS PROHIBITED. TITLE TO THE PLANS AND SPECIFICATIONS REMAINS WITH KHADIV-DESIGN. WITHOUT PREJUDICE VISUAL CONTACT WITH THESE PLANS AND SPECIFICATIONS SHALL INSTITUTE PRIMA FACIE EVIDENCE OF THE ACCEPTANCE OF THE RESTRICTIONS.

Client :

Mr. and Mrs. Alon  
2256 DEODARA DR.  
LOS ALTOS, CA

Project :

Mr. and Mrs. Alon  
2256 DEODARA DR.  
LOS ALTOS, CA

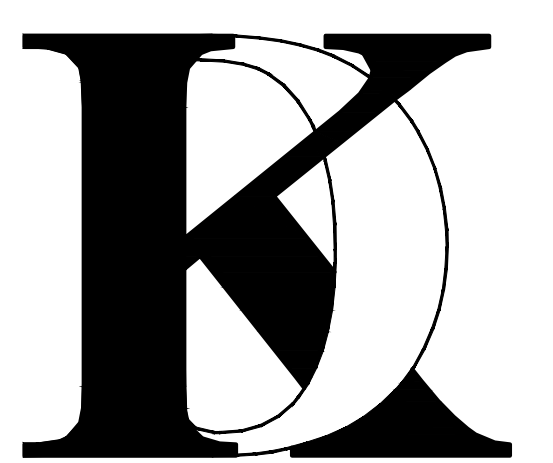

4657 TAMPICO WAY  
SAN JOSE, CA. 95118  
Phone (408) 888-6662  
farnaz@khadivdesign.com

### ***KHADIV-DESIGN***


Date:	12-07-20
Scale:	1/8"=1'-0"
Drawn By :	FK
Job No:	2020.11
Signature :	

Sheet Title :  
**PROPOSED  
CONCEPTUAL  
LANDSCAPE**

Sheet No. :  
**LD-1.0**



# Original Plans - 11/17/21 DRC Meeting

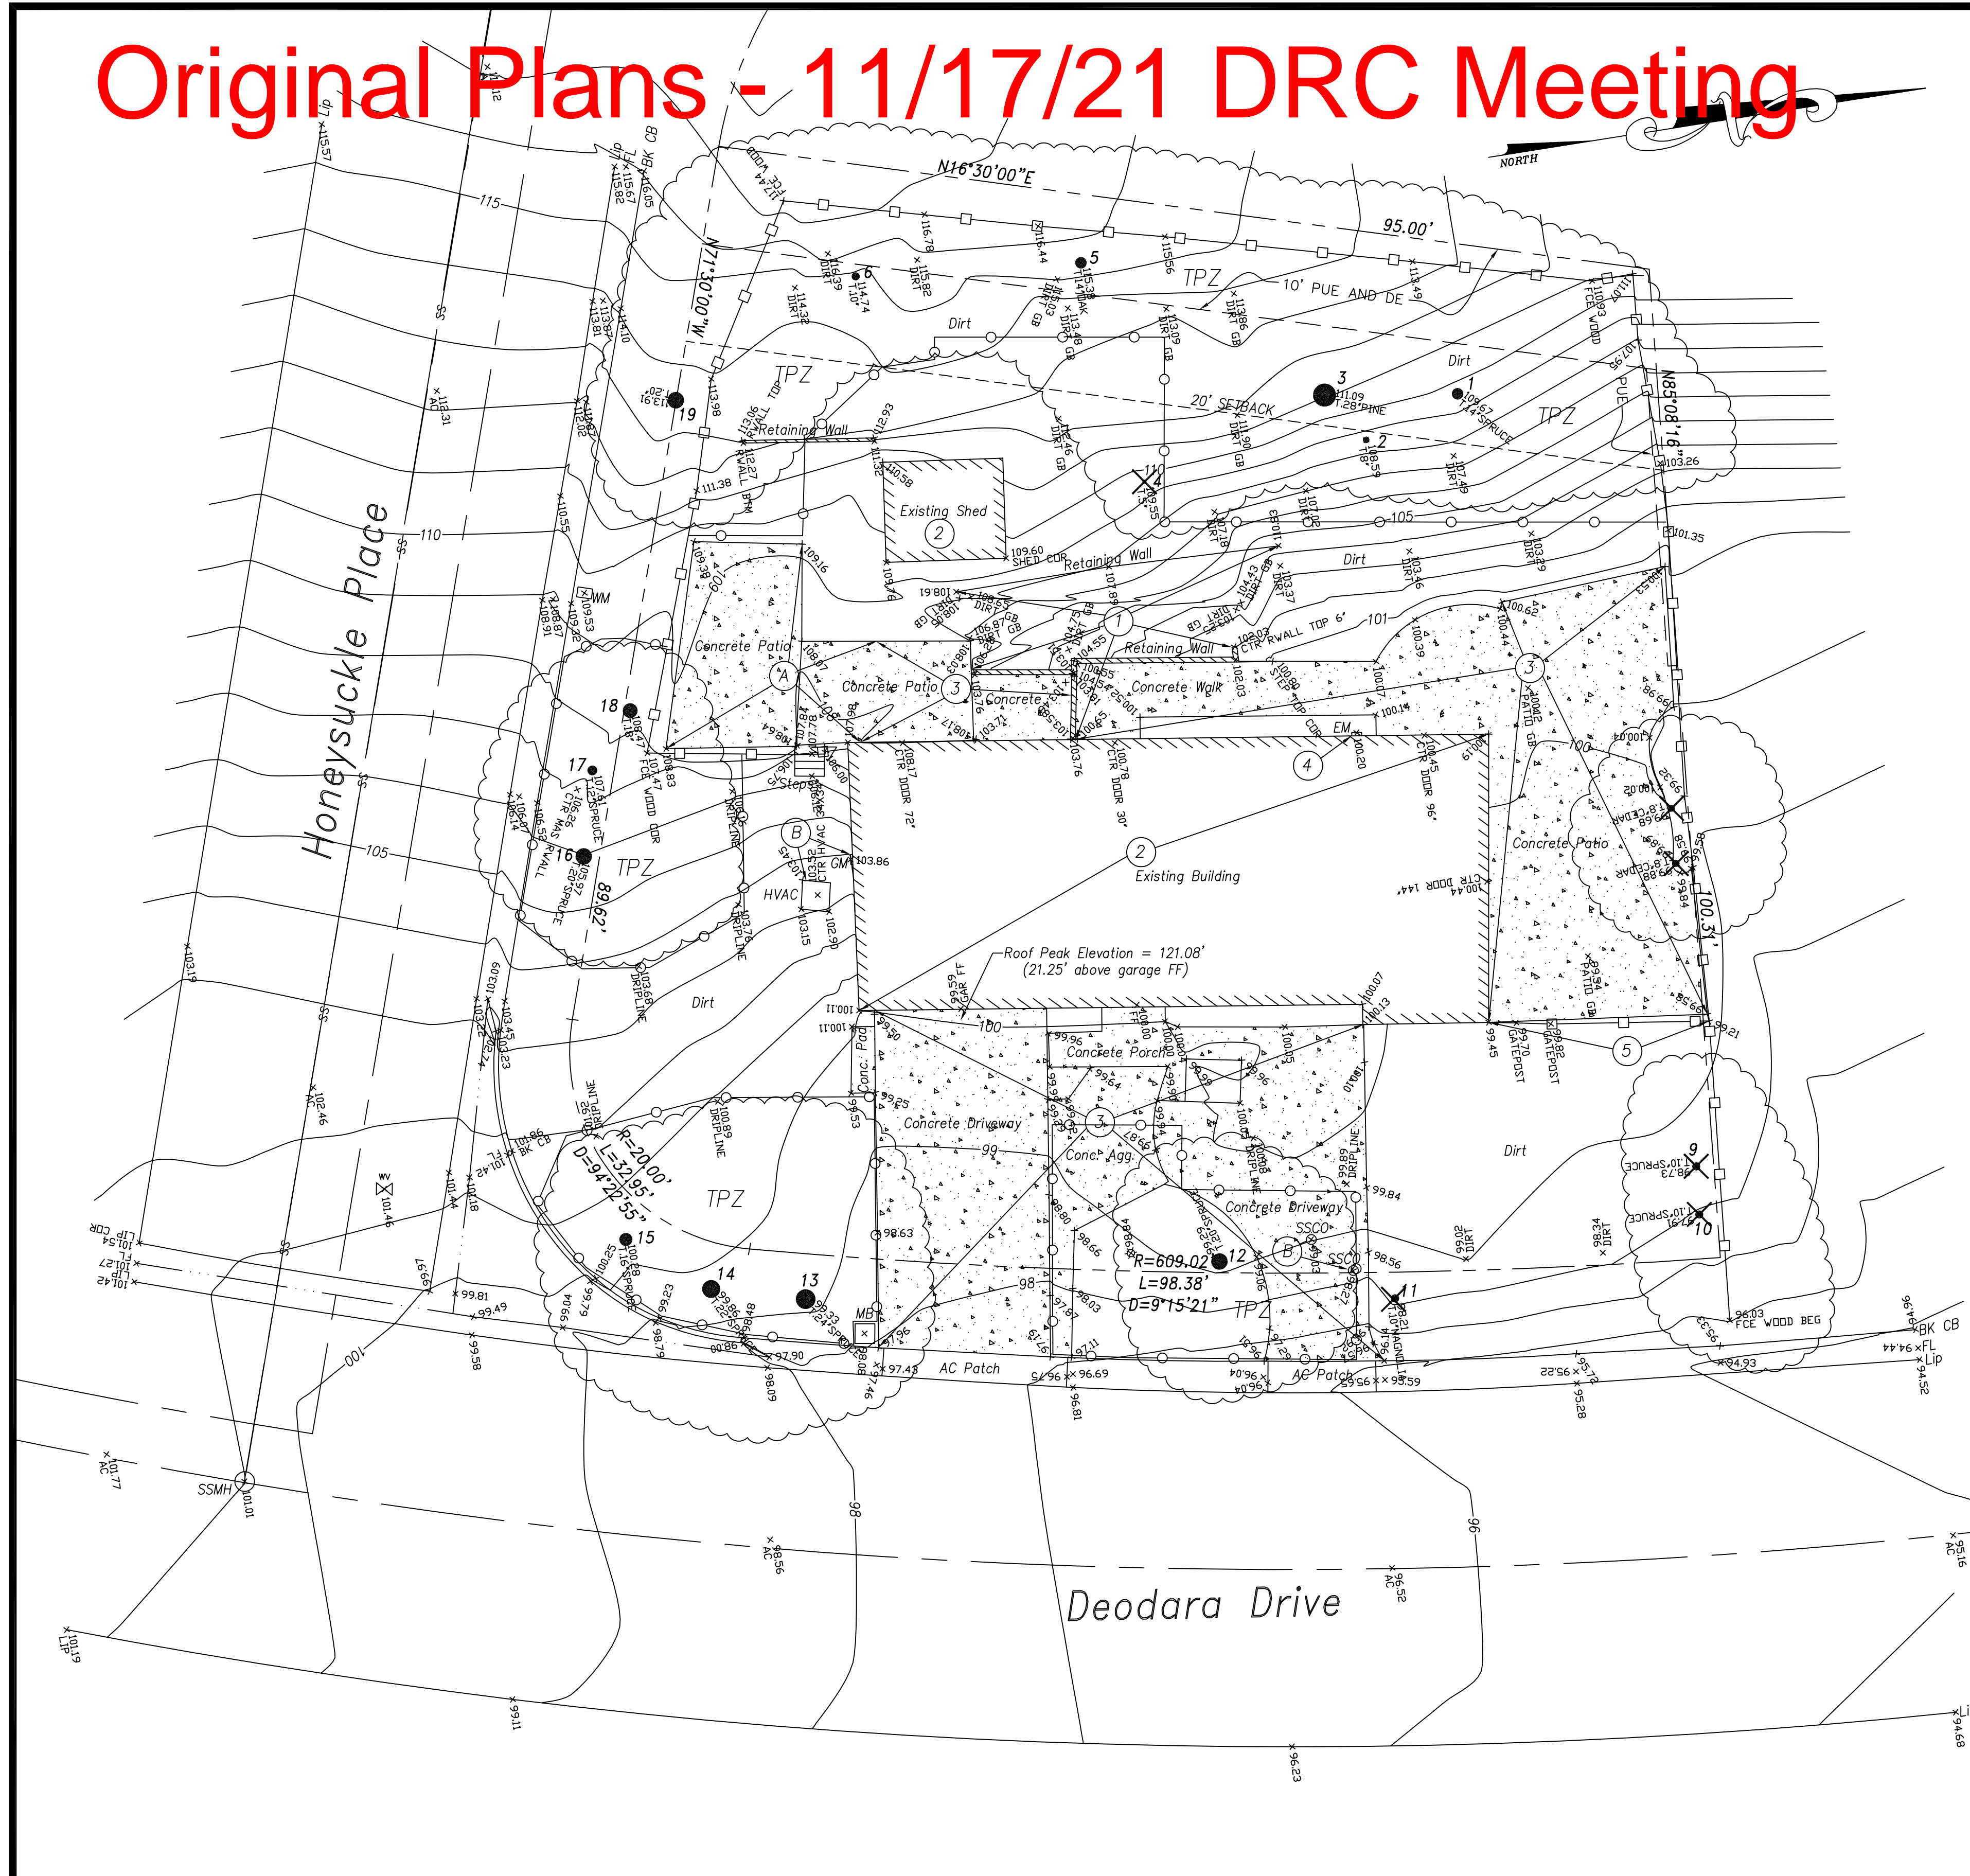


## ARBORIST'S REPORT

ARBORIST'S REPORT FOR THE PROJECT HAS BEEN PREPARED BY KIELTY ARBORIST SERVICES, LLC, DATED JUNE 25, 2021 ATTACHED SEPARATELY. THE PAGES SHOWN BELOW ARE FROM THE SAME REPORT.

**Survey Key:**  
**DBH**-Diameter at breast height (54" above grade)  
**CON**- Condition rating (1-100)  
**HT/SP**- Tree height/ canopy spread  
 \*Indicates neighbor's trees  
**P**-Indicates protected tree by city ordinance  
**R**-Indicates proposed removal

Tree#	Species	DBH	CON	HT/SP	Comments
1	Deodar cedar ( <i>Cedrus deodara</i> )	14.7	B	50/30	Good vigor, poor form, topped in past for utility line clearance.
2	Toyon ( <i>Heteromeles arbutifolia</i> )	3-3-3	C	12/10	Fair vigor, fair form, multi leader at grade.
3P	Monterey pine ( <i>Pinus radiata</i> )	25.3	D	45/35	Fair vigor, poor form, topped in past for utility line clearance, poor species.
4	Toyon ( <i>Heteromeles arbutifolia</i> )	3-3-3-3	C	10/15	Fair to poor vigor, fair form, multi leader at grade.
5P	Coast live oak ( <i>Quercus agrifolia</i> )	15.0	C	30/30	Good vigor, poor form, topped for utilities.
6	Coast live oak ( <i>Quercus agrifolia</i> )	7.9	A	20/15	Good vigor, good form.
7*P	Deodar cedar ( <i>Cedrus deodara</i> )	18est	C	50/30	Good vigor, poor form, topped for utilities.
8*	Privet ( <i>Ligustrum japonicum</i> )	6-6est	D	20/12	Good vigor, poor form, topped, fair screen.
9R	Deodar cedar ( <i>Cedrus deodara</i> )	10.8	A	55/20	Good vigor, good form.
10R	Deodar cedar ( <i>Cedrus deodara</i> )	10.7	A	55/20	Good vigor, good form.
11R	Magnolia ( <i>Magnolia grandiflora</i> )	8.4	F	30/20	Poor vigor, poor form, nearly dead.
12P	Deodar cedar ( <i>Cedrus deodara</i> )	22.0	D	45/30	Good vigor, poor form, topped in past at 6 feet, leans out of ground.
13P	Deodar cedar ( <i>Cedrus deodara</i> )	25.4	B	60/35	Good vigor, poor form, topped in past.
14P	Deodar cedar ( <i>Cedrus deodara</i> )	25.0	B	60/35	Good vigor, poor form, topped in past.
15	Deodar cedar ( <i>Cedrus deodara</i> )	14.2	D	50/20	Fair vigor, poor form, suppressed, no room for tree.
16P	Deodar cedar ( <i>Cedrus deodara</i> )	19.5	B	55/30	Good vigor, poor form, topped.
17	Deodar cedar ( <i>Cedrus deodara</i> )	13.0	B	50/20	Good vigor, poor form, topped.
18P	Green ash ( <i>Fraxinus uhdei</i> )	21.0	D	50/30	Good vigor, poor form, topped at 10 feet.
19P	Green ash ( <i>Fraxinus uhdei</i> )	16.0	D	50/30	Good vigor, poor form, topped at 10 feet.
20P	Monterey pine ( <i>Pinus radiata</i> )	15.0	D	35/30	Fair to poor vigor, poor form, grows towards utilities.

## DEMOLITION LEGEND

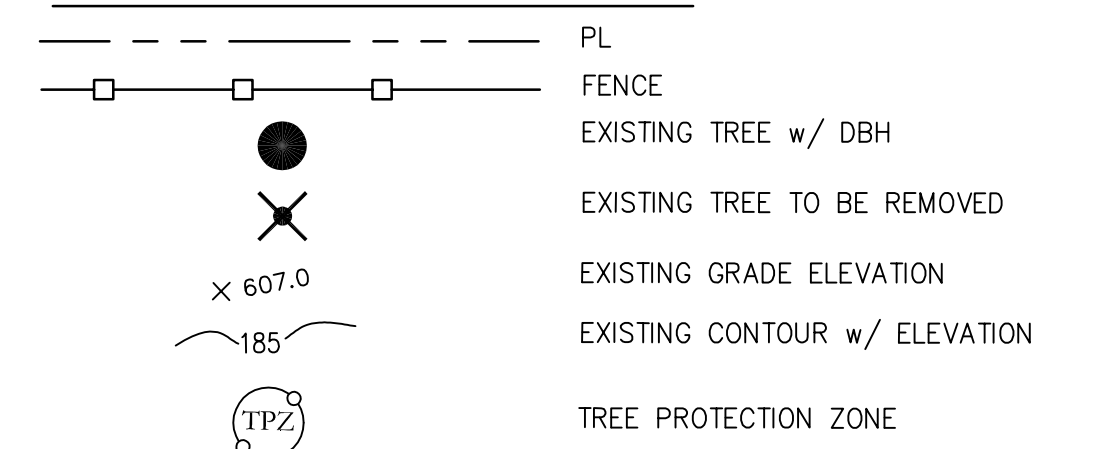

## ABBREVIATIONS

- ASPH. ASPHALT
- CONC. CONCRETE
- EP EDGE OF PAVEMENT
- EX EXISTING
- GM GAS METER
- MB MAIL BOX
- SSCO SANITARY SEWER CLEAN-OUT
- WM WATER METER
- WV WATER VALVE
- JP JOINT POLE
- TPZ TREE PROTECTION ZONE

## DEMOLITION NOTES:


- CONTRACTOR SHALL OBTAIN A DEMOLITION PERMIT FROM THE CITY OF LOS ALTOS BUILDING DEPARTMENT PRIOR TO START OF DEMOLITION.
- THE PROPERTY LINE SHALL BE THE LIMITS OF DEMOLITION UNDER THE GRADING PERMIT. DEMOLITION WITHIN CITY RIGHT-OF-WAY SHALL BE DONE UNDER AN ENCROACHMENT PERMIT WITH THE CITY OF LOS ALTOS.
- CONTRACTOR SHALL COORDINATE UTILITY DISCONNECTIONS WITH THE RESPECTIVE UTILITY AGENCIES PRIOR TO START OF DEMOLITION ON THE SITE.
- UTILITIES TO BE ABANDONED WITHIN THE AREAS OF PROPOSED IMPROVEMENTS SHALL BE REMOVED IN THEIR ENTIRETY OR ABANDONED IN PLACE PER RECOMMENDATIONS IN THE PROJECT SOILS REPORT.

## REMOVAL NOTES

- REMOVE EXISTING RETAINING WALL
- REMOVE EXISTING BUILDING
- REMOVE EXISTING CONCRETE
- REMOVE EXISTING UTILITY
- REMOVE EXISTING FENCE

## PROTECTION NOTES


- A PROTECT EXISTING CONCRETE
- B PROTECT EXISTING UTILITY

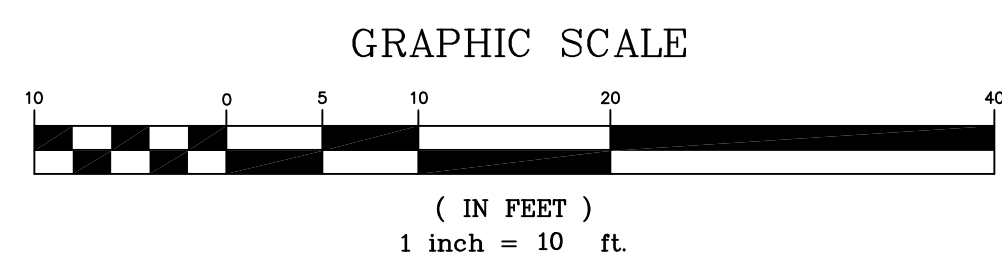

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GROSS LOT AREA = 11,374 SQ. FT. (0.2611 ACRES)

BOUNDARY: BOUNDARY BASED UPON FIELD SURVEY PERFORMED BY OR UNDER DIRECTION OF HELMUT KORSTICK, PLS 7739.

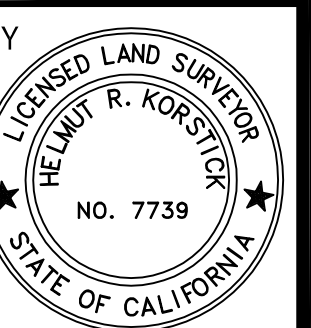

DATE: SEPT. 16, 2021	NO.	BY	DATE	REVISIONS	CITY APPR
SCALE: AS NOTED					
DRAWN: DSK					
DESIGNED: DSK					
ENGINEER: DSK					
MANAGER: DSK					

PREPARED BY, OR UNDER THE DIRECTION OF:  
 NOT APPROVED FOR CONSTRUCTION

PREPARED BY:  
  
 46560 FREMONT BOULEVARD, UNIT NO. 205  
 FREMONT, CA 94538  
 sterlingconsultants@gmail.com PHONE: 510.344.8955

VERTICAL DATUM: HELD ASSUMED ELEVATION OF 100.00' AT THE EXISTING FINISHED FLOOR AT ENTRY DOOR.

BASIS OF BEARINGS: S 71°30'00" E ALONG THE MONUMENT LINE OF HONEYSUCKLE DR. AS SHOWN ON THE MAP OF TRACT 1543, BOOK 66 OF MAPS PAGES 2-3, S.C.C.R.

PREPARED FOR:  
 AMIT ALON & ROZA ANBARI  
 2256 DEODARA DRIVE  
 LOS ALTOS, CA 94024



APN: 342-02-049  
 2256 DEODARA DRIVE  
**EXISTING CONDITION MAP & DEMOLITION PLAN**  
 CITY OF LOS ALTOS SANTA CLARA COUNTY CALIFORNIA

SHEET NO. **C1**  
 OF 2 SHEETS  
 JOB NO. 2020-475


PRINTED: SEPTEMBER 16, 2021




# Original Plans - 11/17/21 DRC Meeting

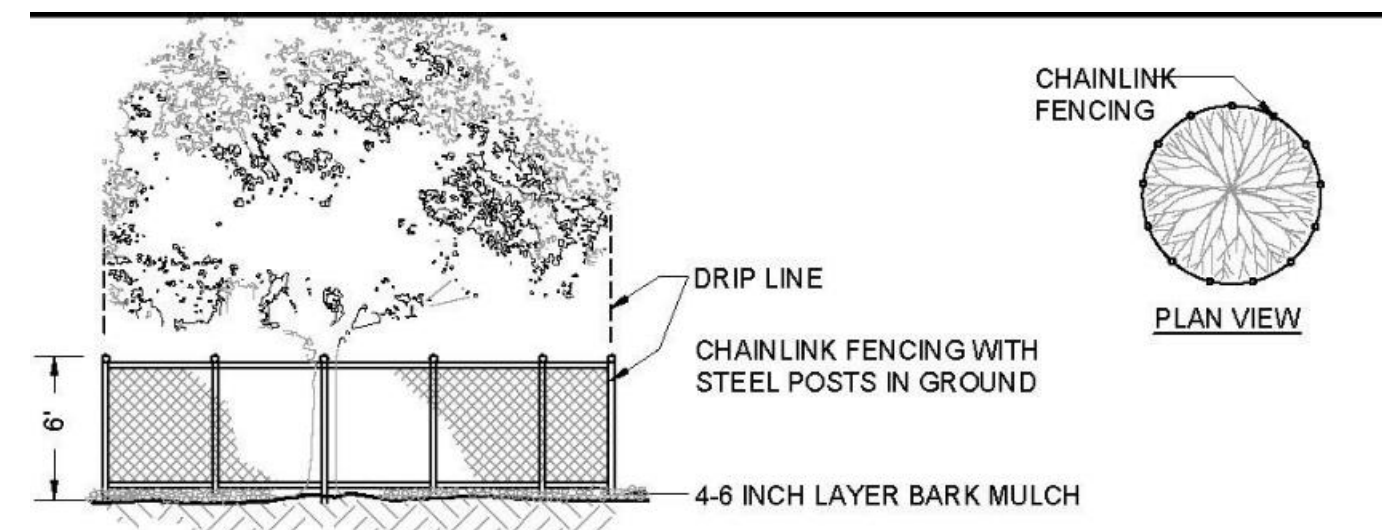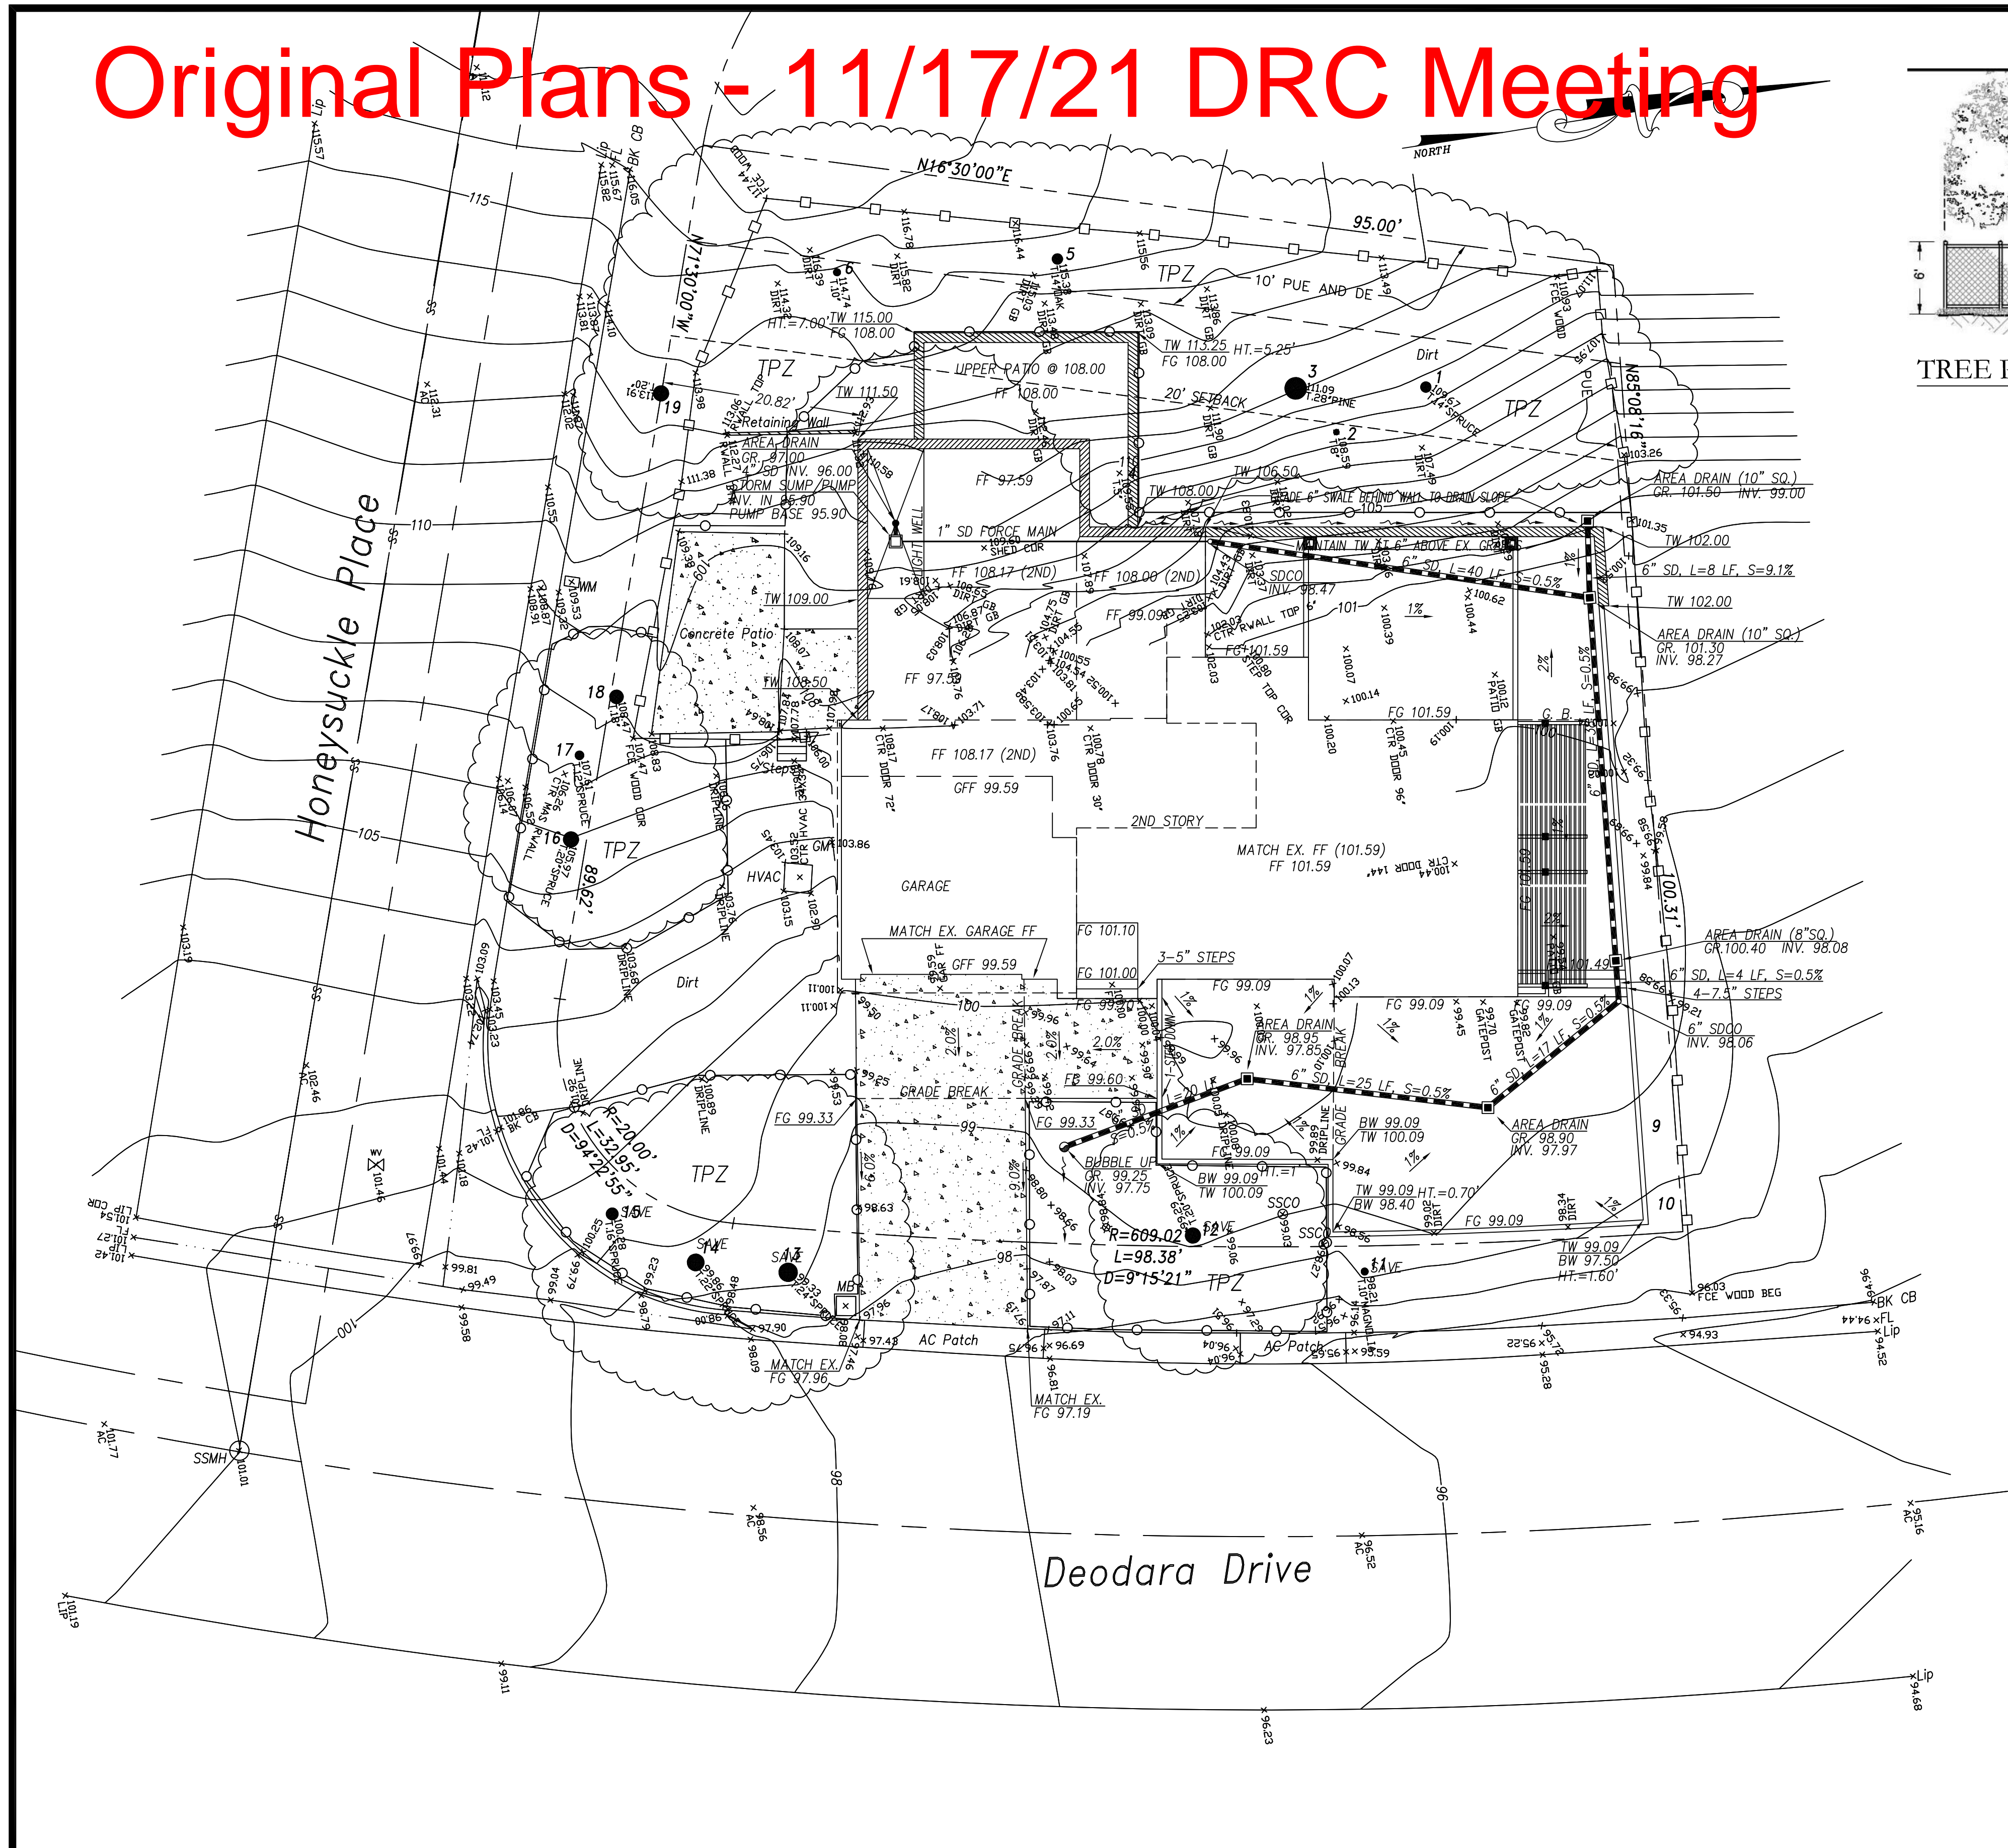


TREE PROTECTION ZONE (TPZ) FENCE - DETAIL  
NOT TO SCALE

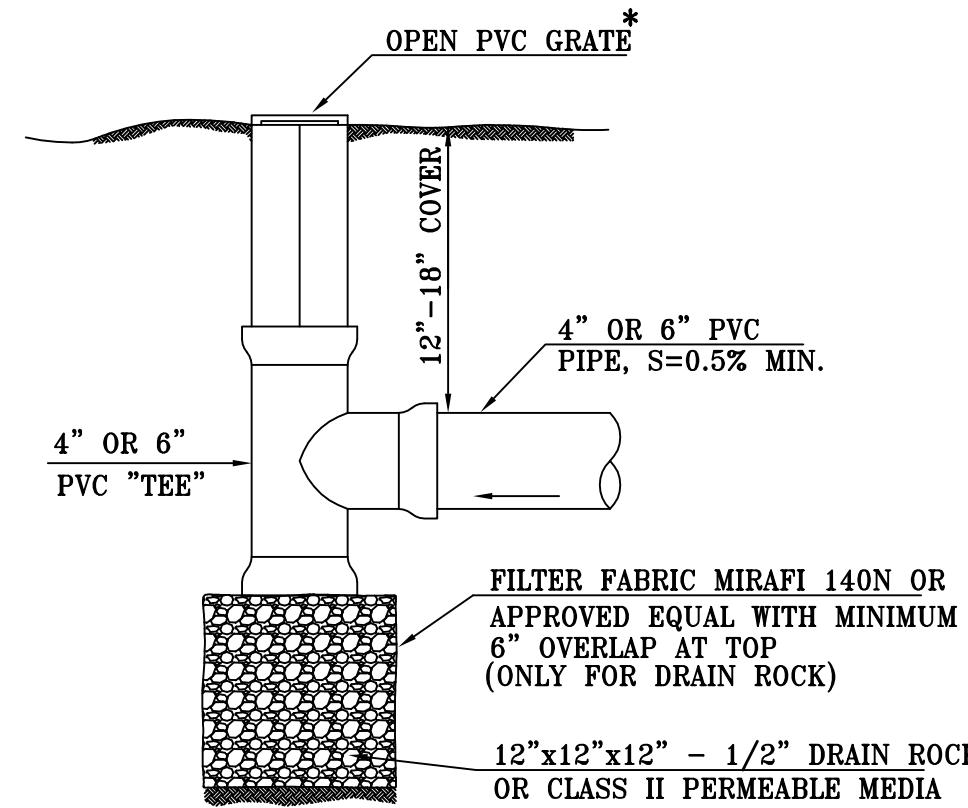

BUBBLE UP DETAIL  
NOT TO SCALE

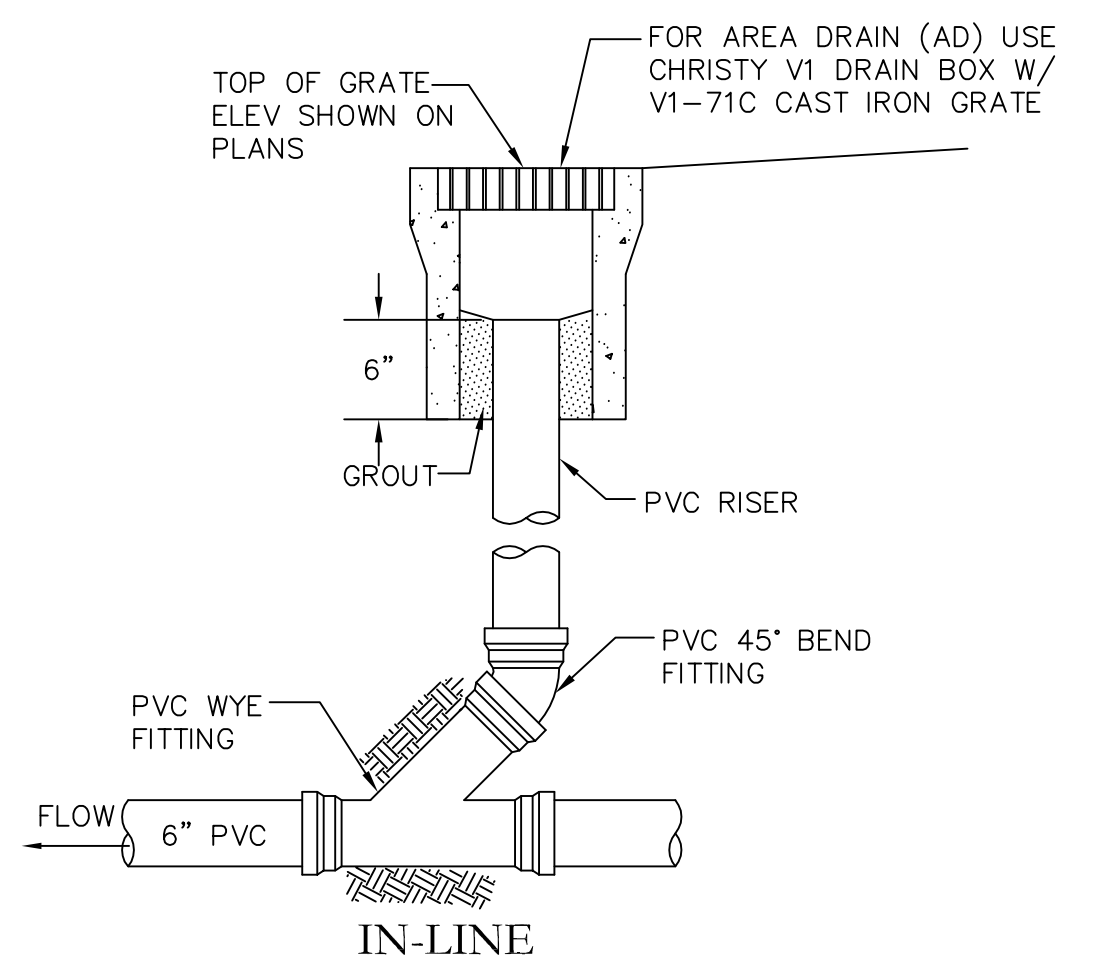

AREA DRAIN - DETAIL  
NOT TO SCALE

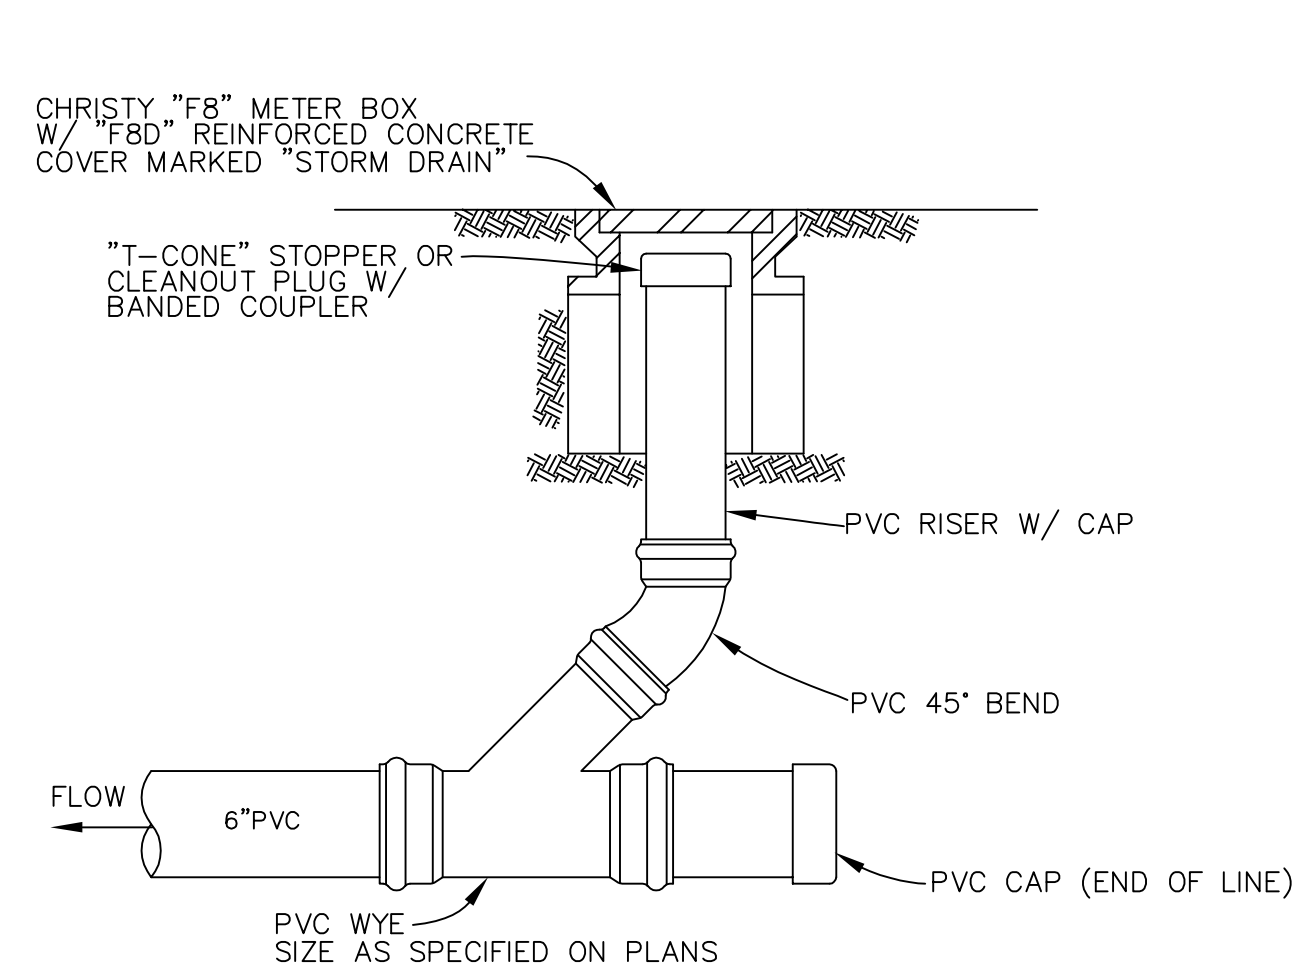

STORM DRAIN CLEANOUT  
NOT TO SCALE

## GRADING NOTES:


- SITE GRADING & EXCAVATIONS SHALL ADHERE TO ALL RECOMMENDATIONS CONTAINED IN THE PROJECT GEOTECHNICAL REPORT.
- ALL GRADES SHOWN ARE FINISHED GRADES, UNLESS OTHERWISE NOTED.
- ALL CUT AND FILL SLOPES AT THE BOUNDARY LINES SHALL BE CONSTRUCTED IN SUCH A MANNER THAT ADJACENT FENCES WILL NOT BE DAMAGED. GRADING SHALL CONFORM AT BOUNDARY LINES.
- ALL CUT SLOPES SHALL BE ROUNDED TO MEET EXISTING GRADES AND BLEND WITH SURROUNDING TOPOGRAPHY. ALL GRADED SLOPES OVER FIVE FEET IN HEIGHT SHALL BE PLANTED WITH SUITABLE GROUND COVER.
- DURING GRADING OPERATIONS, THE CONTRACTOR SHALL IMPLEMENT DUST CONTROL MEASURES BOTH ON-SITE. STREETS SHALL BE SWEEP PER REQUIREMENTS SPECIFIED IN BLUEPRINT FOR CLEAN BAY.
- THE CONTRACTOR SHALL BE RESPONSIBLE FOR VERIFICATION OF SAID GRADING QUANTITIES PRIOR TO THE START OF THE GRADING OPERATION. THE CONTRACTOR SHALL ALSO BE RESPONSIBLE FOR DISTRIBUTING ANY EXCESS MATERIAL OR SUPPLY MATERIAL FOR DEFICIENCIES TO BRING PAVEMENT OR LOTS TO REQUIRED GRADE. CLARIFICATION OF GRADING SHALL BE DONE BY THE ENGINEER.
- THE PROPERTY OWNER IS RESPONSIBLE FOR THE REPAIR AND/OR REPLACEMENT OF ANY DAMAGED EXISTING IMPROVEMENTS WITHIN THE PUBLIC STREET RIGHT OF WAY.
- WASTEWATER GENERATED DURING CONSTRUCTION SHALL NOT BE DISCHARGED TO THE STORM DRAIN SYSTEM. THIS INCLUDES WASTE FROM PAINTING, SAWCUTTING, CONCRETE WORK, ETC. THE CONTRACTOR SHALL MAKE ARRANGEMENTS TO ELIMINATE DISCHARGES TO THE STORM DRAIN SYSTEM AND, IF NECESSARY, PROVIDE AN AREA FOR ON-SITE WASHING ACTIVITIES DURING CONSTRUCTION. MATERIALS WHICH COULD CONTAMINATE STORM RUNOFF SHALL BE STORED IN AREAS WHICH ARE DESIGNED TO PREVENT EXPOSURE TO RAINFALL AND TO NOT ALLOW STORM WATER TO RUN ONTO THE AREA.
- FLUSHING OF STREETS/PARKING LOTS TO REMOVE DIRT AND CONSTRUCTION DEBRIS IS PROHIBITED UNLESS PROPER SEDIMENT CONTROLS ARE USED. AREAS REQUIRING CLEANING SHOULD BE SWEEP.
- WHERE UNSTABLE OR UNSUITABLE MATERIALS ARE ENCOUNTERED DURING SUBGRADE PREPARATION, THE AREA IN QUESTION SHALL BE OVER EXCAVATED AND REPLACED BY SELECT BACKFILL MATERIAL AS NEEDED.
- WHERE ABANDONED UNDERGROUND STRUCTURES ARE ENCOUNTERED IN THE STREET AREAS, REMOVE TO SUFFICIENT DEPTH TO ALLOW UNDERGROUND LINES TO CROSS, BACKFILL AND COMPACT DURING ROUGH GRADING. THE INSPECTOR MAY REQUIRE FURTHER WORK TO BE DONE IF VISUAL INSPECTION INDICATES SO DURING CONSTRUCTION.
- PRIOR TO ANY GRADING, DEMOLITION OF THE SITE SHOULD BE COMPLETED. DEMOLITION SHOULD INCLUDE THE COMPLETE REMOVAL OF ALL SURFACE AND SUBSURFACE STRUCTURES. IF ANY OF THE FOLLOWING ARE ENCOUNTERED: TREE ROOT SYSTEMS, CONCRETE, SEPTIC TANKS, GAS OR OIL TANKS, STORM INLETS, IRRIGATION PIPES, FOUNDATIONS, ASPHALT, DEBRIS AND TRASH, THESE SHOULD ALSO BE REMOVED, WITH THE EXCEPTION OF ITEMS SPECIFIED BY THE OWNER FOR SALVAGE.
- ALL ONSITE STORM DRAIN INLETS SHALL BE INSTALLED WITH "NO DUMPING DRAINS TO BAY" STENCILS.
- EARTHWORK QUANTITIES SHOWN ON THESE PLANS ARE APPROXIMATE ESTIMATED QUANTITIES AND ARE FURNISHED FOR THE CITY'S INFORMATION ONLY. THE ACTUAL AMOUNT MAY VARY DEPENDING ON COMPACTION, CONSOLIDATION, STRIPPING AND THE CONTRACTOR'S METHOD OF OPERATION.

## EARTHWORK SUMMARY

MEASURED RAW CUT :	404	CY
MEASURED RAW FILL :	8	CY
<b>ESTIMATED EXPORT:</b>	<b>396</b>	<b>CY</b>

EARTHWORK QUANTITIES SHOWN HEREON ARE APPROXIMATE ONLY FOR ESTABLISHMENT OF FEES. CONTRACTORS SHALL BASE BID AND OR CONTRACT AMOUNTS UPON THEIR OWN EARTHWORK ESTIMATES FOR COMPLETION OF THE WORK SHOWN HEREON, NOT ON THE QUANTITIES SHOWN ABOVE.  
NO ADJUSTMENTS HAVE BEEN APPLIED FOR SHRINK OR SWELL.

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SCALE: AS NOTED					
DRAWN: DSK					
DESIGNED: DSK					
ENGINEER: DSK					
MANAGER: DSK					
NO.	BY	DATE	REVISIONS	CITY APPR	

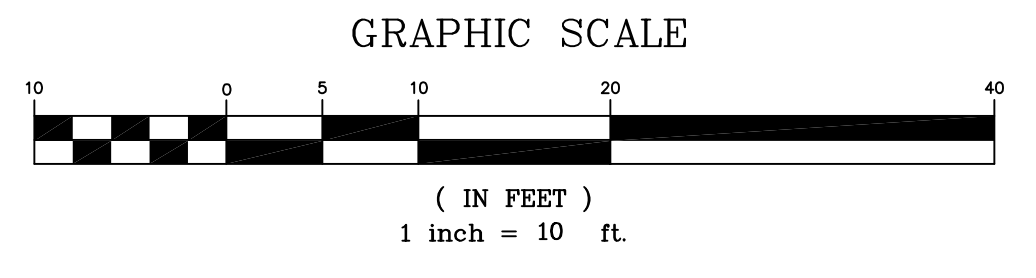PREPARED BY, OR UNDER THE DIRECTION OF:  
NOT APPROVED FOR CONSTRUCTION

PREPARED BY:  
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46560 FREMONT BOULEVARD, UNIT NO. 205  
FREMONT, CA 94538  
sterlingconsultants@gmail.com PHONE: 510.344.8955

PREPARED FOR:  
AMIT ALON & ROZA ANBARI  
2256 DEODARA DRIVE  
LOS ALTOS, CA 94024

APN: 342-02-049  
2256 DEODARA DRIVE  
**PRELIMINARY GRADING & DRAINAGE PLAN**  
CITY OF LOS ALTOS SANTA CLARA COUNTY CALIFORNIA

SHEET NO. **C2**  
OF 2 SHEETS  
JOB NO. 2020-475

PRINTED: SEPTEMBER 16, 2021