
NEW SINGLE FAMILY HOUSE FOR TAWARI'S

705 Vista Grande, Los Altos, CA 94024-3159

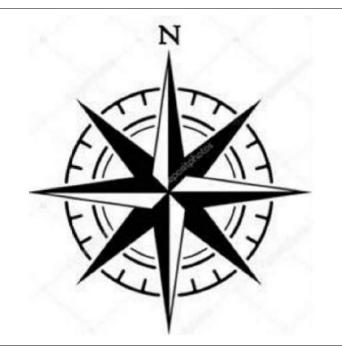

SITE DIRECTION



SHEET NUMBER	DRAWING NAME	ISSUE DATE
A-1.001	TITLE SHEET	02-16-2023
A-1.002	SITE CONTEXT MAP	02-16-2023
A-1.003	NEIGHBOURHOOD CONTEXT	02-16-2023
A-1.004	SITE LAYOUT	02-16-2023
A-1.005	SITE DEMOLITION LAYOUT	02-16-2023
A-1.006	TREE PROTECTION PLAN	02-16-2023
A-2.001	FIRST FLOOR PLAN	02-16-2023
A-2.002	SECOND FLOOR PLAN	02-16-2023
A-2.003	ROOF PLAN	02-16-2023
A-3.001	FRONT AND REAR ELEVATION	02-16-2023
A-3.002	LEFT AND RIGHT ELEVATION	02-16-2023
A-4.001	SECTION A-A AND B-B	02-16-2023
A-4.002	SECTION C-C	02-16-2023
A-5.001	DOOR SCHEDULE	02-16-2023
A-5.002	WINDOW SCHEDULE	02-16-2023
A-6.001	AREA CALCULATON	02-16-2023
A-7.001	TYPICAL DETAILS	02-16-2023
A-7.002	MATERIAL BOARD	02-16-2023
C-1	GRADING AND DRAINAGE PLAN	02-16-2023
C-2	DETAILS	02-16-2023
C-3	EROSION CONTROL PLAN	02-16-2023
C-4	STANDARD DETAILS	02-16-2023
L-1	COVER SHEET	02-16-2023
L-2	LANDSCAPE LAYOUT	02-16-2023
L-3	PLANTING PLAN	02-16-2023
\$U-1 /	TOPOGRAPHIC MAP	02-16-2023
SU-2	TENTATIVE MAP	02-16-2023
U-1	UTILITY PLAN	02-16-2023

SCOPE OF WORK

DEMOLITION OF 3,126 SF OF EXISTING RESIDENCE STRUCTURE, NEW CONSTRUCTION OF 3,827 SF MAIN HOUSE AND 757 SF ATTACHED ADU TWO STORY SINGLE FAMILY RESIDENCE OVER LOT 12,166 SF.

ZONING COMPLIANCE

THE PROJECT SHALL COMPLY WITH 2019 CALIFORNIA RESIDENTIAL CODE 2019 CALIFORNIA MECHANICAL CODE 2019 CALIFORNIA PLUMBING CODE 2019 CALIFORNIA ELECTRICAL CODE 2019 CALIFORNIA ENERGY CODE 2019 CALIFORNIA GREEN BUILDING STANDARDS CODE

TYPE OF CONSTRUCTION: **SECTION 1.1.3.1**

LOT AREA: 12,166 SF

NEW STRUCTURE

TOTAL FLOOR AREA

MAIN HOUSE LIVING AREA: 3744 SF

TOTAL COUNTABLE AREA: 4,501 SF

FRONT YARD SETBACK CALCULATIONS FRONTYARD AREA = 2,307 SF HARDSCAPE AREA = 890 SF TOTAL SOFTSCAPE AREA = 1,417 SF

2019 CALIFORNIA BUILDING CODE (CBC)

CITY OF LOS ALTOS APN: 189-58-070

ZONE: R-1-10

HISTORICAL: NO

NEW TWO STORY ALLOWABLE FLOOR AREA: 5,160.9 SF

ADU LIVING AREA: 757 SF

TOTAL SOFTSCAPE AREA (%) = 61.4%

SITE ANALYSIS

	EXISTING	PR	OPOSED	ALLOWED
LOT COVERAGE LAND AREA COVERED BY ALL STRUCTURES THAT ARE OVER 6FT IN HEIGHT	3126 SF (25.70%)	3,634 SF (<u>29.87%</u>)	FIRST LEVEL = 2222 SF ADU = 757 SF PATIO = 655 SF TOTAL = 3634 SF	3,650 SF /1 (30%)
FLOOR AREA MEASURED TO THE OUTSIDE SURFACE OF EXTERIOR WALLS	3126 SF (25.70 %)	3827 SF (<u>31.45%</u>)	FIRST LEVEL = 2222 SF SECOND LEVEL = 1522 SF COVERED PORCH = 83 SF TOTAL = 3827 SF	(32 55 %)
			ADU = 757 SF	ADU = 1,200 SF

SETBACKS

		EXISTING	PROPOSED	ALLOWED
	FRONT (FIRST/SECOND)	20' 0"	25' / 34' 6 1/2"	25' 0"/ 25' 0"
Λ	REAR (FIRST/SECOND)	2' 0"	29' 8 1/2" / 44' 6 1/2"	25' 0" / 25' 0"
	RIGHT- EXTERIOR STREET SIDE (FIRST/SECOND)	12' 0"	20' / 24' 11 1/2"	20' 0" / 20' 0"
	LEFT (FIRST/SECOND)	7' 11"	30' 4 1/2 / 30' 4 1/2"	10' 0" / 17' 6"
	ADU	-	5' 6"	4'
	HEIGHT OF THE BUILDING	14' 0"	26' 8 1/2"	27' 0"

SQUARE FOOTAGE BREAKDOWN					
	EXISTING	CHANGE IN	PROPOSED		
HABITABLE AREA	1003 SF	4041 SF FIRST (EX. GARAGE) = 2519 SECOND (EX. = 1522	4041 SF		
NON-HABITABLE AREA DOES NOT INCLUDE COVERED PORCHES OR OPEN STRUCTURES	696 SF	460 SF GARAGE = 460 SF	460 SF		

PROJECT DIRECTORY OWNER: SANDESH TAWARI & SHIKHA TAWARI

RW ENGNIEERING

408-262-1899

ARCHITECT: LIVIO BUILDING SYSTEMS

LANDSCAPE ARCHITECT: PVMLA LANDSCAPE ARCHITECTURE 650-270-0966 info@pvmla.com

CIVIL ENGINEER

/LAND SURVEYOR:

DEFERRED SUBMITTALS

FIRE SPRINKLERS IN ACCORDANCE WITH NFPA 13D AND STATE AND LOCAL REQUIREMENTS NOTE THAT PER CRC 313.3.7, A SIGN OR VALVE TAG SHALL BE INSTALLED AT THE MAIN SHUTOFF VALVE TO THE WATER DISTRIBUTION SYSTEM STATING THE FOLLOWING: WARNING, THE WATER SYSTEM FOR THIS HOME SUPPLIES FIRE SPRINKLERS THAT REQUIRE CERTAIN FLOWS AND PRESSURES TO FIGHT A FIRE. DEVICES THAT RESTRICT THE FLOW OR DECREASE THE PRESSURE OR AUTOMATICALLY SHUT OFF THE WATER TO THE FIRE SPRINKLER SYSTEM, SUCH AS WATER SOFTENERS, FILTRATION SYSTEMS AND AUTOMATIC SHUTOFF VALVES, SHALL NOT BE ADDED TO THIS SYSTEM WITHOUT A REVIEW OF THE FIRE SPRINKLER SYSTEM BY A FIRE PROTECTION SPECIALIST. DO NOT REMOVE THIS SIGN.


GENERAL NOTES


- 1. HERS VERIFICATION REQUIRED FOR THE HVAC COOLING, HVAC DISTRIBUTION SYSTEM FAN SYSTEMS, AND IAQ (INDOOR AIR QUALITY).
- 2. AT FINAL INSPECTION, A MANUAL, COMPACT DISC, WEB-BASED REFERENCE, OR OTHER ACCEPTABLE MEDIA INCLUDING ITEMS THROUGH 10 IN ACCORDANCE WITH CGBSC SECTION 4.410.1 SHALL BE PLACED IN THE BUILDING.
- 3. ALL ADHESIVES, SEALANTS, CAULKS, PAINTS, COATINGS, AND AEROSOL PAINT CONTAINERS MUST REMAIN ON THE SITE FOR FIELD VERIFICATION BY THE BUILDING INSPECTOR.
- 4. PRIOR TO ENCLOSING THE WALL AND FLOOR FRAMING, CONFIRMATION MUST BE PROVIDED TO THE BUILDING INSPECTOR SHOWING THE FRAMING MEMBERS DO NOT EXCEED 19% MOISTURE CONTENT.
- 5. PRIOR TO OCCUPANCY OF THE BUILDING, PROVIDE A LETTER FROM THE CERTIFIED GREENPOINT RATER THAT VERIFIES COMPLIANCE WITH THE CHECKLIST AND THE MINIMUM REQUIRED POINTS WERE ACHIEVED.
- 6. PROPERTY LINE SURVEY WILL BE COMPLETED BY LICENSED SURVEYOR AND PROVIDED TO THE BUILDING INSPECTOR PRIOR TO
- 7. BUILDING HEIGHT VERIFICATION WILL BE COMPLETED BY LICENSED SURVEYOR AND PROVIDED TO THE BUILDING INSPECTOR PRIOR
- TO FRAMING INSPECTION 8. INSTALLATION INSTRUCTIONS FOR ALL LISTED EQUIPMENT SHALL BE PROVIDED TO THE BUILDING INSPECTOR AT ROUGH INSPECTION

VICINITY MAP

N.T.S



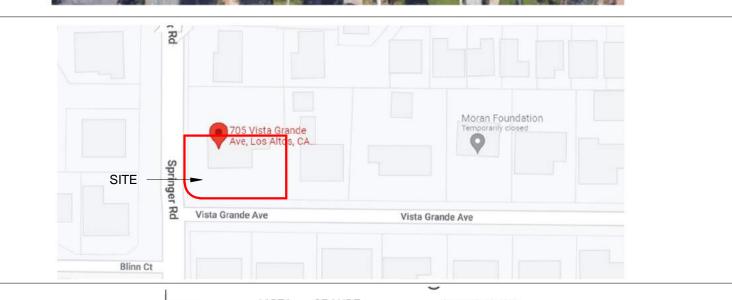

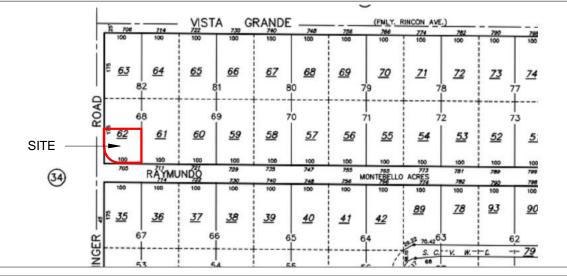

REVISIONS:					
REV.	DESCRIPTION	DATE	REV BY		
À	REVISED AS PER PLANNER'S COMMENTS	12-16-2022	SAGAR		
<u>^</u> 2\	REVISED AS PER PLANNER'S COMMENTS	02-16-2022	SAGAR		
	-				

NOTES:

NOTES:

- ALL DIMENSIONS ARE IN FEET AND INCHES.
- DRAWING SHALL NOT BE SCALED AND ONLY WRITTEN DIMENSIONS SHALL BE FOLLOWED. ALL CENTERLINES ARE FROM THE CENTER OF
- COLUMN/ WALL AND THE DIMENSIONS GIVEN ARE CENTERLINE DIMENSIONS- -UNLESS OTHERWISE MENTIONED. IN CASE OF ANY DISCREPANCY FOUND IN DRAWINGS
- AND DETAILS, IT SHALL BE BROUGHT TO THE NOTICE OF THE ARCHITECT, AND RECTIFIED, PRIOR TO ITS EXECUTION. THIS DRAWING IS ISSUED STRICTLY WITH AN
- UNDERSTANDING THAT IT WILL BE USED ONLY FOR THE PURPOSE MENTIONED AND SHALL BE RETURNED AFTER COMPLETION.
- ·LARGER SCALE DRAWINGS AND DETAILS SUPERCEDE THE SMALLER SCALE DRAWINGS AND DETAILS. THIS DRAWING SHALL BE REFERRED ONLY FOR THE
- PURPOSE MENTIONED IN ITS TITLE (FLOORING PATTERN, FALSE CEILING, SHUTTERING PATTERN, ELECTRICAL, PLUMBING, ETC.)

THIS DOCUMENT IS THE PROPERTY OF LIVIO BUILDING SYSTEMS AND SHALL NOT BE REFERRED, REPRODUCED, COPIED, ETC, WITHOUT EXPLICIT WRITTEN PERMISSION FROM LIVIO BUILDING SYSTEMS, LOS ALTOS, CA USA

PROJECT: 705 VISTA GRANDE AVE-LOT B, LOS ALTOS, CA

TITLE SHEET

DATE: 02-16-2023


DRAWN BY: SAGAR CHECKED BY: SUBHENDU

SCALE: 1/4" = 1'-0"


SHEET NO:

CONTACT: 650-209-6500 A-1.001


ADDRESS: 329 S San Antonio Road Suite #4, Los Altos, CA 94022 team@golivio.com

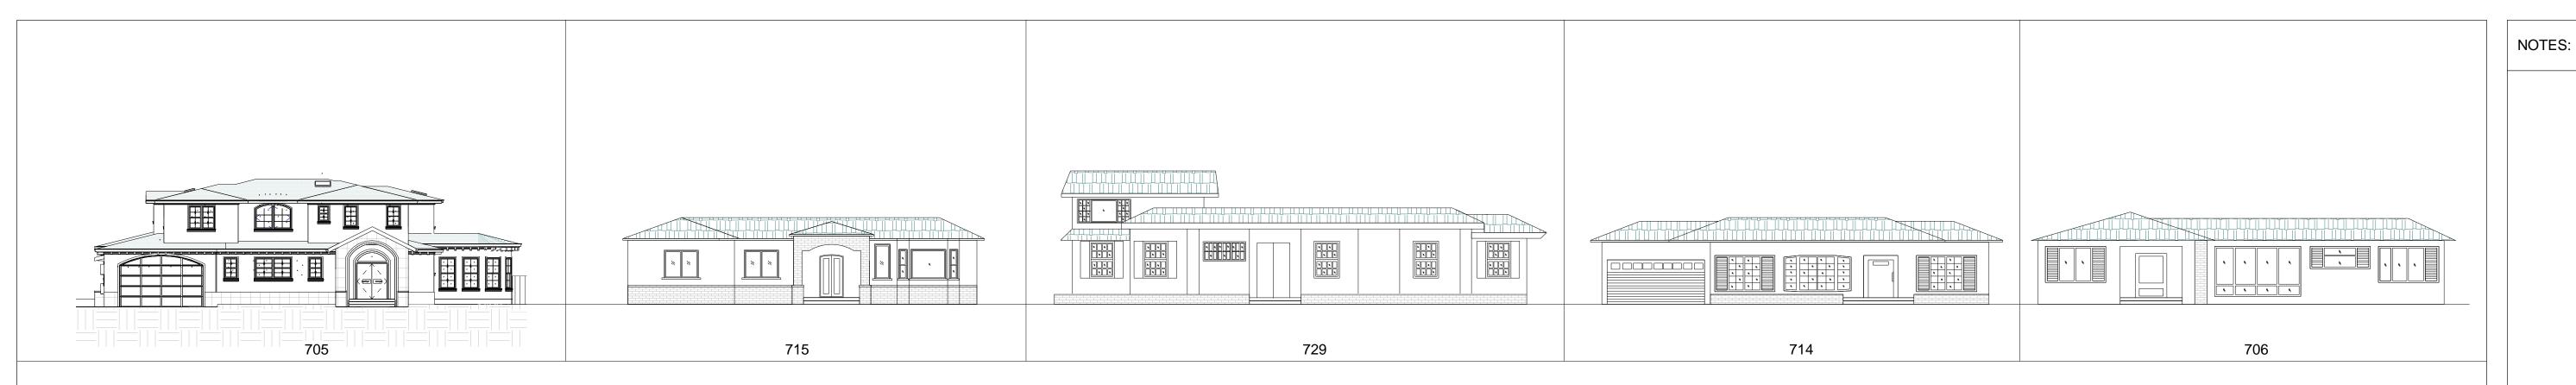

VISTA GRANDE AVE

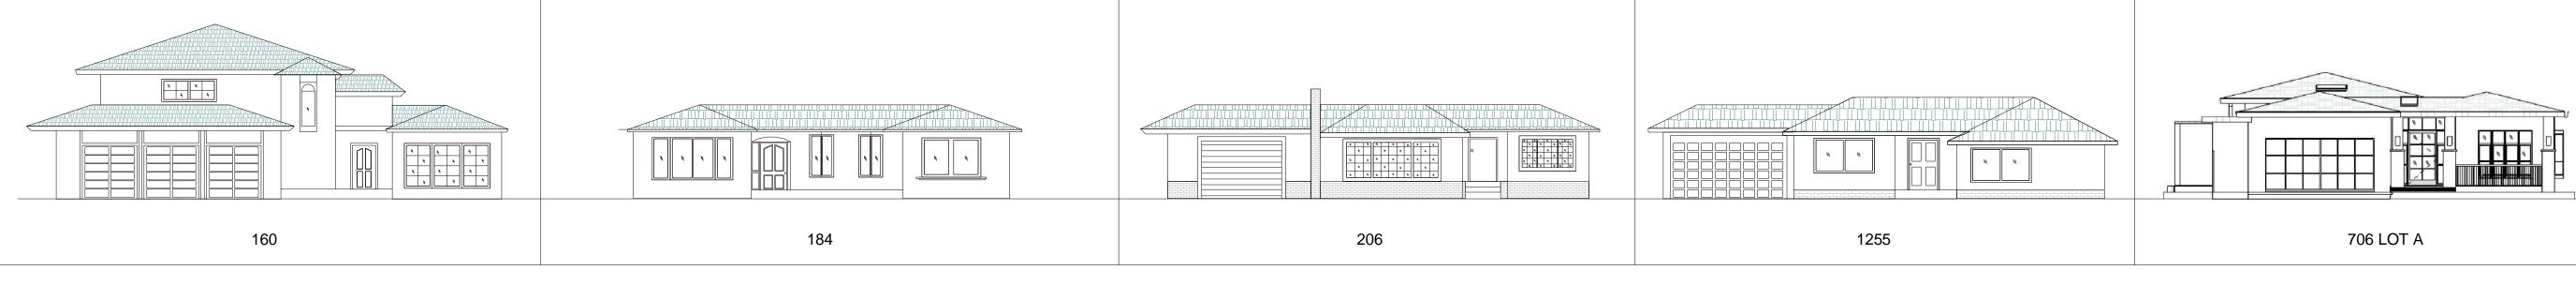

SPRINGER RD

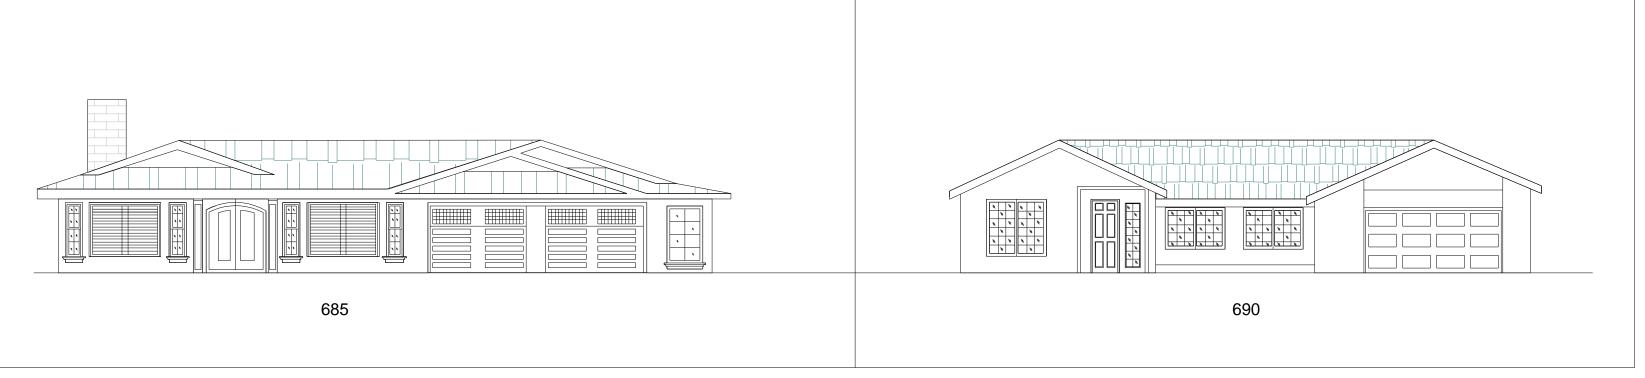


BLINN CT





VIEW LOOKING OF 705 VISTA GRANDE LOT B EXISTING HOUSE

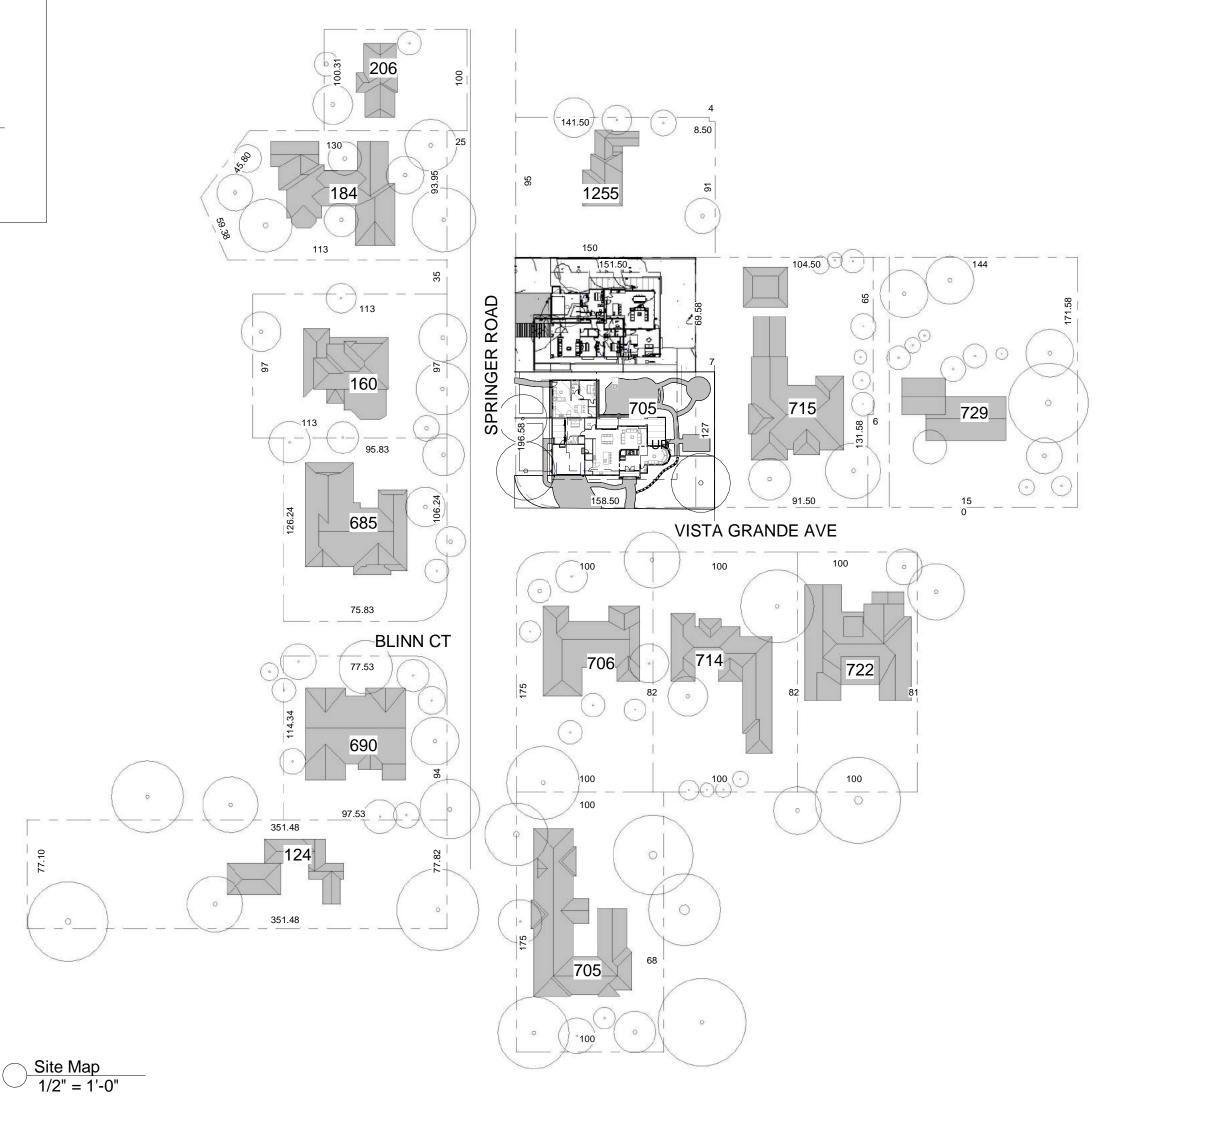



REV.	DESCRIPTION	DATE	REV I
À	REVISED AS PER PLANNER'S COMMENTS	12-16-2022	SAGAR
<u>^</u> 2	REVISED AS PER PLANNER'S COMMENTS	02-16-2022	SAGAR

NOTES:

- ALL DIMENSIONS ARE IN FEET AND INCHES.
- DRAWING SHALL NOT BE SCALED AND ONLY WRITTEN DIMENSIONS SHALL BE FOLLOWED. ALL CENTERLINES ARE FROM THE CENTER OF COLUMN/ WALL AND THE DIMENSIONS GIVEN ARE
- CENTERLINE DIMENSIONS- -UNLESS OTHERWISE MENTIONED. IN CASE OF ANY DISCREPANCY FOUND IN DRAWINGS
- AND DETAILS, IT SHALL BE BROUGHT TO THE NOTICE OF THE ARCHITECT, AND RECTIFIED, PRIOR TO ITS EXECUTION. THIS DRAWING IS ISSUED STRICTLY WITH AN UNDERSTANDING THAT IT WILL BE USED ONLY FOR
- THE PURPOSE MENTIONED AND SHALL BE RETURNED AFTER COMPLETION.
- ·LARGER SCALE DRAWINGS AND DETAILS SUPERCEDE THE SMALLER SCALE DRAWINGS AND DETAILS.
- THIS DRAWING SHALL BE REFERRED ONLY FOR THE PURPOSE MENTIONED IN ITS TITLE (FLOORING PATTERN, FALSE CEILING, SHUTTERING PATTERN, ELECTRICAL, PLUMBING, ETC.)

THIS DOCUMENT IS THE PROPERTY OF LIVIO BUILDING SYSTEMS AND SHALL NOT BE REFERRED, REPRODUCED, COPIED, ETC, WITHOUT EXPLICIT WRITTEN PERMISSION FROM LIVIO BUILDING SYSTEMS, LOS ALTOS, CA USA

PROJECT: 705 VISTA GRANDE AVE-LOT B, LOS ALTOS, CA

SITE CONTEXT MAP

DATE: 02-16-2023 DRAWN BY: SAGAR CHECKED BY: SUBHENDU



CONTACT: 650-209-6500

A-1.002

SCALE: As indicated ADDRESS: 329 S San Antonio Road Suite #4, Los Altos, CA 94022 team@golivio.com













685

ONE STORY, HIP AND GABLE ROOF


690

ONE STORY, HIP AND GABLE ROOF

BLINN CT





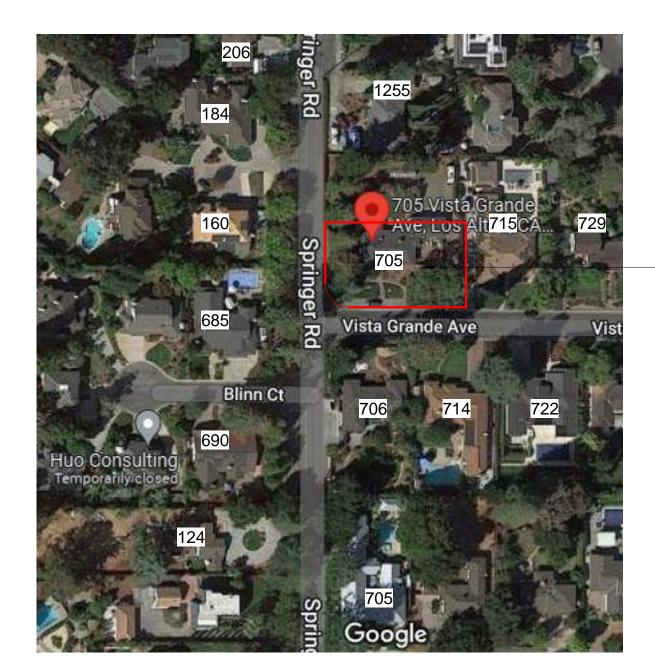

CONTEXT MAP

REV.	DESCRIPTION	DATE	RI
À	REVISED AS PER PLANNER'S COMMENTS	12-16-2022	SAGAF
<u>^</u> 2\	REVISED AS PER PLANNER'S COMMENTS	02-16-2022	SAGAF

NOTES:

705 VISTA GRANDE AVENUE,

LOS ALTOS, CA

NOTES:

- ALL DIMENSIONS ARE IN FEET AND INCHES.
- DRAWING SHALL NOT BE SCALED AND ONLY WRITTEN DIMENSIONS SHALL BE FOLLOWED. ALL CENTERLINES ARE FROM THE CENTER OF COLUMN/ WALL AND THE DIMENSIONS GIVEN ARE
- CENTERLINE DIMENSIONS- -UNLESS OTHERWISE MENTIONED. IN CASE OF ANY DISCREPANCY FOUND IN DRAWINGS
- AND DETAILS, IT SHALL BE BROUGHT TO THE NOTICE OF THE ARCHITECT, AND RECTIFIED, PRIOR TO ITS EXECUTION. THIS DRAWING IS ISSUED STRICTLY WITH AN
- UNDERSTANDING THAT IT WILL BE USED ONLY FOR THE PURPOSE MENTIONED AND SHALL BE RETURNED AFTER COMPLETION.
- ·LARGER SCALE DRAWINGS AND DETAILS SUPERCEDE THE SMALLER SCALE DRAWINGS AND DETAILS.
- THIS DRAWING SHALL BE REFERRED ONLY FOR THE PURPOSE MENTIONED IN ITS TITLE (FLOORING PATTERN, FALSE CEILING, SHUTTERING PATTERN, ELECTRICAL, PLUMBING, ETC.)

THIS DOCUMENT IS THE PROPERTY OF LIVIO BUILDING SYSTEMS AND SHALL NOT BE REFERRED, REPRODUCED, COPIED, ETC, WITHOUT EXPLICIT WRITTEN PERMISSION FROM LIVIO BUILDING SYSTEMS, LOS ALTOS, CA USA

PROJECT: 705 VISTA GRANDE AVE-LOT B, LOS ALTOS, CA

NEIGHBOURHOOD CONTEXT

DATE:	02-16-2023
DRAWN BY:	SAGAR
CHECKED BY:	SUBHENDU



As indicated SCALE: ADDRESS: 329 S San Antonio Road Suite #4, Los Altos, CA 94022 A-1.003

CONTACT: 650-209-6500 EMAIL: team@golivio.com

S89°30'90"E AREA TO BE DEMOLISHED NEW WOODEN FENCING WITH 6' HEIGHT OLD & NEW WOODEN FENCING WITH PATHWAY ADU ENTRY ⊏>UP REDWOOD 24" 25' - 0" FIRST & SECOND LEVEL FRONT ALLOWED SETBACK FAUX LAWN 💸 70' - 0 1/2" 2STANCE BETWEEN CENTER OF THE ROAD TO PROPOSED FRONT SETBACH OF THE BUILDING FAUX LAWN PERMEABLE WALKWAY FIRST STORY SECOND STORY TERRACE OLD & NEW WOODEN FENCING OLD & NEW WOODEN FENCING WITH 6' HEIGHT 25' - 0" FIRST AND SECOND LEVEL ALLOWED REAR SET BACK 25' - 0" PIRST LEVEL FRONT PROPOSED SETBACK -SECOND STORY BALCONY -SECOND STORY-REDWOOD 34' - 6 1/2" SECOND LEVEL FRONT PROPOSED SETBAC LEVEL 1 SETBACK LINE DECOMPOSED GRANITE PATIO 44' - 6 1/2" SECOND LEVEL REAR PROPOSED SETBACK LEVEL 2 PROPOSED SETBACK LINE (N) SSCO __⁄____ss__ EM DEODAR ĈĒDAR CONCRETE PATHWAY TR-1 40" CORK OAK CONCRETE ≅DRIVEWAY 27.2" (♥) TR-18 (122) CONCRETE NEW WOODEN FENCING WALKWAY NEW WOODEN FENCING WITH \$89°3**\[\]**00"**E** 158.50 (N) SSCO PROPERTY LINE PROPERTY LINE ROPERTY LINE *%*CSS EXISTING WM PROPOSED WM ROLLED CURB 29' - 8 1/2" VISTA GRANDE AVENUE 20.00' S89°30'00"E 158.50' S89°30'00"E 1619.72 (1620.00') MON-MON BASIS OF BEARINGS SS 1 SITE PLAN 1/8" = 1'-0"

SITE BENCHMARK

BASIS OF BEARINGS

ARROYO ROAD AS SHOWN ON MAP OF

THE BEARING S89°30'00"E OF CENTERLINE OF

SUBDIVISION OF MONTEBELLO ACRES FILED IN

BOOK "X" OF MAPS AT PAGE 1-3, SANTA CLARA

SET NAIL ELEVATION=122.48

NAVD 1988 DATUM

COUNTY RECORDS.

SITE DATA

705 VISTA GRANDE LOS ALTOS, CA APN: 189-58-070

AREA=12,177 S.F.

NOTES:

--OH--OH--OH--

SITE LEGENDS

AREA TO BE DEMOLISHED

PROPOSED MAIN HOUSE SECOND STOREY FOOTPRINT

SETBACK LINE PROPERTY LINE OVERHEAD LINE

JOINT TRENCH

SANITORY SEWER

WATER LINE FIRST STOREY





REVISIONS:

REV.	DESCRIPTION	DATE	REV BY	
<u> </u>	REVISED AS PER PLANNER'S COMMENTS	12-16-2022	SAGAR	
<u>^</u> 2\	REVISED AS PER PLANNER'S COMMENTS	02-16-2022	SAGAR	

NOTES:

MENTIONED.

- ALL DIMENSIONS ARE IN FEET AND INCHES. DRAWING SHALL NOT BE SCALED AND ONLY WRITTEN
- DIMENSIONS SHALL BE FOLLOWED. ALL CENTERLINES ARE FROM THE CENTER OF COLUMN/ WALL AND THE DIMENSIONS GIVEN ARE CENTERLINE DIMENSIONS- -UNLESS OTHERWISE
- IN CASE OF ANY DISCREPANCY FOUND IN DRAWINGS AND DETAILS, IT SHALL BE BROUGHT TO THE NOTICE OF THE ARCHITECT, AND RECTIFIED, PRIOR TO ITS EXECUTION.
- THIS DRAWING IS ISSUED STRICTLY WITH AN UNDERSTANDING THAT IT WILL BE USED ONLY FOR THE PURPOSE MENTIONED AND SHALL BE RETURNED AFTER COMPLETION.
- ·LARGER SCALE DRAWINGS AND DETAILS SUPERCEDE THE SMALLER SCALE DRAWINGS AND DETAILS.
- THIS DRAWING SHALL BE REFERRED ONLY FOR THE PURPOSE MENTIONED IN ITS TITLE (FLOORING PATTERN, FALSE CEILING, SHUTTERING PATTERN,

THIS DOCUMENT IS THE PROPERTY OF LIVIO BUILDING SYSTEMS AND SHALL NOT BE REFERRED, REPRODUCED, COPIED, ETC, WITHOUT EXPLICIT WRITTEN PERMISSION FROM LIVIO BUILDING

SYSTEMS, LOS ALTOS, CA USA PROJECT: 705 VISTA GRANDE AVE-LOT B, LOS ALTOS, CA

ELECTRICAL, PLUMBING, ETC.)

SITE LAYOUT

DATE: 02-16-2023

DRAWN BY: JUNED CHECKED BY: SUBHENDU

SCALE:

ADDRESS: 329 S San Antonio Road Suite #4, Los Altos, CA 94022 CONTACT: 650-209-6500 A-1.004 team@golivio.com

As indicated

NEIGHBORING HOUSE S89°30'00"E 151.50' NEIGHBORING GARAGE DECK \$89°30'00"E 7.00' CONC PATIO GARAGE PAVER D/W TO BE DEMOLISHED NEIGHBORING HOUSE 7 RO HATCHED AREA TO BE DEMOLISHED CONC PATIO SPRINGE CHIMNEY PORCH PAVER D/W (122) S89°30'00"E 158.50' D/W ROLLED CURB VISTA GRANDE AVENUE 20.00' S89°30'00"E 1619.72%(1620.00') MON-MON BASIS OF BEARINGS

SITE BENCHMARK

BASIS OF BEARINGS

THE BEARING S89°30'00"E OF CENTERLINE OF

ARROYO ROAD AS SHOWN ON MAP OF SUBDIVISION OF MONTEBELLO ACRES FILED IN BOOK "X" OF MAPS AT PAGE 1-3, SANTA CLARA

1 SITE DEMOLITION 3/32" = 1'-0"

SET NAIL ELEVATION=122.48 NAVD 1988 DATUM

COUNTY RECORDS.

SITE DATA

705 VISTA GRANDE

LOS ALTOS, CA APN: 189-58-070

AREA=12,109 S.F.

NOTES:

REVISIONS:

NOTES:

MENTIONED.

ITS EXECUTION.

SYSTEMS, LOS ALTOS, CA USA

DATE: 02-16-2023

CHECKED BY: SUBHENDU

SCALE: 3/32" = 1'-0"

A-1.005

DRAWN BY: SAGAR

SITE DEMOLITION LAYOUT

AFTER COMPLETION.

ELECTRICAL, PLUMBING, ETC.)

DESCRIPTION

ALL DIMENSIONS ARE IN FEET AND INCHES.

ALL CENTERLINES ARE FROM THE CENTER OF COLUMN/ WALL AND THE DIMENSIONS GIVEN ARE CENTERLINE DIMENSIONS- -UNLESS OTHERWISE

OF THE ARCHITECT, AND RECTIFIED, PRIOR TO

THE SMALLER SCALE DRAWINGS AND DETAILS.

PURPOSE MENTIONED IN ITS TITLE (FLOORING PATTERN, FALSE CEILING, SHUTTERING PATTERN,

THIS DOCUMENT IS THE PROPERTY OF LIVIO BUILDING SYSTEMS AND SHALL NOT BE REFERRED,

REPRODUCED, COPIED, ETC, WITHOUT EXPLICIT WRITTEN PERMISSION FROM LIVIO BUILDING

PROJECT: 705 VISTA GRANDE AVE-LOT B, LOS ALTOS, CA

CONTACT: 650-209-6500

EMAIL: team@golivio.com

ADDRESS: 329 S San Antonio Road Suite #4, Los Altos, CA 94022

THIS DRAWING IS ISSUED STRICTLY WITH AN

DRAWING SHALL NOT BE SCALED AND ONLY WRITTEN DIMENSIONS SHALL BE FOLLOWED.

IN CASE OF ANY DISCREPANCY FOUND IN DRAWINGS

AND DETAILS, IT SHALL BE BROUGHT TO THE NOTICE

UNDERSTANDING THAT IT WILL BE USED ONLY FOR THE PURPOSE MENTIONED AND SHALL BE RETURNED

·LARGER SCALE DRAWINGS AND DETAILS SUPERCEDE

THIS DRAWING SHALL BE REFERRED ONLY FOR THE


REVISED AS PER PLANNER'S COMMENTS

REVISED AS PER PLANNER'S COMMENTS

DATE

12-16-2022

02-16-2022

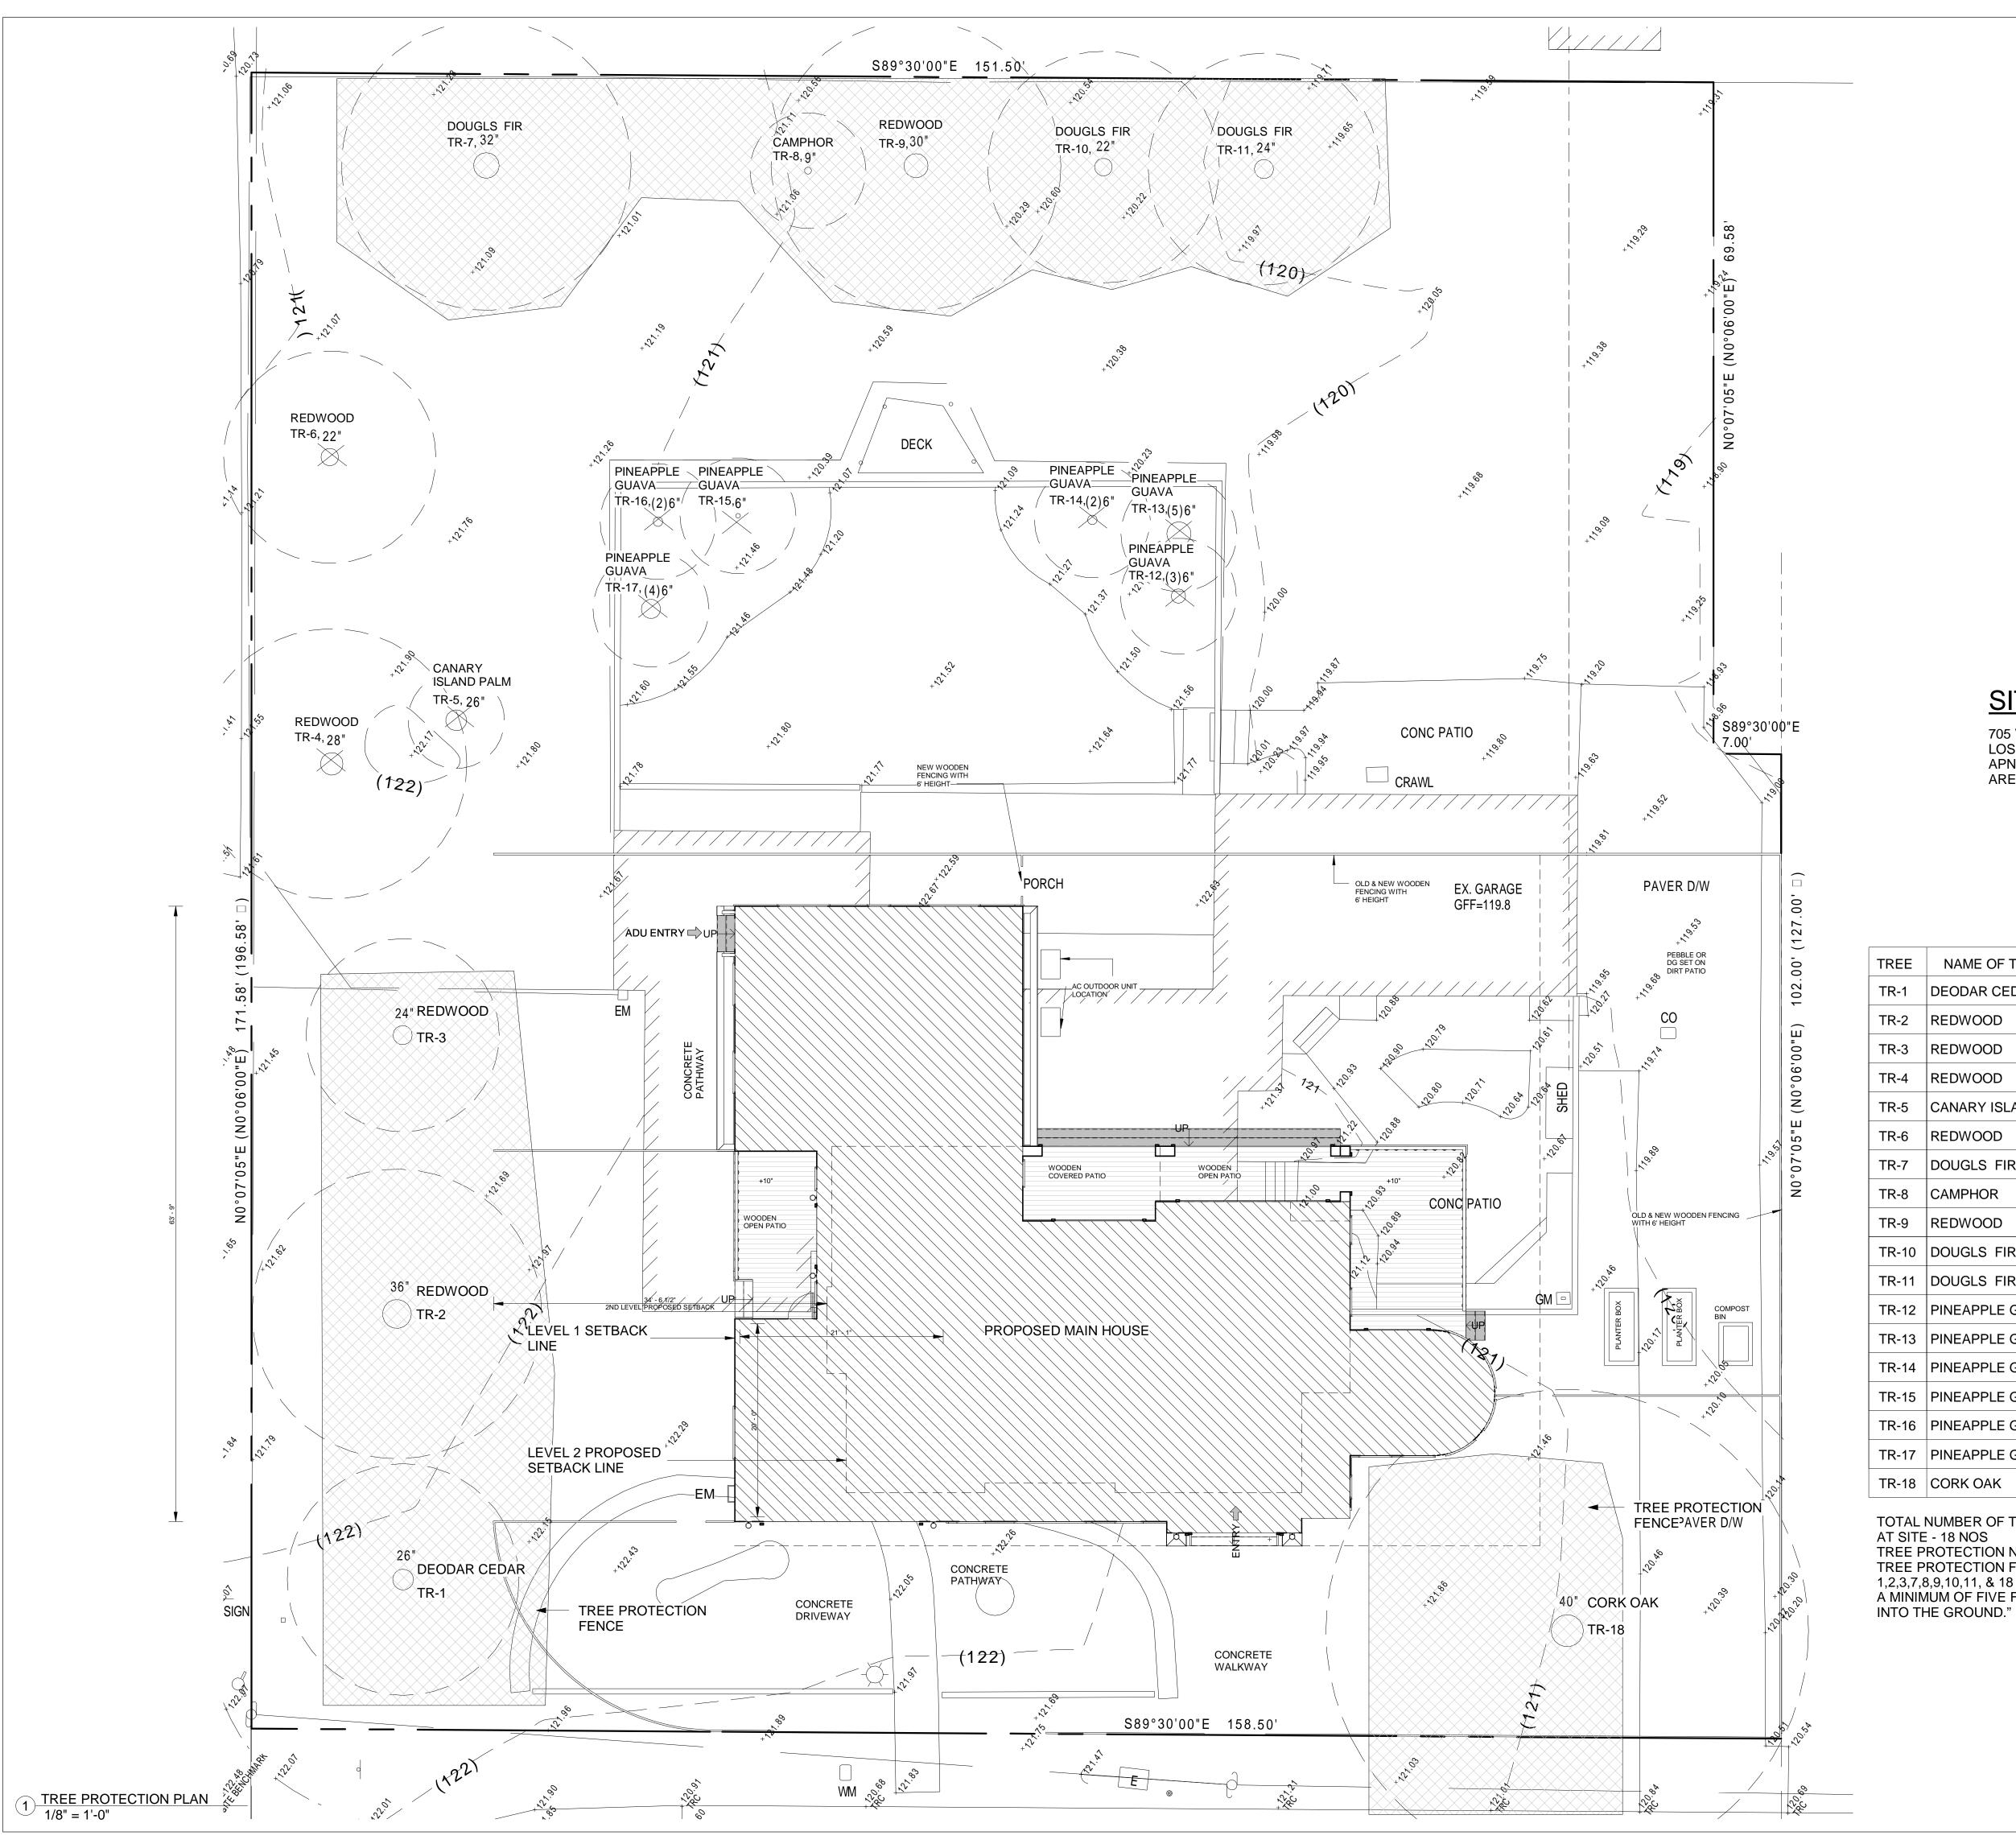

SITE DATA

705 VISTA GRANDE AVE, LOS ALTOS, CA APN: 189-58-070 AREA: 12,177 SF

TREE	NAME OF TREE	SIZE	NOTE
TR-1	DEODAR CEDAR	26"	PROTECTED
TR-2	REDWOOD	36"	PROTECTED
TR-3	REDWOOD	24"	PROTECTED
TR-4	REDWOOD	28"	REMOVAL
TR-5	CANARY ISLAND PALM	26"	REMOVAL
TR-6	REDWOOD	22"	REMOVAL
TR-7	DOUGLS FIR	32"	PROTECTED
TR-8	CAMPHOR	9"	PROTECTED
TR-9	REDWOOD	30"	PROTECTED
TR-10	DOUGLS FIR	22"	PROTECTED
TR-11	DOUGLS FIR	24"	PROTECTED
TR-12	PINEAPPLE GUAVA	6"	REMOVAL
TR-13	PINEAPPLE GUAVA	6"	REMOVAL
TR-14	PINEAPPLE GUAVA	6"	REMOVAL
TR-15	PINEAPPLE GUAVA	6"	REMOVAL
TR-16	PINEAPPLE GUAVA	6"	REMOVAL
TR-17	PINEAPPLE GUAVA	6"	REMOVAL
TR-18	CORK OAK	40"	PROTECTED

TOTAL NUMBER OF TREES EXISTED

TREE PROTECTION NOTE:

TREE PROTECTION FENCING AROUND TREES NO. 1,2,3,7,8,9,10,11, & 18 (DRIP LINE) SHALL BE CHAIN LINK AND

A MINIMUM OF FIVE FEET IN HEIGHT WITH POSTS DRIVEN



REVISIONS :
REVISIONS :

NOTES:

REV.	DESCRIPTION	DATE	REV BY		
À	REVISED AS PER PLANNER'S COMMENTS	12-16-2022	SAGAR		
<u>^</u> 2\	REVISED AS PER PLANNER'S COMMENTS	02-16-2022	SAGAR		

NOTES:

- ALL DIMENSIONS ARE IN FEET AND INCHES. DRAWING SHALL NOT BE SCALED AND ONLY WRITTEN
- DIMENSIONS SHALL BE FOLLOWED. ALL CENTERLINES ARE FROM THE CENTER OF COLUMN/ WALL AND THE DIMENSIONS GIVEN ARE CENTERLINE DIMENSIONS- -UNLESS OTHERWISE
- MENTIONED. IN CASE OF ANY DISCREPANCY FOUND IN DRAWINGS AND DETAILS, IT SHALL BE BROUGHT TO THE NOTICE OF THE ARCHITECT, AND RECTIFIED, PRIOR TO
- ITS EXECUTION. THIS DRAWING IS ISSUED STRICTLY WITH AN UNDERSTANDING THAT IT WILL BE USED ONLY FOR
- THE PURPOSE MENTIONED AND SHALL BE RETURNED AFTER COMPLETION. ·LARGER SCALE DRAWINGS AND DETAILS SUPERCEDE
- THE SMALLER SCALE DRAWINGS AND DETAILS.
- THIS DRAWING SHALL BE REFERRED ONLY FOR THE PURPOSE MENTIONED IN ITS TITLE (FLOORING PATTERN, FALSE CEILING, SHUTTERING PATTERN,

ELECTRICAL, PLUMBING, ETC.) THIS DOCUMENT IS THE PROPERTY OF LIVIO BUILDING SYSTEMS AND SHALL NOT BE REFERRED,

REPRODUCED, COPIED, ETC, WITHOUT EXPLICIT WRITTEN PERMISSION FROM LIVIO BUILDING SYSTEMS, LOS ALTOS, CA USA


PROJECT: 705 VISTA GRANDE AVE-LOT B, LOS ALTOS, CA TREE PROTECTION PLAN

02-16-2023

DRAWN BY: SAGAR CHECKED BY: SUBHENDU

SCALE: As indicated ADDRESS: 329 S San Antonio Road Suite #4, Los Altos, CA 94022 CONTACT: 650-209-6500 A-1.006

team@golivio.com

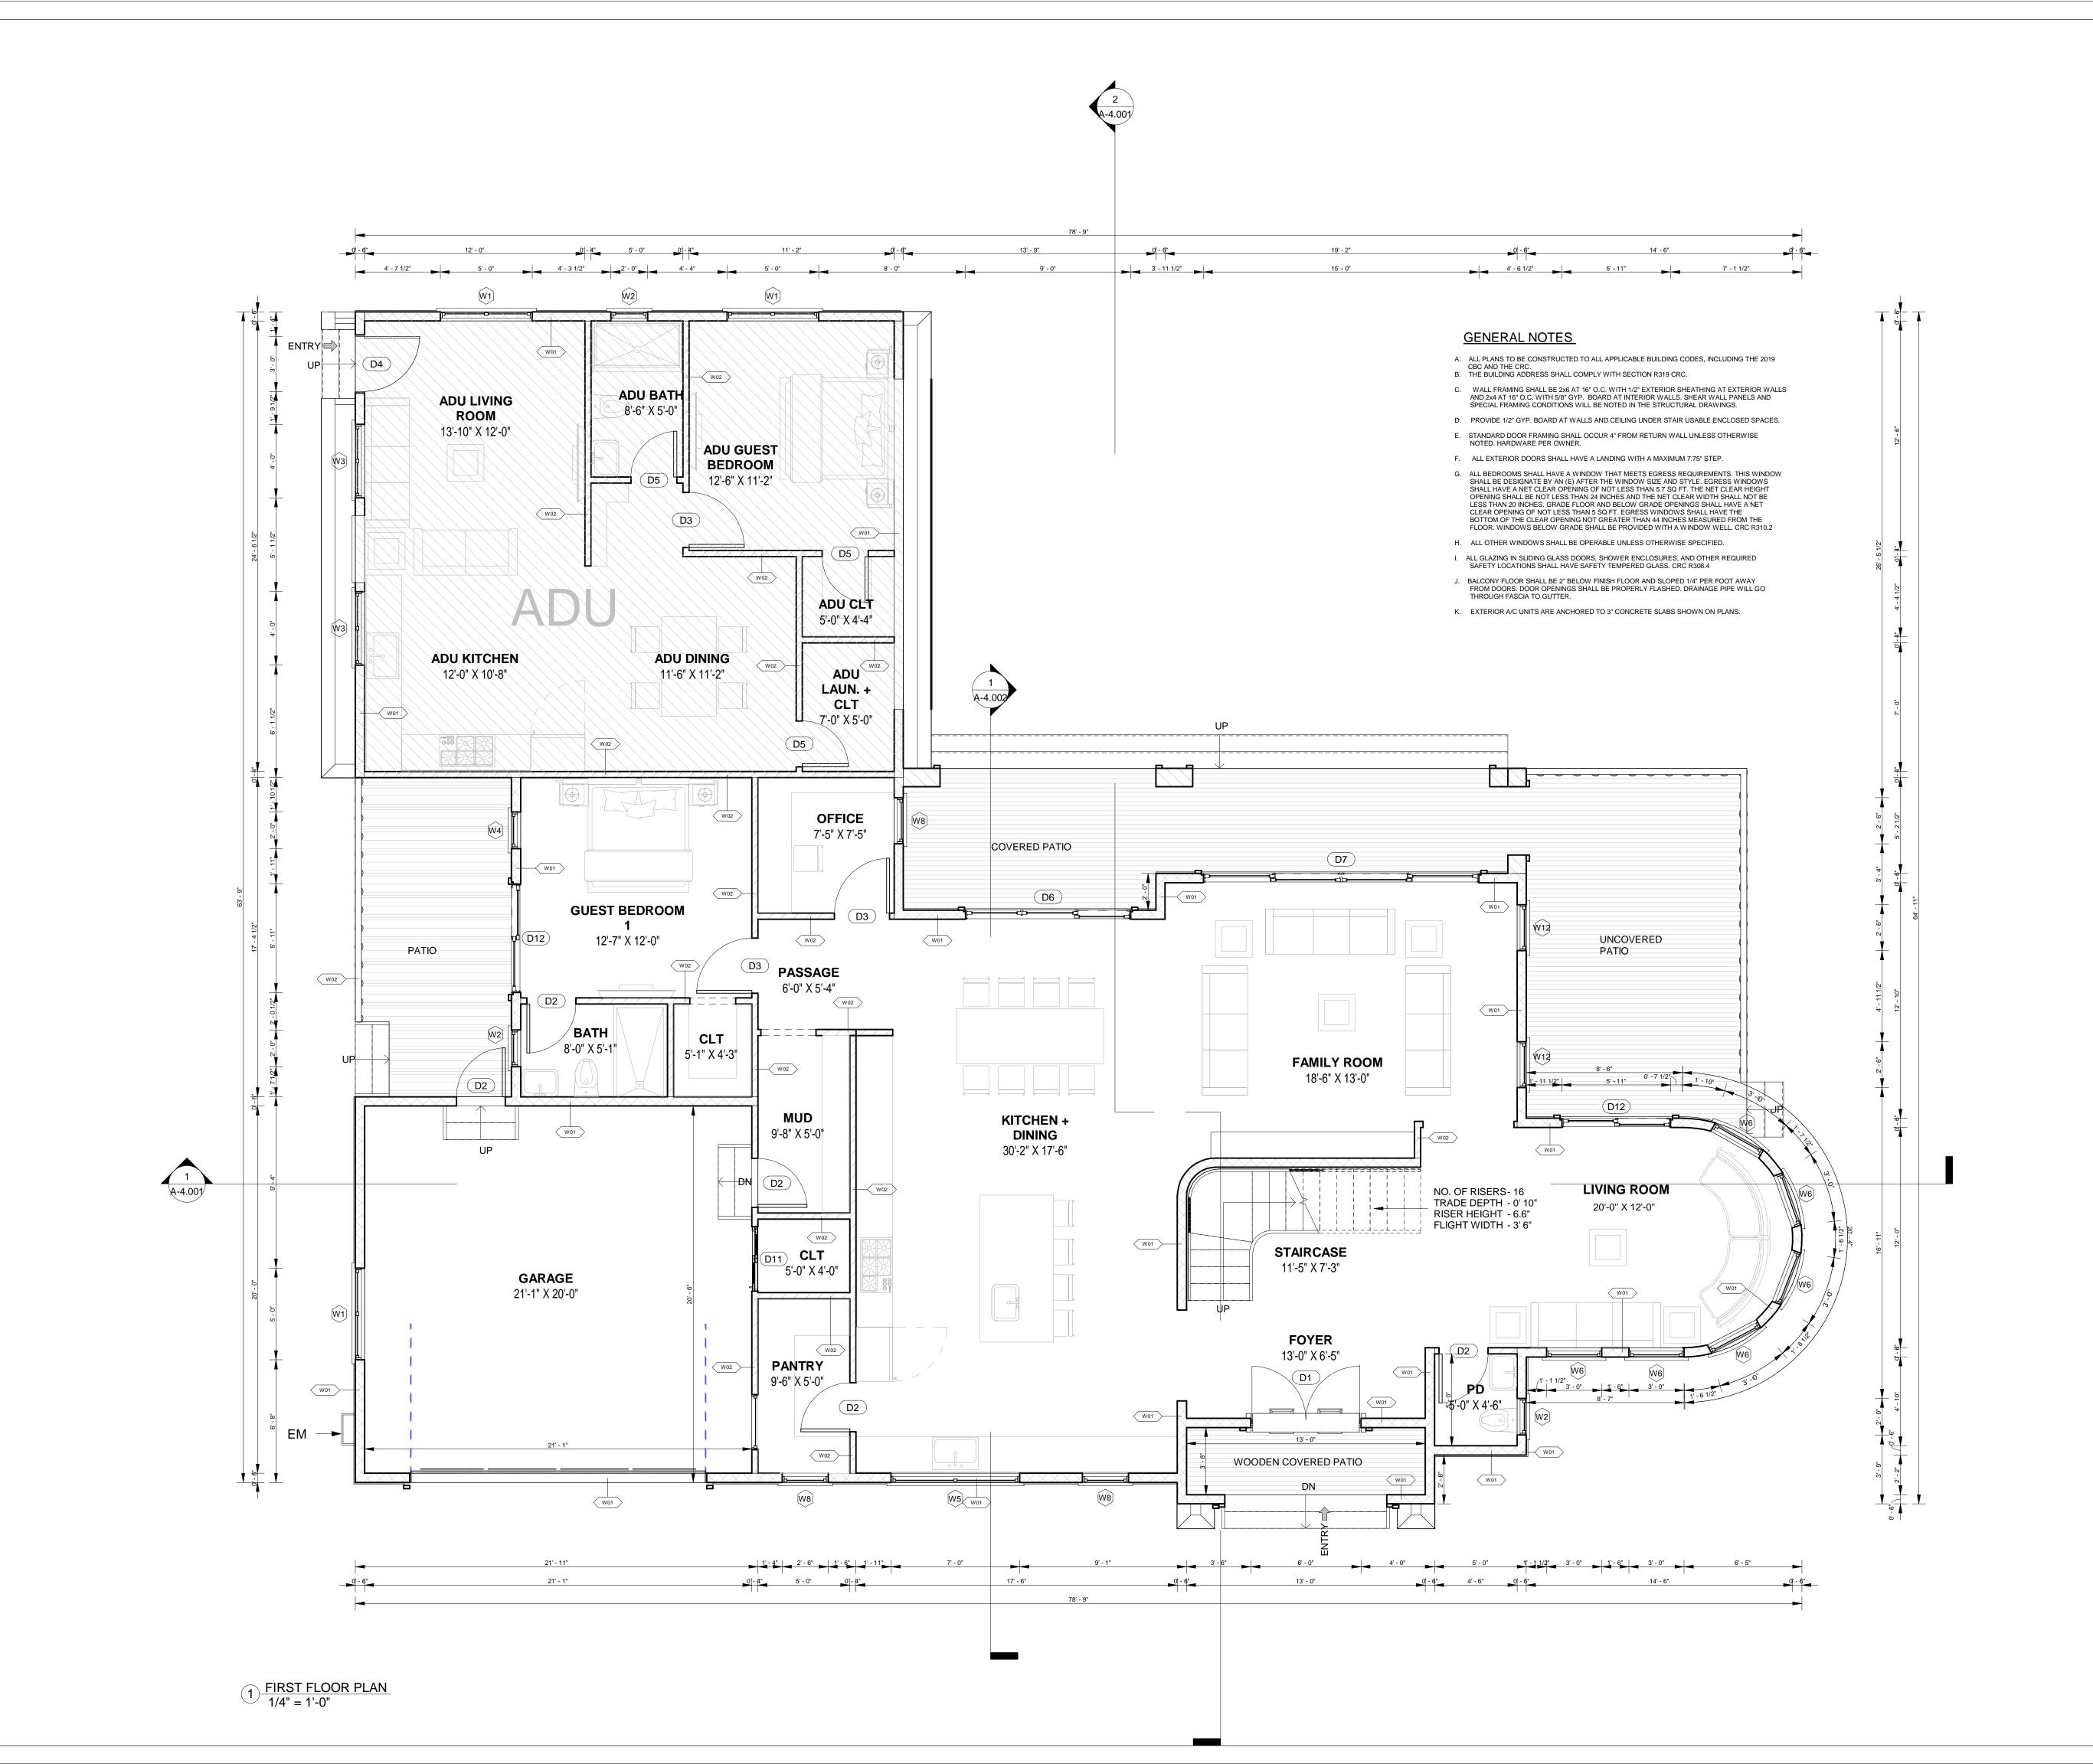



WALL LEGEND (FIRST FLOOR)

BASIC WALL : INT WALL 4"

BASIC WALL : GENERIC 6"



REVI	SIONS :
REV.	

INLV.	DESCRIPTION	DATE	KLVDI
À	REVISED AS PER PLANNER'S COMMENTS	12-16-2022	SAGAR
<u>^</u> 2\	REVISED AS PER PLANNER'S COMMENTS	02-16-2022	SAGAR
	·		
	·		

NOTES:

- ALL DIMENSIONS ARE IN FEET AND INCHES. DRAWING SHALL NOT BE SCALED AND ONLY WRITTEN
- DIMENSIONS SHALL BE FOLLOWED. ALL CENTERLINES ARE FROM THE CENTER OF
- COLUMN/ WALL AND THE DIMENSIONS GIVEN ARE CENTERLINE DIMENSIONS- -UNLESS OTHERWISE MENTIONED.
- IN CASE OF ANY DISCREPANCY FOUND IN DRAWINGS AND DETAILS, IT SHALL BE BROUGHT TO THE NOTICE OF THE ARCHITECT, AND RECTIFIED, PRIOR TO ITS EXECUTION. THIS DRAWING IS ISSUED STRICTLY WITH AN
- UNDERSTANDING THAT IT WILL BE USED ONLY FOR THE PURPOSE MENTIONED AND SHALL BE RETURNED AFTER COMPLETION.
- ·LARGER SCALE DRAWINGS AND DETAILS SUPERCEDE
- THE SMALLER SCALE DRAWINGS AND DETAILS. THIS DRAWING SHALL BE REFERRED ONLY FOR THE
- PURPOSE MENTIONED IN ITS TITLE (FLOORING PATTERN, FALSE CEILING, SHUTTERING PATTERN, ELECTRICAL, PLUMBING, ETC.)

THIS DOCUMENT IS THE PROPERTY OF LIVIO BUILDING SYSTEMS AND SHALL NOT BE REFERRED, REPRODUCED, COPIED, ETC, WITHOUT EXPLICIT WRITTEN PERMISSION FROM LIVIO BUILDING SYSTEMS, LOS ALTOS, CA USA

PROJECT: 705 VISTA GRANDE AVE-LOT B, LOS ALTOS, CA


FIRST FLOOR PLAN

DATE: 02-16-2023

DRAWN BY: SAGAR CHECKED BY: SUBHENDU

SCALE: 1/4" = 1'-0"

A-2.001

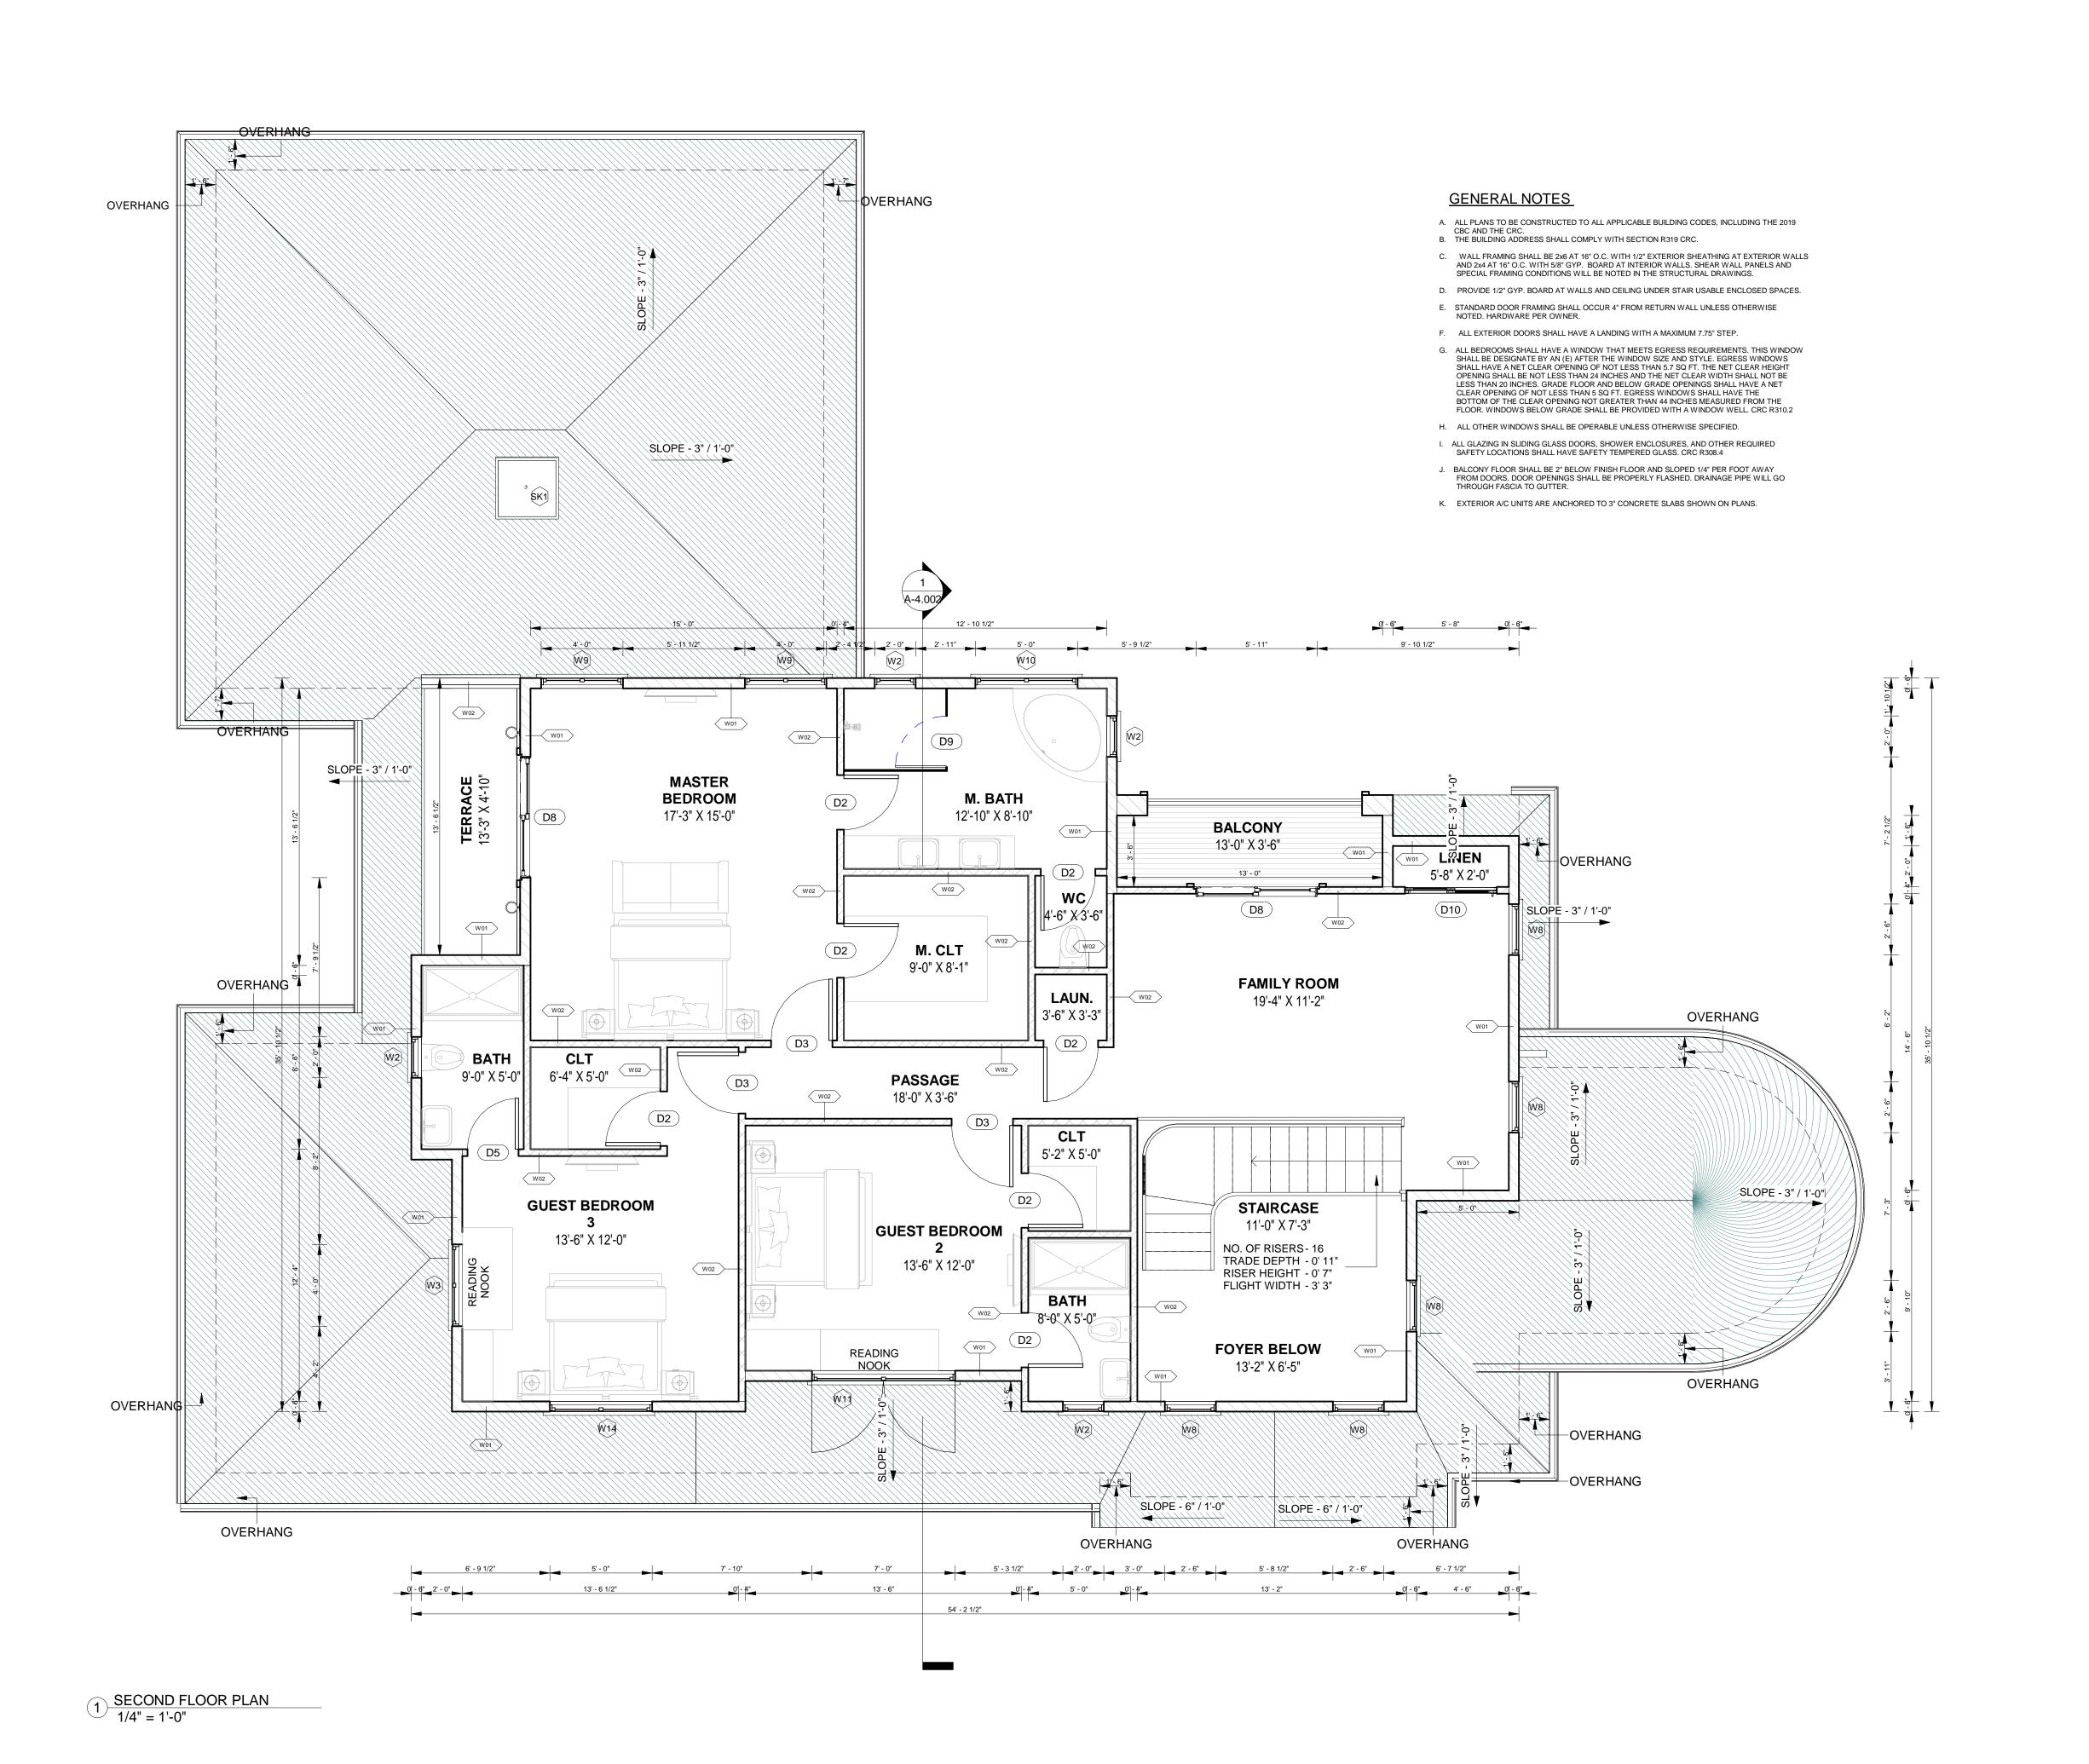

WALL LEGEND (SECOND FLOOR)

BASIC WALL : INT WALL 4"

BASIC WALL : GENERIC 6"



REVI	SIONS:		
REV.	DESCRIPTION	DATE	REV BY
À	REVISED AS PER PLANNER'S COMMENTS	12-16-2022	SAGAR
<u>^</u> 2\	REVISED AS PER PLANNER'S COMMENTS	02-16-2022	SAGAR
		·	

NOTES:

- ALL DIMENSIONS ARE IN FEET AND INCHES.
- DRAWING SHALL NOT BE SCALED AND ONLY WRITTEN
- DIMENSIONS SHALL BE FOLLOWED.
 ALL CENTERLINES ARE FROM THE CENTER OF
 COLUMN/ WALL AND THE DIMENSIONS GIVEN ARE
 CENTERLINE DIMENSIONS- -UNLESS OTHERWISE
 MENTIONED.
- IN CASE OF ANY DISCREPANCY FOUND IN DRAWINGS AND DETAILS, IT SHALL BE BROUGHT TO THE NOTICE OF THE ARCHITECT, AND RECTIFIED, PRIOR TO ITS EXECUTION.
 THIS DRAWING IS ISSUED STRICTLY WITH AN
- UNDERSTANDING THAT IT WILL BE USED ONLY FOR THE PURPOSE MENTIONED AND SHALL BE RETURNED AFTER COMPLETION.

 LARGER SCALE DRAWINGS AND DETAILS SUPERCEDE
- THE SMALLER SCALE DRAWINGS AND DETAILS.
- THIS DRAWING SHALL BE REFERRED ONLY FOR THE PURPOSE MENTIONED IN ITS TITLE (FLOORING PATTERN, FALSE CEILING, SHUTTERING PATTERN, ELECTRICAL, PLUMBING, ETC.)

THIS DOCUMENT IS THE PROPERTY OF LIVIO BUILDING SYSTEMS AND SHALL NOT BE REFERRED, REPRODUCED, COPIED, ETC, WITHOUT EXPLICIT WRITTEN PERMISSION FROM LIVIO BUILDING SYSTEMS, LOS ALTOS, CA USA

PROJECT: 705 VISTA GRANDE AVE-LOT B, LOS ALTOS, CA

SECOND FLOOR PLAN


DATE: 02-16-2023

DRAWN BY: SAGAR

DRAWN BY: SAGAR
CHECKED BY: SUBHENDU

SCALE: 1/4" = 1'-0"

A-2.002

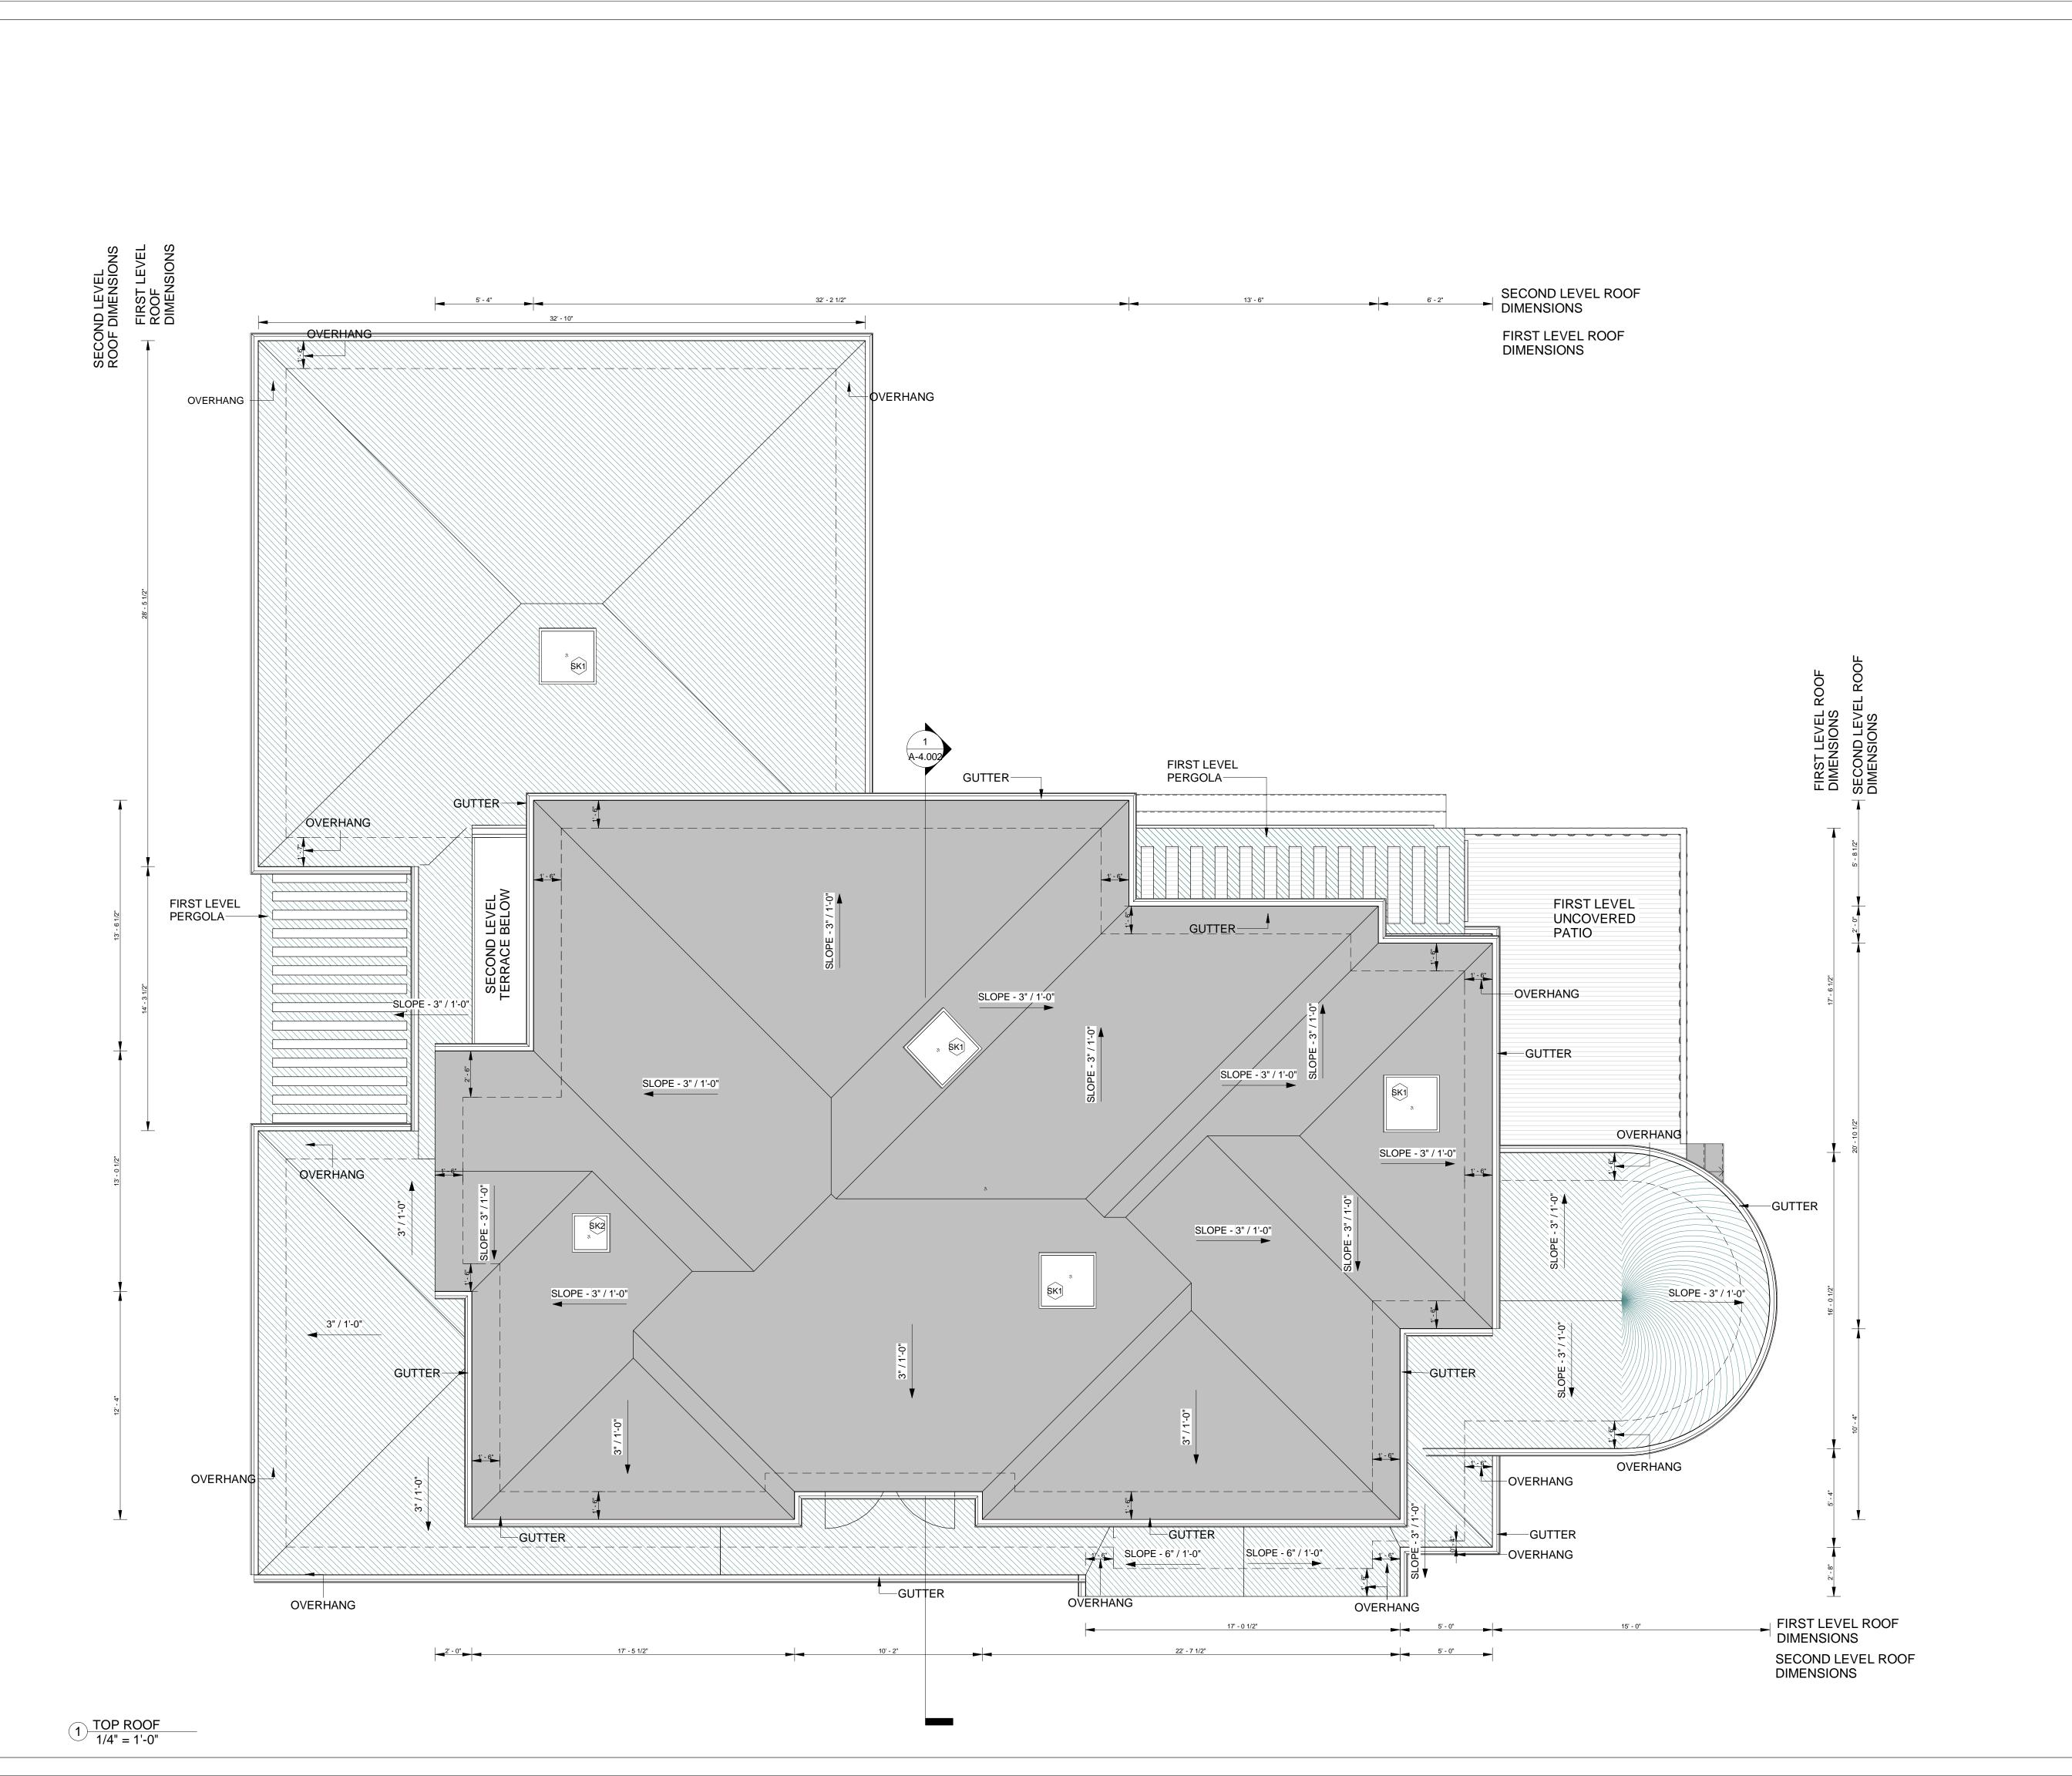





REV	ISIONS:		
REV.	DESCRIPTION	DATE	REV BY
<u> 1</u>	REVISED AS PER PLANNER'S COMMENTS	12-16-2022	SAGAR
<u>^</u> 2	REVISED AS PER PLANNER'S COMMENTS	02-16-2022	SAGAR

- ALL DIMENSIONS ARE IN FEET AND INCHES.
- DRAWING SHALL NOT BE SCALED AND ONLY WRITTEN DIMENSIONS SHALL BE FOLLOWED.
 ALL CENTERLINES ARE FROM THE CENTER OF
- COLUMN/ WALL AND THE DIMENSIONS GIVEN ARE CENTERLINE DIMENSIONS- -UNLESS OTHERWISE MENTIONED.
 IN CASE OF ANY DISCREPANCY FOUND IN DRAWINGS
- AND DETAILS, IT SHALL BE BROUGHT TO THE NOTICE OF THE ARCHITECT, AND RECTIFIED, PRIOR TO ITS EXECUTION.
 THIS DRAWING IS ISSUED STRICTLY WITH AN
- UNDERSTANDING THAT IT WILL BE USED ONLY FOR THE PURPOSE MENTIONED AND SHALL BE RETURNED AFTER COMPLETION.
- ·LARGER SCALE DRAWINGS AND DETAILS SUPERCEDE THE SMALLER SCALE DRAWINGS AND DETAILS.
- THE SMALLER SCALE DRAWINGS AND DETAILS.

 THIS DRAWING SHALL BE REFERRED ONLY FOR THE PURPOSE MENTIONED IN ITS TITLE (FLOORING
- PURPOSE MENTIONED IN ITS TITLE (FLOORING PATTERN, FALSE CEILING, SHUTTERING PATTERN, ELECTRICAL, PLUMBING, ETC.)

THIS DOCUMENT IS THE PROPERTY OF LIVIO BUILDING SYSTEMS AND SHALL NOT BE REFERRED, REPRODUCED, COPIED, ETC, WITHOUT EXPLICIT WRITTEN PERMISSION FROM LIVIO BUILDING SYSTEMS, LOS ALTOS, CA USA

PROJECT: 705 VISTA GRANDE AVE-LOT B, LOS ALTOS, CA

ROOF PLAN

DATE: 02-16-2023

DRAWN BY: SAGAR


LIVI

SCALE: 1/4" = 1'-0"

SHEET NO:

A-2.003

CHECKED BY: SUBHENDU

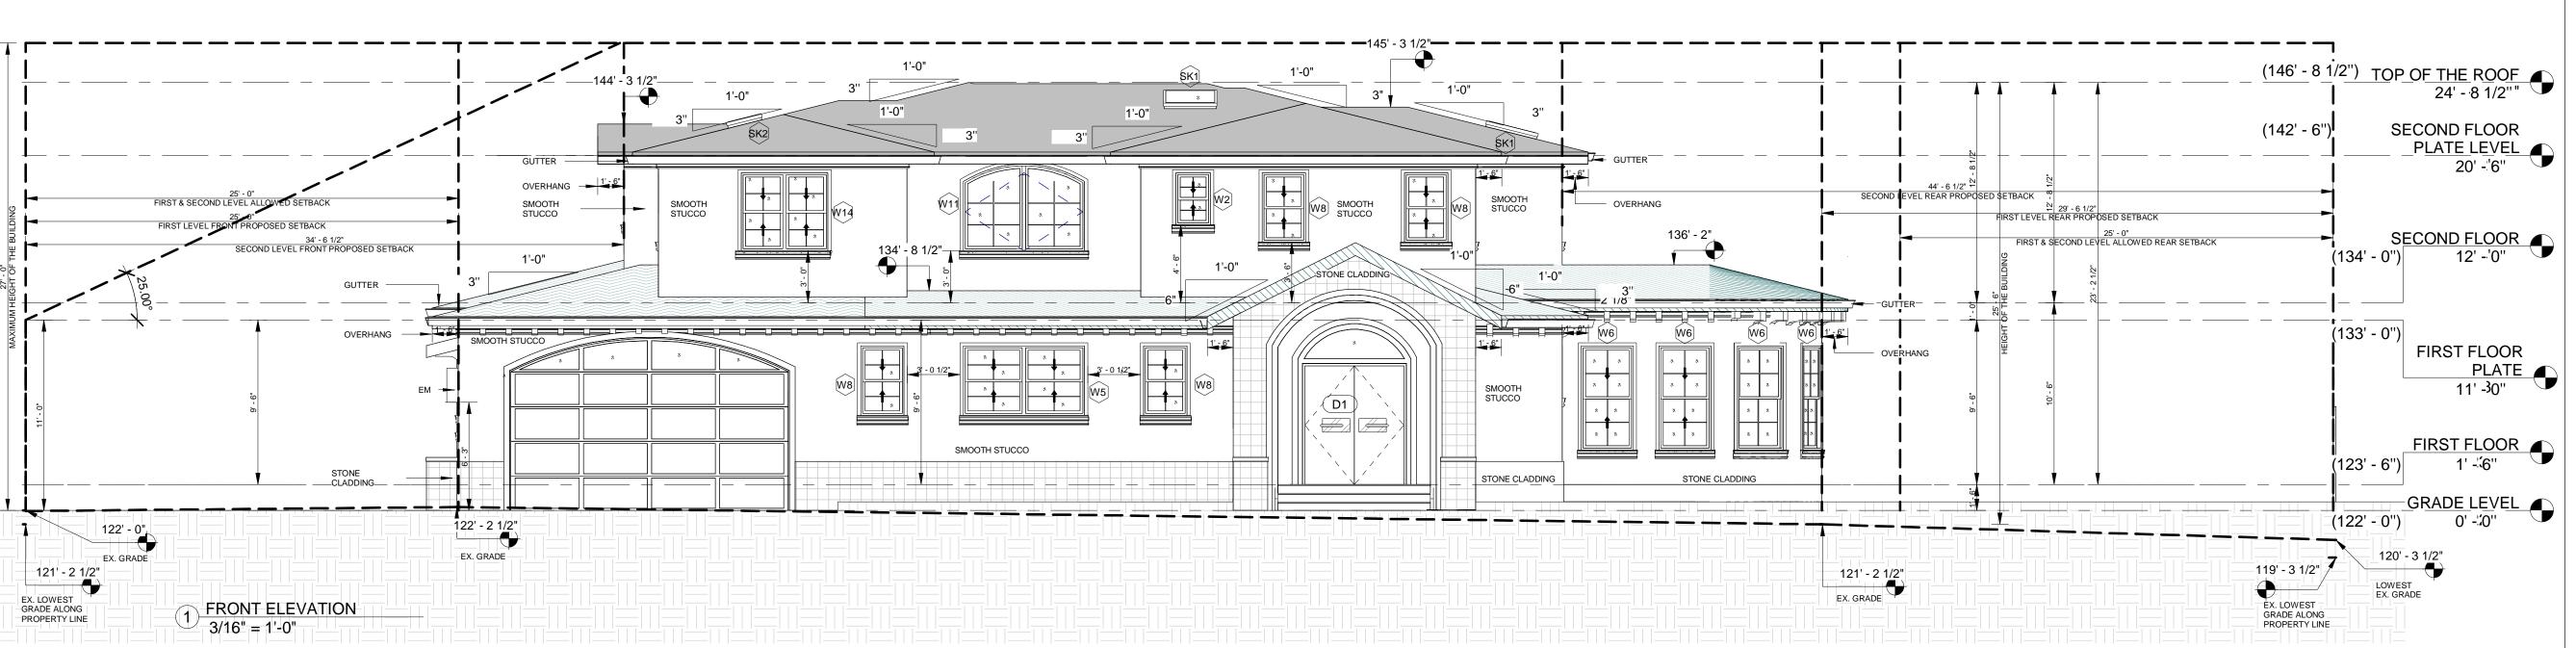



REVISIONS: DESCRIPTION DATE **REV BY** REVISED AS PER PLANNER'S COMMENTS 12-16-2022 REVISED AS PER PLANNER'S COMMENTS 02-16-2022

NOTES:

- ALL DIMENSIONS ARE IN FEET AND INCHES. DRAWING SHALL NOT BE SCALED AND ONLY WRITTEN DIMENSIONS SHALL BE FOLLOWED.
 - ALL CENTERLINES ARE FROM THE CENTER OF COLUMN/ WALL AND THE DIMENSIONS GIVEN ARE CENTERLINE DIMENSIONS- -UNLESS OTHERWISE MENTIONED. IN CASE OF ANY DISCREPANCY FOUND IN DRAWINGS
- AND DETAILS, IT SHALL BE BROUGHT TO THE NOTICE OF THE ARCHITECT, AND RECTIFIED, PRIOR TO ITS EXECUTION. THIS DRAWING IS ISSUED STRICTLY WITH AN
- UNDERSTANDING THAT IT WILL BE USED ONLY FOR THE PURPOSE MENTIONED AND SHALL BE RETURNED AFTER COMPLETION. ·LARGER SCALE DRAWINGS AND DETAILS SUPERCEDE
- THE SMALLER SCALE DRAWINGS AND DETAILS.
- THIS DRAWING SHALL BE REFERRED ONLY FOR THE PURPOSE MENTIONED IN ITS TITLE (FLOORING PATTERN, FALSE CEILING, SHUTTERING PATTERN, ELECTRICAL, PLUMBING, ETC.)

THIS DOCUMENT IS THE PROPERTY OF LIVIO BUILDING SYSTEMS AND SHALL NOT BE REFERRED, REPRODUCED, COPIED, ETC, WITHOUT EXPLICIT WRITTEN PERMISSION FROM LIVIO BUILDING SYSTEMS, LOS ALTOS, CA USA

PROJECT: 705 VISTA GRANDE AVE-LOT B, LOS ALTOS, CA


FRONT AND REAR ELEVATION

DATE: 02-16-2023

DRAWN BY: SAGAR CHECKED BY: SUBHENDU

SCALE: 3/16" = 1'-0"

SHEET NO: A-3.001

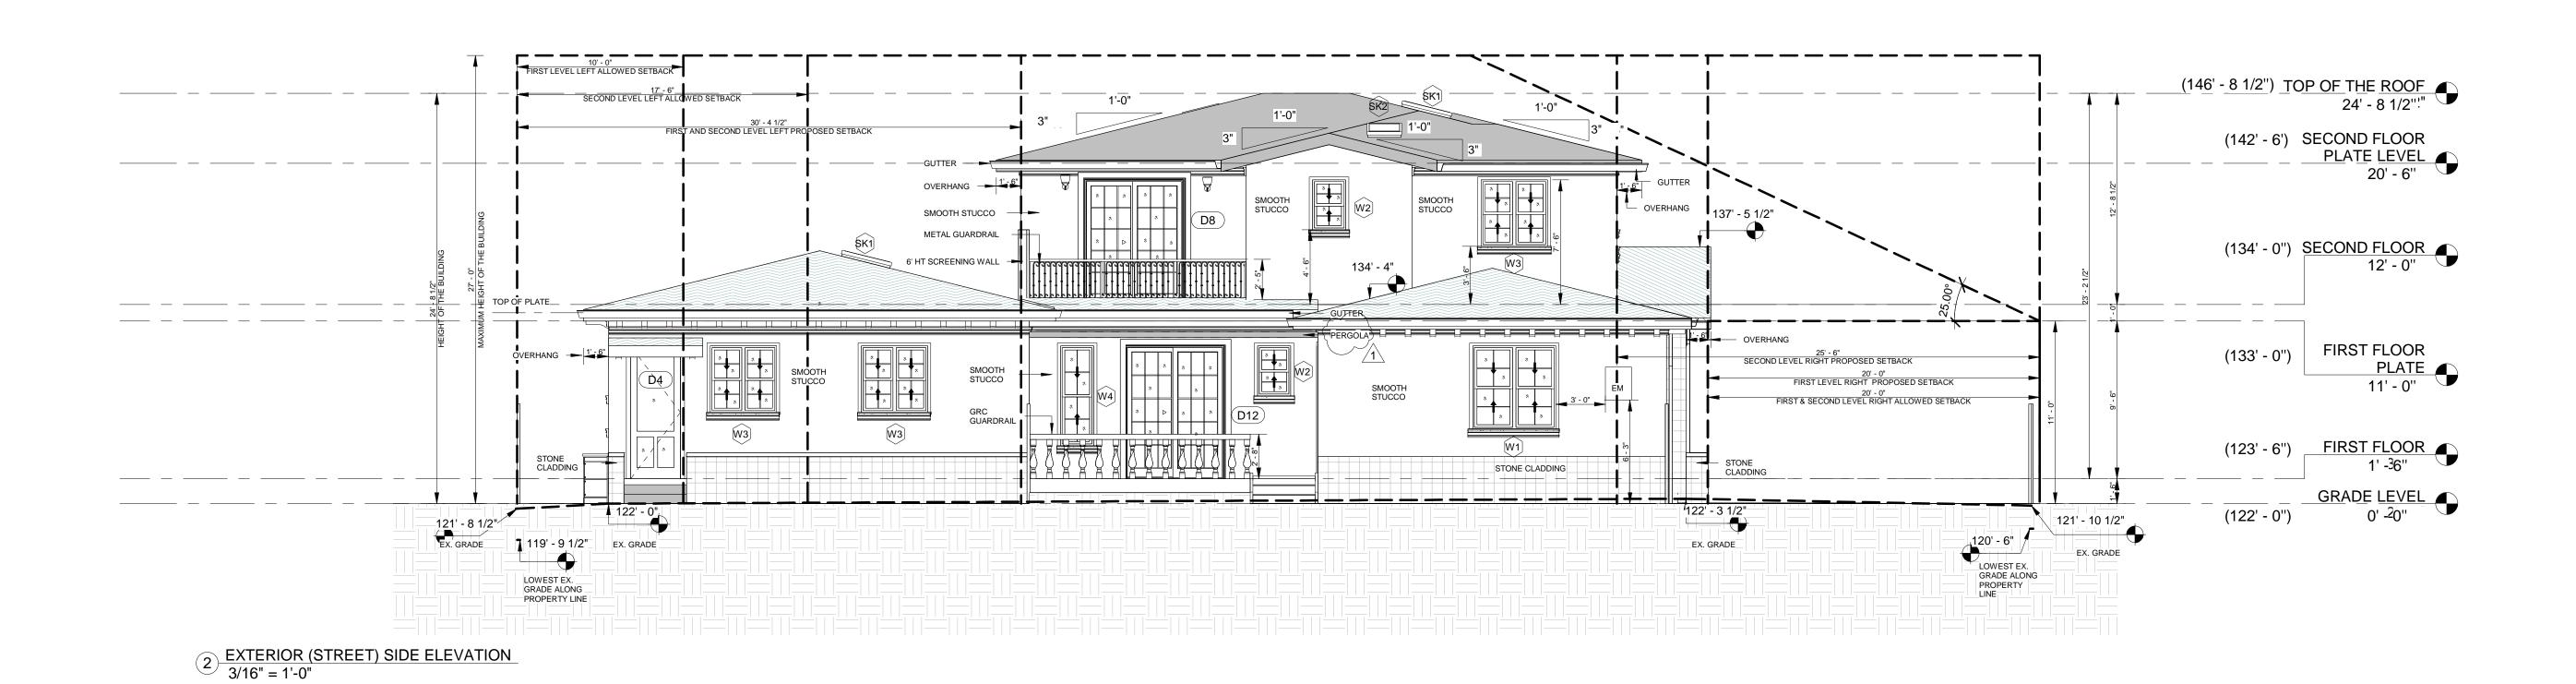

30' - 4 1/2"
SECOND LEVEL LEFT PROPOSED SETBACK (146' - 8 1/2") TOP OF THE ROOF 24' - 8 1/2"" 30' - 4 1/2" FIRST LEVEL LEFT PROPOSED SETBACK SECOND FLOOR 17' - 6"
SECOND LEVEL LEFT ALLOWED SETBACK (142' - 6") PLATE LEVEL 20' - 6" 10' - 0"
FIRST LEVEL LEFT ALLOWED SETBACK 20' - 0"
FIRST & SECOND LEVEL RIGHT ALLOWED SETBACK STUCCO (134' - 0") <u>SECOND FLOOR</u> 12' - 0" 1'-0" 25' - 6"
SECOND LEVEL RIGHT PROPOSED SETBACK τ̄ο 134' - 0 1/2" 1 6" W6 (133' - 0") | FIRST FLOOR SMOOTH STUCCO — OVERHANG PLATE 11' - 0" SMOOTH STUCCO 5' - 6" SMOOTH STUCCO STONE CLADDING (123' - 6") FIRST FLOOR 1' -36" STONE CLADDING (122' - 0") GRADE LEVEL 0' -20" 120' - 9" EX. GRADE 119' - 9 1/2" 120' - 3 1/2" EX. GRADE EX. GRADE LOWEST EX. GRADE ALONG PROPERTY LINE

1 RIGHT ELEVATION 3/16" = 1'-0"

REVI	SIONS :	
REV.	DESCRIPTION	

INLV.	DESCRIPTION	DAIL	INLV DI
À	REVISED AS PER PLANNER'S COMMENTS	12-16-2022	SAGAR
<u>^</u> 2\	REVISED AS PER PLANNER'S COMMENTS	02-16-2022	SAGAR

NOTES:

NOTES:

- ALL DIMENSIONS ARE IN FEET AND INCHES. DRAWING SHALL NOT BE SCALED AND ONLY WRITTEN
- DIMENSIONS SHALL BE FOLLOWED. ALL CENTERLINES ARE FROM THE CENTER OF COLUMN/ WALL AND THE DIMENSIONS GIVEN ARE CENTERLINE DIMENSIONS- -UNLESS OTHERWISE MENTIONED.
- IN CASE OF ANY DISCREPANCY FOUND IN DRAWINGS AND DETAILS, IT SHALL BE BROUGHT TO THE NOTICE OF THE ARCHITECT, AND RECTIFIED, PRIOR TO ITS EXECUTION. THIS DRAWING IS ISSUED STRICTLY WITH AN
- UNDERSTANDING THAT IT WILL BE USED ONLY FOR THE PURPOSE MENTIONED AND SHALL BE RETURNED AFTER COMPLETION. ·LARGER SCALE DRAWINGS AND DETAILS SUPERCEDE
- THE SMALLER SCALE DRAWINGS AND DETAILS.
- THIS DRAWING SHALL BE REFERRED ONLY FOR THE PURPOSE MENTIONED IN ITS TITLE (FLOORING PATTERN, FALSE CEILING, SHUTTERING PATTERN, ELECTRICAL, PLUMBING, ETC.)

THIS DOCUMENT IS THE PROPERTY OF LIVIO BUILDING SYSTEMS AND SHALL NOT BE REFERRED, REPRODUCED, COPIED, ETC, WITHOUT EXPLICIT WRITTEN PERMISSION FROM LIVIO BUILDING SYSTEMS, LOS ALTOS, CA USA

PROJECT: 705 VISTA GRANDE AVE-LOT B, LOS ALTOS, CA


LEFT AND RIGHT ELEVATION


DATE: 02-16-2023

DRAWN BY: SAGAR CHECKED BY: SUBHENDU

SCALE: 3/16" = 1'-0"

A-3.002

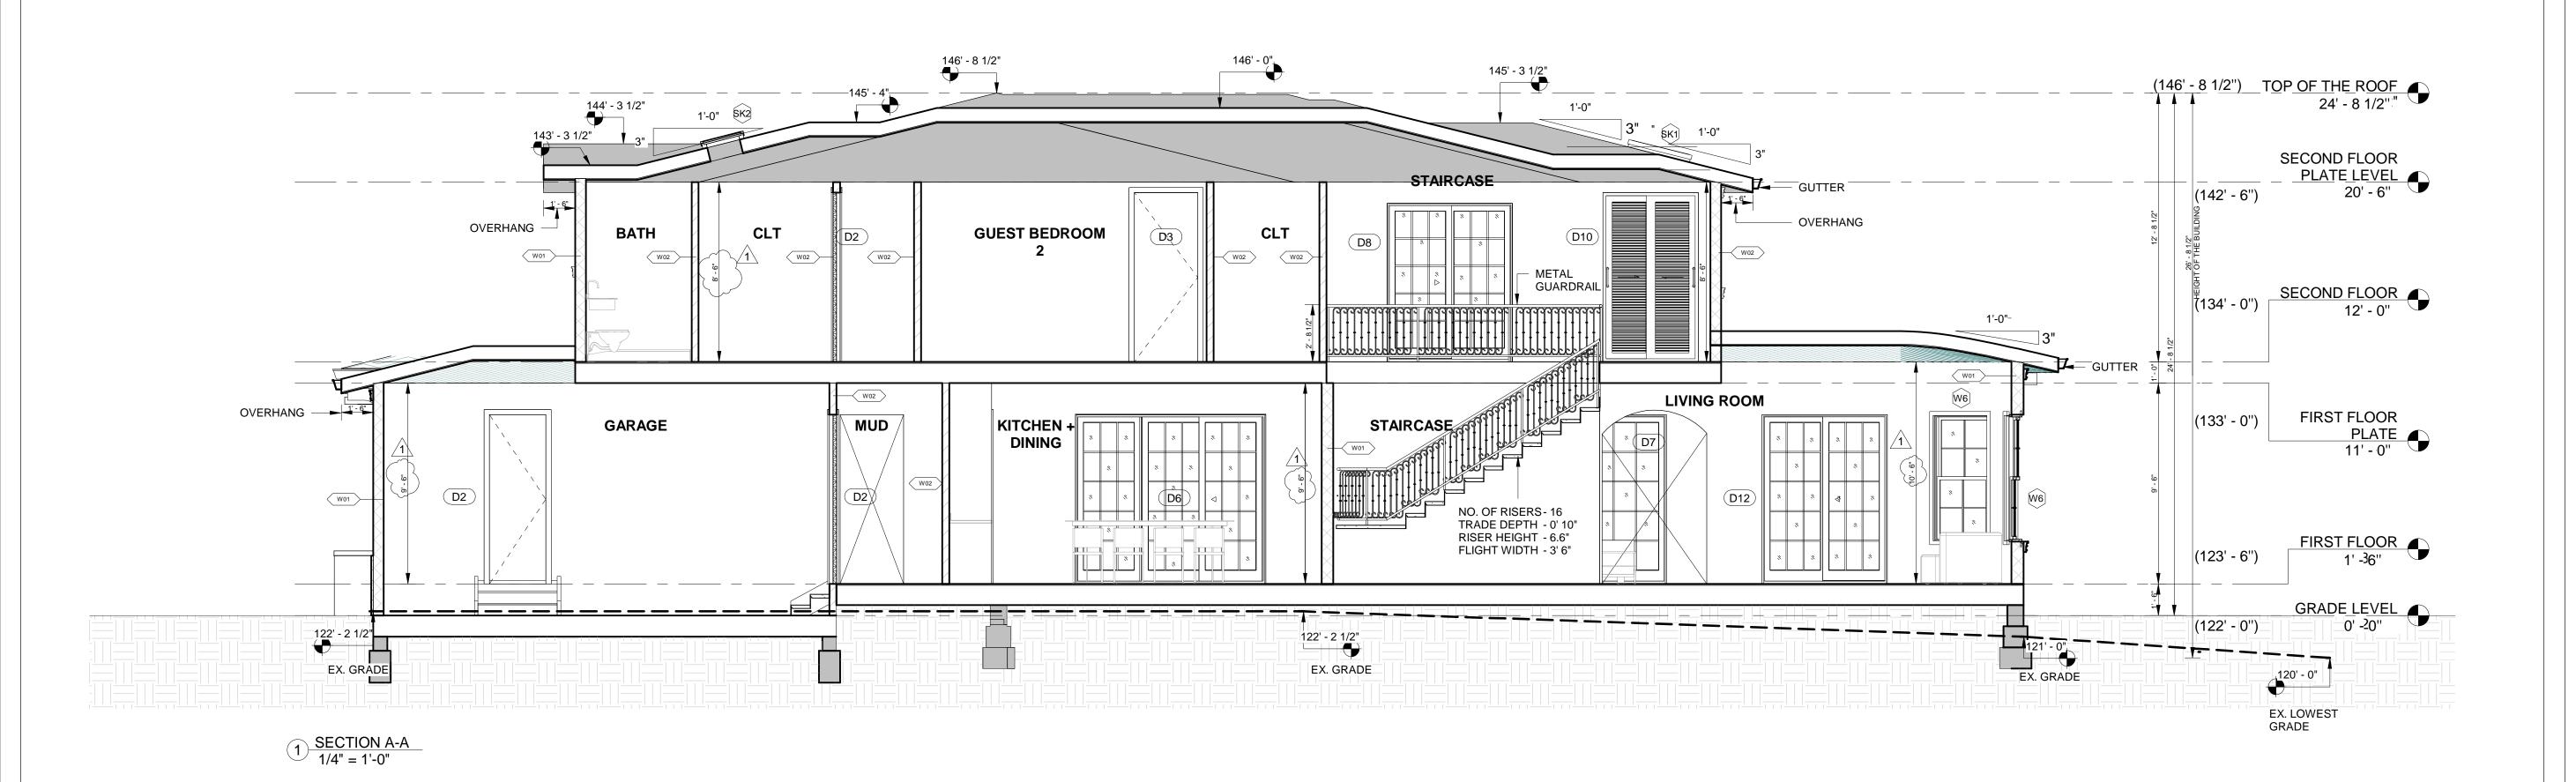

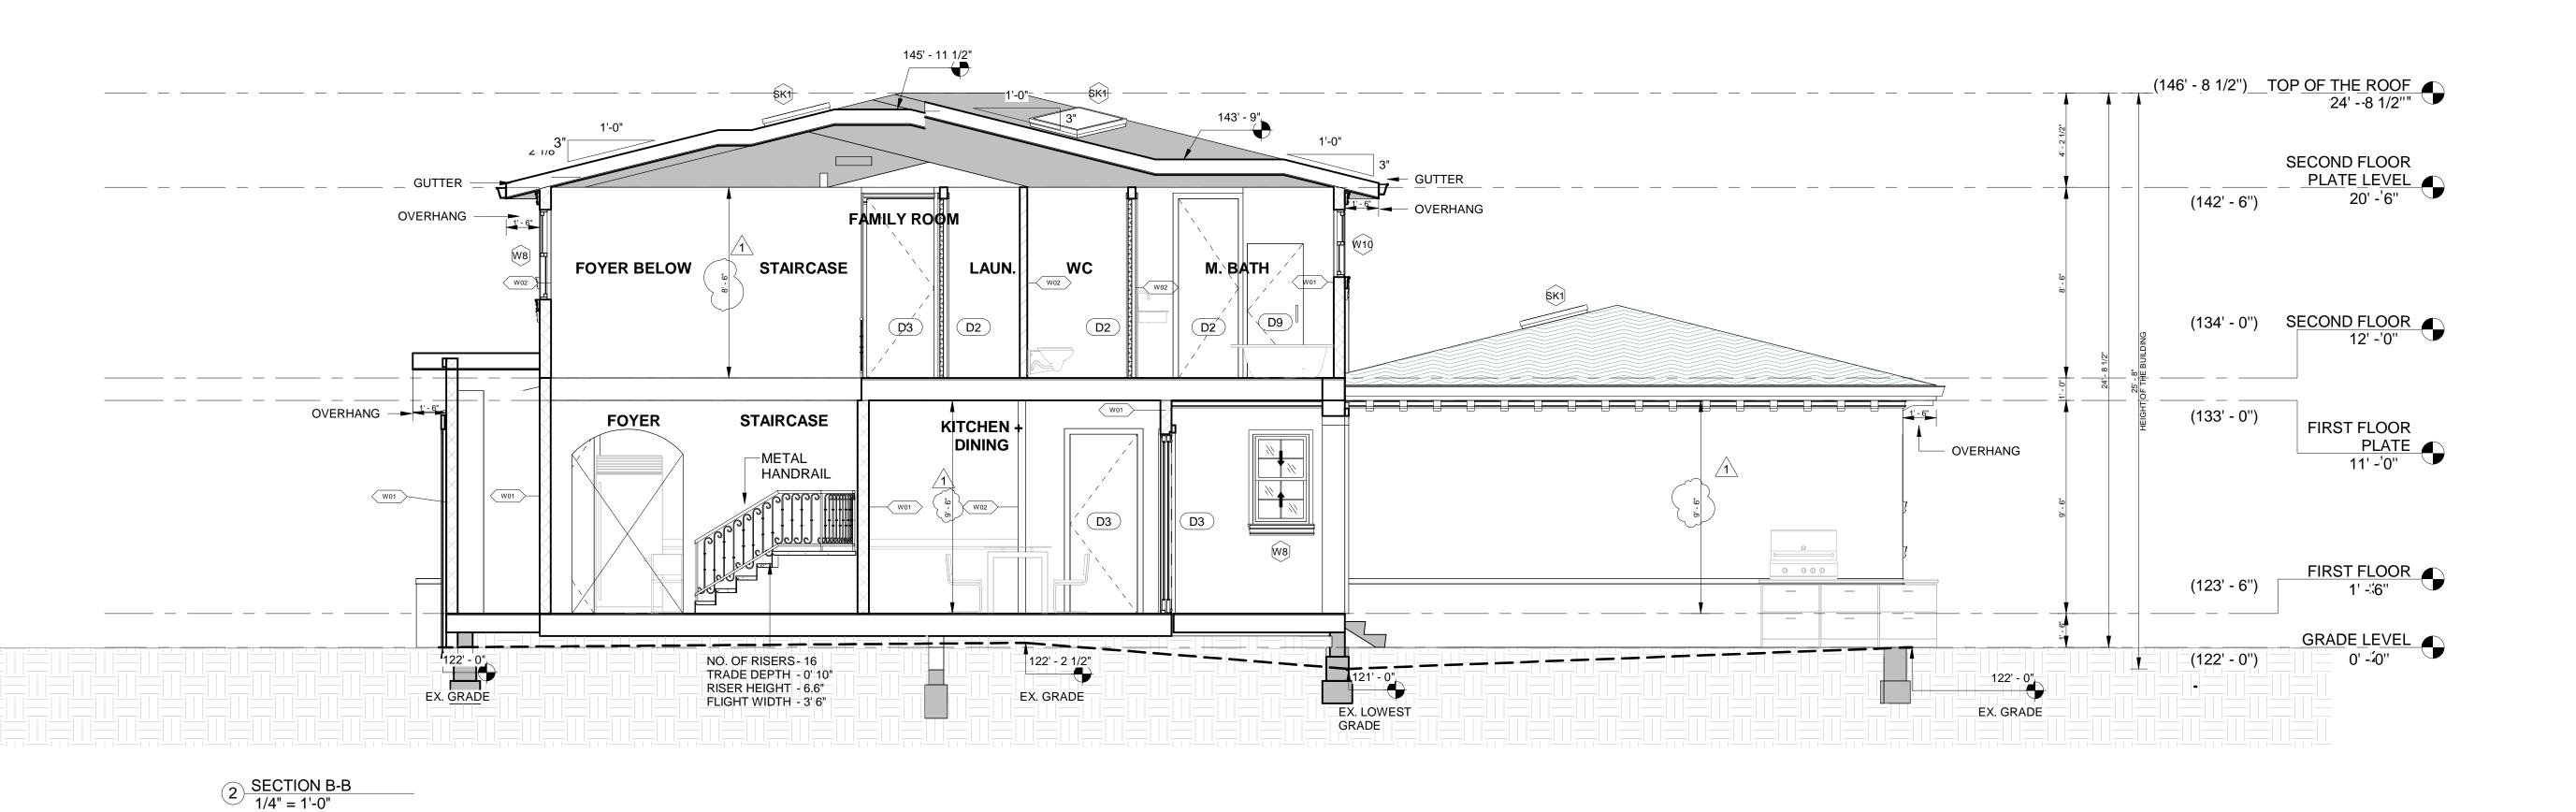

	REVI	SIONS:		
İ	REV.	DESCRIPTION	DATE	REV BY
	À	REVISED AS PER PLANNER'S COMMENTS	12-16-2022	SAGAR
	<u>^</u> 2\	REVISED AS PER PLANNER'S COMMENTS	02-16-2022	SAGAR
- 1				

NOTES:

- ALL DIMENSIONS ARE IN FEET AND INCHES.
 DRAWING SHALL NOT BE SCALED AND ONLY WRITTEN
- DIMENSIONS SHALL BE FOLLOWED.
 ALL CENTERLINES ARE FROM THE CENTER OF COLUMN/ WALL AND THE DIMENSIONS GIVEN ARE CENTERLINE DIMENSIONS--UNLESS OTHERWISE
- IN CASE OF ANY DISCREPANCY FOUND IN DRAWINGS AND DETAILS, IT SHALL BE BROUGHT TO THE NOTICE OF THE ARCHITECT, AND RECTIFIED, PRIOR TO ITS EXECUTION.

 THE RECUTION.
- THIS DRAWING IS ISSUED STRICTLY WITH AN UNDERSTANDING THAT IT WILL BE USED ONLY FOR THE PURPOSE MENTIONED AND SHALL BE RETURNED AFTER COMPLETION.
- ·LARGER SCALE DRAWINGS AND DETAILS SUPERCEDE THE SMALLER SCALE DRAWINGS AND DETAILS.
- THIS DRAWING SHALL BE REFERRED ONLY FOR THE PURPOSE MENTIONED IN ITS TITLE (FLOORING PATTERN, FALSE CEILING, SHUTTERING PATTERN, ELECTRICAL, PLUMBING, ETC.)

THIS DOCUMENT IS THE PROPERTY OF LIVIO BUILDING SYSTEMS AND SHALL NOT BE REFERRED, REPRODUCED, COPIED, ETC, WITHOUT EXPLICIT WRITTEN PERMISSION FROM LIVIO BUILDING SYSTEMS, LOS ALTOS, CA USA

PROJECT: 705 VISTA GRANDE AVE-LOT B, LOS ALTOS, CA

SECTION A-A AND B-B

MENTIONED.

DATE: 02-16-2023

DRAWN BY: SAGAR


CHECKED BY: SUBHENDU

LIVI

SCALE: 1/4" = 1'-0"

A-4.001

SHEET NO:

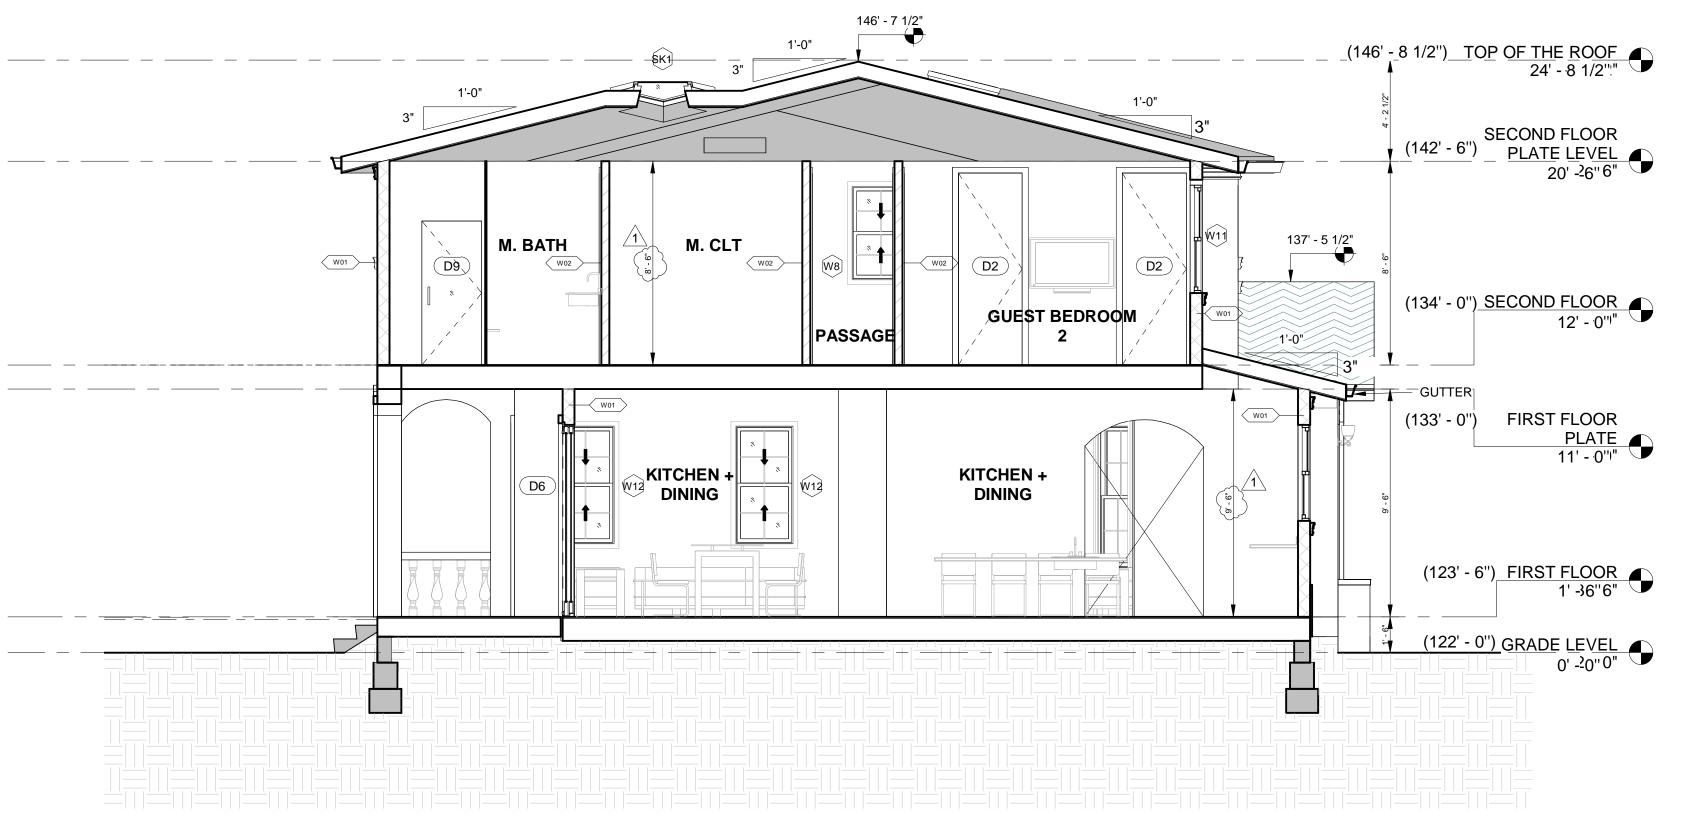

1 SECTION C-C 1/4" = 1'-0"

REV. DESCRIPTION DATE REV BY

REVISED AS PER PLANNER'S COMMENTS 12-16-2022 SAGAR

REVISED AS PER PLANNER'S COMMENTS 02-16-2022 SAGAR

NOTES:

NOTES:

- ALL DIMENSIONS ARE IN FEET AND INCHES.
- DRAWING SHALL NOT BE SCALED AND ONLY WRITTEN
- DIMENSIONS SHALL BE FOLLOWED.
 ALL CENTERLINES ARE FROM THE CENTER OF COLUMN/ WALL AND THE DIMENSIONS GIVEN ARE CENTERLINE DIMENSIONS- -UNLESS OTHERWISE MENTIONED.
- IN CASE OF ANY DISCREPANCY FOUND IN DRAWINGS AND DETAILS, IT SHALL BE BROUGHT TO THE NOTICE OF THE ARCHITECT, AND RECTIFIED, PRIOR TO ITS EXECUTION.

 THIS PRAYMING IS ISSUED STRICTLY WITH AN
- THIS DRAWING IS ISSUED STRICTLY WITH AN UNDERSTANDING THAT IT WILL BE USED ONLY FOR THE PURPOSE MENTIONED AND SHALL BE RETURNED AFTER COMPLETION.
- LARGER SCALE DRAWINGS AND DETAILS SUPERCEDE
- THE SMALLER SCALE DRAWINGS AND DETAILS.
 THIS DRAWING SHALL BE REFERRED ONLY FOR THE PURPOSE MENTIONED IN ITS TITLE (FLOORING PATTERN, FALSE CEILING, SHUTTERING PATTERN,

THIS DOCUMENT IS THE PROPERTY OF LIVIO BUILDING SYSTEMS AND SHALL NOT BE REFERRED, REPRODUCED, COPIED, ETC, WITHOUT EXPLICIT WRITTEN PERMISSION FROM LIVIO BUILDING

PROJECT: 705 VISTA GRANDE AVE-LOT B, LOS ALTOS, CA

ELECTRICAL, PLUMBING, ETC.)

SECTION C-C

SYSTEMS, LOS ALTOS, CA USA

DATE: 02-16-2023


DRAWN BY: SAGAR
CHECKED BY: SUBHENDU

LIVI

SCALE: 1/4" = 1'-0"

ADDRESS: 329 S San Antonio Road Suite #4, Los Altos, CA 94022
CONTACT: 650-209-6500
EMAIL: team@golivio.com

A-4.002

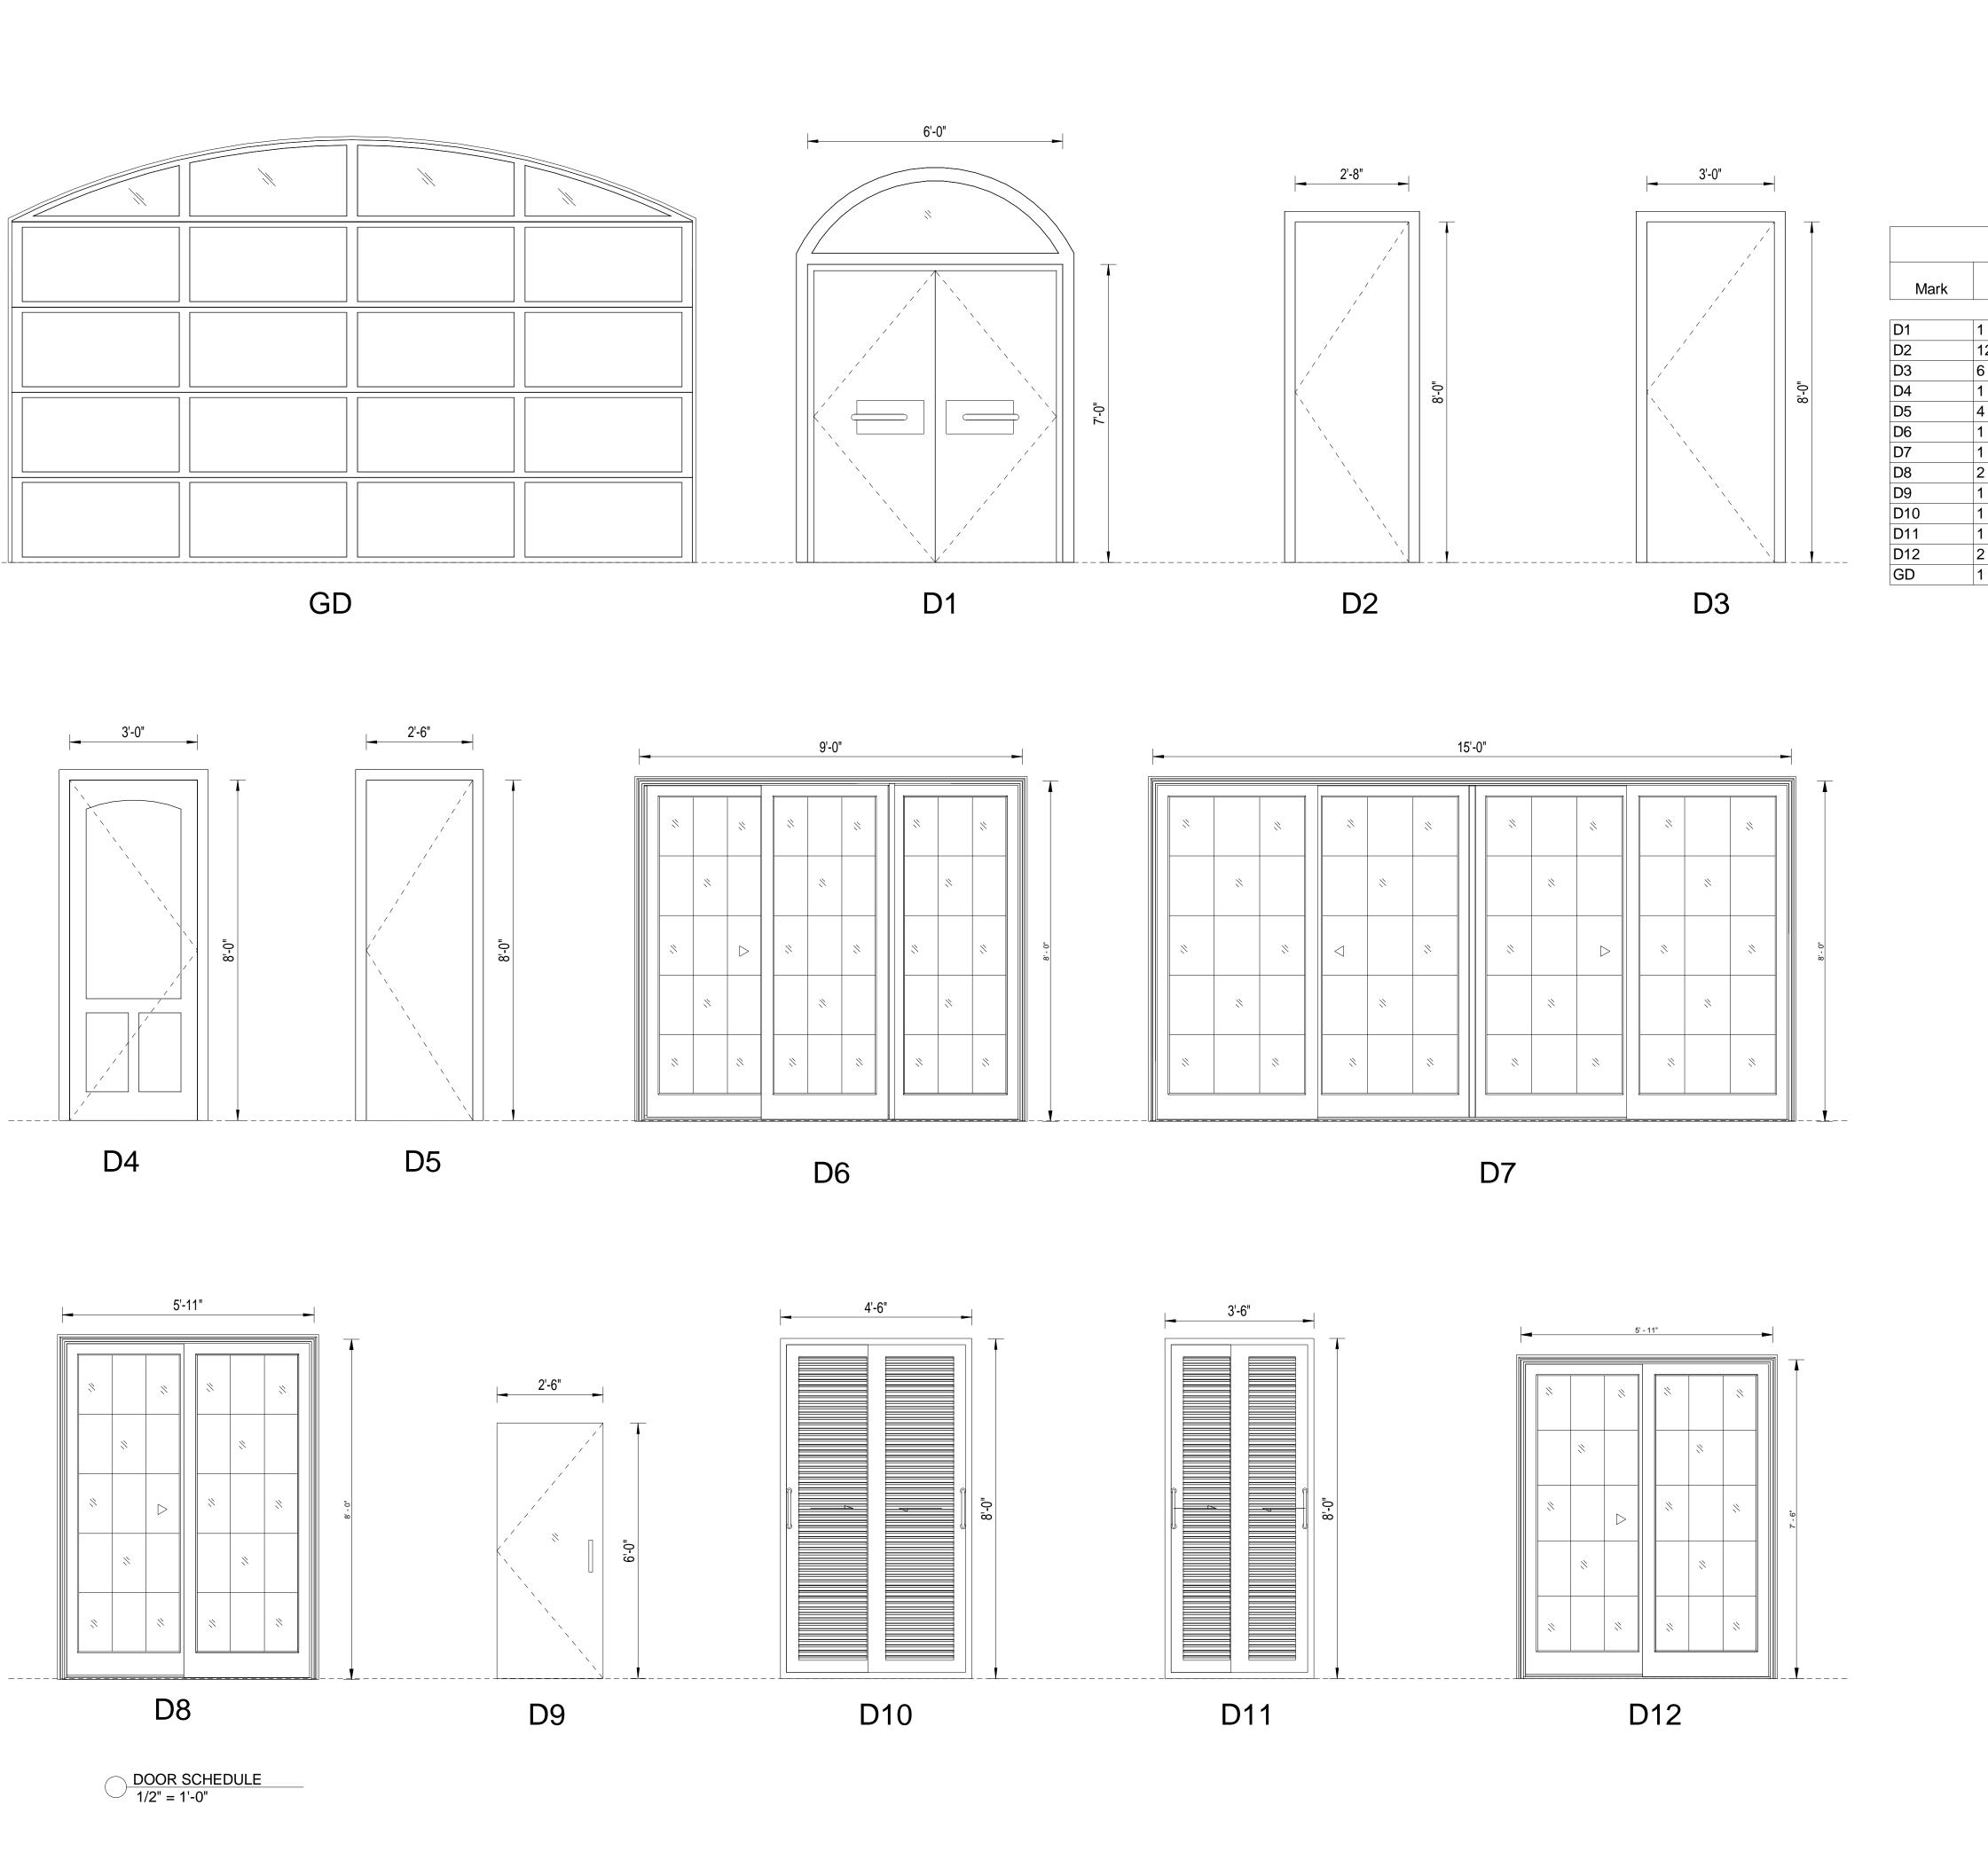

	Door Schedule				
Mark	Count	Width	Height	Head Height	
D1	1	6' - 0"	7' - 0"	7' - 0"	
D2	12	2' - 8"	8' - 0"	8' - 0"	
D3	6	3' - 0"	8' - 0"	8' - 0"	
D4	1	3' - 0"	8' - 0"	8' - 0"	
D5	4	2' - 6"	8' - 0"	8' - 0"	
D6	1	9' - 0"	8' - 0"	8' - 0"	
D7	1	15' - 0"	8' - 0"	8' - 0"	
D8	2	5' - 11"	7' - 6"	7' - 6"	
D9	1	2' - 6"	6' - 0"	6' - 0"	
D10	1	4' - 6"	8' - 0"	8' - 0"	
D11	1	3' - 6"	8' - 0"	8' - 0"	
D12	2	5' - 11"	8' - 0"	8' - 0"	
GD	1	16' - 0"	8' - 0"	8' - 0"	

REVISIONS:

REV.	DESCRIPTION	DATE	REV BY
À	REVISED AS PER PLANNER'S COMMENTS	12-16-2022	SAGAR
<u>^</u> 2\	REVISED AS PER PLANNER'S COMMENTS	02-16-2022	SAGAR

NOTES:

NOTES:

- ALL DIMENSIONS ARE IN FEET AND INCHES.
- DRAWING SHALL NOT BE SCALED AND ONLY WRITTEN DIMENSIONS SHALL BE FOLLOWED.
- ALL CENTERLINES ARE FROM THE CENTER OF COLUMN/ WALL AND THE DIMENSIONS GIVEN ARE CENTERLINE DIMENSIONS- -UNLESS OTHERWISE
- MENTIONED. IN CASE OF ANY DISCREPANCY FOUND IN DRAWINGS AND DETAILS, IT SHALL BE BROUGHT TO THE NOTICE OF THE ARCHITECT, AND RECTIFIED, PRIOR TO ITS EXECUTION.
- THIS DRAWING IS ISSUED STRICTLY WITH AN UNDERSTANDING THAT IT WILL BE USED ONLY FOR THE PURPOSE MENTIONED AND SHALL BE RETURNED AFTER COMPLETION.
- ·LARGER SCALE DRAWINGS AND DETAILS SUPERCEDE
- THE SMALLER SCALE DRAWINGS AND DETAILS. THIS DRAWING SHALL BE REFERRED ONLY FOR THE
- PURPOSE MENTIONED IN ITS TITLE (FLOORING PATTERN, FALSE CEILING, SHUTTERING PATTERN, ELECTRICAL, PLUMBING, ETC.)

THIS DOCUMENT IS THE PROPERTY OF LIVIO BUILDING SYSTEMS AND SHALL NOT BE REFERRED, REPRODUCED, COPIED, ETC, WITHOUT EXPLICIT WRITTEN PERMISSION FROM LIVIO BUILDING SYSTEMS, LOS ALTOS, CA USA

PROJECT: 705 VISTA GRANDE AVE-LOT B, LOS ALTOS, CA


DOOR SCHEDULE

CHECKED BY: SUBHENDU

SCALE: 1/2" = 1'-0"

DATE: 02-16-2023 DRAWN BY: SAGAR



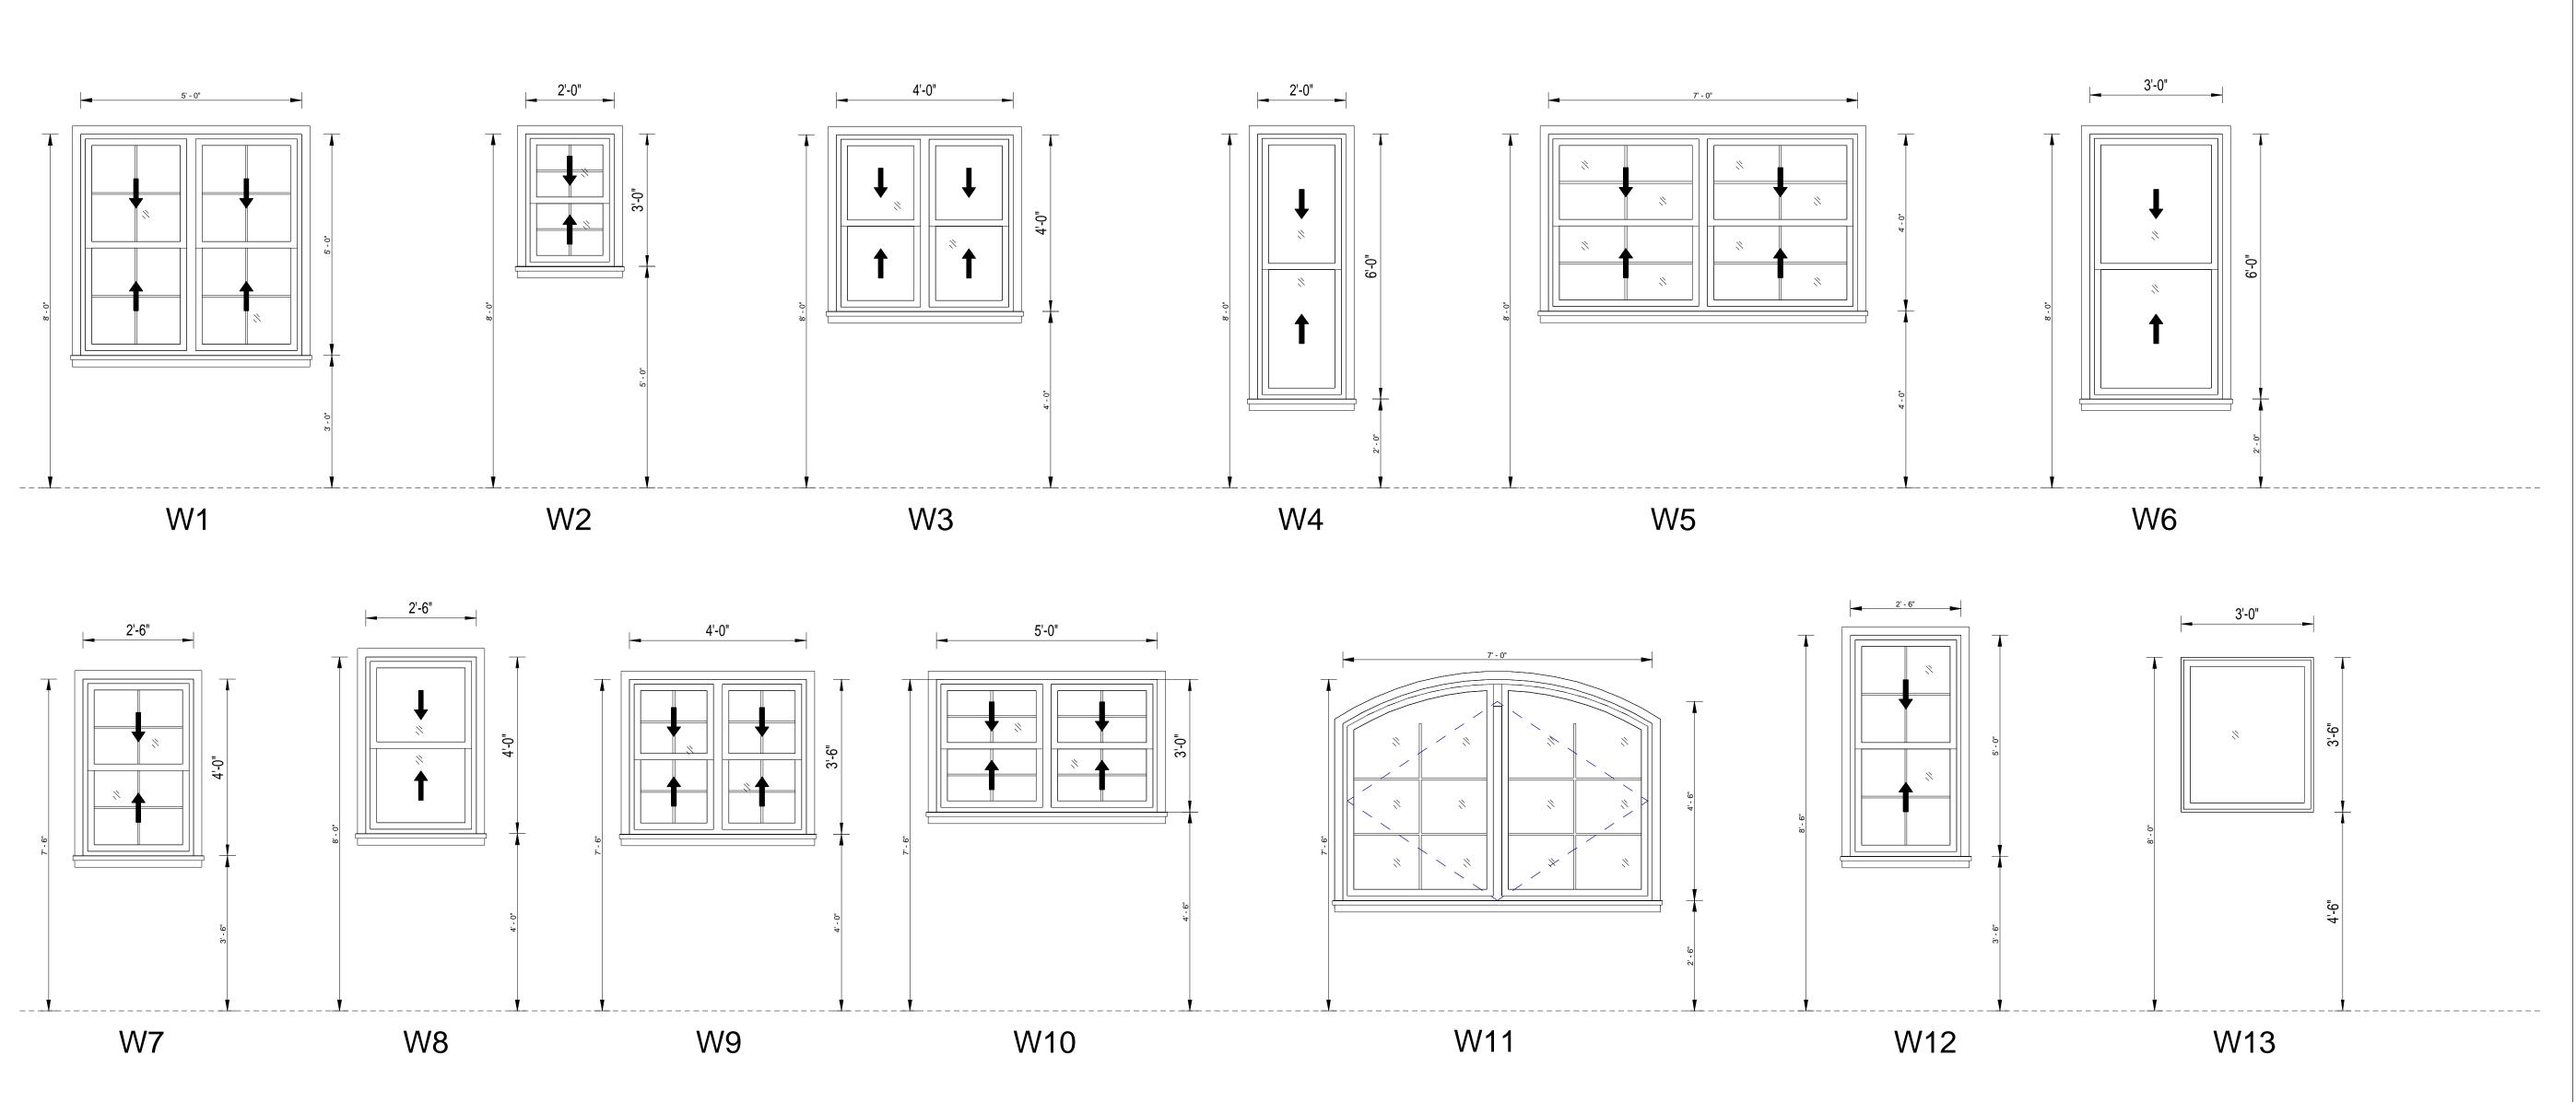

7' - 10"	5-0"	3.00		
	W14	SK1	SK2	


WINDOW SCHEDULE

1/2" = 1'-0"

	IIW	NDOW SCH	EDULE		
Mark Count Width Height Height					
SK1	4	3' - 0"	3' - 0"		
SK2	1	2' - 0"	2' - 0"		
W1	3	5' - 0"	5' - 0"	8' - 0"	
W2	7	2' - 0"	3' - 0"		
W3	3	4' - 0"	4' - 0"		
W4	1	2' - 0"	6' - 0"	8' - 0"	
W5	1	7' - 0"	4' - 0"	8' - 0"	
W6	6	3' - 0"	6' - 0"	8' - 0"	
W7	1	2' - 6"	4' - 0"	7' - 6"	
W8	7	2' - 6"	4' - 0"		
W9	2	4' - 0"	3' - 6"	7' - 6"	
W10	1	5' - 0"	3' - 0"	7' - 6"	
W11	1	7' - 0"	4' - 6"	7' - 6"	
W12	2	2' - 6"	5' - 0"	8' - 0"	
W13	1	3' - 0"	3' - 6"	8' - 0"	
W14	1	5' - 0"	4' - 6"	7' - 6"	

REVISIONS: DESCRIPTION DATE REVISED AS PER PLANNER'S COMMENTS 12-16-2022 REVISED AS PER PLANNER'S COMMENTS 02-16-2022 SAGAR NOTES: ALL DIMENSIONS ARE IN FEET AND INCHES. DRAWING SHALL NOT BE SCALED AND ONLY WRITTEN DIMENSIONS SHALL BE FOLLOWED. ALL CENTERLINES ARE FROM THE CENTER OF COLUMN/ WALL AND THE DIMENSIONS GIVEN ARE CENTERLINE DIMENSIONS- -UNLESS OTHERWISE MENTIONED. IN CASE OF ANY DISCREPANCY FOUND IN DRAWINGS AND DETAILS, IT SHALL BE BROUGHT TO THE NOTICE OF THE ARCHITECT, AND RECTIFIED, PRIOR TO ITS EXECUTION. THIS DRAWING IS ISSUED STRICTLY WITH AN UNDERSTANDING THAT IT WILL BE USED ONLY FOR THE PURPOSE MENTIONED AND SHALL BE RETURNED AFTER COMPLETION. ·LARGER SCALE DRAWINGS AND DETAILS SUPERCEDE THE SMALLER SCALE DRAWINGS AND DETAILS. THIS DRAWING SHALL BE REFERRED ONLY FOR THE PURPOSE MENTIONED IN ITS TITLE (FLOORING PATTERN, FALSE CEILING, SHUTTERING PATTERN, ELECTRICAL, PLUMBING, ETC.) THIS DOCUMENT IS THE PROPERTY OF LIVIO BUILDING SYSTEMS AND SHALL NOT BE REFERRED, REPRODUCED, COPIED, ETC, WITHOUT EXPLICIT WRITTEN PERMISSION FROM LIVIO BUILDING SYSTEMS, LOS ALTOS, CA USA PROJECT: 705 VISTA GRANDE AVE-LOT B, LOS ALTOS, CA WINDOW SCHEDULE DATE: 02-16-2023 DRAWN BY: SAGAR CHECKED BY: SUBHENDU SCALE: 1/2" = 1'-0" ADDRESS: 329 S San Antonio Road Suite #4, Los Altos, CA 94022 CONTACT: 650-209-6500 A-5.002 EMAIL: team@golivio.com

NOTES:

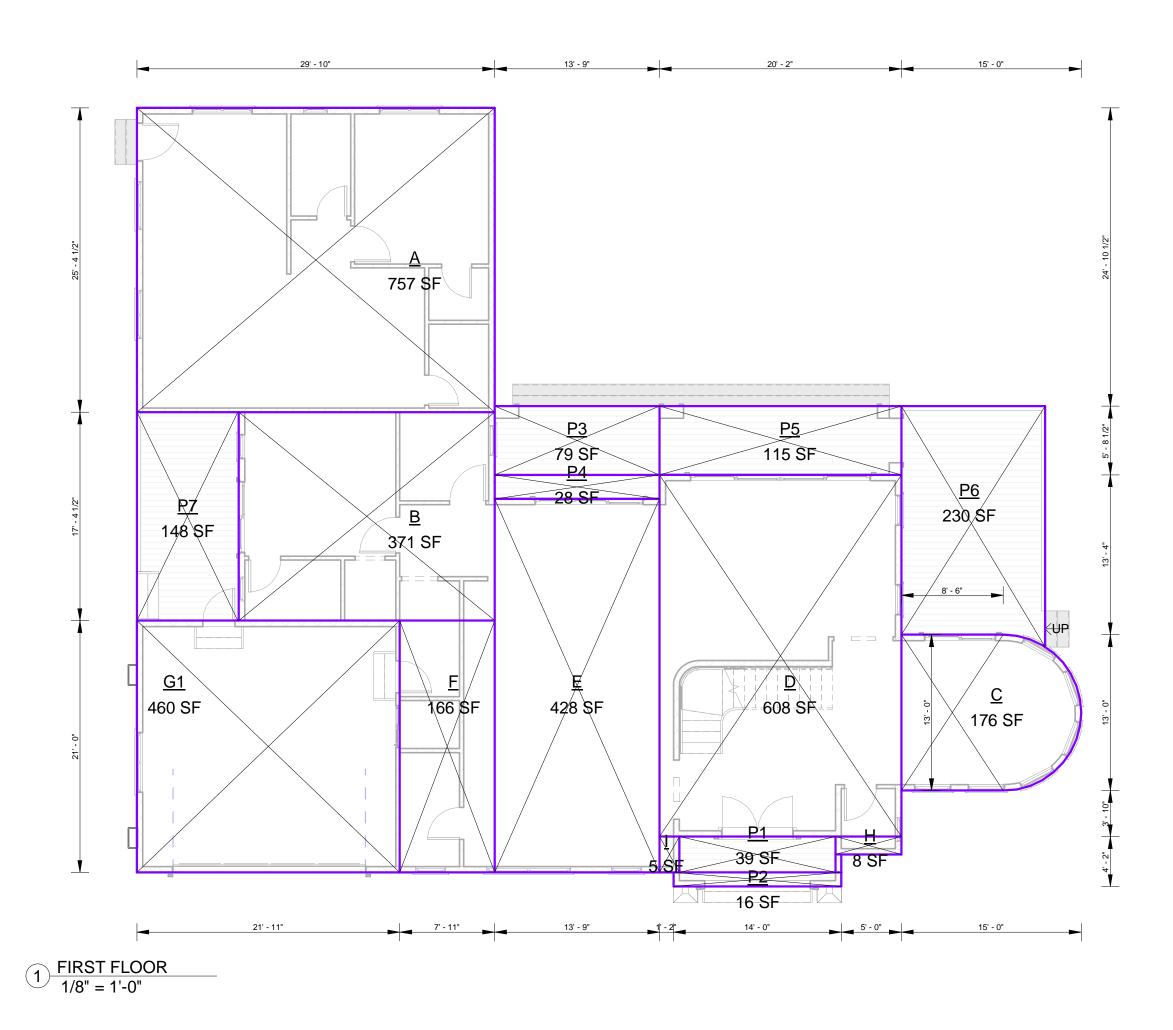

FIRST LEVEL

FIRST FLOOR AREA CALCULATION


		T	T
Name	AREA LENGTH	AREA WIDTH	Area
В	21' - 4"	17' - 4 1/2"	371 SF
С	-	-	176 SF
D	30' - 2"	20' - 2"	608 SF
E	31' - 2"	13' - 9"	428 SF
F	21' - 0"	7' - 11"	166 SF
G1	21' - 11"	21' - 0"	460 SF
Н	5' - 6"	1' - 6"	8 SF
I	3' - 0"	1' - 8"	5 SF
Grand total	1: 8	1	2222 SF

CALCULATIONS FOR C

AREA = SQUARE + HALF CIRCLE AREA = 110 + 66 AREA = 176 SF

Name	AREA LENGTH	AREA WIDTH	Are
Α	29' - 10"	25' - 4 1/2"	757 SF
Grand tota	l: 1		757 SF
PAT	TIO AND PORCH A	REA CALCULA	TION
Name	AREA LENGTH	AREA WIDTH	Area
P1	13' - 0"	3' - 0"	39 SF
P2	14' - 0"	1' - 2"	16 SF
P3	13' - 9"	5' - 8 1/2"	79 SF
P4	13' - 9"	2' - 0"	28 SF
P5	20' - 2"	5' - 8 1/2"	115 SF
P6	20' - 5"	11' - 3"	230 SF
P7	17' - 4 1/2"	8' - 6"	148 SF
Grand tota			655 SF

SECOND LEVEL

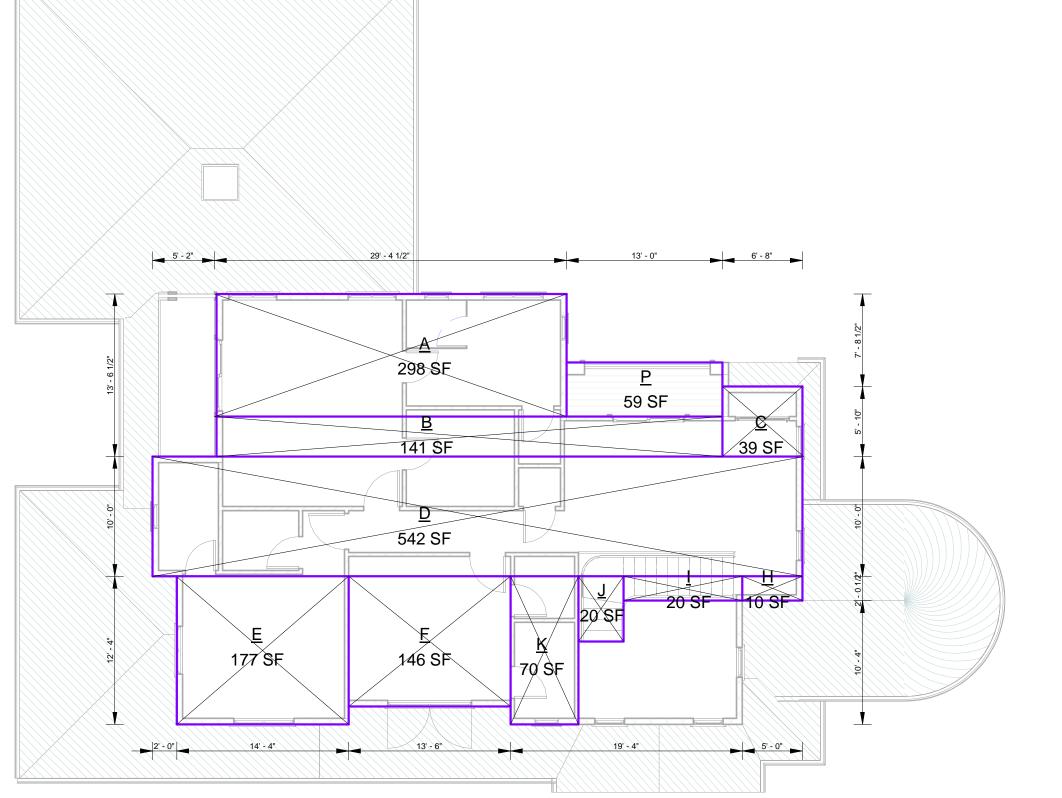

SECOND FLOOR AREA CALCULATION						
Name AREA LENGTH AREA WIDTH Area						
Α	29' - 2 1/2"	10' - 2 1/2"	298 SF			
В	42' - 2 1/2"	3' - 4"	141 SF			
С	6' - 8"	5' - 10"	39 SF			
D	54' - 2 1/2"	10' - 0"	542 SF			
E	14' - 4"	12' - 4"	177 SF			
F	13' - 6"	10' - 10"	146 SF			
Н	5' - 0"	2' - 0 1/2"	10 SF			
1	9' - 11"	2' - 0 1/2"	20 SF			
J	5' - 5"	3' - 9"	20 SF			
K	12' - 4"	5' - 8"	70 SF			
Р	13' - 0"	4' - 6"	59 SF			
Grand total: 11 1522 SF						

CALCULATIONS

TOTAL FLOOR AREA = FIRST LEVEL AREA + SECOND LEVEL AREA + + COVERED PORCH (P1 + P2 + P4)

TOTAL FLOOR AREA = 2,222 + 1,522 + 83

TOTAL FLOOR AREA = 3,827 SF

ADU FLOOR AREA = 757 SF

ALLOWABLE FLOOR AREA = 3,960.9 SF

ALLOWABLE ADU = 1200 SF

TOTAL LOT COVERAGE AREA = FIRST LEVEL AREA + PATIO AREA (P1 + P2 + P3 + P4 + P5 + P6 + P7) + ADU

TOTAL LOT COVERAGE AREA = 2,222 + 655 + 757

TOTAL LOT COVERAGE AREA = 3,634 SF

ALLOWABLE LOT COVERAGE AREA = 3,649.8 SF

NET LOT AREA = 1,2166 SF (WITHOUT EASEMENT)

GROSS LOT AREA = 1,2166 SF (WITH EASEMENT)

ALLOWED ADU = 1,200 SF

ALLOWED FLOOR AREA (EX. ADU) = 3,960.9 SF

ALLOWED TOTAL FLOOR AREA (INC. ADU) = 3,960.9 + 1,200 = 5,160.9 SF

ALLOWED LOT COVERAGE = 3,649.8 SF

REVISIONS :

NOTES:

REV.	DESCRIPTION	DATE	REV BY
<u> </u>	REVISED AS PER PLANNER'S COMMENTS	12-16-2022	SAGAR
2\	REVISED AS PER PLANNER'S COMMENTS	02-16-2022	SAGAR

- ALL DIMENSIONS ARE IN FEET AND INCHES.
- DRAWING SHALL NOT BE SCALED AND ONLY WRITTEN
- DIMENSIONS SHALL BE FOLLOWED. ALL CENTERLINES ARE FROM THE CENTER OF COLUMN/ WALL AND THE DIMENSIONS GIVEN ARE CENTERLINE DIMENSIONS- -UNLESS OTHERWISE
- IN CASE OF ANY DISCREPANCY FOUND IN DRAWINGS AND DETAILS, IT SHALL BE BROUGHT TO THE NOTICE OF THE ARCHITECT, AND RECTIFIED, PRIOR TO ITS EXECUTION.
- THIS DRAWING IS ISSUED STRICTLY WITH AN UNDERSTANDING THAT IT WILL BE USED ONLY FOR THE PURPOSE MENTIONED AND SHALL BE RETURNED AFTER COMPLETION.
- ·LARGER SCALE DRAWINGS AND DETAILS SUPERCEDE
- THE SMALLER SCALE DRAWINGS AND DETAILS. THIS DRAWING SHALL BE REFERRED ONLY FOR THE PURPOSE MENTIONED IN ITS TITLE (FLOORING PATTERN, FALSE CEILING, SHUTTERING PATTERN,

ELECTRICAL, PLUMBING, ETC.) THIS DOCUMENT IS THE PROPERTY OF LIVIO BUILDING SYSTEMS AND SHALL NOT BE REFERRED,

PROJECT: 705 VISTA GRANDE AVE-LOT B, LOS ALTOS, CA

REPRODUCED, COPIED, ETC, WITHOUT EXPLICIT WRITTEN PERMISSION FROM LIVIO BUILDING

AREA CALCULATON

SYSTEMS, LOS ALTOS, CA USA

MENTIONED.

DATE: 02-16-2023 DRAWN BY: SAGAR


CHECKED BY: SUBHENDU


SCALE: 1/8" = 1'-0"

A-6.001

ADDRESS: 329 S San Antonio Road Suite #4, Los Altos, CA 94022 CONTACT: 650-209-6500 team@golivio.com

2 SECOND FLOOR 1/8" = 1'-0"

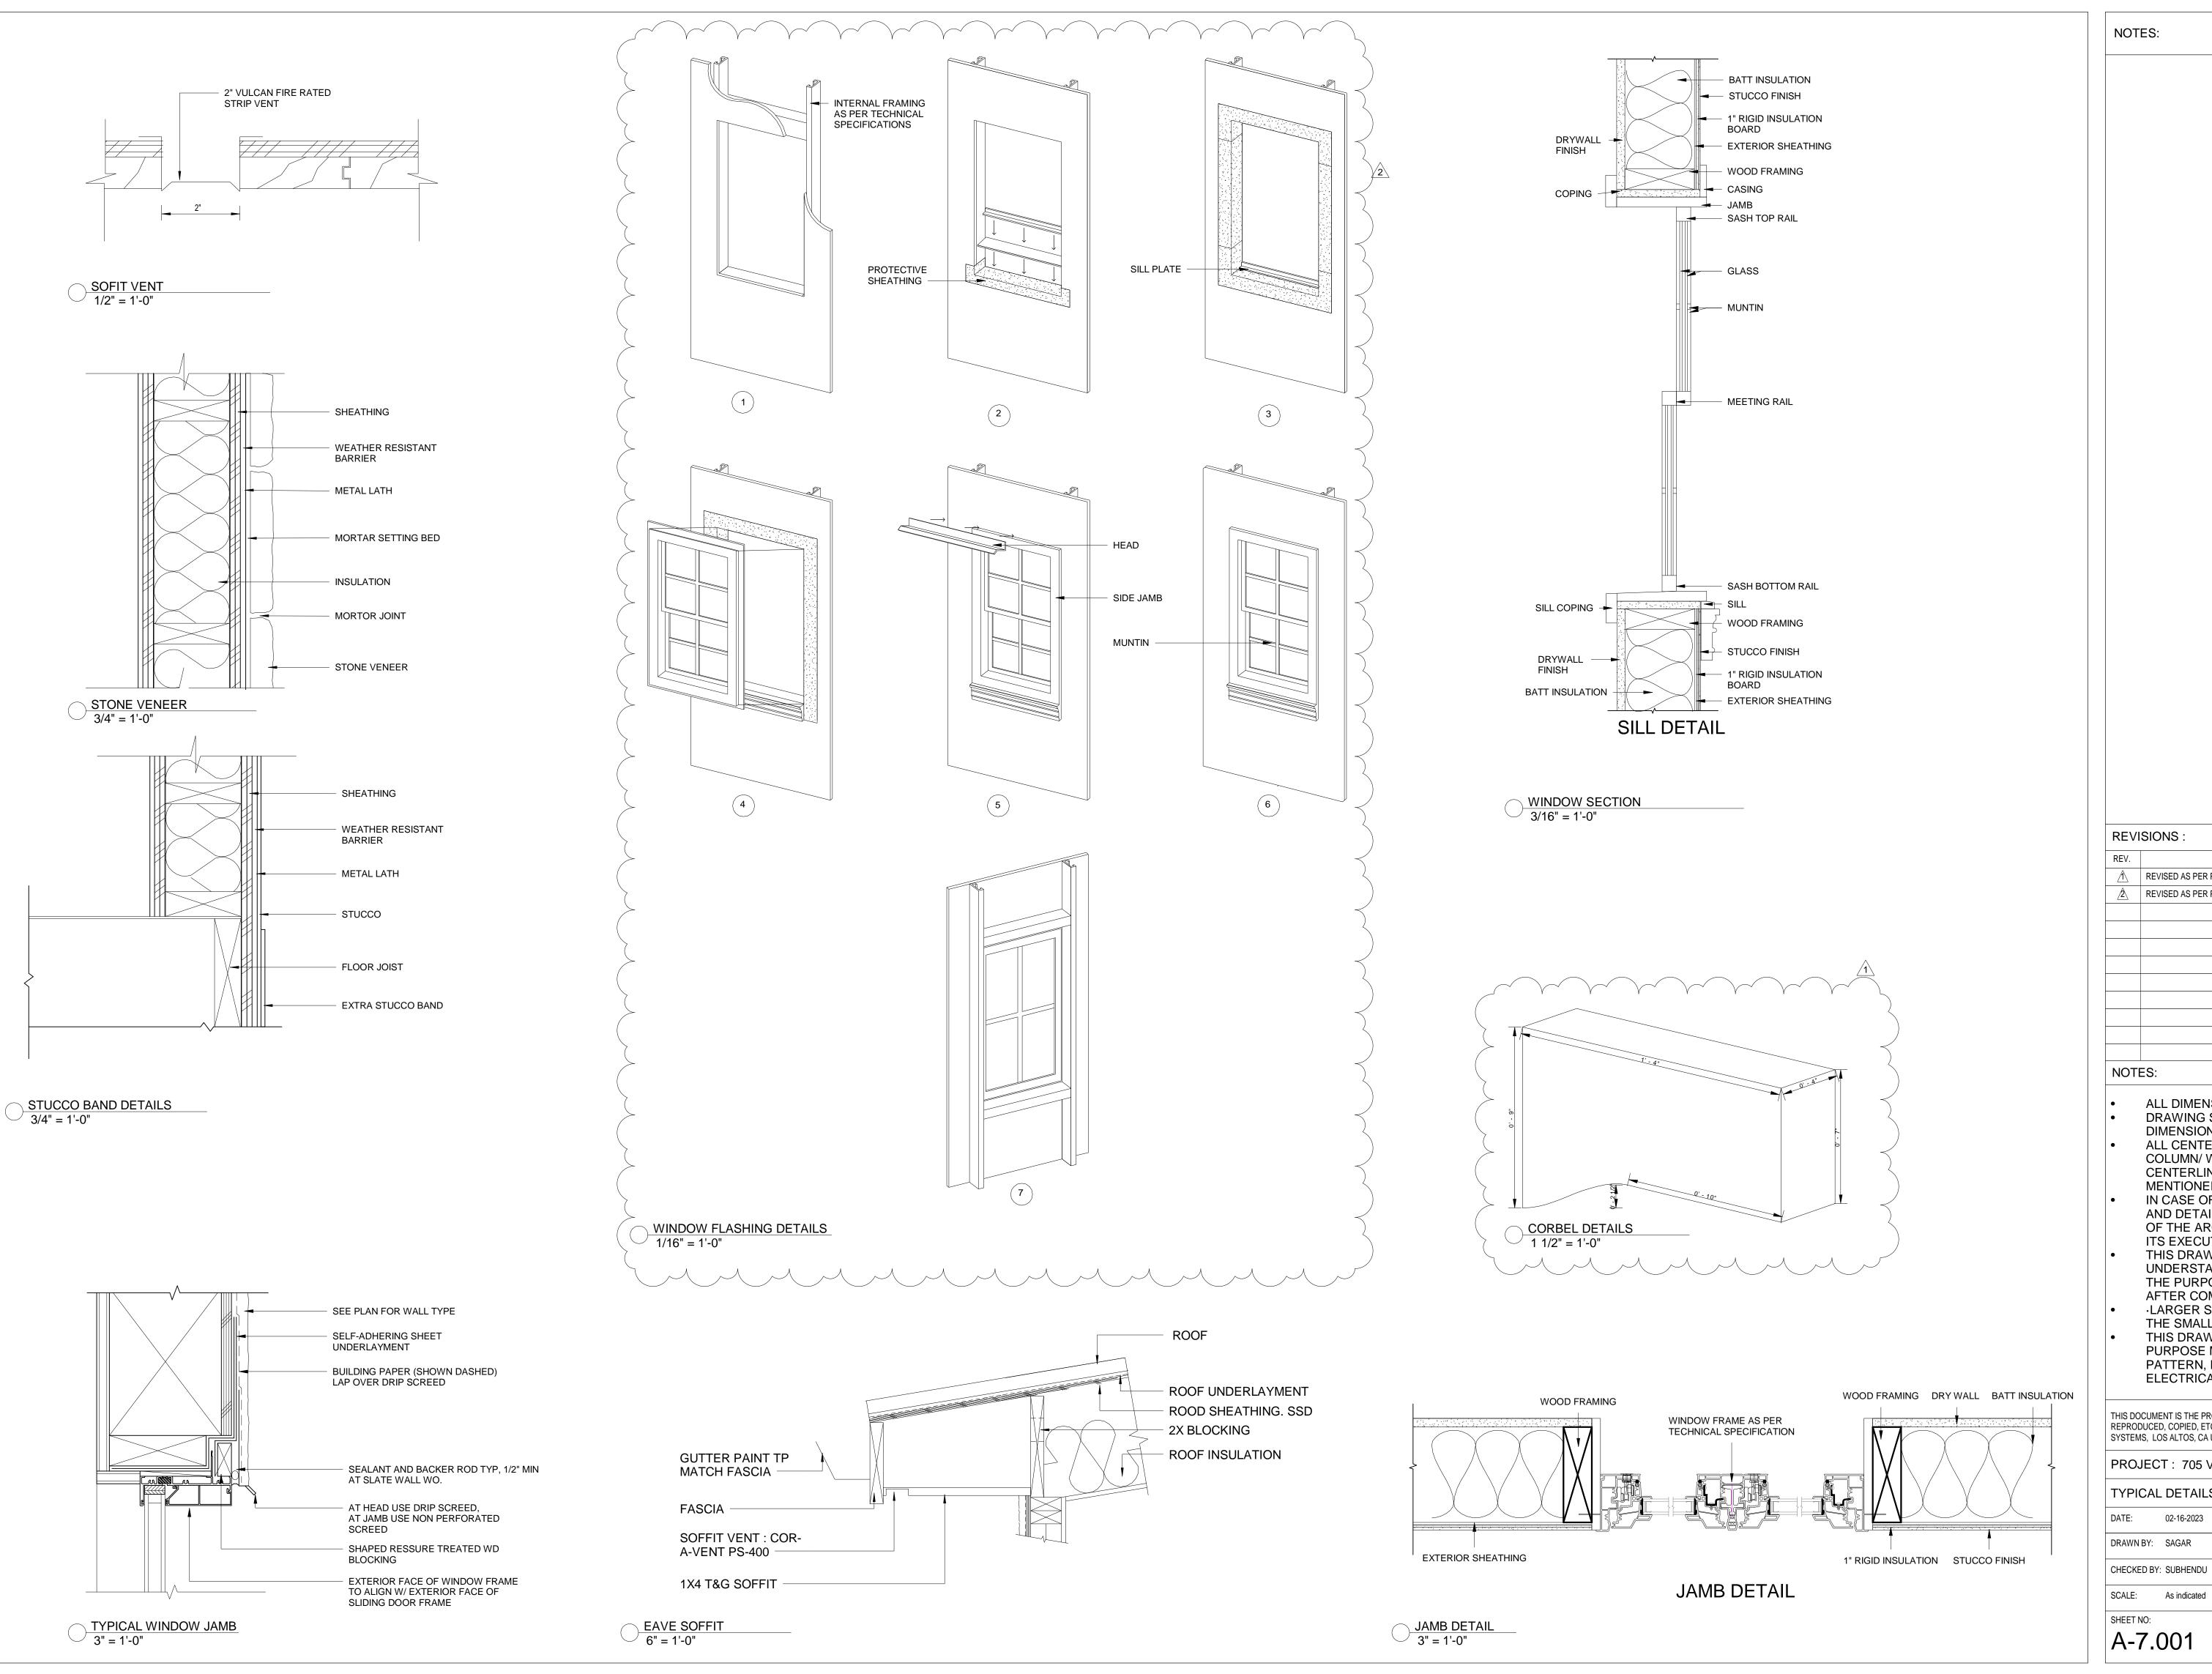

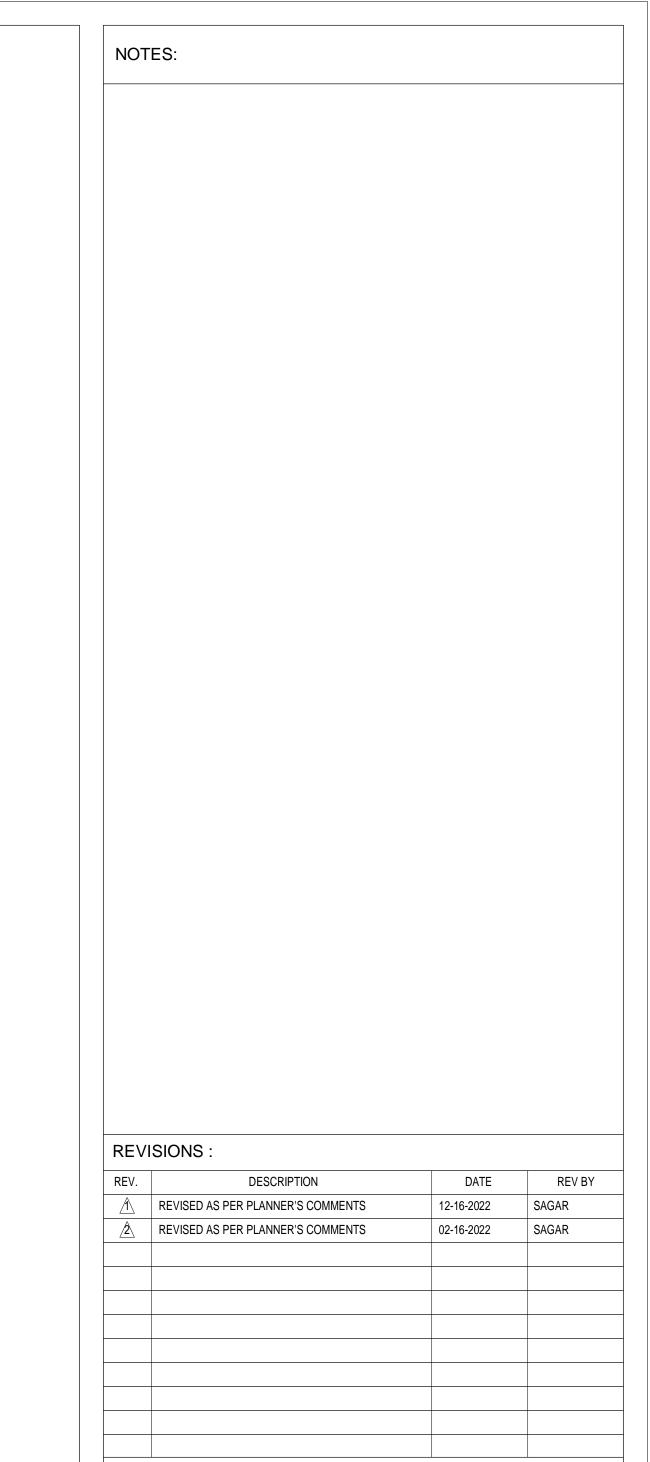

ALL DIMENSIONS ARE IN FEET AND INCHES. DRAWING SHALL NOT BE SCALED AND ONLY WRITTEN

DIMENSIONS SHALL BE FOLLOWED. ALL CENTERLINES ARE FROM THE CENTER OF COLUMN/ WALL AND THE DIMENSIONS GIVEN ARE CENTERLINE DIMENSIONS- -UNLESS OTHERWISE MENTIONED.

IN CASE OF ANY DISCREPANCY FOUND IN DRAWINGS AND DETAILS, IT SHALL BE BROUGHT TO THE NOTICE OF THE ARCHITECT, AND RECTIFIED, PRIOR TO ITS EXECUTION. THIS DRAWING IS ISSUED STRICTLY WITH AN

UNDERSTANDING THAT IT WILL BE USED ONLY FOR THE PURPOSE MENTIONED AND SHALL BE RETURNED AFTER COMPLETION. ·LARGER SCALE DRAWINGS AND DETAILS SUPERCEDE

THE SMALLER SCALE DRAWINGS AND DETAILS.

THIS DRAWING SHALL BE REFERRED ONLY FOR THE

PURPOSE MENTIONED IN ITS TITLE (FLOORING PATTERN, FALSE CEILING, SHUTTERING PATTERN, ELECTRICAL, PLUMBING, ETC.)

THIS DOCUMENT IS THE PROPERTY OF LIVIO BUILDING SYSTEMS AND SHALL NOT BE REFERRED, REPRODUCED, COPIED, ETC, WITHOUT EXPLICIT WRITTEN PERMISSION FROM LIVIO BUILDING SYSTEMS, LOS ALTOS, CA USA

PROJECT: 705 VISTA GRANDE AVE-LOT B, LOS ALTOS, CA

TYPICAL DETAILS

DRAWN BY: SAGAR



SCALE: As indicated



MATERIAL BOARD

MISCELLANEOUS





DOUBLE SLIDING DOOR

METAL HAND RAIL

EXTERIOR COLOR / MATERIAL SCHEDULE MATERIAL / APPLICATION COLOR **MANUFACTURE** ROOF CLAY TILES ROOFING BROWN GAF OR EQ SMOOTH STUCCO **BEIGE** NA RUSTIC RUBBLE STONE CLADDING NA **BROWN** STERLING OR EQ WOODEN GARAGE DOOR METAL WINDOW FRAMES JELWEN OR EQ **BROWN** DOUBLE SLIDING GLASS DOOR BROWN JELWEN OR EQ METAL GUARDRAIL **BLACK** STAIRSUPPLIES OR EQ **GREY** CONCRETE WALKWAY * NOTES: EXACT COLORS TO BE VERIFIED WITH OWNER & ARCHITECT

EVI	SIONS :	

KEV	EVISIONS.					
REV.	DESCRIPTION	DATE	REV BY			
Â	REVISED AS PER PLANNER'S COMMENTS	12-16-2022	SAGAR			
<u>^</u> 2	REVISED AS PER PLANNER'S COMMENTS	02-16-2022	SAGAR			

NOTES:

NOTES:

- ALL DIMENSIONS ARE IN FEET AND INCHES.
- DRAWING SHALL NOT BE SCALED AND ONLY WRITTEN DIMENSIONS SHALL BE FOLLOWED. ALL CENTERLINES ARE FROM THE CENTER OF
- COLUMN/ WALL AND THE DIMENSIONS GIVEN ARE CENTERLINE DIMENSIONS- -UNLESS OTHERWISE MENTIONED. IN CASE OF ANY DISCREPANCY FOUND IN DRAWINGS
- AND DETAILS, IT SHALL BE BROUGHT TO THE NOTICE OF THE ARCHITECT, AND RECTIFIED, PRIOR TO ITS EXECUTION. THIS DRAWING IS ISSUED STRICTLY WITH AN
- UNDERSTANDING THAT IT WILL BE USED ONLY FOR THE PURPOSE MENTIONED AND SHALL BE RETURNED AFTER COMPLETION.
- ·LARGER SCALE DRAWINGS AND DETAILS SUPERCEDE
- THE SMALLER SCALE DRAWINGS AND DETAILS.
- THIS DRAWING SHALL BE REFERRED ONLY FOR THE PURPOSE MENTIONED IN ITS TITLE (FLOORING PATTERN, FALSE CEILING, SHUTTERING PATTERN, ELECTRICAL, PLUMBING, ETC.)

THIS DOCUMENT IS THE PROPERTY OF LIVIO BUILDING SYSTEMS AND SHALL NOT BE REFERRED, REPRODUCED, COPIED, ETC, WITHOUT EXPLICIT WRITTEN PERMISSION FROM LIVIO BUILDING SYSTEMS, LOS ALTOS, CA USA

PROJECT: 705 VISTA GRANDE AVE-LOT B, LOS ALTOS, CA

MATERIAL BOARD

DATE:


SCALE:

02-16-2023 DRAWN BY: SAGAR CHECKED BY: SUBHENDU

12" = 1'-0"

ADDRESS: 329 S San Antonio Road Suite #4, Los Altos, CA 94022 CONTACT: 650-209-6500 team@golivio.com

A-7.002

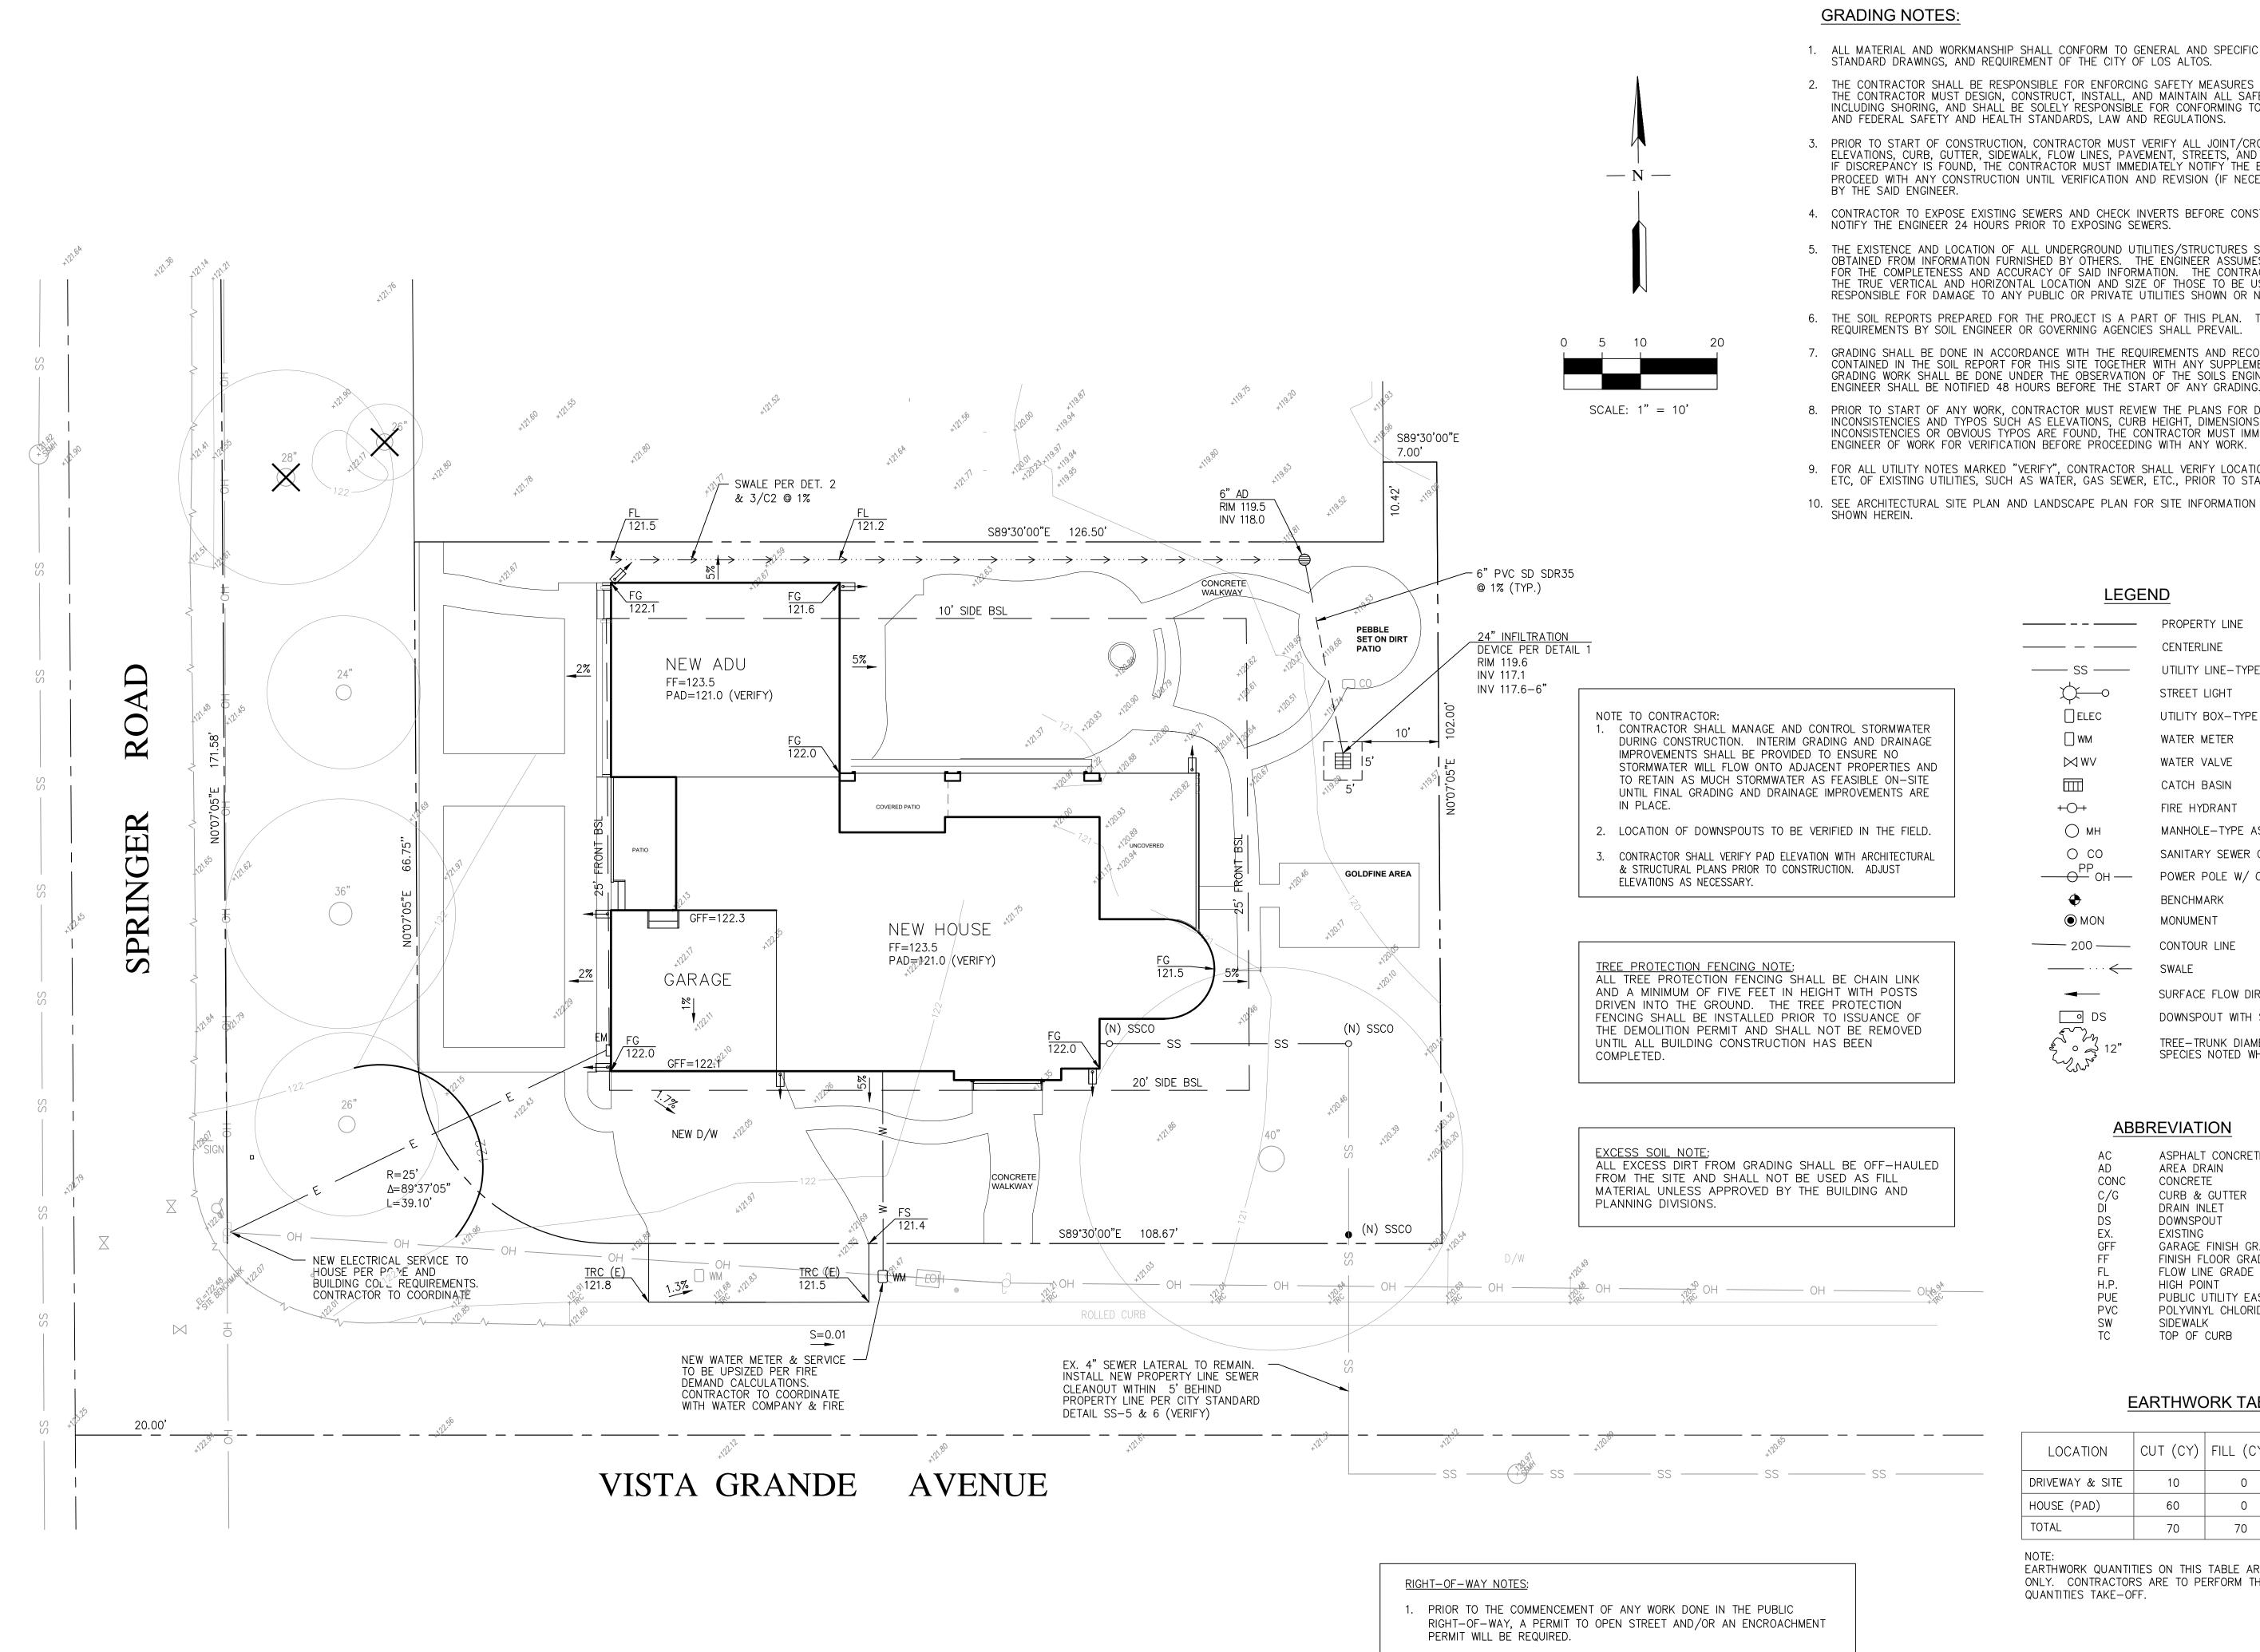

- 1. ALL MATERIAL AND WORKMANSHIP SHALL CONFORM TO GENERAL AND SPECIFIC PROVISIONS,
- 2. THE CONTRACTOR SHALL BE RESPONSIBLE FOR ENFORCING SAFETY MEASURES AND REGULATIONS. THE CONTRACTOR MUST DESIGN, CONSTRUCT, INSTALL, AND MAINTAIN ALL SAFETY DEVICES, INCLUDING SHORING, AND SHALL BE SOLELY RESPONSIBLE FOR CONFORMING TO ALL LOCAL, STATE, AND FEDERAL SAFETY AND HEALTH STANDARDS, LAW AND REGULATIONS.
- 3. PRIOR TO START OF CONSTRUCTION, CONTRACTOR MUST VERIFY ALL JOINT/CROSSING LOCATIONS, ELEVATIONS, CURB, GUTTER, SIDEWÁLK, FLOW LINES, PAVEMENT, STREETS, ÁND ALL GRADE JOINTS IF DISCREPANCY IS FOUND. THE CONTRACTOR MUST IMMEDIATELY NOTIFY THE ENGINEER AND NOT PROCEED WITH ANY CONSTRUCTION UNTIL VERIFICATION AND REVISION (IF NECESSARY) IS COMPLETED
- 4. CONTRACTOR TO EXPOSE EXISTING SEWERS AND CHECK INVERTS BEFORE CONSTRUCTING NEW SEWERS.
- 5. THE EXISTENCE AND LOCATION OF ALL UNDERGROUND UTILITIES/STRUCTURES SHOWN HEREON WERE OBTAINED FROM INFORMATION FURNISHED BY OTHERS. THE ENGINEER ASSUMES NO RESPONSIBILITY FOR THE COMPLETENESS AND ACCURACY OF SAID INFORMATION. THE CONTRACTOR MUST ASCERTAIN THE TRUE VERTICAL AND HORIZONTAL LOCATION AND SIZE OF THOSE TO BE USED AND SHALL BE RESPONSIBLE FOR DAMAGE TO ANY PUBLIC OR PRIVATE UTILITIES SHOWN OR NOT SHOWN HEREON.
- 6. THE SOIL REPORTS PREPARED FOR THE PROJECT IS A PART OF THIS PLAN. THE MOST STRINGENT REQUIREMENTS BY SOIL ENGINEER OR GOVERNING AGENCIES SHALL PREVAIL.
- 7. GRADING SHALL BE DONE IN ACCORDANCE WITH THE REQUIREMENTS AND RECOMMENDATIONS CONTAINED IN THE SOIL REPORT FOR THIS SITE TOGETHER WITH ANY SUPPLEMENTS THERETO. ALL GRADING WORK SHALL BE DONE UNDER THE OBSERVATION OF THE SOILS ENGINEER. THE SOIL
- 8. PRIOR TO START OF ANY WORK, CONTRACTOR MUST REVIEW THE PLANS FOR DESIGN INCONSISTENCIES AND TYPOS SUCH AS ELEVATIONS, CURB HEIGHT, DIMENSIONS, SLOPES, ETC. IF INCONSISTENCIES OR OBVIOUS TYPOS ARE FOUND, THE CONTRACTOR MUST IMMEDIATELY NOTIFY THE ENGINEER OF WORK FOR VERIFICATION BEFORE PROCEEDING WITH ANY WORK.
- 9. FOR ALL UTILITY NOTES MARKED "VERIFY", CONTRACTOR SHALL VERIFY LOCATION, SIZE, MATERIAL, ETC, OF EXISTING UTILITIES, SUCH AS WATER, GAS SEWER, ETC., PRIOR TO STARTING CONSTRUCTION.
- 10. SEE ARCHITECTURAL SITE PLAN AND LANDSCAPE PLAN FOR SITE INFORMATION AND NOTES NOT

LEGEND

— – – PROPERTY LINE CENTERLINE UTILITY LINE-TYPE AS NOTED STREET LIGHT ELEC UTILITY BOX-TYPE AS NOTED WATER METER \bowtie WV WATER VALVE CATCH BASIN FIRE HYDRANT \bigcirc MH MANHOLE-TYPE AS NOTED O CO SANITARY SEWER CLEANOUT POWER POLE W/ OVERHEAD WIRE BENCHMARK MONUMENT CONTOUR LINE SURFACE FLOW DIRECTION DOWNSPOUT WITH SPLASH-BLOCK

ABBREVIATION

TREE-TRUNK DIAMETER IN INCHES

SPECIES NOTED WHEN KNOWN

ASPHALT CONCRETE AREA DRAIN CONC CONCRETE C/G CURB & GUTTER DRAIN INLET DOWNSPOUT EXISTING GARAGE FINISH GRADE FINISH FLOOR GRADE FLOW LINE GRADE HIGH POINT PUBLIC UTILITY EASEMENT PVC POLYVINYL CHLORIDE SIDEWALK

EARTHWORK TABLE

TOP OF CURB

LOCATION	CUT (CY)	FILL (CY)	EXPORT (C)
DRIVEWAY & SITE	10	0	
HOUSE (PAD)	60	0	
TOTAL	70	70	70

EARTHWORK QUANTITIES ON THIS TABLE ARE FOR INFORMATION ONLY. CONTRACTORS ARE TO PERFORM THEIR OWN QUANTITIES TAKE-OFF.

2. ANY DAMAGED RIGHT-OF-WAY INFRASTRUCTURES AND OTHERWISE

DISPLACED CURB AND GUTTER SHALL BE REMOVED AND REPLACED AS DIRECTED BY THE CITY ENGINEER OR HIS DESIGNEE. CONTRACTOR SHALL

COORDINATE WITH PUBLIC WORKS DEPARTMENT AT (650) 947-2680.

DATE: 7/10/2022 SCALE: AS NOTED DESIGNED BY: RW DRAWN BY: RW SHEET NO.

FRW ENGINEERING
CIVIL ENGINEERS • LAND S
505 ALTAMONT DRIVE
MILPITAS, CA 95035
(P) (408) 262–1899
(FAX) (408) 824–5556

ไมู้ 50541

 \Box

(P.

AND

Ŋ

SID

R


NEW 705


AND PLAN

GRADING

06-30-23

OF 4 SHEETS

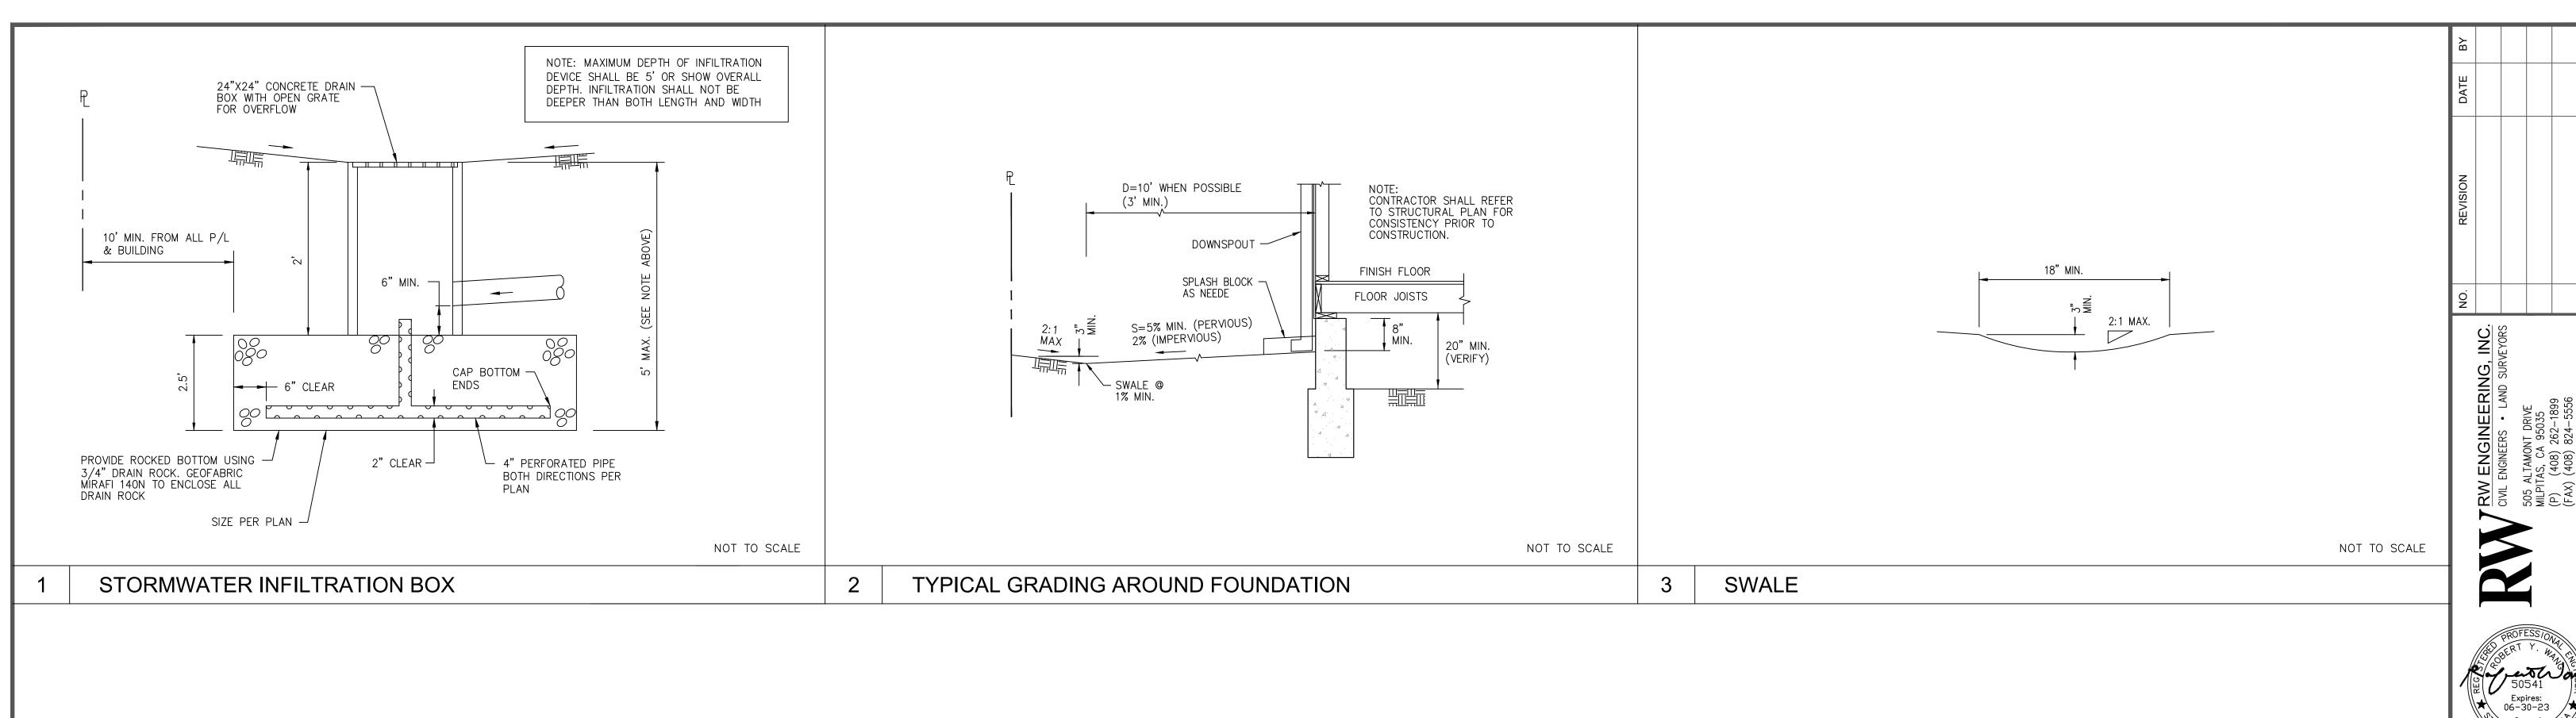

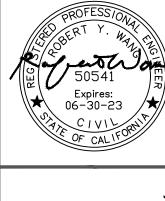

NEW RESIDENCE (PARCEL B)
705 VISTA GRANDE AVENUE
LOS ALTOS, CA
SANTA CLARA COUNT

DETAILS

DATE: 7/10/2022 SCALE: AS NOTED DESIGNED BY: RW DRAWN BY: RW

OF 4 SHEETS

GENERAL EROSION AND SEDIMENT CONTROL NOTES:

- 1. THIS PLAN IS INTENDED TO BE USED FOR INTERIM EROSION AND SEDIMENT CONTROL ONLY AND IS NOT TO BE USED FOR FINAL ELEVATIONS OR PERMANENT IMPROVEMENTS.
- 2. OWNER/ CONTRACTOR SHALL BE RESPONSIBLE FOR MONITORING EROSION AND SEDIMENT CONTROL MEASURES PRIOR, DURING, AND AFTER STORM EVENTS.
- 3. REASONABLE CARE SHALL BE TAKEN WHEN HAULING ANY EARTH, SAND, GRAVEL, STONE, DEBRIS, PAPER OR ANY OTHER SUBSTANCE OVER ANY PUBLIC STREET, ALLEY OR OTHER PUBLIC PLACE. SHOULD ANY BLOW, SPILL, OR TRACK OVER AND UPON SAID PUBLIC OR ADJACENT PRIVATE PROPERTY, IMMEDIATE REMEDY SHALL OCCUR.
- 4. SANITARY FACILITIES SHALL BE MAINTAINED ON THE SITE.
- 5. DURING THE RAINY SEASON, ALL PAVED AREAS SHALL BE KEPT CLEAR OF EARTH MATERIAL AND DEBRIS. THE SITE SHALL BE MAINTAINED SO AS TO MINIMIZE SEDIMENT LADEN RUNOFF TO ANY STORM DRAINAGE SYSTEM, INCLUDING EXISTING DRAINAGE SWALES AND WATER COURSES.
- 6. CONSTRUCTION OPERATIONS SHALL BE CARRIED OUT IN SUCH A MANNER THAT EROSION AND WATER POLLUTION WILL BE MINIMIZED. STATE AND LOCAL LAWS CONCERNING POLLUTION ABATEMENT SHALL BE COMPLIED WITH.
- 7. CONTRACTOR SHALL PROVIDE DUST CONTROL AS REQUIRED BY THE APPROPRIATE FEDERAL, STATE, AND LOCAL AGENCY REQUIREMENTS.

EROSION AND SEDIMNET CONTROL MEASURES

- 1. THE FACILITIES SHOWN ON THIS PLAN ARE DESIGNED TO CONTROL EROSION AND SEDIMENT DURING THE RAINY SEASON, OCTOBER 15 TO APRIL 15. FACILITIES ARE TO BE OPERABLE PRIOR TO OCTOBER 1 OF ANY YEAR. GRADING OPERATIONS DURING THE RAINY SEASON WHICH LEAVE DENUDED SLOPES SHALL BE PROTECTED WITH EROSION CONTROL MEASURES IMMEDIATELY FOLLOWING GRADING ON THE SLOPES.
- 2. THIS PLAN COVERS ONLY THE FIRST WINTER FOLLOWING GRADING WITH ASSUMED SITE CONDITIONS AS SHOWN ON THE EROSION CONTROL PLAN. PRIOR TO SEPTEMBER 15, THE COMPLETION OF SITE IMPROVEMENT SHALL BE EVALUATED AND REVISIONS MADE TO THIS PLAN AS NECESSARY WITH THE APPROVAL OF THE CITY ENGINEER. PLANS ARE TO BE RESUBMITTED FOR CITY APPROVAL PRIOR TO SEPTEMBER 1 OF EACH SUBSEQUENT YEAR UNTIL SITE IMPROVEMENTS ARE ACCEPTED BY THE CITY AND COUNTY.
- 3. CONSTRUCTION ENTRANCES SHALL BE INSTALLED PRIOR TO COMMENCEMENT OF GRADING. ALL CONSTRUCTION TRAFFIC ENTERING ONTO THE PAVED ROADS MUST CROSS THE STABILIZED CONSTRUCTION ENTRANCE WAYS. (ALSO INCLUDE THIS NOTE ON GRADING PLANS.)
- 4. CONTRACTOR SHALL MAINTAIN STABILIZED ENTRANCE AT EACH VEHICLE ACCESS POINT TO EXISTING PAVED STREETS. ANY MUD OR DEBRIS TRACKED ONTO PUBLIC STREETS SHALL BE REMOVED DAILY AND AS REQUIRED BY THE CITY AND COUNTY.
- 5. IF HYDROSEEDING IS NOT USED OR IS NOT EFFECTIVE BY 10/10, THEN OTHER IMMEDIATE METHODS SHALL BE IMPLEMENTED, SUCH AS EROSION CONTROL BLANKETS, OR A THREE—STEP APPLICATION OF 1) SEED, MULCH, FERTILIZER 2) BLOWN STRAW 3) TACKIFIER AND MULCH.
- 6. INLET PROTECTION SHALL BE INSTALLED AT OPEN INLETS TO PREVENT SEDIMENT FROM ENTERING THE STORM DRAIN SYSTEM.
 INLETS NOT USED IN CONJUNCTION WITH EROSION CONTROL ARE TO BE BLOCKED TO PREVENT ENTRY OF SEDIMENT.
- 7. LOTS WITH HOUSES UNDER CONSTRUCTION WILL NOT BE HYDROSEEDED. EROSION PROTECTION FOR EACH LOT WITH A HOUSE UNDER CONSTRUCTION SHALL CONFORM TO THE TYPICAL LOT EROSION CONTROL DETAIL SHOWN ON THIS SHEET.
- 8. THIS EROSION AND SEDIMENT CONTROL PLAN MAY NOT COVER ALL THE SITUATIONS THAT MAY ARISE DURING CONSTRUCTION DUE TO UNANTICIPATED FIELD CONDITIONS. VARIATIONS AND ADDITIONS MAY BE MADE TO THIS PLAN IN THE FIELD. NOTIFY THE CITY REPRESENTATIVE OF ANY FIELD CHANGES.

MAINTENANCE NOTES

- 1. MAINTENANCE IS TO BE PERFORMED AS FOLLOWS:
- A. REPAIR DAMAGES CAUSED BY SOIL EROSION OR CONSTRUCTION AT THE END OF EACH WORKING DAY. B. SWALES SHALL BE INSPECTED PERIODICALLY AND MAINTAINED AS NEEDED.
- C. SEDIMENT TRAPS, BERMS, AND SWALES ARE TO BE INSPECTED AFTER EACH STORM AND REPAIRS MADE AS NEEDED.

 D. SEDIMENT SHALL BE REMOVED AND SEDIMENT TRAP RESTORED TO ITS ORIGINAL DIMENSIONS WHEN SEDIMENT HAS
- ACCUMULATED TO A DEPTH OF 1 FOOT.

 E. SEDIMENT REMOVED FROM TRAP SHALL BE DEPOSITED IN A SUITABLE AREA AND IN SUCH A MANNER THAT IT WILL NOT
- 2. ROCK BAG INLET PROTECTION SHALL BE CLEANED OUT WHENEVER SEDIMENT DEPTH IS ONE HALF THE HEIGHT OF ONE ROCK

HYDROSEEDING:

F. RILLS AND GULLIES MUST BE REPAIRED.

- 1. ALL WORK SHALL BE PERFORMED IN ACCORDANCE WITH THE MANUFACTURER'S RECOMMENDATIONS, CALTRANS STANDARD SPECIFICATIONS, AND UNDER THE DIRECTION OF THE SOIL ENGINEER IN THE FIELD.
- 2. ALL AREAS SPECIFIED FOR HYDROSEEDING SHALL BE NOZZLE PLANTED WITH STABILIZATION MATERIAL CONSISTING OF FIBER, SEED, FERTILIZER AND WATER, MIXED AND APPLIED IN THE FOLLOWING PROPORTIONS AVAILABLE FROM PACIFIC COAST SEED, LIVERMORE (925) 373-4417:

FIBER (HYDROSTRAW AND TACK MULCH)
COLOR (GREEN TO GOLD)
FERTILIZER (16-20-0)
M-BINDER

WATER, AS REQUIRED FOR APPLICATION

2500 LBS/ACRE 55 LBS/ACRE 350 LBS/ACRE 125 LB/ACRE

LEGEND

ROCKED CONSTRUCTION ENTRANCE

FIBER ROLL

PORTABLE TOILET WITH SECONDARY CONTAINMENT


CONCRETE WASH AREA

TREE PROTECTION FENCE

TREE PROTECTION FENCING NOTE:
ALL TREE PROTECTION FENCING SHALL BE CHAIN LINK
AND A MINIMUM OF FIVE FEET IN HEIGHT WITH POSTS
DRIVEN INTO THE GROUND. THE TREE PROTECTION
FENCING SHALL BE INSTALLED PRIOR TO ISSUANCE OF
THE DEMOLITION PERMIT AND SHALL NOT BE REMOVED
UNTIL ALL BUILDING CONSTRUCTION HAS BEEN
COMPLETED.

NO. REVISION DATE BY

CIVIL ENGINEERS • LAND SURVEYOR:
505 ALTAMONT DRIVE
MILPITAS, CA 95035
(P) (408) 262–1899
(FAX) (408) 824–5556
FAX) (408) 824–5556

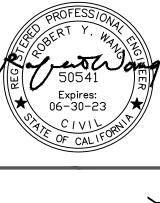

RESIDENCE (PARCEL B)
//STA GRANDE AVENUE

EROSION CONTROL &
TREE PROTECTION
PLAN

NEW 705 \

DATE: 7/10/2022

SCALE: AS NOTED


DESIGNED BY: RW


DRAWN BY: RW


SHEET NO.


C-3


OF 4 SHEETS

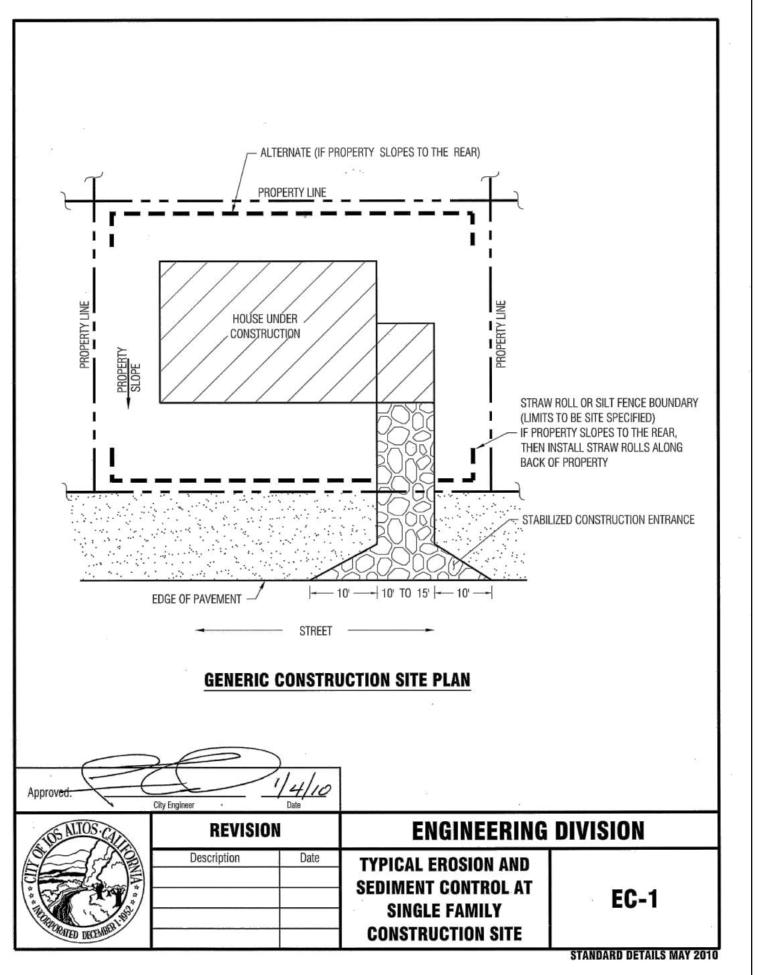


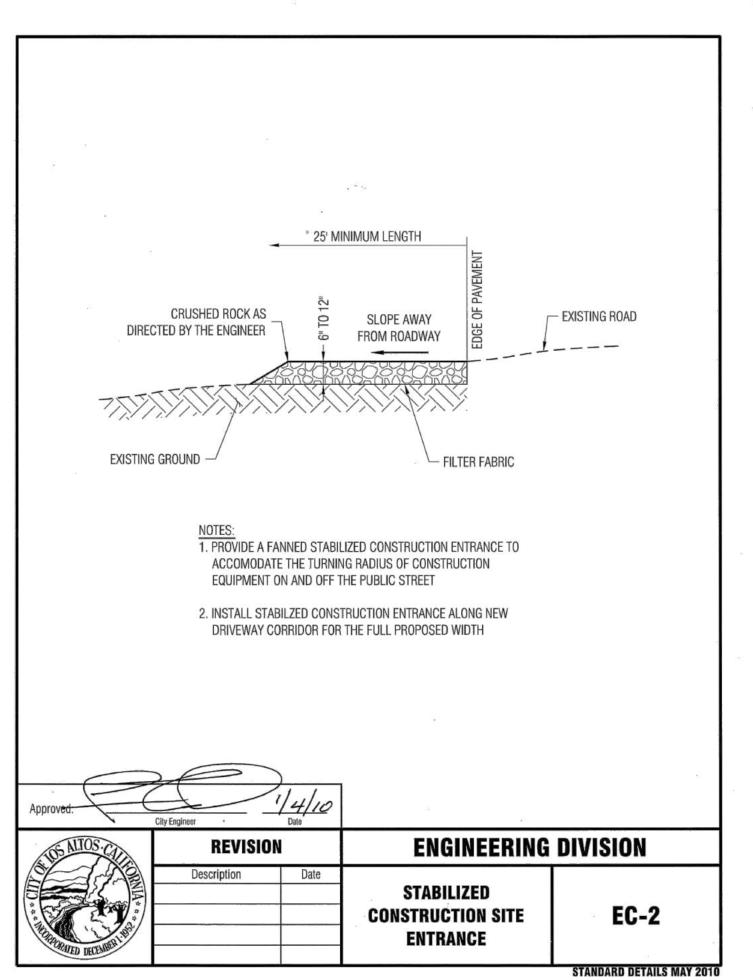

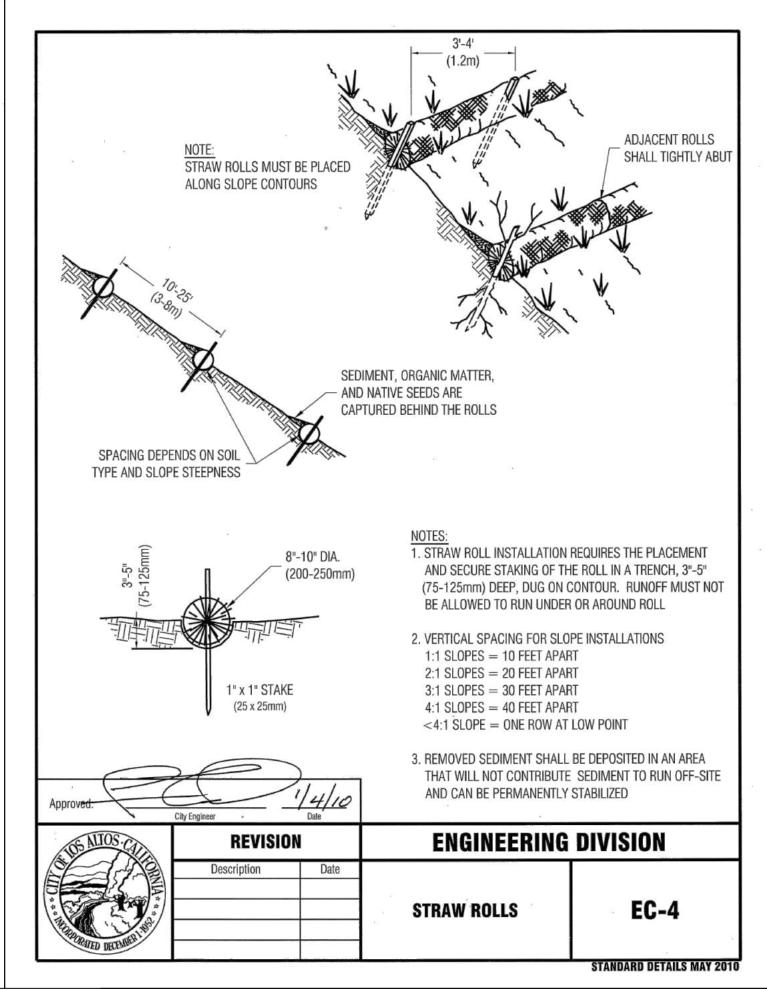

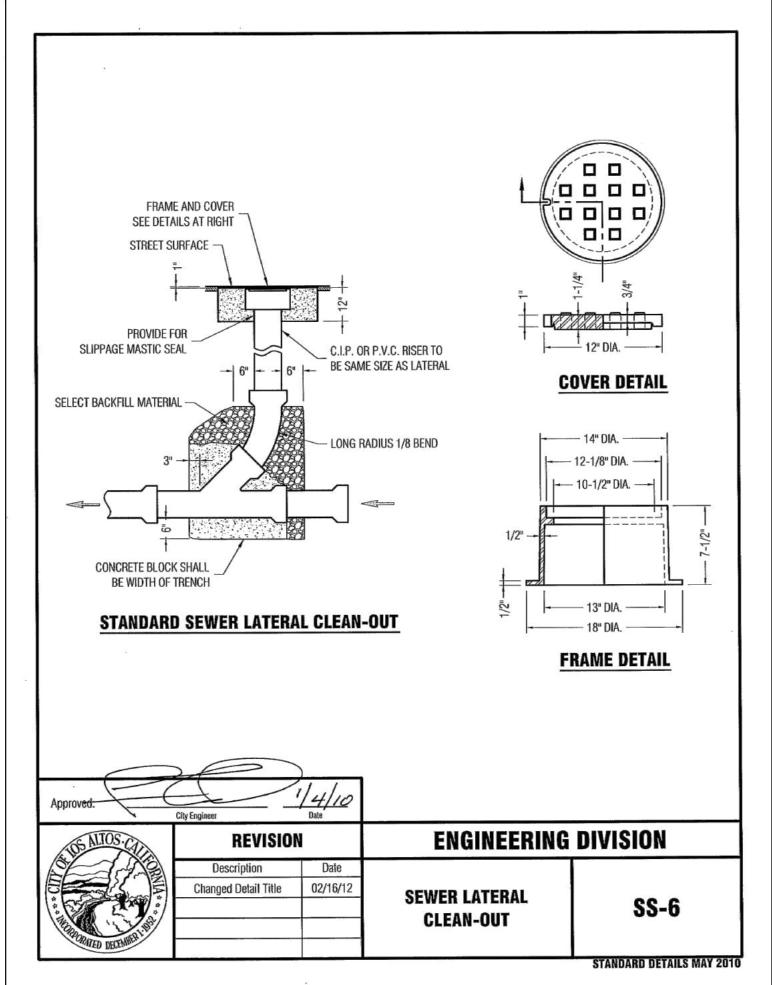

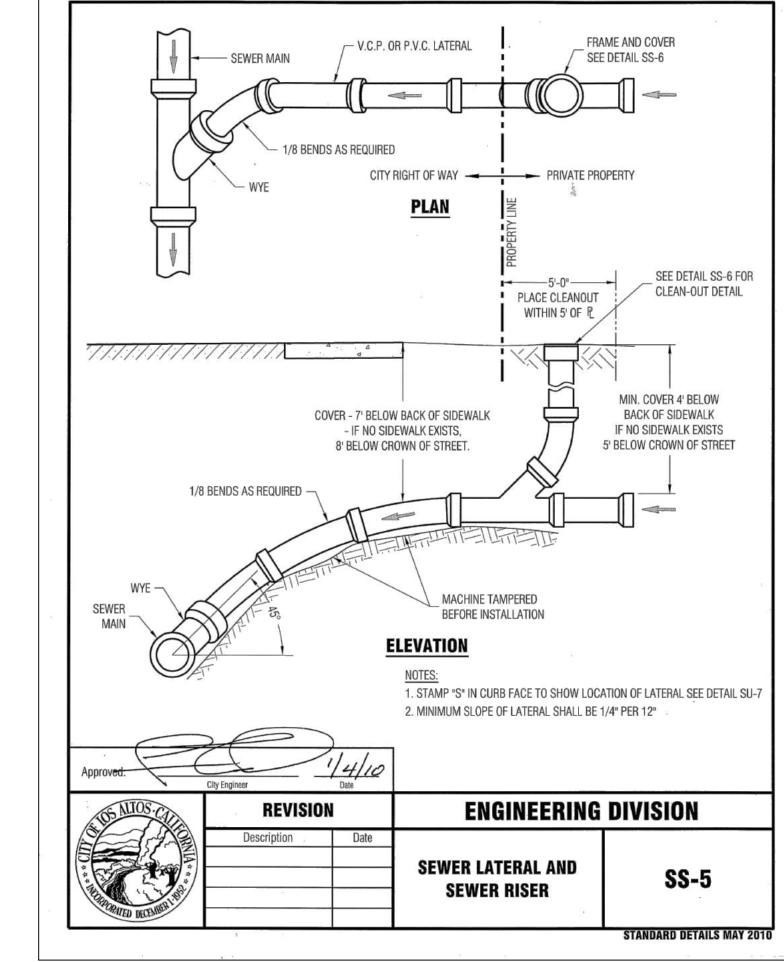

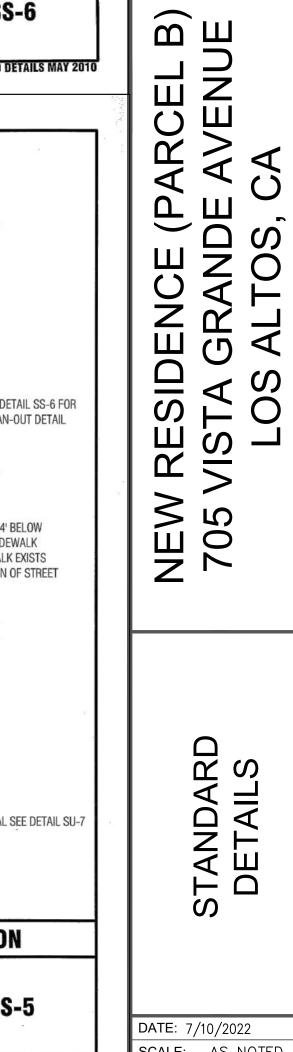


NEW 705 STANDARD DETAILS

FRW ENGINEERING, INC.
CIVIL ENGINEERS • LAND SURVEYORS
505 ALTAMONT DRIVE
MILPITAS, CA 95035
(P) (408) 262-1899

DATE: 7/10/2022 SCALE: AS NOTED DESIGNED BY: RW DRAWN BY: RW SHEET NO.



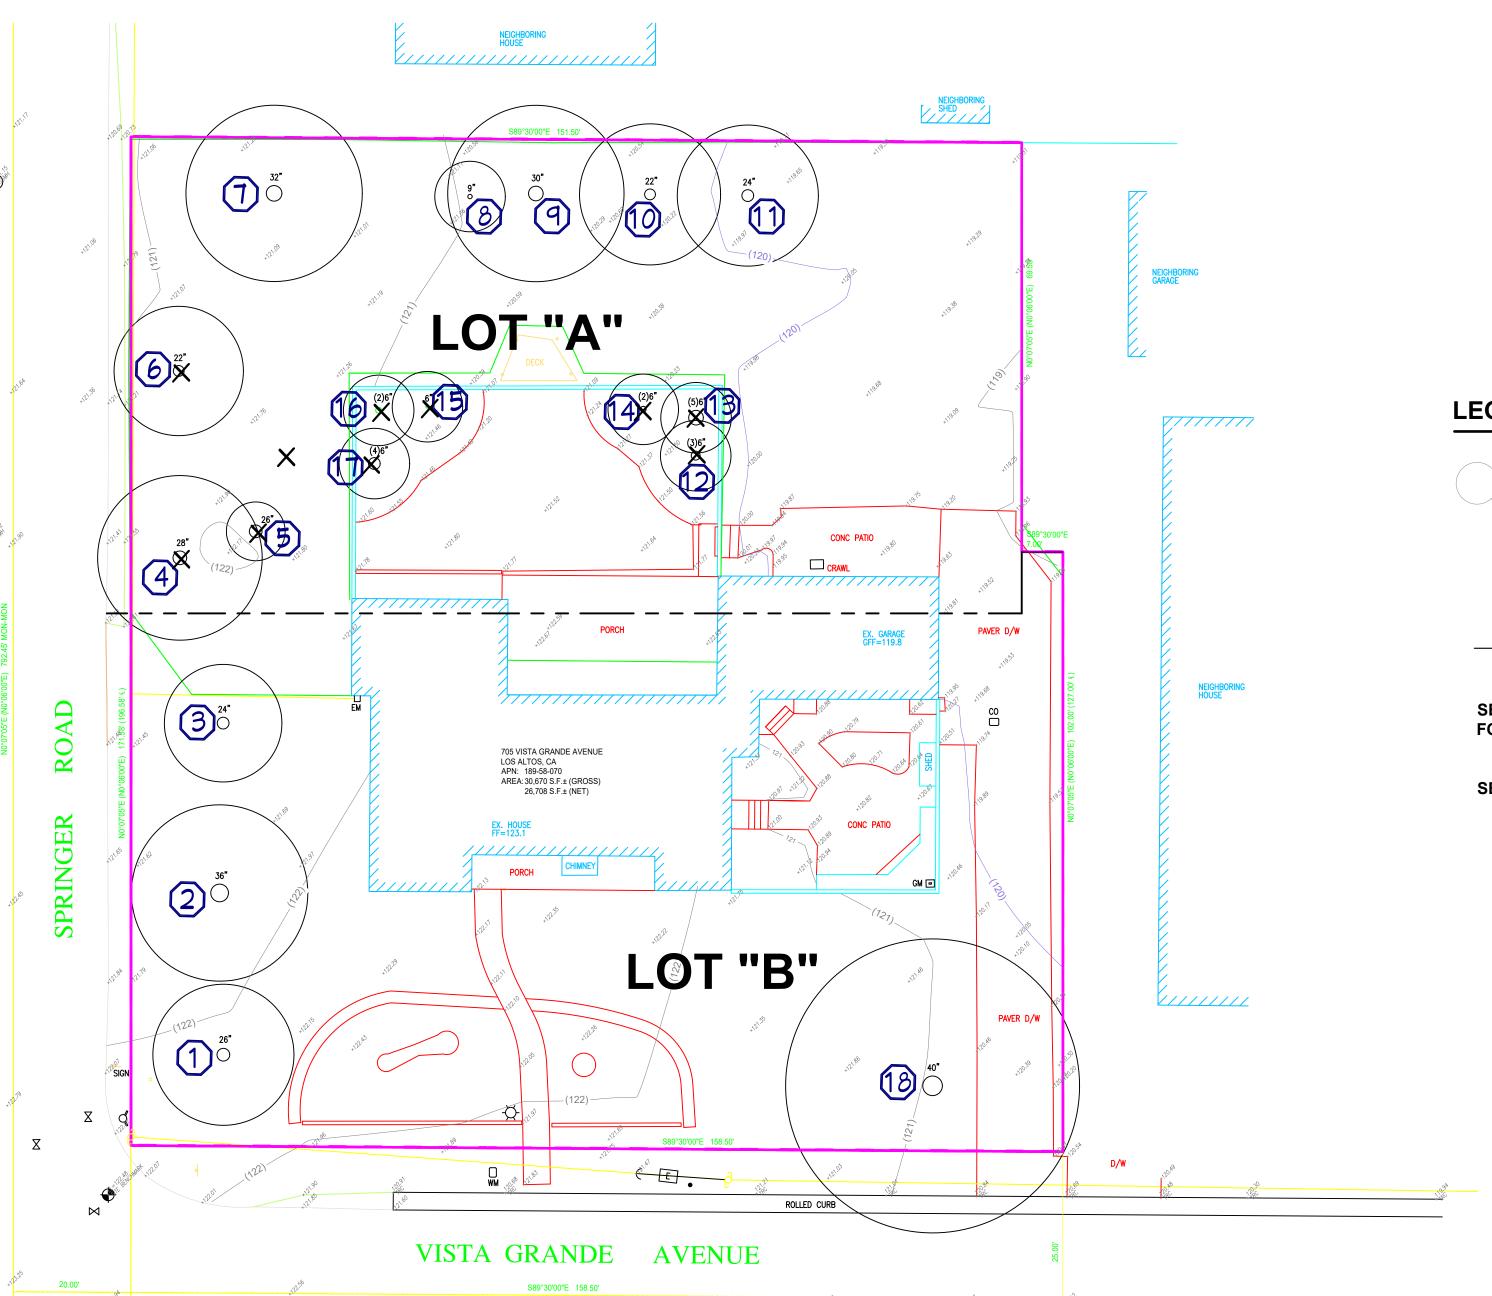

LEGEND



EXISTING TREE CANOPY, TYPICAL



TREES TO REMOVE, TYPICAL

————— TREE PROTECTION FENCING; REFER TO ARBORIST REPORT ALL REMAINING TREES

SEE ENGINEERING DRAWINGS SHEETS FOR LOT DESCRIPTION AS WELL AS GRADING INFORMATION

SEE ARBORIST REPORT FOR TREE REMOVAL INFORMATION

PLANTING SCHEDULE

SYMBOL	QTY	SIZE	BOTANICAL NAME	COMMON NAME	NOTES
1)	1	2 7 " dia	CEDRUS DEODARA	DEODAR CEDAR	EXISTING / PROTECT
2	1	38" dia	SEQUOIA SEMPERVIRENS	REDMOOD	EXISTING / PROTECT
3	1	26" dia	SEQUOIA SEMPERVIRENS	REDMOOD	EXISTING / PROTECT
4	1	26" dia	SEQUOIA SEMPERVIRENS	REDMOOD	REMOVE
5	1	26" dia	PHOENIX CANARIENSIS	CANARY ISLAND PALM	REMOVE
6	1	23" dia	SEQUOIA SEMPERVIRENS	REDMOOD	REMOVE
7)	1	34" dia	PSEUDOTSUGA MENZIESII	DOUGLAS FIR	EXISTING / PROTECT
8	1	9" dia	CINNMOMUN CAMPHORA	CAMPHOR TREE	EXISTING / PROTECT
9	1	25" dia	SEQUOIA SEMPERVIRENS	REDMOOD	EXISTING / PROTECT
10	1	24" dia	PSEUDOTSUGA MENZIESII	DOUGLAS FIR	EXISTING / PROTECT
1)	1	25" dia	PSEUDOTSUGA MENZIESII	DOUGLAS FIR	EXISTING / PROTECT
2	1	7" dia	ACCA SELLOWIANA	PINEAPLE GUAVE	REMOVE
13)	1	7" dia	ACCA SELLOWIANA	PINEAPLE GUAVE	REMOVE
14)	1	გ" dia	ACCA SELLOWIANA	PINEAPLE GUAVE	REMOVE
15)	1	7" dia	ACCA SELLOWIANA	PINEAPLE GUAVE	REMOVE
16)	1	6" dia	ACCA SELLOWIANA	PINEAPLE GUAVE	REMOVE
1	1	7" dia	ACCA SELLOWIANA	PINEAPLE GUAVE	REMOVE
18)	1	41" dia	QUERCUS SUBER	CORK OAK	EXISTING / PROTECT

PROJECT DATA

PROJECT ADDRESS: 705 VISTA GRANDE AVE OWNER: SANDESH & SHIKHA TAMARI

OCCUPANCY GROUP: 3032 SQ. FT. TOTAL LANDSCAPE SF.: PROJECT TYPE: NEW LANDSCAPE WATER SUPPLY: POTABLE MATER

SCOPE OF WORK 1. INSTALL NEW LANDSCAPE FRONT AND BACK 2. INSTALL NEW DRIP IRRIGATION SYSTEM 3. COMPLY WITH CITY WATER ORDINANCE ARCHITECT: LIVIO 889 SAN ANTONIO RD. SUITE 110 LOS ALTOS, CA 94022 650-380-0644

TEAM@GOLIVIO.COM ENGINEER: RW ENGINEERING INC 505 ALTAMONT DR MILPITAS, CA 95035 408-262-1899 ARBORIST: Kielty Arborist Services LLC Certified Arborist WE#0476A

STATEMENT: I AGREE TO COMPLY WITH THE REQUIREMENTS OF THE WATER EFFICIENT LANDSCAPE ORDINANCE AND SUBMIT A COMPLETE LANDSCAPE DOCUMENTATION PACKAGE

P.O. Box 6187 San Mateo, CA 94403 650- 515-9783

NOTES

STANDARDS FOR TREE PROTECTION OF TREES DURING GRADING AND CONSTRUCTION OPERATIONS

THE PURPOSE OF THIS APPENDIX IS TO OUTLINE STANDARDS PERTAINING TO THE PROTECTION OF 14.18.200 OF CHAPTER 14.18. THE STANDARDS ARE BRAD. A LICENSED LANDSCAPE ARCHITECT OR INTERNATIONAL SOCIETY OF ARBORICULTURE CERTIFIED ARBORIST SHALL BE RETAINED TO CERTIFY THE APPLICABILITY OF THE STANDARDS AND DEVELOP ADDITIONAL STANDARDS AS NECESSARY TO ENSURE THE PROPERTY CARE, MAINTENANCE, AND SURVIVAL OF TREES DESIGNATED FOR

STANDARDS

PROTECTION.

I. A PLOT PLAN SHALL BE PREPARED DESCRIBING THE RELATIONSHIP OF PROPOSED GRADING AND UTILITY TRENCHING TO THE TREES DESIGNATED FOR PRESERVATION. CONSTRUCTION AND GRADING SHOULD NOT SIGNIFICANTLY RAISE OR LOWER THE GROUND LEVEL BENEATH TREE DRIP LINES, IF THE GROUND LEVEL IS PROPOSED FOR MODIFICATION BENEATH THE DRIP LINE, THE ARCHITECT/ARBORIST SHALL ADDRESS AND MITIGATE THE IMPACT TO THE TREE (S) 2. ALL TREES TO BE PRESERVED ON THE PROPERTY AND ALL TREES ADJACENT TO THE PROPERTY SHALL BE PROTECTED AGAINST DAMAGE DURING CONSTRUCTION OPERATIONS BY CONSTRUCTION A FOUR FEET HIGH FENCE AROUND THE DRIP LINE, AND ARMOR AS NEEDED. THE EXTENT OF FENCING AND ARMORING SHALL BE DETERMINED BY THE LANDSCAPE ARCHITECT. THE TREE PROTECTION SHALL BE PLACED BEFORE ANY EXCAVATION OR GRADING IS BEGUN AND SHALL BE MAINTAINED IN

REPAIR FOR THE DURATION OF THE CONSTRUCTION WORK. 3. NO CONSTRUCTION OPERATIONS SHALL BE CARRIED ON WITHIN THE DRIP LINE AREA OF ANY TREI DESIGNATED TO BE SAVED EXCEPT AS IS AUTHORIZED BY THE DIRECTOR OF COMMUNITY

4. IF TRENCHING IS REQUIRED TO PENETRATE THE PROTECTION BARRIER OF THE TREE, THE SECTION OF TRENCH IN THE DRIP LINE SHALL BE HAND DUG SO AS TO PRECLUDE THE CUTTING OF ROOTS. PRIOR TO INITIATING ANY TRENCHING WITHIN THE BARRIER APPROVAL BY STAFF WITH CONSULTATION OF AN ARBORIST SHALL BE COMPLETED.

5. TREES WHICH REQUIRE ANY DEGREE OF FILL AROUND THE NATURAL GRADE SHALL BE GUARDED BY RECOGNIZED STANDARDS OF TREE PROTECTION AND DESIGN OF TREE WELLS. 6. THE AREA UNDER THE DRIP LINE OF THE TREE SHALL BE KEPT CLEAN. NO CONSTRUCTION MATERIALS NOR CHEMICALS SOLVENTS SHALL BE STORED OR DUMPED UNDER THE TREE. 7. FIRES FOR ANY REASON SHALL NOT BE MADE WITHIN FIFTY FEET OF ANY TREE SELECTED TO REMAIN AND SHALL BE LIMITED IN SEE AND KEPT UNDER CONSTANT SURVEILLANCE. 8. THE GENERAL CONTRACTOR SHALL USE A TREE SERVICE LICENSEE, AS DEFINED BY THE CALIFORNIA BUSINESS AND PROFESSIONAL CODE, TO PRUNE AND CUT OF THE BRANCHES THAT MUST BE REMOVED DURING THE GRADING OR CONSTRUCTION. NO BRANCHES OR ROOTS SHALL BE CUT UNLESS AT FIRST REVIEWED BY THE LANDSCAPE ARCHITECT/ARBORIST WITH APPROVAL OF

9. ANY DAMAGE TO EXISTING TREE CROWNS OR ROOT SYSTEMS SHALL BE REPAIRED IMMEDIATELY BY AN APPROVED TREE SURGEON. 10. NO STORAGE OF CONSTRUCTION MATERIALS OR PARKING SHALL BE PERMITTED WITHIN THE DRIP LINE AREA OF ANY TREE DESIGNATED TO BE SAVED.

11. TREE PROTECTION REGULATIONS SHALL BE POSTED ON PROTECTIVE FENCING AROUND TREES TO BE PROTECTED.

GENERAL NOTES

PROJECT SHALL BE EXECUTED BY A CLASS "B" OR CLASS "C-27" CONTRACTOR. HE OR SHE SHALL BE RESPONSIBLE FOR VERIFYING EXISTING CONDITIONS AS WELL AS TO CONTACT USA UNDERGROUND SERVICE ALERT AT 1800-642-2444 PRIOR TO CONSTRUCTION.

CHANGES IN LAYOUT DESIGN SHALL BE APPROVED BY ARCHITECT AND OWNER PRIOR TO CONSTRUCTION. DRAINAGE SHALL BE KEPT POSITIVE AT ALL TIMES (AWAY FROM STRUCTURES. DRAINED TO A DISCHARGE POINT. SEE DRAINAGE PLANS)


CONTRACTOR SHALL BE RESPONSIBLE FOR ITEMS DAMAGED WHILE CONSTRUCTION. ACCESSIBILITY TO SITE PROVIDED BY OWNER. THIS IS NOT A SURVEYORS

CONTACT ARCHITECT FOR ANY CHANGES OR DISCREPANCIES

VERIFY PLANTING MATERIAL QUANTITY AND LOCATION

DOCUMENT. VERIFY GRADING ON SITE ALL WORK TO BE PERFORMED ACCORDING TO CITY AND STATE BUILDING CODES.

VICINITY MAP

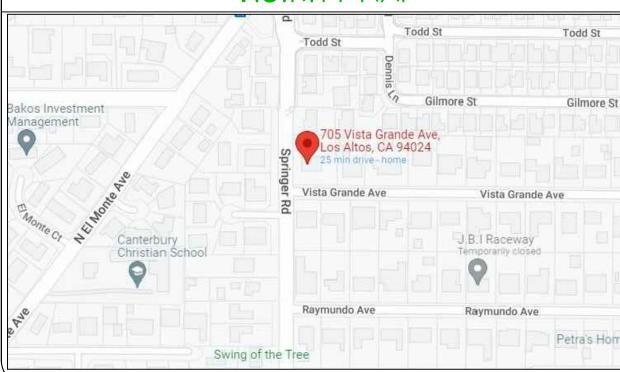

SHEET INDEX

L-1 COVER SHEET / (E) TREES L-2 LANDSCAPE LAYOUT PLANTING PLAN / CONCEPTUAL PLANTING



NDI 194 Ø 4400

Z &

4460

DROUGHT TOLERANT CONCEPTUAL PLANTING SCHEDULE SYMBOL QTY SIZE **BOTANICAL NAME** COMMON NAME CEANOTHUS HORIZONTALIS CARMEL CREEPER STICKY MONKEY FLOWER MIMULUS AURANTIACUS SALVIA GREGGII ASSORTED 8 ARCTOSTAPHYLOS HOOKERY HOKKERI MANZANITA SALVIA PEROVSKIA BLUE SPIRE RUSIAN SAGE WALKWAY STICKY MONKEY FLOWER MIMULUS AURANTIACUS NATURAL STONE PEBBLE OR BEDROOM SET ON DIRT WATERLESS ARCTOSTAPHYLOS EMERALD CARPET PATIO CISTUS SALVIFOLIUS PROSTATUS SAGELEAF ROCKROSE **FAUX LAWN ADU LIVING** BENCH ALYOGYNE HUEGELII BLUE HIBISCUS DG PATIO CISTUS X SKANBERGII PINK ROCKROSE ALL EDGES PLASTIC ACACIA GREGGII MAIT A MINUTE BUSH BEDROOM BENDER BOARD BENDER BOARD TO RECEIVE 3" MIN. OF SALVIA LEUCANTHA MEXICAN BUSH SAGE REDWOOD BARK FENCE VERBENA BONARIENSIS **FAUX LAWN** PERMEABLE WALKWAY LONICERA HISPIDULA CALIFORNIA HONEYSUCKLE COVERED PATIO ALL EDGES LAVANDULA STOECHA ALBA SPANISH LAVANDER SALT BUSH FAMILY ROOM DG GOLDFINE RED FRINGE FLOWER LOROPETALUM CHINENSE RUBRUM STEP WALKWAY DODONEA VISCOSA DG. PATIO RHAMNUS CALIFORNICA LEATHERLEAF | COFFEEBERRY SALVIA PEROVSKIA KITCHEN + DINING LIVING ROOM SUCCULENTS / ASSORTED SUCCULENTS GARAGE KALANCHOE CALANDIVA / AND OR KALANCHOE ALL EDGES EUPHORBIA TIRUCALLI FIRE STICKS /PLASTIC/ BENDER BOARD ALL PLANTING MATERIAL TO MEET WATER ORDINANCE, MUST BE WATER TOLERANT OR DROUGHT RESISTANT NATURAL ALL PLANTING AREAS SHALL RECEIVE 3" MIN OF BARK. OVER A FILTER WEED FABRIC BARRIER · BOBORES BERT ALL IRRIGATION SYSTEM SHALL BE A DRIP SYSTEM WITH A WATERING SCHEDULE THAT MEET THE CITY WALKWAY REQUIREMENTS FOR WATER ALLOWANCE AND SCHEDULE. AREAS INSIDE THE FRONT OAK # 18, # 1, #2, # 3 TREES TO REMAIN AS IS STUCCO FACED 3' TALL ALL EXISTING TREES MUST BE PROTECTED WITH A PERIMETER FENCE. SEE DETAIL THIS PAGE ♦ FENCE AND PILLARS WALKWAY CROWN DRIP LINE OR OTHER LIMIT OF TREE PROTECTION AREA. SEE STUCCO FACED 3' TALL TREE PRESERVATION PLAN FOR FENCE ALIGNMENT. FENCE AND PILLARS STUCCO FACED 3' TALL 2" X 6' STEEL POSTS FENCE AND PILLARS - TREE PROTECTION OR APPROVED 25' STREET DEDICATION AREA FENCE: HIGH DENSITY PROPERTY LINE **EQUAL** SEE SHEET 1 POLYETHYLENE FENCING RW ENGINEERING INC. WITH 3.5" X 1.5" OPENINGS. COLOR: 3" LAYER OF CHIP-ORANGE. STEEL POSTS WM MULCH OVER THE INSTALLED AT 8' -0" O.C. PROTECTED ROOT ZONES STREET VISTA GRANDE AVENUE MIN. 8.5" X 11" SIGN_ LAMINATED IN PLASTIC, SPACED EVERY 50' ALONG THE FENCE - MAINTAIN EXISTING

LANDSCAPE ELEMENTS	SQ. FT.	OTHER
PLANTING AREAS (MINUS STREET DEDICATION 6860-2492 SF)	4,368	
PERMEABLE CALSTONE PAVERS WALKS, DRIVEWAY, PATIOS	1,941	
DECOMPOSED GRANITE AREAS	1,135	
FAUX LAMN	509	
MATERLESS MATERFALL AND POND	56	
RAISED BACK YARD DECK AREA NOT COVERED	364	
STONE PATH FRONT YARD	75	
LOT SIZE (DOES NOT INCLUDE DEDICATION AREA)	12,166	
HOUSE (LEVEL1 & ADU 2229+757=2986 SF + LEVEL 2 1655 SF)	4641	
PLANTING AREAS	4,368	
STREET DEDICATION DO NOT DISTURB BY SPRINGER RD SIDE	7,300	-2,492
DO NOT DISTURB NATURAL AREA UNDER # 18 OAK DRIP LINE	-1,336	2,7 12
PROPOSED TOTAL LANDSCAPED AREAS	3,032	

ALL PLANTING AND IRRIGATION MATERIAL TO COMPLY WITH CITY ORDINANCES

	TREE PLANTING SCHEDULE				
SYMB <i>O</i> L	QTY	SIZE	BOTANICAL NAME	COMMON NAME	NOTES
1	1	27" dia	CEDRUS DEODARA	DEODAR CEDAR	EXISTING / PROTECT
2	1	38" dia	SEQUOIA SEMPERVIRENS	REDWOOD	EXISTING / PROTECT
3	1	26" dia	SEQUOIA SEMPERVIRENS	REDWOOD	EXISTING / PROTECT
4	1	26" dia	SEQUOIA SEMPERVIRENS	REDWOOD	REMOVE
(4) (13)	1	41" dia	QUERCUS SUBER	CORK OAK	EXISTING / PROTECT
5	1	24" box	DIOSPYRUS KAKI	JAPANESE PERSIMMON	
6	1	24" box	PISTACIA CHINENSIS	CHINESE PISTACHE	PRIVACY TREE
7	1	36" box	PISTACIA CHINENSIS	CHINESE PISTACHE	PRIVACY TREE
8	1	24" box	PISTACIA CHINENSIS	CHINESE PISTACHE	PRIVACY TREE
9	1	24" box	ARBUTUS MARINA	STRAMBERRY TREE	
10	1	24" box	ARBUTUS MARINA	STRAMBERRY TREE	

1			
_	PERVIOUS / IMPERV	IOUS COYERAGE	1
	FRONT YARD	2,307 SQ. FT.	i
	IMPERVIOUS PAVERS	780 SQ. FT.	9
	IMPERVIOUS 3' FENCE	35 SQ. FT.	
	STONE PATH	75 SQ. FT.	
	TOTAL IMPERVIOUS	890 SQ. FT.	
	% PERVIOUS	39%	

REUSE EXISTING ON SITE PAVERS IN LOT "B" SAVE PAVERS FROM BEING HAULED AWAY AT DEMOLITION

WELO IRRIGATION NOTES

- 1. AUTOMATIC IRRIGATION CONTROLLERS ARE REQUIRED AND MUST USE EVAPOTRANSPIRATION OR SOIL MOISTURE SENSOR DATA AND UTILIZE A RAIN SENSOR 2. IRRIGATION CONTROLLERS SHALL BE A TYPE WHICH DOES NOT LOSE PROGRAMMING DATA IN
- THE EVENT THE PRIMARY POWER SOURCE IS INTERRUPTED. 3. PRESSURE REGULATORS SHALL BE INSTALLED ON THE IRRIGATION SYSTEM TO ENSURE THE DYNAMIC PRESSURE OF THE SYSTEM IS WITHIN THE MANUFACTURER'S RECOMMENDED
- 4. MANUAL SHUT-OFF VALVES (SUCH AS A GATE VALVE, BALL VALVE, OR BUTTERFLY VALVE) SHALL BE INSTALLED AS CLOSE TO POSSIBLE TO THE POINT OF CONNECTION OF THE WATER
- 5. ALL IRRIGATION EMISSION DEVICES MUST MEET THE REQUIREMENTS SET IN THE ANSI STANDARD, ASABE/ICC 802-2014 "LANDSCAPE IRRIGATION SPRINKLER AND EMITTER STANDARD." ALL SPRINKLER HEADS INSTALLED IN THE LANDSCAPE MUST DOCUMENT A DISTRIBUTION UNIFORMITY LOW QUARTER OF 0.65 OR HIGHER USING THE PROTOCOL DEFINED
- 6. DEDICATED IRRIGATION METERS ARE REQUIRED FOR NON-RESIDENTIAL PROJECTS WITH MORE THAN 1,000 SQ. FT. OF LANDSCAPE AREA.

REQUIRED PRIOR TO FINAL INSPECTION:

- a. CERTIFICATE OF COMPLETION AND CERTIFICATE OF INSTALLATION, FOLLOWING INSTALLATION OF LANDSCAPING MATERIALS AND IRRIGATION HARDWARE
- b. IRRIGATION SCHEDULE LANDSCAPE AND IRRIGATION MAINTENANCE SCHEDULE

LANDSCAPE AND IRRIGATION INSTALLATION REPORT

e. LANDSCAPE MAINTENANCE AGREEMENT

TREE PROTECTION FENCING

KEEP OUT

TREE

PROTECTION

PROTECTION REQUIREMENTS PER JURISDICTION.

B. IRRIGATE AS NEEDED TO MAINTAIN HEALTH OF TREE.

F. NO MATERIALS SHALL BE STORED INSIDE FENCE.

C. KEEP EXPOSED ROOTS MOIST.


INSTALLATION AND REMOVAL.

A. SEE ARBORIST REPORT FOR ADDITIONAL PROTECTION REQUIREMENTS. COMPLY WITH ALL TREE


D. NO PRUNING SHALL BE PERFORMED EXCEPT UNDER THE DIRECTION OF APPROVED ARBORIST.


E. NO EQUIPMENT SHALL OPERATE INSIDE THE PROTECTIVE FENCING INCLUDING DURING FENCE

" I HAVE COMPLIED WITH THE CRITERIA OF THE ORDINANCE AND APPLIED THEM FOR THE EFFICIENT USE OF WATER IN THE LANDSCAPE DESIGN PLAN"

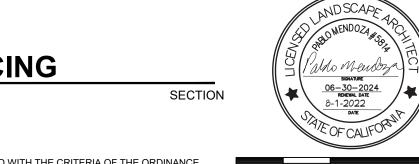

GRADE WITHIN THE TREE PROTECTION FENCE UNLESS OTHERWISE INDICATED ON THE PLANS

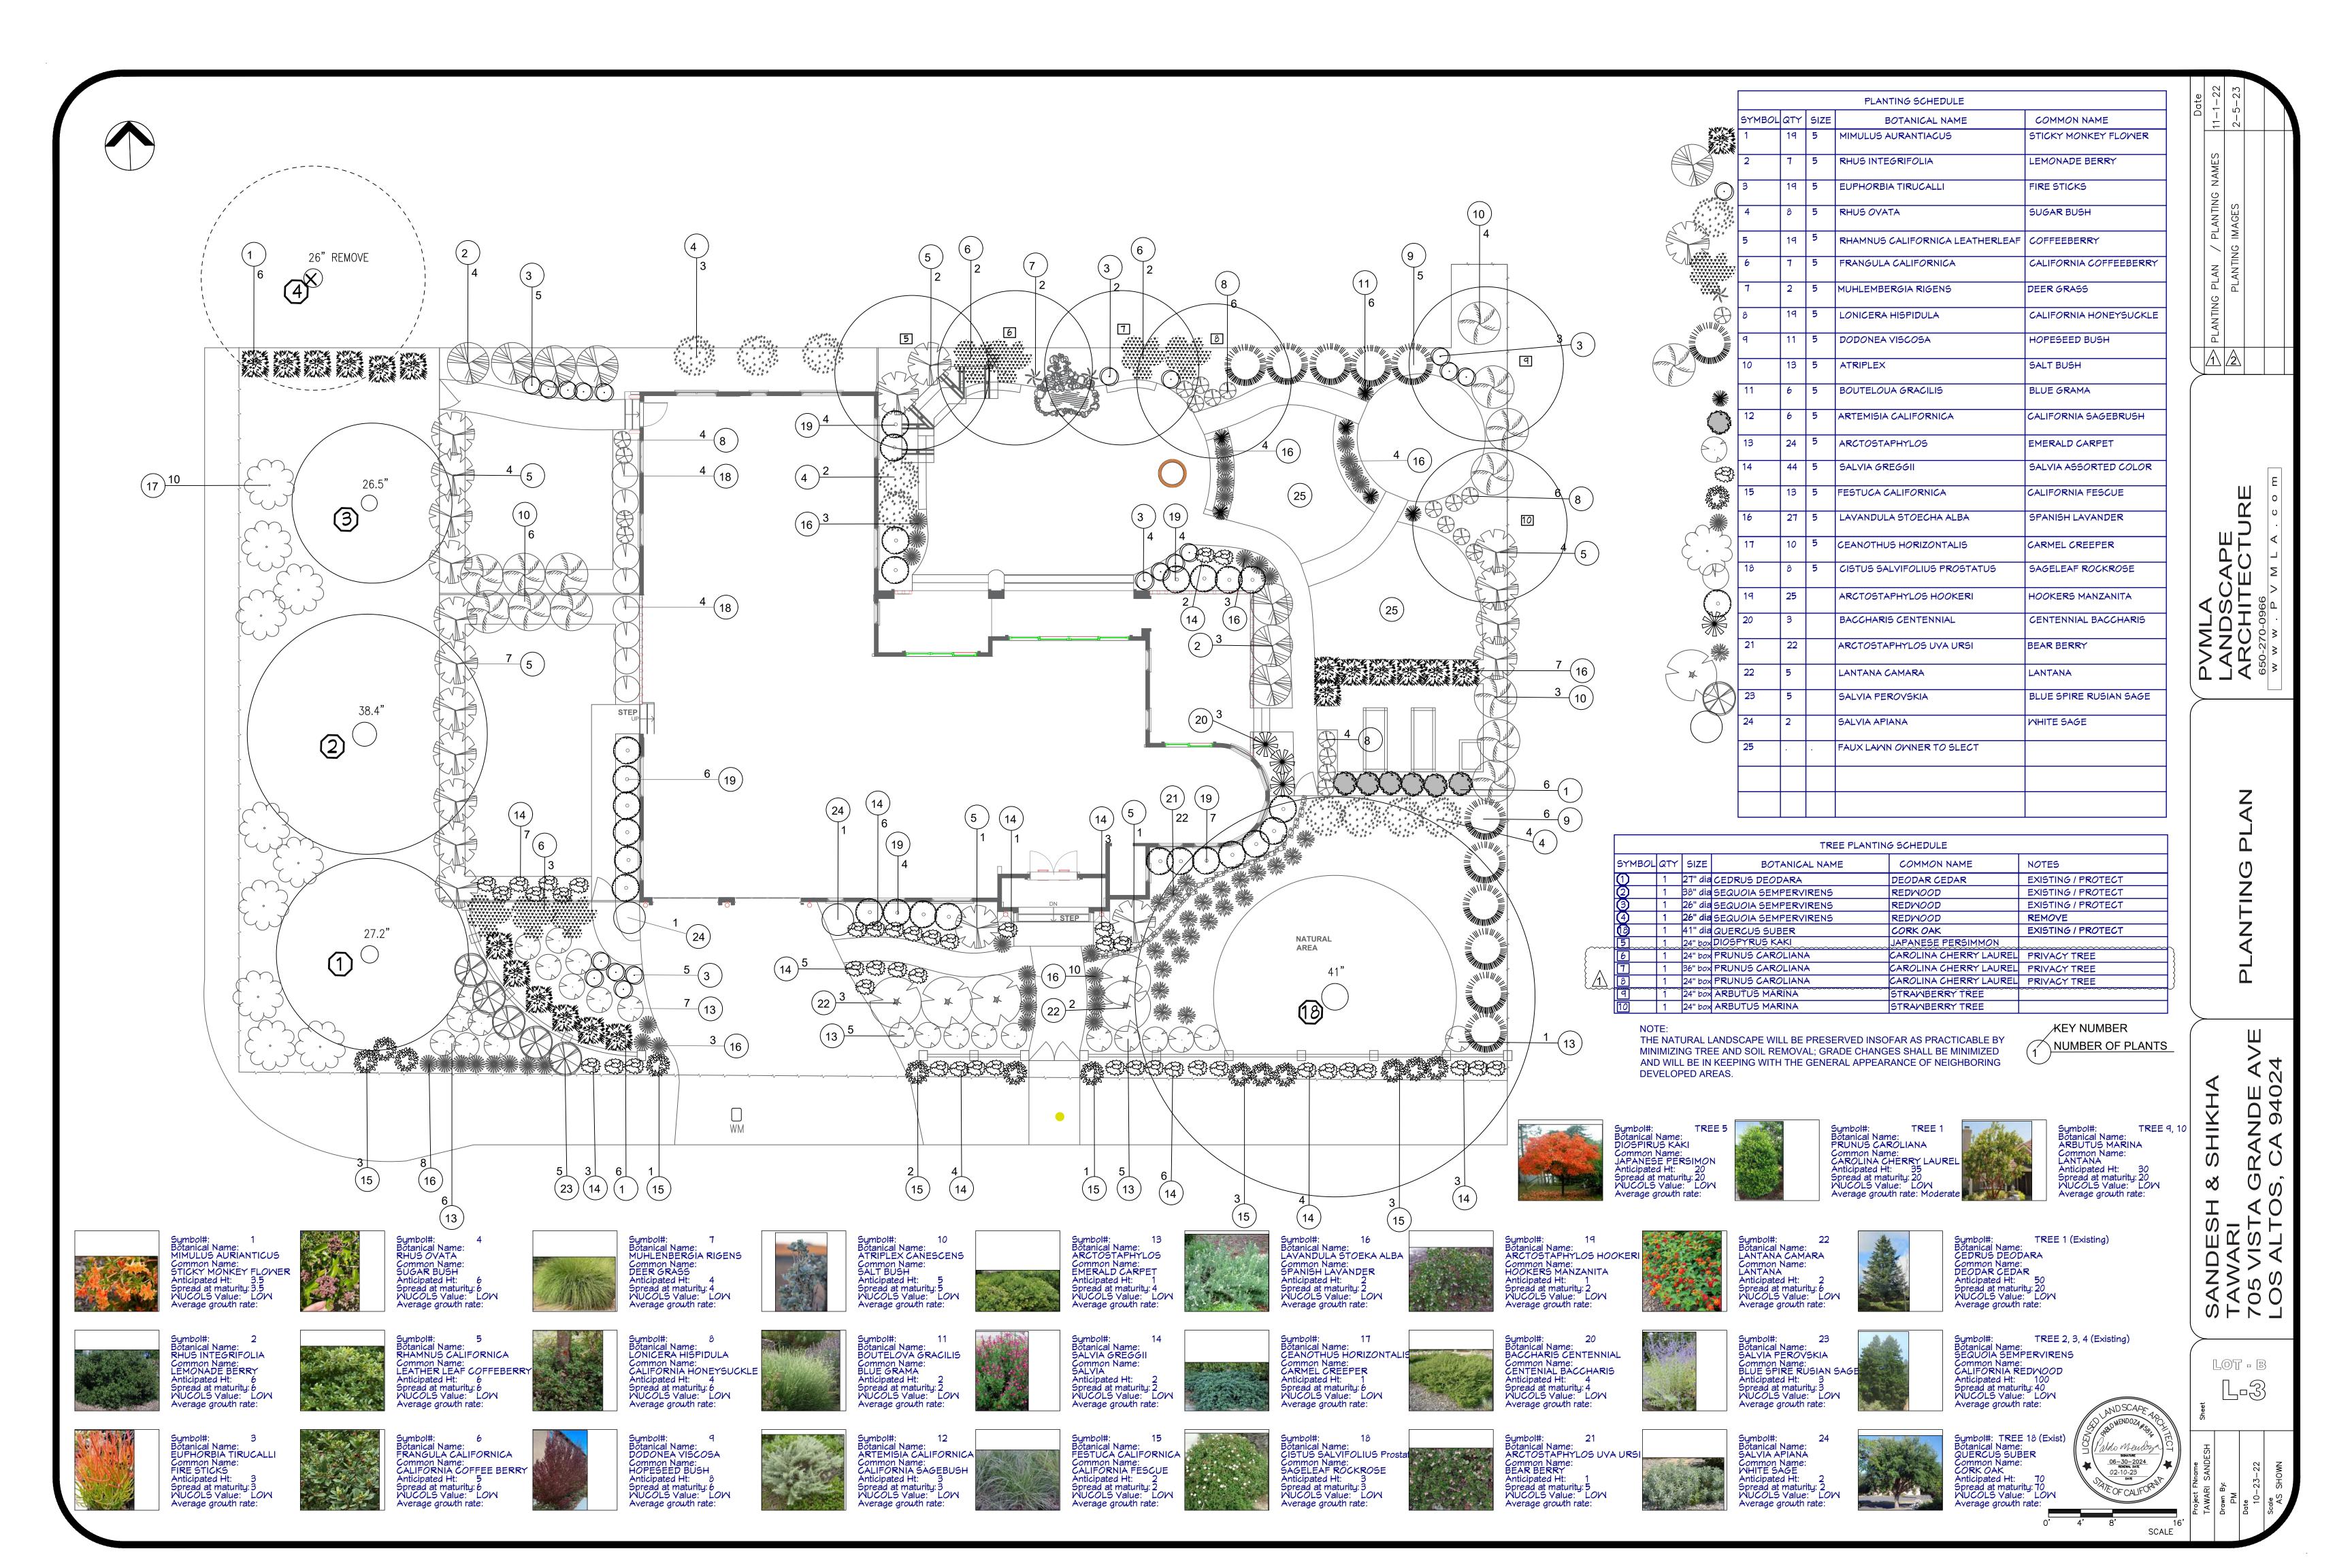

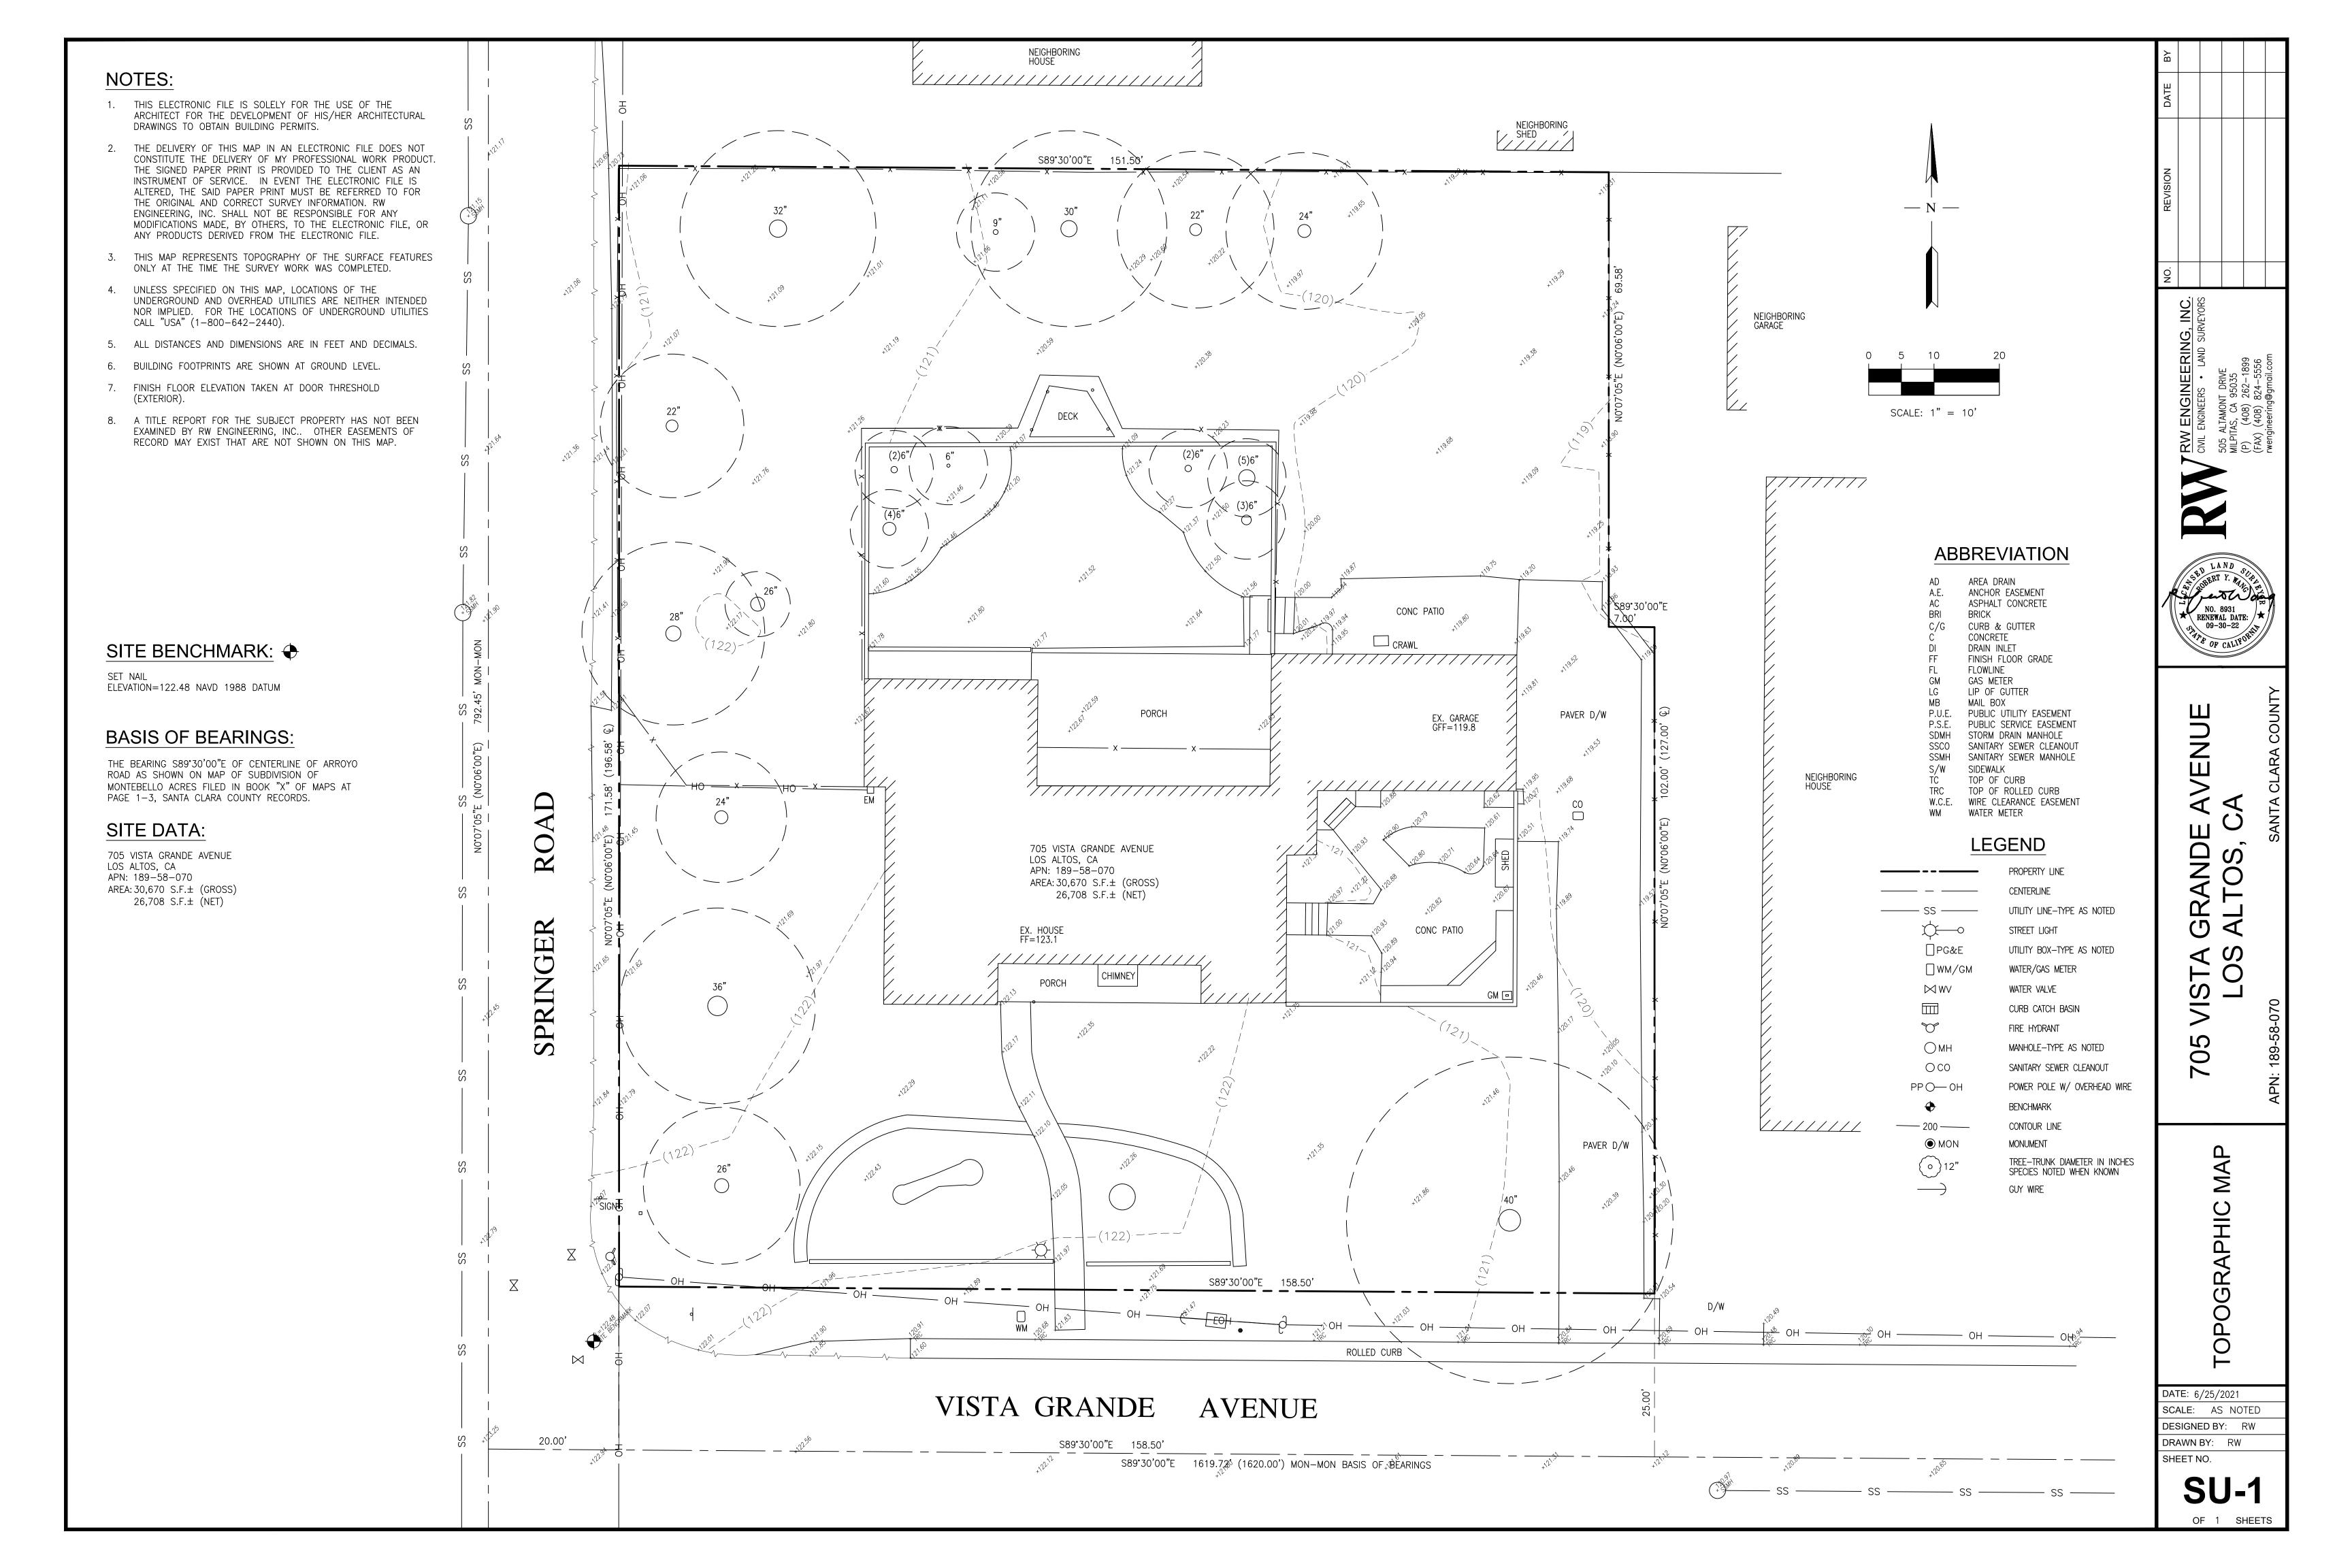

BASIS OF BEARINGS

THE BEARING SOUTH 89°30'00" EAST OF THE CENTERLINE OF ARROYO ROAD AS SHOWN ON THAT MAP FILED FOR RECORD IN BOOK "X" OF MAPS AT PAGES 1-3, SANTA CLARA COUNTY RECORDS, WAS TAKEN AS THE BASIS OF BEARINGS SHOWN UPON THIS MAP.

WALES AND THE STATE OF THE STAT

REFERENCES

- (R1) MAP OF SUBD. OF MOTEBELLO ACRES ("X" M 1-3)
- (R2) GRANT DEED DN. 24964088
- (R3) ROS (348 M 36)

LANDS OF ROTSCHI

S89'30'00"E 151.50'

126.50

LANDS OF TAWARI

DN. 24964088

PARCEL A

10,120 S.F.±

S89°30'00"E 126.50'

PARCEL B

11,166 S.F.±

158.50'

158.50'

108.67

R=25' Δ=89°37'05" L=39.10'

DN. 24825957

2.5" BRASS DISK, PUNCHED IN WELL,

(R3)(R5)

20'

| 20.00'

N0°07'05"E 792.45' MON-MON (N0°06'00"E)(R1) (NORTH 792.37'(R4)

ROAD

SPRINGER

2.5" BRASS DISK, PUNCHED IN WELL

PER (R4)(R5)

COURT

BLINN

25.00


45.00'

49.83'

2.5" BRASS DISK, PUNCHED IN WELL

PER (R5)

- (R4) ROS (462 M 33)
- (R5) TRACT 7643 (537 M 38-39)
- (R6) CERTIFICATE OF CORRECTION (DN. 8450086)

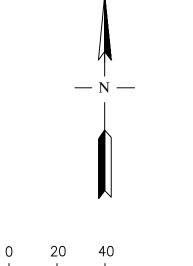



TRACT 1141

(42 MAPS 16-17)

MAP OF SUBDIVISION

OF MONTEBELLO ACRES

(X MAPS 1-3)

84

LANDS OF MEHROTRA

DN. 21403354

10

83

- S89°30'00"E

7.00'

10.42'

PARCEL MAP

CONSISTING OF TWO (2) SHEETS

BEING A SUBDIVISION OF LOT 83, MAP OF SUBDIVISION OF MONTEBELLO ACRES. FILED FOR RECORD IN BOOK "X" OF MAPS, AT PAGES 1, 2, & 3, SANTA CLARA COUNTY RECORDS, AND LYING ENTIRELY WITHIN THE

> CITY OF LOS ALTOS SANTA CLARA COUNTY CALIFORNIA

> > MAY, 2022

RW RW ENGINEERING, INC. 505 ALTAMONT DRIVE MILPITAS, CA 95035

LEGEND


DISTINCTIVE BORDER AND BOUNDARY ADJACENT PROPERTY LINE CENTERLINE OR MONUMENT LINE NEW PARCEL LINE TIE LINE \circ SET 3/4" IRON PIPE WITH PLASTIC PLUG & TACK, TAGGED LS 8931 MONUMENT FOUND AS NOTED


RECORD DATA AS NOTED

CENTERLINE P.O.B. POINT OF BEGINNING

NOTES

- 1. ALL DISTANCES AND DIMENSIONS SHOWN ARE
- IN FEET AND DECIMALS THEREOF.
- 2. THE AREA WITHIN THE DISTINCTIVE BORDER IS 0.704 ACRE, MORE OR LESS.
- 3. THE DISTINCTIVE BORDER LINE DENOTES THE BOUNDARY OF THE SUBDIVISION.

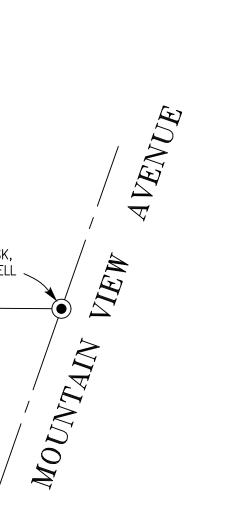

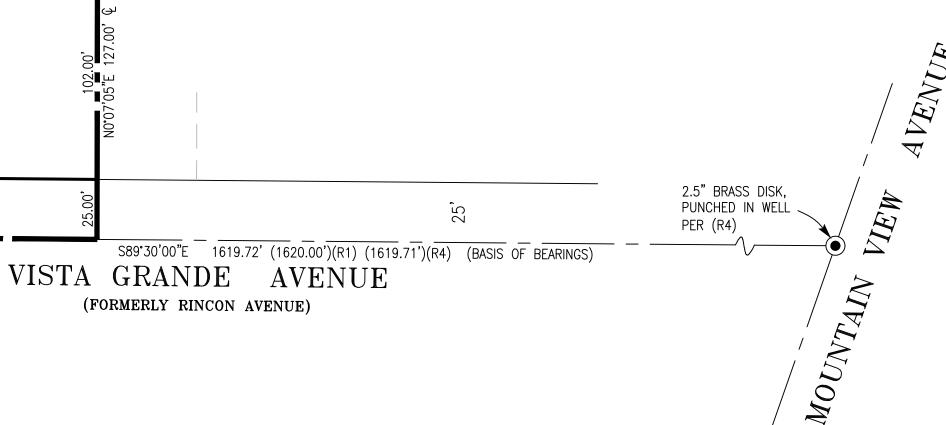

SHEET 2 OF 2

PORCH PAVER D/W EX. GARAGE GFF=119.8 ∕ADU ENTRY 🖒 UP 705 VISTA GRANDE AVENU CONC PATIO RING LEVEL 1 SETBACK _ LEVEL 2 PROPOSED *_ SETBACK LINE -EM⊨ PAVER D/W CONCRETE + SIGNI CONCRETE DRIVEWAY (122) CONCRETE (N) SSCO S89°30'00"E 158.50' NEW ELECTRICAL SERVICE TO HOUSE PER PROPOSED WM ROLLED CURB VISTA GRANDE **AVENUE** 20.00' S89°30'00"E 158.50' S89°30'00"E 1619.72 (1620.00') MON-MON BASIS OF BEARINGS

1 UTILITY PLAN 1/8" = 1'-0"

SITE BENCHMARK

BASIS OF BEARINGS

THE BEARING S89°30'00"E OF CENTERLINE OF ARROYO ROAD AS SHOWN ON MAP OF SUBDIVISION OF MONTEBELLO ACRES FILED IN

BOOK "X" OF MAPS AT PAGE 1-3, SANTA CLARA COUNTY RECORDS.

SET NAIL ELEVATION=122.48

NAVD 1988 DATUM

SITE DATA

705 VISTA GRANDE LOS ALTOS, CA

APN: 189-58-070 AREA=12,109 S.F.

NOTES:

UTILITY LEGENDS

—W——W— WATER LINE

—JT—JT—JT— JOINT TRENCH



REVISIONS:					
REV.	DESCRIPTION	DATE	REV BY		
À	REVISED AS PER PLANNER'S COMMENTS	12-16-2022	SAGAR		
<u>^</u> 2\	REVISED AS PER PLANNER'S COMMENTS	02-16-2022	SAGAR		

- ALL DIMENSIONS ARE IN FEET AND INCHES.
- DRAWING SHALL NOT BE SCALED AND ONLY WRITTEN DIMENSIONS SHALL BE FOLLOWED.
- ALL CENTERLINES ARE FROM THE CENTER OF COLUMN/ WALL AND THE DIMENSIONS GIVEN ARE CENTERLINE DIMENSIONS- -UNLESS OTHERWISE MENTIONED.
- IN CASE OF ANY DISCREPANCY FOUND IN DRAWINGS AND DETAILS, IT SHALL BE BROUGHT TO THE NOTICE OF THE ARCHITECT, AND RECTIFIED, PRIOR TO ITS EXECUTION. THIS DRAWING IS ISSUED STRICTLY WITH AN
- UNDERSTANDING THAT IT WILL BE USED ONLY FOR THE PURPOSE MENTIONED AND SHALL BE RETURNED AFTER COMPLETION.
- ·LARGER SCALE DRAWINGS AND DETAILS SUPERCEDE THE SMALLER SCALE DRAWINGS AND DETAILS.
- THIS DRAWING SHALL BE REFERRED ONLY FOR THE PURPOSE MENTIONED IN ITS TITLE (FLOORING PATTERN, FALSE CEILING, SHUTTERING PATTERN, ELECTRICAL, PLUMBING, ETC.)

THIS DOCUMENT IS THE PROPERTY OF LIVIO BUILDING SYSTEMS AND SHALL NOT BE REFERRED, REPRODUCED, COPIED, ETC, WITHOUT EXPLICIT WRITTEN PERMISSION FROM LIVIO BUILDING SYSTEMS, LOS ALTOS, CA USA

PROJECT: 705 VISTA GRANDE AVE-LOT B, LOS ALTOS, CA

UTILITY PLAN

DATE: 02-16-2023

DRAWN BY: SAGAR

CHECKED BY: SUBHENDU

SHEET NO:

SCALE: 1/8" = 1'-0"