


IQBAL RESIDENCE

NEW SINGLE FAMILY RESIDENCE + ACCESSORY DWELLING UNIT

899 MADONNA WAY
LOS ALTOS, CA 94024

LOCATION MAP

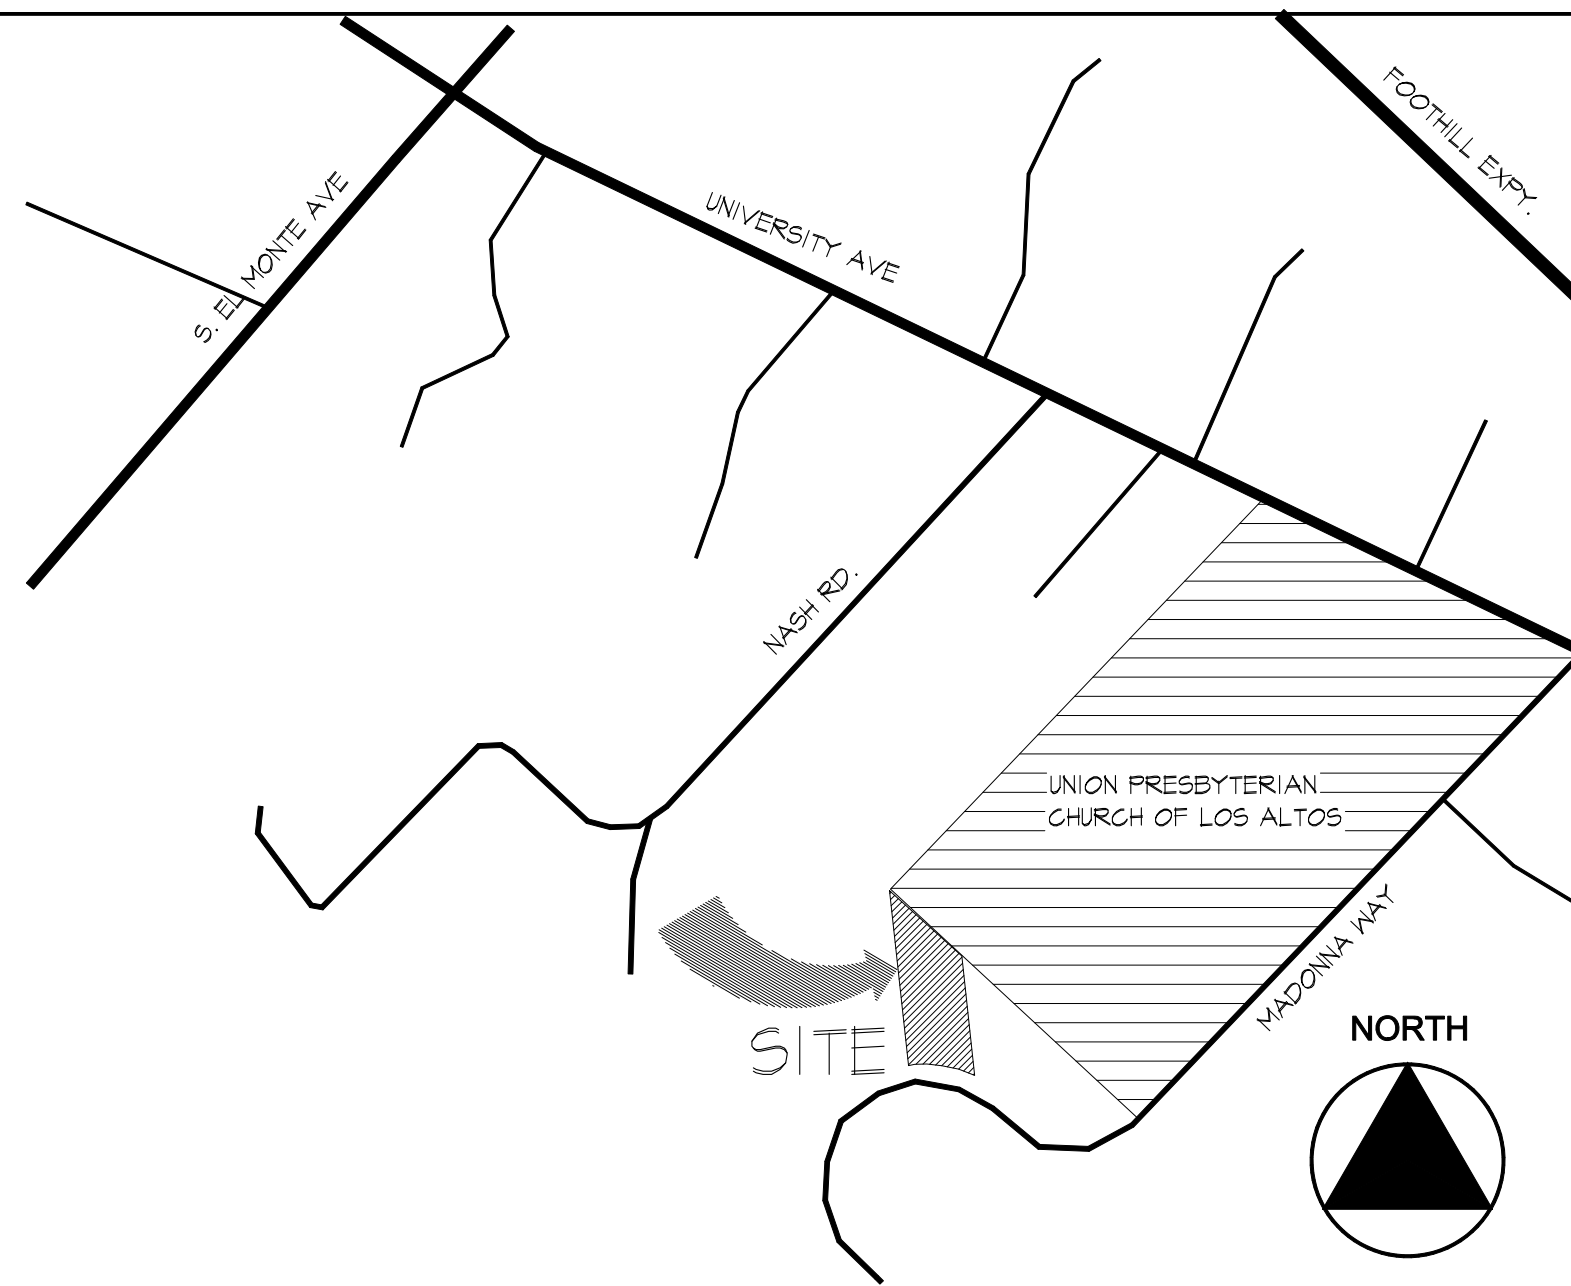

PROJECT CONTACT

PROJECT DESIGNER/ENGINEER
CIBOTTI ENGINEERING
12935 ALCOSTA BLVD, #2025
SAN RAMON, CA 94583
(408) 464-8410
scott@cibotti.com

PROPERTY OWNER:
KHURRAM IQBAL
33 LYELL STREET
LOS ALTOS, CA 94022
(408) 839-1267
iqbalkhurram@hotmail.com

LANDSCAPE ARCHITECT
GREGORY LEWIS LANDSCAPE ARCHITECT
736 PARK WAY
SANTA CRUZ, CA 95065
(831) 359-0960
EMAIL: lewislandscape@sbcglobal.net

CIVIL ENGINEER
WEC & ASSOCIATES
2625 MIDDLEFIELD ROAD, #650
PALO ALTO, CA 94306
(650) 823-6466
ed@weceng.com

ARBORIST
KIELTY ARBORIST SERVICES
P. O. BOX 6187
SAN MATEO, CA 94403
(650) 515-9783
kkarbor0476@yahoo.com

GREEN BUILDING CONSULTANT
JEROY LLC
P.O. BOX 60792
PALO ALTO, CA 94306
(408) 677-6588
EMAIL: richarddyang@yahoo.com



DRAWING INDEX

ARCHITECTURAL

- A1 TITLE SHEET
- A1.1 SITE CONTEXT
- A1.2 NEIGHBORHOOD PHOTOS
- A1.3 COLOR SITE PLAN & RENDERING
- A2 PROPOSED SITE PLAN
- A2.1 SITE PHOTOS
- A3 PROPOSED MAIN LEVEL FLOOR PLAN
- A4 PROPOSED LOWER LEVEL FLOOR PLAN
- A5 PROPOSED ROOF PLAN
- A6 FLOOR & COVERAGE AREA CALCULATIONS
- A7 PROPOSED EXTERIOR ELEVATION
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GREEN BUILDING

- CG 2019 CALGREEN NOTE
- CG2 2019 CALGREEN CHECKLIST

CIVIL

- CO TOPOGRAPHIC SURVEY
- C1 GRADING AND DRAINAGE PLAN

LANDSCAPE

- L1 PLANTING PLAN

PROJECT SUMMARY TABLE

ZONING COMPLIANCE			
	EXISTING	PROPOSED	ALLOWED/REQUIRED
LOT COVERAGE: <small>LAND AREA COVERED BY ALL STRUCTURES THAT ARE OVER 6 FEET IN HEIGHT</small>	0 (0%)	3,530.6 S.F. (21.7%)	3,822.9 S.F. (30.0%)
FLOOR AREA: <small>MEASURED TO THE OUTSIDE SURFACES OF EXTERIOR WALLS</small>	0 (0%)	4,023.0 S.F. (31.6%)	4,024.3 S.F. (31.6%)
SETBACKS: FRONT REAR RIGHT SIDE LEFT SIDE	N/A	MAIN FLR./LOWER FLR. 25'-0" 34'-6" 7'-7" / 15'-1 1/4" 7'-7" / 15'-2 3/4"	MAIN FLR./LOWER FLR. 25'-0" 25'-0" 7'-7 1/4" / 15'-1 1/4" 7'-7 1/4" / 15'-1 1/4"
HEIGHT:	0	27'-0"	27'-0"
SQUARE FOOTAGE BREAKDOWN			
	EXISTING	CHANGE IN	TOTAL PROPOSED
HABITABLE LIVING AREA: <small>INCLUDES HABITABLE BASEMENT AREAS</small>	N/A	3,587.2 S.F.	3,587.2 S.F.
NON-HABITABLE AREA: <small>(DOES NOT INCLUDE COVERED PORCHES OR OPEN STRUCTURES)</small>	N/A	435.8 S.F.	435.8 S.F.
LOT CALCULATION			
NET LOT AREA	12,743 S.F.		
FRONT YARD HARDSCAPE AREA <small>HARDSCAPE AREA IN THE FRONT YARD SETBACK SHALL NOT EXCEED 50%</small>	164.0 S.F. (2.3%)		
LANDSCAPING BREAKDOWN	TOTAL HARDSCAPE AREA (EXISTING AND PROPOSED): 5620.9 S.F. EXISTING SOFTSCAPE (UNDISTURBED) AREA: 6892.0 S.F. NEW SOFTSCAPE AREA: 4301.9 S.F. SUM OF ALL THREE SHOULD EQUAL THE SITE'S NET LOT AREA		

PROJECT SCOPE

NEW CONSTRUCTION OF A TWO-STORY, SINGLE STORY HOUSE (INCLUDING AN ATTACHED 2-CAR GARAGE) AND ATTACHED 849 S.F. ADU.
PRIMARY EXTERIOR BUILDING MATERIALS ARE CEMENT PLASTER AND HARDIE PLANK SIDING.

PROJECT SUMMARY

APN:	336-03-030
USE:	SINGLE FAMILY RESIDENCE
ZONING DISTRICT:	RI-10
TYPE OF CONSTRUCTION:	V-B
OCCUPANCY GROUP:	R3/ U
SIZE OF LOT:	47-12,743 S.F. (0.29 ACRE)
ALLOWABLE LOT COVERAGE:	3,822.9 S.F.
PROPOSED LOT COVERAGE:	3,530.6 S.F.
ADDITIONAL LOT COVERAGE FROM ADU:	444.2 S.F.
MAX. ALLOWABLE FLOOR AREA: (11,000 S.F. X 35%+ 1,743 S.F. X 10%)	4,024.3 S.F.
FLOOR AREAS OF STRUCTURE	
ATTACHED GARAGE	435.8 S.F.
MAIN LEVEL FLOOR AREA	2,042.2 S.F.
LOWER LEVEL FLOOR AREA:	1,485.0 S.F.
TOTAL FLOOR AREA:	4,023.0 S.F.
ATTACHED ACCESSORY DWELLING UNIT (ADU):	849 S.F.
MAXIMUM BUILDING HEIGHT:	27'-0"
PROPOSED BUILDING HEIGHT:	27'-0"
REQUIRED PARKING:	2
PARKING PROVIDED:	2

APPLICABLE CODES

2019 CRC, CBC (FOR STRUCTURAL), CFC, GFC, GEC, CALIFORNIA ENERGY CODE AND CITY OF LOS ALTOS ORDINANCES
ALL CONSTRUCTION TO COMPLY WITH 2019 CALIFORNIA GREEN BUILDING CODE.

REVISIONS

CIBOTTI ENGINEERING
12935 ALCOSTA BLVD #2025
SAN RAMON, CA 94583
BUS: (925) 829-0920
EMAIL: SCOTT@CIBOTTI.COM


IQBAL RESIDENCE
NEW SINGLE FAMILY HOUSE & ADU
899 MADONNA WAY
LOS ALTOS, CA 94024

TITLE SHEET

DATE	MAY 16, 2022
SCALE	
DRAWN	
APN#	336-03-030
SHEET	A1
OF	SHEETS



UNION PRESBYTERIAN CHURCH OF LOS ALTOS

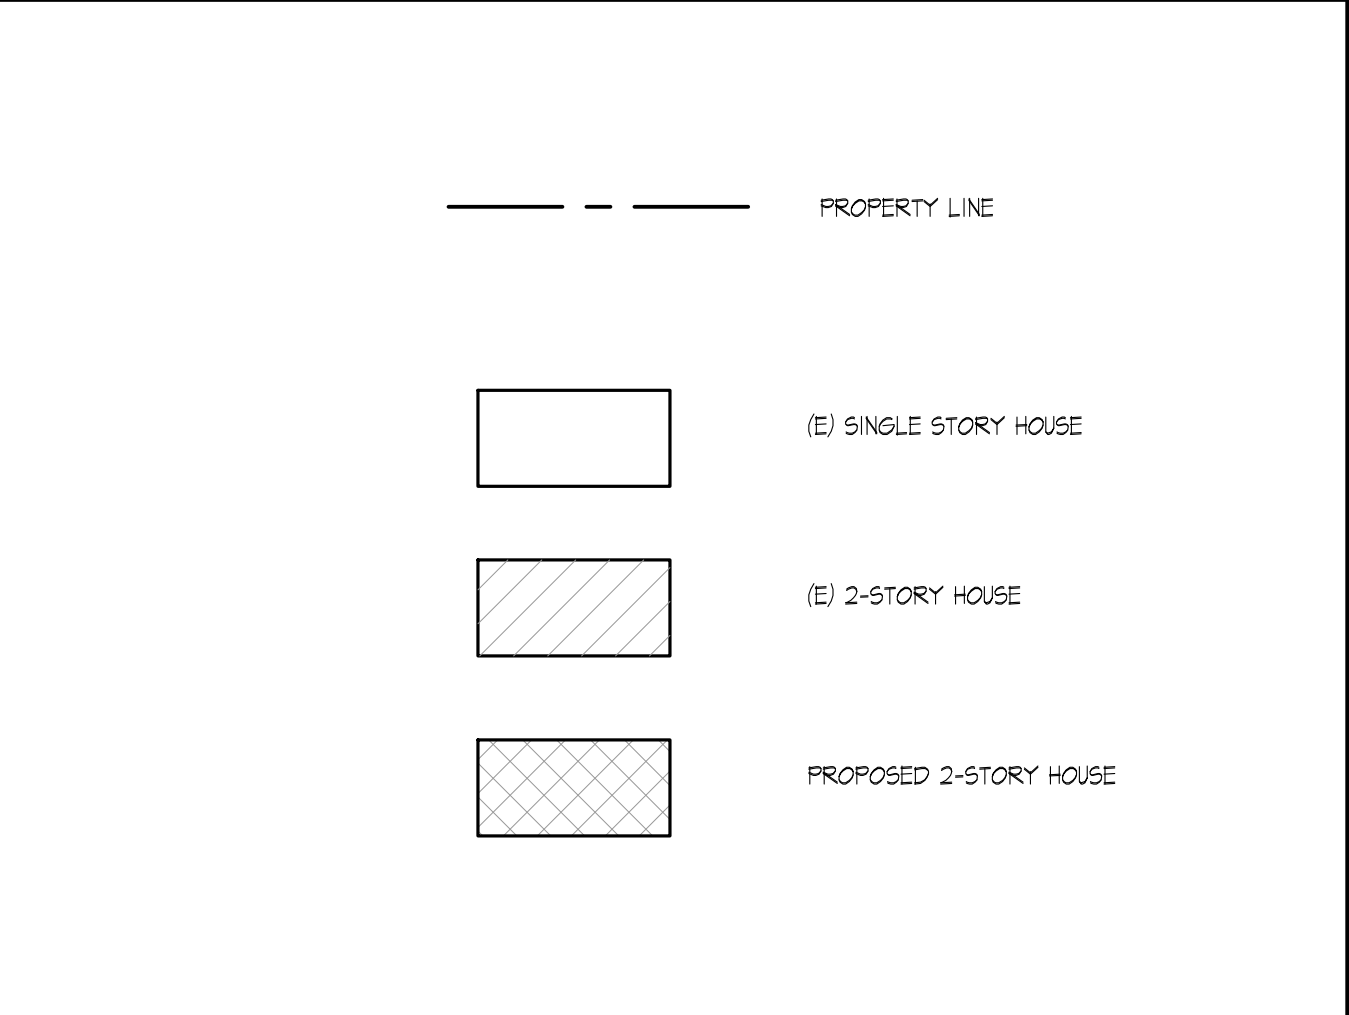

LEGEND

CONTEXTUAL MAP

DATE MAY 16, 2022
SCALE
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APN# 336-03-030
SHEET
A1.1

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IQBAL RESIDENCE
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NO.	DATE	REVISIONS

① SITE CONTEXT

1/30"=1'-0"



④ 899 MADONNA- VIEW FROM UPPER STREET



③ 899 MADONNA- VIEW FROM LOWER STREET



② 901 MADONNA- STREET VIEW TO REAR YARD



① 901 MADONNA- FRONT



⑧ 900 MADONNA- FRONT



⑦ 890 MADONNA



⑥ 893 MADONNA



⑤ 897 MADONNA



⑫ 908 MADONNA (VIEW FROM PRIVATE RD.)



⑪ 906 MADONNA (VIEW FROM PRIVATE RD.)



⑩ 904 MADONNA (VIEW FROM PRIVATE RD.)



⑨ 900 MADONNA- SIDE STREET

REVISIONS

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NEIGHBORHOOD PHOTOS

DATE MAY 16, 2022
 SCALE
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 APN# 336-03-030
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A1.2
 OF SHEETS



② VIEW FROM STREET GOING UPHILL



③ VIEW FROM STREET GOING DOWNHILL



① COLOR SITE PLAN w/ TREES & LANDSCAPING

REVISIONS


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 LOS ALTOS, CA 94024


COLOR SITE PLAN & RENDERING

DATE	MAY 16, 2022
SCALE	
DRAWN	
APN#	336-03-030
SHEET	A1.3
OF	SHEETS

TREE #	SPECIES	DBH	HEIGHT	RETAIN OR REMOVE
1	COAST LIVE OAK	13"	25'	RETAINED
2	COAST LIVE OAK	15"	45'	REMOVE
3	COAST LIVE OAK	18"	40'	REMOVE
4	INCENSE CEDAR	11"	45'	RETAINED
5	COAST LIVE OAK	14"	20'	REMOVED
6	COAST LIVE OAK	19"	50'	REMOVED
7	COAST LIVE OAK	13"	40'	REMOVED
8	COAST LIVE OAK	20"	40'	REMOVED
9	COAST LIVE OAK	13'-8"-1"	40'	RETAINED
10	COAST LIVE OAK	19"	40'	REMOVED
11	COAST LIVE OAK	16"	40'	RETAINED
12	COAST LIVE OAK	10'-16"	40'	REMOVED
13	COAST LIVE OAK	18"	40'	RETAINED
14	COAST LIVE OAK	16'-22"	40'	RETAINED

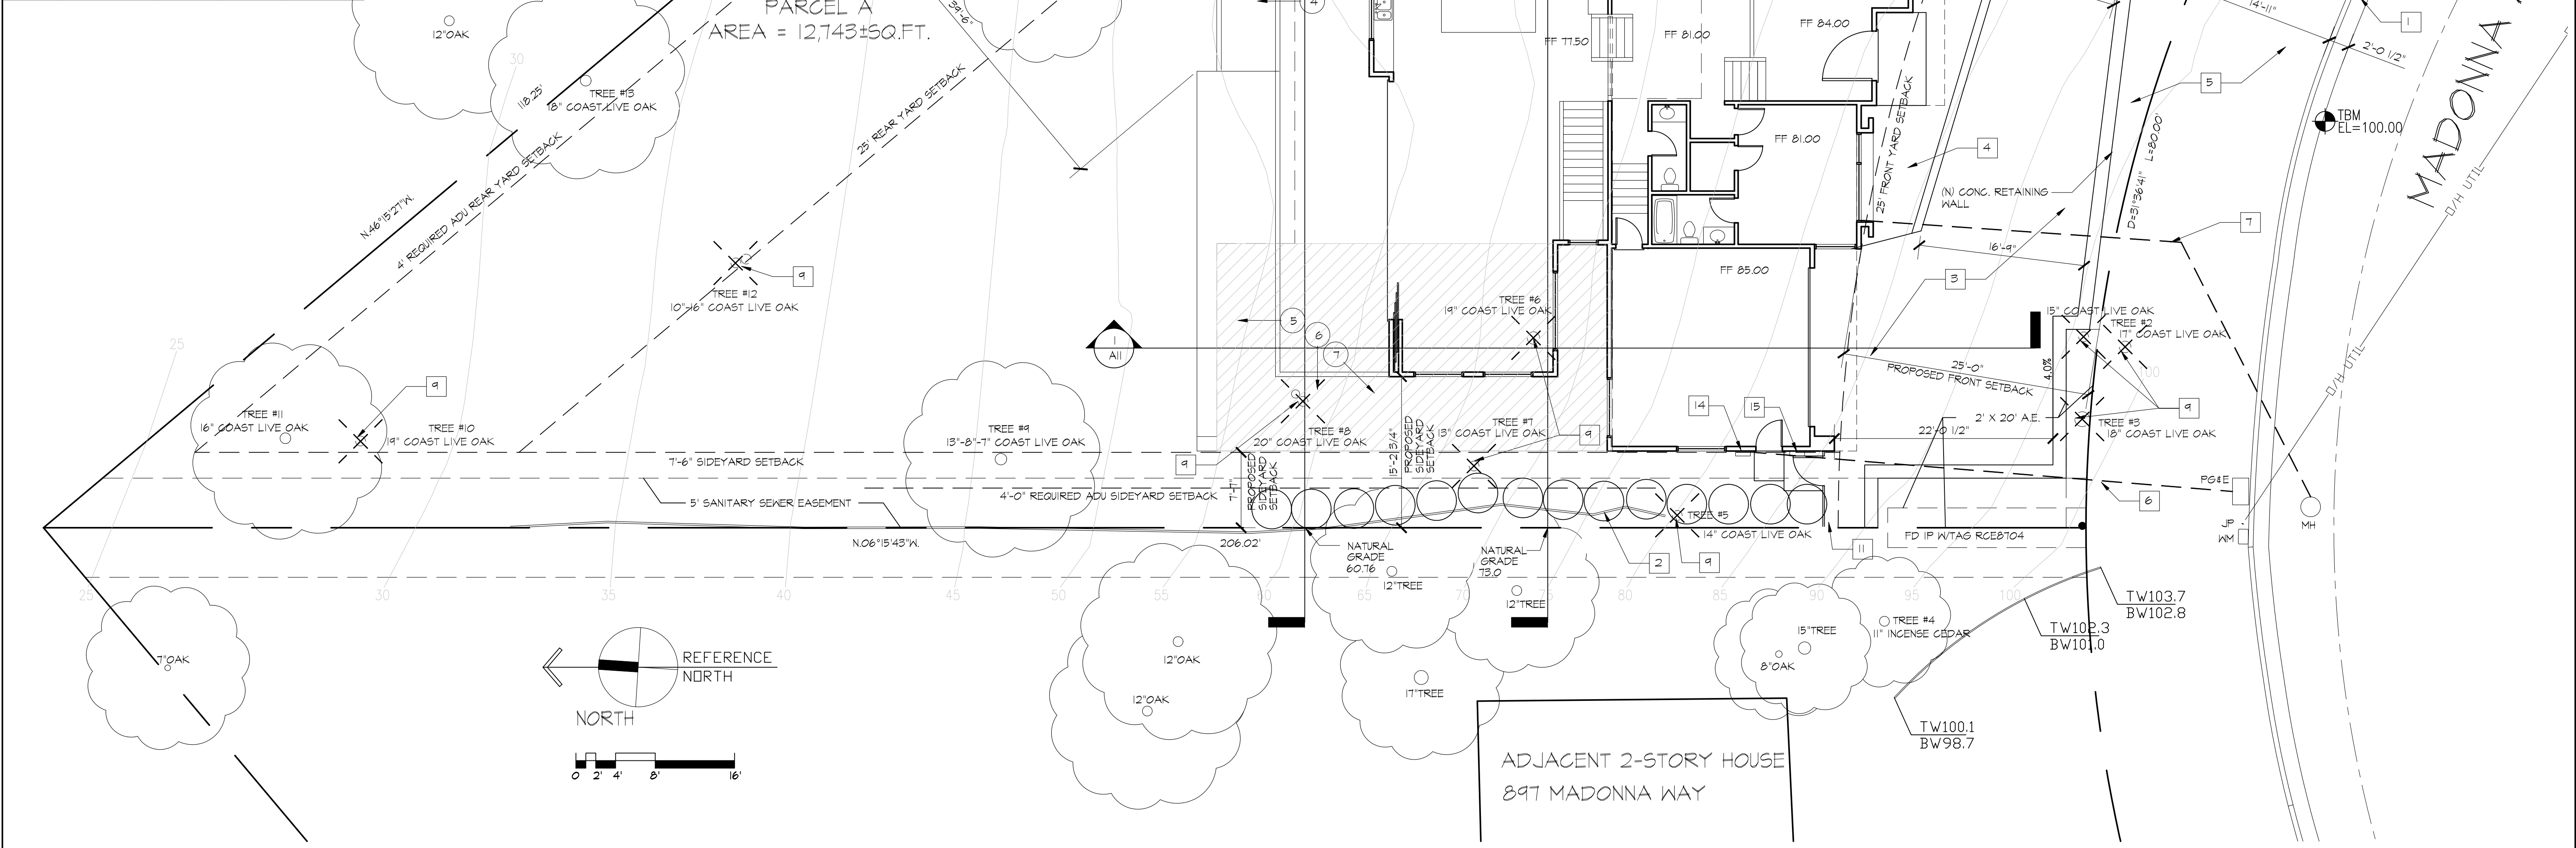

① PROPOSED SITE PLAN 1/8"=1'-0"

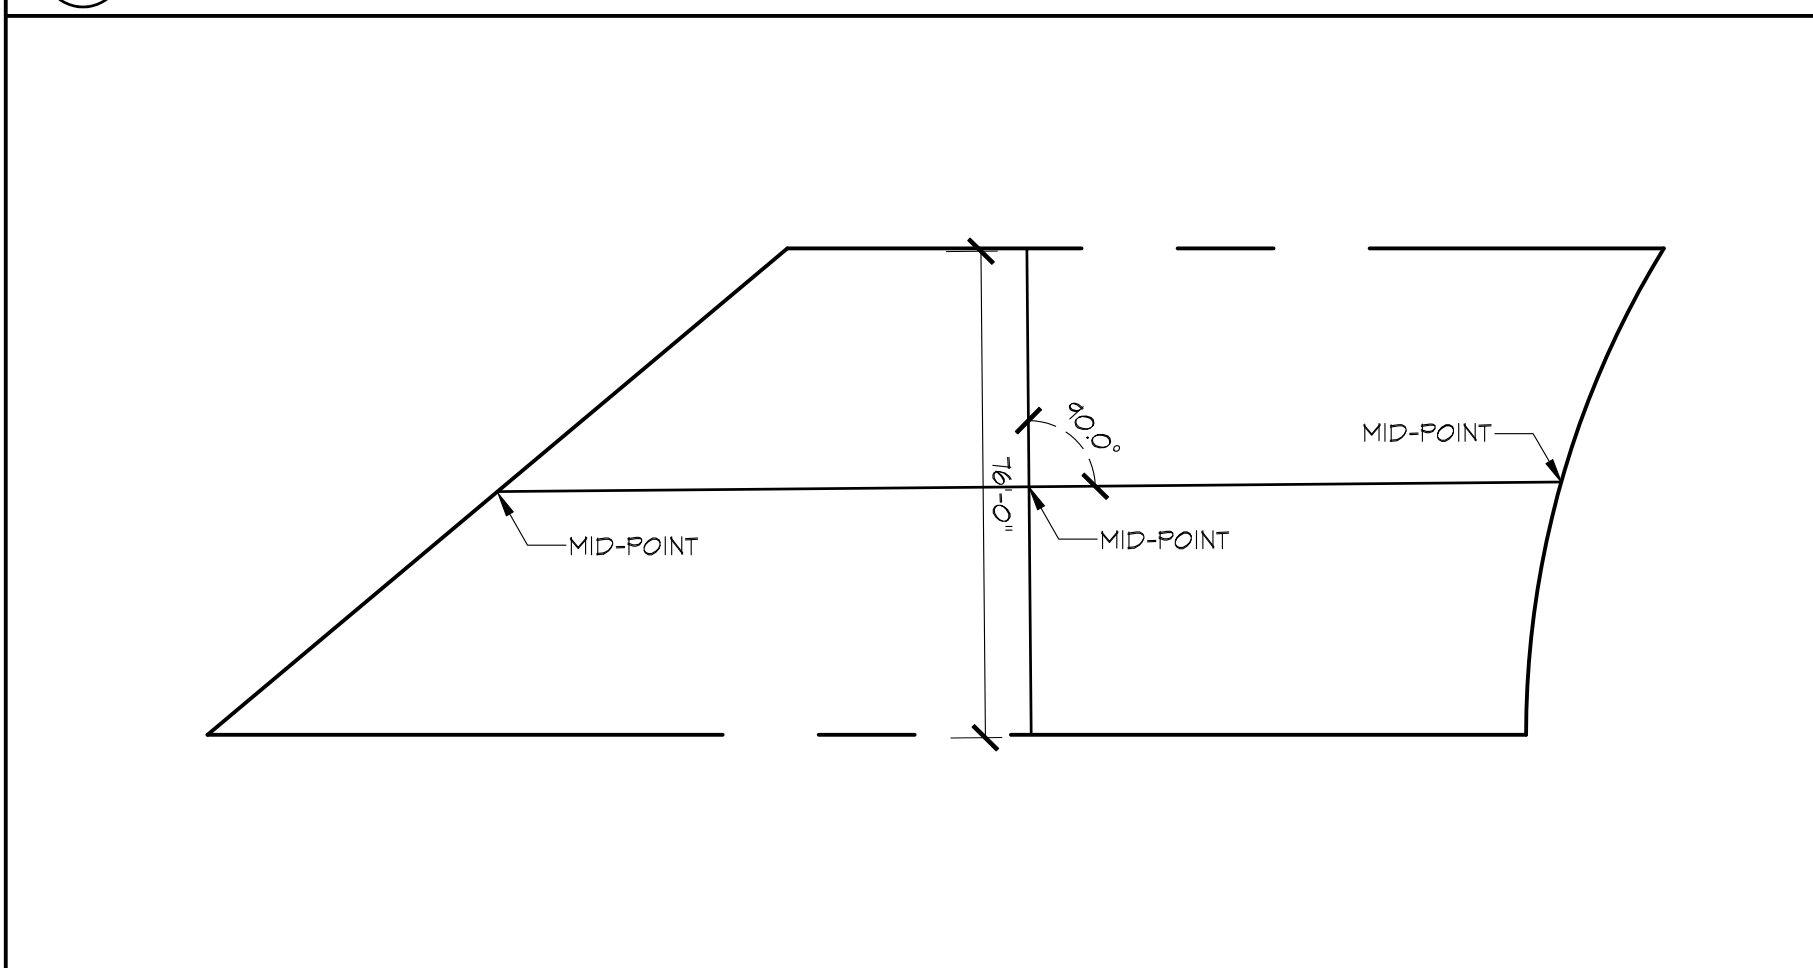


② LOT WIDTH DIAGRAM 1/30"=1'-0"

- GENERAL NOTES**
- BUILDING SETBACK VERIFICATION: PRIOR TO FOUNDATION INSPECTION BY THE CITY, THE LLS OF RECORD SHALL PROVIDE A WRITTEN CERTIFICATION THAT ALL BUILDING SETBACKS ARE PER THE APPROVED PLANS.
 - ALL REMAINING EXISTING LANDSCAPE TO BE PROTECTED FROM DAMAGE DURING CONSTRUCTION, TYPICAL.
 - REMOVE EXISTING LANDSCAPE WHERE NEW CONSTRUCTION OCCURRED. VERIFY WITH OWNER FOR ITEM TO BE SAVED AND REUSED.
 - REMOVE EXISTING FENCE WHERE NEW CONSTRUCTION OCCURRED.
 - PREPARE SITE FOR NEW CONSTRUCTION WHERE OCCURRED. SEE NEW FLOOR PLAN.
 - ANY CONSTRUCTION WITHIN THE CITY RIGHT-OF-WAY MUST HAVE AN APPROVED PERMIT FOR CONSTRUCTION IN THE PUBLIC STREET PRIOR TO COMMENCEMENT OF WORK. APPLY FOR THIS PERMIT AT THE PUBLIC WORKS ENGINEERING (PWE) DIVISION. **THE PERFORMANCE OF THIS WORK IS NOT AUTHORIZED BY THE BUILDING PERMIT ISSUANCE BUT SHOWN ON THE BUILDING PERMIT FOR INFORMATION ONLY.**
 - REFER TO CIVIL ENGINEERING DRAWINGS FOR DOWNSPOUT/ SPLASH BLOCK LOCATIONS.
 - SEE SOIL REPORT FOR SITE & FOUNDATION COMPACTION & GRADING REQUIREMENTS.

GENERAL NOTES

- KEYNOTES**
- (E) STREET CURB & GUTTER
 - (E) HD. FENCE TO REMAIN.
 - NEW PERMEABLE PAVEMENT DRIVEWAY.
 - NEW PERMEABLE PAVEMENT WALKWAY.
 - (N) LANDSCAPING. SEE LANDSCAPING PLANS.
 - JOINT TRENCH FOR UNDERGROUND ELECTRICAL & GAS LINES.
 - NEW 4" SEWER LINE.
 - NEW 2" WATER LINE WITH NEW WATER METER. COORDINATE WITH WATER COMPANY.
 - REMOVE (E) TREE.
 - PROTECTION TREE PROTECTION FENCING PER CITY'S STANDARDS.
 - 6' TALL HD. GATE & FENCE.
 - HEAT PUMP UNITS UNDER STAIRWAY ON CONC. PAD. UNITS SHALL MEET LOS ALTOS AG NOISE REQUIREMENTS.
 - DECOMPOSED GRANITE (D.G.) WALKWAY.
 - ELEC. PANEL & METER (400 AMP)
 - GAS METER (FOR COOKING APPLIANCE)

KEYNOTES

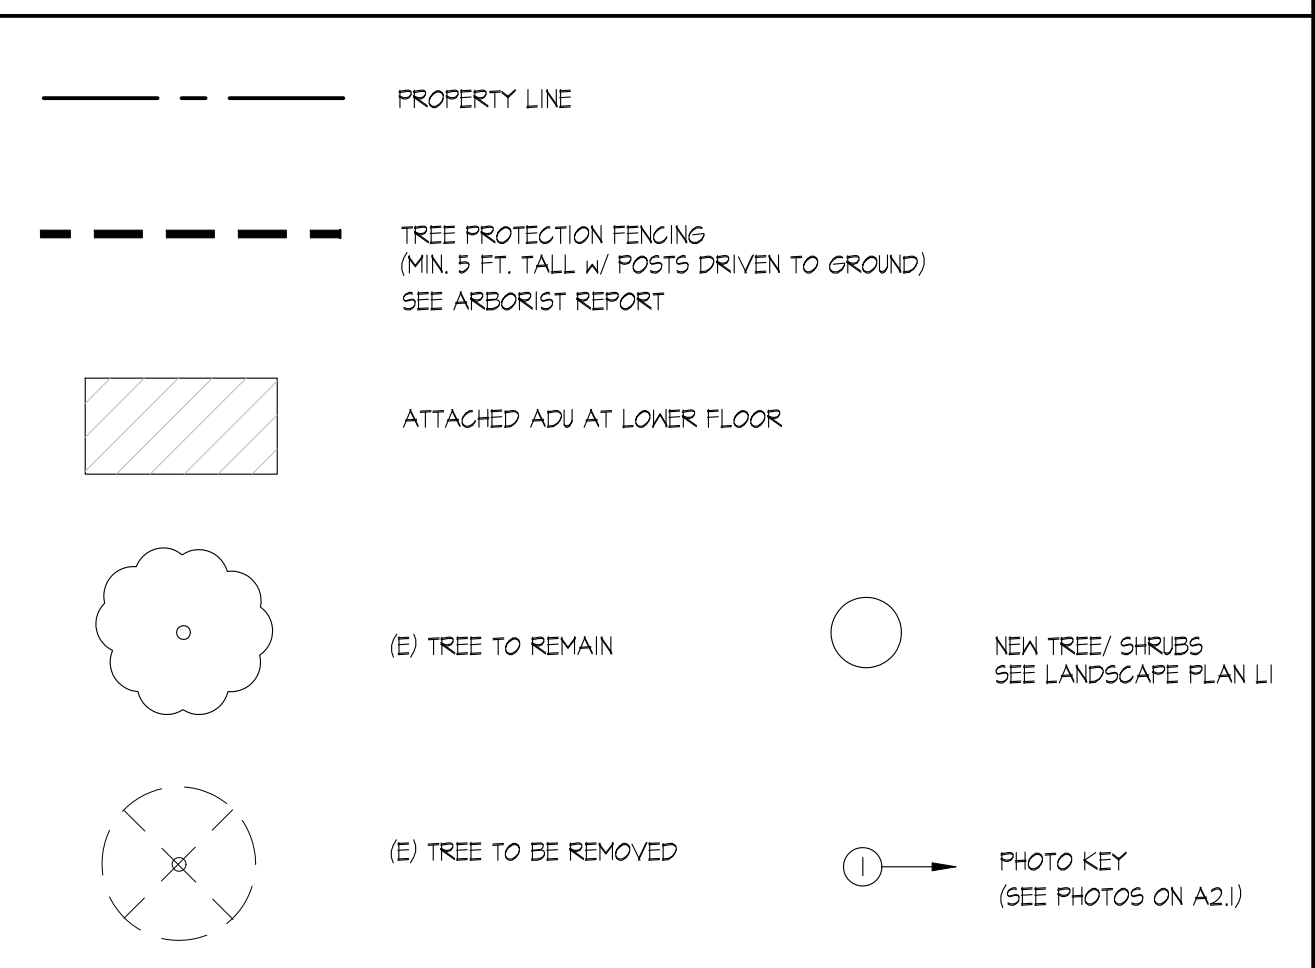

LEGEND

REVISIONS		

CIBOTTI ENGINEERING
12935 ALCOSTA BLVD #2025
SAN RAMON, CA 94583
BUS: (925) 829-0920
EMAIL: SCOTT@CIBOTTI.COM

**IQBAL RESIDENCE
NEW SINGLE FAMILY HOUSE & ADU**
899 MADONNA WAY
LOS ALTOS, CA 94024

PROPOSED SITE PLAN

DATE MAY 16, 2022
SCALE
DRAWN
AP# 336-03-030
SHEET
A2
OF SHEETS



④ VIEW FROM BALCONY TO NORTHWEST

③ VIEW FROM BALCONY TO NORTH

② VIEW FROM BALCONY TO EAST

① VIEW FROM BALCONY TO SOUTHEAST



⑦ VIEW FROM BALCONY TO WEST

⑥ VIEW FROM BALCONY TO NORTHWEST

⑤ VIEW FROM BALCONY TO NORTH


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IQBAL RESIDENCE
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 LOS ALTOS, CA 94024

SITE PHOTOS

DATE MAY 16, 2022
 SCALE
 DRAWN
 APN# 336-03-030
 SHEET
A2.1
 OF SHEETS



REVISIONS

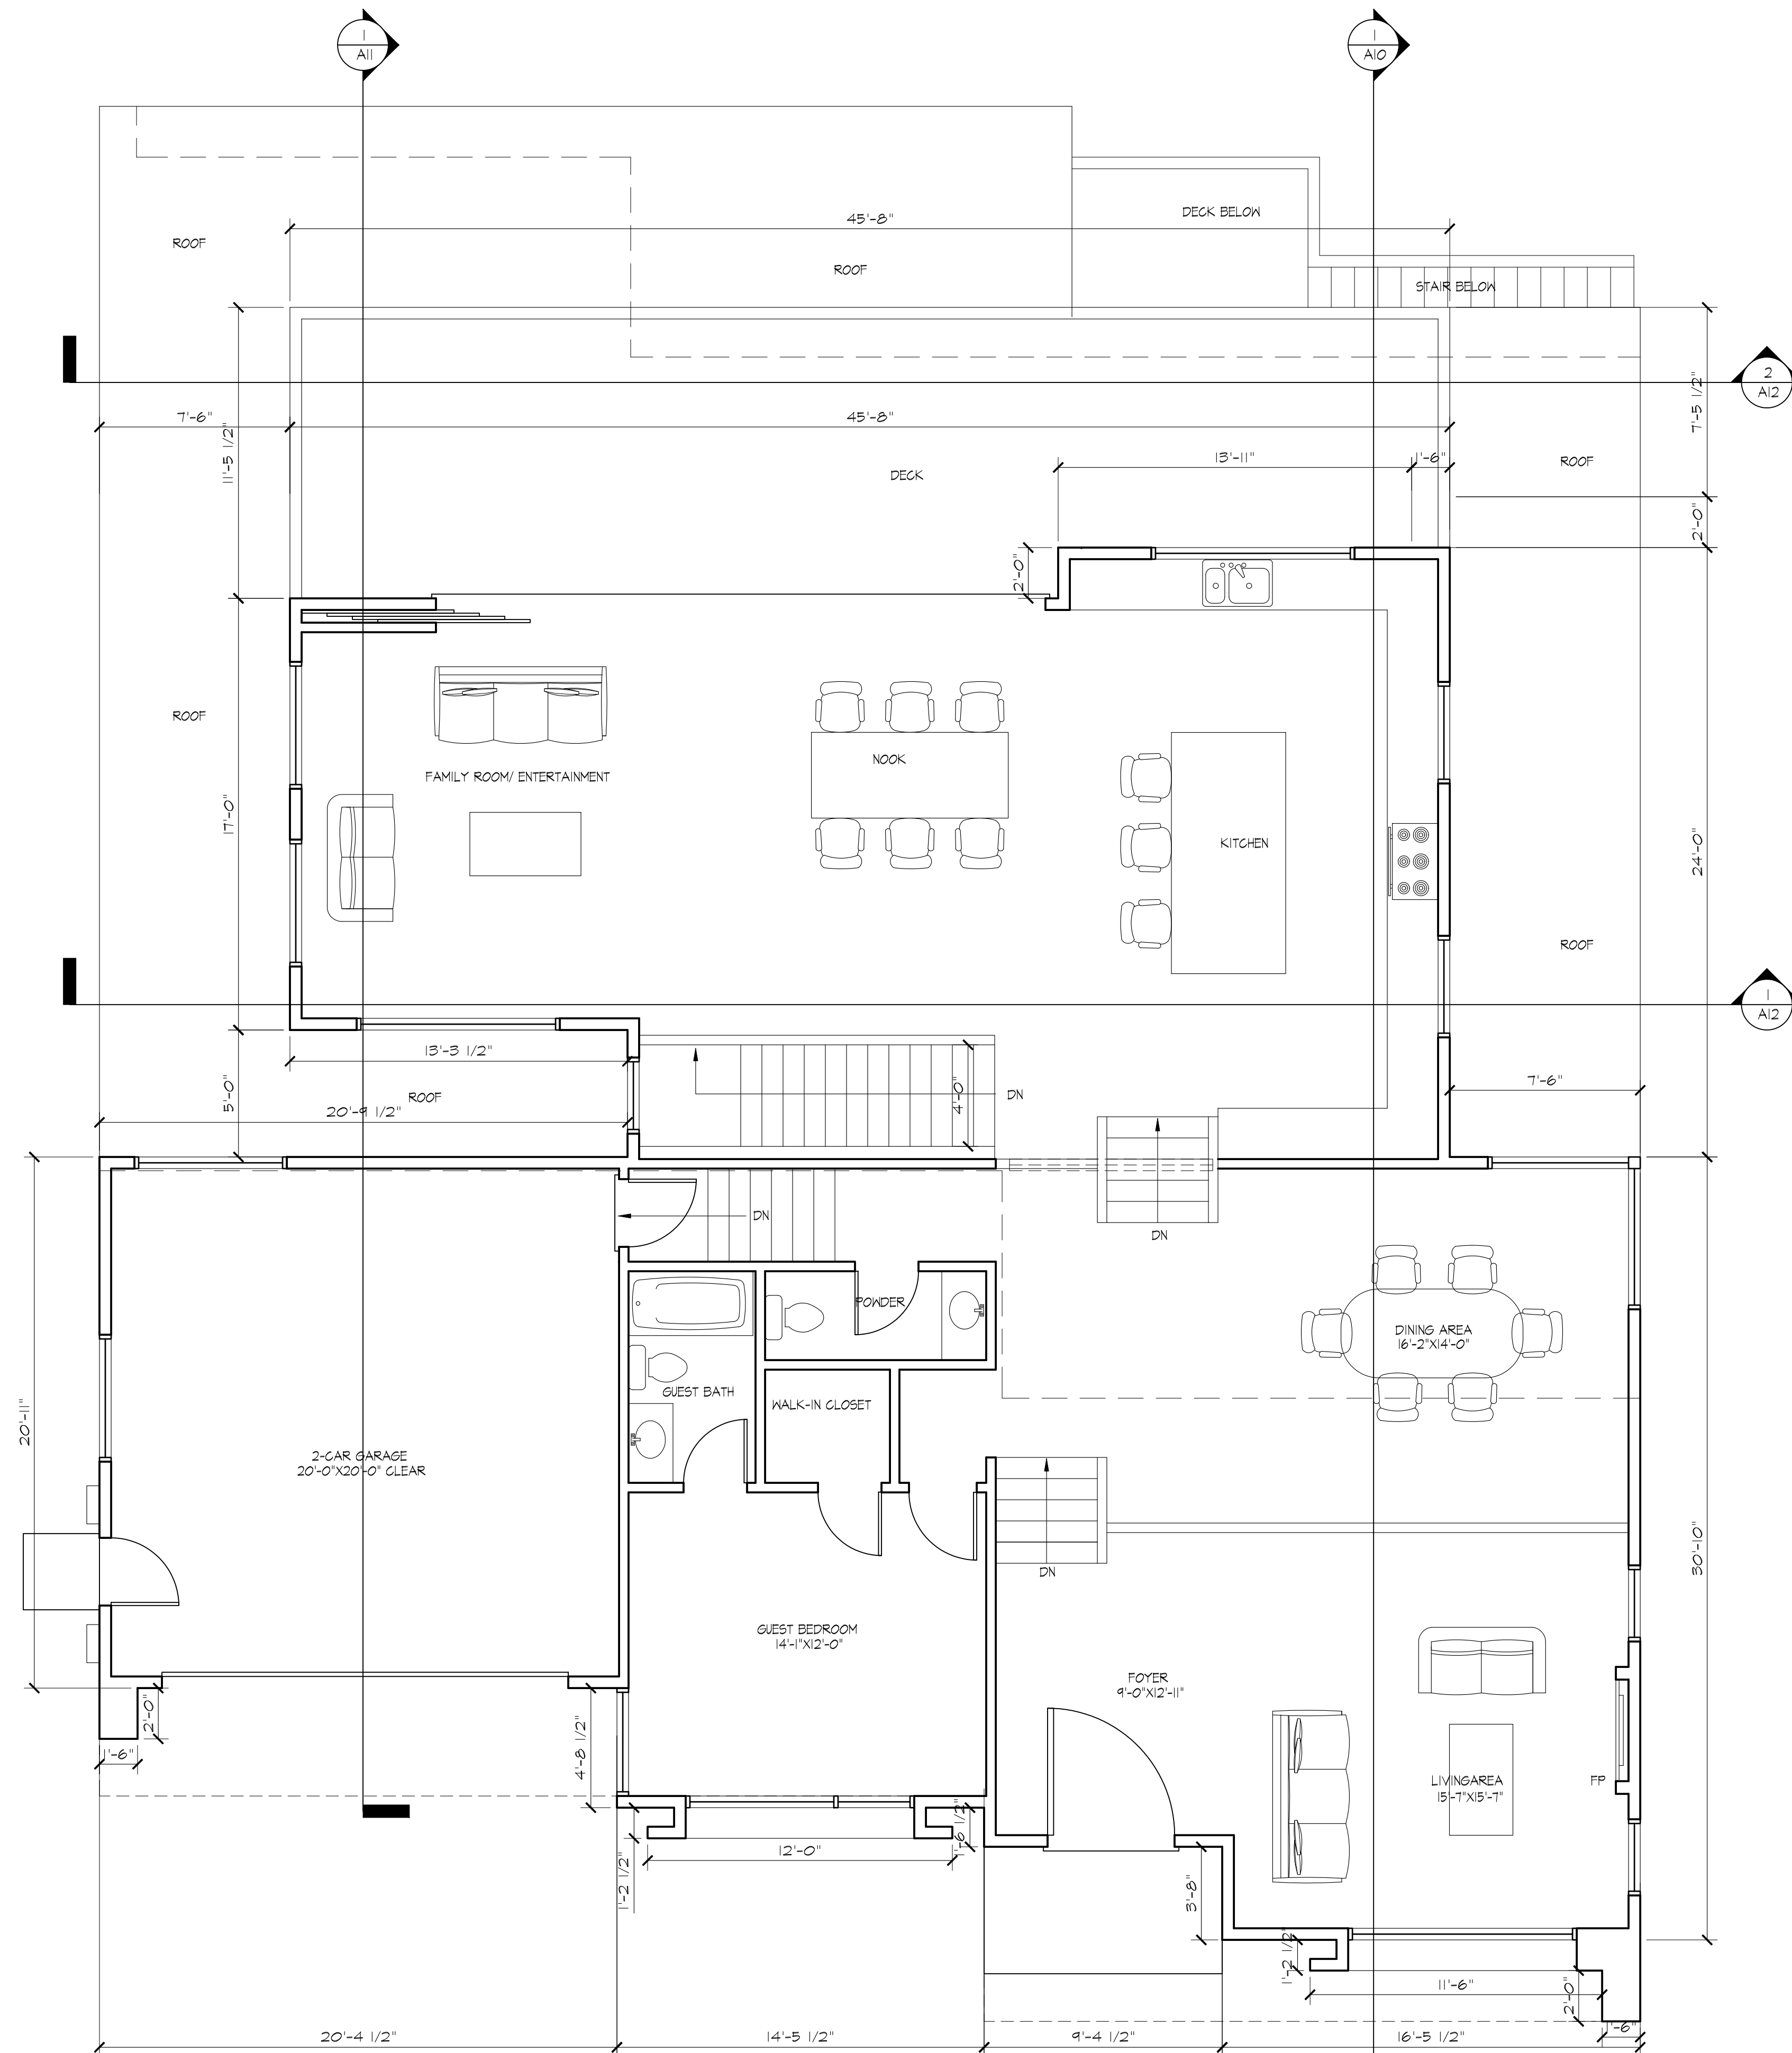
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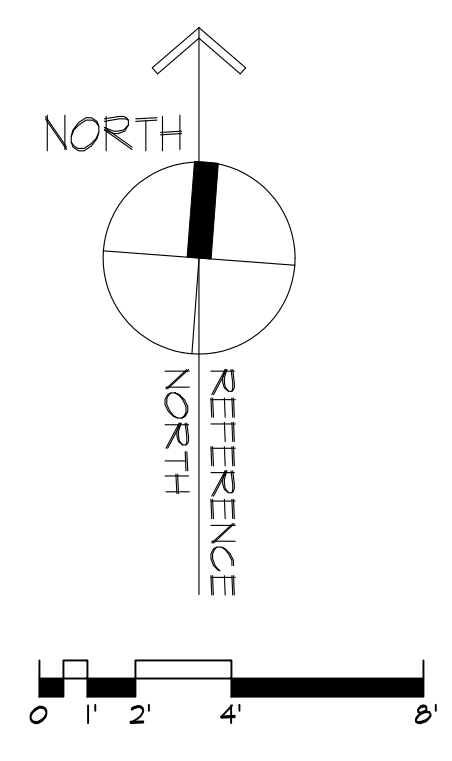
MAIN LEVEL FLOOR PLAN

DATE MAY 16, 2022
 SCALE
 DRAWN
 APN# 336-03-030
 SHEET

A3
 OF SHEETS



ADU 849 S.F.

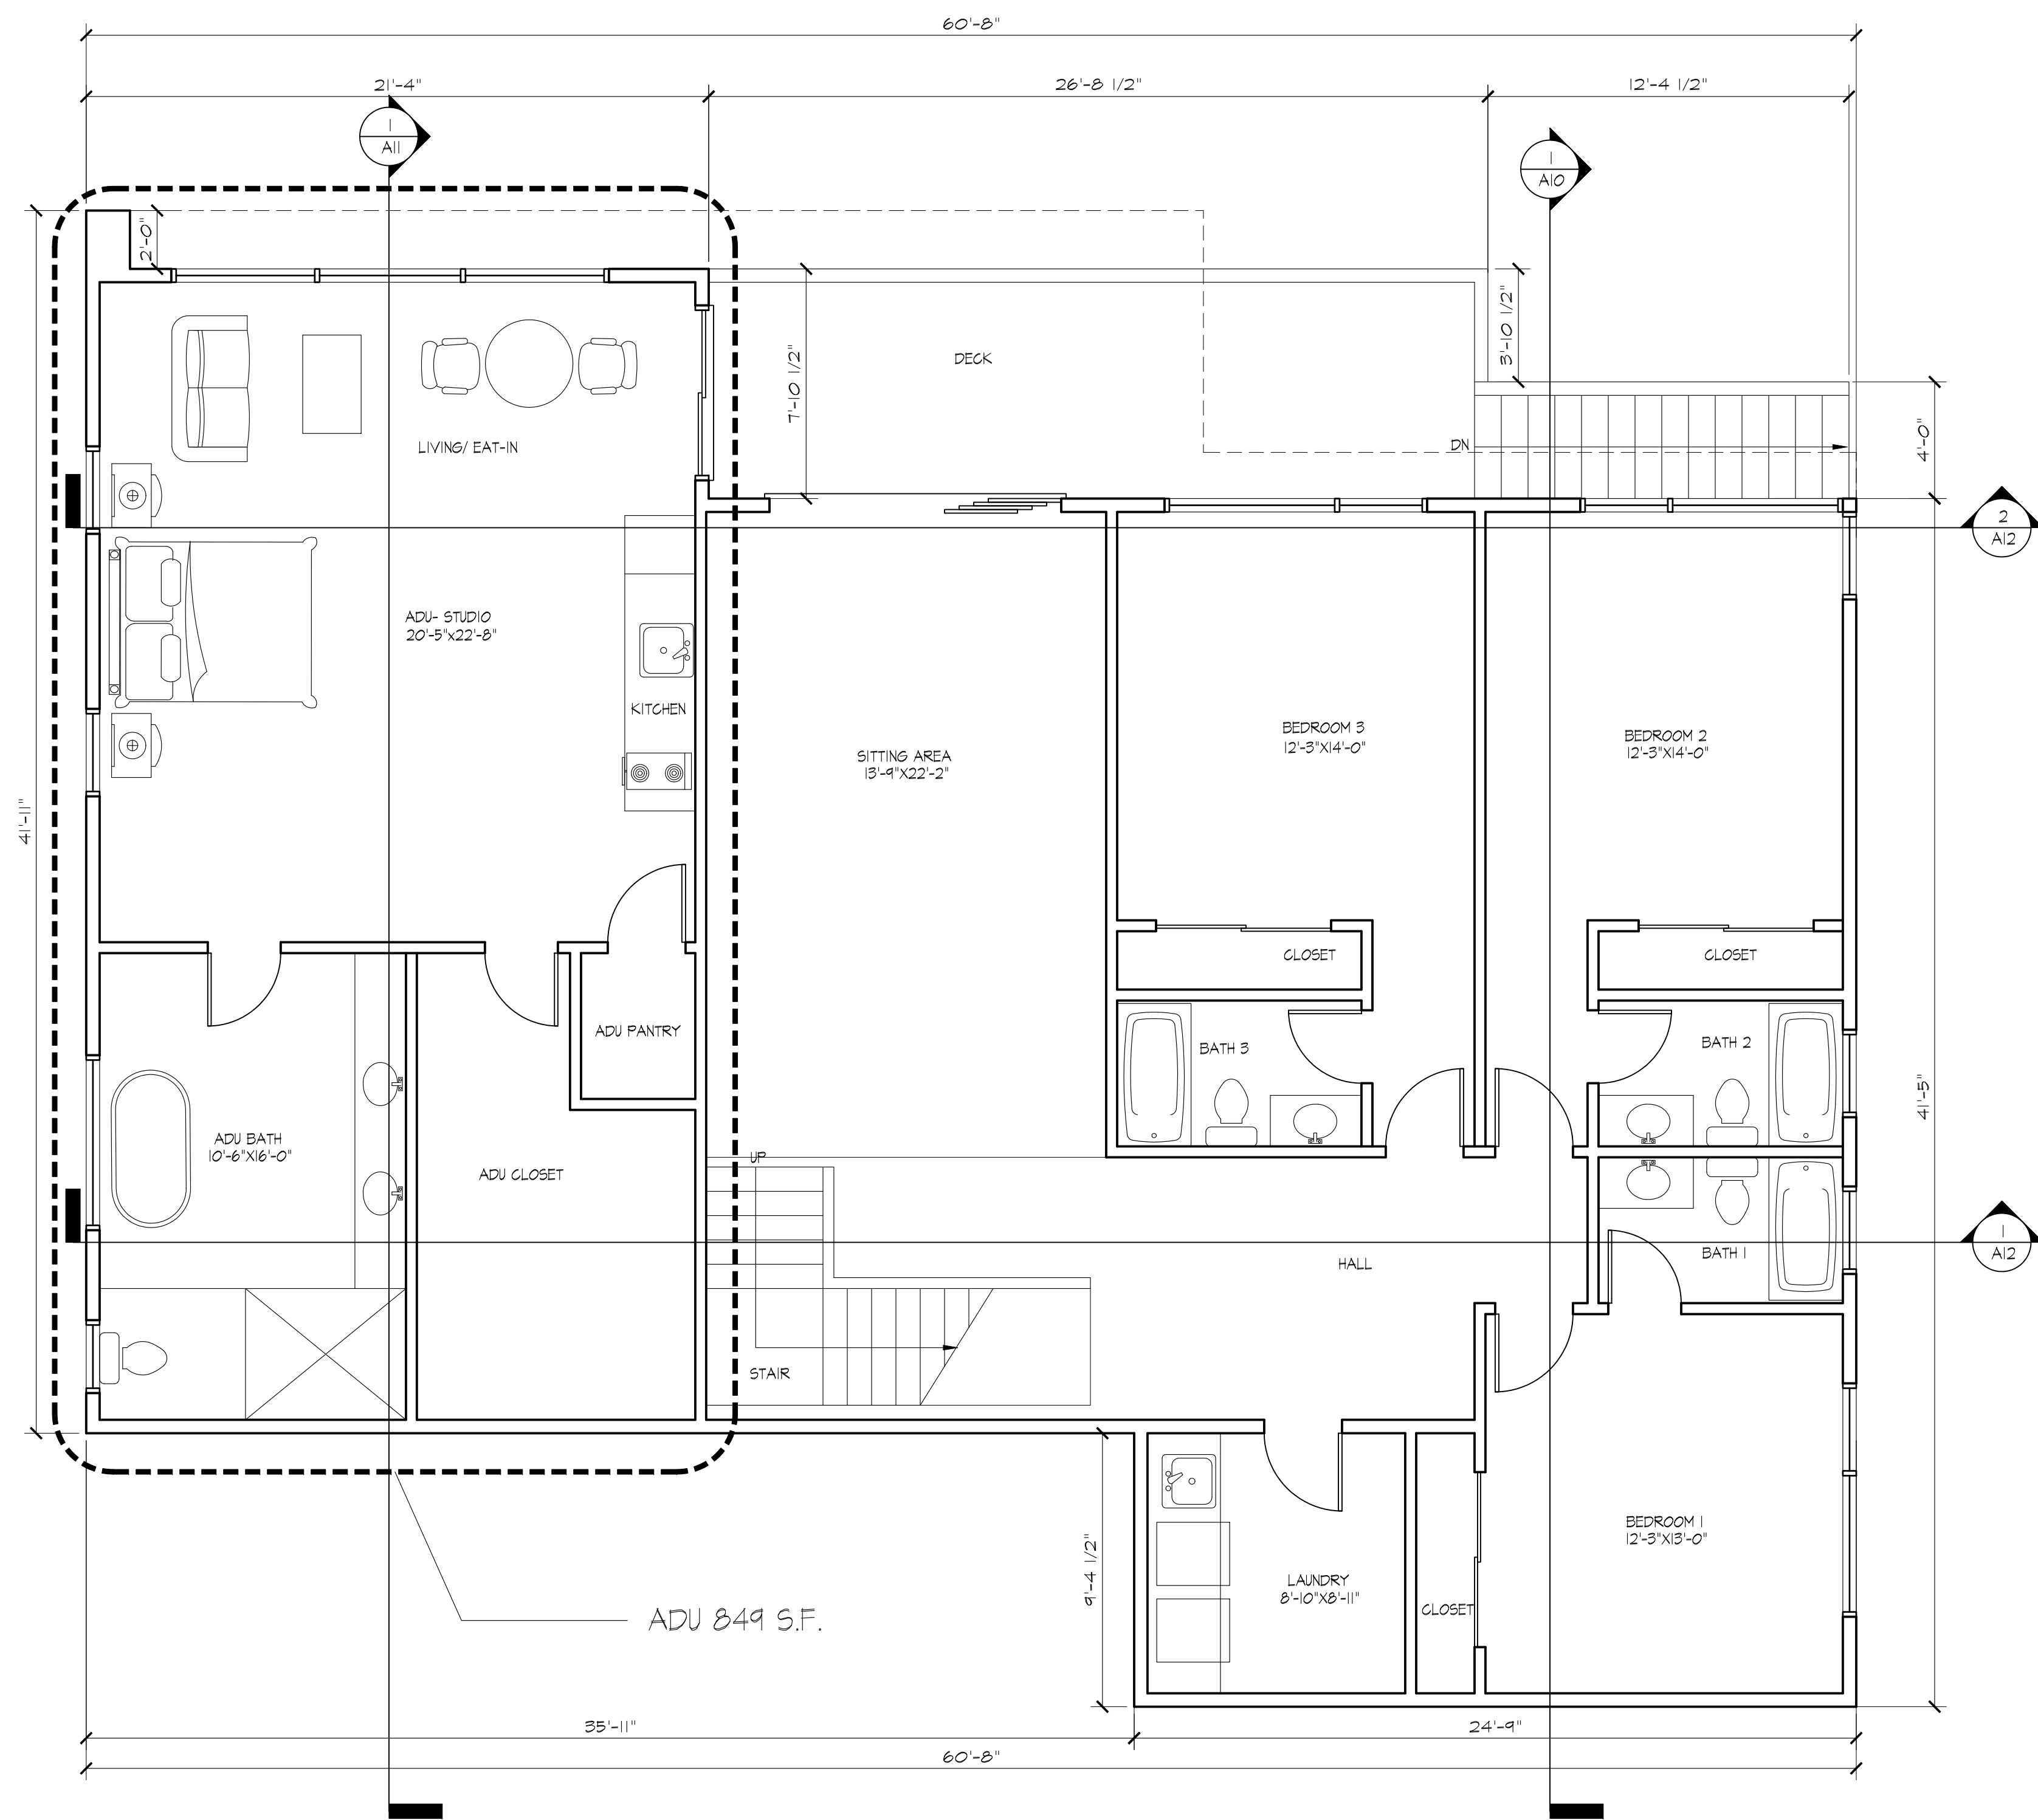

REVISIONS



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IQBAL RESIDENCE
NEW SINGLE FAMILY HOUSE & ADU
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 LOS ALTOS, CA 94024

LOWER LEVEL FLOOR PLAN

DATE: MAY 16, 2022
 SCALE:
 DRAWN:
 APN# 336-03-030
 SHEET:

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 OF SHEETS

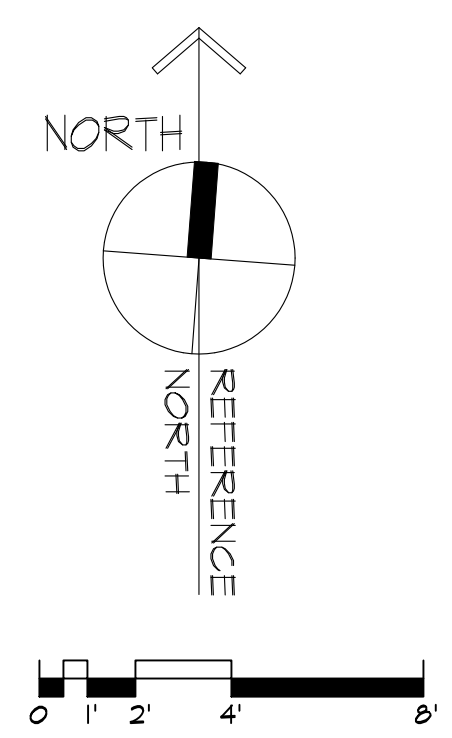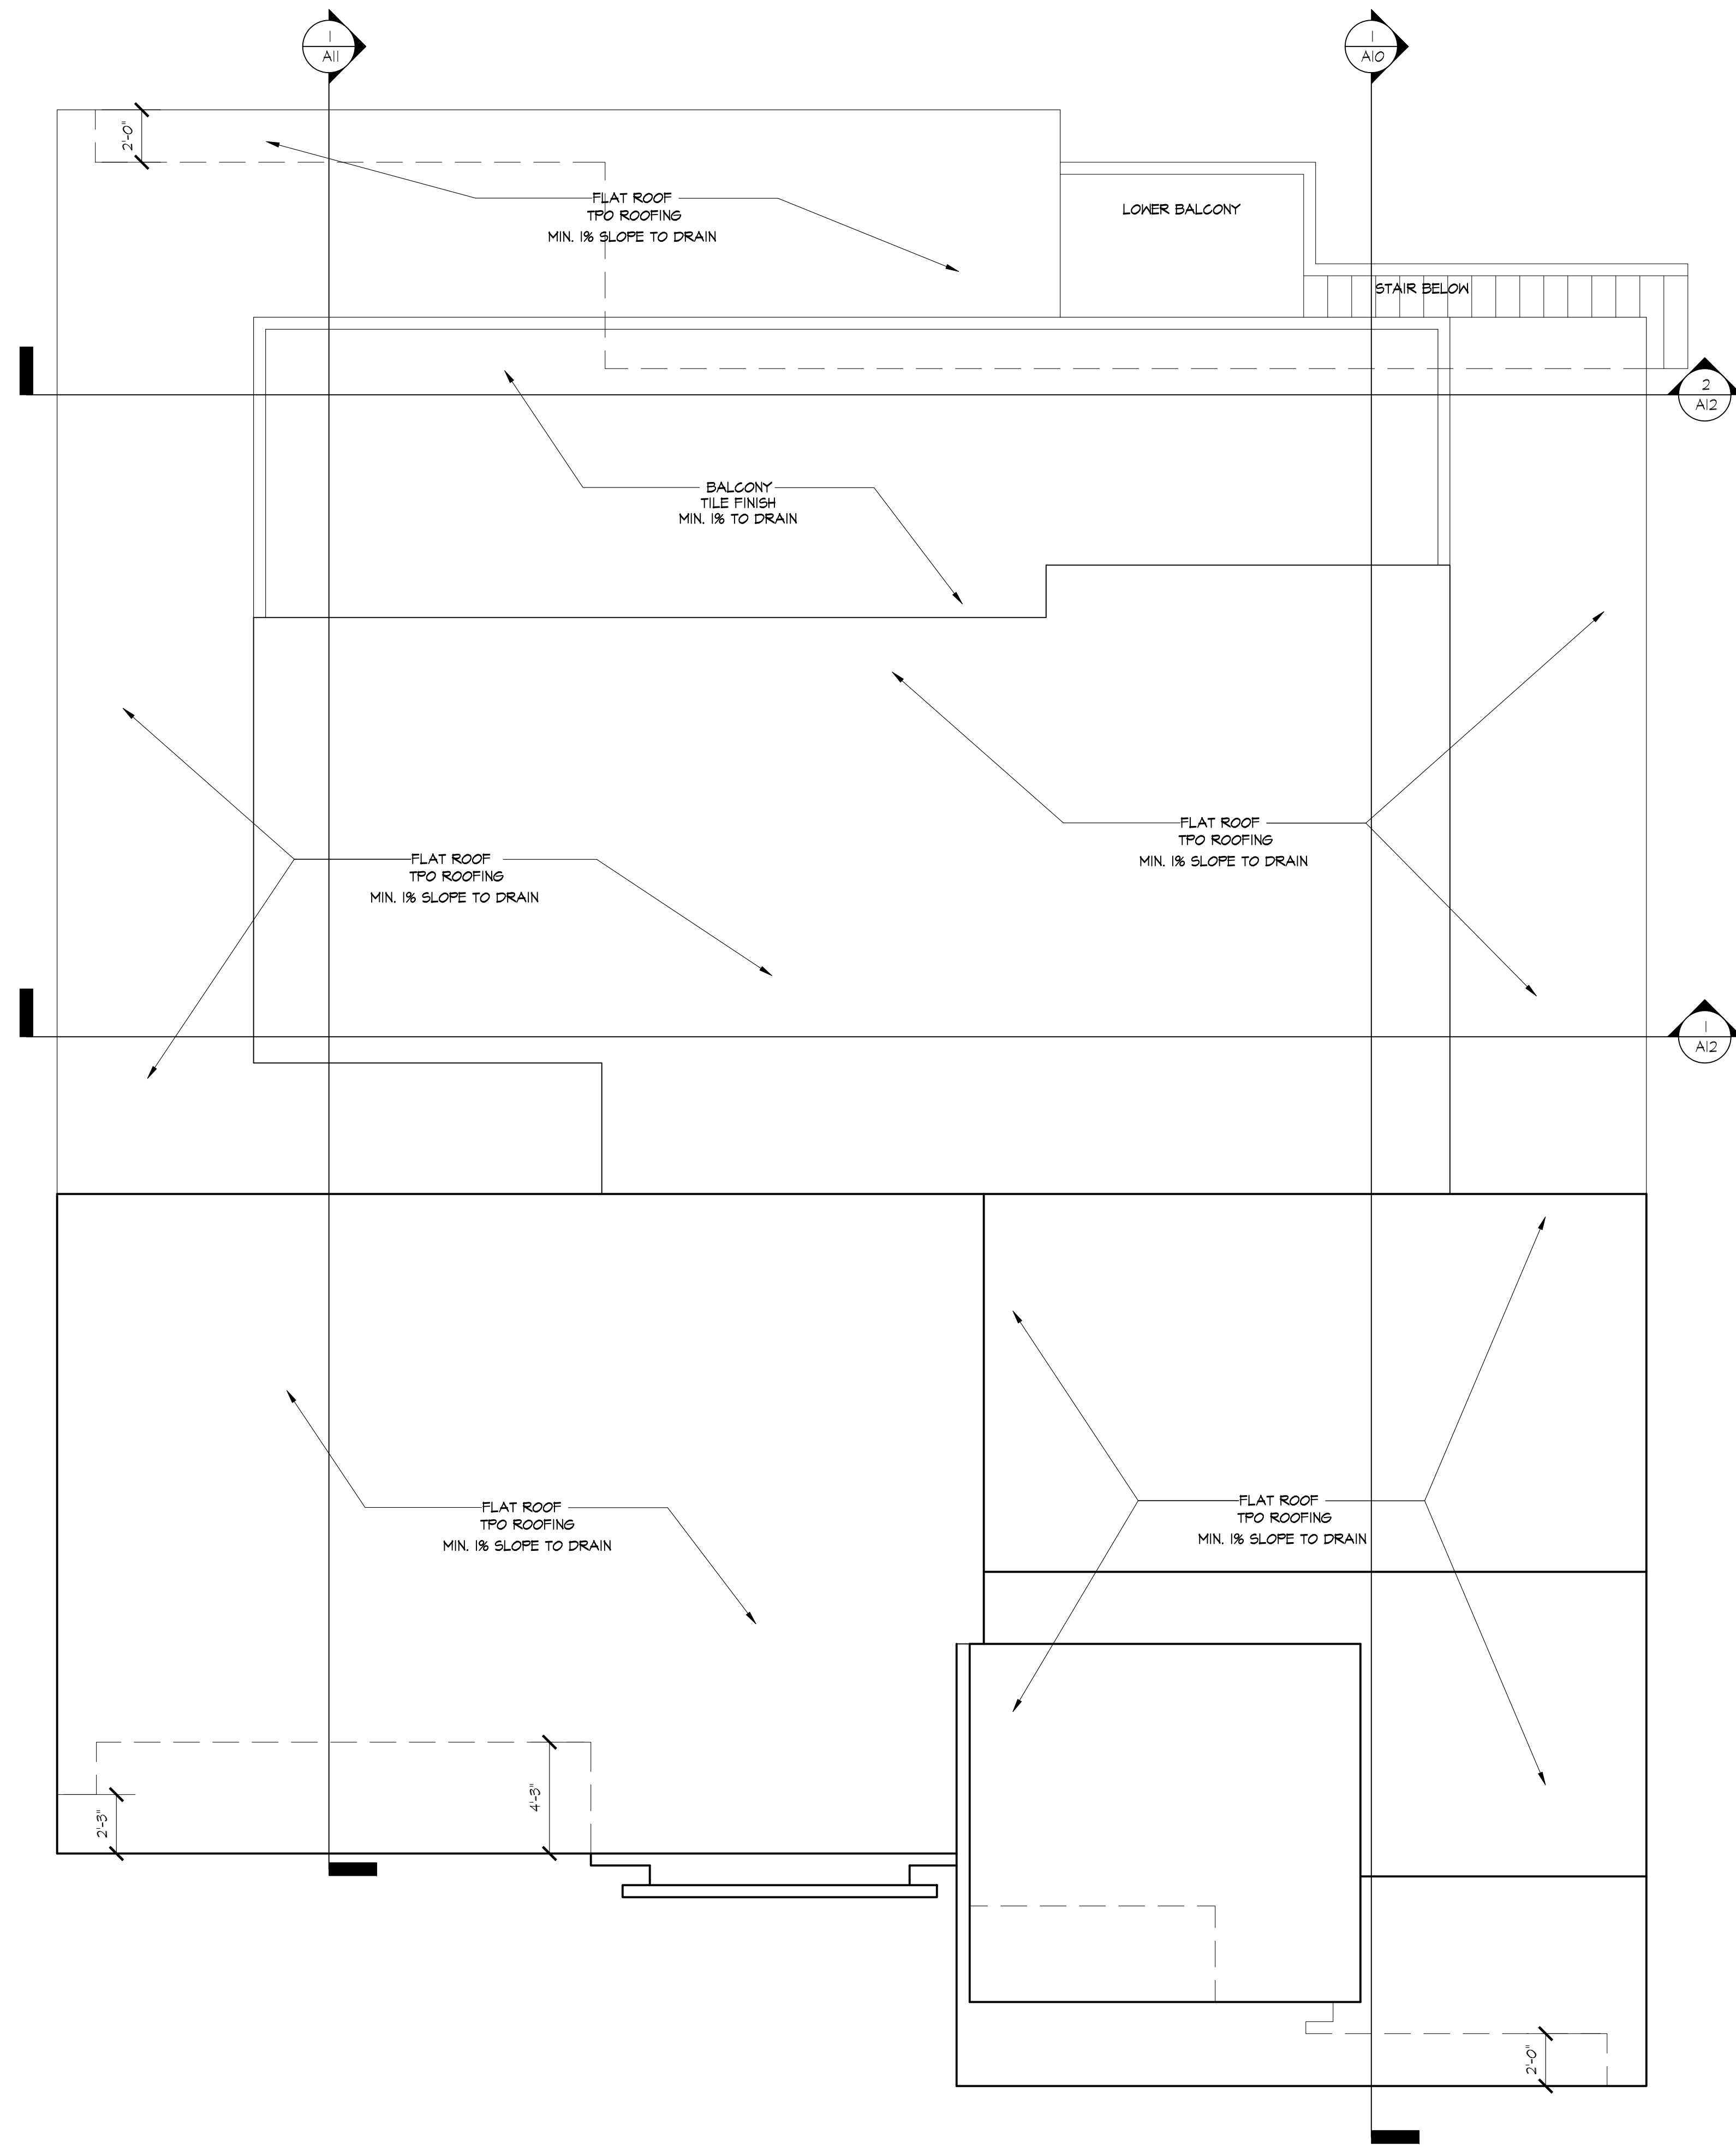

REVISIONS


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IQBAL RESIDENCE
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PROPOSED ROOF PLAN

DATE MAY 16, 2022
 SCALE
 DRAWN
 APN# 336-03-030
 SHEET

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 OF SHEETS



FLOOR AREA CALCULATION

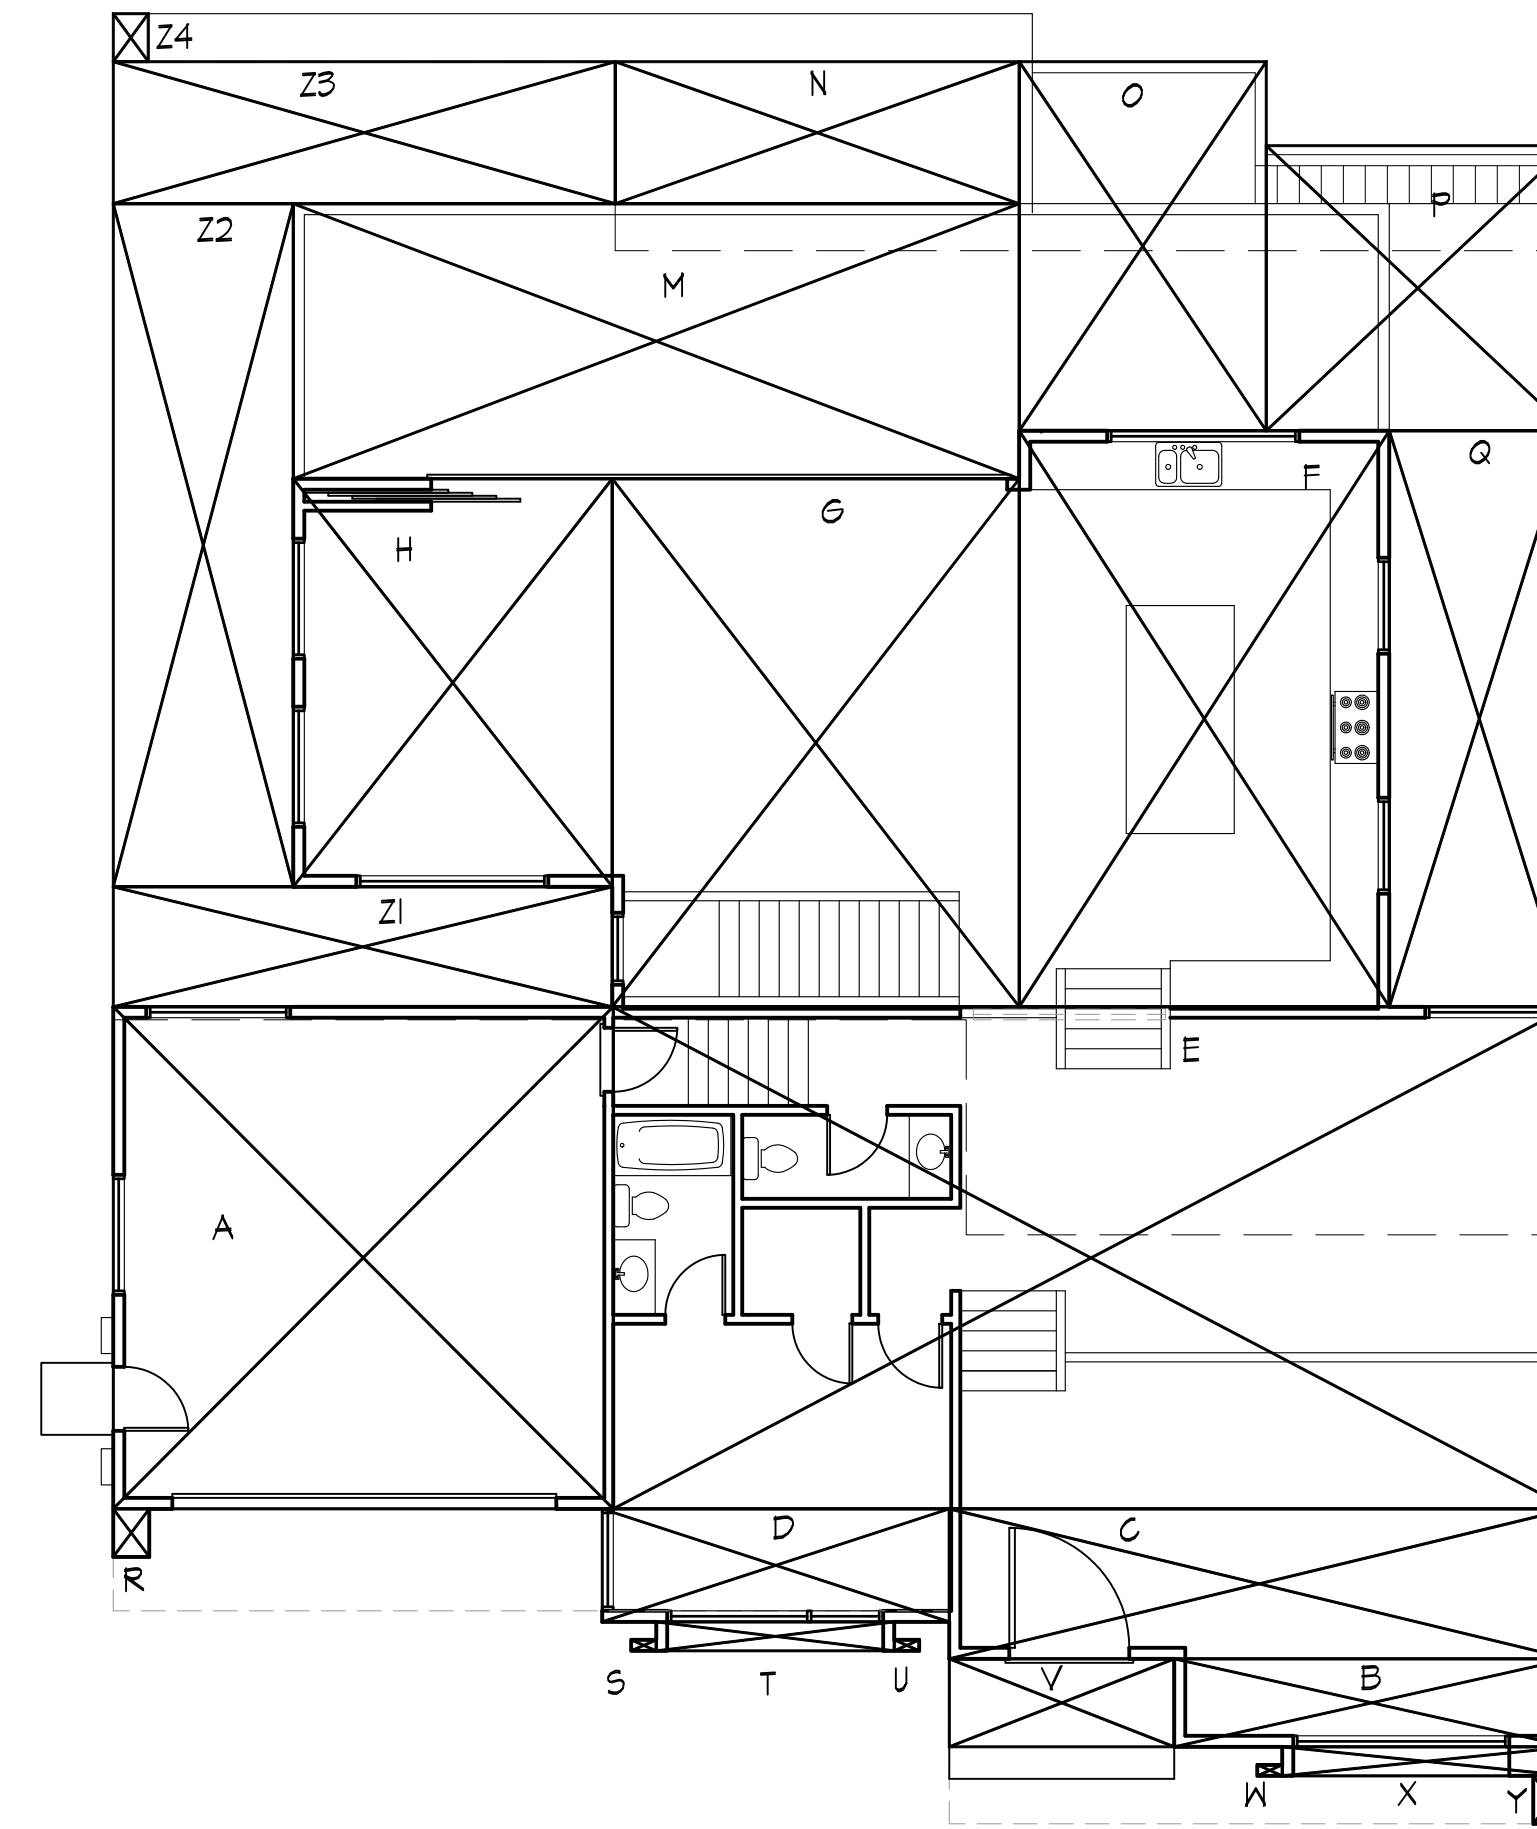MAIN LEVEL FLOOR

SECTION	DIMENSIONS	AREA
A	20'-10" X 20'-11"	435.8
B	16'-5 1/2" X 3'-8"	60.3
C	25'-10" X 6'-3"	161.5
D	14'-5 1/2" X 4'-8 1/2"	68.1
E	39'-10" X 20'-11"	833.2
F	15'-5" X 24'-0"	370.0
G	16'-11 1/2" X 22'-0"	373.1
H	13'-3 1/2" X 17'-0"	226.0
SUBTOTAL		2528.0

LOWER LEVEL FLOOR

SECTION	DIMENSIONS	AREA
I	24'-9" X 9'-4 1/2"	232.0
J	39'-5" X 32'-0 1/2"	1263.0
SUBTOTAL		1495.0

TOTAL FLOOR AREA FOR MAIN HOUSE 4023 SF < 4024 SF

ATTACHED ACCESSORY DWELLING UNIT (ADU)

SECTION	DIMENSIONS	AREA
K	21'-4" X 7'-10 1/2"	168.0
L	21'-3" X 32'-0 1/2"	680.9
SUBTOTAL		848.9

TOTAL FLOOR AREA FOR ADU 848.9 SF < 850 SF

FLOOR COVERAGE CALCULATION

SECTION	DIMENSIONS	AREA
A	20'-10" X 20'-11"	435.8
B	16'-5 1/2" X 3'-8"	60.3
C	25'-10" X 6'-3"	161.5
D	14'-5 1/2" X 4'-8 1/2"	68.1
E	39'-10" X 20'-11"	833.2
F	15'-5" X 24'-0"	370.0
G	16'-11 1/2" X 22'-0"	373.1
H	13'-3 1/2" X 17'-0"	226.0
M	30'-3" X 11'-5 1/2"	346.6
N	16'-10" X 5'-11"	99.6
O	10'-3 1/2" X 15'-4 1/2"	158.2
P	12'-7 1/2" X 11'-10 1/2"	149.9
Q	7'-6" X 24'-0"	180.0
R	1'-6" X 2'-0"	3.0
S	1'-0 1/2" X 0'-5 1/2"	0.5
T	9'-11" X 1'-2 1/2"	12.0
U	1'-0 1/2" X 0'-5 1/2"	0.5
V	9'-4 1/2" X 3'-8"	34.4
W	1'-0 1/2" X 0'-5 1/2"	0.5
X	11'-11 1/2" X 1'-2 1/2"	14.4
Y	1'-6" X 2'-0"	3.0
TOTAL		3530.6


TOTAL COVERAGE 3530.6 SF < 3822.9 SF

ADDITIONAL COVERAGE FROM ADU

SECTION	DIMENSIONS	AREA
Z1	20'-9 1/2" X 5'-0"	104.0
Z2	7'-6" X 28'-5 1/2"	213.4
Z3	20'-11" X 5'-11"	123.8
Z4	1'-6" X 2'-0"	3.0
TOTAL		444.2

1 MAIN LEVEL FLOOR AREA CALCULATION

1/8"=1'-0"

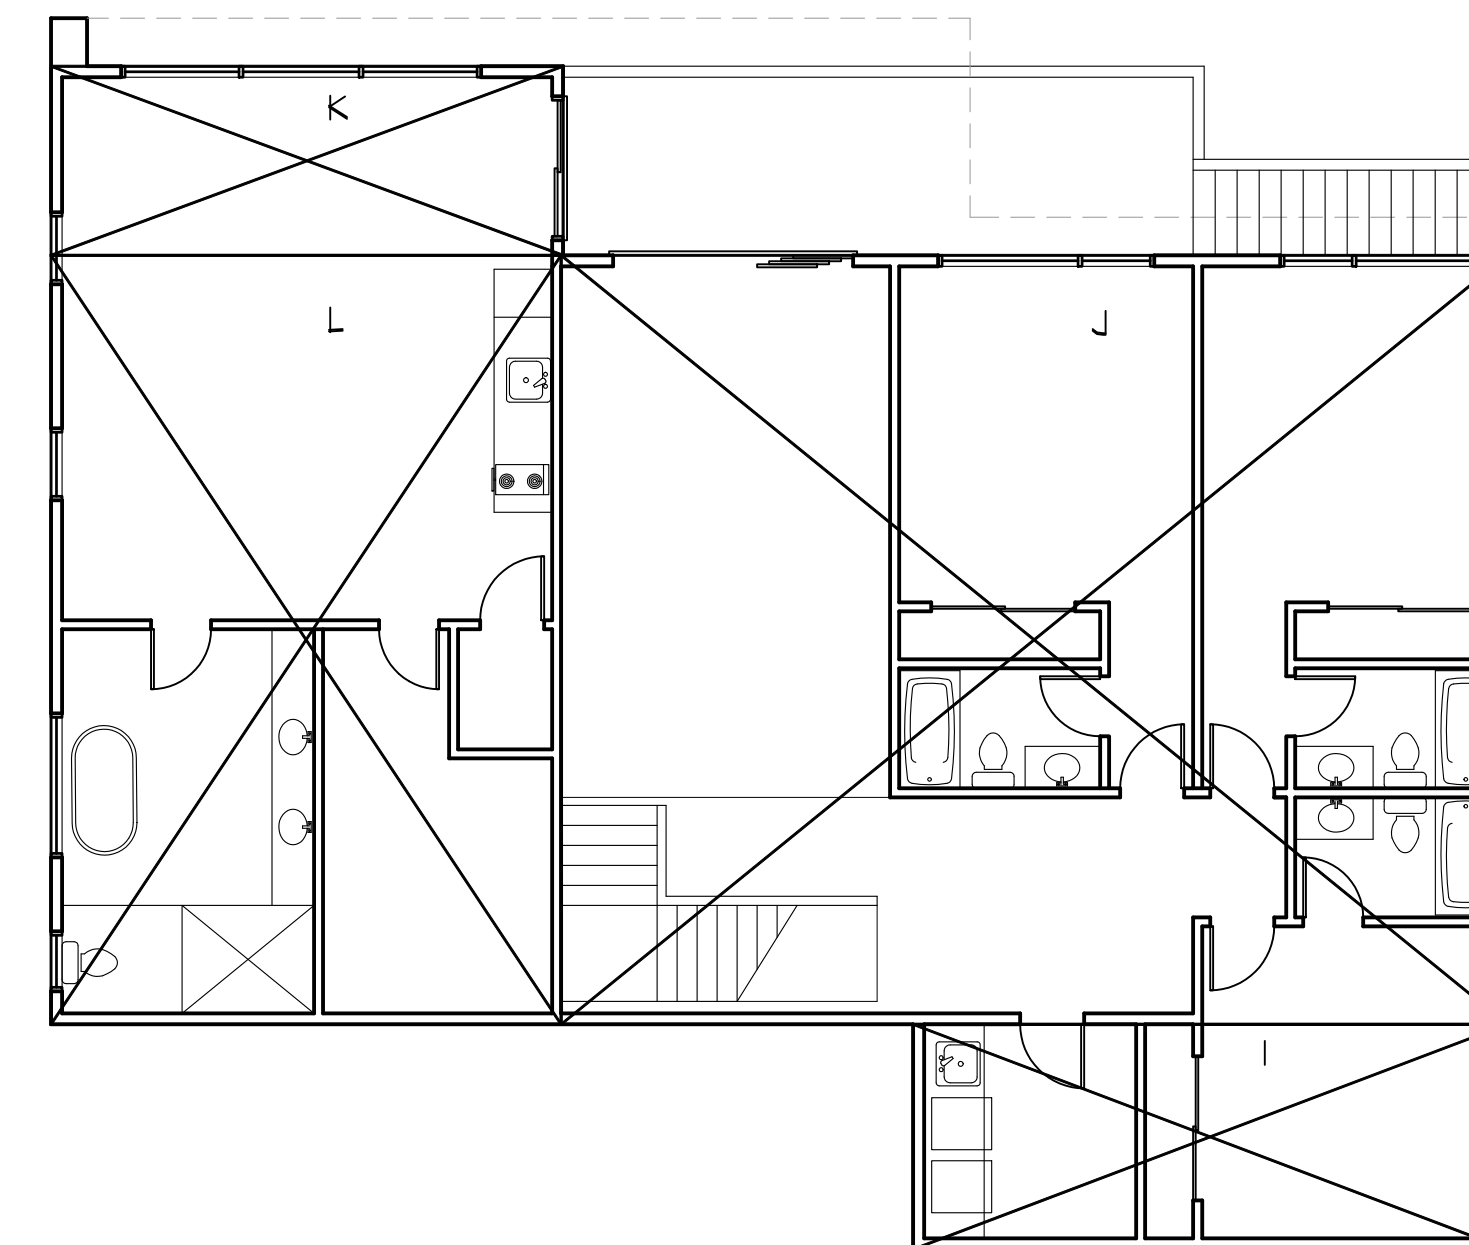

2 LOWER LEVEL FLOOR AREA CALCULATION

1/8"=1'-0"

REVISIONS

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12935 ALCOSTA BLVD #2025
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899 MADONNA WAY
LOS ALTOS, CA 94024

FLOOR & COVERAGE
AREA CALCULATIONS

DATE MAY 16, 2022


SCALE

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APN# 336-03-030


SHEET

A6
OF SHEETS

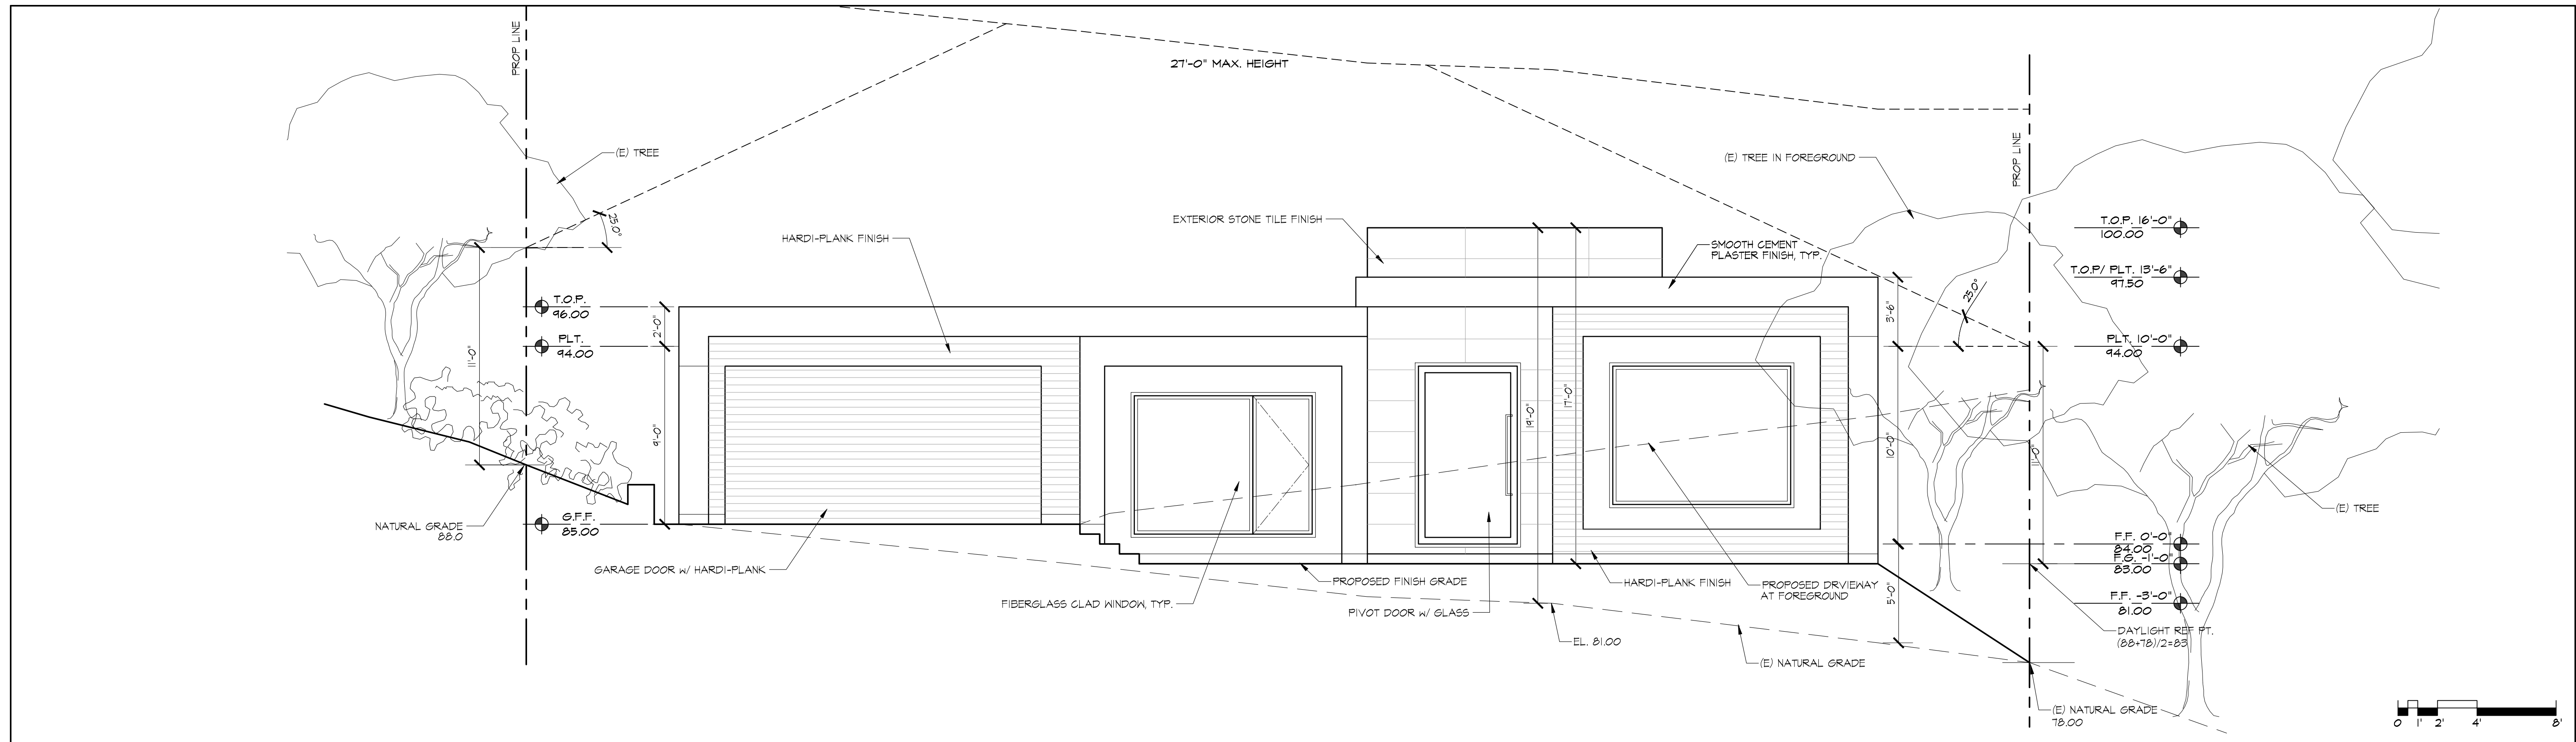

① PROPOSED STREET ELEVATION (SOUTH)

1/4" = 1'-0"

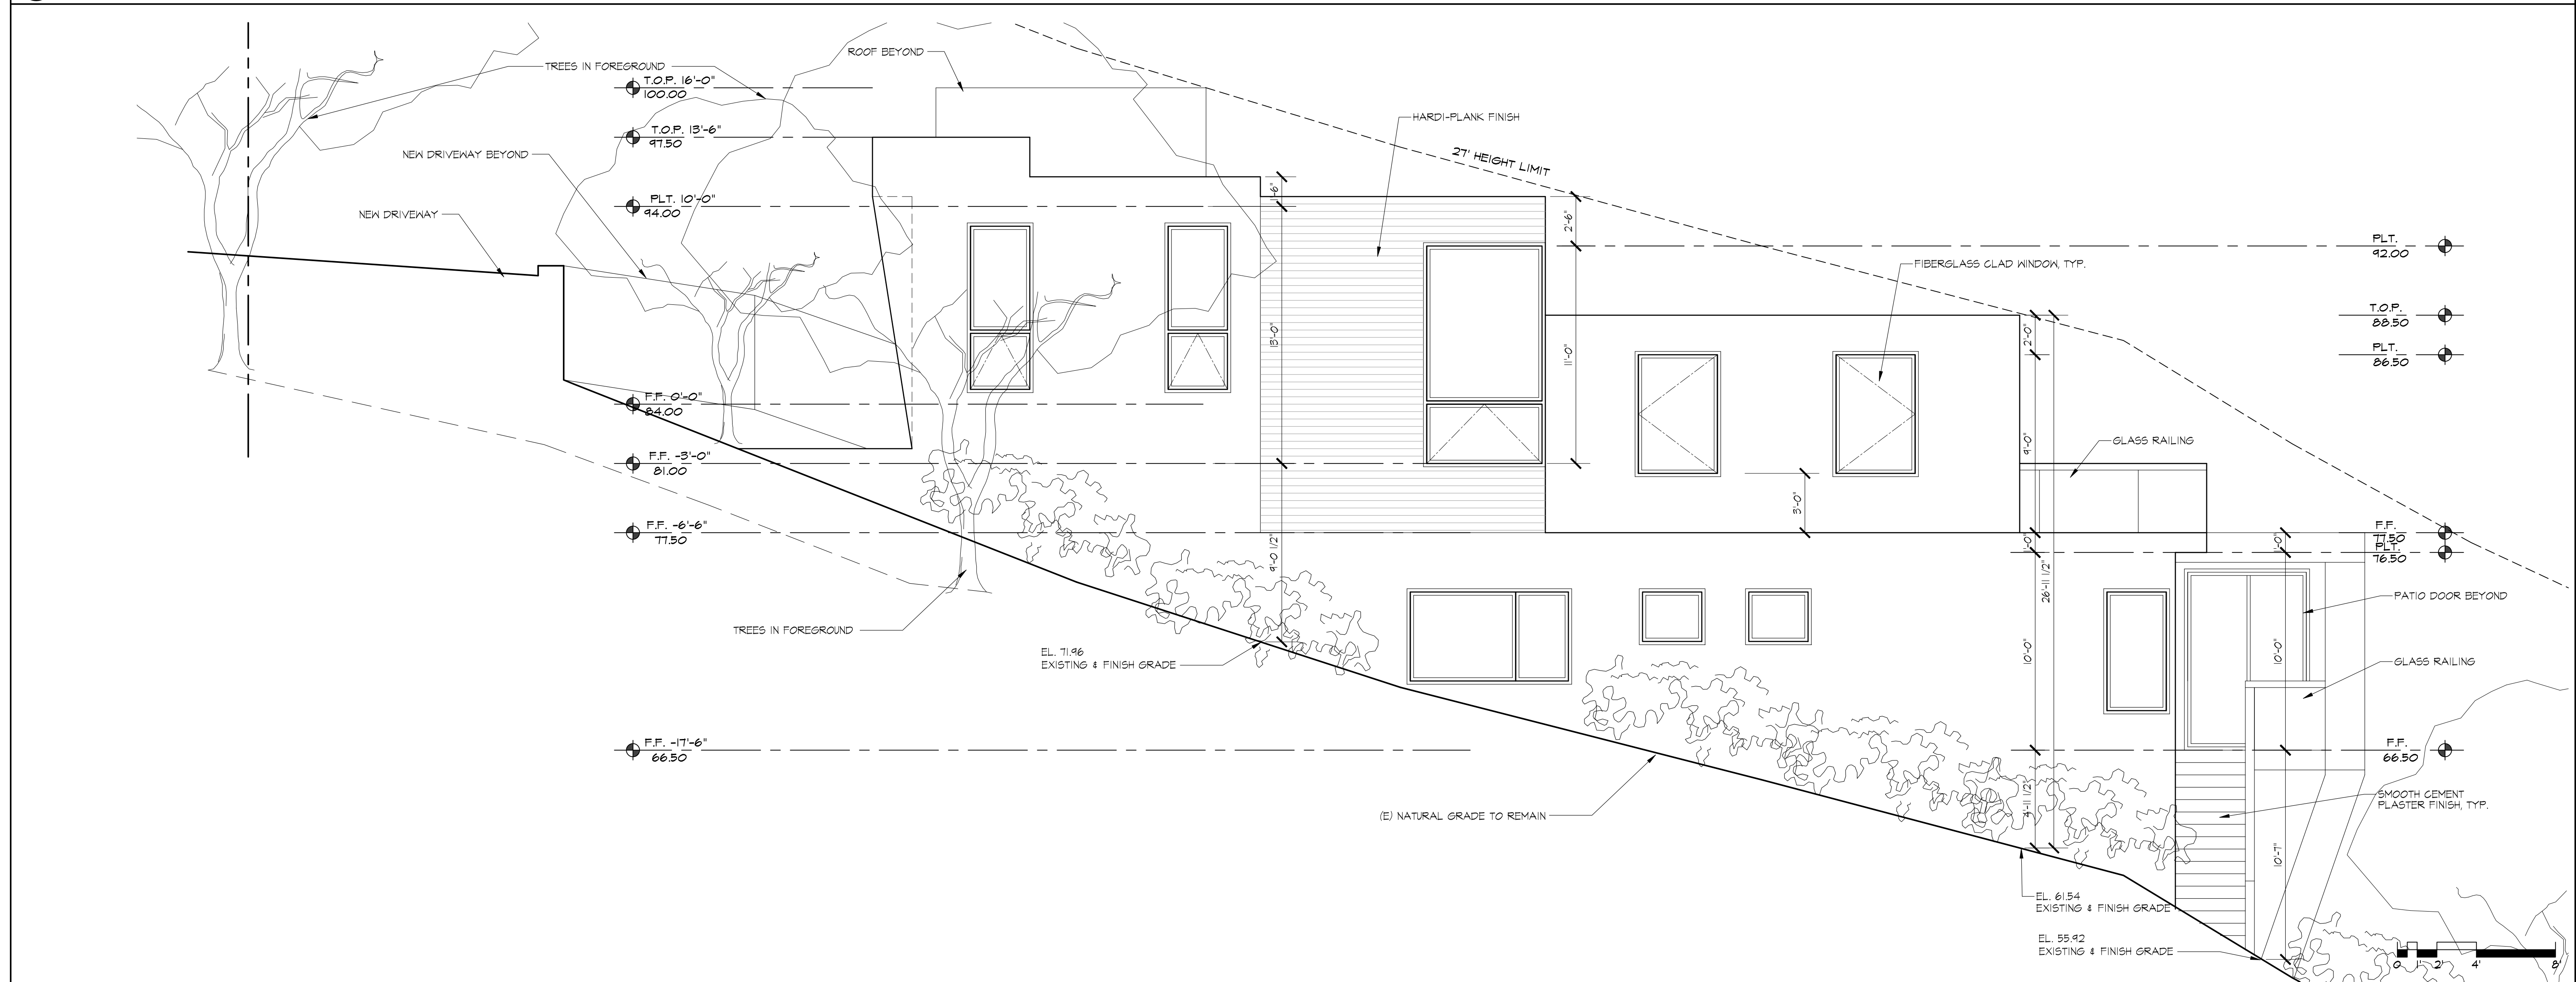

② PROPOSED RIGHT SIDE ELEVATION (EAST)

1/4" = 1'-0"

REVISIONS


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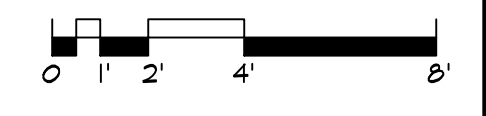
PROPOSED EXTERIOR ELEVATIONS

DATE: MAY 16, 2022
 SCALE:
 DRAWN:
 AP# 336-03-030
 SHEET

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 OF SHEETS



1 PROPOSED LEFT SIDE ELEVATION (WEST)

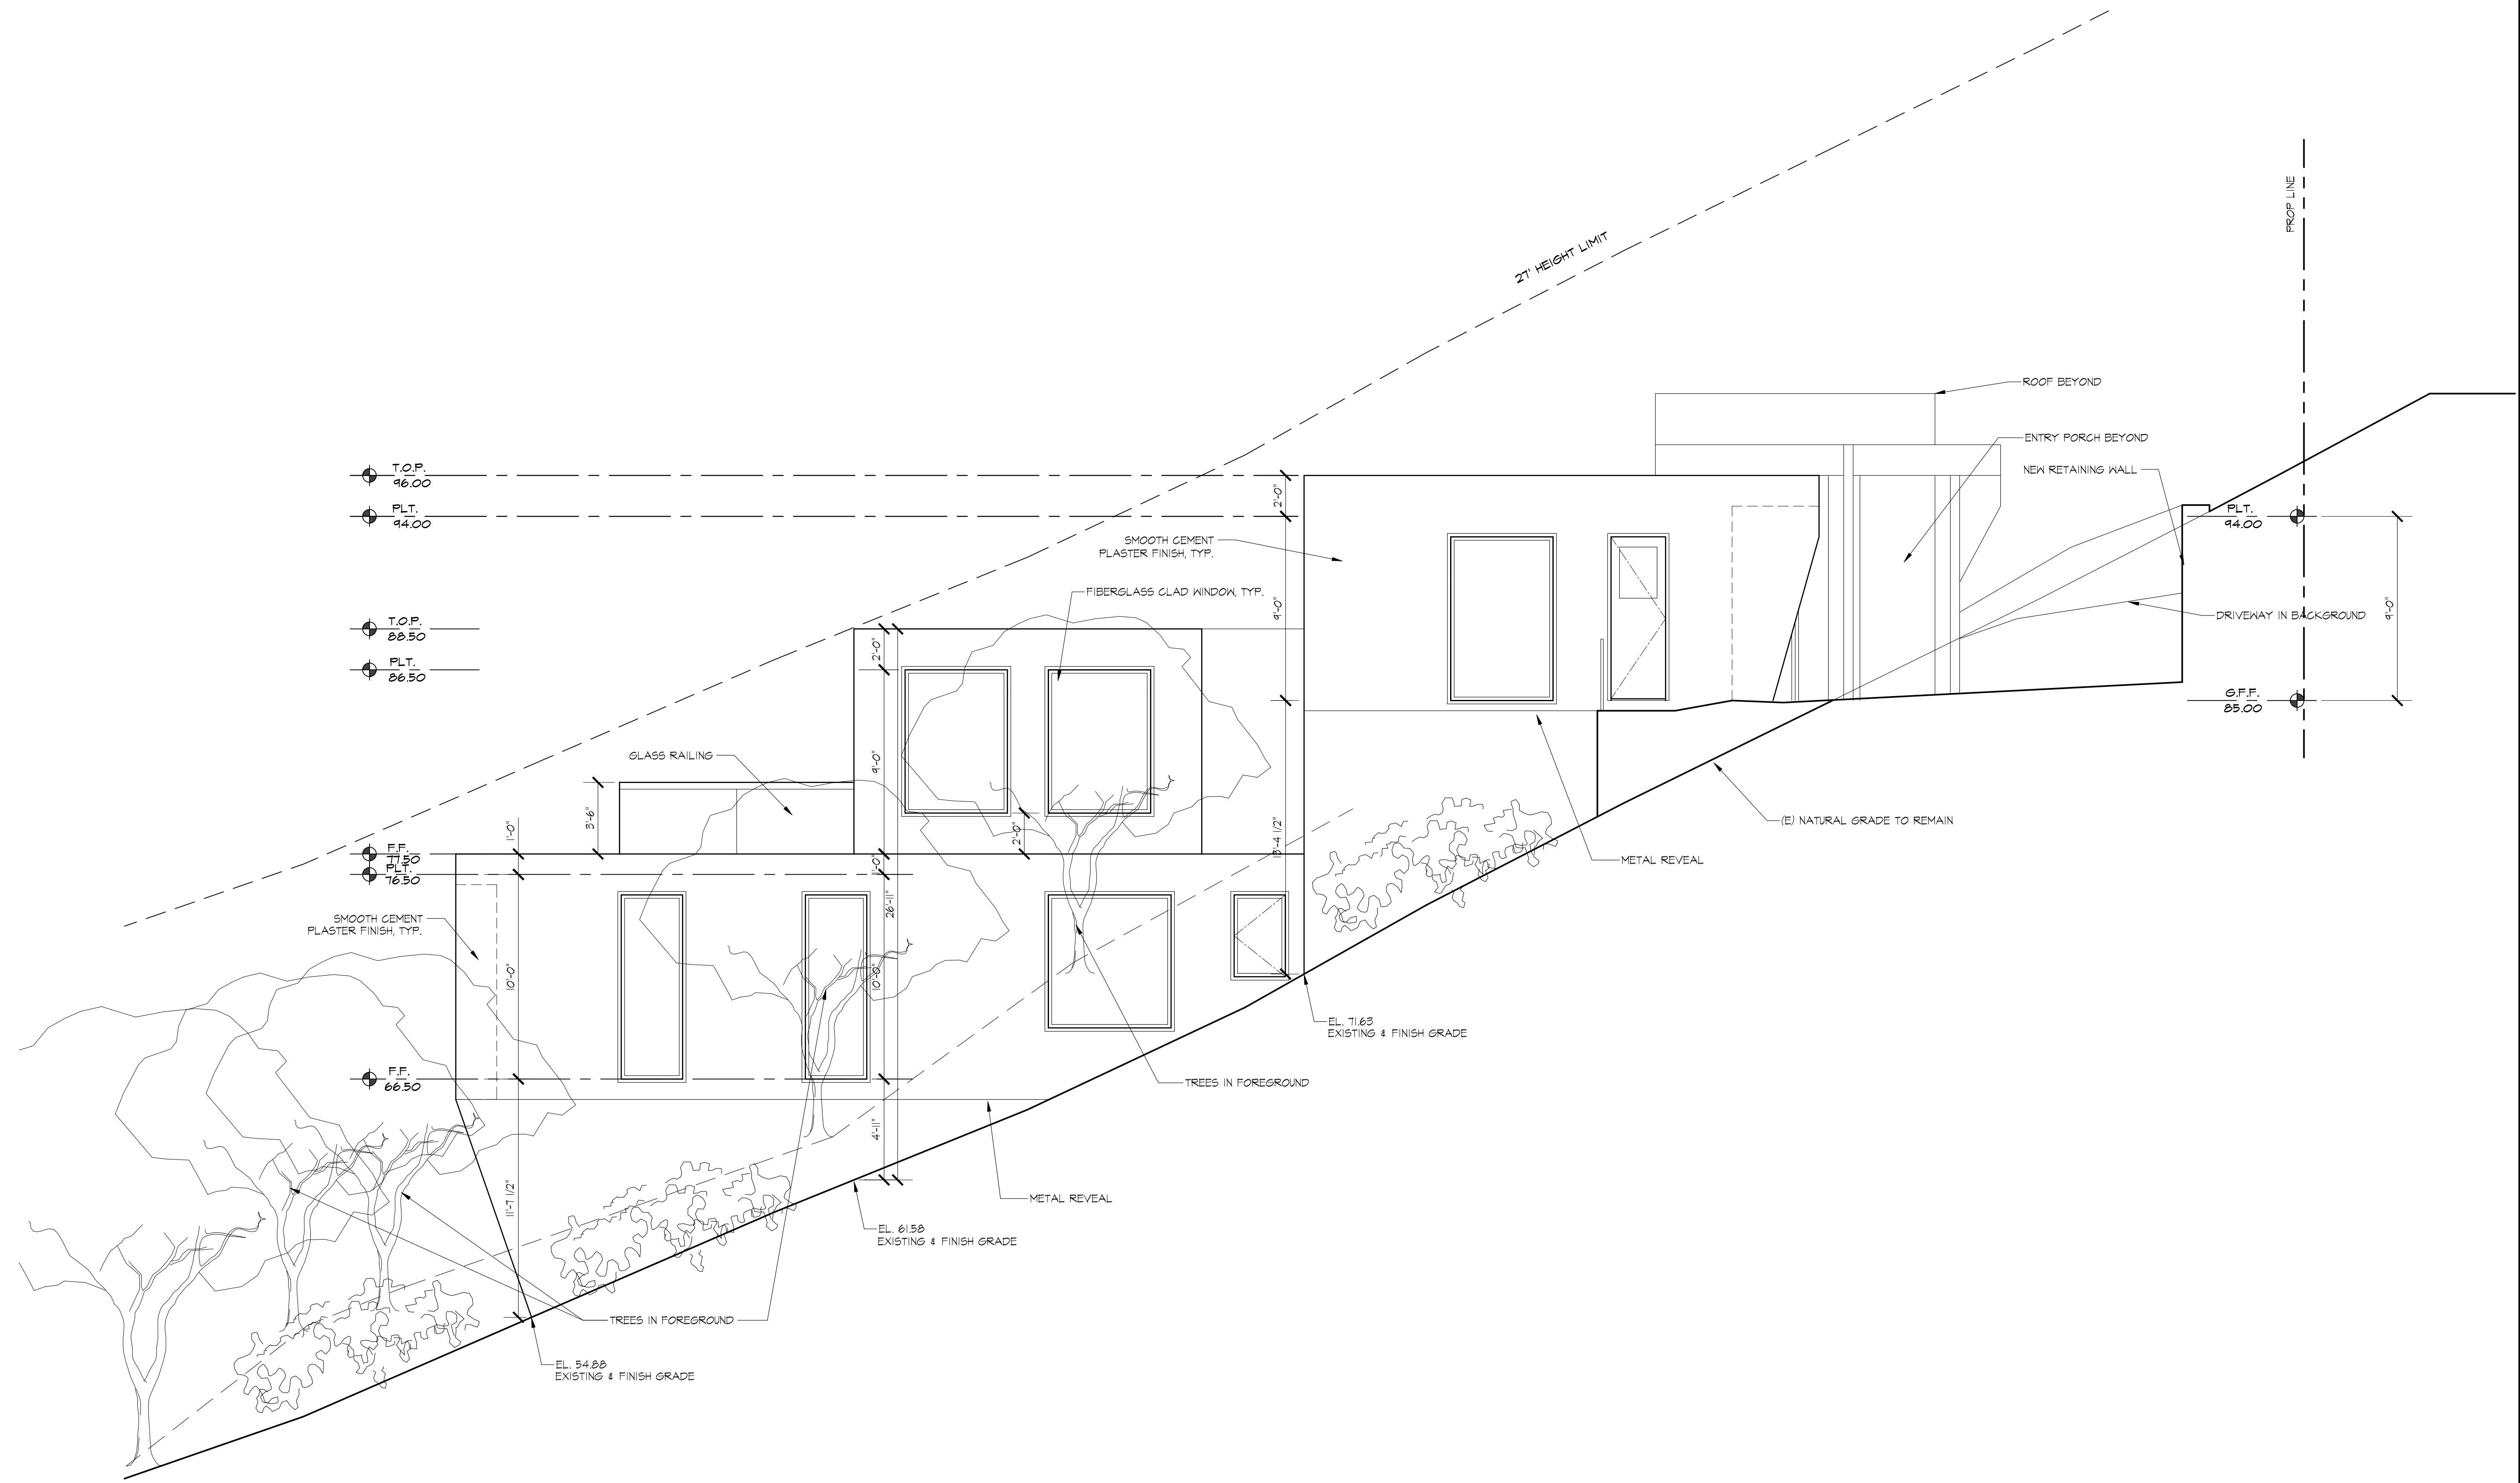

REVISIONS

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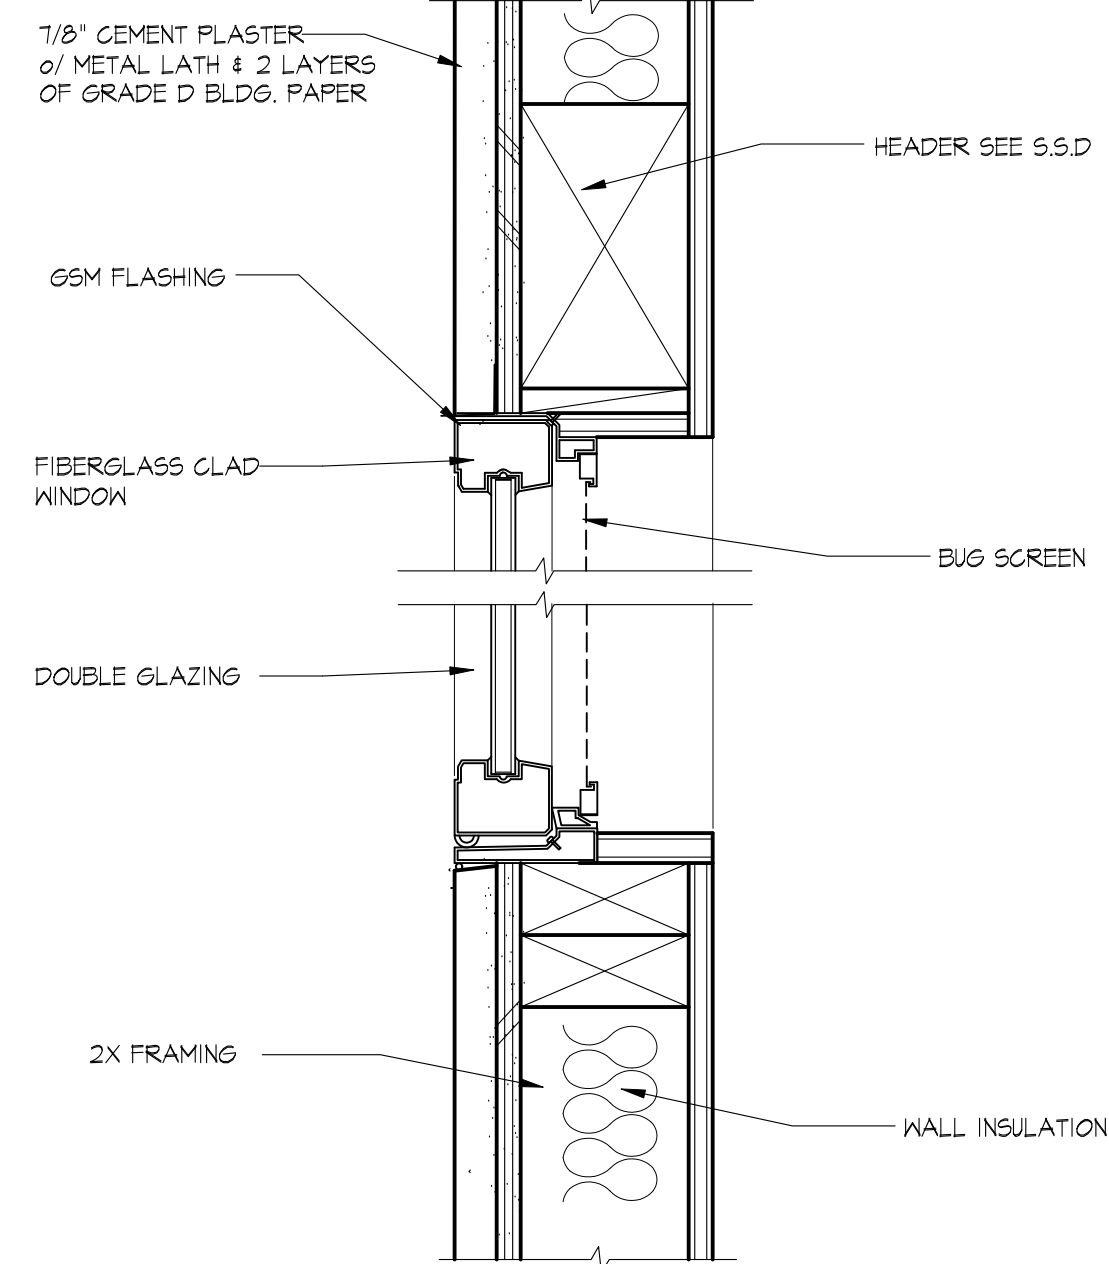
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PROPOSED EXTERIOR ELEVATION

DATE MAY 16, 2022
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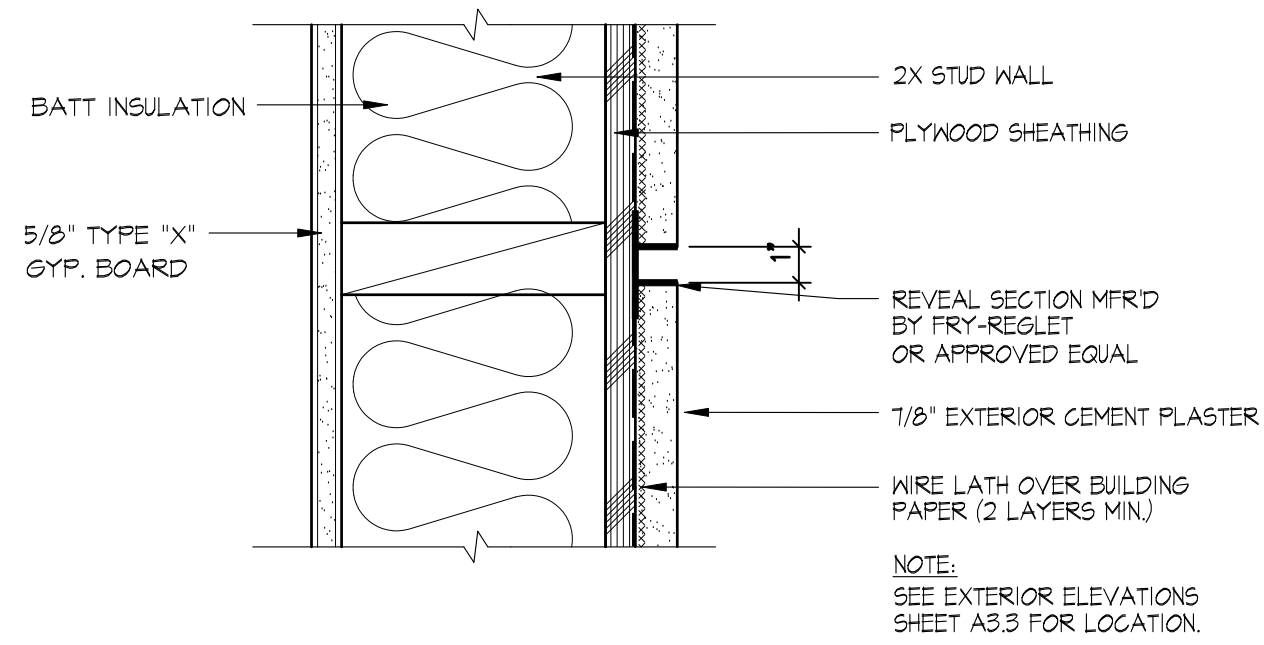
A8
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1/4" = 1'-0"



② TYPICAL WINDOW DETAIL

3" = 1'-0"




③ STUCCO REVEAL DETAIL


3" = 1'-0"



④ GLASS RAILING

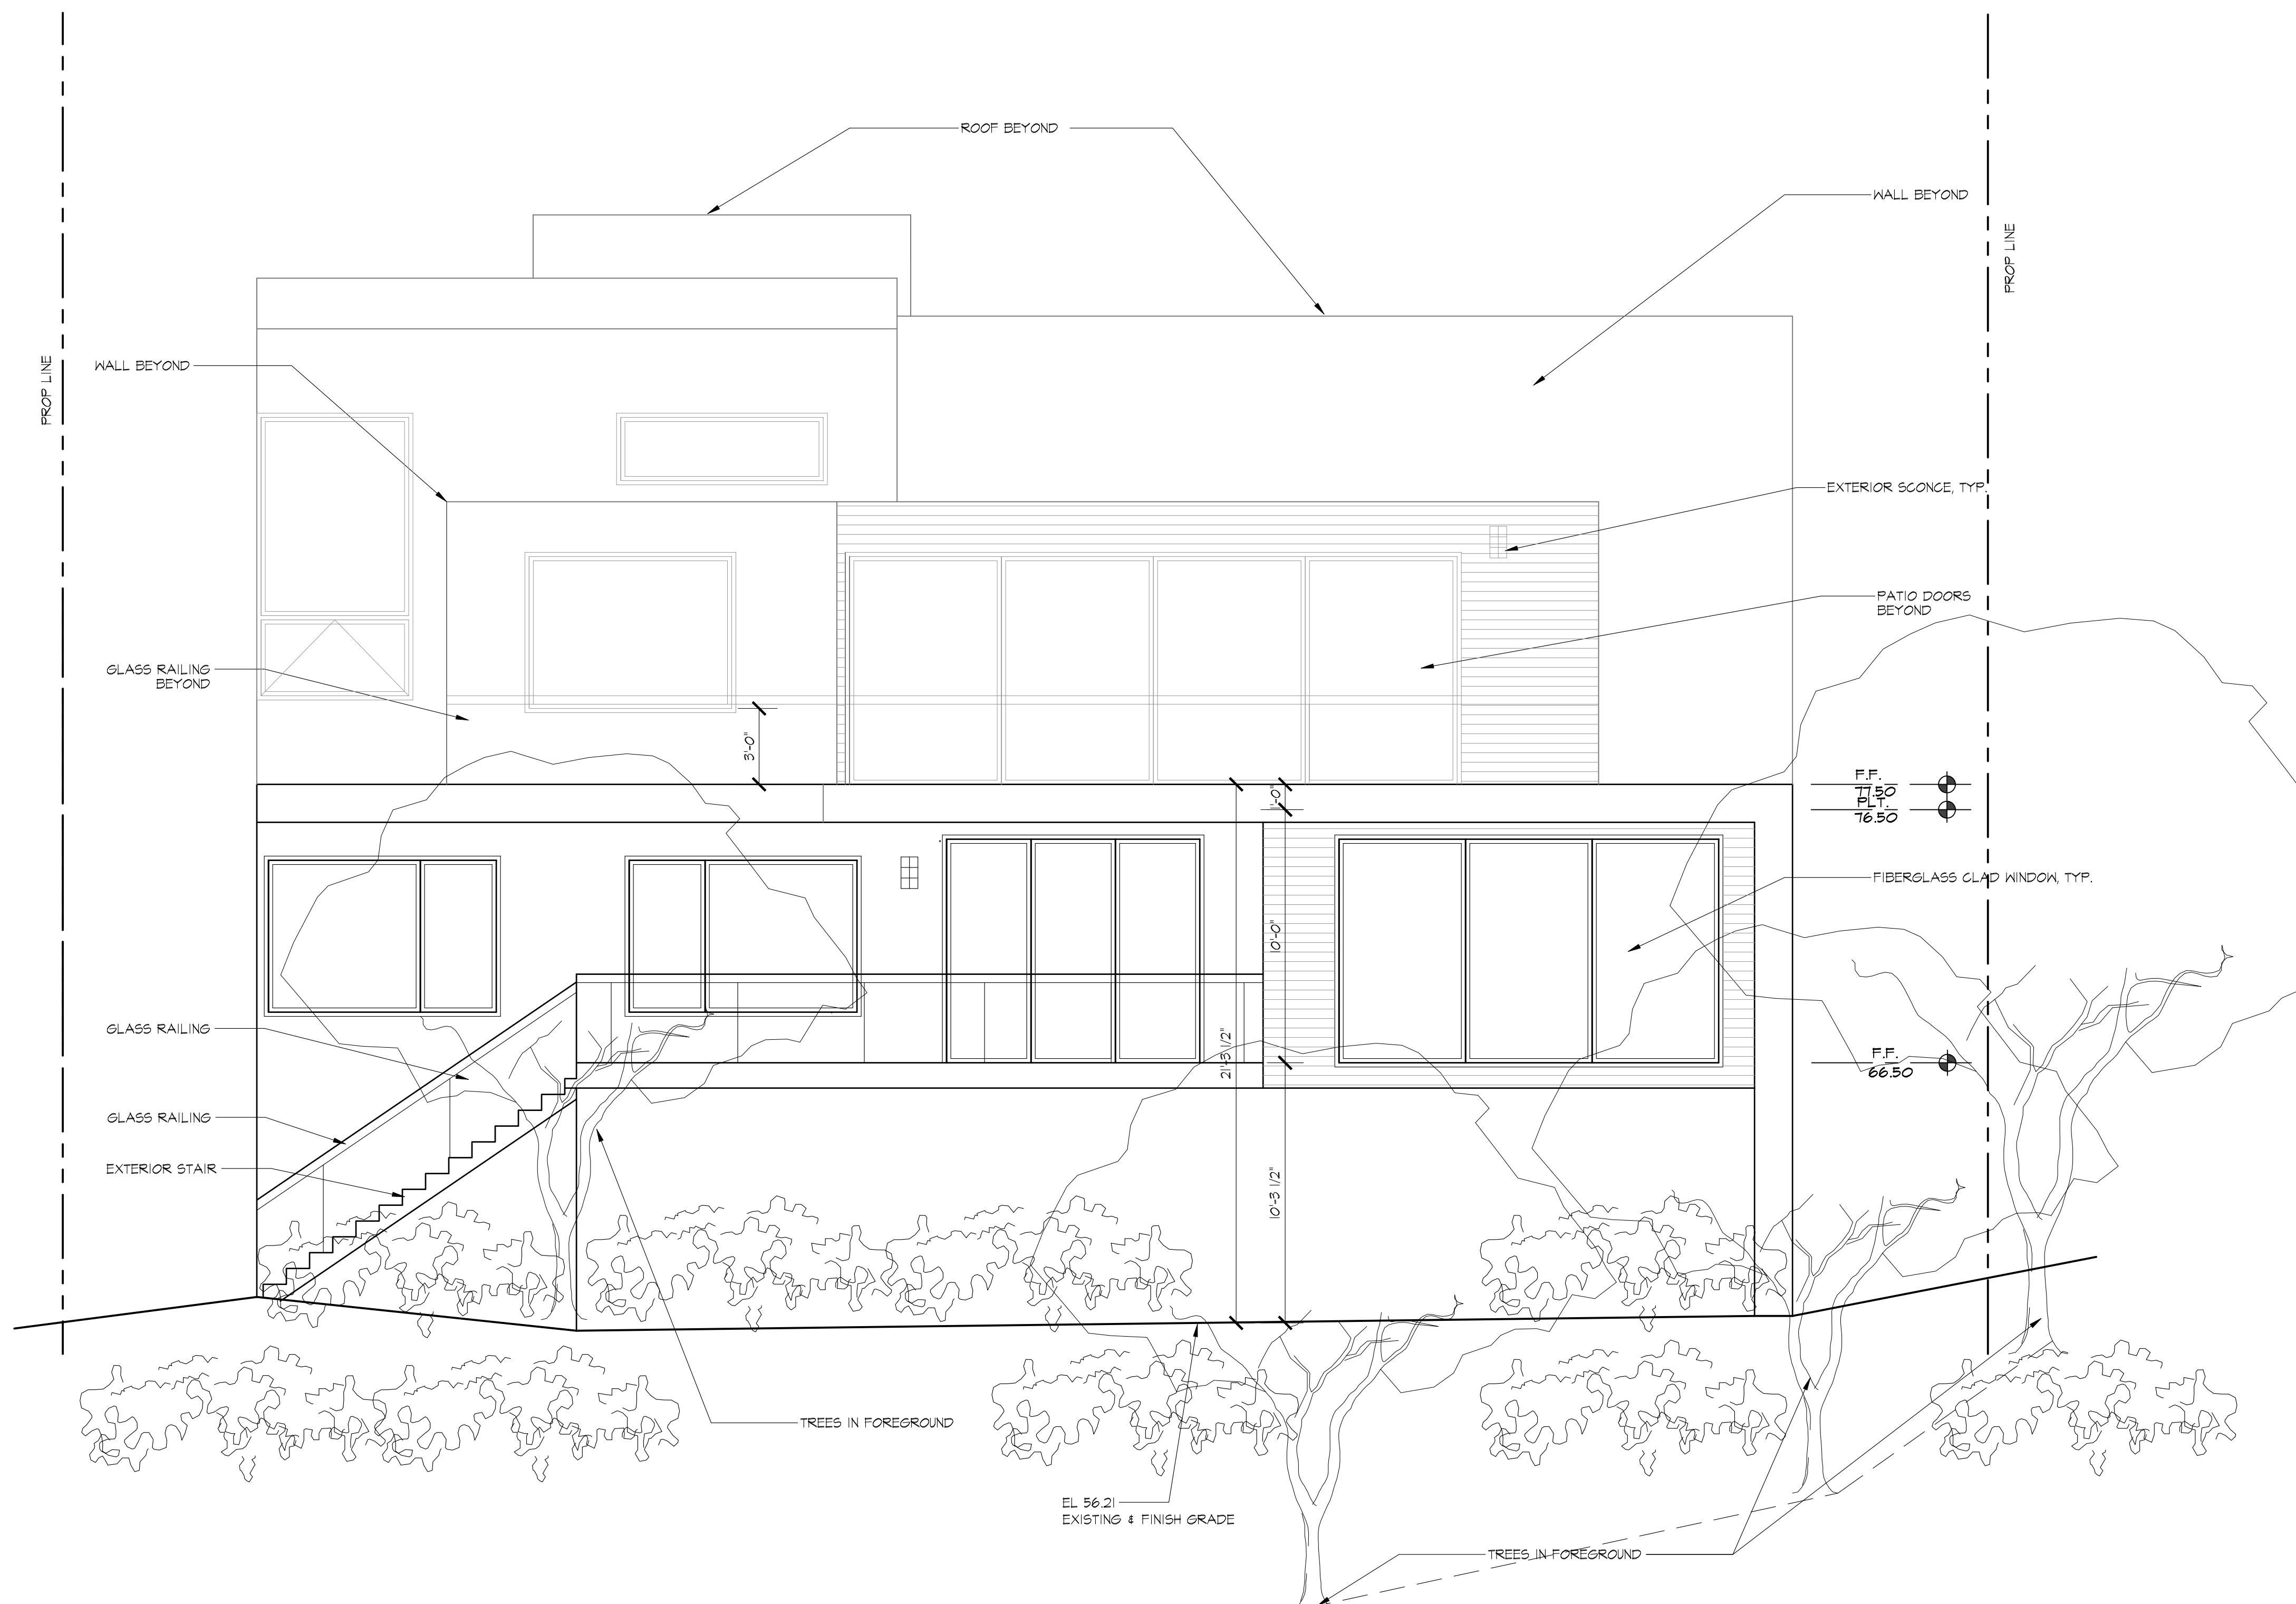

① PROPOSED REAR ELEVATION (NORTH)

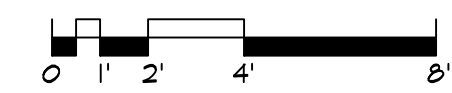

1/4" = 1'-0"

REVISIONS


CIBOTTI ENGINEERING
12935 ALCOSTA BLVD #2025
SAN RAMON, CA 94583
BUS: (925) 829-0920
EMAIL: SCOTT@CIBOTTI.COM

**IQBAL RESIDENCE
NEW SINGLE FAMILY HOUSE & ADU**
899 MADONNA WAY
LOS ALTOS, CA 94024

PROPOSED EXTERIOR ELEVATION

DATE MAY 16, 2022
SCALE
DRAWN
AP# 336-03-030
SHEET

A9
OF SHEETS

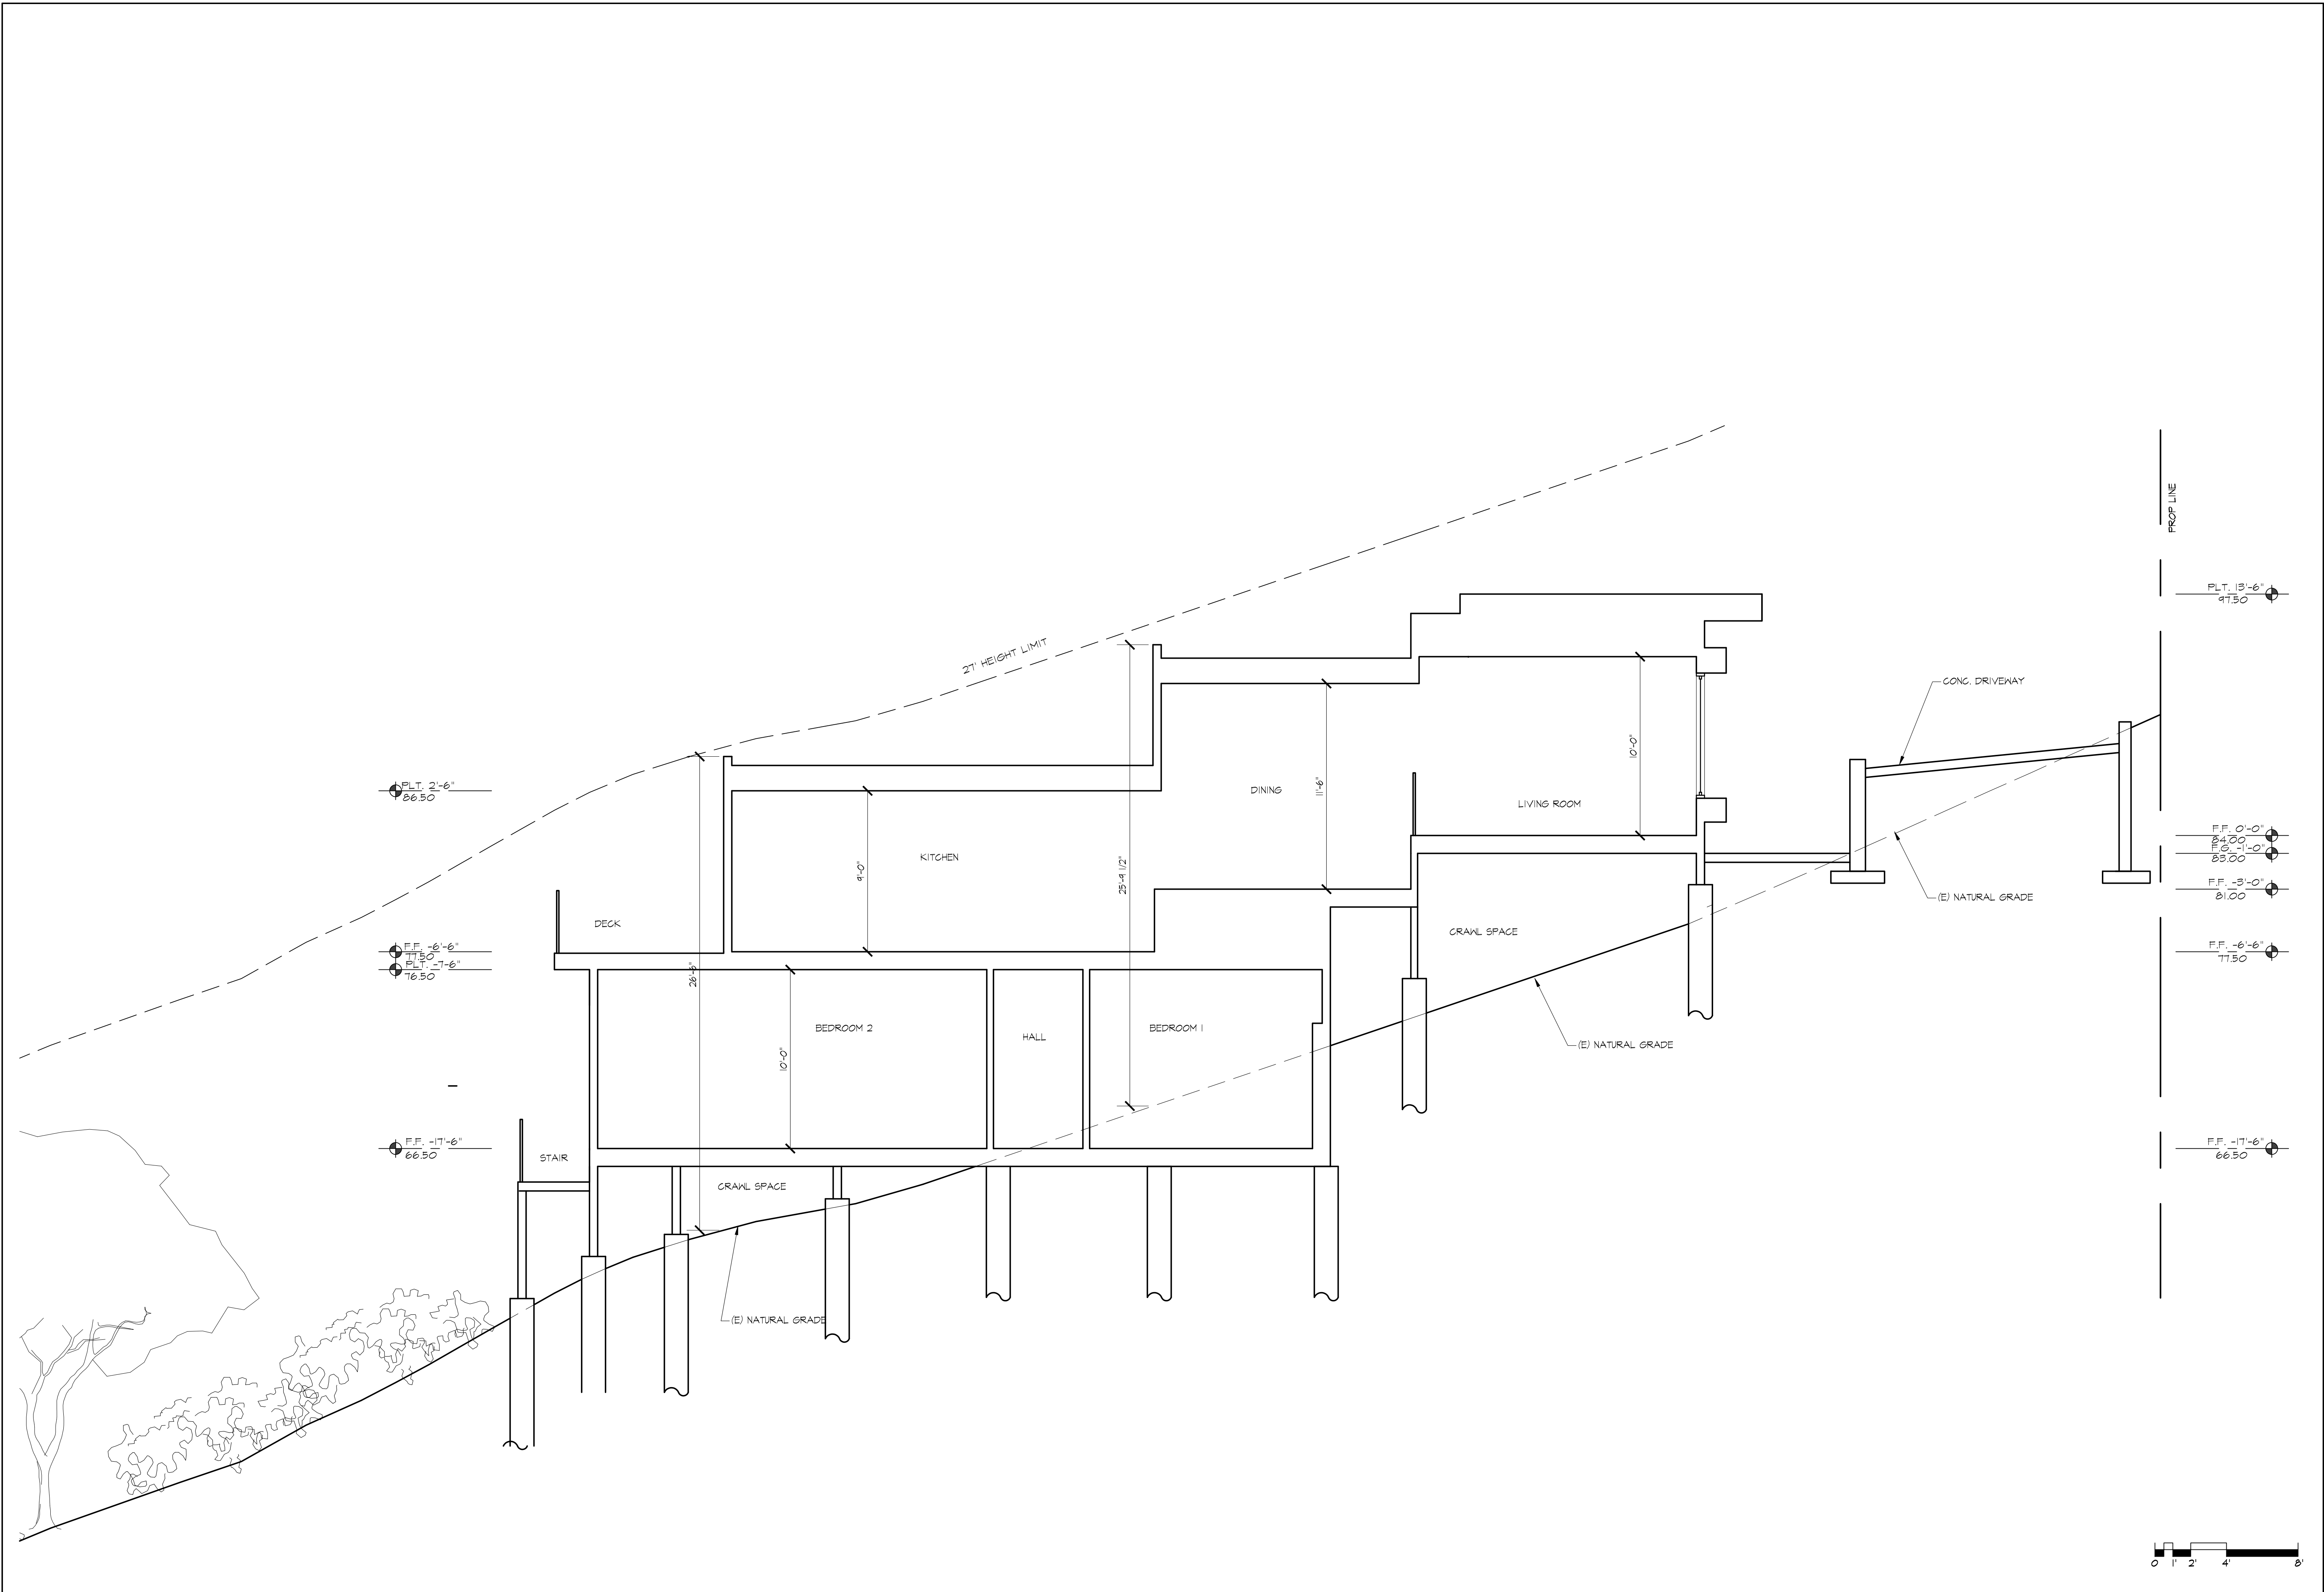

REVISIONS

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 12935 ALCOSTA BLVD #2025
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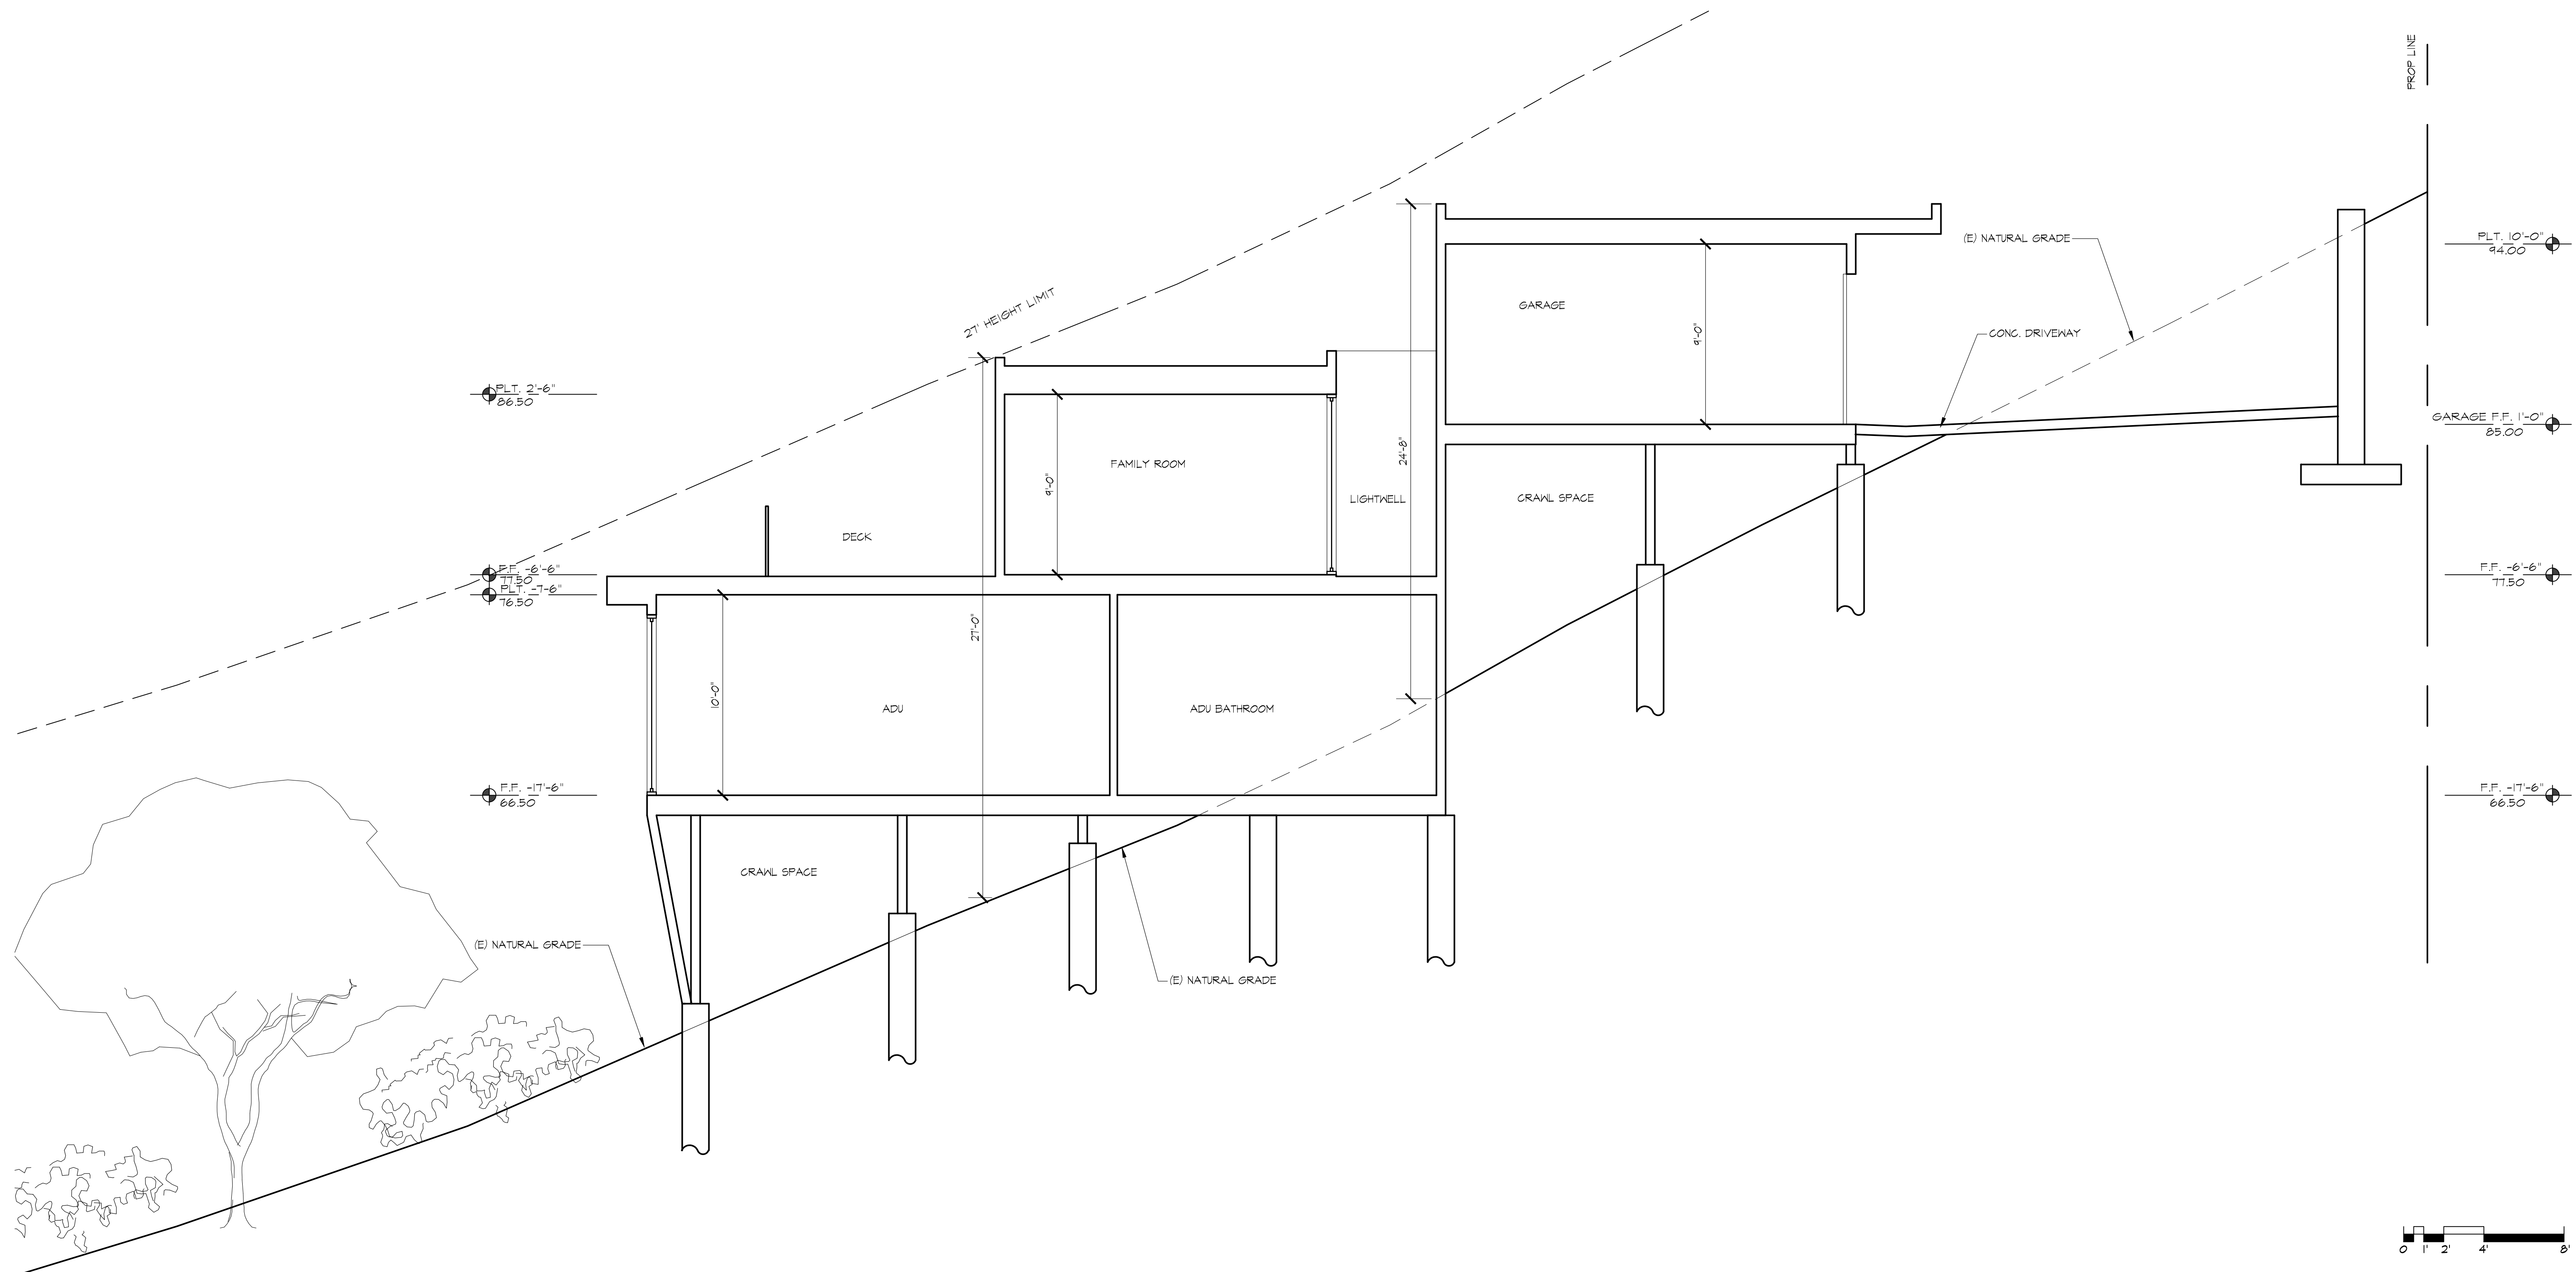
IQBAL RESIDENCE
 NEW SINGLE FAMILY HOUSE & ADU
 899 MADONNA WAY
 LOS ALTOS, CA 94024

BUILDING SECTION

DATE	MAY 16, 2022
SCALE	
DRAWN	
AP#	336-03-030
SHEET	A10

Ⓛ BUILDING SECTION

1/4" = 1'-0"



1 BUILDING SECTION

1/4" = 1'-0"

REVISIONS	


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BUILDING SECTION


DATE MAY 16, 2022
 SCALE
 DRAWN
 APN# 336-03-030
 SHEET

A11
 OF SHEETS



① BUILDING SECTION

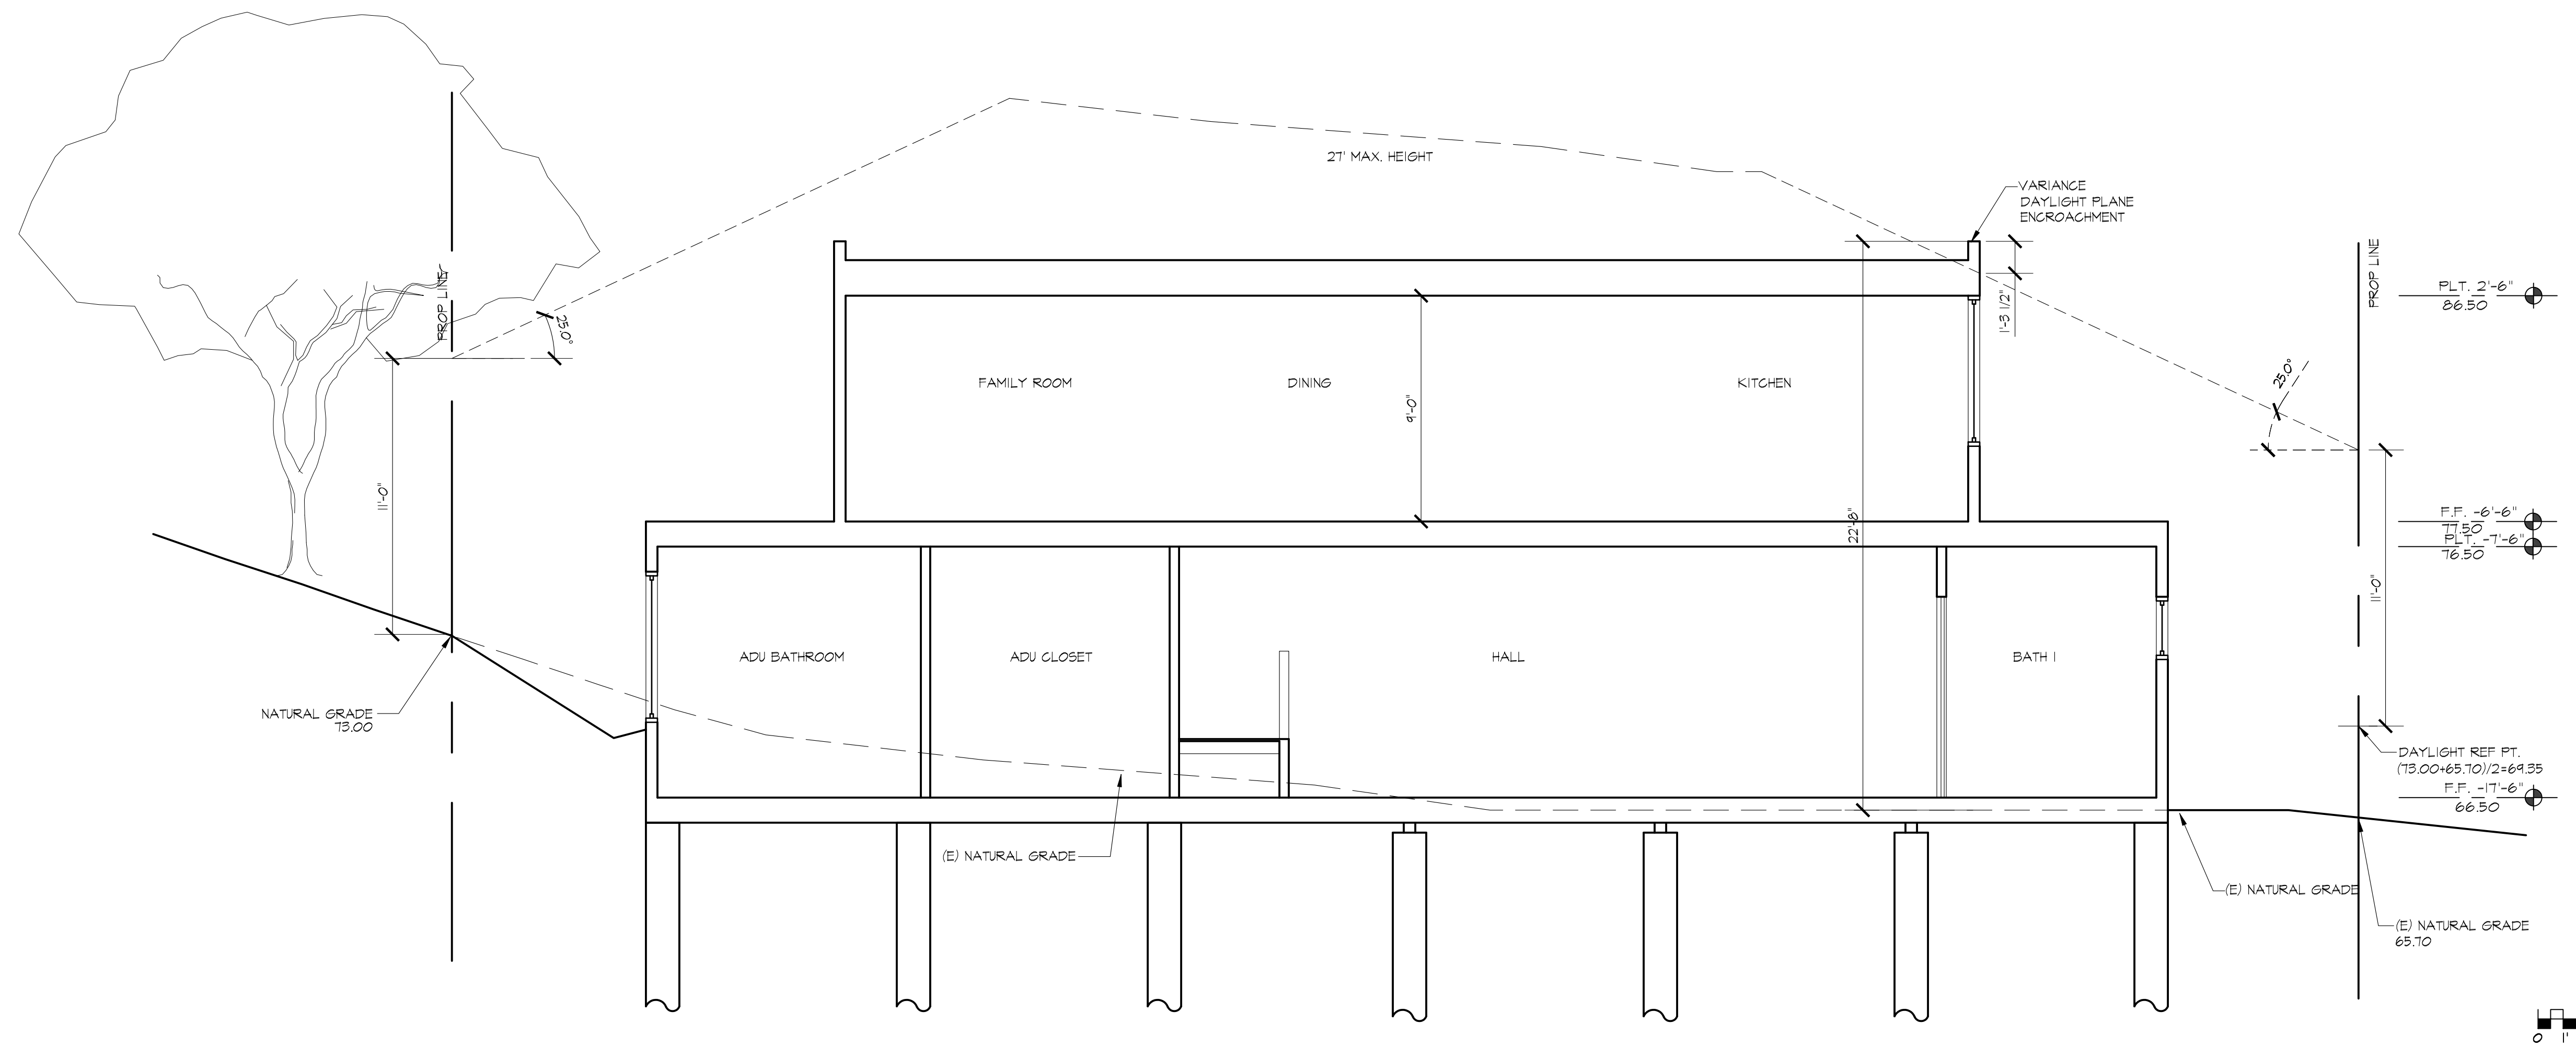1/4" = 1'-0"

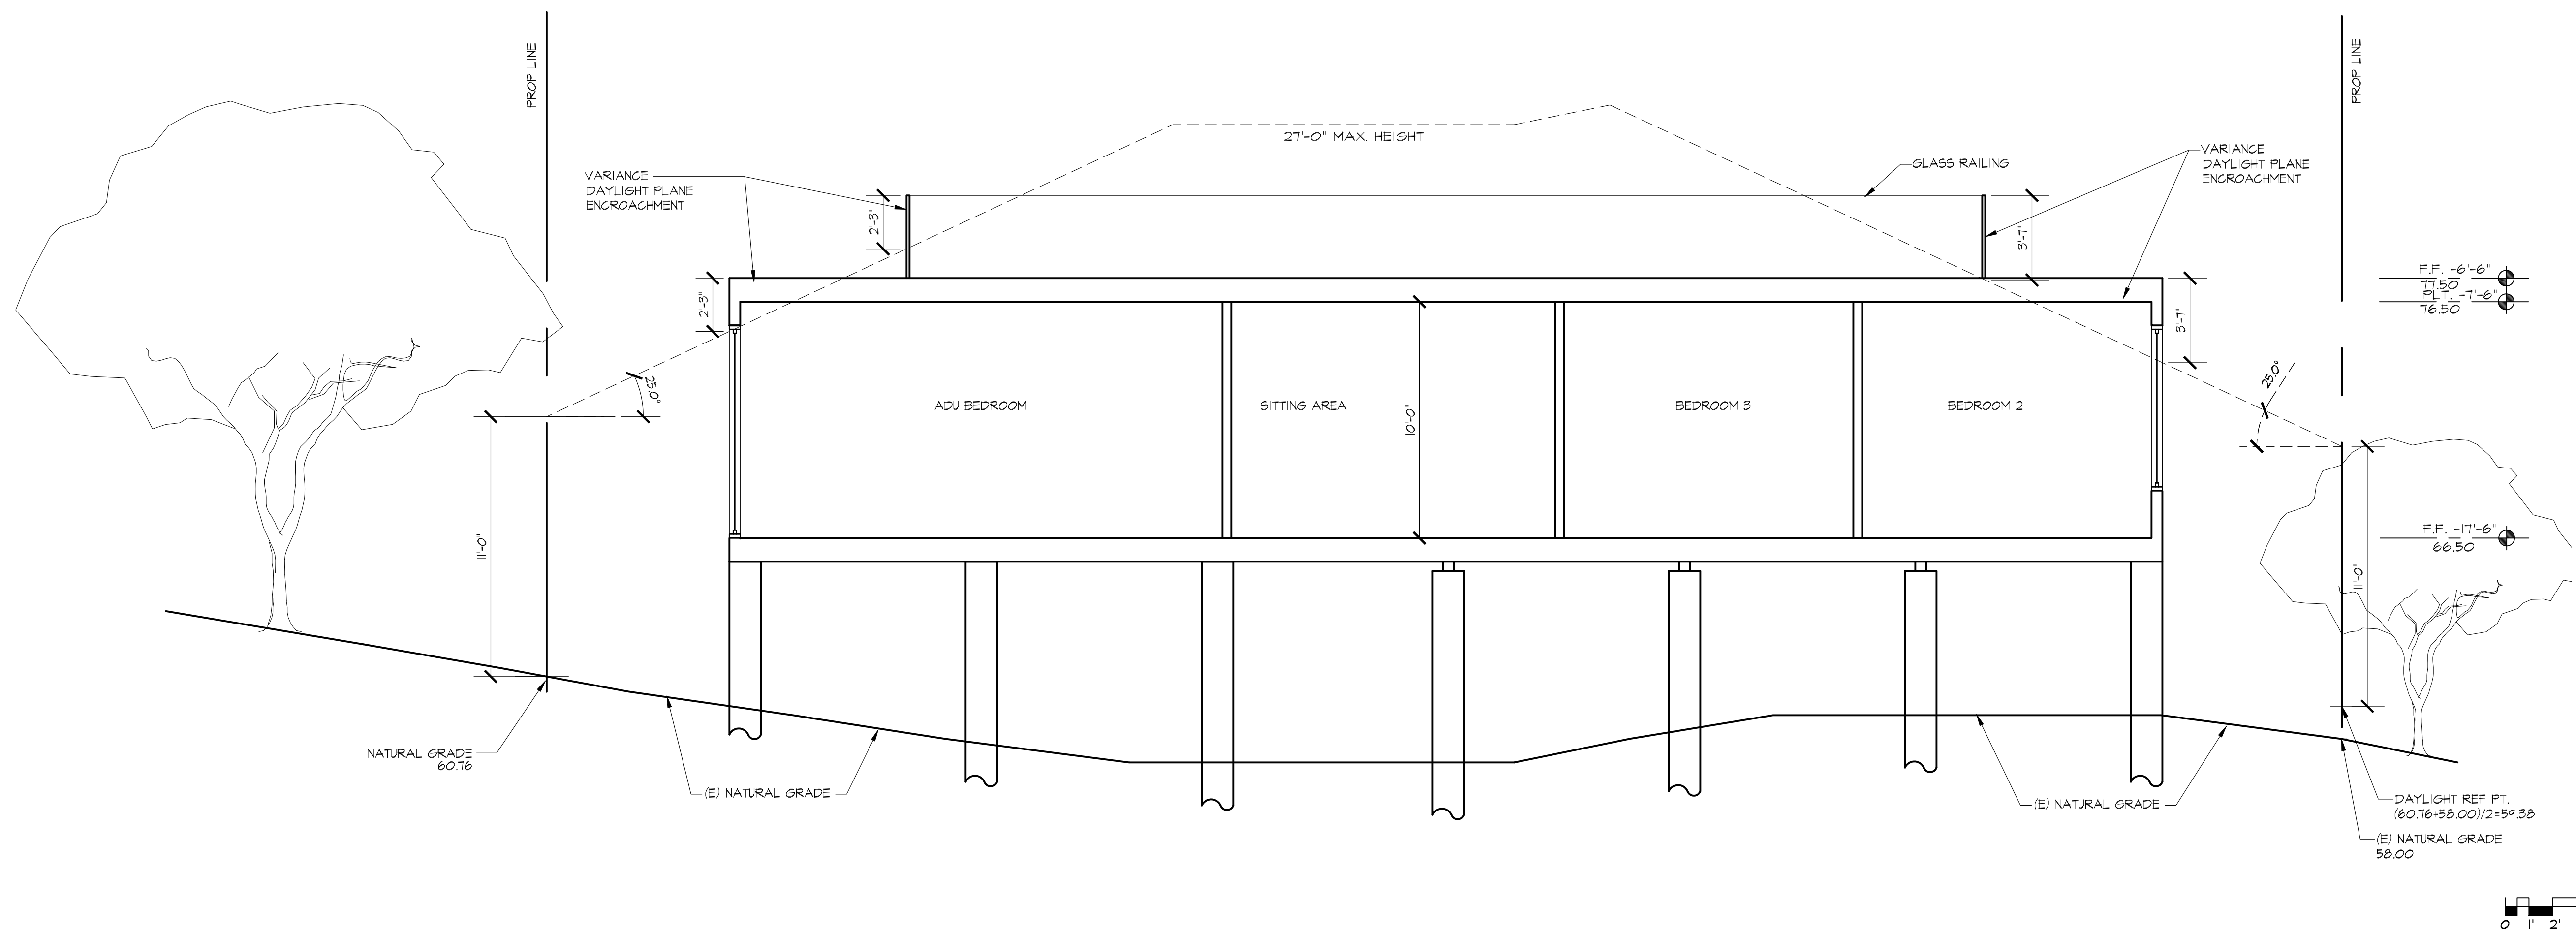

② BUILDING SECTION

1/4" = 1'-0"

REVISIONS


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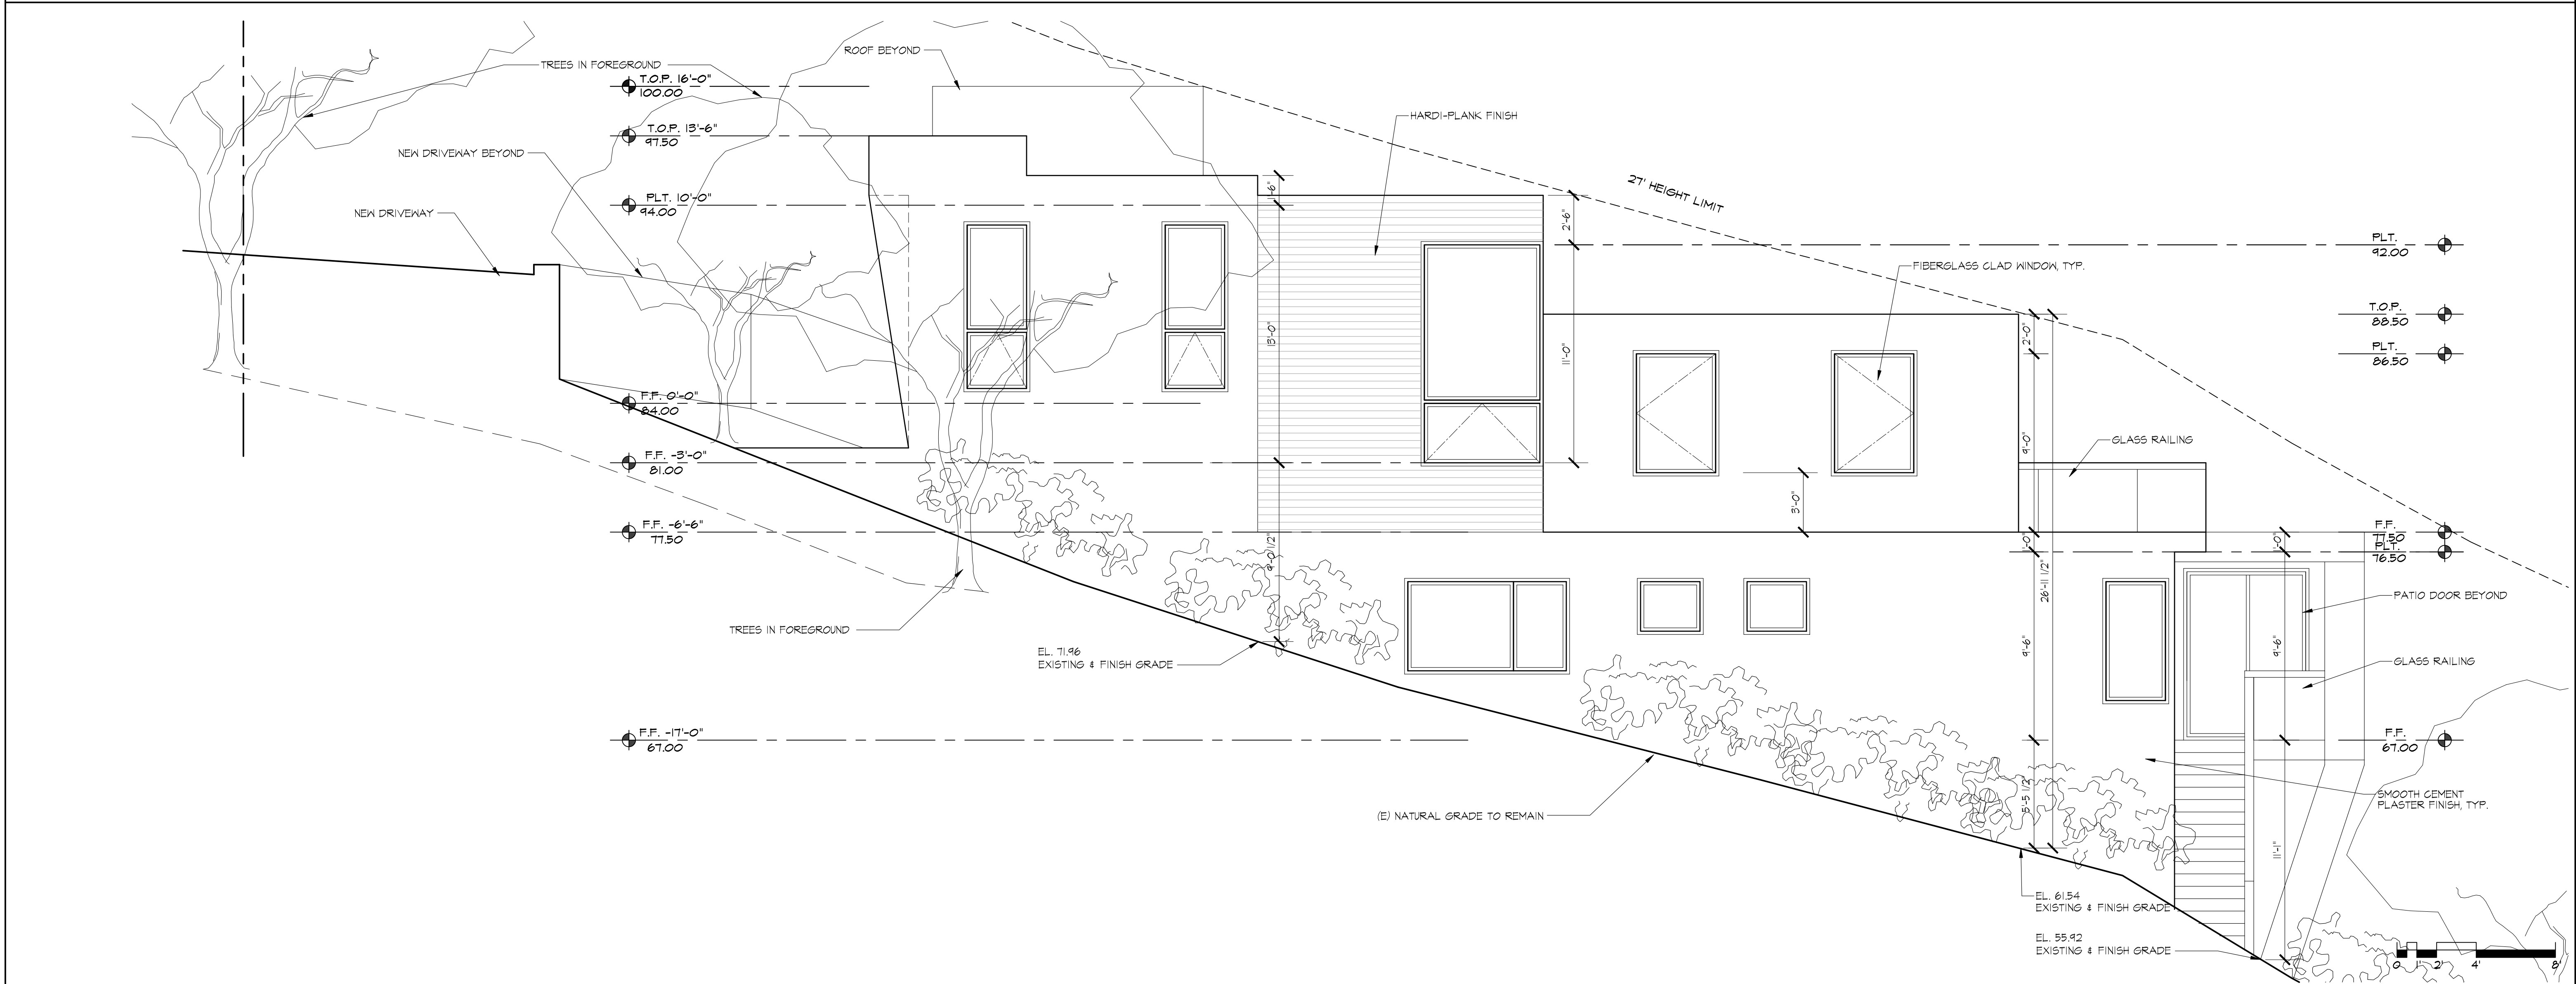
BUILDING SECTIONS

DATE MAY 16, 2022
 SCALE
 DRAWN
 APN# 336-03-030
 SHEET

A12
 OF SHEETS



1 PROPOSED STREET ELEVATION (SOUTH) 1/4" = 1'-0"

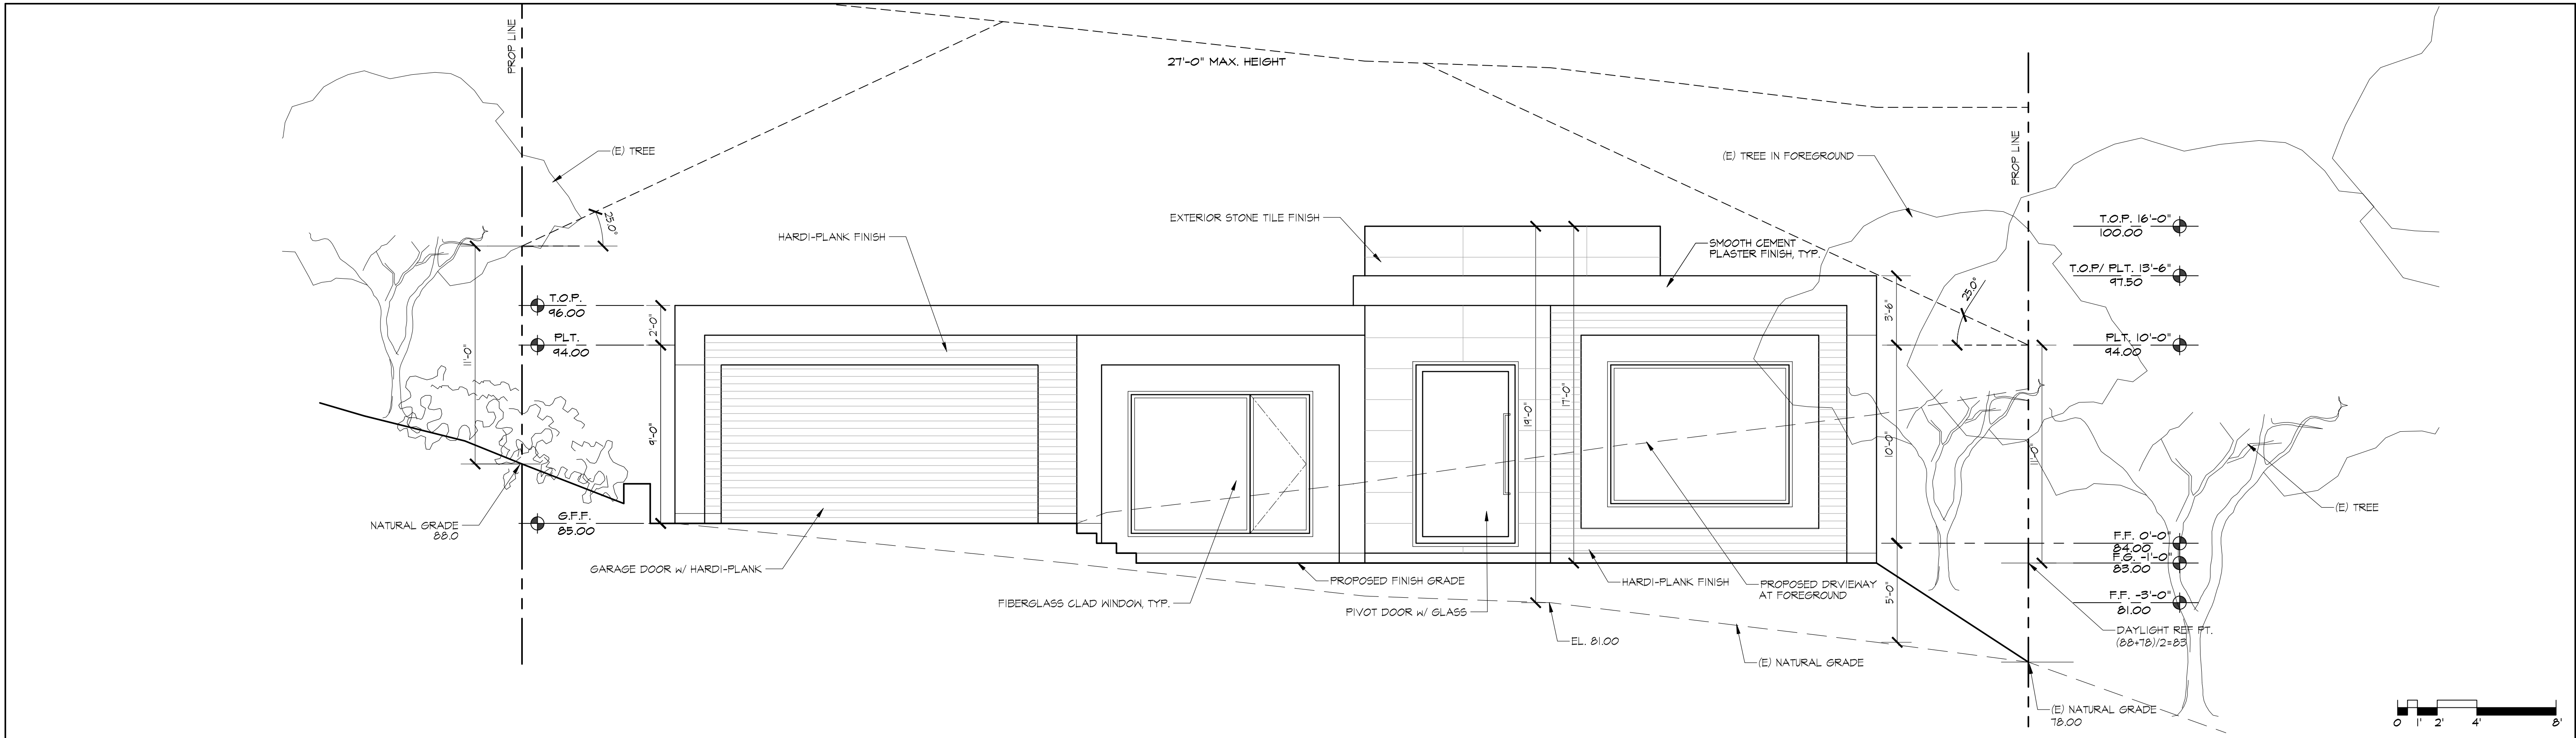

2 PROPOSED RIGHT SIDE ELEVATION (EAST) 1/4" = 1'-0"


REVISIONS

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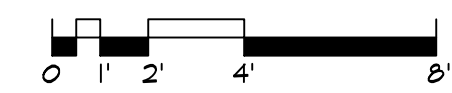
IQBAL RESIDENCE
NEW SINGLE FAMILY HOUSE & ADU
899 MADONNA WAY
LOS ALTOS, CA 94024

PROPOSED EXTERIOR ELEVATIONS

DATE	MAY 16, 2022
SCALE	
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APP#	336-03-030
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OF	

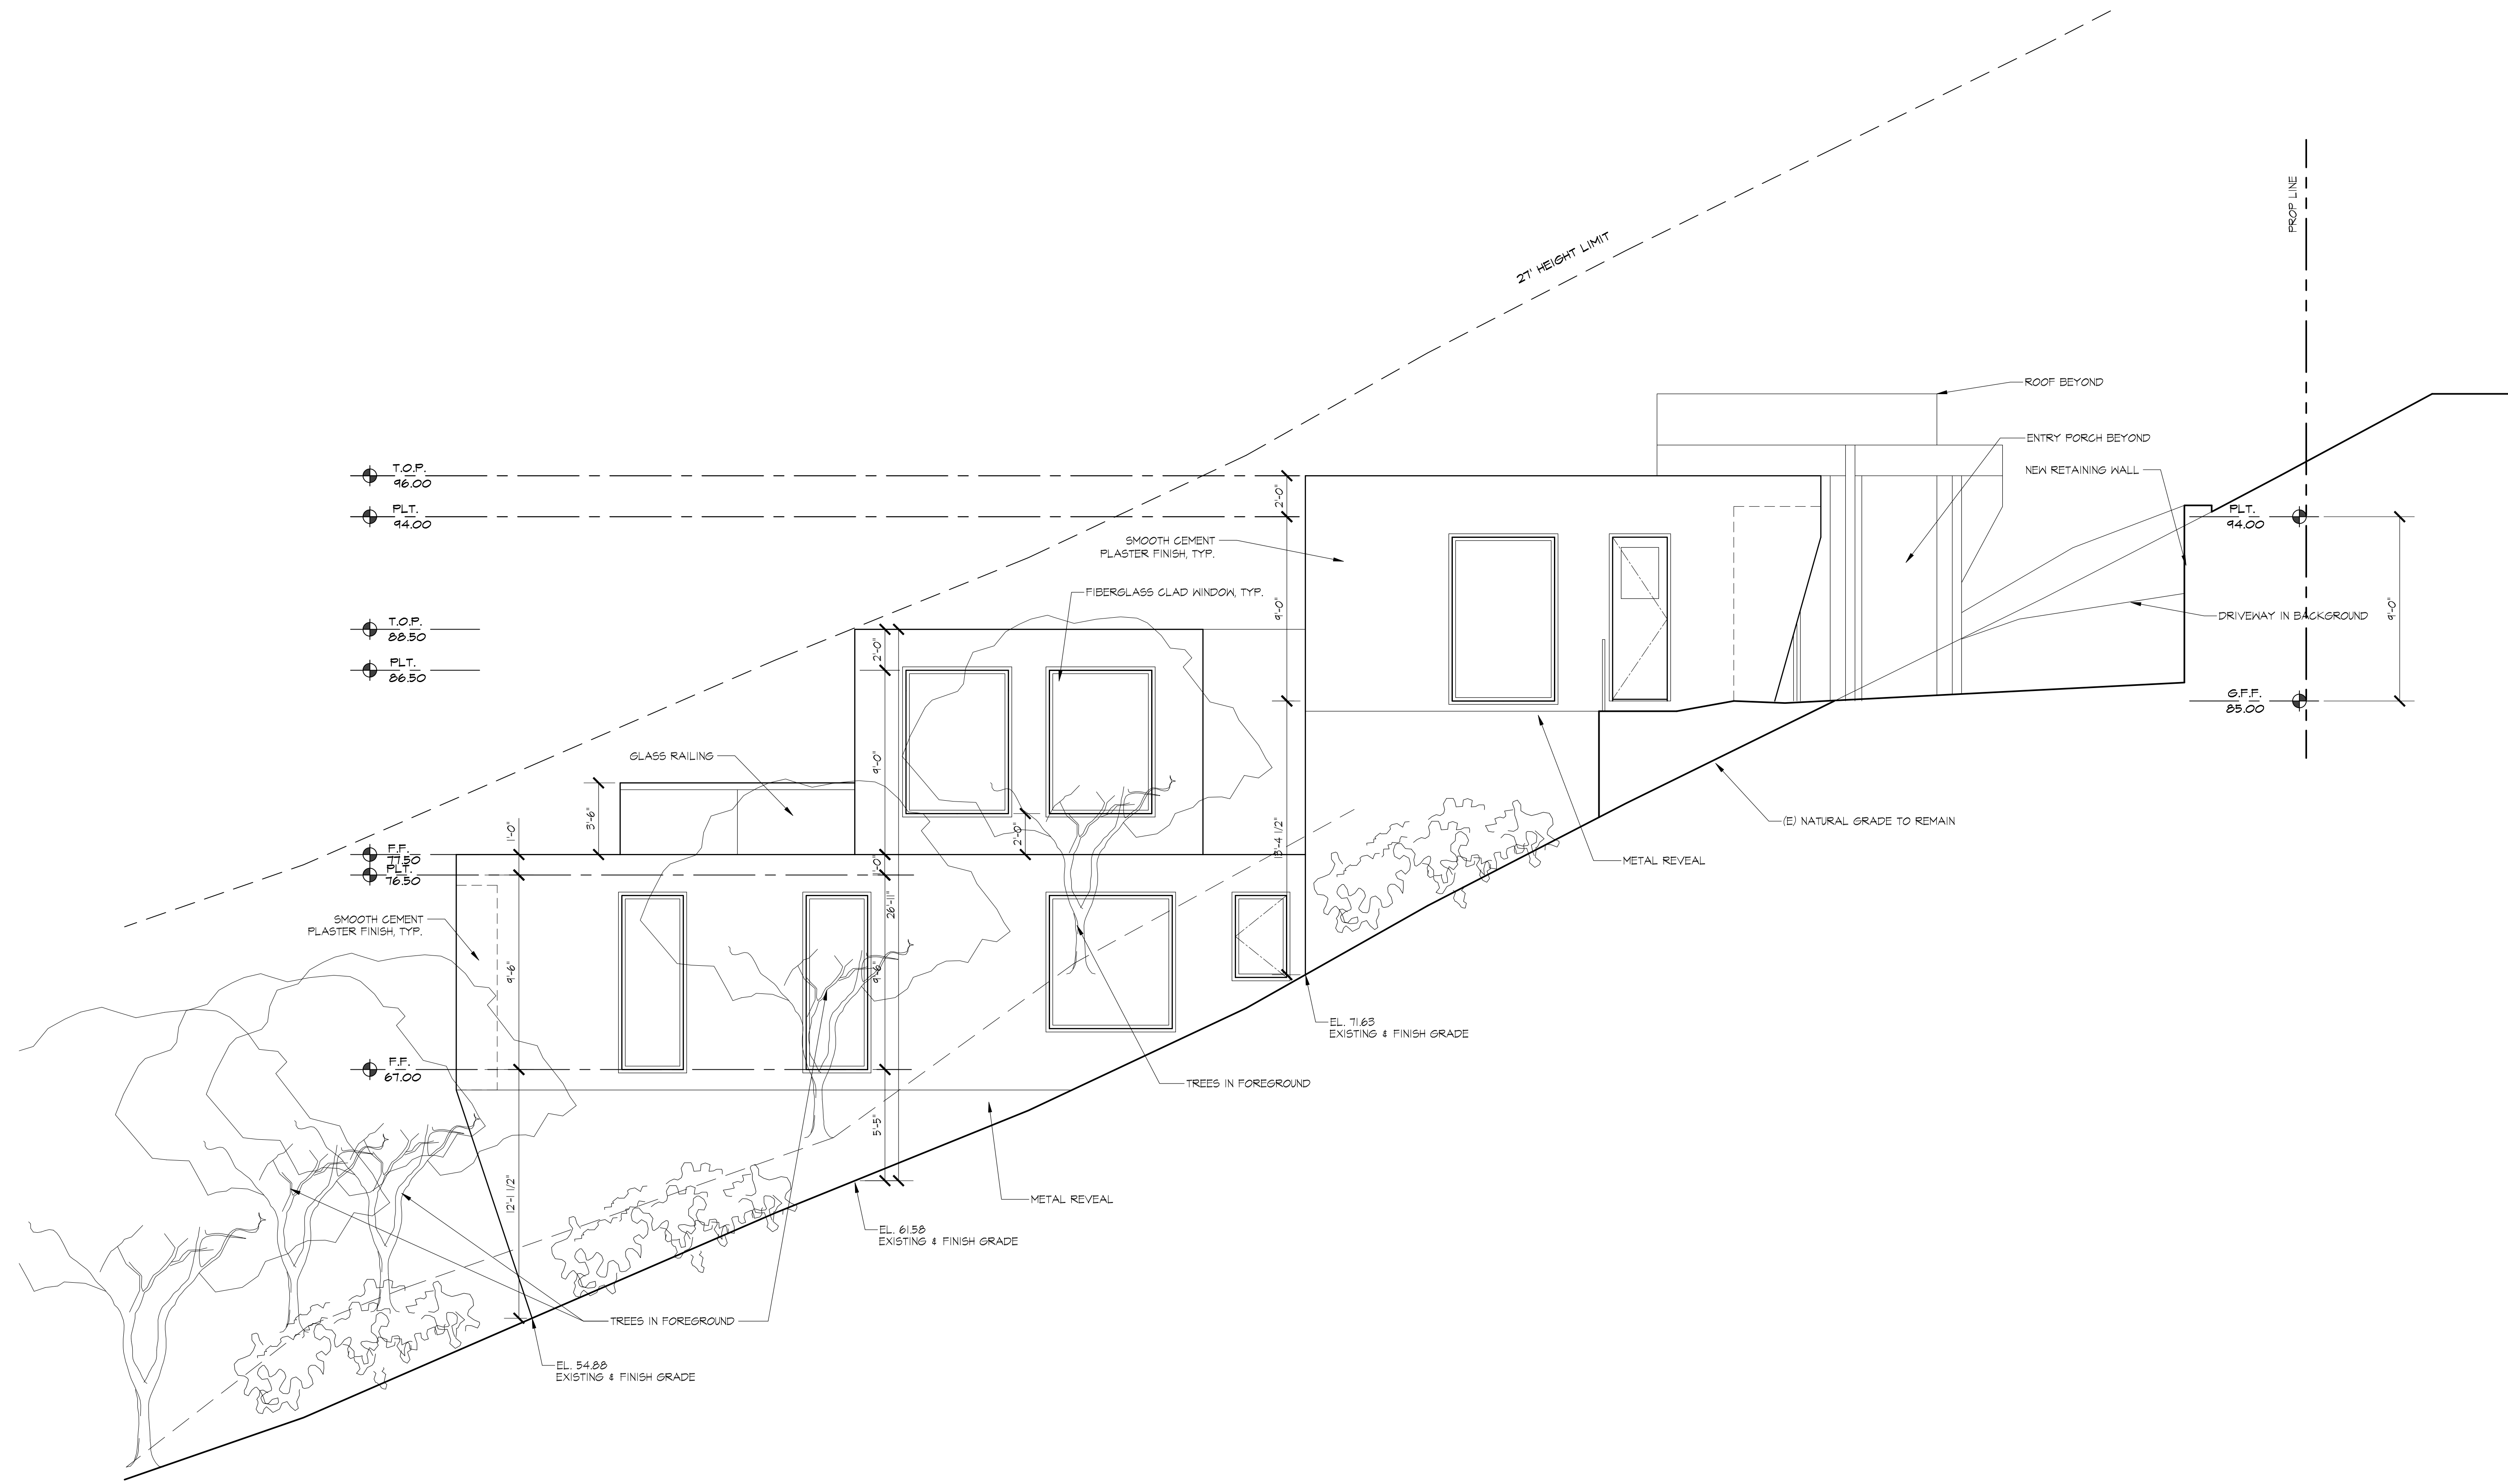

1 PROPOSED LEFT SIDE ELEVATION (WEST)



REVISIONS

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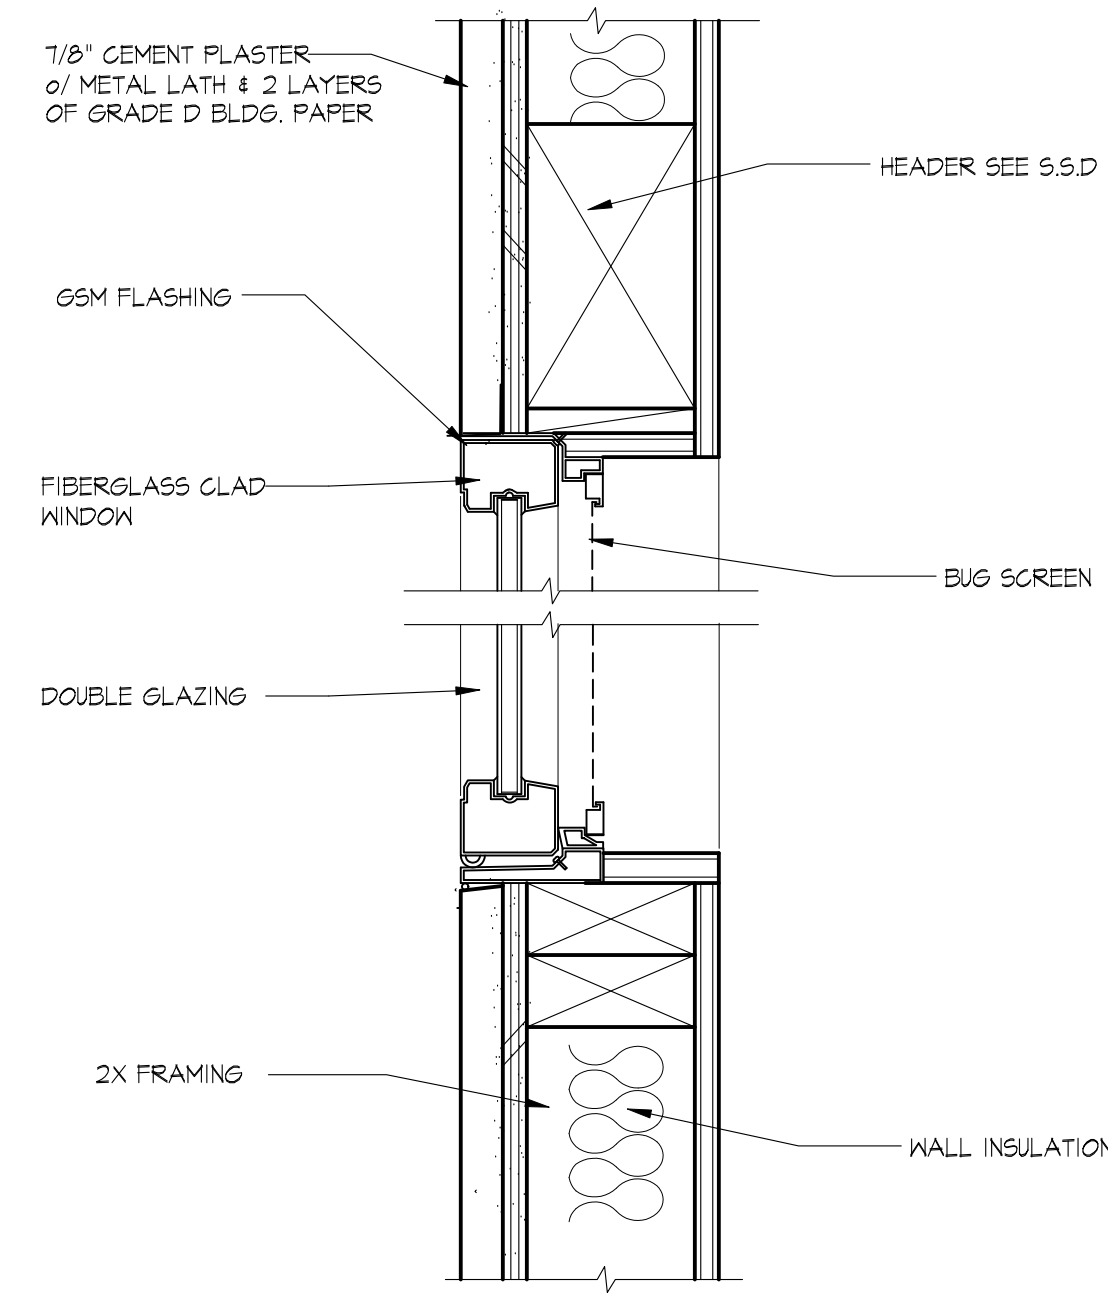
IQBAL RESIDENCE
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 LOS ALTOS, CA 94024

PROPOSED EXTERIOR ELEVATION

DATE MAY 16, 2022
 SCALE
 DRAWN
 APN# 336-03-030
 SHEET


A8-B
 OF SHEETS

1/4" = 1'-0"



② TYPICAL WINDOW DETAIL

3" = 1'-0"

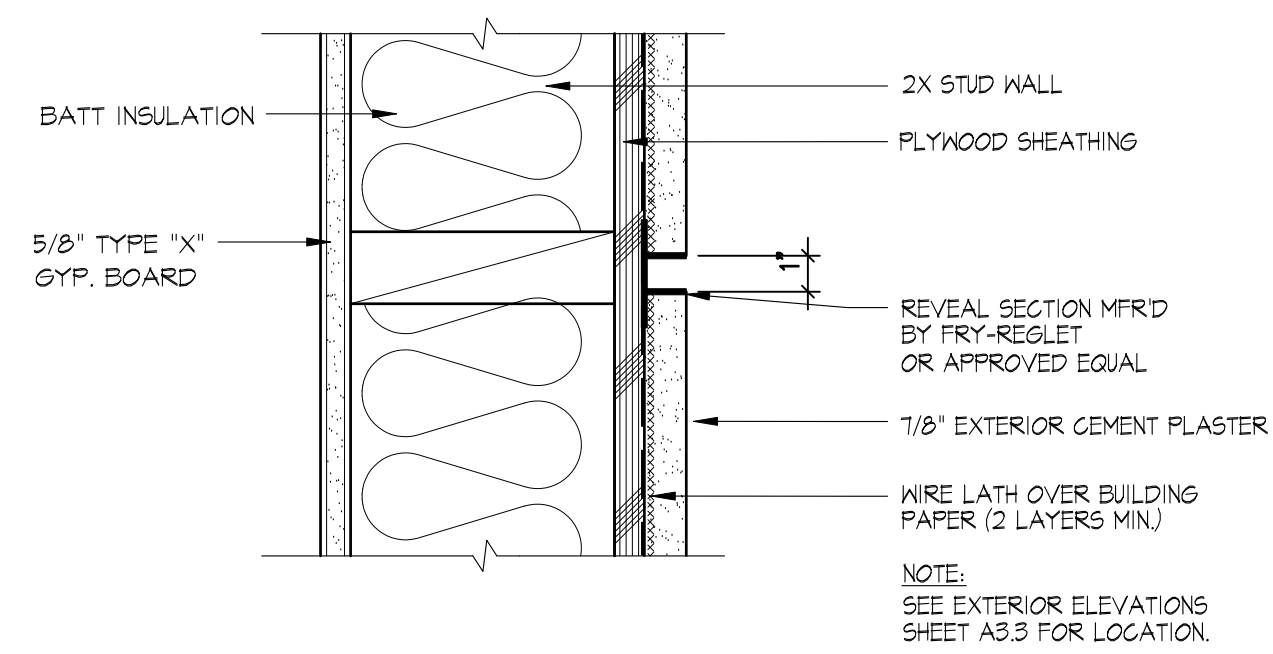


③ STUCCO REVEAL DETAIL


3" = 1'-0"



④ GLASS RAILING

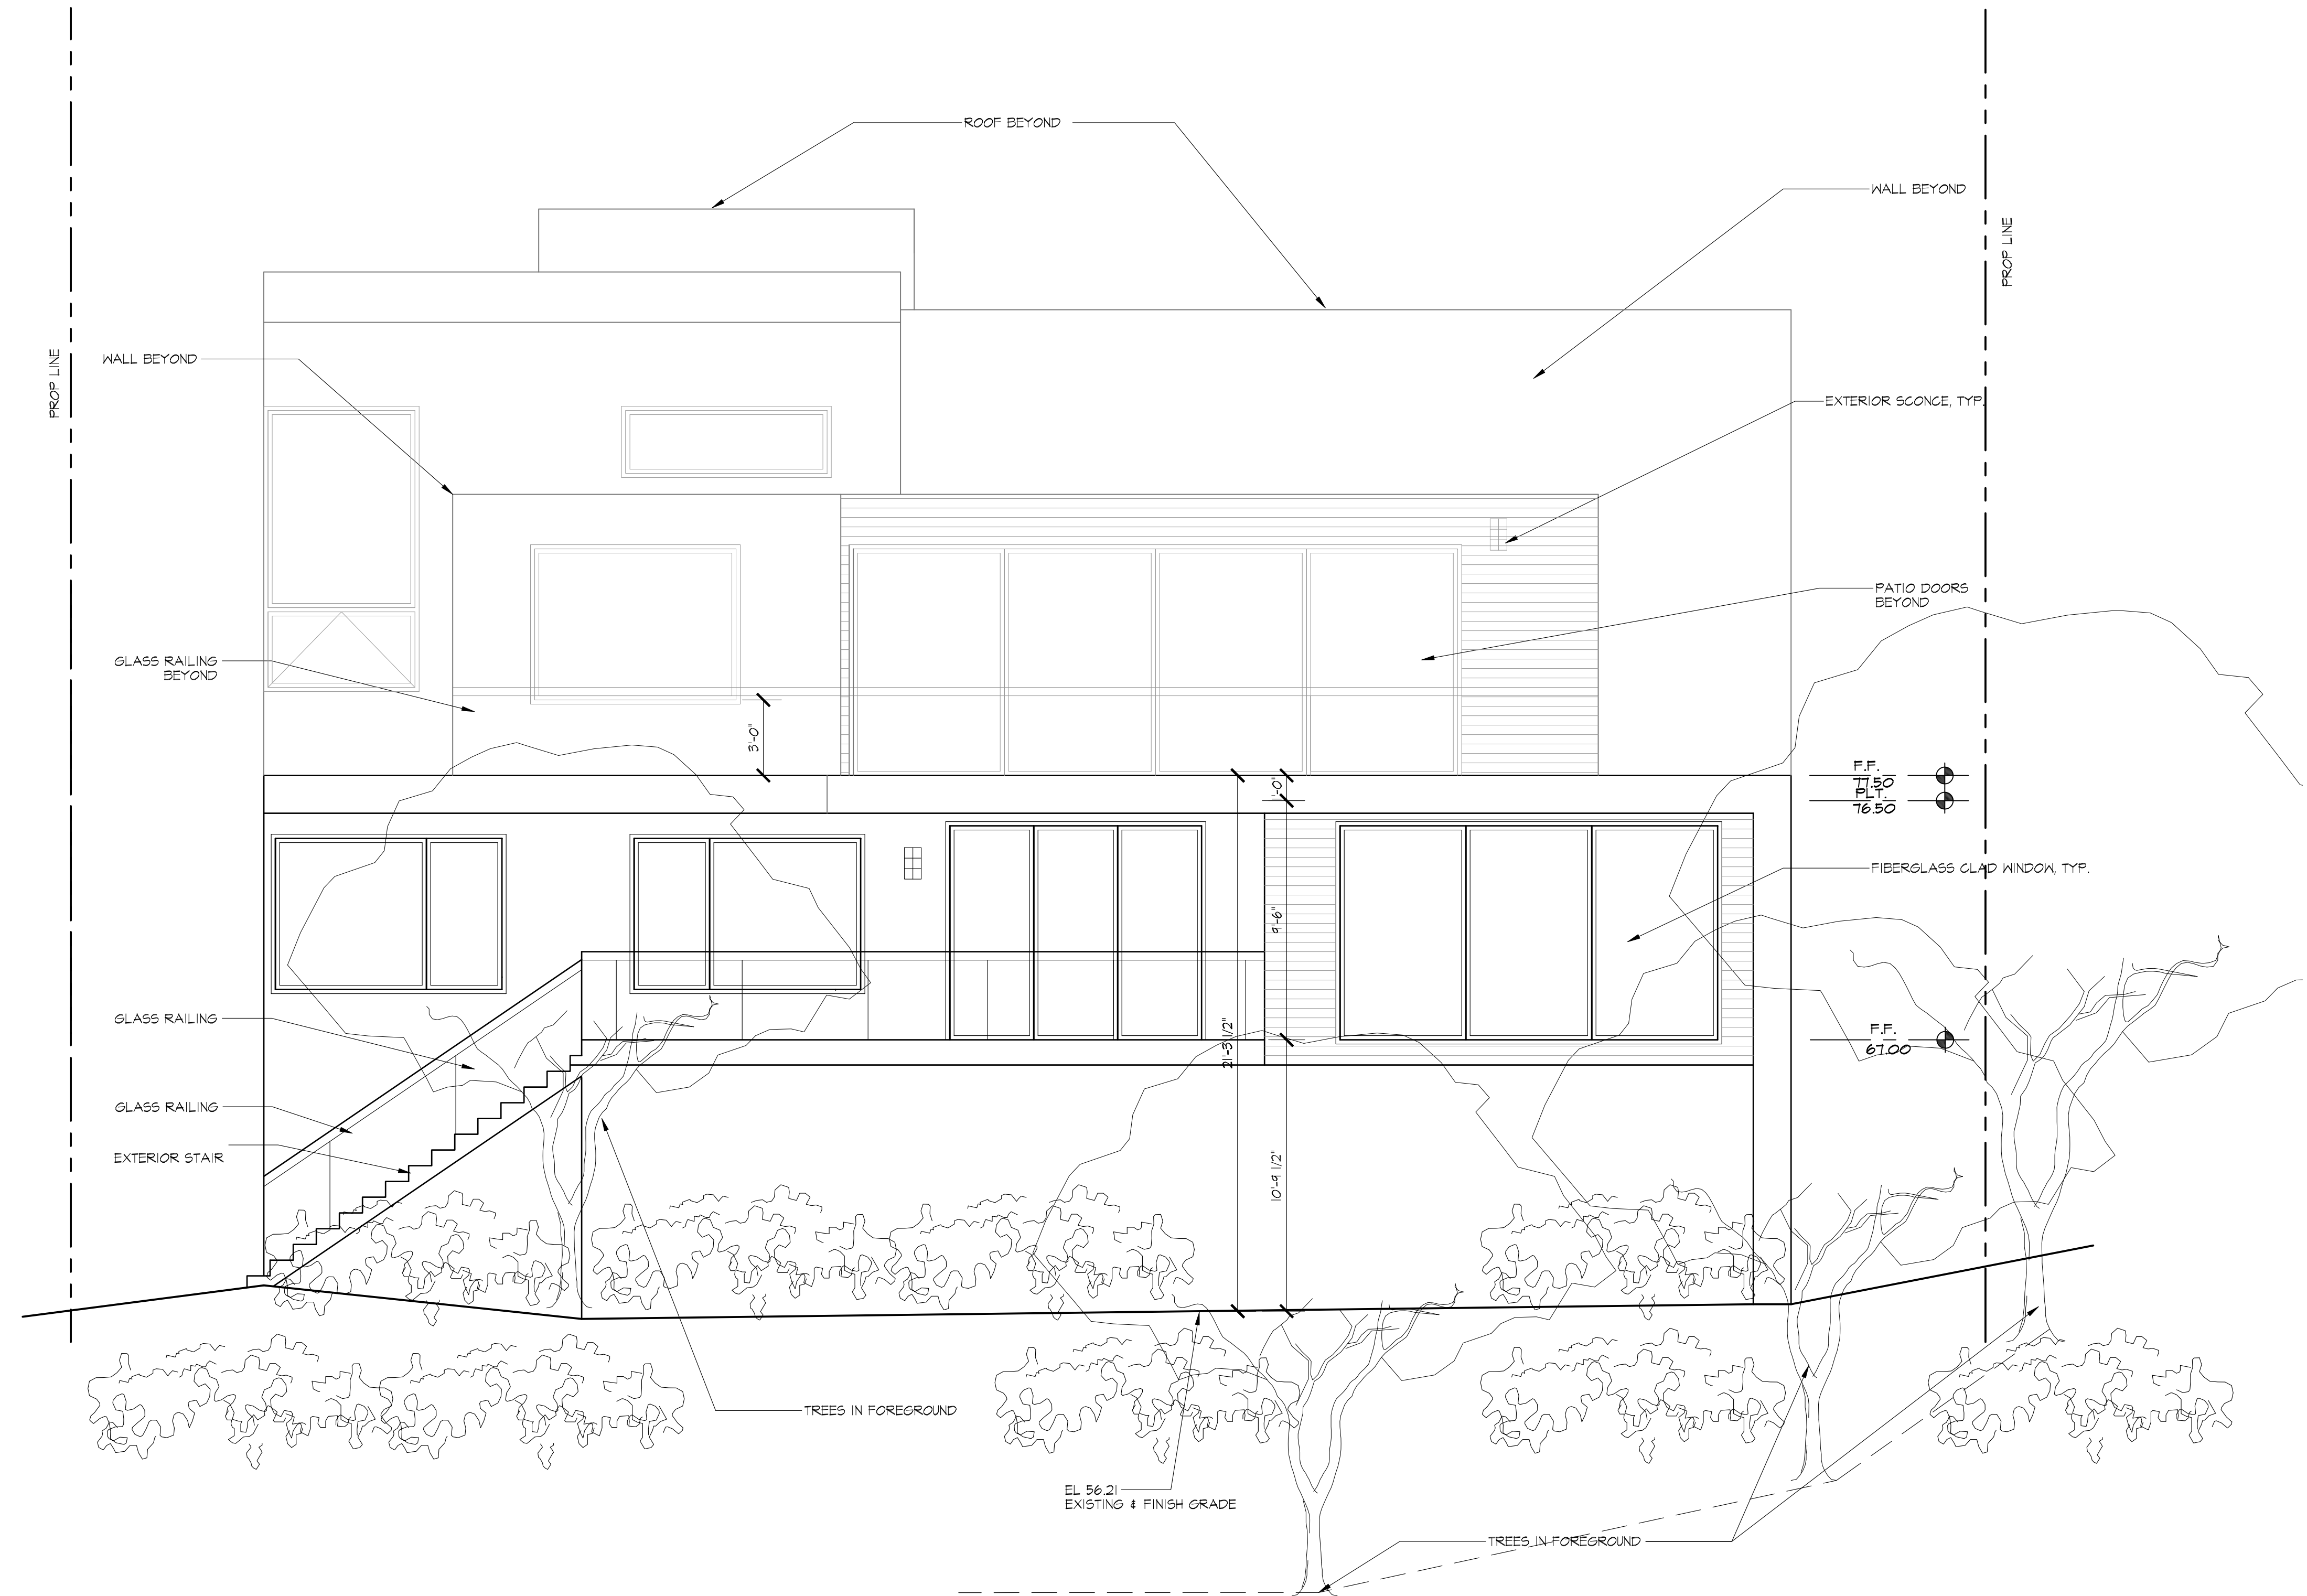

① PROPOSED REAR ELEVATION (NORTH)

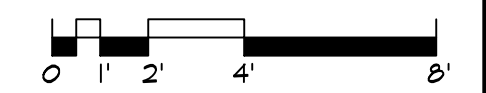

1/4" = 1'-0"

REVISIONS


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**IQBAL RESIDENCE
 NEW SINGLE FAMILY HOUSE & ADU**
 899 MADONNA WAY
 LOS ALTOS, CA 94024

PROPOSED EXTERIOR ELEVATION

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 DRAWN
 AP# 336-03-030
 SHEET

A9-B
 OF SHEETS

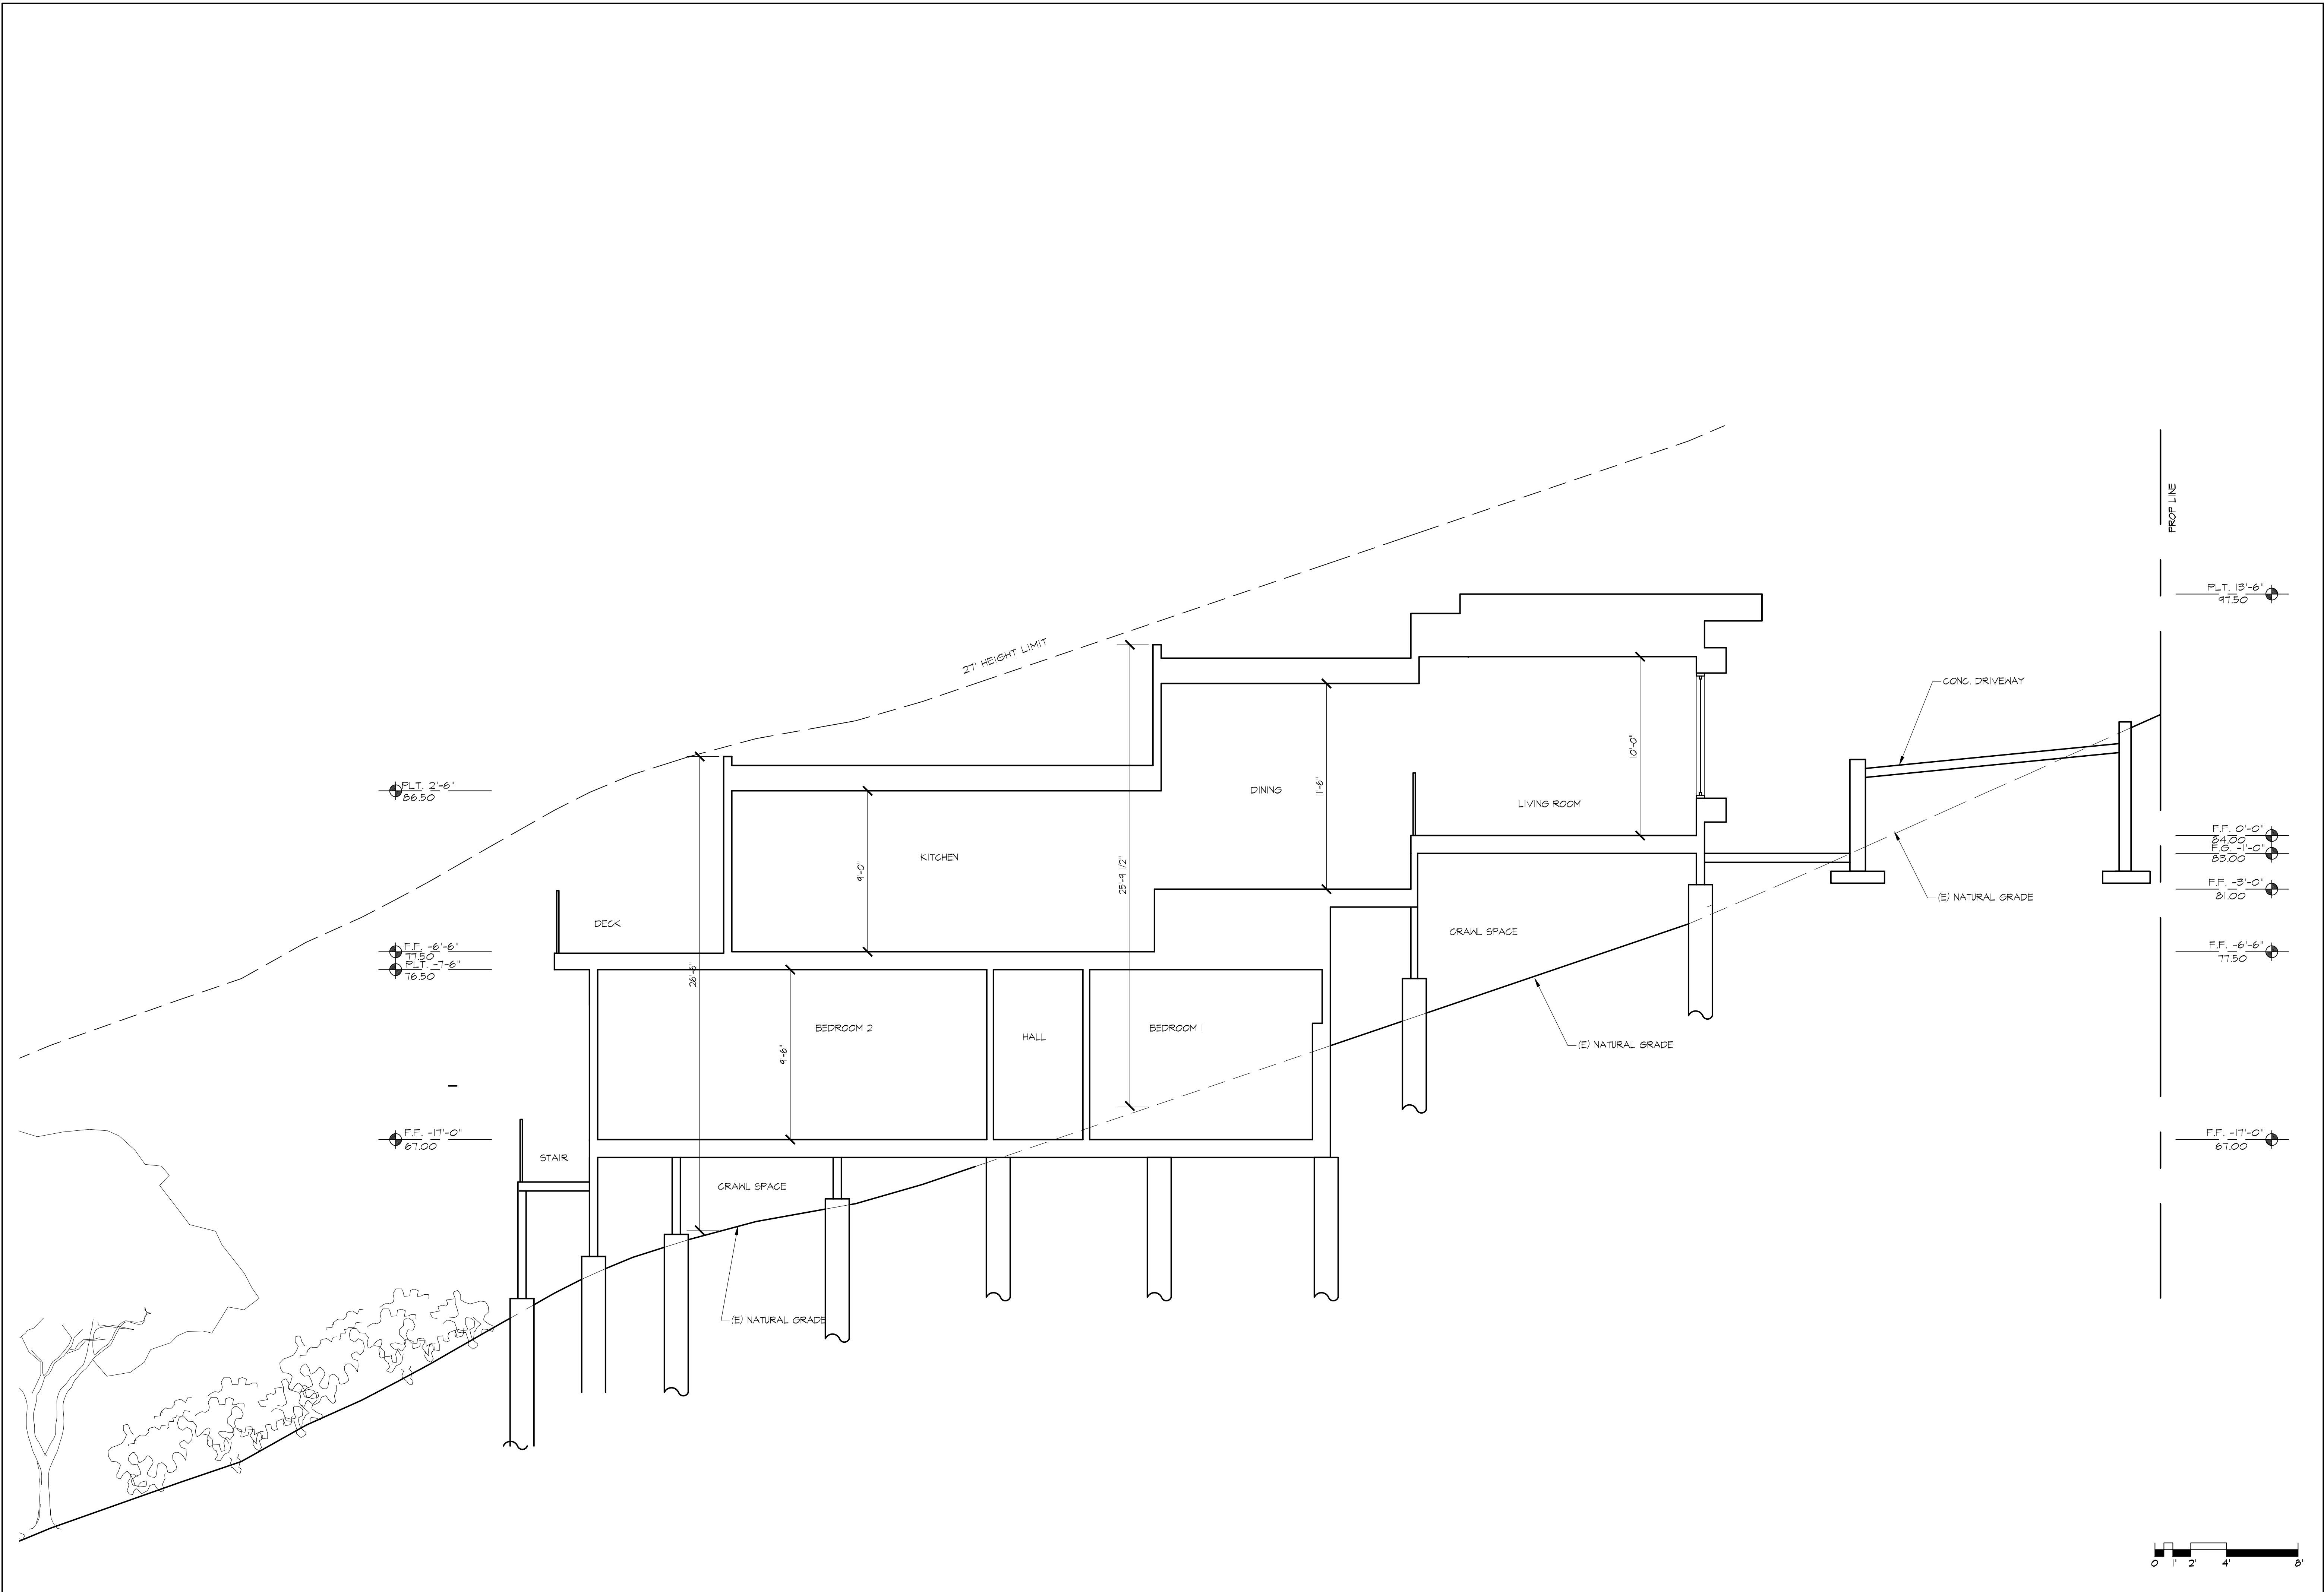


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**IQBAL RESIDENCE
 NEW SINGLE FAMILY HOUSE & ADU**
 899 MADONNA WAY
 LOS ALTOS, CA 94024

BUILDING SECTION


DATE MAY 16, 2022
 SCALE
 DRAWN
 APN# 336-03-030
 SHEET




1/4" = 1'-0"

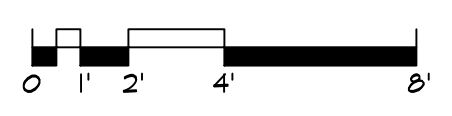Ⓛ BUILDING SECTION

A10-B
 OF SHEETS

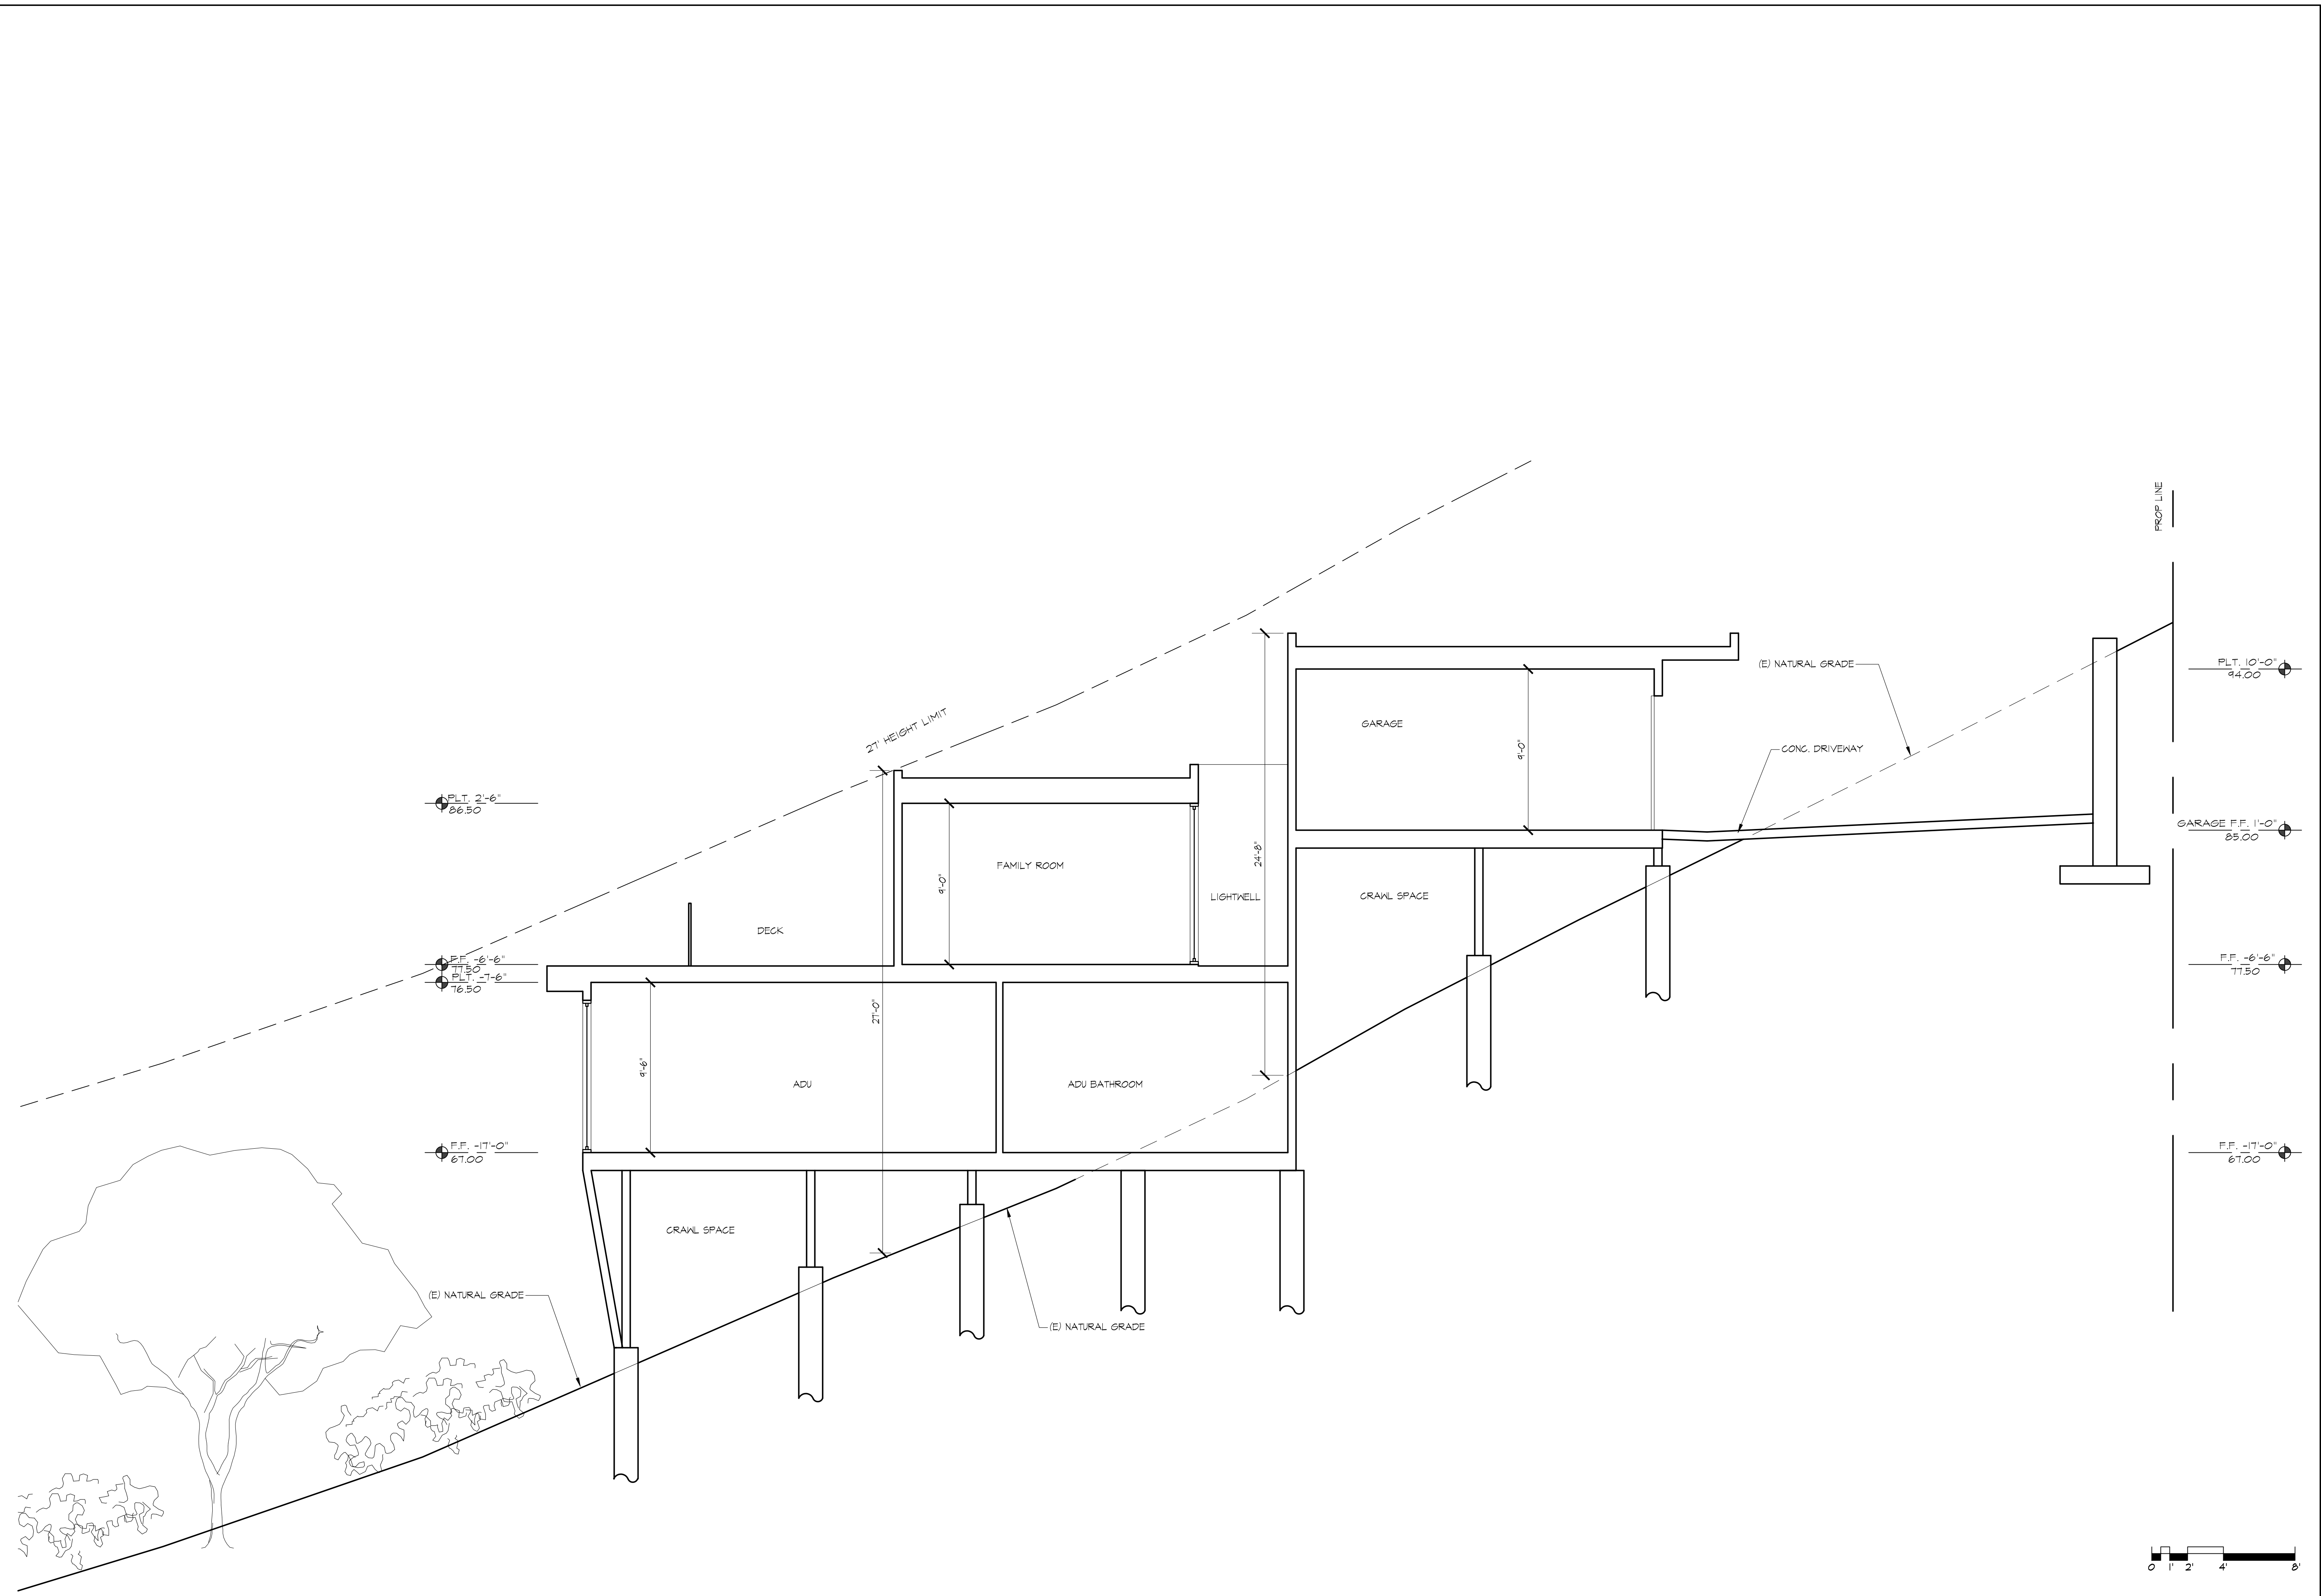

① BUILDING SECTION

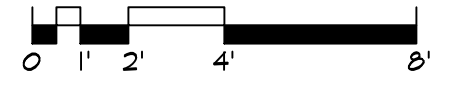

1/4" = 1'-0"


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IQBAL RESIDENCE
 NEW SINGLE FAMILY HOUSE & ADU
 899 MADONNA WAY
 LOS ALTOS, CA 94024


BUILDING SECTION

DATE	MAY 16, 2022
SCALE	
DRAWN	
APN#	336-03-030
SHEET	A11-B
OF SHEETS	



1 BUILDING SECTION

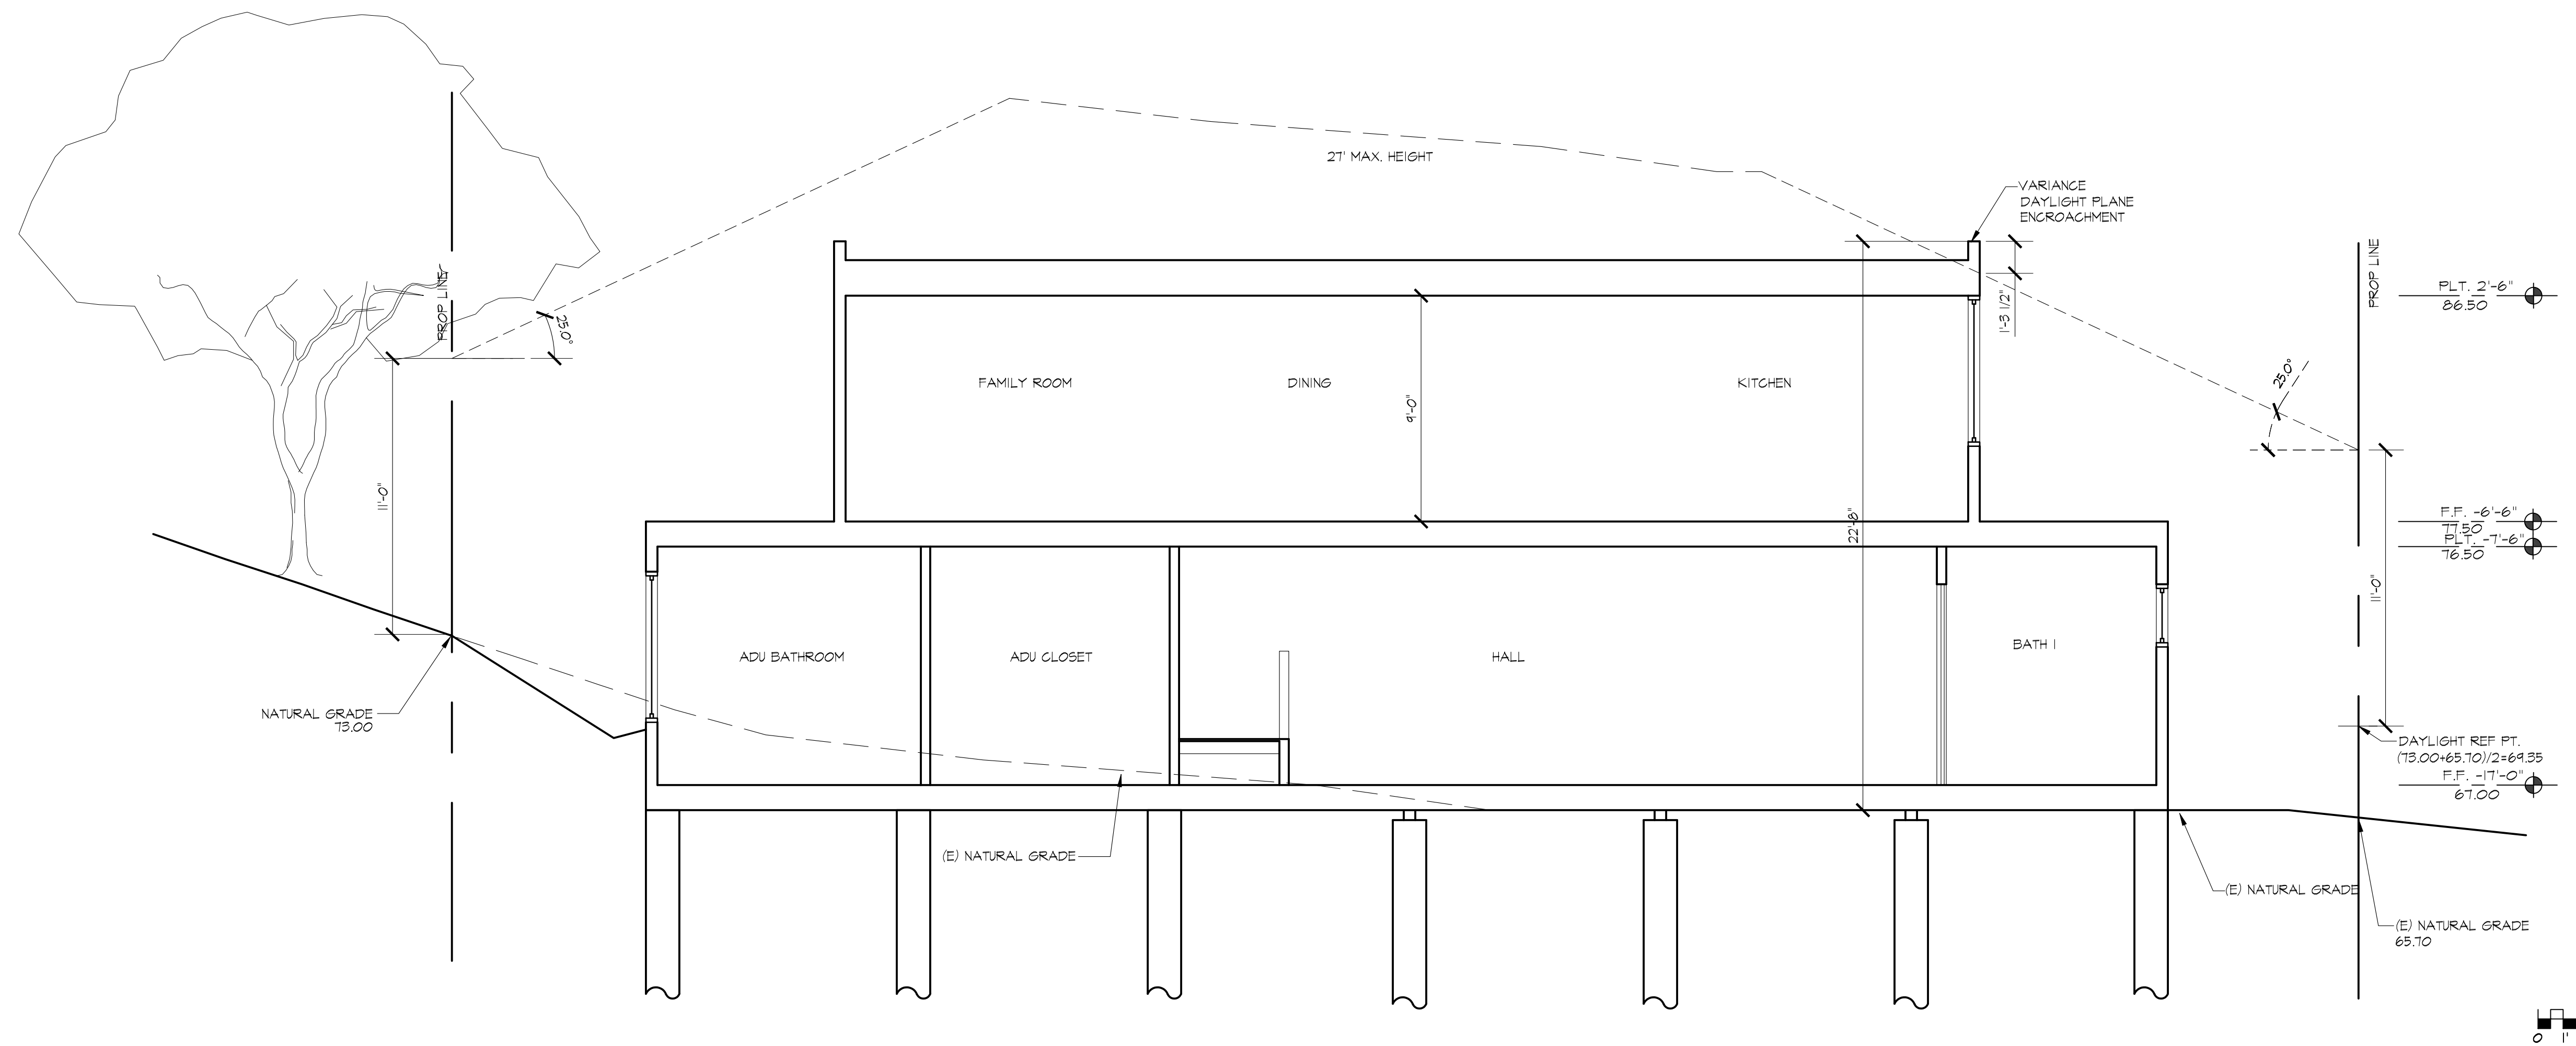1/4" = 1'-0"

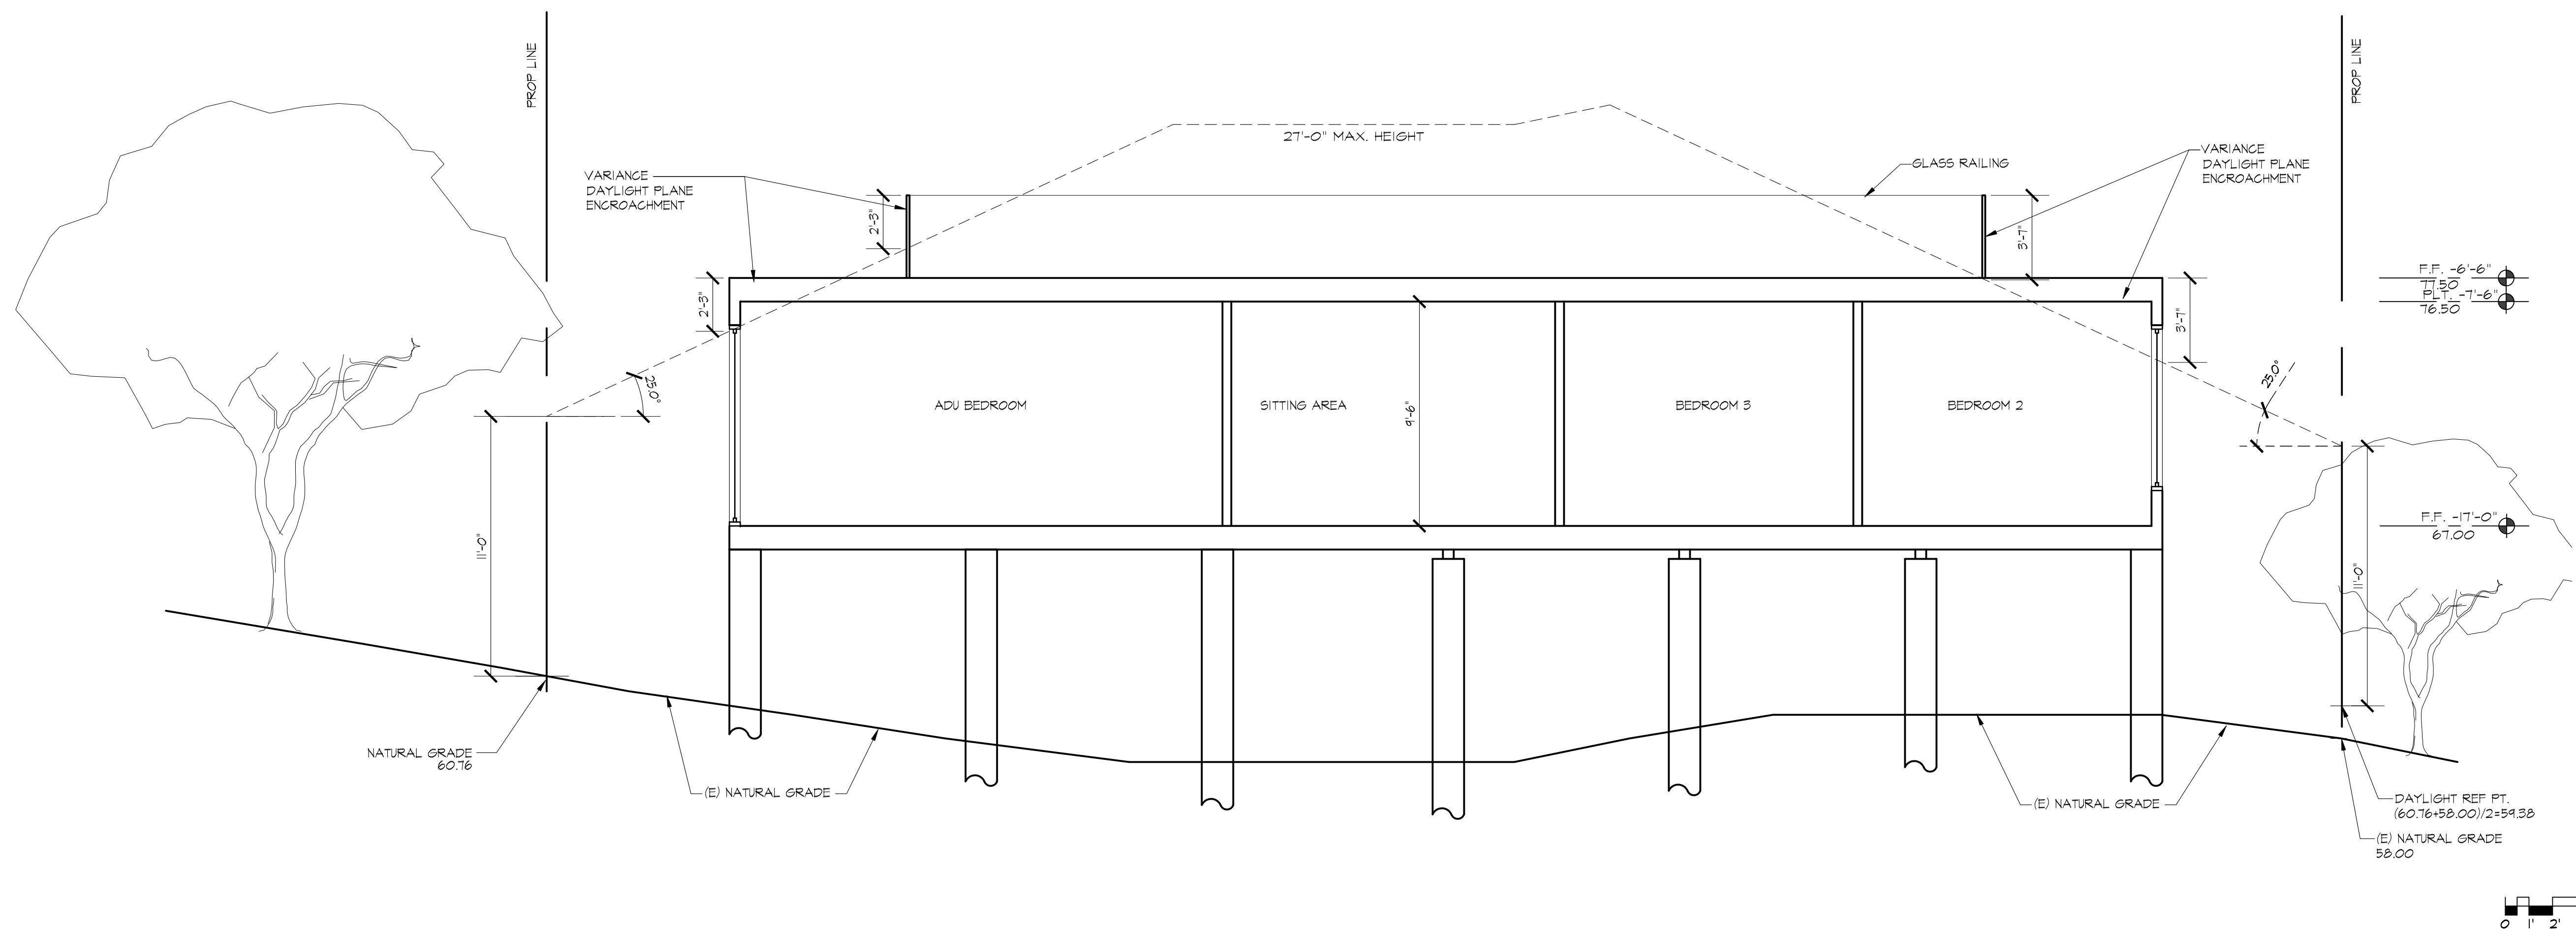

2 BUILDING SECTION

1/4" = 1'-0"


REVISIONS

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IQBAL RESIDENCE
 NEW SINGLE FAMILY HOUSE & ADU
 899 MADONNA WAY
 LOS ALTOS, CA 94024

BUILDING SECTIONS

DATE	MAY 16, 2022
SCALE	
DRAWN	
AP#	336-03-030
SHEET	A12-B
OF	SHEETS

**CALGREEN SIGNATURE DECLARATIONS**

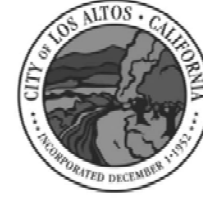Project Name: Iqbal Residence - New Single Family House & ADU

Project Address: 899 Madonna Way, Los Altos, CA 94024

Project Description: New Single Family House with attached ADU

SECTION 1 - DESIGN VERIFICATION
Complete all lines of Section 1 - "Design Verification" and **SUBMIT THE ENTIRE CHECKLIST (COLUMNS 2 AND 3) WITH THE PLANS AND BUILDING PERMIT APPLICATION TO THE BUILDING DEPARTMENT.**The design professional responsible for compliance with CalGreen Standards has reviewed the plans and certifies that the items checked above are hereby incorporated into the project plans and will be implemented into the project in accordance with the requirements set forth in the **2019 California Green Building Standards Code** as adopted by the City of Los Altos.

	11/1/2021
Design Professional's Signature	Date

Kevin Huang	
Design Professional's Name (Please Print)	

	11/1/2021
Signature of Green Point Rater/Certified ICC CalGreen Special Inspector/Consulting Group	Date

Richard Yang	(408) 677-6588
Name of Green Point Rater/Inspector (Please Print)	Phone No.

richard@jbrcyllc.com	GPR2009-301, ICC8786778
Email Address	License No.

SECTION 2 - IMPLEMENTATION VERIFICATION
Complete, sign and submit the completed checklist, including column 3, together with all original signatures on Section 2 to the Building Department **PRIOR TO BUILDING DEPARTMENT FINAL INSPECTION.**I have inspected the work and have received sufficient documentation to verify and certify that the project identified above was constructed in accordance with this Green Building Checklist and in accordance with the requirements of the **2019 California Green Building Standards Code** as adopted by the City of Los Altos.

Signature of Licensed Green Point Rater/Certified ICC CalGreen Special Inspector/Consulting Group	Date
---	------

Name of Green Point Rater/Inspector (Please Print)	Phone No.
--	-----------

Email address	License No.
---------------	-------------

ENVIRONMENTAL QUALITY

Fireplaces		
4.503.1 Any installed gas fireplace shall be a direct-vent sealed-combustion type. Any installed woodstove or pellet stove shall comply with US EPA New Source Performance Standards (NSPS) emission limits as applicable, and shall have a permanent label indicating they are certified to meet the emission limits. Woodstoves, pellet stoves and fireplaces shall also comply with applicable local ordinances.	☺	
Pollutant Control		
4.504.1 Duct openings and other related air distribution component openings shall be covered during construction.	☺	
4.504.2.1 Adhesives, sealants and caulks shall be compliant with VOC and other toxic compound limits.	☺	
4.504.2.2 Paints, stains and other coatings shall be compliant with VOC limits.	☺	
4.504.2.3 Aerosol paints and coatings shall be compliant with product weighted MIR limits for ROC and other toxic compounds.	☺	
4.504.2.4 Documentation shall be provided to verify that compliant VOC limit finish materials have been used.	☺	
4.504.3 Carpet and carpet systems shall be compliant with VOC limits.	☺	
4.504.4 80 percent of floor area receiving resilient flooring shall comply with specified VOC criteria.	☺	
4.504.5 Particleboard, medium density fiberboard (MDF) and hardwood plywood used in interior finish systems shall comply with low formaldehyde emission standards.	☺	
Interior Moisture Control		
4.505.2 Vapor retarder and capillary break is installed at slab-on-grade foundations.	☺	
4.505.3 Moisture content of building materials used in wall and floor framing is checked before enclosure.	☺	
Indoor Air Quality and Exhaust		
4.506.1 Each bathroom shall be provided with the following: 1. ENERGY STAR fans ducted to terminate outside of the building. 2. Fans must be controlled by a humidity control (separate or built-in); OR functioning as a component of a whole-house ventilation system. 3. Humidity controls with manual or automatic means of adjustment, capable of adjustment between a relative humidity range of \pm 50 percent to a maximum of 80 percent	☺	

Environmental Comfort		
4.507.2 Duct systems are sized, designed, and equipment is selected using the following methods: 1. Establish heat loss and heat gain values according to ANSI/ACCA 2 Manual J-2016 or equivalent. 2. Size duct systems according to ANSI/ACCA 1 Manual D-2016 or equivalent. 3. Select heating and cooling equipment according to ANSI/ACCA 3 Manual S-2014 or equivalent.	☺	
Installer and Special Inspector Qualifications		
Qualifications		
702.1 HVAC system installers are trained and certified in the proper installation of HVAC systems.	☺	
702.2 Special inspectors employed by the enforcing agency must be qualified and able to demonstrate competence in the discipline they are inspecting.	☺	
Verifications		
703.1 Verification of compliance with this code may include construction documents, plans, specifications builder or installer certification, inspection reports, or other methods acceptable to the enforcing agency which show substantial conformance. 1. Green building measures listed in this table may be mandatory if adopted by a city, county, or city and county as specified in Section 101.7 2. Required prerequisite for this Tier 3. These measures are currently required elsewhere in statute or in regulation	☺	

**2019 CALGREEN RESIDENTIAL CHECKLIST****MANDATORY ITEMS - Version 1.01.20**COMMUNITY DEVELOPMENT DEPARTMENT - BUILDING DIVISION
KIRK BALLARD, BUILDING OFFICIAL
ONE NORTH SAN ANTONIO ROAD • LOS ALTOS, CA 94022-3088
(650) 947-2752 • FAX/EMAIL- BUILDING@LOSALTOSCA.GOV • WWW.LOSALTOSCA.GOV**PURPOSE:**

The 2019 CALGreen Code applies to all newly constructed hotels, motels, lodging houses, dwellings, dormitories, condominiums, shelters, congregate residences, employee housing, factory-built housing and other types of dwellings with sleeping accommodations and new accessory buildings associated with such uses. This section also applies to additions and alterations where there is an increase in conditioned space and specifies that these requirements only apply to the specific area of the addition or alteration. Existing site and landscaping improvements that are not otherwise disturbed are not subject to the requirements of CALGreen.

Project Name: Iqbal Residence - New Single Family House & ADU

Project Address: 899 Madonna Way, Los Altos, CA 94024

Project Description: New Single Family House with attached ADU

Instructions (for projects of 300 sq. ft. or more):

- The owner or owner's agent shall employ a licensed qualified green-point rater (www.buildgreen.org) experienced with the 2019 California Green Building Standards Codes to verify and assure that all required work described herein is properly planned and implemented in the project.
- The green-point rater, in collaboration with the design professional shall review Column 2 of this checklist, and initial all applicable measures, sign and date Section 1 - Design Verification at the end of this checklist, prior to submittal. Applicant to include these pages into the construction plans as well as provide (2) separate 8-1/2" x 11" signed copies.
PRIOR TO FINAL INSPECTION BY THE BUILDING DEPARTMENT: The Green-Point Rater shall complete Column 3 and sign and Date Section 2 - Implementation Verification at the end of this checklist and submit the completed form to the Building Department.

MANDATORY FEATURE OR MEASURE	COLUMN 2 Project Requirements Rater to initial applicable measures prior to submitting forms	COLUMN 3 Verification Rater to verify during construction as applicable to project
Planning and Design - Site Development		
4.106.2 A plan is developed and implemented to manage storm water drainage during construction	☺	
4.106.3 Construction plans shall indicate how site grading or a drainage system will manage all surface water flows to keep water from entering buildings.	☺	
4.106.4 Provide capability for electric vehicle charging for one- and two-family dwellings; townhouses with attached private garages; multifamily dwellings; and hotels/motels in accordance with Section 4.106.4.1, 4.106.4.2 or 4.106.4.3 as applicable.	☺	

Energy Efficiency -

General		
4.201.1 Building meets or exceeds the requirements of the California Building Energy Efficiency Standards ¹ .	☺	
Water Efficiency and Conservation - Indoor Water Use		
4.303.1 Plumbing fixtures (water closets and urinals) and fittings (faucets and showerheads) installed in residential buildings shall comply with the prescriptive requirements of Sections 4.303.1.1 through 4.303.1.4.4.	☺	
4.303.2 Plumbing fixtures and fittings required in Section 4.303.1 shall be installed in accordance with the California Plumbing Code, and shall meet the applicable referenced standards.	☺	
4.303.1.4.3 Metering faucets in residential buildings shall not deliver more than 0.2 gallons per cycle.		
Outdoor Water Use		
4.304.1 Residential developments shall comply with a local water efficient landscape ordinance or the current California Department of Water Resources' Model Water Efficient Landscape Ordinance (MWELO), whichever is more stringent.	☺	
Material Conservation and Resource Efficiency - Enhanced Durability and Reduced Maintenance		
4.406.1 Annular spaces around pipes, electric cables, conduits or other openings in plates at exterior walls shall be protected against the passage of rodents by closing such openings with cement mortar, concrete masonry or similar method acceptable to the enforcing agency.	☺	
Construction Waste Reduction, Disposal and Recycling		
4.408.1 Recycle and/or salvage for reuse a minimum of 65 percent of the nonhazardous construction and demolition waste in accordance with one of the following: 1. Comply with a more stringent local construction and demolition waste management ordinance, or 2. A construction waste management plan per Section 4.408.2; or 3. A waste management company per Section 4.408.3; or 4. The waste stream reduction alternative per Section 4.408.4.	☺	
Building Maintenance and Operation		
4.410.1 An operation and maintenance manual shall be provided to the building occupant or owner.	☺	
4.410.2 Where 5 or more multifamily dwelling units are constructed on a building site, provide readily accessible areas that serve the entire building and are identified for the depositing, storage and collection of non-hazardous materials for recycling, including (at a minimum) paper, corrugated cardboard, glass, plastics, organic waste, and metals or meet a lawfully enacted local recycling ordinance, if more restrictive. See exception for rural jurisdictions	N/A	

REVISIONS

CIBOTTI ENGINEERING
12935 ALICOSTA BLVD #2025
SAN RAMON, CA 94583
BUS: (925) 829-0920
EMAIL: SCOTT@CIBOTTI.COMIQBAL RESIDENCE
NEW SINGLE FAMILY HOUSE & ADU

2019 CALGREEN CHECKLIST

DATE: NOVEMBER 2, 2021

SCALE:

DRAWN:

APP# 336-03-030

SHEET


CG2

OF SHEETS

AVERAGE SLOPE:

CONTOUR	L (FT)	CONTOUR	L (FT)	CONTOUR	L (FT)	CONTOUR	L (FT)	CONTOUR	L (FT)	CONTOUR	L (FT)
25	9.5	39	72.2	53	77.7	67	79.4	81	85.33	95	43.94
26	17.7	40	76.0	54	78.1	68	79.7	82	85.62	96	32.44
27	26.2	41	77.3	55	78.5	69	80.2	83	85.98	97	18.72
28	32.9	42	77.1	56	79.0	70	80.6	84	86.35	98	12.97
29	36.0	43	76.9	57	79.5	71	81.0	85	86.69	99	8.21
30	38.8	44	76.8	58	80.1	72	81.3	86	86.96	100	3.96
31	42.4	45	76.6	59	80.7	73	81.8	87	87.15		
32	46.4	46	76.7	60	81.2	74	82.3	88	87.34		
33	50.7	47	76.9	61	81.6	75	82.8	89	87.43		
34	55.0	48	77.5	62	81.7	76	83.4	90	87.54		
35	58.9	49	77.9	63	81.6	77	83.9	91	87.69		
36	62.2	50	77.6	64	80.6	78	84.4	92	74.38		
37	65.6	51	77.5	65	79.4	79	84.7	93	65.07		
38	68.8	52	77.5	66	79.3	80	85.1	94	50.78		

TOTAL CONTOUR LINE LENGTH (FT) 5219.5
 CONTOUR INTERVAL (FT) 1
 LOT AREA (SF) 12,743
 LOT AREA (ACRE) 0.293
 AVERAGE SLOPE = 41.0%

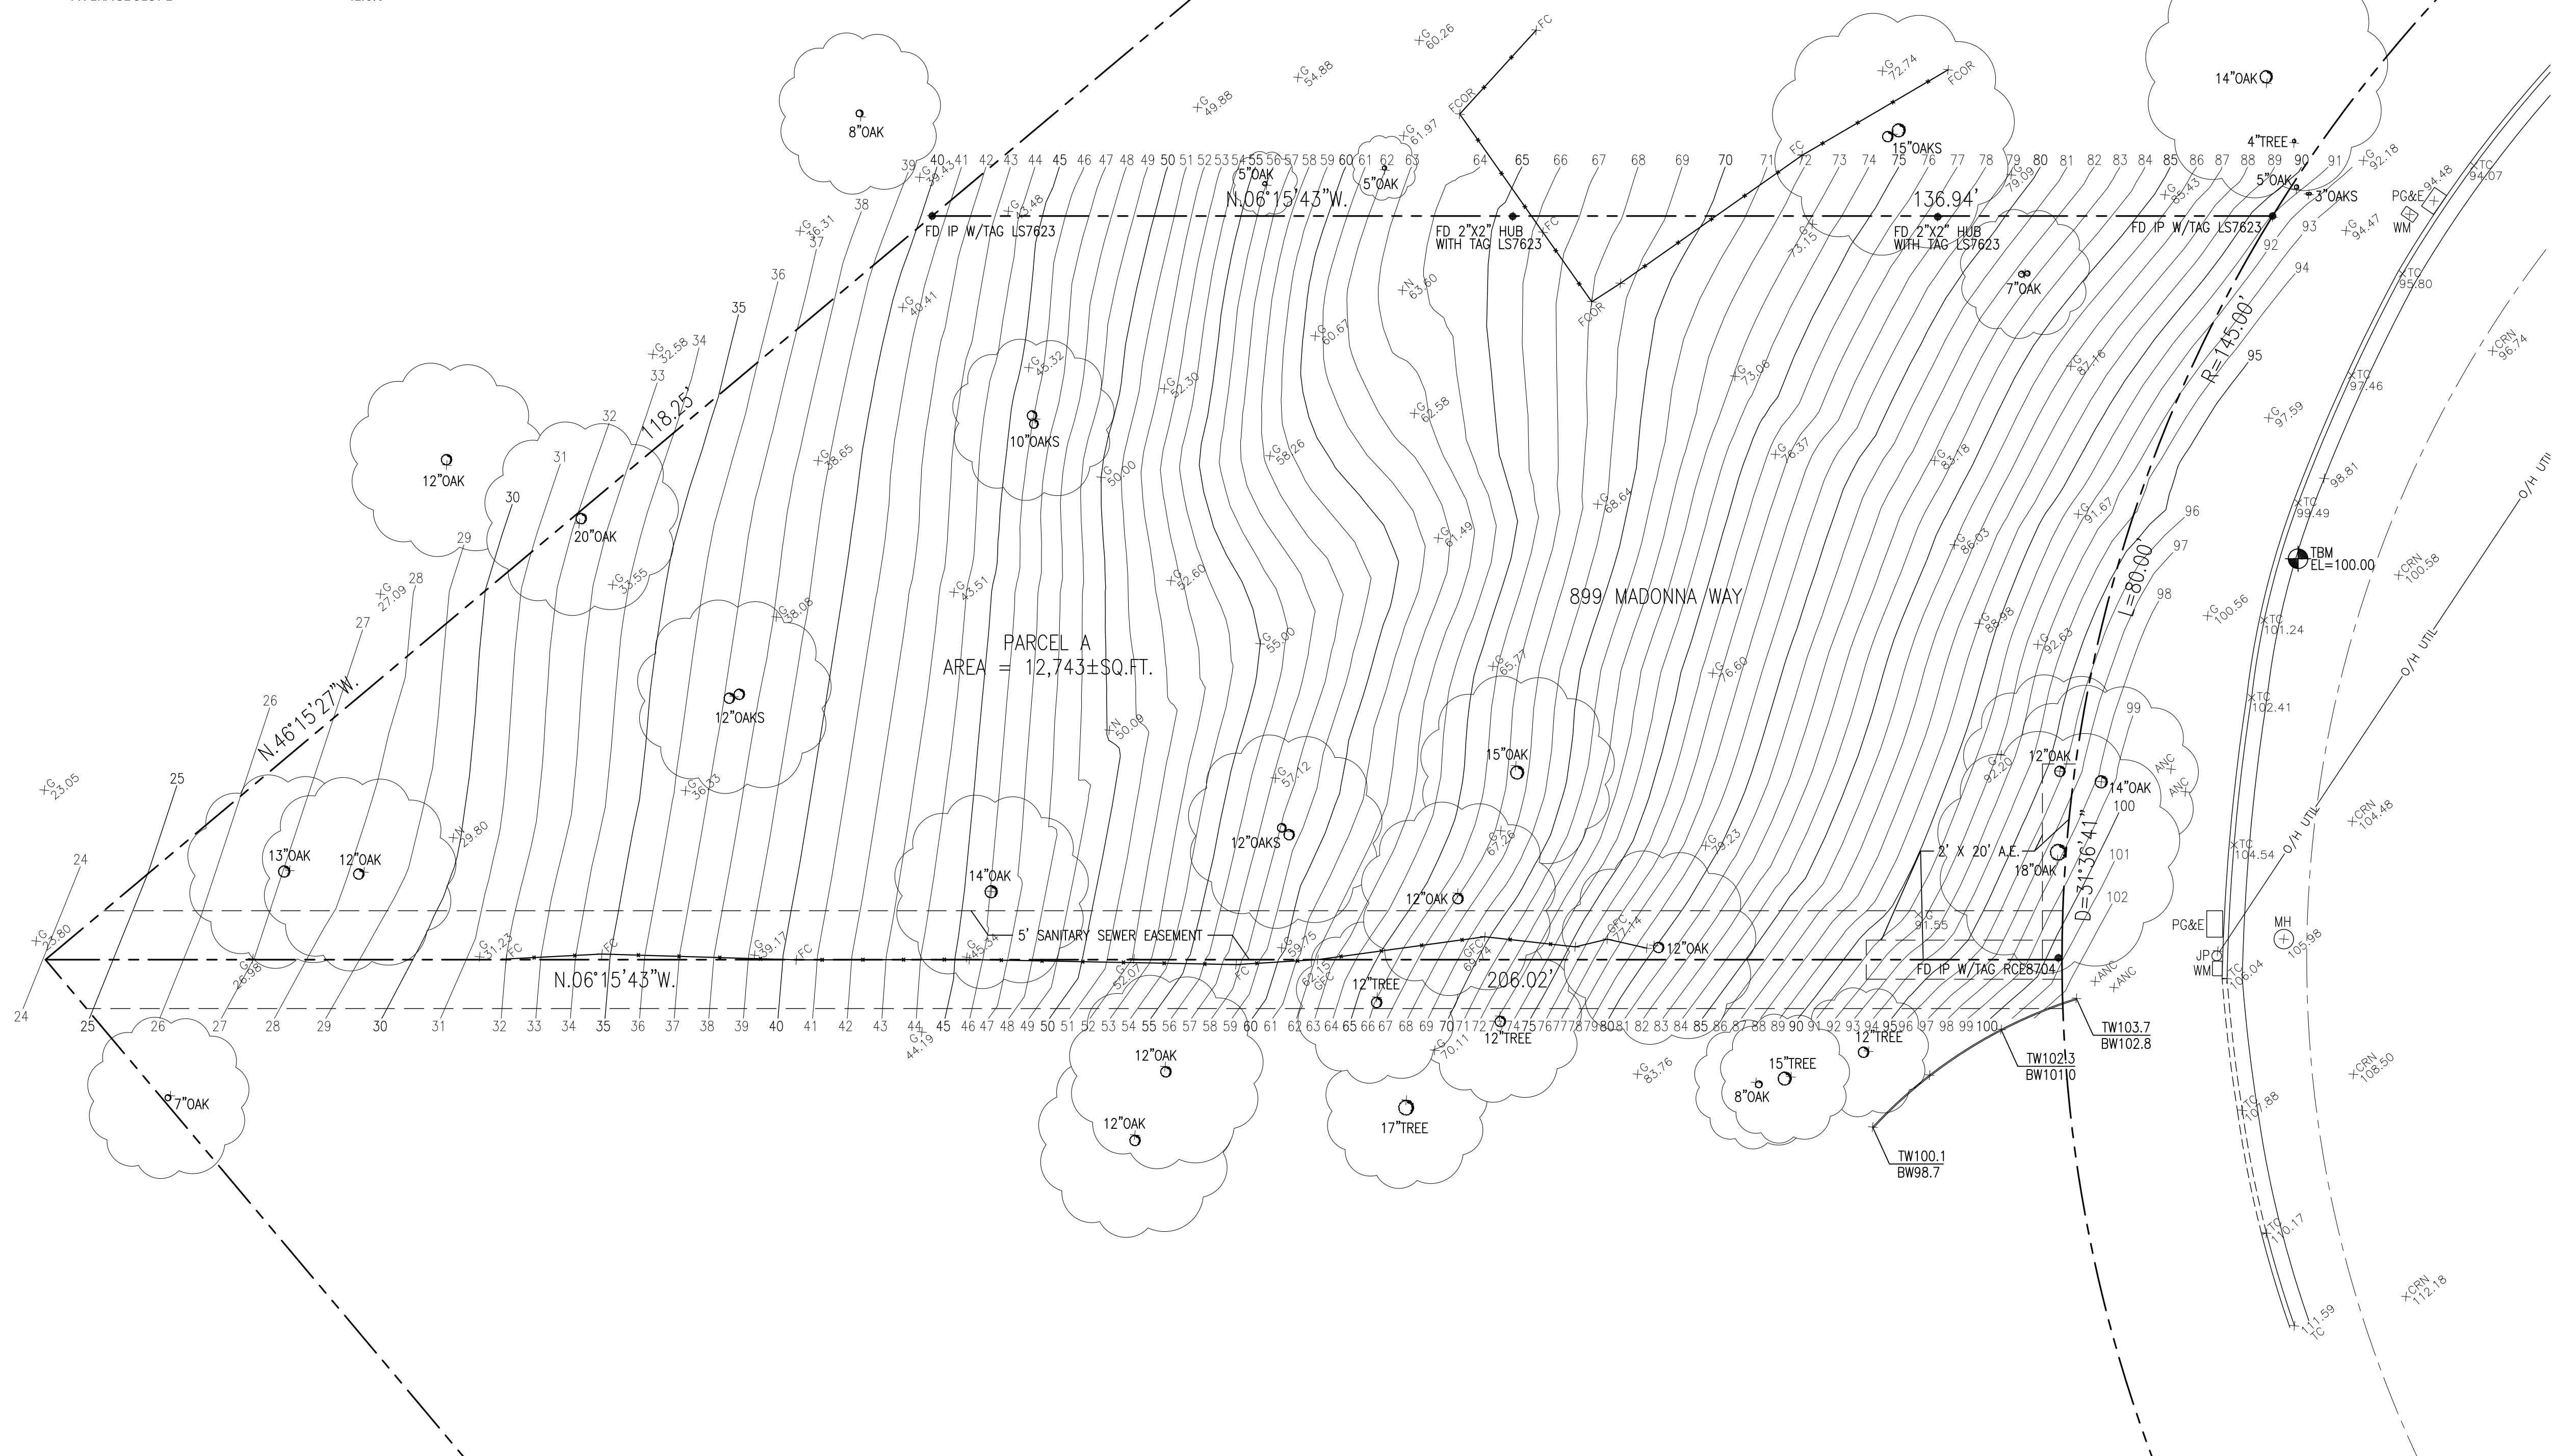

LEGEND:

- AC ASPHALT CONCRETE
- BC BUILDING CORNER
- BW BACK OF WALK
- CB CATCH BASIN
- CMP CORRUGATED METAL PIPE
- CO CLEAN OUT
- CRN CROWN
- DW DRIVEWAY
- EC EDGE OF CONCRETE
- EM ELECTRIC METER
- EP EDGE OF PAVEMENT
- FCOR FENCE CORNER
- FD FOUND
- FF FINISHED FLOOR
- FL FLOW LINE
- FH FIRE HYDRANT
- FW FRONT OF WALK
- G GROUND
- GC GARAGE CORNER
- GF GARAGE FACE/FRONT
- GFC GROUND AT FENCE
- GM GAS METER
- HCR HANDICAP RAMP
- INV INVERT
- IP IRON PIPE
- JP JOINT POLE
- LG LIP OF GUTTER
- LG OVERHEAD
- PC PROPERTY CORNER
- PC PROPERTY CORNER
- RM RETAINING WALL
- SL STREET LIGHT
- SSCO SANITARY SEWER CLEANOUT
- SSMH SANITARY SEWER MANHOLE
- SDMH STORM DRAIN MANHOLE
- TBC TOP BACK ROLLED CURB
- TC TOP OF CURB
- TOB TOP OF BANK
- TOE TOE OF BANK
- TP TOP OF PAVEMENT
- TRC TOP OF ROLLED CURB
- TW TOP OF WALL
- U/G UNDERGROUND
- VCP VITRIFIED CLAY PIPE
- WV WATER VALVE
- WM WATER METER BOX
- CTV- CABLE TELEVISION LINE
- E- ELECTRICAL LINE
- G- GAS LINE
- SS- SANITARY SEWER LINE
- SD- STORM DRAIN LINE
- T- TELEPHONE LINE
- W- WATER LINE

BASIS OF BEARINGS:

THE BEARING, N47°15'00"W, OF THE CENTER LINE OF MADONNA WAY, AS SHOWN ON THAT CERTAIN MAP FILED IN THE OFFICE OF THE RECORDER OF SANTA CLARA COUNTY, STATE OF CALIFORNIA, IN BOOK 151 OF MAPS AT PAGE 49, WAS USED AS THE BASIS OF BEARINGS SHOWN ON THIS MAP.

BASIS OF ELEVATION:

TBM ELEV=100.00 (ASSUMED)

UTILITY NOTE:

UNDERGROUND UTILITIES. SHOWN PER SURFACE EVIDENCE AND RECORD MAPS. MAY BE DIFFERENT THAN AS SHOWN. BEFORE EXCAVATION, CALL UNDERGROUND SERVICE ALERT (USA) 1-800-642-2444.

NOTE:

1. MEASUREMENT OF BUILDING LINE IS TO THE FACE OF STUCCO OR SIDING

NEW RESIDENCE

899 MADONNA WAY
 LOS ALTOS, CA
 APN: 336-03-030



2625 MIDDLEFIELD RD #658
 PALO ALTO, CA 94306
 TEL: (650) 823-6466
 FAX: (650) 887-1294

LICENSE STAMPS AND SIGNATURE



ISSUED

No.	Description	Date

DATE: JUNE 30, 2021
 SCALE: 1"=10'
 DRAWN: BG
 JOB: 10078

SHEET TITLE:

TOPOGRAPHIC SURVEY

SHEET NO.

C.0

GRADING AND DRAINAGE NOTES:

1. CONTRACTOR TO VERIFY ALL CONTROLLING DIMENSIONS WITH ARCHITECTURAL PLANS AND SHALL VISIT THE SITE AND FAMILIARIZE THEMSELVES WITH ALL EXISTING CONDITIONS. THEY SHALL BRING ANY DISCREPANCIES TO THE ATTENTION OF THE ENGINEER PRIOR TO PROCEEDING. VERIFY THE LOCATIONS OF ALL UNDERGROUND UTILITIES BEFORE STARTING CONSTRUCTION. ANY SITE WORK THAT DEVIATES FROM WHAT IS SHOWN ON THE PLANS SHALL HAVE THE ENGINEER'S APPROVAL PRIOR TO PROCEEDING WITH THE DEVIATING WORK ITEM. CONTRACTOR SHALL CALL "UNDERGROUND SERVICE ALERT" (800) 642-2444 PRIOR TO EXCAVATION.
2. THE SITE SHALL BE FINE GRADED TO PROVIDE A MINIMUM OF 5% ACROSS VEGETATED OR DIRT AREA AND 2% ACROSS HARDSCAPED AREA, AWAY FROM THE BUILDING PERIMETER. EXISTING DRAINAGE COMING FROM ADJACENT PROPERTIES SHALL BE MAINTAINED. IN NO CASE SHALL THE FINAL GRADING INCREASE SHEET FLOW ONTO ADJACENT PROPERTIES.
3. UNLESS SHOWN ON THE PLAN OTHERWISE, HOUSE AND GARAGE MUST HAVE DOWN SPOUTS THAT ARE DIRECTED TO SPLASH BLOCKS (2 FEET LONG) THAT DEFLECT THE WATER AWAY FROM BUILDING FOUNDATION BY SURFACE DRAINAGE. ALL DOWNSPOUT AND GUTTER SHALL BE GALV. SHEET METAL.
4. CONTRACTOR SHALL OBTAIN A STREET WORK PERMIT FROM PUBLIC WORKS ENGINEERING FOR ANY PROPOSED CONSTRUCTION WHICH WILL IMPACT THE USE OF THE SIDEWALK, STREET AND ALLEY OR ON THE PROPERTY IN WHICH THE CITY HOLDS AN INTEREST.
5. ANY CONSTRUCTION WITHIN THE CITY RIGHT-OF WAY MUST HAVE AN APPROVED PERMIT FOR CONSTRUCTION IN THE PUBLIC STREET PRIOR TO COMMENCEMENT OF THIS WORK. THE PERFORMANCE OF THIS WORK IS NOT AUTHORIZED BY THE BUILDING PERMIT ISSUANCE BUT SHOWN ON THE BUILDING PERMIT FOR INFORMATION ONLY.
6. IF GROUNDWATER OR RUNOFF WATER IS ENCOUNTERED AND REQUIRES REMOVAL FROM THE EXCAVATION AREA, ALL EXCAVATION AND/OR BUILDING ACTIVITIES MUST IMMEDIATELY STOP. THE PLAN FOR THE DEWATERING OF THE EXCAVATION MUST BE DESIGNED AND SUBMITTED FOR APPROVAL TO THE PUBLIC WORKS-ENGINEERING DIVISION. ONCE APPROVAL OF THE PLAN DESIGN HAS BEEN RECEIVED, IMPLEMENTATION OF THE PLAN IS REQUIRED PRIOR TO THE COMMENCEMENT OF THE EXCAVATION AND/OR BUILDING ACTIVITIES.

GENERAL NOTES 5


EARTHWORK QUANTITIES:

CUT(OUTSIDE BLDG FOOTPRINT)	20 C.Y.
CUT(INSIDE BLDG FOOTPRINT)	210 C.Y.
FILL	25 C.Y.
BALANCE	205 C.Y.

EARTHWORK QUANTITIES SHOWN ARE FOR PLANNING PURPOSES ONLY. CONTRACTOR SHALL PERFORM THEIR OWN EARTHWORK QUANTITY CALCULATION AND USE THEIR CALCULATION FOR BIDDING AND COST ESTIMATING PURPOSES.

CUT AND FILL EST.	4	ABBREVIATION	3	LEGEND	2
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AB	AGGREGATE BASE	GB	GRADE BREAK	SS	SANITARY SEWER	SL	STREET LIGHT
AC	ASPHALT CONCRETE	GM	GAS METER	E	ELECTRIC	IRR	IRRIGATION
AD	AREA DRAIN	GR	GRATE ELEVATION	TV	TV/CABLE TV	X	FENCE
BW	BOTTOM OF WALL	HP	HIGH POINT	FS	FIRE SERVICE	JT	JOINT TRENCH
CB	CATCH BASIN	INV	INVERT ELEVATION	W	DOMESTIC WATER	O/H	OVERHEAD WIRES
CIP	CAST IRON PIPE	JT	JOINT TRENCH	T	TELEPHONE	16.07	(E) SPOT ELEVATION
CL	CENTER LINE	JP	JOINT POLE	G	NATURAL GAS	16.07	(N) SPOT ELEVATION
CONC	CONCRETE	LD	LANDSCAPE DRAIN	FM	FORCE MAIN		
CS	CRAWL SPACE ELEV.	LF	LINEAR FEET				
DD	DECK DRAIN	(N)	NEW	DS	SPLASH BLOCK, MIN. 2 FEET LONG DEFLECT THE WATER AWAY FROM BOTH BLDG. DOWNSPOUT		
DIP	DUCT IRON PIPE	RIM	RIM ELEVATION				
DS	DOWNSPOUT	S	SLOPE				
DWY	DRIVEWAY	SD	STORM DRAIN LINE				
(E)	EXISTING	SDCO	STORM DRAIN CLEANOUT				
EG	EXISTING GRADING	SDFM	STORM DRAIN FORCED MAIN				
EM	ELECTRICAL METER	SS	SANITARY SEWER				
EP	EDGE OF PAVEMENT	SSCO	SANITARY SEWER CLEANOUT				
FF	FINISH FLOOR ELEVATION	TW	TOP OF WALL ELEVATION				
FG	FINISHED GROUND ELEV.	TYP	TYPICAL				
FP	FINISHED PAVEMENT	W	DOMESTIC WATER LINE				
FS	FINISH SURFACE ELEV	WM	WATER METER				

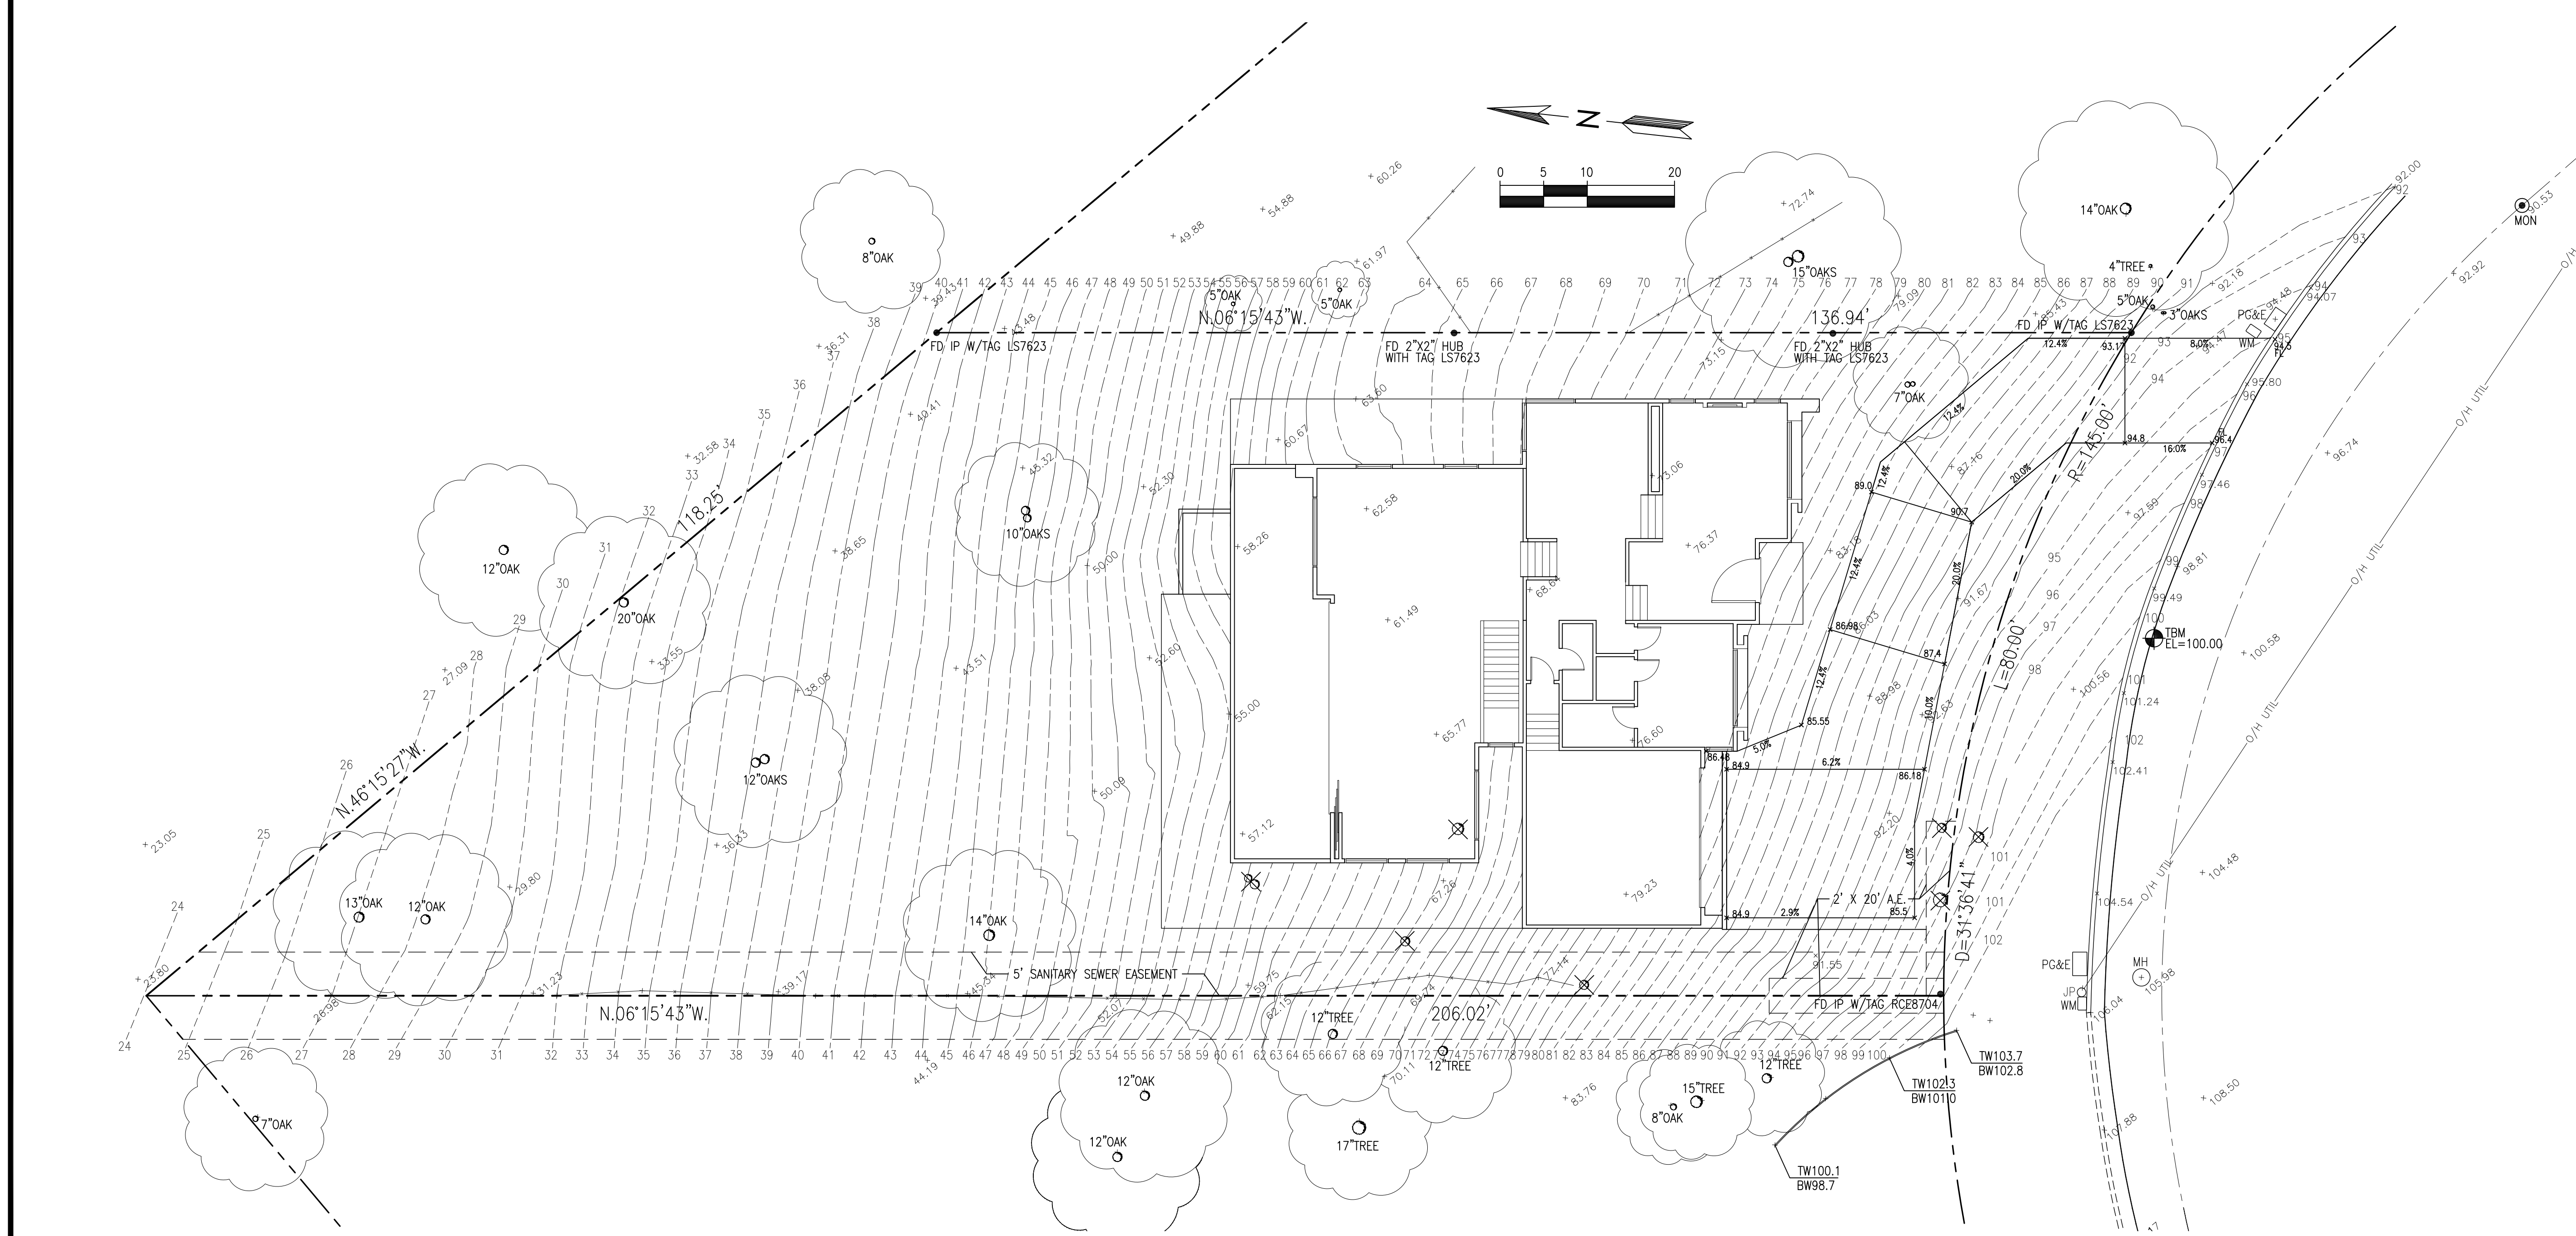

GRADING AND DRAINAGE PLAN SCALE: 1"=10' 1

NEW RESIDENCE

899 MADONNA WAY
LOS ALTOS, CA
APN: 336-03-030



2625 MIDDLEFIELD RD #658
PALO ALTO, CA 94306
TEL: (650) 823-6466
FAX: (650) 887-1294

LICENSE STAMPS AND SIGNATURE



ISSUED

No.	Description	Date

DATE: OCT 2, 2021
SCALE: AS SHOWN
DRAWN: J
JOB: 10078

SHEET TITLE:

GRADING & DRAINAGE PLAN

SHEET NO.

C.1

Planting Notes

- 1 LESS THAN 25% OF PLANTING AREA IS TURF (THERE IS NO LIVE TURF IN FRONT YARD)
- 2 PLANTS WITH SIMILAR WATER NEEDS ARE GROUPED WITHIN HYDROZONES. EACH HYDROZONE SHALL BE CONTROLLED BY A SEPARATE GROUP OF VALVES
- 3 AT LEAST 4 CUBIC YARDS OF COMPOST (BFI SUPER HUMUS) AND 16 POUNDS OF 12-12-12 FERTILIZER PER 1000 SF OF PLANTING AREA SHALL BE THOROUGHLY TILLED INTO THE TOP 8 INCHES OF SOIL (EXCEPT UNDER CANOPY OF EXISTING TREES TO BE SAVED) OR FOLLOW THE AMENDMENT AND FERTILIZER RECOMMENDATIONS OF A SOIL FERTILITY TEST AND ANALYSIS FROM A SOIL LAB (HIGHLY RECOMMENDED)
- 4 INSTALL 3 INCH DEEP LAYER OF TOP DRESS MULCH ON ALL EXPOSED SOIL SURFACES OF PLANTING AREAS EXCEPT IN AREAS OF DIRECT SEEDING APPLICATION OR SOD LAWN. PROVIDE SAMPLES AND PRICES PRIOR TO FINALIZING BID
- 5 GRADING SHALL BE DESIGNED TO MINIMIZE SOIL EROSION, RUN-OFF AND WATER WASTE ADDITIONAL NOTES
- 6 SEE SHEETS L4 AND L5 FOR PLANTING AND IRRIGATION DETAILS AND SPECIFICATIONS IN FINAL CONSTRUCTION DRAWINGS FOR BUILDING PERMIT
- 7 DON'T TRENCH TOO CLOSE TO STRUCTURES WITHOUT THE APPROVAL OF THE BUILDING ARCHITECT, CIVIL, OR STRUCTURAL ENGINEER
- 8 PRIOR TO ORDERING PLANTS OR SIGNING FINAL CONTRACT FOR WORK MAKE SURE YOU HAVE THE MOST CURRENT SET OF APPROVED PLANS AND MAKE SURE THERE ARE NO CHANGES TO THE PLANT CHOICES
- 9 ADJUST FINAL LOCATIONS OF PLANTS TO AVOID CONFLICTS WITH UTILITIES, LIGHTS, AND IRRIGATION COMPONENTS. SCREEN VALVES AND UTILITIES WITH PLANTS. DON'T PUT PLANTS TOO CLOSE TO PAVING OR BUILDINGS
- 10 GRADING AND DRAINAGE TO BE DONE ACCORDING TO THE APPROVED GRADING AND DRAINAGE PLANS DONE BY OTHERS

Landscape Site Legend

- 1 Driveway - Permeable Pavers - Manuf., series, pattern, and color to be determined by owner
- 2 Front walkways - Permeable Pavers - Manuf., series, pattern, and color to be determined by owner
- 3 Consider 4 foot wide "front path" that has permeable pavers that have a little different color or pattern than driveway
- 4 6 foot tall x 3 foot wide gate
- 5 6 foot tall solid wood fence
- 6 Paving and other improvements in Right of Way to be as per City of Los Altos specifications
- 7 4 foot wide side yard conc. path with steps as required

Plant Legend

KEY	QTY	SIZE	SPACING	WUCOLS	BOTANICAL NAME	COMMON NAME	MATURE SIZE
		GALLONS					Height x Width
LANDSCAPE SCREENING							
PG	-	15	10'	MED	Podocarpus gracilior	Fern Pine	20' - 60' x 10'-20'
GROUND COVERS							
RP	-	1	3' - 5'	LOW	Rosmarinus prostratus	Prostrate Rosemary	
PP	-	1	3' - 5'	LOW	Pelargonium peltatum white	Ivy Geranium	
E	-	1	3' - 5'	HIGH	Equisetum hyemale	Horsetail	
LP	-	1	3' - 5'	LOW	Lomandra Platinum		
DV	-	1	3' - 5'	LOW	Diets iridioides	Fortnight Lily	

Ask owners if they want to upsize some of 1 gal plants to 5 gal plants

Plant quantities are for planning purposes only. Contractor to do own plant count and install all plants on plan

"I have complied with the criteria of the Water Conservation in Landscaping Ordinance and applied them for the efficient use of water in the landscape design plan"

Greg Lewis

Gregory Lewis - Landscape Architect Lic. #2176 1/4/22

THERE IS A TOTAL OF 700 sf of PROPOSED PLANTING AREA IN THE FRONT YARD AND SIDE YARD NOT INCLUDING THE ROW



Podocarpus gracilior - Fern Pine

