


NEW RESIDENCE FOR

NAMRITA & SUKU CHETTIAR



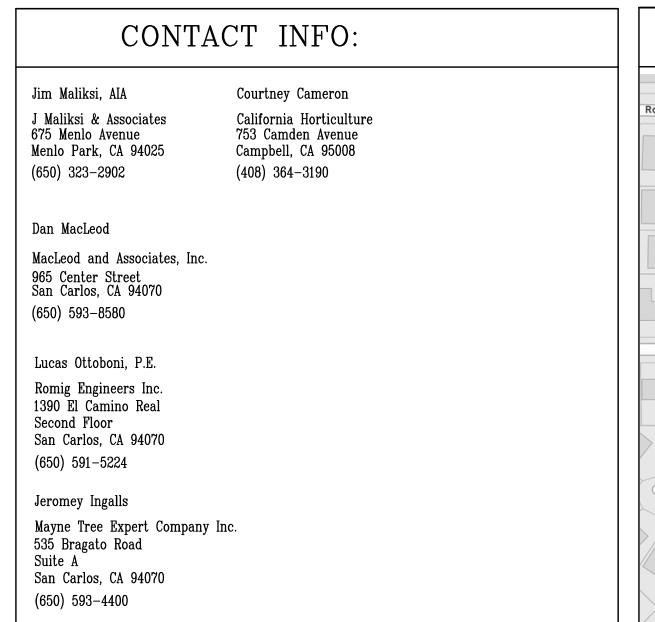

SCOPE OF WORK PROJECT INCLUDES: DEMOLITION OF EXISTING 1 STORY RESIDENCE, (E) PATIOS & HARDSCAPE SURFACES TO BE REMOVED. (N) 2 STORY RESIDENCE WITH BASEMENT, NEW COVERED SIDE PATIO, DRIVEWAY, WALKWAYS, LANDSCAPING AND OTHER HARDSCAPE SURFACES. GENERAL INFORMATION OCCUPANCY GROUP: (PER SANTA CLARA COUNTY CENTRAL FIRE TYPE V-B TYPE OF CONSTRUCTION: STORIES: PROTECTION DISTRICT, FIRE SPRINKLERS: ⊠-YES □-NO INSTALL NFPA 13D

GROUND FLOOR (HABITABLE): 2,026.4 S.F.

455.3 S.F.

1,239.4 S.F.

5,279.0 S.F.

GARAGE

SECOND FLOOR

TOTAL BUILDING AREA:

FIRE SPRINKLERS)

PROJECT DATA OWNERS: NAMRITA & SUKU CHETTIAR 746 CASA BONITA COURT LOS ALTOS, CA 94024 A.P.N.#: 189-41-085 ZONE: LOT AREA: 10,632 S.F. MAXIMUM LOT COVERAGE = (30%)Lot Area = 3,189.6 S.F. MAXIMUM FLOOR AREA = MAXIMUM FLOOR AREA ... FOR LOTS = 3,721.2 S.F. WITH A NET SITE AREA NOT EXCEEDING 11,000 SQUARE FEET, THE MAXIMUM FLOOR AREA SHALL BE THIRTY-FIVE (35) PERCENT OF THE LOT AREA.

DEFERRED SUBMITTALS

1. NFPA 13D FIRE SPRINKLER DESIGN & SUBMITTAL UNDER SEPARATATE PERMIT. FIRE SPRINKLER PLANS SHALL BE SUBMITTED DIRECTLY TO THE SANTA CLARA COUNTY FIRE DEPARTMENT BY A CALIFORNIA LICENSED C-16 FIRE SPRINKLER CONTRACTOR.

TABLE OF CONTENTS

CENTEDAT	THEODYAMION
GENERAL	INFORMATION
A-0.1	COVER SHEET
A-0.2	NEIGHBORHOOD CONTEXT MAP
A-0.3	NEIGHBORHOOD CONTEXT PHOTOS
A-0.4	NEIGHBORHOOD CONTEXT PHOTOS

CIVIL

TOPOGRAPHY SURVEY PLAN PRELIMINARY GRADING AND DRAINAGE PLAN PRELIMINARY UTILITY PLAN

LANDSCAPE

COVER SHEET SCREENING PLAN PLANTING PLAN IRRIGATION & HYDROZONE PLAN

Front

HEIGHT:

Rear

SITE DEMO & TREE PROTECTION PLAN

A-1.2

EXISTING FLOOR PLAN EXISTING ROOF PLAN EXISTING EXTERIOR ELEVATIONS

NEW FLOOR AREA DIAGRAM AND AREA CALCULATIONS

BASEMENT FLOOR PLAN A-3GROUND FLOOR PLAN

A-4SECOND FLOOR PLAN ROOF PLAN

FRONT ELEVATION & RIGHT SIDE ELEVATION REAR ELEVATION & LEFT SIDE ELEVATION

OBLIQUE ELEVATION @ DAYLIGHT PLANE & SECTION A-A

SECTION B-B & SECTION C-C

ZONING COMPLIANCE LOT COVERAGE: 2,654.1 square feet Land area covered by all structures that are over 6 feet in height FLOOR AREA: 2,452.9 square feet (18.2%) 3721.2 square feet 3,721.2 square fee Measured to the outside surfaces of (35.0%) exterior walls SETBACKS: 31.88 feet 13.63 feet/21.13 feet 12.0 feet/19.63 feet Right side $(1^{st}/2^{nd})$ Left side (1st/2nd)

SQUARE FOOTAGE BREAKDOWN

	Existing	Change in	Total Proposed
HABITABLE LIVING AREA: Includes habitable basement areas	1,975.1 square feet	2,848.6 square feet	4,823.7 square feet
NON- HABITABLE AREA: Does not include covered porches or open structures	477.8 square feet	- 22.5 square feet	455.3 square feet

15.0 feet

LOT CALCULATIONS

NET LOT AREA:		10,632 square feet			
FRONT YARD HARDSC Hardscape area in the front yar	APE AREA: d setback shall not exæed 50%	984.3 square feet (.31.%)			
Landscaping Breakdown:	Existing softscape (ur New softscape (new o	(existing and proposed): 5,917.0 sq ft adisturbed) area: 9 sq ft or replaced landscaping) area: 4,715.0 sq ft agual the site's net lot area			

PROJECT TITLE & LOCATION

NEW RESIDENCE FOR

> SUKU & NAMRITA CHETTIAR

746 CASA BONITA COURT LOS ALTOS, CA 94024

REVISION

J MALIKSI & ASSOC. ARCHITECTURE - INTERIOR DESIGN

675 MENLO AVENUE MENLO PARK, CA 94025 TEL. NO. 650 323 2902 FAX NO. 650 323 6433




NO. DATE ISSUE GTM 7-14-23 FOR DESIGN REVIEW GTM 5-19-23 FOR DESIGN REVIEW

ALL DRAWINGS AND MATERIALS APPEARING HEREIN CONSTITUTE THE ORIGINAL AND UNPUBLISHED WORK OF THE ARCHITECT AND MAY NOT BE DUPLICATED, USED OR DISCLOSED WITHOUT THE PRIOR WRITTEN CONSENT OF THE ARCHITECT.

© 2022 JIM MALIKSI & ASSOCIATES DRAWING TITLE

COVER SHEET, SHEET INDEX, PROJECT DATA, ZONING COMPLIANCE

SCALE: 1/8" = 1'-0" PROJECT NAME: CHETTIAR CADD FILE NO. DRAWING NO.

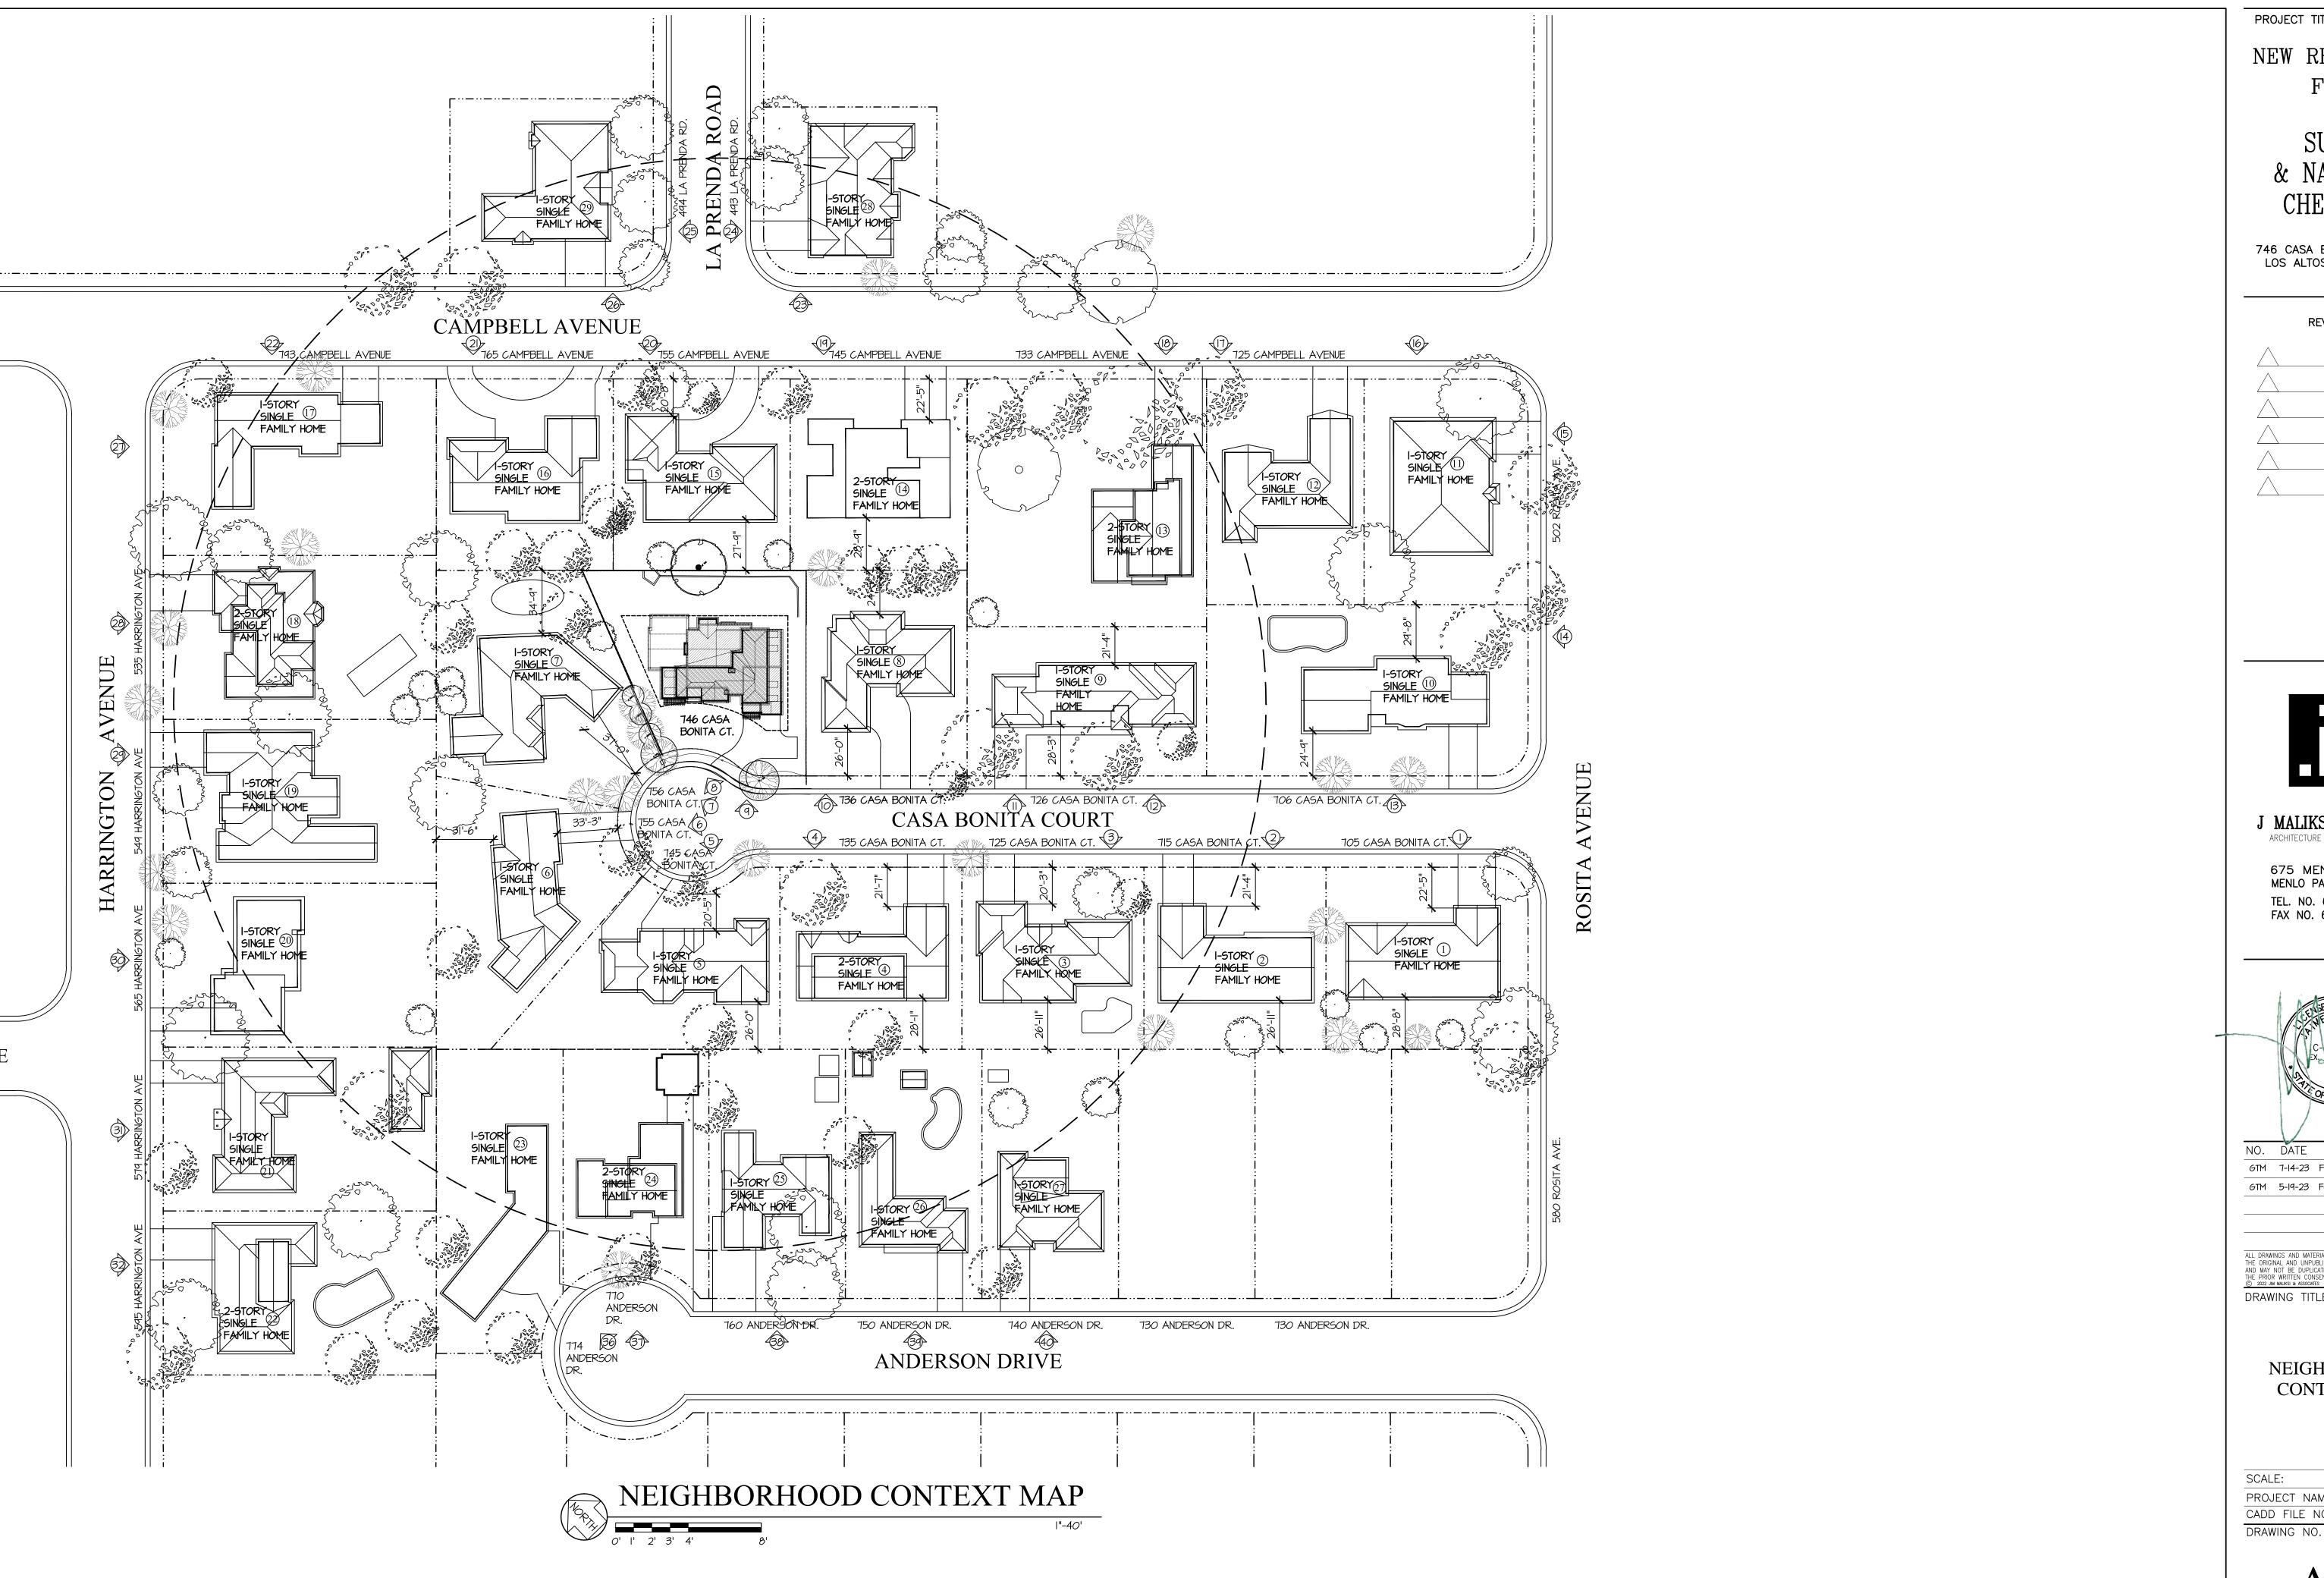


NEW RESIDENCE FOR

> SUKU & NAMRITA CHETTIAR

746 CASA BONITA COURT LOS ALTOS, CA 94024

REVISION

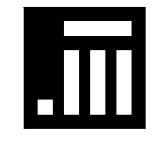

J MALIKSI & ASSOC.

ARCHITECTURE - INTERIOR DESIGN

675 MENLO AVENUE MENLO PARK, CA 94025 TEL. NO. 650 323 2902 FAX NO. 650 323 6433



NO. DATE ISSUE GTM 7-14-23 FOR DESIGN REVIEW GTM 5-19-23 FOR DESIGN REVIEW

ALL DRAWINGS AND MATERIALS APPEARING HEREIN CONSTITUTE THE ORIGINAL AND UNPUBLISHED WORK OF THE ARCHITECT AND MAY NOT BE DUPLICATED, USED OR DISCLOSED WITHOUT THE PRIOR WRITTEN CONSENT OF THE ARCHITECT.

© 2022 JIM MALIKSI & ASSOCIATES DRAWING TITLE


> NEIGHBORHOOD CONTEXT MAP

AS SHOWN PROJECT NAME: CADD FILE NO.

A-0.2



16 502 ROSITA AVENUE

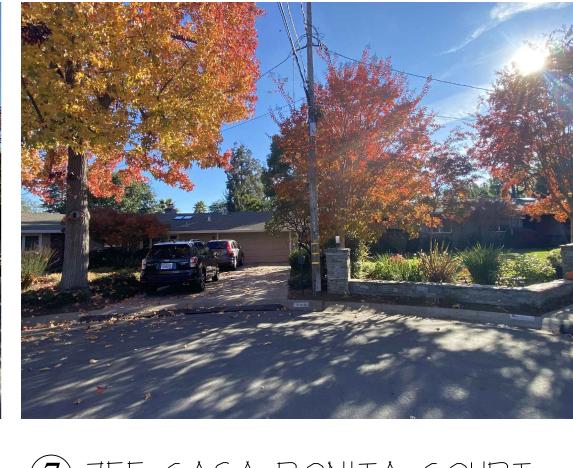





(3) 725 CASA BONITA COURT (4) 735 CASA BONITA COURT (5) 745 CASA BONITA COURT













19 745 CAMPBELL AVENUE



20 755 CAMPBELL AVENUE

15 502 ROSITA AVENUE

NO. DATE ISSUE

J MALIKSI & ASSOC.

ARCHITECTURE - INTERIOR DESIGN

675 MENLO AVENUE MENLO PARK, CA 94025

TEL. NO. 650 323 2902 FAX NO. 650 323 6433

PROJECT TITLE & LOCATION

NEW RESIDENCE

FOR

SUKU

& NAMRITA

CHETTIAR

746 CASA BONITA COURT LOS ALTOS, CA 94024

NEIGHBORHOOD **CONTEXT PHOTOS**

SCALE:	N.T.S.
PROJECT NAME:	CHETTIAR
CADD FILE NO.	
DRAWING NO.	


A-0.3







18 733 CAMPBELL AVENUE

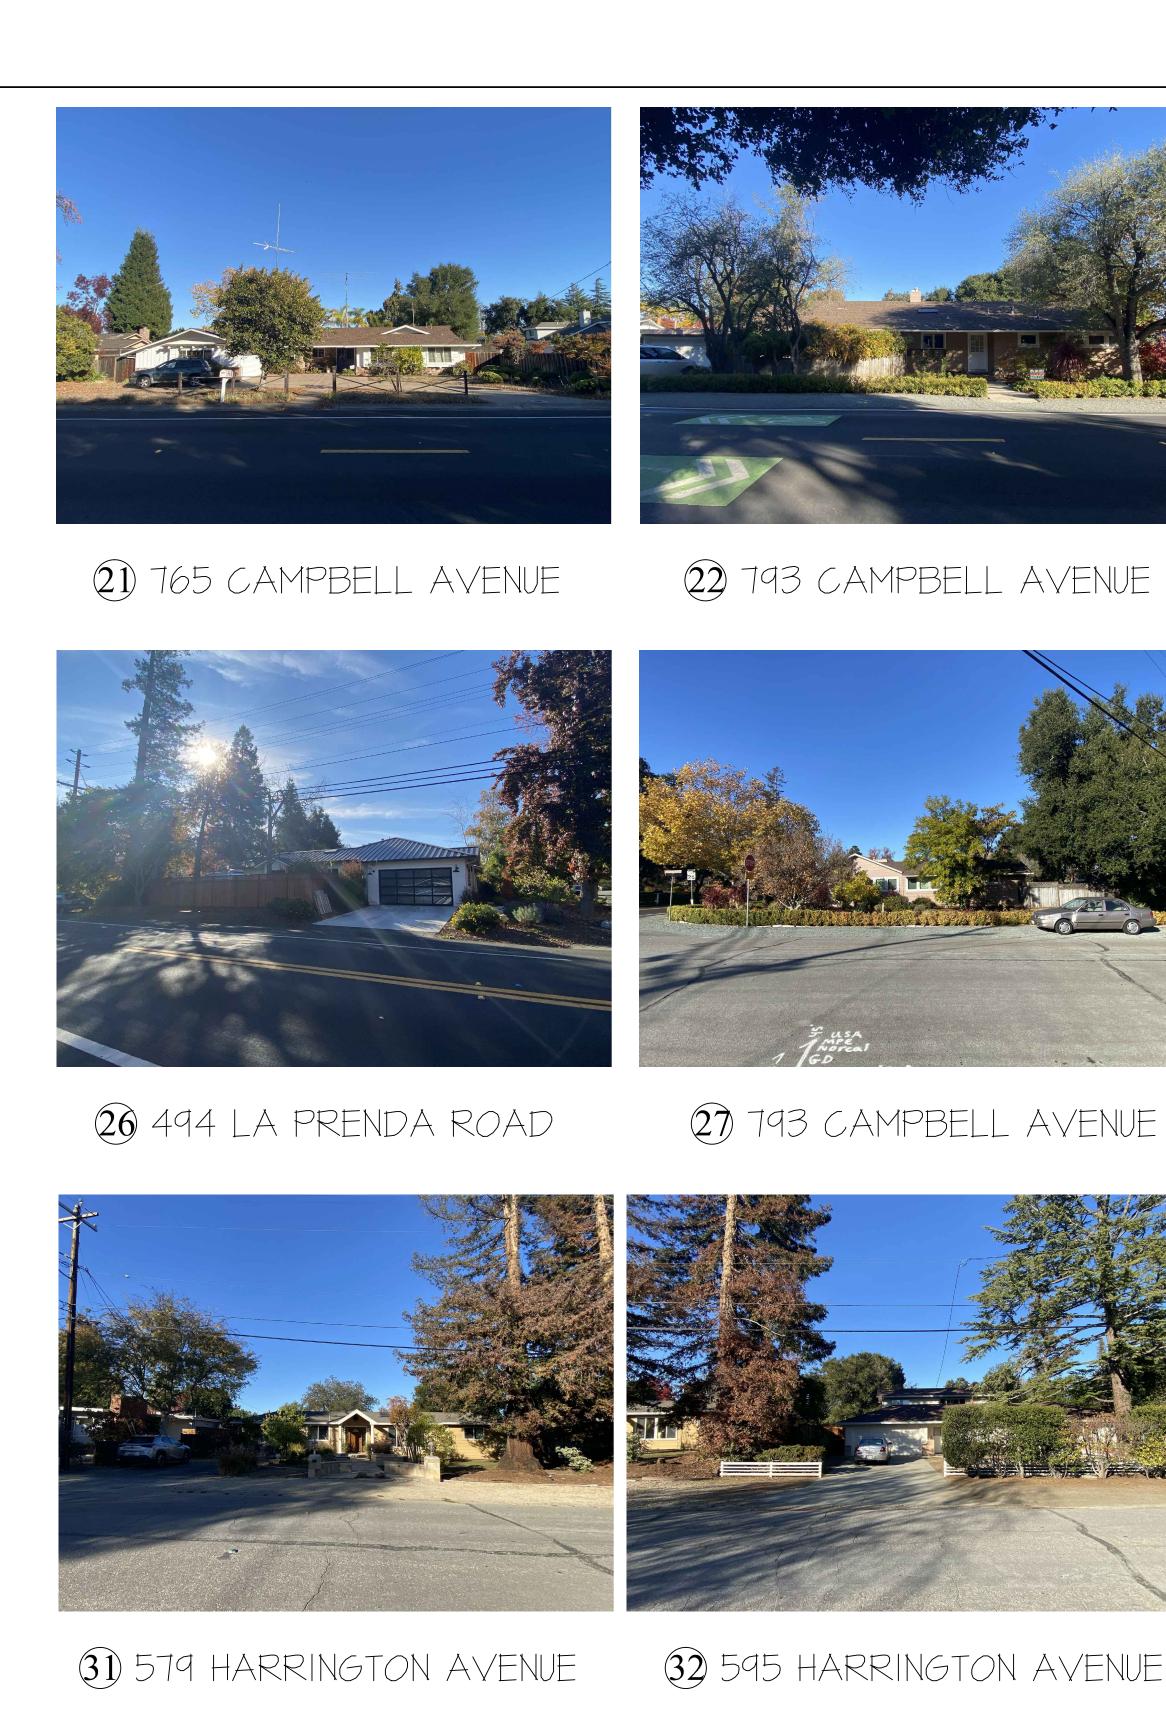

36 774 ANDERSON DRIVE






37 770 ANDERSON DRIVE



23 493 LA PRENDA ROAD



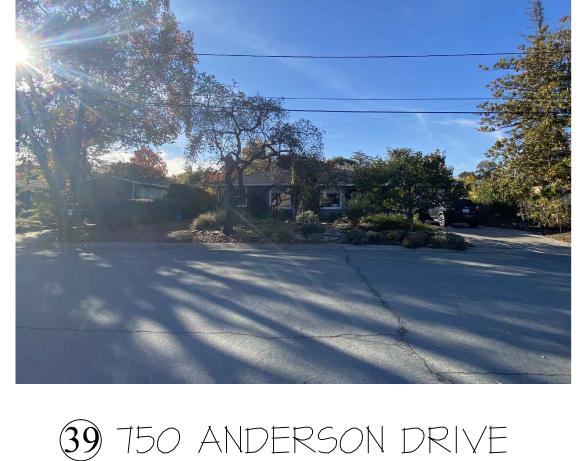


24 493 LA PRENDA ROAD


28 535 HARRINGTON AVENUE 29 549 HARRINGTON AVENUE







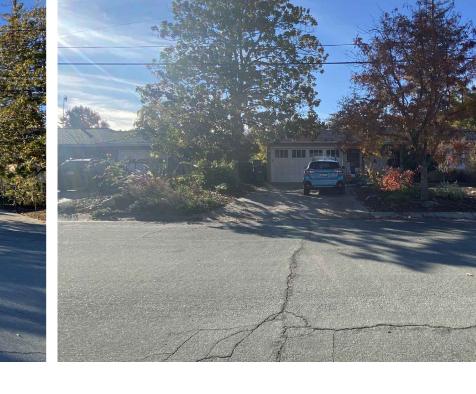

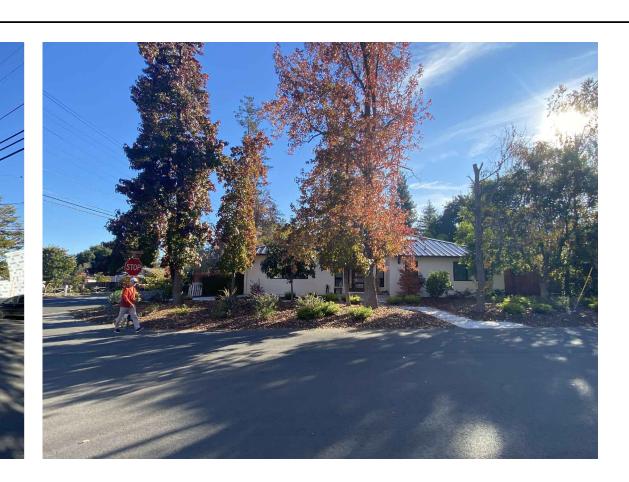

25 494 LA PRENDA ROAD



30 565 HARRINGTON AVENUE



35 621 HARRINGTON AVENUE



40 740 ANDERSON DRIVE



PROJECT TITLE & LOCATION

NEW RESIDENCE

FOR

SUKU

& NAMRITA

CHETTIAR

746 CASA BONITA COURT LOS ALTOS, CA 94024

J MALIKSI & ASSOC.

ARCHITECTURE - INTERIOR DESIGN

675 MENLO AVENUE MENLO PARK, CA 94025 TEL. NO. 650 323 2902 FAX NO. 650 323 6433




NO. DATE ISSUE

DRAWING TITLE

NEIGHBORHOOD **CONTEXT PHOTOS**

PROJECT NAME: CADD FILE NO. DRAWING NO.

A-0.4

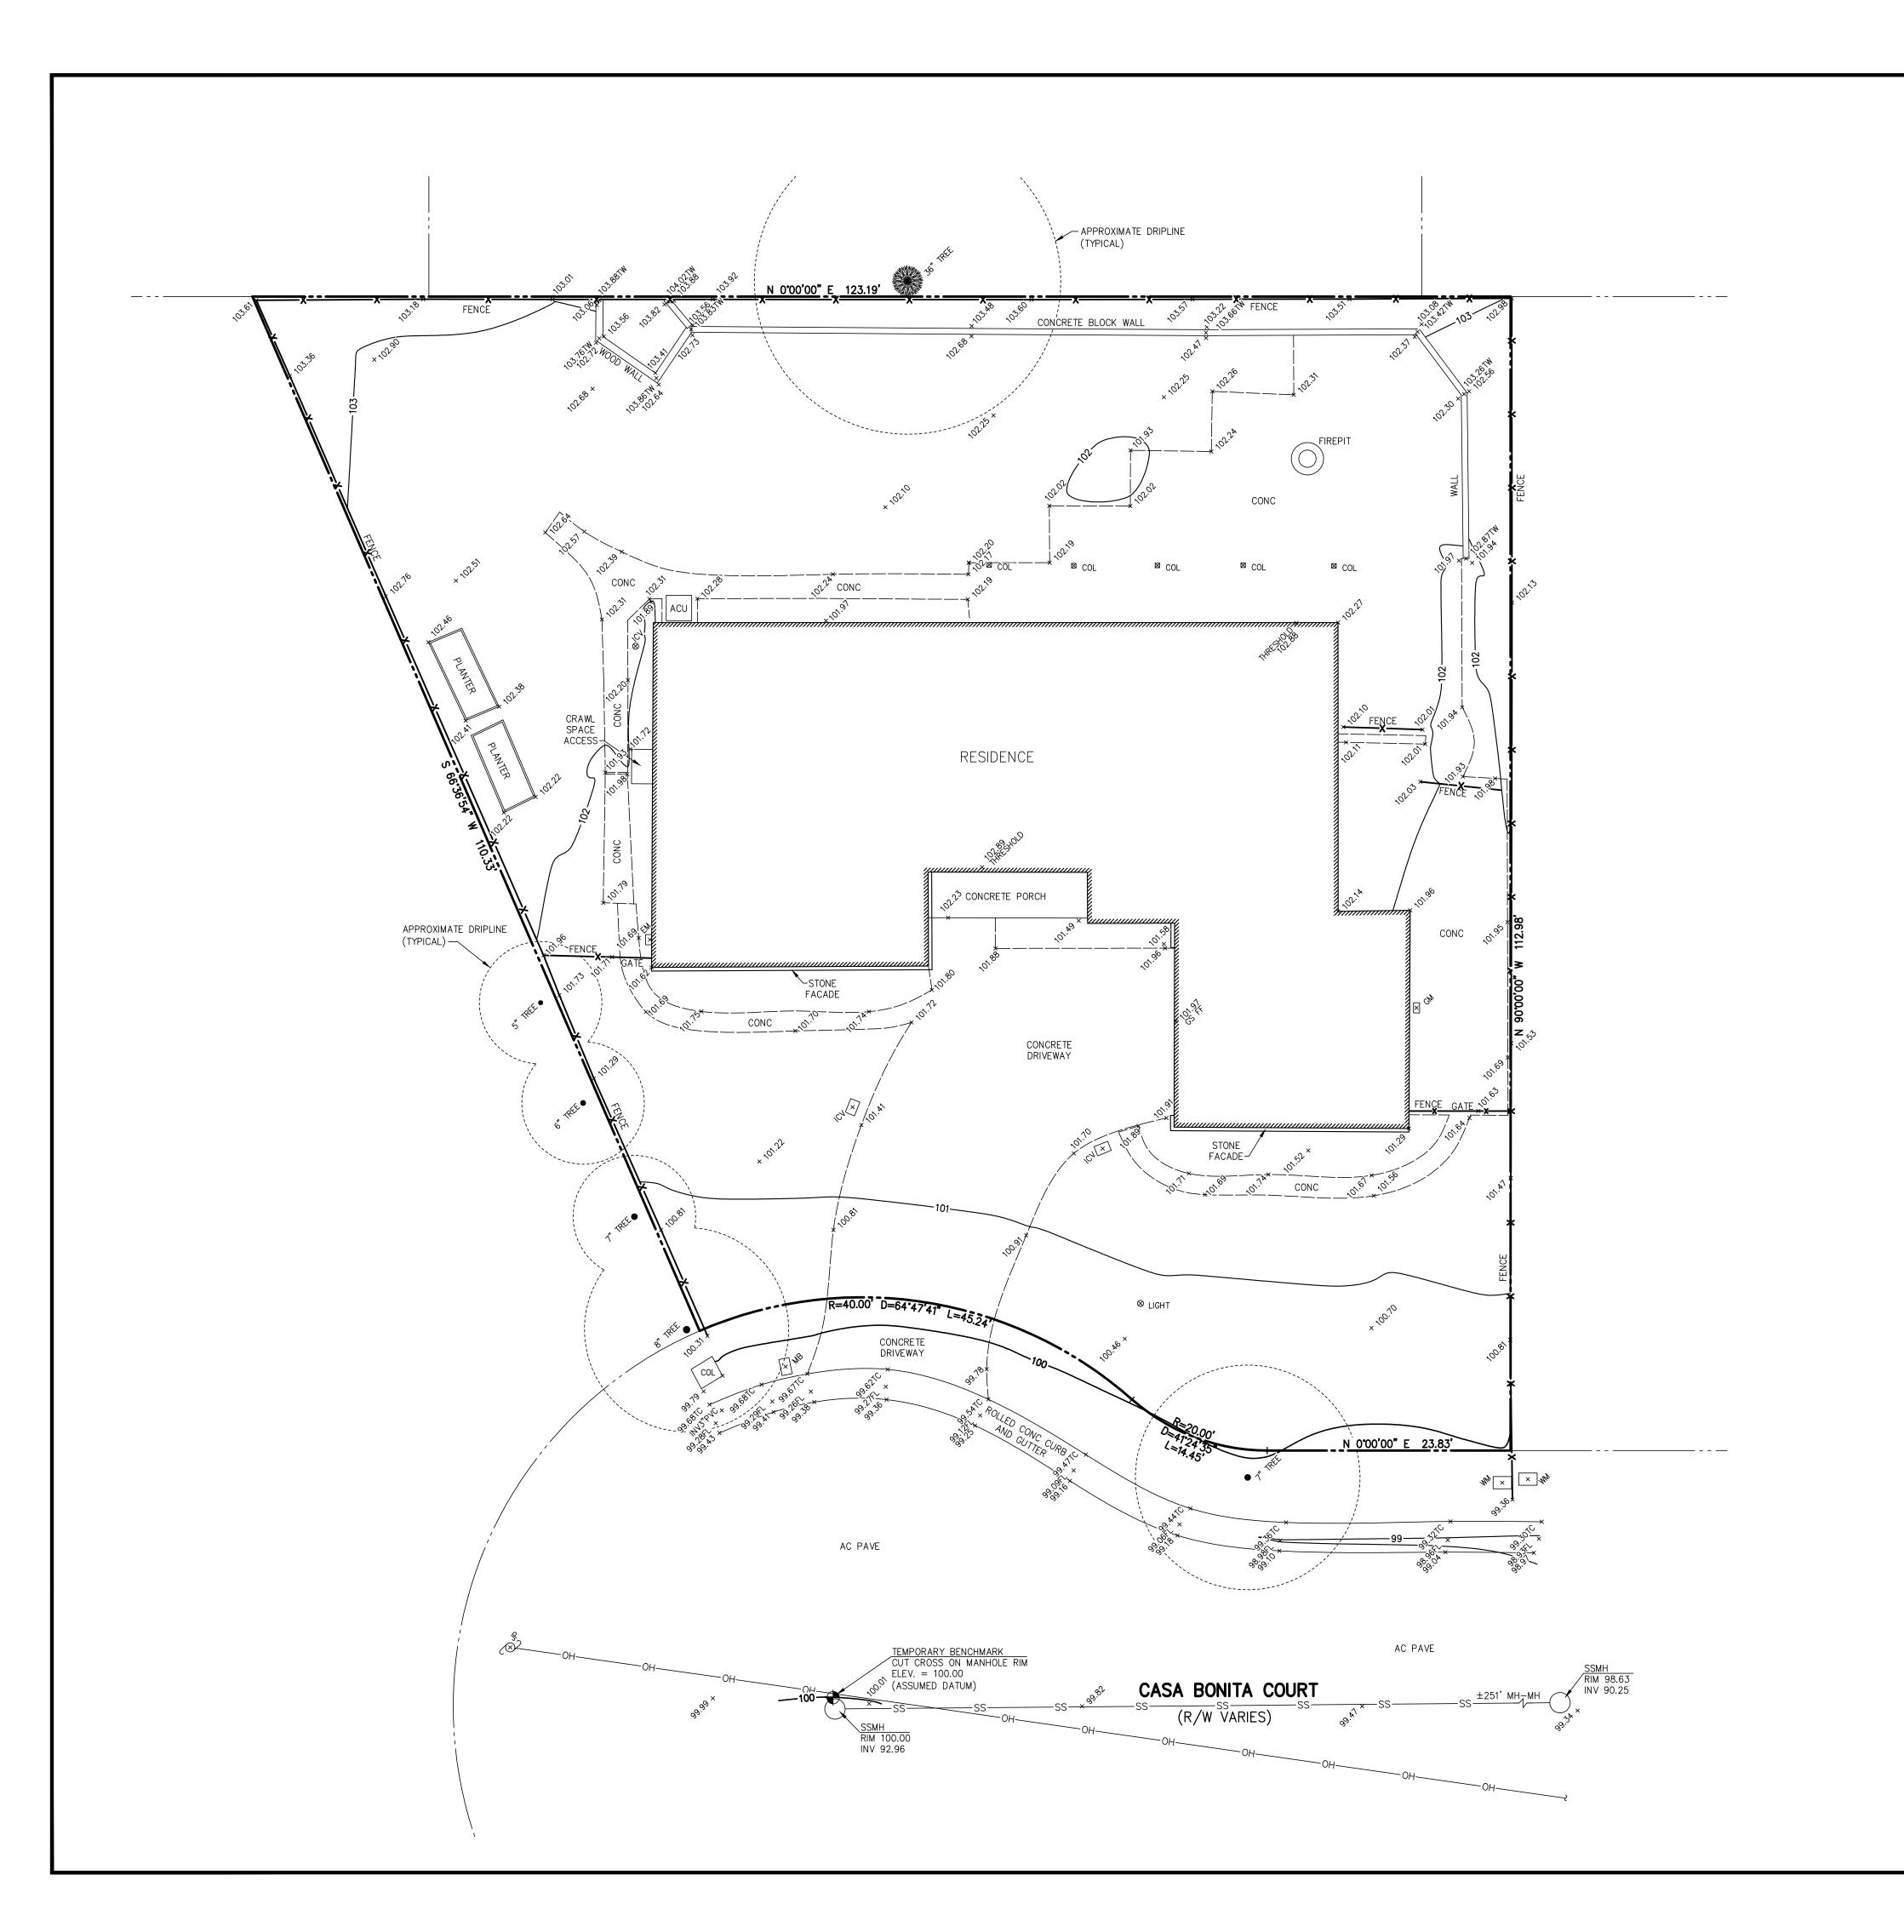

<u>LEGEND</u>

PROPERTY LINE AC PAVE ASPHALT CONCRETE PAVEMENT COLUMN COL CONCRETE ELECTRIC METER FLOWLINE GAS METER GM GS FF GARAGE SLAB FINISH FLOOR IRRIGATION CONTROL VALVE ICV INVERT JOINT UTILITY POLE MAILBOX SANITARY SEWER MANHOLE TOP OF CURB TOP OF WALL WATER METER TREE W/ SIZE OVERHEAD UTILITY LINE SANITARY SEWER LINE


LOT AREA:

= 10,632 SQ. FT. \pm = 0.244 ACRES \pm

UTILITY NOTE:

THE UTILITIES EXISTING ON THE SURFACE AND SHOWN ON THIS DRAWING HAVE BEEN LOCATED BY FIELD SURVEY. ALL UNDERGROUND UTILITIES SHOWN ON THIS DRAWING ARE FROM RECORDS OF THE VARIOUS UTILITY COMPANIES AND THE SURVEYOR/ENGINEER DOES NOT ASSUME RESPONSIBILITY FOR THEIR COMPLETENESS, INDICATED LOCATION, OR SIZE. RECORD UTILITY LOCATION SHOULD BE CONFIRMED BY EXPOSING THE UTILITY.



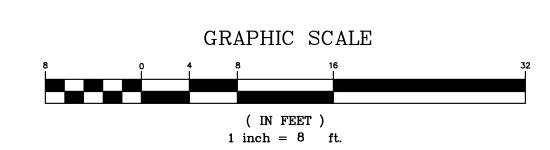

No. 5304

OF CALIFORNIA

OF CALIFORN

|ACLEOD AND ASSOCIATES

CIVIL ENGINEERING • LAND SURVEYING

CENTER STREET • SAN CARLOS • CA 94070 • (650) 593-858

PREPARED FOR:

NAMRITA AND SUKU

CHETTIAR

965

746 CASA BONITA COURT
A.P.N. 189-41-085
LOT 5, 18 MAPS 101

DRAWN BY: EM/MD


DESIGNED BY: --
CHECKED BY: DGM

SCALE: 1"=8'

DATE: 06-10-22

DRAWING NO.

DRAWING NO.
5263—TOPO
SHEET
1 OF 3

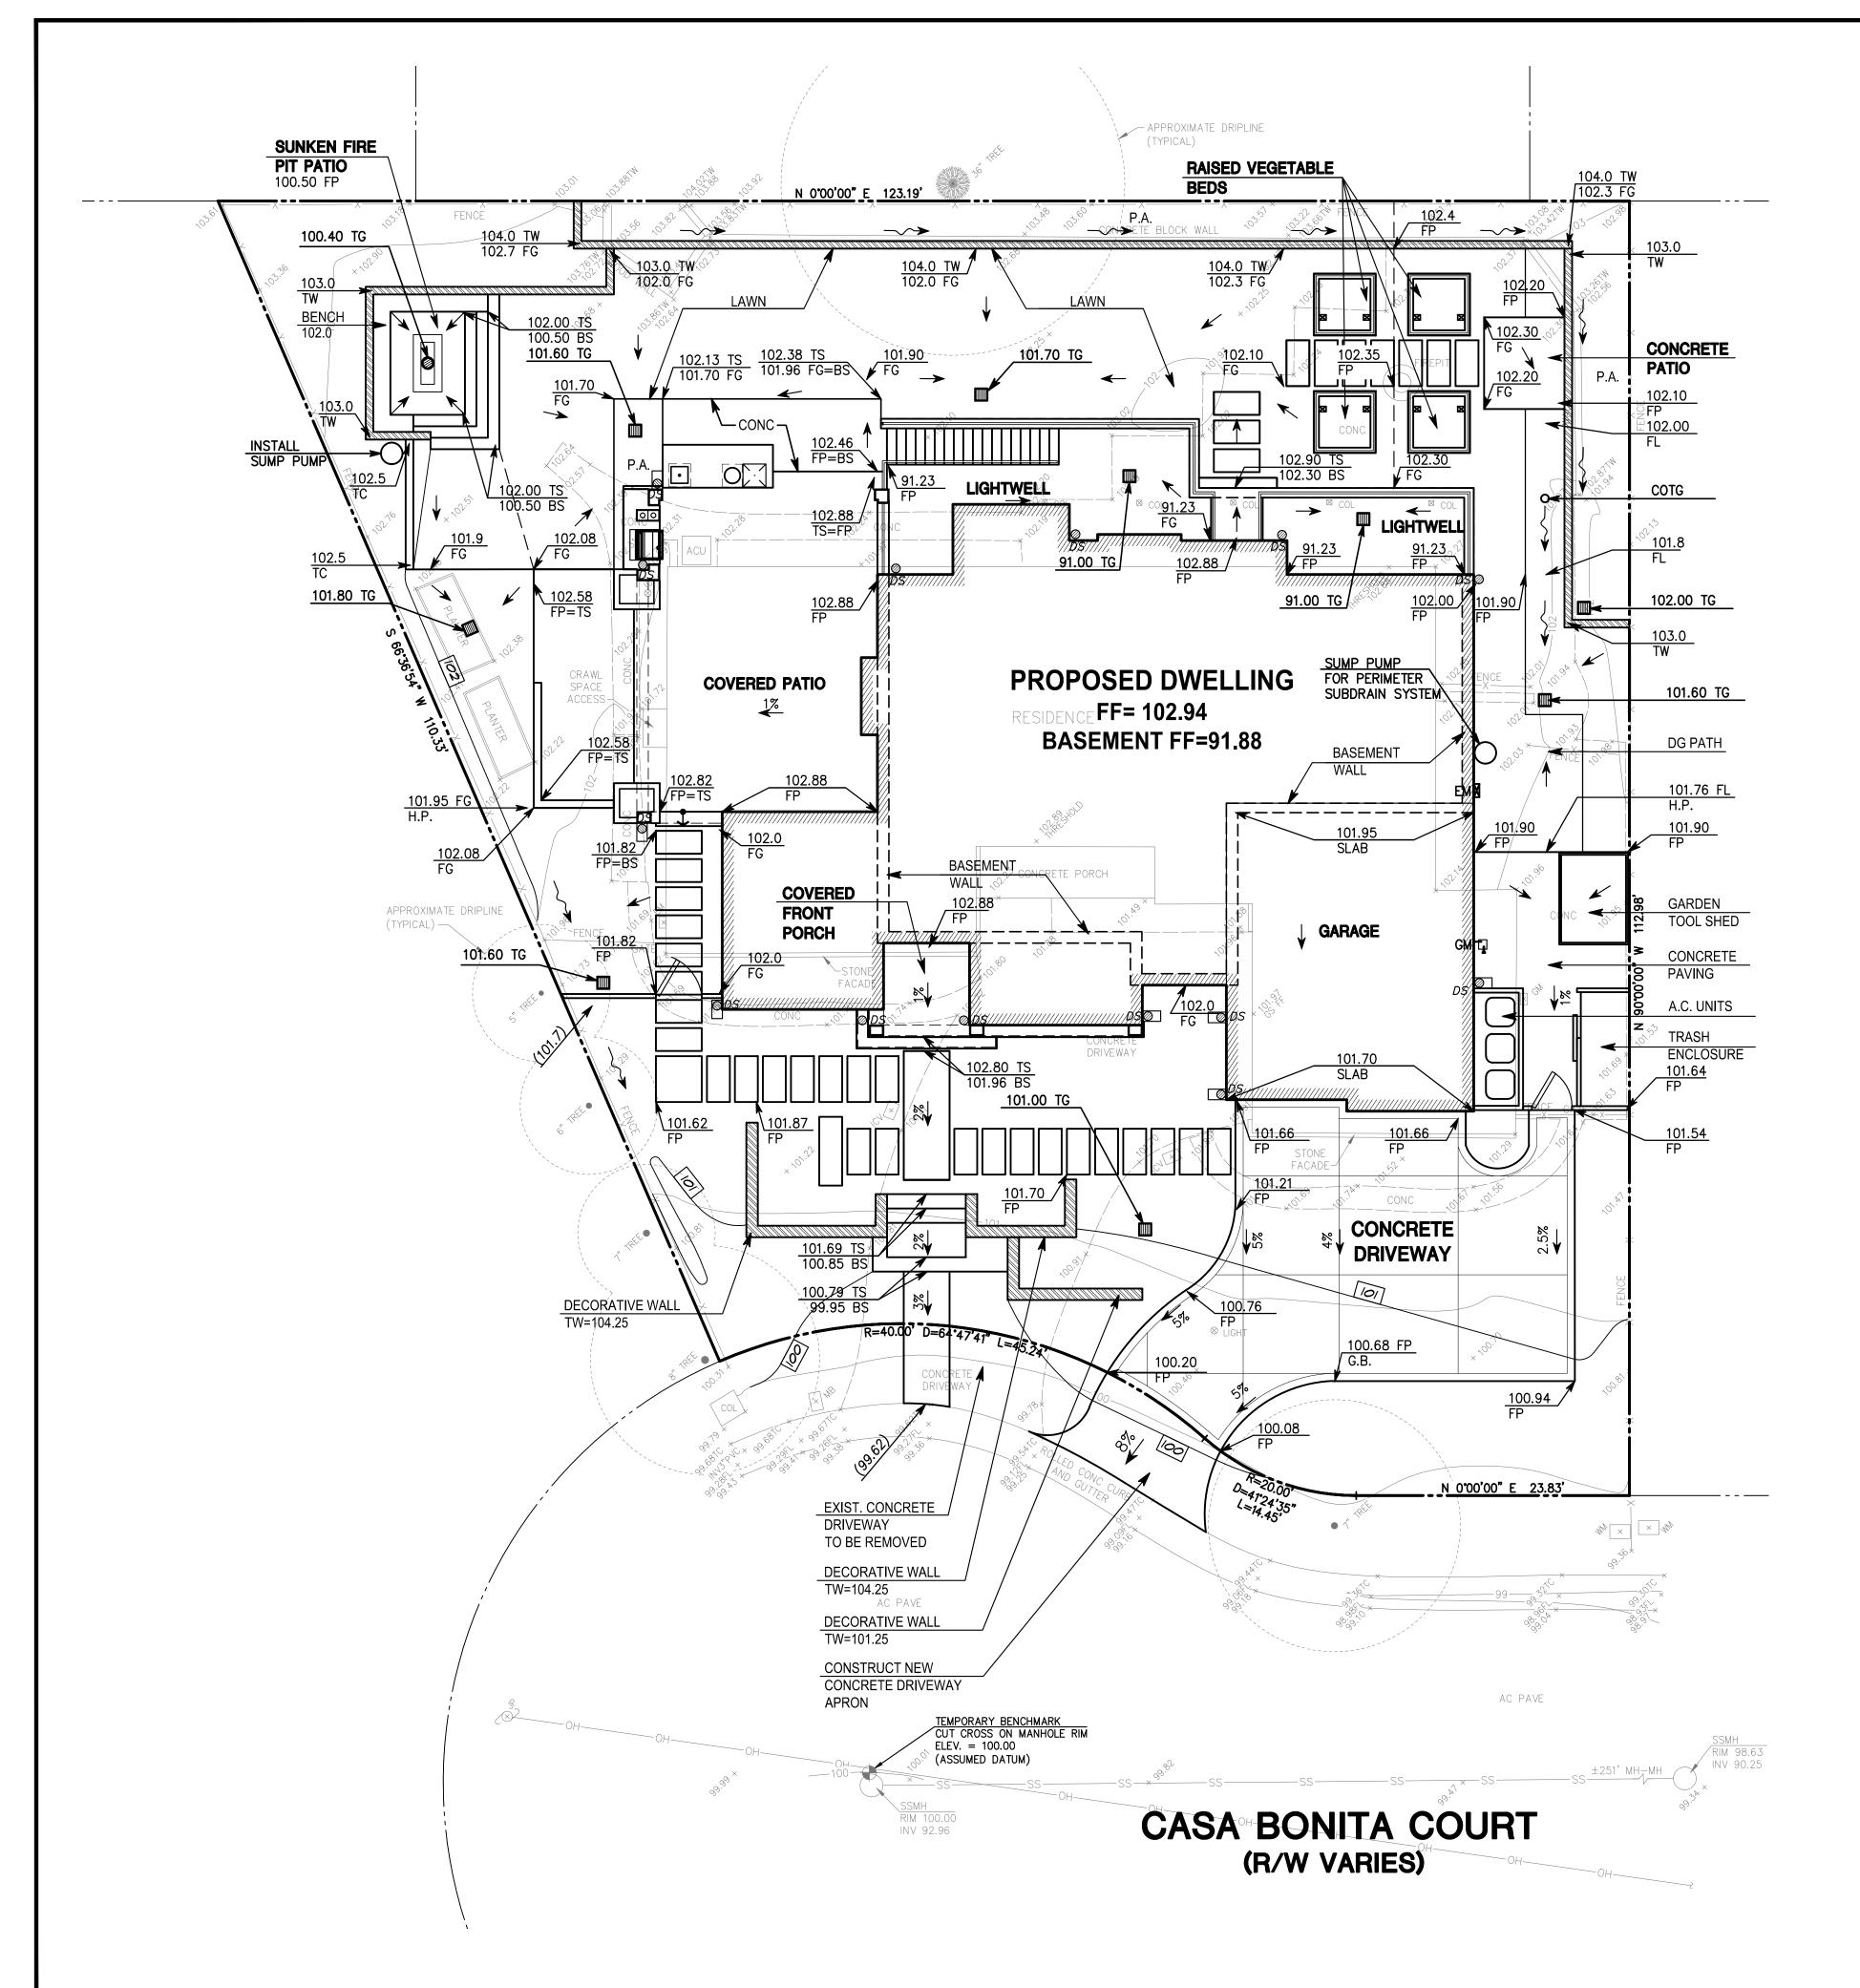

GENERAL NOTES:

- 1. ALL MATERIALS SHALL BE FURNISHED AND INSTALLED BY THE CONTRACTOR UNLESS OTHERWISE NOTED.
- 2. WHEN APPLICABLE, ALL CONSTRUCTION MATERIALS AND METHODS SHALL COMPLY WITH THE ORDINANCES, SPECIFICATIONS AND STANDARDS OF THE CITY OF LOS ALTOS, UNLESS OTHERWISE
- 3. CONTRACTOR SHALL NOTIFY UNDERGROUND SERVICE ALERT (U.S.A.) PRIOR TO START OF CONSTRUCTION. PHONE (800) 227-2600.
- 4. UNLESS OTHERWISE SPECIFIED, ALL ON-SITE AREA DRAINS SHALL BE CHRISTY-TYPE PRECAST CONCRETE OR APPROVED EQUAL.
- 5. THE CONTRACTOR SHALL BE RESPONSIBLE FOR DISTRIBUTING ANY EXCESS MATERIAL OR SUPPLYING MATERIAL FOR DEFICIENCIES TO BRING DRIVEWAY AND BUILDING PADS TO REQUIRED GRADE.
- 6. UTILITIES AND UNDERGROUND FACILITIES INDICATED ARE FOR INFORMATION ONLY. IT IS THE CONTRACTOR'S RESPONSIBILITY TO VERIFY THE LOCATION AND DEPTH WITH THE APPROPRIATE AGENCIES. NEITHER THE OWNER NOR THE CITY OR THE ENGINEER ASSUMES RESPONSIBILITY THAT THE UTILITIES AND UNDERGROUND FACILITIES INDICATED WILL BE THE UTILITIES AND UNDERGROUND FACILITIES ENCOUNTERED.
- THE CONTRACTOR IS RESPONSIBLE FOR MATCHING EXISTING SURROUNDING LANDSCAPE AND OTHER IMPROVEMENTS WITH A SMOOTH TRANSITION IN PAVING, GRADING, ETC., AND TO AVOID ABRUPT OR APPARENT CHANGES OR CROSS SLOPES, LOW SPOTS OR HAZARDOUS CONDITIONS.
- 8. THE CONTRACTOR SHALL OBTAIN NECESSARY PERMITS FOR ALL WORK SHOWN ON THIS PLAN.
- 9. UNLESS OTHERWISE SPECIFIED, ALL STORM DRAIN PIPES SHALL BE P.V.C. PER ASTM D-3034 SDR 35 BELL AND SPIGOT RUBBER GASKET JOINTS OR BETTER.
- 10. UNLESS OTHERWISE SPECIFIED, ALL SANITARY SEWER GRAVITY PIPES SHALL BE PVC SDR 26 WITH BELL AND SPIGOT RUBBER GASKET JOINTS OR BETTER.
- 11. UNLESS OTHERWISE SPECIFIED ALL FORCEMAIN LINES (SEWER EJECTOR PIPES) SHALL BE HDPE DR 11 OR BETTER
- 12. STORM DRAIN AND SANITARY SEWER INSTALLATIONS SHALL BEGIN FROM THE DOWNSTREAM POINT OF CONNECTION.
- 13. ANY DAMAGED RIGHT-OF-WAY INFRASTUCTURES AND OTHERWISE DISPLACED CURB AND GUTTER SHALL BE REMOVED AND REPLACED AS DIRECTED BY THE CITY ENGINEER OR HIS DESIGNEE. CONTRACTOR SHALL COORDINATE WITH PUBLIC WORKS DEPARTMENT AT (650) 947-2680
- 14. PRIOR TO THE COMMENCEMENT OF ANY WORK DONE IN THE PUBLIC-OF-WAY, A PERMIT TO OPEN STREET AND/OR AN ENCROACHMENT PERMIT WILL BE REQUIRED.

LEGEND:

ASPHALT CONCRETE PAVEMENT BOTTOM OF STEP BACKFLOW PREVENTER
CONCRETE COLUMN
• • • • • • • • • • • • • • • • • • • •
CLEANOUT TO FINISH GRADE
ELECTRIC METER
ELECTRIC BOX
EDGE OF PAVEMENT
FINISH FLOOR
FLOWLINE
FINISH PAVEMENT
FINISH GRADE
GARAGE SLAB FINISH FLOOR
GRADE BREAK

GAS METER H.P. HIGH POINT INVERT INV ICV JOINT UTILITY POLE MAILBOX P.A.

SSMH TC

──FM**──**


SWALE \longrightarrow DS 🔘

UTILITY NOTE:


THE UTILITIES EXISTING ON THE SURFACE AND SHOWN ON THIS DRAWING HAVE BEEN LOCATED BY FIELD SURVEY. ALL UNDERGROUND UTILITIES SHOWN ON THIS DRAWING ARE FROM RECORDS OF THE VARIOUS UTILITY COMPANIES AND THE SURVEYOR/ENGINEER DOES NOT ASSUME RESPONSIBILITY FOR THEIR COMPLETENESS, INDICATED LOCATION, OR SIZE. RECORD UTILITY LOCATION SHOULD BE CONFIRMED BY EXPOSING THE UTILITY.

GEOTECHNICAL ENGINEER NOTES:

SUB-SLAB DRAINAGE. BASEMENT RETAINING WALL DRAINAGE AND BACKFILL, FOUNDATION CONSTRUCTION, SLAB SUBGRADE AND NON-EXPANSIVE FILL PREPARATION, UTILITY TRENCH BACKFILLING. PAVEMENT CONSTRUCTION, AND SITE DRAINAGE SHOULD BE PERFORMED IN ACCORDANCE WITH THE GEOTECHNICAL REPORT PREPARED BY ROMIG ENGINEERS, INC., DATED MARCH 14, 2023. ROMIG ENGINEERS SHOULD BE NOTIFIED AT LEAST 48 HOURS IN ADVANCE OF ANY EARTHWORK OR FOUNDATION CONSTRUCTION AND SHOULD OBSERVE AND TEST DURING EARTHWORK AND FOUNDATION CONSTRUCTION AS RECOMMENDED IN THE GEOTECHNICAL REPORT. ROMIG ENGINEERS SHOULD BE NOTIFIED AT LEAST 5 DAYS PRIOR TO EARTHWORK, TRENCH BACKFILL AND SUBGRADE PREPARATION WORK TO ALLOW TIME FOR SAMPLING OF ON-SITE SOIL AND LABORATORY COMPACTION CURVE TESTING TO BE PERFORMED PRIOR TO ON-SITE COMPACTION DENSITY TESTING.

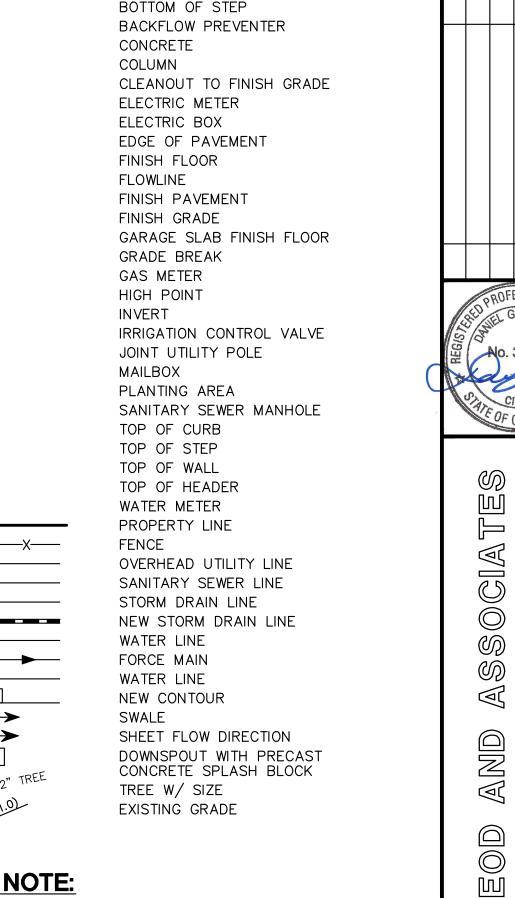


EARTHWORK, BASEMENT SUBGRADE PREPARATION, PIER DRILLING,

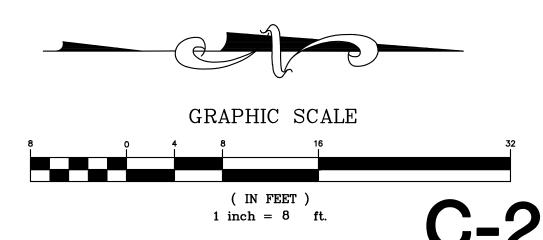

DRAWN BY: DESIGNED BY: CHECKED BY: DGM

SCALE: 1"=8" DATE: 05/17/2 DRAWING NO. 5263-GRAD

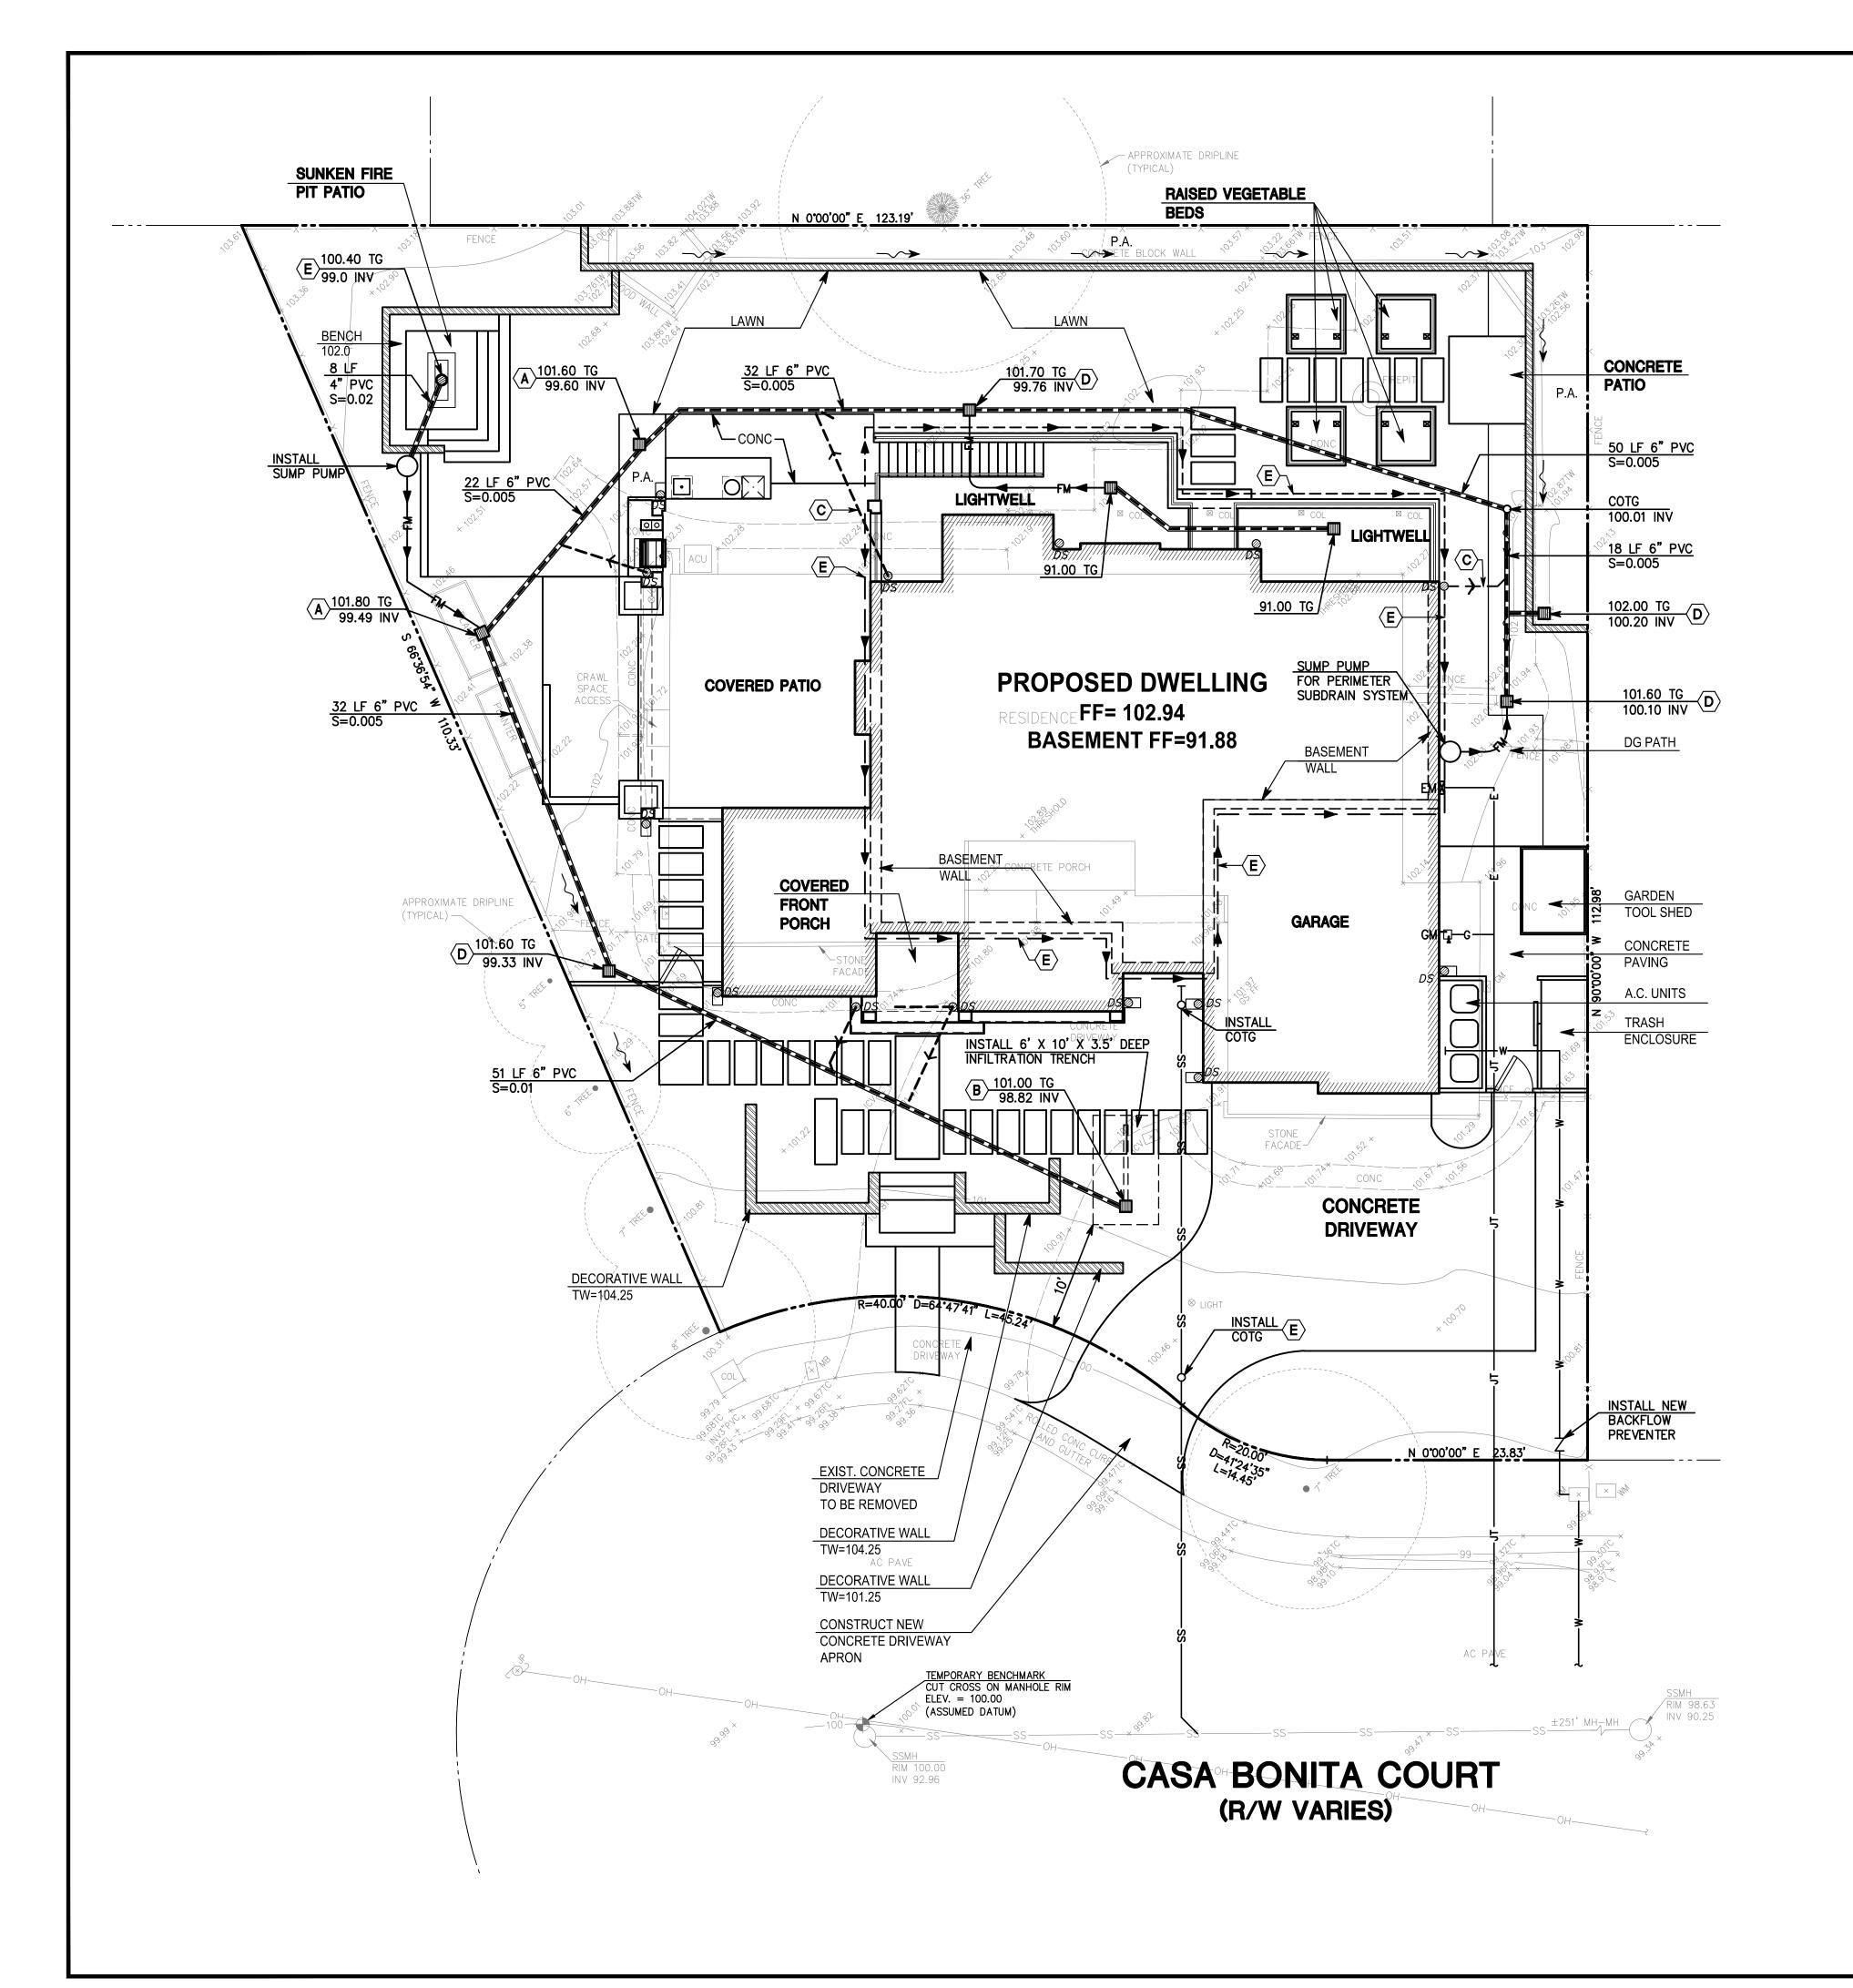

CONSTRUCTION NOTES:

- (A) INSTALL 12" X 12" PRECAST CONCRETE DRAIN BOX WITH GRATE COVER COVER BY HARDCASTLE CONCRETE OR APPROVED EQUAL.
 - INSTALL BOTTOMLESS 16" X 16" PRECAST CONCRETE DRAIN BOX WITH GRATE COVER BY CHRISTY OR APPROVED EQUAL.
 - CONNECT DOWNSPOUT WITH 4" PVC AT 1% MIN. SLOPE
- INSTALL 12" X 12" PLASTIC DRAIN BOX WITH GRATE COVER COVER BY NDS OR APPROVED EQUAL.
- INSTALL 4" PVC SUBDRAIN PIPE AT 1% MIN. SLOPE

LEGEND:

AC PAVE

BS	BOTTOM OF STEP					
BFP	BACKFLOW PREVENTER					
CONC	CONCRETE					
COL	COLUMN					
COTG	CLEANOUT TO FINISH GRADE					
EM	ELECTRIC METER					
EB	ELECTRIC BOX					
EP	EDGE OF PAVEMENT					
FF	FINISH FLOOR					
FL	FLOWLINE					
FP	FINISH PAVEMENT					
FG	FINISH GRADE					
GS FF	GARAGE SLAB FINISH FLOOF					
CB	CDADE DDEAK					

INV ICV

P.A. SSMH

DS 🛭

EXISTING GRADE

UTILITY NOTE:

THE UTILITIES EXISTING ON THE SURFACE AND SHOWN ON THIS DRAWING HAVE BEEN LOCATED BY FIELD SURVEY. ALL UNDERGROUND UTILITIES SHOWN ON THIS DRAWING ARE FROM RECORDS OF THE VARIOUS UTILITY COMPANIES AND THE SURVEYOR/ENGINEER DOES NOT ASSUME RESPONSIBILITY FOR THEIR COMPLETENESS, INDICATED LOCATION, OR SIZE. RECORD UTILITY LOCATION SHOULD BE CONFIRMED BY EXPOSING THE UTILITY.

	00110112	
	COLUMN	
	CLEANOUT TO FINISH GRADE	
	ELECTRIC METER	
	ELECTRIC BOX	
	EDGE OF PAVEMENT	
	FINISH FLOOR	
	FLOWLINE	
	FINISH PAVEMENT	
	FINISH GRADE	
	GARAGE SLAB FINISH FLOOR	
	GRADE BREAK	
	GAS METER	
	HIGH POINT	PROFES
	INVERT	RED G. I
	IRRIGATION CONTROL VALVE	PROFES PARTIEL G. /
	JOINT UTILITY POLE	원 No. 35
	MAILBOX	Mill Jan
	PLANTING AREA	100
	SANITARY SEWER MANHOLE	CIVITATE OF CA
	TOP OF CURB	OF CA
	TOP OF STEP	
	TOP OF WALL	10
	TOP OF HEADER	(M)
	WATER METER	
	PROPERTY LINE	
X	FENCE	
-OH	OVERHEAD UTILITY LINE	${\mathbb Q}$
-SS	SANITARY SEWER LINE	
-SD	STORM DRAIN LINE	
	NEW STORM DRAIN LINE	SOCIATE
-W	WATER LINE	
-FM ──	FORCE MAIN	
_JT	WATER LINE	<i>®</i> و
101	NEW CONTOUR	
~ ~	SWALE	
→	SHEET FLOW DIRECTION	AND
	DOWNSPOUT WITH PRECAST	
" TOFF	CONCRETE SPLASH BLOCK	
●12" TREE	TREE W/ SIZE	
(101.0)	EXISTING GRADE	7

ASPHALT CONCRETE PAVEMENT

DRAWN BY:

SCALE:

DATE:

DRAWING NO.

DESIGNED BY:

CHECKED BY: DGM

5263-UTIL

GRAPHIC SCALE

(IN FEET) 1 inch = 8 ft.



2022 CALIFORNIA PLUMBING CODE

2022 CALIFORNIA PLUMBING CODE 2022 CEC ELECTRICAL CODE

2022 ENERGY CODE

2022 CALIFORNIA MECHANICAL CODE

2022 CALIFORNIA GREEN BUILDING STANDARDS CODE

(CALGREEN RESIDENTIAL CHECKLIST)

SITE DATA

APN: 189-41-085

ADDRESS: 746 CASA BONITA COURT LOS ALTOS, CA 94024

ZONING DISTRICT: R1-10

OCCUPANCY USE: SINGLE FAMILY RESIDENTIAL

LOT AREA: 10,632 S.F.

MAXIMUM FLOOR AREA 30%: 3,189.6 S.F.

PROPOSED FLOOR AREA: 3,135 S.F.

FRONT, REAR, SIDE SETBACKS: 25'-O" FRONT AND REAR 10'-O" SIDES

FRONT YARD IMPERVIOUS COVERAGE: 934.18 SF (42%)

FRONT YARD ALLOWABLE IMPERVIOUS COVERAGE: TOTAL 2,212 SF (50%)= 1,106 SF

(22,3, 1,1.22

PROJECT DIRECTORY

DWNERS: SUKU AND NAMARITA CHETTIAR 746 CASA BONITA CT.

LOS ALTOS, CA 94024 PH: (408) 761-8678

NT: COURTNEY CAMERON

CALIFORNIA HORTICULTURE LANDSCAPE CONSTRUCTION INC.

753 CAMDEN AVENUE CAMPBELL, CA 95008 CA LIC. #641851 PH: (408) 364-3190

PROJECT DESCRIPTION

SCOPE OF WORK INDICATED IN THESE LANDSCAPE DRAWINGS INCLUDES:

CARPENTRY ITEMS: VEGETABLE BEDS, CUT OFF FENCING AT SIDE YARDS WITH GATES, IPE WOOD BENCH, SUNKEN FIRE PIT IPE DECK AND REDWOOD TRELLISES FOR CLIMBING VEGETABLES.

LANDSCAPE HARDSCAPE ITEMS: CMU WALLS 3' MAX HIGH WITH STUCCO VENEER, STONE VENEER STEPS AND WALKWAYS, STEPPING PADS AND POURED COLORED CONCRETE DRIVEWAY AND SIDE YARD PATH.

LANDSCAPE STRUCTURE ITEMS: OUTDOOR KITCHEN AND DECORATIVE POTS.

LEGEND




DRIVEWAY PAVING: 6" THICK POURED COLORED CONCRETE SET OVER 6" DEPTH CLASS II BASEROCK COMPACTED TO 95%.

PEDESTRIAN PAVING: 4" MIN. THICK CONCRETE W/ #3 REBAR @ 18" O.C.B.W. OVER 4" DEPTH CLASS II BASEROCK COMPACTED TO 95%. THIN STONE VENEER MORTAR SET TO BE SELECTED BY HOME OWNER



LAWN: GRASS FROM DELTA BLUEGRASS TO BE SELECTED BY OWNER.

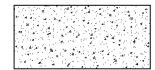


DECOMPOSED GRAVEL PAVING: 1" DEPTH WITH BINDER AS SELECTED BY OWNER OVER 4" DEPTH CLASS II BASEROCK COMPACTED TO 95%.

GARDEN WALLS: VARY IN HEIGHT NOT TO EXCEED 3' HIGH MAX, OUT OF CMU BLOCK WITH A SMOOTH STUCCO VENEER ON ALL SIDES

HEADER BOARD: BLACK STEEL HEADERBOARD & STAKES. INSTALL BETWEEN GRAVEL AREAS & LAWN & PLANTING AREAS LOCATIONS PER PLAN.

PLANTING AREA: AMENDED NATIVE SOIL WITH NEW PLANTING PER PLANTING PLAN

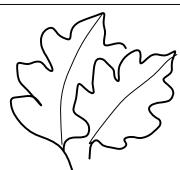

California Horticulture

LANDSCAPE CONSTRUCTION INCORPORATED

Avenue Campbell, CA 95008

753 Camden

Phone 408-364-3190 FAX 408-364-3199

Contractors License B & C-27 & C-53

Chettiar Residence

Scale: 1/8" = 1' - 0"

Sheet: Cover Sheet

Drawn by: CC Revisions: 7 26 23

Date: 5-5-2023

Revisions: 7_26_23

SHEET

Lo





California Horticulture

LANDSCAPE CONSTRUCTION INCORPORATED 753 Camden

408-364-3190

Campbell, CA 95008

FAX 408-364-3199

Contractors License B & C-27 & C-53


641851

Scale: 1/8" = 1' - 0"


Drawn by: CC

Revisions: 7_26_23

SHEET

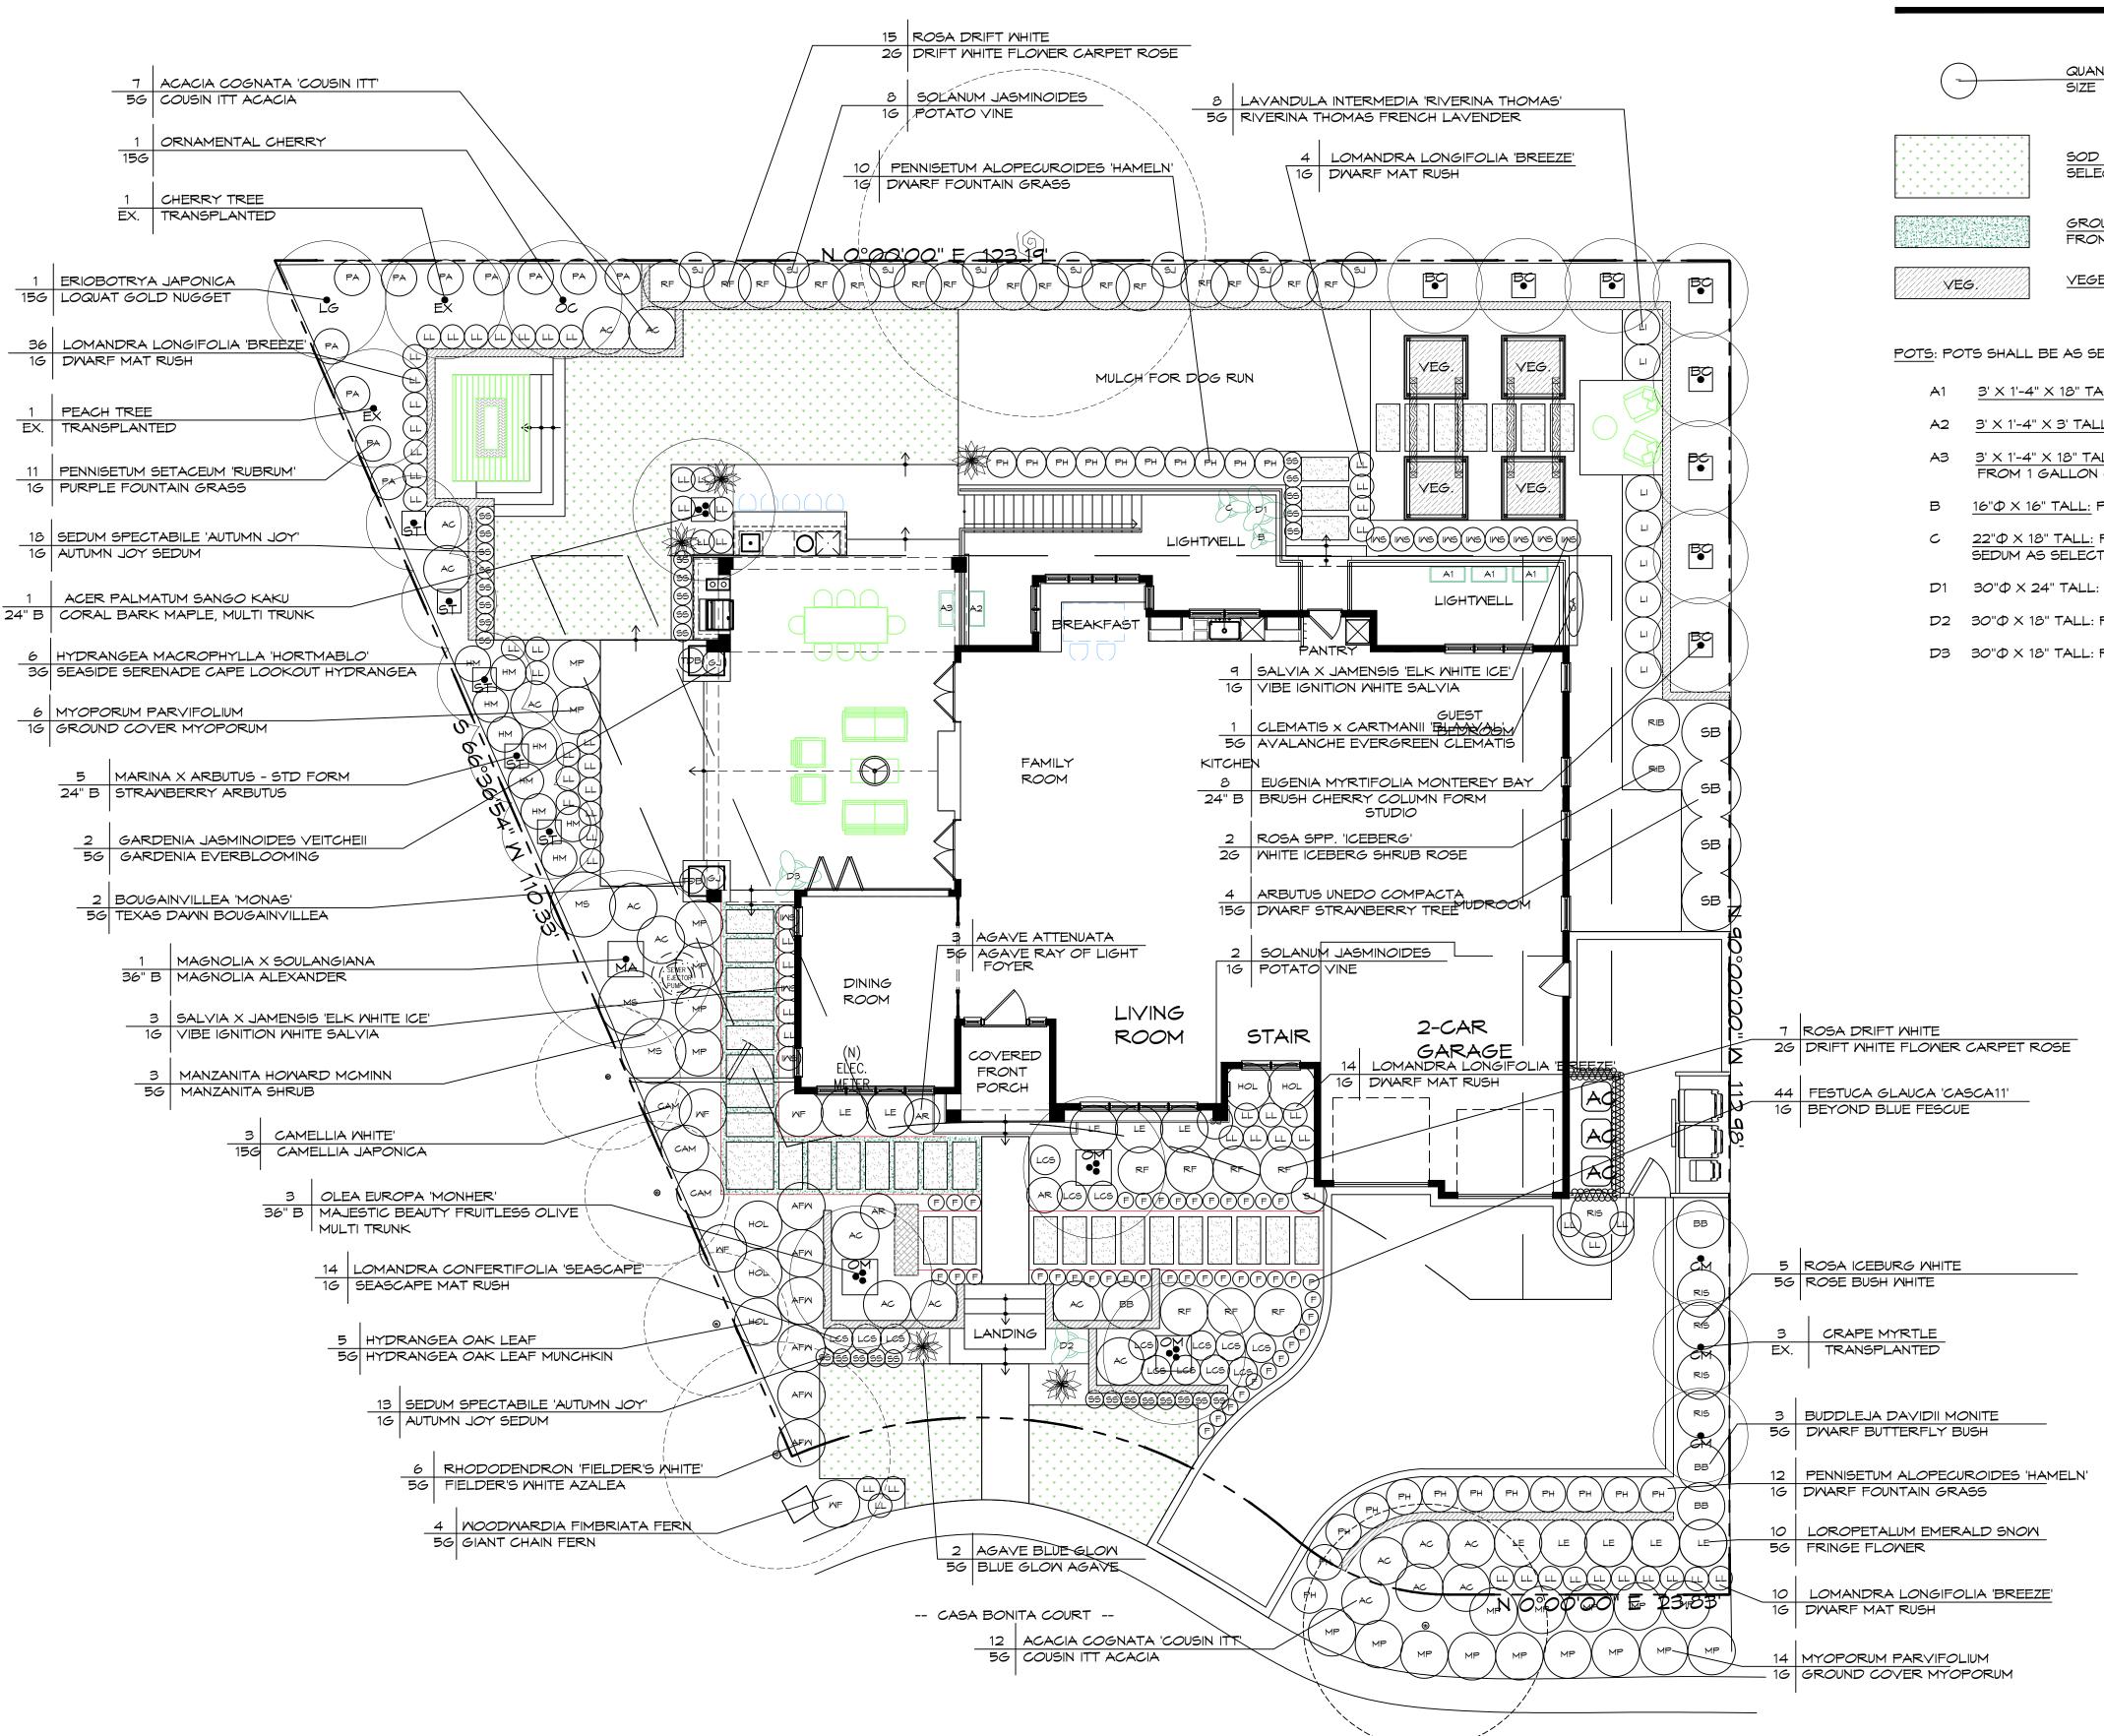

PLANTING LEGEND

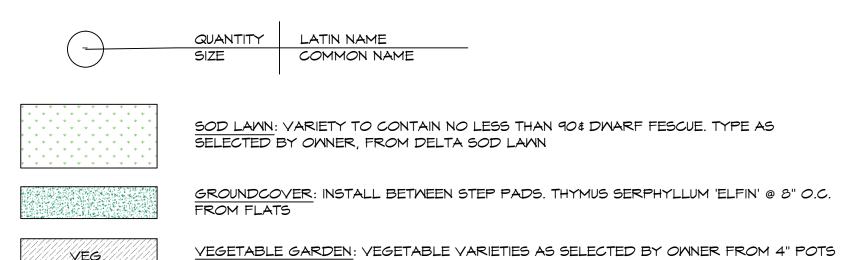

POTS: POTS SHALL BE AS SELECTED BY OWNER. GENERAL SIZES NOTED.

- A1 $3' \times 1'-4" \times 18"$ TALL: PLANT W/ (2) CAST IRON ASPIDISTRA ELATIOR 1 GALLON
- A2 $3' \times 1'-4" \times 3'$ TALL: PLANT WITH (1) SOLANUM JASMINOIDES FROM 5 GALLON CAN
- 3 <u>3' X 1'-4" X 18" TALL:</u> PLANT WITH (2) LIRIOPE MUSCARI AND (1) CLIVIA MINIATA FROM 1 GALLON CANS
- B 16"Φ X 16" TALL: PLANT WITH SUCCULENTS AS SELECTED BY OWNER
- C $22"\Phi \times 18"$ TALL: PLANT WITH (1) ALOE NOBILIS FROM 1 GALLON CAN AND TRAILING SEDUM AS SELECTED BY OWNER
- D1 30" \$\Phi \times 24" TALL: PLANT WITH (1) ALOE VERA FROM 5 GALLON CAN
- D2 30" \$\Phi X 18" TALL: PLANT W/ (1) ALOE VERA FROM 5 GALLON CAN
- D3 $30"\Phi \times 18"$ TALL: PLANT W/ SUCCULENTS AS SELECTED BY OWNER

Chettiar Residence

California

Horticulture

LANDSCAPE

INCORPORATED

Campbell, CA

408-364-3190

FAX 408-364-3199

Contractors License

B & C-27 & C-53 641851

CONSTRUCTION

Scale: 1/8" = 1' - 0"

Sheet: Planting Plan


Date: 5-5-2023

Drawn by: CC/WB

Revisions: 7_26_23

SHEET

L2

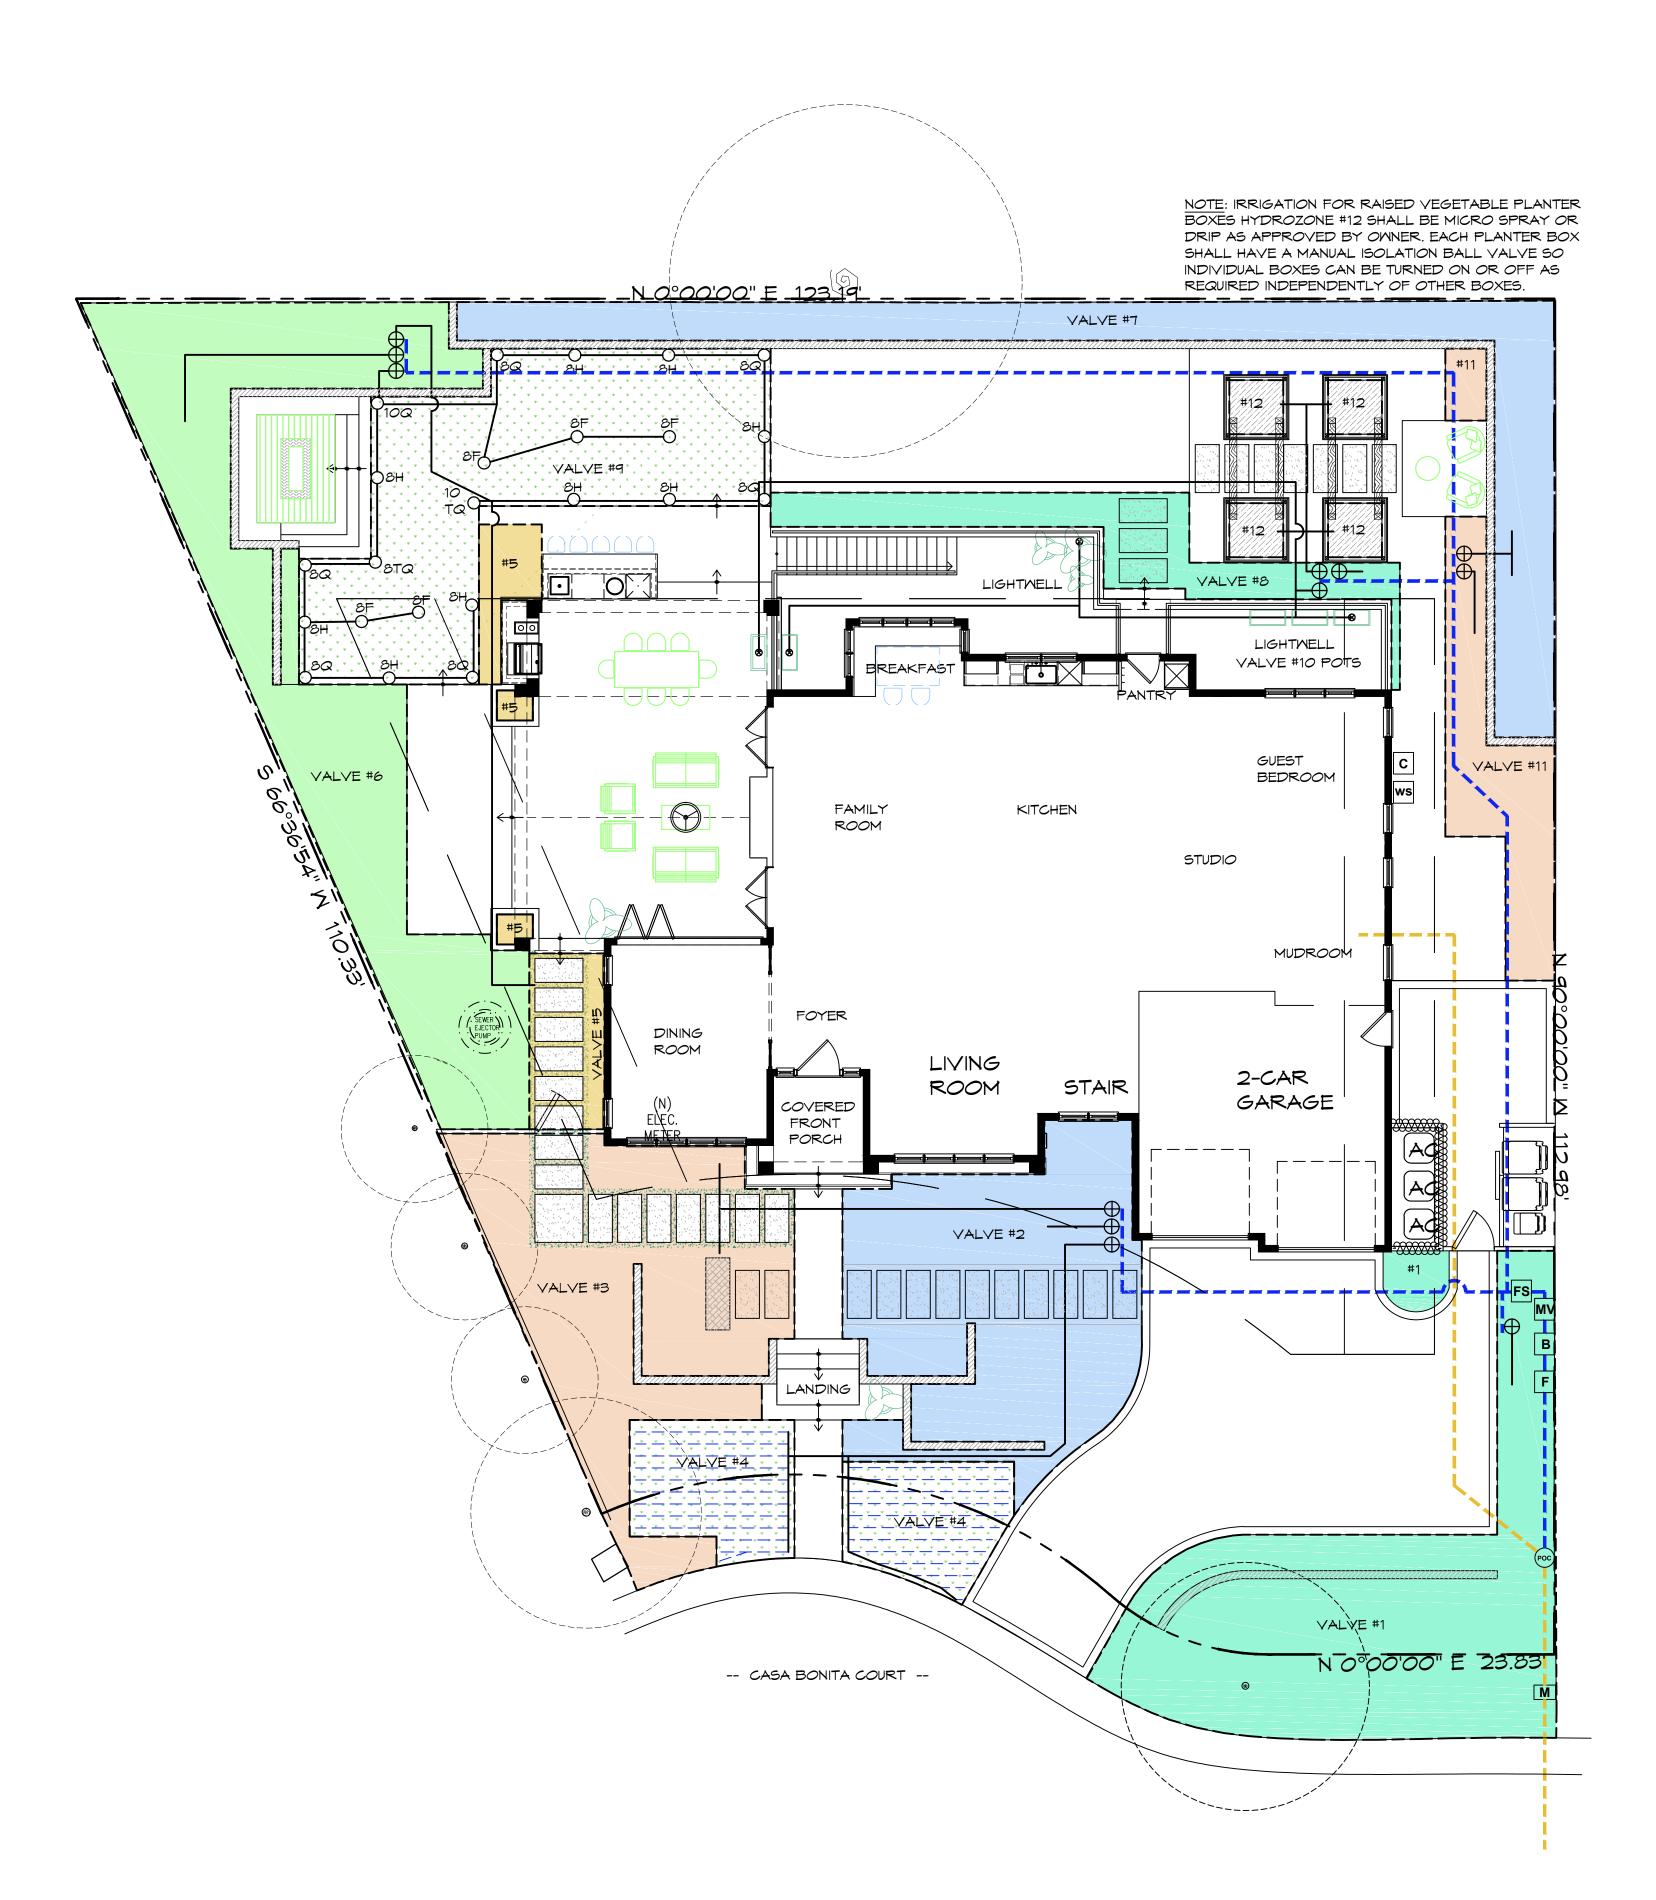

LEGEND

<u> </u>	IRRIGATION HYDROZONE: INDICATES LIMITS OF IRRIGATION ZONE AND RESPECTIVE VALVE NUMBER. ALL IRRIGATION ZONES SHALL BE 1 GPH PRESSURE COMPENSATING DRIP EMITTERS UNLESS OTHERWISE NOTED. EACH 1 AND 5 GALLON PLANT SHALL RECIEVE 2 EMITTERS. 15 GALLON PLANTS SHALL RECEIVE 6 EMITTERS. BOX PLANTS AND TRANSPLANTED MATERIAL SHALL RECEIVE 10 EMITTERS.
Овн	POP-UP SPRAY HEAD: LAWN SPRAY IRRIGATIO - RAIN BIRD 1800 SERIES 6" POP UP BODIES W/ RAINBIRD MPR SERIES MATCHED PRECIPITATION RATE SPRAY NOZZLES W/ RESPECTIVE RADIUS & PATTERN AS INDICATED
С	IRRIGATION CONTROL CLOCK: TORO 'TMC-424E-OD' WITH (2) \times 'TSM-8F' FLOW SENSING EXPANSION MODULES (20 TOTAL STATIONS). PLUG INTO 120 VOLT GFCI OUTLET ON HOUSE EXTERIOR WALL.
ws	MEATHER SENSOR: TORO 'TWRS' WIRELESS RAIN SENSOR. MOUNT IN LOCATION AS APPROVED BY CONTRACTOR.
M	MATER METER: EXISTING DOMESTIC SERVICE METER
F	FILTER: RAINBIRD QUICK CHECK BASKET FILTER W/ 120 MESH SCREEN. SIZE PER MAINLINE
В	BACKFLOW PREVENTER: TFEBCO 825Y 1" BACKFLOW ASSEMBLY W/ ISOLATION SHUTOFF VALVES. LOCATE 12" ABOVE GRADE IN PLANTING AREA. SCREEN FROM VIEW W/ ADJACENT PLANTING.
MV	MASTER VALVE: IRRITROL 700 SERIES 1 $\frac{1}{2}$ " VALVE ASSEMBLY. LOCATE IN VALVE BOX.
FS	FLOW SENSOR: TORO 'TFS-150' FLOW SENSOR. LOCATE IN VALVE BOX
\oplus	SOLENOID VALVE: IRRITROL ULTRAFLOM 700 SERIES 1" VALVE W/ 30 PSI PRESSURE REGULATOR. LOCATE IN VALVE BOX.
8	\underline{POT} STUB: STUB FOR POT IRRIGATION, TRANSITION FROM PVC TO POLY LINE W/LASER SOAKER LOOP IN EACH ADJACENT POT.
POC	POINT OF CONNECTION: IRRIGATION MAINLINE 'T' CONNECTION TO EXISTING DOMESTIC SERVICE LINE. LOCATE IN VALVE BOX W/ BALL VALVE TO ISOLATE IRRIGATION MAINLINE.
	DOMESTIC WATER SERVICE LINE: EXISTING BY OTHERS
	IRRIGATION MAINLINE: 1 1/2" SCHEDULE 40 PVC; 18" MIN. BURIAL
	IRRIGATION LATERAL LINE: SCHEDULE 40 PVC SIZE AS REQUIRED. 12" MIN. BURIAL
	SUB SURFACE DRIPLINE: FOR SMALL LAWN AREA; RAINBIRD 'XFS-09-12' .9 GPH EMITTERS @ 12" O.C. SPACING. SET TUBES 12" O.C. BURIED UNDER SOD LAWN. STAGGER EMITTER LAYOUT BETWEEN ADJACENT ROWS.

		Water Efficient Landscape Worksheet							
#	HYDRO ZONE NAME	HYDROZONE DESCRIPTION	PLANT FACTOR (PF)	IRRIG. METHOD	IRRIGATION EFFICENCY (IE)	ETAF (PF/IE)	LANDSCAPE AREA	ETAF x AREA	ESTIMATED TOT WATER USE(ETWU)
	Regular Landscape Areas								
#1	FRONT YARD - RIGHT SIDE OF DRIVEWAY	Low water use	0.2	Drip	0.81	0.25	724	179	4733
#2	FRONT YARD - CENTER	Low water use	0.3	Drip	0.81	0.37	458	170	4491
#3	FRONT YARD - LEFT SIDE	Med water use	0.4	Drip	0.81	0.49	500	247	6537
#4	FRONT YARD - LAWN	High water use	0.8	Drip sub s	0.81	0.99	281	278	7347
#5	SOUTH SIDE YARD AGAINST HOUSE	Low water use	0.2	Drip	0.81	0.25	108	27	706
#6	SOUTH SIDE YARD AGAINST FENCE	Low water use	0.2	Drip	0.81	0.25	729	180	4765
#7	BACK YARD AGAINST BACK FENCE	Med water use	0.4	Drip	0.81	0.49	460	227	6014
#8	BACK YARD AGAINST LIGHTWELLS	Low water use	0.3	Drip	0.81	0.37	140	52	1373
#9	BACK YARD LAWN	High water use	0.8	Spray	0.75	1.07	609	650	17198
#10	POTS	Low water use	0.3	Drip	0.81	0.37	24	9	235
#11	NORTH SIDE YARD	Low water use	0.3	Drip	0.81	0.37	1	203	5374
						TOTALS	4034	2220	58772
	Special Landscape Areas								
#12	VEGETABLE BEDS					1	80	80	2118
						TOTALS	80	80	2118
	Eto for Los Altos = 45.4						ETV	NU Total	60890
		(45.4)(.62)[(.55x4470)+((155)x8	30)]	Maxim	um Allo	wed Water Al	lowance	63465
		Regular Landscape A	reas	1	All Landscape Are	eas			
		Total ETAF x Area	2220		Total ETAF x Area	2300	1		
		Total Area	4034		Total Area	4114			
		Average ETAF	0.550		Sitewide ETAF	0.559	ł		

		IRRIGATION SCHEDULE							Annual	Annual						
Month ETO		>	January 1.5	February 1.8	March 3.1	April 4.1	May 5.5	June 5.8	July 6.5	August 5.9	September 5.0	October 3.3	November 1.8	December 1.0	TOTAL 45.4	Gallons Applied TOTAL
ZONE #	FLOW RATE (GPM)	RUN INTERVAL x PER WEEK			N	IONTH	ILY RU	N TIME	E IN M	IINUTES						
Regular La	andscape Are	as														
#1	2.23	2	45	54	93	123	165	174	195	177	150	99	54	30	1359	3031
#2	3.1	2	45	54	93	123	165	174	195	177	150	99	54	30	1359	4213
#3	1.25	2	45	54	93	123	165	174	195	177	150	99	54	30	1359	1699
#4	3.72	3	135	162	279	369	495	522	585	531	450	297	162	90	4077	15166
#5	1	2	45	54	93	123	165	174	195	177	150	99		30	1359	1359
#6	4	2	45	54	93	123	165	174	195	177	150	99		30	1359	5436
#7	2.1	2	45	54	93	123	165	174	195	177	150	99		30	1359	2854
#8	1	2	45	54	93	123	165	174	195	177	150	99		30	1359	1359
#9	13.81	3	54	65	112	148	198	209	234	212	180	119		36	1631	22521
#10	1	4	60		124	164	220	232	260	236	200	132	,,,,,,,,,,,,,,,,,,,,,,,,,,,,,,,,,,,,,,,	40	1812	1812
#11	1	2	45	54	93	123	165	174	195	177	150	99	54	30	1359	1359
Special La	ndscape Area	as														
#12	1	4	45	54	93	123	165	174	195	177	150	99	54	30	1359	1359
TOTAL MIN	IUTES RUN PEI	R MONTH	654	785	1352	1788	2398	2529	2834	2572	2180	1439	785	436	19751	
											ANNUAL TOT	AL GALLON	S APPLIED			62168

California Horticulture LANDSCAPE CONSTRUCTION INCORPORATED

753 Camden Campbell, CA

408-364-3190

95008

FAX 408-364-3199

Contractors License B & C-27 & C-53

641851


Scale: 1/8" = 1' - 0"

Sheet: IRRIGATION & HYDROZONE PLAN

Drawn by: WB

Revisions: 7_26_23

SHEET

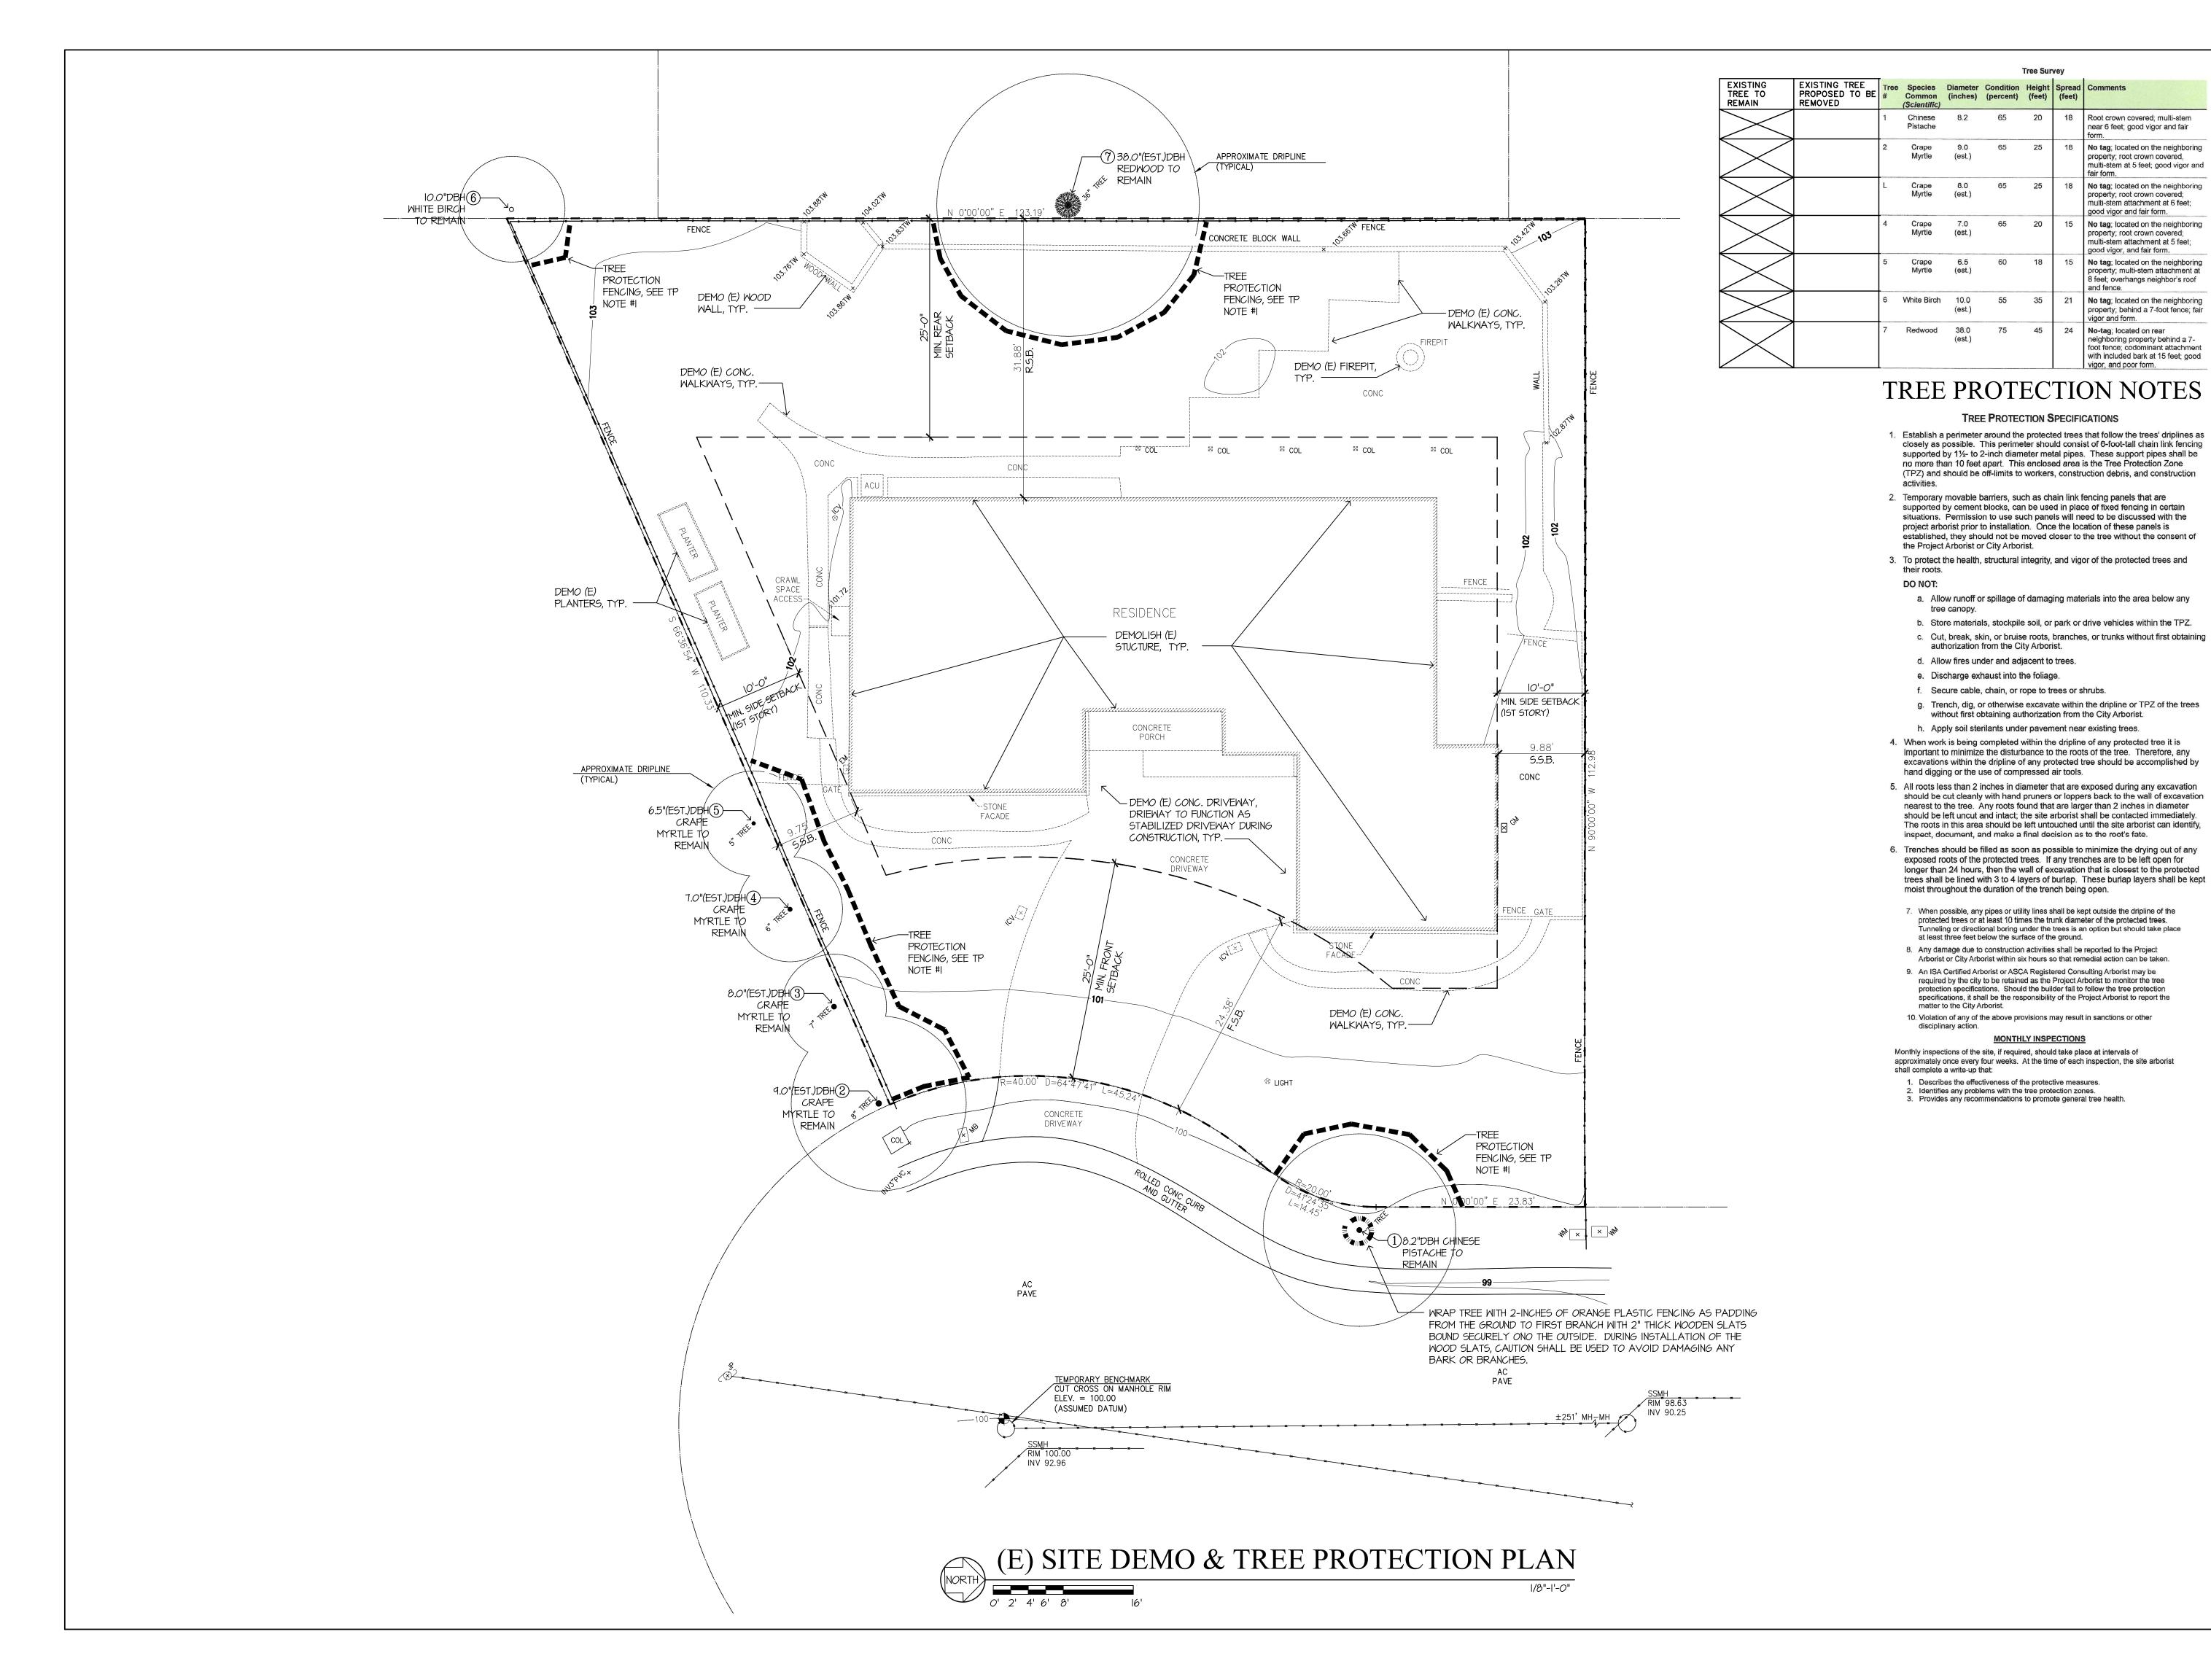

18 Root crown covered: multi-stem

Myrtle

Crape Myrtle

Myrtle

7.0

near 6 feet; good vigor and fair

No tag; located on the neighboring

No tag; located on the neighboring property; root crown covered; multi-stem attachment at 6 feet;

No tag; located on the neighboring

multi-stem attachment at 5 feet; good vigor, and fair form. No tag; located on the neighboring

property; multi-stem attachment at

8 feet; overhangs neighbor's roof

No tag; located on the neighboring

vigor and form.

TREE PROTECTION SPECIFICATIONS

a. Allow runoff or spillage of damaging materials into the area below any

b. Store materials, stockpile soil, or park or drive vehicles within the TPZ.

authorization from the City Arborist. Allow fires under and adjacent to trees. e. Discharge exhaust into the foliage.

f. Secure cable, chain, or rope to trees or shrubs.

c. Cut, break, skin, or bruise roots, branches, or trunks without first obtaining

g. Trench, dig, or otherwise excavate within the dripline or TPZ of the trees

without first obtaining authorization from the City Arborist.

protected trees or at least 10 times the trunk diameter of the protected trees.

Arborist or City Arborist within six hours so that remedial action can be taken.

required by the city to be retained as the Project Arborist to monitor the tree protection specifications. Should the builder fail to follow the tree protection

MONTHLY INSPECTIONS

specifications, it shall be the responsibility of the Project Arborist to report the

at least three feet below the surface of the ground.

disciplinary action.

Tunneling or directional boring under the trees is an option but should take place

h. Apply soil sterilants under pavement near existing trees.

No-tag; located on rear neighboring property behind a 7foot fence; codominant attachment

property; behind a 7-foot fence; fair

with included bark at 15 feet; good

property; root crown covered;

multi-stem at 5 feet; good vigor and

property; root crown covered,

good vigor and fair form.

NEW RESIDENCE FOR

SUKU

746 CASA BONITA COURT LOS ALTOS, CA 94024

REVISION



J MALIKSI & ASSOC. ARCHITECTURE - INTERIOR DESIGN

675 MENLO AVENUE MENLO PARK, CA 94025 TEL. NO. 650 323 2902 FAX NO. 650 323 6433



NO. DATE ISSUE GTM 7-14-23 FOR DESIGN REVIEW


DRAWING TITLE

GTM 5-19-23 FOR DESIGN REVIEW

ALL DRAWINGS AND MATERIALS APPEARING HEREIN CONSTITUTE THE ORIGINAL AND UNPUBLISHED WORK OF THE ARCHITECT

SITE DEMO & TREE PROTECTION PLAN

SCALE: 1/8" = 1'-0" PROJECT NAME: CHETTIAR CADD FILE NO. DRAWING NO.

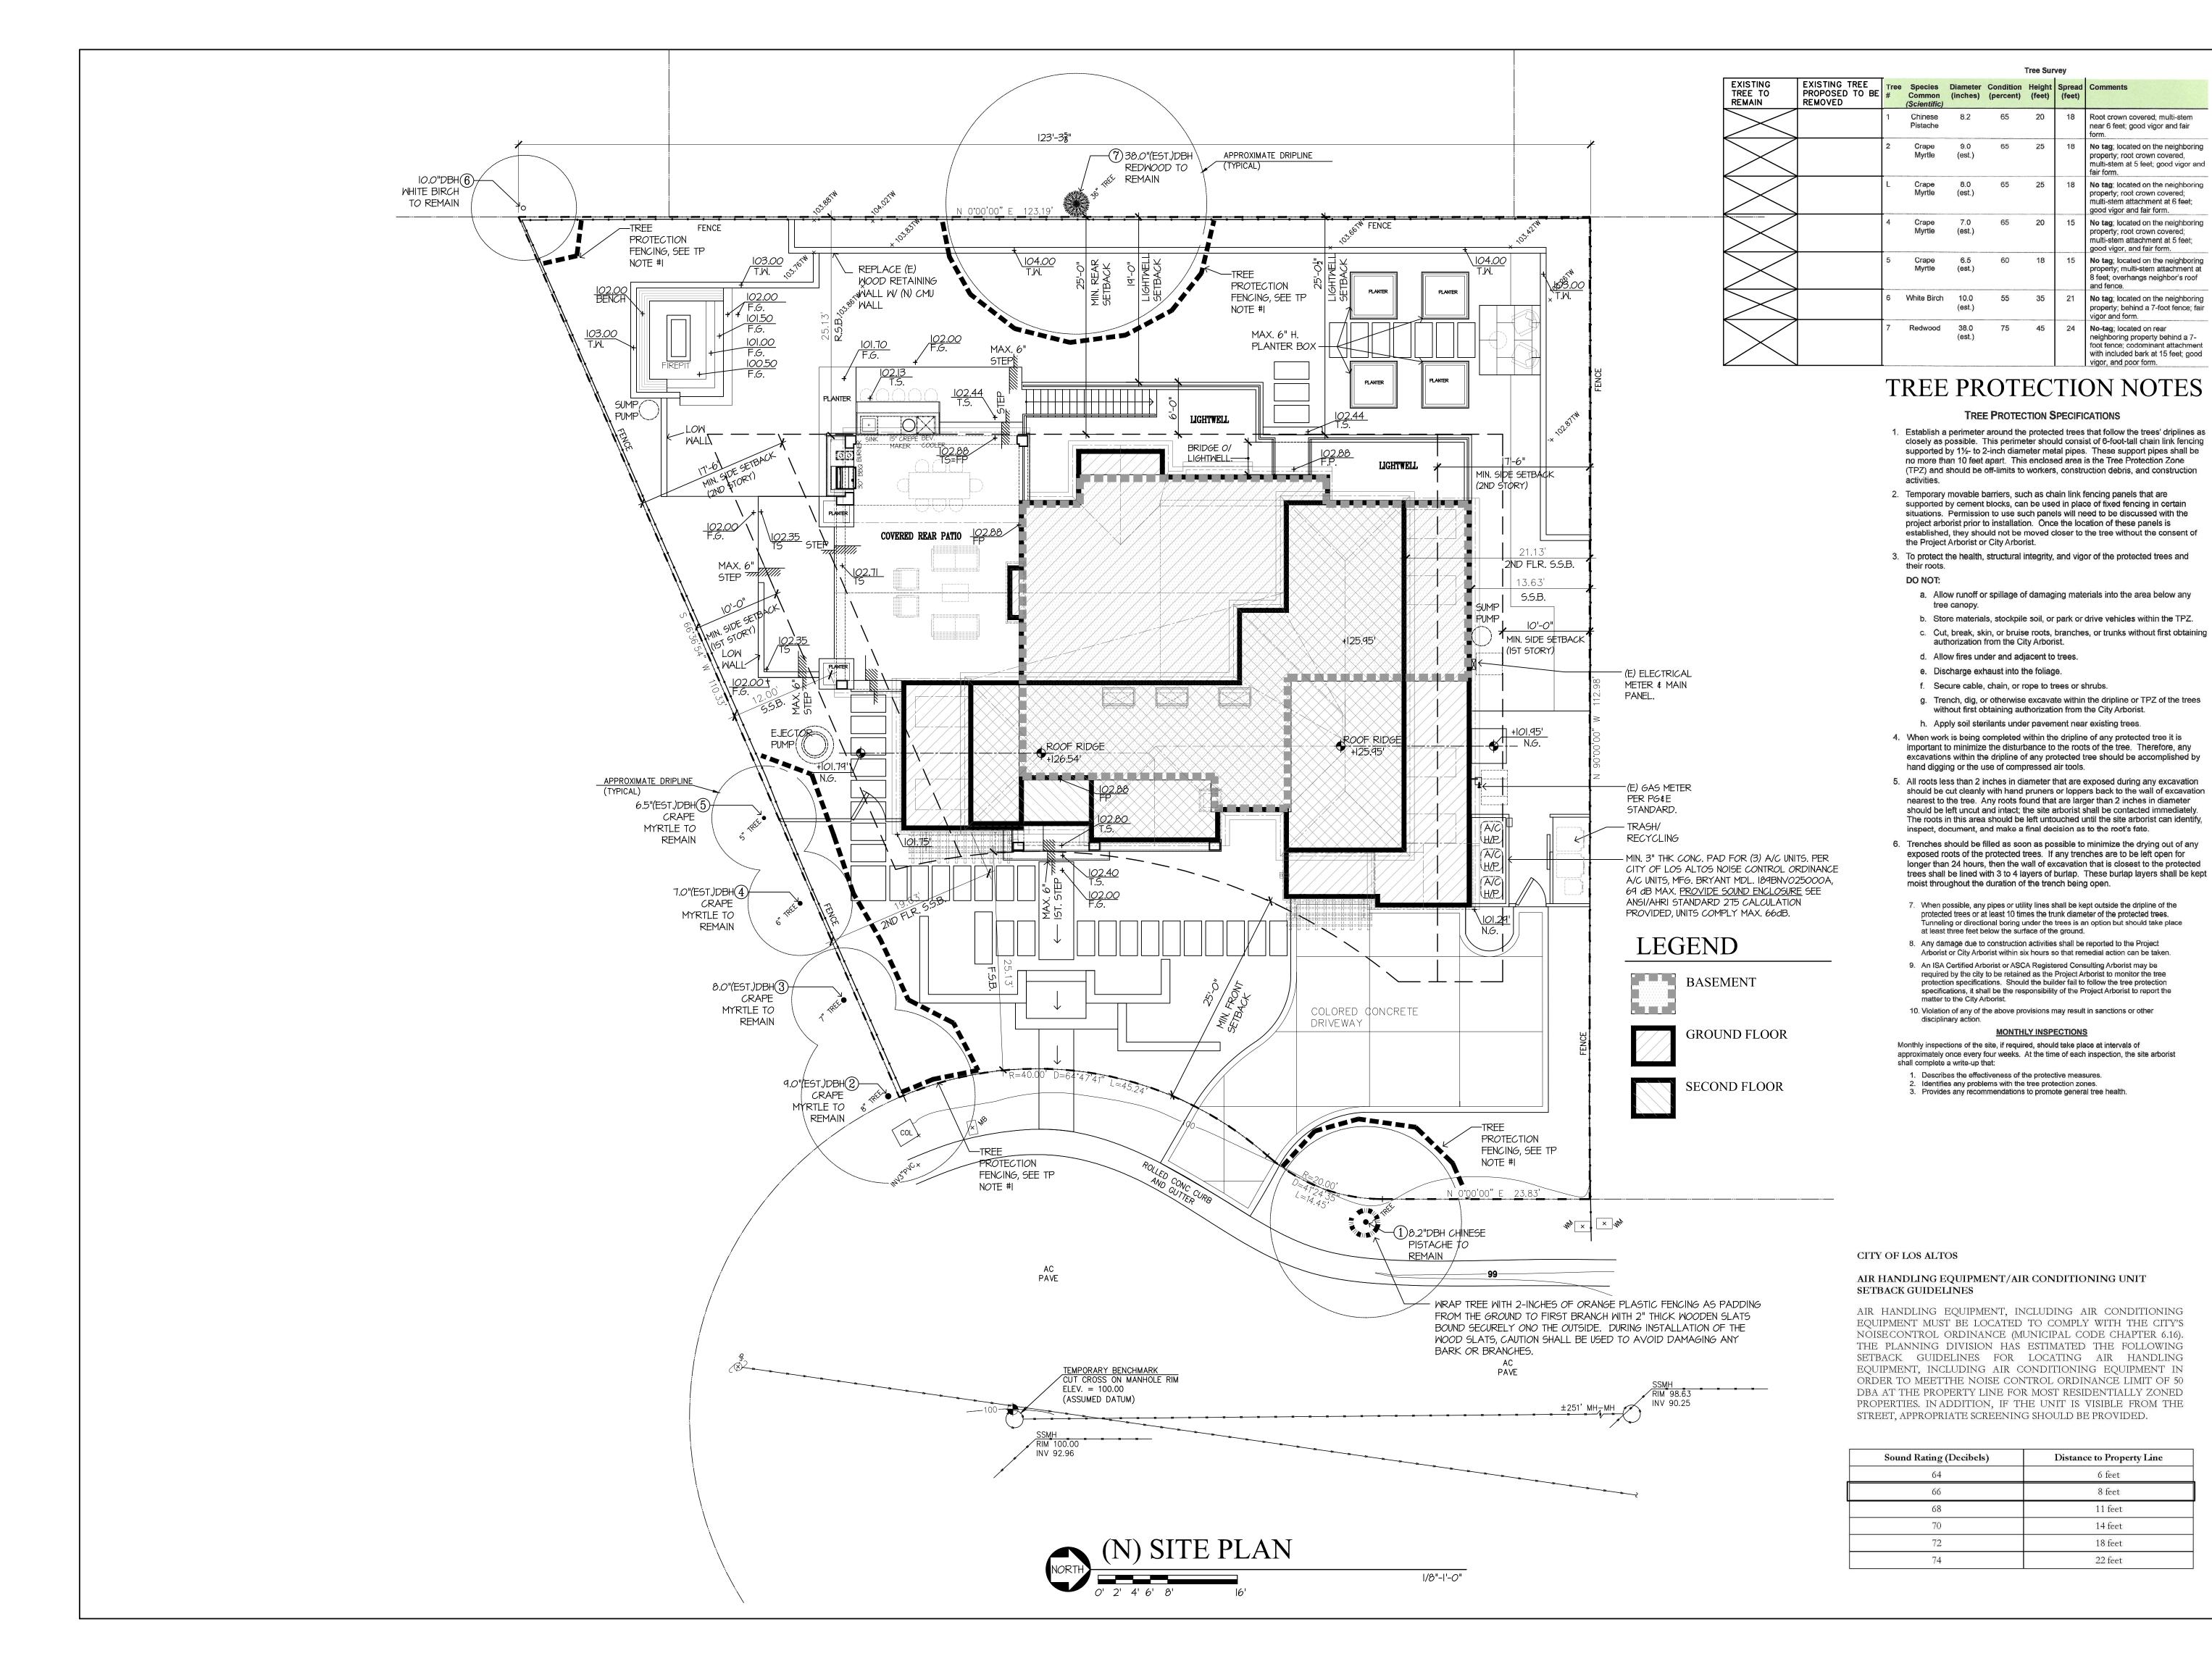

NEW RESIDENCE FOR

Root crown covered: multi-stem

property; root crown covered,

near 6 feet; good vigor and fair

No tag; located on the neighboring

No tag; located on the neighboring

No tag; located on the neighboring

multi-stem attachment at 5 feet;

No tag; located on the neighboring

No tag; located on the neighboring

neighboring property behind a 7-

foot fence; codominant attachment

with included bark at 15 feet; good

property; behind a 7-foot fence; fair

property; multi-stem attachment at 8 feet; overhangs neighbor's roof

property; root crown covered;

good vigor, and fair form.

vigor and form.

No-tag; located on rear

property; root crown covered; multi-stem attachment at 6 feet;

good vigor and fair form.

multi-stem at 5 feet; good vigor and

SUKU

746 CASA BONITA COURT LOS ALTOS, CA 94024

REVISION



J MALIKSI & ASSOC. ARCHITECTURE - INTERIOR DESIGN

675 MENLO AVENUE MENLO PARK, CA 94025 TEL. NO. 650 323 2902 FAX NO. 650 323 6433



NO. DATE ISSUE GTM 7-14-23 FOR DESIGN REVIEW

GTM 5-19-23 FOR DESIGN REVIEW

GTM 12-22-22

GTM II-23-22

Distance to Property Line 6 feet

8 feet

11 feet 14 feet

18 feet

22 feet


ALL DRAWINGS AND MATERIALS APPEARING HEREIN CONSTITUTE
THE ORIGINAL AND UNPUBLISHED WORK OF THE ARCHITECT
AND MAY NOT BE DUPLICATED, USED OR DISCLOSED WITHOUT
THE PRIOR WRITTEN CONSENT OF THE ARCHITECT.

© 2022 JIM MALIKSI & ASSOCIATES

DRAWING TITLE

SITE PLAN

SCALE:	1/8" = 1'-0"
PROJECT NAME:	CHETTIAR
CADD FILE NO.	
DRAWING NO.	

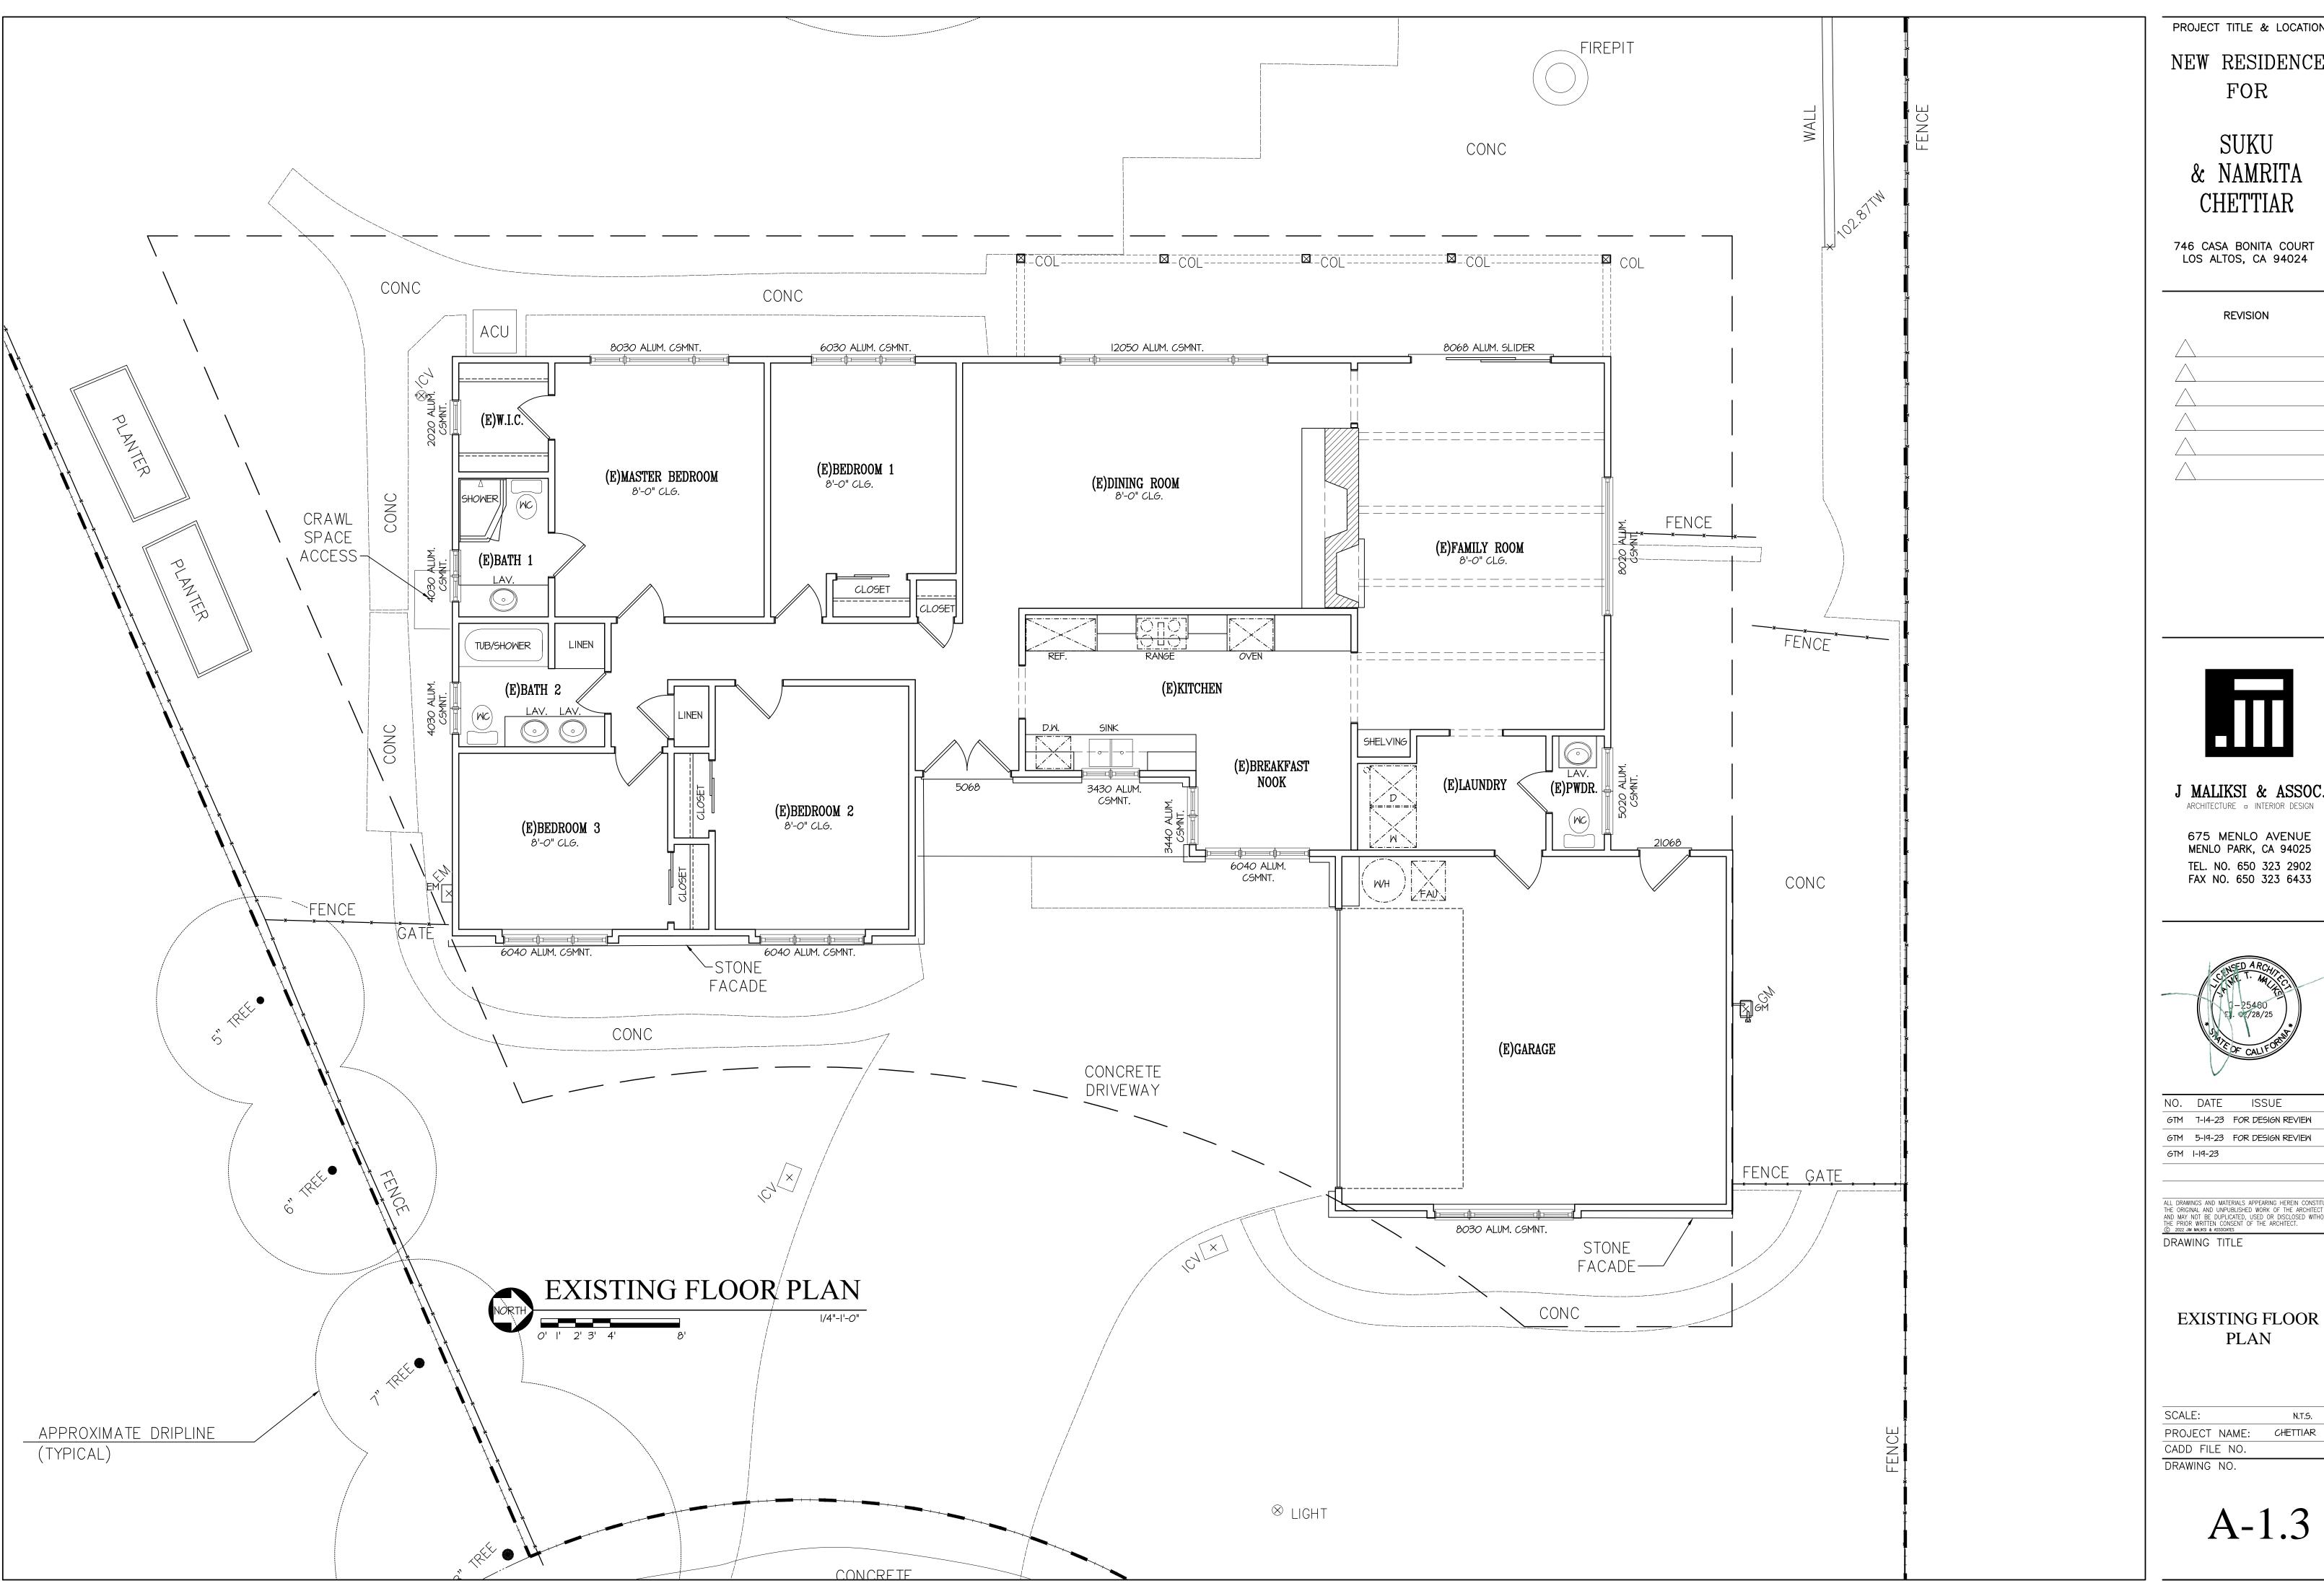


NEW RESIDENCE FOR

> SUKU & NAMRITA CHETTIAR

746 CASA BONITA COURT LOS ALTOS, CA 94024

REVISION

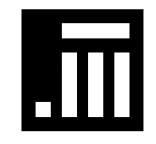

J MALIKSI & ASSOC.

ARCHITECTURE - INTERIOR DESIGN

675 MENLO AVENUE MENLO PARK, CA 94025 TEL. NO. 650 323 2902 FAX NO. 650 323 6433



NO. DATE ISSUE GTM 7-14-23 FOR DESIGN REVIEW


GTM 5-19-23 FOR DESIGN REVIEW

ALL DRAWINGS AND MATERIALS APPEARING HEREIN CONSTITUTE
THE ORIGINAL AND UNPUBLISHED WORK OF THE ARCHITECT
AND MAY NOT BE DUPLICATED, USED OR DISCLOSED WITHOUT
THE PRIOR WRITTEN CONSENT OF THE ARCHITECT.

© 2022 JIM MALIKSI & ASSOCIATES

PLAN

N.T.S. PROJECT NAME: CHETTIAR

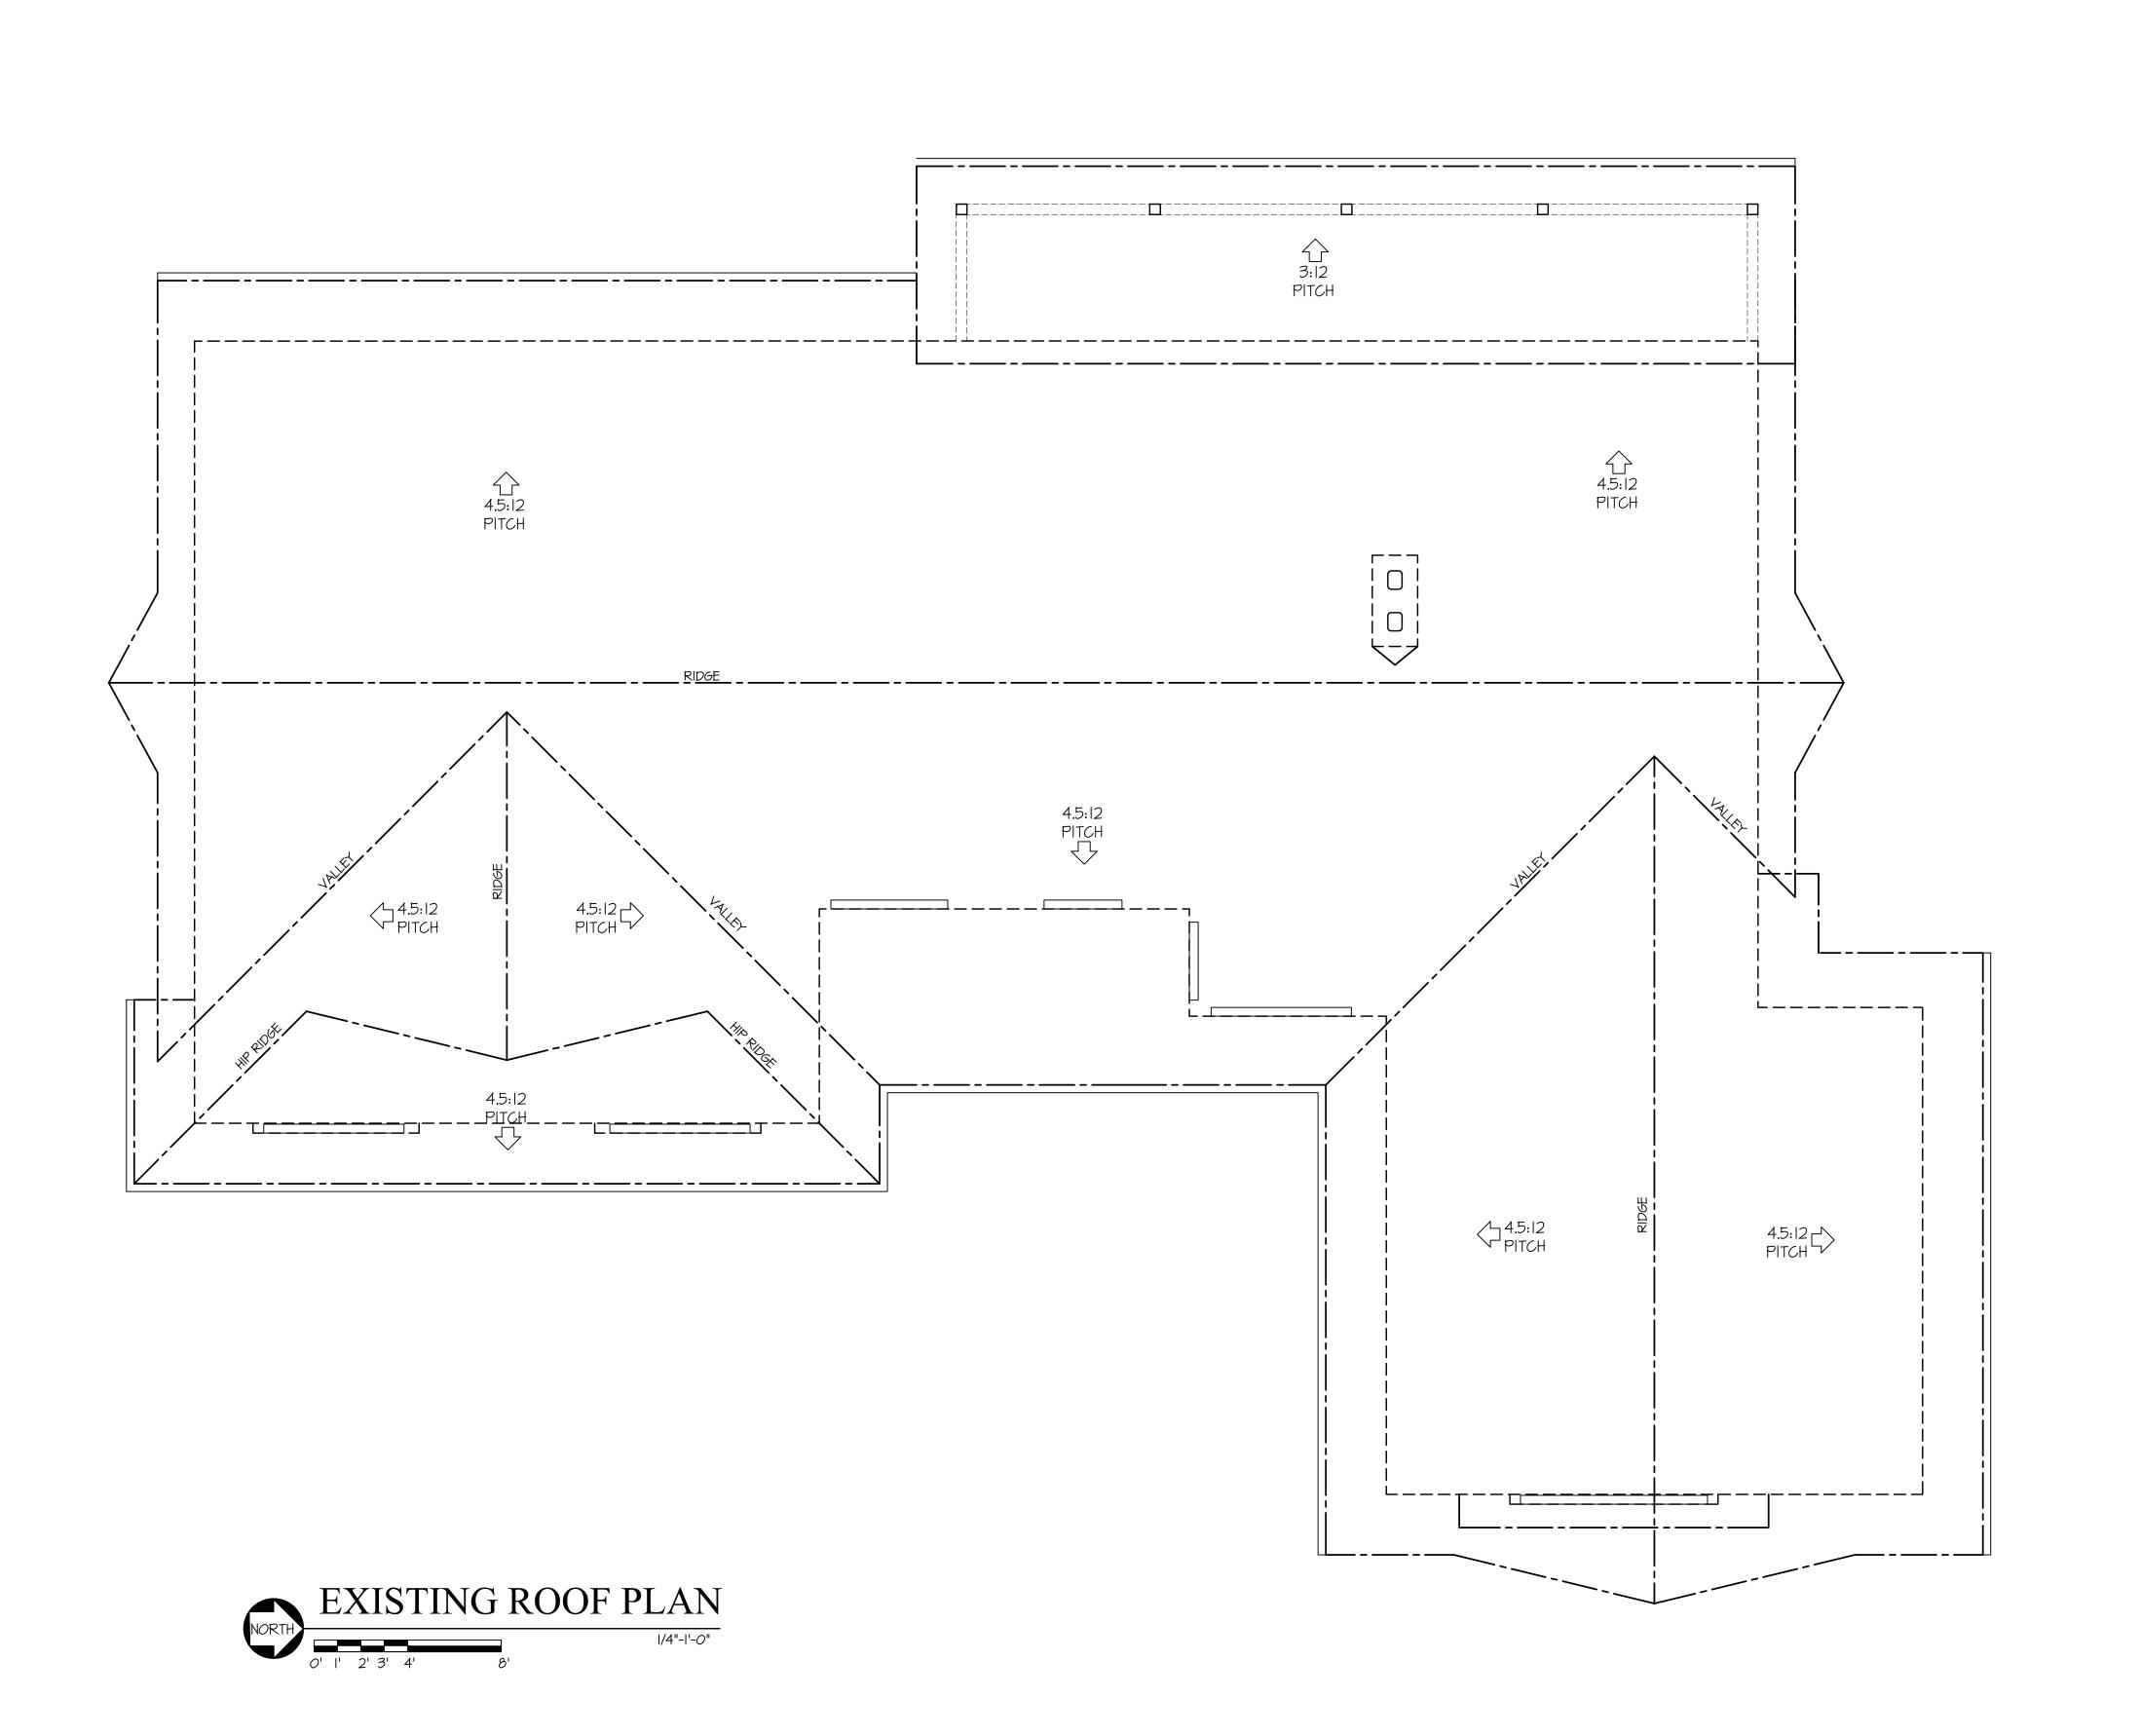

NEW RESIDENCE FOR

> SUKU & NAMRITA CHETTIAR

746 CASA BONITA COURT LOS ALTOS, CA 94024

REVISION



J MALIKSI & ASSOC ARCHITECTURE - INTERIOR DESIGN

675 MENLO AVENUE MENLO PARK, CA 94025 TEL. NO. 650 323 2902 FAX NO. 650 323 6433



NO. DATE ISSUE

6TM 7-14-23 FOR DESIGN REVIEW

GTM 5-19-23 FOR DESIGN REVIEW
GTM 1-19-23

ALL DRAWINGS AND MATERIALS APPEARING HEREIN CONSTITUTE
THE ORIGINAL AND UNPUBLISHED WORK OF THE ARCHITECT
AND MAY NOT BE DUPLICATED, USED OR DISCLOSED WITHOUT
THE PRIOR WRITTEN CONSENT OF THE ARCHITECT.

© 2022 JIM MALKSI & ASSOCIATES

DRAWING TITLE

EXISTING ROOF PLAN


SCALE: N.T.5.

PROJECT NAME: CHETTIAR

CADD FILE NO.

DRAWING NO.

A-1.4

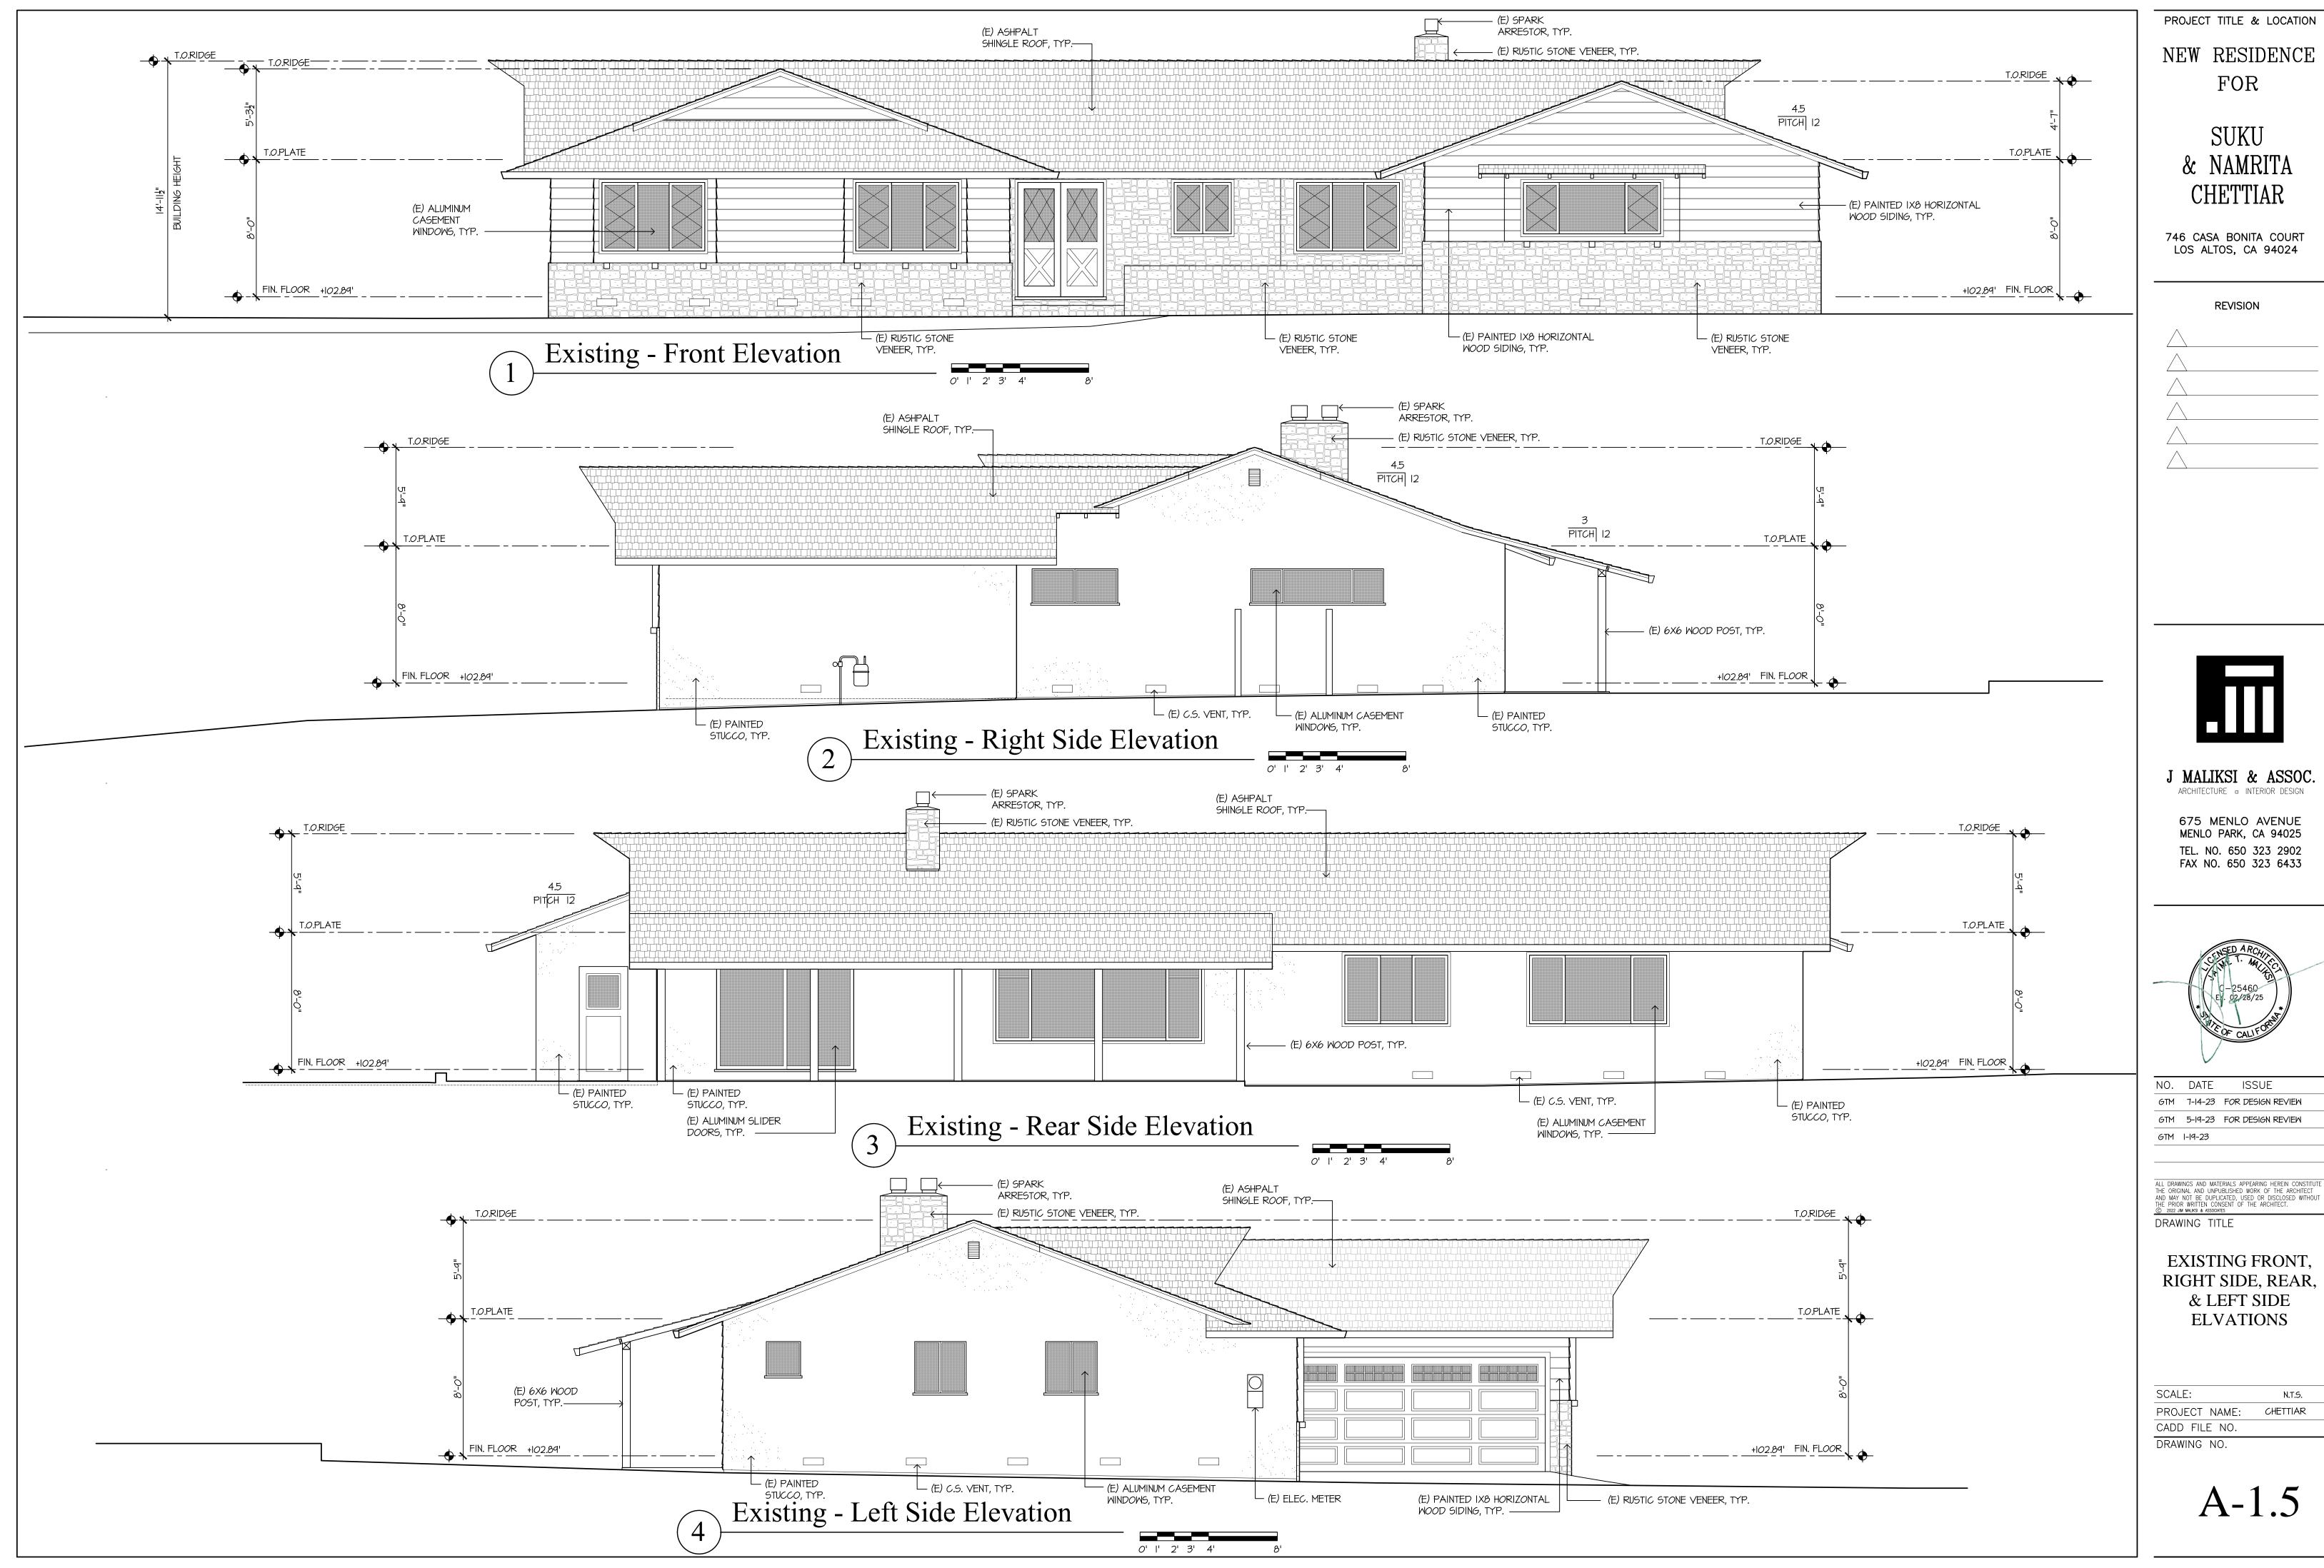



BECTION	AKI

BASEMENT (DOES NOT COUNT TOWARDS FAR)

1	6'-7" X 32'-2"	211.8 S.F.
2	15'-6" X 35'-1 1/2"	544.4 S.F.
3	13'-8" X 23'-9"	324.5 S.F.
4	16'-3 1/2" X 20'-9 1/2"	338.7 S.F.
5	9'-2 1/2" X 15'-0 1/2"	138.5 S.F.

TOTAL BASEMENT FLOOR AREA: 1557.9 S.F.

(FAR) FLOOR AREA RATIO CALCULATIONS

SECTION **AREA**

GROUND FLOOR

6	10'-2" X 5'-11"	60.1	S.F.
7	16'-9" X 20'-8 1/2"	346.9	S.F.
8	1'-5" X 6'-9"	9.6	S.F.
9	13'-8 1/2" X 23'-8"	324.4	S.F.
10	5'-3 1/2" X 27'-8 1/2"	146.6	S.F.
11	6'-11 1/2" X 24'-9"	172.2	S.F.
12	9'-4" X 25'-11"	242.0	S.F.
13	14'-1" X 17'-3"	242.9	S.F.
14	7'-6" X 11'-5 1/2"	85.9	S.F.
15	15'-1" X 18'-7 1/2"	280.9	S.F.
16	7'-4 1/2" X 15'-1 1/2"	110.9	S.F.
17	10'-6" X 21'-1"	221.4	S.F.
18	9'-4" X 20'-11"	195.3	S.F.
19	1'-9" X 22'-1"	38.6	S.F.
20	7'-3 1/2"X 0'-6 1/2"	4.0	S.F.

2481.7 S.F. TOTAL GROUND FLOOR AREA

SECOND FLOOR

TOTA	L SECOND FLOOR AREA	1239.4 S.F
25	14'-0 1/2" X 40'-6"	570.4 S.F
24	5'-4 1/2" X 8'-4"	44.8 S.F
23	7'-4" X 15'-1 1/2"	110.9 S.F
22	15'-1" X 18'-7 1/2"	280.9 S.F
21	16'-9"X 13'-10 1/2"	232.4 S.F

3721.1 S.F. **TOTAL FLOOR AREA:**

35.0%

3721.2 S.F. ALLOWABLE FLOOR AREA

35.0%

LOT COVERAGE

MAIN HOUSE FOOTPRINT 2481.7 S.F.

COVERED PORCH/ PATIOS

(DOES NOT COUNT TOWARDS FAR (FLOOR AREA RATIO)

26	7'-6" X 5'-9 1/2"	43.4 S.F.
27	23'-10" X 1'-0"	23.8 S.F.
28	8'-9" X 1'-4 1/2'	12.0 S.F.
/ 29	6'-5" X 7'-0"	45.2 S.F.
30	13'-6 1/2' X 8'-0"	108.3 S.F.
31	1'-0" X 7'-5 1/2"	7.5 S.F.
32	7'-5 1/2" X 22'-2"	165.4 S.F.
33	13'-6 1/2" X 6'-8 1/2'	90.8 S.F.
> 34	12'-1 1/2" X 6'-9"	81.8 S.F.
(35	13'-6 1/2" X 6'-8 1/2'	90.8 S.F. 🗸
TOT	AL COVERED PORCH/ PATIOS	669.0 S.F.

TOTAL COVERED PORCH/ PATIOS


TOTAL LOT COVERAGE 3150.7 S.F.

29.6%

ALLOWABLE LOT COVERAGE 3189.6 S.F.

30.0%


10632.0 S.F. SITE AREA

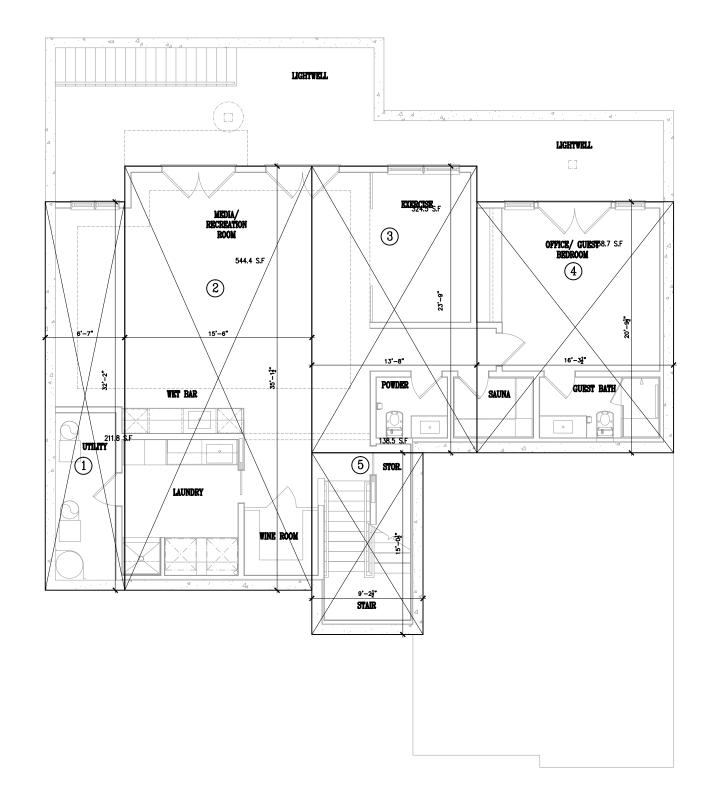


BASEMENT AREA DIAGRAM

LEGEND



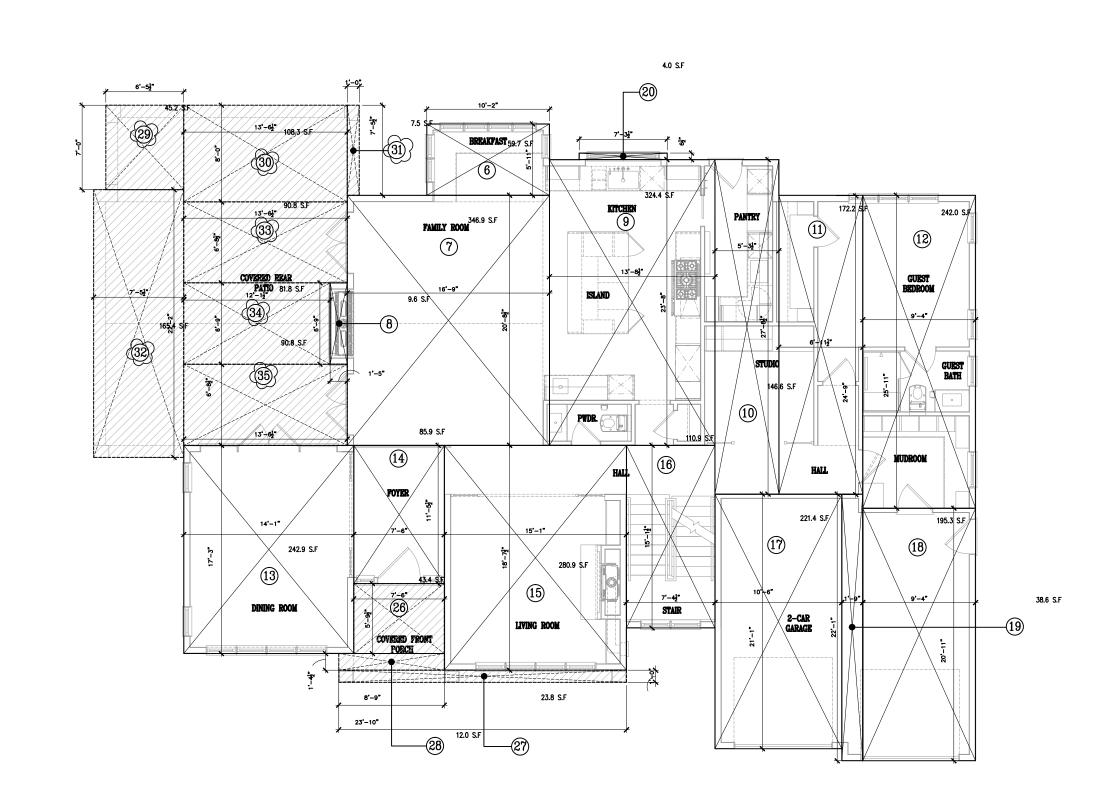

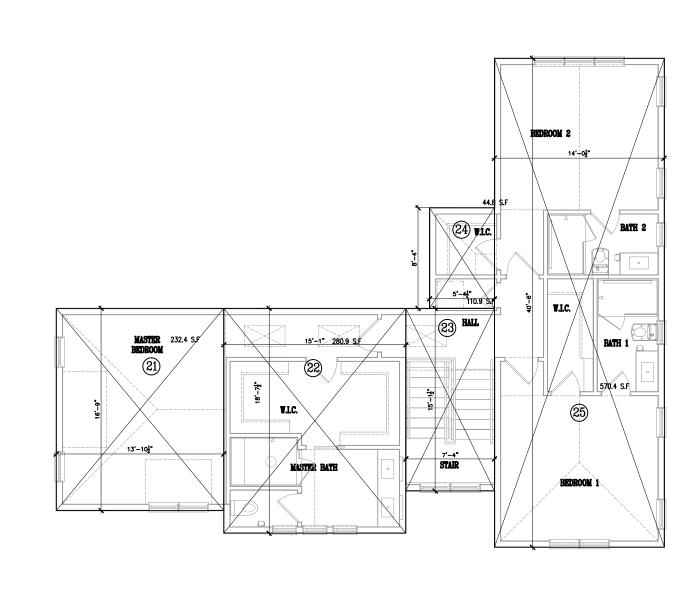





PROJECT TITLE & LOCATION

NEW RESIDENCE FOR

> SUKU & NAMRITA CHETTIAR

746 CASA BONITA COURT LOS ALTOS, CA 94024

REVISION



J MALIKSI & ASSOC.

675 MENLO AVENUE MENLO PARK, CA 94025 TEL. NO. 650 323 2902 FAX NO. 650 323 6433




NO. DATE ISSUE GTM 7-14-23 FOR DESIGN REVIEW GTM 5-19-23 FOR DESIGN REVIEW 8-30-23 FOR DESIGN REVIEW

DRAWING TITLE

(N) FLOOR AREA DIAGRAM & AREA **CALCULATIONS**


N.T.S. PROJECT NAME: CADD FILE NO. DRAWING NO.

A-1.6

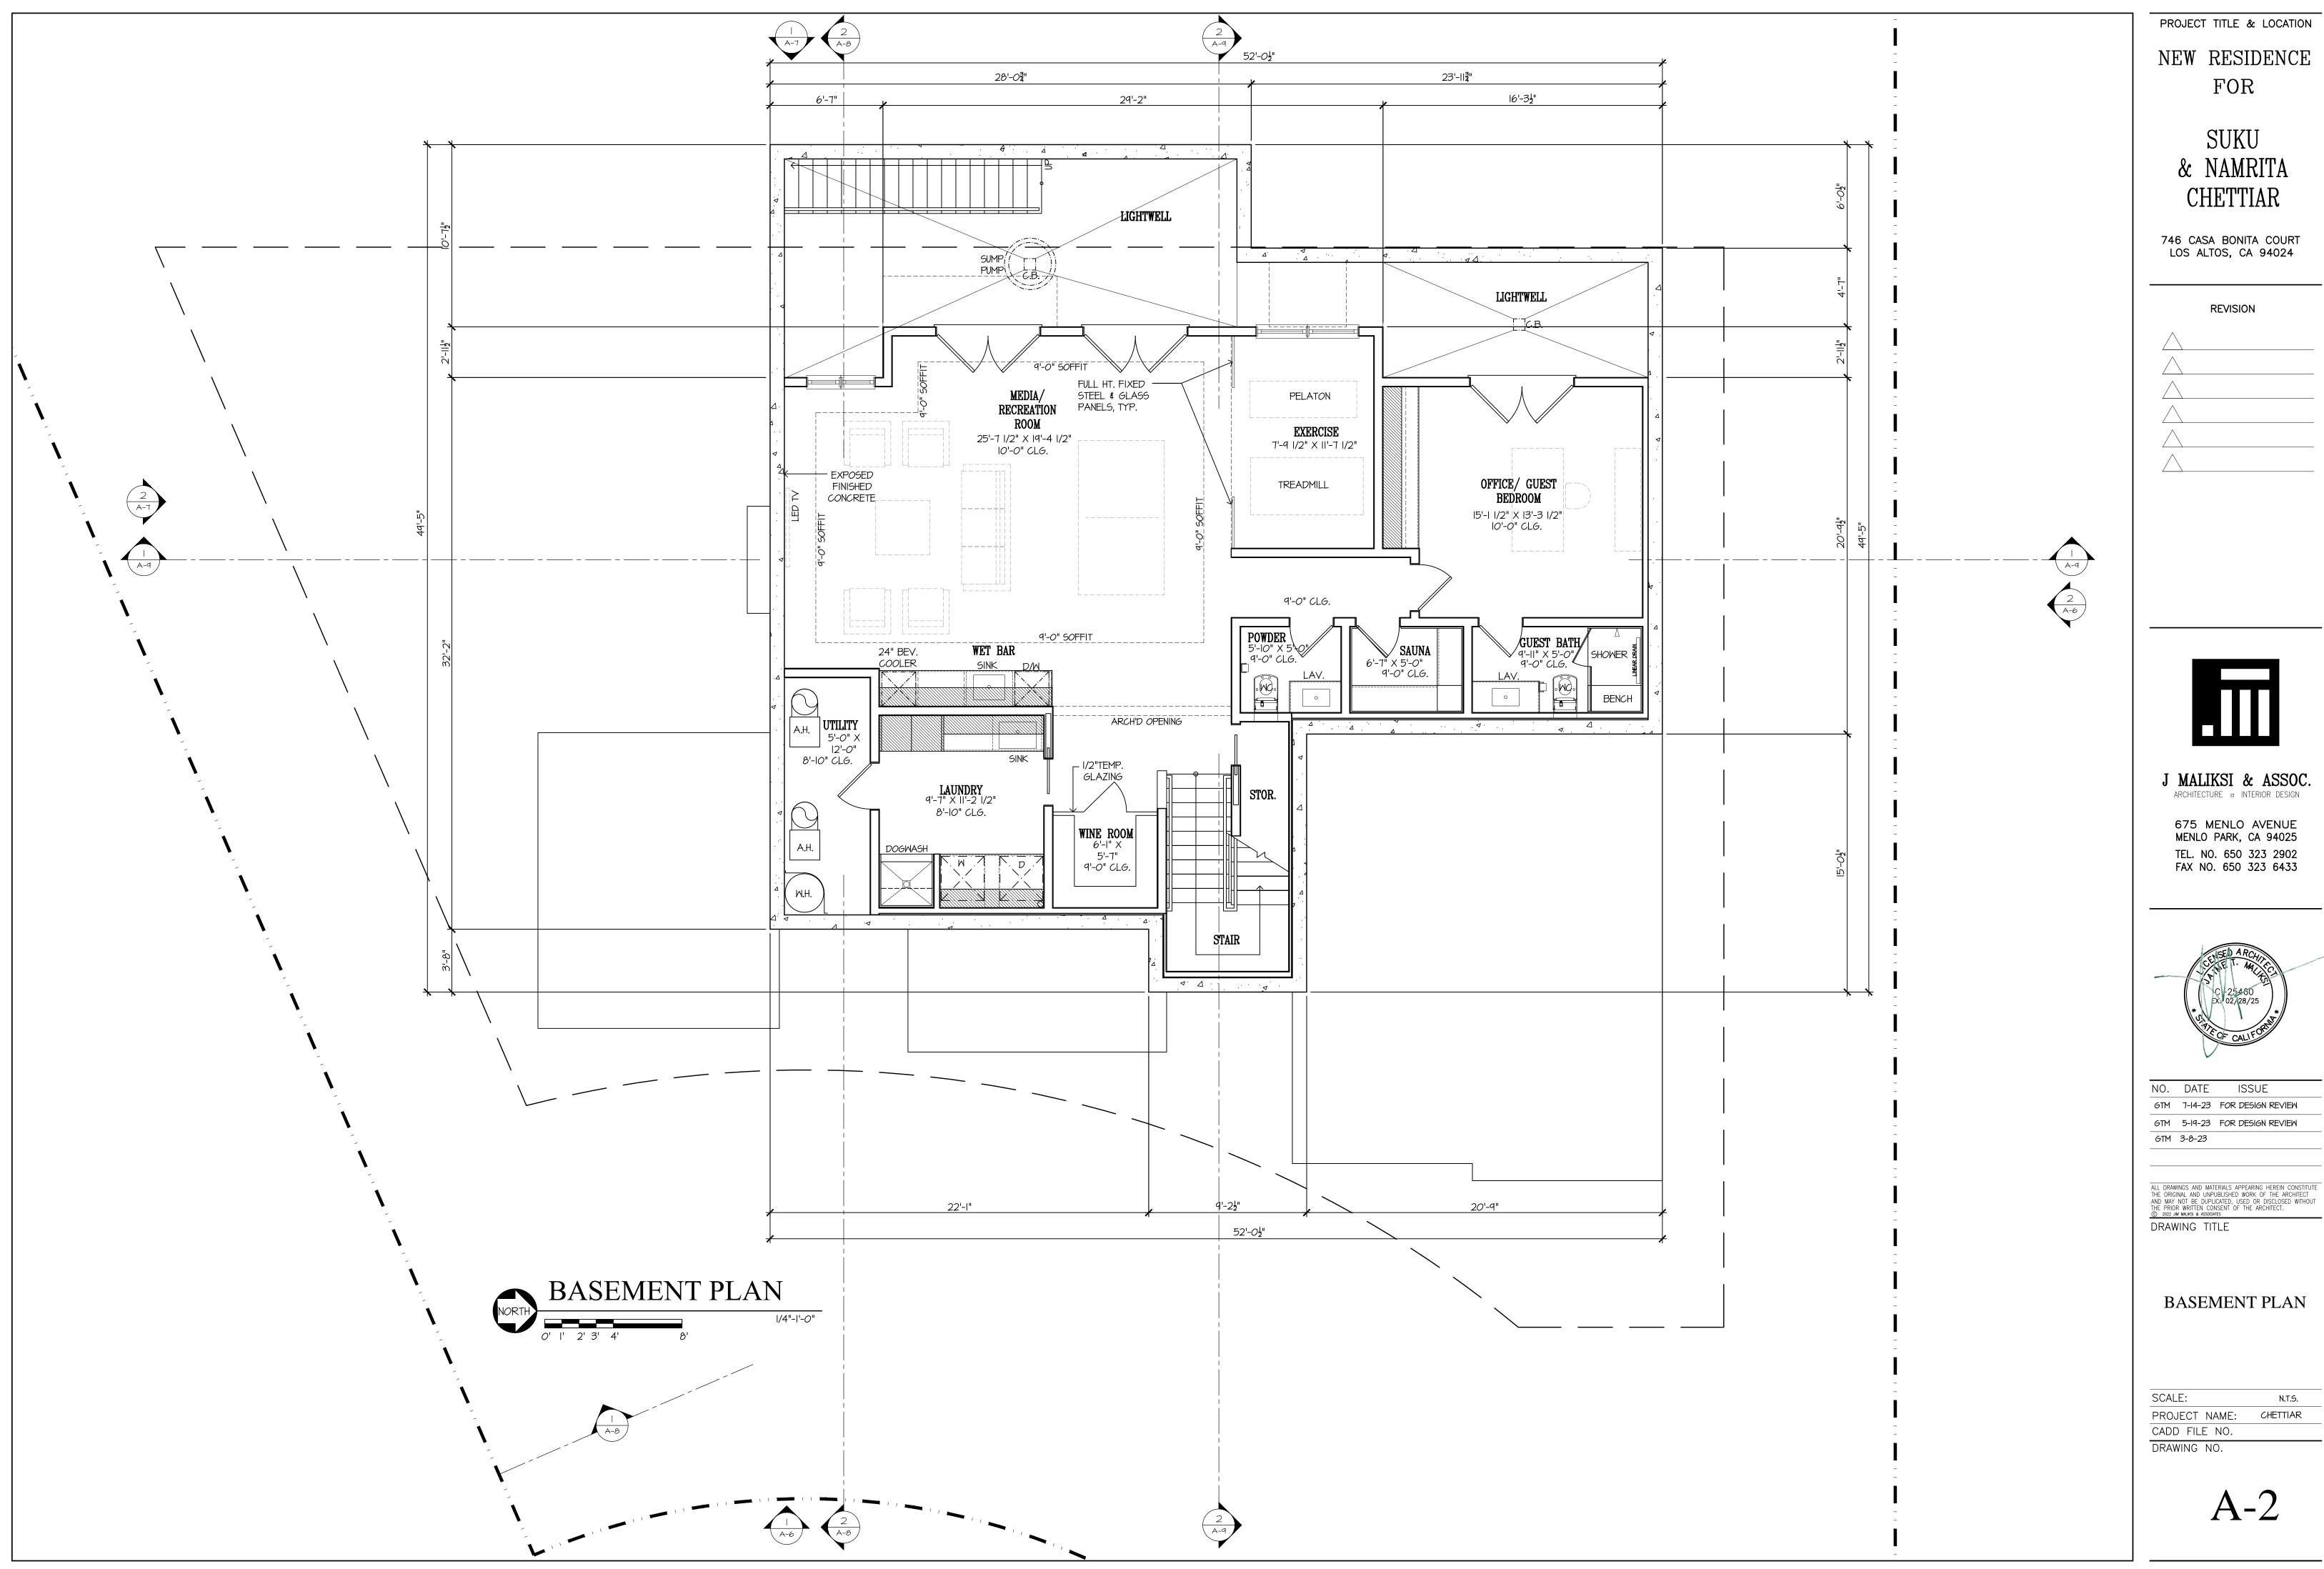




CHETTIAR

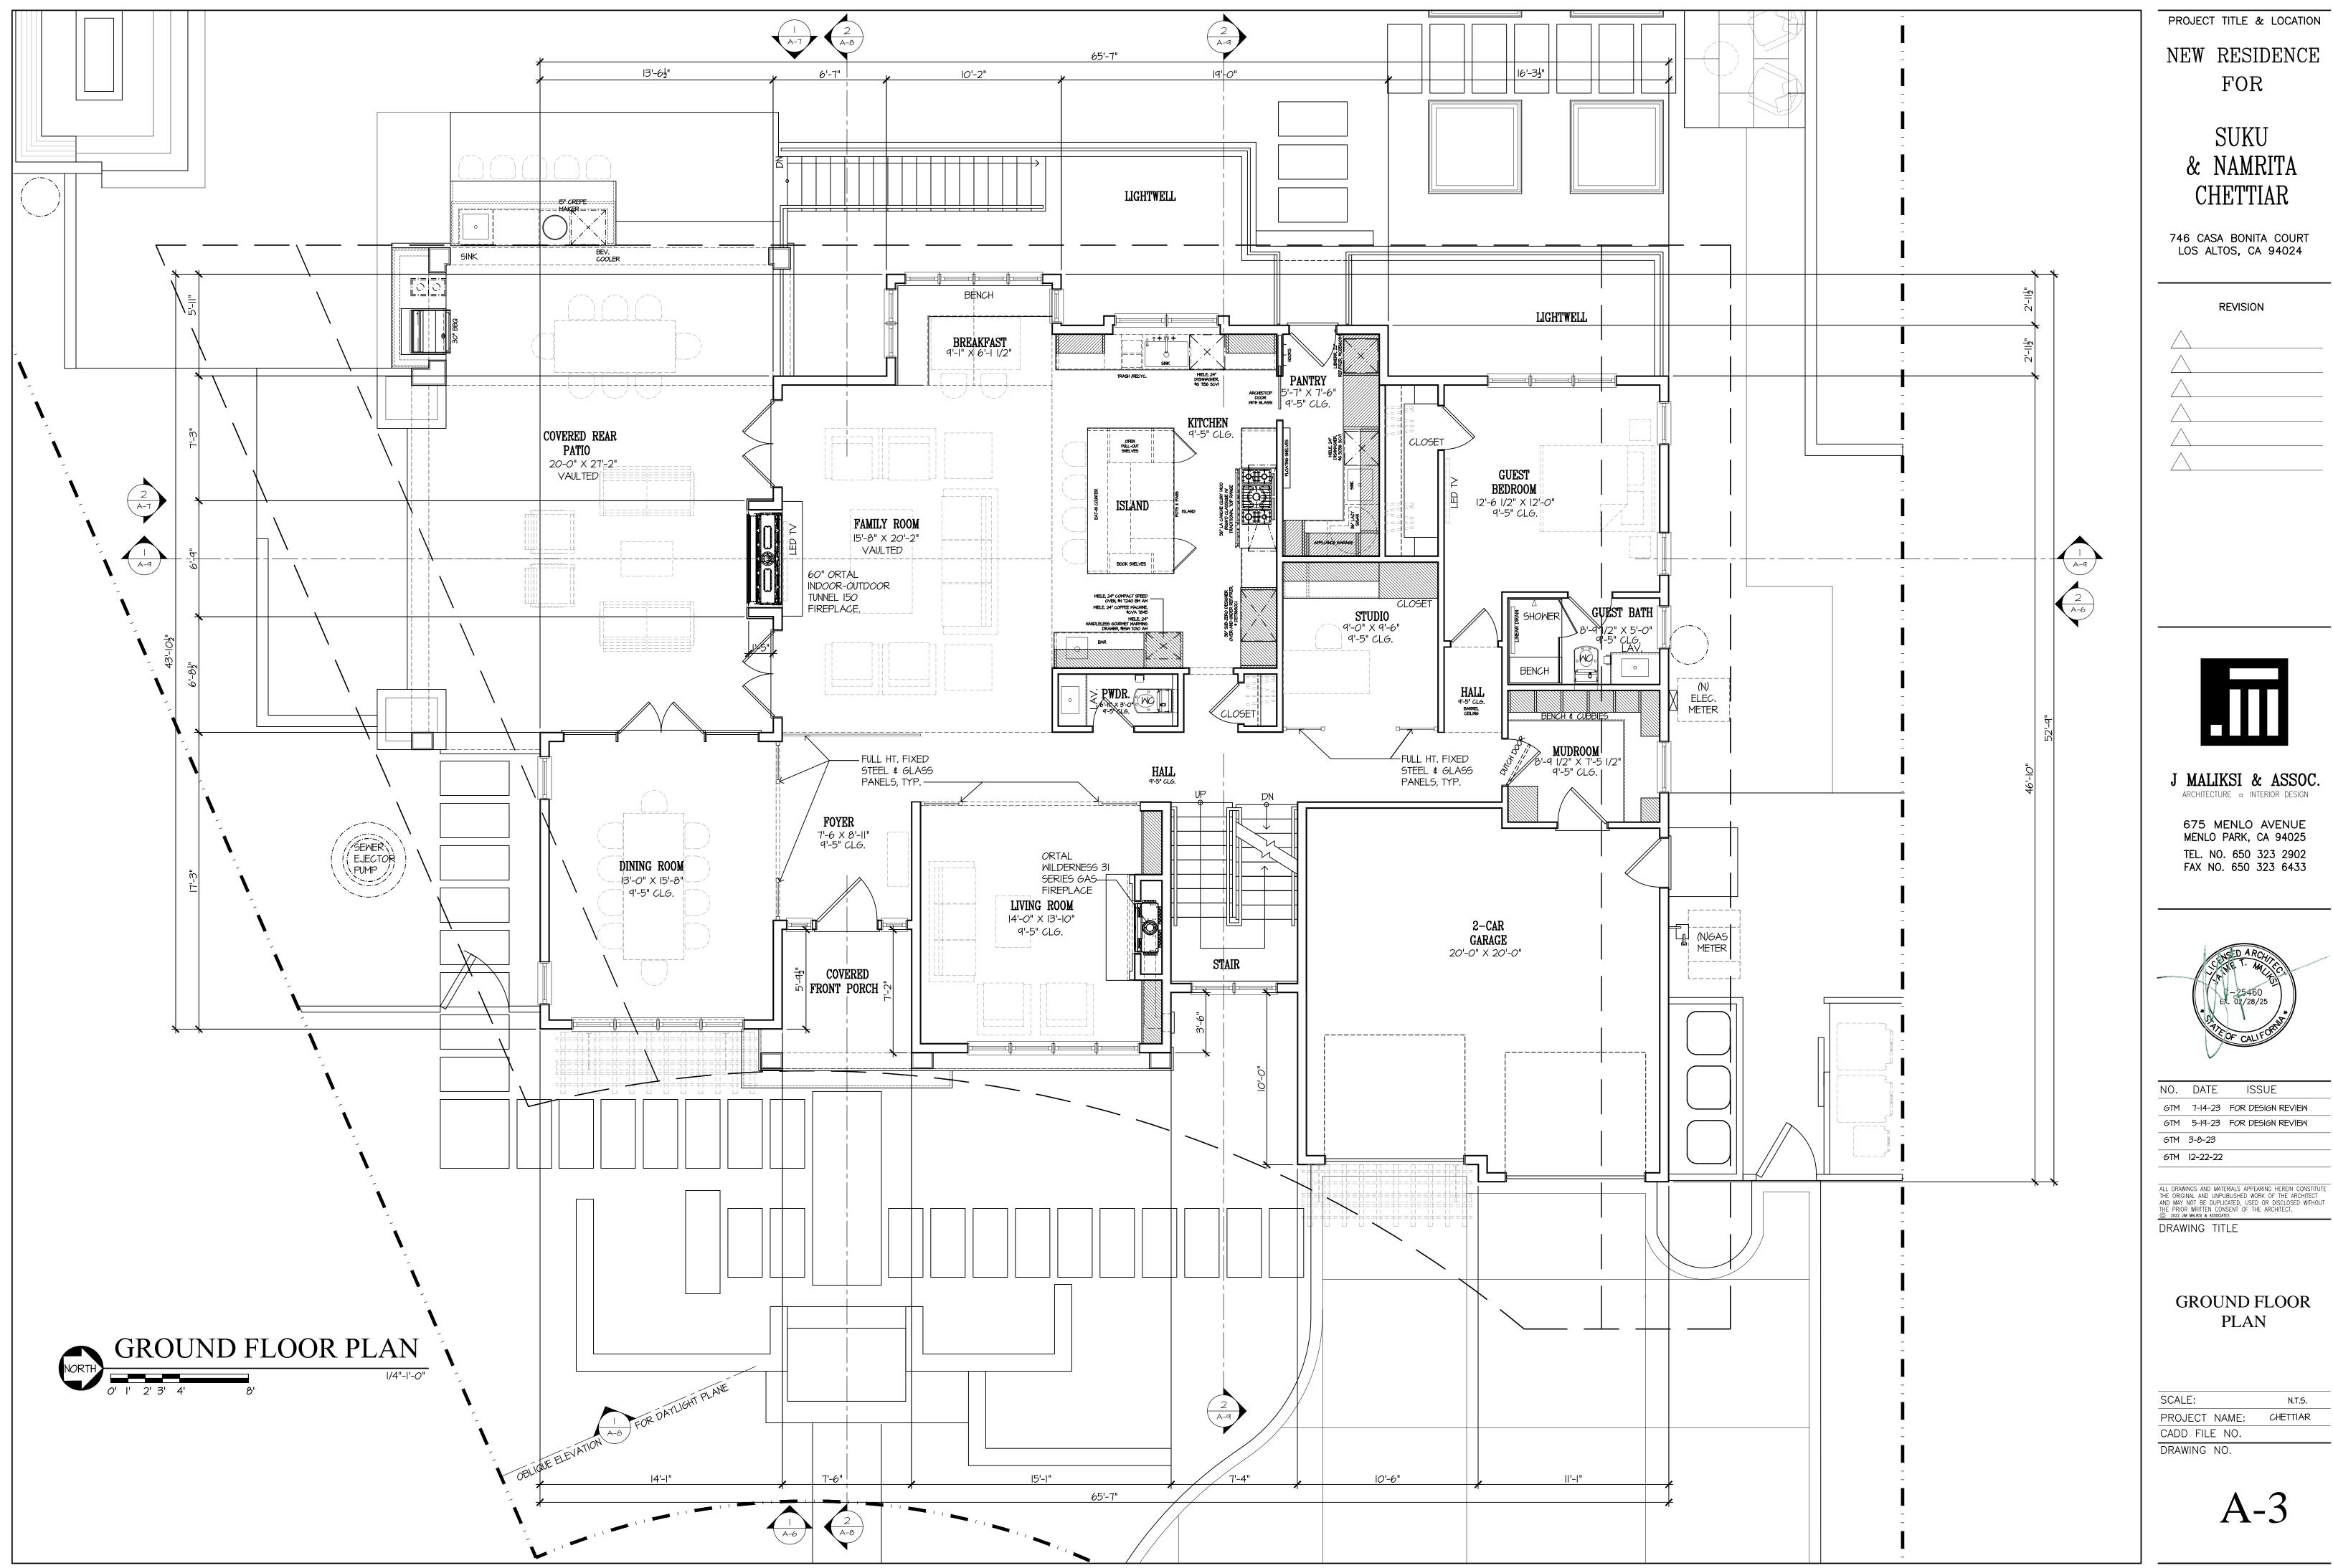




N.T.S. CHETTIAR

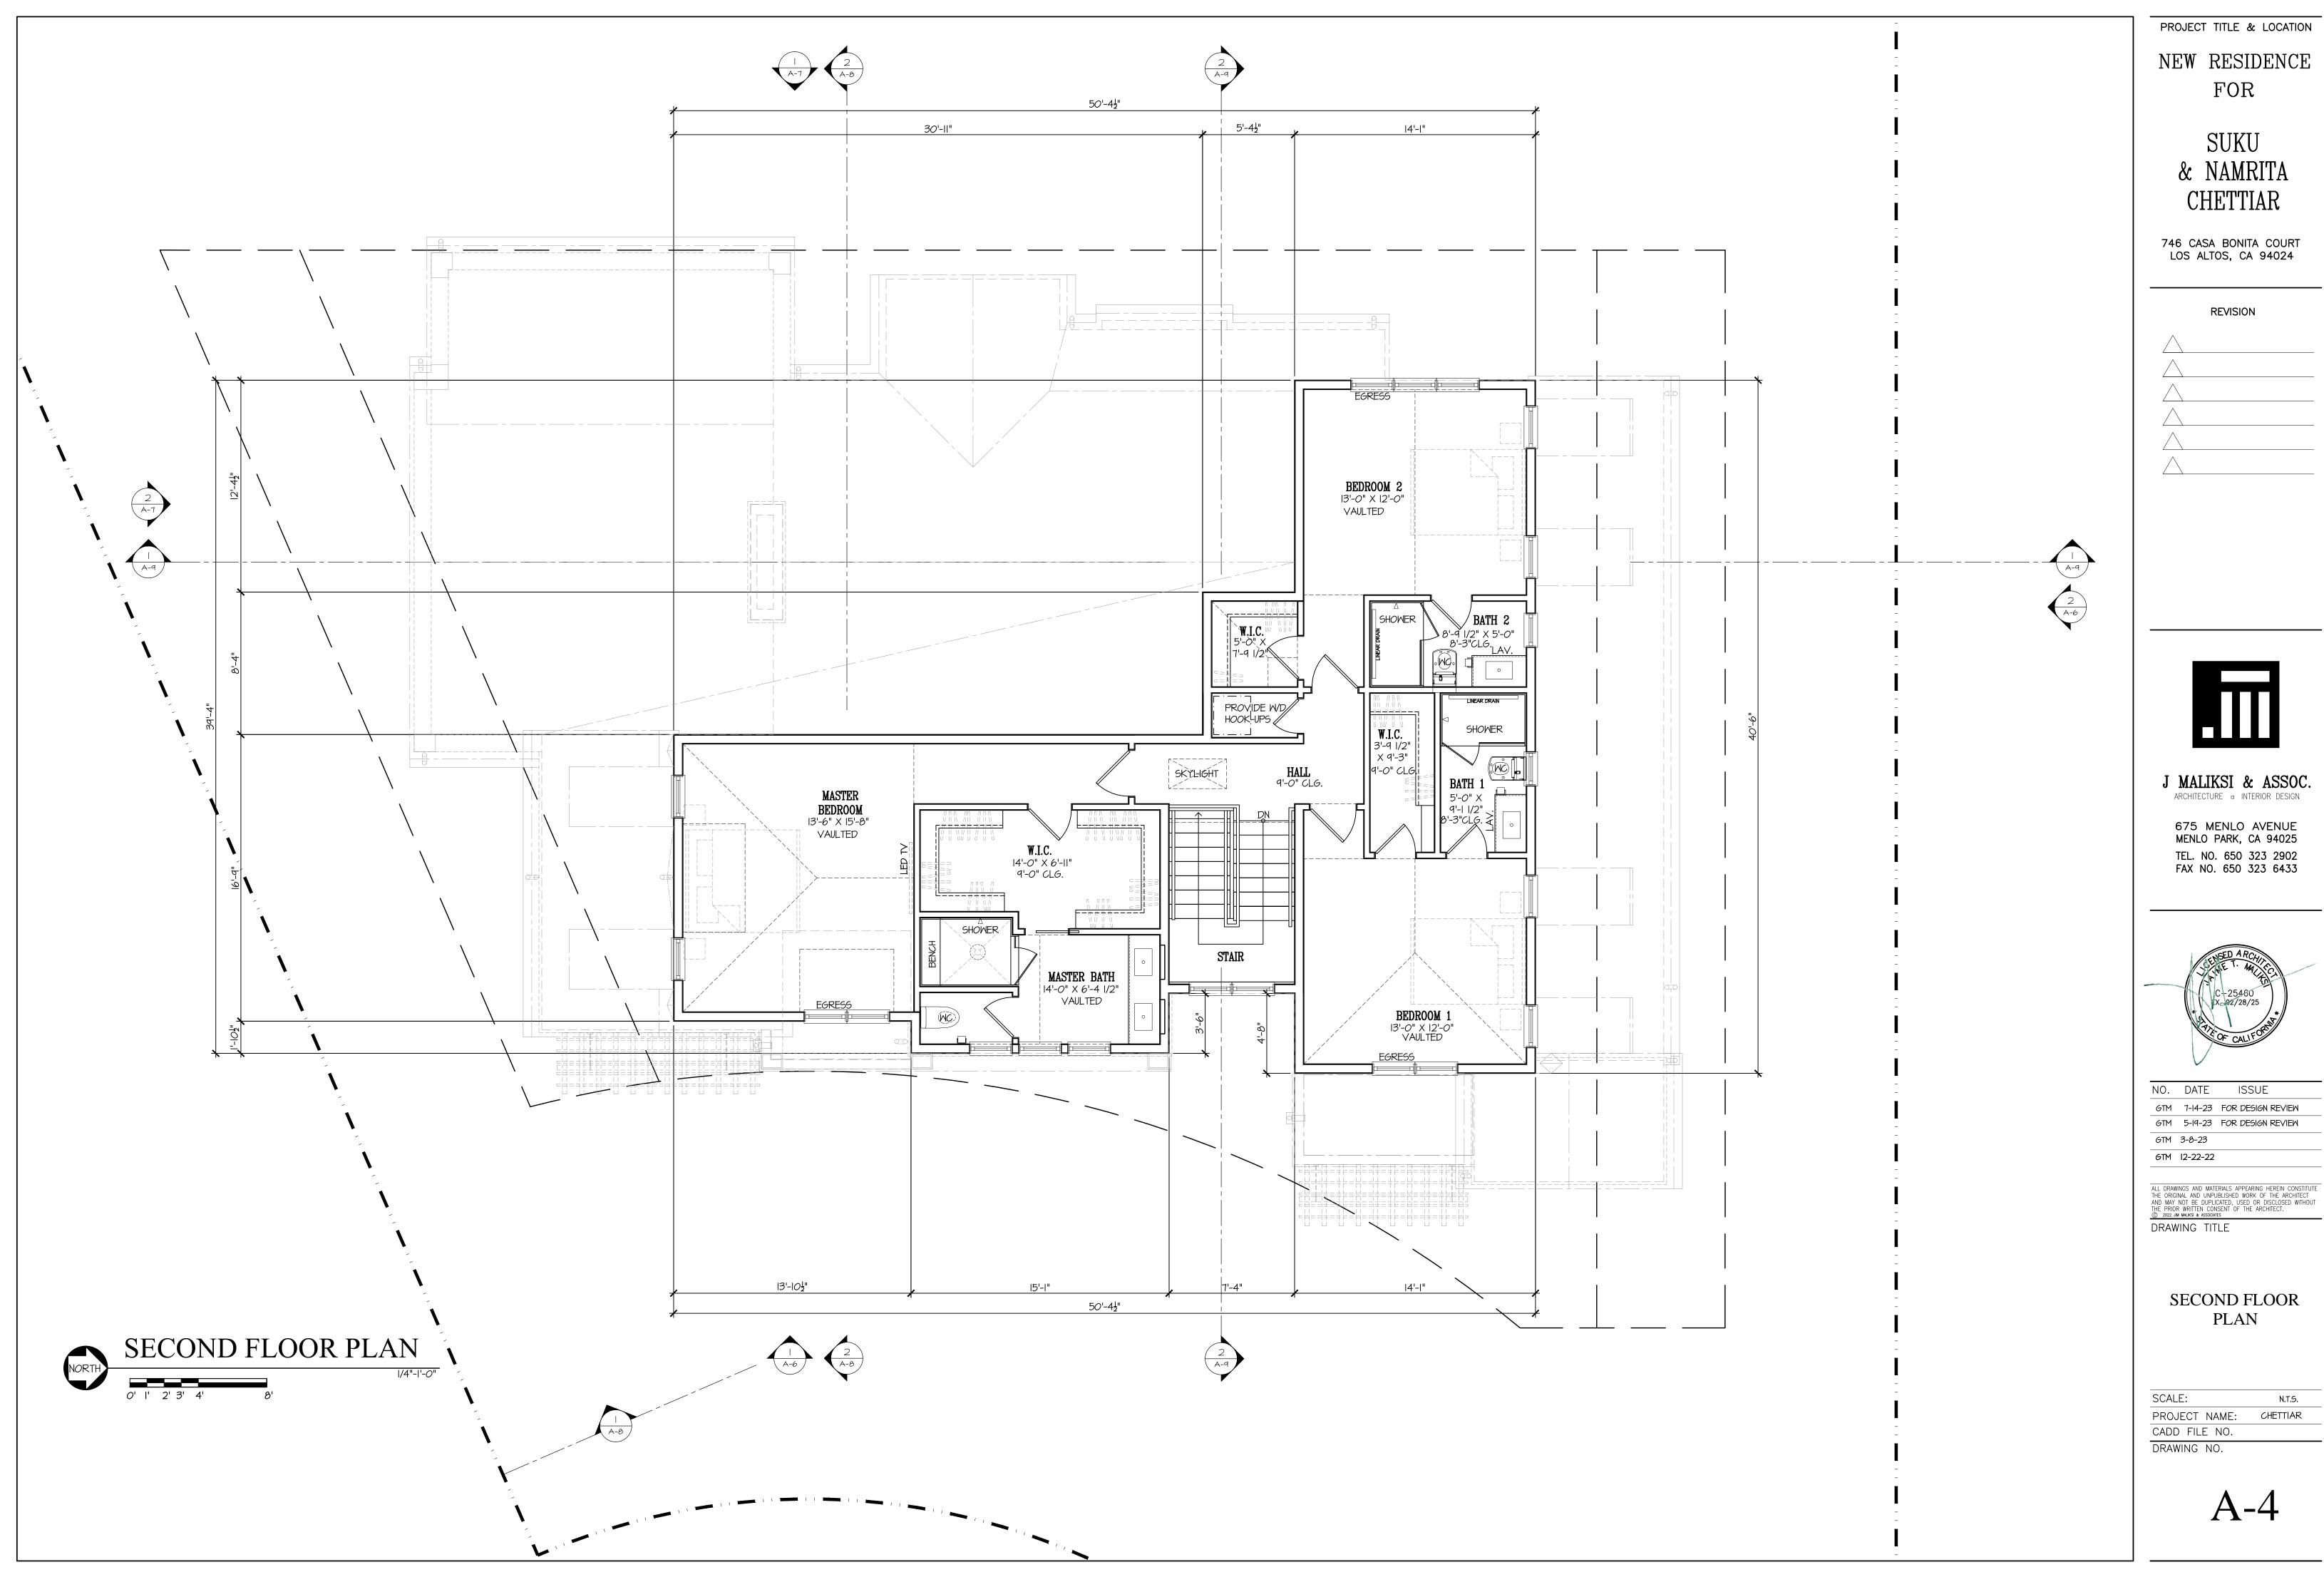



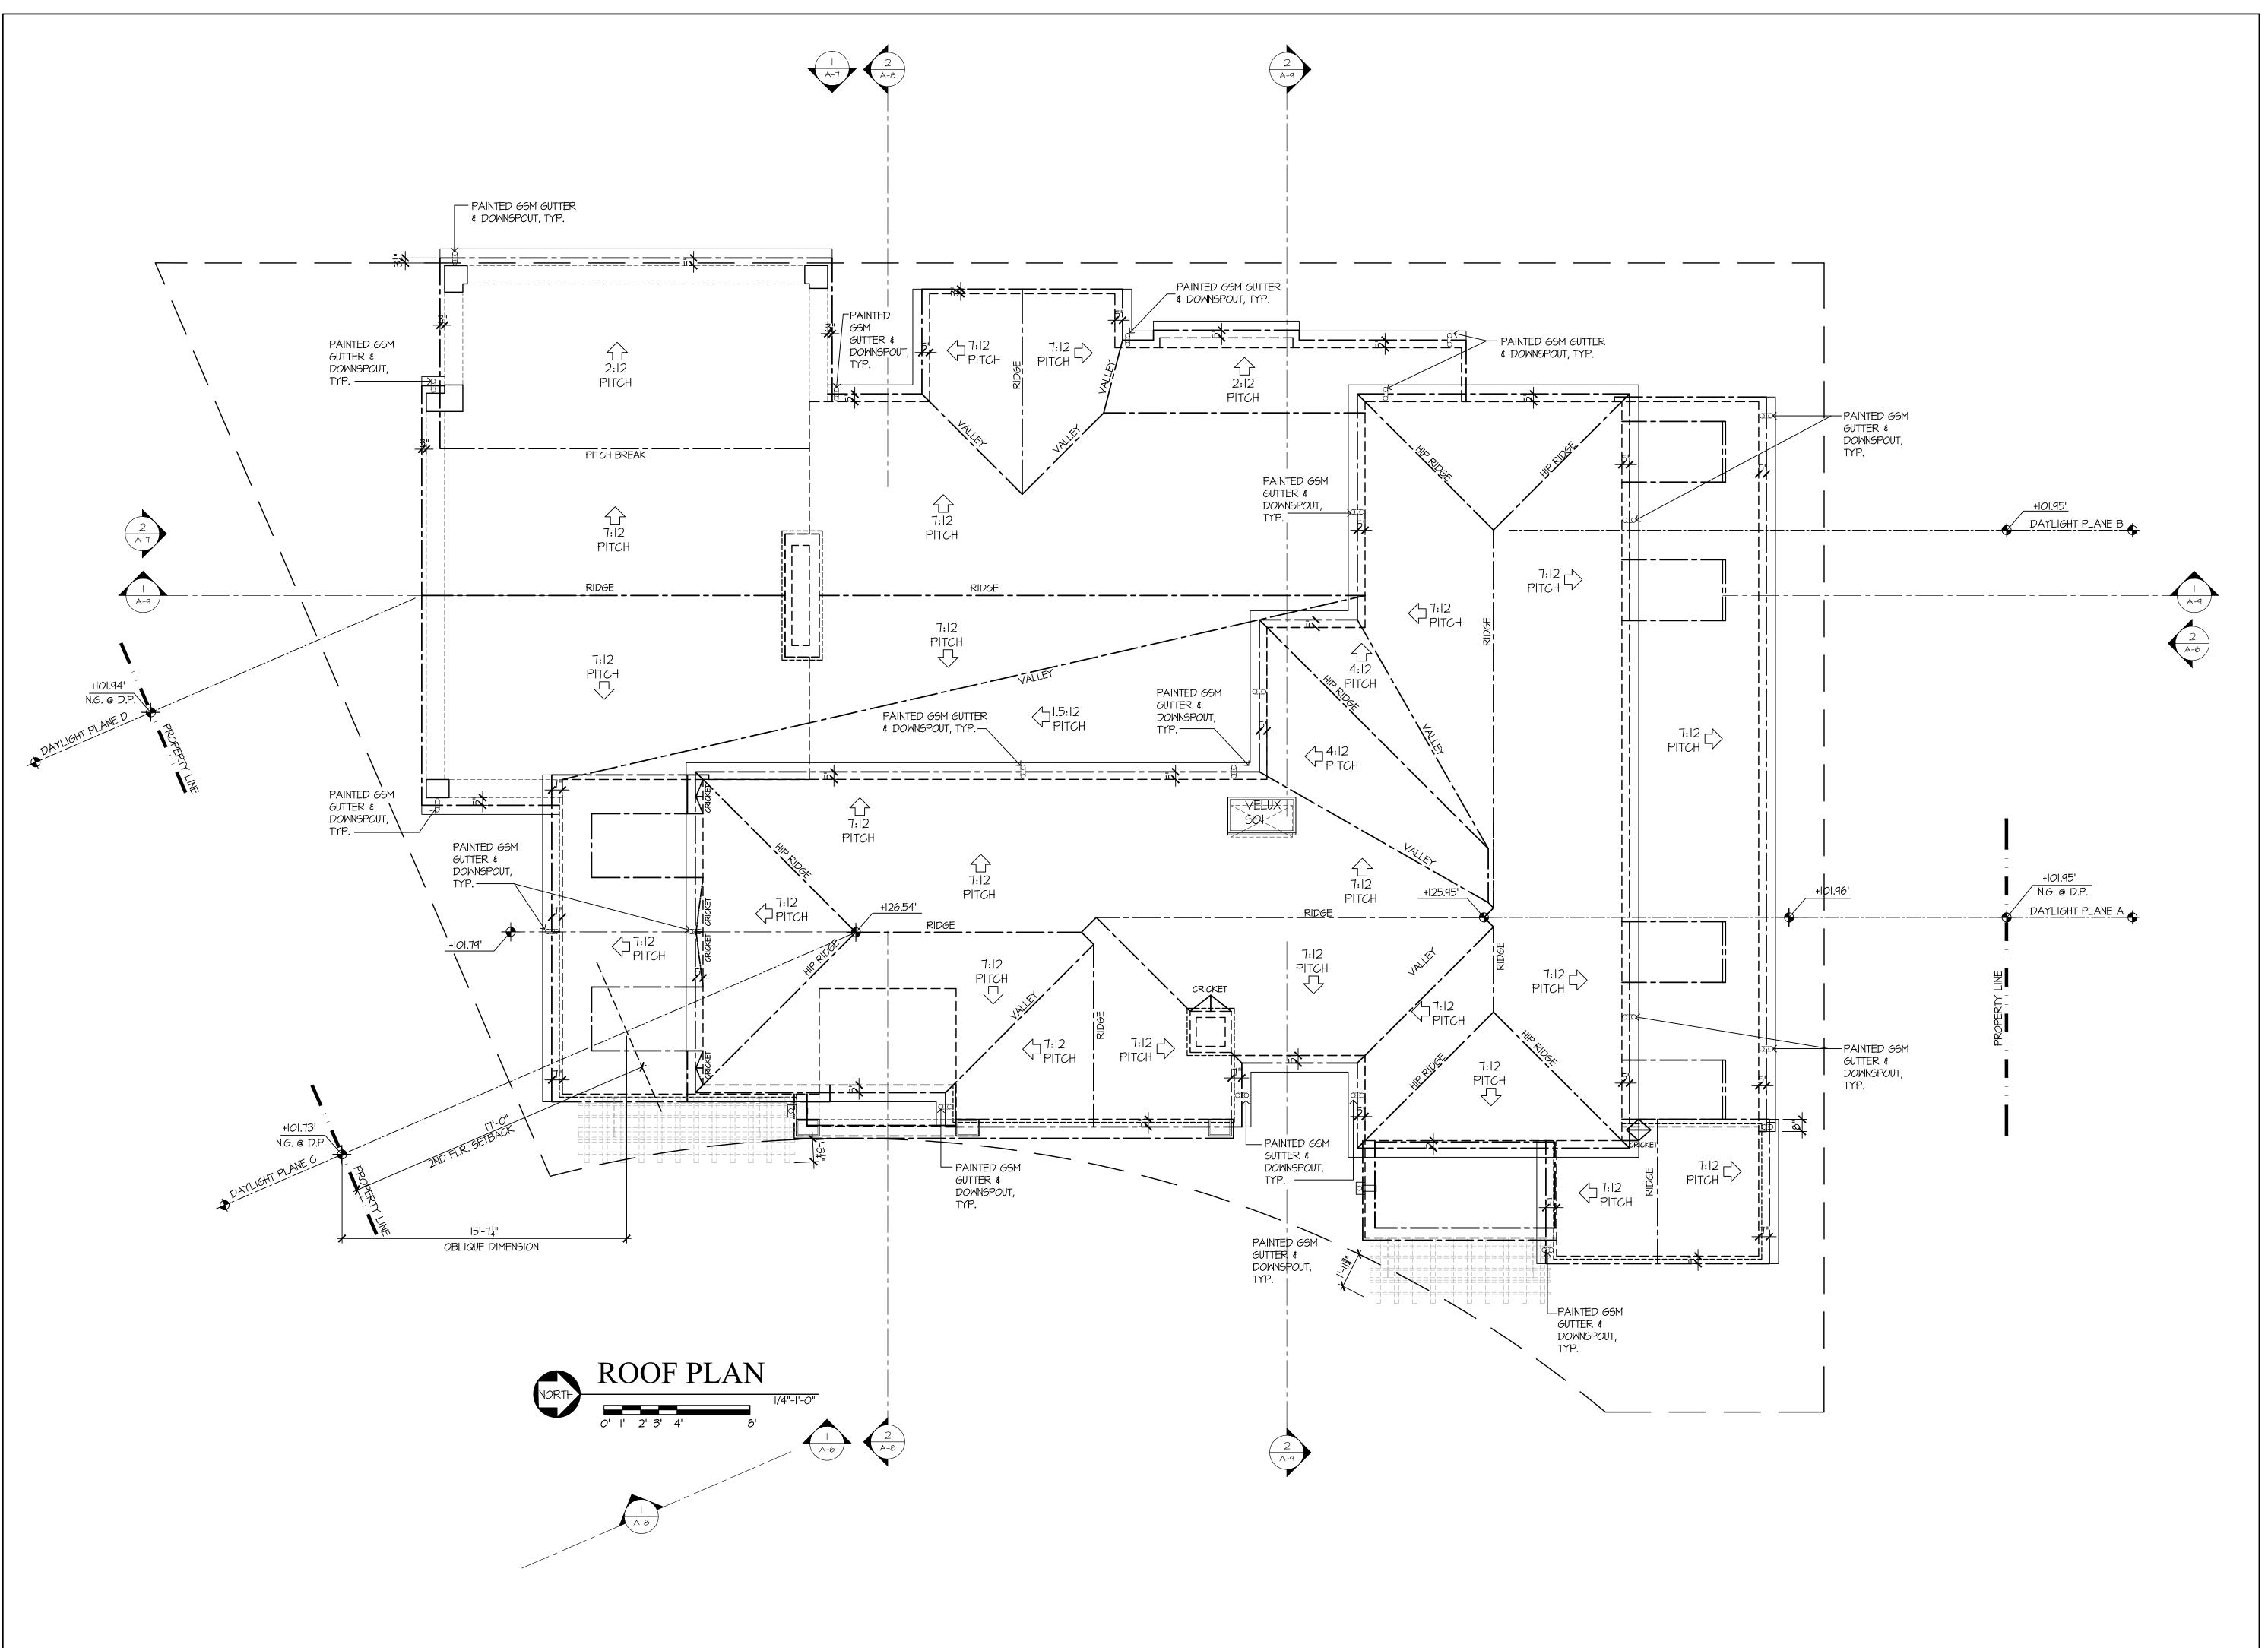

NEW RESIDENCE FOR

SUKU & NAMRITA CHETTIAR

746 CASA BONITA COURT LOS ALTOS, CA 94024

REVISION



J MALIKSI & ASSOC.

675 MENLO AVENUE MENLO PARK, CA 94025 TEL. NO. 650 323 2902 FAX NO. 650 323 6433



NO. DATE ISSUE

GTM 7-14-23 FOR DESIGN REVIEW

GTM 5-19-23 FOR DESIGN REVIEW

GTM 3-8-23

ALL DRAWINGS AND MATERIALS APPEARING HEREIN CONSTITUTE THE ORIGINAL AND UNPUBLISHED WORK OF THE ARCHITECT AND MAY NOT BE DUPLICATED, USED OR DISCLOSED WITHOUT THE PRIOR WRITTEN CONSENT OF THE ARCHITECT.

© 2022 JIM MALKSI & ASSOCIATES

DRAWING TITLE

ROOF PLAN


SCALE:

PROJECT NAME: CHETTIAR

CADD FILE NO.

DRAWING NO.

A-5

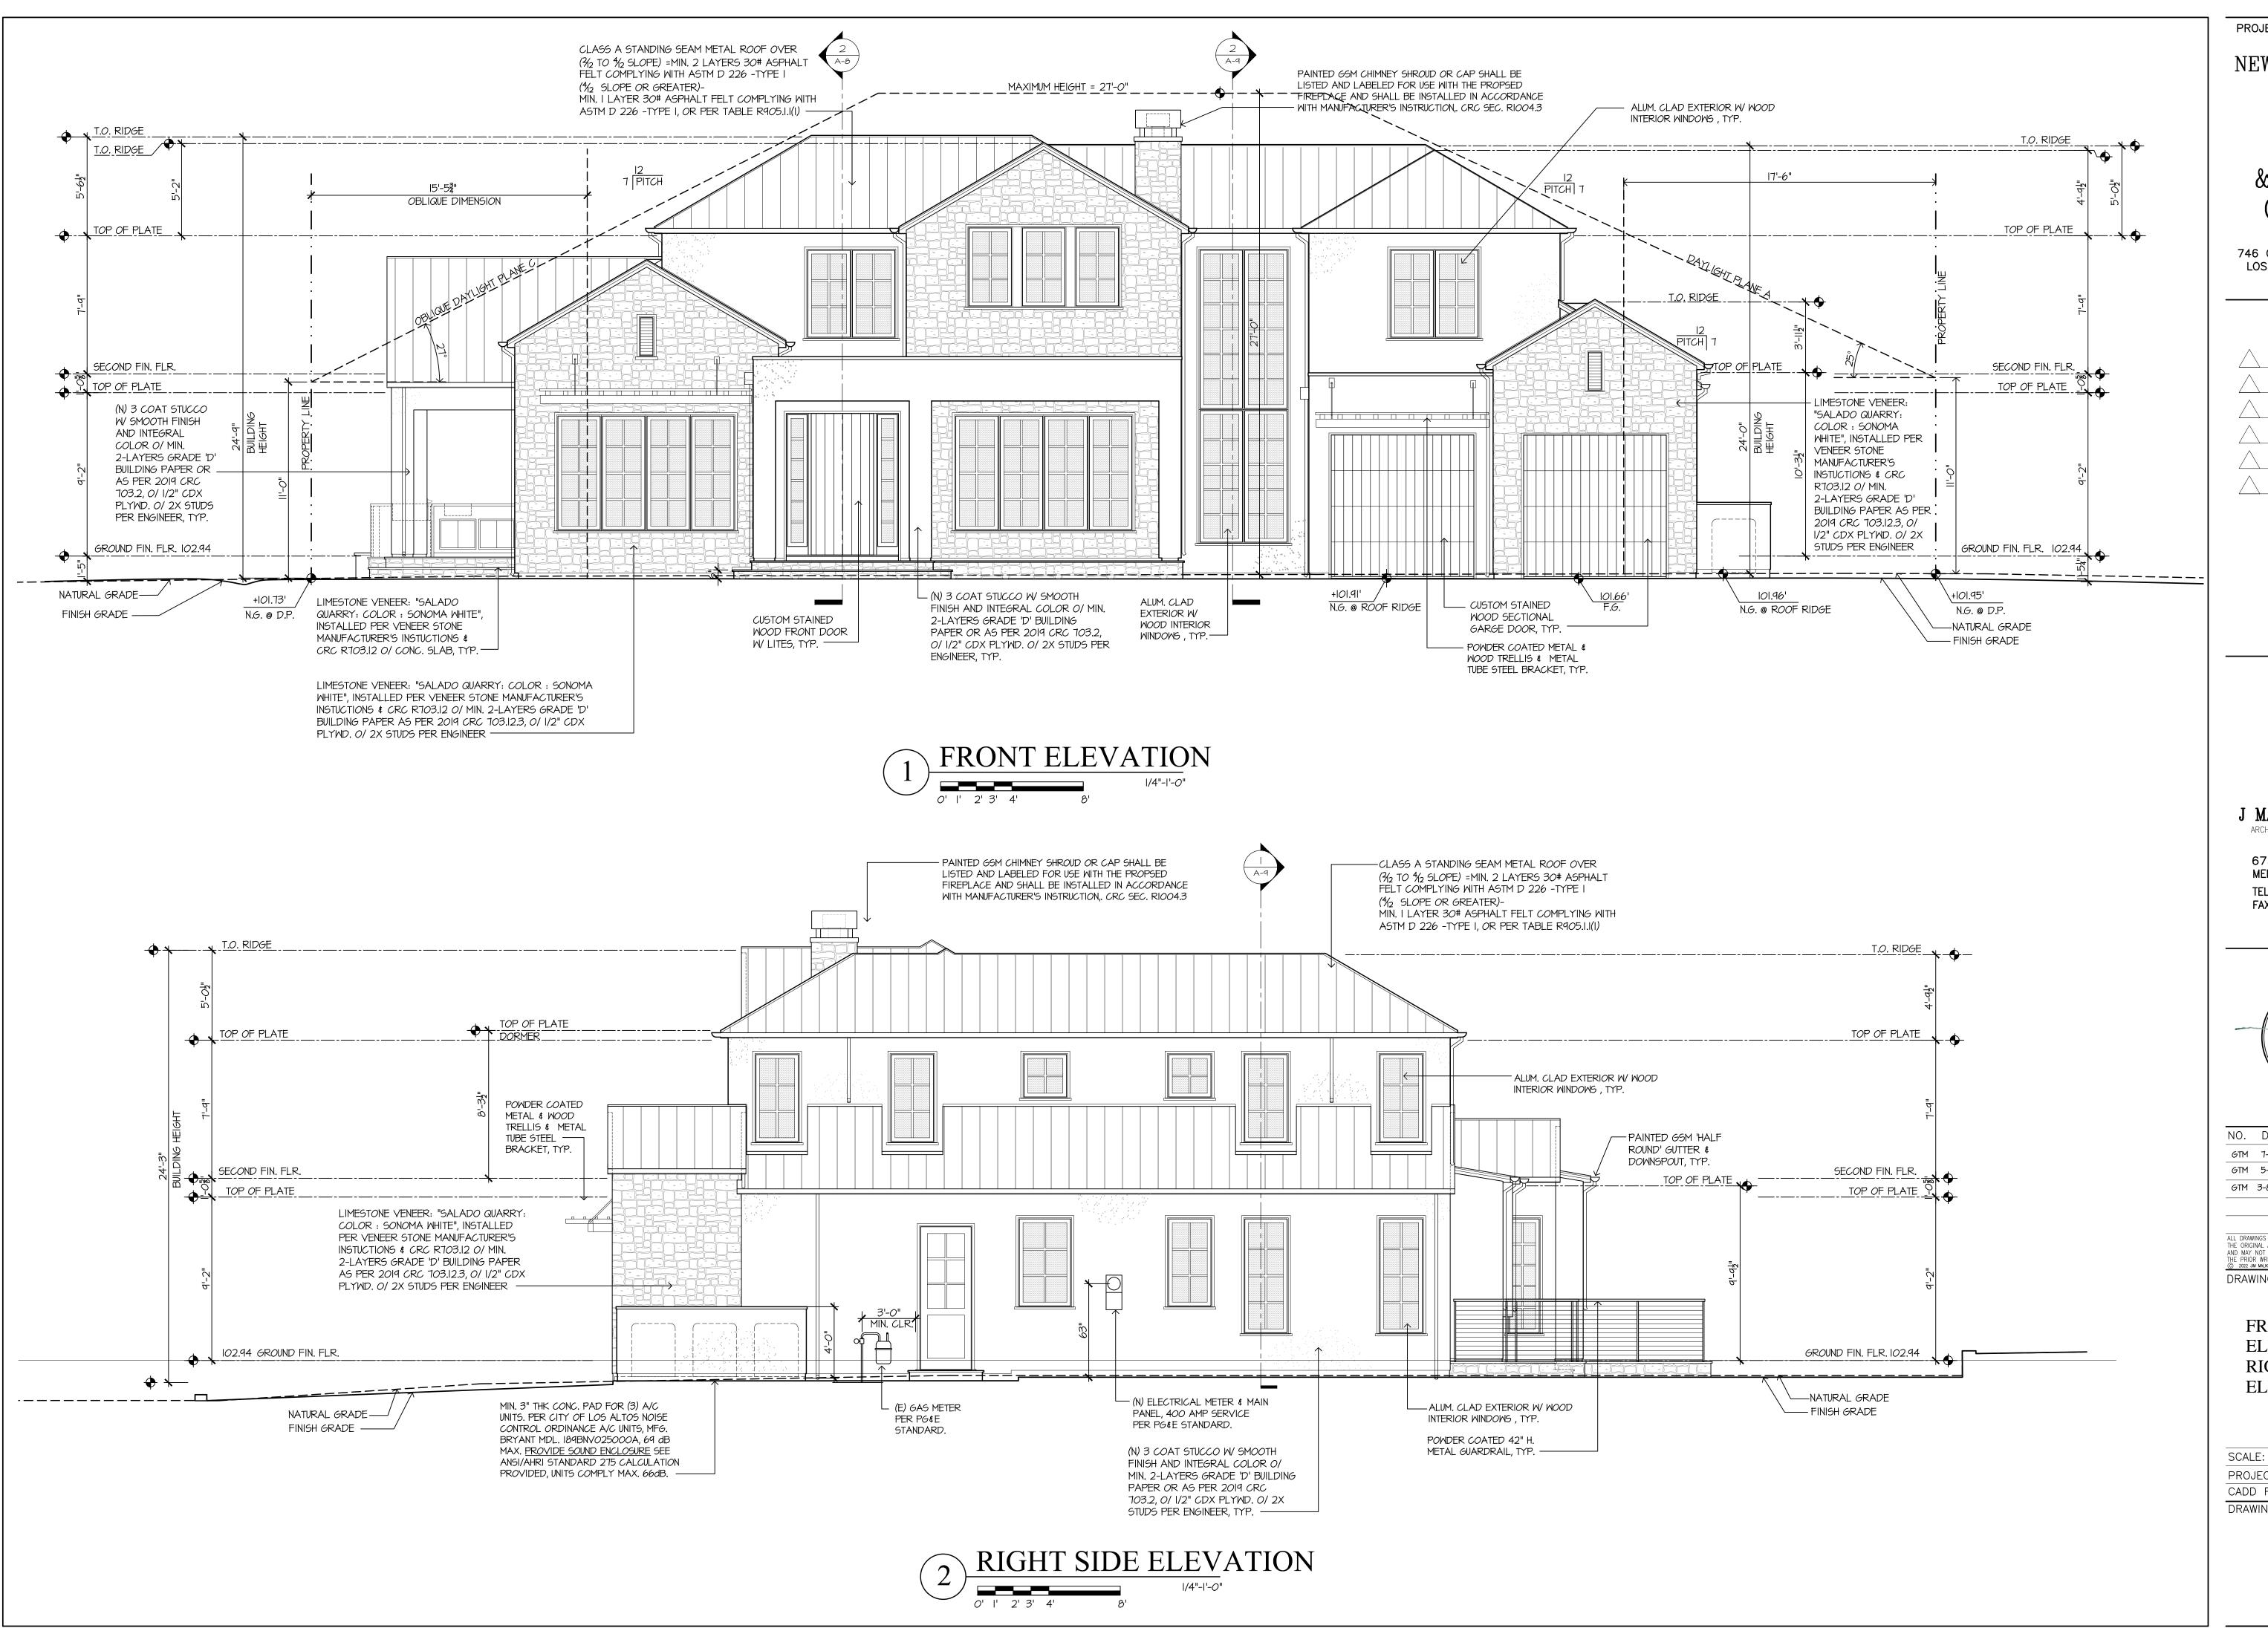

NEW RESIDENCE FOR

SUKU & NAMRITA CHETTIAR

746 CASA BONITA COURT LOS ALTOS, CA 94024

REVISION



J MALIKSI & ASSOC.

675 MENLO AVENUE MENLO PARK, CA 94025 TEL. NO. 650 323 2902 FAX NO. 650 323 6433



NO. DATE ISSUE

6TM 7-14-23 FOR DESIGN REVIEW

GTM 5-19-23 FOR DESIGN REVIEW
GTM 3-8-23

ALL DRAWINGS AND MATERIALS APPEARING HEREIN CONSTITUTE THE ORIGINAL AND UNPUBLISHED WORK OF THE ARCHITECT AND MAY NOT BE DUPLICATED, USED OR DISCLOSED WITHOUT THE PRIOR WRITTEN CONSENT OF THE ARCHITECT.

© 2022 JIM MALIKSI & ASSOCIATES

DRAWING TITLE

FRONT
ELEVATION &
RIGHT SIDE
ELEVATION


SCALE:

PROJECT NAME: CHETTIAR

CADD FILE NO.

DRAWING NO.

A-6

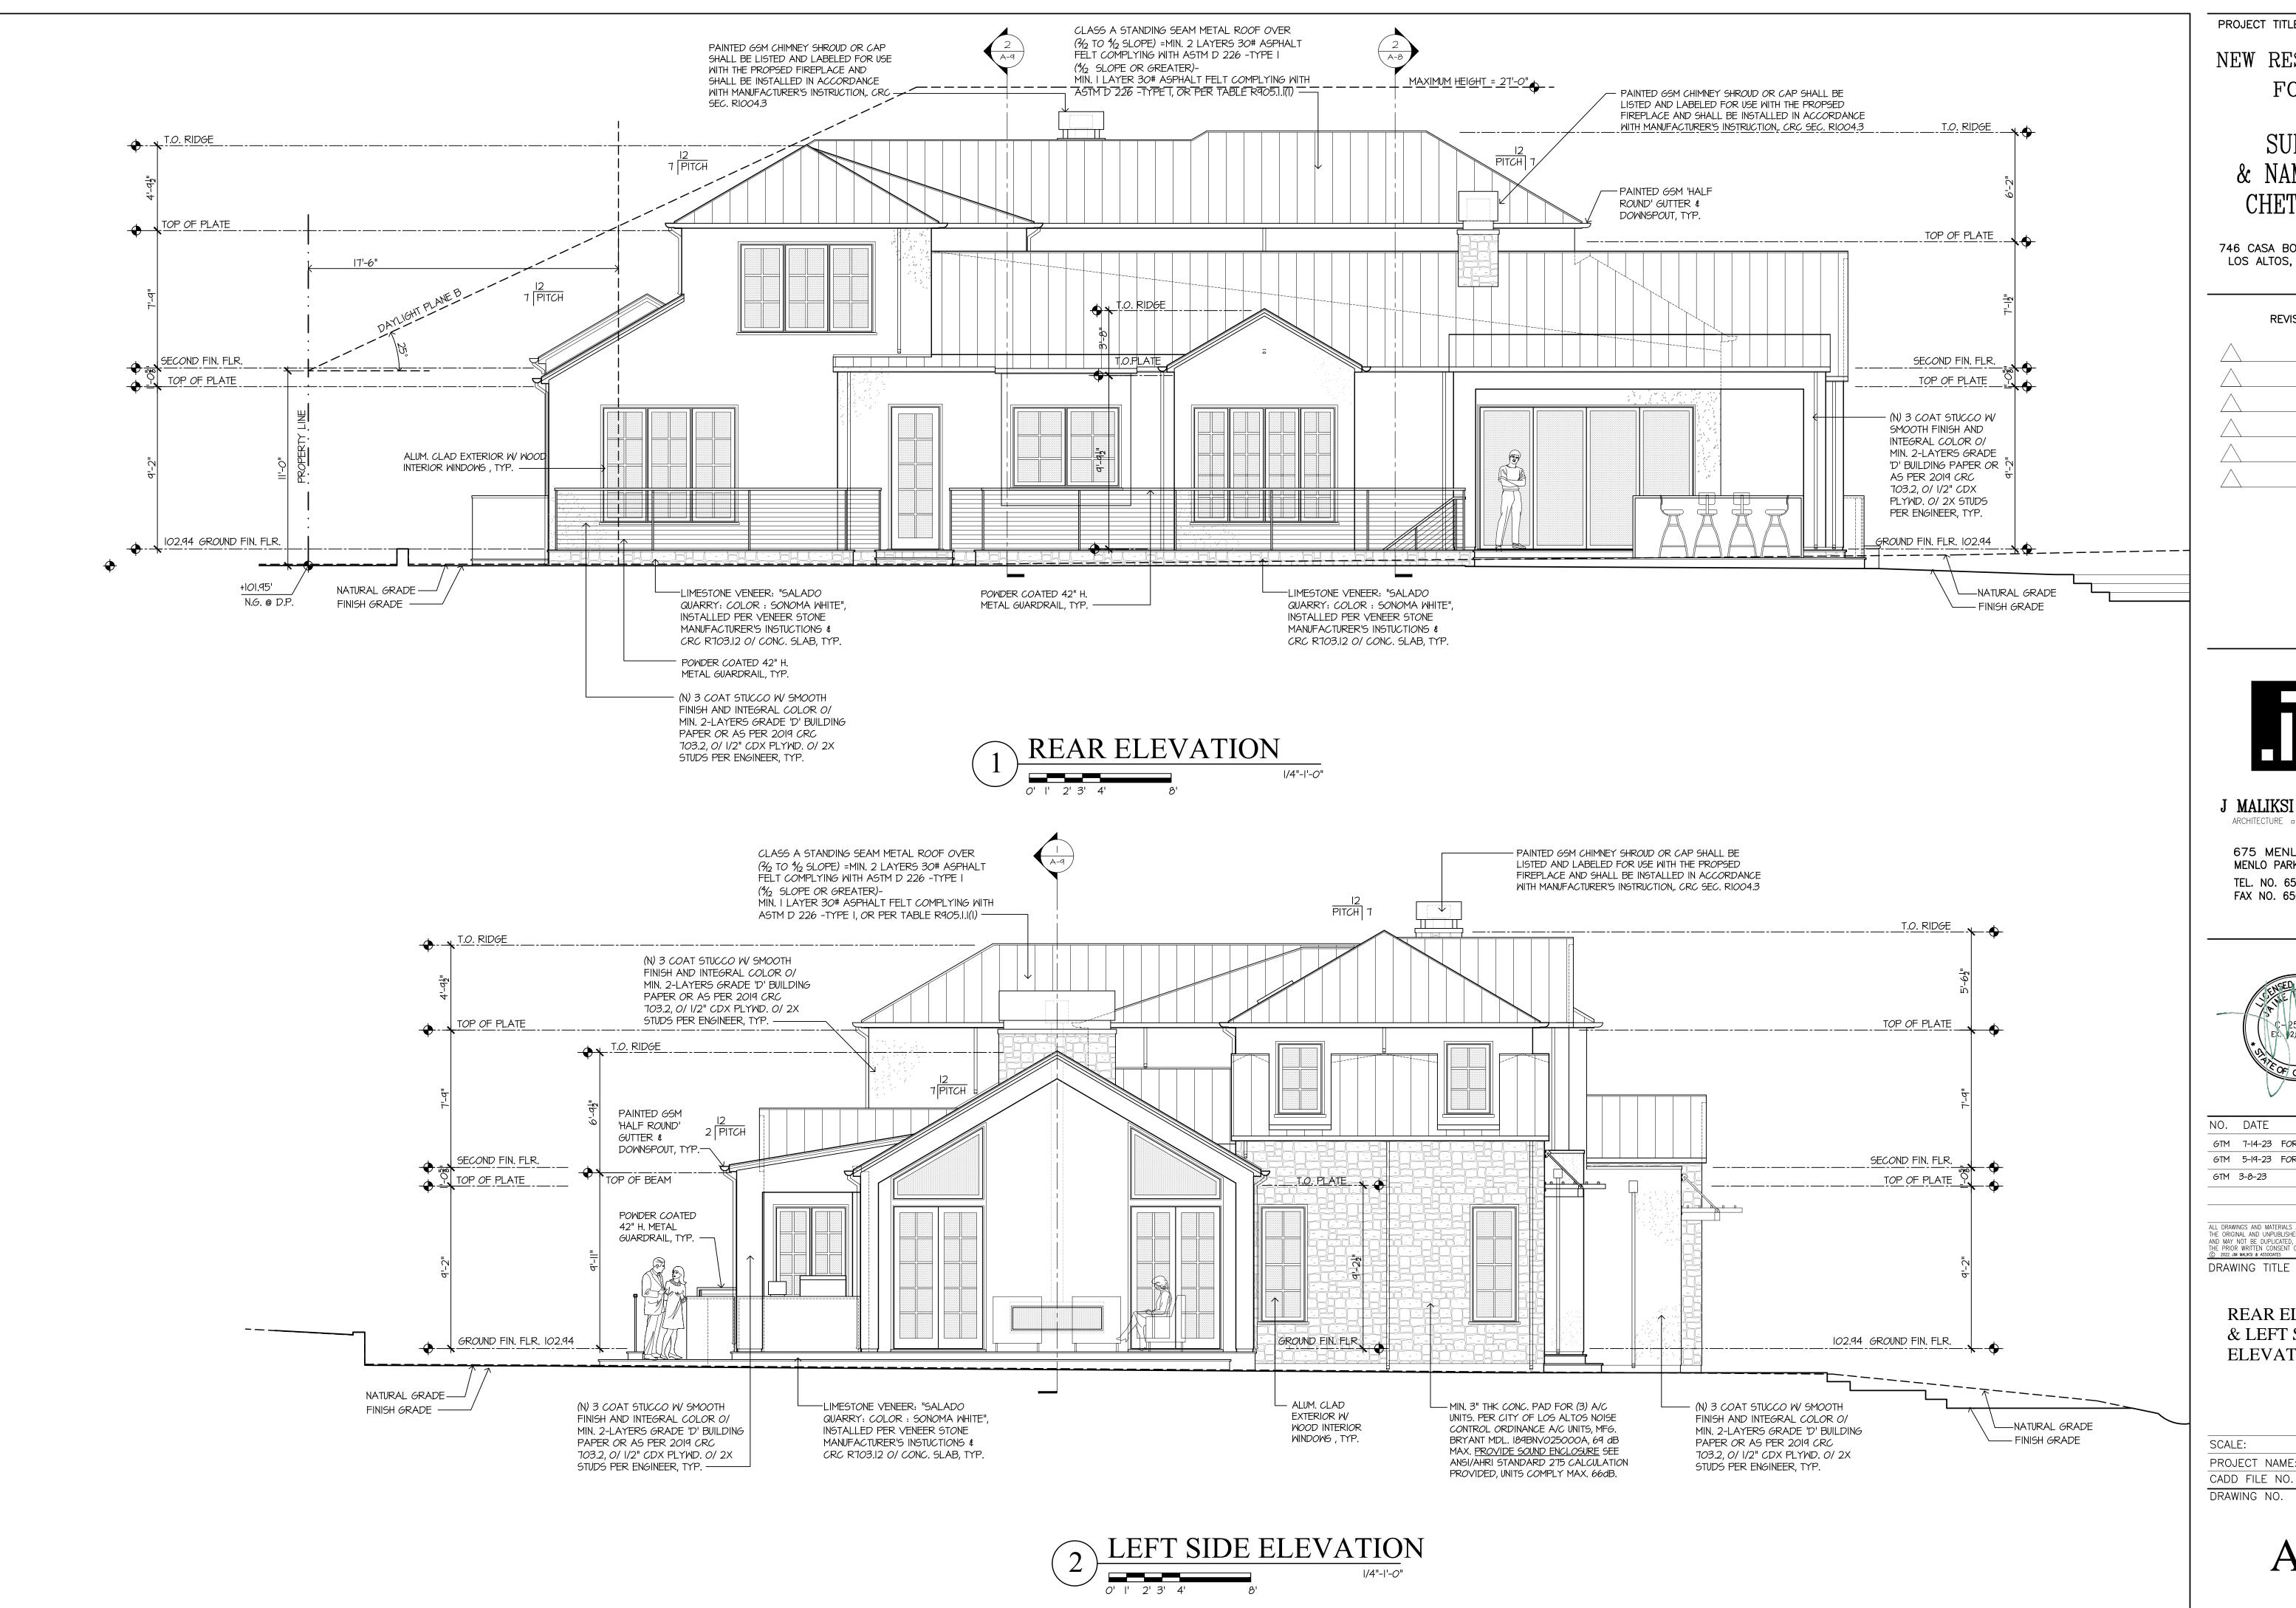

NEW RESIDENCE FOR

> SUKU & NAMRITA CHETTIAR

746 CASA BONITA COURT LOS ALTOS, CA 94024

REVISION



J MALIKSI & ASSOC. ARCHITECTURE - INTERIOR DESIGN

675 MENLO AVENUE MENLO PARK, CA 94025 TEL. NO. 650 323 2902 FAX NO. 650 323 6433




NO. DATE ISSUE GTM 7-14-23 FOR DESIGN REVIEW GTM 5-19-23 FOR DESIGN REVIEW

ALL DRAWINGS AND MATERIALS APPEARING HEREIN CONSTITUTE
THE ORIGINAL AND UNPUBLISHED WORK OF THE ARCHITECT
AND MAY NOT BE DUPLICATED, USED OR DISCLOSED WITHOUT
THE PRIOR WRITTEN CONSENT OF THE ARCHITECT.

© 2022 JIM MALIKSI & ASSOCIATES

REAR ELEVATION & LEFT SIDE **ELEVATION**

SCALE: N.T.S. PROJECT NAME: CHETTIAR CADD FILE NO.

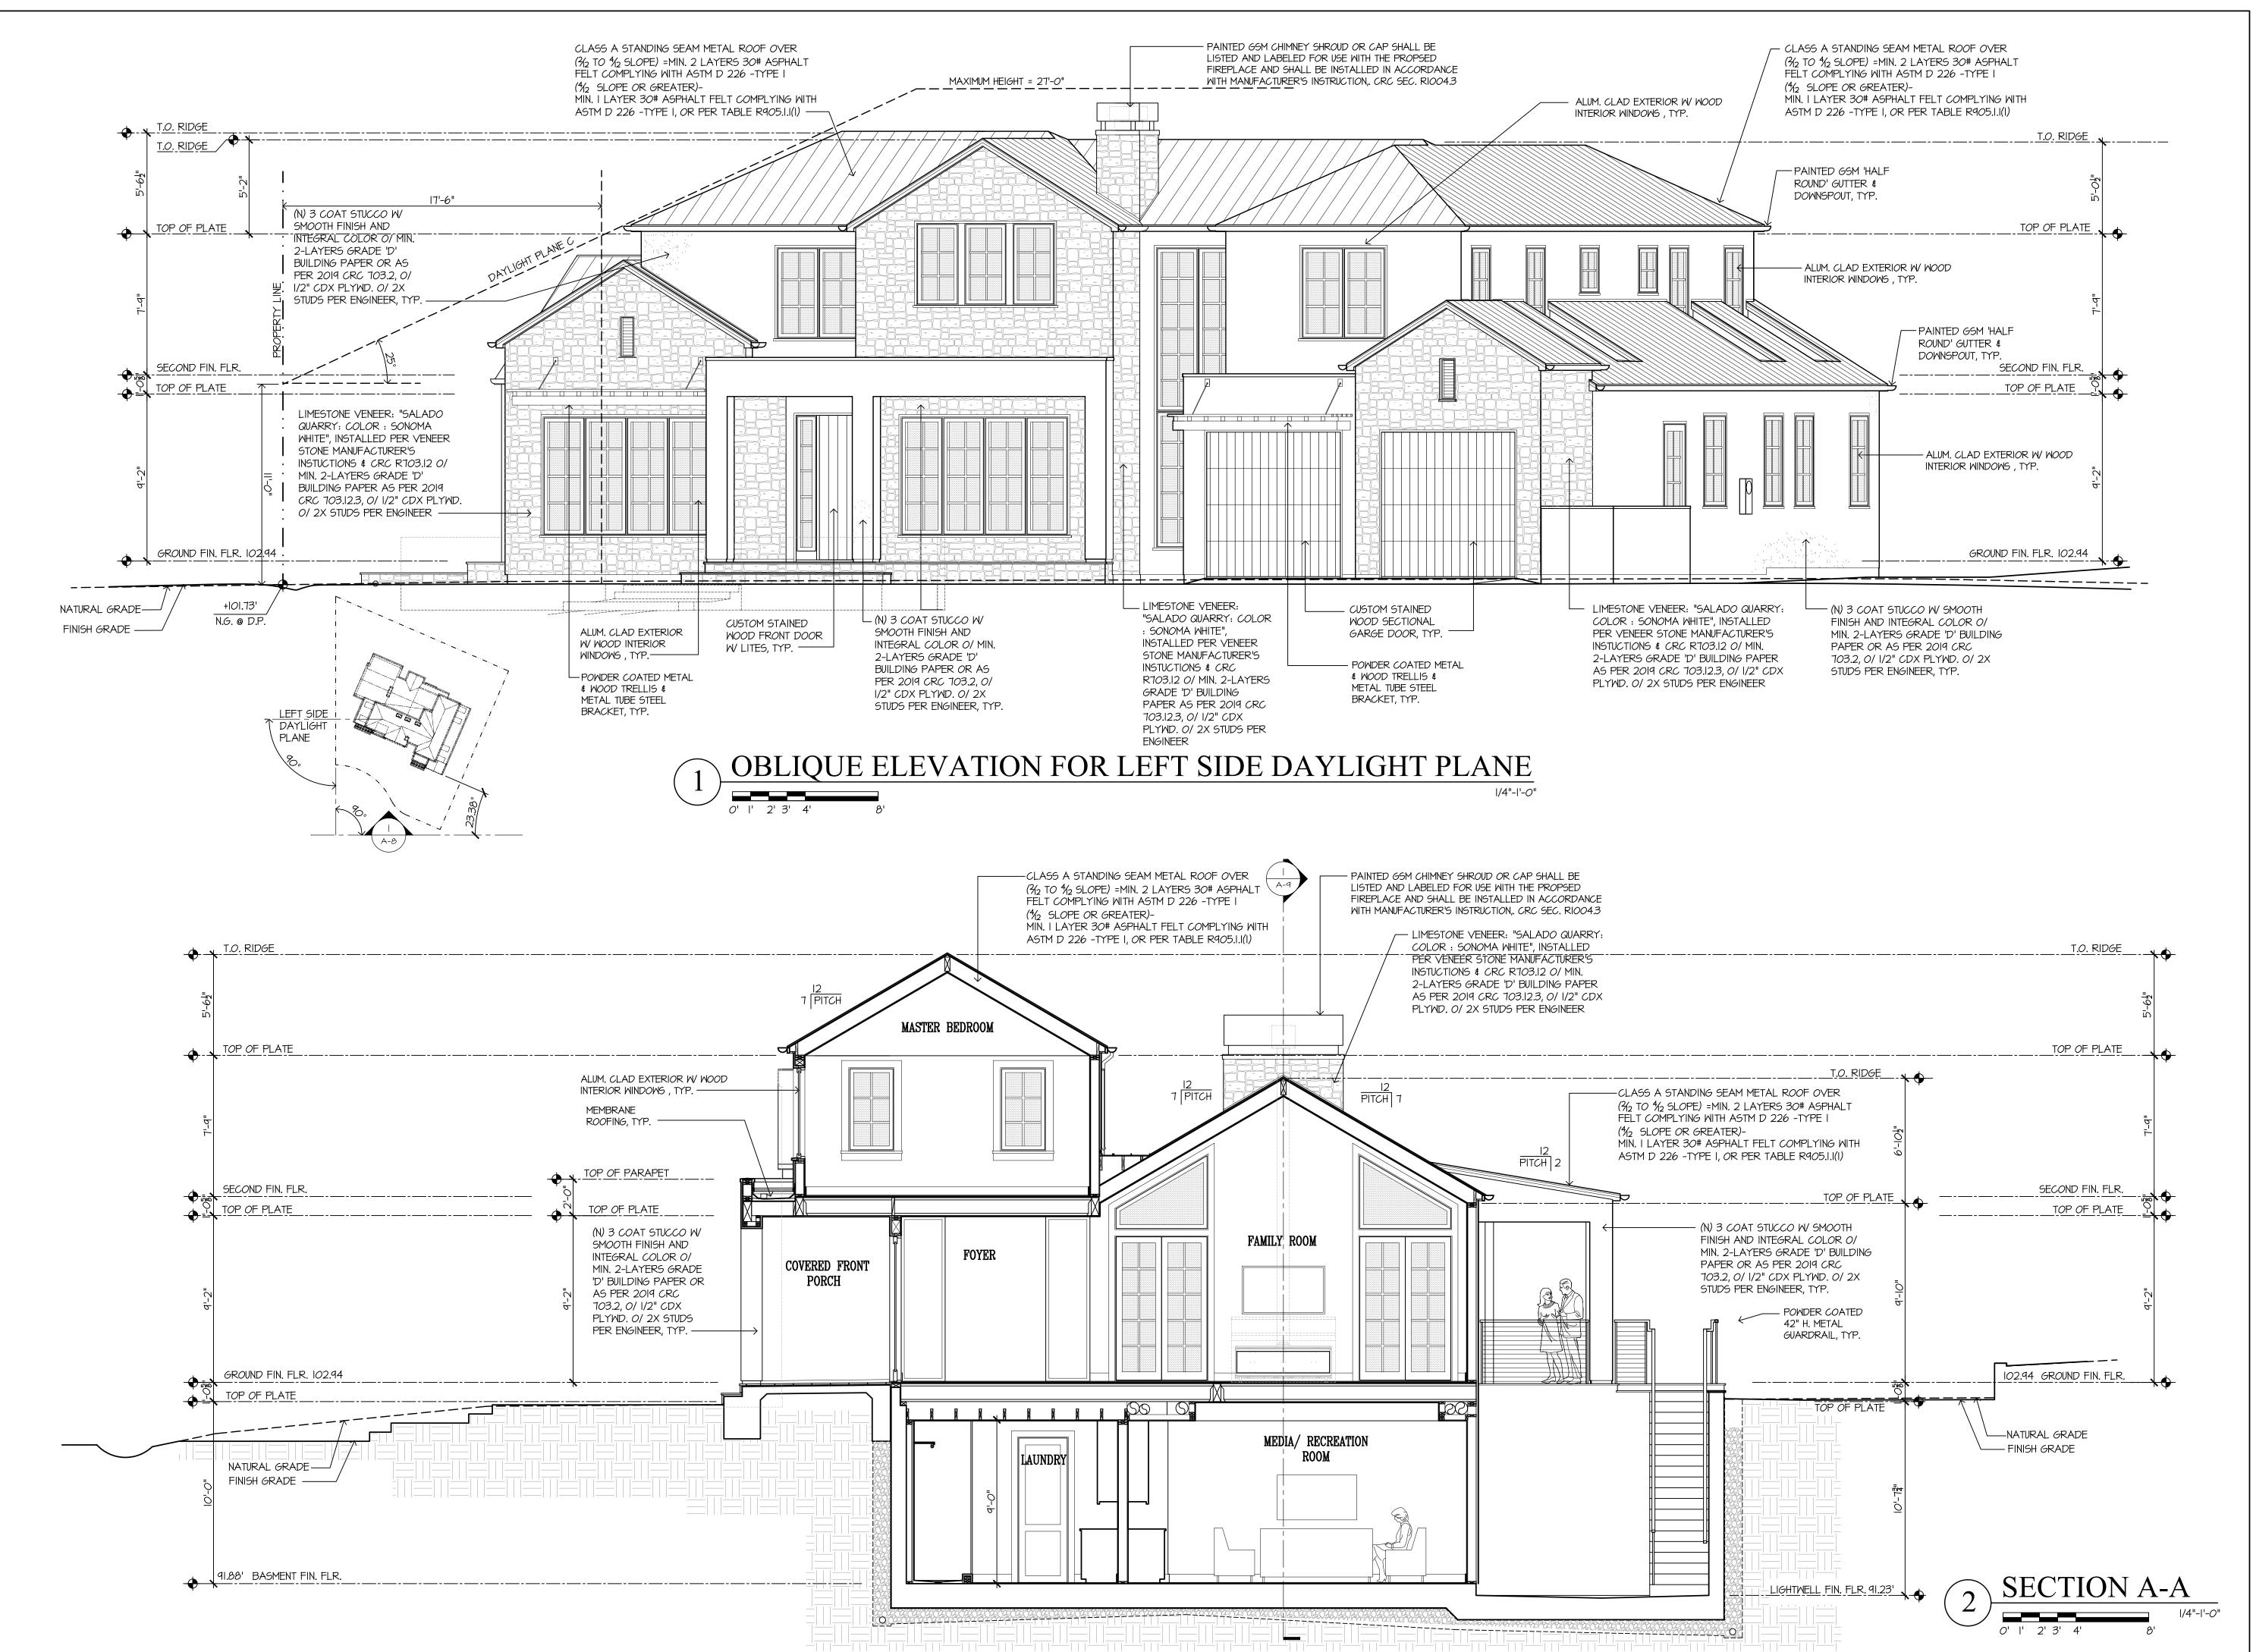

NEW RESIDENCE FOR

SUKU & NAMRITA CHETTIAR

746 CASA BONITA COURT LOS ALTOS, CA 94024

REVISION



J MALIKSI & ASSOC.

675 MENLO AVENUE MENLO PARK, CA 94025 TEL. NO. 650 323 2902 FAX NO. 650 323 6433



NO. DATE ISSUE

6TM 7-14-23 FOR DESIGN REVIEW

GTM 5-19-23 FOR DESIGN REVIEW

ALL DRAWINGS AND MATERIALS APPEARING HEREIN CONSTITUTE
THE ORIGINAL AND UNPUBLISHED WORK OF THE ARCHITECT
AND MAY NOT BE DUPLICATED, USED OR DISCLOSED WITHOUT
THE PRIOR WRITTEN CONSENT OF THE ARCHITECT.

© 2022 JIM MALIKSI & ASSOCIATES

OBLIQUE FRONT &
RIGHT SIDE

RIGHT SIDE ELEVATION FOR DAYLIGHT PLANE & SECTION A-A


SCALE:

PROJECT NAME: CHETTIAR

CADD FILE NO.

DRAWING NO.

A-8

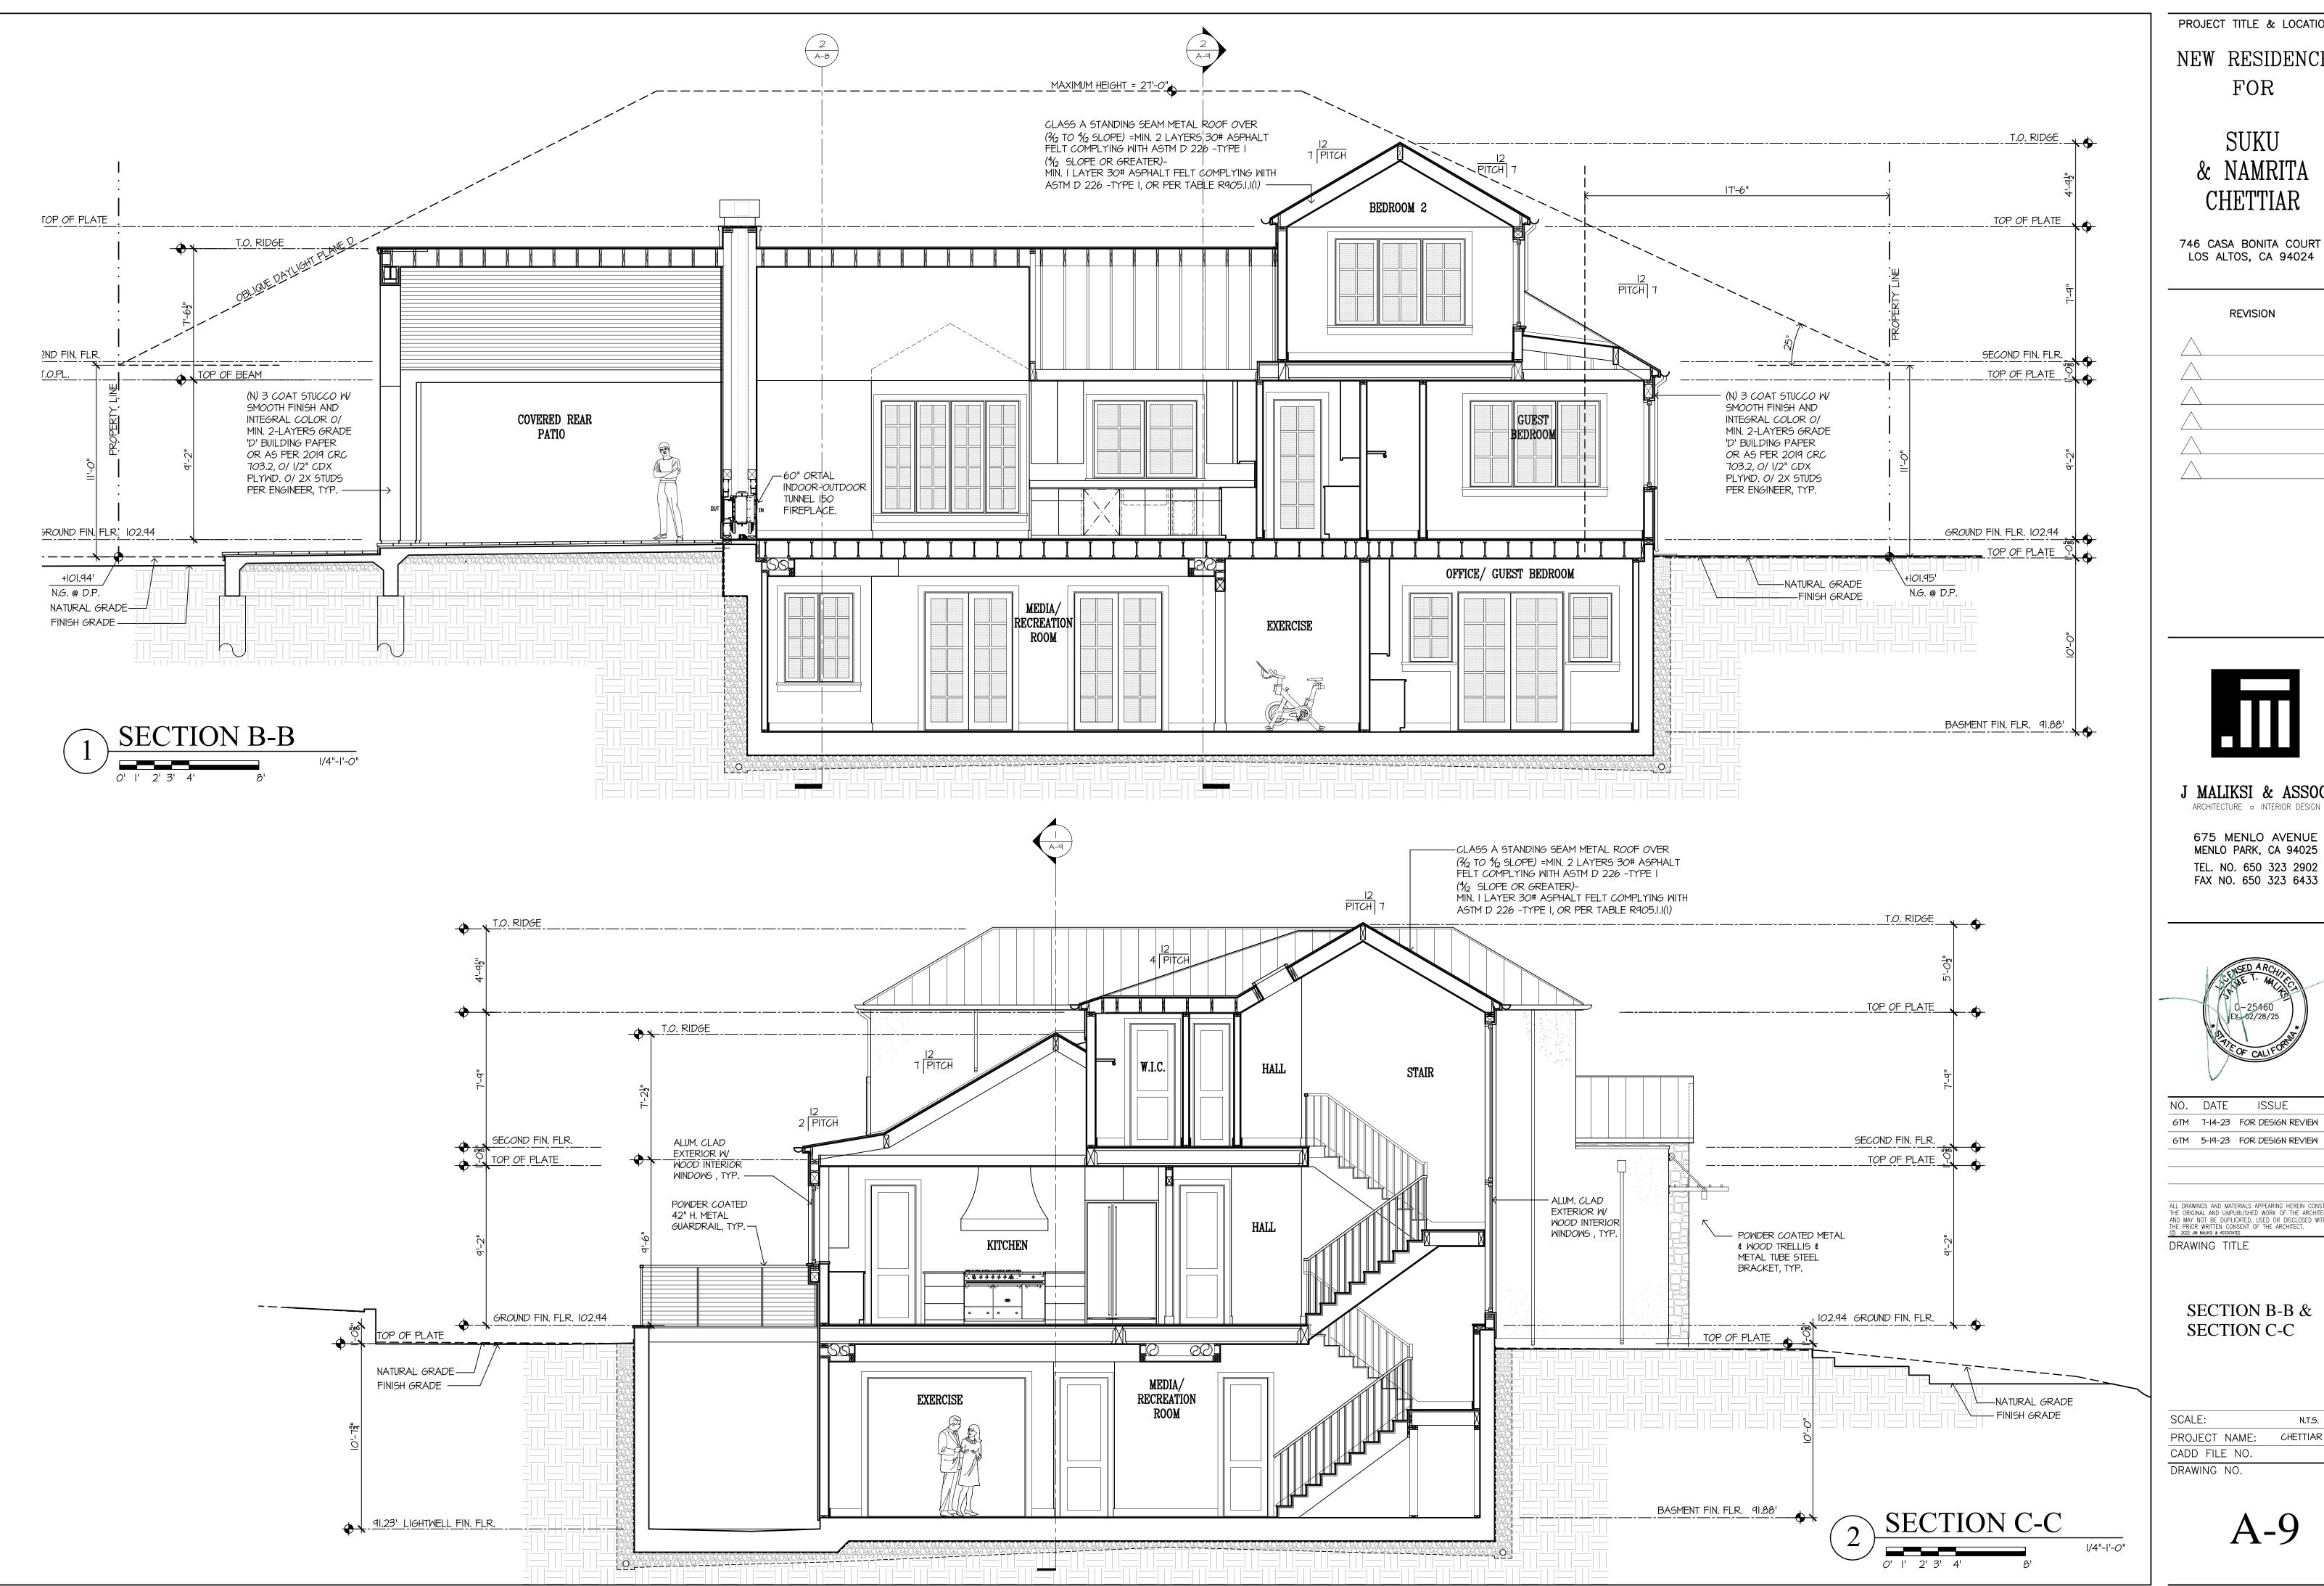

NEW RESIDENCE FOR

> SUKU CHETTIAR

746 CASA BONITA COURT LOS ALTOS, CA 94024

REVISION



J MALIKSI & ASSOC. ARCHITECTURE - INTERIOR DESIGN

675 MENLO AVENUE MENLO PARK, CA 94025 TEL. NO. 650 323 2902 FAX NO. 650 323 6433



NO. DATE ISSUE GTM 7-14-23 FOR DESIGN REVIEW

ALL DRAWINGS AND MATERIALS APPEARING HEREIN CONSTITUTE THE ORIGINAL AND UNPUBLISHED WORK OF THE ARCHITECT AND MAY NOT BE DUPLICATED, USED OR DISCLOSED WITHOUT THE PRIOR WRITTEN CONSENT OF THE ARCHITECT.

© 2022 JIM MALKSI & ASSOCIATES

SECTION B-B &

SCALE: N.T.S.

PROJECT NAME: CHETTIAR CADD FILE NO. DRAWING NO.