905 LEONELLO AVE

LOS ALTOS CA 94024 NEW 2-STORY SINGLE FAMILY HOUSE

PERMIT SUBMISSION SET:

ATTACHMENT G

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LANDSCAPE

SEPARATE PERMIT.

SOLAR PANEL REQUIRED PER TITLE-24

UNDER A SEPARATE PERMIT.

SOLAR PANEL:

kylechan

3561 HOMESTEAD ROAD SUITE 222, SANTA CLARA, CA 95051 669-244-3111 www.kylechan.com kyle@kylechan.com

PROGRESS SET 7.28.2022

² \ 12.5.2022

ackslash PLAN CHECK COMMENTS 1 \ 10.10.2022 ↑ PLAN CHECK COMMENTS



ELECTRONIC PLAN REVIEW

ZHANG RESIDEN NEW RESIDEN 905 LEONELL LOS ALTOS, C,

COVER SHEET

CITY STAMP:

PROJECT NUMBER: 2112 905 LEONELLO AVE





VICINITY MAP ZONING INFORMATION (ADU) Mountair For ADUS of 850 Square Feet or Less View ADU ZONING COMPLIANCE TABLE Allowed/Required FLOOR AREA: (including 850 square feet 660 square feet pasement and attic) SETBACKS: 52'1"feet Front <u>56'</u> feet Right side(1st/2nd) <u>47'11</u>feet / <u>N/A</u>feet <u>4</u> feet / <u>4</u> feet Left side (1st/2nd) 6'<u>17/8"</u> feet / <u>N/A</u> feet <u>4</u> feet / <u>4</u> feet _0__feet (ATTACHED) To the primary dwelling ROOF OVERHANG AREA: (Applicable where roof overhangs are extended four feet or greater) N/A square feet N/A square feet Lot Coverage: N/A % 1<u>5'1 7/8"</u>feet _16__feet **HEIGHT:** LOT CALCULATIONS NET LOT AREA: 10,825 square feet Hardscape area in the front yard setback shall not exceed 50% ______square feet (\frac{38.9}{}) Total hardscape area (existing and proposed): 6,073sq ft Existing softscape (undisturbed) area: 1,591 sq ft LANDSCAPING New softscape (new or replaced landscaping) area. 161 sq ft BREAKDOWN: Sum of all three should equal the site's net lot area

PROJECT TEAM

DAIHUA ZHANG & PEIRAN SONG

905 LEONELLO AVE

LOS ALTOS, CA 94024

WEC & ASSOCIATES

PALO ALTO, CA 94306

LANDSCAPE ARCHITECT

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kyle@kylechan.com

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3561 HOMESTEAD ROAD #222

TITLE-24 ENERGY CONSULTANT

SAN LUIS OBISPO, CA 93403

PO BOX 4736

PH:805-904-9048

title24@yahoo.com

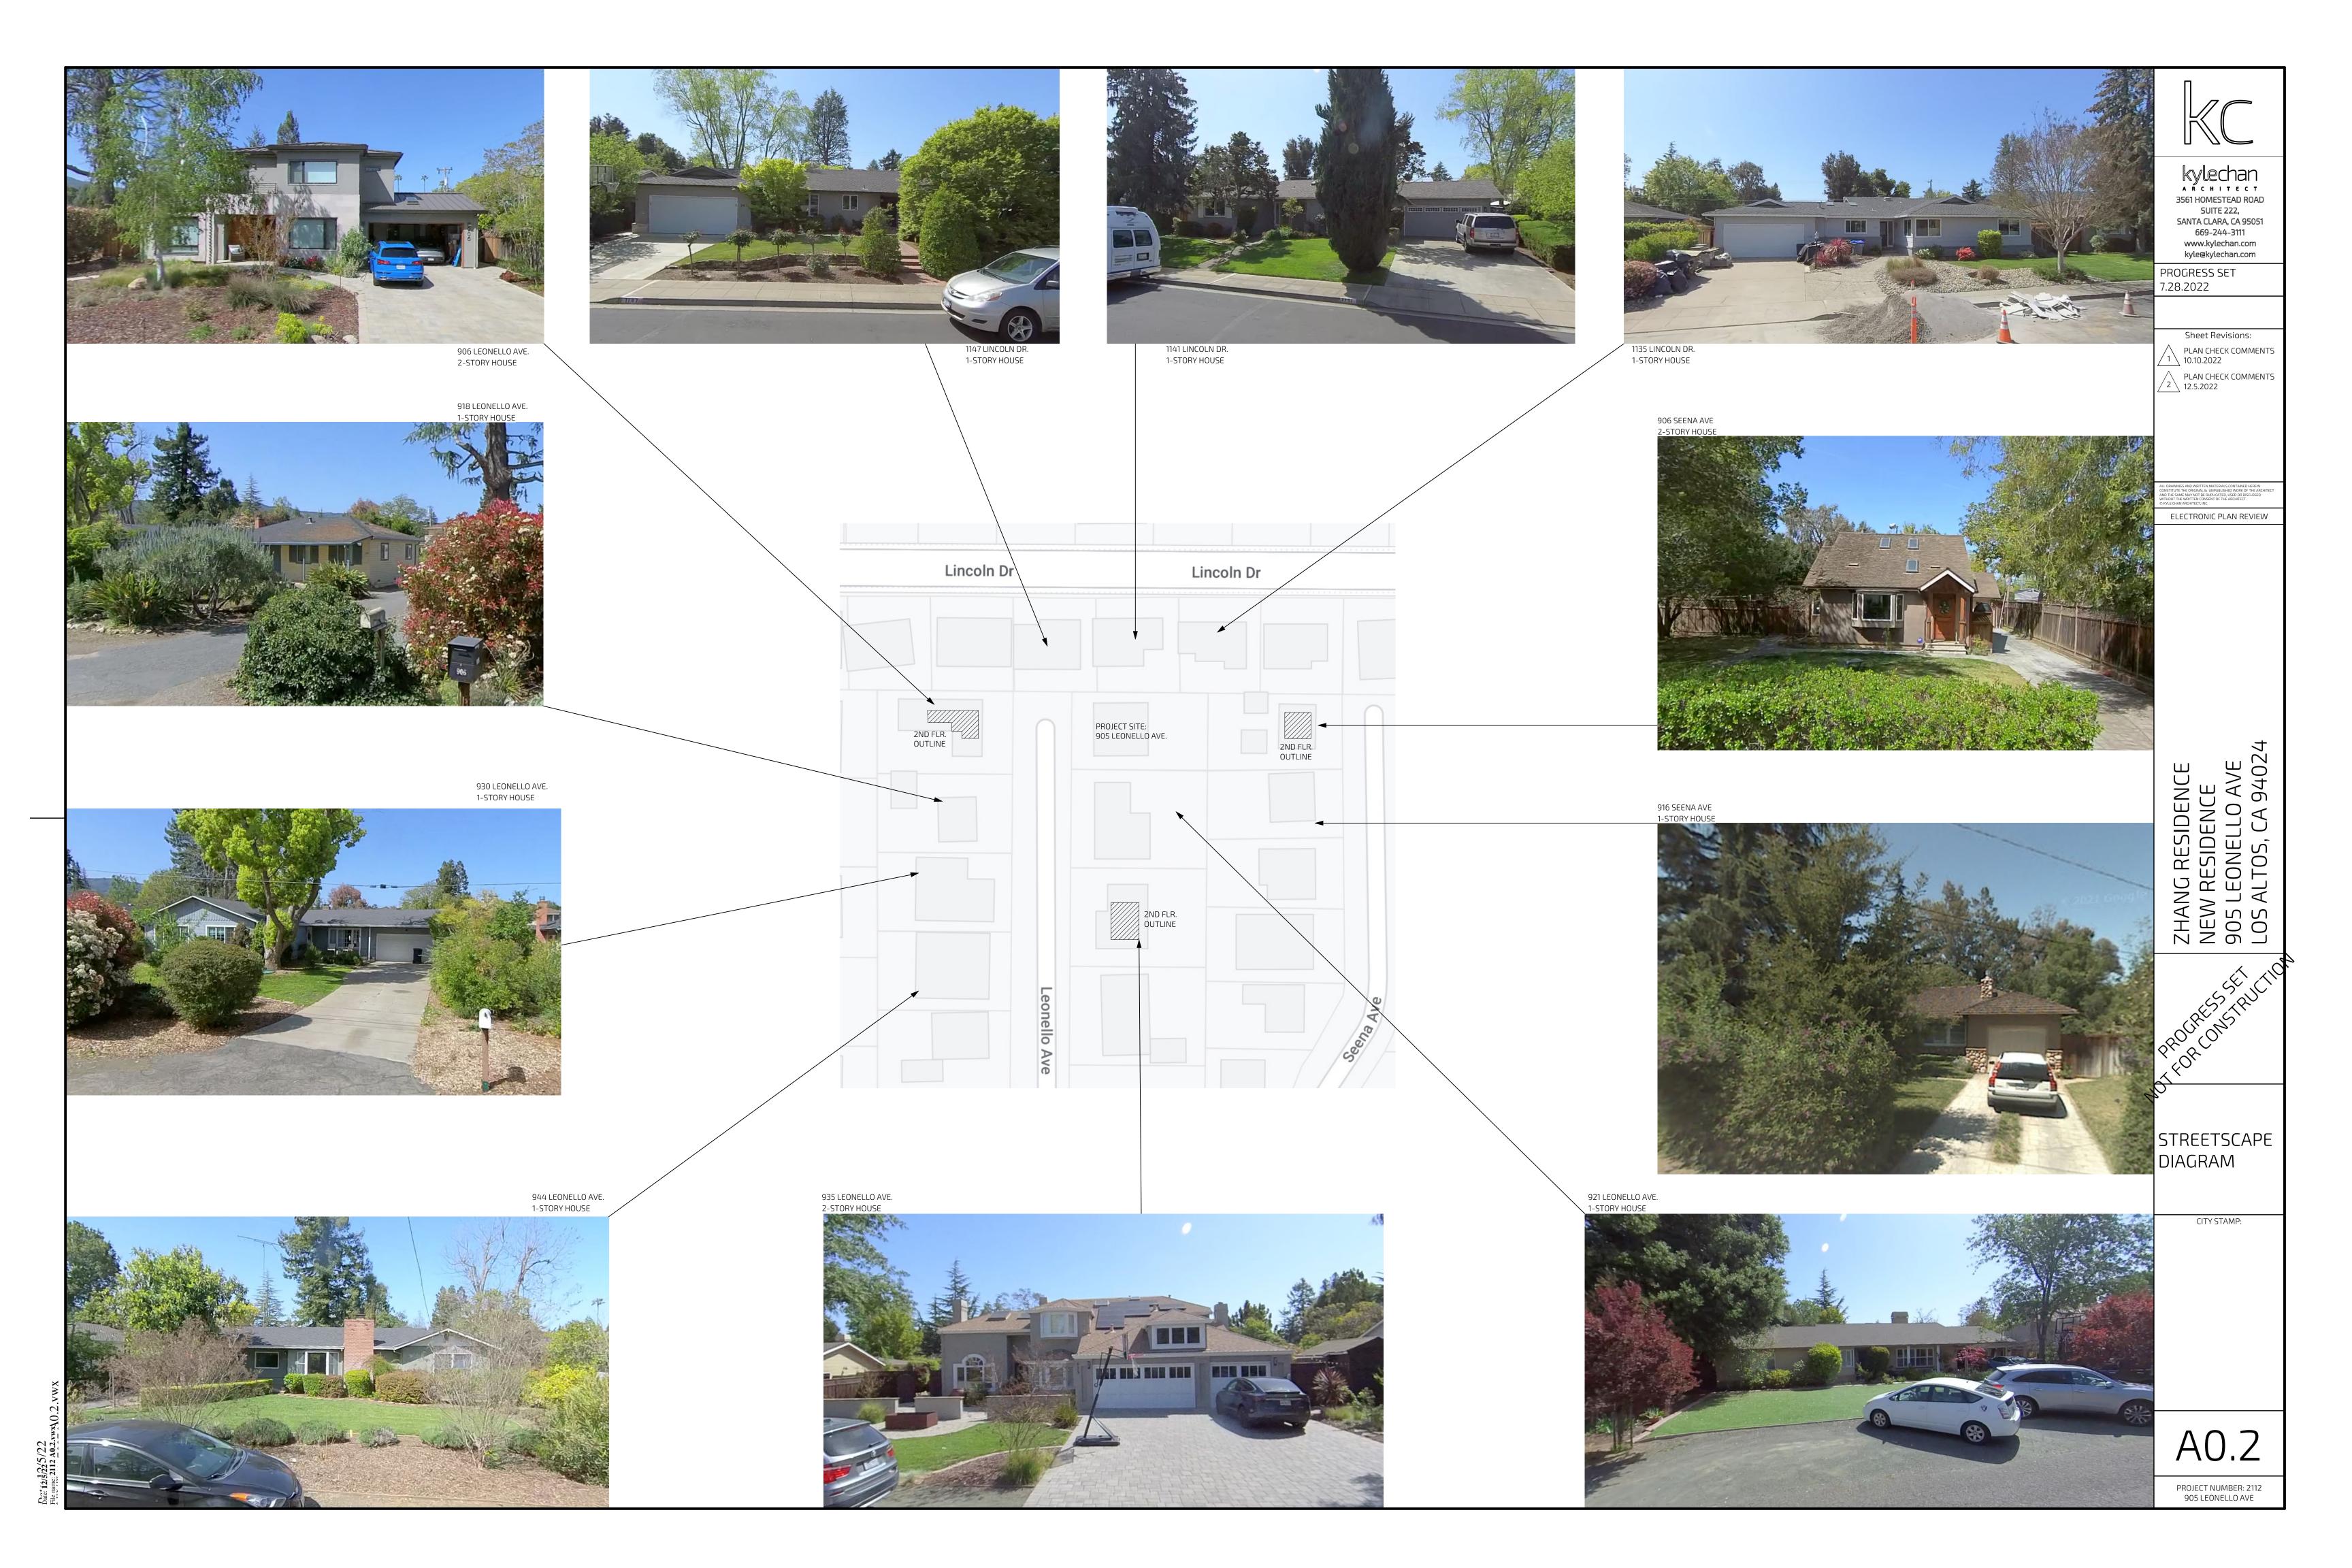
GENERAL CONTRACTOR

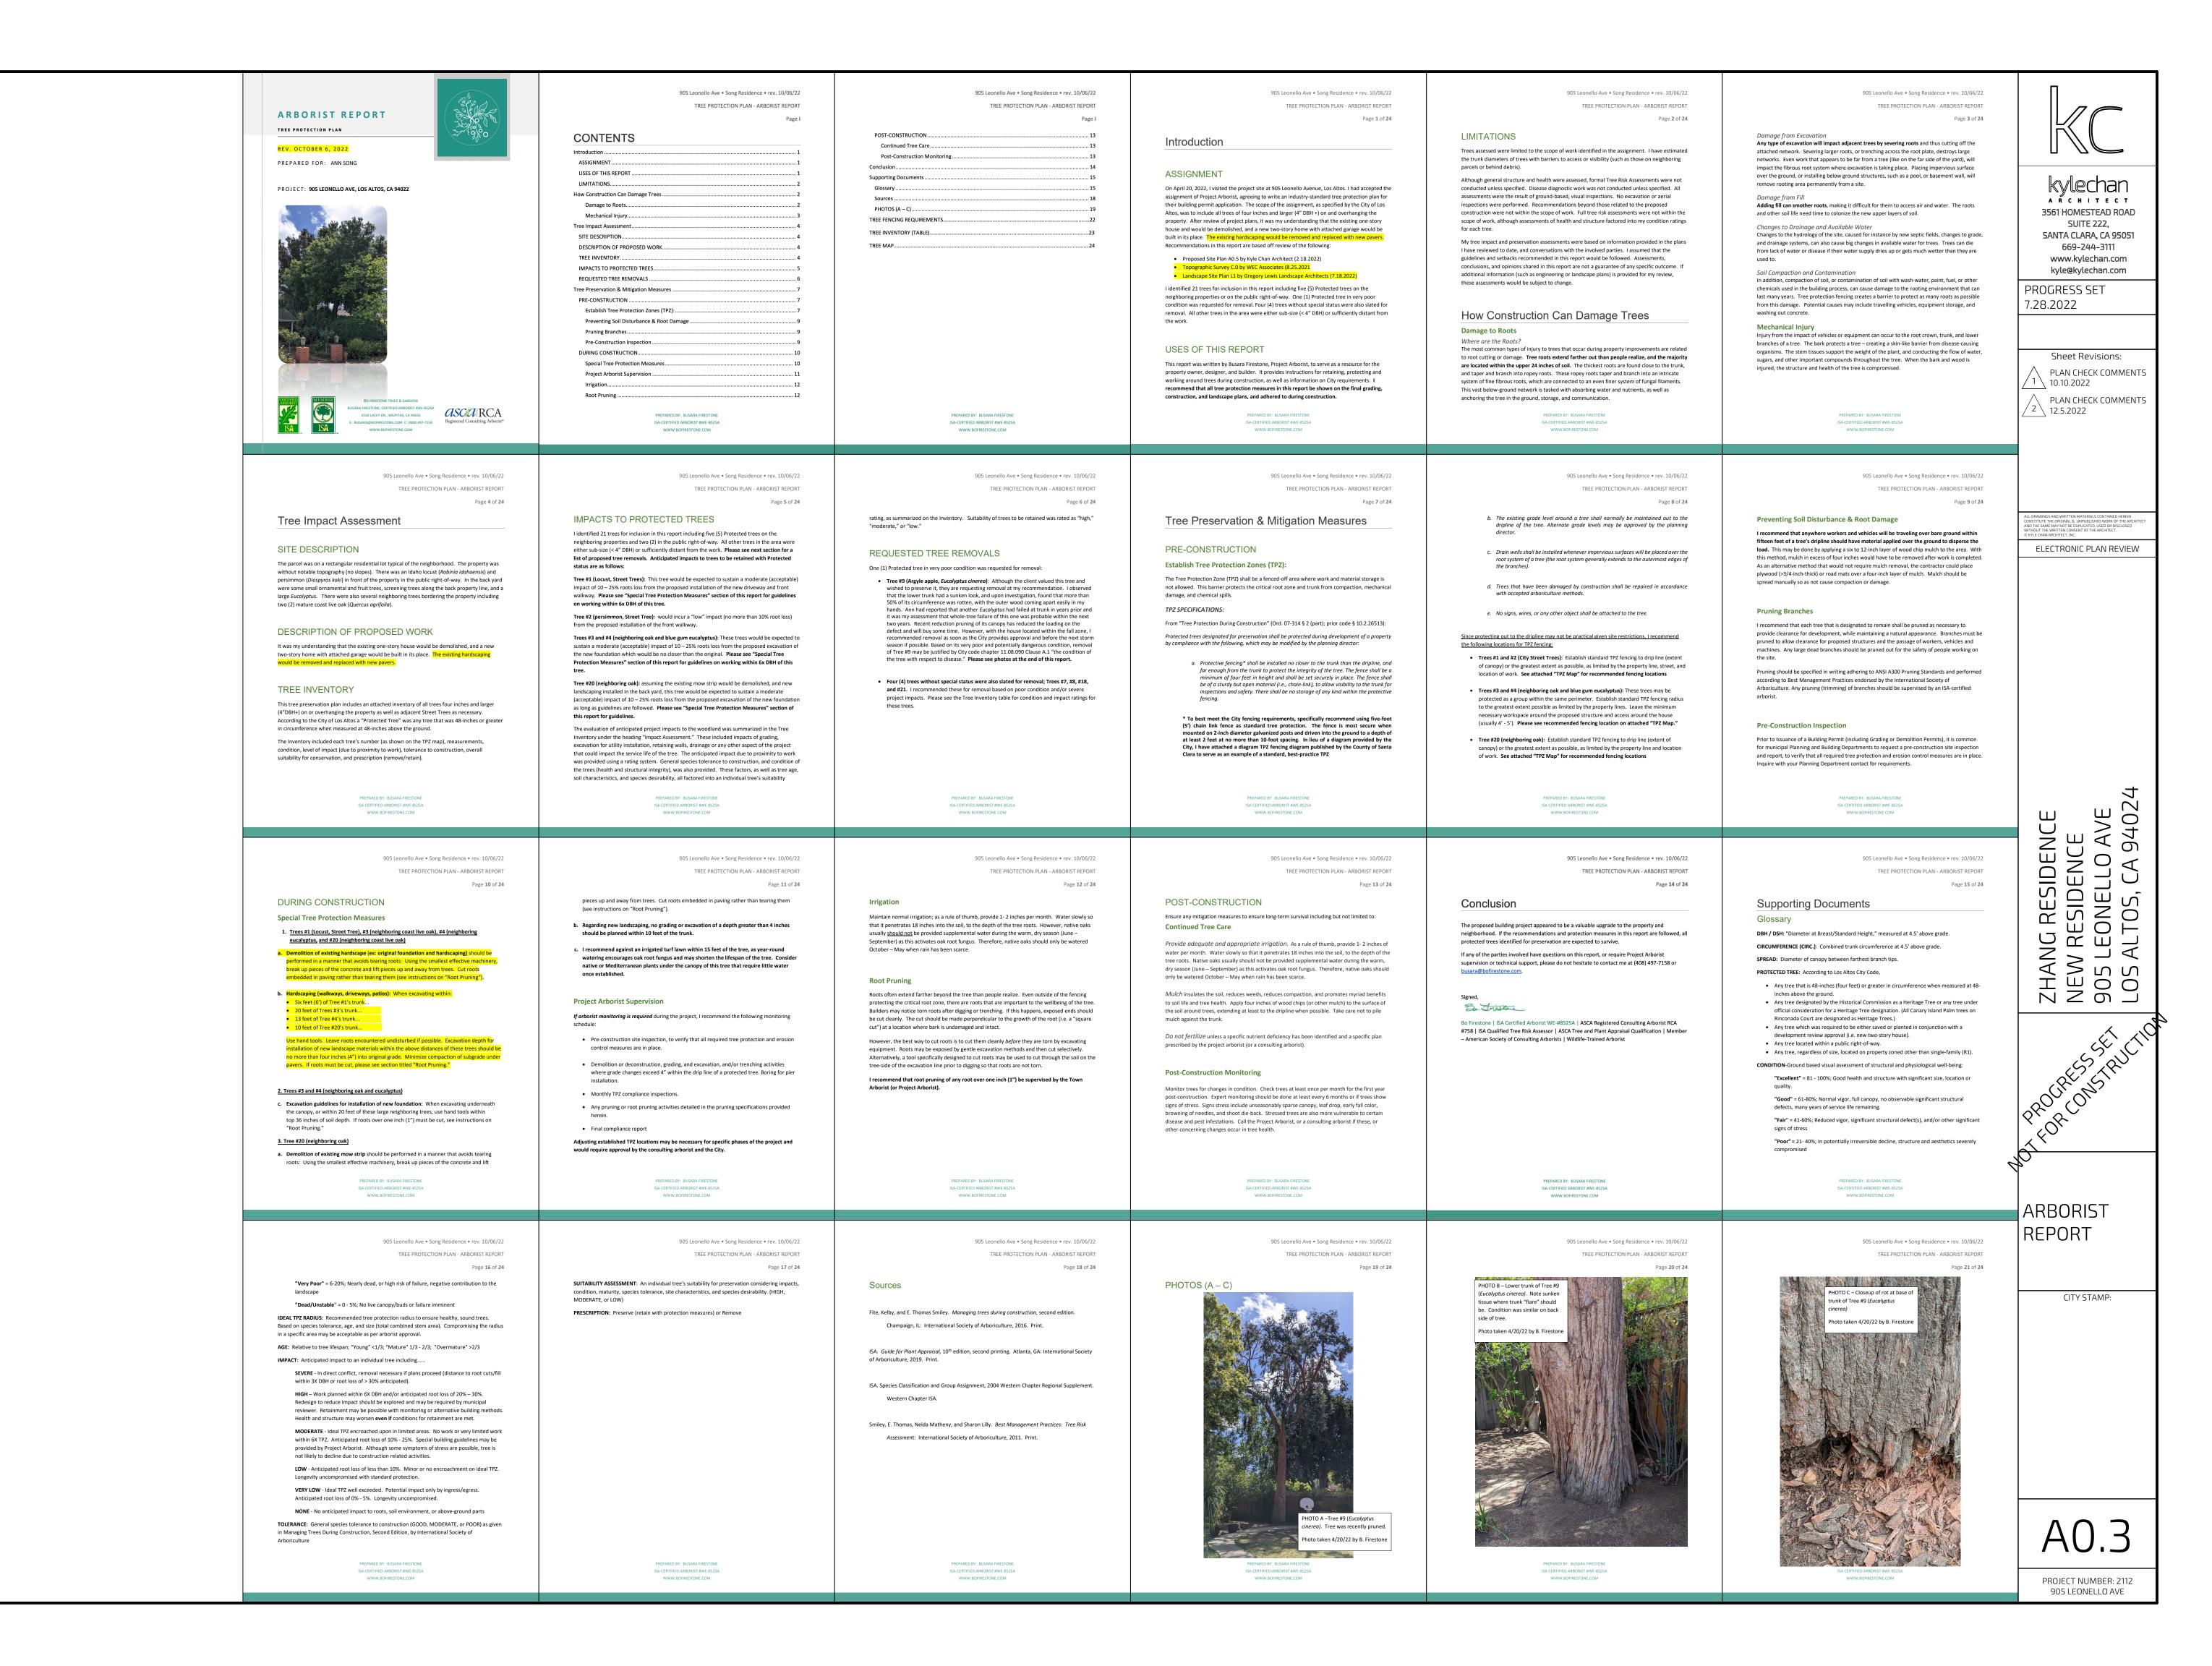
CARSTAIRS ENERGY CALCULATIONS

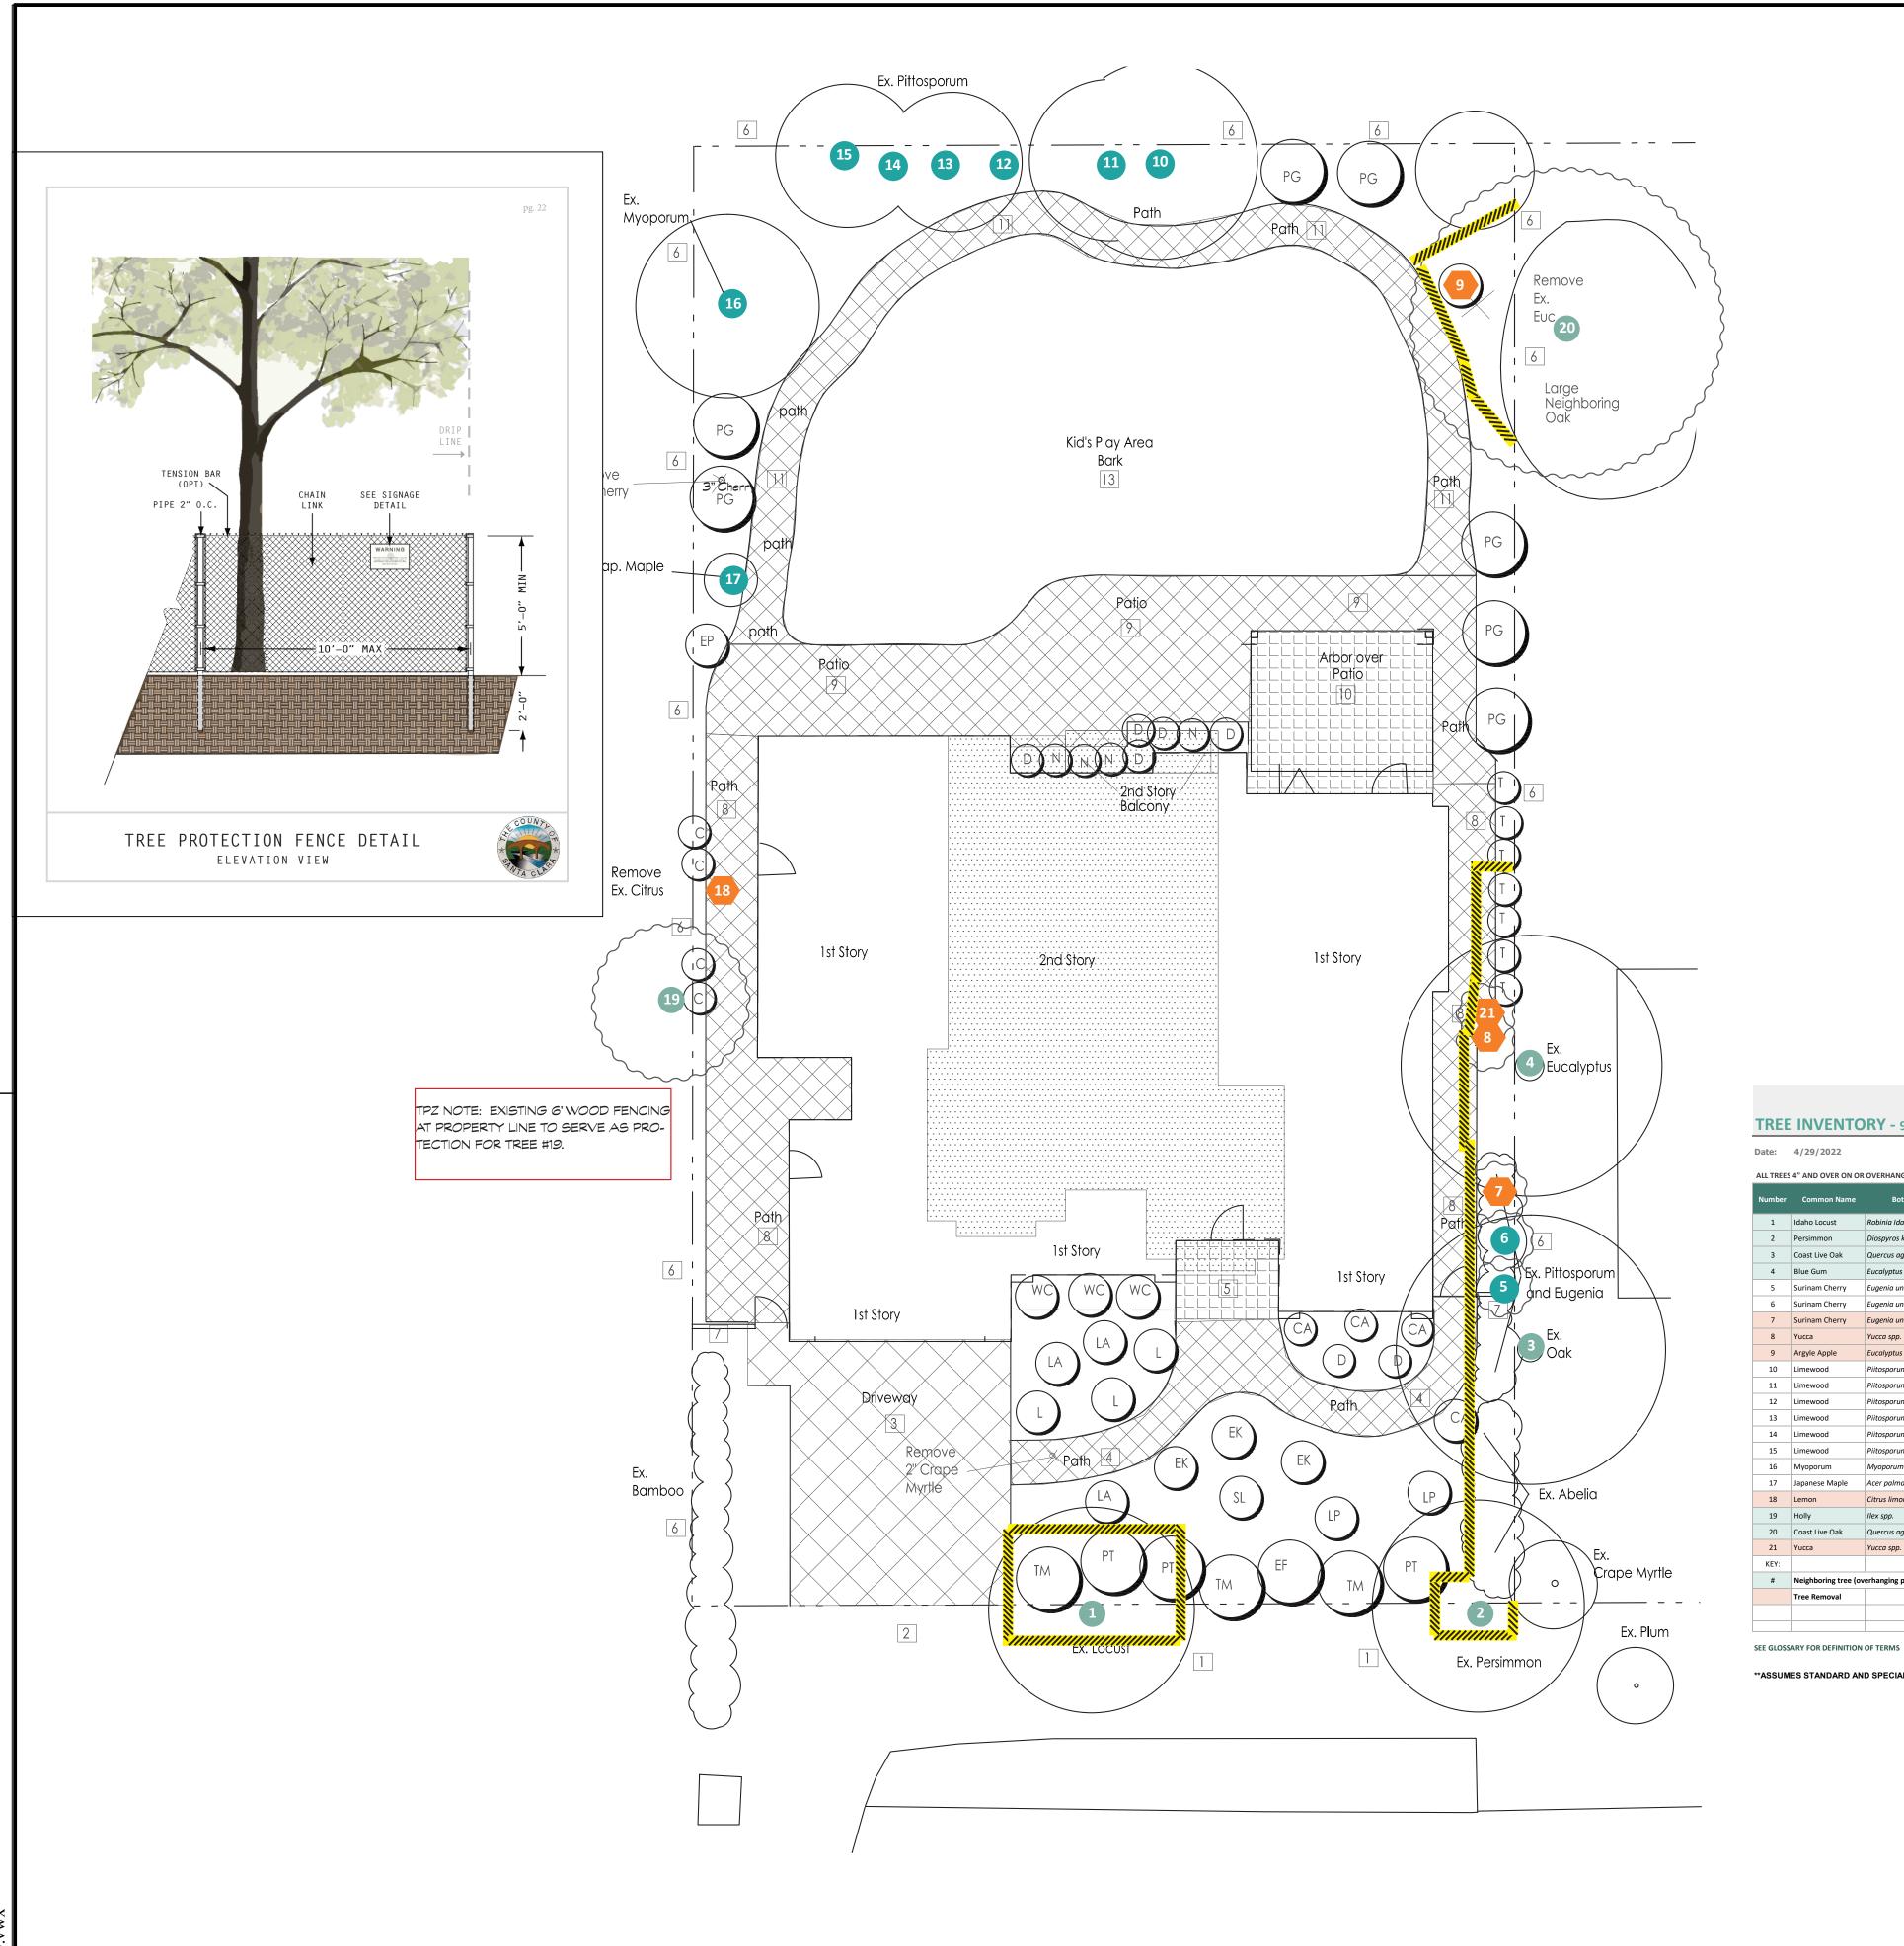
ZONING INFORM	ATION (MAI	N HOUSE)	PROJECT INFORMATION		
	ZONING COMPI	LIANCE	PROJECT DESCRIPTION:	1. DEMOLISH EXISTING RESIDENCE	
	Existing	Proposed	Allowed/Required		2. PROPOSE NEW 2-STORY SINGLE FAMILY
Lot Coverage: Land area covered by all structures that are over 6 feet in height	square feet (<u>24.5</u> %)	3,146 square feet (29 %)	3,247 square feet (30 %)	APN:	RESIDENCE 3. PROPOSE NEW ATTACHED ADU (660 SF) 189-20-014
FLOOR AREA:	2,600 square feet	3,787 square feet	3,789 square feet	CONSTRUCTION TYPE:	V-B
Measured to the outside surfaces of exterior walls	(<u>24.0</u> %)	(<u>34.9</u> %)	(<u>35</u> %)	OCCUPANCY:	R-3 / U
SETBACKS: Front Rear Right side (1 st /2 nd) Left side (1 st /2 nd)	24'9 feet 55'1 feet 12'2 feet/NA feet 11'9 feet/NA feet	25' feet 46'2 feet 7'9.5 feet/21'7.5 feet 9'2.3 feet/22'6.5 feet	25' feet 25' feet 7'9.5 feet/15'3.5 feet 7'9.5 feet/15'3.5 feet (10% LOT WIDTH 74')	BUILDING CODES:	2019 CBC (BASED ON 2018 IBC) 2019 CRC (BASED ON 2018 IRC) 2019 CEC (BASED ON 2017 NEC) 2019 CMC (BASED ON 2018 UMC) 2019 CPC (BASED ON 2018 UPC) 2019 CALIFORNIA ENERGY CODE 2019 CFC (BASED ON 2018 IFC) 2019 CALIFORNIA GREEN BUILDING
HEIGHT:	1 <u>2'10"</u> feet	<u>24'4"</u> feet	<u>27</u> feet		STANDARDS CODE (CALGREEN) CITY MUNICIPAL CODE
SQUA	ARE FOOTAGE B	REAKDOWN		ALL APPLICABLE LOCAL, COUNTY, STATE AND FEDERAL CODES, LAWS	
	Existing	Change in	Total Proposed		& REGULATIONS
HABITABLE LIVING AREA: Includes habitable basement areas	2,198 square feet	square feet	3,787 square feet	NO GAS POLICY:	FOR THE NEW SINGLEFAMILY HOME, NO GAS IS ALLOWED PER CITY REACH CODES.
NON- HABITABLE AREA: Does not include covered porches or open structures	402 square feet	43 square feet	445 square feet	FIRE SPRINKLER:	A RESIDENTIAL FIRE SPRINKLER SYSTEM IS REQUIRED IN ACCORDANCE WITH NFPA 13D AND STATE AND LOCAL REQUIREMENTS FIRE SPRINKLER SYSTEM TO BE APPROVED UNDER A
					CERARATE DEPART

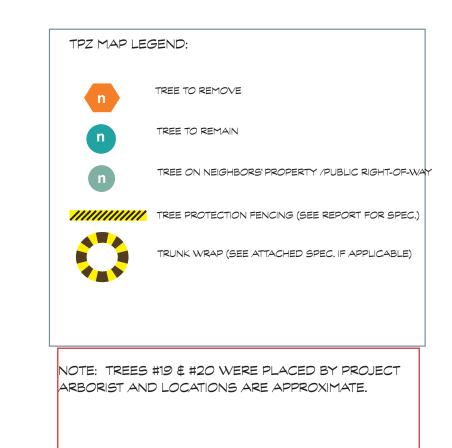
SQUA	ARE FOUTAGE B	REARDOWN	
	Existing	Change in	Total Proposed
HABITABLE LIVING AREA: Includes habitable basement areas	2,198 square feet	1,589 square feet	3,787 square feet
NON- HABITABLE AREA: Does not include covered porches or open structures	402 square feet	43 square feet	445 square feet
	LOT CALCULA	TIONS	
NET LOT AREA:		<u>10,825</u> square feet	

NET LOT AREA:	10,825 square feet		
FRONT YARD HARDSCAPE ARI Hardscape area in the front yard setback s	·	square feet (38.9%)
LANDSCAPING BREAKDOWN:	Total hardscape area (e Existing softscape (un New softscape area: Sum of all three should eq	,	6,073 sq ft 1,591 sq ft 3,161 sq ft









		ORY - 905 Leonello	7 10 0, 200		.020										pg. 23
Date:	4/29/2022														
ALL TREES 4" AND OVER ON OR OVERHANGING THE PROPERTY TREE IMPACT ASSESSMENT															
Number	Common Name	Botanical Name	DBH (inches)	math. DBH (inches)		Spread (feet)	Status	Condition	Age	Species Tolerance	TPZ mult. Factor	Ideal TPZ Radius (ft)	Impact Level **	Suitability Rating	Prescription
1	Idaho Locust	Robinia Idahoensis	11	11	30	15	PROTECTED	FAIR	MATURE	MODERATE	12	11	MODERATE**	MODERATE	PRESERVE
2	Persimmon	Diospyros kaki	8	8	25	12	PROTECTED	FAIR	MATURE	HIGH	8	5	LOW	MODERATE	PRESERVE
3	Coast Live Oak	Quercus agrifolia	est. 40	40	50	30	PROTECTED	FAIR	MATURE	HIGH	8	27	MODERATE	MODERATE	PRESERVE
4	Blue Gum	Eucalyptus globulus	est. 25	25	55	20	PROTECTED	FAIR	MATURE	MODERATE	12	25	MODERATE	MODERATE	PRESERVE
5	Surinam Cherry	Eugenia uniflora	6	6	15	5	(not protected)	FAIR	OVERMATURE	MODERATE	15	8	MODERATE	MODERATE	PRESERVE
6	Surinam Cherry	Eugenia uniflora	6	6	15	5	(not protected)	FAIR	OVERMATURE	MODERATE	15	8	MODERATE	MODERATE	PRESERVE
7	Surinam Cherry	Eugenia uniflora	7	7	15	5	(not protected)	VERY POOR	OVERMATURE	MODERATE	15	9	MODERATE	LOW	REMOVE (X)
8	Yucca	Yucca spp.	10	10	10	5	(not protected)	FAIR	MATURE	MODERATE	12	10	SEVERE	MODERATE	REMOVE (X)
9	Argyle Apple	Eucalyptus cinerea	32	32	55	20	PROTECTED	VERY POOR	MATURE	MODERATE	12	32	MODERATE	LOW	REMOVE (X)
10	Limewood	Piitosporum eugenioides	8, 7.5, 7	13	30	20	(not protected)	FAIR	OVERMATURE	MODERATE	15	16	MODERATE	MODERATE	PRESERVE
11	Limewood	Piitosporum eugenioides	8, 5.5	10	30	15	(not protected)	FAIR	OVERMATURE	MODERATE	15	13	MODERATE	MODERATE	PRESERVE
12	Limewood	Piitosporum eugenioides	8	8	30	10	(not protected)	FAIR	OVERMATURE	MODERATE	15	10	MODERATE	MODERATE	PRESERVE
13	Limewood	Piitosporum eugenioides	8, 7	11	30	15	(not protected)	FAIR	OVERMATURE	MODERATE	15	14	MODERATE	MODERATE	PRESERVE
14	Limewood	Piitosporum eugenioides	14	14	30	15	(not protected)	FAIR	OVERMATURE	MODERATE	15	18	MODERATE	MODERATE	PRESERVE
15	Limewood	Piitosporum eugenioides	13	13	25	20	(not protected)	FAIR	OVERMATURE	MODERATE	15	16	MODERATE	MODERATE	PRESERVE
16	Myoporum	Myoporum laetum	9	9	20	20	(not protected)	FAIR	MATURE	MODERATE	12	9	MODERATE	LOW	PRESERVE
17	Japanese Maple	Acer palmatum	4	4	10	10	(not protected)	FAIR	MATURE	MODERATE	12	4	MODERATE	MODERATE	PRESERVE
18	Lemon	Citrus limon	4	4	10	10	(not protected)	FAIR	MATURE	MODERATE	12	4	SEVERE	LOW	REMOVE (X)
19	Holly	Ilex spp.	est. 6, (2) 4	8	15	15	(not protected)	FAIR	MATURE	HIGH	8	5	MODERATE	MODERATE	PRESERVE
20	Coast Live Oak	Quercus agrifolia	est. 18	18	40	30	PROTECTED	FAIR	MATURE	HIGH	8	12	MODERATE	MODERATE	PRESERVE
21	Yucca	Yucca spp.	4	4	10	5	(not protected)	FAIR	MATURE	MODERATE	12	4	SEVERE	LOW	REMOVE (X)
KEY:															
#	Neighboring tree (or	verhanging property) / public rig	ht-of-way												
	Tree Removal														

**ASSUMES STANDARD AND SPECIAL TREE PROTECTION MEASURES ARE FOLLOWED.

Prepared by Busara Firestone ISA Certified Arborist #WE-8525A



DATE: rev. 10/06/22

TPZ ELEMENTS DRAWN: B. FIRESTONE ISA-CERTIFIED ARBORIST #WE-8525A

BASE MAP: SITE PLAN L1 by GREGORY LEWIS LAND-SCAPE ARCHITECT (07/18/2022)

> ARBORIST REPORT pg. 24

kylechan 3561 HOMESTEAD ROAD SUITE 222, SANTA CLARA, CA 95051 669-244-3111 www.kylechan.com kyle@kylechan.com

PROGRESS SET 7.28.2022

> Sheet Revisions: PLAN CHECK COMMENTS

1 \ 10.10.2022 PLAN CHECK COMMENTS <u>/ 2 \</u> 12.5.2022

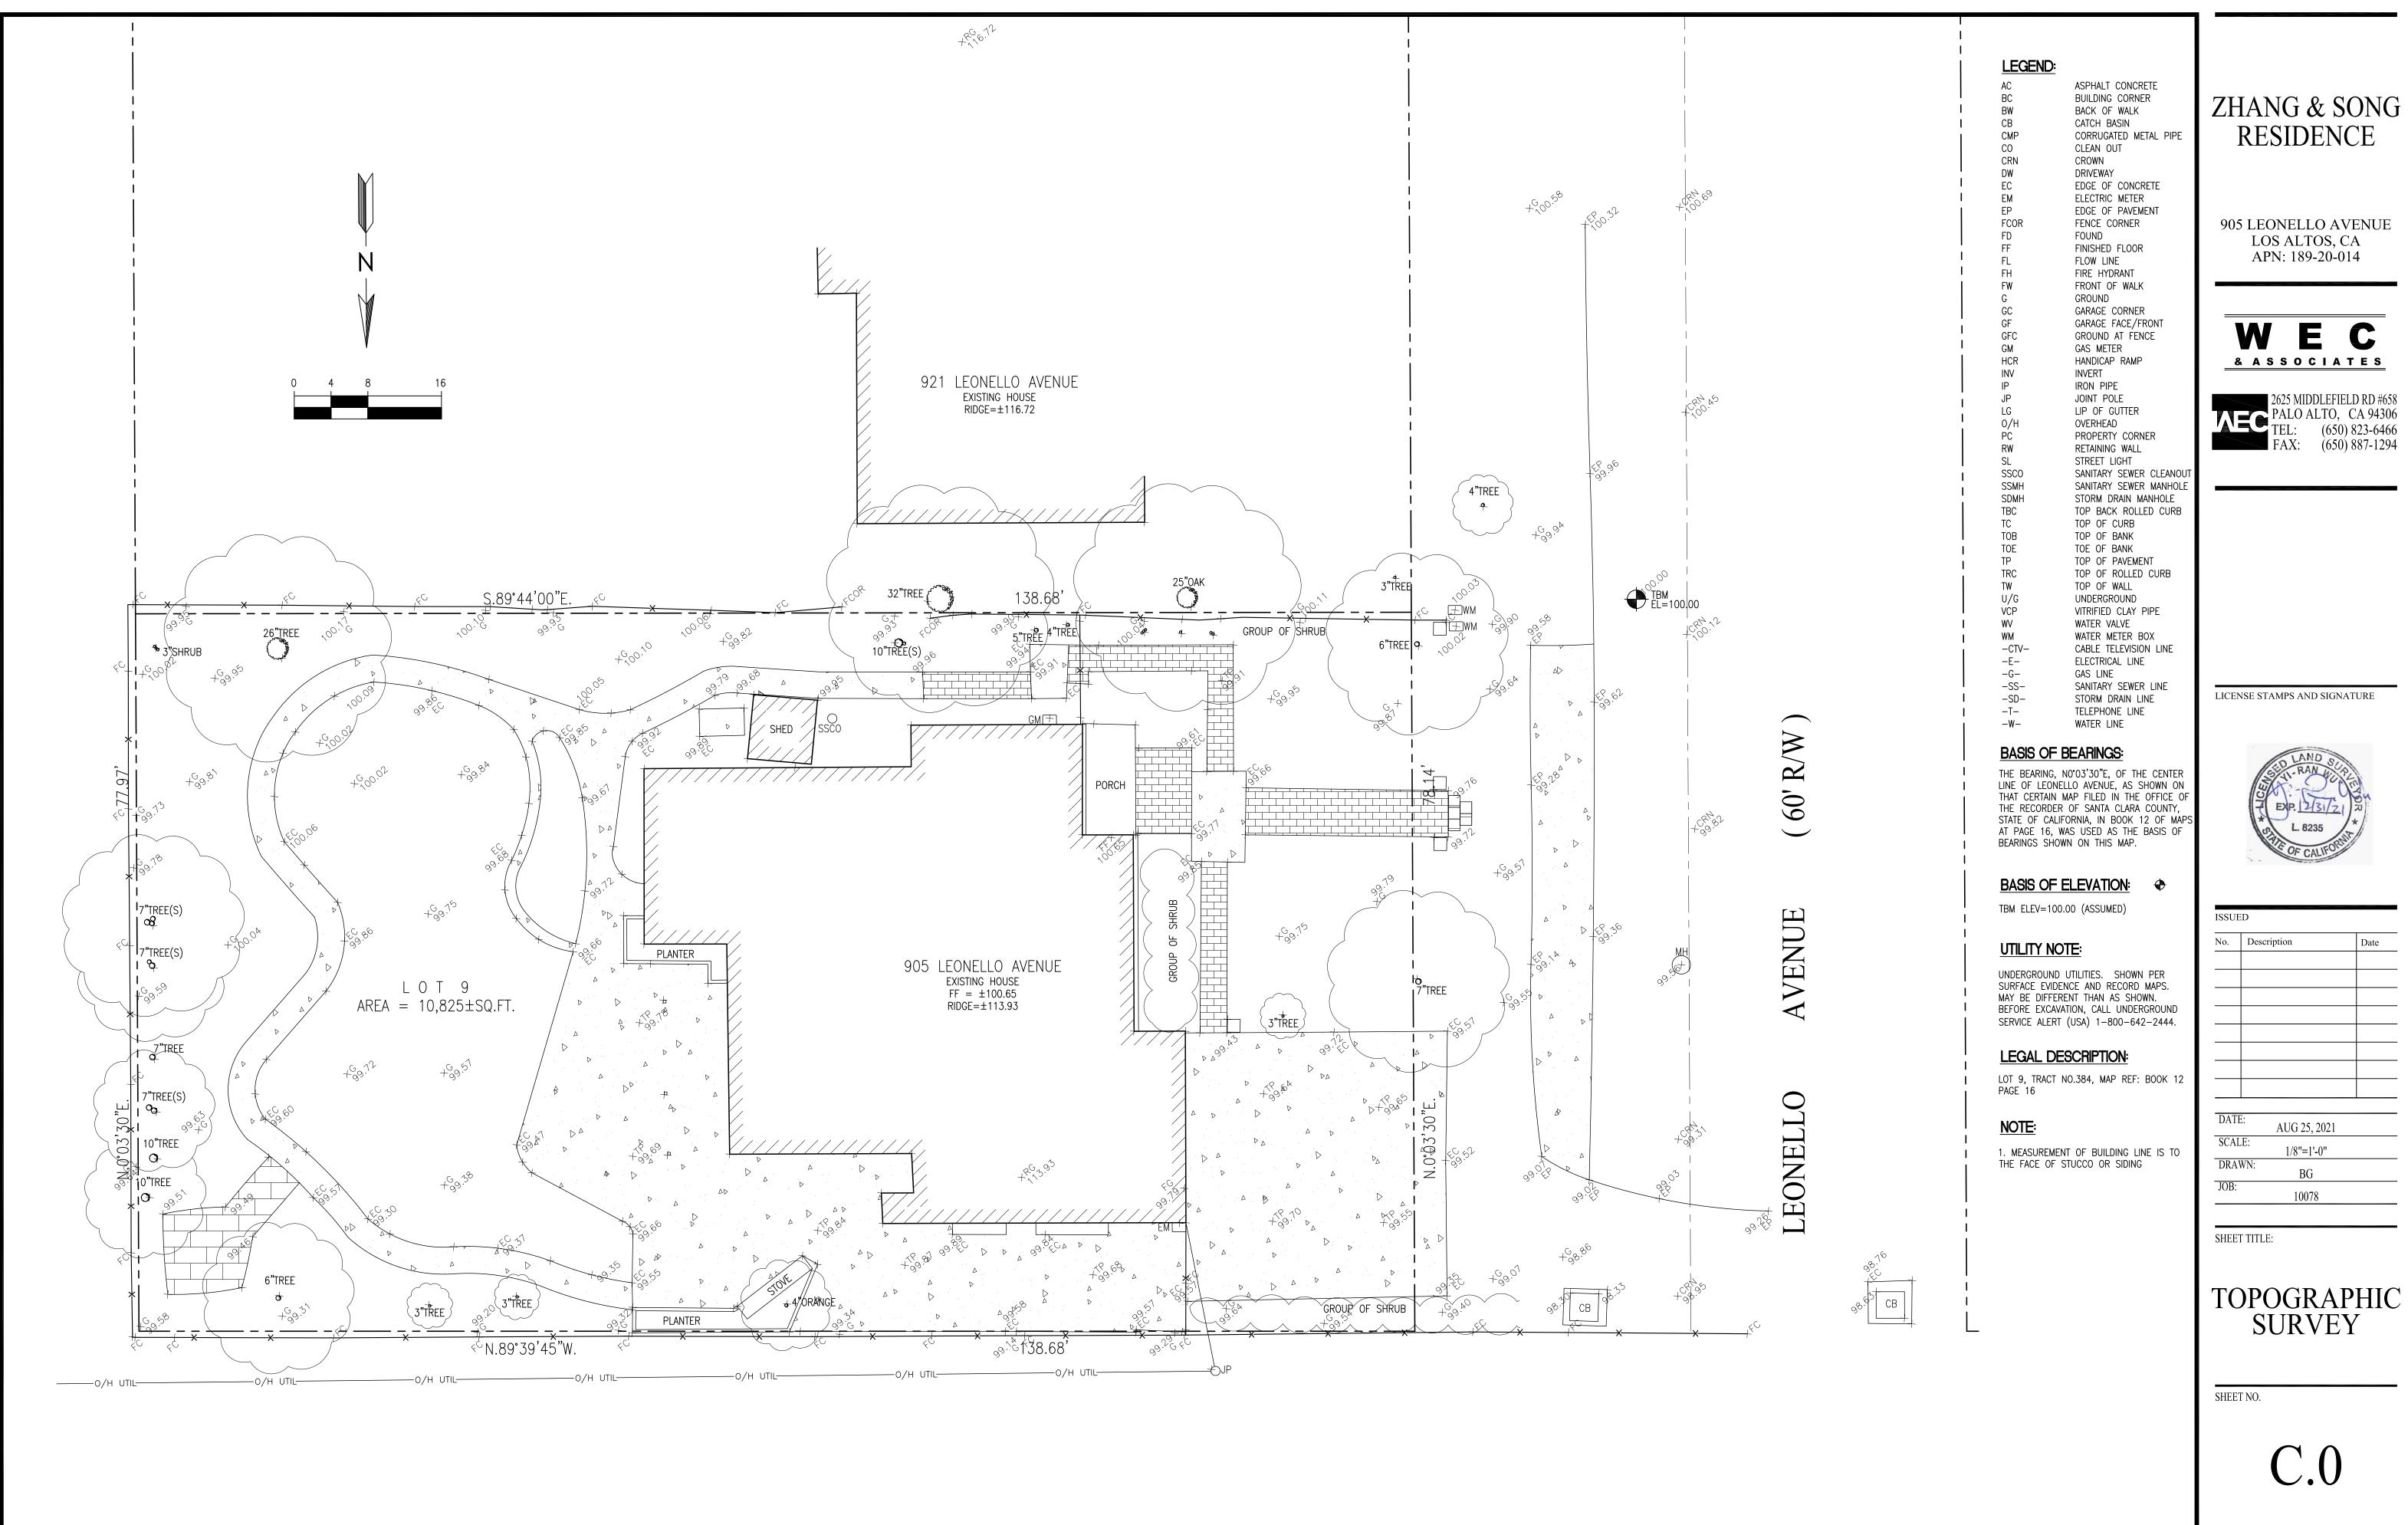
ELECTRONIC PLAN REVIEW

ZHANG NEW RE 905 LEC LOS ALT

ARBORIST PTZ PLAN

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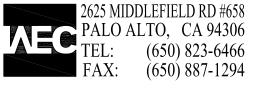
PROJECT NUMBER: 2112 905 LEONELLO AVE



RESIDENCE

905 LEONELLO AVENUE LOS ALTOS, CA APN: 189-20-014

& ASSOCIATES




LICENSE STAMPS AND SIGNATURE




No.	Description	Date
DAT	E: AUG 25, 2021	
SCAI	LE: 1/8"=1'-0"	
DRA		
JOB:	10078	


TOPOGRAPHIC SURVEY

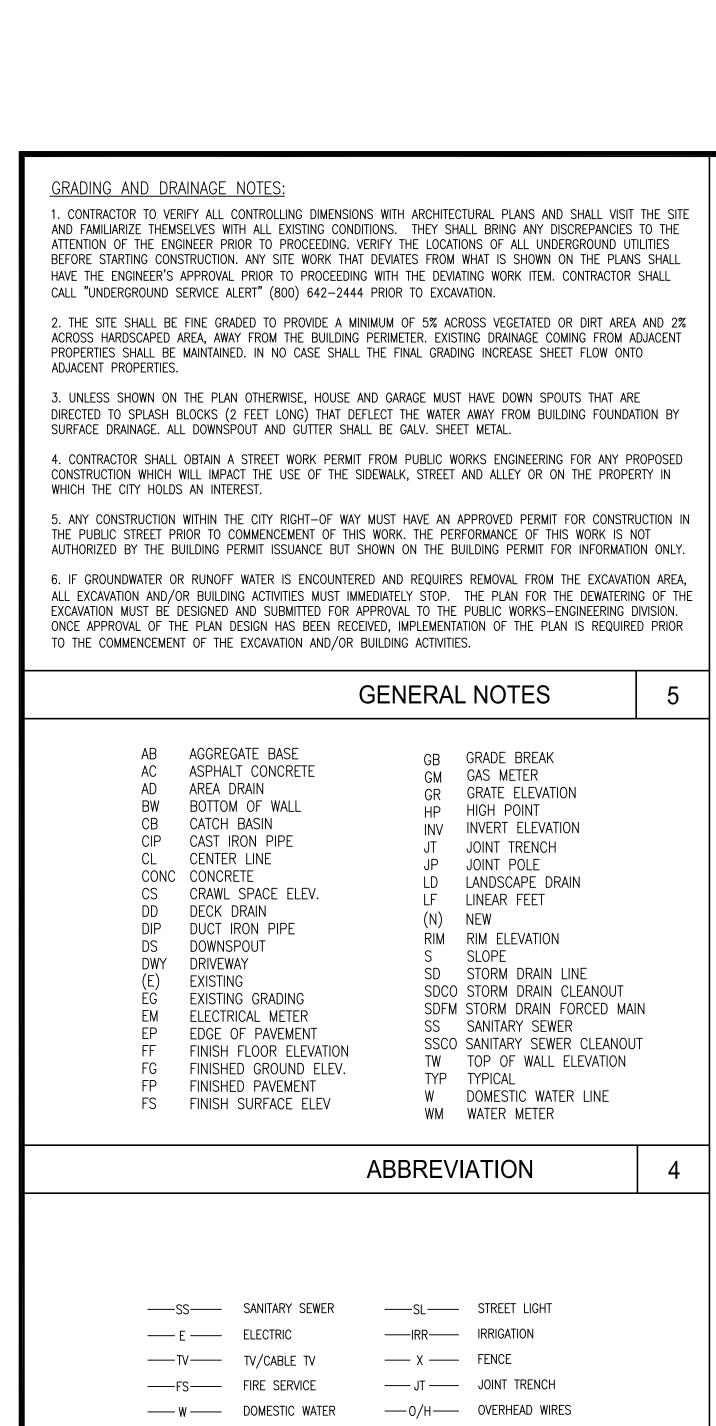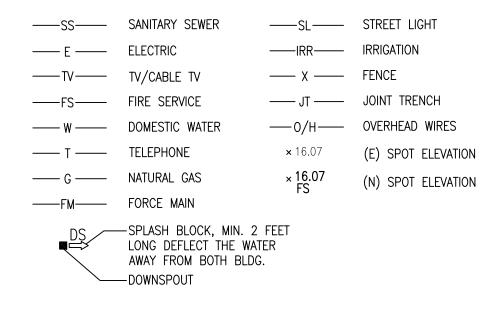SHEET NO.





LEGEND

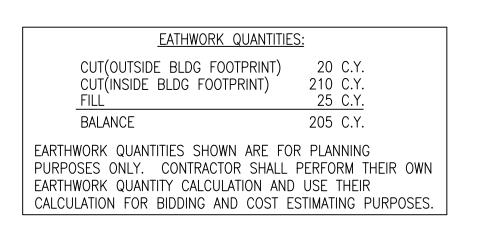

CUT AND FILL EST.

LEONELLO AVENUE (60' R/W)

GRADING AND DRAINAGE PLAN SCALE 1**17 1

77.97**'**

% **3** 7 **8 3** 7 7 7 TREE(S)

`**●** AD5 ¹

1ST FF=101.0

♠ AD6

10"TREE OF OTTREE 7"TREE(S)

RIM=99.5

\JNV=97.5

6"TREE

99.4 3"TREE

3"SHRUB

32"TREE الحمر

KEY NOTES

SEE 6/C.3

2 POP-UP, SEE 5/C.3

EASEMENT LINE

RETENTION (10'X10'X2")

AND INV ELEV. SEE DETAIL 4/C.3

DRAINAGE FEATURE TABLE

FEATURE | RIM | INV

AD1 100.1 98.6

AD2 100.0 98.5

AD3 | 99.9 | 98.4

AD4 99.9 98.3 AD5 99.9 98.4

AD6 99.9 98.4

1 INFILTRATION DEVICE, 6'X6', 3' DEEP, GR=99.7,

3 SLOPE DRIVEWAY TOWARDS THE LANDSCAPED AREA

5 AREA DRAIN, SEE DRAINAGE FEATURE TABLE FOR RIM

6 CONTRACTOR TO FIELD VERIFY EXISTING SEWER LINE

INSTALLED, SHALL BE WITHIN 5' FROM ROADWAY

SOLID PVC SD LINE -------

GRADE BREAK -----

4 DEPRESSED LANDSCAPE AREA FOR IMPROVED STORMWATER

LOCATION AND INSTALL SEWER LINE BETWEEN BUILDING AND EXISTING SEWER LATERAL. NEW SSCO, IF TO BE

ZHANG & SONG RESIDENCE

905 LEONELLO AVENUE LOS ALTOS, CA APN: 189-20-014

WEC & A S S O C I A T E S

2625 MIDDLEFIELD RD #658 PALO ALTO, CA 94306 TEL: (650) 823-6466 FAX: (650) 887-1294

LICENSE STAMPS AND SIGNATURE



No.	Description	Dat
DAT	Г	
DAT	JULY 14, 2022	
SCA	LE: AS SHOWN	
DRA	WN:	
JOB:	10078	

DRAINAGE PLAN

GRADING &

SHEET NO.

C.

EROSION CONTROL AND BEST MANAGEMENT PRACTICE:

1. CONTRACTOR SHALL ASSUME THE CONCEPTS ON THE EROSION CONTROL PLAN/NOTES, IF PROVIDED, ARE MINIMUM REQUIREMENTS, THE FULL EXTENTS OF WHICH ARE TO BE DETERMINED BY CONTRACTOR. CONTRACTOR IS RESPONSIBLE FOR THE EXACT DESIGN AND EXTENT OF CONTRACTOR'S INTENDED USE AND MANAGEMENT OF THE CONSTRUCTION SITE.

2. ALL EROSION CONTROL FACILITIES SHALL BE INSPECTED BY THE CONTRACTOR AND REPAIRED AS REQUIRED AT THE CONCLUSION OF EACH WORKING DAY DURING THE RAINY SEASON. REPAIRS TO DAMAGED FACILITIES SHALL BE MADE IMMEDIATELY UPON DISCOVERY.

3. THE CONTRACTOR SHALL REMOVE ANY ACCUMULATION OF SILT OR DEBRIS FROM THE EROSION CONTROL SEDIMENT BASINS FOLLOWING EACH STORM AND SHALL CLEAR THE OUTLET PIPES OF ANY BLOCKAGE.

4. STOCKPILED MATERIAL SHALL BE COVERED WITH VISQUEEN OR TARPAULIN UNTIL THE MATERIAL IS REMOVED FROM THE SITE. ANY REMAINING BARE SOIL THAT EXISTS AFTER THE STOCKPILE HAS BEEN REMOVED SHALL BE COVERED UNTIL A NATURAL GROUND COVER IS ESTABLISHED OR IT MAY BE SEEDED OR PLANTED TO PROVIDE GROUND COVER PRIOR TO THE FALL RAINY SEASON.

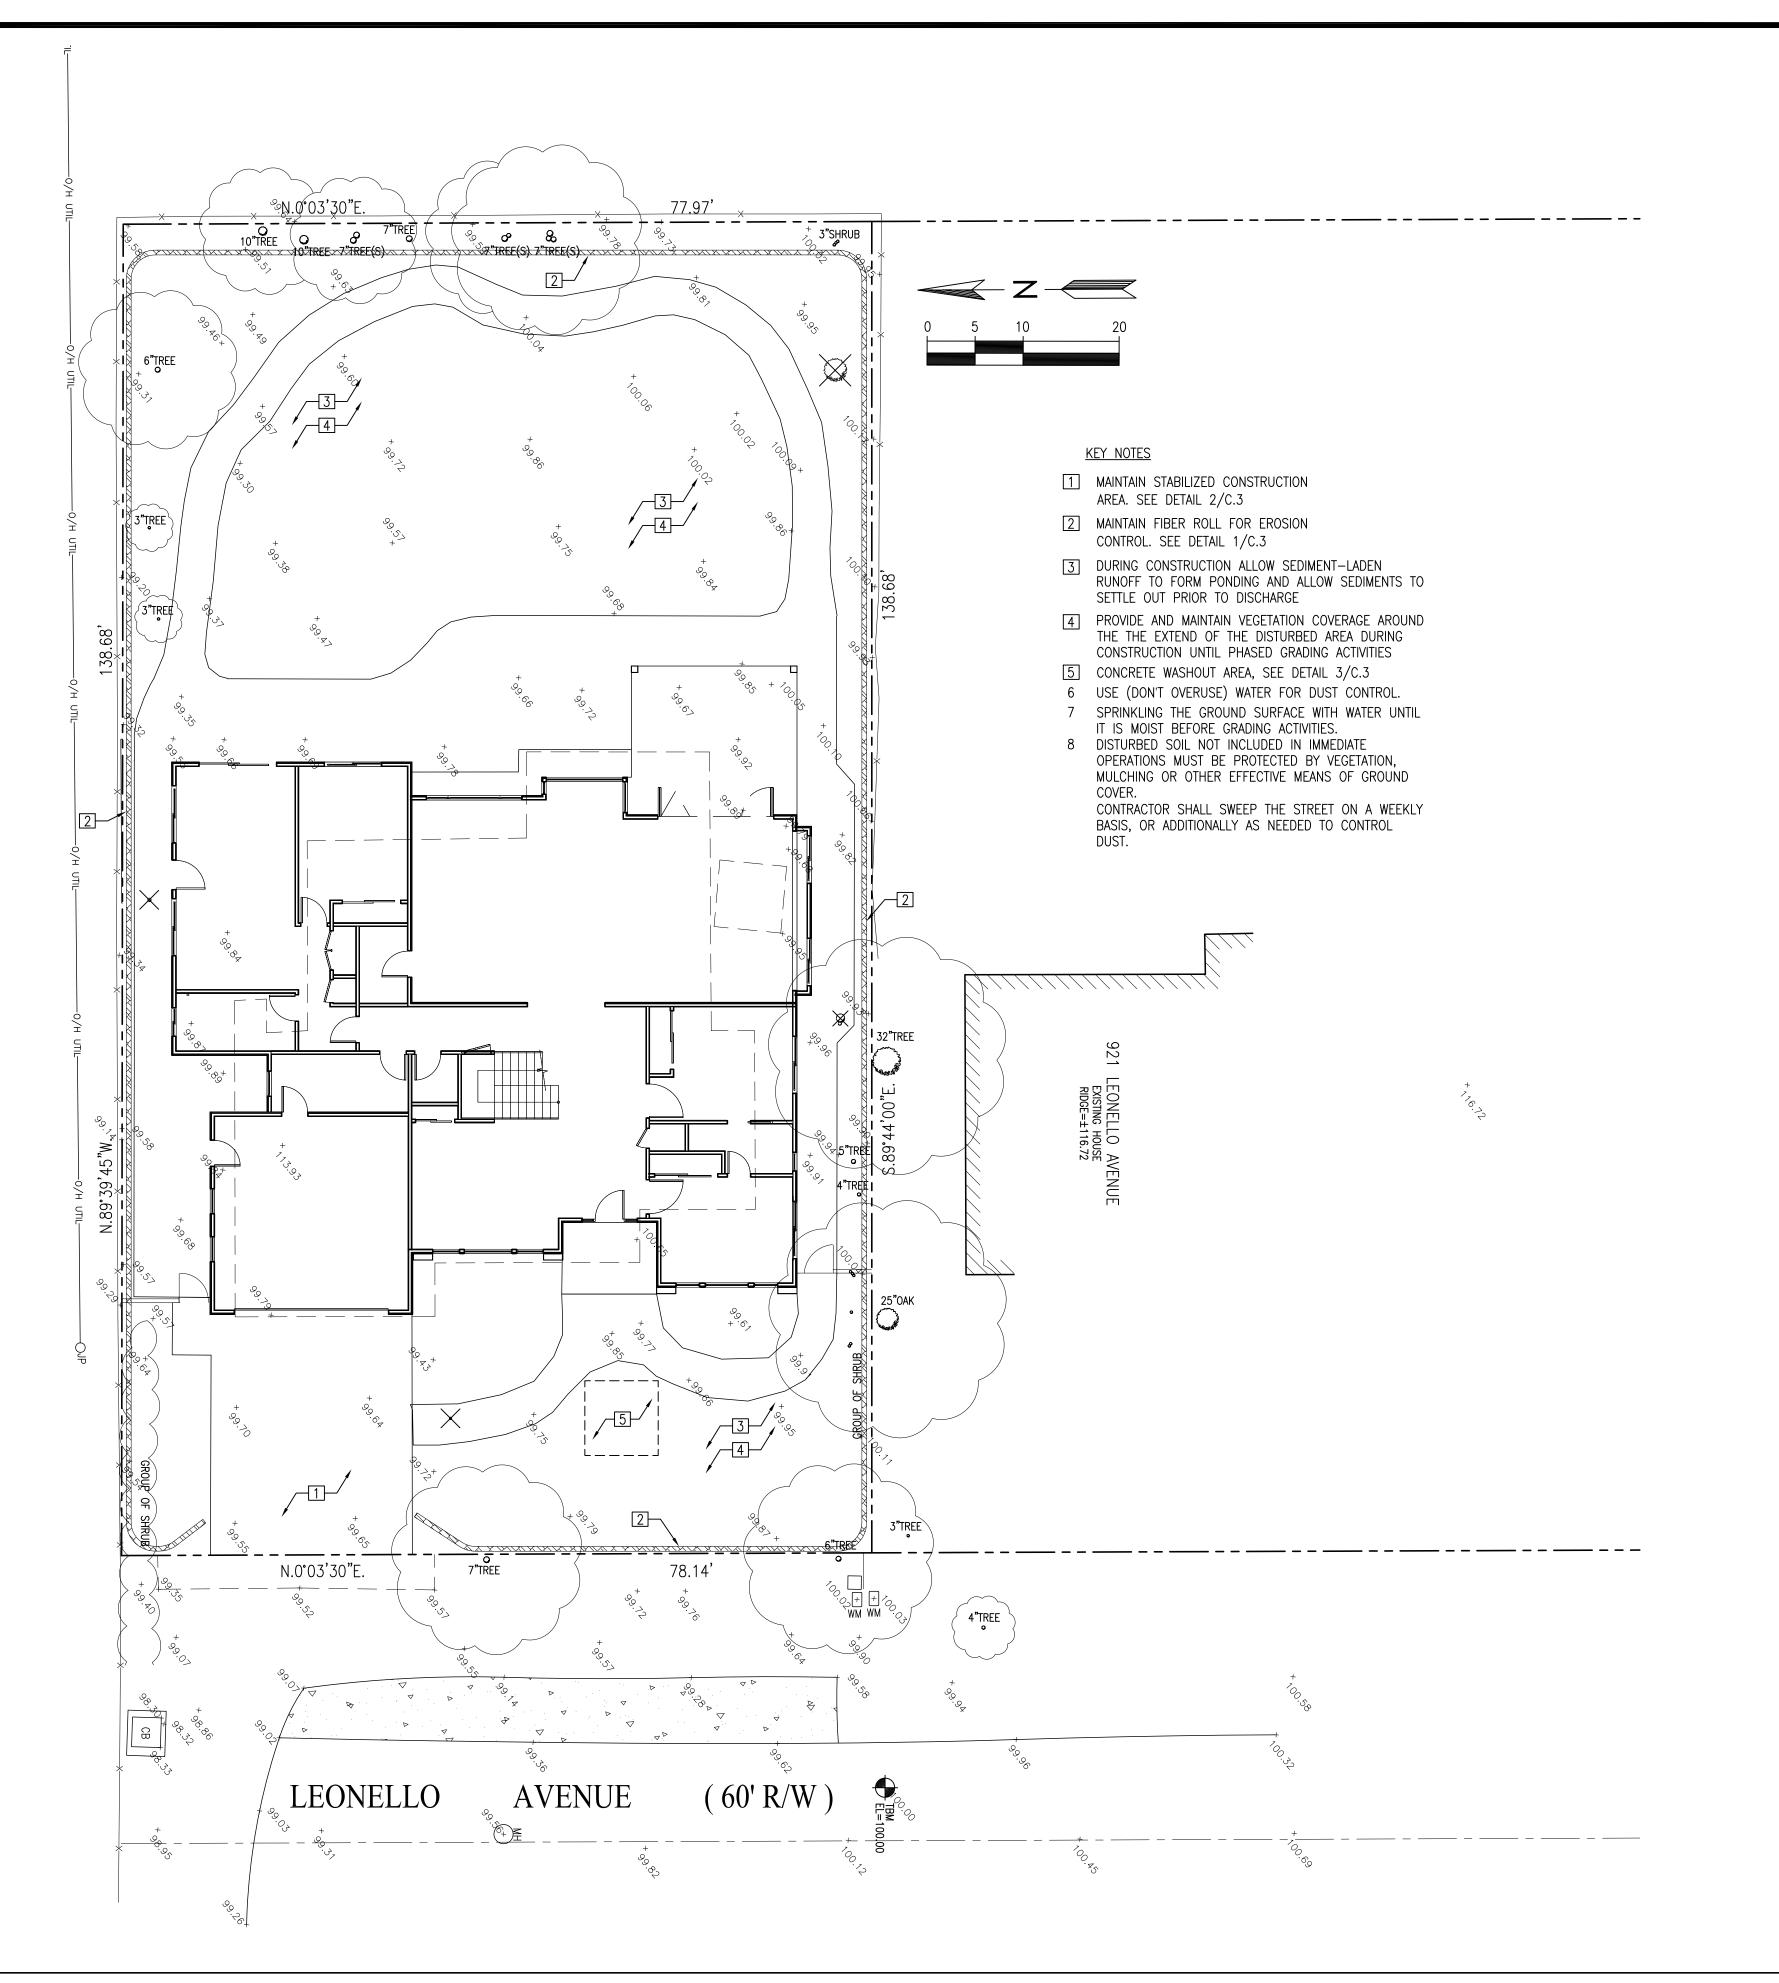
5. PROTECT ADJACENT PROPERTIES AND UNDISTURBED AREAS FROM CONSTRUCTION IMPACTS USING VEGETATIVE BUFFER STRIPS, SEDIMENT BARRIERS OR FILTER, DIKES, MULCHING OR OTHER MEASURES AS APPROPRIATE.

6. CONTRACTOR SHALL MAINTAIN ADJACENT STREETS IN A NEAT, CLEAN, DUST FREE AND SANITARY CONDITION AT ALL TIMES. CONTRACTOR SHALL BE RESPONSIBLE FOR ANY CLEAN UP ON ADJACENT STREETS AFFECTED BY THEIR CONSTRUCTION. NO STOCKPILING OF BUILDING MATERIALS WITHIN THE PUBLIC RIGHT—OF WAY IS

7. PROTECT DOWN SLOPE DRAINAGE COURSES, STREAMS AND STORM DRAINS WITH ROCK FILLED SAND BAGS, TEMPORARY DRAINAGE SWALES, SILT FENCES, EARTH BERMS, STORM DRAIN INLET FILTERS AND/OR STRAW BALES USED ONLY IN CONJUNCTION WITH PROPERLY INSTALLED SILT FENCES. PROVIDE ROCKED DRIVEWAY FOR SITE ACCESS DURING CONSTRUCTION.

GENERAL NOTES


2



ZHANG & SONG RESIDENCE

905 LEONELLO AVENUE LOS ALTOS, CA APN: 189-20-014

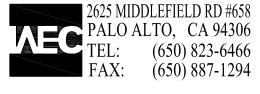W E C & ASSOCIATES



LICENSE STAMPS AND SIGNATURE




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JOB:	10078	

SHEET TITLE:

EROSION CONTROL PLAN

SHEET NO.

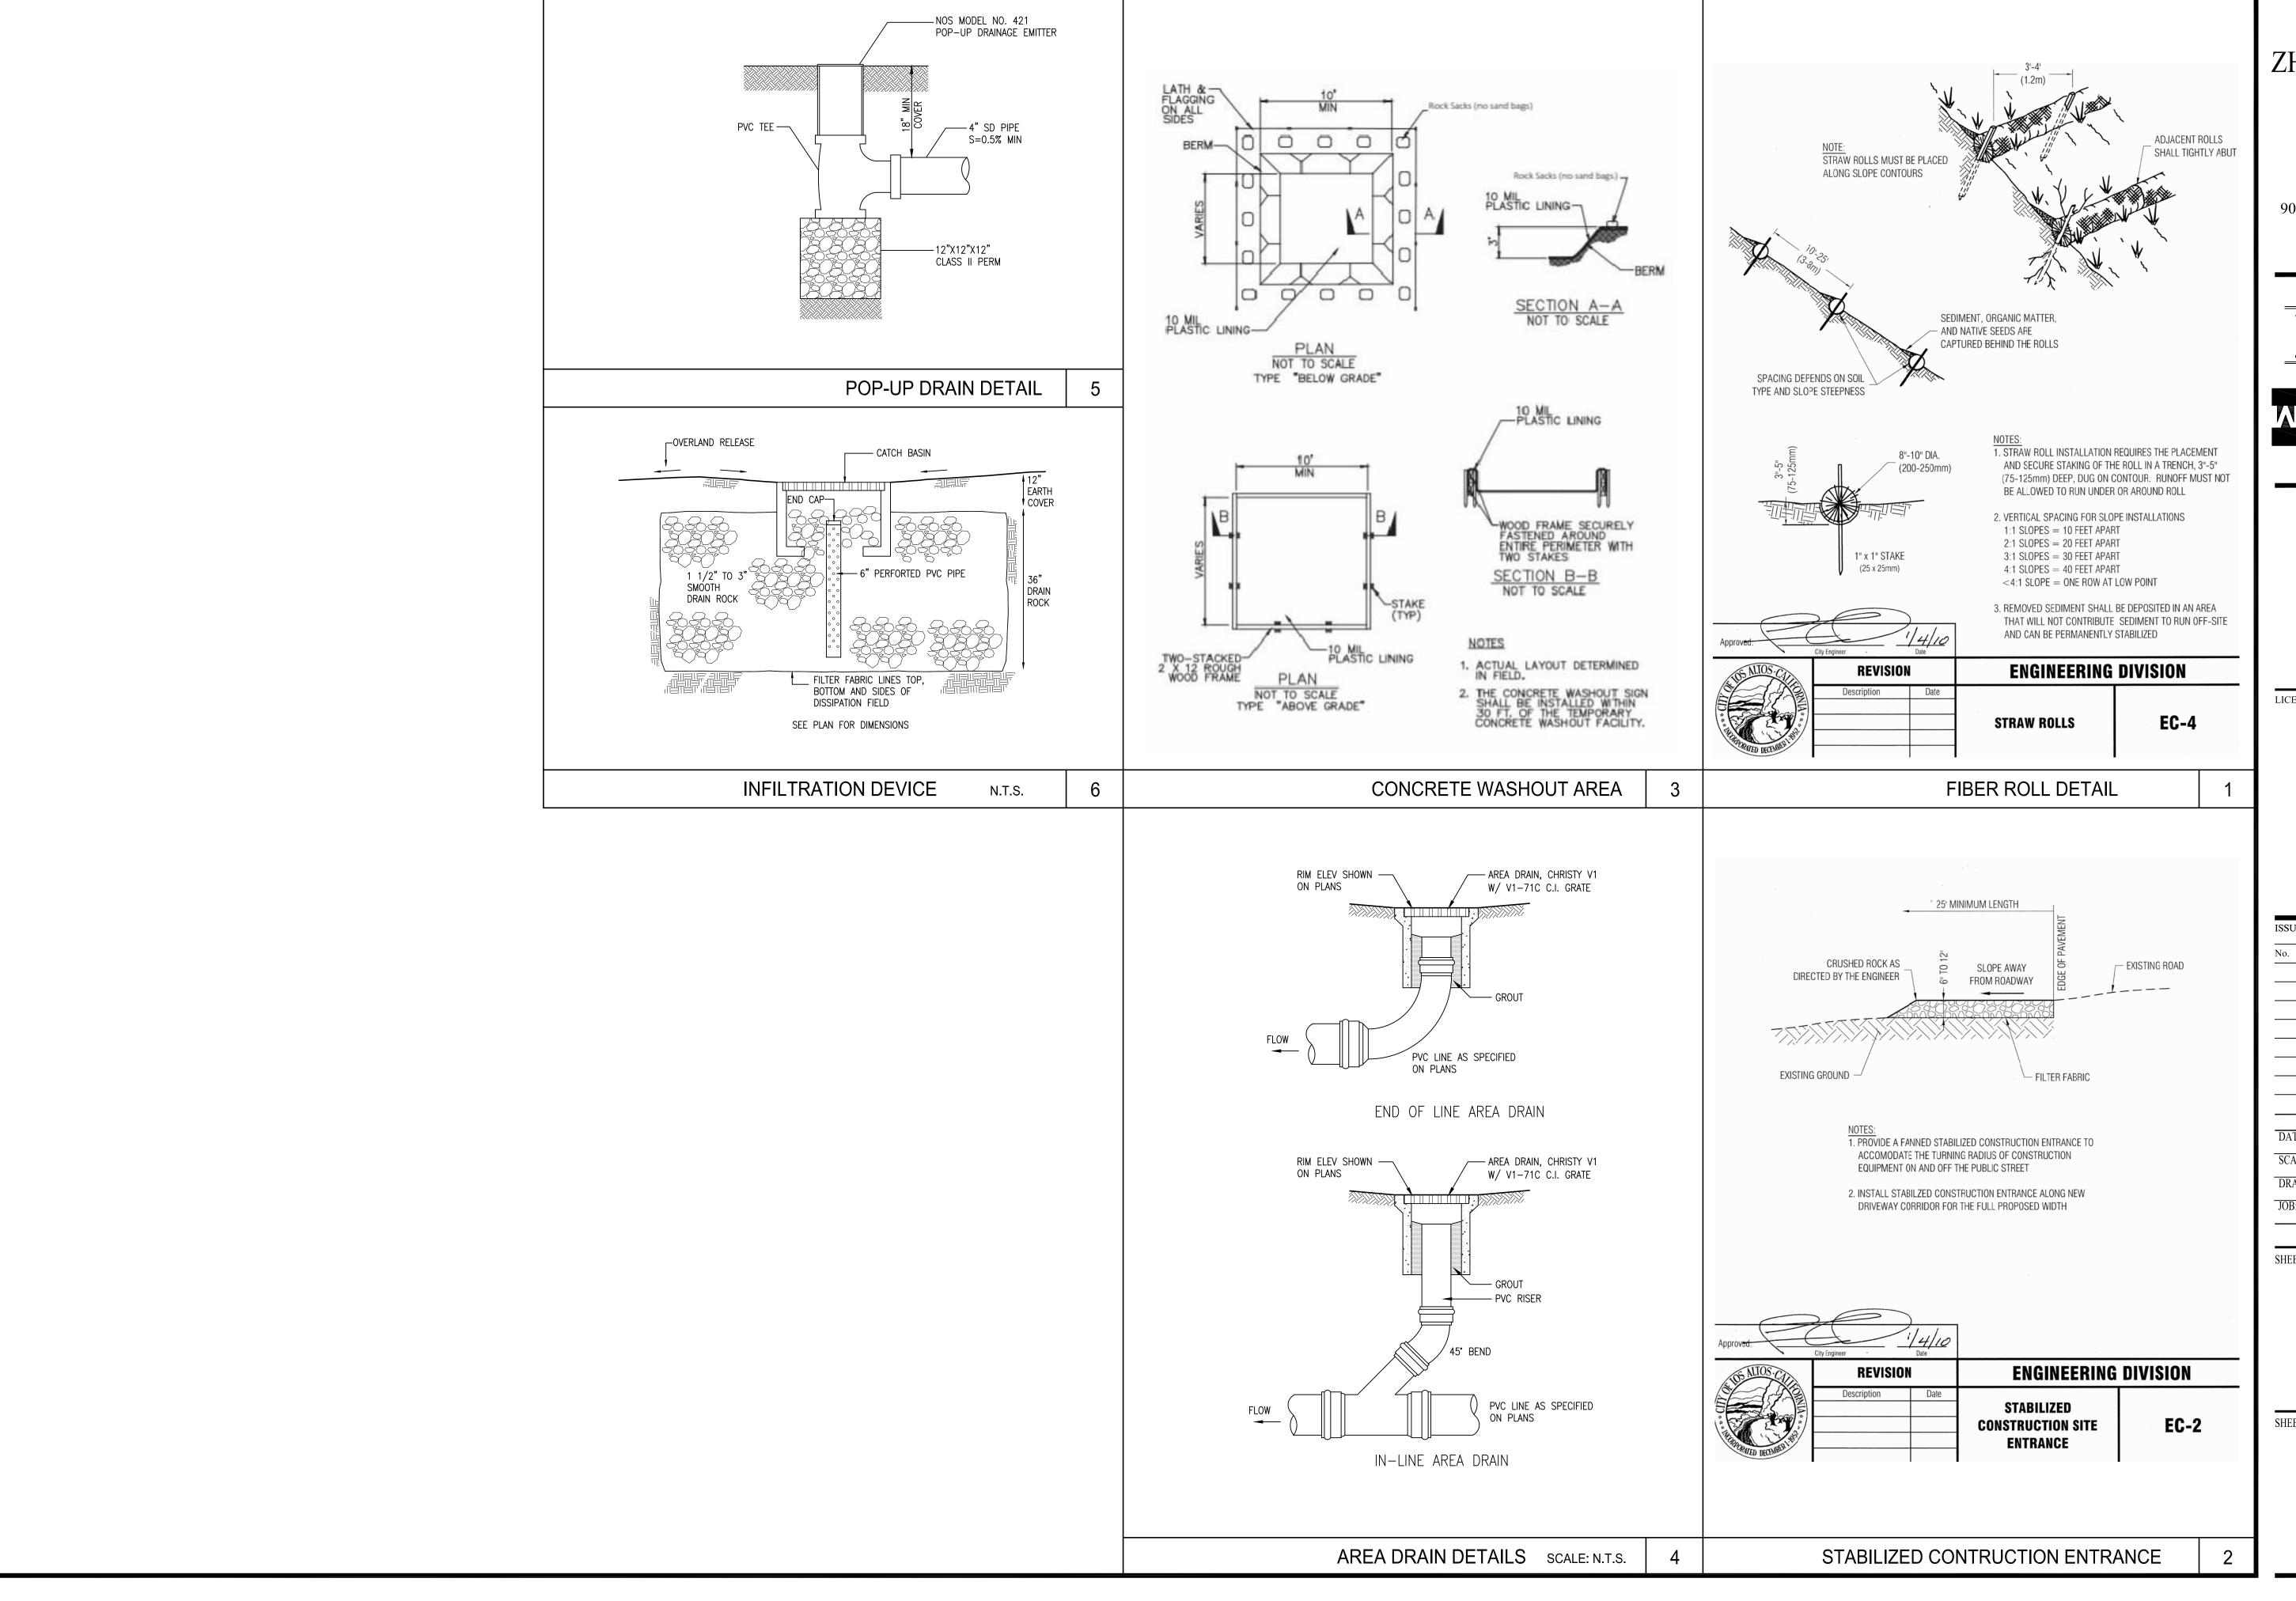
C.2



ZHANG & SONG RESIDENCE

905 LEONELLO AVENUE LOS ALTOS, CA APN: 189-20-014

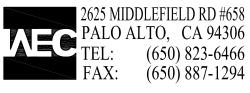WEC & ASSOCIATES



LICENSE STAMPS AND SIGNATURE





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DAT	JULY 14, 2022	
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JOB:		
	10078	

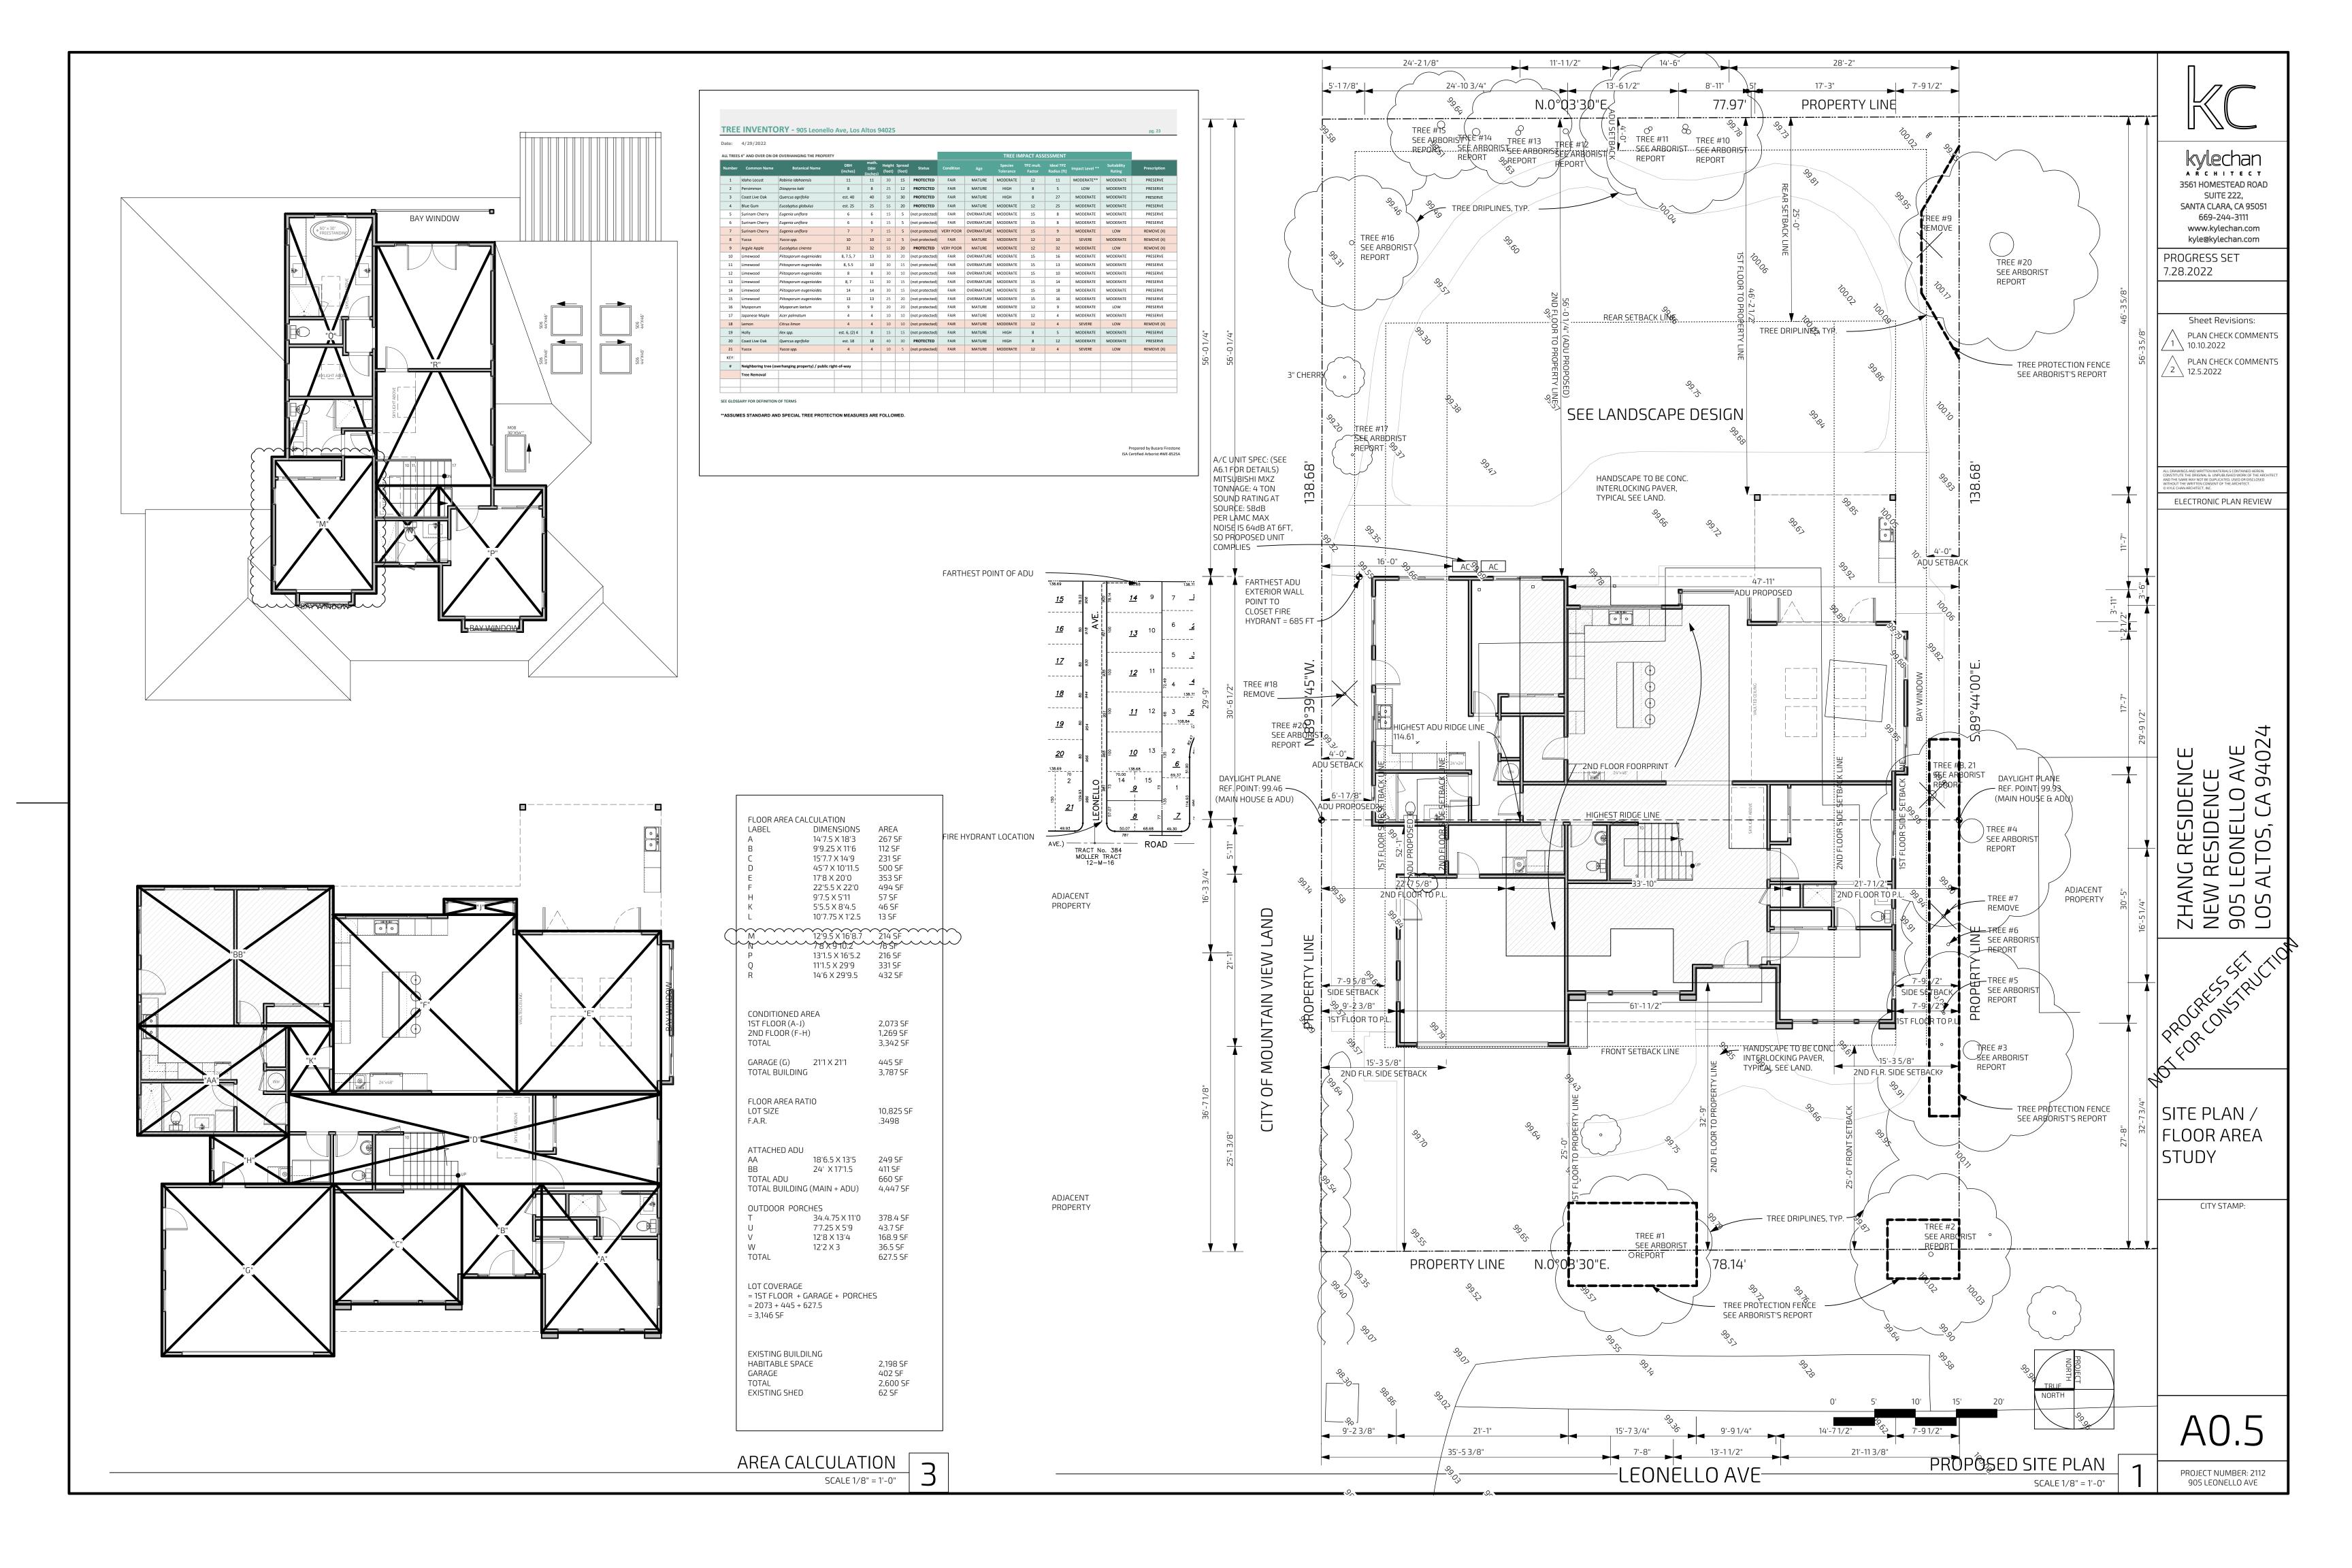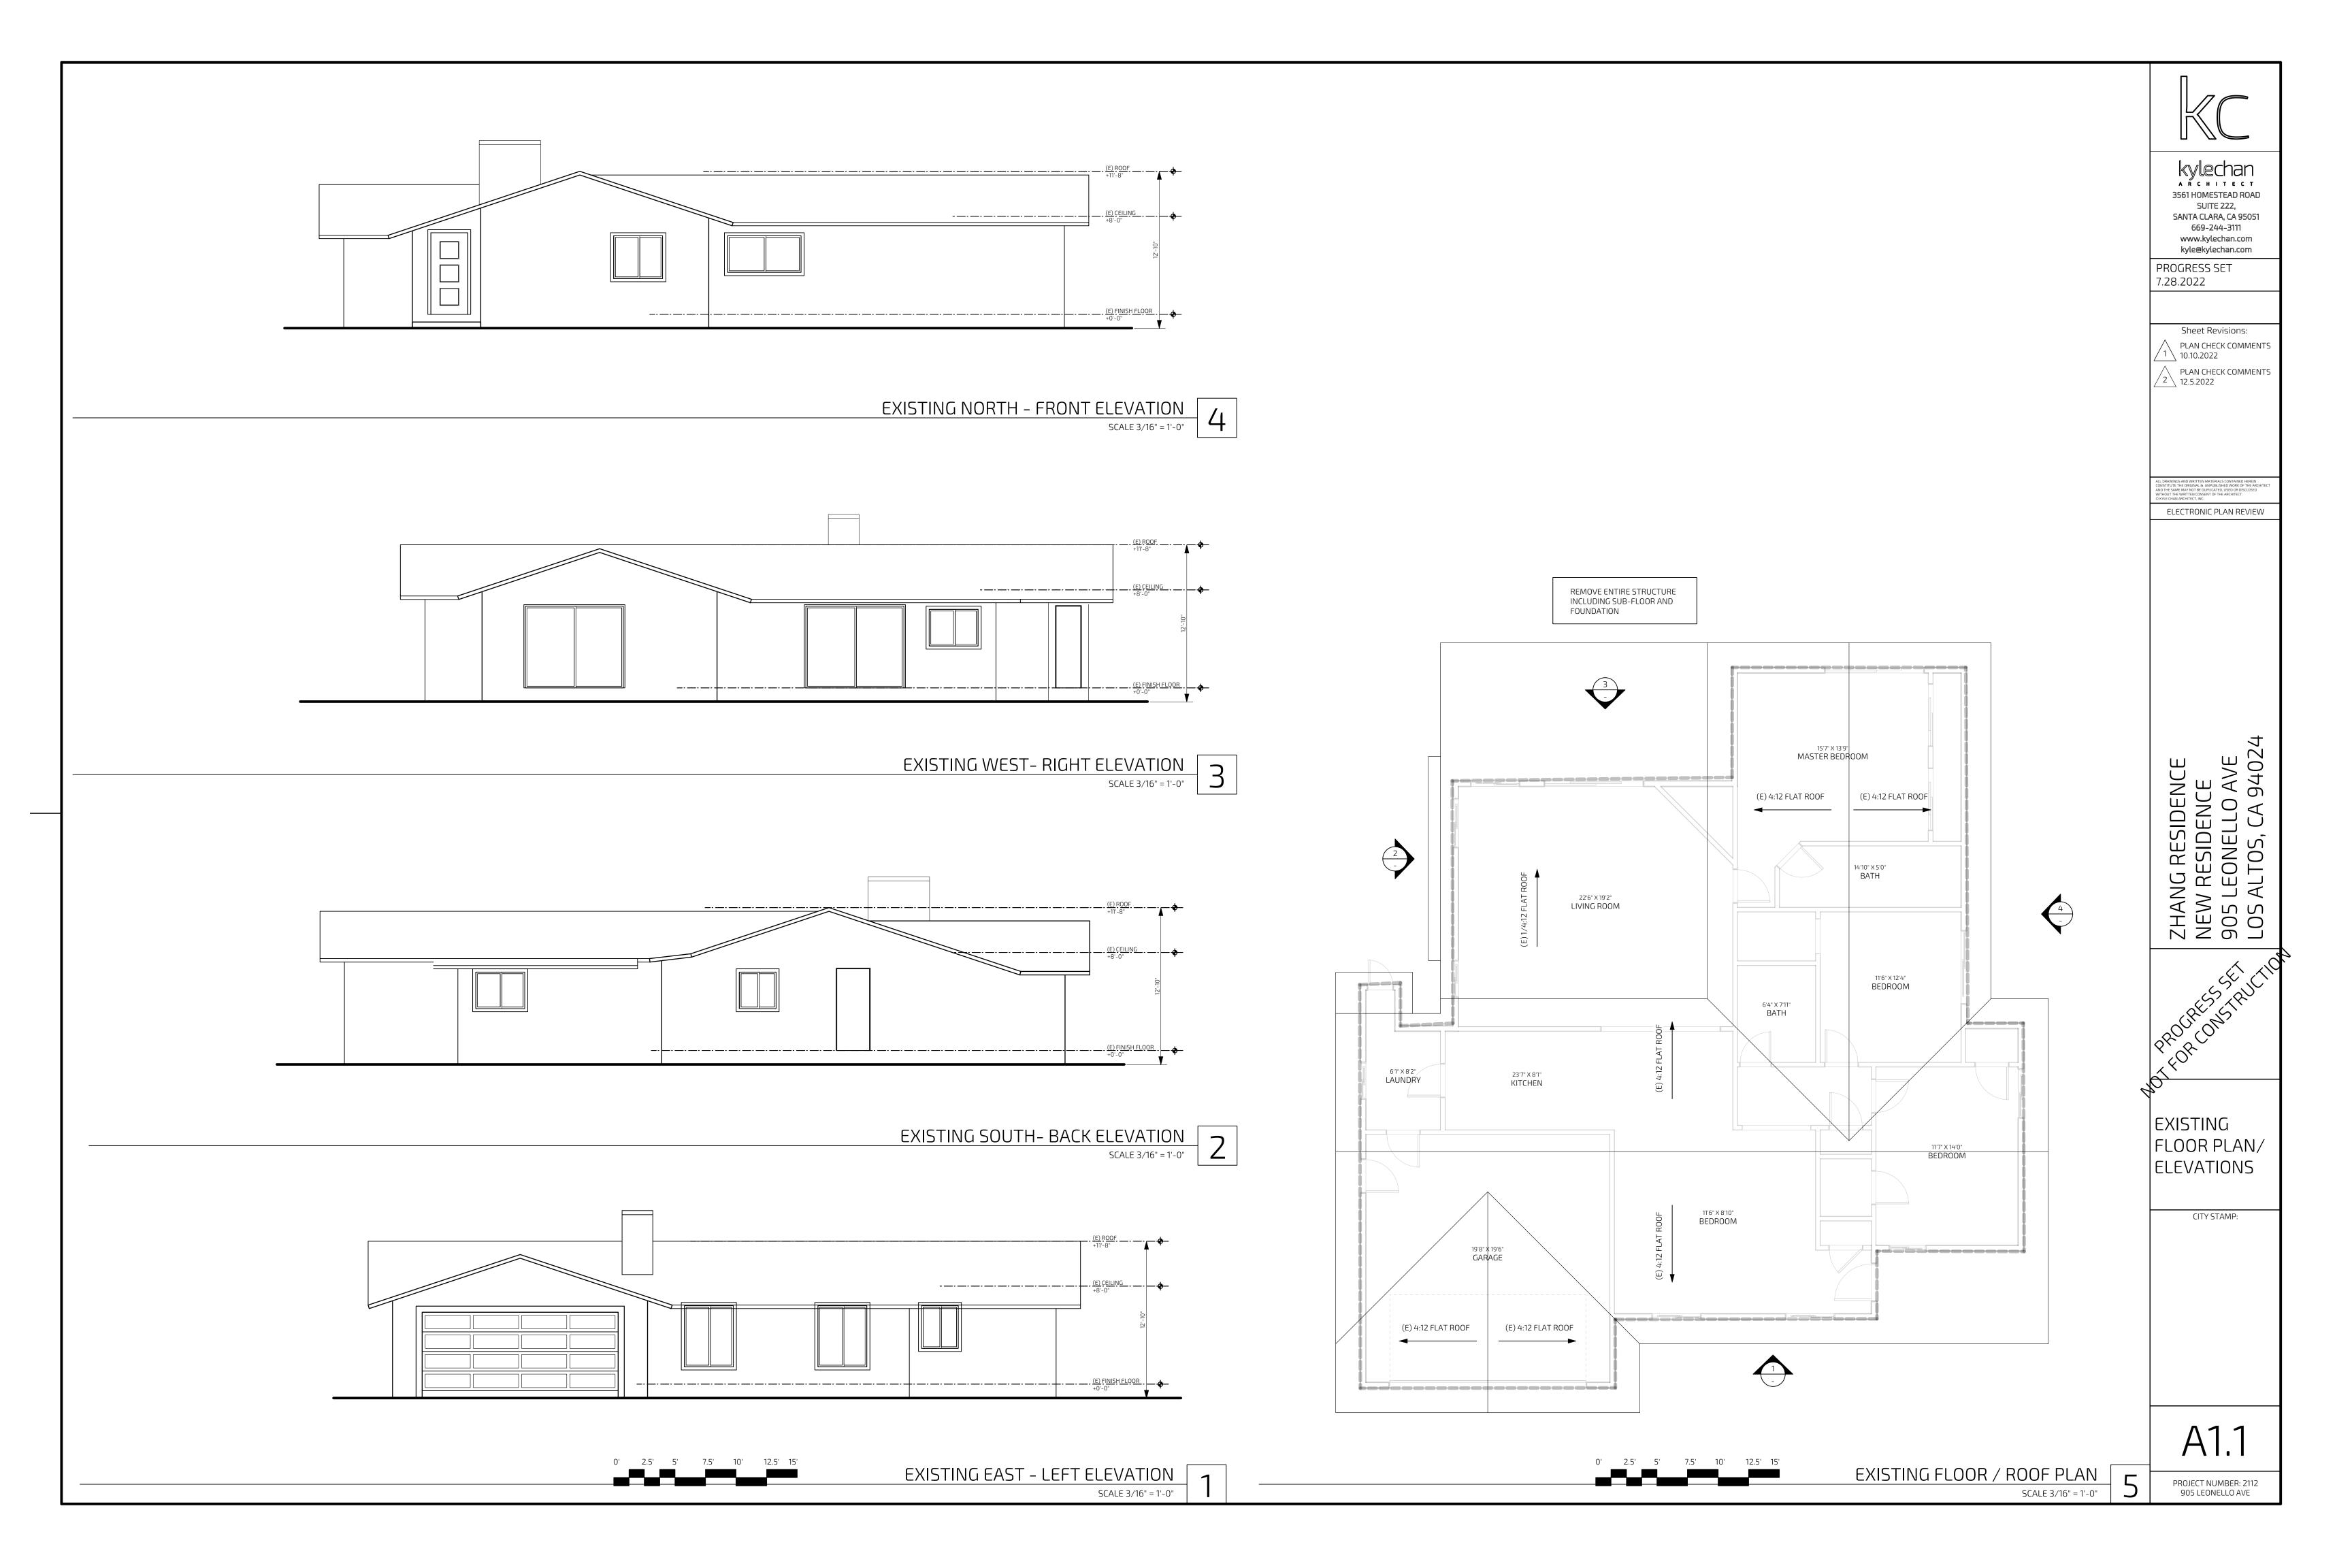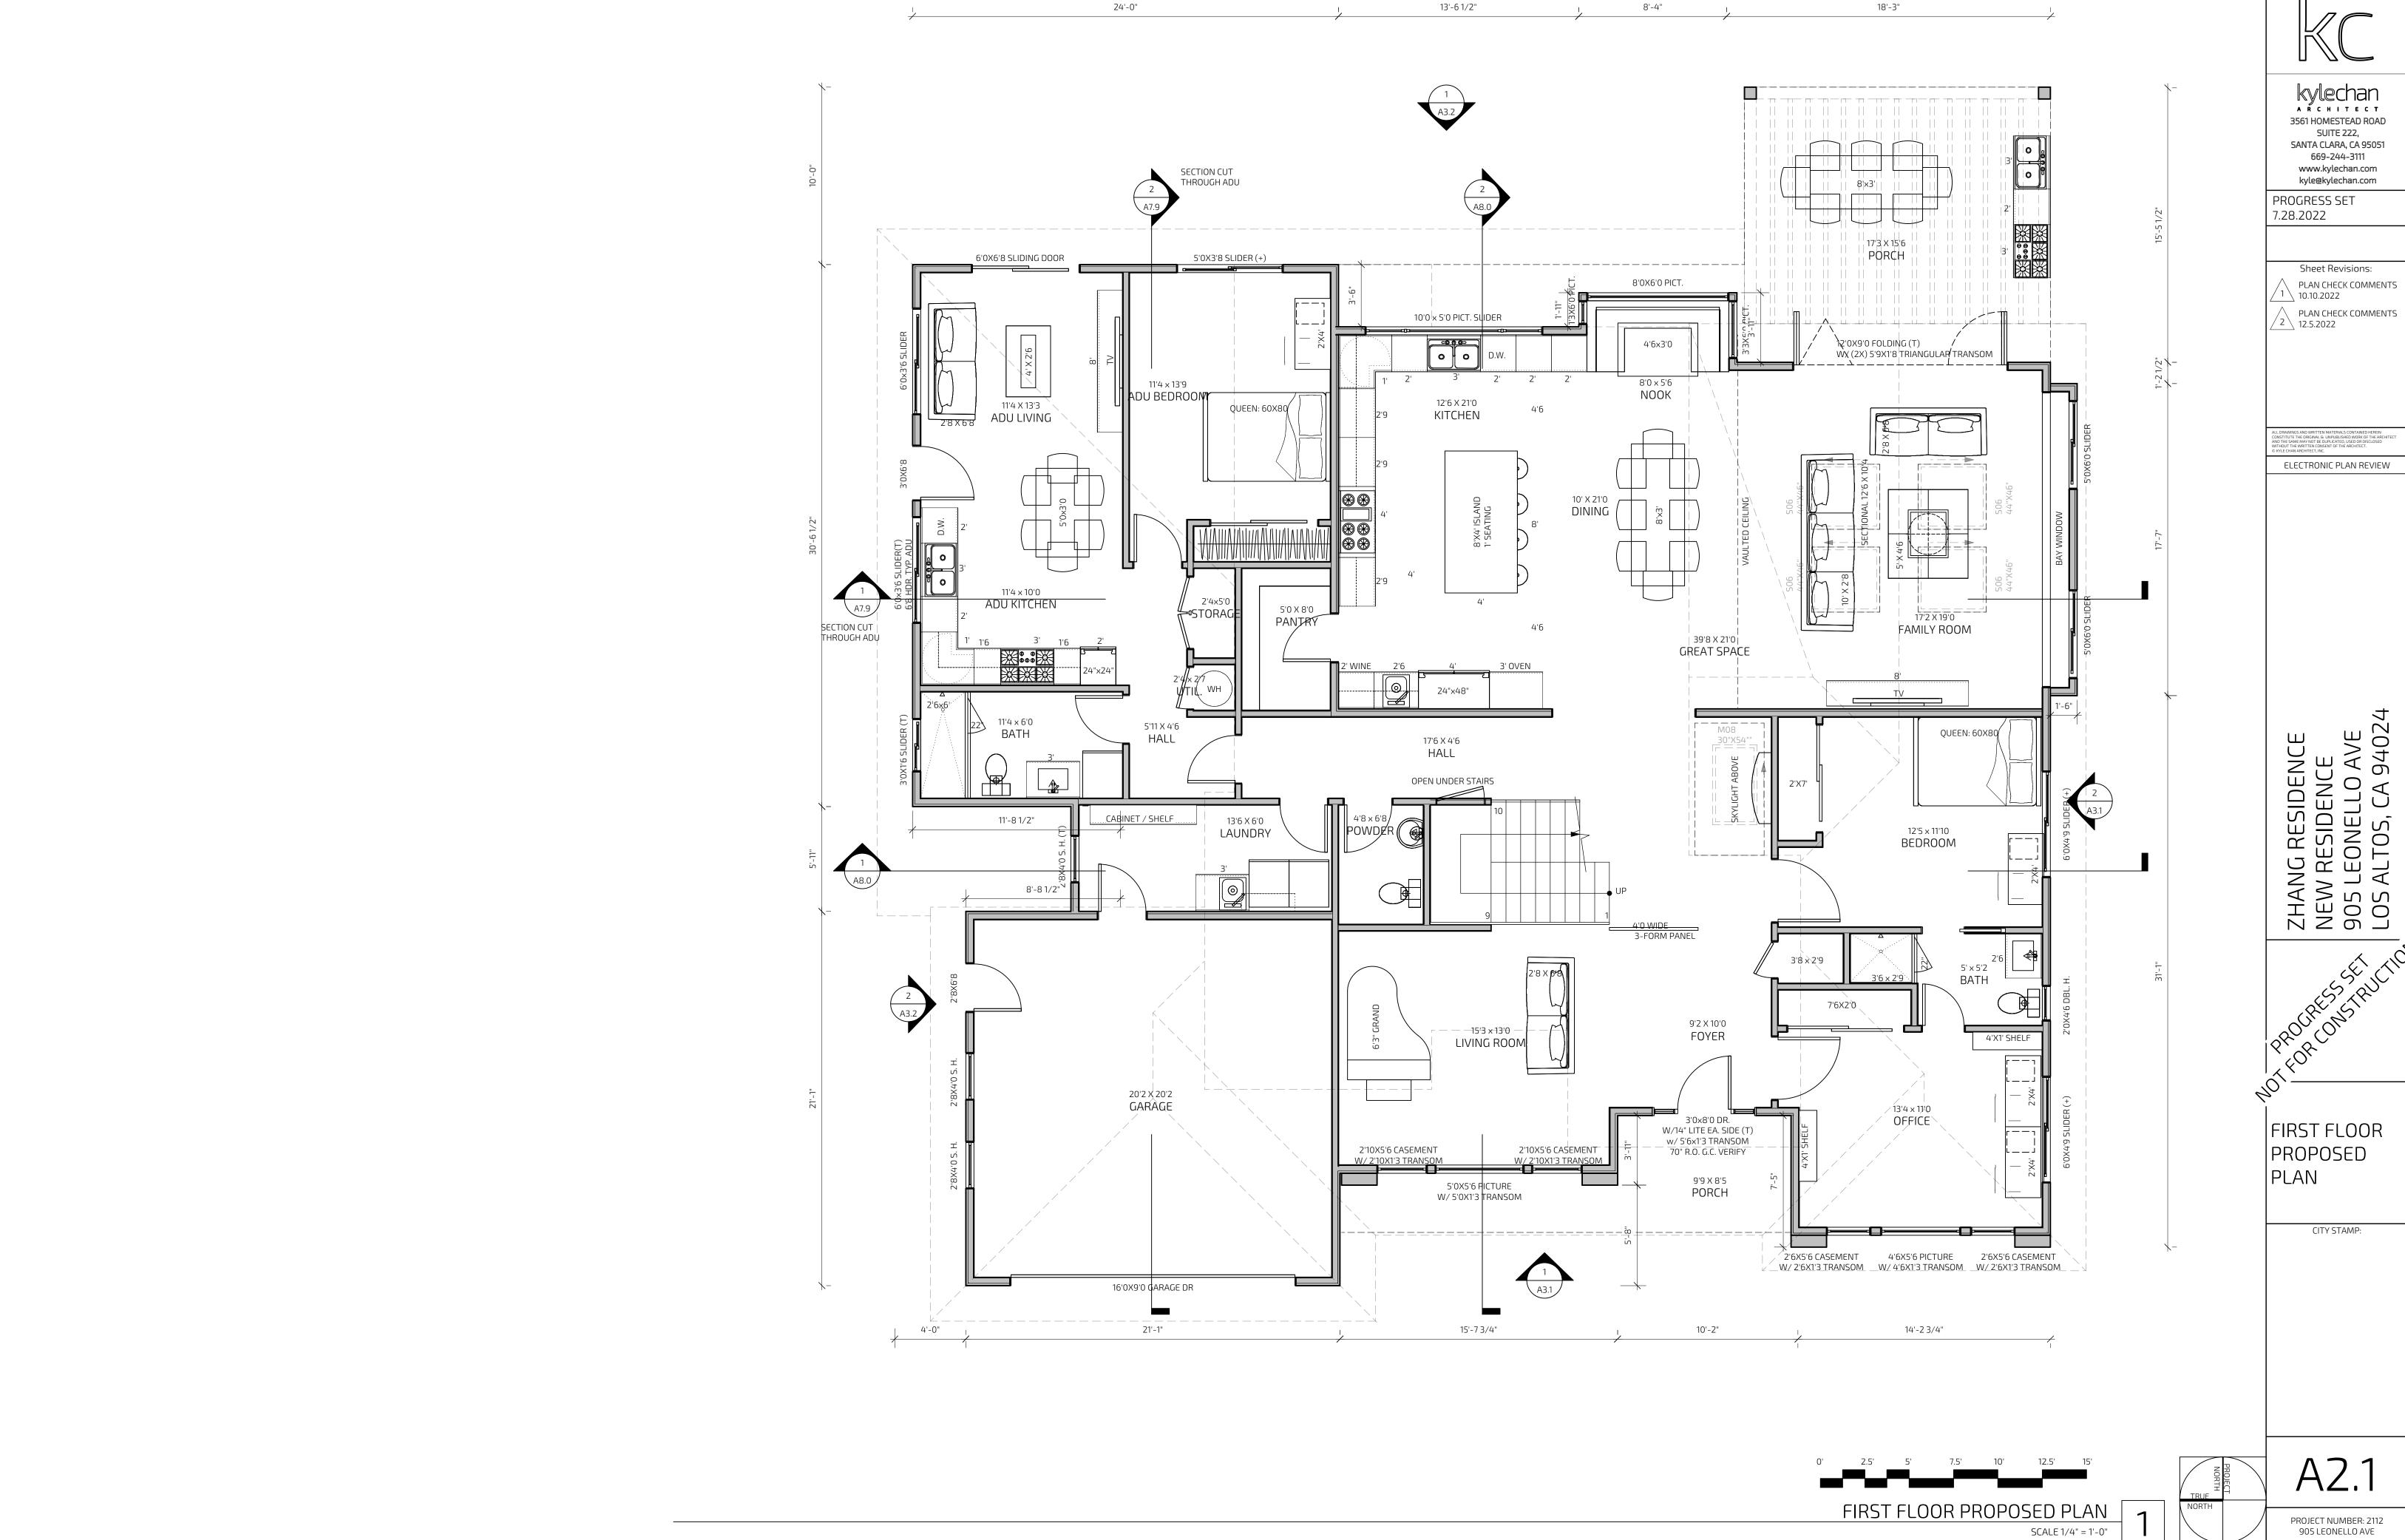
DETAILS

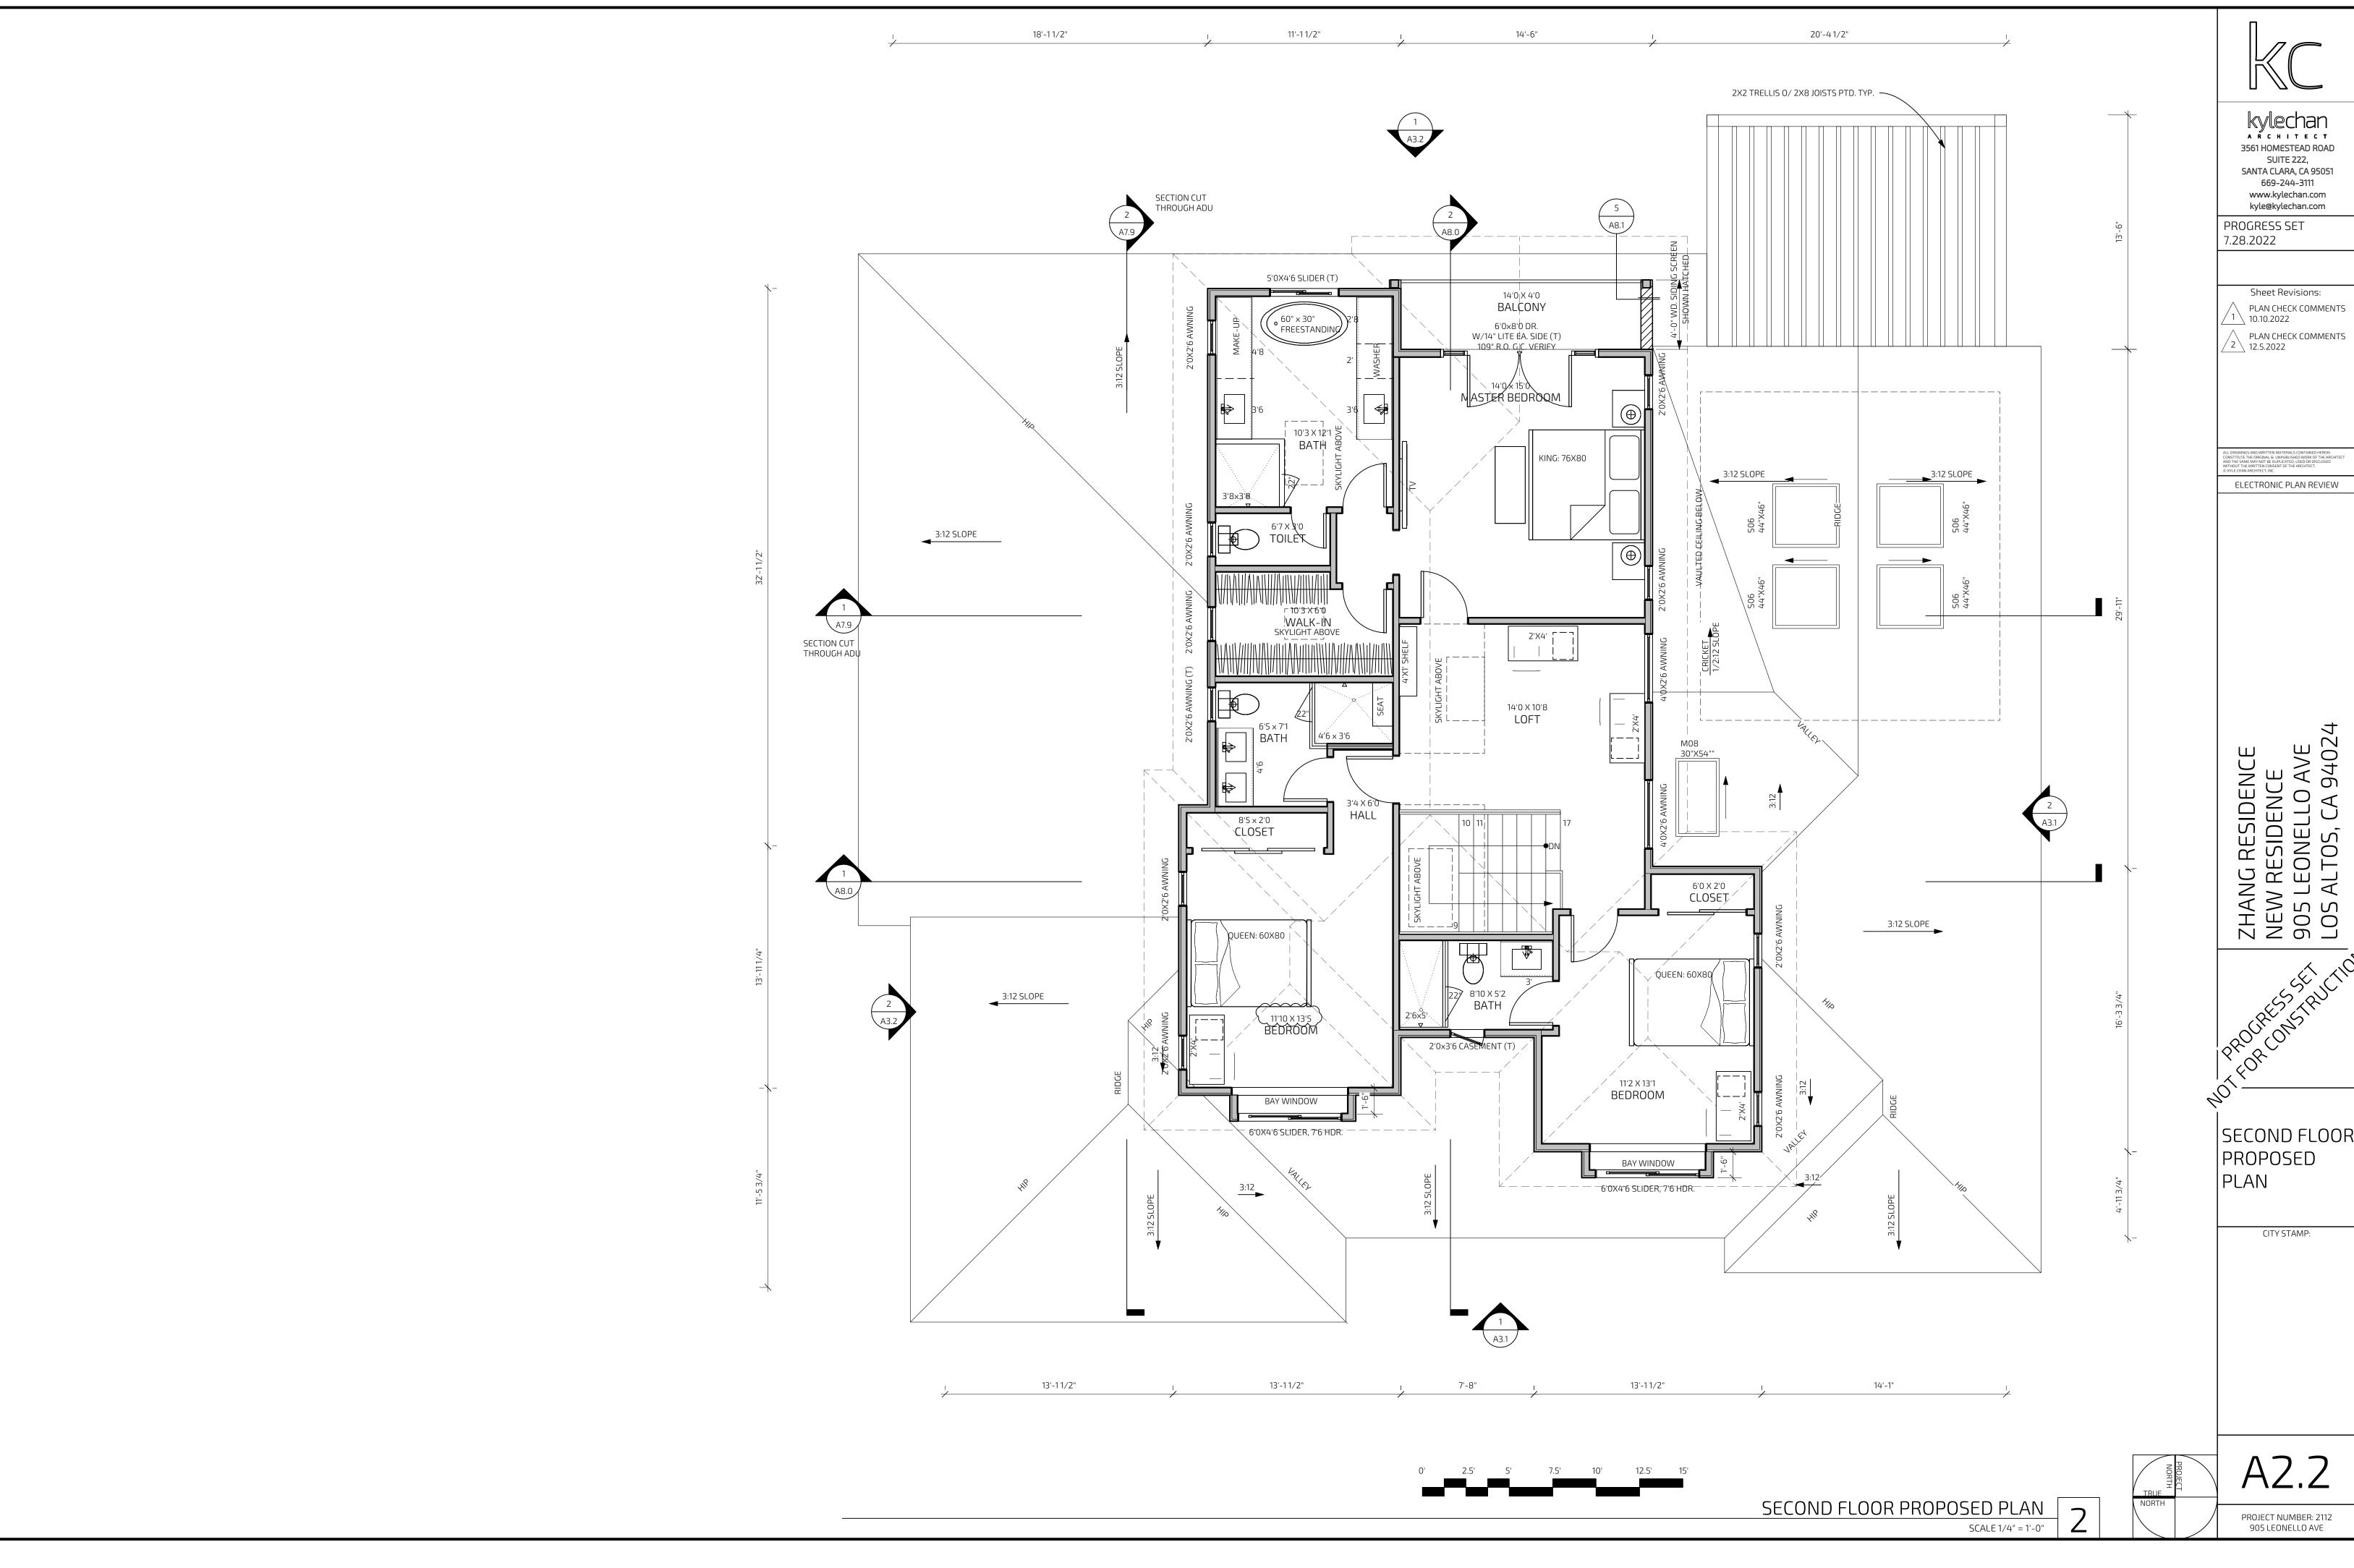
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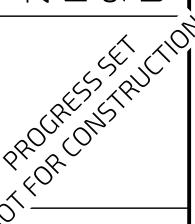
C.3

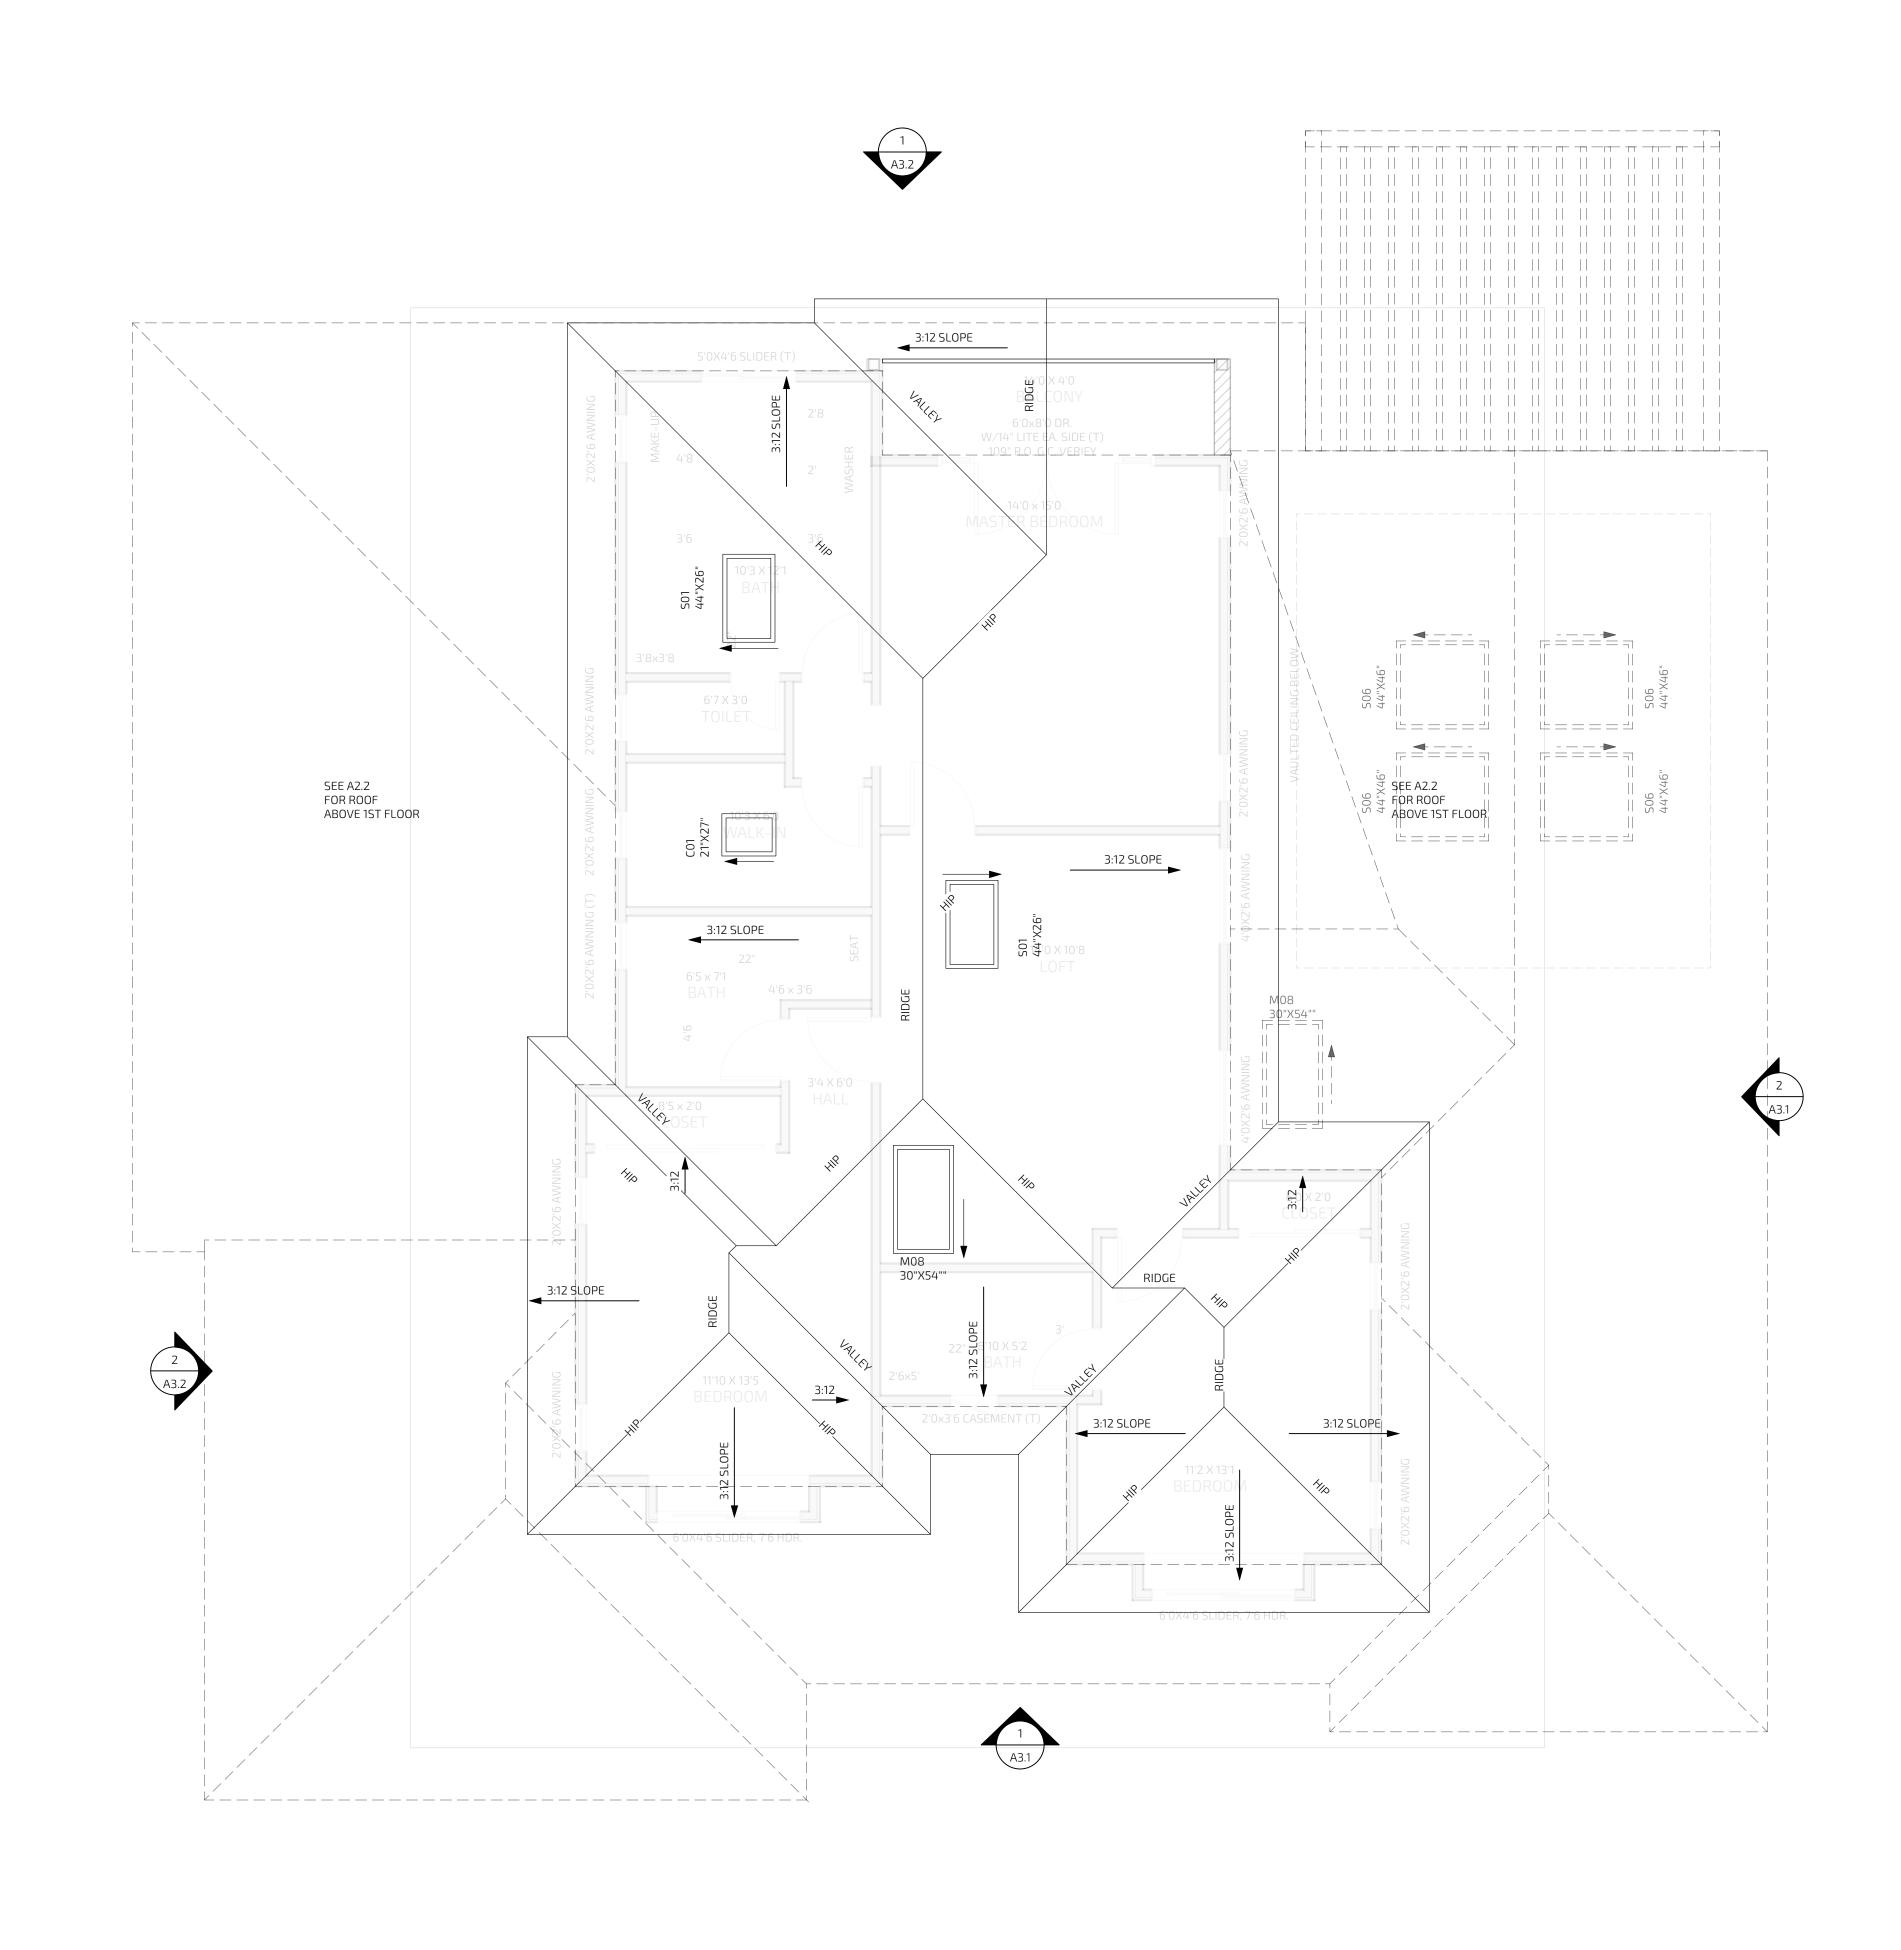












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PROGRESS SET 7.28.2022

Sheet Revisions:

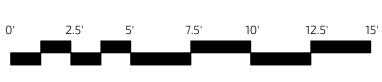
\ PLAN CHECK COMMENTS 1 \ 10.10.2022 PLAN CHECK COMMENTS 12.5.2022

ELECTRONIC PLAN REVIEW


ZHANG RESIDE NEW RESIDE 905 LEONELI LOS ALTOS, C

PROPOSED ROOF PLAN

CITY STAMP:




PROPOSED ROOF PLAN SCALE 1/4" = 1'-0"

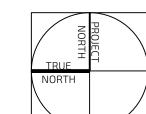

A2.3

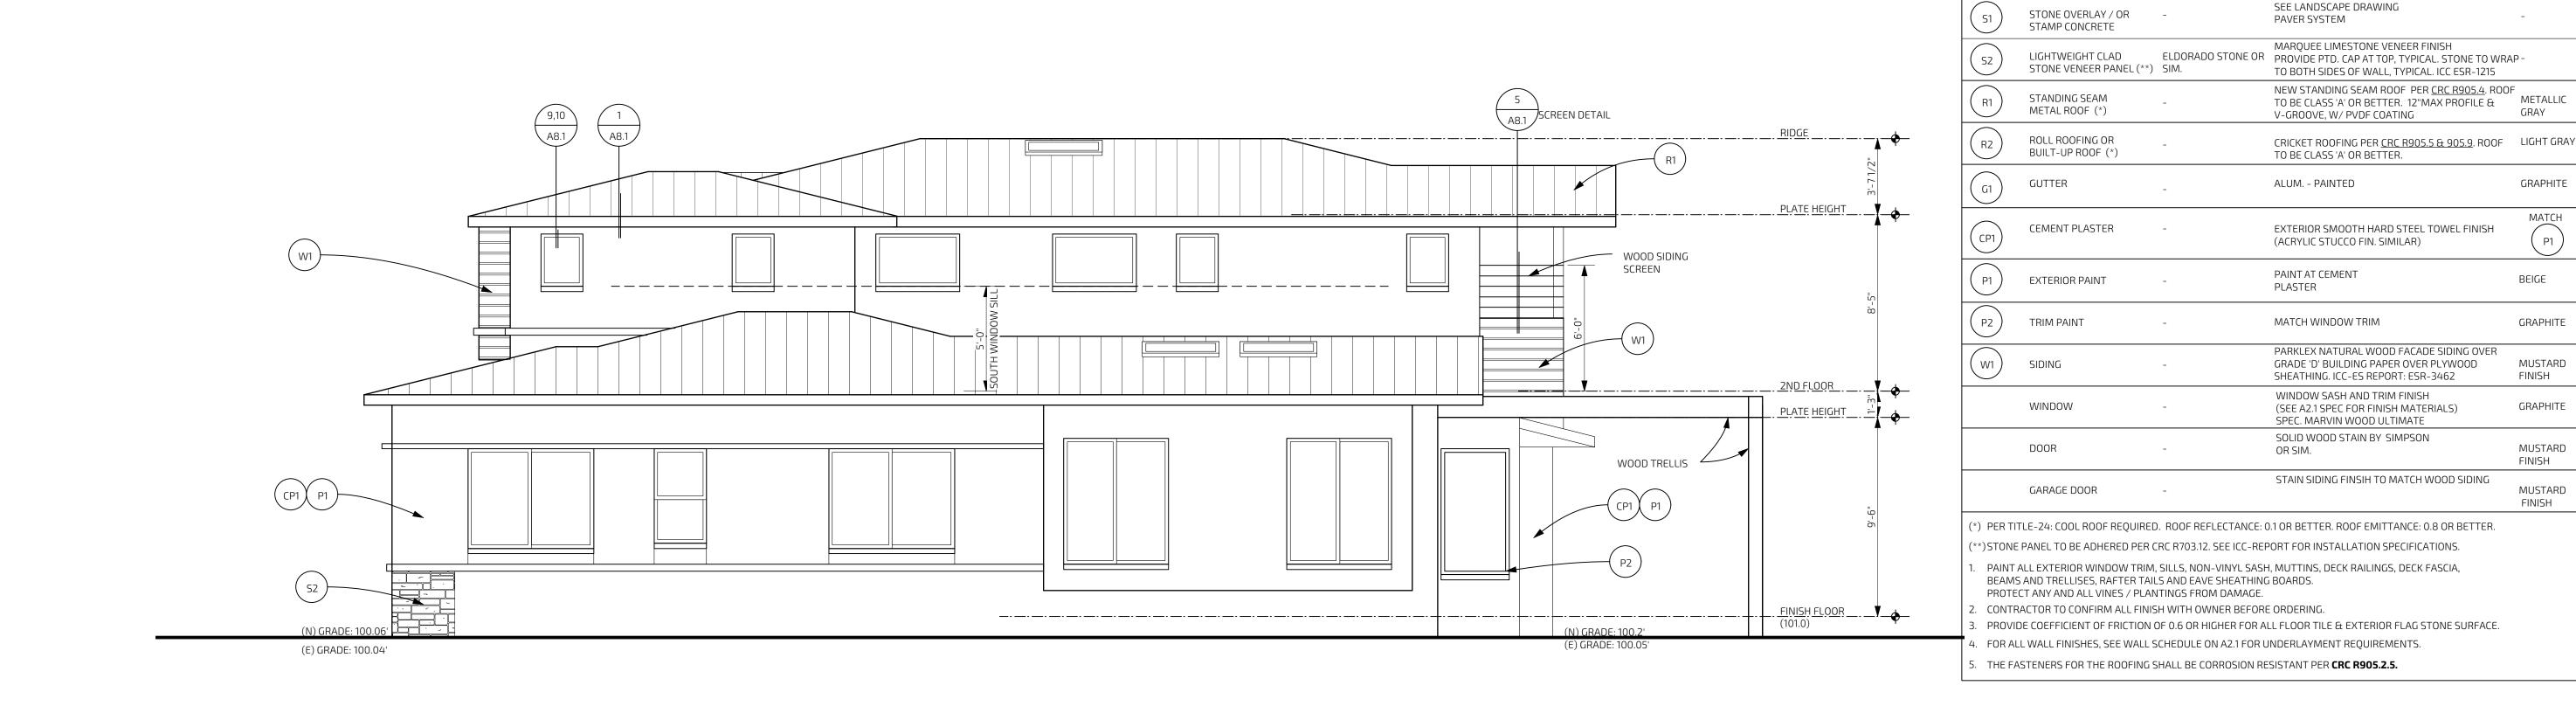PROJECT NUMBER: 2112 905 LEONELLO AVE



PROPOSED RIGHT (SOUTH) ELEVATION 7

PROPOSED FRONT (WEST) ELEVATION

DAYLIGHT PLANE GRADING REF. PT: (99.93)

SCALE 1/4" = 1'-0"

EXTERIOR FINISH SCHEDULE

MFR./DEALER

MODEL #/ DESCRIPTION/ LOCATION

COLOR

MATCH

kylechan

ARCHITECT

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Sheet Revisions:

ELECTRONIC PLAN REVIEW

CITY STAMP:

PROJECT NUMBER: 2112

905 LEONELLO AVE

PLAN CHECK COMMENTS

PLAN CHECK COMMENTS

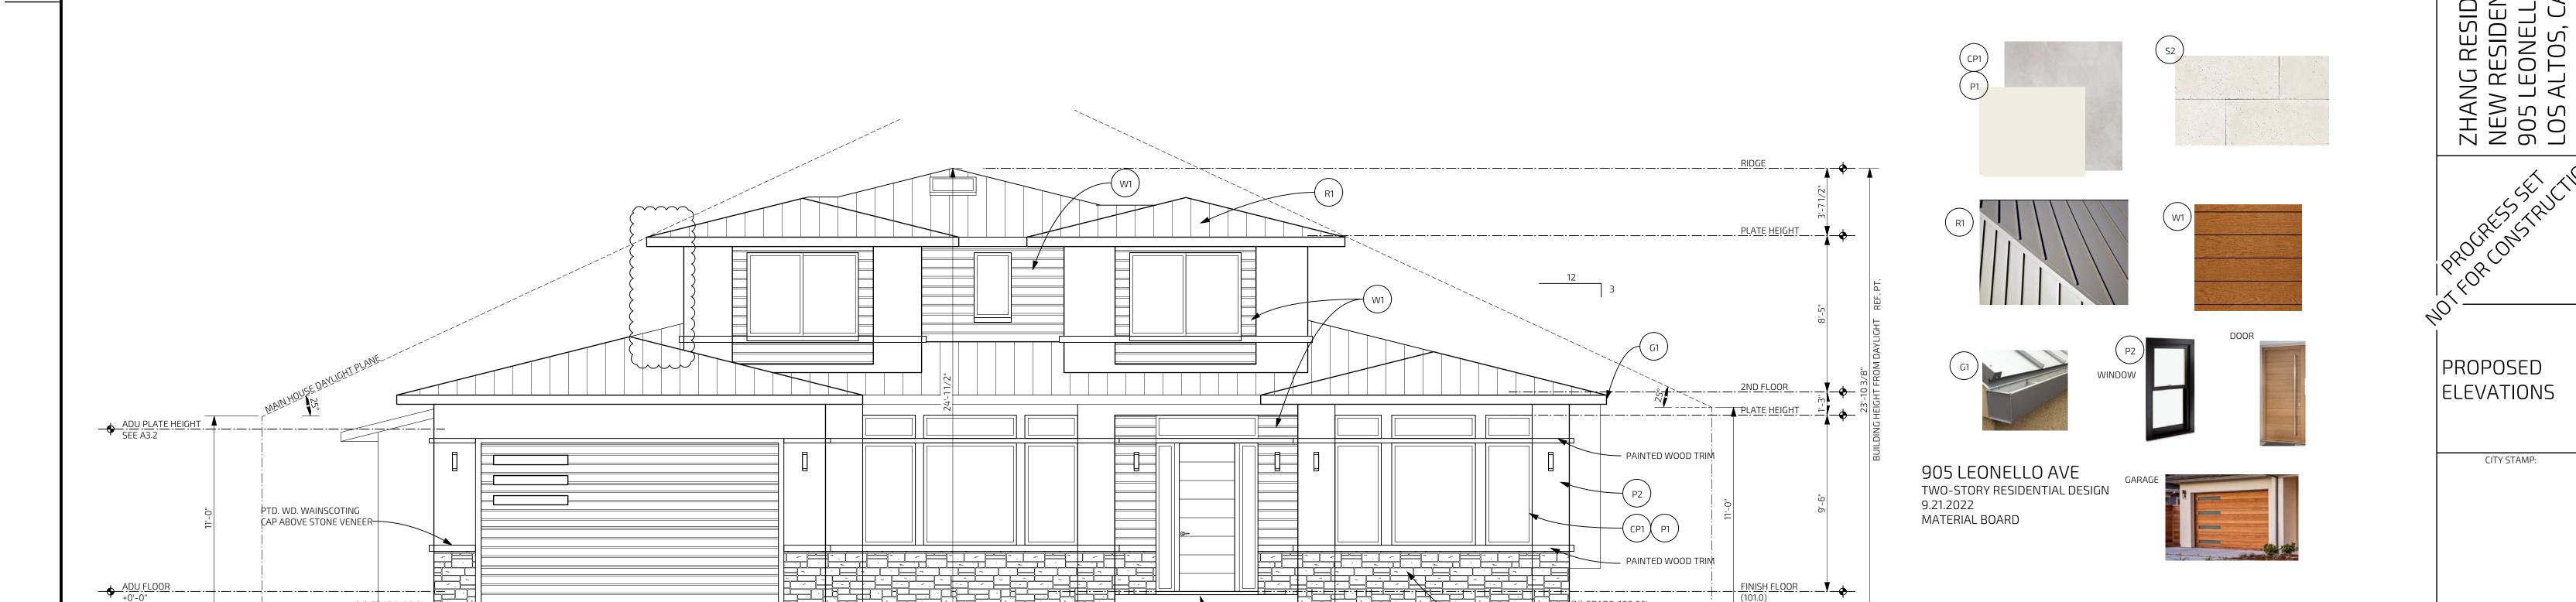
PROGRESS SET

10.10.2022

2 \ 12.5.2022


7.28.2022


SYMBOL MATERIAL





HIGHEST BUILDING HEIGHT

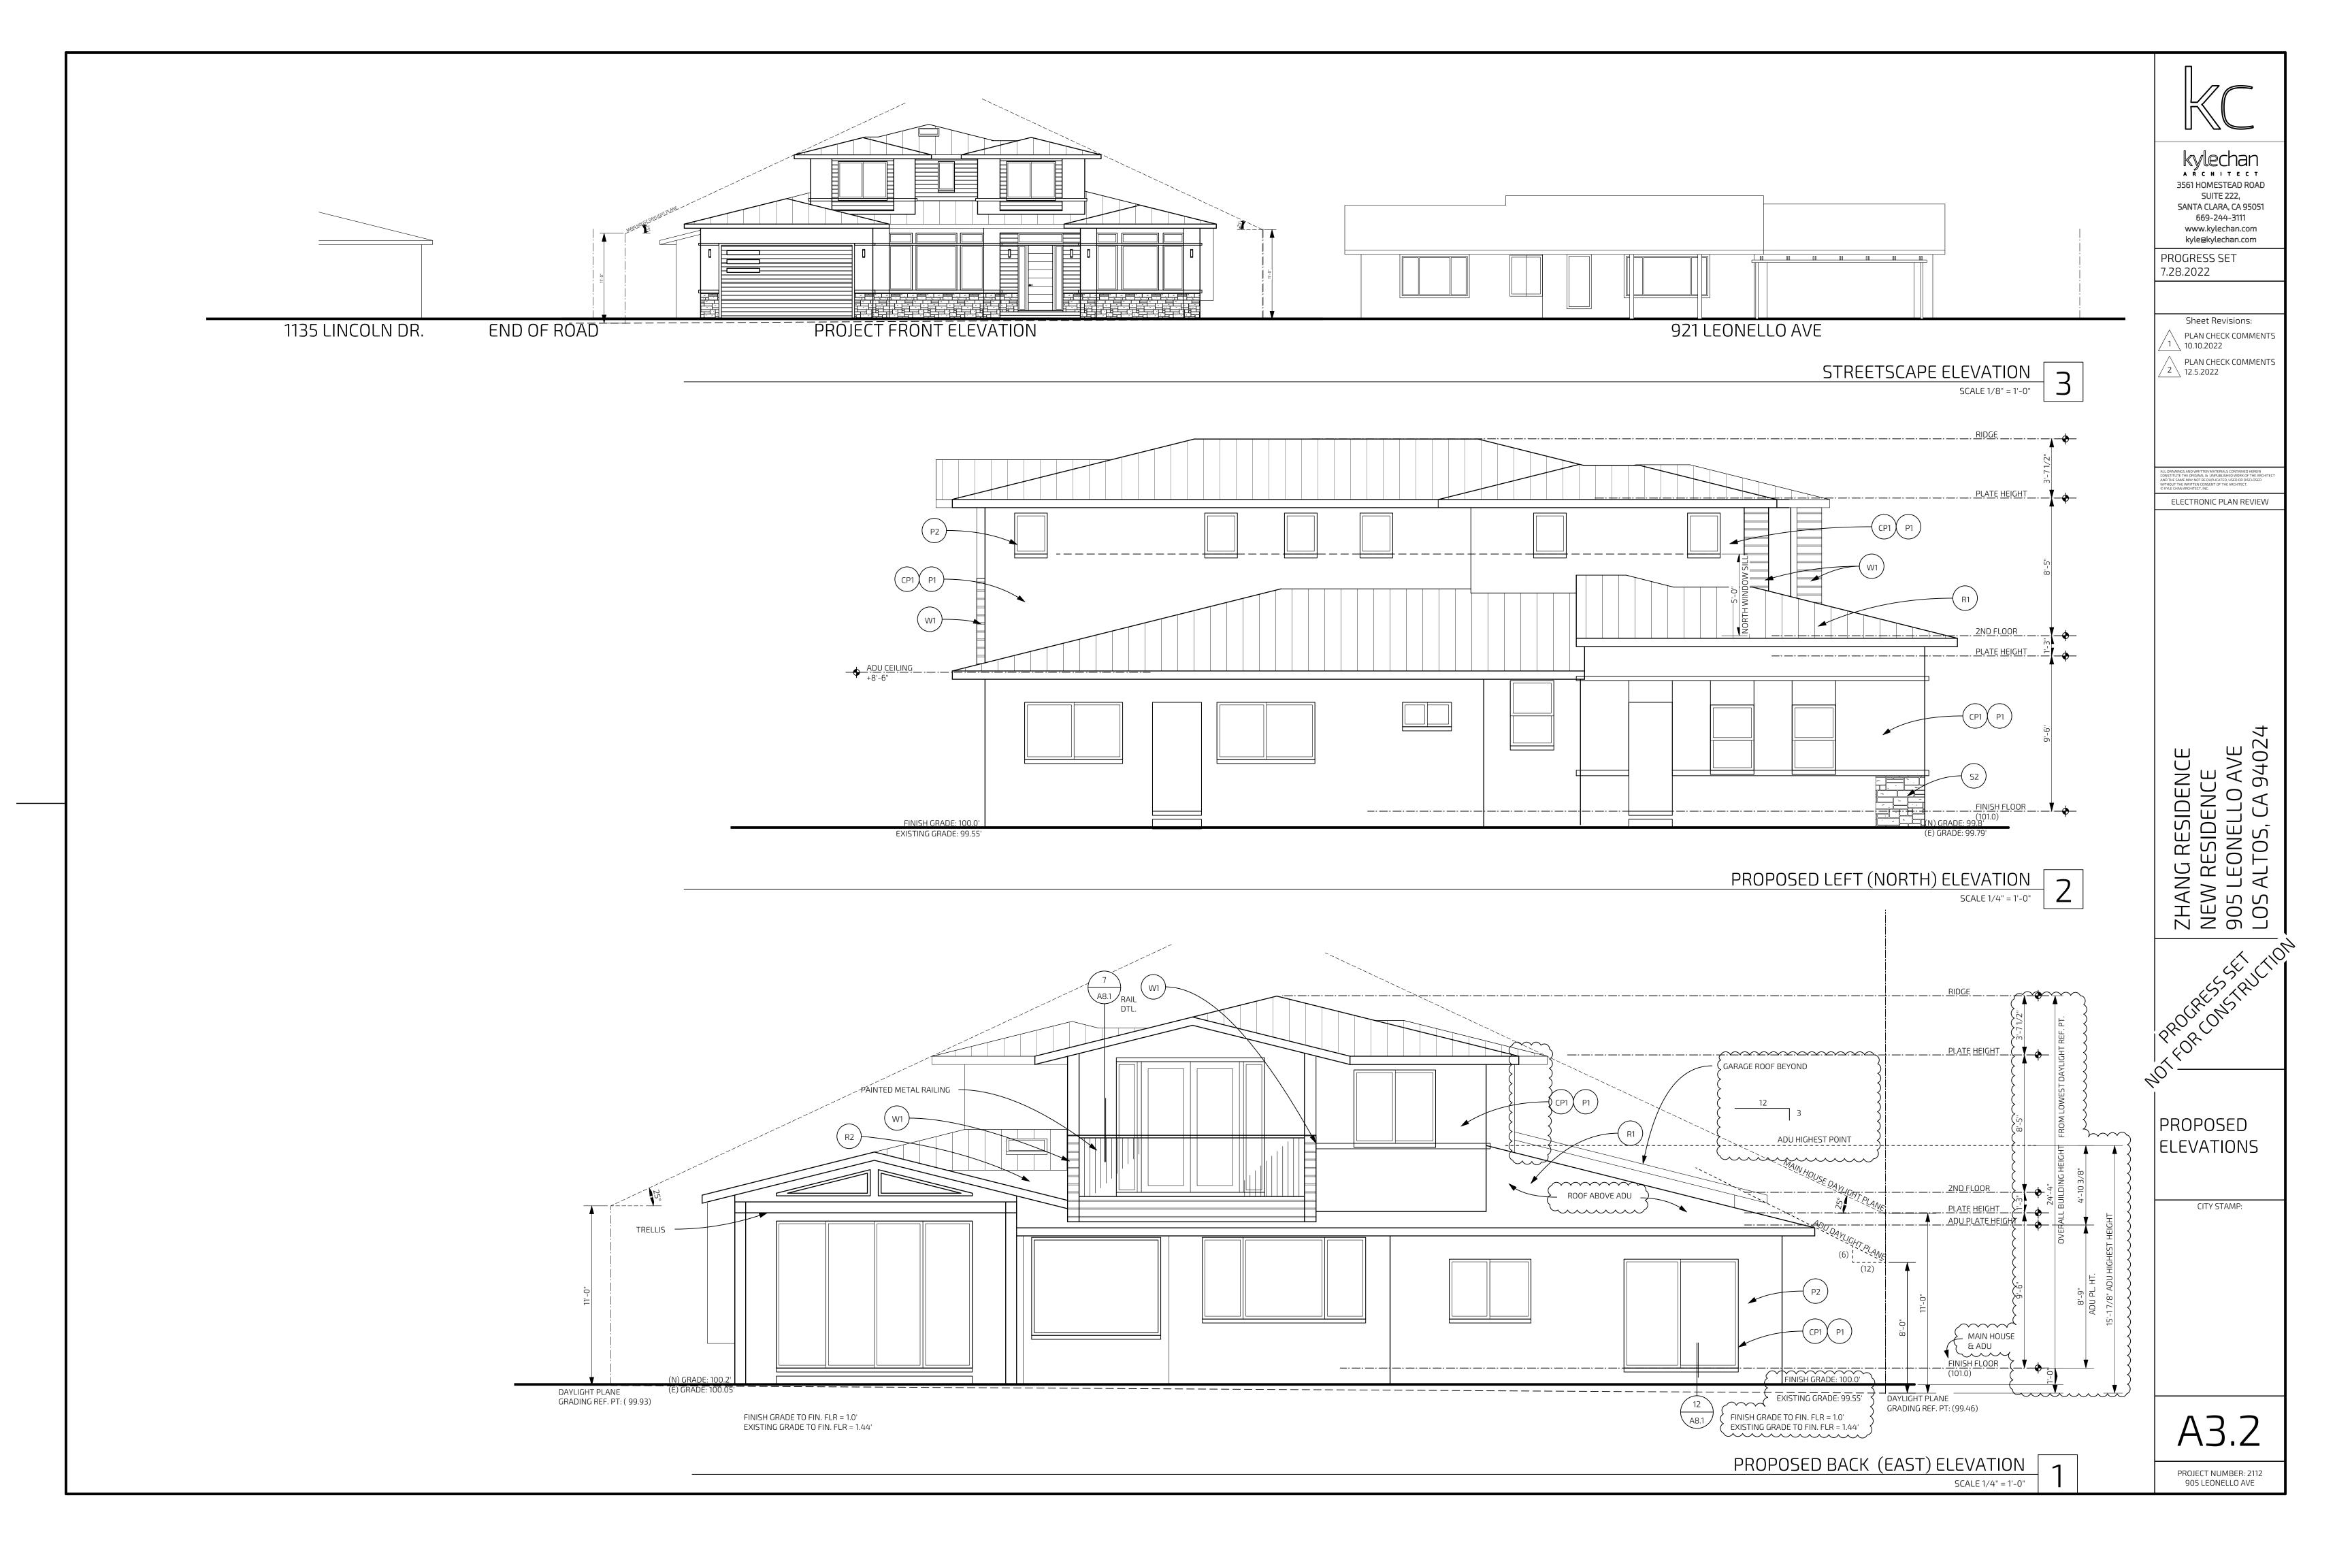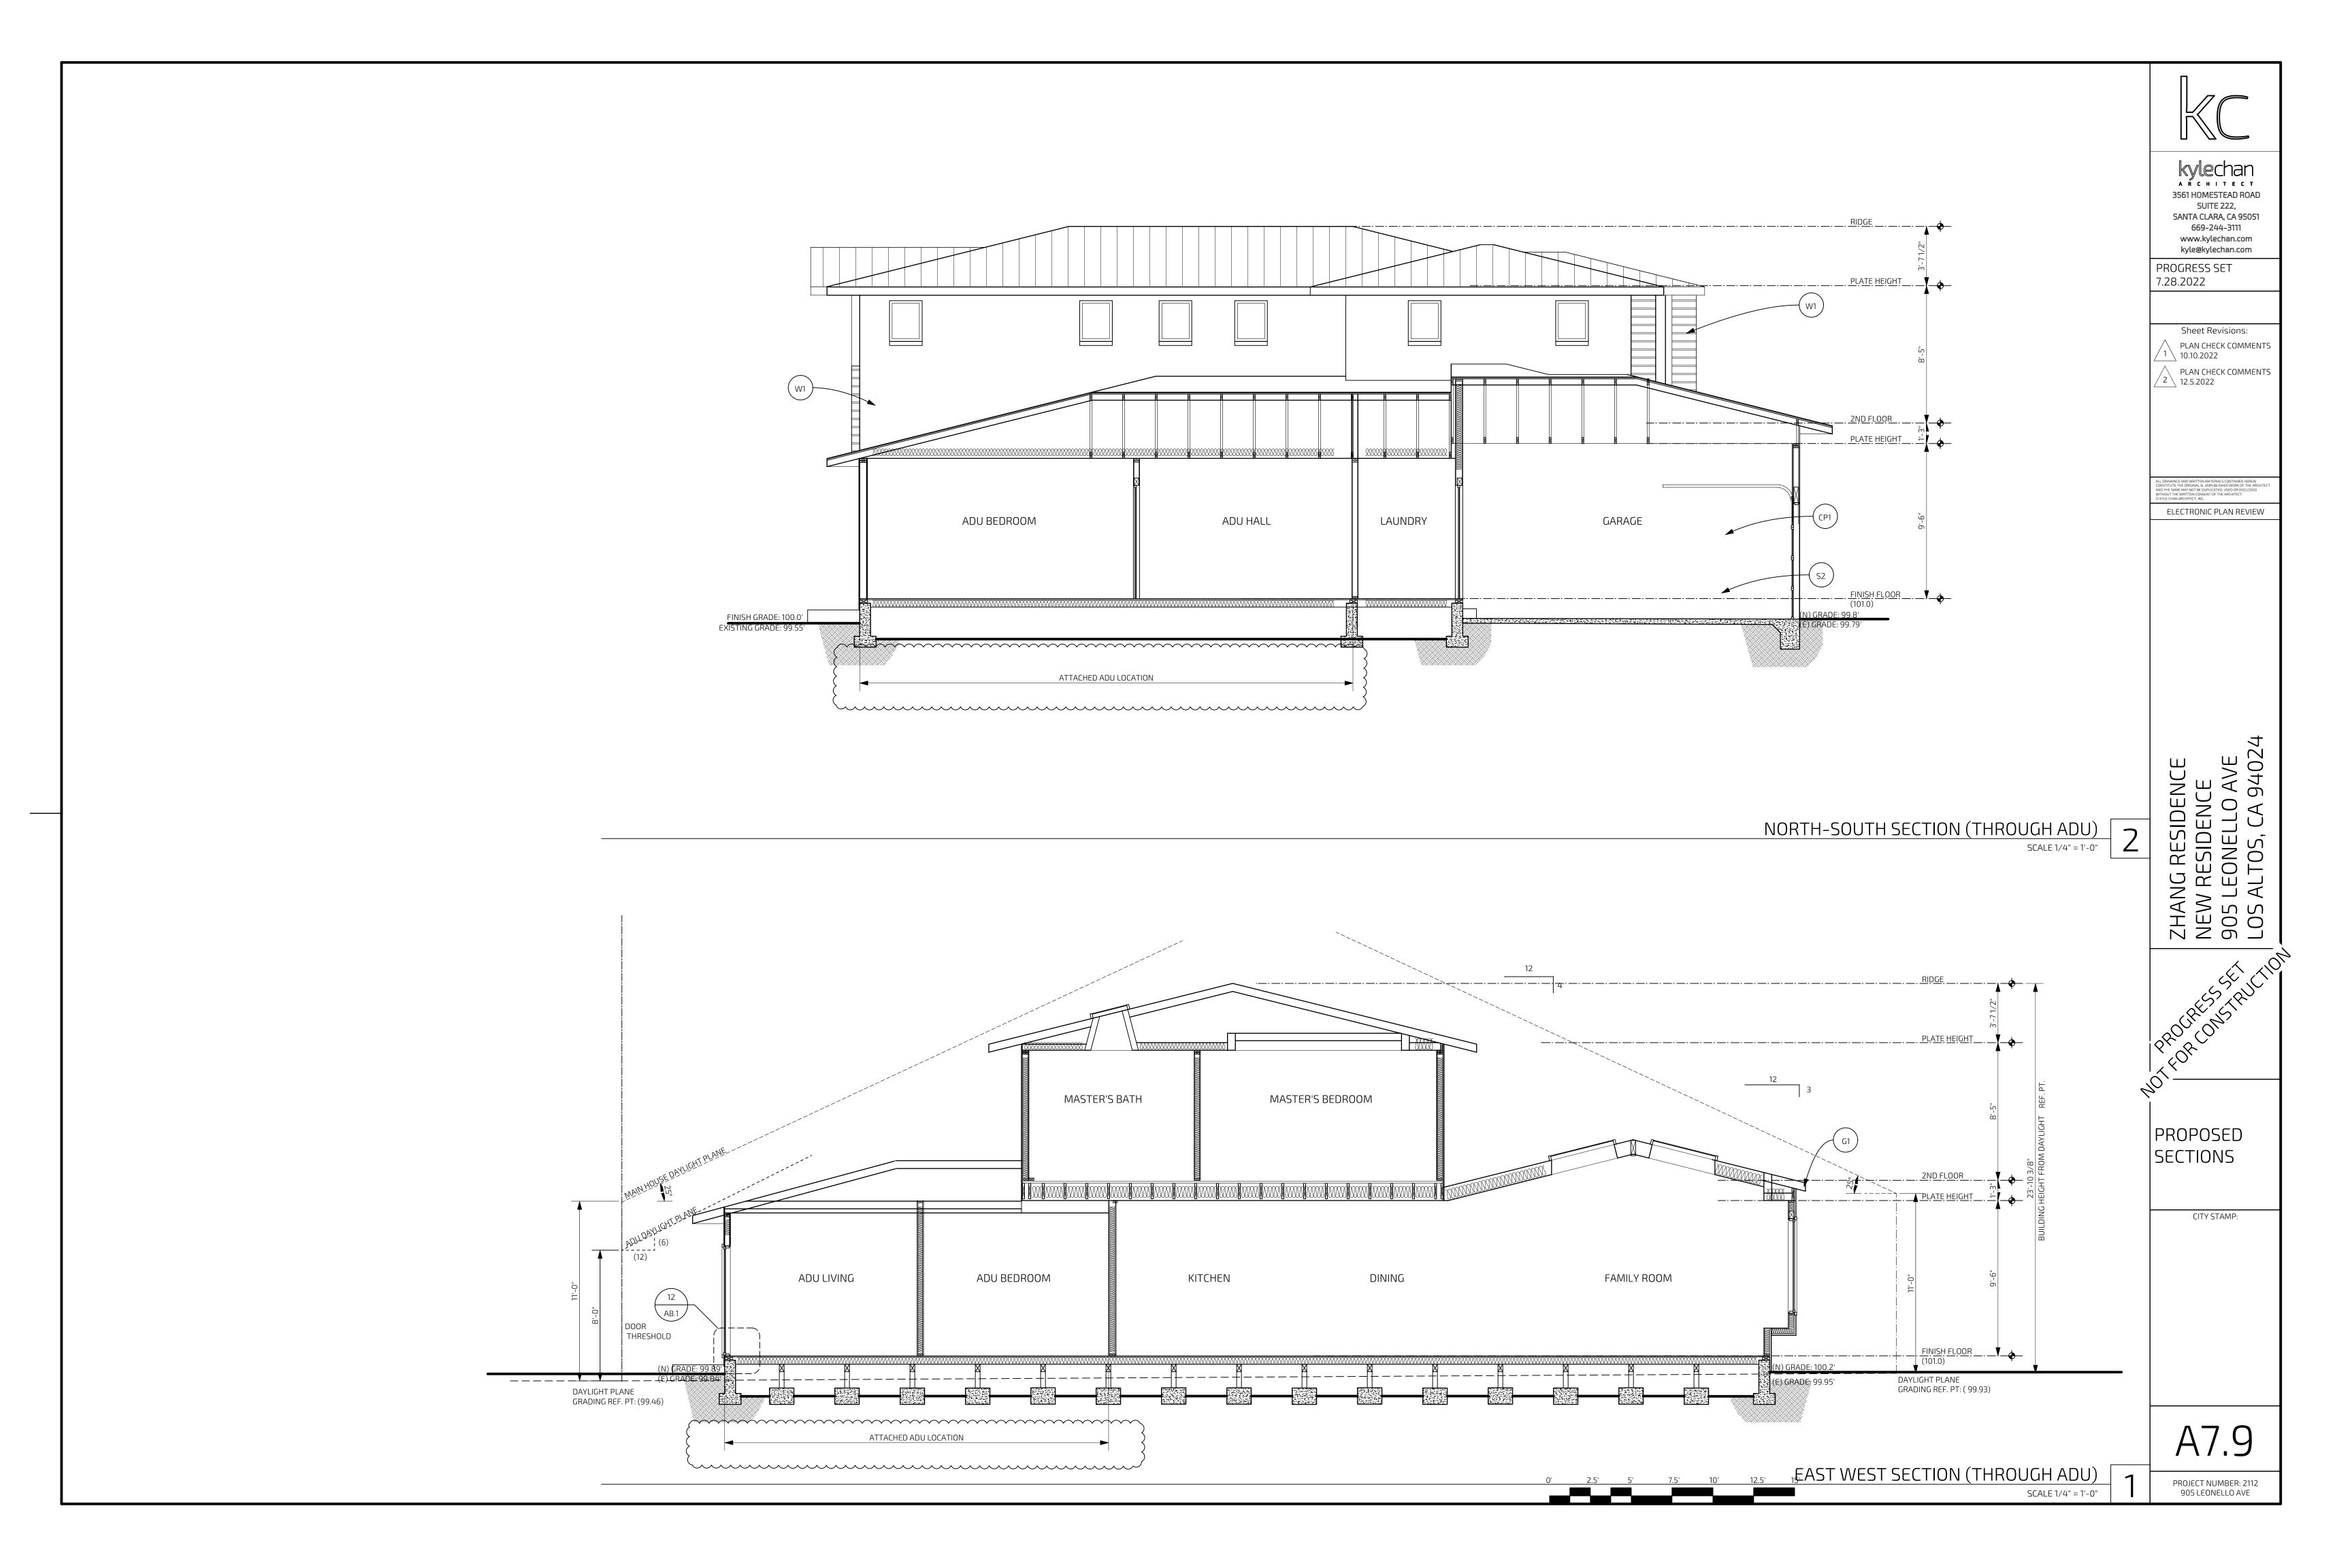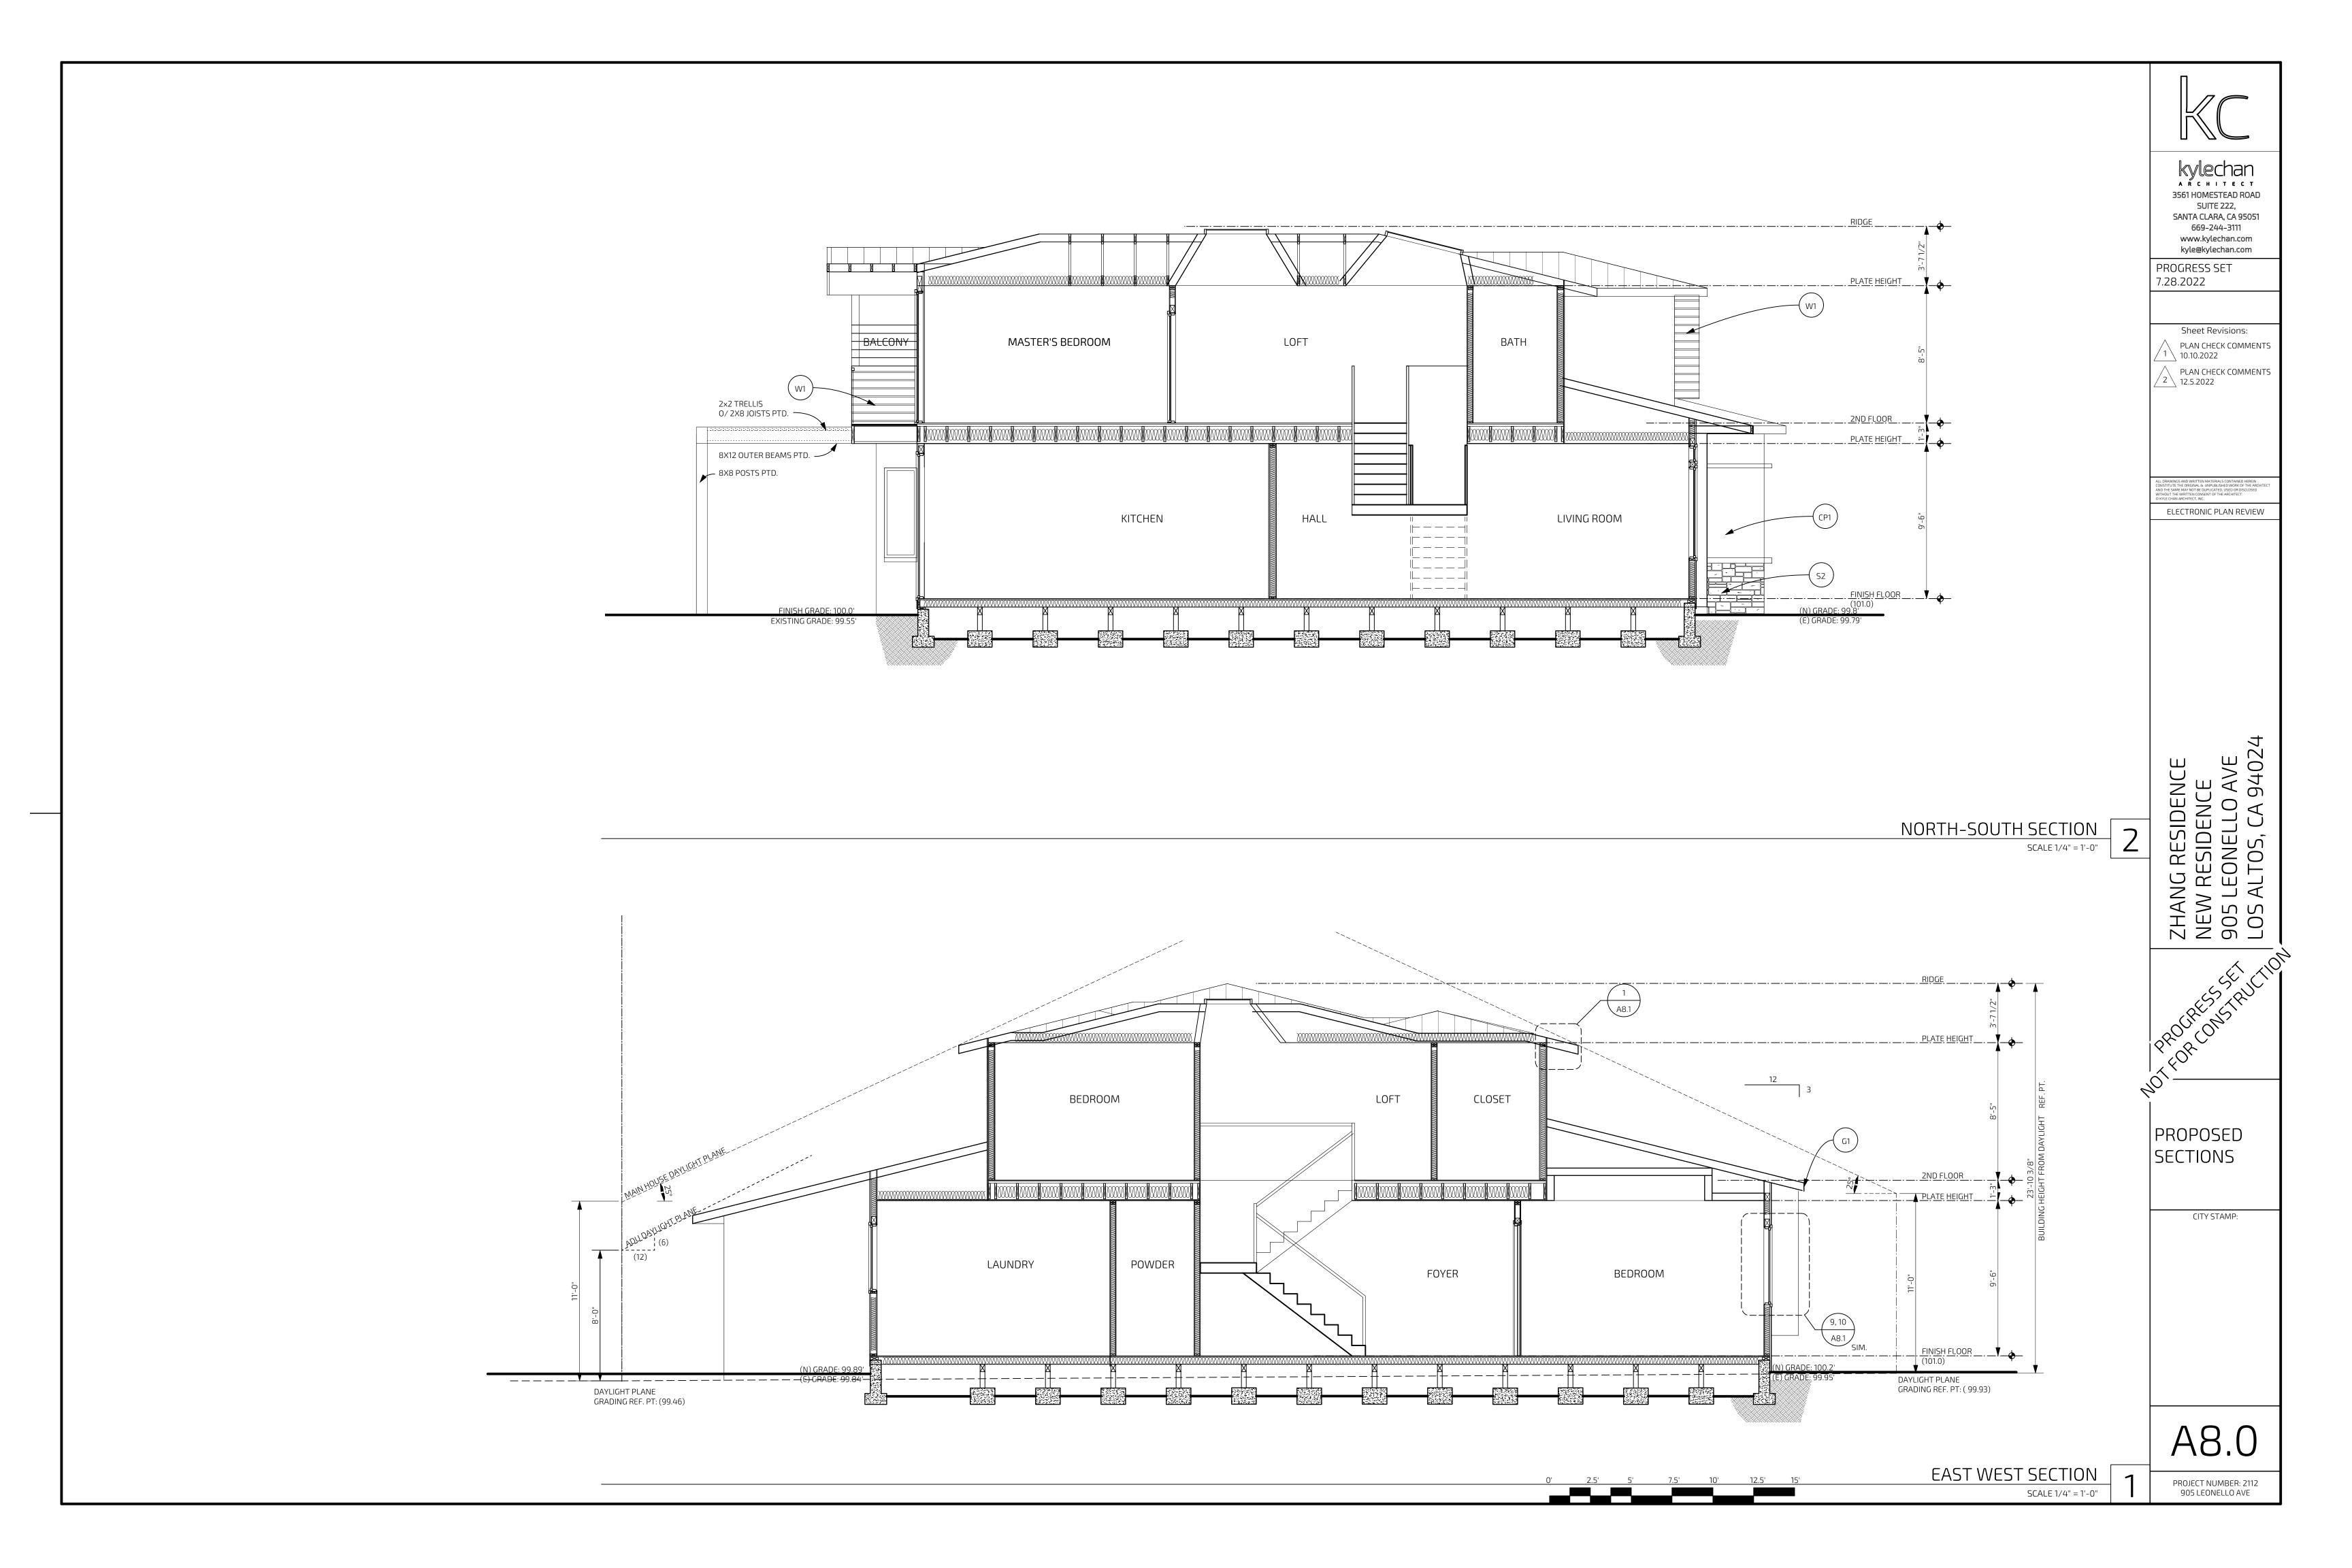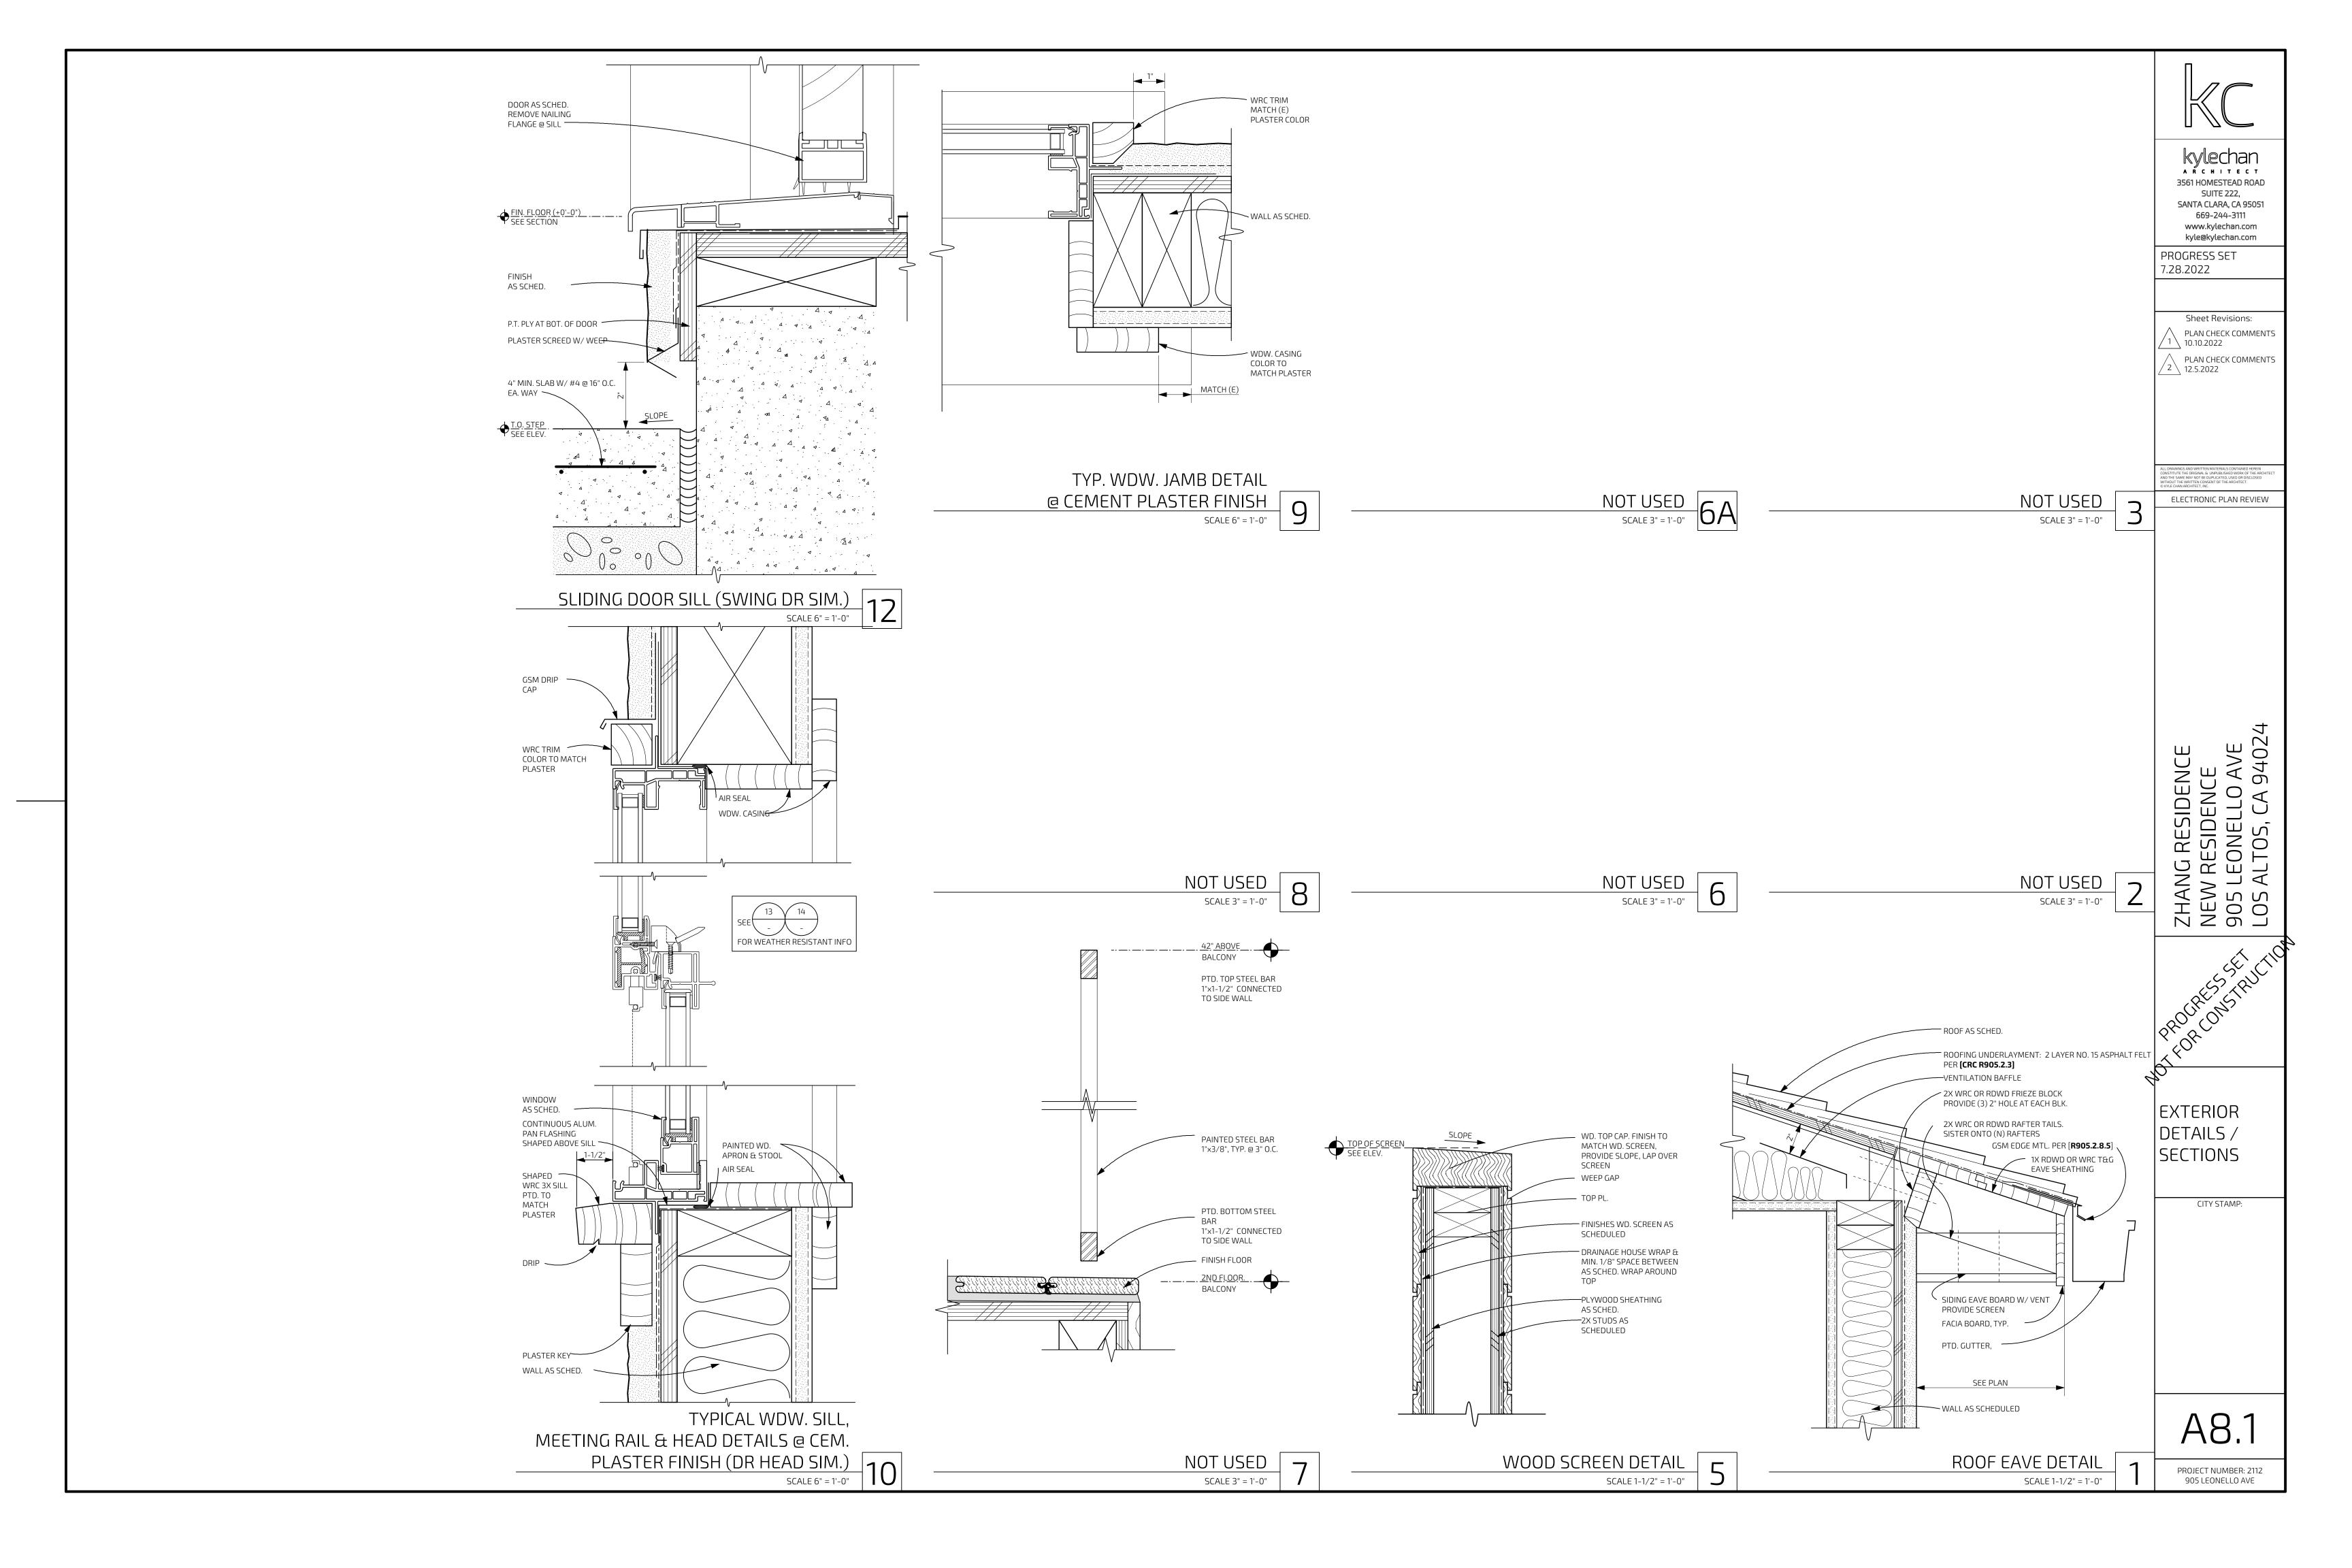DAYLIGHT PLANE GRADING REF. PT: (99.46)









Plant Legend KEY QTY SIZE SPACING WUCOLS BOTANICAL NAME COMMON NAME Mature High x Width GALLONS RATING TALL SCREENIING SHRUBS 20 - 60'x10-20' Podocarpus gracilior 15 3' - 5' Fern Pine growth rate 12" to 24" per year SHRUBS Pittosporum tobira Tree Mallow Lavatera Barnsley Echium fastuosum Pride of Madiera Westringia compacta or Morning Light VINES Trachelospermum jasminoides Star Jasmine Clytostoma callistigoides Lavender Trumpet Vine CDOLIND COVEDS

GROUND COV	/FK2	
L -	1	

L	-	1	3' - 5'	LOW	Limonium perezii	Sea Statice
EK	-	1	3' - 5'	LOW	Erigeron karvinskianus	Santa Barbara Daisy
LP	-	1	3' - 5'	LOW	Lomandra Platinum	
SL	-	1	4' - 8'	LOW	Salvia leucantha	Mexican Sage
Ν	-	1	3' - 5'	LOW	Nandina Gulf Stream	
EP	-	1	5'-7'	LOW	Euryops pectinatis	Euryops Daisy
LA	-	1	3'-6'	LOW	Lavandula - selected by owner	Lavender
D	-	1	2'-4'	LOW	Aeonium canariense Mint Sauce	er
CA	_	1	3' - 5'	LOW	Crassula ovata	Jade Plant
EP	-	1	3' - 5'	LOW	Euryops pectinatus	Euryops Daisy

Ask owners if they want to upsize some of 1 gal plants to 5 gal plants Plant quantities are for planning purposes only. Contractor to do own plant count and install all plants on plan

Planting Notes

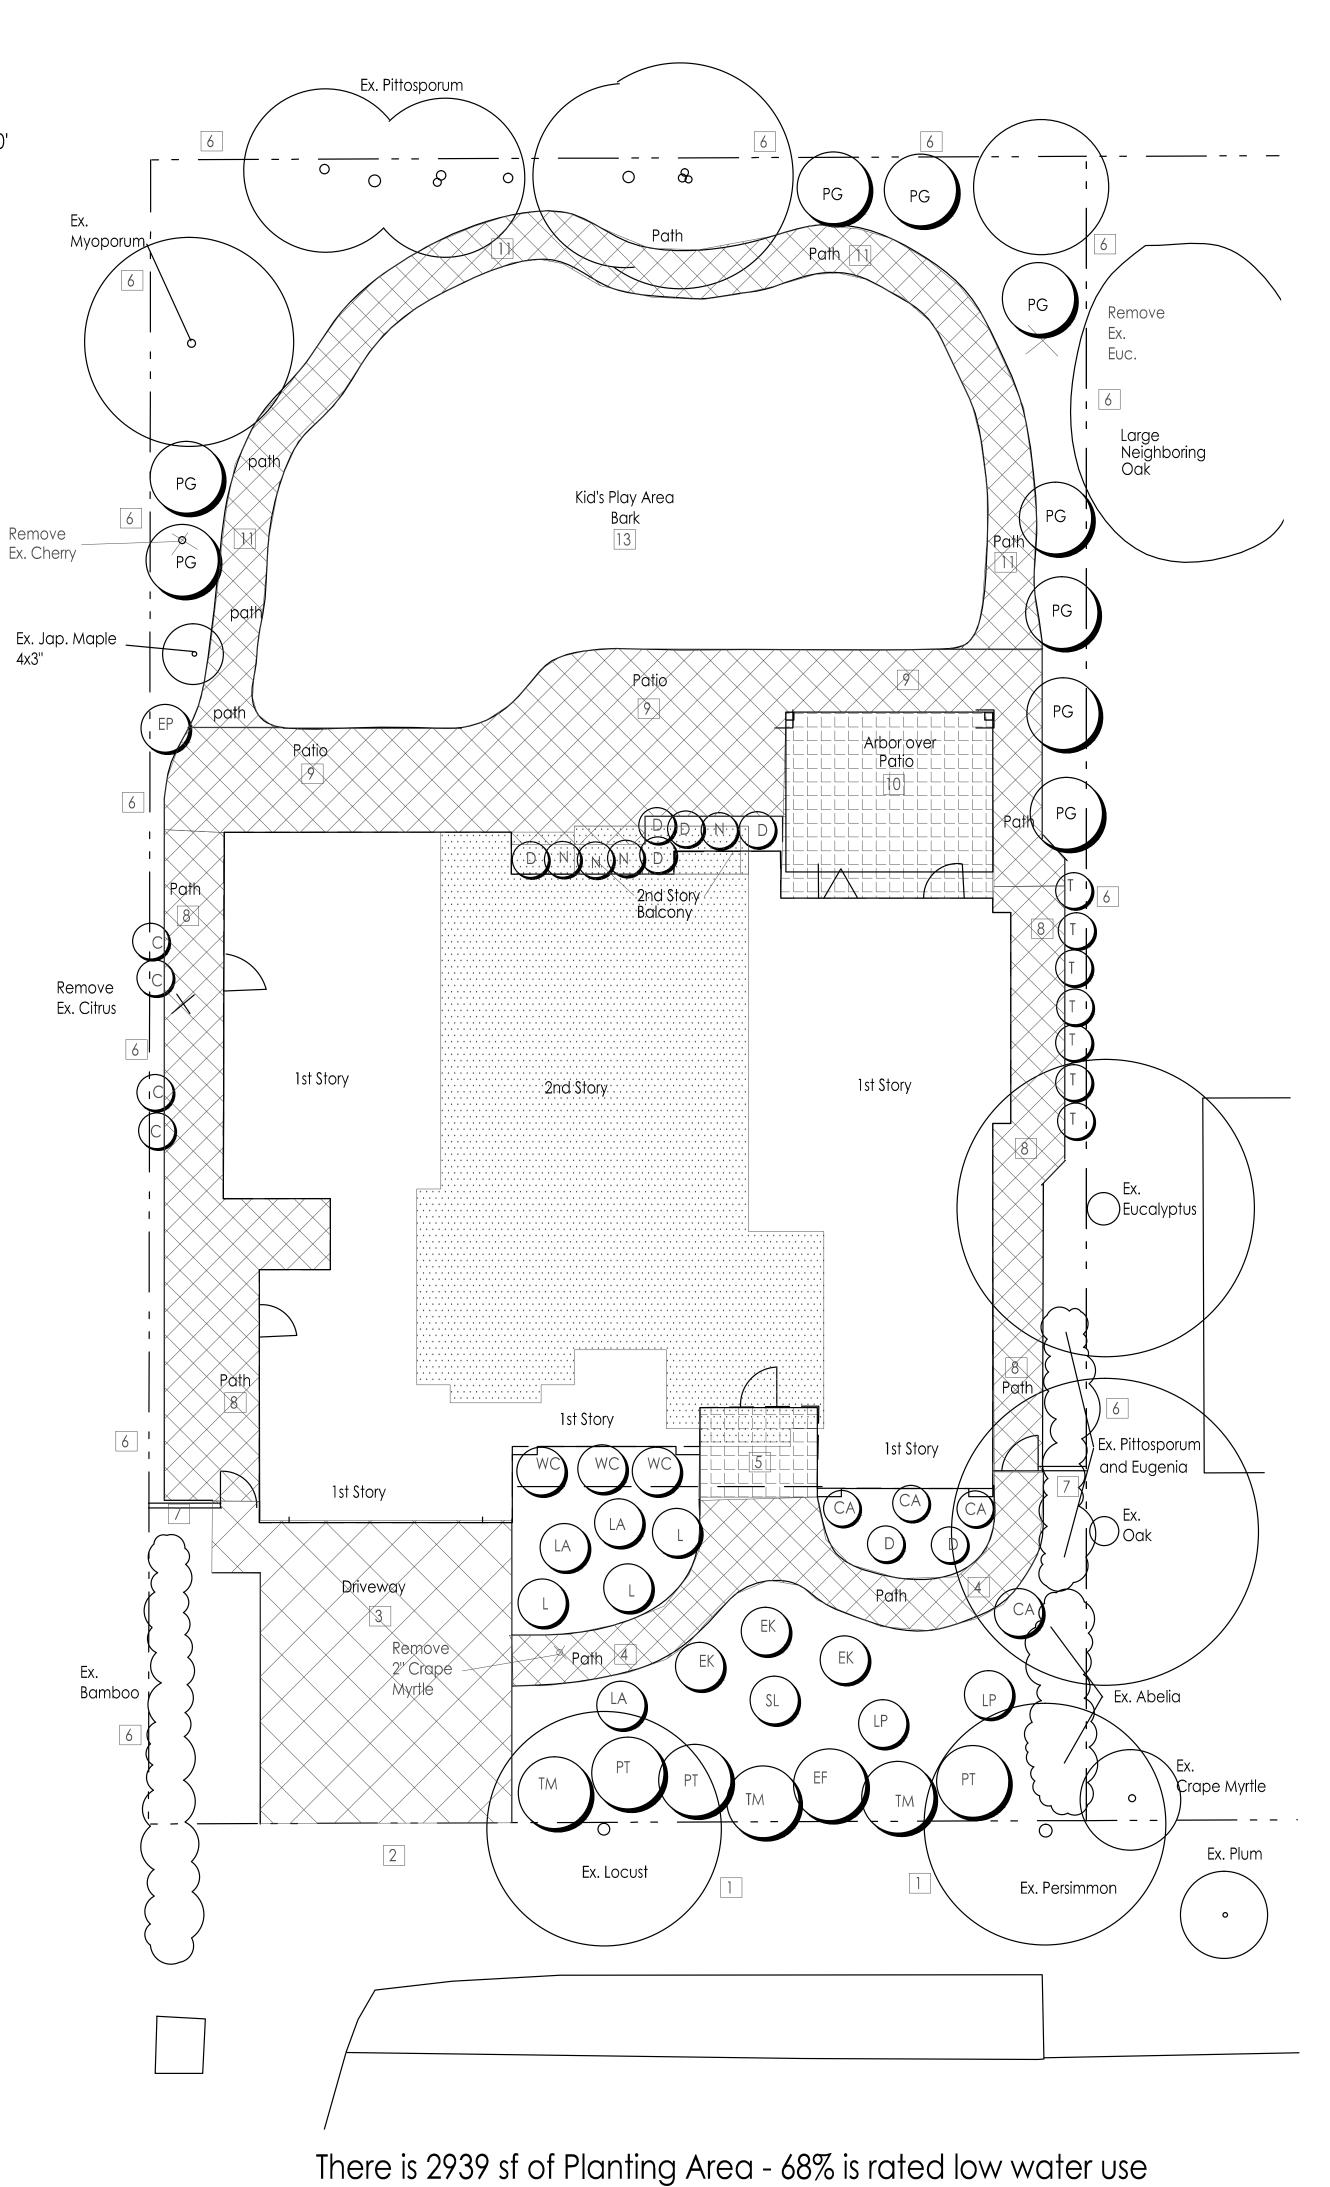
- LESS THAN 25% OF PLANTING AREA IS TURF THERE IS NO REAL TURF
- PLANTS WITH SIMILAR WATER NEEDS ARE GROUPED WITHIN HYDROZONES. EACH HYDROZONE SHALL BE CONTROLLED BY A SEPARATE GROUP OF VALVES
- AT LEAST 4 CUBIC YARDS OF COMPOST (BFI SUPER HUMUS) AND 16 POUNDS OF 12-12-12 FERTILIZER PER 1000 SF OF PLANTING AREA SHALL BE THOUROUGHLY TILLED INTO THE TOP 8 INCHES OF SOIL (EXCEPT UNDER CANOPY OF EXISTING TREES TO BE SAVED) OR FOLLOW THE AMENDMENT AND FERTILIZER RECOMMENDATIONS OF A SOIL FERTILITY TEST AND ANALYSIS FROM A SOIL LAB (HIGHLY RECOMMENDED)
- 4 INSTALL 3 INCH DEEP LAYER OF TOP DRESS MULCH ON ALL EXPOSED SOIL SURFACES OF PLANTING AREAS EXCEPT IN AREAS OF DIRECT SEEDING APPLICATION OR SOD LAWN. USE WOOD CHIP TYPE MULCH TO BE SELECTED BY OWNERS. PROVIDE SAMPLES AND PRICES PRIOR TO FINALIZING BID
- 5 GRADING SHALL BE DESIGNED TO MINIMIZE SOIL EROSION, RUN-OFF AND WATER WASTE ADDITIONAL
- 6 FINAL CONSTRUCTION DRAWINGS TO INCLUDE PLANTING AND IRRIGATION DETAILS AND **SPECIFICATIONS**
- 7 DON'T TRENCH TOO CLOSE TO STRUCTURES WITHOUT THE APPROVAL OF THE BUILDING ARCHITECT, CIVIL, OR STRUCTURAL ENGINEER
- 8 PRIOR TO ORDERING PLANTS OR SIGNING FINAL CONTRACT FOR WORK MAKE SURE YOU HAVE THE MOST CURRENT SET OF APPROVED PLANS AND MAKE SURE THERE ARE NO CHANGES TO THE PLANT CHOICES
- 9 ADJUST FINAL LOCATIONS OF PLANTS TO AVOID CONFLICTS WITH UTILITIES, LIGHTS, AND IRRIGATION COMPONENTS. SCREEN VALVES AND UTILITIES WITH PLANTS. DON'T PUT PLANTS TOO CLOSE TO PAVING OR BUILDINGS
- 10 GRADING AND DRAINAGE TO BE DONE ACCORDING TO THE APPROVED GRADING AND DRAINAGE PLANS DONE BY



Existing Pittosporum and Myoporum North and East rear yard Landscape Screening



Existing Pittosporum and neihboring Oak South East area of rear yard Landscape Screen



Landscape Site Legend

- Compacted baserock and gravel in ROW for parking
- AC paving in ROW to connect road to driveway
- Driveway Interlocking pavers manuf., style, pattern, and color to be selected by owners
 - Front walk Interlocking pavers a little different than driveway but complimentary to it- manuf., style, pattern, and color to be selected by owners
- Front porch tile on concrete base or plain conc. finish and pattern to be selected by owner
- Existing solid redwood 6' + 1' lattice fence
- New solid redwood 6' + 1' lattice fence with matching gate
- Side yard paths Interlocking pavers same as front
- Rear Patio Conc. interlocking pavers to be selected by
- Covered Patio tile on concrete base or plain conc. finish and pattern to be selected by owner
- Path way Interlocking pavers same as front

12

Kid's Play Area - bark

Impervious Paving in Front Yard Setback

Total Area in Front Yard Setback 78' x25' = 1950 sf

Driveway = 540.6 sfFront walk = 218 sf

Total impervious = 758.6 sf 758.6/1950 = 38.9% OK

Landscape Screening

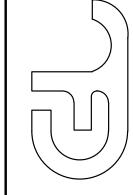
- 1 Along the rear fence there are mature, tall Pittosporum. We are filling a gap with
- 2 Along the north fence in the rear yard there is a mature Myoporum tree and a Japanese Maple. We are adding Podocarpus between them.
- 3 On the south east side of the rear yard there is a large Oak next door and a large eucalyptus next door on the south side of the proposed house. we are adding some Podocarpus

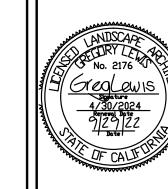


Landscape Screening Podocarpus gracilior

Revision

LANDSCAPE





<u>S</u>: 905

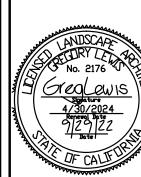
1/8" = 1'-0" 0' 4' 8'

LANDSCAPE SITE PLAN PLANTING & SCREENING

Revision

GREGORY LEWIS LANDSCAPE ARCHITECT 736 Park Way Santa Cruz, CA 95065 (831) 359-0960 lewislandscape@sbcglobal.net





Los Altos, esidenc Ave., Δ 905 Leonello Ne≪

1/8" = 1'-0" 0' 4' 8'

LANDSCAPE SCREENING PLAN


ote 7/18/22 As Noted

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Existing Pittosporum and Myoporum

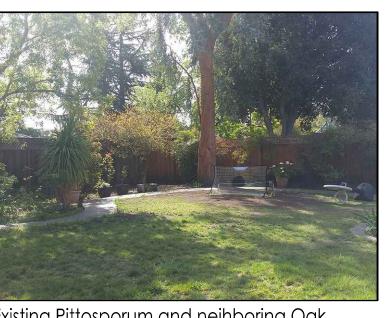North and East rear yard Landscape Screening



Existing Pittosporum and neihboring Oak
South East area of rear yard Landscape Screen