

# LANSING 5MW (AC)/6.25MW(DC) PV SYSTEM 528 LANSINGVILLE RD, LANSING NY 14882

**UTILITY SUBMISSION - MAY 24, 2022** 



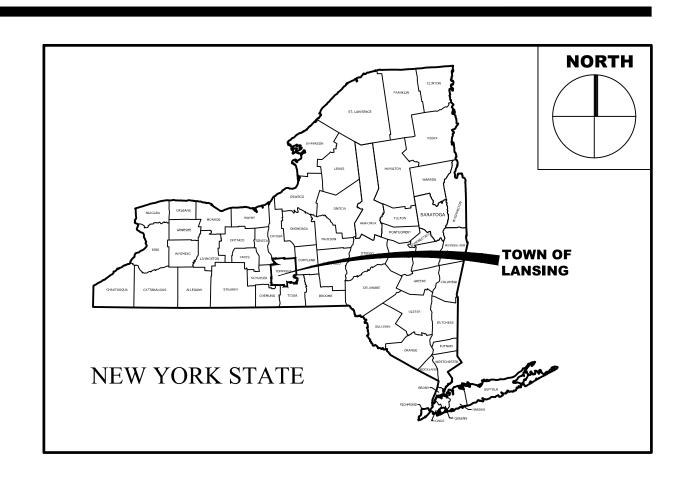

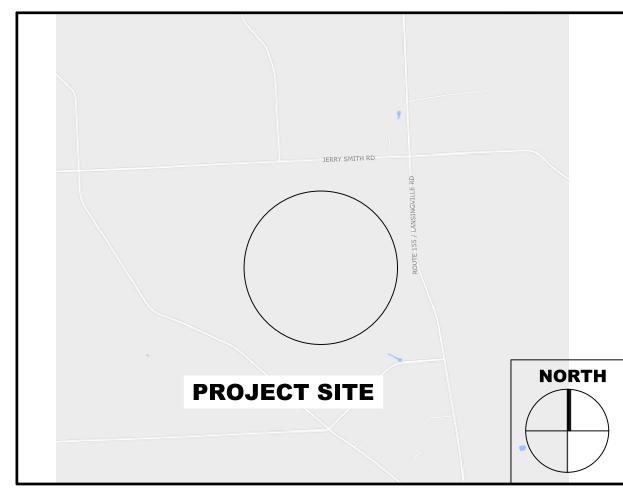

**SITE LOCATION MAP** 

## **DRAWING LIST**

		<b>–</b>
SHEET ID	SHEET TITLE	SHEET NUMBER
G-001	COVER PAGE	1
E-101	ELECTRICAL SITE PLAN	2
E-601	ELECTRICAL ONE-LINE DIAGRAM	3
E-602	ELECTRICAL THREE-LINE DIAGRAM	4
E-603	ELECTRICAL SCHEDULES	5

# **UTILITY SUBMISSION**

### © **2022**

C.T. MALE ASSOCIATES


WARNING: IT IS A VIOLATION OF THE LAW FOR ANY PERSON, UNLESS ACTING UNDER THE DIRECTION OF A LICENSED ARCHITECT, TO ALTER AN ITEM IN ANY WAY. IF AN ITEM BEARING THE SEAL OF AN ARCHITECT IS ALTERED, THE ALTERING ARCHITECT SHALL AFFIX TO HIS ITEM THE SEAL AND THE NOTATION "ALTERED BY" FOLLOWED BY HIS SIGNATURE AND THE DATE OF SUCH ALTERATION, AND A SPECIFIC DESCRIPTION OF THE ALTERATION. ARCHITECTURE
- COMMISSIONER'S REGULATIONS PART 69.5.

WARNING: IT IS A VIOLATION OF THIS LAW FOR ANY PERSON, UNLESS HE IS ACTING UNDER THE DIRECTION OF A LICENSED PROFESSIONAL ENGINEER OR LAND SURVEYOR, TO ALTER AN ITEM IN ANY WAY. IF AN ITEM BEARING THE SEAL OF AN ENGINEER OR LAND SURVEYOR IS ALTERED, THE ALTERING ENGINEER OR LAND SURVEYOR SHALL AFFIX TO THE ITEM HIS SEAL AND THE NOTATION "ALTERED BY" FOLLOWED BY HIS SIGNATURE AND THE DATE OF SUCH ALTERATION, AND A SPECIFIC DESCRIPTION OF THE ALTERATION. PROFESSIONAL ENGINEERING AND LAND SURVEYING - ART. 145,

# C.T. MALE ASSOCIATES

Engineering, Surveying, Architecture, Landscape Architecture & Geology, D.P.C.


50 CENTURY HILL DRIVE, LATHAM, NY 518.786.7400 COBLESKILL, NY • GLENS FALLS, NY • POUGHKEEPSIE, NY JOHNSTOWN, NY • RED HOOK, NY • SYRACUSE, NY

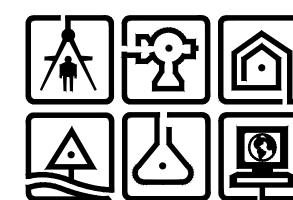

PROJECT NO. 22.2303 DRAWING NO.

G-001

SHEET 1 OF 5

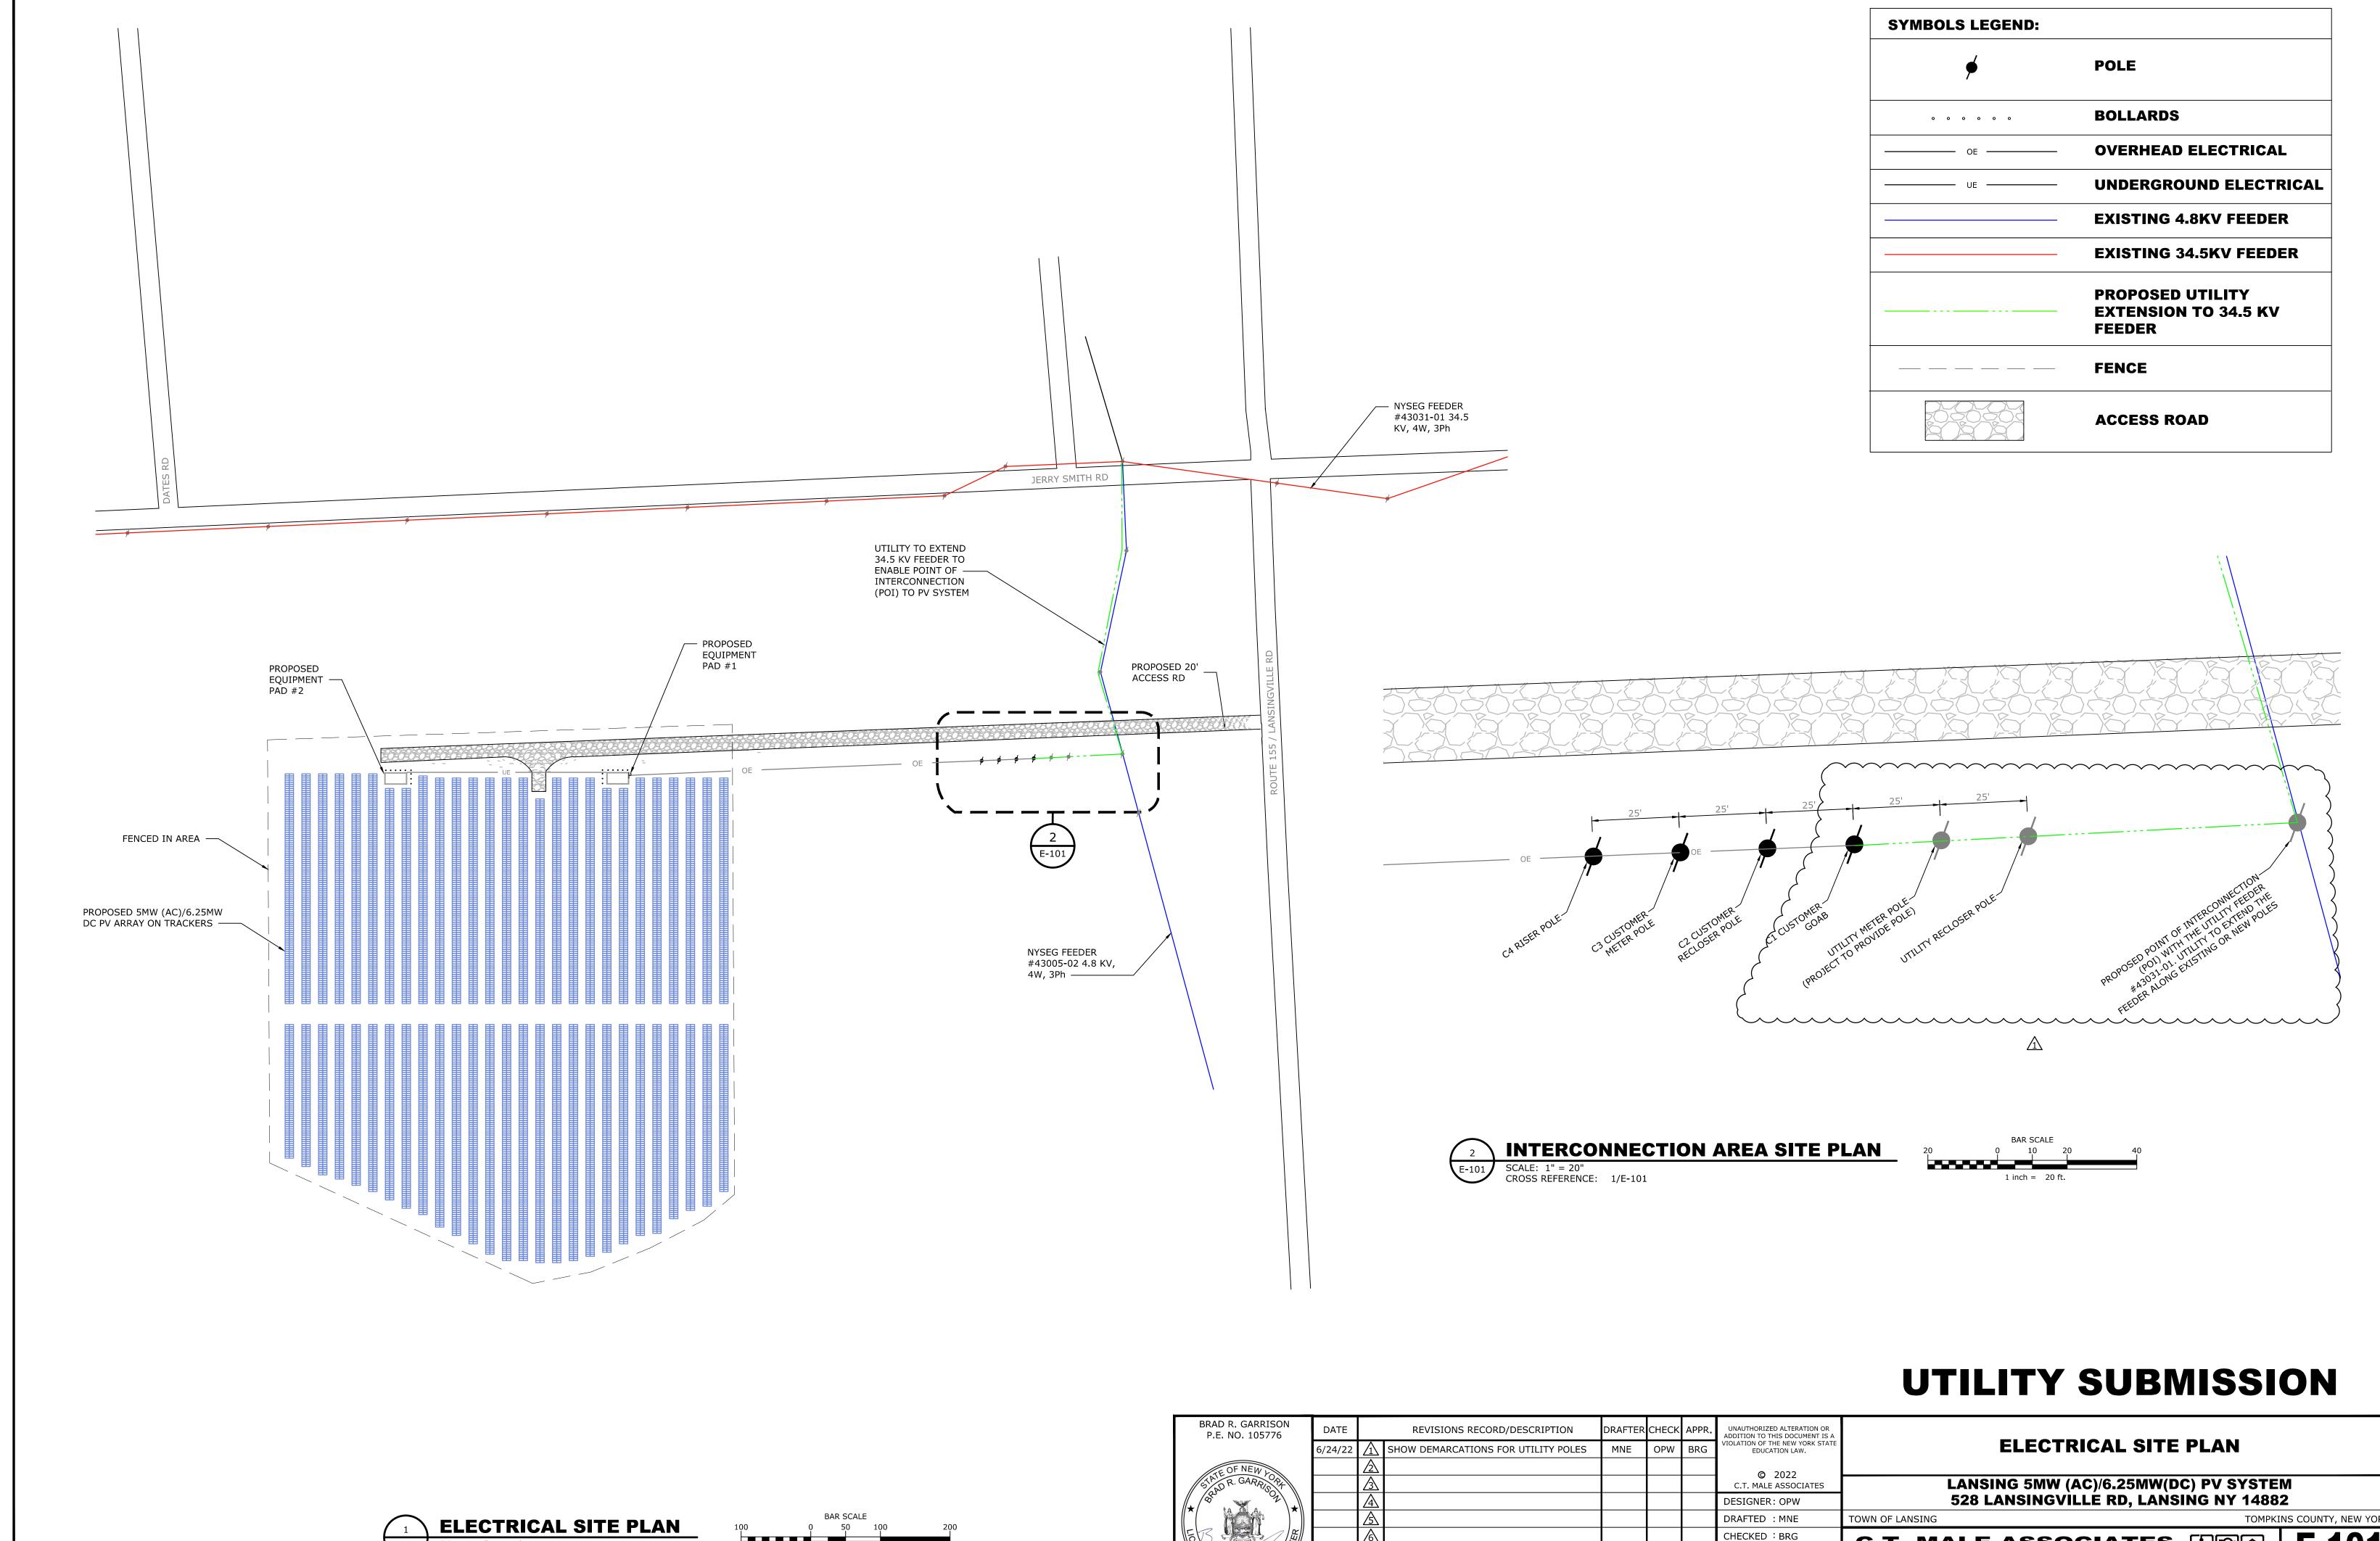


SCALE: 1" = 100' CROSS REFERENCE: NONE

1 inch = 100 ft.

DWG. NO: 22-2303

PROJ. NO : 22.2303

SCALE: AS NOTED

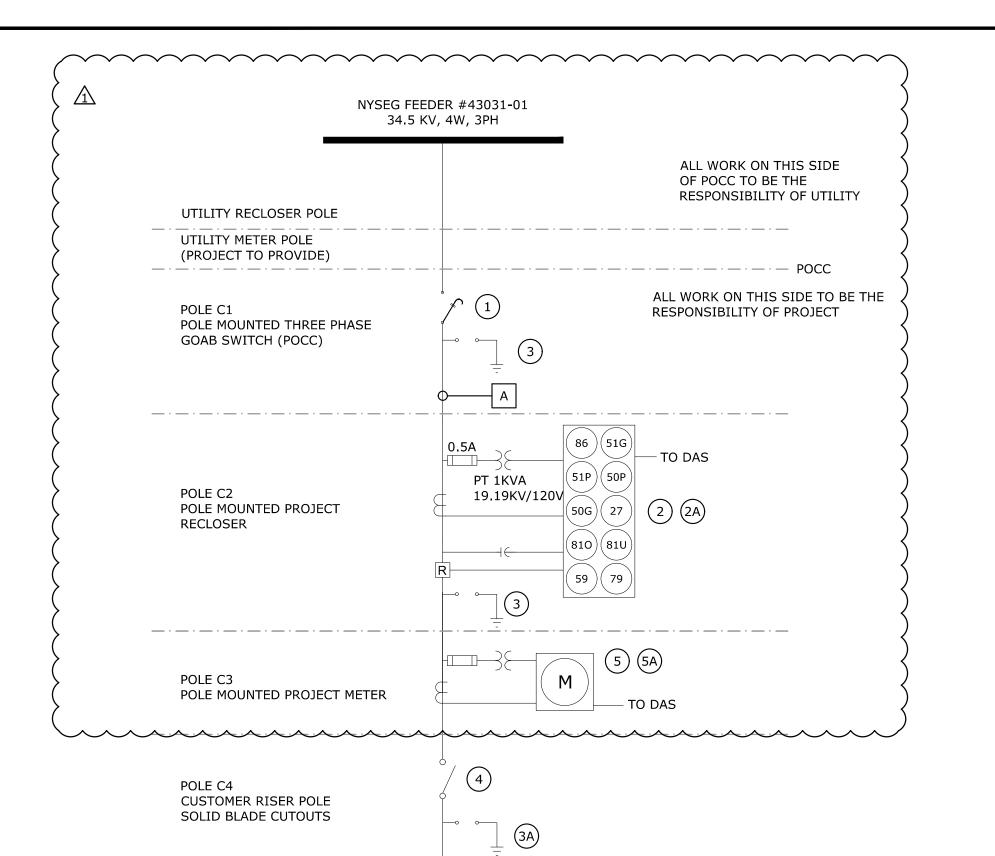

PAD MOUNTED ZIG-ZAG

GROUNDING TRANSFORMER

334KVA, 13.2KV, Z=4%, X/R=4

SWBD-01

6

4000A, 600/346V, 3PH, 4W

(TYP OF 19)

INV-1-19

125KW

1500VCD

		PROTEC	TIVE REL	AY SETTI	NGS						
TRIP FUNCTIONS				VOLTAGE SETTINGS							
		REQUIRED VOLTAGE PICKUP	TRIR CETTING 0/	TRIP SETTING (PRIMARY	TOTAL CLEARING TIME	RELAY TD					
FUNCTION	ANSI	RANGE	TRIP SETTING %	VOLTS)	(SECONDS)	(SECONDS)	(CYCLES)	(SECONDS)	(CYCLES)		
UNDERVOLTAGE 1	27	V < 50%	50%	9959.3	1.10	1.05	63.00	0.05	3.00		
JNDERVOLTAGE 2	27	50% ≤ V ≤ 88%	88%	17528.4	17528.4 2.00		117.00	0.05	3.00		
OVERVOLTAGE PHASE 1	59P	110% < V < 120%	110%	21910.4	2.00	1.95	117.00	0.05	3.00		
OVERVOLTAGE PHASE 2	59P	V > 120%	120%	23902.3	0.16	0.11	6.50	0.05	3.00		
TRIP FUNCTIONS				FREQUENCY	SETTINGS						
		REQUIRED FREQUENCY	TRIP SETTING (HERTZ)	TOTAL CLEARING TIME	RELAY	TD	G&W V	IPER ST			
FUNCTION	ANSI	PICKUP RANGE	THE SETTING (TERTE)	(SECONDS)	(SECONDS)	(CYCLES) (SECONDS)		(CYCLES)			
UNDERFREQUENCY 1	81U	≤ 56.5 HZ	56.5	0.16	0.11	6.25	0.05	3.00			
UNDERFREQUENCY 2	81U	≤ 58.5 HZ	58.5	300.00	299.94 17546.75 299.94 18356.50		0.05	3.00			
OVERFREQUENCY 1	810	61.2 HZ ≤ F < 62 HZ	61.2	300.00			0.05	3.00			
OVERFREQUENCY 2	810	> 62 HZ	62.0	0.16	0.11	6.75 0.05 3.00	3.00				
TRIP FUNCTIONS			OVERCURREI	NT SETTINGS							
FUNCTION		TAP	CURRENT (A)	CURVE	TIME DIAL	TIME DELAY (CYC)					
TIME OVERCURRENT PHASE	51P	0.52	104.59	U4	0.50	0					
TIME OVERCURRENT GROUND	51G	0.13	25.00	U4	0.50	0					
FUNCTION		ТАР	CURRENT (A)	TIME DELAY (CYC)							
TIME OVERCURRENT PHASE	50P	4.18	836.70	0.00							
TIME OVERCURRENT GROUND	50G	1.25	250.00	0.00							
TRIP FUNCTIONS		AUTO RECLOSE	SETTINGS								
FUNCTION	ANSI	TIME DELAY (S)	TIME DELAY (CYC)								
RECLOSING	79	300	18000								

- TO DAS

15A, 2P

CONTROL POWER PANEL-02

5KVA

600V/240**-**120V

30A

15A, 1P

15A, 1P

XFMR-02

2500KVA

600V/346V

Z=5.75%

X/R=6

125KW

INV-40

1500VCD

4000A

SWBD-02

CUSTOMER

METER

UTILITY RECEPTACLE

15A, 1P

15A, 1P

4000A, 600/346V, 3PH, 4W

(TYP OF 19)

INV-21-39

125KW

1500VCD

12

34.5KV/19.9KV

## **SYMBOLS LEGEND:**

— · — · — DEMARKS SEPARATION BETWEEN POLES — — — COMMUNICATION (NON-POWER) CONNECTION ———— POWER CONNECTION — · — · — EQUIPMENT ENCLOSURE CIRCUIT BREAKER

SOLID BLADE CUTOUT

FUSED CUTOUT

INVERTER SURGE ARRESTER

TRANSFORMER

WYE - GROUNDED

CABLE TAG - SEE SHEET E-603

EQUIPMENT TAG - SEE SHEET E-603

14 OR 15

6.252

5.000

## **NOTES:**

- 1. INTERCONNECTION UTILITY COMPANY IS NYSEG.
- 2. ALL EQUIPMENT ON THE LINE SIDE OF THE POINT OF COMMON COUPLING (POCC) IS TO BE PROVIDED AND INSTALLED BY NYSEG, UNLESS NOTED OTHERWISE.
- 3. INTERCONNECTION DETAILS E.G. LOCATIONS OF EQUIPMENT, SCOPE OF RESPONSIBILITY, TESTING REQUIREMENTS, ARE SUBJECT TO CHANGE AND NOT FINAL UNTIL APPROVED BY NYSEG.
- 4. PROJECT GOAB SWITCH SHALL BE READILY ACCESSIBLE (24/7) AND EQUIPPED WITH DOUBLE LOCKS FOR OPERATION EITHER BY THE PROJECT OR BY NATIONAL GRID.
- 5. PROTECTIVE RELAYS SHALL BE PROVIDED WITH DC BATTERY BACKUP AND FAIL-SAFE TRIP CHARGED FROM AC AUXILIARY POWER.
- 6. CONDUCTORS SIZED AS PER THE NEC 2017 REQUIREMENTS.
- 7. CUSTOMER ELECTRICAL EQUIPMENT WILL BE SERVICE ENTRANCE RATED AS IS REQUIRED BY NYSEG ESB 756B (7.2.1).
- 8. PV SYSTEM WILL HAVE A 5-MINUTE HEALTHY GRID RECONNECT FEATURE PROGRAMMED INTO THE RECLOSER. THIS WILL BE PROGRAMMED INTO THE RECLOSER TO DEFEAT THE CLOSE BUTTON AND BLOCK CLOSE UNTIL THE 5 MINUTE TIMER HAS COMPLETED. SETTINGS WILL BE PER IEEE 1547 SECTION 4.2.6 FOR 5 MINUTES. VOLTAGES WILL BE SET WITHIN ANSI C84.1 TABLE 1, RANGE B (6.84KV - 7.56KV ON 7.2KV BASE) AND FREQUENCY WILL BE WITHIN 59.3-60.5HZ. THE 5 MINUTE TIME INTERVAL WILL RESTART IF VOLTAGE OR FREQUENCY FALLS OUT OF THIS WINDOW.
- 9. PROTECTIVE RELAY ALARM CIRCUIT TO BE WIRED OR PROGRAMMED TO TRIP SWITCH FOR REDUNDANCY PER NYSEG REQUIREMENTS. THIS IS RELAY FAIL SAFE PROTECTION. FOR RECLOSER THE ALARM WORD BIT IS USED TO TRIP (AND BLOCK CLOSE) ON LOSS OF DC POWER AND ON RELAY FAULURES. BTFAIL IS USED FOR BATTERY FAILURE. LOSS OF 120VAC POWER TO THE RELAY WILL TRIP AND BLOCK/CLOSE. TRIP WILL BE IN LESS THAN 2.0 SECONDS.
- 10. GROUNDING TRANSFORMER IS PROTECTED BY RELAY (51G, WHICH IS ALSO USED FOR UTILITY PROTECTION), AND CAN ONLY BE DISCONNECTED BY RELAY.
- 11. INVERTER VOLTAGE AND FREQUENCY OUT-OF-RANGE DISCONNECTION TO BE IN ACCORDANCE WITH THE

#### **PROJECT SUMMARY** PRISM SOLAR, PV MODULE MAKE / MODEL PST-445W-M72H STC MODULE POWER (WP) 445 QTY OF MODULES 14050 CHINT CPS INVERTER MAKE / MODEL SCH125KTL-DO/US-600 INVERTER NAMEPLATE (KW) 125 QTY OF INVERTERS 40 25 MODULES PER STRING


STRINGS PER INVERTER

TOTAL DC POWER RATING (MWDC)

TOTAL AC POWER RATING (MWAC)

# **UTILITY SUBMISSION**

**ELECTRICAL ONE-LINE DIAGRAM** 

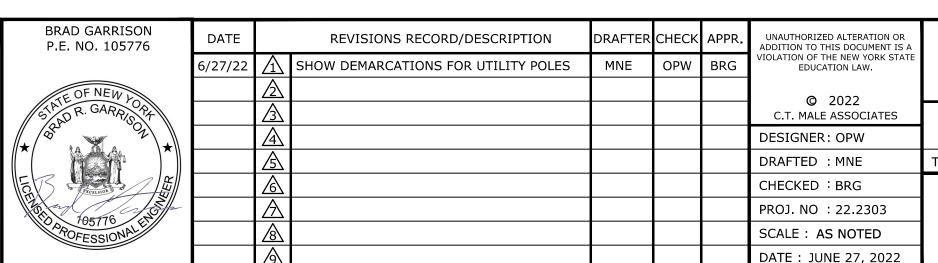

- DAS (8)

- UTILITY RECEPTACLE

	LANSING 5MW (AC)/6.25MW(DC) 528 LANSINGVILLE RD, LANSING		
ANSING		TOMPKI	NS COUNTY, NEW YOR
	ALE ASSOCIATES D		E CO4

C.T. MALE ASSOCIATES Engineering, Surveying, Architecture, Landscape Architecture & Geology, D.P.C. 50 CENTURY HILL DRIVE, LATHAM, NY 12110 PH: 518.786.7400 COBLESKILL, NY • GLENS FALLS, NY • POUGHKEEPSIE, NY

JOHNSTOWN, NY • RED HOOK, NY • SYRACUSE, NY

E-601 DWG. NO: 22-2303

- TO DAS

) 15A, 2P

**CONTROL POWER PANEL-01** 

5KVA

| 600V/240**-**120V

2500KVA

600V/346V

Z=5.75% X/R=6


125KW

1500VCD

INV-20

34.5 KV/19.9KV

## **ELECTRICAL ONE-LINE DIAGRAM** SCALE: NONE CROSS REFERENCE: NONE

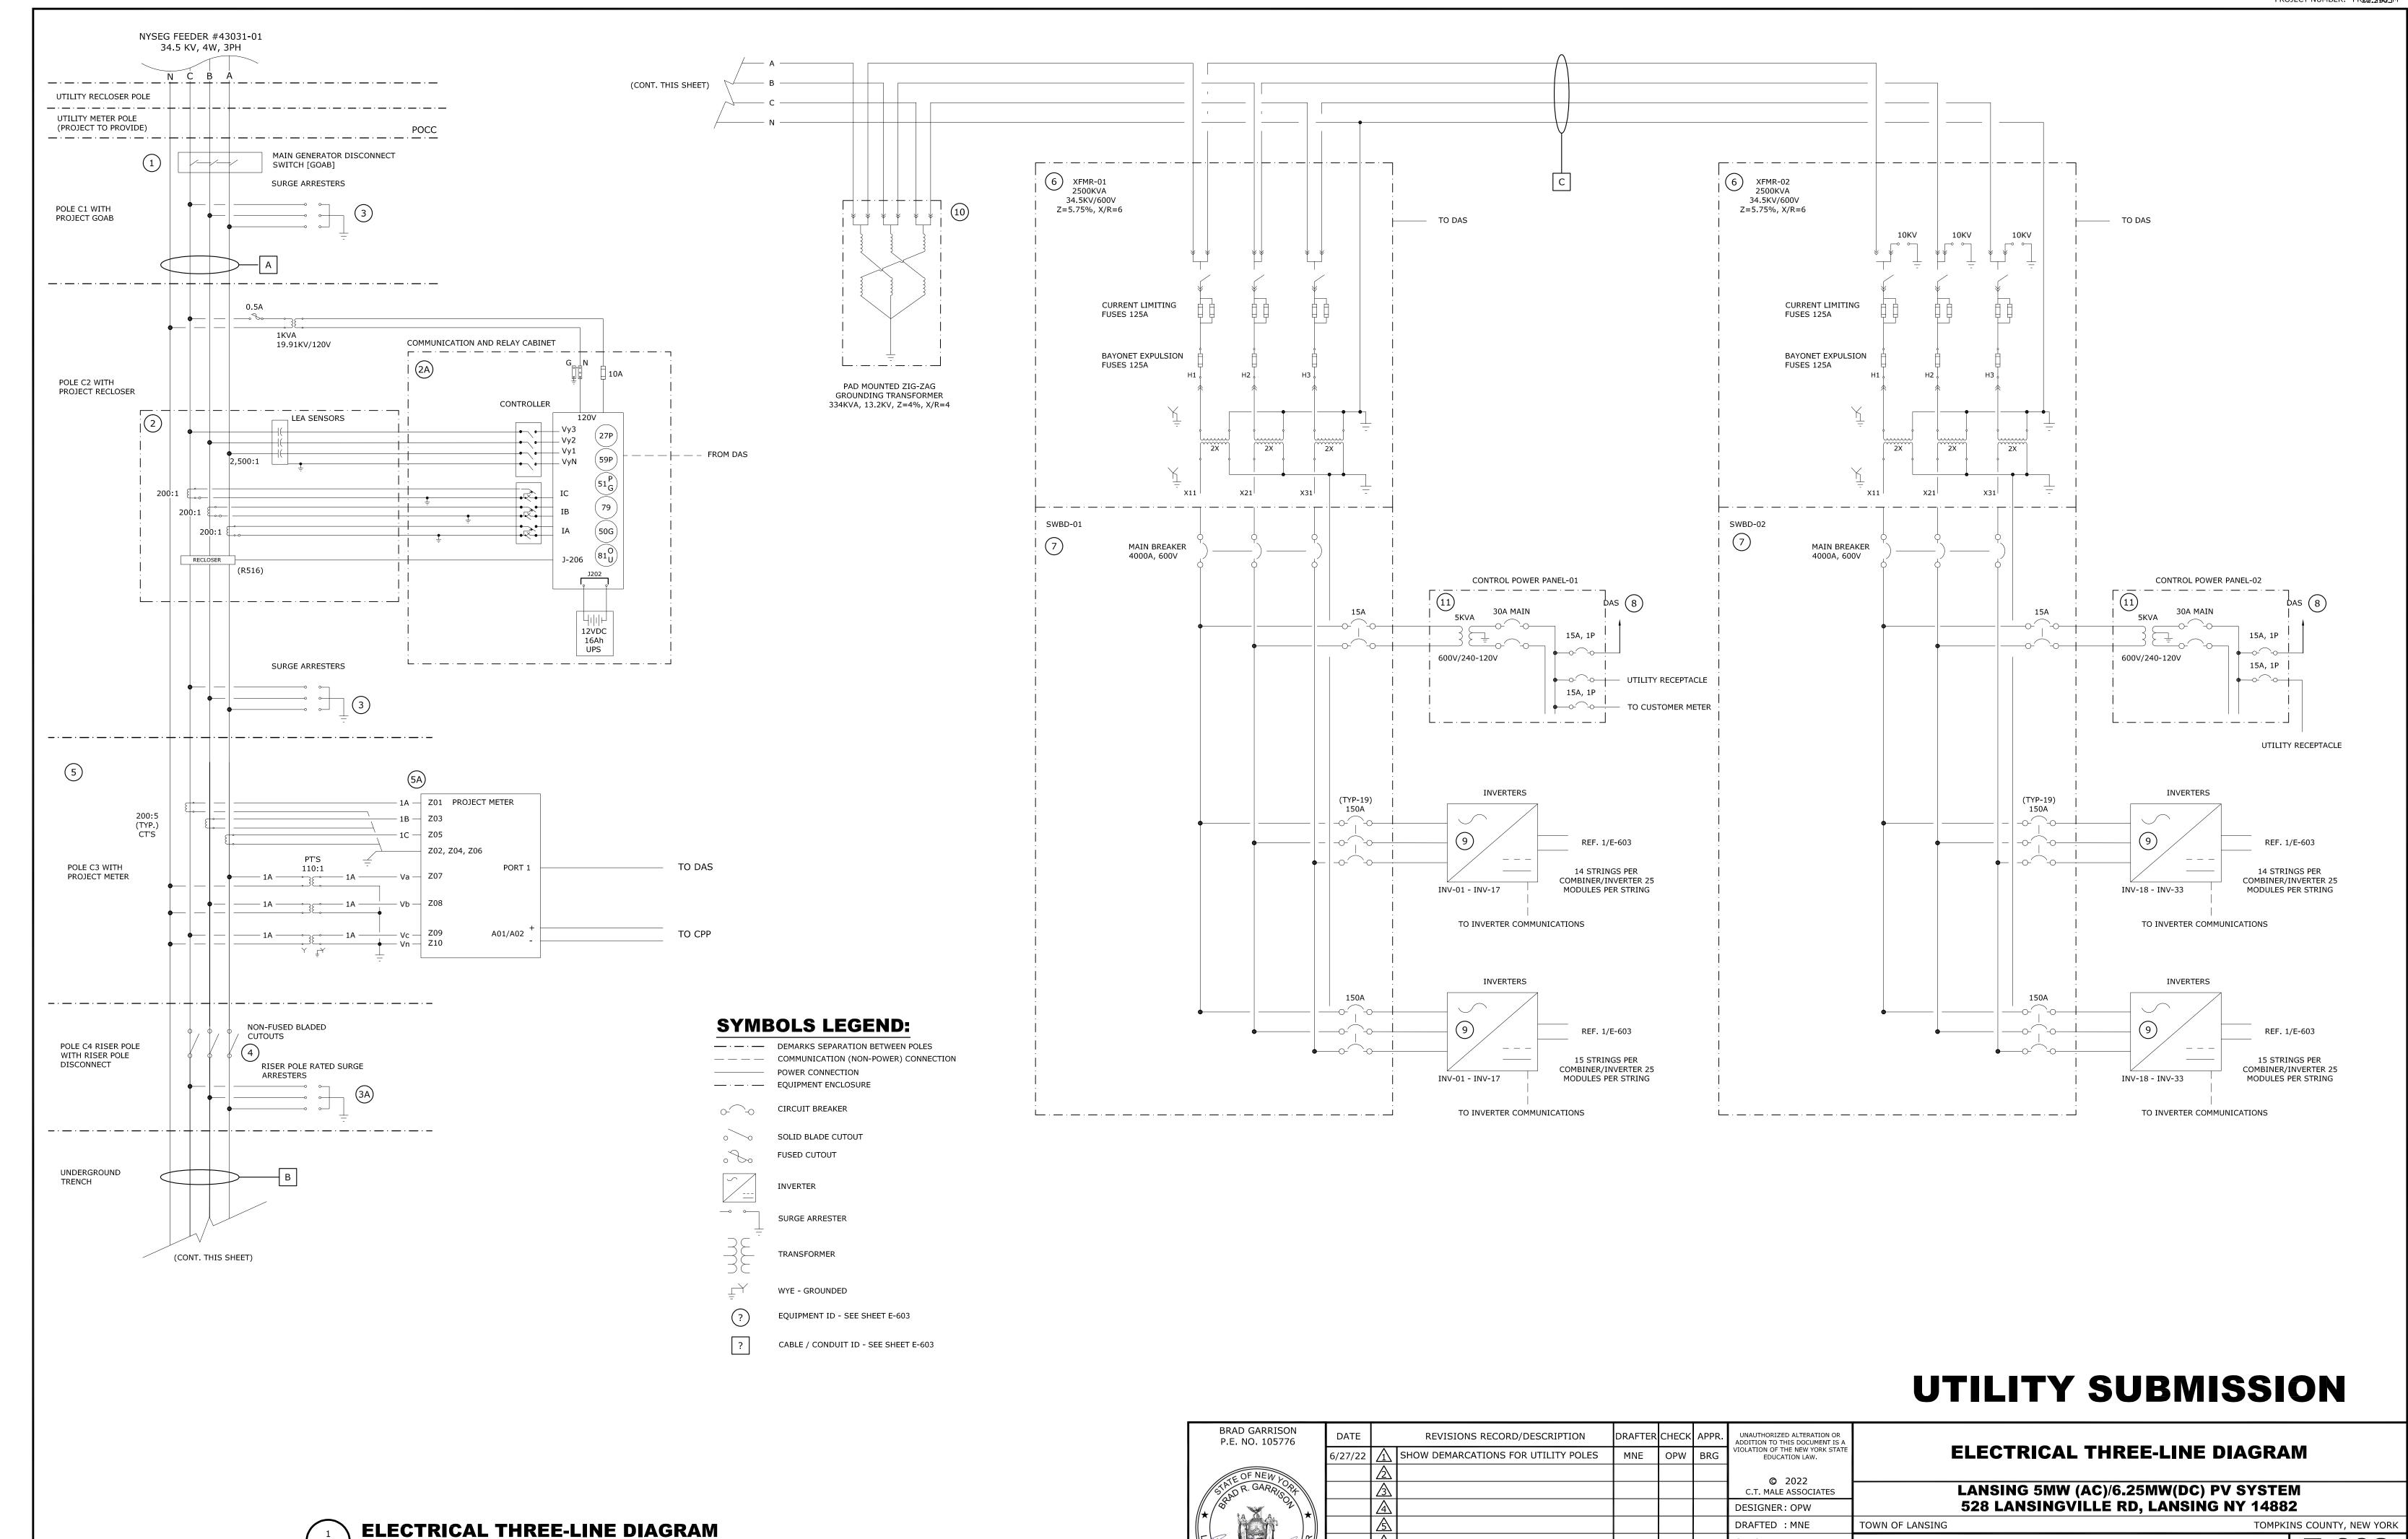

CROSS REFERENCE: 1/E-603

CHECKED : BRG

PROJ. NO : 22.2303

SCALE: AS NOTED

DATE: JUNE 27, 2022

C.T. MALE ASSOCIATES


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COBLESKILL, NY • GLENS FALLS, NY • POUGHKEEPSIE, NY JOHNSTOWN, NY • RED HOOK, NY • SYRACUSE, NY

DWG. NO: 22-2303

	CABLE SCHEDULE														
ID	FROM	то	# CONDUCTORS	VOLTAGE	MAX CURRENT (A)	MIN CONDUCTOR AMPACITY REQUIRED (A)	CONDUCTOR AMPACITY (A)	CONDUCTOR SIZE, DESCRIPTION	# NEUTRAL	NEUTRAL SIZE	# GROUND	GROUND SIZE	INSULATION TYPE	# CONDUIT	CONDUIT SIZE
Α	POCC	RISER POLE	4	34500	83.7	104.6	185/110*	#2 AWG, ACSR SPARROW 6/1	1	#2 SPARROW	-	-	-	-	-
В	RISER POLE	XFMR-01	3	34500	83.7	104.6	130**	#2 AWG, AL, MV-105, 35KV, 133%, URD 1/3 NEUTRAL	-	CONCENTRIC	-	-	EPR	1	2" SCH 40 PVC
С	XFMR-01	XFMR-02	3	34500	41.8	52.3	75**	#6 AWG, AL, MV-105, 35KV, 133%, URD 1/3 NEUTRAL	-	CONCENTRIC	-	-	EPR	1	2" SCH 40 PVC

<sup>\*</sup> UNDER 25 C AMBIENT WIND AND SUN CONDITIONS / UNDER 25C AMBIENT NO WIND AND SUN CONDITIONS \*\* CONDUCTOR AMPACITY BASED ON NEC (2017) TABLE 310.60(C)(78)

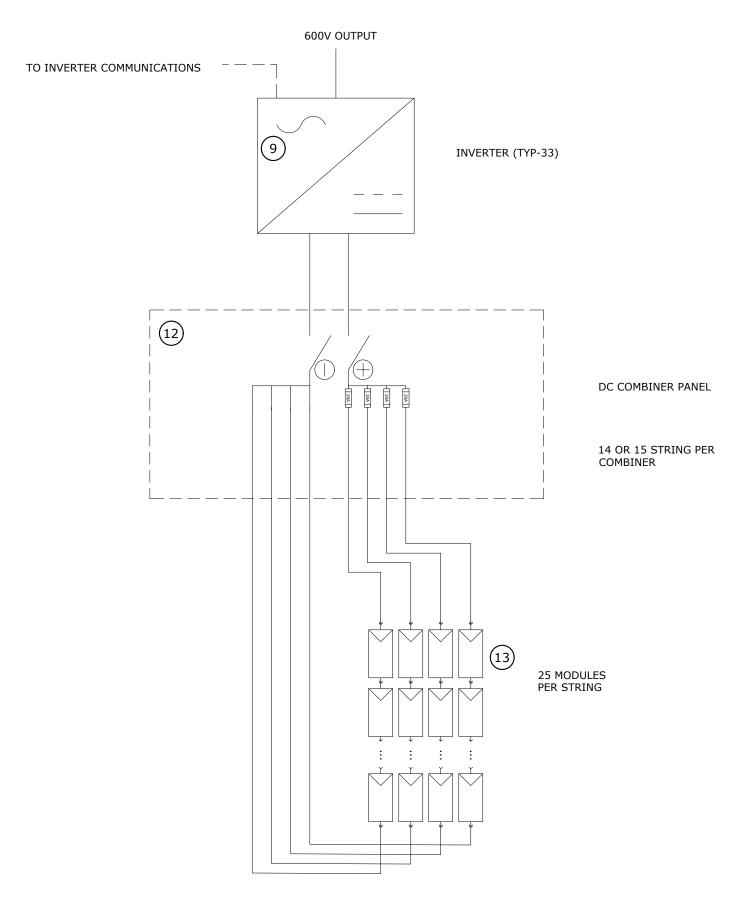

	TYPICAL I	NVERTER CONFIGURATION
E-603	SCALE: NONE CROSS REFERENCE:	1/E-602

				EQUIP	MENT S	SCHED	ULE	
ID	EQUIPMENT NAME	QTY	MAKE / MODEL	VOLTAGE (V)	AMPERAGE (A)	NEMA RATING	KAIC RATING	DESCRIPTION
1	GOAB SWITCH	1	S&C OR EQUAL	-	600	-	N/A	34.5 KV, ALDUTI-RUPTER SWITCH
2	POLE MOUNTED RECLOSER	1	G&W ELECTRIC VIPER	-	800	3R	16	38 KV
3	RECLOSER CONTROLLER	1	SEL-651R-2	120	-	3R	-	SEL-0651R22CXGA8 AE112230XX
4	HEAVY DUTY DISTRIBUTION CLASS ARRESTER	6	HUBBELL, PDV-100 OR EQUAL	-	-	-	-	SURGE ARRESTER 27KV, 22 MCOV
5	PROJECT METER	1	ABB OR EQUAL	-	400	3R	N/A	38KV, 600A, 95KV BIL, 3PH, 60 HZ
6	SOLID-BLADE CUTOUT	3	ABB, NCX OR EQUAL	-	300	-	12KA	-
7	RISER POLE RATED - HEAVY DUTY DISTRIBUTION CLASS ARRESTER	3	HUBBELL, PDV-100 OR EQUAL	-	-	-	-	SURGE ARRESTER 27KV, 22 MCOV
8	STEP-UP XFMR	1	COOPER POWER ENVIROTRAN	-	-		N/A	2,500KVA, 34.5KV/19.9KV/600V/347V, Z=5.75%
9	SWITCHBOARD	1	EATON POW-R LINE C SWITCHBOARD	600	4,000	3R	35	SWITCHBOARD, 3-PHASE, 4W, 600V, 4000A, NEMA 3R, 4000A MCB
10	ZIG-ZAG GROUNDING TRANSFORMER	1	TBD	-	-	3R	-	-
11	INVERTER	40	CHINT CPS SCH125KTL-DO/US-600	600	120	4X	N/A	STRING INVERTER
12	CONTROL POWER PANEL	1	EATON P60G11S0512 OR EQUAL	1	30	3R	18	MINI-POWR ZONE WITH 5KVA XFMR
13	DAS	1	ALSO ENERGY OR EQUAL	120	-	4X	-	-
14	DC COMBINER PANEL	40	SOLARBOS OR EQUAL	1,500	400	3R	N/A	-
15	PHOTOVOLTAIC MODULE	14050	PRISM SOLAR, PST-445W-M72H	1,500	12	N/A	N/A	

# **UTILITY SUBMISSION**

	UNAUTHORIZED ALTERATION OR ADDITION TO THIS DOCUMENT IS A	APPR.	CHECK	DRAFTER	REVISIONS RECORD/DESCRIPTION	DATE	BRAD R. GARRISON P.E. NO. 105776
ELECTRICAL	VIOLATION OF THE NEW YORK STATE EDUCATION LAW.	BRG	OPW	MNE	SHOW DEMARCATIONS FOR UTILITY POLES	/27/22 🛕	
	© 2022					<u> </u>	TE OF NEW LO
LANSING 5MW (AC)/6.2	C.T. MALE ASSOCIATES					<u> </u>	STAD R. GARAGO PA
528 LANSINGVILLE RD	DESIGNER: OPW					4	1
TOWN OF LANSING	DRAFTED : MNE					S	
C.T. MALE ASSOCIA	CHECKED : BRG					<u></u>	TO TROUBLE OF THE PARTY OF THE
Engineering, Surveying, Architecture, Landscape Architecture & Geo	PROJ. NO : 22.2303					A	105176
50 CENTURY HILL DRIVE, LATHAM, NY 12110 PH: 518.78 COBLESKILL, NY • GLENS FALLS, NY • POUGHKEEPSIE, N	SCALE: AS NOTED					<u> </u>	POFESSIONALE
JOHNSTOWN, NY • RED HOOK, NY • SYRACUSE, NY	DATE : JUNE 27, 2022					Ø	

# . SCHEDULES

6.25MW(DC) PV SYSTEM RD, LANSING NY 14882