3-27-2025 SUBMISSION

# CONLON CORNERS 3-LOT MINOR SUBDIVISION

JESSE YOUNG Conlon Road, Lansing, New York 14882





# DRAWING LIST

**GENERAL** 

G-001 COVER SHEET

SHEIVE LAND SURVEYING

SUBDIVISION PLAT

CIVIL


C-101 EXISTING CONDITIONS PLAN

C-102 EROSION AND SEDIMENT CONTROL PLAN

C-103 GROUND DISTURBANCE AND AND UTILITY PLANS

## PROJECT INFORMATION PROJECT LOCATION PLAN DATE: 3/27/2025 JOB NUMBER: 24-31 APPLICANT: JESSE YOUNG APPLICANT ADDRESS: 3105 N. TRIPHAMMER ROAD, SUITE #1 LANSING, NY 14882 **LOCATION** APPLICANT PHONE: 607-533-0346 APPLICANT EMAIL: JESSE@YOUNGBROS.COM PROJECT ADDRESS: CONLON ROAD LANSING, NY 14882 PARCEL INFORMATION: TAX MAP NO. 31.-1-11.22 183.716 ACRES TO ROW


G-001

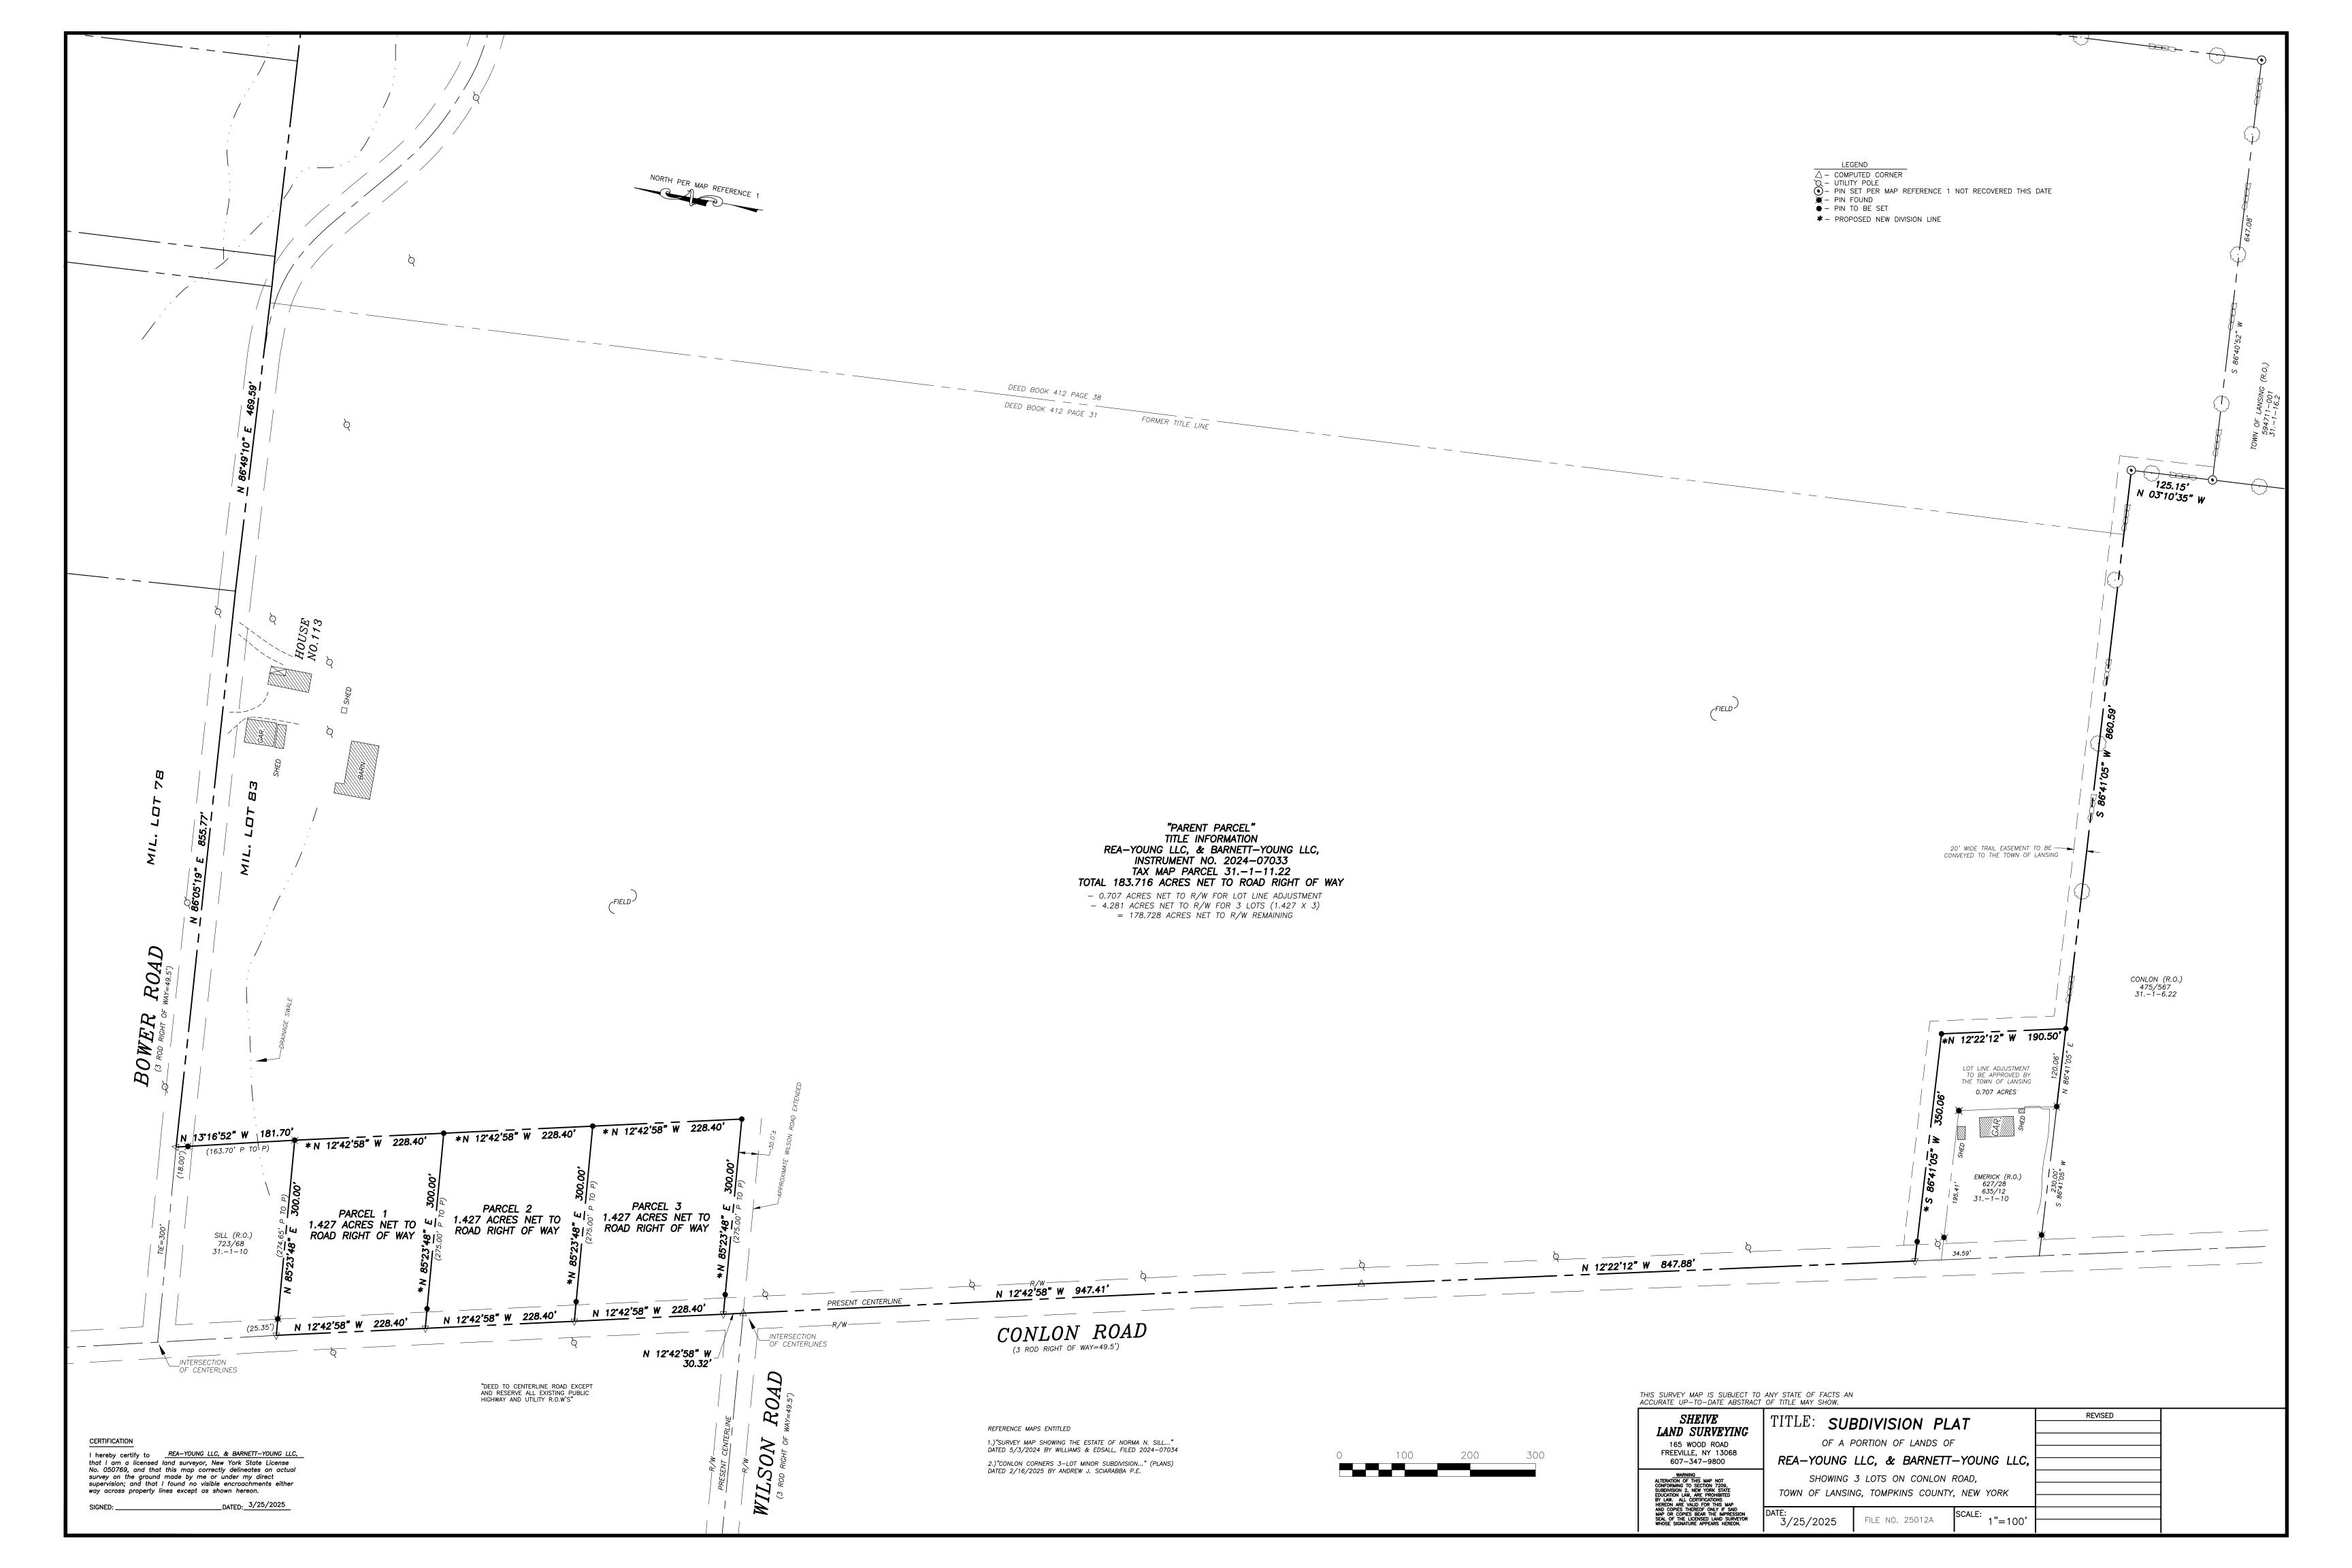





SCIARABBA ENGINEERING, PLLC 9664 Kingtown Road Trumansburg, NY 14886 607-327-0578 www.sciarabbaengplus.com

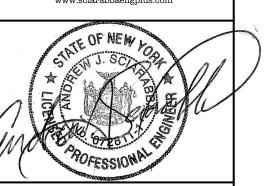

#### **WARNING**:

It is a violation of Section 7209, Subdivision 2 of the New York State Education Law for any person, unless he or she is working under the direction of a licensed engineer, to alter an item in any way. If an item bearing the seal of an engineer is altered, the altering engineer shall affix to the item his or her seal and the notation "altered by" followed by his or her signature, the date of such alteration, and a

specific description of the alteration.


REVISION 6	
REVISION 5	
REVISION 4	
REVISION 3	
REVISION 2	
REVISION 1	REISSUED 3/27/2025
PROJECT NUMBER	24-31
DATE	2/25/2025

DRAWING TITLE

**EXISTING** CONDITIONS PLAN

1"=200'

C-101

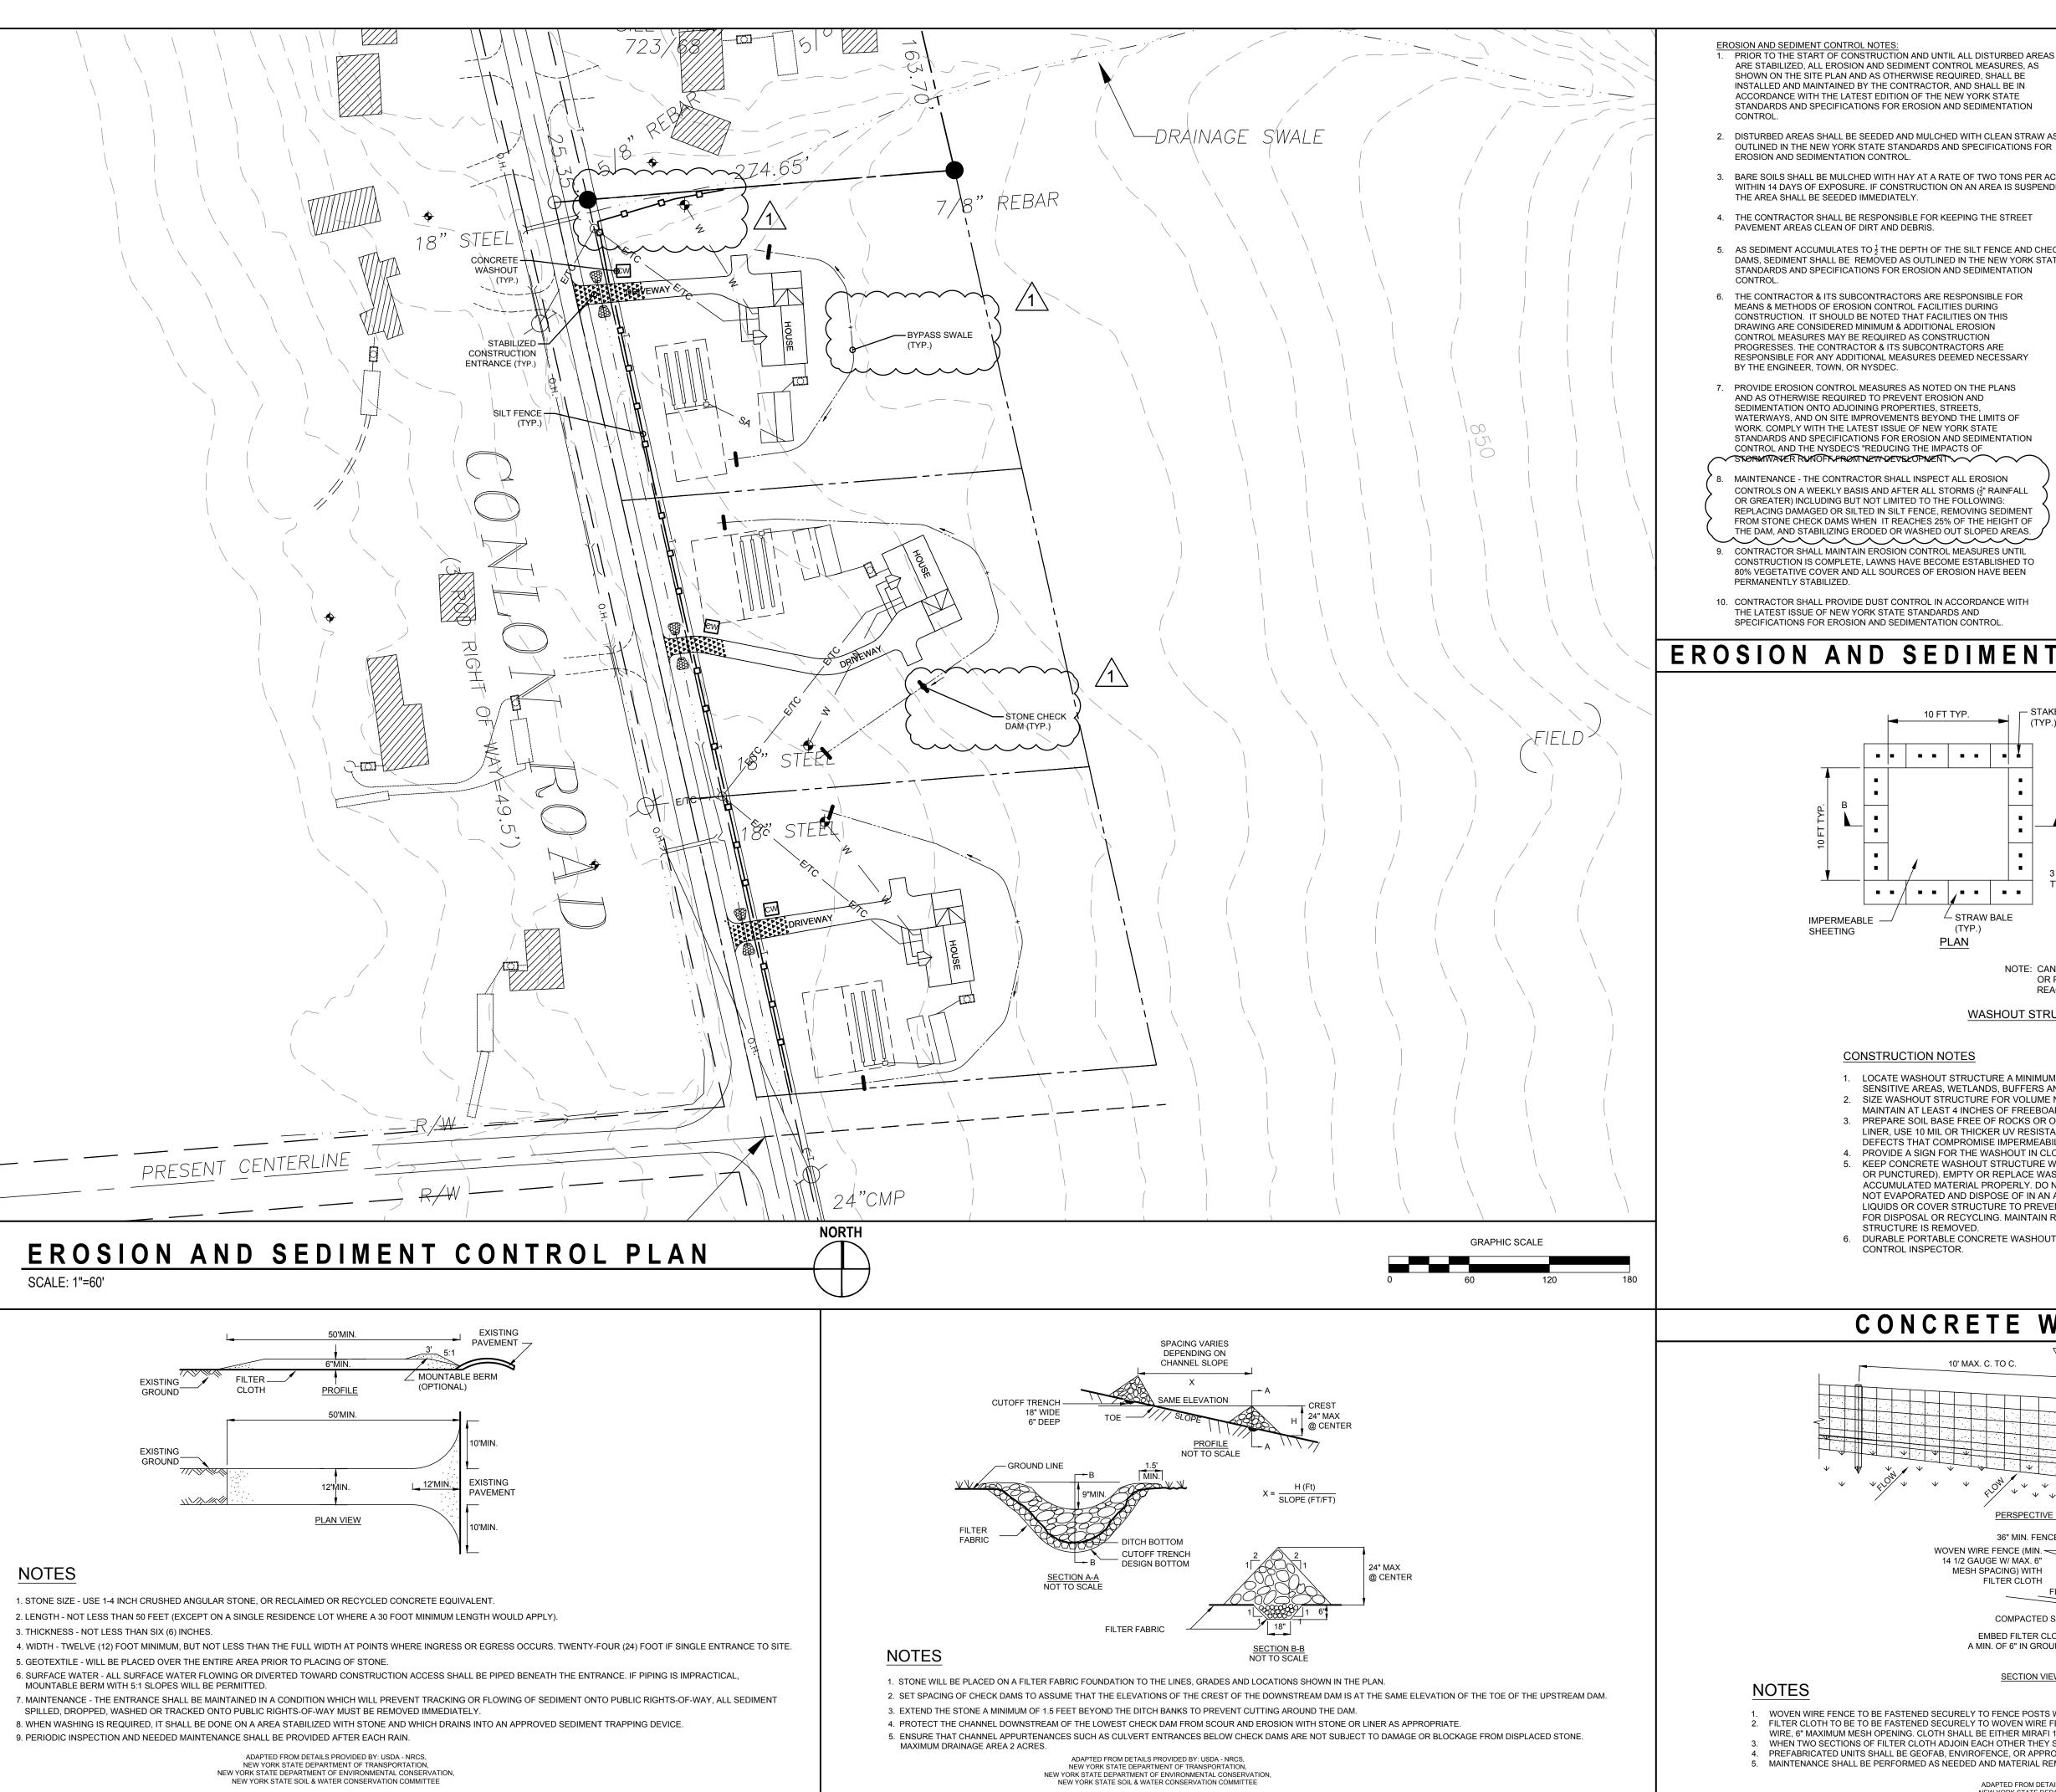

STABILIZED CONSTRUCTION ENTRANCE - NOT TO SCALE

STONE CHECK DAM-NOT TO SCALE

EROSION AND SEDIMENT CONTROL NOTES:

1. PRIOR TO THE START OF CONSTRUCTION AND UNTIL ALL DISTURBED AREAS ARE STABILIZED, ALL EROSION AND SEDIMENT CONTROL MEASURES, AS SHOWN ON THE SITE PLAN AND AS OTHERWISE REQUIRED. SHALL BE INSTALLED AND MAINTAINED BY THE CONTRACTOR, AND SHALL BE IN

- ACCORDANCE WITH THE LATEST EDITION OF THE NEW YORK STATE STANDARDS AND SPECIFICATIONS FOR EROSION AND SEDIMENTATION 2. DISTURBED AREAS SHALL BE SEEDED AND MULCHED WITH CLEAN STRAW AS
- EROSION AND SEDIMENTATION CONTROL. 3. BARE SOILS SHALL BE MULCHED WITH HAY AT A RATE OF TWO TONS PER ACRE
- WITHIN 14 DAYS OF EXPOSURE. IF CONSTRUCTION ON AN AREA IS SUSPENDED, THE AREA SHALL BE SEEDED IMMEDIATELY.
- 4. THE CONTRACTOR SHALL BE RESPONSIBLE FOR KEEPING THE STREET PAVEMENT AREAS CLEAN OF DIRT AND DEBRIS.
- 5. AS SEDIMENT ACCUMULATES TO <sup>1</sup>/<sub>2</sub> THE DEPTH OF THE SILT FENCE AND CHECK DAMS, SEDIMENT SHALL BE REMOVED AS OUTLINED IN THE NEW YORK STATE STANDARDS AND SPECIFICATIONS FOR EROSION AND SEDIMENTATION
- 6. THE CONTRACTOR & ITS SUBCONTRACTORS ARE RESPONSIBLE FOR MEANS & METHODS OF EROSION CONTROL FACILITIES DURING CONSTRUCTION IT SHOULD BE NOTED THAT FACILITIES ON THIS DRAWING ARE CONSIDERED MINIMUM & ADDITIONAL EROSION CONTROL MEASURES MAY BE REQUIRED AS CONSTRUCTION PROGRESSES. THE CONTRACTOR & ITS SUBCONTRACTORS ARE RESPONSIBLE FOR ANY ADDITIONAL MEASURES DEEMED NECESSARY BY THE ENGINEER, TOWN, OR NYSDEC.
- AND AS OTHERWISE REQUIRED TO PREVENT EROSION AND SEDIMENTATION ONTO ADJOINING PROPERTIES, STREETS, WATERWAYS, AND ON SITE IMPROVEMENTS BEYOND THE LIMITS OF WORK. COMPLY WITH THE LATEST ISSUE OF NEW YORK STATE STANDARDS AND SPECIFICATIONS FOR EROSION AND SEDIMENTATION CONTROL AND THE NYSDEC'S "REDUCING THE IMPACTS OF STORMWAVER RUNOFT FROM NEW DEVELOPMENT! MAINTENANCE - THE CONTRACTOR SHALL INSPECT ALL EROSION
- THE DAM, AND STABILIZING ERODED OR WASHED OUT SLOPED AREAS. 9. CONTRACTOR SHALL MAINTAIN EROSION CONTROL MEASURES UNTIL CONSTRUCTION IS COMPLETE, LAWNS HAVE BECOME ESTABLISHED TO 80% VEGETATIVE COVER AND ALL SOURCES OF EROSION HAVE BEEN PERMANENTLY STABILIZED.

## SEQUENCE OF CONSTRUCTION:

- INSTALL SILT FENCE AND STABILIZED CONSTRUCTION ENTRANCES AS SHOWN ON PLAN PRIOR TO BEGINNING EARTHWORK OPERATIONS.
  - REMOVE ALL TREES, STUMPS, AND BRUSH PRIOR TO BEGINNING EARTHWORK OPERATIONS.
  - 3. STRIP AND STOCKPILE TOPSOIL.
  - 4. SURROUND ALL STOCKPILE AREAS WITH SILT FENCE.
  - 5. INSTALL BYPASS SWALES AND STONE CHECK DAMS 6. INSTALL CONCRETE WASHOUTS.

  - 7. COMPLETE SITE AND UTILITY IMPROVEMENTS. 8. FINE GRADE, SEED, AND MULCH ALL DISTURBED LAWN AREAS WITHIN
  - FOURTEEN (14) DAYS OF DISTURBANCE. REMOVE TEMPORARY SILT FENCE AND STONE CHECK DAMS ONLY
  - AFTER SITE IS COMPLETELY STABILIZED AND ALL DISTURBED LAWN AREAS HAVE ACHIEVED 80% VEGETATIVE GROWTH.




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## EROSION AND SEDIMENT CONTROL NOTES - NOT TO SCALE




REACH 3 FT DEPTH WASHOUT STRUCTURE WITH STRAW BALES

OR PARTIALLY EXCAVATED TO

## **CONSTRUCTION NOTES**

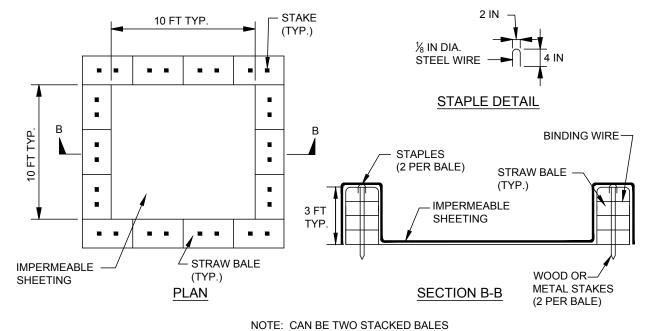- 1. LOCATE WASHOUT STRUCTURE A MINIMUM OF 100 FEET AWAY FROM OPEN CHANNELS, STORM DRAIN INLETS, SENSITIVE AREAS, WETLANDS, BUFFERS AND WATER COURSES AND AWAY FROM CONSTRUCTION TRAFFIC.
- SIZE WASHOUT STRUCTURE FOR VOLUME NECESSARY TO CONTAIN WASH WATER, SOLIDS AND RAINFALL AND MAINTAIN AT LEAST 4 INCHES OF FREEBOARD. TYPICAL DIMENSIONS ARE 10 FEET X 10 FEET X 3 FEET DEEP. PREPARE SOIL BASE FREE OF ROCKS OR OTHER DEBRIS THAT MAY CAUSE TEARS OR HOLES IN THE LINER. FOR LINER, USE 10 MIL OR THICKER UV RESISTANT, IMPERMEABLE SHEETING, FREE OF HOLES AND TEARS OR OTHER DEFECTS THAT COMPROMISE IMPERMEABILITY OF THE MATERIAL.
- PROVIDE A SIGN FOR THE WASHOUT IN CLOSE PROXIMITY TO THE FACILITY. KEEP CONCRETE WASHOUT STRUCTURE WATER TIGHT. REPLACE IMPERMEABLE LINER IF DAMAGED (E.G., RIPPED OR PUNCTURED). EMPTY OR REPLACE WASHOUT STRUCTURE THAT IS 75 PERCENT FULL, AND DISPOSE OF ACCUMULATED MATERIAL PROPERLY. DO NOT REUSE PLASTIC LINER. WET-VACUUM STORED LIQUIDS THAT HAVE NOT EVAPORATED AND DISPOSE OF IN AN APPROVED MANNER. PRIOR TO FORECASTED RAINSTORMS, REMOVE LIQUIDS OR COVER STRUCTURE TO PREVENT OVERFLOWS. REMOVE HARDENED SOLIDS, WHOLE OR BROKEN UP. FOR DISPOSAL OR RECYCLING. MAINTAIN RUNOFF DIVERSION AROUND EXCAVATED WASHOUT STRUCTURE UNTIL
- DURABLE PORTABLE CONCRETE WASHOUT BASINS OR TUBS MAY BE USED WITH THE APPROVAL OF THE EROSION

# CONCRETE WASHOUT - NOT TO SCALE

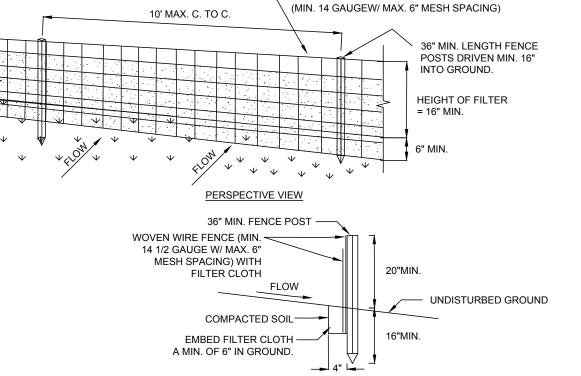

- WOVEN WIRE FENCE TO BE FASTENED SECURELY TO FENCE POSTS WITH WIRE TIES OR STAPLES. POSTS SHALL BE STEEL EITHER "T" OR "U" TYPE OR HARDWOOD. FILTER CLOTH TO BE TO BE FASTENED SECURELY TO WOVEN WIRE FENCE WITH TIES SPACED EVERY 24" AT TOP AND MID SECTION. FENCE SHALL BE WOVEN
- WIRE, 6" MAXIMUM MESH OPENING. CLOTH SHALL BE EITHER MIRAFI 100X, STABILINKA T140N, OR APPROVED EQUIVALENT. WHEN TWO SECTIONS OF FILTER CLOTH ADJOIN EACH OTHER THEY SHALL BE OVERLAPPED BY SIX INCHES AND FOLDED.
- PREFABRICATED UNITS SHALL BE GEOFAB, ENVIROFENCE, OR APPROVED EQUIVALENT. MAINTENANCE SHALL BE PERFORMED AS NEEDED AND MATERIAL REMOVED WHEN "BULGES" DEVELOP IN THE SILT FENCE.

SECTION VIEW

NEW YORK STATE DEPARTMENT OF TRANSPORTATION

SILT FENCE- NOT TO SCALE

**REVISION 5 REVISION 4 REVISION 3 REVISION 2** REVISION 1 3/27/2025 REV PER TOWN COMMENTS 2/25/2025 AS NOTED DRAWING TITLE

**EROSION** AND **SEDIMENT** CONTROL

DRAWING NUMBER

C-102

