9-24-2025 REVISED SITE PLAN SUBMISSION

# 164 AUBURN ROAD

# PROPOSED OFFICE BUILDING

S.E.E. ASSOCIATES HOLDINGS, LLC 2415 N. Triphammer Road Suite 9 Ithaca, New York 14850





## DRAWING LIST

## **GENERAL**

G-001 **COVER SHEET** 

CIVIL

**EXISTING CONDITIONS PLAN** C-101 C-103 SITE PLAN AND DETAILS

DEMOLITION AND EROSION AND SEDIMENT CONTROL PLAN AND DETAILS

GRADING DRAINAGE AND UTILITY PLAN AND DETAILS

PLANTING PLAN AND DETAILS C-106

## **ARCHITECTURAL**


PROPOSED FLOOR PLAN A-1 PROPOSED ELEVATIONS


E-1 ELECTRICAL POWER & LIGHTING PLAN


PHOTOMETRIC PLAN


# 0

G-001

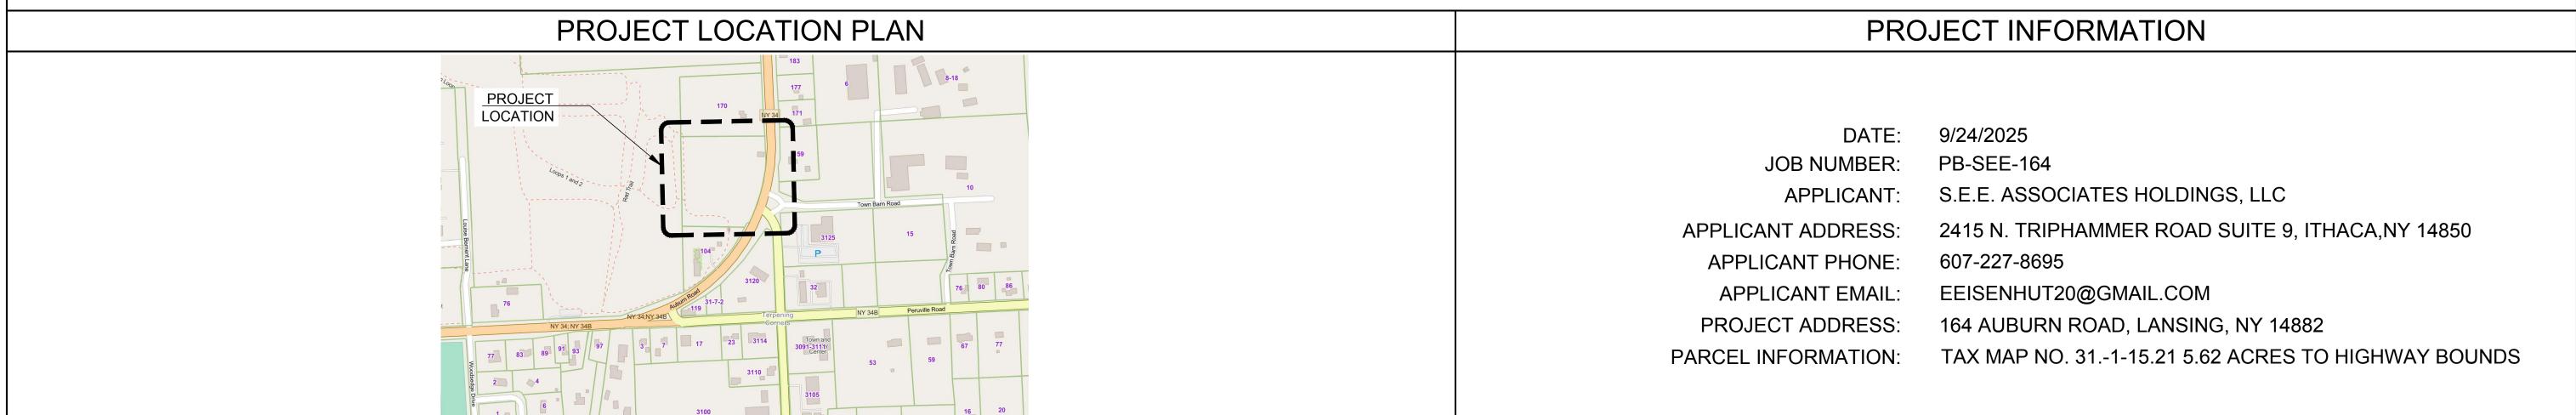

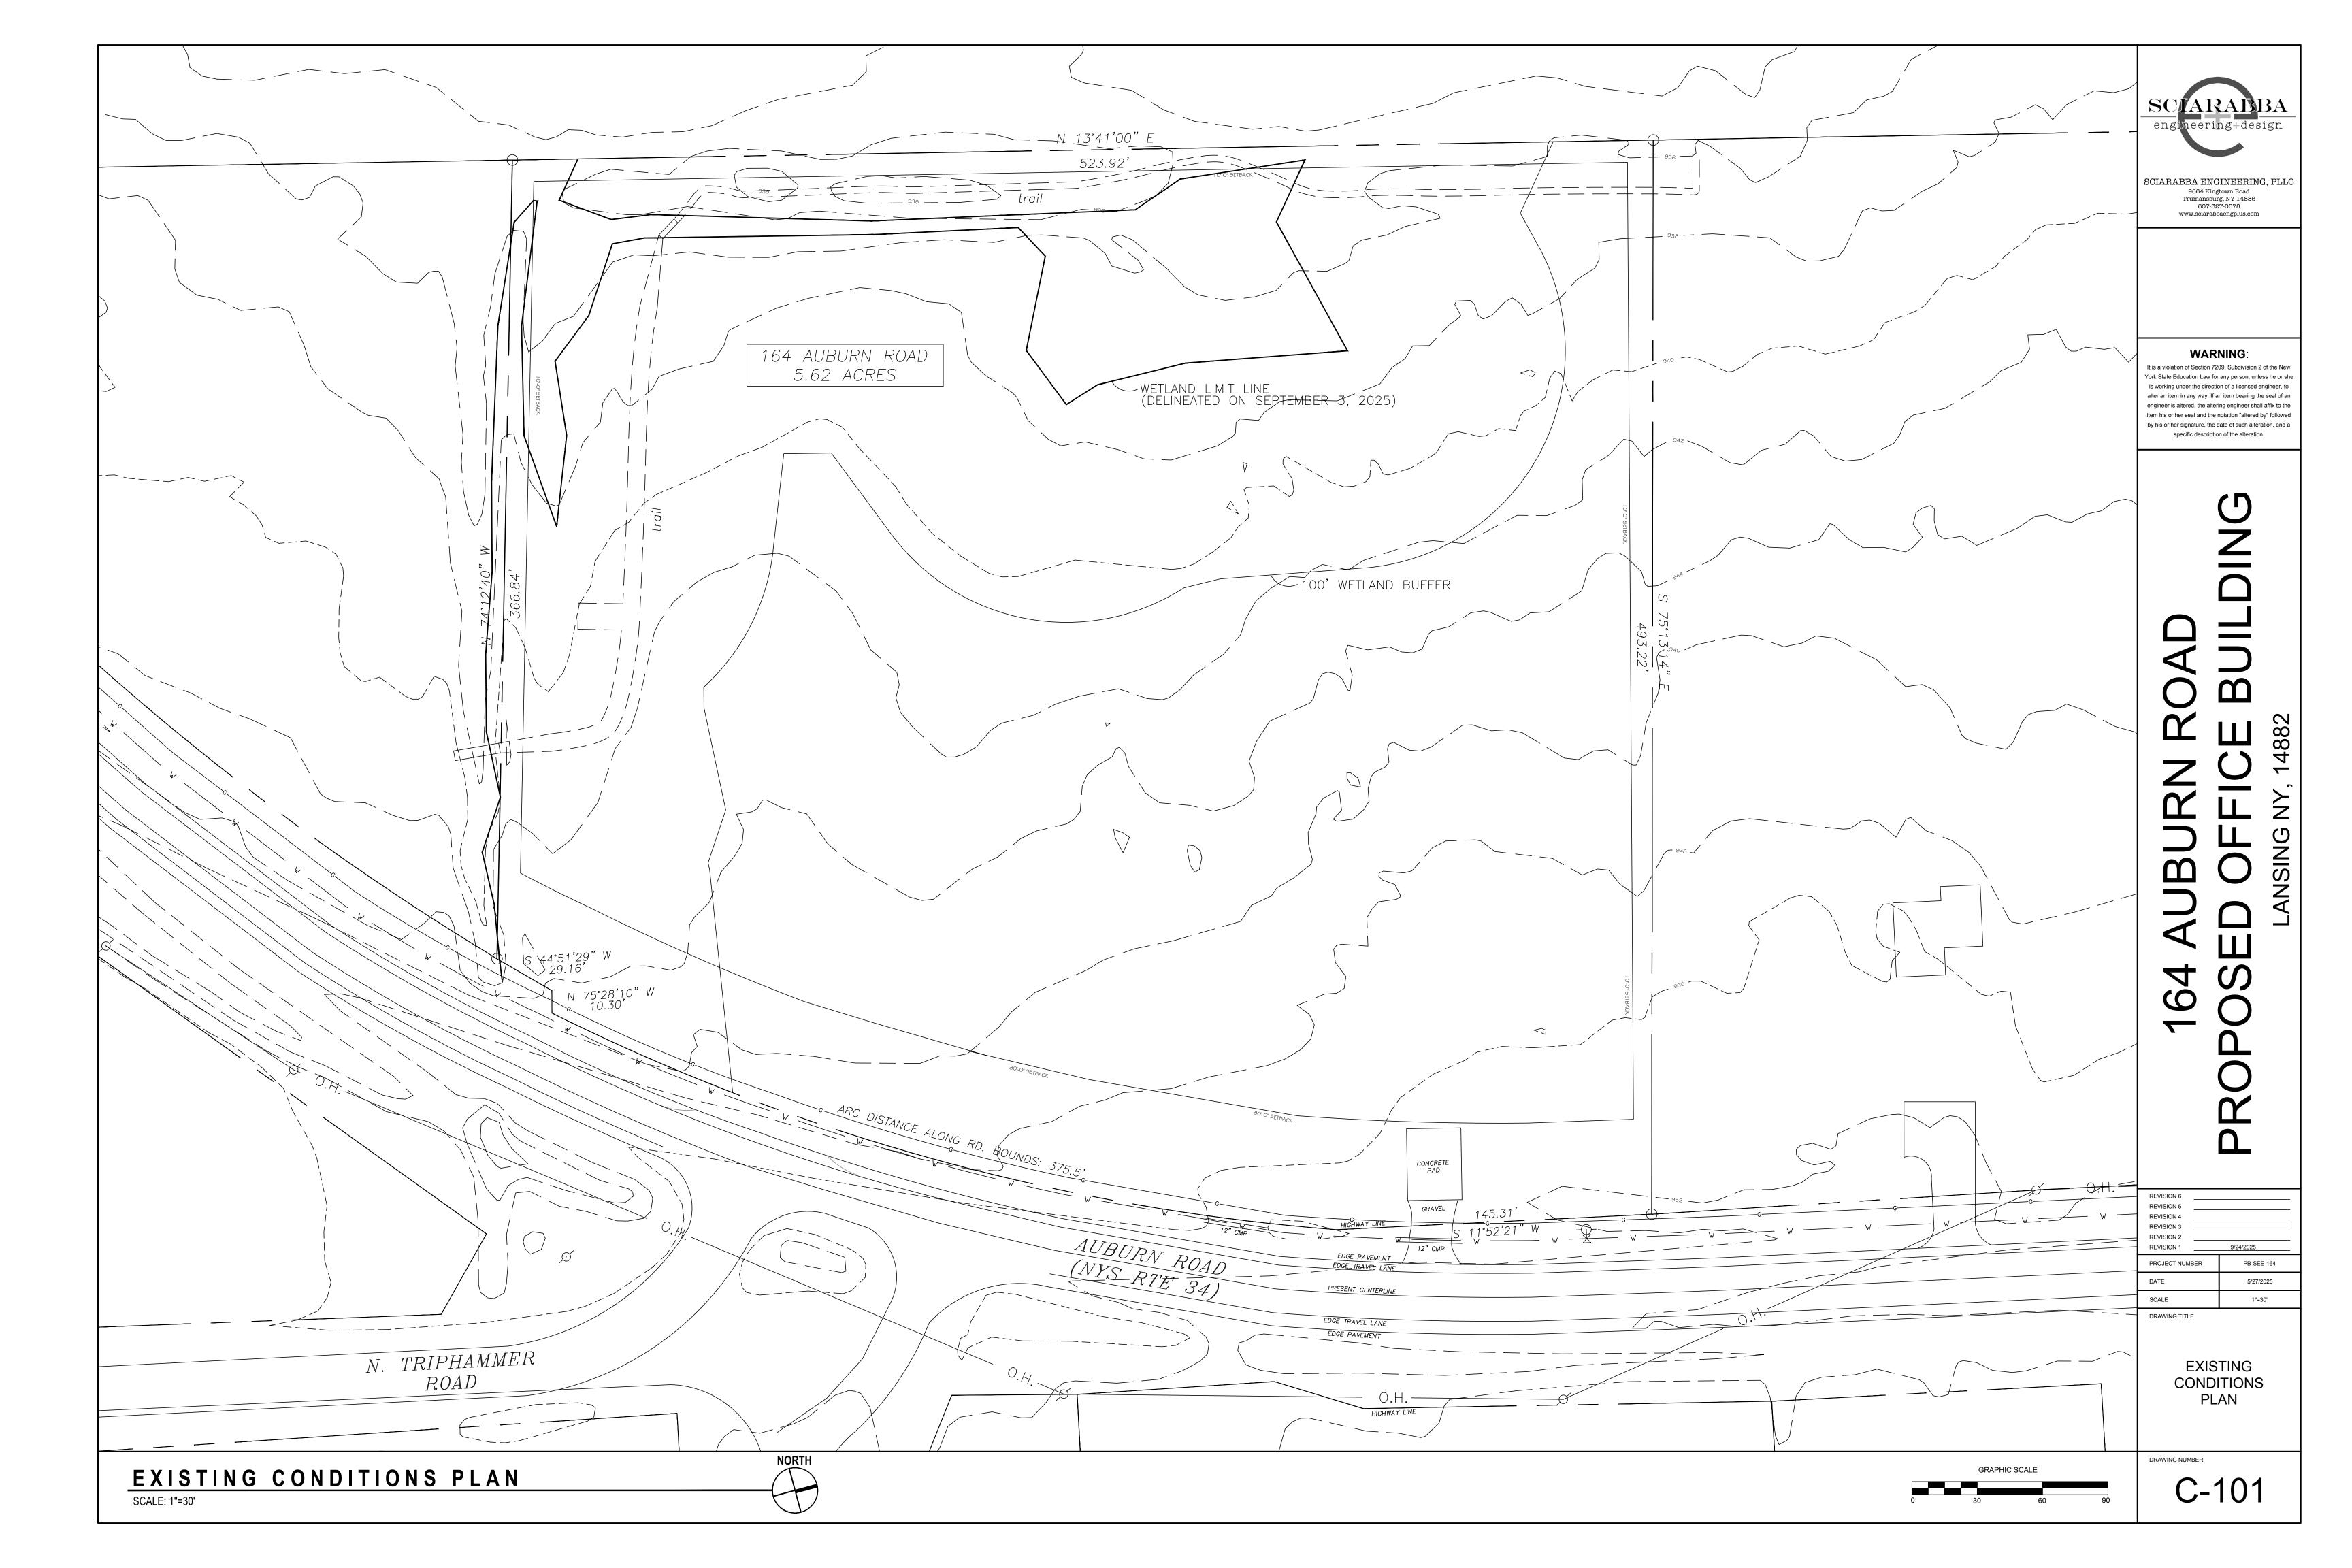

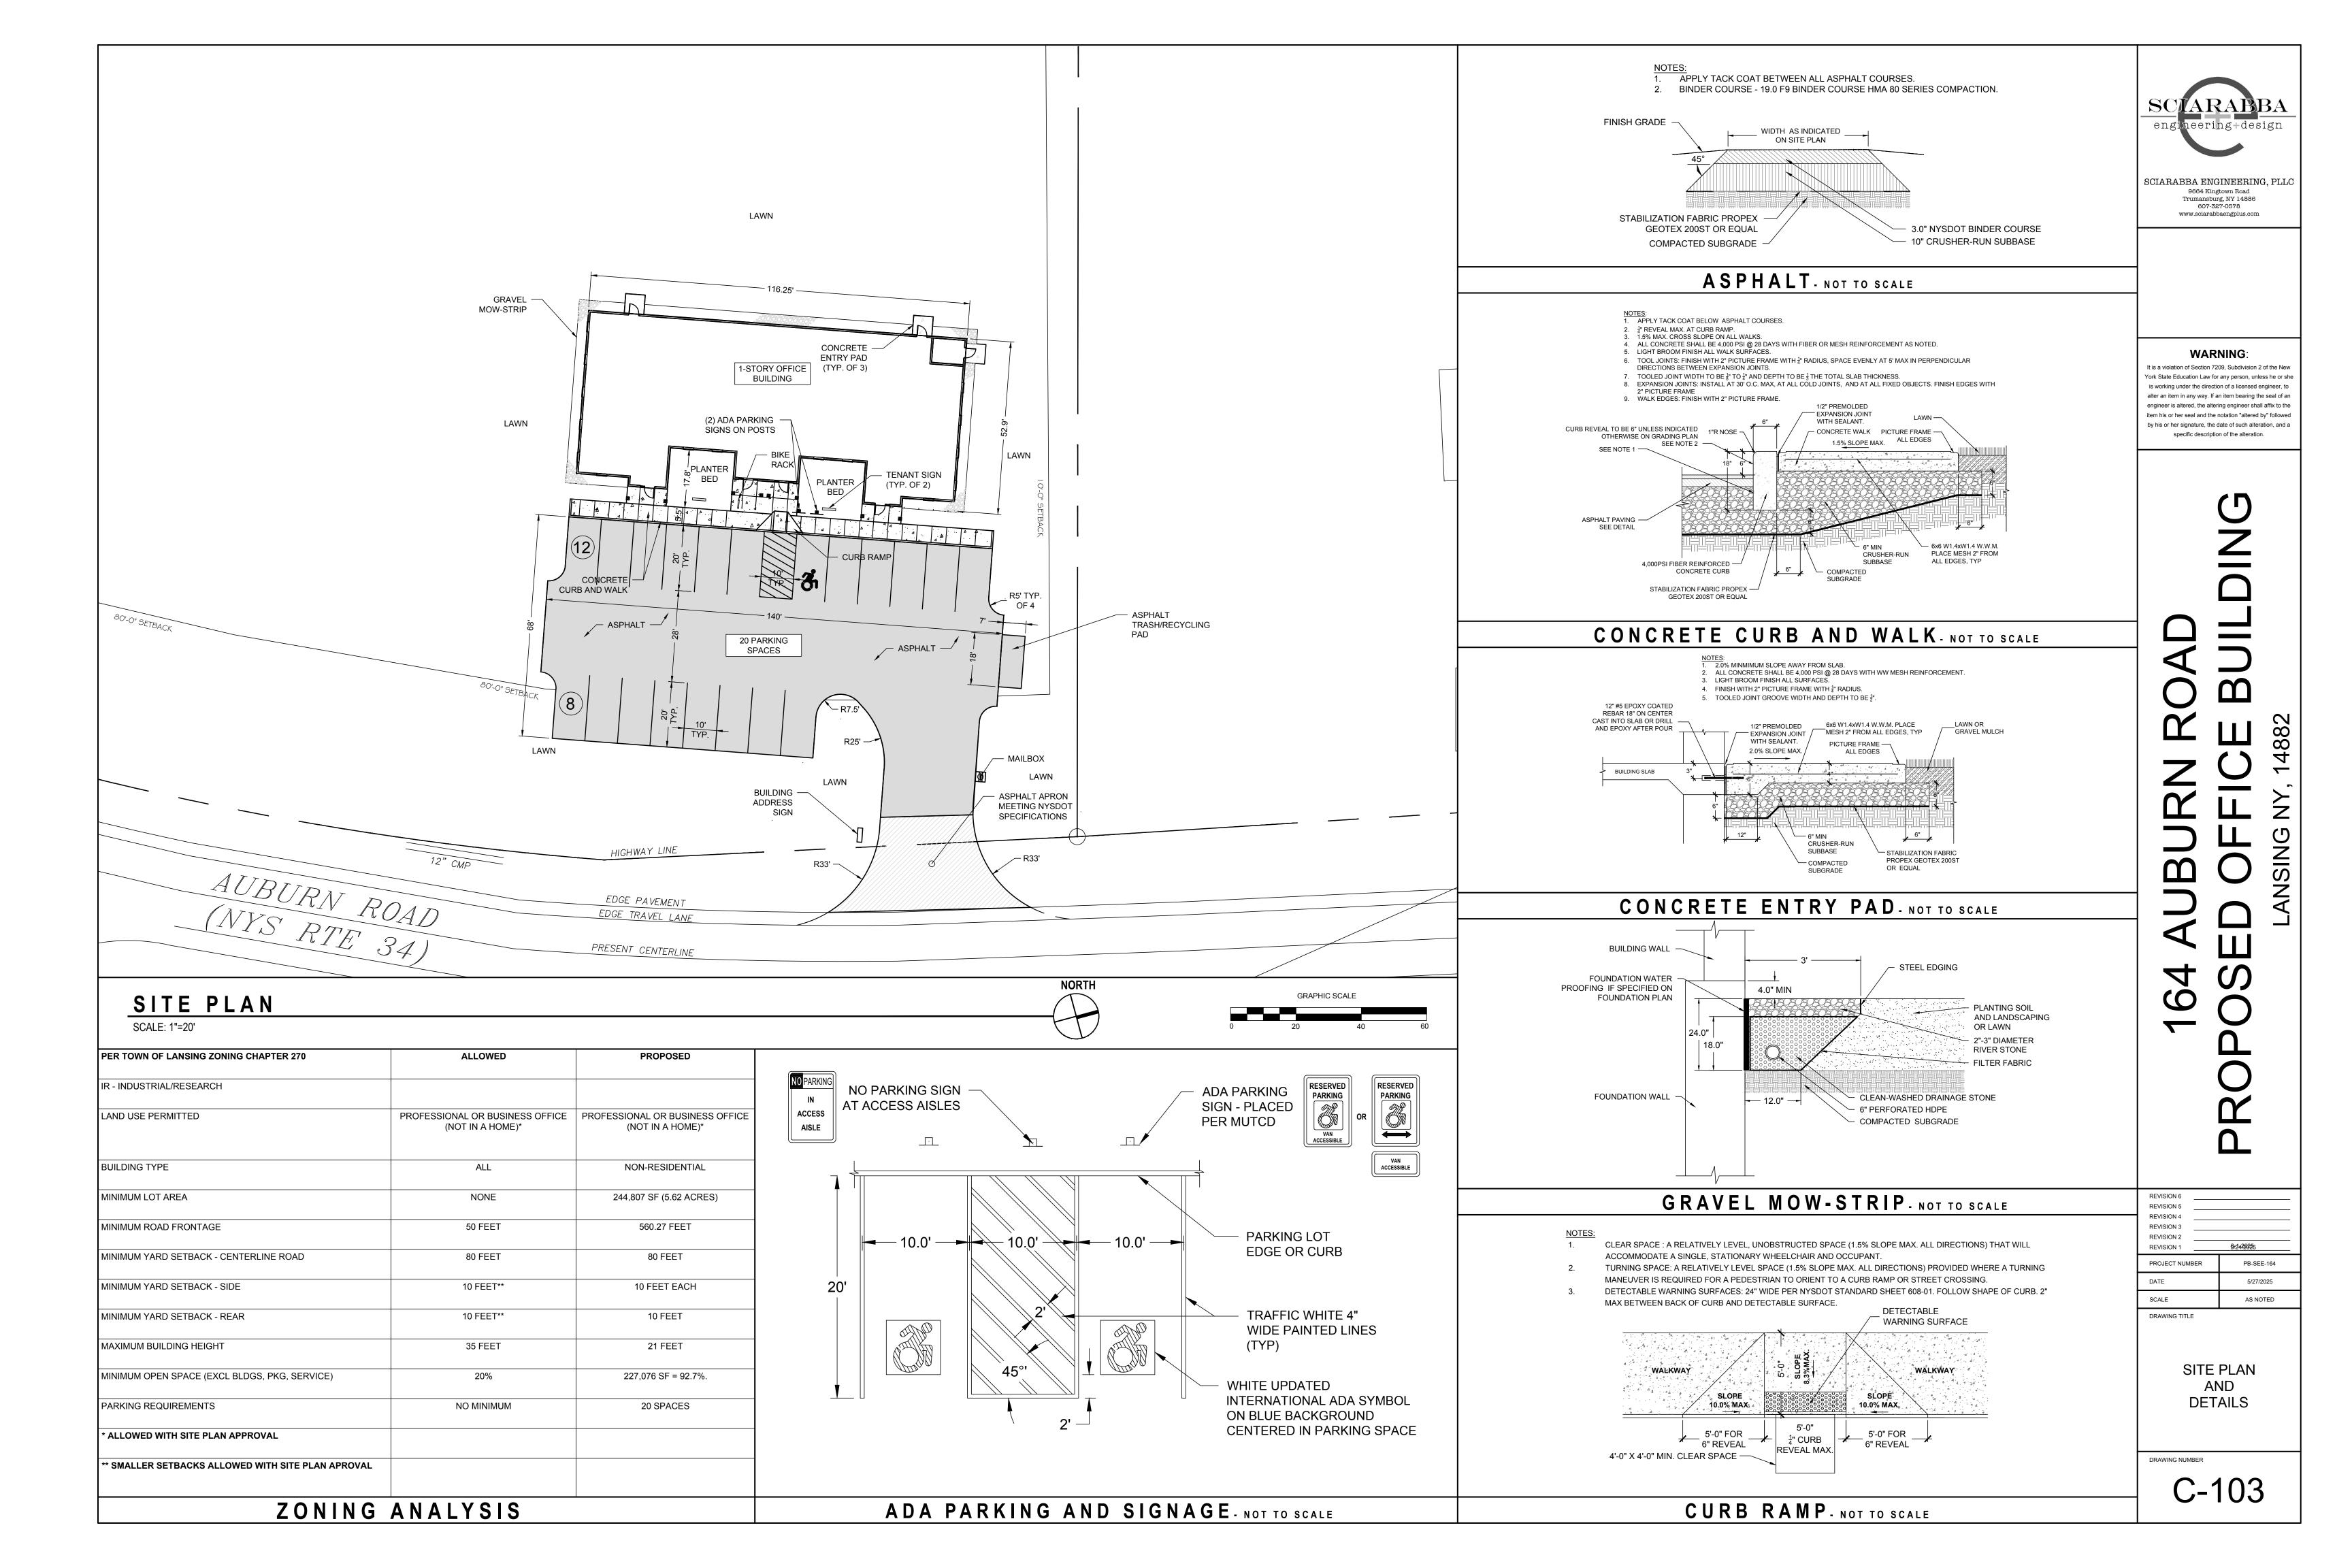

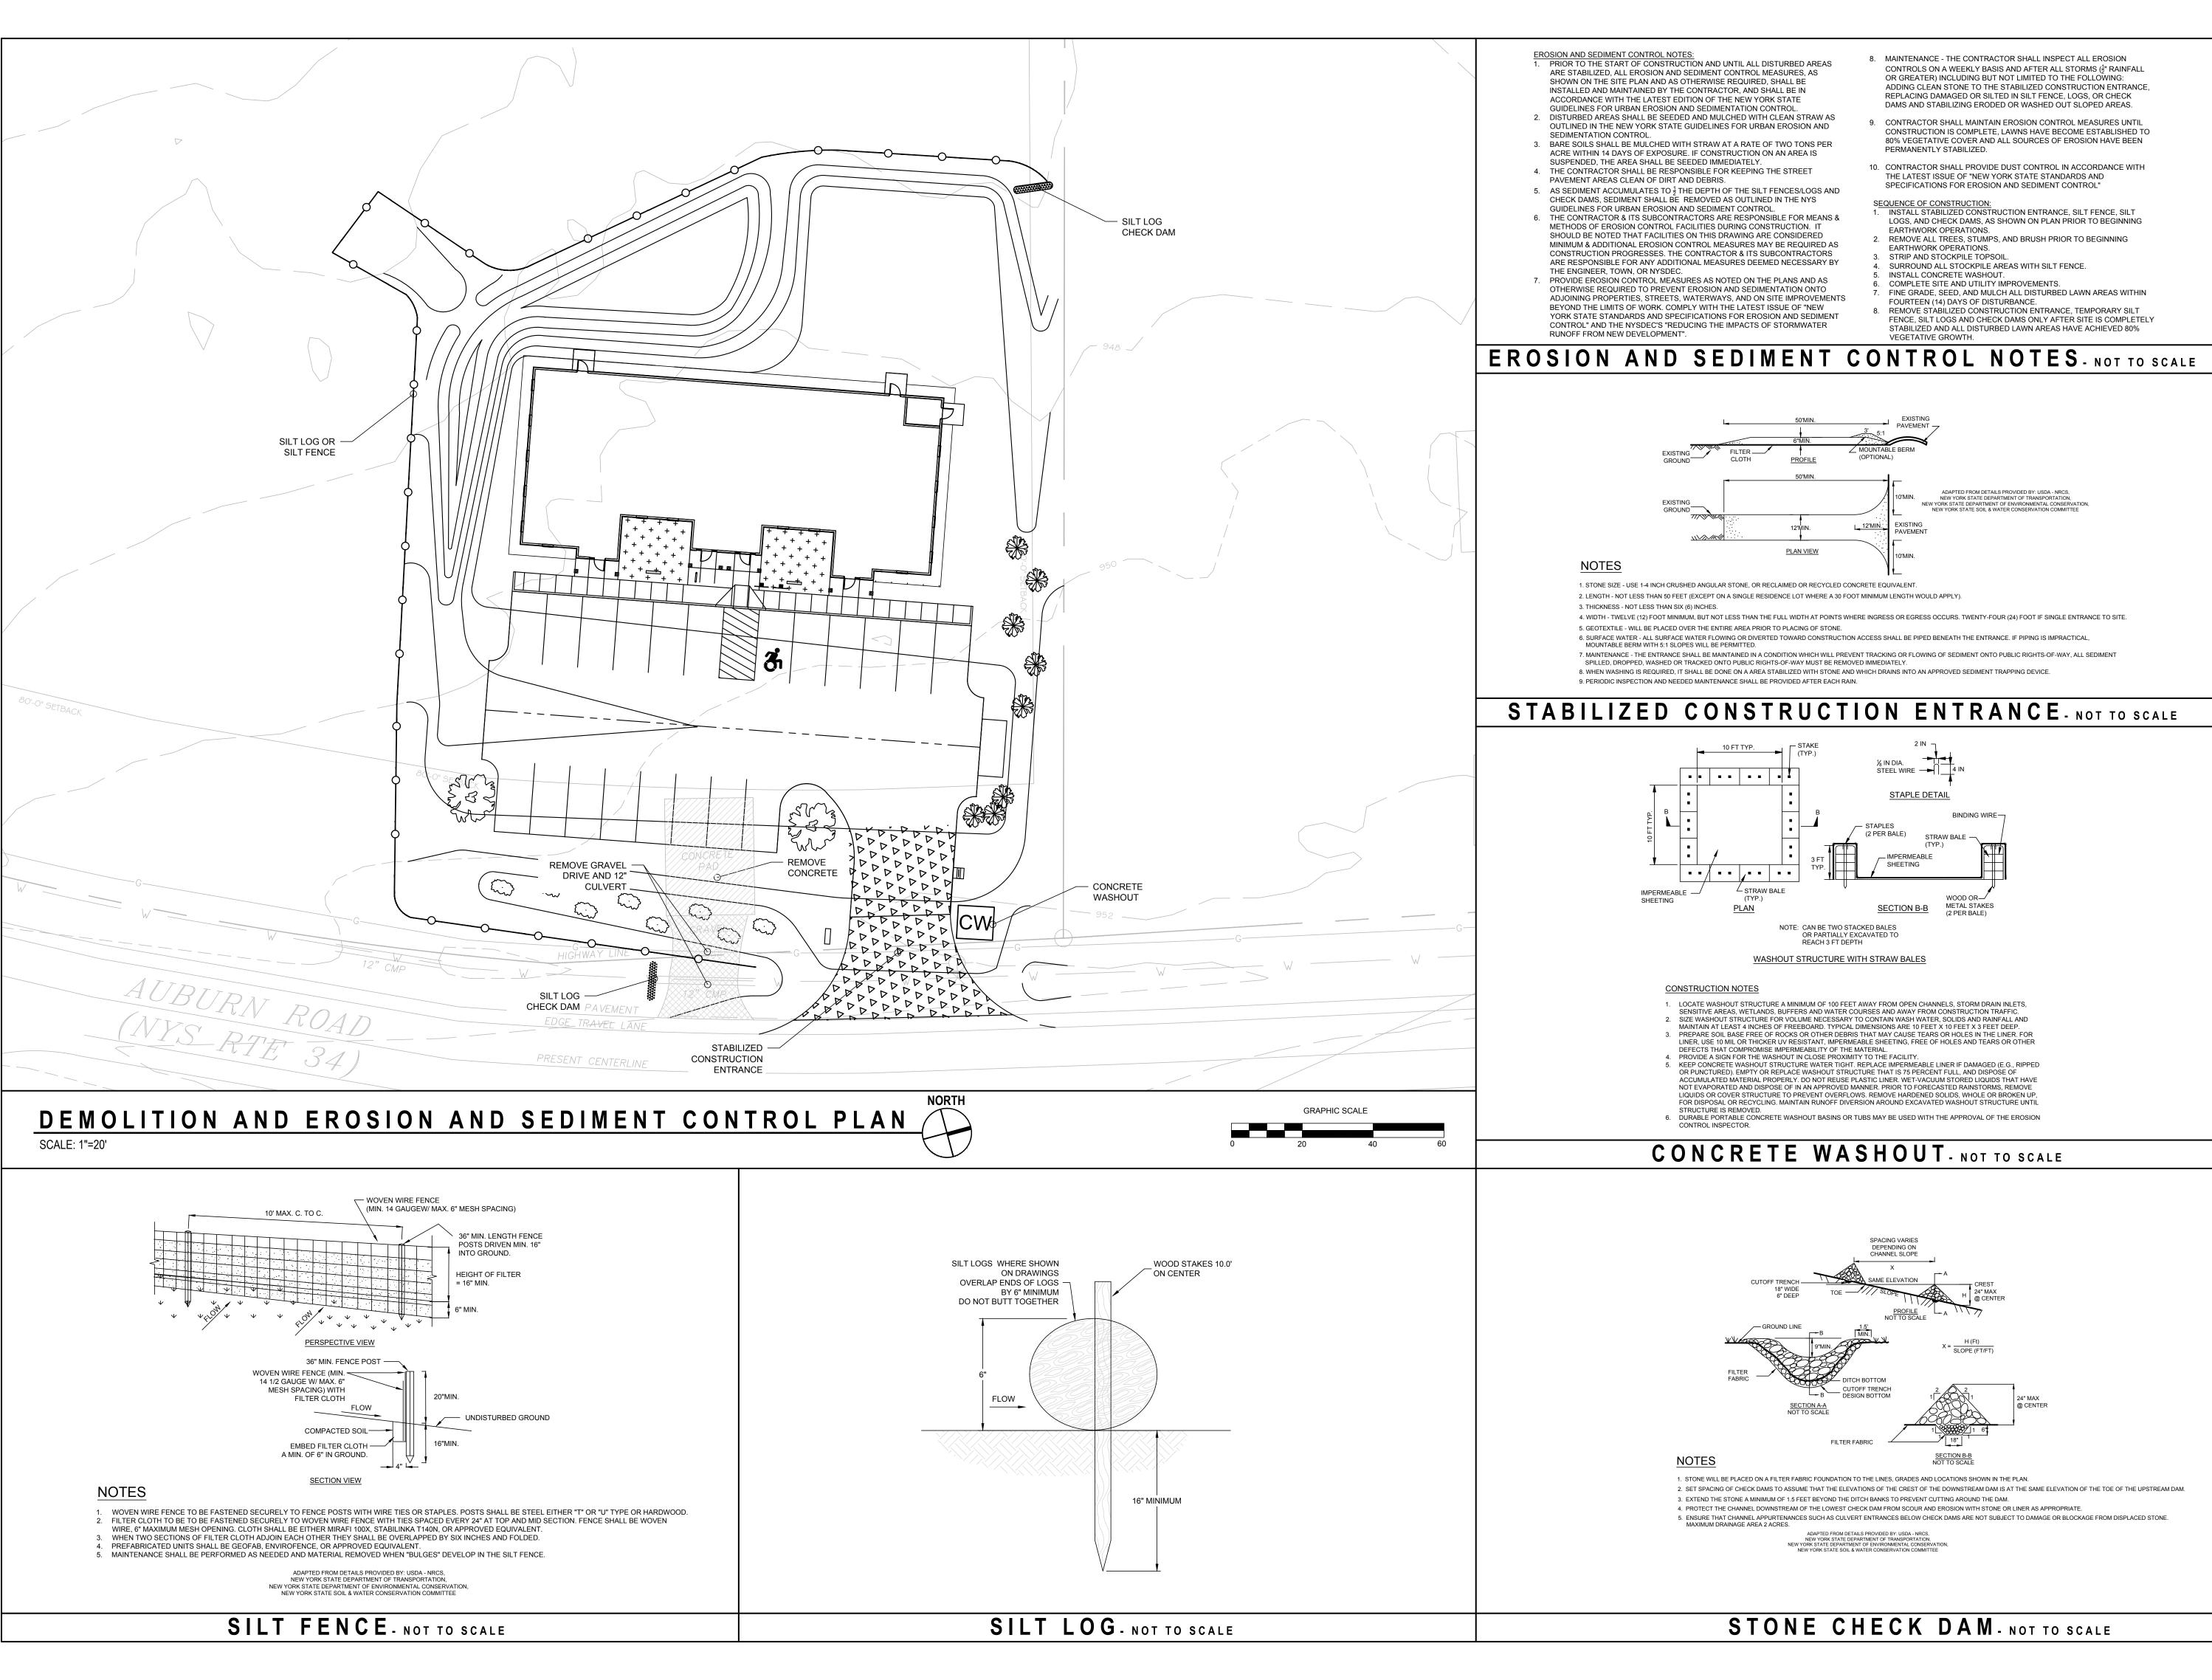

engineering+design


SCIARABBA ENGINEERING, PLLO 9664 Kingtown Road Trumansburg, NY 14886 607-327-0578

www.sciarabbaengplus.com

**WARNING**:

It is a violation of Section 7209, Subdivision 2 of the New

York State Education Law for any person, unless he or she is working under the direction of a licensed engineer, to alter an item in any way. If an item bearing the seal of ar engineer is altered, the altering engineer shall affix to the item his or her seal and the notation "altered by" followed by his or her signature, the date of such alteration, and a specific description of the alteration.

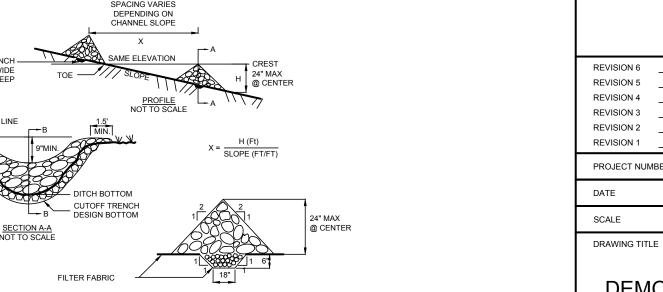

DRAWING NUMBER

C-104

DEMOLITION AND

**EROSION AND** 

SEDIMENT CONTROL


AND DETAILS


PLAN


9/24/2025

5/27/2025

AS NOTED

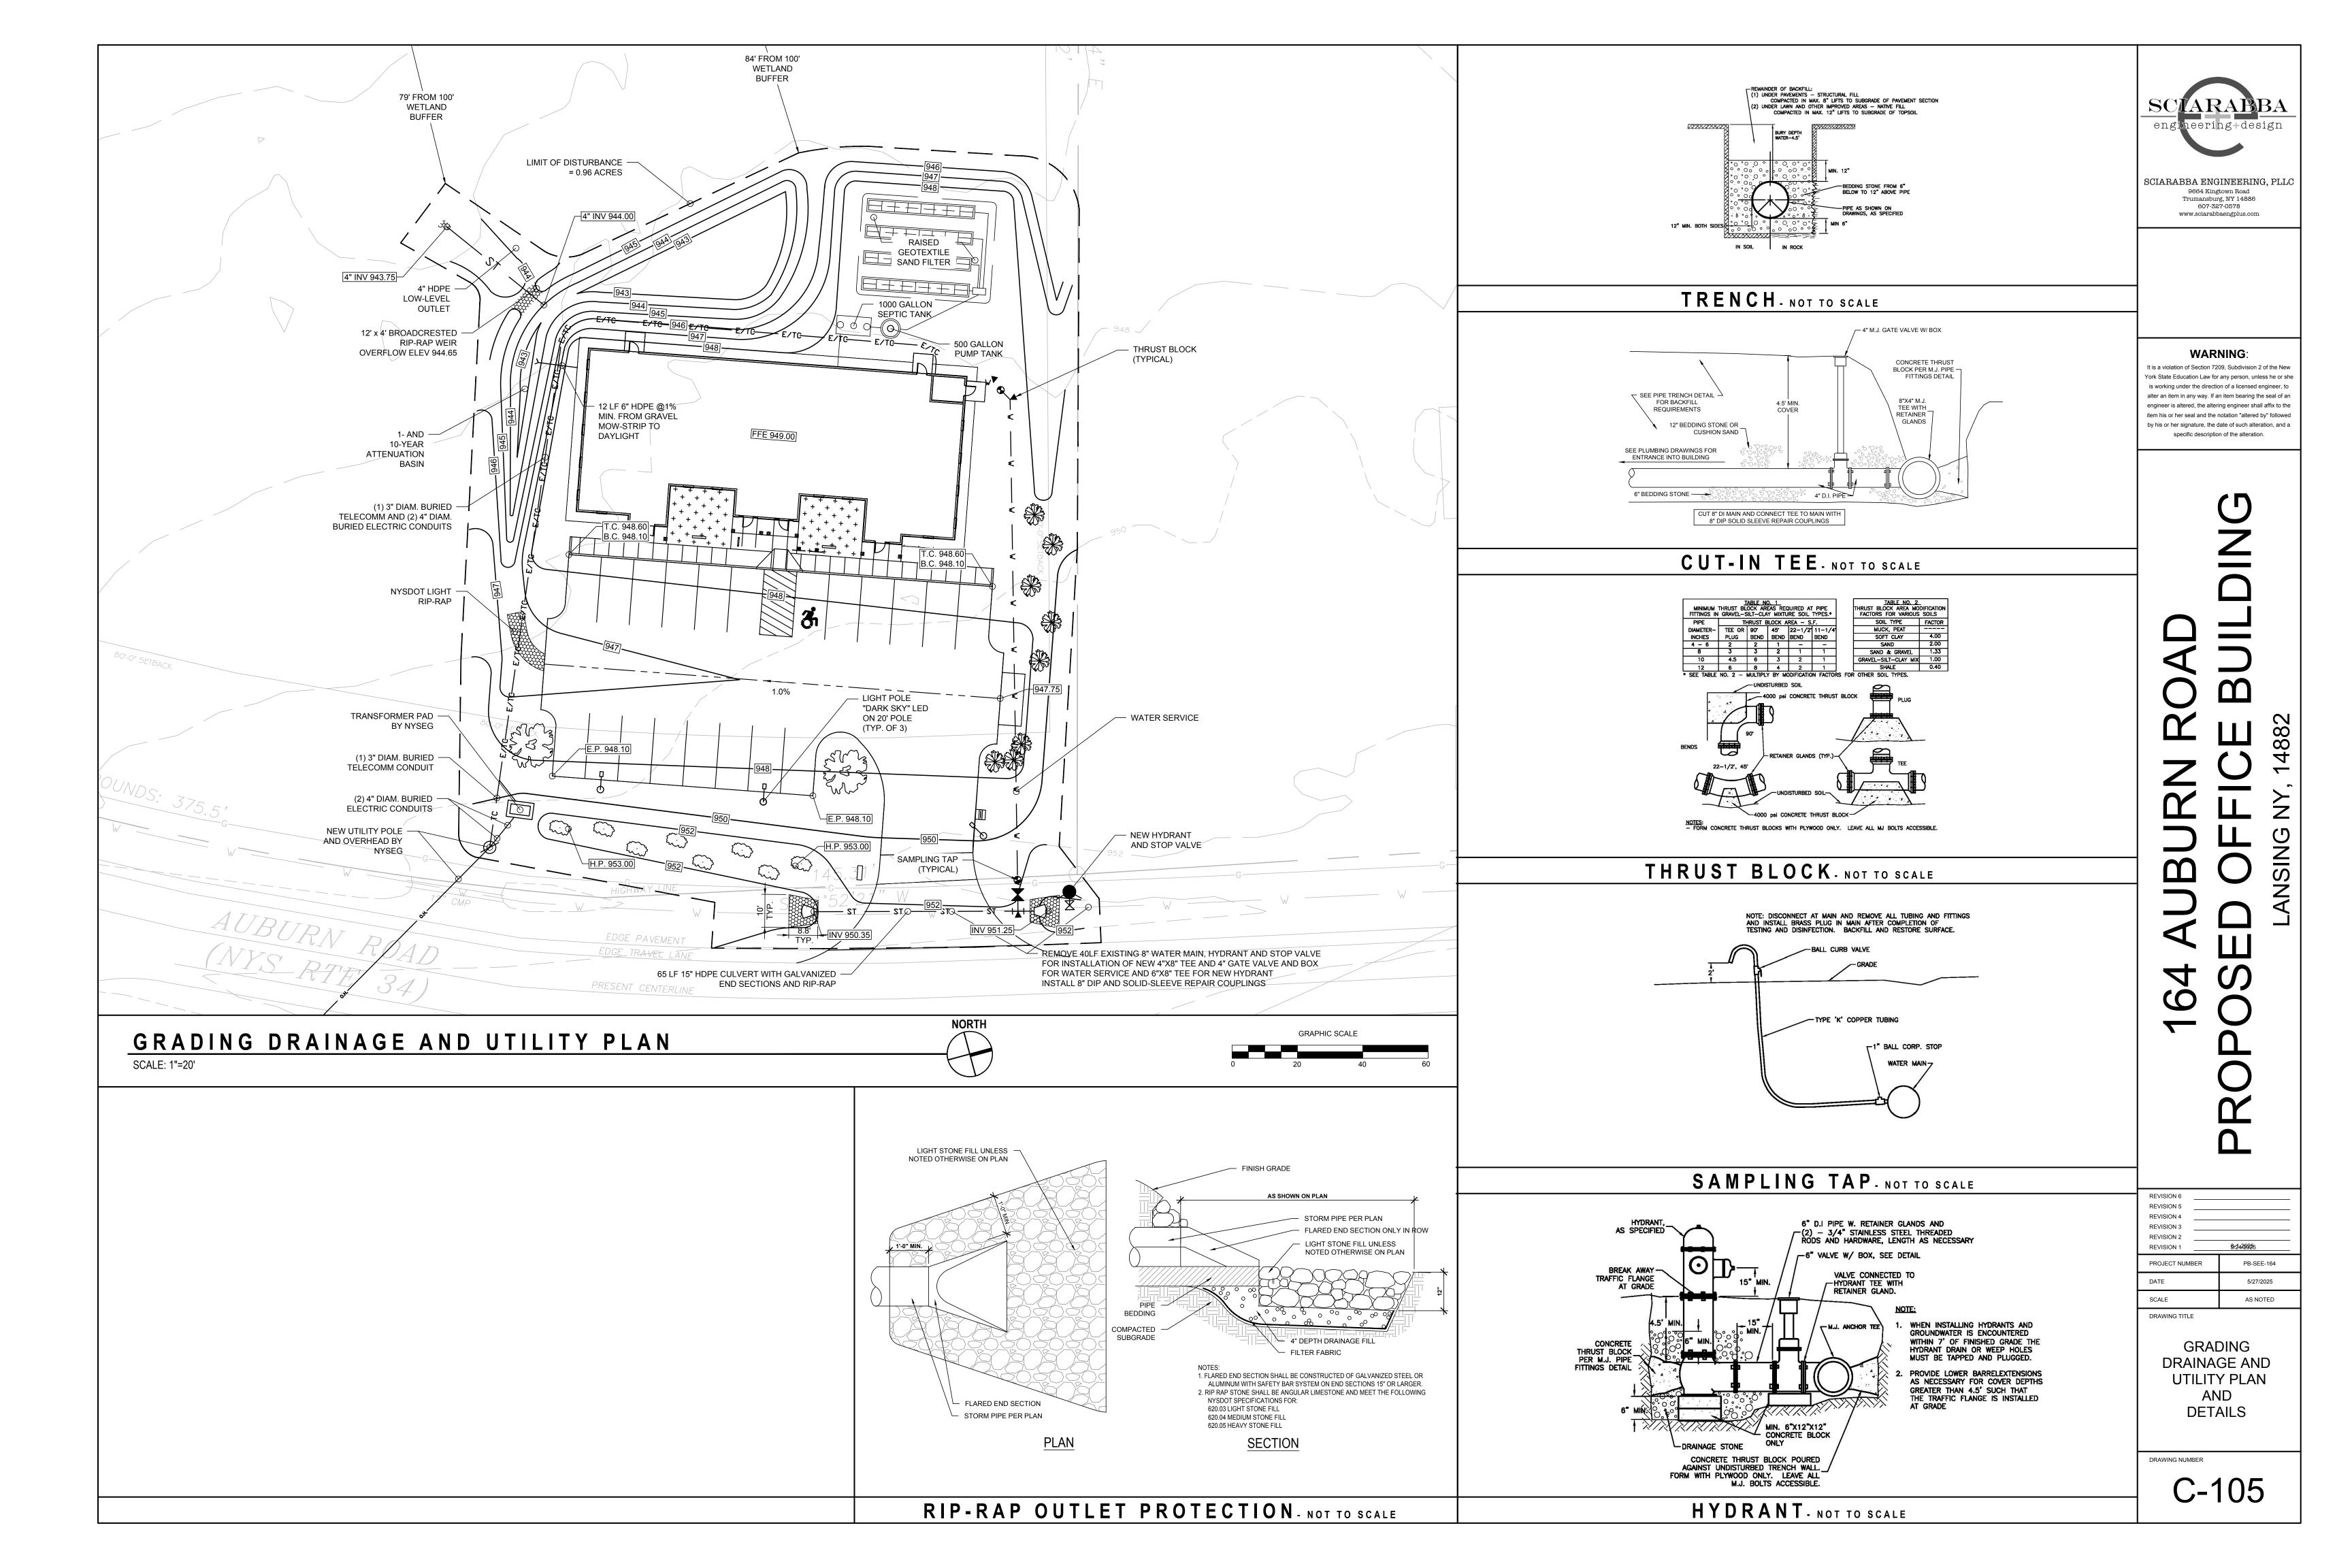

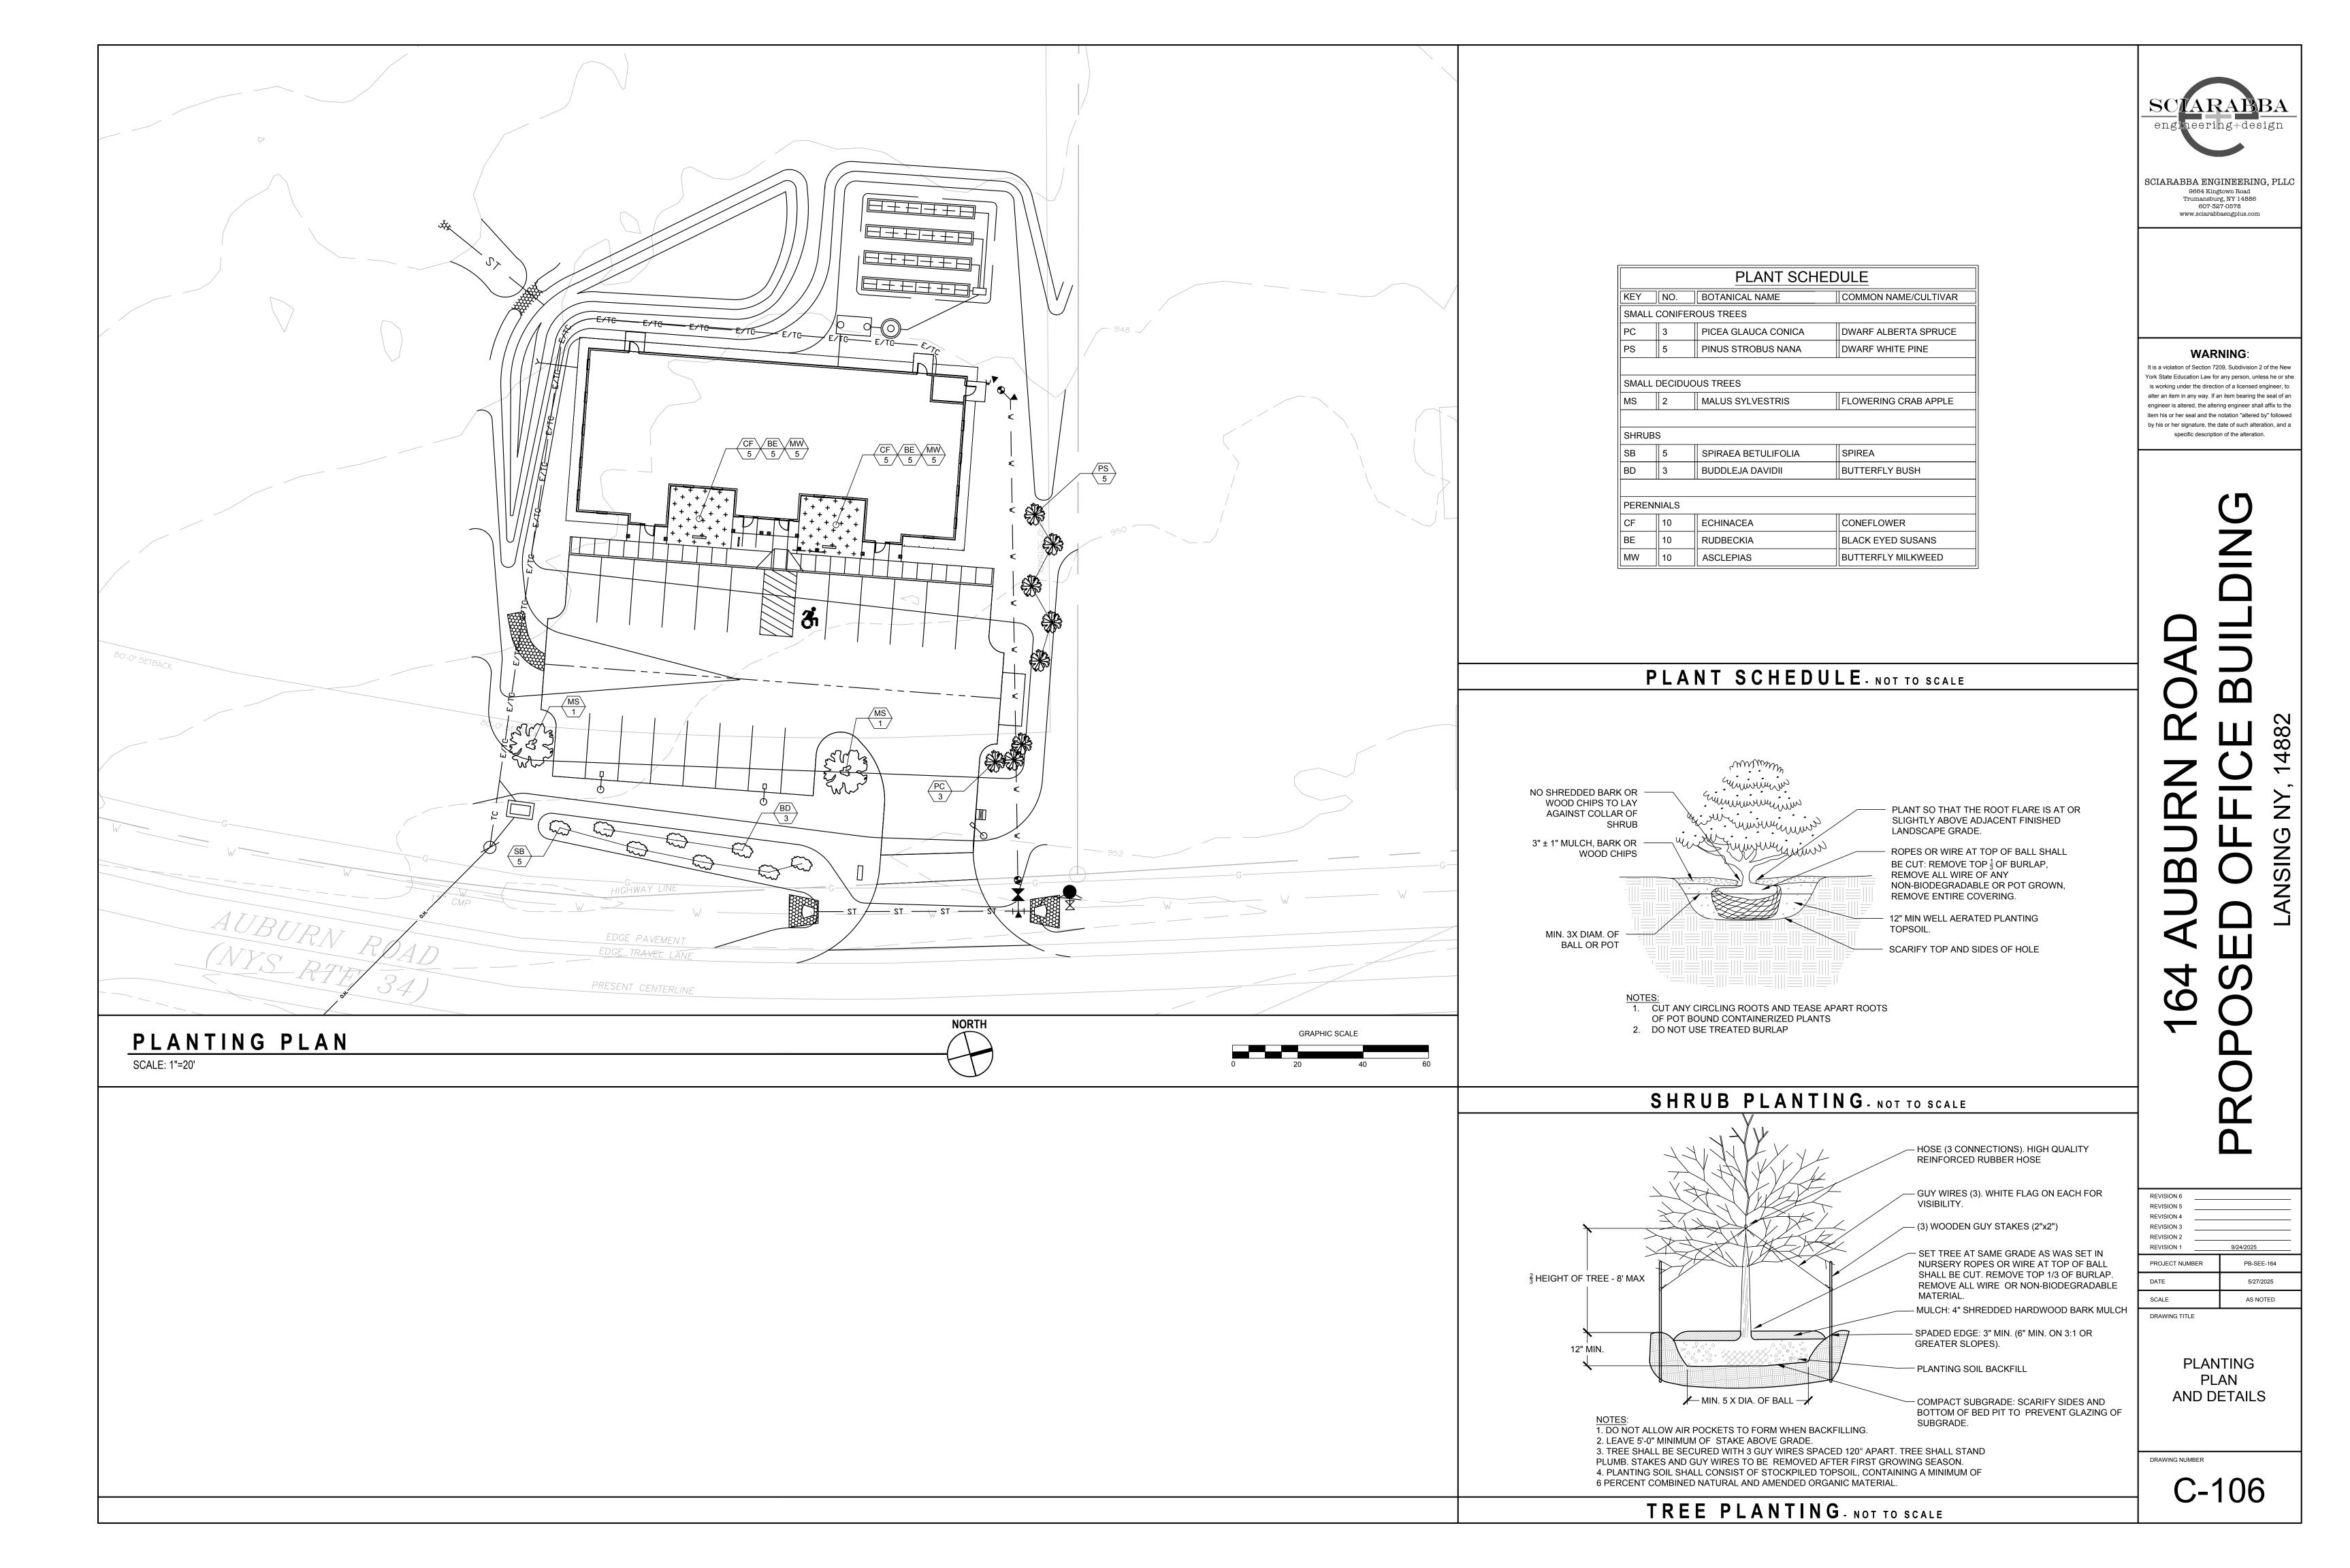

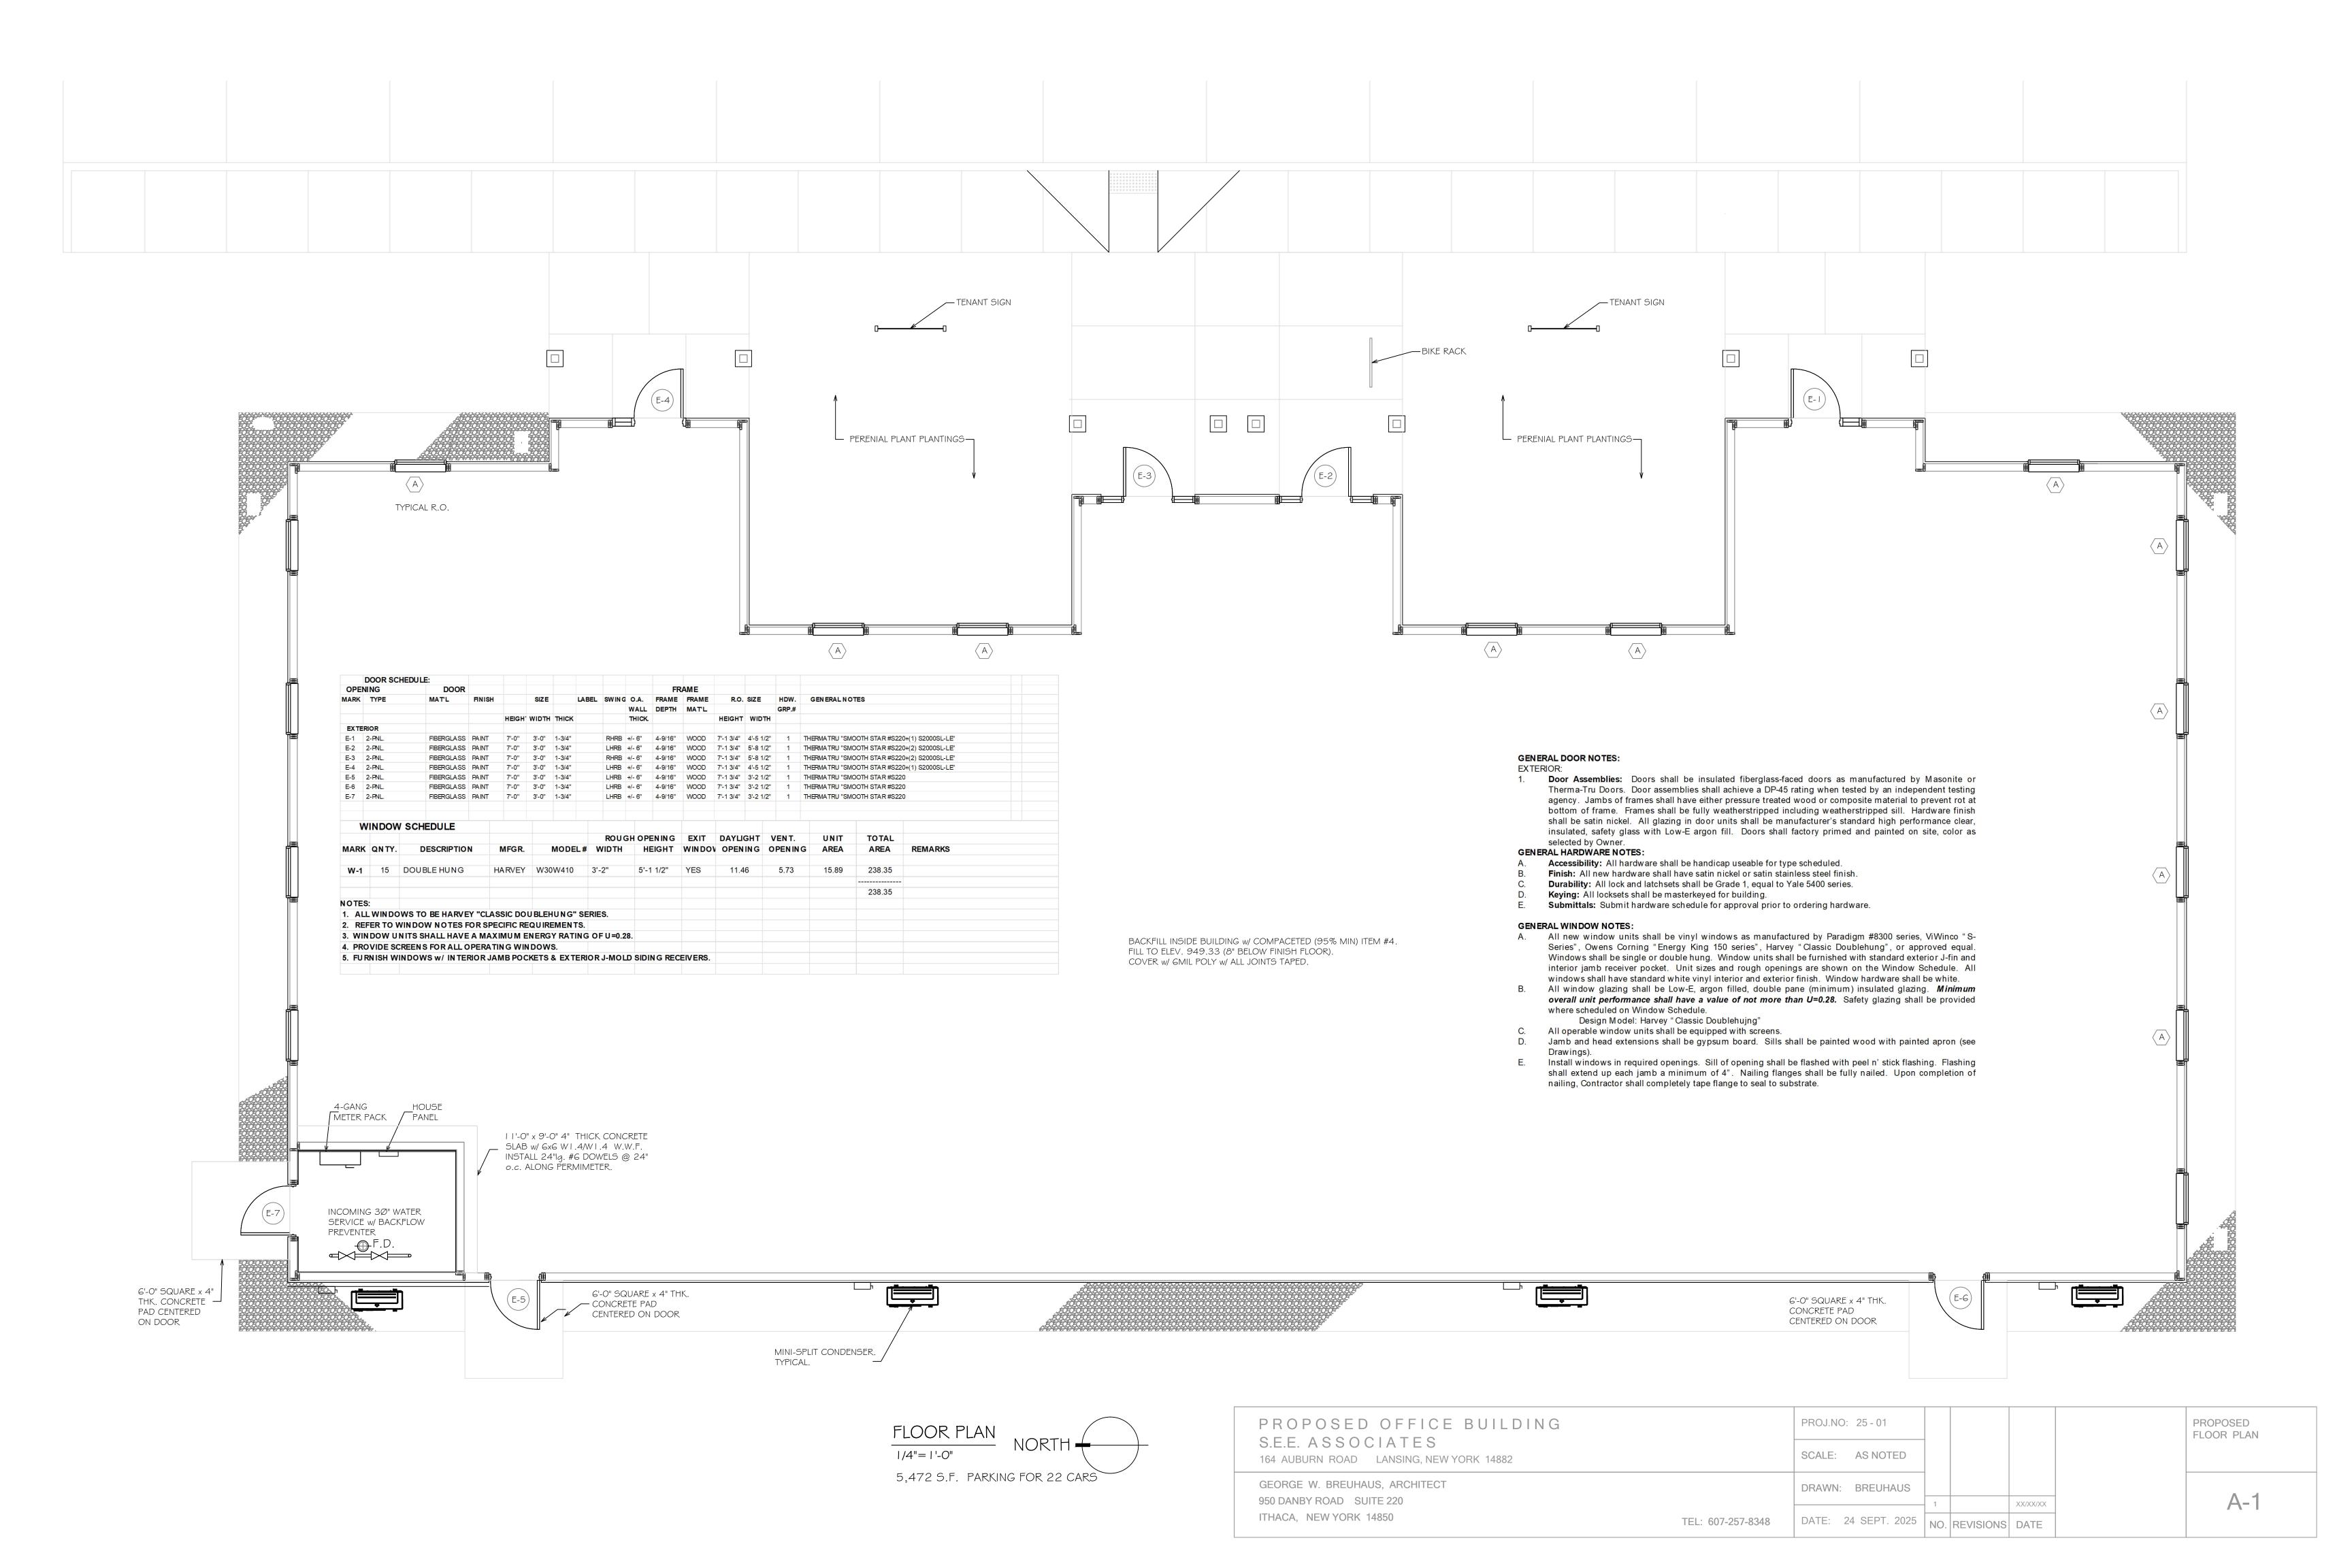




EAST ELEVATION

1/4"= 1'-0"



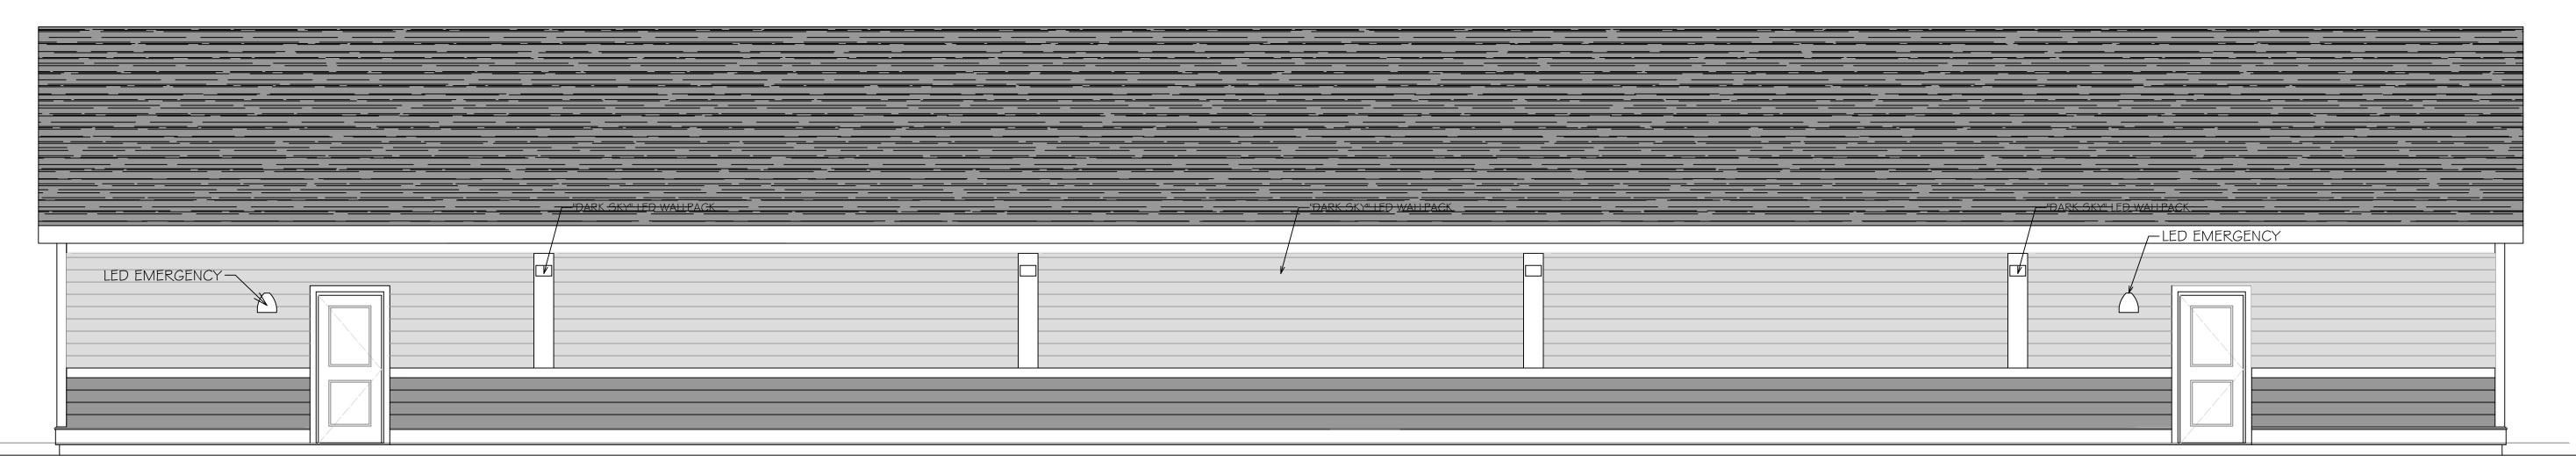

## EXTERIOR FINISHES: OPTION #1

LAP SIDING - MATERIALS:

- Lap siding shall be pre-primed treated "strand" material equal to Louisiana-Pacific SmartSide. Siding shall be furnished as 7-7/8" high x 16'-0" long.
- Fasteners: Use galvanized or stainless steel nails. Follow manufacture's spacing requirements.
   Paint: Acrylic latex exterior house paint, color as chosen by Owner.

## Paint: Acrylic late SIDING INSTALLATION

- 1. Store siding in covered bundles located indoors, spaced off the floor structure. Allow siding to acclimate to
- ambient conditions prior to installing on structure.Install lap siding in strict accordance with manufacturer's instructions.
- Siding shall be installed with all necessary accessories and trims as required to provide a complete job.
  Coordinate installation with specified trims to insure necessary coverage as-needed to compensate for
  thermal expansion and prevent water infiltration. Provide additional necessary manufacturer's standard trim
  components if needed.
- 4. Lap siding shall be installed as a single piece to greatest degree possible. Where necessary, butt joints shall be spaced and caulked as required by manufacturer. Space butt joints so that joints are at least 3'-0" apart from course to course. Back all butt joints with a strip of 30# building felt.
- 5. All "cut" ends shall be field-primed prior to installation.
- 6. Follow manufacturer's instructions for spacing fasteners.
  7. Follow manufacturer's recommendations for all cuts, both "rip"
- Follow manufacturer's recommendations for all cuts, both "rip" and cross-cut.
   Paint siding with minimum one (1) coat of acrylic latex exterior house paint, color as chosen by Owner.

## RUNNING TRIM:

- 1. Running trims hall be factory-primed boards made from preservative treated wood strand or filler substrate solid that is homogenous and free of voids, holes, cracks, foreign inclusions and other defects. Trim shall offer reversible surface consisting of smooth one side and cedar textured on the opposite side. Board shall be finished with square edges. Trim shall be painted color(s) as chosen by Owner. Trims from the following
  - firms will be considered: a. MiraTEC
  - b. LP Smartside Trim and Fascia.

    All trim shall have a 25 year warranty. Thickness shall be a minimum of ¾" as-needed to allow coverage of specified siding. Standard lengths shall be 16'-0", minimum. Width shall be as shown on Drawings, or if not

nails or stainless steel trim-head screws. Countersink fasteners and fill void with putty or sealant as

- shown, as scheduled below.

  2. Install composite trim in strict accordance with manufacturer's instructions and recommendations. All cuts and/or unfinished edges shall be sanded to impart smooth finish similar to face of trim boards. Corner trims shall have 4" strip of Vycor backing intersection of trim with lap siding. Fasten trim to wall with stainless steel
- recommended by trim manufacturer.

  When running lengths exceed 16'-0", account for thermal expansion. Allow a gap as recommended by manufacturer and seal with specified sealant.

## ROOFING NOTES:

- Asphalt Fiberglass Roofing Shingles: Shingles shall be Class A (UL 790), capable of withstanding 130 mph wind exposure and come with a limited lifetime transferrable warranty. Color shall be as chosen by Owner.
- Shingles shall be nailed and NOT stapled.

  2. Shingles shall be installed over 30# felt underlayment, unless installed over "zip-panel", in which case the underlayment is optional. Underlayment shall be installed "shingled" so as to not "buck" water.
- 3. Ice & Watershield: 40 mil self-adhering rubberized asphalt membrane. Install continuous row(s) of Ice and Watershield along all eaves. Line all valleys with 1 row of Ice and Watershield membrane. Ice & Watershield shall extend beyond interior face of wall by a minimum of 24". ICE & WATERSHIELD INSTALLATION IS REQUIRED REGARDLESS OF TYPE OF SHEATHING INSTALLED.

## WEST ELEVATION

1/4"= | '-0"

PROPOSED OFFICE BUILDING
S.E.E. ASSOCIATES
164 AUBURN ROAD LANSING, NEW YORK 14882

GEORGE W. BREUHAUS, ARCHITECT
950 DANBY ROAD SUITE 220
ITHACA, NEW YORK 14850

PROJ.NO: 25-01

SCALE: AS NOTED

DRAWN: BREUHAUS

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DATE: 24 SEPT. 2025
NO. REVISIONS DATE

