WILDLIFE RESOLUTIONS EQUIPMENTSTORAGE BUILDING

35 TOWN BARN RD. LANSING, NY 14882

CLIENT:


MR. JOHN HATFIELD
WILDLIFE RESOLUTIONS
757 WARREN ROAD, UNIT 4465
ITHACA, NY 14852

ENGINEER:

LAKESIDE ENGINEERING 83 FALL STREET SENECA FALLS, NY 13148




GENERAL/CIVIL DRAWINGS INDEX		
SHEET NUMBER SHEET NAME		
T-100	TITLE SHEET	
C-001	EXISTING SITE SURVEY	
C-002	EXISTING SITE TOPOGRAPHY	
C-100	EXISTING AERIAL SITE PLAN	
C-101	EXISTING SITE PLAN	
C-200	PROPOSED AERIAL SITE PLAN	
C-201	PROPSOED SITE PLAN	
C-300	EROSION & SEDIMENT CONTROL PLAN	

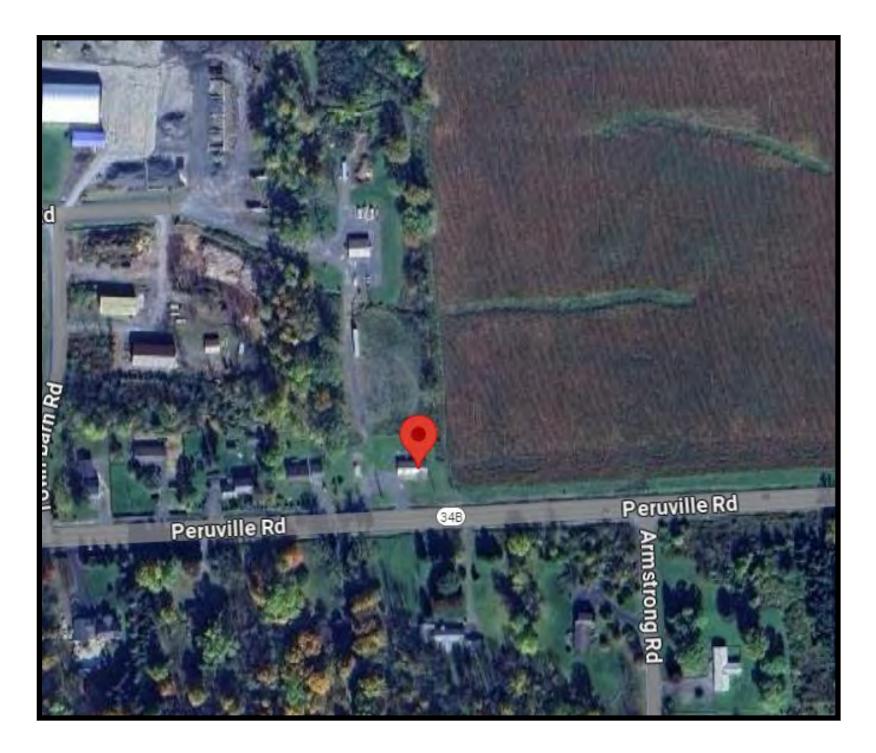

PROJECT LOCATION

AERIAL VIEW



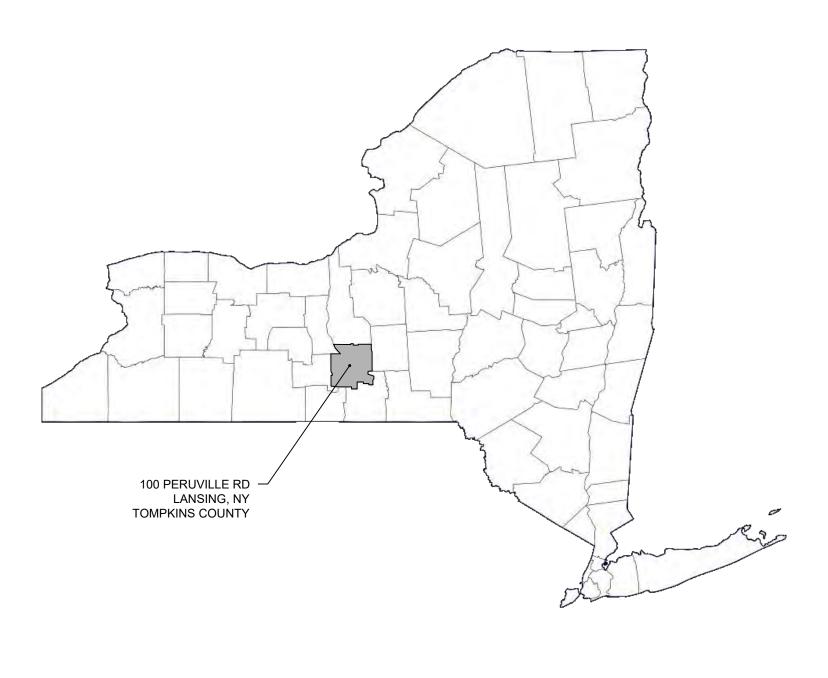

COUNTY MAP





LAKESIDE ENGINEERING Robert G. Harner, PE, PLLC 83 Fall Street Seneca Falls, NY 13148 Robert@LakesideEng.com www.LakesideEng.com 607-725-5824

STORAGE BUILDING
WILDLIFE RESOLUTIONS
757 WARREN ROAD (UNIT 4465)
ITHACA, NY 14853

MARK DATE DESCRIPTION

REVISIONS

PROJECT NO: 20240207

DATE: 02/28/2024

SCALE: AS SHOWN

"UNAUTHORIZED ALTERATION OR ADDITION TO PLANS BEARIN A LICENSED ENGINEER'S OR ARCHITECTS SEAL, IS A VIOLATIC OF SECTION 7209 OF THE NEW YORK STATE EDUCATION LAW


TITLE SHEET

T-100

JOHN B. HATFIELD AND SARA M. L. HATFIELD TOWN OF LANSING ~ COUNTY OF TOMPKINS

STATE OF NEW YORK TAX MAP NOS. 30.-1-22 AND 30.-1-23

REFERENCE DEED: INSTR. NO. 2018-09893

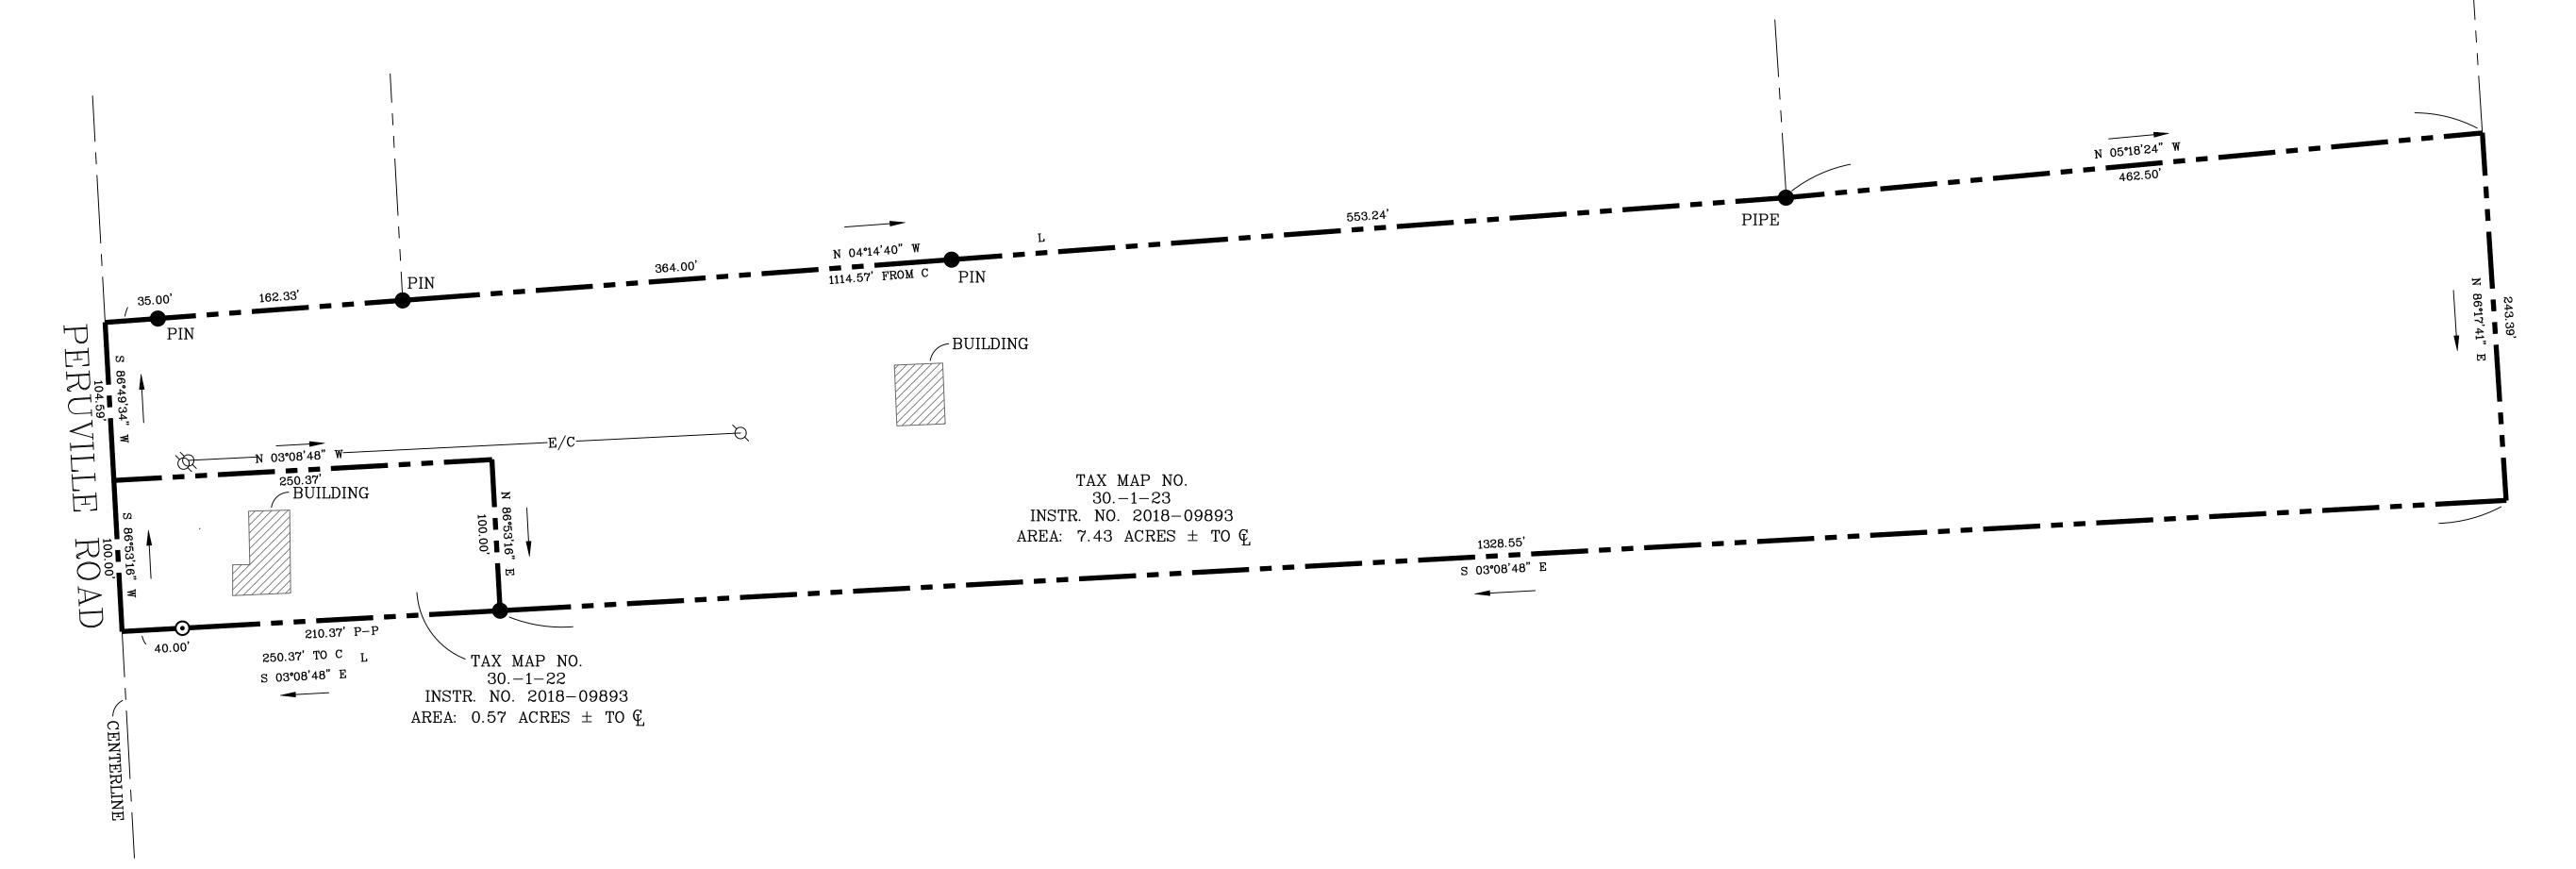

EXISTING SITE SURVEY

SCALE: 1"=60'

GENERAL NOTES

- CONTRACTOR SHALL FIELD VERIFY ALL SITE CONDITIONS PRIOR TO THE START OF WORK.
- 2. ANY DISCREPANCIES OR UNFORESEEN CONDITIONS OBSERVED IN THE FIELD SHALL BE REPORTED TO THE ENGINEER FOR REVIEW.
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LOT DETAILS			
LOCATION	EXISTING	PROPOSED	
FRONT SETBACK	519 FT	162 FT	
REAR SETBACK	1,033 FT	1,033 FT	
SIDE (NORTH) SETBACK	66 FT	15 FT	
SIDE (SOUTH) SETBACK	107 FT	107 FT	
FRONTAGE	104 FT	104 FT	
LOT SIZE	7.43 AC	7.43 AC	
LOT COVERAGE	7.6 %	9.3 %	
BUILDING HEIGHT	23 FT	29 FT	
OPEN SPACE	92.4 %	90.7 %	

- FRONT SETBACK LESS THAN 60 FT WITH SITE PLAN APPROVAL FOR IR ZONED PARCEL.
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- PER §270-20 LOT IN TWO DISTRICTS: WHEN LOT IS DIVIDED BY A DISTRICT BOUNDARY LINE, THE REGULATIONS OF EITHER DISTRICT MAY BE EXTENDED FOR A DISTANCE OF 50 FEET INTO THE OTHER DISTRICT, AT THE LOT OWNER'S DISCRETION.

R1 ZONING REQUIREMENTS		
LOT ITEM	ORDINANCE	
FRONT SETBACK (FROM CL OF ROAD)	60 FT	
REAR SETBACK	25 FT	
SIDE SETBACK	15 FT	
MIN. FRONTAGE	150 FT	
MAX LOT AREA	40,000 SF	
MAX LOT COVERAGE	25 %	
MAX BUILDING HEIGHT	35 FT	
MIN. OPEN SPACE	75 %	
IR ZONING REQUIREMENTS		
LOT ITEM	ORDINANCE	
FRONT SETBACK (FROM CL OF ROAD)	60 FT	
REAR SETBACK	10 FT	
SIDE SETBACK	10 FT	
MIN. FRONTAGE	50 FT	
MAX LOT AREA	NONE	

MAX LOT COVERAGE

MAX BUILDING HEIGHT

MIN. OPEN SPACE

	1 1
60 FT	PROP
25 FT	EXIST
15 FT	EXIST
150 FT	PROP
000 SF	
25 %	SILT F
35 FT	MAJO
	MINOF
75 %	-
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60 FT	
60 FT	
60 FT 10 FT	
60 FT 10 FT 10 FT	
60 FT 10 FT 10 FT 50 FT	

35 FT

20 %

LEGEND	
EXISTING STRUCTURE	
PROPOSED STRUCTURE	
EXISTING ASPHALT	
EXISTING LANDSCAPING	
PROPERTY LINES	
SILT FENCE	SFSF
MAJOR CONTOUR (2.5' INTERVAL)	
MINOR CONTOUR (0.5' INTERVAL)	
FREE/SHRUB/PLANTING	



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WILDLIFE RES 757 WARREN ITHACA, NY 14

GRAPHIC SCALE (HORIZONTAL)

EXISTING SITE SURVEY


REVISIONS

"UNAUTHORIZED ALTERATION OR ADDITION TO PLANS BEARING A LICENSED ENGINEER'S OR ARCHITECTS SEAL, IS A VIOLATION OF SECTION 7209 OF THE NEW YORK STATE EDUCATION LAW"

JOHN B. HATFIELD AND SARA M. L. HATFIELD TOWN OF LANSING ~ COUNTY OF TOMPKINS

STATE OF NEW YORK

TAX MAP NOS. 30.-1-22 AND 30.-1-23 REFERENCE DEED: INSTR. NO. 2018-09893

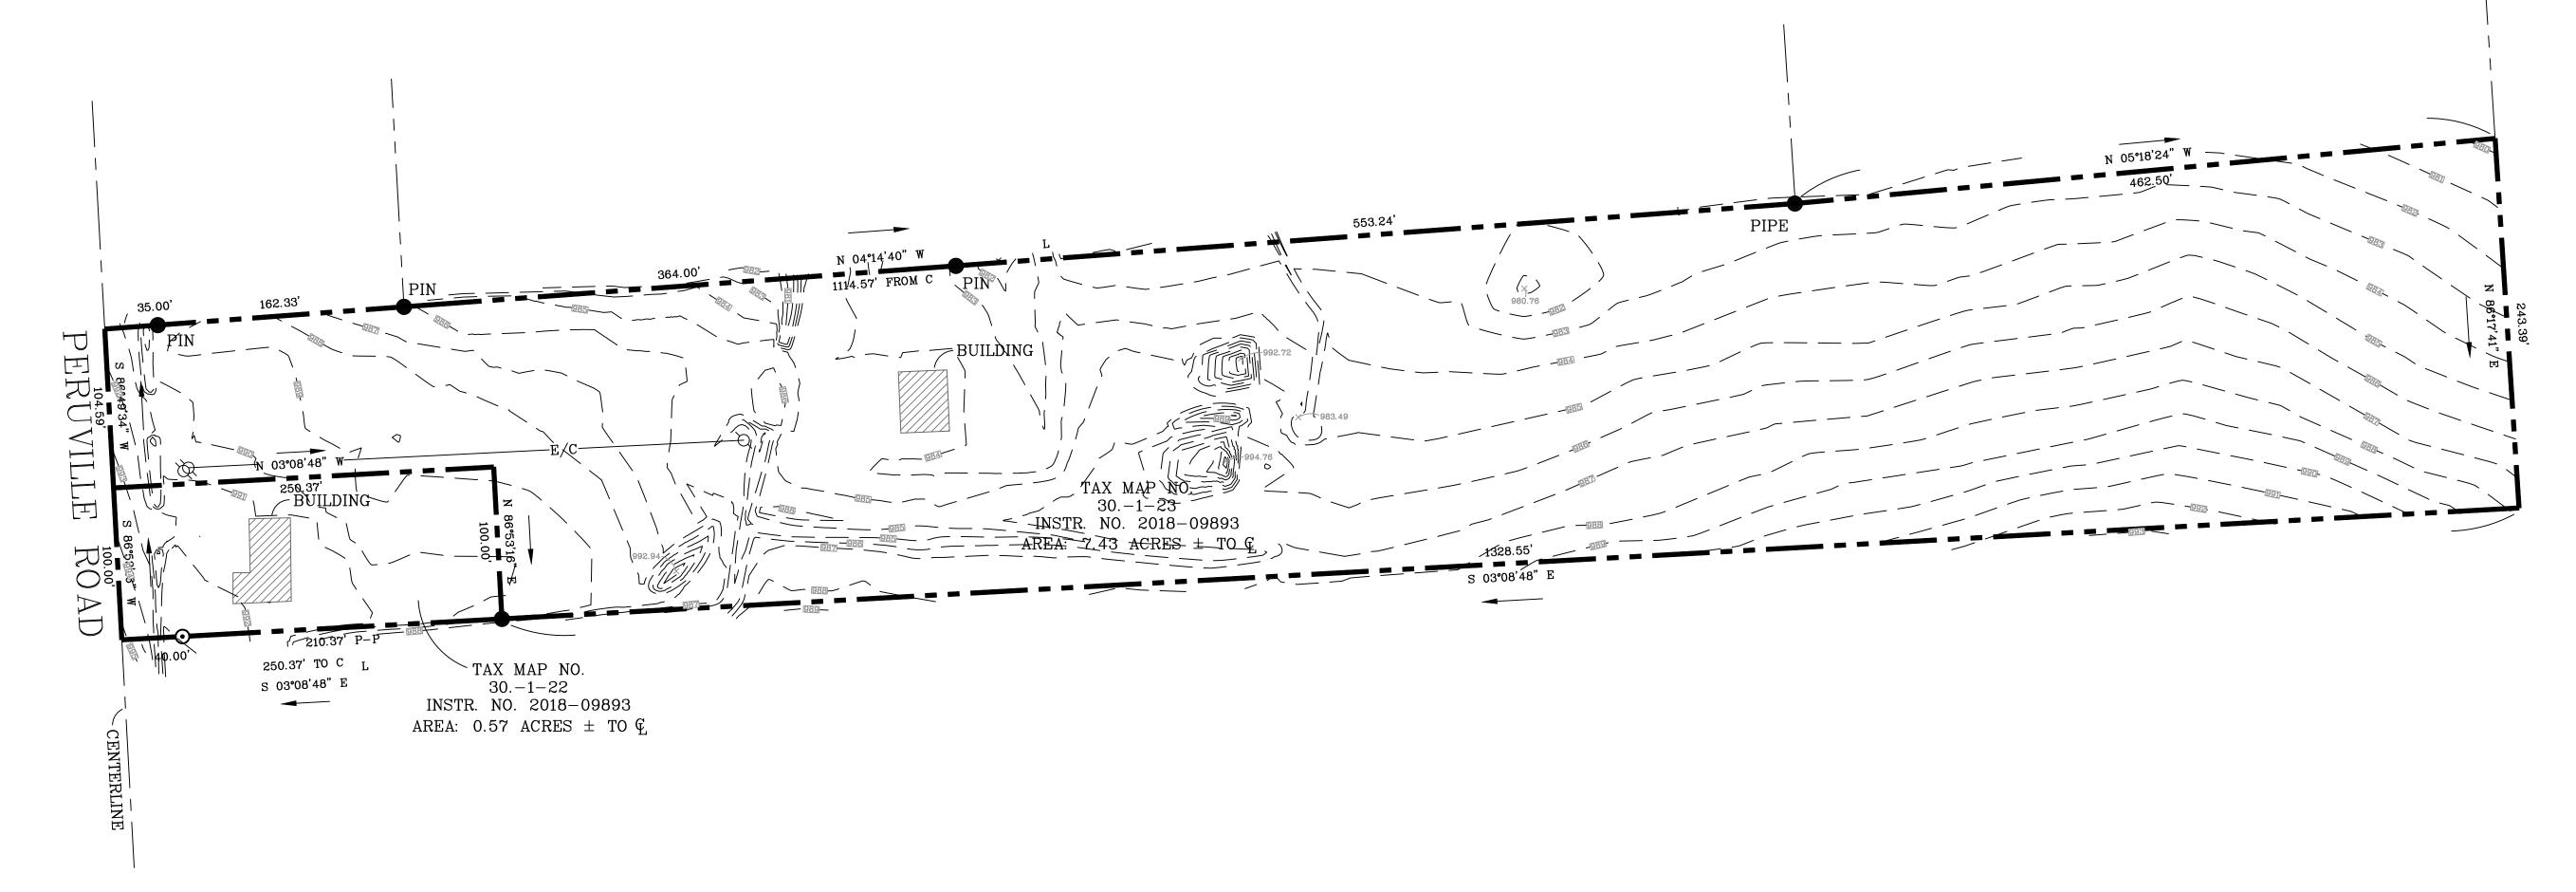

EXISTING SITE TOPOGRAPHY

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FRONT SETBACK (FROM CL OF ROAD)	60 FT	
REAR SETBACK	10 FT	
SIDE SETBACK	10 FT	
MIN. FRONTAGE	50 FT	
MAX LOT AREA	NONE	
MAX LOT COVERAGE	80 %	

MAX BUILDING HEIGHT

MIN. OPEN SPACE

JINANGE	E	XIST
60 FT	PI	ROP
25 FT	E	XIST
15 FT		XIST
150 FT	_	ROP
000 SF		
25 %	S	ILT F
35 FT	М	AJOI
	М	INOF
75 %	TI	REE/
DINANCE		
60 FT		
10 FT		
10 FT		
50 FT		
NONE		
80 %		

35 FT

20 %

LEGEND	
XISTING STRUCTURE	
ROPOSED STRUCTURE	
XISTING ASPHALT	
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ROPERTY LINES	
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REE/SHRUB/PLANTING	*



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WILDLIFE RES 757 WARREN ITHACA, NY 14

REVISIONS "UNAUTHORIZED ALTERATION OR ADDITION TO PLANS BEARING A LICENSED ENGINEER'S OR ARCHITECTS SEAL, IS A VIOLATION OF SECTION 7209 OF THE NEW YORK STATE EDUCATION LAW"

GRAPHIC SCALE (HORIZONTAL)

EXISTING SITE TOPOGRAPHY

GRAPHIC SCALE (HORIZONTAL) 0 60 180 SCALE:1"=60'-0"

C1 EXISTING AERIAL SITE PLAN
SCALE: 1"=60'

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GENERAL NOTES

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MIN. FRONTAGE	150 FT		
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MAX LOT COVERAGE	25 %		
MAX BUILDING HEIGHT 35 FT			
MIN. OPEN SPACE	75 %		
IR ZONING REQUIREMENTS			
LOT ITEM	ORDINANCE		
FRONT SETBACK (FROM CL OF ROAD)	60 FT		
REAR SETBACK 10 FT			
SIDE SETBACK 10 FT			
MIN. FRONTAGE 50 FT			
MAX LOT AREA NONE			
MAX LOT COVERAGE	80 %		
MAX BUILDING HEIGHT 35 FT			
MIN. OPEN SPACE	20 %		

LEGEND	
EXISTING STRUCTURE	
PROPOSED STRUCTURE	
EXISTING ASPHALT	
EXISTING LANDSCAPING	
PROPERTY LINES	
SILT FENCE	SFSF
MAJOR CONTOUR (2.5' INTERVAL)	
MINOR CONTOUR (0.5' INTERVAL)	
TREE/SHRUB/PLANTING	

LAKESIDE ENGINEERING

Engineering | Design | Permitting

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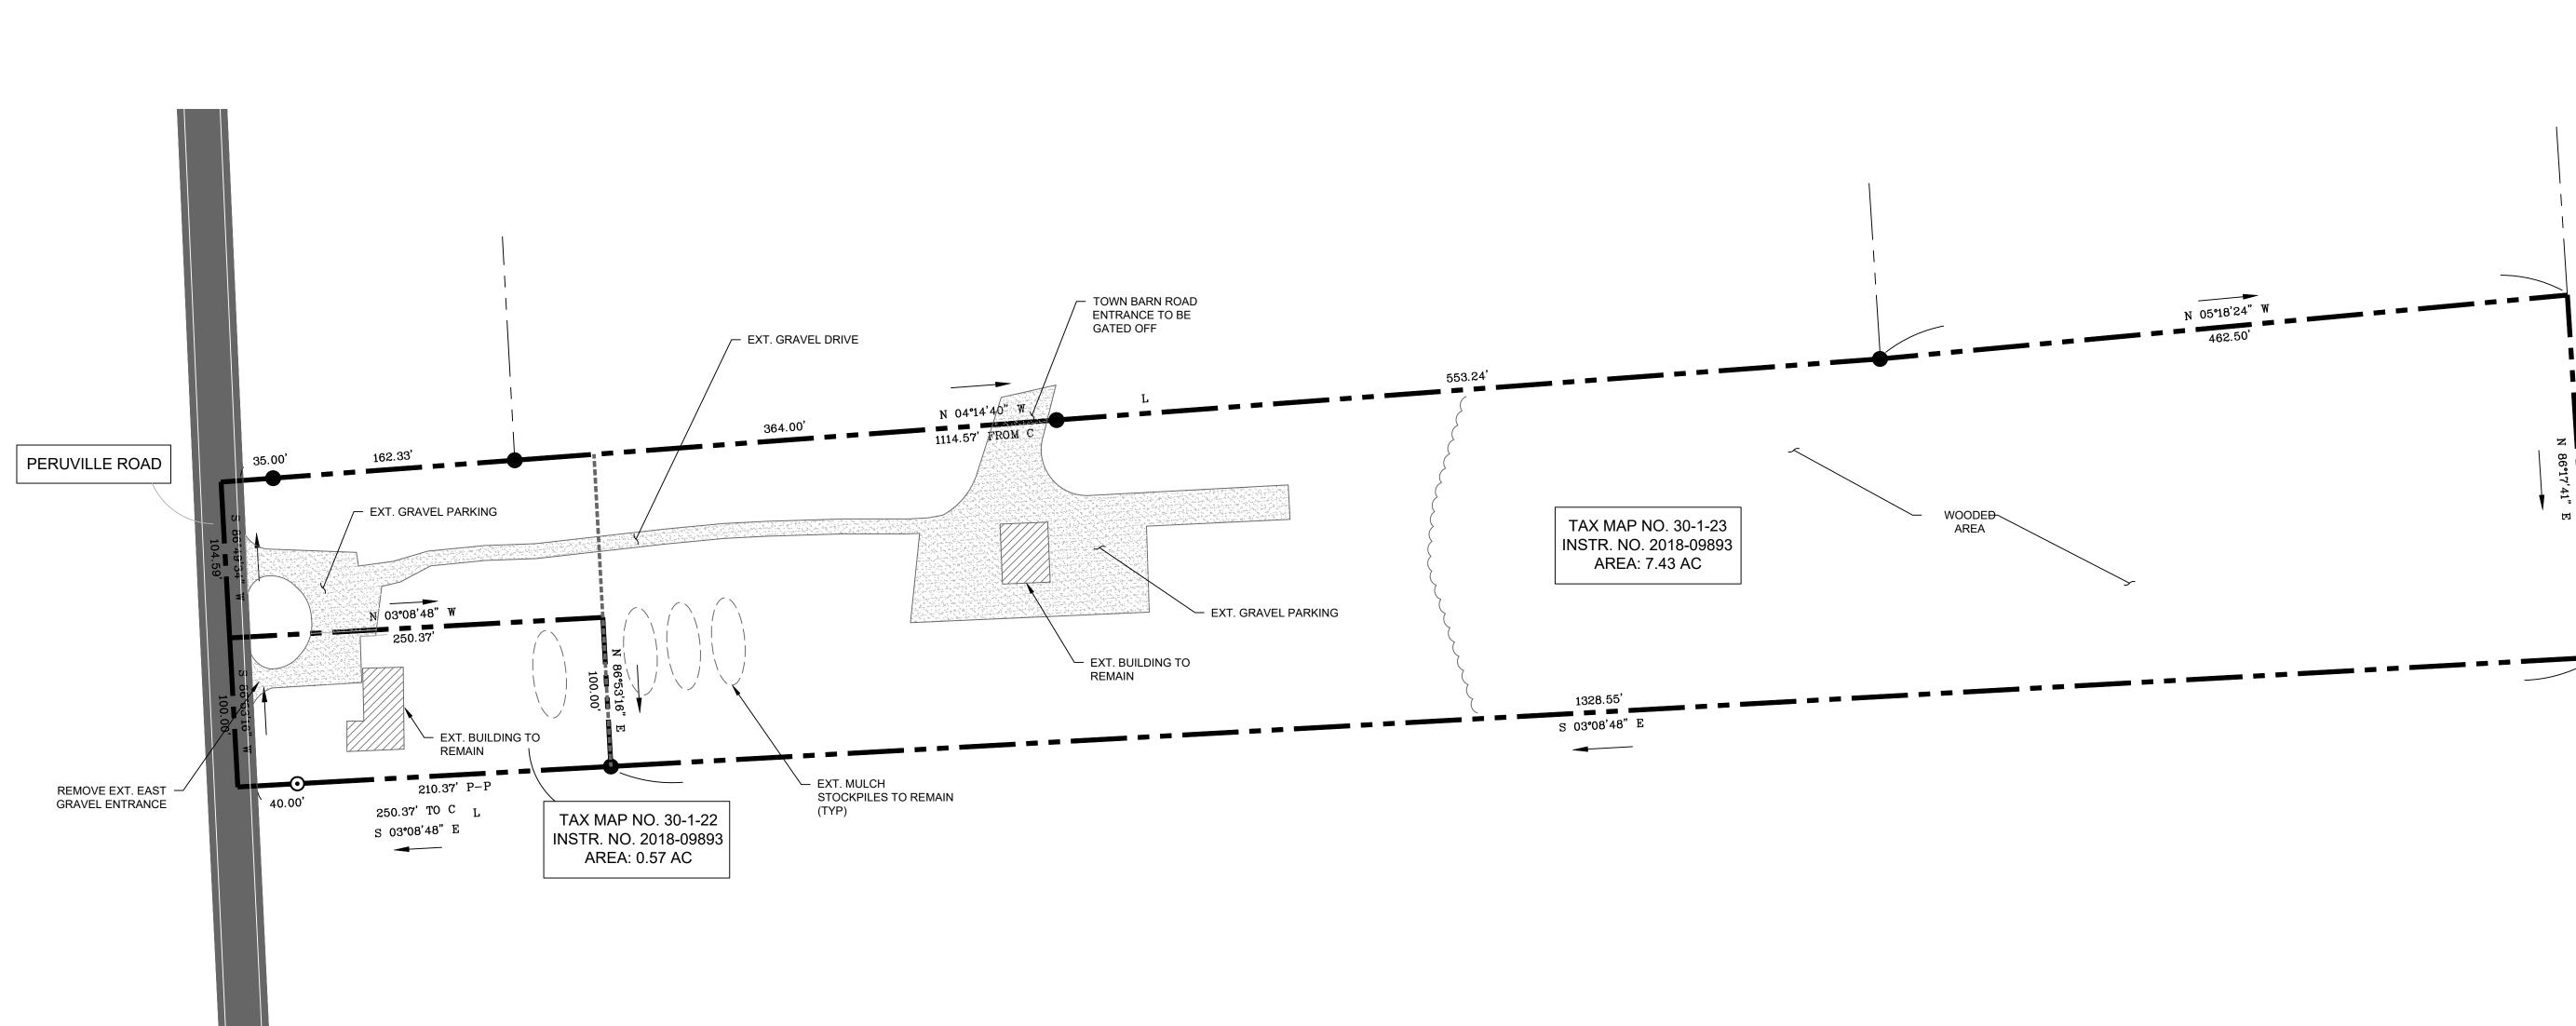
WILDLIFE RESOLUTIONS
757 WARREN ROAD (UNIT 44)

BUILDING


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	02	2/28/2024		
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UTHORIZED ALTERATION OR ADDITION TO PLANS BEARING ENSED ENGINEER'S OR ARCHITECTS SEAL, IS A VIOLATION ECTION 7209 OF THE NEW YORK STATE EDUCATION LAW"				

EXISTING AERIAL SITE PLAN

C-100



GRAPHIC SCALE (HORIZONTAL)
0 60 180

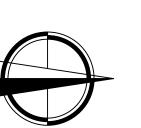

SCALE: 1"=60'

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MAX LOT COVERAGE	25 %		
MAX BUILDING HEIGHT	35 FT		
MIN. OPEN SPACE	75 %		
IR ZONING REQUIREMEN	TS		
LOT ITEM	ORDINANCE		
FRONT SETBACK (FROM CL OF ROAD)	60 FT		
REAR SETBACK	10 FT		
SIDE SETBACK	10 FT		
SIDE SETBACK MIN. FRONTAGE	10 FT 50 FT		
MIN. FRONTAGE	50 FT		
MIN. FRONTAGE MAX LOT AREA	50 FT NONE		

R1 ZONING REQUIREMENTS

LEGEND	
EXISTING STRUCTURE	
PROPOSED STRUCTURE	
EXISTING ASPHALT	
EXISTING LANDSCAPING	
PROPERTY LINES	
SILT FENCE	SFSF
MAJOR CONTOUR (2.5' INTERVAL)	
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TREE/SHRUB/PLANTING	
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2	LAKESIDI	F	FNG	IN	NEERING
F	Engineering			-	

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STORAGE BUILDING WILDLIFE RESOLUTIONS 757 WARREN ROAD (UNIT 4465 ITHACA, NY 14853

EXISTING SITE PLAN

REVISIONS

"UNAUTHORIZED ALTERATION OR ADDITION TO PLANS BEARING A LICENSED ENGINEER'S OR ARCHITECTS SEAL, IS A VIOLATION OF SECTION 7209 OF THE NEW YORK STATE EDUCATION LAW"

C-101

GRAPHIC SCALE (HORIZONTAL) 0 60 180 SCALE:1"=60'-0"

PROPOSED SITE AERIAL PLAN SCALE: 1"=60'

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MAX BUILDING HEIGHT	35 FT
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LOT ITEM	ORDINANCE
FRONT SETBACK (FROM CL OF ROAD)	60 FT
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MIN. FRONTAGE	50 FT
MAX LOT AREA	NONE
MAX LOT COVERAGE	80 %
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LEGEND	
EXISTING STRUCTURE	
PROPOSED STRUCTURE	
EXISTING ASPHALT	
EXISTING LANDSCAPING	
PROPERTY LINES	
SILT FENCE	SFSF
MAJOR CONTOUR (2.5' INTERVAL)	
MINOR CONTOUR (0.5' INTERVAL)	
TREE/SHRUB/PLANTING	

12	LAKESIDE ENGINEERING
	Engineering Design Permitting


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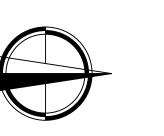
WILDLIFE RESOLUTIONS 757 WARREN ROAD (UNIT 44

MARK	DATE	DESCRIPTION
REVISIONS		
ROJECT NO: 20240207		
ATE: 02/28/2024		
CALE: AS SHOWN		
UNAUTHORIZED ALTERATION OR ADDITION TO PLANS BEARING A LICENSED ENGINEER'S OR ARCHITECTS SEAL, IS A VIOLATION OF SECTION 7209 OF THE NEW YORK STATE EDUCATION LAW"		

PROPOSED SITE AERIAL PLAN

C-200



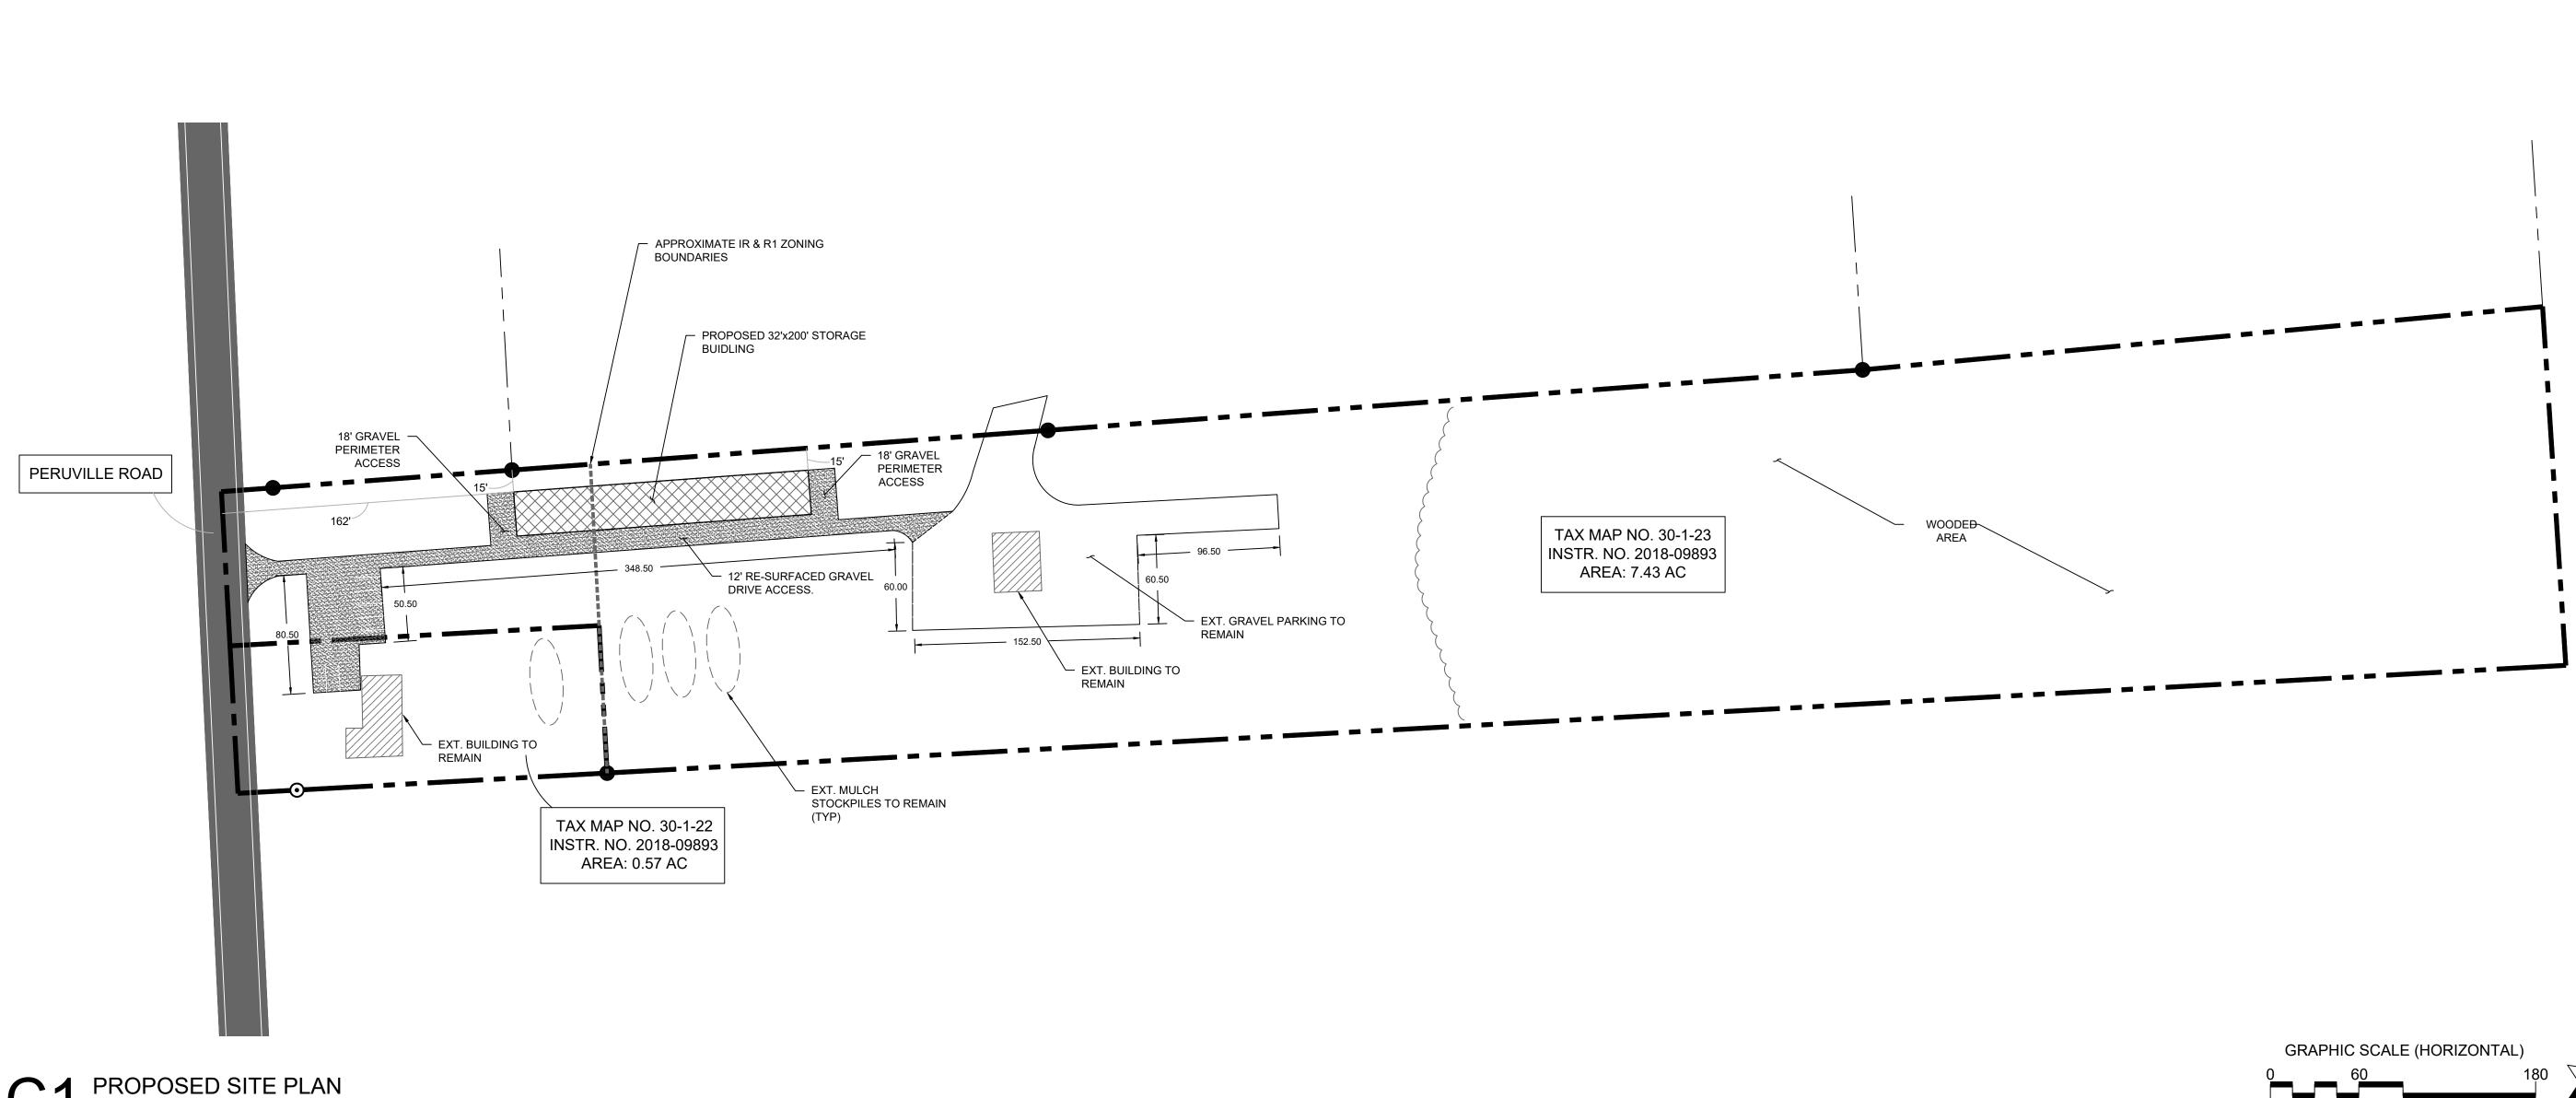

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20 %

MIN. OPEN SPACE

LEGEND	
EXISTING STRUCTURE	
PROPOSED STRUCTURE	
EXISTING ASPHALT	
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PROPERTY LINES	
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MINOR CONTOUR (0.5' INTERVAL)	
TREE/SHRUB/PLANTING	

2	LAKESIDE ENGINEERIN	١G
	Engineering Design Permitting	


LAKESIDE ENGINEERING Robert G. Harner, PE, PLLC 83 Fall Street Seneca Falls, NY 13148 Robert@LakesideEng.com www.LakesideEng.com 607-725-5824


SOLUTIONS N ROAD (UNIT 4 14853 BUILDING WILDLIFE RES 757 WARREN ITHACA, NY 14

PROPOSED SITE PLAN


REVISIONS

"UNAUTHORIZED ALTERATION OR ADDITION TO PLANS BEARING A LICENSED ENGINEER'S OR ARCHITECTS SEAL, IS A VIOLATION OF SECTION 7209 OF THE NEW YORK STATE EDUCATION LAW"

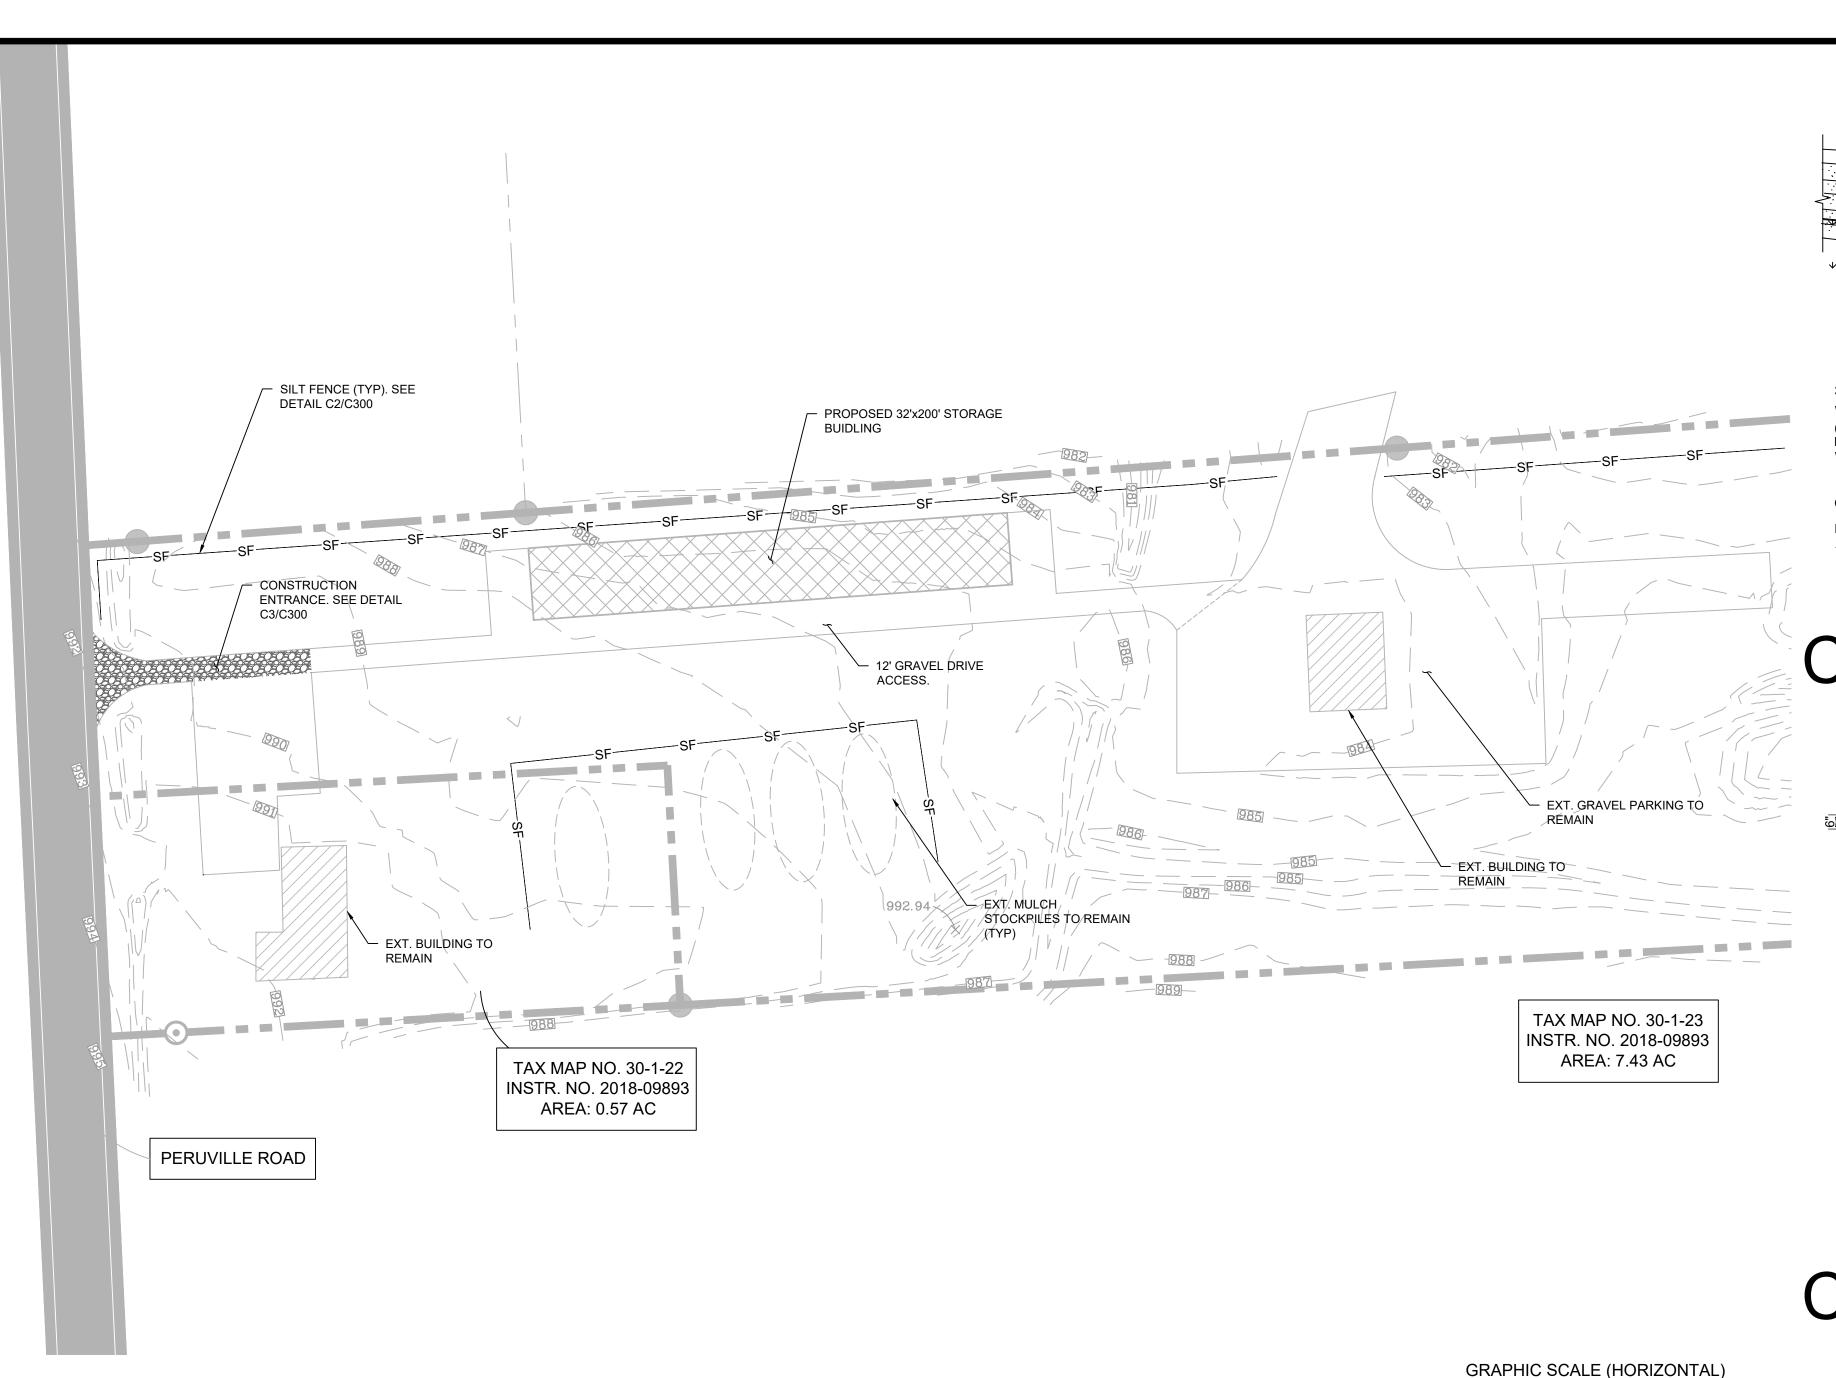

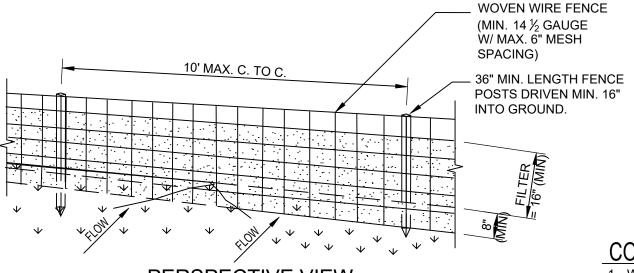

PERSPECTIVE VIEW

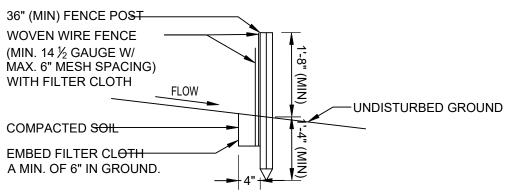

SECTION VIEW

CONSTRUCTION SPECIFICATIONS:

- 1. WOVEN WIRE FENCE TO BE FASTENED SECURELY TO FENCE POSTS WITH WIRE TIES OR STAPLES. POSTS SHALL BE STEEL EITHER "T" OR "U" TYPE
- 2. FILTER CLOTH TO BE FASTENED SECURELY TO WOVEN WIRE FENCE WITH TIES SPACED EVERY 24" AT TOP AND MID SECTION. FENCE SHALL BE WOVEN WIRE, 12 ½ GAUGE, 6" MAXIMUM MESH OPENING.
- BE OVER-LAPPED BY SIX INCHES AND FOLDED. FILTER CLOTH SHALL BE EITHER FILTER X, MIRAFI 100X, STABILINKA T140N, OR APPROVED EQUIVALENT.


3. WHEN TWO SECTIONS OF FILTER CLOTH ADJOIN EACH OTHER THEY SHALL

5. MAINTENANCE SHALL BE PERFORMED AS NEEDED AND MATERIAL

REMOVED WHEN "BULGES" DEVELOP IN THE SILT FENCE.

4. PREFABRICATED UNITS SHALL BE GEOFAB, ENVIROFENCE, OR APPROVED EQUIVALENT.

50' (MIN) <u>PROFILE</u>

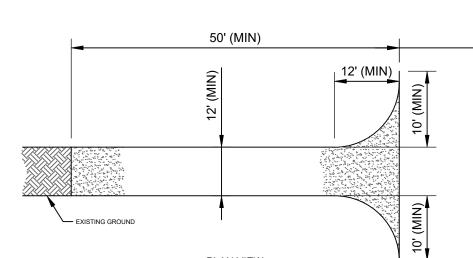

CONSTRUCTION SPECIFICATIONS:

- 1. STONE SIZE: USE 2" STONE, OR RECLAIMED OR RECYCLED CONCRETE EQUIVALENT.
- 2. NOT LESS THAN 50 FEET (EXCEPT ON A SINGLE RESIDENCE LOT WHERE A 30 FOOT MINIMUM LENGTH WOULD APPLY).
- 3. THICKNESS: NOT LESS THAN SIX (6) INCHES.
- 4. TWELVE (12) FOOT MINIMUM, BUT NOT LESS THAN THE FULL WIDTH AT POINTS WHERE INGRESS OR EGRESS OCCURS. TWENTY-FOUR (24) FOOT IF SINGLE ENTRANCE
- EXISTING PAVEMENT 5. FILTER CLOTH: WILL BE PLACED OVER THE ENTIRE AREA PRIOR TO PLACING OF STONE.
 - 6. SURFACE WATER: ALL SURFACE WATER FLOWING OR DIVERTED TOWARD CONSTRUCTION ENTRANCES SHALL BE PIPED ACROSS THE ENTRANCE. IF PIPING IS IMPRACTICAL, A MOUNTABLE BERM WITH 5:1 SLOPES WILL BE PERMITTED.
 - 7. MAINTENANCE: THE ENTRANCE SHALL BE MAINTAINED IN A CONDITION WHICH WILL PREVENT TRACKING OR FLOWING OF SEDIMENT ONTO PUBLIC RIGHTS-OF-WAY. ALL SEDIMENT SPILLED, DROPPED, WASHED OR TRACKED ONTO PUBLIC RIGHTS-OF-WAY MUST BE REMOVED IMMEDIATELY.
 - 8. WHEN WASHING IS REQUIRED, IT SHALL BE DONE ON AN AREA STABILIZED WITH STONE AND WHICH DRAINS INTO AN APPROVED SEDIMENT TRAPPING DEVICE.
 - 9. PERIODIC INSPECTION AND NEEDED MAINTENANCE SHALL BE PROVIDED AFTER EACH RAIN.

C3 CONSTRUCTION ENTRANCE SCALE: NTS

EROSION & SEDIMENT CONTROL PLAN

GENERAL NOTES

- CONTRACTOR SHALL FIELD VERIFY ALL SITE CONDITIONS PRIOR TO THE START OF WORK.
- ANY DISCREPANCIES OR UNFORESEEN CONDITIONS OBSERVED IN THE FIELD SHALL BE REPORTED TO THE ENGINEER FOR REVIEW.
- CONTRACTOR SHALL PERFORM ALL WORK IN ACCORDANCE WITH APPLICABLE FEDERAL, STATE, AND LOCAL CODES INCLUDING BUT NOT LIMITED TO THE INTERNATIONAL BUILDING CODE.
- 4. CONTRACTOR SHALL OBTAIN ALL BUILDING PERMITS AND COORDINATE WITH APPLICABLE AGENCIES PRIOR TO THE START OF WORK.
- CONTRACTOR SHALL CONTACT UDIG NEW YORK FOR UTILITY LOCATING PRIOR TO THE START OF WORK.
- CONTRACTOR SHALL PROTECT AND PRESERVE ALL EXISTING STRUCTURES NOT INCLUDED IN THE SCOPE OF WORK.
- ALL PROPERTY LINES SHALL BE VERIFIED PRIOR TO START OF WORK. PROPERTY LINES ARE APPROXIMATE AND REFERENCED FROM LAND SURVEY PROVIDED OWASCO LAND SURVEYING DATED 01/15/2024.

LOT DETAILS		
LOCATION	EXISTING	PROPOSED
FRONT SETBACK	519 FT	162 FT
REAR SETBACK	1,033 FT	1,033 FT
SIDE (NORTH) SETBACK	66 FT	15 FT
SIDE (SOUTH) SETBACK	107 FT	107 FT
FRONTAGE	104 FT	104 FT
LOT SIZE	7.43 AC	7.43 AC
LOT COVERAGE	7.6 %	9.3 %
BUILDING HEIGHT	23 FT	29 FT
OPEN SPACE	92.4 %	90.7 %

- FRONT SETBACK LESS THAN 60 FT WITH SITE PLAN APPROVAL FOR IR ZONED PARCEL
- SIDE SETBACK LESS THAN 10 FT WITH SITE PLAN APPROVAL FOR IR ZONED PARCEL.
- PER §270-20 LOT IN TWO DISTRICTS: WHEN LOT IS DIVIDED BY A DISTRICT BOUNDARY LINE, THE REGULATIONS OF EITHER DISTRICT MAY BE EXTENDED FOR A DISTANCE OF 50 FEET INTO THE OTHER DISTRICT, AT THE LOT OWNER'S DISCRETION.

R1 ZONING REQUIREMENTS		
LOT ITEM	ORDINANCE	
FRONT SETBACK (FROM CL OF ROAD)	60 FT	
REAR SETBACK	25 FT	
SIDE SETBACK	15 FT	
MIN. FRONTAGE	150 FT	
MAX LOT AREA	40,000 SF	
MAX LOT COVERAGE	25 %	
MAX BUILDING HEIGHT	35 FT	
MIN. OPEN SPACE	75 %	
IR ZONING REQUIREMENTS		
LOT ITEM	ORDINANCE	
FRONT SETBACK (FROM CL OF ROAD)	60 FT	
REAR SETBACK	10 FT	
SIDE SETBACK	10 FT	
MIN. FRONTAGE	50 FT	

MAX LOT AREA

MAX LOT COVERAGE

MAX BUILDING HEIGHT

MIN. OPEN SPACE


NONE

80 %

35 FT

20 %

LEGEND	
EXISTING STRUCTURE	
PROPOSED STRUCTURE	
EXISTING ASPHALT	
EXISTING LANDSCAPING	
PROPERTY LINES	
SILT FENCE	SFSF
MAJOR CONTOUR (2.5' INTERVAL)	
MINOR CONTOUR (0.5' INTERVAL)	
TREE/SHRUB/PLANTING	

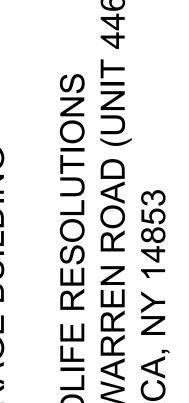

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607-725-5824

WILI 757 ITHA REVISIONS

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EROSION SEDIMENT CONTROL PLAN