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December 16, 2024

VIA EMAIL AND HAND DELIVERY

Zoning Board of Appeals and Planning Board Town of Lansing 29 Auburn Road Ithaca, NY 14882 Attn: John Zepko, Director of Planning and Code Enforcement jzepko@lansingtown.com

> RE: Application for a use variance from the Zoning Board of Appeals and site plan approval from the Planning Board by Bell Atlantic Mobile Systems LLC d/b/a Verizon to construct and operate a 145' wireless telecommunications tower (plus 4' lightning rod) and associated improvements on land owned by Community Rec Center Inc. located near 1767 East Shore Drive (S.B.L. # 37.1-6-9) in the Town of Lansing, Tompkins County, New York (Verizon "<u>Reach Run</u>" site)

Dear Mr. Zepko and Members of the Zoning Board of Appeals and Planning Board:

By application dated September 25, 2024, Bell Atlantic Mobile Systems LLC d/b/a Verizon ("<u>Verizon</u>") submitted the above-referenced Application (the "<u>Application</u>") to the Town of Lansing Zoning Board of Appeals and Planning Board (the "<u>Town</u>") for the above-referenced project.

Thereafter, at the Town Planning Board meeting on November 18, 2024, the Planning Board had comments and requested additional information (the "<u>Planning Board Comments</u>"). The Planning Board Comments are reproduced below in bold italicized type, with Verizon's response in regular type:

1. The Planning Board confirmed that the previously approved Crown Tower was approved in 2017 at 95' AGL. The Town Planner indicated he would send us details of the approval.

Mr. Molesso provided this information via email on November 20, 2024.

2. They said the Crown site was located on a small lot and they doubt very much we could fit a 145' tower there. Please confirm whether or not a 95' tower on that parcel would work (since it's apparently a higher elevation).

Since our last meeting, the Project RF design engineer, Wasif Sharif, has determined that a 145' tower at the prior Crown location will not provide adequate RF coverage to the Reach Run cell (and, a 145' tower would not meet the required 185' tower setback on the former Crown site).

3. Complete a balloon fly. They balloon fly must get photos from the following locations: East Shore Dr. coming up from Ithaca, Triphammer Road, Top of Teeter, East Shore Circle, Hill Crest Road and Rte. 34 heading south.

Verizon has been working with Town Staff and its engineering group to schedule a balloon fly and coordinate the necessary logistics (see below).

4. Please install a 4' x 8' sign on the property announcing the date of the balloon fly. We will need to coordinate that with a sign company and obtain desired wording of the sign from the Town.

As stated above, we are working with Mr. Molesso regarding the wording of the sign. Verizon will arrange for erection of a sign containing language suggested/ approved by the Planning Board.

5. They want to know whether a 130' tower will work. If not, why?

As outlined on page 30 of the RF report submitted as $\underline{\text{Exhibit F}}$ to the Application, a 130' tower will not provide reliable wireless telecommunications service to the Reach Run cell.

6. Will a co-location on the tower's water tower site located at the West end of Bone Plain Road/Schofield Road work? If not, why?

No. The water tower is located 2.8 miles away – too far to deliver reliable service to the coverage area.

7. They want the appropriate fall zone added to the plan (whatever the tower height ends up being, plus 40').

Enclosed as <u>Exhibit S</u> are revised project plans (the "<u>Revised Plans</u>") that include the engineered fall zone.

8. Are we on the existing tower located at Searles Road/Conlon Road?

Verizon is already co-located on this tower. It is the Lansing North site depicted on Exhibit F.

9. Incorporate significant landscaping around the compound to mitigate the visibility of same as from East Shore Drive.

See Sheet LA100 of the Revised Plans; Verizon has reconfigured the tower compound to maintain the required drainage and to add evergreen trees along the compound/driveway.

Please do not hesitate to contact me if you have any questions or if you require any additional information.

Thank you.

Sincerely, Jared C. Lusk

JCL/mkv Enclosures cc: Brett Morgan


EXHIBIT S

BELL ATLANTIC MOBILE SYSTEMS LLC d/b/a



SITE NAME: REACH RUN **ZONING DRAWINGS**

PROJECT ID: 17215090 MDG LOCATION ID: 5000007341

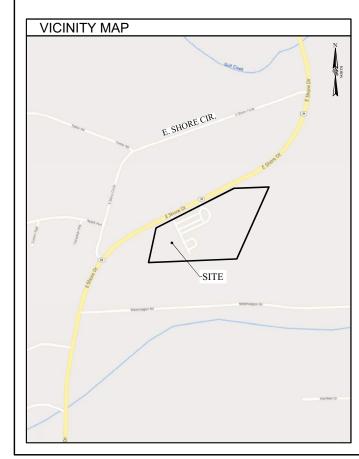


SITE INFORM	(NEAR) 1767 E SHORE DR		
SITE ADDRESS:	ITHACA, NEW YORK 14850		
	THACA, NEW FORK 14650		
MUNICIPALITY:	TOWN OF LANSING		
COUNTY:	TOMPKINS		
COONTT.			
TAX MAP NUMBER:	37.1-6-9 (13.36 ACRES PER TAX MAP)		
ZONING DISTRICT:	R2 (RESIDENTIAL - MODERATE DENSITY)		
TOWER SETBACK REQ.:	189' (HEIGHT OF TOWER + 40'), 195' PROVIDED		
LATITUDE:	42.517646°(42° 31' 03.53"N)		
LONGITUDE:	-76.504810°(76° 30' 17.32"W)		
BASE ELEVATION:	840'± AMSL		
STRUCTURE HEIGHT & TYPE:	145' MONOPOLE TOWER		
PROPOSED ANT. CENTERLINE:	140' + AGI		
PROPOSED ANT. TIP HEIGHT:	144' ± AGL		
HIGHEST APPURTENANCE:	149' ± AGL (PROPOSED LIGHTNING ROD)		
HIGHEST APPURTENANCE:	149° ± AGL (PROPOSED LIGHTNING ROD)		
PROPERTY OWNER:	COMMUNITY REC CENTER INC.		
	1767 E SHORE DR		
	ITHACA, NEW YORK 14850		
APPLICANT:	BELL ATLANTIC MOBILE SYSTEMS, LLC		
	d/b/a VERIZON WIRELESS		
	1275 JOHN STREET, SUITE 100		
	WEST HENRIETTA, NY 14586		
	CONTACT: MAGGIE HAYES		
	PHONE: (585) 321-5390		
LIMITS OF DISTURBANCE:	0.19± ACRES		

HEET	DECODIDITION	REV	REVISION
#	DESCRIPTION	NO	DATE
GA001	TITLE SHEET	3	12/10/2024
GA002	GENERAL NOTES	3	12/10/2024
/A100	SCHEMATIC TOTAL HOLDINGS	3	12/10/2024
/A100	SURVEY PLAN	3	12/10/2024
/A101 /A110	SURVET PLAN SURVEY NOTES AND DESCRIPTIONS	3	12/10/2024
		- 5	12/10/2024
CA100	OVERALL SITE PLAN	3	12/10/2024
CA110	COMPOUND PLAN	3	12/10/2024
CA120	GRADING AND EROSION CONTROL PLAN	3	12/10/2024
A100	LANDSCAPE PLAN AND DETAILS	3	12/10/2024
CA200	TOWER ELEVATION AND ANTENNA ORIENTATION PLAN	3	12/10/2024
0/1200			12/10/2024
CA500	EQUIPMENT ELEVATIONS	3	12/10/2024
CA501	SITE DETAILS	3	12/10/2024
CA502	GRADING AND EROSION CONTROL DETAILS	3	12/10/2024

Ø UDI	G·N
]	DIGS
FIBER PROVIDER:	TI
PLANNER:	TI
CONTACT:	TI
ELECTRIC PROVID	ER: N
ESR #:	TI
ACCOUNT #:	TI
PLANNER:	TI
PHONE:	TI

DO	NOT	SC	ALE
THESE	DRAWIN	GS ARE	FORM
SIZED	VERSION	S ARE I	NOT P
PLANS	EXISTIN	G DIME	NSION
THE EN	IGINEER	IN WRI	ring c
OR BE	RESPON	SIBLE F	OR SA

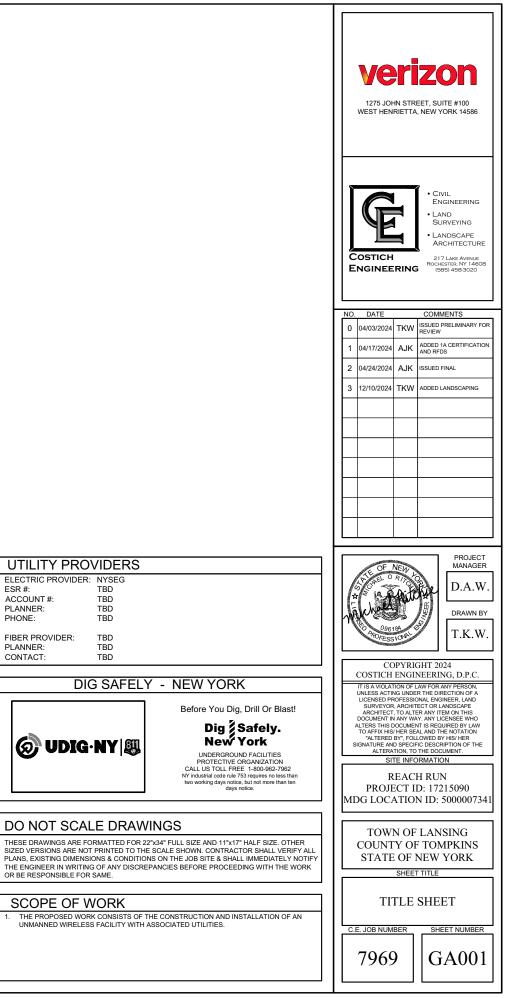

LEGEND		GENERAL NOTES	SOIL AND EROSION CONTROL NOTES	REFERENCES
	SECTION/PARCEL BOUNDARY MIN. BUILDING SETBACK	1. ALL WORK SHALL CONFORM TO THE REQUIREMENTS OF THE 2018 INTERNATIONAL BUILDING CODE (IBC), 2020 BUILDING CODE OF NEW YORK STATE, THE NATIONAL ELECTRIC	1. TEMPORARY SEDIMENTATION ENTRAPMENT AREAS SHALL BE PROVIDED AT KEY LOCATIONS TO INTERCEPT AND CLARIFY SILT LADEN RUNOFF FROM THE SITE.	10. ANTENNAS SHALL BE INSTALLED SHEET SUPPLIED BY VERIZON V
	CENTER LINE EXIST. RIGHT-OF-WAY LINE	SAFETY CODE AND OTHER APPLICABLE LOCAL, STATE AND FEDERAL CODES 2. CONTRACTOR SHALL VISIT THE JOB SITE AND FAMILIARIZE HIMSELF WITH ALL CONDITIONS	2. SILT THAT LEAVES THE SITE IN SPITE OF THE REQUIRED PRECAUTIONS SHALL BE COLLECTED AND REMOVED AS DIRECTED BY APPROPRIATE MUNICIPAL AUTHORITIES.	
	EXISTING EASEMENT LINE.	AFFECTING THE PROPOSED WORK AND MAKE PROVISIONS AS TO THE COST THEREOF. CONTRACTOR SHALL BE RESPONSIBLE FOR FAMILIARIZING HIMSELF WITH ALL CONTRACT	3. AT THE COMPLETION OF THE PROJECT. ALL TEMPORARY SILTATION DEVICES SHALL BE	EROSION AND SE
	EXIST. CONCRETE CURB EXIST. EDGE OF PAVEMENT	DOCUMENTS, FIELD CONDITIONS AND DIMENSIONS AND CONFIRMING THAT THE WORK MAY BE ACCOMPLISHED AS SHOWN PRIOR TO PROCEEDING WITH CONSTRUCTION. ANY	REMOVED AND THE AFFECTED AREAS REGRADED, OR TREATED IN ACCORDANCE WITH THE APPROVED SITE PLANS.	TEMPORARY EROSION AND SEDIMEN
w_ <u>w</u> w	EXIST. EDGE OF GRAVEL	DISCREPANCIES SHALL BE BROUGHT TO THE ATTENTION OF THE ENGINEER PRIOR TO THE COMMENCEMENT OF WORK.	4. ALL SEDIMENTATION ENTRAPMENT STRUCTURES WILL BE INSPECTED AND MAINTAINED ON A	GENERAL MEASURES:
	 EXISTING WATER MAIN, VALVE, & HYDRANT. EXISTING SANITARY SEWER, & MANHOLE. 	 PLANS ARE NOT TO BE SCALED. THESE PLANS ARE INTENDED TO BE A DIAGRAMMATIC OUTLINE ONLY, UNLESS OTHERWISE NOTED. THE WORK SHALL INCLUDE FURNISHING 	REGULAR BASIS. 5. CONTRACTOR TO INSTALL EROSION CONTROL MEASURES (SILT FENCE AND/ OR COMPOST	1. AS MUCH AS IS PRACTICAL, EXIS COMPLETION OF CONSTRUCTIO
	EXISTING DRAINAGE SEWER, FIELD INLET, INLET MANHOLE, MANHOLE, & END SECTION.	MATERIALS, EQUIPMENT, APPURTENANCES, AND LABOR NECESSARY TO EFFECT ALL INSTALLATIONS AS INDICATED ON THE DRAWINGS.	FILTER SOCKS) AROUND AREAS BEING DISTURBED DURING CONSTRUCTION AND AS NECESSARY.	VEGETATION SHALL BE ESTABL
OH OH OH	EXISTING OVERHEAD UTILITIES	4. DIMENSIONS SHOWN ARE TO FINISH SURFACES, UNLESS OTHERWISE NOTED. SPACING	6. CONTRACTOR TO INSTALL SILT FENCE OR COMPOST FILTER SOCKS DOWNSLOPE OF ALL	2. SITE PREPARATION ACTIVITIES OF SOIL DISRUPTION.
тттттттт	EXISTING TELEPHONE EXISTING UNDERGROUND UTILITIES	BETWEEN EQUIPMENT IS REQUIRED CLEARANCE. THEREFORE, IT IS CRITICAL TO FIELD VERIFY DIMENSIONS. SHOULD THERE BE ANY QUESTIONS REGARDING THE CONTRACT	UTILITY TRENCHES.	PARTICULAR MEASURES:
G G G	- EXISTING GAS - EXISTING ELECTRIC	DOCUMENTS, EXISTING CONDITIONS AND/OR DESIGN INTENT, THE CONTRACTOR SHALL BE RESPONSIBLE FOR OBTAINING A CLARIFICATION FROM THE CARRIER'S AUTHORIZED	 DISTANCES SHOWN FROM THE WETLANDS IF ANY ON THE CONSTRUCTION PLANS AND SOIL EROSION AND SEDIMENT CONTROL PLANS ESTABLISH THE MINIMUM SEPARATION PERMITTED BETWEEN THE PROPOSED CONSTRUCTION ACTIVITIES AND BOUNDARY OF THE WETLANDS. 	1. DRAINAGE DITCH SEDIMENT FIL STONE MEETING NYS-DOT LIGH
ww	EXISTING WATER LINE	REPRESENTATIVE OR THE ENGINEER PRIOR TO PROCEEDING WITH THE WORK. 5. DETAILS ARE INTENDED TO SHOW END RESULT OF DESIGN. MINOR MODIFICATIONS MAY BE	7.1. AREA OF DISTURBANCE LINES SHALL BE CLEARLY DELINEATED IN THE FIELD BY	SEDIMENT AND MINIMIZE ITS RE WEIR AND BE CONSTRUCTED W
E&T	EXISTING ELEC & TELE EXISTING CABLE TV	REQUIRED TO SUIT JOB DIMENSIONS OR CONDITIONS, AND SUCH MODIFICATIONS SHALL BE INCLUDED AS PART OF THE WORK.	INSTALLING ORANGE CONSTRUCTION FENCING AROUND THE ENTIRE PROPOSED CONSTRUCTION AREA. EXCEPT AS NECESSARY TO PROVIDE MITIGATION PLANTINGS,	TERMINUS. CHECK DAMS SHALL THE DOWNSTREAM DAM IS AT T
F F		6. CONTRACTOR SHALL RECEIVE CLARIFICATION IN WRITING, AND SHALL RECEIVE IN WRITING	NO ENCROACHMENT BEYOND THESE LIMITS BY WORKERS OR MACHINERY SHALL BE PERMITTED.	2. SILT FENCES AND COMPOST FIL STOCKPILES OF FILL, TOPSOIL A
	EXISTING LIGHT CONTROL EXISTING GUARD RAIL	AUTHORIZATION TO PROCEED BEFORE STARTING WORK ON ANY ITEMS NOT CLEARLY DEFINED OR IDENTIFIED BY THE CONTRACT DOCUMENTS.	7.2. GRADING AND CLEARING AND OTHER CONSTRUCTION-RELATED ACTIVITIES SHALL	PERIODS LESS THAN 30 DAYS. S ANCHORED AND MAINTAINED IN
O Come come	TREE, HEDGE, EDGE OF WOODS	 CONTRACTOR SHALL NOTIFY THE CONSTRUCTION MANAGER OF ALL PRODUCTS OR ITEMS NOTED AS "EXISTING" WHICH ARE NOT FOUND TO BE IN THE FIELD. 	TAKE PLACE ONLY WITHIN THE DELINEATED AREA OF DISTURBANCE LINES. THESE AREAS OF DISTURBANCE LINES REPRESENT THE MAXIMUM LIMITS OF CONSTRUCTION ACTIVITIES. EVERY ATTEMPT SHALL BE MADE TO FURTHER REDUCE GRADING AND	REMOVED AND STOCKPILING AR STABILIZED.
	EXISTING SWALE BARBED WIRE, STOCKADE,	8. CONTRACTOR SHALL SUPERVISE AND DIRECT THE WORK USING THE BEST CONSTRUCTION	CLEARING ACTIVITIES WITHIN THE AREA OF DISTURBANCE LINES BY MAINTAINING NATURAL VEGETATION AND TOPOGRAPHY WHEREVER PRACTICABLE.	3. TOPSOIL AND FILL THAT IS TO R
<u> </u>	CHAIN LINKED FENCE	SKILLS AND ATTENTION. CONTRACTOR SHALL BE SOLELY RESPONSIBLE FOR CONSTRUCTION MEANS, METHODS, TECHNIQUES, SEQUENCES, PROCEDURES, AND FOR	7.3. ALL CONSTRUCTION AND CONSTRUCTION RELATED-ACTIVITIES OCCURRING ON THIS	30 DAYS SHALL BE STABILIZED E STOCKPILED MATERIAL SHALL B OF CONVENTIONAL EQUIPMENT
× 420.4	EXISTING CONTOUR EXISTING SPOT ELEVATION @ X	COORDINATING ALL PORTIONS OF THE WORK UNDER CONTRACT, UNLESS OTHERWISE NOTED.	SITE SHALL COMPLY WITH THE STANDARDS AND RECOMMENDATIONS OF THE NEW YORK STATE STANDARDS AND SPECIFICATIONS FOR EROSION AND SEDIMENT	APPLICATION AND MULCH ANCH
	CONCRETE PAD/ CONCRETE SIDEWALK	 ERECTION SHALL BE DONE IN A WORKMANLIKE MANNER BY COMPETENT EXPERIENCED WORKMEN IN ACCORDANCE WITH APPLICABLE CODES AND THE BEST ACCEPTED 	CONTROL. 7.4. PRIOR TO THE COMMENCEMENT OF ANY SITE WORK, THE APPLICANT SHALL STAKE THE	4. IN NO CASE SHALL ERODIBLE MA STREAM, OR OTHER SURFACE V
	- PROPOSED EASEMENT LINE.	WORKMEN IN ACCORDANCE WITH APPLICABLE CODES AND THE BEST ACCEPTED PRACTICE. ALL MEMBERS SHALL BE LAID PLUMB AND TRUE AS INDICATED ON THE DRAWINGS.	7.4. PRIOR TO THE COMMENCEMENT OF ANY SITE WORK, THE APPLICANT SHALL STAKE THE LOCATION OF THE CONSTRUCTION ACTIVITY FOR INSPECTION AND APPROVAL BY THE TOWN ENGINEER (IF REQUIRED).	PERMANENT AND TEMPORARY EROS
wv 🕱		10. CONTRACTOR SHALL BE RESPONSIBLE FOR THE SAFETY OF THE WORK AREA, ADJACENT	7.5. ALL SOIL EROSION AND SEDIMENTATION CONTROL MEASURES SHOWN ON THIS PLAN	1. PERMANENT AND TEMPORARY COMPLETION OF CONSTRUCTIO
w ° w · ° · · · · · · ·	 PROPOSED WATER MAIN, VALVE, & HYDRANT. PROPOSED SANITARY SEWER, & MANHOLE. 	AREAS, AND BUILDING OCCUPANTS THAT ARE LIKELY TO BE AFFECTED BY THE WORK UNDER THIS CONTRACT. WORK SHALL CONFORM TO ALL OSHA REQUIREMENTS.	SHALL BE IN PLACE PRIOR TO THE START OF ANY SITE WORK. THE TOWN ENGINEER SHALL HAVE INSPECTED THE INSTALLATION OF ALL REQUIRED SOIL EROSION AND	DISTURBED FOR 21 DAYS OR MC TEMPORARY VEGETATION SHAL
	PROPOSED DRAINAGE SEWER, FIELD INLET, INLET MANHOLE, MANHOLE, & END SECTION.	11. CONTRACTOR SHALL COORDINATE HIS WORK AND SCHEDULE HIS ACTIVITIES AND	SEDIMENTATION CONTROL MEASURES PRIOR TO THE AUTHORIZATION TO PROCEED WITH ANY PHASE OF THE SITE WORK (IF REQUIRED).	ALL DISTURBED AREAS SHALL B FOLLOWING DISTURBANCE TO S
он	PROPOSED OVERHEAD UTILITIES	WORKING HOURS IN ACCORDANCE WITH THE REQUIREMENTS OF THE OWNER. 12. CONTRACTOR SHALL BE RESPONSIBLE FOR COORDINATING HIS WORK WITH THE WORK OF	7.6. THROUGHOUT THE CONSTRUCTION PERIOD, A QUALIFIED PROFESSIONAL RETAINED BY THE APPLICANT SHALL, ON AT LEAST A WEEKLY BASIS, PRIOR TO ANY PREDICTED RAIN	RE-ESTABLISHMENT OF VEGETA
F F F F	PROPOSED FIBER PROPOSED UNDERGROUND UTILITIES	OTHERS AS IT MAY RELATE TO RADIO EQUIPMENT, ANTENNAS AND ANY OTHER PORTIONS OF THE WORK.	EVENT AND AFTER RUNOFF-PRODUCING RAIN EVENT, INSECT THE SOIL EROSION AND SEDIMENTATION CONTROL MEASURES TO ENSURE THEIR PROPER FUNCTIONING.	A. AN ADEQUATE SEEDBED AND REMOVING SURFAC
GG	PROPOSED GAS SERVICE	13. CONTRACTOR SHALL MAINTAIN LIABILITY INSURANCE TO PROTECT THE OWNER AND	7.7. ALL DRAINAGE STRUCTURES AND ANY OTHER REQUIRED UTILITY APPURTENANCES	B. LIME SHALL BE APPLIED
E E E E E	PROPOSED ELECTRIC SERVICE PROPOSED ELECTRIC AND FIBER	CARRIER.	SHALL BE INSTALLED AS REQUIRED BY TOWN SPECIFICATIONS AND AS SHOWN ON THESE PLANS.	C. FERTILIZER (5-10-10 MIXT RESULTS OR AT A RATE (
SF SF SF	 PROPOSED SILT FENCE PROPOSED ORANGE CONSTRUCTION FENCE 	14. INSTALL ALL EQUIPMENT AND MATERIALS IN ACCORDANCE WITH MANUFACTURER'S RECOMMENDATIONS UNLESS SPECIFICALLY INDICATED OR WHERE LOCAL CODES OR	7.8. IF THE APPLICANT, DURING THE COURSE OF CONSTRUCTION, ENCOUNTERS SUCH CONDITIONS AS FLOOD AREAS, UNDERGROUND WATER, SOFT OR SILTY AREAS.	D. DISTURBED AREAS WHIC
LOD-LOD-	PROPOSED LIMITS OF DISTURBANCE	REGULATIONS TAKE PRECEDENCE. 15. MAKE NECESSARY PROVISIONS TO PROTECT EXISTING SURFACES, EQUIPMENT,	IMPROPER DAINAGE, OR OTHER UNUSUAL CIRCUMSTANCES OR CONDITIONS THAT WERE NOT FORESEEN IN THE ORIGINAL PLANNING, THEY SHALL REPORT SUCH	GREATER THAN 14 DAYS TEMPORARY GROUND CO
CFS CFS	PROPOSED COMPOST FILTER SOCK	IMPROVEMENTS, PIPING, ANTENNA AND ANTENNA CABLES. REPAIR ANY DAMAGE THAT OCCURS DURING CONSTRUCTION.	CONDITIONS IMMEDIATELY TO THE TOWN ENGINEER. THE APPLICANT MAY SUBMIT, IF THEY SO DESIRE, THEIR RECOMMENDATIONS AS THE SPECIAL TREATMENT TO BE	ACRE. DURING THE WINT (CEREAL RYE) PER ACRE
SITE NOTES		16. REPAIR ALL EXISTING SURFACES DAMAGED DURING CONSTRUCTION SUCH THAT THEY	GIVEN SUCH AREAS TO SECURE ADEQUATE, PERMANENT AND SATISFACTORY CONSTRUCTION. THE TOWN ENGINEER, WITHOUT UNNECESSARY DELAY, SHALL	E. PERMANENT SEEDING SH RATE FOR ROUGH OR OC
1. ALL SITE WORK SHALL BE AS INDICATED O	N THE DRAWINGS.	MATCH AND BLEND WITH ADJACENT SURFACES.	INVESTIGATE THE CONDITION OR CONDITIONS, AND SHALL EITHER APPROVE THE APPLICANT'S RECOMMENDATION TO CORRECT THE CONDITIONS, ORDER A	8 LBS EMPIRE BIRDSFOO 20 LBS TALL FESCUE PER
2. RUBBISH, STUMPS, DEBRIS, STICKS, STONI THE SITE AND DISPOSED OF LEGALLY.	ES AND OTHER REFUSE SHALL BE REMOVED FROM	 KEEP CONTRACT AREA CLEAN, HAZARD FREE, AND DISPOSE OF ALL DEBRIS AND RUBBISH. EQUIPMENT NOT SPECIFIED AS REMAINING ON THE PROPERTY OF THE OWNER SHALL BE REMOVED. LEAVE PREMISES IN CLEAN CONDITION AND FREE FROM PAINT SPOTS, DUST, 	MODIFICATION THEROF, OR ISSUE THEIR OWN SPECIFICATION FOR THE CORRECTION OF THE CONDITIONS. IN THE EVENT OF THE APPLICANT'S DISAGREEMENT WITH THE DECISION OF THE TOWN ENGINEER, OR IN THE EVENT OF A SIGNIFICANT CHANGE	2 LBS REDTOP OR 5 LBS
3. THE SITE SHALL BE GRADED TO CAUSE SU	IRFACE WATER TO FLOW AWAY FROM THE	OR SMUGGES OF ANY NATURE. CONTRACTOR SHALL BE RESPONSIBLE FOR MAINTAINING ALL ITEMS UNTIL COMPLETION OF CONSTRUCTION.	RESULTING TO THE SITE PLAN OR ANY CHANGE THAT INVOLVES WETLAND REGULATED AREAS, THE MATTER SHALL BE DECIDED BY THE PLANNING BOARD. ANY SUCH	FOR MOWED AREAS: 65 LBS KENTUCKY BLUEG
PROPOSED PLATFORM.		18. CONTRACTOR SHALL VERIFY ALL DIMENSIONS AND CONDITIONS IN THE FIELD PRIOR TO	CONDITIONS OBSERVED BY THE PLANNING BOARD OR ITS AGENTS SHALL BE SIMILARLY TREATED.	65 LBS RYEGRASS (PERE F. ALL SEEDING SHALL BE F
 NO FILL OR EMBANKMENT MATERIAL SHALL MATERIALS, SNOW OR ICE SHALL NOT BE F 		FABRICATION AND ERECTION OF ANY MATERIAL. ANY UNUSUAL CONDITIONS SHALL BE REPORTED TO THE ATTENTION OF THE ENGINEER.		HYDROSEEDING, UNLESS
5. THE SUBGRADE SHALL BE COMPACTED AN TO FINISHED SURFACE APPLICATION.	ID BROUGHT TO A SMOOTH UNIFORM GRADE PRIOR	19. CONTRACTOR SHALL SECURE ALL NECESSARY BUILDING PERMITS AND INSPECTIONS AND PAY ALL REQUIRED FEES.		G. ALL DISTURBED AREAS S APPLYING 2 TONS OF STI
 6. ALL EXISTING ACTIVE SEWER, WATER, GAS 	S, ELECTRIC, AND OTHER UTILITIES WHERE	20. PROVIDE A PORTABLE FIRE EXTINGUISHER WITH A RATING OF NOT LESS THAN 2-A OR	1. TOPOGRAPHY SHOWN FROM A FIELD SURVEY BY COSTICH ENGINEERING ON 3/13/2024 HORIZONTAL AND VERTICAL DATA OBTAINED THROUGH NYSDOT CORS NETWORK	ANCHORED BY APPLYING HYDROSEEDER, OR TUCK
ENCOUNTERED IN THE WORK, SHALL BE PI FOR THE PROPER EXECUTION OF THE WO	ROTECTED AT ALL TIMES, AND WHERE REQUIRED RK, SHALL BE RELOCATED AS DIRECTED BY THE	2-A/10-BC WITHIN 75 FEET TRAVEL DISTANCE TO ALL PORTIONS OF THE BUILDOUT AREA DURING CONSTRUCTION.	REFERENCED TO THE FOLLOWING MONUMENT: CORTLAND CORS STATION	ANCHORING TOOLS TO A ACROSS SLOPES ALONG
ENGINEER. EXTREME CAUTION SHOULD BE OR PIER DRILLING AROUND OR NEAR UTILI	E USED BY THE CONTRACTOR WHEN EXCAVATING TIES.	21. ALL BROCHURES, OPERATING AND MAINTENANCE MANUALS, CATALOGS, SHOP DRAWINGS	-LATITUDE: 42-35-03.70726 (N) NAD 83 (CORS) -LONGITUDE: 076-12-40.79269 (W)	2. ALL UNNECESSARY REMOVAL O NOT BE STORED NOR MACHINER
		AND OTHER DOCUMENTATION SHALL BE TURNED OVER TO CARRIER AT COMPLETION OF CONSTRUCTION.	-ELLIP HEIGHT: 330.887 METERS NAVD 88 (CORS)	REMAIN.
	WORK, SHALL BE REMOVED AND/OR CAPPED, AT POINTS WHICH WILL NOT INTERFERE WITH THE HE APPROVAL OF THE ENGINEER.	22. COMPLETE JOB SHALL BE GUARANTEED FOR A PERIOD OF ONE (1) YEAR AFTER THE DATE OF ACCEPTANCE BY CARRIER. ANY WORK, MATERIALS, OR EQUIPMENT FOUND TO BE	 BOUNDARY SURVEY HAS NOT BEEN PERFORMED BY COSTICH ENGINEERING. BOUNDARY SHOWN HEREON IS APPROXIMATE AND DETERMINED BY LIMITED FIELD LOCATION OF BOUNDARY EVIDENCE, REVIEW OF TITLE COMMITMENT, IF PROVIDED, AND OVERLAY OF 	
	ISTURBED BY THE WORK SHALL BE GRADED TO A	DEFECTIVE DURING THAT PERIOD SHALL BE CORRECTED IMMEDIATELY UPON WRITTEN NOTIFICATION AT NO ADDITIONAL COST TO CARRIER.	COUNTY TAX MAPS AND/OR COUNTY GIS MAPPING.	1. THE CONTRACTOR SHALL ON A FUNCTION OF ALL TEMPORARY I
UNIFORM SLOPE, FERTILIZED, SEEDED, AN	D COVERED WITH MULCH.	23. RIGGING OPERATIONS SHALL BE DONE IN ACCORDANCE WITH STATE AND FEDERAL	3. STEWART TITLE INSURANCE COMPANY TITLE NO. 71269805, HAVING AN EFFECTIVE DATE OF OCTOBER 12, 2023	2. TO ASSURE PROPER FUNCTION.
EROSION CONTROL MEASURES, IF REQUIR		SAFETY REGULATIONS (OSHA). COSTICH ENGINEERING, CARRIER AND THE OWNER SHALL BE HELD HARMLESS IN THE EVENT THE CONTRACTOR DOES NOT FOLLOW SUCH SAFETY	 PER THE NYSDEC FRESHWATER WETLANDS MAP, THERE ARE NO STATE WETLANDS IN PROJECT AREA. 	CONDITION AND REINFORCED, E WASHOUTS SHALL BE IMMEDIAT
CONFORMANCE WITH THE STATE GUIDELIN	NES AND ANY LOCAL REGULATIONS. PLETED WITHIN 72 HOURS OF THE COMPLETION OF	REGULATIONS. 24. CONTRACTOR SHALL PROVIDE ACCESS TO THE SITE AND ASSIST THE RADIO EQUIPMENT	5. PER THE NATIONAL WETLANDS INVENTORY MAPS, THERE ARE NO FEDERAL WETLANDS IN THE PROJECT AREA.	FURTHER EROSION.
10. ALL RESTORATION ISSUES SHALL BE COM THE WORK ACTIVITY OR WITHIN A REASON CONSTRUCTION MANAGER/ENGINEER.		 CONTRACTOR SHALL PROVIDE ACCESS TO THE SITE AND ASSIST THE RADIO EQUIPMENT VENDOR AND THE ANTENNA INSTALLATION CONTRACTOR AS THEY MAY REQUIRE. 	6. PER A WETLAND AND WATERBODIES DELINEATION REPORT PREPARED BY EARTH	3. SEDIMENT SHALL BE REMOVED ABOUT 0.5 FEET DEEP AT THE FI
11. CARE SHALL BE TAKEN TO RETAIN NATURA	AL GROWTH AND PREVENT DAMAGE TO TREES		DIMENSIONS, INC., EDI PROJECT CODE: W20C24, DATED APRIL 4, 2024. THERE ARE WETLANDS JUST WEST OF THE PROJECT AREA.	ONCE IT REACHES 1/2 THE FILTE FILTER SOCKS SHALL BE REPAIF
WITHIN AND OUTSIDE THE LIMITS OF CONS BY EQUIPMENT AND MATERIALS. ANY DAM	STRUCTION AND SPECIFIED WORK AREAS CAUSED IAGE TO THIS NATURAL GROWTH SHALL BE		7. PER THE ERSI/FEMA PROJECT IMPACT HAZARD INFORMATION AND AWARENESS SITE MAP THERE IS NO 100 YR. FLOOD PLAIN IN THE PROJECT AREA.	4. ALL SEEDED AREAS SHALL BE F ACCORDING TO SPECIFICATION
RESTORED AT THE EXPENSE OF THE CONTRACT			8. SURVEY MAP PREPARED BY T.G. MILLER P.C. ENGINEERS AND SURVEYORS, JOB NO. S01631,	VIGOROUS, DENSE VEGETATIVE
12. ALL AREAS DISTURBED BY THE CONTRACT BY THE CONTRACTOR.	OR WITHOUT AUTHORIZATION SHALL BE RESTORED		DATED SEPTEMBER 13, 2001. 8. TOPOGRAPHIC MAP PREPARED BY T.G. MILLER P.C. ENGINEERS AND SURVEYORS, JOB NO.	
	S AN EXISTING UTILITY SERVICE CAUSING AN		S19300, DATED APRIL 28, 2021.	
	IMMEDIATELY COMMENCE WORK TO RESTORE		9. 1A CERTIFICATION PREPARED BY COSTICH ENGINEERING D.P.C., PROJECT NO. 7969, SITE	

LLED IN ACCORDANCE WITH SITE SPECIFIC RF ANTENNA DESIGN ON WIRELESS: FUZE PROJECT ID: 17215090, DATED 04/16/2024.

SEDIMENT CONTROL MEASURES

MENT CONTROL MEASURES

EXISTING VEGETATION SHALL BE PRESERVED. FOLLOWING THE ABLISHED ON ALL EXPOSED SOILS.

IES SHALL BE PLANNED TO MINIMIZE THE SCOPE AND DURATION

FILTERS: DITCHES, SHALL RECEIVE CHECK DAMS WITH 2-9 INCH IGHT STONE FILL REQUIREMENTS SO AS TO EFFECTIVELY TRAF RELEASE OFF-SITE, CHECK DAMS SHALL HAVE A 9" MINIMUM TO WITHIN EACH DITCH BEGINNING AT ITS DOWNSTREAM HALL BE PLACED WITHIN THE CHANNEL SO THAT THE CREST OF AT THE ELEVATION OF THE TOE OF THE UPSTREAM DAM

T FILTER SOCKS SHALL BE CONSTRUCTED AROUND ALL OIL AND EXCAVATED OVERBURDEN THAT ARE TO REMAIN FOR /S. SILT FENCES AND COMPOST FILTER SOCKS SHALL BE D IN GOOD CONDITION UNTIL SUCH TIME AS STOCKPILES ARE AREAS ARE BROUGHT TO FINAL GRADE AND PERMANENTLY

O REMAIN STOCKPILED ON-SITE FOR PERIODS GREATER THAN ED BY SEEDING, PRIOR TO THE SEEDING OPERATION, THE LL BE GRADED AS NEEDED AND FEASIBLE TO PERMIT THE USE ENT FOR SEEDBED PREPARATION, SEEDING, MULCH NCHORING.

E MATERIALS BE STOCKPILED WITH 25 FEET OF ANY DITCH, CE WATER BODY.

ROSION AND SEDIMENT CONTROL MEASURES

RY VEGETATIVE COVER: IMMEDIATELY FOLLOWING THE TION ACTIVITY OR WHERE WORK IS DELAYED AND WILL NOT BE R MORE IN ANY PORTION OF THE SITE. PERMANENT OR SHALL BE ESTABLISHED WITHIN 14 DAYS ON ALL EXPOSED SOILS LL BE SEEDED AND MULCHED AS SOON AS PRACTICAL TO STABILIZE BARE SOIL AND PROMOTE THE PROMPT GETATION.

BED SHALL BE PREPARED BY SCARIFYING COMPACTED SOIL FACE DEBRIS AND OBSTACLES.

IED SUFFICIENTLY TO ATTAIN A SOIL ACIDITY pH OF 6.0 TO 7.0.

MIXTURE OR EQUIVALENT) SHALL BE APPLIED PER SOIL TEST ATE OF 600 LBS PER ACRE.

VHICH WILL REMAIN TEMPORARILY FALLOW FOR PERIODS AYS SHALL BE SEEDED AT THE FOLLOWING RATE TO PRODUCE D COVER: 30 LBS RYEGRASS (ANNUAL OR PERENNIAL) PER VINTER, USE 100 LBS CERTIFIED "AROOSTOCK" WINTER RYE

G SHALL BE APPLIED ON 4" MIN. TOPSOIL AT THE FOLLOWING R OCCASIONAL MOWING AREAS: FOOT TIREFOIL OR COMMON WHITE CLOVER PER ACRE. PER ACRE PLUS LBS RYEGRASS (PERENNIAL) PER ACRE

LUEGRASS PER ACRE PERENNIAL) PER ACRE

BE PERFORMED USING THE BROADCAST METHOD OR ESS OTHERWISE APPROVED

AS SHALL BE STABILIZED SUBSEQUENT TO SEEDING BY STRAW MULCH PER ACRE. STRAW MULCH SHALL BE YING 750 LBS OF WOOD FIBER MULCH PER ACRE WITH A UCKING THE MULCH WITH SMOOTH DISCS OR OTHER MULCH TO A DEPTH OF 3". MULCH ANCHORING TOOLS SHALL BE PULLED ONG TOPOGRAPHIC CONTOURS.

AL OF HEALTHY TREES SHALL BE AVOIDED. MATERIALS SHALL NERY OPERATED WITHIN THE DRIP-LINE OF THE TREES TO


SEDIMENT CONTROL MEASURES:


N A DAILY BASIS INSPECT AND MAINTAIN THE INTEGRITY AND RY EROSION AND SEDIMENT CONTROL MEASURES N OF THE CONSTRUCTION PROCESS.

ION. SILTATION BARRIERS SHALL BE MAINTAINED IN GOOD ED, EXTENDED, REPAIRED OR REPLACED AS NECESSARY. DIATELY REPAIRED, RE-SEEDED AND PROTECTED FROM


VED FROM BEHIND THE SEDIMENT FENCE WHEN IT BECOMES HE FENCE AND FROM BEHIND THE COMPOST FILTER SOCKS ILTER SOCK HEIGHT. THE SEDIMENT FENCE AND COMPOST PAIRED AS NECESSARY TO MAINTAIN BARRIER

BE FERTILIZED, RESEEDED AS NECESSARY, AND MULCHED TIONS IN THE VEGETATIVE PLAN IN ORDER TO MAINTAIN A TIVE COVER.

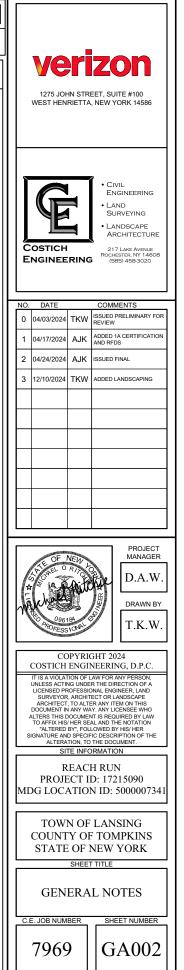

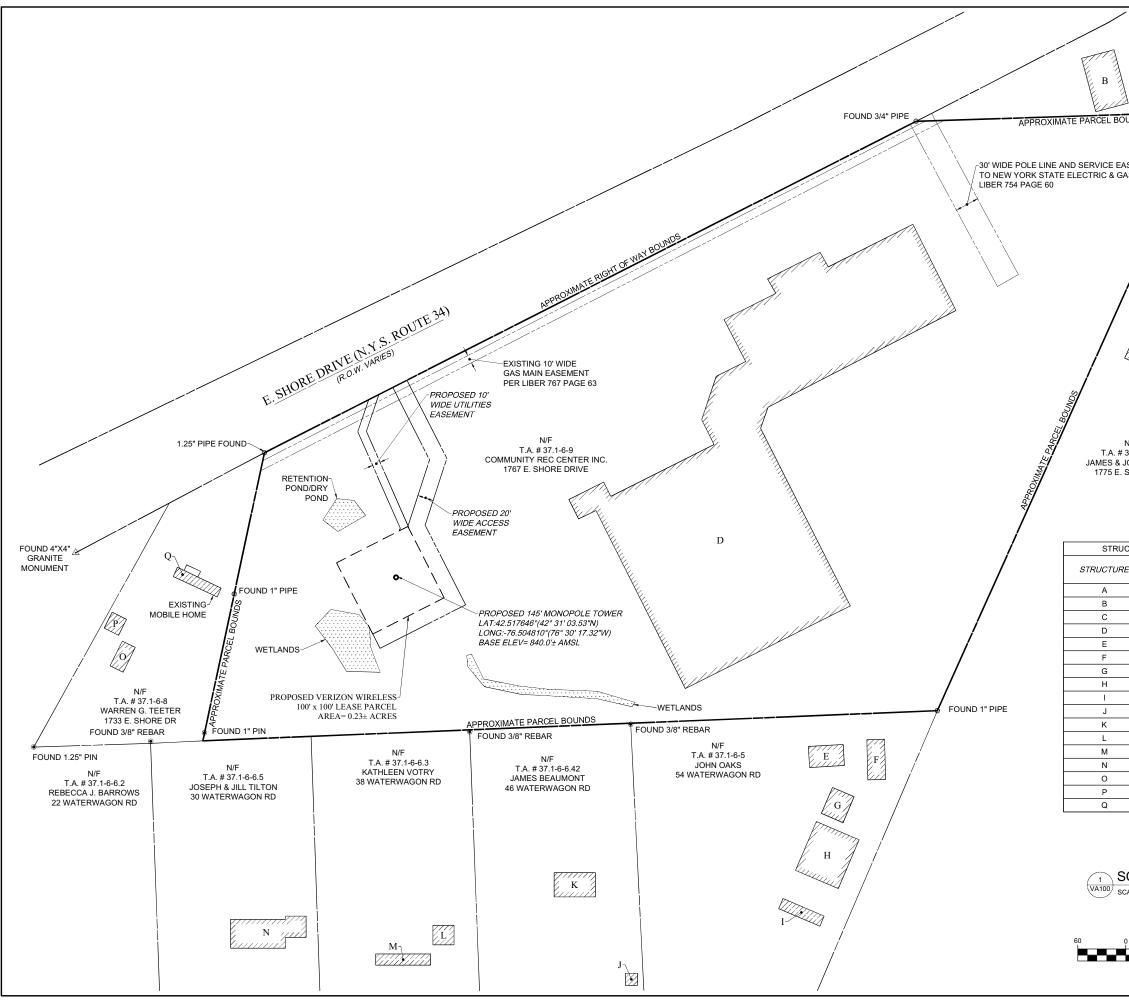

N/F T.A.# 37.1-9-14 JOHN OAKS 1793 E. SHORE DR	Verizon 1275 JOHN STREET, SUITE #100 WEST HENRIETTA, NEW YORK 14586
ASEMENT BAS FOUND 1/2" REBAR WITH CAP	Costich Engineering 217 Law Avenue (395) 4593020
N/F	NO. DATE COMMENTS 0 04/03/2024 TKW ISSUED PRELIMINARY FOR REVIEW 1 04/17/2024 AJK ADDED 1A CERTIFICATION AND RFDS 2 04/24/2024 AJK ISSUED FINAL 3 12/10/2024 TKW ADDED LANDSCAPING
37.1-6-2.2 JOHN YOUNG SHORE DR JCTURE SETBACKS DISTANCE TO PROPOSED TOWER	
1132'± 1050'± 950'± 235'± 555'± 630'± 605'±	D.A.W. DRAWN BY T.K.W. COPYRIGHT 2024 COSTICH ENGINEERING, D.P.C.
610± 630± 570± 420± 440± 440± 340±	IT IS A VIOLATION OF LAW FOR ANY PERSON, UNLESS ACTING UNDER THE DIRECTION OF A LICENSED PROFESSIONAL ENGINEER, LAND SURVEYOR, ARCHITECT OR LANDSCAPE ARCHITECT, TO ALTER ANY TIEM ON THIS DOCUMENT IN ANY WAY. ANY LICENSEE WHO ALTERS THIS DOCUMENT IS REQUIRED BY LAW TO AFFX HIS/HER SEAL AND THE NOTATION "ALTERS THIS DOCUMENT IS AND HER TO SIGNATURE AND SPECIFIC DESCRIPTION OF THE ALTERSTRON, TO THE DOCUMENT. SITE INFORMATION REACH RUN
345± 220'± SCHEMATIC TOTAL HOLDINGS	PROJECT ID: 17215090 MDG LOCATION ID: 5000007341 TOWN OF LANSING COUNTY OF TOMPKINS STATE OF NEW YORK SHEET TITLE
1" = 120'(11 x 17 SHEET) GRAPHIC SCALE 0 30 60 120 240 (IN FEET) 1 inch = 60 ft (22" x 34" SHEET) 1 inch = 120ft. (11" x 17" SHEET)	SCHEMATIC TOTAL HOLDINGS C.E. JOB NUMBER SHEET NUMBER 7969 VA100

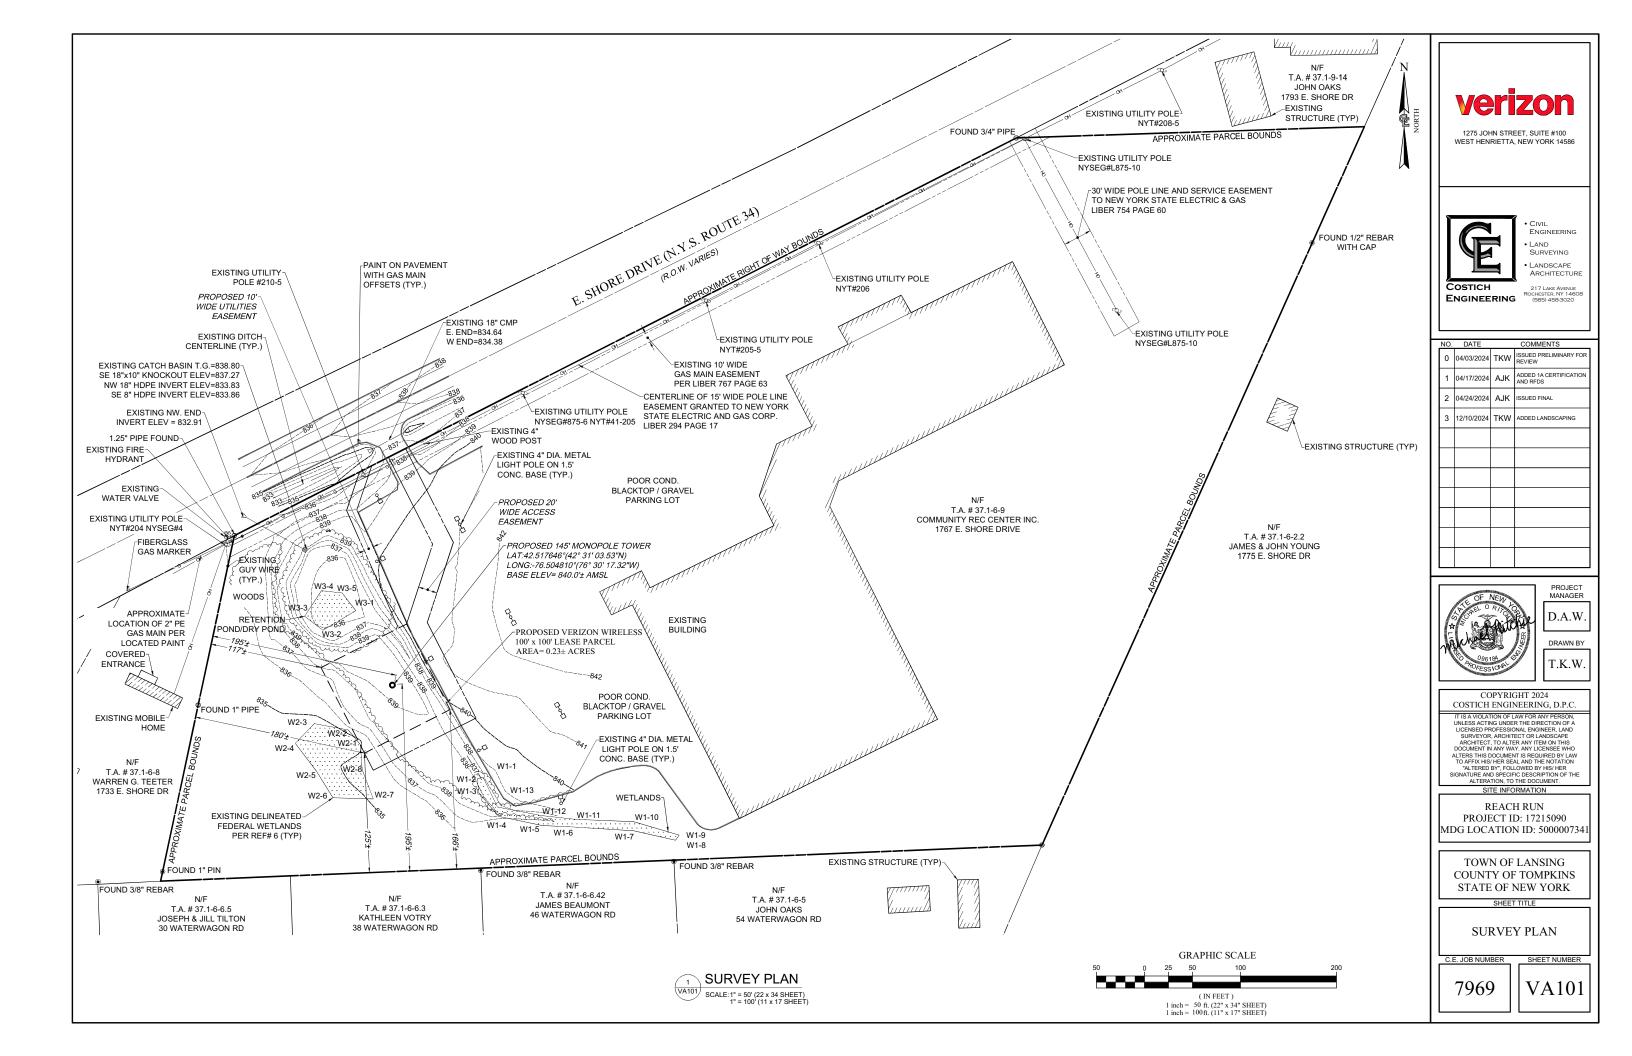

TITLE REVIEW

PER STEWART TITLE INSURANCE COMPANY TITLE NO. 71269805, HAVING AN EFFECTIVE DATE OF OCTOBER 12, 2023, SURVEY PERTINENT DETERMINATIONS ARE:

- 16. APPROPRIATION BY THE PEOPLE OF THE STATE OF NEW YORK DATED FEBRUARY 18, 1963 AND RECORDED FEBRUARY 18, 1963 IN LIBER 443 OF DEEDS, PAGE 802. APPROPRIATION IS A FEE PARCEL ALONG AND ADJACENT TO EAST SHORE DRIVE - N.Y. S. ROUTE 34 AND IS APPROXIMATELY 20 FEET WIDE AND FALLS WITHIN THE EXISTING RIGHT-OF-WAY LINE OF EAST SHORE DRIVE - N.Y.S. ROUTE 34.
- 17. EASEMENT GRANTED BY STEVE SEBASTIAN (JR.) AND HAZEL SEBASTIAN TO NEW YORK STATE ELECTRIC AND GAS CORPORATION, DATED OCTOBER 1, 1946 AND RECORDED NOVEMBER 2, 1946 IN LIBER 294 OF DEEDS, PAGE 17. PARCEL SUBJECT A 15' WIDE POLE LINE EASEMENT PARALLEL AND ADJACENT TO EAST SHORE DRIVE - N.Y. S. ROUTE 34. THE PROPOSED ACCESS AND UTILITIES EASEMENT WILL CROSS SAID POLE LINE EASEMENT.
- 18. EASEMENT GRANTED BY COMMUNITY RECREATIONAL CENTER INC. BY ANDREW SCIARABBA CHAIRMAN TO NEW YORK STATE ELECTRIC & GAS CORPORATION, DATED JUNE 29, 1995 AND RECORDED JULY 21, 1995 IN LIBER 754 OF DEEDS, PAGE 60. PARCEL IS SUBJECT TO A 30' WIDE POLE LINE AND SERVICE EASEMENT COMMENCING AT NYSEG POLE # 10. UNABLE TO PLOT SAID EASEMENT UNTIL NYSEG POLE 10 IS LOCATED IN THE FIELD.
- EASEMENT GRANTED BY COMMUNITY RECREATIONAL CENTER INC. TO NEW YORK STATE ELECTRIC AND GAS CORPORATION, DATED OCTOBER 10, 1995 AND RECORDED DECEMBER 26, 1995 IN LIBER 764 OF DEEDS, PAGE 63. PARCEL SUBJECT A 10' GAS MAIN EASEMENT WHOSE CENTERLINE IS 55 FEET SOUTHERLY PARALLEL WITH EAST SHORE DRIVE - N.Y. S. ROUTE 34. THE PROPOSED ACCESS AND UTILITIES EASEMENT WILL CROSS SAID GAS MAIN EASEMENT.

ACCESS EASEMENT DESCRIPTION

ALL THAT TRACT OR PARCEL OF LAND SITUATE IN THE TOWN OF LANSING, COUNTY OF TOMPKINS, STATE OF NEW YORK, ALL AS SHOWN ON A MAP ENTITLED "REACH RUN - SURVEY PLAN", PREPARED BY COSTICH ENGINEERING, D.P.C., HAVING DRAWING NUMBER 7969, SHEET NUMBER VA101 AND A LAST REVISION DATE OF 04/03/2024, AND BEING MORE PARTICULARLY BOUNDED AND DESCRIBED AS FOLLOWS:

COMMENCING AT A POINT ON THE ASSUMED SOUTHEASTERLY RIGHT OF WAY LINE OF EAST SHORE DRIVE, N.Y.S. ROUTE 34 (R.O.W. VARIES), SAID POINT BEING ON THE ASSUMED COMMON LINE OF LANDS NOW OR FORMERLY OWNED BY COMMUNITY RECREATIONAL CENTER, INC. (T.A. # 37.1-6-9) TO THE EAST AND LANDS NOW OR FORMERLY OWNED BY WARREN G. TEETER (T.A. # 37.1-6-8) TO THE WEST; THENCE

- A.N63°02'37"E, ALONG SAID SOUTHEASTERLY RIGHT OF WAY LINE OF EAST SHORE DRIVE, N.Y.S. ROUTE 34, A DISTANCE OF 180.03 FEET TO THE POINT AND PLACE OF BEGINNING: THENCE
 - N63°02'37"E, CONTINUING ALONG SAID SOUTHEASTERLY RIGHT OF WAY LINE OF EAST SHORE DRIVE, N.Y.S. ROUTE 34, A DISTANCE OF 20.00 FEET TO A POINT; THENCE
- 2. S26°57'23"E, A DISTANCE OF 109.76 FEET TO A POINT; THENCE
- 3. S18°02'37"W, A DISTANCE OF 87.65 FEET TO A POINT; THENCE
- 4. S26°57'23"E, A DISTANCE OF 111.72 FEET TO A POINT; THENCE
- 5. S63°02'37"W, A DISTANCE OF 120.00 FEET TO A POINT; THENCE
- N26°57'23"W, A DISTANCE OF 20.00 FEET TO A POINT BEING THE SOUTHWESTERLY CORNER OF THE PROPOSED VERIZON WIRELESS LEASE PARCEL; THENCE
- N63°02'37"E, ALONG THE SOUTHERLY LINE OF SAID PROPOSED VERIZON WIRELESS LEASE PARCEL, A DISTANCE OF 100.00 FEET TO THE SOUTHEAST CORNER OF SAID LEASE PARCEL; THENCE
- 8. N26°57'23"W, ALONG THE EASTERLY LINE OF SAID PROPOSED VERIZON WIRELESS LEASE PARCEL, A DISTANCE OF 100.00 FEET TO THE NORTHEAST CORNER OF SAID LEASE PARCEL; THENCE
- 9. N18°02'37"E, A DISTANCE OF 87.65 FEET TO A POINT; THENCE
- 10. N26°57'23"W, A DISTANCE OF 101.48 FEET TO THE POINT AND PLACE OF BEGINNING. CONTAINING 0.188 ACRES OF LAND, MORE OR LESS.

LEASE PARCEL DESCRIPTION

ALL THAT TRACT OR PARCEL OF LAND SITUATE IN THE TOWN OF LANSING, COUNTY OF TOMPKINS, STATE OF NEW YORK, ALL AS SHOWN ON A MAP ENTITLED "REACH RUN - SURVEY PLAN", PREPARED BY COSTICH ENGINEERING, D.P.C., HAVING DRAWING NUMBER 7969, SHEET NUMBER VA101 AND A LAST REVISION DATE OF 04/03/2024, AND BEING MORE PARTICULARLY BOUNDED AND DESCRIBED AS FOLLOWS:

COMMENCING AT A POINT ON THE ASSUMED SOUTHEASTERLY RIGHT OF WAY LINE OF EAST SHORE DRIVE, N.Y.S. ROUTE 34 (R.O.W. VARIES), SAID POINT BEING ON THE ASSUMED COMMON LINE OF LANDS NOW OR FORMERLY OWNED BY COMMUNITY RECREATIONAL CENTER, INC. (T.A. # 37.1-6-9) TO THE EAST AND LANDS NOW OR FORMERLY OWNED BY WARREN G. TEETER (T.A. # 37.1-6-8) TO THE WEST; THENCE

- A. S33°15'32"E, ALONG A TIE LINE THROUGH LANDS NOW OR FORMERLY OWNED BY COMMUNITY RECREATIONAL CENTER, INC. (T.A. # 37.1-6-9), A DISTANCE OF 164.45 FEET TO THE POINT AND PLACE OF BEGINNING; THENCE
 - 1. N63°02'37"E, A DISTANCE OF 100.00 FEET TO A POINT; THENCE
 - 2. S26°57'23"E, A DISTANCE OF 100.00 FEET TO A POINT; THENCE
 - 3. S63°02'37"W, A DISTANCE OF 100.00 FEET TO A POINT; THENCE
 - 4. N26°57'23"W, A DISTANCE OF 100.00 FEET TO THE POINT AND PLACE OF BEGINNING. CONTAINING 0.230 ACRES OF LAND, MORE OR LESS.

SURVEY NOTES

 TOPOGRAPHY SHOWN FROM A FIELD SURVEY BY COSTICH ENGINEERING ON 3/13/2024 HORIZONTAL AND VERTICAL DATA OBTAINED THROUGH NYSDOT CORS NETWORK REFERENCED TO THE FOLLOWING MONUMENT:

 CORTLAND CORS STATION

 -LATITUDE: 42-35-03.70726 (N)
 NAD 83 (CORS)

 -LONGITUDE: 076-12-40.79269 (W)

 -ELLIP HEIGHT: 330.887 METERS
 NAVD 88 (CORS)


- BOUNDARY SURVEY HAS NOT BEEN PERFORMED BY COSTICH ENGINEERING. BOUNDARY SHOWN HEREON IS APPROXIMATE AND DETERMINED BY LIMITED FIELD LOCATION OF BOUNDARY EVIDENCE, REVIEW OF TITLE COMMITMENT, IF PROVIDED, AND OVERLAY OF COUNTY TAX MAPS AND/OR COUNTY GIS MAPPING.
- 3. STEWART TITLE INSURANCE COMPANY TITLE NO. 71269805, HAVING AN EFFECTIVE DATE OF OCTOBER 12, 2023
- 4. PER THE NYSDEC FRESHWATER WETLANDS MAP, THERE ARE NO STATE WETLANDS IN PROJECT AREA.
- 5. PER THE NATIONAL WETLANDS INVENTORY MAPS, THERE ARE NO FEDERAL WETLANDS IN THE PROJECT AREA.
- 6. PER A WETLAND AND WATERBODIES DELINEATION REPORT PREPARED BY EARTH DIMENSIONS, INC., EDI PROJECT CODE: W20C24, DATED APRIL 4, 2024. THERE ARE WETLANDS JUST WEST OF THE PROJECT AREA.
- PER THE ERSI/FEMA PROJECT IMPACT HAZARD INFORMATION AND AWARENESS SITE MAP THERE IS NO 100 YR. FLOOD PLAIN IN THE PROJECT AREA.
- 8. SURVEY MAP PREPARED BY T.G. MILLER P.C. ENGINEERS AND SURVEYORS, JOB NO. S01631, DATED SEPTEMBER 13, 2001.
- 8. TOPOGRAPHIC MAP PREPARED BY T.G. MILLER P.C. ENGINEERS AND SURVEYORS, JOB NO. S19300, DATED APRIL 28, 2021.
- 1A CERTIFICATION PREPARED BY COSTICH ENGINEERING D.P.C., PROJECT NO. 7969, SITE NAME: REACH RUN, DATED APRIL 15, 2024.


UTILITIES EASEMENT DESCRIPTION


ALL THAT TRACT OR PARCEL OF LAND SITUATE IN THE TOWN OF LANSING, COUNTY OF TOMPKINS, STATE OF NEW YORK, ALL AS SHOWN ON A MAP ENTITLED "REACH RUN - SURVEY PLAN", PREPARED BY COSTICH ENGINEERING, D.P.C., HAVING DRAWING NUMBER 7969, SHEET NUMBER VA101 AND A LAST REVISION DATE OF 04/03/2024, AND BEING MORE PARTICULARLY BOUNDED AND DESCRIBED AS FOLLOWS:


COMMENCING AT A POINT ON THE ASSUMED SOUTHEASTERLY RIGHT OF WAY LINE OF EAST SHORE DRIVE, N.Y.S. ROUTE 34 (R.O.W. VARIES), SAID POINT BEING ON THE ASSUMED COMMON LINE OF LANDS NOW OR FORMERLY OWNED BY COMMUNITY RECREATIONAL CENTER, INC. (T.A. # 37.1-6-9) TO THE EAST AND LANDS NOW OR FORMERLY OWNED BY WARREN G. TEETER (T.A. # 37.1-6-8) TO THE WEST; THENCE

- A. N63°02'37"E, ALONG SAID SOUTHEASTERLY RIGHT OF WAY LINE OF EAST SHORE DRIVE, N.Y.S. ROUTE 34, A DISTANCE OF 146.28 FEET TO THE POINT AND PLACE OF BEGINNING; THENCE
- 1. N63°02'37"E, CONTINUING ALONG SAID SOUTHEASTERLY RIGHT OF WAY LINE OF EAST SHORE DRIVE, N.Y.S. ROUTE 34, A DISTANCE OF 14.31 FEET TO A POINT; THENCE
- 2. S18°43'36"W, A DISTANCE OF 48.63 FEET TO A POINT; THENCE
- 3. S23°46'50"E, A DISTANCE OF 131.43 FEET TO A POINT; THENCE
- 4. S18°02'37"W, A DISTANCE OF 0.65 FEET TO A POINT ALONG THE PROPOSED VERIZON WIRELESS LEASE PARCEL; THENCE
- 5. N26°57'23"W, ALONG SAID PROPOSED VERIZON WIRELESS LEASE PARCEL, A DISTANCE OF 2.21 FEET TO A THE NORTHEASTERLY CORNER OF SAID PROPOSED VERIZON WIRELESS LEASE PARCEL; THENCE
- 6. S63°02'37"W, ALONG SAID PROPOSED VERIZON WIRELESS LEASE PARCEL, A DISTANCE OF 11.93 FEET TO A POINT; THENCE
- 7. N18°02'37"E, A DISTANCE OF 3.71 FEET TO A POINT; THENCE
- 8. N23°46'50"W, A DISTANCE OF 131.50 FEET TO A POINT; THENCE
- 9. N18°43'36"E, A DISTANCE OF 42.28 FEET TO THE POINT AND PLACE OF BEGINNING. CONTAINING 0.041 ACRES OF LAND, MORE OR LESS.

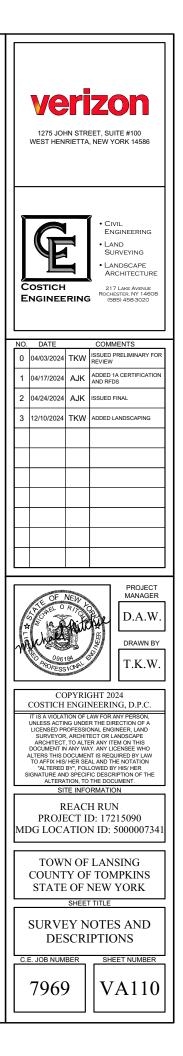

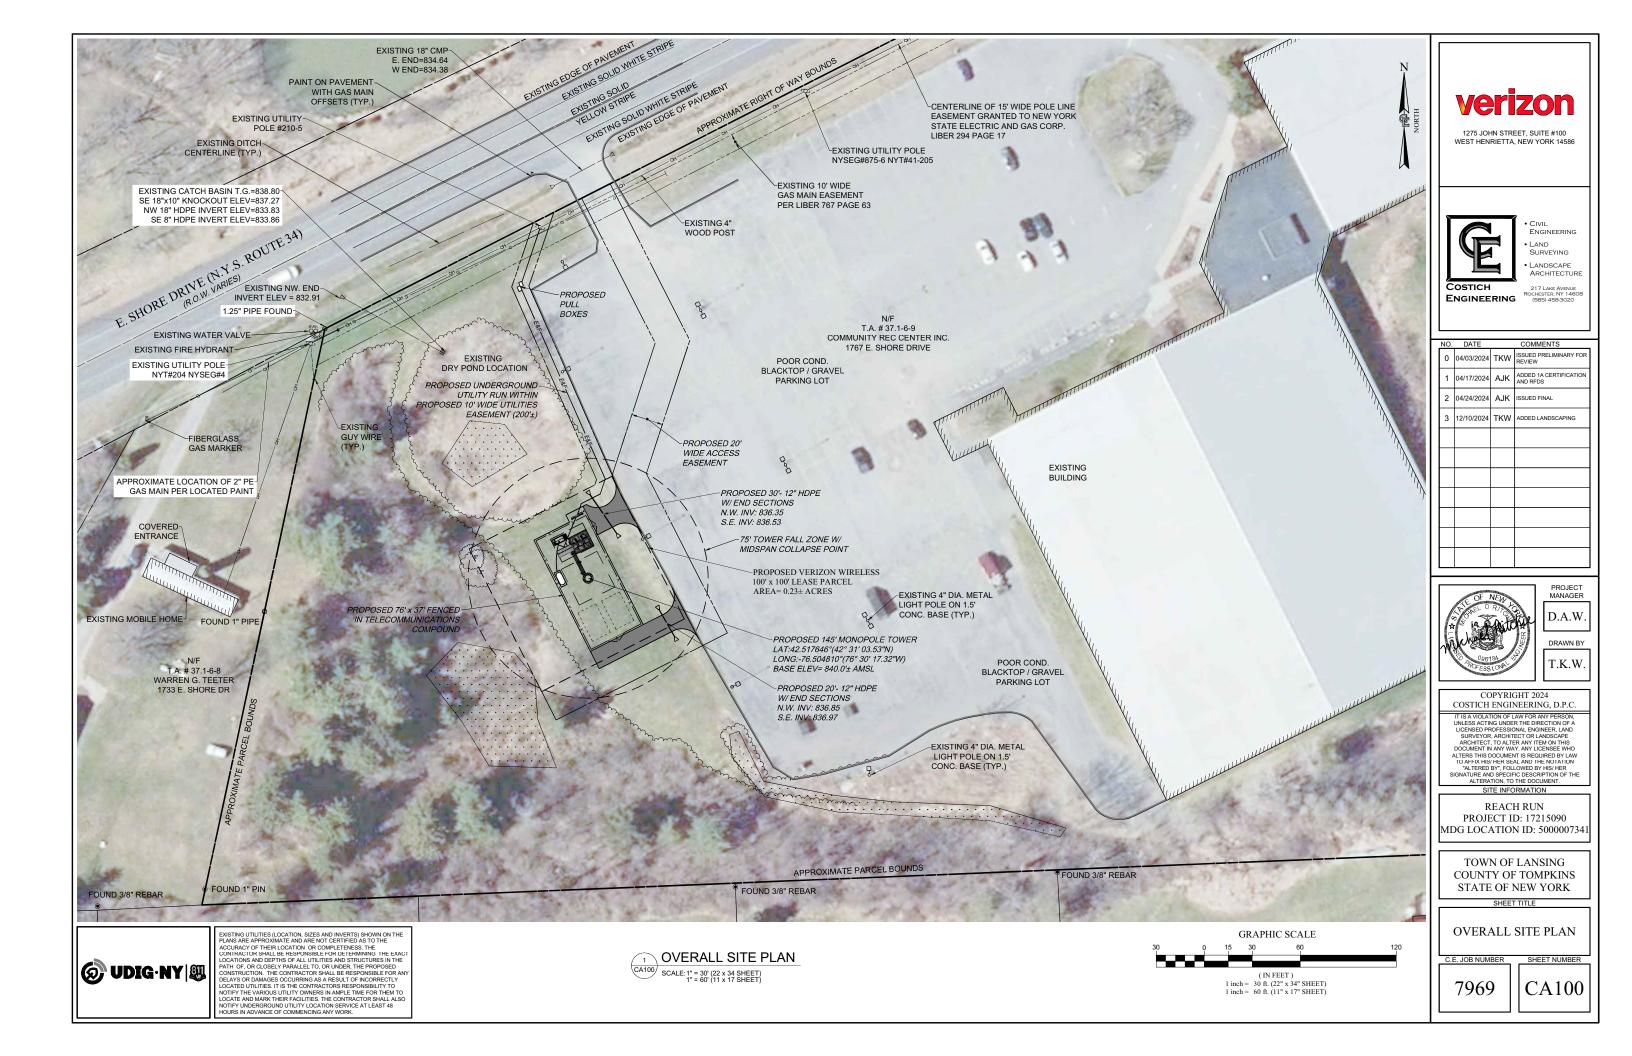

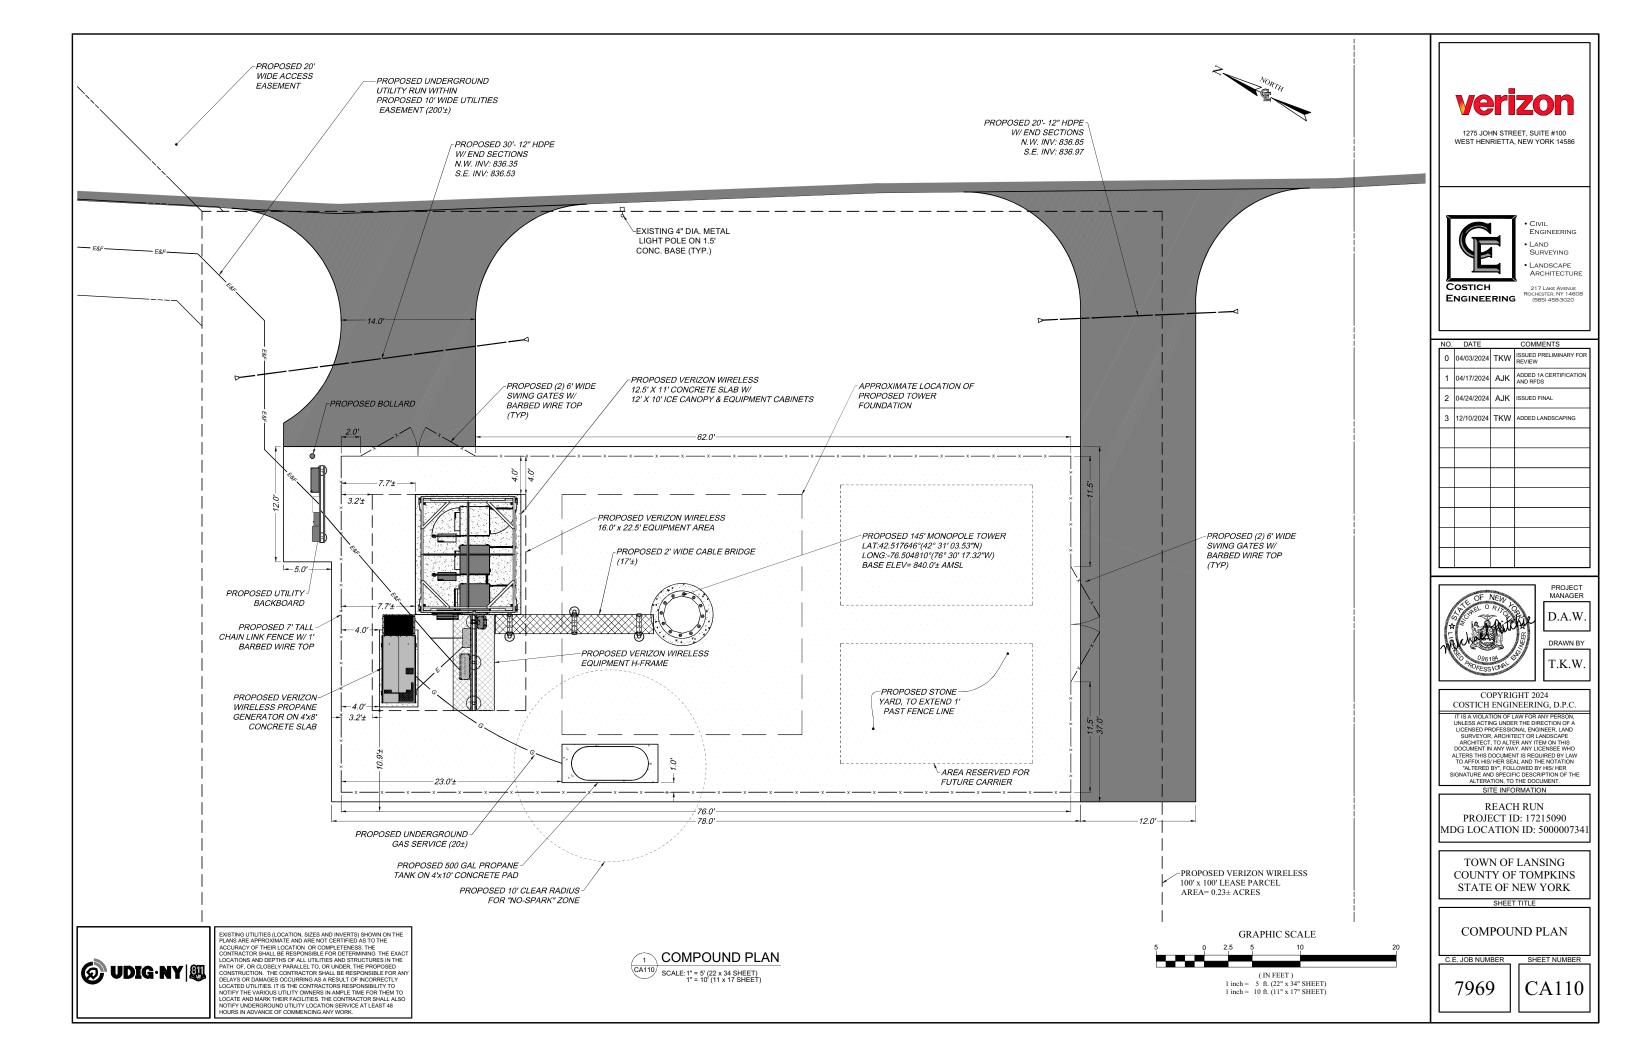


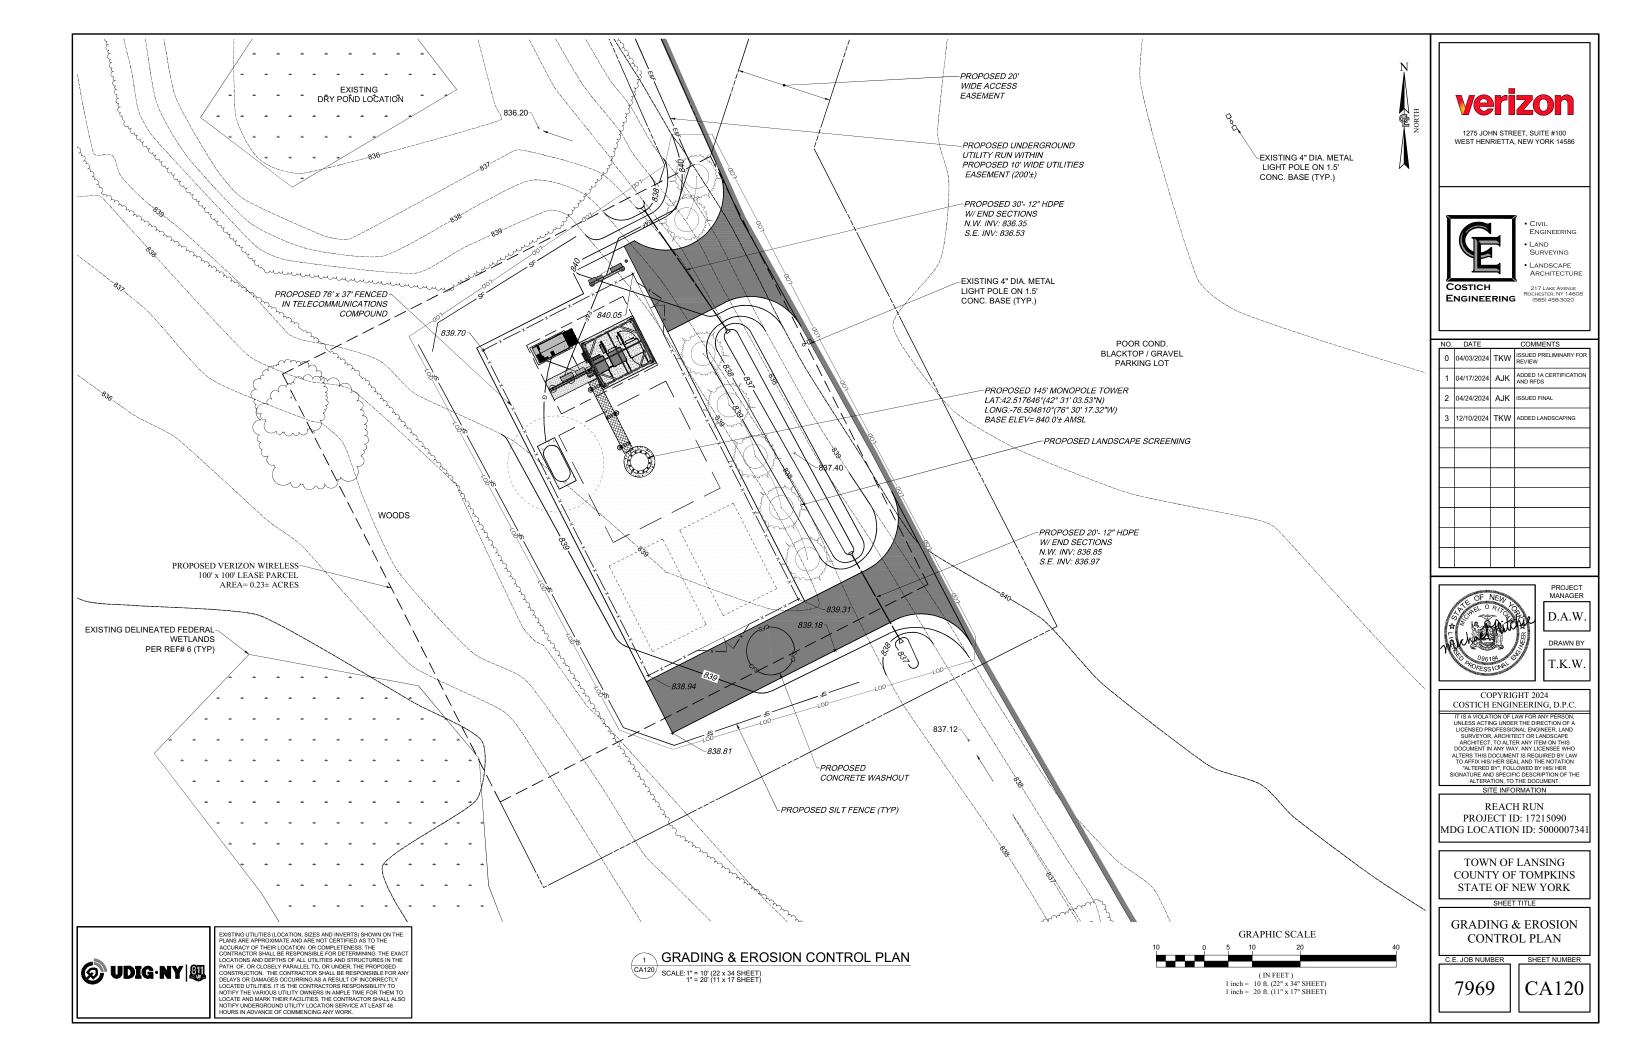

- AND MATERIAL OF ALL LANDSCAPING PRIOR TO COMMENCING WORK


- UNDERGROUND UTILITIES, RELOCATE SAID TREES TO A MINIMUM OF 5' FROM BALL TO UTILITIES


- REMOVED FROM THE SITE AND REPLACED WITH MATERIAL OF THE SAME SPECIES, QUANTITY, AND SIZE MEETING ALL PLANT
- WATERING, SPRAYING, MULCHING, FERTILIZING, AND REMOVAL OF STAKES AND GUYS) AND NEWLY ESTABLISHED LAWN AREAS UNTIL THE WORK IS ACCEPTED IN TOTAL BY THE OWNER.

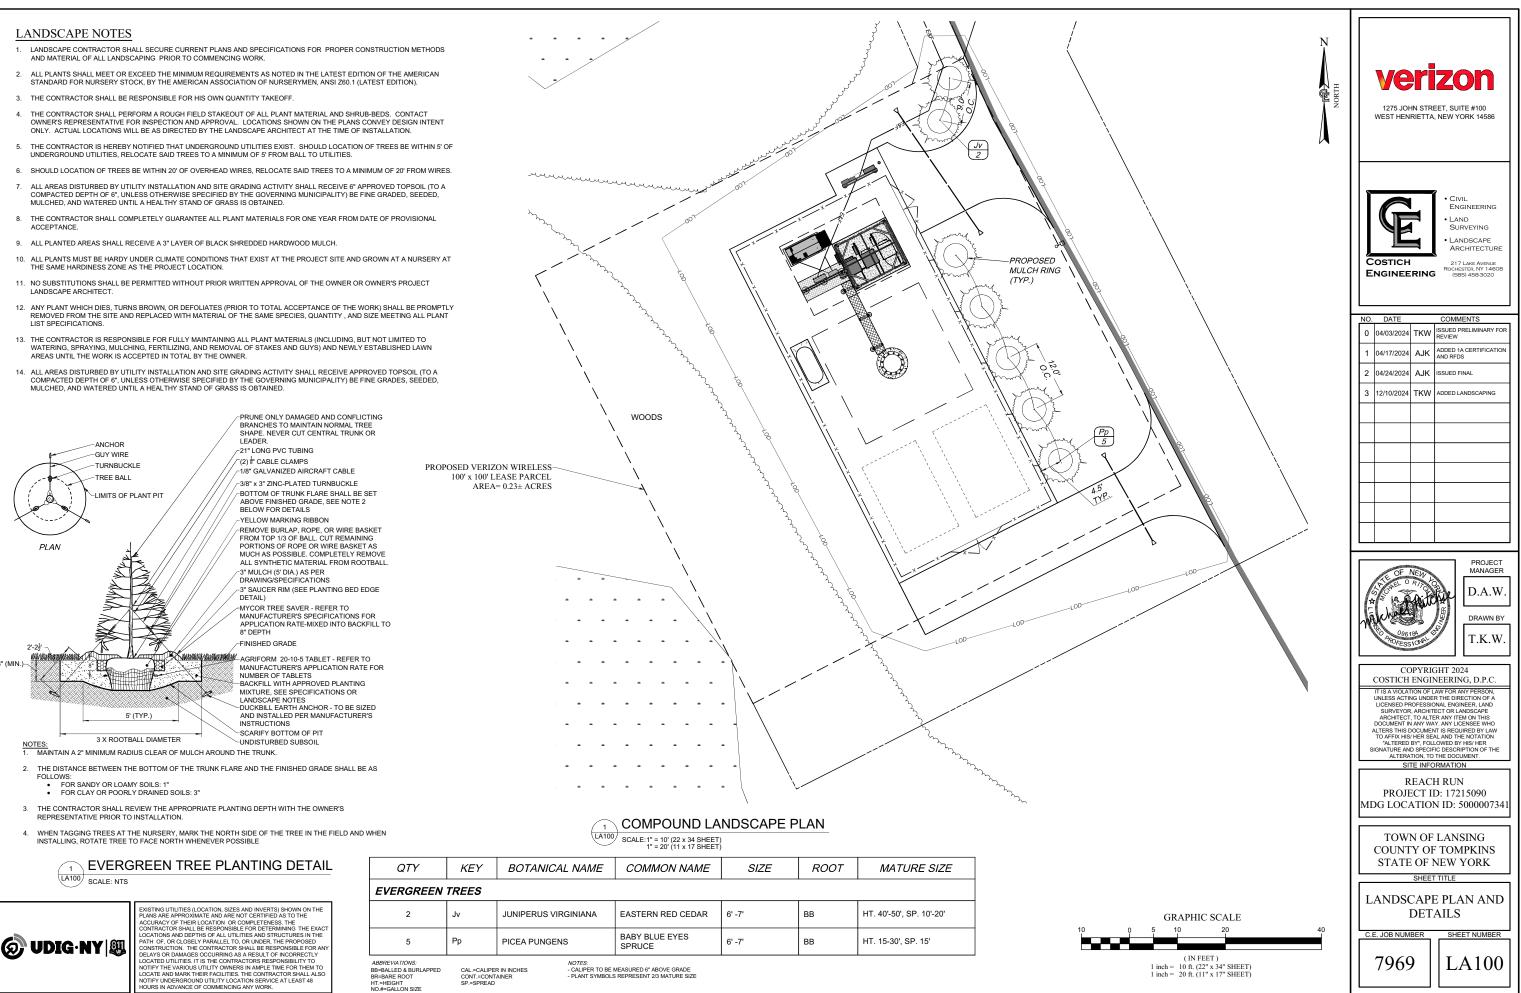



DIDIG ONY (ALL ALSO ON DIDIG ONY (ALL ALSO		
	Ĵ UDIG∙NY∣∰	PLANS ARE APPROXIMATE AND ARE NOT CERTIFIED AS TO THE ACCURACY OF THEIR LOCATION OR COMPLETENESS. THE CONTRACTOR SHALL BE RESPONSIBLE FOR DETERMINING THE EXACT LOCATIONS AND DEPTHA OF ALL UTILITIES AND STRUCTURES IN THE PATH OF, OR CLOSELY PARALLEL TO, OR UNDER, THE PROPOSED CONSTRUCTION, THE CONTRACTOR SHALL BE RESPONSIBLE FOR ANY DELAYS OR DAMAGES OCURRING AS A RESULT OF INCORRECTLY LOCATED UTILITIES. IT IS THE CONTRACTORS RESPONSIBILITY TO NOTIFY THE VARIOUS UTILITY OWNERS IN AMPLE TIME FOR THEM TO LOCATE AND MARK THEIR FACILITIES. THE CONTRACTOR SHALLALSO NOTIFY UNDERGROUND UTILITY LOCATION SERVICE AT LEAST 48


EVERGREEN TREES							
2	vL	JUNIPERUS VIR	GINIANA	EASTERN RED CEDAR	6' -7'	вв	HT. 40'-50', SP. 1
5	Рр	PICEA PUNGENS		BABY BLUE EYES SPRUCE	6' -7'	вв	HT. 15-30', SP. 1
			MEASURED 6* ABOVE GRADE S REPRESENT 2/3 MATURE SIZE				

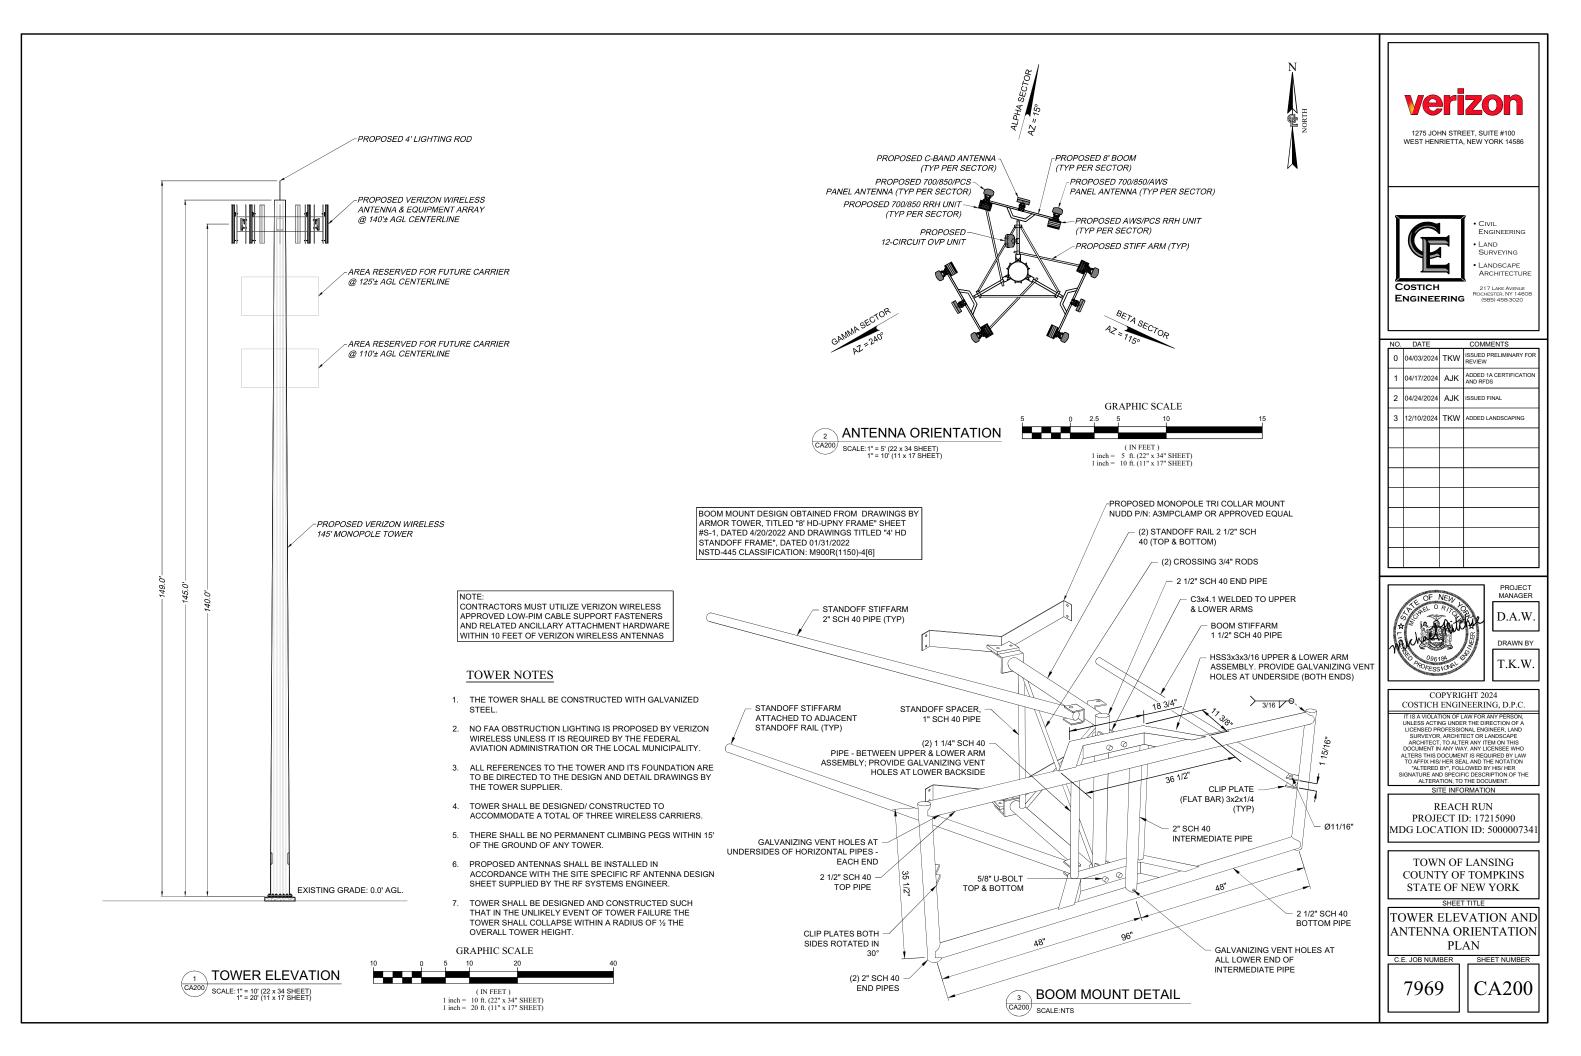

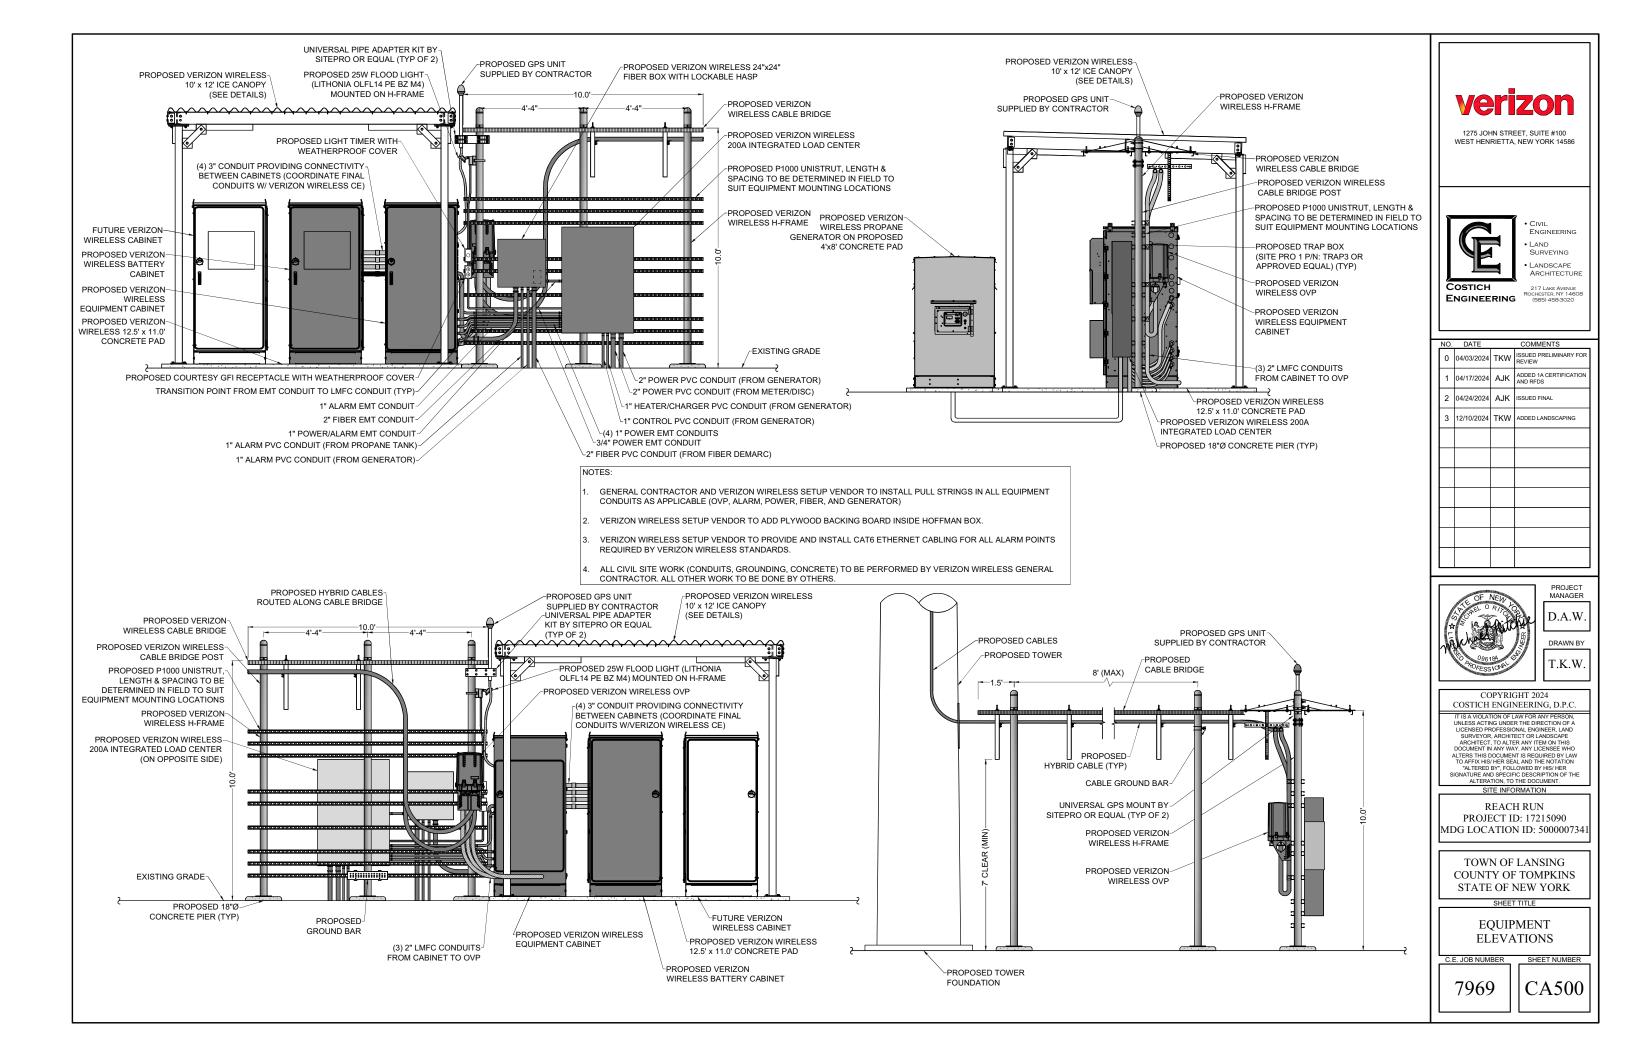

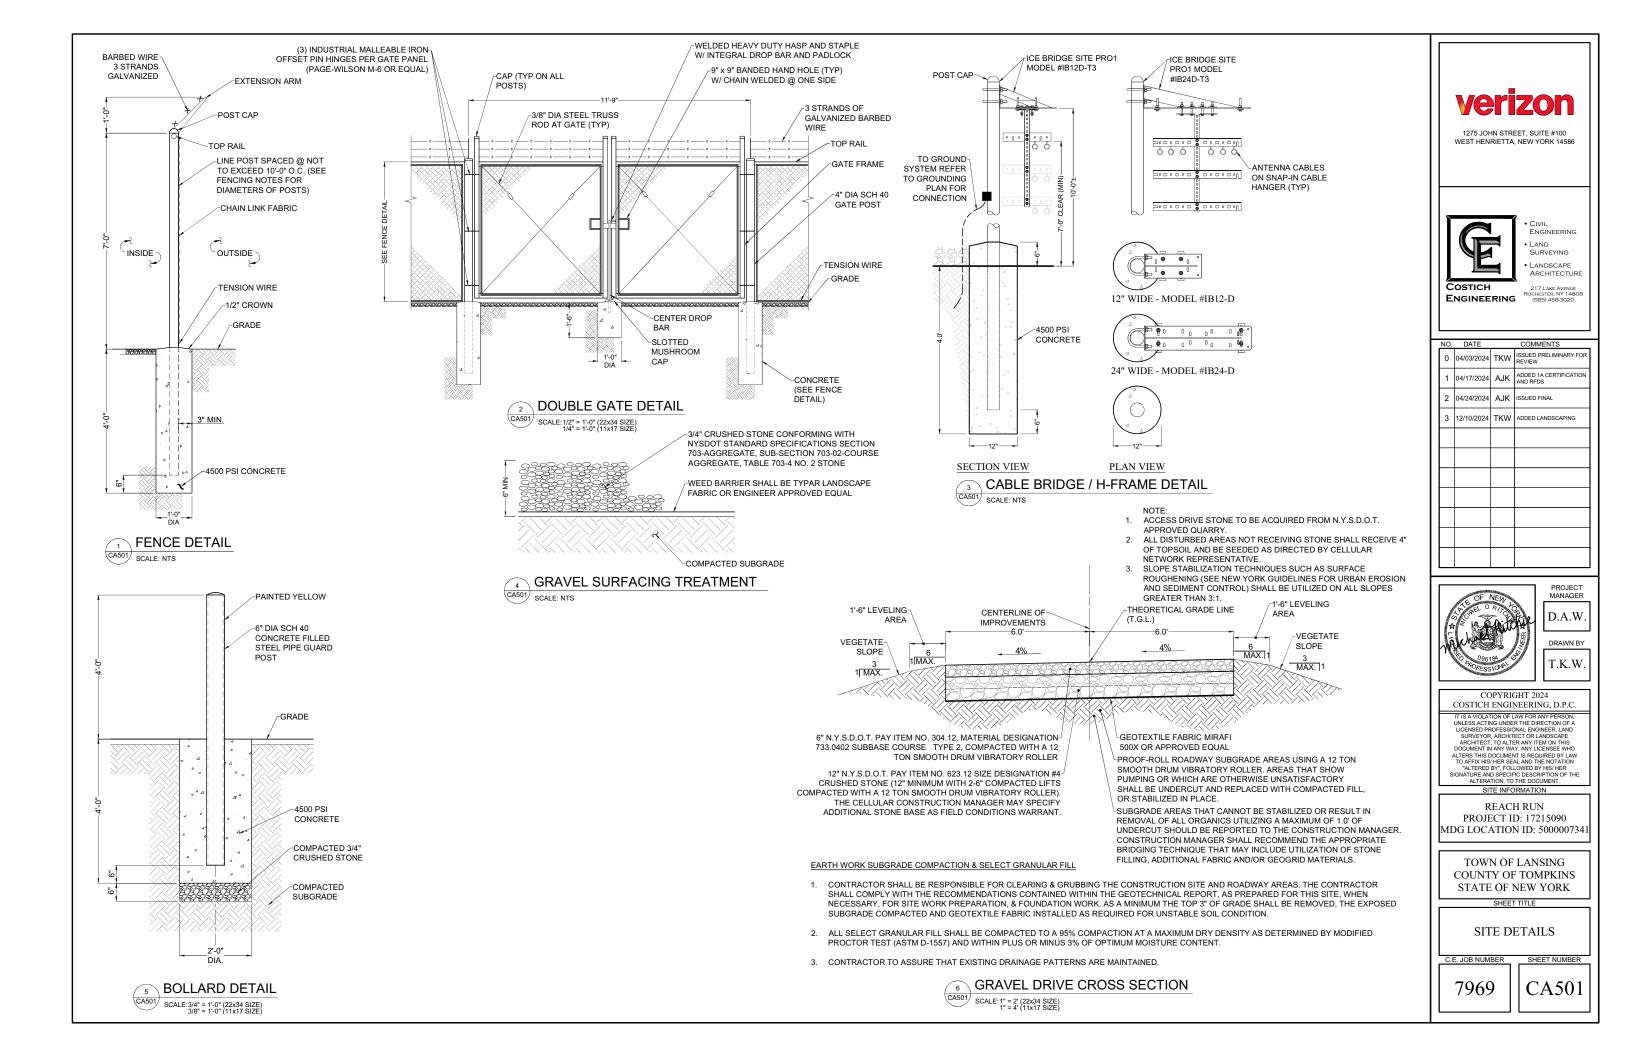


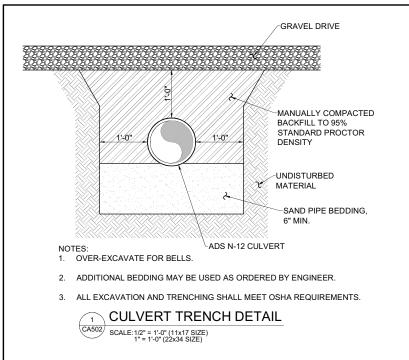

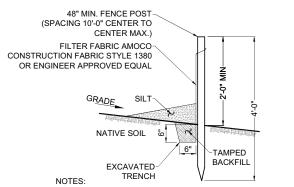

- SILT FENCE SHALL BE MAINTAINED IN PLACE DURING CONSTRUCTION AND SOIL STABILIZATION PERIOD. 1.
- 2. CONTRACTOR SHALL CONSTRUCT SILT FENCE IN ACCORDANCE WITH MANUFACTURER'S REQUIREMENTS.
- 3. EXCAVATE TRENCH 6" WIDE X 6" DEEP. BURY BOTTOM 12" OF FABRIC AND TAMP IN PLACE.
- WHEN FENCE IS NO LONGER NEEDED, THE ACCUMULATED SILT, ALL THE POSTS AND 4. FABRIC SHALL BE REMOVED AND TRENCH BACK FILLED WITH TOPSOIL AND SEEDED.



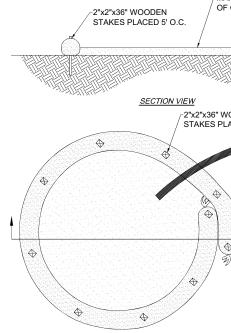

NOTES: <u>PLAN VIEW</u> FOR ANY PROJECT ON WHICH CONCRETE WILL BE POURED OR OTHERWISE FOR MUST BE PROVIDED FOR THE CLEANING OF CHUTES, MIXERS, AND HOPPERS OF FACILITY WILL BE USED AT THE SOURCE OF THE CONCRETE.

- 1. UNDER NO CIRCUMSTANCES MAY WASH WATER FROM THESE VEHICLES BE 2. CONCRETE WASHOUT SHALL BE UNDERLAYED WITH 4 MIL. THICK PLASTIC F
- 3. MAKE SURE THAT PROPER SIGNAGE IS PROVIDED TO DRIVERS SO THAT TH WASHOUT FACILITIES.
- WASHOUT FACILITIES. WASHOUT FACILITIES SHOULD NOT BE PLACED WITHIN 50 FEET OF STORM I INSTALL ON FLAT GRADE NOT TO EXCEED 2%. CONCRETE WASHOUT MAY BE STACKED IN A PYRAMIDAL CONFIGURATION F 4
- 5
- CONCRETE WASHOUT MAY BE DIRECT SEEDED AT THE TIME OF INSTALLAT
- THEY SHOULD BE IN A CONVENIENT LOCATION FOR THE TRUCKS, PREFERA BEING POURED.
- 9. CONCRETE WASHOUT NOT TO BE LESS THAN 6' IN DIAMETER.

CONCRETE WASHOU CA502 SCALE: NTS

MAXIMUM DEPTH OF CONTAMINATED WATER IS 50% OF CONCRETE WASHOUT HEIGHT. 18" DIAMETER FILTREXX SOXX (ALSO AVAILABLE IN 8", 12" AND 24" DIAMETERS) 6" WOODEN 5 PLACED 5' O.C.	VERIZON 1275 JOHN STREET, SUITE #100 WEST HENRIETTA, NEW YORK 14586
PUMP CONTAMINATED WATER INTO CONCRETE WASHOUT TM 18" DIAMETER FILTREXX® SOXX (ALSO AVAILABLE IN 8", 12" AND 24" DIAMETERS	Costich Engineering Costich Engineering (BBS) 458-3020
FORMED ON SITE, A SUITABLE WASHOUT FACILITY	NO. DATE COMMENTS 0 04/03/2024 TKW ISSUED PRELIMINARY FOR REVIEW 1 04/17/2024 AJK ADDE 1A CERTIFICATION AND RFDS 2 04/24/2024 AJK ISSUED FINAL
AS OF THE DELIVERY VEHICLES UNLESS SUCH A SS BE ALLOWED TO ENTER ANY SURFACE WATERS. TIC BUFFER. T THEY ARE AWARE OF THE PRESENCE OF DRM DRAINS, OPEN DITCHES OR SURFACE WATERS. TION FOR ADDED HEIGHT AND STABILITY. LATION. TERABLY NEAR THE PLACE WHERE THE CONCRETE IS HOUT DETAIL	3 12/10/2024 TKW ADDED LANDSCAPING
	PROJECT MANAGER D.A.W. DRAWN BY COPYRIGHT 2024 COSTICH ENGINEERING, D.P.C. IT IS A VIOLATION OF LAW FOR MAY PERSON, UNLESS ACTING UNDER THE DIRECTION OF A
	LICENSED PROFESSIONAL ENGINEER, LAND SURVEYOR, ARCHITECT OR LANDSCAPE ARCHITECT, TO ALTER ANY ITEM ON THIS DOCUMENT IN ANY WAY. ANY LICENSEE WHO ALTERS THIS DOCUMENT IS REQUIRED BY LAW TO AFTX HIS/HER SEAL AND THE NOTATION "ALTERED BY", FOLLOWED BY HIS/HER SIGNATION, TO THE DOCUMENT. SITE INFORMATION SITE INFORMATION REACH RUN PROJECT ID: 17215090 MDG LOCATION ID: 5000007341
	TOWN OF LANSING COUNTY OF TOMPKINS STATE OF NEW YORK SHEET TITLE GRADING & EROSION CONTROL DETAILS
	C.E. JOB NUMBER SHEET NUMBER 7969 CA502