
# **COVINGTON WOODS II** SITE PLANS

LOT 1, LANSING TOWNE CENTRE NORTH, **CITY OF LANSING, LEAVENWORTH COUNTY, KANSAS 66043** 

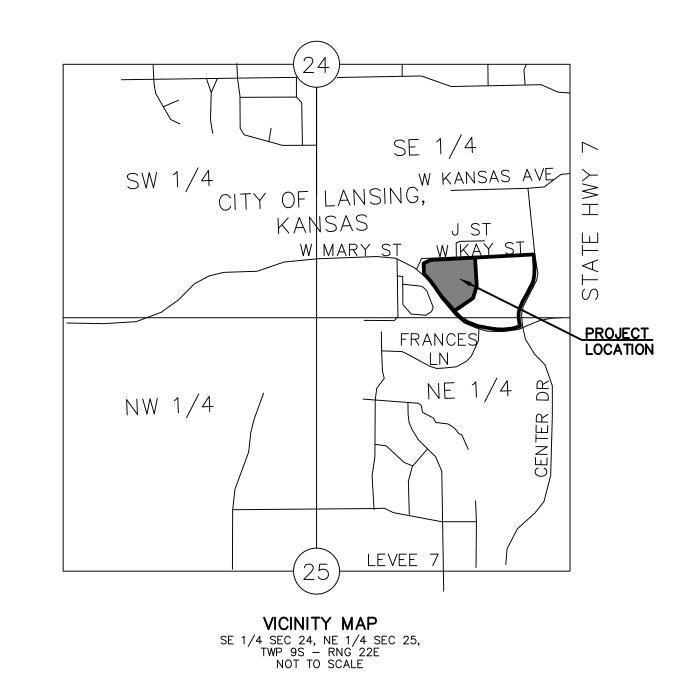

# Sheet List Table

COO1 TITLE SHEET C100 OVERALL SITE PLAN C200 DIMENSION PLAN C210 COORDINATE TABLE C300 GRADING PLAN C400 EROSION CONTROL PLAN - PHASE I C410 EROSION CONTROL PLAN - PHASE II C420 EROSION CONTROL PLAN - PHASE III C500 UTILITY PLAN ARCHITECTURAL SITE PLAN SL1 SITE LIGHTING SL2 SITE LIGHTING UNIT PLANS BUILDING 1 PLAN & ELEVATIONS BUILDING 2 PLANS AB3 BUILDING 2 ELEVATIONS AB4 BUILDING 3 PLANS AB5 BUILDING 3 ELEVATIONS CLUBHOUSE PLAN CA2 CLUBHOUSE ELEVATIONS MAINT GAR. & TRASH PLANS & ELEVATIONS CP-1 PRE DEVELOPMENT LANDSCAPE PLAN CP-2 LANDSCAPE DETAILS & NOTES

THE WESTERN 4.726 ACRES OF LOT 1, LANSING TOWNE CENTRE, A SUBDIVISION IN THE CITY OF LANSING, LEAVENWORTH COUNTY, KANSAS, RECORDED IN DOCUMENT #2008P00022 AT THE REGISTER OF DEEDS OFFICE IN LEAVENWORTH COUNTY, KANSAS, MORE PARTICULARLY DESCRIBED AS FOLLÖWS:

BEGINNING AT THE NORTHWESTERN MOST CORNER OF SAID LOT 1, SAID POINT ALSO BEING ON THE SOUTH RIGHT OF WAY LINE OF WEST KAY STREET AS NOW ESTABLISHED; THENCE NORTH 87°02'20" EAST ON THE NORTH LINE OF SAID LOT 1, A DISTANCE OF 460.08 FEET TO A POINT; THENCE SOUTH 03°18'19" EAST, A DISTANCE OF 297.16 FEET TO A POINT; THENCE SOUTH 16°59'54" WEST, A DISTANCE OF 129.64 FEET TO A POINT; THENCE SOUTH 55°23'50" WEST, A DISTANCE OF 231.36 FEET TO A POINT ON THE SOUTHWESTERLY LINE OF SAID LOT 1, SAID POINT ALSO BEING ON THE NORTHEASTERLY RIGHT OF WAY LINE OF WEST MARTY STREET AS NOW ESTABLISHED; THENCE NORTH 39°56'39" WEST ON THE SOUTHWESTERLY LINE OF SAID LOT 1, A DISTANCE OF 221.54 FEET TO A POINT; THENCE NORTH 34°34'26" WEST CONTINUING ON SAID SOUTHWESTERLY LINE, A DISTANCE OF 128.71 FEET TO A POINT; THENCE ON A CURVE TO THE LEFT CONTINUING ON SAID SOUTHWESTERLY LINE, HAVING A RADIUS OF 686.17 FEET, A DELTA ANGLE OF 10°51'03" AND AN ARC LENGTH OF 129.95 FEET TO A POINT ON THE WEST LINE OF SAID LOT 1; THENCE NORTH 01°46'43" WEST ON SAID WEST LINE, A DISTANCE OF 130.87 FEET TO A POINT; THENCE ON A CURVE TO THE RIGHT CONTINUING ON SAID WEST LINE, HAVING A RADIUS OF 232.47 FEET, A DELTA ANGLE OF 11°39'44" AND AN ARC LENGTH OF 47.32 FEET TO A POINT; THENCE NORTH 73°58'15" EAST CONTINUING ON SAID WEST LINE, A DISTANCE OF 11.50 FEET TO A POINT; THENCE NORTH 16°01'45" WEST CONTINUING ON SAID WEST LINE, A DISTANCE OF 1.53 FEET TO THE POINT OF BEGINNING. CONTAINS 205,883 SQUARE FEET OR 4.726 ACRES MORE OR LESS.

NO FIELD WORK WAS PERFORMED AT THIS TIME AND THIS DESCRIPTION DOES NOT MEET THE REQUIREMENTS OF K.S.A. 19-1434, WHICH REQUIRES A SURVEY TO BE FILED WHEN CREATING A NEW PARCEL OR DESCRIPTION FOR THE TRANSFER OF REAL

END OF DESCRIPTION

# PREPARED FOR:

ZIMMERMAN PROPERTIES, LLC. 1329 LARK ST. SPRINGFIELD, MO 65804 PHONE: (417)-883-1632 CONTACT: MANDI PASWATERS EMAIL: mpaswaters@wilhoitproperties.com

# PREPARED BY: KAW VALLEY

ENGINEERING, INC. 14700 W 114TH TERR LENEXA, KANSAS 66215 PHONE: (913) 894-5150 CONTACT: KYLE KIPPES EMAIL: kippes@kveng.com

OWNER: CITY OF LANSING 800 1ST TERRACE LANSING, KS 66043

<u>LAND AREA:</u>
TOTAL = 205,883 SF OR 4.73 AC±

ZONING: "R-4" - MULTIFAMILY RESIDENTIAL DISTRICT

PROPOSED USE:
MULTIFAMILY RESIDENCIES

By jgentzler

# Reviewed By WW Dept

SAFETY NOTICE TO CONTRACTOR

IN ACCORDANCE WITH GENERALLY ACCEPTED CONSTRUCTION PRACTICES, THE CONTRACTOR WILL BE SOLELY AND COMPLETELY RESPONSIBLE FOR CONDITIONS OF THE JOB SITE, INCLUDING SAFETY OF ALL PERSONS AND PROPERTY DURING PERFORMANCE OF THE WORK. THIS REQUIREMENT WILL APPLY CONTINUOUSLY AND NOT BE LIMITED TO NORMAL WORKING HOURS.

# WARRANTY / DISCLAIMER

THE DESIGNS REPRESENTED IN THESE PLANS ARE IN ACCORDANCE WITH ESTABLISHED PRACTICES OF CIVIL ENGINEERING FOR THE DESIGN FUNCTIONS AND USES INTENDED BY THE OWNER AT THIS TIME. HOWEVER, NEITHER KAW VALLEY ENGINEERING, INC NOR ITS PERSONNEL CAN OR DO WARRANTY THESE DESIGNS OR PLANS AS CONSTRUCTED, EXCEPT IN THE SPECIFIC CASES WHERE KAW VALLEY ENGINEERING PERSONNEL INSPECT AND CONTROL THE PHYSICAL CONSTRUCTION ON A CONTEMPORARY BASIS AT THE SITE.

# CAUTION - NOTICE TO CONTRACTOR

CONFLICTS PRIOR TO ANY CONSTRUCTION.

THE CONTRACTOR IS SPECIFICALLY CAUTIONED THAT THE LOCATION AND/OR ELEVATION OF EXISTING UTILITIES AS SHOWN ON THESE PLANS IS BASED ON RECORDS OF THE VARIOUS UTILITY COMPANIES AND, WHERE POSSIBLE, MEASUREMENTS TAKEN IN THE FIELD. THE INFORMATION IS NOT TO BE RELIED ON AS BEING EXACT OR COMPLETE. THE CONTRACTOR MUST CALL THE APPROPRIATE UTILITY COMPANY AT LEAST 72 HOURS BEFORE ANY EXCAVATION TO REQUEST EXACT FIELD LOCATION OF UTILITIES. IT SHALL BE THE RESPONSIBILITY OF THE CONTRACTOR TO RELOCATE ALL EXISTING UTILITIES WHICH CONFLICT WITH PROPOSED IMPROVEMENTS SHOWN ON THE PLANS. THE CONTRACTOR SHALL EXPOSE EXISTING UTILITIES AT LOCATIONS OF POSSIBLE

KYLE G. KIPPES ENGINEER KS # 20913

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COVINGTON WOODS
WEST MARY STREET AND W
LANSING, KANSAS 66043

C23\_1644

DESIGNER DRAWN BY

KGK HAS/JQN 1644SP

SHEET

THIS DRAWING SHALL NOT BE UTILIZED BY ANY PERSON, FIRM, OR CORPORATION IN WHOLE OR IN PART WITHOUT THE SPECIFIC PERMISSION OF KAW VALLEY ENGINEERING, INC.


**Reviewed by CED** 09/07/2023 3:33:41 PM

# **No Comments**

09/11/2023 9:44:19 AM

# **Reviewed by Public Works**

09/12/2023 3:12:41 PM By mspickelmier

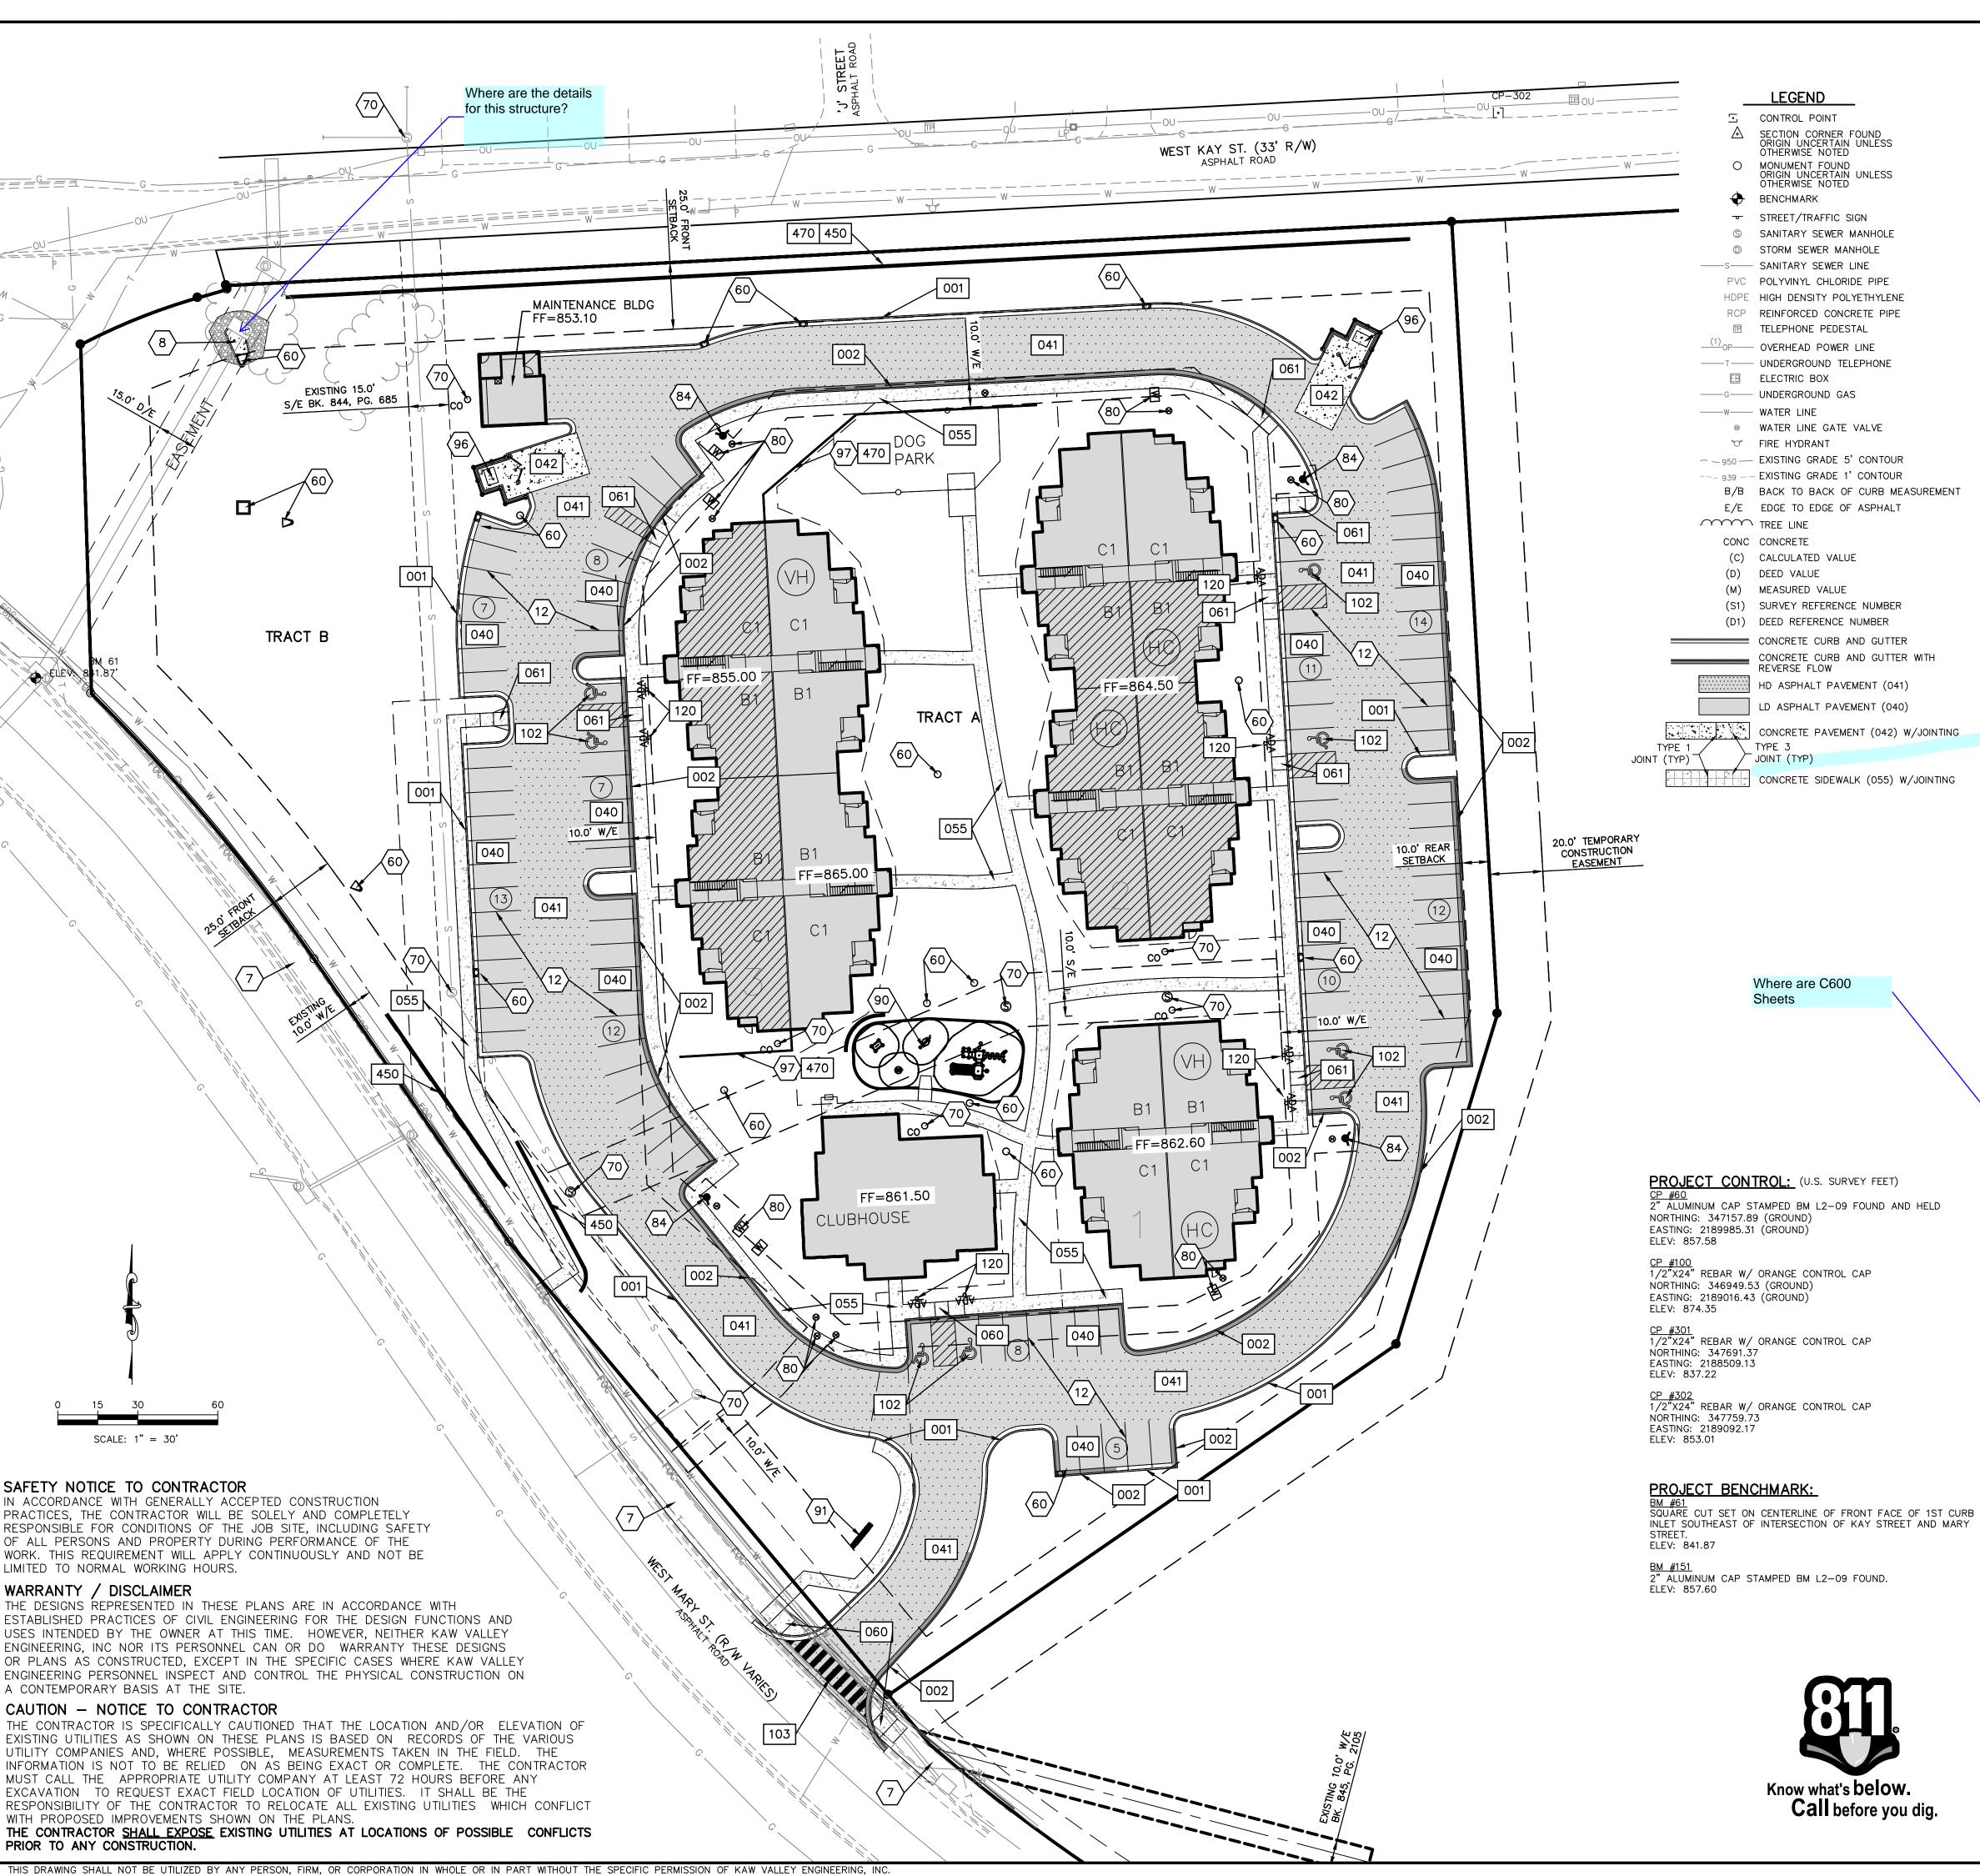

LEGEND

CONTROL POINT SECTION CORNER FOUND ORIGIN UNCERTAIN UNLESS OTHERWISE NOTED

MONUMENT FOUND ORIGIN UNCERTAIN UNLESS OTHERWISE NOTED

BENCHMARK ▼ STREET/TRAFFIC SIGN

S SANITARY SEWER MANHOLE STORM SEWER MANHOLE 

PVC POLYVINYL CHLORIDE PIPE HDPE HIGH DENSITY POLYETHYLENE RCP REINFORCED CONCRETE PIPE

TELEPHONE PEDESTAL OVERHEAD POWER LINE ——T—— UNDERGROUND TELEPHONE 

-----W----- WATER LINE 

♥ FIRE HYDRANT ~ -950 - EXISTING GRADE 5' CONTOUR --- 939 -- EXISTING GRADE 1' CONTOUR

B/B BACK TO BACK OF CURB MEASUREMENT E/E EDGE TO EDGE OF ASPHALT TREE LINE

CONC CONCRETE (C) CALCULATED VALUE

> (D) DEED VALUE (M) MEASURED VALUE (S1) SURVEY REFERENCE NUMBER

(D1) DEED REFERENCE NUMBER CONCRETE CURB AND GUTTER CONCRETE CURB AND GUTTER WITH

REVERSE FLOW HD ASPHALT PAVEMENT (041)

LD ASPHALT PAVEMENT (040) CONCRETE PAVEMENT (042) W/JOINTING

TYPE 3 JOINT (TYP)

Where are C600

Know what's below.

Call before you dig.

Sheets

DETAILS - SEE DETAIL SHEETS C190 AND C191 FOR THE FOLLOWING DETAILS

CONCRETE CURB AND GUTTER CURB AND GUTTER - DRY CURB ASPHALT PAVEMENT HEAVY DUTY ASPHALT PAVEMENT

MATERIAL TESTING AND PHOTOGRAPHS.

PREPARED FOR:

SPRINGFIELD, MO 65804

PHONE: (417)-883-1632

CONTACT: MANDI PASWATERS

EMAIL: mpaswaters@wilhoitproperties.com

1. COORDINATE START-UP AND ALL CONSTRUCTION ACTIVITIES WITH OWNER.

2. CONSTRUCTION METHODS AND MATERIALS NOT SPECIFIED IN THESE

PLANS ARE TO MEET OR EXCEED THE CITY OF LANSING TECHNICAL

3. ALL CONSTRUCTION WORK AND UTILITY WORK OUTSIDE OF PROPERTY

BOUNDARIES SHALL BE PERFORMED IN COOPERATION WITH AND IN

ACCORDANCE WITH REGULATIONS OF THE AUTHORITIES CONCERNED.

4. PUBLIC CONVENIENCE AND SAFETY: THE CONTRACTOR SHALL CONDUCT

THE WORK IN A MANNER THAT WILL INSURE, AS FAR AS PRACTICABLE,

THE LEAST OBSTRUCTION TO TRAFFIC, AND SHALL PROVIDE FOR THE

CONVENIENCE AND SAFETY OF THE GENERAL PUBLIC AND RESIDENTS

5. ALL DIMENSIONS SHOWN ARE TO THE BACK OF CURB UNLESS OTHERWISE

6. ALL TRAFFIC CONTROL DEVICES, INSTALLATION AND OPERATIONS SHALL

7. PAINT FOR STRIPING ON PUBLIC STREETS, HIGHWAYS AND ENTRANCES

CONTRACTOR TO PROVIDE INSPECTION SERVICE FOR FILL PLACEMENT

INCLUDING BUT NOT LIMITED TO DAILY LOGS, COMPACTION RESULTS,

PAVEMENT, RETAINING WALL AND PRIVATE UTILITIES INSTALLATION.

COPIES OF INSPECTION REPORTS ARE TO BE PROVIDED TO CITY,

CONFORM WITH THE "MANUAL ON UNIFORM TRAFFIC CONTROL DEVICES".

SHALL BE REFLECTORIZED PAINT CONFORMING TO THE SPECIFICATIONS OR

REQUIREMENTS OF THE AUTHORITY GOVERNING THE STREET OR HIGHWAY.

ALONG AND ADJACENT TO HIGHWAYS IN THE CONSTRUCTION AREA.

1329 LARK ST.

**CONSTRUCTION NOTES:** 

SPECIFICATIONS.

ZIMMERMAN PROPERTIES, LLC.

PREPARED BY:

ENGINEERING, INC.

14700 W 114TH TERR.

LENEXA, KANSAS 66215

PHONE: (913) 894-5150

CONTACT: KYLE KIPPES

EMAIL: kippes@kveng.com

KAW VALLEY

HEAVY DUTY CONCRETE PAVEMENT CONCRETE SIDEWALK SIDEWALK RAMPS

PRIVATE SIDEWALK RAMPS 90° ACCESSIBLE & VAN ACCESSIBLE SPACE STRIPING PEDESTRIAN CROSSING

ACCESSIBLE PARKING SIGNAGE RETAINING WALL - CONTRACTOR SHALL PROVIDE RETAINING WALL DESIGN SIGNED AND SEALED BY AN ENGINEER LICENSED IN THE STATE OF KANSAS

470 FENCE

EXISTING SIDEWALK CONCRETE SWALE

WHITE PARKING LOT STRIPING (SHERWIN-WILLIAMS TM 2160 LEAD FREE OR APPROVED EQUAL)

STORM STRUCTURE (SEE C600 SERIES SHEETS) SANITARY SEWER APPURTENANCES (SEE SHEET C500)

WATER APPURTENANCES (SEE SHEET C500) FIRE HYDANT (SEE SEPARATE WATER MAIN PLANS) PLAYGROUND

MONUMENT SIGN (SEE ARCHITECTURAL PLAN) TRASH ENCLOSURE (SEE ARCHITECTURAL PLAN) CAST IN PLACE STEM WALL

**FLOOD STATEMENT:** 

THE SURVEYED PROPERTY IS SHOWN TO BE LOCATED IN ZONE "X" (AREAS DETERMINED TO BE OUTSID OF THE 0.2% ANNUAL CHANCE FLOODPLAIN) AS DEPICTED ON THE FLOOD INSURANCE RATE MAP NO. 20103C0232G, MAP REVISED JULY 16, 2015, CITY OF LANSING, LEAVENWORTH COUNTY, KANSAS.

3. ALL DIMENSIONS ARE TO BACK OF CURB UNLESS NOTED OTHERWISE.

4. ALL DIMENSIONS ARE PERPENDICULAR TO PROPERTY LINE.

5. ACTUAL SIGN LOCATIONS TO BE COORDINATED WITH CONSTRUCTION

LOCATION DETERMINED BY A SCALED GRAPHICAL PLOT OF THE FLOOD INSURANCE RATE MAP.

1. CONTRACTOR SHALL REFER TO ARCHITECTURAL PLANS FOR EXACT LOCATIONS AND DIMENSIONS OF ENTRANCE, SLOPED PAVING, EXIT PORCHES, RAMPS, TRUCK DOCKS, PRECISE BUILDING DIMENSIONS AND EXACT BUILDING UTILITY ENTRANCE LOCATIONS.

2. THESE PLANS HAVE <u>NOT</u> BEEN VERIFIED WITH FINAL ARCHITECTURAL CONTRACT DRAWINGS. CONTRACTOR SHALL VERIFY AND NOTIFY THE ENGINEER OF ANY DISCREPANCIES. CONTRACTOR IS FULLY RESPONSIBLE FOR REVIEW AND COORDINATION OF ALL DRAWINGS AND CONTRACTOR

MANAGER.

20913

KYLE G. KIPPES ENGINEER KS # 20913

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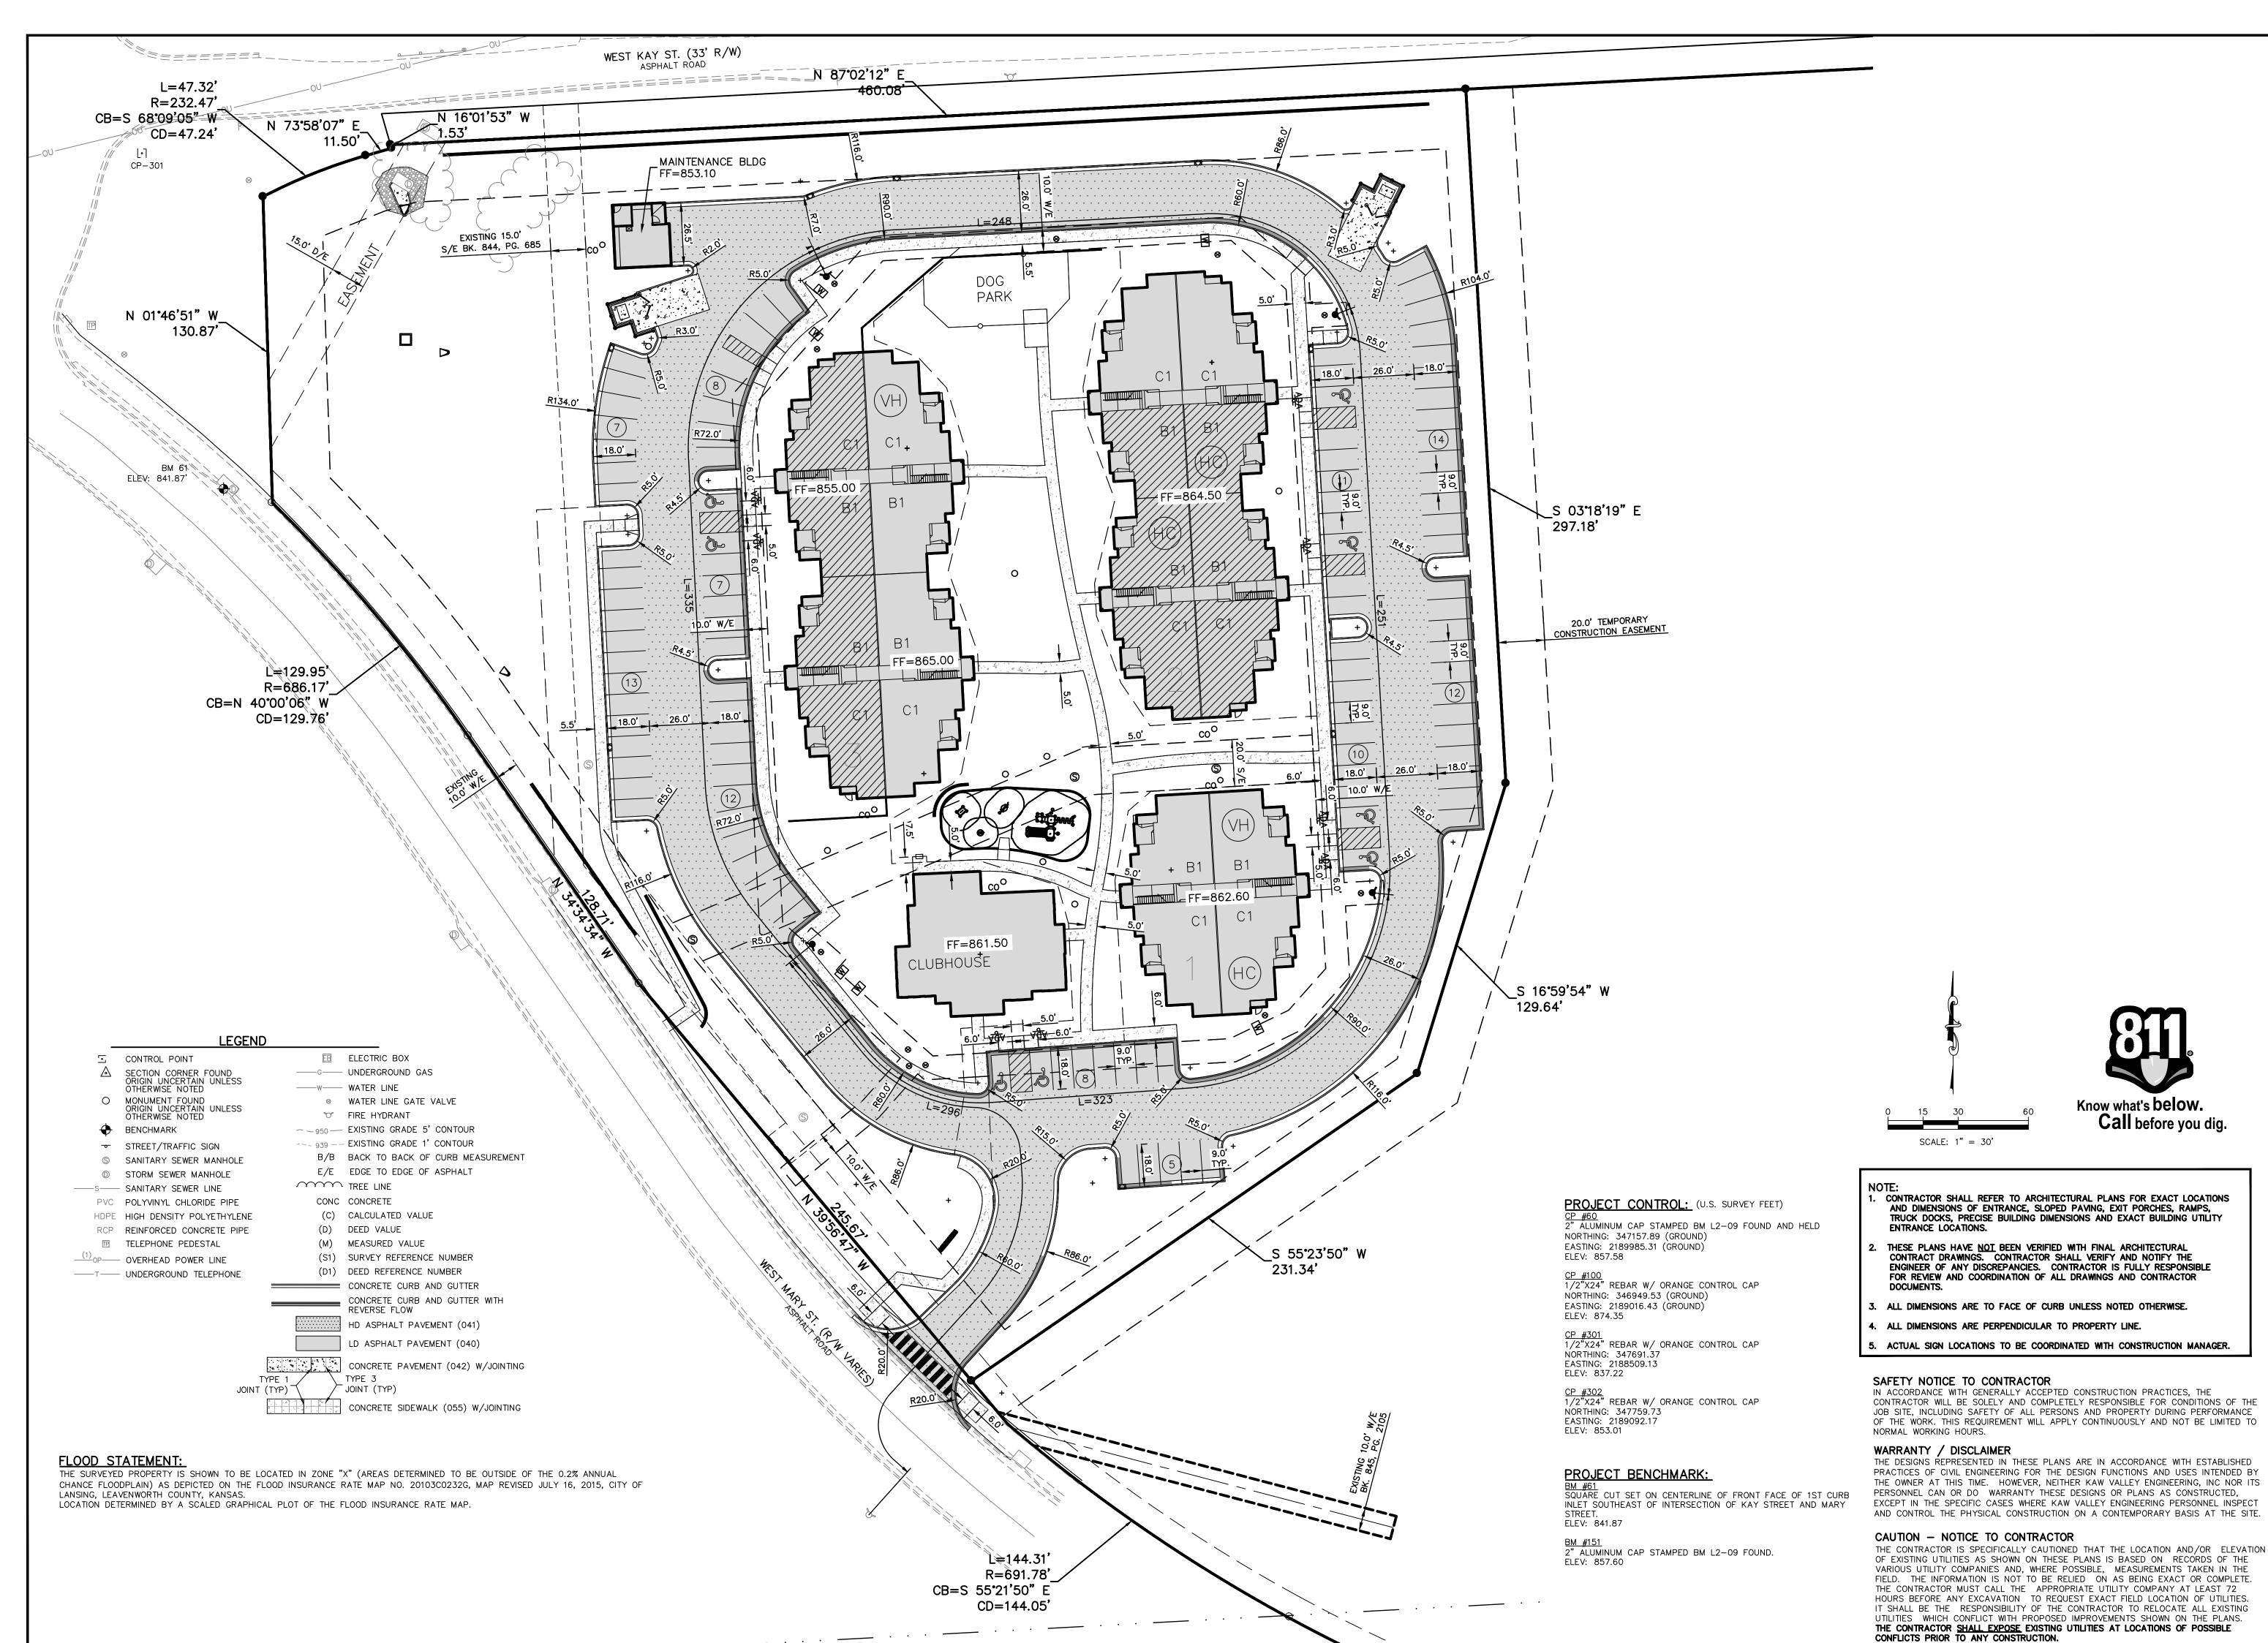
COVINGTON WOODS
WEST MARY STREET AND W
LANSING, KANSAS 66043
SITE PLANS
SITE PLANS

PROJ. NO. C23\_1644

DESIGNER DRAWN BY

KGK HAS/JQN 1644SP SHEET

C100





KYLE G. KIPPES **ENGINEER** KS # 20913

ENGINEERING

S

COVINGTON WOODS
WEST MARY STREET AND W
LANSING, KANSAS 66043
SITE PLANS
DIMENSION PLAN

C23\_1644

DESIGNER DRAWN BY KGK HAS/JQN

1644DIM

C200

THIS DRAWING SHALL NOT BE UTILIZED BY ANY PERSON, FIRM, OR CORPORATION IN WHOLE OR IN PART WITHOUT THE SPECIFIC PERMISSION OF KAW VALLEY ENGINEERING, INC.

### GRADING NOTES:

. THE CONSTRUCTION AREA SHALL BE CLEARED, GRUBBED, AND STRIPPED OF TOPSOIL AND ORGANIC MATTER FROM ALL AREAS TO BE OCCUPIED BY BUILDING AND PAVING. TOPSOIL FOR REPLACEMENT ON SLOPES MAY BE STOCKPILED ON SITE. EXCESS TOPSOIL MAY BE WASTED IN FILL SLOPES PROVIDED THAT NO TOPSOIL WILL BE WASTED WITHIN 10 FEET OF THE EDGE OF THE BUILDING OR PARKING AREA. BURNING OF TIMBER WILL NOT BE PERMITTED UNLESS APPROVAL IS OBTAINED FROM GOVERNING OFFICIALS. STRIPPING EXISTING TOPSOIL AND ORGANIC MATTER SHALL BE TO A MINIMUM DEPTH OF 6 INCHES.

2. AREAS TO RECEIVE FILL SHALL BE SCARIFIED AND THE TOP 8-INCH DEPTH COMPACTED TO 95% STANDARD PROCTOR DENSITY. ANY UNSUITABLE AREAS SHALL BE UNDERCUT AND REPLACED WITH SUITABLE MATERIAL BEFORE ANY FILL MATERIAL

3. OFF-SITE FILL MATERIAL SHALL HAVE A PLASTICITY INDEX OF 25 OR LESS, A LIQUID LIMIT OF 45 OR LESS AND CONTAIN NO ROCK LARGER THAN FOUR INCHES. OFF-SITE FILL MATERIAL SHALL BE APPROVED BY THE OWNER ENGINEER PRIOR TO BRINGING ON SITE.

4. EARTHWORK UNDER THE BUILDING SHALL COMPLY WITH THE PROJECT ARCHITECTURAL PLANS. OTHER FILL MATERIAL SHALL BE MADE IN LIFTS NOT TO EXCEED EIGHT INCHES DEPTH COMPACTED TO 95% STANDARD PROCTOR DENSITY. FILL MATERIAL MAY INCLUDE ROCK FROM ON-SITE EXCAVATION IF CAREFULLY PLACED SO THAT LARGE STONES ARE WELL DISTRIBUTED AND VOIDS ARE COMPLETELY FILLED WITH SMALLER STONES, EARTH, SAND OR GRAVEL TO FURNISH A SOLID EMBANKMENT. NO ROCK LARGER THAN THREE INCHES IN ANY DIMENSION NOR ANY SHALE SHALL BE PLACED IN THE TOP 12 INCHES OF EMBANKMENT.

5. AREAS THAT ARE TO BE CUT TO SUBGRADE LEVELS SHALL BE PROOF ROLLED WITH A MODERATELY HEAVY LOADED DUMP TRUCK OR SIMILAR APPROVED CONSTRUCTION EQUIPMENT TO DETECT UNSUITABLE SOIL CONDITIONS.

6. IN ALL AREAS OF EXCAVATION, IF UNSUITABLE SOIL CONDITIONS ARE ENCOUNTERED, A QUALIFIED GEOTECHNICAL ENGINEER SHALL RECOMMEND TO THE OWNER ENGINEER THE METHODS OF UNDERCUTTING AND REPLACEMENT OF PROPERLY COMPACTED, APPROVED FILL MATERIAL. ALL PROOFROLLING AND UNDERCUTTING SHOULD BE PERFORMED DURING A PERIOD OF DRY WEATHER.

7. THE CONTRACTOR SHALL BE RESPONSIBLE FOR THE CONTROL OF DUST AND DIRT RISING AND SCATTERING IN THE AIR DURING CONSTRUCTION AND SHALL PROVIDE WATER SPRINKLING OR OTHER SUITABLE METHODS OF CONTROL. THE CONTRACTOR SHALL COMPLY WITH ALL GOVERNING REGULATIONS PERTAINING TO ENVIRONMENTAL PROTECTION.

8. ALL SLOPES ARE TO BE 3:1 OR FLATTER UNLESS OTHERWISE INDICATED.

9. ALL SLOPES EXCEEDING 3:1 SHALL BE PROTECTED BY RIP RAP, CONCRETE PAVING, OR OTHER METHODS INDICATED ON THESE PLANS, THAT WILL PREVENT EROSION AND PLACED SUCH THAT THE SURFACE IS FLUSH WITH SURROUNDING GROUND AND SHAPED TO CHANNEL WATER IN DIRECTIONS INDICATED.

10. ALL SLOPES AND AREAS DISTURBED BY CONSTRUCTION SHALL BE GRADED SMOOTH AND FOUR INCHES OF TOPSOIL APPLIED. IF ADEQUATE TOPSOIL IS NOT AVAILABLE ON-SITE, THE CONTRACTOR SHALL PROVIDE TOPSOIL, APPROVED BY THE OWNER, AS NEEDED. THE AREA SHALL THEN BE SEEDED, FERTILIZED, MULCHED, WATERED AND MAINTAINED UNTIL HARDY GRASS GROWTH IS ESTABLISHED IN ALL AREAS. ANY AREAS DISTURBED FOR ANY REASON SHALL BE CORRECTED BY THE CONTRACTOR AT NO ADDITIONAL COST TO THE OWNER PRIOR TO FINAL ACCEPTANCE OF THE PROJECT.

11. CONTRACTOR SHALL USE SILT FENCE, STRAW BALES OF HAY OR OTHER MEANS OF CONTROLLING EROSION ALONG THE EDGE OF THE PROPERTY OR OTHER BOTTOM OF SLOPE LOCATIONS.

12. CONTRACTOR IS TO REMOVE AND DISPOSE OF ALL DEBRIS, RUBBISH AND OTHER MATERIALS RESULTING FROM PREVIOUS AND CURRENT DEMOLITION OPERATIONS.

13. THE CONTRACTOR SHALL TAKE ALL PRECAUTIONS NECESSARY TO AVOID PROPERTY DAMAGE TO ADJACENT PROPERTIES DURING THE CONSTRUCTION PHASES OF THIS PROJECT. THE CONTRACTOR WILL BE HELD SOLELY RESPONSIBLE FOR ANY DAMAGES TO THE ADJACENT PROPERTIES OCCURRING DURING THE CONSTRUCTION PHASES OF THIS PROJECT.

14. IT IS NOT THE DUTY OF THE ENGINEER OR THE OWNER TO REVIEW THE ADEQUACY OF THE CONTRACTOR'S SAFETY MEASURES, IN, ON OR NEAR THE CONSTRUCTION SITE AT ANY TIME DURING CONSTRUCTION.

16. PIPE LENGTHS ARE CENTER TO CENTER OF STRUCTURE OR TO END OF END SECTIONS.

17. CONTRACTOR TO PROVIDE WALL DETAILS AND PLANS SEALED BY A KANSAS LICENSED ENGINEER. WALL DESIGNER TO VERIFY BEARING CAPACITY AND GLOBAL STABILITY FOR WALL CALCULATIONS.

	LEGEND		
_ _	CONTROL POINT	EB	ELECTRIC BOX
$\triangle$	SECTION CORNER FOUND	———G——	UNDERGROUND GAS
	ORIGIN UNCERTAIN UNLESS OTHERWISE NOTED	W	WATER LINE
0	MONUMENT FOUND ORIGIN UNCERTAIN UNLESS	8	WATER LINE GATE VALVE
	OTHERWISE NOTED	~	FIRE HYDRANT
<b>�</b>	BENCHMARK	~ ~ 950 —	EXISTING GRADE 5' CONTOUR
<del>- 0-</del>	STREET/TRAFFIC SIGN	939	EXISTING GRADE 1' CONTOUR
S	SANITARY SEWER MANHOLE	B/B	BACK TO BACK OF CURB MEASUREME
0	STORM SEWER MANHOLE	E/E	EDGE TO EDGE OF ASPHALT
——s—	SANITARY SEWER LINE	$\sim\sim$	TREE LINE
PVC	POLYVINYL CHLORIDE PIPE	CONC	CONCRETE
HDPE	HIGH DENSITY POLYETHYLENE	(C)	CALCULATED VALUE
RCP	REINFORCED CONCRETE PIPE	(D)	DEED VALUE
TP	TELEPHONE PEDESTAL	(M)	MEASURED VALUE
(1) 	OVERHEAD POWER LINE	(S1)	SURVEY REFERENCE NUMBER
—т—	UNDERGROUND TELEPHONE	(D1)	DEED REFERENCE NUMBER

IF DISCREPANCIES EXIST BETWEEN THE GRADING NOTES BELOW AND THE RECOMMENDATIONS OUTLINED IN THE PROJECT GEOTECHNICAL REPORT, THE RECOMMENDATIONS OUTLINED IN THE GEOTECHNICAL REPORT SHALL GOVERN.

# FLOOD STATEMENT:

THE SURVEYED PROPERTY IS SHOWN TO BE LOCATED IN ZONE "X" (AREAS DETERMINED TO BE OUTSIDE OF THE 0.2% ANNUAL CHANCE FLOODPLAIN) AS DEPICTED ON THE FLOOD INSURANCE RATE MAP NO. 20103C0232G, MAP REVISED JULY 16, 2015, CITY OF LANSING, LEAVENWORTH LOCATION DETERMINED BY A SCALED GRAPHICAL PLOT OF THE FLOOD INSURANCE RATE MAP.

SAFETY NOTICE TO CONTRACTOR

IN ACCORDANCE WITH GENERALLY ACCEPTED CONSTRUCTION PRACTICES, THE CONTRACTOR WILL BE SOLELY AND COMPLETELY RESPONSIBLE FOR CONDITIONS OF THE JOB SITE, INCLUDING SAFETY OF ALL PERSONS AND PROPERTY DURING PERFORMANCE OF THE WORK. THIS REQUIREMENT WILL APPLY CONTINUOUSLY AND NOT BE LIMITED TO NORMAL WORKING HOURS.

# WARRANTY / DISCLAIMER


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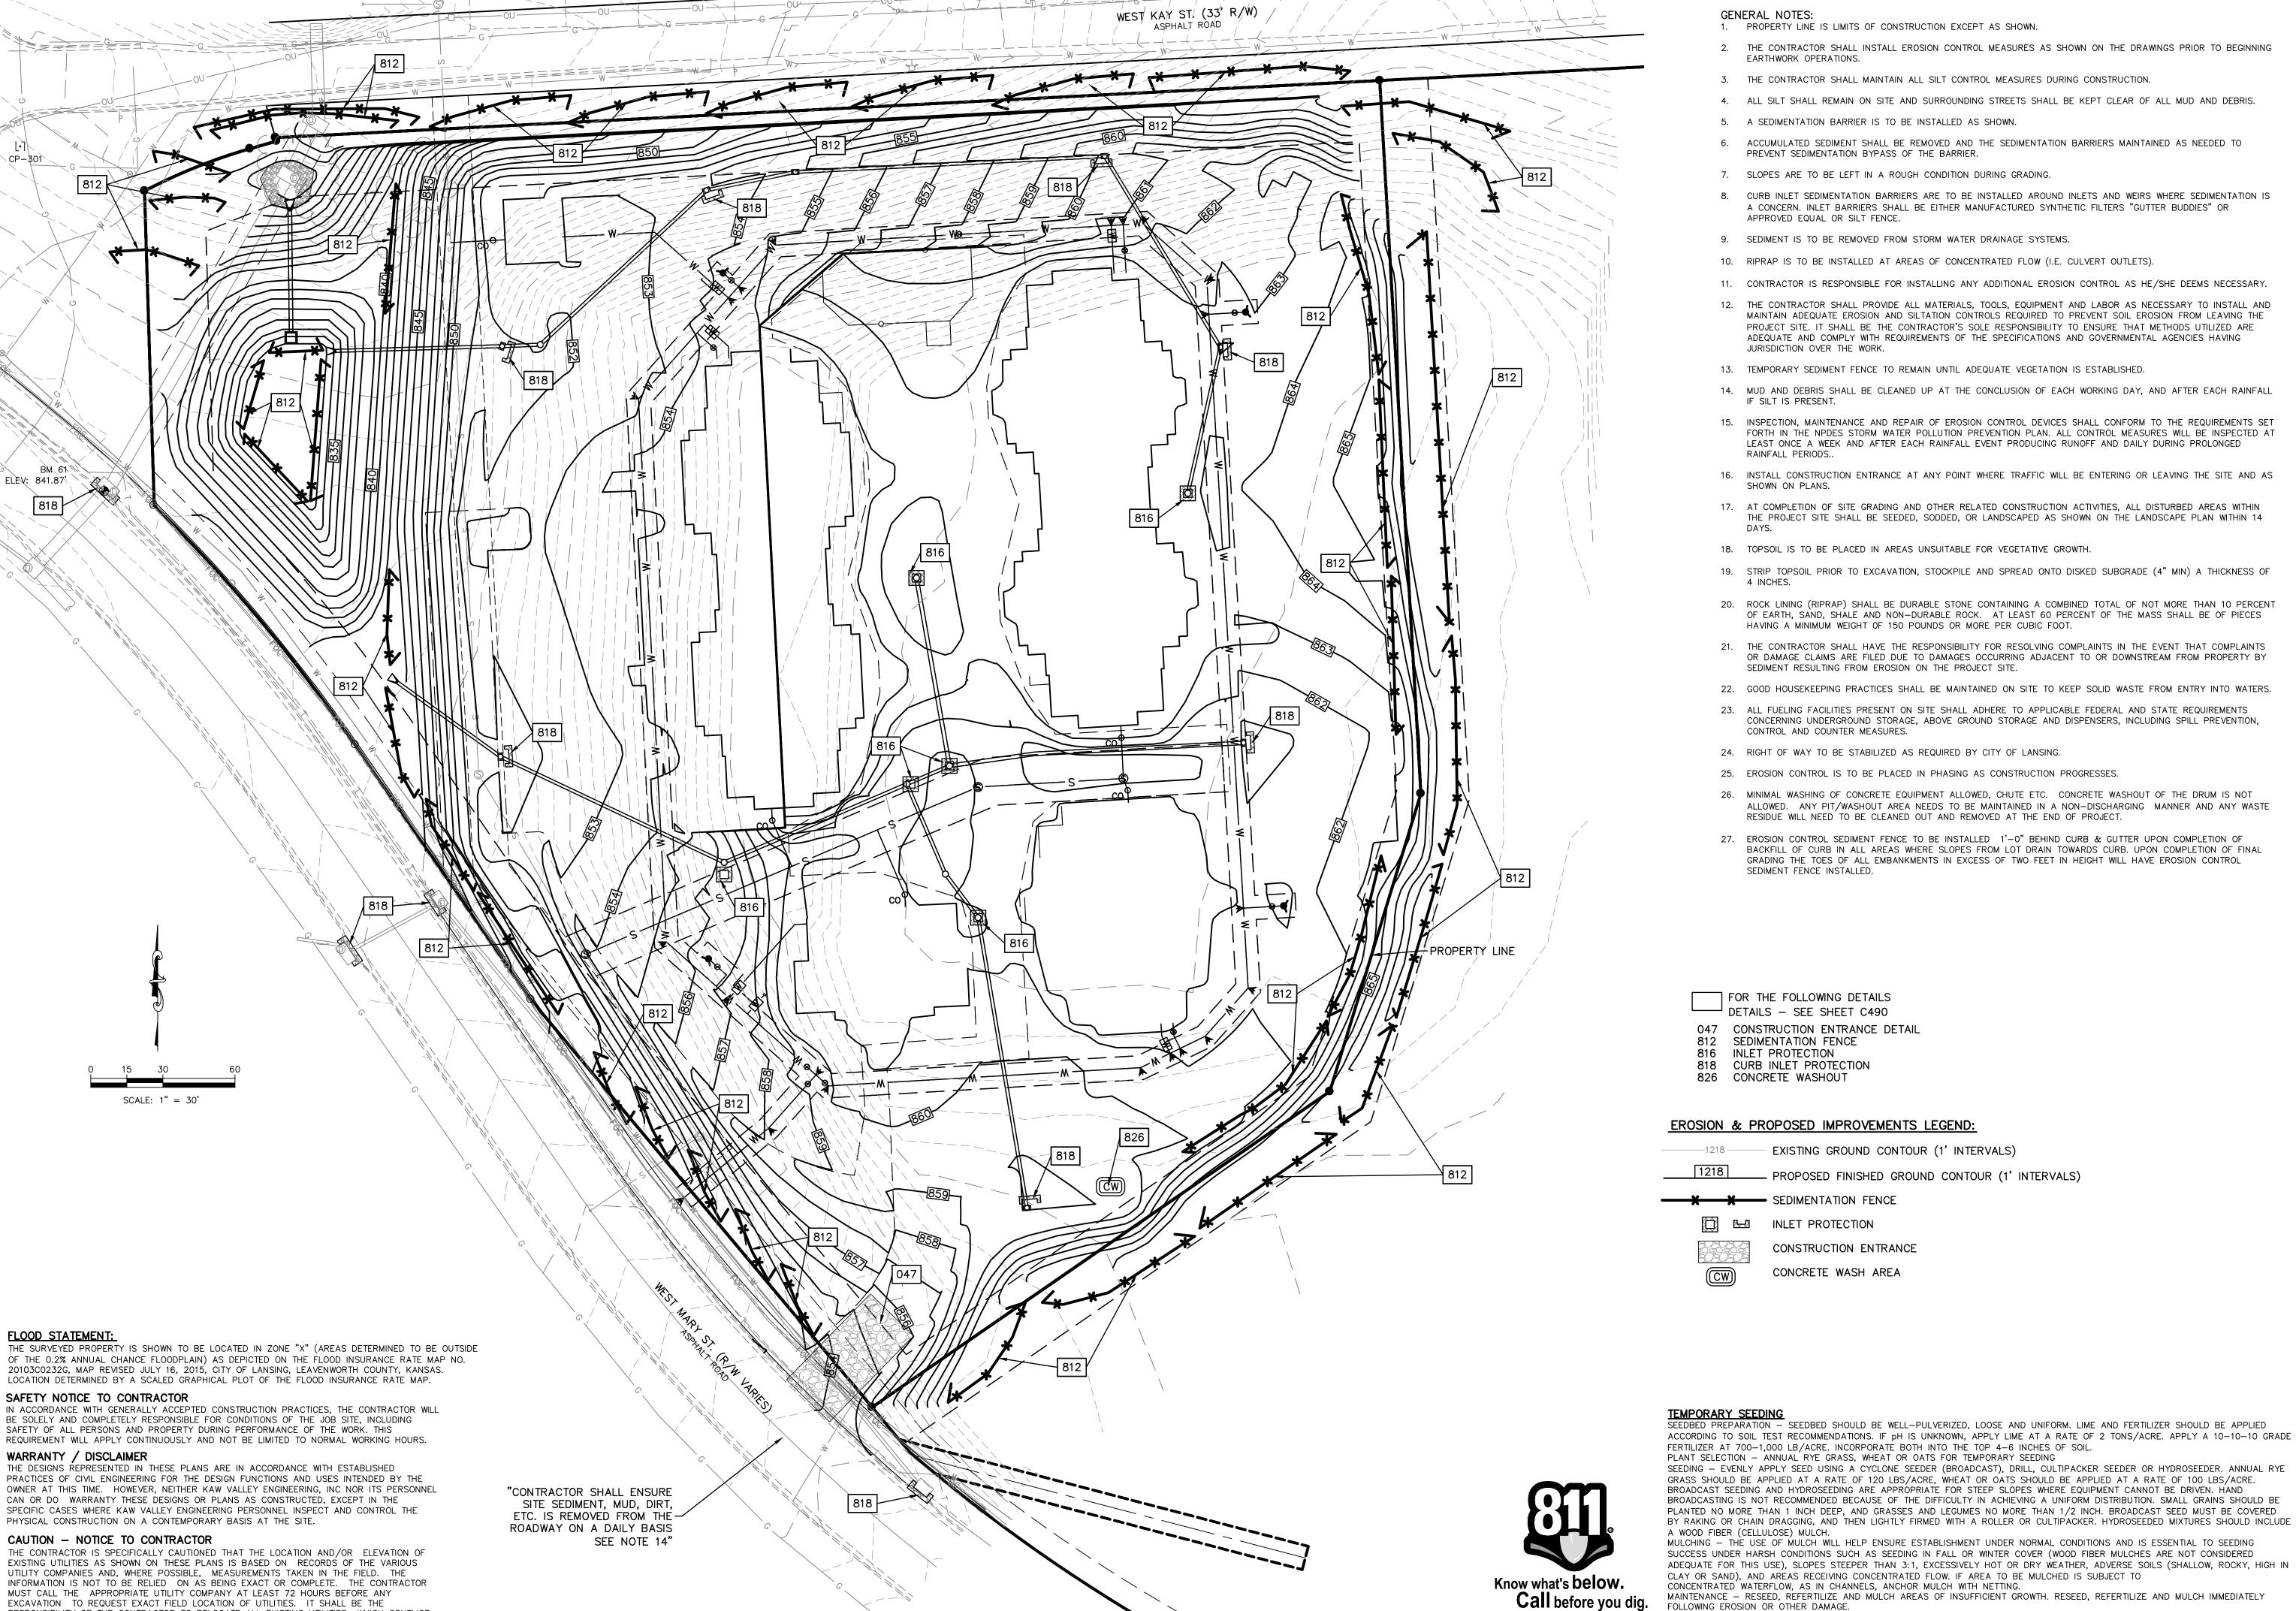
# CAUTION - NOTICE TO CONTRACTOR

THE CONTRACTOR IS SPECIFICALLY CAUTIONED THAT THE LOCATION AND/OR ELEVATION OF EXISTING UTILITIES AS SHOWN ON THESE PLANS IS BASED ON RECORDS OF THE VARIOUS UTILITY COMPANIES AND, WHERE POSSIBLE, MEASUREMENTS TAKEN IN THE FIELD. THE INFORMATION IS NOT TO BE RELIED ON AS BEING EXACT OR COMPLETE. THE CONTRACTOR MUST CALL THE APPROPRIATE UTILITY COMPANY AT LEAST 72 HOURS BEFORE ANY EXCAVATION TO REQUEST EXACT FIELD LOCATION OF UTILITIES. IT SHALL BE THE RESPONSIBILITY OF THE CONTRACTOR TO RELOCATE ALL EXISTING UTILITIES WHICH CONFLICT WITH PROPOSED IMPROVEMENTS SHOWN ON THE PLANS. THE CONTRACTOR SHALL EXPOSE EXISTING UTILITIES AT LOCATIONS OF POSSIBLE CONFLICTS PRIOR



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FOLLOWING EROSION OR OTHER DAMAGE.

PERMANENT SEEDING

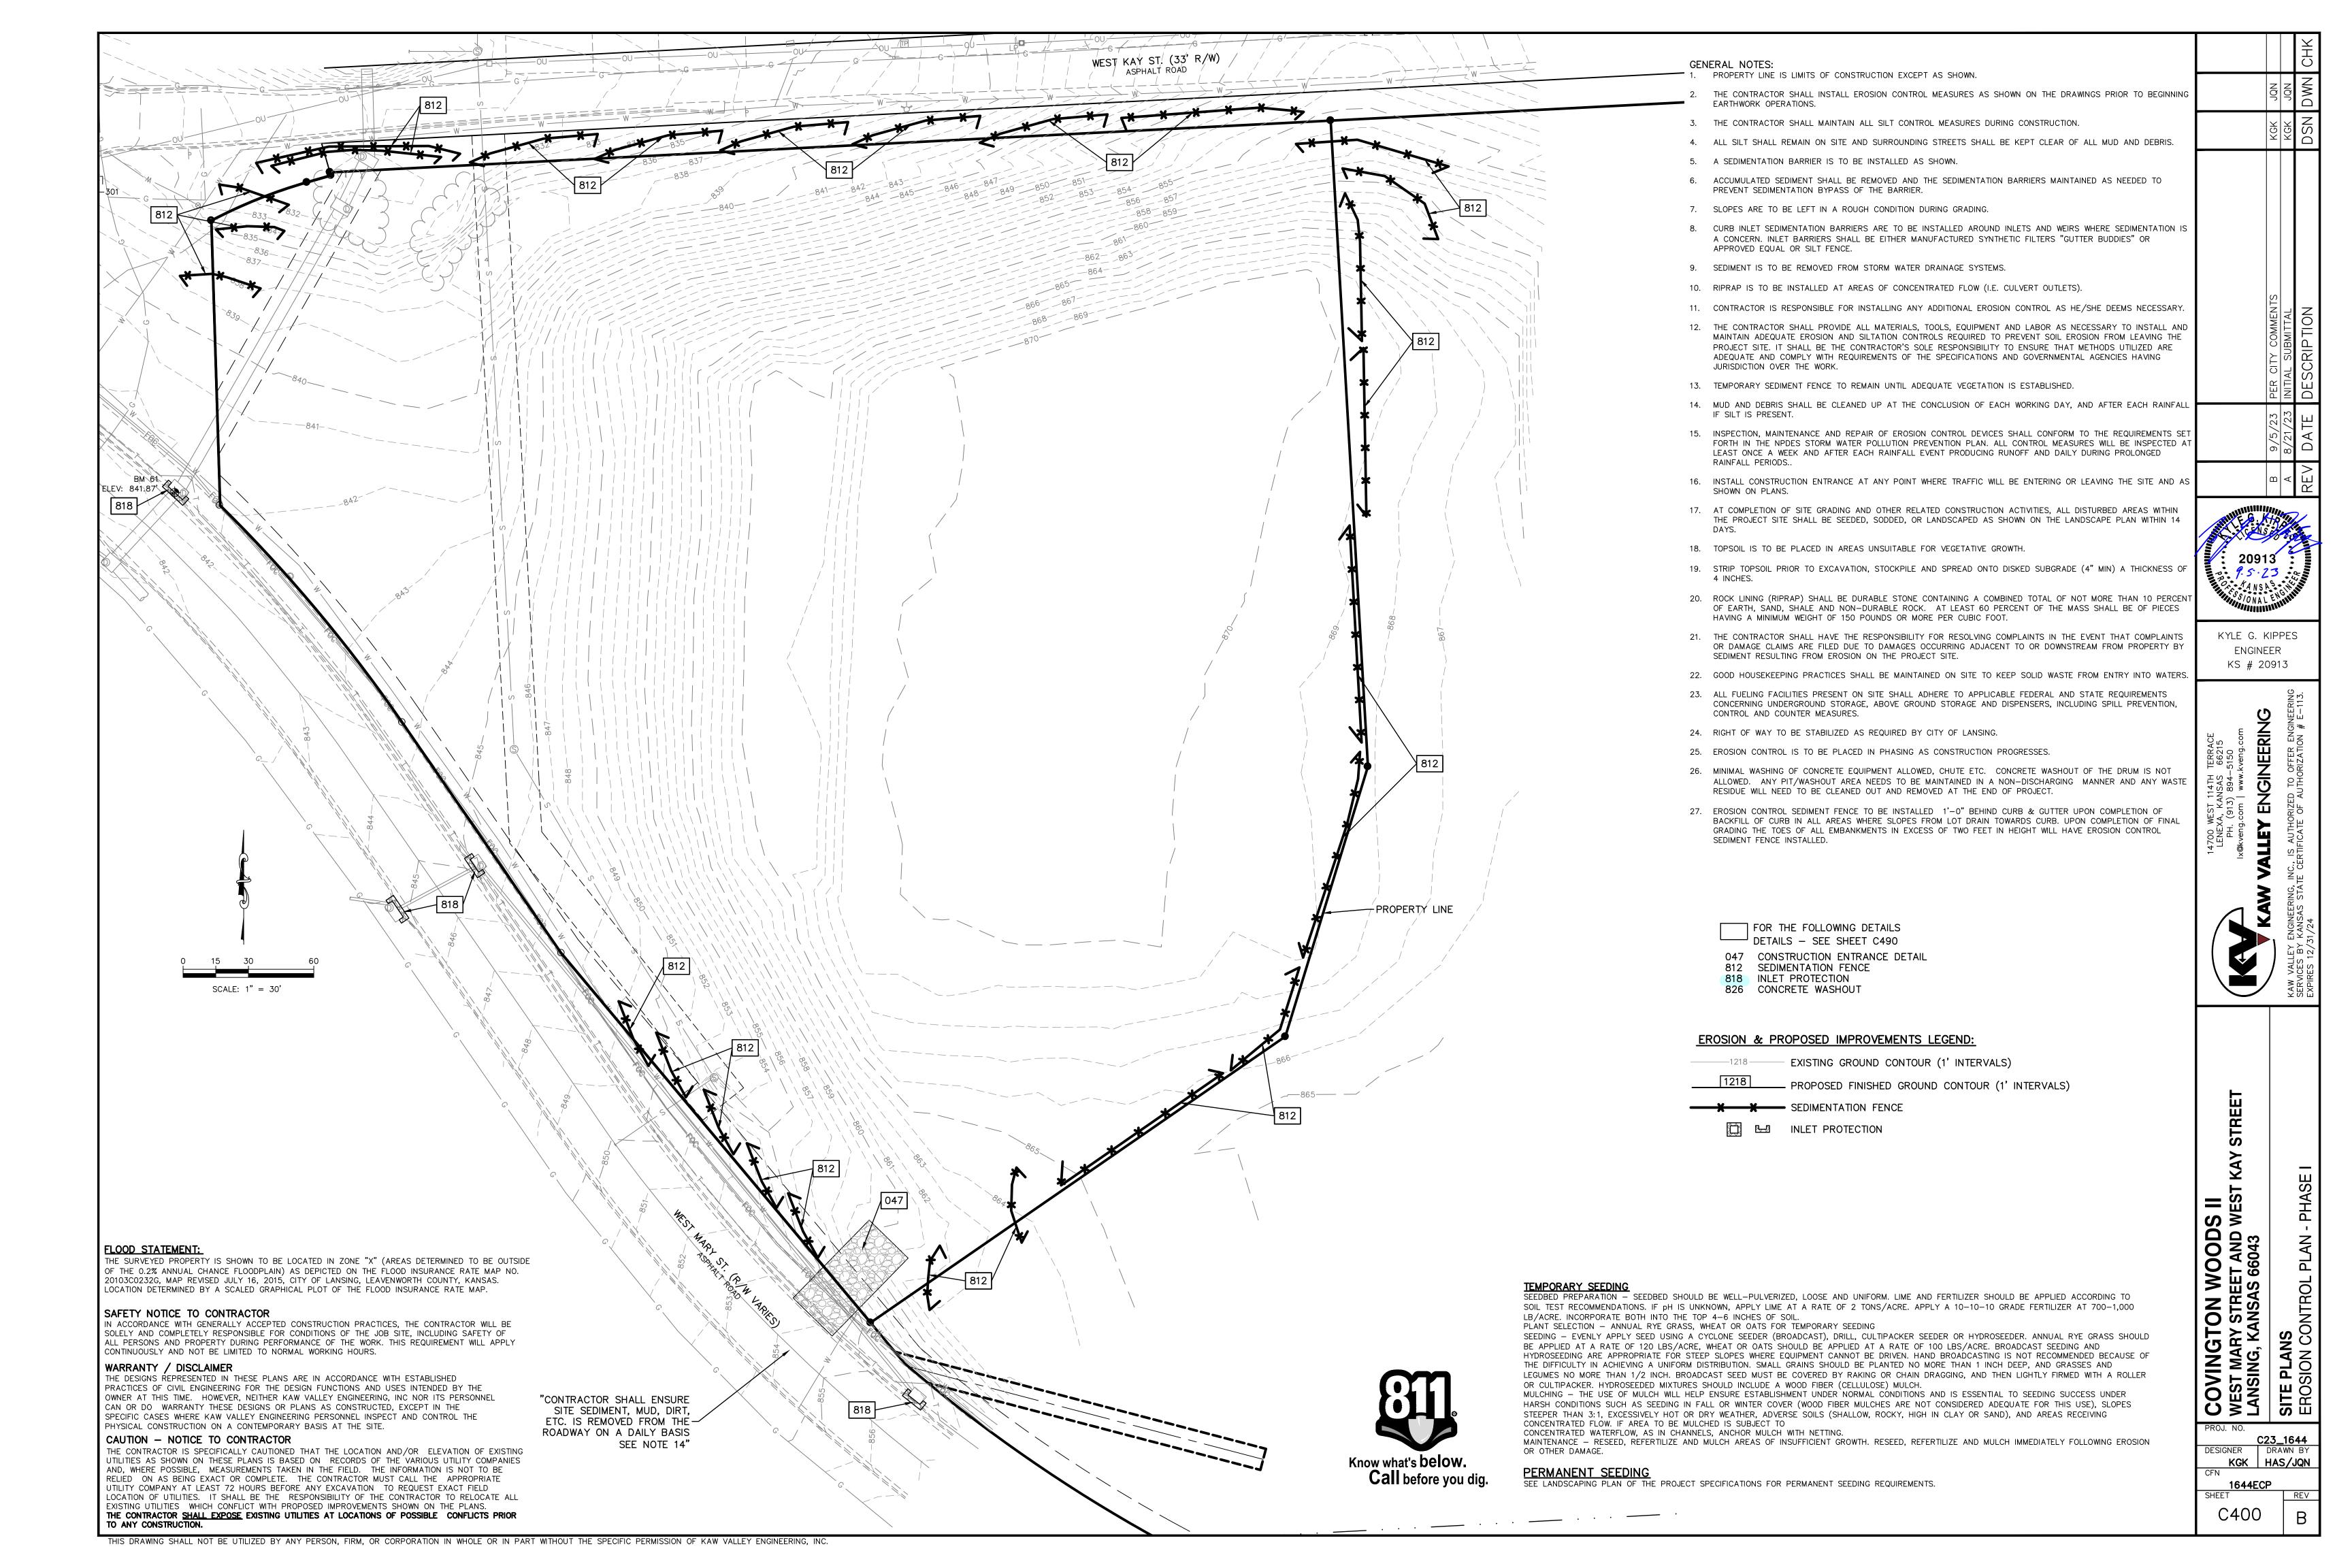SEE LANDSCAPING PLAN OF THE PROJECT SPECIFICATIONS FOR PERMANENT SEEDING REQUIREMENTS.

KYLE G. KIPPES ENGINEER KS # 20913

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COVINGTON WO
WEST MARY STREET A
LANSING, KANSAS 66
SITE PLANS
EROSION CONTROL PL

C23\_1644


DESIGNER DRAWN BY KGK HAS/JQN

1644ECP2 SHEET

THE CONTRACTOR SHALL EXPOSE EXISTING UTILITIES AT LOCATIONS OF POSSIBLE CONFLICTS PRIOR TO ANY CONSTRUCTION. THIS DRAWING SHALL NOT BE UTILIZED BY ANY PERSON, FIRM, OR CORPORATION IN WHOLE OR IN PART WITHOUT THE SPECIFIC PERMISSION OF KAW VALLEY ENGINEERING, INC.

RESPONSIBILITY OF THE CONTRACTOR TO RELOCATE ALL EXISTING UTILITIES WHICH CONFLICT

WITH PROPOSED IMPROVEMENTS SHOWN ON THE PLANS.

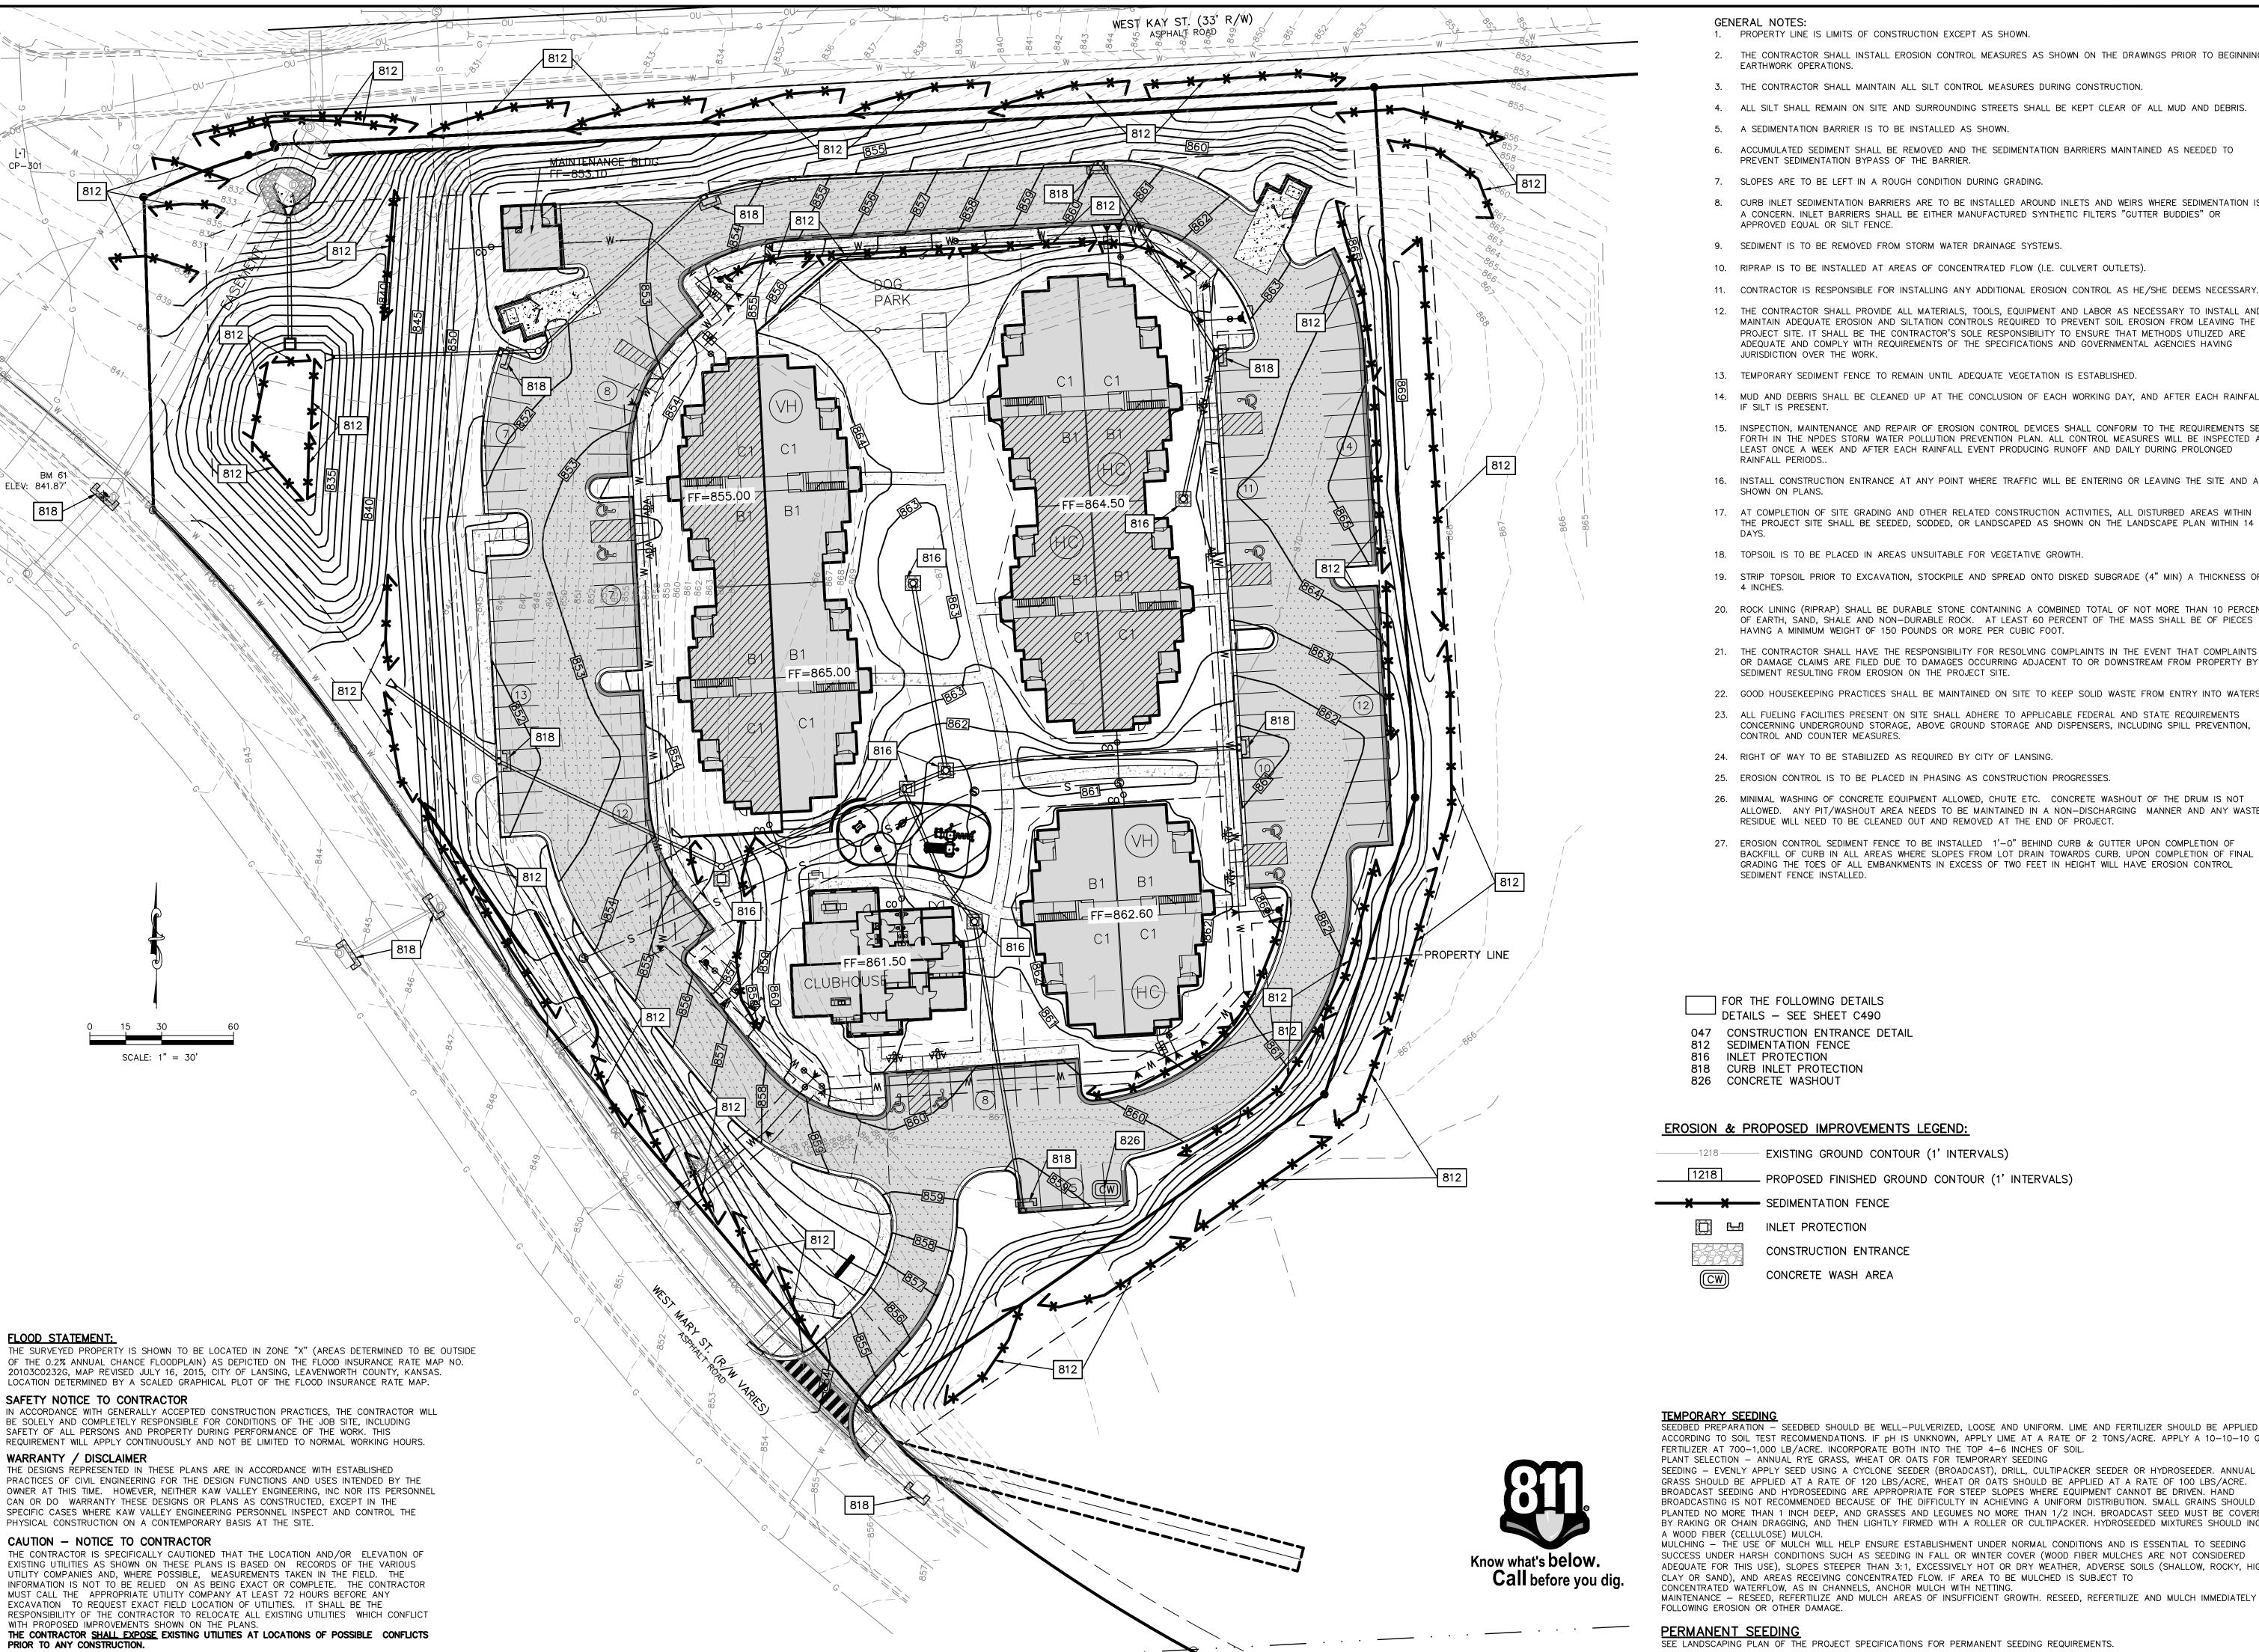

2. THE CONTRACTOR SHALL INSTALL EROSION CONTROL MEASURES AS SHOWN ON THE DRAWINGS PRIOR TO BEGINNING

4. ALL SILT SHALL REMAIN ON SITE AND SURROUNDING STREETS SHALL BE KEPT CLEAR OF ALL MUD AND DEBRIS.

6. ACCUMULATED SEDIMENT SHALL BE REMOVED AND THE SEDIMENTATION BARRIERS MAINTAINED AS NEEDED TO

8. CURB INLET SEDIMENTATION BARRIERS ARE TO BE INSTALLED AROUND INLETS AND WEIRS WHERE SEDIMENTATION IS A CONCERN. INLET BARRIERS SHALL BE EITHER MANUFACTURED SYNTHETIC FILTERS "GUTTER BUDDIES" OR

11. CONTRACTOR IS RESPONSIBLE FOR INSTALLING ANY ADDITIONAL EROSION CONTROL AS HE/SHE DEEMS NECESSARY.

12. THE CONTRACTOR SHALL PROVIDE ALL MATERIALS, TOOLS, EQUIPMENT AND LABOR AS NECESSARY TO INSTALL AND MAINTAIN ADEQUATE EROSION AND SILTATION CONTROLS REQUIRED TO PREVENT SOIL EROSION FROM LEAVING THE PROJECT SITE. IT SHALL BE THE CONTRACTOR'S SOLE RESPONSIBILITY TO ENSURE THAT METHODS UTILIZED ARE ADEQUATE AND COMPLY WITH REQUIREMENTS OF THE SPECIFICATIONS AND GOVERNMENTAL AGENCIES HAVING

14. MUD AND DEBRIS SHALL BE CLEANED UP AT THE CONCLUSION OF EACH WORKING DAY, AND AFTER EACH RAINFALL

15. INSPECTION, MAINTENANCE AND REPAIR OF EROSION CONTROL DEVICES SHALL CONFORM TO THE REQUIREMENTS SET FORTH IN THE NPDES STORM WATER POLLUTION PREVENTION PLAN. ALL CONTROL MEASURES WILL BE INSPECTED AT LEAST ONCE A WEEK AND AFTER EACH RAINFALL EVENT PRODUCING RUNOFF AND DAILY DURING PROLONGED

16. INSTALL CONSTRUCTION ENTRANCE AT ANY POINT WHERE TRAFFIC WILL BE ENTERING OR LEAVING THE SITE AND AS

17. AT COMPLETION OF SITE GRADING AND OTHER RELATED CONSTRUCTION ACTIVITIES, ALL DISTURBED AREAS WITHIN THE PROJECT SITE SHALL BE SEEDED, SODDED, OR LANDSCAPED AS SHOWN ON THE LANDSCAPE PLAN WITHIN 14

19. STRIP TOPSOIL PRIOR TO EXCAVATION, STOCKPILE AND SPREAD ONTO DISKED SUBGRADE (4" MIN) A THICKNESS OF

20. ROCK LINING (RIPRAP) SHALL BE DURABLE STONE CONTAINING A COMBINED TOTAL OF NOT MORE THAN 10 PERCENT OF EARTH, SAND, SHALE AND NON-DURABLE ROCK. AT LEAST 60 PERCENT OF THE MASS SHALL BE OF PIECES

21. THE CONTRACTOR SHALL HAVE THE RESPONSIBILITY FOR RESOLVING COMPLAINTS IN THE EVENT THAT COMPLAINTS OR DAMAGE CLAIMS ARE FILED DUE TO DAMAGES OCCURRING ADJACENT TO OR DOWNSTREAM FROM PROPERTY BY

22. GOOD HOUSEKEEPING PRACTICES SHALL BE MAINTAINED ON SITE TO KEEP SOLID WASTE FROM ENTRY INTO WATERS.

23. ALL FUELING FACILITIES PRESENT ON SITE SHALL ADHERE TO APPLICABLE FEDERAL AND STATE REQUIREMENTS CONCERNING UNDERGROUND STORAGE, ABOVE GROUND STORAGE AND DISPENSERS, INCLUDING SPILL PREVENTION,

26. MINIMAL WASHING OF CONCRETE EQUIPMENT ALLOWED, CHUTE ETC. CONCRETE WASHOUT OF THE DRUM IS NOT ALLOWED. ANY PIT/WASHOUT AREA NEEDS TO BE MAINTAINED IN A NON-DISCHARGING MANNER AND ANY WASTE

27. EROSION CONTROL SEDIMENT FENCE TO BE INSTALLED 1'-0" BEHIND CURB & GUTTER UPON COMPLETION OF BACKFILL OF CURB IN ALL AREAS WHERE SLOPES FROM LOT DRAIN TOWARDS CURB. UPON COMPLETION OF FINAL GRADING THE TOES OF ALL EMBANKMENTS IN EXCESS OF TWO FEET IN HEIGHT WILL HAVE EROSION CONTROL

SEEDBED PREPARATION — SEEDBED SHOULD BE WELL—PULVERIZED, LOOSE AND UNIFORM. LIME AND FERTILIZER SHOULD BE APPLIED ACCORDING TO SOIL TEST RECOMMENDATIONS. IF pH IS UNKNOWN, APPLY LIME AT A RATE OF 2 TONS/ACRE. APPLY A 10-10-10 GRADE

SEEDING - EVENLY APPLY SEED USING A CYCLONE SEEDER (BROADCAST), DRILL, CULTIPACKER SEEDER OR HYDROSEEDER. ANNUAL RYE GRASS SHOULD BE APPLIED AT A RATE OF 120 LBS/ACRE, WHEAT OR OATS SHOULD BE APPLIED AT A RATE OF 100 LBS/ACRE. BROADCAST SEEDING AND HYDROSEEDING ARE APPROPRIATE FOR STEEP SLOPES WHERE EQUIPMENT CANNOT BE DRIVEN. HAND BROADCASTING IS NOT RECOMMENDED BECAUSE OF THE DIFFICULTY IN ACHIEVING A UNIFORM DISTRIBUTION. SMALL GRAINS SHOULD BE PLANTED NO MORE THAN 1 INCH DEEP, AND GRASSES AND LEGUMES NO MORE THAN 1/2 INCH. BROADCAST SEED MUST BE COVERED BY RAKING OR CHAIN DRAGGING, AND THEN LIGHTLY FIRMED WITH A ROLLER OR CULTIPACKER. HYDROSEEDED MIXTURES SHOULD INCLUDE

MULCHING - THE USE OF MULCH WILL HELP ENSURE ESTABLISHMENT UNDER NORMAL CONDITIONS AND IS ESSENTIAL TO SEEDING SUCCESS UNDER HARSH CONDITIONS SUCH AS SEEDING IN FALL OR WINTER COVER (WOOD FIBER MULCHES ARE NOT CONSIDERED ADEQUATE FOR THIS USE), SLOPES STEEPER THAN 3:1, EXCESSIVELY HOT OR DRY WEATHER, ADVERSE SOILS (SHALLOW, ROCKY, HIGH IN

SEE LANDSCAPING PLAN OF THE PROJECT SPECIFICATIONS FOR PERMANENT SEEDING REQUIREMENTS.



KYLE G. KIPPES ENGINEER KS # 20913


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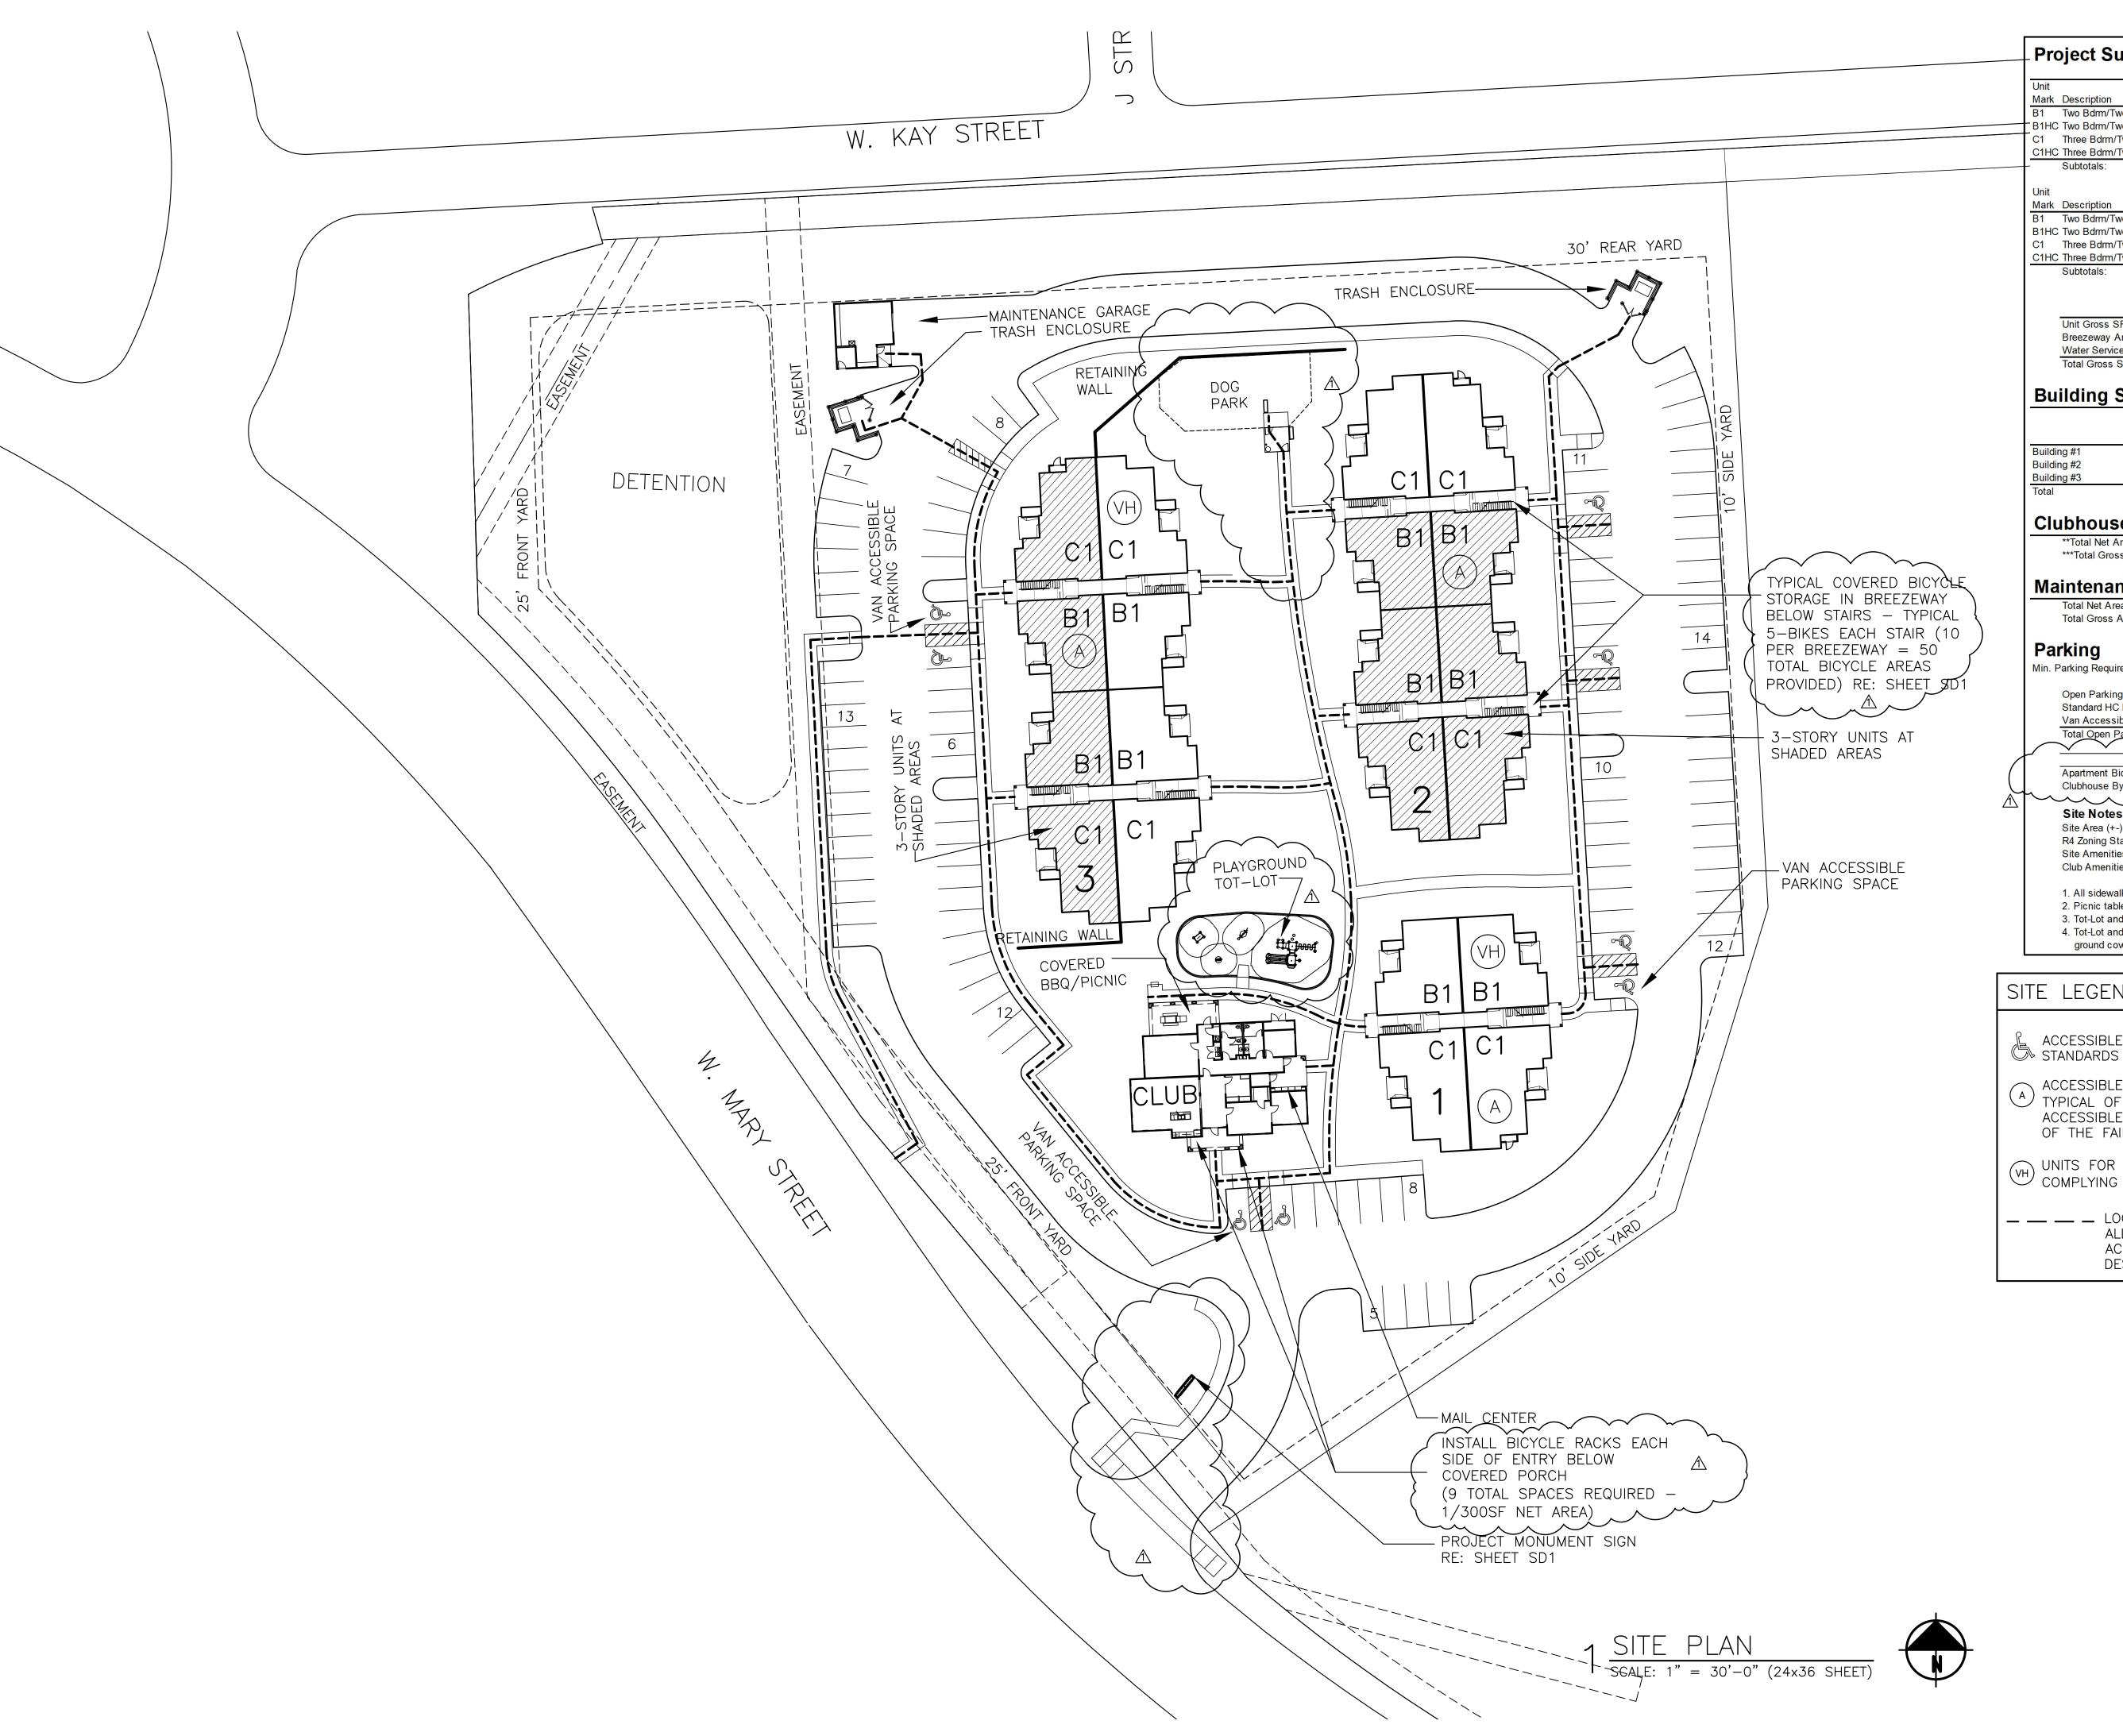
COVINGTON WO
WEST MARY STREET A
LANSING, KANSAS 66
SITE PLANS
EROSION CONTROL PL


C23\_1644

DESIGNER DRAWN BY KGK HAS/JQN 1644ECP3 SHEET

C420




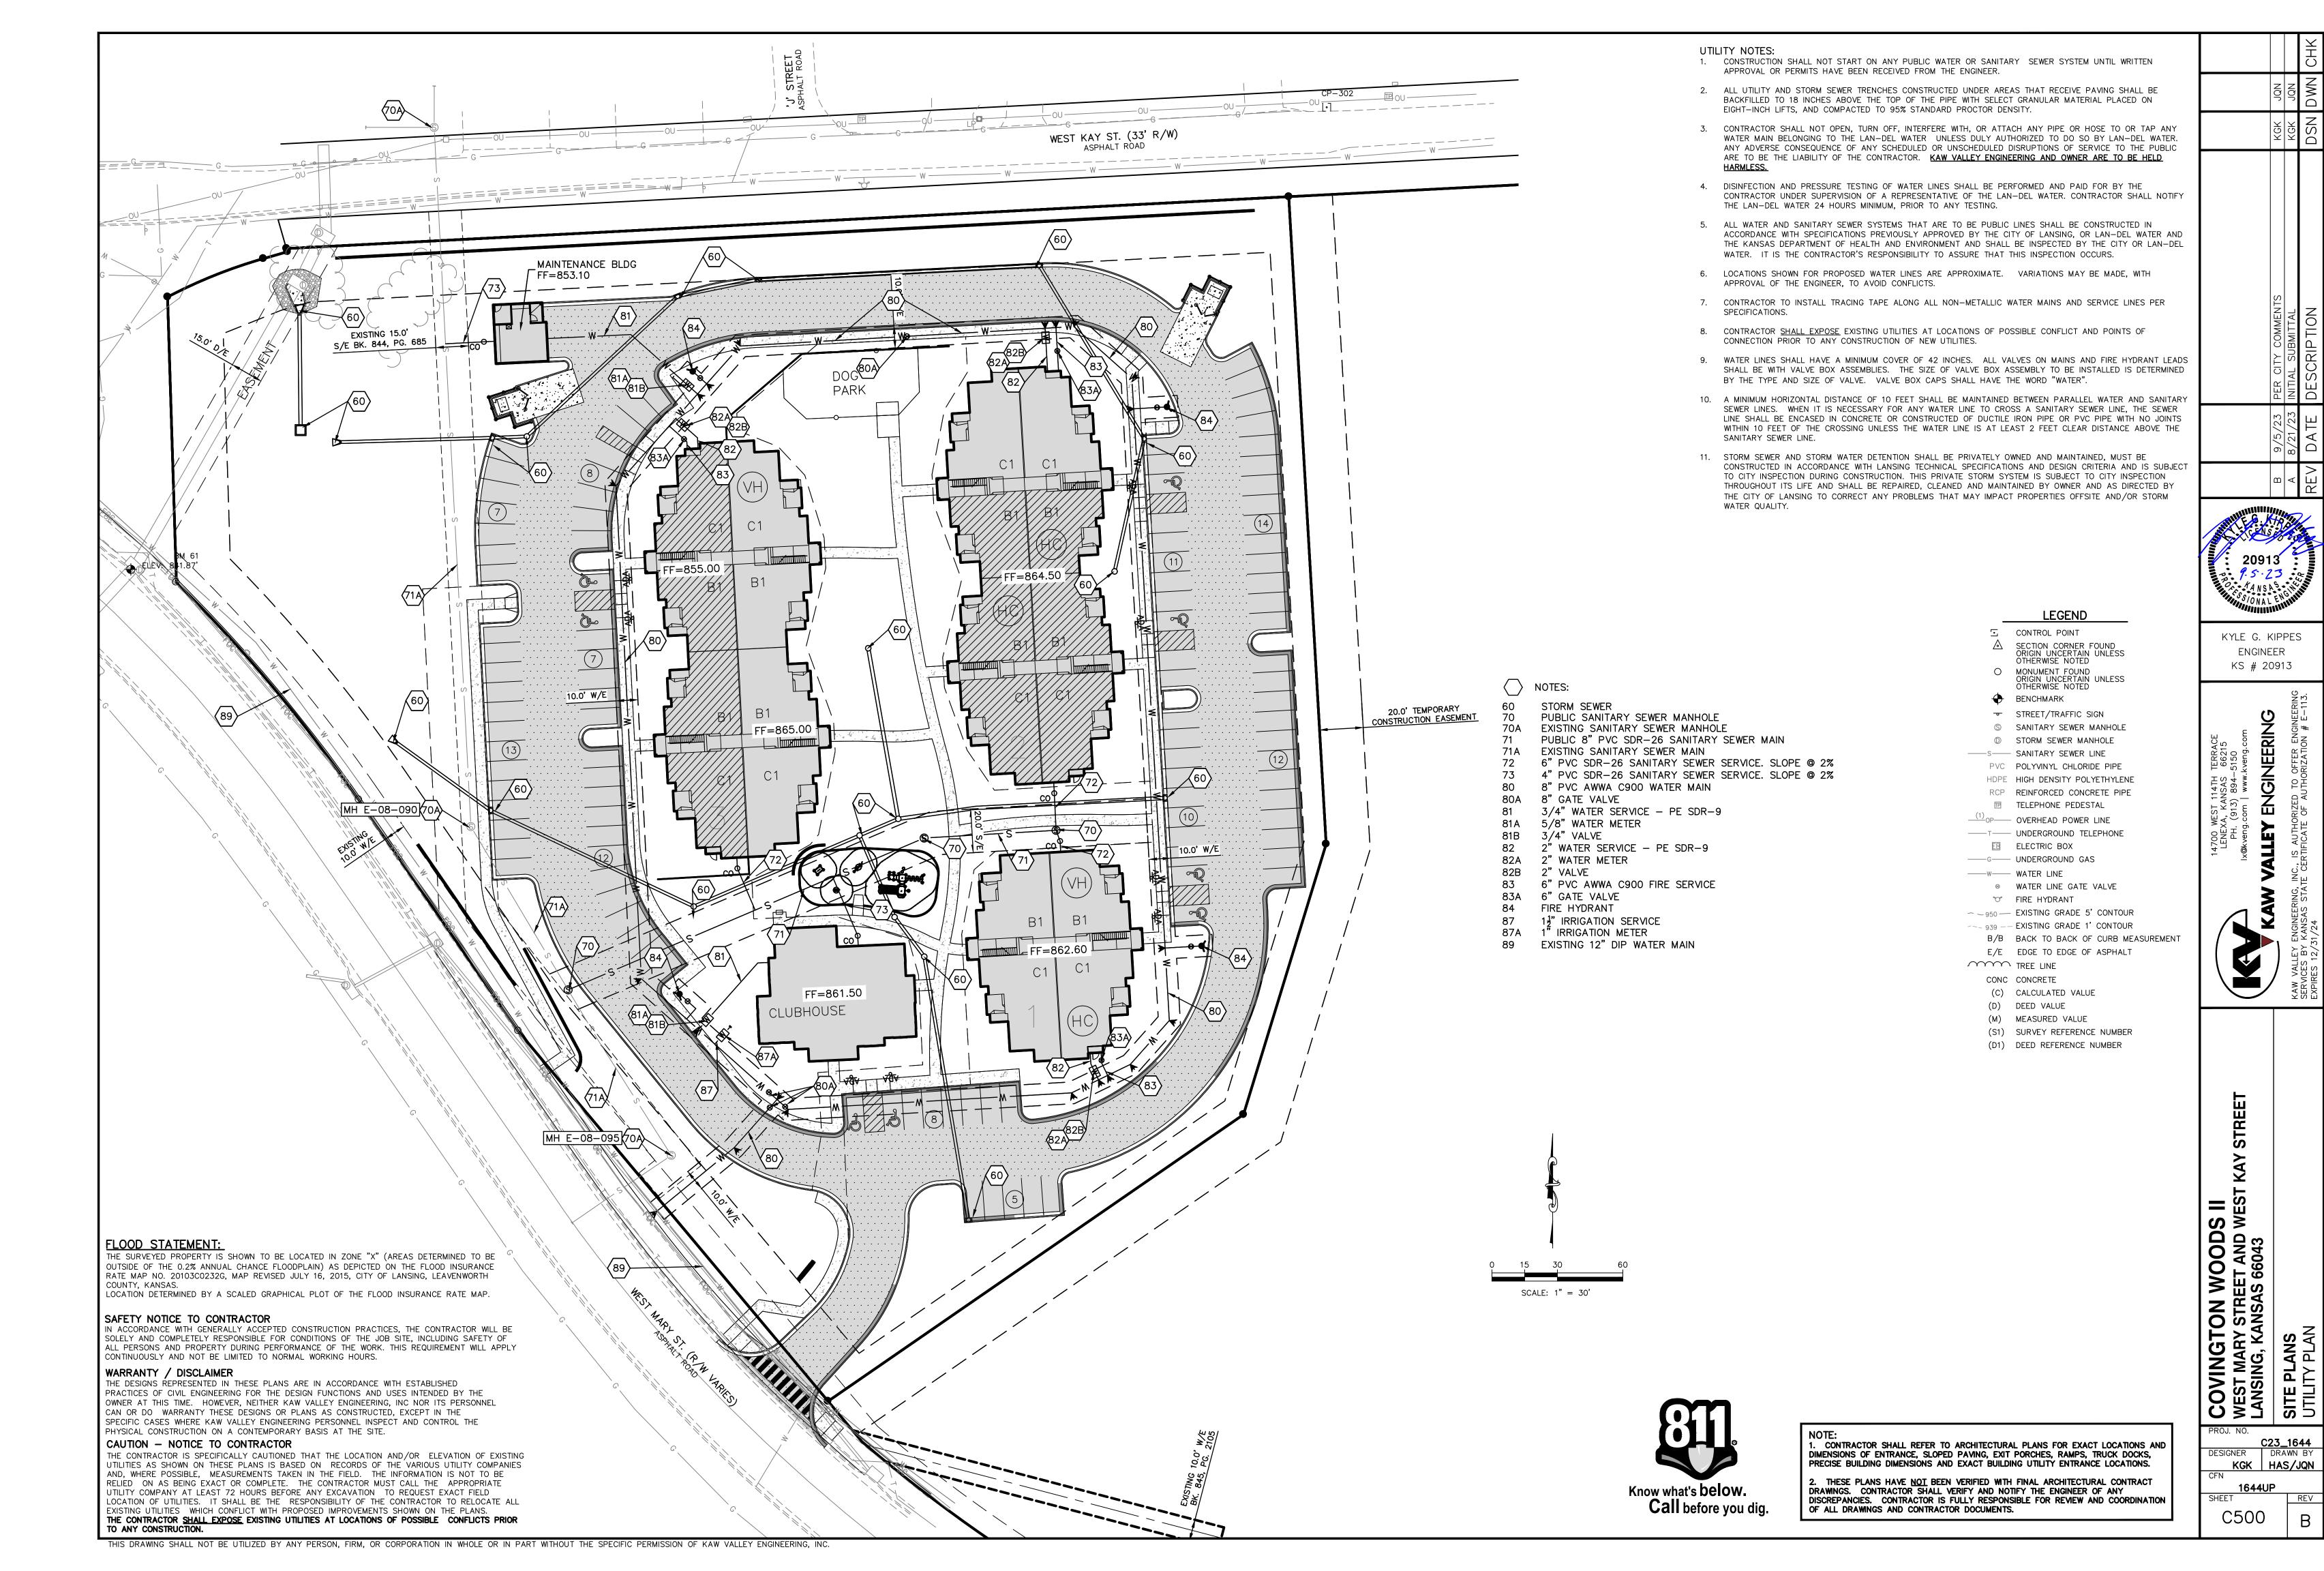


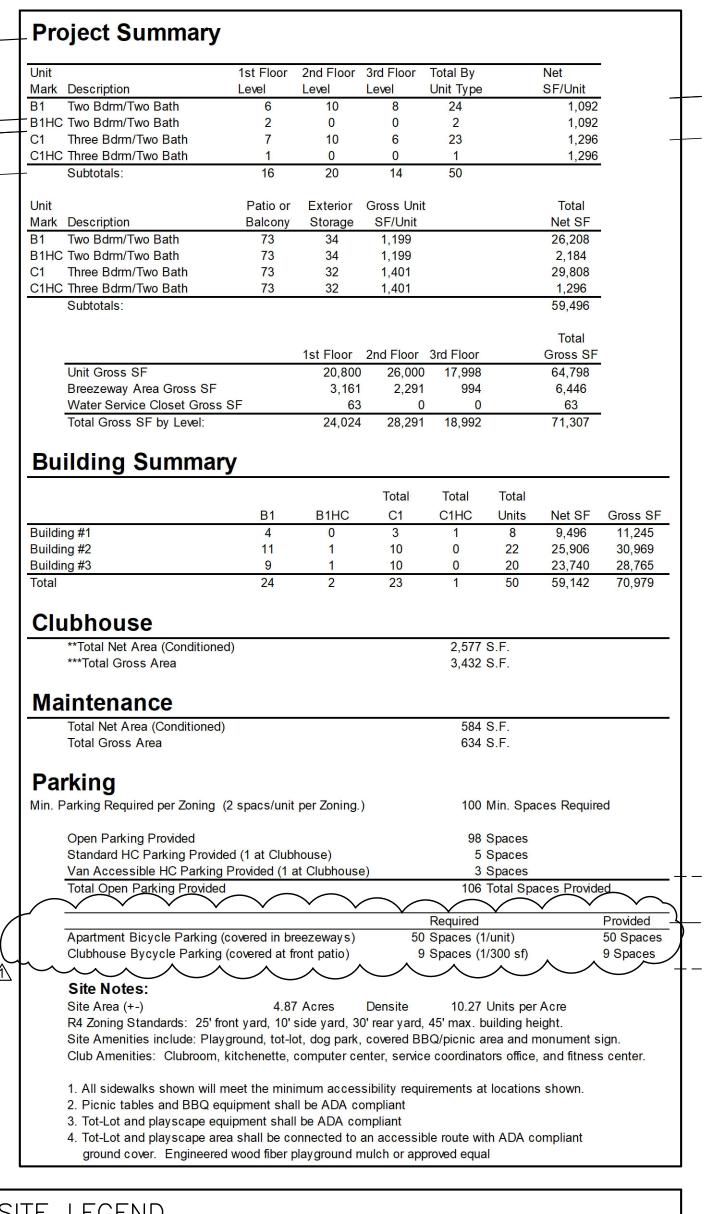



# SITE LEGEND


- ACCESSIBLE PARKING COMPLYING WITH UFAS AND ANSI ACCESSIBILITY STANDARDS FOR STANDARD AND VAN ACCESSIBILITY
- ACCESSIBLE UNIT COMPLYING WITH UFAS, ACCESSIBILITY STANDARDS TYPICAL OF 3 TOTAL UNITS (5% MINIMUM). ALL OTHER UNITS ACCESSIBLE BY GRADE LEVEL SHALL COMPLY WITH THE STANDARDS OF THE FAIR HOUSING DESIGN MANUAL.
- UNITS FOR HEARING AND VISUAL IMPAIRMENTS AT NOTED LOCATIONS COMPLYING WITH UFAS STANDARDS. 2-TOTAL UNIT (2% MINIMUM).
- \_ \_ \_ LOCATION OF ACCESSIBLE ROUTE (MINIMUM) CONNECTING ALL GRADE LEVEL UNITS TO ALL SITE AMENITIES WITH ACCESSIBLE ROUTE MEETING UFAS, AND FAIR HOUSING DESIGN MANUAL STANDARDS.

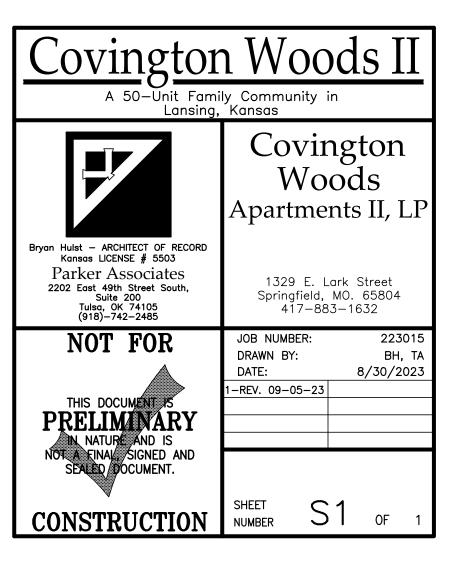


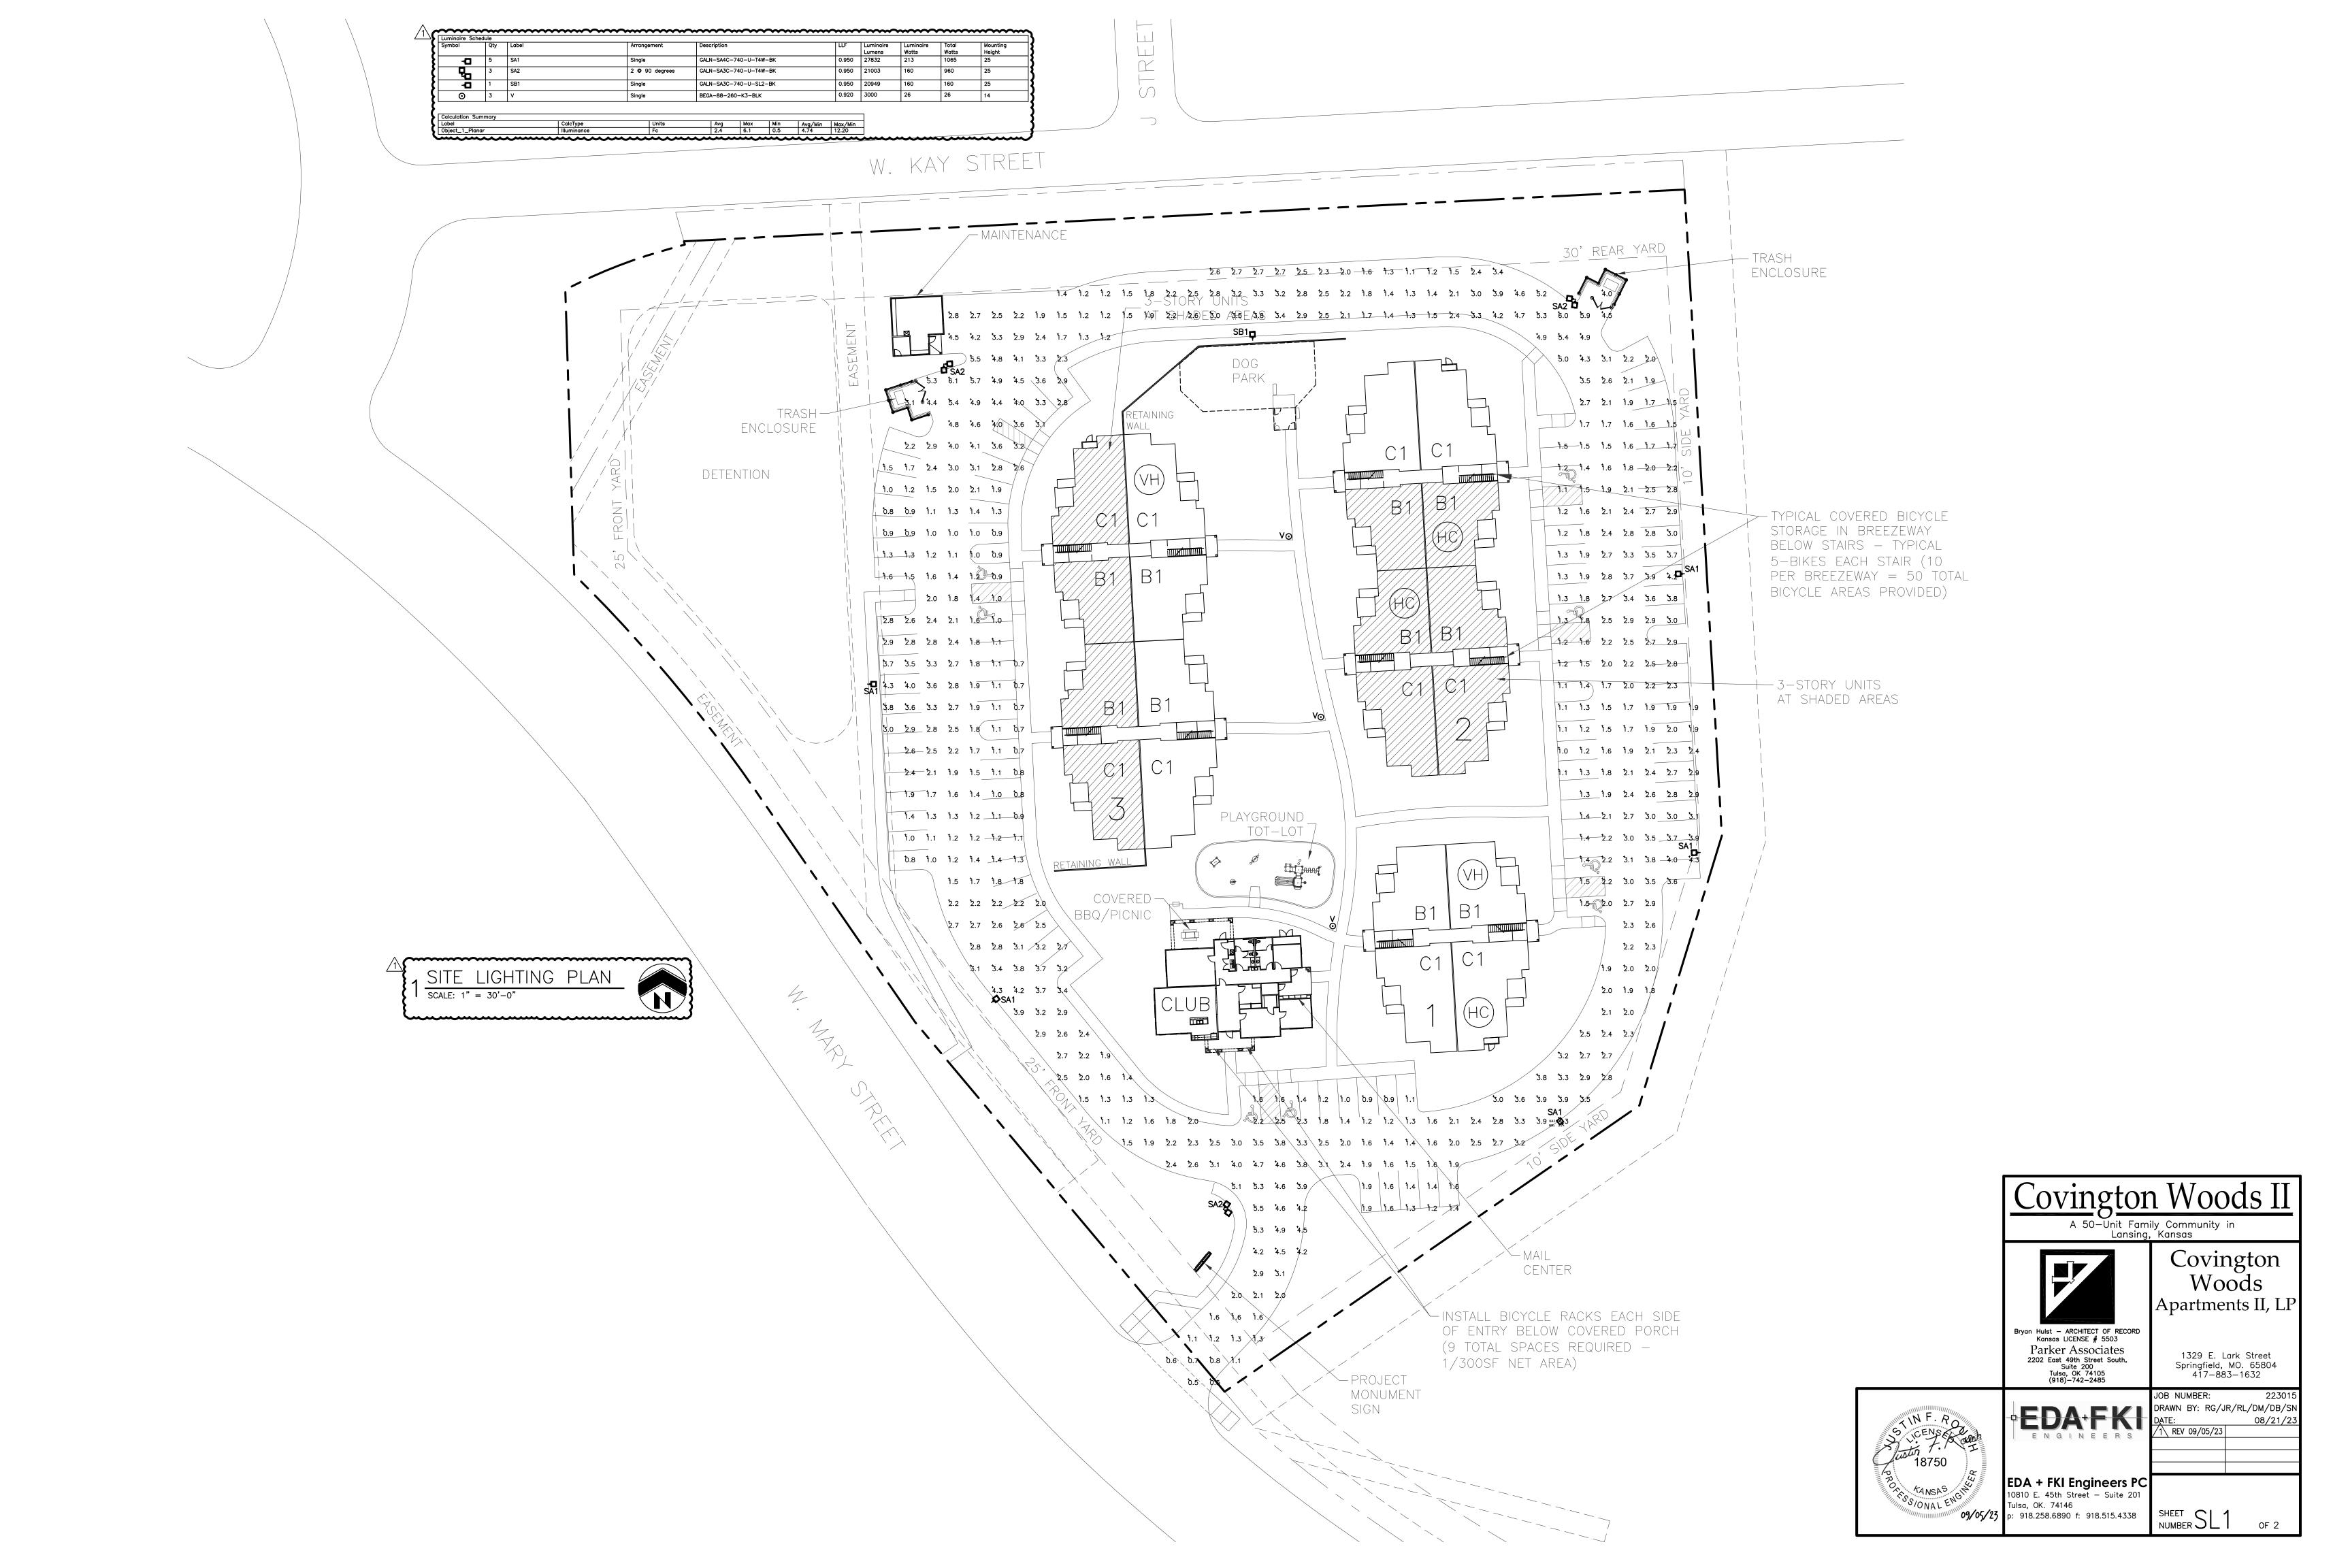


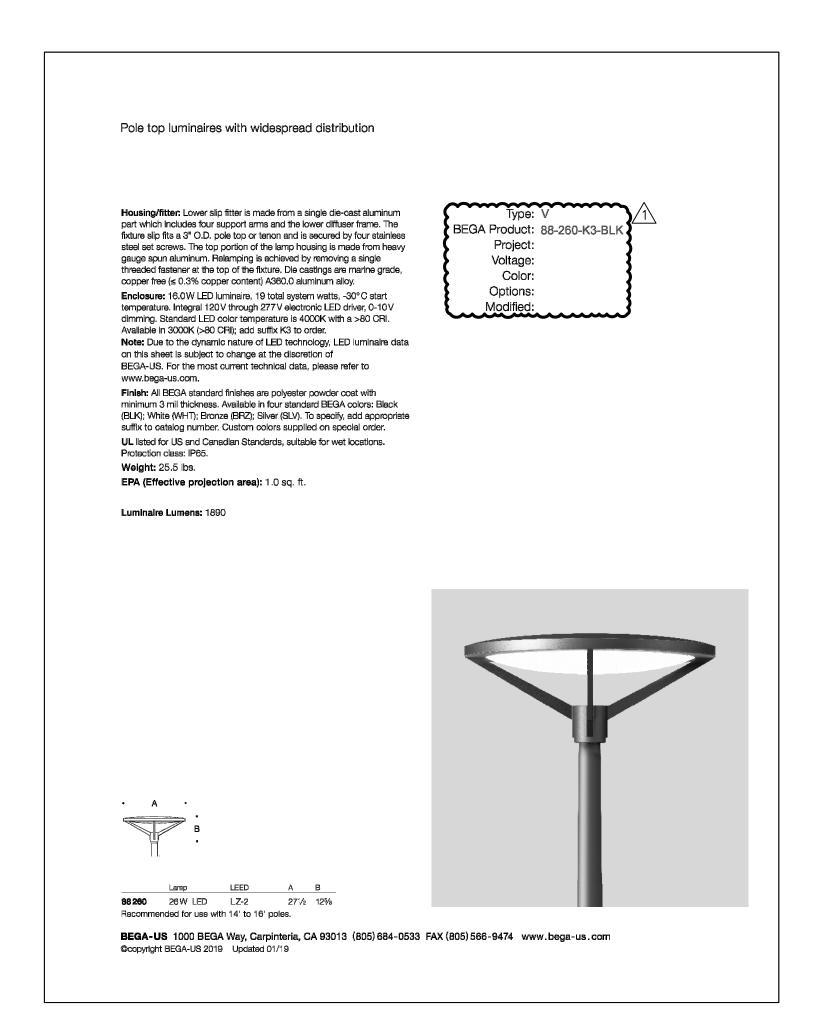

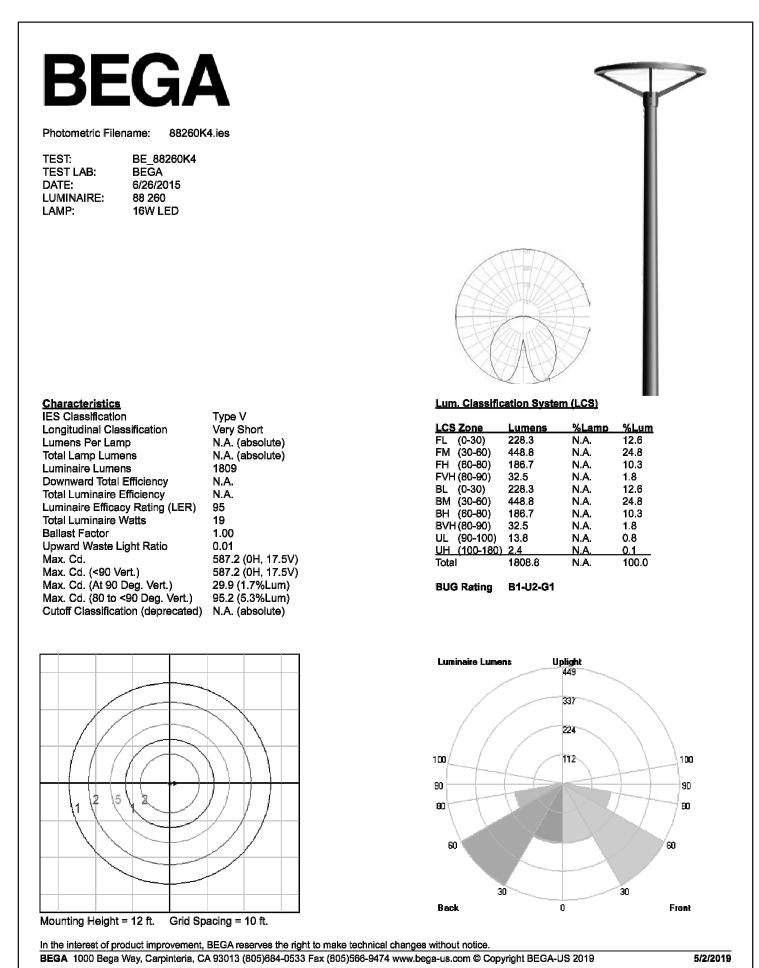

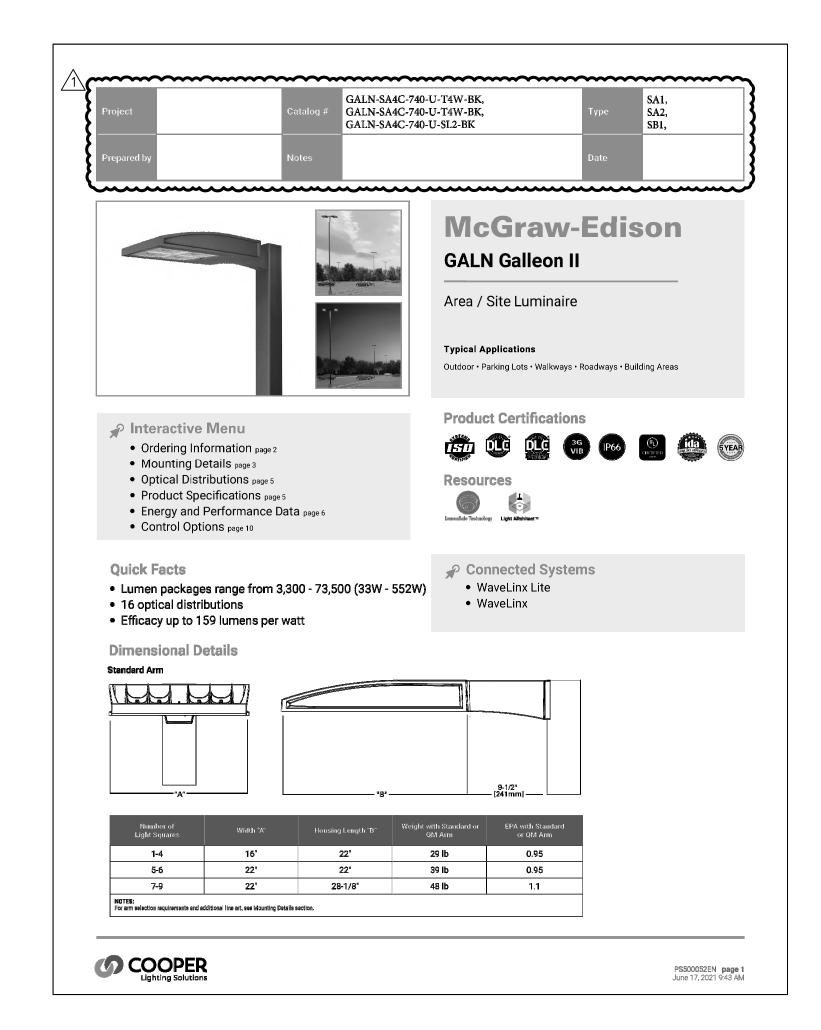

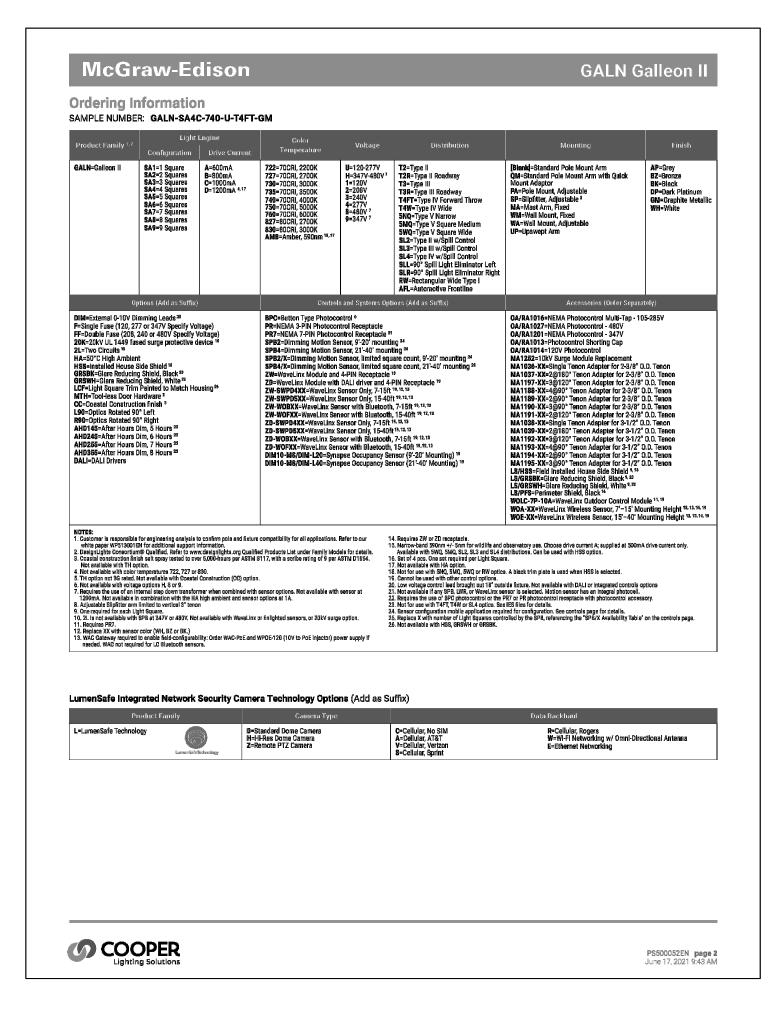


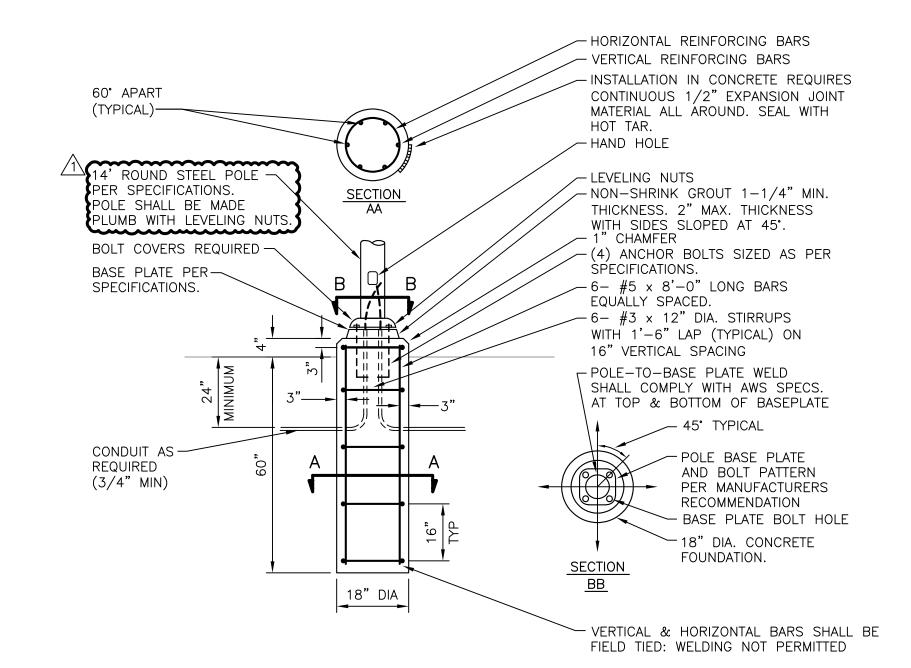

3500 PSI MIN. 28 DAY COMPRESSIVE STRENGTH CONC. WITH GRADE 60 REBARS.
 IF WATER IS PRESENT IN HOLE, REMOVE BEFORE POURING CONCRETE.
 FOUNDATION EXCAVATION SHALL BE BY 18" AUGER IN UNDISTURBED OR PROPERLY COMPACTED FILL PER SPECIFICATIONS.

2 POLE BASE DETAIL


NOT TO SCALE TYPICAL FOR TYPE "V"

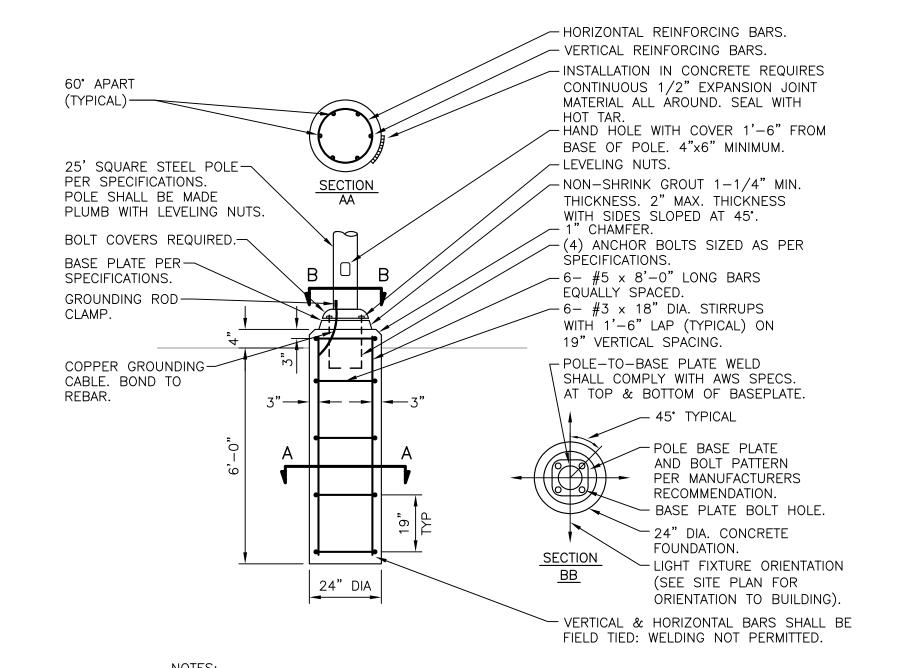


1 3500 PSI MIN. 28 DAY COMPRESSIVE STRENGTH CONC. WITH GRADE 60 REBARS.
2 IF WATER IS PRESENT IN HOLE, REMOVE BEFORE POURING CONCRETE.
3 FOUNDATION EXCAVATION SHALL BE BY 24" AUGER IN UNDISTURBED OR PROPERLY COMPACTED FILL PER SPECIFICATIONS.


POLE BASE DETAIL


NOT TO SCALE TYPICAL FOR TYPE "SA1/SA2/SB1"

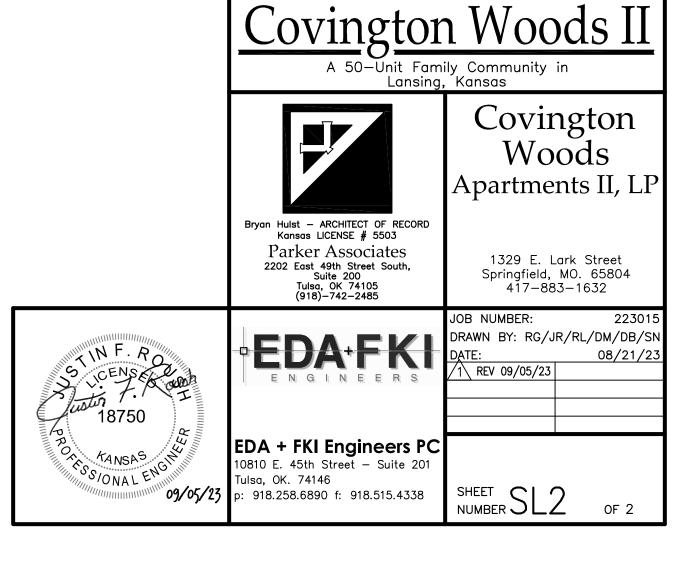

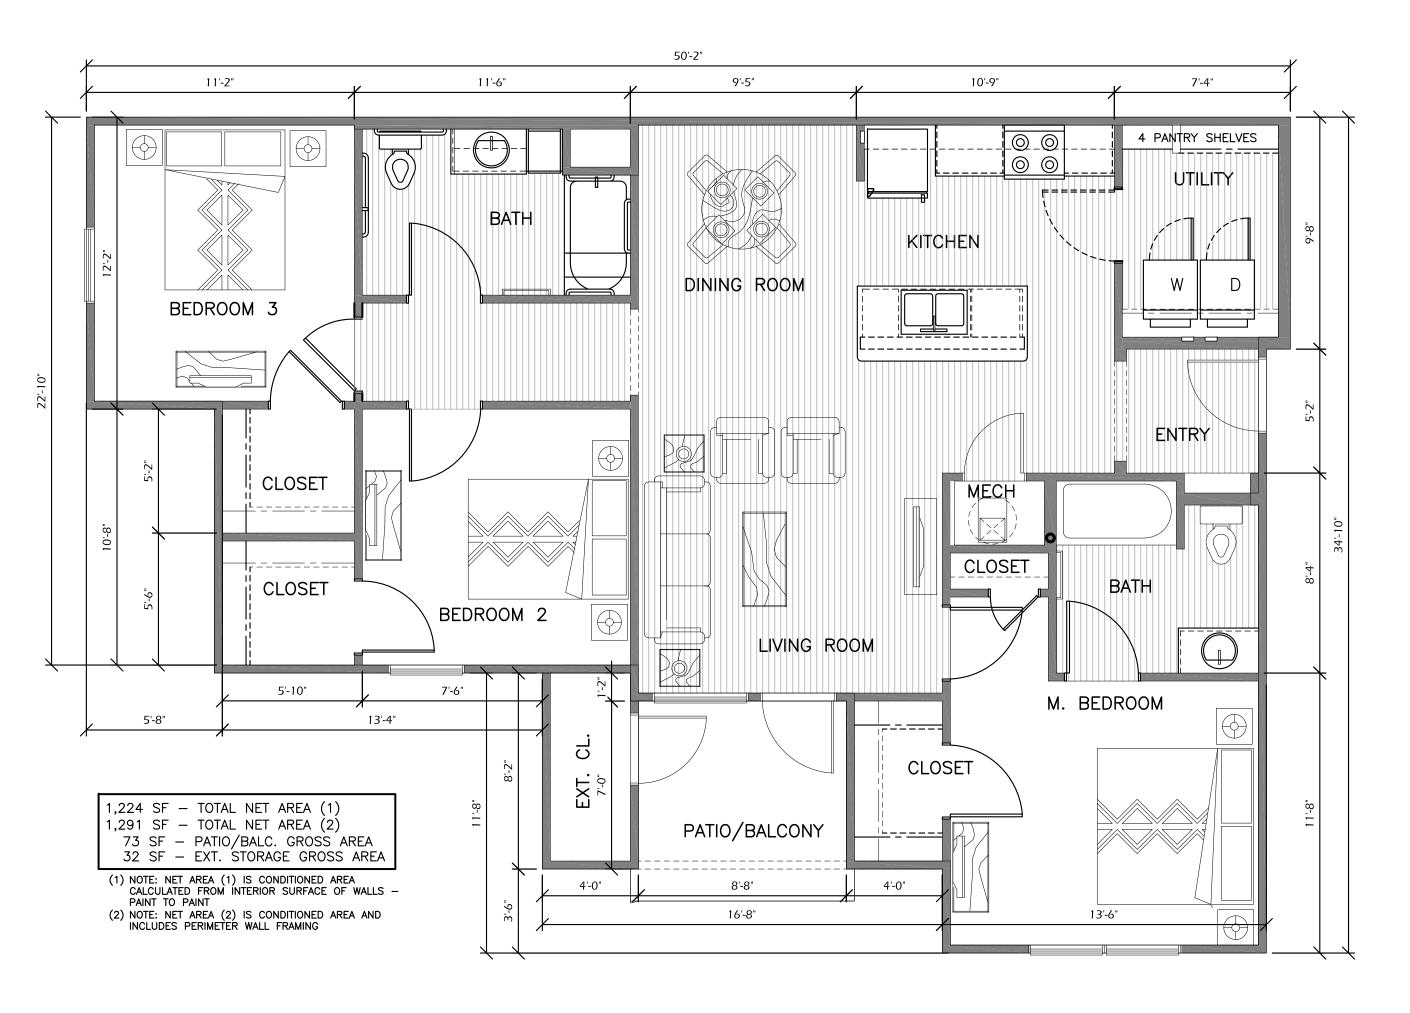



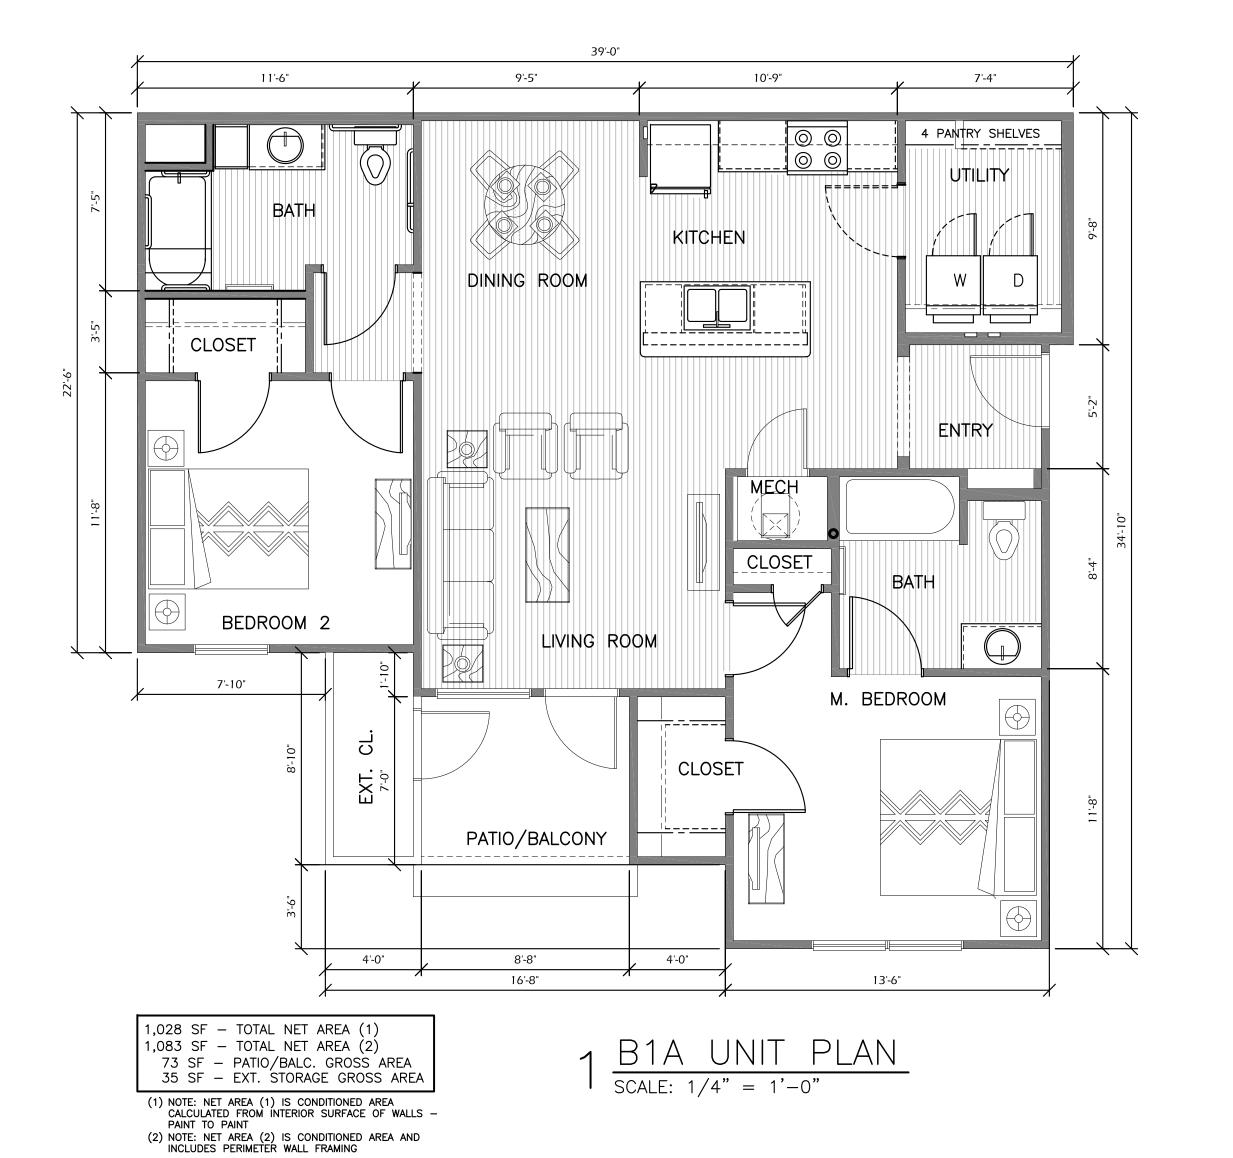

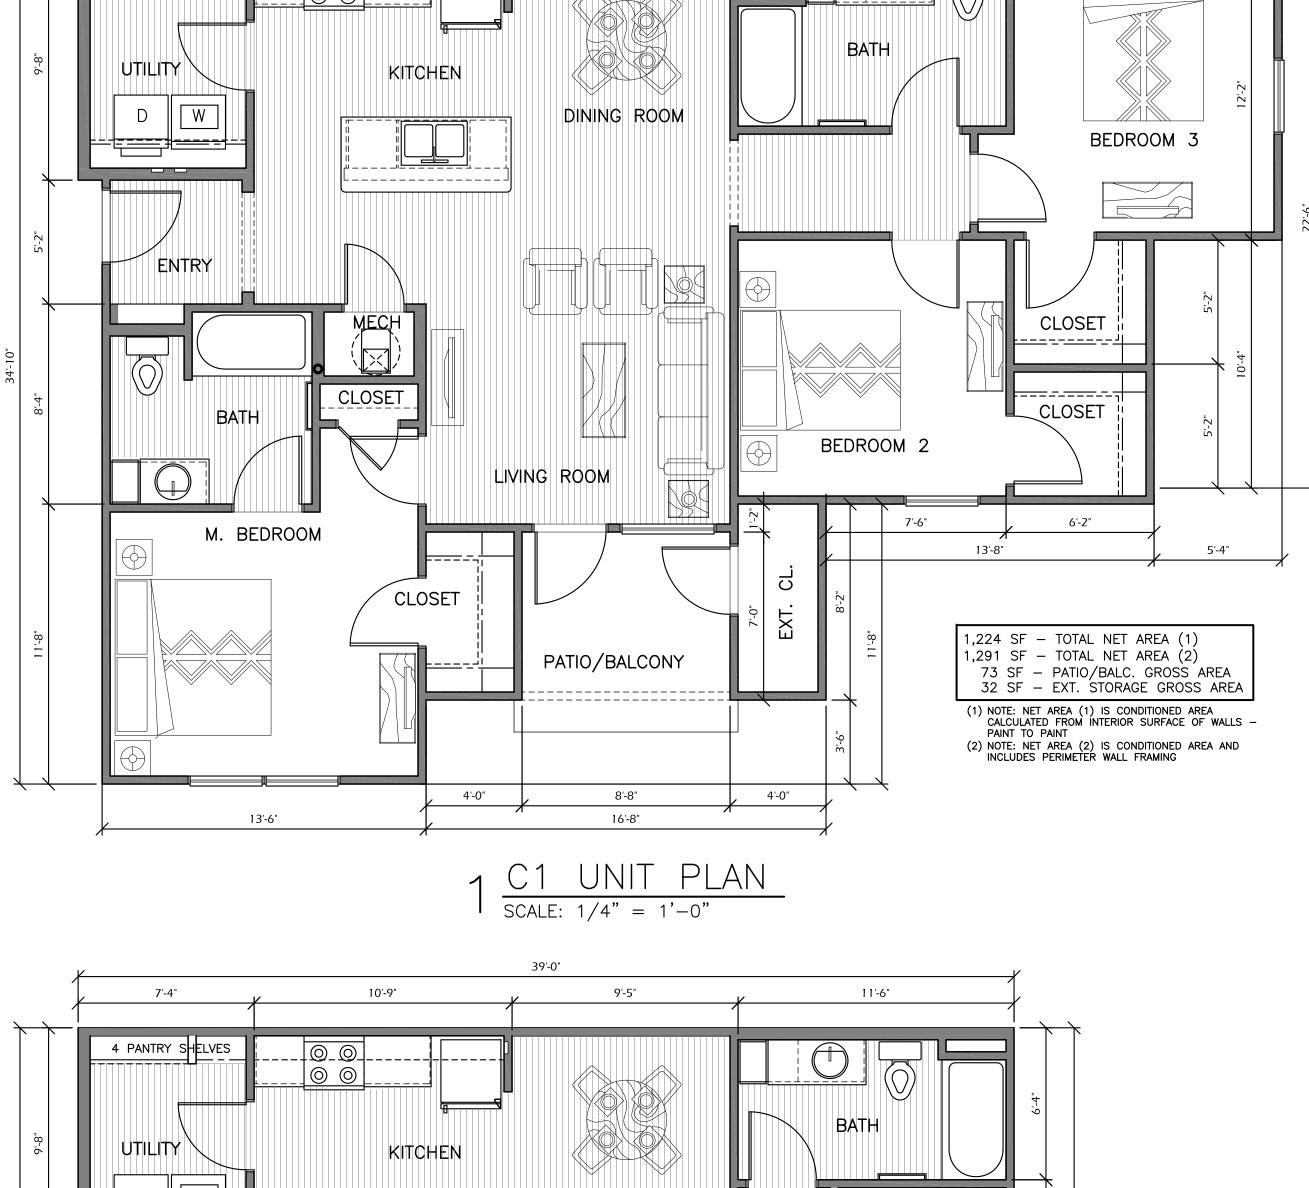

50'-2"

11'-6"

(1) NOTE: NET AREA (1) IS CONDITIONED AREA CALCULATED FROM INTERIOR SURFACE OF WALLS — PAINT TO PAINT

(2) NOTE: NET AREA (2) IS CONDITIONED AREA AND INCLUDES PERIMETER WALL FRAMING


11'-2"


9'-5"


7'-4"

4 PANTRY SHELVES


10'-9"

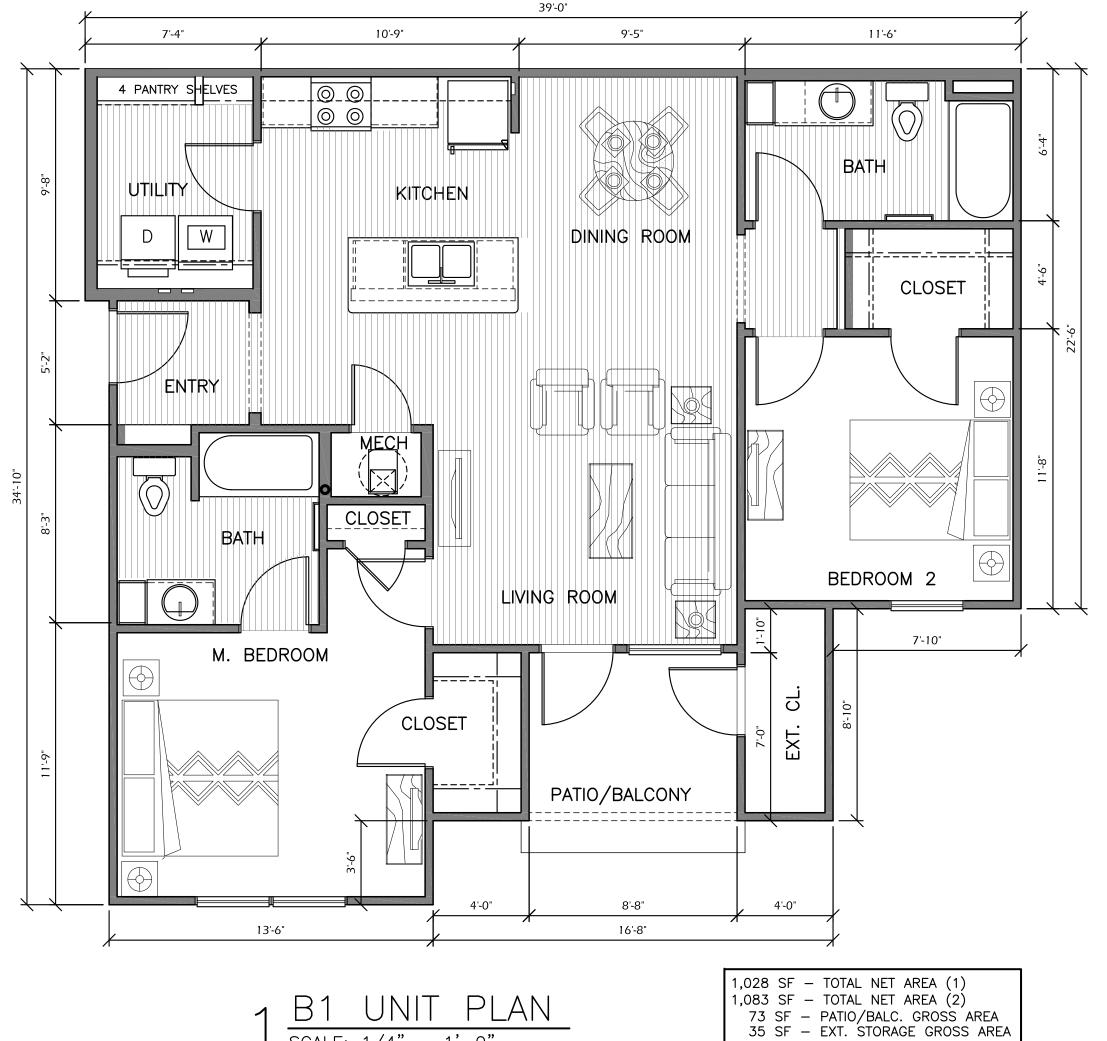

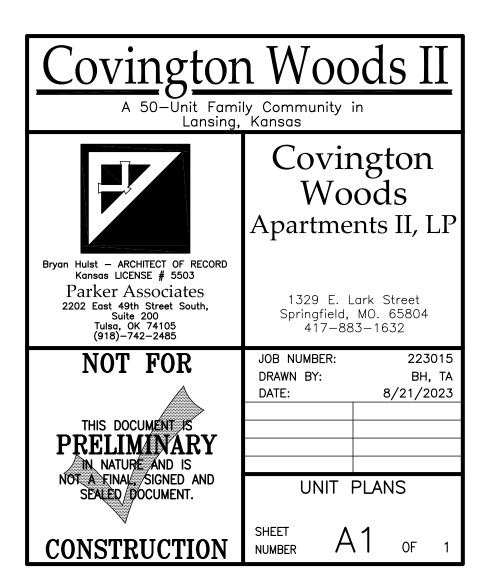


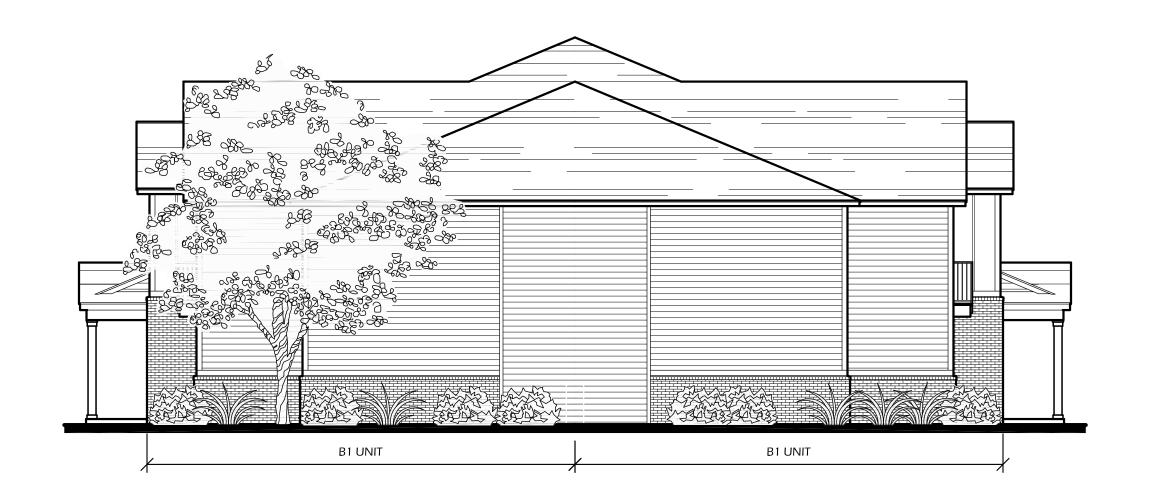

 $5 \frac{\text{BUILDING 1 NORTH ELEVATION}}{\frac{1}{8"} = \frac{1}{-0"}}$ 

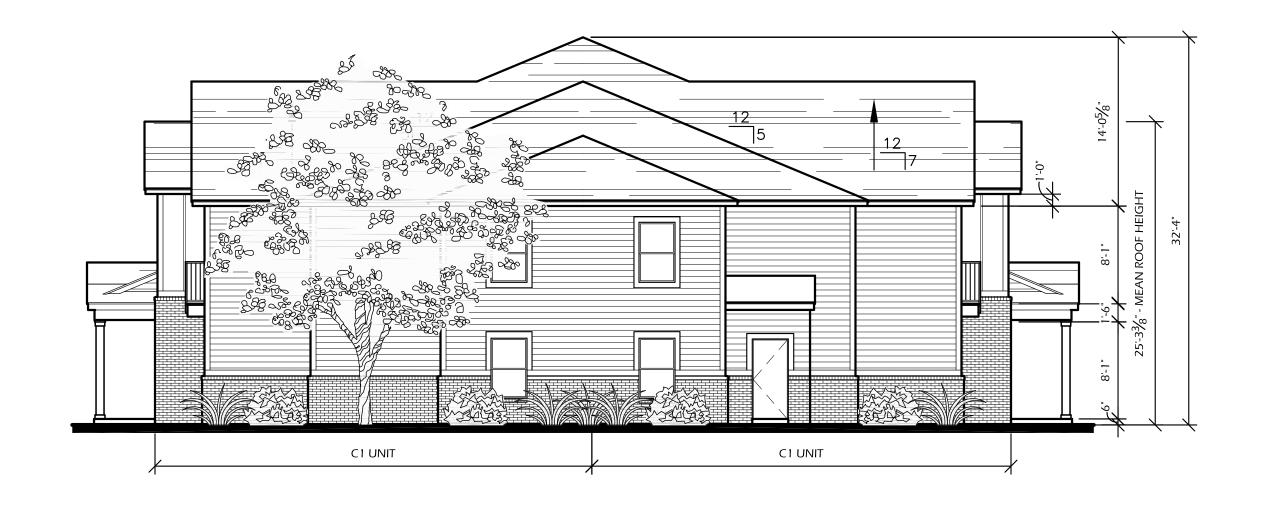


 $4 \frac{\text{BUILDING 1 SOUTH ELEVATION}}{\frac{1}{8"} = \frac{1}{0}$ 

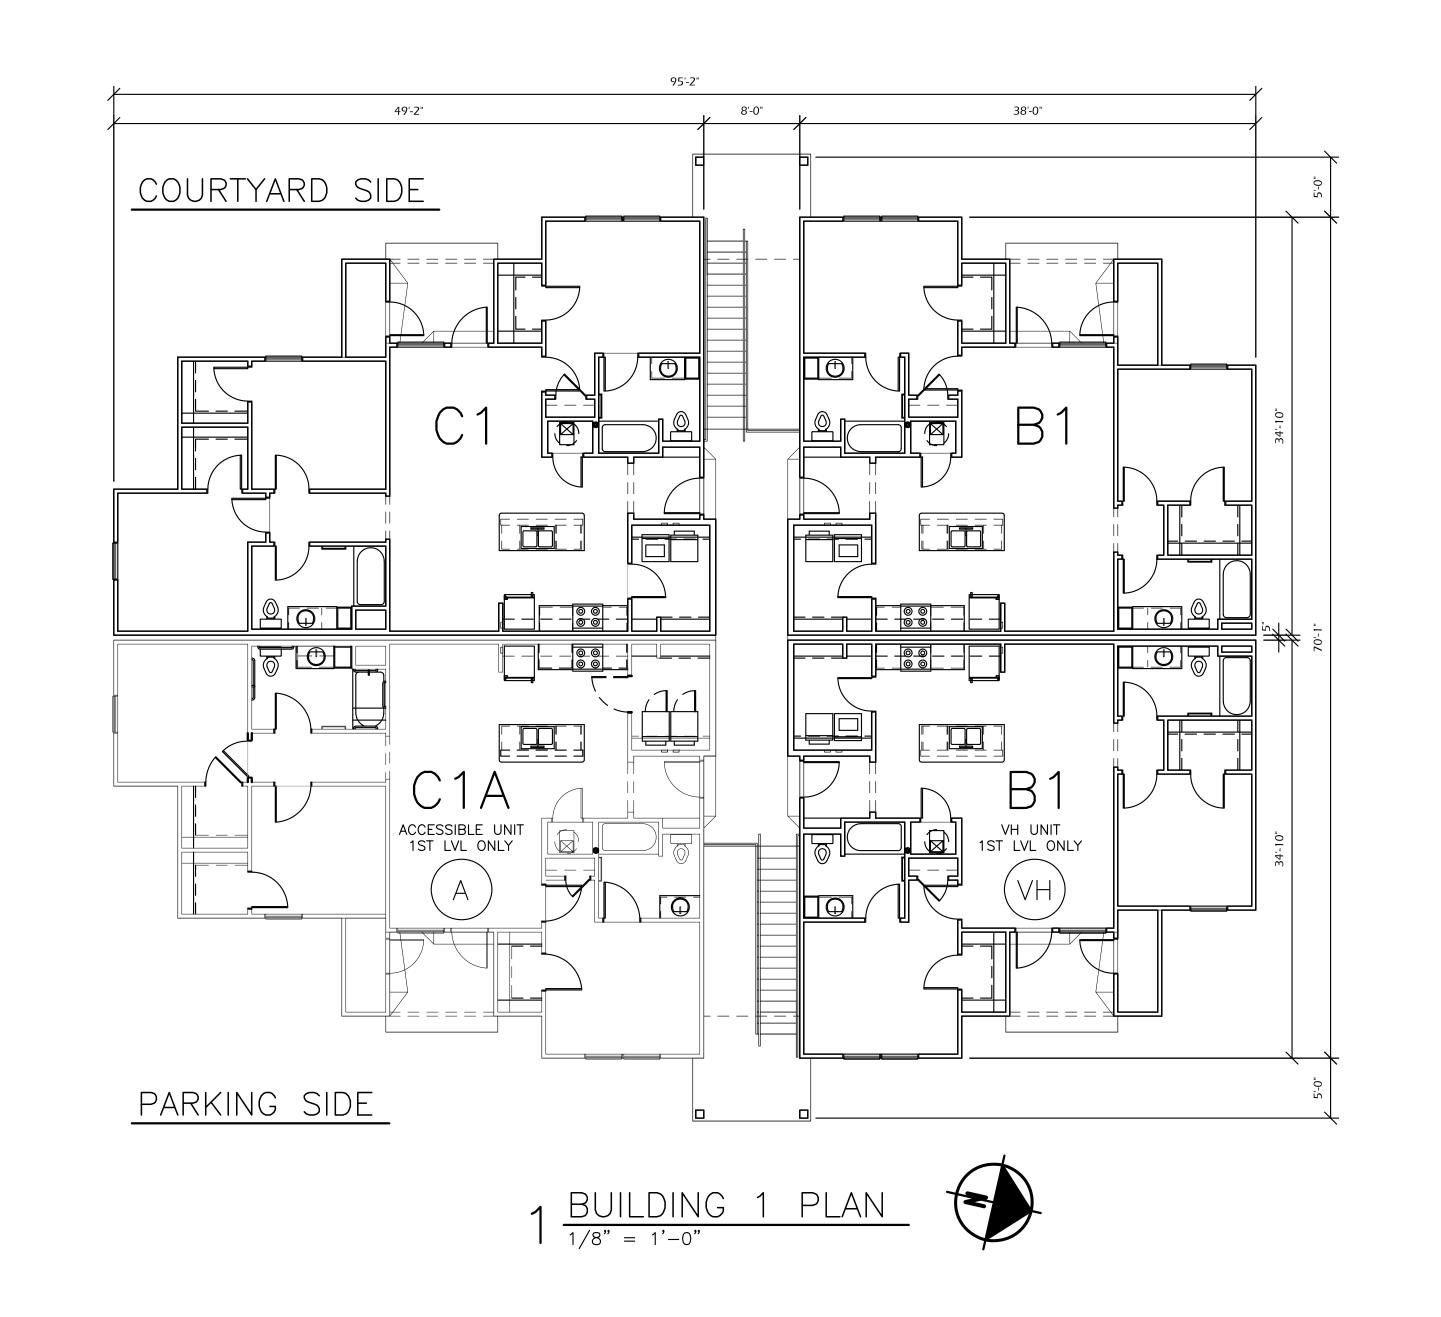


Covington Woods Apartments II, LP

1329 E. Lark Street Springfield, MO. 65804 417-883-1632

223015 BH, TA 8/21/2023

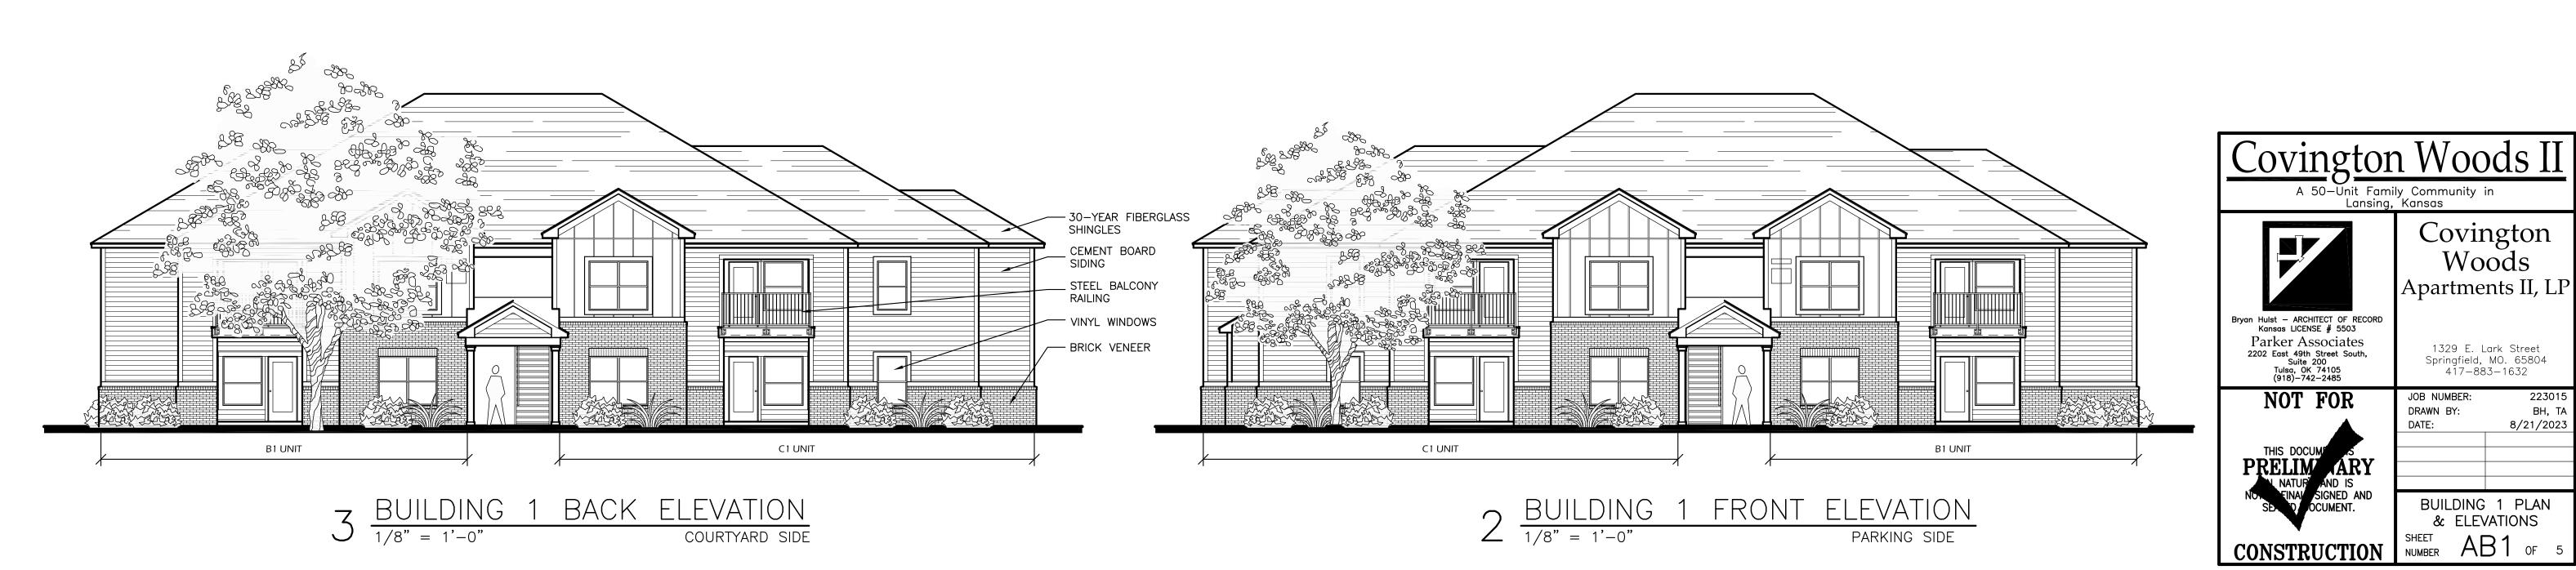

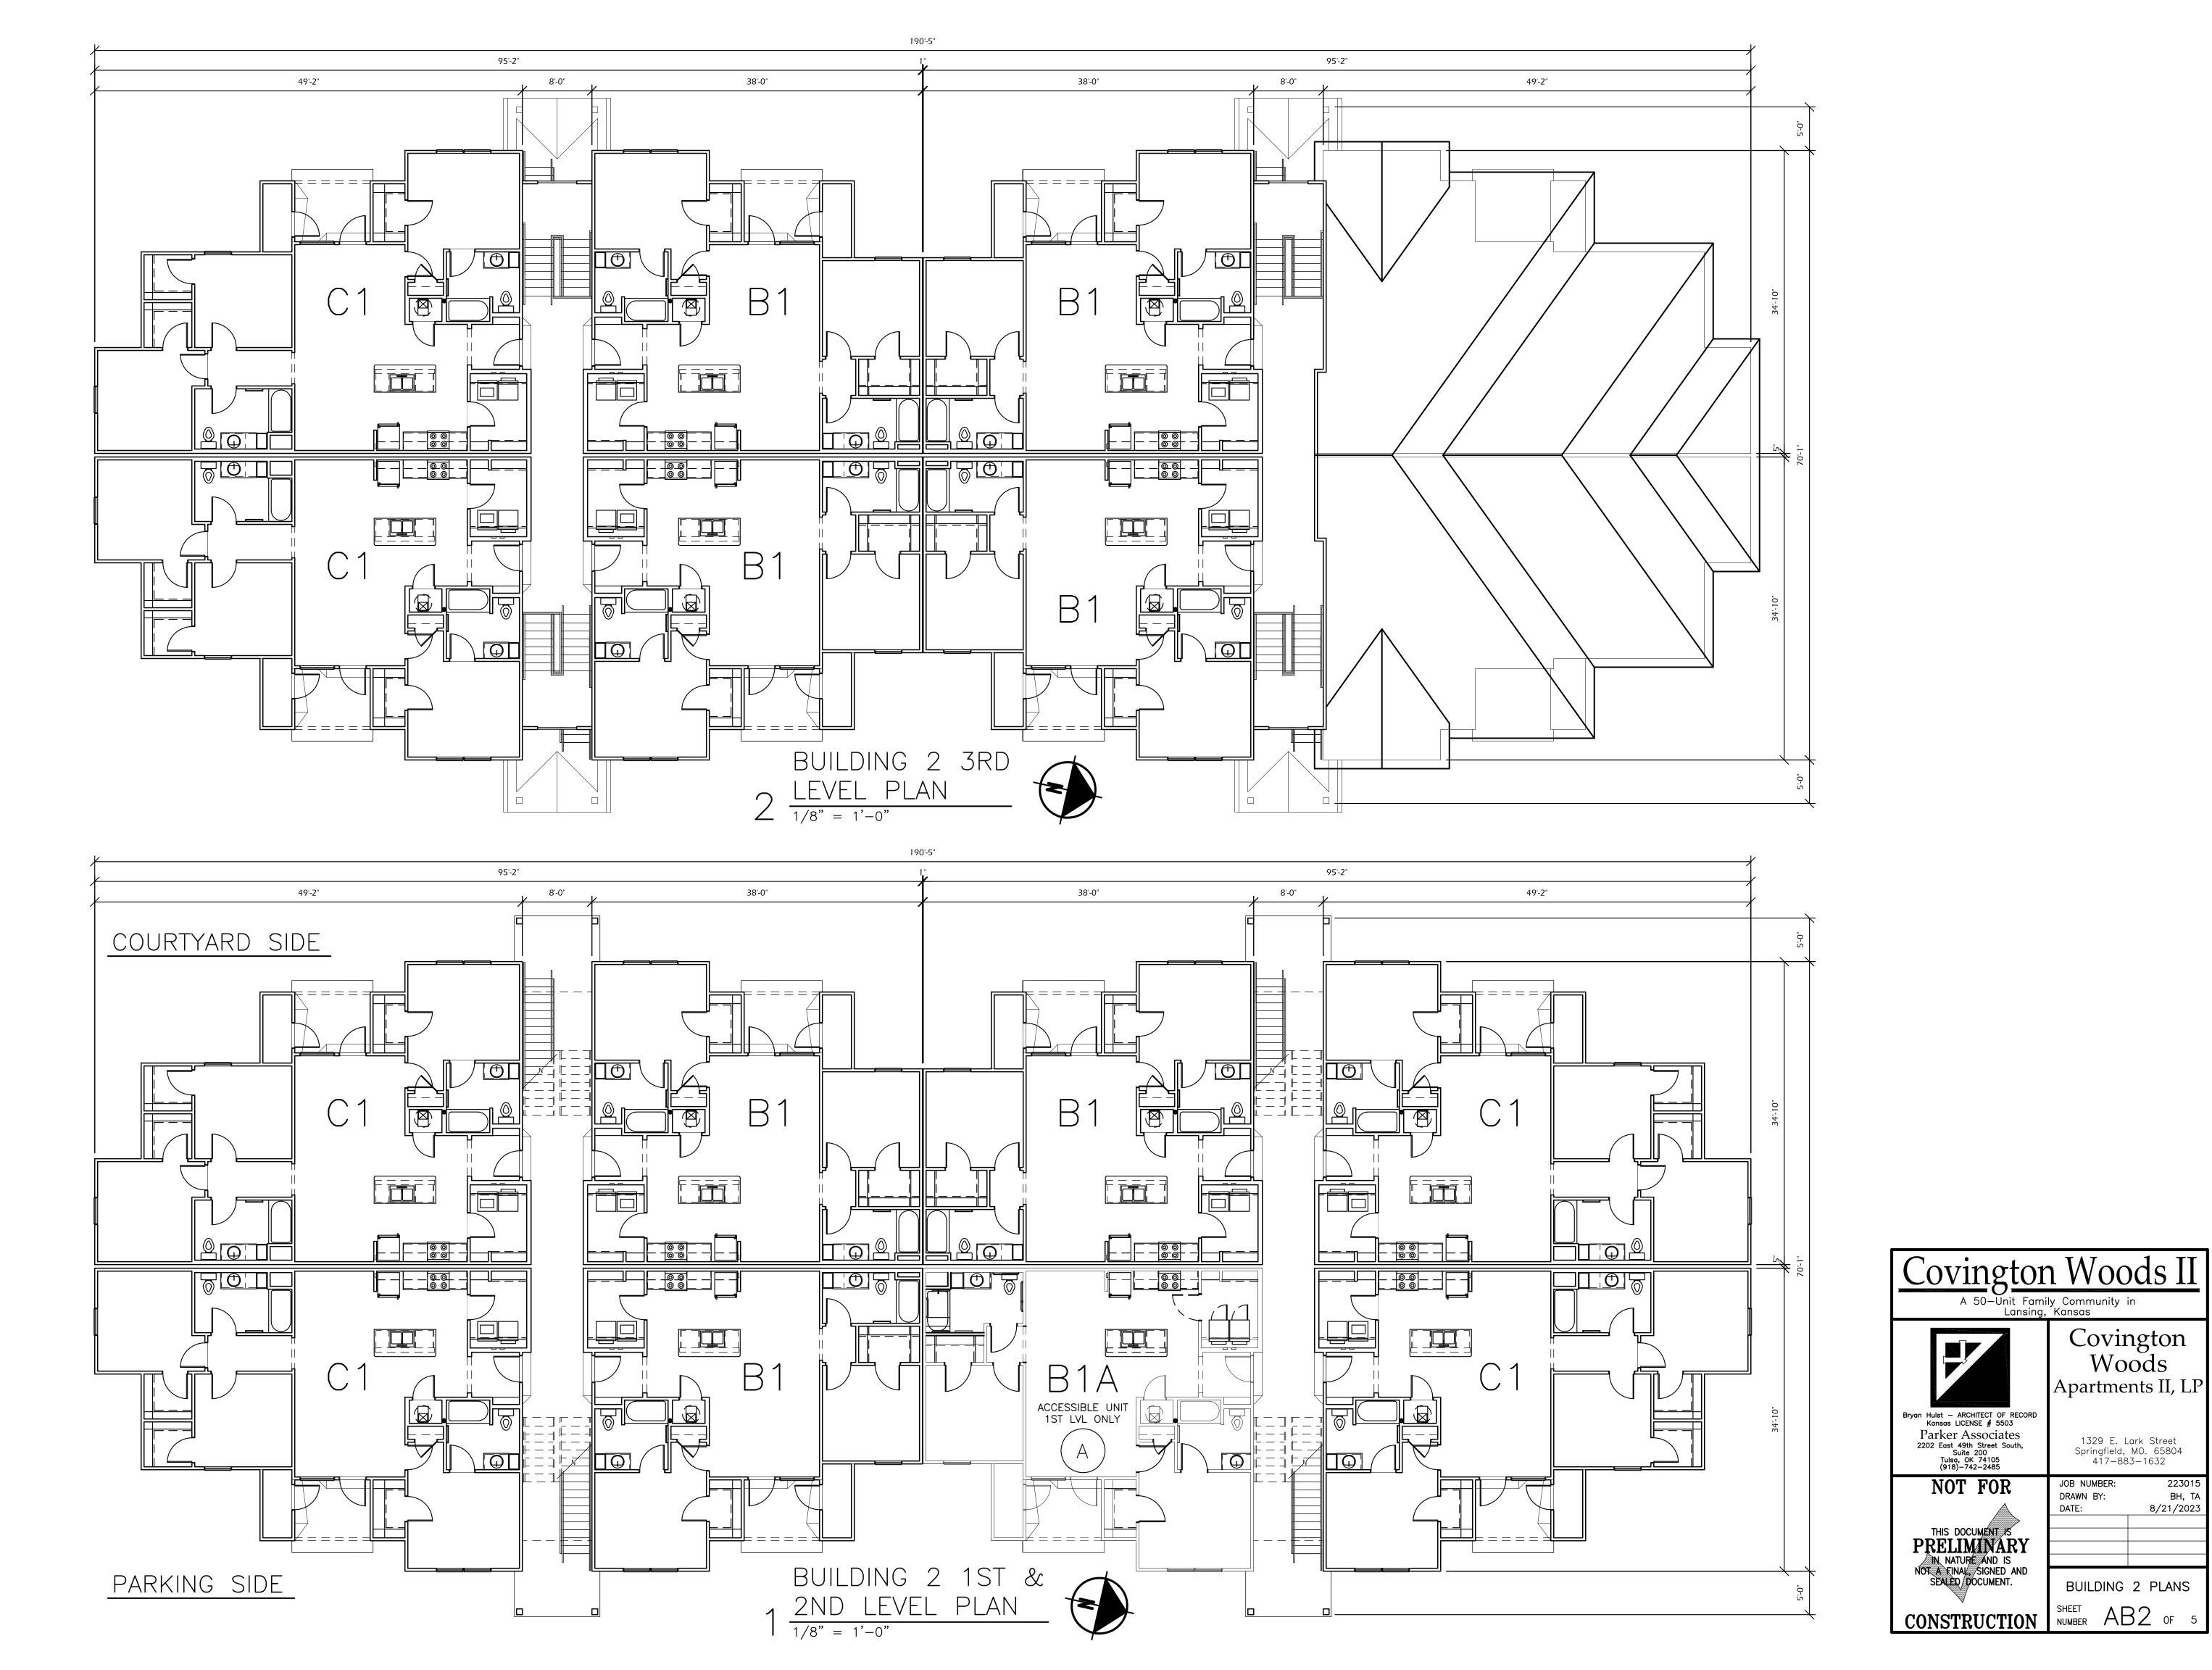

Covington Woods

Apartments II, LP

1329 E. Lark Street Springfield, MO. 65804 417-883-1632


BUILDING 2 PLANS


223015 BH, TA 8/21/2023









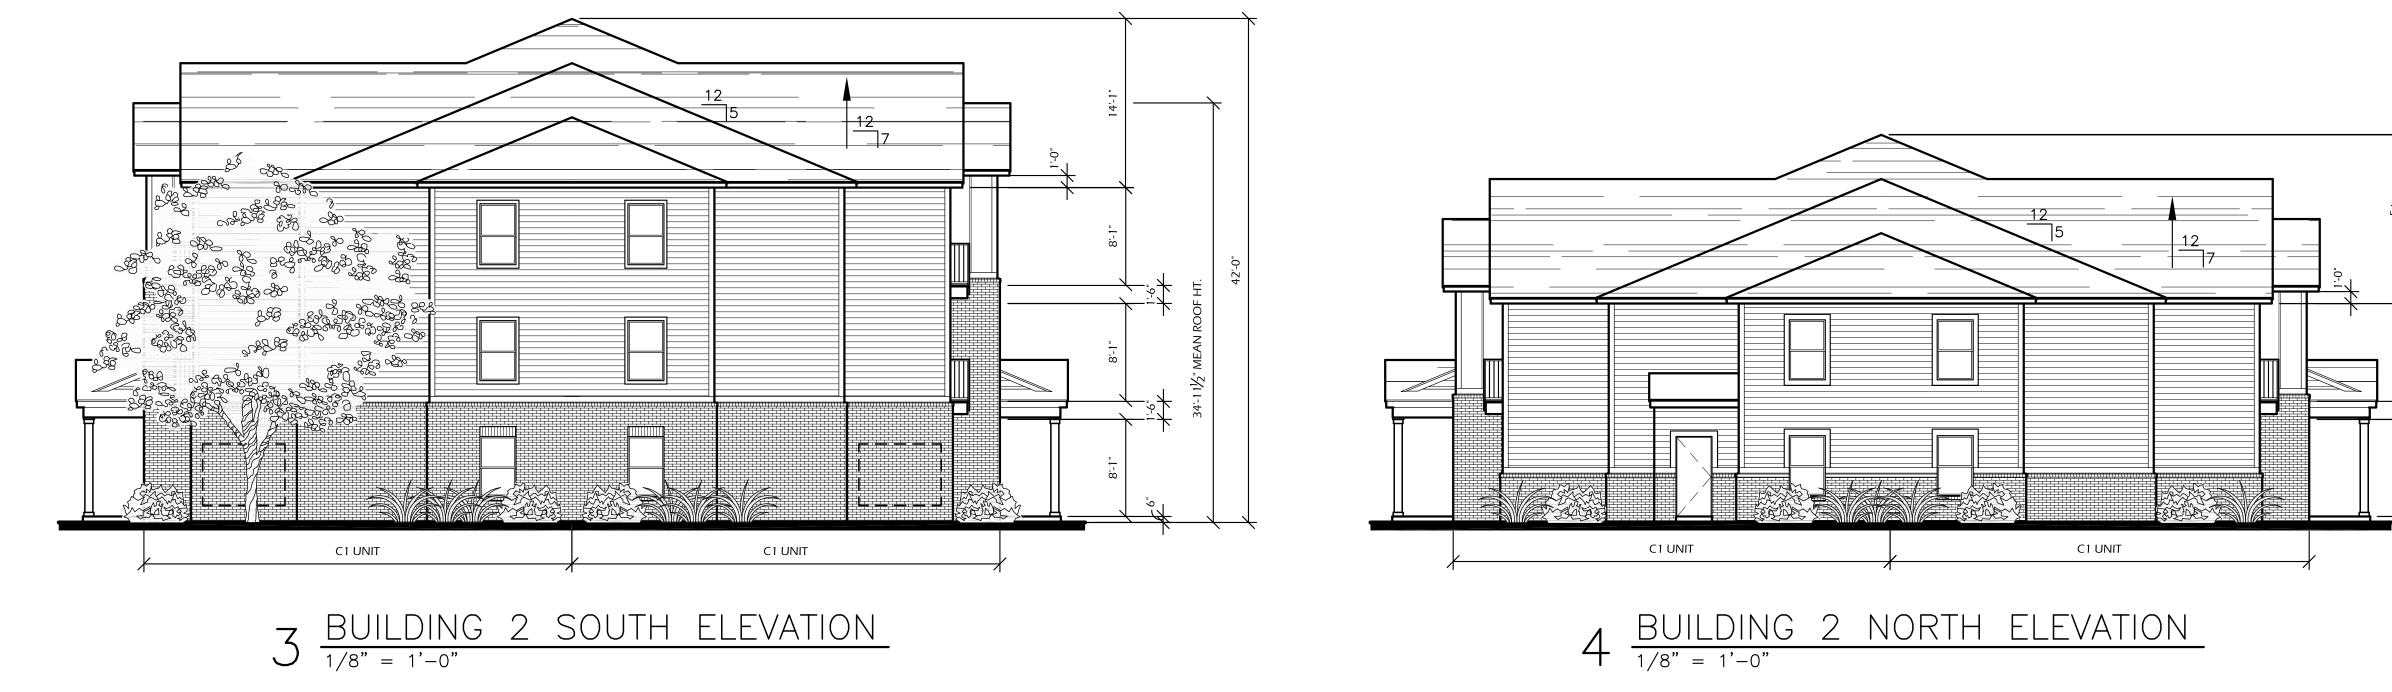

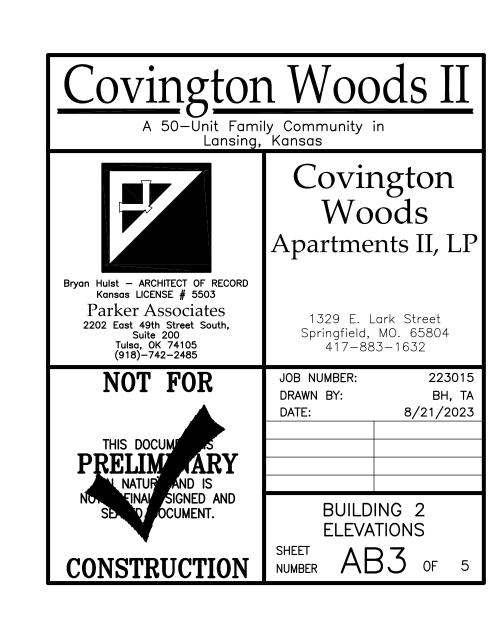

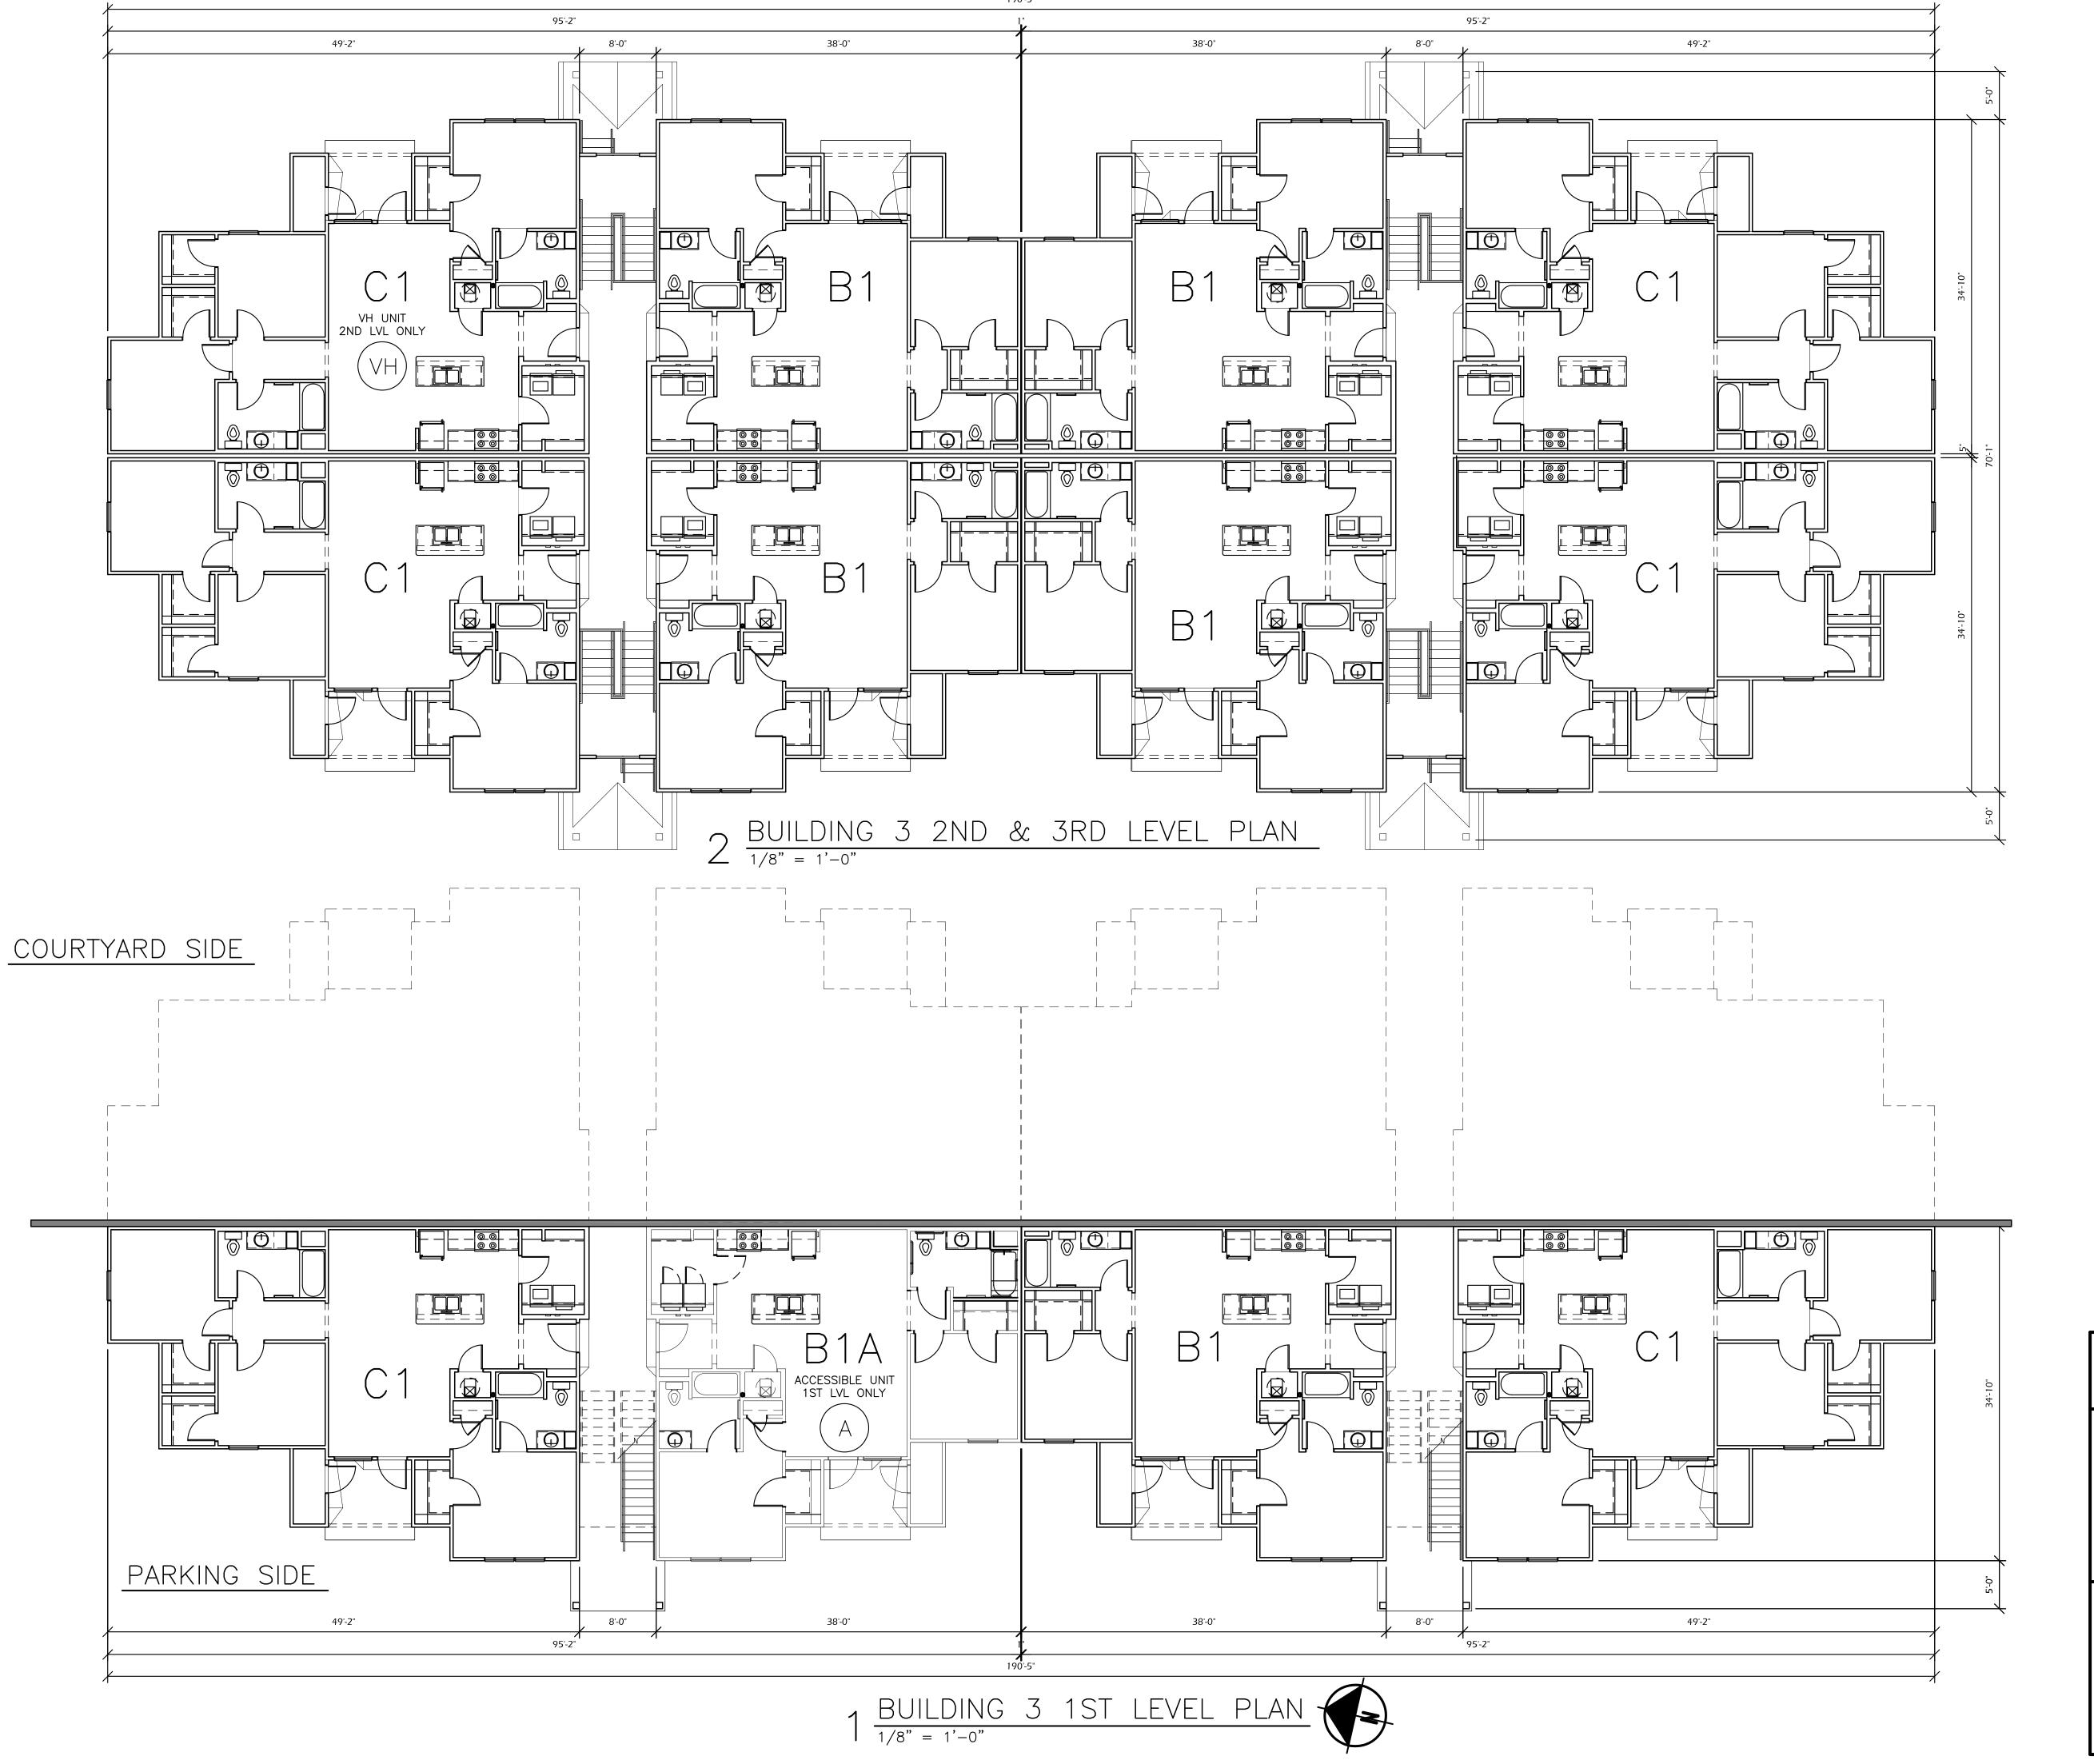


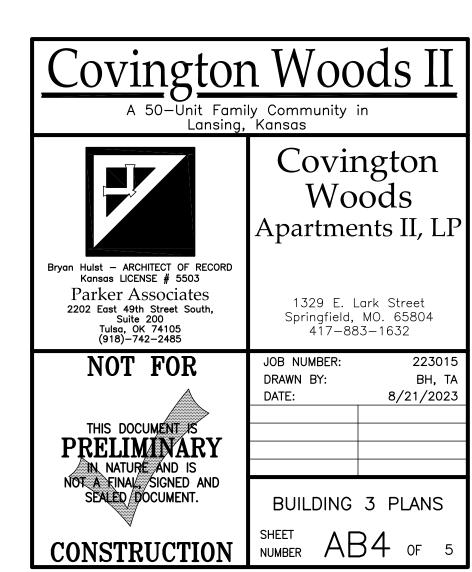










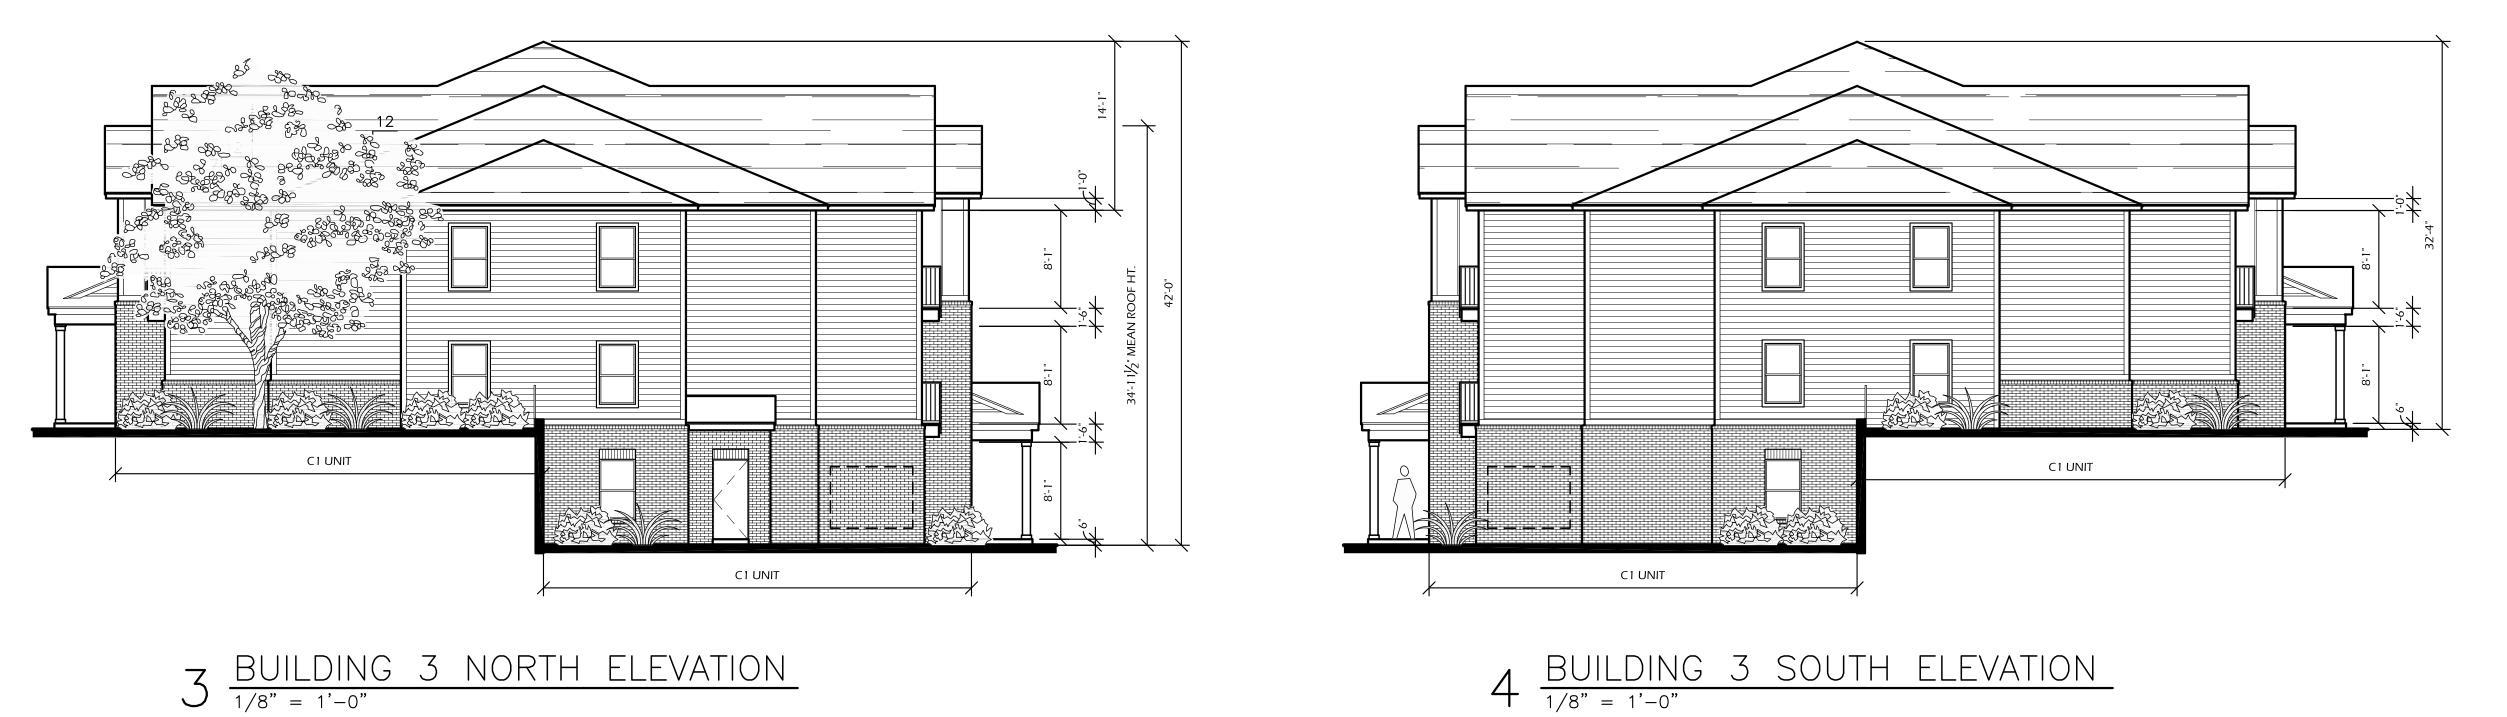


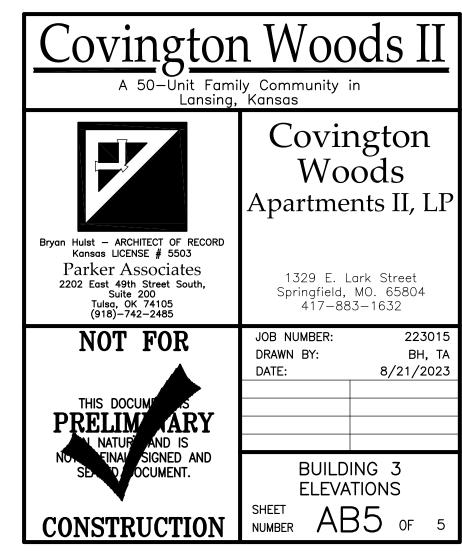

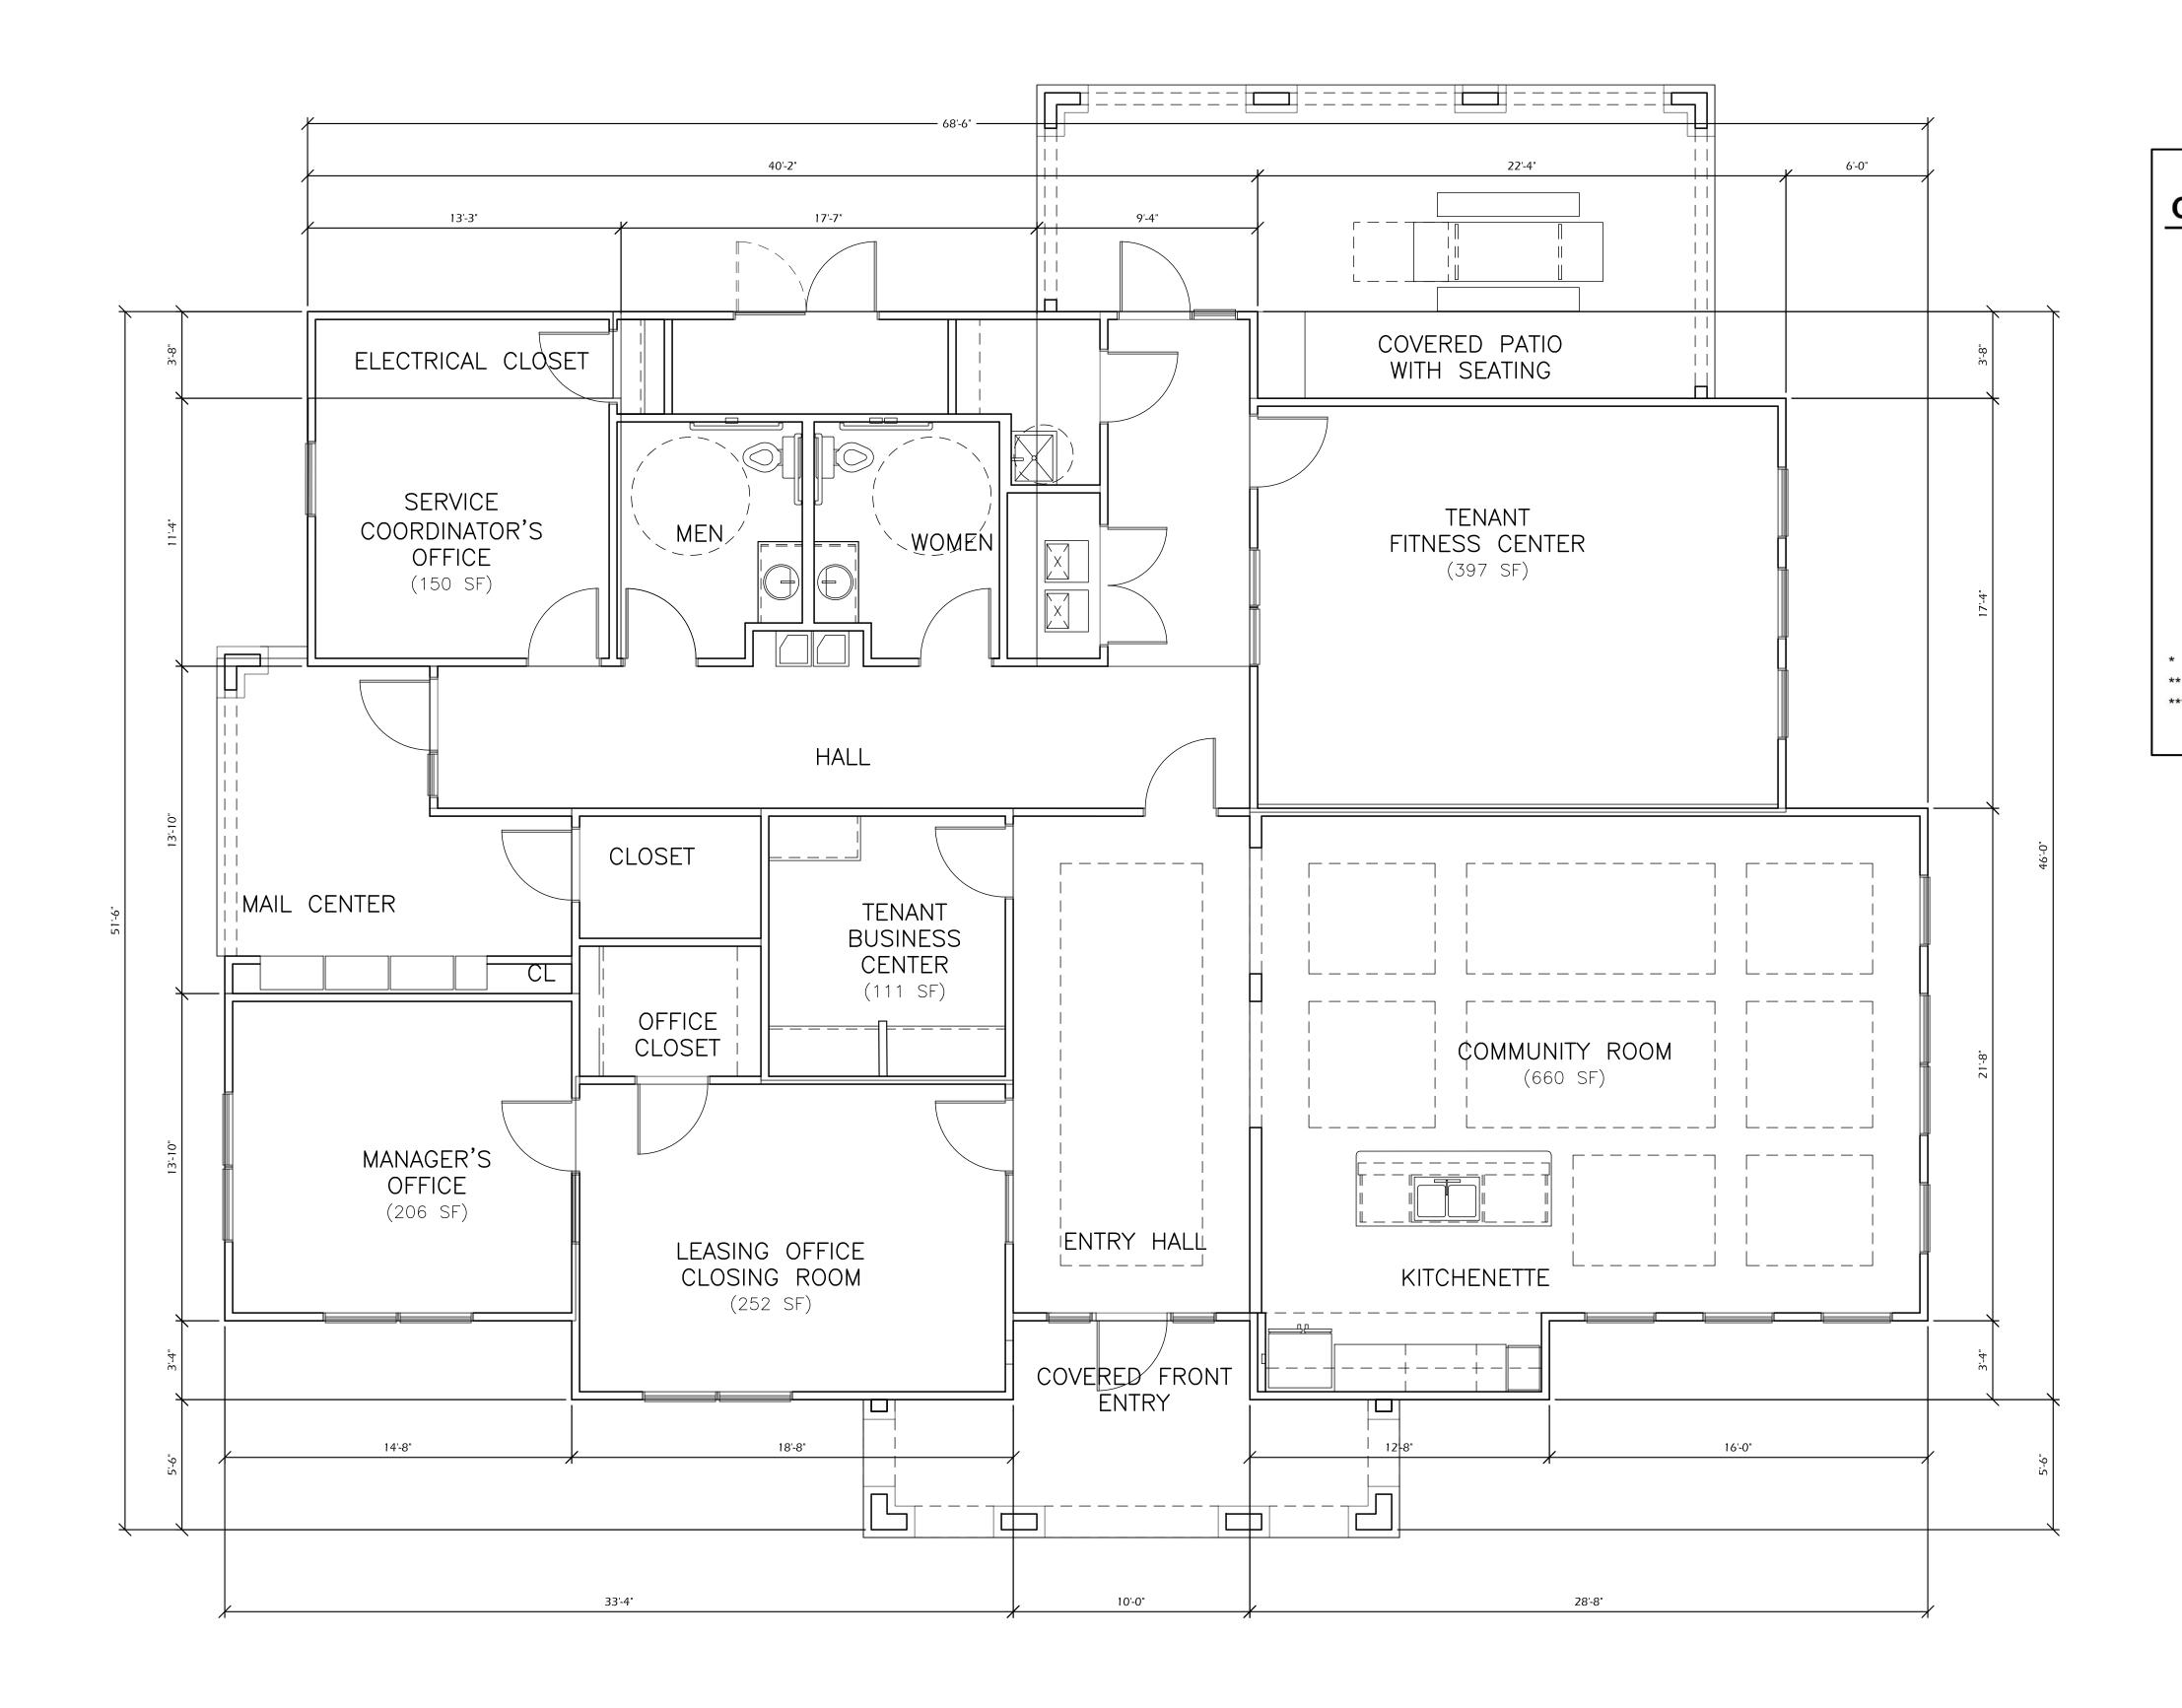



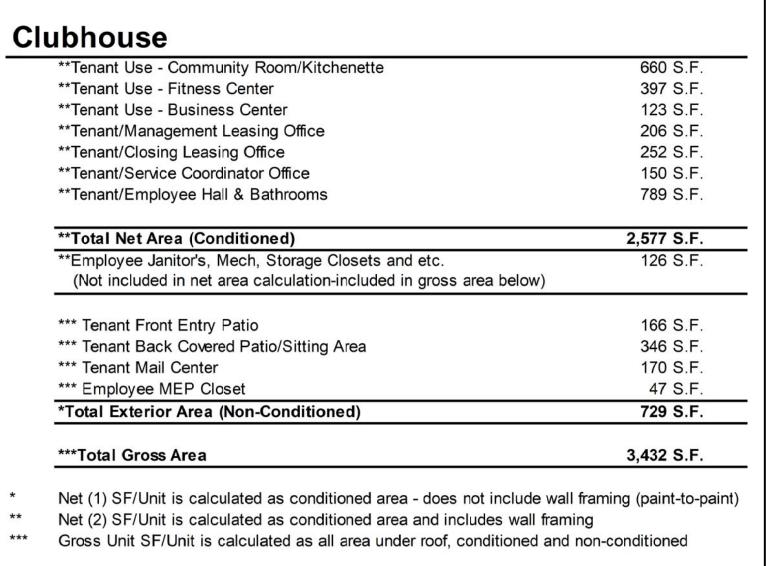

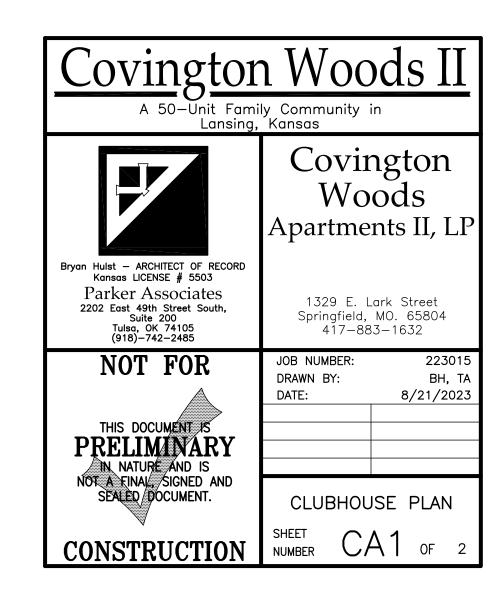




# 4 CLUBHOUSE WEST ELEVATION $\frac{1/4" = 1'-0"}{}$

# $\frac{\text{CLUBHOUSE EAST ELEVATION}}{\frac{1}{4"} = \frac{1}{0}}$





# $2 \frac{\text{CLUBHOUSE REAR (NORTH) ELEVATION}}{\frac{1}{4"} = \frac{1}{0}$

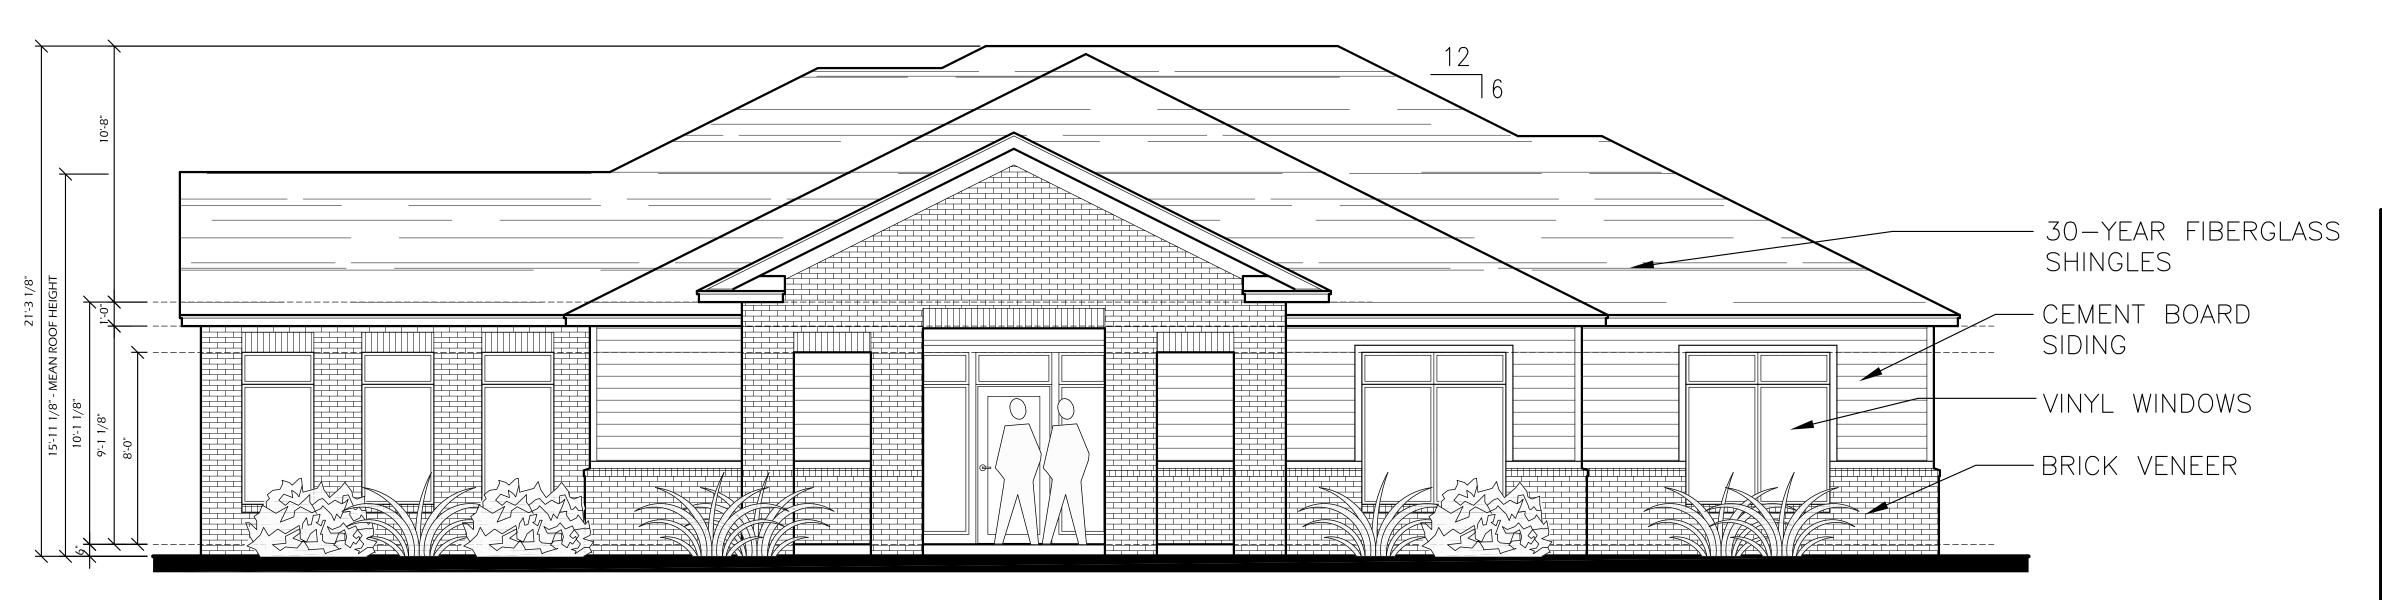

CLUBHOUSE FRONT (SOUTH) ELEVATION

1/4" = 1'-0"

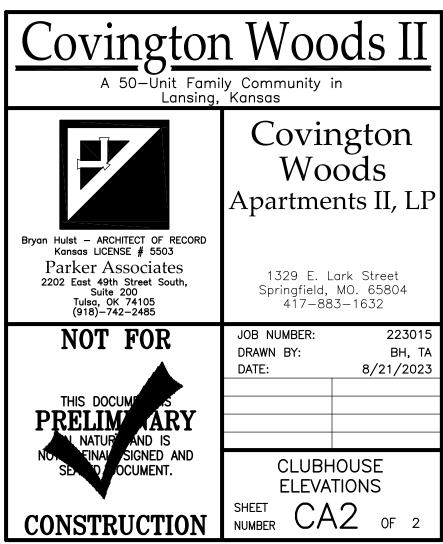

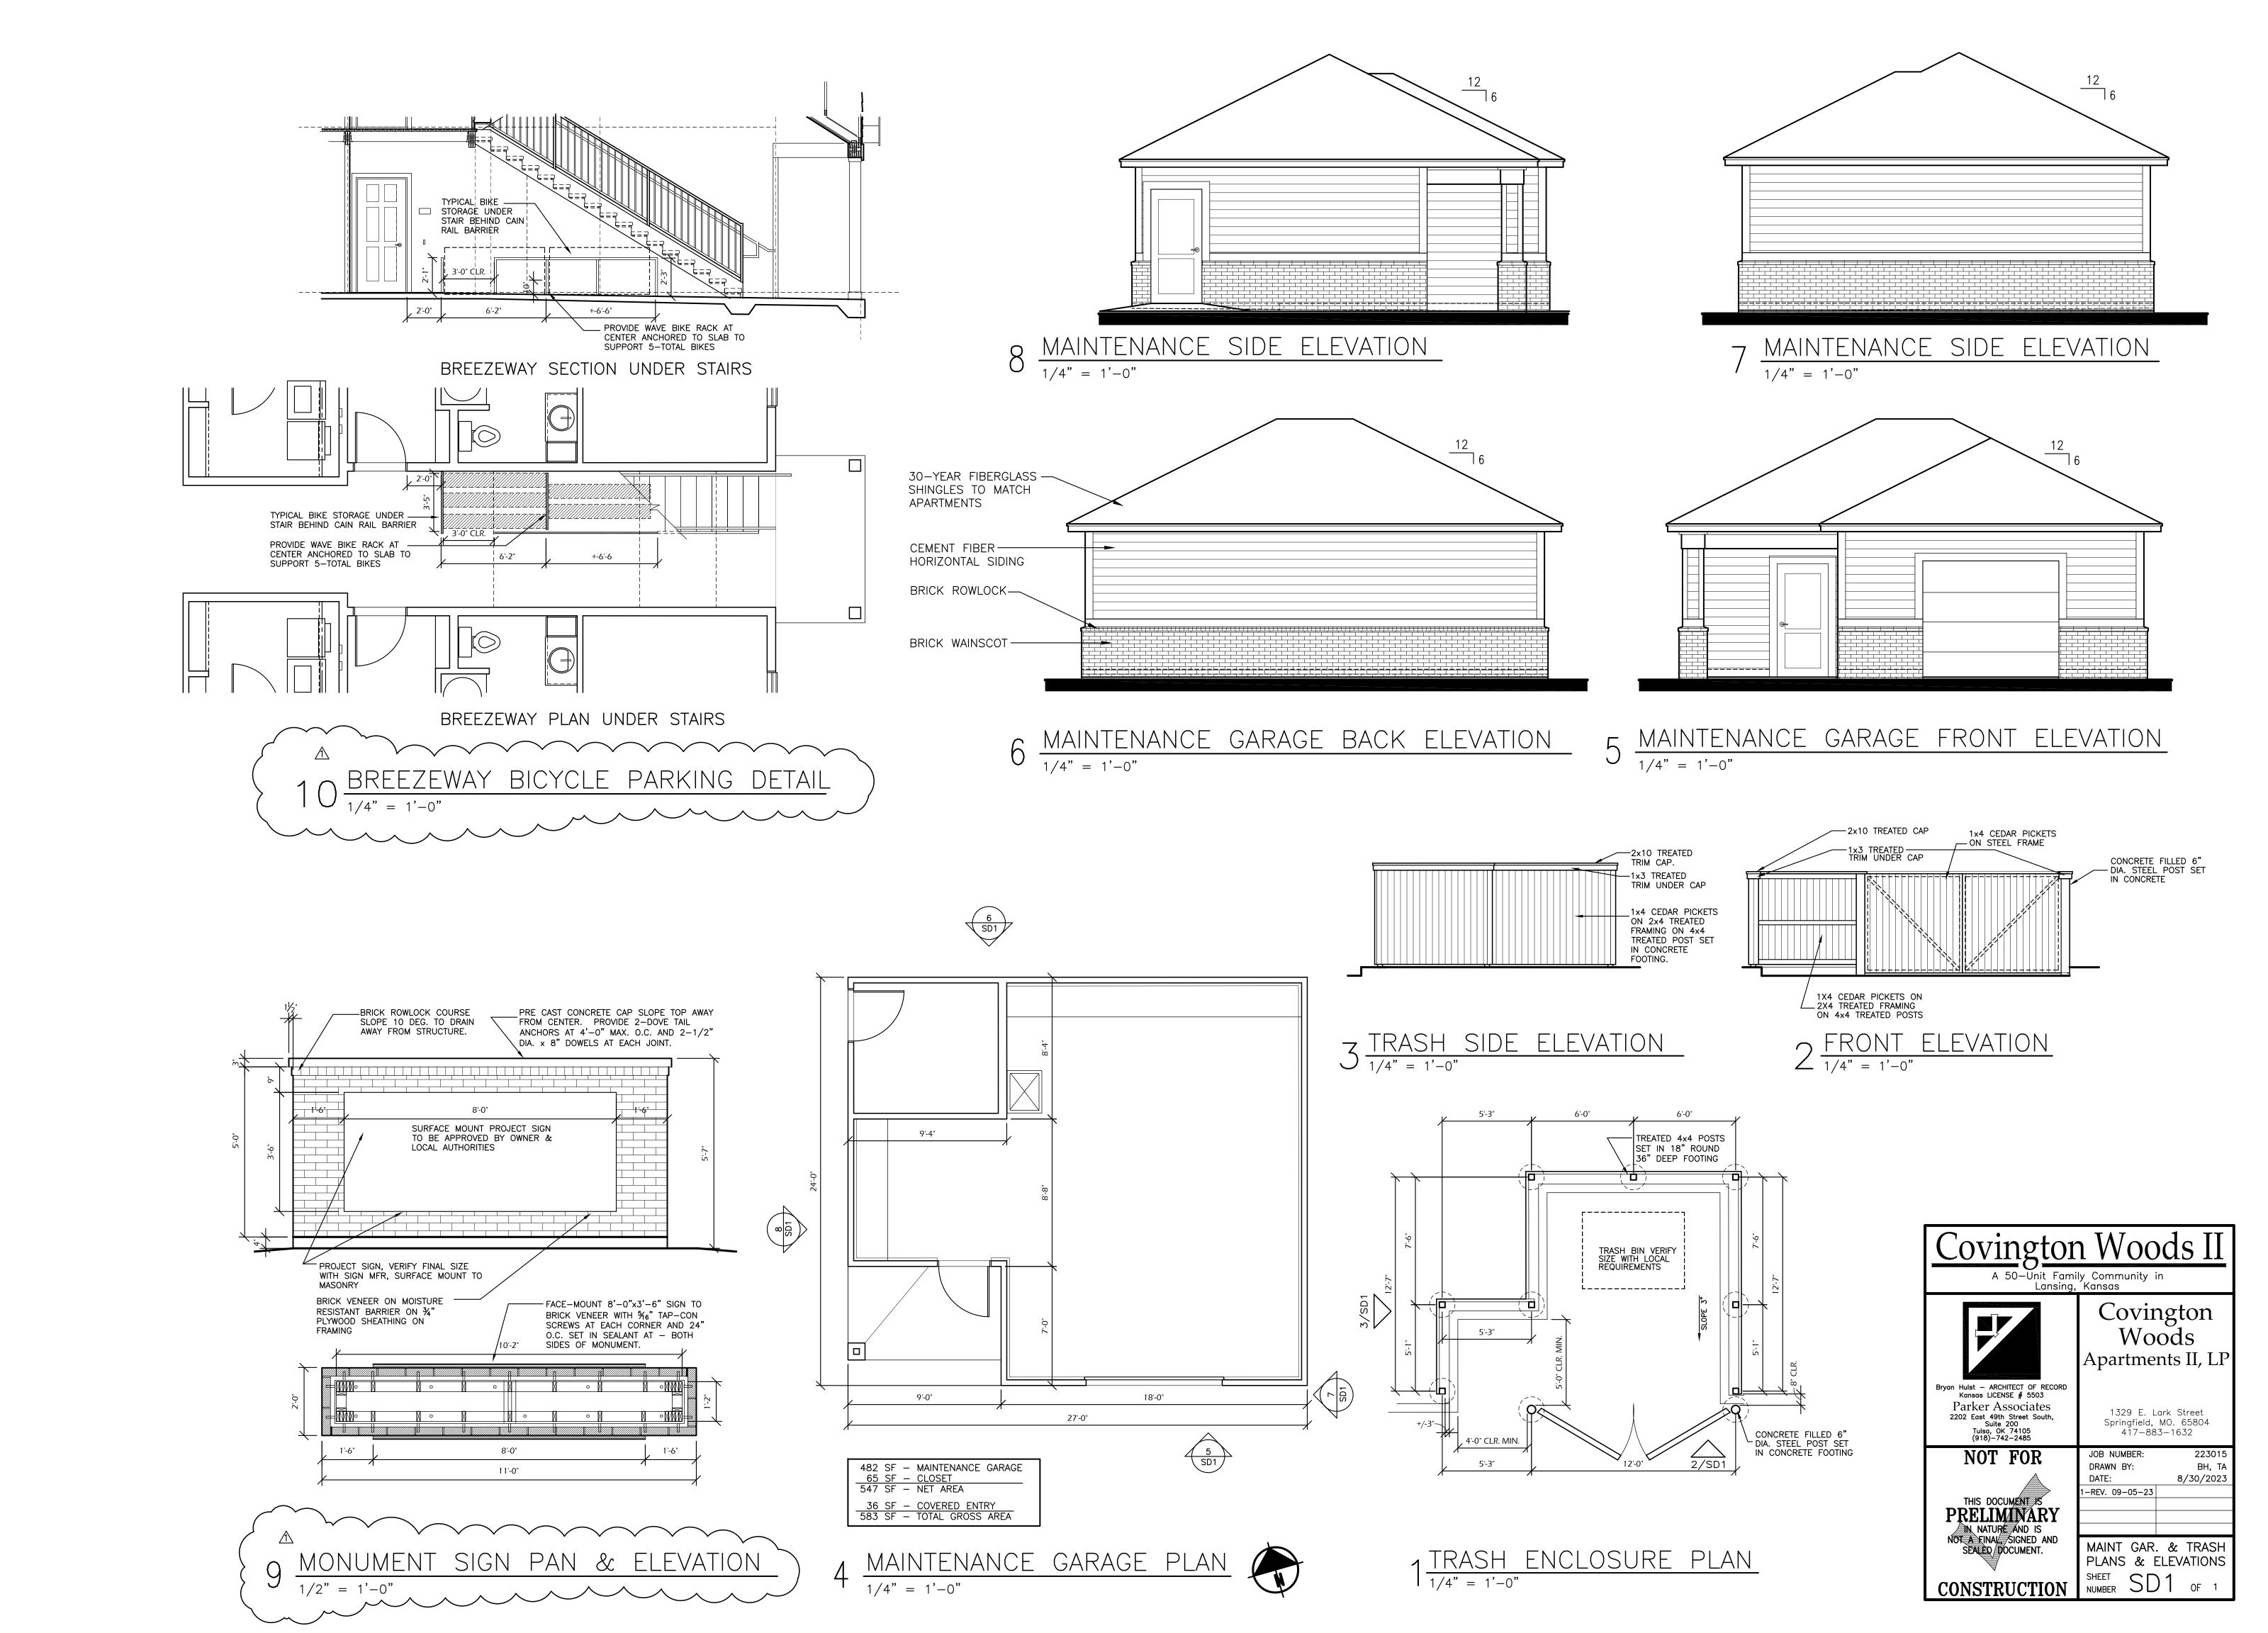



CITY OF LANCING I/C LAND						
CITY OF LANSING, KS LANDSCAPE REQUIREMENTS						
STREET FRONTAGE TREE REQUIREMENT						
(TWO) 2 TREES PER 40 LINEAR FEET OF STREET FRONTAGE (W/ 30' BUILDING SETBACKS)						
_	TREES REQUIRED	TREES PROVIDED				
W. MARY ST. = 451LF	23	23				
W. KAY ST. = 651 LF	33	33				
PERIMETER LANDSCAPE STRIP						
ALL PERIMETERS OF PLATTED AREAS SHALL REQUIRE A PERIMETER LANDSCAPE STRIP BEING A MINIMUM OF (5) FIVE FEET WIDE.						
_	REQUIRED	PROVIDED				
RECEPTACLE SCREENING						
SCREENING OF OUTDOOR TRASH RECEPTACLES SHALL OCCUR FOR ALL NEW DEVELOPMENTS.						
_	REQUIRED	PROVIDED				
PERIMETER PARKING LOT LANDSCAPING						
(ONE) 1 SHADE TREE AND (FIVE) 5 SHRUBS ARE REQUIRED FOR EVERY 35 LINEAR FEET OF ROAD FRONTAGE.						
	TREES REQUIRED	TREES PROVIDED				
PERIMETER PARKING = 456 LF	13	13				
_	SHRUBS REQUIRED	SHRUBS PROVIDED				
PERIMETER PARKING = 456 LF	65	71				


DETAILED LANDSCAPE PLAN TO IMPLEMENT PLANTS RECOMMENDED BY THE CITY OF LANSING ZONING CODE. APPROVED TREE LIST FROM "GREAT TREES FOR KANSAS CITY REGION (PROVIDED BY ROBERT WHITMAN, ASLA, AICP, LEED AP DEC. 2013)

PL	_ANT	SCH	<b>IED</b>	IJL
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	PLANT SCHE	DULE						
	TREES	CODE	QTY	COMMON NAME	BOTANICAL NAME	CONT	CAL	SIZE
^_		STMAP	4	SHANTUNG MAPLE	ACER TRUNCATUM	B&B	2" CAL	8`-10` HT.
		ERB	4	EASTERN REDBUD	CERCIS CANADENSIS	B&B	2" CAL	8`-10` HT.
		DOGW	3	KOUSA DOGWOOD	CORNUS KOUSA	B&B	2" CAL	7`-8` HT.
Not	on Tree list. Revi	ise	3	SHADEMASTER HONEY LOCUST	GLEDITSIA TRIACANTHOS INERMIS 'SHADEMASTER'	B&B	3" CAL	10`-12` HT.
		TAYJ	13	TAYLOR JUNIPER	JUNIPERUS VIRGINIANA 'TAYLOR'	B&B		7`-8` HT.
	}	RRCRB	1	ROYAL RAINDROPS® CRABAPPLE	MALUS X 'JFS-KW5'	B&B	2" CAL	7`-8` HT.
	YOU WANTED	CBS	6	COLORADO BLUE SPRUCE	PICEA PUNGENS 'KOSTER'	B&B		7`-8` HT.
Independent of the loans	A law a	BOSP	22	BOSNIAN PINE	PINUS HELDREICHII	B&B		7`-8` HT.
الم (۱۳۰۰)		LPT	12	LONDON PLANE TREE	PLATANUS X ACERIFOLIA	B&B	3" CAL	10`-12` HT.
	3	BOAK	22	BURR OAK	QUERCUS MACROCARPA	B&B	3" CAL	10`-12` HT.
~~\ ~~\		SOAK	15	SHUMARD OAK	QUERCUS SHUMARDII	B&B	3" CAL	10`-12` HT.
£ ,	3	ВСҮР	8	BALD CYPRESS	TAXODIUM DISTICHUM	B&B	3" CAL	10`-12` HT.; 4`-5` SPD.
√lu	A O A A A A A A A A A A A A A A A A A A	GGA	18	GREEN GIANT ARBORVITAE	THUJA X 'GREEN GIANT'	B&B		7`-8` HT.




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# DATE DESCRIPTION


	ISSUE		
	PLANS		
DATE:	09.18.2023		
PROJECT#	23038		
DESIGN:	BN		
DRAWN:	BN		
CHECKED:	DA		
	SHEET TITLE		
PRE DEVELOPMENT LANDSCAPE PLAN			

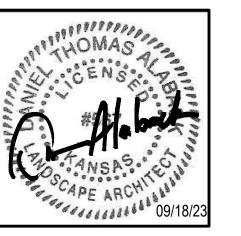


SPECIFIED MULCH AT 2" CAREFULLY REMOVE DEPTH - DO NOT PLACE ANY EXCESS SOIL ON **AGAINST TRUNK** TOP OF ROOT BALL TO EXPOSE ROOT FLARES TOP OF ROOT BALL 2" ABOVE FINISH GRADE **EXISTING GRADE** REMOVE ALL TWINE SCARIFY BOTTOM AND AND/OR WIRE BASKET SIDES OF THE PLANT PIT AND TOP 1/3 OF THE **BURLAP FROM ROOT BALL** BACKFILL WITH AMENDED SOIL AS SPECIFIED ELEVATE CENTER OF PIT 4" AND COMPACT **UNDISTURBED** TO PREVENT SETTLING SUBGRADE 2.5X WIDER THAN ROOT BALL DIAMETER

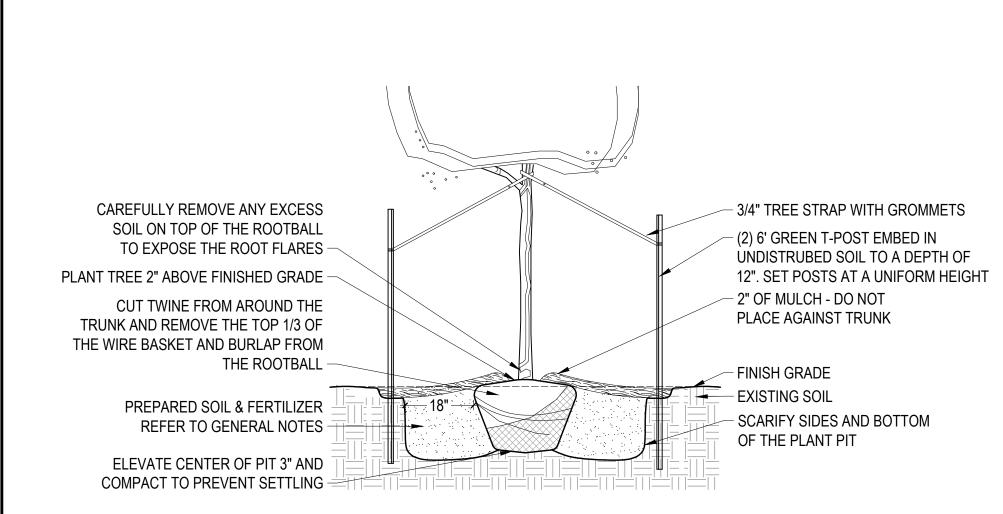TREE PLANTING DETAIL


B TREE PLANTING - EVERGREEN

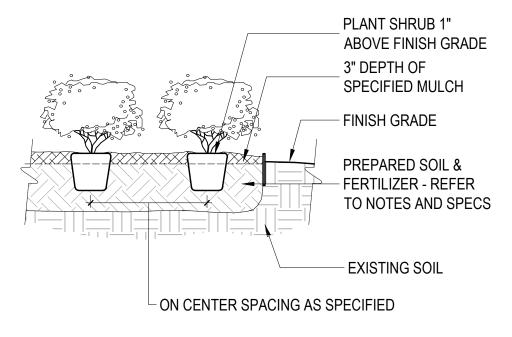

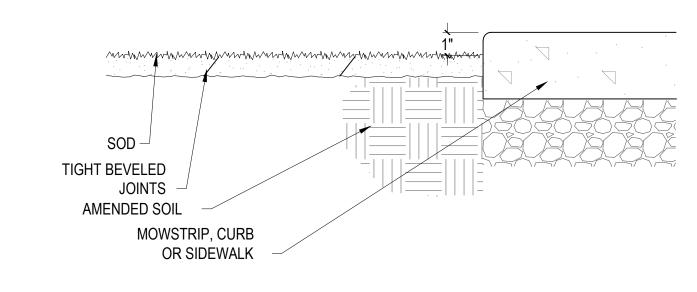

SHRUB PLANTING
SCALE: N.T.S.

SOD INSTALLATION
SCALE: N.T.S

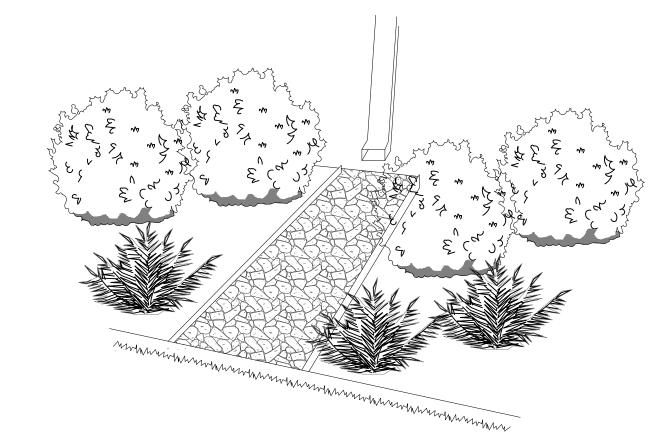

E DOWNSPOUT TREATMENT (TYP)
SCALE: N.T.S.

SCALE: N.T.S.

### **GENERAL NOTES**

CALL 811 FOR INFORMATION ON THE LOCATION OF ALL UNDERGROUND UTILITIES. CONTACT PRIOR TO DIGGING. CONTRACTOR SHALL BE RESPONSIBLE FOR ANY DAMAGE CAUSED TO THE UTILITIES (BOTH OVERHEAD AND BURIED) WHICH MAY OCCUR DUE TO HIS ACTION OR LACK THEREOF ON THE PROJECT SITE DURING LANDSCAPE OR IRRIGATION INSTALLATION. CONTRACTOR SHALL SEEK THE ASSISTANCE OF LOCAL UTILITIES AND THE OWNER IN LOCATING THE UTILITIES PRIOR TO PERFORMING CONSTRUCTION OPERATIONS IN ANY AREA.

PLANT TREES TWO (2) INCHES ABOVE FINISHED GRADE. CUT TWINE FROM AROUND THE TRUNK AND PULL BACK THE BURLAP & WIRE FROM THE TOP 1/3 OF THE ROOT BALL. CAREFULLY REMOVE ANY EXCESS SOIL ON TOP OF THE ROOT BALL TO EXPOSE THE ROOT FLARES.

PLANT SHRUBS ONE (1) INCH ABOVE FINISHED GRADE. ALL PLANTING BEDS SHALL HAVE POSITIVE DRAINAGE OUT OF BEDS AND AWAY FROM BUILDINGS, PERMANENT STRUCTURES, AIR CONDENSER UNITS, UTILITY BOXES, SIDEWALKS, ETC.

CROWN LANDSCAPE ISLANDS IN PARKING LOT 3" ABOVE TOP OF CURB OR AS DIRECTED ON DRAWING.

### **BED PREPARATION**

ALL LANDSCAPE BEDS SHALL HAVE A MINIMUM 12" DEPTH SOIL MIXTURE COMPRISED OF A THREE (3) INCH LAYER OF BACK TO NATURE SOIL CONDITIONER, ONE (1) INCH LAYER OF AGED STERILIZED COW MANURE AND NINE (9) INCH LAYER OF EXISTING TOPSOIL. ROTO-TILL AMENDMENTS AND TOPSOIL TO A DEPTH OF 12" UNTIL A SMOOTH EVEN MIXTURE IS ACHIEVED. INCORPORATE ROOTS TRANSPLANT ONE-STEP AT A RATE OF 5 POUNDS PER 100 SQUARE FEET, AND MENDER'S DRY MOLASSES AT A RATE OF 3 LBS PER 100 SQUARE FEET INTO THE TOP 3"-4" OF TOPSOIL.

ALL PLANTING BEDS SHALL BE DELINEATED AS SHOWN ON THE PLANS WITH A SHOVEL CUT EDGE, UNLESS OTHERWISE NOTED FOR STEEL BED EDGING. INSTALL PRO-STEEL 3/16" X 4" BLACK STEEL BED EDGING WHERE INDICATED.

# **MULCH**

MULCH ALL TREE WELLS AND PLANTING BEDS WITH SHREDDED HARDWOOD MULCH TO A DEPTH OF THREE (3) INCHES. TOP OF MULCH LAYER SHALL BE PLACED ONE (1) INCH BELOW TOP OF CURBS, WALKS, AND ALL OTHER HARDSCAPE STRUCTURES.

A MINIMUM FIVE (5) FOOT DIAMETER AREA OF MULCH SHALL BE PROVIDED AROUND ALL TREES LOCATED OUTSIDE OF PLANTING BEDS. MULCH ALL TREE WELLS OUTSIDE OF PLANTING BEDS WITH SHREDDED HARDWOOD MULCH TO A DEPTH OF THREE (3) INCHES.

MULCH SHALL NOT BE PLACED AGAINST THE TRUNKS OF TREES.

### LAWN

ALL AREAS DISTURBED BY CONSTRUCTION, SHALL BE RE-VEGETATED WITH SOLID SLAB SOD. SOD SHALL BE TURF HYBRID BLEND TALL FESCUE. WATER AND ROLL IN ACCORDANCE WITH STANDARD NURSERY PRACTICE.

PRIOR TO LAYING SOD, APPLY FERTILIZER ACCORDING TO TIME OF INSTALLATION: APRIL 1 - SEPT 31;

APPLY 10-20-10 FERTILIZER AT A RATE OF 1/2 POUND OF NITROGEN PER 1,000 S.F. OF LAWN AREA OCTOBER 1 - MARCH 31;

APPLY 16-8-8 FERTILIZER AT A RATE OF 1 POUND OF NITROGEN PER 1,000 S.F. OF LAWN AREA.

HYDROSEED AREAS WITH THE FOLLOWING GUIDELINES. BERMUDA BASE FOR APRIL 1ST-SEPTEMBER 30TH & FESCUE/RYE MIX FOR OCTOBER 1ST THRU MARCH 31ST. PRIOR TO APPLICATION, ROUGHEN THE SLOPE, FILL AREA, OR AREA TO BE SEEDED WITH THE FURROWS TRENDING ALONG THE CONTOURS. ROLLING WITH A CRIMPING OR PUNCHING TYPE ROLLER OR TRACK WALKING IS REQUIRED ON ALL SLOPES PRIOR TO HYDRO-SEEDING. TRACK WALKING SHALL ONLY BE USED WHERE OTHER METHODS ARE IMPRACTICAL. APPLY A STRAW MULCH TO KEEP SEEDS IN PLACE AND TO MODERATE SOIL MOISTURE AND TEMPERATURE UNTIL THE SEEDS GERMINATE AND GROW.

# **GRADING**

PROVIDE POSITIVE DRAINAGE AWAY FROM BUILDING AND OUT OF PLANTING BEDS. GRADING SHALL BE PERFORMED TO PREVENT PONDING IN LAWN AREAS. PROVIDE A SMOOTH TRANSITION BETWEEN THE SITE AND ADJACENT PROPERTIES.

# IRRIGATION

ALL DESIGNATED AREAS OF THE SITE ARE TO BE IRRIGATED WITH A FULLY AUTOMATIC PERMANENT UNDERGROUND IRRIGATION SYSTEM. REFER TO IRRIGATION PLANS FOR DETAILED IRRIGATION SYSTEM DRAWINGS. COORDINATE WITH LANDSCAPE INSTALLATION. PROVIDE AN AS-BUILT IRRIGATION DOCUMENT FOR OWNER'S FILE WHEN COMPLETED



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# VINGTON WOODS APARTMENTS

REVISIONS:
# DATE DESCRIPTION

PLANS

DATE: 09.18.2023

PROJECT # 23038

DESIGN: BN

DRAWN: BN

CHECKED: DA

SHEET TITLE

LANDSCAPE DETAILS
& NOTES

CP-2