44 East Flint

New Construction 44 E. Flint St. Lake Orion, MI 48362

General Scope of Work

- 1. New construction of a 4 story mixed-use building
- 2. General site improvements

<u>Owner</u>

J.S. Capitol Group 155 Romeo Rd., Suite 300 Rochester, MI 48307

Architect

Krieger | Klatt Architects Inc. (Jeff Klatt, R.A.) 400 E. Lincoln Áve. Ste. A Royal Oak, MI 48067 P.248.414.9270 F.248.414.9275

Civil


Stonefield Engineering & Design 555 S. Old Woodward Ave. Ste. 12L Birmingham, MI 48009 P.248.247.1115


	Sheet Index				
Sheet Number	Sheet Name	2024.05.06 - SPA	2024.06.24 - Discussion Item	1	2024.09.03 - BZA Submittal
G.001	Cover Sheet	•	•	•	•
1 of 1	Topographic Survey	•	•		
C.100	Architectural Site Plan	•	•	•	•
C.102	Photometric Plan	•	•	•	•
A.101	First Floor Plan	•	•	•	•
A.102	Second-Third Floor Plans	•	•		•
A.103	Fourth Floor Plan	•	•		•
A.200	Exterior Elevations	•	•	•	•
A.201	Exterior Elevations	•	•		•
A.300	Exterior Renderings	•	•	•	•
A.301	Exterior Renderings		•	•	•



View of front facade from E. Flint St.



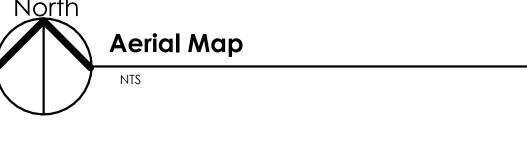

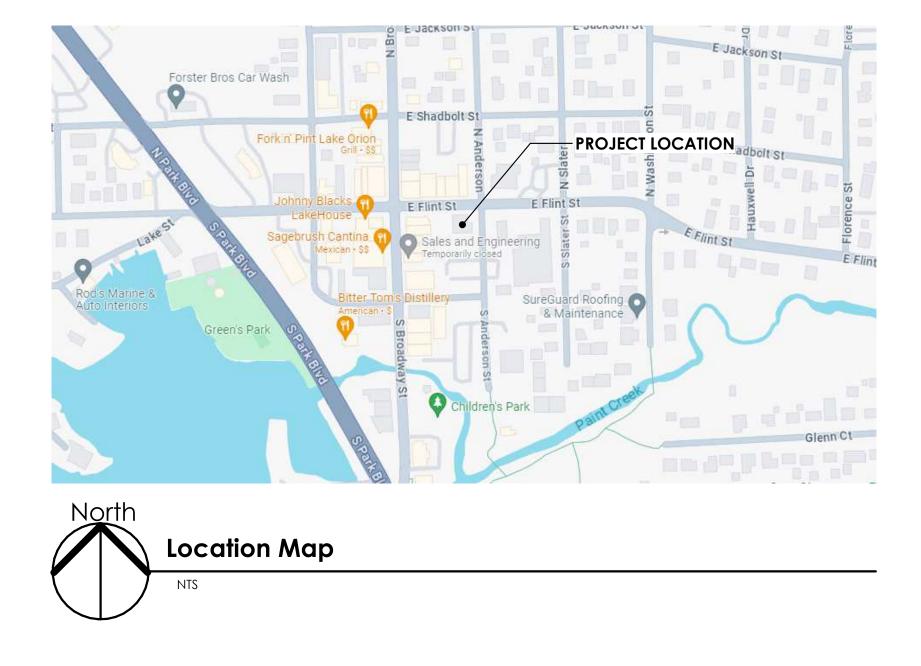

KRIEGER KLATT ARCHITECTS

400 E. Lincoln, Ste. A | Royal Oak, MI 48067 **P:** 248.414.9270 **F:** 248.414.9275 www.kriegerklatt.com

<u>Client:</u>

J.S. Capitol Group 155 Romeo Rd., Suite 300 Rochester, MI 48307

Project: 44 East Flint **V**ST

Issued	Description	В
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06.24.2024	Discussion Item	
07.08.2024	SPA - Rev. 1	
09.03.2024	BZA Submittal	

Seal:



– Note:

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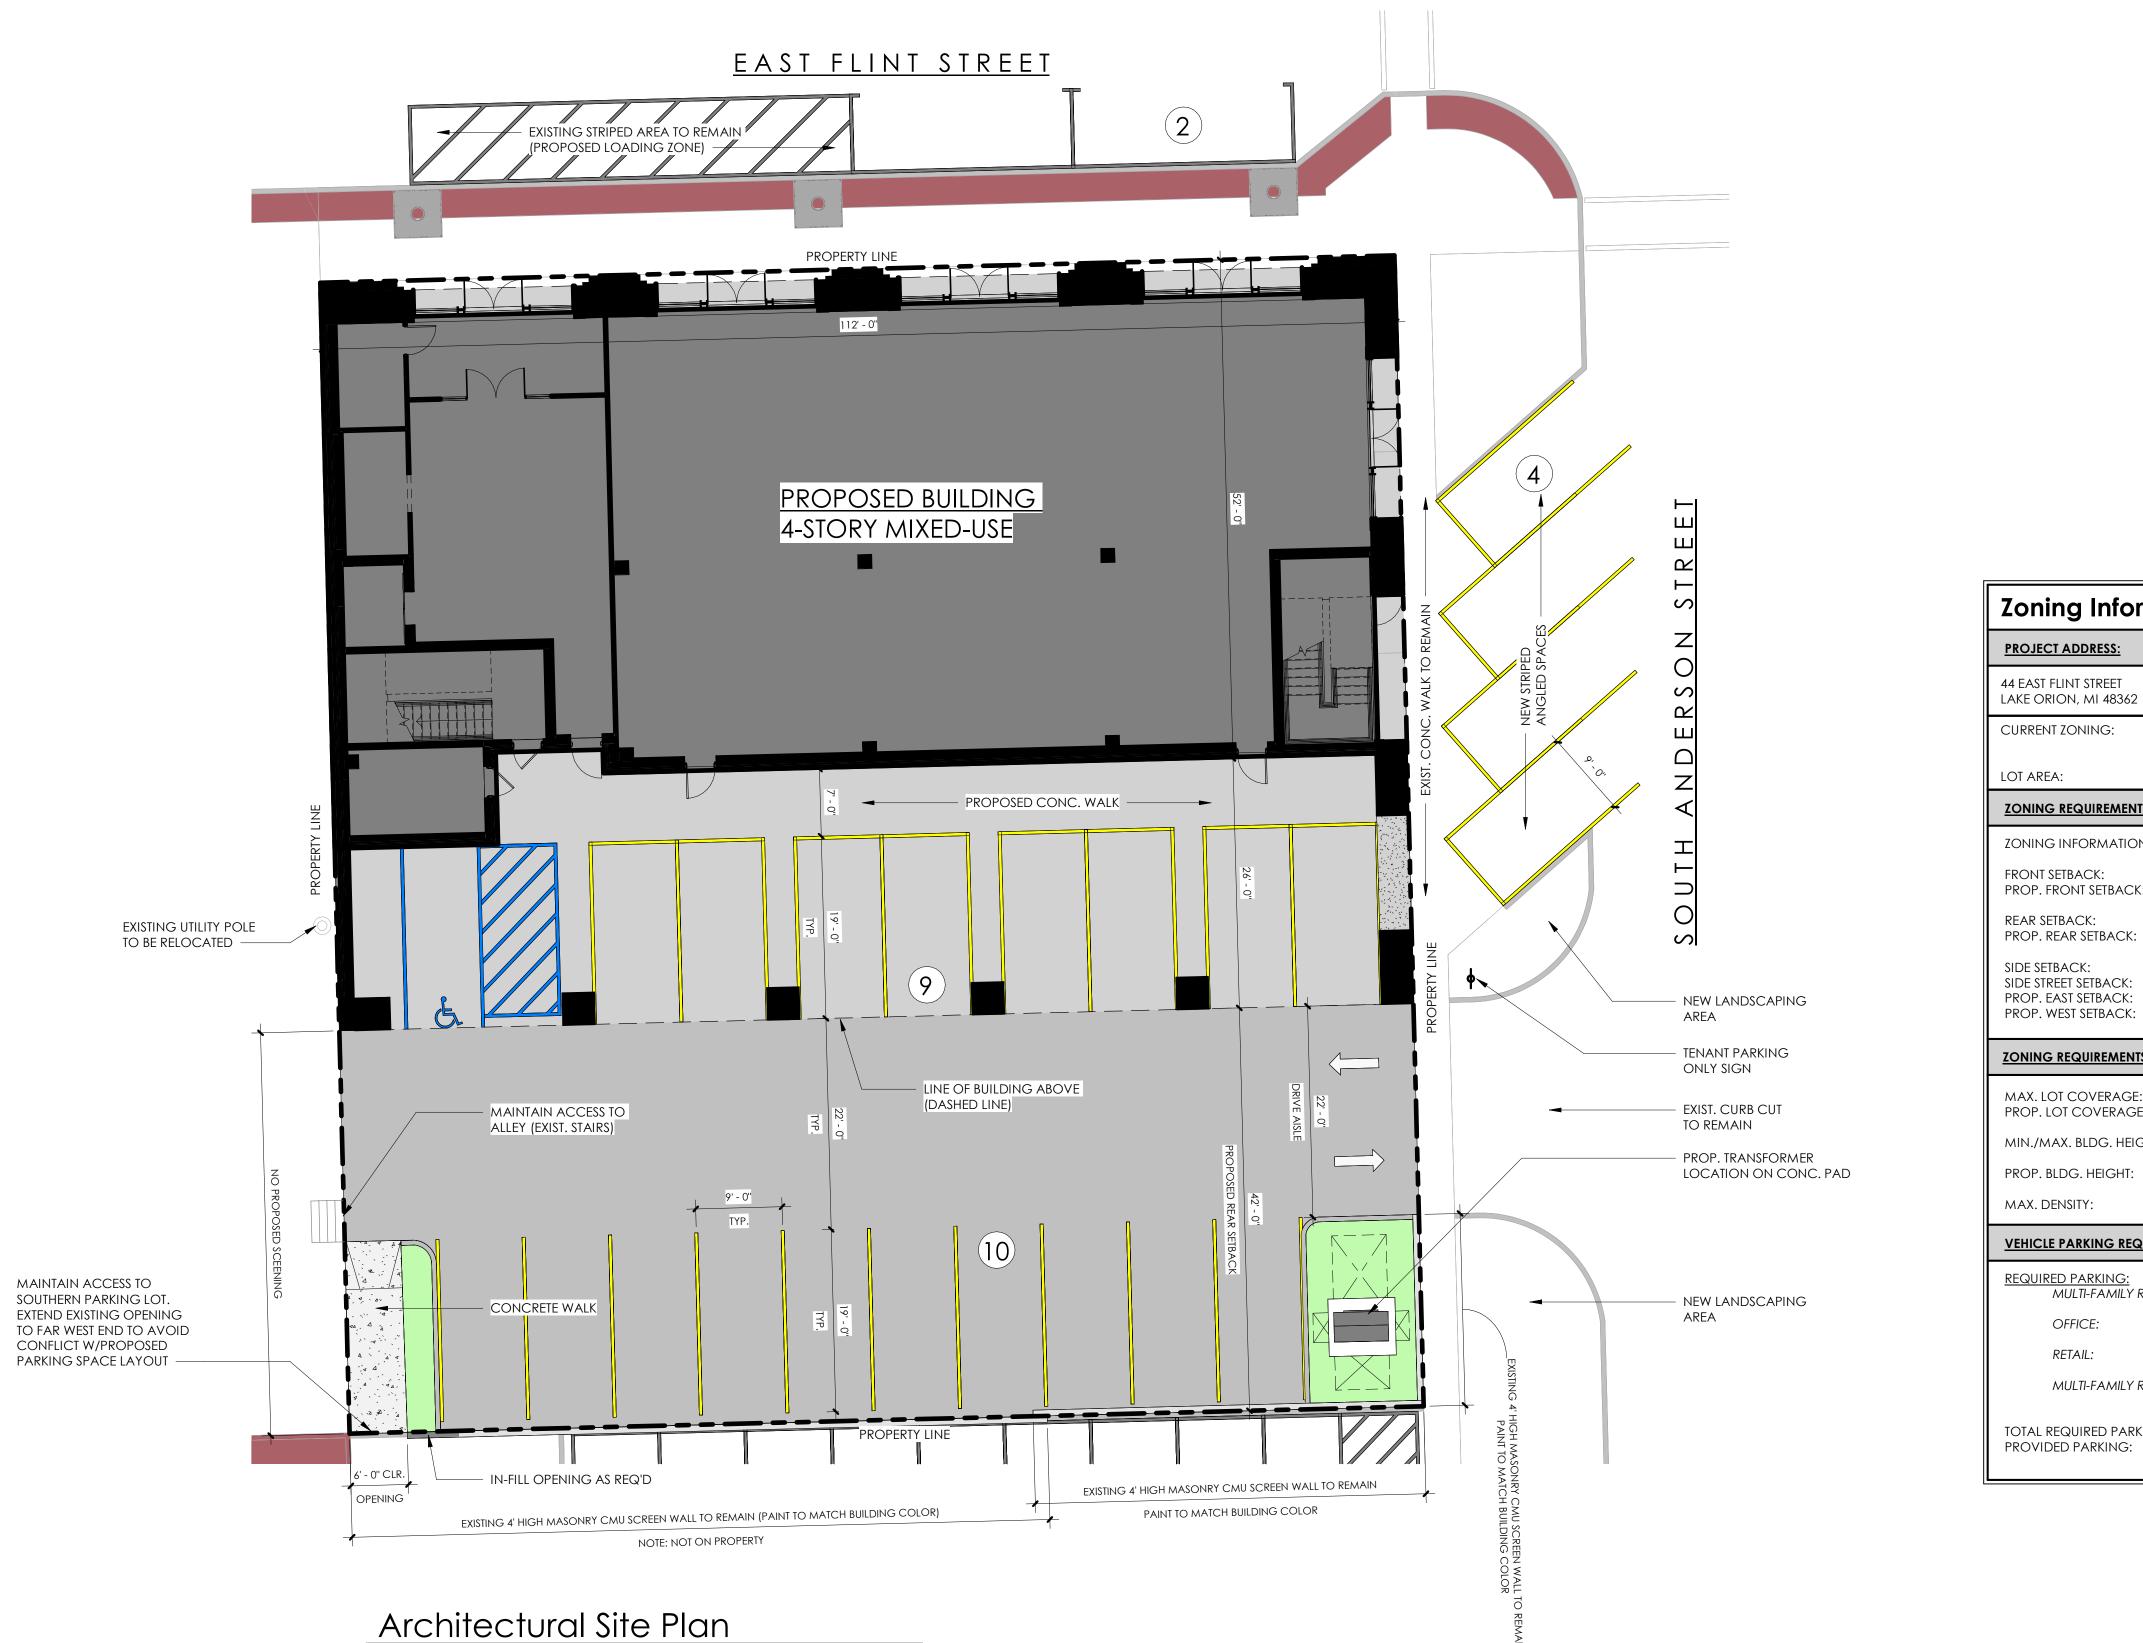
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Sheet Title: Cover Sheet

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Sheet Number:



1'' = 10'-0''

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2		
	OWNTOWN CENT GHT OVERLAY D	
13,440 \$	SQ.FT. (0.31 ACR	ES)
<u>NTS:</u>		
ON BELOV	v is based on d	C ZONING DISTRICT
CK:	0' MINIMUM, 1 0'-0''	0' MAXIMUM
<:	0' MINIMUM 42'-0"	
	10' MINIMUM 0'MINIMUM, 10 0'-0'' 0'-0'')' MAXIMUM
NTS (CONT	<u>.):</u>	
GE: GE:	100% 8,386 / 13,440 =	= 62.4%
ight:	3-STORIES; 36'-0 4-STORIES; 52'-0 4-STORIES; 52'-)" (HEIGHT OVERLAY DISTRICT)
	NONE	
QUIREME	NTS:	
resident	ΠAL:	2 SPACE PER UPPER LEVEL DWELLING UNIT
		NONE REQUIRED IN DC ZONING DISTRICT
		NONE REQUIRED IN DC ZONING DISTRICT
(resident	ΠAL:	10 UNITS X 2 =20 SPACES 20 SPACES REQUIRED
rking: :		20 PARKING SPACES 19 PARKING SPACES

KRIEGER KLATT Architects 400 E. Lincoln, Ste. A | Royal Oak, MI 48067 **P:** 248.414.9270 **F:** 248.414.9275 www.kriegerklatt.com

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J.S. Capitol Group 155 Romeo Rd., Suite 300 Rochester, MI 48307

Project:

44 East Flint 44 East Flint St. Lake Orion, MI 48362

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07.08.2024	SPA - Rev. 1	
09.03.2024	BZA Submittal	
03.03.2024	DZA Submittai	
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Seal:



Note:

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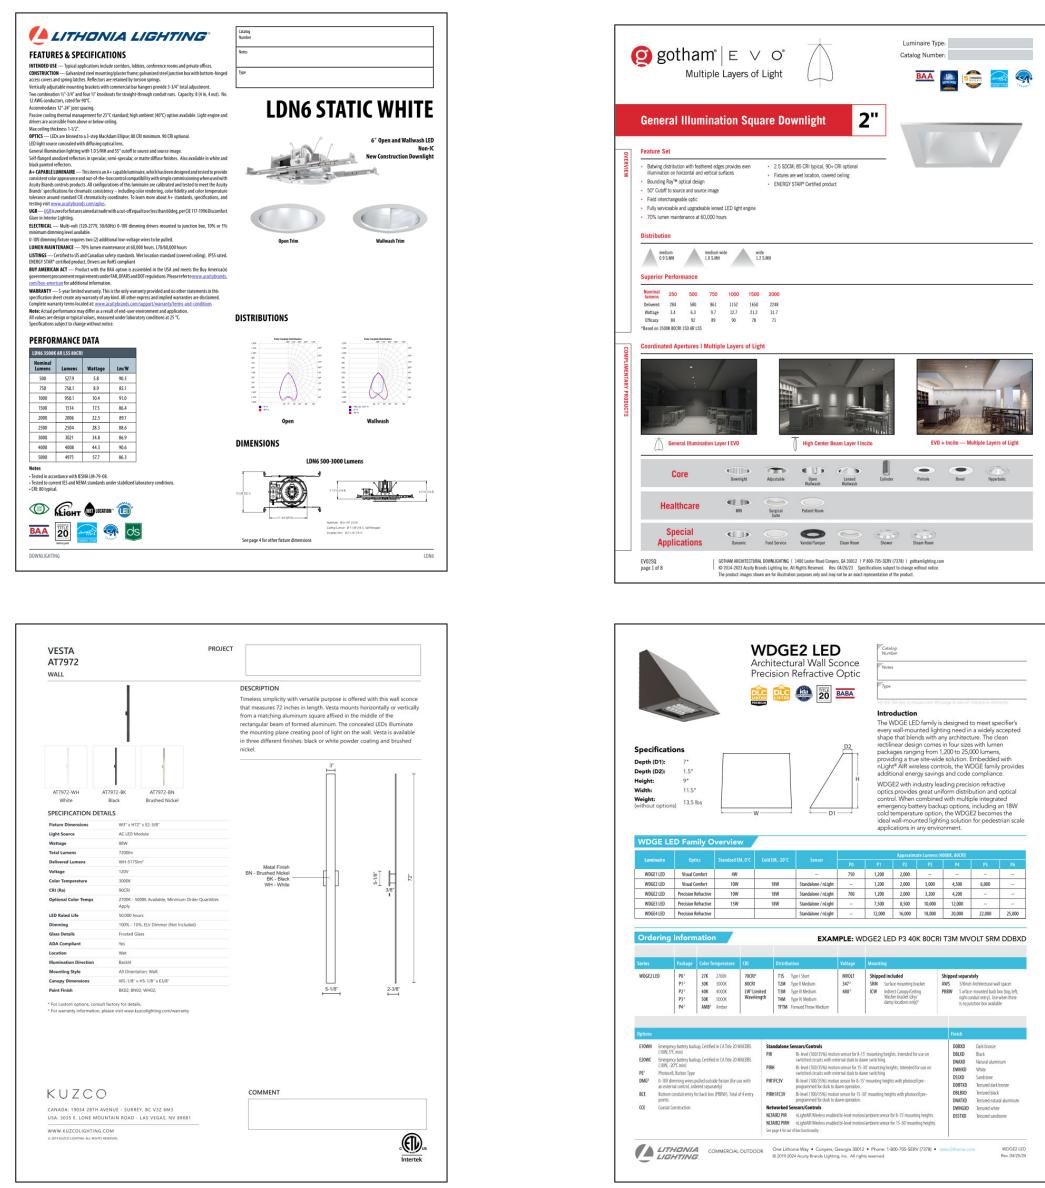
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Architectural Site Plan

Project Number: Project Number Scale:

Sheet Number:



Statistics Description	Symbol	Avg	Max	Min	Max/Min	Avg/Min
Parking Area	*	1.9 fc	7.4 fc	0.4 fc	18.5:1	4.8:1
Parking Property Line	+	0.5 fc	0.8 fc	0.2 fc	4.0:1	2.5:1
Overall		0.8 fc	7.4 fc	0.0 fc	N/A	N/A

General Note

- 1. SEE SCHEDULE FOR LUMINAIRE MOUNTING HEIGHT.
- 2. SEE LUMINAIRE SCHEDULE FOR LIGHT LOSS FACTOR.
- 3. CALCULATIONS ARE SHOWN IN FOOTCANDLES AT: 0' 0"

THE ENGINEER AND/OR ARCHITECT MUST DETERMINE APPLICABILITY OF THE LAYOUT TO EXISTING / FUTURE FIELD CONDITIONS. THIS LIGHTING LAYOUT REPRESENTS ILLUMINATION LEVELS CALCULATED FROM LABORATORY DATA TAKEN UNDER CONTROLLED CONDITIONS IN ACCORDANCE WITH ILLUMINATING ENGINEERING SOCIETY APPROVED METHODS. ACTUAL PERFORMANCE OF ANY MANUFACTURER'S LUMINAIRE MAY VARY DUE TO VARIATION IN ELECTRICAL VOLTAGE, TOLERANCE IN LAMPS, AND OTHER VARIABLE FIELD CONDITIONS. MOUNTING HEIGHTS INDICATED ARE FROM GRADE AND/OR FLOOR UP.

THESE LIGHTING CALCULATIONS ARE NOT A SUBSTITUTE FOR INDEPENDENT ENGINEERING ANALYSIS OF LIGHTING SYSTEM SUITABILITY AND SAFETY. THE ENGINEER AND/OR ARCHITECT IS RESPONSIBLE TO REVIEW FOR MICHIGAN ENERGY CODE AND LIGHTING QUALITY COMPLIANCE.

UNLESS EXEMPT, PROJECT MUST COMPLY WITH LIGHTING CONTROLS REQUIRMENTS DEFINED IN ASHRAE 90.1 2013. FOR SPECIFIC INFORMATION CONTACT GBA CONTROLS GROUP AT ASG@GASSERBUSH.COM OR 734-266-6705.

Alternates Note

THE USE OF FIXTURE ALTERNATES MUST BE RESUBMITTED TO THE CITY FOR APPROVAL.

Ordering Note


FOR INQUIRIES CONTACT GASSER BUSH AT QUOTES@GASSERBUSH.COM OR 734-266-6705.

Drawing Note

THIS DRAWING WAS GENERATED FROM AN ELECTRONIC IMAGE FOR ESTIMATION PURPOSE ONLY. LAYOUT TO BE VERIFIED IN FIELD BY OTHERS.

Mounting Height Note

MOUNTING HEIGHT IS MEASURED FROM GRADE TO FACE OF FIXTURE. POLE HEIGHT SHOULD BE CALCULATED AS THE MOUNTING HEIGHT LESS BASE HEIGHT.

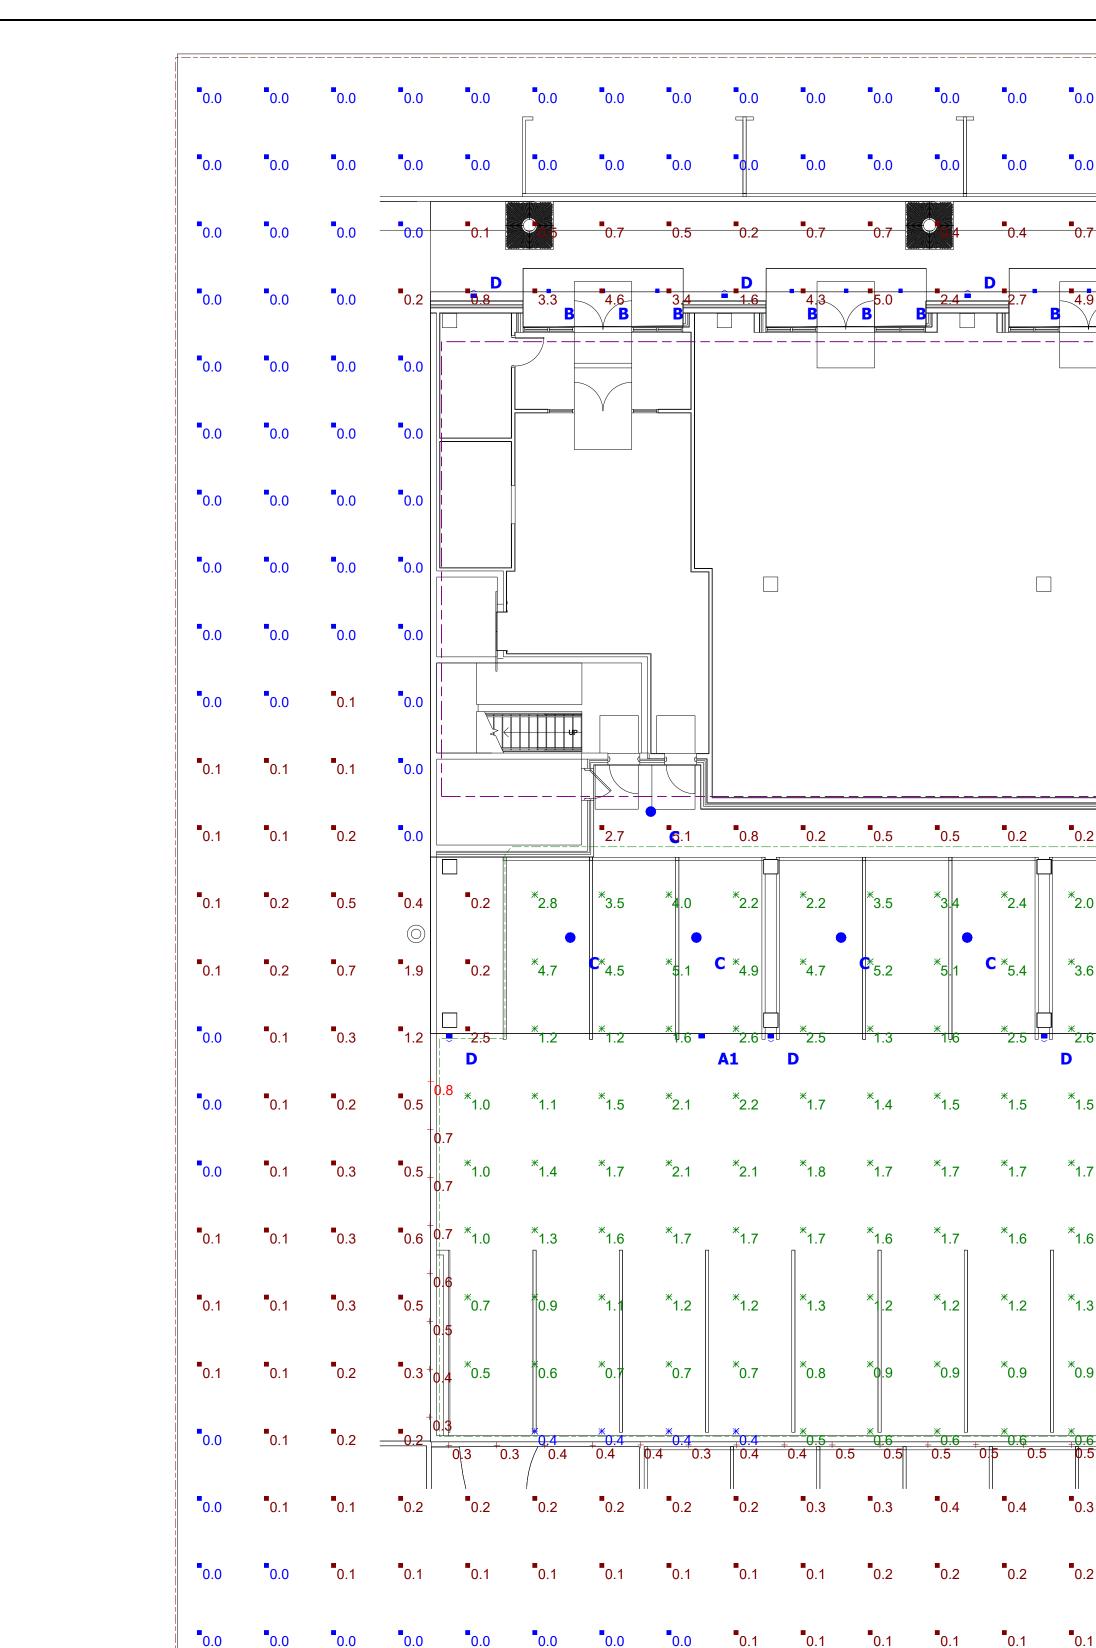

Schedul	е							
Symbol	Label	QTY	Manufacturer	Catalog	Description	Lamp Output	LLF	Input Power
	A1	2	Lithonia Lighting	WDGE2 LED P4 40K 70CRI TFTM	WDGE2 LED WITH P4 - PERFORMANCE PACKAGE, 4000K, 70CRI, TYPE FORWARD THROW MEDIUM OPTIC	4742	0.9	46.6589
	A2	1	Lithonia Lighting	WDGE2 LED P1 40K 70CRI T2M	WDGE2 LED WITH P1 - PERFORMANCE PACKAGE, 4000K, 70CRI, TYPE 2 MEDIUM OPTIC	1427	0.9	11.1658
	В	12	Gotham Architectural Lighting	EVO2SQ 40/02 AR LD WD	EVO 2 INCH RECESSED DOWNLIGHT, SQUARE, 4000K, 250 LUMENS, CLEAR, MATTE-DIFFUSE, WIDE, 80 CRI	280	0.9	3.38
	С	8	Lithonia Lighting	LDN6 40/07 LO6AR LD	6IN LDN, 4000K, 750LM, CLEAR, MATTE DIFFUSE REFLECTOR, CRI80	679	0.9	8.91
	D	13	Kuzco Lighting	AT7972-WH	Wall Mounted	5146	0.9	96.7

<u>Plan View</u> Scale - 1" = 10ft

B

0.0	•0.0	0.0	•0.0	•0.0	•0.0	0.0	●0.0 □	•0.0	0.0	0 .0	0 .0	•0.0
0.0	0.0	0.0	0 .0	•0.0 A	0.0	•0.1	0.0	0.0	0 .0	0 .0	0 .0	•0.0
0 .7	0.6	0.2	0.6	• _{0.7}	0.5	0.1	0 .1	0 .0	0.0	0 .0	0.0	•0.0
B B B	4.1 B	D 1.5	3.6	4.7 B	<u>8.1</u>	P 0.6	0.2	0 .1	0.0	0.0	0.0	•0.0
							D ^{0.2}	0.1	0 .1	0 .1	0.0	0.0
							0.1	0.1	0 .1	0 .1	0.0	0.0
							0.2	0.7	0.2	0 .1	0.0	•0.0
]							D 1.9	— 1.0	0.2	0 .1	0.0	0.0
							2.2	1.1	0.2	0 .1	0.1	0.0
							1.6	0.9	0.3	0 .1	0.1	0.0
							0.5	0.8	0.3	0.2	0.1	0 .1
0.2	0.5	0.5	0.2	0.2	2 .0	4.0	1.2	1 .0	0.4	0.2	0.1	0 .1
*2.0	*3.7	*3.2	[*] 2.8	*1.3	*4.5	*6.8	D 2.5	1.2	0.5	0.2	0 .1	•0.1
*3.6	⁶ 5.5	*4.9	C * _{6.1}	*2.3	*7.\$	*3.8	5.2	1 .4	0 .4	0.1	■ 0.1	•0.0
2.6 D	1.6	* 1.6 A1	* 2.4	■ 2.8 D	*1.4	*2.3	1.9 .8	0 .4	0.1	0.0	0.0	0.0
1.5	[] 1.9	[*] 2.2	[*] 2.0	[*] 1.5	^{**} 1.2	*0.8 +0	•	0.2	0 .1	0.0	0.0	0.0
1.7	[] 2.0	[*] 2.2	[*] 2.1	^{**} 1.6	[*] 1.3		.6 0.4	0.2	0 .1	0.0	0.0	0.0
*1.6	*1.8	*1.7	*1.7	*1.5	*1.2	* <u>0.8</u> 0	0.4	0.2	■ 0.1	0 .0	0 .0	•0.0
1.3	[] 1.3	*1.2	[*] 1.2	*1.1	* 0.8	0.6	.5 0.4	0.2	0 .1	0.0	0.0	•0.0
*0.9	*0.8	*0.7	*0.7	*0.7	0.6	0 .4 0.4	4 0.3 3	0.2	0 .1	0.0	0.0	•0.0
<u>*</u> <u>+0.6</u> ↓0.5	0.5 0.5 0.5	<u>.*</u> 0.4 0.4	* <u>+4</u> 0.4	0.4 0.4 0.4	+0.4 	0.3 0.3	0.2	0.1	0 .1	0.0	0.0	0.0
0.3	0 .3	0.2	0.2	0.2	0.2	0.2	• 0.1	•0.1	0 .1	0.0	0.0	0.0
0.2	0.1	0.1	•0.1	0 .1	0 .1	0.1	0 .1	0 .1	0.0	0.0	0.0	0.0
0 .1	•0.1	0.0	0 .0	0.0	0.0	0.0	0.0	0.0	0.0	0.0	0.0	•0.0
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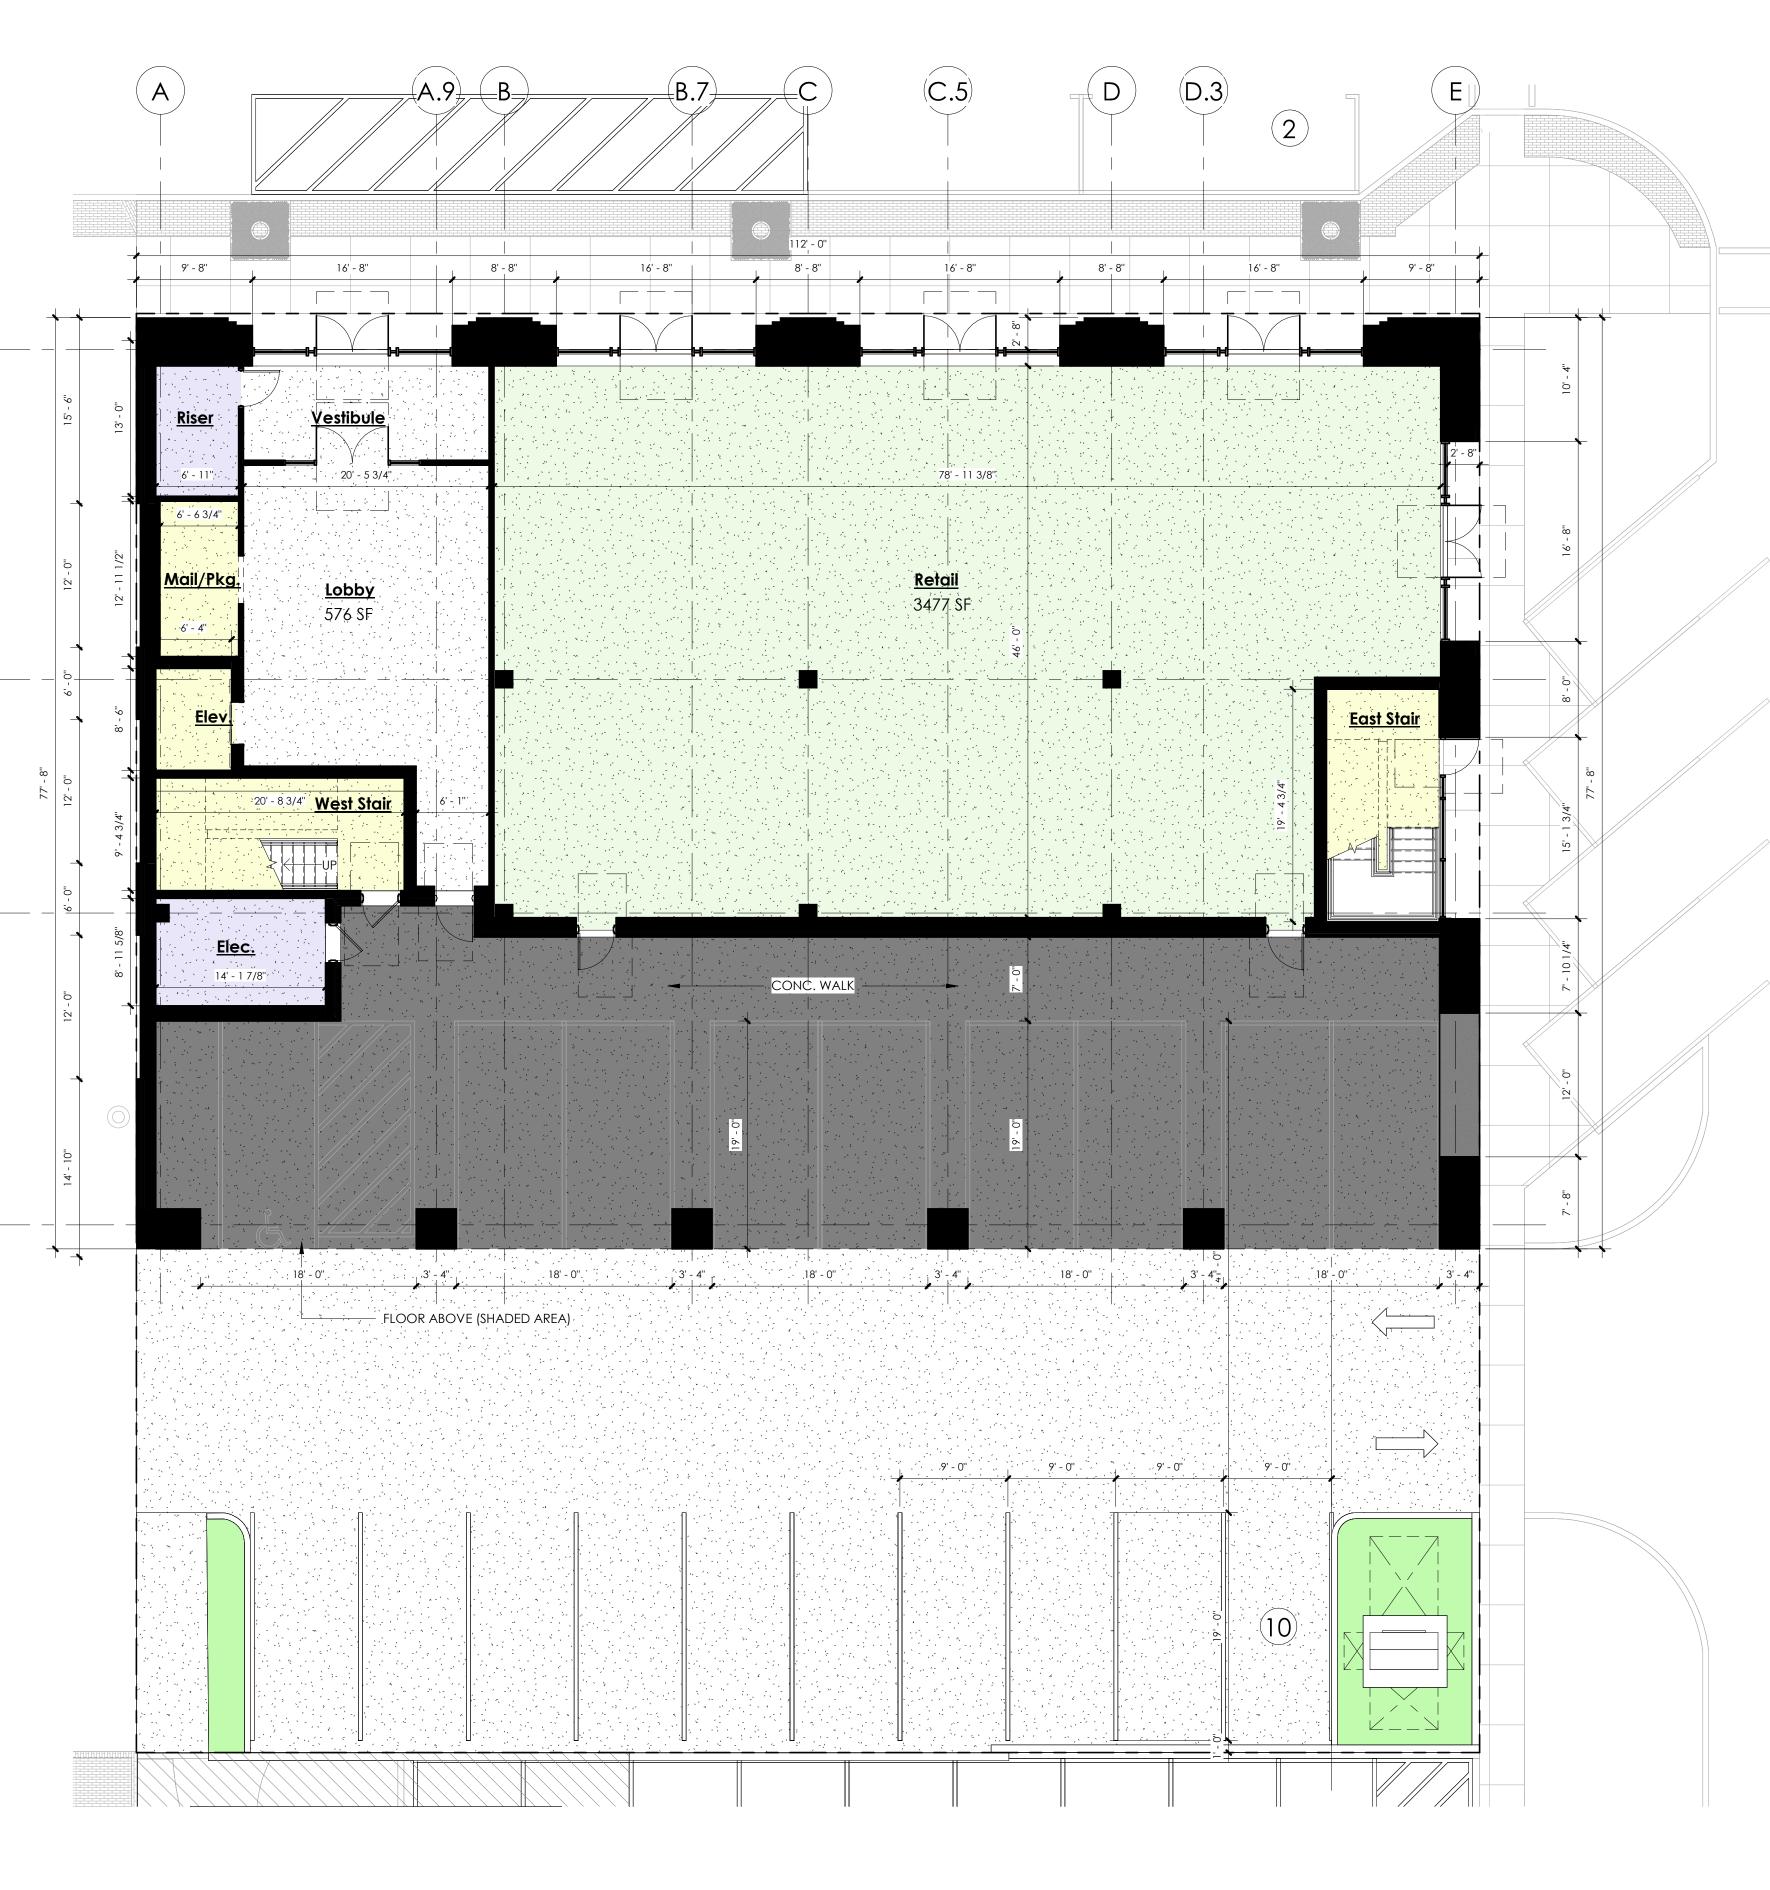
UT ATES COM 44 E FLINT PHOTOMETRIC LAYOU GASSER BUSH ASSOCIA WWW.GASSERBUSH.CO

Designer KS Date 05/03/2024 Scale Not to Scale Drawing No. #24-29039_V1

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First Floor Plan

Project: 44 East Flint 44 East Flint St. Lake Orion, MI 48362 $\mathbf{\mathcal{L}}$ _ 5 $\mathbf{\mathcal{L}}$ Ш Note: $\mathbf{\mathcal{L}}$

Issued Description By 05.06.2024 SPA 06.24.2024 Discussion Item 07.08.2024 SPA - Rev. 1 09.03.2024 BZA Submittal

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<u>Client:</u>

J.S. Capitol Group 155 Romeo Rd., Suite 300 Rochester, MI 48307

unit mix	r •
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	1 bedroom	2 BEDROOM	Т
3RD FLOOR	1 UNITS	4 UNITS	Ľ
4TH FLOOR	1 UNITS	4 UNITS	Ľ
TOTAL	2 UNITS	8 UNITS	1



TOTAL 5 UNITS 5 UNITS 10 UNITS

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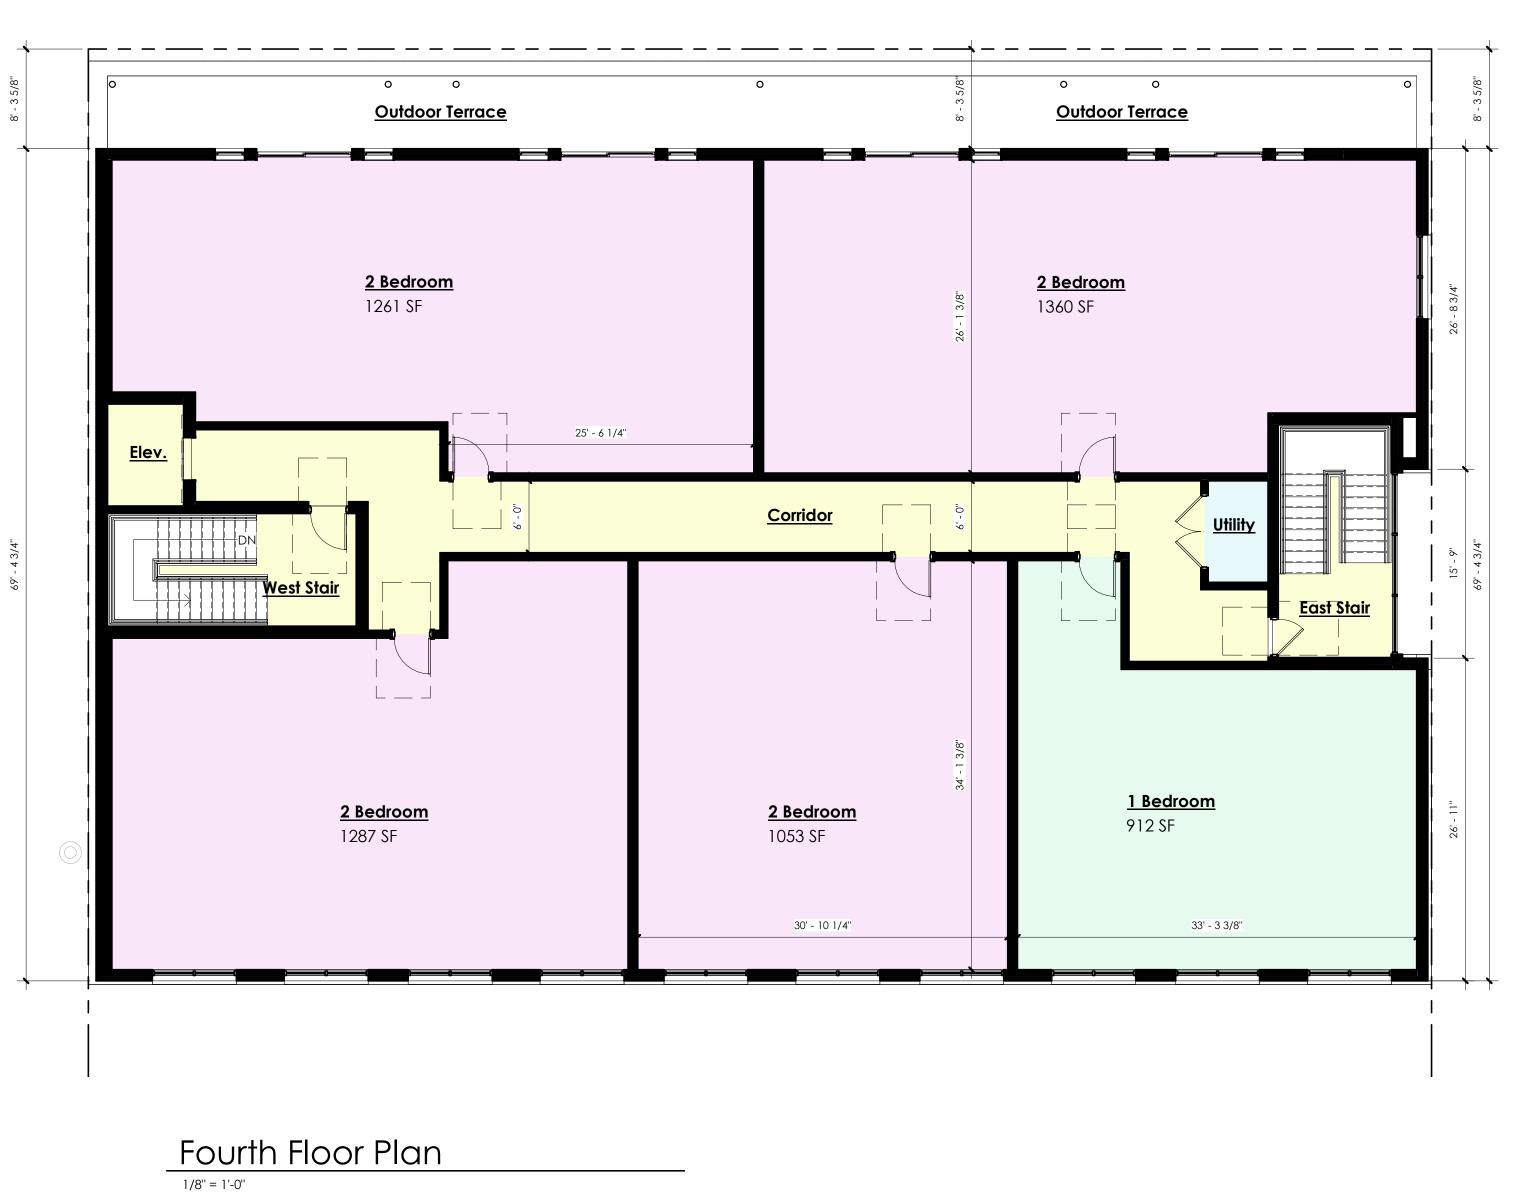
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Second-Third Floor Plans

Project Number: Project Number Scale:

Sheet Number:





UNIT MIX							
	1 bedroom	2 BEDROOM	TOTAL				
3RD FLOOR	1 UNITS	4 UNITS	5 UNITS				
4TH FLOOR	1 UNITS	4 UNITS	5 UNITS				
TOTAL	2 UNITS	8 UNITS	10 UNITS				

Project: 44 East Flint 44 East Flint St. Lake Orion, MI 48362 Ζ Note: field. $\mathbf{\mathcal{L}}$


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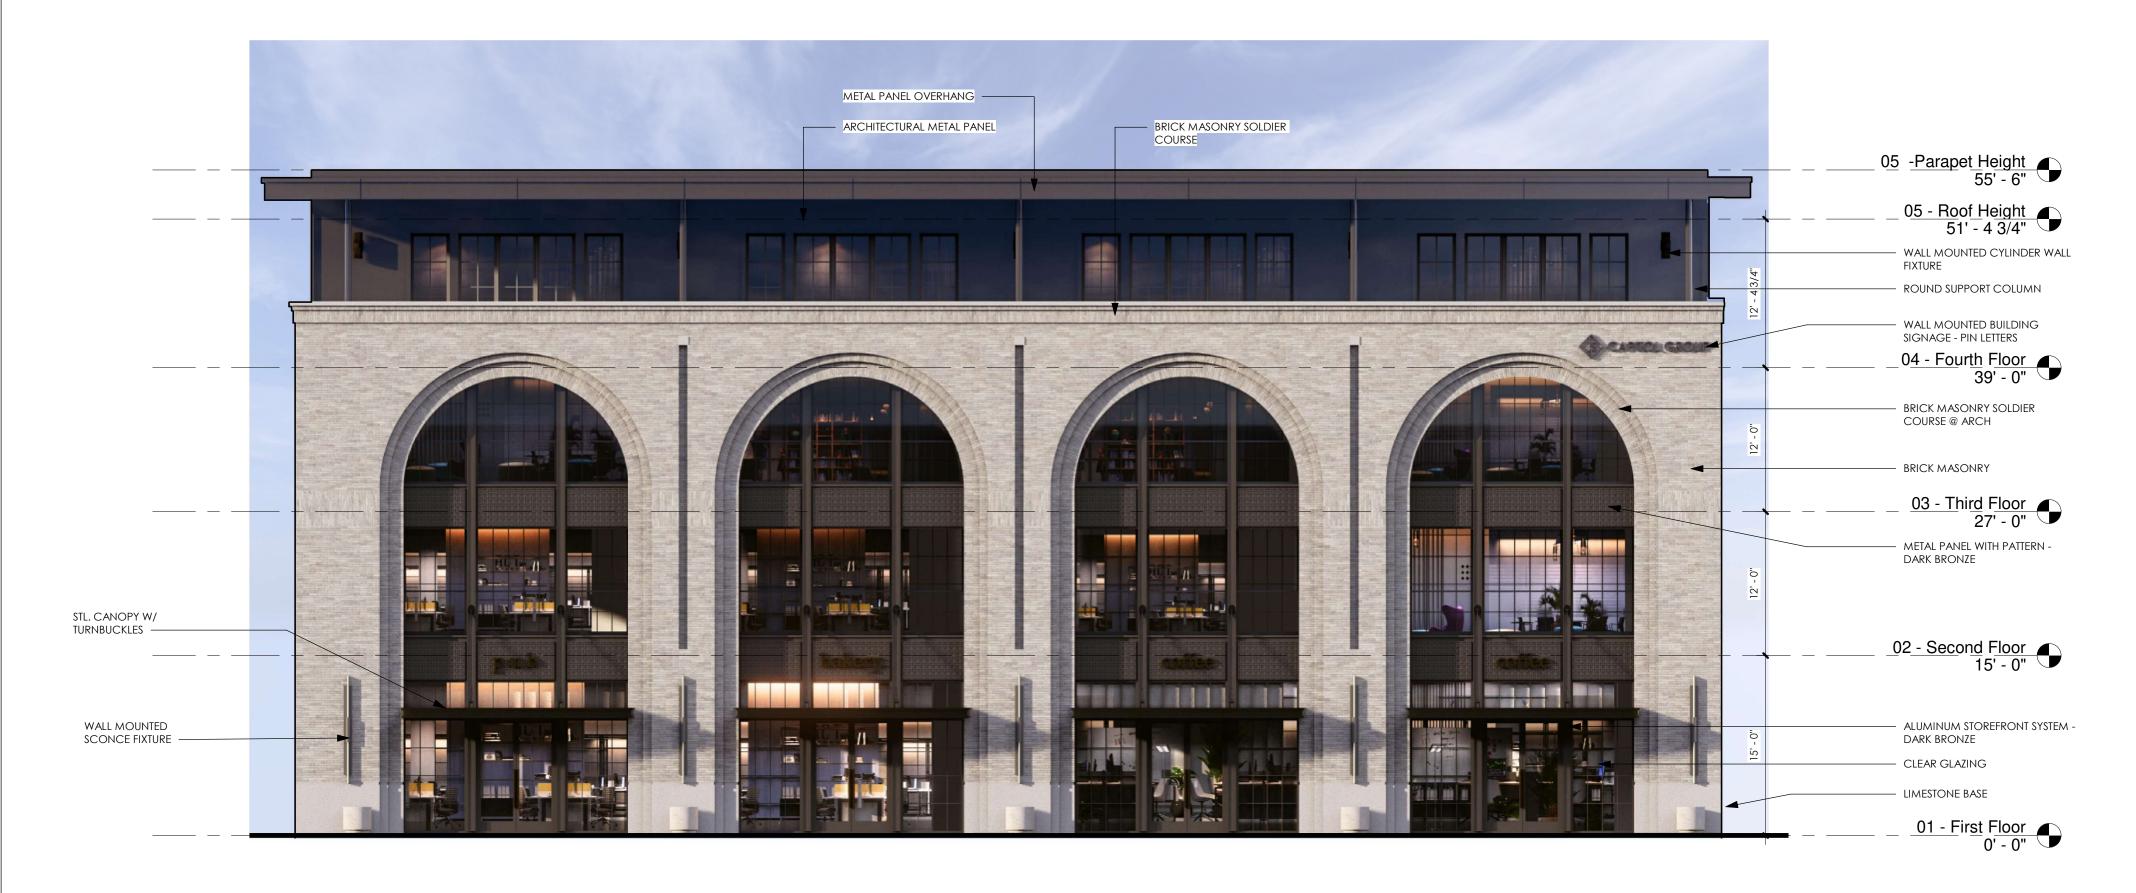
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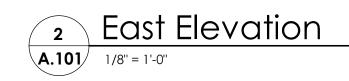
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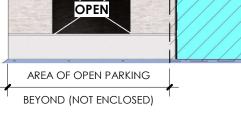











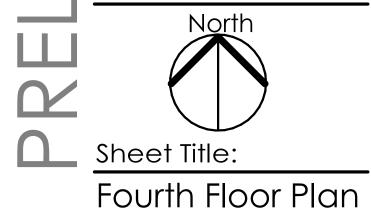

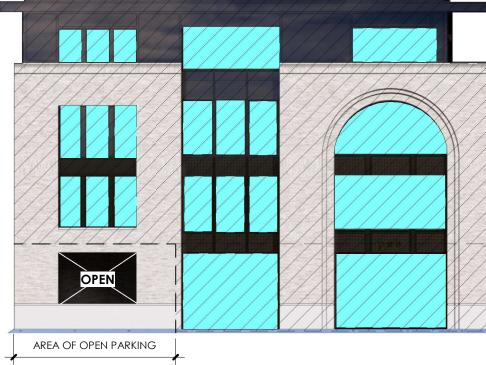

- 3. GLAZING PERCENTAGE:

North Elevation 1/16'' = 1'-0''

__05_ -<u>Parapet Height</u> 55' - 6"

_0<u>5 - Roof Height</u> 51' - 4 3/4"

- BRICK MASONRY SOLDIER COURSE @ ARCH

_04 - Fourth Floor 39' - 0"

03 - Thir<u>d Floor</u> 27' - 0"

ARCHITECTURAL METAL PANEL

ALUMINUM STOREFRONT SYSTEM -

BRICK MASONRY


02 - Second Floor 15' - 0"

DARK BRONZE

- CLEAR GLAZING

LIMESTONE BASE

01 - First Floor 0' - 0"

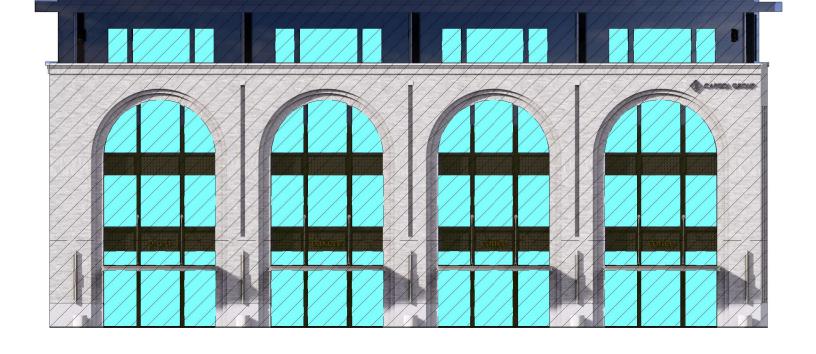

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seal.

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North Arrow:

Sheet Title: Exterior Elevations

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Scale:

Sheet Number:

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793 SQ. FT. 422 SQ. FT. (422 / 793)

3,292 SQ. FT. 1,060 SQ. FT. (1,060 / 3,292)

GLAZING PERCENTAGE (NORTH ELEVATION): 1. OVERALL FIRST FLOOR FACADE AREA : 2. OVERALL WINDOW AREA :

1,732 SQ. FT.

932 SQ. FT.

(932 / 1,855)

4,837 SQ. FT.

1,552 SQ. FT.

(1,552 / 4,837)

50.2% PROPOSED > 50% REQUIRED

32% PROPOSED > 30% REQUIRED

3. GLAZING PERCENTAGE:

4. OVERALL UPPER FLOOR FACADE AREA:


5. OVERALL WINDOW AREA 6. GLAZING PERCENTAGE:

GLAZING PERCENTAGE (EAST ELEVATION): 1. OVERALL FIRST FLOOR FACADE AREA :


2. OVERALL FIRST FLOOR WINDOW AREA :

4. OVERALL UPPER FLOOR FACADE AREA: 5. OVERALL UPPER FLOOR WINDOW AREA 6. GLAZING PERCENTAGE:

53.2% PROPOSED > 50% REQUIRED 32% PROPOSED > 30% REQUIRED

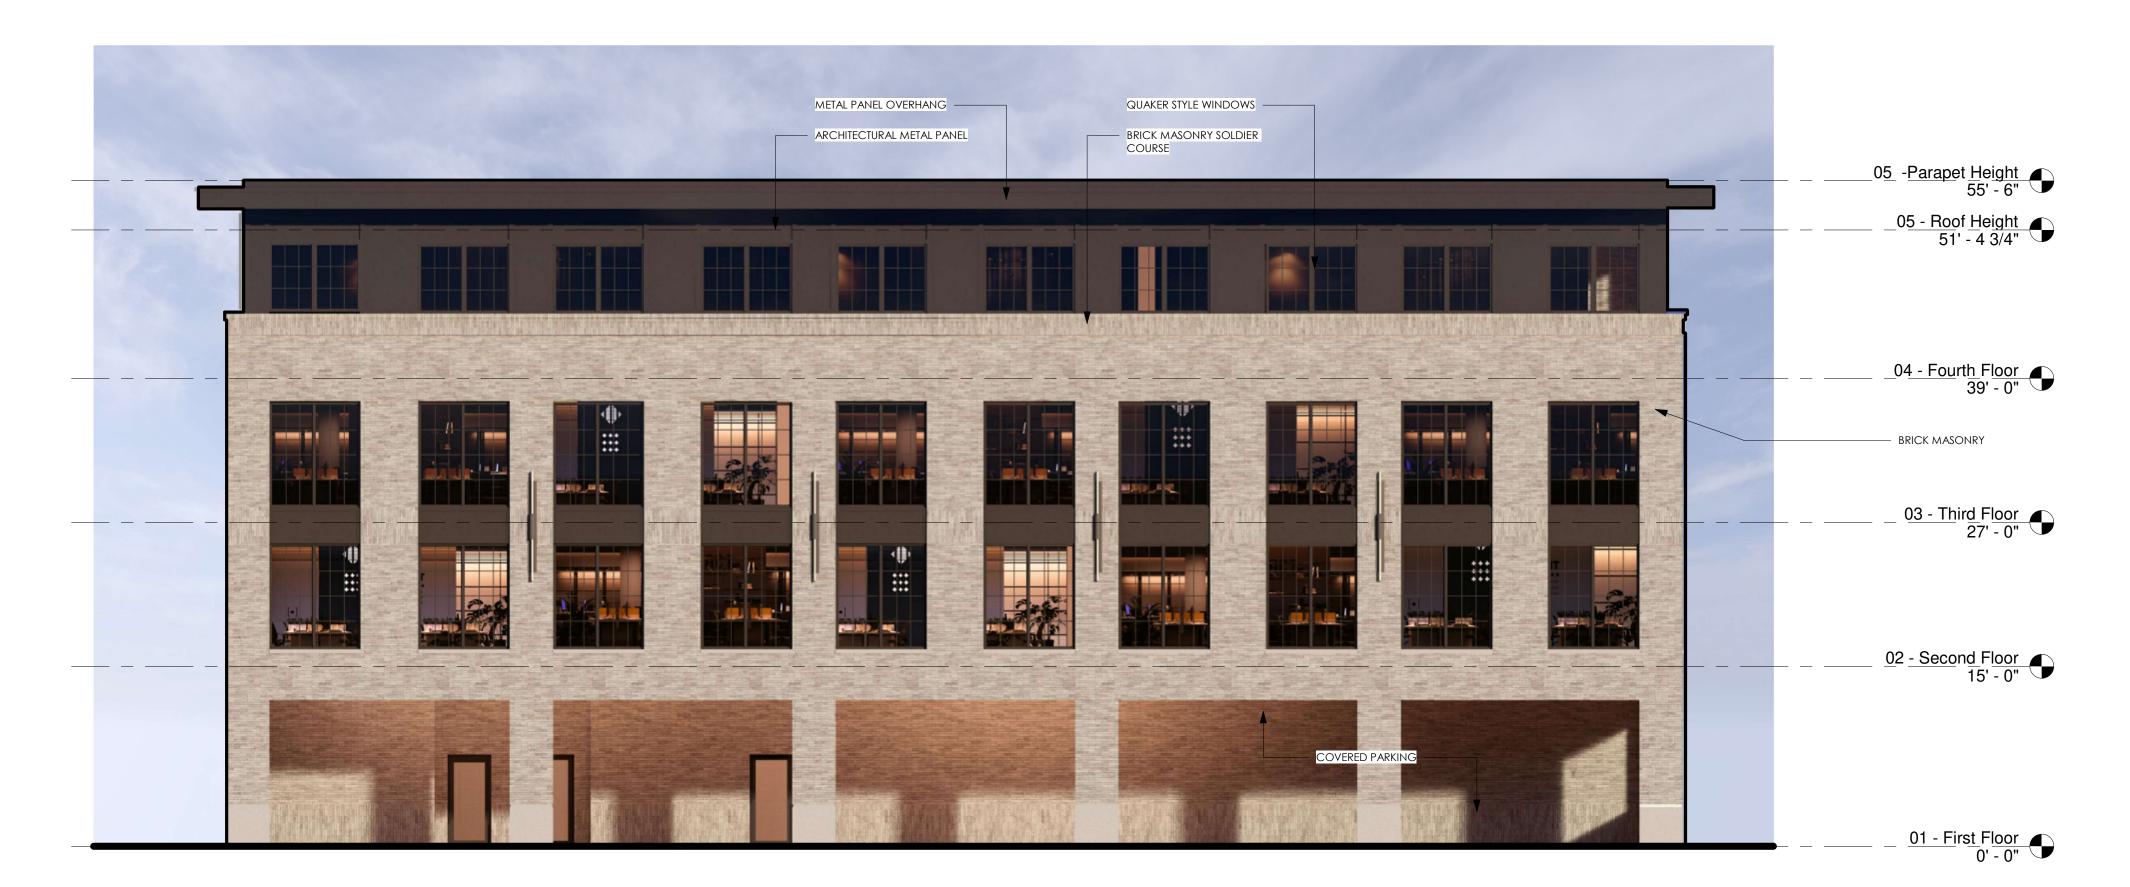



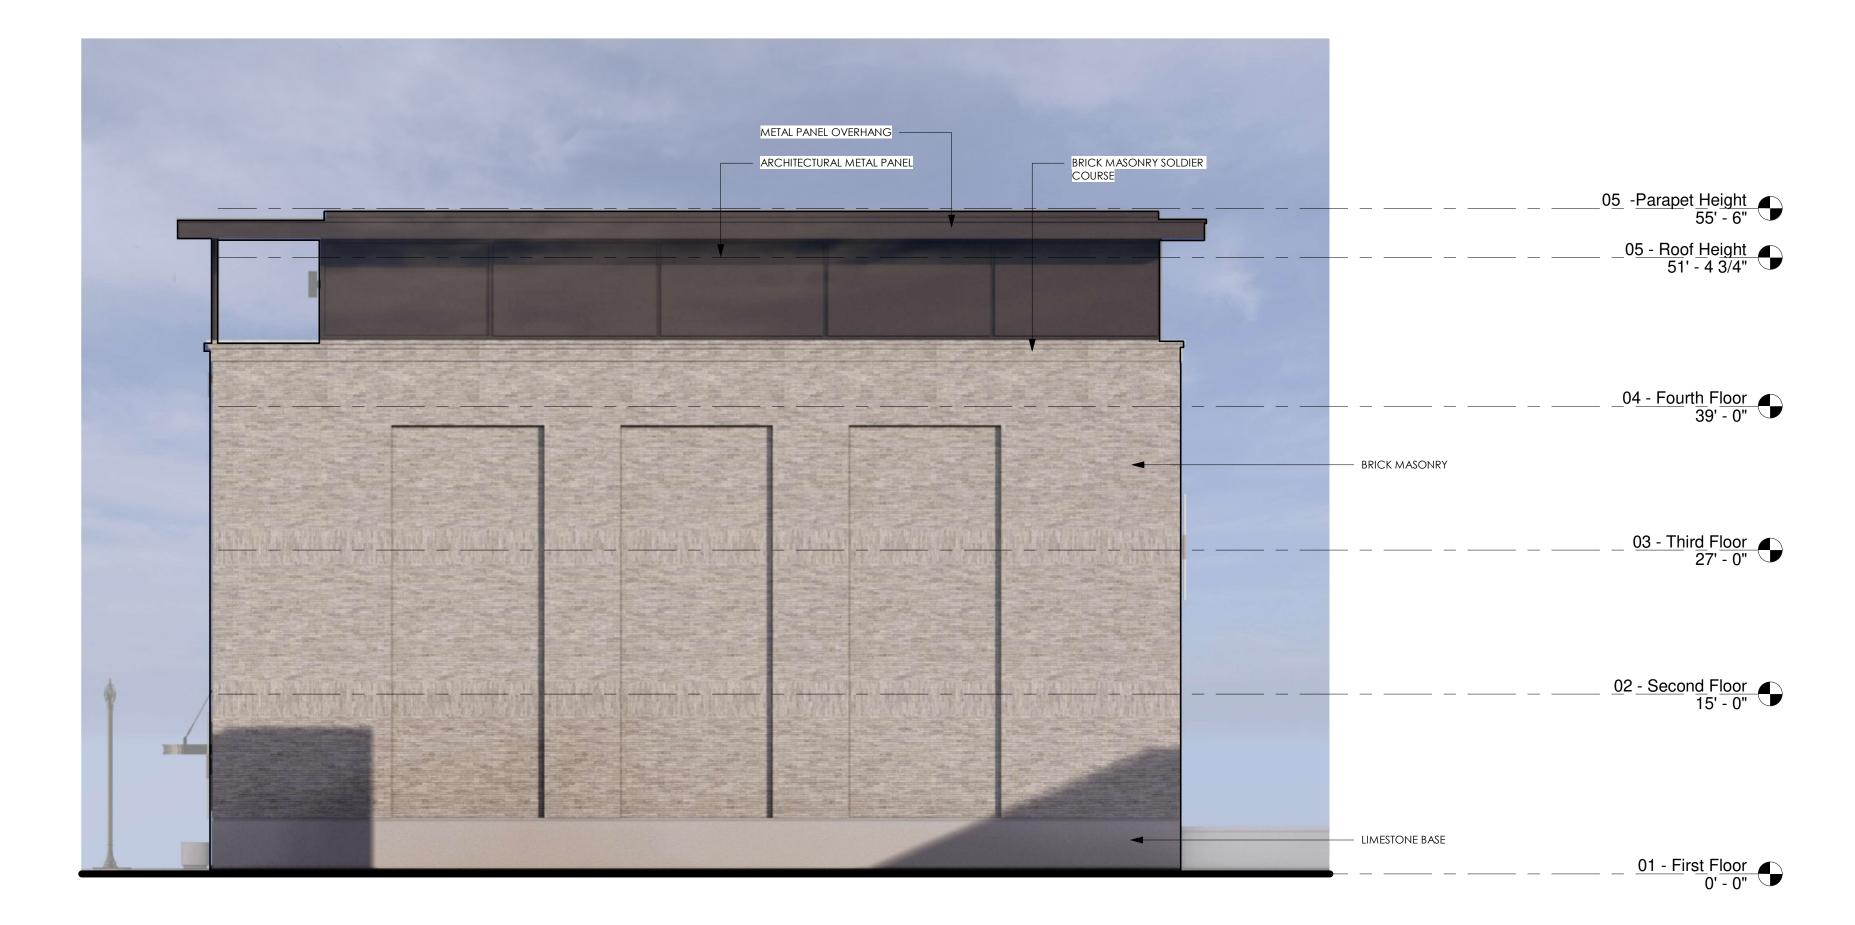



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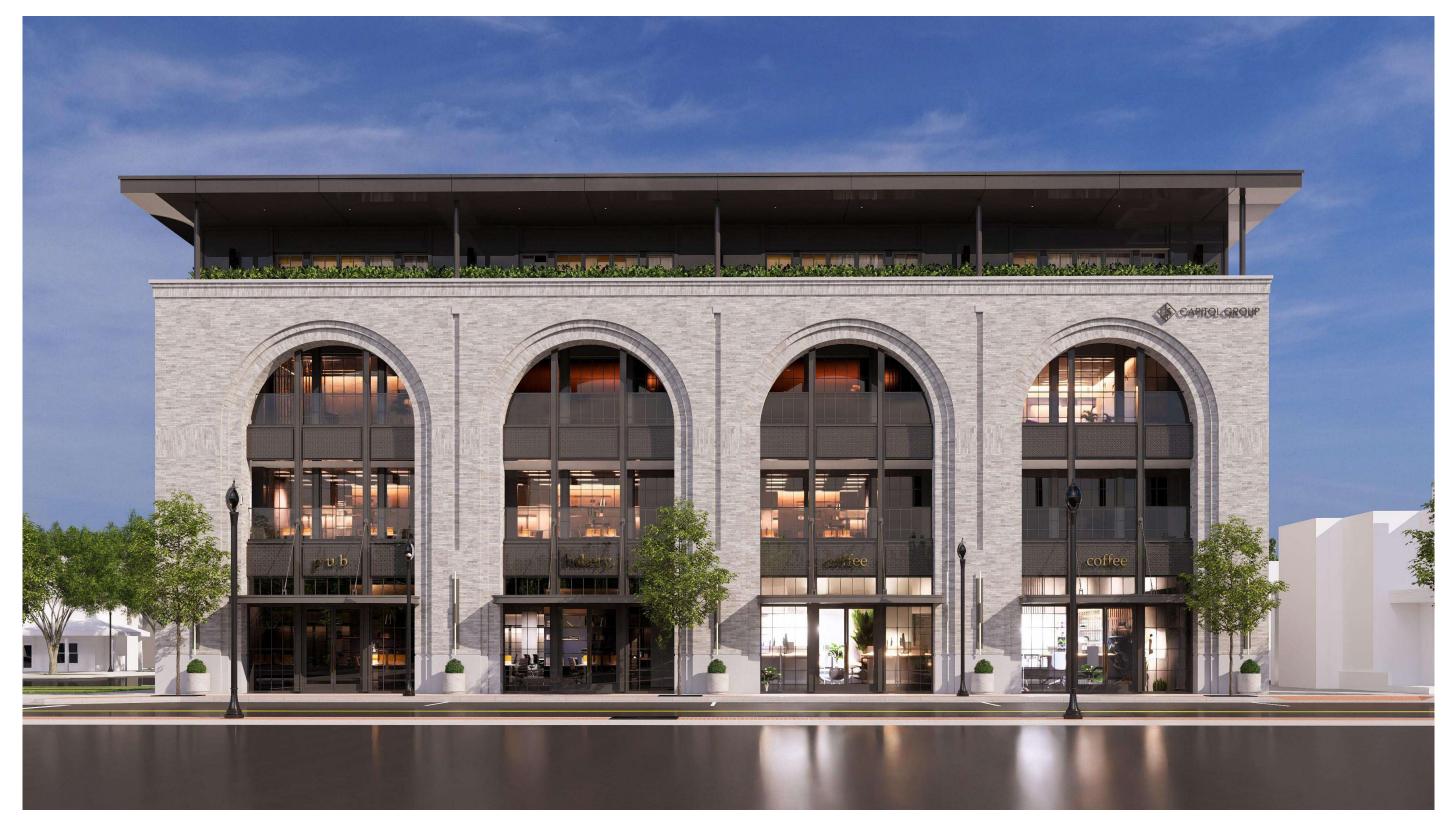
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Sheet Title: Exterior Elevations

Project Number: Project Number Scale:

Sheet Number:

 $\mathbf{\mathcal{L}}$ **JST** $\mathbf{\mathcal{L}}$ Note:



View of front facade from E. Flint St.



View across front facade from parking



View from intersection of S. Anderson St. and E. Flint St.



View of commercial space entry

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North Arrow:

Sheet Title: Exterior Renderings

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View of front facade from E. Flint St.



View of West facade



View of signage



View of back facade

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North Arrow:

Sheet Title: Exterior Renderings

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Sheet Number: A.30



44 EAST FLINT STREET PROPOSED MIXED-USE BUILDING

LOCATION MAP SCALE: I" = 800'±




AERIAL MAP SCALE: I" = 50'±



SITE DEVELOPMENT PLANS FOR

PARCEL ID: 09-02-481-007 & 09-02-481-008 44 EAST FLINT STREET VILLAGE OF LAKE ORION OAKLAND COUNTY, MICHIGAN

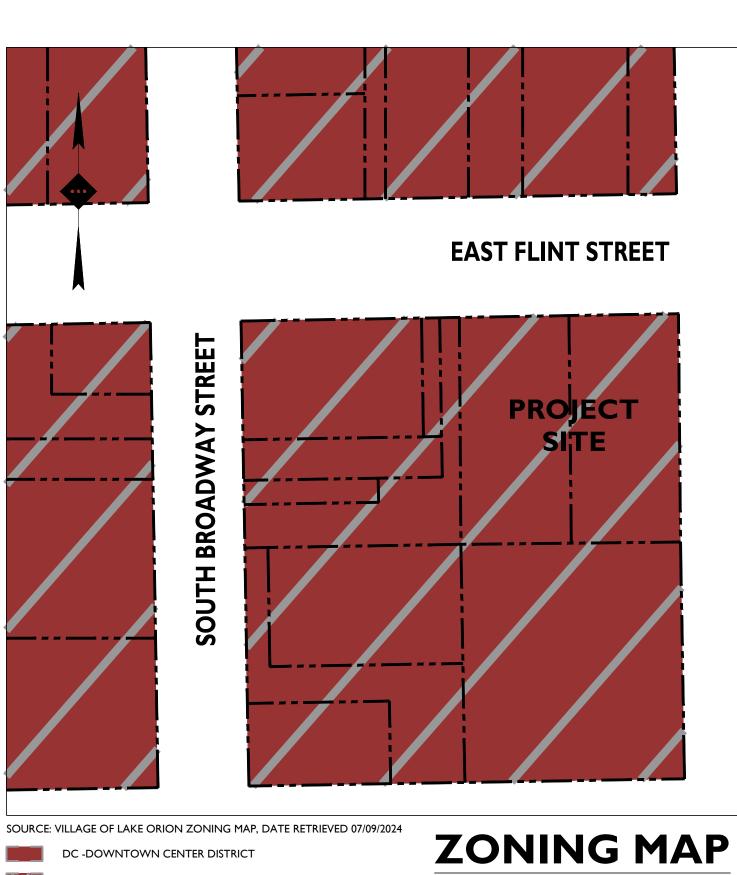

DC - DOWNTOWN CENTER DISTRICT W/ HEIGHT OVERLAY

PLANS PREPARED BY:



Birmingham, MI \cdot New York, NY \cdot Salem, MA Princeton, NJ \cdot Tampa, FL \cdot Rutherford, NJ www.stonefieldeng.com


555 S. Old Woodward, Suite 12L, Birmingham, MI 48009 Phone 248.247.1115

PLAN REFERENCE MATERIALS:

I. THIS PLAN SET REFERENCES THE FOLLOWING DOCUMENTS INCLUDING, BUT NOT LIMITED TO: TOPOGRAPHICAL SURVEY PREPARED BY AB-SB LAND

SCALE: $I'' = 50' \pm$

- SURVEY, P.C., DATED 03/07/2021 ARCHITECTURAL PLANS PREPARED BY KRIEGER KLATT
- ARCHITECTS, DATED 07/08/2024 AERIAL MAP PROVIDED BY NEARMAP, DATE RETRIEVED
- 07/09/2024 ZONING MAP PROVIDED BY VILLAGE OF LAKE ORION,
- DATE RETRIEVED 07/09/2024 2. ALL REFERENCE MATERIAL LISTED ABOVE SHALL BE
- CONSIDERED A PART OF THIS PLAN SET AND ALL INFORMATION CONTAINED WITHIN THESE MATERIALS SHALL BE UTILIZED IN CONJUNCTION WITH THIS PLAN SET. THE CONTRACTOR IS RESPONSIBLE TO OBTAIN A COPY OF EACH REFERENCE AND REVIEW IT THOROUGHLY PRIOR TO THE START OF CONSTRUCTION.

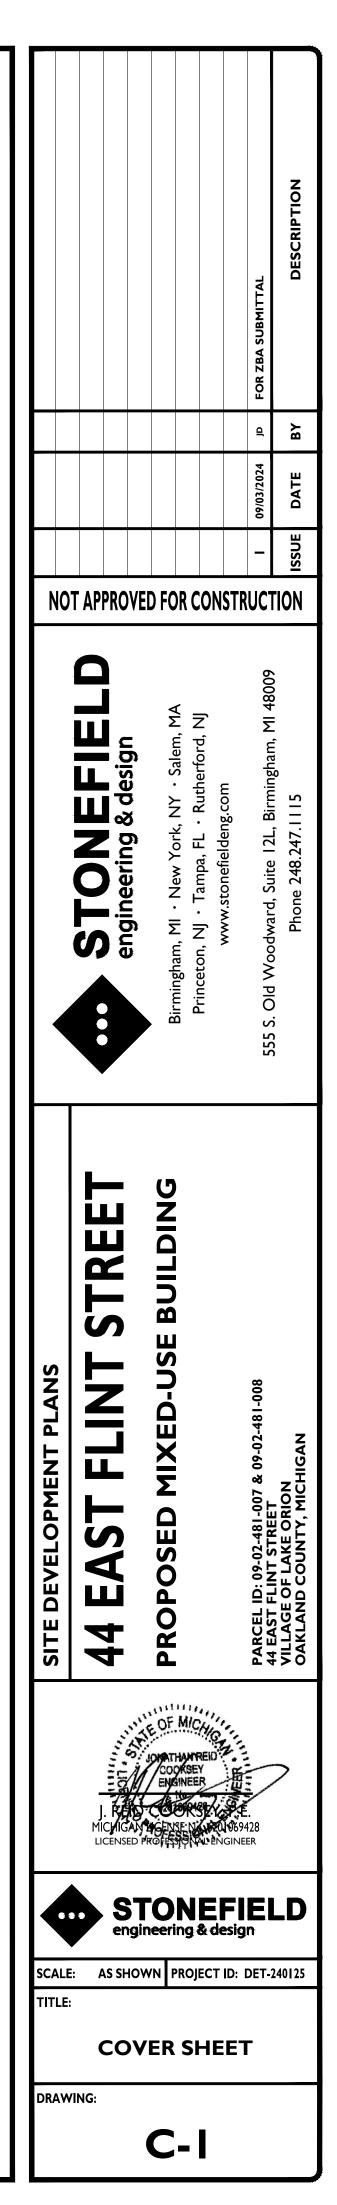

APPLICANT

JS CAPITOL GROUP 155 ROMEO ROAD, SUITE 300 **ROCHESTER, MI 48307** PAUL@JSCAPITOL.COM


ARCHITECT

KREIGER KLATT ARCHITECTS 2120 E I I MILE ROAD ROYAL OAK, MI 48067 248.414.9270 JEFF@KREIGERKLATT.COM

THE SITE DOES NOT FALL WITHIN THE 100-YEAR FLOODPLAIN OR CONTAIN ANY WETLANDS




STREET Ζ ANDERSO SOUTH

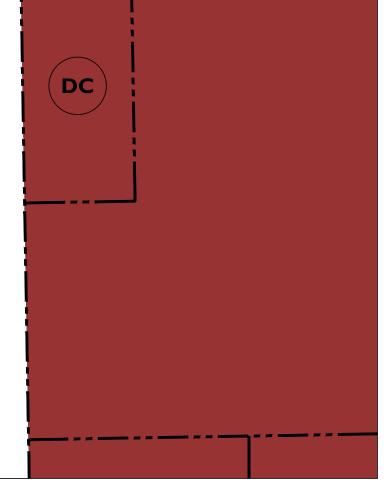

SHEET #
C-1
C-2
C-3
C-4
C-5
C-6
C-7

ADDITIONAL SHEETS				
DRAWING TITLE	SHEET #			
TOPOGRAPHIC SURVEY	I OF I			

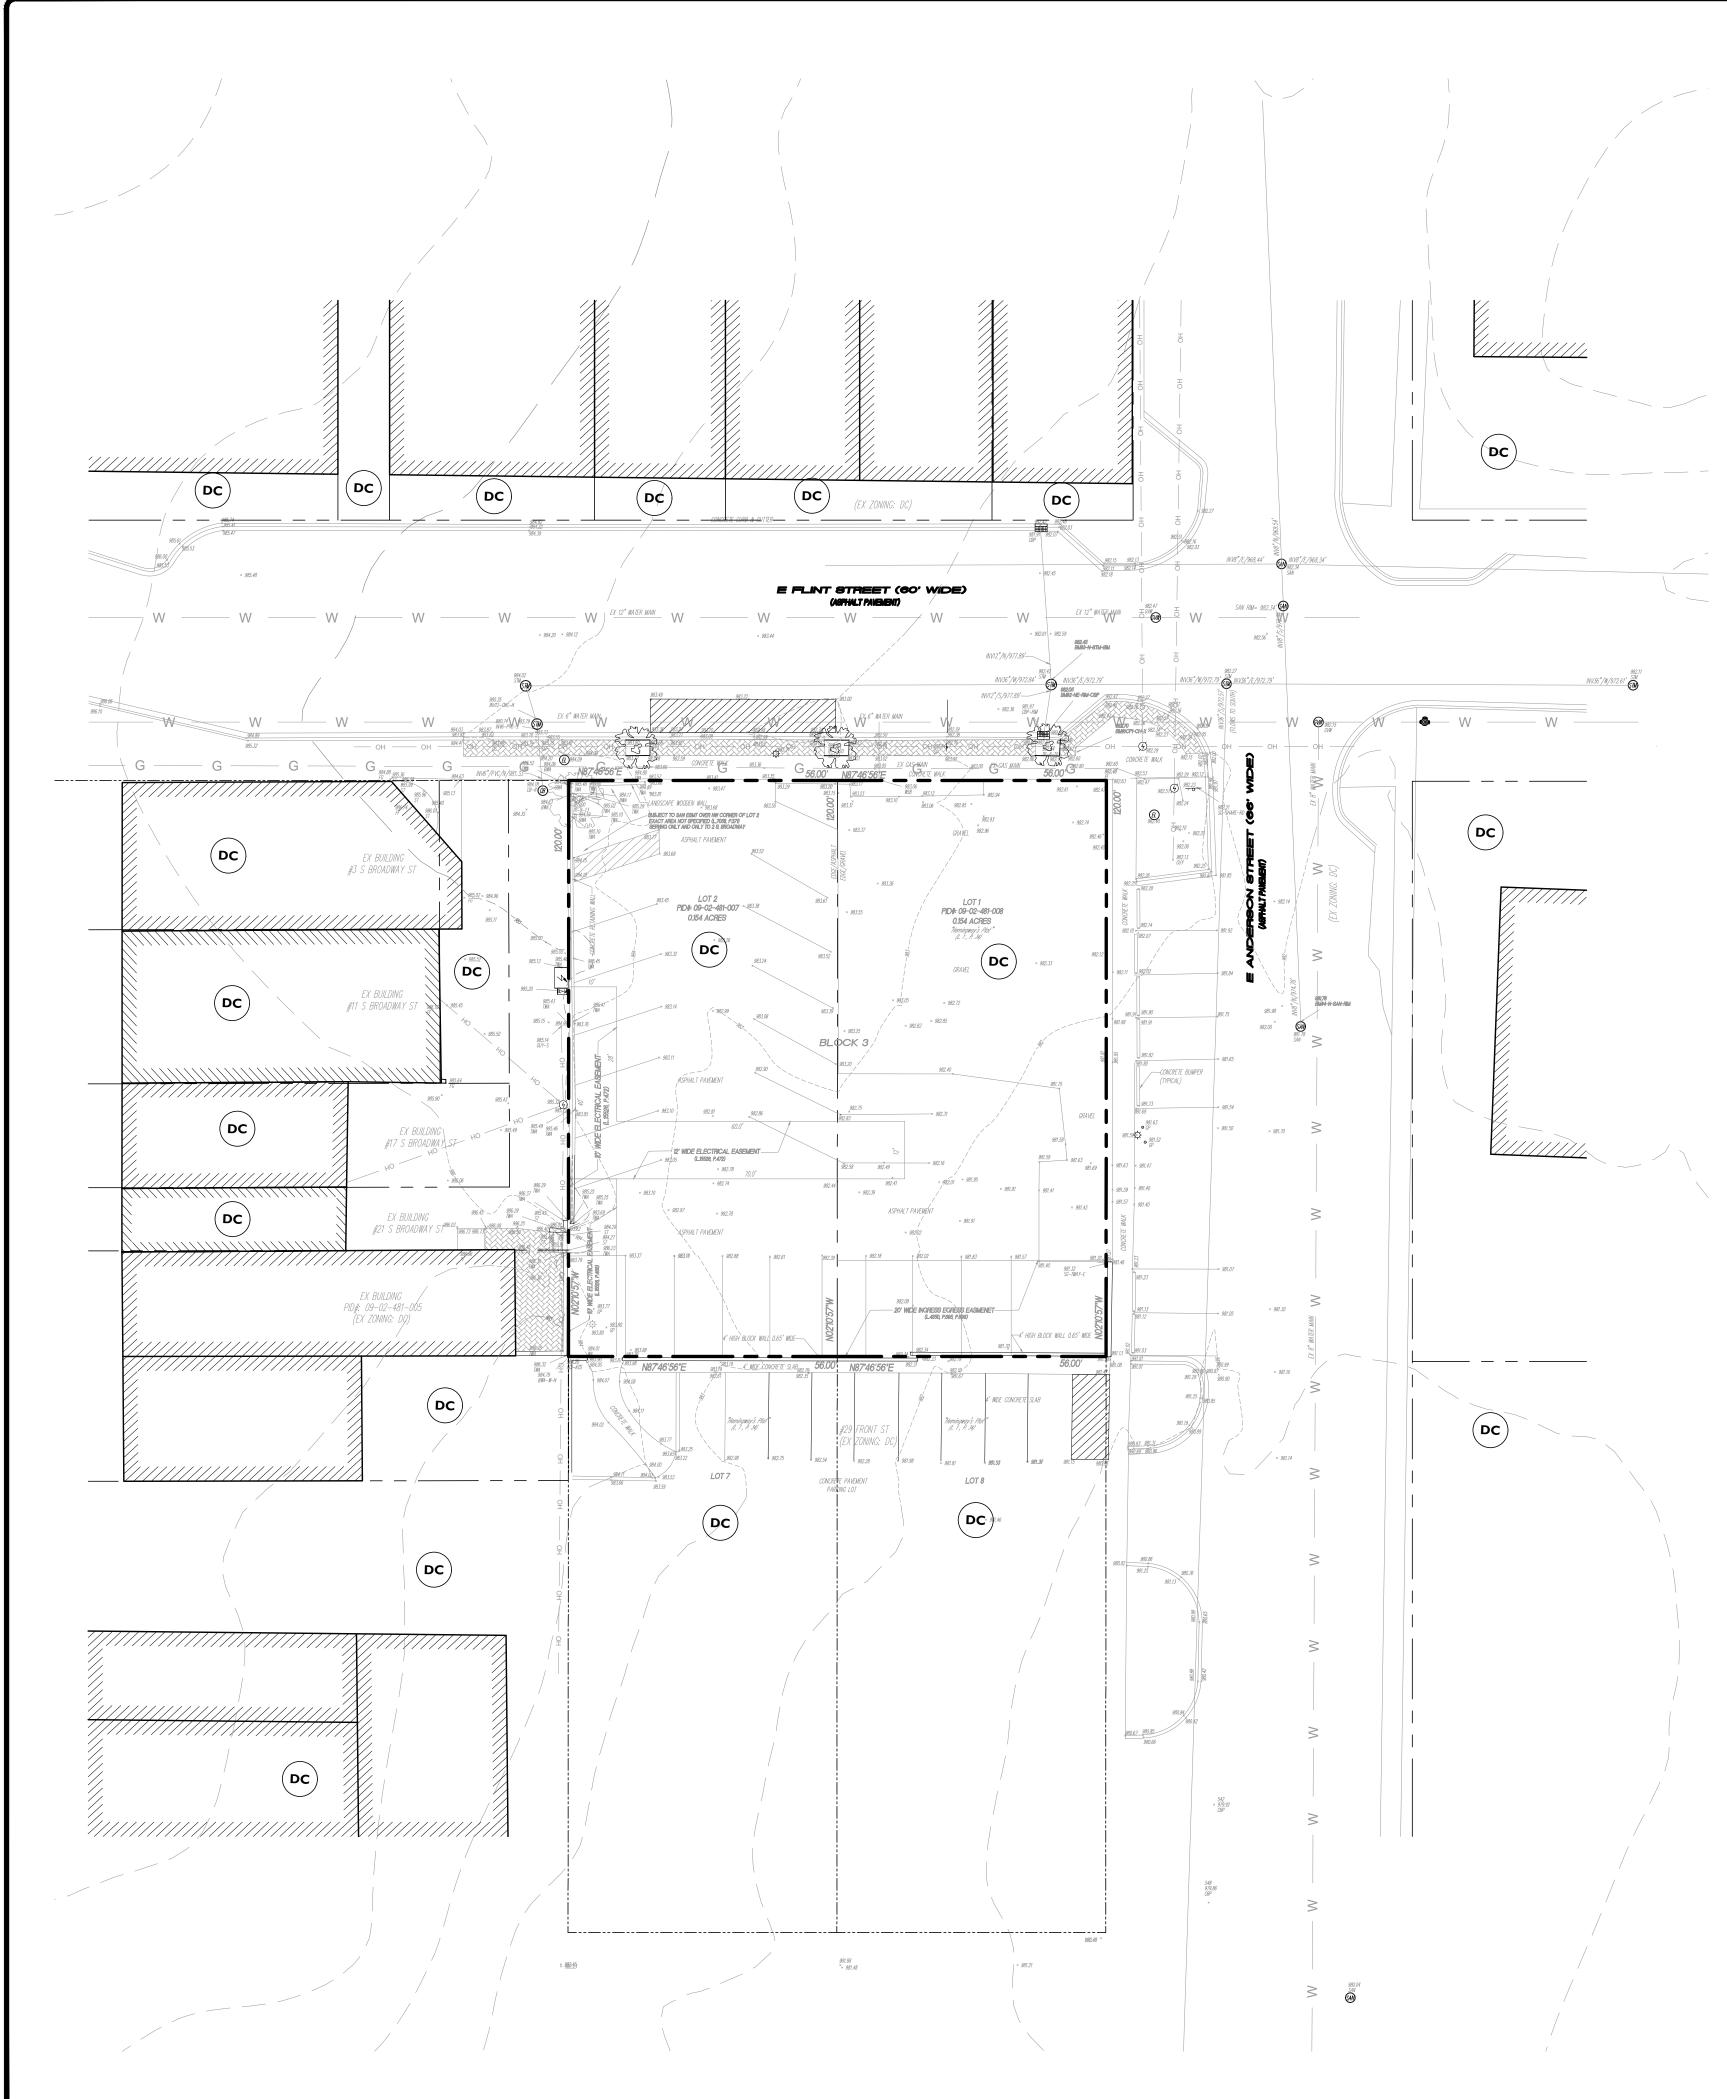

2024/DET-2401 25 JS CAPITAL - 44 EAST FLINT STREET, LAKE ORION, MI/CADDI/LOT/SDP-02-EXST.DV

GENERAL NOTES

-Utility information as shown herein are compilation of field observation and City's records, therefore no guarantee could be given as to their exact location and depth. An excavation might be needed in order to determine utility position.

-All measurements as shown herein are existing.

-All symbols as shown herein are not to scale.

—While surveying the property as shown herein, entire site was covered with snow and ice. AB—SB Land Survey, P.C. shell not be held liable if some of the site features were omitted.

—All measured elevations are expressed in North American Vertical Datum as of 1988. (NAVD88)

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LEGAL DESCRIPTION


#44 E Flint Street, Lake Orion, MI, 48362
Part of the E ½ of the SE 1/4 of Section 2, Town 4 North, Range 10 East, Village of Lake Orion, Oakland County, Michigan, being more particularly described as follows:
LOT 1 of BLOCK 3 of "Hemingway's Plat", as being recorded in Liber 1 of Plats, on Page 34, Oakland County Records.
Containing: 6,720 Square Feet--0.154 Acres, more or less.
Parcel Identification Number:# 09-02-481-008.
Subject to the rights of a public and any easements and/or restrictions of record or otherwise.

Vacant, E Flint Street, Lake Orion, MI, 48362 Part of the E ½ of the SE 1/4 of Section 2, Town 4 North, Range 10 East, Village of Lake Orion, Oakland County, Michigan, being more particularly described as follows: LOT 2 of BLOCK 3 of "Hemingway's Plat", as being recorded in Liber 1 of Plats, on Page 34, Oakland County Records. Containing: 6,720 Square Feet---0.154 Acres, more or less. Parcel Identification Number:# 09-02-481-007. Subject to the rights of a public and any easements and/or restrictions of record or otherwise.

> TOTAL LAND AREA 13,440 ± SQUARE FEET 0.308 ± ACRES


FLOOD NOTE


Subject property as depicted herein, DOES NOT LIE in a Special Flood Hazard Area (SFHA), according to Flood Insurance Rate Map (FIRM) No. 260588, Panel No. 0236, Suffix "F", being effective as of September 29, 2006.

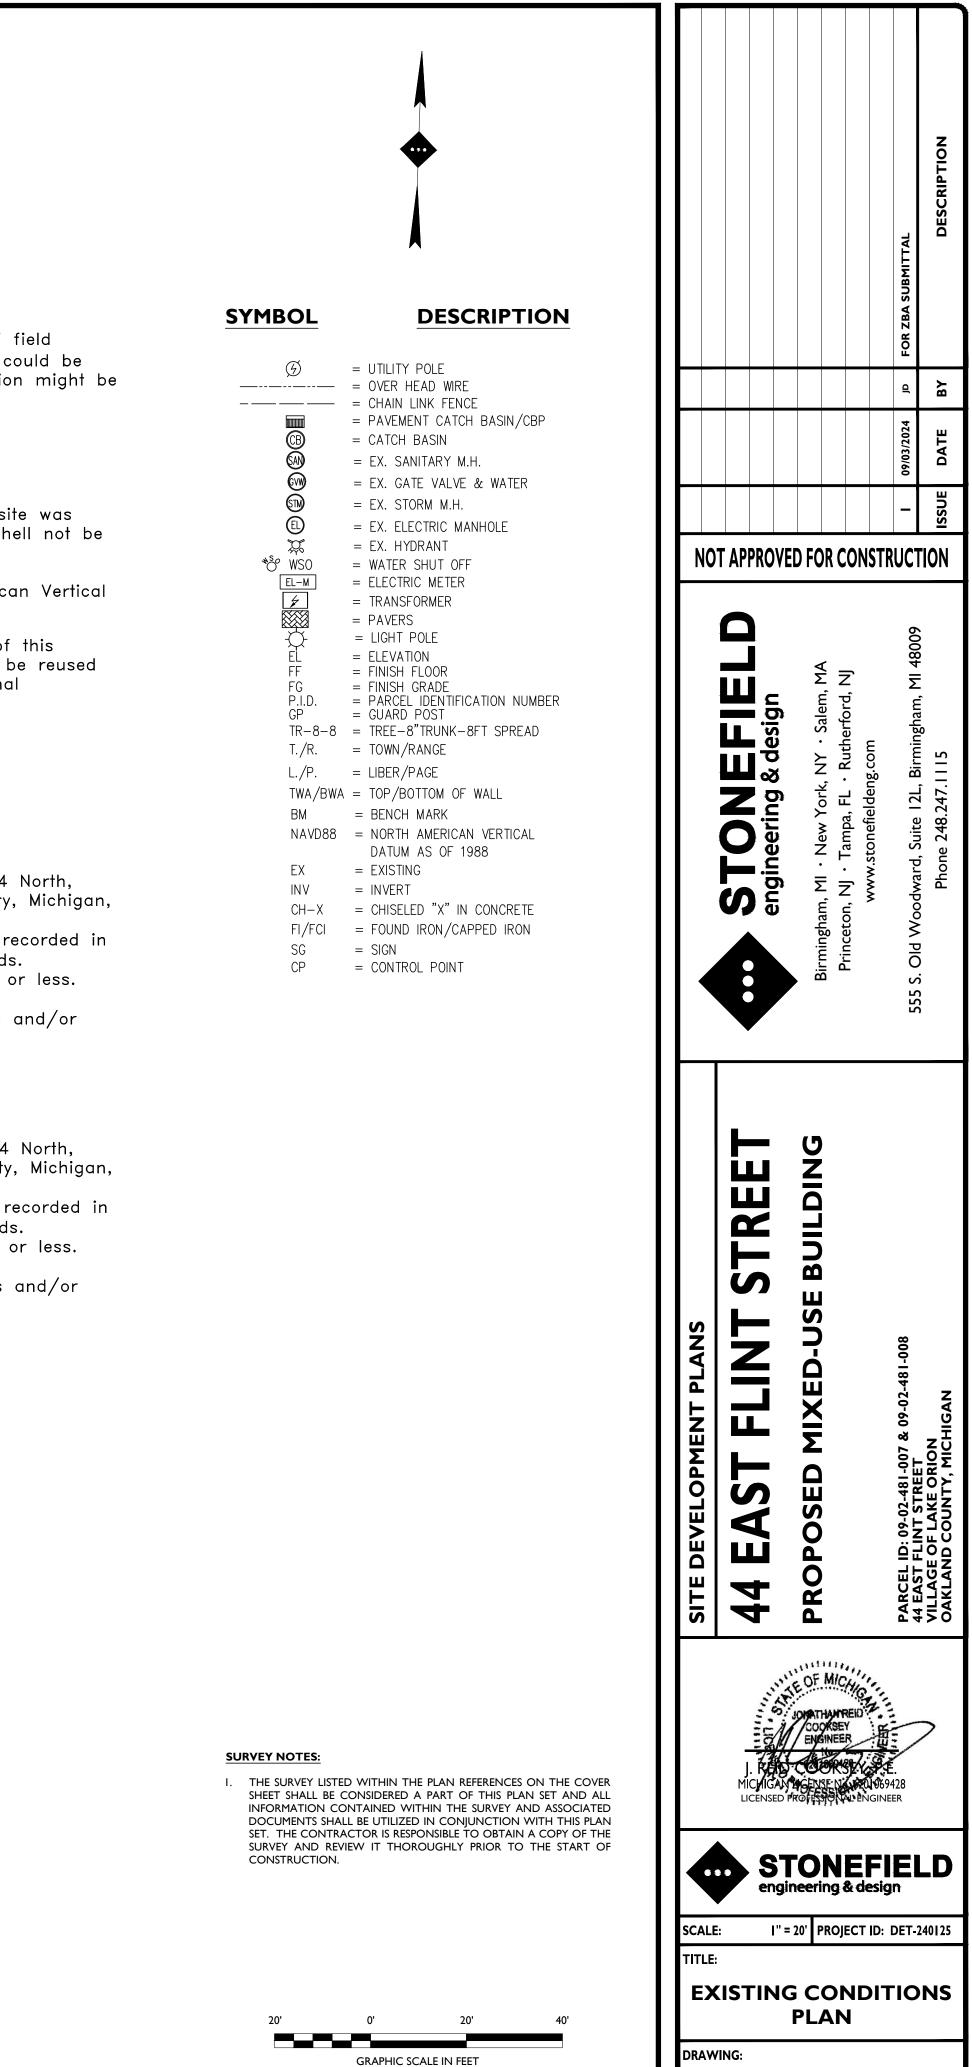

I" = 20'


C-2

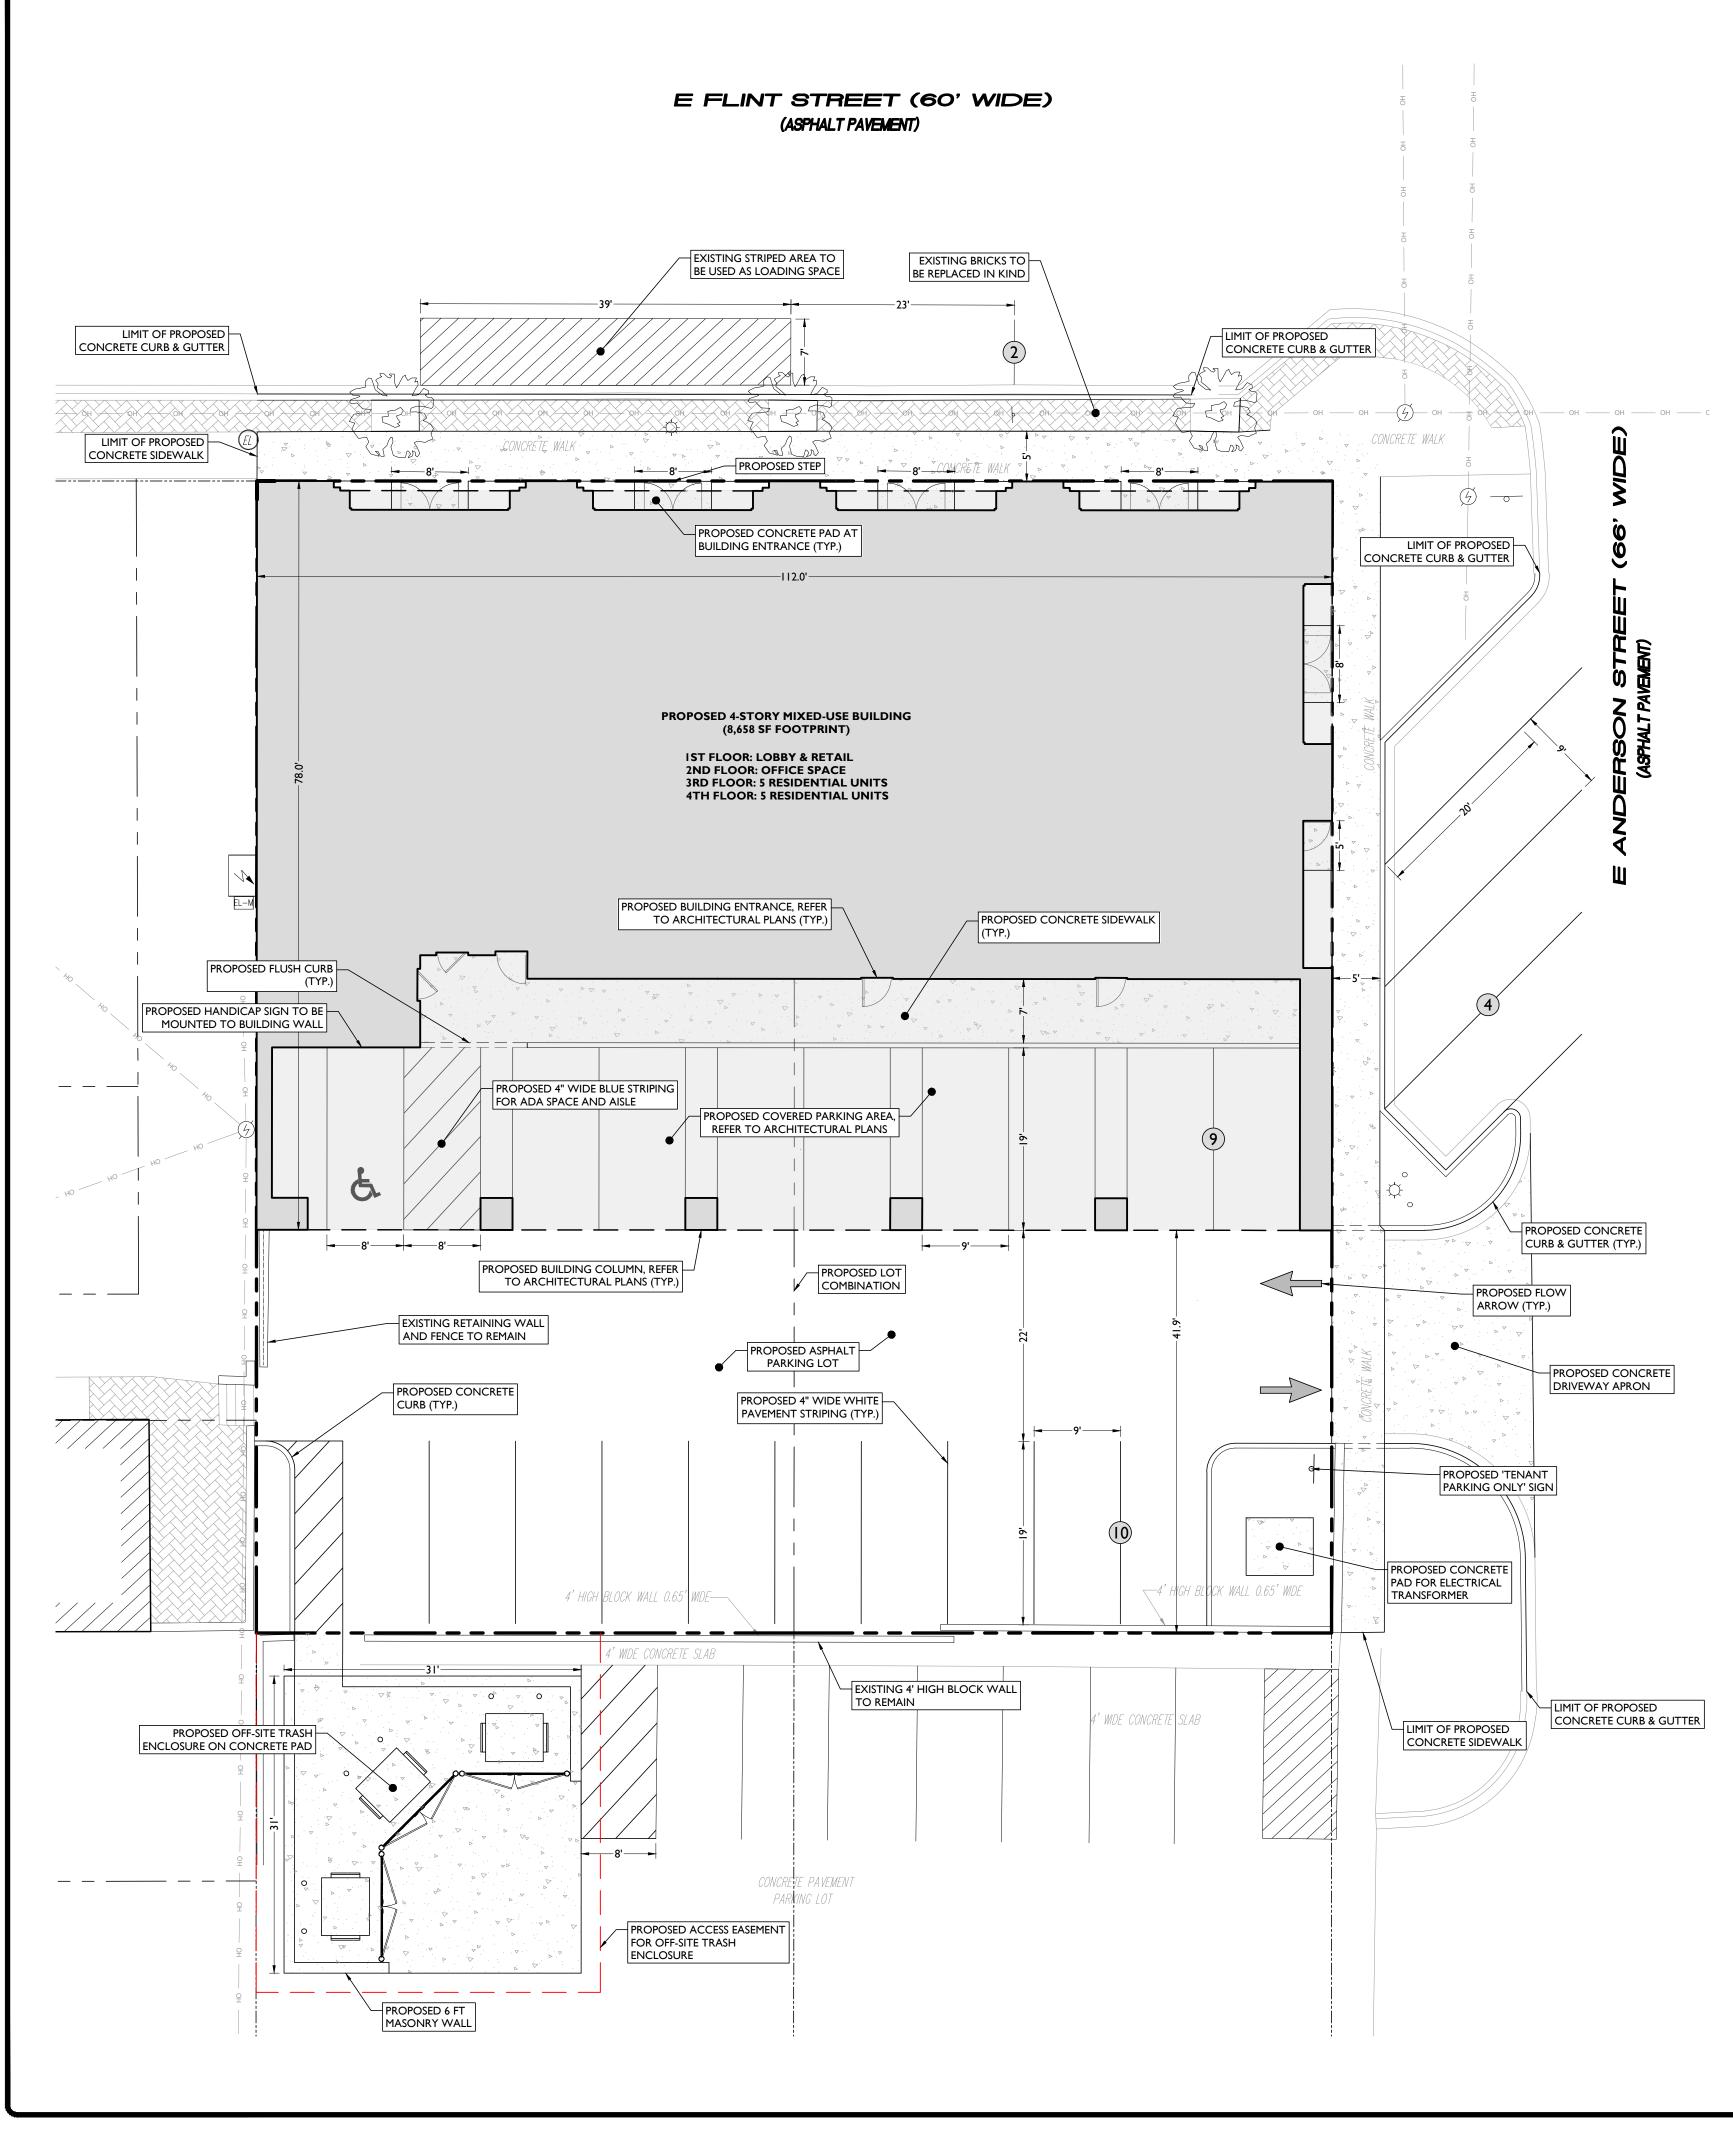


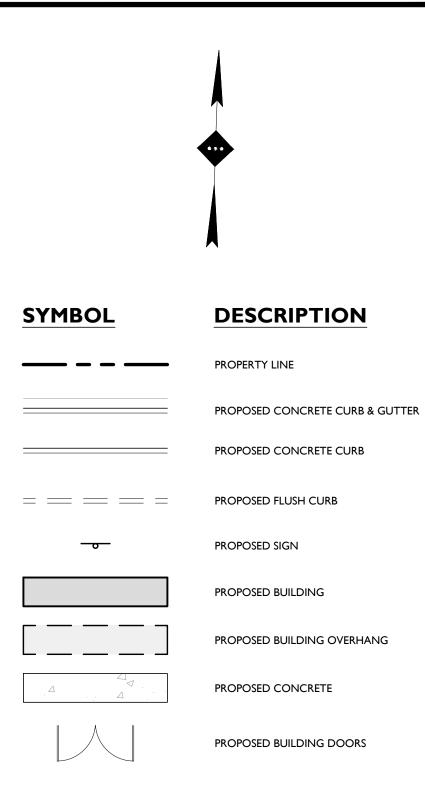




- THE CONTRACTOR SHALL VERIFY AND FAMILIARIZE THEMSELVES WITH THE EXISTING SITE CONDITIONS AND THE PROPOSED SCOPE OF WORK (INCLUDING DIMENSIONS, LAYOUT, ETC.) PRIOR TO INITIATING THE IMPROVEMENTS IDENTIFIED WITHIN THESE DOCUMENTS. SHOULD ANY DISCREPANCY BE FOUND BETWEEN THE EXISTING SITE CONDITIONS AND THE PROPOSED WORK THE CONTRACTOR SHALL NOTIFY STONEFIELD ENGINEERING & DESIGN, LLC. PRIOR TO THE START OF CONSTRUCTION.
 THE CONTRACTOR SHALL OBTAIN ALL NECESSARY PERMITS AND
- ENSURE THAT ALL REQUIRED APPROVALS HAVE BEEN OBTAINED PRIOR TO THE START OF CONSTRUCTION. COPIES OF ALL REQUIRED PERMITS AND APPROVALS SHALL BE KEPT ON SITE AT ALL TIMES DURING CONSTRUCTION.
- 3. ALL CONTRACTORS WILL, TO THE FULLEST EXTENT PERMITTED BY LAW, INDEMNIFY AND HOLD HARMLESS STONEFIELD ENGINEERING & DESIGN, LLC. AND IT'S SUB-CONSULTANTS FROM AND AGAINST ANY DAMAGES AND LIABILITIES INCLUDING ATTORNEY'S FEES ARISING OUT OF CLAIMS BY EMPLOYEES OF THE CONTRACTOR IN ADDITION TO CLAIMS CONNECTED TO THE PROJECT AS A RESULT OF NOT CARRYING THE PROPER INSURANCE FOR WORKERS COMPENSATION, LIABILITY INSURANCE, AND LIMITS OF COMMERCIAL GENERAL LIABILITY INSURANCE.
- 4. THE CONTRACTOR SHALL NOT DEVIATE FROM THE PROPOSED IMPROVEMENTS IDENTIFIED WITHIN THIS PLAN SET UNLESS APPROVAL IS PROVIDED IN WRITING BY STONEFIELD ENGINEERING & DESIGN, LLC.
 5. THE CONTRACTOR IS RESPONSIBLE TO DETERMINE THE MEANS AND
- METHODS OF CONSTRUCTION.
 6. THE CONTRACTOR SHALL NOT PERFORM ANY WORK OR CAUSE DISTURBANCE ON A PRIVATE PROPERTY NOT CONTROLLED BY THE PERSON OR ENTITY WHO HAS AUTHORIZED THE WORK WITHOUT PRIOR WRITTEN CONSENT FROM THE OWNER OF THE PRIVATE PROPERTY.
- THE CONTRACTOR IS RESPONSIBLE TO RESTORE ANY DAMAGED OR UNDERMINED STRUCTURE OR SITE FEATURE THAT IS IDENTIFIED TO REMAIN ON THE PLAN SET. ALL REPAIRS SHALL USE NEW MATERIALS TO RESTORE THE FEATURE TO ITS EXISTING CONDITION AT THE CONTRACTORS EXPENSE.
 CONTRACTOR IS RESPONSIBLE TO PROVIDE THE APPROPRIATE SHOP
- DRAWINGS, PRODUCT DATA, AND OTHER REQUIRED SUBMITTALS FOR REVIEW. STONEFIELD ENGINEERING & DESIGN, LLC. WILL REVIEW THE SUBMITTALS IN ACCORDANCE WITH THE DESIGN INTENT AS REFLECTED WITHIN THE PLAN SET.
 THE CONTRACTOR IS RESPONSIBLE FOR TRAFFIC CONTROL IN
- ACCORDANCE WITH MANUAL ON UNIFORM TRAFFIC CONTROL DEVICES, LATEST EDITION.
 10. THE CONTRACTOR IS REQUIRED TO PERFORM ALL WORK IN THE PUBLIC RIGHT-OF-WAY IN ACCORDANCE WITH THE APPROPRIATE GOVERNING AUTHORITY AND SHALL BE RESPONSIBLE FOR THE
- PROCUREMENT OF STREET OPENING PERMITS. 11. THE CONTRACTOR IS REQUIRED TO RETAIN AN OSHA CERTIFIED SAFETY INSPECTOR TO BE PRESENT ON SITE AT ALL TIMES DURING CONSTRUCTION & DEMOLITION ACTIVITIES.
- 12. SHOULD AN EMPLOYEE OF STONEFIELD ENGINEERING & DESIGN, LLC. BE PRESENT ON SITE AT ANY TIME DURING CONSTRUCTION, IT DOES NOT RELIEVE THE CONTRACTOR OF ANY OF THE RESPONSIBILITIES AND REQUIREMENTS LISTED IN THE NOTES WITHIN THIS PLAN SET.

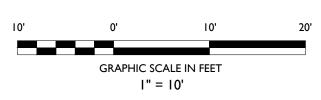

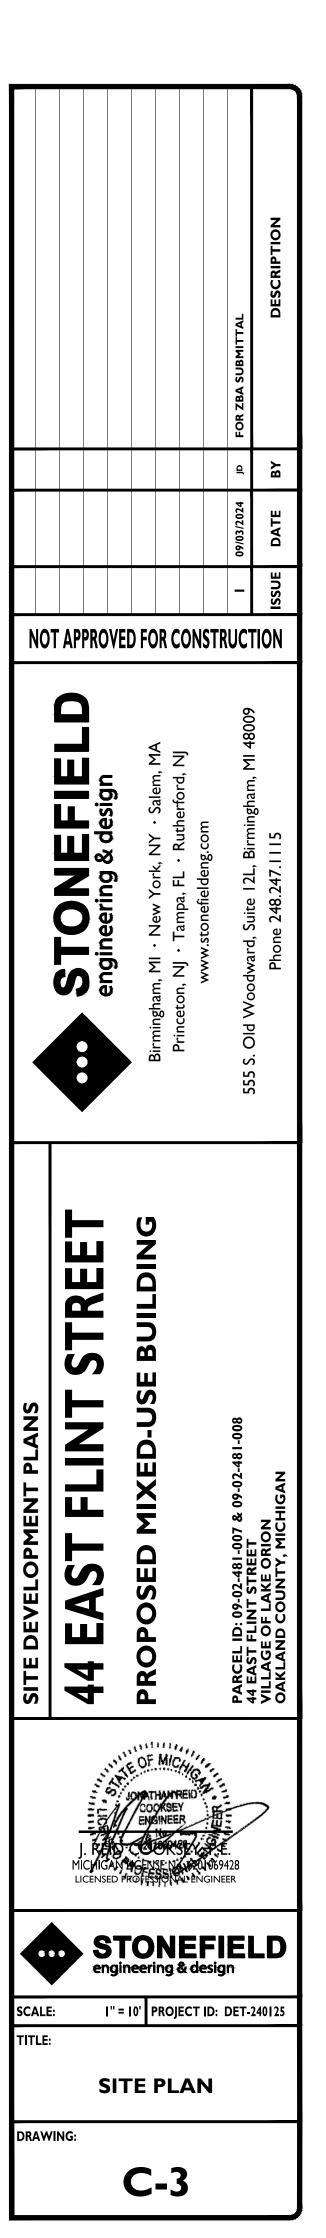

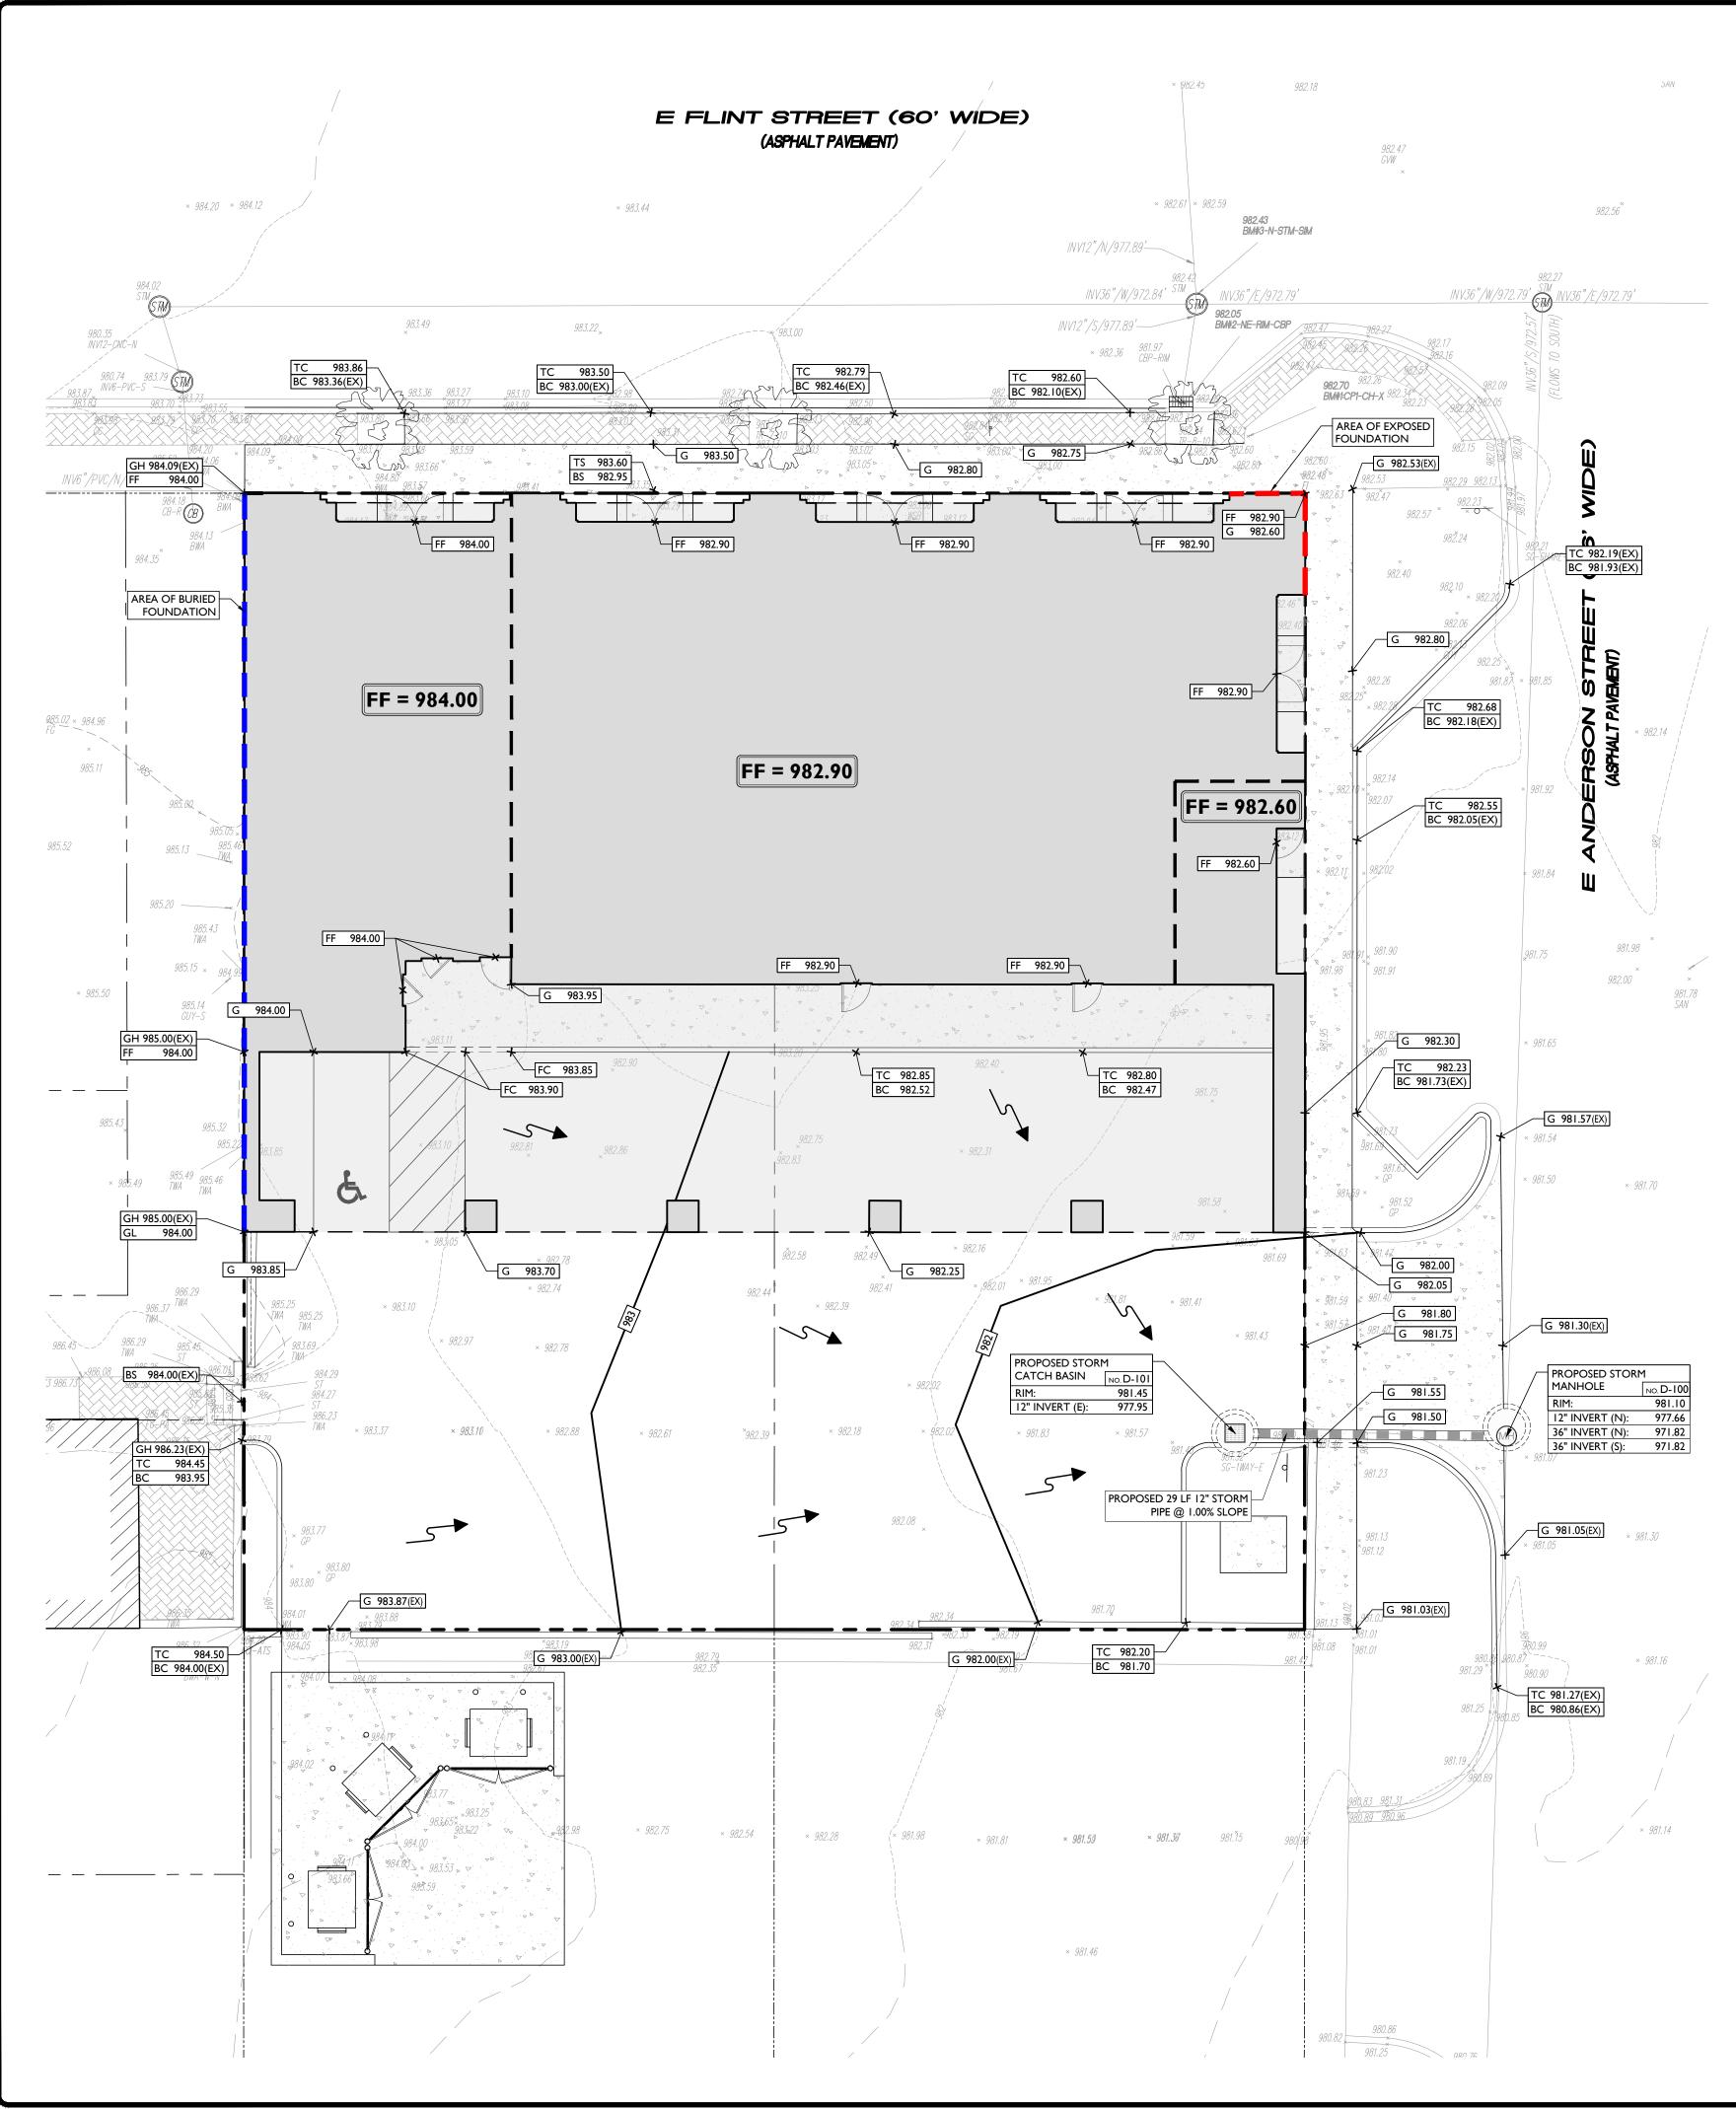

BENCHMARKS


SITE BENCH MARK NO. I: TOP OF CHISELED "X" IN CONCRETE WALK, BEING 8.5 FEET NW'LY FROM THE NE CORNER OF LOT I OF THE SUBJECT PROPERTY. EL=982.70' (NAVD88).

SITE BENCH MARK NO. 2 NE RIM OF PAVEMENT CATCH BASIN, BEING15.9 FEET NW'LY FROM THE NE CORNER OF LOT I OF THE SUBJECT PROPERTY. EL=982.05' (NAVD88).

SITE BENCH MARK NO. 3: NORTH RIM OF A STORM MANHOLE, BEING 10 FEET N'LY FROM BM#2. EL=982.43' (NAVD88).

GRADING NOTES

- ALL FILL MATERIALS BROUGHT TO THE SITE. 2. THE CONTRACTOR IS REQUIRED TO PROVIDE TEMPORARY AND/OR
- STABILITY OF THE SURROUNDING SOILS. APPROVAL PRIOR TO POURING CURBS. COVERS AND RESET ALL EXISTING UTILITY COVERS WITHIN THE
- AUTHORITY REGULATIONS. FOLLOWS: CURB GUTTER: CONCRETE SURFACES:
- ASPHALT SURFACES: 6. A MINIMUM SLOPE OF 1.00% SHALL BE PROVIDED AWAY FROM ALL
- RESPONSIBLE TO DETERMINE THE DEPTH TO GROUNDWATER AT THE LOCATION OF THE PROPOSED STRUCTURE. IF GROUNDWATER IS
- FROM THE GOVERNING STORM SEWER SYSTEM AUTHORITY.

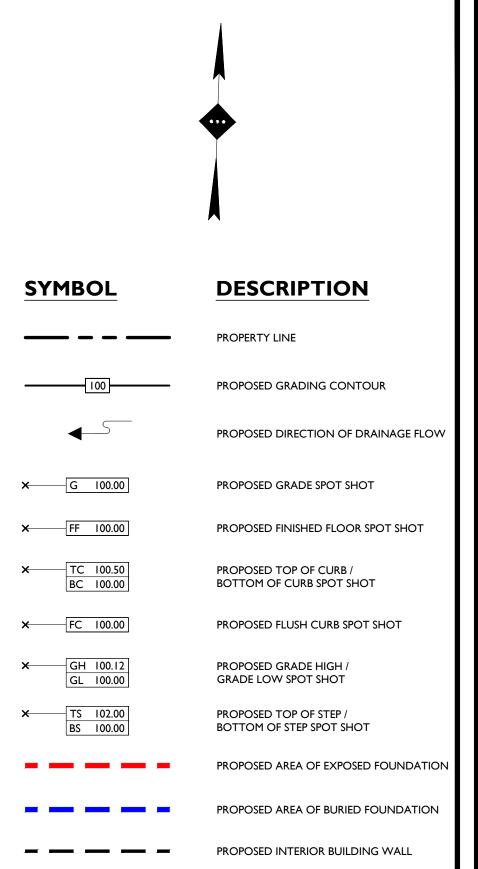

ON-SITE STORMWATER DETENTION IS NOT REQUIRED PER OCWRC STORMWATER MANAGEMENT REQUIREMENTS AS DEVELOPMENT CONSTRUCTION ACTIVITY IS LESS THAN | ACRE

I. ALL SOIL AND MATERIAL REMOVED FROM THE SITE SHALL BE DISPOSED OF IN ACCORDANCE WITH LOCAL, STATE, AND FEDERAL REQUIREMENTS. ANY GROUNDWATER DE-WATERING PRACTICES SHALL BE PERFORMED UNDER THE SUPERVISION OF A QUALIFIED PROFESSIONAL. THE CONTRACTOR IS REQUIRED TO OBTAIN ALL NECESSARY PERMITS FOR THE DISCHARGE OF DE-WATERED GROUNDWATER. ALL SOIL IMPORTED TO THE SITE SHALL BE CERTIFIED CLEAN FILL. CONTRACTOR SHALL MAINTAIN RECORDS OF

PERMANENT SHORING WHERE REQUIRED DURING EXCAVATION ACTIVITIES, INCLUDING BUT NOT LIMITED TO UTILITY TRENCHES, TO ENSURE THE STRUCTURAL INTEGRITY OF NEARBY STRUCTURES AND 3. PROPOSED TOP OF CURB ELEVATIONS ARE GENERALLY 4 INCHES TO 7

INCHES ABOVE EXISTING GRADES UNLESS OTHERWISE NOTED. THE CONTRACTOR WILL SUPPLY ALL STAKEOUT CURB GRADE SHEETS TO STONEFIELD ENGINEERING & DESIGN, LLC. FOR REVIEW AND 4. THE CONTRACTOR IS RESPONSIBLE TO SET ALL PROPOSED UTILITY


PROJECT LIMITS TO PROPOSED GRADE IN ACCORDANCE WITH ANY APPLICABLE MUNICIPAL, COUNTY, STATE AND/OR UTILITY 5. MINIMUM SLOPE REQUIREMENTS TO PREVENT PONDING SHALL BE AS


> 0.50% 1.00% 1.00%


BUILDINGS. THE CONTRACTOR SHALL ENSURE POSITIVE DRAINAGE FROM THE BUILDING IS ACHIEVED AND SHALL NOTIFY STONEFIELD ENGINEERING & DESIGN, LLC. IF THIS CONDITION CANNOT BE MET. 7. FOR PROJECTS WHERE BASEMENTS ARE PROPOSED, THE DEVELOPER IS

ENCOUNTERED WITHIN THE BASEMENT AREA, SPECIAL CONSTRUCTION METHODS SHALL BE UTILIZED AND REVIEWED/APPROVED BY THE CONSTRUCTION CODE OFFICIAL. IF SUMP PUMPS ARE UTILIZED, ALL DISCHARGES SHALL BE CONNECTED DIRECTLY TO THE PUBLIC STORM SEWER SYSTEM WITH APPROVAL ADA NOTES

- I. THE CONTRACTOR SHALL MAINTAIN A MAXIMUM 2.00% SLOPE IN ANY DIRECTION WITHIN THE ADA PARKING SPACES AND ACCESS AISLES
- 2. THE CONTRACTOR SHALL PROVIDE COMPLIANT SIGNAGE AT ALL ADA PARKING AREAS IN ACCORDANCE WITH STATE GUIDELINES. THE CONTRACTOR SHALL MAINTAIN A MAXIMUM 5.00% RUNNING 3. SLOPE AND A MAXIMUM OF 2.00% CROSS SLOPE ALONG WALKWAYS
- WITHIN THE ACCESSIBLE PATH OF TRAVEL (SEE THE SITE PLAN FOR THE LOCATION OF THE ACCESSIBLE PATH). THE CONTRACTOR IS RESPONSIBLE TO ENSURE THE ACCESSIBLE PATH OF TRAVEL IS 36 INCHES WIDE OR GREATER UNLESS INDICATED OTHERWISE WITHIN THE PLAN SET. 4. THE CONTRACTOR SHALL MAINTAIN A MAXIMUM 2.00% SLOPE IN
- ANY DIRECTION AT ALL LANDINGS. LANDINGS INCLUDE, BUT ARE NOT LIMITED TO, THE TOP AND BOTTOM OF AN ACCESSIBLE RAMP, AT ACCESSIBLE BUILDING ENTRANCES, AT AN AREA IN FRONT OF A WALK-UP ATM, AND AT TURNING SPACES ALONG THE ACCESSIBLE PATH OF TRAVEL. THE LANDING AREA SHALL HAVE A MINIMUM CLEAR AREA OF 60 INCHES BY 60 INCHES UNLESS INDICATED OTHERWISE WITHIN THE PLAN SET.
- THE CONTRACTOR SHALL MAINTAIN A MAXIMUM 8.33% RUNNING SLOPE AND A MAXIMUM 2.00% CROSS SLOPE ON ANY CURB RAMPS ALONG THE ACCESSIBLE PATH OF TRAVEL. WHERE PROVIDED, CURB RAMP FLARES SHALL NOT HAVE A SLOPE GREATER THAN 10.00% IF A LANDING AREA IS PROVIDED AT THE TOP OF THE RAMP. FOR ALTERATIONS, A CURB RAMP FLARES SHALL NOT HAVE A SLOPE GREATER THAN 8.33% IF A LANDING AREA IS NOT PROVIDED AT THE TOP OF THE RAMP. CURBS RAMPS SHALL NOT RISE MORE THAN 6 INCHES IN ELEVATION WITHOUT A HANDRAIL. THE CLEAR WIDTH OF A CURB RAMP SHALL BE NO LESS THAN 36 INCHES WIDE.
- 6. ACCESSIBLE RAMPS WITH A RISE GREATER THAN 6 INCHES SHALL CONTAIN COMPLIANT HANDRAILS ON BOTH SIDES OF THE RAMP AND SHALL NOT RISE MORE THAN 30" IN ELEVATION WITHOUT A LANDING AREA IN BETWEEN RAMP RUNS. LANDING AREAS SHALL ALSO BE PROVIDED AT THE TOP AND BOTTOM OF THE RAMP. 7. A SLIP RESISTANT SURFACE SHALL BE CONSTRUCTED ALONG THE
- ACCESSIBLE PATH AND WITHIN ADA PARKING AREAS. THE CONTRACTOR SHALL ENSURE A MAXIMUM OF 1/4 INCHES 8. VERTICAL CHANGE IN LEVEL ALONG THE ACCESSIBLE PATH. WHERE A CHANGE IN LEVEL BETWEEN 1/4 INCHES AND 1/2 INCHES EXISTS, CONTRACTOR SHALL ENSURE THAT THE TOP 1/4 INCH CHANGE IN LEVEL IS BEVELED WITH A SLOPE NOT STEEPER THAN I UNIT VERTICAL AND 2 UNITS HORIZONTAL (2:1 SLOPE). 9. THE CONTRACTOR SHALL ENSURE THAT ANY OPENINGS (GAPS OR HORIZONTAL SEPARATION) ALONG THE ACCESSIBLE PATH SHALL NOT ALLOW PASSAGE OF A SPHERE GREATER THAN 1/2 INCH.

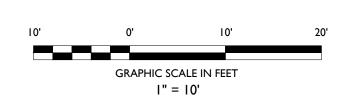

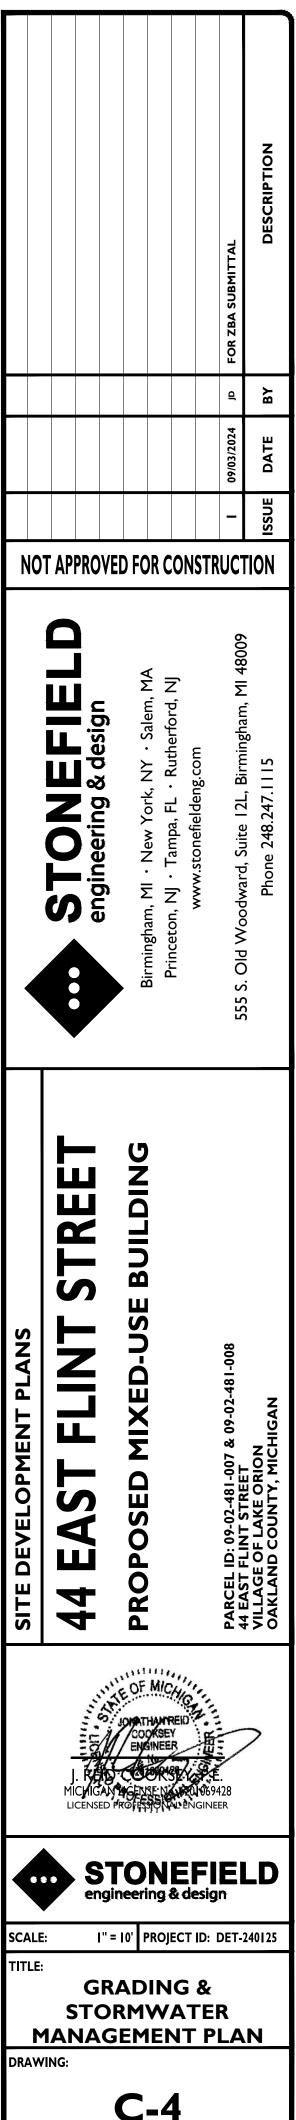

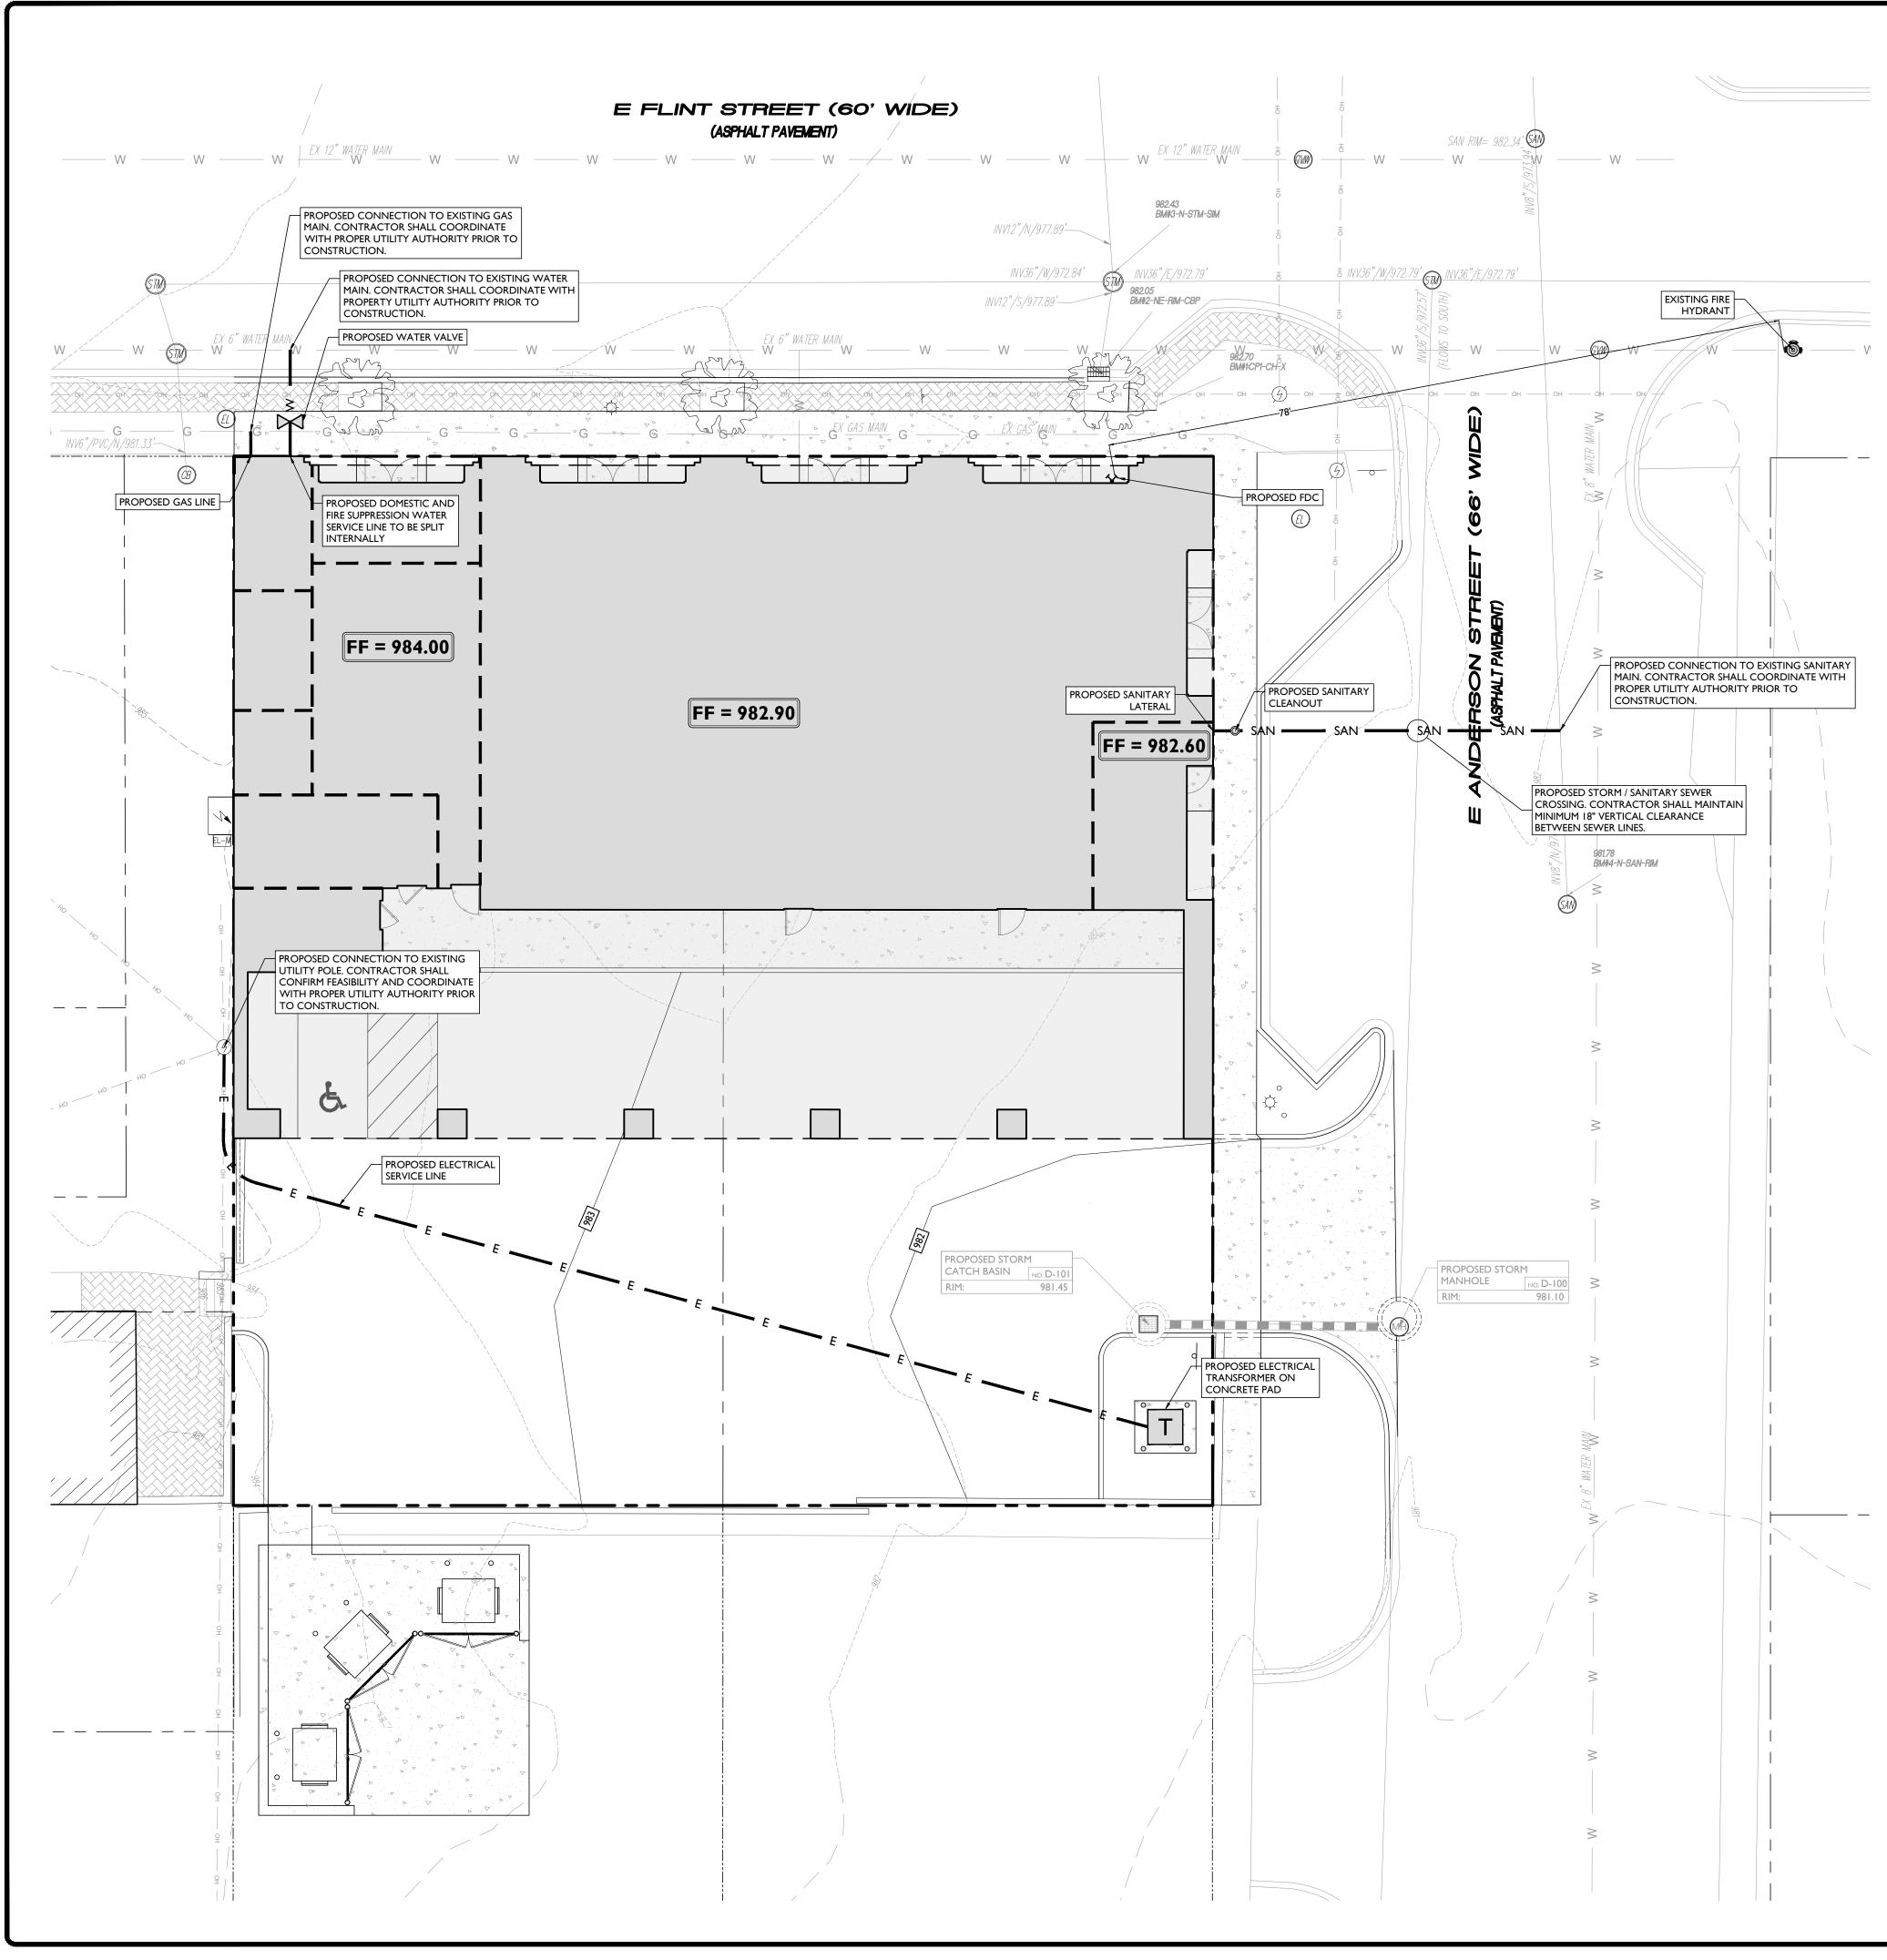


BENCHMARKS

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R S I. THE CONTRACTOR IS REQUIRED TO CALL THE APPROPRIATE AUTHORITY FOR NOTICE OF CONSTRUCTION/EXCAVATION AND UTILITY MARK OUT PRIOR TO THE START OF CONSTRUCTION IN ACCORDANCE WITH STATE LAW. CONTRACTOR IS REQUIRED TO Ζ CONFIRM THE HORIZONTAL AND VERTICAL LOCATION OF UTILITIES IN THE FIELD. SHOULD A DISCREPANCY EXIST BETWEEN THE FIELD LOCATION OF A UTILITY AND THE LOCATION SHOWN ON THE PLAN SET OR SURVEY, THE CONTRACTOR SHALL NOTIFY STONEFIELD ENGINEERING & DESIGN, LLC. IMMEDIATELY IN WRITING. 2. THE CONTRACTOR IS RESPONSIBLE TO PROTECT AND MAINTAIN IN OPERATION ALL UTILITIES NOT DESIGNATED TO BE REMOVED. 3. THE CONTRACTOR IS RESPONSIBLE FOR REPAIRING ANY DAMAGE TO ANY EXISTING UTILITY IDENTIFIED TO REMAIN WITHIN THE LIMITS OF THE PROPOSED WORK DURING CONSTRUCTION. 4. A MINIMUM HORIZONTAL SEPARATION OF 10 FEET IS REQUIRED 0 S BETWEEN ANY SANITARY SEWER SERVICE AND ANY WATER LINES. IF THIS SEPARATION CANNOT BE PROVIDED, A CONCRETE VEL ENCASEMENT SHALL BE UTILIZED FOR THE SANITARY SEWER SERVICE AS APPROVED BY STONEFIELD ENGINEERING & DESIGN, LLC. 5. ALL WATER LINES SHALL BE VERTICALLY SEPARATED ABOVE SANITARY SEWER LINES BY A MINIMUM DISTANCE OF 18 INCHES. IF THIS SEPARATION CANNOT BE PROVIDED, A CONCRETE ENCASEMENT ш SHALL BE UTILIZED FOR THE SANITARY SEWER SERVICE AS APPROVED オ 6. THE CONTRACTOR TO PERFORM A TEST PIT PRIOR TO \mathbf{A} ร CONSTRUCTION (RECOMMEND 30 DAYS PRIOR) AT LOCATIONS OF EXISTING UTILITY CROSSINGS FOR WATER AND SANITARY SEWER CONNECTION IMPROVEMENTS. SHOULD A CONFLICT EXIST, THE CONTRACTOR SHALL IMMEDIATELY NOTIFY STONEFIELD 7. THE CONTRACTOR IS RESPONSIBLE FOR COORDINATING GAS,

ELECTRIC AND TELECOMMUNICATION CONNECTIONS WITH THE APPROPRIATE GOVERNING AUTHORITY. 8. CONTRACTOR SHALL START CONSTRUCTION OF ANY GRAVITY


BY STONEFIELD ENGINEERING & DESIGN, LLC.

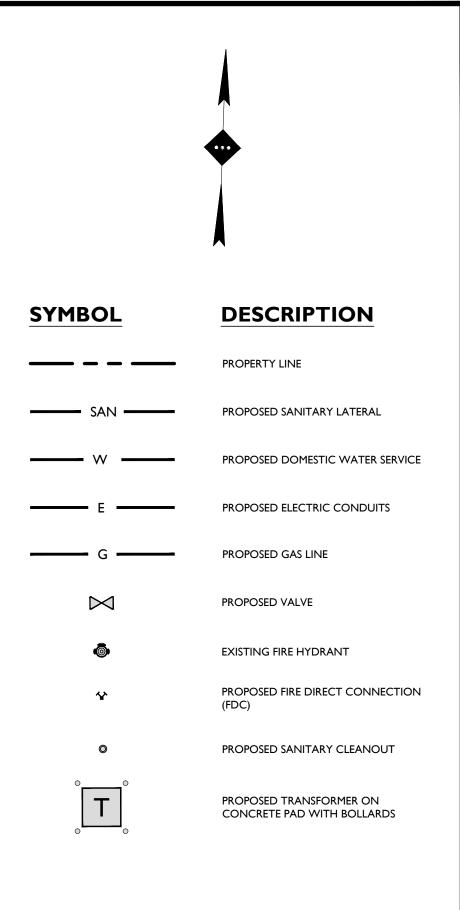
ENGINEERING & DESIGN, LLC. IN WRITING.

DRAINAGE AND UTILITY NOTES

- SEWER AT THE LOWEST INVERT AND WORK UP-GRADIENT. 9. THE CONTRACTOR IS RESPONSIBLE TO MAINTAIN A RECORD SET OF PLANS REFLECTING THE LOCATION OF EXISTING UTILITIES THAT HAVE BEEN CAPPED, ABANDONED, OR RELOCATED BASED ON THE DEMOLITION/REMOVAL ACTIVITIES REQUIRED IN THIS PLAN SET. THIS DOCUMENT SHALL BE PROVIDED TO THE OWNER FOLLOWING COMPLETION OF WORK.
- 10. THE CONTRACTOR IS RESPONSIBLE TO MAINTAIN A RECORD OF THE AS-BUILT LOCATIONS OF ALL PROPOSED UNDERGROUND INFRASTRUCTURE. THE CONTRACTOR SHALL NOTE ANY DISCREPANCIES BETWEEN THE AS-BUILT LOCATIONS AND THE LOCATIONS DEPICTED WITHIN THE PLAN SET. THIS RECORD SHALL BE PROVIDED TO THE OWNER FOLLOWING COMPLETION OF WORK.

GRAPHIC SCALE IN FEET 1" = 10'

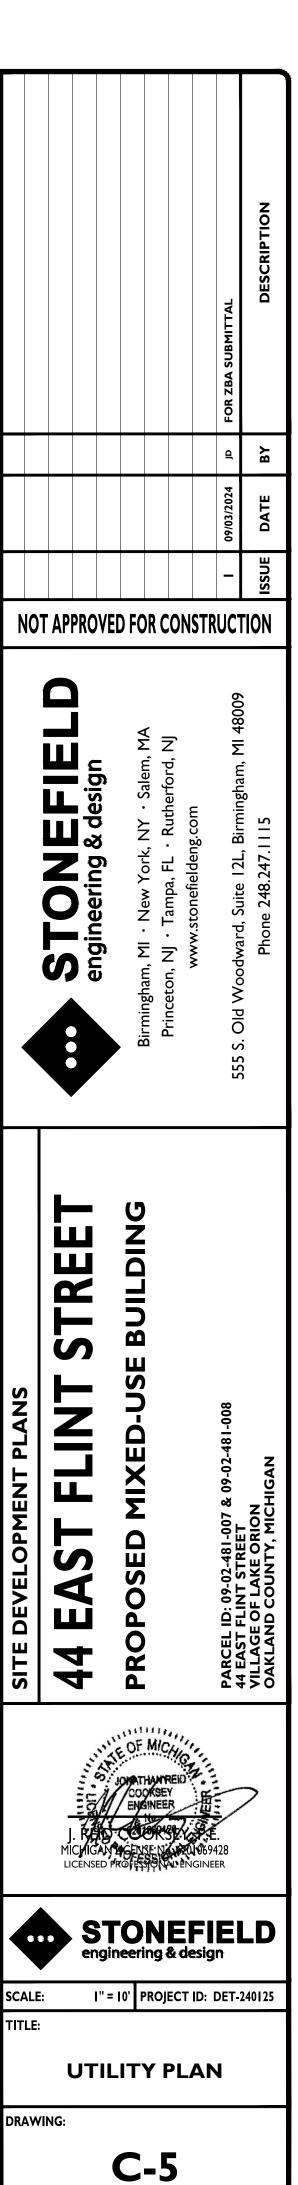

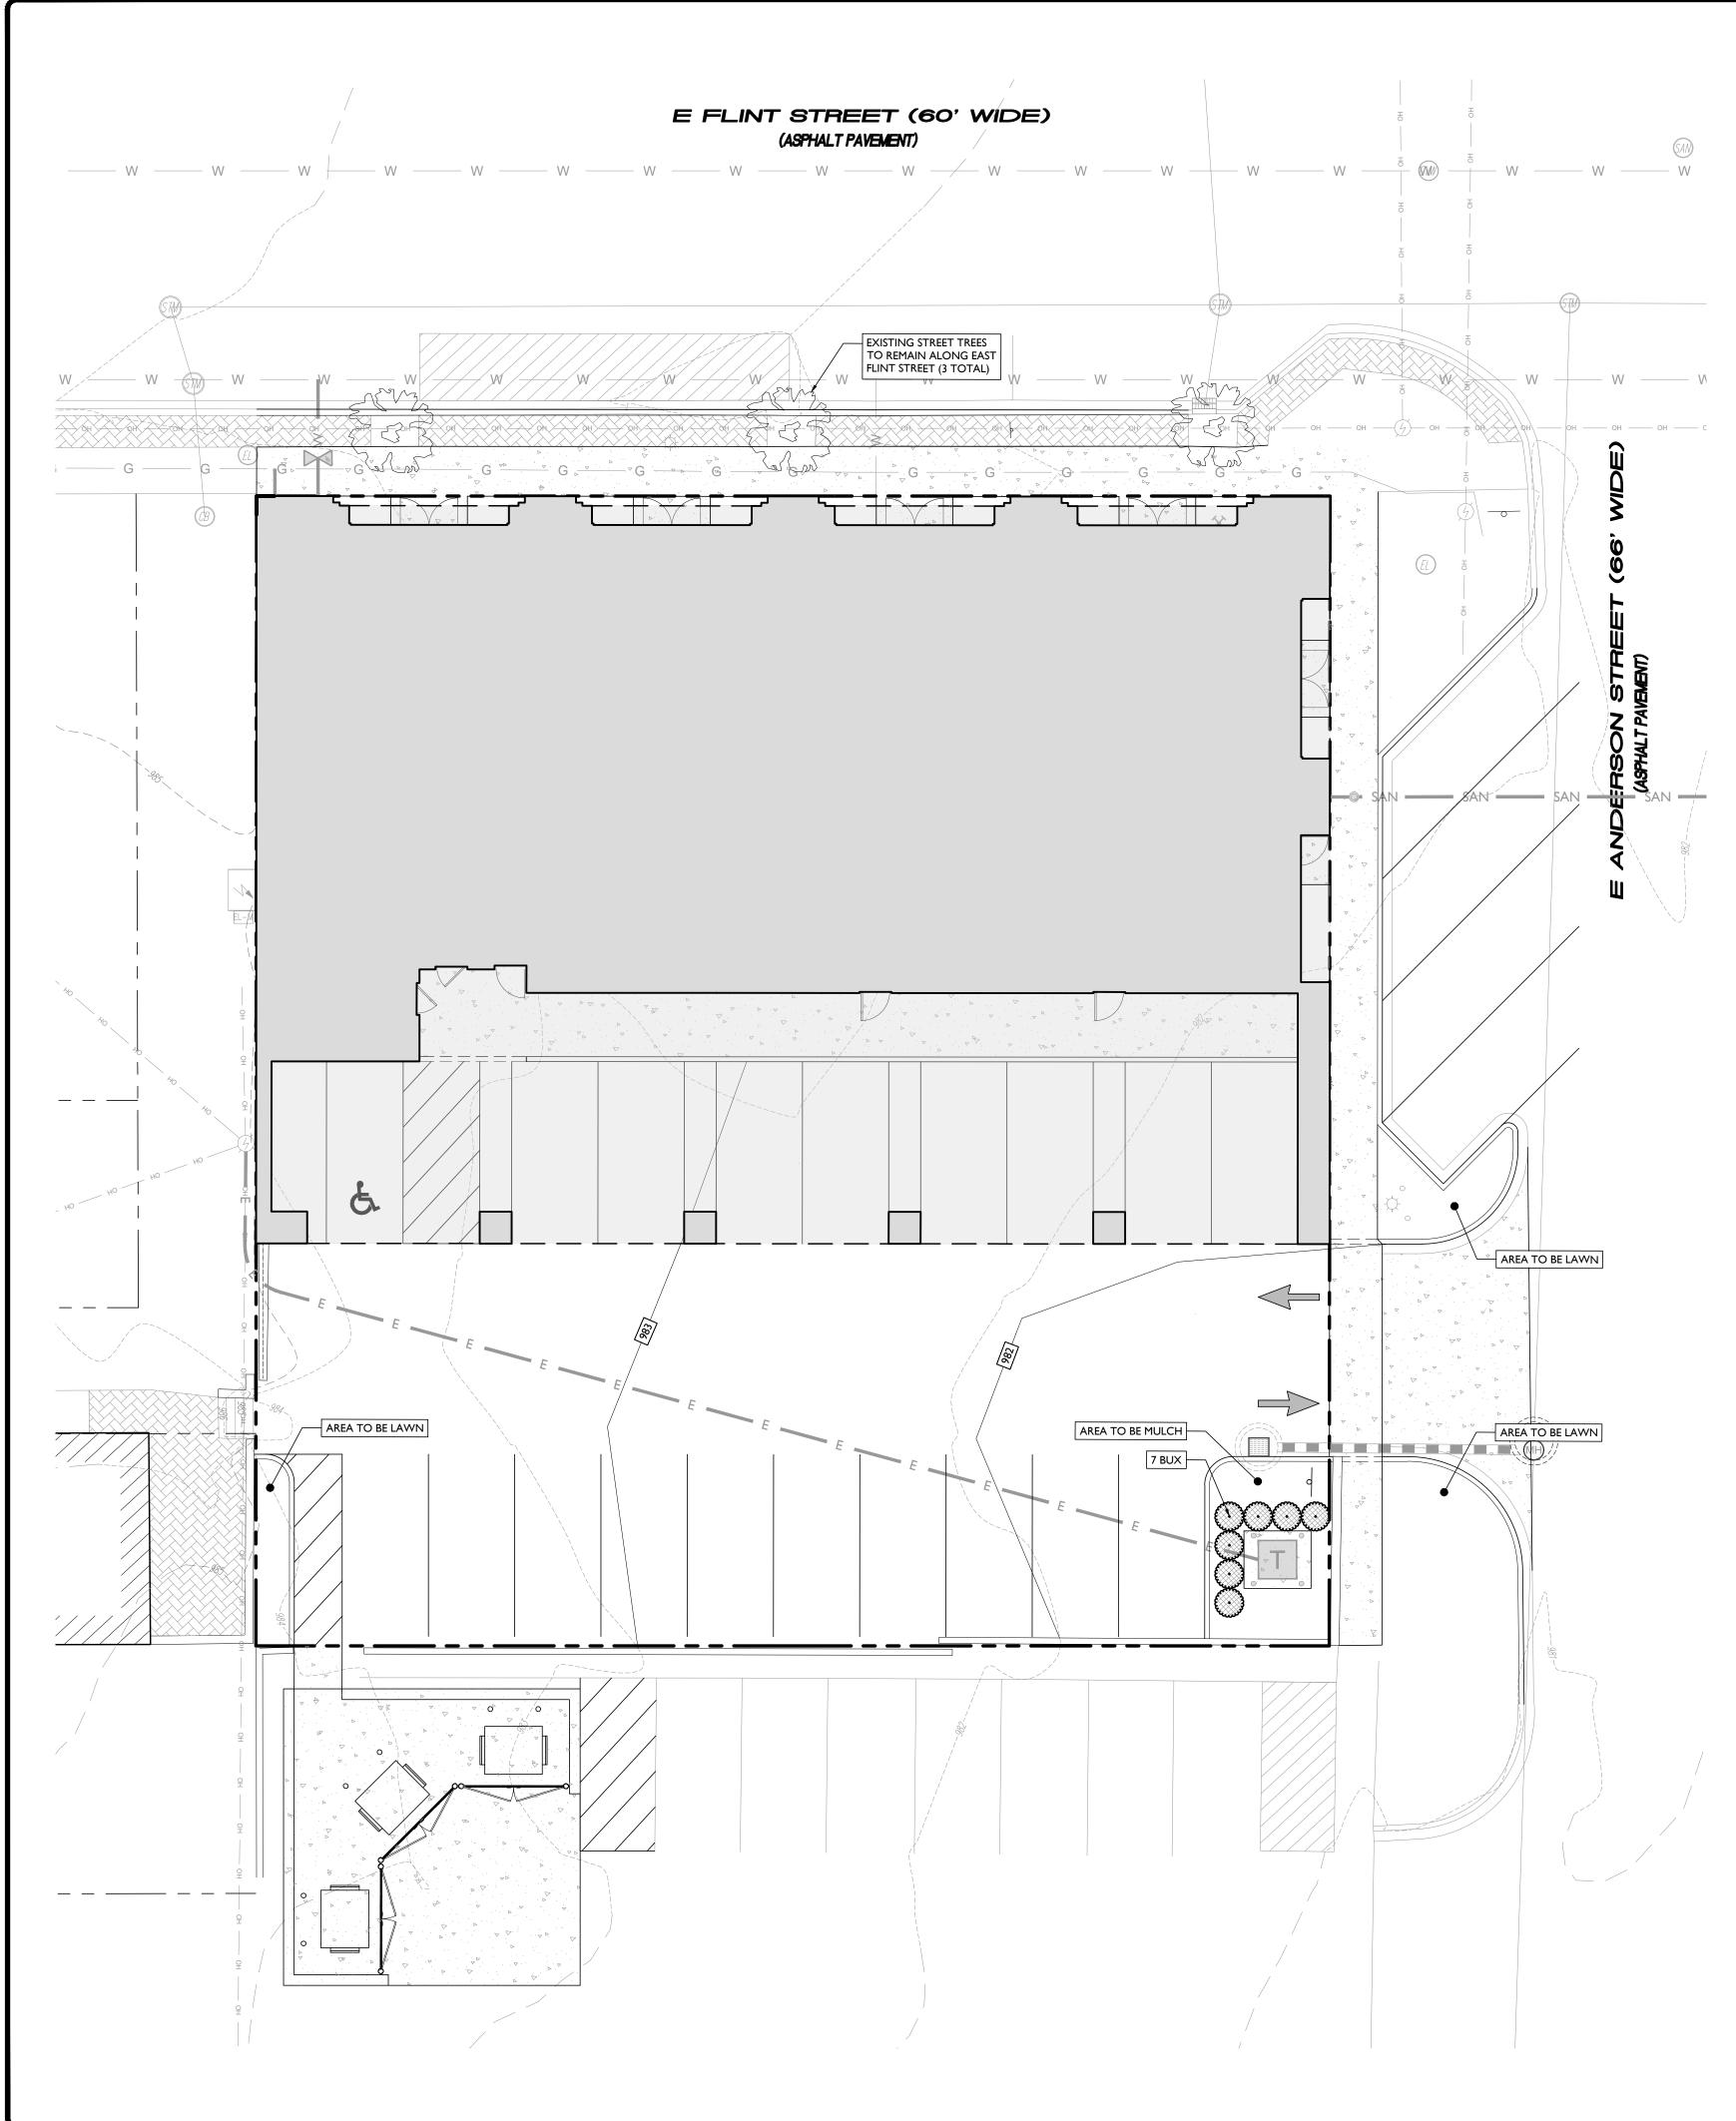

	LANDSCAPING REQUIREMENTS	
CODE SECTION	REQUIRED	PROPOSED
	DC DOWNTOWN LANDSCAPING	
§ 15.02.C.	PARCELS IN DC - DOWNTOWN DISTRICT ARE EXEMPT FROM LANDSCAPING REQUIREMENTS EXCEPT FOR:	
§ 15.02.C.1.	TREES REQUIRED TO ENHANCE BUILDING AND STREET	COMPLIES
§ 15.02.C.2.	PLANTER BOXES OR OTHER LANDSCAPE FEATURES REQUIRED WHERE APPROPRIATE	COMPLIES
§ 15.02.C.3.	OUTDOOR UTILITY EQUIPMENT SHALL BE SCREENED	COMPLIES

PLANT SCHEDULE						
SYMBOL	CODE	QTY	BOTANICAL NAME	COMMON NAME	SIZE	CONTAINER
EVERGREEN SHRUBS						
\odot	BUX	7	BUXUS X 'GREEN MOUNTAIN'	GREEN MOUNTAIN BOXWOOD	18" - 24"	POT
\bigcirc	SEM	5	BUXUS SEMPERVIRENS 'SUFFRUTICOSA'	SUFFRUTICOSA COMMON BOXWOOD	18" - 24"	POT

NOTE: IF ANY DISCREPANCIES OCCUR BETWEEN AMOUNTS SHOWN ON THE LANDSCAPE PLAN AND WITHIN THE PLANT LIST, THE PLAN SHALL DICTATE.




LANDSCAPING NOTES

- THE CONTRACTOR SHALL RESTORE ALL DISTURBED GRASS AND LANDSCAPED AREAS TO MATCH EXISTING CONDITIONS UNLESS INDICATED OTHERWISE WITHIN THE PLAN SET.
 THE CONTRACTOR SHALL RESTORE ALL DISTURBED LAWN AREAS WITH A MINIMUM 4 INCH LAYER OF TOPSOIL AND SEED.
 THE CONTRACTOR SHALL RESTORE MULCH AREAS WITH A MINIMUM 3 INCH LAYER OF MULCH .
 THE MAXIMUM SLOPE ALLOWABLE IN LANDSCAPE RESTORATION AREAS SHALL BE 3 FEET HORIZONTAL TO I FOOT VERTICAL (3:1 SLOPE) UNLESS INDICATED OTHERWISE WITHIN THE PLAN SET.
 THE CONTRACTOR IS REQUIRED TO LOCATE ALL SPRINKLER HEADS
- 5. THE CONTRACTOR IS REQUIRED TO LOCATE ALL SPRINKLER HEADS IN AREA OF LANDSCAPING DISTURBANCE PRIOR TO CONSTRUCTION. THE CONTRACTOR SHALL RELOCATE SPRINKLER HEADS AND LINES IN ACCORDANCE WITH OWNER'S DIRECTION WITHIN AREAS OF DISTURBANCE.
- 6. THE CONTRACTOR SHALL ENSURE THAT ALL DISTURBED LANDSCAPED AREAS ARE GRADED TO MEET FLUSH AT THE ELEVATION OF WALKWAYS AND TOP OF CURB ELEVATIONS EXCEPT UNLESS INDICATED OTHERWISE WITHIN THE PLAN SET. NO ABRUPT CHANGES IN GRADE ARE PERMITTED IN DISTURBED LANDSCAPING AREAS.


GRAPHIC SCALE IN FEET 1" = 10'

NO		VED F		CON	STR	I 09/03/2024 JD FOR ZBA SUBMITTAL	C ISSUE DATE BY DESCRIPTION
	APPROVED FOR CONSTRUCTION STOON ADD ADD ADD ADD ADD ADD ADD ADD ADD AD						
SITE DEVELOPMENT PLANS	44 EAST FLINT STREET					PARCEL ID: 09-02-481-007 & 09-02-481-008	VILLAGE OF LAKE ORION OAKLAND COUNTY, MICHIGAN
	OF MICH JOHATHANNEED COOKSEY ENGINEER J. REND COOKSEY ENGINEER MICHIGAN HGENSE NA BOUN69428 LICENSED PROFESSION AN ENGINEER						
SCALE TITLE:	StoneField engineering & design SCALE: I" = 10' PROJECT ID: DET-240125 TITLE: LANDSCAPING PLAN DRAWING:						

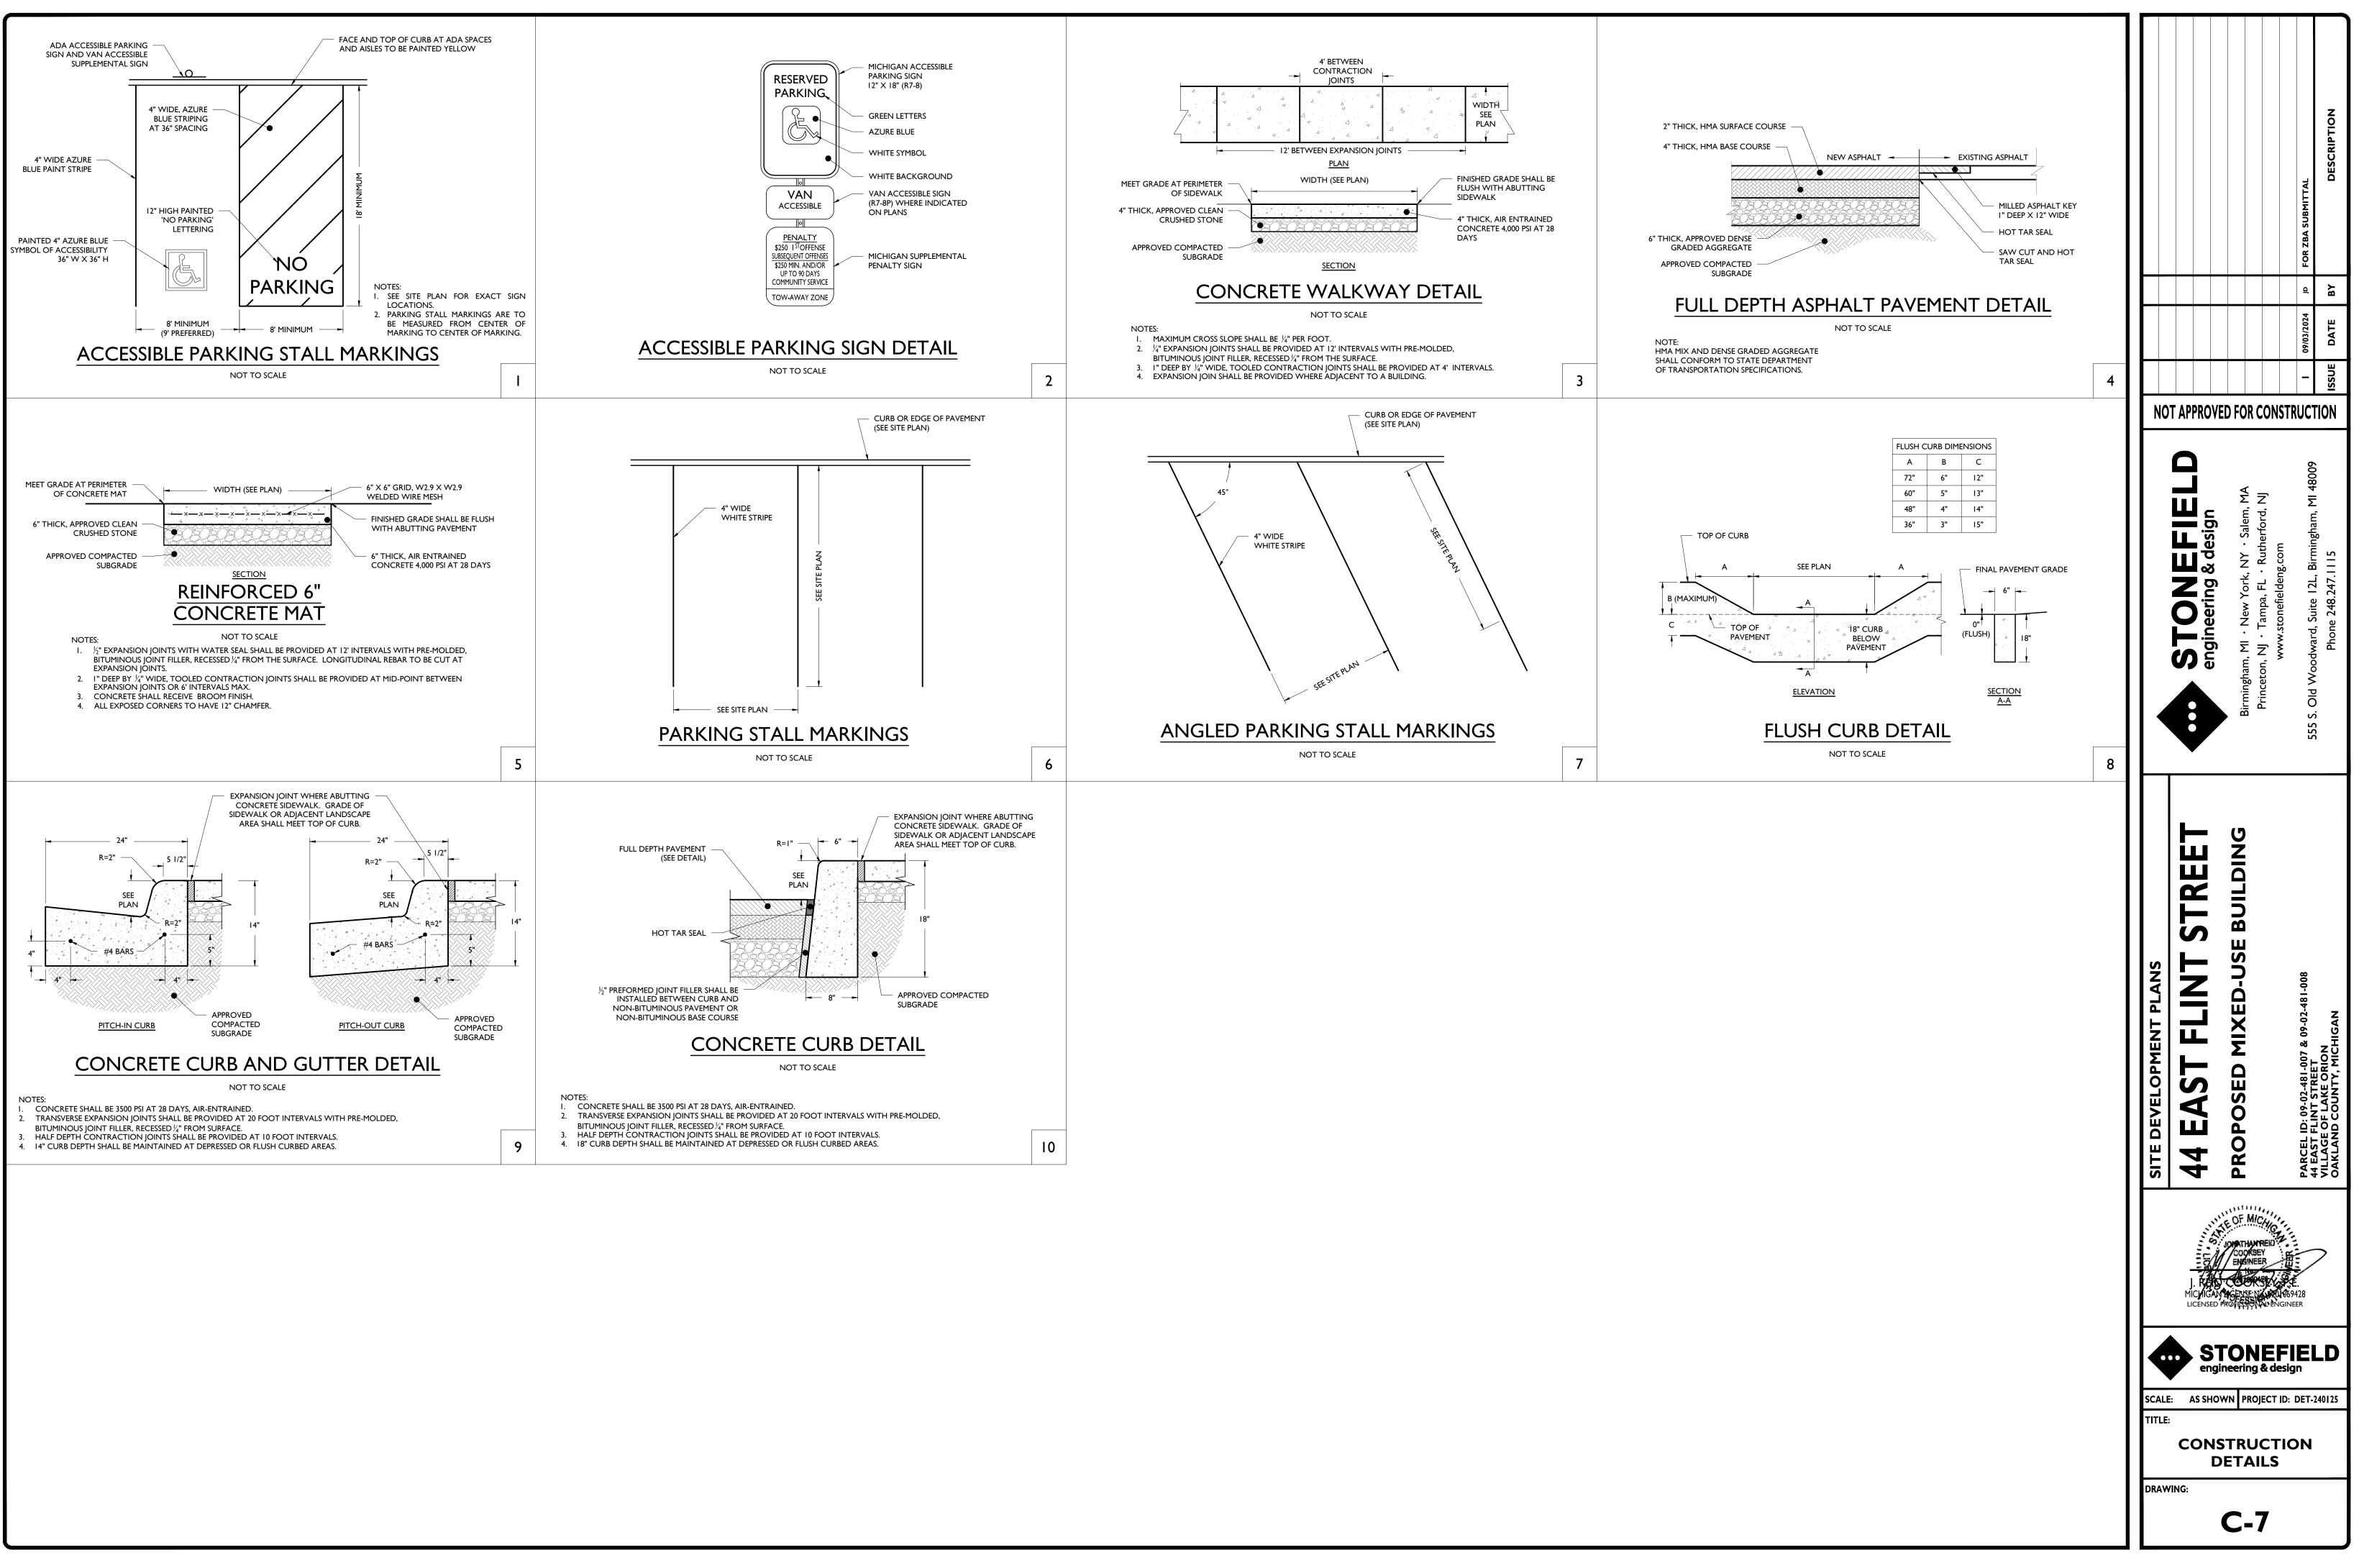





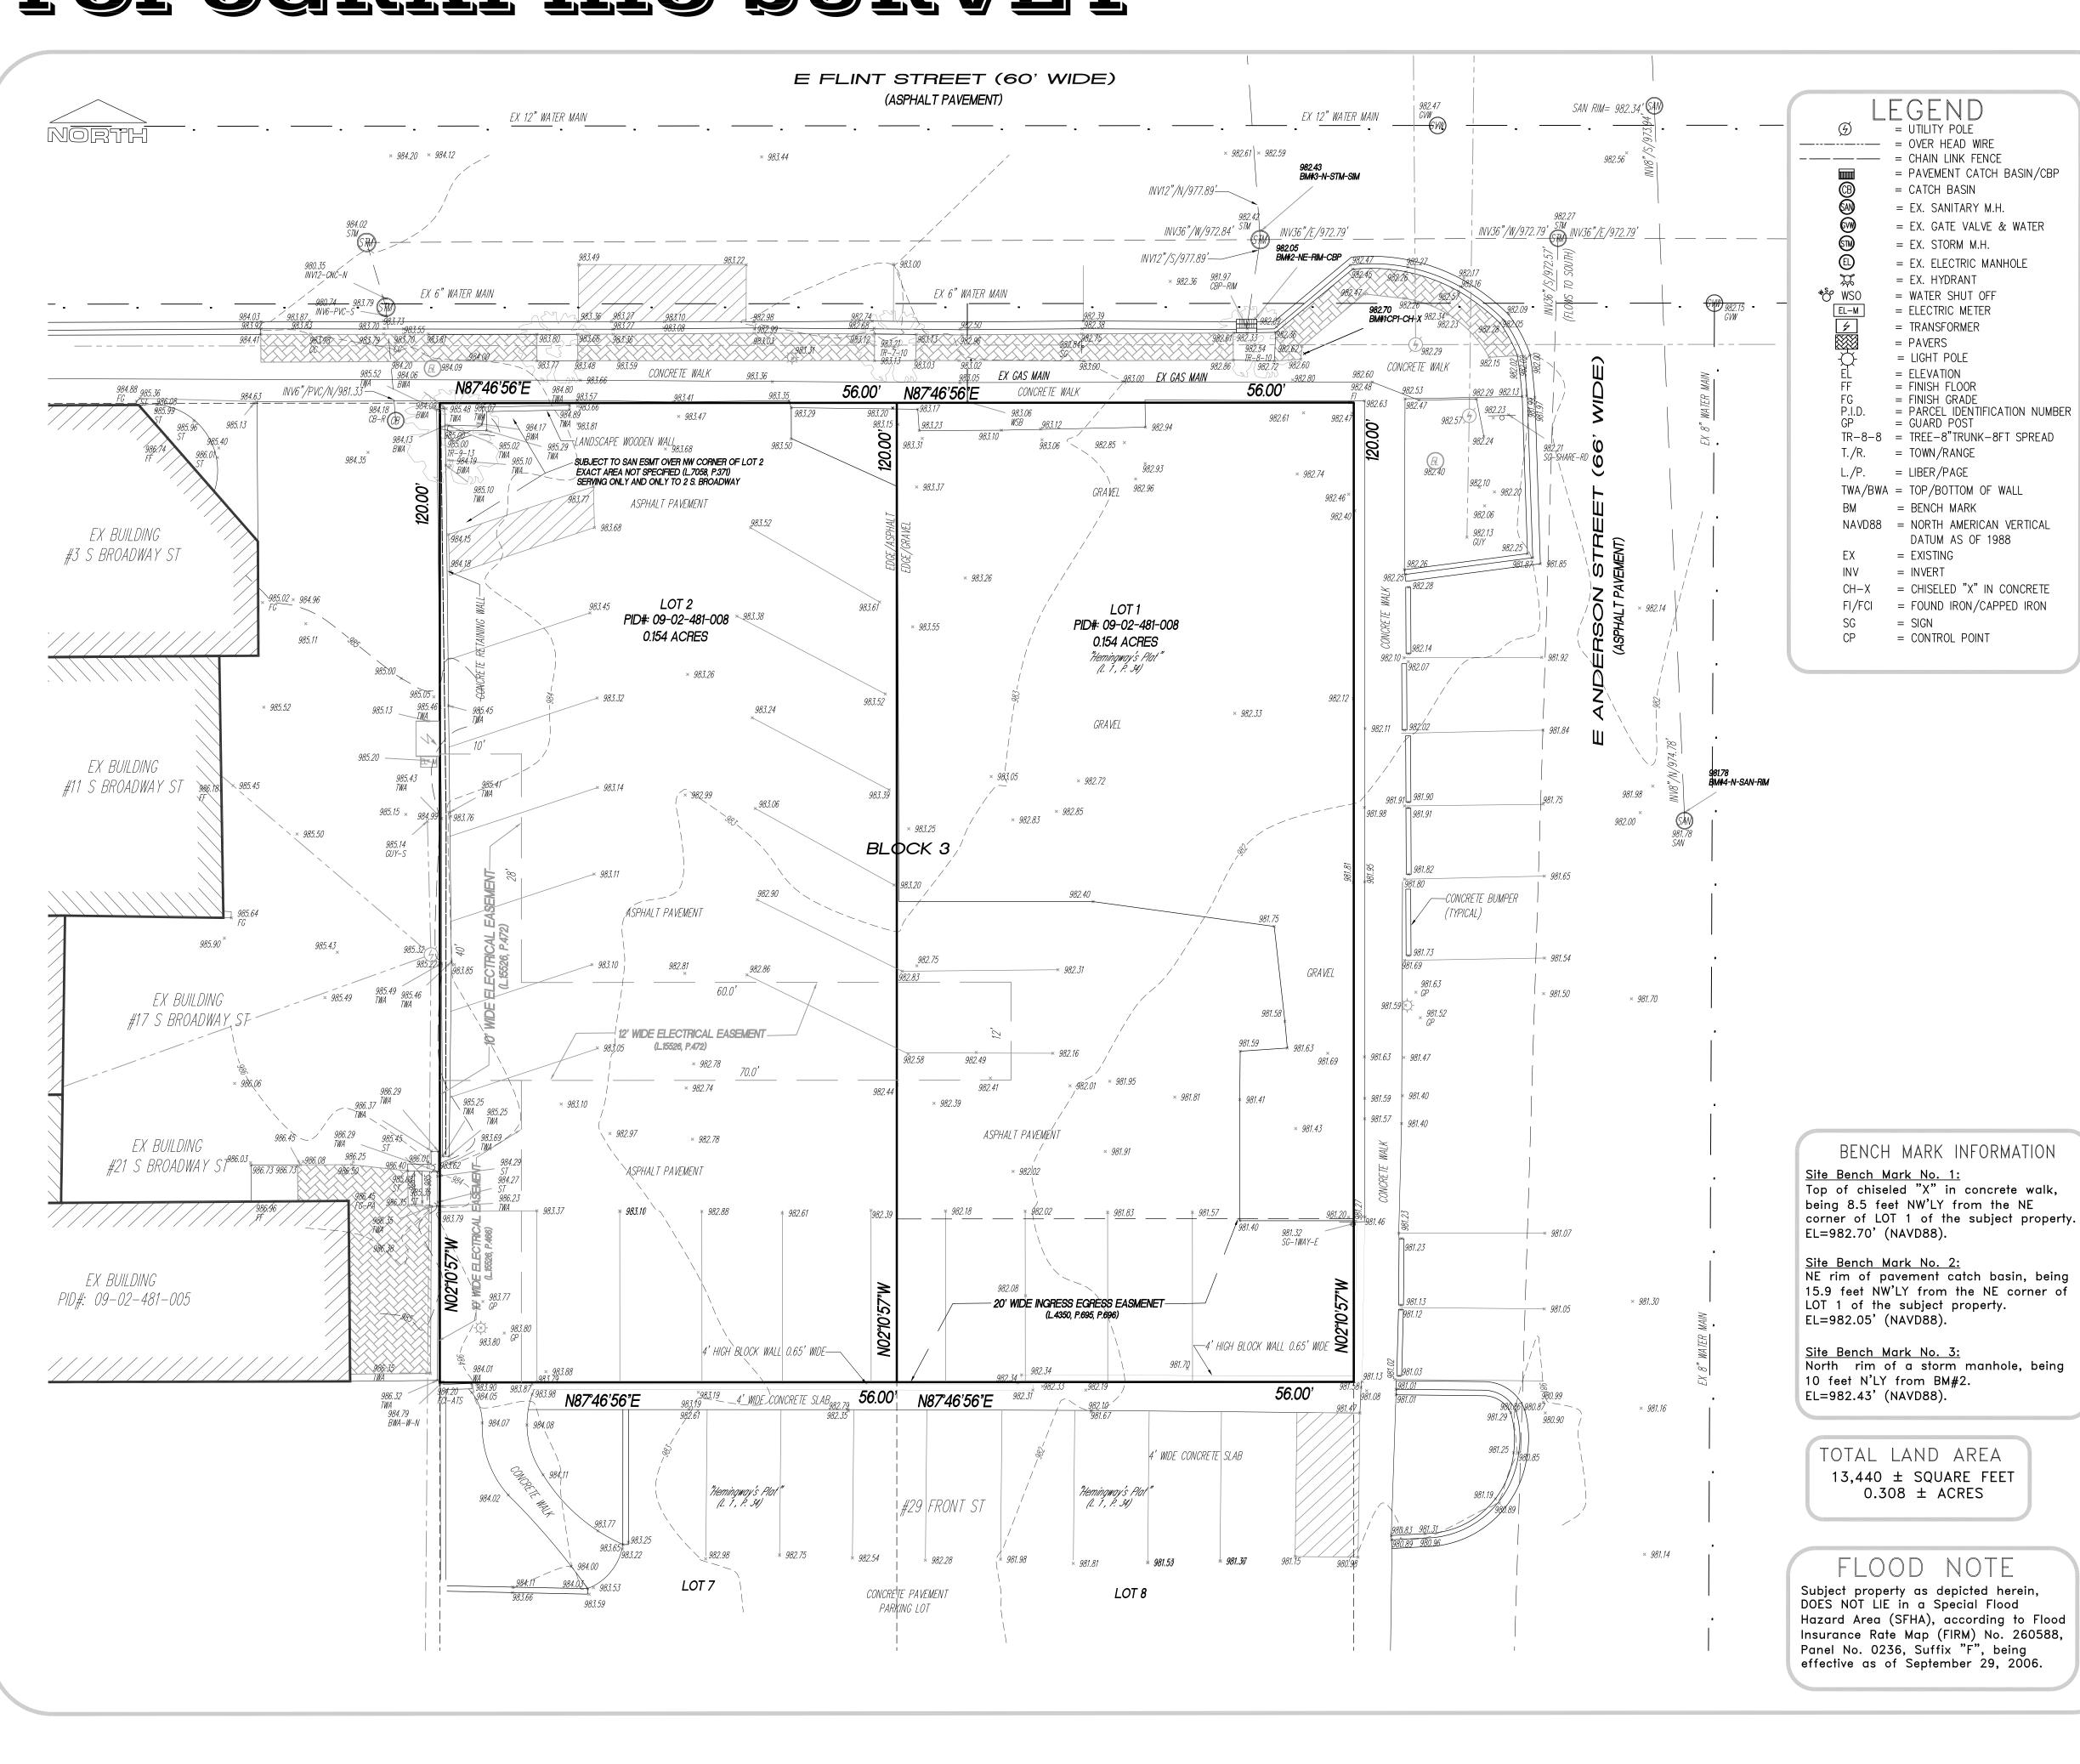

™ NO	F

= PAVEMENT CATCH BASIN/CBP


= EX. GATE VALVE & WATER = EX. ELECTRIC MANHOLE

= PARCEL IDENTIFICATION NUMBER

= TREE-8"TRUNK-8FT SPREAD

DATUM AS OF 1988

= CHISELED "X" IN CONCRETE = FOUND IRON/CAPPED IRON

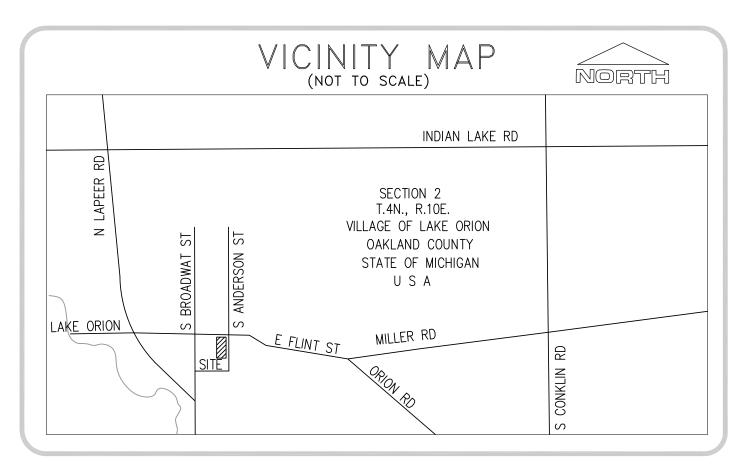

GENERAL NOTES

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-All measurements as shown herein are existing.

-All symbols as shown herein are not to scale.

-While surveying the property as shown herein, entire site was covered with snow and ice. AB-SB Land Survey, P.C. shell not be held liable if some of the site features were omitted.

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_EGAL DESCRIPTION

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Mende Bezanovski, P.S. 49430 Professional Surveyor in the State of Michigan

