
3322 BOUTWELL RD.

LAKE WORTH BEACH, FLORIDA 33461

LANDSCAPE SITEPLAN SET 09/30/2020

		INDEX OF DRAWINGS
		DESCRIPTION
		(LANDSCAPE SITEPLAN SET)
1	L0-00	LANDSCAPE INDEX
2	L0-01	LANDSCAPE NOTES
3	L0-02	LANDSCAPE CALCULATIONS
4	L0-03	TREE SURVEY
5	L1-00	TREE DISPOSITION PLAN
6	L1-01	TREE MITIGATION PLAN
7	L1-10	RENDERED PLAN
8	L1-11	HARDSCAPE PLAN
9	L1-20	TREE PLAN
10	L1-30	SHRUB PLAN
11	L5-10	HARDSCAPE DETAILS
12	L5-20	PLANTING DETAILS
13	L6-00	TREE DISPOSITION & MITIGATION SCHEDULES
14	L6-10	LANDSCAPE SCHEDULES

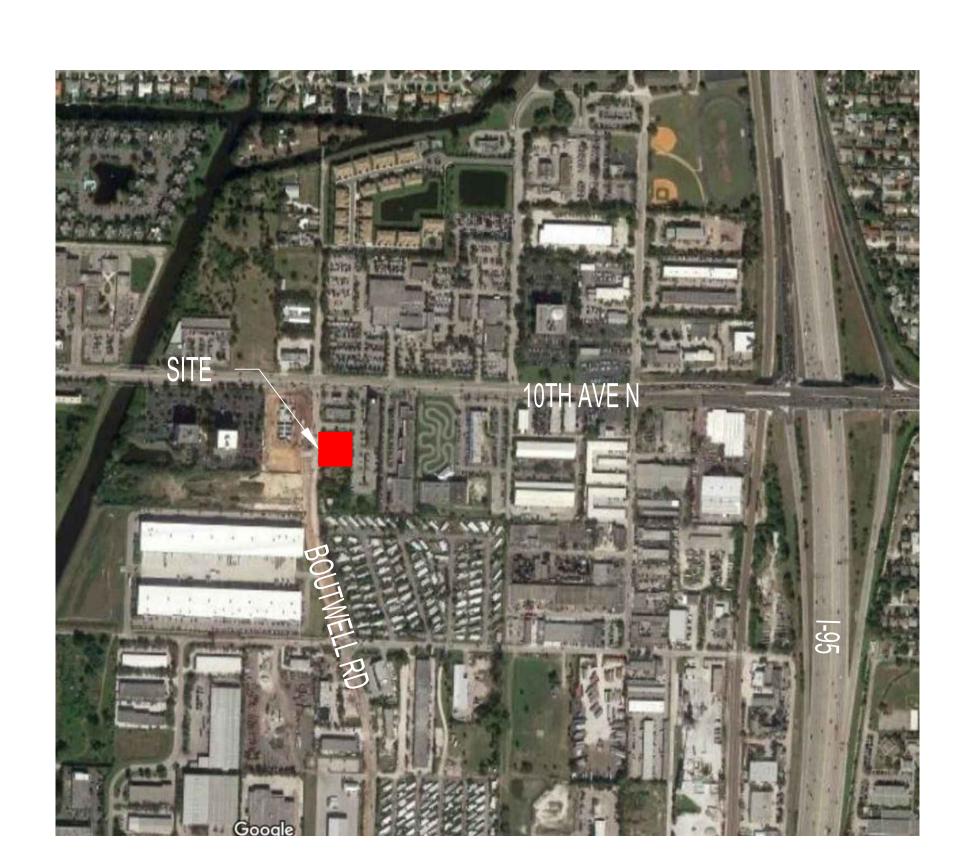

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DRAWING NAME: LANDSCAPE INDEX SCALE: DATE: 09/30/2020

GENERAL NOTES

- 1. These plans reflect the scope of the Landscape Architect external services. For Architectural, Civil, Lighting please refer to the appropriate consultant documents.
- 2. The locations of all site amenities are approximate and may be adjusted in the field with owner and/or their representatives approval. See plans for locations of fixed amenities.
- 3. The locations of plants, as shown in these plans, are approximate. The final locations may be adjusted to accommodate unforeseen field conditions to comply with safety criteria, to avoid creating unsafe sight conditions, or as otherwise directed by or approved by the landscape architect or owner's representative.
- 4. Construction shall comply with all local building codes.
- 5. All dimensions shall be verified in the field prior to construction. Written dimensions shall take precedence over scaled drawings.
- 6. If a discrepancy should arise between layout geometry and design intent, design intent shall take
- 7. A Tree Protection Plan shall be provided prior to the issuance of a building permit.
- 8. A Tree Care & Watering plan shall be submitted prior to the issuance of a building permit.
- 9. All existing and proposed utilities will be verified prior to the issuance of a building permit, and will be adequately screened from sight by landscape materials.

GENERAL GRADING NOTES

- 1. All grading information outside the below grade parking decks provided is intended for aesthetic purposes and to show relationships only. For detailed grading information see Civil Engineers drawings.
- 2. Rough grading and site preparation shall be completed for review by Landscape Architect / or owners representative prior to final grading.
- 3. Roadway grading and transition areas to be reviewed and approved by Civil / Traffic Engineer.
- 4. Grading and calculations for retention areas to be provided by Civil Engineers.
- 5. Contractor shall not substantially modify grading plan without the approval of designer. All site aesthetic grading is subject to review and approval of the landscape architect or owner's representative.
- 6. Contours for earth mounds shall be smooth, continuous arcs. Side slopes shall be smooth and even in transition and void of depressions. Careful attention should be given to the grading plans concerning the
- 7. All graded areas shall be dragged with a drag mat or hand radeel to blend in small imperfections and round off any sharp lines that may have been constructed by equipment. All areas to be planted shall have no water holding pockets.

IRRIGATION NOTES

- 1. All landscaped areas within the property shall be irrigated with automatic irrigation system which shall utilize well and/or domestic water supply.
- 2. Irrigation system shall be equipped with rain sensor.
- 3. Irrigation system shall provide 100% coverage. Plans will be submitted prior to the issuance of a building permit.

GENERAL LANDSCAPE NOTES

- 1. The Contractor shall be responsible for verifying all underground utilities prior to digging in any area. The contractor shall notify all necessary utility companies 48 hours minimum prior to digging for verification of all underground utilities, irrigation and all other obstructions and coordinate with Owner's Representative prior to initiating operations. Drawings are prepared according to the best information available at the time of preparing documents.
- 2. The contractor is responsible to ensure proper watering and maintenance of new and relocated plant materials during the one year warranty period.
- 3. Contractor is to report any discrepancies between the construction drawings and field conditions to the Owner's Representative immediately.
- 4. Landscape Contractor shall coordinate all work with related contractors and with the general construction of the project in order not to impede the progress of the work of others or the contractor's own work. Landscape contractor shall provide schedule of his/her work two weeks in advance, beginning two weeks prior to commencing landscape trade construction.
- 5. The location of the landscape holding area will be identified by the Owner or Owner's Representative. The Contractor shall adhere to the access routes to and from the holding area without disrupting or impeding access to the site by others. Contractor is responsible for the maintenance of all plant materials, including temporary irrigation and fertilization if necessary during construction, while being held in landscape holding areas.
- 6. The Contractor shall bear all costs of testing of soils, amendments, etc. associated with the work and included in the specifications. Prior to commencement of the landscape planting work the Contractor shall provide complete soil tests with recommendations for soil treatment in the construction area.
- 7. Landscape Contractor shall field stake the location of all plant material or field stake the plants prior to initiating installation for the review and approval of the Owner's representative and/or Landscape Architect. Note: No planting shall commence until there is a functional irrigation system in the area to be planted. No trees shall be planted on top of irrigation lines.
- 8. Landscape Contractor shall field adjust location of plant material as necessary to avoid damage to all existing underground utilities and/ or existing above ground elements. All changes required shall be completed at the Contractor's expense and shall be coordinated with Owner's Representative and the Landscape Architect.
- 9. Any substitutions in size and/or plant species must be approved by the Landscape Architect or Owner's Representative prior to modification of the contract, purchasing and delivery of plants. All plants will be subject to approval by Landscape Architect and/or Owner's Representative before planting can begin. All plant materials will not include any plants considered to be invasive by the City of Lake Worth Beach.
- 10. Contractor shall refer to the landscape planting details, general notes and the project manual and/or specifications for turtner and complete landscape planting instructions.
- 11. Landscape Contractor shall coordinate all planting work with permanent or temporary irrigation work. Landscape Contractor shall be responsible for all hand watering as required by Owner's Representative to supplement irrigation watering and rainfall. Landscape Contractor shall be responsible for hand watering in all planting areas, regardless of the status of existing or proposed irrigation.
- 12. Landscape Contractor shall clean the work areas at the end of each working day. Rubbish and debris shall be collected and deposited off-site or in an approved disposal area daily. All materials, products and equipment shall be stored in an organized fashion as directed by the Owner's Representative.
- 13. Landscape Contractor shall re-grade all areas disturbed by plant removal, relocation and/or installation work. Landscape Contractor shall replace (by equal size and quality) any and all existing or new plant material disturbed or damaged by plant removal, relocation, and/or installation work.
- 14. Site distance concerns must be maintained for clear site visibility from thirty (30) inches to seventy-two (72) inches, tree trunks are excluded as specified in appropriate municipal codes.
- 15. Guying / staking practices shall not permit nails, screws, wires, etc., to penetrate outer surface of any tree or palm. Trees or palms rejected due to this practice shall be replaced at the Contractor's expense.
- 16. Burlap material, wire cages, plastic straps, etc., must be cut and removed from top one-third (1/3) of root ball.
- 17. Trees grown in grow bags or grow bag type material are not allowed.
- 18. All planting materials shall meet or exceed local requirements as specified by local plant standards.
- 19. All landscape installations shall meet or exceed the minimum requirements as shown in appropriate municipal codes.
- 20. The Contractor shall be responsible for the guarantee of all plant material for a period of twelve (12) months from the date of substantial completion. Substantial completion constitutes the beginning of guarantee period.
- 21. Plant size specifications take precedence over container size.
- 22. Contractor to verify quantities and report any discrepancies to Owners representative and/or Landscape Architect.
- 23. All plant material shall be graded Florida #1 or better.

SOIL PREPARATION AND SOIL MIX

- 1. All plants noted for removal shall be relocated as shown on plans or removed and properly disposed of offsite at contractors expense unless otherwise noted.
- 2. Before finishing top soil grading, scarify & rake subsoil clear of stones (1" diameter and larger), debris, rubbish, and remaining roots from removed plant material to a depth of 6".
- 3. Plant holes should be dug and the sides and bottom of the hole should be stable, regardless of depth. Soil scarification is necessary if sides of the hole are compacted
- 4. Contractor to apply approved pre-emergent herbicide in accordance with manufacturer's rate and specifications. Contractors to provide manufacturer's specifications for approval.
- 5. Planting soil mix for planters, trees, shrubs, and ground cover & grasses shall be determined by soil analysis prior to planting landscape.

The planting soil mix should be what comes out of the hole so the plant adapts to the surrounding/existing soil and grows into it. This is why the sides and the bottom of the planting hole should never be compacted with the digging implements. Never fertilize newly planted plants and trees. Please note that peat moss will eventually decompose and clog soil pores thereby inhibiting the plants water and oxygen consumption.

- 6. Topsoil shall be natural, fertile, agricultural soil capable of sustaining vigorous plant growth. It shall be of uniform composition throughout, with admixture of subsoil, it shall be free of stones, lumps, live plants and their roots, sticks, and other extraneous material. Top soil brought in should match as well as possible the existing soil texture and Ph. Planted material should never be "mounded" or raised; the soil will eventually wash away exposing the roots and it will be difficult to establish the plant material due to drought and excessive soil transpiration. All plant/tree material should be installed with the root collar exposed (approximately 1/2" to1"). Landscape contractor should find the uppermost lateral root and plant that just below the soil surface.
- 7. Smooth topsoil without compaction to two inches (2") below finish grade in areas to be sodded without
- 8. Finish grade all topsoil areas to a smooth non-compacted, even surface assuring positive drainage away from the structures and eliminate any low areas except in retention areas where water may collect.
- 9. Contractor to remove debris and excess material immediately from job site while keeping in mind that heavy equipment will compact soil to the detriment of water drainage and the health of the newly installed plants. All planting areas with compacted soil will have surfaces scarified to a min. of 6" in depth.


PLANTING SPECIFICATIONS

- 1. The contractor is responsible for maintaining, in full, all planting areas (including watering, spraying, mulching, mowing, fertilizing, etc.) Until the job is accepted, in full, by the owner, its representative and Landscape Architect.
- 2. All plant material shall be protected during transport and delivery to final location with shade cloth or other acceptable means of windburn prevention. Plant/tree material shall conform to Florida # 1 as described in Florida grades & standards, the lastest issue.
- 3. All trees must be guyed or staked as shown in details.
- 4. When plant material is delivered onsite, it shall not be laid down for more than two hours. Plant material when stored onsite shall be placed and maintained in good condition in a vertical position. All plants held onsite shall be kept watered regularly in sufficient amounts to permit continuous and vigorous growth.
- 5. Installation of all plant material shall be installed in a sound, workmanlike manner and according to accepted good planting and tree relocation procedures with the quality of plant materials as hereinafter described. All elements of landscaping shall be installed so as to meet all applicable ordinances and code requirements.
- 6. There shall be no chains or cables used directly on trees or palms, handle with 2" minimum width nylon straps or equal.
- 7. Contractor shall assure drainage and percolation of all planting pits. Prior to installation of plant material, contractor shall fill all tree pits with water before planting to assure that proper drainage and percolation is available. Correct if required to assure percolation. Contractor is responsible for replacement of all plants lost due to inadequate drainage conditions. Plant/tree material that has bark scraped off due to shipping, handling, and installation issues may be rejected upon inspection by the L.A.
- 8. Contractor to request inspection of project in writing. If all work is satisfactory and complete in accordance with conditions of contract documents, then the owner, its representative, and landscape architect shall declare the project substantially complete.
- 9. Substantial completion constitutes the beginning of guarantee period.
- 10. Contractor to replace rejected plant within two (2) weeks of notice.
- 11. Crown pruning of any trees or palms is generally not approved by the national arborist association standards. When it is approved, it must be done in writing.
- 12. Xeriscaping principles as outlined in the South Florida Water Management District Xeriscape Plant Guide 2 shall be applied throughout landscape installation and maintenance.

DRAWING ORGANIZATION

1. DRAWING NUMBERING SYSTEM

THE DRAWING NUMBER FOR EACH SHEET CONSISTS OF THE FOLLOWING:

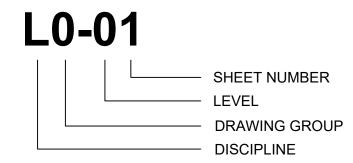

2. DRAWING GROUP

LANDSCAPE DRAWINGS ARE ORGANIZED INTO THE FOLLOWING GROUPS:


- **L0** = GENERAL
- **L1** = PLANS
- **L2** = ELEVATIONS
- **L3** = SECTIONS
- **L4** = ENLARGEMENTS L5 = DETAILS
- **L6** = SCHEDULES

3. SHEET NUMBER

EACH DRAWING SHEET WITHIN EACH GROUP/MULTIPLE SHALL BE NUMBERED SEQUENTIALLY FROM 01 TO 99.

4. DRAWING NUMBER EXAMPLES:

L0-01 LANDSCAPE NOTES

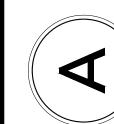

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RAWING NAME: LANDSCAPE NOTES DATE: 09/30/2020

SITE LANDSCAPE CALCULATIONS SITE DATA

MUNICIPALITY LAKEWORTH BEACH ZONING CLASSIFICATION MUW - Mixed use West PROPERTY ADDRESS 3322 Boutwell Rd. LOT AREA 22500 SF = .5 ACRES **IMPERVIOUS AREA** 9,576 SF PERVIOUS AREA 5,277 SF STREET TREE REQUIREMENTS:

STREET TREES REQUIRED (150 LF/25 LF) STREET TREES PROVIDED (RIGHT OF WAY CONSTRAINTS, < 5' SIDEWALK)

ROW BUFFER REQUIREMENTS:

TREES REQUIRED (150 LF/ 25 LF)

BUFFER AREA PROVIDED

TREES PROVIDED SHRUBS REQUIRED (150 LF/ 2 LF) SHRUBS PROVIDED 152 BUFFER AREA REQUIRED (150 LF X 5 SF)

1,122

1052

1077

1,140

1,950

1,360

1,742

INTERIOR SITE PLANTING REQUIREMENTS: TREES REQUIRED (4,915 SF/ 225 SF)

NATIVE TREES REQUIRED (75%): NATIVE TREES PROVIDED (100%): SHRUBS REQUIRED (384 LF X 5 SF/ 5 SF) SHRUBS PROVIDED NATIVE SHRUBS & GROUNDCOVER REQUIRED (75%): NATIVE SHRUBS & GROUNDCOVER PROVIDED (99%):

BUFFER AREA REQUIRED (228 LF X 5 SF) **BUFFER AREA PROVIDED**

OFF-STREET PARKING PLANTING REQUIREMENTS:

PLANTING SF REQUIRED (6,800 SF X 20%) PLANTING SF PROVIDED TREES REQUIRED (1,742 / 125 SF) TREES PROVIDED BUFFER TREES REQUIRED (220 LF / 20')

TOTAL TREES REQUIRED: TOTAL TREES PROVIDED:


BUFFER TREES PROVIDED

TOTAL SHRUBS & GROUNDCOVER REQUIRED: TOTAL SHRUBS & GROUNDCOVER PROVIDED:


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DRAWING NAME: LANDSCAPE CALCS. SCALE: DATE: 09/30/2020 PROJECT NUMBER:1913



TREE SURVEY

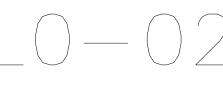


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DRAWING NAME: TREE SURVEY DATE: 09/30/2020
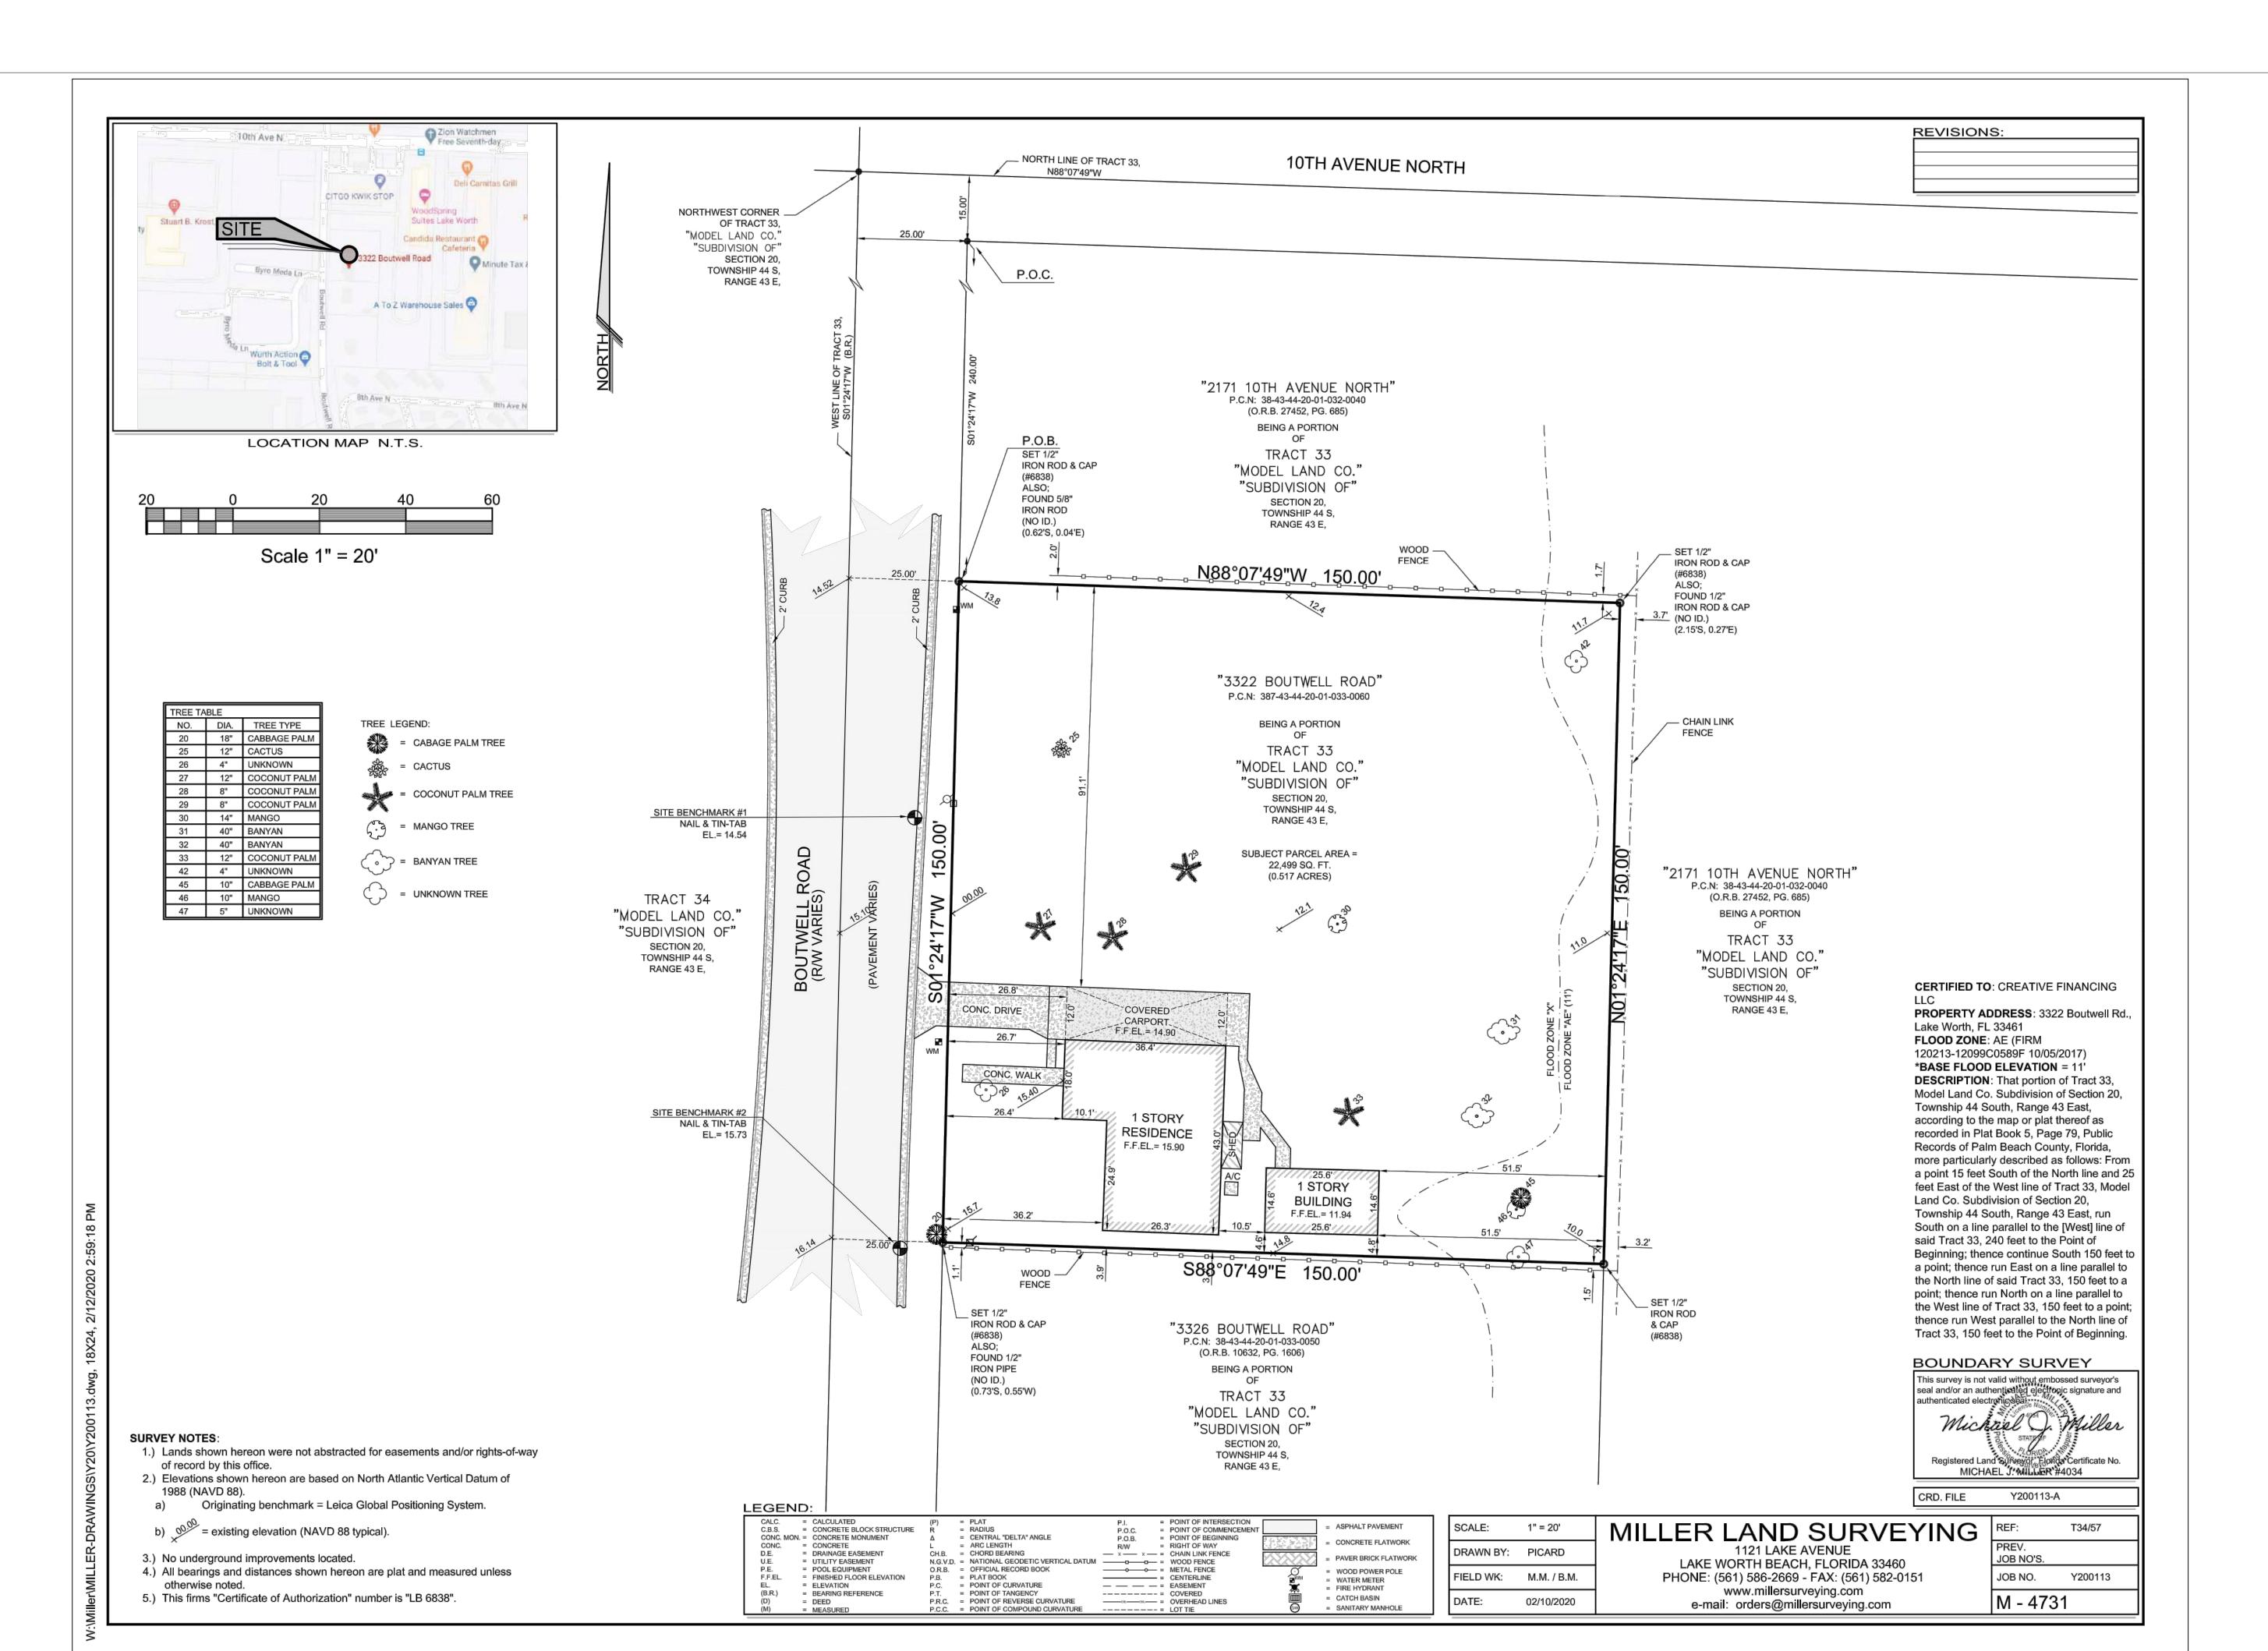
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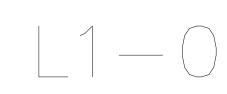


drawing name: TREE DISPOSITION PLAN SCALE: 1/8" = 1'-0" DATE: 09/30/2020PROJECT NUMBER:1913




4 COMMISSION 01/03/2022 COMMENT

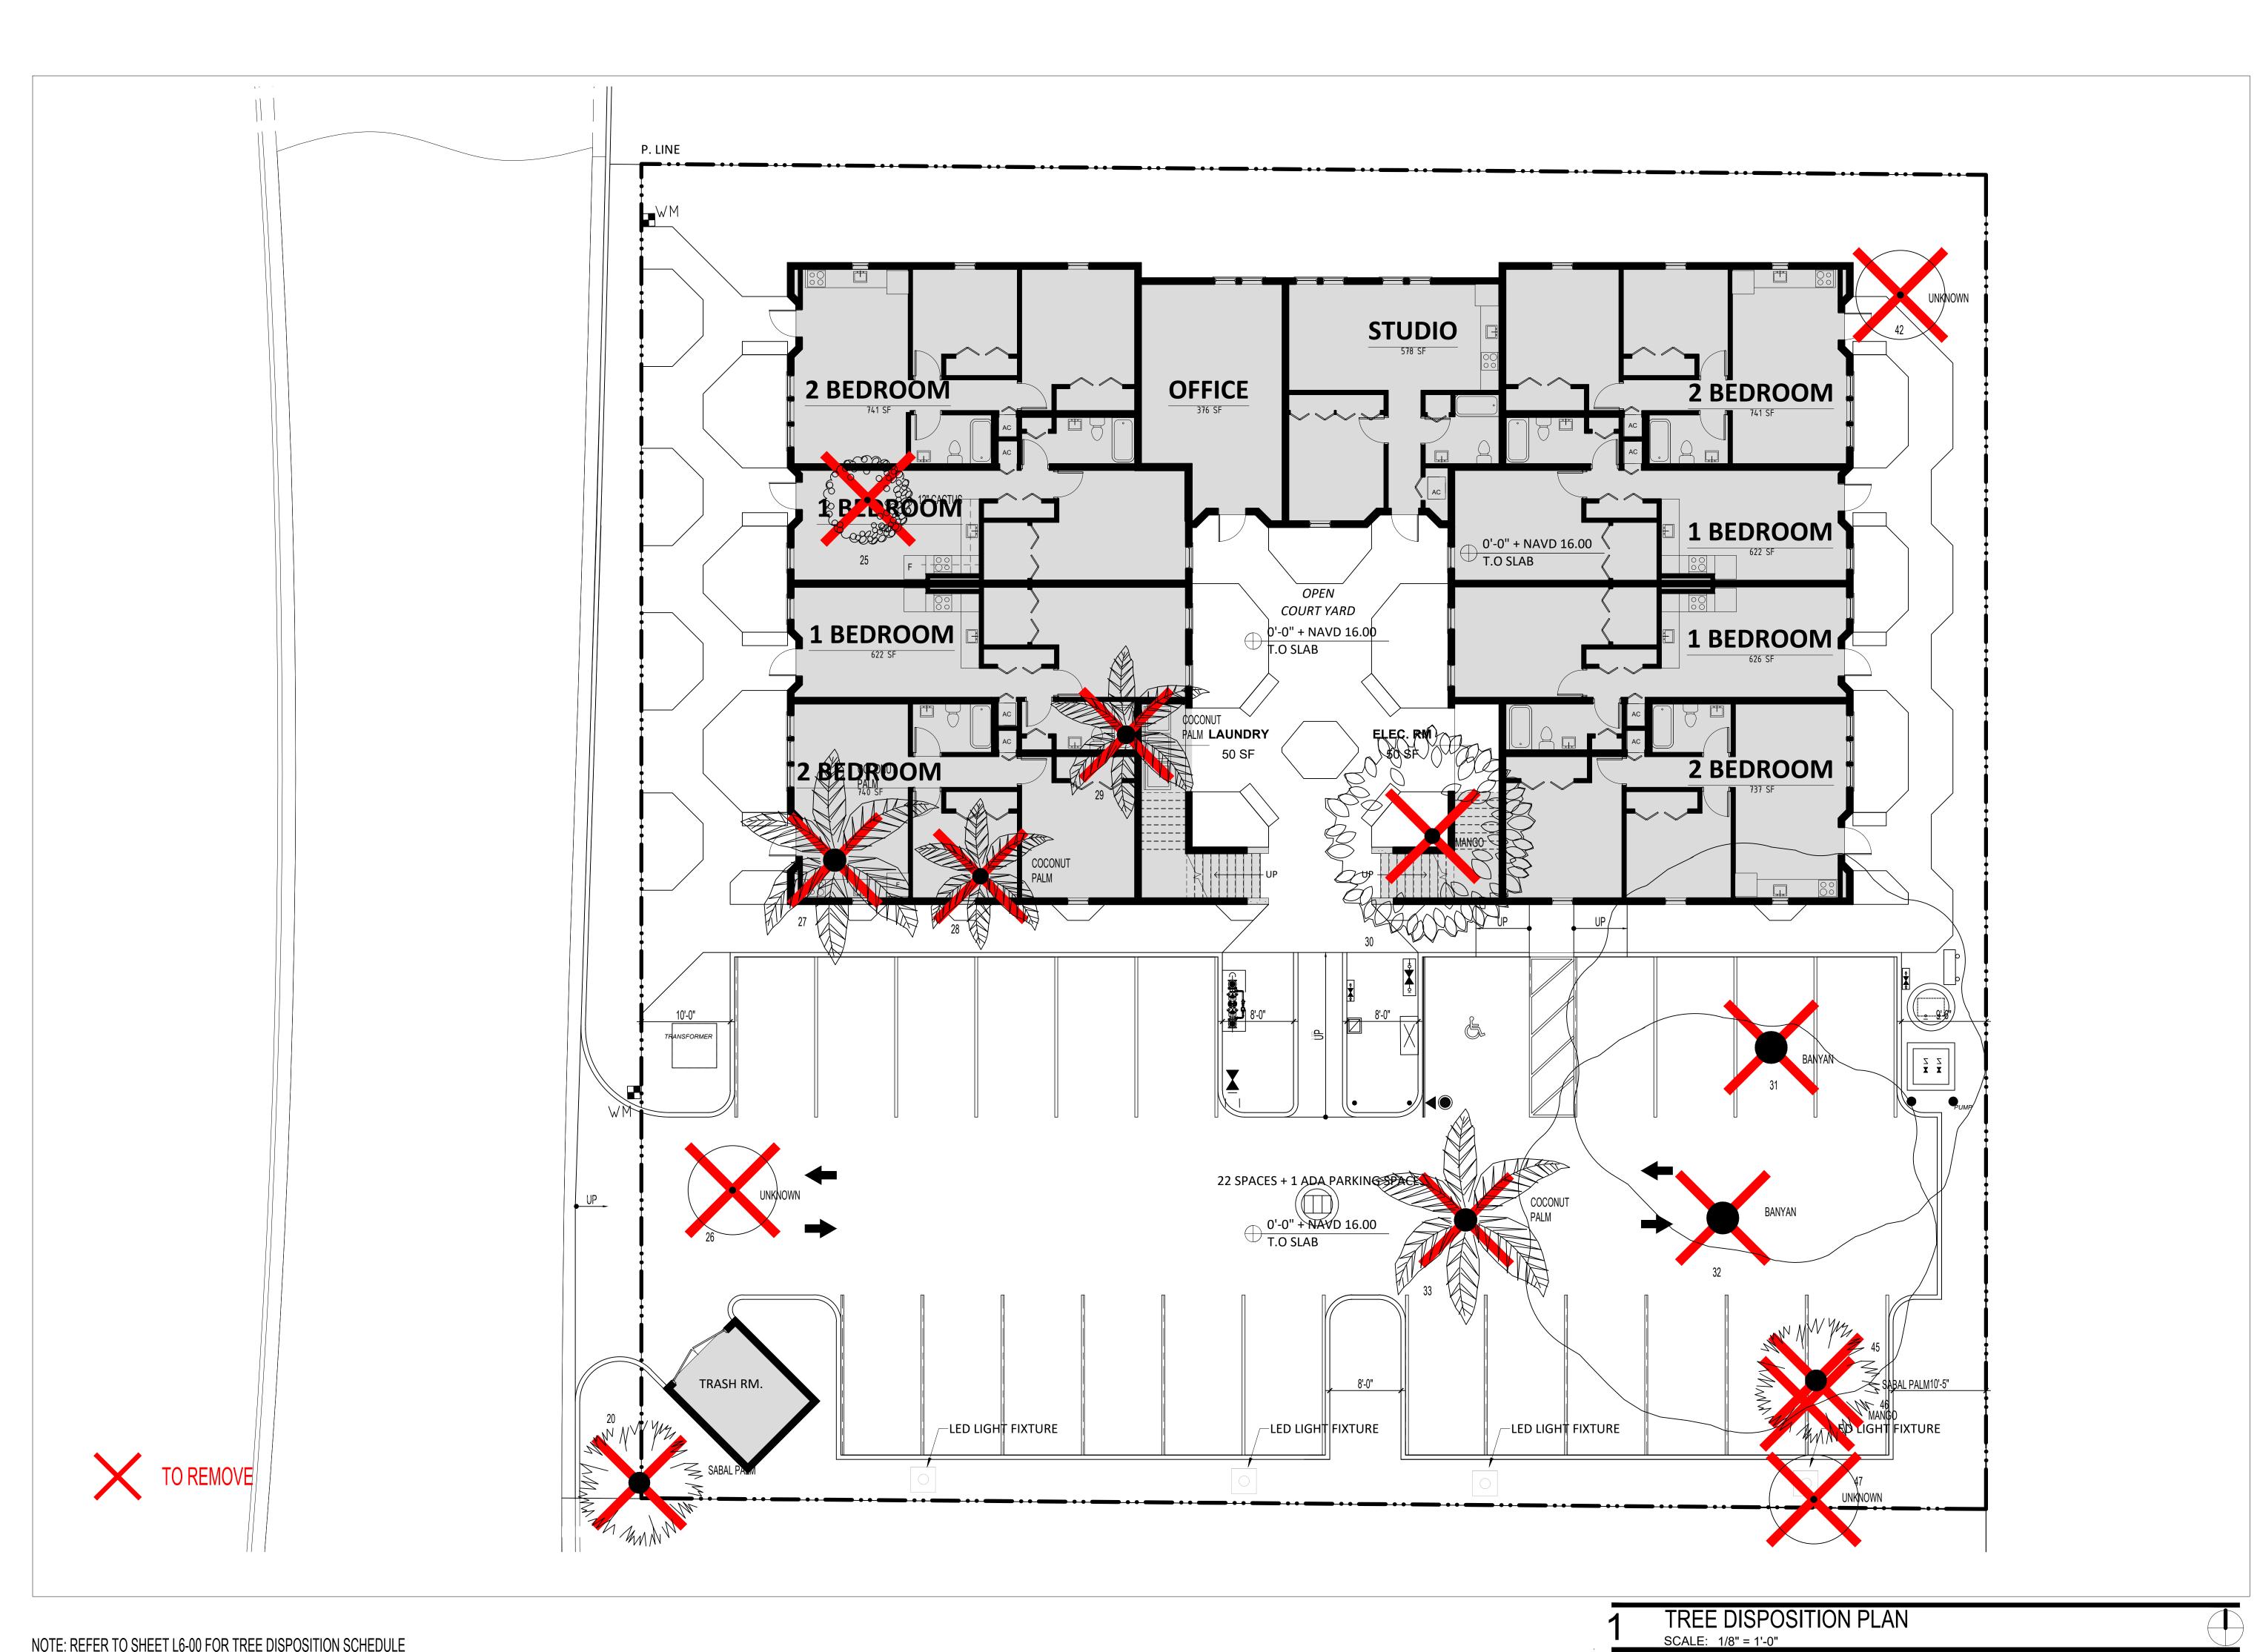
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DRAWING NAME: TREE MITIGATION PLAN SCALE: 1/8" = 1'-0" DATE: 09/30/2020PROJECT NUMBER: 1913



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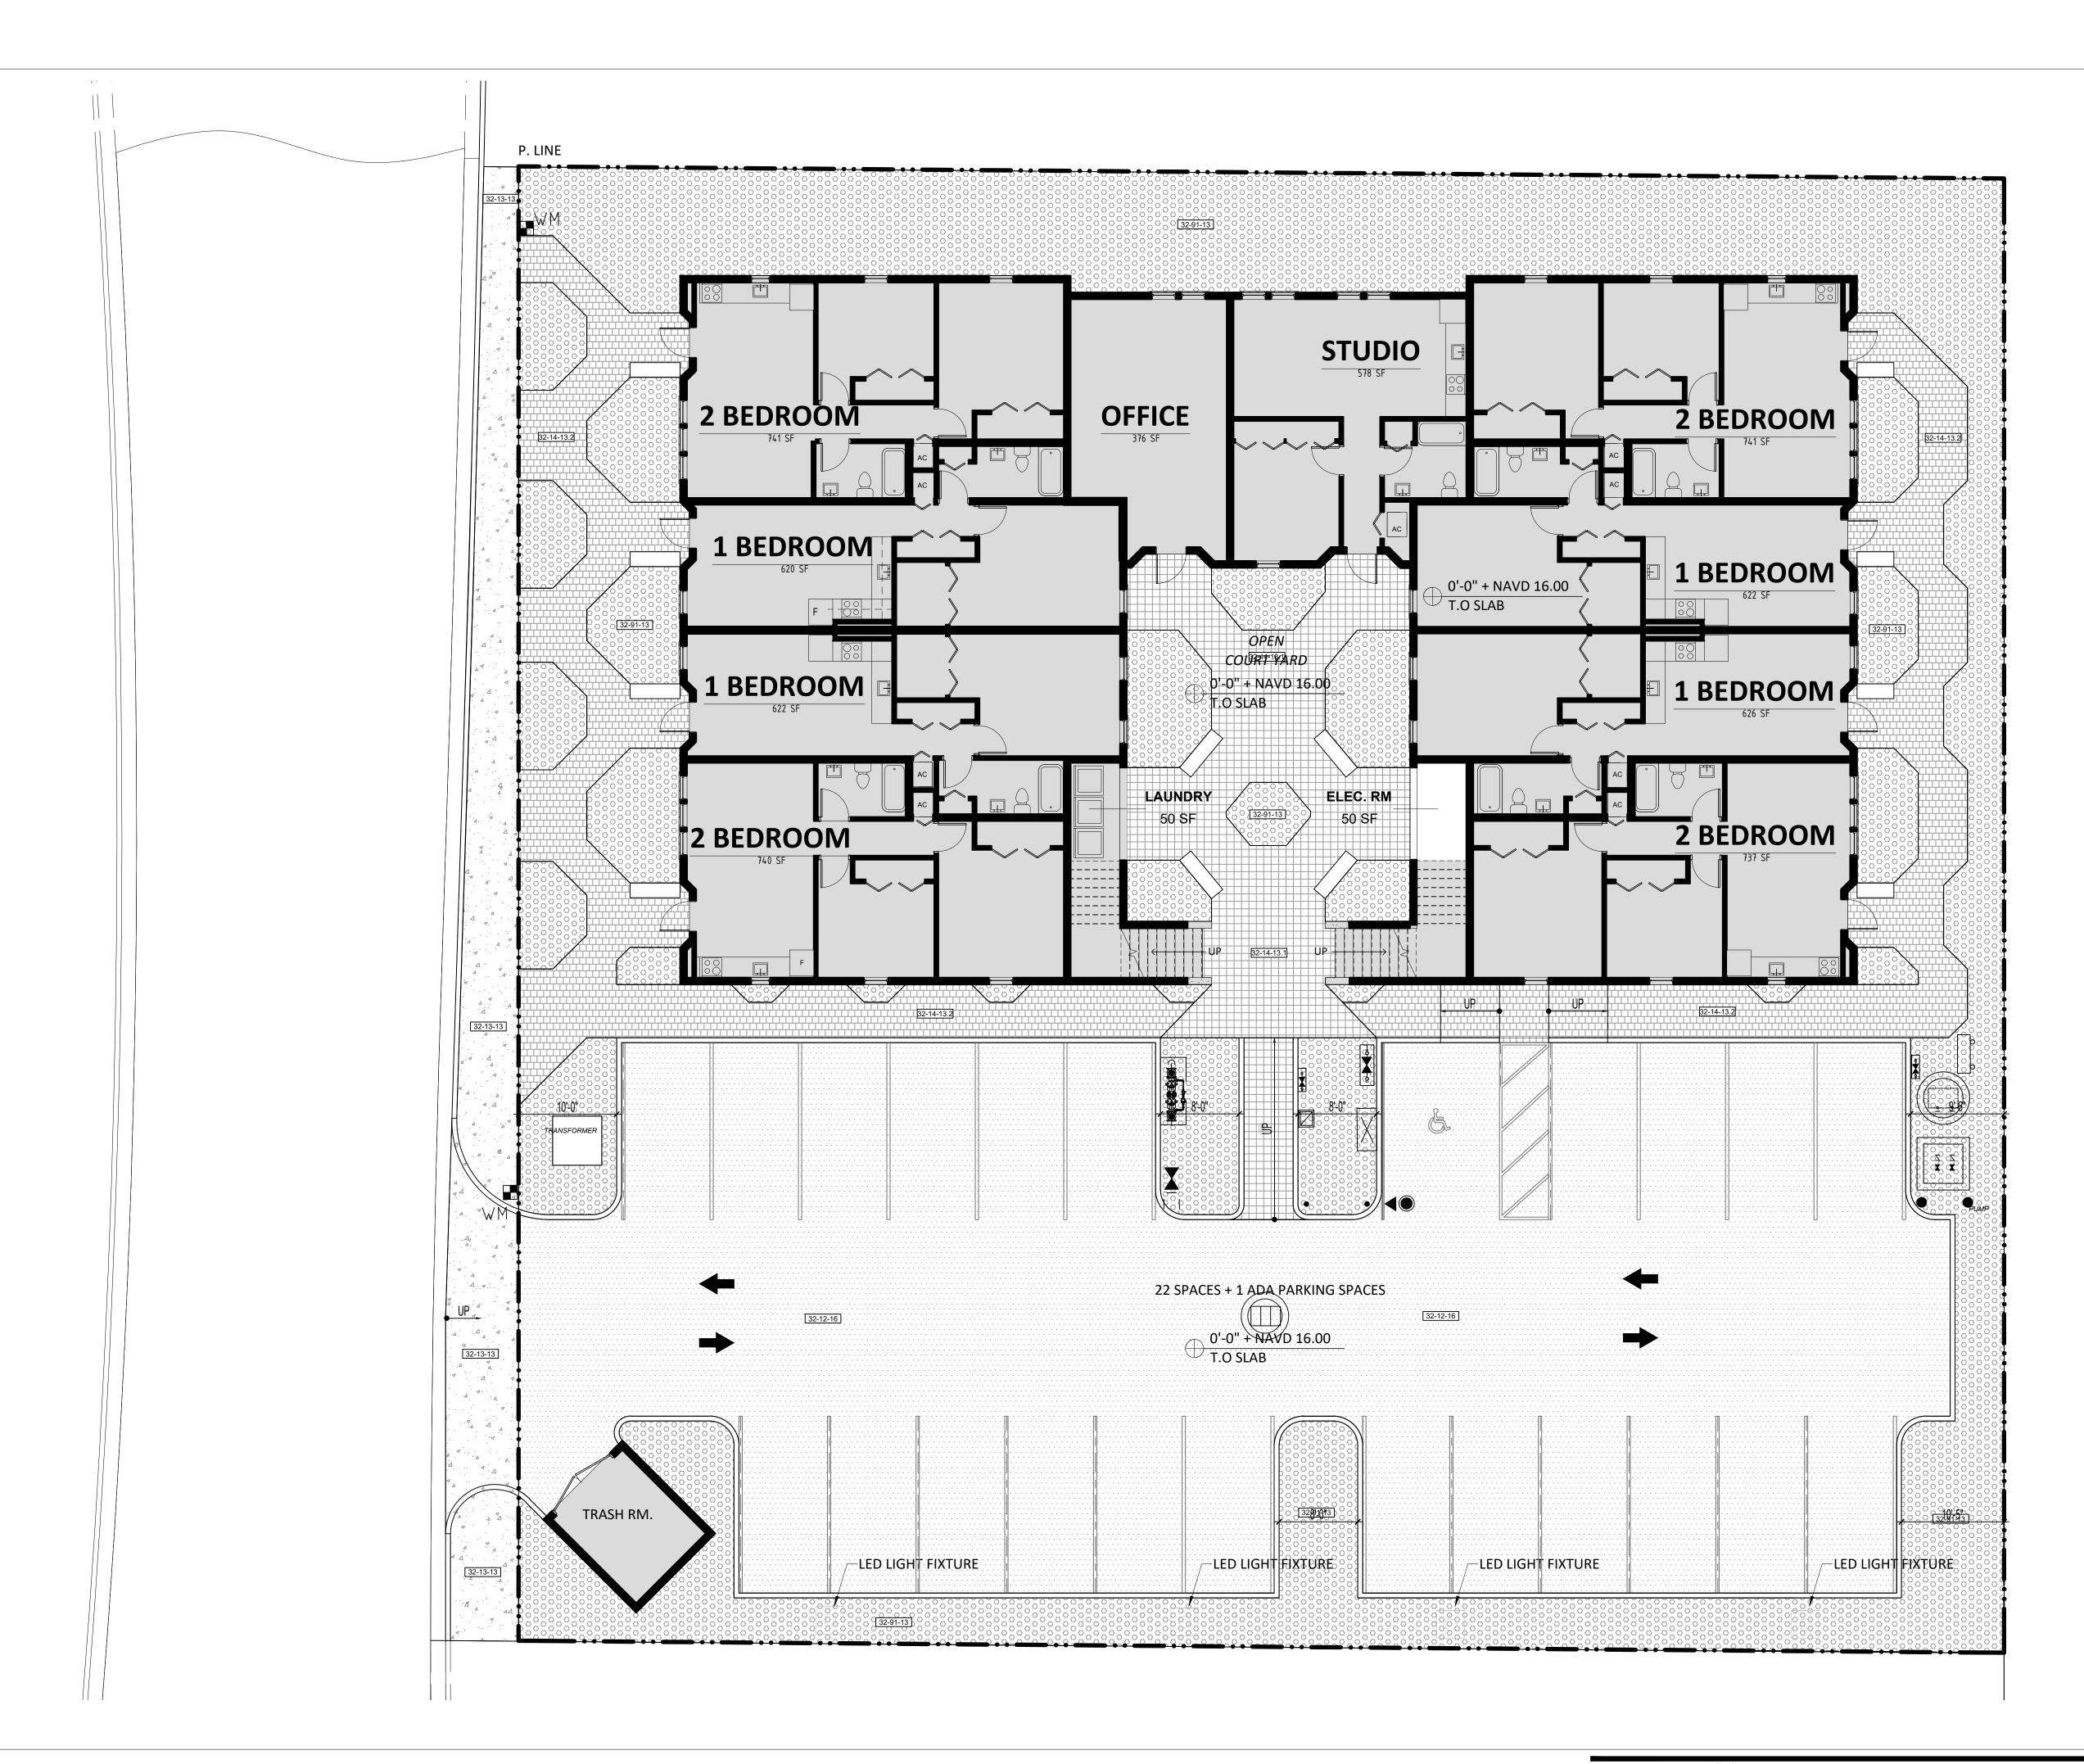
DRAWING NAME: RENDERED PLAN

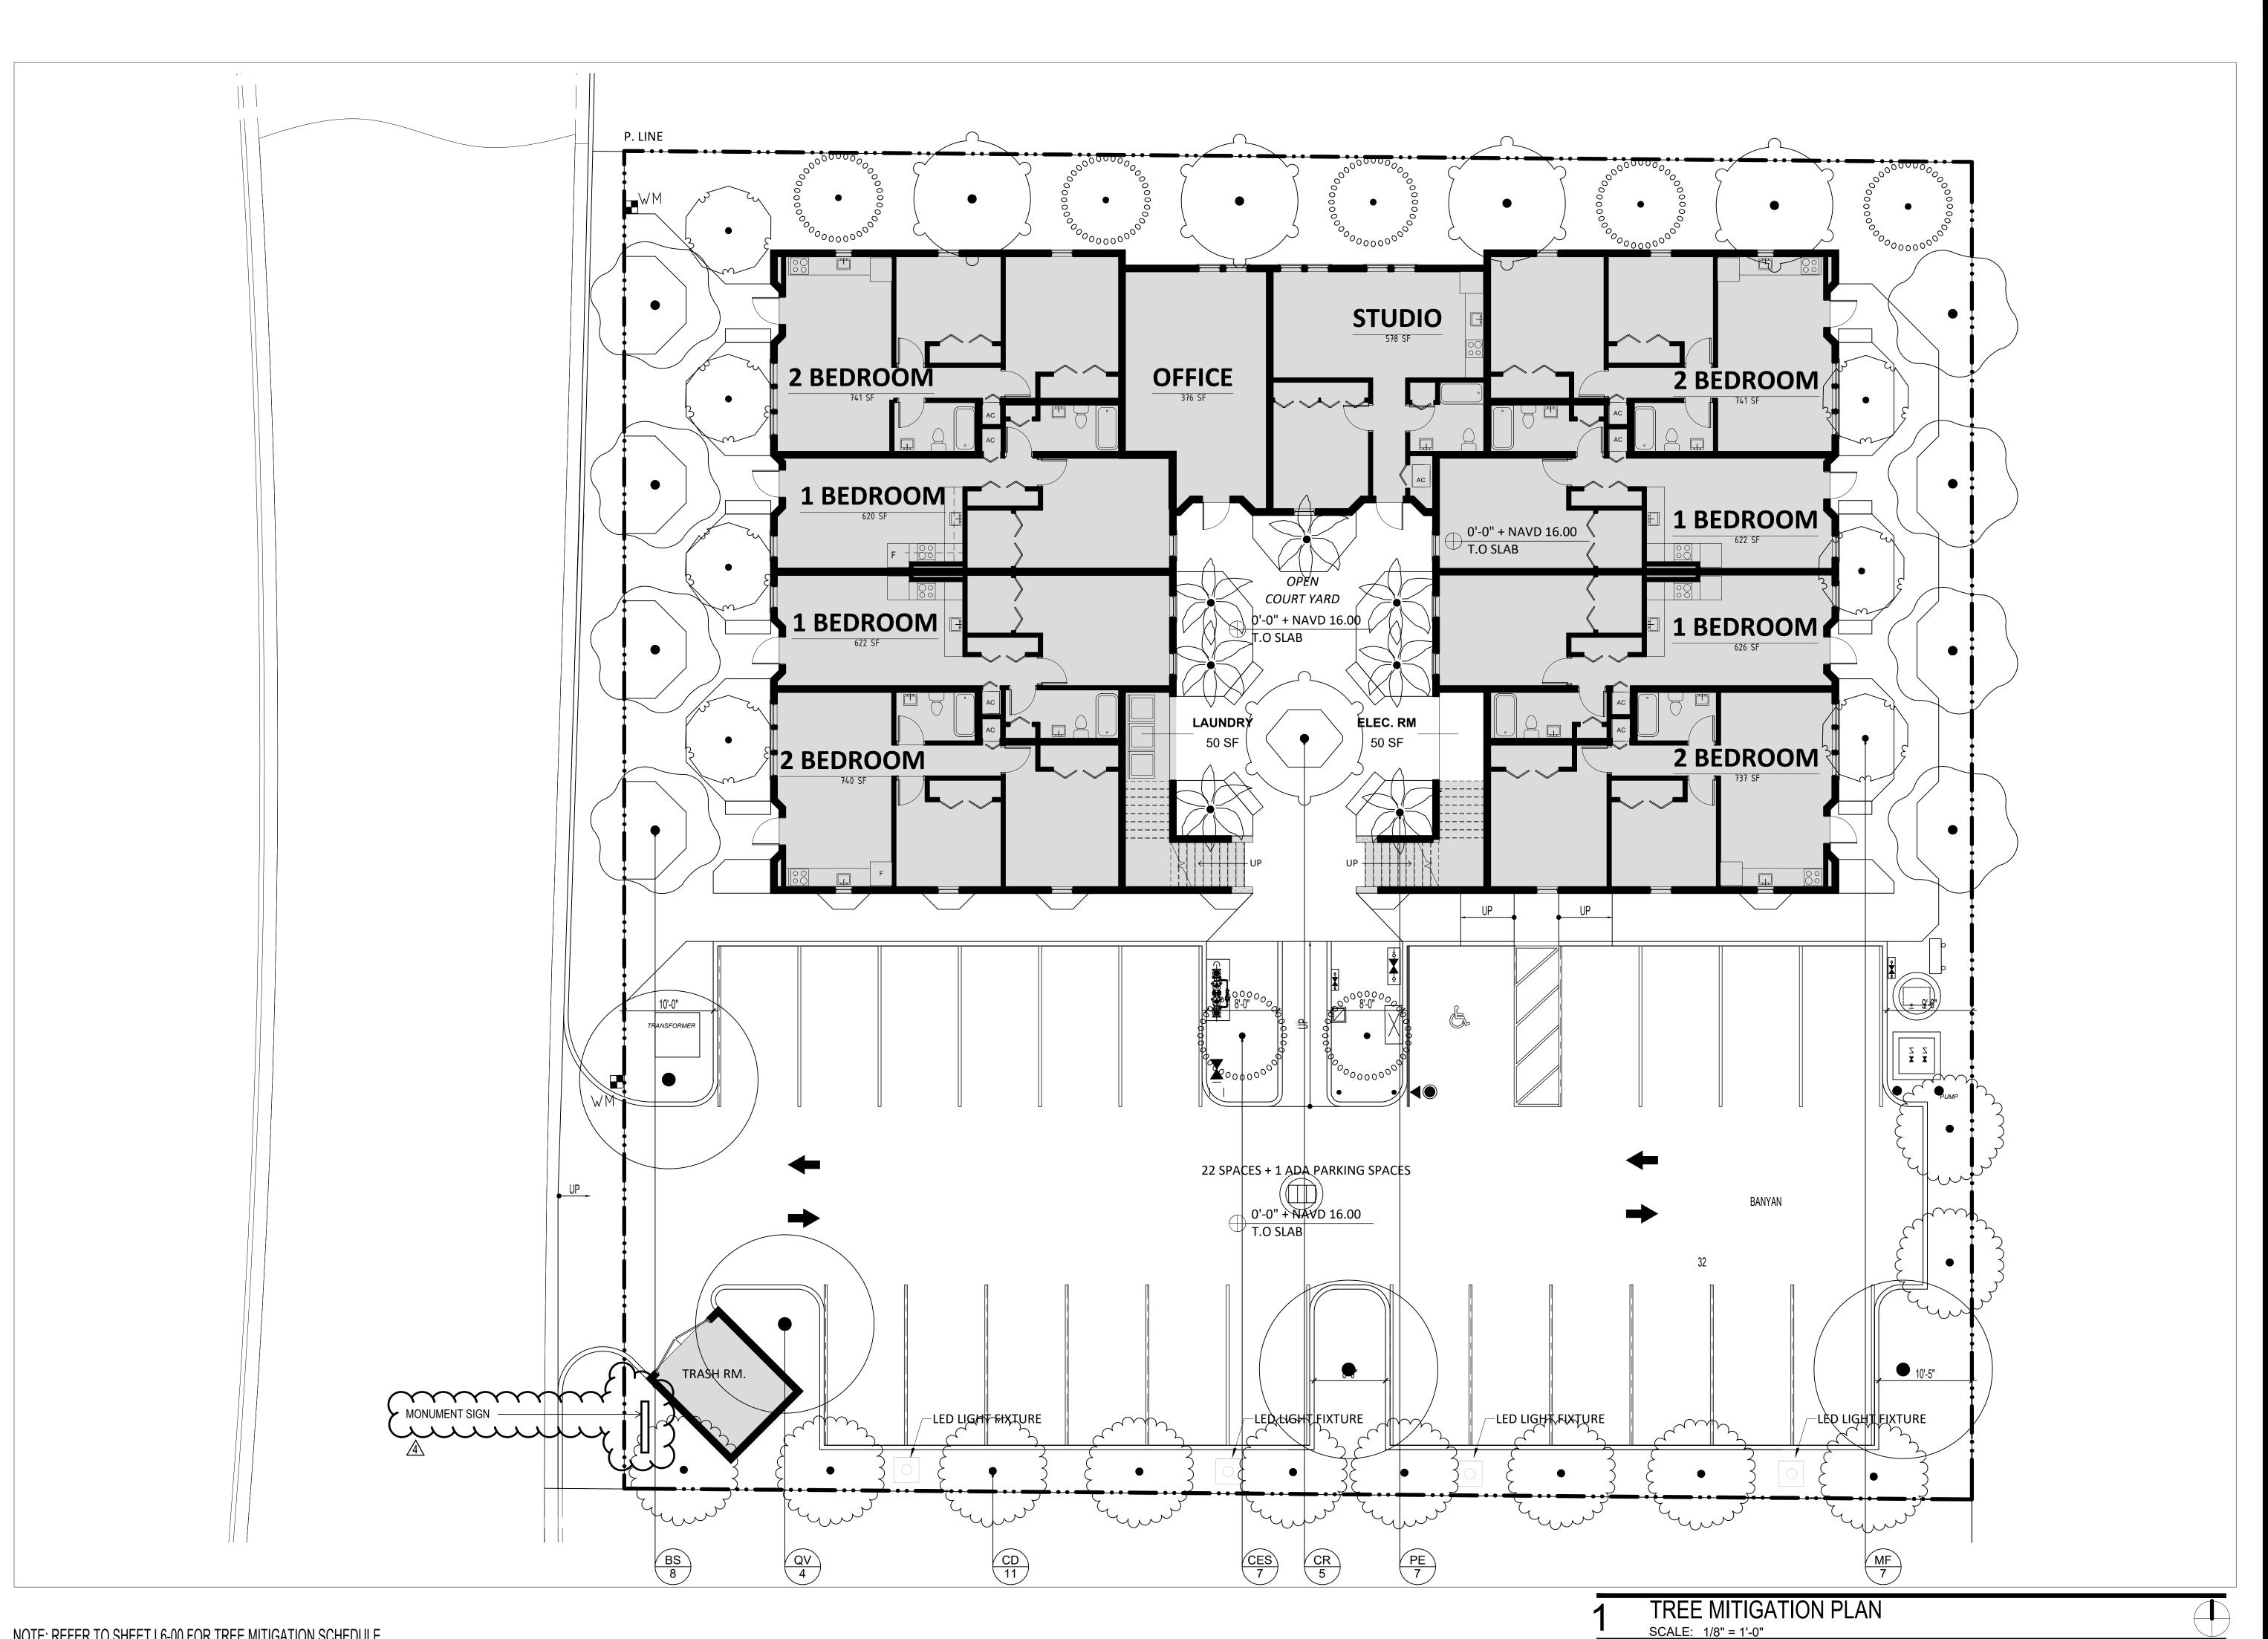SCALE: 1/8" = 1'-0" DATE: 09/30/2020

PROJECT NUMBER: 1913
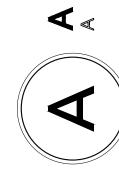
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DRAWING NAME: HARDSCAPE PLAN SCALE: 1/8" = 1'-0" DATE: 09/30/2020PROJECT NUMBER: 1913




COMMISSION 01/03/2022 COMMENT

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drawing name: TREE PLAN SCALE: 1/8" = 1'-0" DATE: 09/30/2020PROJECT NUMBER: 1913

SCALE: 1/8" = 1'-0"

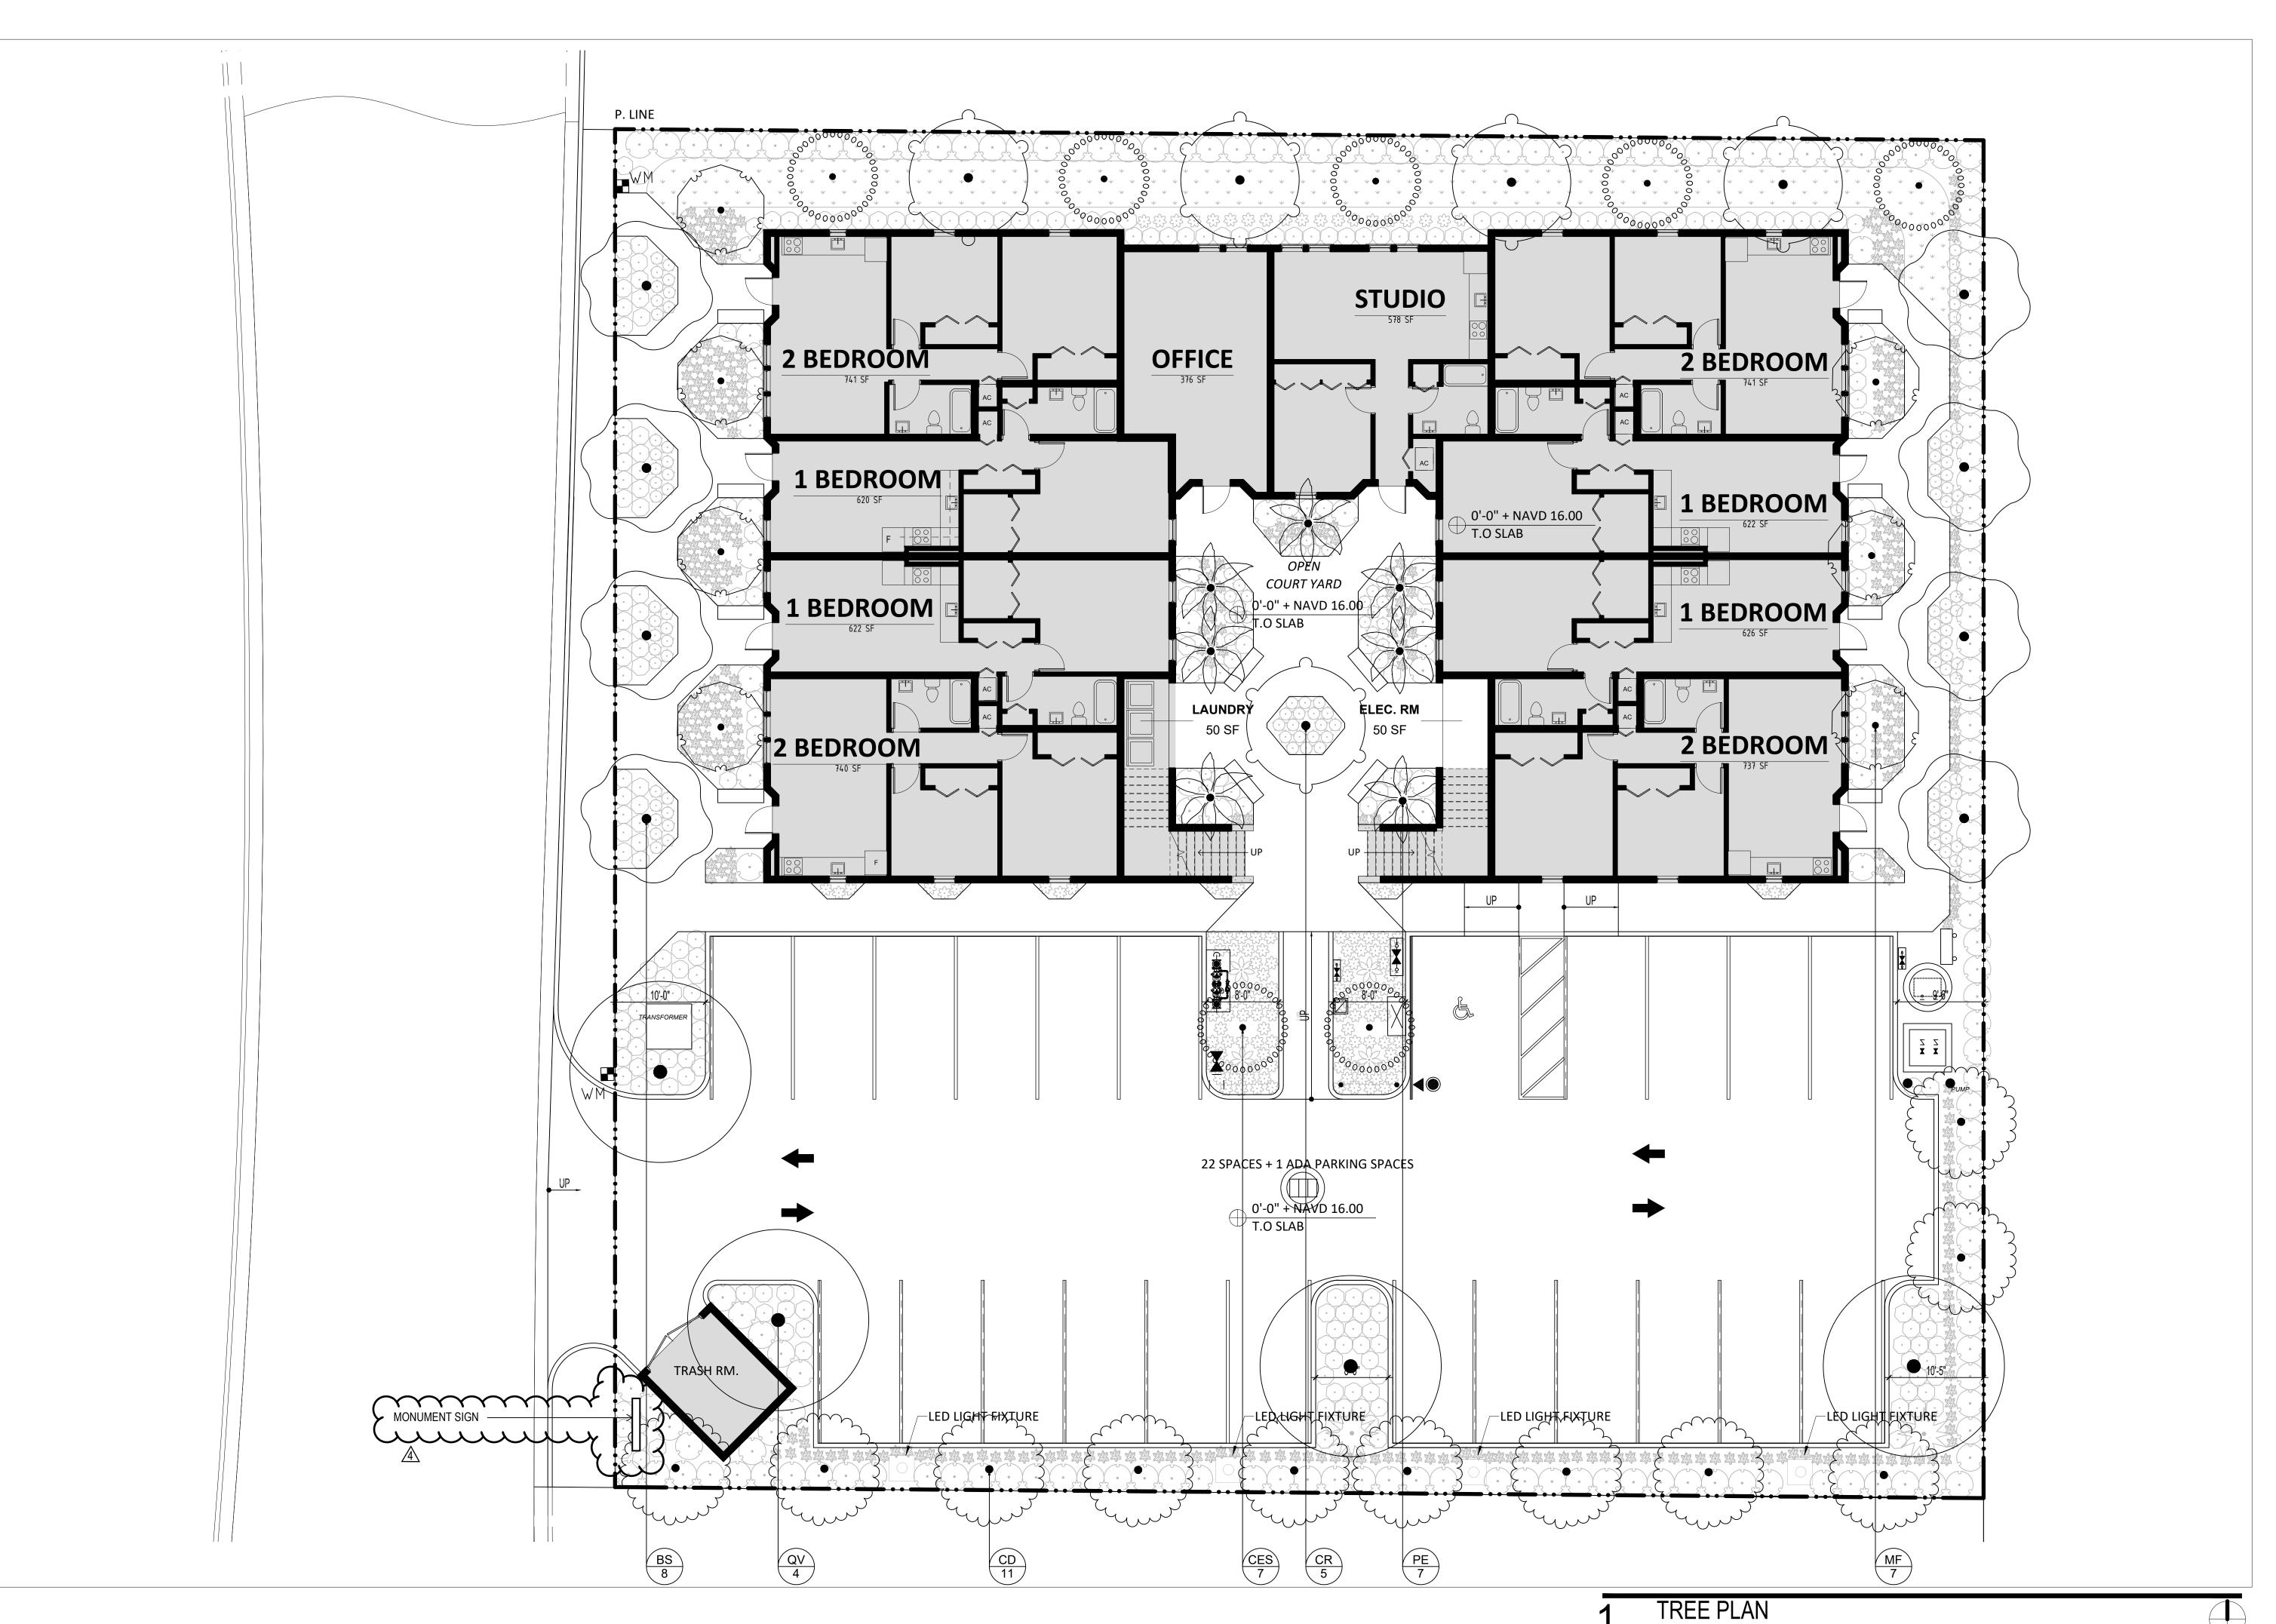


COMMISSION 01/03/2022 **COMMENT**

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DRAWING NAME: SHRUB PLAN SCALE: 1/8" = 1'-0" DATE: 09/30/2020PROJECT NUMBER:1913


SCALE: 1/8" = 1'-0"

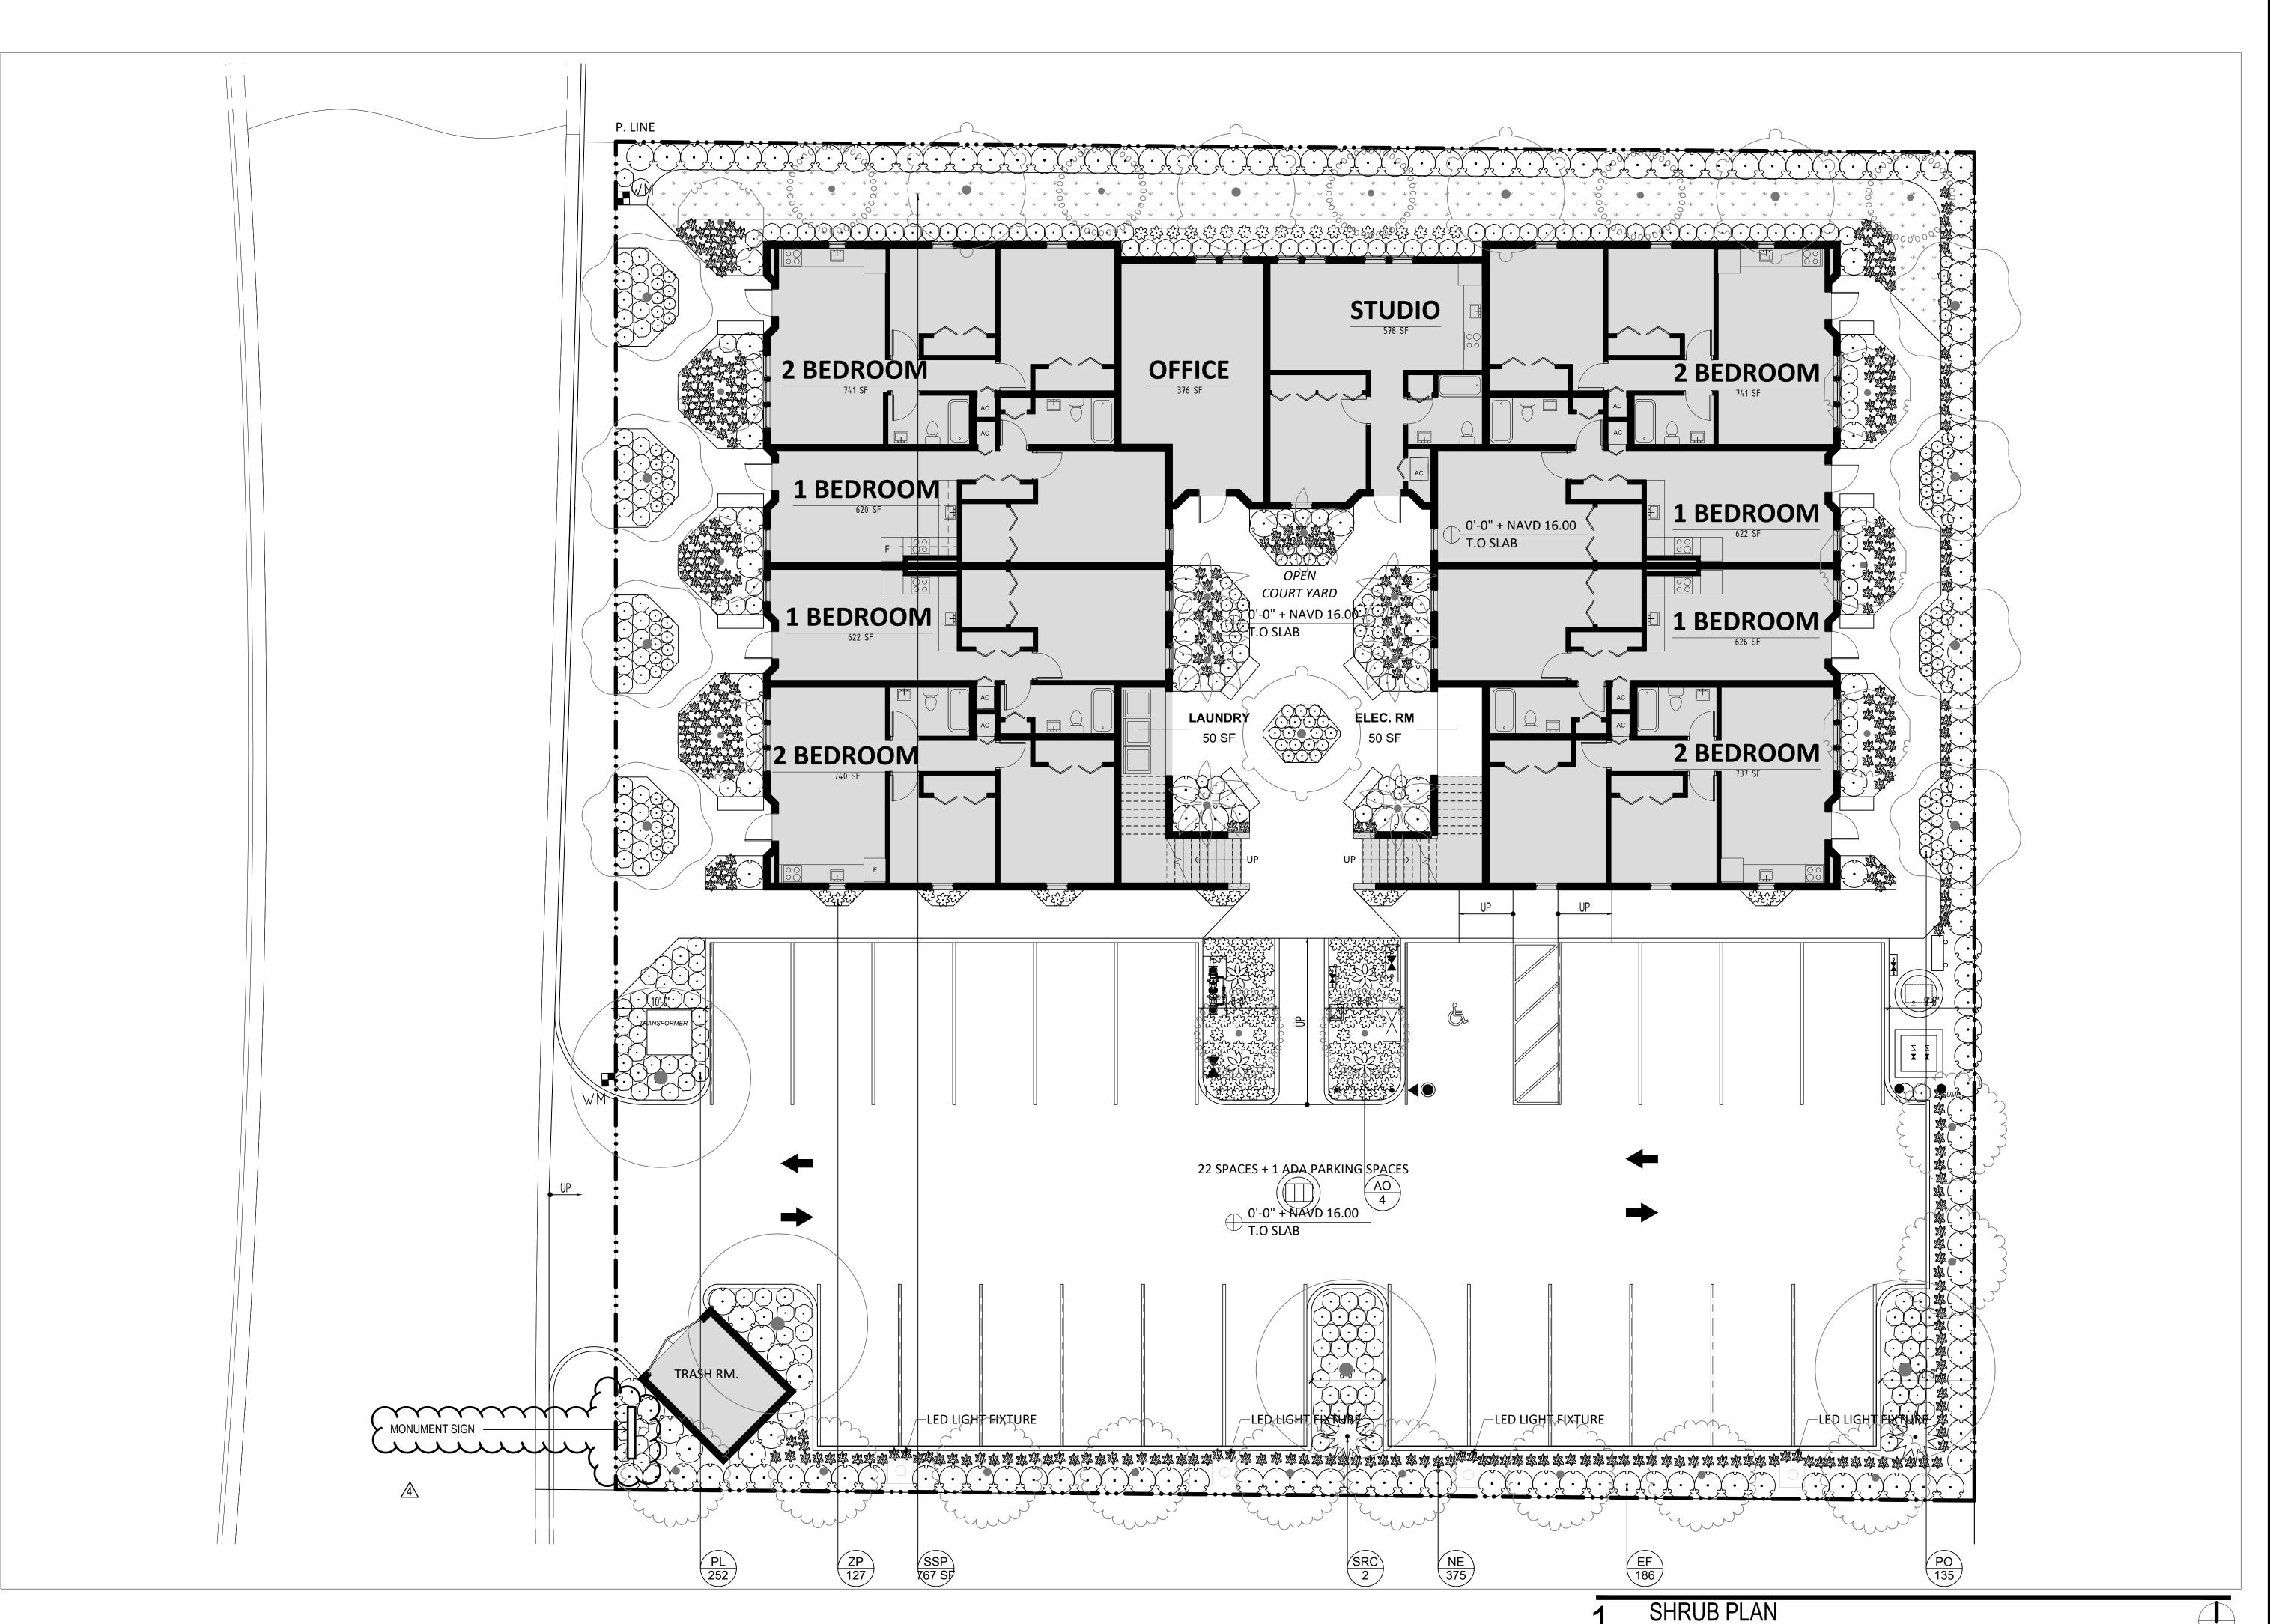

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DRAWING NAME: HARDSCAPE DETAILS PROJECT NUMBER:1913

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DRAWING NAME: PLANTING DETAILS
SCALE: DATE: 09/30/2020
PROJECT NUMBER: 1913

CODE	SYMBOL	BOTANICAL NAME	COMMON NAME	DBH	NATIVE	DISPOSITION	CALC. D
20	and was	Sabal palmetto	Cabbage Palm	18"	Yes	REMOVE	0"
25		-	Cactus	12"	-	REMOVE	12"
26	X	-	UNKNOWN	4"	-	REMOVE	4"
27		Cocos nucifera	Coconut Palm	12"	No	REMOVE	0"
28		Cocos nucifera	Coconut Palm	8"	No	REMOVE	0"
29		Cocos nucifera	Coconut Palm	8"	No	REMOVE	0"
30		Mangifera indica	Mango	14"	No	REMOVE	14"
31		Ficus spp.	Banyan	40"	-	REMOVE	40"
32		Ficus spp.	Banyan	40"	-	REMOVE	40"
33		Cocos nucifera	Coconut Palm	12"	No	REMOVE	0"
42	X	-	UNKNOWN	4"	-	REMOVE	4"
45	MAN MAN AND AND AND AND AND AND AND AND AND A	Sabal palmetto	Cabbage Palm	10"	Yes	REMOVE	0"
46	ANN THE PROPERTY OF THE PARTY O	Mangifera indica	Mango	10"	No	REMOVE	10"
47		-	UNKNOWN	5"	-	REMOVE	5"
		TOTA	AL REMOVED DBH				129"
		TOTAL	_ PALMS REMOVED				6

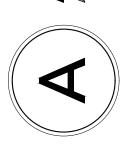NOTE: REFER TO SHEET L1-00 FOR TREE DISPOSITION PLAN

			TR	EE MITIGA	TION	SCH	EDU	ILE			
TREES	CODE	QTY	BOTANICAL NAME	COMMON NAME	HEIGHT	SPREAD	DBH	CLEAR TRUNK	NATIVE	DROUGHT	TOTAL DBH
•	BS	8	Bursera simaruba	Gumbo Limbo	20'	10'	6"	5'	Yes	Yes	48
£ • 33	CD	11	Coccoloba diversifolia	Pigeon Plum	12'	6'	2"	3.5'	Yes	Yes	22
00000000000000000000000000000000000000	CES	7	Conocarpus erectus var. sericeus	Silver Buttonwood	10'	5'	1.5"	3'	Yes	Yes	10.5
	CR	5	Clusia rosea	Pitch Apple	14'	7'	3"	4'	Yes	Yes	15
200	MF	7	Myrcianthes fragrans	Simpsons Stopper	10'	5'	1.5"	3'	Yes	Yes	10.5
•	QV	4	Quercus virginiana	Live Oak	20'	10'	6"	5'	Yes	Yes	24
PALMS	CODE	QTY	BOTANICAL NAME	COMMON NAME	HEIGHT	SPREAD	DBH	CLEAR TRUNK	NATIVE	DROUGHT	
	PE	7	Ptychosperma elegans	Alexander Palm - Double	12'	12'	4"	6' GW	No	Yes	_
·	1			TOTAL MITIGATI	ION DBH	1	I	1		1	130"
				TOTAL PALMS PF	ROPOSED						7

NOTE: REFER TO SHEET L1-01 FOR TREE MITIGATION PLAN

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SUE # DESCRIPTION DATE



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DRAWING NAME: DISPOSITION SCHEDULES
SCALE: DATE: 09/30/2020

				TREE SCH	EDUL	.E				
TREES	CODE	QTY	BOTANICAL NAME	COMMON NAME	HEIGHT	SPREAD	DBH	CLEAR TRUNK	NATIVE	DROUGHT
•	BS	8	Bursera simaruba	Gumbo Limbo	20'	10'	6"	5'	Yes	Yes
£ • 33	CD	11	Coccoloba diversifolia	Pigeon Plum	12'	6'	2"	3.5'	Yes	Yes
00000000000000000000000000000000000000	CES	7	Conocarpus erectus var. sericeus	Silver Buttonwood	10'	5'	1.5"	3'	Yes	Yes
	CR	5	Clusia rosea	Pitch Apple	14'	7'	3"	4'	Yes	Yes
2000	MF	7	Myrcianthes fragrans	Simpsons Stopper	10'	5'	1.5"	3'	Yes	Yes
•	QV	4	Quercus virginiana	Live Oak	20'	10'	6"	5'	Yes	Yes
PALMS	CODE	QTY	BOTANICAL NAME	COMMON NAME	HEIGHT	SPREAD	DBH	CLEAR TRUNK		DROUGHT
	PE	7	Ptychosperma elegans	Alexander Palm - Double	12'	12'	4"	6' GW	No	Yes

NOTE: REFER TO SI	コロロエ しょ もつ ロヘロ	D TDEE DI AI
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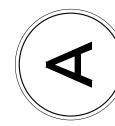
	SH	IRU	B & GROL	JNDCOVI	ER S	CHE	DUL	Ε	
SHRUBS	CODE	QTY	BOTANICAL NAME	COMMON NAME	HEIGHT	SPREAD	GAL	NATIVE	DROUGHT
	AO	4	Alcantarea odorata	Silver Bromeliad	2.5'	3'	7G	No	Yes
•	EF	186	Eugenia foetida	Spanish Stopper	4'	2'	7G	Yes	Yes
•	PL	252	Psychotria ligustrifolia	Bahama Coffee	2'	2'	3G	Yes	Yes
	SRC	2	Serenoa repens 'Cinerea'	Silver Saw Palmetto	2'	2'	7G	Yes	Yes
	ZP	127	Zamia pumila	Coonite	1.5'	1.5'	3G	Yes	Yes
GROUNDCOVERS	CODE	QTY	BOTANICAL NAME	COMMON NAME	HEIGHT	SPREAD	GAL	NATIVE	DROUGHT
	NE	375	Nephrolepis exaltata	Boston Fern	1'	1'	1G	Yes	Yes
	PO	135	Peperomia obtusifolia	Baby Rubber Plant	1'	1'	1G	Yes	Yes
SOD	CODE	QTY	BOTANICAL NAME	COMMON NAME	HEIGHT	SPREAD	GAL	NATIVE	DROUGHT
	SSP	767 sf	Stenotaphrum secundatum 'Palmetto'	St. Augustine Palmetto	Flat			No	Yes

NOTE: REFER TO SHEET L1-13 FOR SHRUB PLAN

		HARDSCAPE SCHEDULE	
		32 EXTERIOR IMPROVEMENTS	
SYMBOL	CODE	DESCRIPTION	QTY
	32-12-16	ITEM: Asphalt Paving APPLICATION: Site Driveways	7,025 sf
Δ	32-13-13	ITEM: Concrete Paving APPLICATION: Right-of-Way Sidewalk FINISH: Broomed / Brushed	853 sf
	32-14-13.1	ITEM: Pedestrian Precast Pervious Concrete Unit Paving APPLICATION: Courtyard MANUFACTURER: Tremron PRODUCT: Pervious Paver SIZE: Olde Towne, 6"x4", 6"x6", 6"x9" COLOR: Sierra	913 sf
	32-14-13.2	ITEM: Pedestrian Precast Pervious Concrete Unit Paving APPLICATION: Walkways MANUFACTURER: Tremron PRODUCT: Pervious Paver SIZE:4"x8" COLOR: Sand Dune	1,762 sf
	32-91-13	ITEM: Mulching APPLICATION: Planting beds TYPE: Mini-Pine Bark Nuggets	5,306 sf

NOTE: REFER TO SHEET L1-11 FOR HARDSCAPE PLAN

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DRAWING NAME: LANDSCAPE SCHEDULES
SCALE: DATE: 09/30/2020