

# MIXED USE DEVELOPMENT 1432 N Dixie Hwy,

LAKE WORTH BEACH, FL 33460



# **ABBREVIATIONS**

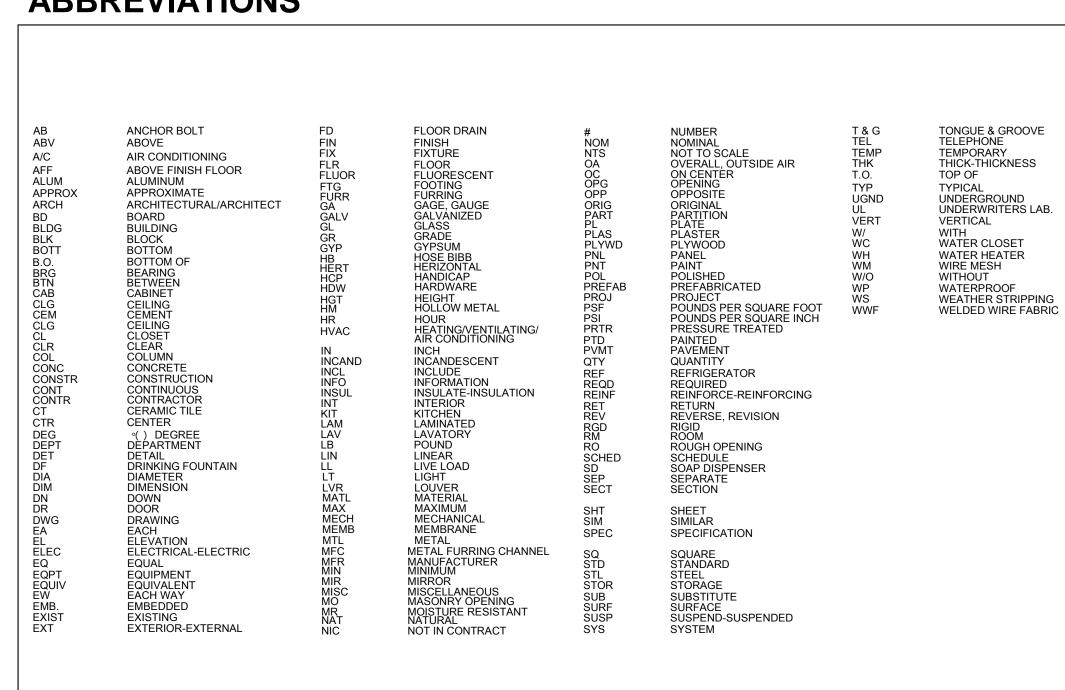

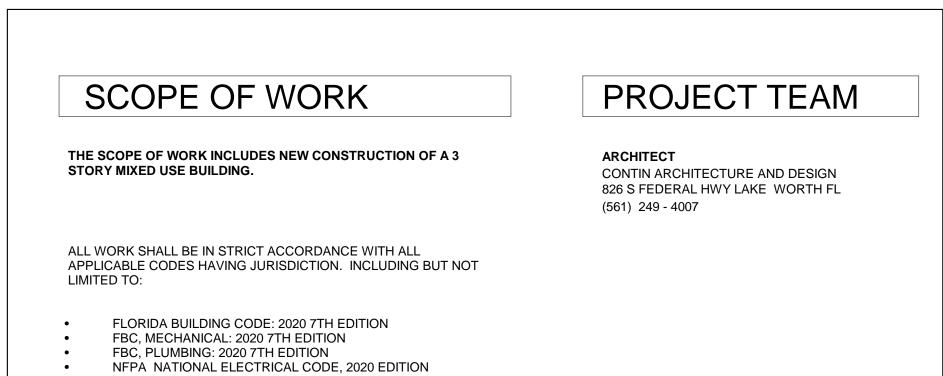

	Sheet List				
Sheet Number	Sheet Name	Discipline Order			
00	Index Sheet	1-GENERAL			
LP100	Planting Plan	2-LANDSCAPE			
LP101	Planting Detail	2-LANDSCAPE			
LP102	Disposition & Mitigation Plan	2-LANDSCAPE			
C-0.0	CIVIL COVER SHEET	3-CIVIL			
C-1.0	PAVING, GRADING AND DRAINAGE PLAN	3-CIVIL			
C-2.0	PAVING, GRADING AND DRAINAGE DETAILS	3-CIVIL			
C-3.0	WATER AND SEWER PLAN	3-CIVIL			
C-4.0	WATER AND SEWER DETAILS	3-CIVIL			
C-5.0	STORMWATER POLLUTION PREVENTION PLAN	3-CIVIL			
C-6.0	STORMWATER POLLUTION PREVENTION DETAILS	3-CIVIL			
A00	Site Details	4-ARCHITECTURAL			
<b>4100</b>	Site Plan	4-ARCHITECTURAL			
A101	Level 2 Floor Plan	4-ARCHITECTURAL			
4102	Level 3 Floor Plan	4-ARCHITECTURAL			
<b>4104</b>	Roof Plan	4-ARCHITECTURAL			
A201	Elevations	4-ARCHITECTURAL			
A301	3D Front	4-ARCHITECTURAL			
A302	3D Rear	4-ARCHITECTURAL			
A202	Elevations	4-ELECTRICAL			
E0	Photometric Plan	4-ELECTRICAL			

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#### **REGISTERED ARCHITECT:**

JUAN CRISTOBAL CONTIN

FL LICENSE # AR94935

826 S. FEDERAL HIGHWAY

LAKE WORTH, FL 33460



#### CLIENT:

GG&P Properties, Inc. Michael
Gizewski

PROJECT TITLE:
Mixed Use Development

PROJECT ADDRESS:

1432 N Dixie Hwy

DATE:	6/30/2023 10:55:51
	AM
ISSUED:	ISSUED
DRAWN BY	:RG

## REVISIONS:

CHECKED BY:

1	5/10/2023	

#### SCALE/NORTH POINT:

AS SHOWN

DRAWING TITLE

Index Sheet


DRAWING STATUS:



## Site Images





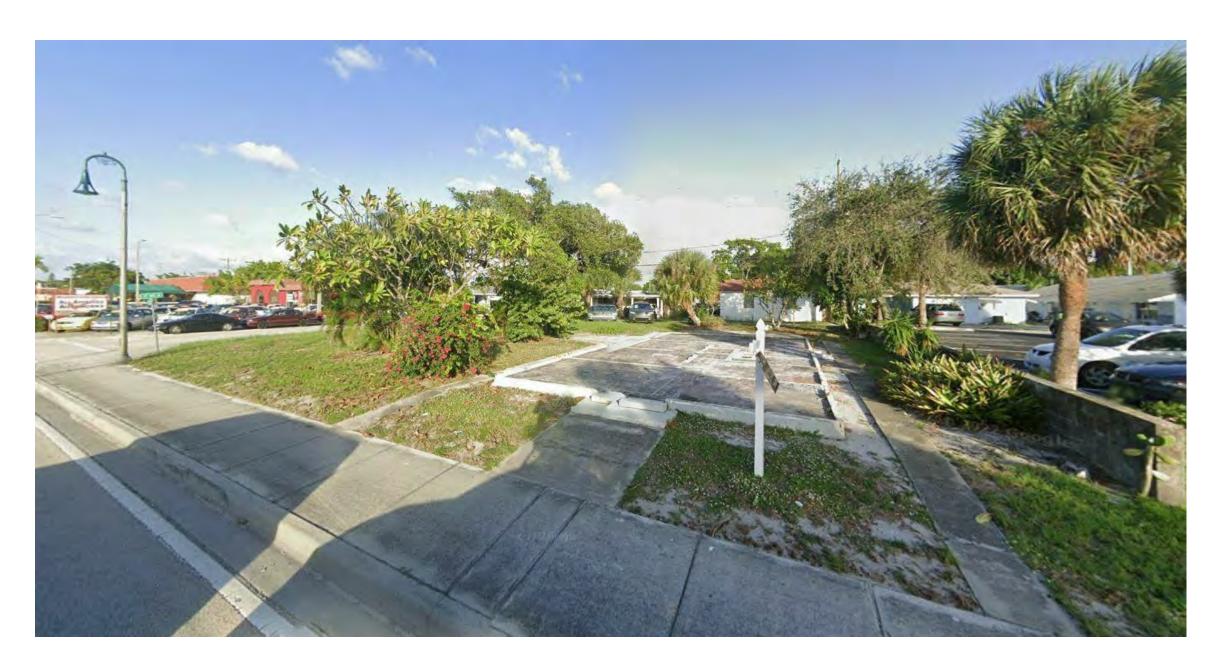

## Adjacent Sites







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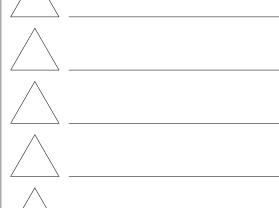
PROJECT TITLE:

Mixed Use Development

PROJECT ADDRESS: 1432 N Dixie Hwy

DATE: 6/30/2023	3 10:55:51
	AM
ISSUED:	ISSUED
DRAWN BY:	RG
CHECKED BY:	JC

REVISIONS:



SCALE/NORTH POINT:

AS SHOWN

DRAWING TITLE

Site Images

DRAWING STATUS:


DRAWING NUMBER:

01

## COMMERCIAL PROPERTIES ALONG DIXIE HWY





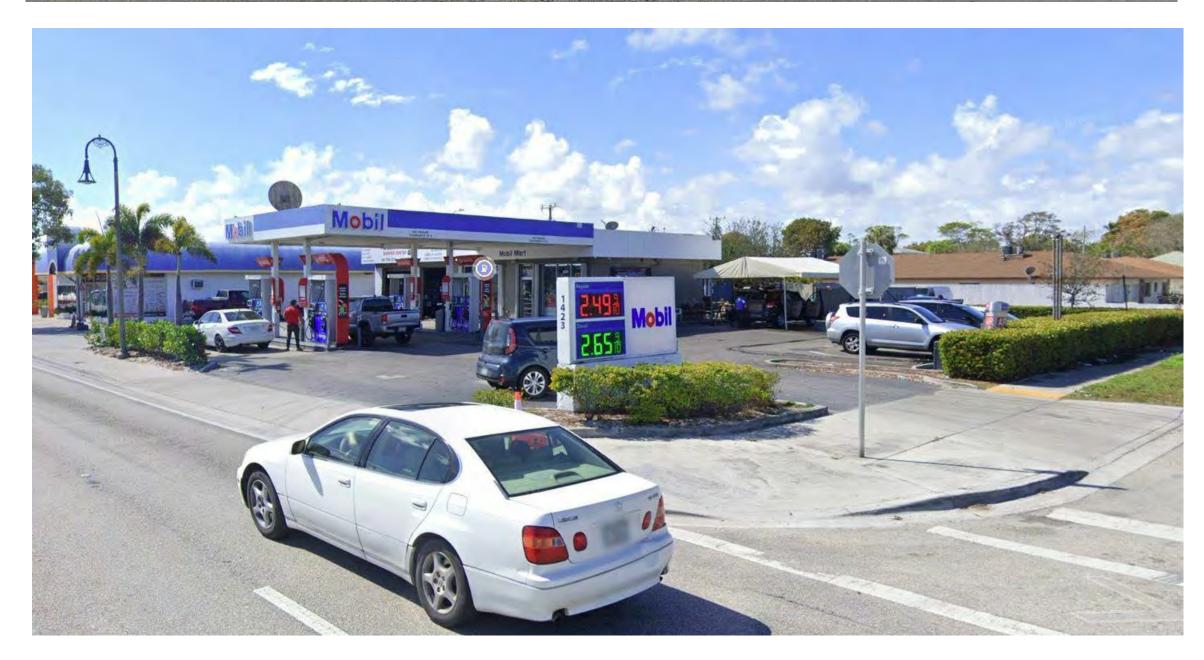

## MIXED USE ALONG DIXIE HWY



MULTIFAMILY DISTRICT ALONG REAR OF PROPERTY





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PROJECT ADDRESS:

1432 N Dixie Hwy

DATE: \_\_\_\_\_6/30/2023 10:55:52 AM ISSUED: \_\_\_\_\_ISSUED DRAWN BY: \_\_\_\_\_RG

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Adjacent Sites


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02

## CAR DEALERSHIP

## 15TH AVE N



1 Existing Site 1" = 10'-0"
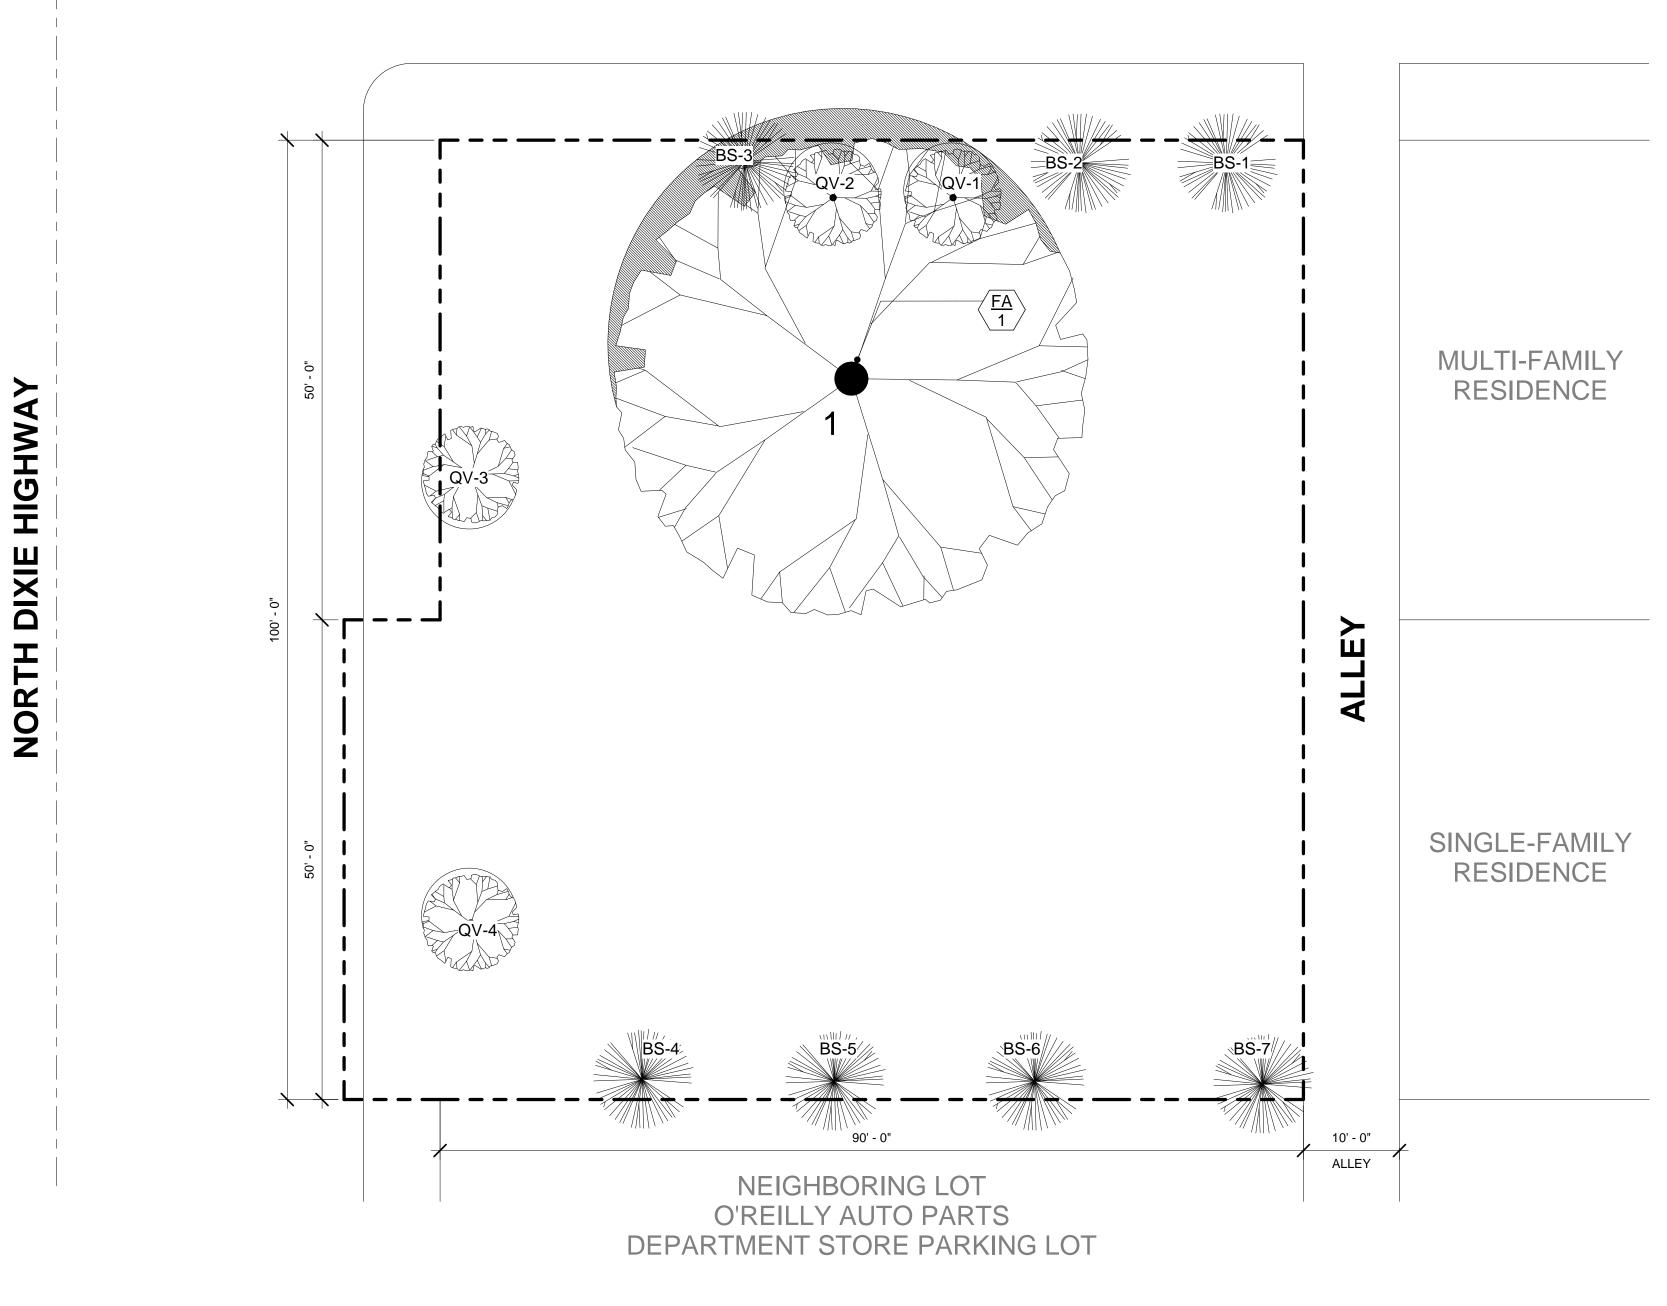
## **EXISTING SITE CONDITIONS**

- 1. THERE IS AN EXISTING STANGLER FIG TREE ON THE SITE. ARBORIST HAS PROVIDED A REPORT FOR THE EXISTING SURVEY. ATTACHED TO THIS APPLICATION.
- 2. THERE IS FOUNDATION REMAINING ON SITE FROM THE PREVIOUSLY DEMOLISHED STRUCTURE. THIS WILL NEED TO BE ADDRESSED BEFORE NEW WORK IS PERFORMED.
- 3. CITY NOTED THAT THE ALLEYWAY WILL MOST LIKELY REQUIRE IMPROVEMENT.

## **EXISTING PLANTS**

KEY	LABEL	BOTANICAL NAME	COMMON NAME	DIAMETER (DBH)	HEIGHT	SPREAD
FA	1	FICUS AUREA	Strangler fig	80"	20'	50'
				80"		

**TOTAL DBH** 

#### BASIS OF REMOVAL OF TREES - Sec. 23.6-1 (m)(7)(a):

1. The tree, or trees, are located in an area where a structure or improvement will be placed in accordance with other development provisions in the City Code of Ordinances, and retention of the trees is such that no reasonable economic use can be made of the property without removal of the trees, and the tree, or trees, cannot be relocated on or off the property because of age, type or size of tree.

REPLACED WITH

## PARTIAL - PROPOSED PLANT LIST

KEY	QTY.	BOTANICAL NAME	COMMON NAME	REMARKS	DBH/caliper inch-per-inch
QV	4	QUERCUS VIRGINIANA	LIVE OAK	18' HT x 12-14' spr./ full,dense/ min 6" cal/ 6' c.t. (NATIVE)	6" cal <u>X (4) TREES PROVIDED</u> = 24"
BS	7	BURSERA SIMARUBA	GUMBO LIMBO	16-18ft HT, 12-14ft Spr, min 8" Cal, 6-6.5ft CT (NATIVE)	8" cal <u>X (7) TREES PROVIDED</u> = 56"

TOTAL CALIPER TO BE PROVIDED = 80"

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JUAN CRISTOBAL CONTIN

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826 S. FEDERAL HIGHWAY

LAKE WORTH, FL 33460



CLIENT:

GG&P Properties, Inc. Michael
Gizewski

PROJECT TITLE:

Mixed Use Development

PROJECT ADDRESS:

1432 N Dixie Hwy

REVISIONS:

CHECKED BY:\_

5/10/2023 6/2/2023

SCALE/NORTH POINT:

AS SHOWN


DRAWING TITLE

Disposition & Mitigation Plan

DRAWING STATUS:

DRAWING NUMBER:

LP102

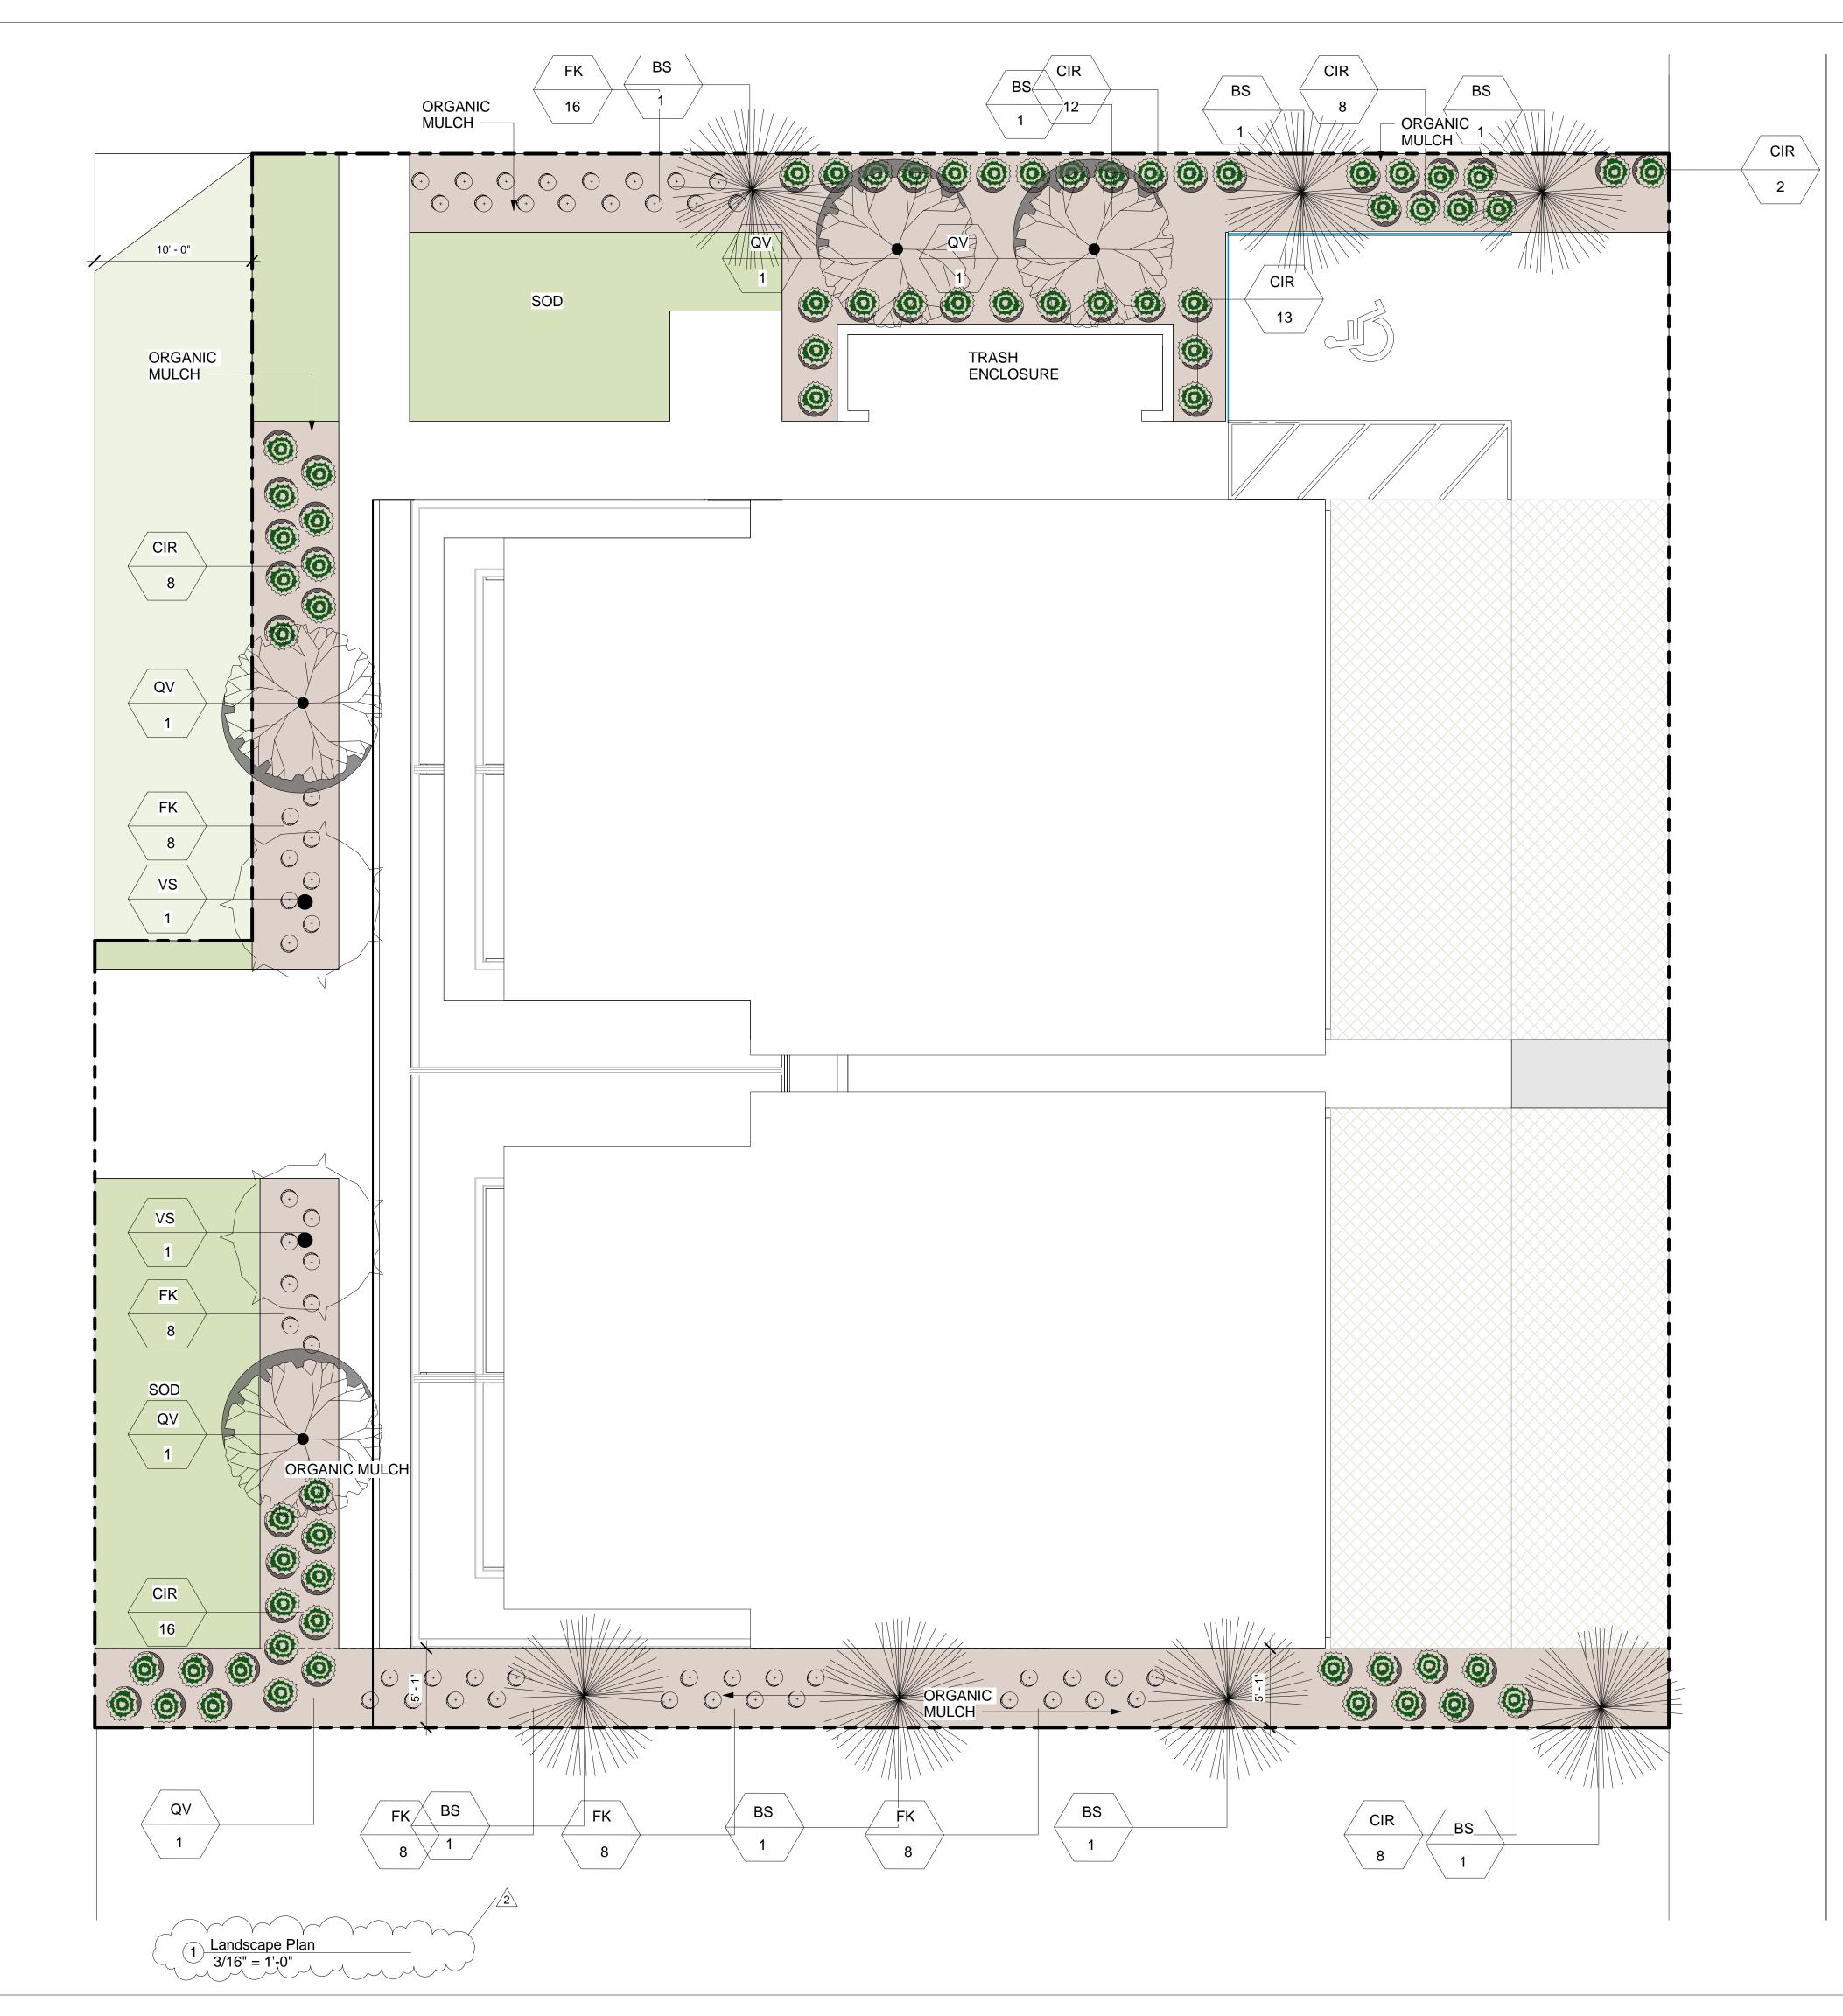

(2) NEW AND EXISTING MULTIPLE-FAMILY, COMMERCIAL AND INDUSTRIAL DEVELOPMENT

D. INTERIOR LANDSCAPING REQUIREMENTS RELATING TO AREAS EXCLUSIVE OF VEHICULAR PARKING AREAS AND BUILDING FOOTPRINTS.

1.ALL PERVIOUS AREAS OF A SITE THAT NOT ASSOCIATED WITH REQUIRED WATER RETENTION SHALL BE PROVIDED LANDSCAPING MEETING THE FOLLOWING STANDARDS:

A. AT LEAST ONE (1) SMALL TREE FOR EACH TWO HUNDRED TWENTY-FIVE (225) SQUARE FEET OR FRACTION THEREOF, OR

B. AT LEAST ONE (1) MEDIUM TREE FOR EACH FOUR HUNDRED (400) SQUARE FEET OR FRACTION THÈREOF, OR

C. AT LEAST ONE (1) LARGE TREE FOR EACH SIX HUNDRED TWENTY-FIVE (625) SQUARE FEET OR FRACTION THEREOF, OR

D.A COMBINATION OF SMALL, MEDIUM AND/OR LARGE TREES, WHEN AGGREGATED MEET THE SQUARE FOOTAGE TREE RATIO AS OUTLINED IN A. THROUGH C.


#### TOTAL PERVIOUS AREA OF SITE: 3,460 SQ FT.

11 LARGE TREES - 4 LIVE OAK, 7 GUMBO LIMBO -

2 MEDIUM TREES - VEITCHIA PALM

REQUIRED		PROPOSED	
TYPE	QUANTITY	QUANTITY	SF CALCULATION
SMALL TREE	1 PER 225 SQ. FT. -OR-		
MEDIUM	1 PER 400 SQ. FT. -OR-	2	800
LARGE	1 PER 625 SQ. FT.	11	6,875
COMBINATION	3,460 SQ FT.	13	7,675



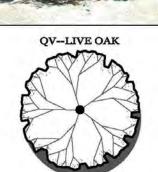











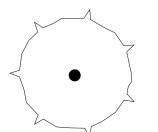



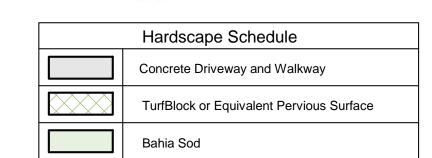

CIR--COCOPLUM

NOTE: ALL TREES ALONG THE ALLEYWAY AND WITHIN CLOSE PROXIMITY TO ANY UTILITY MUST COMPLY WITH THE ROOT BARRIER DETAIL AS SHOWN ON SHEET L101.

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**REGISTERED ARCHITECT:** 

JUAN CRISTOBAL CONTIN

FL LICENSE # AR94935

826 S. FEDERAL HIGHWAY

LAKE WORTH, FL 33460



#### CLIENT:

GG&P Properties, Inc. Michael Gizewski

#### PROJECT TITLE: Mixed Use Development


PROJECT ADDRESS: 1432 N Dixie Hwy

6/30/2023 9:45:06 ISSUED ISSUED: DRAWN BY: RG

6/2/2023



CHECKED BY:

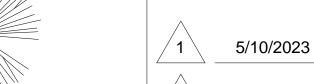



SCALE/NORTH POINT:

AS SHOWN

DRAWING TITLE Planting Plan

DRAWING STATUS:

#### LANDSCAPE SPECIFICATIONS

#### SCOPE OF WORK:

The scope of work for the Landscape Contractor includes furnishing all plants, materials and equipment and labor needed for installation of plant materials as indicated on plans and/or in these specifications.

#### 2. PLANT MATERIALS:

A. All plant materials shall be nursery grown unless otherwise noted. Abbreviations on plant list:

- C.T. (indicates clear trunk)
  Spr. (indicates spread)
  Ct. (indicates clear trunk measurement from top of ball, to first branching)
- O.A. (indicates overall height from top of ball to mid point of current season's growth)

  B. Quality and Size: Plants shall have a habit of growth that
- is normal for the species and shall be healthy, vigorous and equal or exceed the measurements specified in the plant list, which are the minimum acceptable sizes. Plants shall be measured before pruning with branches in normal position. Any necessary pruning shall be done at the time of planting. Requirements for measurements, branching, grading, quality, balling and burlapping of plants in the plant list generally follow the code of standards currently recommended by the American Association of Nurserymen, Inc., in the American Standard of Nursery Stock. Plant materials shall be graded Florida No. 1 or better as outlined under Grades & Standards for nursery plants,
- requirements specified, but do not have the normal balance of height and spread typical for the respective plant, shall not be accepted. All plants shall be free of weeds or any other objectionable vegetation.

  C. Quantities: All quantities indicated on the plant list are

intended as a guide for the bidders and does not relieve the

bidder of his responsibility to do a comprehensive plant take

off. Should a discrepancy occur between the bidder's take

off and the plant list quantity, the Landscape Architect is to

be notified for the clarification prior to the submission of

State Plant Board of Florida, latest edition. Plants that meet the

bids.

D. Substitution: Plant substitution requests by the Contractor will be considered by the Landscape Architect only upon submission of proof that any plant is not obtainable in the type and size specified. The Landscape Architect shall determine the nearest equivalent replacement in an obtainable size and variety. The unit price of the substitute item shall not exceed the bid item replaced, without

#### 3. COMMERCIAL FERTILIZERS:

approval of the owner.

- A. Commercial fertilizer shall be an organic (6.6.6) fertilizer containing nitrogen, phosphoric acid and potash in equal percentages of available plant food by weight. Nitrogen shall be not less that 50 % from organic source. Inorganic chemical nitrogen shall not be derived from the sodium form of nitrate. Fertilizers shall be delivered to the site unopened in original containers, each bearing the manufacturer's guaranteed analysis. Any fertilizer that becomes caked or otherwise damaged shall not be
- B. Planting tablets shall be tightly compressed, long lasting, slow release fertilizer tablets with a potential acidity of not more that % by weight and having an analysis of 20.10.5.

#### 4. PLANTING SOIL:

Planting soil shall be sandy loam and shall contain a minimum amount of decomposed organic matter. Planting soil shall be free of clay, stones, plants, roots and other foreign materials which may be a hinderance to planting operations or be detrimental to good plant growth. Soil shall be delivered in a loose friable condition and be applied in accordance with the Planting Specifications.

## 5. MULCH:

Mulches shall not contain sticks larger that 1/4 inch in diameter, stones, or other foreign material that will prevent the eventual decay of the mulch necessary for its complete effectiveness. Mulch shall be applied evenly

#### Water for plan

A. Root Protection:

WATER:

Water for planting will be available at the site and will be provided by the Owner. All conditions regarding site water shall be verified by Contractor prior to submission of bids.

#### PROTECTION OF PLANTS:

- I. Balled and Burlapped Plants:Plants designated "B & B" (balled and burlapped) shall be dug with firm natural balls of earth of sufficient diameter and depth to encompass the fibrous and feeding root system necessary for full recovery of plant. Balls shall be firmly wrapped with burlap.
  All collected plants shall be B&B.
- Container Grown Plants: Plants grown in containers
  will be accepted as "B & B" providing that all other
  specified requirements are met. Container grown plants
  shall meet plant sizes as specified on the plant list and
  on the Drawings, and shall not be governed by
  container sizes.
- B. Protection During Transportation: All plant material shall be protected from possible bark injury or breakage of branches. All plants transported by open trucks shall be adequately covered to prevent windburn, drying or damage.
- C. Protection After Delivery: Plants which cannot be planted immediately on delivery to the site shall be covered with moist soil, mulch, or other protection from the drying of wind and sun. All plants shall be watered as necessary until planted. Storage period shall not exceed seventy-two (72) hours.
- D. Protection of Palms (If Applicable): Only a minimum of fronds shall be removed from the crown of the palm trees to facilitate moving and handling. With the exception of Cabbage Palms, which shall be "hurricane cut".
- E. <u>Protection During Planting:</u> Trees moved by winch or crane shall be thoroughly protected from chain marks, girdling or bark slippage by means of burlap, wood battens, or other approved methods.

#### 8. <u>IMPLEMENTION</u>

- A. <u>Layout:</u> Locations of plants and outlines of shrub beds are indicated on the PLAN. All tree, palm, and accent locations shall be staked in the field by the Contractor, so as to satifactorily match the locations indicated on the plan. Any unforseen underground utilities shall be verified by General Contractor and communicated to L.A. ASAP so that necessary adjustments can be made.
- B. <u>Soil Preparation</u>: Soil shall be prepared in accordance with specifications outlined in statement 4.

- C. Excavation for Planting: Excavation of plant pits shall be circular in outline and shall extend to the required subgrades as specified hereunder. The minimum depth of plant pits specified below shall be measured from the finish grade. Mass planting beds shall be stripped of all vegetation prior to planting.
- D. Balled and Burlapped Plants After final setting, loosen burlap wrappings exposing the top of the root ball, leaving the ball unbroken. Remove excessive amounts of burlap to eliminate voids which may be caused upon decomposition.
- E. Container Grown Plants: Container grown plants shall, when delivered, have sufficient growth to hold earth intact when removed from container and shall not be root bound. Plant pits for container materials shall be formed flat on the bottom to avoid air pockets at the bottom of the root balls and containers shall be removed carefully to prevent damage to plant or root system.
- F. Pit Sizes: Minimum diameter (width) and depth of planting pits for balled and burlapped, and container grown plants shall be as follows:

  I. Diameter Trees: 18" greater than diameter of ball or
- spread of roots.Diameter Shrubs: 6" greater than diameter of ball or spread of roots.
- 3. Depth Trees and Shrubs: 4" greater than depth of ball or roots to provide 4" of topsoil backfill under the rootball. (Large, heavy trees and shrubs may sit directly on unexcavated pit bottom if it is determined that undue settlement may occur.)
- Depth Vine Groundcovers: Pits shall conform to accepted nursery practice for the particular species and equal the plant pot depth plus one (1) inch.
- $\emph{G}.$  Setting Trees and Shrubs Unless otherwise specified, all trees and shrubs shall be planted in pits, centered, and set on four inches (4") of compacted planting soil to such depths that the finished grade level of the plant after settlement shall be the same as that at which the plant was grown. They shall be planted upright and faced to give the best appearance or relationship to adjacent structures. No burlap shall be pulled out from under the balls. Platforms, wire, and surplus binding from top and sides of the balls, shall be removed. All broken or frayed roots shall be cut off cleanly. Soil shall be placed and compacted thoroughly, avoiding injury and shall be settled by watering. No filling around trunks will be permitted. After the ground settles, additional soil shall be filled in to the level of the finished grade allowing for three inches (3") of mulch. Form a shallow saucer around each plant by placing a ridge of soil along the edge of the plant pit.
- H. Setting Palms: All palms shall be planted in sand, thoroughly washed in during planting operations and with a shallow saucer depression left at the soil line for future waterings. Saucer areas shall be top dressed two inches (2") deep with topsoil raked and left in a neat, clean
- I. <u>Fertilization:</u> When setting trees, palms and shrubs, place in each plant hole Planting Tablets, 20-10-5 formula, 21 gram, according to the following:

above middle of ball.

- J. Correct Placement of Tablets: Position the plant in the hole and backfill no higher than halfway up the root ball. Place the recommended number of tablets evenly around the perimeter of, and immediately adjacent to, the root ball at a depth which is between the middle and the bottom of the root ball. Complete backfilling as described above, under setting trees, palms and shrubs.
- K. Pruning: Remove dead and broken branches from all plant materials. Prune to retain typical growth habit of individual species with as much height and spread as is practicable. Make all pruning cuts with a sharp instrument flush with trunk or adjacent branch, in such a manner as to ensure elimination of stubs. "Headback" cuts, right angle to line of growth, will not be permitted and trees will not be poled or topped. Paint all cuts 1/2" in diameter and larger with approved waterproof antiseptic tree paint and remove
- with approved waterproof antiseptic tree paint and remove trimmings from site.

  L. Guying and Staking: Guy all trees 1 1 1/2" in caliper and greater in three (3) directions with double strands of No. 12 galvanized wire attached to approved anchors driven below grade. When securing wires to trees, cover all wires which may come in contact with any part of tree with new rubber hose. Place guys not less that 1/3 of the height of tree above finished diameter or more, if possible. All hoses shall be interlocked around tree trunk. Place anchors
- so that guys are equally spaced and at 45 degree angles to horizontal. Keep guys tight until project completion. In staking palms and broadleaf trees no nails or other fasteners will directly penetrate the trunks. Wood 2 x 4 battens 12 inches long, separated by a minimum of four (4) layers of burlap can be attached to the trunk of the trees with metal banding. Stakes can only be nailed to the wooden
- M. Excess Excavated Soil: Excess excavated soil shall be disposed of by the Contractor at no additional expense to

#### 9. SOD (When Applicable):

- A. <u>Soil</u>: The contractor shall submit a unit price per cubic yard for the supply and distribution of planting soil as herein before specified, to be applied at a depth of one inch (1") to all areas receiving sod.
- B. Grades: Finish (fine) grade all landscape areas, eliminating all bumps, depressions, sticks, stones and other debris to the satisfaction of the Landscape Architect prior to the application of sod. If supplemental topsoil is to be spread, no sod shall be laid until the depth of this soil has been approved.
- C. The sod shall be as called for on the Landscape Drawings, Sod shall be of firm tough texture, having a compact growth of grass with good root development, and shall contain no Bermuda Grass, weeds, or any other objectionable vegetation. The soil embedded in the sod shall be good earth, free from stones and debris and all sod shall be free from fungus, vermin and other diseases.
- D. Before being cut and lifted, the sod shall have been mowed at least three times with a lawn mover, with the final mowing not more that seven (7) days before the sod is cut. The sod shall be carefully cut into uniform dimensions.
- E. Solid sod shall be laid with closely abutting joints with a tamped or rolled, even surface. It shall be the responsibility of the contractor to bring the sod edge in a neat, clean manner to the edge of all paving and shrub areas.

#### 10. CLEAN UP:

Any soil, peat or similar material which has been brought onto any paved areas shall be removed promptly, keeping these areas clean as the work progresses. Upon completion of the planting, all excess soil, stones and debris which has not been previously cleaned up shall be removed from the

#### 11. MAINTENANCE:

- A. Maintenance shall begin immediately after each plant is planted and shall continue until all planting has passed final inspection and acceptance. Maintenance shall include watering, weeding, cultivating, removal of dead materials, resetting plants to proper grades or upright positions and restoration of the planting saucer and any other necessary operations. Proper protection to lawn areas shall be provided and any damage resulting from planting operations shall be repaired promptly.
- B. All trees shall be deep watered for a period of 90 days after planting.
- C. In the event of the threat of serious damage resulting from insects of disease prior to final acceptance, the plants shall be treated by preventative or remedial measures approved for good horticultural practice at no additional cost to the Owner.

#### 12. INSPECTION AND ACCEPTANCE:

- A. <u>Inspection:</u> Inspection of work to determine completion of contract, exclusive of the possible replacement of plants, will be made by the Owner and /or Landscape Architect, at the conclusion of all planting and at the written request of the Contractor.
- B. Acceptance: After inspection, the contractor will be notified by the Owner and/or Landscape Architect of the acceptance of all plant material and workmanship, exclusive of the possible replacement of plants subject to guarantee.

#### 13. GUARANTEE AND REPLACEMENT:

- A. Guarantee: The Contractor, as part of his Contract, shall furnish a written guarantee warranting all materials, workmanship and plant materials, except sod, for a period of six (6) months from the time of completion and acceptance. All plant materials shall be alive and in satisfactory condition and growth for each specific kind of plant at the end of the guarantee period. Where vandalism is agreed by the Landscape Architect as the cause for replacement, the Contractor shall not be responsible for replacement during the six month guarantee after final acceptance.
- \*Trees and Palms shall be guaranteed for twelve (12) months.
- B. Sod shall be guaranteed for a two (2) month period, dating from final acceptance and any lawn care which becomes necessary during the completion period will be the responsibility of the Contractor to ensure a vigorous strand of grass.

#### **GENERAL NOTES**

- Contractor shall field verify all site conditions prior to initiating planting installation. All existing planting shall remain intact and undisturbed unless otherwise noted on the plans.
- Contractor shall notify all necessary utility companies 48 hours
  minimum prior to digging for verification of all underground
  utilities, irrigation and all other obstructions and coordinate
  with Owner's Representative prior to initiating operations.
  Drawings are prepared according to the best information available
- at the time of preparing these documents.


  3. Contractor shall familiarize himself/herself with existing site conditions prior to initiating planting. All existing site furnishings, paving, landscape and other elements to remain shall
- be protected from any damage unless otherwise noted.


  4. Report any discrepancies between the construction drawings and
- Landscape contractor shall coordinate all work with related contractors and with the general construction of the project in order not to impede the progress of the work of others or the


field conditions to JBD Design, Inc. immediately.


- Contractor's own work.


  6. The location of the landscape holding area will be identified by the owner's representative. The contractor shall adhere to the access routes to and from the holding area without disrupting or
- 7. All plant material shall be in full and strict accordance to Florida No. 1 grade, according to the "Grades and Standards for Nursery Plants", (latest edition) published by the Florida Department of Agriculture and Consumer Services, the project manual and/or specifications. Plant materials shall exceed in some instances some specifications if necessary to meet the minimum requirements
- All container and caliper sizes noted on plant list are minimum. Increase size if necessary to conform to plant size and specifications.
- Plants shall be placed on a triangular spacing configuration (staggered spacing). Plant center to center dimensions (O.C.) are listed under "Comments" on the plant list.
- Landscape Contractor shall field stake the location of all plant material prior to initiating installation for the review and approval of the Owner's Representative and/or Landscape
- 11. Landscape Contractor shall field adjust location of plant material as necessary to avoid damage to all existing underground utilities and/or existing above ground elements.
- Contractor shall mulch all new plant material throughout and completely to depth specified.
- 13. Any substitutions in size and/or plant material must be approved by the Landscape Architect. All plants will be subject to approval by Landscape Architect and/or Owner's Representative before planting can begin.
- 14. Contractor shall refer to the landscape planting details, plant list, general notes and the specifications for further and complete landscape planting instructions.
- 15. Landscape Contractor shall coordinate all planting work with irrigation work. Landscape Contractor shall be responsible for all hand watering as required by Owner's Representative to supplement irrigation watering and rainfall. Landscape Contractor shall be responsible for hand watering in all planting areas, regardless of the status of existing or proposed
- 16. Landscape Contractor shall clean the work areas at the end of each working day. Rubbish and debris shall be collected and deposited off-site daily. All materials, products and equipment shall be stored in an organized fashion as directed by the Owner's Representative.
- 17. Landscape Contractor shall regrade all areas disturbed by plant

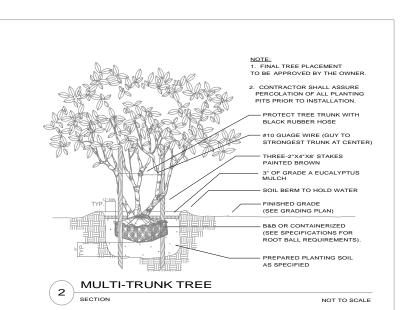


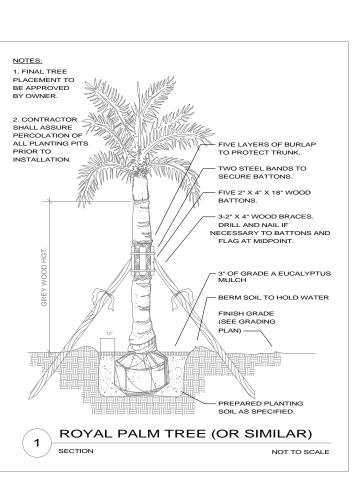


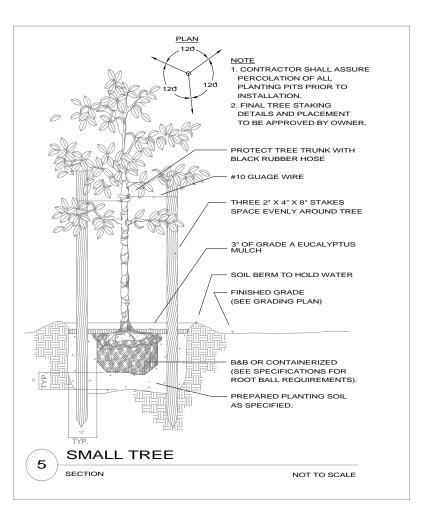

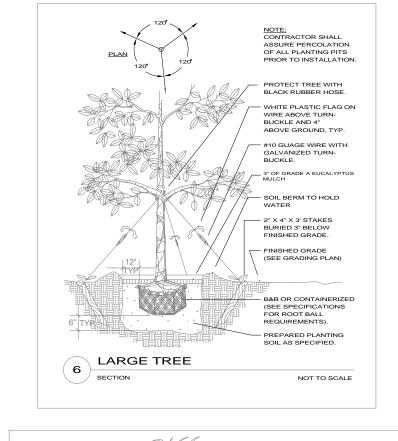

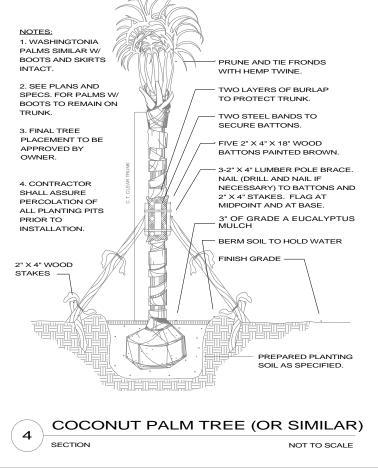

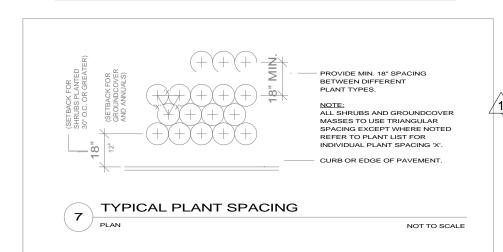

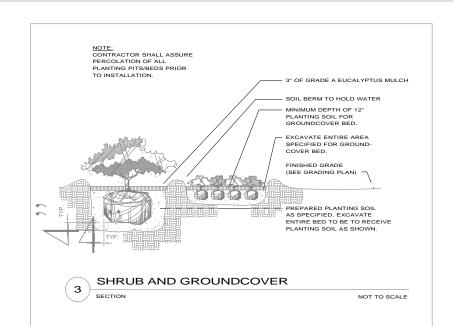



#### SPECIFICATIONS:

CPU-SERIES: CPU12-2, CPU 24-2, CPU 36-2, CPU 48-2, CPU 60-2


A. THE ROOT BARRIER SHALL BE CPU-UTILITY SERIES PANELS MANUFACTURED BY CENTURY PRODUCTS, 1144 N.
GROVE STREET, ANAHEIM, CA 92806 (714) 632-7083 OR APPROVED EQUIVALENT.

B. BARRIERS ARE BLACK, EXTRUDED, MODULAR PANELS MANUFACTURED USING RECYCLED POLYETHYLENE
PLASTIC WITH ULTRAVIOLET INHIBITORS. EACH PANEL HAS FLEXIBLE, EXTRUDED, 90' VERTICAL ROOT DIVERTING
RIBS PROTRUDING ½"-¾" IN HEIGHT WITH A MINIMUM THICKNESS OF 0.080" AND ARE PLACED 6" (15 CM) APART.
INTERLOCKING, PANEL TO PANEL JOINING SYSTEM DESIGNED TO FOLD HORIZONTALLY FOR TIGHTER FIT
PROVIDES FOR AN INSTANT ASSEMBLY BY SLIDING ONE PANEL INTO ANOTHER.

THICKNESS: 0.080"

POLYETHYLENE	
0.080"	
ASTM TEST	VALUE
METHOD	POLYETHYLENE
D638	COPOLYMER
D638	4100 TO 4300 PSI
D638	40%
-	150,000 PSI
D747	-
D1822	125,000
-	PSI 50FT. LBS/IN
D1693	-
D2240	1 HR.
	0.080" ASTM TEST METHOD D638 D638 D638 - D747 D1822 - D1693

HARDNESS, SHORE D
LINEAR APPLICATION: FOR ROOT PRUNING OF EXISTING TREES OR IN PLANTING SITUATIONS
WHERE ONE OR MORE TREES ARE IN CLOSE PROXIMITY TO HARDSCAPES.
TREE WELL APPLICATION: FOR NEW TREE PLANTING OR WHEN THE HARDSCAPE ENCIRCLES
THE PLANTER.

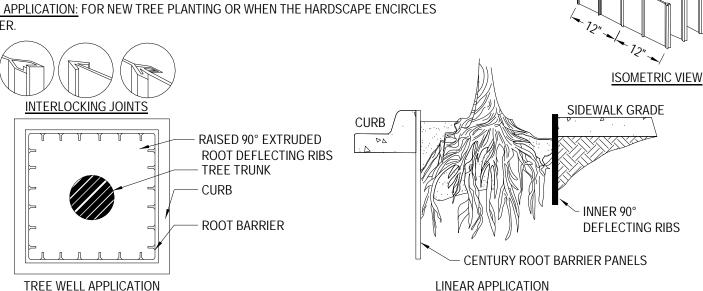

-FLEXIBLE TOP SAFETY EDGE

- 90° 1/2"- 3/4" RAISED RIB, SIDE

WELL APPLICATIONS

RIBS, SPACED APART

1' (30CM) SECTIONS

SYSTEM

-VERSATILE BARRIER FOR LINEAR OR TREE

-MANUFACTURED WITH RECYCLED PLASTIC

-RAISED 90° EXTRUDED ROOT DEFLECTING

INTERLOCKING PANEL TO PANEL JOINING

-ADJUSTABLE ANTI-LIFT POLYETHYLENE

PANELS WHICH CAN BE SEPARATED INTO

TREE WELL APPLICATION

- INSTALLATION TO BE COMPLETED IN ACCORDANCE WITH MANUFACTURER'S SPECIFICATIONS.
   ALL DIMENSIONS ARE CONSIDERED TRUE AND REFLECT MANUFACTURER'S SPECIFICATIONS.
- DO NOT SCALE DRAWING.
   THESE DRAWINGS ARE NOT FOR CONSTRUCTION PURPOSES AND ARE FOR INFORMATION PURPOSES ONLY. ALL INFORMATION
  CONTAINED HEREIN WAS CURRENT AT THE TIME OF DEVELOPMENT BUT MUST BE REVIEWED AND APPROVED BY THE PRODUCT
  MANUFACTURER TO BE CONSIDERED ACCURATE.
- 5. TOLERANCES MAY VARY IN ORDER TO MAINTAIN THE INTEGRITY OF POST-CONSUMER MATERIALS AND ASSURE THE MATERIAL STRUCTURE. WE MAKE NO OTHER WARRANTIES, EXPRESS OR IMPLIED, AND SPECIFICALLY DISCLAIM THE WARRANTY OF MERCHANTABILITY OR FITNESS FOR A PARTICULAR PURPOSE.
- 6. CONTRACTOR'S NOTE: FOR PRODUCT AND COMPANY INFORMATION VISIT www.CADdetails.com/info REFERENCE NUMBER 005-019.

UTILITY GRADE ROOT BARRIER PANELS

- APPLICATION DETAIL

#### 2 - APPLICATION DETAIL 1" = 1'-0"

## **Plant List**

				,
KEY	QTY.	BOTANICAL NAME	COMMON NAME	REMARKS
CIR	67	CHRYSOBALANUS ICACO	Cocoplum	#3 full,dense/ 24" hgt. x 24" spr./ 24" o.c. (NATIVE)
QV	4	QUERCUS VIRGINIANA	Live Oak	18' o.a. x 12' spr./ full,dense/ min 4.5" cal/ 6' c.t. (NATIVE)
		2		
FK	56	TRIPSACUM DACTYLOIDES	FAKAHATCHEE GRASS	3 gal. full dense/ 18"x 18" / (NATIVE)
VS	2	VEITCHIA SP.	VEITCHIA PALM	Grade #1, Heavy, 14ft HT, 6ft CT
BS	7	BURSERA SIMARUBA	GUMBO LIMBO	16-18ft HT, 12-14ft Spr, min 8" Cal, 6-6.5ft CT (NATIVE)
		/2		
	660 SF	BAHIA SOD		
	136	TOTAL NUMBER OF PLANTS P	ROPOSED	
	136 OR 100%	TOTAL NUMBER OF NATIVE P	LANTS PROVIDED	
		2		

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REGISTERED ARCHITECT:
JUAN CRISTOBAL CONTIN

| | 826 S. FEDERAL HIGHWAY

FL LICENSE # AR94935

LAKE WORTH, FL 33460



#### CLIENT:

GG&P Properties, Inc. Michael Gizewski

## PROJECT TITLE:

Mixed Use Development

PROJECT ADDRESS: 1432 N Dixie Hwy

DATE: 6/30/2023 9:45:18
AM
ISSUED: ISSUED

RG

REVISIONS:

DRAWN BY:

CHECKED BY:

/1\	5/10/2023	
2	6/2/2023	

SCALE/NORTH POINT:

DRAWING TITLE


Planting Detail

AS SHOWN

DRAWING STATUS:

DRAWING NUMBER:

LP101

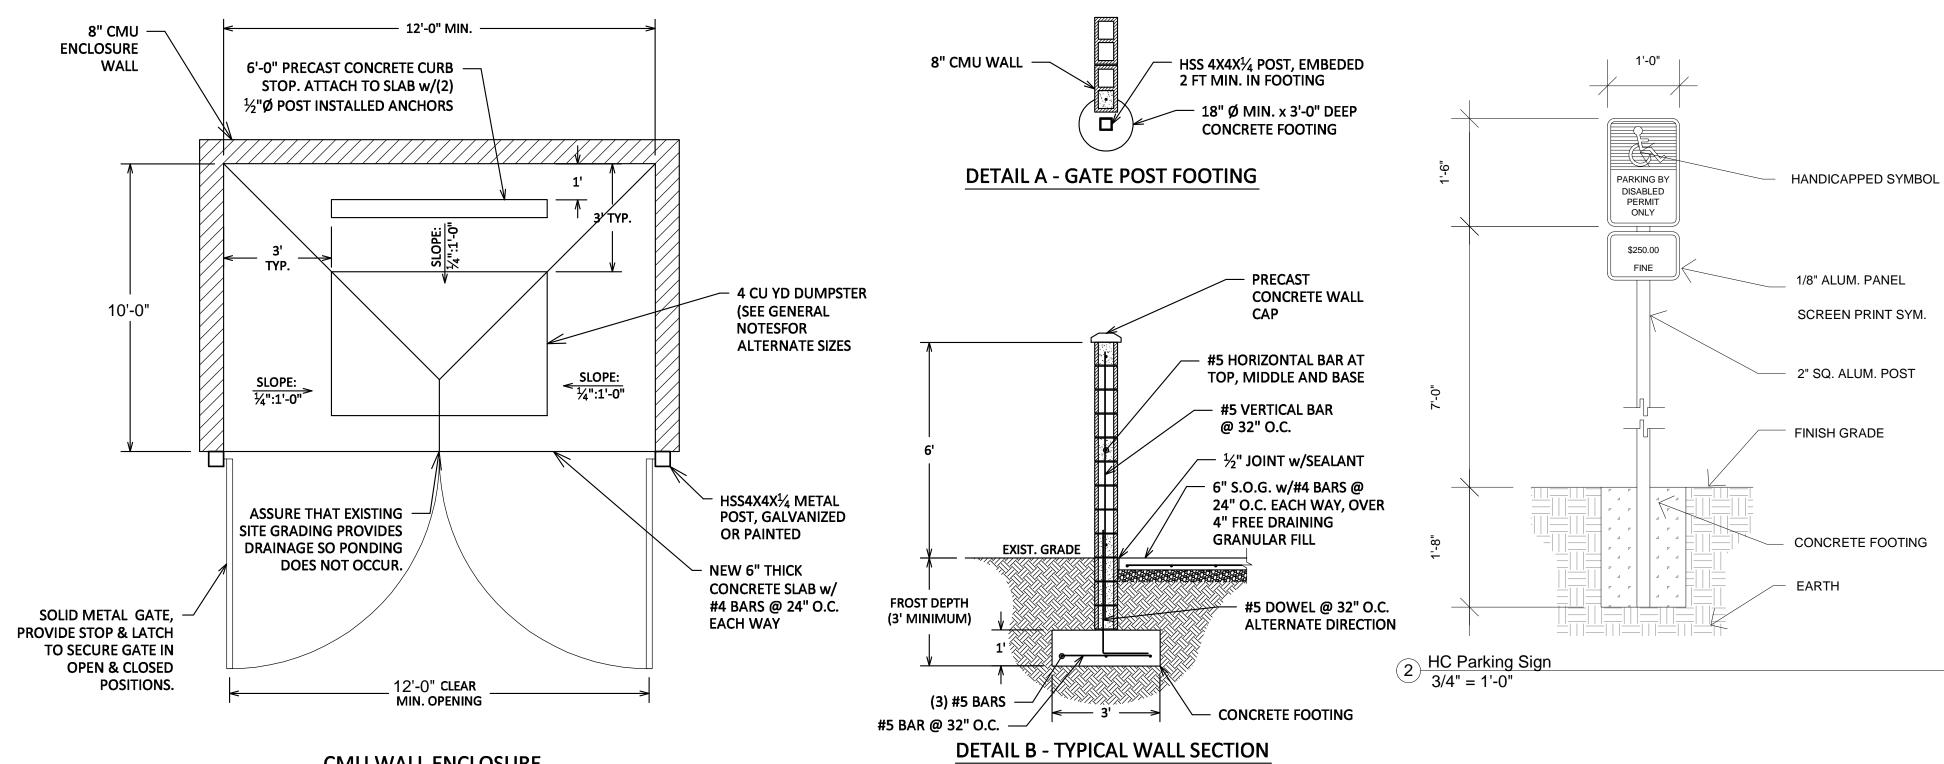


#### CMU WALL ENCLOSURE


#### LDR: SEC. 23.6-1. (C.)(3) (H.) - .


- All dumpster and refuse areas shall be screened with opaque fencing or walls with an exterior landscape screen of shrub hedging or other continuous decorative landscaping that is a minimum height of twenty-four (24) inches at installation and shall be maintained at no less than three-fourths (¾) of the total height of the enclosure. All ground level mechanical
- equipment shall be screened with shrub hedging or opaque fencing or walls. Chain link or similar type open fencing shall not be permitted.


#### **SEC. 12-7. - DUMPSTER REQUIREMENTS.**


- (2) For new dumpsters placed in operation after the date this ordinance is adopted, shall be appropriately screened and gated and shall be set on a reinforced concrete slab, six (6) inches thick.
- Be a minimum of 10' deep by 12' wide unless granted a written variance by the public services director or designee.
- Be provided with a concrete service apron or curb cut if applicable 6" thick.
- Be provided with side and rear guides to ensure the dumpster does not damage the enclosure.
- (6) The concrete slab should have a 2% slope. It shall be shaped as to drain in accordance with the drainage on site.

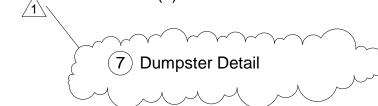

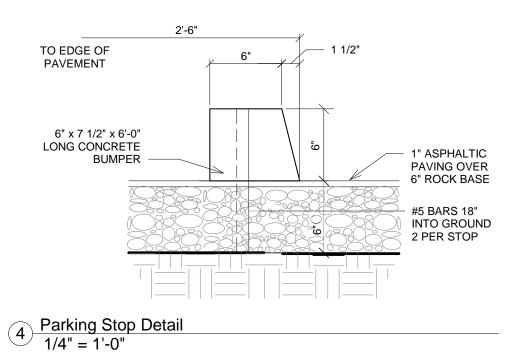

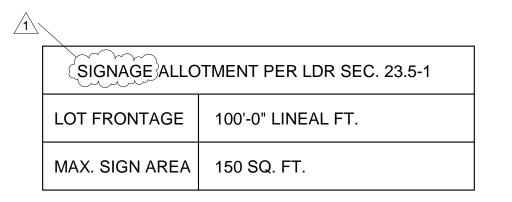

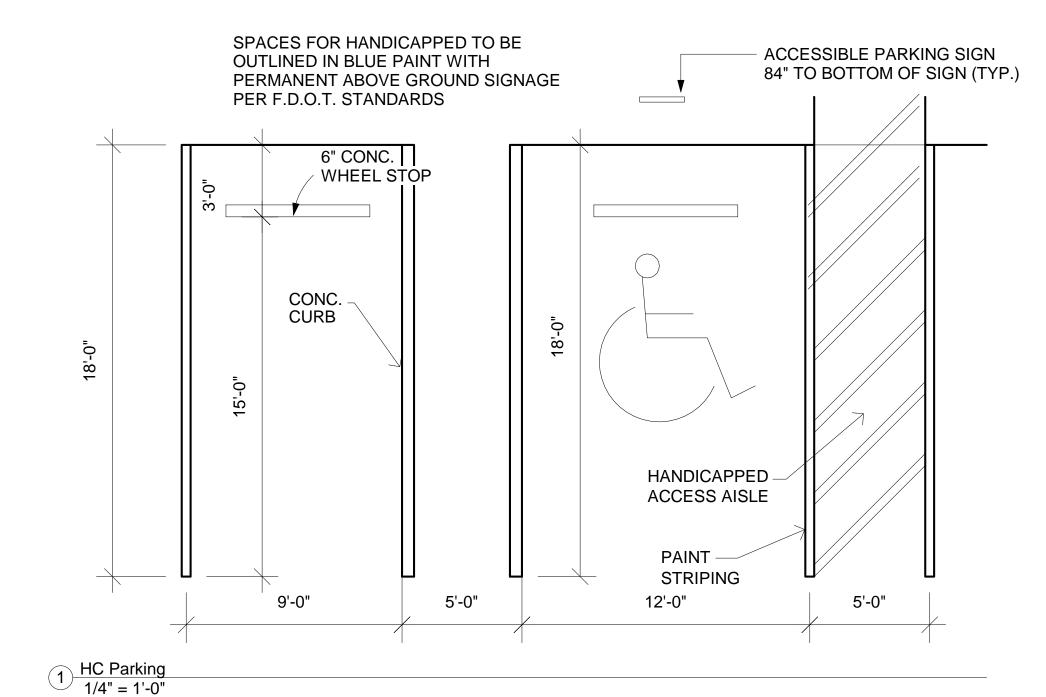

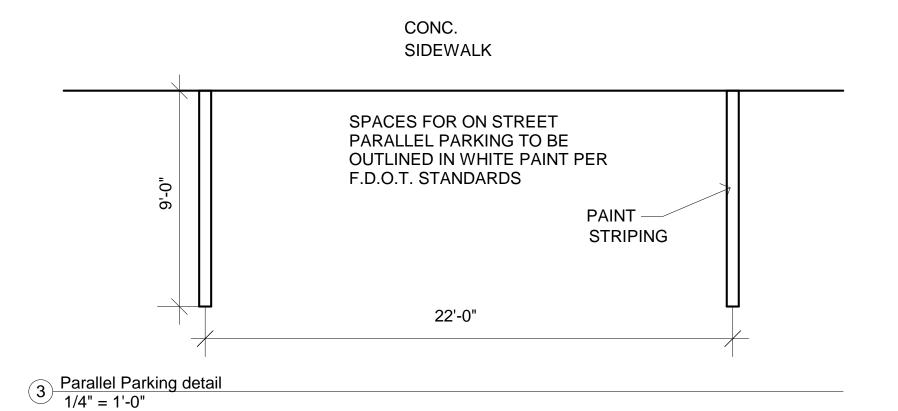

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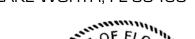
#### **REGISTERED ARCHITECT:**

JUAN CRISTOBAL CONTIN

FL LICENSE # AR94935

826 S. FEDERAL HIGHWAY

LAKE WORTH, FL 33460





#### CLIENT:

GG&P Properties, Inc. Michael Gizewski

PROJECT TITLE: Mixed Use Development

PROJECT ADDRESS:

1432 N Dixie Hwy

DATE: 6/30/2023 10:55:55 ISSUED ISSUED: \_ DRAWN BY:

## **REVISIONS:**

CHECKED BY:\_

01/23/23

### SCALE/NORTH POINT:


AS SHOWN

## DRAWING TITLE

Site Details

DRAWING STATUS:



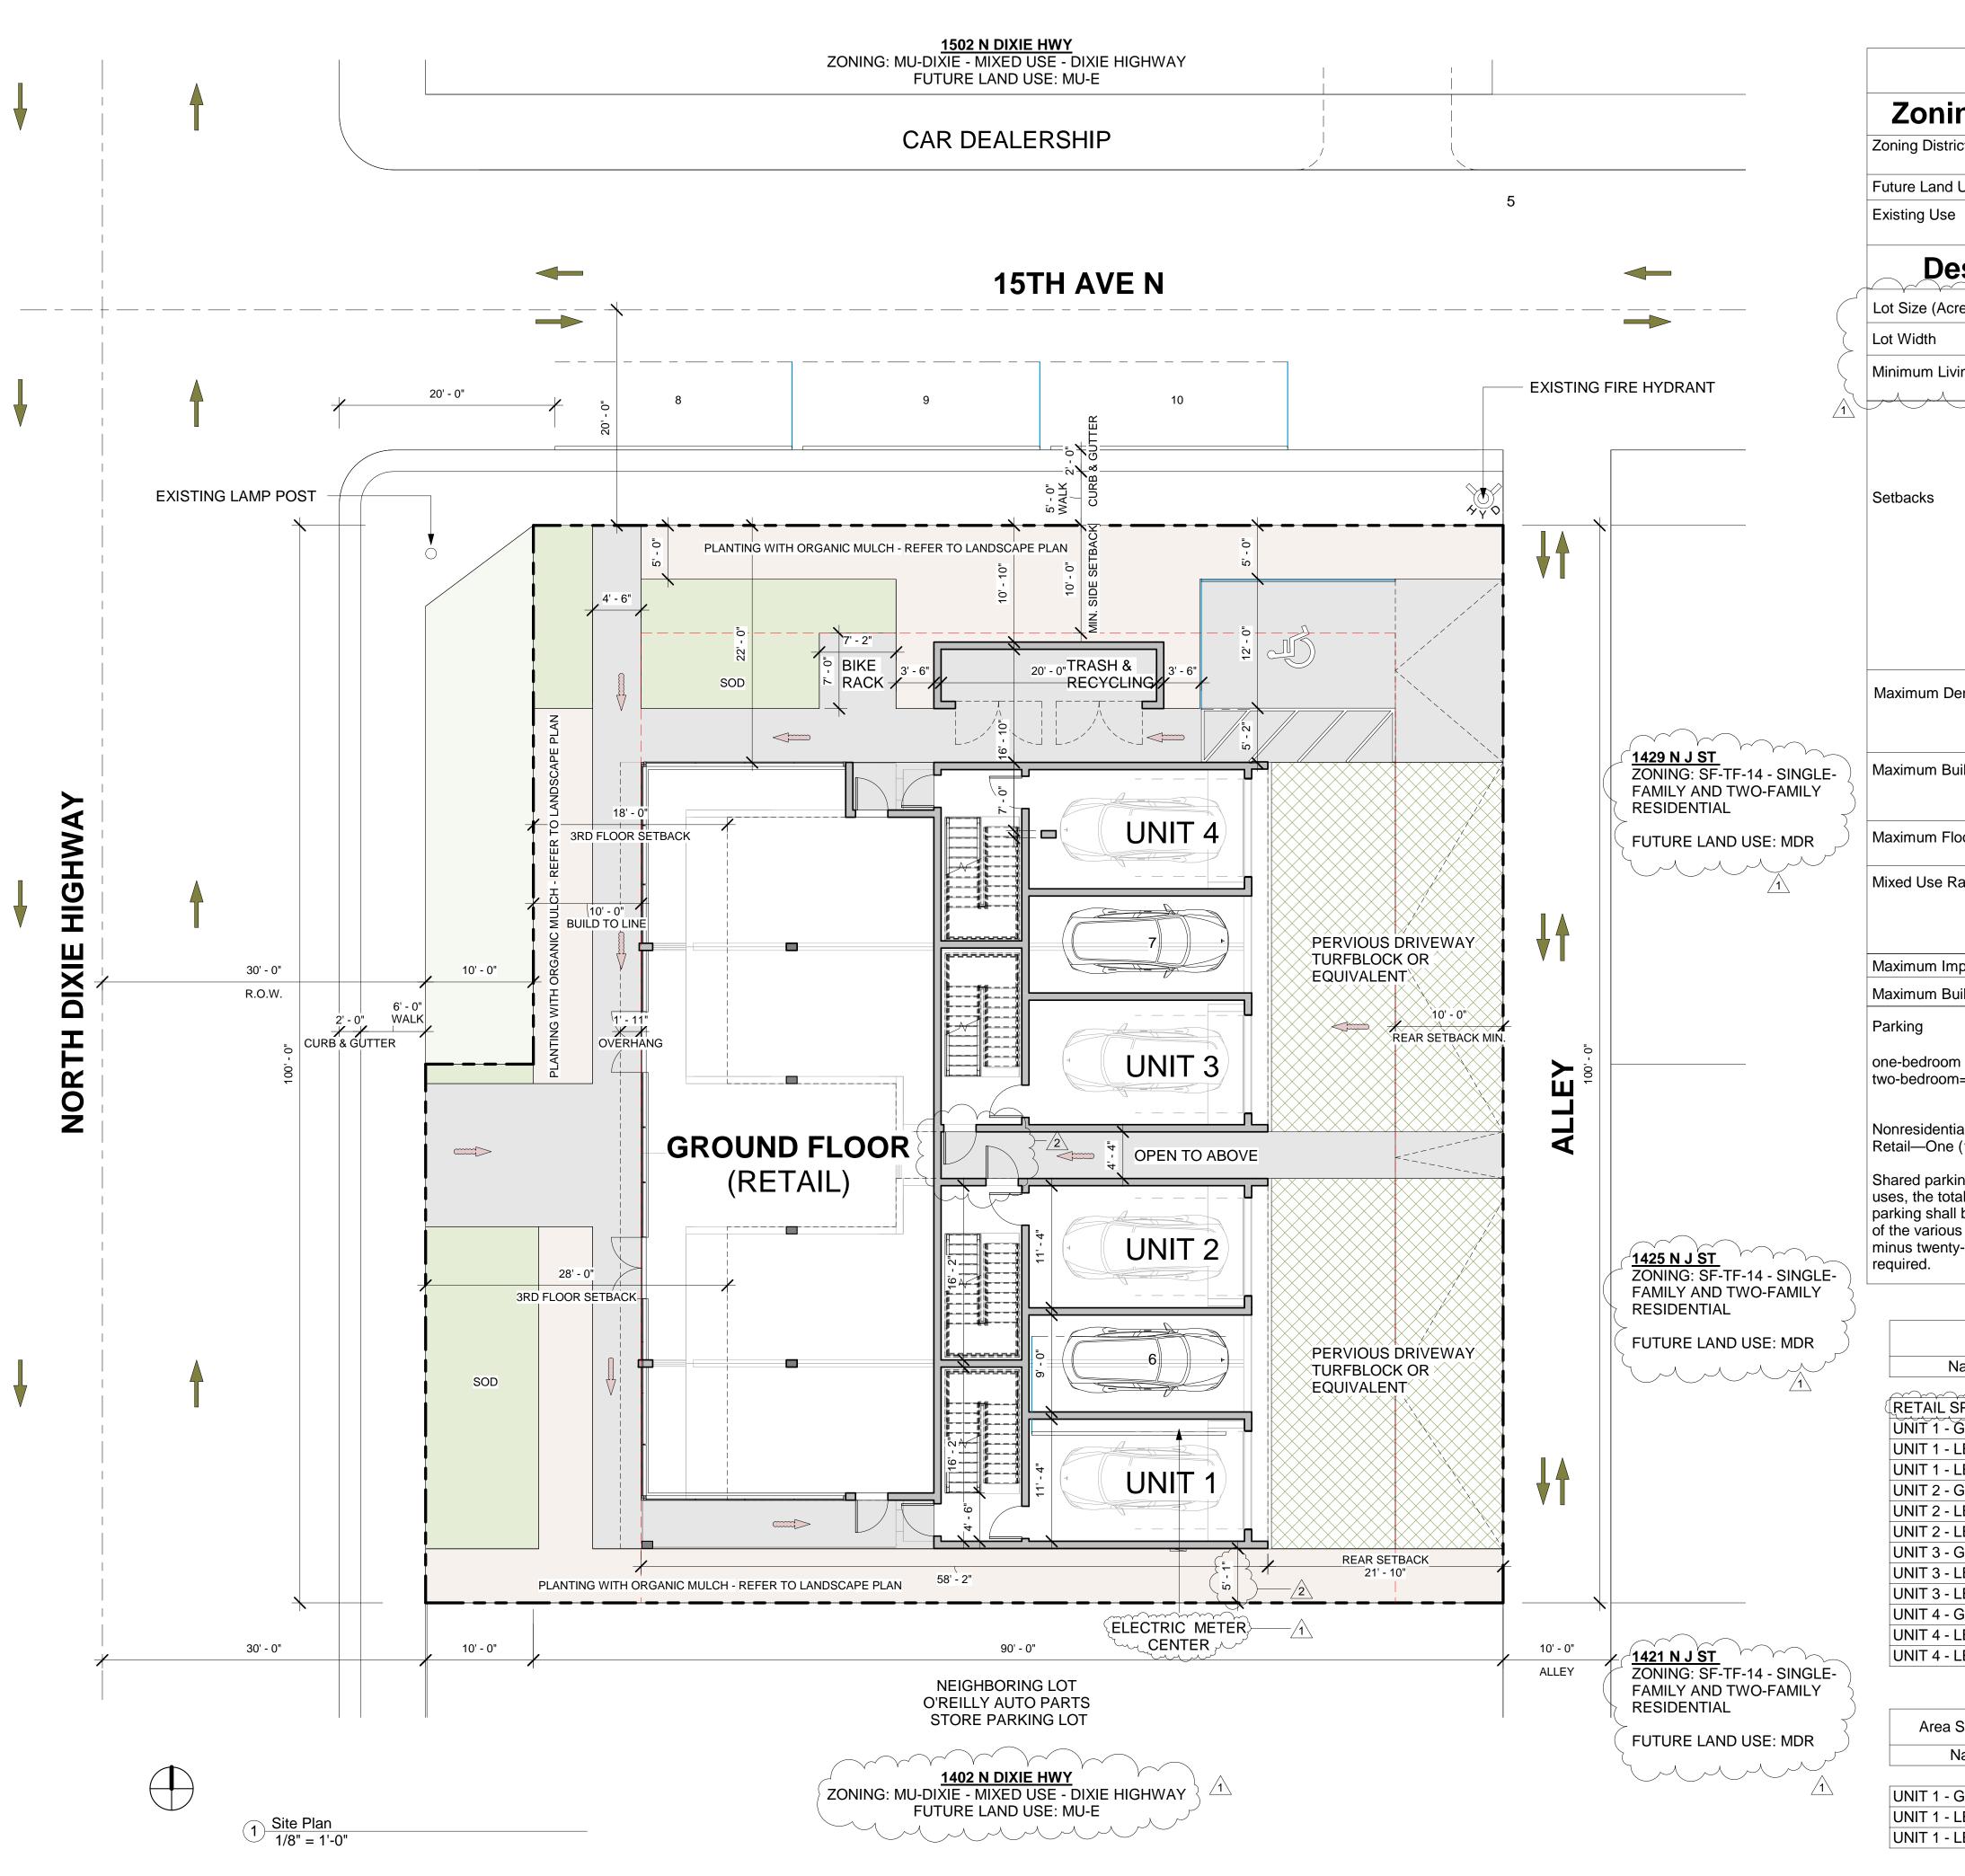

			Site Da	ta Table		
Zoning	Zoning and FLU		Exis	sting	Proposed	
Zoning District	Zoning District		MU-DIXIE - Mixed Use Dixie Hwy		MU-DIXIE - Mixed Use Dixie Hwy	
Future Land Use		M	U-E			
Existing Use		VAC	CANT	MIXED USE - MULTI-FAMILY +COMMERCIAL		
Desc	Description		Req	uired	Provided	
Lot Size (Acreage	Lot Size (Acreage and SF)		(East Side of	Dixie) 6,500 SF	0.218 Acres (9,500 SF)	
Lot Width			50 ft. (on East si	ide of Dixie Highway)	100 ft.	
Minimum Living A	Area		Multiple- Family -	750 square feet 2 BR	SEE AREA SCHEDULE	
	Front		10 ft. minimum r	not to exceed 22 ft.	10 ft.	
				above - 8' to 12' to minimum	Additional 8 ft. = 18 ft.	
Setbacks	Rear			t depth when next to strict. 10 ft. in general.	23' - 4"	
			Third Story and above - 8' to 12' inaddition to minimum		23' - 4"	
	Side	North	10'-0" on street  0 ft. on interior lot.		22 ft.	
	Side	South			5 ft.	
Maximum Densit	у		(East Side of Dixie) Max density 1 du per each 2,175 SF net lot area (4.36 dwelling units)		4 UNITS	
Maximum Buildin	g Height		30'-0" (max 2 stories)	Sustainable Bonus 35'-0" (max 3 stories)	33'-0" (3 stories)	
Maximum Floor A	rea Ratio Li	mitation	0.90 (8,550 SF)	Sustainable Bonus 1.40 (13,300 SF)	9,418 SF	
Mixed Use Ratio			75% Residential		4 UNITS X 1,892 S.F = 7,568 SF (80%)	
			25% Nor	n-Residential Max.	1,850 SF (20%)	
Maximum Impern	neable Spac	ce Coverage	65% (6,175 SF)		61.8 % (5,874) SF	
Maximum Building Coverage		45% (4,	,275 SF) /2	42.1% (4,003) SF		
Parking one-bedroom = (1.5) spaces per unit. two-bedroom= (1.75) spaces per unit.		<b>Two-bedroom</b> = (1.75) spaces per unit x 4 dwelling units  7 PARKING SPACES		7 OFF-STREET PARKING + 3 ON-STREET PARKING 10 PARKING SPOTS TO BE PROVIDED		
Nonresidential us Retail—One (1) s	pace per 50	•	Retail =One (1) space per 500 SF of space.  = 1940 SF / 500SF  = 3.88 PARKING SPACES  TOTAL OF  (2) USES = 11 PARKING SPACES		+ 4 bicycle rack spaces = 11 PARKING ALTERNATES: can replace 2.5 parking spots (25% of Total) THESE INCLUDE: A. four (4) bicycle rack spaces shall	
Shared parking: uses, the total receptive parking shall be to the various use	quirement for he sum of the es computed	or off-street ne requirements			count as one (1) parking space B.two (2) motorcycle or scooter spaces shall count as one (1) parking space	

Name	Area
RETAIL SPACE 2	1850 SF
JNIT 1 - GARAGE	405 SF
JNIT 1 - LEVEL 2	768 SF
JNIT 1 - LEVEL 3	719 SF
UNIT 2 - GARAGE	405 SF
JNIT 2 - LEVEL 2	768 SF
UNIT 2 - LEVEL 3	719 SF
UNIT 3 - GARAGE	405 SF
JNIT 3 - LEVEL 2	768 SF
UNIT 3 - LEVEL 3	719 SF
UNIT 4 - GARAGE	405 SF
UNIT 4 - LEVEL 2	768 SF
UNIT 4 - LEVEL 3	719 SF
	9418 SF

Area Schedule (TYF	P. UNIT)
Name	Area
UNIT 1 - GARAGE	405 SF

UNIT 1 - GARAGE 405 SF
UNIT 1 - LEVEL 2 768 SF
UNIT 1 - LEVEL 3 719 SF
1892 SF

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REGISTERED ARCHITECT:
IUAN CRISTOBAL CONTIN

LICENSE # AR94935

826 S. FEDERAL HIGHWAY

AKE WORTH, FL 33460



CLIENT:

GG&P Properties, Inc. Vichael Gizewski

PROJECT TITLE:

Mixed Use Development

ROJECT ADDRESS:

432 N Dixie Hwy

ATE: 6/30/2023 9:43:31 AM

SUED: ISSUED

RAWN BY: RG

REVISIONS:

1 01/23/23

2 06/02/23

00/02/23

SCALE/NORTH POINT:
AS SHOWN

DRAWING TITLE

Site Plan

DRAWING STATUS:

DRAWING NUMBER:



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FL LICENSE # AR94935

826 S. FEDERAL HIGHWAY

LAKE WORTH, FL 33460



CLIENT:

GG&P Properties, Inc. Michael Gizewski

PROJECT TITLE:

Mixed Use Development

PROJECT ADDRESS:

1432 N Dixie Hwy

DATE:	6/30/2023 9:54:29
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DRAWN BY	:R(

REVISIONS:

CHECKED BY:

2	06/02/23	

SCALE/NORTH POINT:

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DRAWING TITLE

Level 2 Floor Plan

DRAWING STATUS:

DRAWING NUMBER:



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FL LICENSE # AR94935

826 S. FEDERAL HIGHWAY

LAKE WORTH, FL 33460



CLIENT:

GG&P Properties, Inc. Michael Gizewski

PROJECT TITLE:

Mixed Use Development


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REVISIONS:

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SCALE/NORTH POINT:


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DRAWING TITLE


Level 3 Floor Plan

DRAWING STATUS:

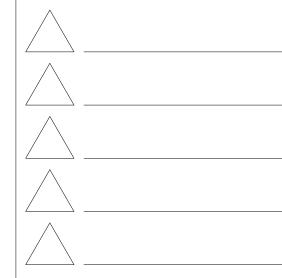DRAWING NUMBER:

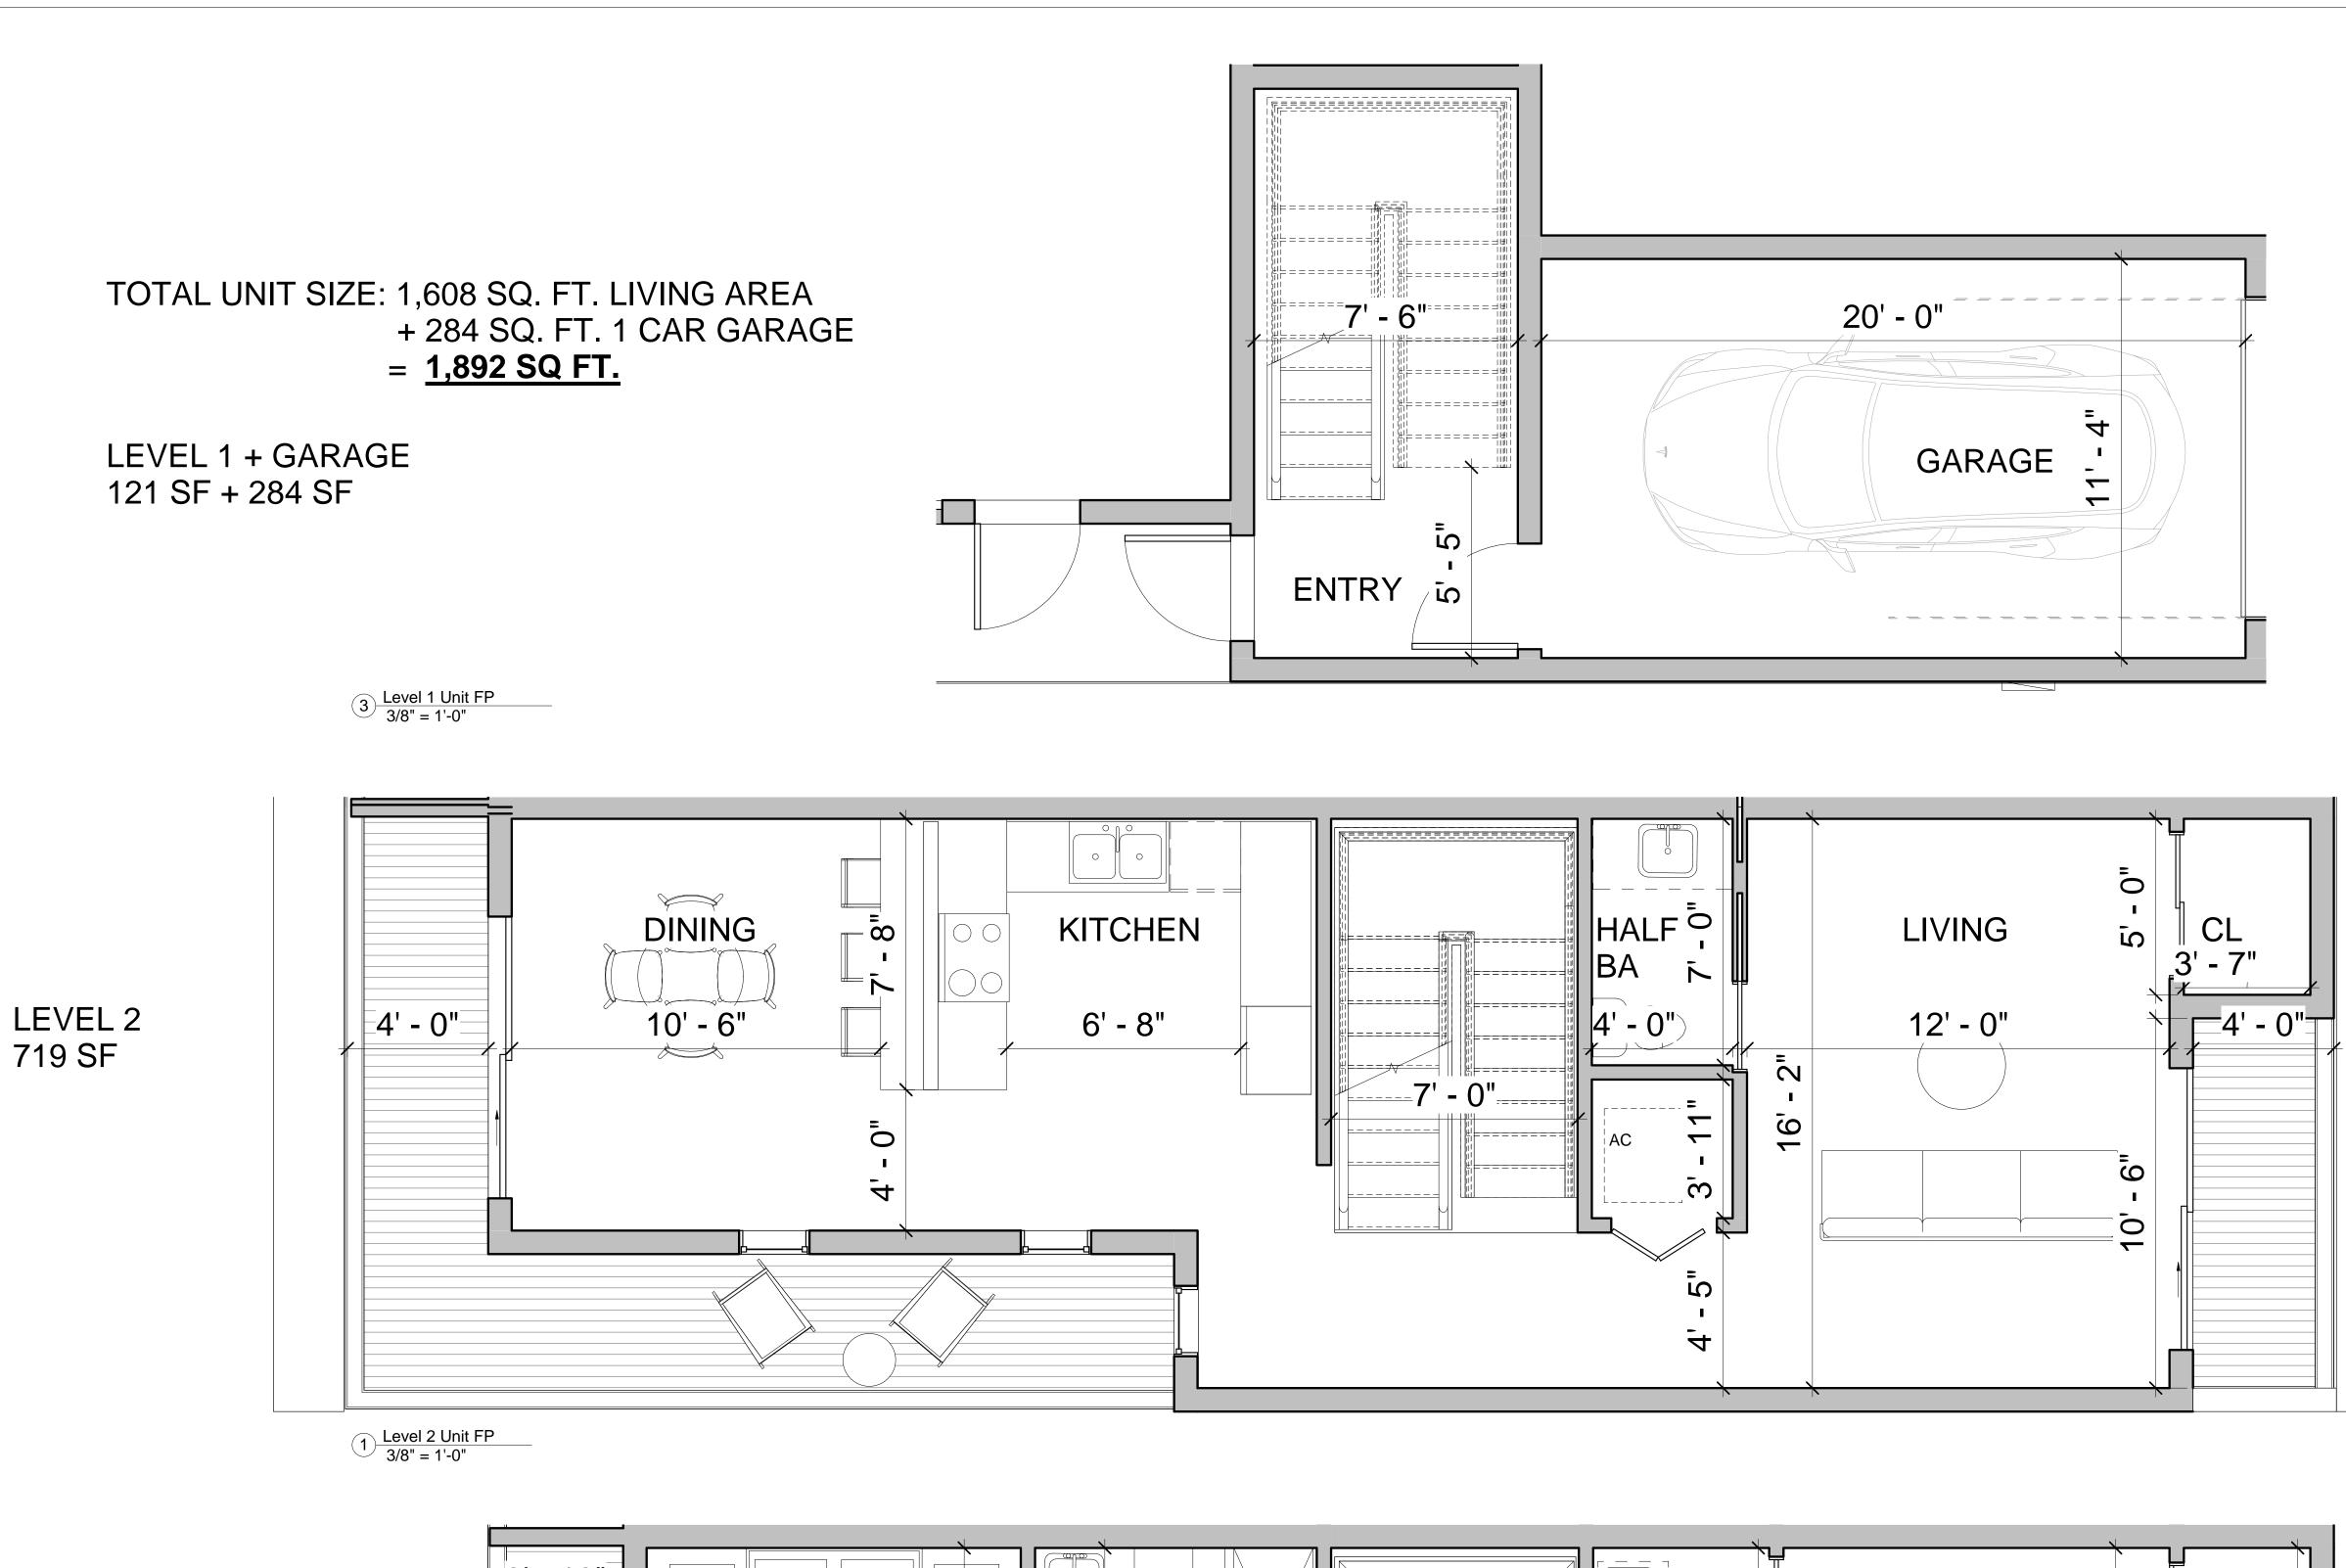

LEVEL 3 768 SF

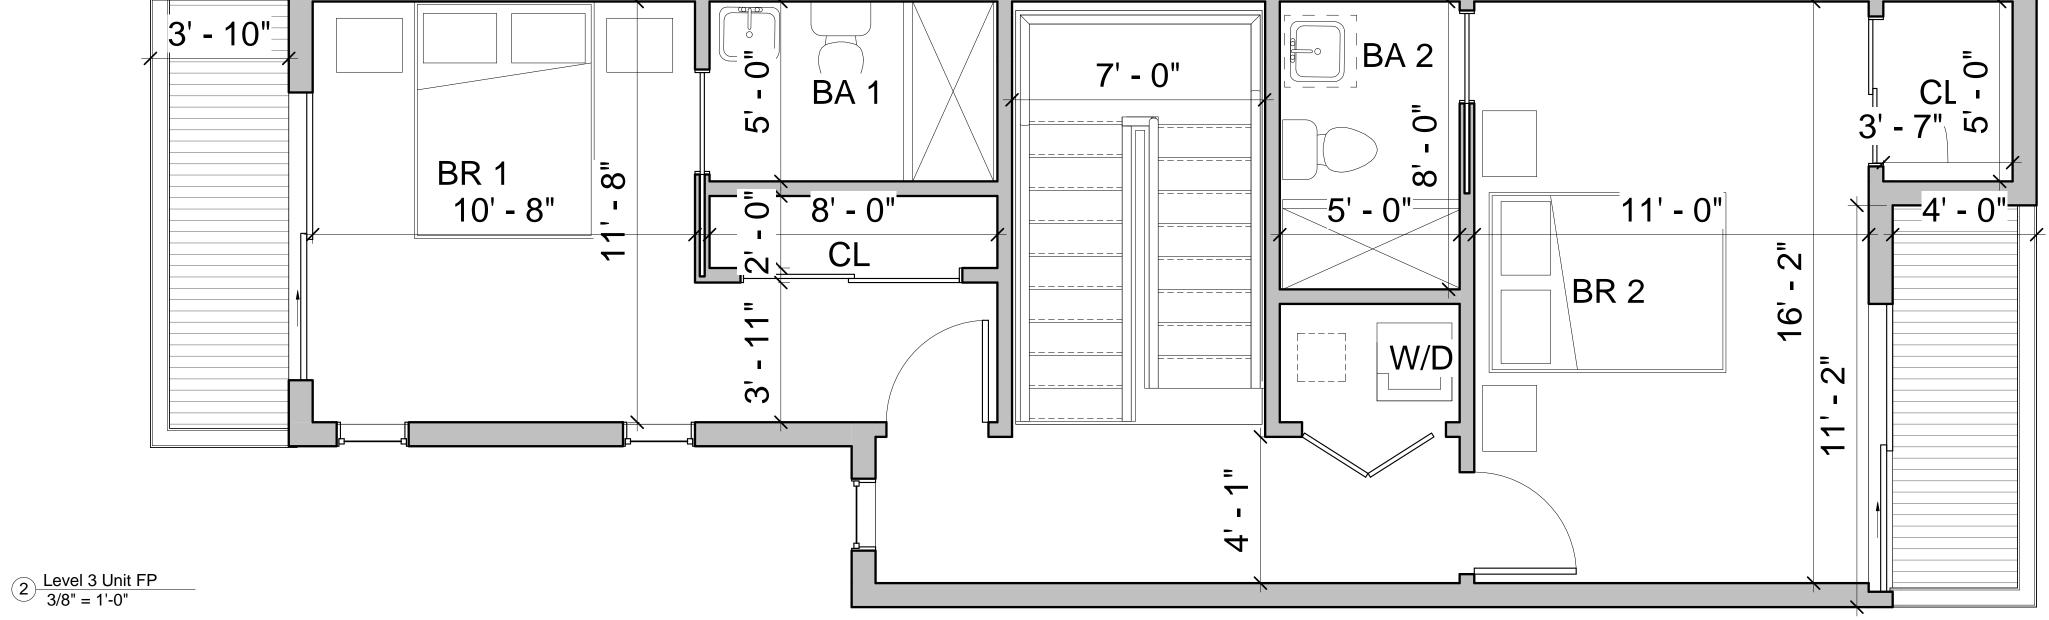

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LAKE WORTH, FL 33460



CLIENT:

GG&P Properties, Inc. Michael Gizewski

PROJECT TITLE:

Mixed Use Development

PROJECT ADDRESS:


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DATE: \_\_\_\_\_6/30/2023 9:43:53 AM ISSUED: \_\_\_\_\_ ISSUED

DRAWN BY: \_\_\_\_\_ RG

CHECKED BY: \_\_\_\_\_ JC

REVISIONS:

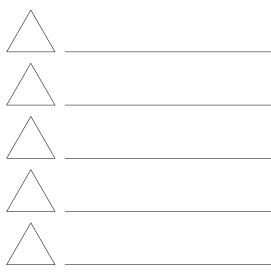


SCALE/NORTH POINT:

AS SHOWN

DRAWING TITLE
Unit Floor Plans

DRAWING STATUS:

DRAWING NUMBER:

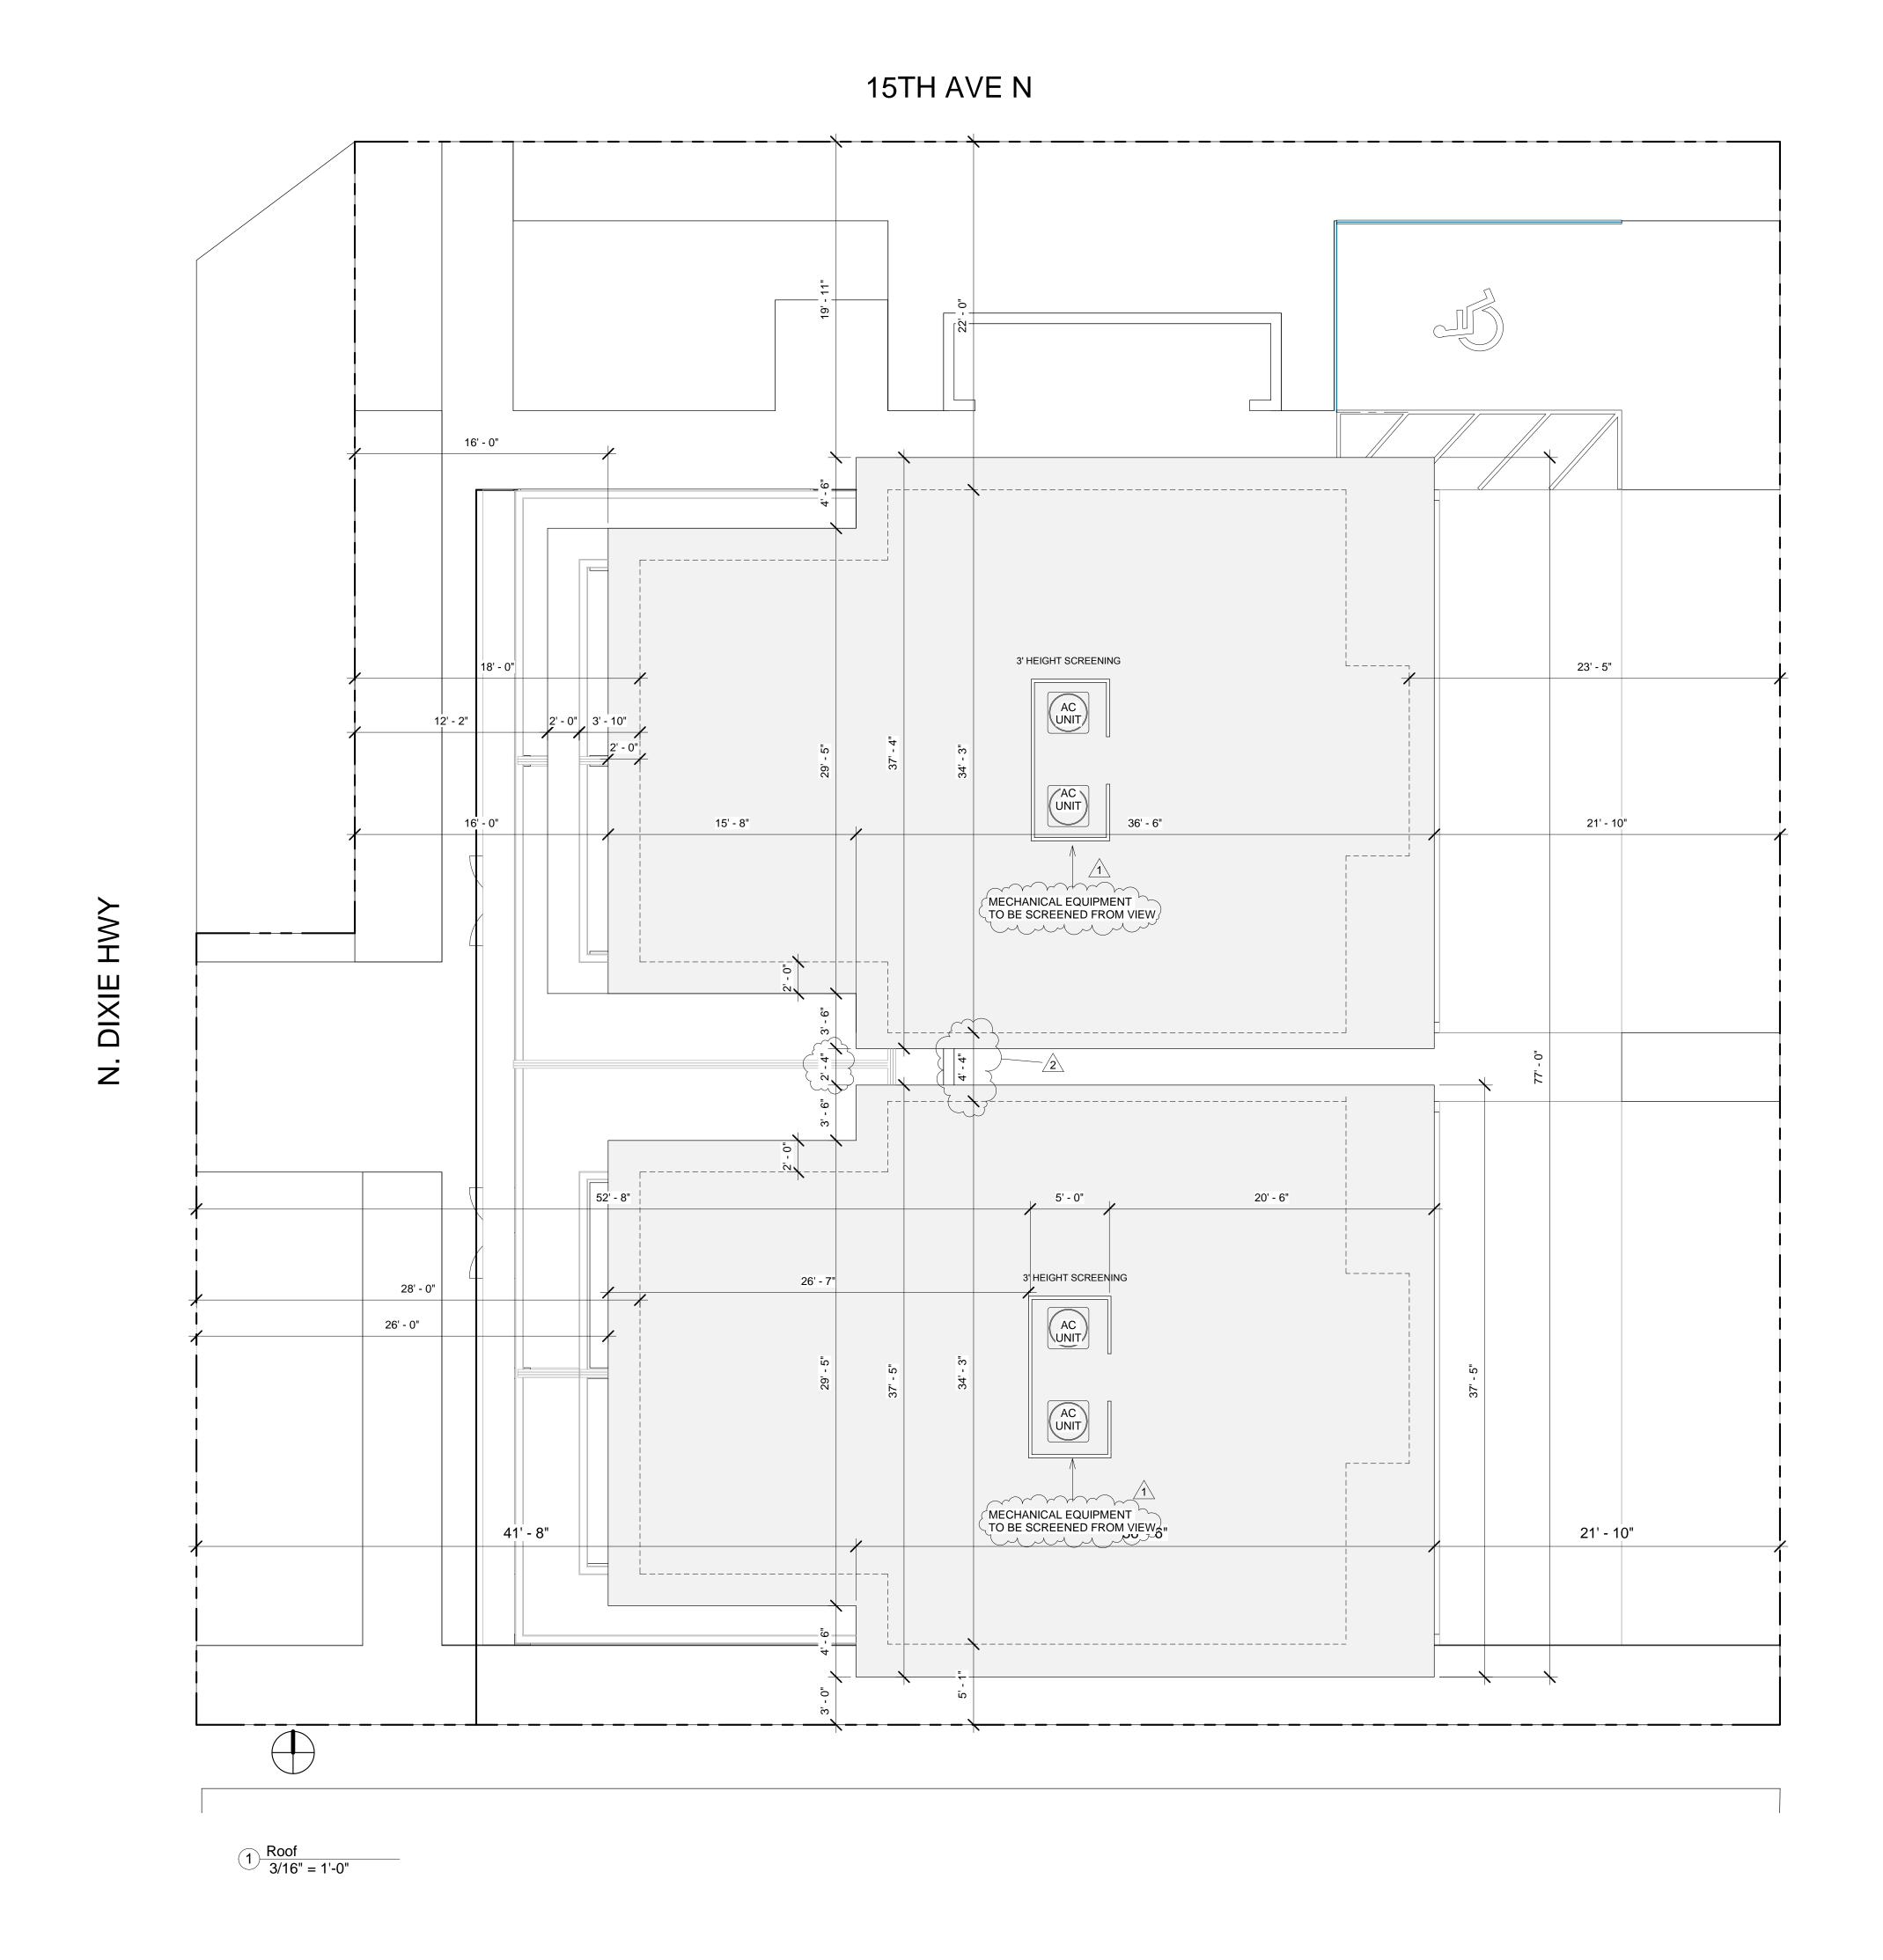

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CLIENT:

GG&P Properties, Inc. Michael Gizewski

PROJECT TITLE:

Mixed Use Development

PROJECT ADDRESS:

1432 N Dixie Hwy

REVISIONS:

CHECKED BY:\_

1 01/23/23 2 06/02/23

SCALE/NORTH POINT:

AS SHOWN


DRAWING TITLE

Roof Plan

DRAWING STATUS:

DRAWING NUMBER:



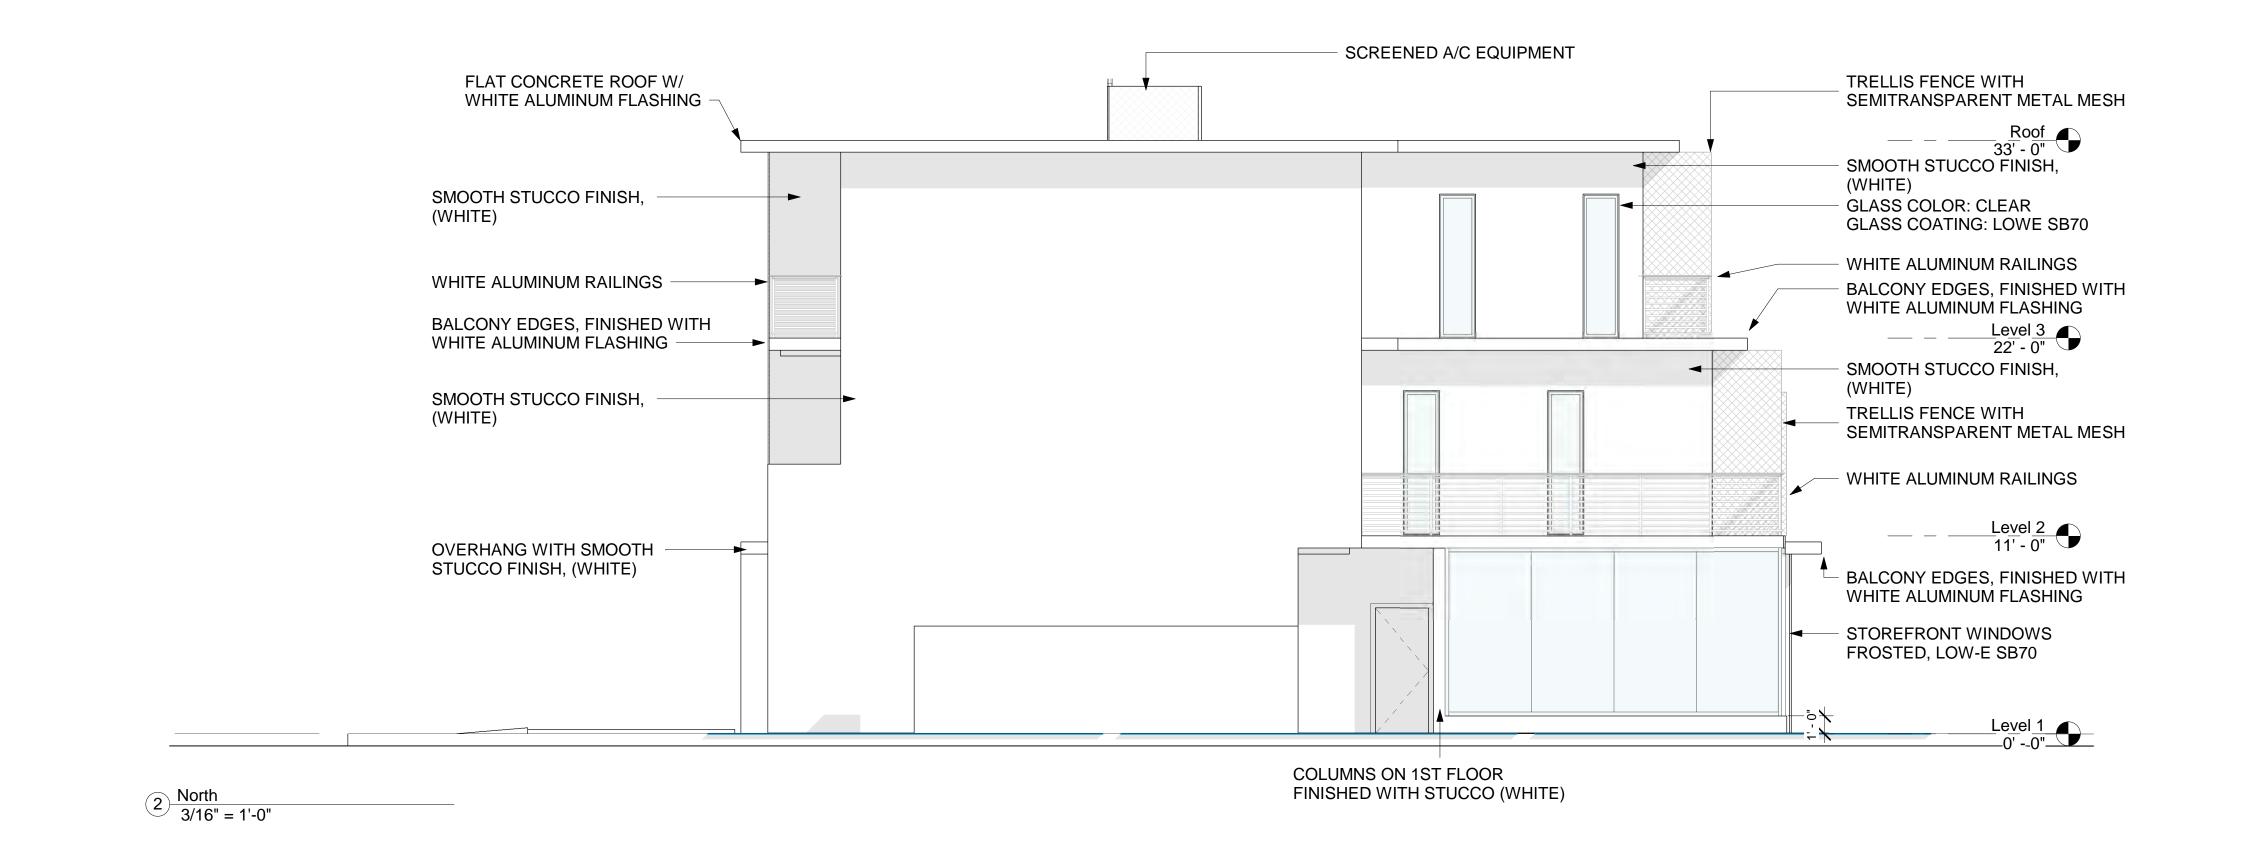

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LAKE WORTH, FL 33460



CLIENT:

GG&P Properties, Inc. Michael Gizewski

PROJECT TITLE:

Mixed Use Development

PROJECT ADDRESS:


1432 N Dixie Hwy

DATE: \_\_\_\_\_6/30/2023 9:44:23 AM
ISSUED: \_\_\_\_\_ ISSUED

DRAWN BY: \_\_\_\_\_ RG

CHECKED BY: \_\_\_\_\_ JC

REVISIONS:

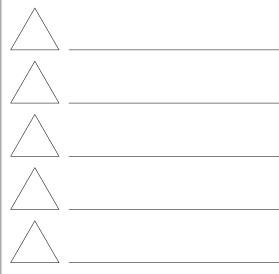

SCALE/NORTH POINT:


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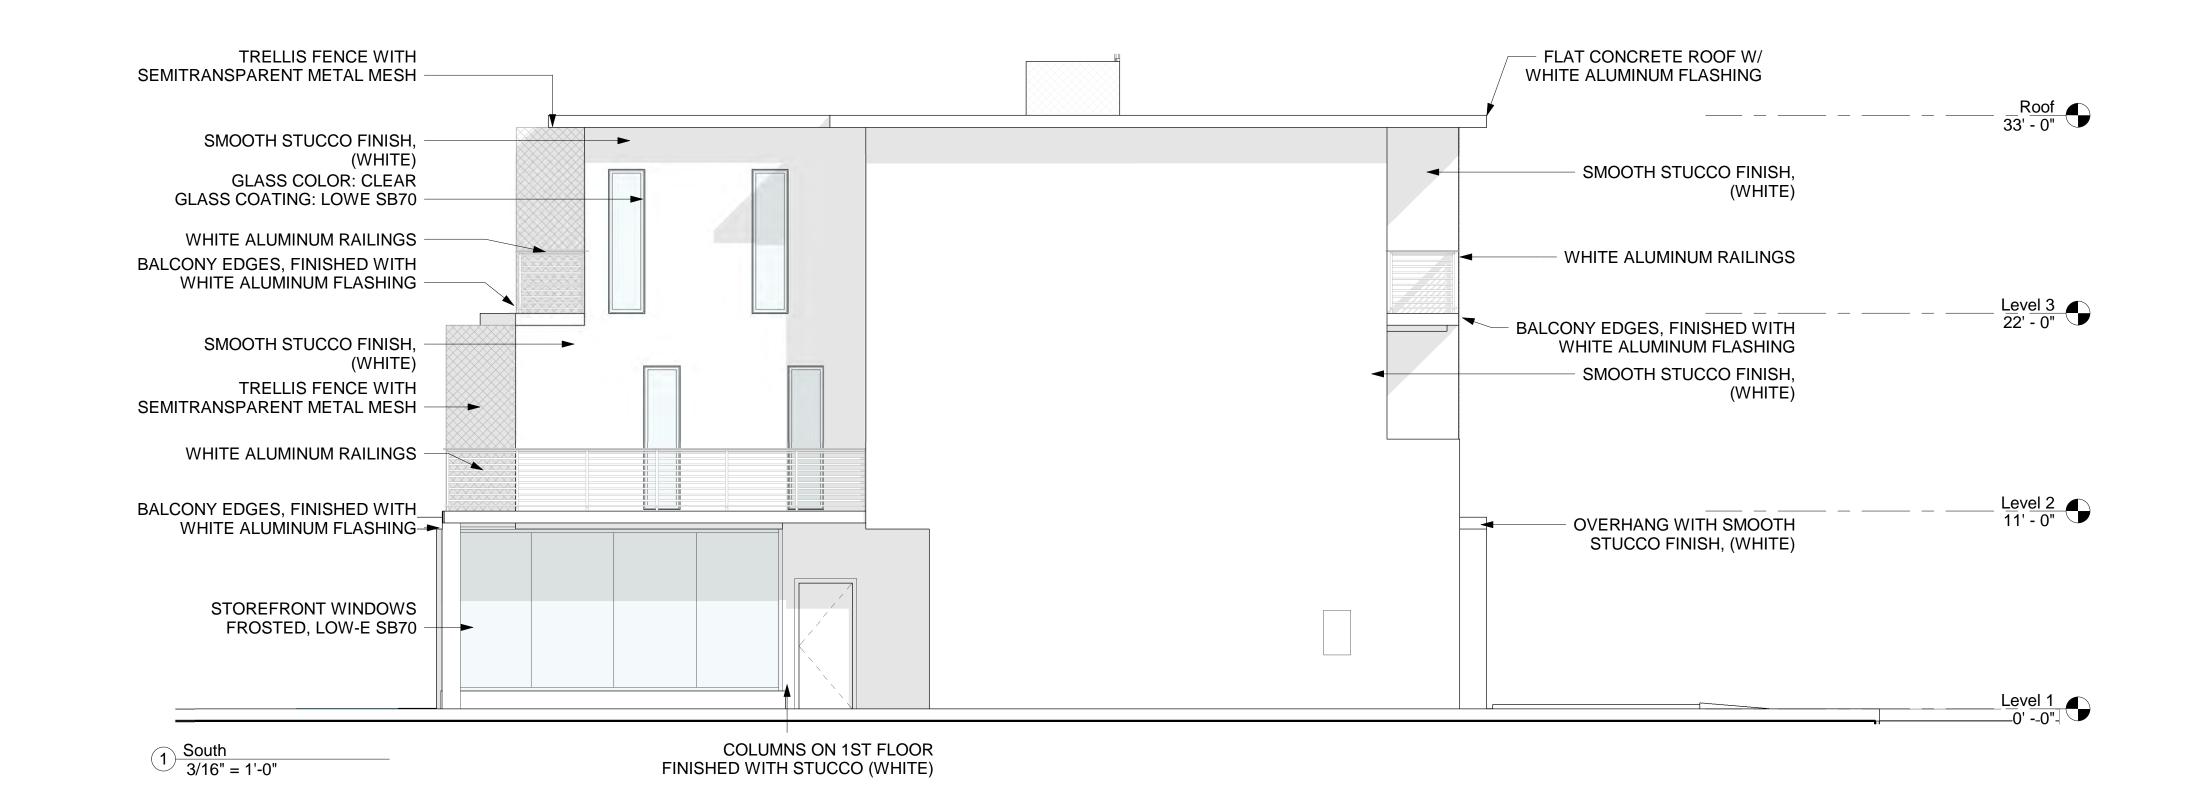
DRAWING TITLE

Elevations

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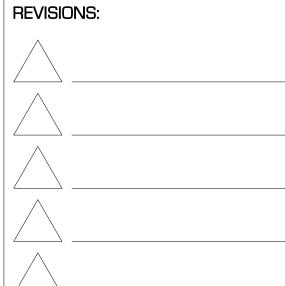
PROJECT TITLE:

Mixed Use Development

PROJECT ADDRESS:

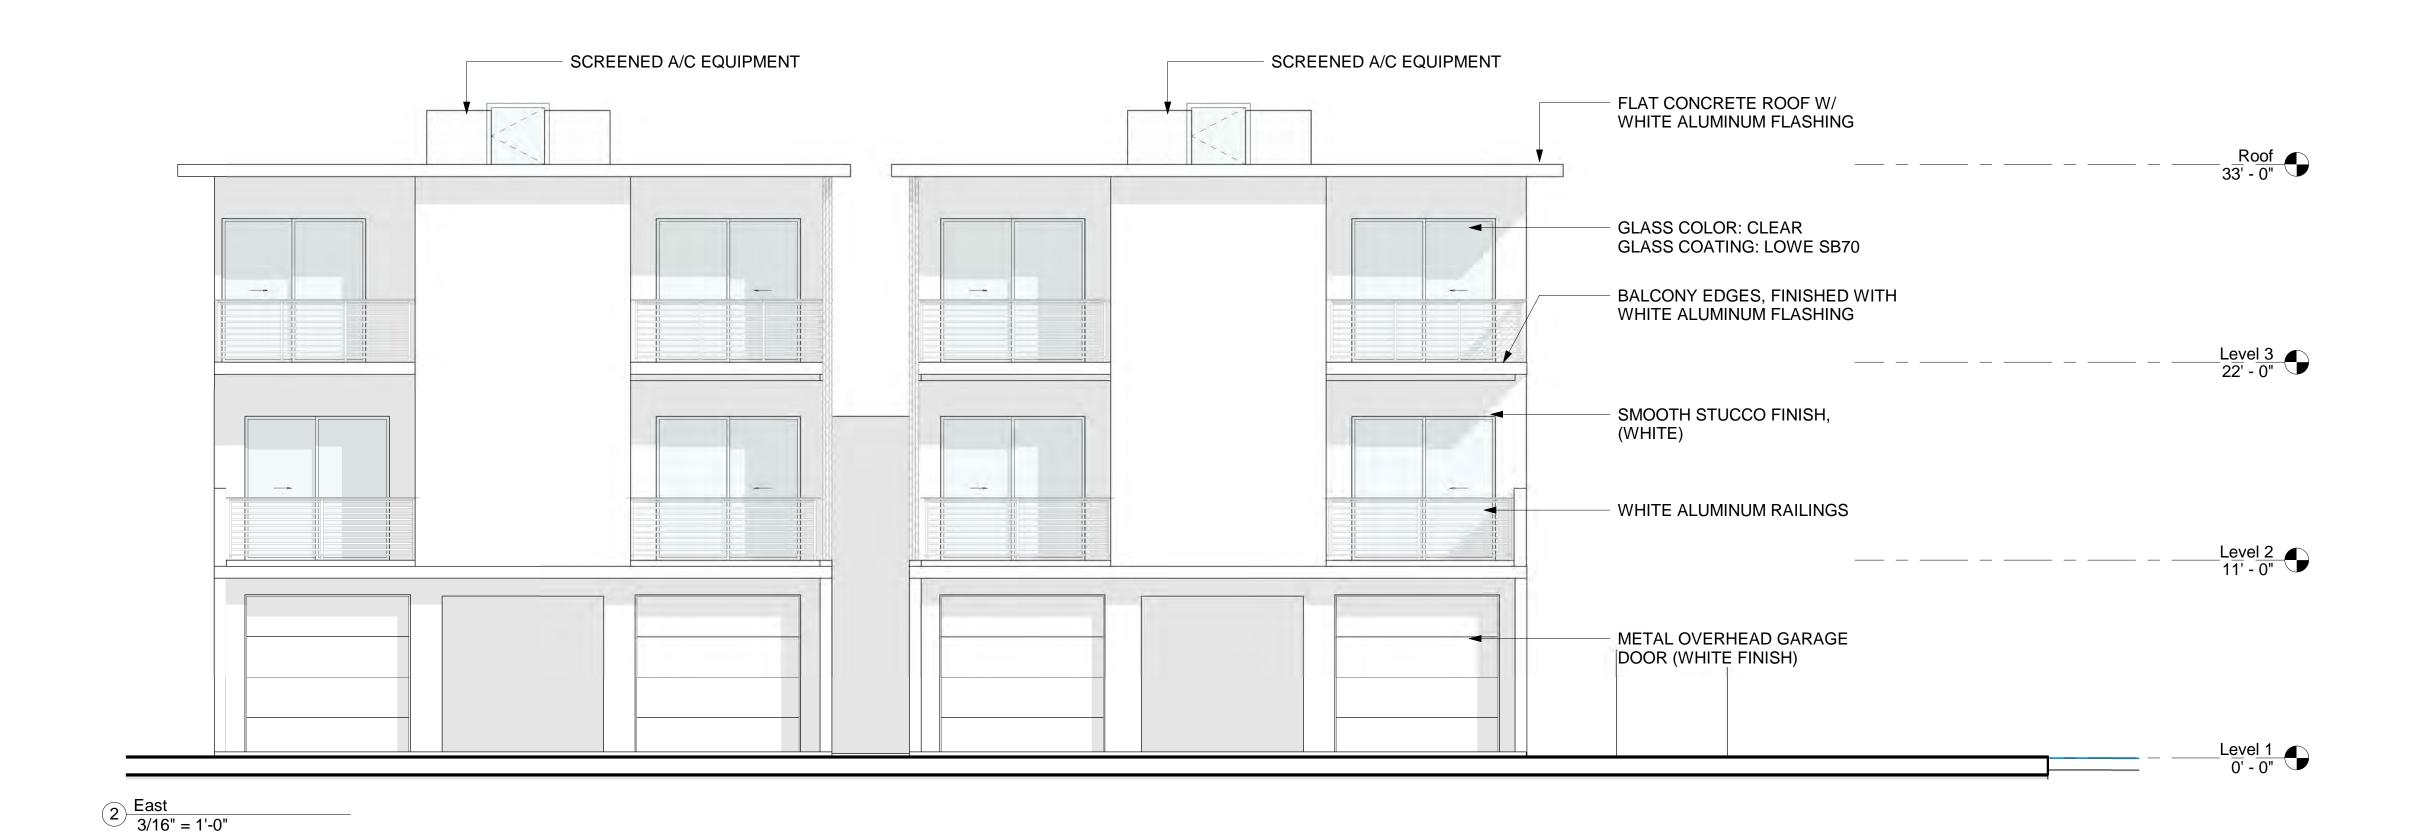1432 N Dixie Hwy

DATE:	6/30/2023 9:44:44
DATE	AM
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CHECKED B	Y:JC



SCALE/NORTH POINT:

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DRAWING TITLE

Elevations

DRAWING STATUS:





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JUAN CRISTOBAL CONTIN

FL LICENSE # AR94935

826 S. FEDERAL HIGHWAY

LAKE WORTH, FL 33460



#### CLIENT:

GG&P Properties, Inc. Michael Gizewski

PROJECT TITLE:
Mixed Use Development

PROJECT ADDRESS: 1432 N Dixie Hwy


DATE: 6/30/2023 10:56:01

AM
ISSUED: ISSUED

DRAWN BY: RG

REVISIONS:

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## SCALE/NORTH POINT:

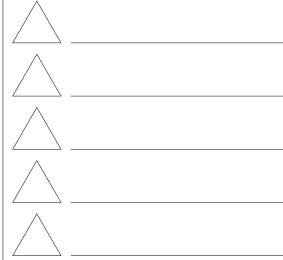AS SHOWN

DRAWING TITLE

3D Front

DRAWING STATUS:

DRAWING NUMBER:



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JUAN CRISTOBAL CONTIN

FL LICENSE # AR94935

826 S. FEDERAL HIGHWAY

LAKE WORTH, FL 33460



CLIENT:


GG&P Properties, Inc. Michael Gizewski

PROJECT TITLE: Mixed Use Development

PROJECT ADDRESS: 1432 N Dixie Hwy

DATE: 6/30/2023 10:56:06 ISSUED ISSUED: DRAWN BY:\_ RG

REVISIONS:

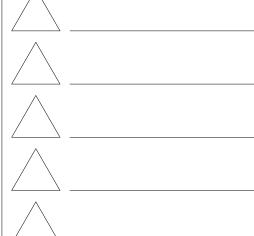

SCALE/NORTH POINT:

AS SHOWN

DRAWING TITLE

3D Rear

DRAWING STATUS:







