
MAPLE RIDGE RANCH

KRONENWETTER, WI

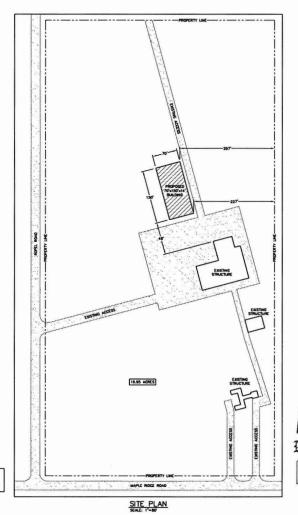

LOACS: SHOW
- (Po) - 50.0 PSF
- (ca) - 0.00 - (u) - 1.00
- (G) - 1.10
- (PI) # 31.85 PSF
- (cs) - 0.93
- (Pa) = 32.32 PS
- (u) - 20.00 PSF
"WITH UNBALANCED LOADS AS REQUIRED
MIND.
W-1000 Month 201
- B.W.S 115 MPH - EXPOSURE - C
SESSIC
- SEISMIC IMPORTANCE FACTOR: 1.00
CONFIGENT SOS: 0.052
- SPECTRA RESPONSE
COEFFICIENT SDI: 0.050
- SITE CLASSIFICATION: Q - SEISMIC DESIGN CATEGORY: A
- acianic ocasin chilochi:
TRUSS DEAD LOADS
- DLTC - 7 PSF - DLDC - 7 PSF
- DLBC - Z PSF

TATE	JOR STRUCTURAL COMPONENTS
THE DE	F MANUFACTURING STRUCTURAL COMPONENTS (COLUMNS, TRUSSES, AND STEEL) ARE USED IN SIGN OF THIS BUILDING, ANY DEVATIONS OR SUBSTITUTIONS OF THESE MATERIALS REQUIRE A GRORE DUE TO THE DESIGN VALUES OF THE MATERIALS SPECIFIED.
	NGE ORDER CAN BE OBTAINED FROM ENGINEERING@MIDWESTMANUFACTURING.COM AND IS ID FOR ANY STRUCTURAL, LAYOUT, OR MATERIAL CHANGES.
COLUMNS:	- ALL LAURATED COLLAIMS SHALL BE MIDNEST MANUFACTURING'S, RIVET CLINCHED, WITH STEEL REMFORCED JOINTS UNLESS SPECIFIED OTHERWISE.
RUSSES	- DESIGNED HI ACCORDANCE DI 2015 ISC TH APPROCÉS DESCRIPTO DE 15 ISC TH APPROCÉS DE 15 ISC
STEEL PANEL:	- WOWET MANAGEMENTS PRO-POS STEEL PANEL OUT STRONG THE STEEL PANEL OUT CAN WARD CONTINE PLAN 25 OF PROSPHATE OUT THE PANEL WARDARY THE STRUCTURE STRONG HASTING THE STEEL OUT THE PANEL WARDARY THE OUT THE OUT THE PANEL WARDARY THE OUT T

	SHEET INDEX
94007 #	SHEET DESCRIPTION
\$1	STE PLAN AND BUILDING SPECIFICATIONS
52	ELEVATIONS
53	FOUNDATION PLAN AND DETAILS
54	FLOOR PLAN
\$5	ROOF FRAMING PLAN
50	SDEWALL SECTION AND SECTION DETAILS
57	ENDWALL SECTION AND SECTION DETAILS
SA	OVERHEAD DOOR DETAILS
59	STEEL APPLICATION DETAILS AND GENERAL NOT
\$10	RESTROOM DETAILS






RIDGE


		RA	NCH		
	KR	RONEN	WETTER, WI		
PROF. ENGINEER:			MATT BUSHEE		
PLAN DESIGNER: DRAWN BY:		GNER:	MATT BUSHEE		
		:			
DATE:			1/28/2025		
SCALE:			AS NOTED		
Г		REV	ISIONS		
NO	DATE	DE	SCRIPTION	BY	
1					
,	П			Т	


1					
2					
эн	EET TIT	LE:			_
		SITE	PLAN	AND	


BUILDING SPECIFICATIONS FILE NAME: SOOB25WI


S1

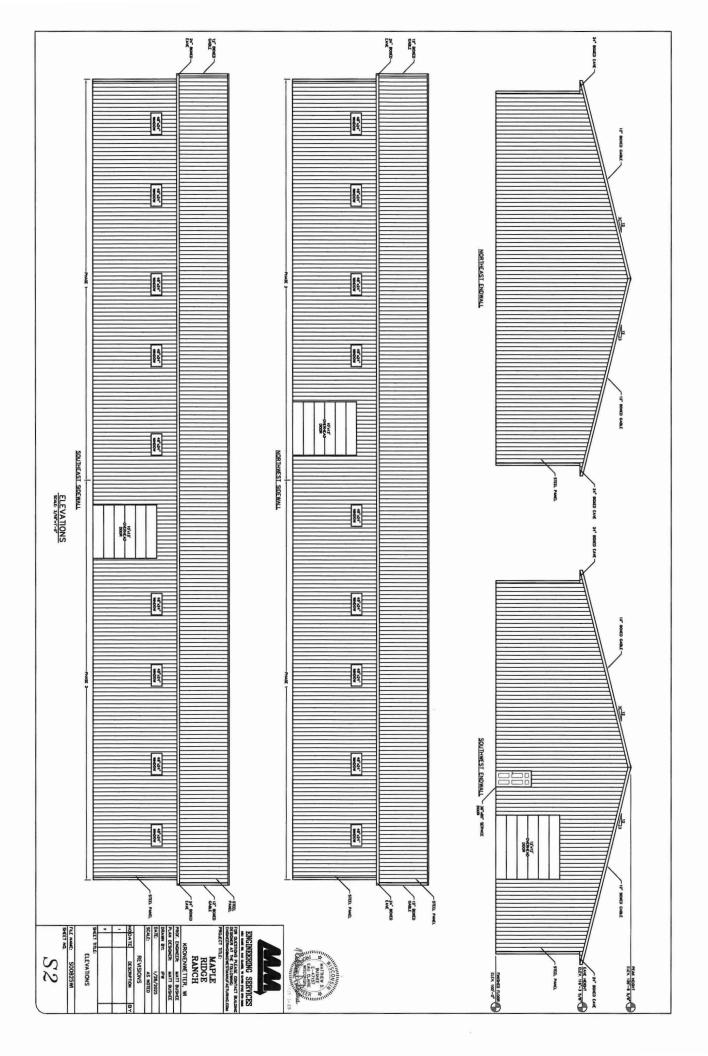


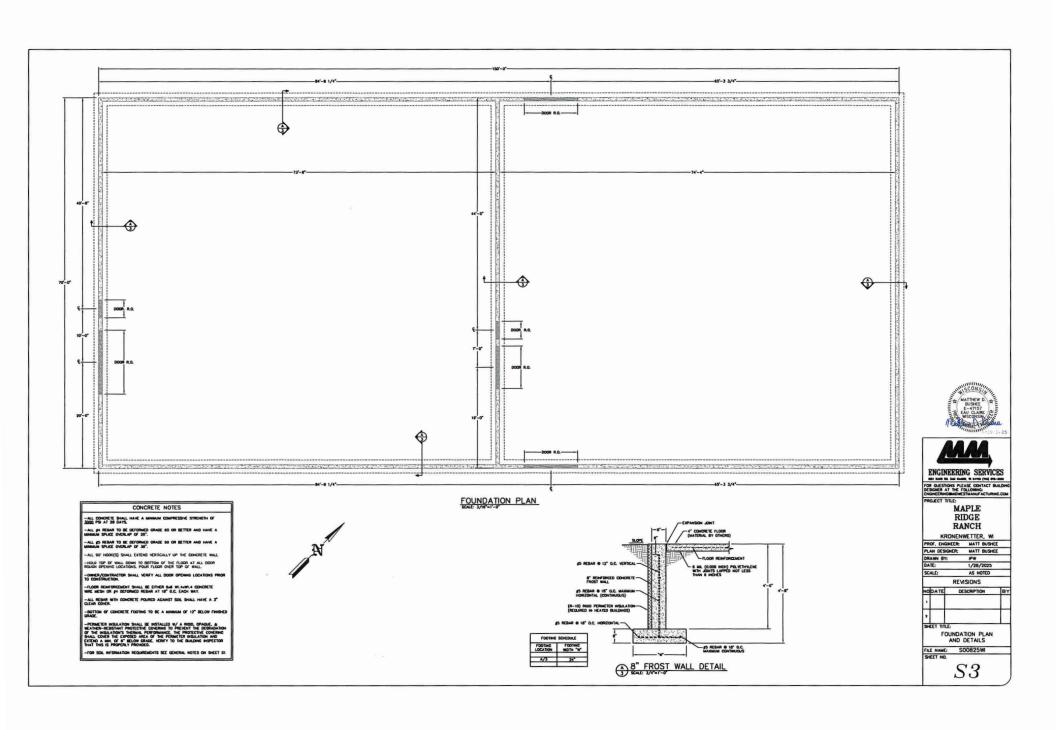


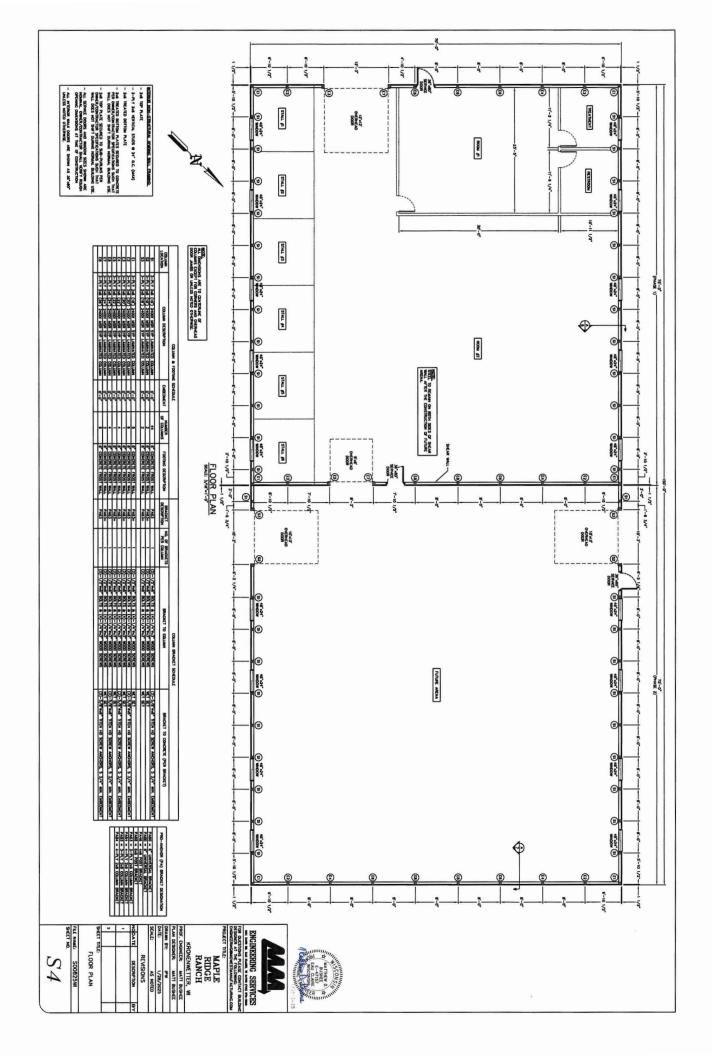


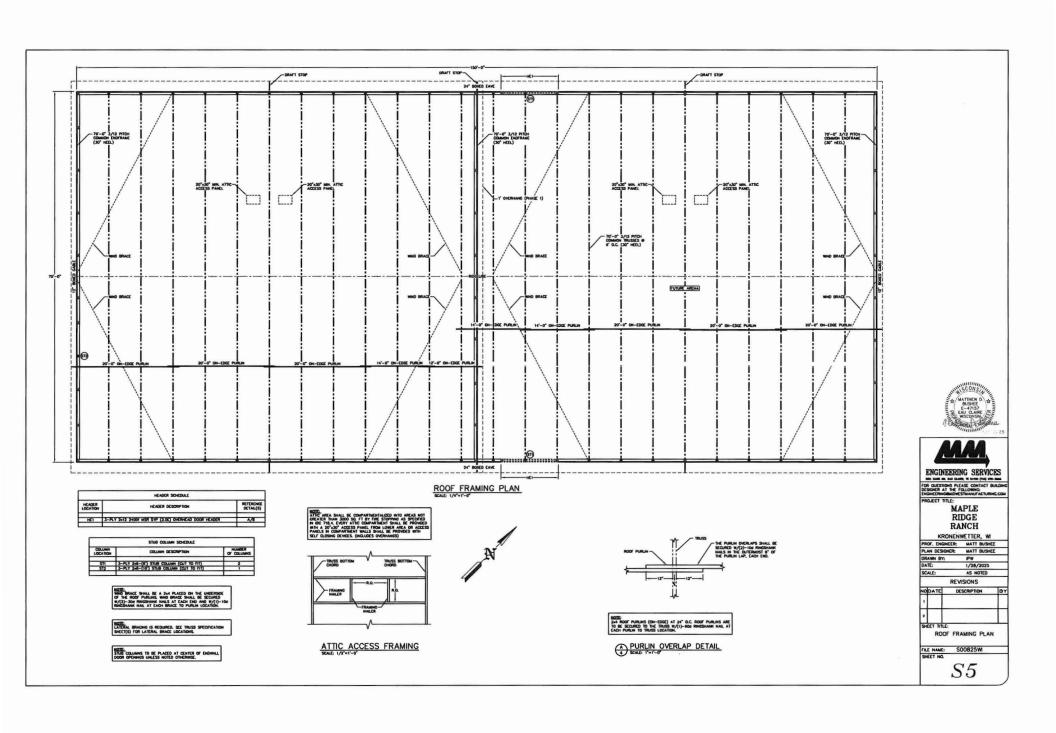

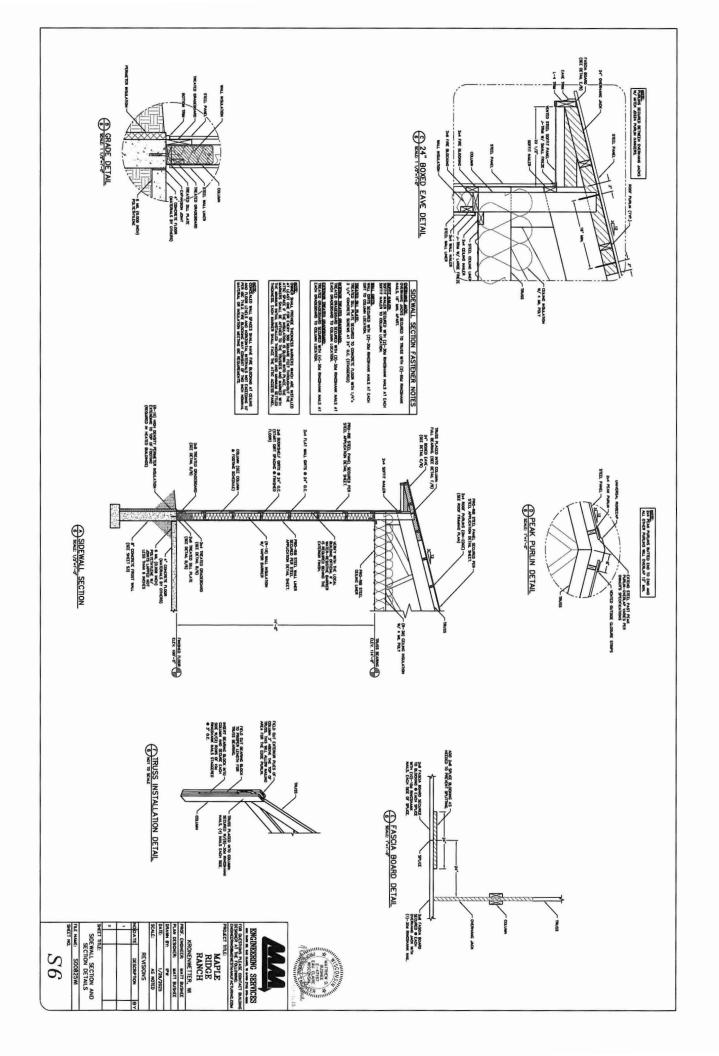

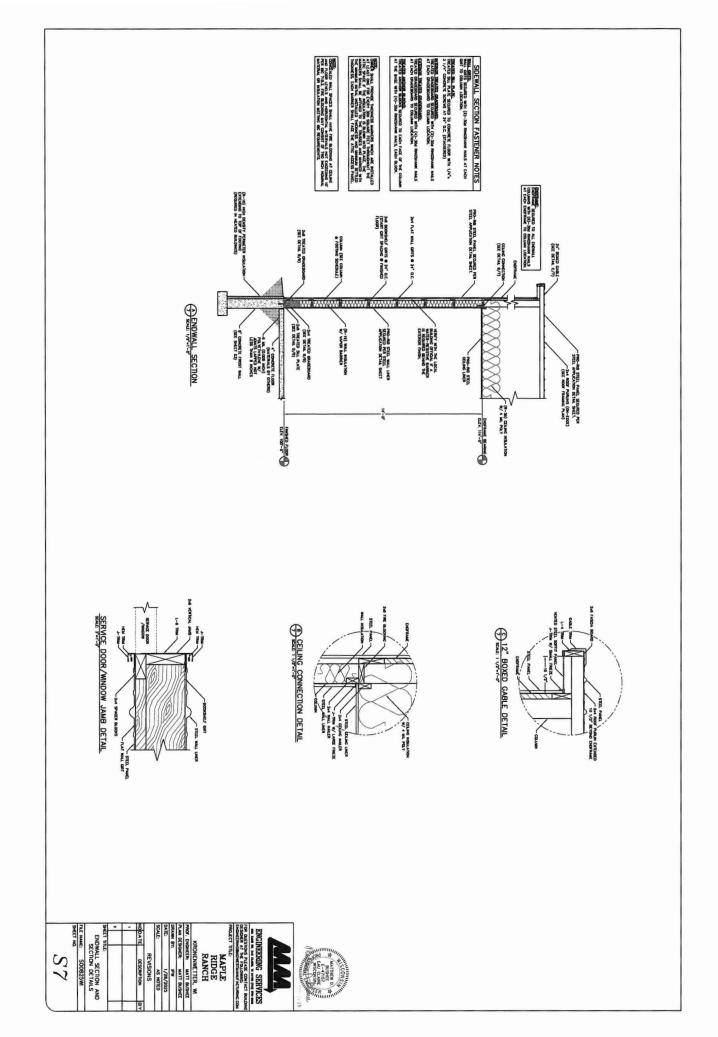

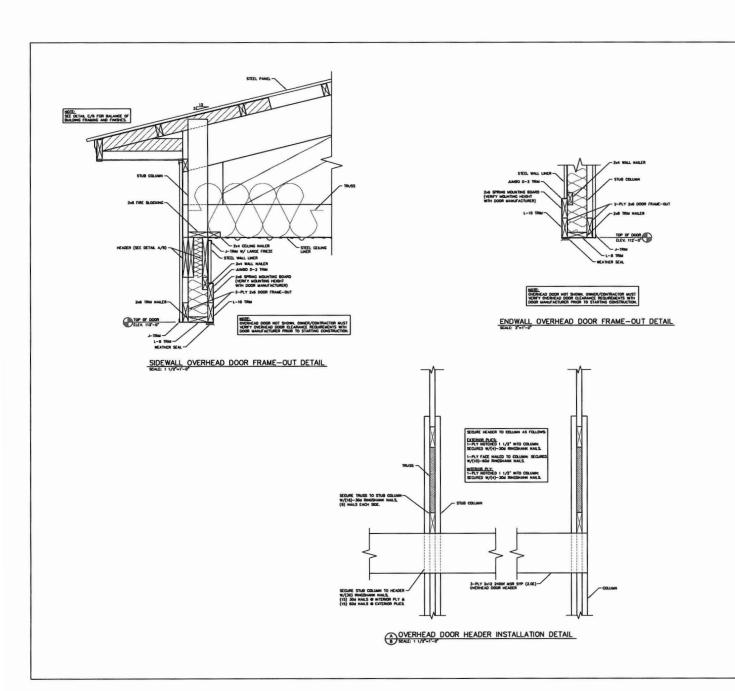

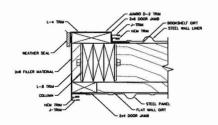

HOTE.

OVERHEAD DOOR NOT SHOWN, OWNER/CONTRACTOR MUST
VERHY OVERHEAD DOOR CLARANCE REQUIREMENTS WITH
DOOR MANUFACTURER PROR TO STARTING CONSTRUCTION.

OVERHEAD DOOR JAMB DETAIL





ENGINEERING SERVICES
TO OUESTIONS PLEASE CONTACT BUILDING
DESIGNER AT THE FOLLOWING.
ENGINEERING MICHIGAN ACTURING. COM-

MAPLE RIDGE RANCH


KRONENWETTER, WI
PROF. NORMERE MATT BUSHEE
PLAN DESIGNER MATT BUSHEE
DRAIN BY: P*
DATE: 1/28/2025
SCALE: AS HOTED
REVISIONS
NOIDATE DESCRIPTION


2 SHEET TILE:


OVERHEAD DOOR DETAILS

FILE NAME: S00825WI SHEET NO.

S8

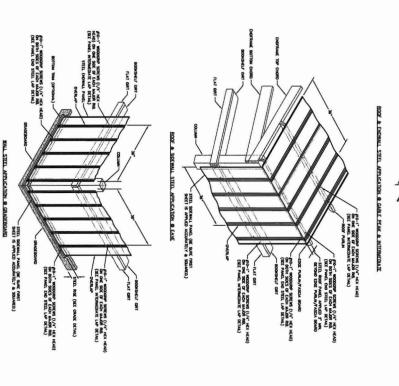

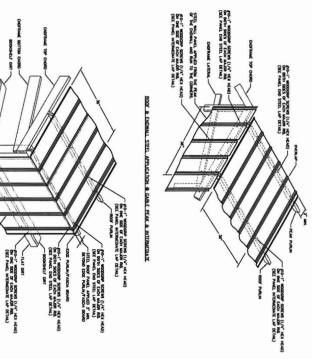

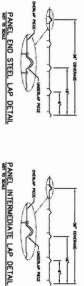



THE ANTI-STATION DRAW CHANNEL HAST BE CLEAR OF DESIGN AND DESTRUCTIONS FOR THE PANCE'S ABLITY TO MINIOR POPULATE AND ACTINE WOODS THE STEEL PANCE. Lecture industria s oricl, a and original of as (extents and to account of as of extents and account of as of extents and account of PROPER LAPPING OF STEEL PARCE IS VERY IMPORTANT IN THE PARCE'S ABULTY TO PREVENT LEARNING, OVERSEATING AND

PLEASE NOTE

DESIGNATE AND DESIGNATION OF THE PROPAGATION OF THE DRAWNES WITH THE PARAMETER CONTRACTIO AND ASSESSABLES TO CONTRACT AND ASSESSABLES AND DESIGNATION AND ASSESSABLES AND ASSE

GENERAL NOTES

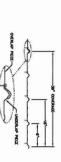

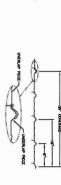





- CERAN-A-STAR 1050 PAINT SYSTEM

ALL DETORNED REINNE SHALL MEET AND GRADE SO ON BETTER.

ALL FASTDADES SHALL BE AS USTED BELOW UNLESS OTHERWISE HOTED, OTHERWISE,

MARY FASTINESS (POST FRAME MAIS)

15d ENCISHANK HALS (,145°s)

30d RENCISHANK HALS (,177°s)

60d RENCISHANK HALS (,200°s)

PROF. ENGMEER: MATT BUSHEE
PLAN DESIGNER: MATT BUSHEE
DRAWN BY: IPW
DATE: 1/28/2025
SCALE: AS NOTED

EXIT HOUTS

HEATING, VENTING, AND AR COND

TIONING REQUIREMENTS NERE NOT ADDRESSED ON THE DRAWNES AND SHOULD BE APPROVED BY

LECTRICAL REQUIREMENTS WERE NOT ADDRESSED ON THE DRAWNES AND SHOULD BE INSTALLED IN ACCOMMANCE WITH THE WITHOULD ELECTRICAL CODE AND ANY LOCAL CODES. UNIONG REQUIREMENTS WERE NOT ADDRESSED ON THE DRAWNES AND SHOULD DE INSTALLED IN ACCORDANCE WITH REQUIRED RELIEF INFORMET BRUCHE CURRENC CONSTRUCTION SHALL BE CONTRACTORS' RESPONSIBLITE, RETIRE TO INCS-RE AND/OR BIO SAMANY RETI "GOOD FOR HANDAN, RETELLAR, RESTRAINED AND BRACKE OF TRUSSES", BY THE TRUSS TAKE RETIRET (TP) AND THE COD TRUSS COLNEL OF AUDIECA (MTCA).

996 SHAL RELIMENTED AT AL HAIS, TO REASE CONTRADE DIAMENTOR FOR A MARKING OF DIE USS THAN 80 TER HOUSE OF HAIMPHONE DES TO REASE CONTRADE DIAMENTOR TO A MERISON FOLICIBED, USS THEM 80 I TERMAN SHITMEST, MAI DEMANT OF AN AND HOUSE THE RESTAULTION OF THE CONTRIBUTE OF THE CONTRIBUTE

ANED AS SPECIFED IN NIPA NO. 10 (BY OTHERS). (NERFY WITH LOCAL INSPECTOR)

DIPLY WIN KC/ANS A117.1 CHAPTER 4. (MERT WIN LOCAL INSPECTOR)

SHEDIS ON SHOW

ALL PROPED GRADES TO SLOPE AMAY FROM BUILDING AT A MIN. 35 GRADE FOR PROPER DRAWNING (ZE FOR SPERMOUS SURFACES) ALL STEE, PARCES AND TRANSE PRODUCTS SHOULD BE HANDLED AND STORED PER HAND-ACTURED SPECIFICATIONS.

al bita products, i.e. jost harches, trass tes, fraibac angles, (te., shal be securito per hana acturen's Specifications unless hotto otherwise.

STEEL APPLICATION DETAILS AND GENERAL NOTES S00825W

STEEL APPLICATION DETAILS

