

STAFF REPORT KETCHUM PLANNING AND ZONING COMMISSION MEETING OF OCTOBER 14, 2025

PROJECT: Warm Springs Townhomes

FILE NUMBER: P24-063

APPLICATION: Design Review

PROPERTY OWNER: 108-110 Ritchie LLC (Presidio Vista Properties)

ARCHITECT: Ro Rockett Design, LLC – Zac Rockett (architect)

LOCATION: 108 Ritchie Dr

(Warm Springs Village Subdivision 2nd Revision Lot 3A Blk 4)

ZONING: Tourist 3000 - (T-3000)

OVERLAY: None

REVIEWER: Morgan Landers, AICP – Director of Planning and Building

NOTICE: A public meeting notice for the project was mailed to all property

owners within 300 feet of the project site and all political subdivisions on

August 20, 2025. The notice was published in the Idaho Mountain

Express on August 20, 2025. A notice was posted on the project site on September 2, 2025, and the city's website on August 19, 2025. A public hearing was held on September 9, 2025 and continued to a date certain

(October 14th) following Commission deliberations.

EXECUTIVE SUMMARY

The applicant has submitted a Design Review application for the development of 12-, three- and four-bedroom, townhouse units at 108 Ritchie Dr (the "subject property"). The subject property is zoned Tourist 3000 (T-3000) and is vacant (See Figure 1). The development proposes to utilize the city's density bonus program for increased FAR and is therefore subject to the minimum residential density requirements of the Ketchum Municipal Code. 11 of the townhouse units range in size from approximately 2,500 SF to 4,400 SF with the twelfth unit being approximately 1,900 SF. The units within the development would be accessed by a private road entering from Ritchie Dr. Each townhouse has dedicated garage parking within each unit. The full project plans are included as Attachment A.



Figure 1: Subject Property

At the September 9, 2025 hearing, staff provided an overview of the proposed development and requested the Commission discuss key design elements related to the bulk and flatness of the buildings and materials of deck railings. Staff also presented some conditions of approval recommended if the Commission determined that approval of the project was warranted. Following staff presentation, applicant presentation, questions from the Commission and public comment, the Commission conducted deliberations and provided feedback to the applicant on areas that needed to be further addressed to fully meet design review criteria for approval. Those items included:

- Issues related to the underground boiler (exhaust fumes and noise)
- Visitor parking concerns
- Bulk and flatness of the structures

The staff memorandum with recommended conditions is included as Attachment B in this report. A recording of the September 9, 2025 meeting can be watched here.

The applicant has since revised the design drawings to address some of the comments provided by staff and the Commission. The revised design drawings are included as Attachment A to this report. Staff recommend the Commission review the revisions provided by the applicant and provide feedback as to whether the changes adequately address the Commission's concerns.

ANALYSIS

The applicant has made the following revisions to the design drawings:

- 1. The access road between Buildings 1 and 3 has been shifted towards Building 1 by 10 feet. The adjustment in the road alignment created space for Buildings 1 and 3 to be offset slightly at the mid-point of the building.
- 4. The design drawings have been updated to include bicycle parking and drought resistance species. Cross sections have been added to assist the Commission is their evaluation of the development. The cross sections further illustrate the relationship between the development and the site topography.

- 5. The boiler vault has not been moved to a new location on the site, however, the applicant made modifications to the locations of the vent pipe and intake pipe to minimize noise and exhaust. The boiler vent has been rerouted to extend up through building 3 to the roof, which will help eliminate the concern over pluming (steam rising) from that element. Exhaust from the boiler is only water-based steam with no odor. The applicant also had their mechanical engineers review and confirm the decibel level of the boiler unit. The unit produces 66db of sound, which is lower than a typical vacuum cleaner at 70db. Since the boiler is in a concrete vault below grade, no noise will be heard by adjacent property owners. The vent pipe itself emits no noise. Visually, steam will be noticeable during cold months which dissipates quickly.
- 6. Bulk/Mass Revisions The applicant has represented to staff that splitting Buildings 1 and 3 into two separate buildings is not feasible. Rather than physically creating two separate buildings, the revised plans proposed to offset both buildings at the midpoint of the structure. Additional articulation has been added to Building 3 to reduce the 'flatness' previously of concern. Juliet balconies have been added to the north façade of building 4 to reduce the 'flatness' that the building previously presented. Glass guardrail caps have been changed to a metal rail.

None of the proposed changes impact the development's compliance with zoning and dimensional standards.

STAFF RECOMMENDATION

Staff recommend the Commission review the revised Design Review application and provide direction on items outlined above in the staff report. Following that review, the Commission has the following options:

- Continue the application to a date certain or uncertain with a request for revisions or more information.
- Approve the application with conditions
- Deny the application

If the Commission chooses to move forward with approving the application as presented or revised, staff recommend the following conditions of approval be considered. The Commission may delete, revise, or add to the conditions of approval based on the discussion.

- 1. The term of Design Review approval shall be twelve (12) months from the date that the Findings of Fact, Conclusions of Law, and Decision are adopted by the Planning and Zoning Commission or upon appeal, the date the approval is granted by the Council. Extensions may be granted per KMC 17.96.090.B.
- 2. This Design Review approval is based on the plans dated October 14, 2025 and the information presented and approved at the September 9, 2025 and October 14, 2025 Planning and Zoning Commission meetings included as Exhibit A. The building permit plans must conform to the approved Design Review plans unless otherwise approved in writing by the Planning and Zoning Commission or Administrator. Any building or site discrepancies which do not conform to the approved plans will be subject to removal.
- 3. As a voluntary contribution, in exchange for an increase in FAR pursuant to KMC 17.124.040, a total community housing contribution of 4,429 square feet is required. A FAR Exceedance Agreement between the applicant and the City to memorialize how the community housing

- contribution will be met shall be reviewed and approved by City Council, signed, and recorded prior to issuance of a building permit for the project.
- 4. For driveways less than 18 feet in length, "No Parking" signs shall be installed on or adjacent to every driveway prior to certificate of occupancy for each building.
- 5. A final landscape plan shall be provided for review and approval prior to building permit issuance. Said landscaping plan shall provide a detailed plan list showing the drought tolerance level of each proposed species. Species must be a minimum of "moderately" drought tolerant, "highly" drought tolerant is preferred.
- 6. Pursuant to KMC 17.125.060, the development shall provide a minimum of 6 bicycle racks, each serving two bicycles. The location and design shall be submitted, reviewed, and approved by the Planning Department prior to issuance of the first building permit.
- 7. The development shall utilize internal transformer locations for the development first. Street facing transformers shall only be utilized if no other alternative is feasible. All transformers shall be adequately screened from public view. Final transformer locations and screening proposals shall be reviewed and approved by the Planning Department prior to installation.
- 8. The grass-crete areas shown in Exhibit A shall always remain clear of snow. In the event snow storage cannot be accommodated by designated snow storage areas, snow shall be hauled off site to always ensure unobstructed access for fire and emergency vehicles.
- 9. Prior to building permit submittal, the applicant shall investigate the existence of fiber optic conduit. If none is found, the civil plans shall be revised to reflect the addition of fiber optic conduit along the subject property.
- 10. A preliminary plat application shall be submitted prior to building permit issuance. If the development is to be constructed in multiple phases, the preliminary plat application must include a request for a phased development agreement per KMC 16.04.110.
- 11. At time of building permit, the applicant shall submit final civil drawings prepared by an engineer registered in the State of Idaho that provide specifications for all right-of-way improvements, including sidewalks, alley asphalt, streetlights, utilities, and drainage facilities, for final review and approval by the City Engineer, Streets Department, Utilities Department, and Planning Department.
- 12. All exterior light fixtures shall be at a maximum color temperature of 2700 Kelvins.
- 13. All boulder retaining walls shall be set back a minimum of one foot unless authorization from adjacent property owners is provided at the time of building permit application.
- 14. In addition to the requirements set forth in this Design Review approval, this project shall comply with all applicable local, state, and federal laws.

Attachments:

- A. Staff Report of September 9, 2025 Planning and Zoning Commission
- B. Revised Project Plans



ATTACHMENT A:

September 9, 2025 - PZ Commission Staff Report



STAFF REPORT KETCHUM PLANNING AND ZONING COMMISSION MEETING OF SEPTEMBER 9, 2025

PROJECT: Warm Springs Townhomes

FILE NUMBER: P24-063

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ARCHITECT: Ro Rockett Design, LLC – Zac Rockett (architect)

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EXECUTIVE SUMMARY

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Figure 1: Subject Property

road entering from Ritchie Dr. Each townhouse has dedicated garage parking within each unit. The full project plans are included as Attachment B.

The project is subject to Design Review pursuant to Ketchum Municipal Code §17.96 as the property is a new multi-family development. A pre-application design review meeting was held with the Commission on April 23, 2024. CLICK HERE to listen to the recording of that meeting. Feedback from the Commission and staff has been incorporated into the development, resulting in substantial changes to the exterior design of the development. All city departments have completed their review of the development. At this time, all technical items have been resolved through corrections in the project plans and potential conditions of approval. However, planning staff does believe additional review and discussion on key architectural design review criteria is warranted prior to approval. See below for discussion of these items. Additionally, Attachment C includes the review of zoning compliance with dimensional standards, parking, and dark skies. Attachment D includes the review of all applicable design review criteria. No Public comments have been received prior to packet publication.

BACKGROUND

The subject property was previously two vacant lots. Prior to the adoption of Interim Ordinance 1234, an application was filed with the city to consolidate the lots (P22-027). The consolidation of the lots was approved on July 18, 2022 by the Ketchum City Council.

The Planning and Building Department received a Pre-Application Design Review application on November 17, 2023 and a public meeting with the Commission was held on April 23, 2024. At the pre-application meeting, the Commission provided a variety of feedback on the design of the project. An overview of that feedback can be found below in the design review criteria section of the staff report.

The Planning and Building Department received the Design Review application on July 22, 2024 and conducted multiple rounds of review to address comments, most specifically related to exterior design of the buildings.

Analysis

Per KMC 17.96.050.A Criteria. The Commission shall determine the following before approval is given for design review:

- 1. The project does not jeopardize the health, safety or welfare of the public.
- 2. The project generally conforms with the goals, policies, and objectives of the adopted comprehensive plan.
- 3. The project conforms to all applicable standards and criteria as set forth in this chapter, this title, and any other standards as adopted or amended by the City of Ketchum from time to time.

Criteria 1 & 2

The 2014 Comprehensive Plan designates the subject property's future land use as "Medium Density Residential". Appropriate uses in this designation include single-family, duplexes, and other attached-unit types such as townhouses. The plan also states that multi-family housing is appropriate in many locations. The proposed development includes two multi-family buildings (Buildings 1 and 3) and two duplex units (Buildings 2 and 4). Staff believes the proposed development meets the intent of the future land use designation as proposed.

Chapter 4 of the comprehensive plan, Community Design and Neighborhoods, states that "Infill and development projects should be contextually appropriate to the neighborhood and development in which they will occur" (Policy CD-1.3). The plan also states that "Each new project should be well-designed and attractive and should complement surrounding land uses and existing neighborhood character" (Policy CD-1.4). The surrounding Warm Springs neighborhood is characterized by a variety of two- and three-story multi-family and duplex developments. Figure 2 shows the subject property highlighted in yellow and surrounding properties. The surrounding properties have an outline of the buildings. Where no building is shown, the property is either vacant or has a single-family residence. As shown in the image,



Figure 2: Surrounding Neighborhood Development

most of the surrounding properties have a similar development pattern as the proposed development.

Staff believes that the type of development proposed is appropriate for the neighborhood, however, staff does believe that the design of the development should be further considered. Following the preapplication design review meeting and first round of comments from staff on the final design review, the applicant made substantial changes to the exterior design of the building. Staff believes these changes have dramatically improved the compatibility of the development; however, staff does have further comments on the undulation/relief of certain facades, glass railing details on decks, and window detailing. See discussion below for additional discussion.

Criteria 3: Zoning and Design Review Standards

Zoning and Dimensional Standards

Staff reviewed the application for applicable zoning and dimensional standards including setbacks, building height, open site area, floor area ratio, parking, dark skies, and other applicable requirements. A full review of zoning and dimensional standards can be found in Attachment C. As proposed, the development meets most of the zoning requirements. Two items were missed by staff during the department review related to bicycle parking and retaining walls. These items are addressed through conditions of approval 6 and 13 and will be verified for compliance at the time of building permit review.

As noted above, the applicant is utilizing the FAR density bonus program. The base FAR permitted in the T-3000 zone district is 0.5, but can be increased to 1.6 with community housing mitigation. The proposed development has an FAR of 1.37 as shown on Sheets A-000 and A-002 of the application materials. The applicant has elected to pay a fee in-lieu of community housing for their mitigation and will be required to pay approximately \$2.4 million in housing in-lieu fees. The detailed calculation of the fee can be found in Attachment C.

Design Review Criteria

As noted above, the Planning and Zoning Commission provided a variety of feedback items to the applicant during the pre-application meeting. In general, that feedback included concerns related to:

- Deck railing transparency and amount of glazing proposed
- Monochromatic color palette and contrast of materials
- Size/scale/mass of the buildings specifically the length of the larger buildings along Ritchie Dr.
- Incongruous proportions of the structures
- Material orientation the design proposed mostly vertical siding orientation and other vertical architectural elements

Following the pre-application meeting and first round of review from departments, the applicant team elected to take a different approach to the design of the buildings. See figures below for the initial development proposed at the pre-application meeting compared to the proposed development today.

View from Ritchie Dr.



Figure 3: Initial Application



Figure 4: Current Proposal

View of the Rear



Figure 5: Initial Application



Figure 6: Current Proposal

View from South/West



Figure 7: Initial Proposal



Figure 8: Current Proposal

View from North/East



Figure 99: Initial Proposal



Figure 10: Current Proposal

Overall, staff believes the current proposal is significantly more compatible with the surrounding neighborhood. The color palette, the roof detailing, and the landscape plan address many of the Commission's early concerns. However, staff believe there are still items worth discussing prior to approval of the development.

Bulk/Mass/Flatness

The Ketchum design review criteria address the bulk and mass of buildings through a few different criteria. Staff believe there are two that directly speak to this development:

- KMC 17.96.060.F.5 Building walls shall provide undulation/relief, thus reducing the appearance of bulk and flatness.
- KMC 17.96.060.F.2 The building character shall be clearly defined by the use of architectural features.

The current proposal takes care in ensuring that the street frontage of the development is well articulated and detailed to enhance the streetscape. The initial proposal contained a significant number of vertical elements that elongated and enhanced the size of the structures along the street. The current proposal relies on horizontal elements, such as the cantilevered decks, which reduces the perceived size of the structures. Unfortunately, that same level of detailing does not translate to the other exterior facades of the development that will be visible from public view. More specifically, the south/west and north/east facades (see Figures 7 through 10 above).

Staff believe these facades to be quite flat and lack architectural features that provide interest and relief from the flat appearance of the structures. It is clear the applicant is drawing inspiration from historic mining structures that often feature tall narrow windows in a repetitive pattern. However, the recessed nature of the windows with minimal trim contributes to the flat nature of the elevations. Staff believe the addition of some key architectural features could assist in adding interest to these elevations. Additionally, the Commission commented on the front façade of Building 3 (see Figures 7 and 8) noting that interior buildings should have similar consideration as the others. Staff agrees that continuity throughout the development is critical and also understands the varying degree of architectural detailing between interior and exterior facing facades. Some considerations for Building 3 may be the reduction of the roof overhang so it is no longer flush with the first and second levels of the building. The applicant could also consider some window trim options to add interest to the facades.

Materials

The Commission provided feedback during the pre-application design review related to the monochromatic color palette and transparency of the decks. As shown in the project plans, the color palette has been adjusted dramatically to a darker and richer brown. Staff believe this color choice is much more compatible with the surrounding structures and allows the buildings to recess into the landscape more. The applicant has also changed the railings along the decks from glass to solid, with a small glass railing on top. KMC 17.96.060.F.3 states "There shall be continuity of materials, colors and signing within the project". Staff believe there is continuity of materials and colors within the project with the exception of the glass railing. Staff recommends the consideration of a metail railing detail rather than the glass railing proposed. See figures below that identify the glass railing currently proposed.





Utilities

The civil and landscape plans both show proposed locations of transformers to serve the development. KMC 17.96.060.D.2 states "Utilities shall be located underground and utility, power, and communication lines within the development site shall be concealed from public view". Multiple transformers are necessary to serve all 12 units. Per the letter from Idaho Power dated May 17, 2024, the final location of the transformers has not been finalized until further analysis by Idaho Power is conducted. The letter does state that the proposed locations are acceptable, and all may not be needed. Condition of approval #7 states that the development shall utilize internal transformer locations for the development first and that street facing transformers shall only be utilized if no other alternative is feasible. All transformers shall be adequately screened from public view and final screening proposals shall be reviewed and approved by the Planning Department prior to installation.

Staff Recommendation

Staff recommends the Commission review the Design Review Application and provide direction on items outlined above in the staff report. Following direction, the Commission has the following options:

- Continue the application to a date certain or uncertain with a request for revisions or more information.
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- 14. In addition to the requirements set forth in this Design Review approval, this project shall comply with all applicable local, state, and federal laws.

Attachments:

- A. Application and Supplemental Materials
- B. Project Plans
- C. Zoning and Dimensional Standards Analysis
- D. Design Review Standards Analysis



ATTACHMENT B:

Project Plans



WARM SPRINGS **TOWNHOMES** KETCHUM, ID

108-110 RITCHIE LLC P.O. BOX 14001-174 KETCHUM, ID 83340 TEL: 603.801.0419

BUILDING ARCHITECT:

RO | ROCKETT DESIGN 1031 W. MANCHESTER BLVD. UNIT 6 INGLEWOOD, CA 90301 TEL: 213.784.0014

STRUCTURAL ENGINEER:

ZFA STRUCTURAL ENGINEERS 601 MONTGOMERY STREET SUITE 1450 SAN FRANCISCO, CA 94111 TEL: 415.243.4091

MECHANICAL, ELECTRICAL, PLUMBING ENGINEER:

PROFICIENT ENGINEERING 4704 HARLAN STREET SUITE 620 DENVER, CO 80212 TEL: 720.779.3556

CIVIL ENGINEER:

GALENA BENCHMARK ASSOCIATES 100 BELL DRIVE SUITE C KETCHUM, ID 83340 TEL: 208.726.9512

LANDSCAPE ARCHITECT:

EGGERS ASSOCIATES 560 NORTH 2ND AVENUE KETCHUM, ID 83340 TEL: 208.725.0988

DESCRIPTION DESIGN REVIEW APP DESIGN REVIEW APP REV

WARM SPRINGS TOWNHOMES

DESIGN REVIEW APPLICATION / OCTOBER 14, 2025

DESCRIPTION

3-4 STORY MULTI-FAMILY RESIDENCE WITH 12 UNITS (4 BUILDINGS) WITH 23 INTERIOR, PRIVATE GARAGE PARKING SPACES. SCOPE OF WORK INCLUDES NEW CONSTRUCTION OF FOUNDATION, ERECTION OF STRUCTURE, CIVIL, LANDSCAPING, HARDSCAPING AND FINISHES.

PROJECT ADDRESS 108 / 110 RITCHIE DRIVE KETCHUM, ID 83340

APPLICABLE CODES
ALL CONSTRUCTION SHALL COMPLY WITH: 2018 INTERNATIONAL BUILDING CODE*

2018 INTERNATIONAL RESIDENTIAL CODE* 2018 INTERNATIONAL FIRE CODE WITH LOCAL AMENDMENTS*

2018 INTERNATIONAL ENERGY CONSERVATION CODE*
2018 INTERNATIONAL SWIMMING POOL AND SPA CODE 2018 INTERNATIONAL EXISTING BUILDING CODE

2018 INTERNATIONAL PROPERTY MAINTENANCE CODE TITLE 15 KETCHUM MUNICIPAL CODE

APPENDIX M OF THE IBC AS AMENDED BY THE CITY OF KETCHUM ALL APPLICABLE COUNTY ORDINANCES

*AS AMENDED BY THE IDAHO BUILDING CODE BOARD AND INCLUDING NOTED APPENDICES.

CONTRACTOR SHALL KEEP A COPY OF THE ABOVE CODE SECTIONS ON THE JOB SITE AT ALL TIMES. JURISDICTIONAL AGENCY SHALL BE THE KETCHUM BUILDING DEPARTMENT.

CLIMATE ZONE:

PROJECT DATA LOT AREA: ZONING DESIGNATION: OCCUPANCY: CONSTRUCTION TYPE:

T-3000 (TOURIST ZONE) MULTI-FAMILY (PRIVATÉ CONDOS) TYPE V

1. THE CONTRACTOR SHALL BE RESPONSIBLE FOR ALL DRAWINGS, CALCULATIONS, GOVERNMENTAL AGENCY APPROVALS AND FEES TO COMPLETE THIS WORK. CONTRACTOR/SUBCONTRACTORS SHALL SUBMIT MECHANICAL. ELECTRICAL, COMMUNICATIONS AND PLUMBING DRAWINGS TO ROCKETT DESIGN FOR PREVIEW OF DEVICE TYPES, LOCATIONS AND QUANTITIES, HVAC ZONING/THERMOSTAT LOCATIONS, ETC. PRIOR TO SUBMITTING FOR PERMIT AND CONSTRUCTION.

2. THESE DOCUMENTS ARE INTENDED TO INCLUDE ALL LABOR, MATERIALS, EQUIPMENT AND SERVICES REQUIRED TO COMPLETE ALL WORK DESCRIBED HEREIN. IT IS THE RESPONSIBILITY OF THE CONTRACTOR TO BRING TO THE ATTENTION OF THE ARCHITECT ANY CONDITIONS WHICH WILL NOT PERMIT CONSTRUCTION ACCORDING TO THE INTENTIONS OF THESE DOCUMENTS. IT IS THE RESPONSIBILITY OF THE ARCHITECT TO PROVIDE DETAILS AND/OR DIRECTIONS REGARDING DESIGN INTENT WHERE IT IS ALTERED BY EXISTING CONDITIONS OR WHERE NEGLECTED IN THE DOCUMENTS.


3. ANY MATERIALS PROPOSED FOR SUBSTITUTION OF THOSE SPECIFIED, OR CALLED OUT BY TRADE NAME, IN THESE DOCUMENTS SHALL BE PRESENTED TO THE ARCHITECT FOR REVIEW. THE CONTRACTOR SHALL SUBMIT SAMPLES WHEN REQUIRED BY THE ARCHITECT, AND ALL SUCH SAMPLES SHALL BE REVIEWED BY THE ARCHITECT BEFORE THE WORK IS PERFORMED. WORK MUST CONFORM TO THE REVIEWED SAMPLES. ANY WORK WHICH DOES NOT CONFORM SHALL BE REMOVED AND REPLACE WITH WORK WHICH CONFORMS AT THE CONTRACTOR'S EXPENSE. SUBCONTRACTORS SHALL SUBMIT REQUESTS AND SAMPLES FOR REVIEW THROUGH THE GENERAL CONTRACTOR WHEN WORK IS LET THROUGH HIM OR HER. REQUIRED VERIFICATIONS AND SUBMITTALS TO BE MADE IN ADEQUATE TIME AS NOT TO DELAY WORK IN PROGRESS.

4. SHOP DRAWINGS SHALL BE SUBMITTED TO THE ARCHITECT FOR HIS OR HER REVIEW WHERE CALLED IS BEGUN, AND WORK SHALL CONFORM TO THE REVIEWED SHOP DRAWINGS, SUBJECT TO REPLACEMENT AS REQUIRED IN PARAGRAPH "E" ABOVE.

5. DO NOT SCALE DRAWINGS. CONTRACTOR SHALL VERIFY ALL DIMENSIONAL DISCREPANCIES WITH

6. CONTRACTOR SHALL VERIFY AND COORDINATE ALL OPENINGS THROUGH FLOORS, CEILINGS, AND WALLS WITH ALL ARCHITECTURAL, STRUCTURAL, MECHANICAL, PLUMBING AND ELECTRICAL

7. CONTRACTOR WILL ASSUME RESPONSIBILITY OF ITEMS REQUIRING COORDINATION AND RESOLUTION DURING THE BIDDING PROCESS. 8. BUILDING TO BE FULLY SPRINKLERED PER NFPA 13D. CONTRACTOR TO PROVIDE FIRE SPRINKLER SYSTEM DESIGN AND SHOP DRAWINGS TO COMFORM TO THESE STANDARDS.

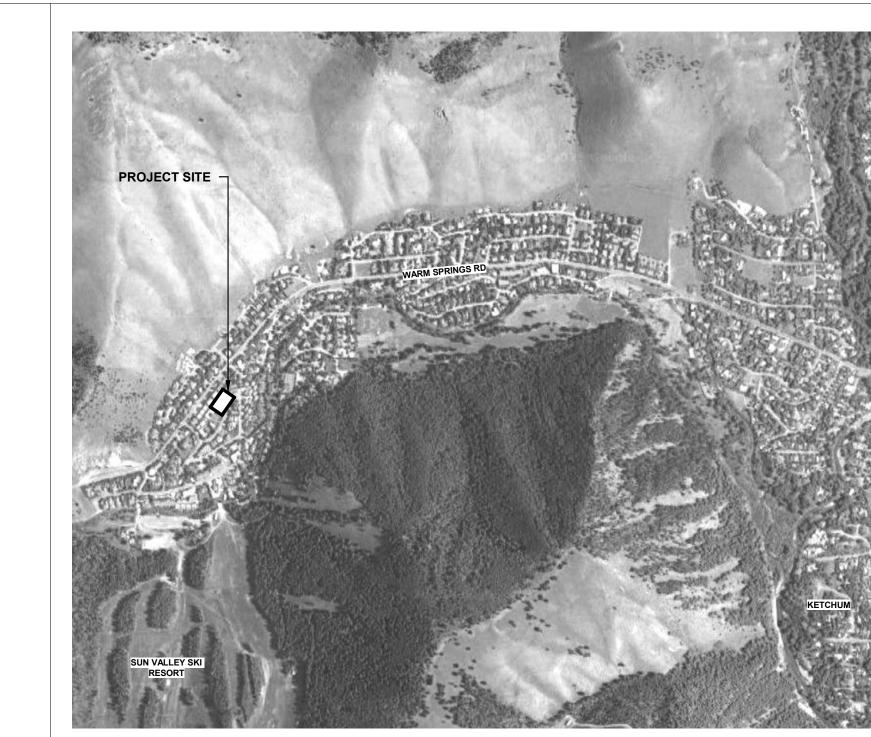

All designs, ideas, arrangements and plans indicated by these drawings are the property and copyright of the Architect and shall neither be used on any other work nor be disclosed to any other person for any use whatsoever without written permission.

RO|ROCKETT DESIGN and/or its principals and employees waives any and all liability or responsibility for problems that may occur when these plans, drawings, specifications, and/or designs are followed without the designer's guidance with ambiguities, or conflicts which are alleged.

WARM SPRINGS TOWNHOMES KETCHUM, ID

108 & 110 RITCHIE DR. KETCHUM, IDAHO

DRAWING TITLE:

COVER SHEET

PROJECT NUMBER

DRAWING NUMBER:

PROJECT DESCRIPTION NTS **PROJECT NOTES** PROJECT LOCATION ©2025, RO | ROCKETT DESIGN, INC.



	CDOSS
	GROSS
BLDG UNIT	AREA 541 SF
1A (GARAGE) 1A (LEVEL 01)	844 SF
1A (LEVEL 01)	1375 SF
1A (LEVEL 03)	1241 SF
17 (LL VLL 00)	4000 SF
1B (GARAGE)	541 SF
1B (LEVEL 01)	844 SF
1B (LEVEL 02)	1375 SF
1B (LEVEL 03)	1240 SF
, , ,	4000 SF
1C (GARAGE)	522 SF
1C (LEVEL 01)	817 SF
1C (LEVEL 02)	1325 SF
1C (LEVEL 03)	1191 SF
	3855 SF
1D (GARAGE)	494 SF
1D (LEVEL 01)	595 SF
1D (LEVEL 02)	1062 SF
1D (LEVEL 03)	943 SF
	3093 SF
2A (GARAGE)	548 SF
2A (LEVEL 01)	708 SF
2A (LEVEL 02)	1237 SF
2A (LEVEL 03)	1138 SF
OD (OADAOE)	3631 SF
2B (GARAGE)	548 SF
2B (LEVEL 01)	708 SF
2B (LEVEL 02)	1237 SF
2B (LEVEL 03)	1138 SF 3631 SF
3A (GARAGE)	436 SF
BA (LEVEL 01)	816 SF
BA (LEVEL 02)	1175 SF
3A (LEVEL 02)	976 SF
57 (LL VLL 00)	3403 SF
3B (GARAGE)	436 SF
3B (LEVEL 01)	749 SF
3B (LEVEL 02)	1108 SF
3B (LEVEL 03)	893 SF
	3186 SF
3C (GARAGE)	441 SF
3C (LEVEL 01)	727 SF
BC (LEVEL 02)	1091 SF
BC (LEVEL 03)	852 SF
. , ,	3111 SF
3D (GARAGE)	356 SF
BD (LEVEL 01)	585 SF
BD (LEVEL 02)	887 SF
BD (LEVEL 03)	703 SF
	2532 SF
4A (GARAGE)	476 SF
4A (LEVEL 01)	677 SF
4A (LEVEL 02)	1111 SF
4A (LEVEL 03)	859 SF
	3123 SF
4B (GARAGE)	476 SF
4B (LEVEL 01)	677 SF
4B (LEVEL 02)	1112 SF
4B (LEVEL 03)	859 SF
B (LL VLL 00)	3123 SF

WARM SPRINGS TOWNHOMES KETCHUM, ID

OWNER:

108-110 RITCHIE LLC P.O. BOX 14001-174 KETCHUM, ID 83340 TEL: 603.801.0419

BUILDING ARCHITECT:

RO | ROCKETT DESIGN 1031 W. MANCHESTER BLVD. UNIT 6 INGLEWOOD, CA 90301 TEL: 213.784.0014

STRUCTURAL ENGINEER:

ZFA STRUCTURAL ENGINEERS
601 MONTGOMERY STREET SUITE 1450
SAN FRANCISCO, CA 94111
TEL: 415.243.4091

MECHANICAL, ELECTRICAL, PLUMBING ENGINEER:

PROFICIENT ENGINEERING 4704 HARLAN STREET SUITE 620 DENVER, CO 80212 TEL: 720.779.3556

CIVIL ENGINEER:

GALENA BENCHMARK ASSOCIATES 100 BELL DRIVE SUITE C KETCHUM, ID 83340 TEL: 208.726.9512

LANDSCAPE ARCHITECT:

EGGERS ASSOCIATES 560 NORTH 2ND AVENUE KETCHUM, ID 83340 TEL: 208.725.0988

ISSUE DESCRIPTION DATE
1 DESIGN REVIEW APP 25.09.09
2 DESIGN REVIEW APP REV 25.10.14

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WARM SPRINGS TOWNHOMES
KETCHUM, ID

108 & 110 RITCHIE DR. KETCHUM, IDAHO

DRAWING TITLE:

SITE PLAN - BUILDING AREAS


SEAL:

PROJECT NUMBER
2305

DRAWING NUMBER:

A-000

1/8" = 1'-0" SITE PLAN - BUILDING INFORMATION AREAS

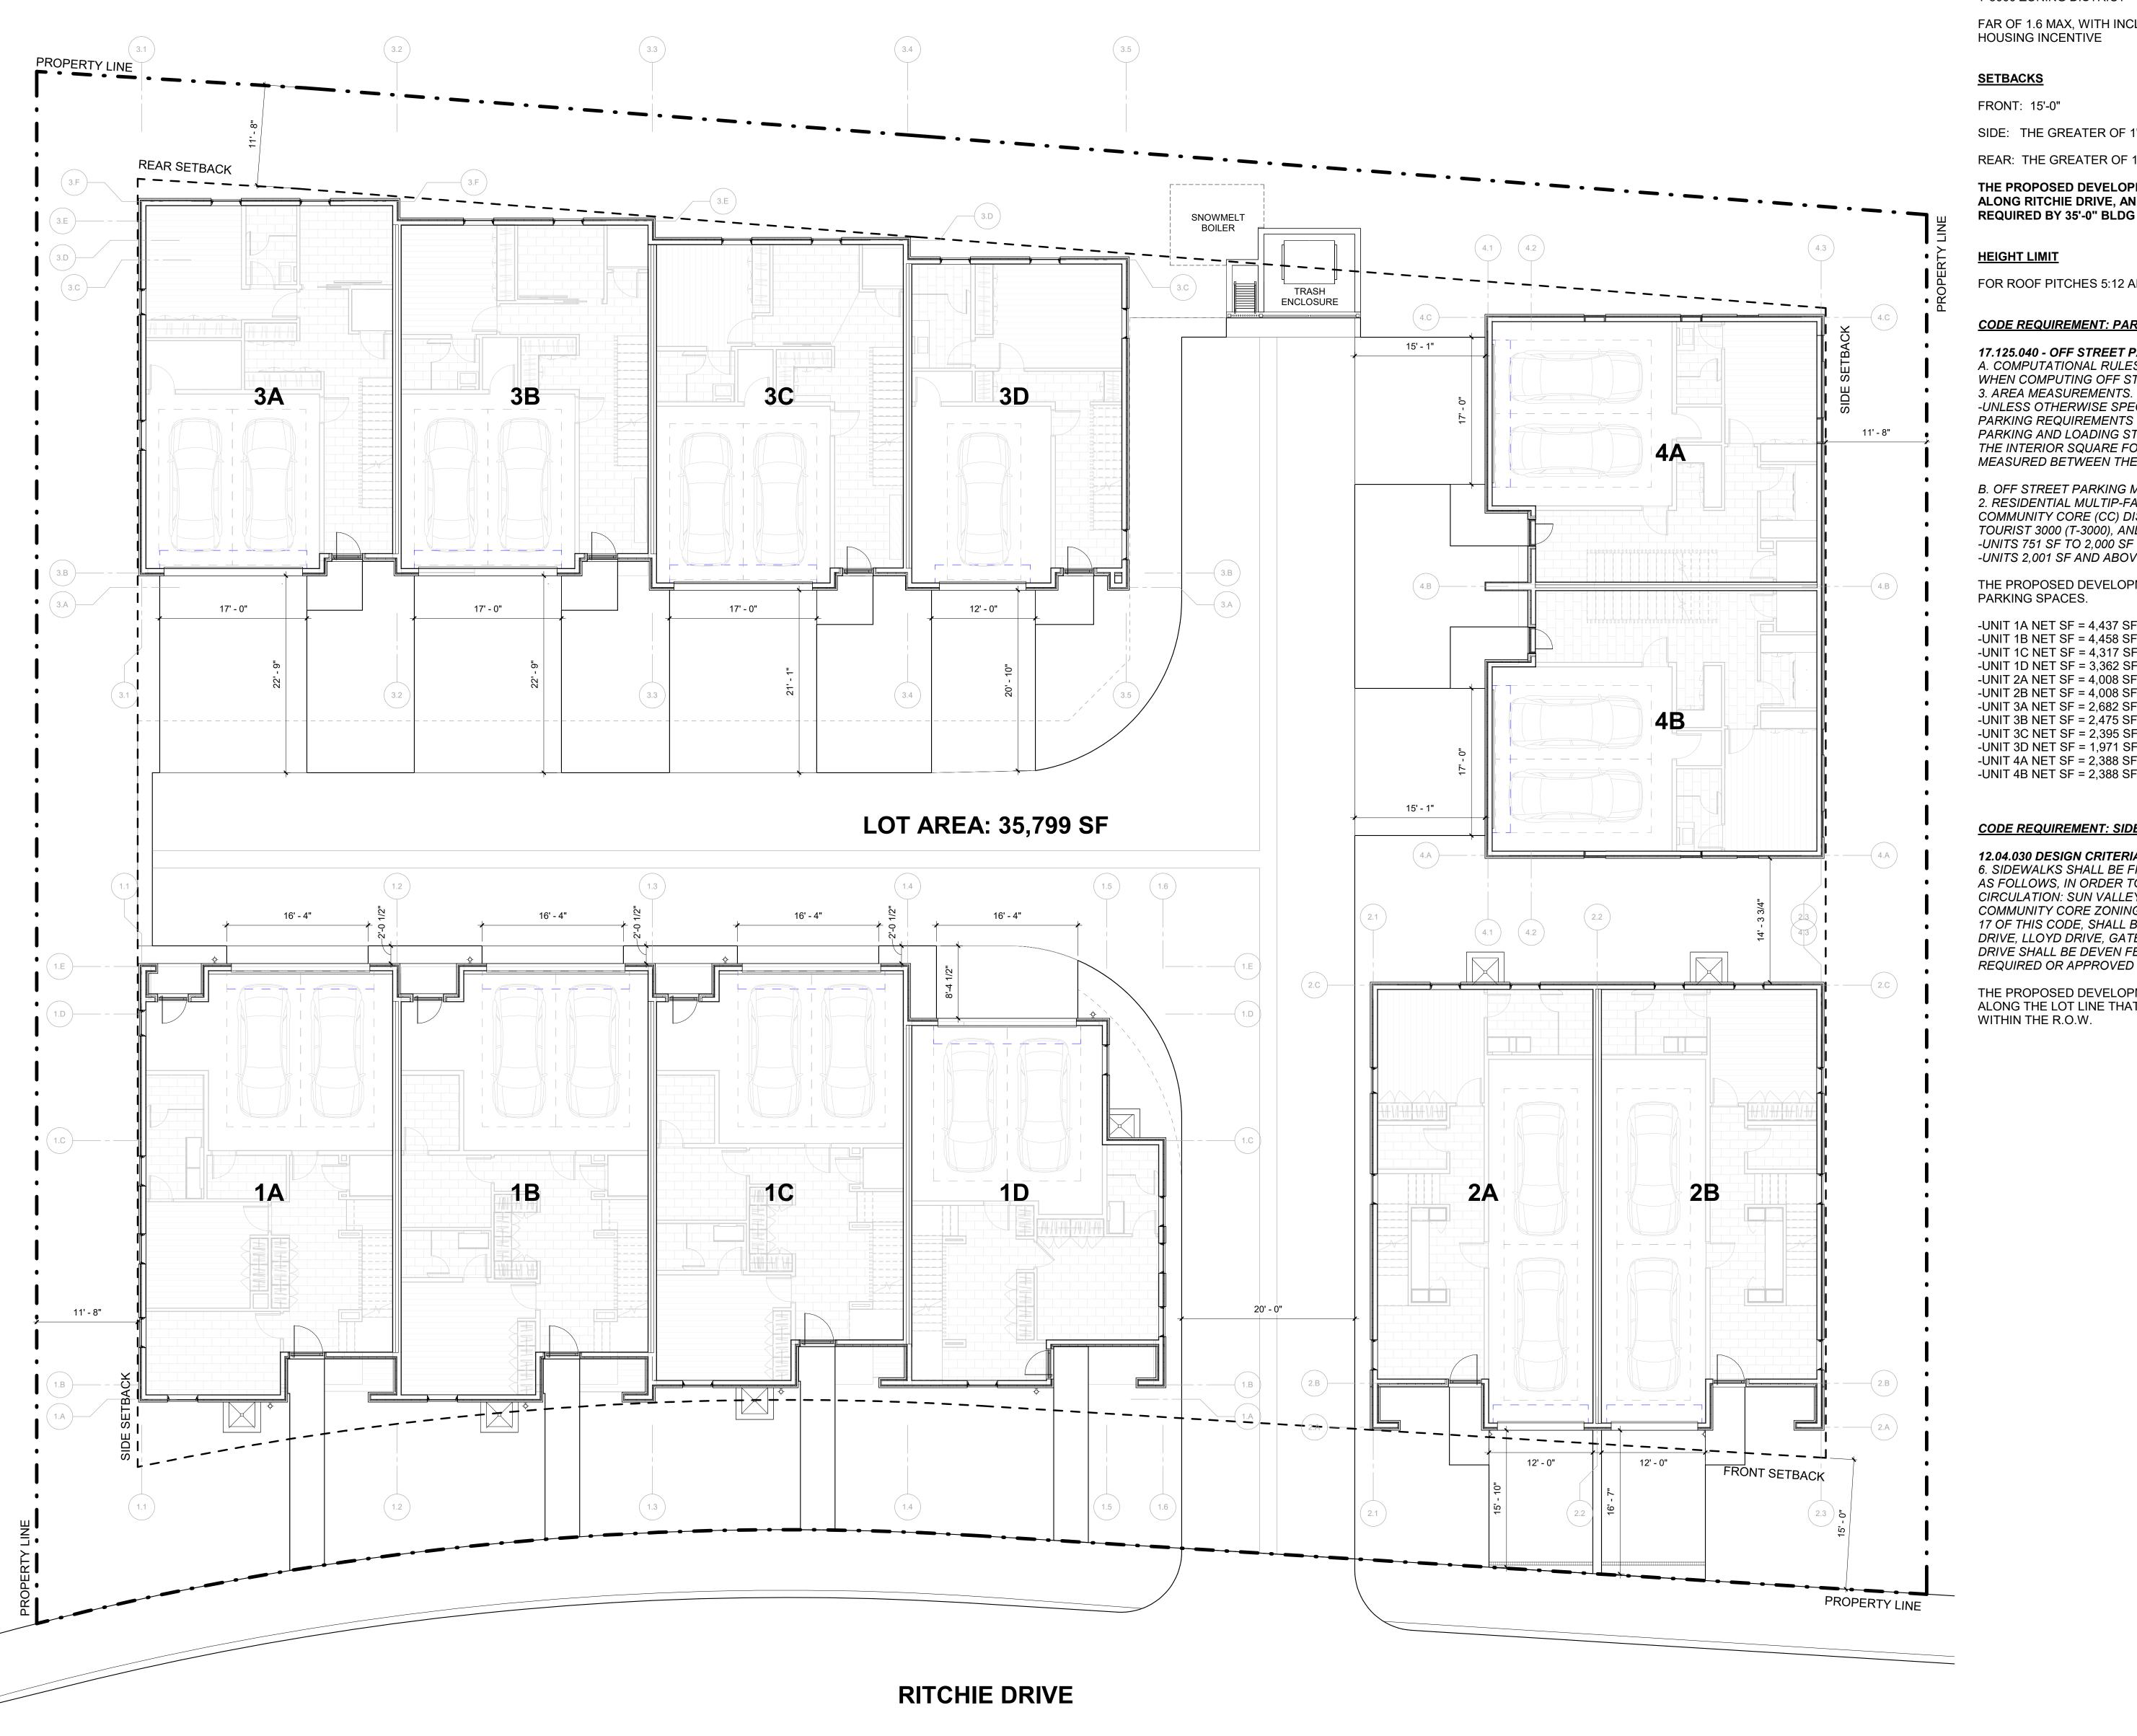

1/8" = 1'-0" SITE PLAN - BUILDING INFORMATION

T-3000 ZONING DISTRICT

ZONING

FAR OF 1.6 MAX, WITH INCLUSIONARY

SIDE: THE GREATER OF 1' FOR EVERY 3' OF BLDG HT, OR 5'

REAR: THE GREATER OF 1' FOR EVERY 3' OF BLDG HT, OR 5'

THE PROPOSED DEVELOPMENT HAS A 15' SETBACK ALONG RITCHIE DRIVE, AND 11'-8" SIDE AND REAR AS REQUIRED BY 35'-0" BLDG HEIGHTS.

FOR ROOF PITCHES 5:12 AND UNDER = 35'-0"

CODE REQUIREMENT: PARKING

17.125.040 - OFF STREET PARKING AND LOADING CALCULATIONS A. COMPUTATIONAL RULES. THE FOLLOWING RULES APPLY WHEN COMPUTING OFF STREET PARKING AND LOADING REQ.

-UNLESS OTHERWISE SPECIFICALLY NOTED, RESIDENTIAL PARKING REQUIREMENTS FOR ALL SQUARE FOOTAGE BASED PARKING AND LOADING STANDARDS SHALL BE COMPUTED ON THE INTERIOR SQUARE FOOTAGE OF EACH RESIDENTIAL UNIT, MEASURED BETWEEN THE INTERIOR WALLS OF THE UNIT.

B. OFF STREET PARKING MATRIX.

2. RESIDENTIAL MULTIP-FAMILY DWELLING WITHIN THE COMMUNITY CORE (CC) DISTRICT AND THE TOURIST (T), TOURIST 3000 (T-3000), AND TOURIST 4000 (T-4000) -UNITS 751 SF TO 2,000 SF - 1 PARKING SPACE -UNITS 2,001 SF AND ABOVE - 2 PARKING SPACES

THE PROPOSED DEVELOPMENT INCLUDES 23 TOTAL INTERIOR PARKING SPACES.

- -UNIT 1A NET SF = 4,437 SF (2 PARKING SPACES) -UNIT 1B NET SF = 4,458 SF (2 PARKING SPACES)
- -UNIT 1C NET SF = 4,317 SF (2 PARKING SPACES)
- -UNIT 1D NET SF = 3,362 SF (2 PARKING SPACES) -UNIT 2A NET SF = 4.008 SF (2 PARKING SPACES)
- -UNIT 2B NET SF = 4,008 SF (2 PARKING SPACES)
- -UNIT 3A NET SF = 2,682 SF (2 PARKING SPACES) -UNIT 3B NET SF = 2,475 SF (2 PARKING SPACES)
- -UNIT 3C NET SF = 2,395 SF (2 PARKING SPACES) -UNIT 3D NET SF = 1,971 SF (1 PARKING SPACE)
- -UNIT 4A NET SF = 2,388 SF (2 PARKING SPACES) -UNIT 4B NET SF = 2,388 SF (2 PARKING SPACES)

CODE REQUIREMENT: SIDEWALKS

12.04.030 DESIGN CRITERIA. M. SIDEWALKS, CURB AND GUTTER. 6. SIDEWALKS SHALL BE FIVE FEET WIDE, EXCEPT SPECIFICALLY AS FOLLOWS, IN ORDER TO ACCOMMODATE HEAVY PEDESTRIAN CIRCULATION: SUN VALLEY ROAD AND MAIN STREET WITHIN THE COMMUNITY CORE ZONING DISTRICT (CC), AS DEFINED IN TITLE 17 OF THIS CODE, SHALL BE EIGHT FEET IN WIDTH; AND SKYWAY DRIVE, LLOYD DRIVE, GATES ROAD, RITCHIE DRIVE AND HOWARD DRIVE SHALL BE DEVEN FEET IN WIDTH, UNLESS OTHERWISE REQUIRED OR APPROVED BY THE CITY COUNCIL.

THE PROPOSED DEVELOPMENT INCLUDES A 7'-0" WIDE SIDEWALK ALONG THE LOT LINE THAT IS ADJACENT TO RITCHE DRIVE WITHIN THE R.O.W.

WARM SPRINGS TOWNHOMES KETCHUM, ID

OWNER:

108-110 RITCHIE LLC P.O. BOX 14001-174 KETCHUM, ID 83340 TEL: 603.801.0419

BUILDING ARCHITECT:

RO | ROCKETT DESIGN 1031 W. MANCHESTER BLVD. UNIT 6 INGLEWOOD, CA 90301

TEL: 213.784.0014

STRUCTURAL ENGINEER: **ZFA STRUCTURAL ENGINEERS**

601 MONTGOMERY STREET SUITE 1450 SAN FRANCISCO, CA 94111

TEL: 415.243.4091

MECHANICAL, ELECTRICAL, PLUMBING ENGINEER:

PROFICIENT ENGINEERING 4704 HARLAN STREET SUITE 620 DENVER, CO 80212

CIVIL ENGINEER:

TEL: 720.779.3556

TEL: 208.726.9512

GALENA BENCHMARK ASSOCIATES 100 BELL DRIVE SUITE C KETCHUM, ID 83340

LANDSCAPE ARCHITECT:

EGGERS ASSOCIATES 560 NORTH 2ND AVENUE KETCHUM, ID 83340 TEL: 208.725.0988

DESCRIPTION DESIGN REVIEW APP 25.09.09 DESIGN REVIEW APP REV 25.10.14

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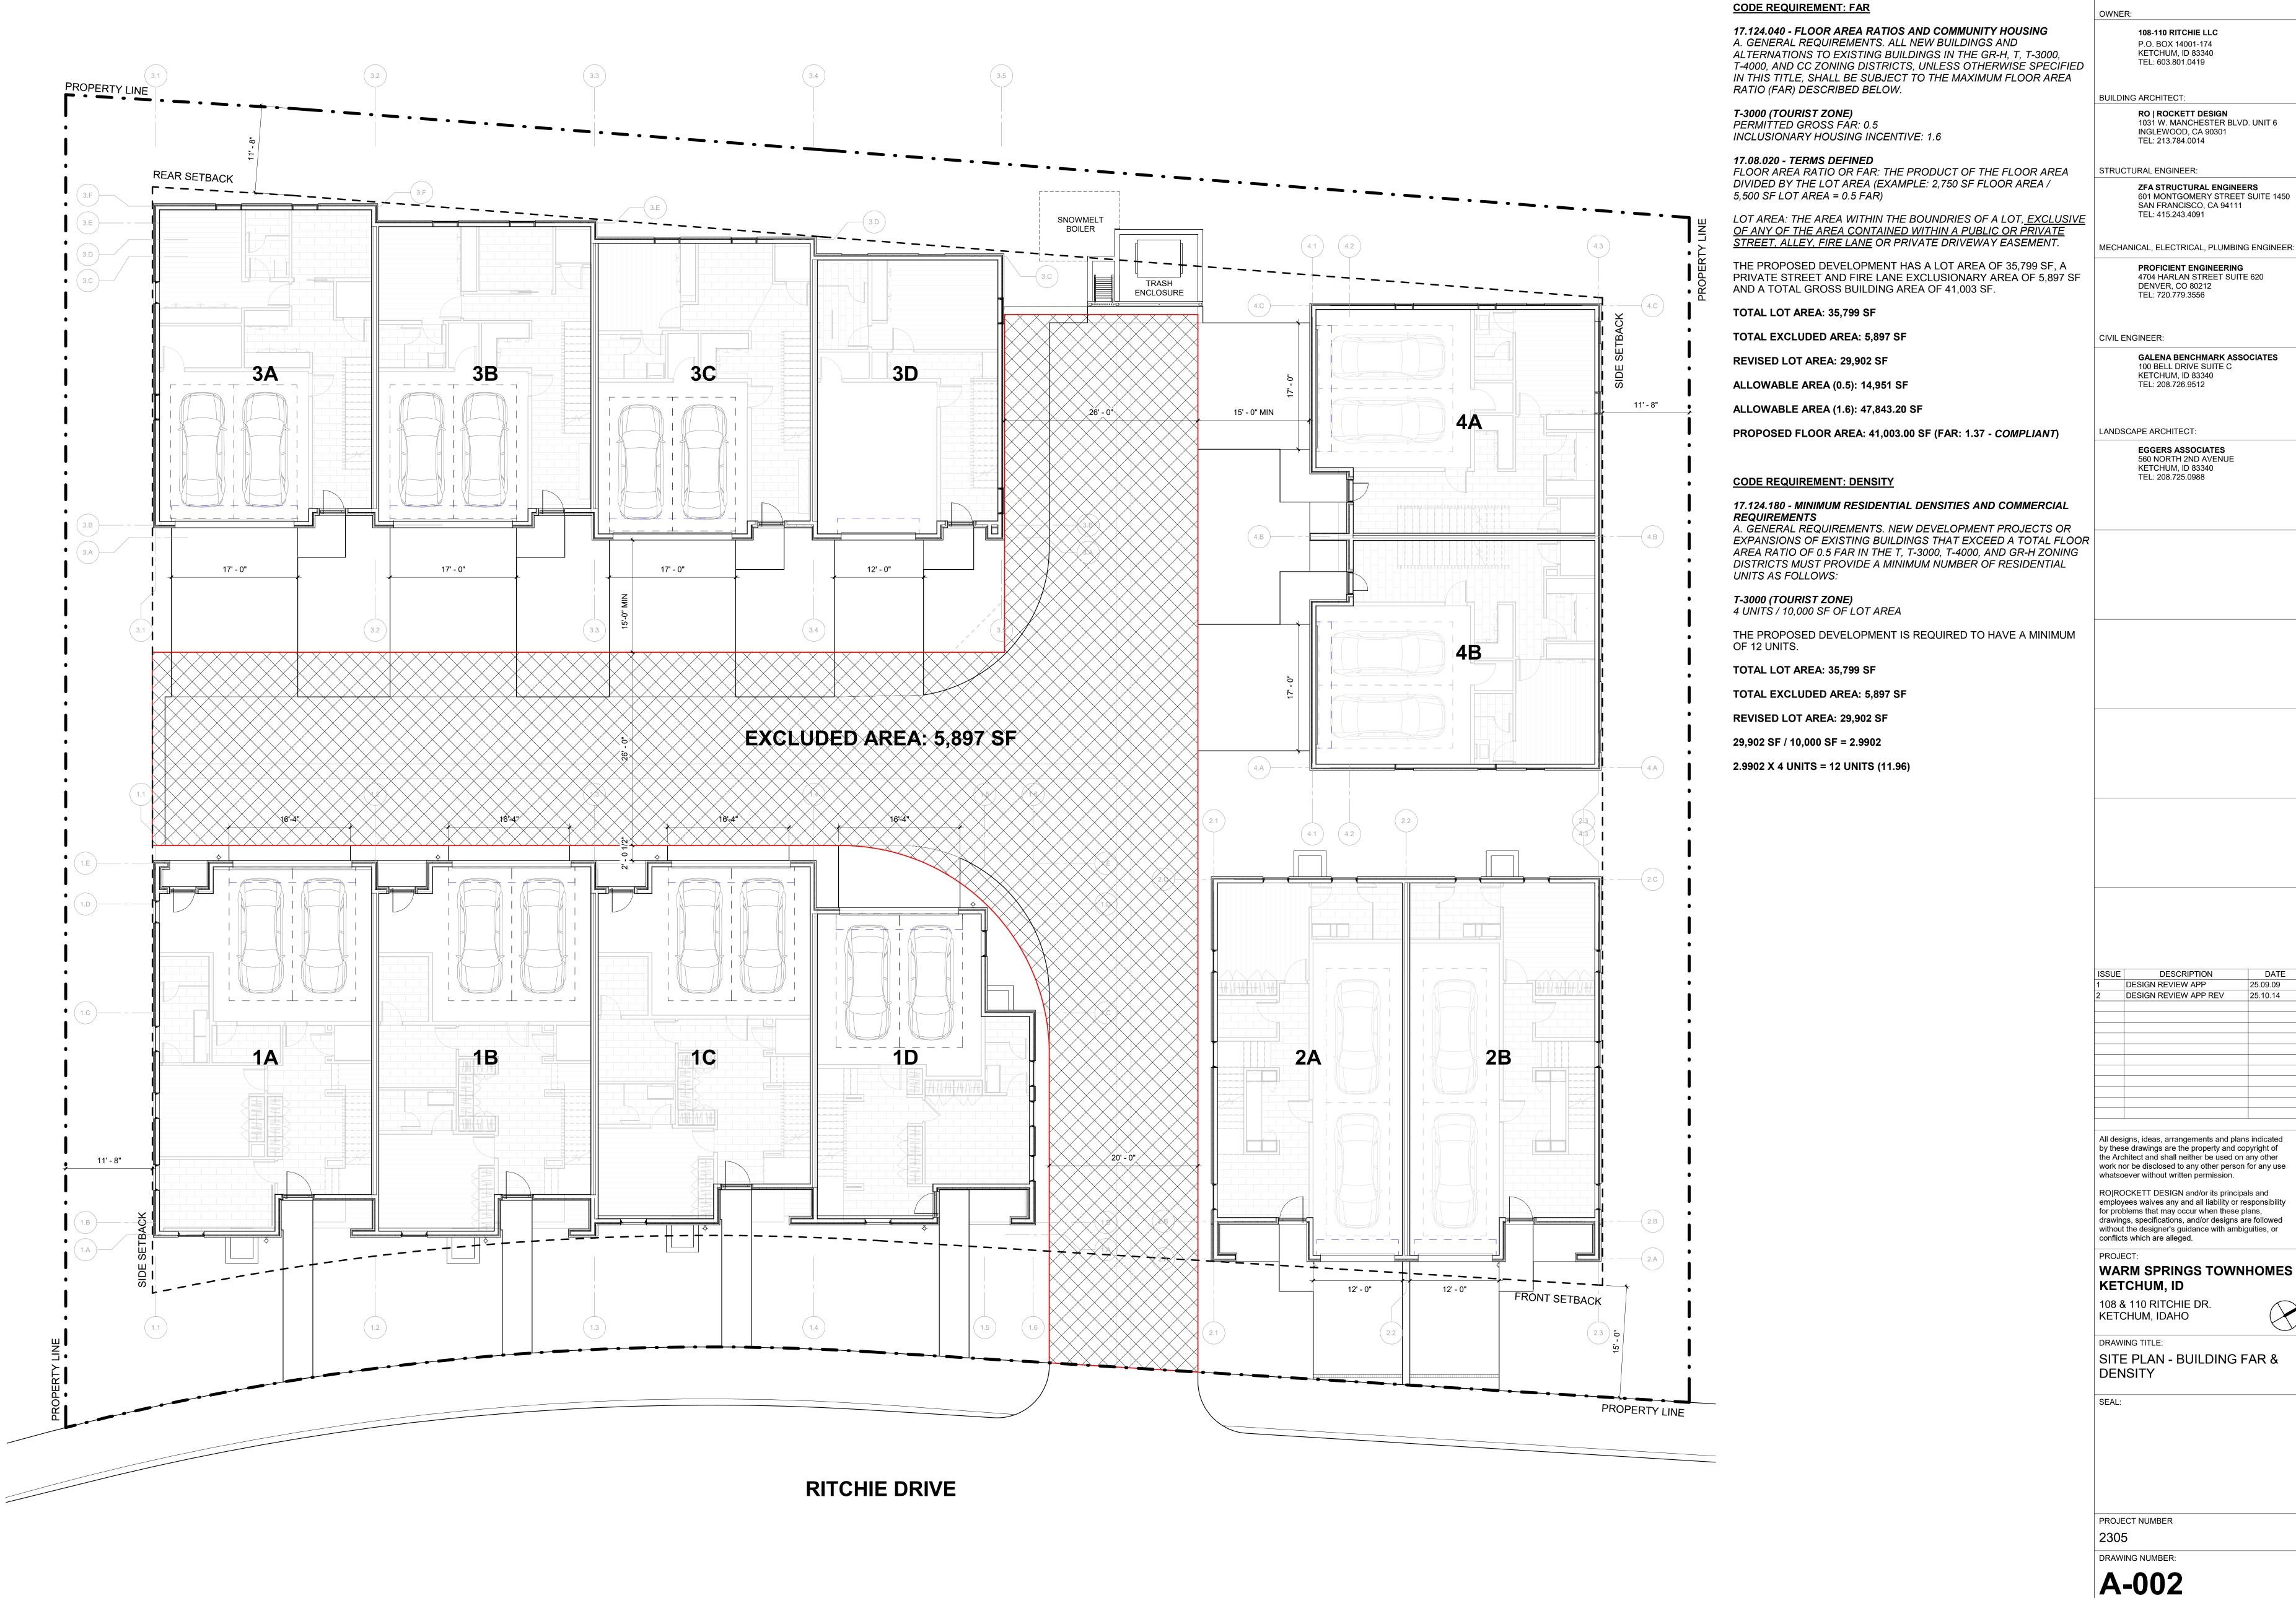
WARM SPRINGS TOWNHOMES KETCHUM, ID 108 & 110 RITCHIE DR.

KETCHUM, IDAHO

DRAWING TITLE: SITE PLAN - BUILDING CODES

PROJECT NUMBER DRAWING NUMBER:


A-001




1/8" = 1'-0" SITE PLAN - BUILDING INFORMATION B

WARM SPRINGS TOWNHOMES KETCHUM, ID

25.09.09

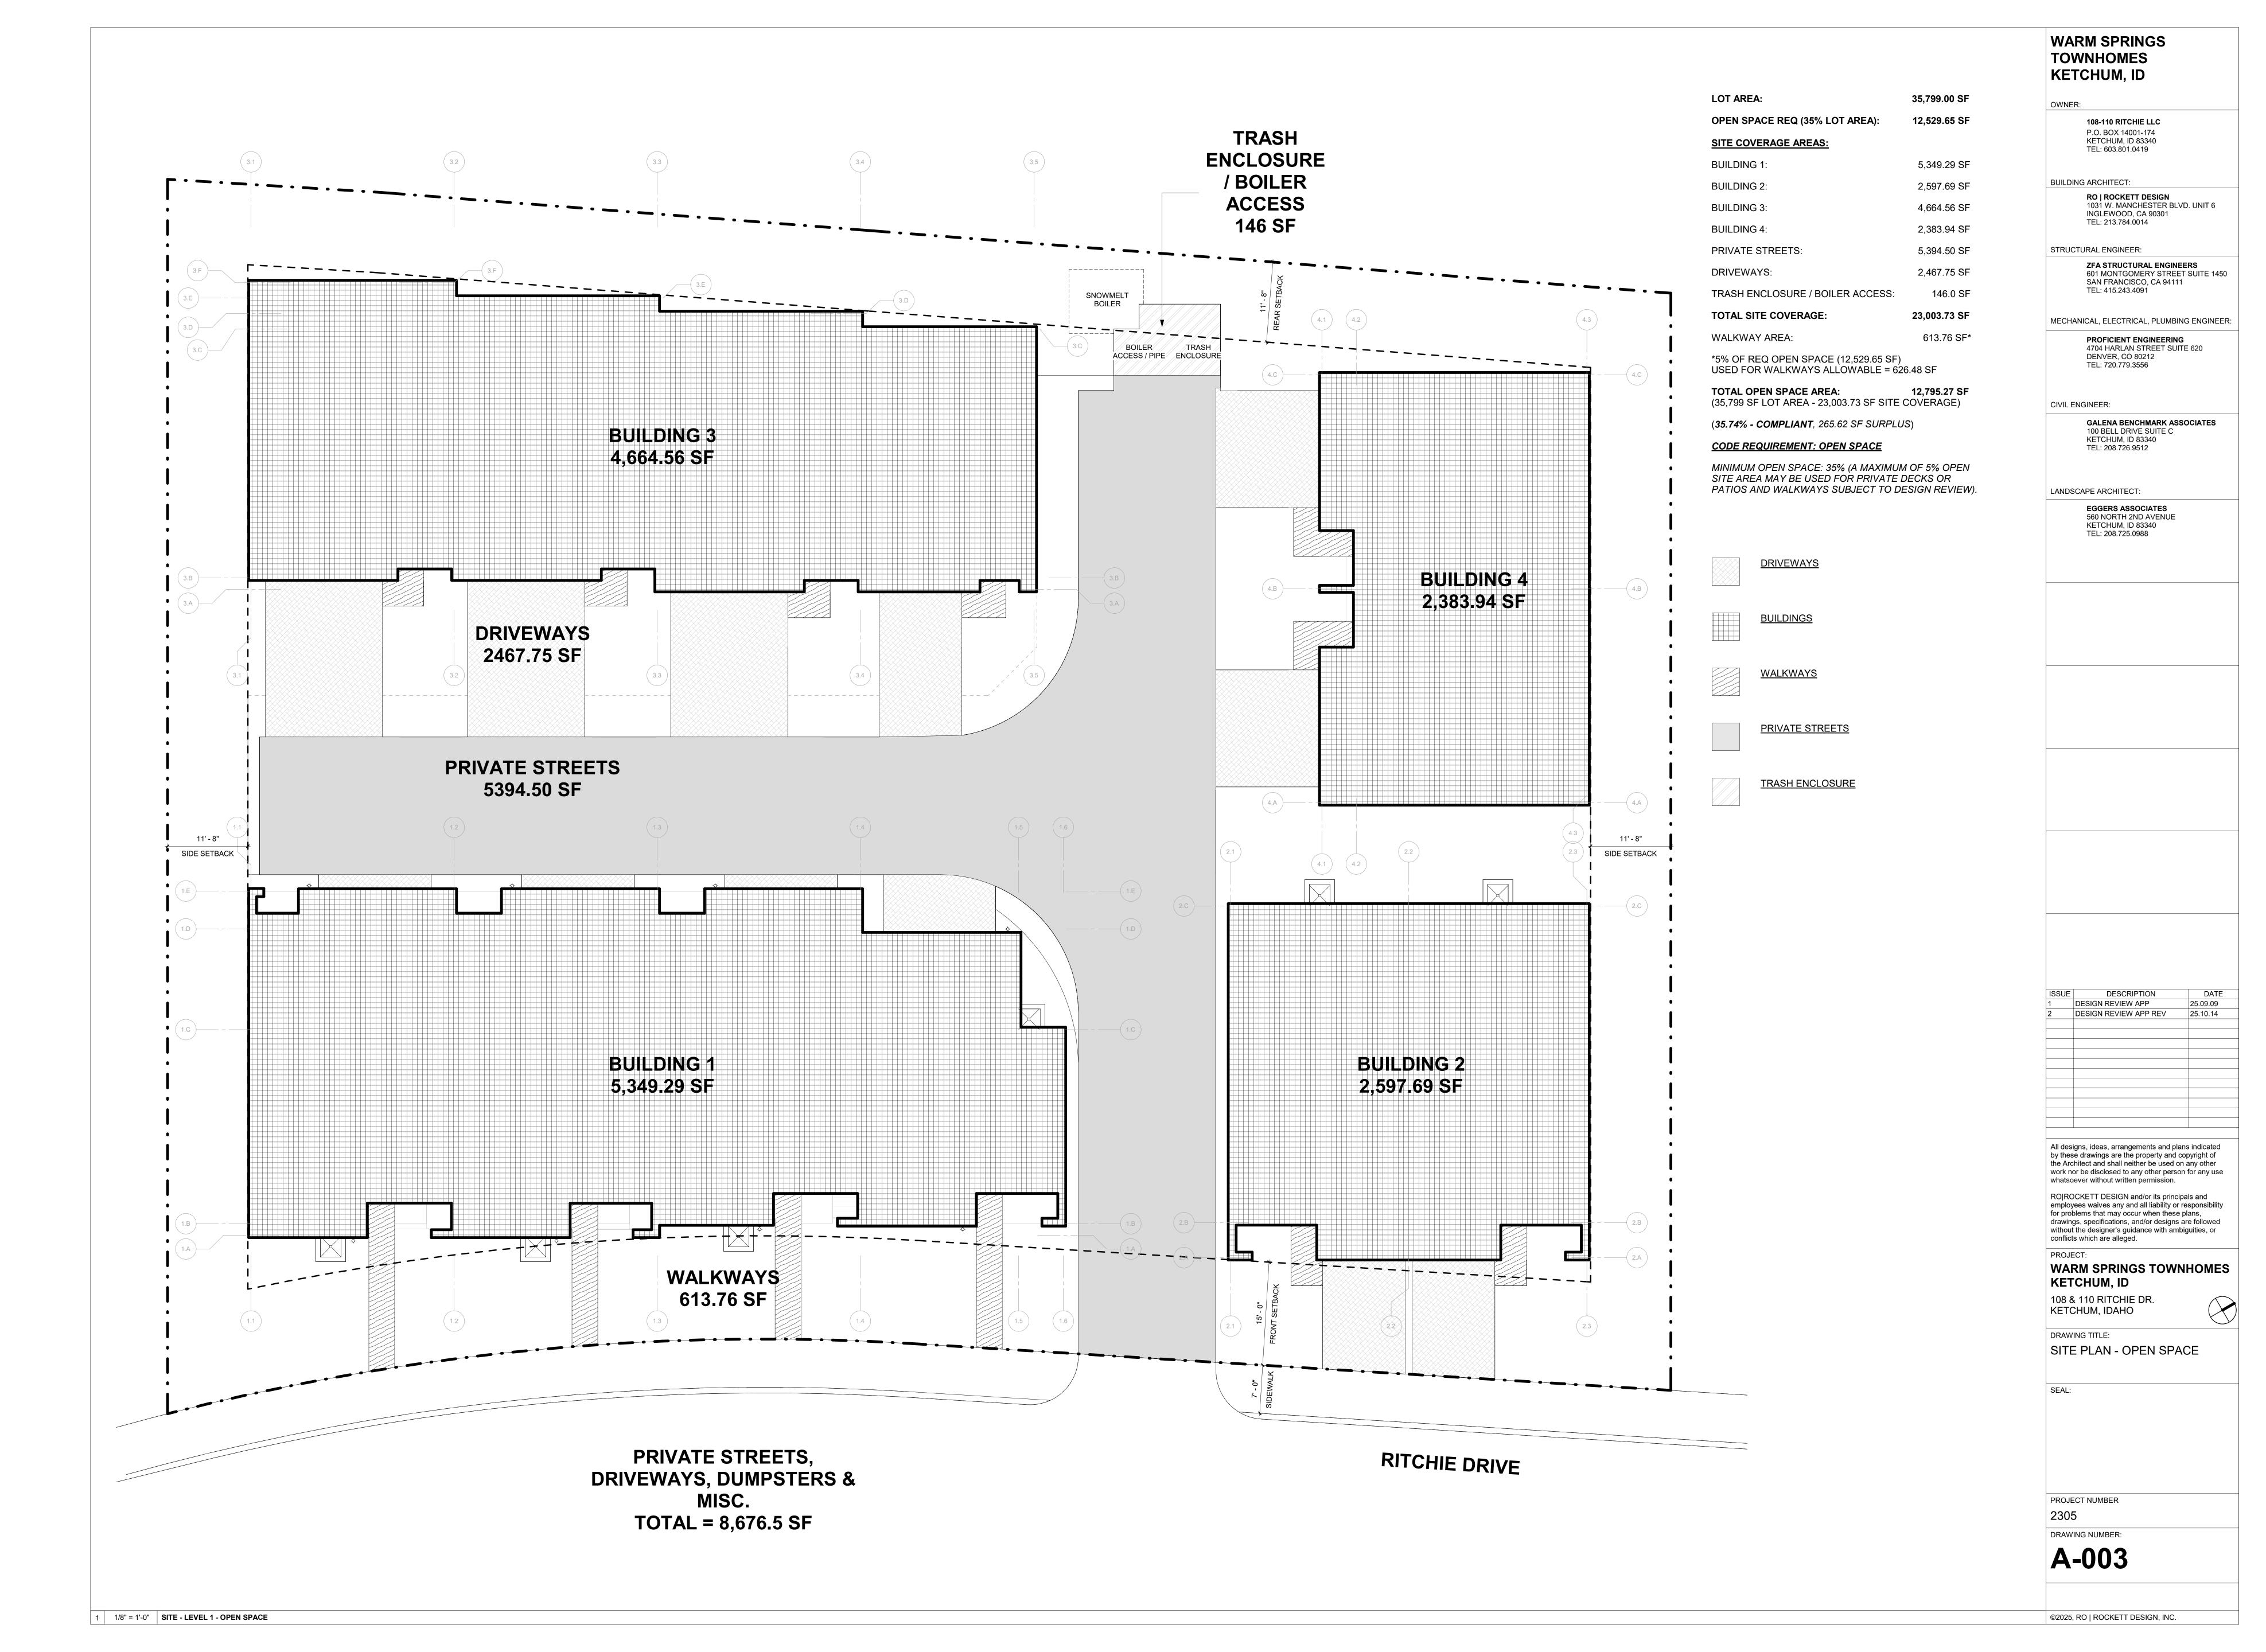

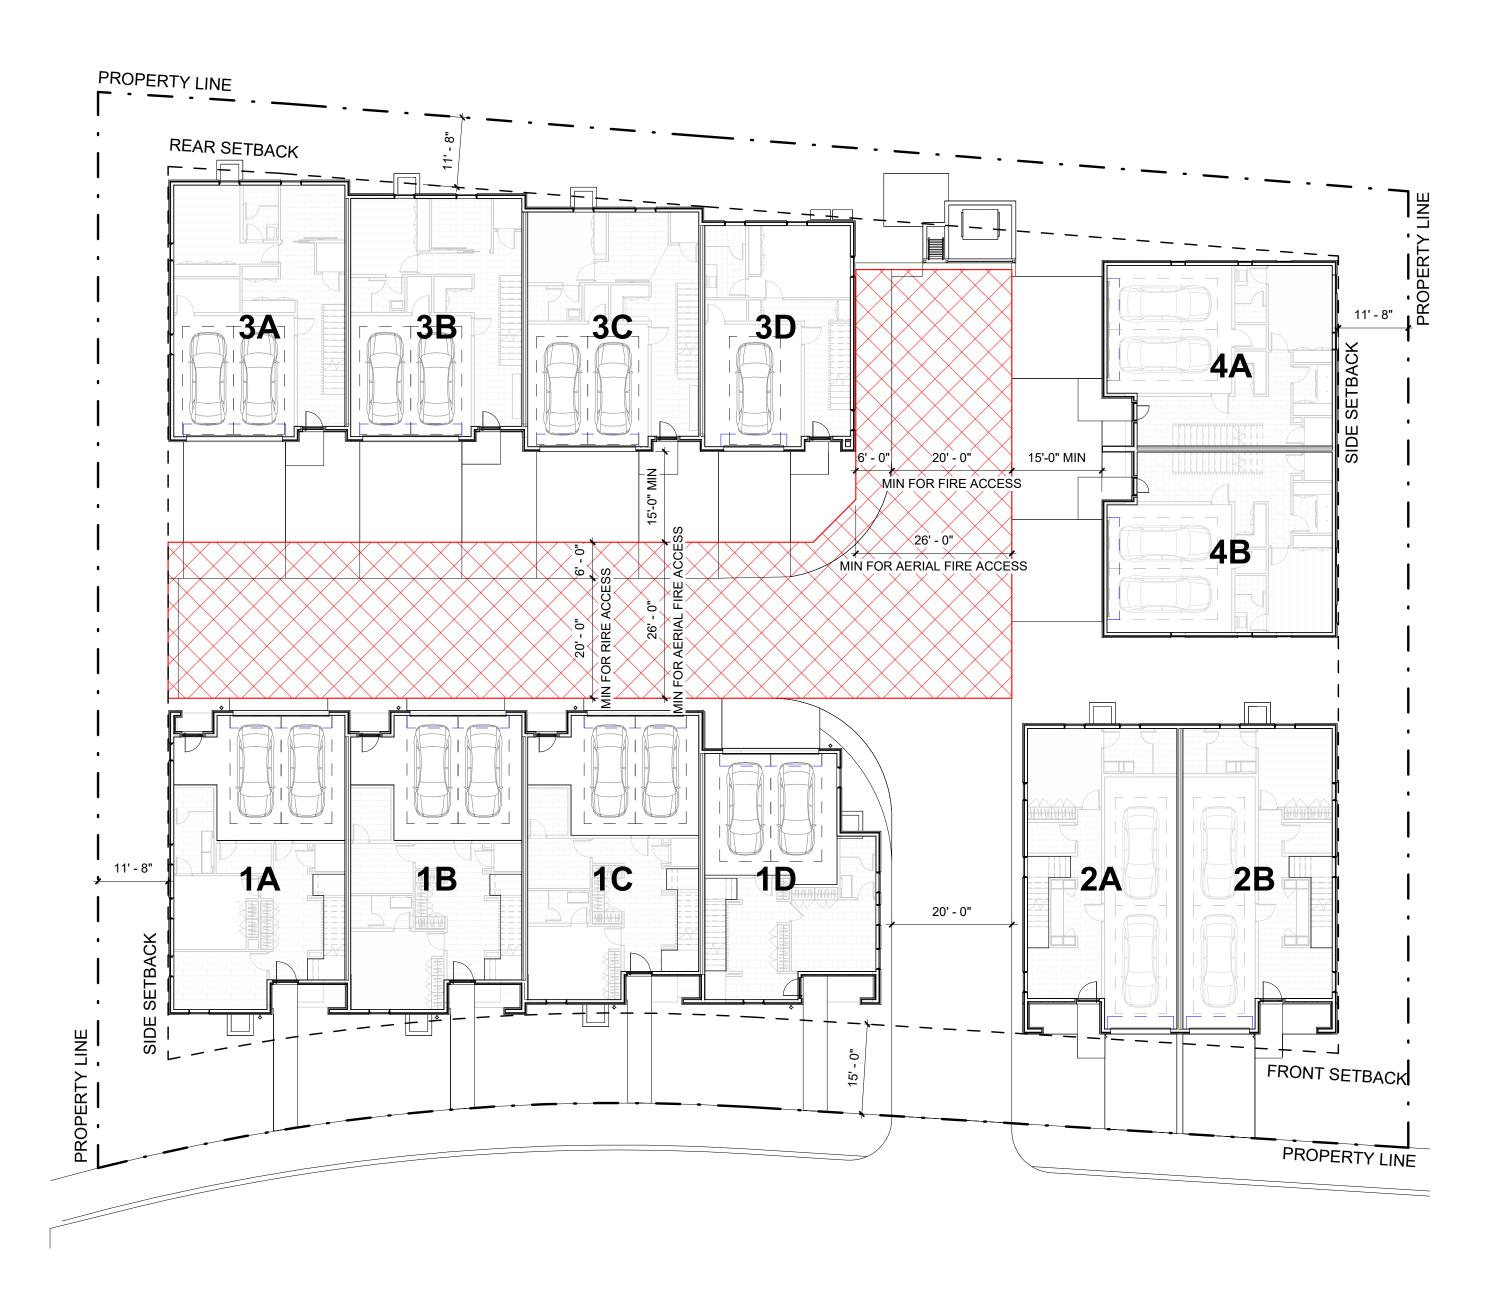

CODE REQUIREMENT: FIRE ACCESS


APPENDIX D OF 2018 IFC, SECTION D105 - AERIAL FIRE APPARATUS ACCESS ROADS

D105.1 - WHERE THE VERTICAL DISTANCE BETWEEN THE GRADE PLANE AND THE HIGHEST ROOF SURFACE EXCEEDS 30 FEET, APPROVED FIRE APPARATUS ACCESS ROADS SHALL BE PROVIDED. FOR PURPOSES OF THIS SECTION, THE HIGHEST ROOF SURFACE SHALL BE DETERMINED BY MEASUREMENT TO THE EAVE OF A PITCHED ROOF, THE INTERSECTION OF THE ROOF TO EXTERIOR WALL, OR THE TOP OF PARAPET WALLS, WHICHEVER IS GREATER.


D105.2 - AERIAL FIRE APPARATUS ACCESS ROADS SHALL HAVE A MINIMUM UNOBSTRUCTED WIDTH OF 26 FEET, EXCLUSIVE OF SHOULDERS, IN THE IMMEDIATE VICINITY OF THE BUILDING OR PORTION THEREOF.

D105.3 - ONE OR MORE OF THE REQUIRED ACCESS ROUTES MEETING THIS CONDITION SHALL BE LOCATED NOT LESS THAN 15 FEET AND NOT GREATER THAN 30 FEET FROM THE BUILDING AND SHALL BE POSITIONED PARALLEL TO ONE ENTIRE SIDE OF THE BUILDING. THE SIDE OF THE BUILDING ON WHICH THE AERIAL FIRE APPARATUS ACCESS ROAD IS POSITIONED SHALL BE APPROVED BY THE FIRE CODE OFFICIAL.

THE PROPOSED DEVELOPMENT HAS A 20 FOOT WIDE PRIVATE ROAD THAT WOULD PROVIDE ACCESS TO THE INTERIOR OF THE SITE AND A DESIGNATED 20 FOOT WIDE PORTION OF THE ROAD FOR AERIAL FIRE ACCESS TO BUILDING 3 AND 4. ADDITIONALLY, BUILDING 3 AND 4 ARE SETBACK 15 FEET FROM THE EDGE OF THE FIRE ACCESS ROAD.

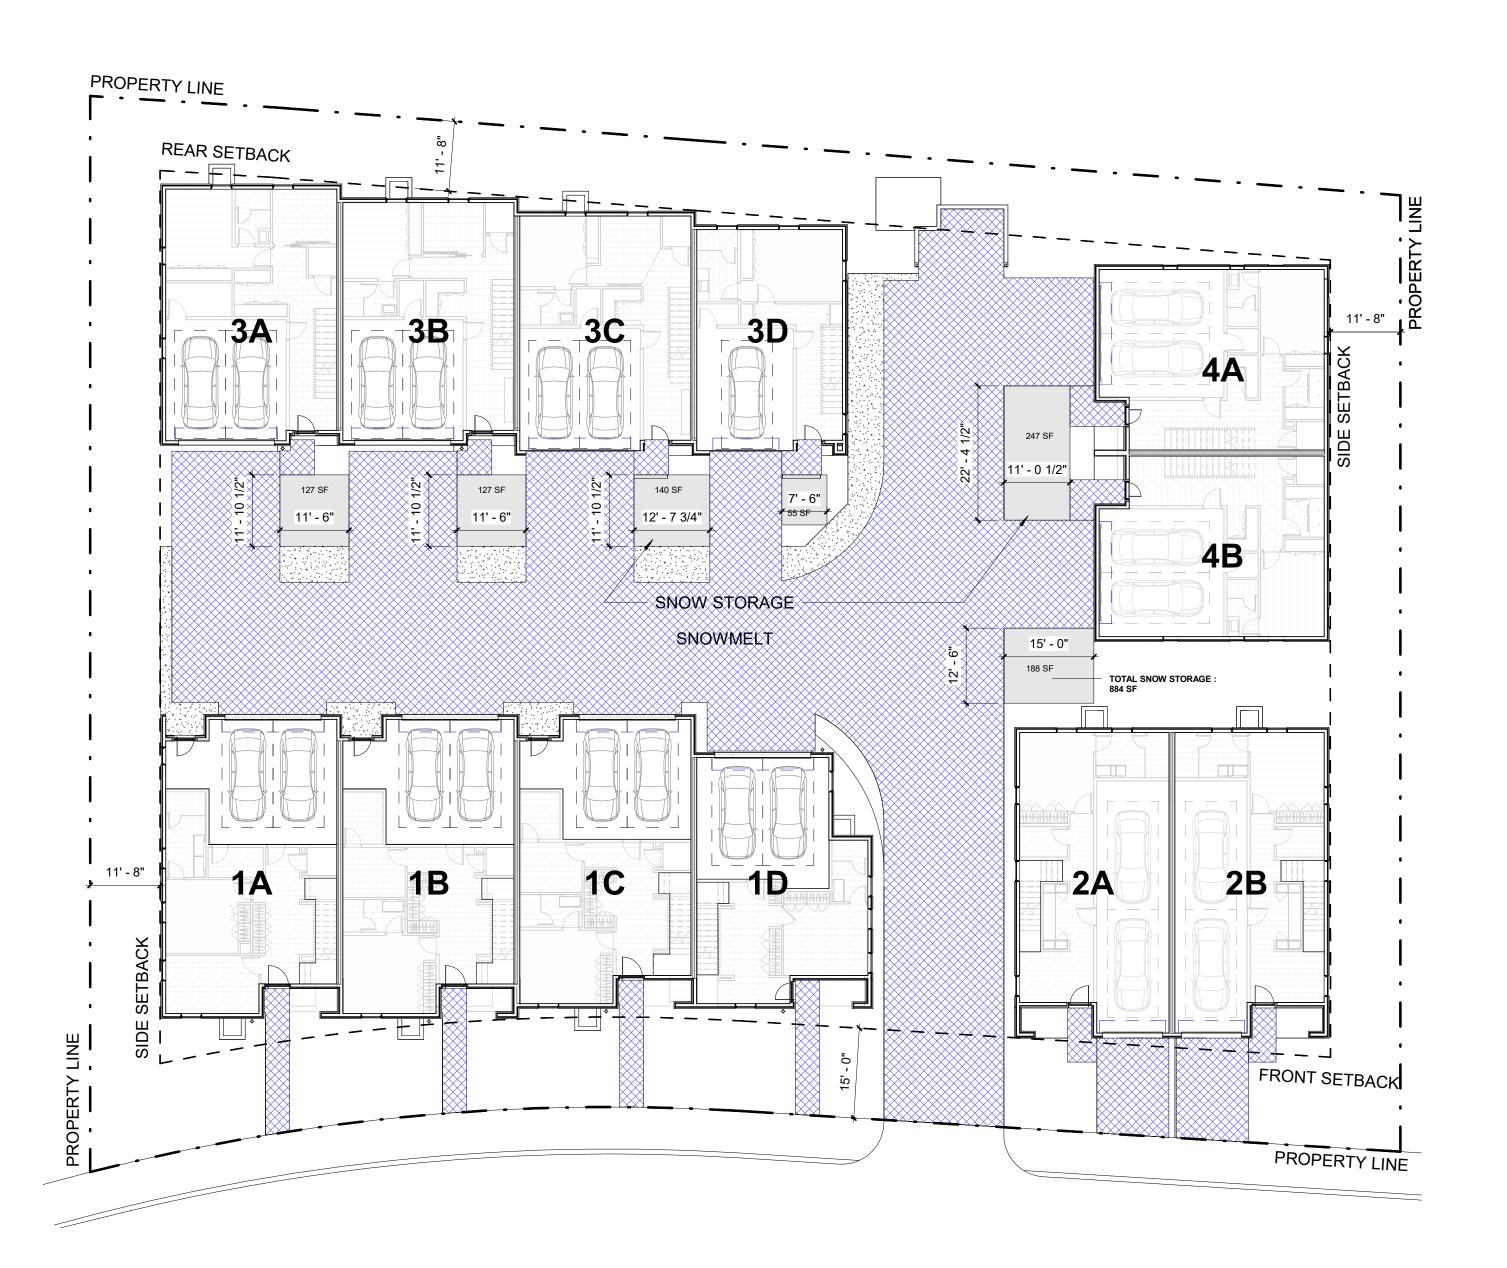

CODE REQUIREMENT: SNOWMELT

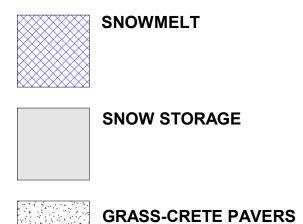

H. SNOW STORAGE

- 1 SNOW STORAGE AREAS SHALL NOT BE LESS THAN THIRTY PERCENT (30%) OF THE IMPROVED PARKING AND PEDESTRIAN CIRCULATION AREAS. 2 - SNOW STORAGE AREAS SHALL BE PROVIDED ON SITE.
- 3 A DESIGNATED SNOW STORAGE AREA SHALL NOT HAVE ANY DIMENSION LESS THAN FIVE FEET (5') AND SHALL BE A MINIMUM OF TWENTY FIVE SQUARE FEET (25 SF)
 4 IN LIEU OF PROVIDING SNOW STORAGE AREAS, SNOWMELT AND HAULING OF SNOW MAY BE ALLOWED.
- THE PROPOSED DEVELOPMENT WILL PROVIDE SITE SNOWMELT FOR ALL DRIVEWAYS, PATHWAYS, AND PRIVATE ROADS. SNOWMELT BOILER EQUIPMENT WILL BE SUBGRADE, LOCATED AT THE END OF THE PRIVATE ROAD AND SCREENED FROM VIEW OF NEIGHBORS. SEE MEP FOR DETAILED SNOWMELT PLANS.
- THERE IS 638 SF OF GRASS-CRETE SCHEDULED FOR FIRE ACCESS THAT WILL NOT HAVE SNOWMELT. THESE AREAS WILL BE SHOVELED AND AN ADDITIONAL 884 SF OF SNOW STORAGE HAS BEEN DESIGNATED ON SITE.

WARM SPRINGS TOWNHOMES KETCHUM, ID

OWNER:

108-110 RITCHIE LLC P.O. BOX 14001-174 KETCHUM, ID 83340 TEL: 603.801.0419

BUILDING ARCHITECT:

RO | ROCKETT DESIGN 1031 W. MANCHESTER BLVD. UNIT 6 INGLEWOOD, CA 90301 TEL: 213.784.0014

STRUCTURAL ENGINEER:

ZFA STRUCTURAL ENGINEERS
601 MONTGOMERY STREET SUITE 1450
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LANDSCAPE ARCHITECT:

EGGERS ASSOCIATES 560 NORTH 2ND AVENUE KETCHUM, ID 83340 TEL: 208.725.0988

JE DESCRIPTION DATE
DESIGN REVIEW APP 25.09.09
DESIGN REVIEW APP REV 25.10.14

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WARM SPRINGS TOWNHOMES
KETCHUM, ID

108 & 110 RITCHIE DR. KETCHUM, IDAHO

DRAWING TITLE:

SITE PLAN - FIRE ACCES

SITE PLAN - FIRE ACCESS & SNOWMELT

SEAL:


PROJECT NUMBER

2305

DRAWING NUMBER:

A-004

1/16" = 1'-0" | SITE PLAN - FIRE ACCESS REQUIREMENTS | 2 | 1/16" = 1'-0" | SITE PLAN - SNOWMELT

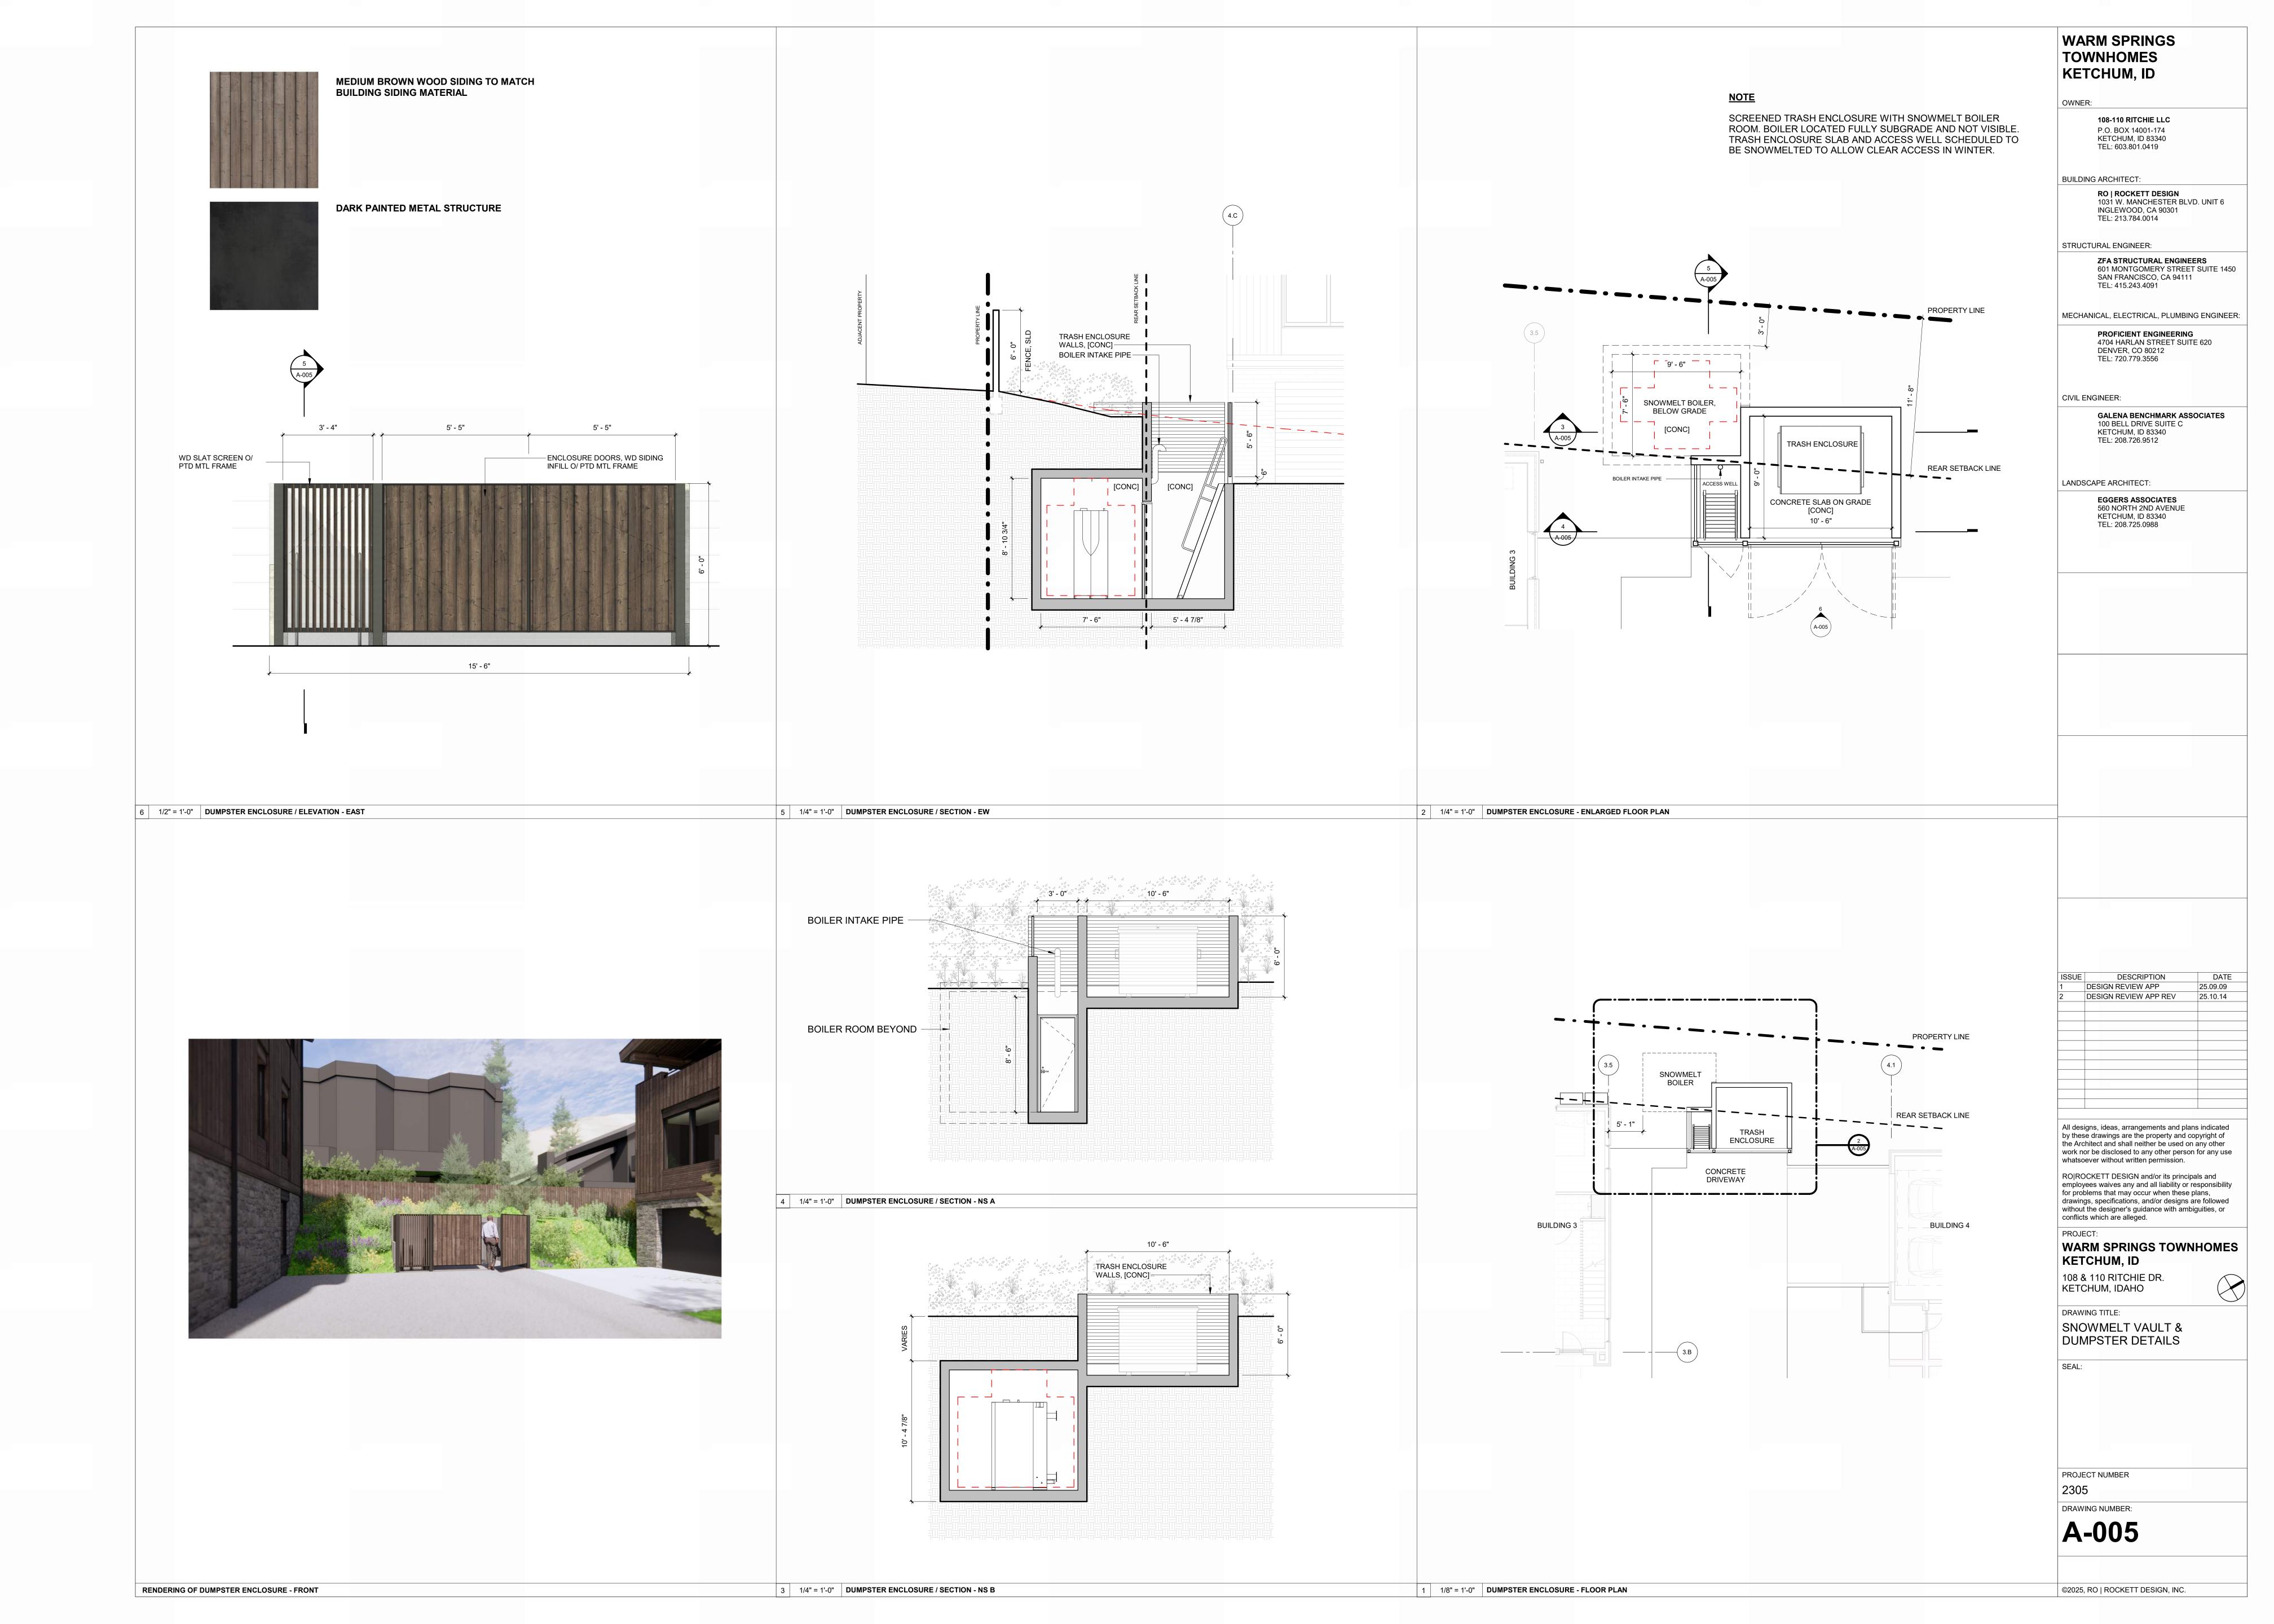

CLEAR CREEK DISPOSAL

PO Box 130 • Ketchum, ID 83340 • Phone 208.726.9600 • www.ccdisposal.com

June 14, 2024

Planning & Zoning City of Ketchum P O Box 2315 Ketchum, ID 83340

Via email:

Re: 108 Richie Drive

To whom It May Concern,

Please consider this letter as a will serve for the above address. Attached to this email are plans for a 12-unit townhome project to be built. When built according to the plans the enclosure is ample for a dumpster to service the project.

Conditions that will need to be maintained:

- Snow and Ice removal to and inside of the enclosure
- Access to the enclosure and the turn around area for egress
- Gates maintained in working order

Multiple pickup days may be necessary to accommodate the amount of waste generated

depending on type(s) of occupancy.

Respectfully,

Clear Creek Disposal

.108 Richie Drive





Presidio Vista Properties Hank Moore Senior Development Manager 603-801-0419 hank@presidiovistaproperties.com May 13, 2024

RE: 108 & 110 Richie Dr., Ketchum Idaho 83340. Lots 3 & 4 Warm Springs Village Subdivision. County of Blaine.

This letter is to serve as verification of the availability of natural gas currently to the above referenced project in Ketchum, Idaho.

The total estimated cost of extending our natural gas infrastructure and satisfying current tariffs to serve the above entity is the responsibility of the contractor/ owner of said project and must be paid in advance of construction.

Extensions of our natural gas mains and services will be provided and installed in accordance with our current tariffs, guidelines, policies and provisions on file with the Idaho Public Utilities Commission.

If you need further information regarding this project, please call me at 208-737-6314.

Sincerely,

Lance D. McBride

Lance D. McBride Energy Services Representative Sr. lance.mcbride@intgas.com 208-737-6314

Hank Moore

Bennett, Cheryl < CBennett2@idahopower.com> Friday, May 17, 2024 10:27 AM

Sent: Hank Moore To: Cc: Erik de Bruijn Will Serve Email

Hank and Erik,

You can provide this email to the city of Ketchum for your application:

I have reviewed the proposed project by Presidio Vista Properties for 12 luxury townhomes on Ritchie Drive.

As this is in the preliminary stages, I have not finalized my design on the project. The proposed transformer locations may work, but I'll have to review when I get into my design phase. I have indicated where they may also be placed depending on the voltage drop, once I get into it. Additionally, we need 10' of clearance to the front of the transformers for safe electrical operation. They can be landscaped on side and rear, no matter where they are placed. We do have primary power on Ritchie Drive, but again, until I start my design, I will not know if I need another device to pick it up (sector) and/or have to cross Ritchie Drive to get to it.

Once the customer makes formal application for design the company will provide electrical service to the project subject to obtaining of any required easements, rights of way, and in compliance with the statues of the State of Idaho and the tariffs of the company on file with the Idaho Public Utilities Commission (PUC), in particular, the General Rules and Regulations, covering new service attachments and distribution line installations or alterations. The tariff is subject to change from time to time upon approval by the Idaho PUC.

Below is the initial review I have made. Please let me know if you have additional questions or comments.

KETCHUM, ID

TOWNHOMES

WARM SPRINGS

OWNER:

108-110 RITCHIE LLC P.O. BOX 14001-174 KETCHUM, ID 83340 TEL: 603.801.0419

BUILDING ARCHITECT:

RO | ROCKETT DESIGN 1031 W. MANCHESTER BLVD. UNIT 6 INGLEWOOD, CA 90301 TEL: 213.784.0014

STRUCTURAL ENGINEER:

ZFA STRUCTURAL ENGINEERS 601 MONTGOMERY STREET SUITE 1450 SAN FRANCISCO, CA 94111 TEL: 415.243.4091

MECHANICAL, ELECTRICAL, PLUMBING ENGINEER:

PROFICIENT ENGINEERING 4704 HARLAN STREET SUITE 620 DENVER, CO 80212 TEL: 720.779.3556

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LANDSCAPE ARCHITECT:

EGGERS ASSOCIATES 560 NORTH 2ND AVENUE KETCHUM, ID 83340 TEL: 208.725.0988

DESCRIPTION

DESIGN REVIEW APPLICATION 25.09.09

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WARM SPRINGS TOWNHOMES KETCHUM, ID

108 & 110 RITCHIE DR. KETCHUM, IDAHO


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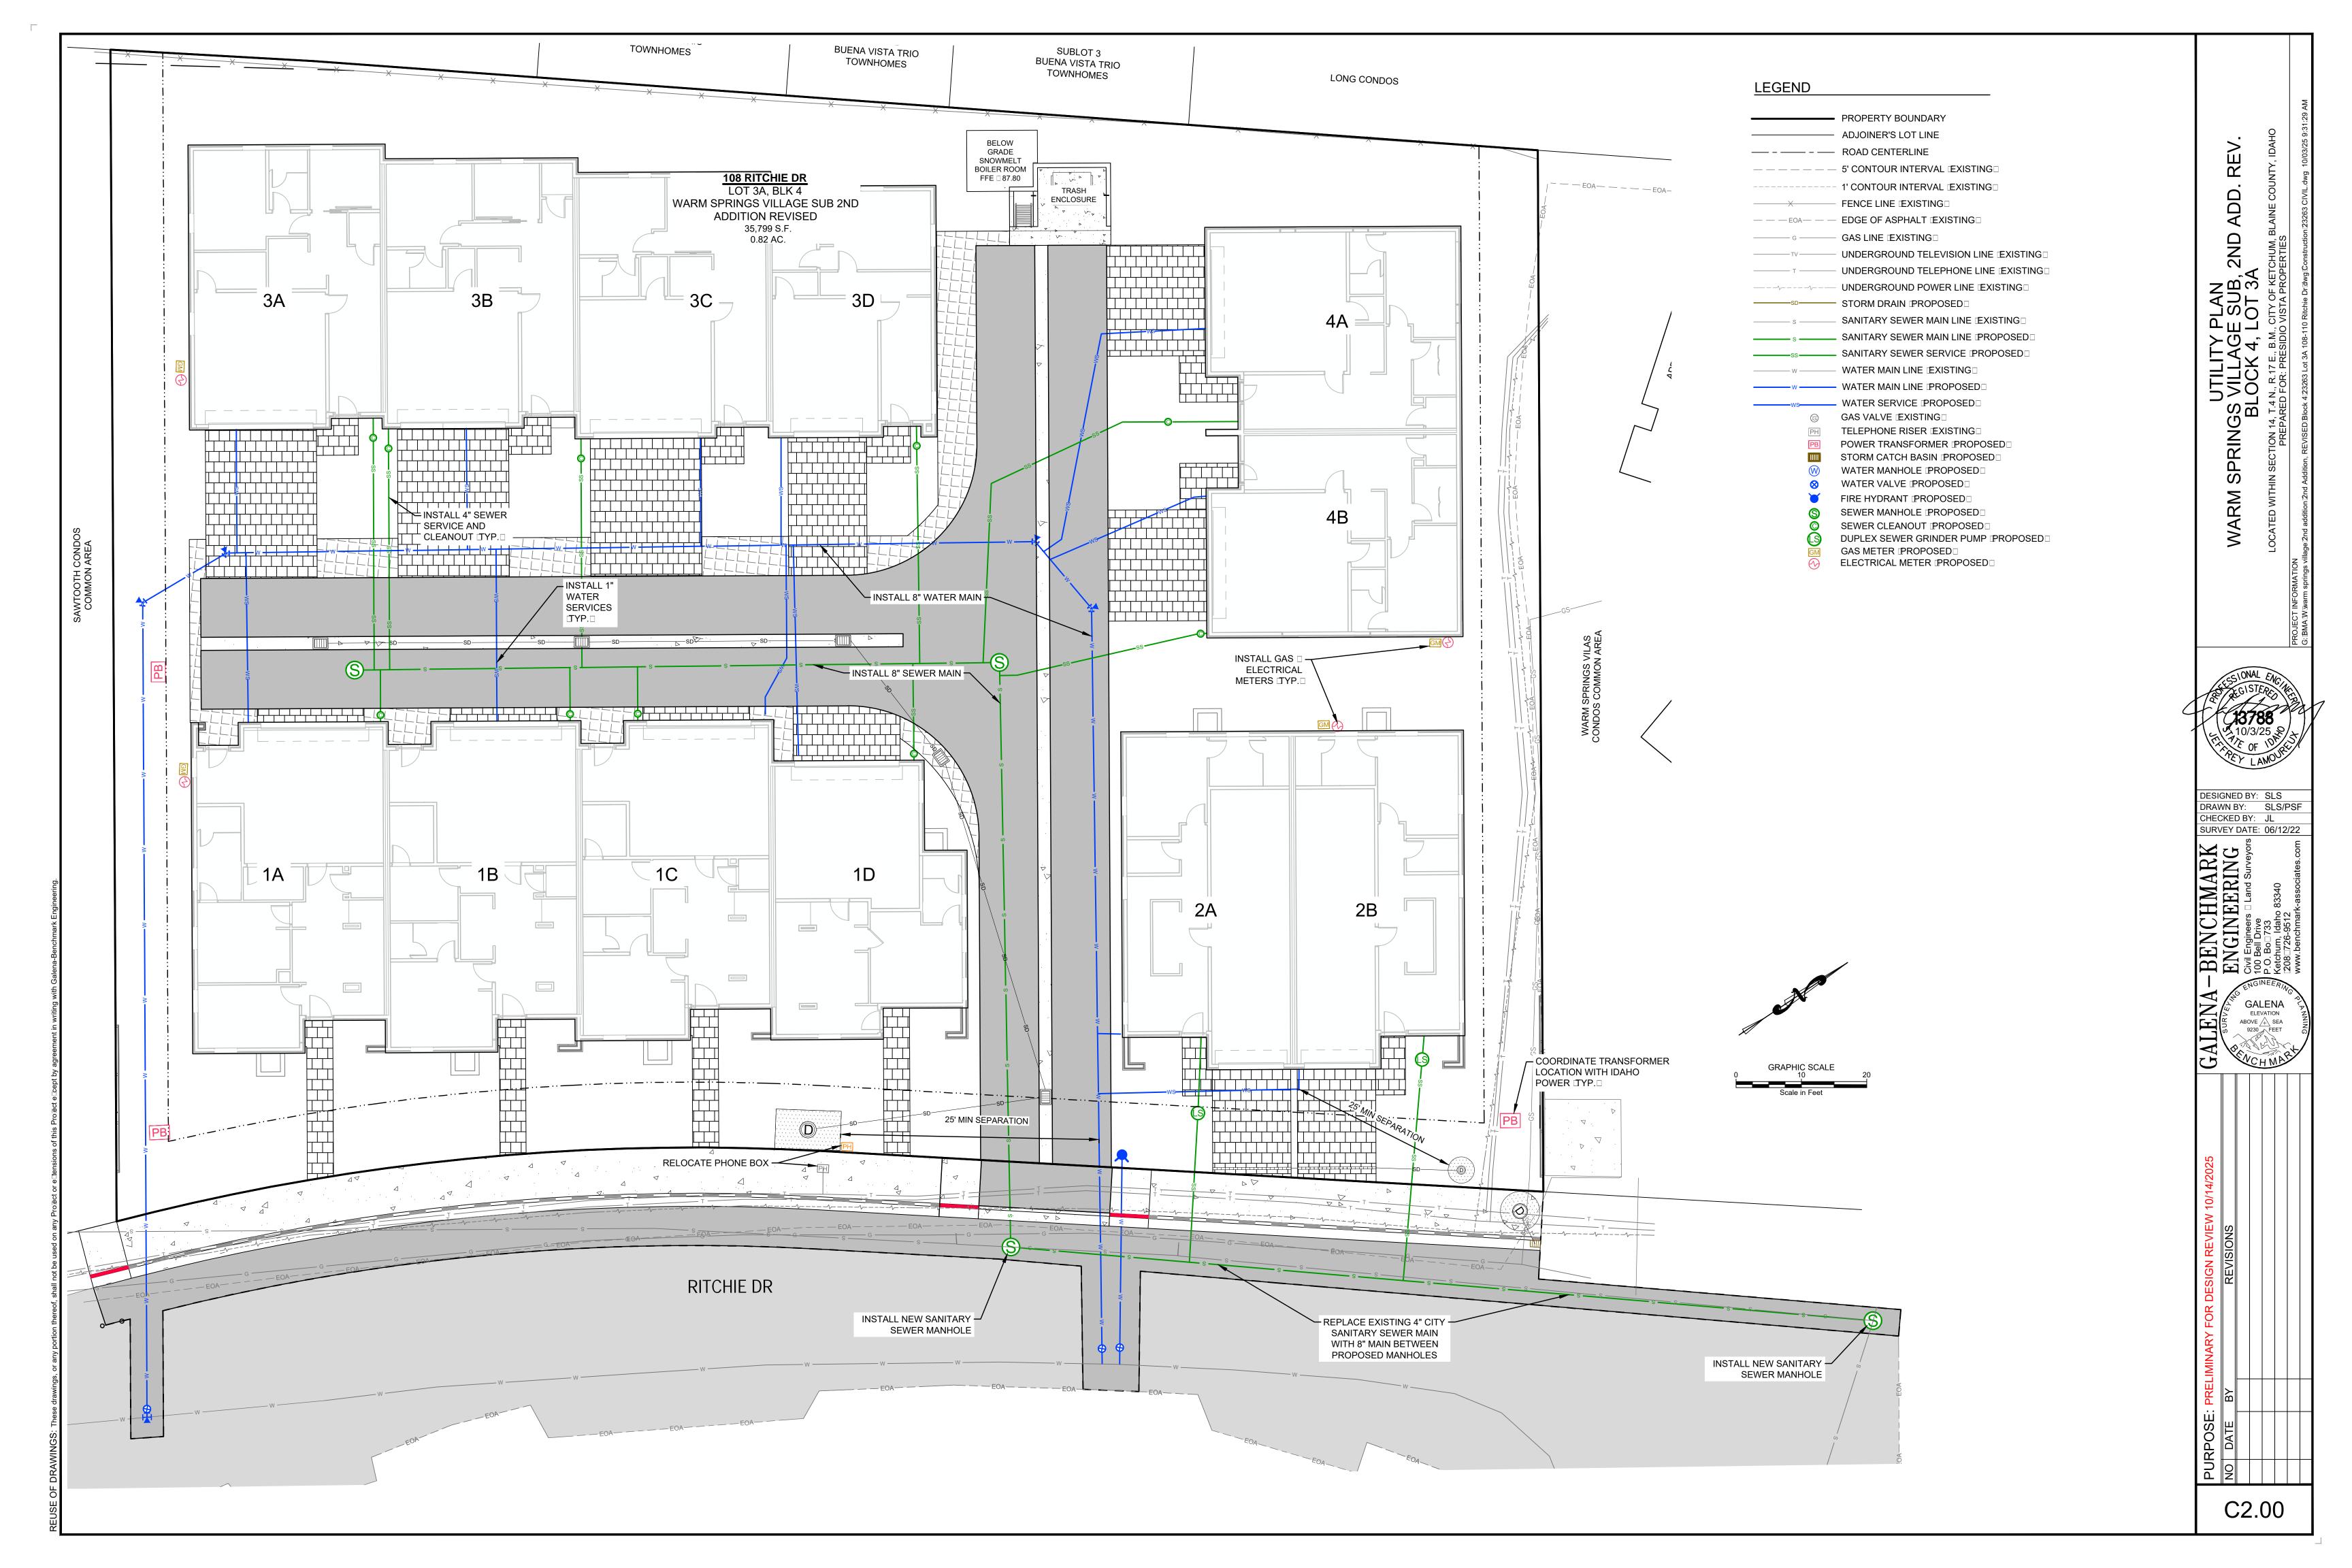
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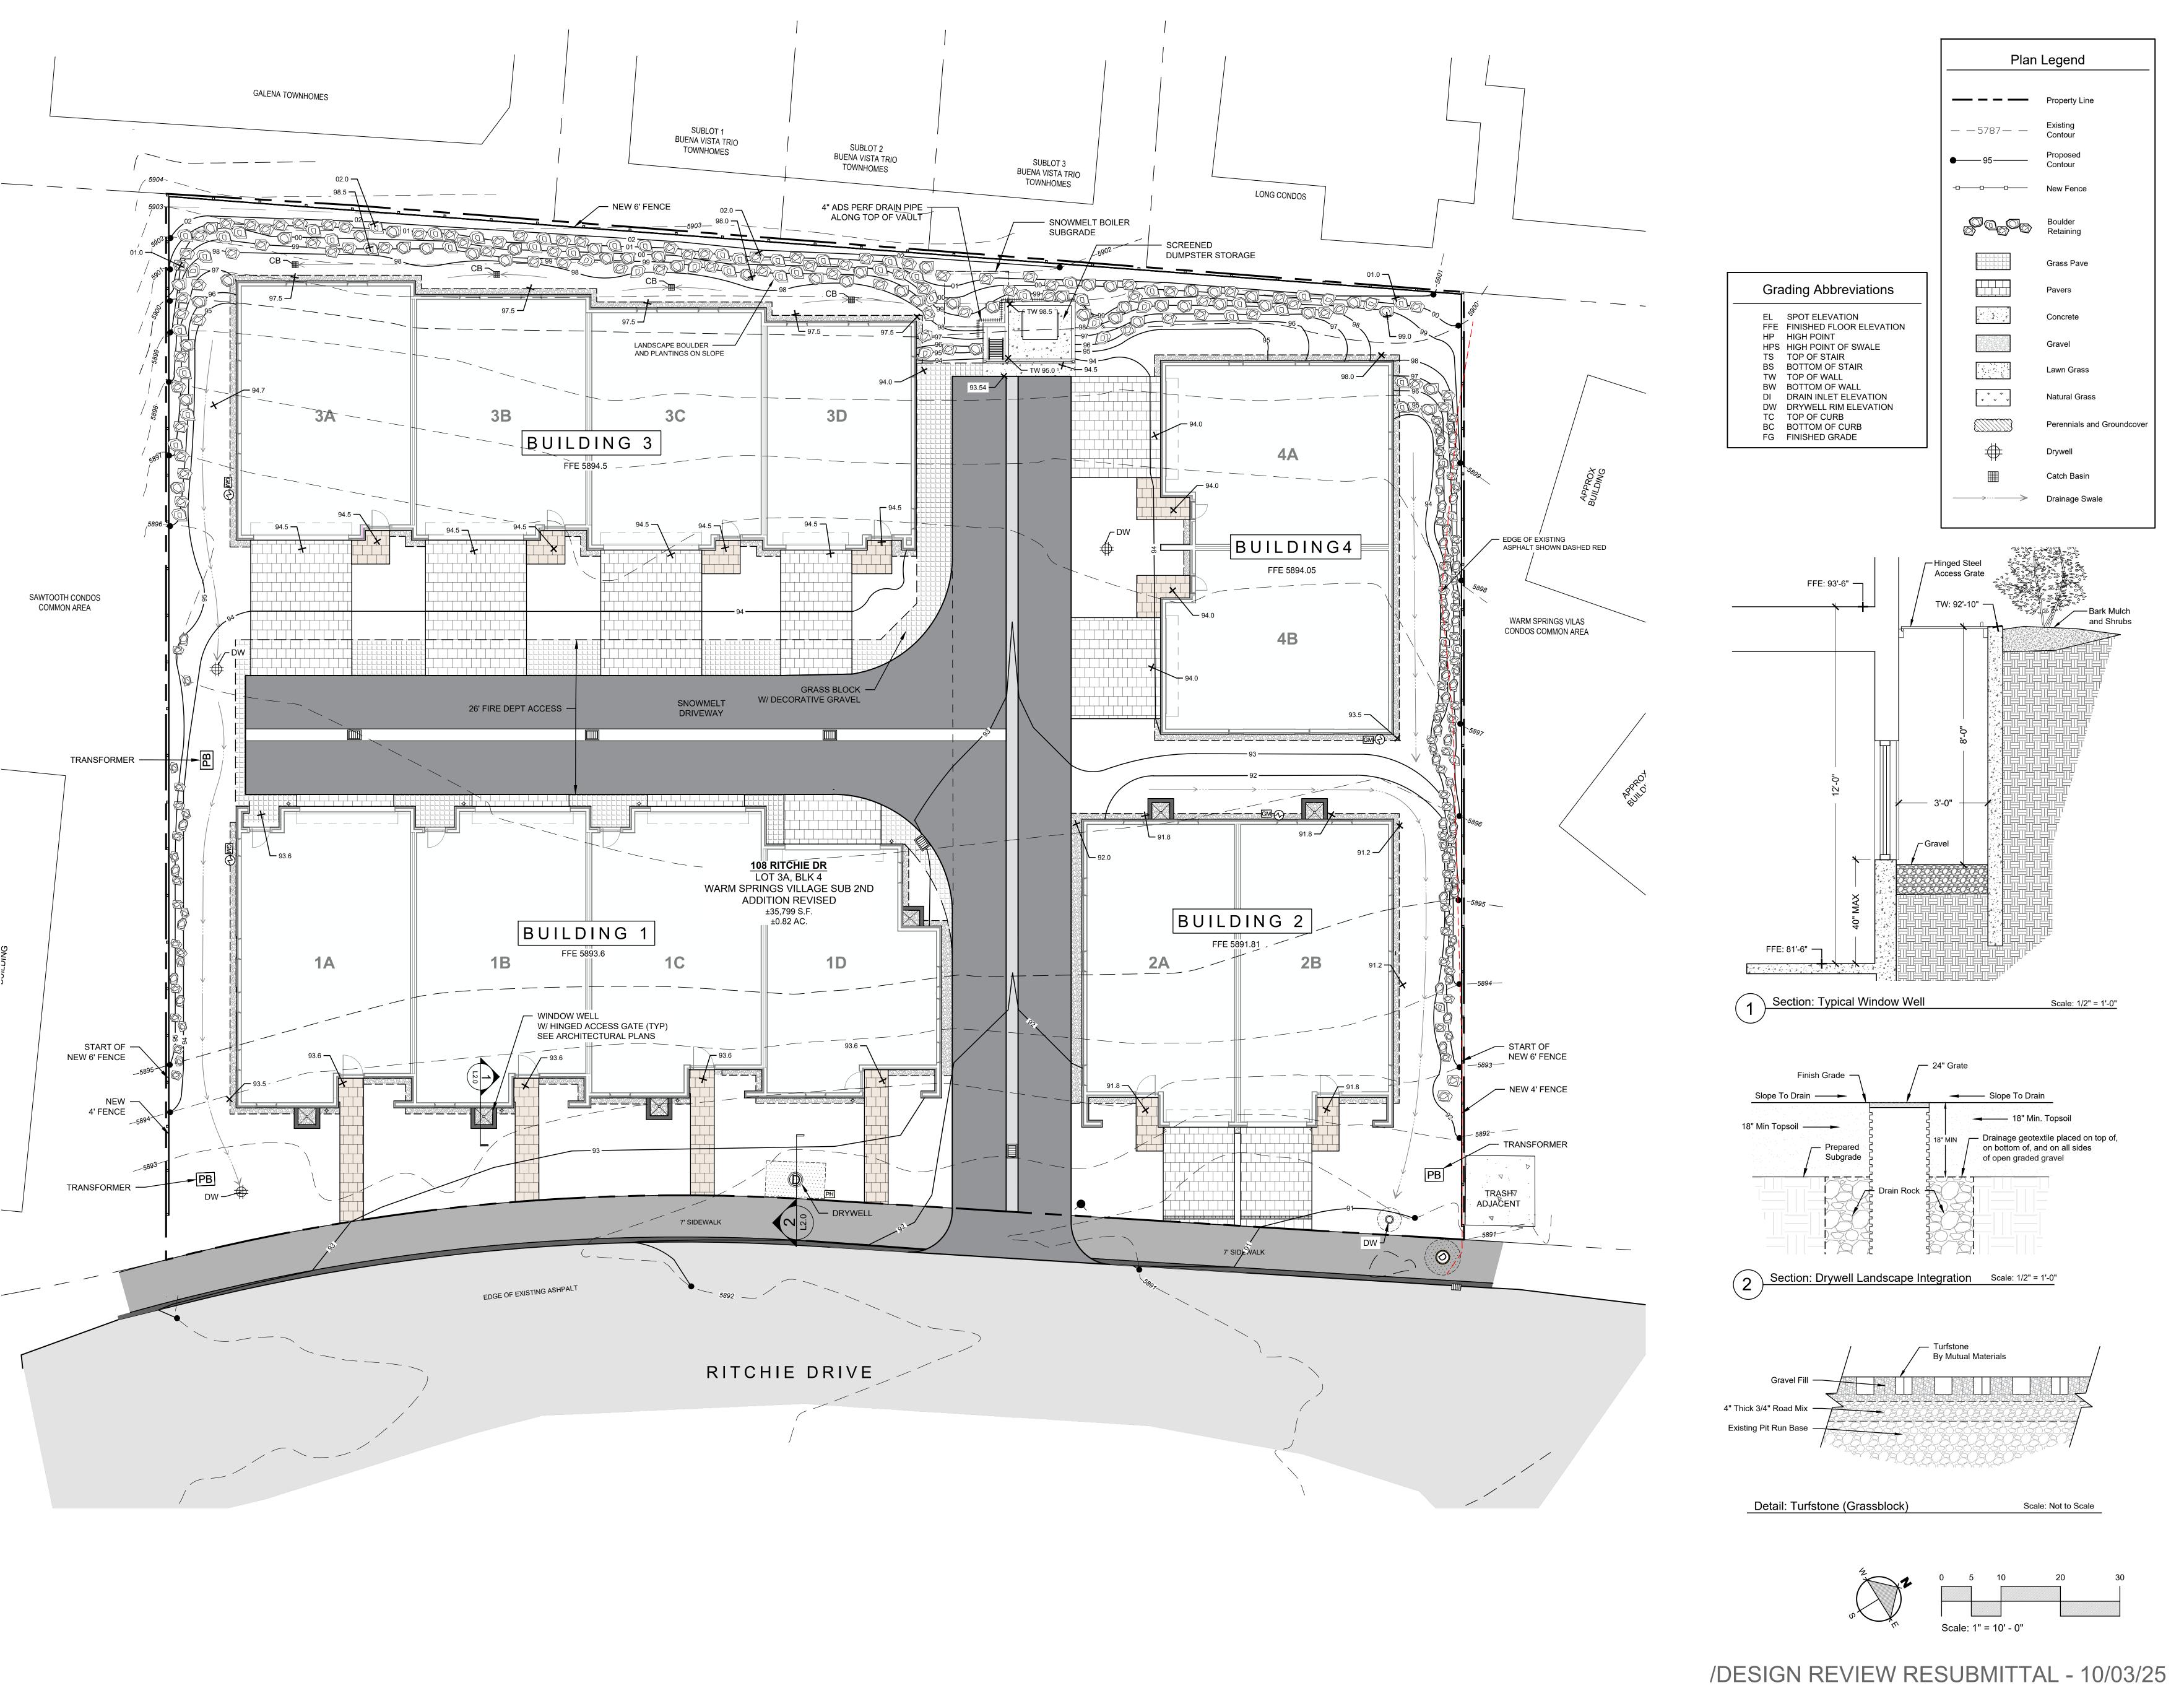
DRAWING NUMBER: **A-006**

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INTERMOUNTAIN GAS COMPANY WILL SERVE 1 NTS **IDAHO POWER WILL SERVE LETTER** NTS CLEAR CREEK DISPOSAL WILL SERVE LETTER





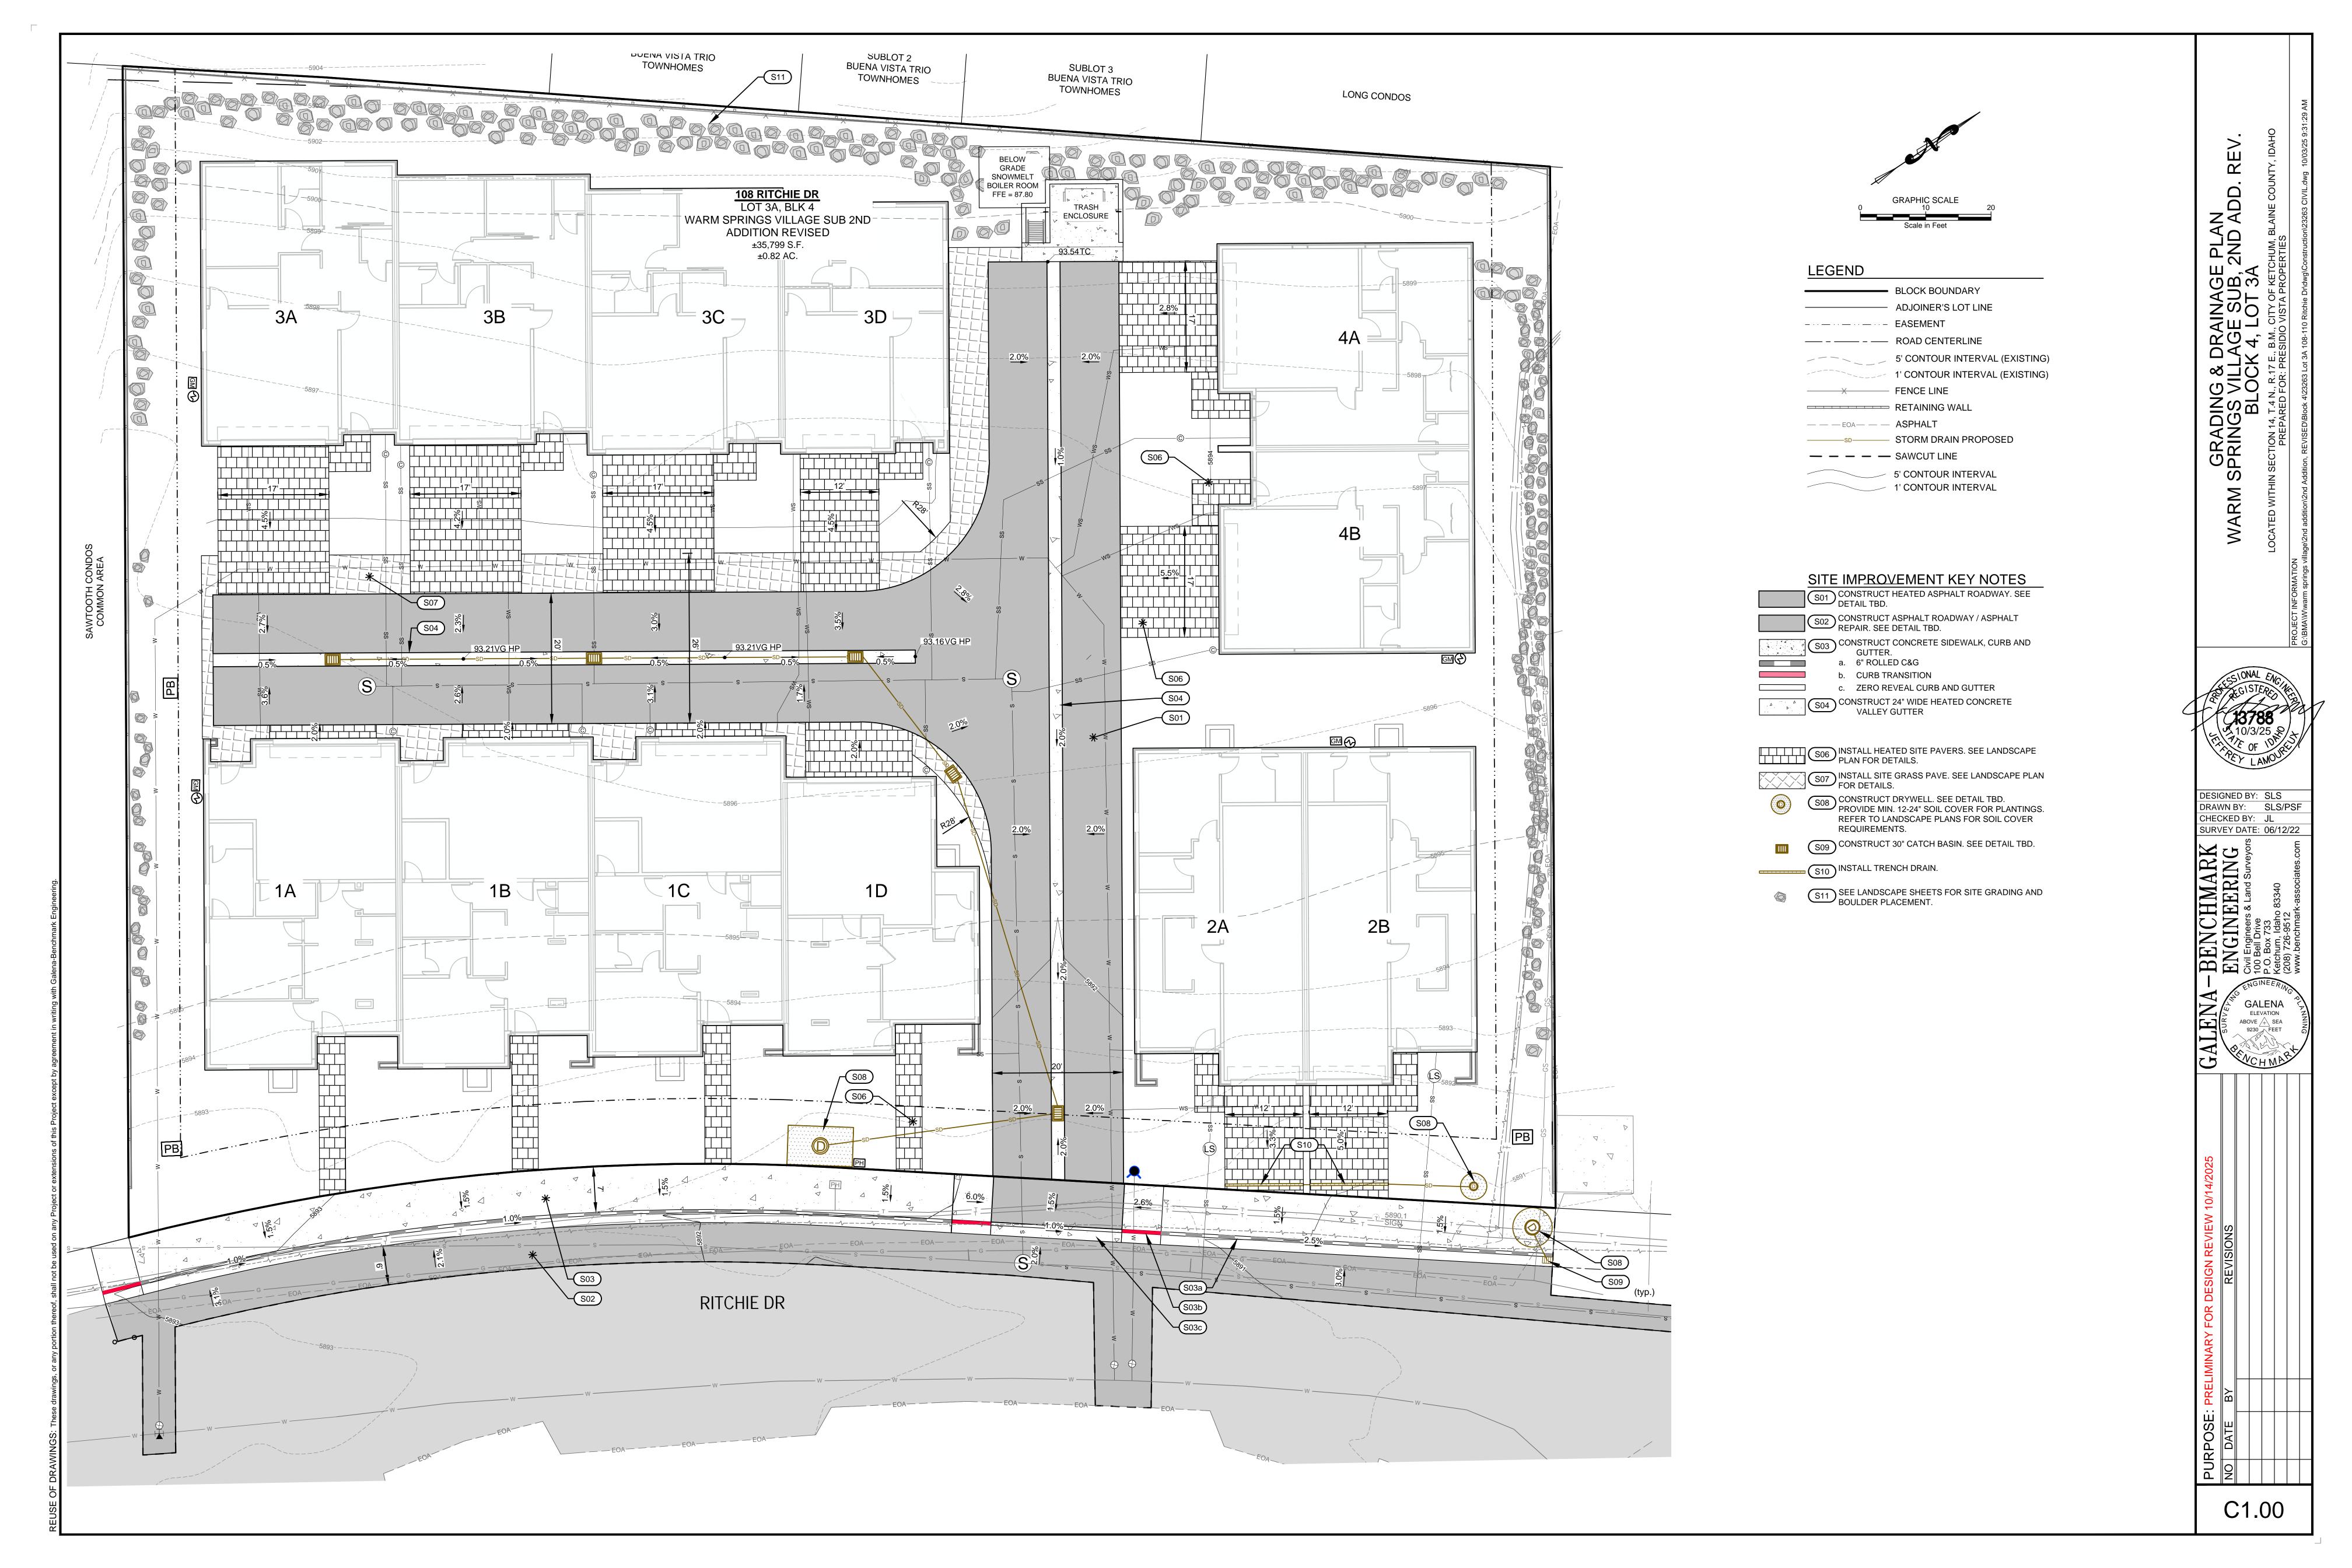


Warm Springs

Job No: 23.31 Scale: 1"=10'-0" ssue/Revisions: Date: Concept Update 07/10/ Design Review 11/06/


DR Resubmission 10/03/2


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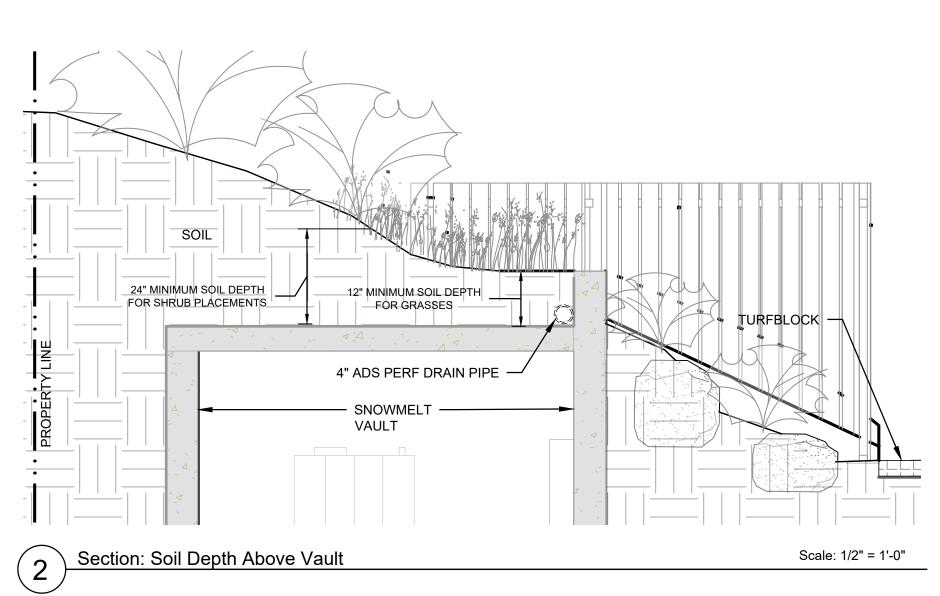


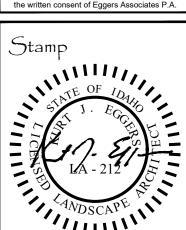
Sheet Title: Grading





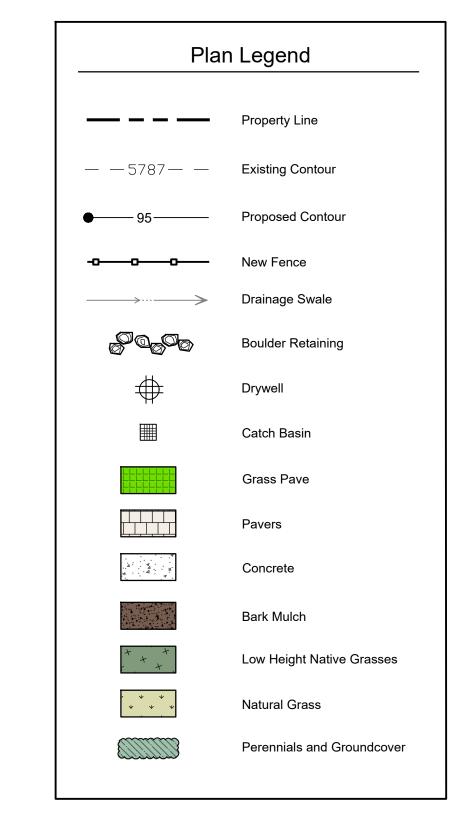

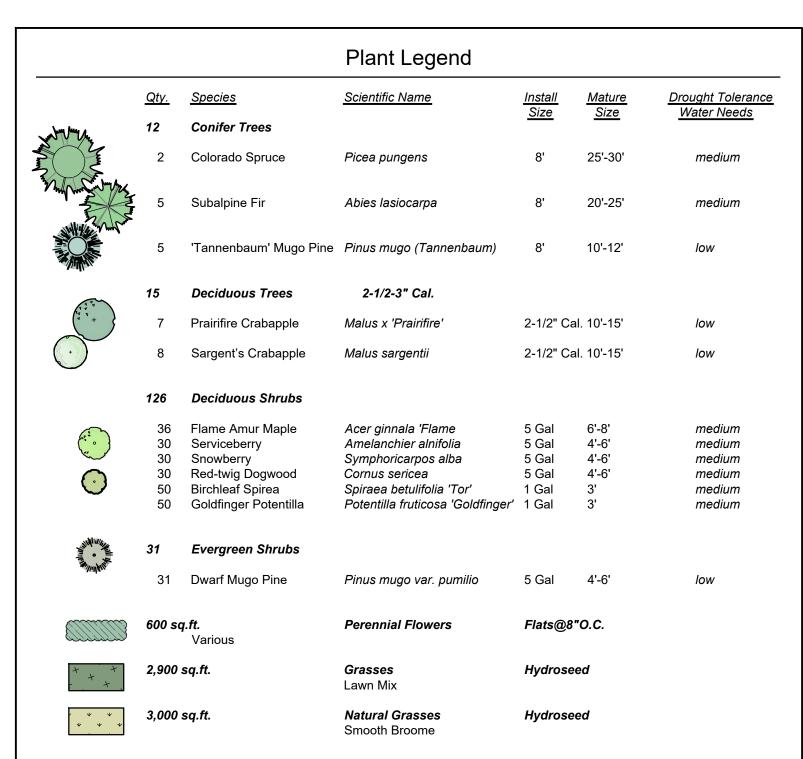

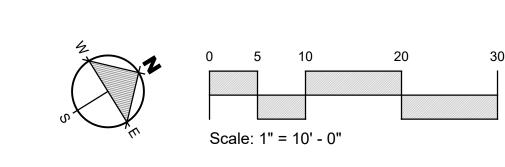

DESIGN REVIEW RESUBMITTAL - 10/03/25

Warm Springs

EGGERS ASSOCIATES, P.A.

[landscape architecture]

3. Box 953

T(208) 725-0988

108 & 110 Kichie Drive
Lots 3 & 4
Warm Springs Village Subd

Job No: 23.31

Scale: 1"=10'-0"

Issue/Revisions: Date:

Concept Update 07/10/24

 Concept Update
 07/10/2

 Design Review
 11/06/2

 DR Resubmission
 03/14/2

 DR Resubmission
 06/25/2


 DR Resubmission
 07/17/2

 DR Resubmission
 08/04/2

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DR Resubmission 10/03/2

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Sheet Title:
Landscape
Plan


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Warm Springs

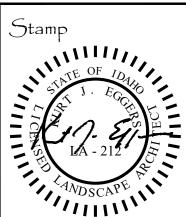
Job No: 23.31 Scale: 1"=10'-0" Issue/Revisions: Date: Concept Update 07/10/2

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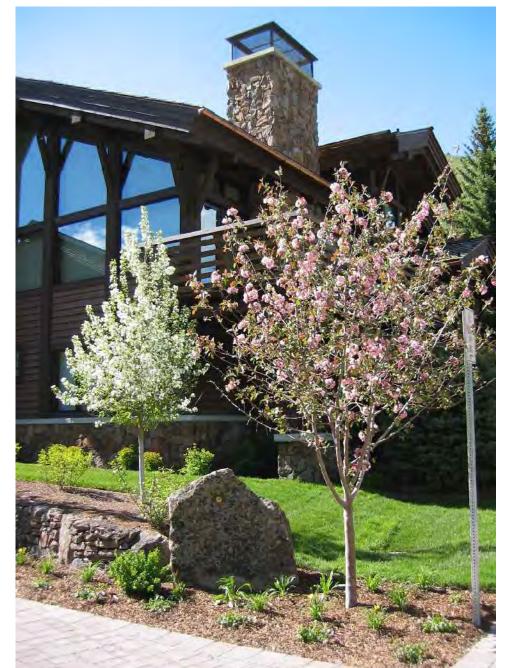
Sheet Title: Fencing


Sheet No:

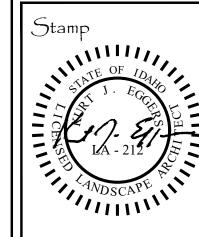

Sheet Title:
Plant
Materials

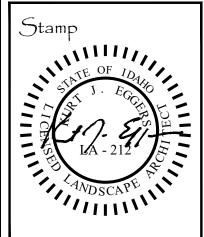Sheet No:



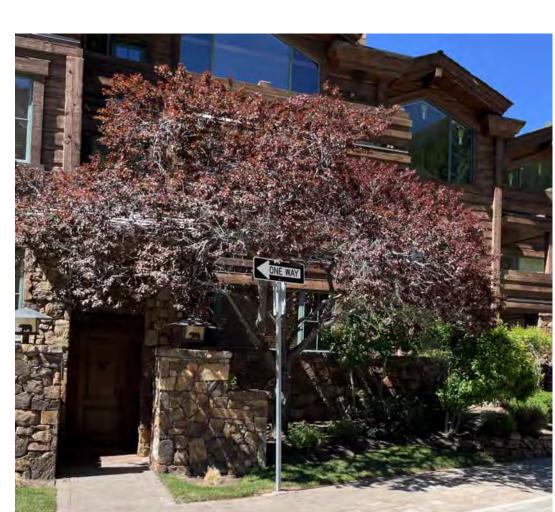










Mugo Pine Tree (6 - 8 Feet Installation Height)

Streetside Example: Low Natural Grass (Scottish Links)

PLANT MATERIALS

Flowering Crab Trees (8 Feet Installation Height)

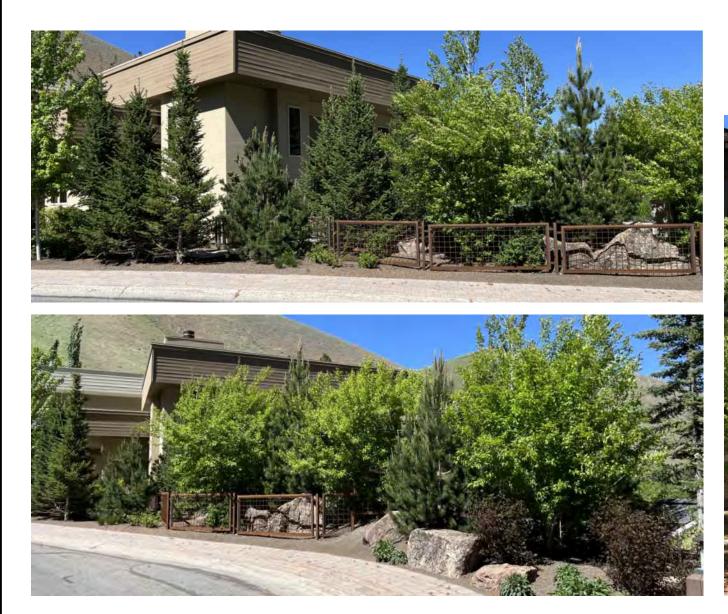











STREET PLANTING EXAMPLES



Transformer Screening

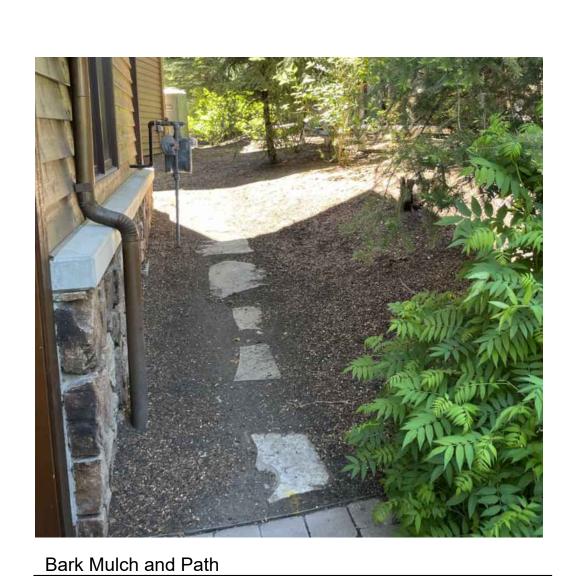



HARDSCAPE MATERIALS

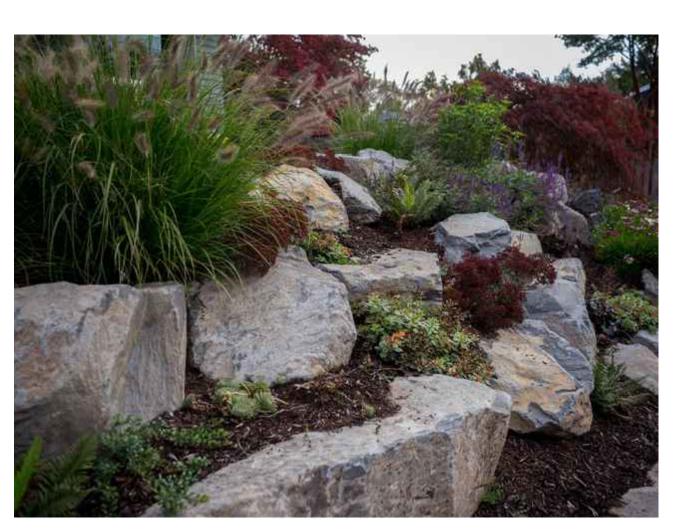

Landscape Boulders With Plantings

Driveable Permeable Pavers / Filled with Decorative Gravel

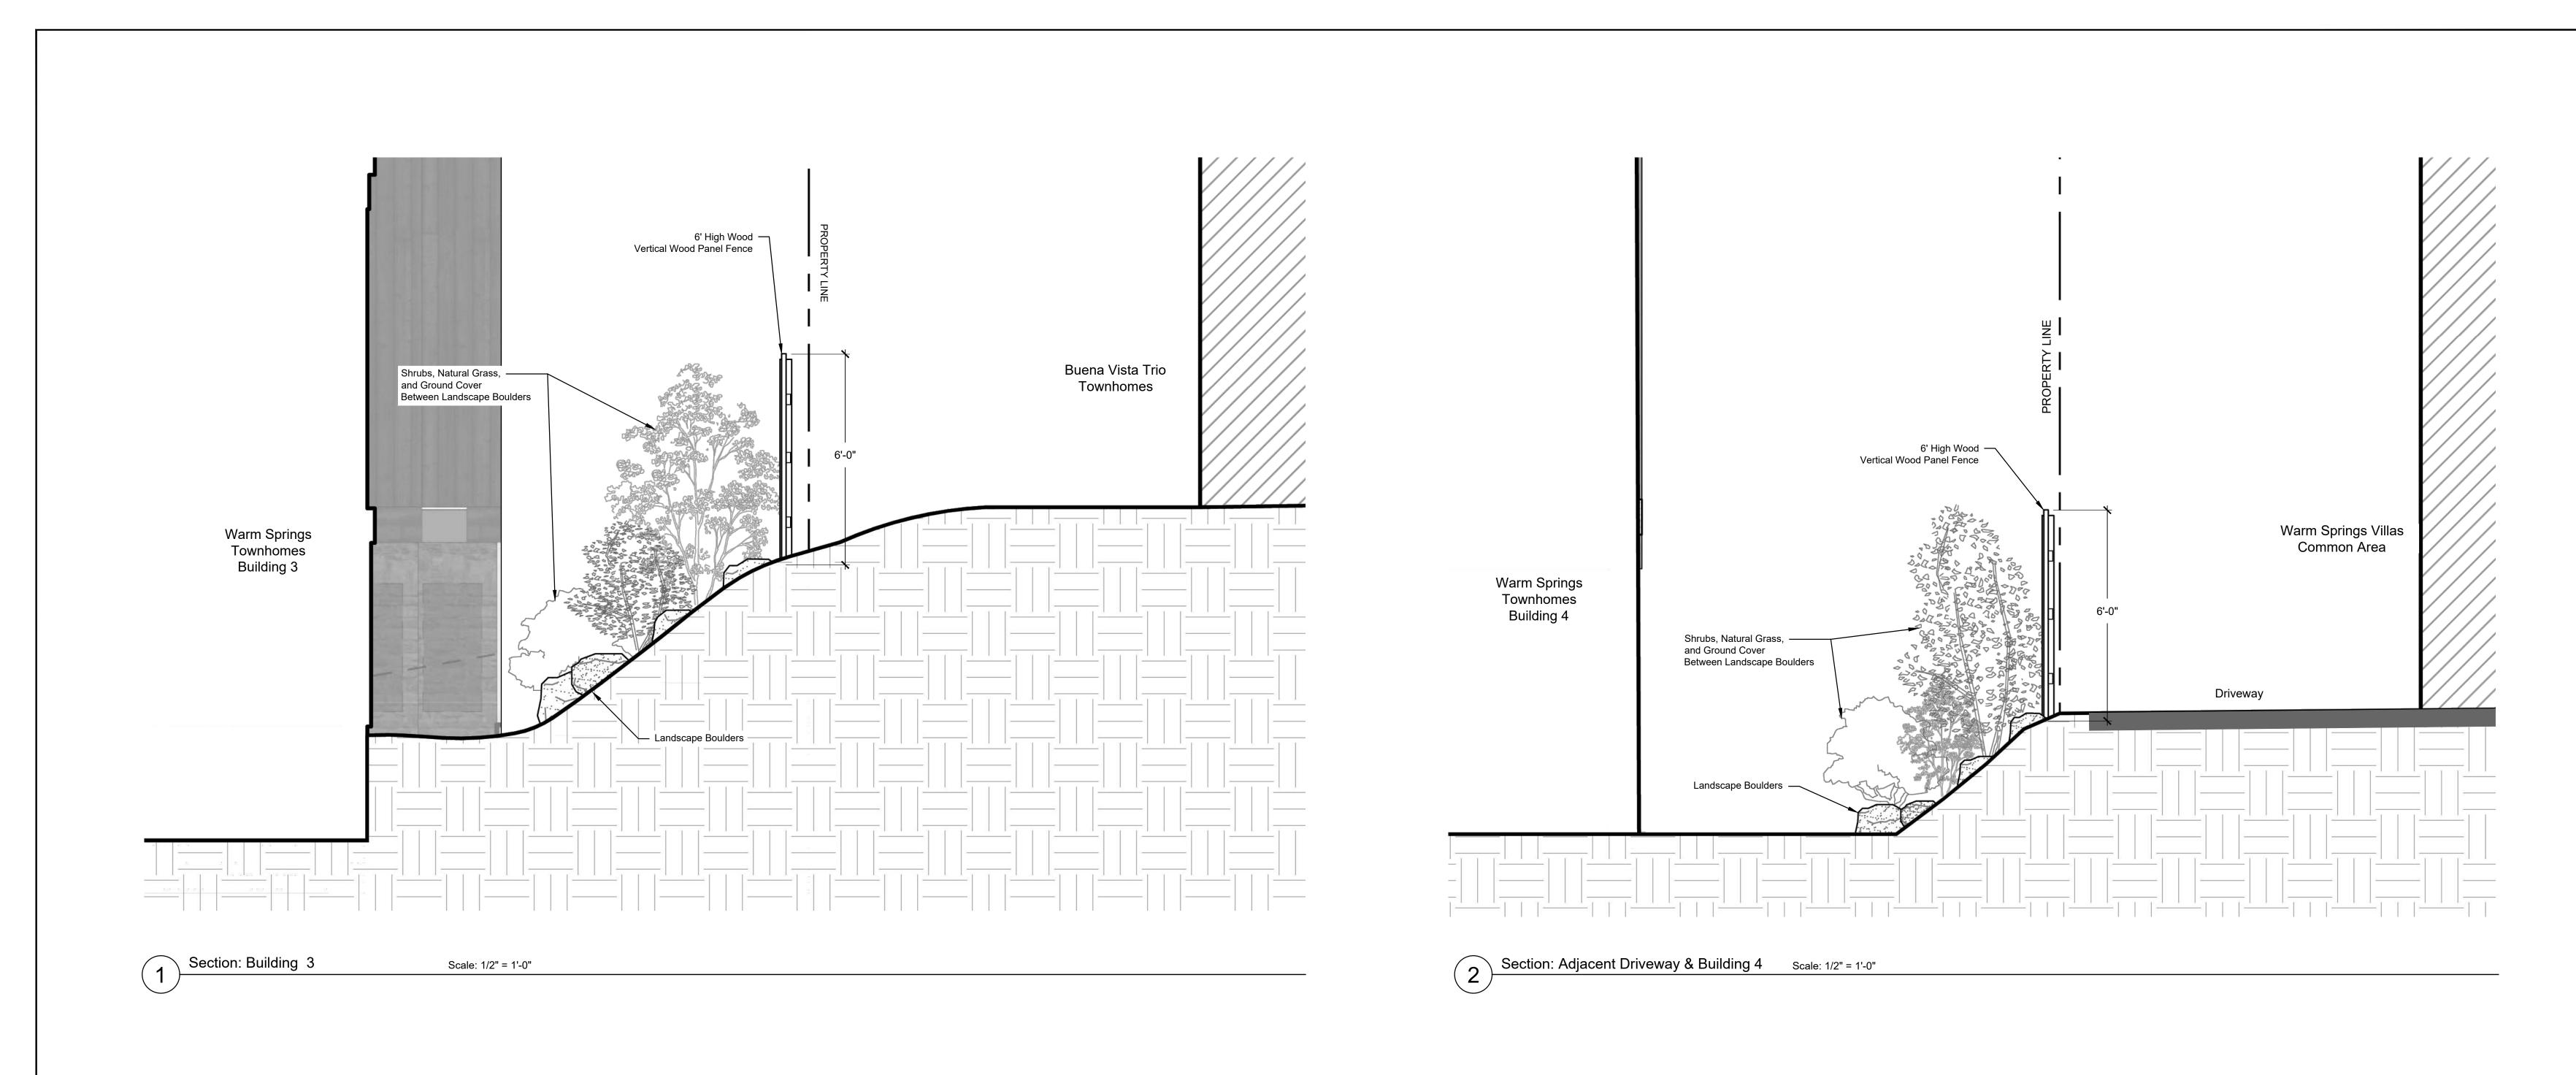

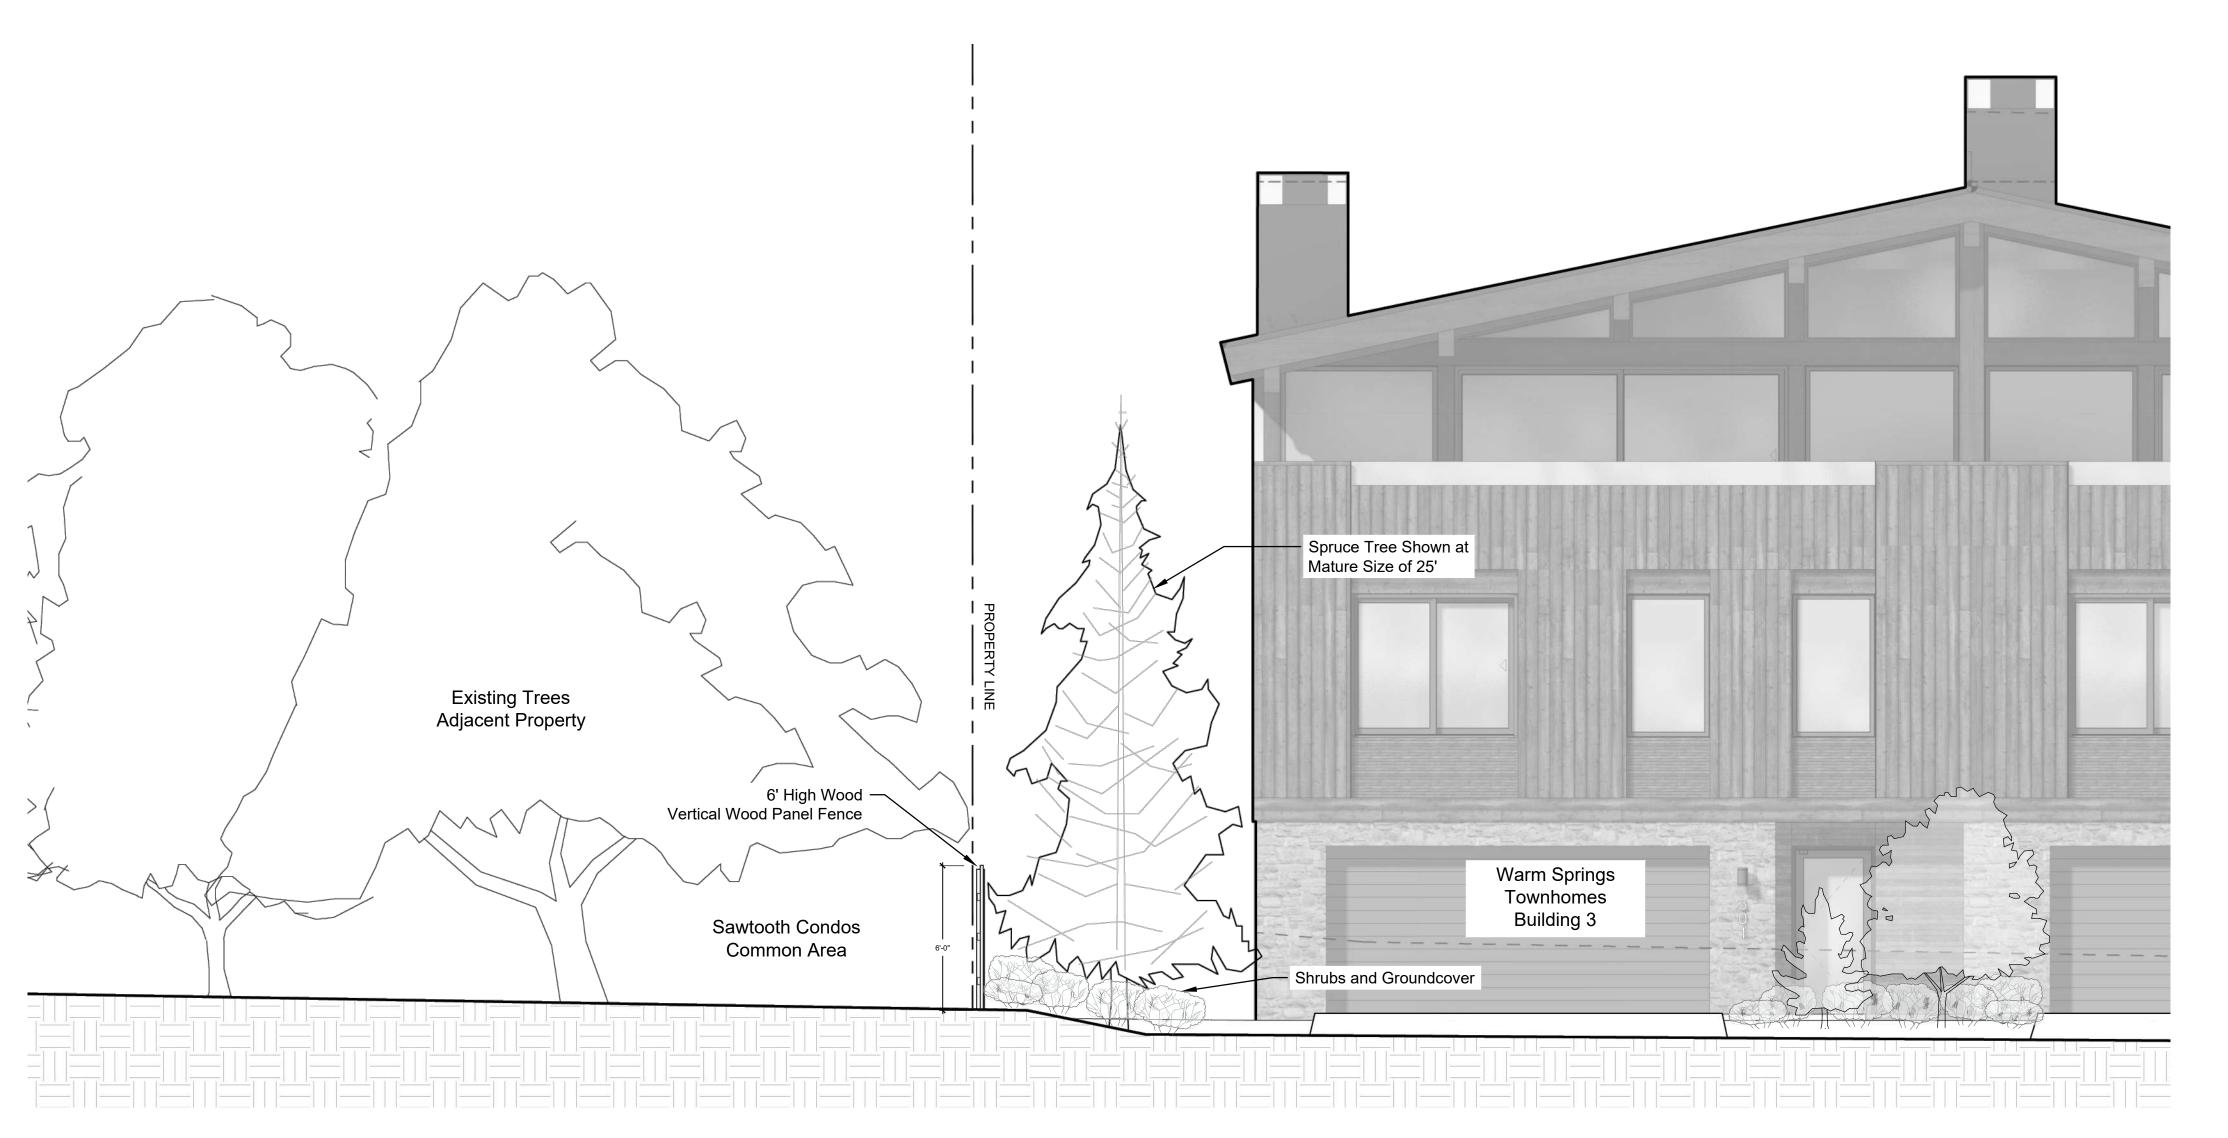

3 Elevation: Adjacent Common Area & Building 3

Scale: 1/4" = 1'-0"

Warm Springs

EGGERS ASSOCIATES, P.A.

[landscape architecture]
.O.Box 953

Warm Springs Village Subd.

Job No: 23.31

Scale:

|ssue/Revisions: Date:

 Concept Update
 07/10/24

 Design Review
 11/06/24


 DR Resubmission
 03/14/25

 DR Resubmission
 06/25/25

DR Resubmission 08/04/25

DR Resubmission 10/03/25

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Sheet Title: Site Sections

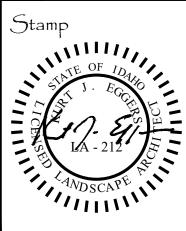Sheet No:

CD	CONDENSATE DRAIN	MV	MIXING VALVE
CONT	CONTINUATION	O/H	OVERHEAD
CW	COLD WATER	G	NATURAL GAS
DN	DOWN	PD	PUMPED DISCHARGE
ET	EXPANSION TANK	PRV	PRESSURE REDUCING VALVE
EWC	ELECTRIC WATER COOLER	RP	RECIRCULATION PUMP
ex.	EXISTING	S, SAN	SANITARY
FCO	FLOOR CLEANOUT	SH	SHOWER
FD	FLOOR DRAIN	SK	SINK
FHB	FREEZEPROOF HOSE BIBB	TP	TRAP PRIMER
FS	FLOOR SINK	TYP	TYPICAL
FRH	FREEZEPROOF ROOF HYDRANT	UR	URINAL
FWH	FREEZEPROOF WALL HYDRANT	V	VENT
GCO	GRADE CLEANOUT	VTR	VENT THROUGH ROOF
GI	GREASE INTERCEPTOR	WC	WATER CLOSET
НВ	HOSE BIBB	W.C.	WATER COLUMN
HD	HUB DRAIN	WCO	WALL CLEANOUT
HWS	HOT WATER SUPPLY	WHA	WATER HAMMER ARRESTER
HWR	HOT WATER RETURN	WMB	WASHING MACHINE BOX

	COLD WATER PIPE
	HOT WATER PIPE
	HOT WATER RETURN PIPE
s	SANITARY PIPE
	VENT PIPE
G	NATURAL GAS PIPE
	GREASE WASTE PIPE
o	PIPE UP / PIPE DOWN
	PIPE TEE FROM TOP / TEE FROM BOTTOM
	PIPE CAP / PIPE CONTINUATION
\	DIRECTIONAL FLOW ARROW
- \$ - - ₹ -	BALL VALVE / CHECK VALVE
— <u>×</u> — —×—	MIXING VALVE / PRESSURE REDUCING VALVE
	FLOOR DRAIN / FLOOR SINK
	WATER HAMMER ARRESTOR
<u> </u>	GAS COCK / GAS SOLENOID VALVE
∞	P-TRAP
©:	HUB DRAIN
•	FLOOR CLEANOUT / GRADE CLEANOUT
8	VENT THROUGH ROOF
<u> </u>	PIPE CLEANOUT / WALL CLEANOUT

LEGEND	
SYMBOLS	DESCRIPTION
•	DUCT UP
	DUCT UP
	DUCT DOWN
UNIT #	EQUIPMENT TYPE EQUIPMENT NUMBER. WHERE A LETTER IS USED, THERE ARE MULTIPLE

INSTANCES

SPECIFICATIONS

IT IS THE CONTRACTOR'S RESPONSIBILITY TO CONTACT THE LOCAL GAS UTILITY PROVIDER TO CONFIRM THE AVAILABILITY OF THE INDICATED DESIGN DELIVERY PRESSURE PRIOR TO COMMENCING WORK.

ALL GAS PIPING SHALL BE INSTALLED IN STRICT ACCORDANCE WITH THE INTERNATIONAL FUEL GAS CODE AND NFPA 54.

REQUIREMENT, CONTRACTOR SHALL PROVIDE APPROPRIATE PRESSURE REGULATING VALVE.

VENT LIMITER IS ACCEPTABLE WHERE APPROVED BY THE LOCAL JURISDICTION).

ABOVE GRADE GAS PIPING SHALL BE SCHEDULE 40 BLACK STEEL (ASTM A53/A53M). FITTINGS SHALL BE ASME B I G.3 MALLEABLE IRON OR ASTM A234/A234M WROUGHT STEEL WELDING TYPE. JOINTS SHALL BE THREADED OR WELDED TO ASME B31.1.

BELOW GRADE GAS PIPING SHALL BE FLEXIBLE POLYETHYLENE TUBING AND SHALL COMPLY WITH ASTM D25 | 3 AND CSA B | 37.4, AND SHALL BE INSTALLED IN ACCORDANCE WITH IFGC SECTION 402. I 1.2. PROVIDE MANUFACTURED RISER ASSEMBLY TO TRANSITION FROM TUBING TO ABOVEGROUND METALLIC PIPING.

SHUTOFF VALVES SHALL BE PROVIDED AND LOCATED IN PLACES SO AS TO PROVIDE ACCESS FOR OPERATION AND SHALL BE INSTALLED SO AS TO BE PROTECTED FROM DAMAGE. ALL GAS FIRED APPLIANCES ARE PROVIDED WITH A GAS PRESSURE OF 7"W.C. AT FINAL EQUIPMENT CONNECTION. IF 7"W.C. EXCEEDS EQUIPMENT'S SPECIFIC INLET PRESSURE

GAS PIPING ON ROOF SURFACES SHALL BE ELEVATED NO LESS THAN 3½" INCHES ABOVE ROOF SURFACE AND SHALL BE CLAMPED TO RUBBER CHANNEL SUPPORTS (MIFAB C I O SERIES OR EQUAL). PROVIDE SUPPORT AT EVERY ELBOW. THE MAXIMUM SPACING OF SUPPORTS SHALL BE: 🔏 PIPE: 5'-0", ¾" TO 1¼" PIPING: 6'-0", 1½" AND LARGER: 12'-0". VERTICAL PIPING SHALL BE SUPPORTED AT BASE, TOP AND AT 10' INTERVALS (MINIMUM).

ALL EXTERIOR GAS PIPING ON ROOF SHALL BE PRIMED AND PAINTED O.S.H.A. YELLOW. GAS PIPING RUNNING ON EXTERIOR WALLS SHALL BE PRIMED AND PAINTED TO MATCH BUILDING WALL.

EXPOSED GAS PIPING SHALL BE IDENTIFIED BY A YELLOW LABEL MARKED 'GAS' IN BLACK LETTERS. ALL PIPING GREATER THAN 7"W.C. SERVICE PRESSURE SHALL BE IDENTIFIED BY A YELLOW LABEL WITH BLACK LETTERS INDICATING THE PIPING SYSTEM PRESSURE. THE SYSTEM SHALL BE MARKED AT THE BEGINNING, ALL ENDS AND AT INTERVALS NOT EXCEEDING 5

FEET ALONG ITS EXPOSED LENGTH.

BALL VALVES: THREE PIECE BODY, FULL PORT, CHROME PLATED BALL, BLOWOUT PROOF STEM, TFE SEATS, UL LISTED FOR FLAMMABLE LIQUIDS, 600 PSI WOG, THREADED ENDS. PRESSURE REGULATOR VALVE: SINGLE STAGE AND SUITABLE FOR NATURAL GAS, STEEL JACKET AND CORROSION RESISTANT COMPONENTS, THREADED FOR REGULATORS NPS 2 AND SMALLER. PROVIDE SHUTOFF VALVE IMMEDIATELY AHEAD OF REGULATOR, AND INSTALL TEST PORTS ON EITHER SIDE REGULATOR, WITH UPSTREAM TEST PORT DOWNSTREAM OF SHUTOFF VALVE. REGULATORS SHALL BE INSTALLED PER IFGC SECTION 410. FOR 2PSI INLET, PROVIDE MAXITROL '325-L' SERIES. PROVIDE VENT PROTECTOR FOR EXTERIOR APPLICATIONS. FOR INTERIOR APPLICATIONS, VENT SHALL BE PIPED TO THE EXTERIOR WITH TURNDOWN AND SCREEN PROTECTOR (REGULATOR EQUIPPED WITH FACTORY PROVIDED

SHUTOFF VALVES SHALL BE PROVIDED IN ACCORDANCE WITH IFGC 409. INSTALL MANUAL GAS SHUTOFF VALVE FOR EACH GAS APPLIANCE AHEAD OF CORRUGATED STAINLESS STEEL TUBING OR COPPER CONNECTOR. SHUTOFF SHALL BE WITHIN 6' OF APPLIANCE.

INSTALL UNIONS IN PIPES NPS 2 AND SMALLER, ADJACENT TO EACH VALVE, AT FINAL CONNECTION TO EACH PIECE OF EQUIPMENT.

ALL GAS PIPING INSTALLED BENEATH THE BUILDING SLAB SHALL BE ENCASED IN WROUGHT IRON CONDUIT. PIPING SHALL BE PROTECTED AND INSTALLED ACCORDING TO THE INTERNATIONAL FUEL GAS CODE SECTION 404.14.

WATER HEATERS SHALL BE U.L. LISTED AND SHALL MEET OR EXCEED THE STANDBY LOSS REQUIREMENTS OF U.S. DEPT. OF ENERGY AND CURRENT EDITION OF ASHRAE/IESNA 90.1. WATER HEATERS SHALL HAVE I 50PSI WORKING PRESSURE AND BE EQUIPPED WITH EXTRUDED HIGH DENSITY ANODE ROD AND HIGH TEMPERATURE CUTOFF SWITCH. WATER HEATERS SHALL BE THERMOSTATICALLY CONTROLLED AND SET TO 120° UNLESS OTHERWISE NOTED. WATER HEATERS SHALL BE INSTALLED ON SUSPENDED PLATFORM, STEEL STAND OR

WATER HEATERS SHALL HAVE A MINIMUM 3 YEAR LIMITED WARRANTY.

CONCRETE PAD. AS INDICATED ON DRAWINGS.

TANK TYPE WATER HEATERS

WATER HEATERS SHALL BE INSTALLED LEVEL AND PLUMB. FIELD COORDINATE EXACT WATER HEATER LOCATION. MAINTAIN MANUFACTURER'S RECOMMENDED CLEARANCES, AND INSTALL SUCH THAT CONTROLS AND DEVICES ARE ACCESSIBLE FOR SERVICING.

INSTALL SHUTOFF VALVES IN COLD WATER INLET AND HOT WATER OUTLET. INSTALL THERMOMETER ON HOT WATER OUTLET. WATER HEATER SHALL HAVE ASME RATED COMBINATION TEMPERATURE AND PRESSURE RELIEF VALVE IN TOP PORTION OF TANK (FACTORY OR FIELD INSTALLED). PIPE RELIEF VALVE OUTLET TO FLOOR DRAIN. MOP SINK, INDIRECT WASTE RECEPTOR OR TO EXTERIOR. MAINTAIN CONTINUOUS DOWNWARD PITCH TOWARD DISCHARGE LOCATION, AND PROVIDE AIR GAP AT DISCHARGE LOCATION. WHERE WATER HEATER DRAIN PAN IS INDICATED ON PLANS, ROUTE DRAIN TO SAME LOCATION AS RELIEF VALVE AND DISCHARGE WITH AIR GAP.

HANGERS SHALL BE COMPLETE WITH RODS AND SUPPORTS PROPORTIONED TO THE SIZE OF PIPE TO BE SUPPORTED, IN ACCORDANCE WITH THE MANUFACTURER'S RECOMMENDATIONS.

SIZE HANGERS FOR INSULATED PIPING TO BEAR ON OUTSIDE OF INSULATION. PROVIDE INSULATION PROTECTORS AT HANGERS BEARING ON THE OUTSIDE OF INSULATION. PROVIDE A RIGID INSERT OR RIGID INSULATION AT EACH INSULATION PROTECTOR.

WHERE SEVERAL PIPES 2/4" AND SMALLER RUN PARALLEL AND IN THE SAME PLANE, THEY MAY BE SUPPORTED ON GANG OR MULTIPLE HANGERS. LARGER PIPING SHALL BE

PIPING SHALL BE SUPPORTED IN ACCORDANCE WITH IPC SECTION 308, AND SPACING OF HANGERS SHALL NOT EXCEED THE LIMITS SET FORTH IN TABLE 308.5. PIPES SHALL BE SUPPORTED WITHIN 1'-O" OF EACH ELBOW.

VERTICAL PIPE SUBJECT TO MOVEMENT SHALL BE SUPPORTED FROM THE WALL BY MEANS OF A PIPE CLAMP.

SUPPORT DOMESTIC WATER PIPING IN SPACES BEHIND PLUMBING FIXTURES BY BRACKETS AND U-BOLTS SECURED TO WASTE AND VENT STACKS. SIZE U-BOLTS TO BEAR ON THE

AFTER HANGER RODS ARE INSTALLED IN FINISHED CONCRETE CEILING, FILL THE REMAINING OPENING WITH CEMENT SO THAT NO HOLE SHOWS AT THE CEILING.

WHERE COPPER PIPING IS USED, NONFERROUS METAL SUPPORT(S) OR PROPER ISOLATION BETWEEN DISSIMILAR MATERIALS SHALL BE PROVIDED.

PIPE HANGERS AND SUPPORTS SHALL BE FURNISHED AND INSTALLED IN ACCORDANCE WITH RECOMMENDATIONS SET FORTH IN MANUFACTURER'S STANDARDIZATION SOCIETY

STANDARD PRACTICES NO. SP-69 AND SP-58. SIFFVES SHALL BE PROVIDED WHERE PIPES PASS THROUGH WALLS, FLOORS AND ROOFS.

PROVIDE STANDARD WEIGHT STEEL SLEEVES IN CONCRETE AND MASONRY CONSTRUCTION. PROVIDE 26GA GALVANIZED SHEET METAL SLEEVES IN INTERIOR DRYWALL CONSTRUCTION. SLEEVES SHALL BE THE FULL THICKNESS OF WALLS AND SHALL ALLOW FOR THE FULL THICKNESS OF PIPE INSULATION, WHERE APPLICABLE. SLEEVES MAY BE OMITTED WHEN OPENINGS ARE CORE DRILLED FOR CONCEALED VERTICAL AND HORIZONTAL PIPING. SLEEVES ARE NOT REQUIRED AT INDIVIDUAL PLUMBING

SLEEVES FOR ALL PIPING PENETRATING FIRE RATED WALLS AND FLOORS SHALL BE PROVIDED WITH 3M PIPE BARRIER NO. CP-25 FIRE PROOFING CAULKING, OR EQUAL, IN ANNULAR SPACE BETWEEN SLEEVE AND PIPING. CONTRACTOR SHALL VERIFY THE RATING OF THE WALL AND CONFIRM THE PENETRATION PROTECTION PROVIDED MEETS THAT RATING. PENETRATIONS THROUGH OUTSIDE WALLS SHALL BE WATERTIGHT. CAULK BETWEEN PLUMBING PIPE AND SLEEVE. PACK WITH FIBERGLASS AND CAULK, I" DEEP AT EACH FACE WITH

WASTE AND VENT PIPING SYSTEMS AND ACCESSORIES SANITARY PIPING SHALL BE PVC SCHEDULE 40 SOLID WALL PIPE AND DWV FITTING SYSTEM.

FIXTURES OR IN CONCRETE FLOOR SLABS ON GRADE, UNLESS OTHERWISE NOTED.

PIPE AND FITTINGS SHALL BE MANUFACTURED FROM PVC COMPOUND WITH A CELL CLASS OF 12454 PER ASTM D-1784 AND CONFORM WITH NATIONAL SANITATION FOUNDATION (NSF) STANDARD 14. PIPE SHALL BE IRON PIPE SIZE (IPS) CONFORMING TO ASTM D-1785 AND ASTM D-2665. INJECTION MOLDED FITTINGS SHALL CONFORM TO ASTM D-2665. FABRICATED FITTINGS SHALL CONFORM TO ASTM F-1866. SOLVENT CEMENTS SHALL CONFORM TO ASTM D-2564. PRIMER SHALL CONFORM TO ASTM F-656. BURIED PIPE SHALL

WASTE AND VENT PIPING SHALL BE TESTED IN ACCORDANCE WITH THE GOVERNING CODES. AT A MINIMUM, WASTE PIPING SHALL BE TESTED WITH AT LEAST 10 FOOT OF WATER HEAD PRESSURE APPLIED.

ALL VENTS THROUGH ROOF SHALL BE LOCATED AT LEAST 10'-0" AWAY FROM ANY AIR INTAKE, EVAPORATIVE COOLER, OR ANY OTHER DEVICE THAT WOULD DRAW AIR FROM THE VENT. FLASH AROUND ALL PIPES PENETRATING THROUGH ROOF WITH STANDARD MANUFACTURED FLASHINGS. FLASHING SHALL BE SHEET METAL WITH RUBBER GASKETS AND SHALL EXTEND INTO ROOFING AND UP PIPE DISTANCES IN ACCORDANCE WITH THE LOCAL CODE.

NO DOUBLE COMBINATION FITTINGS MAY BE UTILIZED IN THE HORIZONTAL.

NON-HARDENING SEALANT BETWEEN PIPE AND SLEEVE.

WHERE TWO HORIZONTAL PIPES (BACK-TO-BACK WATER CLOSETS OR TWO SANITARY BRANCHES) COMBINE IN THE VERTICAL, A DOUBLE COMBINATION WYE EIGHTH BEND FITTING SHALL BE INSTALLED. DOUBLE SANITARY TEE OR SANITARY CROSS IS NOT ACCEPTABLE.

WHERE DRAWINGS REQUIRE CONNECTION TO EXISTING SANITARY SEWER PIPING IN BUILDING, IT IS THE CONTRACTOR'S RESPONSIBILITY TO FIELD DETERMINE EXACT LOCATION, DEPTH AND DIRECTION OF FLOW PRIOR TO COMMENCING WORK. CONTRACTOR SHALL ALERT ARCHITECT/ENGINEER IF THERE IS A POTENTIAL ISSUE MAINTAINING PROPER SLOPE IN CONNECTING TO EXISTING, OR IF THERE IS A MORE DIRECT CONNECTION POSSIBLE. CONTRACTOR SHALL CONFIRM THAT ANY EXISTING PIPING TO BE REUSED IS CLEAN, FREE OF DEFECTS. ADEQUATELY SLOPED 1/8"/FT MINIMUM) AND THAT THERE ARE NO DIPS THAT COULD HOLD WATER. PROVIDE CAMERA SCOPING TO DOCUMENT THIS INFORMATION. CONTRACTOR SHALL ALERT ARCHITECT/ENGINEER OF ANY DEFICIENCIES.

DOMESTIC WATER SYSTEMS AND ACCESSORIES WATER PIPING ABOVE SLAB: TYPE 'L' HARD DRAWN COPPER TUBING, ASTM B88, WROUGHT SOLDER JOINTS, ANSI B16.22.

WATER PIPING BELOW SLAB: TYPE 'K' SOFT DRAWN COPPER TUBING, WITH NO JOINTS BELOW SLAB, ASTM B88.

ALL DOMESTIC HOT WATER PIPING SHALL HAVE A MINIMUM PRESSURE RATING OF LOOPSI AT L80°F.

DOMESTIC WATER PIPING SHALL BE TESTED IN ACCORDANCE WITH ALL GOVERNING CODES. PIPING SHALL BE PURGED OF DELETERIOUS MATTER AND DISINFECTED PRIOR TO UTILIZATION. PIPING TO BE FLUSHED AND STERILIZED IN ACCORDANCE WITH IPC 610.1 AND ALL APPLICABLE LOCAL AND STATE HEALTH DEPARTMENT STANDARDS.

BALL VALVES SHALL BE TWO-PIECE BRONZE BODY, LARGE PORT WITH SOLID, SMOOTH BORE CHROME PLATED BRASS BALL. SEATS SHALL BE REINFORCED TFE WITH TEFLON PACKING RING AND THREADED ADJUSTABLE PACKING NUT. PROVIDE STEM EXTENSION AS NEEDED TO PROVIDE HANDLE ON OUTSIDE OF PIPE INSULATION. VALVES SHALL BE APOLLO 70 OR

BACKFLOW PREVENTERS SHALL BE INSTALLED IN ACCESSIBLE LOCATIONS FOR EASE OF TESTING AND SERVICING. FOR BACKFLOW PREVENTERS WITH VENT CONNECTIONS. ROUTE VENT LINE TO NEAREST DRAIN AND DISCHARGE WITH AIR GAP. BACKFLOW PREVENTERS SHALL BE TESTED IN ACCORDANCE WITH IPC 3 | 2. | 0.2. CONTRACTOR SHALL PROVIDE CERTIFICATIONS THAT STATE DEVICES HAVE BEEN TESTED AND APPROVED.

THERMOMETERS SHALL BE 9" ADJUSTABLE ANGLE, 30°-180°F RANGE (TRERICE BX9 OR EQUAL). PRESSURE GAUGES SHALL BE 4½" DIAL SIZE, 0-160PSI (TRERICE 600CB OR EQUAL). CONTRACTOR SHALL FIELD VERIFY INCOMING DOMESTIC WATER PRESSURE TO CONFIRM ADEQUATE PRESSURE TO SERVE THE DOMESTIC WATER SYSTEM. CONTRACTOR SHALL ALERT ENGINEER TO A POTENTIAL LOW PRESSURE CONDITION. WHERE PRESSURE EXCEEDS 80PSI, PROVIDE PRESSURE REGULATING VALVE (WATTS LF223) AND UPSTREAM STRAINER (WATTS LSF777).

CONTRACTOR SHALL FIELD COORDINATE LOCATION OF ACCESSIBLE ISOLATION VALVES ON DOMESTIC HOT \$ COLD WATER SUPPLIES TO FIXTURES OR GROUPS OF FIXTURES SUCH THAT THEY MAY BE SHUT OFF FOR SERVICING. SERVICE AND HOSE BIBB VALVES SHALL BE IDENTIFIED. ALL OTHER VALVES INSTALLED IN LOCATIONS THAT ARE NOT ADJACENT TO THE FIXTURE(S) SHALL BE IDENTIFIED, INDICATING THE FIXTURE(S) SERVED.

INSULATE ALL DOMESTIC HOT WATER AND HOT WATER RECIRCULATION PIPING IN ACCORDANCE WITH IECC TABLE C403.2.10. PIPE UP TO 14: 1" THICK INSULATION. PIPE 1/5" OR LARGER: IX" THICK INSULATION

INSULATE ALL HORIZONTAL COLD WATER PIPING LOCATED ABOVE CEILING, VERTICAL PIPING LOCATED IN AN EXTERIOR WALL, EXPOSED PIPING (I.E. MECH ROOMS). PIPE UP TO I ": 🖊" THICK. PIPING 1/4" AND OVER: I "THICK INSULATION. ALL WATER AND DRAINAGE PIPING INSTALLED IN EXTERIOR WALLS SHALL BE WRAPPED IN I "THICK PIPE INSULATION AND BE LOCATED ON THE INTERIOR SIDE OF THE BUILDING INSULATION. IF INSTALLED IN EXTERIOR BLOCK WALLS, INTERSTITIAL SPACES SHALL BE FILLED WITH FOAM INSULATION.

ALL JOINTS SHALL BE SEALED WITH MATCHING VAPOR BARRIER TAPE.

INSULATION SHALL HAVE A K-FACTOR (AVERAGE THERMAL CONDUCTIVITY) NOT TO EXCEED 0.27 BTU-IN/HR x SQFT x °F.

PIPING PASSING UNDER FOOTINGS OR THROUGH FOUNDATION WALLS SHALL BE PROVIDED WITH A SLEEVE TWICE THE DIAMETER OF THE PIPE. OPEN ENDS OF SLEEVES SHALL BE SEALED. PIPING PASSING THROUGH CONCRETE OR CINDER WALLS AND FLOORS OR OTHER CORROSIVE MATERIAL SHALL BE PROTECTED IN ACCORDANCE WITH IPC 305.1. ALL PIPING INSTALLED THROUGH HOLES OR NOTCHES IN STUDS, JOISTS, RAFTERS OR SIMILAR MEMBERS SHALL BE PROTECTED BY STEEL SHIELD PLATES IN ACCORDANCE WITH IPC 305.6. VERTICAL STACKS IN WOOD CONSTRUCTION SHALL BE PROTECTED FROM BUILDING SETTLING WITH COMPRESSION/EXPANSION FITTINGS AND PIPE CLAMPS INSTALLED PER MANUFACTURER'S RECOMMENDATIONS (FERNCO XJ SERIES OR EQUAL).

SPECIFICATIONS

APPLICABLE CODES

INTERNATIONAL FIRE CODE (IFC), 2018 EDITION 2020 IFC CO AMENDMENTS

INTERNATIONAL PLUMBING CODE (IPC), 2018 EDITION 2020 IPC CO AMENDMENTS INTERNATIONAL MECHANICAL CODE (IMC), 2018 EDITION

2020 IMC CO AMENDMENTS INTERNATIONAL FUEL GAS CODE (IFGC), 2018 EDITION 2020 IFGC CO AMENDMENTS

NTERNATIONAL ENERGY CONSERVATION CODE (IECC), 2018 EDITION 2020 SUPPLEMENTS AND AMENDMENTS

GENERAL NOTES:

REFER TO ARCHITECTURAL REFLECTED CEILING PLANS FOR EXACT LOCATION OF ALL CEILING MOUNTED EQUIPMENT.

AREAS SHALL BE PAINTED FLAT BLACK. PAINT BLACK BEHIND ALL GRILLES.

ALL FIRE SEPARATIONS MUST BE PROTECTED WHEN APPLICABLE.

ALL DUCT DIMENSIONS INDICATED IN THESE DOCUMENTS ARE INSIDE-CLEAR DIMENSIONS. PORTIONS OF DUCTWORK OR PIPING VISIBLE THROUGH GRILLES AND REGISTERS IN FINISHED

ALL WIRING IN THE CEILING PLENUM SHALL BE PLENUM RATED CABLE.

MOUNTING FRAME OF CEILING MOUNTED AIR DISTRIBUTION DEVICES SHALL BE COMPATIBLE WITH CEILING TYPE. REFER TO ARCHITECTURAL DRAWINGS FOR CEILING TYPE.

PROVIDE NEW FILTERS (MERV 7 OR BETTER PER OWNER) FOR ALL APPLICABLE HVAC

EQUIPMENT AT THE END OF CONSTRUCTION.

ALL MATERIAL IN PLENUM MUST MEET FIRE AND SMOKE SPREAD AS REQUIRED BY NFPA 90A. ALL ROOF PENETRATIONS TO BE 12" APART AND AT LEAST 12" AWAY FROM CURBS, WALLS, AND DRAIN SUMPS TO PROVIDE ROOFING CONTRACTOR WITH SUFFICIENT ACCESS FOR FLASHING EACH ROOF PENETRATION.

SUBSTITUTIONS MUST BE APPROVED IN WRITING BY ARCHITECT PRIOR TO BID SUBMISSION. CONTRACTOR SHALL REVIEW ALL CONTRACT DOCUMENTS AND SHALL BE FAMILIAR WITH THE SCOPE AND REQUIREMENTS OF THIS PROJECT. ANY DISCREPANCIES OR LACK OF CLARITY IN THE DOCUMENTS SHALL BE IDENTIFIED TO THE ARCHITECT OR ENGINEER PRIOR TO THE SUBMISSION OF PRICING BIDS. WITH A SUBMITTED BID, CONTRACTOR IS ACCEPTING THESE DOCUMENTS AS SUFFICIENT DEFINITION OF THE SCOPE OF WORK, AND ANY ADDITIONAL COSTS BASED ON UNCLARITY OF CONTRACT DOCUMENTS WILL NOT BE CONSIDERED.

THE CONTRACTOR SHALL REFERENCE THE FULL SET OF CONSTRUCTION DOCUMENTS DURING PRICING AND CONSTRUCTION FOR COORDINATION BETWEEN DISCIPLINES RELATIVE TO THE MECHANICAL SCOPE.

EXISTING CONDITIONS:

CONTRACTOR SHALL VISIT THE SITE AND UNDERSTAND JOB CONDITIONS BEFORE SUBMITTING A PROPOSAL. IT SHALL BE THE CONTRACTOR'S RESPONSIBILITY TO VERIFY LOCATIONS AND SIZES OF ALL EXISTING UTILITY SERVICES PRIOR TO SUBMITTING HIS PROPOSAL. NO CONSIDERATION WILL BE GIVEN TO CLAIMS FOR EXTRA COST ARISING FROM CONTRACTOR'S FAILURE TO BE FULLY COGNIZANT OF JOB OR SITE CONDITIONS EXISTING AT TIME OF ACCEPTANCE OF BID.

ACTIVE SERVICES: WHEN ENCOUNTERED IN WORK, PROTECT, BRACE, SUPPORT EXISTING ACTIVE SEWERS, GAS AND OTHER SERVICES REQUIRED FOR PROPER EXECUTION OF WORK. IF EXISTING ACTIVE SERVICES ARE ENCOUNTERED THAT REQUIRE RELOCATION, RELOCATE AS APPROVED. DO NOT PREVENT OR DISTURB OPERATION OF ACTIVE SERVICES THAT ARE TO

INACTIVE SERVICES: WHEN ENCOUNTERED IN WORK, REMOVE, CAP OR PLUG INACTIVE

INTERRUPTION OF SERVICES: WHERE WORK MAKES TEMPORARY SHUT-DOWNS OF SERVICES UNAVOIDABLE, SHUT DOWN AT NIGHT, OR AT SUCH TIMES AS APPROVED BY OWNER, WHICH WILL CAUSE LEAST INTERFERENCE WITH ESTABLISHED OPERATING ROUTINE. ARRANGE WORK TO ASSURE THAT SERVICES WILL BE SHUT DOWN ONLY DURING TIME ACTUALLY REQUIRED TO MAKE NECESSARY CONNECTION TO EXISTING WORK.

WHERE EXISTING WALLS, CEILINGS, FLOORS, ETC., ARE CUT OR OTHERWISE DAMAGED DURING CONSTRUCTION, REPAIR ALL SURFACES TO THEIR ORIGINAL CONDITION.

SHOP DRAWINGS:

SUBMIT SHOP DRAWINGS FOR REVIEW. PDF FILES PREFERRED. SHOP DRAWINGS SHALL BE BOUND INTO VOLUMES (FILES), WITH EACH VOLUME (FILE) CONTAINING ONE COPY OF ALL SHOP DRAWINGS. ALL SHOP DRAWINGS SHALL BE SUBMITTED SIMULTANEOUSLY: NO SHOP DRAWINGS WILL BE CHECKED UNTIL ALL HAVE BEEN SUBMITTED.

SUBMITTALS SHALL BE SUPPORTED BY DESCRIPTIVE MATERIAL, SUCH AS CATALOG CUTS. DIAGRAMS, PERFORMANCE CURVES AND CHARTS PUBLISHED BY THE MANUFACTURER, TO SHOW CONFORMANCE TO SPECIFICATION AND DRAWING REQUIREMENTS; MODEL NUMBERS ALONE WILL NOT BE ACCEPTABLE. ALL LITERATURE SHALL CLEARLY INDICATE THE SPECIFIED MODEL NUMBER, DIMENSIONS, ARRANGEMENT, RATING AND CHARACTERISTICS OF THE PROPOSED EQUIPMENT. CAPACITIES AND RATINGS SHALL BE BASED ON CONDITIONS INDICATED OR SPECIFIED HEREIN. ANY DEVIATIONS FROM SPECIFIED EQUIPMENT (PARTICULARLY THOSE WHICH REQUIRE COORDINATION WITH OTHER TRADES) SHALL BE CLEARLY NOTED IN A CONCISE LIST ON A SEPARATE SHEET.

TEST AND BALANCE:

TEST AND BALANCE (TAB) CONTRACTOR SHALL HOLD A CURRENT NATIONAL BALANCING COUNCIL (NBC) CERTIFICATION AND POSSESS ACCURATE AND CALIBRATED INSTRUMENTS. TAB WORK AND REPORTS SHALL BE PER NBC PRACTICAL STANDARDS. PROCEDURES AND FORMS. ACCEPTIBLE ALTERNATIVE TAB FIRM CERTIFICATIONS/PROCEDURES: NEBB, AABC, OR

PRIOR TO COMMENCEMENT OF THE TAB WORK, THE MECHANICAL SYSTEMS ARE TO BE STARTED AND FULLY FUNCTIONING. A CHECKLIST PRIOR TAB WORK IS TO BE SENT TO THE INSTALLING CONTRACTOR AND RETURNED ATTESTING TO THE READINESS OF THE SYSTEMS

FOR BALANCING. PREFERRED TAB FIRM: P-TAB.COM

GUARANTEE THAT EACH PIECE OF APPARATUS SHALL BE OF THE CUSTOMARY STANDARD AND

GUARANTEE THAT THE AIR SYSTEMS SHALL OPERATE WITHOUT AERODYNAMIC NOISE GENERATED FROM THE FAULTY INSTALLATION OF DUCT WORK OR ANY COMPONENT OF THE AIR DISTRIBUTION SYSTEM.

QUALITY FURNISHED BY THE DESIGNED MANUFACTURER FOR THAT CATALOG NUMBER.

GUARANTEE THAT ALL SYSTEMS AND COMPONENTS SHALL BE PROVIDED WITH A ONE YEAR WARRANTY FROM THE TIME OF DATE OF SUBSTANTIAL COMPLETION. THE WARRANTY SHALL COVER ALL MATERIALS AND WORKMANSHIP. DURING THIS WARRANTY PERIOD, ALL DEFECTS IN MATERIALS AND WORKMANSHIP SHALL BE CORRECTED BY REPAIR OR REPLACEMENT WITHOUT INCURRING ADDITIONS TO THE CONTRACT.

SNOW MELT BOILER WATER PIPING:

CONDENSER WATER PIPING SHALL BE SCHEDULE 40 STEEL PIPE: GROOVED. MECHANICAL JOINT COUPLING AND FITTINGS: AND GROOVED MECHANICAL JOINTS.

SNOW MELT BOILER WATER PIPING INSULATION:

CONDENSER WATER PIPING SHALL BE INSULATED WITH 1-1/2" CELLULAR GLASS WITH ALL SERVICE JACKET (ASJ) OR 1-1/2" MINERAL FIBER PREFORMED PIPE. TYPE 1. WITH ASJ.



108-110 RITCHIE LLC

P.O. BOX 14001-174

KETCHUM, ID 83340

TEL: 603.801.0419

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BUILDING ARCHITECT:

RO | ROCKETT DESIGN 1031 W. MANCHESTER BLVD. UNIT 6 INGLEWOOD, CA 90301

STRUCTURAL ENGINEER: ZFA STRUCTURAL ENGINEERS 601 MONTGOMERY STREET SUITE 1450 SAN FRANCISCO, CA 94111

MECHANICAL, ELECTRICAL, PLUMBING ENGINEER:

PROFICIENT ENGINEERING 4704 HARLAN STREET SUITE 620 DENVER. CO 80212

CIVIL ENGINEER:

GALENA BENCHMARK ASSOCIATES 100 BELL DRIVE SUITE C KETCHUM. ID 83340

LANDSCAPE ARCHITECT:

EGGERS ASSOCIATES 560 NORTH 2ND AVENUE KETCHUM, ID 83340 TEL: 208.725.0988

TEL: 208.726.9512

GEOTECHNICAL ENGINEER:

LIGHTING DESIGNER:

AUDIO / VISUAL / CONTROLS:

GENERAL CONTRACTOR:

DESCRIPTION DESIGN REVIEW SUBMISSION 7/10/2024 DESIGN REVIEW RESUBMISSION DESIGN REVIEW 3/14/2025 RESUBMISSION DESIGN REVIEW 6/25/2025 RESUBMISSION

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PROJECT: WARM SPRINGS TOWNHOMES


108 RITCHIE DRIVE KETCHUM, ID 83340

conflicts which are alleged.


DRAWING TITLE:



PROJECT NUMBER 2000.01 DRAWING NUMBER:

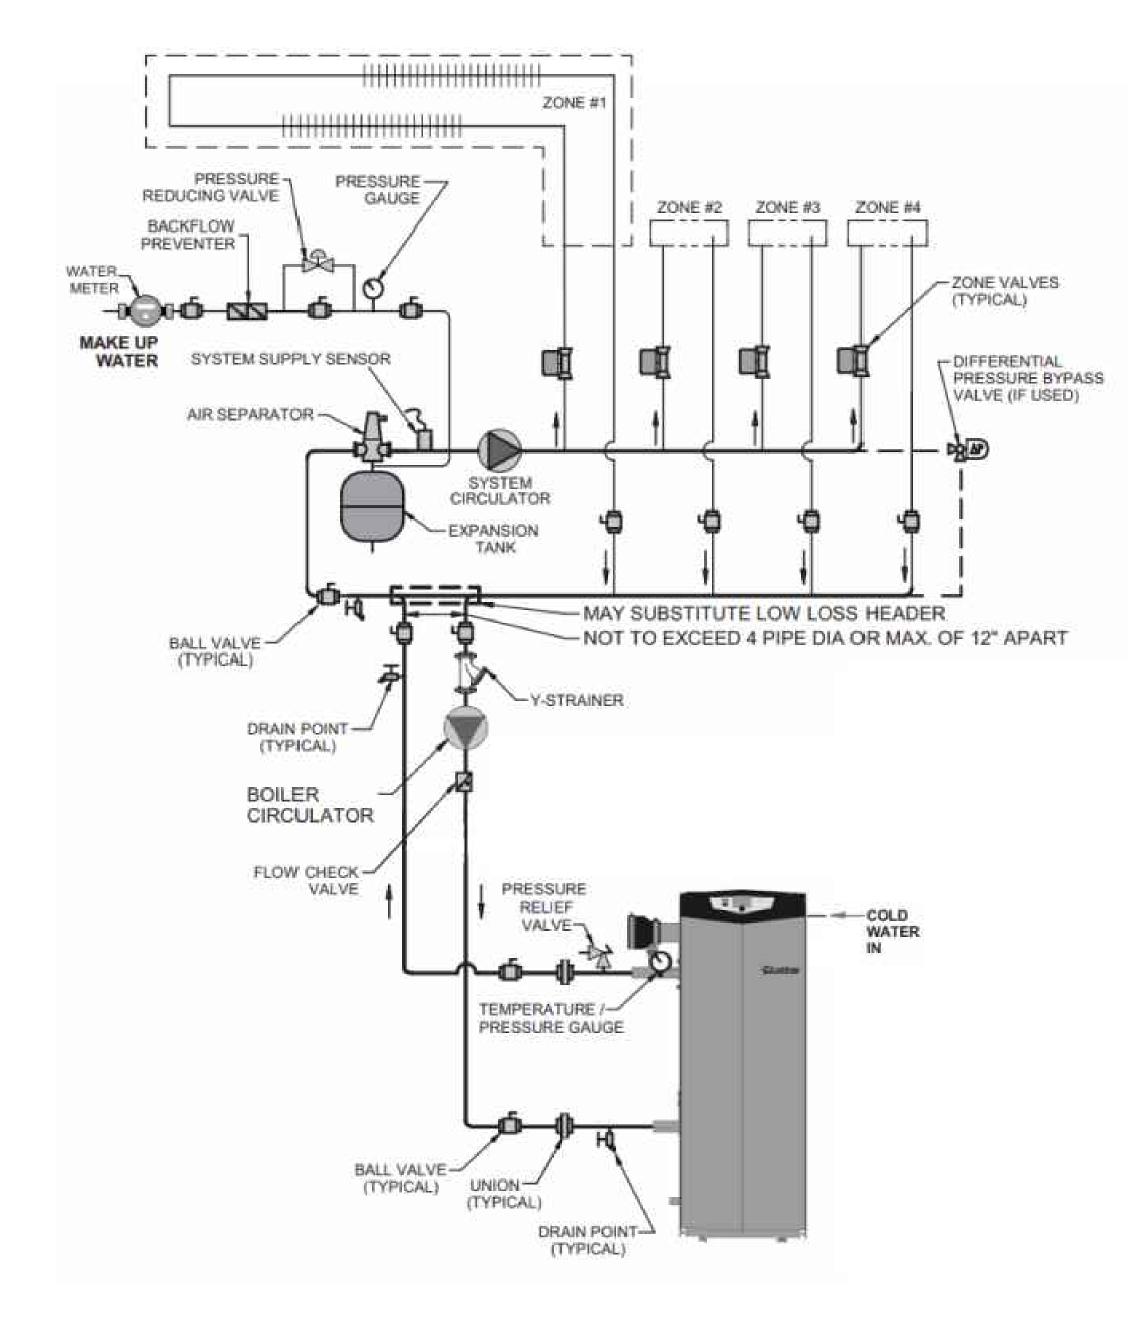

BOILER INSTALLATION DETAIL
NO SCALE

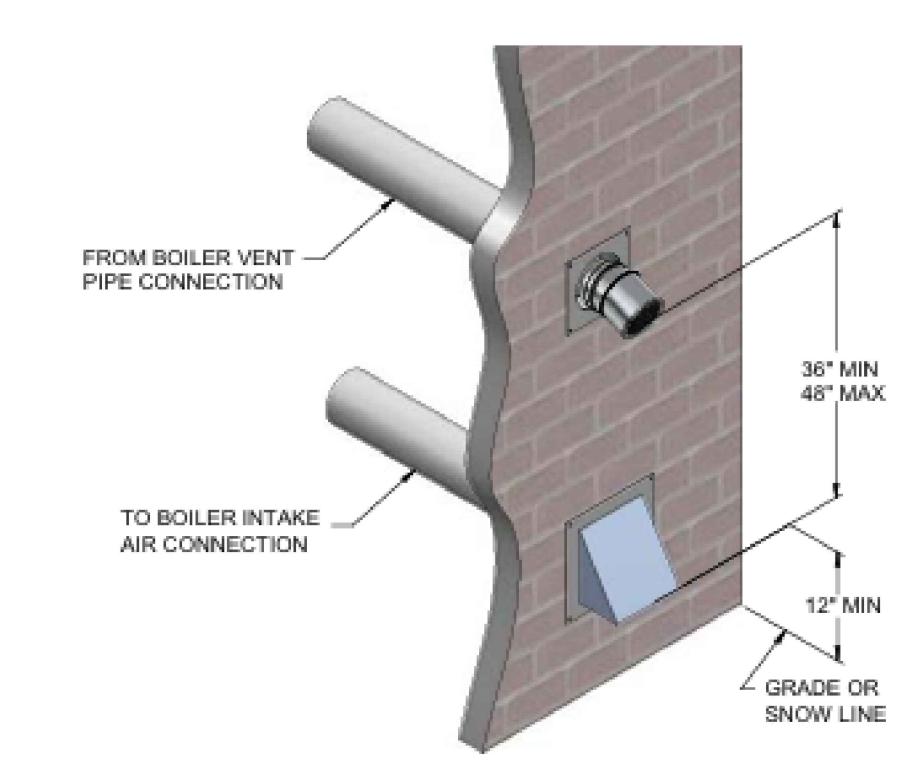

BOILER SIDEWALL TERMINATION DETAIL
NO SCALE

HOT WATER BOILER

			WATER			HEATER				THERMAL	OPERATING				Ę	>=N 1 A	PKS			
MARK	SERVES	BASIS OF DESIGN	GPM	EWT (ºF)	LWT (9F)	INPUT (MBH)	OUTPUT (MBH)	DECIBEL (dB)	TURN DOWN	RN FEETCIENCY	WEIGHT (LBS)	KLIMAKK								
				(-1)	(-1)	(IVIDIT)	(IVIDIT)			, ,	, ,	J	2	3	4	5	6	7	8	9
B- I	BUILDING B RAMP	FB1751	145.0	40	121	1,751.0	1,684.0	66	25:1	96.2	250	Х	Х	Х	X	Х	X	Х	Х	X

NOTES:

- A. SELECTIONS ARE BASED ON LOCHINVAR. EQUAL
 - PRODUCTS BY AERCO, PATTERSON KELLEY, HYDROTHERM.
- B. SEE ELECTRICAL DRAWINGS FOR ELECTRICAL POWER INFORMATION.C. THERMAL EFFICIENCY IS BASED ON AHRI EFFICIENCY 80°F TO 180°F.

REMARKS:

- I. SINGLE POINT POWER CONNECTION.
- 2. DISCONNECT SWITCH PROVIDED BY THE ELECTRICAL SUBCONTRACTOR.
- 3. FACTORY PROVIDED MULTI-BOILER CONTROL SYSTEM.
- 4. OUTDOOR AIR RESET.

5. BAS INTERFACE (BACNET).

- 6. DIRECT VENT SEALED COMBUSTION CONFIGURATION.
- 7. CONCENTRIC VENT KIT.
- 8. HIGH \$ LOW GAS PRESSURE SWITCHES WITH MANUAL RESET.
- CONTROLS 55 GALLON E-GLYCOL FEEDER. INSTALL PER MANUFACTURER'S

9. 50%-50% PROPYLENE GLYCOL AND WATER SOLUTION. PROVIDE ADVANTAGE

INSTRUCTIONS. PROVIDE WITH BAS INTERFACE (BACNET).

PUMP SCHEDULE

					IMPELLER	MAX		PUMP	PUMP	OPERATING	BASIS	REMARKS
MARK	SERVICE / DUTY	TYPE	GPM	HEAD	DIAMETER	NPSHR	MOTOR	SPEED	EFF	WEIGHT	OF DESIGN	REWARKS
				(FT)	(IN)	(PSI)	(HP)	(RPM)	(%)	(LBS)	MODEL	1 2 3 4 5 6 7 8
P-IA	B-4: PRIMARY LOOP	ECM HIGH-EFFICIENCY	145	11.000	10"	4.35	2.1	4760	36	52	TACO VR25M5F	x x x x x x x x x
P-1B	B-4: SECONDARY LOOP	ECM HIGH-EFFICIENCY	145	13.900	10"	4.4	5	4400	63	72	TACO SKV3009D	x x x x x x x x x

NOTES (APPLY TO ALL):

- A. SEE ELECTRICAL DRAWINGS FOR ELECTRICAL POWER INFORMATION
- B. BASIS OF DESIGN: TACO AND GRUNDFOS
- ACCEPTABLE ALTERNATES: BELL & GOSSETT, ARMSTRONG, AURORA.

REMARKS:

- I. FLEXIBLE COUPLING.
- 2. DISCONNECT SWITCH BY THE ELECTRICAL SUBCONTRACTOR.
- 3. SUCTION DIFFUSER WITH INTEGRAL STRAINER.
- 4. INVERTER DUTY MOTOR WITH VFD. VFD PROVIDED BY THE ELECTRICAL SUBCONTRACTOR.
- 5. DDC CONTROL. INTERLOCK WITH BAS.
- 6. FIELD INSTALLED DIFFERENTIAL PRESSURE SENSOR AT MOST CRICITAL POINT.

8. PUMP IS PROVIDED WITH BOILER AND IS SHOWN FOR REFERENCE ONLY


7. PUMP \$ INERTIA BASE MOUNTED ON CONCRETE HOUSEKEEPING PAD PROVIDED BY OTHERS.

MANIFOLD SCHEDULE

				REQUIRED	SUPPLIED	MANIFOLD	MANIFOLD	CIRCUIT	S/R	TOTAL
MARK	BOILER	CIRCUITS	GPM	TEMP	TEMP	TYPE	HEAD LOSS	HEAD LOSS	HEAD LOSS	HEAD LOSS
				(°F)	(°F)	(FT)	(FT)	(FT)	(FT)	(FT)
MANIFOLD I	B-1	6	14.17	115	121	PRO-BALANCE 1-1/4" STAINLESS STEEL MANIFOLD WITH GAUGES	5.2	10.2	0	15
MANIFOLD 2	B-1	5	10.98	116	121	PRO-BALANCE 1-1/4" STAINLESS STEEL MANIFOLD WITH GAUGES	3.9	10.1	0	14
MANIFOLD 3	B-1	12	31.36	115	121	PRO-BALANCE 1-1/4" STAINLESS STEEL MANIFOLD WITH GAUGES	13.9	13.6	0	28
MANIFOLD 4	B-1	4	10.48	116	121	PRO-BALANCE 1-1/4" STAINLESS STEEL MANIFOLD WITH GAUGES	5.1	13.0	0	18
MANIFOLD 5	B-1	1.1	26.83	117	121	PRO-BALANCE 1-1/4" STAINLESS STEEL MANIFOLD WITH GAUGES	10.7	14.2	0	25
MANIFOLD 6	B-1	7	17.80	116	121	PRO-BALANCE 1-1/4" STAINLESS STEEL MANIFOLD WITH GAUGES	6.7	14.1	0	21
MANIFOLD 7	B-1	ı	1.90	112	121	PRO-BALANCE 1-1/4" STAINLESS STEEL MANIFOLD WITH GAUGES	2.7	7.5	0	10
MANIFOLD 8	B-1	2	3.01	123	121	PRO-BALANCE 1-1/4" STAINLESS STEEL MANIFOLD WITH GAUGES	1.9	3.9	0	6
MANIFOLD 9	B-1	8	18.81	115	121	PRO-BALANCE 1-1/4" STAINLESS STEEL MANIFOLD WITH GAUGES	6.0	13.0	0	19
MANIFOLD 10	B-1	4	6.59	117	121	PRO-BALANCE 1-1/4" STAINLESS STEEL MANIFOLD WITH GAUGES	2.0	4.3	0	6
MANIFOLD I I	B-1	2	2.56	117	121	PRO-BALANCE 1-1/4" STAINLESS STEEL MANIFOLD WITH GAUGES	2.7	9.5	0	12

NOTES (APPLY TO ALL):

A. REFER TO SNOW MELT SYSTEM LOOP DRAWINGS FOR MORE INFORMATION.

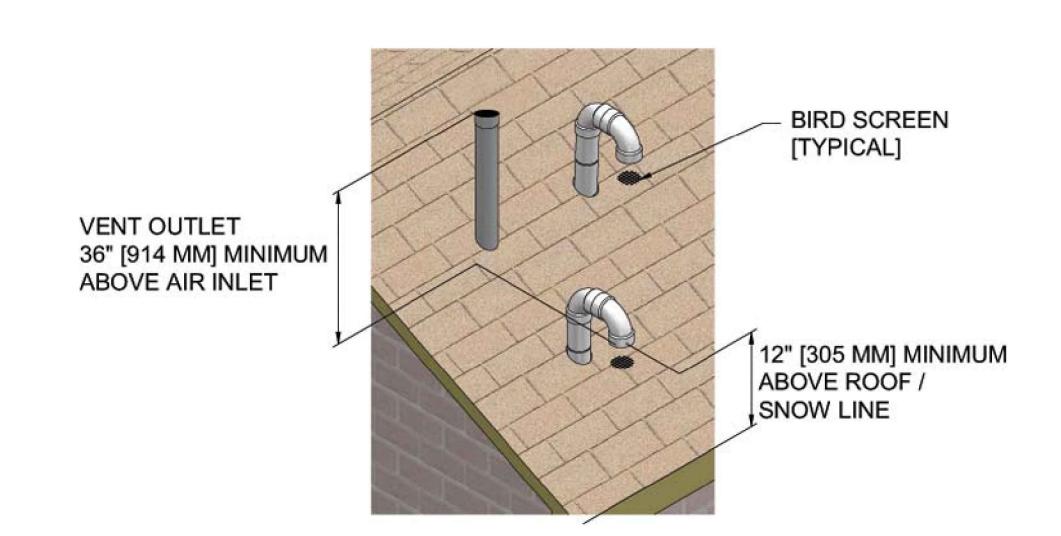

BOILER VERTICAL TERMINATION DETAIL
NO SCALE



WARM SPRINGS TOWNHOMES KETCHUM, IDAHO

108-110 RITCHIE LLC P.O. BOX 14001-174

KETCHUM, ID 83340

TEL: 603.801.0419

TEL: 213.784.0014

BUILDING ARCHITECT:

RO | ROCKETT DESIGN

1031 W. MANCHESTER BLVD. UNIT 6
INGLEWOOD, CA 90301

STRUCTURAL ENGINEER:

ZFA STRUCTURAL ENGINEERS601 MONTGOMERY STREET SUITE 1450
SAN FRANCISCO, CA 94111

TEL: 415.243.4091

DENVER, CO 80212 TEL: 720.779.3556

MECHANICAL, ELECTRICAL, PLUMBING ENGINEER:

PROFICIENT ENGINEERING

4704 HARLAN STREET SUITE 620

CIVIL ENGINEER:

GALENA BENCHMARK ASSOCIATES

100 BELL DRIVE SUITE C

LANDSCAPE ARCHITECT:

EGGERS ASSOCIATES
560 NORTH 2ND AVENUE

KETCHUM, ID 83340 TEL: 208.725.0988

KETCHUM, ID 83340

TEL: 208.726.9512

GEOTECHNICAL ENGINEER:

LIGHTING DESIGNER:

AUDIO / VISUAL / CONTROLS:

GENERAL CONTRACTOR:

ISSUE	DESCRIPTION	DATE
	DESIGN REVIEW SUBMISSION	7/10/2024
1	DESIGN REVIEW RESUBMISSION	11/5/2024
2	DESIGN REVIEW RESUBMISSION	3/14/2025

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WARM SPRINGS TOWNHOMES

PROJECT:

108 RITCHIE DRIVE

KETCHUM, ID 83340


conflicts which are alleged.

DRAWING TITLE: SCHEDULES DETAILS



PROJECT NUMBER 2000.01

MO.2

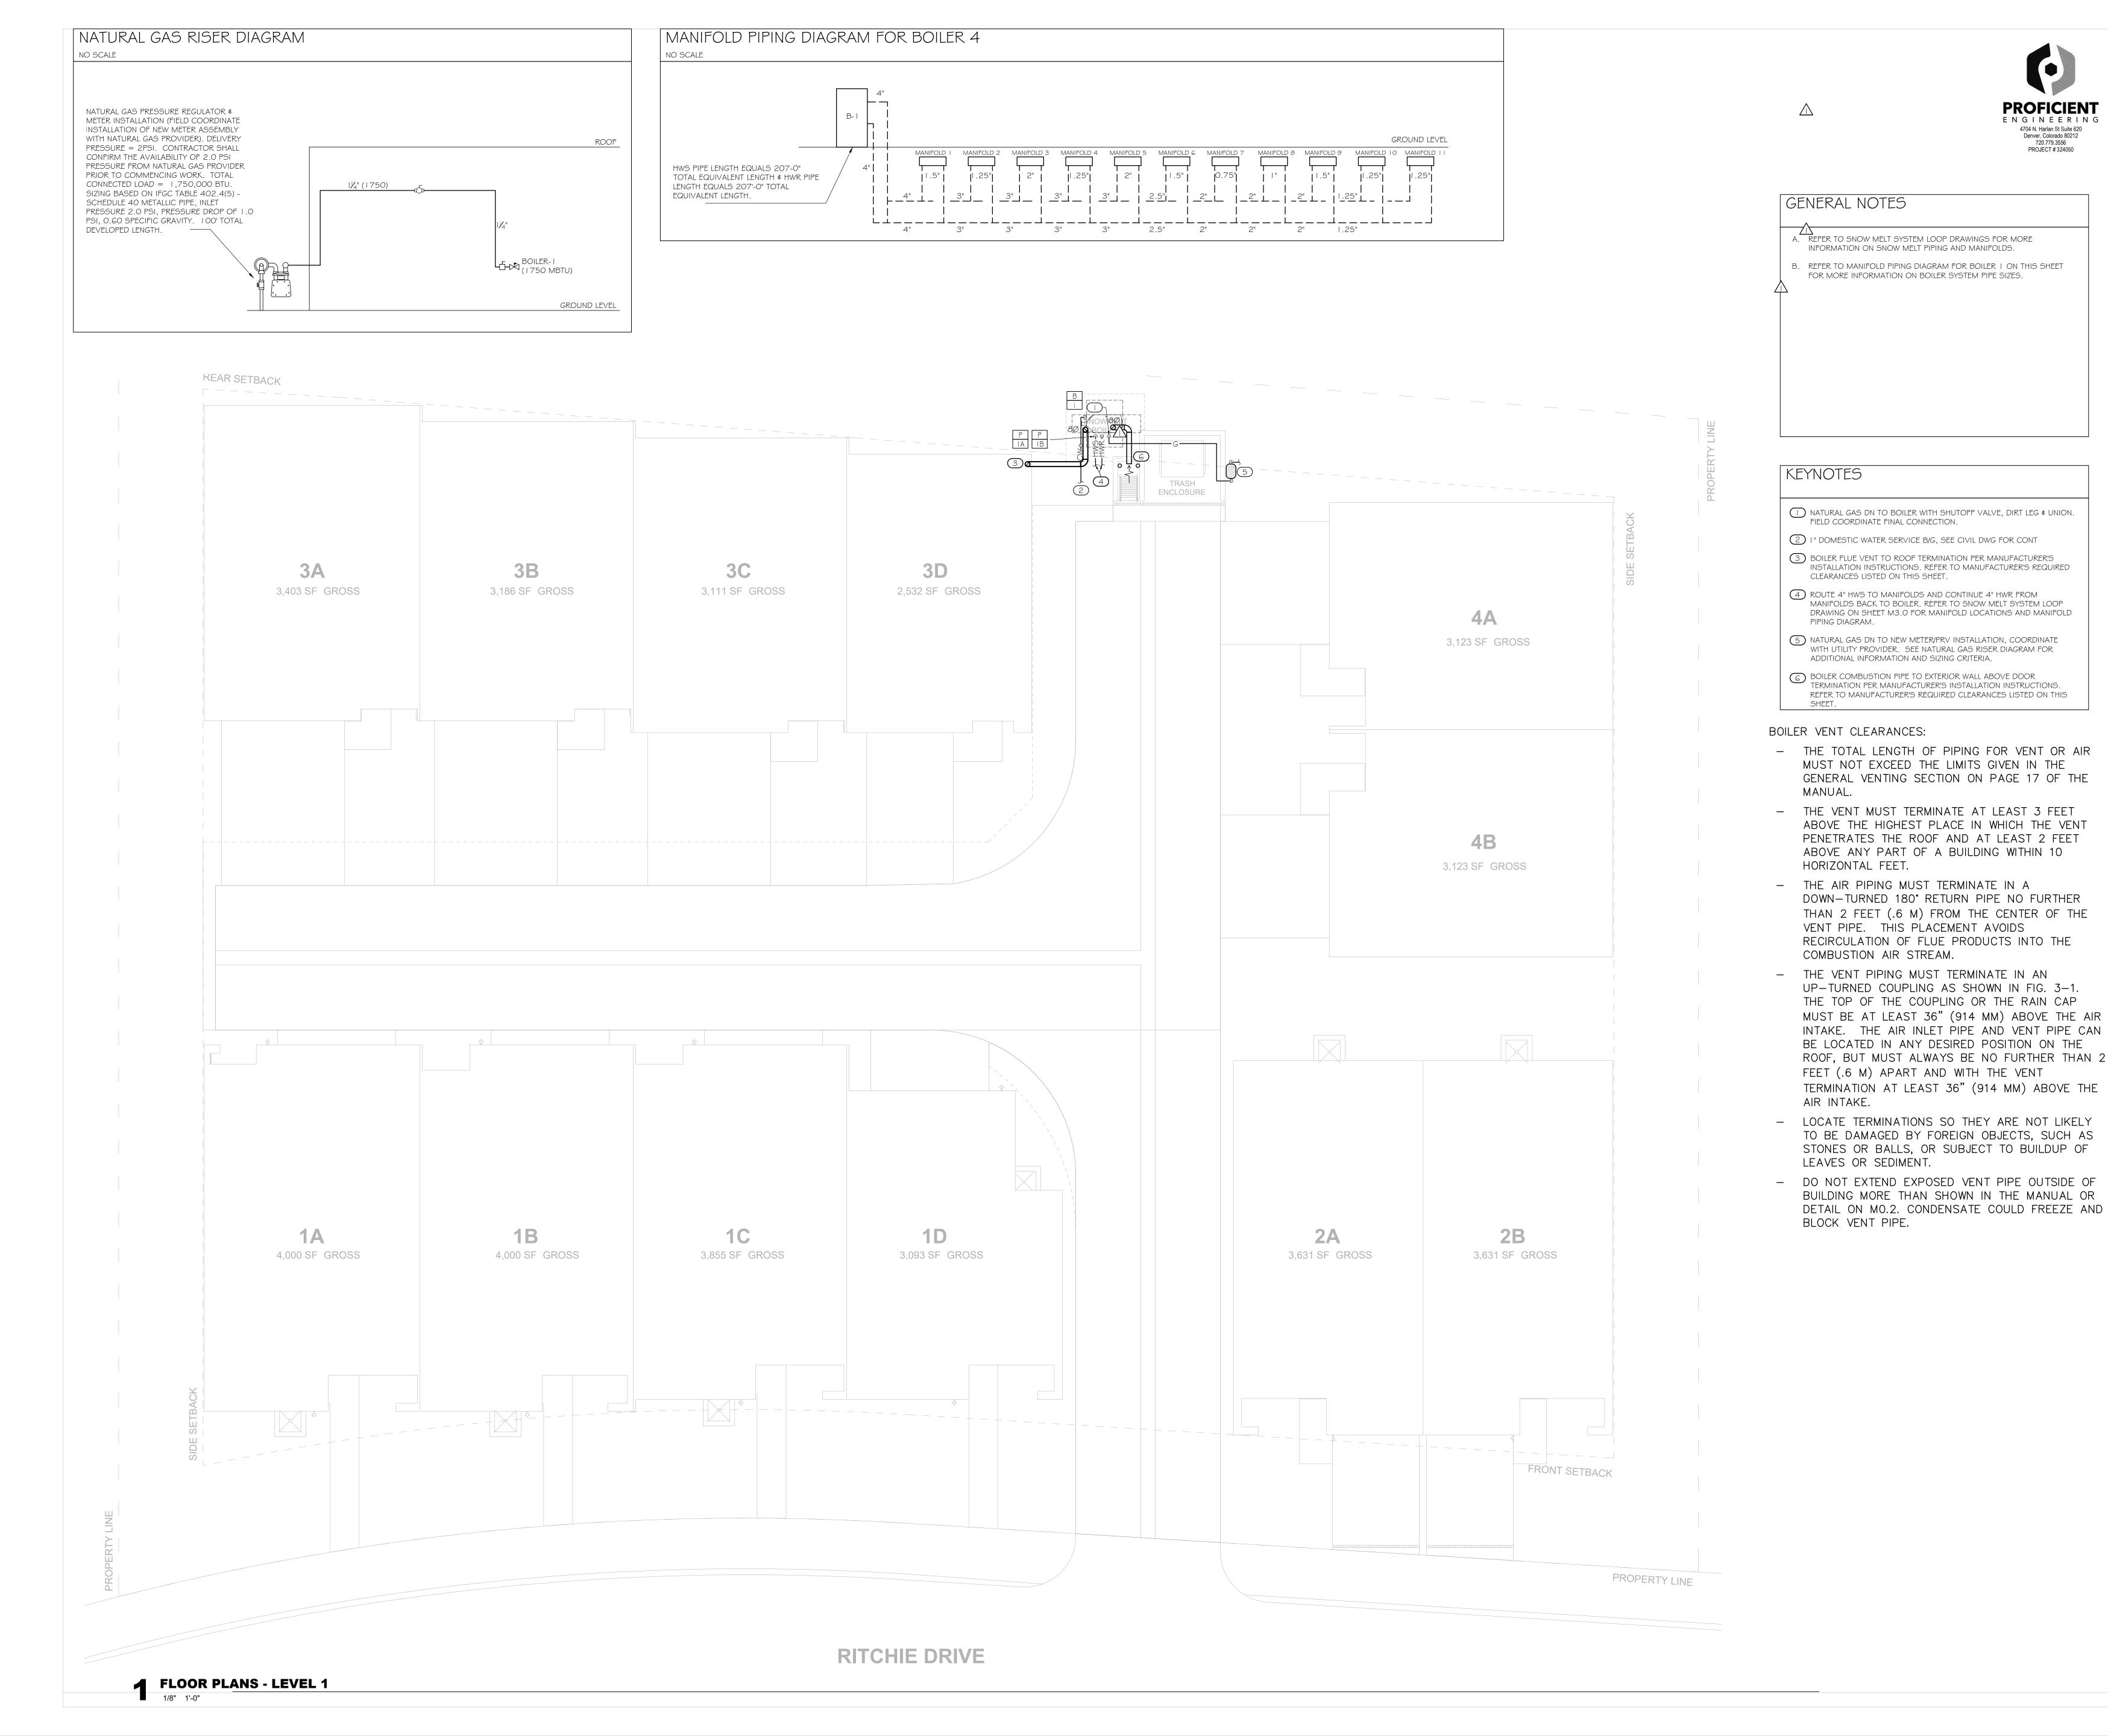

WARM SPRINGS **TOWNHOMES** KETCHUM, IDAHO **PROFICIENT**

ENGINEERING

4704 N. Harlan St Suite 620 Denver, Colorado 80212 720.779.3556

PROJECT # 324050

108-110 RITCHIE LLC P.O. BOX 14001-174 KETCHUM, ID 83340 TEL: 603.801.0419

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TEL: 213.784.0014

TEL: 415.243.4091

ZFA STRUCTURAL ENGINEERS 601 MONTGOMERY STREET SUITE 1450 SAN FRANCISCO, CA 94111

MECHANICAL, ELECTRICAL, PLUMBING ENGINEER:

PROFICIENT ENGINEERING 4704 HARLAN STREET SUITE 620 DENVER, CO 80212

CIVIL ENGINEER: GALENA BENCHMARK ASSOCIATES

100 BELL DRIVE SUITE C KETCHUM, ID 83340

TEL: 720.779.3556

TEL: 208.726.9512

LANDSCAPE ARCHITECT: EGGERS ASSOCIATES

560 NORTH 2ND AVENUE KETCHUM, ID 83340 TEL: 208.725.0988

GEOTECHNICAL ENGINEER:

LIGHTING DESIGNER:

AUDIO / VISUAL / CONTROLS:

GENERAL CONTRACTOR:

DESCRIPTION DESIGN REVIEW SUBMISSION 7/10/2024 **DESIGN REVIEW** RESUBMISSION DESIGN REVIEW RESUBMISSION DESIGN REVIEW RESUBMISSION

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WARM SPRINGS TOWNHOMES


108 RITCHIE DRIVE KETCHUM, ID 83340

PROJECT:

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DRAWING TITLE:

SNOW MELT DESIGN

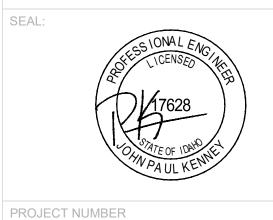

2000.01 DRAWING NUMBER:

M1.0





WARM SPRINGS TOWNHOMES KETCHUM, IDAHO

OWNER: 108-110 RITCHIE LLC
P.O. BOX 14001-174

BUILDING ARCHITECT:

RO | ROCKETT DESIGN

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INGLEWOOD, CA 90301

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TEL: 213.784.0014

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TEL: 720.779.3556

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GALENA BENCHMARK ASSOCIATES

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LANDSCAPE ARCHITECT:

560 NORTH 2ND AVENUE KETCHUM, ID 83340 TEL: 208.725.0988

EGGERS ASSOCIATES

GEOTECHNICAL ENGINEER:

LIGHTING DESIGNER:

AUDIO / VISUAL / CONTROLS:

GENERAL CONTRACTOR:

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DESIGN REVIEW SUBMISSION 7/10/2024
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WARM SPRINGS TOWNHOMES

108 RITCHIE DRIVE KETCHUM, ID 83340

conflicts which are alleged.

DRAWING TITLE:

SNOW MELT SYSTEM LOOP




2000.01

DRAWING NUMBER:

PROJECT NUMBER

M3.0

Statistics						
Description	Symbol	Avg	Max	Min	Max/Min	Avg/Min
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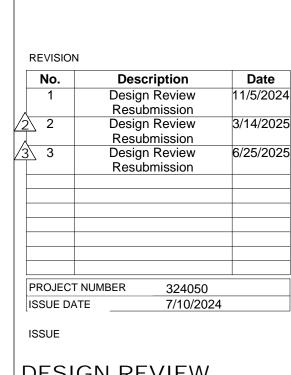
TOWN STAMP

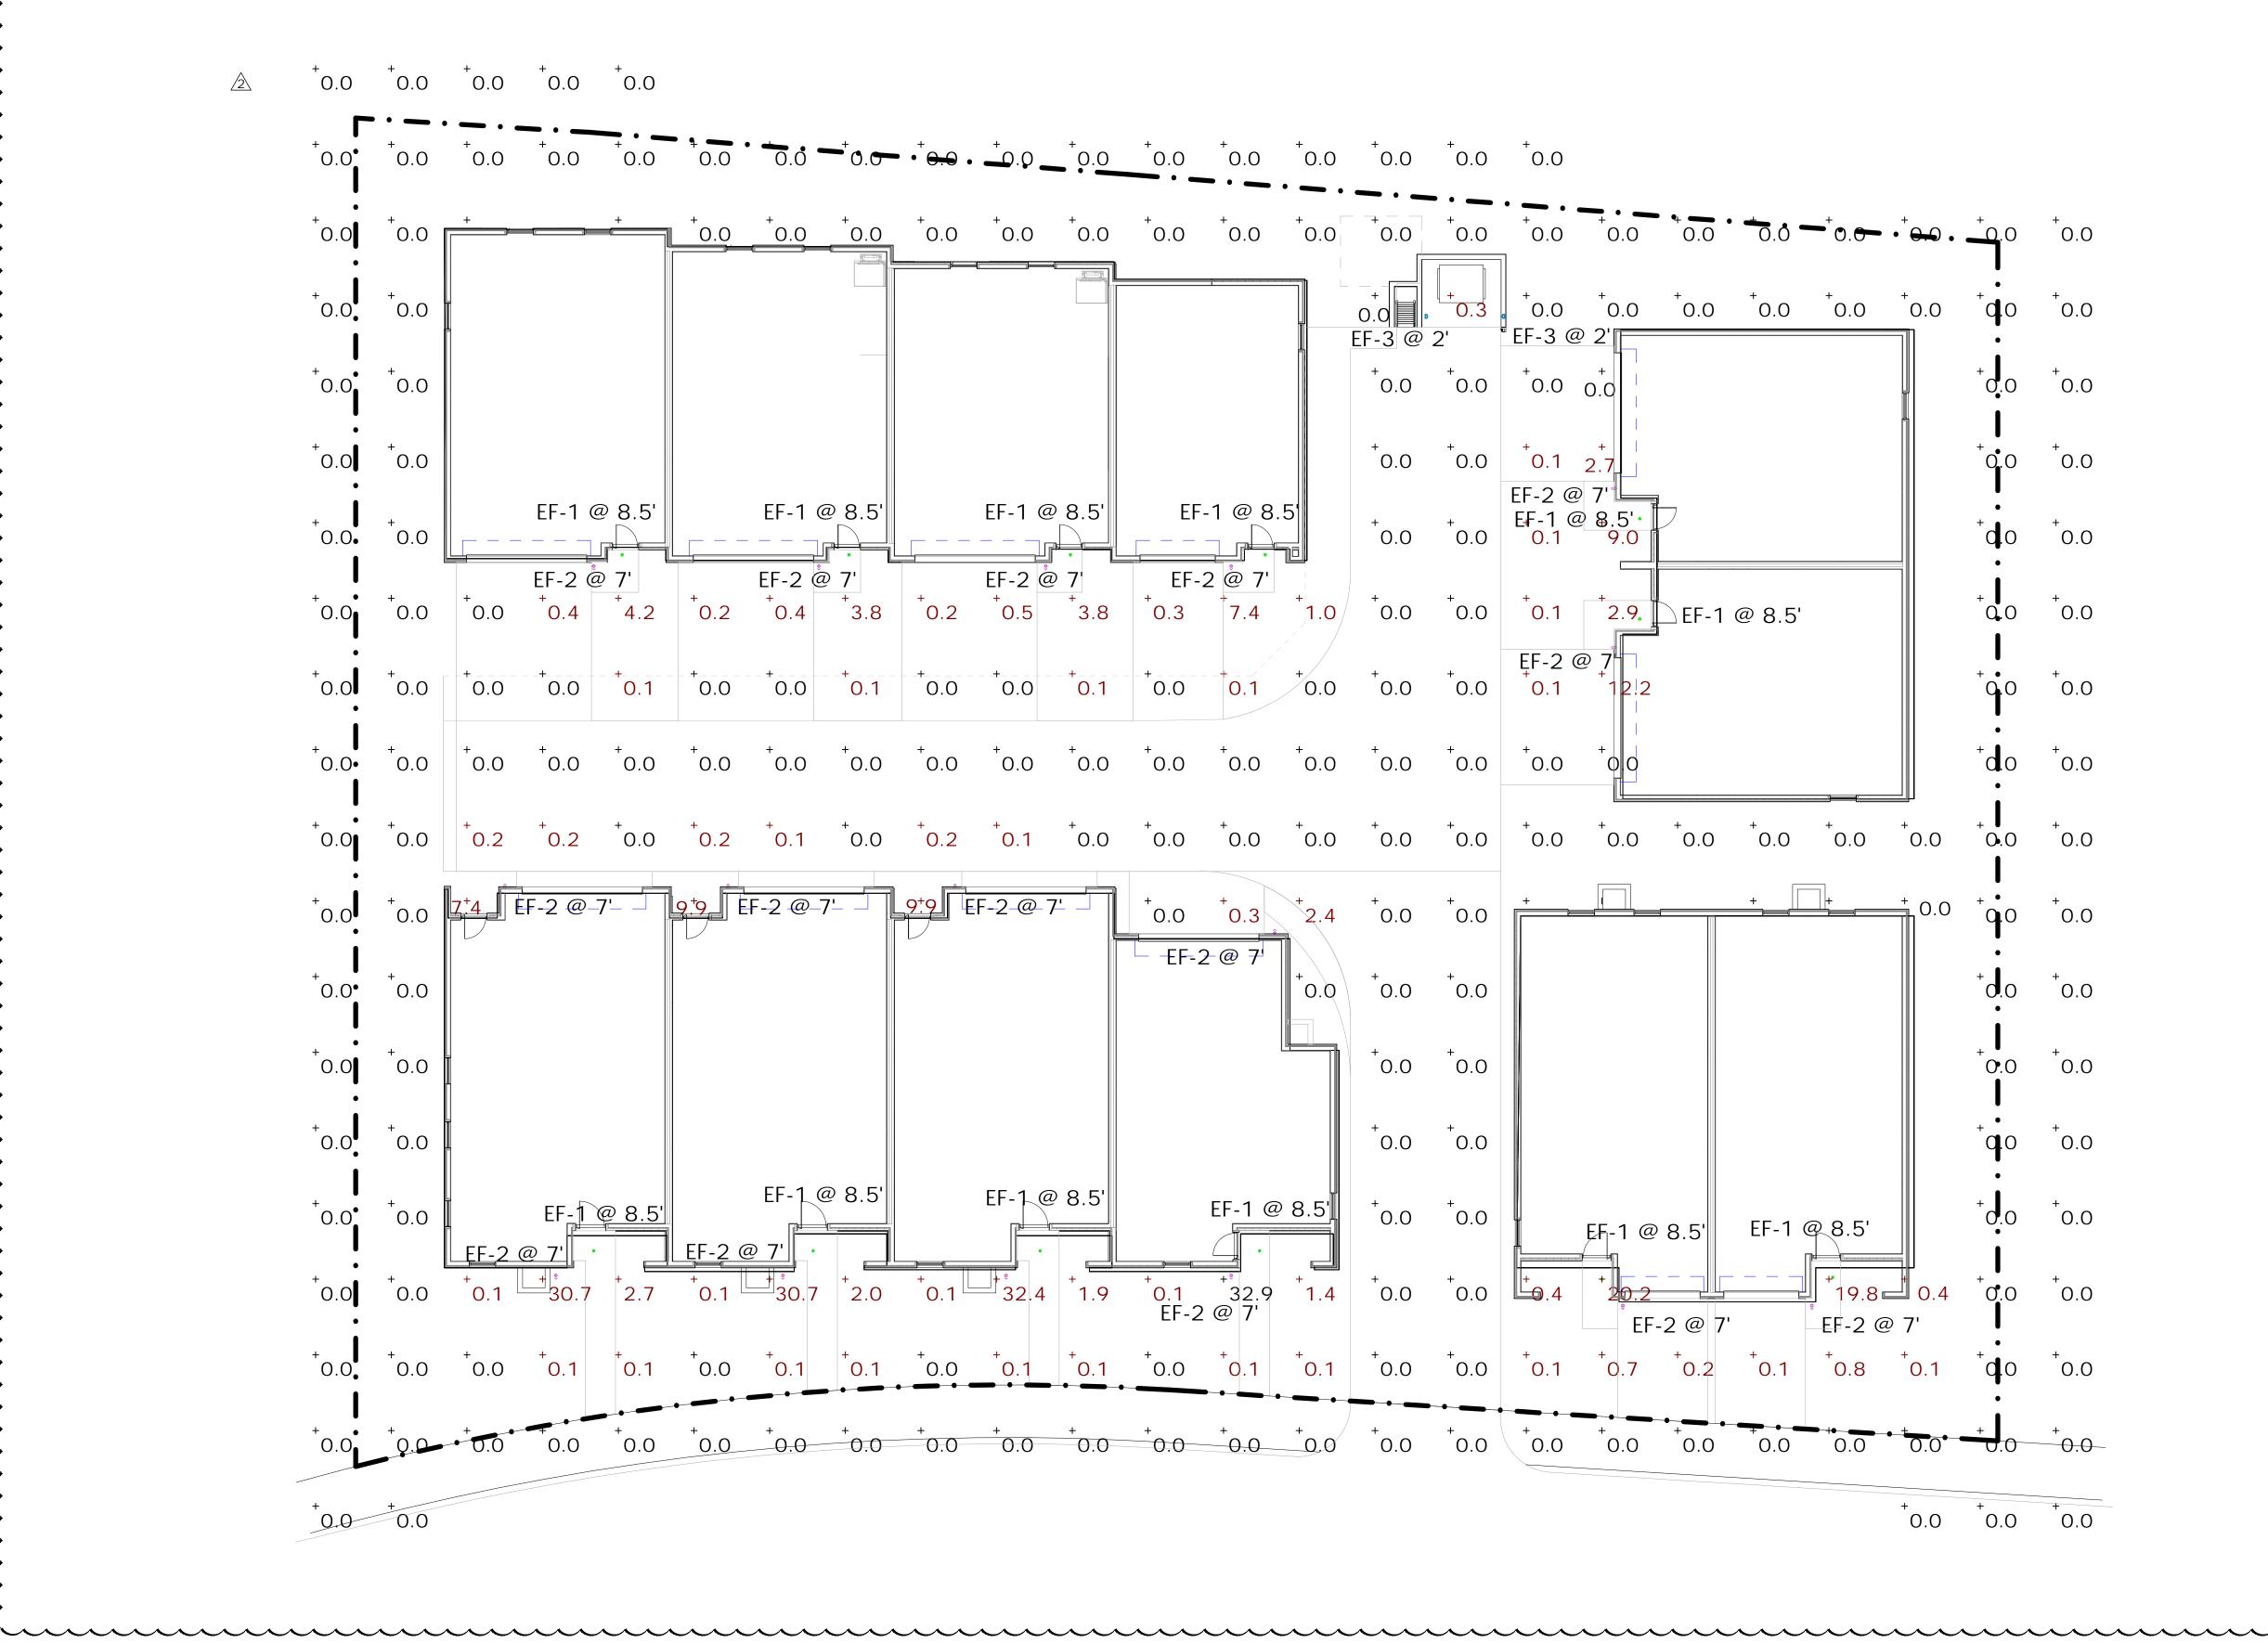



WARM SPRINGS
TOWNHOMES

108 RITCHIE DRIVE
KETCHUM, ID 83340




DESIGN REVIEW APPLICATION

SHEET TITLE

SITE PHOTOMETRIC

SHEET N

E0.10

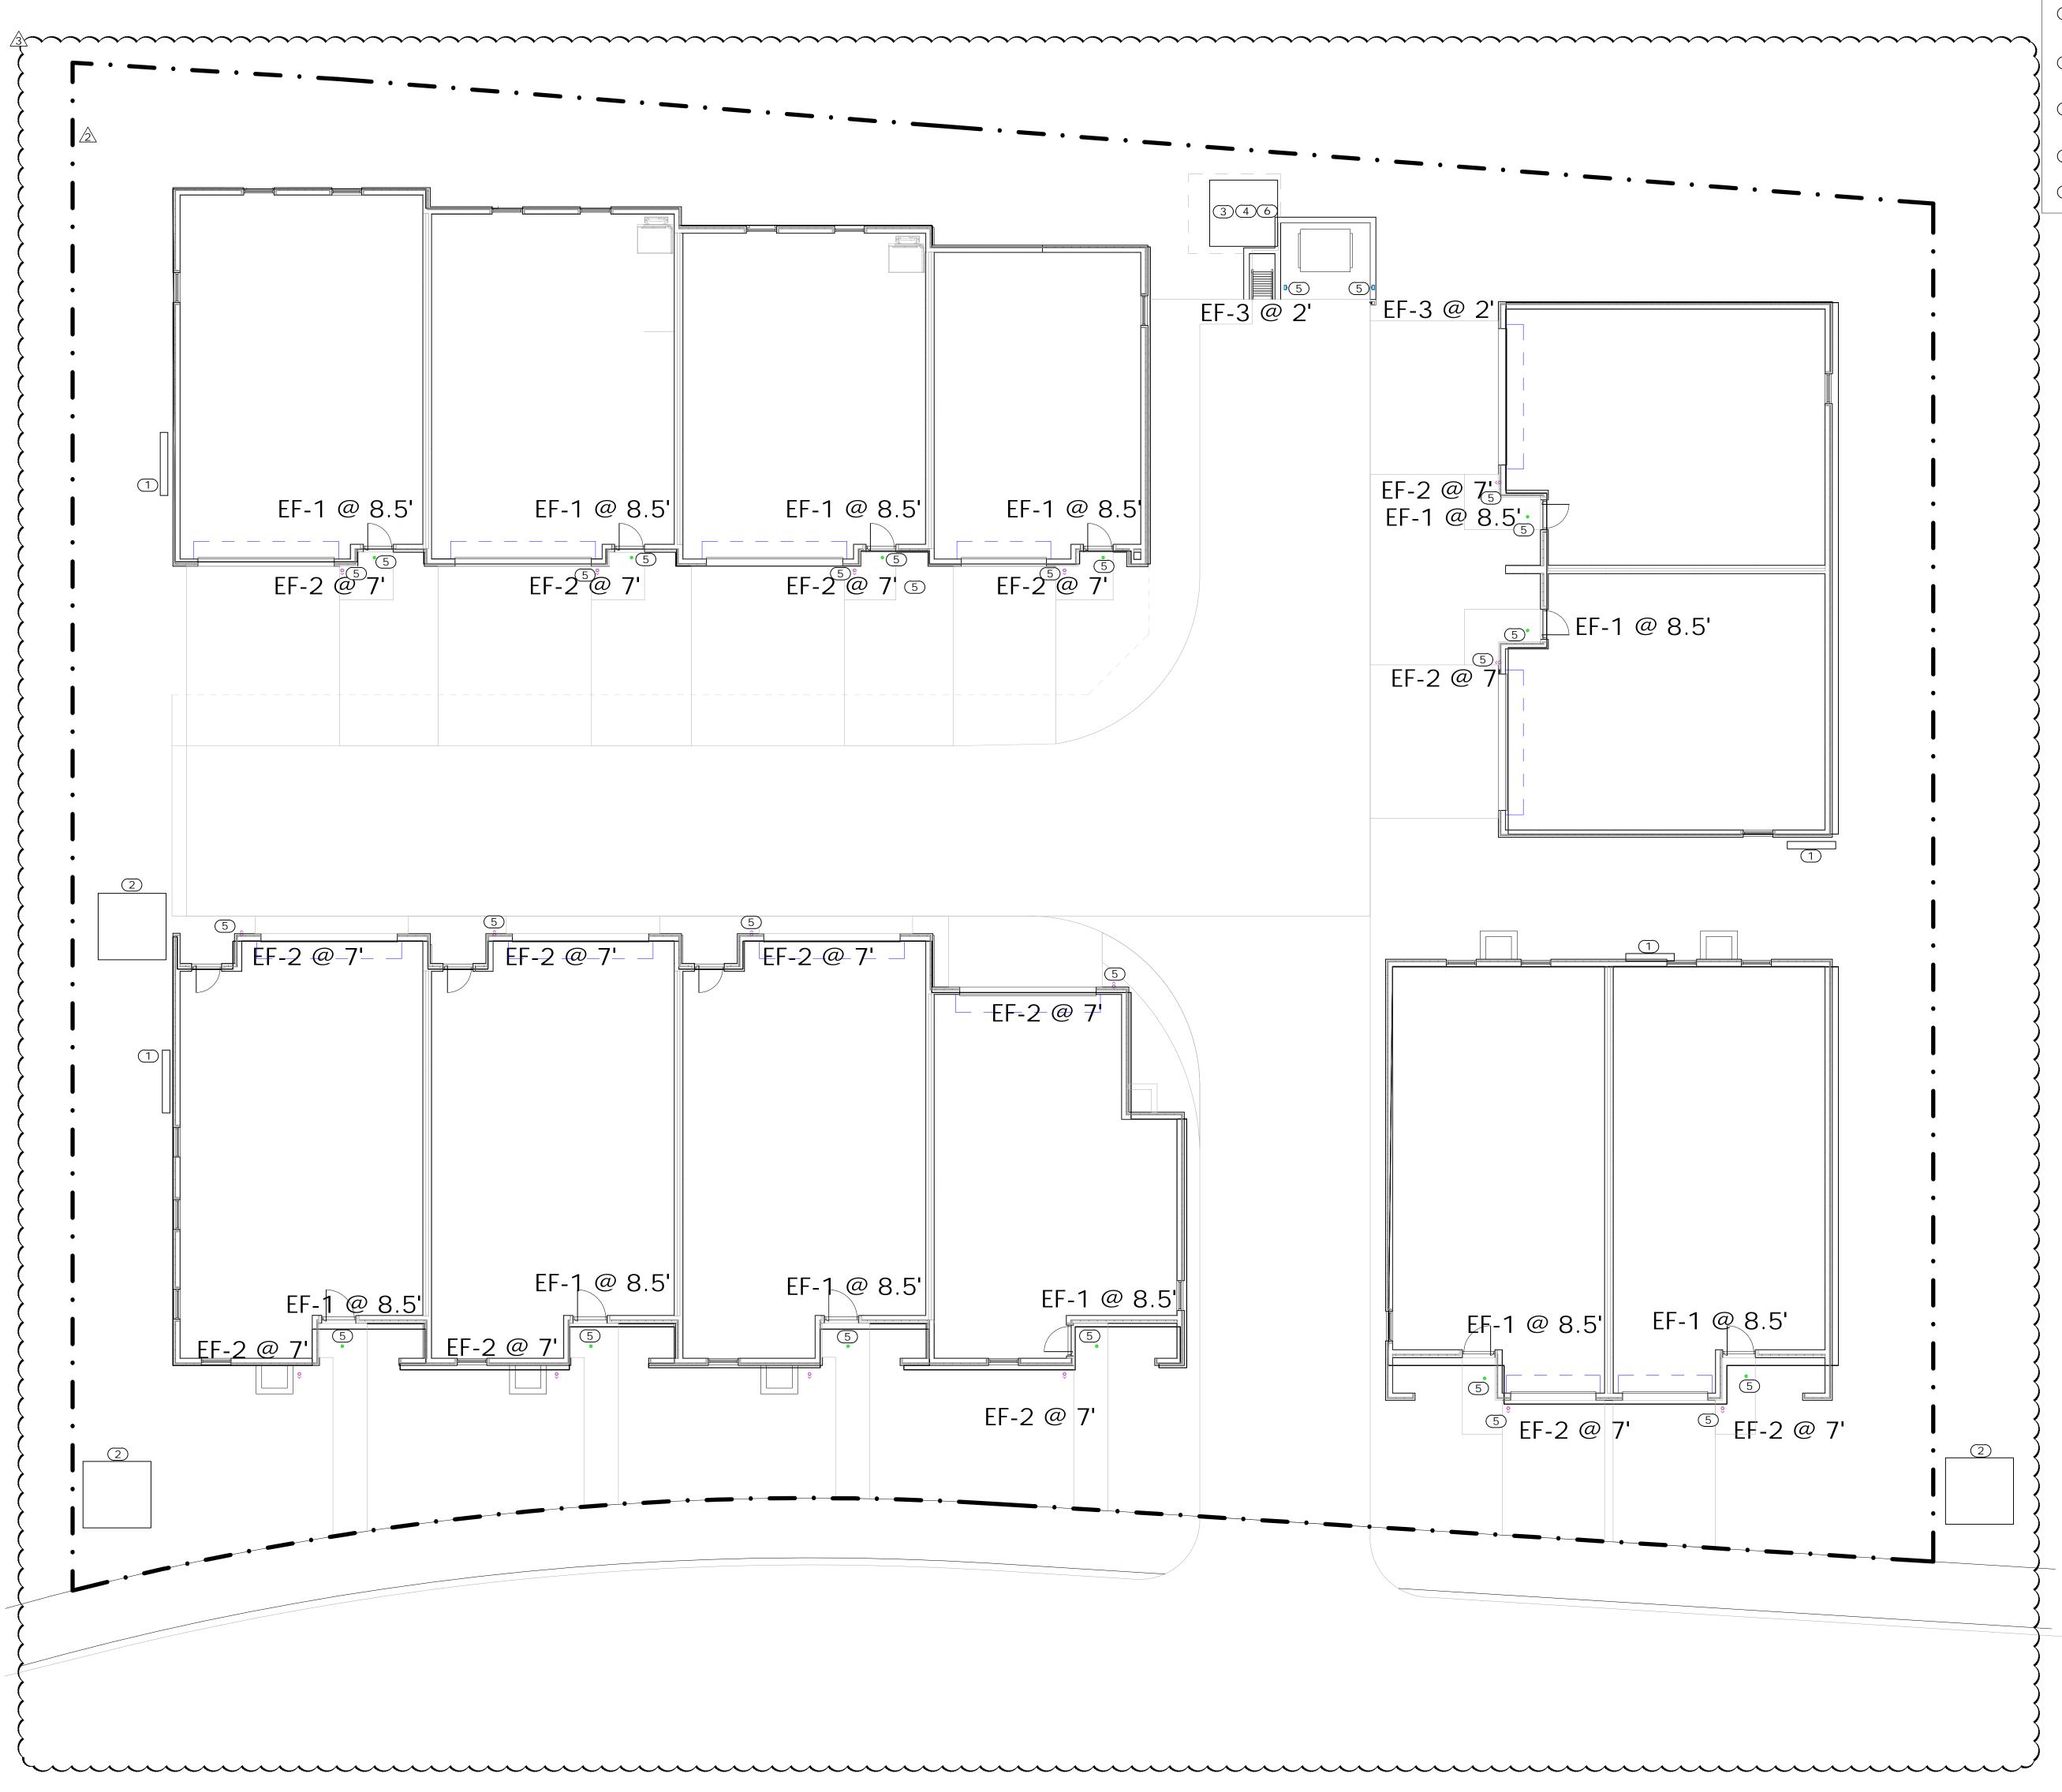

1 FLOOR PLANS - LEVEL 1
1/8" = 1'-0"

GENERAL NOTES


ALL SITE AND EXTERIOR BUILDING LIGHTING FIXTURES SHALL CONFORM TO DARK SKY REQUIREMENTS AS NECESSARY TO MEET LOCAL JURISDICTIONAL CODES.

KEYNOTES

- 1 PROPOSED LOCATION FOR MAIN SERVICE DISCONNECT AND UNIT METERING STACK. REFERENCE ARCHITECTURAL PLANS FOR EXACT LOCATION.
- 2 PROPOSED UTILITY TRANSFORMER LOCATION. COORDINATE UTILITY TRANSFORMER LOCATION WITH UTILITY PROVIDER AND BUILDING SERVICE DISCONNECT LOCATION PRIOR TO ROUGH-IN.
- PROVIDE 208, 1PH, 3W, 20A BRANCH CIRCUIT AND 30A/2P/NEMA 3R DISCONNECT FOR PRIMARY LOOP PUMP POWER. CIRCUIT FROM NEAREST HOUSE PANEL. COORDINATE CONNECTION LOCATION WITH PUMP VENDOR PRIOR TO ROUGH-IN.
- PROVIDE 208, 1PH, 3W, 20A BRANCH CIRCUIT AND 30A/2P/NEMA 3R DISCONNECT FOR SECONDARY LOOP PUMP POWER. CIRCUIT FROM NEAREST HOUSE PANEL. COORDINATE CONNECTION LOCATION WITH PUMP VENDOR PRIOR TO ROUGH-IN.
- 5 PROVIDE 120V, 20A BRANCH CIRCUIT VIA PHOTOCELL FOR LUMINARIE CONTROL TO EXTERIOR LUMINAIRE. CIRCUIT FROM TENANT PANEL.
- 6 PROVIDE 120V, 20A BRANCH CIRCUIT FOR BOILER POWER. CIRCUIT FROM NEAREST HOUSE PANEL.




TOWN STAMP

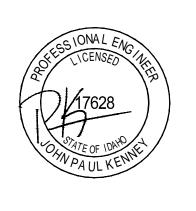

DISCIPLINE STAMP

WARM SPRINGS
TOWNHOMES


108 RITCHIE DRIVE
KETCHUM, ID 83340

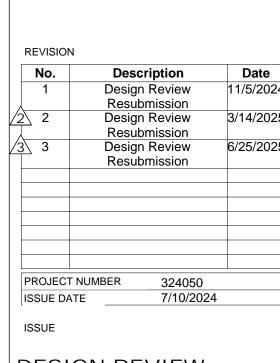



DESIGN REVIEW APPLICATION


SITE PLAN


E0.11

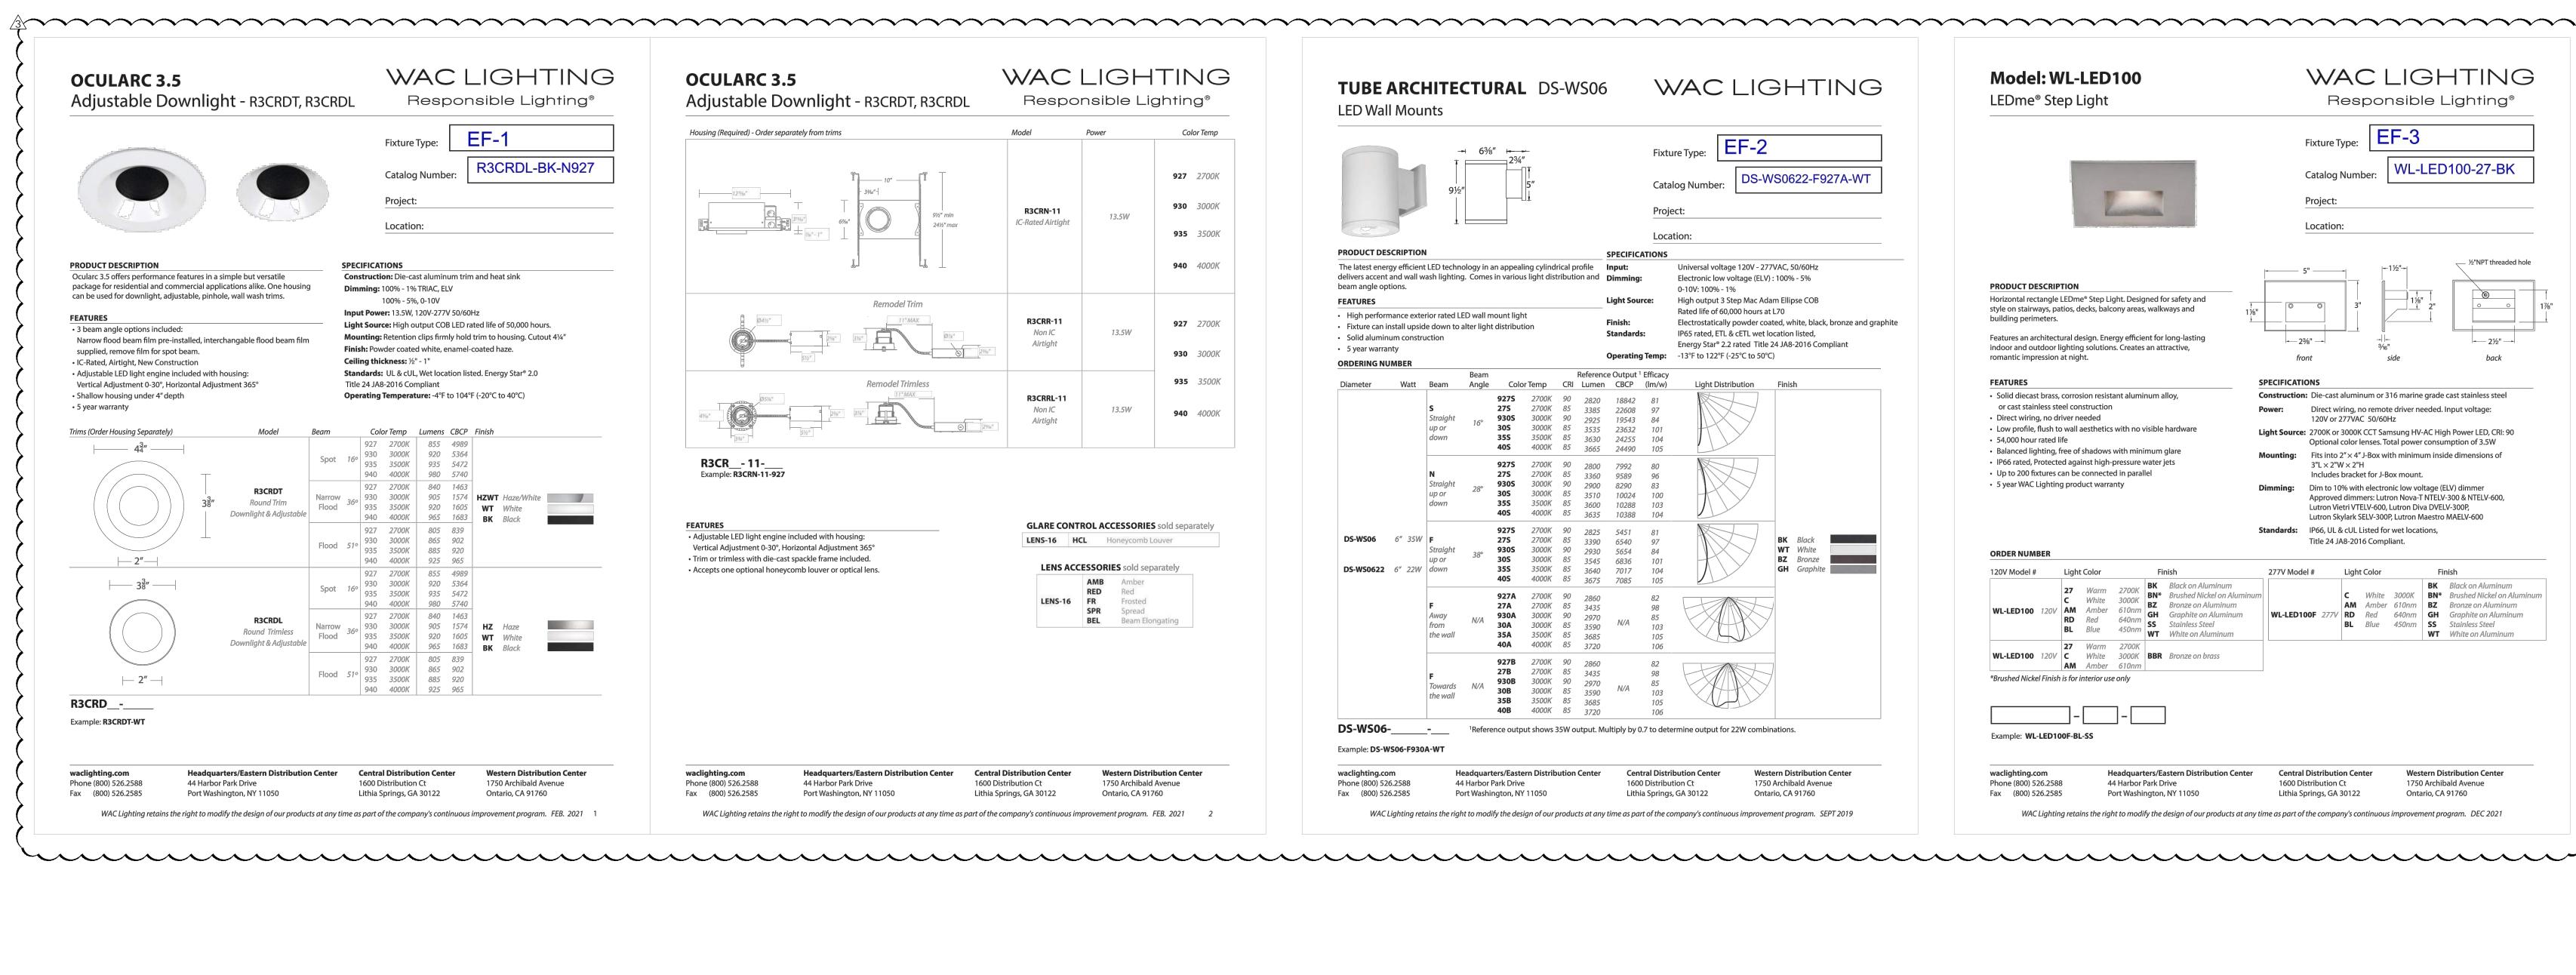

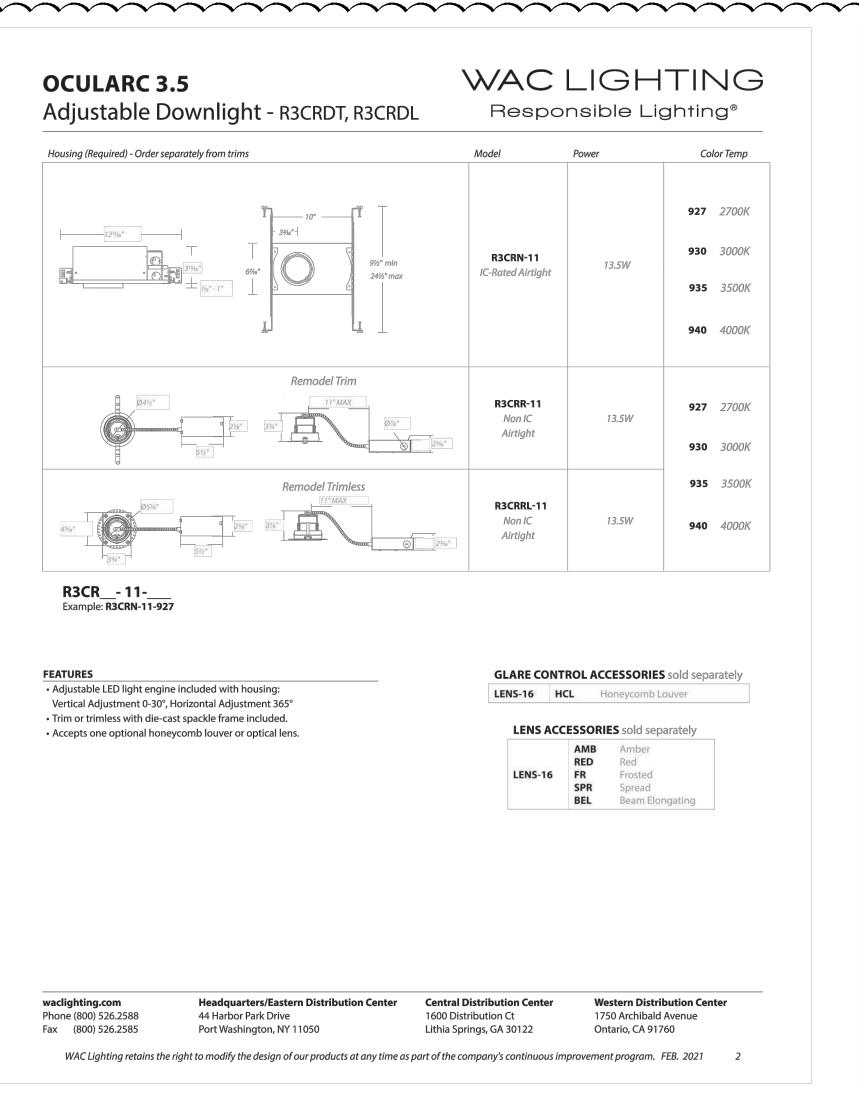

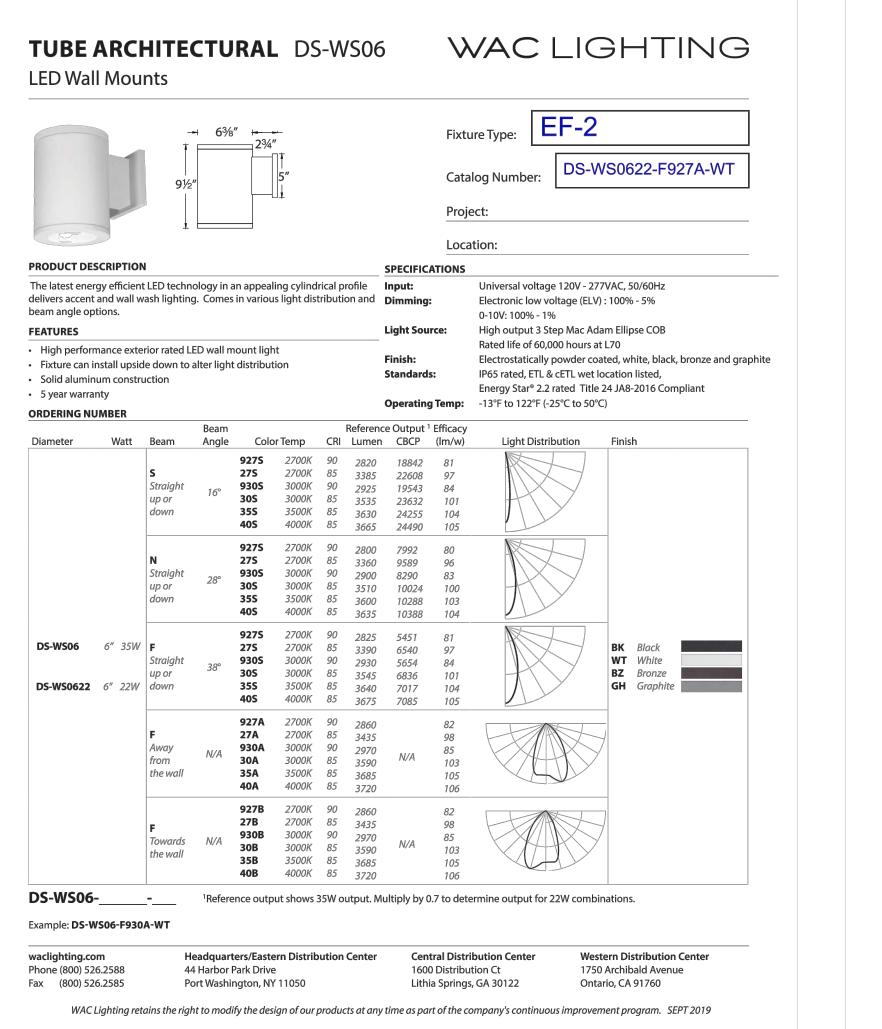

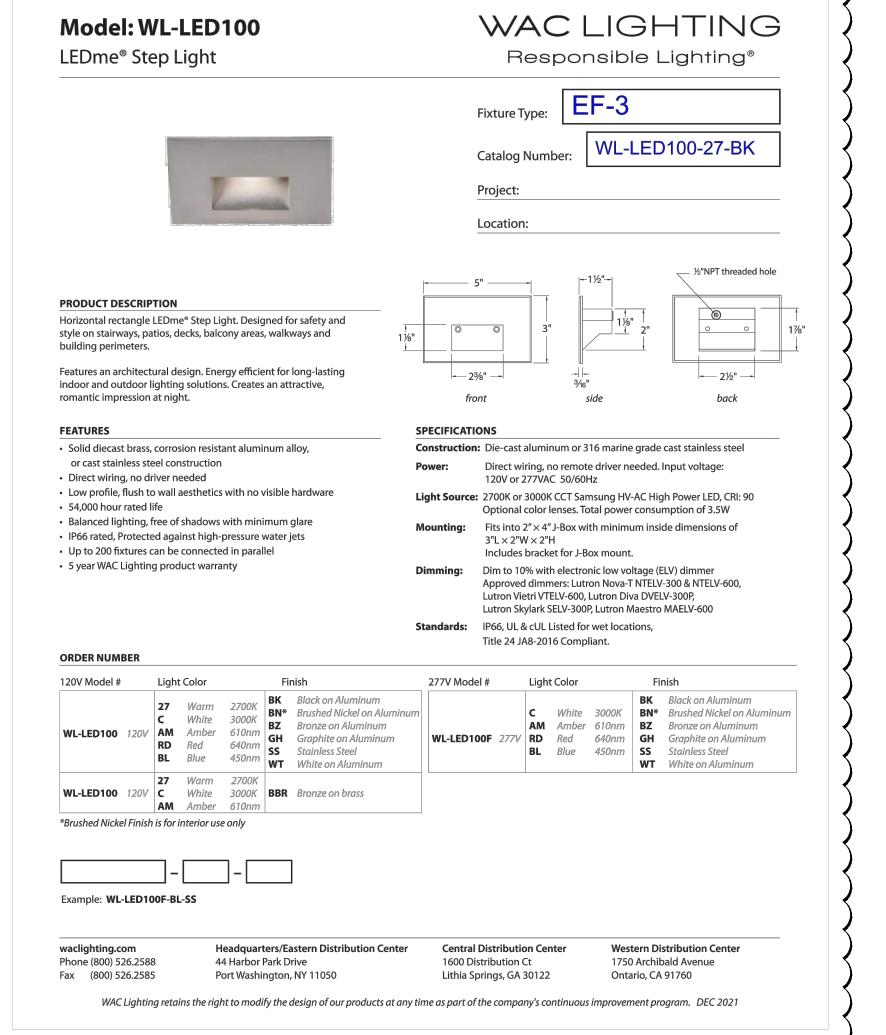


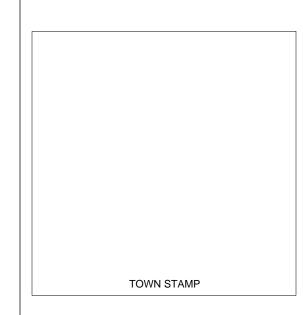






WARM SPRINGS OWNHOME

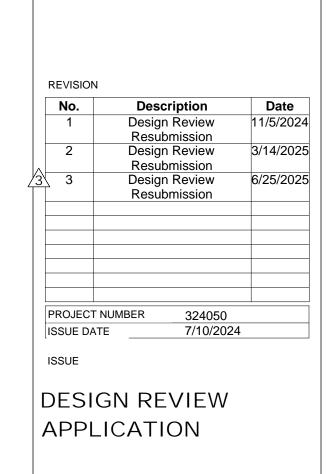

SHEET TITLE

SCHEDULES

E0.12

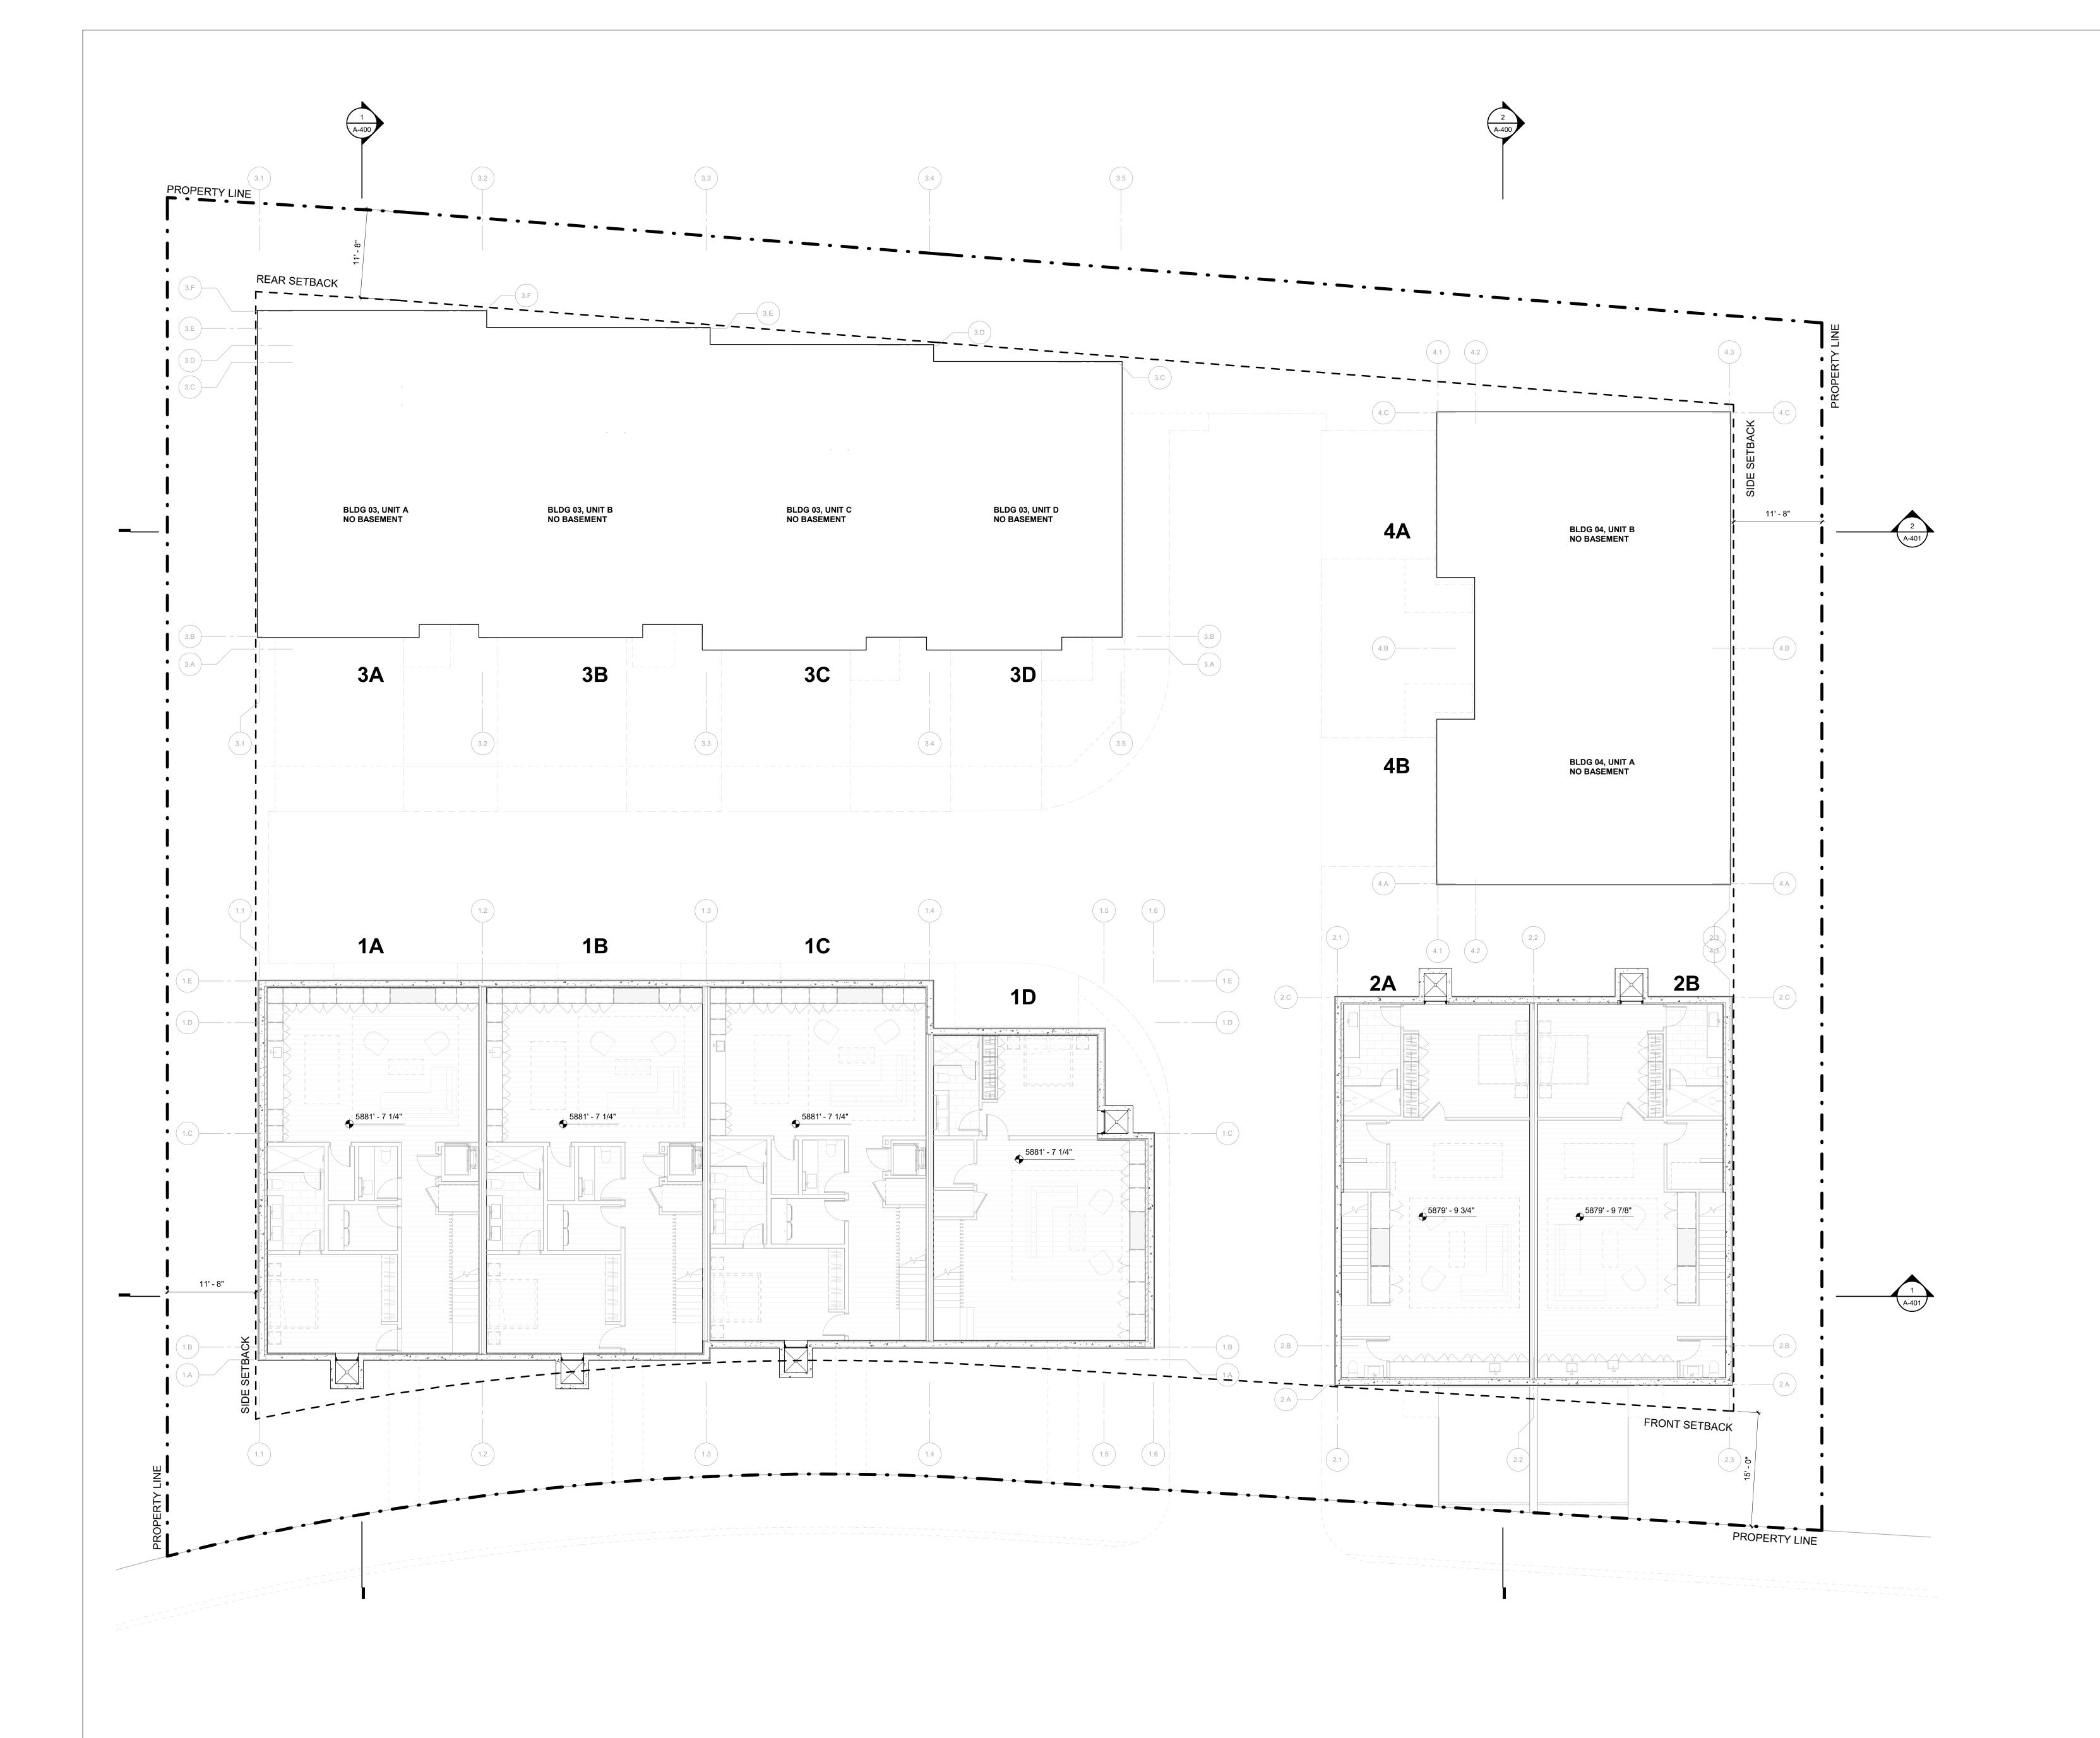

1 1/8" = 1'-0" **OVERALL PLAN - LEVEL 0**

WARM SPRINGS TOWNHOMES KETCHUM, ID

OWNER:

108-110 RITCHIE LLC P.O. BOX 14001-174 KETCHUM, ID 83340 TEL: 603.801.0419

BUILDING ARCHITECT:

RO | ROCKETT DESIGN 1031 W. MANCHESTER BLVD. UNIT 6 INGLEWOOD, CA 90301 TEL: 213.784.0014

STRUCTURAL ENGINEER:

ZFA STRUCTURAL ENGINEERS601 MONTGOMERY STREET SUITE 1450
SAN FRANCISCO, CA 94111
TEL: 415.243.4091

MECHANICAL, ELECTRICAL, PLUMBING ENGINEER:

PROFICIENT ENGINEERING

4704 HARLAN STREET SUITE 620 DENVER, CO 80212 TEL: 720.779.3556

CIVIL ENGINEER:

GALENA BENCHMARK ASSOCIATES 100 BELL DRIVE SUITE C KETCHUM, ID 83340 TEL: 208.726.9512

LANDSCAPE ARCHITECT:

EGGERS ASSOCIATES 560 NORTH 2ND AVENUE KETCHUM, ID 83340 TEL: 208.725.0988

BUE DESCRIPTION DATE
DESIGN REVIEW APP 25.09.09
DESIGN REVIEW APP REV 25.10.14

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PROJECT:
WARM SPRINGS TOWNHOMES
KETCHUM, ID

108 & 110 RITCHIE DR. KETCHUM, IDAHO

DRAWING TITLE:

LEVEL 00 OVERALL FLO


LEVEL 00 OVERALL FLOOR PLAN

SEAL:

PROJECT NUMBER

DRAWING NUMBER:

A-100

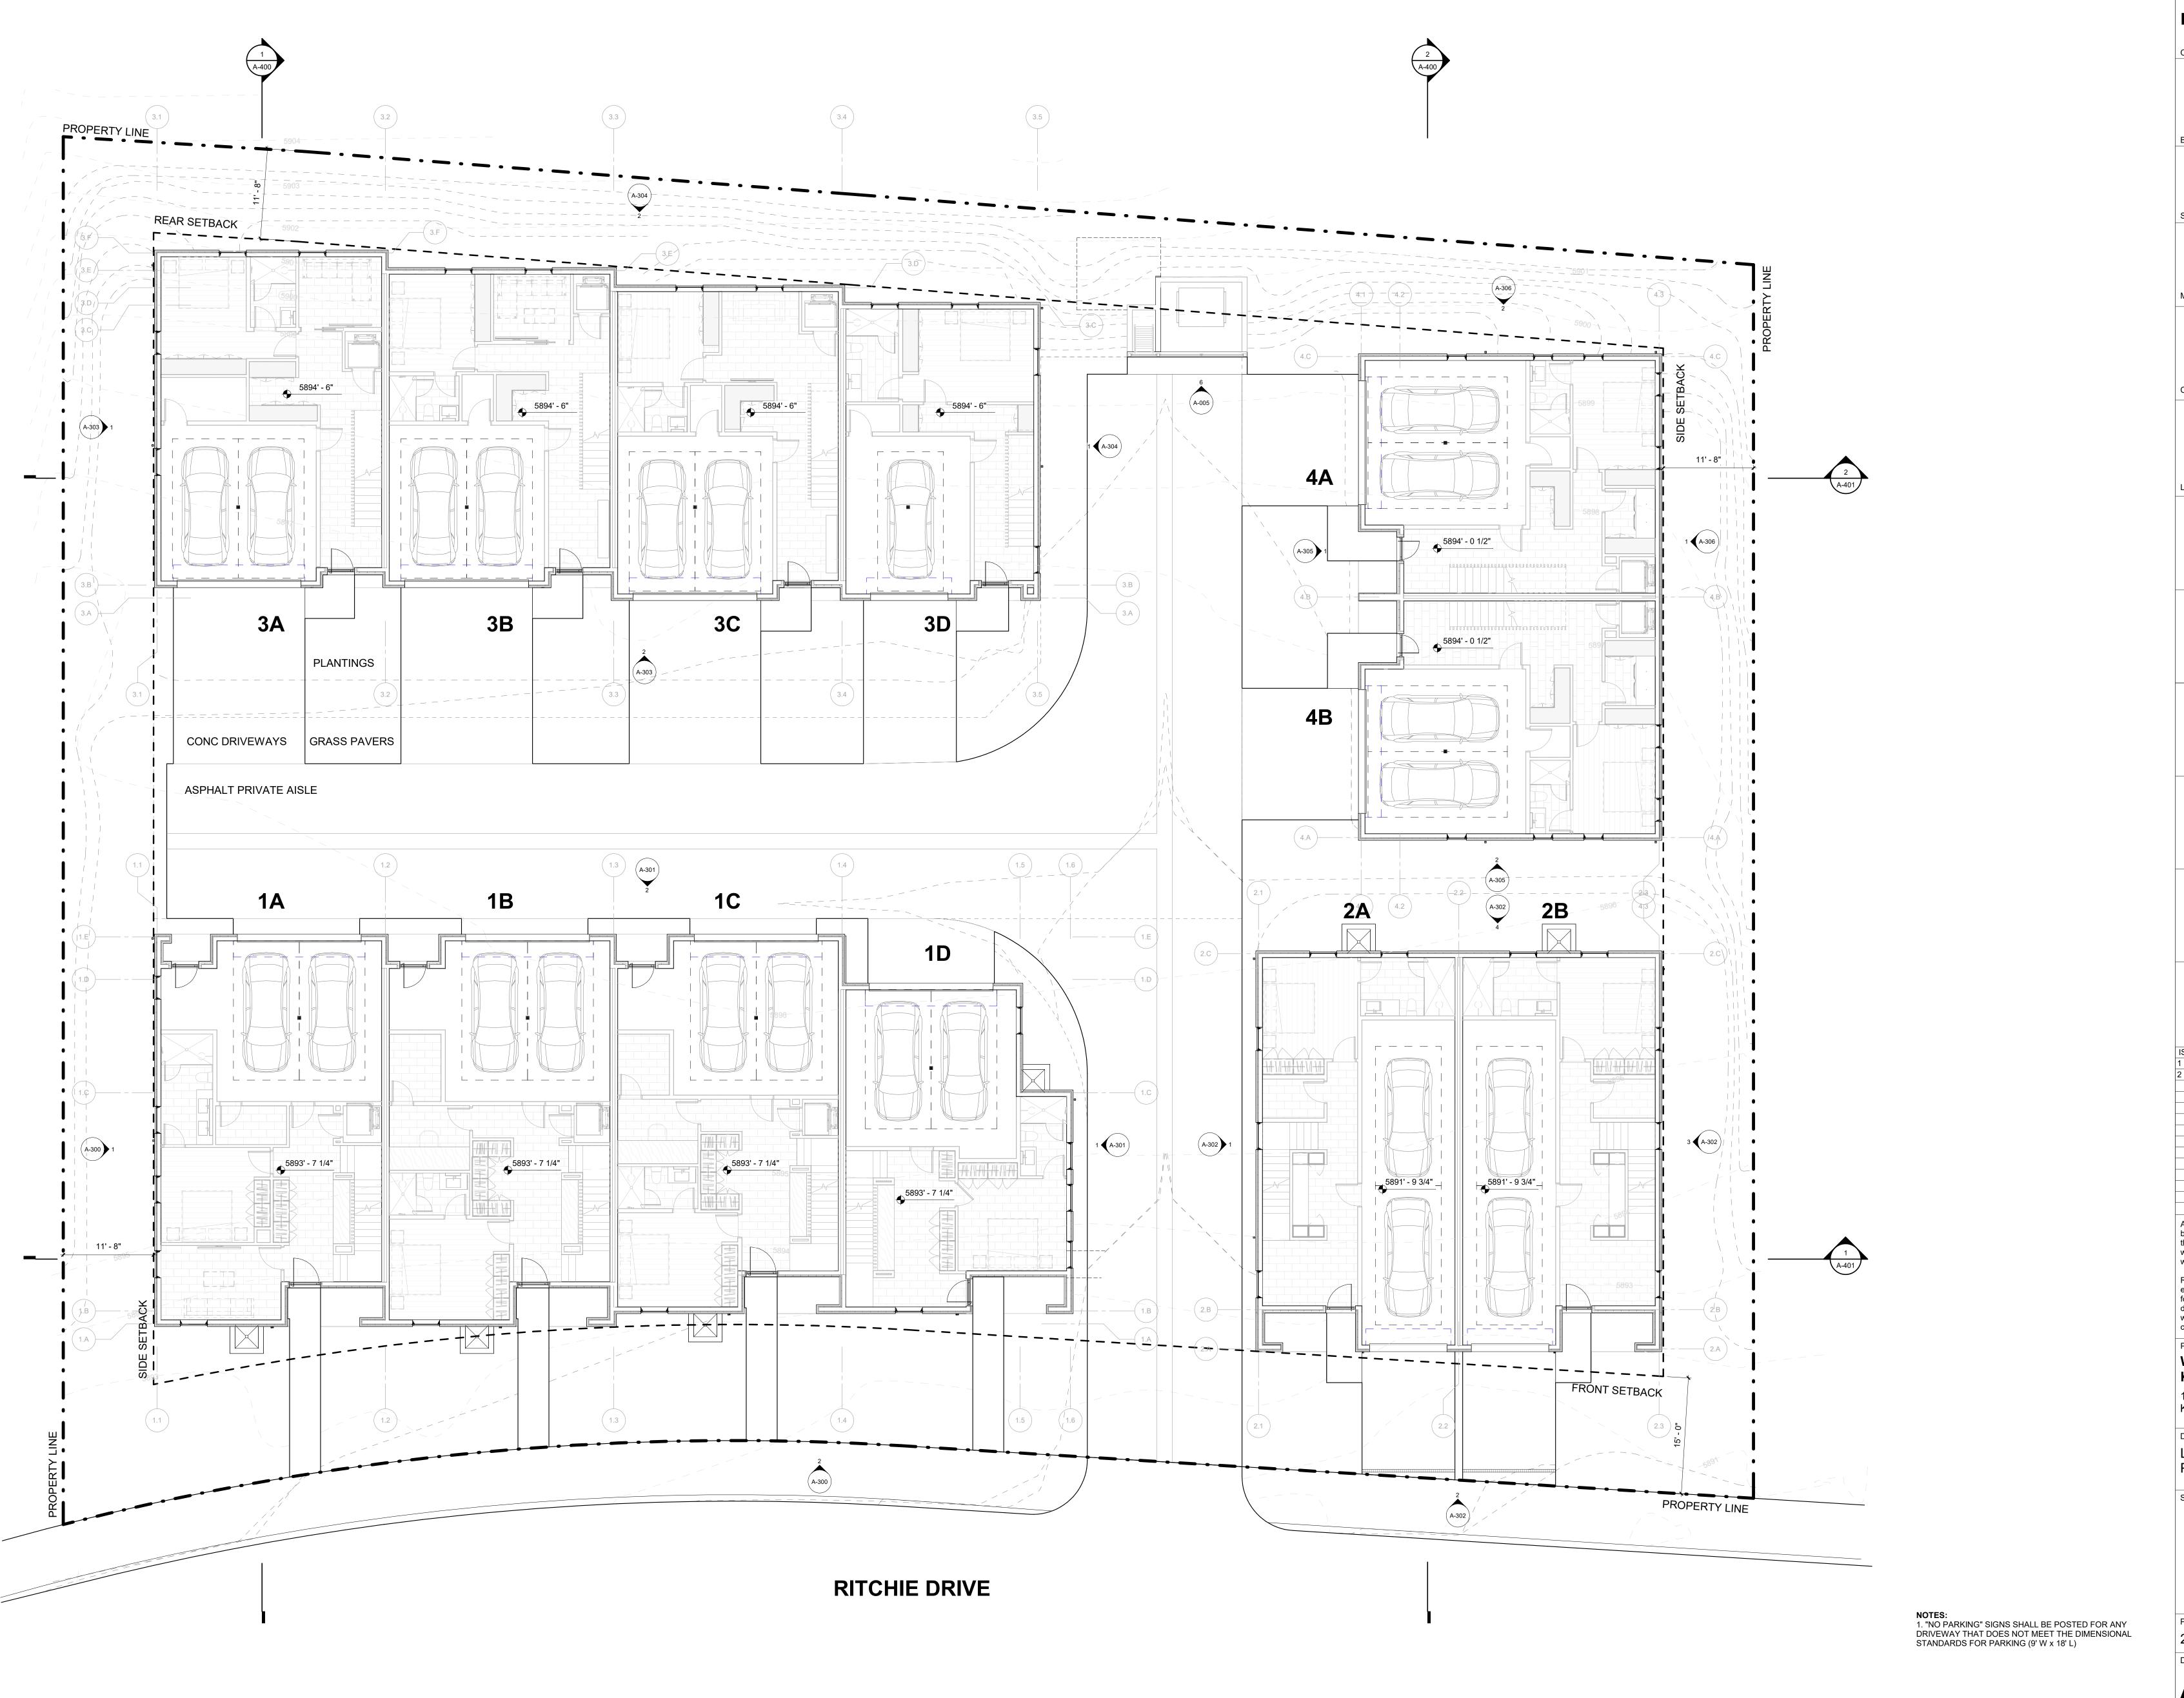

1/8" = 1'-0" **OVERALL PLAN - LEVEL 01**

WARM SPRINGS TOWNHOMES KETCHUM, ID

OWNER:

108-110 RITCHIE LLC P.O. BOX 14001-174 KETCHUM, ID 83340 TEL: 603.801.0419

BUILDING ARCHITECT:

RO | ROCKETT DESIGN 1031 W. MANCHESTER BLVD. UNIT 6 INGLEWOOD, CA 90301 TEL: 213.784.0014

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601 MONTGOMERY STREET SUITE 1450
SAN FRANCISCO, CA 94111
TEL: 415.243.4091

MECHANICAL, ELECTRICAL, PLUMBING ENGINEER:

PROFICIENT ENGINEERING

4704 HARLAN STREET SUITE 620

DENVER, CO 80212 TEL: 720.779.3556

CIVIL ENGINEER:

GALENA BENCHMARK ASSOCIATES 100 BELL DRIVE SUITE C KETCHUM, ID 83340 TEL: 208.726.9512

LANDSCAPE ARCHITECT:

EGGERS ASSOCIATES 560 NORTH 2ND AVENUE KETCHUM, ID 83340 TEL: 208.725.0988

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WARM SPRINGS TOWNHOMES KETCHUM, ID

108 & 110 RITCHIE DR.

DRAWING TITLE:

DRAWING TITLE:


LEVEL 01 OVERALL FLOOR
PLAN

SEAL:

PROJECT NUMBER

DRAWING NUMBER:

A-101

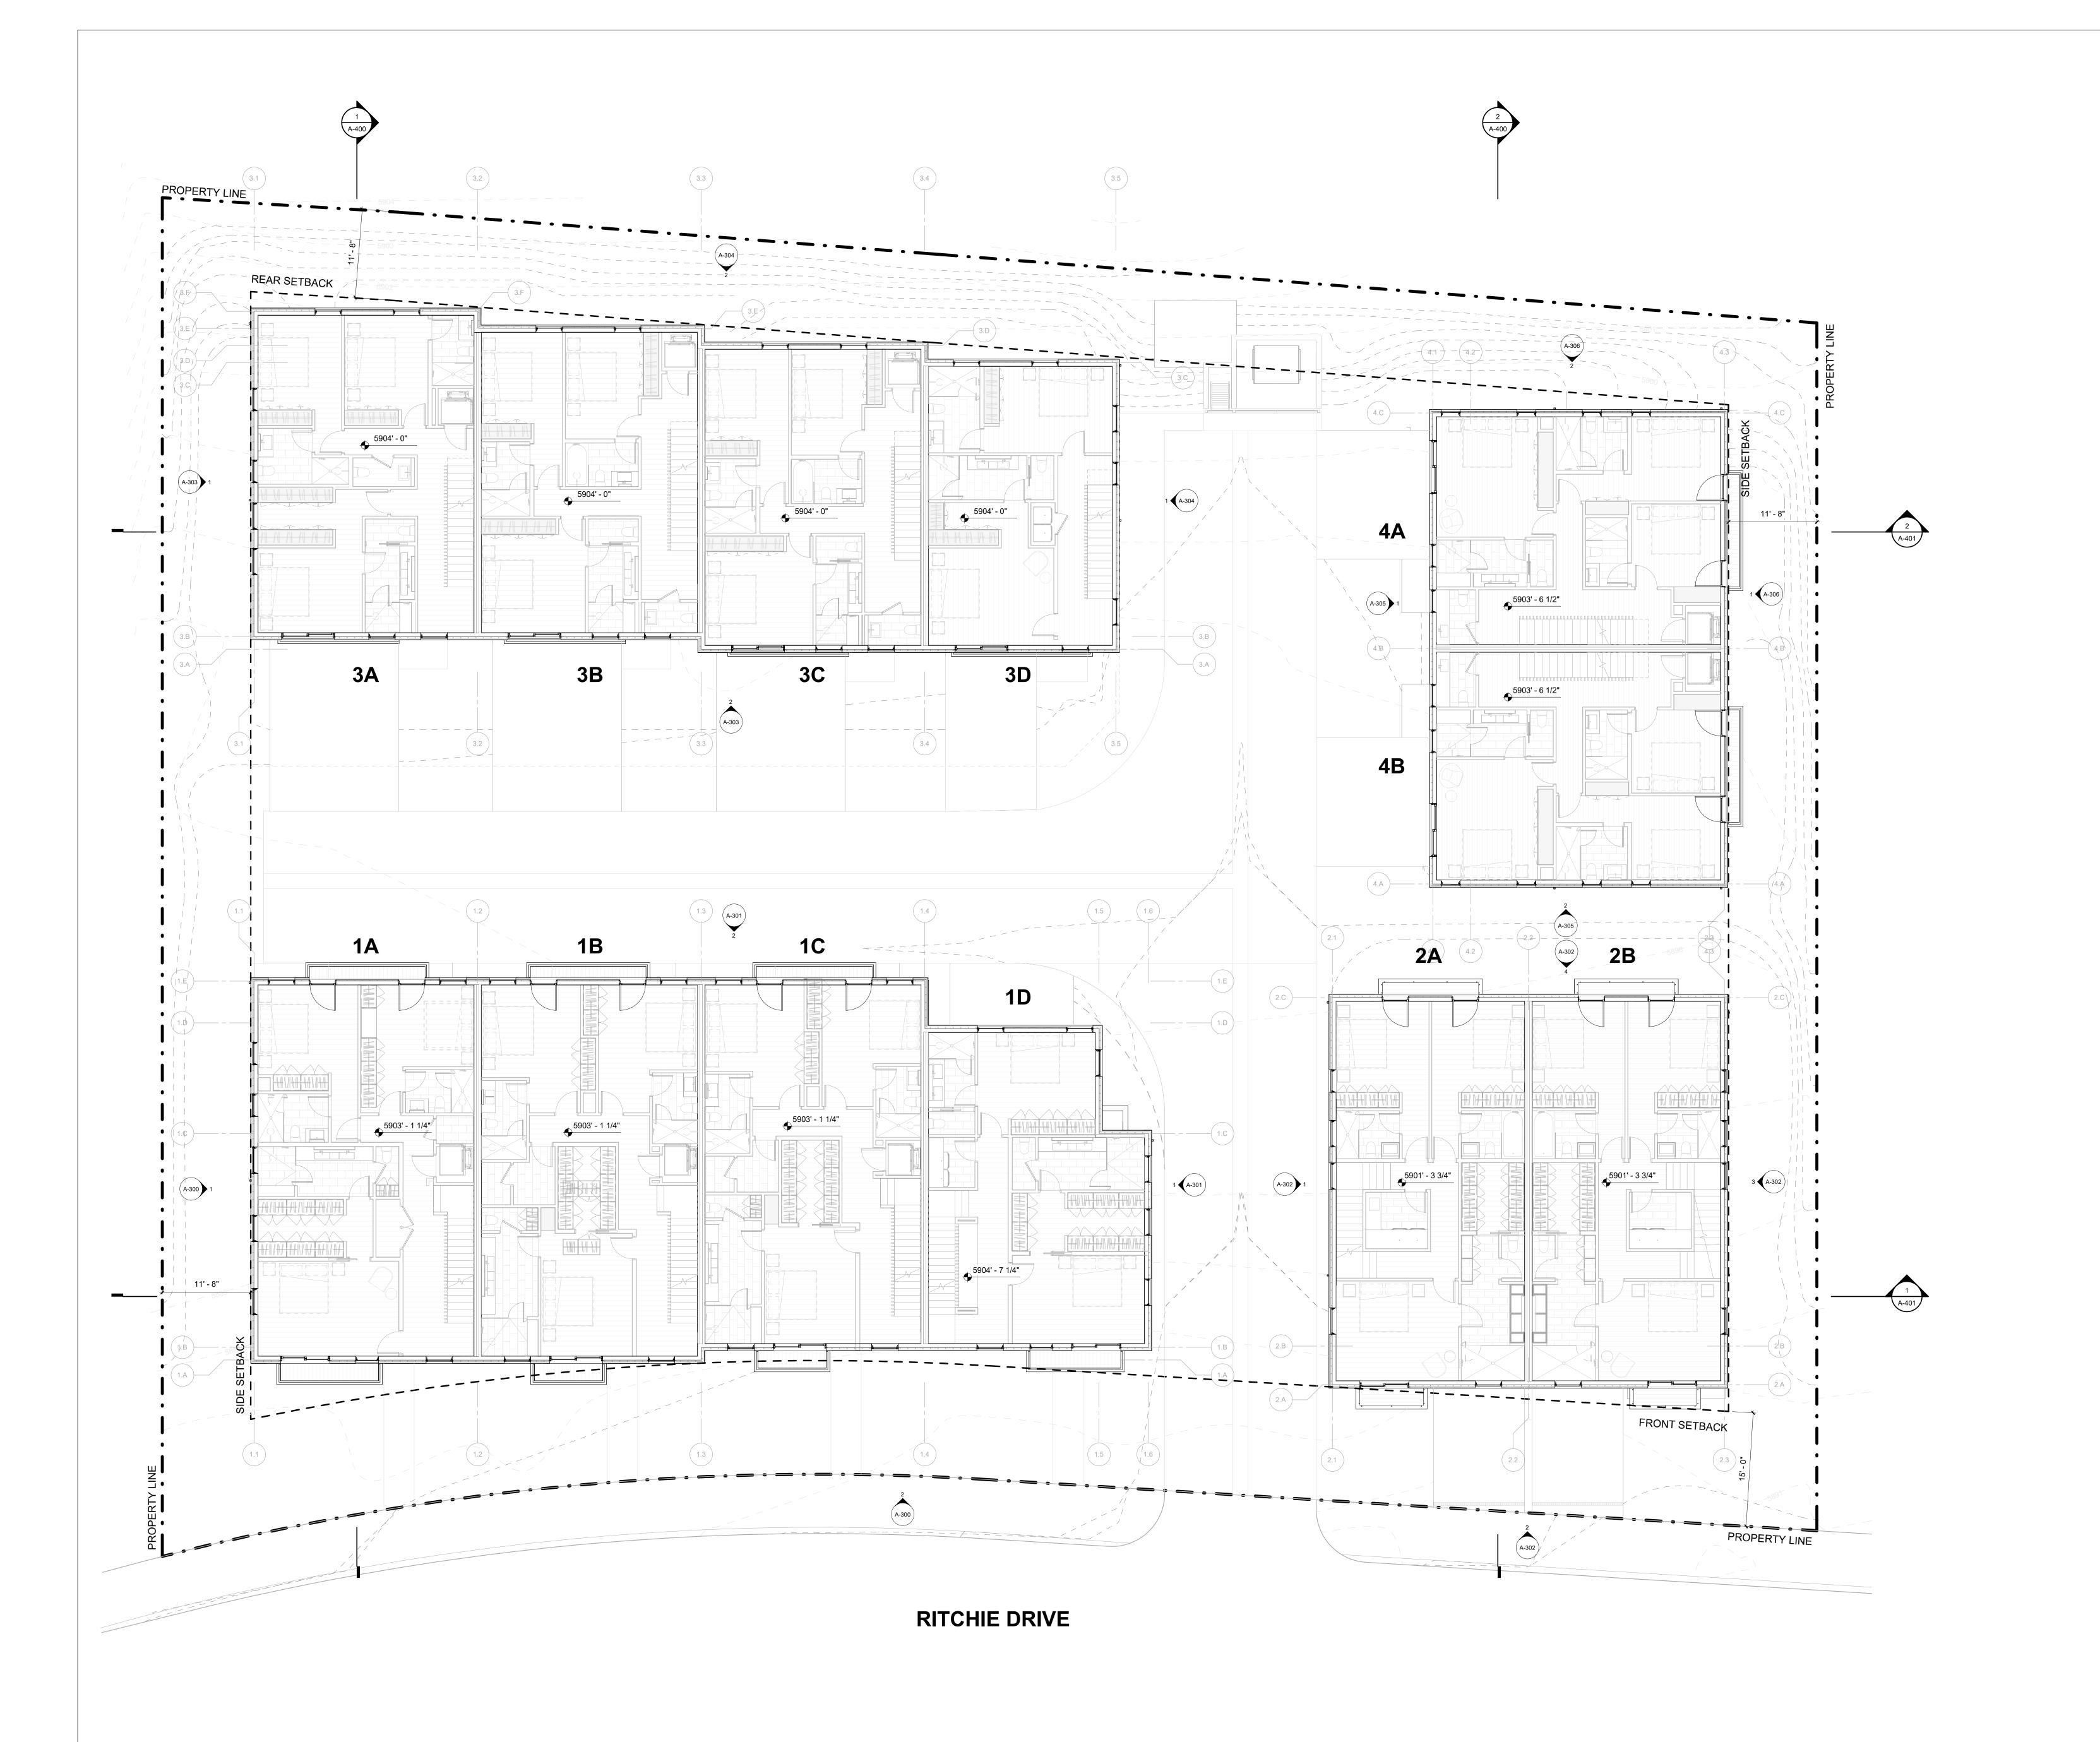

1/8" = 1'-0" **OVERALL PLAN - LEVEL 02**

WARM SPRINGS TOWNHOMES KETCHUM, ID

OWNER:

108-110 RITCHIE LLC P.O. BOX 14001-174 KETCHUM, ID 83340 TEL: 603.801.0419

BUILDING ARCHITECT:

RO | ROCKETT DESIGN 1031 W. MANCHESTER BLVD. UNIT 6 INGLEWOOD, CA 90301 TEL: 213.784.0014

STRUCTURAL ENGINEER:

ZFA STRUCTURAL ENGINEERS
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SAN FRANCISCO, CA 94111
TEL: 415.243.4091

MECHANICAL, ELECTRICAL, PLUMBING ENGINEER:

PROFICIENT ENGINEERING

4704 HARLAN STREET SUITE 620

DENVER, CO 80212 TEL: 720.779.3556

CIVIL ENGINEER:

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LANDSCAPE ARCHITECT:

EGGERS ASSOCIATES 560 NORTH 2ND AVENUE KETCHUM, ID 83340 TEL: 208.725.0988

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DESIGN REVIEW APP REV 25.10.14

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PROJECT:
WARM SPRINGS TOWNHOMES
KETCHUM, ID

108 & 110 RITCHIE DR. KETCHUM, IDAHO

DRAWING TITLE:


LEVEL 02 OVERALL FLOOR

CEAL.

PROJECT NUMBER

DRAWING NUMBER:

A-102

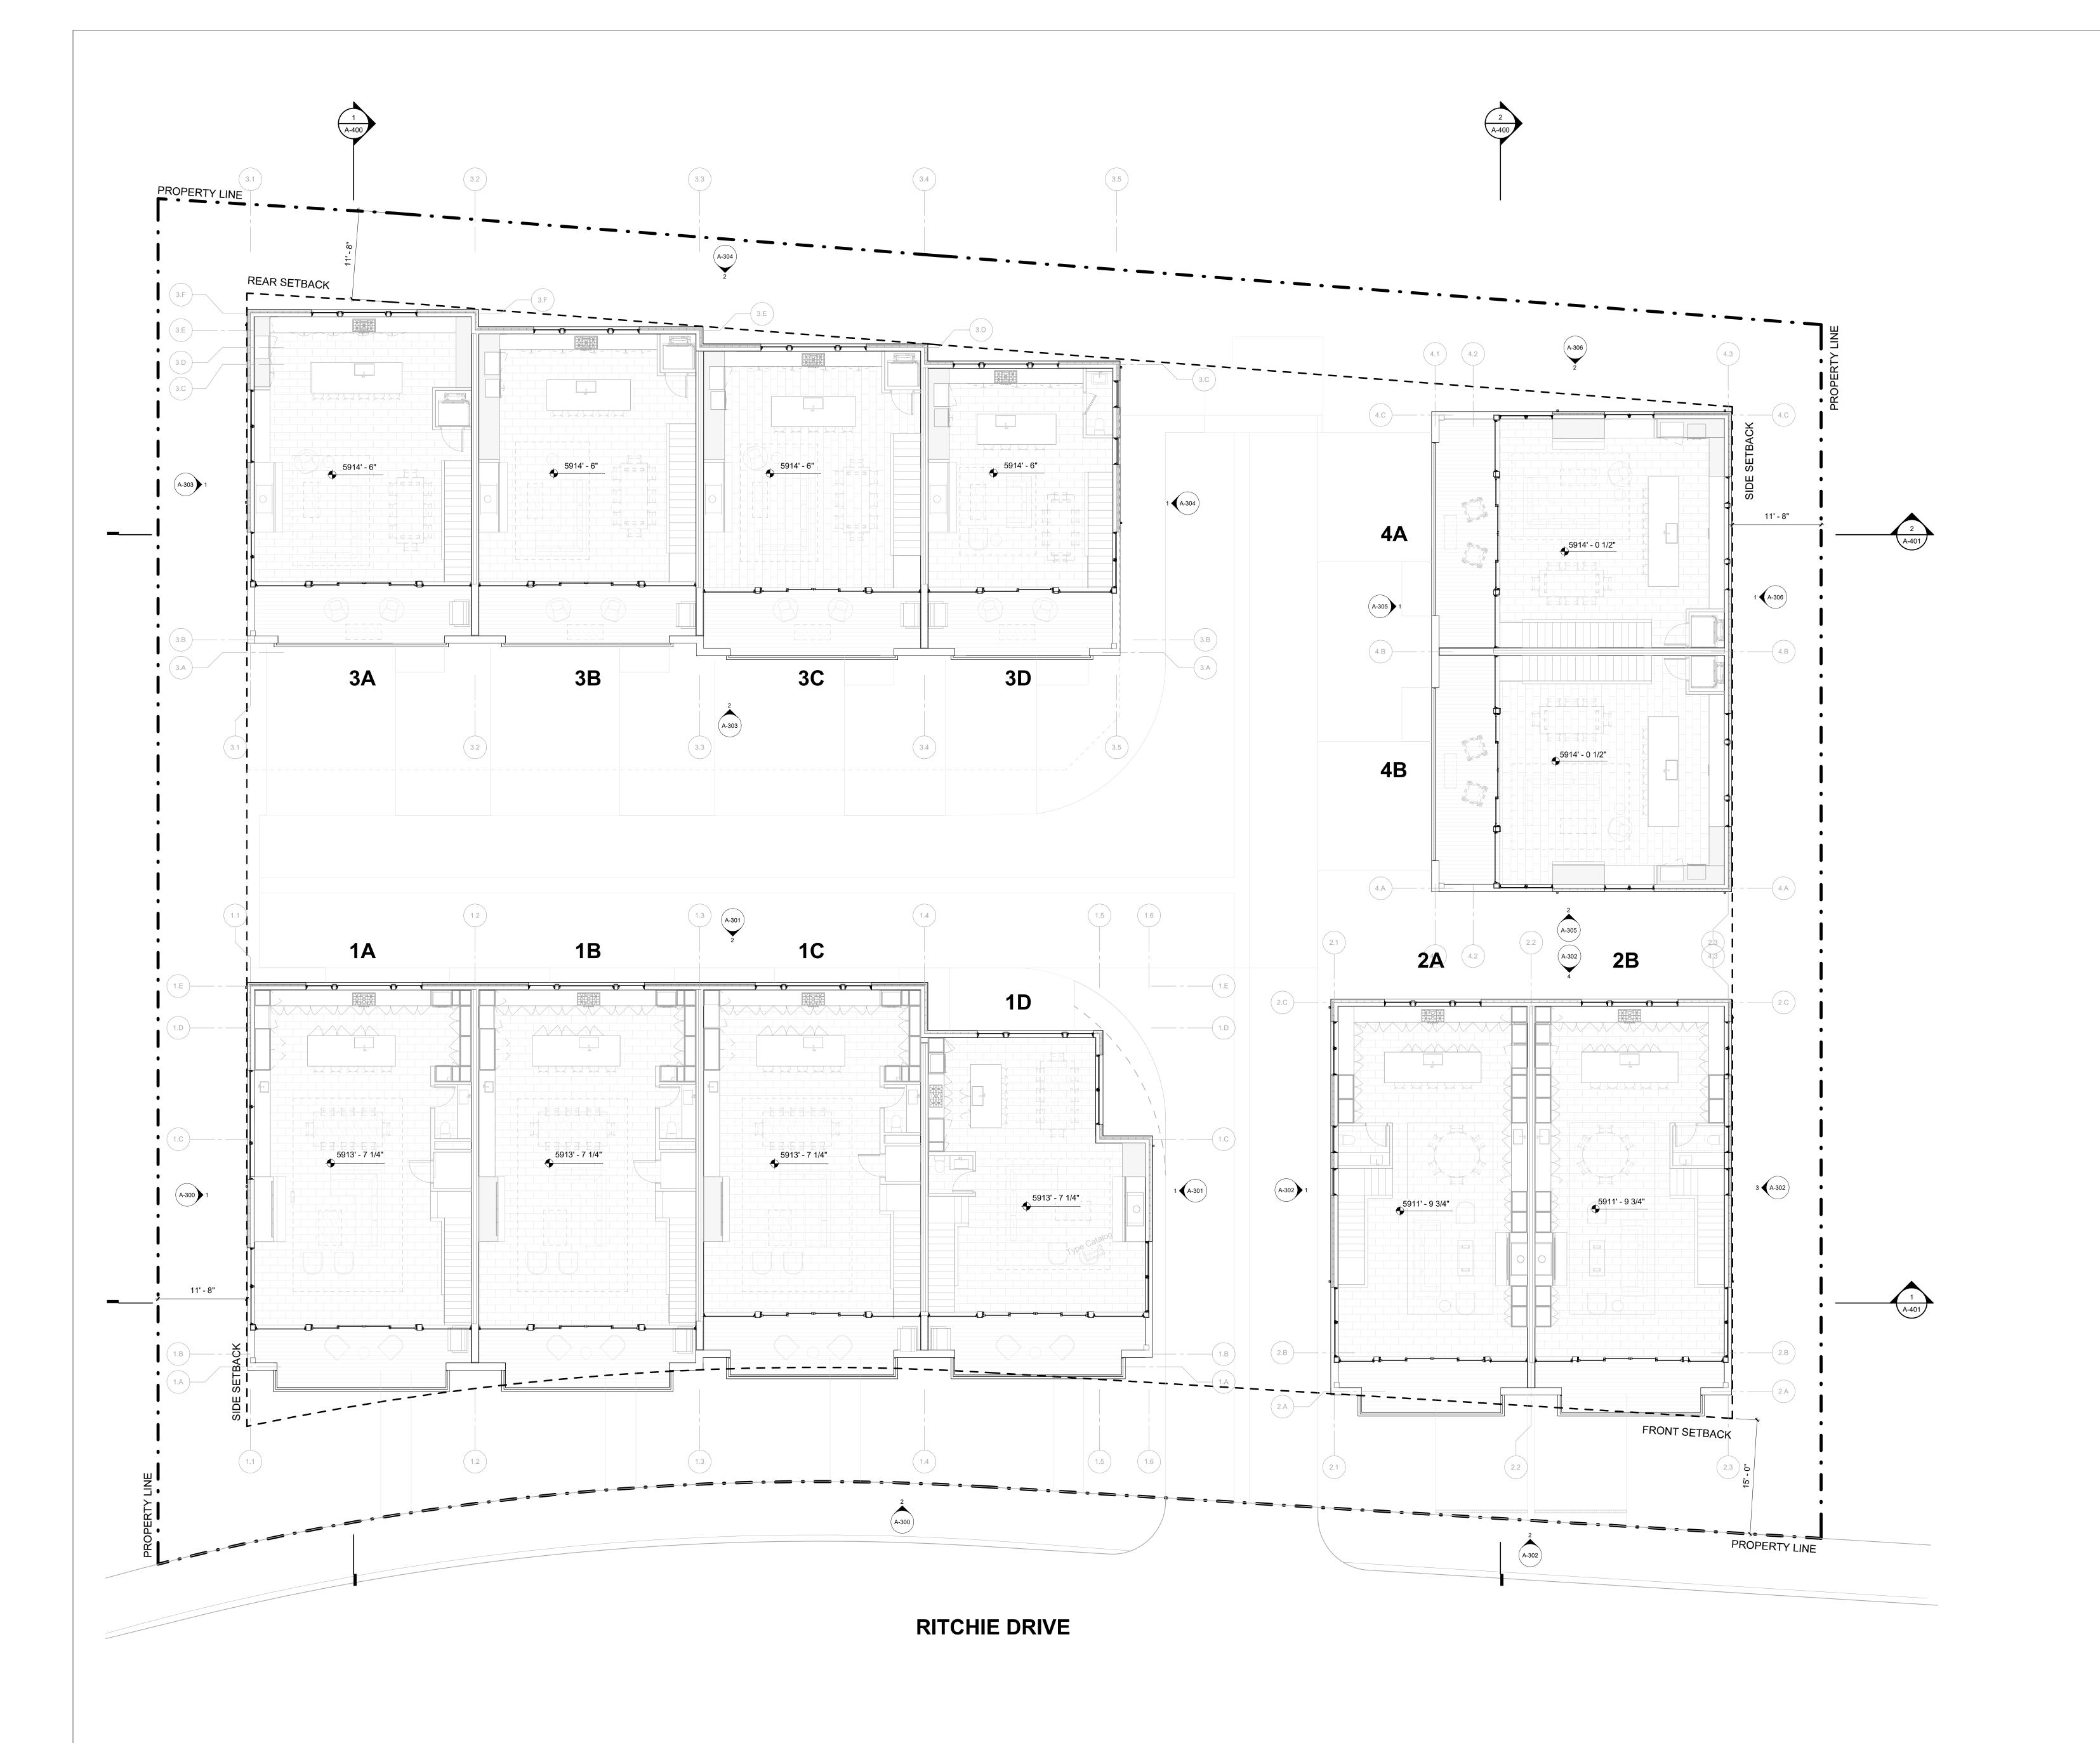

1/8" = 1'-0" **OVERALL PLAN - LEVEL 03**

WARM SPRINGS TOWNHOMES KETCHUM, ID

OWNER:

108-110 RITCHIE LLC P.O. BOX 14001-174 KETCHUM, ID 83340 TEL: 603.801.0419

BUILDING ARCHITECT:

RO | ROCKETT DESIGN 1031 W. MANCHESTER BLVD. UNIT 6 INGLEWOOD, CA 90301 TEL: 213.784.0014

STRUCTURAL ENGINEER:

ZFA STRUCTURAL ENGINEERS601 MONTGOMERY STREET SUITE 1450
SAN FRANCISCO, CA 94111
TEL: 415.243.4091

MECHANICAL, ELECTRICAL, PLUMBING ENGINEER:

PROFICIENT ENGINEERING

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DENVER, CO 80212 TEL: 720.779.3556

CIVIL ENGINEER:

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LANDSCAPE ARCHITECT:

EGGERS ASSOCIATES 560 NORTH 2ND AVENUE KETCHUM, ID 83340 TEL: 208.725.0988

JE DESCRIPTION DATE
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PROJECT:
WARM SPRINGS TOWNHOMES
KETCHUM, ID

108 & 110 RITCHIE DR. KETCHUM, IDAHO

DRAWING TITLE:

LEVEL 03 OVERALL FLOOR


CEAL.

PROJECT NUMBER

2305

DRAWING NUMBER:

A-103

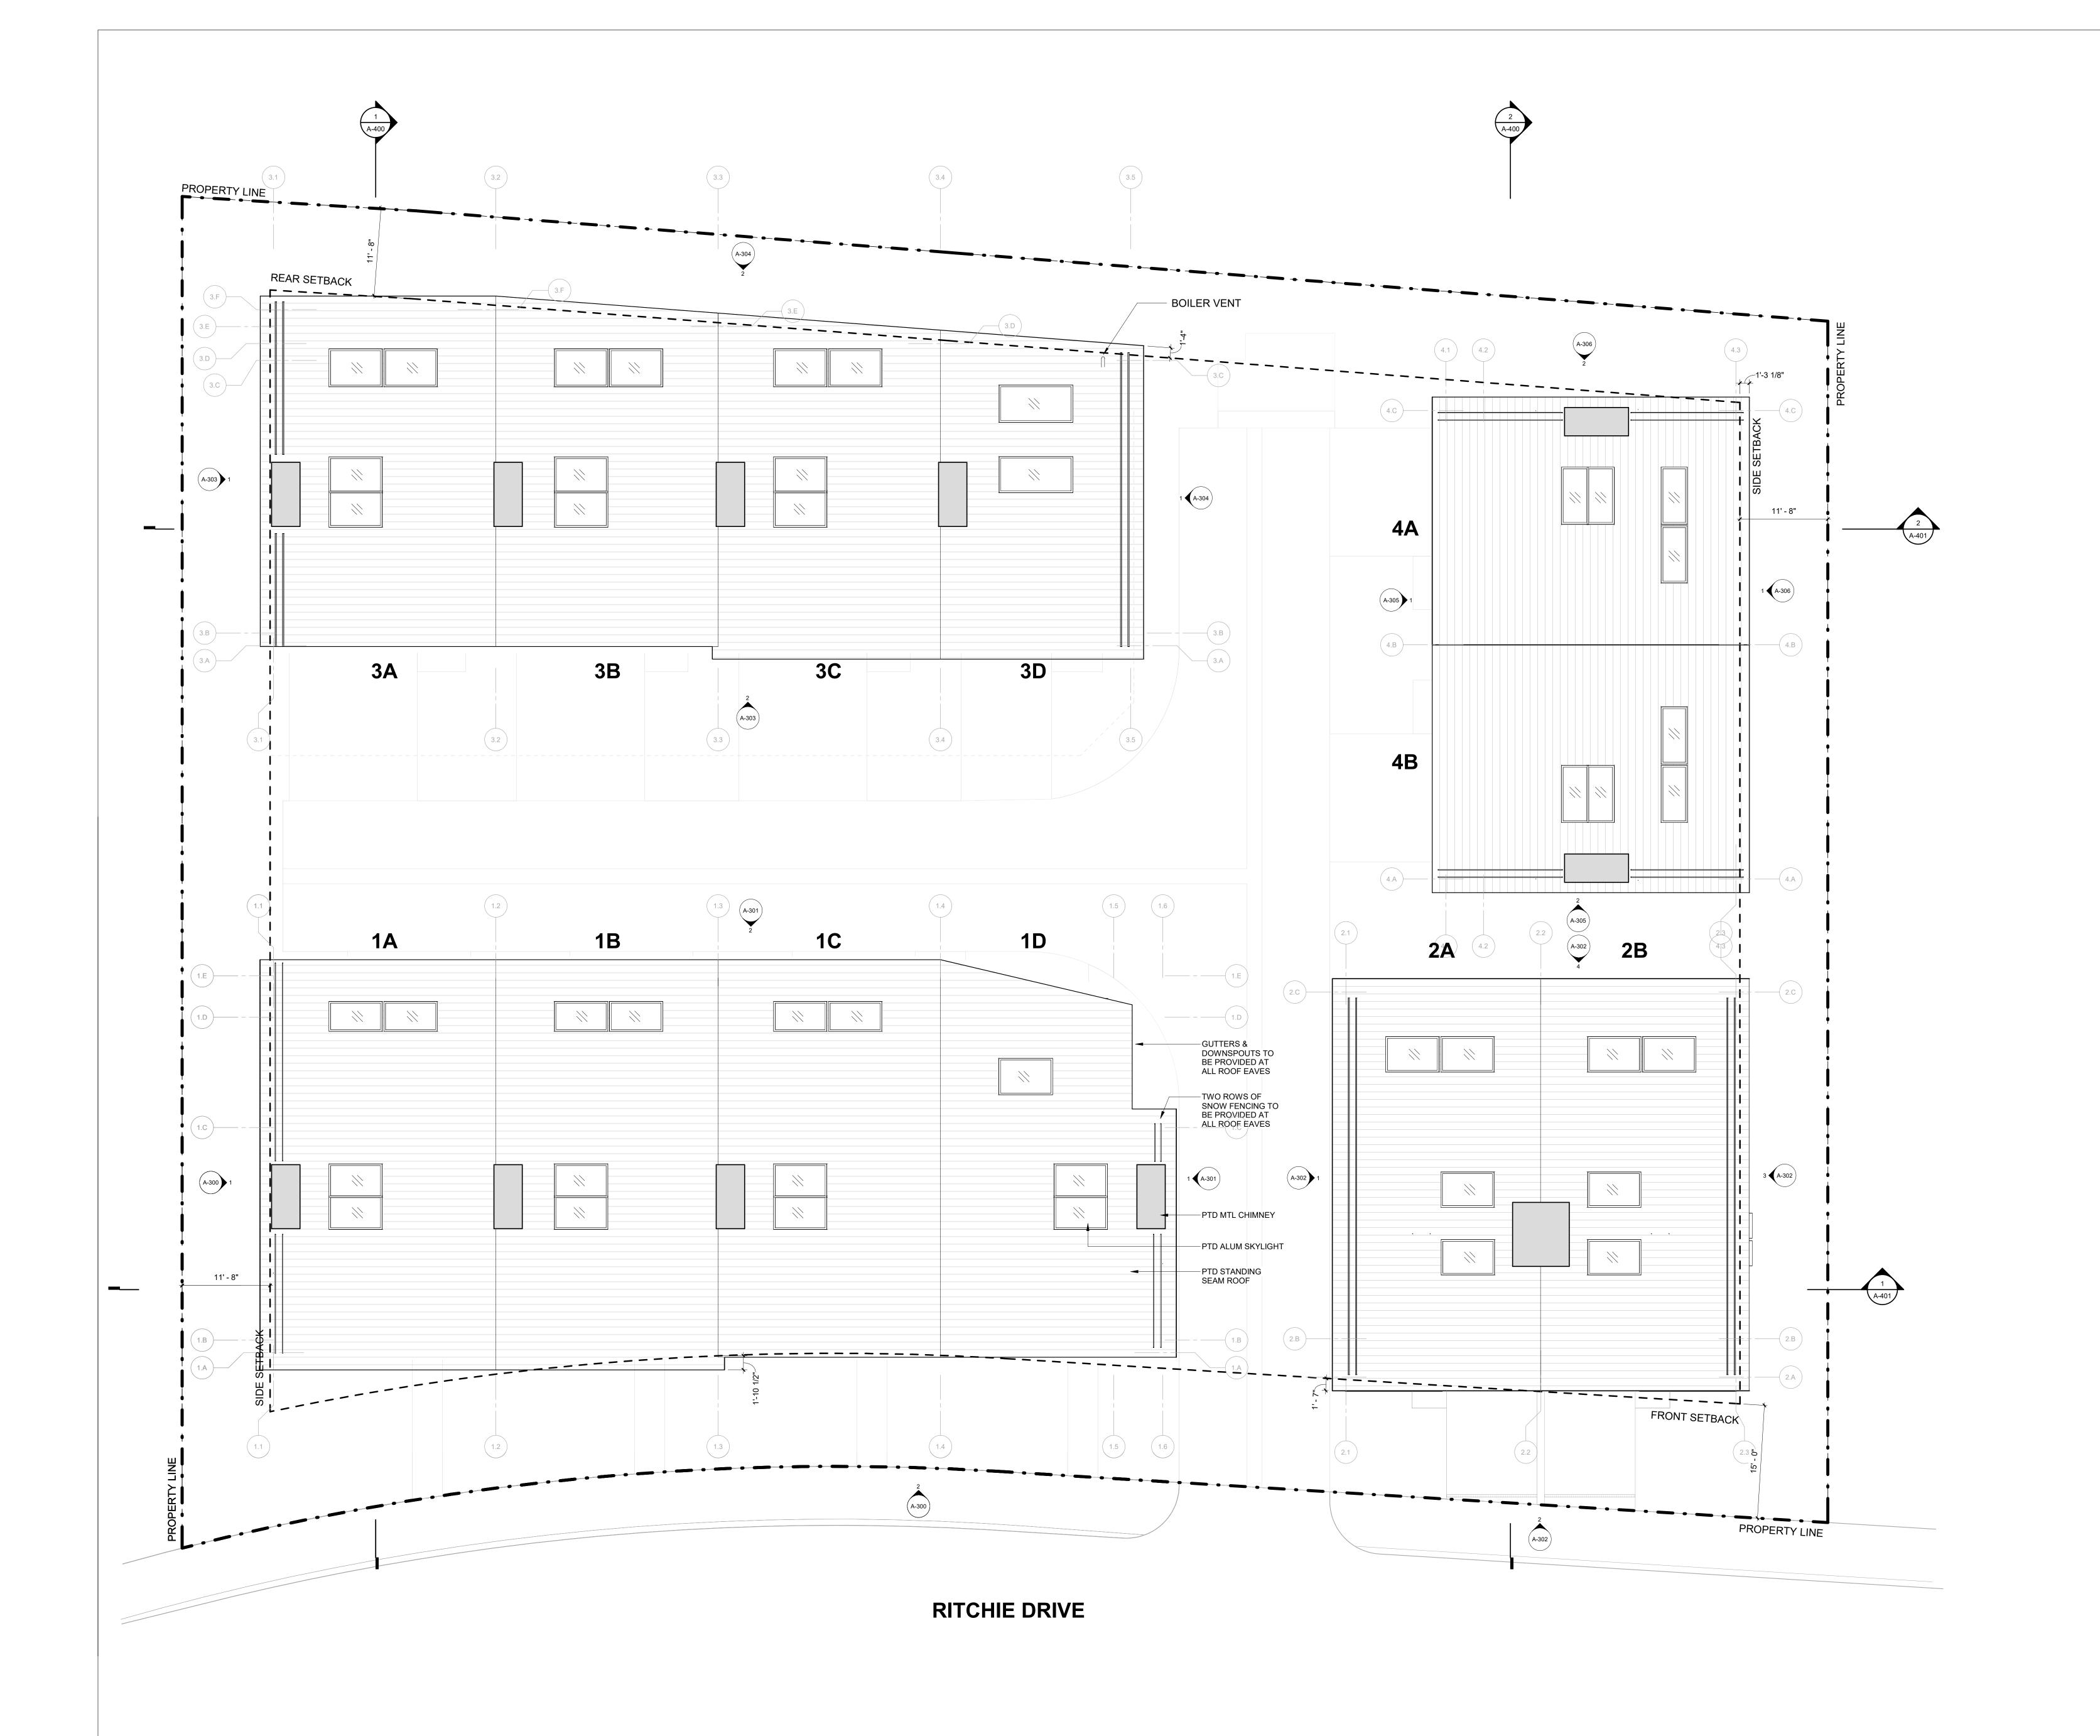

1 1/8" = 1'-0" **OVERALL PLAN - ROOF**

WARM SPRINGS TOWNHOMES KETCHUM, ID

OWNER:

108-110 RITCHIE LLC P.O. BOX 14001-174 KETCHUM, ID 83340 TEL: 603.801.0419

BUILDING ARCHITECT:

RO | ROCKETT DESIGN 1031 W. MANCHESTER BLVD. UNIT 6 INGLEWOOD, CA 90301 TEL: 213.784.0014

STRUCTURAL ENGINEER:

ZFA STRUCTURAL ENGINEERS
601 MONTGOMERY STREET SUITE 1450
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TEL: 415.243.4091

MECHANICAL, ELECTRICAL, PLUMBING ENGINEER:

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CIVIL ENGINEER:

GALENA BENCHMARK ASSOCIATES 100 BELL DRIVE SUITE C KETCHUM, ID 83340 TEL: 208.726.9512

LANDSCAPE ARCHITECT:

560 NORTH 2ND AVENUE KETCHUM, ID 83340 TEL: 208.725.0988

EGGERS ASSOCIATES

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DESIGN REVIEW APP REV 25.10.14

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PROJECT:
WARM SPRINGS TOWNHOMES
KETCHUM, ID

108 & 110 RITCHIE DR. KETCHUM, IDAHO

DRAWING TITLE:

OVERALL ROOF PLAN

SEAL:

PROJECT NUMBER 2305

A-104









WD ACCENT

STN VENEER SIDING

1 1/4" = 1'-0" BUILDING 3 / ELEVATION - SOUTH

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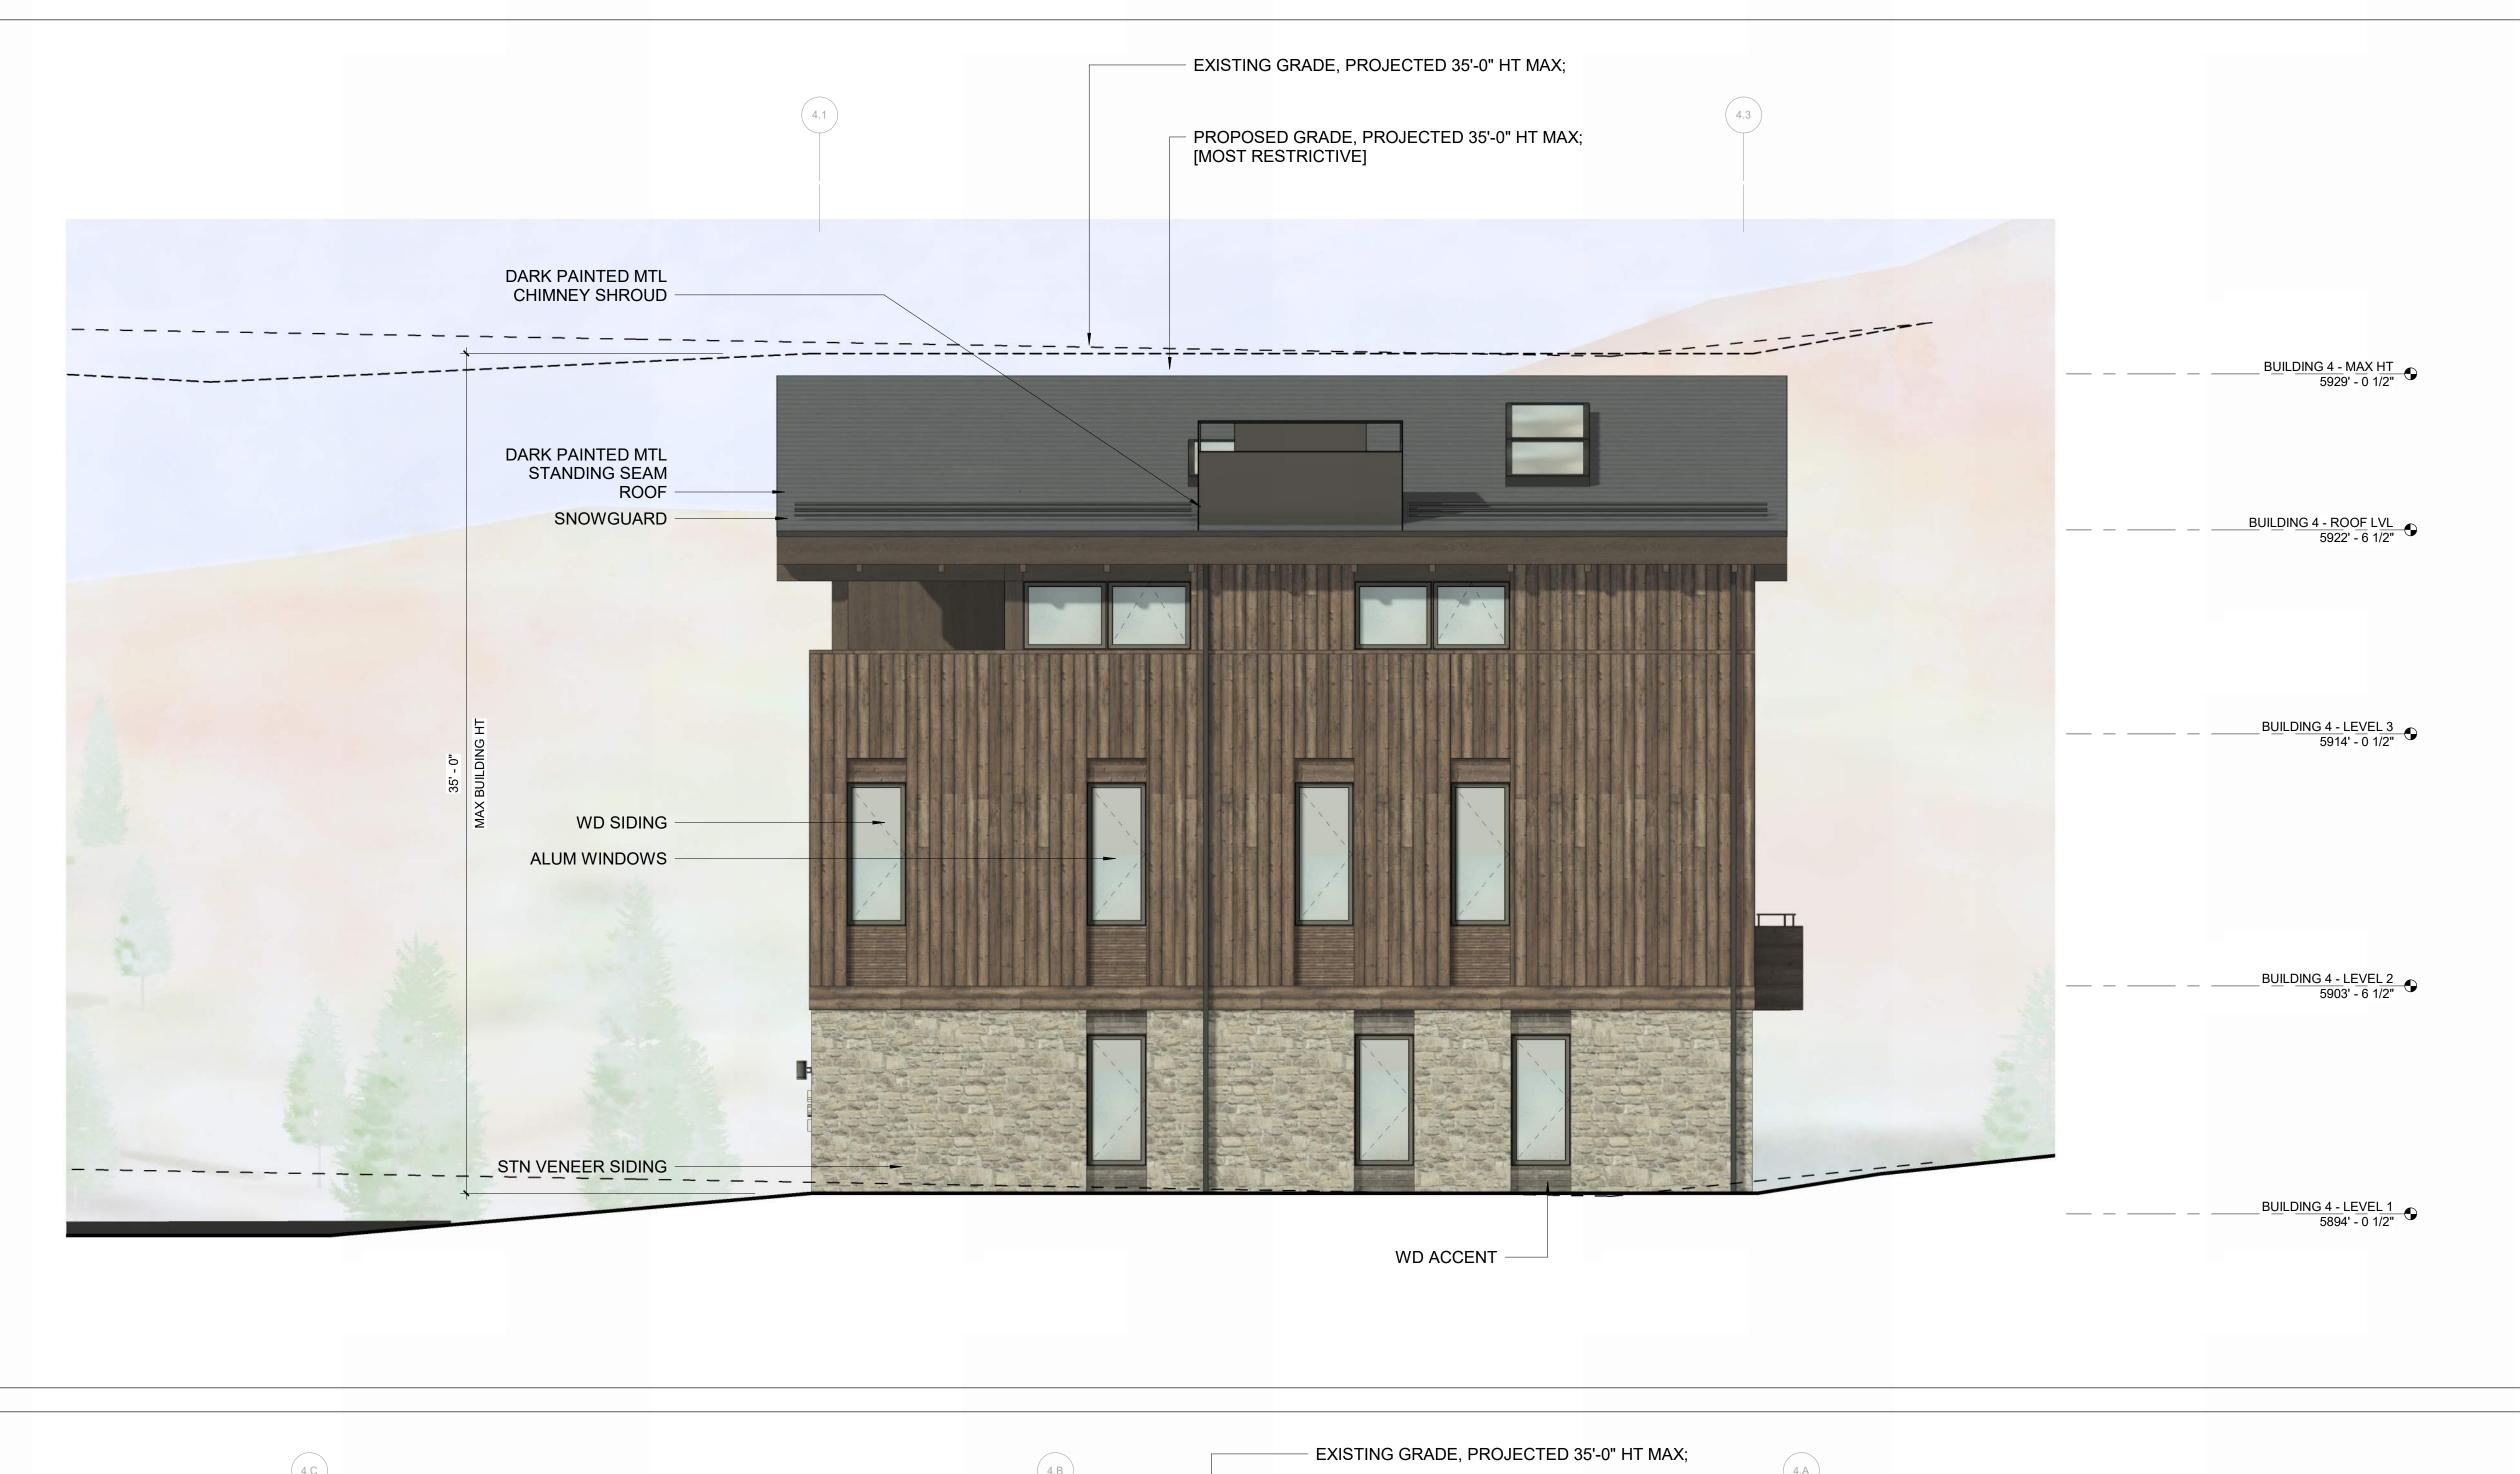
PROJECT NUMBER

DRAWING NUMBER:

A-303

BUILDING 3 - LEVEL 1 5894' - 6"





2 1/4" = 1'-0" **BUILDING 4 / ELEVATION - EAST**

1 1/4" = 1'-0" **BUILDING 4 / ELEVATION - SOUTH**



WARM SPRINGS TOWNHOMES KETCHUM, ID

OWNE

108-110 RITCHIE LLCP.O. BOX 14001-174
KETCHUM, ID 83340
TEL: 603.801.0419

BUILDING ARCHITECT:

RO | ROCKETT DESIGN 1031 W. MANCHESTER BLVD. UNIT 6 INGLEWOOD, CA 90301 TEL: 213.784.0014

STRUCTURAL ENGINEER:

ZFA STRUCTURAL ENGINEERS601 MONTGOMERY STREET SUITE 1450
SAN FRANCISCO, CA 94111
TEL: 415.243.4091

MECHANICAL, ELECTRICAL, PLUMBING ENGINEER:

PROFICIENT ENGINEERING

4704 HARLAN STREET SUITE 620

DENVER, CO 80212 TEL: 720.779.3556

CIVIL ENGINEER:

GALENA BENCHMARK ASSOCIATES 100 BELL DRIVE SUITE C KETCHUM, ID 83340 TEL: 208.726.9512

LANDSCAPE ARCHITECT:

EGGERS ASSOCIATES 560 NORTH 2ND AVENUE KETCHUM, ID 83340 TEL: 208.725.0988

ISSUE DESCRIPTION DATE
1 DESIGN REVIEW APP 25.09.09
2 DESIGN REVIEW APP REV 25.10.14

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WARM SPRINGS TOWNHOMES
KETCHUM, ID

108 & 110 RITCHIE DR. KETCHUM, IDAHO


DRAWING TITLE:
BUILDING ELEVATIONS BUILDING 4


ENI:

PROJECT NUMBER

DRAWING NUMBER:

A-305

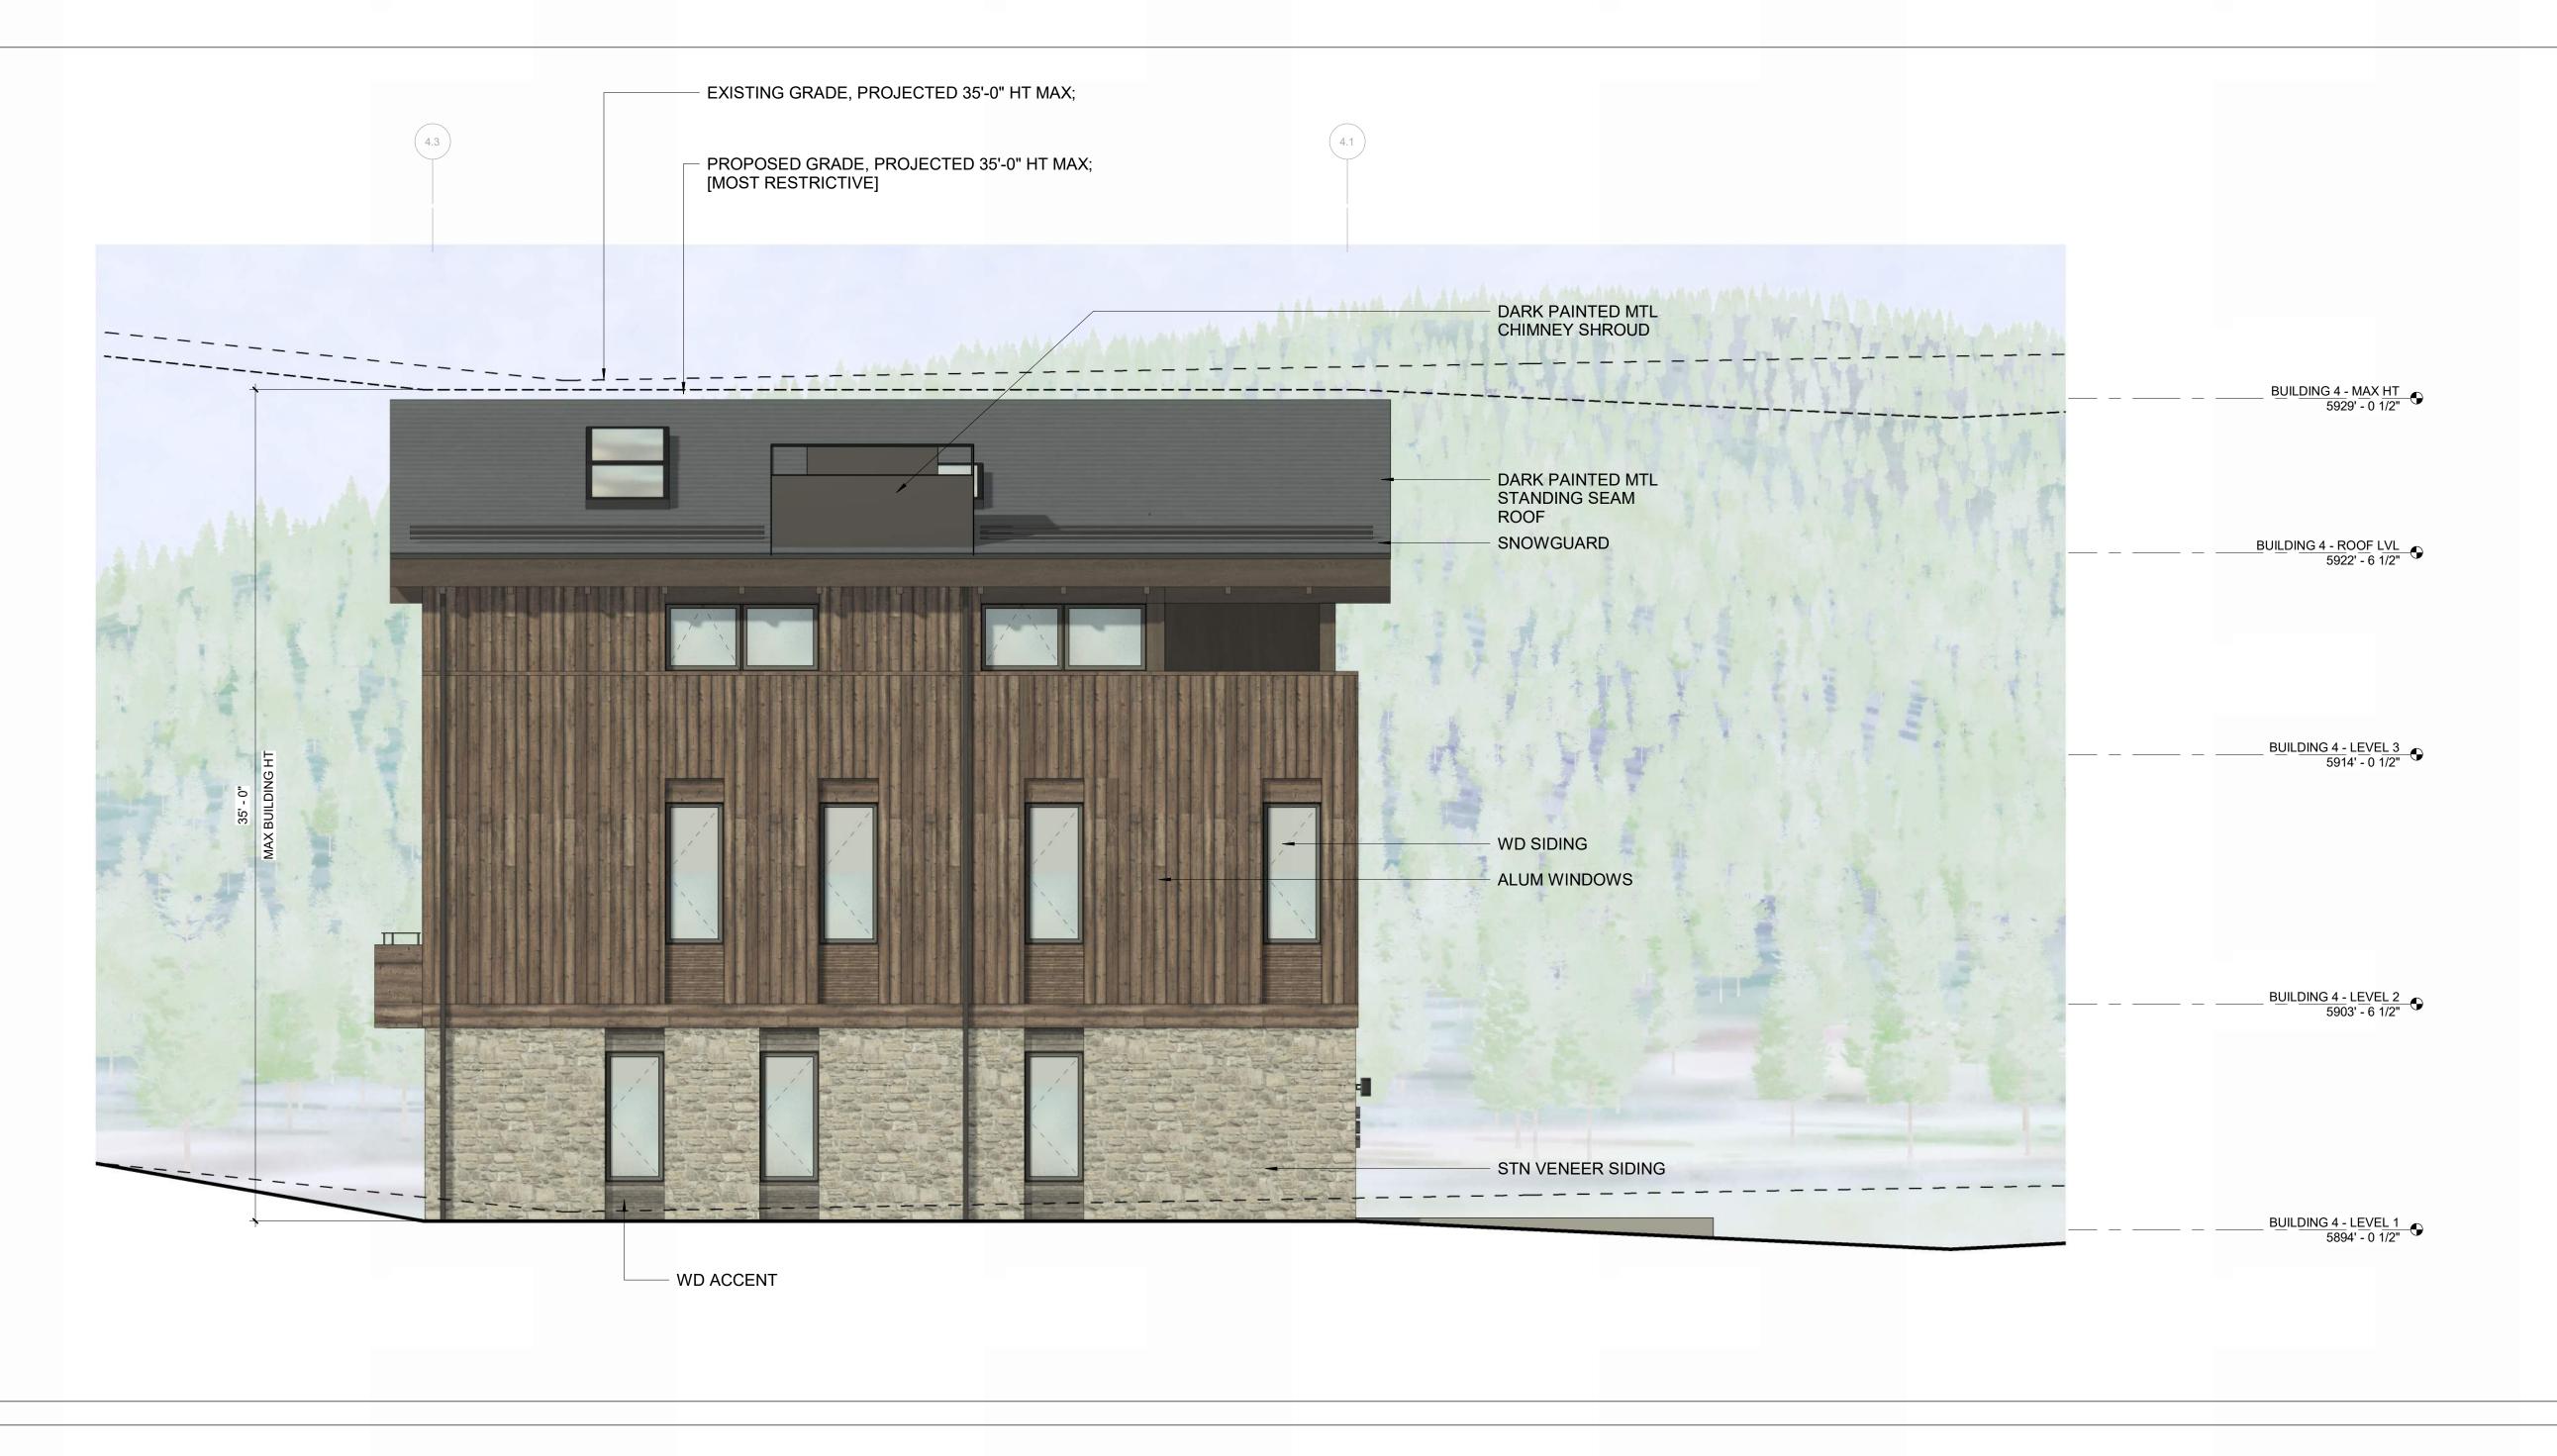

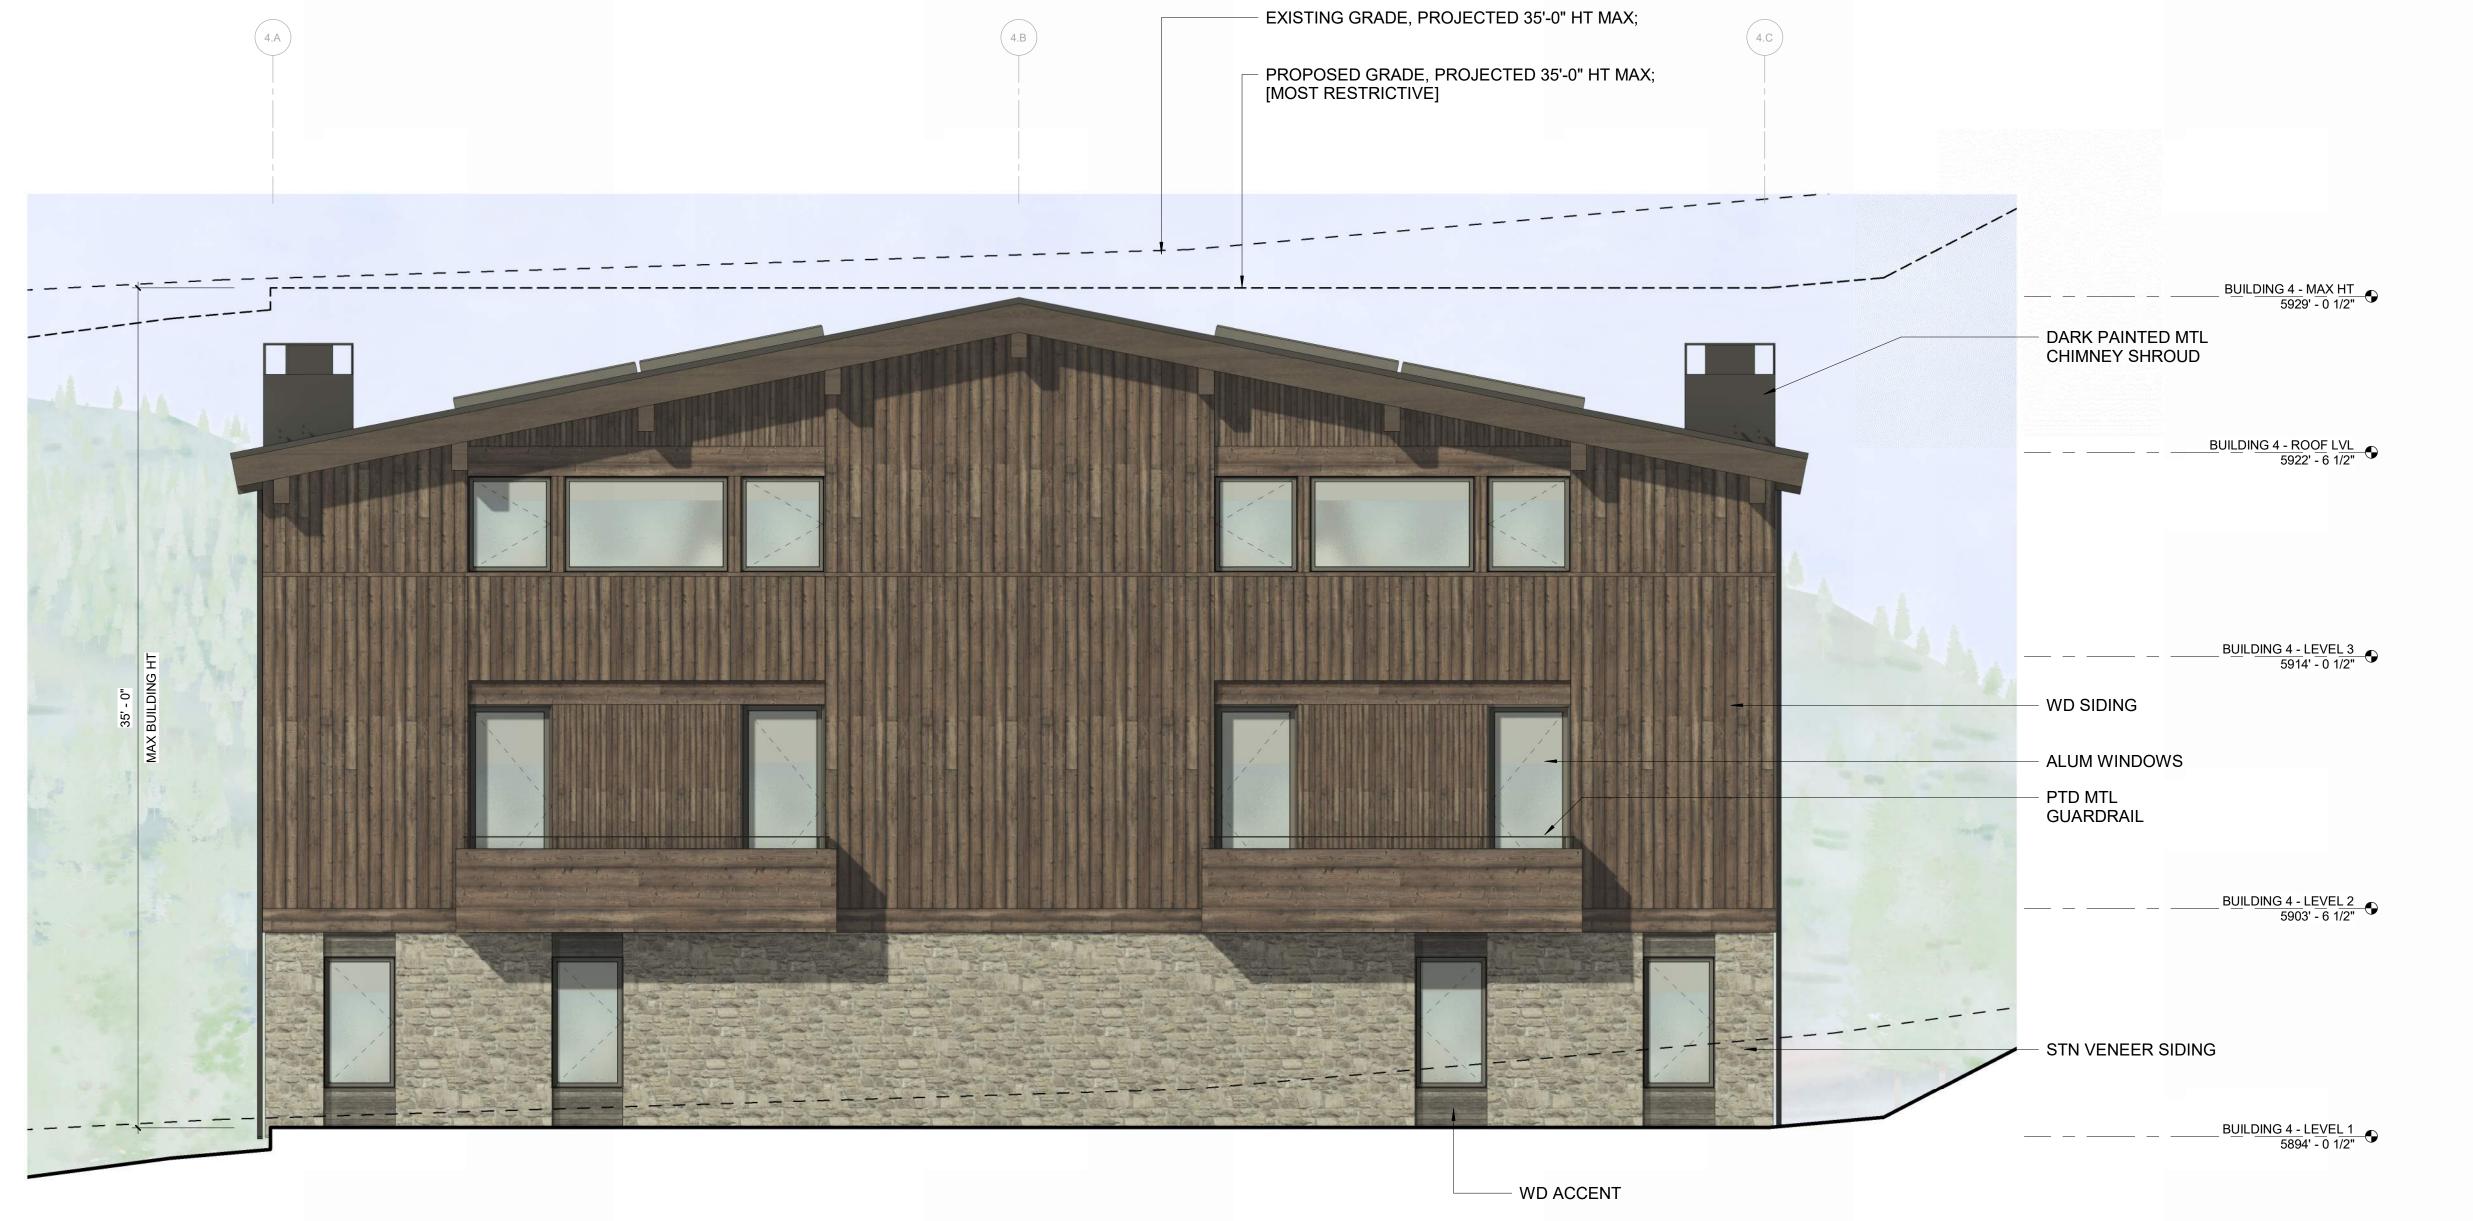

WARM SPRINGS TOWNHOMES KETCHUM, ID

OWNER:

108-110 RITCHIE LLC P.O. BOX 14001-174 KETCHUM, ID 83340 TEL: 603.801.0419

BUILDING ARCHITECT:

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LANDSCAPE ARCHITECT:

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WARM SPRINGS TOWNHOMES KETCHUM, ID

108 & 110 RITCHIE DR. KETCHUM, IDAHO

DRAWING TITLE:
BUILDING ELEVATIONS BUILDING 4

JILDING 4


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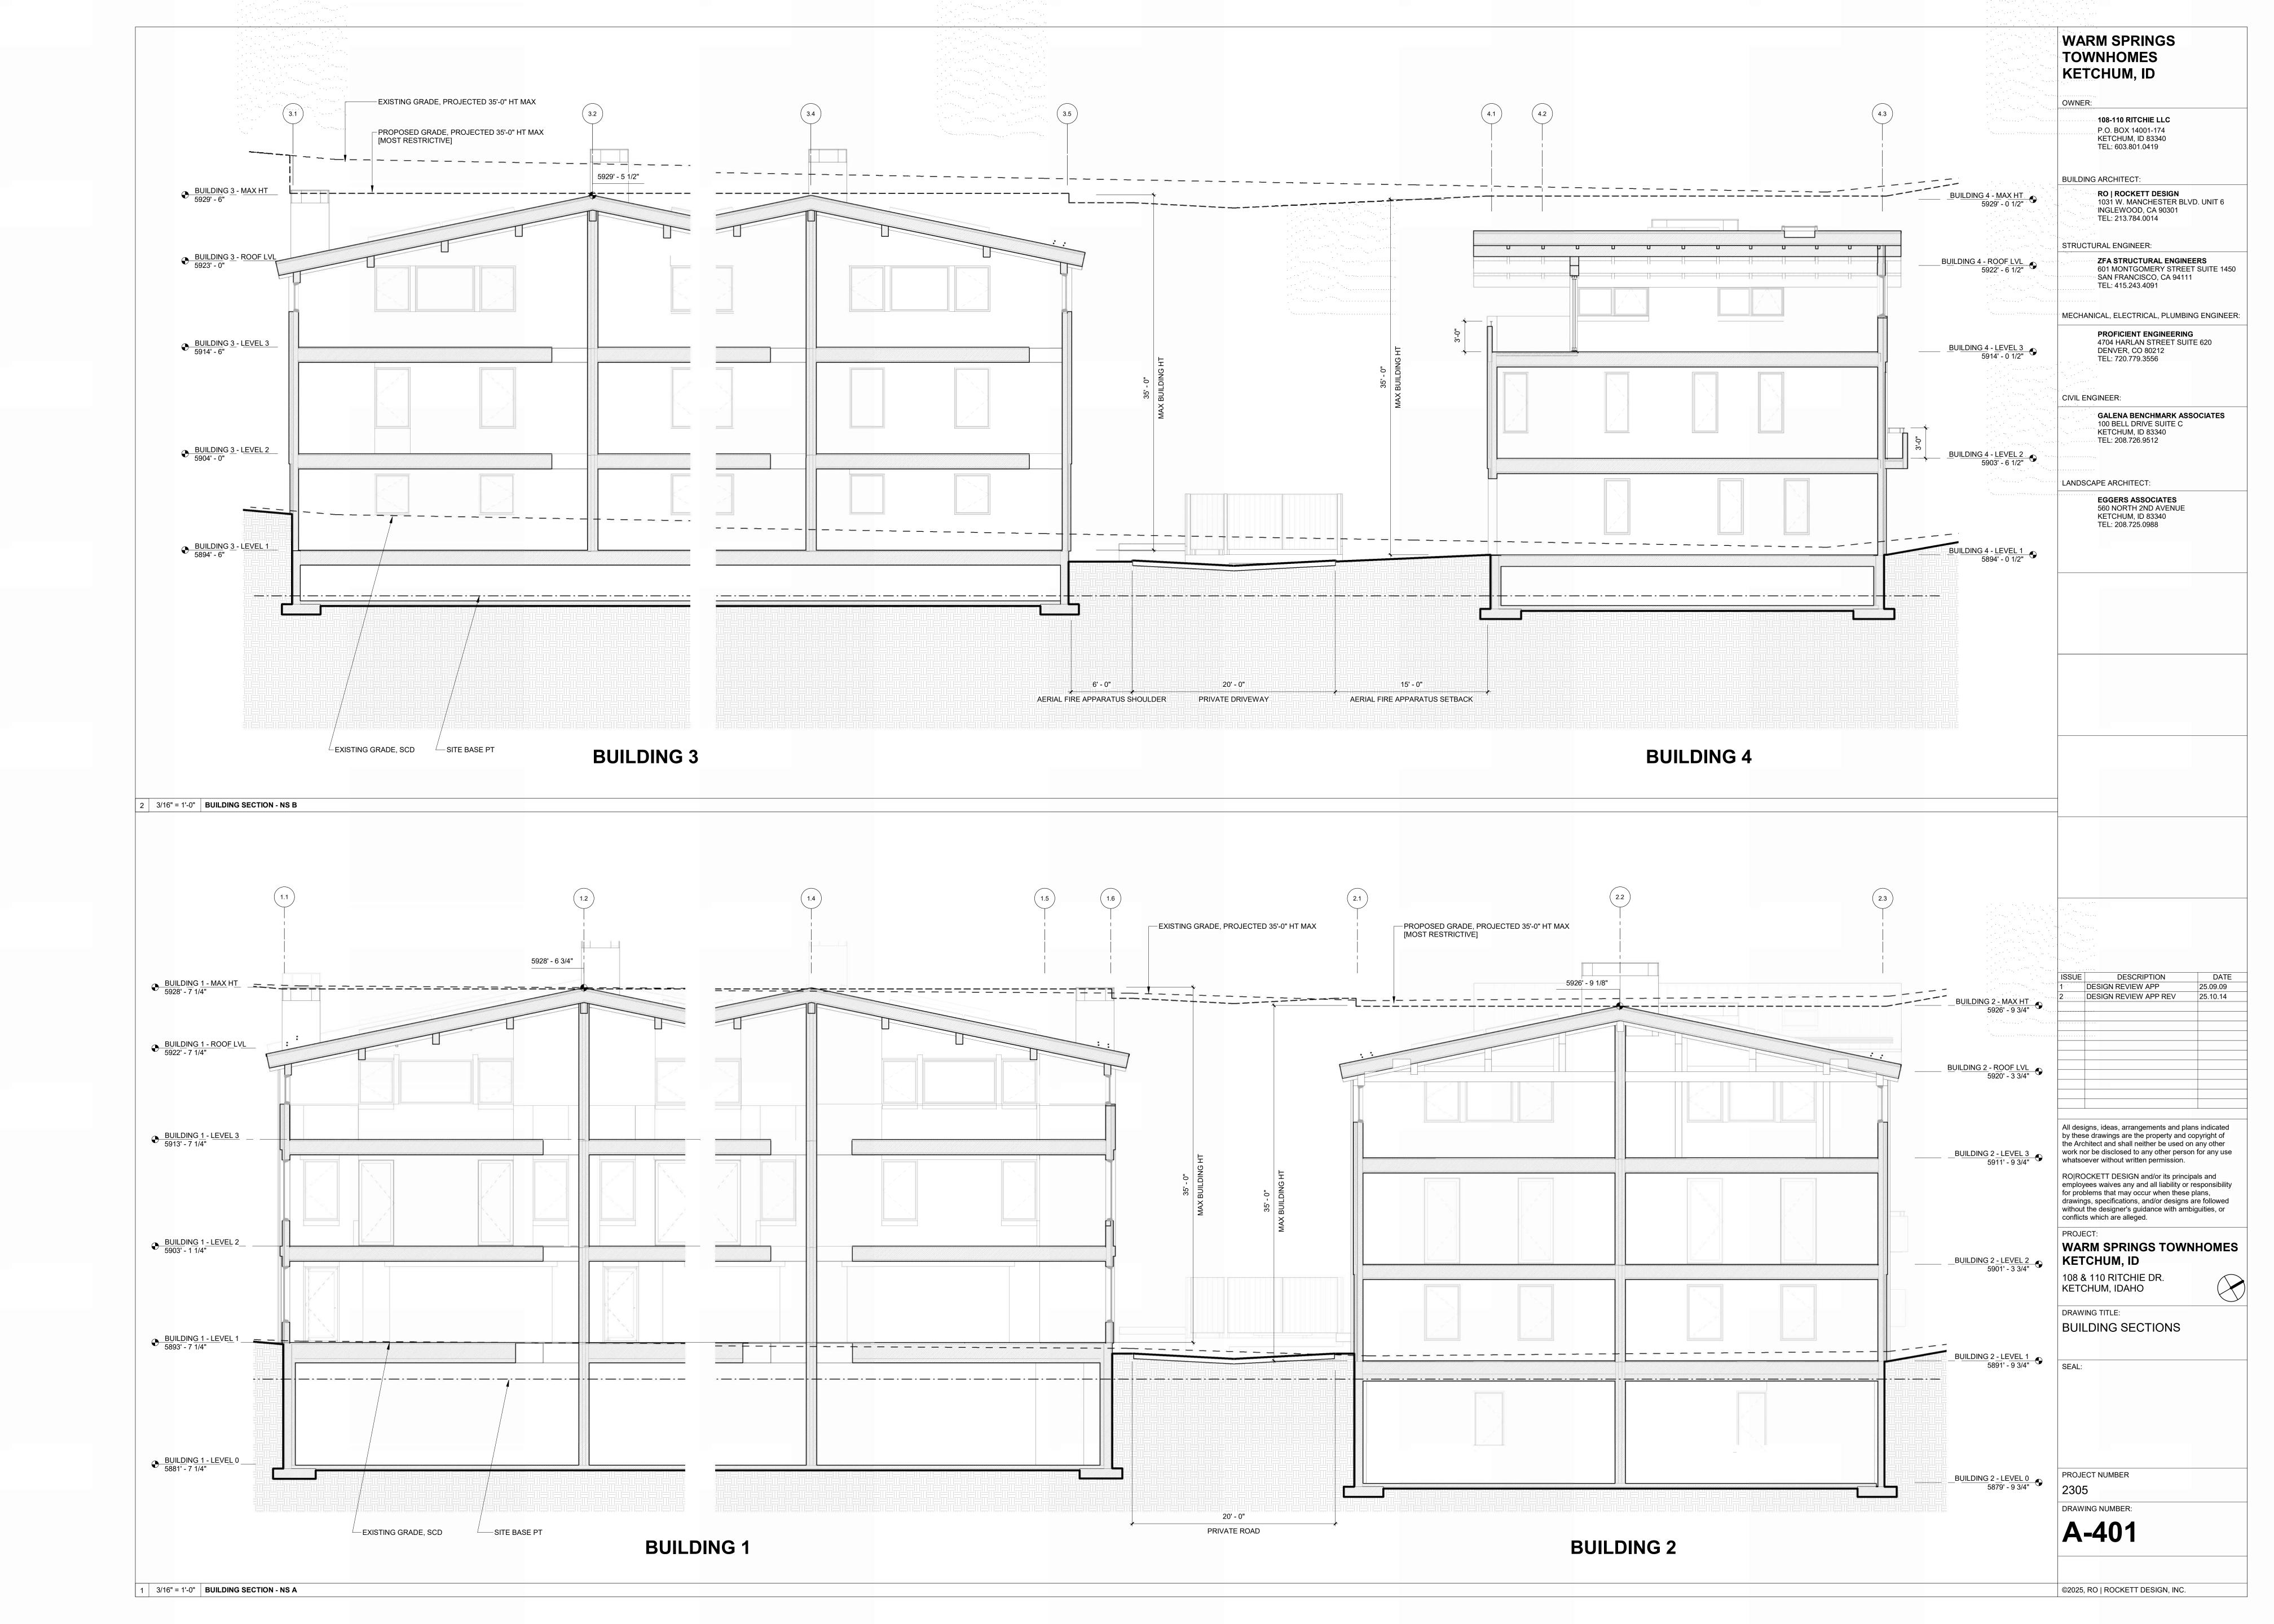
PROJECT NUMBER

A-306

1 1/4" = 1'-0" **BUILDING 4 / ELEVATION - NORTH**

2 1/4" = 1'-0" **BUILDING 4 / ELEVATION - WEST**



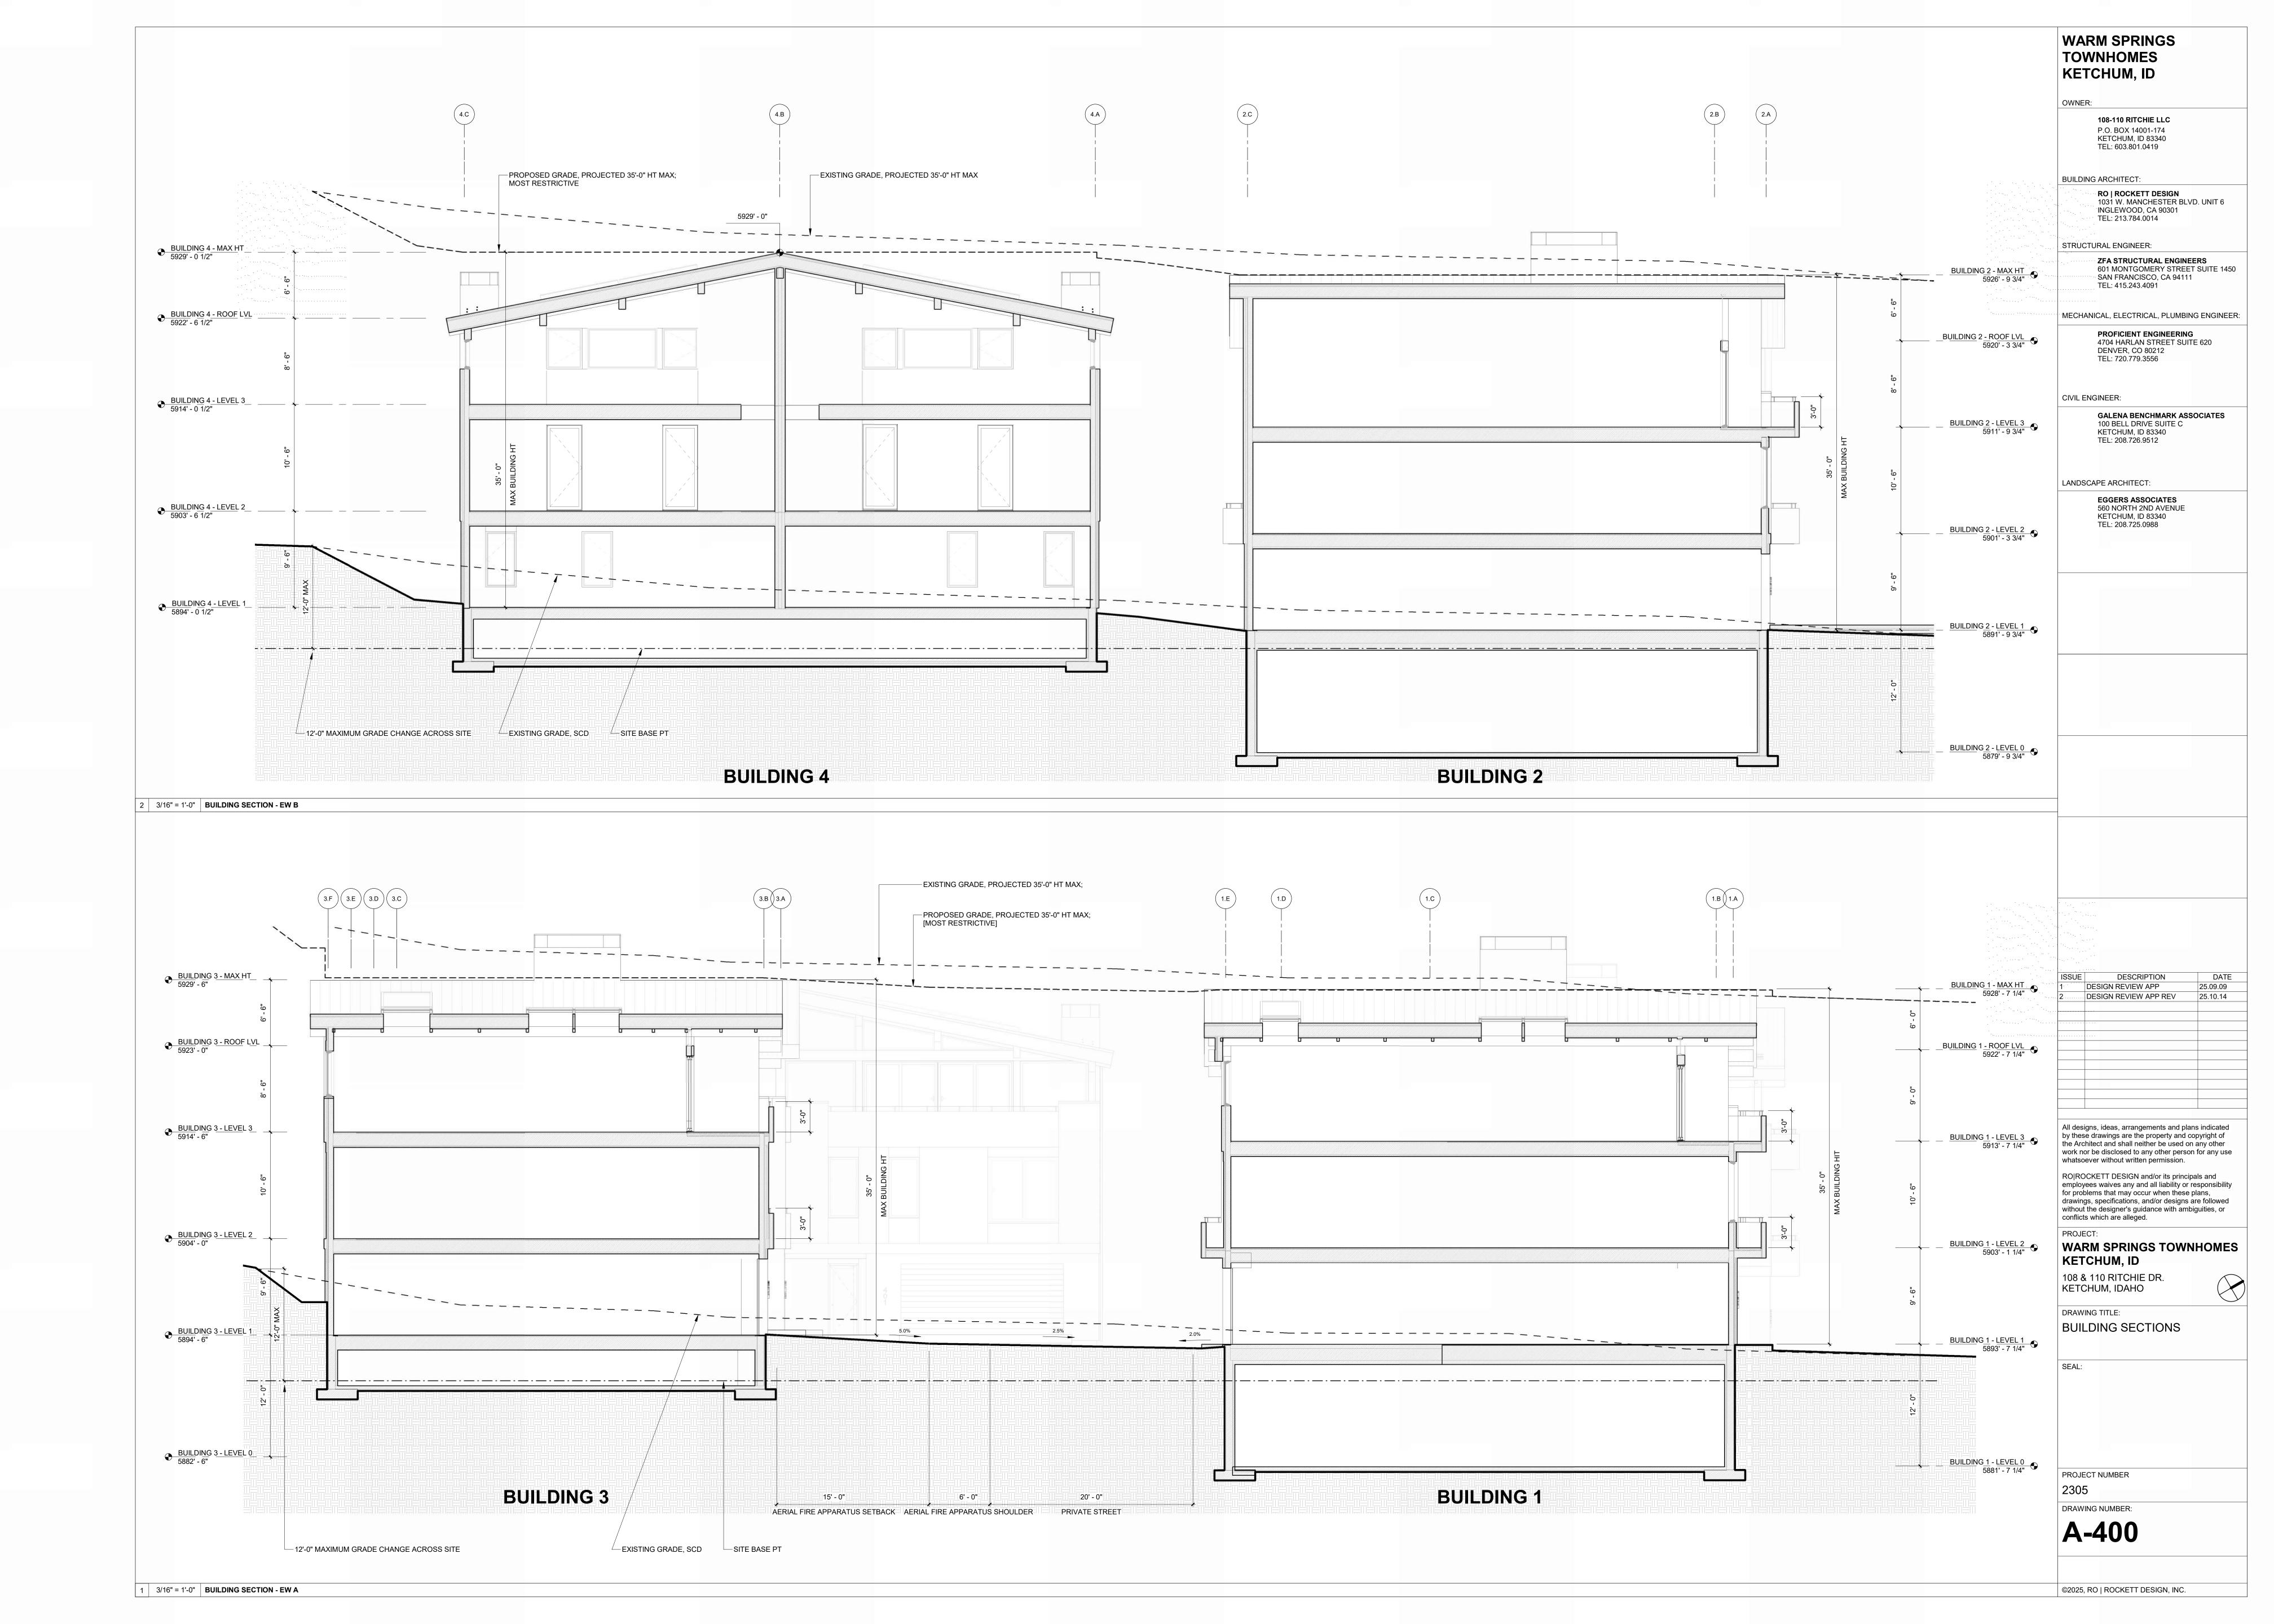





MEDIUM GREY, PARGED FIELD STONE




MEDIUM BROWN, RUSTIC TONGUE AND GROOVE WOOD SIDING W/ FACE NAILING



MEDIUM BROWN, RUSTIC WD BEAMS, FASCIA & ACCENTS



DARK, RUSTIC WD TONGUE AND GROOVE

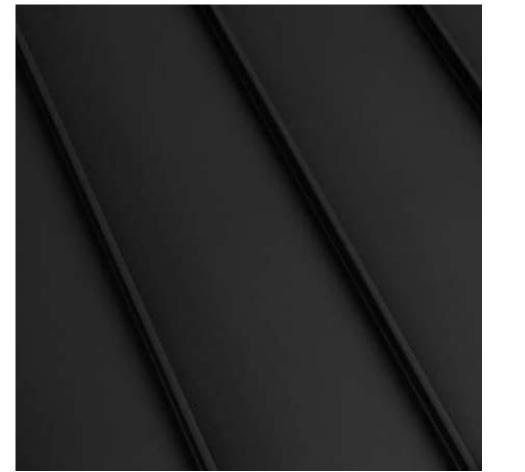

DARK STANDING SEAM ROOF



DARK METAL TRIM & WINDOW FRAMES

WARM SPRINGS TOWNHOMES KETCHUM, ID

OWN

108-110 RITCHIE LLC P.O. BOX 14001-174 KETCHUM, ID 83340 TEL: 603.801.0419

BUILDING ARCHITECT:

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LANDSCAPE ARCHITECT:

EGGERS ASSOCIATES 560 NORTH 2ND AVENUE KETCHUM, ID 83340 TEL: 208.725.0988

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PROJECT:
WARM SPRINGS TOWNHOMES
KETCHUM, ID

108 & 110 RITCHIE DR. KETCHUM, IDAHO

DRAWING TITLE:

MATERIALS

SEAL:

PROJECT NUMBER

DRAWING NUMBER:

A-500



WARM SPRINGS TOWNHOMES KETCHUM, ID

108-110 RITCHIE LLC P.O. BOX 14001-174 KETCHUM, ID 83340 TEL: 603.801.0419

BUILDING ARCHITECT:

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CIVIL ENGINEER:

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LANDSCAPE ARCHITECT:

EGGERS ASSOCIATES 560 NORTH 2ND AVENUE KETCHUM, ID 83340 TEL: 208.725.0988

2 12" = 1'-0" **SITE ELEVATION - EAST**



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WARM SPRINGS TOWNHOMES KETCHUM, ID

108 & 110 RITCHIE DR. KETCHUM, IDAHO

DRAWING TITLE: RENDERED ELEVATIONS

PROJECT NUMBER 2305

DRAWING NUMBER:

A-501



2 | 12" = 1'-0" | **SITE ELEVATION - WEST**



WARM SPRINGS TOWNHOMES KETCHUM, ID

108-110 RITCHIE LLC P.O. BOX 14001-174 KETCHUM, ID 83340 TEL: 603.801.0419

BUILDING ARCHITECT:

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STRUCTURAL ENGINEER:

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CIVIL ENGINEER:

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LANDSCAPE ARCHITECT:

EGGERS ASSOCIATES 560 NORTH 2ND AVENUE KETCHUM, ID 83340 TEL: 208.725.0988

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WARM SPRINGS TOWNHOMES KETCHUM, ID

108 & 110 RITCHIE DR. KETCHUM, IDAHO

DRAWING TITLE:

RENDERED ELEVATIONS

PROJECT NUMBER

DRAWING NUMBER: A-502

1 12" = 1'-0" **SITE ELEVATION - NORTH**



VIEW FROM AERIAL PERSPECTIVE



WARM SPRINGS TOWNHOMES KETCHUM, ID

108-110 RITCHIE LLC P.O. BOX 14001-174 KETCHUM, ID 83340 TEL: 603.801.0419

BUILDING ARCHITECT:

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LANDSCAPE ARCHITECT:

EGGERS ASSOCIATES 560 NORTH 2ND AVENUE KETCHUM, ID 83340 TEL: 208.725.0988

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WARM SPRINGS TOWNHOMES KETCHUM, ID

108 & 110 RITCHIE DR.

KETCHUM, IDAHO

DRAWING TITLE: PERSPECTIVE RENDERINGS

PROJECT NUMBER

DRAWING NUMBER:

A-503



VIEW FROM RITCHIE DRIVE - SOUTH



WARM SPRINGS TOWNHOMES KETCHUM, ID

OWN

108-110 RITCHIE LLC P.O. BOX 14001-174 KETCHUM, ID 83340 TEL: 603.801.0419

BUILDING ARCHITECT:

RO | ROCKETT DESIGN 1031 W. MANCHESTER BLVD. UNIT 6 INGLEWOOD, CA 90301 TEL: 213.784.0014

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LANDSCAPE ARCHITECT:

EGGERS ASSOCIATES 560 NORTH 2ND AVENUE KETCHUM, ID 83340 TEL: 208.725.0988

DESCRIPTION	DATE
DESIGN REVIEW APP	25.09.09
DESIGN REVIEW APP REV	25.10.14

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WARM SPRINGS TOWNHOMES KETCHUM, ID

108 & 110 RITCHIE DR. KETCHUM. IDAHO

KETCHUM, IDAHO

DRAWING TITLE:

DRAWING TITLE:
PERSPECTIVE RENDERINGS

SEAL:

PROJECT NUMBER

DRAWING NUMBER:

A-504

VIEW FROM RITCHIE DRIVE



VIEW TO BUILDING 01 - REAR



WARM SPRINGS TOWNHOMES KETCHUM, ID

OWN

108-110 RITCHIE LLC P.O. BOX 14001-174 KETCHUM, ID 83340 TEL: 603.801.0419

BUILDING ARCHITECT:

RO | ROCKETT DESIGN 1031 W. MANCHESTER BLVD. UNIT 6 INGLEWOOD, CA 90301 TEL: 213.784.0014

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LANDSCAPE ARCHITECT:

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WARM SPRINGS TOWNHOMES KETCHUM, ID

108 & 110 RITCHIE DR. KETCHUM, IDAHO

DRAWING TITLE:

PERSPECTIVE RENDER!

PERSPECTIVE RENDERINGS

OL/ (L.

PROJECT NUMBER 2305

DRAWING NUMBER:

A-505