



City of Ketchum
Planning & Building

STAFF REPORT
KETCHUM PLANNING AND ZONING COMMISSION
MEETING OF DECEMBER 9, 2025

PROJECT: Warm Springs Townhomes

FILE NUMBER: P24-063

APPLICATION: Design Review

PROPERTY OWNER: 108-110 Ritchie LLC (Presidio Vista Properties)

ARCHITECT: Ro Rockett Design, LLC – Zac Rockett (architect)

LOCATION: 108 Ritchie Dr
(Warm Springs Village Subdivision 2nd Revision Lot 3A Blk 4)

ZONING: Tourist 3000 - (T-3000)

OVERLAY: None

REVIEWER: Morgan Landers, AICP – Director of Planning and Building

NOTICE: A public meeting notice for the project was mailed to all property owners within 300 feet of the project site and all political subdivisions on August 20, 2025. The notice was published in the Idaho Mountain Express on August 20, 2025. A notice was posted on the project site on September 2, 2025, and the city's website on August 19, 2025. A public hearing was held on September 9, 2025 and October 14, 2025. At the October 14th meeting, the application was continued to a date certain of November 25, 2025 and further continued to a date certain of December 9, 2025.

EXECUTIVE SUMMARY

The applicant has submitted a Design Review application for the development of 12-, three- and four-bedroom, townhouse units at 108 Ritchie Dr (the “subject property”). The subject property is zoned Tourist 3000 (T-3000) and is vacant (See Figure 1). The development proposes to utilize the city’s density bonus program for increased FAR and is therefore subject to the minimum residential density requirements of the Ketchum Municipal Code. The townhouse units range in size from approximately 2,200 to 3,800 gross square feet. The units within the development are proposed to be accessed by a private road entering from Ritchie Dr. Each townhouse has dedicated garage parking within each unit. The full project plans are included as Attachment A.

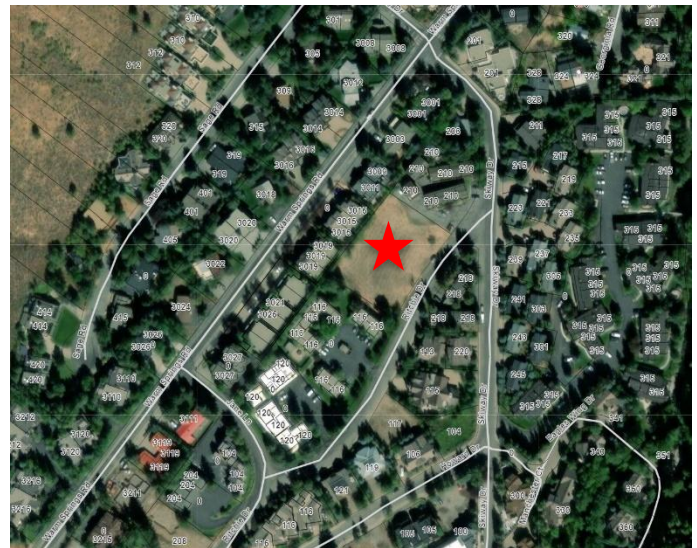


Figure 1: Subject Property

At the October 14, 2025 hearing, staff provided an overview of the proposed development and requested the Commission discuss key design elements related to the bulk and flatness of the buildings and materials of deck railings. Following staff presentation, applicant presentation, questions from the Commission and public comment, the Commission conducted deliberations and provided feedback to the applicant that the bulk and mass of the two larger buildings (Buildings 1 and 3) was not adequately mitigated through architectural treatments and requested the applicant evaluate the breaking the buildings up into two structures or evaluating other ways to continue addressing the issues with bulk and mass of the buildings.

The applicant has since further revised the project to address the comments by the Commission by breaking Buildings 1 and 3 into two separate structures. The initial proposal included for buildings, two with four units each and two with two units each. The current proposal includes a total of six buildings, each with two units. The proposed change results in the following:

- Reduction of the total gross floor area of the buildings
- Reduction in the unit size of the units in Buildings 1 and 3
- Increase of the square footage of the open site area
- No change in building height
- No change in setbacks



Figure 2: Project Rendering

The revised design drawings are included as Attachment A to this report. Attachment B includes the civil, landscape, exterior lighting and snowmelt design plans. Items in Attachment B have not been updated to reflect the revised site layout with six separate buildings but a condition of approval has been recommended to address updating of these documents. Staff have reviewed the revised project against the zoning requirements and the design review standards and believe the project to meet all applicable requirements. Staff believe that by breaking the two largest buildings into two structures, the applicant has responded to the Commissions concerns. Staff recommends the Commission approve the design review application and direct staff to return with findings of fact.

ANALYSIS

At the previous Commission hearing on October 14, 2025, staff understood the Commission's main concern was the project's compliance with design review standard 17.96.060.F.5 "Building walls shall provide undulation/relief, thus reducing the appearance of bulk and flatness". As noted above, the Commission requested the applicant further evaluate was to reduce the appearance of bulk and flatness of the project, specifically buildings 1 and 3. One suggestion made by the Commission was to evaluate breaking Buildings 1 and 3 into two structures. The applicant has complied with the Commission's request and separated Buildings 1 and 3 into two structures each with just over 10 feet of separation between the buildings. Figure 4 is a rendering of the previous proposal for Building 1 and Figure 5 is a rendering of the current proposal.



Figure 4: Previous Proposal – Building 1



Figure 5: Current Proposal - Building 1

Staff believe that separation of the building adds a dimension to the project by providing a view corridor between buildings to the rest of the development and adequately breaks the façade. The building code requires a minimum five-foot separation between structures. Staff is very supportive of the proposed 10+ foot separation of structures as it allows for a clear and distinct separation, shadow casting on adjacent structures, and a clear break in the roof lines. As shown in the additional renderings in the project plans, the building separation also creates the appearance that the buildings are staggered when viewed from certain angles as shown in Figures 6 and 7 below.



Figure 6: Street View - Building 1



Figure 7: Street View - Building 1

As noted above, the landscape plan has not been updated to reflect the proposed design as the development team felt it prudent to receive feedback from the Commission prior to updating the civil and landscape plans. The square footage of open site area of the development will increase with this proposal, however, special care must be taken to thoughtfully landscape the areas between the buildings. The areas between the buildings will get sun exposure at certain times of the day and during certain times of the year. However, plant species selection will need to include drought tolerant and very hardy species to endure longer periods of shade. Staff believe that the areas between the buildings provide an opportunity for placement of mechanical equipment rather than concentrating mechanical equipment to the perimeter of the property. Staff recommends the following conditions of approval to address how the space in between the buildings should be treated:

- The landscape plan shall be revised to reflect the updated building layout and landscape treatments proposed for the space between the structures. Additional shrubs and trees shall be provided at the ends of each of the spaces to maximize sun exposure. Ground cover may include the use of limited rock or wood mulch but shall include grasses at each end of the spaces to smoothly transition to the rest of the landscaped areas.
- The applicant shall evaluate opportunities to locate ground mounted mechanical systems between buildings where feasible to minimize the placement of mechanical systems on the perimeter of the property.

These conditions will ensure the project complies with design review standards 17.96.060.D.2 and 17.96.060.I related to utilities and landscaping.

None of the proposed changes impact the development's compliance with zoning and dimensional standards.

STAFF RECOMMENDATION

The Commission has the following options:

- Continue the application to a date certain or uncertain with a request for revisions or more information.
- Approve the application

- Approve the application with conditions
- Deny the application

Staff recommend the Commission review the revised Design Review application and **approve** the application with the conditions outlined below. The Commission may delete, revise, or add to the conditions of approval based on the discussion.

1. The term of Design Review approval shall be twelve (12) months from the date that the Findings of Fact, Conclusions of Law, and Decision are adopted by the Planning and Zoning Commission or upon appeal, the date the approval is granted by the Council. Extensions may be granted per KMC 17.96.090.B.
2. This Design Review approval is based on the plans dated December 9, 2025 included as Exhibit A, and the information presented and approved at the September 9, 2025, October 14, 2025, and December 9, 2025 Planning and Zoning Commission meetings. The building permit plans must conform to the approved Design Review plans unless otherwise approved in writing by the Planning and Zoning Commission or Administrator. Any building or site discrepancies which do not conform to the approved plans will be subject to removal.
3. As a voluntary contribution, in exchange for an increase in FAR pursuant to KMC 17.124.040, a total community housing contribution of 4,081 square feet is required. A FAR Exceedance Agreement between the applicant and the City to memorialize how the community housing contribution will be met shall be reviewed and approved by City Council, signed, and recorded prior to issuance of a building permit for the project.
4. For driveways less than 18 feet in length, "No Parking" signs shall be installed on or adjacent to every driveway prior to certificate of occupancy for each building.
5. At the time of building permit, the applicant shall submit revised exterior lighting and snowmelt design plans that reflect the revised site layout with six separate buildings for review and approval by the Planning Department.
6. At time of building permit, the applicant shall submit final civil drawings prepared by an engineer registered in the State of Idaho that provide specifications for all right-of-way improvements, including sidewalks, alley asphalt, streetlights, utilities, and drainage facilities, for final review and approval by the City Engineer, Streets Department, Utilities Department, and Planning Department. Revised civil plans shall reflect the updated building layout of six separate buildings.
7. Revised landscape plans that reflect the revised site layout with six separate buildings shall be provided for review and approval by the Planning Department prior to building permit issuance.
8. The landscape plan shall be revised to reflect the updated building layout and landscape treatments proposed for the space between the structures. Additional shrubs and trees shall be provided at the ends of each of the spaces to maximize sun exposure. Ground cover may include the use of limited rock or wood mulch but shall include grasses at each end of the spaces to smoothly transition to the rest of the landscaped areas.
9. The applicant shall evaluate opportunities to locate ground-mounted mechanical systems between buildings where it is feasible to minimize the placement of mechanical systems on the perimeter of the property.
10. Pursuant to KMC 17.125.060, the development shall provide a minimum of 6 bicycle racks, each serving two bicycles. The location and design shall be submitted, reviewed, and approved by the Planning Department prior to issuance of the first building permit.

11. The development shall utilize internal transformer locations for the development first. Street facing transformers shall only be utilized if no other alternative is feasible. All transformers shall be adequately screened from public view. Final transformer locations and screening proposals shall be reviewed and approved by the Planning Department prior to installation.
12. The grass-crete areas shown in Exhibit A shall remain clear of snow at all times. In the event snow storage cannot be accommodated by designated snow storage areas, snow shall be hauled off site to always ensure unobstructed access for fire and emergency vehicles.
13. Prior to building permit submittal, the applicant shall investigate the existence of fiber optic conduit. If none is found, the civil plans shall be revised to reflect the addition of fiber optic conduit along the subject property.
14. A preliminary plat application shall be submitted prior to building permit issuance. If the development is to be constructed in multiple phases, the preliminary plat application must include a request for a phased development agreement per KMC 16.04.110.
15. All exterior light fixtures shall be at a maximum color temperature of 2700 Kelvins.
16. All boulder retaining walls shall be set back a minimum of one foot unless authorization from adjacent property owners is provided at the time of building permit application.
17. In addition to the requirements set forth in this Design Review approval, this project shall comply with all applicable local, state, and federal laws.

Attachments:

- A. Revised Architectural Plans
- B. Civil, Landscape, Exterior Lighting, and Snowmelt Plans – Not Revised



City of Ketchum

ATTACHMENT A:

Revised Architectural Plans

WARM SPRINGS TOWNHOMES

DESIGN REVIEW APPLICATION / DECEMBER 9, 2025

DESCRIPTION
3-4 STORY MULTI-FAMILY RESIDENCE WITH 12 UNITS (4 BUILDINGS) WITH 23 INTERIOR, PRIVATE GARAGE PARKING SPACES. SCOPE OF WORK INCLUDES NEW CONSTRUCTION OF FOUNDATION, ERECTION OF STRUCTURE, CIVIL, LANDSCAPING, HARDSCAPING AND FINISHES.

PROJECT ADDRESS
108 / 110 RITCHIE DRIVE KETCHUM, ID 83340

APPLICABLE CODES
ALL CONSTRUCTION SHALL COMPLY WITH:
2018 INTERNATIONAL BUILDING CODE**
2018 INTERNATIONAL RESIDENTIAL CODE**
2018 INTERNATIONAL FIRE CODE WITH LOCAL AMENDMENTS*
2018 INTERNATIONAL ENERGY CONSERVATION CODE**
2018 INTERNATIONAL SWIMMING POOL AND SPA CODE
2018 INTERNATIONAL EXISTING BUILDING CODE
2018 INTERNATIONAL PROPERTY MAINTENANCE CODE
TITLE 15 KETCHUM MUNICIPAL CODE
APPENDIX M OF THE IBC AS AMENDED BY THE CITY OF KETCHUM
ALL APPLICABLE COUNTY ORDINANCES

*AS AMENDED BY THE IDAHO BUILDING CODE BOARD AND INCLUDING NOTED APPENDICES.

CONTRACTOR SHALL KEEP A COPY OF THE ABOVE CODE SECTIONS ON THE JOB SITE AT ALL TIMES.

JURISDICTIONAL AGENCY SHALL BE THE KETCHUM BUILDING DEPARTMENT.

PROJECT DATA
LOT AREA: 35,799 SF
ZONING DESIGNATION: T-3000 (TOURIST ZONE)
OCCUPANCY: MULTI-FAMILY (PRIVATE CONDOS)
CONSTRUCTION TYPE: TYPE V
CLIMATE ZONE: 6

1. THE CONTRACTOR SHALL BE RESPONSIBLE FOR ALL DRAWINGS, CALCULATIONS, GOVERNMENTAL AGENCY APPROVALS AND FEES TO COMPLETE THIS WORK. CONTRACTOR/SUBCONTRACTORS SHALL SUBMIT MECHANICAL, ELECTRICAL, COMMUNICATIONS AND PLUMBING DRAWINGS TO ROCKETT DESIGN FOR PREVIEW OF DEVICE TYPES, LOCATIONS AND QUANTITIES, HVAC ZONING/THERMOSTAT LOCATIONS, ETC. PRIOR TO SUBMITTING FOR PERMIT AND CONSTRUCTION.
2. THESE DOCUMENTS ARE INTENDED TO INCLUDE ALL LABOR, MATERIALS, EQUIPMENT AND SERVICES REQUIRED TO COMPLETE ALL WORK DESCRIBED HEREIN. IT IS THE RESPONSIBILITY OF THE CONTRACTOR TO BRING TO THE ATTENTION OF THE ARCHITECT ANY CONDITIONS WHICH WILL NOT PERMIT CONSTRUCTION ACCORDING TO THE INTENTIONS OF THESE DOCUMENTS. IT IS THE RESPONSIBILITY OF THE ARCHITECT TO PROVIDE DETAILS AND/OR DIRECTIONS REGARDING DESIGN INTENT WHERE IT IS ALTERED BY EXISTING CONDITIONS OR WHERE NEGLECTED IN THE DOCUMENTS.
3. ANY MATERIALS PROPOSED FOR SUBSTITUTION OF THOSE SPECIFIED, OR CALLED OUT BY TRADE NAME, IN THESE DOCUMENTS SHALL BE PRESENTED TO THE ARCHITECT FOR REVIEW. THE CONTRACTOR SHALL SUBMIT SAMPLES WHEN REQUIRED BY THE ARCHITECT. AND ALL SUCH SAMPLES SHALL BE REVIEWED BY THE ARCHITECT BEFORE THE WORK IS PERFORMED. WORK MUST CONFORM TO THE REVIEWED SAMPLES. ANY WORK WHICH DOES NOT CONFORM SHALL BE REMOVED AND REPLACED WITH WORK WHICH CONFORMS AT THE CONTRACTOR'S EXPENSE. SUBCONTRACTORS SHALL SUBMIT REQUESTS AND SAMPLES FOR REVIEW THROUGH THE GENERAL CONTRACTOR WHEN WORK IS LET THROUGH HIM OR HER. REQUIRED VERIFICATIONS AND SUBMITTALS TO BE MADE IN ADEQUATE TIME AS NOT TO DELAY WORK IN PROGRESS.
4. SHOP DRAWINGS SHALL BE SUBMITTED TO THE ARCHITECT FOR HIS OR HER REVIEW WHERE CALLED FOR ANYWHERE IN THESE DOCUMENTS. REVIEW SHALL BE MADE BY THE ARCHITECT BEFORE WORK IS BEGUN, AND WORK SHALL CONFORM TO THE REVIEWED SHOP DRAWINGS, SUBJECT TO REPLACEMENT AS REQUIRED IN PARAGRAPH "E" ABOVE.
5. DO NOT SCALE DRAWINGS. CONTRACTOR SHALL VERIFY ALL DIMENSIONAL DISCREPANCIES WITH THE ARCHITECT.
6. CONTRACTOR SHALL VERIFY AND COORDINATE ALL OPENINGS THROUGH FLOORS, CEILINGS, AND WALLS WITH ALL ARCHITECTURAL, STRUCTURAL, MECHANICAL, PLUMBING AND ELECTRICAL DRAWINGS.
7. CONTRACTOR WILL ASSUME RESPONSIBILITY OF ITEMS REQUIRING COORDINATION AND RESOLUTION DURING THE BIDDING PROCESS.
8. BUILDING TO BE FULLY SPRINKLERED PER NFPA 13D. CONTRACTOR TO PROVIDE FIRE SPRINKLER SYSTEM DESIGN AND SHOP DRAWINGS TO CONFORM TO THESE STANDARDS.



WARM SPRINGS TOWNHOMES KETCHUM, ID

OWNER:

108-110 RITCHIE LLC
P.O. BOX 14001-174
KETCHUM, ID 83340
TEL: 803.801.0419

BUILDING ARCHITECT:

RO | ROCKETT DESIGN
1031 W. MANCHESTER BLVD. UNIT 6
INGLEWOOD, CA 90301
TEL: 213.784.0014

STRUCTURAL ENGINEER:

ZFA STRUCTURAL ENGINEERS
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SAN FRANCISCO, CA 94111
TEL: 415.243.4091

MECHANICAL, ELECTRICAL, PLUMBING ENGINEER:

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TEL: 720.779.3596

CIVIL ENGINEER:

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TEL: 208.725.9512

LANDSCAPE ARCHITECT:

EGGERS ASSOCIATES
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KETCHUM, ID 83340
TEL: 208.725.0988

ISSUE	DESCRIPTION	DATE
1	DESIGN REVIEW APP	25.09.09
2	DESIGN REVIEW APP REV	25.10.14
3	DESIGN REVIEW APP REV	25.12.09

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PROJECT:
WARM SPRINGS TOWNHOMES KETCHUM, ID
108 & 110 RITCHIE DR.
KETCHUM, IDAHO

DRAWING TITLE:
COVER SHEET

SEAL:

PROJECT NUMBER:
2305

DRAWING NUMBER:

G-000

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WARM SPRINGS
TOWNHOMES
KETCHUM, ID

OWNER:

108-110 RITCHIE LLC
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PROJECT:

WARM SPRINGS TOWNHOMES
KETCHUM, ID
108 & 110 RITCHIE DR.
KETCHUM, IDAHO

DRAWING TITLE:

SITE PLAN - BUILDING AREAS

SEAL:

PROJECT NUMBER

2305

DRAWING NUMBER:

A-000


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LOT AREA:	35,799.00 SF
OPEN SPACE REQ (35% LOT AREA):	12,529.65 SF
SITE COVERAGE AREAS:	
BUILDING 1:	2,770.30 SF
BUILDING 2:	2,440.30 SF
BUILDING 3:	2,840.80 SF
BUILDING 4:	2,437.10 SF
BUILDING 5:	2,000.40 SF
BUILDING 6:	2,433.10 SF
PRIVATE STREETS:	5,394.50 SF
DRIVEWAYS:	2,401.90 SF
TRASH ENCLOSURE / BOILER ACCESS:	146.0 SF
TOTAL SITE COVERAGE:	22,864.40 SF
WALKWAY AREA:	562.60 SF*

*5% OF REQ OPEN SPACE (12,529.65 SF)
USED FOR WALKWAYS ALLOWABLE = 626.48 SF

TOTAL OPEN SPACE AREA: **12,934.60 SF**
(35,799 SF LOT AREA - 22,864.40 SF SITE COVERAGE)

(37.0% - COMPLIANT, 404.95 SF SURPLUS)

CODE REQUIREMENT: OPEN SPACE

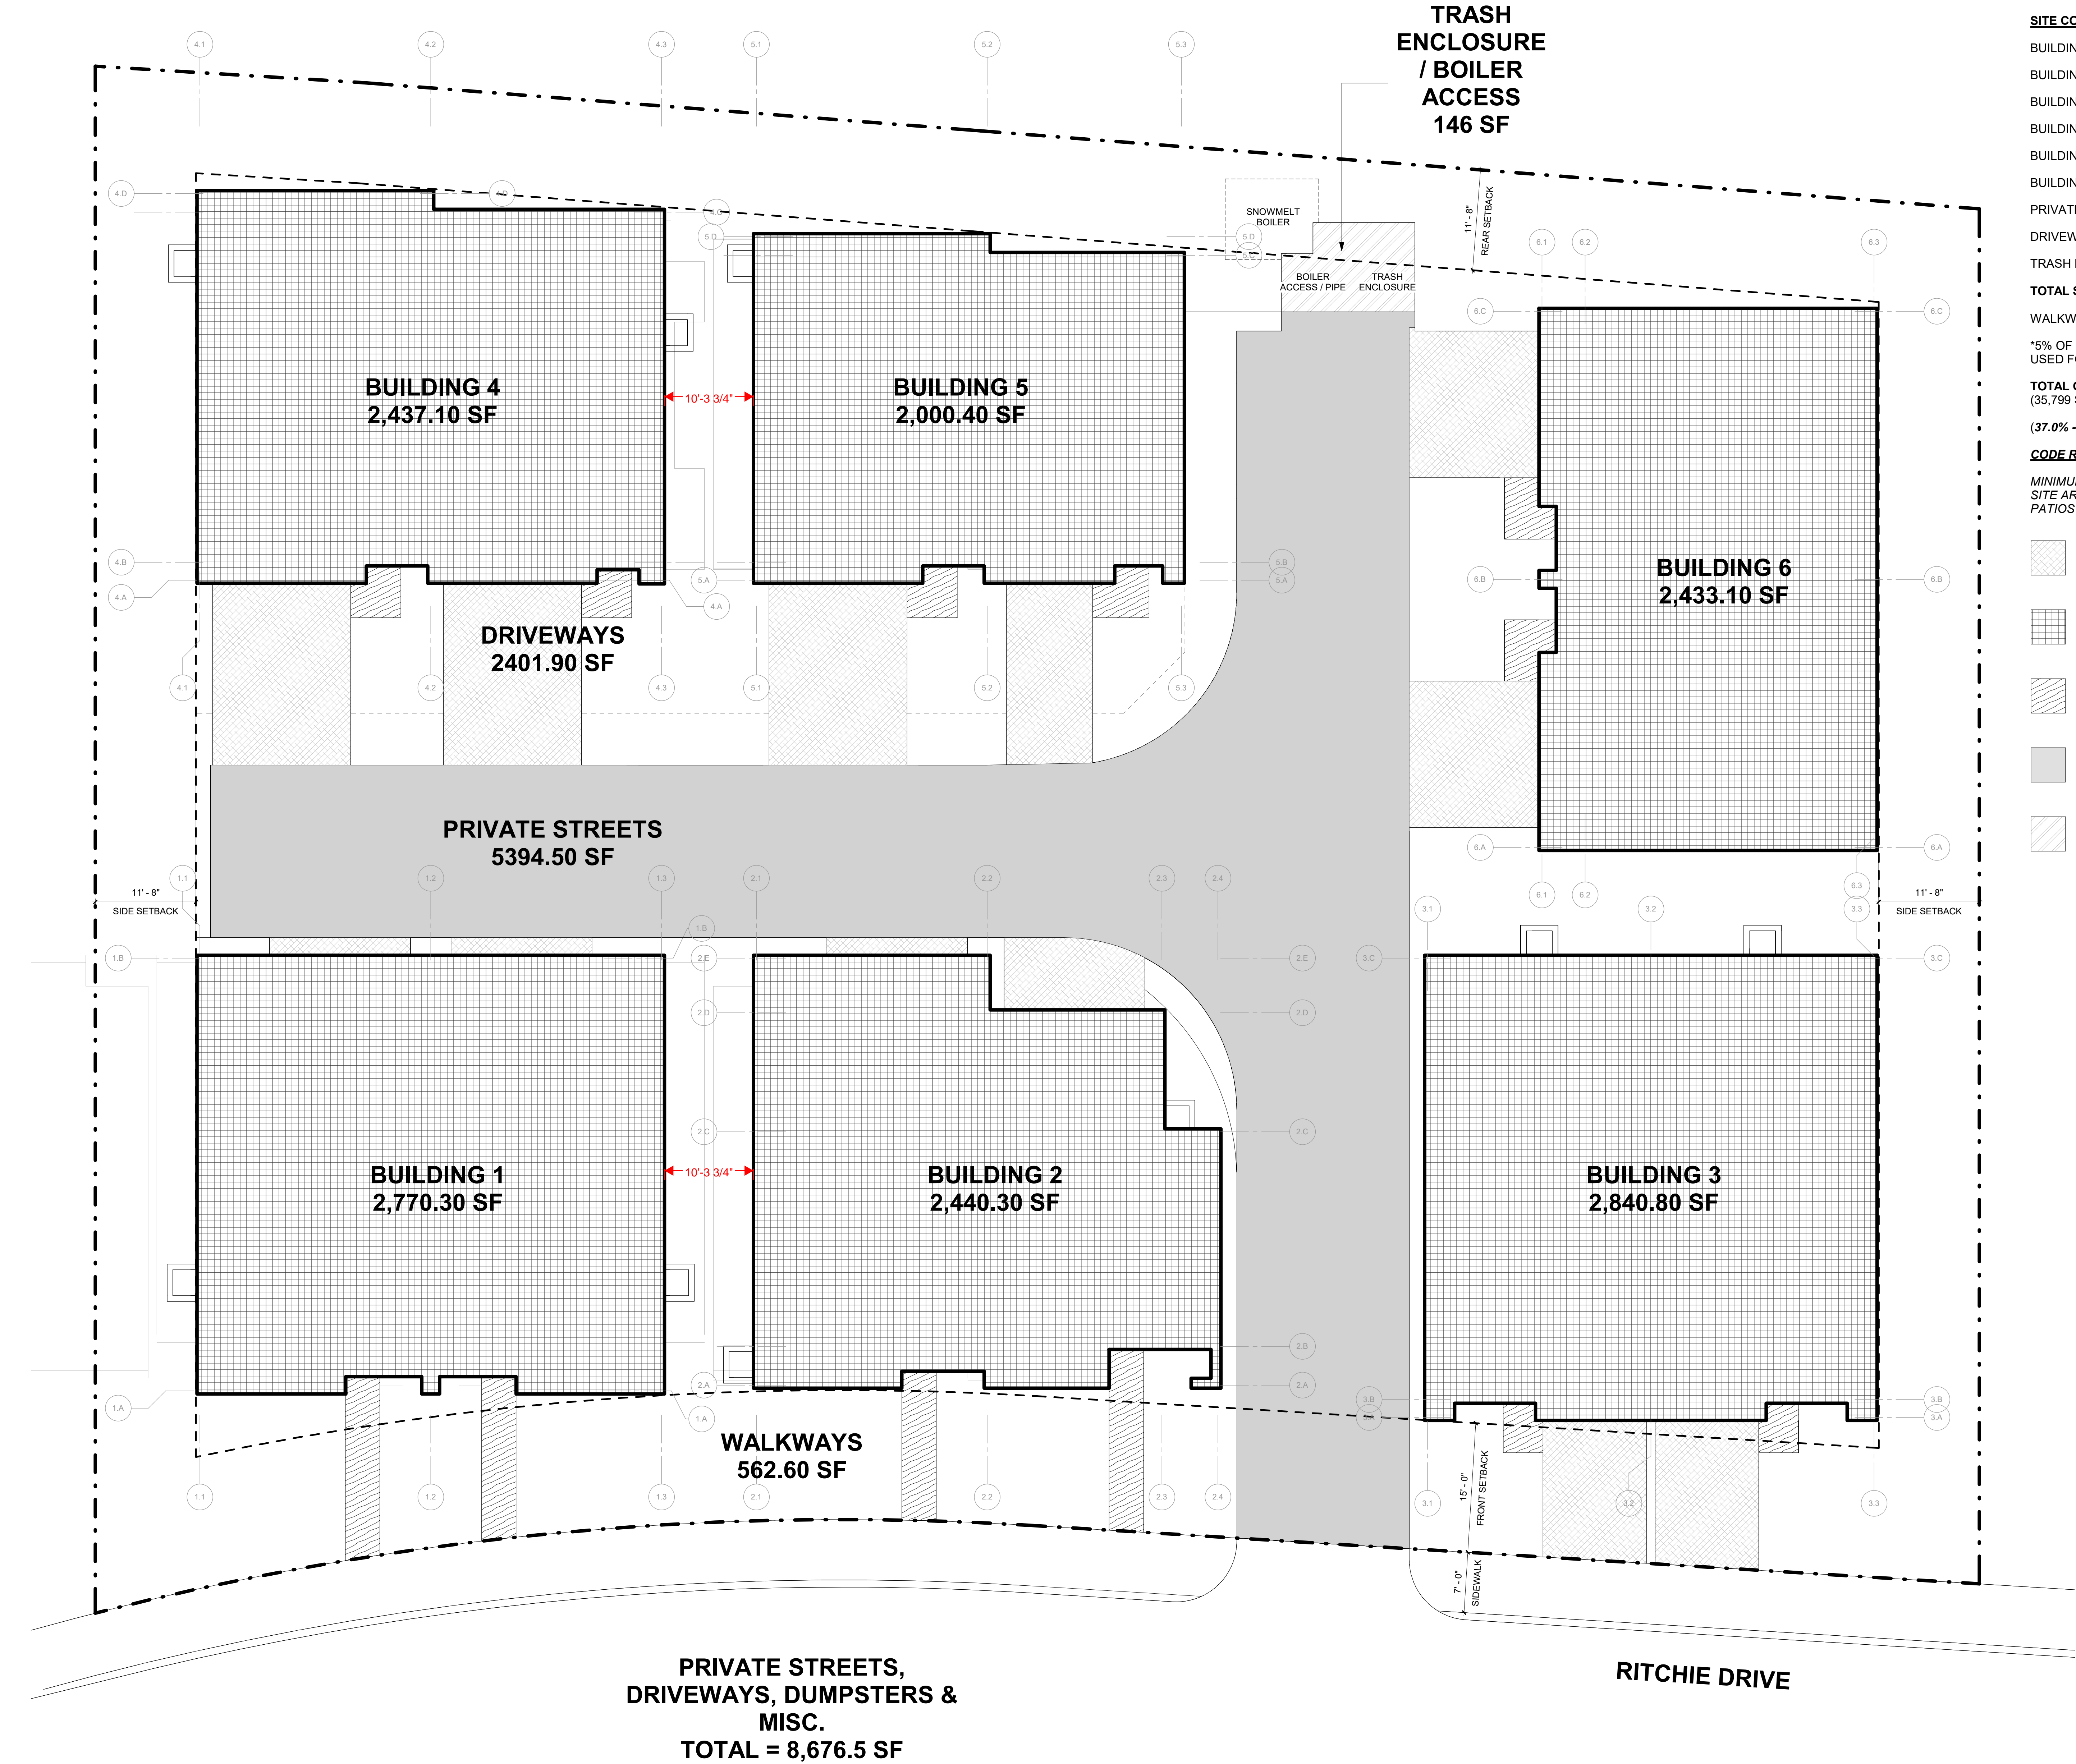MINIMUM OPEN SPACE: 35% (A MAXIMUM OF 5% OPEN SITE AREA MAY BE USED FOR PRIVATE DECKS OR PATIOS AND WALKWAYS SUBJECT TO DESIGN REVIEW).

- DRIVEWAYS
- BUILDINGS
- WALKWAYS
- PRIVATE STREETS
- TRASH ENCLOSURE

WARM SPRINGS TOWNHOMES KETCHUM, ID

OWNER:	108-110 RITCHIE LLC P.O. BOX 14001-174 KETCHUM, ID 83340 TEL: 603.801.0419
BUILDING ARCHITECT:	RO ROCKETT DESIGN 1031 W. MANCHESTER BLVD. UNIT 6 INGLEWOOD, CA 90301 TEL: 213.784.0014
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PROJECT:
WARM SPRINGS TOWNHOMES KETCHUM, ID
108 & 110 RITCHIE DR.
KETCHUM, IDAHO

DRAWING TITLE:
SITE PLAN - OPEN SPACE

SEAL:

PROJECT NUMBER:
2305

DRAWING NUMBER:
A-003

WARM SPRINGS TOWNHOMES KETCHUM, ID

OWNER:

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PROJECT:

WARM SPRINGS TOWNHOMES
KETCHUM, ID
108 & 110 RITCHIE DR.
KETCHUM, IDAHO

DRAWING TITLE:

SITE PLAN - FIRE ACCESS & SNOWMELT

SEAL:

PROJECT NUMBER

2305

DRAWING NUMBER:

A-004

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CODE REQUIREMENT: FIRE ACCESS

APPENDIX D OF 2018 IFC, SECTION D105 - AERIAL FIRE APPARATUS ACCESS ROADS

D105.1 - WHERE THE VERTICAL DISTANCE BETWEEN THE GRADE PLANE AND THE HIGHEST ROOF SURFACE EXCEEDS 30 FEET, APPROVED FIRE APPARATUS ACCESS ROADS SHALL BE PROVIDED. FOR PURPOSES OF THIS SECTION, THE HIGHEST ROOF SURFACE SHALL BE DETERMINED BY MEASUREMENT TO THE EAVE OF A PITCHED ROOF, THE INTERSECTION OF THE ROOF TO EXTERIOR WALL, OR THE TOP OF PARAPET WALLS, WHICHEVER IS GREATER.

D105.2 - AERIAL FIRE APPARATUS ACCESS ROADS SHALL HAVE A MINIMUM UNOBSTRUCTED WIDTH OF 26 FEET, EXCLUSIVE OF SHOULDERS, IN THE IMMEDIATE VICINITY OF THE BUILDING OR PORTION THEREOF.

D105.3 - ONE OR MORE OF THE REQUIRED ACCESS ROUTES MEETING THIS CONDITION SHALL BE LOCATED NOT LESS THAN 15 FEET AND NOT GREATER THAN 30 FEET FROM THE BUILDING AND SHALL BE POSITIONED PARALLEL TO ONE ENTIRE SIDE OF THE BUILDING. THE SIDE OF THE BUILDING ON WHICH THE AERIAL FIRE APPARATUS ACCESS ROAD IS POSITIONED SHALL BE APPROVED BY THE FIRE CODE OFFICIAL.

THE PROPOSED DEVELOPMENT HAS A 20 FOOT WIDE PRIVATE ROAD THAT WOULD PROVIDE ACCESS TO THE INTERIOR OF THE SITE AND A DESIGNATED 20 FOOT WIDE PORTION OF THE ROAD FOR AERIAL FIRE ACCESS TO BUILDING 3 AND 4. ADDITIONALLY, BUILDING 3 AND 4 ARE SETBACK 15 FEET FROM THE EDGE OF THE FIRE ACCESS ROAD.



CODE REQUIREMENT: SNOWMELT

SNOWMELT

SNOW STORAGE

GRASS-CRETE PAVERS

H. SNOW STORAGE

1 - SNOW STORAGE AREAS SHALL NOT BE LESS THAN THIRTY PERCENT (30%) OF THE IMPROVED PARKING AND PEDESTRIAN CIRCULATION AREAS.

2 - SNOW STORAGE AREAS SHALL BE PROVIDED ON SITE.

3 - A DESIGNATED SNOW STORAGE AREA SHALL NOT HAVE ANY DIMENSION LESS THAN FIVE FEET (5') AND SHALL BE A MINIMUM OF TWENTY FIVE SQUARE FEET (25 SF)

4 - IN LIEU OF PROVIDING SNOW STORAGE AREAS, SNOWMELT AND HAULING OF SNOW MAY BE ALLOWED.

THE PROPOSED DEVELOPMENT WILL PROVIDE SITE SNOWMELT FOR ALL DRIVEWAYS, PATHWAYS, AND PRIVATE ROADS. SNOWMELT BOILER EQUIPMENT WILL BE SUBGRADE, LOCATED AT THE END OF THE PRIVATE ROAD AND SCREENED FROM VIEW OF NEIGHBORS. SEE MEP FOR DETAILED SNOWMELT PLANS.




THERE IS 638 SF OF GRASS-CRETE SCHEDULED FOR FIRE ACCESS THAT WILL NOT HAVE SNOWMELT. THESE AREAS WILL BE SHOVELED AND AN ADDITIONAL 966 SF OF SNOW STORAGE HAS BEEN DESIGNATED ON SITE.



MEDIUM BROWN WOOD SIDING TO MATCH
BUILDING SIDING MATERIAL



DARK PAINTED METAL STRUCTURE

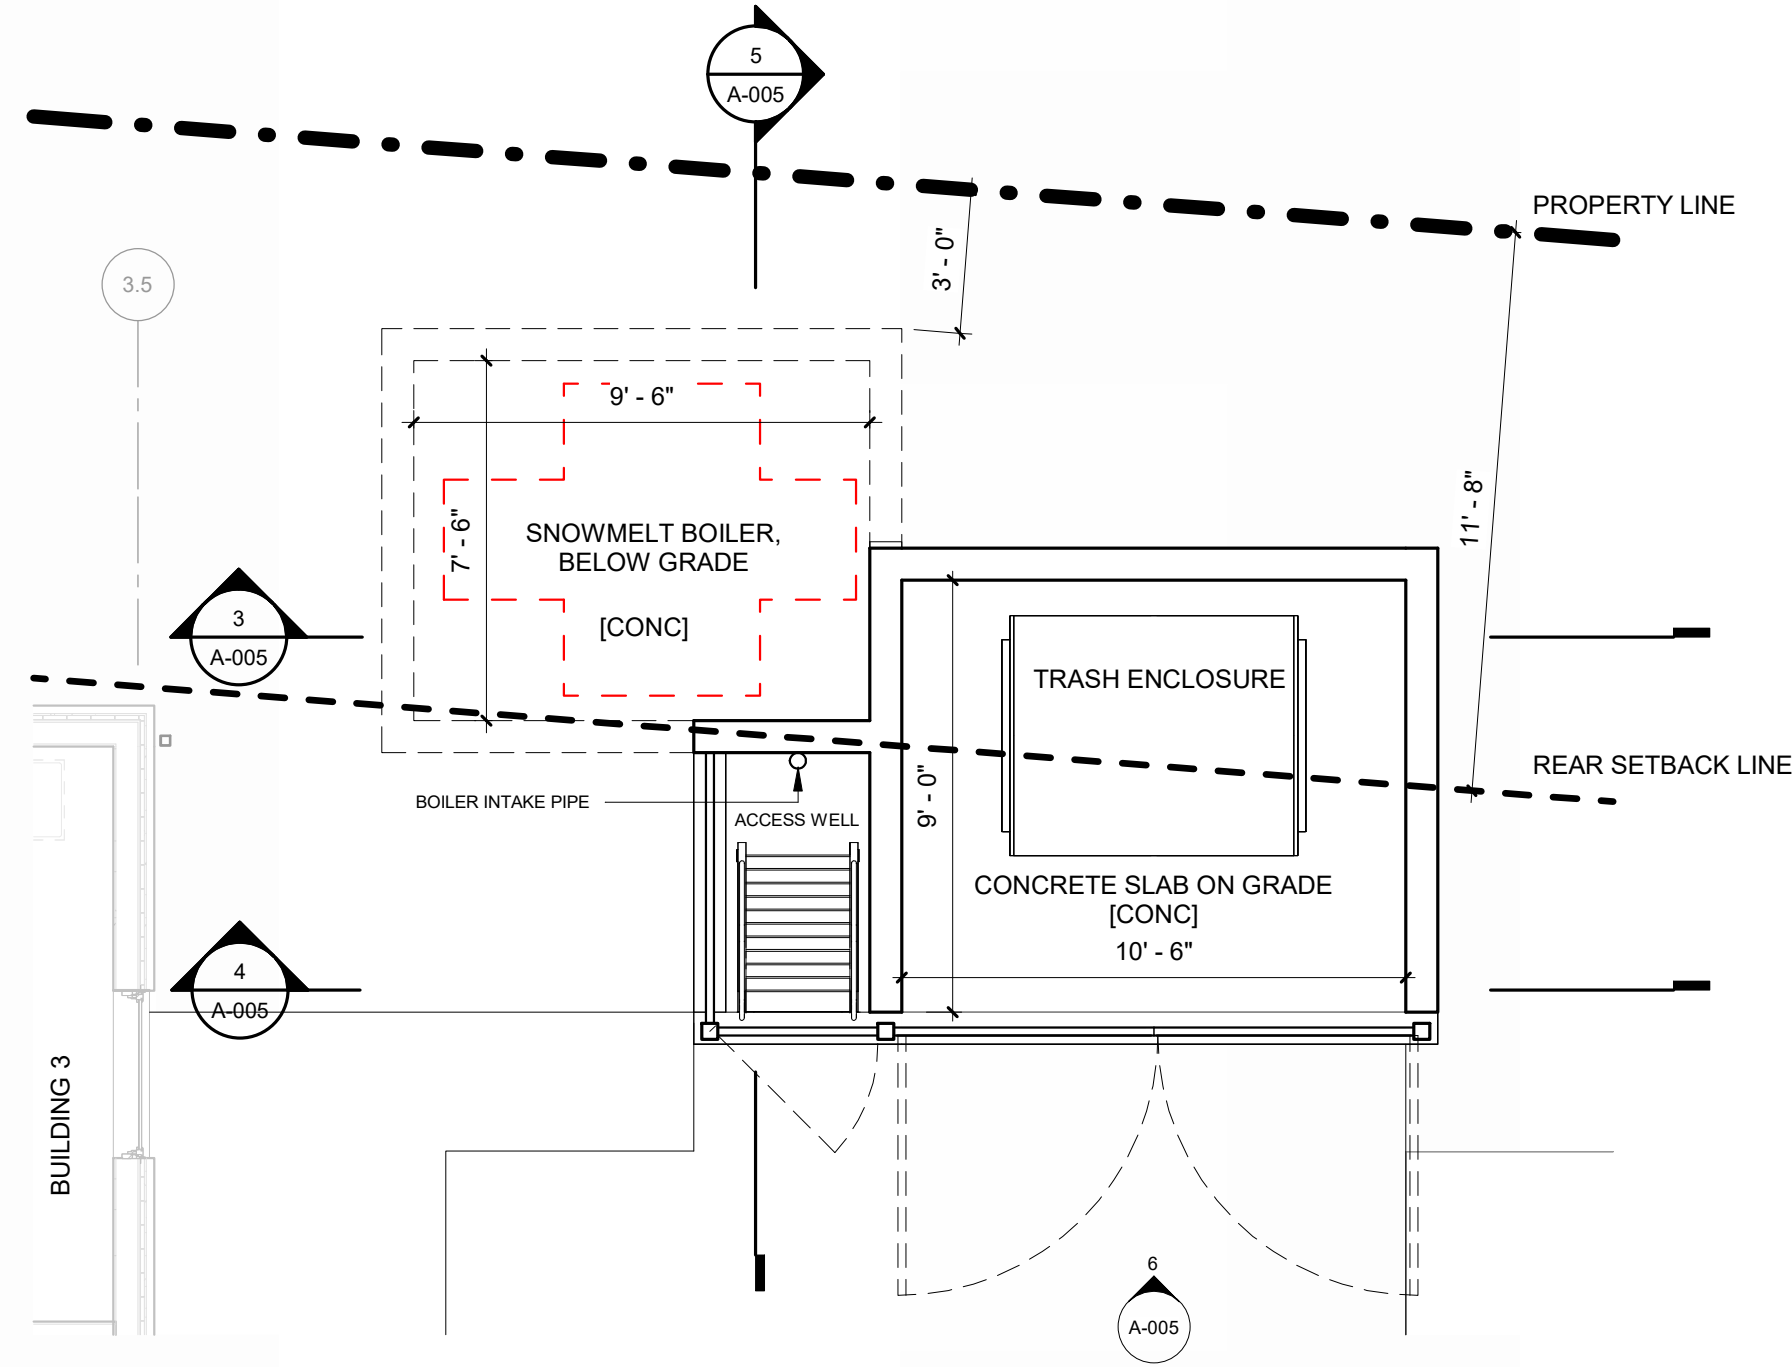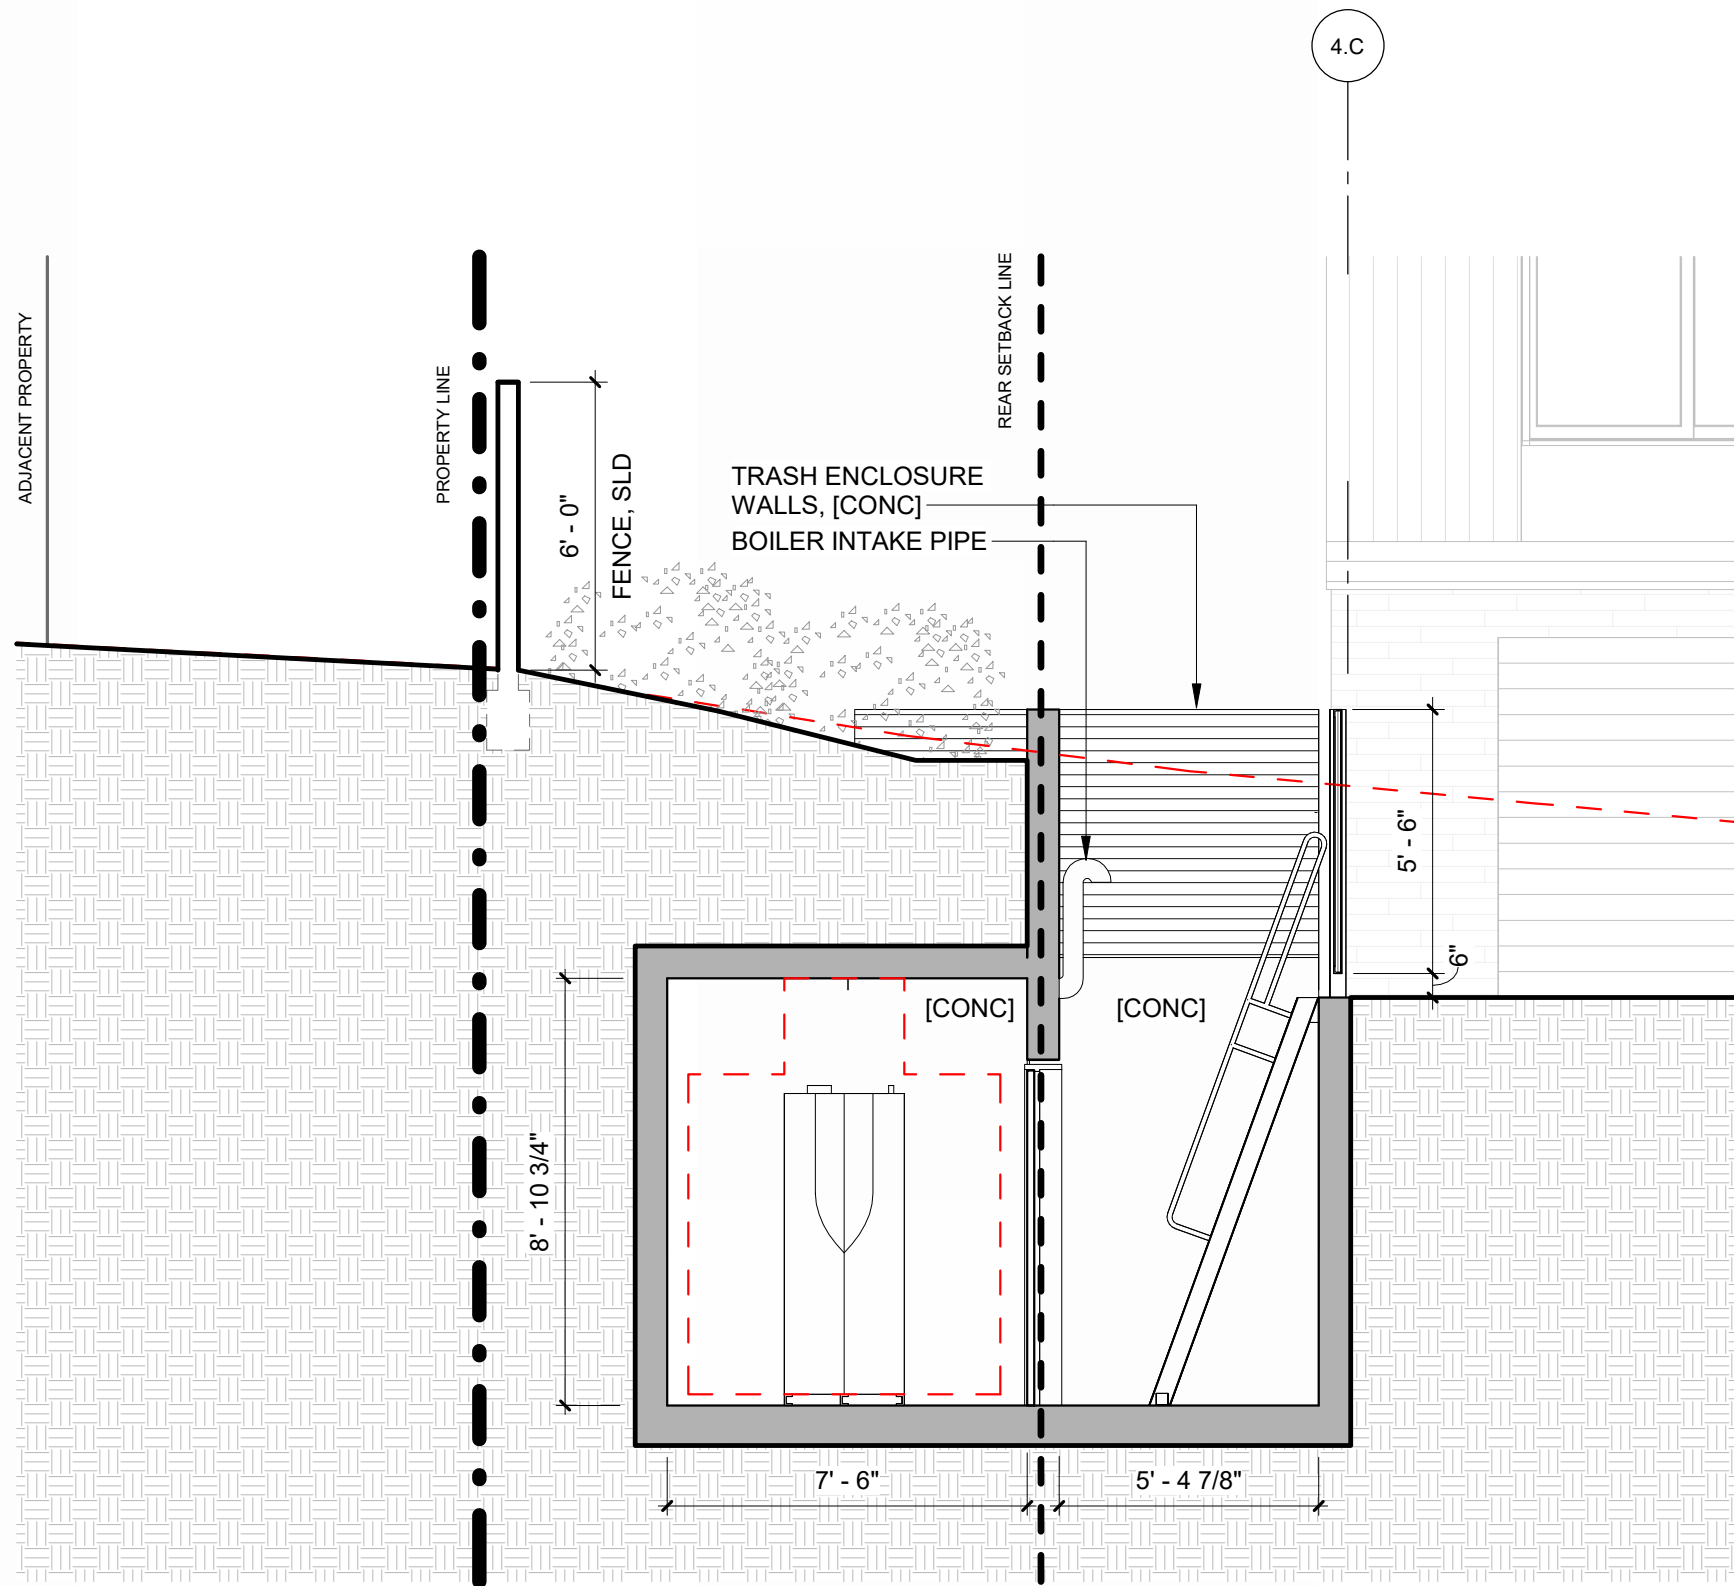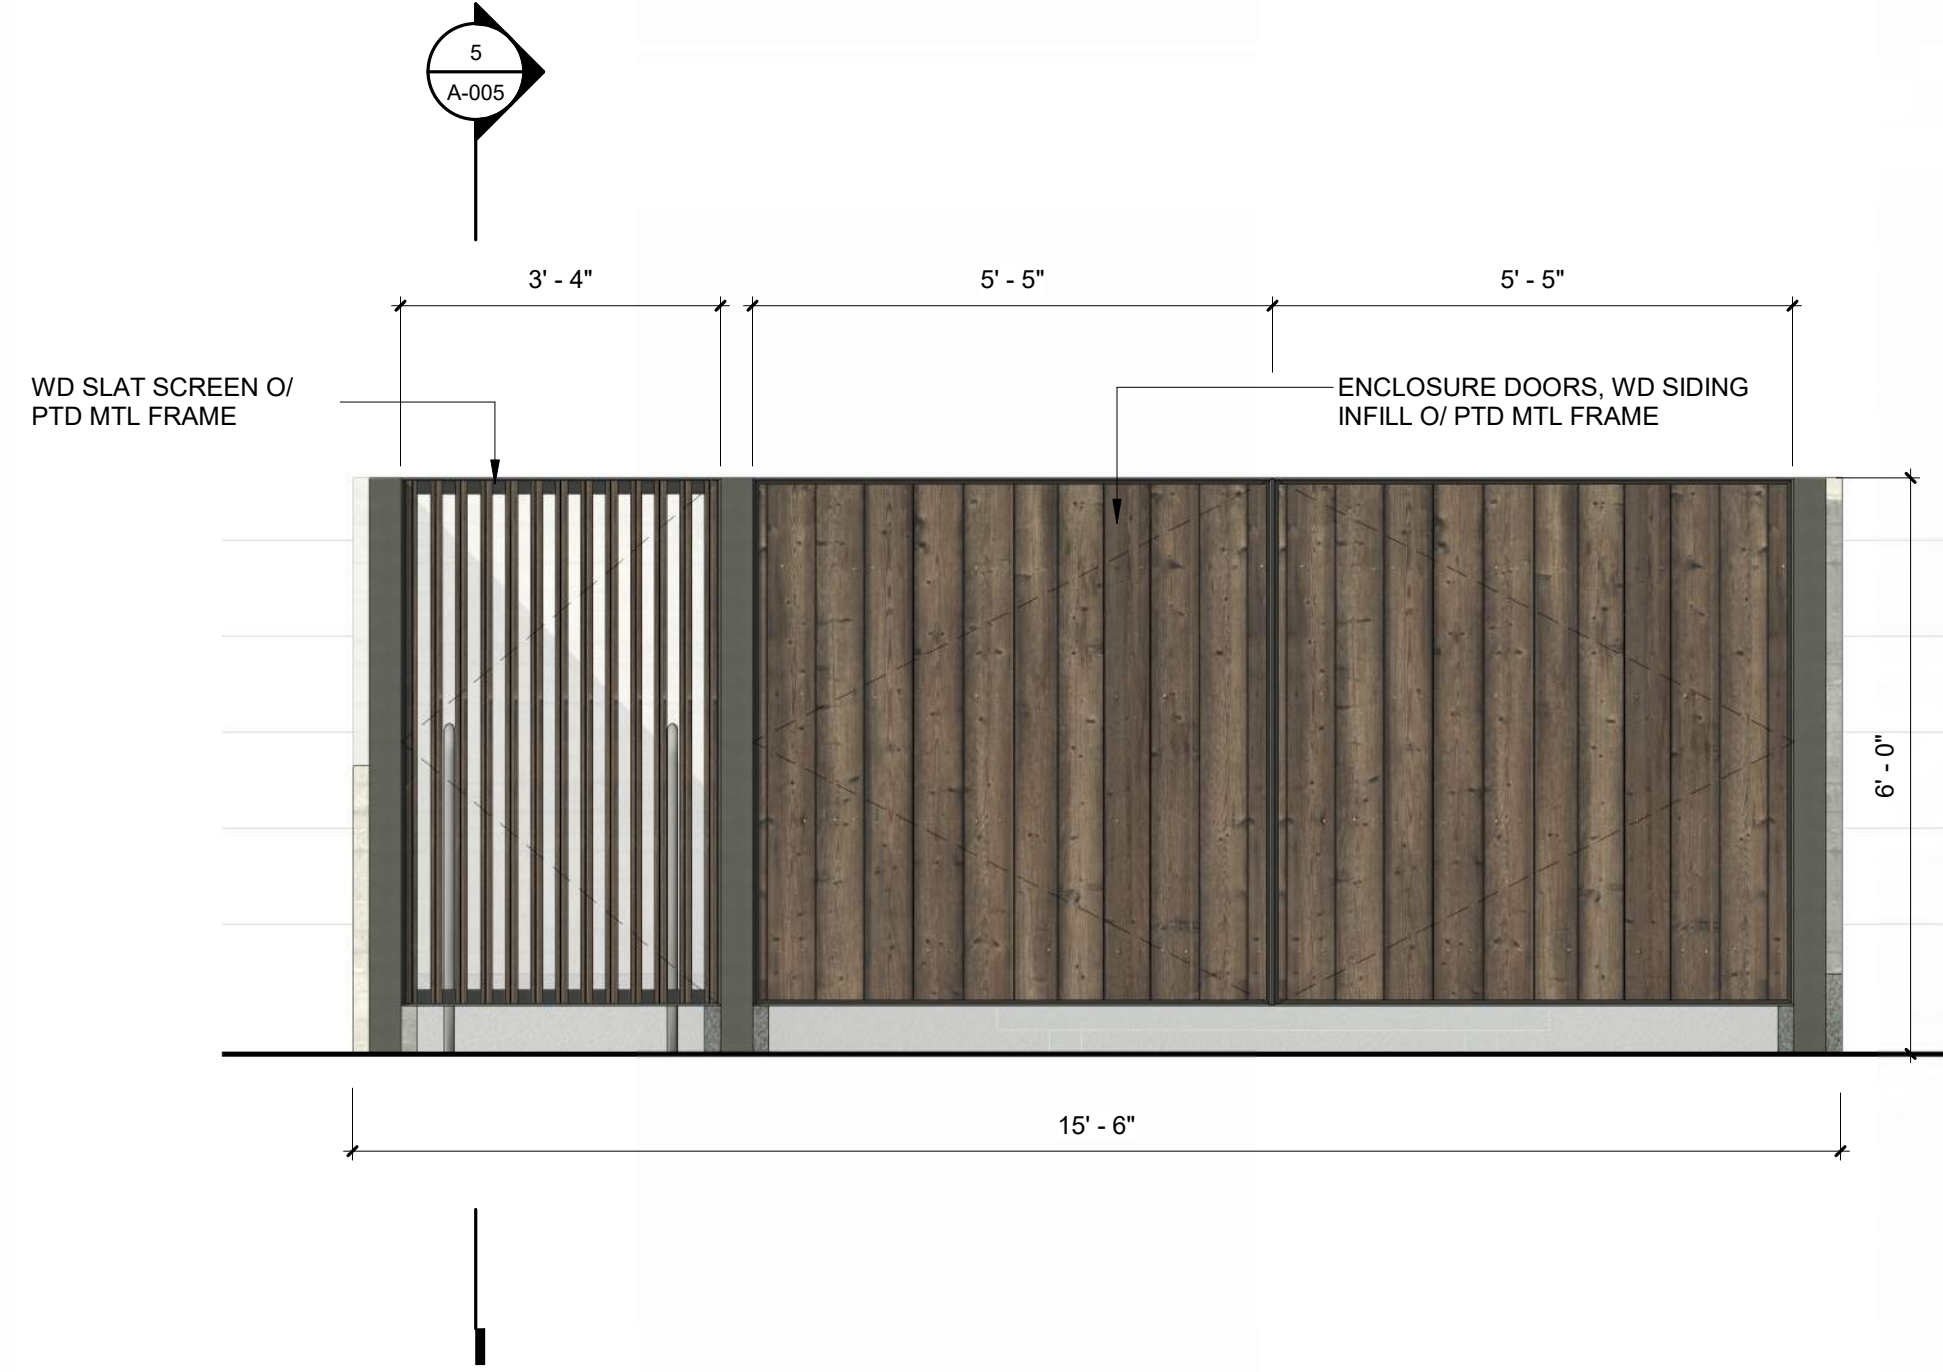

WARM SPRINGS TOWNHOMES KETCHUM, ID

OWNER:

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P.O. BOX 14001-174
KETCHUM, ID 83340
TEL: 803.801.0419

BUILDING ARCHITECT:

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INGLEWOOD, CA 90301
TEL: 213.784.0014

STRUCTURAL ENGINEER:

ZFA STRUCTURAL ENGINEERS
601 MONTGOMERY STREET SUITE 1450
SAN FRANCISCO, CA 94111
TEL: 415.243.4091

MECHANICAL, ELECTRICAL, PLUMBING ENGINEER:

PROFICIENT ENGINEERING
4704 HARLAN STREET SUITE 620
DENVER, CO 80212
TEL: 720.779.3596

CIVIL ENGINEER:

GALENA BENCHMARK ASSOCIATES
100 BELL DRIVE SUITE C
KETCHUM, ID 83340
TEL: 208.725.9512

LANDSCAPE ARCHITECT:

EGGERS ASSOCIATES
560 NORTH 2ND AVENUE
KETCHUM, ID 83340
TEL: 208.725.0988

ISSUE	DESCRIPTION	DATE
1	DESIGN REVIEW APP	25.09.09
2	DESIGN REVIEW APP REV	25.10.14

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PROJECT:
**WARM SPRINGS TOWNHOMES
KETCHUM, ID**
108 & 110 RITCHIE DR.
KETCHUM, IDAHO

DRAWING TITLE:
**SNOWMELT VAULT &
DUMPSTER DETAILS**

SEAL:

PROJECT NUMBER

2305

DRAWING NUMBER:

A-005


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6 1/2" = 1'-0" DUMPSTER ENCLOSURE / ELEVATION - EAST




RENDERING OF DUMPSTER ENCLOSURE - FRONT

5 1/4" = 1'-0" DUMPSTER ENCLOSURE / SECTION - EW

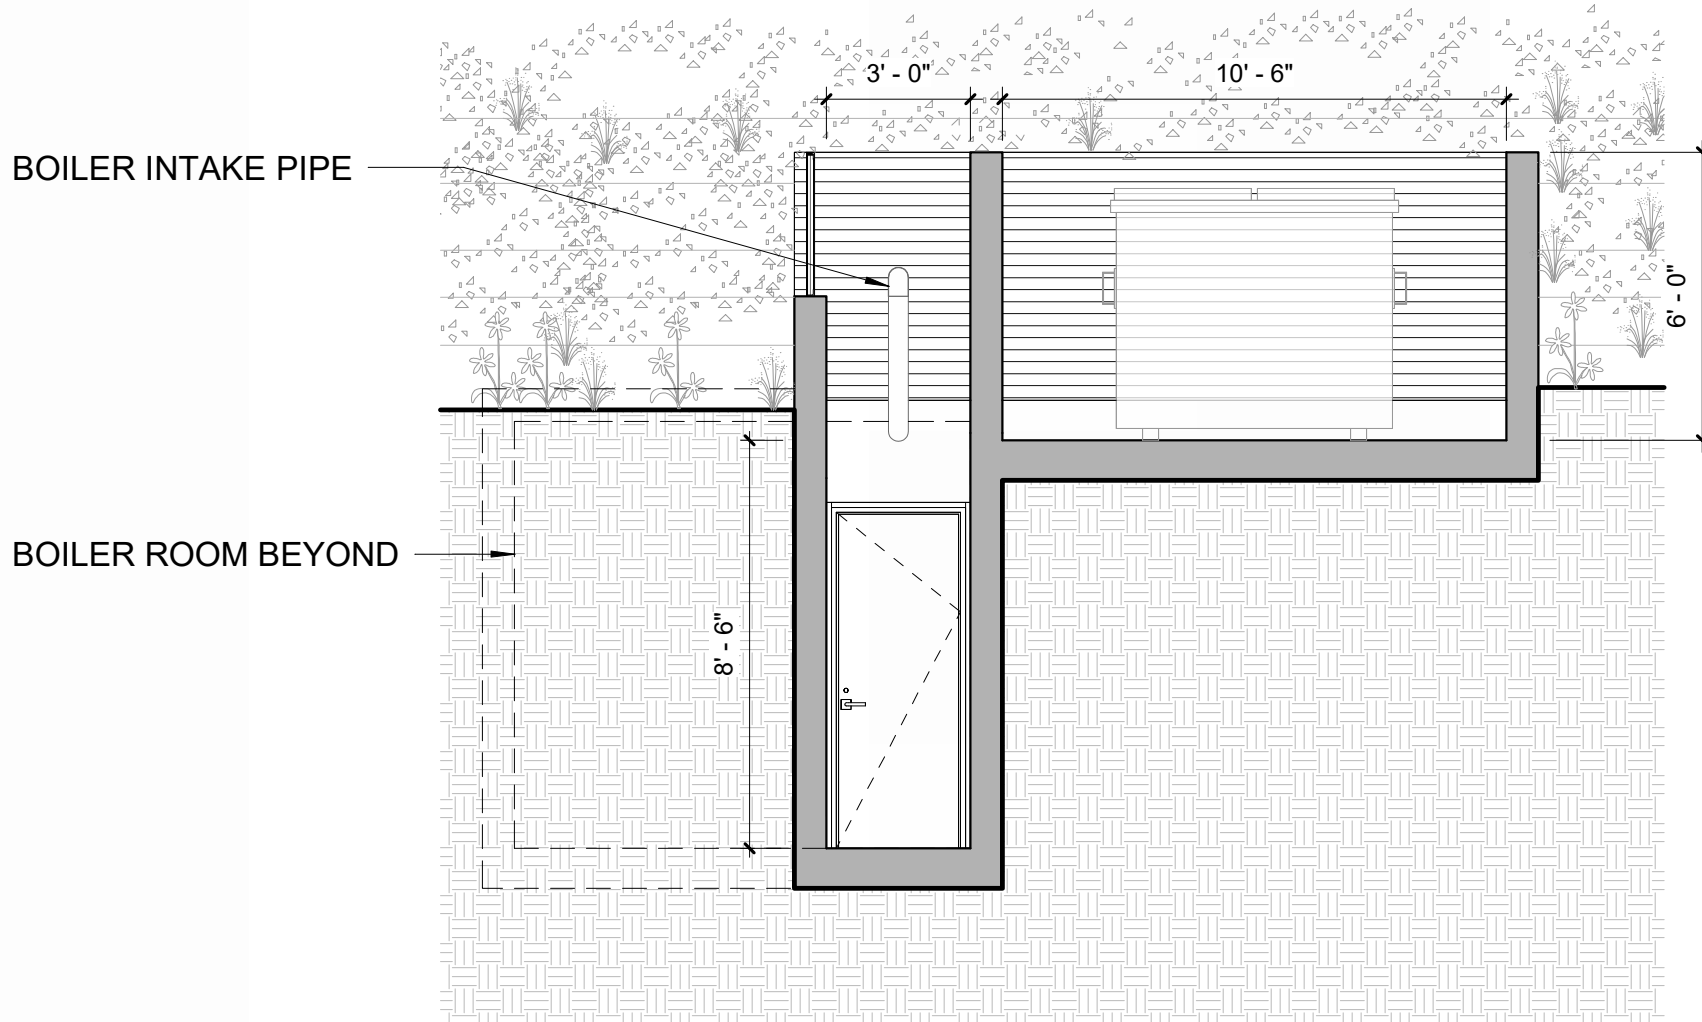


4 1/4" = 1'-0" DUMPSTER ENCLOSURE / SECTION - NS A

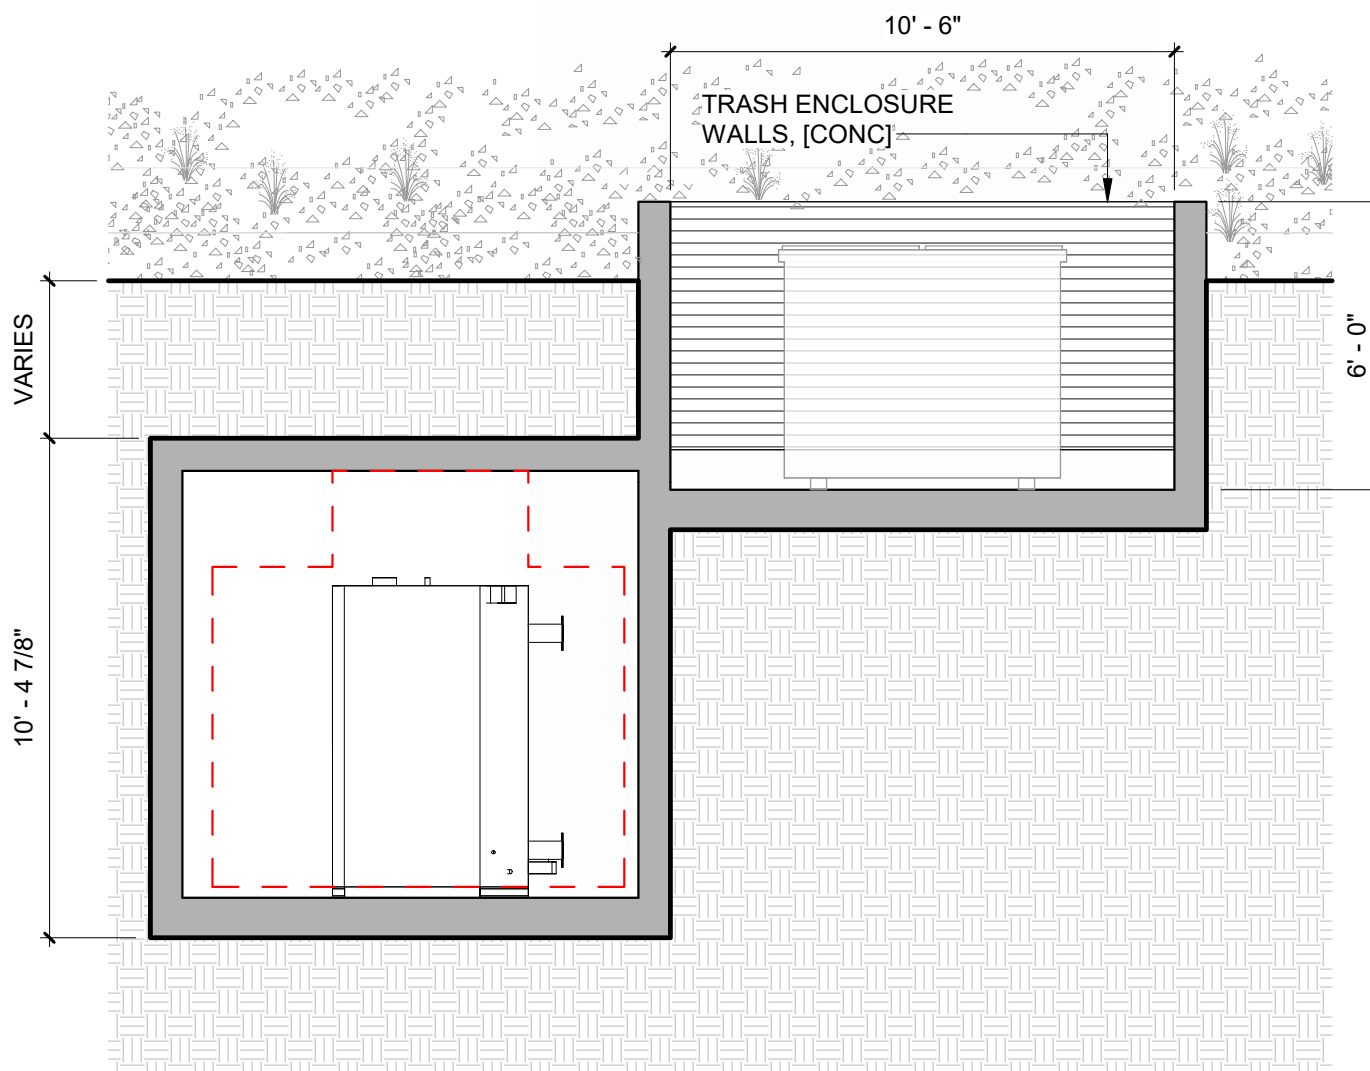

3 1/4" = 1'-0" DUMPSTER ENCLOSURE / SECTION - NS B

2 1/4" = 1'-0" DUMPSTER ENCLOSURE - ENLARGED FLOOR PLAN

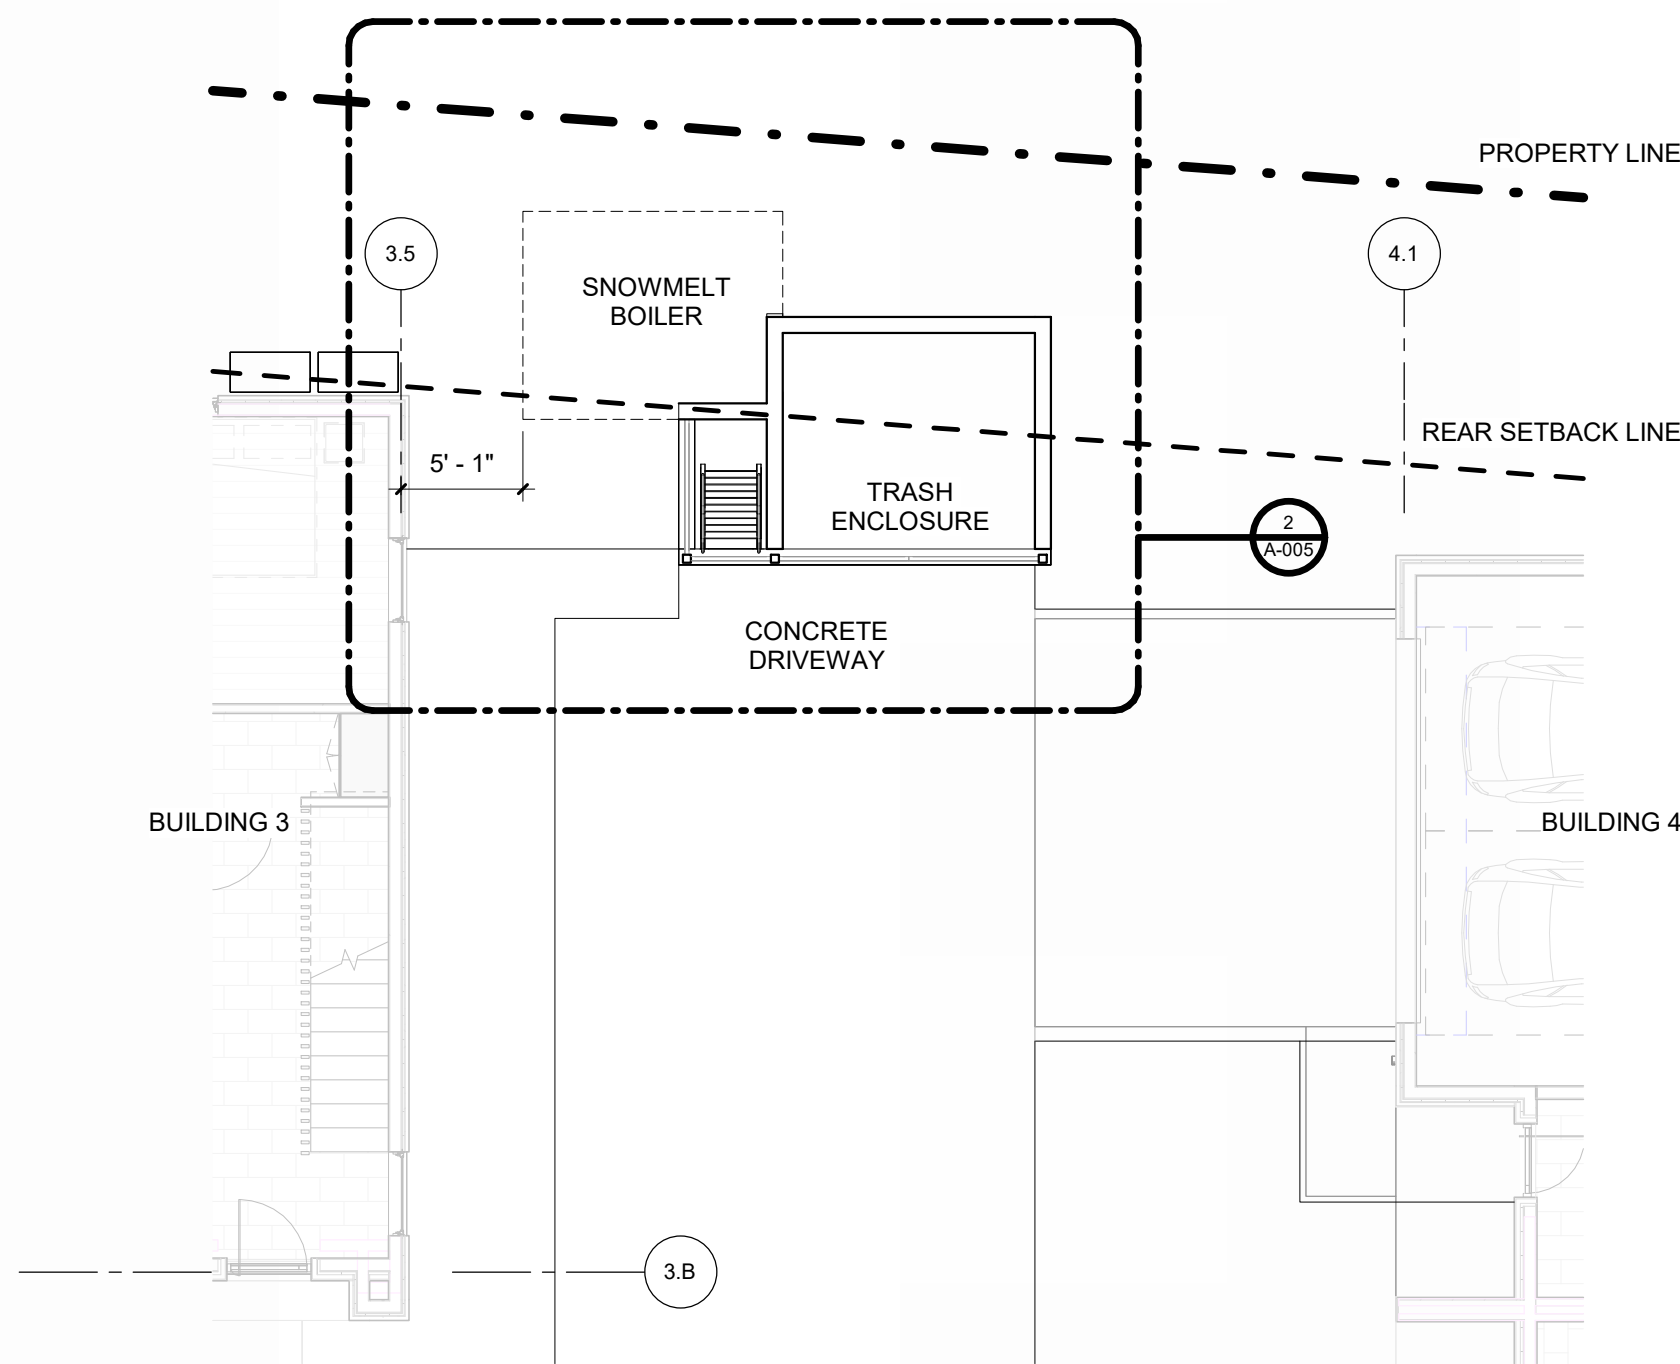

1 1/8" = 1'-0" DUMPSTER ENCLOSURE - FLOOR PLAN

PO Box 130 • Ketchum, ID 83340 • Phone 208.726.9600 • www.ccdisposal.com

Planning & Zoning
City of Ketchum
P O Box 2315
Ketchum, ID 83340

Re: 108 Richie Drive

Please consider this letter as a will serve for the above address. Attached to this email are plans for a 12-unit townhome project to be built. When built according to the plans the enclosure is ample for a dumpster to service the project.

- Snow and Ice removal to and inside of the enclosure
- Access to the enclosure and the turn around area for egress
- Gates maintained in working order

Respectfully,

.108 Richie Drive



Presidio Vista Properties
Hank Moore
Senior Development Manager
603-801-0419
hank@presidiovistaproperties.com

RE: 108 & 110 Richie Dr., Ketchum Idaho 83340. Lots 3 & 4 Warm Springs Village Subdivision. County of Blaine.

This letter is to serve as verification of the availability of natural gas currently to the above referenced project in Ketchum, Idaho.

The total estimated cost of extending our natural gas infrastructure and satisfying current tariffs to serve the above entity is the responsibility of the contractor/ owner of said project and must be paid in advance of construction.

Extensions of our natural gas mains and services will be provided and installed in accordance with our current tariffs, guidelines, policies and provisions on file with the Idaho Public Utilities Commission.

If you need further information regarding this project, please call me at 208-737-6314.

Sincerely,

Lance D. McBride

Lance D. McBride
Energy Services Representative Sr.
lance.mcbride@intgas.com
208-737-6314

From: Bennett, Cheryl <CBennett2@idahopower.com>
Sent: Friday, May 17, 2024 10:27 AM
To: Hank Moore
Cc: Erik de Bruijn
Subject: Will Serve Email

Hank and Erik,

You can provide this email to the city of Ketchum for your application:

I have reviewed the proposed project by Presidio Vista Properties for 12 luxury townhomes on Ritchie Drive.

As this is in the preliminary stages, I have not finalized my design on the project. The proposed transformer locations may work, but I'll have to review when I get into my design phase. I have indicated where they may also be placed depending on the voltage drop, once I get into it. Additionally, we need 10' of clearance to the front of the transformers for safe electrical operation. They can be landscaped on side and rear, no matter where they are placed. We do have primary power on Ritchie Drive, but again, until I start my design, I will not know if I need another device to pick it up (sector) and/or have to cross Ritchie Drive to get to it.

Once the customer makes formal application for design the company will provide electrical service to the project subject to obtaining of any required easements, rights of way, and in compliance with the statutes of the State of Idaho and the tariffs of the company on file with the Idaho Public Utilities Commission (PUC), in particular, the General Rules and Regulations, covering new service attachments and distribution line installations or alterations. The tariff is subject to change from time to time upon approval by the Idaho PUC.

Below is the initial review I have made. Please let me know if you have additional questions or comments.

[illegible]

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PROJECT:
WARM SPRINGS TOWNHOMES
KETCHUM, ID
108 & 110 RITCHIE DR.
KETCHUM, IDAHO

DRAWING TITLE:
WILL SERVE LETTERS

SEAL:

PROJECT NUMBER
2305

DRAWING NUMBER:

A-006

WARM SPRINGS
TOWNHOMES
KETCHUM, ID

OWNER:

108-110 RITCHIE LLC
P.O. BOX 14001-174
KETCHUM, ID 83340
TEL: 603.801.0419

BUILDING ARCHITECT:

RO | ROCKETT DESIGN
1031 W. MANCHESTER BLVD. UNIT 6
INGLEWOOD, CA 90301
TEL: 213.784.0014

STRUCTURAL ENGINEER:

ZFA STRUCTURAL ENGINEERS
601 MONTGOMERY STREET SUITE 1450
SAN FRANCISCO, CA 94111
TEL: 415.243.4091

MECHANICAL, ELECTRICAL, PLUMBING ENGINEER:

PROPIQENT ENGINEERING
4704 HARLAN STREET SUITE 620
DENVER, CO 80212
TEL: 720.779.3596

CIVIL ENGINEER:

GALENA BENCHMARK ASSOCIATES
100 BELL DRIVE SUITE C
KETCHUM, ID 83340
TEL: 208.725.9512

LANDSCAPE ARCHITECT:

EGGERS ASSOCIATES
560 NORTH 2ND AVENUE
KETCHUM, ID 83340
TEL: 208.725.0988

ISSUE	DESCRIPTION	DATE
1	DESIGN REVIEW APP	25.09.09
2	DESIGN REVIEW APP-REV	25.10.14

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PROJECT:

WARM SPRINGS TOWNHOMES
KETCHUM, ID
108 & 110 RITCHIE DR.
KETCHUM, IDAHO

DRAWING TITLE:

LEVEL 00 OVERALL FLOOR
PLAN

SEAL:


PROJECT NUMBER

2305

DRAWING NUMBER:

A-100

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OWNER:

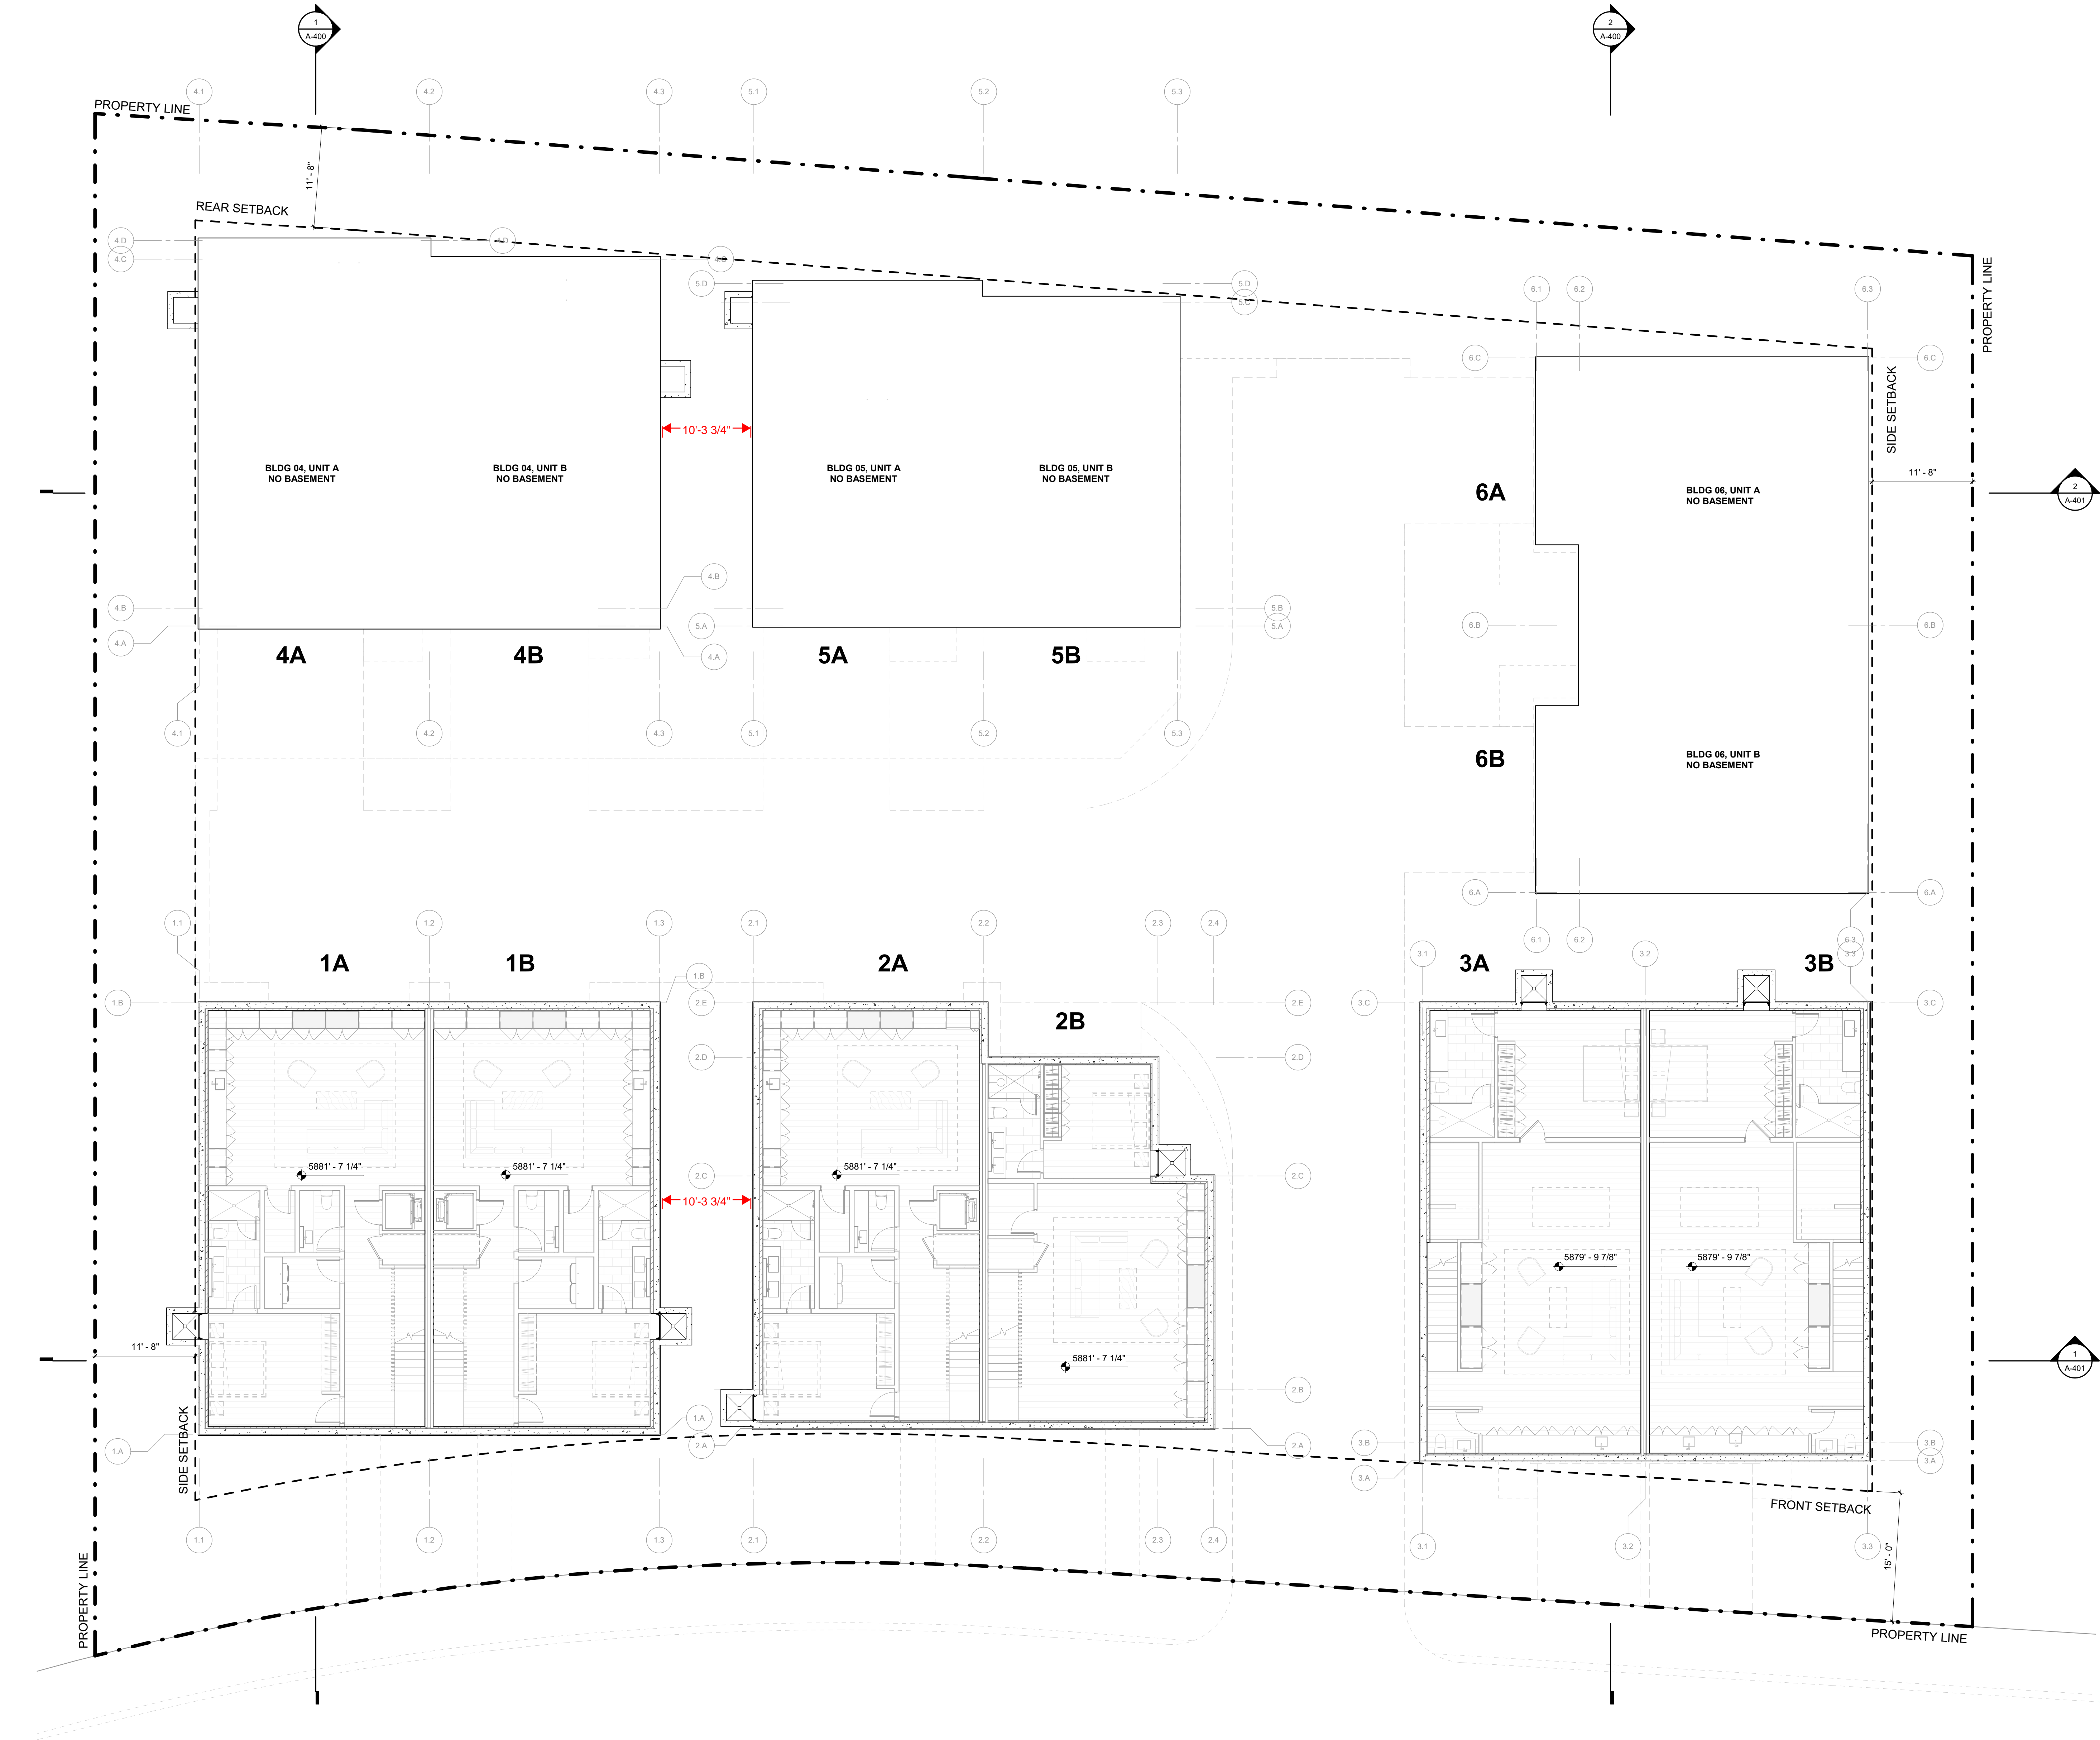108-110 RITCHIE LLC
P O BOX 14001-174
KETCHUM, ID 83340
TEL: 603.801.0419

BUILDING ARCHITECT:

RO J ROCKETT DESIGN
500 W. MANCHESTER BLVD. UNIT 6
INGLEWOOD, CA 90301
TEL: 213.784.0014

STRUCTURAL ENGINEER:

ZFA STRUCTURAL ENGINEERS
601 MONTGOMERY STREET SUITE 1450
SAN FRANCISCO, CA 94111
TEL: 415.243.4081

MECHANICAL, ELECTRICAL, PLUMBING ENGINEER:

PROFICIENT ENGINEERING
4704 HARLAN STREET SUITE 620
DENVER, CO 80212
TEL: 720.779.3596

CIVIL ENGINEER:

GALENA BENCHMARK ASSOCIATES
100 BELL DRIVE SUITE C
KETCHUM, ID 83340
TEL: 208.726.9512

LANDSCAPE ARCHITECT:

EGGERS ASSOCIATES
56 NORTH 2ND AVENUE
KETCHUM, ID 83340
TEL: 208.725.0988

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SEAL: _____

DRAWING NUMBER:

A-101

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NOTES:
1. "NO PARKING" SIGNS SHALL BE POSTED FOR ANY DRIVEWAY THAT DOES NOT MEET THE DIMENSIONAL STANDARDS FOR PARKING (9' W x 18' L)

WARM SPRINGS
TOWNHOMES
KETCHUM, ID

OWNER:

108-110 RITCHIE LLC
P.O. BOX 14001-174
KETCHUM, ID 83340
TEL: 603.801.0419

BUILDING ARCHITECT:

RO | ROCKETT DESIGN
1031 W. MANCHESTER BLVD. UNIT 6
INGLEWOOD, CA 90301
TEL: 213.784.0014

STRUCTURAL ENGINEER:

ZFA STRUCTURAL ENGINEERS
601 MONTGOMERY STREET SUITE 1450
SAN FRANCISCO, CA 94111
TEL: 415.243.4091

MECHANICAL, ELECTRICAL, PLUMBING ENGINEER:

PROPIQENT ENGINEERING
4704 HARLAN STREET SUITE 620
DENVER, CO 80212
TEL: 720.779.3596

CIVIL ENGINEER:

GALENA BENCHMARK ASSOCIATES
100 BELL DRIVE SUITE C
KETCHUM, ID 83340
TEL: 208.725.9512

LANDSCAPE ARCHITECT:

EGGERS ASSOCIATES
560 NORTH 2ND AVENUE
KETCHUM, ID 83340
TEL: 208.725.0988

ISSUE	DESCRIPTION	DATE
1	DESIGN REVIEW APP	25.09.09
2	DESIGN REVIEW APP REV	25.10.14
3	DESIGN REVIEW APP REV	25.12.09

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PROJECT:

WARM SPRINGS TOWNHOMES
KETCHUM, ID

108 & 110 RITCHIE DR.
KETCHUM, IDAHO

DRAWING TITLE:

LEVEL 02 OVERALL FLOOR
PLAN

SEAL:


PROJECT NUMBER

2305

DRAWING NUMBER:

A-102

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WARM SPRINGS
TOWNHOMES
KETCHUM, ID

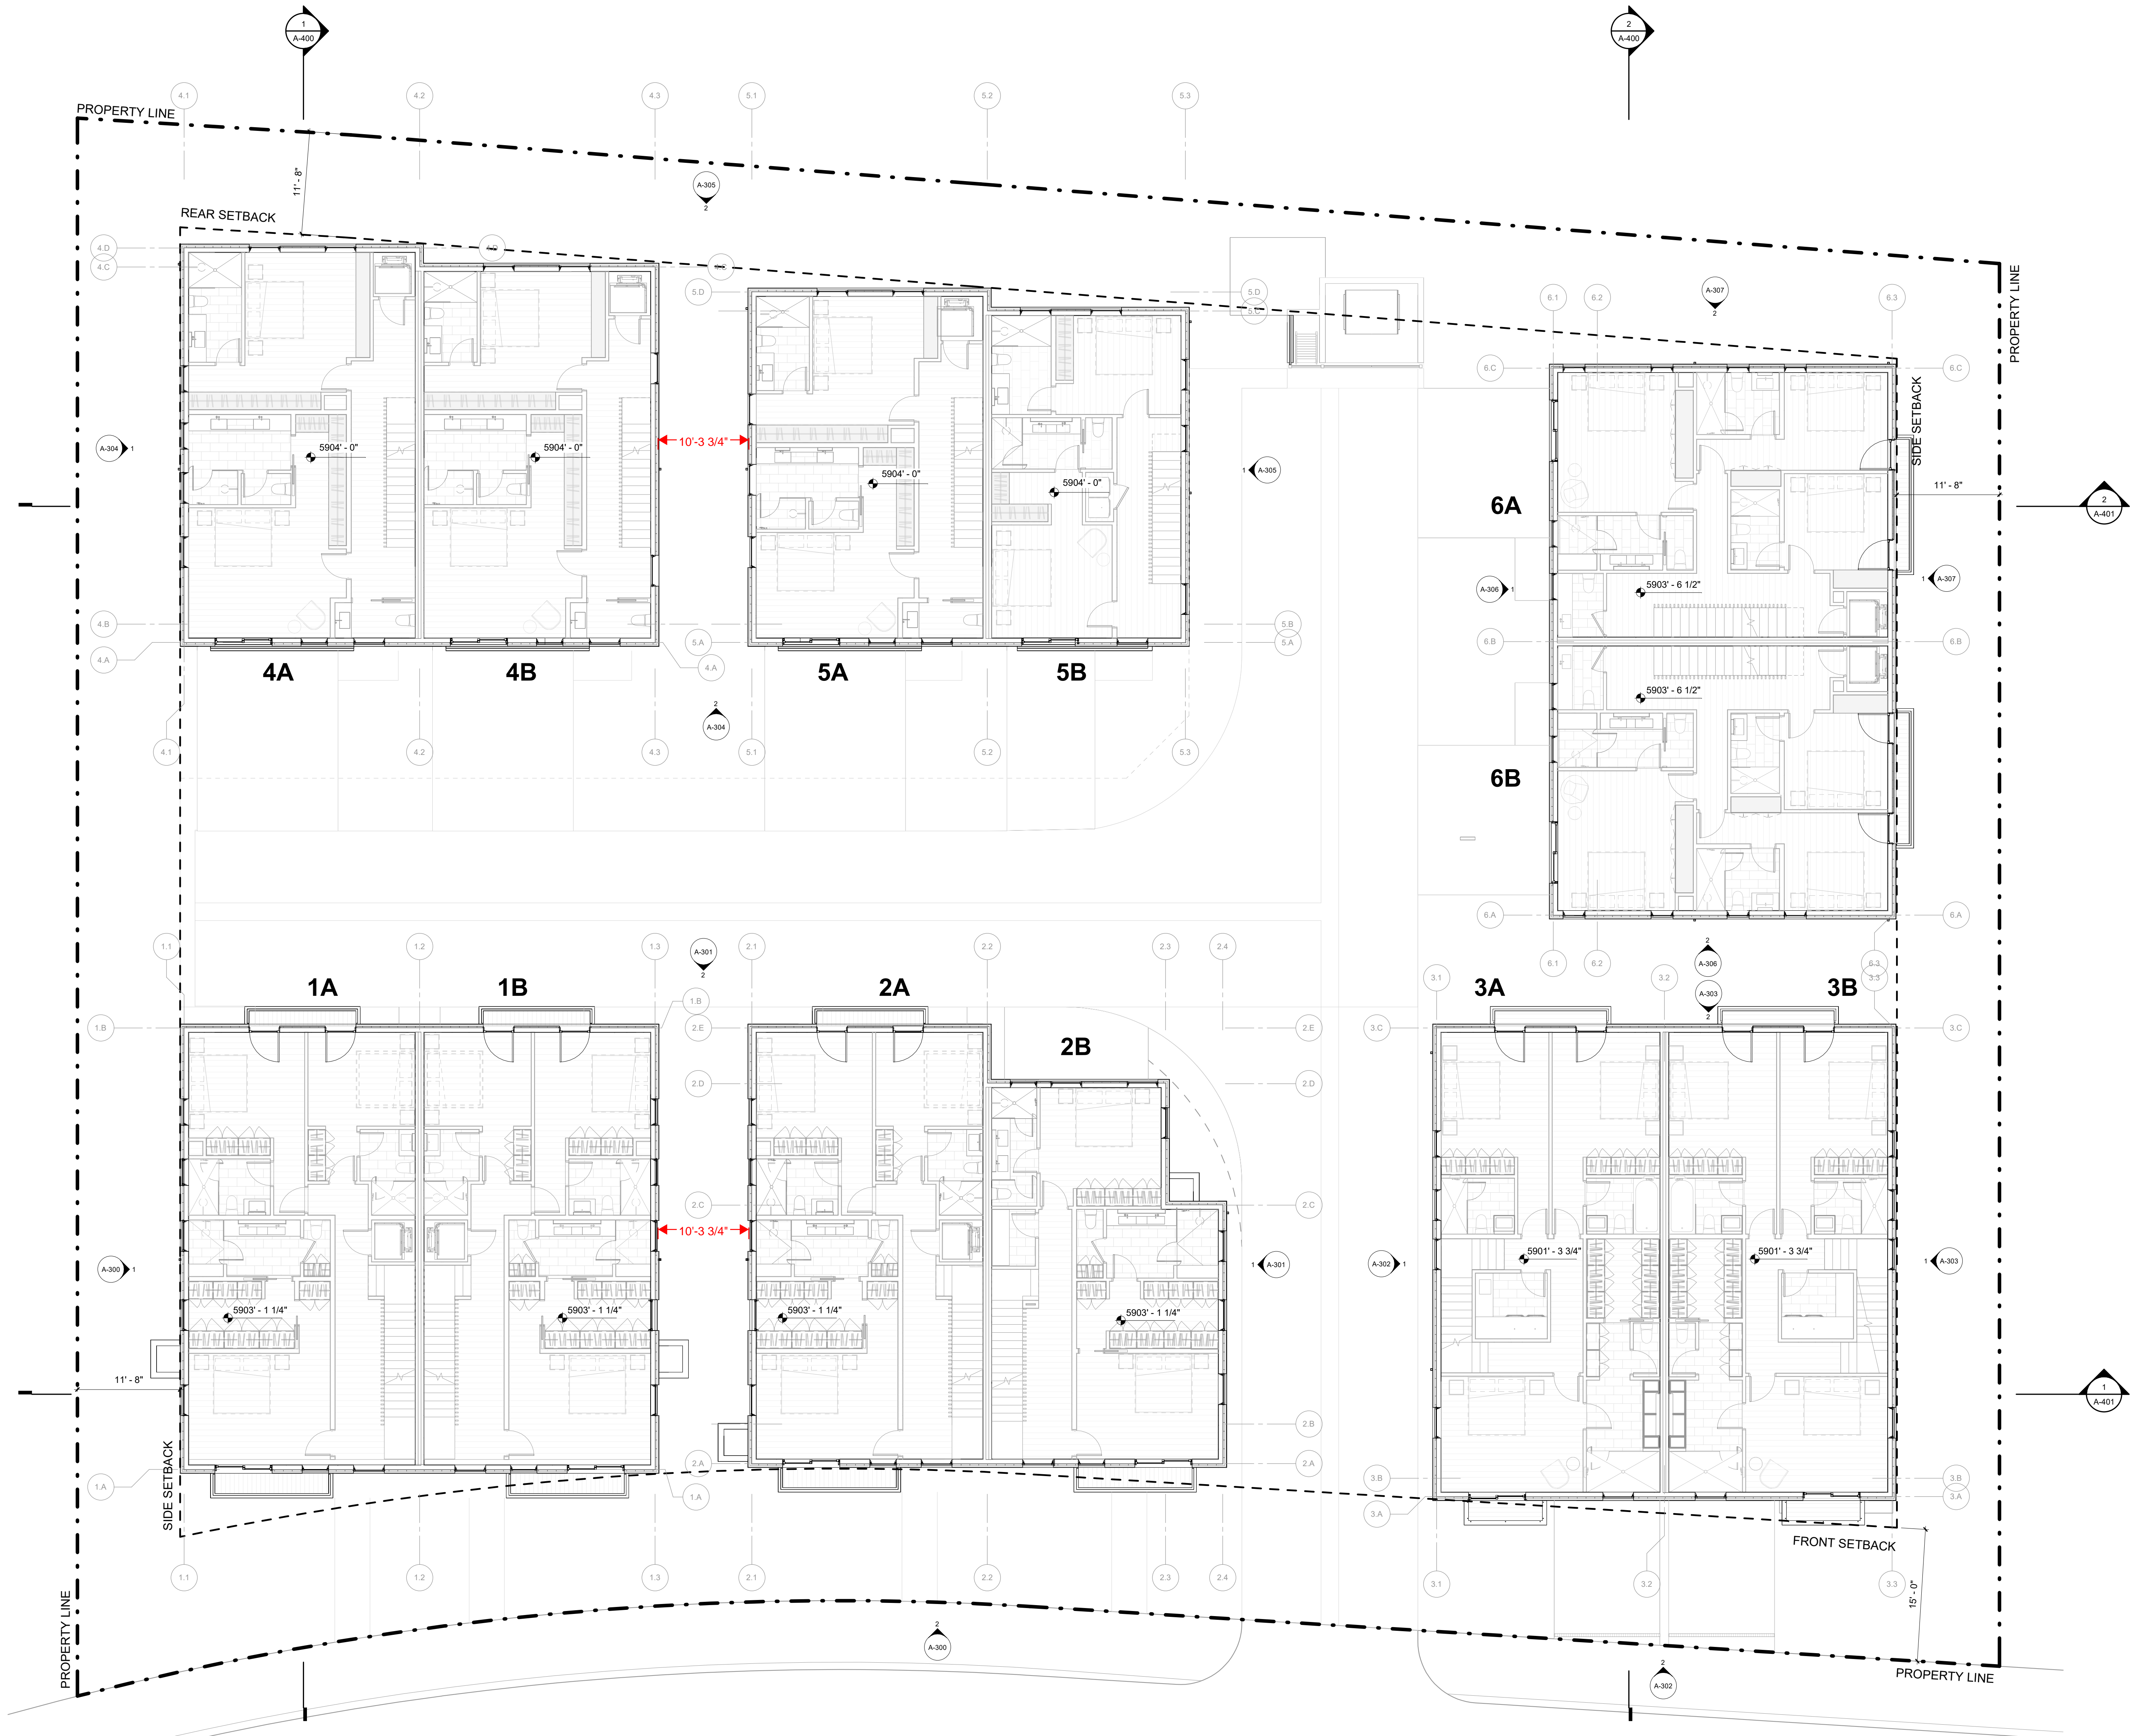OWNER:

108-110 RITCHIE LLC
P.O. BOX 14001-174
KETCHUM, ID 83340
TEL: 603.801.0419

BUILDING ARCHITECT:

RO | ROCKETT DESIGN
1031 W. MANCHESTER BLVD. UNIT 6
INGLEWOOD, CA 90301
TEL: 213.784.0014

STRUCTURAL ENGINEER:

ZFA STRUCTURAL ENGINEERS
601 MONTGOMERY STREET SUITE 1450
SAN FRANCISCO, CA 94111
TEL: 415.243.4091

MECHANICAL, ELECTRICAL, PLUMBING ENGINEER:

PROPIQENT ENGINEERING
4704 HARLAN STREET SUITE 620
DENVER, CO 80212
TEL: 720.779.3596

CIVIL ENGINEER:

GALENA BENCHMARK ASSOCIATES
100 BELL DRIVE SUITE C
KETCHUM, ID 83340
TEL: 208.725.9512

LANDSCAPE ARCHITECT:

EGGERS ASSOCIATES
560 NORTH 2ND AVENUE
KETCHUM, ID 83340
TEL: 208.725.0988

ISSUE	DESCRIPTION	DATE
1	DESIGN REVIEW APP	25.09.09
2	DESIGN REVIEW APP REV	25.10.14

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PROJECT:

WARM SPRINGS TOWNHOMES
KETCHUM, ID

108 & 110 RITCHIE DR.
KETCHUM, IDAHO

DRAWING TITLE:

LEVEL 03 OVERALL FLOOR
PLAN

SEAL:


PROJECT NUMBER

2305

DRAWING NUMBER:

A-103

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WARM SPRINGS
TOWNHOMES
KETCHUM, ID

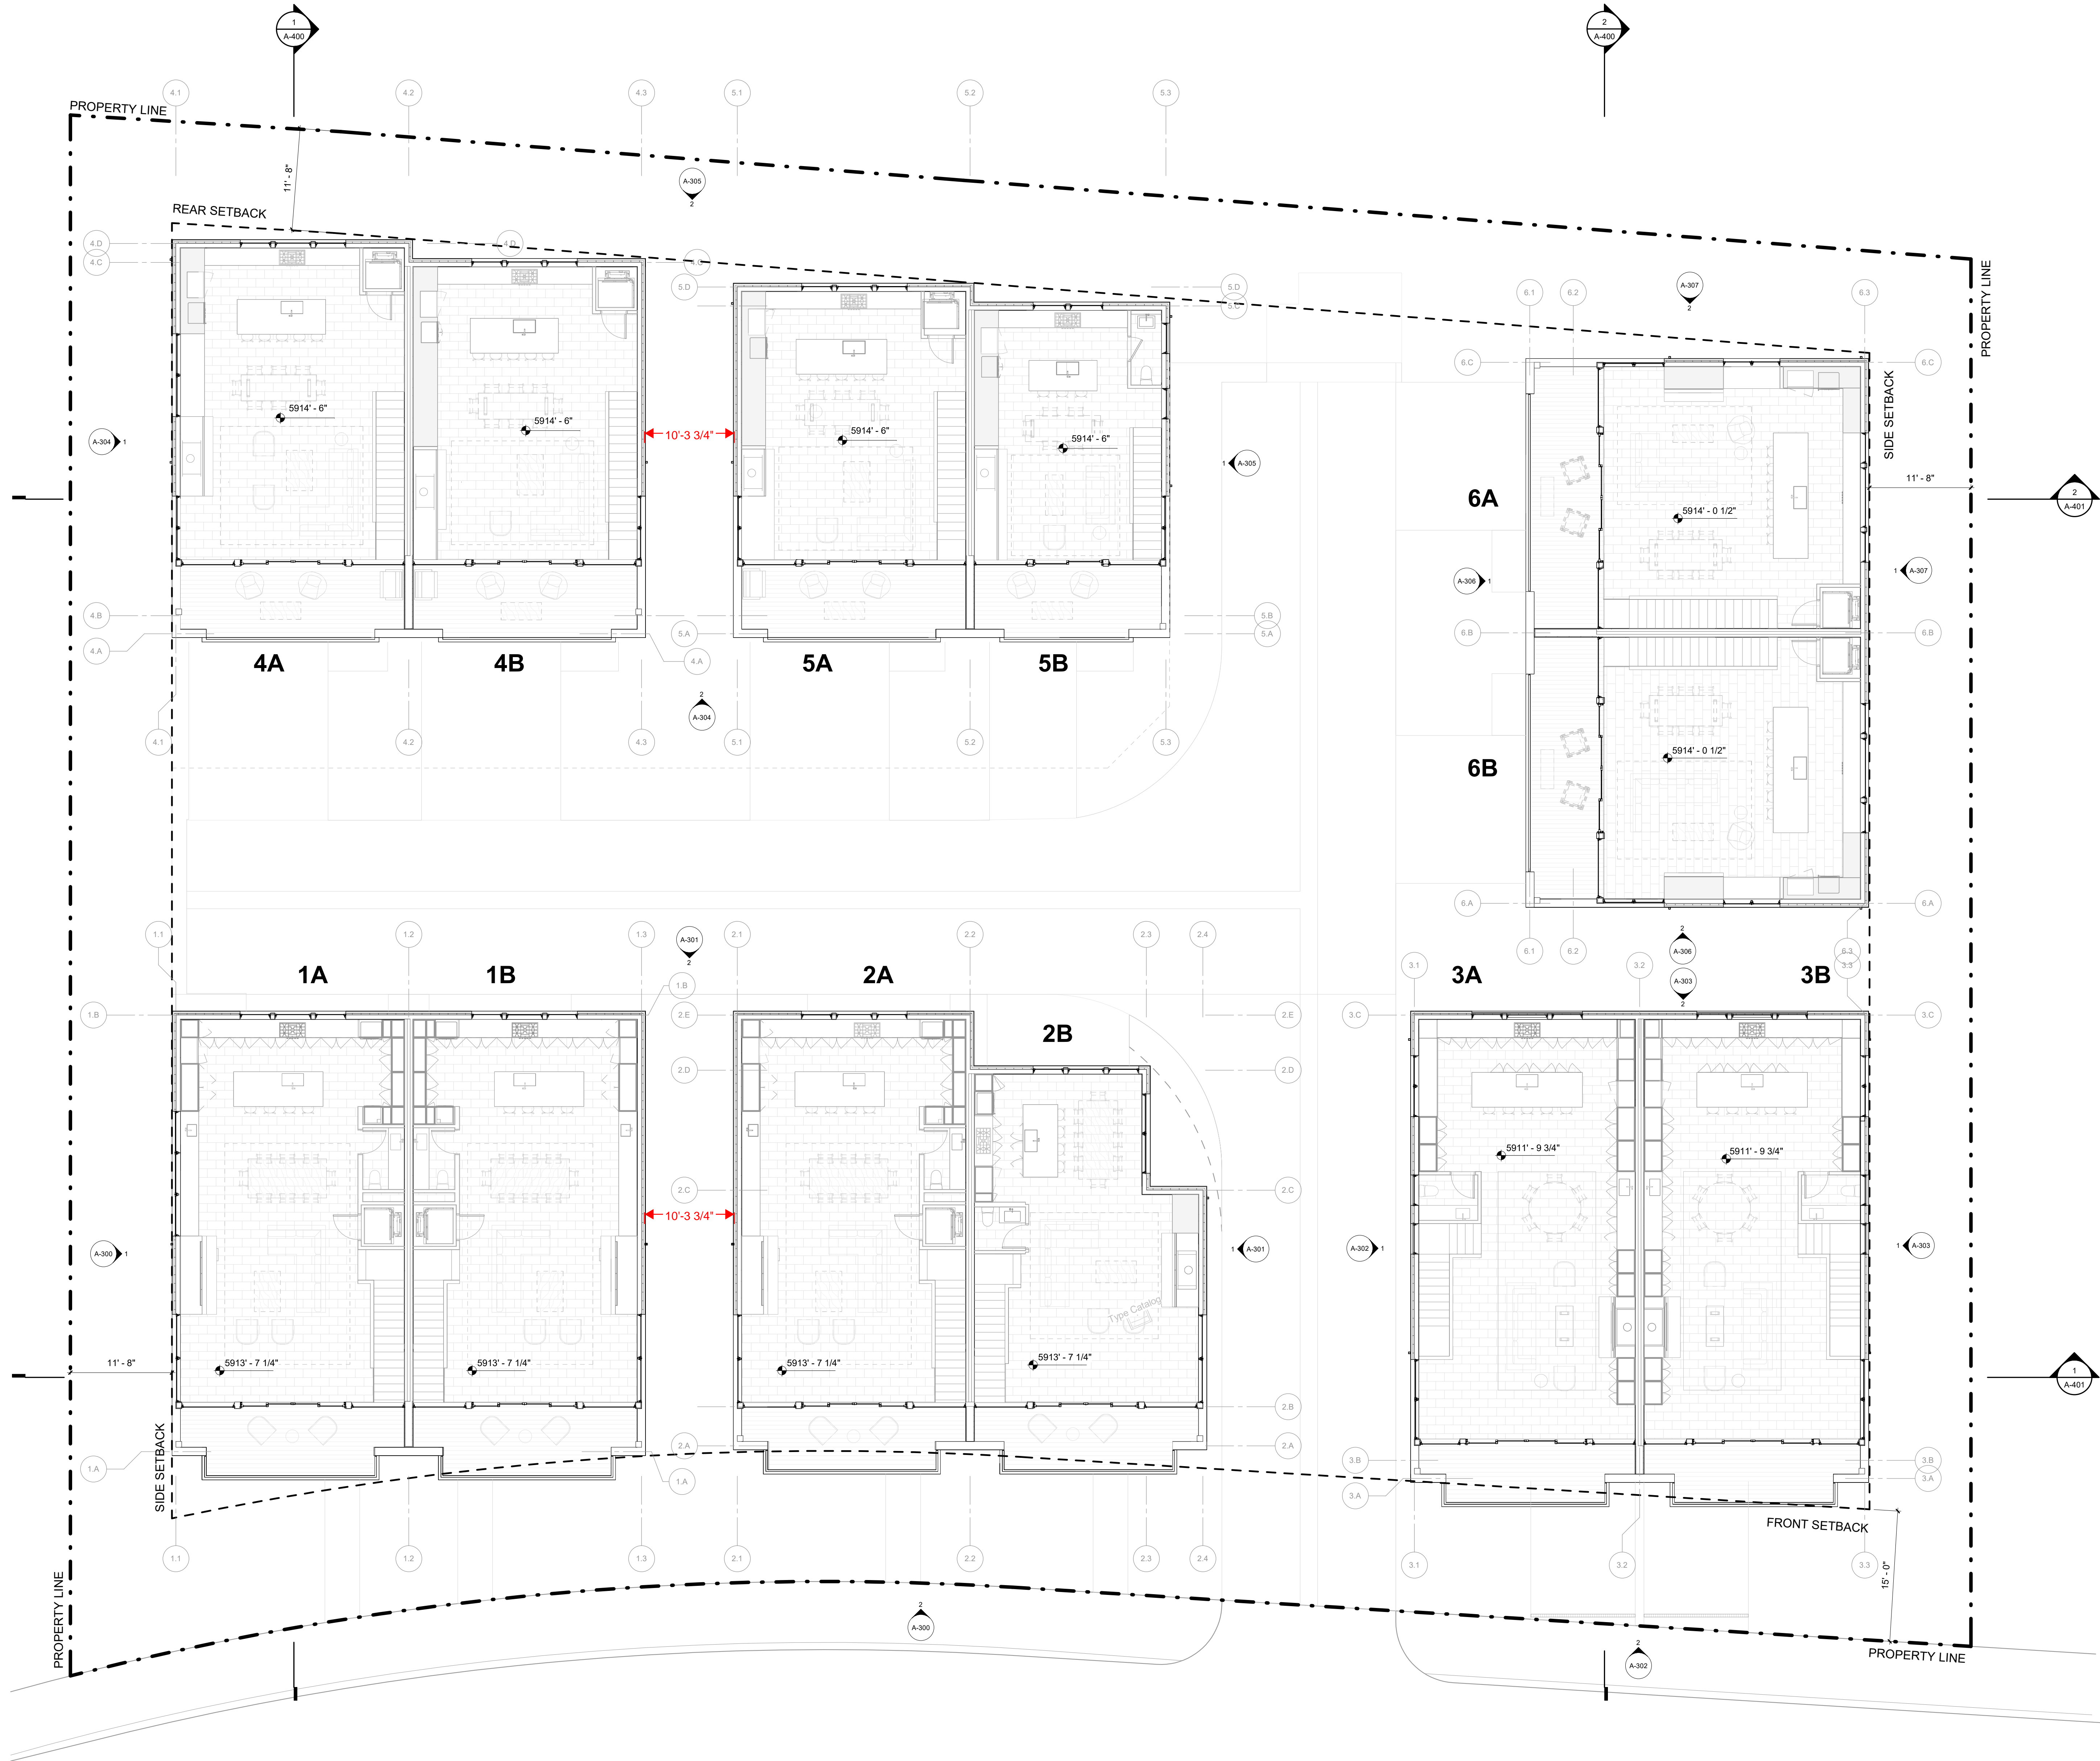OWNER:

108-110 RITCHIE LLC
P.O. BOX 14001-174
KETCHUM, ID 83340
TEL: 603.801.0419

BUILDING ARCHITECT:

RO | ROCKETT DESIGN
1031 W. MANCHESTER BLVD. UNIT 6
INGLEWOOD, CA 90301
TEL: 213.784.0014

STRUCTURAL ENGINEER:

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601 MONTGOMERY STREET SUITE 1450
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MECHANICAL, ELECTRICAL, PLUMBING ENGINEER:

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CIVIL ENGINEER:

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100 BELL DRIVE SUITE C
KETCHUM, ID 83340
TEL: 208.725.9512

LANDSCAPE ARCHITECT:

EGGERS ASSOCIATES
560 NORTH 2ND AVENUE
KETCHUM, ID 83340
TEL: 208.725.0988

ISSUE	DESCRIPTION	DATE
1	DESIGN REVIEW APP	25.09.09
2	DESIGN REVIEW APP REV	25.10.14

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PROJECT:

WARM SPRINGS TOWNHOMES
KETCHUM, ID
108 & 110 RITCHIE DR.
KETCHUM, IDAHO

DRAWING TITLE:

OVERALL ROOF PLAN

SEAL:


PROJECT NUMBER

2305

DRAWING NUMBER:

A-104

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WARM SPRINGS TOWNHOMES KETCHUM, ID

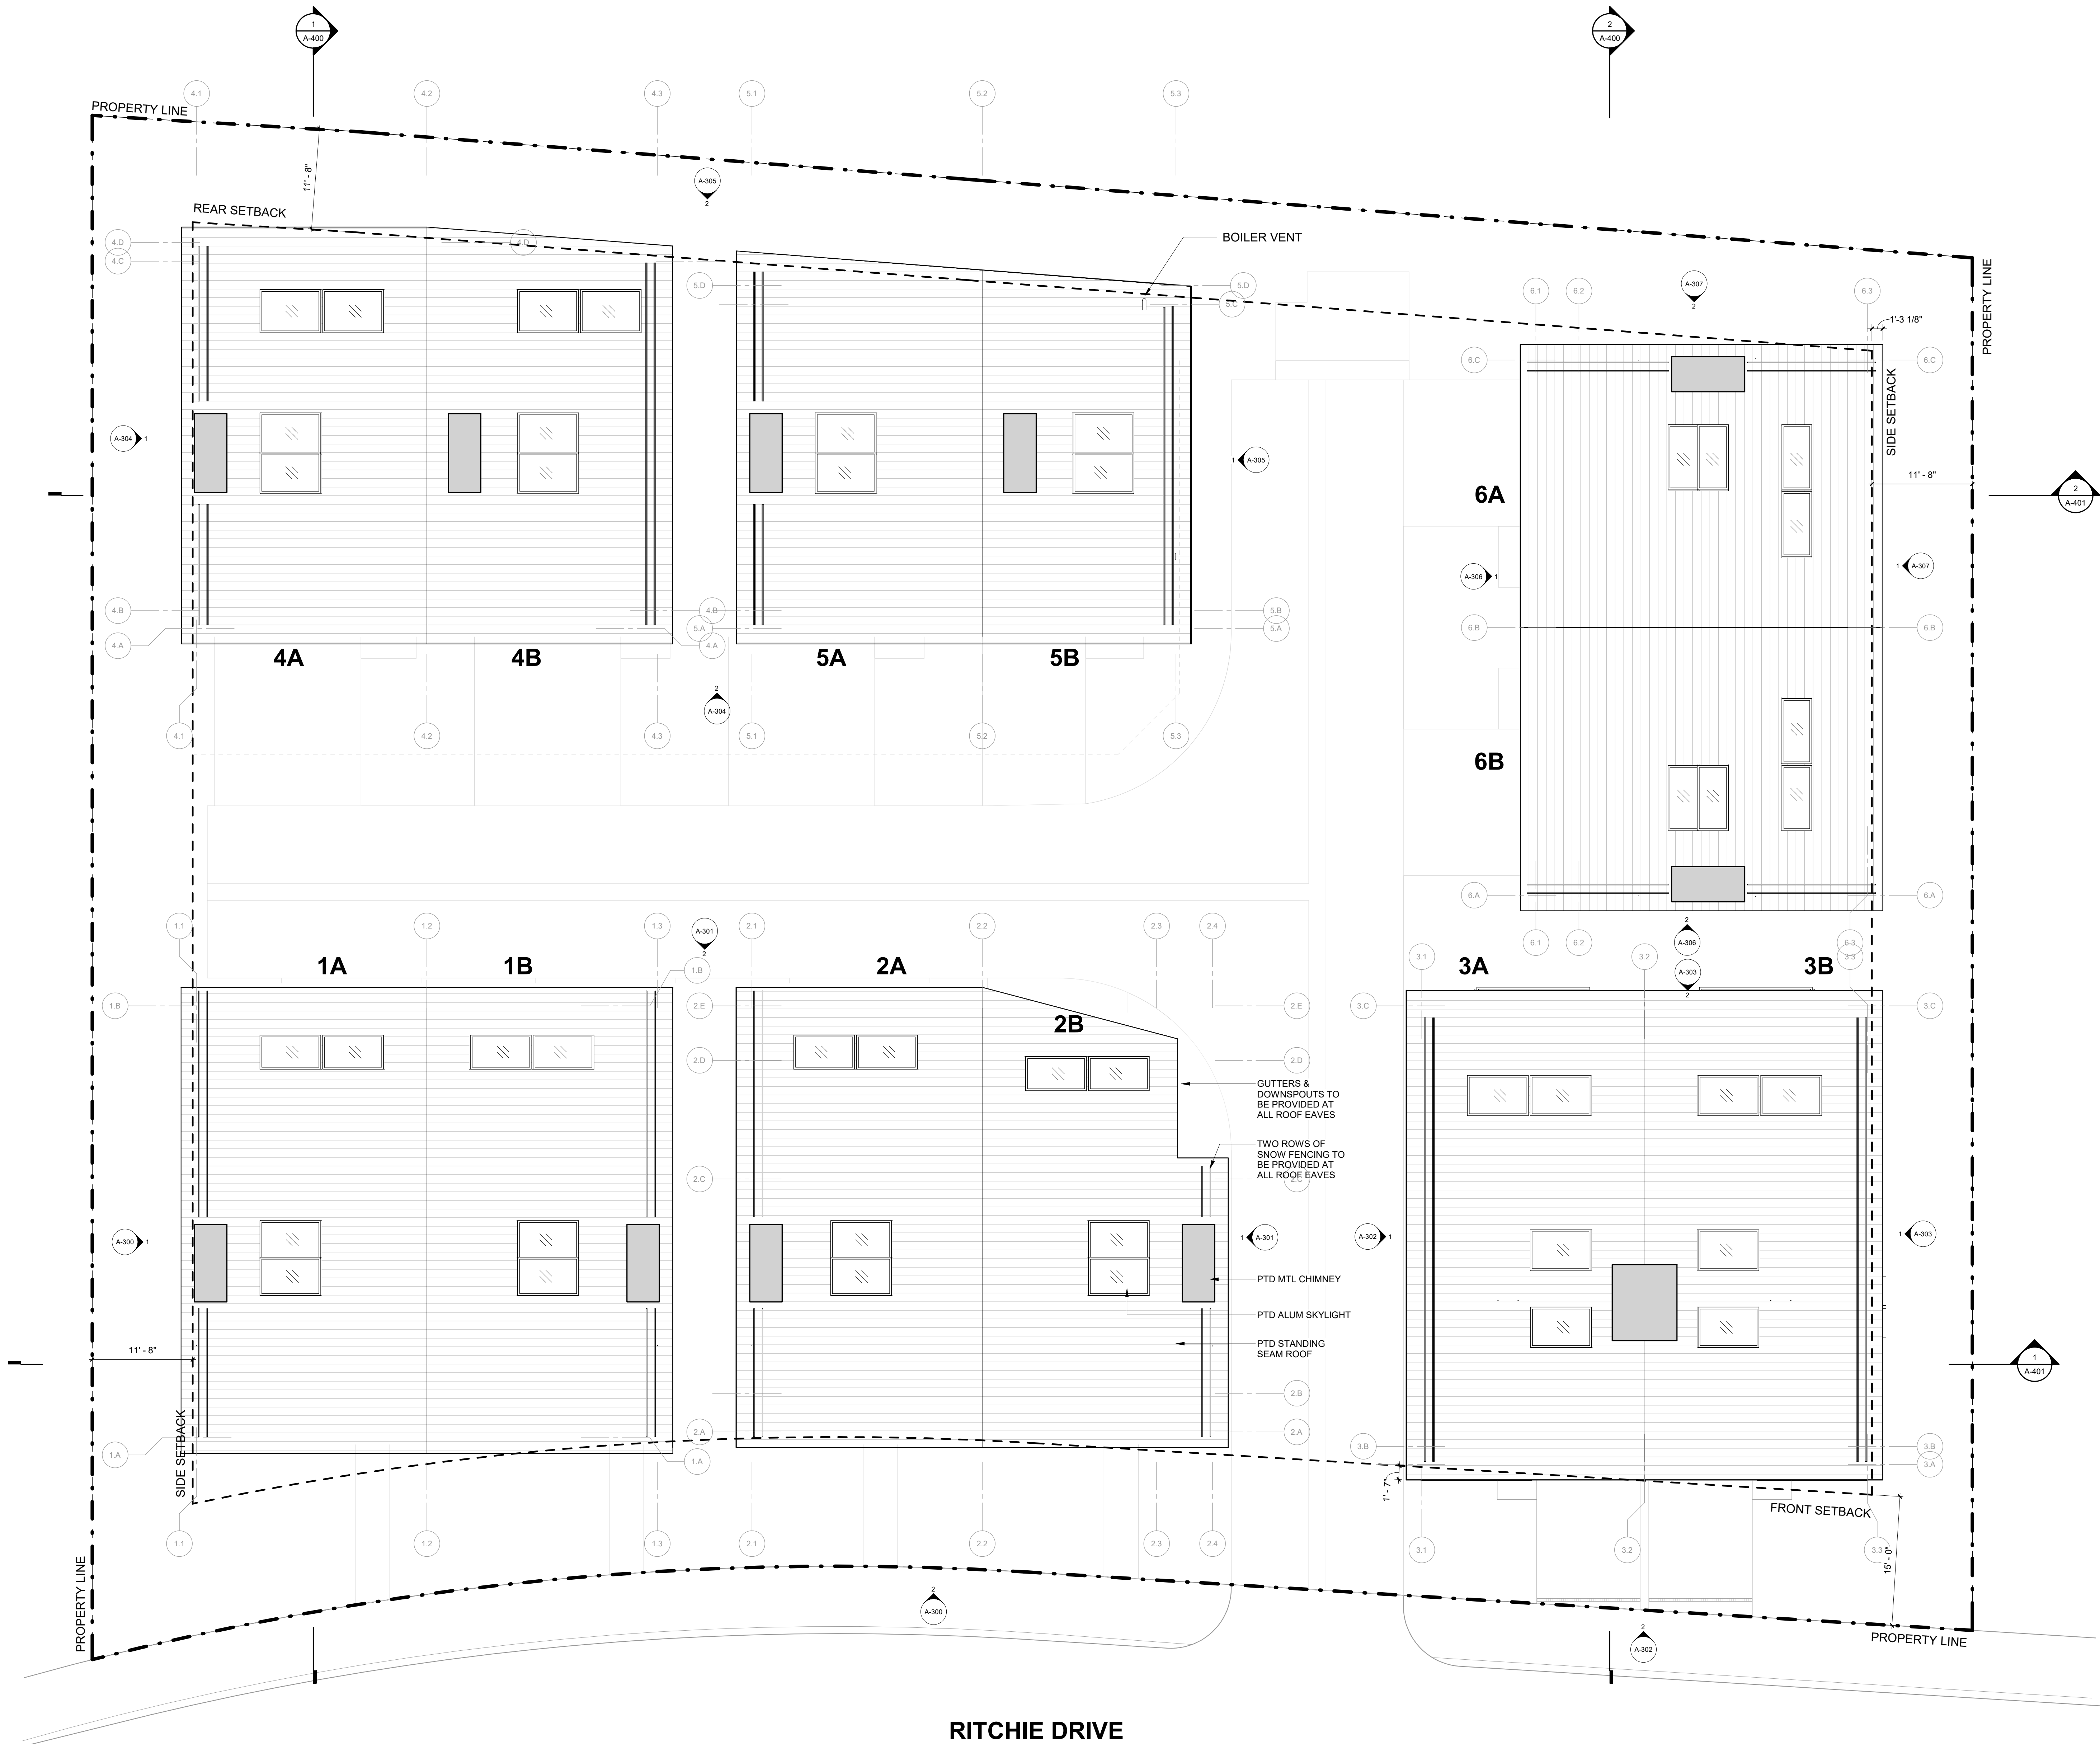OWNER:
108-110 RITCHIE LLC
P.O. BOX 14001-174
KETCHUM, ID 83340
TEL: 603.801.0419


BUILDING ARCHITECT:
RO | ROCKETT DESIGN
1031 W. MANCHESTER BLVD. UNIT 6
INGLEWOOD, CA 90301
TEL: 415.784.0014

STRUCTURAL ENGINEER:
ZFA STRUCTURAL ENGINEERS
601 MONTGOMERY STREET SUITE 1450
SAN FRANCISCO, CA 94111
TEL: 415.243.4091

MECHANICAL, ELECTRICAL, PLUMBING ENGINEER:
PROFICIENT ENGINEERING
4704 HARLAN STREET SUITE 620
DENVER, CO 80212
TEL: 720.779.3596

CIVIL ENGINEER:
GALENA BENCHMARK ASSOCIATES
100 BELL DRIVE SUITE C
KETCHUM, ID 83340
TEL: 208.725.9512

LANDSCAPE ARCHITECT:
EGGERS ASSOCIATES
560 NORTH 2ND AVENUE
KETCHUM, ID 83340
TEL: 208.725.0988

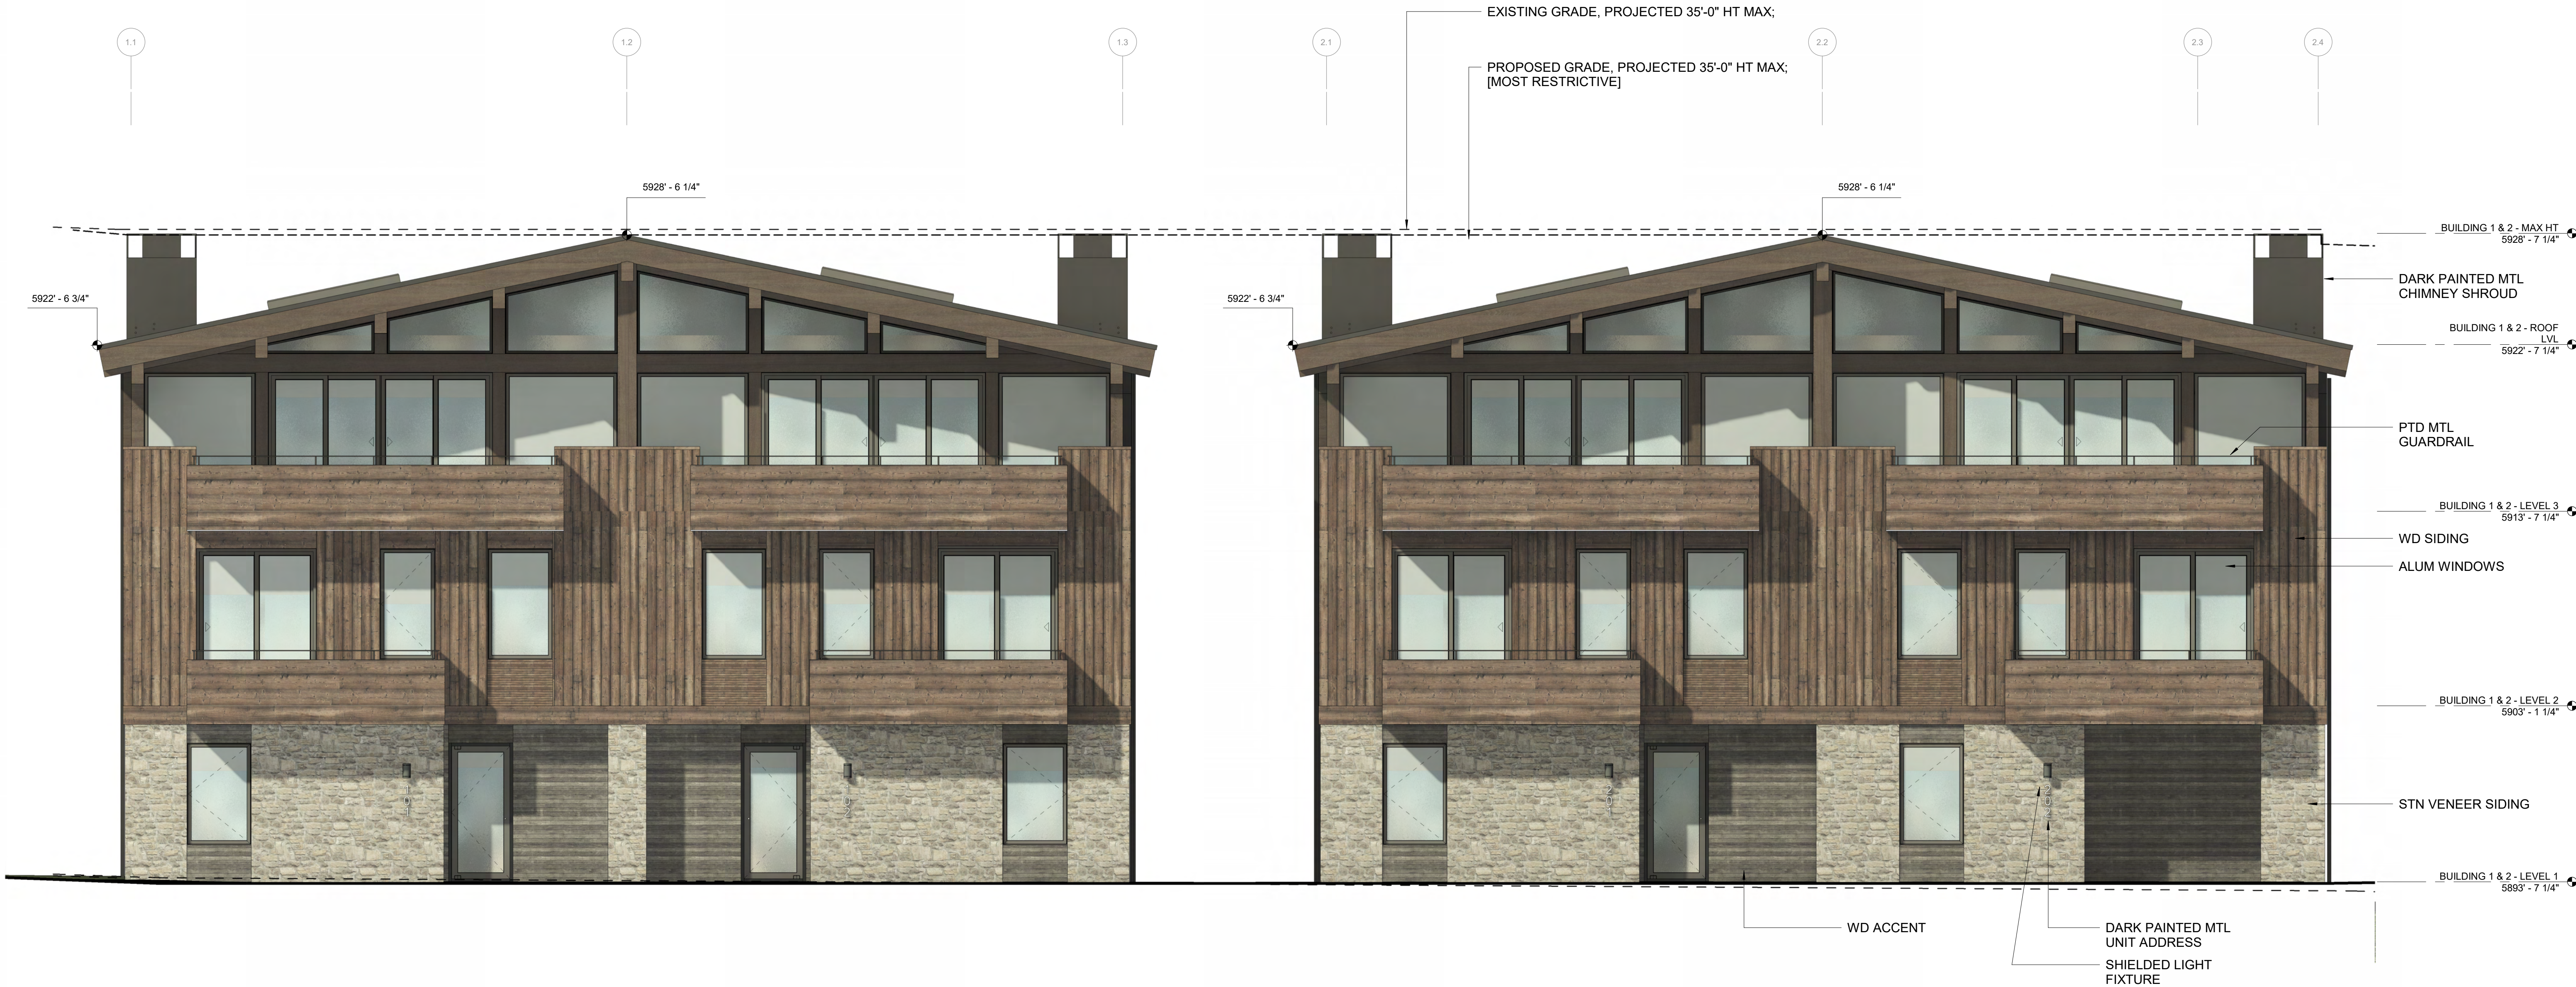

2 1/4" = 1'-0" BUILDING 1 & 2 / ELEVATION - EAST



1 1/4" = 1'-0" BUILDING 1 / ELEVATION - SOUTH

ISSUE	DESCRIPTION	DATE
1	DESIGN REVIEW APP	25.09.09
2	DESIGN REVIEW APP REV	25.10.14
3	DESIGN REVIEW APP REV	25.12.09

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PROJECT:
WARM SPRINGS TOWNHOMES KETCHUM, ID
108 & 110 RITCHIE DR.
KETCHUM, IDAHO

DRAWING TITLE:
BUILDING ELEVATIONS - BUILDING 1 & 2

SEAL:

PROJECT NUMBER
2305

DRAWING NUMBER:
A-300



2 1/4" = 1'-0" BUILDING 1 & 2 / ELEVATION - WEST



1 1/4" = 1'-0" BUILDING 2 / ELEVATION - NORTH

WARM SPRINGS TOWNHOMES
KETCHUM, ID

OWNER:

108-110 RITCHIE LLC
P.O. BOX 14001-174
KETCHUM, ID 83340
TEL: 803.801.0419

BUILDING ARCHITECT:

RO | ROCKETT DESIGN
1031 W. MANCHESTER BLVD. UNIT 6
INGLEWOOD, CA 90301
TEL: 213.784.0014

STRUCTURAL ENGINEER:

ZFA STRUCTURAL ENGINEERS
601 MONTGOMERY STREET SUITE 1450
SAN FRANCISCO, CA 94111
TEL: 415.243.4091

MECHANICAL, ELECTRICAL, PLUMBING ENGINEER:

PROFICIENT ENGINEERING
4704 HARLAN STREET SUITE 620
DENVER, CO 80212
TEL: 720.779.3596

CIVIL ENGINEER:

GALENA BENCHMARK ASSOCIATES
100 BELL DRIVE SUITE C
KETCHUM, ID 83340
TEL: 208.725.9512

LANDSCAPE ARCHITECT:

EGGERS ASSOCIATES
560 NORTH 2ND AVENUE
KETCHUM, ID 83340
TEL: 208.725.0988

ISSUE	DESCRIPTION	DATE
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PROJECT:

WARM SPRINGS TOWNHOMES
KETCHUM, ID
108 & 110 RITCHIE DR.
KETCHUM, IDAHO

DRAWING TITLE:

BUILDING ELEVATIONS -
BUILDING 1 & 2

SEAL:

PROJECT NUMBER

2305

DRAWING NUMBER:

A-301

WARM SPRINGS TOWNHOMES
KETCHUM, ID

OWNER:

108-110 RITCHIE LLC
P.O. BOX 14001-174
KETCHUM, ID 83340
TEL: 603.801.0419

BUILDING ARCHITECT:

RO | ROCKETT DESIGN
1031 W. MANCHESTER BLVD. UNIT 6
INGLEWOOD, CA 90301
TEL: 213.784.0014

STRUCTURAL ENGINEER:

ZFA STRUCTURAL ENGINEERS
601 MONTGOMERY STREET SUITE 1450
SAN FRANCISCO, CA 94111
TEL: 415.243.4091

MECHANICAL, ELECTRICAL, PLUMBING ENGINEER:

PROFICIENT ENGINEERING
4704 HARLAN STREET SUITE 620
DENVER, CO 80212
TEL: 720.779.3596

CIVIL ENGINEER:

GALENA BENCHMARK ASSOCIATES
100 BELL DRIVE SUITE C
KETCHUM, ID 83340
TEL: 208.725.9512

LANDSCAPE ARCHITECT:

EGGERS ASSOCIATES
560 NORTH 2ND AVENUE
KETCHUM, ID 83340
TEL: 208.725.0988

ISSUE	DESCRIPTION	DATE
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PROJECT:

WARM SPRINGS TOWNHOMES
KETCHUM, ID
108 & 110 RITCHIE DR.
KETCHUM, IDAHO

DRAWING TITLE:

BUILDING ELEVATIONS -
BUILDING 3

SEAL:


PROJECT NUMBER

2305


DRAWING NUMBER:

A-302

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2 1/4" = 1'-0" BUILDING 3 / ELEVATION - EAST

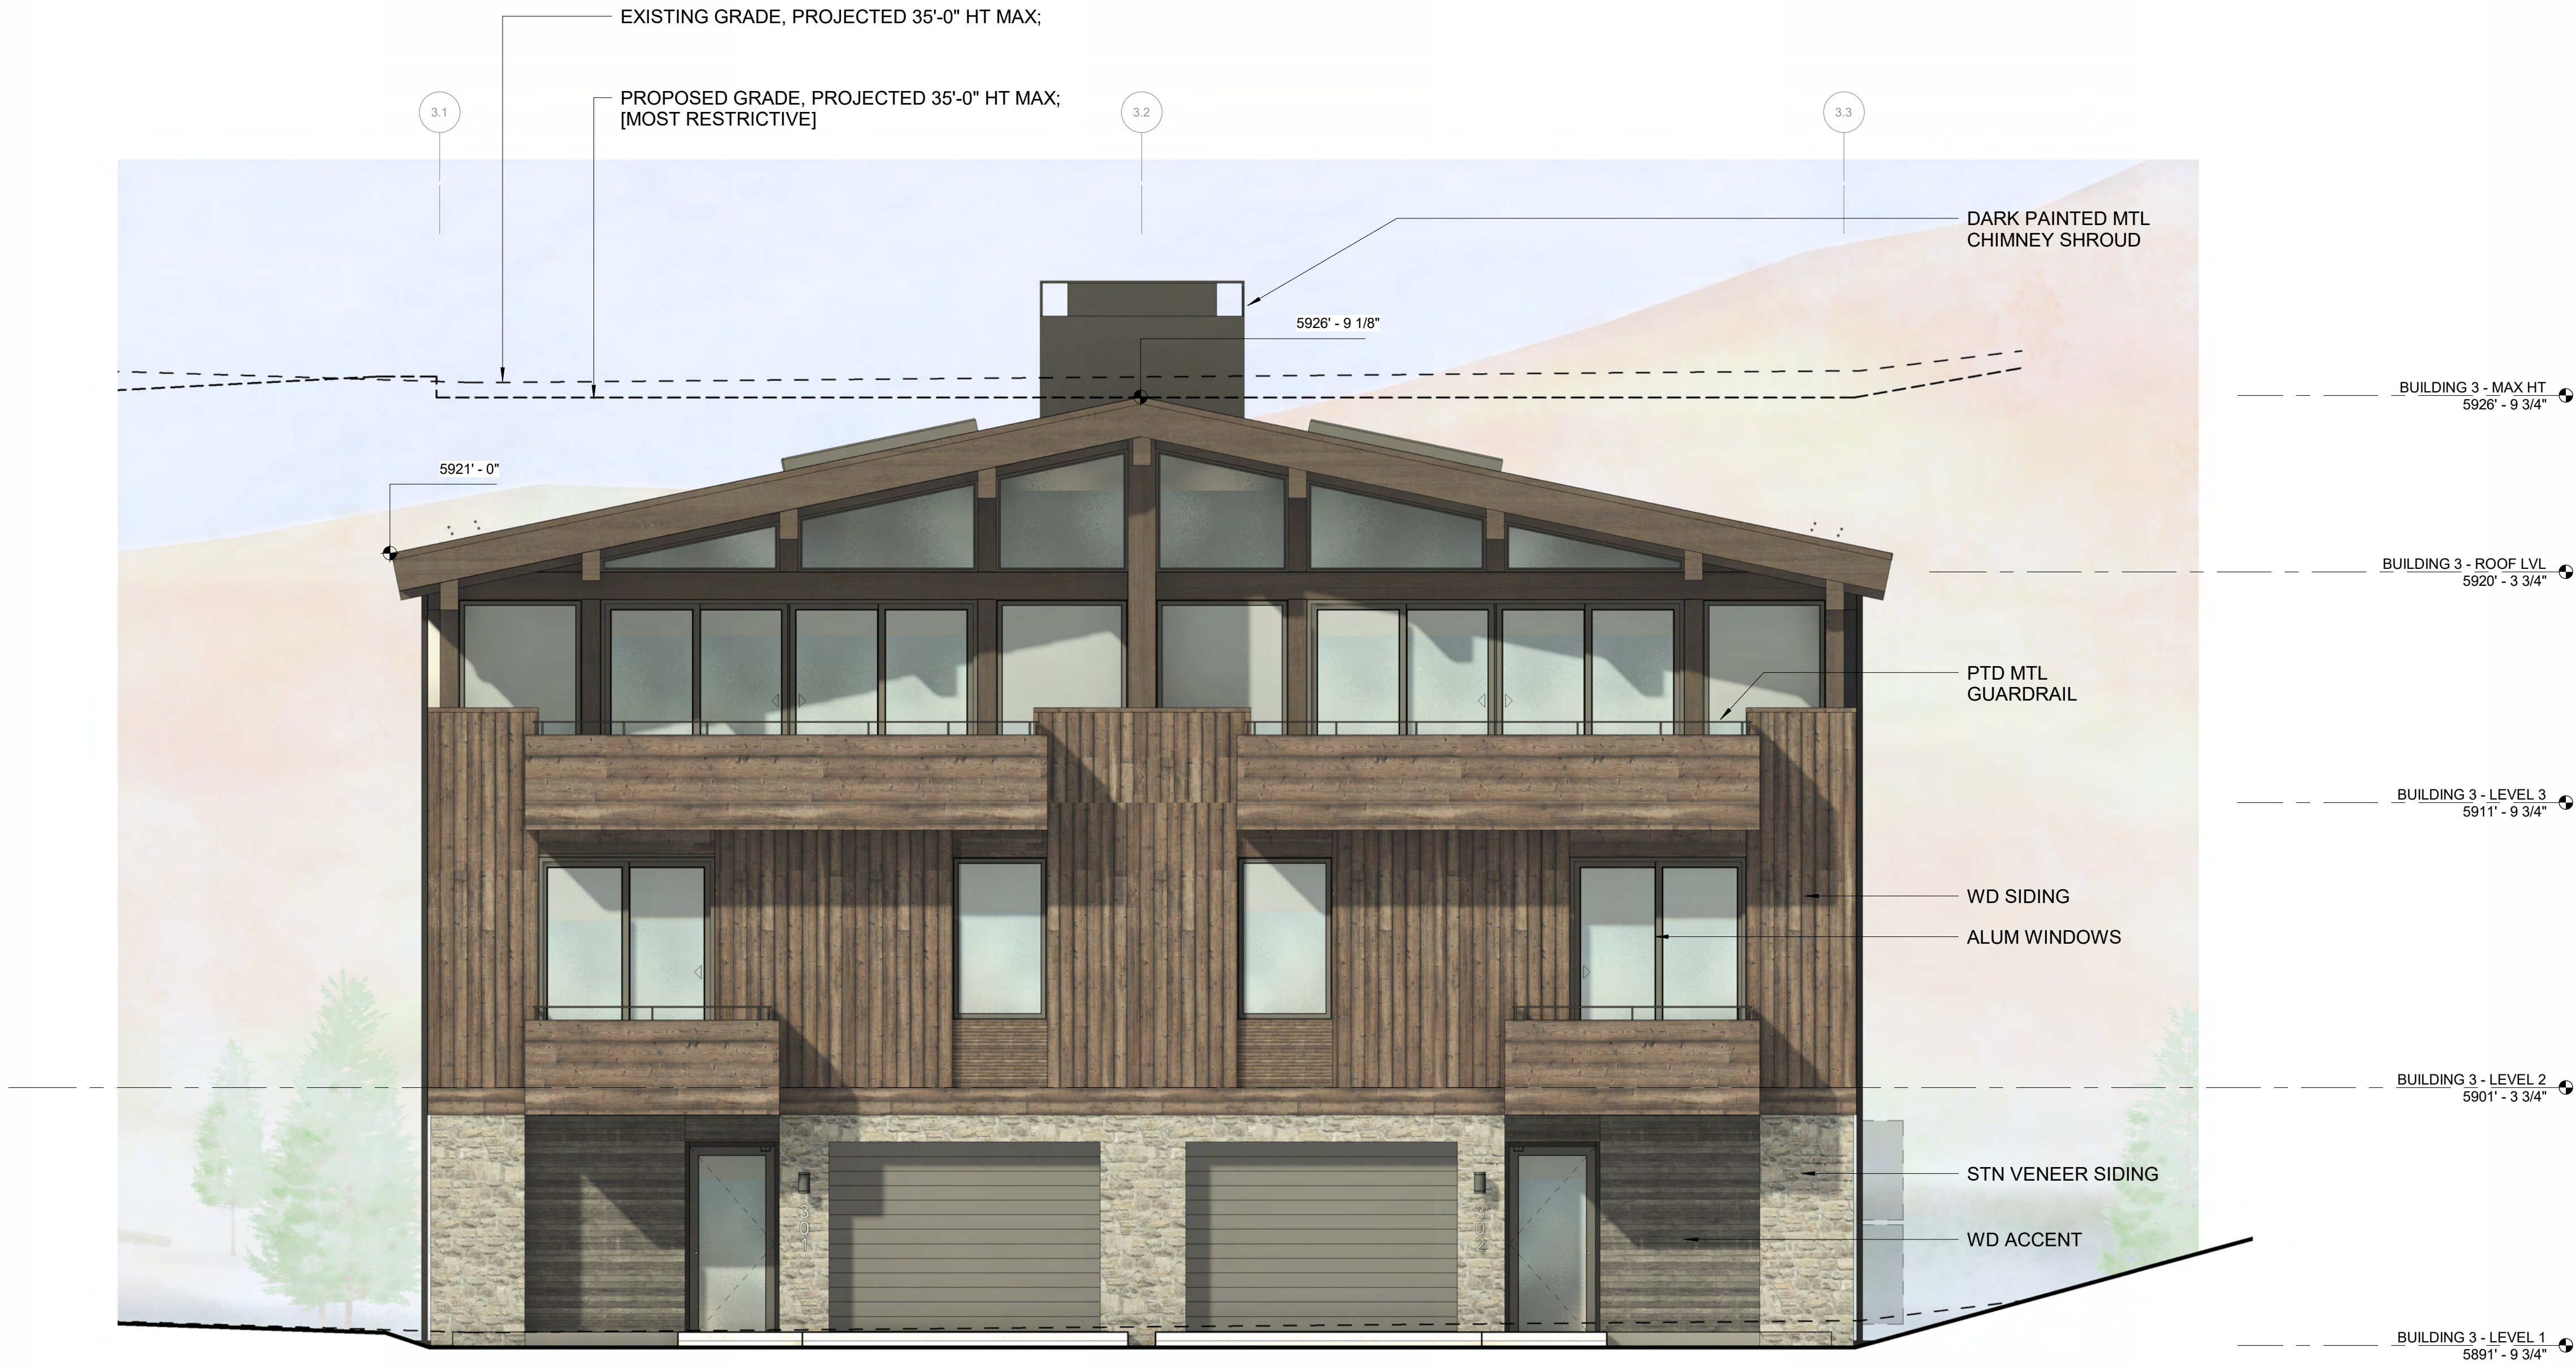

1 1/4" = 1'-0" BUILDING 3 / ELEVATION - SOUTH

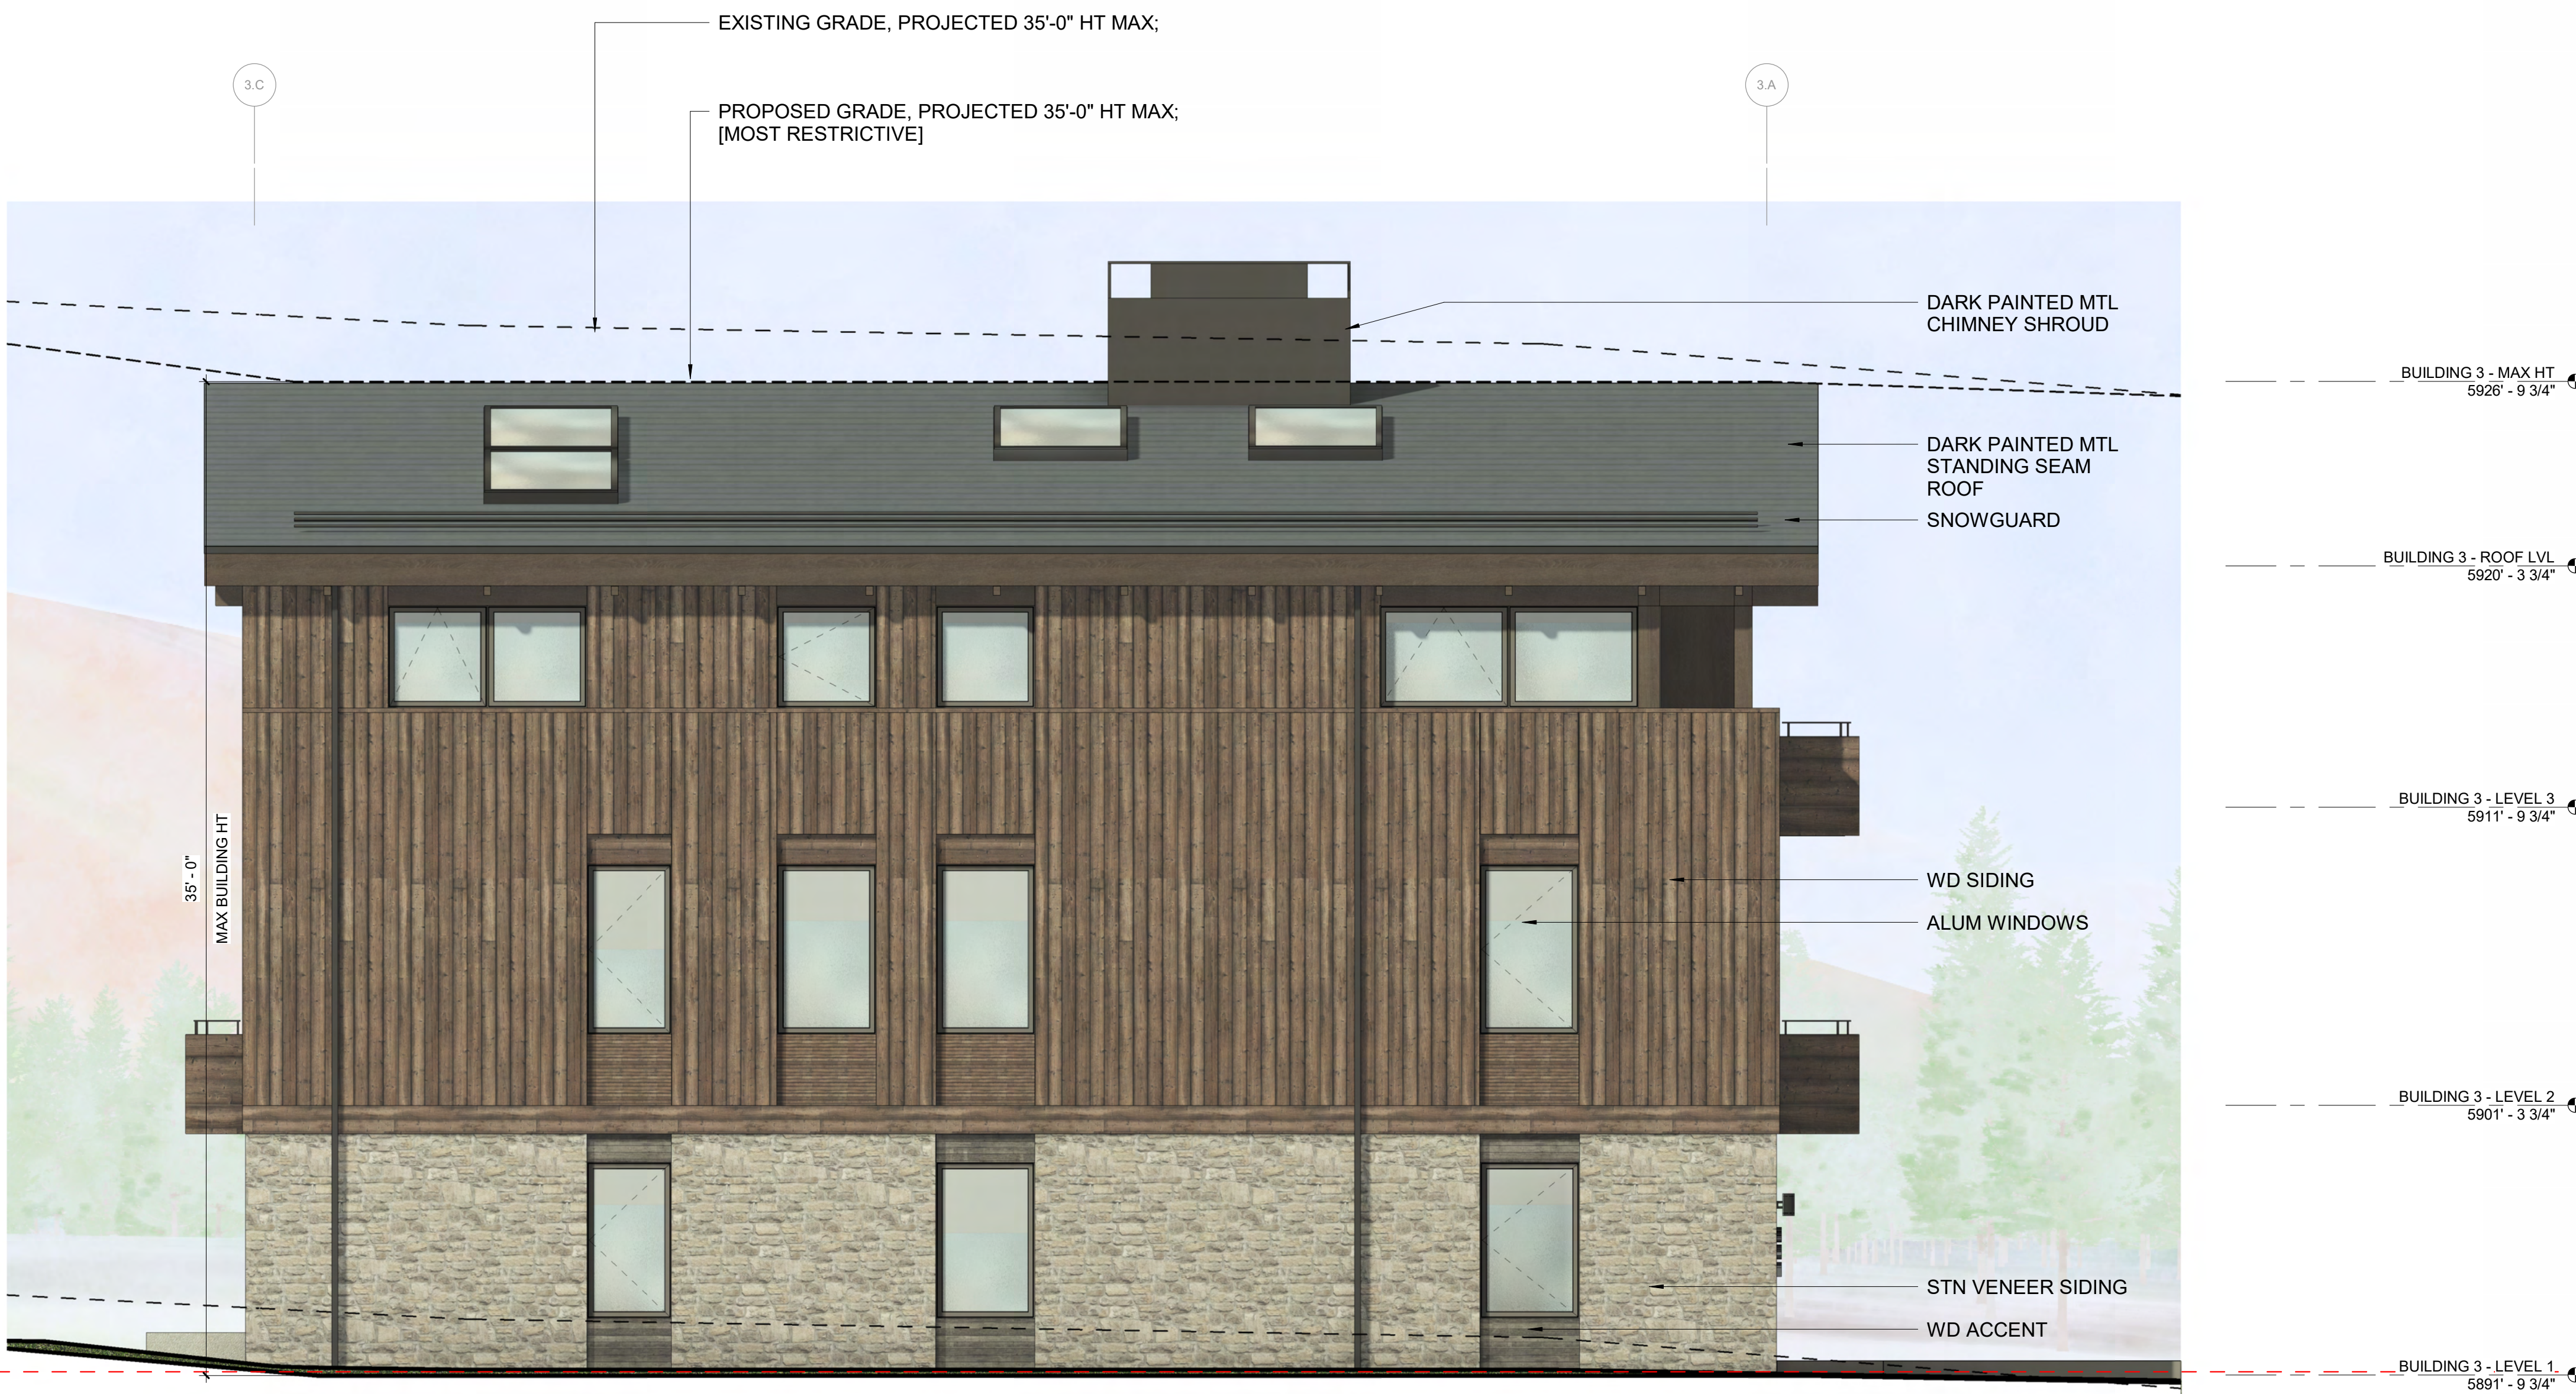WARM SPRINGS TOWNHOMES
KETCHUM, ID

OWNER:

108-110 RITCHIE LLC
P.O. BOX 14001-174
KETCHUM, ID 83340
TEL: 603.801.0419

BUILDING ARCHITECT:

RO | ROCKETT DESIGN
1031 W. MANCHESTER BLVD. UNIT 6
INGLEWOOD, CA 90301
TEL: 213.784.0014

STRUCTURAL ENGINEER:

ZFA STRUCTURAL ENGINEERS
601 MONTGOMERY STREET SUITE 1450
SAN FRANCISCO, CA 94111
TEL: 415.243.4091

MECHANICAL, ELECTRICAL, PLUMBING ENGINEER:

PROFICIENT ENGINEERING
4704 HARLAN STREET SUITE 620
DENVER, CO 80212
TEL: 720.779.3596

CIVIL ENGINEER:

GALENA BENCHMARK ASSOCIATES
100 BELL DRIVE SUITE C
KETCHUM, ID 83340
TEL: 208.725.9512

LANDSCAPE ARCHITECT:

EGGERS ASSOCIATES
560 NORTH 2ND AVENUE
KETCHUM, ID 83340
TEL: 208.725.0988

ISSUE	DESCRIPTION	DATE
1	DESIGN REVIEW APP	25.09.09
2	DESIGN REVIEW APP REV	25.10.14
3	DESIGN REVIEW APP REV	25.12.09

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PROJECT:

WARM SPRINGS TOWNHOMES
KETCHUM, ID
108 & 110 RITCHIE DR.
KETCHUM, IDAHO

DRAWING TITLE:

BUILDING ELEVATIONS -
BUILDING 3

SEAL:


PROJECT NUMBER

2305

DRAWING NUMBER:

A-303


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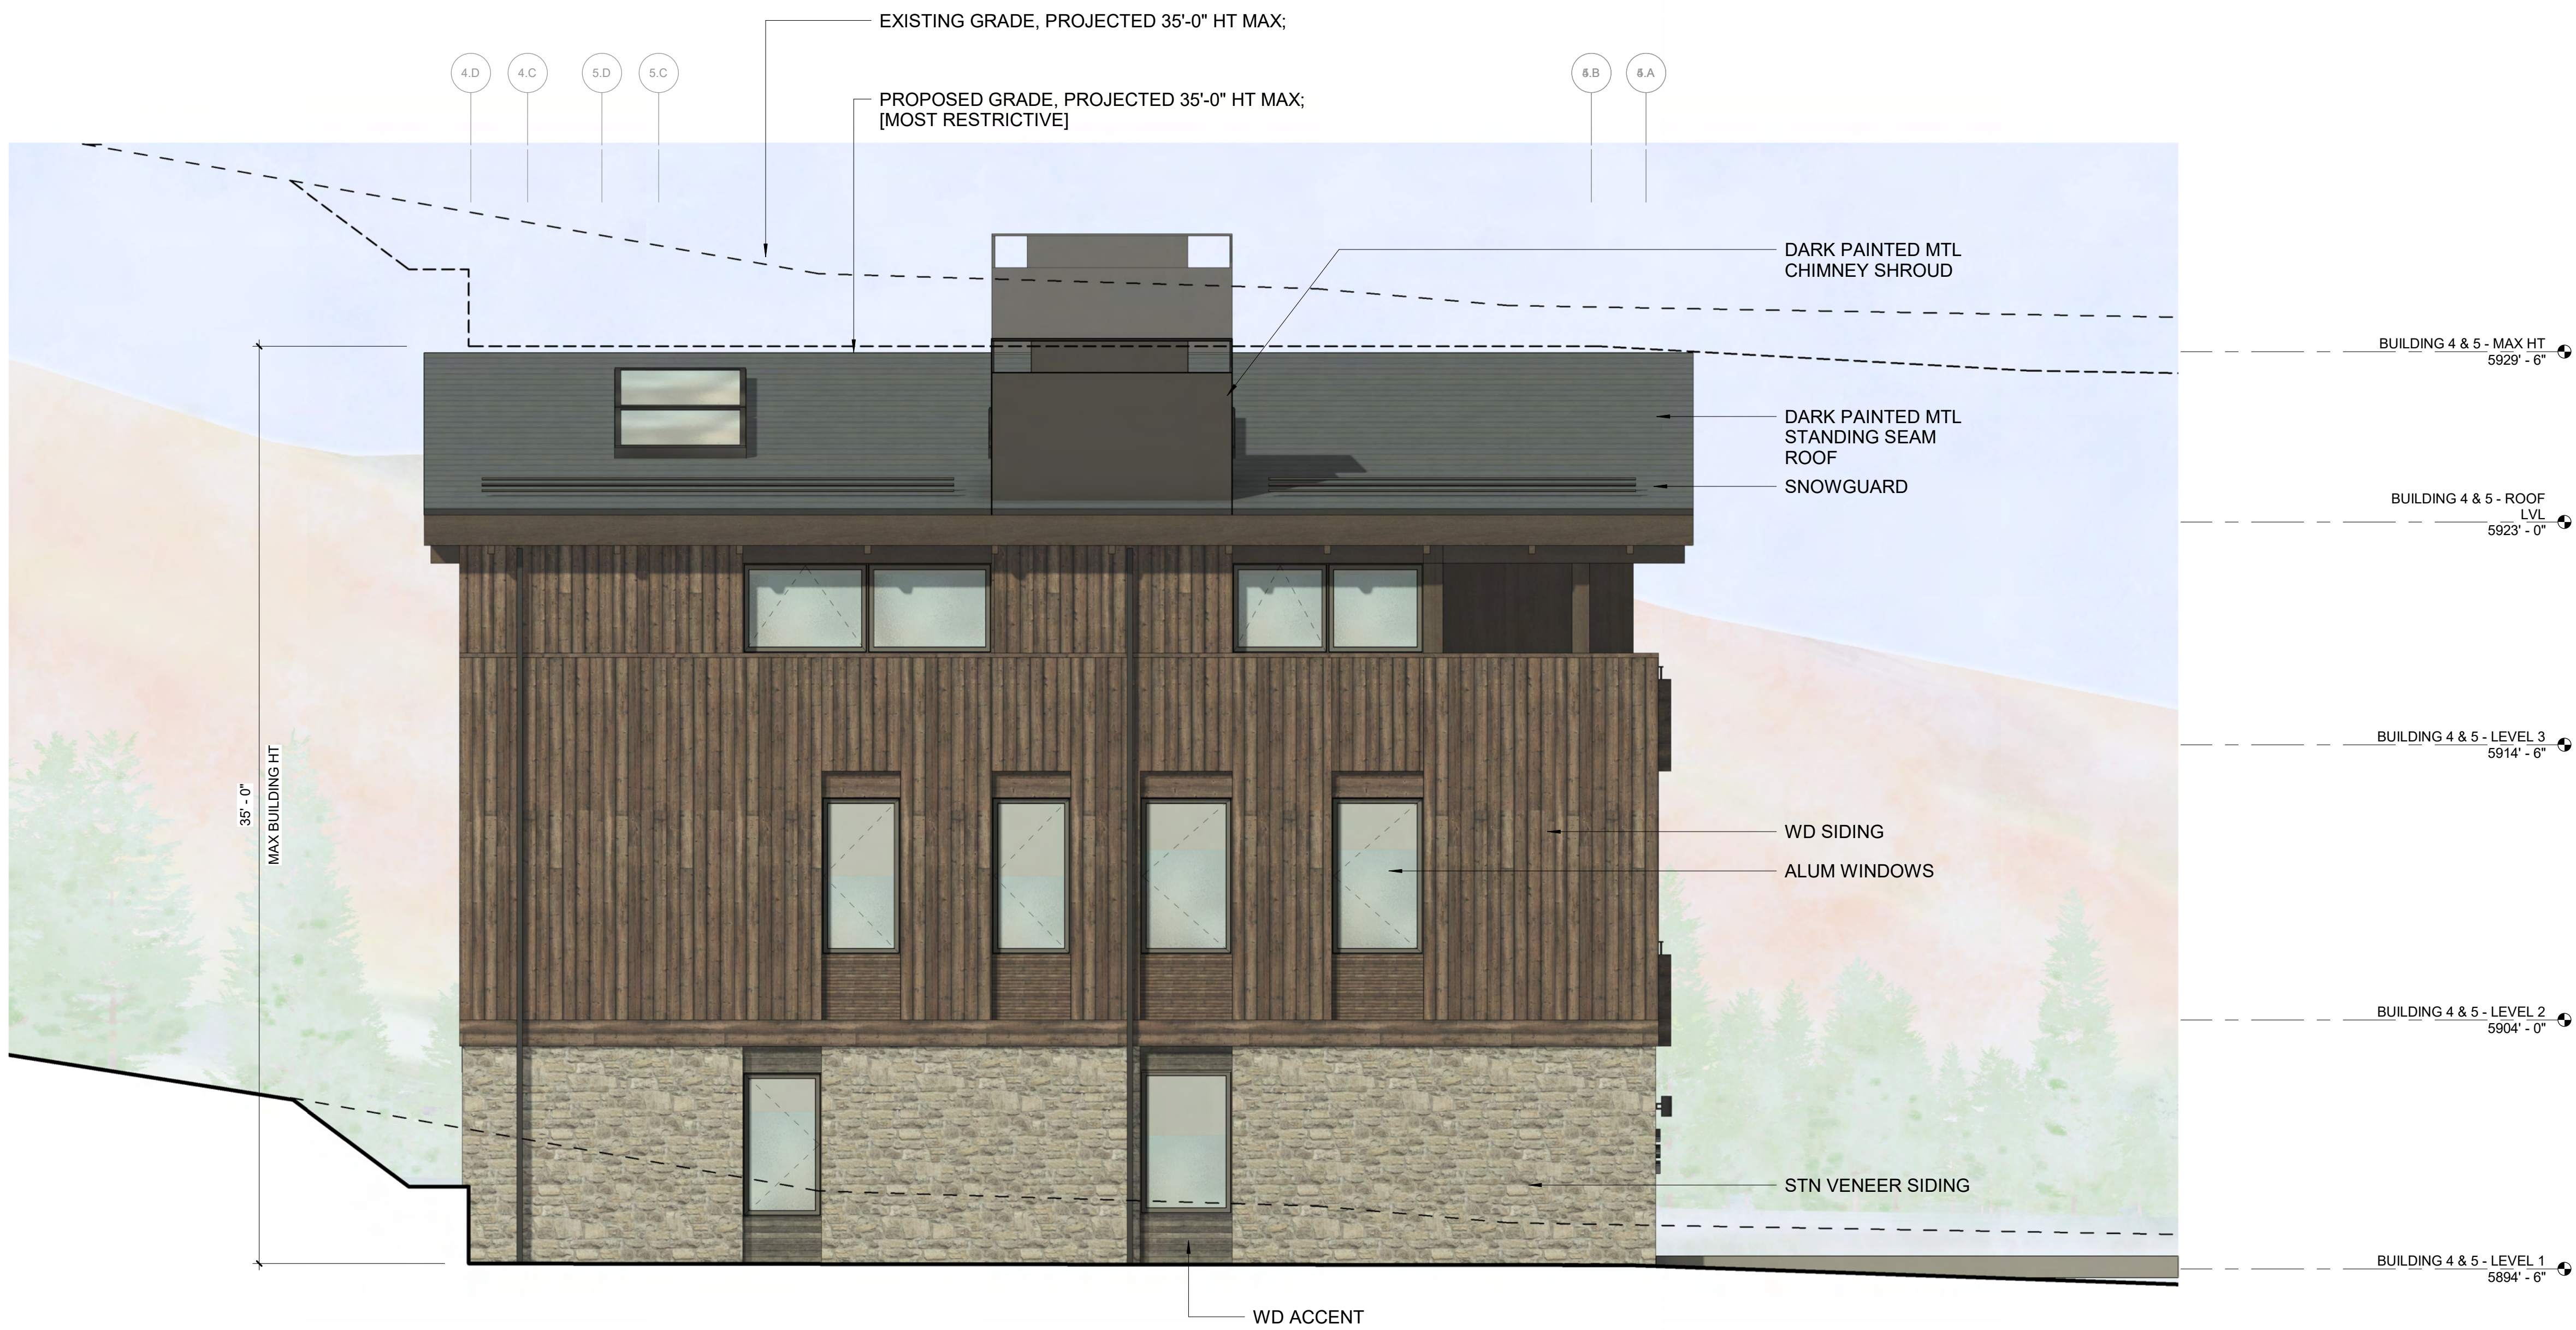
2 1/4" = 1'-0" BUILDING 3 / ELEVATION - WEST

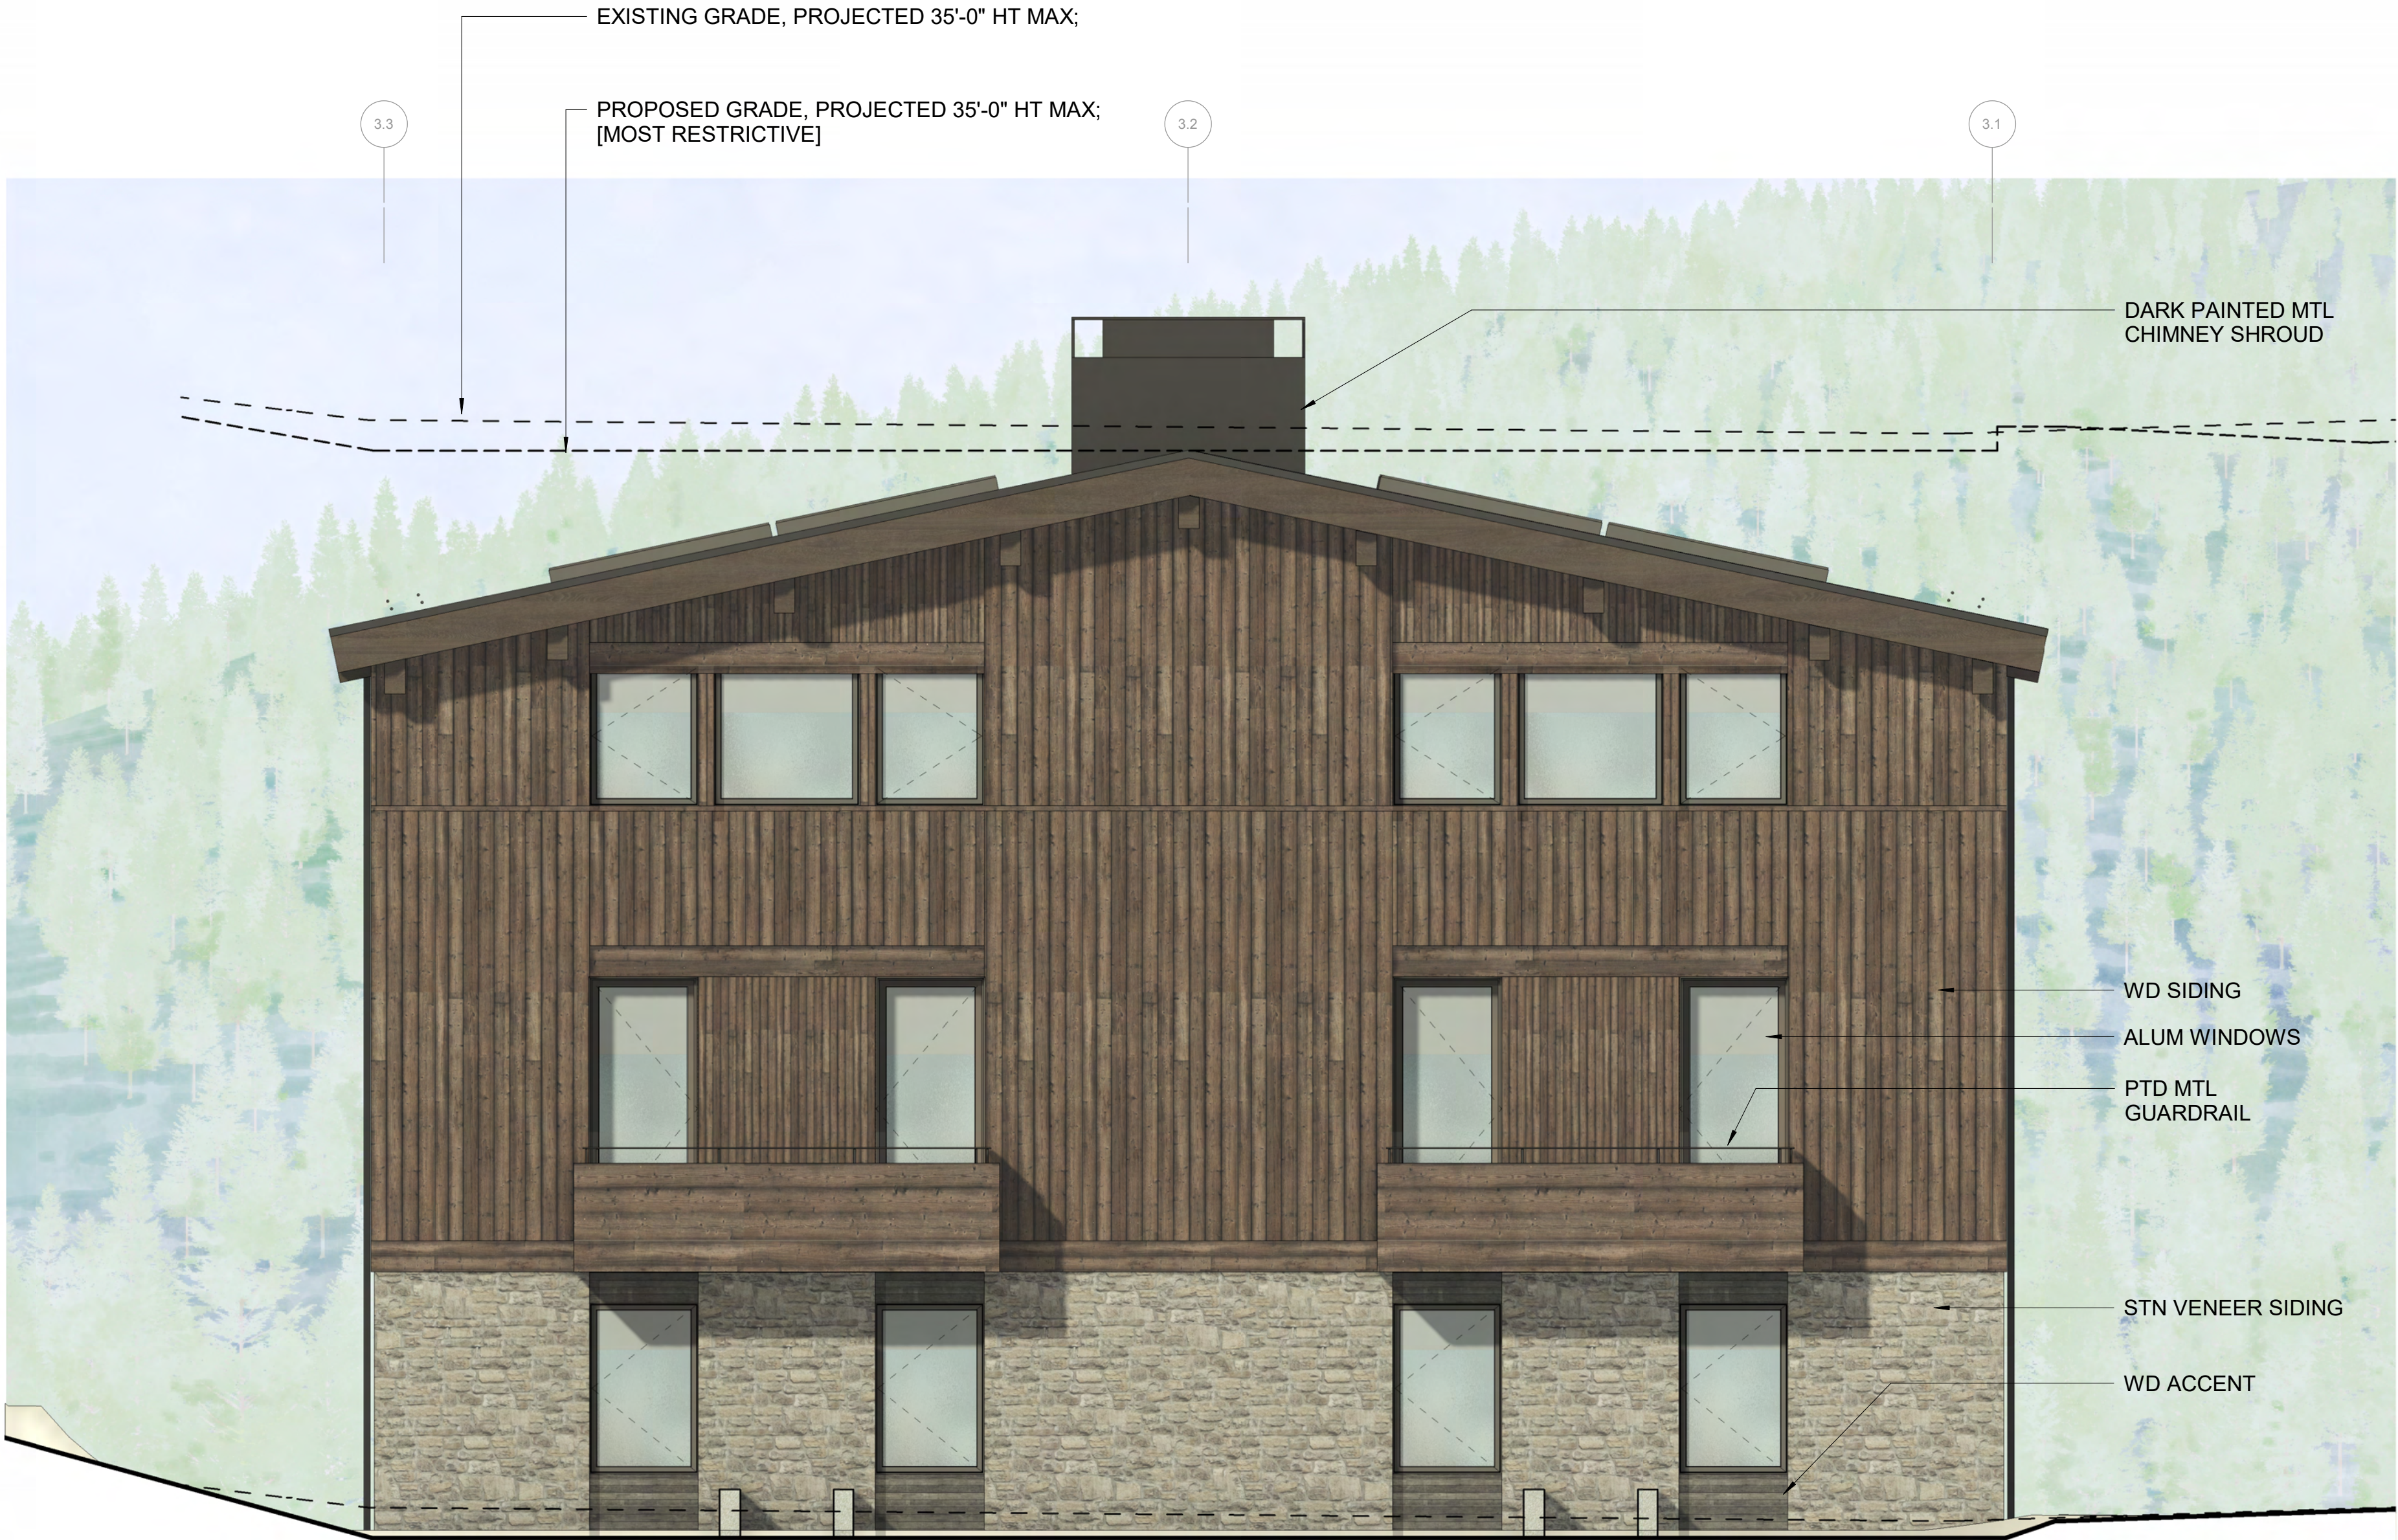

1 1/4" = 1'-0" BUILDING 3 / ELEVATION - NORTH



2 1/4" = 1'-0" BUILDING 4 & 5 / ELEVATION - EAST

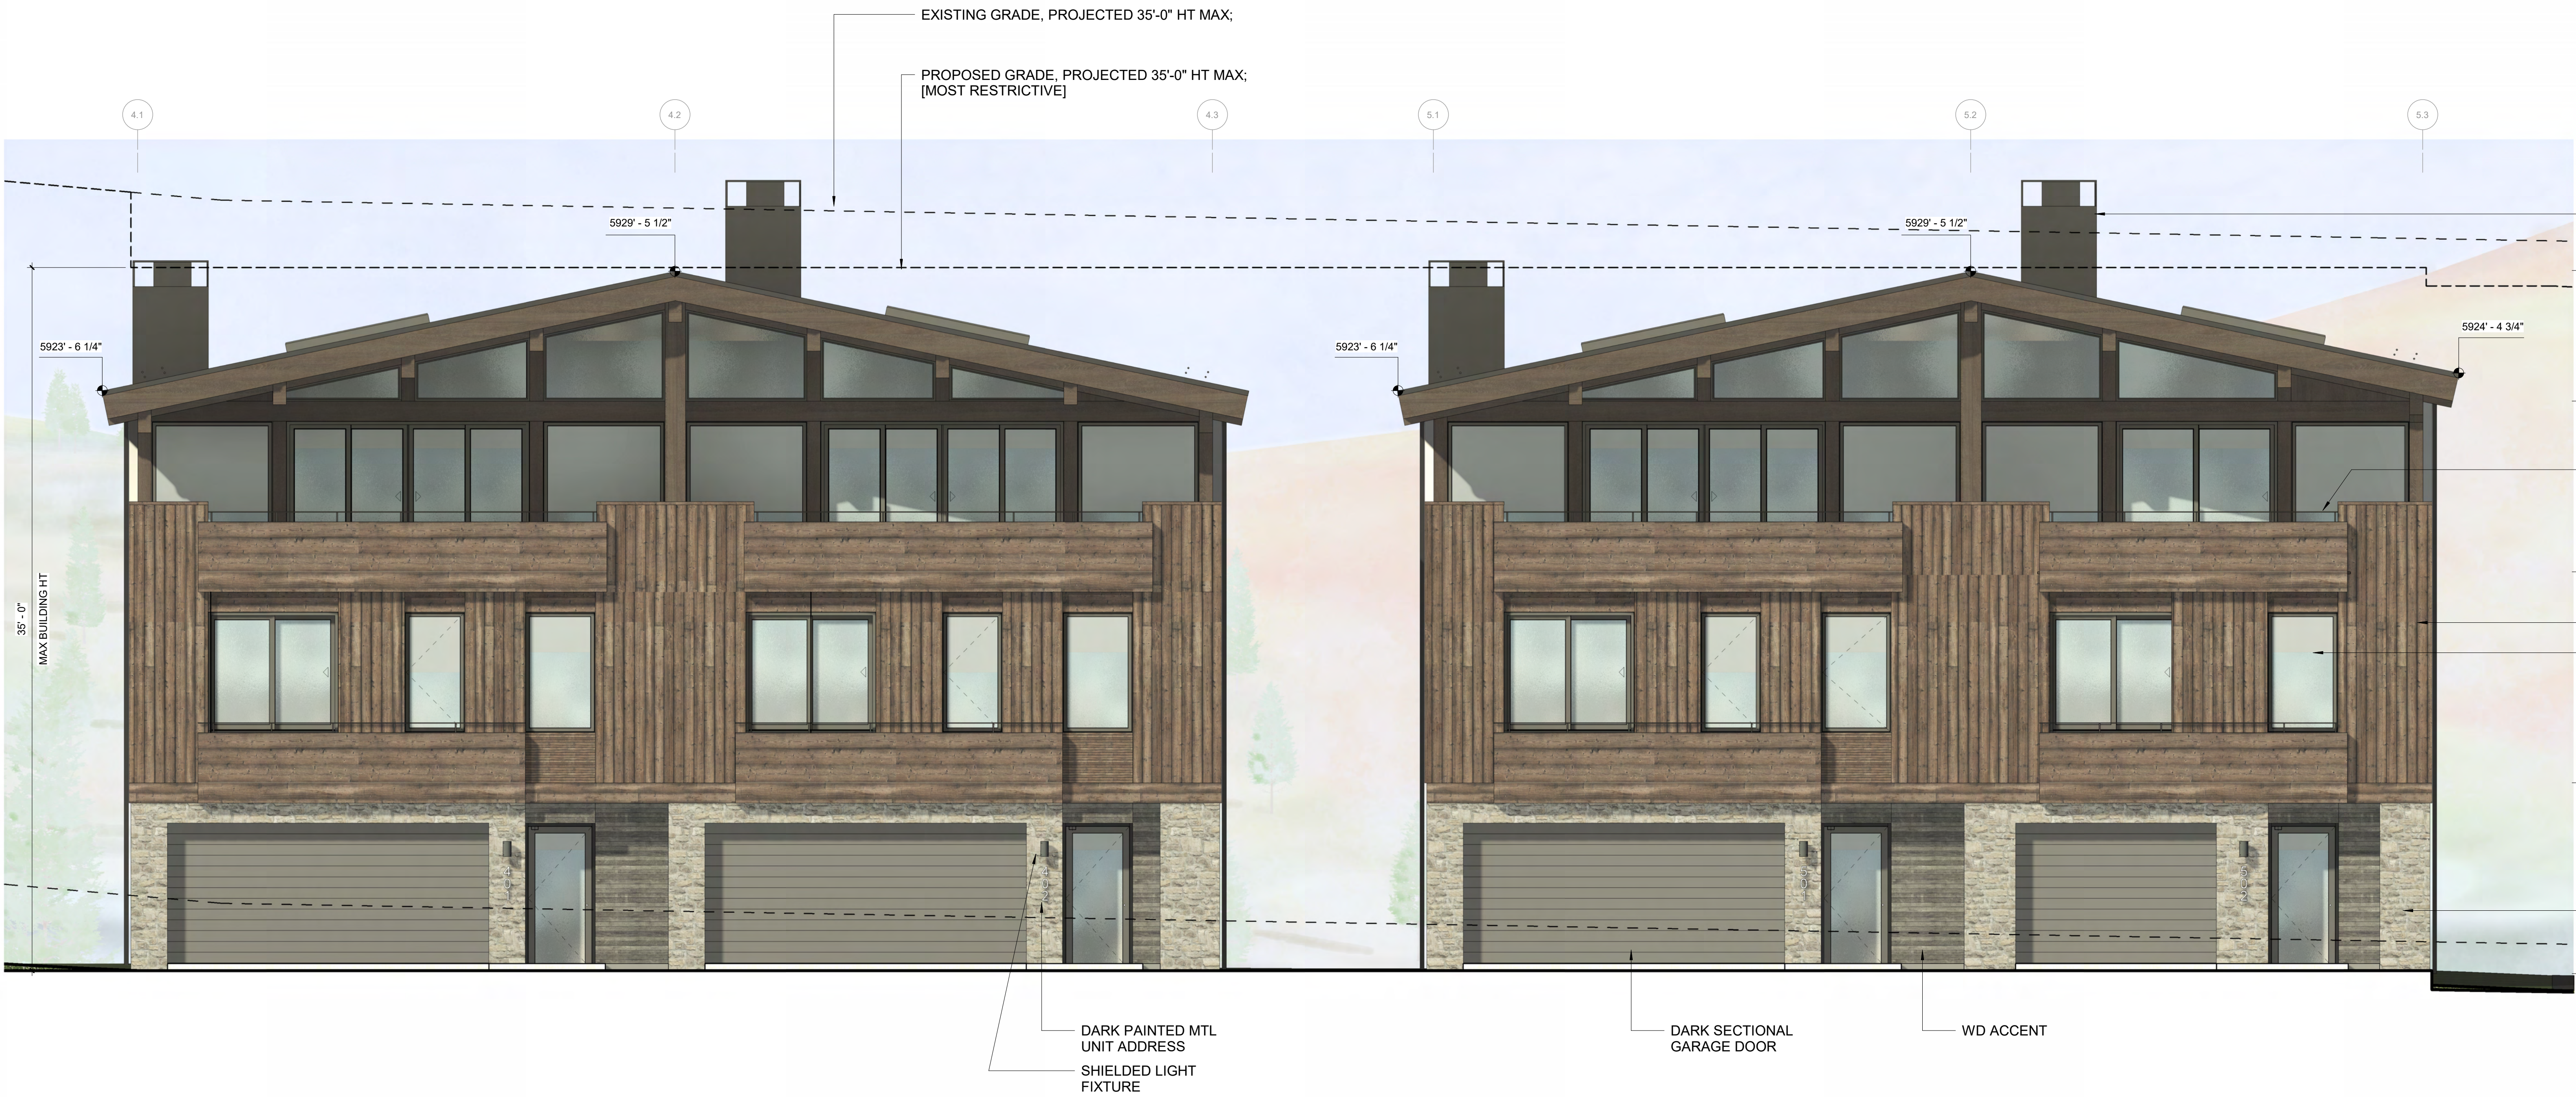

1 1/4" = 1'-0" BUILDING 4 / ELEVATION - SOUTH

WARM SPRINGS
TOWNHOMES
KETCHUM, ID

OWNER:

108-110 RITCHIE LLC
P.O. BOX 14001-174
KETCHUM, ID 83340
TEL: 803.801.0419

BUILDING ARCHITECT:

RO | ROCKETT DESIGN
1031 W. MANCHESTER BLVD. UNIT 6
INGLEWOOD, CA 90301
TEL: 213.784.0014

STRUCTURAL ENGINEER:

ZFA STRUCTURAL ENGINEERS
601 MONTGOMERY STREET SUITE 1450
SAN FRANCISCO, CA 94111
TEL: 415.243.4091

MECHANICAL, ELECTRICAL, PLUMBING ENGINEER:

PROFICIENT ENGINEERING
4704 HARLAN STREET SUITE 620
DENVER, CO 80212
TEL: 720.779.3556

CIVIL ENGINEER:

GALENA BENCHMARK ASSOCIATES
100 BELL DRIVE SUITE C
KETCHUM, ID 83340
TEL: 208.725.9512

LANDSCAPE ARCHITECT:

EGGERS ASSOCIATES
560 NORTH 2ND AVENUE
KETCHUM, ID 83340
TEL: 208.725.0988

ISSUE	DESCRIPTION	DATE
1	DESIGN REVIEW APP	25.09.09
2	DESIGN REVIEW APP REV	25.10.14
3	DESIGN REVIEW APP REV	25.12.09

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PROJECT:

WARM SPRINGS TOWNHOMES
KETCHUM, ID
108 & 110 RITCHIE DR.
KETCHUM, IDAHO

DRAWING TITLE:

BUILDING ELEVATIONS -
BUILDING 4 & 5

SEAL:


PROJECT NUMBER

2305


DRAWING NUMBER:

A-304

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2 1/4" = 1'-0" BUILDING 4 & 5 / ELEVATION - WEST

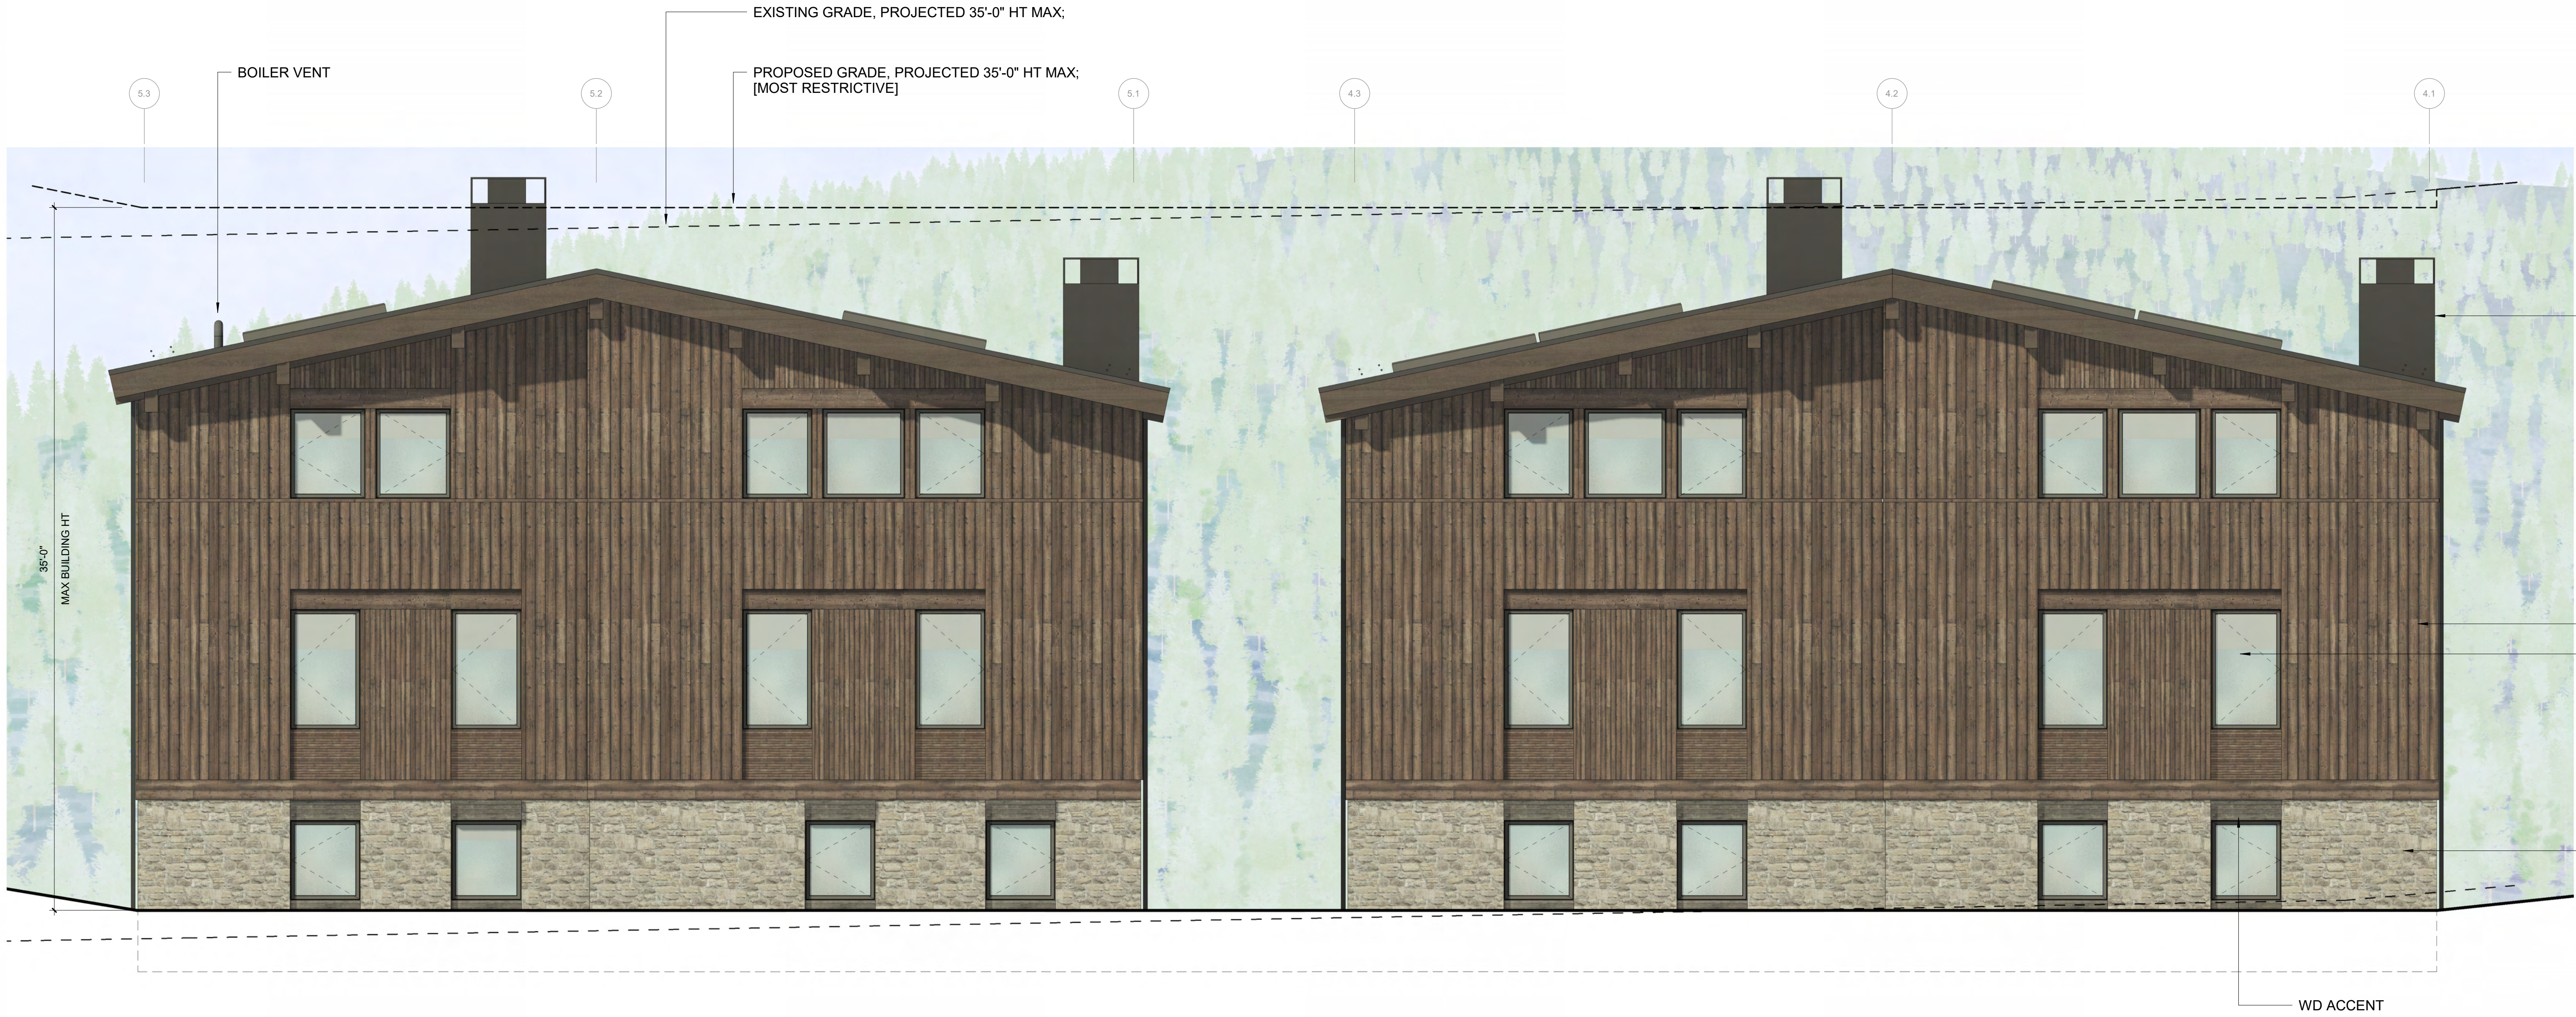

1 1/4" = 1'-0" BUILDING 5 / ELEVATION - NORTH

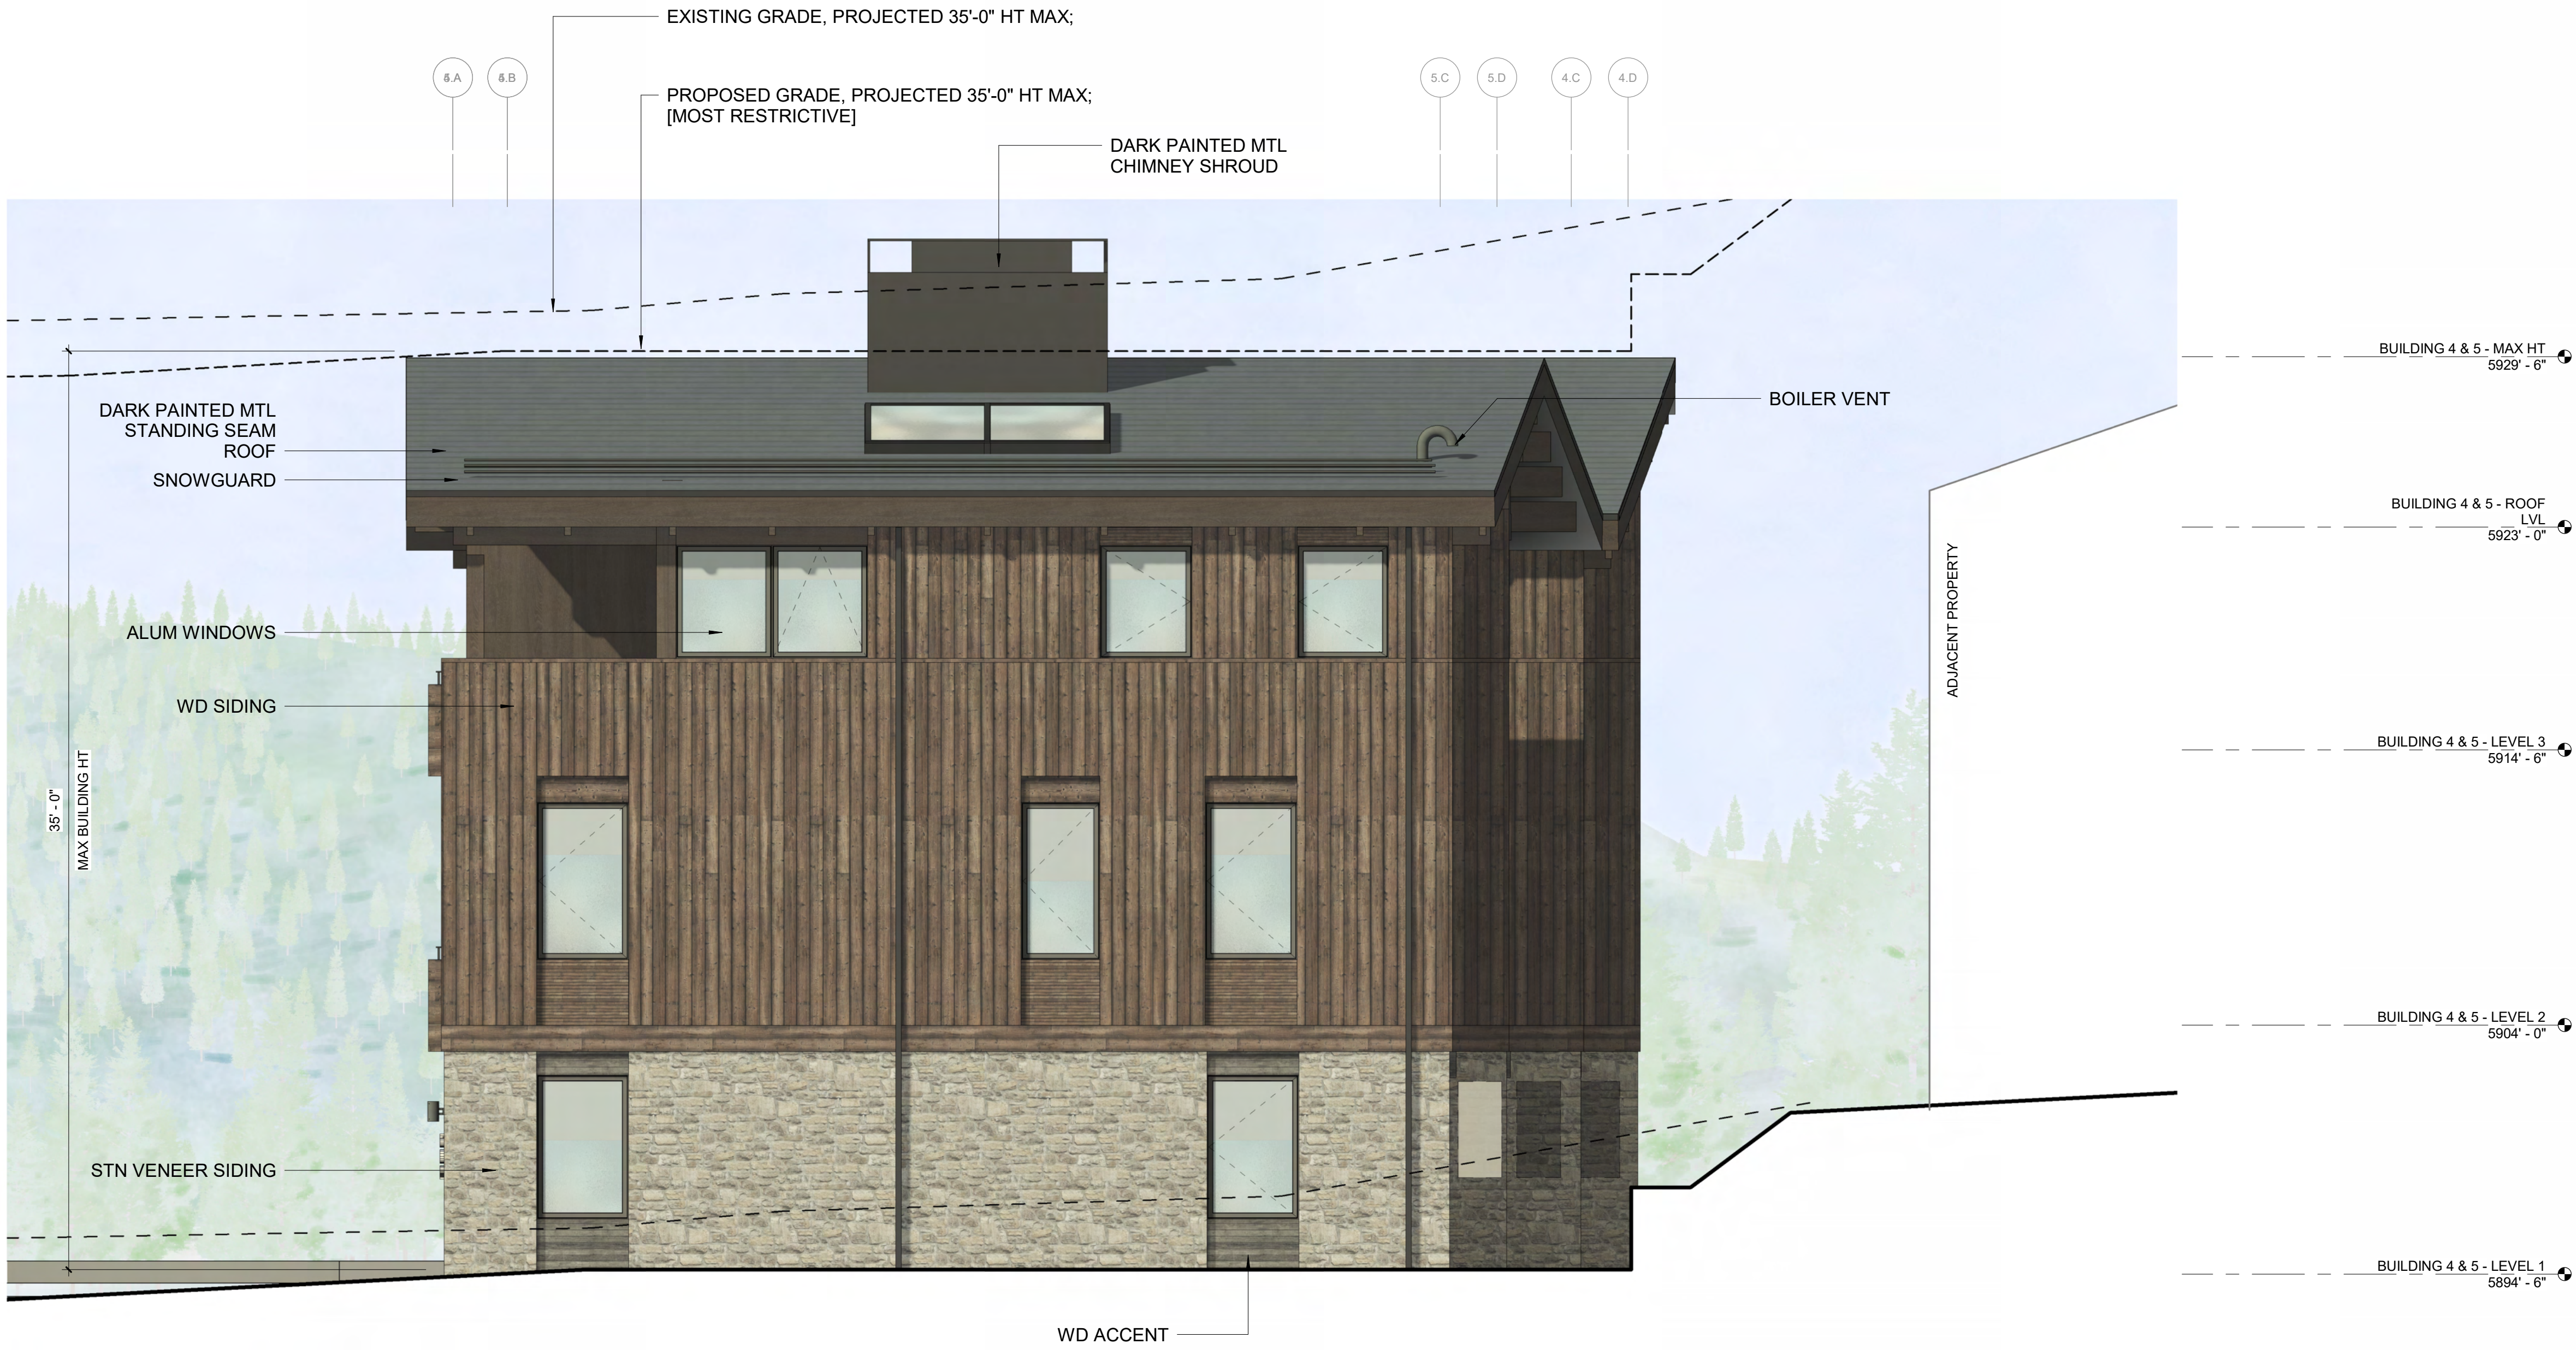WARM SPRINGS TOWNHOMES KETCHUM, ID

OWNER:

108-110 RITCHIE LLC
P.O. BOX 14001-174
KETCHUM, ID 83340
TEL: 603.801.0419

BUILDING ARCHITECT:

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STRUCTURAL ENGINEER:

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MECHANICAL, ELECTRICAL, PLUMBING ENGINEER:

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CIVIL ENGINEER:

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KETCHUM, ID 83340
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LANDSCAPE ARCHITECT:

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KETCHUM, ID 83340
TEL: 208.725.0988

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3	DESIGN REVIEW APP REV	25.12.09

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PROJECT:

WARM SPRINGS TOWNHOMES KETCHUM, ID
108 & 110 RITCHIE DR.
KETCHUM, IDAHO

DRAWING TITLE:

BUILDING ELEVATIONS - BUILDING 4 & 5

SEAL:

PROJECT NUMBER

2305

DRAWING NUMBER:

A-305

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WARM SPRINGS TOWNHOMES
KETCHUM, ID

OWNER:

108-110 RITCHIE LLC
P.O. BOX 14001-174
KETCHUM, ID 83340
TEL: 603.801.0419

BUILDING ARCHITECT:

RO | ROCKETT DESIGN
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INGLEWOOD, CA 90301
TEL: 213.784.0014

STRUCTURAL ENGINEER:

ZFA STRUCTURAL ENGINEERS
601 MONTGOMERY STREET SUITE 1450
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TEL: 415.243.4091

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4704 HARLAN STREET SUITE 620
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TEL: 720.779.3596

CIVIL ENGINEER:

GALENA BENCHMARK ASSOCIATES
100 BELL DRIVE SUITE C
KETCHUM, ID 83340
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LANDSCAPE ARCHITECT:

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KETCHUM, ID 83340
TEL: 208.725.0988

ISSUE	DESCRIPTION	DATE
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PROJECT:

WARM SPRINGS TOWNHOMES
KETCHUM, ID
108 & 110 RITCHIE DR.
KETCHUM, IDAHO

DRAWING TITLE:

BUILDING ELEVATIONS -
BUILDING 6

SEAL:

PROJECT NUMBER

2305

DRAWING NUMBER:

A-306

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2 1/4" = 1'-0" BUILDING 6 / ELEVATION - EAST



1 1/4" = 1'-0" BUILDING 6 / ELEVATION - SOUTH

WARM SPRINGS TOWNHOMES
KETCHUM, ID

OWNER:

108-110 RITCHIE LLC
P.O. BOX 14001-174
KETCHUM, ID 83340
TEL: 603.801.0419

BUILDING ARCHITECT:

RO | ROCKETT DESIGN
1031 W. MANCHESTER BLVD. UNIT 6
INGLEWOOD, CA 90301
TEL: 213.784.0014

STRUCTURAL ENGINEER:

ZFA STRUCTURAL ENGINEERS
601 MONTGOMERY STREET SUITE 1450
SAN FRANCISCO, CA 94111
TEL: 415.243.4091

MECHANICAL, ELECTRICAL, PLUMBING ENGINEER:

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DENVER, CO 80212
TEL: 720.779.3596

CIVIL ENGINEER:

GALENA BENCHMARK ASSOCIATES
100 BELL DRIVE SUITE C
KETCHUM, ID 83340
TEL: 208.725.9512

LANDSCAPE ARCHITECT:

EGGERS ASSOCIATES
560 NORTH 2ND AVENUE
KETCHUM, ID 83340
TEL: 208.725.0988

ISSUE	DESCRIPTION	DATE
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3	DESIGN REVIEW APP REV	25.12.09

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PROJECT:

WARM SPRINGS TOWNHOMES
KETCHUM, ID
108 & 110 RITCHIE DR.
KETCHUM, IDAHO

DRAWING TITLE:

BUILDING ELEVATIONS -
BUILDING 6

SEAL:


PROJECT NUMBER

2305


DRAWING NUMBER:

A-307

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2 1/4" = 1'-0" BUILDING 6 / ELEVATION - WEST

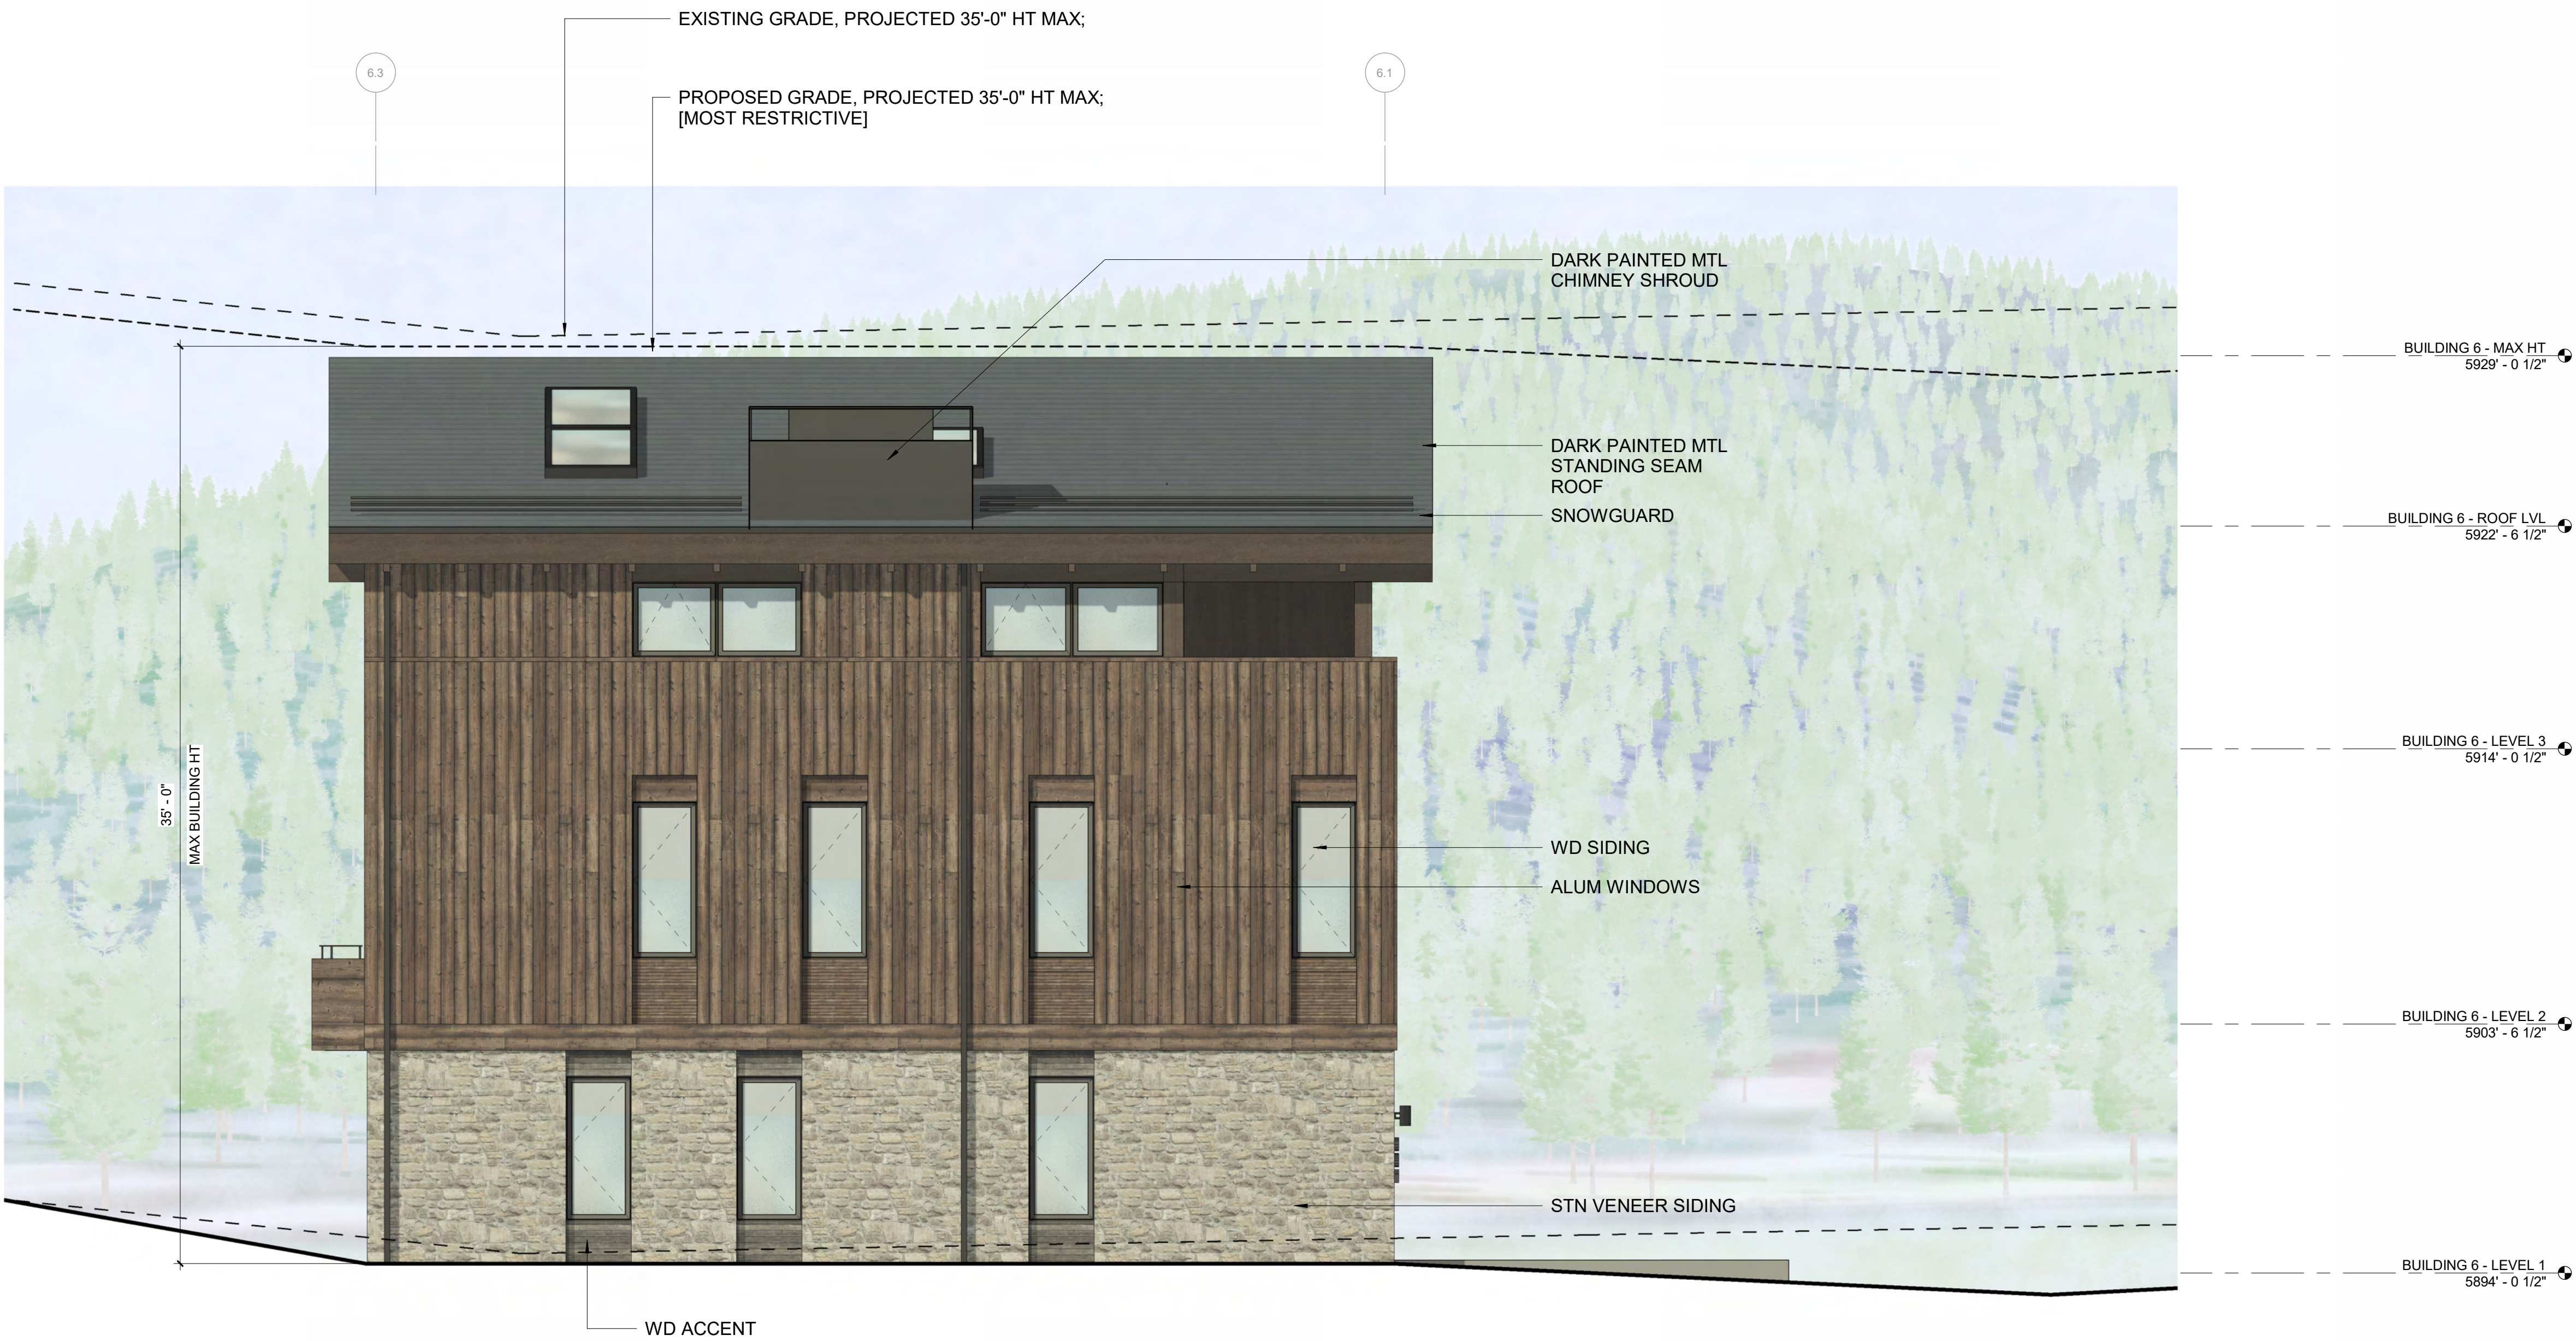

1 1/4" = 1'-0" BUILDING 6 / ELEVATION - NORTH

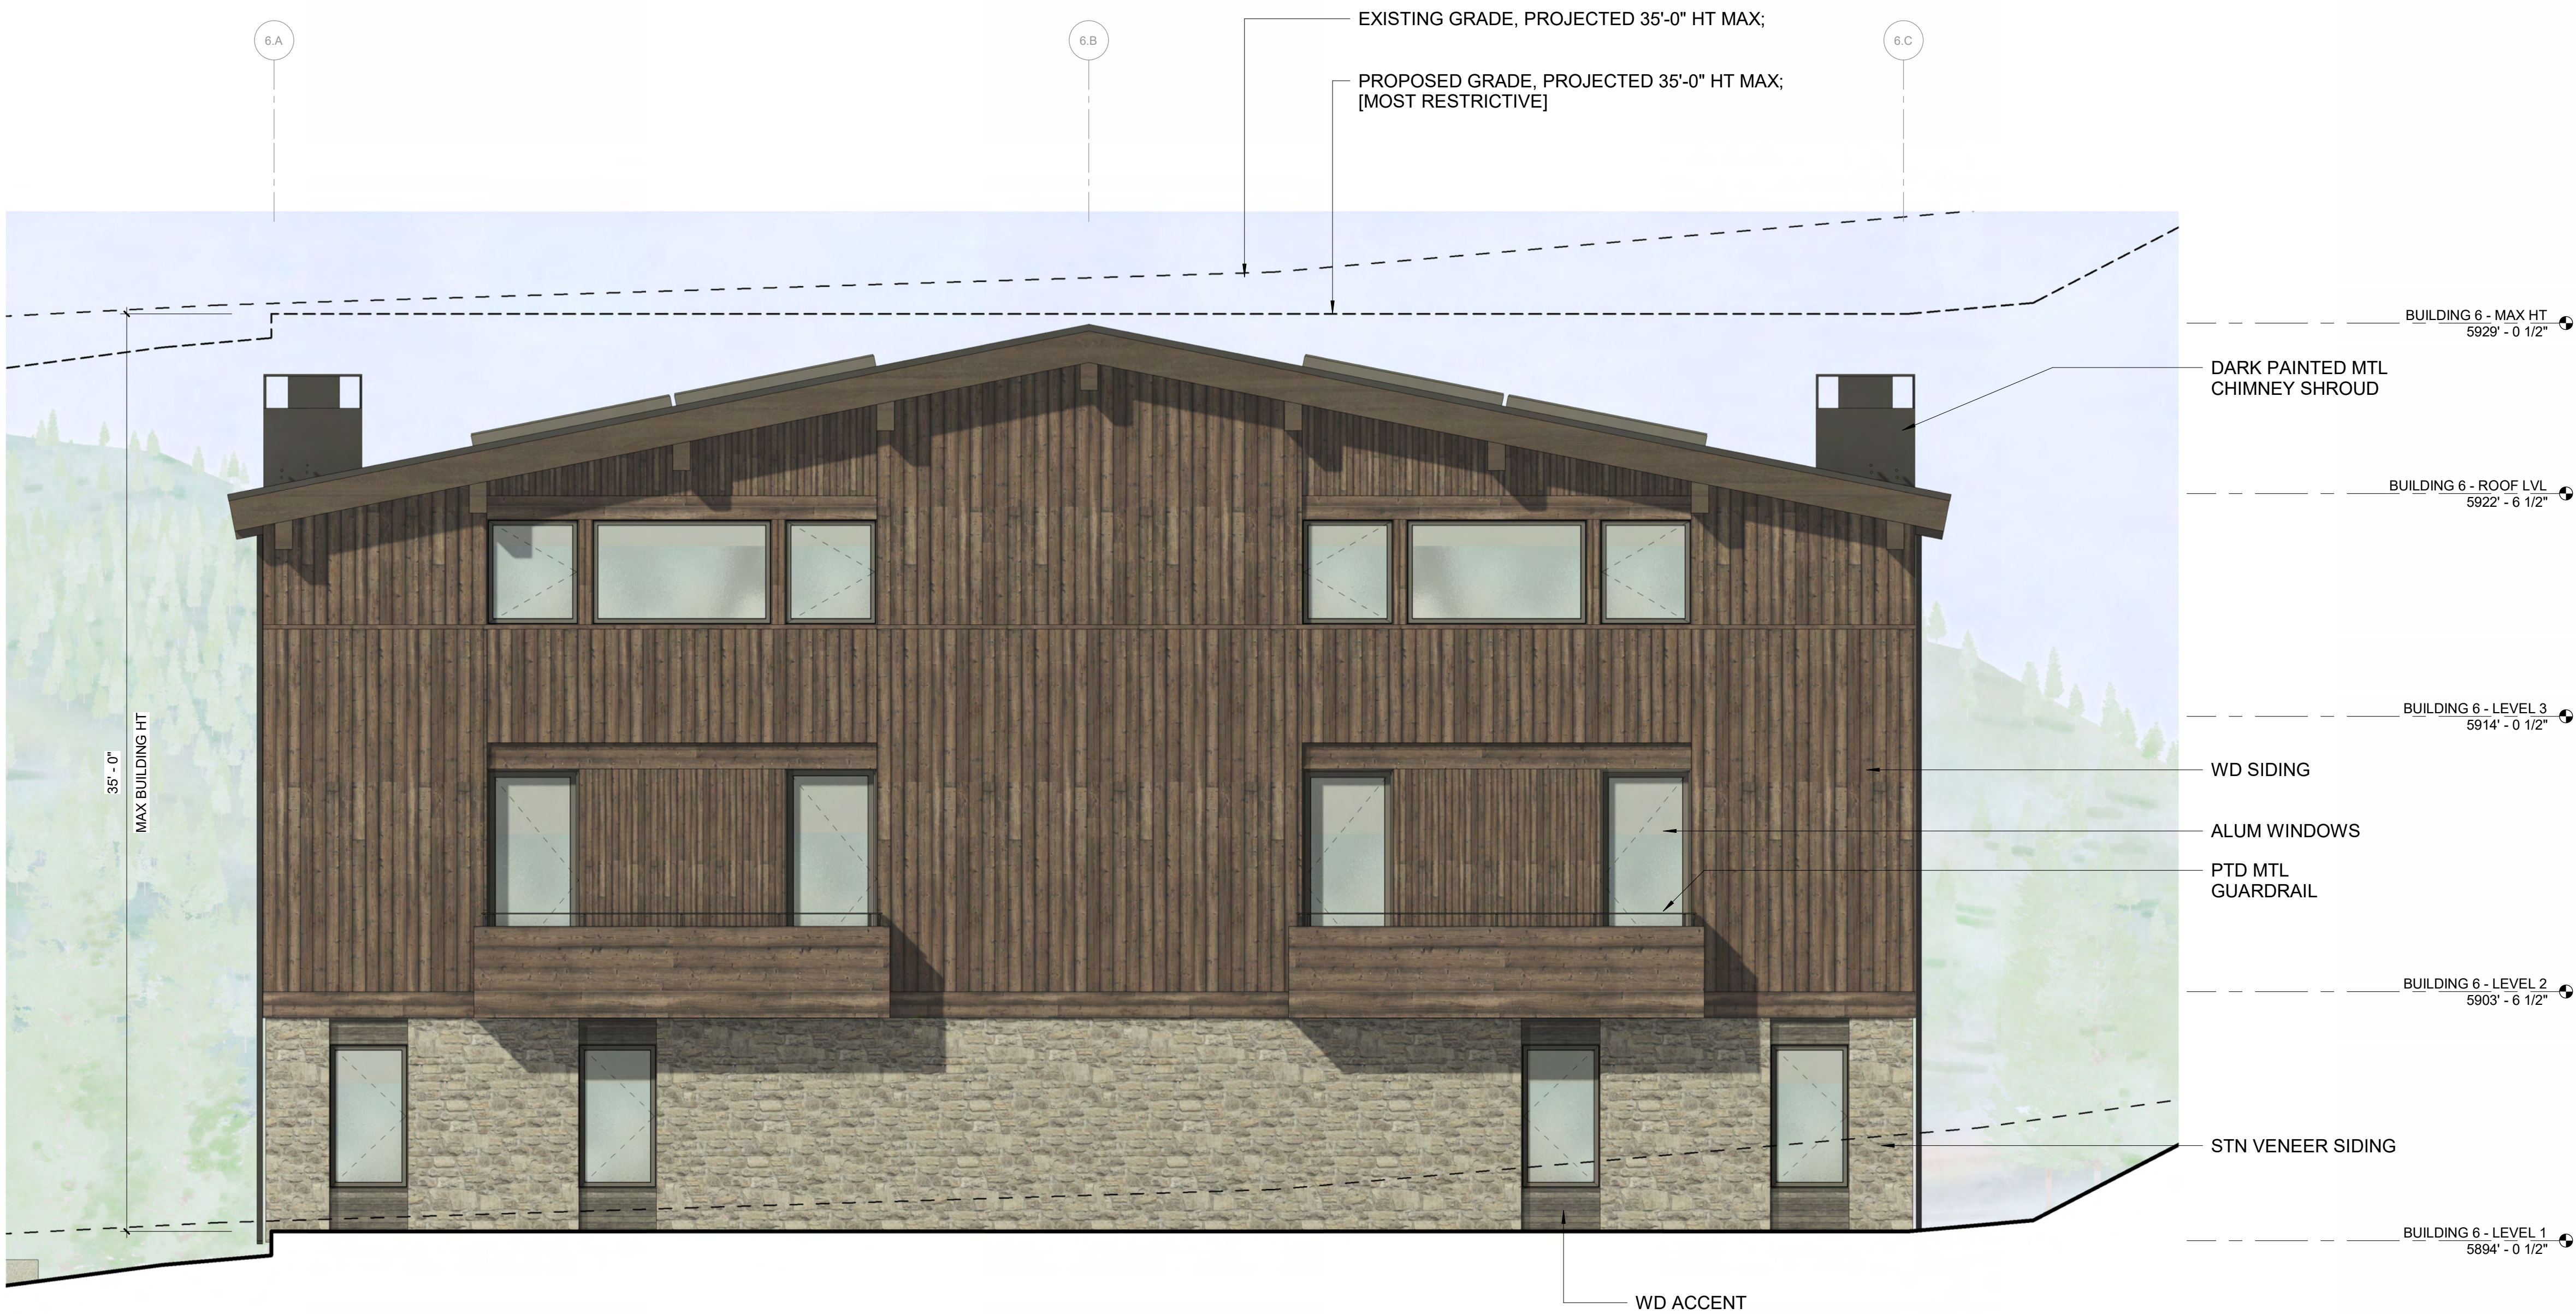OWNER:

108-1179 RITCHIE LLC
P.O. BOX. 14001-174
KETCHUM, ID 83340
TEL: 603.801.0419

BUILDING ARCHITECT:

RO | ROCKET DESIGN
1031 W. MANCHESTER BLVD. UNIT 6
INGLEWOOD, CA 90301
TEL: 713.784.0014

STRUCTURAL ENGINEER:

ZFA STRUCTURAL ENGINEERS
60 MONTGOMERY STREET SUITE 1450
SAN FRANCISCO, CA 94111
TEL: 415.243.4091

Mechanical, Electrical, Plumbing Engineer:

PROFICIENT ENGINEERING
4704 HARLAN STREET SUITE 620
DENVER, CO 80212
TEL: 720.719.3556

CIVIL ENGINEER:

GALENA BENCHMARK ASSOCIATES
100 BELL DRIVE SUITE C
KETCHUM, ID 83340
TEL: 208.726.9512

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SEAL: _____

DRAWING NUMBER:
A-400

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OWNER:

108-110 RITCHIE LLC
P.O. BOX 14001-174
KETCHUM, ID 83340
TEL: 603.801.0419

BUILDING ARCHITECT:

RO J ROCKETT DESIGN
601 W. HANCOCK STREET, BLDV. UNIT 6
INGLEWOOD, CA 90301
TEL: 213.784.0014

STRUCTURAL ENGINEER:

ZFA STRUCTURAL ENGINEERS
601 MONTGOMERY STREET SUITE 1450
SAN FRANCISCO, CA 94111
TEL: 415.243.4081

MECHANICAL, ELECTRICAL, PLUMBING ENGINEER:

PROFICIENT ENGINEERING
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DENVER, CO 80212
TEL: 720.779.3596

CIVIL ENGINEER:

GALENA BENCHMARK ASSOCIATES
100 BELL DRIVE SUITE C
KETCHUM, ID 83340
TEL: 208.726.9512

LANDSCAPE ARCHITECT:

EGGERS ASSOCIATES
56 NORTH 2ND AVENUE
KETCHUM, ID 83340
TEL: 208.725.0988



BUILDING 6

2	3/16" = 1'-0"	BUILDING SECTION - NS B
---	---------------	--------------------------------



BUILDING 3

1	3/16" = 1'-0"	BUILDING SECTION - NS A
---	---------------	-------------------------

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SEAL:

DRAWING NUMBER:

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WARM SPRINGS TOWNHOMES
KETCHUM, ID

OWNER:

108-110 RITCHIE LLC
P.O. BOX 14001-174
KETCHUM, ID 83340
TEL: 803.801.0419

BUILDING ARCHITECT:

RO | ROCKETT DESIGN
1031 W. MANCHESTER BLVD. UNIT 6
INGLEWOOD, CA 90301
TEL: 213.784.0014

STRUCTURAL ENGINEER:

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TEL: 415.243.4091

MECHANICAL, ELECTRICAL, PLUMBING ENGINEER:

PROFICIENT ENGINEERING
4704 HARLAN STREET SUITE 620
DENVER, CO 80212
TEL: 720.779.3596

CIVIL ENGINEER:

GALENA BENCHMARK ASSOCIATES
100 BELL DRIVE SUITE C
KETCHUM, ID 83340
TEL: 208.726.9512

LANDSCAPE ARCHITECT:

EGGERS ASSOCIATES
560 NORTH 2ND AVENUE
KETCHUM, ID 83340
TEL: 208.725.0988

ISSUE	DESCRIPTION	DATE
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PROJECT:
WARM SPRINGS TOWNHOMES
KETCHUM, ID
108 & 110 RITCHIE DR.
KETCHUM, IDAHO

DRAWING TITLE:
MATERIALS

SEAL:

PROJECT NUMBER
2305

DRAWING NUMBER:
A-500



MEDIUM GREY, PARGED FIELD STONE



MEDIUM BROWN, RUSTIC TONGUE AND GROOVE WOOD SIDING W/ FACE NAILING



MEDIUM BROWN, RUSTIC WD BEAMS, FASCIA & ACCENTS



DARK, RUSTIC WD TONGUE AND GROOVE ACCENTS



DARK STANDING SEAM ROOF



DARK METAL TRIM & WINDOW FRAMES

WARM SPRINGS TOWNHOMES
KETCHUM, ID

OWNER:

108-110 RITCHIE LLC
P.O. BOX 14001-174
KETCHUM, ID 83340
TEL: 803.801.0419

BUILDING ARCHITECT:

RO | ROCKETT DESIGN
1031 W. MANCHESTER BLVD. UNIT 6
INGLEWOOD, CA 90301
TEL: 213.784.0014

STRUCTURAL ENGINEER:

ZFA STRUCTURAL ENGINEERS
601 MONTGOMERY STREET SUITE 1450
SAN FRANCISCO, CA 94111
TEL: 415.243.4091

MECHANICAL, ELECTRICAL, PLUMBING ENGINEER:

PROFICIENT ENGINEERING
4704 HARLAN STREET SUITE 620
DENVER, CO 80212
TEL: 720.779.3596

CIVIL ENGINEER:

GALENA BENCHMARK ASSOCIATES
100 BELL DRIVE SUITE C
KETCHUM, ID 83340
TEL: 208.725.9512

LANDSCAPE ARCHITECT:

EGGERS ASSOCIATES
560 NORTH 2ND AVENUE
KETCHUM, ID 83340
TEL: 208.725.0988

ISSUE	DESCRIPTION	DATE
1	DESIGN REVIEW APP	25.09.09
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3	DESIGN REVIEW APP REV	25.12.09

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PROJECT:

WARM SPRINGS TOWNHOMES
KETCHUM, ID

108 & 110 RITCHIE DR.
KETCHUM, IDAHO

DRAWING TITLE:

RENDERED ELEVATIONS

SEAL:

PROJECT NUMBER

2305

DRAWING NUMBER:

G-120

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2 12" = 1'-0" SITE ELEVATION - EAST



1 12" = 1'-0" SITE ELEVATION - SOUTH

WARM SPRINGS TOWNHOMES
KETCHUM, ID

OWNER:

108-110 RITCHIE LLC
P.O. BOX 14001-174
KETCHUM, ID 83340
TEL: 603.801.0419

BUILDING ARCHITECT:

RO | ROCKETT DESIGN
1031 W. MANCHESTER BLVD. UNIT 6
INGLEWOOD, CA 90301
TEL: 213.784.0014

STRUCTURAL ENGINEER:

ZFA STRUCTURAL ENGINEERS
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SAN FRANCISCO, CA 94111
TEL: 415.243.4091

MECHANICAL, ELECTRICAL, PLUMBING ENGINEER:

PROFICIENT ENGINEERING
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DENVER, CO 80212
TEL: 720.779.3596

CIVIL ENGINEER:

GALENA BENCHMARK ASSOCIATES
100 BELL DRIVE SUITE C
KETCHUM, ID 83340
TEL: 208.726.9512

LANDSCAPE ARCHITECT:

EGGERS ASSOCIATES
560 NORTH 2ND AVENUE
KETCHUM, ID 83340
TEL: 208.725.0988

ISSUE	DESCRIPTION	DATE
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3	DESIGN REVIEW APP REV	25.12.09

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PROJECT:

WARM SPRINGS TOWNHOMES
KETCHUM, ID
108 & 110 RITCHIE DR.
KETCHUM, IDAHO

DRAWING TITLE:

RENDERED ELEVATIONS

SEAL:

PROJECT NUMBER

2305

DRAWING NUMBER:

G-121

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2 12" = 1'-0" SITE ELEVATION - WEST



1 12" = 1'-0" SITE ELEVATION - NORTH



VIEW FROM NW RITCHIE DRIVE



VIEW FROM ACROSS RITCHIE DRIVE

WARM SPRINGS
TOWNHOMES
KETCHUM, ID

OWNER:

108-110 RITCHIE LLC
P.O. BOX 14001-174
KETCHUM, ID 83340
TEL: 603.801.0419

BUILDING ARCHITECT:

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INGLEWOOD, CA 90301
TEL: 213.784.0014

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ZFA STRUCTURAL ENGINEERS
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TEL: 415.243.4091

MECHANICAL, ELECTRICAL, PLUMBING ENGINEER:

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DENVER, CO 80212
TEL: 720.779.3596

CIVIL ENGINEER:

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100 BELL DRIVE SUITE C
KETCHUM, ID 83340
TEL: 208.725.9512

LANDSCAPE ARCHITECT:

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KETCHUM, ID 83340
TEL: 208.725.0988

ISSUE	DESCRIPTION	DATE
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3	DESIGN REVIEW APP REV	25.12.09

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PROJECT:

WARM SPRINGS TOWNHOMES
KETCHUM, ID
108 & 110 RITCHIE DR.
KETCHUM, IDAHO

DRAWING TITLE:

RENDERINGS

SEAL:

PROJECT NUMBER

2305

DRAWING NUMBER:

G-130



VIEW FROM SE RITCHIE DRIVE



AERIAL VIEW

WARM SPRINGS
TOWNHOMES
KETCHUM, ID

OWNER:

108-110 RITCHIE LLC
P.O. BOX 14001-174
KETCHUM, ID 83340
TEL: 803.801.0419

BUILDING ARCHITECT:

RO | ROCKETT DESIGN
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TEL: 213.784.0014

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CIVIL ENGINEER:

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KETCHUM, ID 83340
TEL: 208.725.9512

LANDSCAPE ARCHITECT:

EGGERS ASSOCIATES
560 NORTH 2ND AVENUE
KETCHUM, ID 83340
TEL: 208.725.0988

ISSUE	DESCRIPTION	DATE
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PROJECT:

WARM SPRINGS TOWNHOMES
KETCHUM, ID
108 & 110 RITCHIE DR.
KETCHUM, IDAHO

DRAWING TITLE:

RENDERINGS

SEAL:

PROJECT NUMBER

2305

DRAWING NUMBER:

G-131



SIDEYARD VIEW OF BLDG 4 & BLDG 5 - FRONT



SIDEYARD VIEW OF BLDG 1 & BLDG 2 - REAR

WARM SPRINGS TOWNHOMES
KETCHUM, ID

OWNER:

108-110 RITCHIE LLC
P.O. BOX 14001-174
KETCHUM, ID 83340
TEL: 603.801.0419

BUILDING ARCHITECT:

RO | ROCKETT DESIGN
1031 W. MANCHESTER BLVD. UNIT 6
INGLEWOOD, CA 90301
TEL: 213.784.0014

STRUCTURAL ENGINEER:

ZFA STRUCTURAL ENGINEERS
601 MONTGOMERY STREET SUITE 1450
SAN FRANCISCO, CA 94111
TEL: 415.243.4091

MECHANICAL, ELECTRICAL, PLUMBING ENGINEER:

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4704 HARLAN STREET SUITE 620
DENVER, CO 80212
TEL: 720.779.3596

CIVIL ENGINEER:

GALENA BENCHMARK ASSOCIATES
100 BELL DRIVE SUITE C
KETCHUM, ID 83340
TEL: 208.725.9512

LANDSCAPE ARCHITECT:

EGGERS ASSOCIATES
560 NORTH 2ND AVENUE
KETCHUM, ID 83340
TEL: 208.725.0988

ISSUE	DESCRIPTION	DATE
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PROJECT:

WARM SPRINGS TOWNHOMES
KETCHUM, ID
108 & 110 RITCHIE DR.
KETCHUM, IDAHO

DRAWING TITLE:

RENDERINGS

SEAL:

PROJECT NUMBER

2305

DRAWING NUMBER:

G-132



City of Ketchum


ATTACHMENT B:
Civil, Landscape, Exterior
Lighting, and Snowmelt Plans –
Not Revised

REUSE OF DRAWINGS: These drawings, or any portion thereof, shall not be used on any Project or extensions of this Project except by agreement in writing with Galena Benchmark Engineering.



- LEGEND**
- BLOCK BOUNDARY
 - ADJOINER'S LOT LINE
 - EASEMENT
 - ROAD CENTERLINE
 - 5' CONTOUR INTERVAL (EXISTING)
 - 1' CONTOUR INTERVAL (EXISTING)
 - FENCE LINE
 - RETAINING WALL
 - EOA
 - ASPHALT
 - STORM DRAIN PROPOSED
 - SAWCUT LINE
 - 5' CONTOUR INTERVAL
 - 1' CONTOUR INTERVAL

- SITE IMPROVEMENT KEY NOTES**
- S01 CONSTRUCT HEATED ASPHALT ROADWAY. SEE DETAIL TBD.
 - S02 CONSTRUCT ASPHALT ROADWAY / ASPHALT REPAIR. SEE DETAIL TBD.
 - S03 CONSTRUCT CONCRETE SIDEWALK, CURB AND GUTTER.
 - a. 6" ROLLED C&G
 - b. CURB TRANSITION
 - c. ZERO REVEAL CURB AND GUTTER
 - S04 CONSTRUCT 24" WIDE HEATED CONCRETE VALLEY GUTTER
 - S06 INSTALL HEATED SITE PAVERS. SEE LANDSCAPE PLAN FOR DETAILS.
 - S07 INSTALL SITE GRASS PAVE. SEE LANDSCAPE PLAN FOR DETAILS.
 - S08 CONSTRUCT DRYWELL. SEE DETAIL TBD. PROVIDE MIN. 12-24" SOIL COVER FOR PLANTINGS. REFER TO LANDSCAPE PLANS FOR SOIL COVER REQUIREMENTS.
 - S09 CONSTRUCT 30" CATCH BASIN. SEE DETAIL TBD.
 - S10 INSTALL TRENCH DRAIN.
 - S11 SEE LANDSCAPE SHEETS FOR SITE GRADING AND BOULDER PLACEMENT.

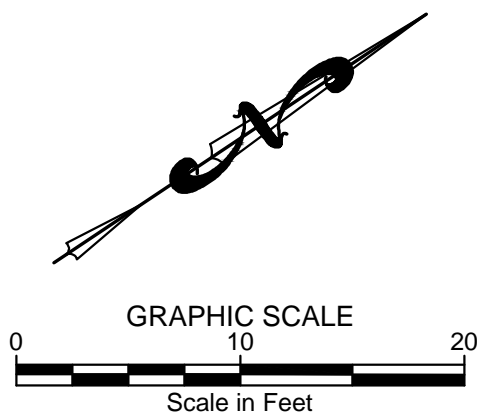


PURPOSE: PRELIMINARY FOR DESIGN REVIEW 10/14/2025

NO. DATE BY REVISIONS

GALENA-BENCHMARK
ENGINEERING

Civil Engineers & Land Surveyors
100 Bell Drive
Ketchum, ID 83340
(208) 726-9512
www.benchmark-associates.com

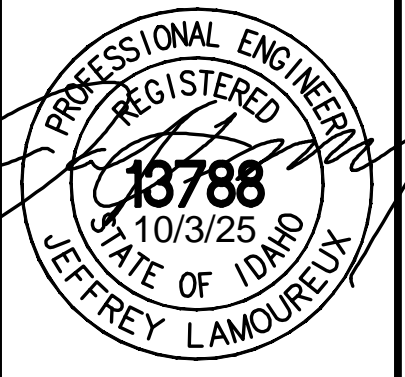


DESIGNED BY: SLS
DRAWN BY: SLS/PSF
CHECKED BY: JL
SURVEY DATE: 06/12/22

GRADING & DRAINAGE PLAN
WARM SPRINGS VILLAGE SUB. 2ND ADD. REV.
BLOCK 4, LOT 3A
LOCATED WITHIN SECTION 14, T.4 N., R.17 E., B.M., CITY OF KETCHUM, BLAINE COUNTY, IDAHO
PREPARED FOR: PRESIDIO VISTA PROPERTIES

PROJECT INFORMATION
C:\BNAW\warm_springs_village\2nd addition\2nd Addition, REVISED\Block 4\22081 Lot 3A 108-110 Ritchie Drive\Construction\22081 CIVIL.dwg 10/03/25 9:31:28 AM


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LEGEND

- PROPERTY BOUNDARY
- ADJOINER'S LOT LINE
- ROAD CENTERLINE
- 5' CONTOUR INTERVAL (EXISTING)
- 1' CONTOUR INTERVAL (EXISTING)
- FENCE LINE (EXISTING)
- EOA - EDGE OF ASPHALT (EXISTING)
- G - GAS LINE (EXISTING)
- TV - UNDERGROUND TELEVISION LINE (EXISTING)
- T - UNDERGROUND TELEPHONE LINE (EXISTING)
- UNDERGROUND POWER LINE (EXISTING)
- SD - STORM DRAIN (PROPOSED)
- S - SANITARY SEWER MAIN LINE (EXISTING)
- SS - SANITARY SEWER MAIN LINE (PROPOSED)
- SS - SANITARY SEWER SERVICE (PROPOSED)
- W - WATER MAIN LINE (EXISTING)
- W - WATER MAIN LINE (PROPOSED)
- WS - WATER SERVICE (PROPOSED)
- GV - GAS VALVE (EXISTING)
- TR - TELEPHONE RISER (EXISTING)
- PT - POWER TRANSFORMER (PROPOSED)
- SCB - STORM CATCH BASIN (PROPOSED)
- WM - WATER MANHOLE (PROPOSED)
- WV - WATER VALVE (PROPOSED)
- FH - FIRE HYDRANT (PROPOSED)
- SM - SEWER MANHOLE (PROPOSED)
- SC - SEWER CLEANOUT (PROPOSED)
- DSP - DUPLEX SEWER GRINDER PUMP (PROPOSED)
- GM - GAS METER (PROPOSED)
- EM - ELECTRICAL METER (PROPOSED)

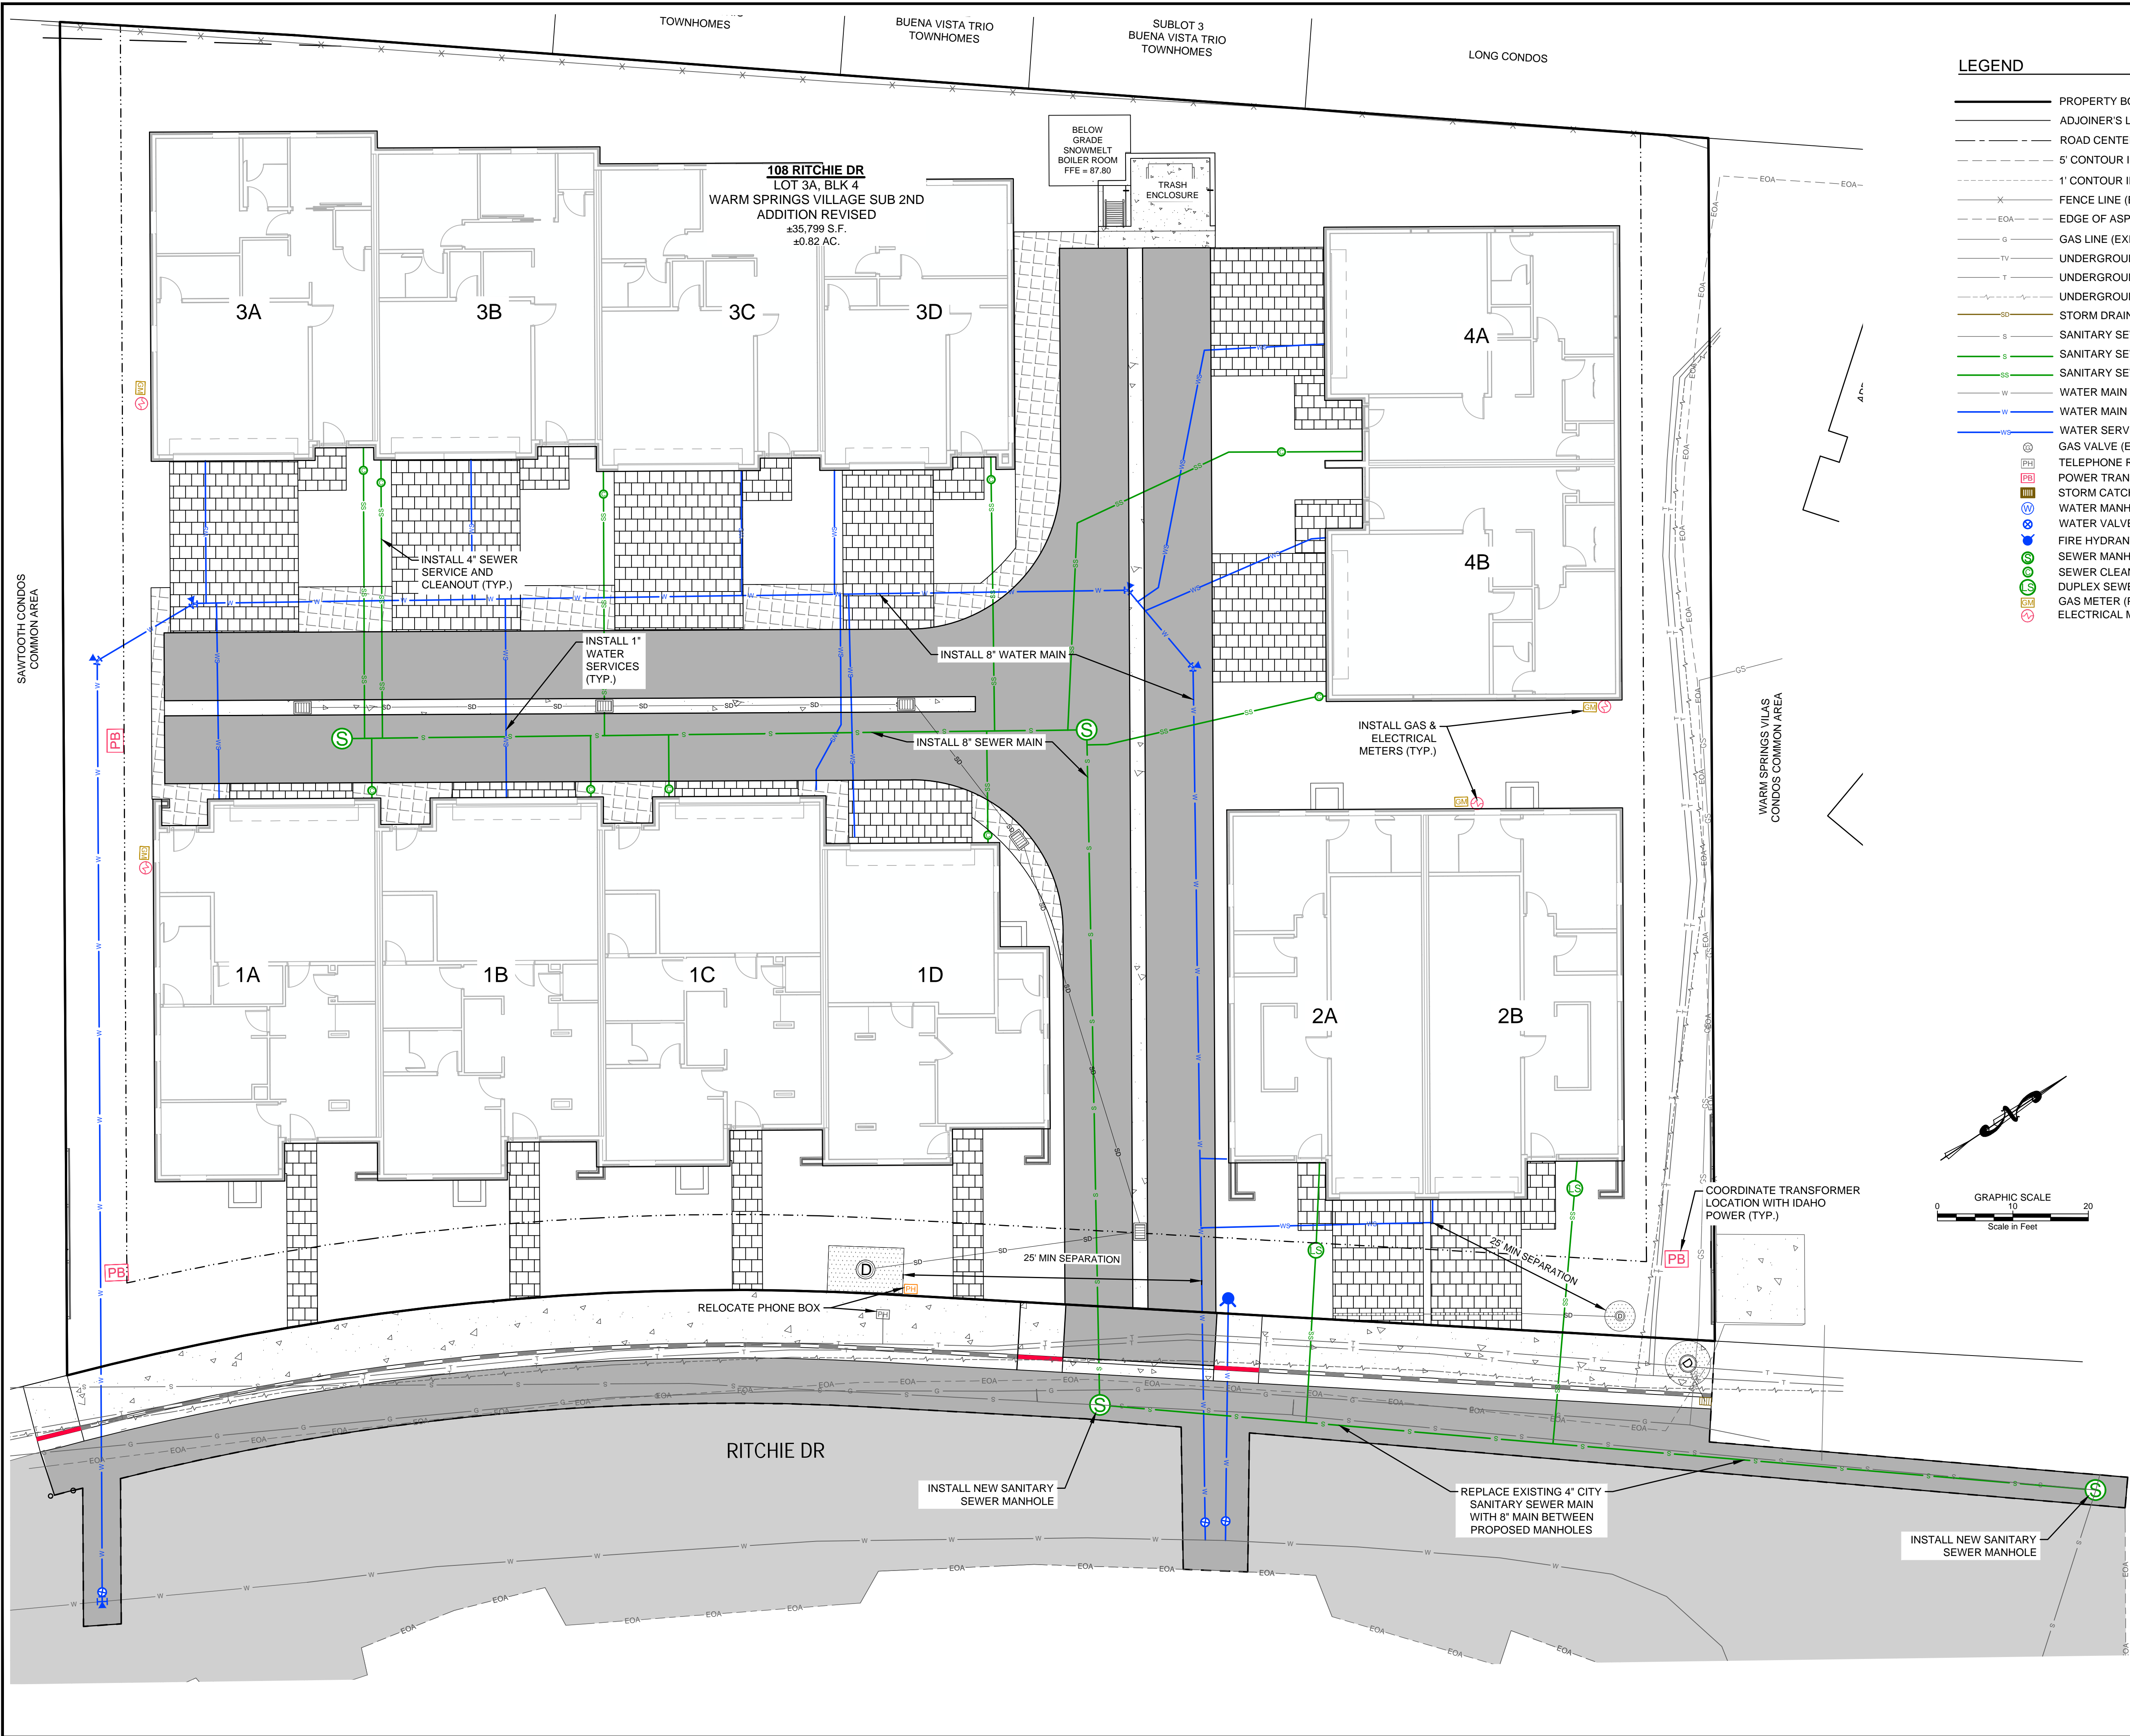

PURPOSE: PRELIMINARY FOR DESIGN REVIEW 10/14/2025

NO. DATE BY REVISIONS
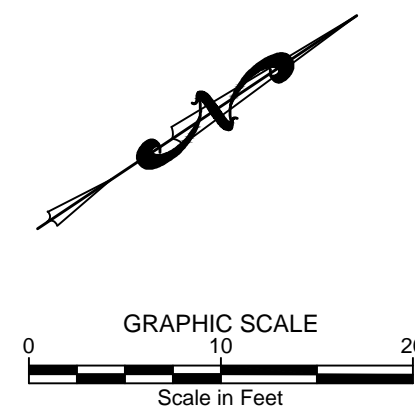
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ELEVATION
ABOVE SEA
LEVEL IN FEET
BENCHMARK


DESIGNED BY: SLS
DRAWN BY: SLS/PSF
CHECKED BY: JL
SURVEY DATE: 06/12/22

PROFESSIONAL ENGINEER
REGISTERED
13788
10/3/25
JEFFREY LAMOREUX
STATE OF IDAHO

UTILITY PLAN
WARM SPRINGS VILLAGE SUB, 2ND ADD. REV.
BLOCK 4, LOT 3A

LOCATED WITHIN SECTION 14, T.4 N., R.17 E., B.M., CITY OF KETCHUM, BLAINE COUNTY, IDAHO
PREPARED FOR: PRESIDIO VISTA PROPERTIES

PROJECT INFORMATION
C:\BNA\Warm Springs Village\2nd Addition, REVISED\Block 4\22081 Lot 3A 108-110 Ritchie Dr\WgConstruction\22081 CIVIL.dwg 10/03/25 9:31:28 AM

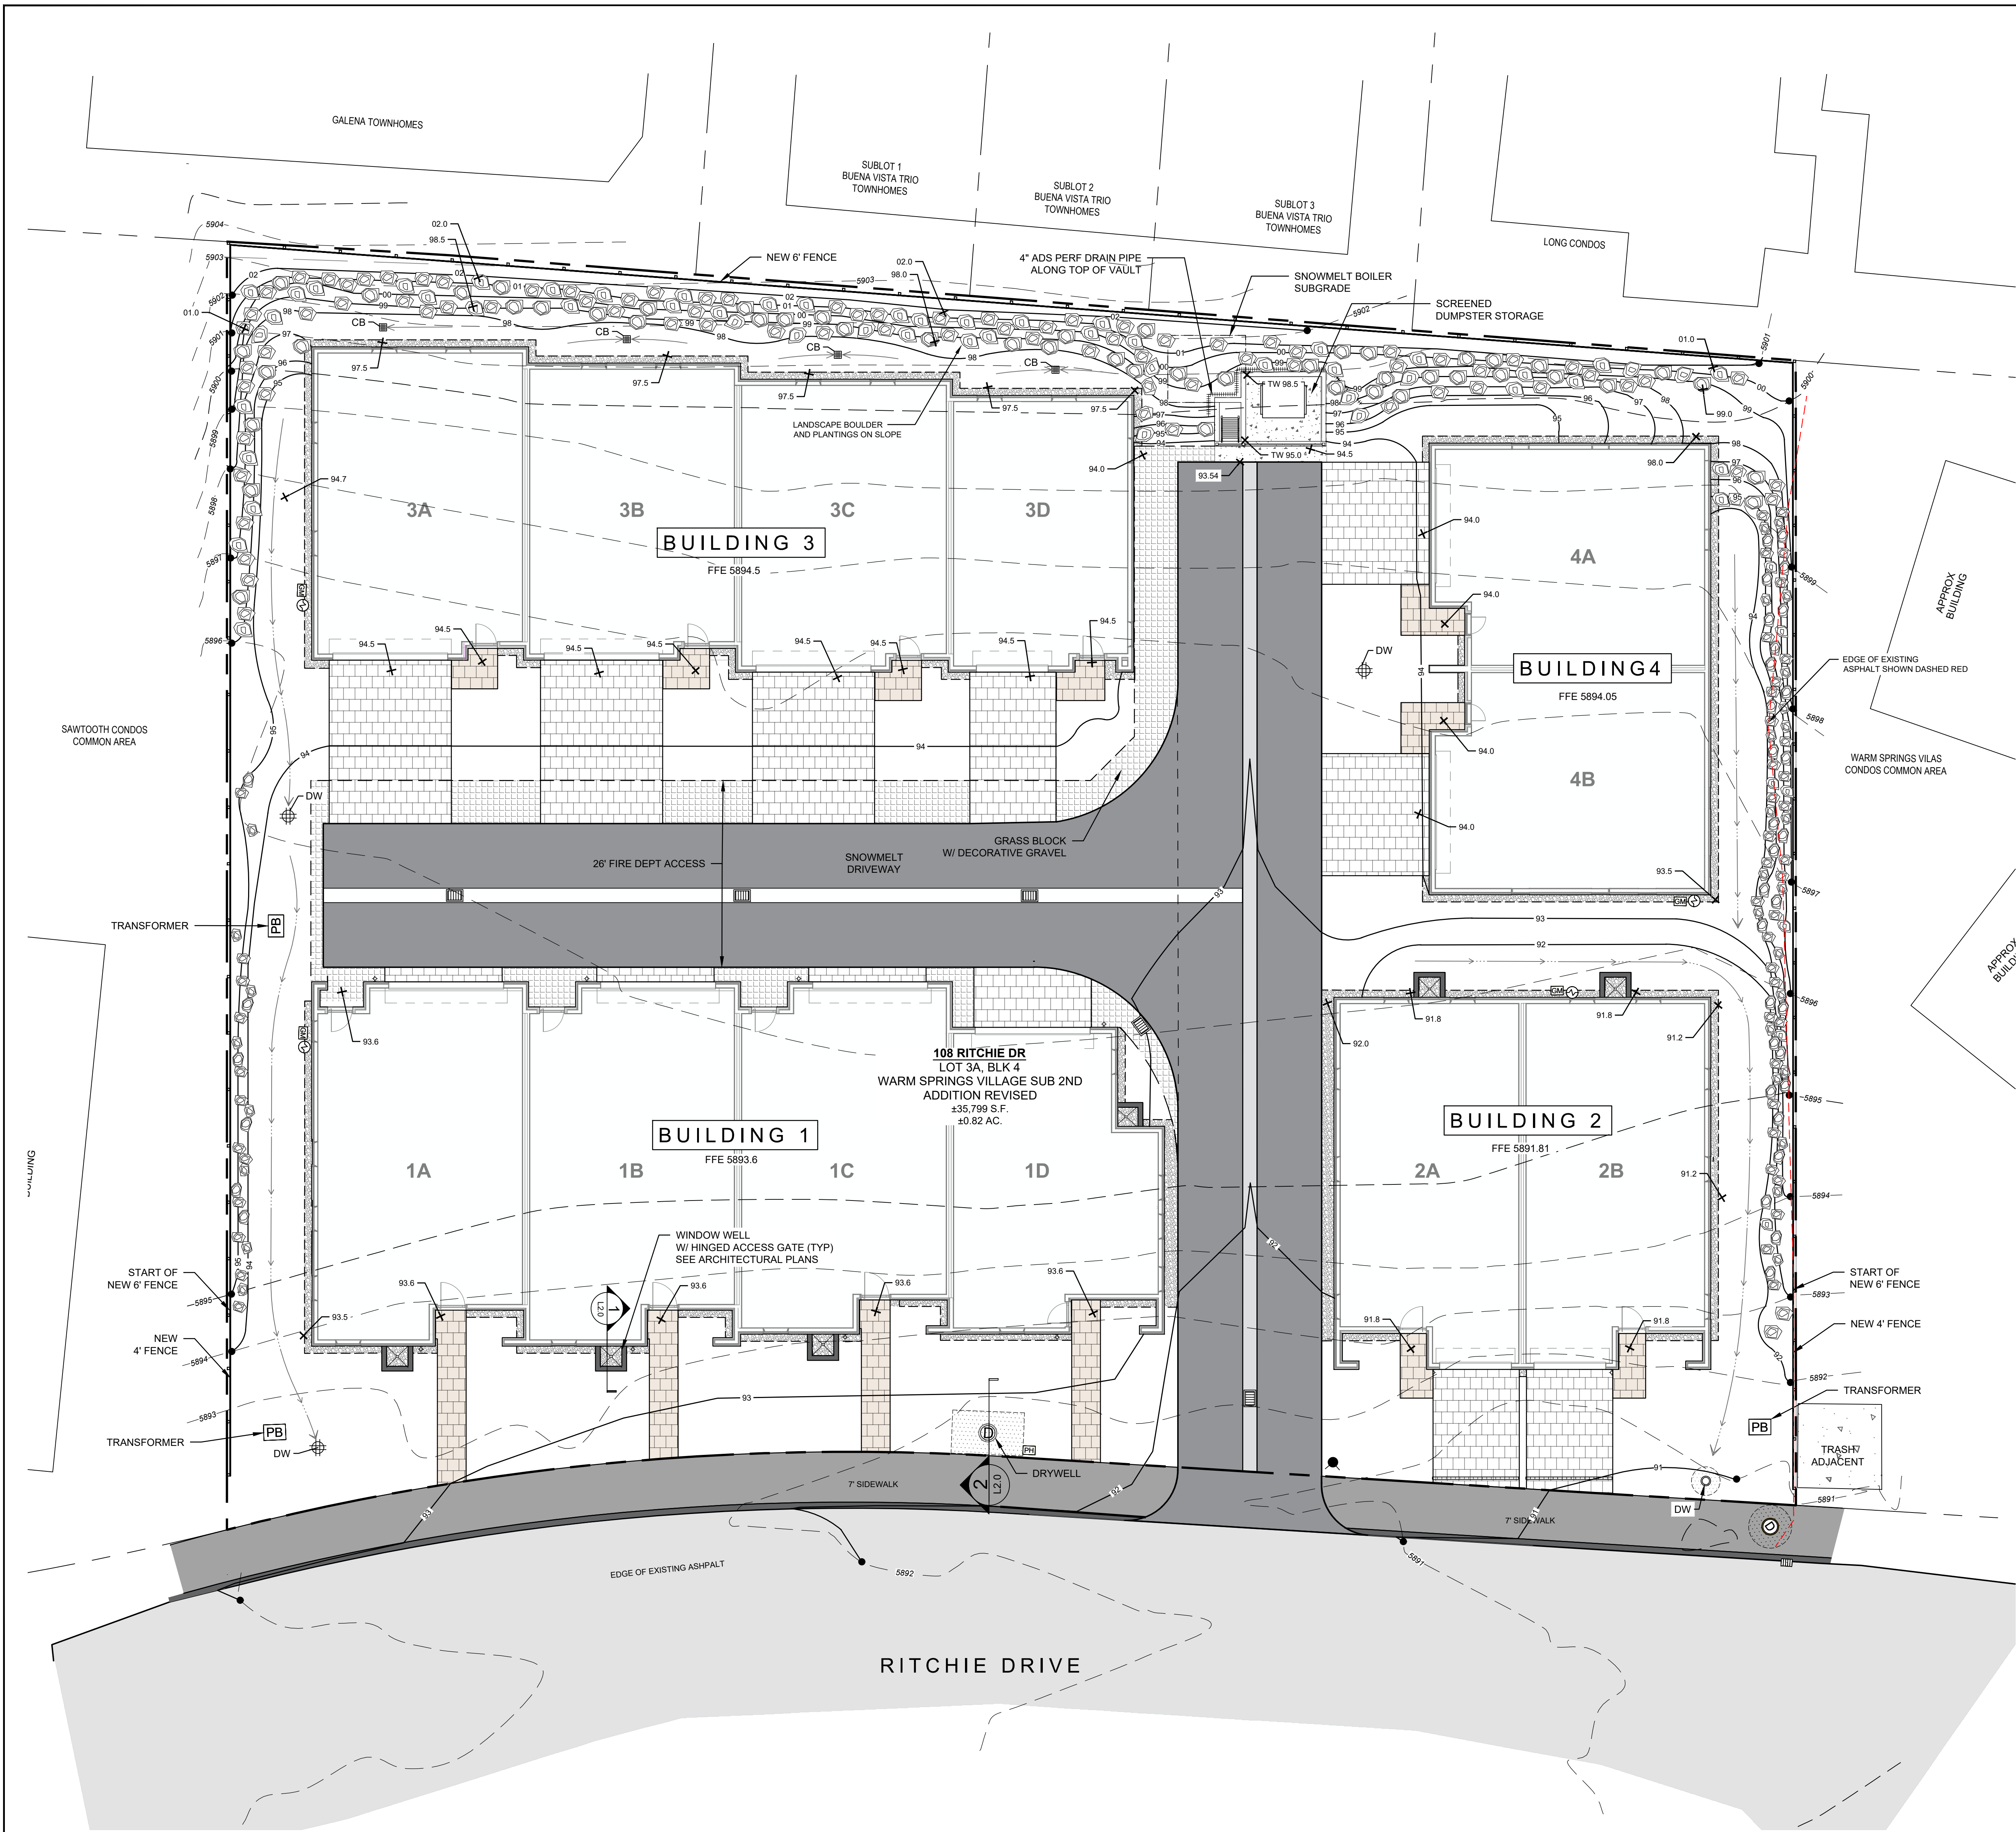

Plan Legend

Property Line

Existing Contour

Proposed Contour

New Fence

Boulder Retaining

Grass Pave

Pavers

Concrete

Gravel

Lawn Grass

Natural Grass

Perennials and Groundcover

Drywell

Catch Basin

Drainage Swale

Grading Abbreviations

EL

SPOT ELEVATION

FFE

FINISHED FLOOR ELEVATION

HP

HIGH POINT

HPS

HIGH POINT OF SWALE

TS

TOP OF STAIR

BS

BOTTOM OF STAIR

TW

TOP OF WALL

BW

BOTTOM OF WALL

DI

DRAIN INLET ELEVATION

DW

DRYWELL RIM ELEVATION

TC

TOP OF CURB

BC

BOTTOM OF CURB

FG

FINISHED GRADE

1 Section: Typical Window Well Scale: 1/2" = 1'-0"

2 Section: Drywell Landscape Integration Scale: 1/2" = 1'-0"

Detail: Turfstone (Grassblock) Scale: Not to Scale


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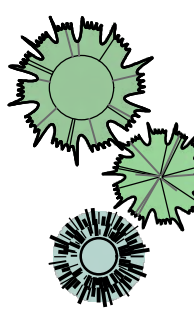
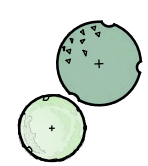



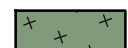

Warm Springs



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P.O. Box 973
Ketchum, ID 83340

108 & 110 Richie Drive
Lots 3 & 4
Warm Springs Village Subd.
Ketchum, Idaho

Job No: 2331
Scale: 1"=10'-0"
Issue/Revisions Date:
Concept Update 07/10/24
Design Review 11/06/24
DR Resubmission 03/14/25
DR Resubmission 06/23/25
DR Resubmission 07/17/25
DR Resubmission 08/04/25
DR Resubmission 10/03/25
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STATE OF IDAHO
J. EGGERS
LANDSCAPE ARCHITECT
No. 2157
Sheet Title:
Grading Plan
Sheet No:
L2.0

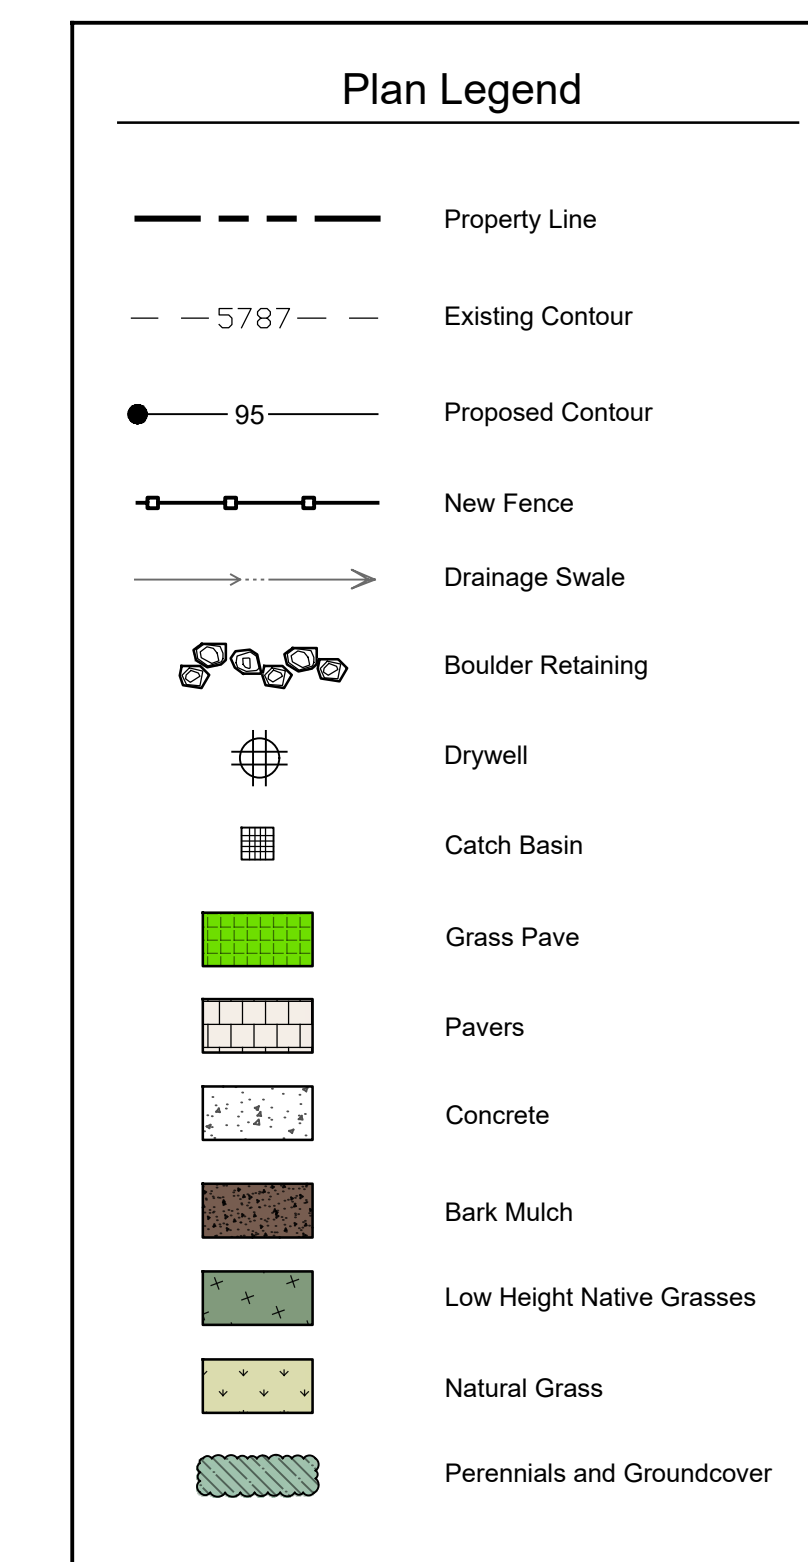

Plant Legend						
<i>Qty.</i>	<i>Species</i>	<i>Scientific Name</i>	<i>Install Size</i>	<i>Mature Size</i>	<i>Drought Tolerance</i>	<i>Water Needs</i>
	12	Conifer Trees				
2	Colorado Spruce	<i>Picea pungens</i>	8'	25'-30'		medium
5	Subalpine Fir	<i>Abies lasiocarpa</i>	8'	20'-25'		medium
5	'Tannenbaum' Mugo Pine	<i>Pinus mugo</i> ('Tannenbaum')	8'	10'-12'		low
	15	Deciduous Trees	2-1/2-3" Cal.			
7	Prairiefire Crabapple	<i>Malus</i> x 'Prairiefire'	2-1/2" Cal.	10'-15'		low
8	Sargent's Crabapple	<i>Malus sargentii</i>	2-1/2" Cal.	10'-15'		low
	126	Deciduous Shrubs				
36	Flame Amur Maple	<i>Acer ginnala</i> 'Flame	5 Gal	6'-8"		medium
3	Serviceberry	<i>Amelanchier alnifolia</i>	5 Gal	4'-6"		medium
3	Snowberry	<i>Symphoricarpos alba</i>	5 Gal	4'-6"		medium
30	Red-wing Dogwood	<i>Cornus sericea</i>	5 Gal	4'-6"		medium
50	Birchleaf Spiraea	<i>Spiraea betulifolia</i> 'Tor'	1 Gal	3'		medium
50	Goldfinger Potentilla	<i>Potentilla fruticosa</i> 'Goldfinger'	1 Gal	3'		medium
	31	Evergreen Shrubs				
31	Dwarf Mugo Pine	<i>Pinus mugo</i> var. <i>pumilo</i>	5 Gal	4'-6"		low
	600 sq.ft.	Perennial Flowers	Flats@8"O.C.			
	Various					
	2,900 sq.ft.	Grasses	Hydroseed			
	Lawn Mix					
	3,000 sq.ft.	Natural Grasses	Hydroseed			
	Smooth Broomrape					

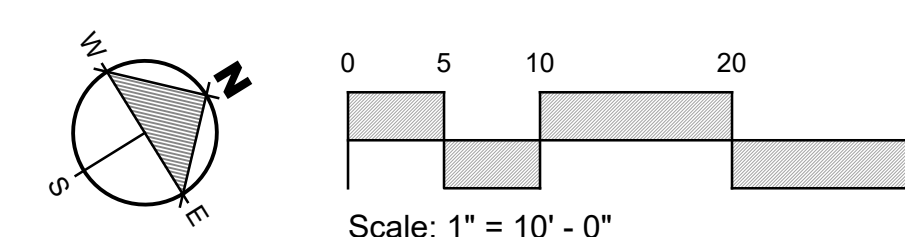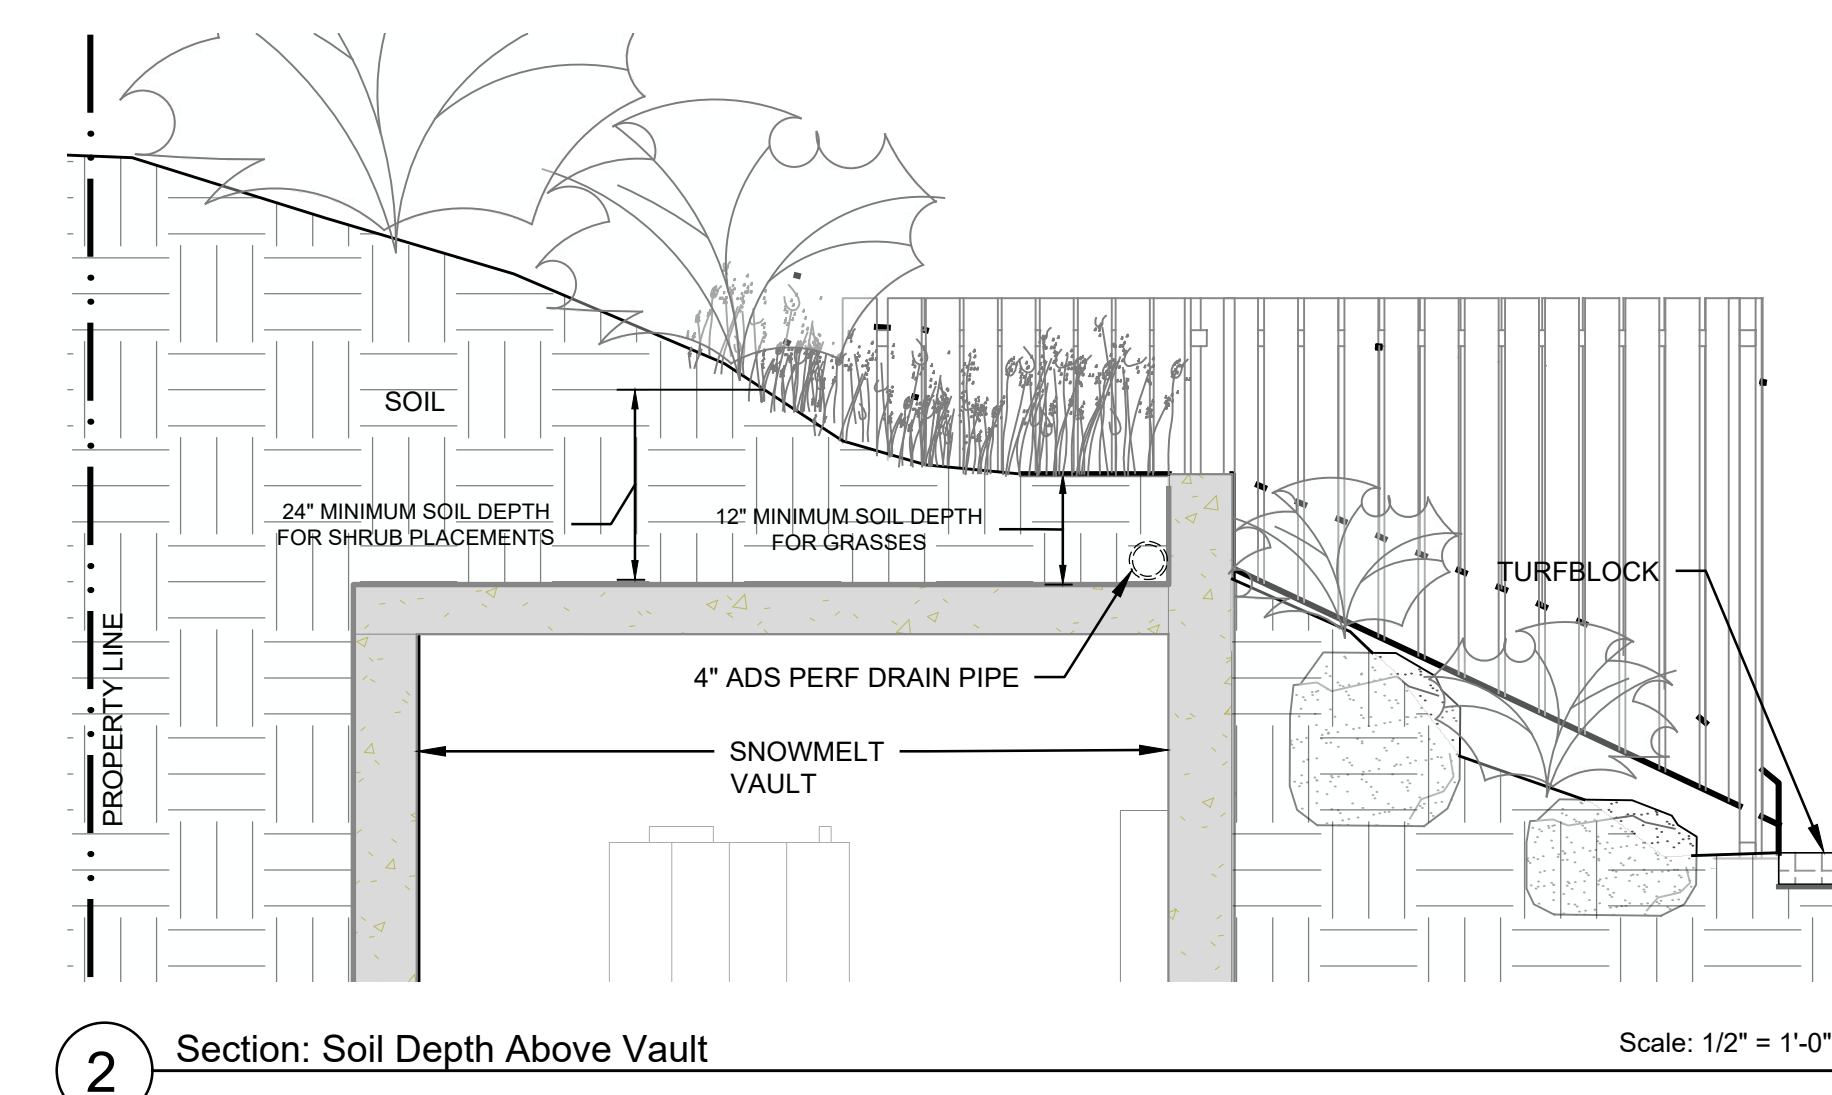




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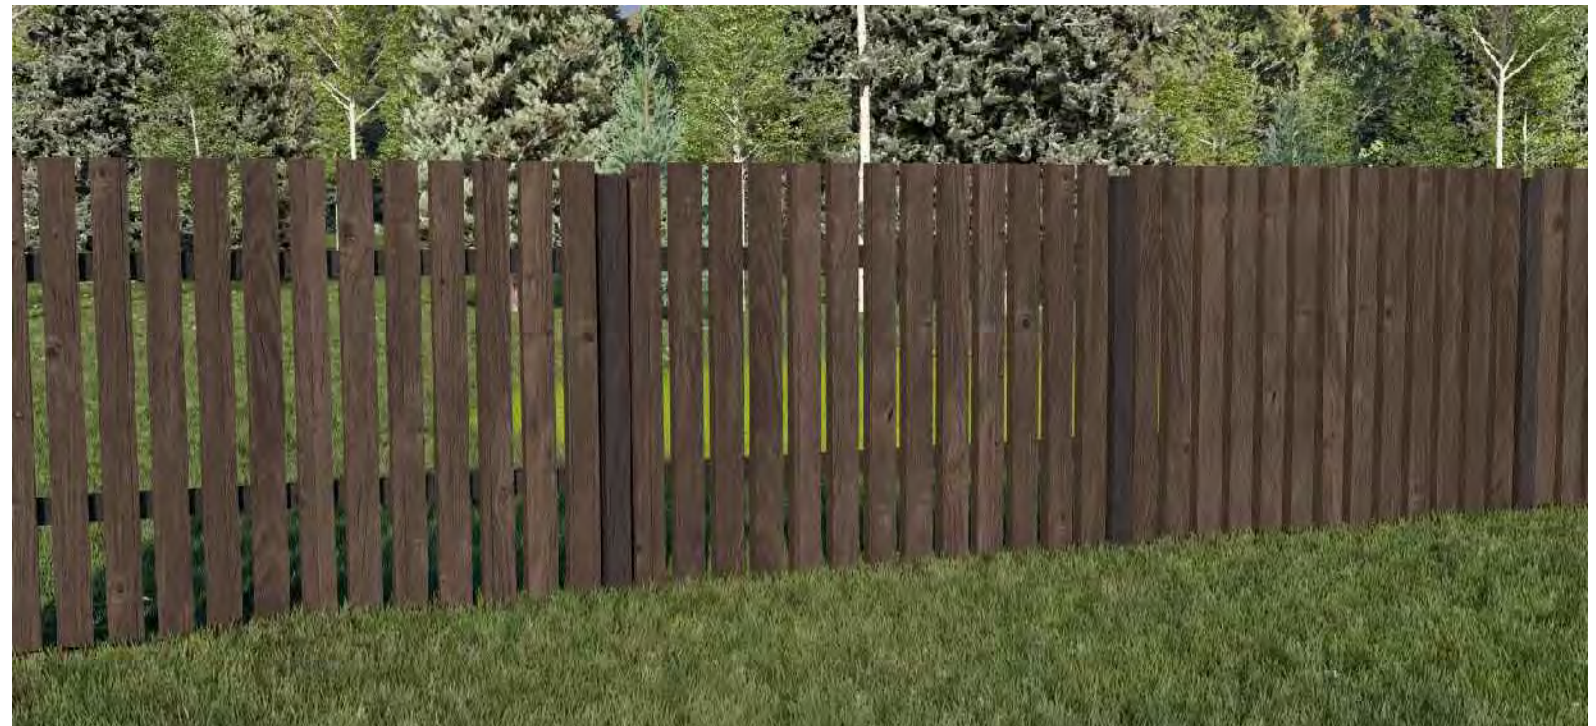
- Property Line
- Existing Contour
- Proposed Contour
- Grass Pave
- Pavers
- Concrete

Fence Legend


- 6 Foot High Fence
- 4 Foot High Fence

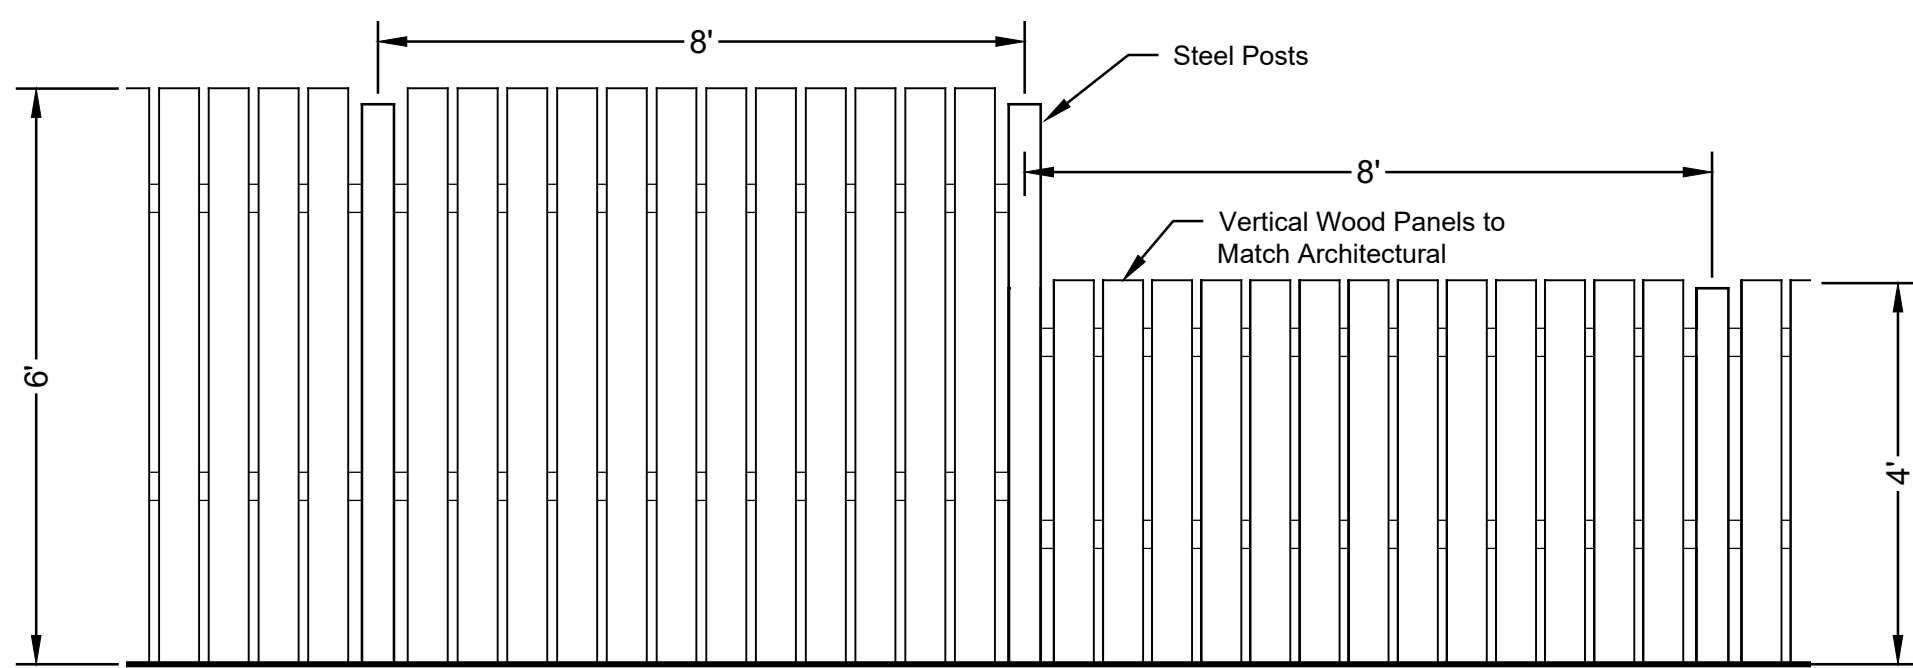

Elevation: 6 and 4 Foot Fencing Scale: 1/2" = 1'-0"



6' High Fence Concept Image

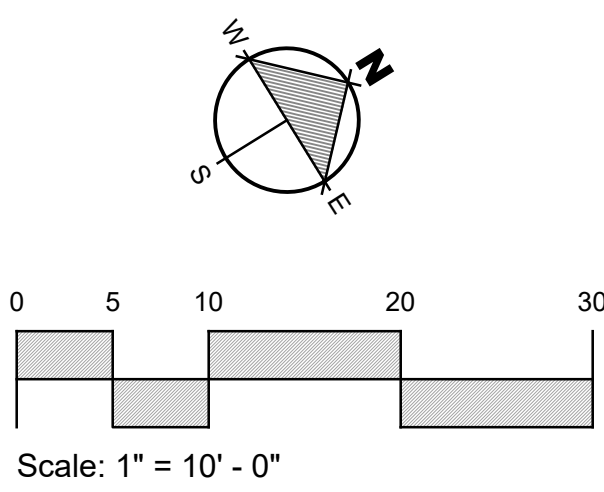

Warm Springs

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108 & 110 Ritchie Drive
Lots 3 & 4
Warm Springs Village Subd.
Ketchum, Idaho

Job No: 23.31
Scale: 1" = 10'-0"

Issue/Revisions	Date:
Concept Update	07/10/24
Design Review	11/06/24
DR Resubmission	03/14/25
DR Resubmission	06/23/25
DR Resubmission	07/17/25
DR Resubmission	08/04/25
DR Resubmission	10/03/25

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J. EGGERS
LANDSCAPE ARCHITECT
NOV 21 2024

Sheet Title:
Fencing Plan

Sheet No:
L3.2



Flowering Crab Trees (8 Feet Installation Height)



Fir Tree (6 - 8 Feet Installation Height)



Spruce Tree (6 - 8 Feet Installation Height)



Mugo Pine Tree (6 - 8 Feet Installation Height)



Streetside Example: Low Natural Grass (Scottish Links)


PLANT MATERIALS



STREET PLANTING EXAMPLES




Transformer Screening

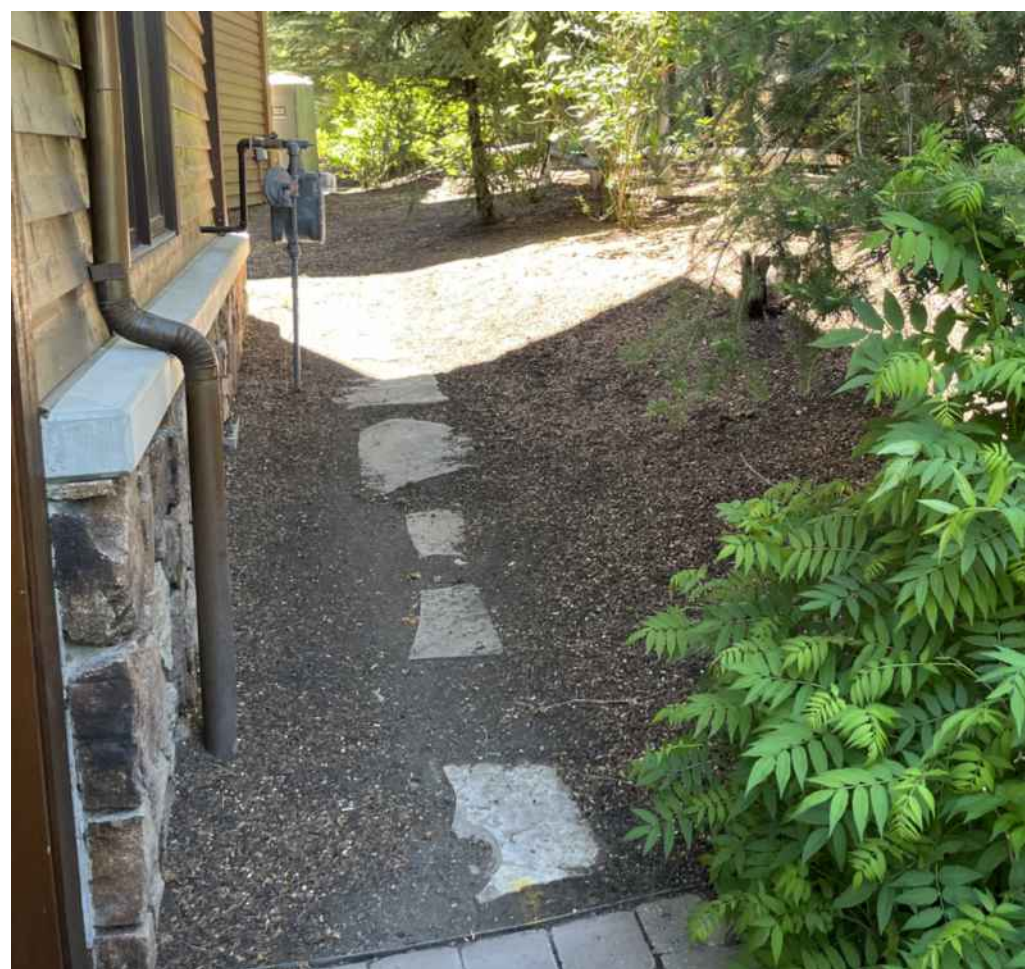

Bark Mulch and Path



Landscape Boulders With Plantings

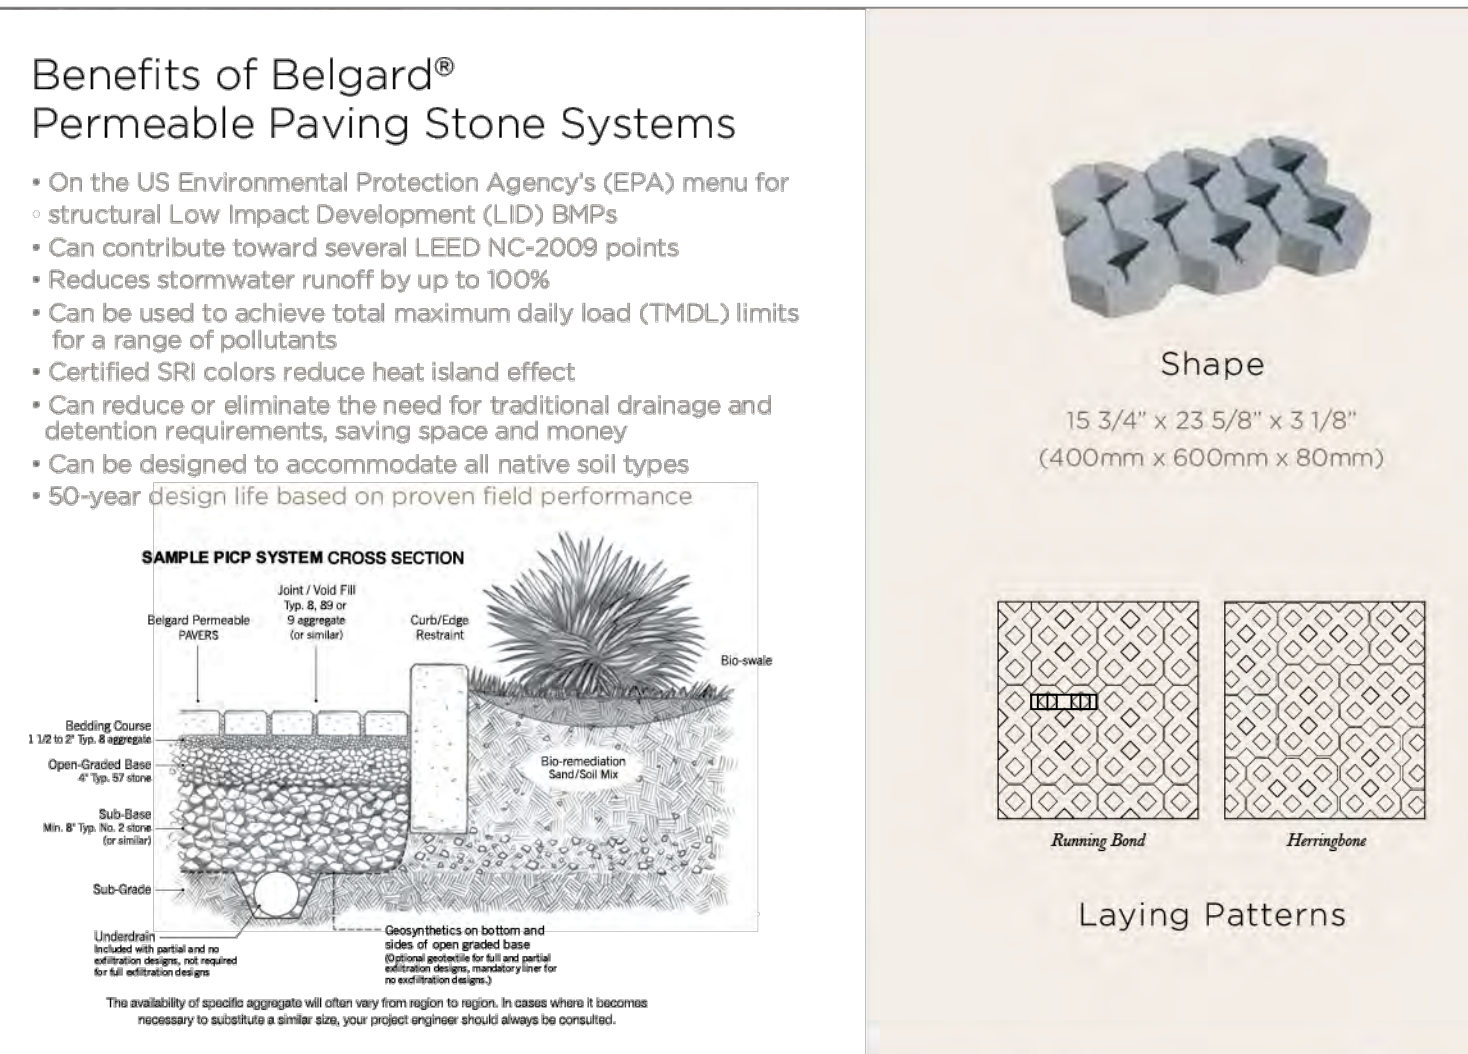

Driveable Permeable Pavers / Filled with Decorative Gravel

Warm
Springs

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Ketchum, ID 83740

108 & 110 Richie Drive
Lots 3 & 4
Warm Springs Village Subd.
Ketchum, Idaho

Job No: 23.31

Scale:

Issue/Revisions: Date:

Concept Update 07/10/24

Design Review 11/06/24

DR Resubmission 03/14/25

DR Resubmission 06/23/25


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DR Resubmission 08/04/25

DR Resubmission 10/03/25


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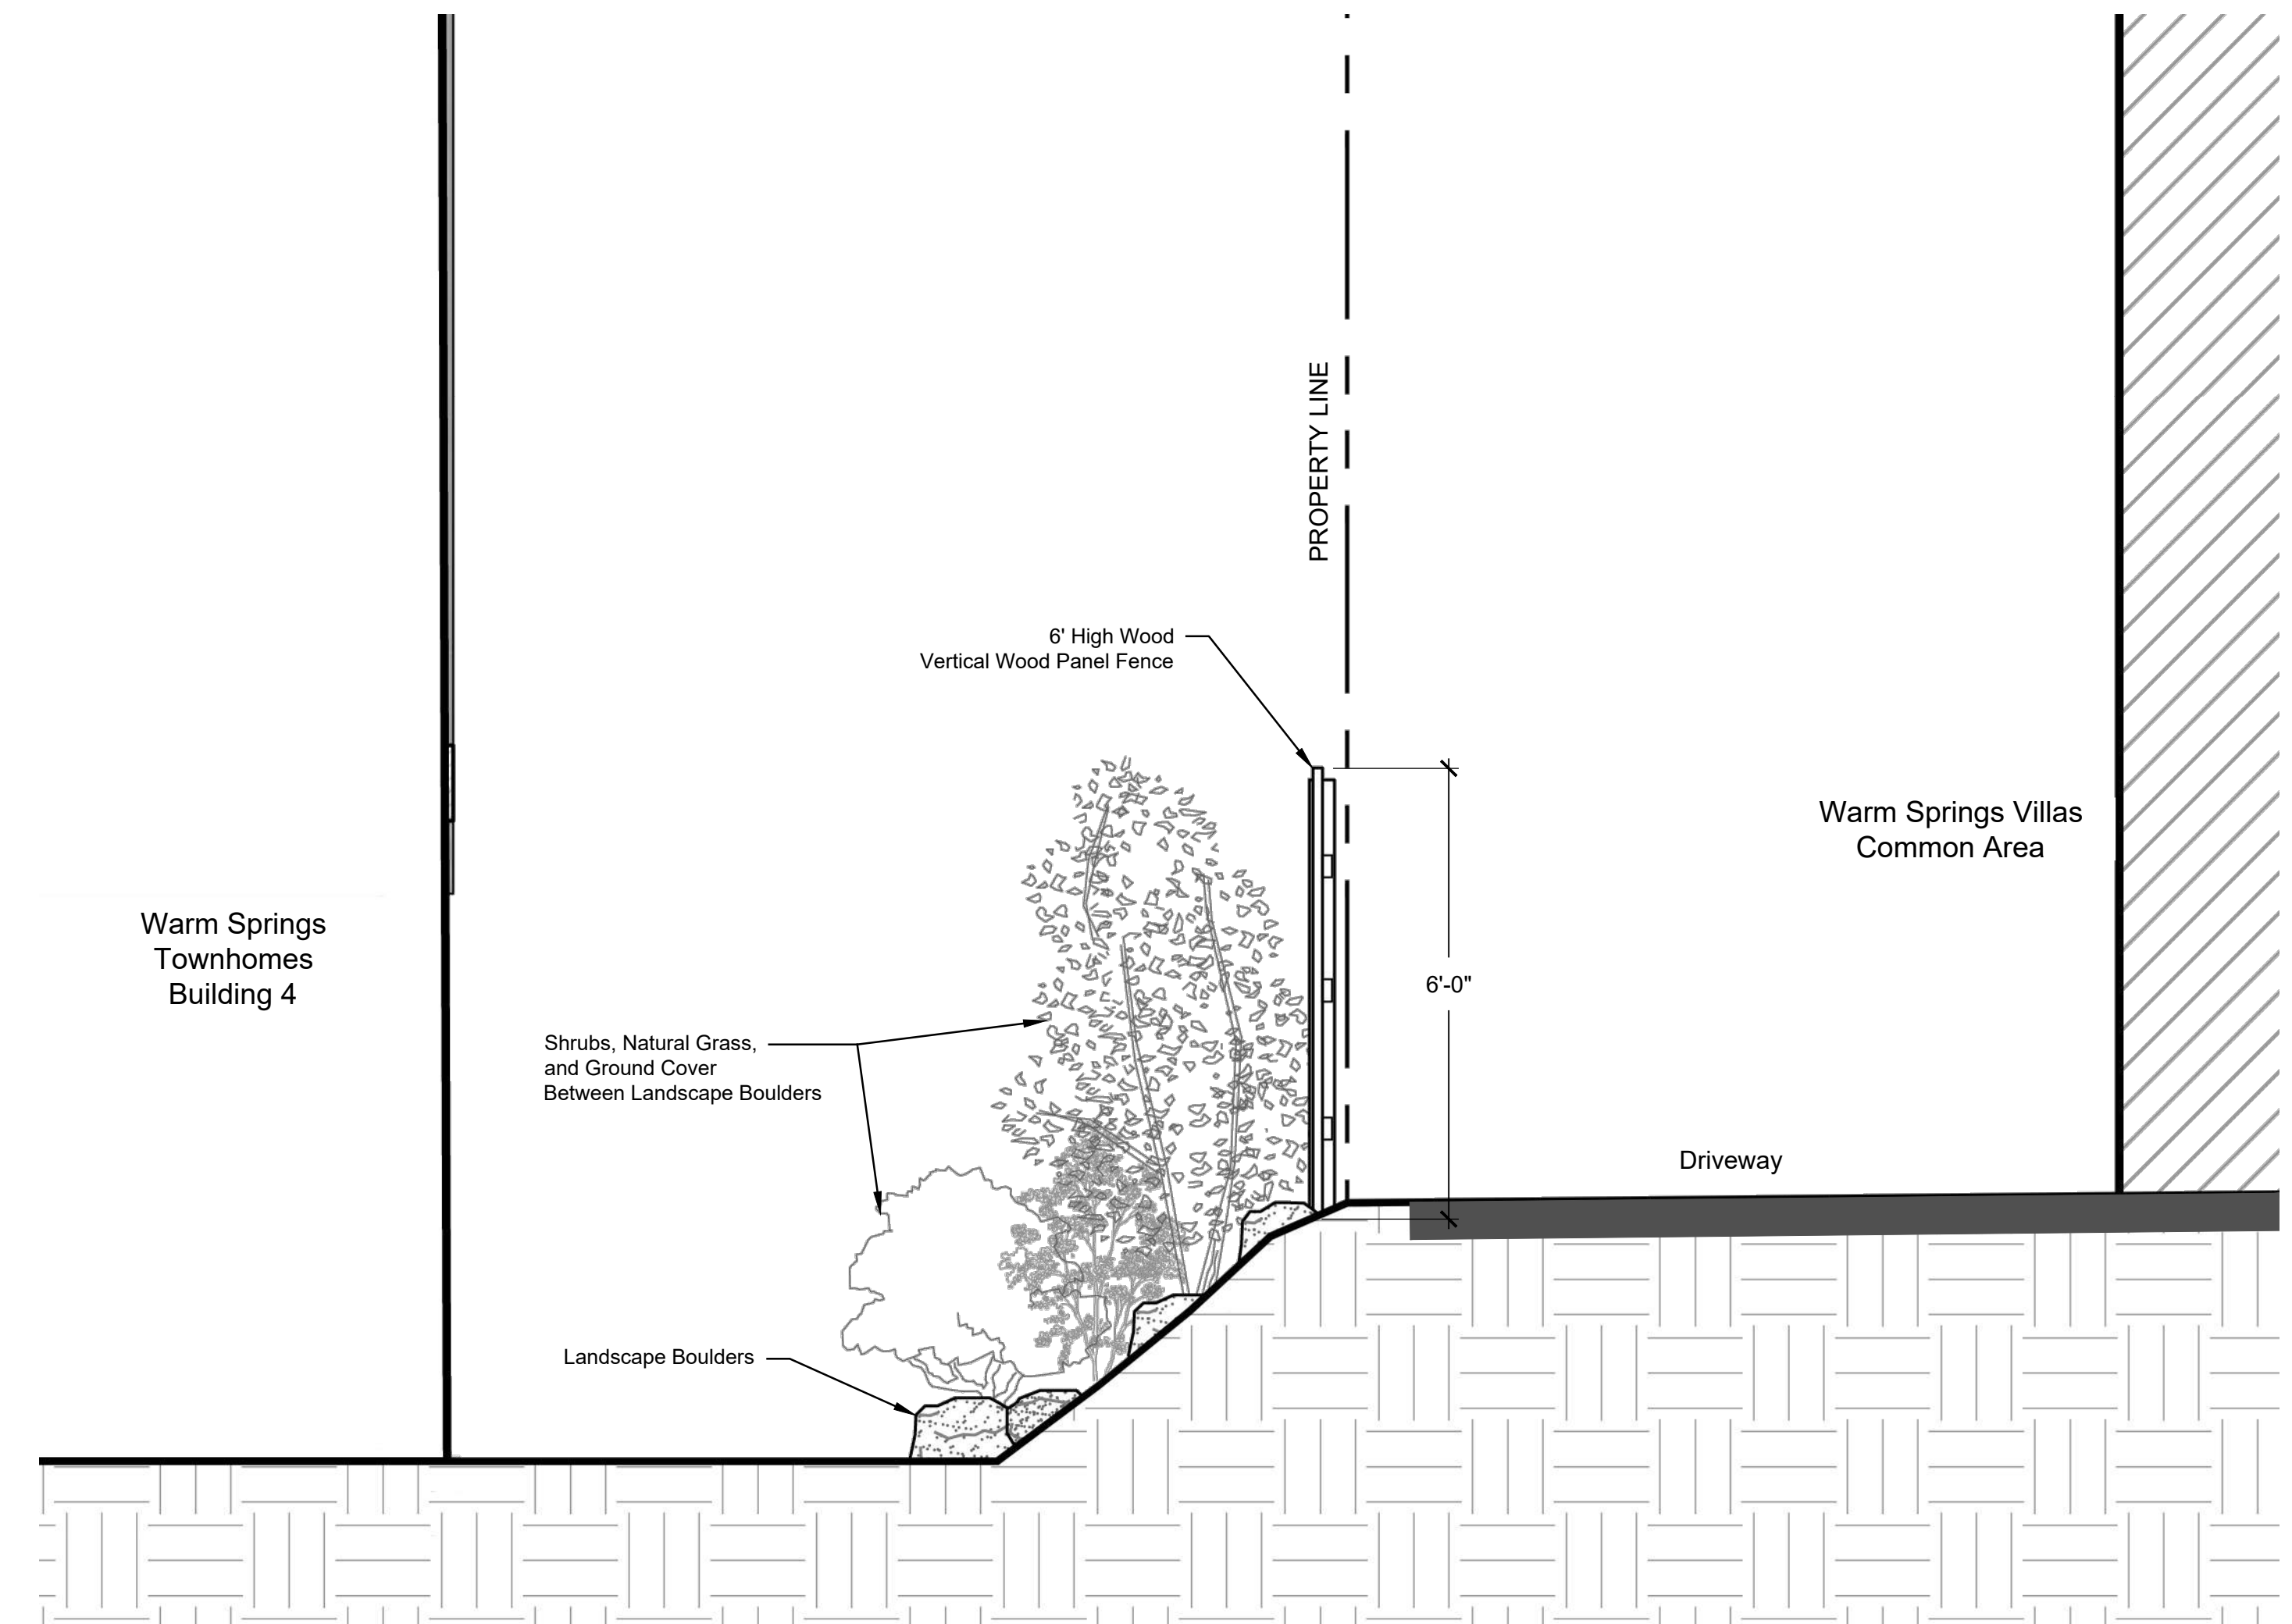


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Plant
Materials


Sheet No:
L4.0

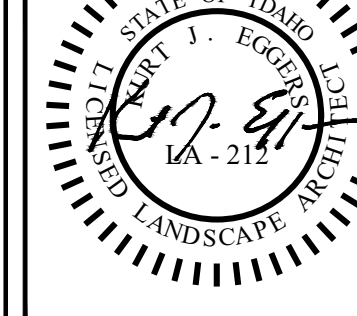

1 Section: Building 3 Scale: 1/2" = 1'-0"

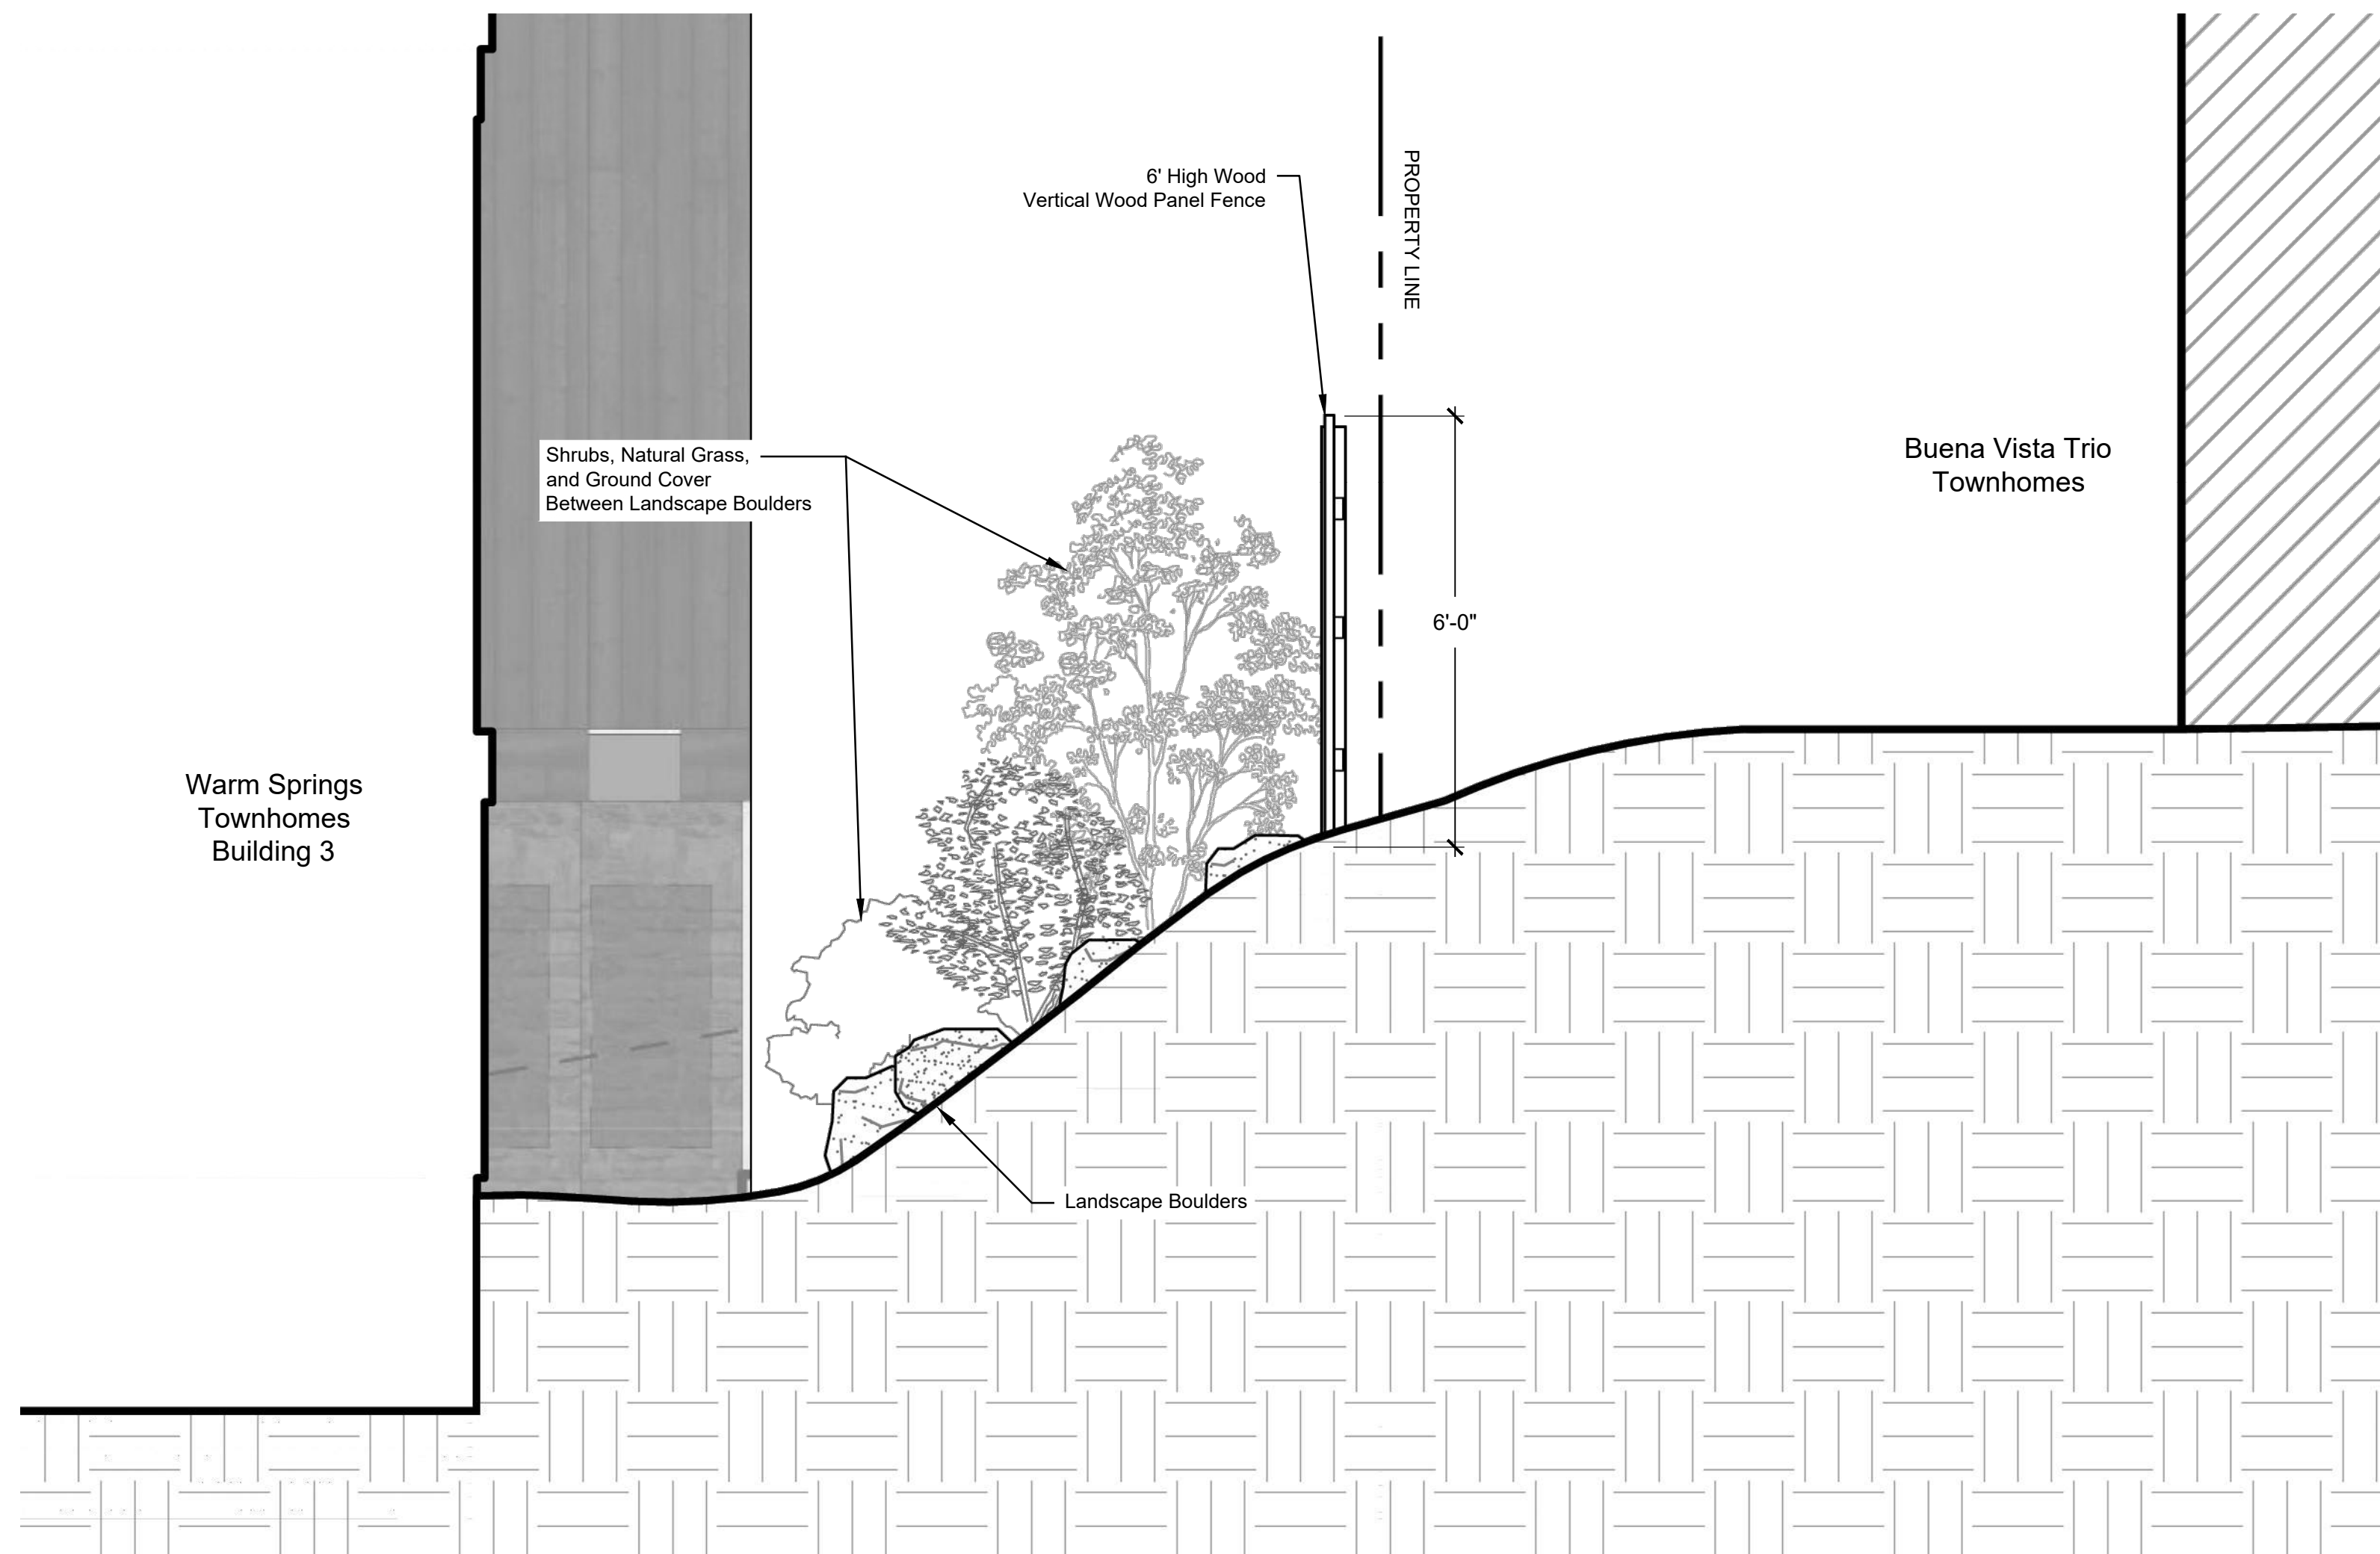

2 Section: Adjacent Driveway & Building 4 Scale: 1/2" = 1'-0"

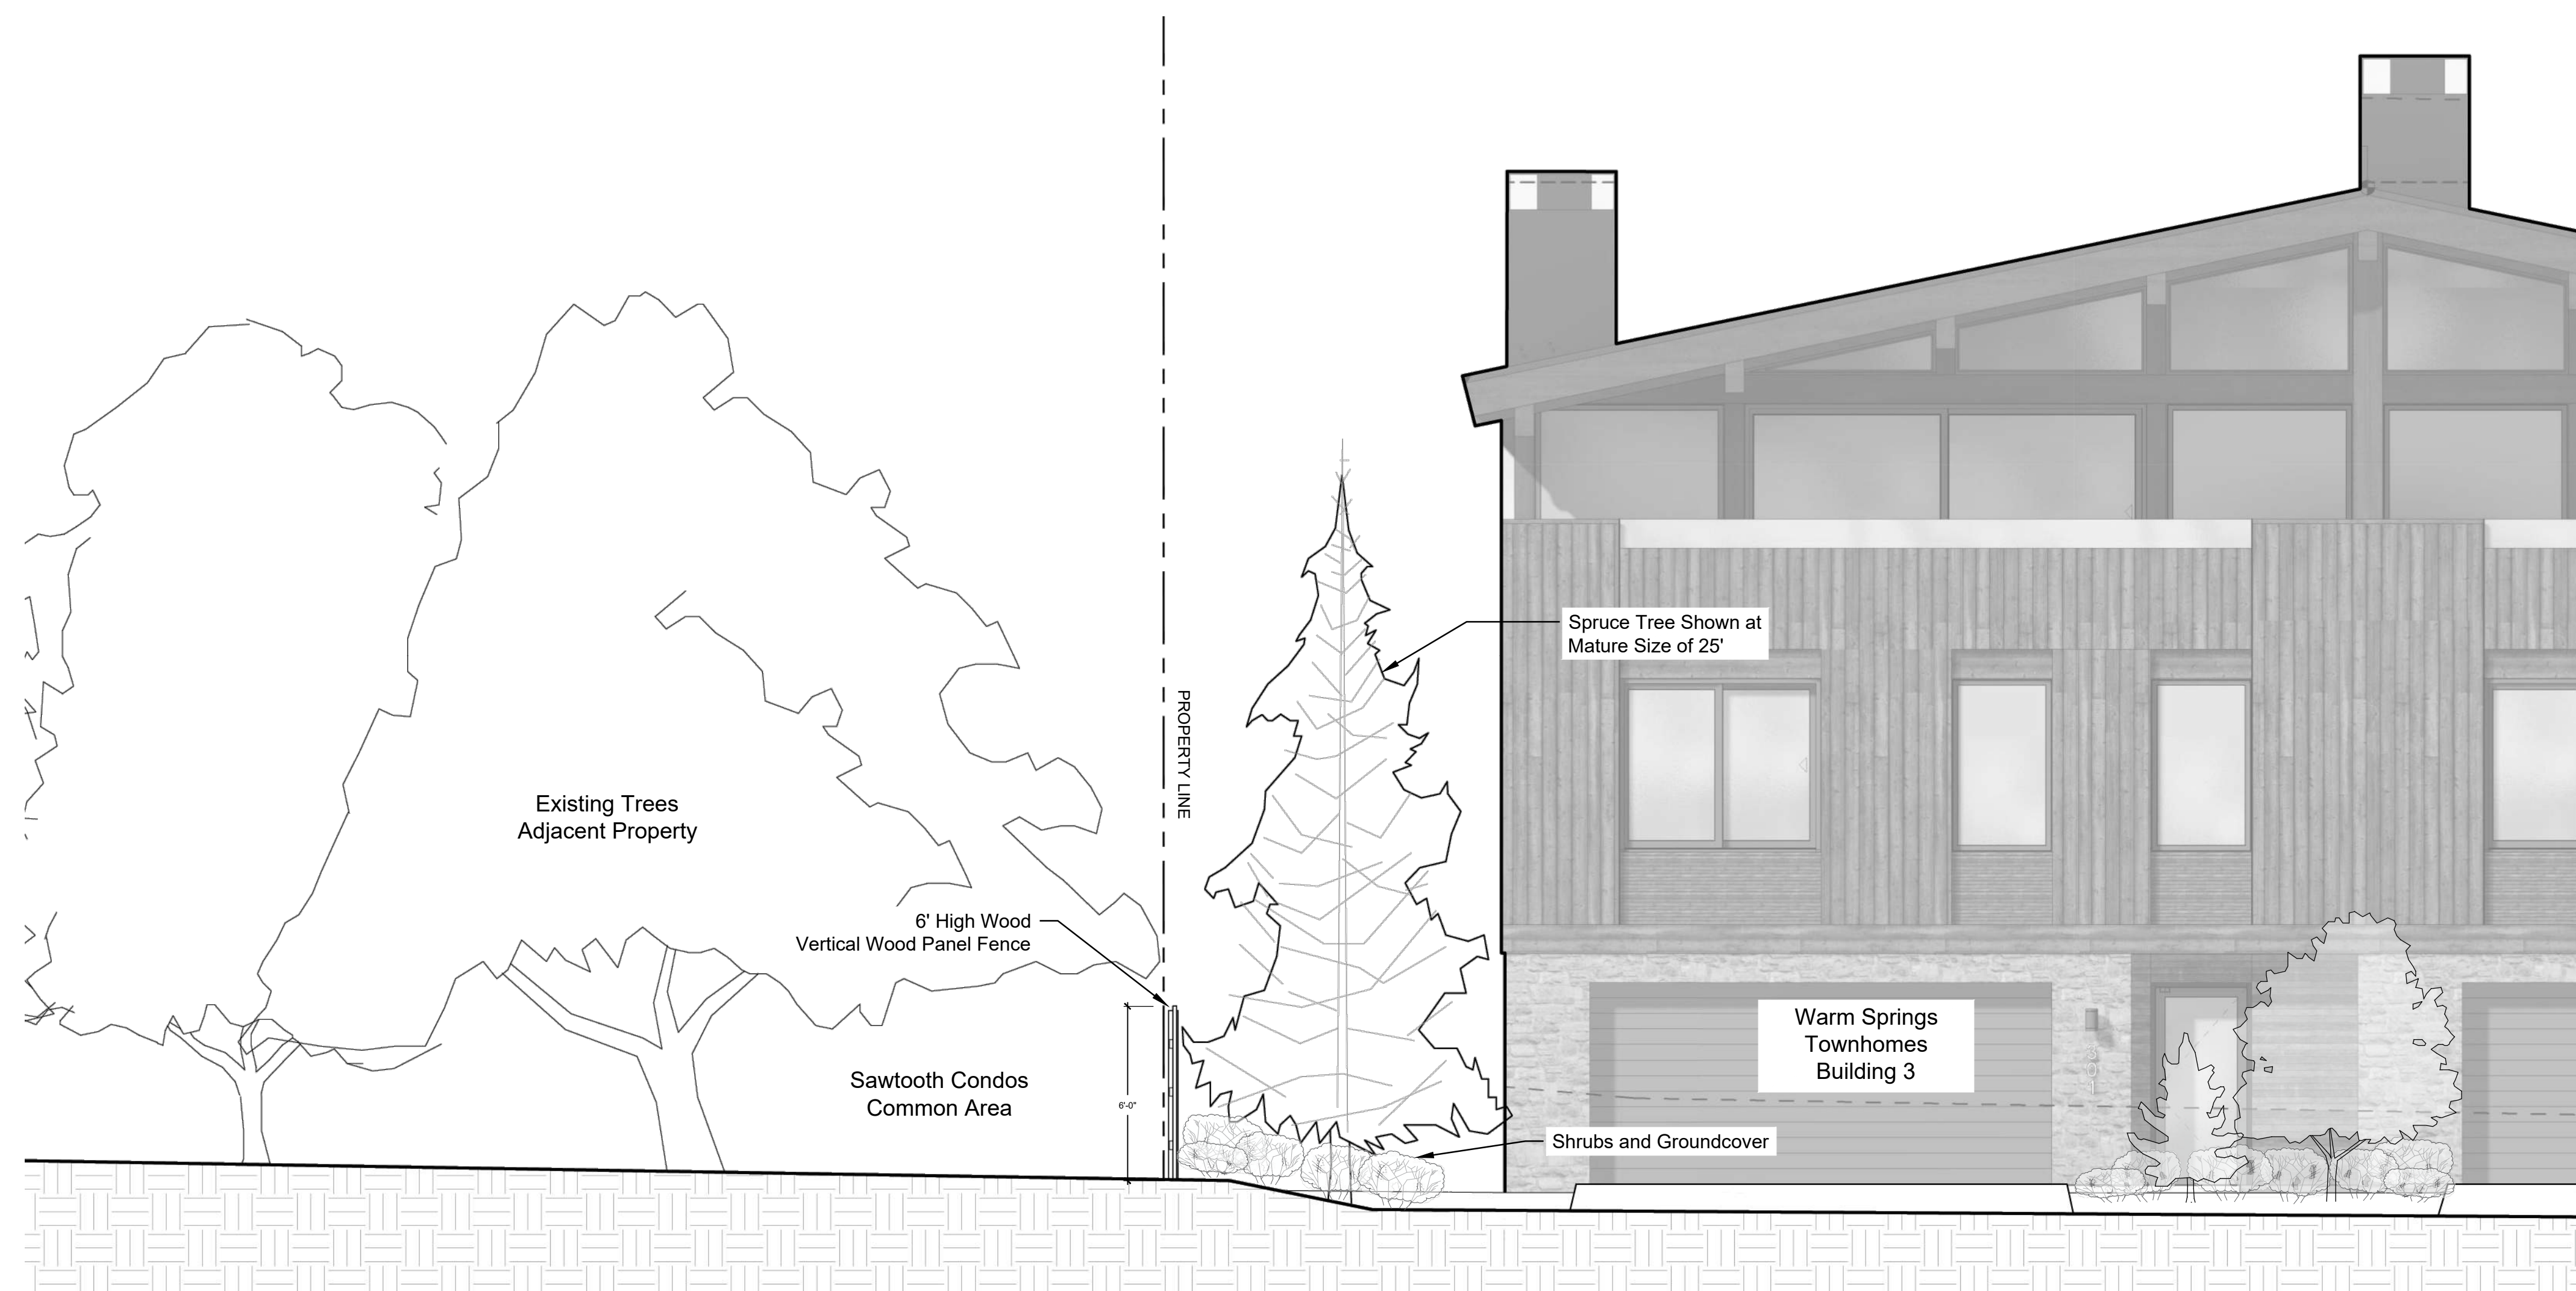

3 Elevation: Adjacent Common Area & Building 3 Scale: 1/4" = 1'-0"

Warm
Springs

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Ketchum, ID 83740


108 & 110 Richie Drive
Lots 3 & 4
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Ketchum, Idaho

Job No: 23.31

Scale:




Issue/Revisions:	Date:
Concept Update	07/10/24
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DR Resubmission	07/17/25
DR Resubmission	08/04/25
DR Resubmission	10/03/25

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Sheet Title:
Site
Sections

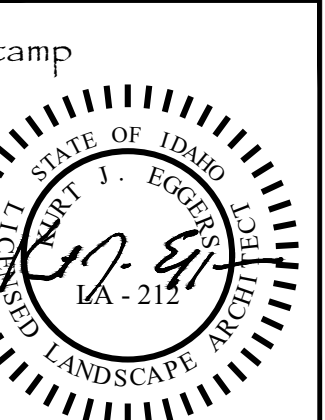Sheet No:
L5.0



HOT WATER BOILER																					
MARK	SERVES	BASIS OF DESIGN	WATER			HEATER		DECIBEL (dB)	TURN DOWN	THERMAL EFFICIENCY (%)	OPERATING WEIGHT (LEBS)	REMARKS									
			GPM	EWT (°F)	LWT (°F)	INPUT (MBH)	OUTPUT (MBH)					1	2	3	4	5	6	7	8	9	10
B-1	BUILDING 6 KAMP	F01751	145.0	40	121	1,751.0	1,684.0	66	25:1	96.2	250	X	X	X	X	X	X	X	X		

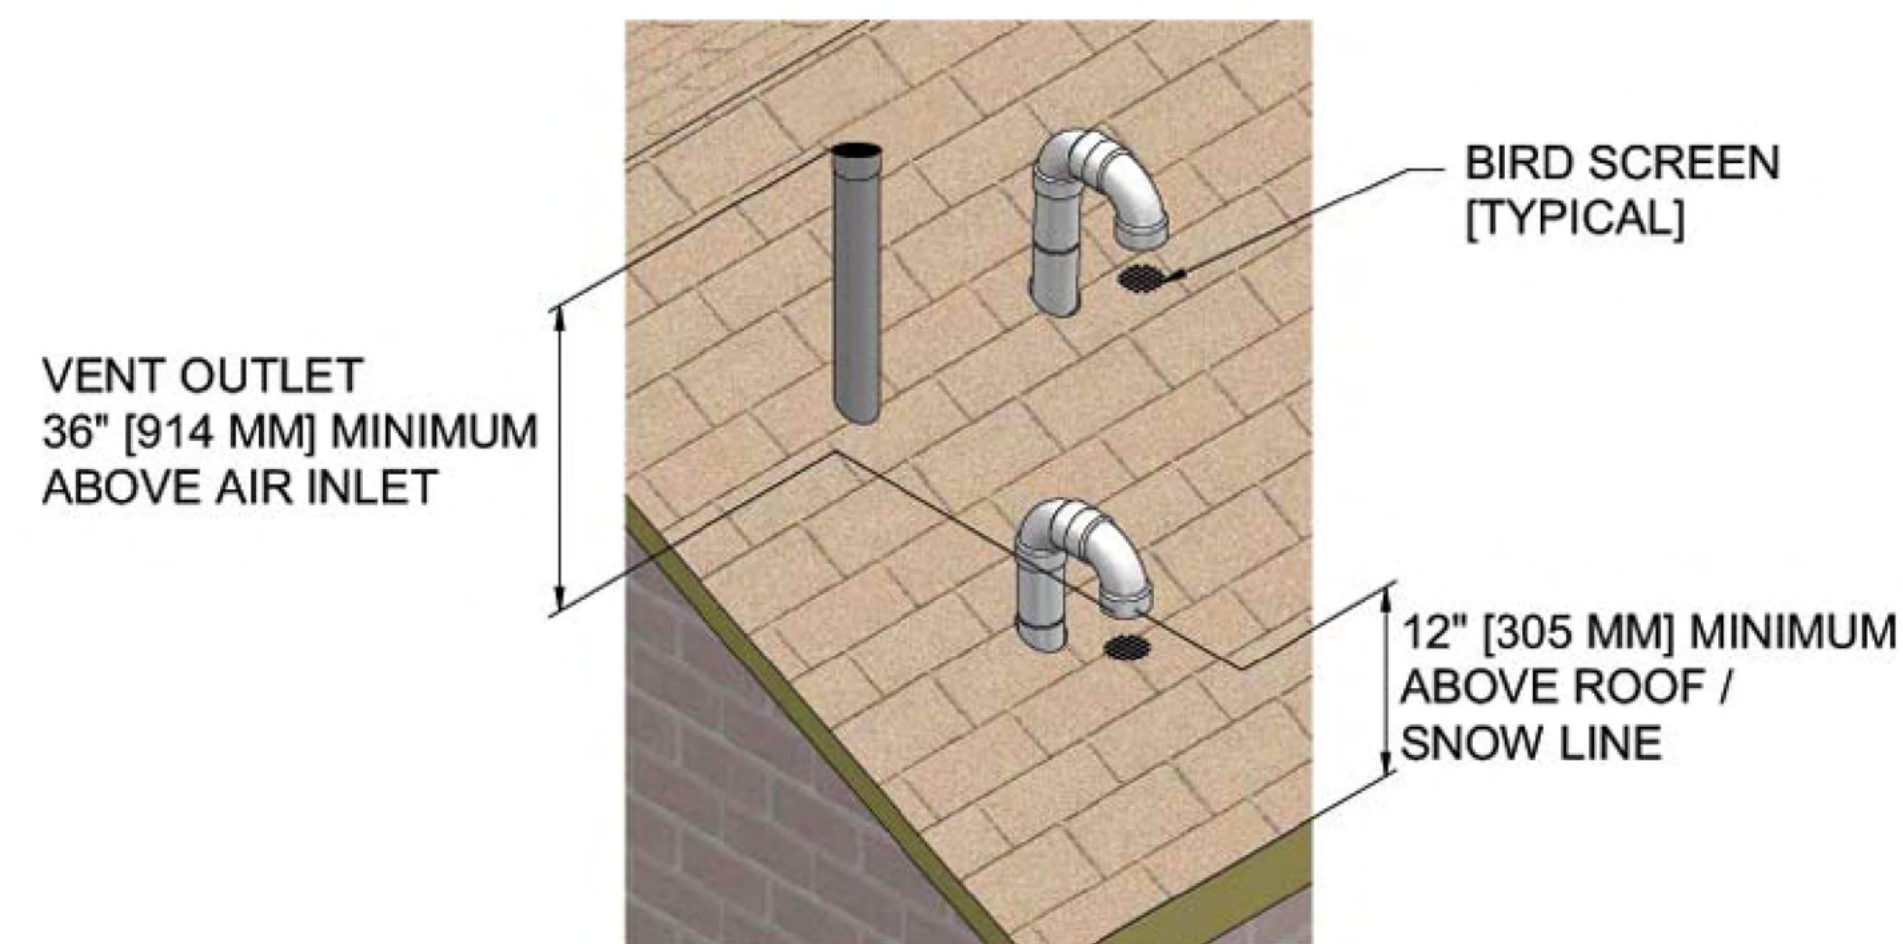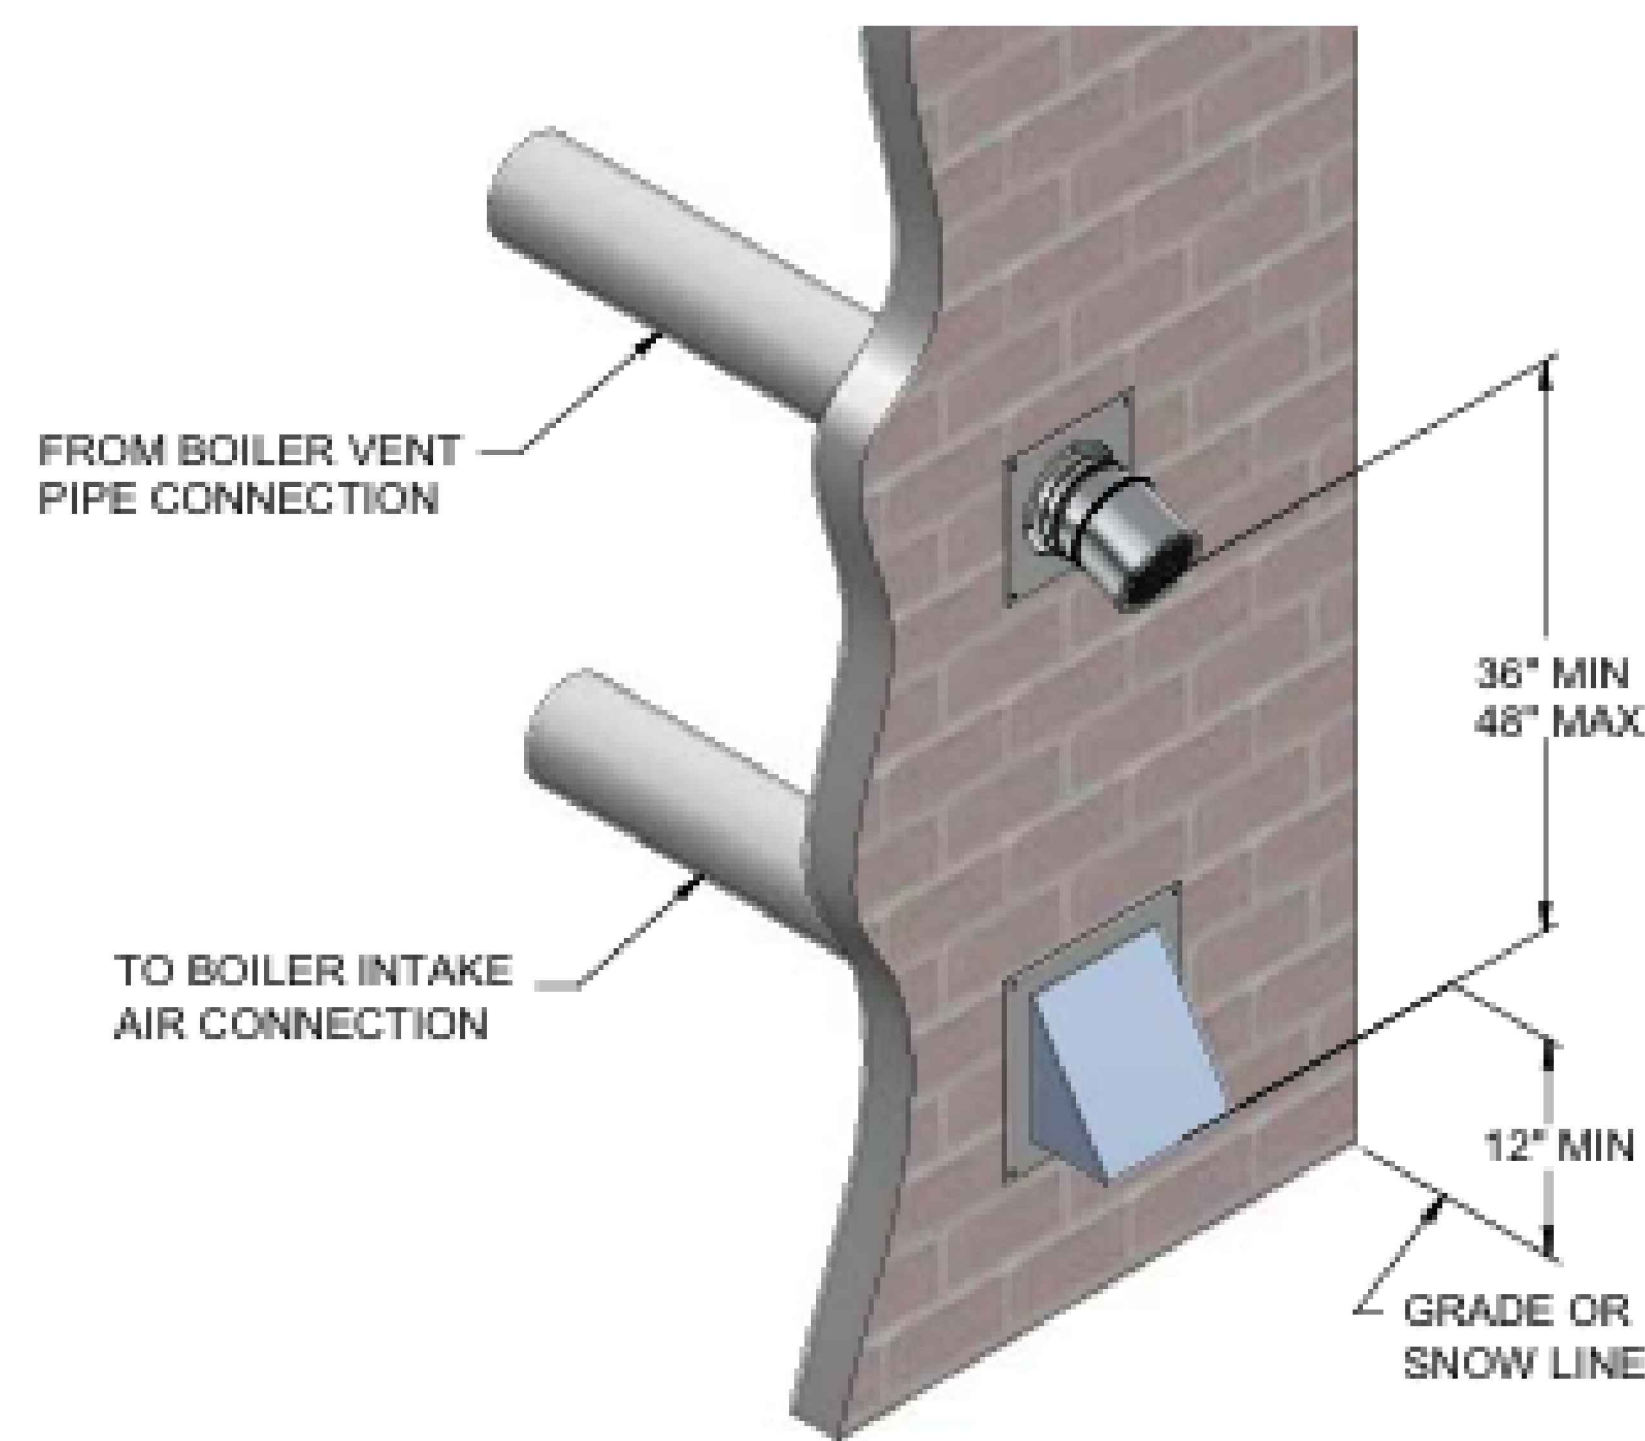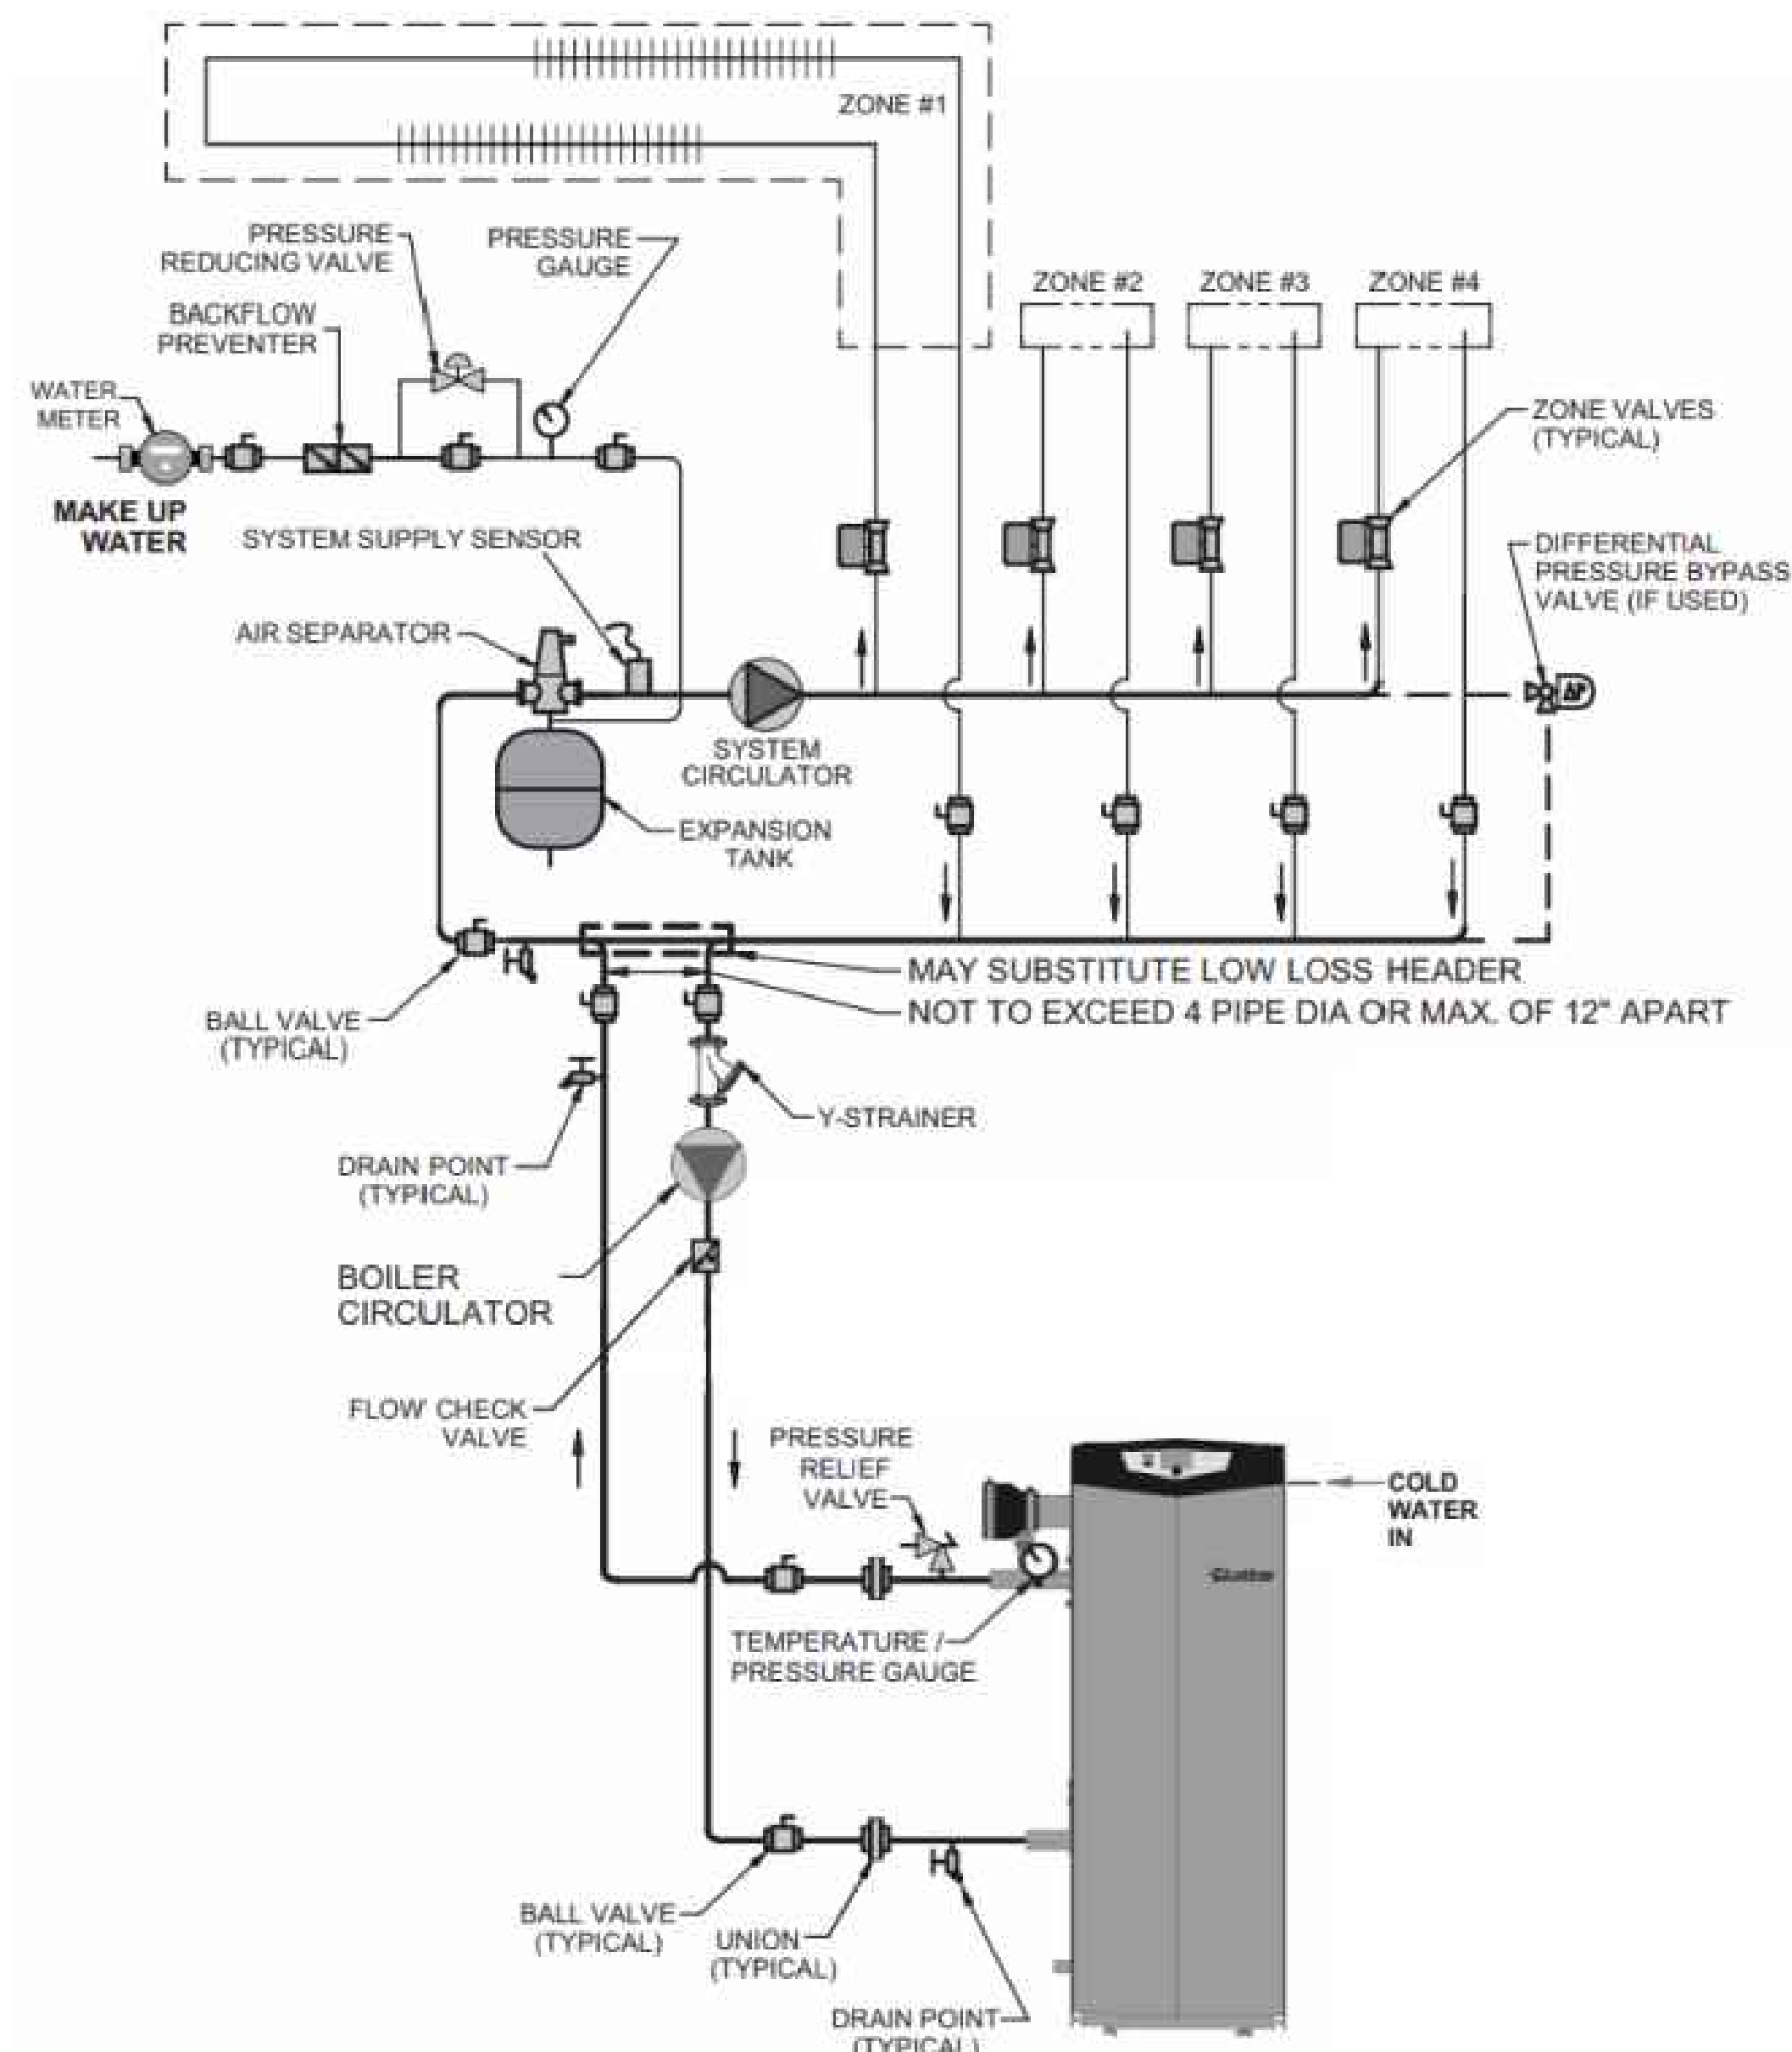NOTES:

A. SELECTIONS ARE BASED ON LOCHINVAR, EQUAL PRODUCTS BY AERCO, PATTERSON KELLEY, HYDROTHERM.

B. SEE ELECTRICAL DRAWINGS FOR ELECTRICAL POWER INFORMATION.

C. THERMAL EFFICIENCY IS BASED ON AHRI EFFICIENCY 80% TO 100%.

REMARKS:

1. SINGLE POINT POWER CONNECTION.

2. DISCONNECT SWITCH PROVIDED BY THE ELECTRICAL SUBCONTRACTOR.

3. FACTORY PROVIDED MULTI-BOILER CONTROL SYSTEM.

4. OUTDOOR AIR RESET.

5. BAS INTERFACE (BAGNET).

6. DIRECT VENT SEALED COMBUSTION CONFIGURATION.

7. CONCENTRIC VENT KIT.

8. HIGH & LOW GAS PRESSURE SWITCHES WITH MANUAL RESET.

9. 50%-50% PROPYLENE GLYCOL AND WATER SOLUTION, PROVIDE ADVANTAGE CONTROLS 55 GALLON E-GLYCOL FEEDER. INSTALL PER MANUFACTURERS INSTRUCTIONS, PROVIDE WITH BAS INTERFACE (BAGNET).

PUMP SCHEDULE																			
MARK	SERVICE / DUTY	TYPE	GPM	HEAD (FT)	IMPELLER DIAMETER (IN)	MAX NPSHR (FtSH)	MOTOR (HP)	PUMP SPEED (RPM)	PUMP EFF (%)	OPERATING W.G.H.T (LBS)	BASIS OF DESIGN MODEL	REMARKS							
												1	2	3	4	5	6	7	8
P-1A	B-4- PRIMARY LOOP	ECM HIGH-EFFICIENCY	145	11,000	10"	4.35	2.1	4760	36	52	TACO VR25M5F	X	X	X	X	X	X		
P-1B	B-4- SECONDARY LOOP	ECM HIGH-EFFICIENCY	145	13,900	10"	4.4	5	4400	63	72	TACO SKV3009D	X	X	X	X	X	X		
NOTES (APPLY TO ALL):																			
A. SEE ELECTRICAL DRAWINGS FOR ELECTRICAL POWER INFORMATION																			
B. BASIS OF DESIGN: TACO AND GRUNDOS																			
ACCEPTABLE ALTERNATES: DELL 4 GOSSETT, ARMSTRONG, AURORA.																			
REMARKS:																			
1. FLEXIBLE COUPLING																			
2. DISCONNECT SWITCH BY THE ELECTRICAL SUBCONTRACTOR.																			
3. SUCTION DIFFUSER WITH INTEGRAL STRAINER.																			
4. INVERTER DUTY MOTOR WITH VFD. VFD PROVIDED BY THE ELECTRICAL SUBCONTRACTOR.																			
5. DDC CONTROL INTERLOCK WITH BAS.																			
6. FIELD INSTALLED DIFFERENTIAL PRESSURE SENSOR AT MOST CRITICAL POINT.																			
7. PUMP 4 INERTIA BASE MOUNTED ON CONCRETE HOUSEKEEPING PAD PROVIDED BY OTHERS.																			
8. PUMP 5 IS PROVIDED WITH BOILER AID/ IS SHOWN FOR REFERENCE ONLY																			

MANIFOLD SCHEDULE										
MARK	BOILER	CIRCUITS	GPM	REQUIRED TEMP (°F)	SUPPLIED TEMP (°F)	MANIFOLD TYPE (°F)	MANIFOLD HEAD LOSS (FT)	CIRCUIT HEAD LOSS (FT)	S/R HEAD LOSS (FT)	TOTAL HEAD LOSS (FT)
MANIFOLD 1	B-1	6	14.17	115	121	INST-PAAN22-105 PAAN22-105S, VAN-PA-1 W-PA-205	5.2	10.2	0	15
MANIFOLD 2	B-1	5	10.98	116	121	INST-PAAN22-105 PAAN22-105S, VAN-PA-1 W-PA-205	3.9	10.1	0	14
MANIFOLD 3	B-1	12	31.36	115	121	INST-PAAN22-105 PAAN22-105S, VAN-PA-1 W-PA-205	13.9	13.6	0	28
MANIFOLD 4	B-1	4	10.48	116	121	INST-PAAN22-105 PAAN22-105S, VAN-PA-1 W-PA-205	5.1	13.0	0	18
MANIFOLD 5	B-1	11	26.63	117	121	INST-PAAN22-105 PAAN22-105S, VAN-PA-1 W-PA-205	10.7	14.2	0	25
MANIFOLD 6	B-1	7	17.80	116	121	INST-PAAN22-105 PAAN22-105S, VAN-PA-1 W-PA-205	6.7	14.1	0	21
MANIFOLD 7	B-1	1	1.90	112	121	INST-PAAN22-105 PAAN22-105S, VAN-PA-1 W-PA-205	2.7	7.5	0	10
MANIFOLD 8	B-1	2	3.01	123	121	INST-PAAN22-105 PAAN22-105S, VAN-PA-1 W-PA-205	1.9	3.9	0	6
MANIFOLD 9	B-1	8	18.81	115	121	INST-PAAN22-105 PAAN22-105S, VAN-PA-1 W-PA-205	6.0	13.0	0	19
MANIFOLD 10	B-1	4	6.59	117	121	INST-PAAN22-105 PAAN22-105S, VAN-PA-1 W-PA-205	2.0	4.3	0	6
MANIFOLD 11	B-1	2	2.56	117	121	INST-PAAN22-105 PAAN22-105S, VAN-PA-1 W-PA-205	2.7	9.5	0	12
NOTES (APPLY TO ALL): A. REFER TO SNOW MELT SYSTEM LOOP DRAWINGS FOR MORE INFORMATION.										

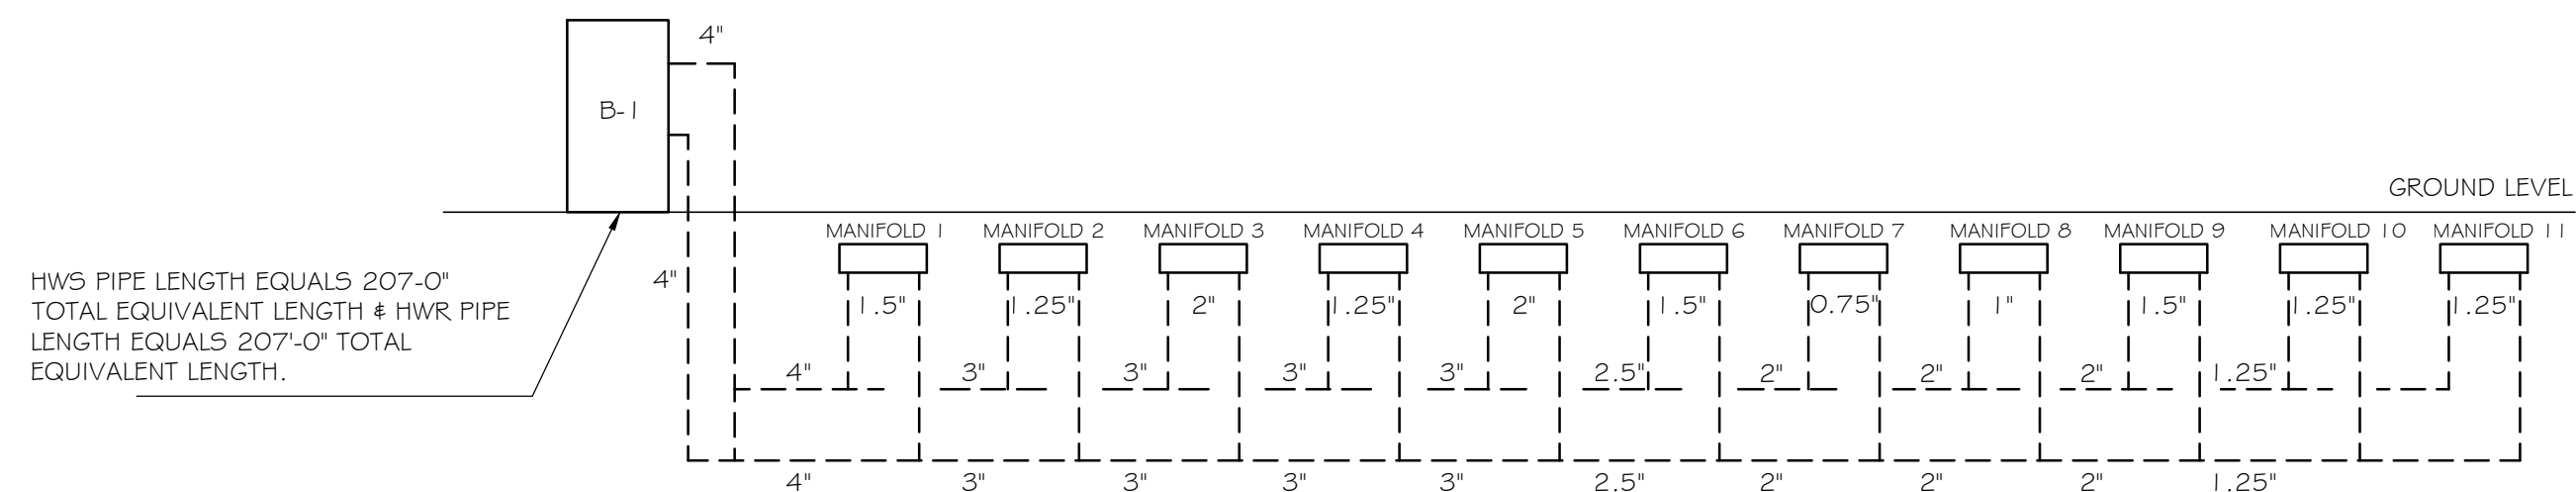
<div>WARM SPRINGS TOWNHOMES KETCHUM, IDAHO</div>		
OWNER: <div>108-110 RITCHIE LLC P.O. BOX 14001-174 KETCHUM, ID 83340 TEL: 603.801.0419</div>		
BUILDING ARCHITECT: <div>RO J ROCKETT DESIGN 1031 W. MANCHESTER BLVD. UNIT 6 INGLEWOOD, CA 90301 TEL: 213.784.0014</div>		
STRUCTURAL ENGINEER: <div>ZFA STRUCTURAL ENGINEERS 601 MONTGOMERY STREET SUITE 1450 SAN FRANCISCO, CA 94111 TEL: 415.243.4091</div>		
MECHANICAL, ELECTRICAL, PLUMBING ENGINEER: <div>PROFICIENT ENGINEERING 4704 HARLAN STREET SUITE 620 DENVER, CO 80212 TEL: 720.779.3556</div>		
CIVIL ENGINEER: <div>GALENA BENCHMARK ASSOCIATES 100 BELL DRIVE SUITE C KETCHUM, ID 83340 TEL: 208.726.9512</div>		
LANDSCAPE ARCHITECT: <div>EGGERS ASSOCIATES 560 NORTH 2ND AVENUE KETCHUM, ID 83340 TEL: 208.725.0988</div>		
GEOTECHNICAL ENGINEER:		
LIGHTING DESIGNER:		
AUDIO / VISUAL / CONTROLS:		
GENERAL CONTRACTOR:		
ISSUE	DESCRIPTION	DATE
1	DESIGN REVIEW RESUBMISSION	7/10/2024 11/5/2024
2	DESIGN REVIEW RESUBMISSION	3/14/2025
3	DESIGN REVIEW RESUBMISSION	6/25/2025
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PROJECT: WARM SPRINGS TOWNHOMES		
108 RITCHIE DRIVE KETCHUM, ID 83340		
DRAWING TITLE: SCHEDULES & DETAILS		
SEAL: <div></div>		
PROJECT NUMBER 2000.01		
DRAWING NUMBER: M0.2		
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NO SCALE

Diagram illustrating a single-phase power system configuration:

- A transformer is connected to a 1750V bus.
- The 1750V bus is connected to a circuit breaker labeled $I_Z' (1750)$.
- The circuit breaker is connected to another 1750V bus.
- This second 1750V bus is connected to a boiler labeled BOILER-1 (1750 MBTU).
- The system is grounded at the transformer and the boiler.

NO SCALE



A. REFER TO SNOW MELT SYSTEM LOOP DRAWINGS FOR MORE INFORMATION ON SNOW MELT PIPING AND MANIFOLDS.

B. REFER TO MANIFOLD PIPING DIAGRAM FOR BOILER 1 ON THIS SHEET FOR MORE INFORMATION ON BOILER SYSTEM PIPE SIZES.

- ① NATURAL GAS DN TO BOILER WITH SHUTOFF VALVE, DIRT LEG + UNION FILL COORDINATE FINAL CONNECTION.
- ② 1" DOMESTIC WATER SERVICE BKG, SEE CIVIL DWG FOR CONT
- ③ BOILER FLUE VENT TO ROOF TERMINATION PER MANUFACTURERS INSTALLATION INSTRUCTIONS. REFER TO MANUFACTURERS REQUIRED CLEARANCES LISTED ON THIS SHEET.
- ④ ROUTE 4" HWS TO MANIFOLDS AND CONTINUE 4" HWR FROM MANIFOLD BACK TO BOILER. REFER TO SNOW MELT SYSTEM LOOP DRAWING ON SHEET M3.0 FOR MANIFOLD LOCATIONS AND MANIFOLD PIPING DIAGRAM.
- ⑤ NATURAL GAS DN TO NEW METRE/RFV INSTALLATION. COORDINATE WITH UTILITY PROVIDER. SEE NATURAL GAS RISER DIAGRAM FOR ADDITIONAL INFORMATION AND SIZING CRITERIA.
- ⑥ BOILER COMBUSTION PIPE TO EXTERIOR WALL ABOVE DOOR TERMINATION PER MANUFACTURERS INSTALLATION INSTRUCTIONS. REFER TO MANUFACTURERS REQUIRED CLEARANCES LISTED ON THIS SHEET.

- THE TOTAL LENGTH OF PIPING FOR VENT OR AIR MUST NOT EXCEED THE LIMITS GIVEN IN THE GENERAL VENTING SECTION ON PAGE 17 OF THE MANUAL.
- THE VENT MUST TERMINATE AT LEAST 3 FEET ABOVE THE HIGHEST PLACE IN WHICH THE VENT PENETRATES THE ROOF AND AT LEAST 2 FEET ABOVE ANY PART OF A BUILDING WITHIN 10 HORIZONTAL FEET.
- THE AIR PIPING MUST TERMINATE IN A DOWN—TURNED 180° RETURN PIPE NO FURTHER THAN 2 FEET (.6 M) FROM THE CENTER OF THE VENT PIPE. THIS PLACEMENT AVOIDS RECIRCULATION OF FLUE PRODUCTS INTO THE COMBUSTION AIR STREAM.
- THE VENT PIPING MUST TERMINATE IN AN UP—TURNED COUPLING AS SHOWN IN FIG. 3—1. THE TOP OF THE COUPLING OR THE RAIN CAP MUST BE AT LEAST 36" (914 MM) ABOVE THE AIR INTAKE. THE AIR INLET PIPE AND VENT PIPE CAN BE LOCATED IN ANY DESIRED POSITION ON THE ROOF, BUT MUST ALWAYS BE NO FURTHER THAN 2 FEET (.6 M) APART AND WITH THE VENT TERMINATION AT LEAST 36" (914 MM) ABOVE THE AIR INTAKE.
- LOCATE TERMINATIONS SO THEY ARE NOT LIKELY TO BE DAMAGED BY FOREIGN OBJECTS, SUCH AS STONES OR BALLS, OR SUBJECT TO BUILDUP OF LEAVES OR SEDIMENT.
- DO NOT EXTEND EXPOSED VENT PIPE OUTSIDE OF BUILDING MORE THAN SHOWN IN THE MANUAL OR DETAIL ON MO.2. CONDENSATE COULD FREEZE AND BLOCK VENT PIPE.

ISSUE	DESCRIPTION	DATE
1	DESIGN REVIEW SUBMISSION	7/10/2024
	DESIGN REVIEW RESUBMISSION	11/5/2024
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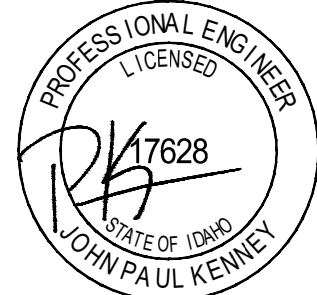
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PROJECT:
WARM SPRINGS TOWNHOMES

108 RITCHIE DRIVE
KETCHUM, ID 83340

DRAWING TITLE:
SNOW MELT DESIGN

SEAL: _____



PROJECT NUMBER
2000.01

DRAWING NUMBER:

M1.0

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4704 N. Harlan St Suite 620
Denver, Colorado 80212
720.779.3556
PROJECT # 324050

OWNER: 108-110 RITCHIE LLC
P.O. BOX 14001-174
KETCHUM, ID 83340
TEL: 603.801.0419

BUILDING ARCHITECT: RO | ROCKETT DESIGN
1031 W. MANCHESTER BLVD. UNIT 6
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SAN FRANCISCO, CA 94111
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LANDSCAPE ARCHITECT:

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560 NORTH 2ND AVENUE
KETCHUM, ID 83340
TEL: 208.725.0988

GEOTECHNICAL ENGINEER:

LIGHTING DESIGNER:

AUDIO / VISUAL / CONTROLS:

GENERAL CONTRACTOR:

ISSUE	DESCRIPTION	DATE
1	DESIGN REVIEW SUBMISSION	7/10/2024
	DESIGN REVIEW RESUBMISSION	11/5/2024
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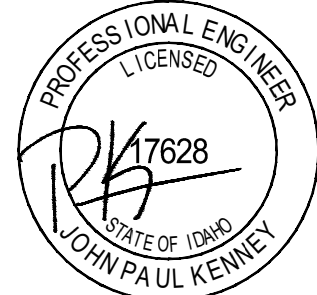
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PROJECT:
WARM SPRINGS TOWNHOMES

108 RITCHIE DRIVE
KETCHUM, ID 83340

DRAWING TITLE:
SNOW MELT DESIGN

SEAL: _____



PROJECT NUMBER
2000.01

DRAWING NUMBER:

M1.0

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**PROFICIENT
ENGINEERING**
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DENVER, COLORADO 80212
720.779.3556
PROJECT # 324050

**WARM SPRINGS
TOWNHOMES
KETCHUM, IDAHO**

OWNER:

108-110 RITCHIE LLC
P.O. BOX 14001-174
KETCHUM, ID 83340
TEL: 603.801.0419

BUILDING ARCHITECT:

RO | ROCKETT DESIGN
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TEL: 208.728.9512

LANDSCAPE ARCHITECT:

EGGERS ASSOCIATES
560 NORTH 2ND AVENUE
KETCHUM, ID 83340
TEL: 208.725.0988

GEOTECHNICAL ENGINEER:

LIGHTING DESIGNER:

AUDIO / VISUAL / CONTROLS:

GENERAL CONTRACTOR:

ISSUE	DESCRIPTION	DATE
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PROJECT:


WARM SPRINGS TOWNHOMES

108 RITCHIE DRIVE
KETCHUM, ID 83340

DRAWING TITLE:

SNOW MELT SYSTEM LOOP

SEAL:

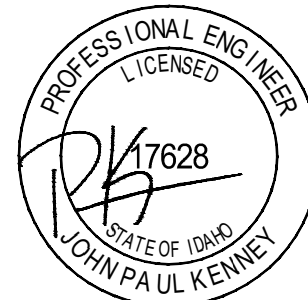

PROJECT NUMBER:

2000.01

DRAWING NUMBER:

M3.0

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PROJECT:

**Warm Springs Snowmelt
REV10 Quote#092925DPMEQ**

CUSTOMER:

PROJECT NO.:

092925DPMEQ

SCALE:

3/16"=1'

DRAWING NAME:

Snow Melt

DRAWN BY:

Dylan Meyer

Created Using LoopCAD 2025 25.0.0396 (9/29/2025)

DATE:

9/29/2025







REVISIONS


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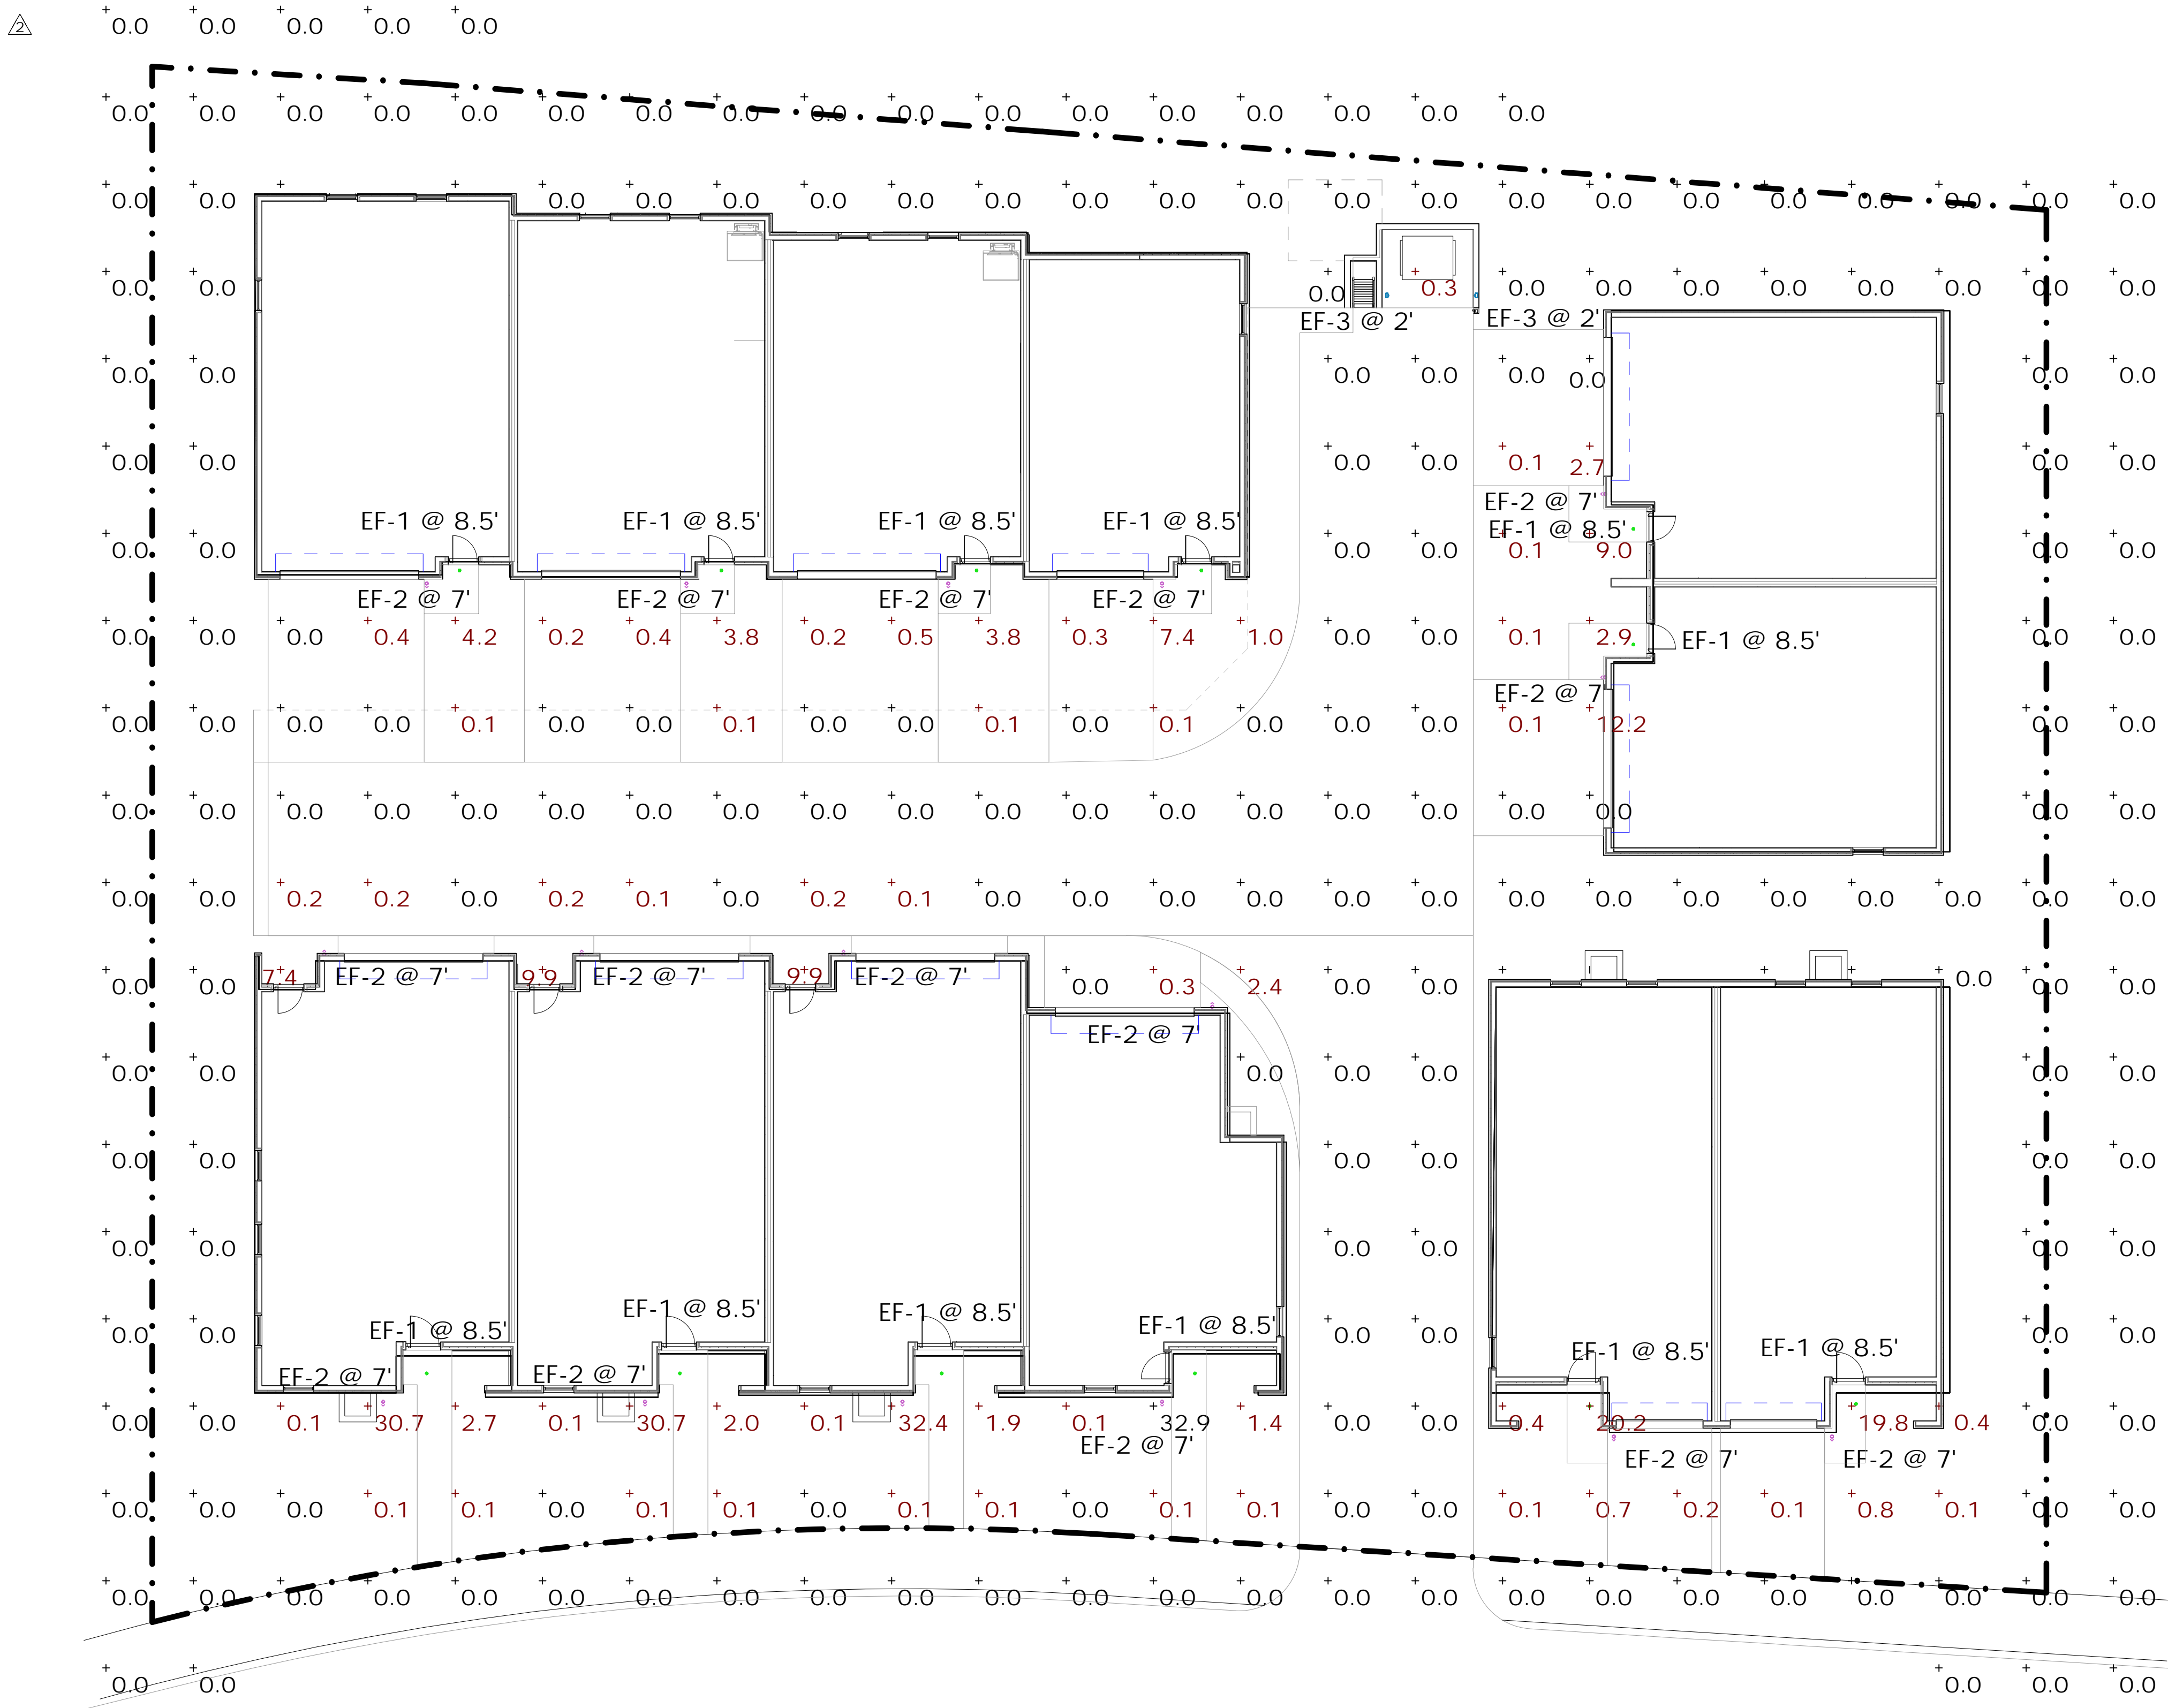
PAGE NO.

1



Schedule										
Symbol	Label	Quantity	Manufacturer	Catalog Number	Description	Filename	Light Loss Factor	Total Lamp Lumens	Wattage	Plot
	EF-1	12	WAC LIGHTING	R3CRDL-BK(N927)	Recessed-mounted Luminaires	R3CRDT-WT(N927).IES	1	842	13.5	 Max: 1463cd
	EF-2	16	WAC LIGHTING	DS-WS0622-F927A-WT	Surface-mounted Luminaires	DS-WS0622-F927A-WT.IES	1	2034	21.8545	 Max: 2567cd
	EF-3	2	WAC Lighting	WL-LED100-27-BK	LED Step light	WL-LED100-C-BK.IES	1	31	4	 Max: 43cd

Statistics						
Description	Symbol	Avg	Max	Min	Max/Min	Avg/Min
Calc Zone #1		0.9 fc	32.9 fc	0.0 fc	N/A	N/A



WARM SPRINGS
TOWNHOMES
108 RITCHIE DRIVE
KETCHUM, ID 83340


REVISION		
No.	Description	Date
1	Design Review	11/5/2024
2	Resubmission	3/14/2025
3	Design Review	6/25/2025

PROJECT NUMBER 324050
ISSUE DATE 7/10/2024

ISSUE
DESIGN REVIEW
APPLICATION

SHEET TITLE
SITE PHOTOMETRIC
SHEET NO.

E0.10

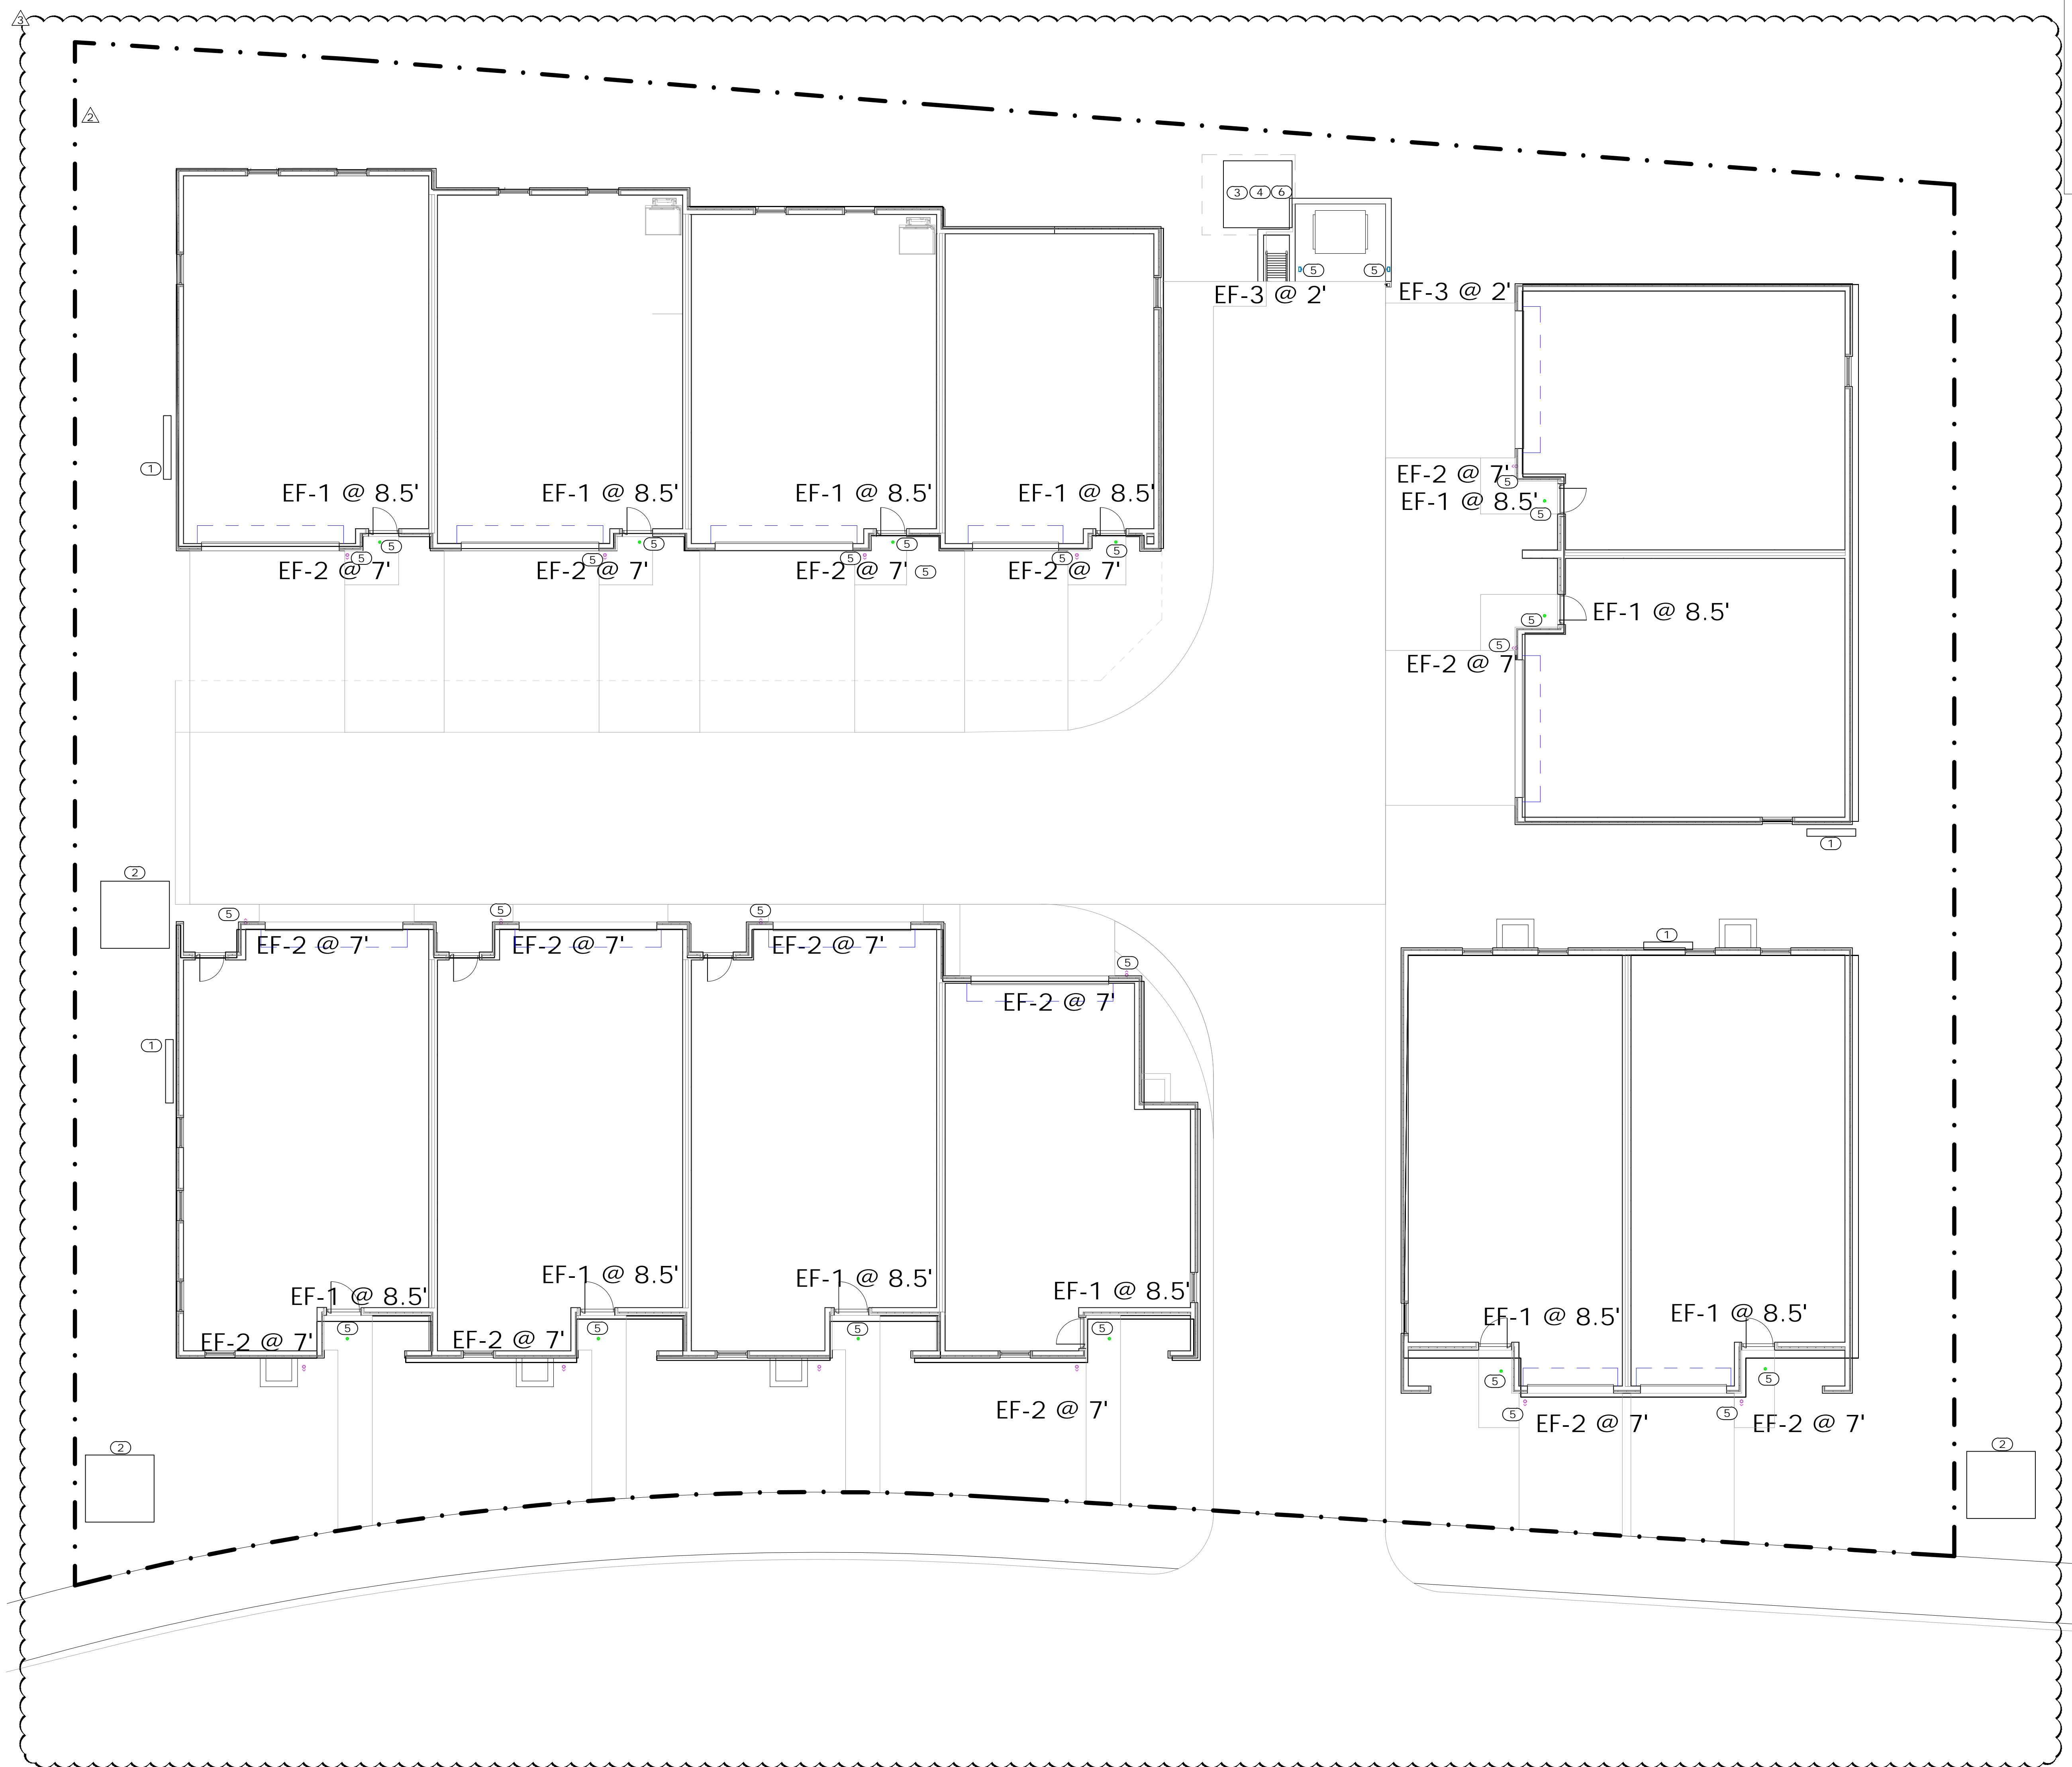

- GENERAL NOTES
- ALL SITE AND EXTERIOR BUILDING LIGHTING FIXTURES SHALL CONFORM TO DARK SKY REQUIREMENTS AS NECESSARY TO MEET LOCAL JURISDICTIONAL CODES.
- KEYNOTES
- 1

PROPOSED LOCATION FOR MAIN SERVICE DISCONNECT AND UNIT METERING STACK. REFERENCE ARCHITECTURAL PLANS FOR EXACT LOCATION.
- 2

PROPOSED UTILITY TRANSFORMER LOCATION. COORDINATE UTILITY TRANSFORMER LOCATION WITH UTILITY PROVIDER AND BUILDING SERVICE DISCONNECT LOCATION PRIOR TO ROUGH-IN.
- 3


PROVIDE 208, 1PH, 3W, 20A BRANCH CIRCUIT AND 30A/2P/NEMA 3R DISCONNECT FOR PRIMARY LOOP PUMP POWER. CIRCUIT FROM NEAREST HOUSE PANEL. COORDINATE CONNECTION LOCATION WITH PUMP VENDOR PRIOR TO ROUGH-IN.
- 4


PROVIDE 208, 1PH, 3W, 20A BRANCH CIRCUIT AND 30A/2P/NEMA 3R DISCONNECT FOR SECONDARY LOOP PUMP POWER. CIRCUIT FROM NEAREST HOUSE PANEL. COORDINATE CONNECTION LOCATION WITH PUMP VENDOR PRIOR TO ROUGH-IN.
- 5

PROVIDE 120V, 20A BRANCH CIRCUIT VIA PHOTOCELL FOR LUMINAIRE CONTROL TO EXTERIOR LUMINAIRE. CIRCUIT FROM TENANT PANEL.
- 6

PROVIDE 120V, 20A BRANCH CIRCUIT FOR BOILER POWER. CIRCUIT FROM NEAREST HOUSE PANEL.

TOWN STAMP

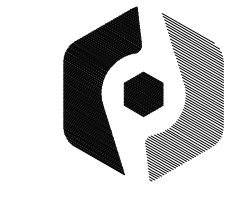**PROFICIENT**
ENGINEERING
4704 N. Harlem St Suite 620
Denver, Colorado 80212
720.779.3556
PROJECT # 324050

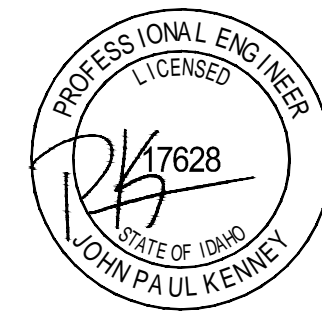
DISCIPLINE STAMP

WARM SPRINGS
TOWNHOMES
108 RITCHIE DRIVE
KETCHUM, ID 83340

REVISION		
No.	Description	Date
1	Design Review	11/5/2024
2	Design Review Resubmission	3/14/2025
3	Design Review Resubmission	6/25/2025

PROJECT NUMBER 324050
ISSUE DATE 7/10/2024
ISSUE

DESIGN REVIEW APPLICATION

SHEET TITLE

SITE PLAN

SHEET NO.

E0.11

OCULARC 3.5
Adjustable Downlight - R3CRDT, R3CRDL

WAC LIGHTING
Responsible Lighting®



Fixture Type: **EF-1**

Catalog Number: **R3CRDL-BK-N927**

Project:

Location:

- PRODUCT DESCRIPTION**
- Ocularc 3.5 offers performance features in a simple but versatile package for residential and commercial applications alike. One housing can be used for downlight, adjustable, pinhole, wall wash trims.
- FEATURES**
- 3 beam angle options included:
 - Narrow flood beam film pre-installed, interchangeable flood beam film supplied, remove film for spot beam.
 - IC-Rated, Airtight, New Construction
 - Adjustable LED light engine included with housing:
 - Vertical Adjustment 0-30°, Horizontal Adjustment 365°
 - Shallow housing under 4" depth
 - 5 year warranty

- SPECIFICATIONS**
- Construction:** Die-cast aluminum trim and heat sink
- Dimming:** 100% - 1% TRIAC, ELV
- Input Power:** 13.5W, 120V-277V 50/60Hz
- Light Source:** High output COB LED rated life of 50,000 hours.
- Mounting:** Retention clips firmly hold trim to housing. Cutout 4 1/2"
- Finish:** Powder coated white, enamel-coated haze.
- CEILING THICKNESS:** 1"
- Standards:** UL & cUL, Wet location listed, Energy Star® 2.0
- Operating Temperature:** -1°F to 104°F (-20°C to 40°C)

Trims (Order Housing Separately)	Model	Beam	Color Temp	Lumens	CBCP	Finish
	R3CRDT Round Trim Downlight & Adjustable	Spot 16°	927 2700K	853 4989		
			930 3000K	920 5364		
			935 3500K	935 5472		
			940 4000K	980 5760		
	R3CRDL Round Trimless Downlight & Adjustable	Flood 51°	927 2700K	840 1463	HZW Haze/White	
			930 3000K	905 1574	WT White	
			935 3500K	920 1605	BK Black	
			940 4000K	965 1683		
	R3CRDL Round Trimless Downlight & Adjustable	Spot 16°	927 2700K	853 4989		
			930 3000K	920 5364		
			935 3500K	935 5472		
			940 4000K	980 5760		
	R3CRDL Round Trimless Downlight & Adjustable	Flood 51°	927 2700K	840 1463	HZ Haze	
			930 3000K	905 1574	WT White	
			935 3500K	920 1605	BK Black	
			940 4000K	965 1683		

R3CRD - -
Example: **R3CRDT-WT**

wacighting.com
Phone (800) 526.2588
Fax (800) 526.2585

Headquarters/Eastern Distribution Center
44 Harbor Park Drive
Port Washington, NY 11050


Central Distribution Center
1600 Distribution Ct
Lithia Springs, GA 30122

Western Distribution Center
1750 Archibald Avenue
Ontario, CA 91760

WAC Lighting retains the right to modify the design of our products at any time as part of the company's continuous improvement program. FEB. 2021 1

OCULARC 3.5
Adjustable Downlight - R3CRDT, R3CRDL

WAC LIGHTING
Responsible Lighting®

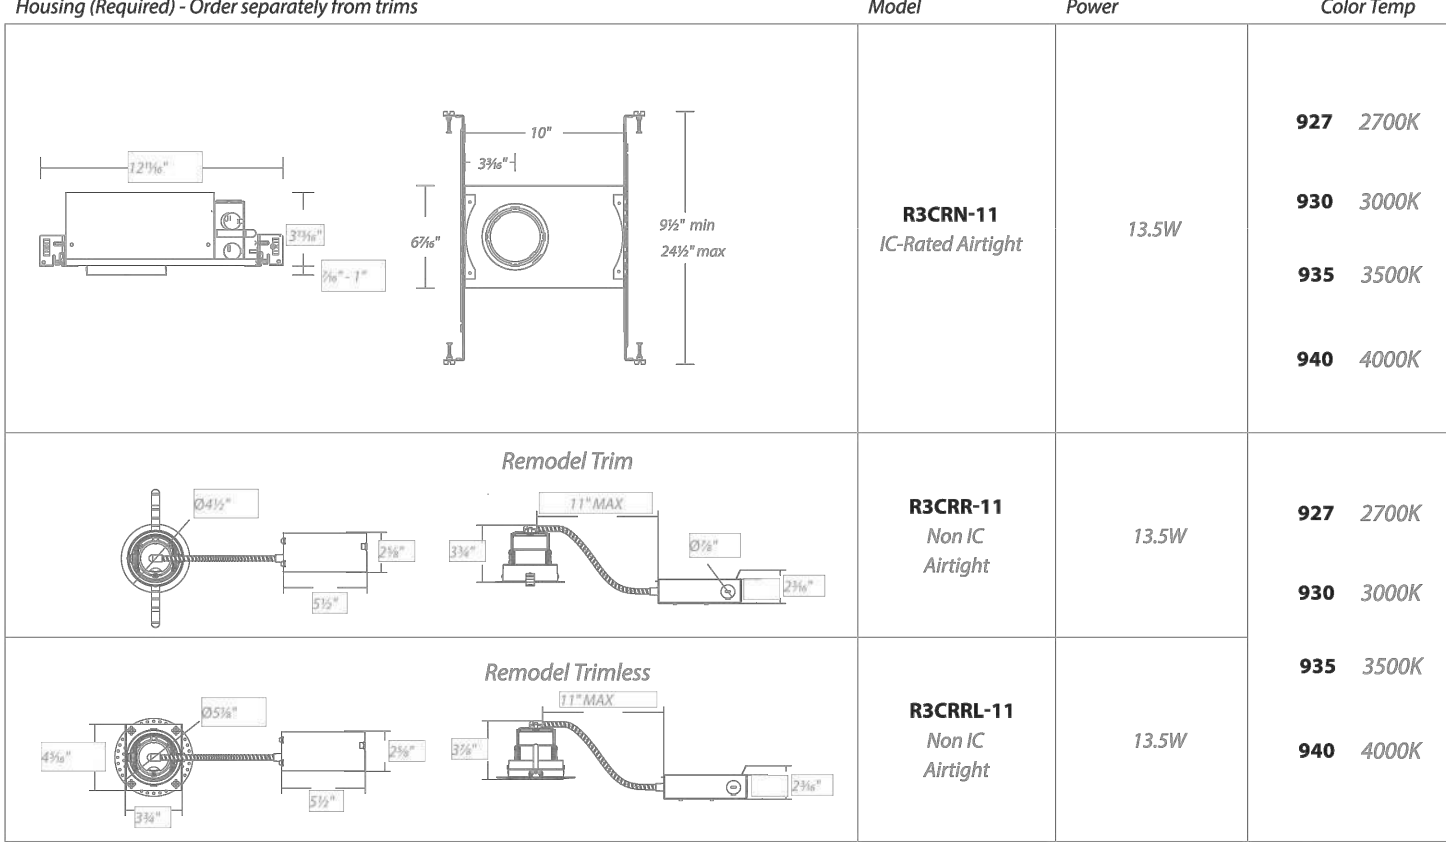

R3CR - 11 -
Example: **R3CRN-11-927**

- FEATURES**
- Adjustable LED light engine included with housing:
 - Vertical Adjustment 0-30°, Horizontal Adjustment 365°
 - Trim or trimless with die-cast speckle frame included.
 - Accepts one optional honeycomb louver or optical lens.

GLARE CONTROL ACCESSORIES sold separately

LENS-16 HCL Honeycomb Louver

LENS ACCESSORIES sold separately

LENS-16

- AMB** Amber
- RED** Red
- FR** Frosted
- SPR** Spread
- BEL** Beam Elongating

wacighting.com
Phone (800) 526.2588
Fax (800) 526.2585

Headquarters/Eastern Distribution Center
44 Harbor Park Drive
Port Washington, NY 11050

Central Distribution Center
1600 Distribution Ct
Lithia Springs, GA 30122

Western Distribution Center
1750 Archibald Avenue
Ontario, CA 91760

WAC Lighting retains the right to modify the design of our products at any time as part of the company's continuous improvement program. FEB. 2021 2

TUBE ARCHITECTURAL DS-WS06
LED Wall Mounts



Fixture Type: **EF-2**

Catalog Number: **DS-WS0622-F927A-WT**

Project:

Location:

- PRODUCT DESCRIPTION**
- The latest energy efficient LED technology in an appealing cylindrical profile delivers accent and wall wash lighting. Comes in various light distribution and beam angle options.
- FEATURES**
- High performance exterior rated LED wall mount light
 - Fixture can install upside down to alter light distribution
 - Solid aluminum construction
 - 5 year warranty
- SPECIFICATIONS**
- Inputs:** Universal voltage 120V - 277VAC, 50/60Hz
- Dimming:** Electronic low voltage (ELV) 100% - 5% 0-10V, 100% - 1%
- Light Source:** High output 3 Step Mac Adam Ellipse COB
- Rated life:** 60,000 hours at L70
- Electrostatically powder coated, white, black, bronze and graphite**
- Finish:** IP65 rated, ETL & cETL wet location listed.
- Standards:** Energy Star® 2.2 rated Title 24 JAS-2016 Compliant
- Operating Temp:** -13°F to 122°F (-23°C to 50°C)

Ordering Number	Diameter	Watt	Beam Angle	Color Temp	Reference Output * Efficacy (lm/w)	Light Distribution	Finish
DS-WS06	6"	35W	Straight up or down	927S	2700K 90 2620		BK Black WT White BZ Bronze GH Graphite
				27S	2700K 85 3385		
				930S	3000K 90 2925		
				35S	3500K 85 3335		
DS-WS0622	6"	22W	Straight up or down	40S	4000K 85 3665		BK Black WT White BZ Bronze GH Graphite
				927S	2700K 90 2825		
				27S	2700K 85 3390		
				930S	3000K 90 2930		
DS-WS06	6"	35W	Straight up or down	35S	3500K 85 3335		BK Black WT White BZ Bronze GH Graphite
				927S	2700K 90 2620		
				27S	2700K 85 3385		
				930S	3000K 90 2925		
DS-WS0622	6"	22W	Straight up or down	40S	4000K 85 3665		BK Black WT White BZ Bronze GH Graphite
				927S	2700K 90 2825		
				27S	2700K 85 3390		
				930S	3000K 90 2930		
DS-WS06	6"	35W	Straight up or down	35S	3500K 85 3335		BK Black WT White BZ Bronze GH Graphite
				927S	2700K 90 2620		
				27S	2700K 85 3385		
				930S	3000K 90 2925		
DS-WS0622	6"	22W	Straight up or down	40S	4000K 85 3665		BK Black WT White BZ Bronze GH Graphite
				927S	2700K 90 2825		
				27S	2700K 85 3390		
				930S	3000K 90 2930		
DS-WS06	6"	35W	Straight up or down	35S	3500K 85 3335		BK Black WT White BZ Bronze GH Graphite
				927S	2700K 90 2620		
				27S	2700K 85 3385		
				930S	3000K 90 2925		
DS-WS0622	6"	22W	Straight up or down	40S	4000K 85 3665		BK Black WT White BZ Bronze GH Graphite
				927S	2700K 90 2825		
				27S	2700K 85 3390		
				930S	3000K 90 2930		

DS-WS06 - -
Example: **DS-WS06-F930A-WT**

wacighting.com
Phone (800) 526.2588
Fax (800) 526.2585

Headquarters/Eastern Distribution Center
44 Harbor Park Drive
Port Washington, NY 11050

Central Distribution Center
1600 Distribution Ct
Lithia Springs, GA 30122

Western Distribution Center
1750 Archibald Avenue
Ontario, CA 91760

WAC Lighting retains the right to modify the design of our products at any time as part of the company's continuous improvement program. SEPT 2019

Model: WL-LED100
LEDme® Step Light

WAC LIGHTING
Responsible Lighting®



Fixture Type: **EF-3**

Catalog Number: **WL-LED100-27-BK**

Project:

Location:

- PRODUCT DESCRIPTION**
- Horizontal rectangle LEDme® Step Light. Designed for safety and style on stairways, patios, decks, balcony areas, walkways and building perimeters.

- Features an architectural design. Energy efficient for long-lasting indoor and outdoor lighting solutions. Creates an attractive, romantic impression at night.

- FEATURES**
- Solid diecast brass, corrosion resistant aluminum alloy, or cast stainless steel construction
 - Direct wiring, no driver needed
 - Low profile, flush to wall aesthetics with no visible hardware
 - 54,000 hour rated life
 - Balanced lighting, free of shadows with minimum glare
 - IP66 rated. Protected against high pressure water jets
 - Up to 200 features can be connected in parallel
 - 5 year WAC Lighting product warranty

- SPECIFICATIONS**
- Construction:** Die-cast aluminum or 316 marine grade cast stainless steel
- Power:** Direct wiring, no remote driver needed. Input voltage: 120V or 277VAC, 50/60Hz
- Light Source:** 2700K or 3000K CCT Samsung HW-AC High Power LED, CRI: 90
- Optional color lenses.** Total power consumption of 3.3W
- Mounting:** Fits into 2" x 4" J-Box with minimum inside dimensions of 3 1/4" x 2 1/4" x 2 1/4"
- Includes bracket for J-Box mount.**
- Dimming:** Dim to 10% with electronic low voltage (ELV) dimmer
- Approved dimmers:** Lutron Nova-T NTELV-300 & NTELV-600, Lutron Vista NTELV-600, Lutron Diva DVELV-300P, Lutron Skylark SELV-300P, Lutron Maestro MAELV-600
- Standards:** IP66, UL & cUL Listed for wet locations, Title 24 JAS-2016 Compliant.

Order Number	Light Color	Finish	277V Model #	Light Color	Finish
WL-LED100	120V	27 Warm 2700K C White 3000K AM Amber 610nm RD Red 640nm BL Blue 450nm	BK Black on Aluminum BN* Brushed Nickel on Aluminum BZ Bronze on Aluminum GH Graphite on Aluminum SS Stainless Steel WT White on Aluminum	27 Warm 2700K C White 3000K AM Amber 610nm RD Red 640nm BL Blue 450nm	BK Black on Aluminum BN* Brushed Nickel on Aluminum BZ Bronze on Aluminum GH Graphite on Aluminum SS Stainless Steel WT White on Aluminum
WL-LED100	120V	27 Warm 2700K C White 3000K AM Amber 610nm	BBR Bronze on brass	27 Warm 2700K C White 3000K AM Amber 610nm	BK Black on Aluminum BN* Brushed Nickel on Aluminum BZ Bronze on Aluminum GH Graphite on Aluminum SS Stainless Steel WT White on Aluminum

*Brushed Nickel Finish is for interior use only

Example: **WL-LED100F-BL-SS**

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PROFICIENT ENGINEERING

4704 N. Harbor St Suite 620

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720.779.3556

PROJECT # 334959

JOHN PAUL KENNEY

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