

KETCHUM FIRE STATION DESIGN REVIEW STAFF REPORT UPDATE KETCHUM PLANNING AND ZONING COMMISSION SPECIAL MEETING OF FEBRUARY 24, 2020

PROJECT: Ketchum Fire Station

FILE NUMBER: P20-013

APPLICATION: Design Review

REPRESENTATIVE: Cole Architects

OWNER: City of Ketchum

LOCATION: 107 Saddle Road (Portion of Tax Lot 6689)

ZONING: Tourist (T)

OVERLAY: None

NOTICE: A public hearing notice for the project was mailed to all owners of property

adjacent to the project site on January 22nd, 2020. The public hearing notice was published in the Idaho Mountain Express on January 22nd, 2020. The Planning & Zoning Commission moved to continue review of the application

during their meeting on February 10th, 2020.

REVIEWER: Abby Rivin, Associate Planner

BACKGROUND

At the February 10th meeting, the Planning & Zoning Commission conducted a site visit and considered the fire station project plans, the applicant's presentation, and public comment. During deliberations, the Commission approved the architectural design of the building including the proposed materials. The applicant has proposed 2 small changes to the project plans: (1) a window has been removed at the rear elevation to address a neighbor's privacy concerns and (2) the carport height has decreased to 15 feet. These minor modifications do not noticeably alter the building design.

The Commission requested the applicant provide the traffic and circulation study, parking plans, and improve the landscaping. These materials are attached as Exhibit A to the Staff Report. These additions provide more evidence to support the project's compliance with all Design Review standards.

TRAFFIC & CIRCULATION

Traffic shall flow safely within the project and onto adjacent streets.

Traffic includes vehicle, bicycle, pedestrian and equestrian use.

Consideration shall be given to adequate sight distances and proper signage (Ketchum Municipal Code §17.96.060.G3).

Neighboring Highway 75, Saddle Road, and Warm Springs Road, the fire station site is centrally located with easy access to main routes that connect to all areas of the City. The circulation plan includes drivethrough apparatus bays and sight windows that enhance safety while minimizing the fire station's impact to neighborhood traffic.



Figure 1: Sight Window Example

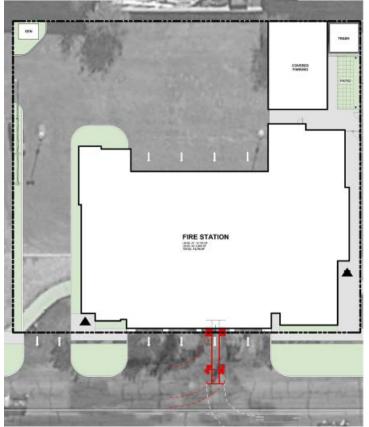


Figure 2: Turning Radius Diagram

The traffic and circulation study recommends additional safety features to reduce conflicts between emergency response and neighborhood traffic. These features include signs, devices, and policies to ensure the safety of pedestrians, bicyclists, drivers, and emergency responders. Staff recommends the Commission provide recommendations to the Ketchum City Council regarding the study's proposed safety treatments. All encroachments, such as signs, within the public right-of-way associated with a development project require review and approval by the Ketchum City Council (Ketchum Municipal Code §17.96.030.C). The Commission recommendations regarding the traffic and circulation study and associated safety features may be memorialized through optional condition of approval #11.

The applicant has provided a diagram showing the turning radius for the largest fire truck

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Staff Report UPDATE
Special Planning & Zoning Commission Meeting of February 24, 2020
City of Ketchum Planning & Building Department

exiting onto Saddle Road. The turning radius diagram demonstrates that emergency responders will be able to exit the fire station onto Saddle Road safely.

LANDSCAPE

Landscaping is required for all projects. Landscape materials and vegetation types specified shall be readily adaptable to a site's microclimate, soil conditions, orientation and aspect, and shall serve to enhance and complement the neighborhood and townscape. All trees, shrubs, grasses and perennials shall be drought tolerant. Native species are recommended but not required. Landscaping shall provide a substantial buffer between land uses, including, but not limited to, structures, streets and parking lots. The development of landscaped public courtyards, including trees and shrubs where appropriate, shall be encouraged (Ketchum Municipal Code §17.96.060.1).

The landscape plan is included on Sheets L1.00 and L1.50 of the project plans. The applicant has added nineteen more plants to augment the landscaping. The proposed landscaping will soften the fire station's hard lines and rectangular mass. Bordering the front property line, the tall grasses and flowering plants enhance the welcoming entryway to the fire station. The living trellis buffers the fire station from the Northwood Place apartments. The grasses, flowering plants, and shrubs complement the fire station's modern design without obstructing lines of sight needed to ensure traffic safety.

PARKING

Non-residential uses in the T-Zone require 1 parking space per 1,000 gross square with the additional exclusion of common and public areas (Ketchum Municipal Code §17.125.040).

The Ketchum Fire Station is 17,507 gross square feet generating a parking demand of 18 parking spaces. The shared parking areas provide 100 spaces on-site to accommodate the fire station's parking demand. Parking for over 320 vehicles may be accommodated through on-street and off-site public parking spaces within the area. At the Commission's request, the applicant has provided a parking diagram showing the YMCA future expansion. The parking diagram shows the 150 on-site parking spaces that will be provided if the YMCA expands in the future. More than enough parking spaces are provided in the area to meet the needs of all users including the fire station and the YMCA.

STAFF RECOMMENDATION

Staff recommends that the Commission consider the additional materials (Exhibit A), the project plans, the applicant's presentation, and any public comment received, deliberate, and <u>approve</u> the Ketchum Fire Station Design Review. The draft Findings of Fact, Conclusions of Law, and Decision have been included as Exhibit B.

RECOMMENDED MOTION

"I move to approve the Ketchum Fire Station Design Review subject to conditions 1-10/conditions 1-11 and authorize the Chair to sign the Findings of Fact, Conclusions of Law, and Decision"

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RECOMMENDED CONDITIONS OF APPROVAL

- 1. This Design Review approval is subject to all comments and conditions as described in the City Department Comments (Table 2), the Zoning and Dimensional Standards Analysis including the off-street parking requirements subject to existing agreements between the City and the YMCA (Table 3), and the Design Review Standards Analysis (Table 4).
- 2. This Design Review approval is based on the plans and information presented and approved at the meeting on the date noted herein. Building Permit plans for all on-site improvements must conform to the approved Design Review plans unless otherwise approved in writing by the Planning and Zoning Commission or Administrator. Any building or site discrepancies which do not conform to the approved plans will be subject to removal.
- 3. All governing ordinances, requirements, and regulations of the Fire Department (2012 International Fire Code and local Fire Protection Ordinance No.1125), Building Department (2012 International Building Code, the 2012 International Residential Code, and Title 15 of Ketchum Municipal Code), Utilities Department, Street Department (Title 12 of Ketchum Municipal Code), and the City Engineer shall be met prior to Certificate of Occupancy.
- 4. The applicant shall submit final civil drawings prepared by an engineer registered in the State of Idaho to include specification for the ROW, utilities, and drainage improvements to be reviewed and approved by the City Engineer, Streets, and Utilities departments prior to issuance of a Building Permit for the project.
- 5. The term of Design Review approval shall be twelve (12) months from the date that the Findings of Fact, Conclusions of Law, and Decision are adopted by the Commission or upon appeal, the date the approval is granted by the Council subject to changes in zoning regulations (KMC §17.96.090).
- 6. All Design Review elements shall be completed prior to issuance of a Certificate of Occupancy for the building.
- 7. All exterior lighting on the property shall be in compliance with Ketchum Municipal Code, Chapter 17.132, Dark Skies, and shall be inspected by Planning Staff and approved prior the issuance of a Certificate of Occupancy for the building.
- 8. The project shall comply with the requirements of §17.124.040 Development Standards as adopted on the date a Building Permit is submitted for the project.
- 9. Prior to issuance of a Building Permit for the project, the applicant shall submit a construction management plans, which addresses each of the standards as set forth in Ketchum Municipal Code, Chapter 15.06 Construction Activity Standards.
- 10. In addition to the requirements set forth in this Design Review approval, this project shall comply with all applicable local, state, and federal laws.
- 11. OPTIONAL Planning & Zoning Commission recommendations to Ketchum City Council regarding the traffic and circulation study and safety treatments.

EXHIBITS:

- A. Response to February 10, 2020 Planning and Zoning Commission Comments
- B. Draft Findings of Fact, Conclusions of Law, and Decision
- C. Ketchum Fire Station: Staff Report: Planning & Zoning Commission Meeting of February 10, 2020

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Exhibit A:

Response

to

February 10, 2020

Planning and Zoning

Commission

Comments



Response to February 10, 2020 Planning and Zoning Commission Comments

The following information is provided in response to the Planning and Zoning Commission comments made at the February 10, 2020 meeting.

Updated Building 3-D Perspective

• A revised perspective to reflect the proposed design and landscaping. (Attachment A)

Landscape Plans

Revised landscape plans showing the plant locations and plant type (Attachment B).

Building Plans

• Revised elevation and floor plans showing the height of the rear carport and removal of a window at rear elevation of the project (Attachment C)

Fire Truck/Engine Turning Radius

• Attachment D is a diagram showing the turning radius for the largest vehicle, the aerial ladder truck. As shown, the truck stays within the northbound lane when exiting north on Saddle Road. There is no conflict with southbound vehicles on Saddle Road.

City and YMCA Parking Agreement

- Attachment E is the diagram showing over 170 on-site parking spaces if the YMCA expands.
- Attachment F is a copy of the Addendum and Amendment to the YMCA/City Parking Agreement.
- Approval of the fire station design review permit will not result in any conflict with the Agreement.

Draft Traffic Analysis

- Attachment G is the preliminary draft of the traffic analysis. The analysis recommends consideration of fire station warning signs with flashing borders to be activated when an emergency vehicle is leaving the fire station.
- Two types of signs would be considered, one targeted at bicyclists/pedestrians and one targeted at drivers.

ATTACHMENT A





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CONSULTANT

PROJECT INFORMATION



KETCHUM FIRE STATION

107 SADDLE ROAD, KETCHUM, ID 83353

ISSUES

PHASE	DESIGN REVIE
DATE	FEBRUARY 24, 20
JOB NUMBER	18-0
MARK DATE	DESCRIPTION


SHEET NAME

3D PERSPECTIVE

SHEET NUMBER

G0.20

ATTACHMENT B

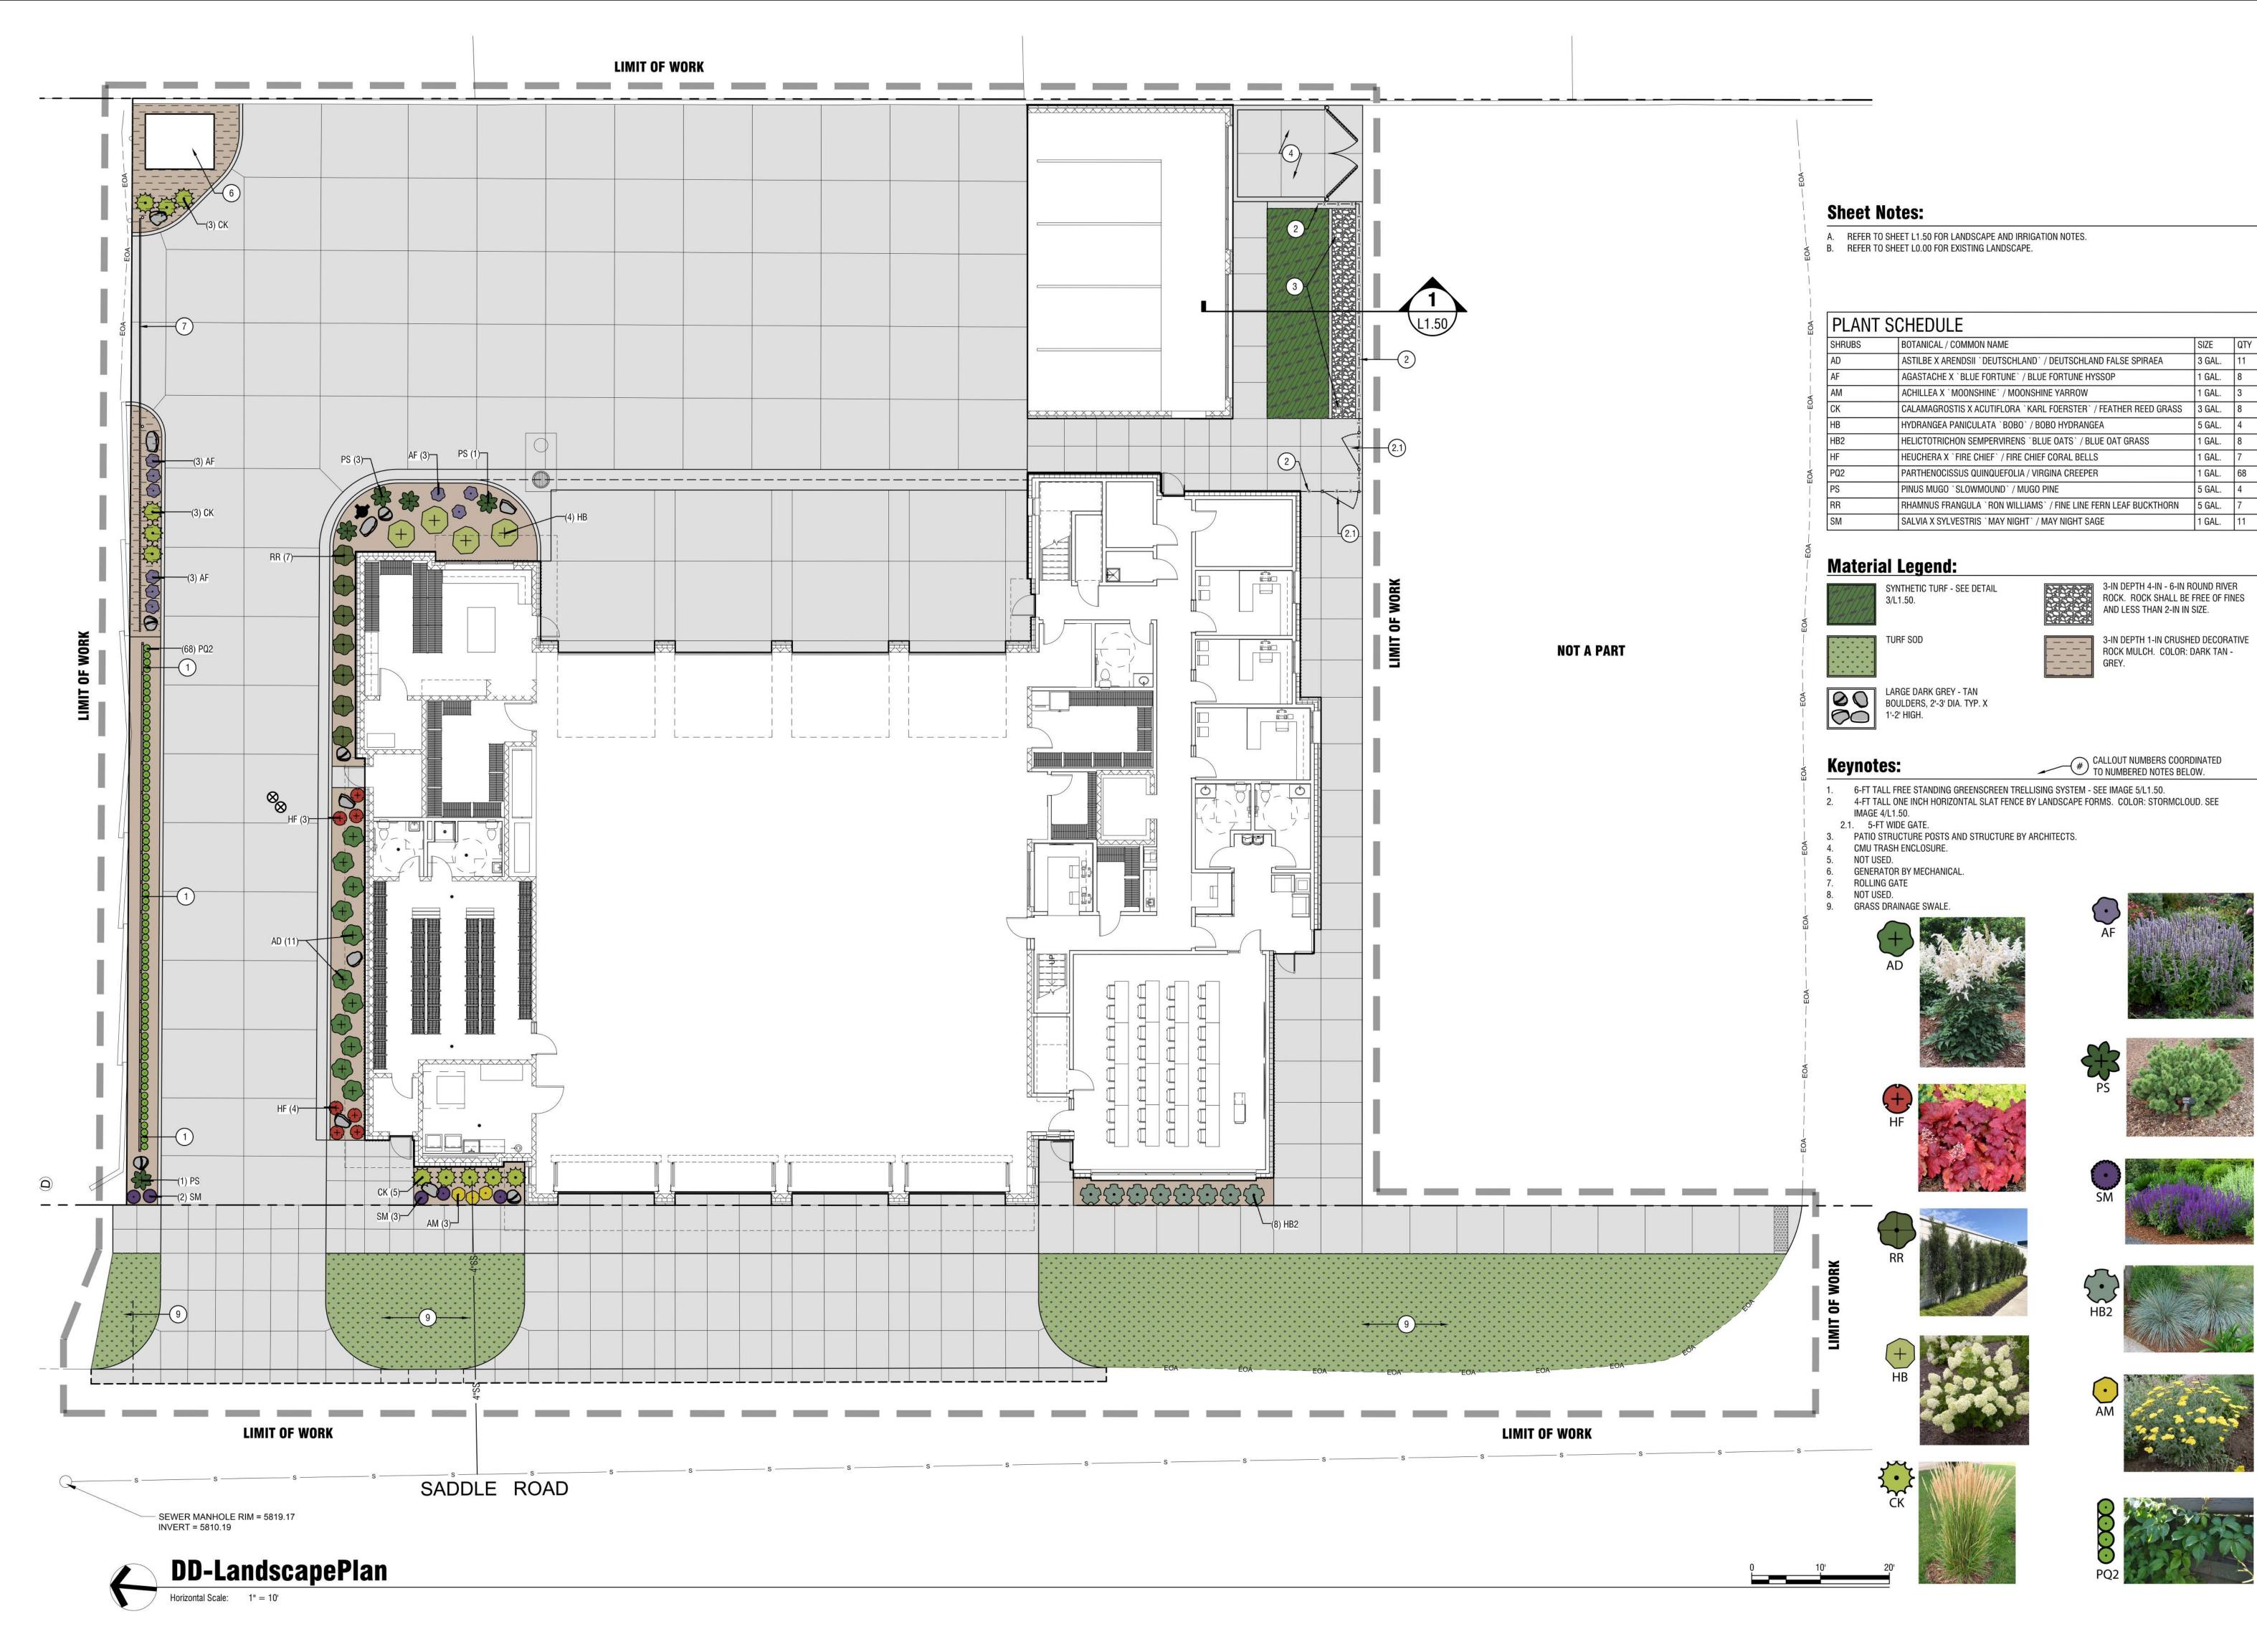



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PROJECT INFORMATION



KETCHUM FIRE STATION

107 SADDLE ROAD, KETCHUM, ID 83353

SSUES

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DATE		FEBRUARY 14, 2020	
JOB NUMBER		18-022	
MARK D	ATE	DESCRIPTION	


SHEET NAME

LANDSCAPEPLAN


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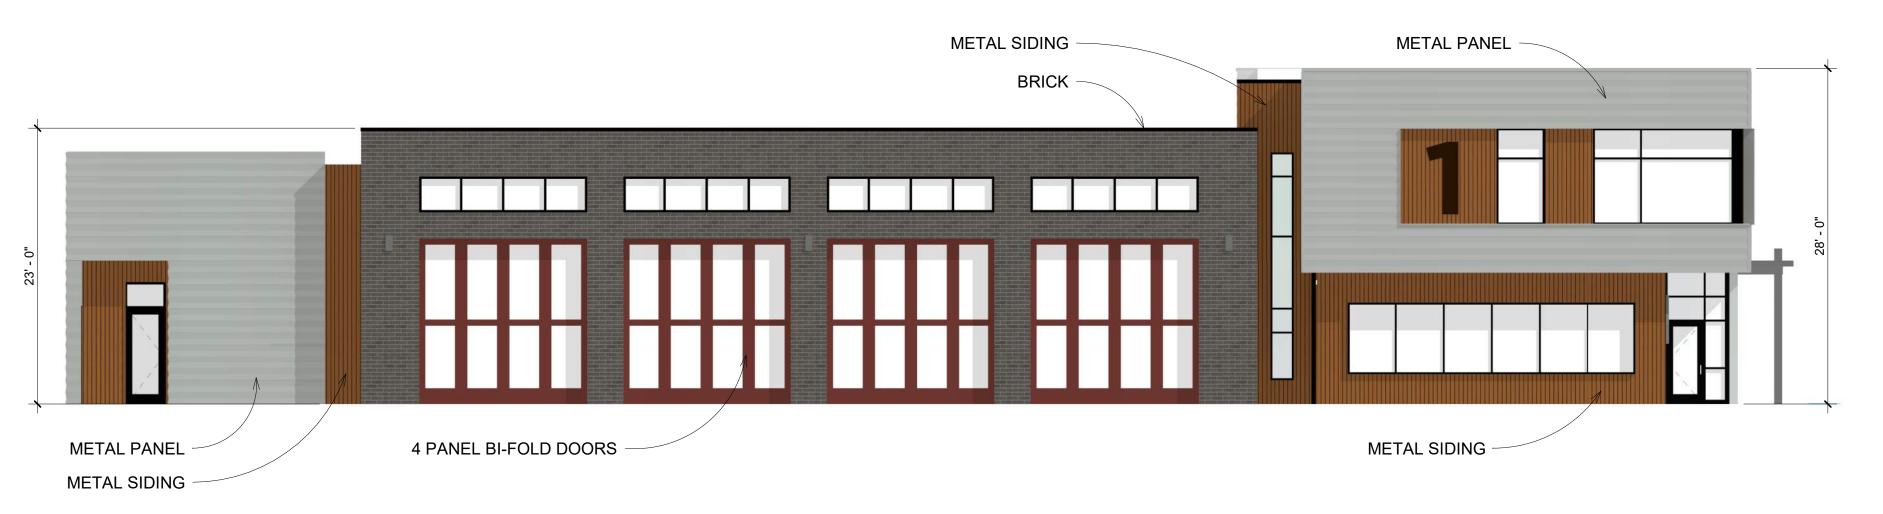
ATTACHMENT C



BRICK METAL PANEL BRICK METAL PANEL METAL PANEL BRICK METAL PANEL

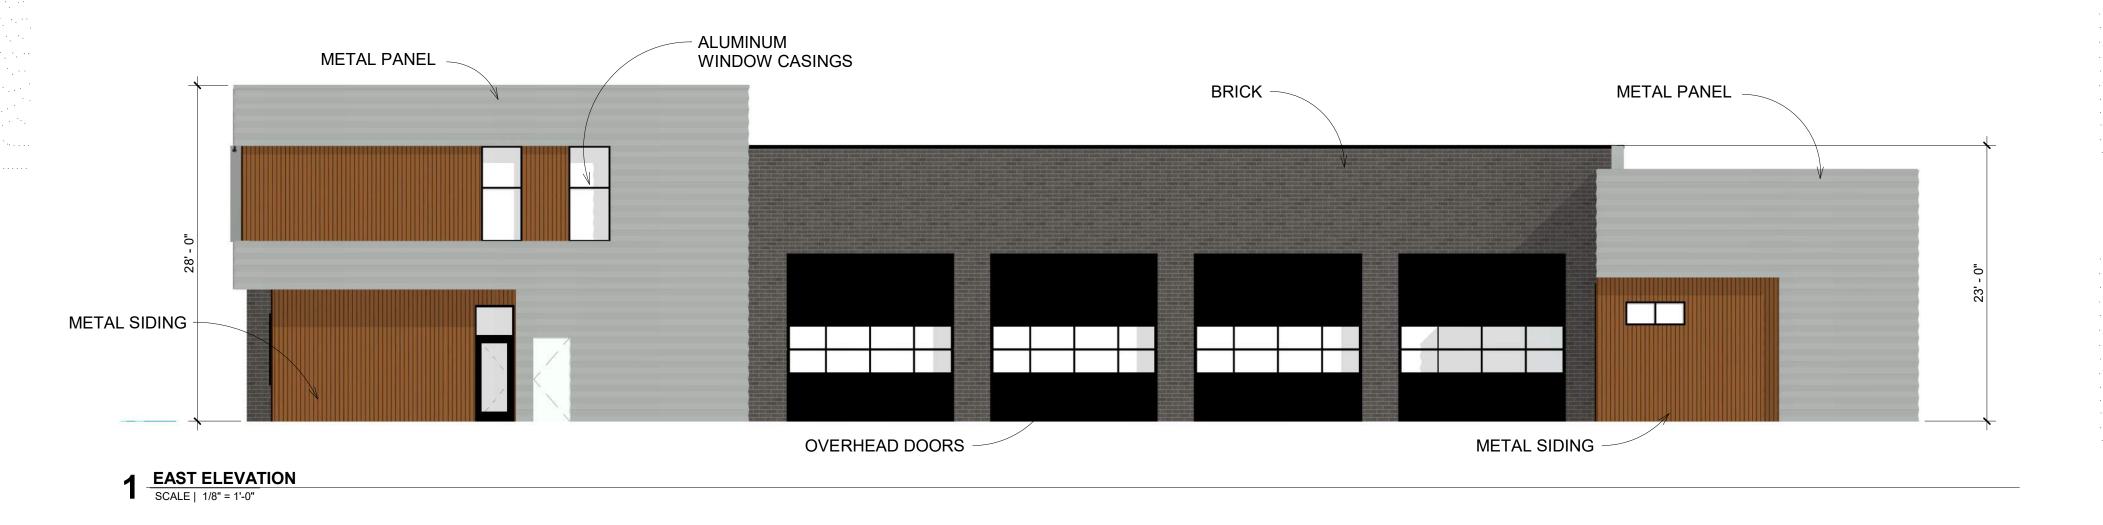

SCALE | 1/8" = 1'-0"

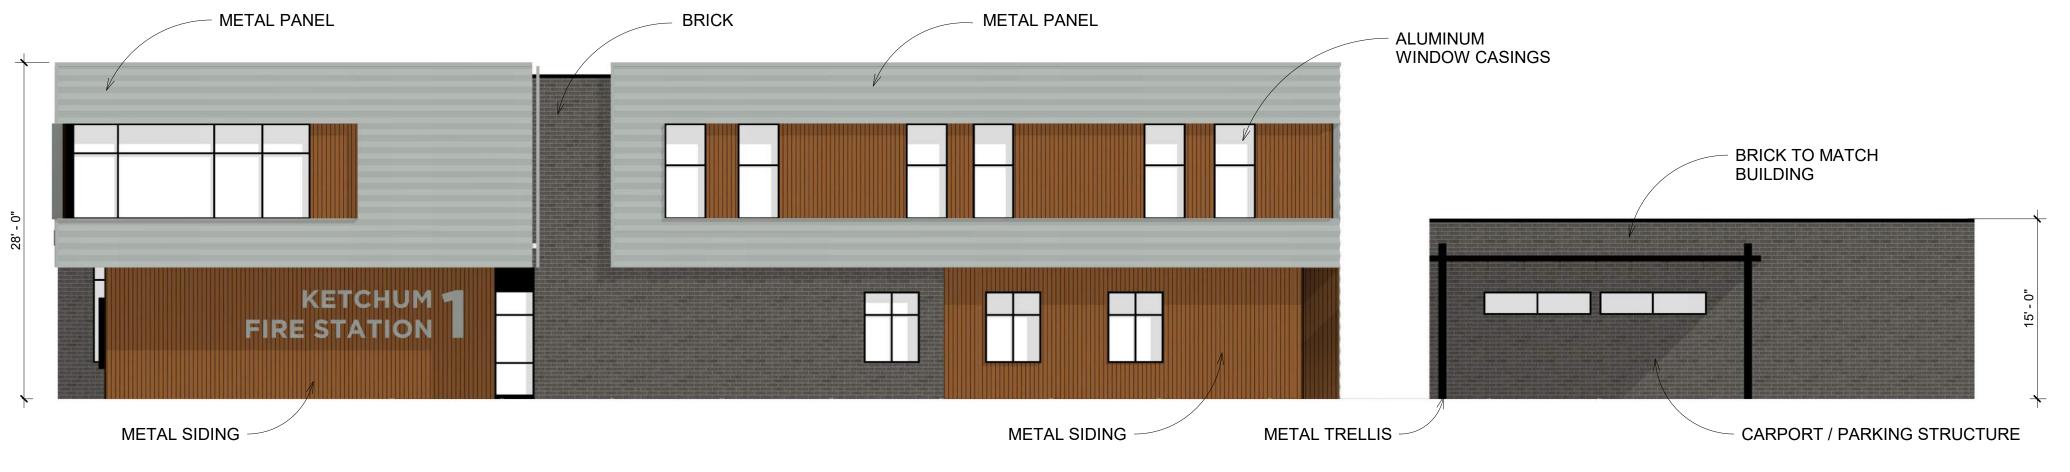

4 WEST ELEVATION
SCALE | 1/8" = 1'-0"

GENERAL NOTES

- A. GENERAL NOTES APPLY TO ALL DRAWING SETS.
- B. FIELD VERIFY ALL DIMENSIONS AND EXISTING CONDITIONS. NOTIFY ARCHITECT IMMEDIATELY IF ANY CONFLICTS OR DISCREPANCIES OCCUR BEFORE PROCEEDING WITH WORK.
- C. CROSS REFERENCES SHOWN ON DRAWINGS DO NOT NECESSARILY INDICATE ALL LIKE CONDITIONS AND DO NOT LIMIT APPLICATION OF ANY DRAWING OR DETAIL. WHERE SPECIFIC DIMENSIONS, DETAILS, OR DESIGN INTENT CANNOT BE DETERMINED, CONSULT THE ARCHITECT PRIOR TO PROCEEDING WITH WORK. IF DESIGN INTENT REMAINS UNCLEAR THEN PROVIDE MOST EXPENSIVE OPTION IN BID.
- D. DIMENSIONS ARE TO GRID LINE OR FACE OF STRUCTURAL MEMBER UNLESS OTHERWISE NOTED. DOOR & WINDOW OPENING DIMENSIONS ARE TO ROUGH OPENING OR CENTERLINE OF OPENING. CONCRETE AND BRICK DIMENSIONS ARE GIVEN TO THE FACE OF CONCRETE OR MASONRY AND TO THE FACE OF ROUGH OPENINGS.



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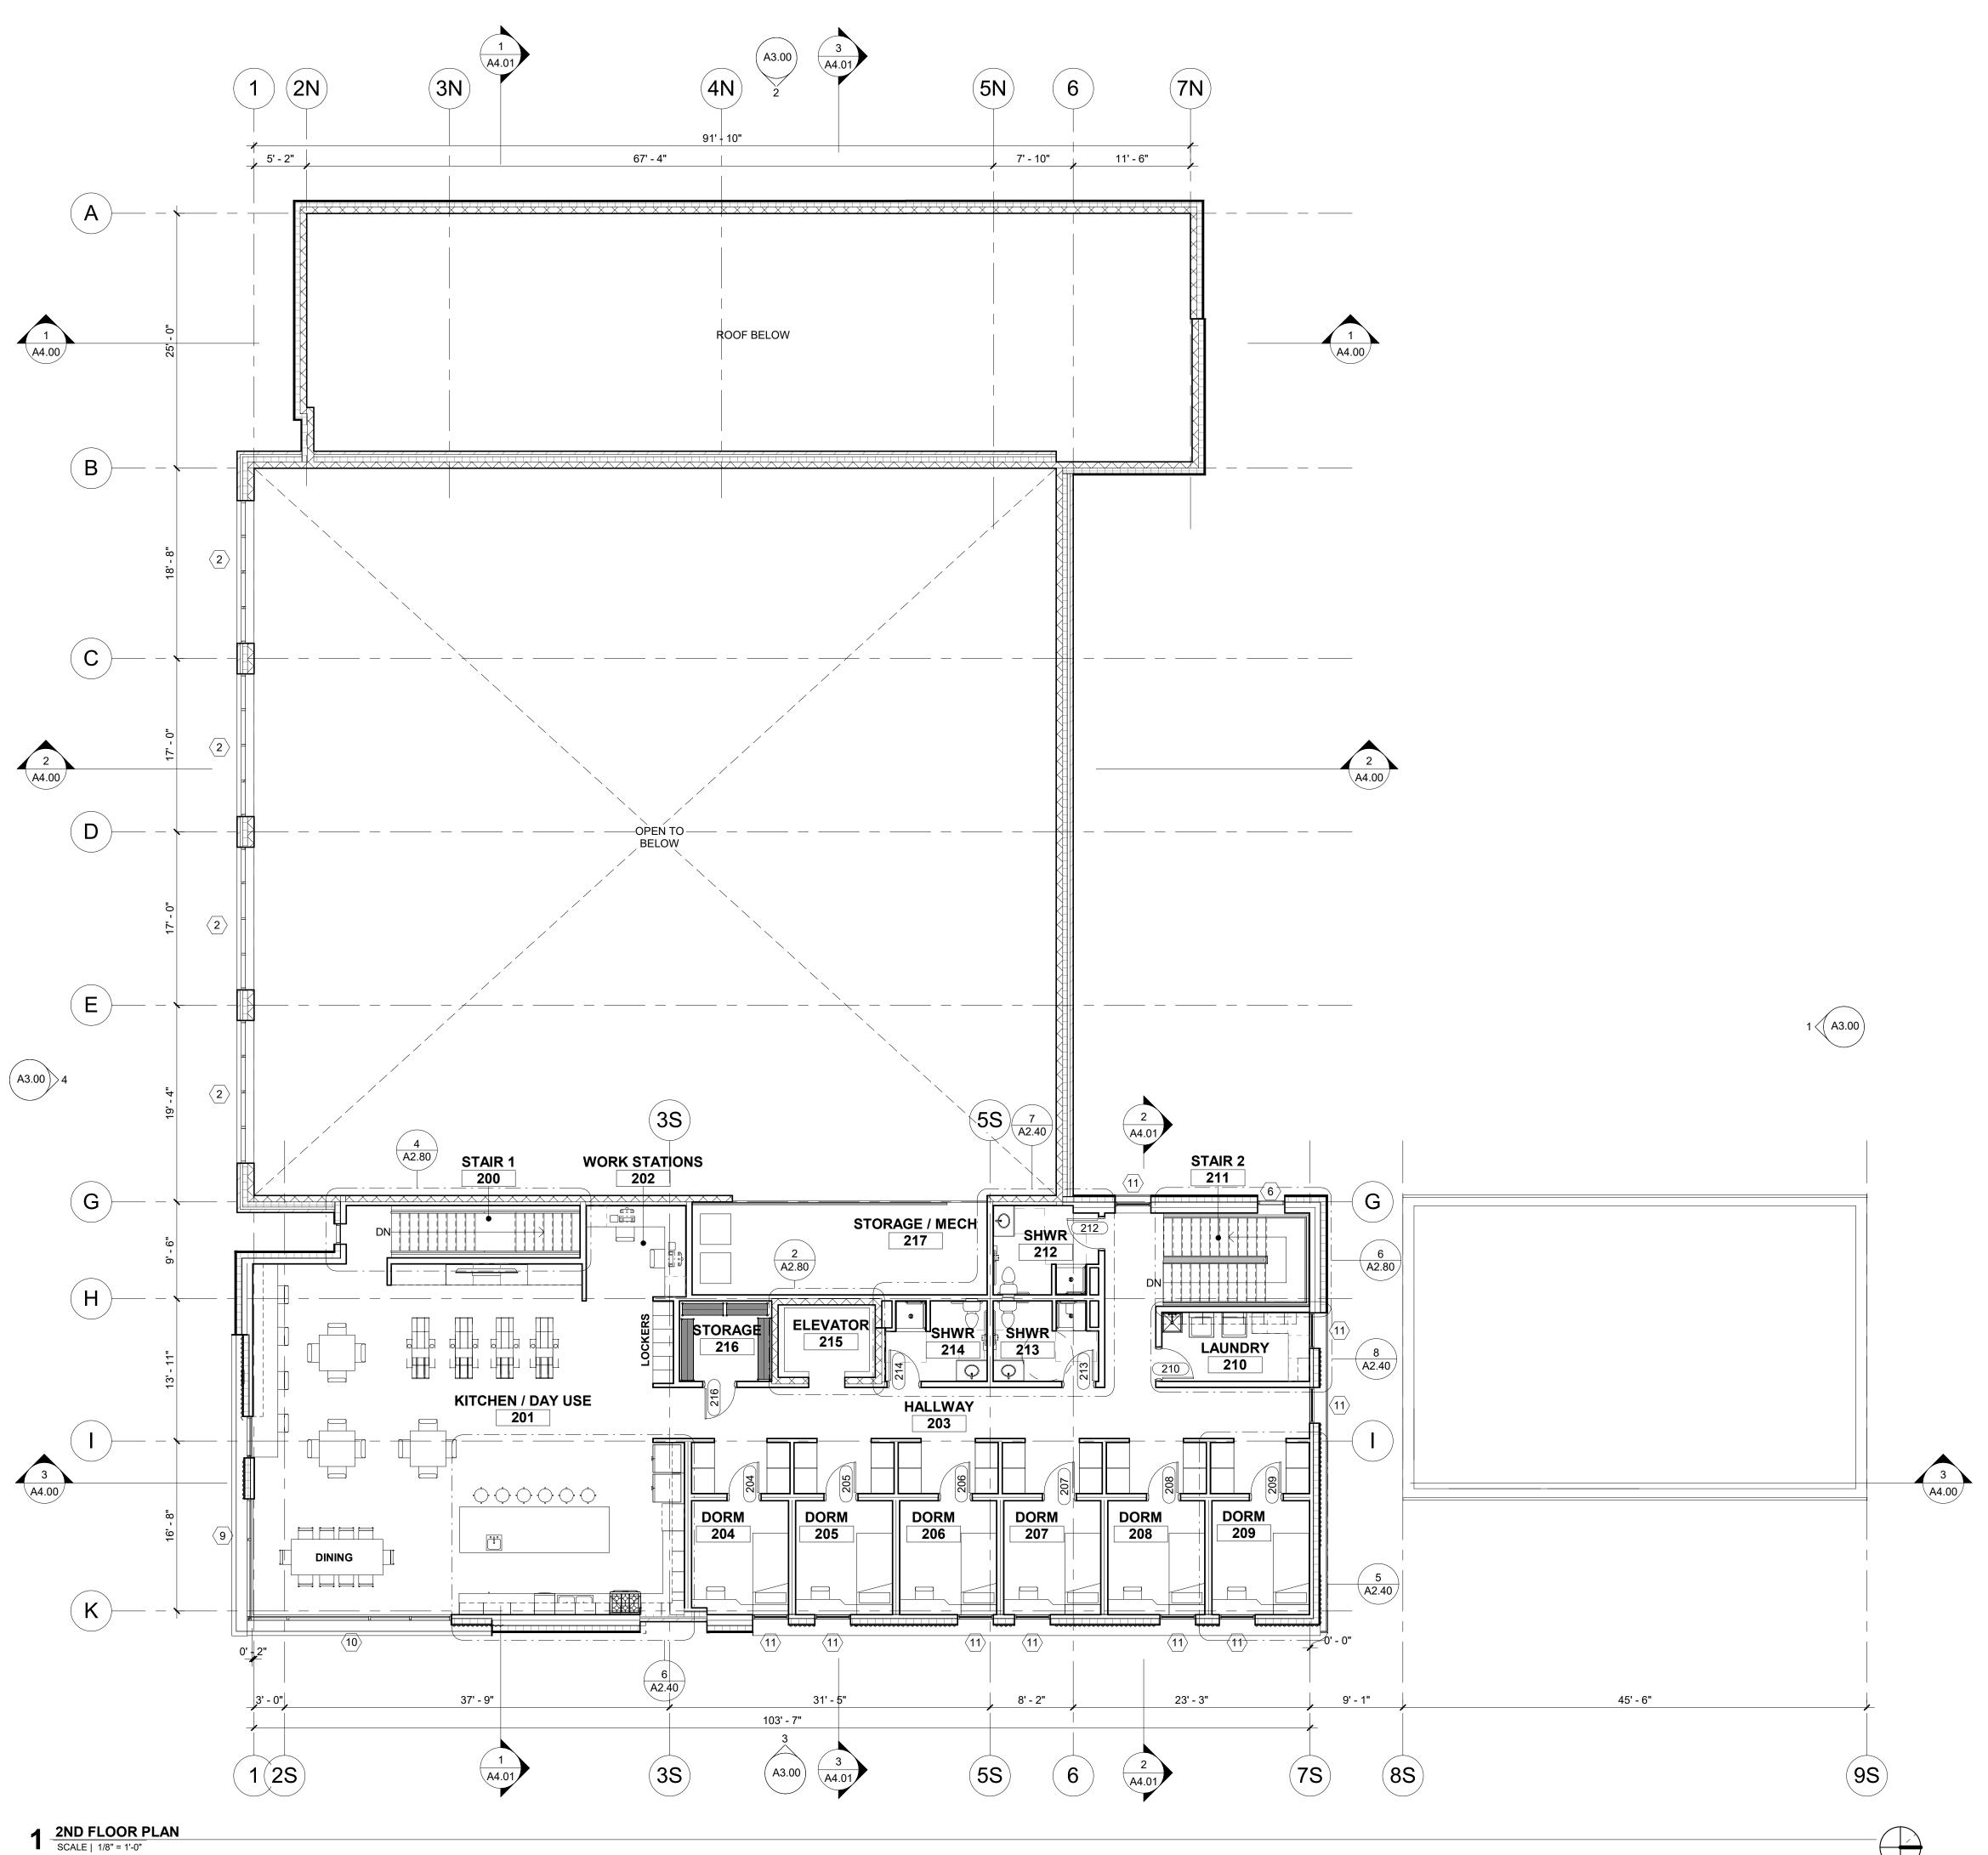
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DATE	FEBRUARY 24, 20
JOB NUMBER	18-0
MARK DATE	DESCRIPTION

SHEET NAME

EXTERIOR ELEVATIONS

SHEET NUMBER

A3.01



GENERAL NOTES

- A. FIELD VERIFY ALL DIMENSIONS AND EXISTING CONDITIONS. NOTIFY ARCHITECT IMMEDIATELY IF ANY CONFLICTS OR DISCREPANCIES OCCUR BEFORE PROCEEDING WITH WORK.
- B. CROSS REFERENCES SHOWN ON DRAWINGS DO NOT NECESSARILY INDICATE ALL LIKE CONDITIONS AND DO NOT LIMIT APPLICATION OF ANY DRAWING OR DETAIL. WHERE SPECIFIC DIMENSIONS, DETAILS, OR DESIGN INTENT CANNOT BE DETERMINED, CONSULT THE ARCHITECT PRIOR TO PROCEEDING WITH WORK. IF DESIGN INTENT REMAINS UNCLEAR THEN PROVIDE MOST EXPENSIVE OPTION IN BID.
- C. PROVIDE SOLID BLOCKING IN WALLS FOR ALL WALL HUNG EQUIPMENT. BLOCKING TO MEET OR EXCEED MANUFACTURER'S RECOMMENDATIONS. FASTEN EQUIPMENT TO WALLS PER MANUFACTURER'S RECOMMENDATIONS. PROVIDE BLOCKING FOR, BUT NOT LIMITED TO THE FOLLOWING: MILLWORK, RAILING, FIRE EXTINGUISHER ACCESSORIES, WALL MOUNTED PLUMBING FIXTURES, SHELVING, ELECTRICAL EQUIPMENT, RESTROOM ACCESSORIES AND DISPLAY ITEMS.
- D. CAULK ALL COUNTERTOPS, BACKSPLASHES AND CABINETS AT LOCATIONS WHERE THEY MEET WALLS. SEAL ALL CUT-OUTS IN COUNTERTOPS.
- E. ERECT DUST PROOF PARTITIONS AS REQUIRED BY OWNER TO PROTECT ADJACENT AREAS.
- F. SEAL AROUND ALL MECHANICAL AND ELECTRICAL EQUIPMENT PENETRATIONS AT WALLS. AT RATED WALLS USE A U.L. APPROVED FIRE-STOPPING MATERIAL.
- G. PROVIDE 4" DOOR JAMBS FROM FACE-OF-FINISH AT ADJACENT WALLS ON THE HINGE SIDE OR UNLESS OTHERWISE INDICATED.
- H. DIMENSIONS ARE TO GRID LINE OR FACE OF STRUCTURAL MEMBER UNLESS OTHERWISE NOTED. DOOR & WINDOW OPENING DIMENSIONS ARE TO ROUGH OPENING OR CENTERLINE OF OPENING. CONCRETE AND BRICK DIMENSIONS ARE GIVEN TO THE FACE OF CONCRETE OR MASONRY AND TO THE FACE OF ROUGH OPENINGS.
- I. WHEN APPLICABLE UNLESS NOTED OTHERWISE, USE CDX PLYWOOD FOR EXTERIOR AND CONCEALED APPLICATIONS AND AB PLYWOOD FOR EXPOSED INTERIOR APPLICATIONS.

KEYNOTES

1. XX



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PROJECT INFORMATION



KETCHUM FIRE STATION

107 SADDLE ROAD, KETCHUM, ID 83353

ISSUES

PHASE		DESIGN REVIEW
DATE		FEBRUARY 24, 2020
JOB NUMBER		18-02
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MARK	DATE	DESCRIPTION

SHEET NAME

FLOOR PLAN -LEVEL 02


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A2.02

ATTACHMENT D

KETCHUM ID FDSITE PLAN

02/20/2020



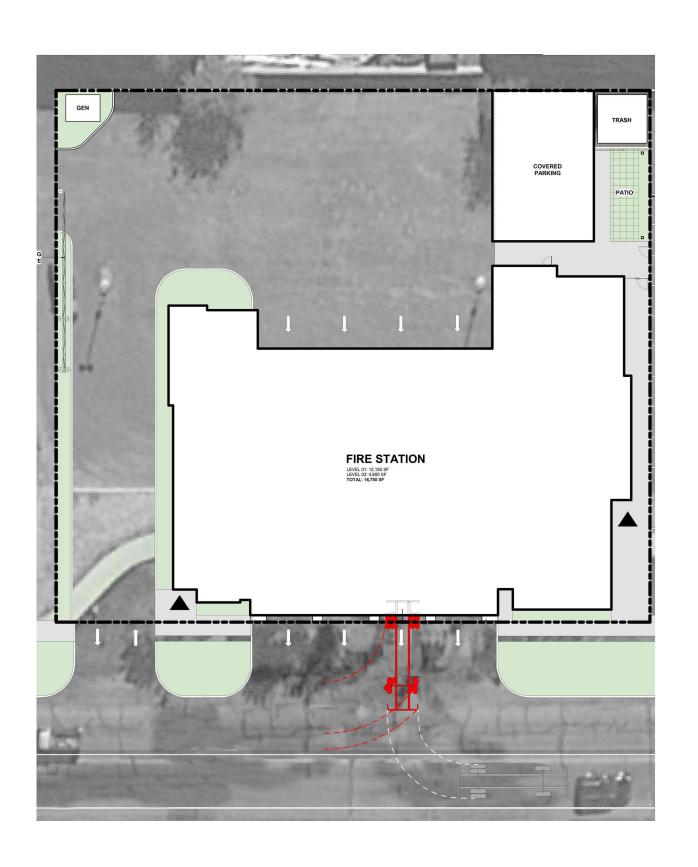






ATTACHMENT E

KETCHUM ID FD




SITE PLAN - CONTEXT

02/20/2020

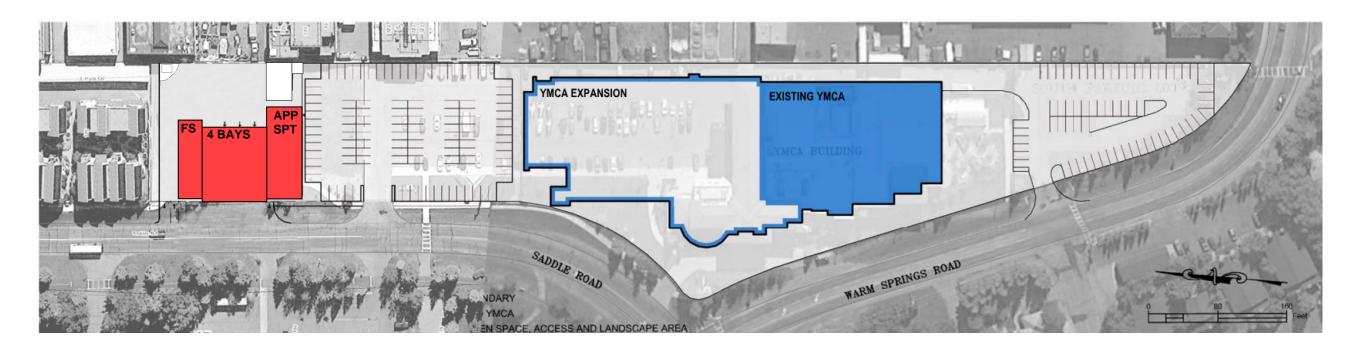



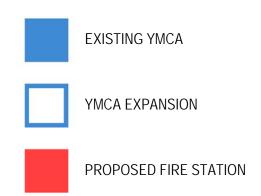





ATTACHMENT F

ADDENDUM AND AMENDMENT TO PARKING AGREEMENT

This ADDENDUM AND AMENDMENT is made and entered into this 4th day of November, 2019, by and between the City of Ketchum, a municipal corporation of the State of Idaho ("Lessor" or "City"), and Wood River Community Young Men's Christian Association, Inc., dba Wood River Community YMCA, an Idaho nonprofit corporation ("Lessee" or "YMCA").

- A. The City leases certain real property to the YMCA ("Leased Property") under the Lease Agreement, dated March 16, 2005, with a First Amendment to Lease, dated April 25, 2013 ("Lease"). The Parties also entered into a Parking Agreement, dated October 12, 2006, ("Parking Agreement") to address parking requirements and joint use arrangements in connection with the lease.
- B. The Parking Agreement covers parking on the Development Parcel, being all remaining property within the identified Park and Ride Lot not leased to the YMCA, and upon which certain joint parking uses were allowed pending future development by City. The YMCA relies upon the availability of sufficient public parking on the City land not leased to the YMCA.
- C. The City is pursuing potential development of a fire station ("City Development") which will impact the Development Parcel with respect to public parking availability. The City desires to minimize impact on the public parking also available to the YMCA. The YMCA supports the City Development and desires to come to an arrangement to accommodate the changing needs of the Parties.
- D. The YMCA is planning for expansion and further development of YMCA facilities as contemplated in the Lease. The City supports the YMCA and its mission in the community, and desires to come to an arrangement to accommodate the changing needs of the Parties.
- E. The Parties desire to continue the existing Lease and Parking Agreement with certain addendums and amendments to address changing needs and clarify the duties of the Parties.

Therefore, the Parties agree to further addend and amend the Lease Agreement, as previously amended, and the Parking Agreement, as follows:

1. Continued Use of Development Parcel for YMCA Parking. The City will continue to permit the YMCA to jointly use public parking facilities on the Development Parcel for the YMCA's parking requirements as generally contemplated within the Lease and Parking Agreement. In the event of any inconsistency between this Addendum and Amendment and the Parking Agreement or Lease this Addendum and Amendment shall govern. Except as amended by this Addendum and Amendment the Lease and Parking Agreement are ratified and affirmed.

2. Vicinity Parking.

The Parties have identified 150 parking spaces as the number of spaces reasonably necessary for the YMCA to continue to generally serve its patrons and fulfill its mission. In consideration of the ongoing cooperative efforts and support between the City and YMCA the City will maintain public parking available for YMCA non-exclusive use within the Vicinity of the YMCA. The Vicinity, for purposes of this Addendum and Amendment, shall be the area as identified on Exhibit A.

Upon completion of the City Development, the City will, at no required expense to the YMCA, develop, manage, and provide public parking in the Vicinity in the amount of at least one-hundred and fifty (150) on-site, on-street, or off-street public parking spaces or other equivalent parking facilities, which the Parties mutually agree are sufficient to ensure that the YMCA reasonably has access to public parking spaces for its ordinary and routine use.

The Parties understand that retaining a certain level of parking more proximate to the YMCA facilities is also desirable. Therefore, to preserve such proximity, at least one-hundred (100) of such public parking spaces will be located On-Site. "On-Site" is defined as illustrated by Exhibit B hereto.

At the time of a building permit for the contemplated YMCA expansion, the City will, at no required expense to the YMCA, increase the development, management, and provision of public parking to at least two-hundred (200) public parking spaces or equivalent parking facilities within the Vicinity. The commitment for On-Site spaces will increase to one-hundred and fifty (150) spaces. The definition of "On-Site" at this time will be expanded to include the additional area illustrated on Exhibit C hereto.

The Parties understand that unique circumstances, special events, and non-routine events will occur and will not be considered interference with the routine provision of generally available public parking.

The Parties understand and agree that ADA compliant spaces will be included to the extent required by law. The Parties also understand and agree that at the time of this Addendum and Amendment these commitments will not include compact car spaces, and that the Parties shall work cooperatively to address changing automobile and parking habits over the course of the Lease.


- 3. No Designated or Committed Parking. The Parties understand and agree that all public parking developed by the City shall be open and available to general public use. None of the On-Site public parking spaces are hereby designated to, reserved, or committed solely to the YMCA.
- 4. Ongoing Cooperative Efforts; Reservation of City Rights. The Parties understand and agree that this Addendum and Amendment is a result of the designated City Development. The Parties acknowledge and agree the City Development is dependent on the electorate's approval of the bond measure on November 5, 2019 which approval is an express condition precedent to the rights and obligations of the Parties hereunder. In the event the bond measure is not approved this Addendum and Agreement will be deemed as without effect and in which case neither Party shall have any further rights or obligations hereunder. Subject to the terms and conditions of this Addendum and

Amendment, the City reserves all general rights to provide, manage, and maintain public parking under its municipal powers. The Parties will endeavor to maintain a cooperative and collaborative effort in addressing parking needs for future development.

This Addendum shall be effective as of the later date of execution below.


CITY OF KETCHUM	Wood River Community Young Men's
Mulh	CHRISTIAN ASSOCIATION, INC.
Neil Bradshaw, Mayor	John Dondero, Board Chair
Date: 11/4/2019	Date: 11/4/2019
Attest: Julian (M)	
Robin Crotty, City Clerk	

ADDENDUM and AMENDMENT EXHIBIT A

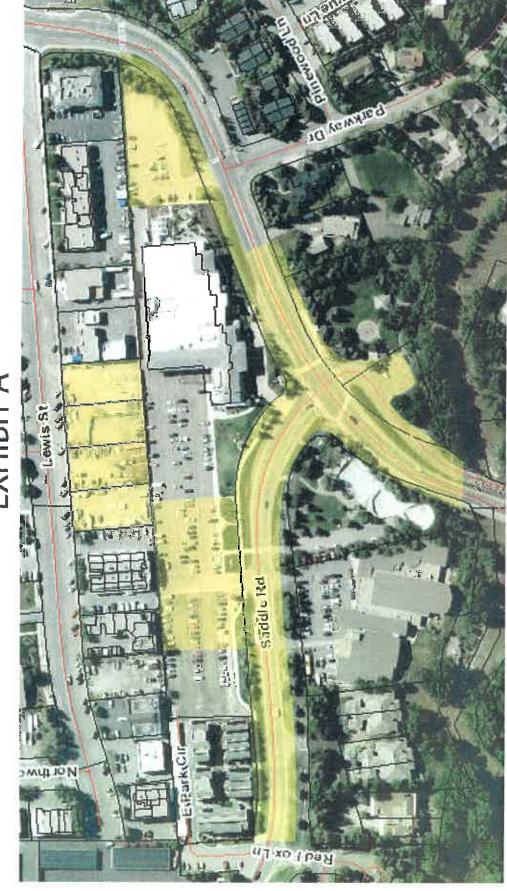

Legend Vicinity


ADDENDUM and AMENDMENT EXHIBIT B

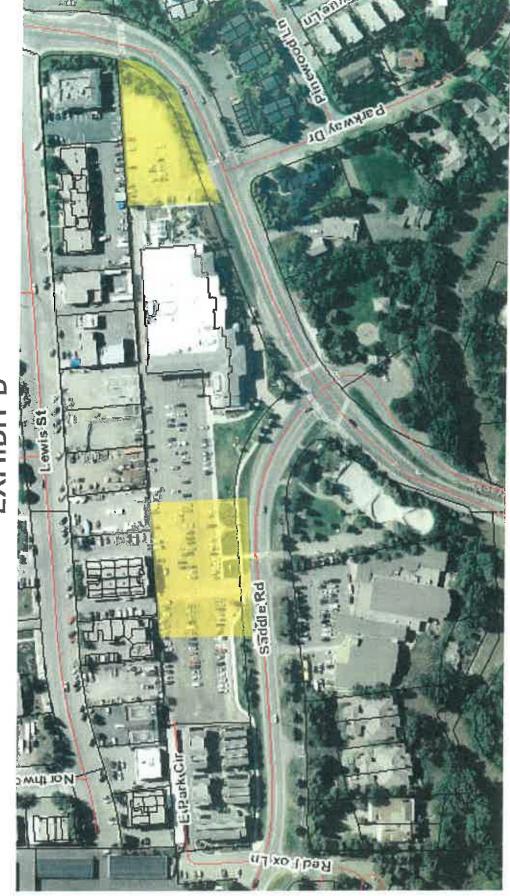

Legend

On-site location for 100 parking spaces prior to YMCA expansion

ADDENDUM and AMENDMENT EXHIBIT C

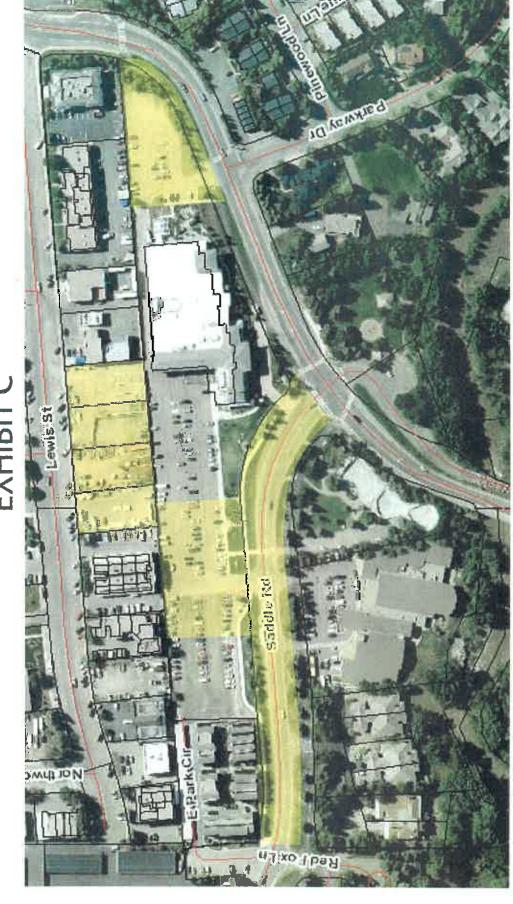

Legend

On-site parking location for 150 parking spaces after YMCA expansion

ATTACHMENT G



To: Suzanne Frick, City Administrator, City of Ketchum

AECOM 756 East Winchester Street Suite 400 Salt Lake City, UT 84107 aecom.com

Project name: Ketchum Fire Station

Traffic Study

Project ref: 60610668

From: Kordel Braley, PE, PTOE; Daniel

Helms, PE, PTOE, RSP₂₁

Date: February 20, 2020

Memo

On behalf of the City of Ketchum, AECOM has reviewed plans for a proposed fire station to be located on the east side of Saddle Road approximately 400 feet north of Warm Springs Road. AECOM's review focused primarily on the transportation and safety impacts of the proposed fire station at surrounding intersections and pedestrian/trail crossings.

The purpose of this memo is to evaluate existing conditions, potential risks, and mitigation measures. This analysis does not provide final design. No new data were collected as part of this analysis. AECOM has relied on data provided by the City and its partners.

Existing Conditions

- Two transit stops near the Fire Station (Warm Springs YMCA and Warm Springs at Parkside) generate, on average, 37 and 32 boardings per day, respectively, based on daily spot counts. Assuming these are doubled to account for alighting, the average number of pedestrians per hour generated from these stops is only 4 and 3, respectively, assuming uniform arrivals and departures throughout the day.
- While no pedestrian crossing data were provided, the area surrounding the proposed fire station incudes several
 pedestrian generators including YMCA, Rotary Park, the Guy Coles Skate Park, Big Wood School, Ernest
 Hemingway School, and multiple trails.
- The intersection of Warm Spring Road and Highway 75 currently has Opticom.
- Traffic counts collected in May 2018 for the intersection of Warm Springs Road and 10th Street were provided by the
 City and show a significant number of trips on Warm Springs Road (nearly 1,000 vehicles per hour during peak
 periods). Counts for Saddle Road were not available. Qualitatively, both of these streets would appear to be
 important routes to the transportation network for this part of Ketchum.

Fire Station Operations

- According to data from the City, the fire department responded to 1,019 calls in 2019, which averages to approximately 20 calls per week.
- Based on discussions with the fire department, it is estimated that the egress distribution from the fire station would likely be 1 to 2 calls per week west on Warm Springs Road, 10 to 11 calls per week east on Warm Springs Road, and 7 to 8 calls per week north on Saddle Road.

Mitigation Measures

Because of the random nature of emergency vehicle deployment, as well as the fact that emergency responders are trained professionals (as opposed to average drivers), an Intelligent Transportation System (ITS) solution could be considered as a mitigation strategy to address concerns to lessen the opportunity of vulnerable road user and emergency vehicle interaction. The ITS solution would be considered lower cost, as opposed to infrastructure improvements such as grade separation. Additional infrastructure improvements may be warranted based on typical traffic conditions, but this would require additional data collection efforts.

A system can be installed that includes Fire Station Warning signs (W11-8) with flashing boarders and/or flashing beacons to be activated when an emergency vehicle is leaving the fire station (see Figures 1 and 2). The signs would be deployed in strategic locations (such as trail crossings, locations near the Big Wood School or the YMCA, near transit stops, and on Saddle Road and Warm Springs Road, see Figure 3) that would alert pedestrians and bicyclists to the presence of an emergency vehicle.¹ Smaller signs are recommended for pedestrian/bicyclist applications.

Infrastructure Considerations

Other infrastructure considerations include the following:

- Solar Power Most devices can be energized using solar power. However, site specific evaluations will need to be
 performed at each location to ensure appropriate levels of sun are available to consistently operate the devices.
 Hard-wired power will be required for locations where sun light cannot be readily captured.
- Opticom In order to make the system work automatically, Opticom is recommended. A receiver could be located directly across the street from the fire station garage door so the system can be activated when the doors open and the emergency vehicle's system is first activated. A back-up activation system could also be placed within the fire station, at the dispatch center, and/or in each emergency vehicle (see Figure 2).

Operational Mitigation Measures

Operations mitigation measures could also be considered including:

- By policy, the fire department could mandate all, or nearly all, emergency vehicles travel north on Saddle Road to SH-75, instead of travelling east on Warm Springs Road. This would remove nearly all conflicts with emergency vehicles at the sensitive intersection locations along Warm Springs Road. According to data from the fire department, using this alternative route would add approximately 0.4 miles to a response south of Warm Springs Road/Main Street but only add about 30 seconds. It is outside of our expertise to weigh in on the merits and costs of this type of operational change. If the fire department did make this change, it would significantly reduce conflicts on Warm Springs Road.
- The fire department should maintain a strict policy against volunteers responding to the fire station in an unsafe manner.

¹ A variety of vendors and systems are available. AECOM does not advocate for specific manufactures. Manufacture specifications should be considered in the design of any implemented system.

Exhibits²



Figure 1. Fire station warning signs with border flashers or beacons.³



Figure 2. Sample manual activation systems.³

² A variety of vendors and systems are available. AECOM does not advocate for specific manufactures. Manufacture specifications should be considered in the design of any implemented system.

³ https://www.tapconet.com/product/emergency-vehicle-warning-system#overview

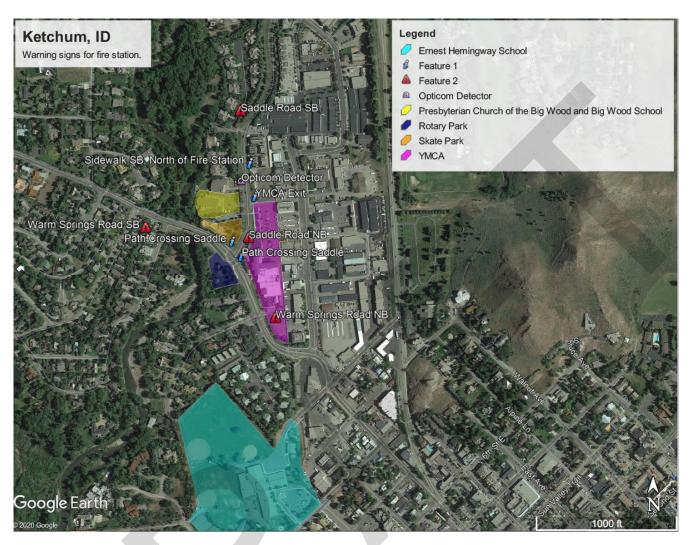


Figure 3. Conceptual layout of warning sign locations that warn drivers and pedestrians/bicyclists.

Exhibit B:

Draft

Findings of Fact, Conclusions of Law, and Decision



City of Ketchum Planning & Building

KETCHUM FIRE STATION DESIGN REVIEW STAFF REPORT KETCHUM PLANNING AND ZONING COMMISSION REGULAR MEETING OF FEBRUARY 10, 2020

PROJECT: Ketchum Fire Station

FILE NUMBER: P20-013

APPLICATION: Design Review

REPRESENTATIVE: Cole Architects

OWNER: City of Ketchum

LOCATION: 107 Saddle Road (Portion of Tax

Lot 6689)

ZONING: Tourist (T)

OVERLAY: None

NOTICE: A public hearing notice for the

project was mailed to all

owners of property adjacent to the project site on January 22nd, 2020. The public hearing notice was published in the Idaho Mountain Express on January

22nd, 2020.

REVIEWER: Abby Rivin, Associate Planner



Figure 1: PUD Parcel Tax Lot 6689

FIRE STATION LOCATION

The new fire station is located on a portion of a larger parcel owned by the City within a Planned Unit Development (PUD) in the Tourist Zone. The PUD includes the Northwood Place apartments, the YMCA, and shared public parking areas all on the same parcel. The fire station site area is 15% of the PUD area with over 150 feet of street frontage along Saddle Road.

The neighborhood connects residential, commercial, recreational, and industrial development. A recreation hub, the multi-use path connects the YMCA to Guy Coles Skate Park and Rotary Park. Across Saddle Road, a townhome development extends north from the Church of the Big Wood.

Industrial buildings, including the Fire Training Facility on Lewis Street, border the east side of the PUD.

The project location and site area meet the Fire Department's operational needs. The Future Land Use Map designates the parcel as Public/Quasi-Public for community services, utilities, and government buildings like the proposed fire station. The City-owned parcel is one of only four properties within the City designated for this type of essential facility. The other Public/Quasi-Public properties are developed with the Community Library, Post Office, and the Wastewater Treatment Plant.

PROJECT COMPLIES WITH DESIGN REVIEW STANDARDS



Figure 2: Fire Station Rendering by Cole Architects

The fire station design balances multiple discordant functions, including living quarters, apparatus and equipment storage, maintenance, decontamination facilities, and administrative offices and training rooms. Occupied by personnel in continuous 24-hour shifts, the fire station design must balance

these different activities while maintaining a healthy and safe environment. The building layout and site design organizes similar functions within distinct areas—the apparatus bays at the center of the station separate the operations and maintenance area from the administrative offices, public meeting room, and residential areas. The orientation and placement of rectangular building shapes facilitate this functional arrangement. The modern design refashions traditional materials like brick to augment visual interest. Details like the red trim across the apparatus-bay windows allude to more traditional firehouse design.

PARKING & TRAFFIC CIRCULATION

By Highway 75, Saddle Road, and Warm Springs, the fire station is centrally located with easy access to main routes that connect to all areas of the City. The circulation plan includes drive-through apparatus bays and sight windows that enhance safety while minimizing the fire station's impact to neighborhood traffic. The City has engaged a professional traffic engineer to identify safety concerns or circulation conflicts. Any improvements necessary to ensure the safety of pedestrians, bicyclists, drivers, and emergency responders will be included in the project plan.

The shared parking areas within the PUD contain 220 public parking spaces. The parking spaces are unrestricted and shared between multiple users. Instead of restricting spaces to an exclusive use, sharing spaces satisfies parking demand by flexibly accommodating various uses during different times of the day. More than enough parking spaces are provided in the PUD to meet the needs of all users including the fire station parking demand.

STAFF RECOMMENDATION

Staff recommends that the Commission consider the project plans, the applicant's presentation, and any public comment received, deliberate, and approve the Ketchum Fire Station Design Review.

ANALYSIS

Staff analysis is provided in Tables 1 through 4 including: (1) the project's alignment with the 2014 Comprehensive Plan, (2) City Department comments, (3) adherence zoning and dimensional standards, and (4) evaluation of Design Review criteria. Project plans are attached as Exhibit A. The *Response to Planning and Zoning Commission Comments on the Fire Station Pre-Application Design Review* included as Exhibit B provides additional information regarding the site selection process, shared parking area, employee housing considerations, and traffic circulation.

Table 1: Comprehensive Plan Analysis

A critical facility that will support the future growth of Ketchum, the new fire station is an essential facility needed to sustain our vibrant mountain town. Providing fire protection and emergency medical services, the Fire Department preserves and enhances quality of life for Ketchum residents and visitors. The 2014 Comprehensive Plan identified the construction of a new, modern fire station as the department's highest priority. By protecting life and property, the Fire Department provides the foundation to support our community vision and shared values. The fire station is consistent with the uses, goals, and policies listed below as specified within the 2014 Comprehensive Plan.

SUPPORTING	COMPLIANCE WITH THE 2014 COMPREHENSIVE PLAN		
SECTION	&		
	STAFF COMMENTS		
Land Use	PRIMARY USES		
Category:	The Public/Quasi-Public category includes uses related to community services, such		
Public/Quasi Public	as schools, libraries, community centers and gardens, arts/culture, hospitals,		
	government, utilities, cemeteries, and places of worship.		
	The fire station is a public facility that delivers an essential service to the		
	community. The project site is one of only four properties within the City designated		
	as an appropriate location for this type of use. The remaining Public/Quasi-Public		
	properties are developed with the Community Library, Post Office, and the		
	Wastewater Treatment Plant.		
	Future Land Use		

Infill and	Ketchum needs a new fire station to sustain our vibrant community and support		
Redevelopment to	future growth. As first responders to fires, public safety and medical emergencies,		
Accommodate	and technical rescues, the Fire Department protects the lives and property of The		
Growth	fire station is a critical facility needed to deliver essential services to protect the		
	community. A vacant and underutilized property within a built-out area, the project		
	site is strategically located for emergency response near major transportation		
	corridors. As Ketchum continues to grow, the Fire Department must respond to		
	increasing demands for services. The fire station is necessary to support the future		
	growth of Ketchum.		
	A Strong and Diverse Economy		
Policy E-2(b)	The Fire Department keeps Ketchum dynamic, resilient, and economically viable. By		
Quality of Life	enhancing delivery of fire protection and emergency services, the fire station project		
Infrastructure	is critical to Ketchum's economic success.		
	Community Design and Neighborhoods		
Policy CD-1.3	The fire station is contextually appropriate located in a neighborhood at the		
Compatible Infill	intersection of commercial, industrial, and residential development.		
and			
Redevelopment			
Projects			
Policy CD-1.5 High-	Centrally located, the fire station is sited near main routes to serve Ketchum		
Quality and	residents and visitors. The project plans include a community room to host public		
Sustainable Design	meetings and events.		
Principles for			
Public Buildings	The fire station will be a LEED certified building.		
and Public			
Outdoor Spaces			
Policy CD-2.5	The fire station will be a LEED certified building to ensure high performance		
Energy and Water	standards for energy and water conservation.		
Efficiency in New			
Development			
	Natural Resource Stewardship		
Policy NR6.1 City	The City of Ketchum will serve as an example by continuing to improve energy		
Leadership in	efficiency and GHG reductions in City facilities and operations.		
Energy Efficiency	,		
and Conservation			
Policy NR6.2	The City should implement policies and programs that enhance opportunities for		
Energy	individuals, businesses, and public organizations to conserve energy and convert to		
Alternatives	renewable resources. The City should support energy conservation in City buildings,		
Virginarise2	vehicles, operations and processes through its own policies, and provide		
	information about techniques for energy efficiency.		
	Public Safety and Utilities		

Goal PSU-1	Ketchum will proactively ensure the safety and welfare of residents by providing high levels of police, fire, and emergency response services. In addition, the City will promote community awareness and involvement with crime prevention and code enforcement. A primary objective is to provide and maintain reliable funding to protect investment in existing fire and police facilities and ensure appropriate levels of service.
Policy PSU-1.3 Fire and Police Service Standards	Future fire and police facility requirements should be determined using level of service (LOS) standards. Level of service should be defined as the optimum level of service desired from the service provider and may differ from the current LOS.
Policy PSU-3.2 Channeling Capital Improvements	The fire station project provides a safety-related capital improvement.

Table 2: City Department Comments

City Department comments are based on the project concept as proposed with the Design Review project plans. All City Departments shall review and approve the project through the Building Permit application process. All comments pertaining to the Design Review drawings are subject to change. All right-of-way improvements must be reviewed and approved by the City Engineer and Streets Department prior to issuance of a Building Permit for the project.

City Department Comments

All City Department requirements and associated specifications for the required improvements must be verified, reviewed, and approved prior to issuance of a Building Permit for the project.

Fire Department:

- It is the General Contractor's responsibility to understand and adhere to all Fire Protection Ordinance #1125 requirements in addition to any and all other City of Ketchum requirements in effect at the time of Building Permit issuance. Failure to comply with all local ordinances and codes may result in project work stoppage as well as criminal penalties.
- The above project shall meet all 2012 International Fire Code requirements in addition to specific City Building and Fire Ordinances.
- Approved address numbers shall be placed in such a position to be plainly visible and legible from the road fronting the property. Numbers and letters shall be a minimum of four (4) inches tall, contrast with their background and be positioned a minimum of forty-eight (48) inches above final grade.
- Vehicle parking and material storage during construction shall not restrict or obstruct public streets or access to any building. A minimum twenty-foot travel lane for emergency vehicle access shall be maintained clear and unobstructed at all times. All required Fire Lanes, including within 15 feet of fire hydrants, shall be maintained clear and unobstructed at all times.
- An approved automatic fire sprinkler system shall be installed throughout the building per City of Ketchum Ordinance #1125 (www.ketchumfire.org) and the National Fire Protection Association Standard 13. An approved fire sprinkler flow bell, Knox box and Fire Department Connection shall be installed in an approved location visible to approaching firefighters. Water service lines to

structures shall be hydraulically calculated for size to meet fire sprinkler flow requirements. Fire sprinkler systems shall be annually tested and maintained per NFPA 25. An approved fire department connection and flow bell shall be installed in a location approved by the fire department and the system shall be supervised by an approved alarm system.

Note: The entire building shall be protected by an NFPA 13 Fire Sprinkler system.

- NOTE: One electronic set of fire sprinkler system plans must be submitted to the Ketchum Fire Department as well as the State Fire Marshal's office and a Ketchum Fire Department Permit must be obtained prior to installation of fire sprinkler systems. Inspections of fire sprinkler systems by the Fire Chief or an appointee are required. Inspections must be scheduled at least 48 hours in advance.
- An approved monitored fire sprinkler alarm system shall be installed per City of Ketchum Ordinance #1125 (www.ketchumfire.org) and the requirements of NFPA 72. Two (2) sets of alarm system plans shall be submitted to the Ketchum Fire Department for approval and a permit is required prior to installation of alarm systems. Inspections of fire detection systems by the Fire Chief or an appointee are required and shall be scheduled at least 48 hours in advance.
- An approved access roadway per 2012 International Fire Code Appendix D (www.ketchumfire.org) shall be installed prior to any combustible construction on the site. The road shall be a minimum of twenty (20) feet in width and capable of supporting an imposed load of at least 75,000 pounds.
- Fire extinguishers shall be installed and maintained per 2012 IFC Section 906 both during construction and upon occupancy of the building.
- An approved key box shall be installed, with the appropriate keys, for emergency fire department access in a location approved by the fire department. The key box shall be a Knox box brand and sized to accommodate keys to every door of the project.
- An 8 ½ by 11 color coded site map of this project shall be provided on paper and electronically to
 the fire department. This site map shall show the locations of gas shut-offs, power shut-offs, fire
 sprinkler riser rooms, fire department connections, alarm panels, Knox boxes, access doors, egress
 windows, stairways and any additional fire department requirements. Exact details for color coded
 "On-Sites" can be found at www.ketchumfire.org.
- Final inspections of all fire department permit required installations by the Fire Chief or an appointee are required and shall be scheduled at least 48 hours in advance. A Final Inspection Checklist can be found at www.ketchumfire.org.
- Fire Department requirements and associated specifications for the required improvements must be verified, reviewed, and approved prior to issuance of a Building Permit for the project.

City Engineer & Streets Department:

- All drainage shall be retained on site including water from any roof drains (KMC §17.96.060.C.1).
 Any roof drain locations will need to be shown on project plans submitted with the Building Permit application.
- All construction for the project must comply with the standards set forth in Ketchum Municipal Code, Chapter 15.06 Construction Activity Standards. The applicant shall submit a Construction Activity Plan addressing all applicable activities (KMC §15.06.030), including how materials will be off-loaded at the site, plan for coordinating with neighbors on temporary closures, temporary traffic control, and construction fencing with appropriate screening, to be reviewed and approved prior to issuance of a Building Permit for the project. Pursuant to KMC §15.06.030.A.2,

- the applicant shall provide notice of the project, construction schedule, and general contractor's contact information to all neighbors with properties adjacent to the project site.
- The Building Permit plans and construction drawings shall meet all applicable sections of Chapter 12 of Ketchum Municipal Code.
- The plans for the ROW improvements must be prepared by a professional engineer licensed in Idaho (KMC §12.04.020. Reconstruction of the city sidewalk is required. Specifications for the ROW improvements shall be indicated on the civil drawings submitted with the Building Permit application to be reviewed and approved by the City Engineer and Streets Department prior to issuance of a Building Permit for the project.
- Recommended separation distance between a dry well and water main is 25'. If a dry well is installed closer than 25' to the water main install 20 mil HDPE groundwater barrier along the water main side of drywell. Barrier should extend of 18 inches below the water main pipe. Minimum distance between a dry well and water main must be 10'.
- Utility locations (electrical, gas) are not permitted in public ROW. If utility upgrades are necessary the applicant will need to coordinate upgrades with Idaho Power and Intermountain Gas. All utilities need to be shown on the plans including the location and size of water and sewer mains and services, gas, electric, TV and phone.
- Drainage improvements constructed shall be equal to the length of the subject property lines adjacent to any public street or private street (KMC §17.96.060C).
- The applicant shall submit a Street and Alley Digging, Excavation, and Trenching ("DIG") Permit
 application with an associated traffic control plan for all construction work within the City rightof-way to be reviewed and approved by the Streets Department. The use of City right-of-way
 for construction including the closure of adjacent streets or sidewalks requires a Temporary Use
 of Right-of-Way Permit ("TURP").
- Final civil drawings for all associated ROW improvements shall be submitted with the Building Permit application to be verified, reviewed, and approved by the City Engineer and Streets Department prior to issuance of a Building Permit for the project.

Utilities:

- The applicant will be responsible for installing connections to the water and sewer system.
- Requirements and specifications for the water and sewer connections will be verified, reviewed, and approved by the Utilities Department prior to issuance of a Building Permit for the project.

Building:

- The building must meet the 2012 International Building Code and Title 15 Buildings and Construction of Ketchum Municipal Code.
- Building Department requirements and associated specifications for the required improvements must be verified, reviewed, and approved prior to issuance of a Building Permit for the project.

Planning and Zoning:

Comments are denoted within the analysis of the project's compliance with the Comprehensive Plan, zoning and dimensional standards, and Design Review evaluation standards.

Table 3: Zoning and Dimensional Standards Analysis

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	Zoning and Dimensional Standards Analysis				
Compliant			Standards and Staff Comments		
	Yes	No	N/A	Guideline	City Standards and Staff Comments

Ketchum Fire Station Design Review

Planning & Zoning Commission Meeting of February 10, 2020

\boxtimes			17.12.030	Minimum Lot Area
			Staff	Required: 8,000 square feet minimum
			Comments	
				Existing:
				Tax Lot 6689 Total: 249,150 square feet
				Fire Station Project Site: 35,139 square feet
\boxtimes			17.12.030	Minimum Open Space
			Staff	Required: 35%/30% (Footnote 5: 5% open site area may be used for
			Comments	private decks or patios and walkways subject to Design Review
				approval)
				Proposed with Ketchum Fire Station:
				YMCA and Greenhouse Building Footprint: 69,282 square feet
				Northwood Place & Carport Building Footprint: 23,402 square feet
				Ketchum Fire Station & Carport Building Footprint: 14,810 square feet Total Building Footprint: 107,494 square feet
				Total Open Space: 141,656 square feet
				Open Space: 57% (141,656square feet open space/249,150 square feet
				Tax Lot 6689 area)
\boxtimes			17.12.030	Floor Area Ratios and Community Housing
		_	Staff	Floor Area Ratio Permitted in Tourist (T) Zoning District
			Comments	FAR Permitted in T Zone: 0.5
				FAR Permitted with Inclusionary Housing Incentive: 1.6
				7 6
				Proposed Floor Area Ratio
				Existing YMCA and Northwood Place Gross Floor Area: 128,806.5
				square feet (YMCA 91,374 gross square feet + Northwood Place
				37,432.5 gross square feet)
				Proposed Ketchum Fire Station Gross Floor Area: 17, 507 gross square
				feet
				Total Gross Floor Area of YMCA, Northwood Place, Ketchum Fire
				Station: 146,313.5 gross square feet
				Floor Area Ratio Proposed: 0.59 (146,313.5 gross square feet/249,150
				square feet TL 6689 area)
				Increase Above 0.5 Permitted FAR: 21,738.5 square feet (146,313.5
				gross floor area-124,575 permitted 0.5 gross floor area)
				20% of Increase: 4,348 square feet
				15% Reduction for Net Livable Floor Area: 3,696 square feet
				Northwood Place is an affordable apartment complex with 32 deed
				restricted community housing units. Comprised of five buildings, the
	<u> </u>		1	restricted sommarity risusing units. Comprised of five bandings, the

			total floor area of Northwood Place is 33,188 square feet, which satisfies the community housing contribution.
\boxtimes		17.12.030	Minimum Building Setbacks
		Staff Comments	Minimum: Front: 15 feet West Side Setback Along Saddle Road Waiver (PUD CUP 04-008): 0 feet East Side Setback Along Interior Property Line Waiver (PUD CUP 09- 023): 0 feet Rear: > 1 per 3 feet in building height, but no less than 10 feet Setback Along Warm Springs Road with Waiver: 20 feet
			The PUD designates the Warm Springs Road boundary as the front property line. Proposed: Front (South/Warm Springs): Greater than 15 feet Rear (North/Park Circle): Greater than 15 feet Side with Waiver (East/Interior): 0 feet Side with Waiver (West/Saddle Road): 0 feet
		17.12.030	
		17.12.030 Staff	Building Height Maximum Parmitted in Tourist Zone: 25 fact
		Comments	Maximum Permitted in Tourist Zone: 35 feet Maximum Permitted with PUD Waiver: 45 feet-6 inches Proposed: The fire station is 29 feet tall.
		17 125 02011	
		Staff Comments	Required: A total of 35% of the linear footage of any street frontage can be devoted to access to off street parking. Existing: YMCA (PUD CUP 04-008 & Design Review CR04-013): 5% Northwood Place (PUD CUP 09-023 & Design Review R09-003): 38 feet/27% Park Circle frontage Proposed: As indicated on the Site Plan (Sheet C2.00), 2 curb cuts are proposed along Saddle Road to facilitate two-way traffic for command vehicles and fire apparatus to exit and enter the fire station. The 2 curb cuts are separated by a grass median. The north access serves as the main entrance and exit for staff vehicles and fire trucks. During an emergency response, firefighters will exit the station from the apparatus-bay curb cut.

			Tax Lot 6689 has 1,747 feet of street frontage along Park Circle, Saddle Road, and Warm Springs Road. The property has 890 feet of street frontage along Saddle Road. The 2 curb cuts have a combined width of 147.5 feet. An existing 30-foot curb cut along Saddle Road serves as the main access to the YMCA. The total width of the driveway accesses along Saddle Road will be 177.5 feet or 20% of the street frontage along Saddle Road.
\boxtimes		17.125.040	Parking Spaces
		Staff	Off-street parking standards apply to any new development and to any
		Comments	new established uses.
			Required: Non-Residential Use in T Zone: 1 parking space per 1,000 gross square feet (Footnote 1: Refer to definition of floor area, gross and with the additional exclusion of common and public areas).
			Proposed:
			Ketchum Fire Station is 17,507 gross square feet generating a parking demand of 18 parking spaces.
			The shared parking areas within the PUD contain 220 public parking spaces. More than enough parking spaces are provided in the PUD to meet the needs of all users including the fire station parking demand.

Table 4: Design Review Standards Evaluation

	Design Review Improvements and Standards (KMC §17.96.060)					
Yes	No	N/A	City Code	City Standards and Staff Comments		
\boxtimes			17.96.060.A1	The applicant shall be responsible for all costs associated with providing		
			Streets	a connection from an existing city street to their development.		
			Staff	Tax Lot 6689 is bordered by Park Circle to the north, Saddle Road to		
			Comments	the west, and Warm Springs to the south. A driveway access along		
				Saddle Road at the north end of the project site provides two-way		
				traffic to the fire station. The apparatus bay curb cut is reserved for		
				emergency response.		
		\boxtimes	17.96.060.A2	All street designs shall be approved by the City Engineer.		
			Streets			
			Staff	No changes are proposed to the street design or lanes of travel within		
			Comments	the Saddle Road right-of-way.		
\boxtimes			17.96.060.B1	All projects under 17.96.010(A) that qualify as a "Substantial		
			Sidewalks	Improvement" shall install sidewalks as required by the Public Works		
				Department.		
			Staff	The fire station is new construction and qualifies as a substantial		
			Comments	improvement project requiring the installation of sidewalks. A		
				concrete path extends the length of the PUD connecting Northwood		

				Place to the YMCA. The path within the project site will be relocated within the Saddle Road right-of-way to align with the existing path. Final civil drawings for all associated ROW improvements shall be
				submitted with the Building Permit application to be verified, reviewed, and approved by the City Engineer and Streets Department prior to issuance of a Building Permit for the project.
				See Table 2 for comments and conditions from the City Engineer & Streets Department.
\boxtimes			17.96.060.B2	Sidewalk width shall conform to the City's right-of-way standards,
			Sidewalks	however the City Engineer may reduce or increase the sidewalk width and design standard requirements at their discretion.
			Staff	All ROW improvements shall be constructed to City ROW standards.
			Comments	The proposed width of the path is 7 feet to match the existing
				sidewalk to the north and south. The City Engineer may reduce or
				increase the sidewalk width and design standard requirements.
				Final civil drawings for all associated ROW improvements shall be
				submitted with the Building Permit application to be verified,
				reviewed, and approved by the City Engineer and Streets Department
				prior to issuance of a Building Permit for the project. See Table 2 for
				review comments and conditions from the City Engineer & Streets
			47.06.060.00	Department.
			17.96.060.B3 Sidewalks	Sidewalks may be waived if one of the following criteria is met: a. The project comprises an addition of less than 250 square feet
			Sidewants	of conditioned space.
				b. The City Engineer finds that sidewalks are not necessary
				because of existing geographic limitations, pedestrian traffic on
				the street does not warrant a sidewalk, or if a sidewalk would
				not be beneficial to the general welfare and safety of the public.
			Staff	N/A the existing pathway must be relocated within the Saddle Road
	 		Comments	right-of-way.
			17.96.060.B4	The length of sidewalk improvements constructed shall be equal to the
			Sidewalks	length of the subject property line(s) adjacent to any public street or
			Staff	private street. The sidewalk will be constructed across the length of the project site
			Comments	along Saddle Road.
\boxtimes		П	17.96.060.B5	New sidewalks shall be planned to provide pedestrian connections to
2			Sidewalks	any existing or future sidewalks adjacent to the site. In addition,
				sidewalks shall be constructed to provide safe pedestrian access to and
				around a building.
			Staff	The new sidewalk along Saddle Road will connect to a path that leads
			Comments	to the fire station's public entrance. The sidewalk extends the length

			of the PUD and connects Northwood Place to the YMCA. This circulation system connects to the BCRD Wood River Trail multi-use path, commonly referred to as the bike path, to the west across Saddle Road through existing crosswalks.
	\boxtimes	17.96.060.B6 Sidewalks	The City may approve and accept voluntary cash contributions in-lieu of the above described improvements, which contributions must be segregated by the City and not used for any purpose other than the provision of these improvements. The contribution amount shall be one hundred ten percent (110%) of the estimated costs of concrete sidewalk and drainage improvements provided by a qualified contractor, plus associated engineering costs, as approved by the City Engineer. Any approved in-lieu contribution shall be paid before the City issues a certificate of occupancy.
		Staff Comments	N/A. Staff does not recommend a voluntary cash contribution in-lieu of improvements for this project.
\boxtimes		17.96.060.C1 Drainage	All storm water shall be retained on site.
		Staff Comments	All storm water shall be retained on site including water from roof drains. Preliminary drainage plans are indicated on Sheets C2.0 and C3.0 of the Design Review submittal drawings. The proposed drainage plan includes a system of drywells and grass drainage swales. Prior to issuance of a Building Permit for the project, the applicant shall submit a final drainage plan indicating grading, catch basins, piping, and drywells (KMC §17.96.040.C.2b & KMC §17.96.060.C.1-4) prepared by a civil engineer licensed in the state to be submitted for review and approval by the City Engineer and Streets Department. See Table 2 for City Department comments including City Engineer and Streets Department conditions.
		17.96.060.C2 Drainage Staff Comments	Drainage improvements constructed shall be equal to the length of the subject property lines adjacent to any public street or private street. See above analysis for Ketchum Municipal Code §17.96.060C1. All drainage improvements are required to meet City standards. All drainage improvements shall be indicated on civil plans prepared by an Idaho licensed engineer and require review and approval from
			the City Engineer & Streets Department prior to issuance of a Building Permit for the project. See Table 2 for review comments and conditions from the City Engineer & Streets Department.
\boxtimes		17.96.060.C3 Drainage	The City Engineer may require additional drainage improvements as necessary, depending on the unique characteristics of a site.

		Ct. CC	
		Staff Comments	A final drainage plan prepared by a civil engineer licensed in the state of Idaho shall be submitted with the Building Permit application to be reviewed and approved by the City Engineer and the Streets Department. The City Engineer may require additional drainage improvements as necessary.
		17.96.060.C.4 Drainage	Drainage facilities shall be constructed per City standards.
		Staff Comments	All drainage facilities within the project site and the public right-of- way shall meet City standards. Final drainage specifications must be included with the civil drawings submitted with the Building Permit application to be reviewed and approved by the City Engineer & Streets Department.
\boxtimes		17.96.060.D1 Utilities	All utilities necessary for the development shall be improved and installed at the sole expense of the applicant.
		Staff Comments	Sheet C4.00 of the project plans show utility connections and locations. All utilities necessary for the fire station must be improved and installed at the sole expense of the applicant. Prior to issuance of a Building Permit, the applicant must secure a will-serve letter from Idaho Power. Final plans will be reviewed and approved by the Utilities Department prior to issuance of a Building Permit for the project. See Table 2 for review comments and conditions from the Utilities Department.
		17.96.060.D2 Utilities	Utilities shall be located underground and utility, power, and communication lines within the development site shall be concealed from public view.
		Staff Comments	All utilities within the development site shall be underground and concealed from public view. See above analysis for Ketchum Municipal Code §17.96.060D1. The generator located at the northeast corner of the project site must be fully screened from public view.
		17.96.060.D3 Utilities	When extension of utilities is necessary all developers will be required to pay for and install two (2") inch SDR11 fiber optical conduit. The placement and construction of the fiber optical conduit shall be done in accordance with city of Ketchum standards and at the discretion of the City Engineer.
		Staff Comments	The applicant is aware of this requirement to install services for high- speed internet to the site. The applicant will work with the City Engineer to identify the location of a fiber line to serve the project.
\boxtimes		17.96.060.E1 Compatibility of Design	The project's materials, colors and signing shall be complementary with the townscape, surrounding neighborhoods and adjoining structures.
		Staff Comments	The exterior elevations (Sheet A3.00) show the proposed materials, colors, and signage. The façade design alternates gray horizontal metal panels with brown vertical metal siding. Projecting towards

			Saddle Road, the four apparatus bays are distinguished from the rest of the fire station with black brick veneer and glass-panel garage doors. The modern building alludes to traditional firehouse design through red detailing framing the garage doors. Integrated with the architecture of the building, the Ketchum Fire Station 1 sign at the south elevation directs attention to the public entryway. In addition to the red firehouse doors, the 1 sign at the front elevation anchors the building as a fire station. Residential, commercial, and light industrial development border the project site and PUD. Most of the surrounding neighborhood is developed with the exception of a few vacant properties in the light industrial area. To the east of the project site, the light industrial buildings are characterized by more simple design styles that combine stucco, concrete, and brick. Directly north of the project site, the Northwood Place façade design uses stone veneer to differentiate from the horizontal siding. Across Saddle Road, buildings including the church and townhomes integrate river rock, stone veneer, stucco, and wood siding into the façade design. The alternation of brick veneer with board-and-batten siding provides visual interest to the YMCA building.
			The materials proposed for the fire station are compatible with the surrounding neighborhood and nearby buildings. The design approach refashions traditional materials combined with contemporary finishes to augment visual interest. The new fire station will add modern style to the eclectic buildings within the neighborhood. The adaptation of traditional materials like the brick complements the more conventional design styles in the neighborhood.
	\boxtimes	17.96.060.E2 Compatibility of Design	Preservation of significant landmarks shall be encouraged and protected, where applicable. A significant landmark is one which gives historical and/or cultural importance to the neighborhood and/or community.
		Staff Comments	N/A. No significant landmarks of historical or cultural importance have been identified on the property. The project site has been used for parking and snow storage.
	\boxtimes	17.96.060.E3 Compatibility of Design	Additions to existing buildings, built prior to 1940, shall be complementary in design and use similar material and finishes of the building being added to.
		Staff Comments	N/A This standard does not apply because the fire station is new construction.
		17.96.060.F1 Architectural	Building(s) shall provide unobstructed pedestrian access to the nearest sidewalk and the entryway shall be clearly defined.

		Staff	The project plans include a path that borders the south side of fire
		Comments	station and directs pedestrians to the public entrance from the shared parking area. This pathway leads to the sidewalk that extends from Northwood Place to the YMCA. This internal circulation system will connect to the bike path across Saddle Road through existing crosswalks. The fire station accommodates diverse spaces from living quarters to
			fire truck storage to maintenance areas to administrative offices. These different fire station functions are separated within the building. The apparatus bays at the center of the station separate the administrative areas and firefighter living quarters from areas dedicated to emergency response operations, maintenance, and storage.
			The design of the entryway at the south elevation includes large windows and doors inviting the public into the facility. The entryway is distinguished from the rest of the fire station by brown metal siding and signage. The emergency response operations area incorporates
			with fewer windows and uses different materials combining the gray metal panels with the black brick.
\boxtimes	П	17.96.060.F2	The building character shall be clearly defined by use of architectural
		Architectural	features.
		Staff Comments	The fire station is characterized by modern design elements with simple building forms and functional floor plans. The orientation and placement of rectangular building shapes with flat roofs at varying heights define the fire station's functional arrangement.
			Separating the operations and maintenance areas from the administrative offices and living quarters, the apparatus bays at the center of the station are defined by the glass-paneled garage doors. These windows will introduce natural light into the apparatus bays while providing pedestrians a unique view of the stored fire engines.
			The southern portion of the building is distinguished from the rest of the fire station through its size, shape, and placement. With significant fenestration, the south façade design welcomes the public into the fire station. The pattern of material placement provides texture to the box building form. The vertical placement of the brown metal siding provides visual relief from the horizontal metal panels and black brick.
\boxtimes		17.96.060.F3	There shall be continuity of materials, colors and signing within the
		Architectural	project.

		Staff	The exterior walls of the building utilize the same metal and brick
		Comments	materials and gray, block, and brown color scheme. Highlighting the apparatus bays, the use of the firehouse red is limited to the apparatus-bay garage doors. The consistent pattern of material placement and colors across all building walls connects the diverse functions of the fire station into one cohesive design.
\boxtimes		17.96.060.F4	Accessory structures, fences, walls and landscape features within the
		Architectural	project shall match or complement the principal building.
		Staff Comments	Accessory Structures The 1,360 square foot carport at the southeast corner of the project site uses the same black brick material as the fire station. A row of rectangular windows at the carport's south elevation provides relief from the black brick veneer. The four parking spaces in the carport will be reserved for staff and command vehicles. A covered patio area will extend to the south of the carport. Utilizing the same material and color palette, the carport and patio match the fire station design theme.
			Fences & Gates In the 1990s, a 5-foot concrete retaining wall was constructed along the side property line to separate Tax Lot 6689 from the industrial area to the east. In addition to the existing CMU wall, the project includes a 4-foot tall patio fence, a 6-foot tall trellis, and a rolling gate (Sheets L1.00 & L1.50). The patio fence will not only enhance privacy, but also limits public access to the Fire Department operations area. Comprised of horizontal slats, the patio fence will match the color of the carport and covered patio. The trellis system separates the fire station from the Northwood Place apartments. Plants attach to panels so that the freestanding trellis will transform into a living fence. Multi-functional, the green trellis will enhance screening and soften the fires station's black, brown, and gray walls.
			Landscape The landscape plan is included on Sheets L1.00 and L1.500 of the project plans. Grass medians border Saddle Road and separate the northern driveway access from the apparatus-bay curb cut reserved for emergency response. Grasses and flowering plants are proposed along the front façade at either side of the center apparatus bays. Softening the building's hard edges, the plants invite and welcome the public into the fire station. Flowering plants and shrubs border the north side of the building softening the gray and brown metals panels. Boulders are incorporated throughout the landscape design providing visual interest.

		17.00.000.00	Duilding walls shall provide and ulation /police the consequence the
\boxtimes		17.96.060.F5	Building walls shall provide undulation/relief, thus reducing the
		Architectural	appearance of bulk and flatness.
		Staff	The fire station design uses rectangular shapes in different forms to
		Comments	reduce the flatness of building walls. The gray metal panels, black
			brick, brown metal siding, and window openings are all unique
			rectangular elements in different sizes and orientations. For example,
			the gray metal panels are placed horizontally and the brown metal
			siding is aligned vertically. This contrast of rectangular shapes
			provides visual interest to the box-shaped building. In addition to this
			rectangular arrangement, color variation and multiple windows and
			doors to breathe life into the fire station. The varying roof heights
			define the separate areas of the building. Projecting beyond the rest
			of the building, the firehouse red detailing highlight framing the glass
			panels focuses attention to the apparatus bays.
\boxtimes		17.96.060.F6	Building(s) shall orient towards their primary street frontage.
		Architectural	
		Staff	The front façade of the building orients towards Saddle Road.
		Comments	
\boxtimes		17.96.060.F7	Garbage storage areas and satellite receivers shall be screened from
		Architectural	public view and located off alleys.
		Staff	The concrete trash enclosure is located at the southeast corner of the
		Comments	project site. In addition to the concrete trash enclosure, the carport
			and fenced patio further screen the dumpster from public view.
			Prior to issuance of a Building Permit for the project, the applicant
			shall submit a will serve letter from Clear Creek Disposal to the
			Planning & Building Department.
			The project plans do not include any satellite receivers.
\boxtimes		17.96.060.F8	Building design shall include weather protection which prevents water
		Architectural	to drip or snow to slide on areas where pedestrians gather and
			circulate or onto adjacent properties.
		Staff	Enhancing weather protection, the flat roof form will prevent water
		Comments	from dripping or snow from sliding from the building. At the main
			entrance, the second floor cantilevers beyond the first floor to cover
			the pedestrian pathway.
\boxtimes		17.96.060.G1	Pedestrian, equestrian and bicycle access shall be located to connect
		Circulation	with existing and anticipated easements and pathways.
		Design	
		Staff	The project plans include a path that directs pedestrians to the public
		Comments	entrance from the shared parking area. This pathway leads to the

		internal circulation system connects to the bike path across Saddle Road through existing crosswalks.
	17.96.060.G2	Awnings extending over public sidewalks shall extend five (5') feet or more across the public sidewalk but shall not extend within two (2') feet of parking or travel lanes within the right of way.
	Circulation Design	N/A. No awnings are proposed to extend across the public sidewalk.
	17.96.060.G3 Circulation Design	Traffic shall flow safely within the project and onto adjacent streets. Traffic includes vehicle, bicycle, pedestrian and equestrian use. Consideration shall be given to adequate sight distances and proper signage.
	Staff Comments	Neighboring Highway 75, Saddle Road, and Warm Springs Road, the fire station site is centrally located with easy access to main routes to all service delivery areas. A driveway access off Saddle Road at the northwest corner of the site will facilitate two-way traffic to and from the fire station. The curb cut along the four apparatus bays will be reserved for emergency response. Sight line windows are incorporated into the building design that allow emergency responders to view any pedestrians or bicyclists approaching the station on the sidewalk and any obstructions in front of the apparatus bays.
		The City has engaged a traffic engineering firm to identify safety concerns and circulation conflicts between neighborhood traffic and Fire Department emergency response operations and identify any mitigation measures. These mitigation measures may include warning signals, traffic control devices, and alert systems. If the traffic study identifies circulation conflicts, the City will implement any mitigation measures necessary to ensure the safety of pedestrians, bicyclists, and drivers in the area.
		A comprehensive analysis of traffic circulation is included within Exhibit B of the Staff Report. Prior to issuance of a Building Permit for the project, the City Engineer and Streets Department shall review the civil drawings to ensure adequate sight distances and proper signage for the proposed
		driveway access.
	17.96.060.G4 Circulation Design	Curb cuts and driveway entrances shall be no closer than twenty (20') feet to the nearest intersection of two or more streets, as measured along the property line adjacent to the right of way. Due to site conditions or current/projected traffic levels or speed, the City Engineer may increase the minimum distance requirements.

			Staff	The project site is located over 250 ft from Saddle Road's intersection
			Comments	with Park Circle and over 400 ft from the Saddle Road and Warm
				Springs Road intersection. Clear sight lines are provided to the north
				and south of the fire station driveways.
				Prior to issuance of a Building Permit for the project, the City Engineer
				and Streets Department shall review the civil drawings to ensure
				adequate sight distances and proper signage for the proposed
				parking access.
\boxtimes	П	П	17.96.060.G5	Unobstructed access shall be provided for emergency vehicles,
			Circulation	snowplows, garbage trucks and similar service vehicles to all necessary
			Design	locations within the proposed project.
			Staff	Clear sight lines are provided to the north and south of the fire station
			Comments	driveways. Sight line windows are incorporated into the building
			Comments	design that allow emergency responders to view any pedestrians or
				bicyclists approaching the station on the sidewalk and any
				obstructions in front of the apparatus bays. The north driveway
				access facilitates two-way traffic for staff vehicles to enter and exit
				the station. The curb cut at the apparatus bays is reserved for
				emergency response.
				emergency response.
				Garbage trucks will access the trash enclosure from the shared
				parking area to the south of the station. As the circulation areas will
				include a snowmelt system, snowplows will not need to remove snow
				from the site.
	П	\boxtimes	17.96.060.H1	Snow storage areas shall not be less than thirty percent (30%) of the
			Snow Storage	improved parking and pedestrian circulation areas.
			Staff	As permitted by KMC §17.96.060.H4, the traffic and pedestrian
			Comments	circulation areas will include a snowmelt system instead of a snow
				storage area.
	П	\square	17.96.060.H2	
				, , , , , , , , , , , , , , , , , , ,
			Staff	N/A. As indicated on Sheet C2.00 of the project plans, the fire station
			Comments	
				§17.96.060.H4.
		\boxtimes	17.96.060.H3	
			Snow Storage	five (5') feet and shall be a minimum of twenty-five (25) square feet.
			Staff	As permitted by KMC §17.96.060.H4, the project site will include a
			Comments	snowmelt system instead of a snow storage area.
\boxtimes			17.96.060.H4	In lieu of providing snow storage areas, snow melt and hauling of snow
			Snow Storage	may be allowed.
			Staff	The fire station paved circulation areas will include a snowmelt
			Comments	system instead of snow storage. Snow-melting all circulation areas
	1			will enhance Fire Department operations and emergency response.
			Comments 17.96.060.H3 Snow Storage Staff Comments 17.96.060.H4 Snow Storage Staff	A designated snow storage area shall not have any dimension less than five (5') feet and shall be a minimum of twenty-five (25) square feet. As permitted by KMC §17.96.060.H4, the project site will include a snowmelt system instead of a snow storage area. In lieu of providing snow storage areas, snow melt and hauling of snow may be allowed. The fire station paved circulation areas will include a snowmelt system instead of snow storage. Snow-melting all circulation areas

\boxtimes		17.96.060.I1	Landscaping is required for all projects.
		Landscaping	
		Staff	The landscape plan is included on Sheets L1.00 and L1.50 of the
		Comments	project plans. The grasses, flowering plants, and shrubs complement
			the fire station's modern design.
\boxtimes		17.96.060.12	Landscape materials and vegetation types specified shall be readily
		Landscaping	adaptable to a site's microclimate, soil conditions, orientation and
			aspect, and shall serve to enhance and complement the neighborhood
			and townscape.
		Staff	The landscape materials and vegetation types shall be readily
		Comments	adaptable to the site's microclimate, soil conditions, orientation, and
			aspect. The proposed landscaping will soften the fire station's hard
			lines and rectangular mass. Bordering the front property line, the tall
			grasses and flowering plants augment the welcoming entryway to the
			fire station.
\boxtimes		17.96.060.13	All trees, shrubs, grasses and perennials shall be drought tolerant.
		Landscaping	Native species are recommended but not required.
		Staff	All proposed landscape materials and vegetation types shall be
		Comments	drought tolerant. The applicant is encouraged to select native species.
\boxtimes		17.96.060.14	Landscaping shall provide a substantial buffer between land uses,
		Landscaping	including, but not limited to, structures, streets and parking lots. The
			development of landscaped public courtyards, including trees and
			shrubs where appropriate, shall be encouraged.
		Staff	The proposed landscaping is appropriate for the fire station project.
		Comments	The living trellis buffers the fire station from the Northwood Place
			apartments. An existing retaining wall separates the project site from
	<u> </u>		the light industrial area.
		17.96.060.J1	Where sidewalks are required, pedestrian amenities shall be installed.
		Public	Amenities may include, but are not limited to, benches and other
		Amenities	seating, kiosks, bus shelters, trash receptacles, restrooms, fountains,
			art, etc. All public amenities shall receive approval from the Public
			Works Department prior to design review approval from the
		Chaff	Commission.
		Staff	The project will realign the existing sidewalk that extends from
		Comments	Northwood Place to the YMCA. The width does not provide sufficient
			clearance to allow public amenities within the sidewalk design while
			still maintaining a clear path of travel as required by ADA. Further,
			sight constraints limit available locations to install amenities as any
			obstruction would conflict with vehicle ingress and egress into the site. Due to associated site constraints and potential conflicts with
			Fire Department operations, the fire station project does not propose
			any exterior public amenities such as benches. The community room
			and public restrooms provided within the fire station satisfy the public
			amenity requirement.
<u></u>			unicinty requirement.

RECOMMENDED MOTION

"I move to approve the Ketchum Fire Station Design Review subject to conditions."


RECOMMENDED CONDITIONS OF APPROVAL

- 1. This Design Review approval is subject to all comments and conditions as described in Tables 2, 3, and 4.
- 2. This Design Review approval is based on the plans and information presented and approved at the meeting on the date noted herein. Building Permit plans for all on-site improvements must conform to the approved Design Review plans unless otherwise approved in writing by the Planning and Zoning Commission or Administrator. Any building or site discrepancies which do not conform to the approved plans will be subject to removal.
- 3. All governing ordinances, requirements, and regulations of the Fire Department (2012 International Fire Code and local Fire Protection Ordinance No.1125), Building Department (2012 International Building Code, the 2012 International Residential Code, and Title 15 of Ketchum Municipal Code), Utilities Department, Street Department (Title 12 of Ketchum Municipal Code), and the City Engineer shall be met prior to Certificate of Occupancy.
- 4. The applicant shall submit final civil drawings prepared by an engineer registered in the State of Idaho to include specification for the ROW, utilities, and drainage improvements to be reviewed and approved by the City Engineer, Streets, and Utilities departments prior to issuance of a Building Permit for the project.
- 5. The term of Design Review approval shall be twelve (12) months from the date that the Findings of Fact, Conclusions of Law, and Decision are adopted by the Commission or upon appeal, the date the approval is granted by the Council subject to changes in zoning regulations (KMC §17.96.090).
- 6. All Design Review elements shall be completed prior to issuance of a Certificate of Occupancy for the building.
- 7. All exterior lighting on the property shall be in compliance with Ketchum Municipal Code, Chapter 17.132, Dark Skies, and shall be inspected by Planning Staff and approved prior the issuance of a Certificate of Occupancy for the building.
- 8. The project shall comply with the requirements of §17.124.040 Development Standards as adopted on the date a Building Permit is submitted for the project.
- 9. Prior to issuance of a Building Permit for the project, the applicant shall submit a construction management plans, which addresses each of the standards as set forth in Ketchum Municipal Code, Chapter 15.06 Construction Activity Standards.
- 10. In addition to the requirements set forth in this Design Review approval, this project shall comply with all applicable local, state, and federal laws.

EXHIBITS:

- A. Project Plans
- B. Response to Planning and Zoning Commission Comments on the Fire Station Pre-Application Design Review

Exhibit A: Project Plans

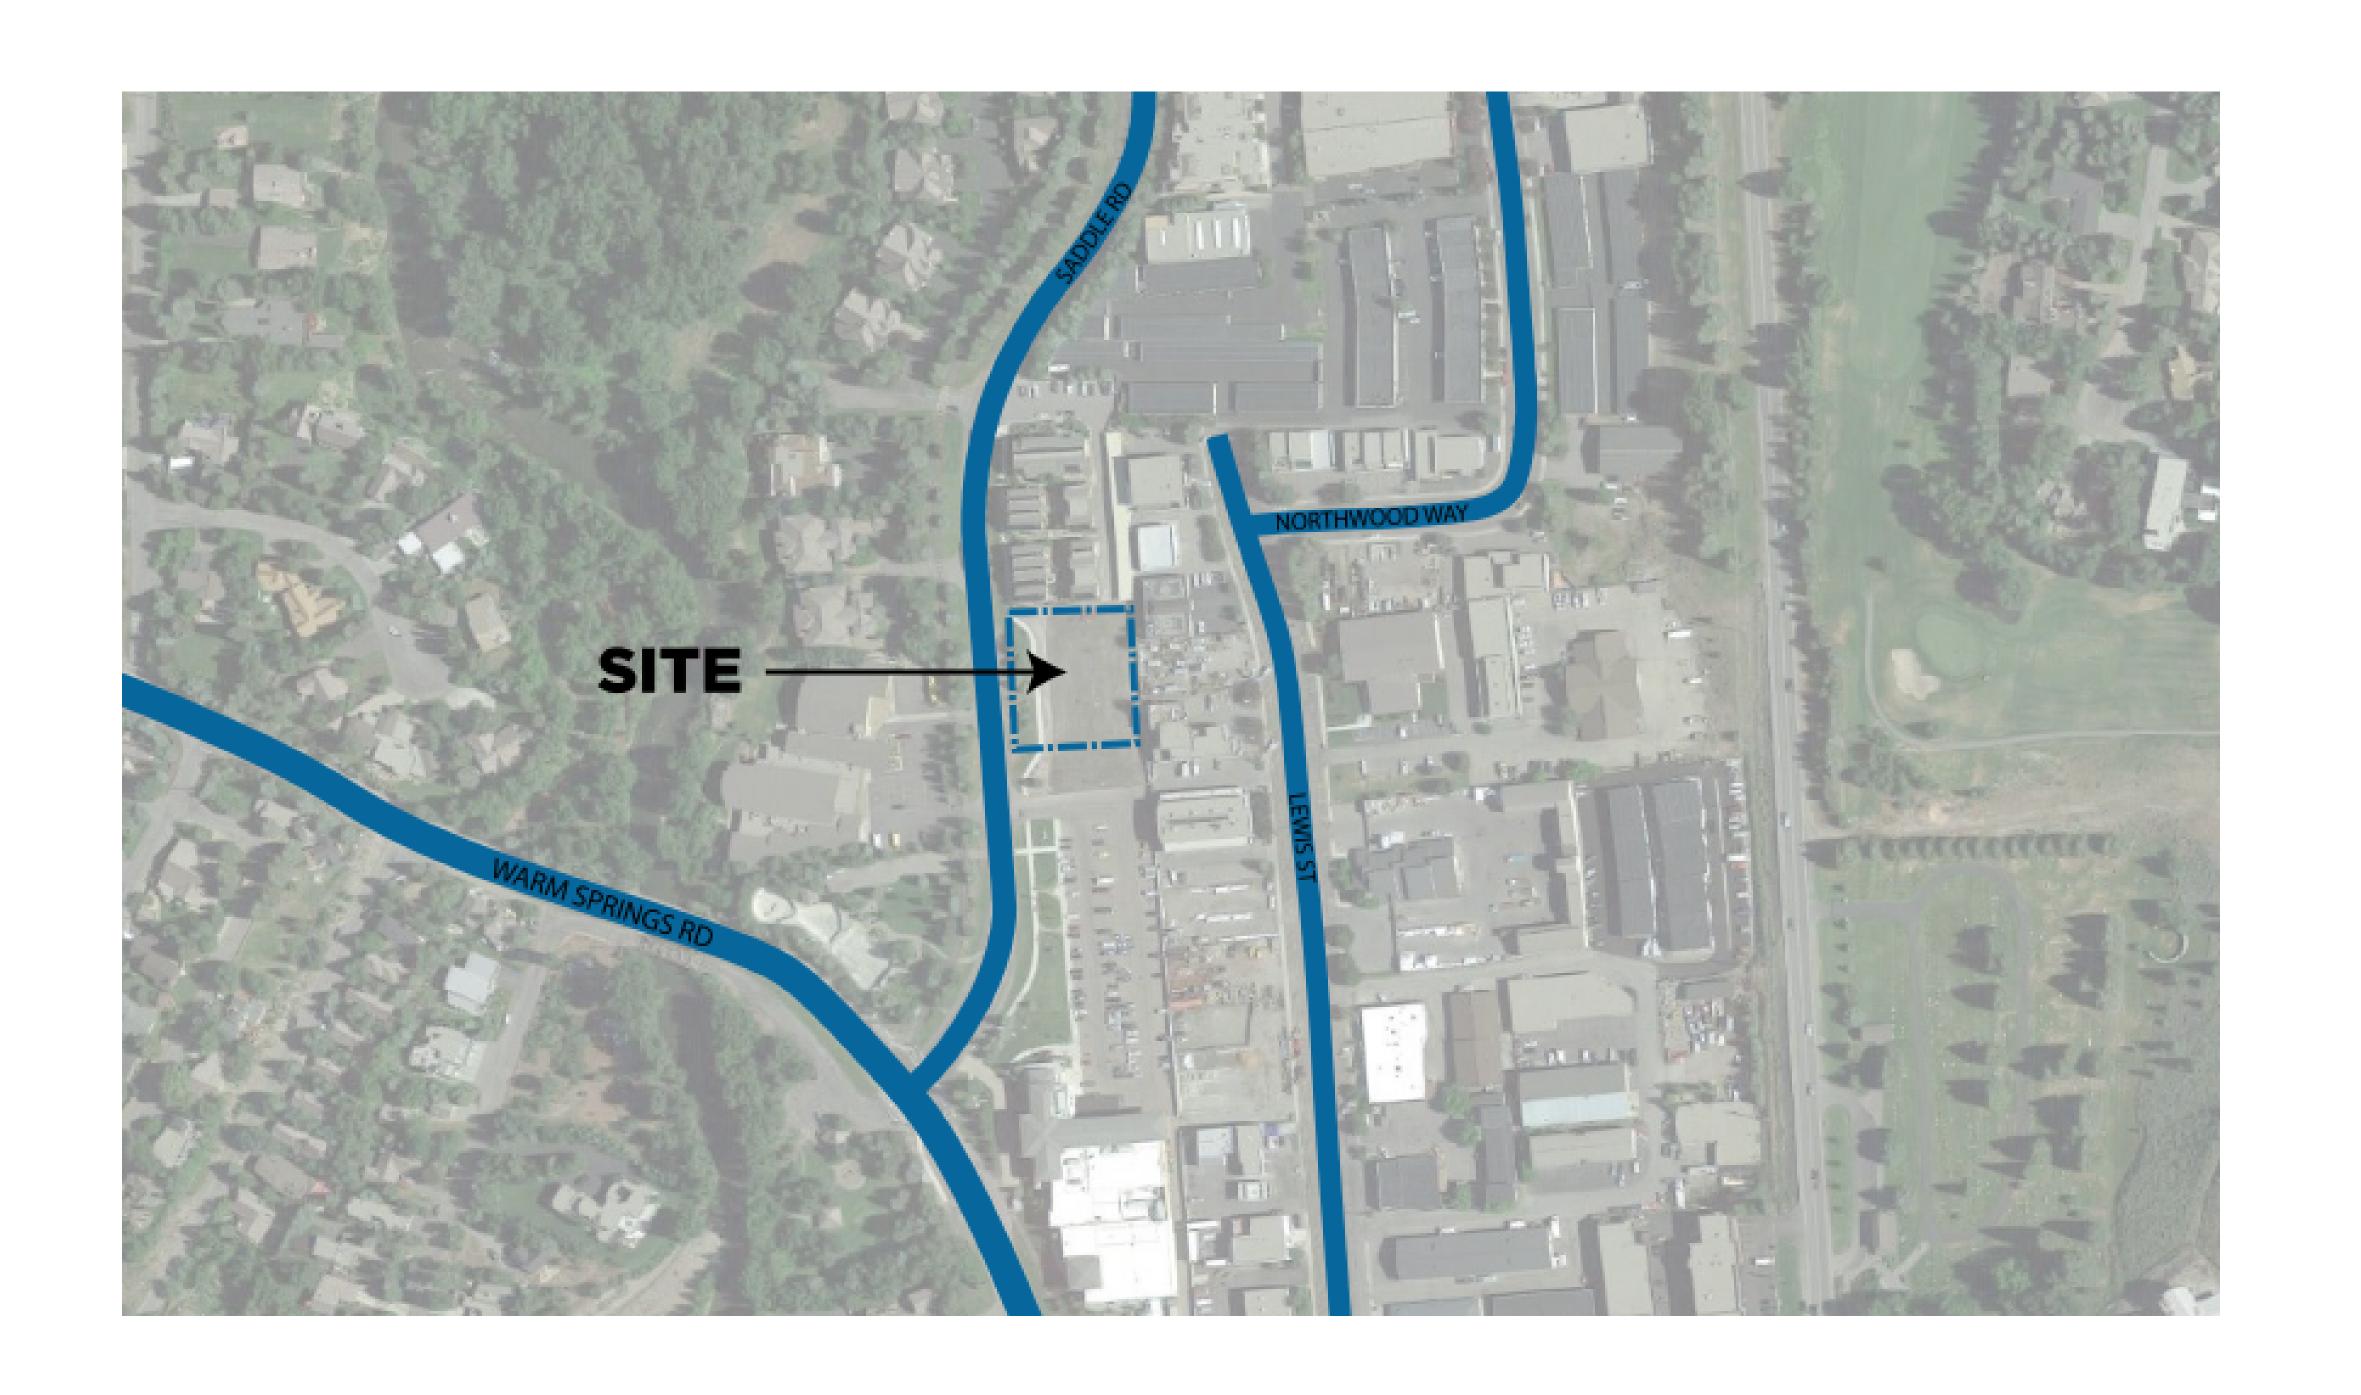



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PROJECT INFORMATION



KETCHUM FIRE STATION

107 SADDLE ROAD, KETCHUM, ID 83353

ISSUES


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JOB NUMBER	18-
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SHEET NUMBER

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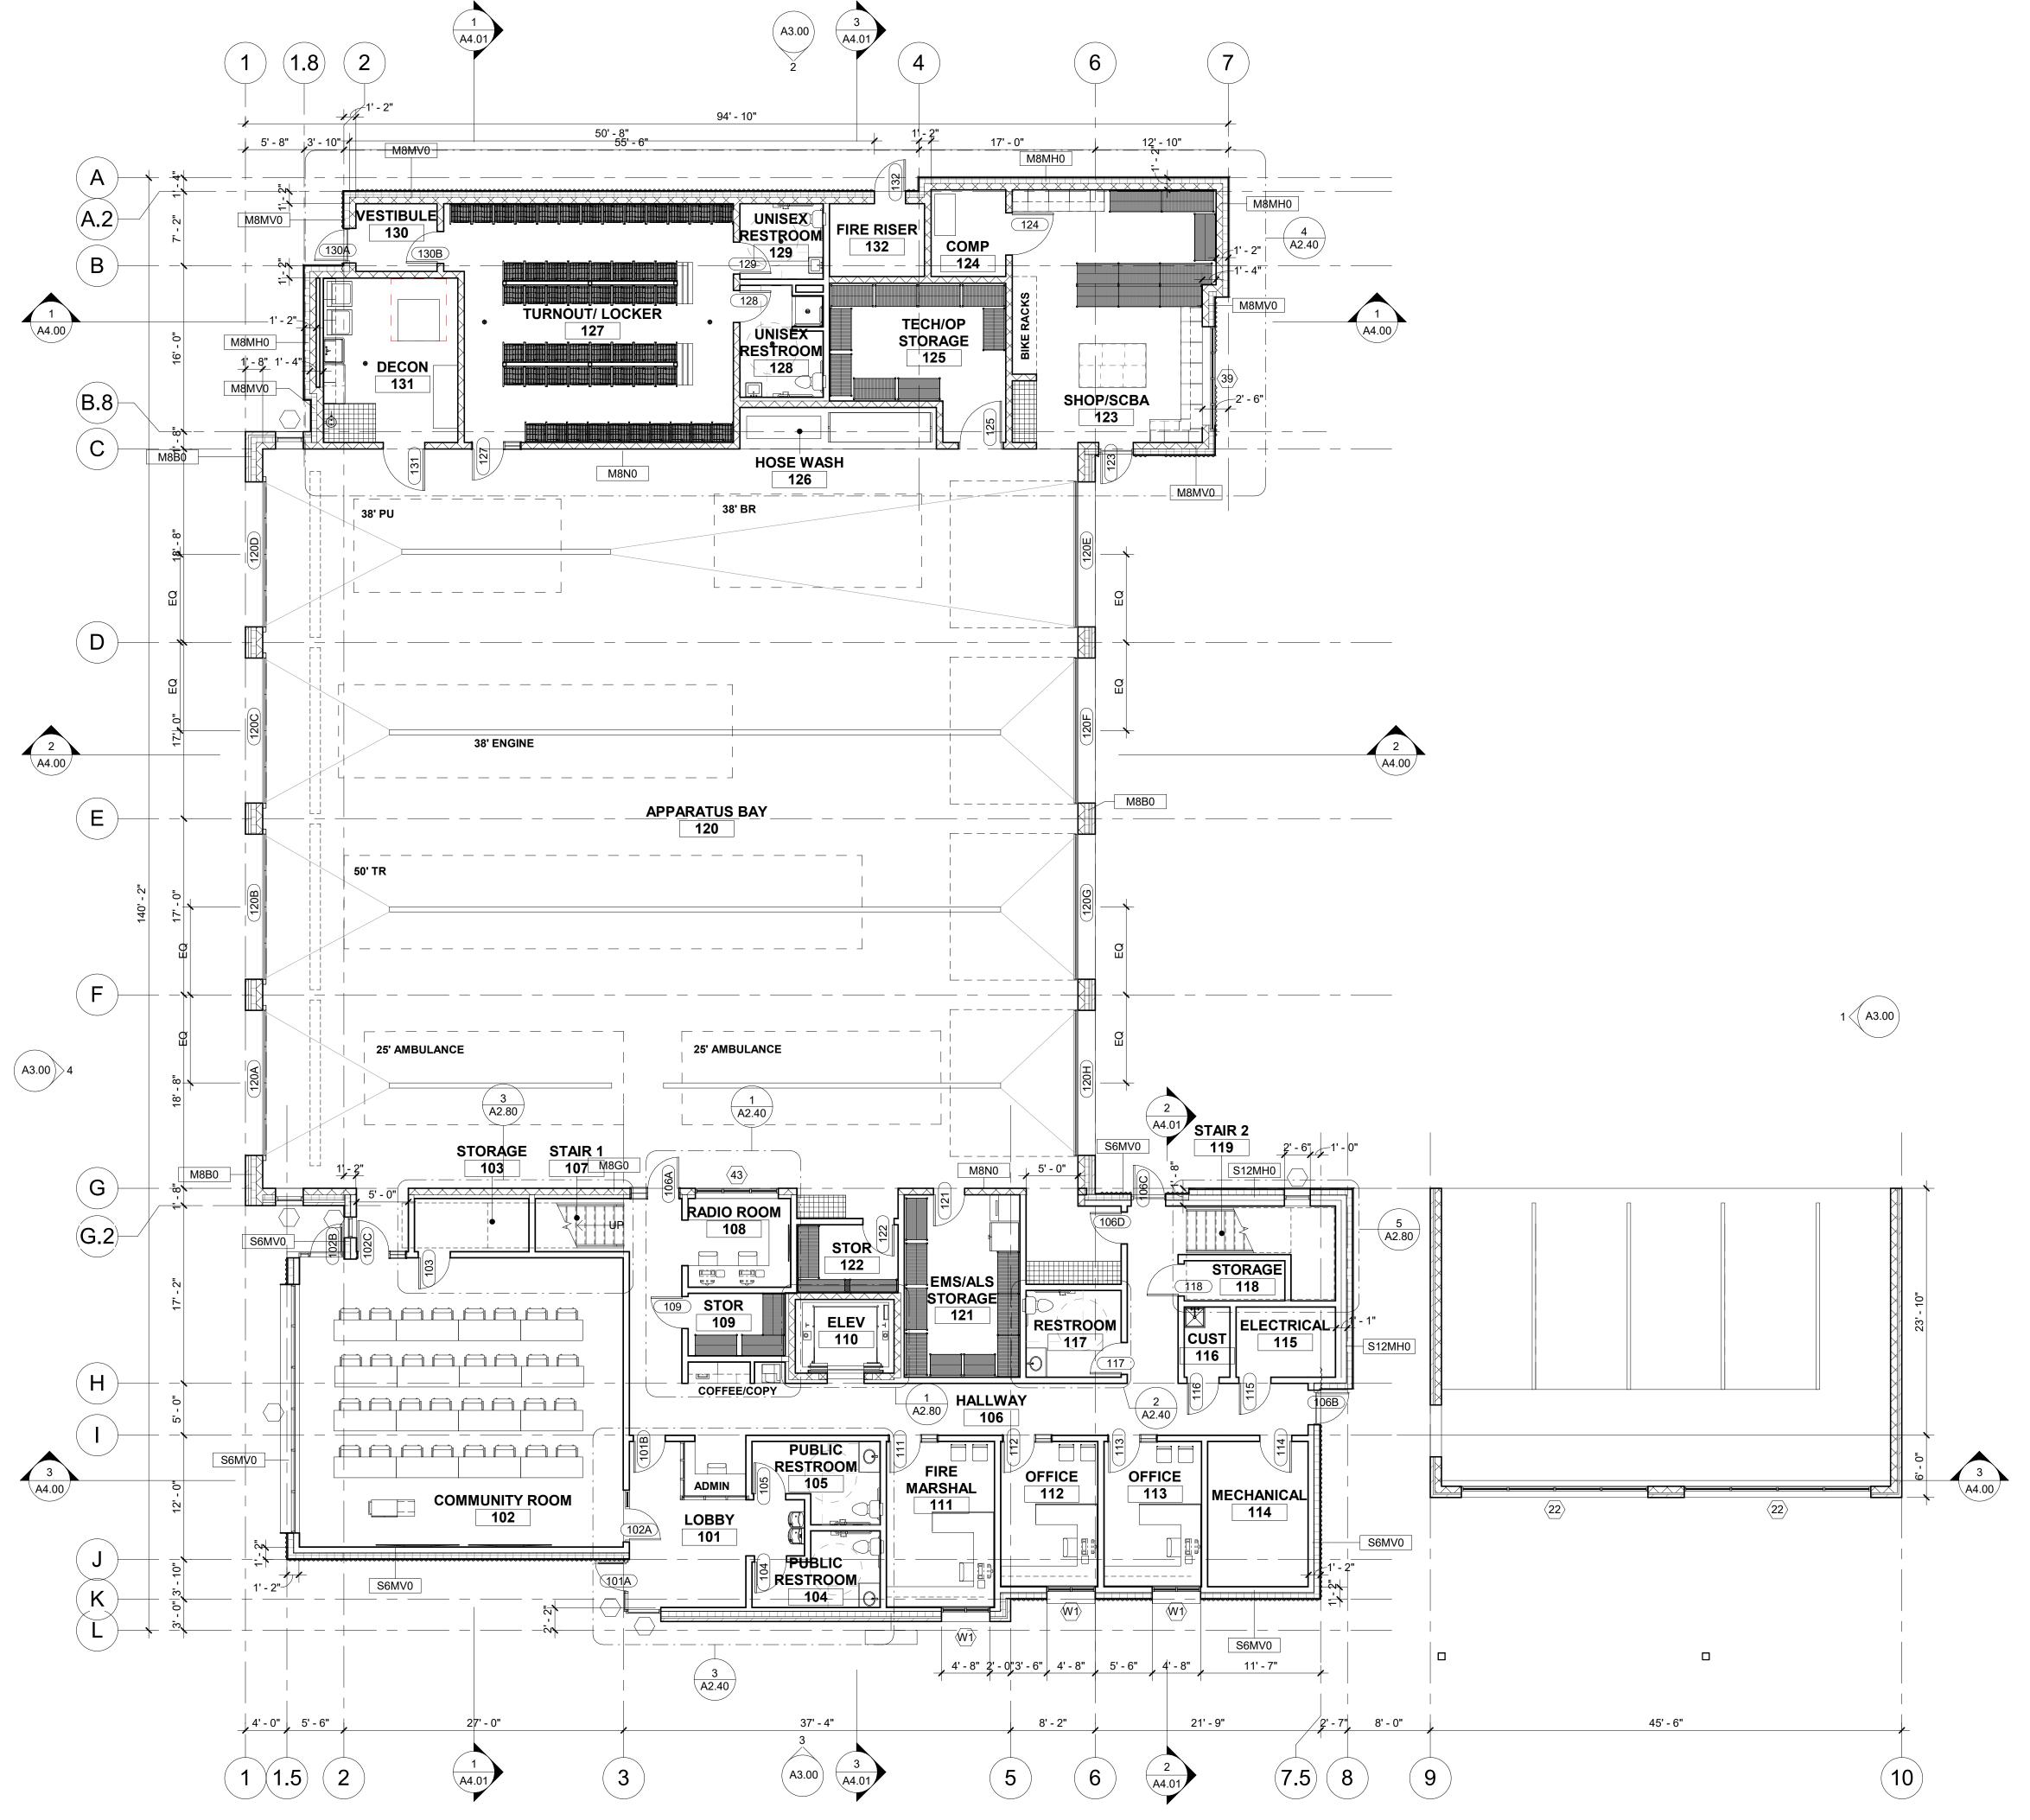
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ARCHITECTURAL SITE PLAN

SHEET NUMBER

A1.00

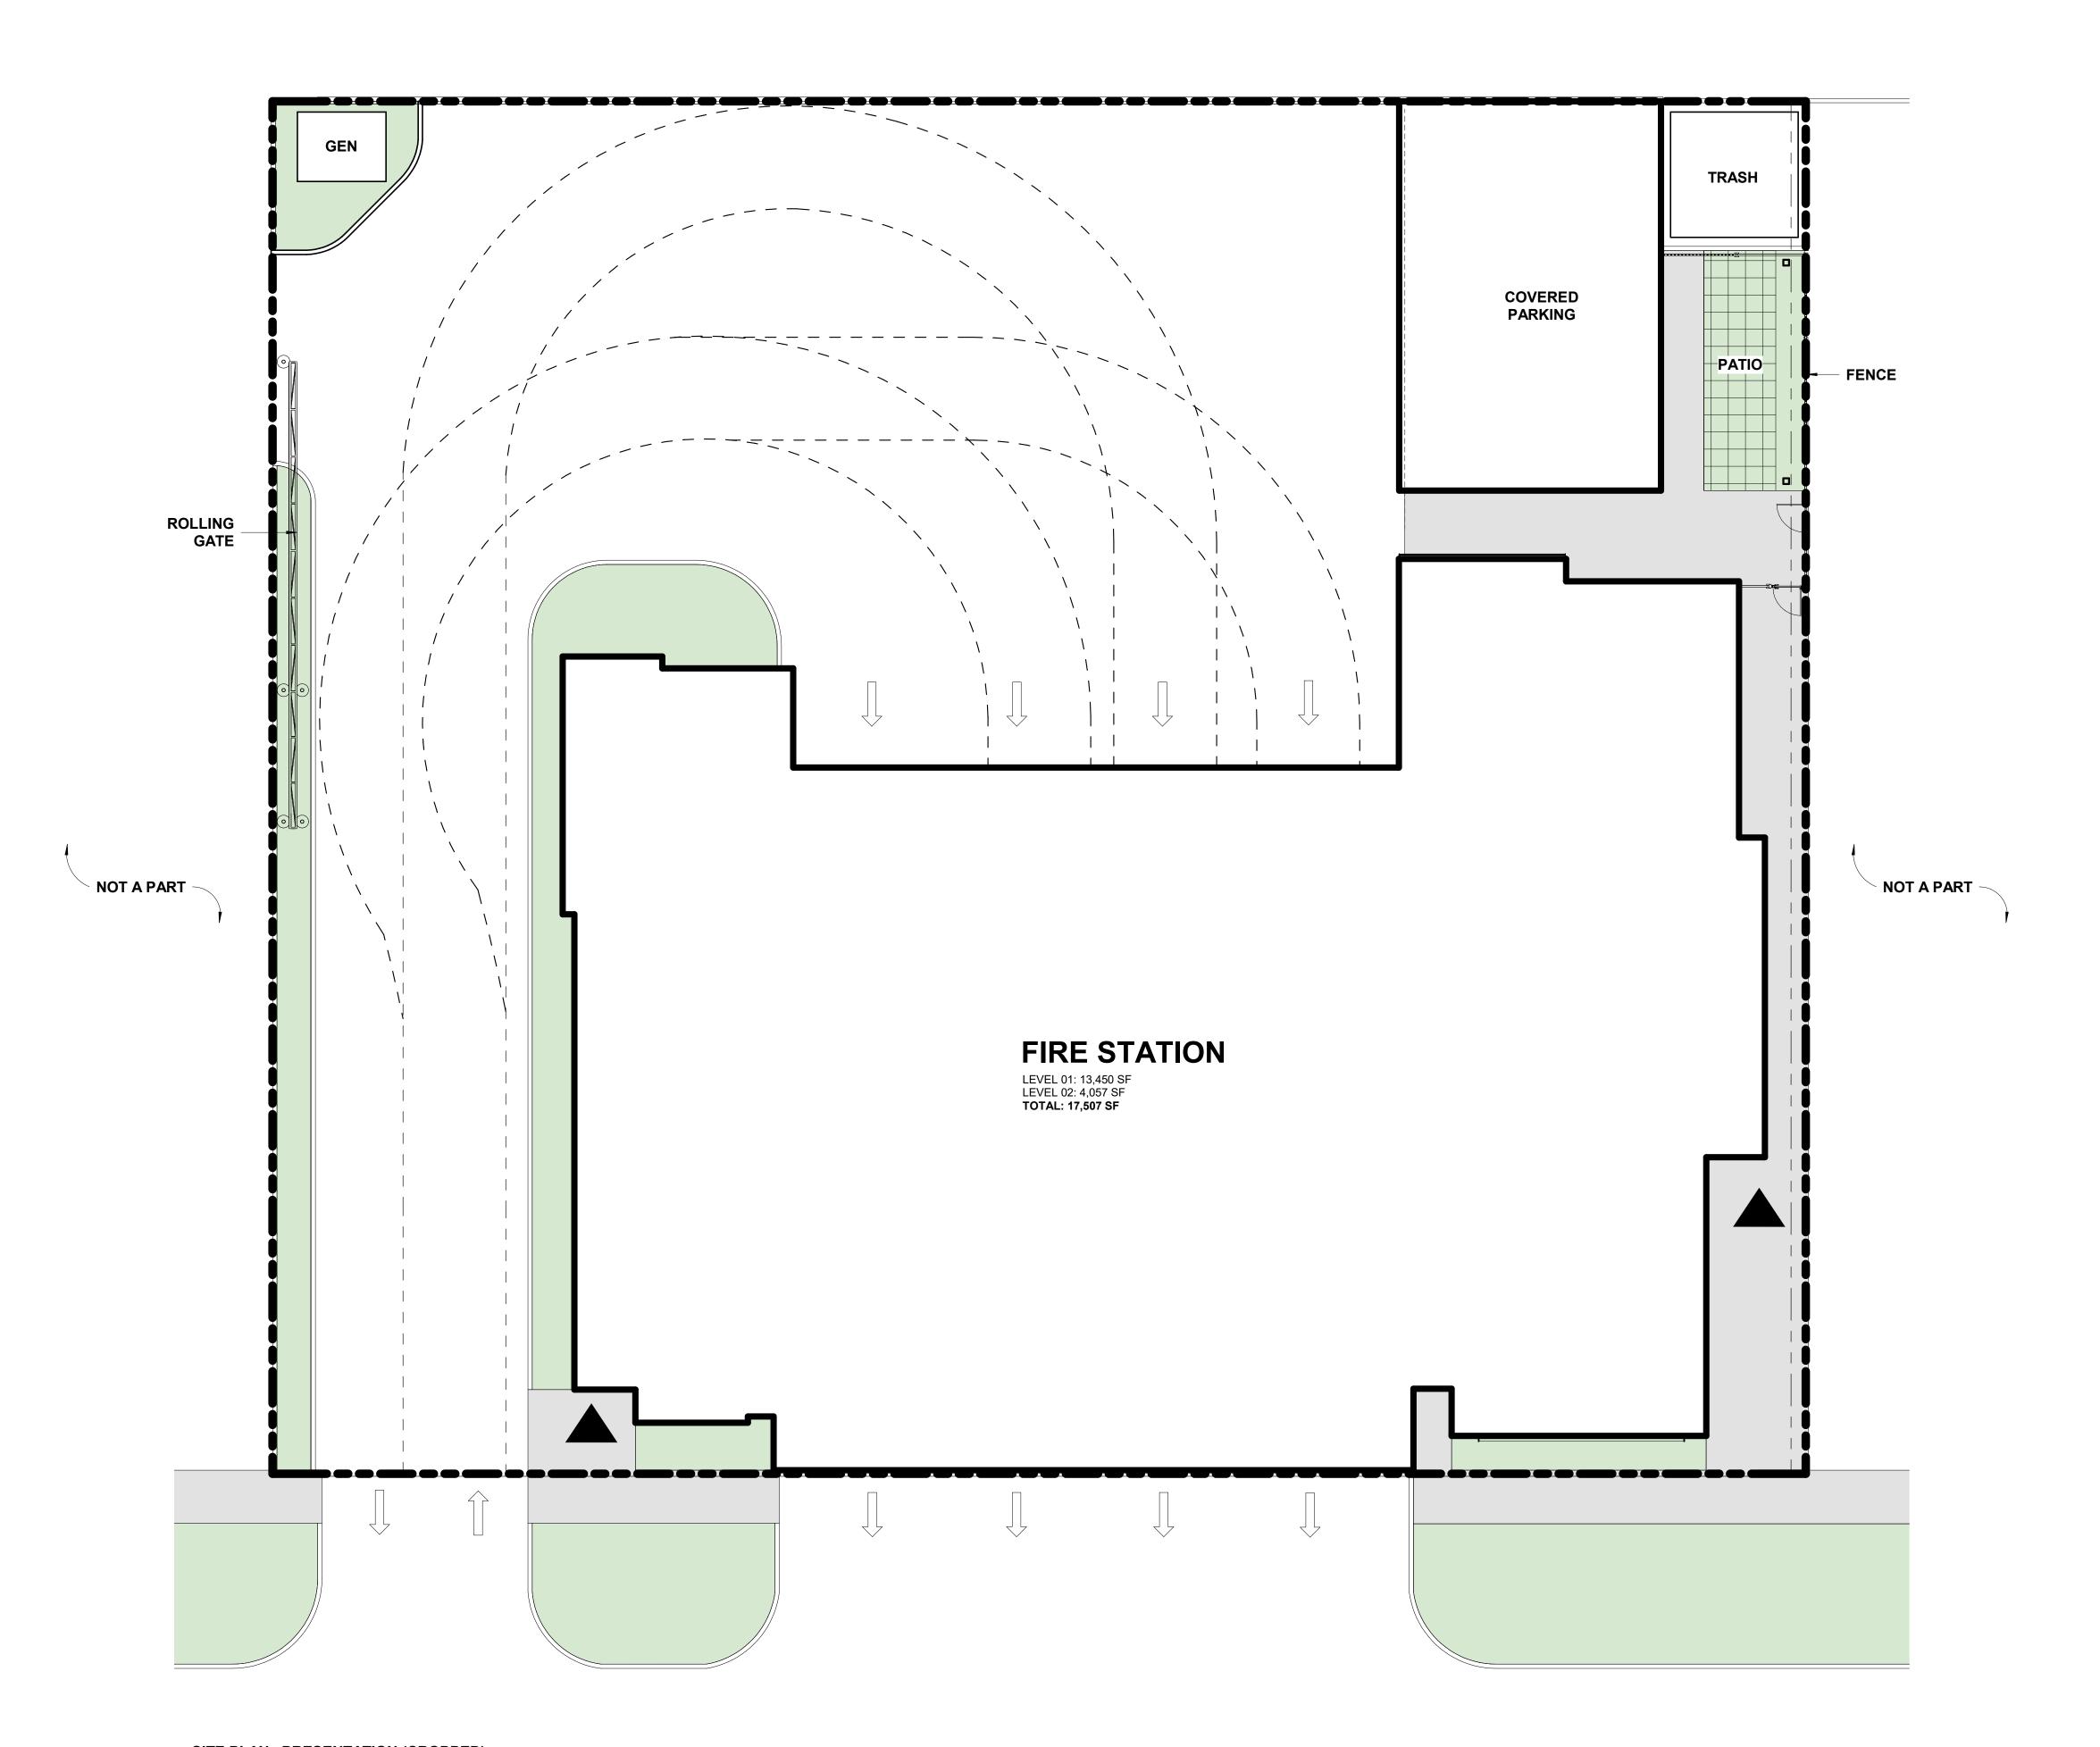

1 SCALE | 1/8" = 1'-0"

GENERAL NOTES

- A. FIELD VERIFY ALL DIMENSIONS AND EXISTING CONDITIONS. NOTIFY ARCHITECT IMMEDIATELY IF ANY CONFLICTS OR DISCREPANCIES OCCUR BEFORE PROCEEDING WITH WORK.
- B. CROSS REFERENCES SHOWN ON DRAWINGS DO NOT NECESSARILY INDICATE ALL LIKE CONDITIONS AND DO NOT LIMIT APPLICATION OF ANY DRAWING OR DETAIL. WHERE SPECIFIC DIMENSIONS, DETAILS, OR DESIGN INTENT CANNOT BE DETERMINED, CONSULT THE ARCHITECT PRIOR TO PROCEEDING WITH WORK. IF DESIGN INTENT REMAINS UNCLEAR THEN PROVIDE MOST EXPENSIVE OPTION IN BID.
- C. PROVIDE SOLID BLOCKING IN WALLS FOR ALL WALL HUNG EQUIPMENT. BLOCKING TO MEET OR EXCEED MANUFACTURER'S RECOMMENDATIONS. FASTEN EQUIPMENT TO WALLS PER MANUFACTURER'S RECOMMENDATIONS. PROVIDE BLOCKING FOR, BUT NOT LIMITED TO THE FOLLOWING: MILLWORK, RAILING, FIRE EXTINGUISHER ACCESSORIES, WALL MOUNTED PLUMBING FIXTURES, SHELVING, ELECTRICAL EQUIPMENT, RESTROOM ACCESSORIES AND DISPLAY ITEMS.
- D. CAULK ALL COUNTERTOPS, BACKSPLASHES AND CABINETS AT LOCATIONS WHERE THEY MEET WALLS. SEAL ALL CUT-OUTS IN COUNTERTOPS.
- E. ERECT DUST PROOF PARTITIONS AS REQUIRED BY OWNER TO PROTECT ADJACENT AREAS.
- F. SEAL AROUND ALL MECHANICAL AND ELECTRICAL EQUIPMENT PENETRATIONS AT WALLS. AT RATED WALLS USE A U.L. APPROVED FIRE-STOPPING MATERIAL.
- G. PROVIDE 4" DOOR JAMBS FROM FACE-OF-FINISH AT ADJACENT WALLS ON THE HINGE SIDE OR UNLESS OTHERWISE INDICATED.
- H. DIMENSIONS ARE TO GRID LINE OR FACE OF STRUCTURAL MEMBER UNLESS OTHERWISE NOTED. DOOR & WINDOW OPENING DIMENSIONS ARE TO ROUGH OPENING OR CENTERLINE OF OPENING. CONCRETE AND BRICK DIMENSIONS ARE GIVEN TO THE FACE OF CONCRETE OR MASONRY AND TO THE FACE OF ROUGH OPENINGS.
- WHEN APPLICABLE UNLESS NOTED OTHERWISE, USE CDX PLYWOOD FOR EXTERIOR AND CONCEALED APPLICATIONS AND AB PLYWOOD FOR EXPOSED INTERIOR APPLICATIONS.



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KETCHUM FIRE STATION

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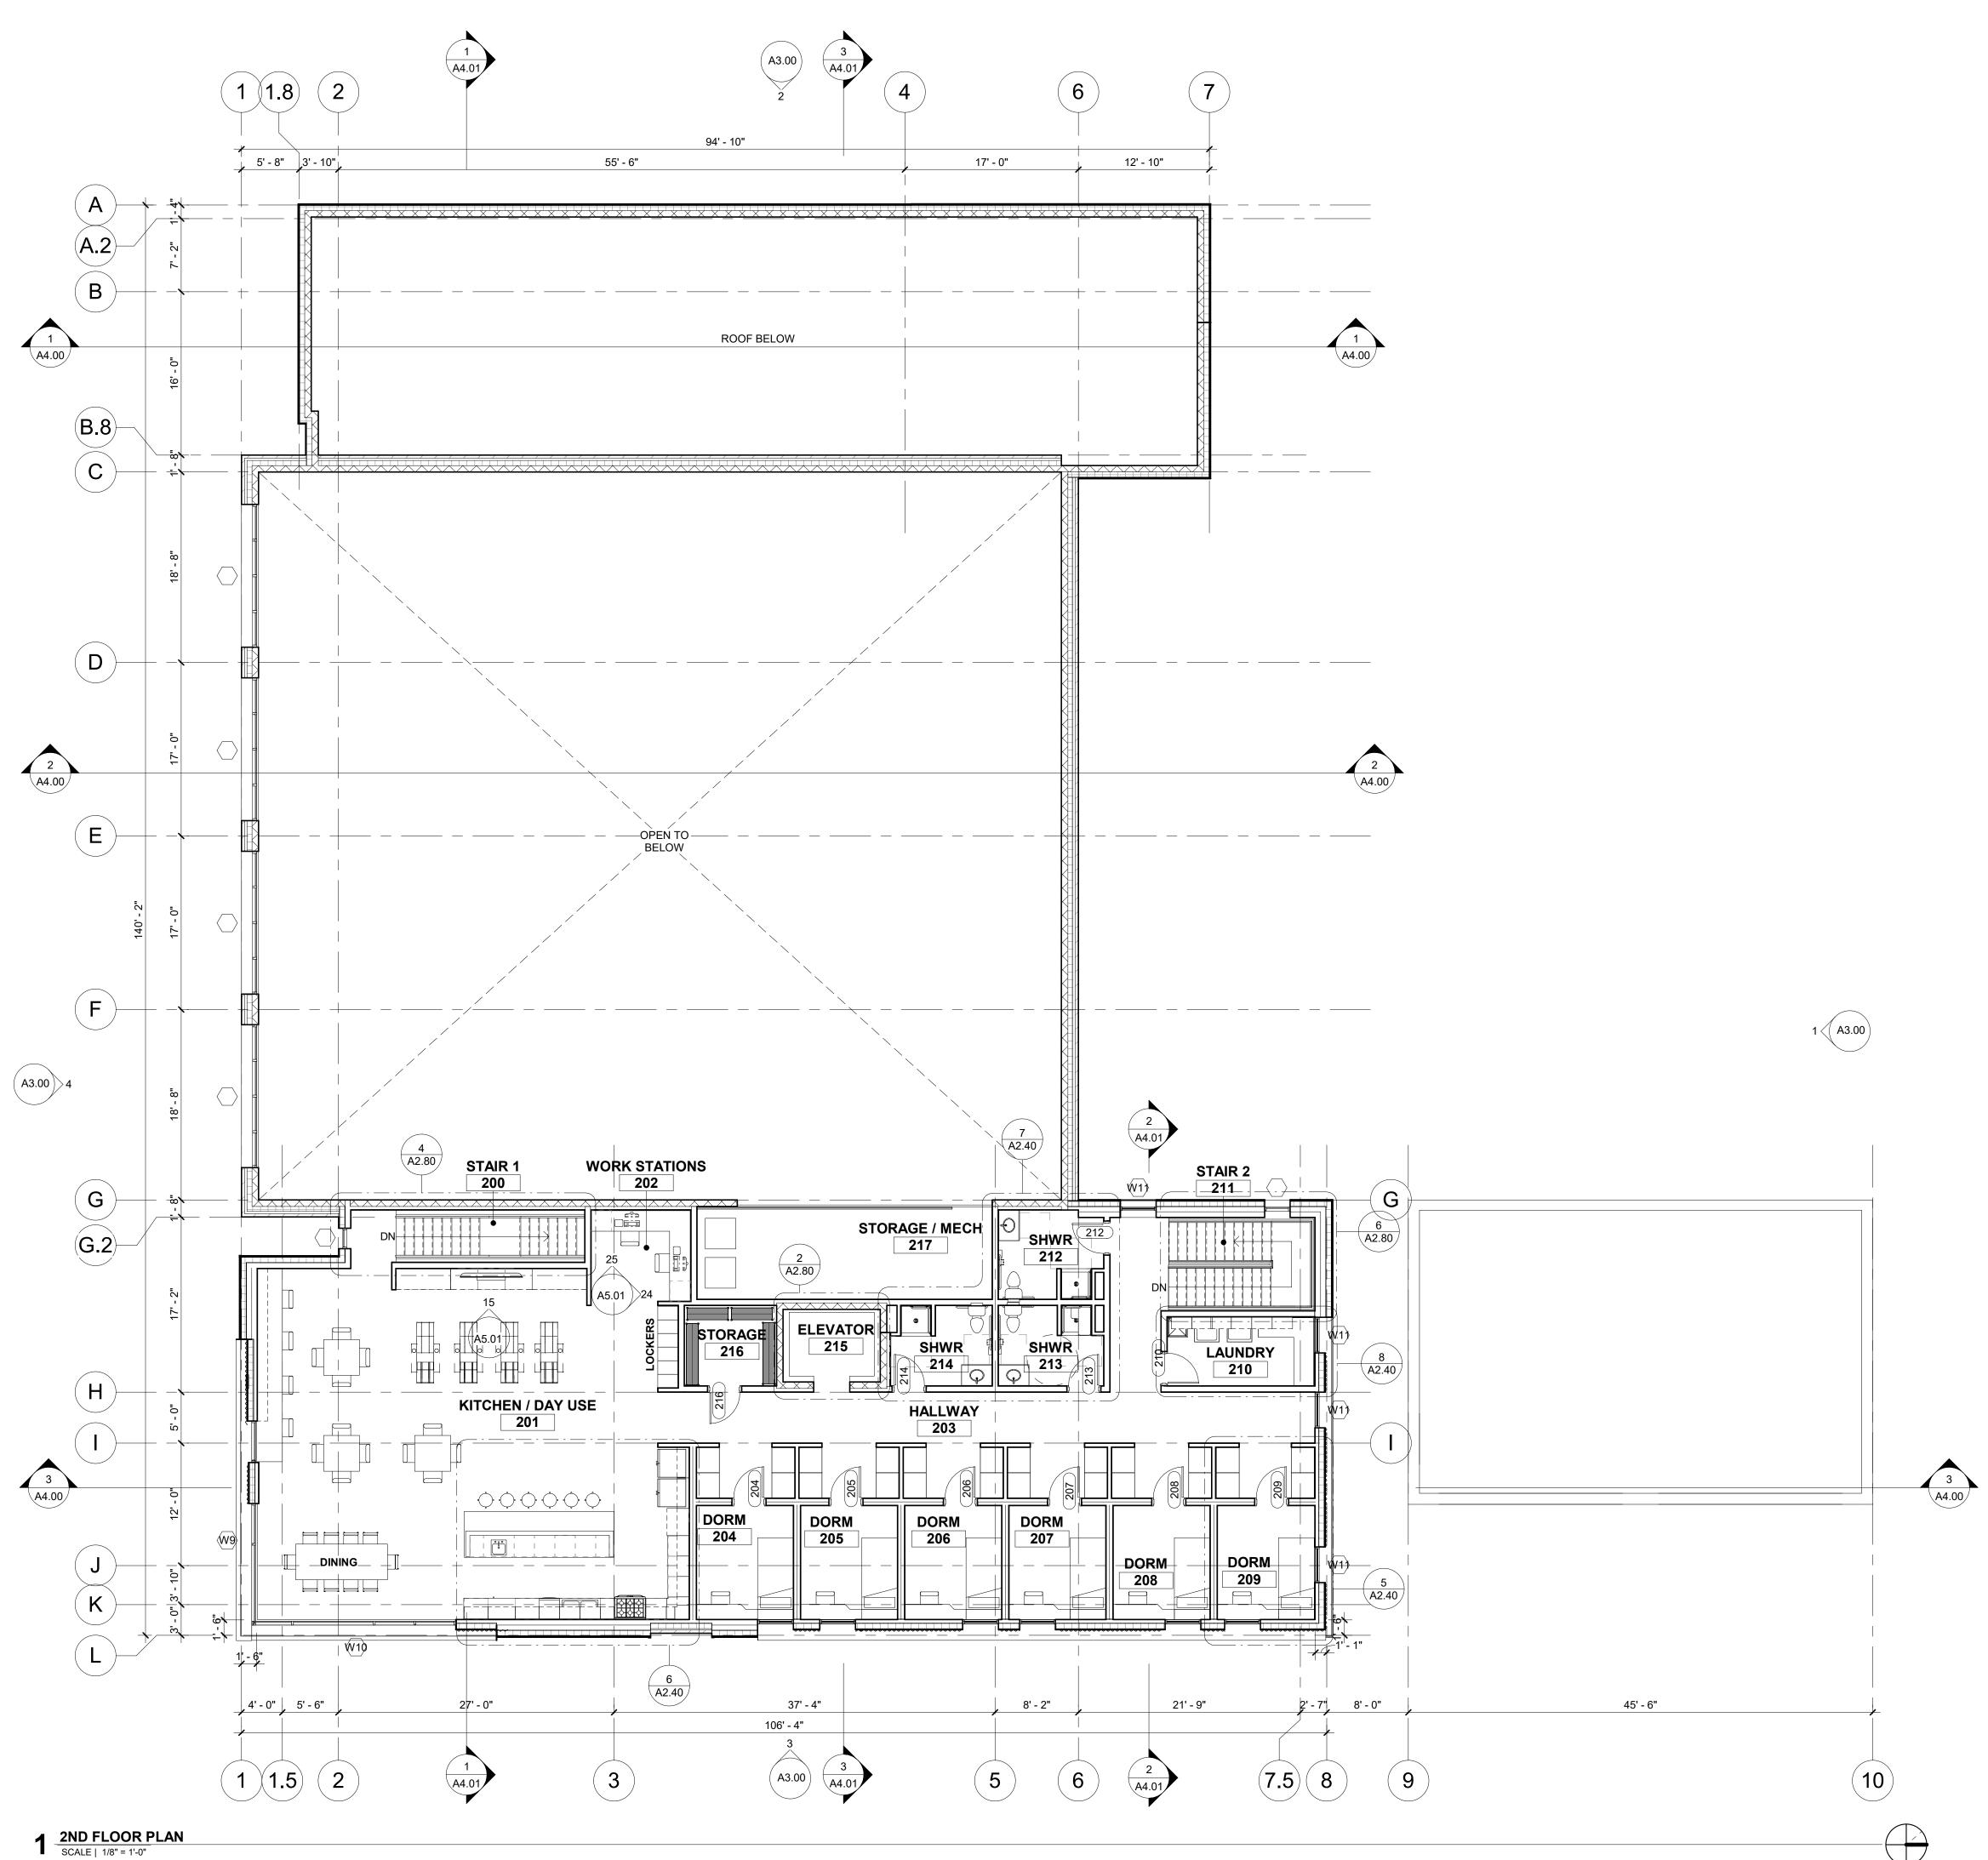
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FLOOR PLAN -LEVEL 01

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A2.01



GENERAL NOTES

- A. FIELD VERIFY ALL DIMENSIONS AND EXISTING CONDITIONS. NOTIFY ARCHITECT IMMEDIATELY IF ANY CONFLICTS OR DISCREPANCIES OCCUR BEFORE PROCEEDING WITH WORK.
- B. CROSS REFERENCES SHOWN ON DRAWINGS DO NOT NECESSARILY INDICATE ALL LIKE CONDITIONS AND DO NOT LIMIT APPLICATION OF ANY DRAWING OR DETAIL. WHERE SPECIFIC DIMENSIONS, DETAILS, OR DESIGN INTENT CANNOT BE DETERMINED, CONSULT THE ARCHITECT PRIOR TO PROCEEDING WITH WORK. IF DESIGN INTENT REMAINS UNCLEAR THEN PROVIDE MOST EXPENSIVE OPTION IN BID.
- C. PROVIDE SOLID BLOCKING IN WALLS FOR ALL WALL HUNG EQUIPMENT. BLOCKING TO MEET OR EXCEED MANUFACTURER'S RECOMMENDATIONS. FASTEN EQUIPMENT TO WALLS PER MANUFACTURER'S RECOMMENDATIONS. PROVIDE BLOCKING FOR, BUT NOT LIMITED TO THE FOLLOWING: MILLWORK, RAILING, FIRE EXTINGUISHER ACCESSORIES, WALL MOUNTED PLUMBING FIXTURES, SHELVING, ELECTRICAL EQUIPMENT, RESTROOM ACCESSORIES AND DISPLAY ITEMS.
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- F. SEAL AROUND ALL MECHANICAL AND ELECTRICAL EQUIPMENT PENETRATIONS AT WALLS. AT RATED WALLS USE A U.L. APPROVED FIRE-STOPPING MATERIAL.
- G. PROVIDE 4" DOOR JAMBS FROM FACE-OF-FINISH AT ADJACENT WALLS ON THE HINGE SIDE OR UNLESS OTHERWISE INDICATED.
- H. DIMENSIONS ARE TO GRID LINE OR FACE OF STRUCTURAL MEMBER UNLESS OTHERWISE NOTED. DOOR & WINDOW OPENING DIMENSIONS ARE TO ROUGH OPENING OR CENTERLINE OF OPENING. CONCRETE AND BRICK DIMENSIONS ARE GIVEN TO THE FACE OF CONCRETE OR MASONRY AND TO THE FACE OF ROUGH OPENINGS.
- I. WHEN APPLICABLE UNLESS NOTED OTHERWISE, USE CDX PLYWOOD FOR EXTERIOR AND CONCEALED APPLICATIONS AND AB PLYWOOD FOR EXPOSED INTERIOR APPLICATIONS.

KEYNOTES

1. XX



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KETCHUM FIRE STATION

107 SADDLE ROAD, KETCHUM, ID 83353

ISSUES


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JOB NUMBER	18-0
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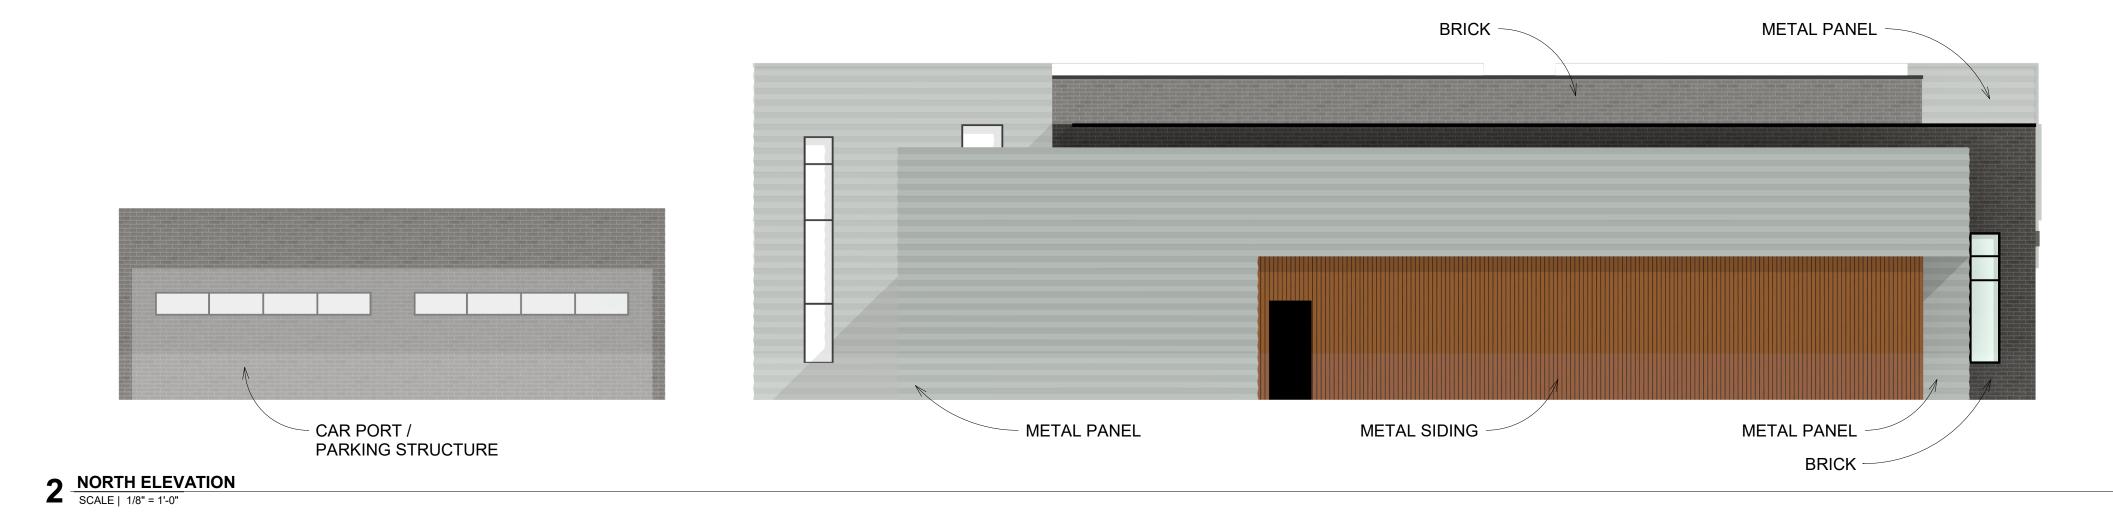
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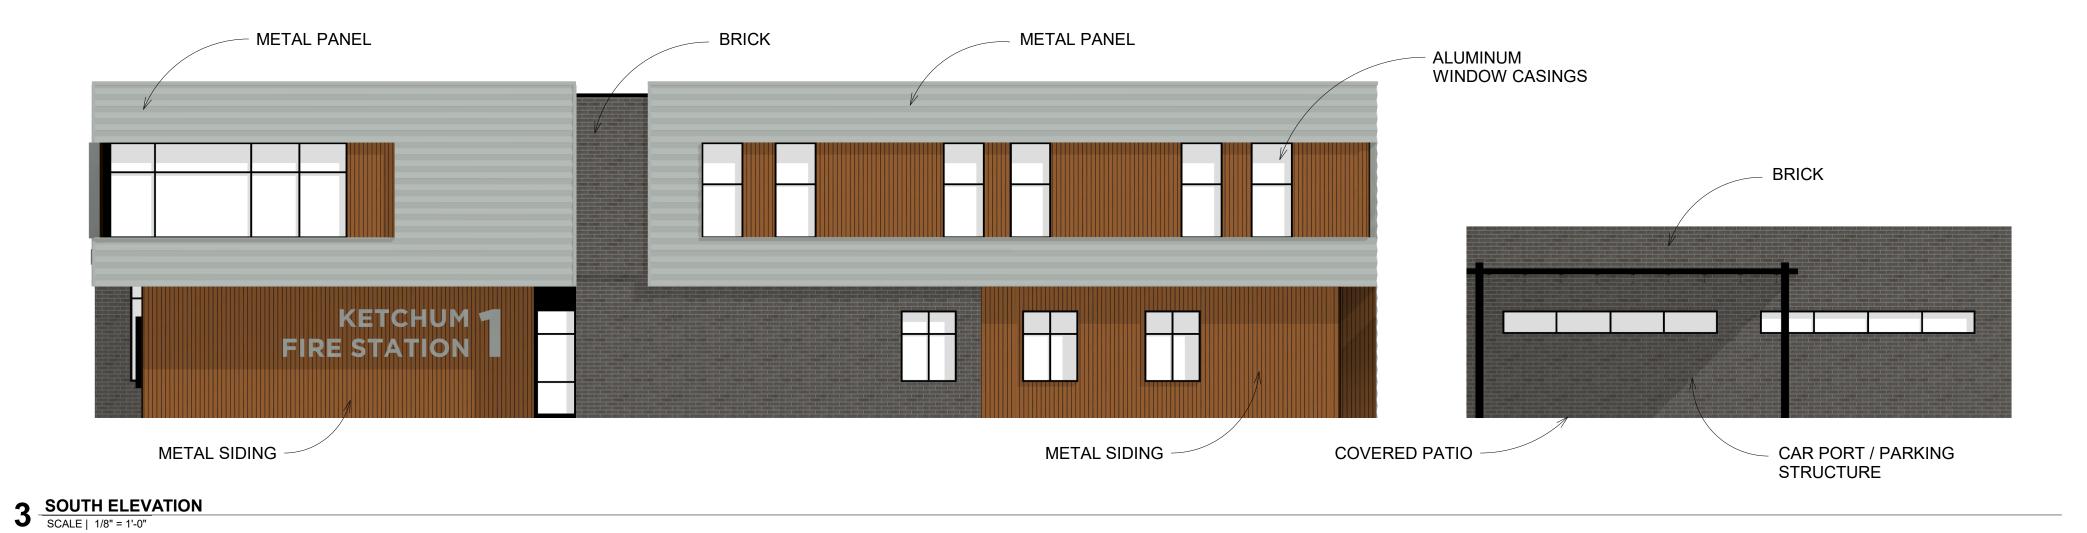
FLOOR PLAN -LEVEL 02


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A2.02







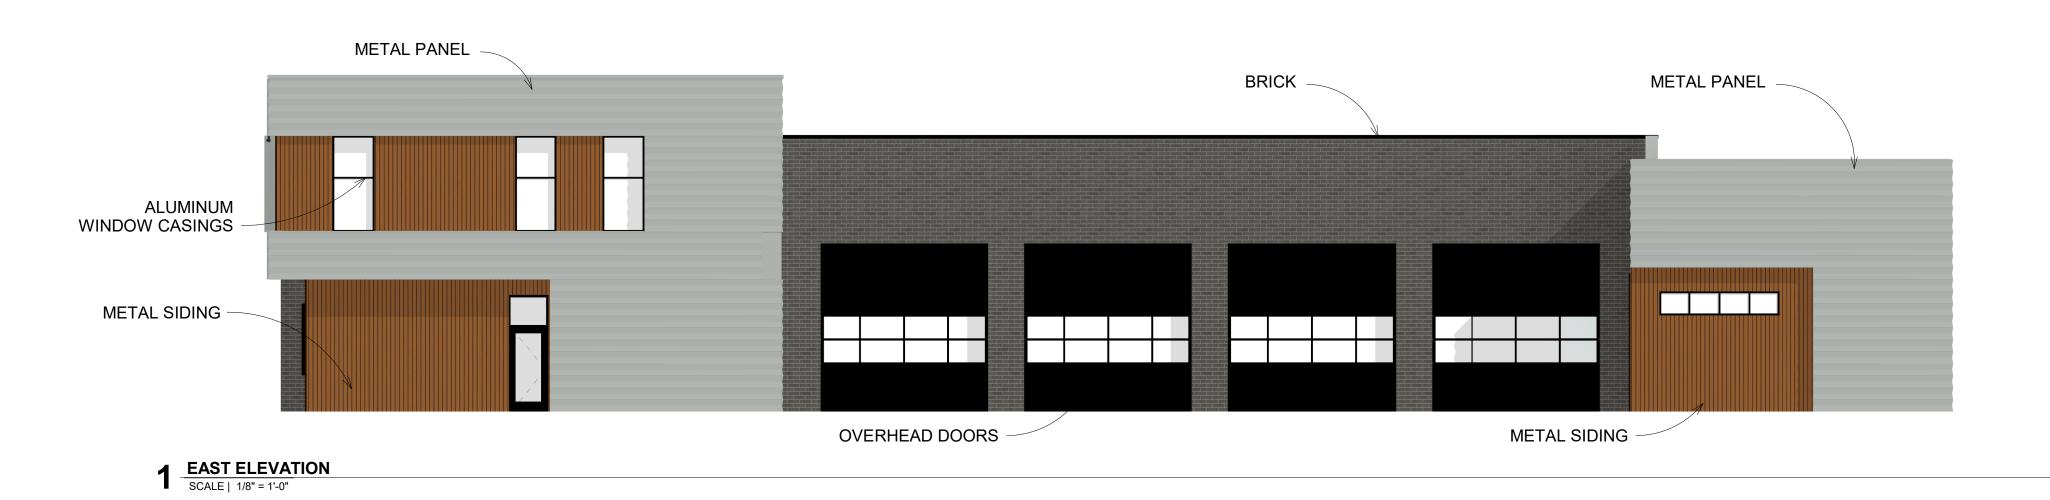

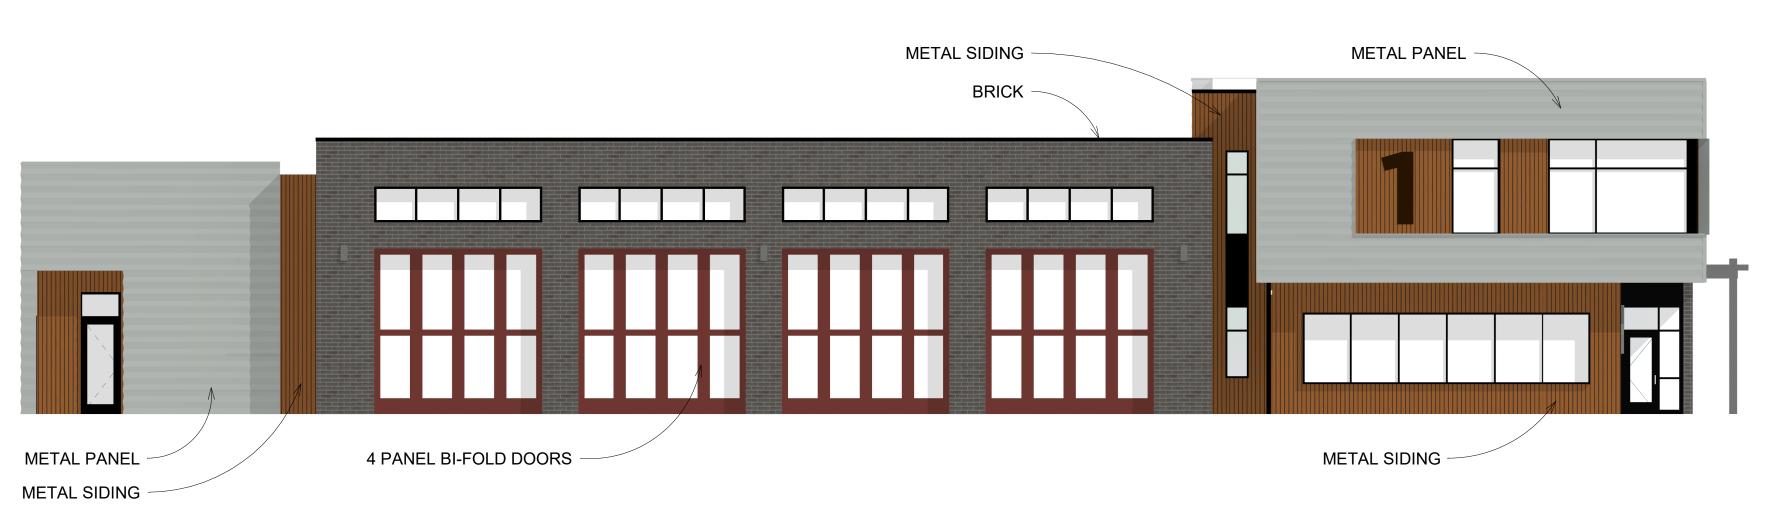4 WEST ELEVATION
SCALE | 1/8" = 1'-0"

GENERAL NOTES

- A. GENERAL NOTES APPLY TO ALL DRAWING SETS.
- B. FIELD VERIFY ALL DIMENSIONS AND EXISTING CONDITIONS. NOTIFY ARCHITECT IMMEDIATELY IF ANY CONFLICTS OR DISCREPANCIES OCCUR BEFORE PROCEEDING WITH WORK.
- C. CROSS REFERENCES SHOWN ON DRAWINGS DO NOT NECESSARILY INDICATE ALL LIKE CONDITIONS AND DO NOT LIMIT APPLICATION OF ANY DRAWING OR DETAIL. WHERE SPECIFIC DIMENSIONS, DETAILS, OR DESIGN INTENT CANNOT BE DETERMINED, CONSULT THE ARCHITECT PRIOR TO PROCEEDING WITH WORK. IF DESIGN INTENT REMAINS UNCLEAR THEN PROVIDE MOST EXPENSIVE OPTION IN BID.
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KETCHUM FIRE STATION

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ISSUES	
PHASE	DESIGN REVIEW
DATE	FEBRUARY 3, 2020
JOB NUMBER	18-022
MARK DATE	DESCRIPTION

SHEET NAME

EXTERIOR ELEVATIONS

SHEET NUMBER

A3.00





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KETCHUM FIRE STATION

107 SADDLE ROAD, KETCHUM, ID 83353

ISSUES


PHASE	DESIGN REVIE	
DATE	FEBRUARY 3, 202	
JOB NUMBER	18-02	
MARK DATE	DESCRIPTION	

SHEET NAME

3D PERSPECTIVE

SHEET NUMBER

G0.20

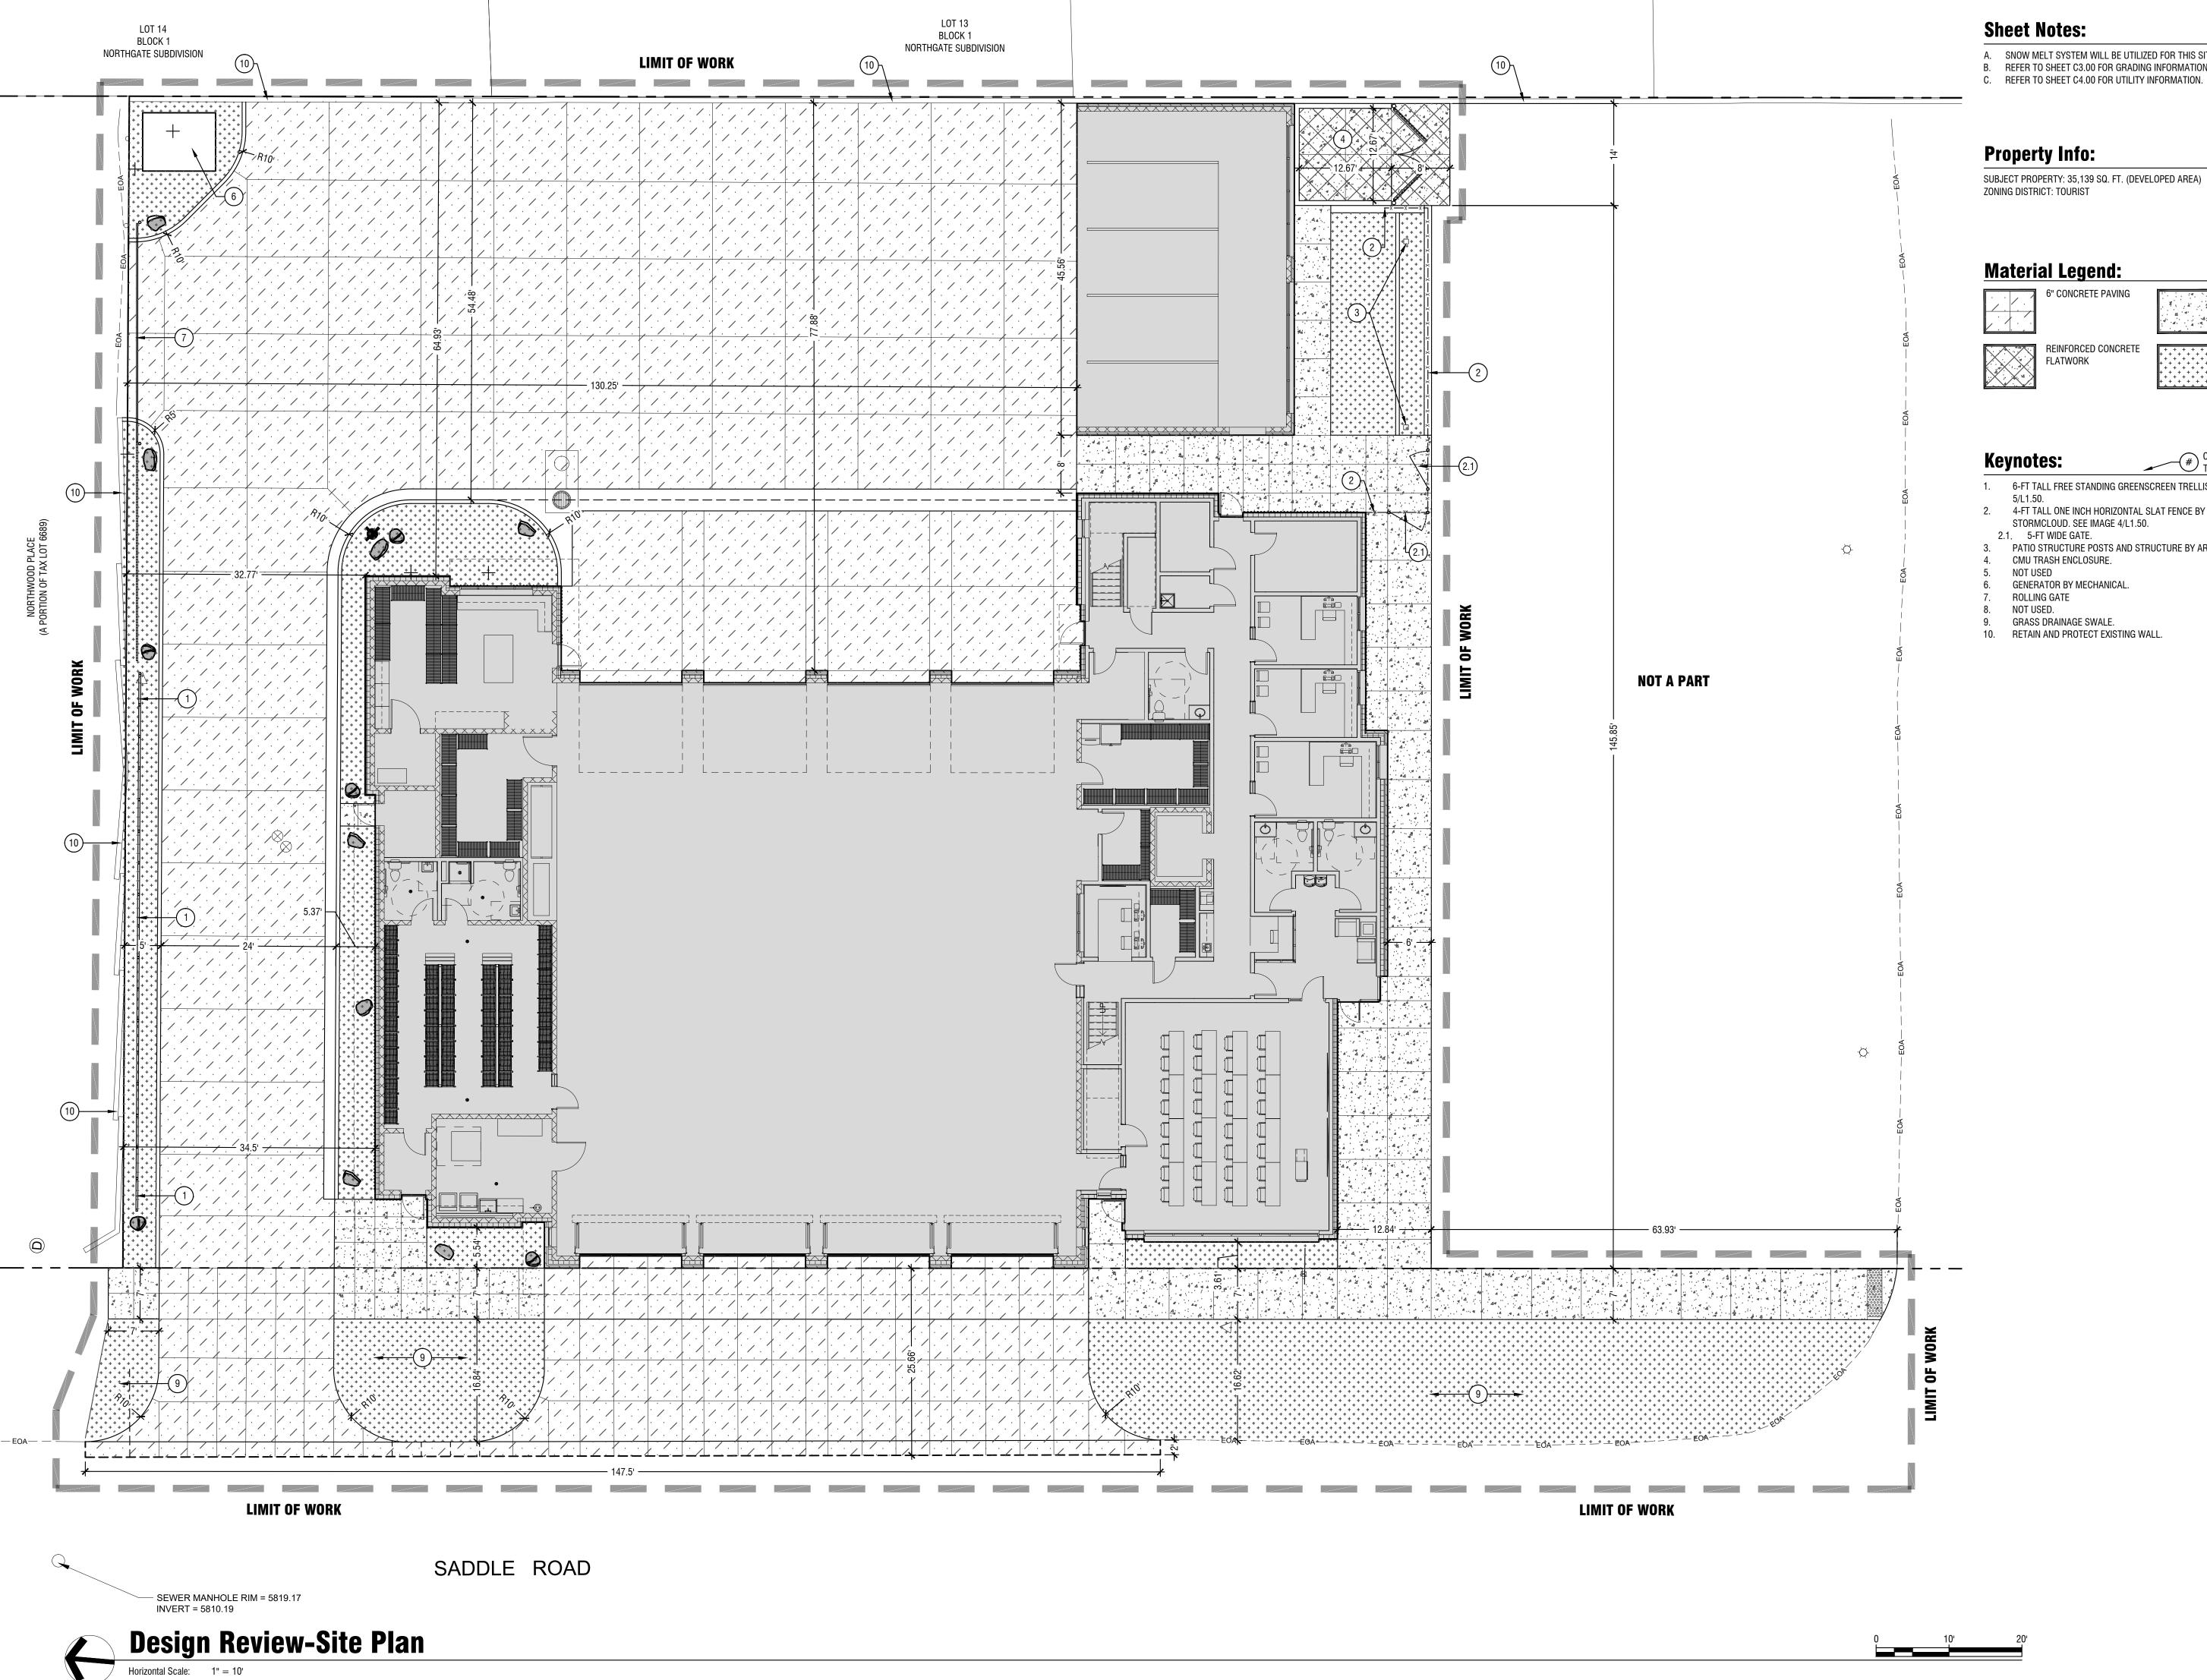

- A. SNOW MELT SYSTEM WILL BE UTILIZED FOR THIS SITE.B. REFER TO SHEET C3.00 FOR GRADING INFORMATION.

SUBJECT PROPERTY: 35,139 SQ. FT. (DEVELOPED AREA)

Material Legend:

STANDARD CONCRETE FLATWORK

LANDSCAPE AREA - REFER TO SHEET L1.00 FOR MORE INFORMATION.

CALLOUT NUMBERS COORDINATED TO NUMBERED NOTES BELOW.

- 1. 6-FT TALL FREE STANDING GREENSCREEN TRELLISING SYSTEM SEE IMAGE
- 2. 4-FT TALL ONE INCH HORIZONTAL SLAT FENCE BY LANDSCAPE FORMS. COLOR: STORMCLOUD. SEE IMAGE 4/L1.50.
- 3. PATIO STRUCTURE POSTS AND STRUCTURE BY ARCHITECTS.
- CMU TRASH ENCLOSURE.
- GENERATOR BY MECHANICAL.
- GRASS DRAINAGE SWALE. 10. RETAIN AND PROTECT EXISTING WALL.

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PROJECT INFORMATION



KETCHUM FIRE STATION

107 SADDLE ROAD, KETCHUM, ID 83353

PHASE **DESIGN REVIEW** FEBRUARY 3, 2020 DATE JOB NUMBER 18-022


MARK DATE DESCRIPTION

SHEET NAME

SITE PLAN

SHEET NUMBER

C2.00

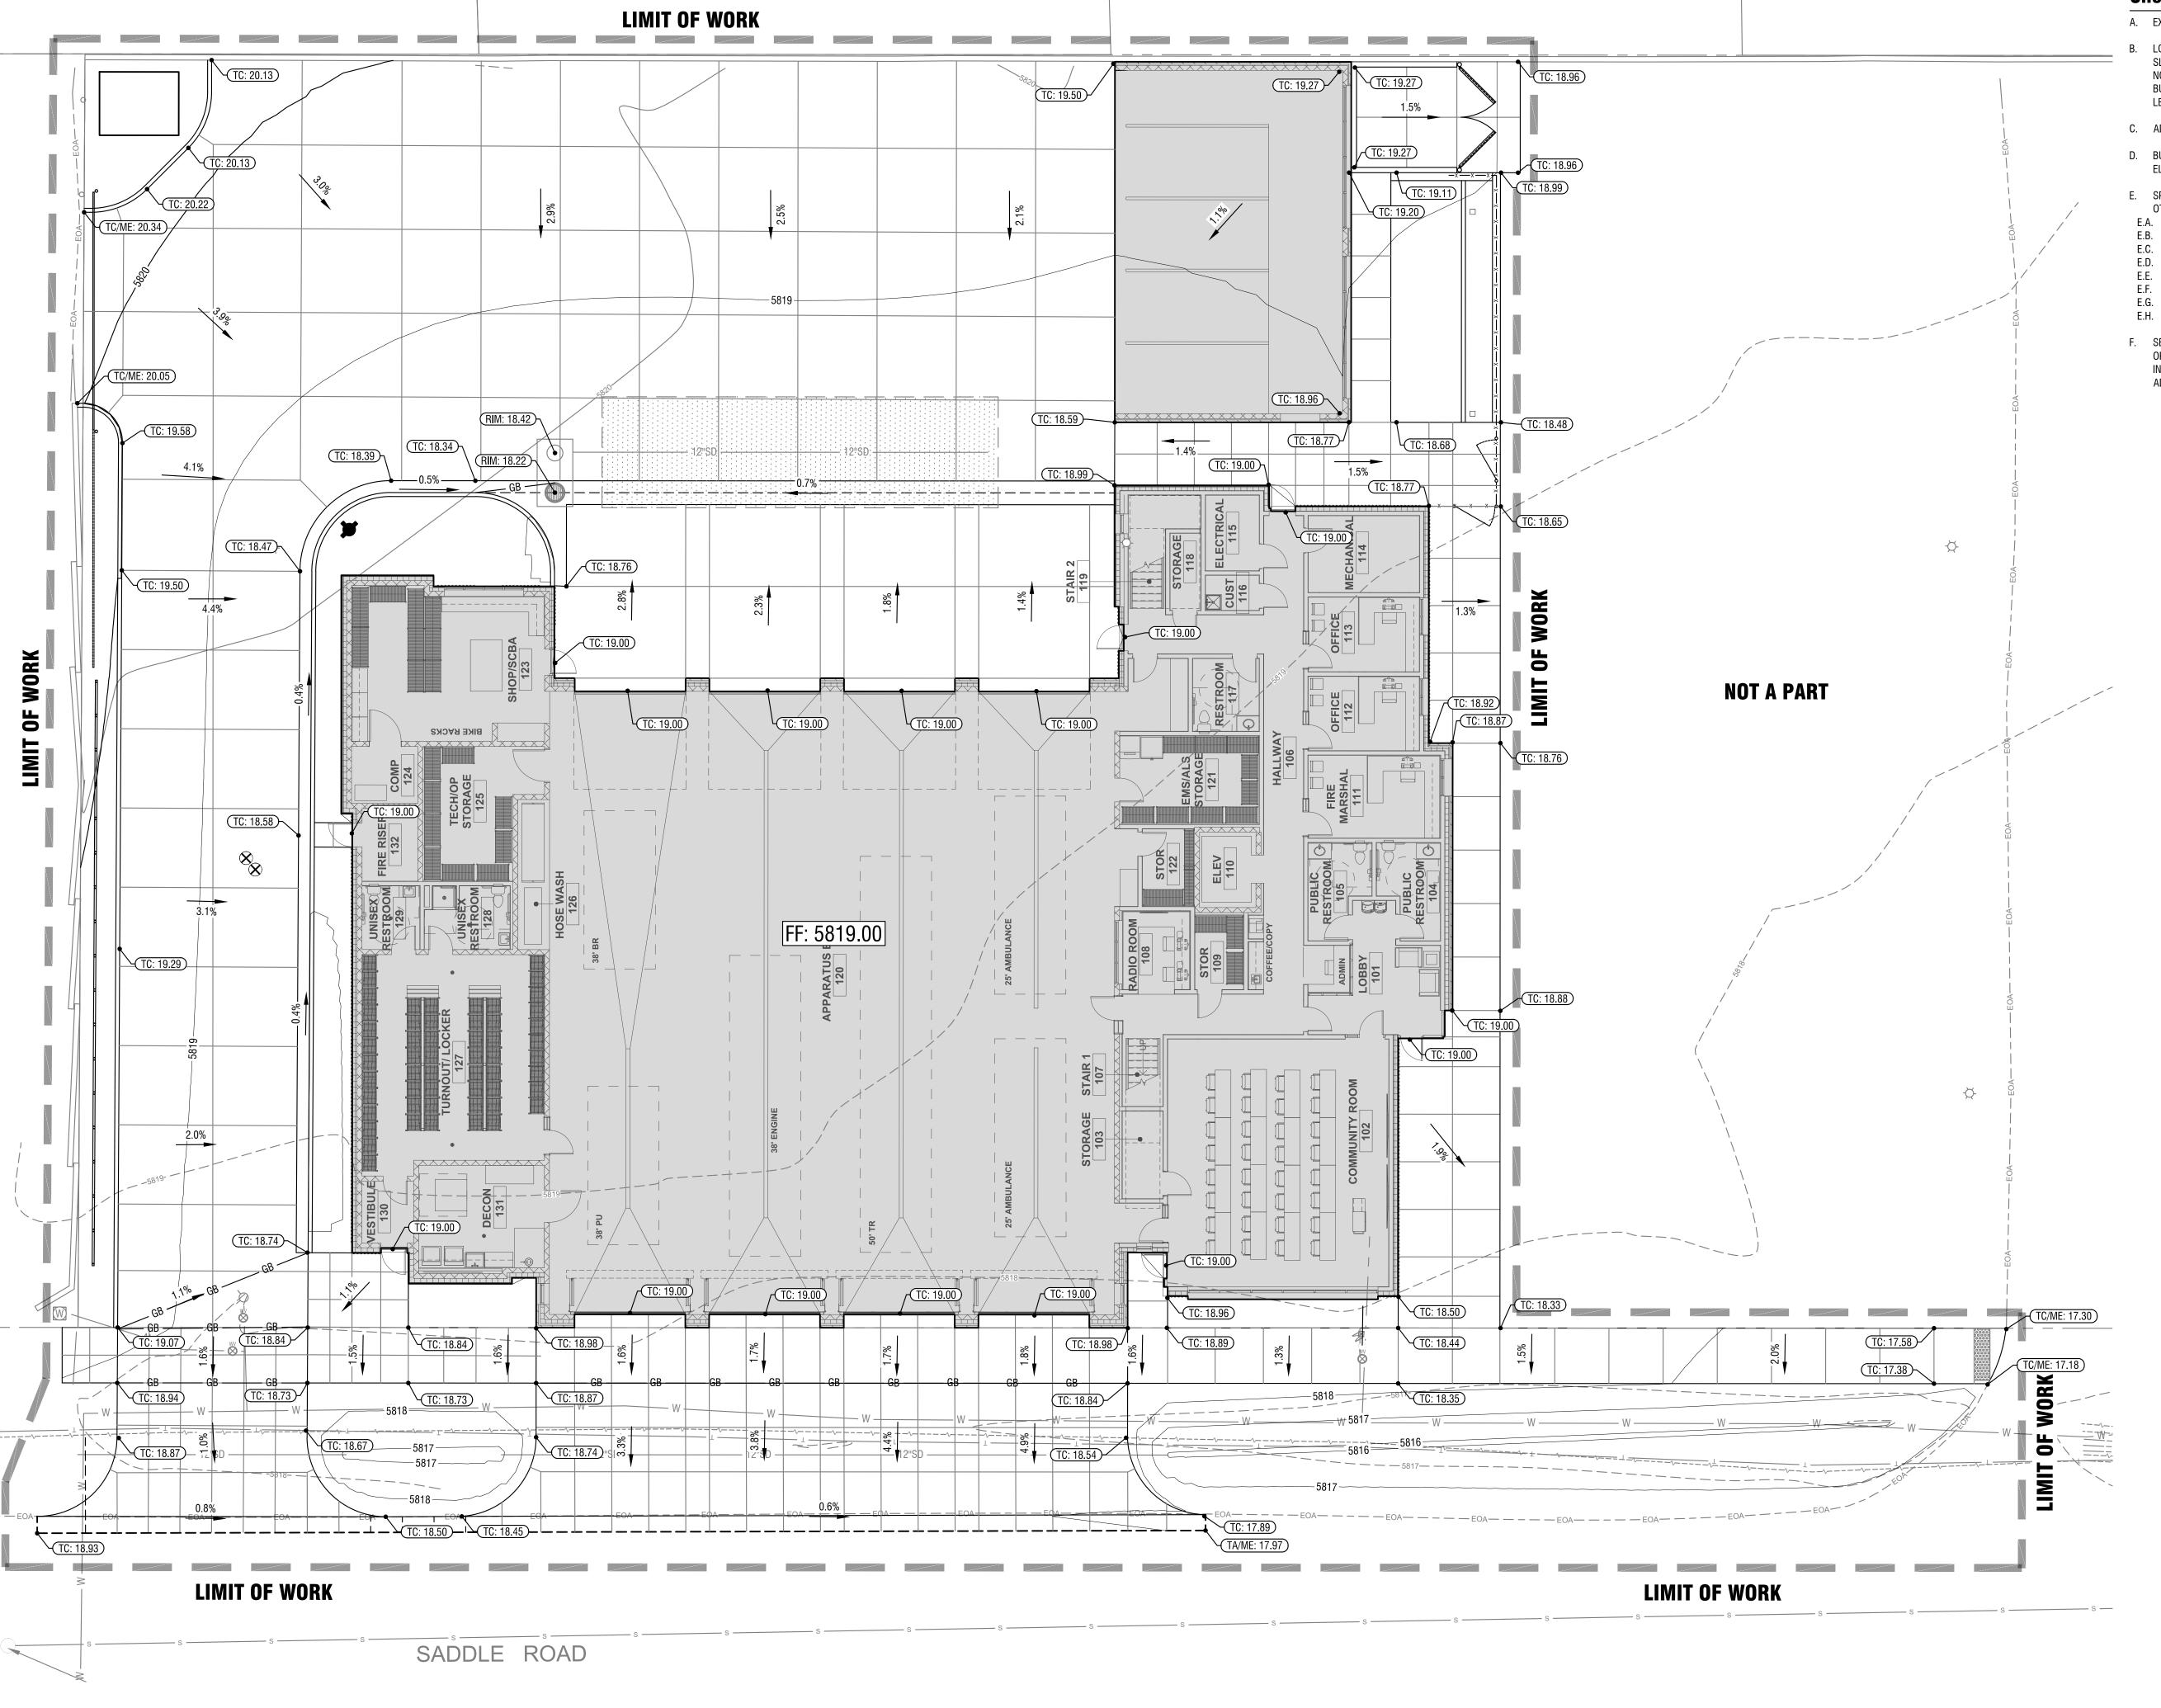

Design Review-Grading Plan

Horizontal Scale: 1" = 10'

Sheet Notes:

- A. EXISTING AND PROPOSED CONTOURS ARE AT A 1-FT INTERVAL.
- B. LONGITUDINAL SLOPE OF ALL SIDEWALKS SHALL NOT EXCEED 5%. CROSS SLOPE SHALL NOT EXCEED 2%. SLOPES WITHIN PEDESTRIAN RAMPS SHALL NOT EXCEED 12:1 SLOPE IN ANY DIRECTION. FLATWORK ADJACENT TO THE BUILDING SHALL NOT EXCEED 2.0% CROSS SLOPE OR HAVE CROSS SLOPE LESS THAN 1.0%.
- C. ADD 2500 FEET TO ALL SPOT ELEVATIONS FOR ACTUAL ELEVATION.
- D. BUILDING FINISH FLOOR ELEVATION 2561.50' REFERS TO ARCHITECTURAL ELEVATION 100'-0".
- E. SPOT ELEVATIONS INDICATE TOP OF CONCRETE SURFACE UNLESS NOTED
- OTHERWISE AS FOLLOWS: E.A. FF = FINISH FLOOR
- E.B. FL=FLOW LINE
- ME= MATCH EXISTING
- RIM = RIM OF STRUCTURETA = TOP OF ASPHALT
- TBC = TOP BACK OF CURB
- E.G. TC = TOP OF CONCRETEE.H. FG = FINISH GRADE
- F. SET FLAT WORK ADJACENT TO BUILDING FLUSH WITH FINISH FLOOR AT DOOR OPENING AND UNIFORMLY TRANSITION TO REVEAL 2" OF STEM WALL UNLESS INDICATED OTHERWISE. SLOPES SHALL NOT EXCEED 2% IN ANY DIRECTION ADJACENT TO THE BUILDING.



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PROJECT INFORMATION



KETCHUM FIRE STATION

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ISSUES


PHASE		DESIGN REVIEW	
DATE		FEBRUARY 3, 202	
JOB NU	MBER	18-02	
MARK	DATE	DESCRIPTION	

SHEET NAME

GRADING PLAN

SHEET NUMBER

C3.00

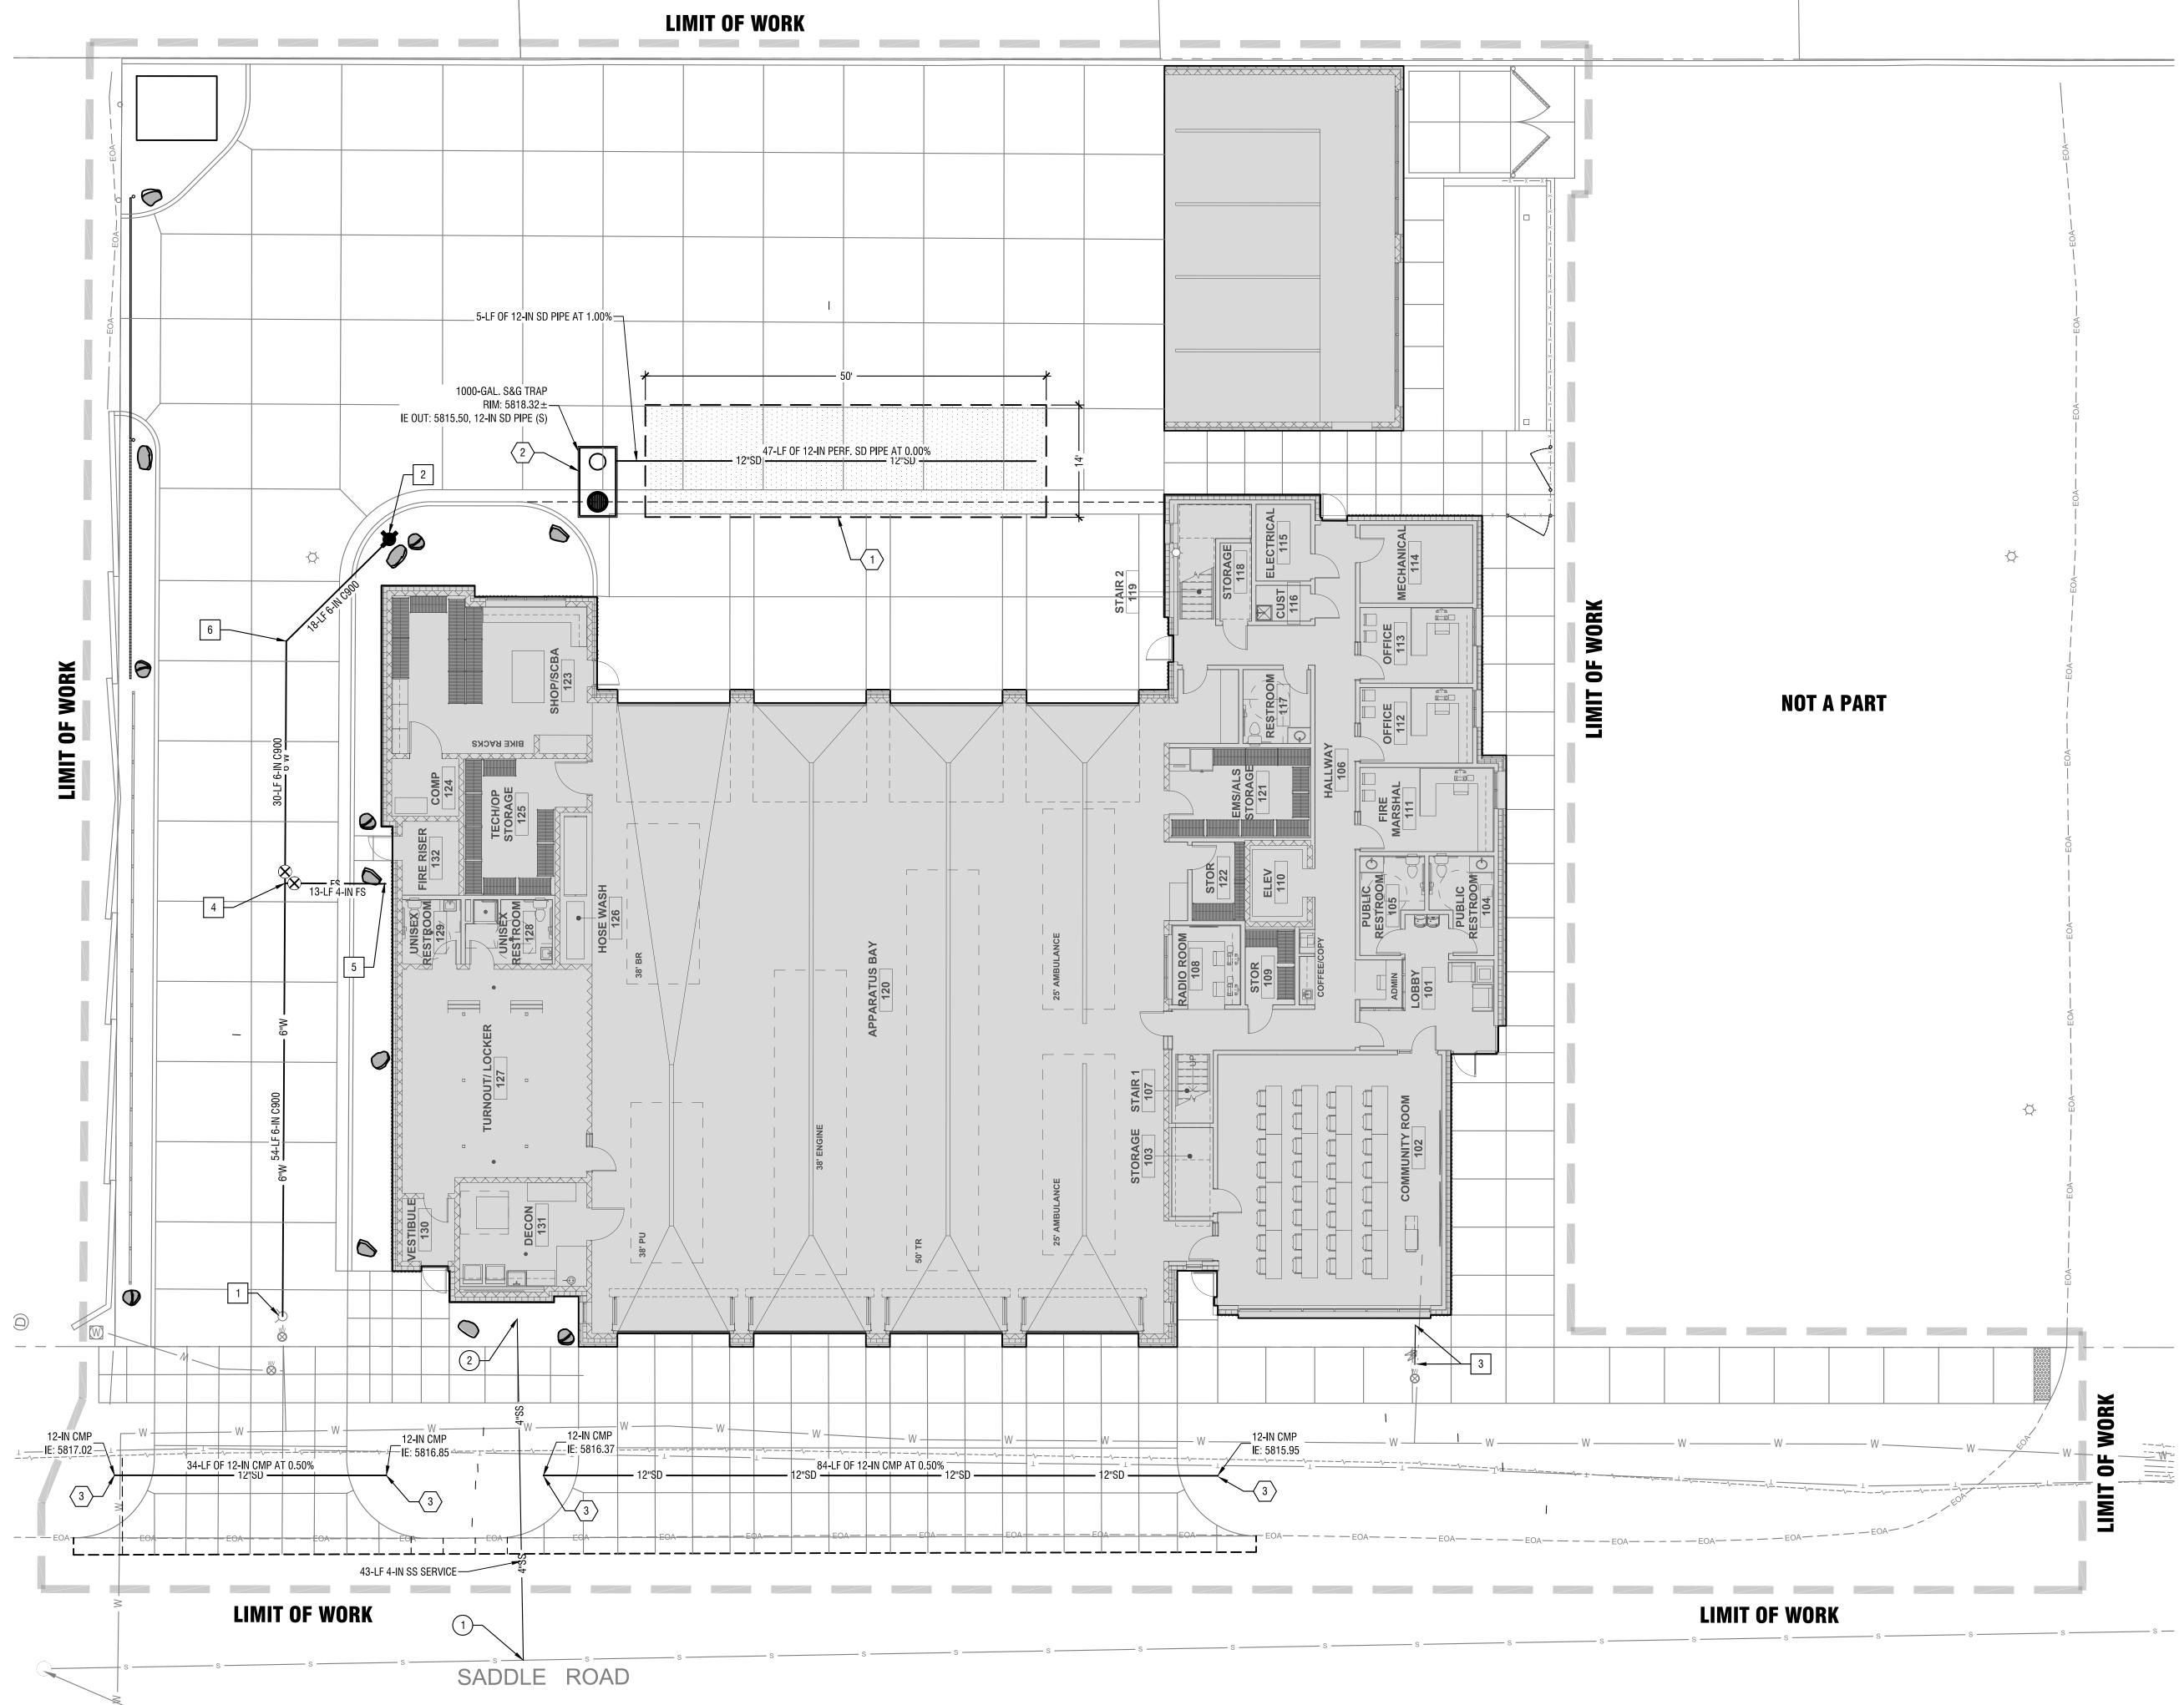

Design Review-Utililties Plan

Horizontal Scale: 1" = 10'

Sheet Notes:

- 1. ALL CONSTRUCTION SHALL BE COMPLETED IN ACCORDANCE WITH THE LATEST EDITION OF THE IDAHO STANDARDS FOR PUBLIC WORKS CONSTRUCTION AND THE CITY OF KETCHUM REVISIONS TO THE ISPWC.
- CONTRACTOR IS RESPONSIBLE FOR VERIFYING LOCATION AND ELEVATION OF ALL TIE IN POINTS PRIOR TO CONSTRUCTION AND SHALL CONTACT THE DESIGN ENGINEER WITH ANY DISCREPANCIES.
- 3. BOTH DOMESTIC AND FIRE SERVICE LINES REQUIRE A BACKFLOW PREVENTION DEVICE AT THE POINT OF ENTRY TO ANY BUILDING. THE TYPE OF DEVICE IS CONTINGENT UPON THE DEGREE OF HAZARD AND MUST MEET IDAHO DEQ STANDARDS. SEE MECHANICAL PLANS FOR BACK FLOW PREVENTION DEVICE.
- 4. PIPE LENGTHS SPECIFIED ARE FROM FITTING TO FITTING OR FITTING TO CONNECTION POINT AND ARE SHOWN FOR CONVENIENCE ONLY AS ACTUAL INSTALLED LENGTH MAY VARY FROM PLAN.

Water Keynotes:




- REMOVE EXISTING FIRE HYDRANT AND REINSTALL AT NEW LOCATION.
- 2. RE-INSTALL FIRE HYDRANT ASSEMBLY PER ISPWC SD-404.
- 3. INSTALL WATER METER PER CITY OF KETCHUM STANDARDS. COORDINATE CONTINUATION WITHIN STRUCTURE PER MECHANICAL PLAN.
- 4. INSTALL FIRE-SERVICE STUB IN COORDINATION WITH BUILDING FIRE SPRINKLER DESIGN. INSTALL APPROPRIATELY SIZED FITTINGS AND THRUST BLOCK PER ISPWC SD-403. COORDINATE SIZES WITH FIRE SPRINKLER DESIGN. APPROXIMATE 4-INCH LINE.
- 5. COORDINATE CONTINUATION OF FIRE SERVICE WITHIN STRUCTURE PER FIRE SPRINKLER DESIGN.
- 6. INSTALL 45° BEND AND THRUST BLOCK PER ISPWC SD-403.

Sewer Keynotes:



- TAP EXISTING SEWER MAIN. COORDINATE CONNECTION WITH THE CITY OF KETCHUM.
- 2. COORDINATE CONTINUATION OF FIRE SERVICE WITHIN STRUCTURE PER FIRE SPRINKLER DESIGN.

Storm Drain Keynotes:

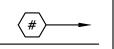

- 1. INSTALL 14'W x 50'L X 7' D SEEPAGE BED.
- 2. INSTALL OLDCASTLE PRECAST 1000 GALLON SAND AND GREASE TRAP OR APPROVED EQUIVALENT.
- 3. INSTALL FLARE END SECTION.




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PROJECT INFORMATION



KETCHUM FIRE STATION

107 SADDLE ROAD, KETCHUM, ID 83353

ISSUES

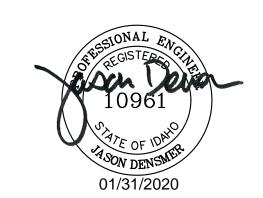
ASE		DESIGN REVIEW
TE		FEBRUARY 3, 2020
B NU	MBER	18-022
ARK	DATE	DESCRIPTION

SHEET NAME

UTILILTIES PLAN

SHEET NUMBER

C4.00

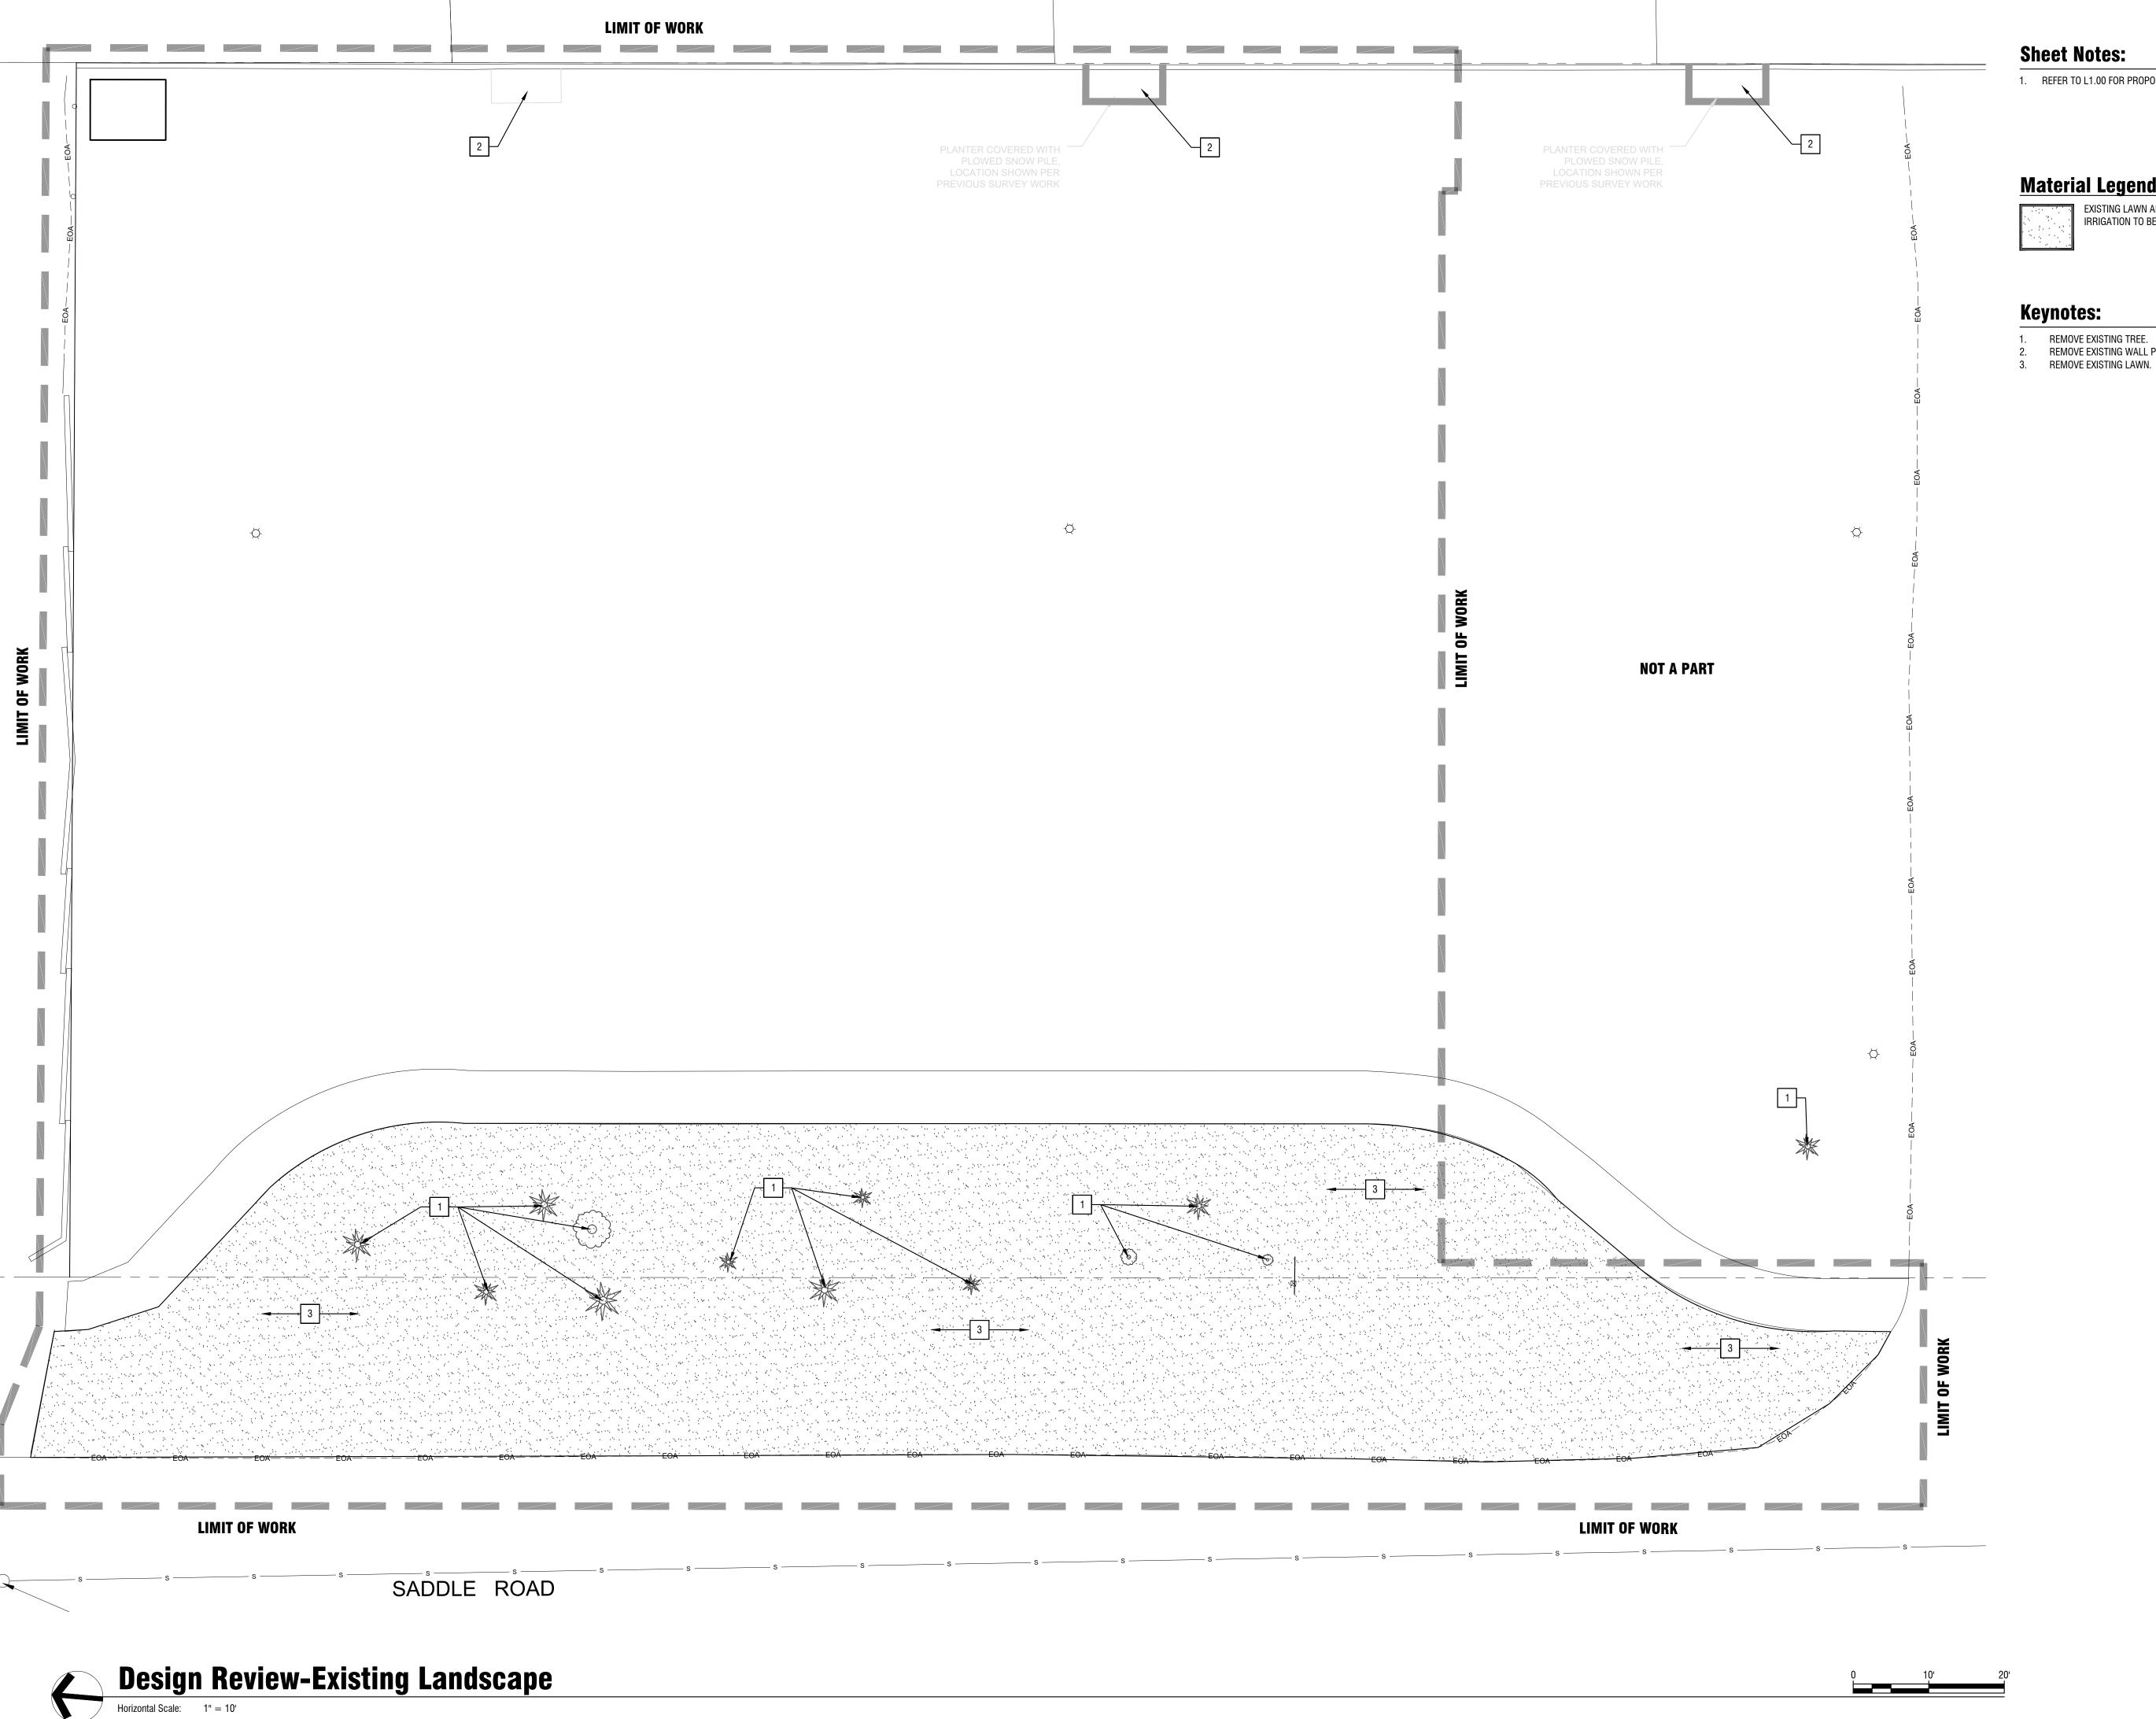

Sheet Notes:

1. REFER TO L1.00 FOR PROPOSED LANDSCAPE.

Material Legend:



EXISTING LAWN AND IRRIGATION TO BE REMOVED

Keynotes:

CALLOUT NUMBERS COORDINATED TO NUMBERED NOTES BELOW.

REMOVE EXISTING TREE. REMOVE EXISTING WALL PLANTER AND VEGETATION IN PLANTER.



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PROJECT INFORMATION



KETCHUM FIRE **STATION**

107 SADDLE ROAD, KETCHUM, ID 83353

ISSUES


PHASE	DESIGN REVIEW
DATE	FEBRUARY 3, 2020
JOB NUMBER	18-022
MARK DATE	DESCRIPTION

SHEET NAME

EXISTING LANDSCAPE

SHEET NUMBER

L0.00

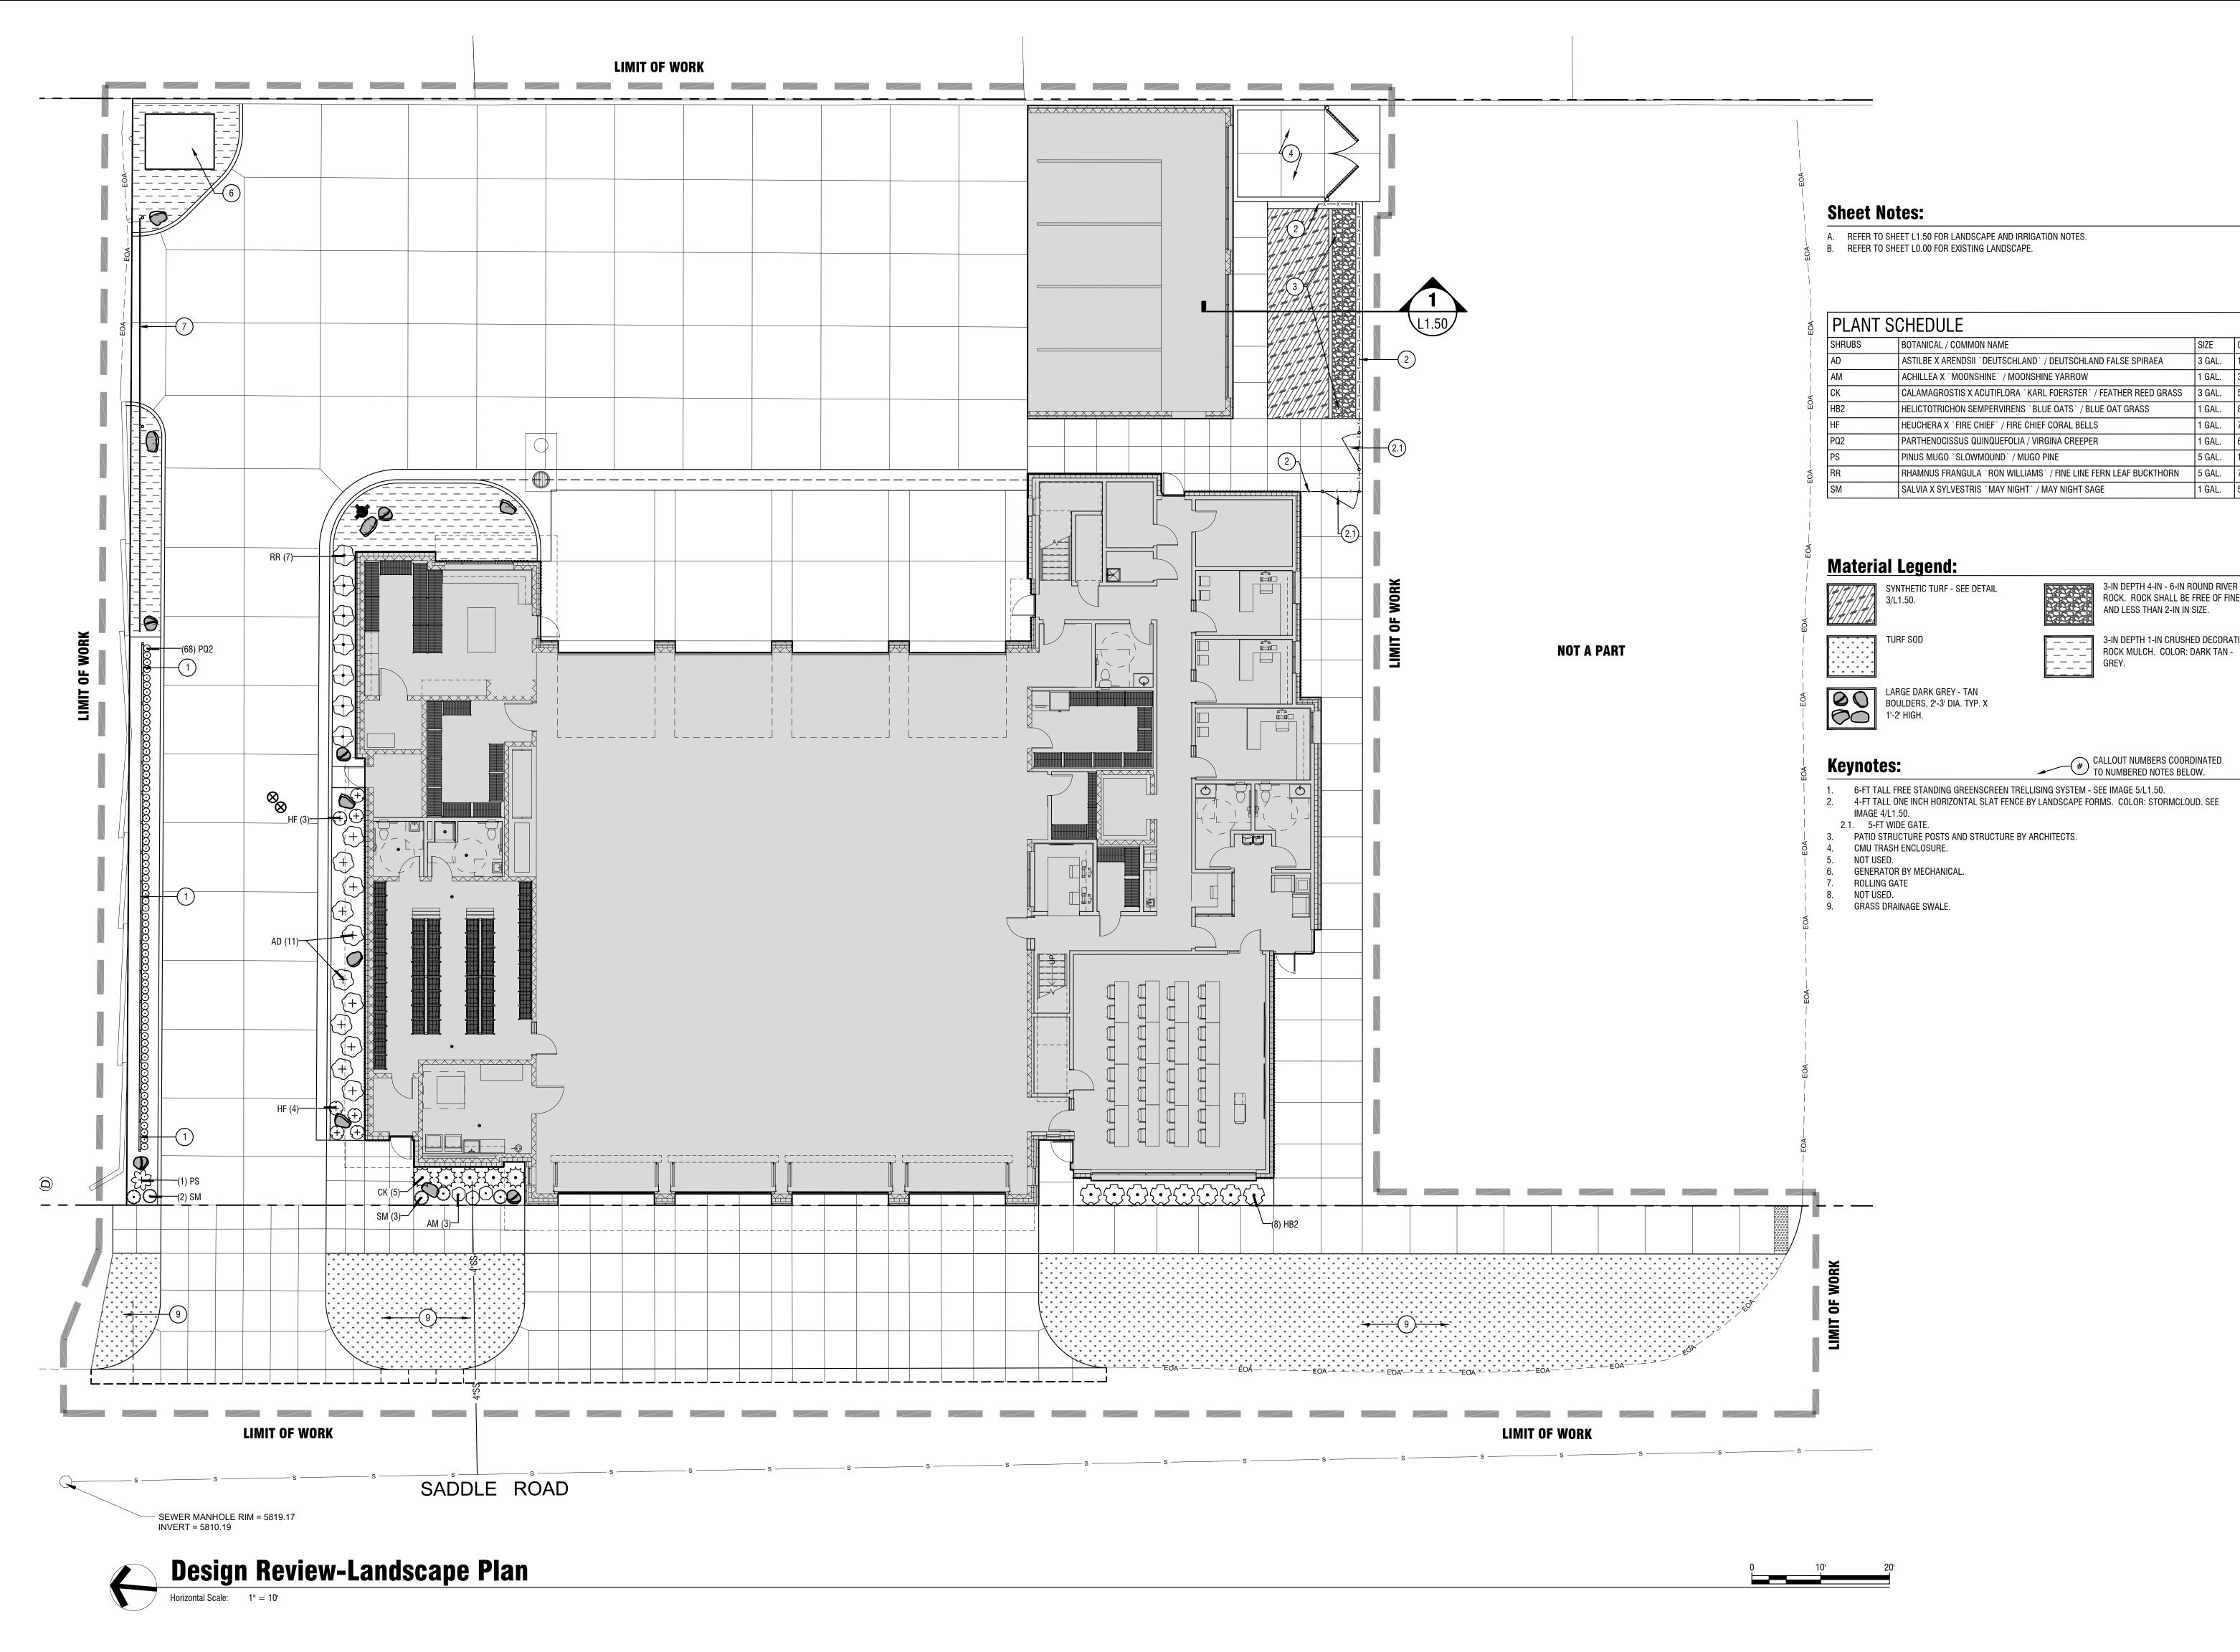



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1 GAL. | 8

1 GAL.

5 GAL.

3-IN DEPTH 4-IN - 6-IN ROUND RIVER

AND LESS THAN 2-IN IN SIZE.

ROCK. ROCK SHALL BE FREE OF FINES

3-IN DEPTH 1-IN CRUSHED DECORATIVE ROCK MULCH. COLOR: DARK TAN -

1 GAL. 68

1 GAL. 5



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PROJECT INFORMATION



KETCHUM FIRE STATION

107 SADDLE ROAD, KETCHUM, ID 83353

ISSUES

PHASE	DESIGN REVIEW
DATE	FEBRUARY 3, 2020
JOB NUMBER	18-022
MARK DATE	DESCRIPTION

SHEET NAME

LANDSCAPE PLAN

SHEET NUMBER

L1.00

Landscape Notes:


- A. CONTRACTOR SHALL REPORT TO LANDSCAPE ARCHITECT ALL CONDITIONS WHICH IMPAIR AND/OR PREVENT THE PROPER EXECUTION OF THIS WORK, PRIOR TO BEGINNING WORK.
- B. FINISH GRADES TO BE SMOOTH AND EVEN GRADIENTS WITH POSITIVE DRAINAGE IN ACCORDANCE WITH SITE GRADING PLAN. REMOVE RIDGES AND FILL DEPRESSIONS, AS REQUIRED TO MEET FINISH GRADES. PLACE 3" OF BARK MULCH, UNLESS SPECIFIED OTHERWISE, OVER SUBGRADE SOIL TO ACHIEVE FINISH GRADE. FINISH GRADE RELATED TO ADJACENT SITE ELEMENTS SHALL BE:
- B.A. 1-INCH BELOW TOP OF ADJACENT PAVEMENT, VALVE BOX, VAULT, ETC.
- B.B. 3-INCHES BELOW TOP OF CURB UNLESS NOTED OTHERWISE. C. ALL PLANTING BEDS SHALL HAVE A MINIMUM OF 18" OF TOPSOIL, SOD AREAS A MINIMUM OF 12" OF TOPSOIL. SPREAD, COMPACT AND FINE GRADE TOPSOIL TO A SMOOTH AND UNIFORM GRADE.
- D. RE-USE EXISTING SURFACE TOPSOIL WHERE POSSIBLE. VERIFY SUITABILITY OF SURFACE SOIL TO PRODUCE TOPSOIL MEETING REQUIREMENTS AND AMEND WHEN NECESSARY. TOPSOIL SHALL BE A LOOSE, FRIABLE, SANDY LOAM, CLEAN AND FREE OF TOXIC MATERIALS, NOXIOUS WEEDS, WEED SEEDS, ROCKS, GRASS OR OTHER FOREIGN MATERIAL AND A PH OF 5.5 TO 7.0. IF ON-SITE TOPSOIL DOES NOT MEET THESE MINIMUM STANDARDS, CONTRACTORS ARE RESPONSIBLE TO EITHER: A) PROVIDE APPROVED IMPORTED TOPSOIL, OR B.) IMPROVE ON-SITE TOPSOIL WITH METHODS APPROVED BY LANDSCAPE ARCHITECT. SUPPLEMENT WITH IMPORTED TOPSOIL WHEN QUANTITIES ARE INSUFFICIENT. CLEAN TOPSOIL OF ROOTS, PLANTS, SODS, STONES, CLAY LUMPS AND OTHER EXTRANEOUS MATERIALS HARMFUL TO
- PLANT GROWTH. E. IF IMPORTED TOPSOIL FROM OFF-SITE SOURCES IS REQUIRED, PROVIDE NEW TOPSOIL THAT IS FERTILE, FRIABLE, NATURAL LOAM, SURFACE SOIL, REASONABLY FREE OF SUBSOIL, CLAY LUMPS, BRUSH, WEEDS AND OTHER LITTER, AND FREE OF ROOTS, STUMPS, STONES LARGER THAN 2 INCHES IN ANY DIMENSION, AND OTHER EXTRANEOUS OR TOXIC MATTER HARMFUL TO PLANT GROWTH.
- F. OBTAIN TOPSOIL FROM LOCAL SOURCES OR FROM AREAS HAVING SIMILAR SOIL CHARACTERISTICS TO THAT FOUND AT PROJECT SITE. OBTAIN TOPSOIL ONLY FROM NATURALLY, WELL-DRAINED SITES WHERE TOPSOIL OCCURS IN A DEPTH OF NOT LESS THAN 4 INCHES.
- G. ALL LANDSCAPE AREAS SHALL BE WEED FREE AT THE TIME OF LANDSCAPE INSTALLATION.REMOVE ALL ROOTS, WEEDS, ROCKS AND FOREIGN MATERIAL ON THE SURFACE.
- H. NEW SHRUB PLANTING. SEE DETAIL 1/L1.50.
- I. ALL PLANT MATERIAL SHALL CONFORM TO THE AMERICAN NURSERYMAN STANDARDS FOR TYPE AND SIZE SHOWN. PLANTS WILL BE REJECTED IF NOT IN A SOUND AND HEALTHY CONDITION.
- J. ALL PLANT MATERIAL SHALL BE GUARANTEED FOR A PERIOD OF ONE YEAR BEGINNING AT THE DATE OF SUBSTANTIAL COMPLETION. REPLACE ALL PLANT MATERIAL FOUND DEAD OR NOT IN A HEALTHY CONDITION IMMEDIATELY WITH THE SAME SIZE AND SPECIES AT NO COST TO THE OWNER.


Automatic Underground Irrigation Notes:


- A. ALL LANDSCAPED AREAS SHALL HAVE AN AUTOMATIC UNDERGROUND SPRINKLER SYSTEM WHICH ENSURES COMPLETE COVERAGE AND PROPERLY ZONED FOR REQUIRED WATER USES.
- B. EACH HYDROZONE IS TO BE IRRIGATED WITH SEPARATE INDIVIDUAL STATIONS. C. POP-UP SPRINKLER HEADS SHALL HAVE A MINIMUM RISER HEIGHT OF 18" AT
- PLANTER BEDS, 6" AT LAWN AREAS.. D. PLANTER BEDS ARE TO HAVE DRIP IRRIGATION SYSTEMS - WITH DRIP CONTROL
- ZONE KIT AND 150 MESH FILTER (MIN.). E. ELECTRONIC WATER DISTRIBUTION/ TIMING CONTROLLERS ARE TO BE PROVIDED.
- MINIMUM CONTROLLER REQUIREMENTS ARE AS FOLLOWS:
- E.A. PRECISE INDIVIDUAL STATION TIMING
- E.B. RUN TIME CAPABILITIES FOR EXTREMES IN PRECIPITATION RATES E.C. AT LEAST ONE PROGRAM FOR EACH HYDROZONE
- E.D. SUFFICIENT MULTIPLE CYCLES TO AVOID WATER RUN-OFF

MAINTENANCE AND REMOVAL. ONLY ONE VALVE PER BOX.

- E.E. POWER FAILURE BACKUP FOR ALL PROGRAMMED INDIVIDUAL VALVED WATERING STATIONS WILL BE DESIGNED AND INSTALLED TO PROVIDE WATER TO RESPECTIVE HYDRO-ZONES.
- F. INDIVIDUAL VALVED WATERING STATIONS WILL BE DESIGNED AND INSTALLED TO PROVIDE WATER TO RESPECTIVE HYDRO-ZONES.
- G. THE IRRIGATION SYSTEM SHALL BE DESIGNED TO PROVIDE 100% COVERAGE WITH HEAD TO HEAD SPACING OR TRIANGULAR SPACING AS APPROPRIATE.
- H. SPRINKLER HEADS SHALL BE ADJUSTED TO REDUCE OVERSPRAY ONTO
- IMPERVIOUS SURFACES SUCH AS SIDEWALKS, DRIVEWAYS, AND PARKING AREA. I. EACH VALVE SHALL BE INSTALLED IN A VALVE BOX LARGE ENOUGH TO ALLOW FOR

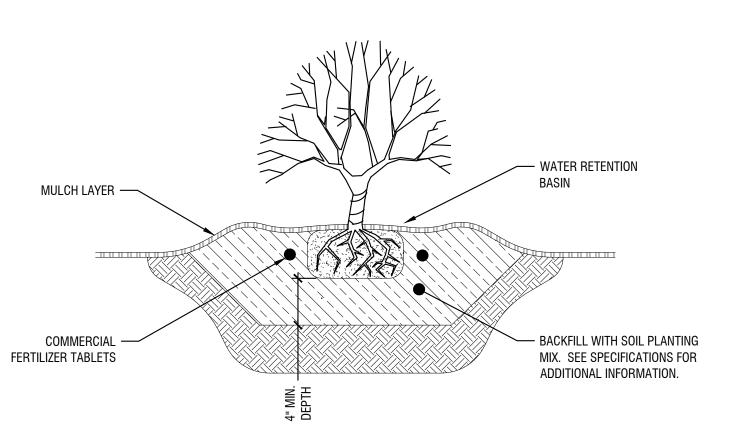

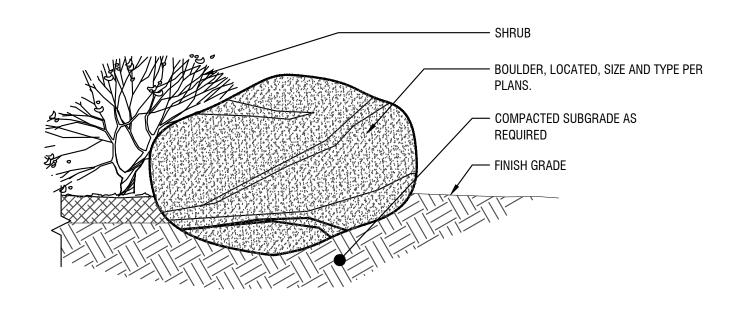

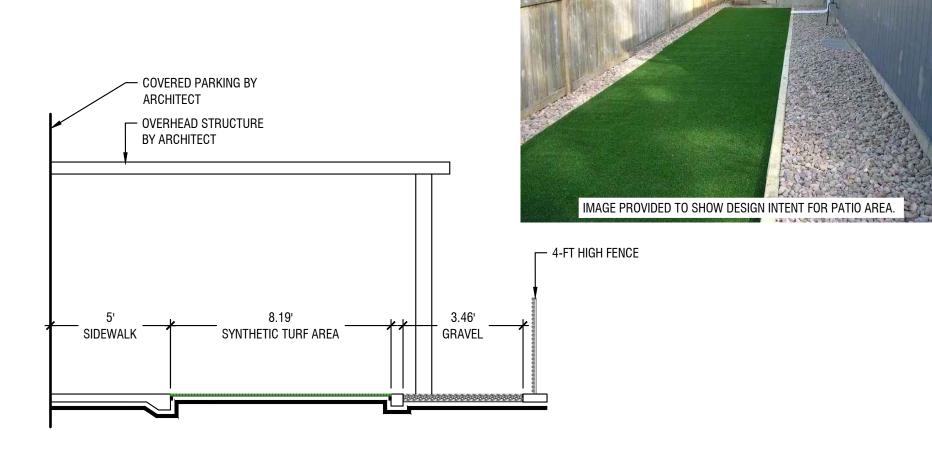

1. NOTIFY LANDSCAPE ARCHITECT WHEN PLACING BOULDERS FOR APPROVAL.

2. PLACE BOULDERS PRIOR TO INSTALLATION OF IRRIGATION SYSTEM. 3. CLEAN ALL BOULDERS OF DIRT AND LOOSE DEBRIS.

4. WHEN PLACING BOULDERS, BURY 1/4 TO 1/3 OF BOULDER BELOW FINISH GRADE.

5. DO NOT SCAR OR DAMAGE BOULDERS.

Shrub Planting

Patio Fence


Scale: NTS

Boulder Installation Scale: NTS

Patio Section Scale: 1/4" = 1'

- HORIZONTAL SLAT FENCE BY LANDSCAPE FORMS



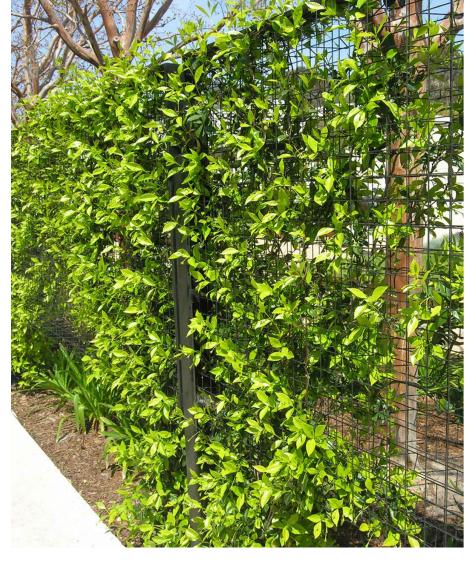

Greenscreen Trellis System

Scale: NTS

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PROJECT INFORMATION



STATION

KETCHUM FIRE

107 SADDLE ROAD, KETCHUM, ID 83353

ISSUES


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DATE	FEBRUARY 3, 202
JOB NUMBER	18-02
MARK DATE	DESCRIPTION

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LANDSCAPE DETAILS

SHEET NUMBER

L1.50

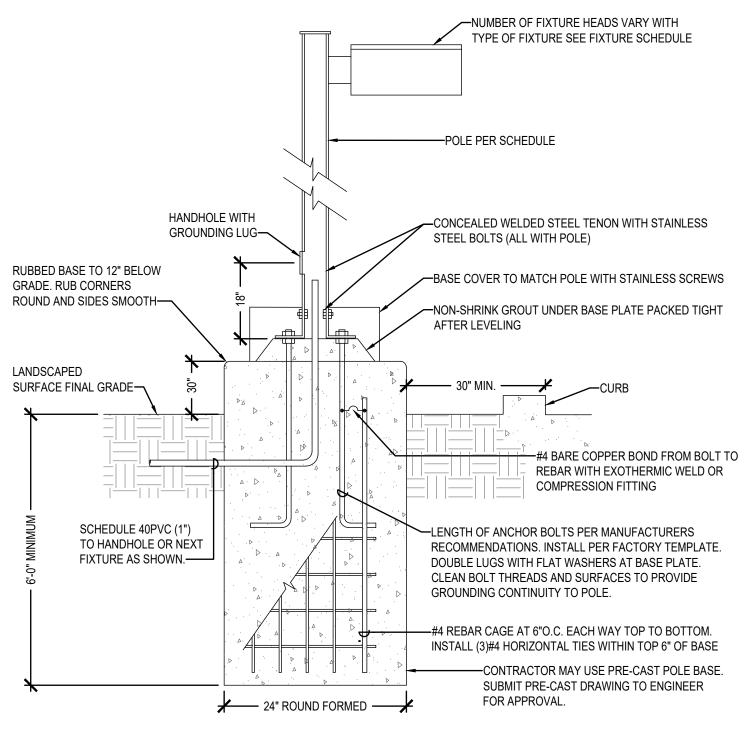

DETAIL NOTES

- 1. INCREASE THE SPECIFIED HEIGHT OF THE POLE BY 2'-0" TO ENSURE UNIFORM FIXTURE MOUNTIAN HEIGHT WHERE THE 6" BASE IS USED.
- 2. PROTECTED AREA IMPLIES THE POLE IS INSTALLED AT LEAST 30" FROM PARKING OR DRIVE AREAS.

SITE LIGHTING POLE BASE DETAIL

ELECTRICAL LEGEND - LIGHTING

RECESSED LIGHT FIXTURE

•□ POLE LIGHT 1 HEAD WITH POLE

H☑ EXTERIOR WALL PACK

YPE	DESCRIPTION	MTG.	LAMPS	WATTAGE	MANUFACTURER
	LED VISUAL COMFORT LENS ON +12'-0"	POLE	LED		LITHONIA NO.
P1	POLE AND +2'-6" CONCRETE BASE	MOUNTED	11,000 LUMENS	85	RAD1 LED SERIES
			2700K		
	LED 4" ROUND RECESSED CAN LIGHT		LED		LITHONIA NO.
RR1		RECESSED	1000 LUMENS	10.6	LDN4 SERIES
			2700K		
	ARCHITECTURAL WALL SCONCE WITH	WALL	LED		LITHONIA NO.
WB1	VISUAL COMFOR LENS	MOUNTED	3000 LUMENS	25	WST LED SERIES
			2700K		
	ARCHITECTURAL WALL SCONCE WITH	WALL	LED		LITHONIA NO.
WB2	VISUAL COMFOR LENS	MOUNTED	1500 LUMENS	11	WST LED SERIES
			2700K		
	ARCHITECTURAL WALL SCONCE WITH	WALL	LED		LITHONIA NO.
WB3	VISUAL COMFOR LENS	MOUNTED	6000 LUMENS	50	WST LED SERIES
			2700K		

LIGHTING CONTROLS NOTES

THE EXTERIOR BUILDING LIGHTING AND POLE LIGHTS WILL BE ROUTED THROUGH THE LIGHTING CONTROL PANEL AND PHOTOCELL. THE LIGHTING CONTROL PANEL WILL TURN LIGHTS ON AND OFF BASED ON A TIMED SCHEDULE AND THE PHOTOCELL WILL TURN LIGHTS ON AND OFF BASED ON LIGHT CONDITIONS. THE EXTERIOR LIGHTS AND POLE LIGHTS WILL ALSO BE EQUIPPED WITH FACTORY INSTALLED MODULES TO ALLOW THE FIXTURES TO BE DIMMED AT A PRESET TIME TO REDUCE LIGHT LEVELS. FOR EXAMPLE FROM DUSK TO 11:00 PM AND 5:00 AM TO 7:00 AM THE FIXTURES COULD BE AT FULL LIGHT OUTPUT. FROM 11:00 PM TO 5:00 AM THE FIXTURES COULD BE DIMMED TO 30% LIGHT OUTPUT. THESE FIXTURE WILL ALSO BE CONNECTED TO THE EMERGENCY ALARM SYSTEM IN THE BUILDING. UPON ACTIVATION OF THE ALARM DURING THE DIMMING PRESET TIME, THESE FIXTURES WOULD RETURN TO FULL LIGHT OUTPUT.



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234 S. WHISPERWOOD WAY, BOISE, ID 83709 PH: (208) 384-0585 MUSGROVE PROJECT NUMBER: 19-366

PROJECT INFORMATION



KETCHUM FIRE STATION

107 SADDLE ROAD, KETCHUM, ID 83353

ISSUE


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DATE	FEBRUARY 3, 202
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ELECTRICAL DETAILS AND NOTES

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PROJECT INFORMATION



KETCHUM FIRE STATION

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ISSUES

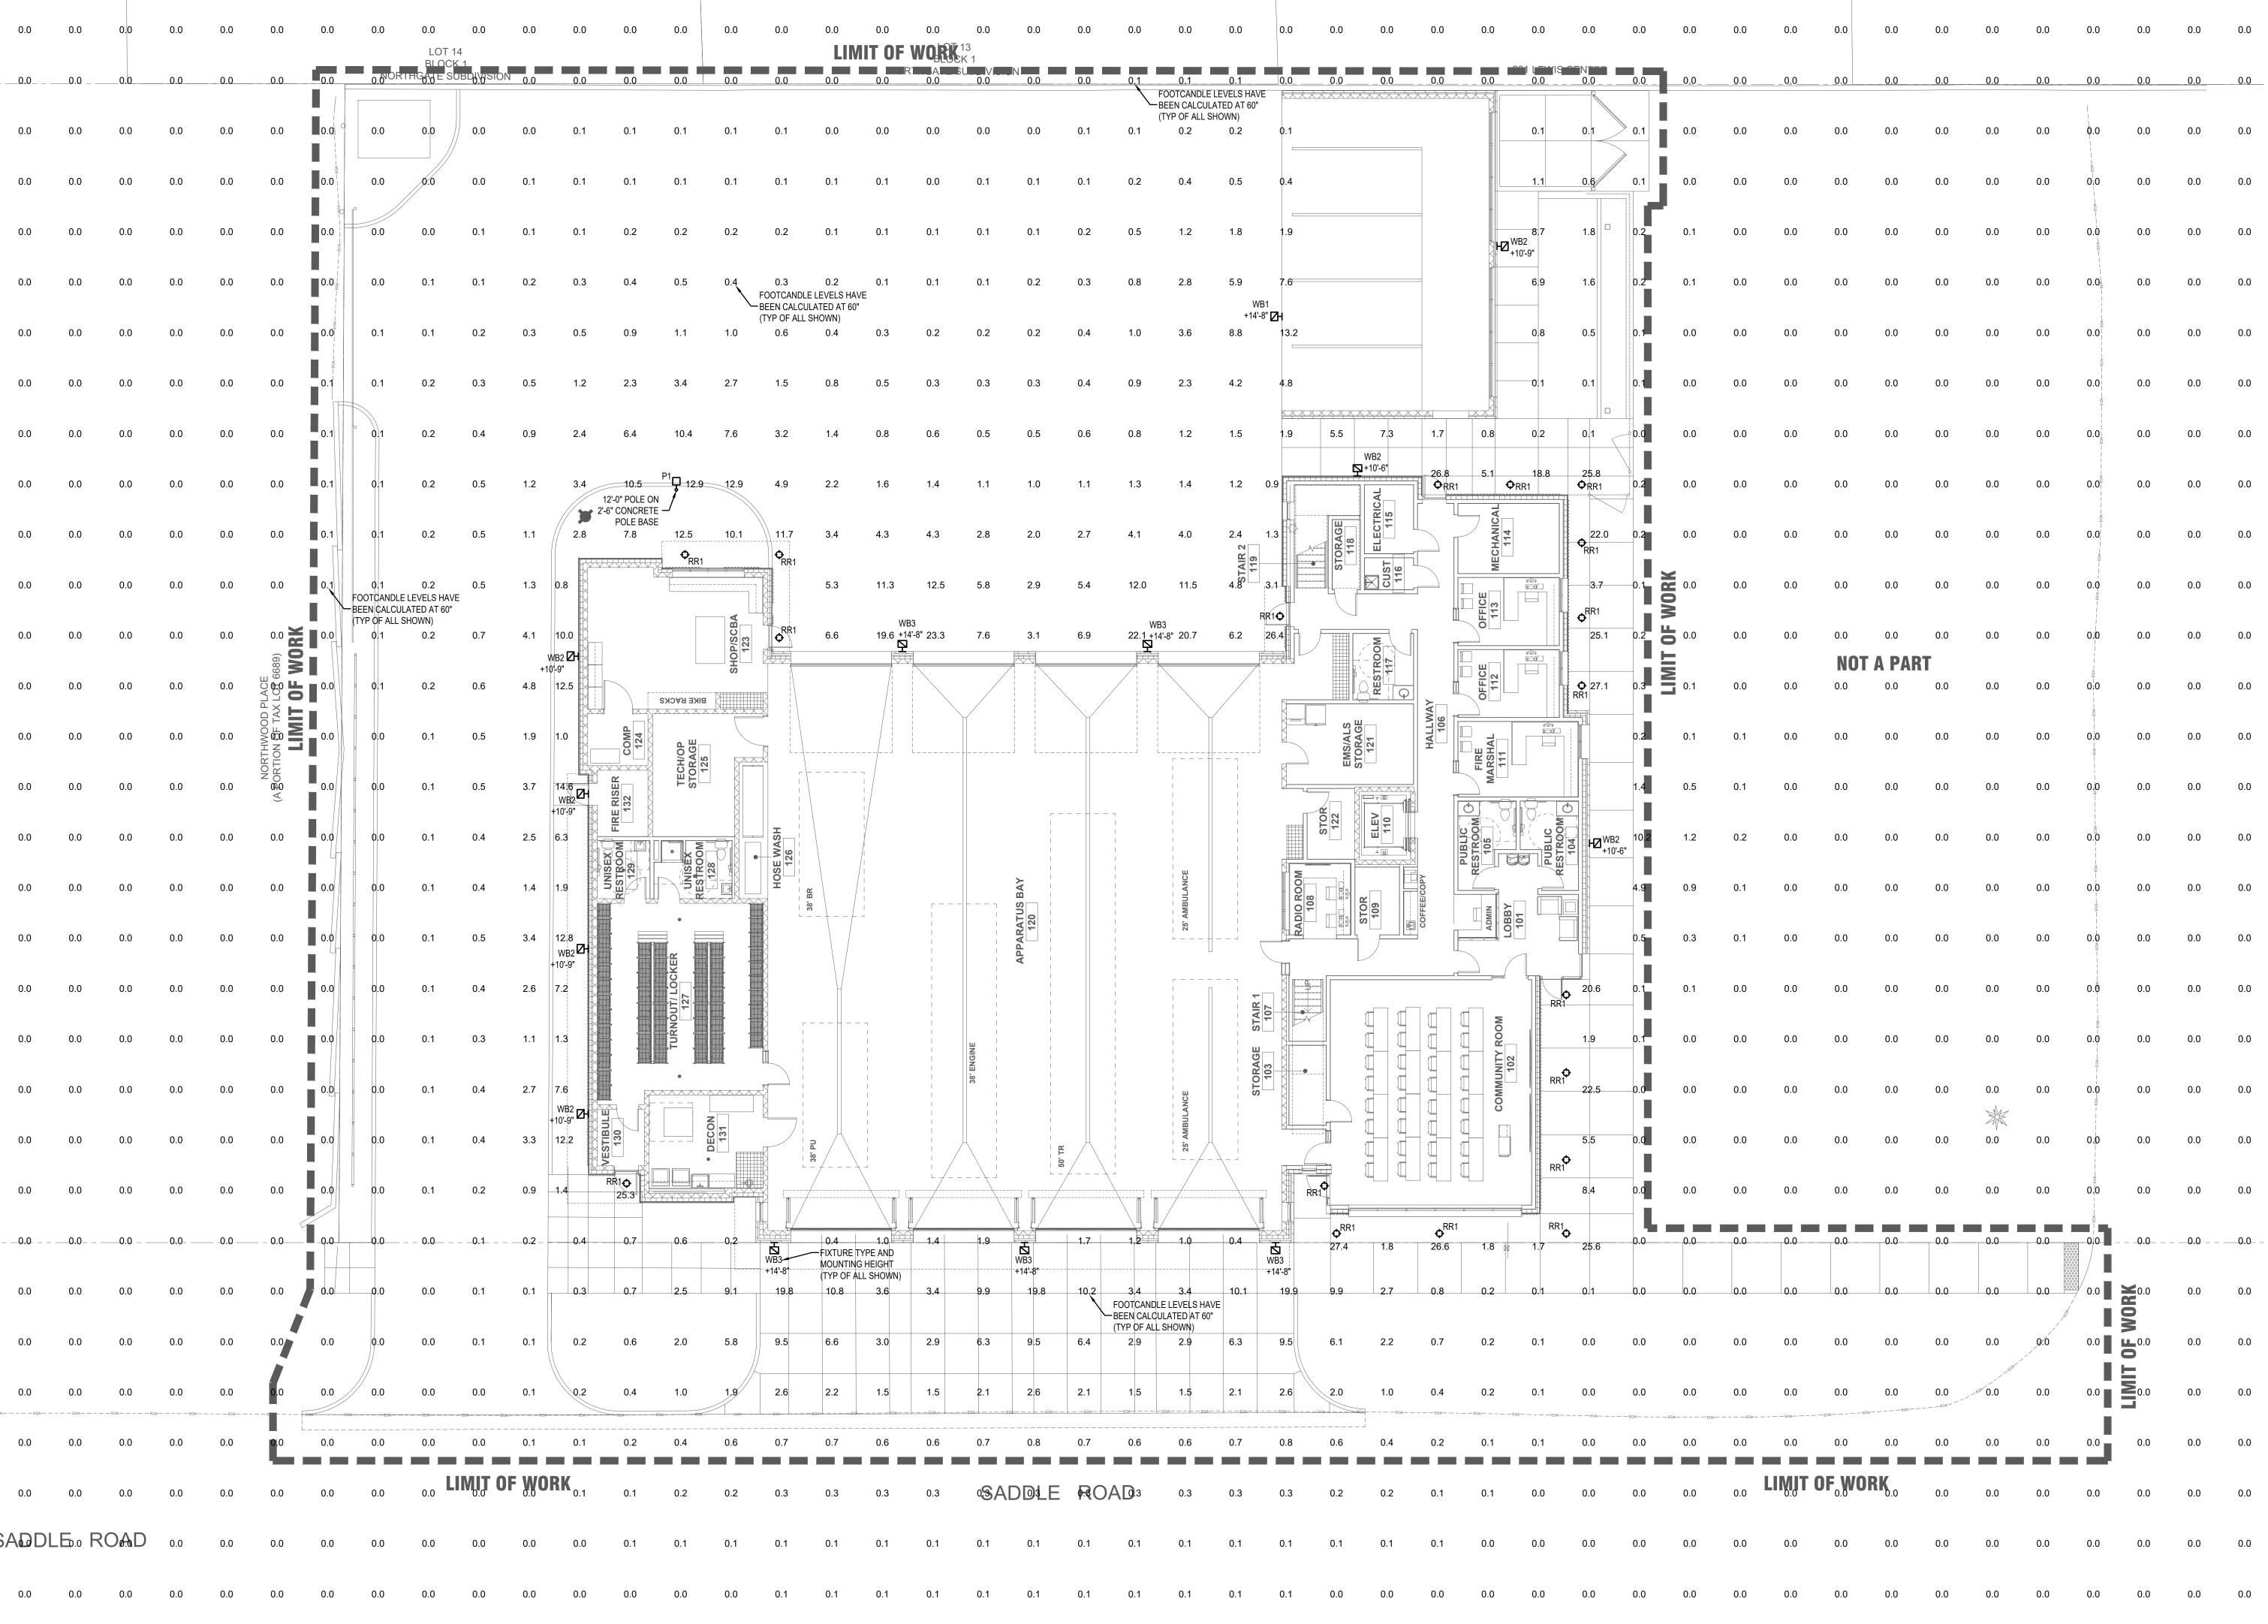PHASE	DESIGN REVIEW
DATE	FEBRUARY 3, 202
JOB NUMBER	18-022

MARK DATE DESCRIPTION

SHEET NAME

PHOTOMETRIC SITE PLAN

SHEET NUMBER

E1.00



WST LED Architectural Wall Sconce


WALL MOUNTED FIXTURES TYPES WB1, WB2 & WB3

NIGHTIME REPOLLY

Specifications Luminaire


Height:	8-1/2" (21.59 cm)
Width:	17" (43.18 cm)
	10_3/16"

20 lbs

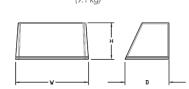


Optional Back Box (PBBW)

(21.56 cm) (43.21 cm)

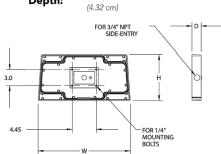

Optional Back Box (BBW)

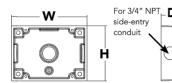

** Capable Luminaire

This item is an A+ capable luminaire, which has been designed and tested to provide consistent color appearance and system-level interoperability.

- All configurations of this luminaire meet the Acuity Brands' specification for chromatic consistency
- This luminaire is A+ Certified when ordered with DTL® controls marked by a shaded background. DTL DLL equipped luminaires meet the A+ specification for luminaire to photocontrol interoperability1
- This luminaire is part of an A+ Certified solution for ROAM® or XPoint™ Wireless control networks, providing out-of-the-box control compatibility with simple commissioning, when ordered with drivers and control options marked by a shaded background¹

To learn more about A+, visit www.acuitybrands.com/aplus.

See ordering tree for details.

A+ Certified Solutions for ROAM require the order of one ROAM node per luminaire. Sold Separately: Link to Roam; Link to DTL DLL

COMMERCIAL OUTDOOR

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Rev. 09/06/19

	Information			WAITII EE. VVJ L	ED P1 40K VF MVOLT DDBT
WST LED					
Series	Performance Package	Color temperature		Voltage	
WST LED	P1 1,500 Lumen package P2 3,000 Lumen package P3 6,000 Lumen package	27K 2700 K 30K 3000 K 40K 4000 K 50K 5000 K	VF Visual comfort forward throw VW Visual comfort wide	MVOLT ¹ 277 ² 120 ² 347 ² 208 ² 480 ² 240 ²	Shipped included (blank) Surface mounting bracket Shipped separately BBW Surface-mounted back box ³ PBBW Premium surface-mounted back box ^{3,4}

	l l		1 :	1		
					Finish (req	
NLTAIR2 PIR NLTAIR2 PIRH PE PER PER5 PER7 PIR PIR1FC3V PIRH PIRH1FC3V SF DF	nLIGHT AIR Wireless enabled motion/ambient sensor for 8'-15' mounting heights \$.6 nLIGHT AIR Wireless enabled motion/ambient sensor for 15'-30' mounting heights \$.6 Photoelectric cell, button type 7 NEMA twist-lock receptacle only (controls ordered separate) 8 Five-wire receptacle only (controls ordered separate) 8 Seven-wire receptacle only (controls ordered separate) 8 Motion/Ambient Light Sensor, 8-15' mounting height \$.6 Motion/ambient sensor, 8-15' mounting height, ambient sensor enabled at 1fc \$.6 180° motion/ambient light sensor, 15-30' mounting height, ambient sensor enabled at 1fc \$.6 Single fuse (120, 277, 347V)² Double fuse (208, 240, 480V)²	E7WC E7WHR E20WH E20WC E23WHR LCE RCE	(cold, 7W) ^{11,12} Remote emergency batter Noncompliant (remote 7W Emergency battery pack 14 Certified in CA Title 20 MA	fy ^{11,13} 8W constant power, EDBS ¹¹ 20°C 18W constant power, EDBS ^{11,12} y backup, CA Title 20	DDBXD DBLXD DNAXD DWHXD DSSXD DDBTXD DBLBXD DNATXD DWHGXD DSSTXD	Dark bronze Black Natural aluminum White Sandstone Textured dark bronze Textured black Textured natural aluminur Textured white Textured sandstone
DS DMG E7WH	Dual switching ^o 0–10V dimming extend out back of housing for external control (control ordered separate) ¹⁰ Emergency battery backup, Non CEC compliant (7W) ¹¹	Shipped s RBPW VG WG	s eparately Retrofit back plate ³ Vandal guard ¹⁵ Wire guard ¹⁵			


WSTVCPBBW DDBXD U Premium Surface - mounted back box WSBBW DDBTXD U Surface - mounted back box

- 1 MVOLT driver operates on any line voltage from 120-277V (50/60 2 Single fuse (SF) requires 120V, 277V or 347V. Double fuse (DF) 3 Also available as a separate accessory; see accessories information 5 Not available with VG or WG. See PER Table.
- 6 Reference Motion Sensor table. 7 Need to specify 120, 208, 240 or 277 voltage


Emergency Battery Operation


The emergency battery backup is integral to the luminaire — no external housing required! This design provides reliable emergency operation while maintaining the aesthetics of the product. All emergency backup configurations include an independent secondary driver with an integral relay to immediately detect AC power loss, meeting interpretations of NFPA 70/NEC 2008 - 700.16 The emergency battery will power the luminaire for a minimum duration of 90 minutes (maximum duration of three hours) from the time supply power is lost, per International Building Code Section 1006 and NFPA 101 Life Safety Code Section 7.9, provided luminaires are mounted at an appropriate height and illuminate an open space with no major obstructions. The examples below show illuminance of 1 fc average and 0.1 fc minimum of the P1 power package and VF distribution product in emergency mode.


10' x 10' Gridlines 8' and 12' Mounting Height

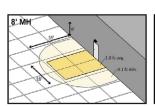

WST LED P1 27K VF MVOLT E7WH

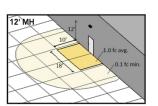

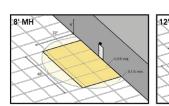

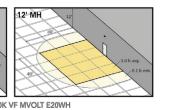

WST LED P2 40K VF MVOLT E20WH

10 DMG option not available with standalone or networked sensors/

9 Not available with Emergency options, PE or PER options.

12 Battery pack rated for -20° to 40°C.13 Comes with PBBW.

16 Must order with fixture; not an accessory.

14 Warranty period is 3-years.

15 Not available with BBW.

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FA LITHONIA LIGHTING

FEATURES & SPECIFICATIONS

 $\textbf{INTENDED USE} \ \ \, \textbf{--} \ \, \textbf{Typical applications include corridors, lobbies, conference rooms and private offices.}$ **CONSTRUCTION** — Galvanized steel mounting/plaster frame; galvanized steel junction box with bottom-hinged access covers and spring latches. Reflectors are retained by torsion springs. Vertically adjustable mounting brackets with commercial bar hangers provide 3-3/4" total adjustment. $\label{two-combination} Two combination 1/2"-3/4" and four 1/2" knockouts for straight-through conduit runs. \ Capacity: 8 (4 in, 20 in, 20$ 4 out). No. 12 AWG conductors, rated for 90°C.

Accommodates 12"-24" joist spacing. Passive cooling thermal management for 25°C standard; high ambient (40°C) option available. Light engine and drivers are accessible from above or below ceiling.

Max ceiling thickness 1-1/2". **OPTICS** — LEDs are binned to a 3-step SDCM; 80 CRI minimum. 90 CRI optional. LED light source concealed with diffusing optical lens.

General illumination lighting with 1.0 S/MH and 55° cutoff to source and source image. Self-flanged anodized reflectors in specular, semi-specular, or matte diffuse finishes. Also available in white and black painted reflectors. ELECTRICAL — Multi-volt (120-277V, 50/60Hz) 0-10V dimming drivers mounted to junction box, 10%

or 1% minimum dimming level available. 0-10V dimming fixture requires two (2) additional low-voltage wires to be pulled. 70% lumen maintenance at 60,000 hours

LISTINGS — Certified to US and Canadian safety standards. Wet location standard (covered ceiling). IP55 rated. ENERGY STAR® certified product. **WARRANTY** — 5-year limited warranty. Complete warranty terms located at: www.acuitybrands.com/CustomerResources/Terms and conditions.aspx **Note:** Actual performance may differ as a result of end-user environment and application.

All values are design or typical values, measured under laboratory conditions at 25 °C.

A+ Capable options indicated

Specifications subject to change without notice.

by this color background.						
ORDERING INFORMATION	Lead times will vary depe	ending on options selected. Con	sult with your sales represe	ntative.	Example: LDN4	35/15 LO4AR LSS MVOLT EZ1
LDN4						
Series	Color temperature	Lumens ¹	Aperture/Trim Color		Finish	Voltage
LDN4 4" round	27/ 2700K 30/ 3000K 35/ 3500K 40/ 4000K 50/ 5000K	05 500 lumens 07 750 lumens 10 1000 lumens 15 1500 lumens 20 2000 lumens 25 2500 lumens 30 3000 lumens 40 4000 lumens	LO4 Downlight LW4 Wallwash	AR Clear WR ² White BR ² Black	LSS Semi-specular LD Matte diffuse LS Specular	MVOLT Multi-volt 120 120V 277 277V 347 ³ 347V

L			40 4000 lumens								
			,								
D	river	Options									
G	Z10 0-10V eldoLED driver with smooth and flicker-free deep dimming performan down to 10%	TRW ⁶ TRBL ⁶ EL ⁵ ELR ⁵	Single fuse White painted flange Black painted flange Emergency battery pack with integr. Power, Not Certified in CA Title 20 M. Emergency battery pack with remot Not Certified in CA Title 20 MAEDBS Emergency battery pack with self-di integral test switch. Not Certified in Emergency battery pack with self-di remote test switch. Not Certified in Emergency battery pack, 10W Const switch. Certified in CA Title 20 MAED Emergency battery pack, 10W Const Certified in CA Title 20 MAEDBS Light® network power/relay pack weldoLED drivers (GZ10, GZ1). nLight® network power/relay pack weldoLED drivers (GZ10, GZ1). ER contri	AEDBS e test switch. 10W Con agnostics, 10W Con CA Title 20 MAEDBS agnostics, 10W Con A Title 20 MAEDBS ant Power with inte BS ant Power with rem with 0-10V dimming	onstant Power, stant Power, stant Power, gral test ote test switch. for non-	N808 NPS80EZ ^{2,10} NPS80EZER ^{7,10} HAO ¹¹ CP ¹² RRL NLTAIR2 ^{8,9} NLTAIRER2 ^{9,10} USPOM 90CRI	(EZÎO, EZI). nLight® dim EZI). ER con High ambie Chicago Ple RELOC®-rea consistent f brands. Refi only in RRL/ nLight® Air nLight® AIR	nmino nmino trols nt op num dy lu factor er to A, RR enab I Dim emer is man	g pack contr g pack contr fixtures on otion (40°C) iminaire cor ry installed RRL for con LB, RRLAE, oled ming Pack gency circu	trols 0-10V eldoLED rols 0-10V eldoLED c emergency circuit.	drivers (EZ10, simple and IBL luminaire ire. Available Controls
Not	t es Overall height varies based on lum refer to dimensional chart on page		12.5" of plenum depth or top access req battery pack maintenance. Available with clear (AR) reflector only.	f		 1% light level. Mu: or NPS80EZ ER. On drivers		11	with HAO.	ight is 5–11/16" for all ify voltage for 3000lm	
2	Not available with finishes. Not available with emergency opti	7	Specify voltage. ER for use with generat EM power. Will require an emergency h	or supply 9 N		CP, NPS80EZ, NPS8	OEZER,	12		gency battery pack of	

10 NLTAIR2 and NLTAIRER2 not recommended for


metal ceiling installations.

4 Must specify voltage 120V or 277V.


DOWNLIGHTING

Distribution Curve	Distribution Data	Output Data	Coefficient of Utilization	Illuminance Data at 30″ Above Floor for a Single Luminaire
--------------------	-------------------	-------------	----------------------------	---


and normal hot feed.

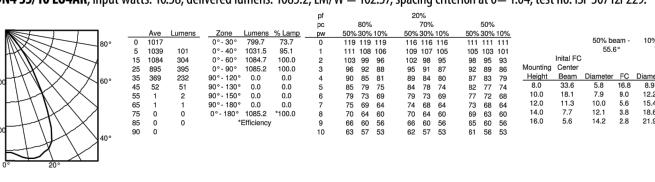

LDN4 35/15 LO4AR, input watts: 17.5, delivered lumens: 1570.1, LM/W = 89.72, spacing criterion at 0 = 1.04, test no. ISF 30712P234.

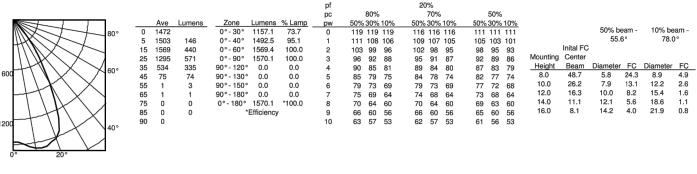

LDN4 35/30 LO4AR, input watts: 32.1, delivered lumens: 3122.6, LM/W = 88.52, spacing criterion at 0 = 1.04, test no. ISF 30712P249.

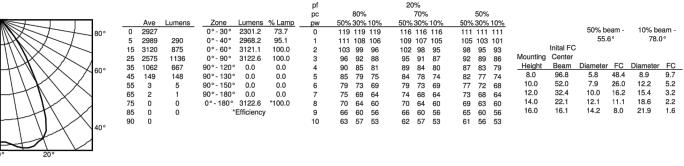

Accessories: Order as separate catalog numbers (shipped separately). Degree of slope must be specified (5D, 10D, 15D, 20D, 25D, 30D). Refer to <u>TECH-190</u>.

INTHONIA LIGHTING®

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RECESSED CANOPY/SOFFIT FIXTURES TYPE RR1



Specifications

Width: 24" (61cm)

Height: 4" (10.2cm)

Weight 29lbs (max): (13.15Kg)

 (0.05 m^2)

24" (61cm)

EPA:

Length: L1



LDN4








PF A	
GYSTAR	CAPABLE

4			
818			

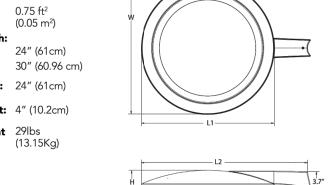

POLE FIXTURES TYPE P1






Introduction

The RADEAN arm mount luminaire is the perfect choice for pedestrian applications where daytime aesthetics and visual comfort are needed. Adding architectural flair to any space, the RADEAN's low-profile shape and smooth curves blend in while adding a touch of elegance.

Perfect for campuses, parks, pedestrian malls, courtyards and pathways, the RADEAN arm mount is the Architect's choice to provide beautiful aesthetics both day and night.

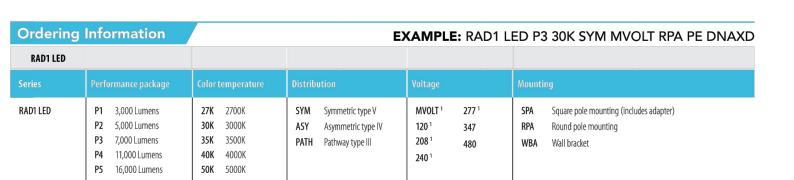

Control options		Other options				Finish (rea	Finish (required)			
Shipped i NLTAIR2 PIR PE FAO	nstalled nLight AIR 2.0 enabled ² Bi-level motion sensor (100% to 30%) ^{2,2,4,5,6} Button photocell ^{2,5} Field adjustable output ^{2,3,7}	SF DF L90 R90	Single Fuse ¹ Double Fuse ¹ Left rotated optics Right rotated optics	Shipp HS	ed separately Houseside shield ⁸	DDBXD DBLXD DNAXD DWHXD	Dark bronze Black Natural aluminum White	DDBTXD DBLBXD DNATXD DWHGXD	Textured dark bronze Textured black Textured natural aluminum Textured white	



Accessories

RADCS Decorative clamshell base for 4" RSS pole (specify finish)

Acuity Part Number

RSS 10 4B DM19RAD DDBXD

RSS 12 4B DM19RAD DDBXD

RSS 14 4B DM19RAD DDBXD

RSS 16 4B DM19RAD DDBXD

RSS 20 4B DM19RAD DDBXD

RSS 25 4B DM19RAD DDBXD

SSS 12 4C DM19RAD DDBXD

SSS 14 4C DM19RAD DDBXD

SSS 16 4C DM19RAD DDBXD

SSS 18 4C DM19RAD DDBXD

SSS 25 4C DM19RAD DDBXD

Drilling Template #20

RSS 18 4B DM19RAD DDBX

RADFBC Full base cover for 4" RSS pole (specify finish) For more control options, visit DTL and ROAM online.

RADHS Houseside shield (shield is white)

Description

10' Round Straight Steel - Template #20 Drilling

14' Round Straight Steel - Template #20 Drilling

16' Round Straight Steel - Template #20 Drilling

18' Round Straight Steel - Template #20 Drilling

20' Round Straight Steel - Template #20 Drilling

25' Round Straight Steel - Template #20 Drilling

10' Square Straight Steel -Template #20 Drilling

12' Square Straight Steel -Template #20 Drilling

14' Square Straight Steel -Template #20 Drilling

16' Square Straight Steel -Template #20 Drilling

18' Square Straight Steel -Template #20 Drilling 20' Square Straight Steel -Template #20 Drilling

25' Square Straight Steel -Template #20 Drilling

RAD1 has a unique drilling pattern. Specify this drilling pattern when

DM28RAD 2 at 180° DM39RAD 3 at 90° *

DM49RAD 4 at 90° * **DM32RAD** 3 at 120°

poles, accessories and educational tools. *Round pole top must be 3.50" O.D. minimum.

specifying poles, per the table below.

Example: SSA 20 4C DM19RAD DDBXD

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* Customer must verify pole loading per required design criteria and specified wind speed. Consult pole specification sheet for additional details.

12' Round Straight Steel - Template #20 Drilling

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For luminaires:

RAD1 LED

DM29RAD 2 at 90° *

234 S. WHISPERWOOD WAY, BOISE, ID 83709 PH: (208) 384-0585 **MUSGROVE PROJECT NUMBER: 19-366**

RAD1 LED

RAD1 LED

Rev. 11/27/19

Rev. 11/27/19

1 MVOLT driver operates on any line voltage from 120-277V (50/60 Hz). Single fuse (SF) requires 120, 277 or 347 voltage option. Double fuse (DF) requires 208, 240 or 480 voltage option.

NLTAIR2 not available with PIR, PE or FAO. Must link to external nLight Air network.

3 PIR will work with FAO, if adjustable dimming level is

PIR must specify 120V, 277V, 347V or 480V. Not available in MVOLT, 208V or 240V.

Used with Mounting

5 PE and PIR are available together. 6 PIR for use on mounting heights under 20'. Field adjustable high-end trim.
 Also available as a separate accessory; see Accessories information. Shield is field rotatable in 45° increments.

PROJECT INFORMATION

CONSULTANT

1008 W Main St

208.345.1800

Boise, Idaho 83702

colearchitects.net

6211 Roosevelt Way NE Seattle, WA 98115

206.522.3820

STAMP

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ARCHITECTURE + PLANNING + DESIGN



MUSGROVE ENGINEERING, P.A.

KETCHUM FIRE STATION

107 SADDLE ROAD, KETCHUM, ID 83353

ISSUES

PHASE		DESIGN REVIE
DATE		FEBRUARY 3, 202
JOB NU	MBER	18-02
MARK	DATE	DESCRIPTION

SHEET NAME

SITE LIGHTING **CUT SHEETS**

SHEET NUMBER



Exhibit B:

Response to Planning and Zoning Commission Comments on the Fire Station Pre-Application Design Review

Response to Planning and Zoning Commission Comments on the Fire Station Pre-Application Design Review

Site Location

While the selection of the fire station site location is not part of the design review process, the following information is provided in response to Commission comments made at the January 13, 2020 meeting.

Between 2001 and 2016, the City evaluated different locations for a new fire station. Sites considered consisted of the following locations:

- City property on Lewis Street
- City property adjacent to the YMCA (north and south properties)
- Stock Building site
- City Hall site

In September 2017 a new site evaluation process was initiated. A group of 11 people that included police and fire personnel, real estate and development professionals, and residents of Ketchum evaluated sites in and around Ketchum and assessed feasibility. All known feasible sites were evaluated. Attachment A provides a summary of the sites evaluated. The group identified 22 locations. These 22 locations were further evaluated for accessibility and other factors, including response time.

Initially, the City site south of the YMCA was identified as a preferred location. However, after public review and comment, that site was no longer under consideration. Two sites emerged as preferred locations, the City owned dirt lot north of the YMCA and the private property at 290 and 298 Northwood Way. The Northwood Way properties were available for purchase for \$3,036,000. Of the two sites, the City Council selected the dirt lot north of the YMCA.

The selected site is suitable with or without consolidation of the north valley fire agencies. The site is centrally located with access to Highway 75, Saddle Road into the City of Sun Valley, and Warm Springs Road.

Unlike some of the other sites considered, this location provides enough area for drive-through apparatus bays. Without drive-through bays, vehicles would have to back into the apparatus bay.

Throughout the 2019 Fire Bond campaign and at the 20 public meetings and open houses, the Saddle Road site was presented as the preferred location. After the bond passed, the City Council conducted a public meeting to review any other proposed locations. No other locations were presented and based on the input from the public and Fire Chief, the Council approved the Saddle Road location.

Parking

As shown in Exhibit A, the fire station is located within a larger parcel owned by the City of Ketchum, it is not a separate parcel.



EXHIBIT A

The parcel contains approximately 170 public parking spaces between the YMCA and fire station and 50 spaces in the parking lot south of the YMCA. Over 100 vehicles can be parked on the street along Saddle Road and in and around Rotary Park. In total, the area can accommodate over 320 vehicles in the surrounding area not including the Presbyterian Church parking lot.

Parking in the area is all shared public parking. No single user has exclusive use or dedicated parking for their use. The City has determined that shared parking is the most efficient, sustainable and cost-effective way to provide parking for the various users in the area. This approach takes advantage of the fact that most parking spaces are only used part time by a particular user. Providing dedicated parking for any single user will result in under-utilized parking and is counter to the transportation and mobility goals of the City.

The parking demands of the fire station will fluctuate depending on the type of emergency call. The existing fire station is in the downtown core adjacent to the most congested and high demand parking area in Ketchum. Firefighters responding to a call must drive into the downtown and typically find parking on the street. While this is not ideal, to date, this practice has not impacted response times. The availability and access to parking for the new fire station is far superior to existing conditions.

On average, there are 2.7 incidents per day. The maximum number of firefighters responding to a major incident is 20. On Tuesday evenings, there would be an average of 16 vehicles coming to either the training facility on Lewis Street and/or the station for training. Training typically occurs between 5-8pm.

Daily, there will be 2-4 firefighters at the station in addition to the Fire Chief, Assistant Chief and Fire Clerk. The two chiefs drive command vehicles which will likely be parked within the fire station bays. Worst case, there is a demand for 5 parking spaces for the full-time staff during the day and as noted above, 20 spaces for other firefighters responding to a major call and approximately 16 spaces during Tuesday training sessions. Based on the available parking around

the site, there will be ample shared parking spaces to meet the parking demand of the station. There are over 60 public spaces within close proximity to the station.

Until the YMCA expands, the number of spaces reasonably necessary to support the YMCA, as identified by the YMCA, is 150 spaces. Assuming the YMCA is at capacity, the Presbyterian Church has an event and there is a major fire call, and all 320 parking places are occupied, the Fire Chief will facilitate parking for firefighters on the fire station site. There is space to park vehicles along the north driveway and in the rear of the station. While it is highly unlikely all uses will have peak parking at the same time, there is a plan in place to handle this situation if it occurs.

The availability of parking is an important issue and based on a careful analysis, the city has determined there is more than enough shared parking to accommodate the needs of all users in the area. In addition to the available parking, the site is located at the intersection of the two highest capacity bus routes (Valley and Blue Route) and within close proximity of the Wood River Multi-Use Path offering ample alternative transportation opportunities. Based on the availability of parking and alternative transportation options, the city is not prepared to dedicate public parking spaces for exclusive use of any use in the area, including the fire station.

Housing

While the decision to include housing within the project is not part of the design review process, the following provides background information on the topic.

The availability of employee housing is a critical issue in the City of Ketchum. Without employees to plow and repair our streets, operate the water and wastewater system, maintain our parks and public facilities, and respond to fire and medical calls, the city simply cannot function and provide critical services. Providing employee housing is a top priority for the Mayor and City Council.

Constructing permanent housing as part of the fire station was contemplated in the early stages of the project development. After input from the full-time firefighters and an evaluation of project costs, it was determined permanent employee housing at this location was not attractive to employees and was expensive to build. Recognizing there is a critical need for employee housing, the Mayor and City Council have put all efforts towards developing over 50 units of community housing at the present city hall site. This project will accommodate employees and, as proposed, is expected to be more cost effective.


In the event there are funds and fire personnel demand to construct permanent housing units on the fire station site, the carport could readily be removed and replaced with housing units and parking. The option exists for future housing on the fire station site.

Traffic Circulation

As mentioned at the January 13th meeting, the City has hired AECOM to conduct a traffic analysis to determine if there will be safety and circulation conflicts between pedestrians, vehicles and emergency vehicles and responders within the general area. If conflicts are identified, mitigation

measures will be implemented. This study is underway and will be presented to the City Council for consideration.

With respect to the circulation in and around the site, there will be a curb cut on the North end of the property providing two-way traffic to the rear of the fire station (Exhibit B). Command and utility vehicles and some staff vehicles will ingress and egress the facility from that north entrance. With current activity, this would be between 10 and 20 vehicles per day entering and exiting. In addition, this entrance will also be the entrance for fire and EMS apparatus. Some EMS apparatus may exit the facility from this location, however emergency response will primarily be from the curb cut at the apparatus bays.

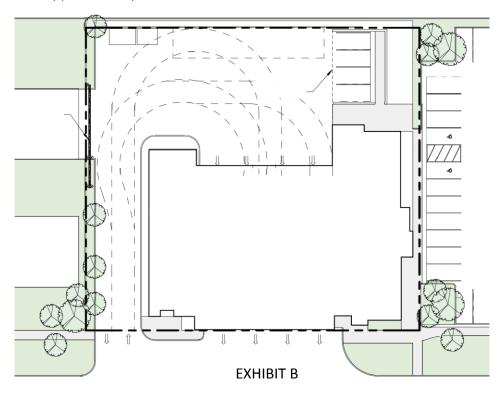

There will be four apparatus bays fronting Saddle Road. Fire and EMS apparatus will be responding to emergencies from these bays. As identified above, on average, there are 2.7 incidents per day and 1.4 apparatus responding to each incident. This amounts to 3.8 apparatus responding daily to incidents. In addition, fire apparatus will be exiting on non-emergency tasks, which currently averages 2 to 4 trips on an average day, Our best estimate is that the number of non-emergency vehicle trips will increase slightly to a total of approximately 5 non-emergency vehicle trips on an average day. Vehicles exiting from the apparatus bays will be almost exclusively re-enter from the north driveway.

Currently 8.1 volunteer trips are made to the station each day. These occur over the course of the day and are not normally at the same time. The maximum number of firefighters responding to a major incident is 20. On Tuesday evenings, there would be an average of 16 vehicles coming to the

station for training. On joint training events, there may also be 2 to 4 fire apparatus coming from other fire departments.

Volunteers and off-duty firefighters may enter the north entrance, park in the joint parking lot south of the fire station or along Saddle Road.

From the emergency apparatus entrance, there are clear sight lines both to the north and south.

AECOM is conducting an analysis to determine if additional traffic and pedestrian control devices are necessary. Should it be determined control devices should be installed, systems such as those shown in Exhibit C could be considered.





STC optically-activated fire station warning signal

EXHIBIT C

The station is designed with sight line windows that will allow apparatus drivers to view pedestrians or bicyclists on sidewalks approaching the station as well as in front of the apparatus. In addition, if determined necessary by AECOM, there are systems to alert pedestrians and bicyclists of vehicles existing the driveway. Exhibit D provides some examples.



EXHIBIT D



EXHIBIT D

Even during emergency response, all apparatus will be required to come to a complete stop prior to pulling on to the roadway. Fire and EMS apparatus will also be required to activate emergency warning lights on the apparatus at all times, and sirens, when appropriate.

Volunteers and off-duty staff are not permitted by law to exceed speed limits or ignore traffic rules. This is also strictly enforced by a "no-tolerance" policy of the fire department.

There is adequate space in the rear courtyard for fire and EMS apparatus to turn around, and adequate space for freight delivery and other service uses.

The safety of first responders arriving and departing during emergencies along with the public around the station will be thoroughly evaluated by professional traffic engineers. If conflicts are identified, the City Council will implement measures to ensure the safety of all users in the area.

Design Comments

The Commission expressed concern over the dark color of the exterior brick. The graphic submitted made the brick appear to be darker than the actual appearance. At the February 10th meeting, samples of brick options will be provided for Commission review and approval.

CITY-OWNED LOTS

CURRENT CITY HALL LOT



Location: NE Corner of East Avenue &

5th Street


Legal: Lot 3A, Block 45

<u>Size</u>: 0.379 acres

Dimensions (WxD): Approx. 110' x 150'

Ownership: City of Ketchum

1ST & WASHINGTON LOT

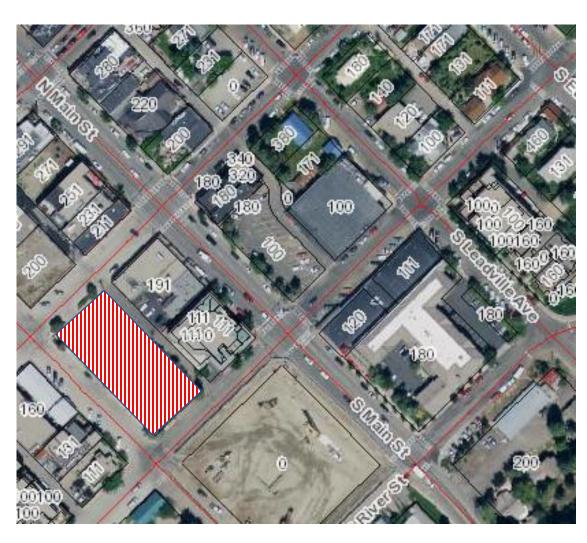

Location: Washington Avenue (btwn 1st

& 2nd Streets)

Legal: Lot 5-8, Block 19

Size: 0.505 acres

Dimensions (WxD): Approx 220' x 100'

Ownership: City of Ketchum/KURA

YMCA SOUTH LOT



Location: Warm Springs Road

Legal: Sec 12 & 13 4N 17E

Size: 0.55 acres

Dimensions (WxD): Approx. 200' x 120'

Ownership: City of Ketchum

YMCA NORTH LOT



Location: Warm Springs Road

Legal: Sec 12 & 13 4N 17E

Size: 0.58 acres

Dimensions (WxD): Approx. 240' x 110'

Ownership: City of Ketchum

CITY-OWNED LEWIS STREET LOTS



Location: Lewis Street

Legal: Lot 7, Block 1 and Lot 6, Block 1

Size: 0.55 acres

Dimensions (WxD): Approx 160' x 150'

Ownership: City of Ketchum

WATER TREATMENT PLANT LOT



Location: Water Treatment Plant


Legal: N/A

Size: Approx. 0.83 acres

Dimensions (WxD): Approx. 160' x 180'

Ownership: City of Ketchum

FOOT OF 9TH STREET LOT

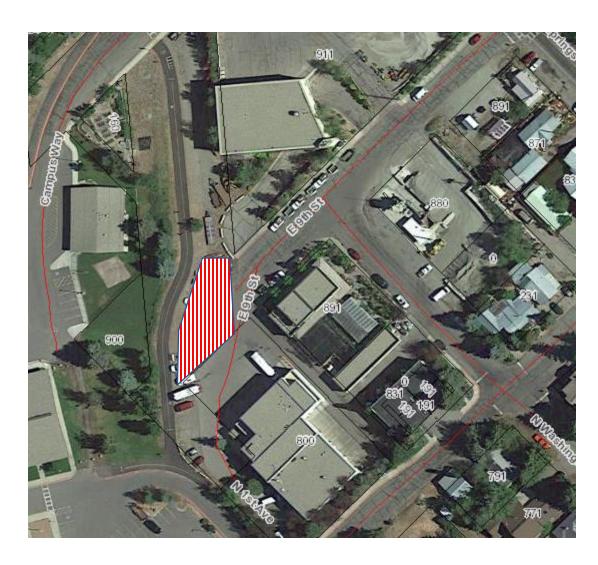

Location: West End of 9th Street

Legal: N/A

Size: Approx. 0.15 acres

Dimensions (WxD): Approx. 80' x 65'

Ownership: City of Ketchum

PRIVATELY-OWNED LOTS

STOCK BUILDING SUPPLY LOT



<u>Location</u>: Lewis Street & Warm Springs

Road.

Legal: Sec 13 4N 17E

Size: 2.432 acres

Dimensions (WxD): Approx. 340' x 305'

Ownership: Private (Warm Springs &

10th LLC).

Market Value: \$2,969,723

1ST AVENUE BETWEEN 4TH & 5TH STREET LOT



Location: 1st Avenue (btwn 4th & 5th

Streets)

Legal: Lot 2 & 3A, Block 56

<u>Size</u>: 0.381 acres


Dimensions (WxD): Appox. 110' x 150'

Ownership: Private (431-471 N 1st

Avenue LLC)

Market Value: \$1,625,330

2ND AVENUE & 2ND STREET LOT

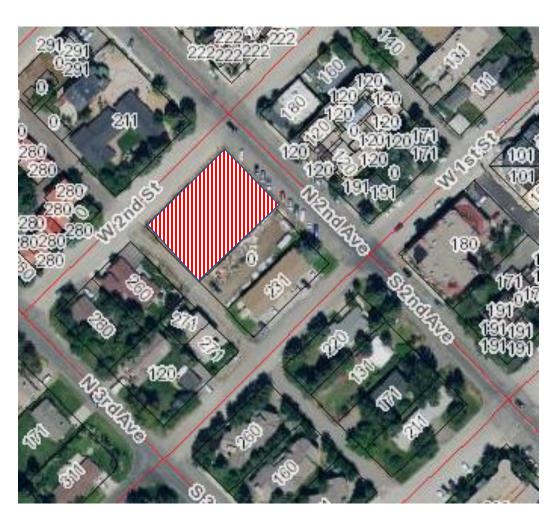

Location: SW Corner of 2nd Avenue & 2nd

Street

Legal: Lots 1 & 2, Block 62

Size: 0.379 acres


Dimensions (WxD): Approx. 110' x 150'

Ownership: Private (Brien Stuart MD

Trustee)

Market Value: \$1,056,000

1ST AVENUE LOT (HOSPICE & MT. EXPRESS)

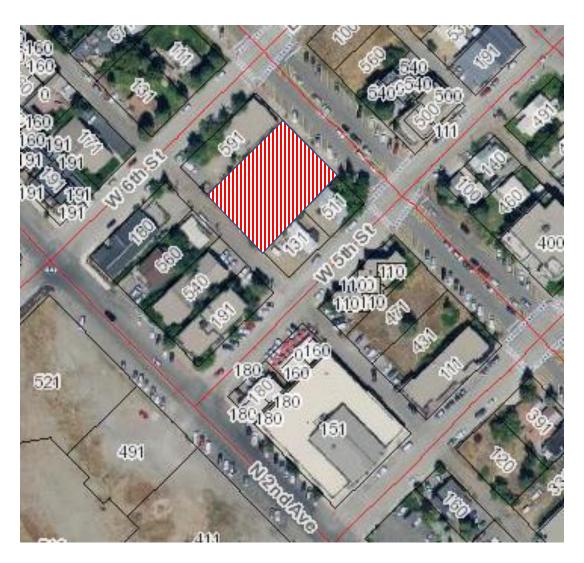

Location: 1st Avenue (btwn 5th & 6th

Streets)

Legal: Lots 2 & 3, Block 55

Size: 0.378 acres


Dimensions (WxD): Approx. 110' x 150'

Ownership: Private (Hardy Foundation

Inc.)

Market Value: \$1,062,728

1st AVENUE AND 6TH STREET LOT

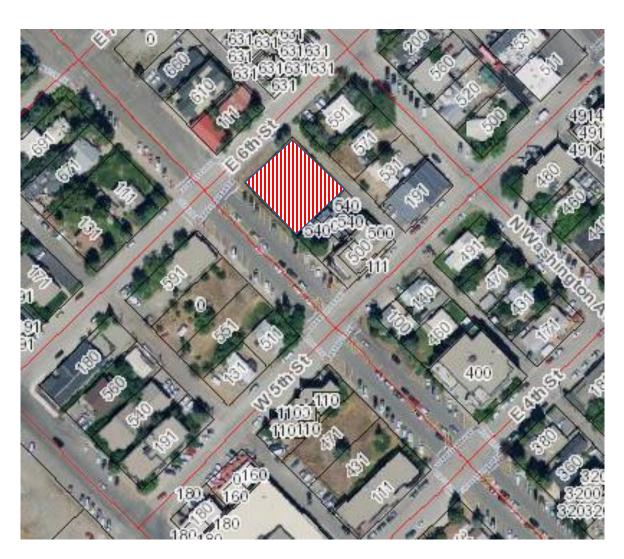

Location: SE Corner of 1st Avenue & 6th

Street

<u>Legal</u>: Lot 5 & 6, Block 35


Size: 0.252 acres

Dimensions (WxD): Approx. 110' x 100'

Ownership: Private (Jack Bariteau)

Market Value: \$880,000

SUN VALLEY ROAD AND 1ST AVENUE LOT

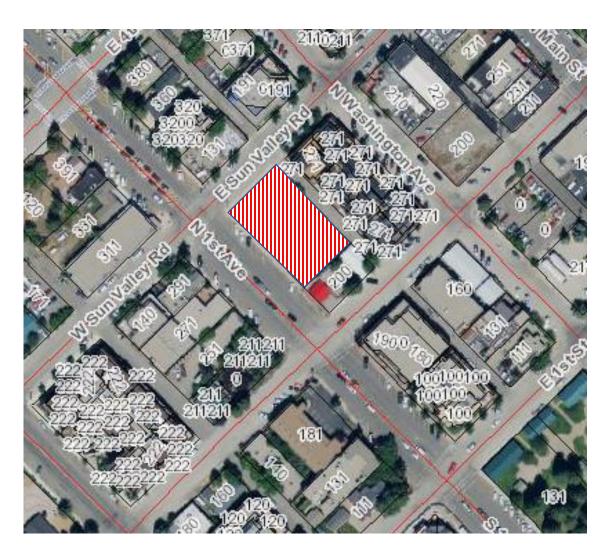

Location: SE Corner of 1st Avenue & SV

Road

Legal: Lot 5A, Block 38

Size: 0.38 acres

Dimensions (WxD): Approx. 165' x 100'

Ownership: Private (260 1st LLC)

Market Value: \$1,617,000

GATEWAY BUILDING LOT



<u>Location</u>: Main Street, South of River

Legal: Lots 3, 21, 22, Block 82

Size: 0.774 acres


<u>Dimensions (WxD)</u>:

Ownership: Private (Idaho Banking

Company, C/O DL Evans)

Market Value: \$2,421,785

OLD POST OFFICE LOT

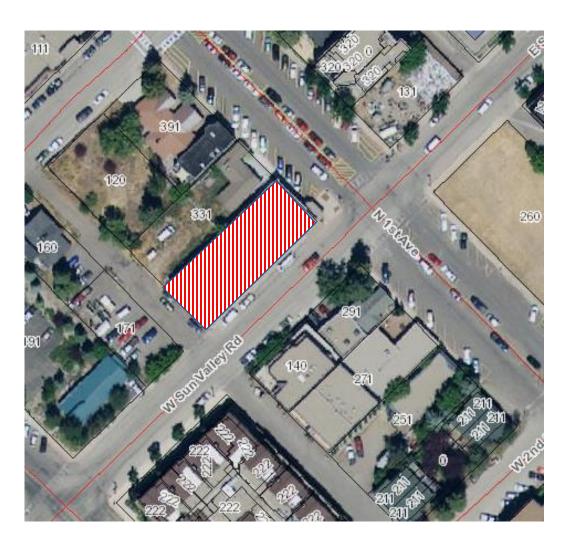

Location: NW Corner of 1st Avenue & SV

Road

Legal: Lot 4, Block 57

Size: 0.189 acres

Dimensions (WxD): Approx. 50' x 150'

Ownership: Private (Geneva Plaza LLC)

Market Value: \$1,144,788

HOT DOG HILL LOT



<u>Location</u>: NE Corner of Main Street & 4th

Street

Legal: Lots 1 & 2, Block 5

Size: 0.252 acres

Dimensions (WxD): Approx. 110' x 100'

Ownership: Private (440 North Main

LLC).

Market Value: \$1,210,000

BARSOTTI LIGHT INDUSTRIAL LOT



Location: SE Corner of Saddle &

Northwood Roads

<u>Legal</u>: Lots 23 & 24

Size: 1.096 acres

Dimensions (WxD): Approx 210' x 200'

Ownership: Private (Barsotti Investment

Company LLC)

Market Value: \$1,388,246

ORGANIZATION-OWNED LOTS

FESITVAL FIELD LOT



Location: Sun Valley Road (East of Town)

<u>Legal</u>: Sec 18 4N 18E


Size: 5.0 acres

Dimensions (WxD): Approx. 300' x 630'

Ownership: Private (City of Sun Valley)

Market Value:

RED BARN LOT

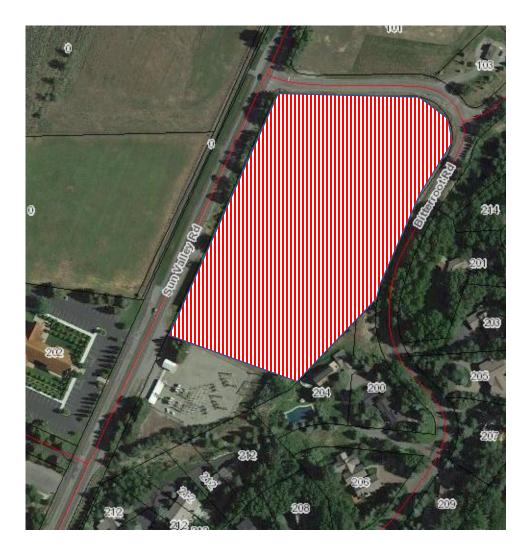

<u>Location</u>: Sun Valley Road (east of town)

<u>Legal</u>: Bitter Root Sub, Lot 3, Block 2

Size: Approx. 7.0 acres


Dimensions (WxD): Approx. 450' x 375'

Ownership: Private (Sun Valley

Company)

Market Value: Unknown

2ND AVENUE & SERENADE LANE LOT

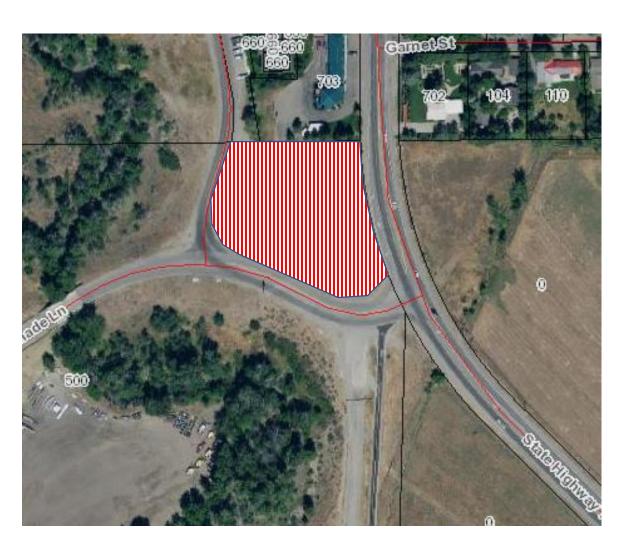

Location: 2nd Avenue @ Serenade Lane

Legal: N/A

Size: Approx. 1.3 acres

Dimensions (WxD): Approx. 210' x 230'

Ownership: Private (Sun Valley

Company)

Market Value: Unknown

SNOW DUMP LOT



Location: Serenade Lane

Legal: N/A

Size: 3.75 acres

Dimensions (WxD): 325' x 500'

Ownership: Private (Sun Valley

Company)

Market Value: Unknown

SIMPLOT LOT



<u>Location</u>: NW Corner of 6th Street & 2nd Avenue.

Legal: Lot 3A, Block 1

Size: 0.72 Acres

Dimensions (WxD): Approx. 175' x 190'

Ownership: Private (Simplot Ketchum

Properties LLC).

Market Value: \$1,717,960

Exhibit C:

Ketchum Fire Station: Staff Report: Planning & Zoning Commission Meeting of February 10, 2020



IN RE:

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Ketchum Fire station

Design Review

Date: February 24, 2020

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KETCHUM PLANNING AND ZONING COMMISSION

FINDINGS OF FACT, CONCLUSIONS OF LAW, AND

DECISION

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File Number: P20-013

FINDINGS REGARDING APPLICATION FILED

PROJECT: Ketchum Fire Station

FILE NUMBER: P20-013

APPLICATION: Design Review

PRE-APPLICATION: The Commission reviewed the Pre-Application (File Number P20-005) and

moved to advance the project to final Design Review on January 13th, 2020.

REPRESENTATIVE: Cole Architects

OWNER: City of Ketchum

LOCATION: 107 Saddle Road (Portion of Tax Lot 6689)

ZONING: Tourist (T)

OVERLAY: None

NOTICE: A public hearing notice for the project was mailed to all owners of property

adjacent to the project site on January 22nd, 2020. The public hearing notice was published in the Idaho Mountain Express on January 22nd, 2020. The Planning & Zoning Commission moved to continue review of the application

during their meeting on February 10th, 2020.

FINDINGS REGARDING PROJECT LOCATION

The new fire station is located on a portion of a larger parcel owned by the City within a Planned Unit Development (PUD) in the Tourist Zone. The PUD includes the Northwood Place apartments, the YMCA, and shared public parking areas all on the same parcel. The fire station site area is 15% of the PUD area with over 150 feet of street frontage along Saddle Road.

The neighborhood connects residential, commercial, recreational, and industrial development. A recreation hub, the multi-use path connects the YMCA to Guy Coles Skate Park and Rotary Park. Across Saddle Road, a townhome development extends north from the Church of the Big Wood. Industrial buildings, including the Fire Training Facility on Lewis Street, border the east side of the PUD.

The project location and site area meet the Fire Department's operational needs. The Future Land Use Map designates the parcel as Public/Quasi-Public for community services, utilities, and government buildings like the proposed fire station. The City-owned parcel is one of only four properties within the City designated for this type of essential facility. The other Public/Quasi-Public properties are developed with the Community Library, Post Office, and the Wastewater Treatment Plant.

FINDINGS REGARDING PROJECT COMPLIANCE WITH DESIGN REVIEW STANDARDS

The fire station design balances multiple discordant functions, including living quarters, apparatus and equipment storage, maintenance, decontamination facilities, and administrative offices and training rooms. Occupied by personnel in continuous 24-hour shifts, the fire station design must balance these different activities while maintaining a healthy and safe environment. The building layout and site design organizes similar functions within distinct areas—the apparatus bays at the center of the station separate the operations and maintenance area from the administrative offices, public meeting room, and residential areas. The orientation and placement of rectangular building shapes facilitate this functional arrangement. The modern design refashions traditional materials like brick to augment visual interest. Details like the red trim across the apparatus-bay windows allude to more traditional firehouse design.

FINDINGS REGARDING PARKING & TRAFFIC CIRCULATION

By Highway 75, Saddle Road, and Warm Springs, the fire station is centrally located with easy access to main routes that connect to all areas of the City. The circulation plan includes drive-through apparatus bays and sight windows that enhance safety while minimizing the fire station's impact to neighborhood traffic. The City has engaged a professional traffic engineer to identify safety concerns or circulation conflicts. Any improvements necessary to ensure the safety of pedestrians, bicyclists, drivers, and emergency responders will be included in the project plan.

The shared parking areas within the PUD contain 220 public parking spaces. The parking spaces are unrestricted and shared between multiple users. Instead of restricting spaces to an exclusive use, sharing spaces satisfies parking demand by flexibly accommodating various uses during different times of the day. More than enough parking spaces are provided in the PUD to meet the needs of all users including the fire station parking demand.

TABLE 1: FINDINGS REGARDING COMPLIANCE WITH COMPREHENSIVE PLAN

A critical facility that will support the future growth of Ketchum, the new fire station is an essential facility needed to sustain our vibrant mountain town. Providing fire protection and emergency medical services, the Fire Department preserves and enhances quality of life for Ketchum residents

Ketchum Fire Station Design Review
Planning & Zoning Commission Meetings of February 10 & 24, 2020
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and visitors. The 2014 Comprehensive Plan identified the construction of a new, modern fire station as the department's highest priority. By protecting life and property, the Fire Department provides the foundation to support our community vision and shared values. The fire station is consistent with the uses, goals, and policies listed below as specified within the 2014 Comprehensive Plan.

SUPPORTING SECTION	COMPLIANCE WITH THE 2014 COMPREHENSIVE PLAN &			
SECTION	COMMISSION FINDINGS			
	CONNINSSIENTINVENIVOS			
Land Use	PRIMARY USES			
Category:	The Public/Quasi-Public category includes uses related to community services, such			
Public/Quasi Public	as schools, libraries, community centers and gardens, arts/culture, hospitals,			
	government, utilities, cemeteries, and places of worship.			
	The fire station is a public facility that delivers an essential service to the			
	community. <u>The project site is one of only four properties within the City designated</u>			
	as an appropriate location for this type of use. The remaining Public/Quasi-Public			
	properties are developed with the Community Library, Post Office, and the			
	Wastewater Treatment Plant.			
Future Land Use				
Infill and	Ketchum needs a new fire station to sustain our vibrant community and support			
Redevelopment to	future growth. As first responders to fires, public safety and medical emergencies,			
Accommodate	and technical rescues, the Fire Department protects the lives and property of The			
Growth	fire station is a critical facility needed to deliver essential services to protect the			
	community. A vacant and underutilized property within a built-out area, the project			
	site is strategically located for emergency response near major transportation			
	corridors. As Ketchum continues to grow, the Fire Department must respond to			
	increasing demands for services. The fire station is necessary to support the future			
	growth of Ketchum.			
Dollar F 2/h)	A Strong and Diverse Economy			
Policy E-2(b)	The Fire Department keeps Ketchum dynamic, resilient, and economically viable. By enhancing delivery of fire protection and emergency services, the fire station project			
Quality of Life Infrastructure	is critical to Ketchum's economic success.			
iiiiasiiucture	is critical to Retenum's economic success.			
D II OD 4 0	Community Design and Neighborhoods			
Policy CD-1.3	The fire station is contextually appropriate located in a neighborhood at the			
Compatible Infill	intersection of commercial, industrial, and residential development.			
and				
Redevelopment				
Projects				

Policy CD-1.5 High-	Centrally located, the fire station is sited near main routes to serve Ketchum		
Quality and	residents and visitors. The project plans include a community room to host public		
Sustainable Design	meetings and events.		
Principles for			
Public Buildings	The fire station will be a LEED certified building.		
and Public			
Outdoor Spaces			
Policy CD-2.5	The fire station will be a LEED certified building to ensure high performance		
Energy and Water	standards for energy and water conservation.		
Efficiency in New			
Development			
	Natural Resource Stewardship		
Policy NR6.1 City	The City of Ketchum will serve as an example by continuing to improve energy		
Leadership in	efficiency and GHG reductions in City facilities and operations.		
Energy Efficiency			
and Conservation			
Policy NR6.2	The City should implement policies and programs that enhance opportunities for		
Energy	individuals, businesses, and public organizations to conserve energy and convert to		
Alternatives	renewable resources. The City should support energy conservation in City buildings,		
	vehicles, operations and processes through its own policies, and provide		
	information about techniques for energy efficiency.		
	Public Safety and Utilities		
Goal PSU-1	Ketchum will proactively ensure the safety and welfare of residents by providing		
	high levels of police, fire, and emergency response services. In addition, the City will		
	promote community awareness and involvement with crime prevention and code		
	enforcement. A primary objective is to provide and maintain reliable funding to		
	protect investment in existing fire and police facilities and ensure appropriate levels		
	of service.		
Policy PSU-1.3 Fire	Future fire and police facility requirements should be determined using level of		
and Police Service	service (LOS) standards. Level of service should be defined as the optimum level of		
Standards	service desired from the service provider and may differ from the current LOS.		
Policy PSU-3.2	The fire station project provides a safety-related capital improvement.		
Channeling Capital			
Improvements			

TABLE 2: FINDINGS REGARDING CITY DEPARTMENT COMMENTS

City Department comments are based on the project concept as proposed with the Design Review project plans. All City Departments shall review and approve the project through the Building Permit application process. All comments pertaining to the Design Review drawings are subject to change.

Ketchum Fire Station Design Review Planning & Zoning Commission Meetings of February 10 & 24, 2020 Findings of Fact, Conclusions of Law, and Decision All right-of-way improvements must be reviewed and approved by the City Engineer and Streets Department prior to issuance of a Building Permit for the project.

City Department Comments

All City Department requirements and associated specifications for the required improvements must be verified, reviewed, and approved prior to issuance of a Building Permit for the project.

Fire Department:

- It is the General Contractor's responsibility to understand and adhere to all Fire Protection Ordinance #1125 requirements in addition to any and all other City of Ketchum requirements in effect at the time of Building Permit issuance. Failure to comply with all local ordinances and codes may result in project work stoppage as well as criminal penalties.
- The above project shall meet all 2012 International Fire Code requirements in addition to specific City Building and Fire Ordinances.
- Approved address numbers shall be placed in such a position to be plainly visible and legible from the road fronting the property. Numbers and letters shall be a minimum of four (4) inches tall, contrast with their background and be positioned a minimum of forty-eight (48) inches above final grade.
- Vehicle parking and material storage during construction shall not restrict or obstruct public streets or access to any building. A minimum twenty-foot travel lane for emergency vehicle access shall be maintained clear and unobstructed at all times. All required Fire Lanes, including within 15 feet of fire hydrants, shall be maintained clear and unobstructed at all times.
- An approved automatic fire sprinkler system shall be installed throughout the building per City of Ketchum Ordinance #1125 (www.ketchumfire.org) and the National Fire Protection Association Standard 13. An approved fire sprinkler flow bell, Knox box and Fire Department Connection shall be installed in an approved location visible to approaching firefighters. Water service lines to structures shall be hydraulically calculated for size to meet fire sprinkler flow requirements. Fire sprinkler systems shall be annually tested and maintained per NFPA 25. An approved fire department connection and flow bell shall be installed in a location approved by the fire department and the system shall be supervised by an approved alarm system.
 - Note: The entire building shall be protected by an NFPA 13 Fire Sprinkler system.
- NOTE: One electronic set of fire sprinkler system plans must be submitted to the Ketchum Fire Department as well as the State Fire Marshal's office and a Ketchum Fire Department Permit must be obtained prior to installation of fire sprinkler systems. Inspections of fire sprinkler systems by the Fire Chief or an appointee are required. Inspections must be scheduled at least 48 hours in advance.
- An approved monitored fire sprinkler alarm system shall be installed per City of Ketchum Ordinance #1125 (www.ketchumfire.org) and the requirements of NFPA 72. Two (2) sets of alarm system plans shall be submitted to the Ketchum Fire Department for approval and a permit is required prior to installation of alarm systems. Inspections of fire detection systems by the Fire Chief or an appointee are required and shall be scheduled at least 48 hours in advance.

- An approved access roadway per 2012 International Fire Code Appendix D (www.ketchumfire.org) shall be installed prior to any combustible construction on the site. The road shall be a minimum of twenty (20) feet in width and capable of supporting an imposed load of at least 75,000 pounds.
- Fire extinguishers shall be installed and maintained per 2012 IFC Section 906 both during construction and upon occupancy of the building.
- An approved key box shall be installed, with the appropriate keys, for emergency fire department access in a location approved by the fire department. The key box shall be a Knox box brand and sized to accommodate keys to every door of the project.
- An 8 ½ by 11 color coded site map of this project shall be provided on paper and electronically to the fire department. This site map shall show the locations of gas shut-offs, power shut-offs, fire sprinkler riser rooms, fire department connections, alarm panels, Knox boxes, access doors, egress windows, stairways and any additional fire department requirements. Exact details for color coded "On-Sites" can be found at www.ketchumfire.org.
- Final inspections of all fire department permit required installations by the Fire Chief or an appointee are required and shall be scheduled at least 48 hours in advance. A Final Inspection Checklist can be found at www.ketchumfire.org.
- Fire Department requirements and associated specifications for the required improvements must be verified, reviewed, and approved prior to issuance of a Building Permit for the project.

City Engineer & Streets Department:

- All drainage shall be retained on site including water from any roof drains (KMC §17.96.060.C.1).
 Any roof drain locations will need to be shown on project plans submitted with the Building Permit application.
- All construction for the project must comply with the standards set forth in Ketchum Municipal Code, Chapter 15.06 Construction Activity Standards. The applicant shall submit a Construction Activity Plan addressing all applicable activities (KMC §15.06.030), including how materials will be off-loaded at the site, plan for coordinating with neighbors on temporary closures, temporary traffic control, and construction fencing with appropriate screening, to be reviewed and approved prior to issuance of a Building Permit for the project. Pursuant to KMC §15.06.030.A.2, the applicant shall provide notice of the project, construction schedule, and general contractor's contact information to all neighbors with properties adjacent to the project site.
- The Building Permit plans and construction drawings shall meet all applicable sections of Chapter 12 of Ketchum Municipal Code.
- The plans for the ROW improvements must be prepared by a professional engineer licensed in Idaho (KMC §12.04.020. Reconstruction of the city sidewalk is required. Specifications for the ROW improvements shall be indicated on the civil drawings submitted with the Building Permit application to be reviewed and approved by the City Engineer and Streets Department prior to issuance of a Building Permit for the project.
- Recommended separation distance between a dry well and water main is 25'. If a dry well is
 installed closer than 25' to the water main install 20 mil HDPE groundwater barrier along the
 water main side of drywell. Barrier should extend of 18 inches below the water main pipe.
 Minimum distance between a dry well and water main must be 10'.

- Utility locations (electrical, gas) are not permitted in public ROW. If utility upgrades are necessary the applicant will need to coordinate upgrades with Idaho Power and Intermountain Gas. All utilities need to be shown on the plans including the location and size of water and sewer mains and services, gas, electric, TV and phone.
- Drainage improvements constructed shall be equal to the length of the subject property lines adjacent to any public street or private street (KMC §17.96.060C).
- The applicant shall submit a Street and Alley Digging, Excavation, and Trenching ("DIG") Permit
 application with an associated traffic control plan for all construction work within the City rightof-way to be reviewed and approved by the Streets Department. The use of City right-of-way
 for construction including the closure of adjacent streets or sidewalks requires a Temporary Use
 of Right-of-Way Permit ("TURP").
- Final civil drawings for all associated ROW improvements shall be submitted with the Building Permit application to be verified, reviewed, and approved by the City Engineer and Streets Department prior to issuance of a Building Permit for the project.

Utilities:

- The applicant will be responsible for installing connections to the water and sewer system.
- Requirements and specifications for the water and sewer connections will be verified, reviewed, and approved by the Utilities Department prior to issuance of a Building Permit for the project.

Building:

- The building must meet the 2012 International Building Code and Title 15 Buildings and Construction of Ketchum Municipal Code.
- Building Department requirements and associated specifications for the required improvements must be verified, reviewed, and approved prior to issuance of a Building Permit for the project.

Planning and Zoning:

Comments are denoted within the analysis of the project's compliance with the Comprehensive Plan, zoning and dimensional standards, and Design Review evaluation standards.

TABLE 3: FINDINGS REGARDING ZONING AND DIMENSIONAL STANDARDS

	Zoning and Dimensional Standards Analysis					
Compliant		nt	Standards and Commission Findings			
Yes	No	N/A	Guideline	City Standards and Commission Findings		
\boxtimes			17.12.030	Minimum Lot Area		
			Commission	Required: 8,000 square feet minimum		
			Findings			
				Existing:		
				Tax Lot 6689 Total: 249,150 square feet		
				Fire Station Project Site: 35,139 square feet		
\boxtimes			17.12.030	Minimum Open Space		
			Commission	Required: 35%/30% (Footnote 5: 5% open site area may be used for		
			Findings	private decks or patios and walkways subject to Design Review		
				approval)		

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			Proposed with Ketchum Fire Station: YMCA and Greenhouse Building Footprint: 69,282 square feet Northwood Place & Carport Building Footprint: 23,402 square feet Ketchum Fire Station & Carport Building Footprint: 14,810 square feet Total Building Footprint: 107,494 square feet Total Open Space: 141,656 square feet Open Space: 57% (141,656square feet open space/249,150 square feet
			Tax Lot 6689 area)
		17.12.030	Floor Area Ratios and Community Housing
		Commission	Floor Area Ratio Permitted in Tourist (T) Zoning District
		Findings	FAR Permitted in T Zone: 0.5
			FAR Permitted with Inclusionary Housing Incentive: 1.6
			Proposed Floor Area Ratio
			Existing YMCA, Future YMCA Expansion, and Northwood Place Gross
			Floor Area: 128,806.5 square feet (YMCA with Future Expansion
			91,374 gross square feet + Northwood Place 37,432.5 gross square
			feet)
			Proposed Ketchum Fire Station Gross Floor Area: 17, 507 gross square feet
			Total Gross Floor Area of YMCA with Future Expansion, Northwood Place, Ketchum Fire Station: 146,313.5 gross square feet Floor Area Ratio Proposed: 0.59 (146,313.5 gross square feet/249,150 square feet TL 6689 area)
	(
			Increase Above 0.5 Permitted FAR: 21,738.5 square feet (146,313.5
			gross floor area-124,575 permitted 0.5 gross floor area) 20% of Increase: 4,348 square feet
			15% Reduction for Net Livable Floor Area: 3,696 square feet
			1970 Heddellom for their Envanie Floor / Hedd 97050 square feet
			Northwood Place is an affordable apartment complex with 32 deed
			restricted community housing units. Comprised of five buildings, the
			total floor area of Northwood Place is 33,188 square feet, which
		47.42.020	satisfies the community housing contribution.
		17.12.030	Minimum Building Setbacks
		Commission	Minimum:
		Findings	Front: 15 feet West Side Setback Along Saddle Road Waiver (PUD CUP 04-008): 0 feet
			East Side Setback Along Interior Property Line Waiver (PUD CUP 09-
			023): 0 feet
<u> </u>	1		

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			Rear: > 1 per 3 feet in building height, but no less than 10 feet Setback Along Warm Springs Road with Waiver: 20 feet The PUD designates the Warm Springs Road boundary as the front property line. Proposed:
			Front (South/Warm Springs): Greater than 15 feet Rear (North/Park Circle): Greater than 15 feet Side with Waiver (East/Interior): 0 feet
			Side with Waiver (West/Saddle Road): 0 feet
\boxtimes		17.12.030	Building Height
		Commission Findings	Maximum Permitted in Tourist Zone: 35 feet Maximum Permitted with PUD Waiver: 45 feet-6 inches
			Proposed:
			The fire station is 29 feet tall.
\boxtimes		17.125.030H	Curb Cut
		Commission Findings	Required: A total of 35% of the linear footage of any street frontage can be devoted to access to off street parking.
			Existing: YMCA (PUD CUP 04-008 & Design Review CR04-013): 5% Northwood Place (PUD CUP 09-023 & Design Review R09-003): 38 feet/27% Park Circle frontage
			Proposed: As indicated on the Site Plan (Sheet C2.00), 2 curb cuts are proposed along Saddle Road to facilitate two-way traffic for command vehicles and fire apparatus to exit and enter the fire station. The 2 curb cuts are separated by a grass median. The north access serves as the main entrance and exit for staff vehicles and fire trucks. During an emergency response, firefighters will exit the station from the apparatus-bay curb cut.
			Tax Lot 6689 has 1,747 feet of street frontage along Park Circle, Saddle Road, and Warm Springs Road. The property has 890 feet of street frontage along Saddle Road. The 2 curb cuts have a combined width of 147.5 feet. An existing 30-foot curb cut along Saddle Road serves as the main access to the YMCA. The total width of the driveway accesses along Saddle Road will be 177.5 feet or 20% of the street frontage along Saddle Road.

\boxtimes		17.125.040	Parking Spaces
		Commission	Off-street parking standards apply to any new development and to any
		Findings	new established uses.
			Required:
			Non-Residential Use in T Zone: 1 parking space per 1,000 gross square
			feet (Footnote 1: Refer to definition of floor area, gross and with the
			additional exclusion of common and public areas).
			Durancead
			Proposed:
			The Ketchum Fire Station is 17,507 gross square feet generating a
			parking demand of 18 parking spaces. The shared parking areas
			provide 100 spaces on-site to accommodate the fire station's parking
			demand. Parking for over 320 vehicles may be accommodated through
			on-street and off-site public parking spaces within the area. At the
			Commission's request, the applicant has provided a parking diagram
			showing the YMCA future expansion. The parking diagram shows the
			150 on-site parking spaces that will be provided if the YMCA expands
			in the future. More than enough parking spaces are provided in the
			area to meet the needs of all users including the fire station and the
			YMCA.

TABLE 4: FINDINGS REGARDING DESIGN REVIEW STANDARDS

	Design Review Improvements and Standards (KMC §17.96.060)						
Yes	No	N/A	City Code	City Standards and Commission Findings			
\boxtimes			17.96.060.A1	The applicant shall be responsible for all costs associated with providing			
			Streets	a connection from an existing city street to their development.			
			Commission	Tax Lot 6689 is bordered by Park Circle to the north, Saddle Road to			
			Findings	the west, and Warm Springs to the south. A driveway access along			
				Saddle Road at the north end of the project site provides two-way			
				traffic to the fire station. The apparatus bay curb cut is reserved for			
				emergency response.			
		\boxtimes	17.96.060.A2	All street designs shall be approved by the City Engineer.			
			Streets				
			Commission	No changes are proposed to the street design or lanes of travel within			
			Findings	the Saddle Road right-of-way.			
\boxtimes			17.96.060.B1	All projects under 17.96.010(A) that qualify as a "Substantial			
			Sidewalks	Improvement" shall install sidewalks as required by the Public Works			
				Department.			
			Commission	The fire station is new construction and qualifies as a substantial			
			Findings	improvement project requiring the installation of sidewalks. A			

Ketchum Fire Station Design Review

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			concrete path extends the length of the PUD connecting Northwood
			Place to the YMCA. The path within the project site will be relocated
			within the Saddle Road right-of-way to align with the existing path.
			Final civil drawings for all associated ROW improvements shall be
			submitted with the Building Permit application to be verified,
			reviewed, and approved by the City Engineer and Streets Department
			prior to issuance of a Building Permit for the project.
			See Table 2 for comments and conditions from the City Engineer &
			Streets Department.
\boxtimes		17.96.060.B2	Sidewalk width shall conform to the City's right-of-way standards,
		Sidewalks	however the City Engineer may reduce or increase the sidewalk width
			and design standard requirements at their discretion.
		Commission	All ROW improvements shall be constructed to City ROW standards.
		Findings	The proposed width of the path is 7 feet to match the existing
			sidewalk to the north and south. The City Engineer may reduce or
			increase the sidewalk width and design standard requirements.
			Final civil drawings for all associated ROW improvements shall be
			submitted with the Building Permit application to be verified,
			reviewed, and approved by the City Engineer and Streets Department
			prior to issuance of a Building Permit for the project. See Table 2 for
			review comments and conditions from the City Engineer & Streets
			Department.
	\boxtimes	17.96.060.B3	Sidewalks may be waived if one of the following criteria is met:
		Sidewalks	a. The project comprises an addition of less than 250 square feet
			of conditioned space.
			b. The City Engineer finds that sidewalks are not necessary
			because of existing geographic limitations, pedestrian traffic on
			the street does not warrant a sidewalk, or if a sidewalk would
			not be beneficial to the general welfare and safety of the public.
		Commission	N/A the existing pathway must be relocated within the Saddle Road
		Findings	right-of-way.
\boxtimes		17.96.060.B4	The length of sidewalk improvements constructed shall be equal to the
		Sidewalks	length of the subject property line(s) adjacent to any public street or
			private street.
		Commission	The sidewalk will be constructed across the length of the project site
		Findings	along Saddle Road.
\boxtimes		17.96.060.B5	New sidewalks shall be planned to provide pedestrian connections to
		Sidewalks	any existing or future sidewalks adjacent to the site. In addition,

			Commission	sidewalks shall be constructed to provide safe pedestrian access to and around a building.
			Commission Findings	The new sidewalk along Saddle Road will connect to a path that leads to the fire station's public entrance. The sidewalk extends the length of the PUD and connects Northwood Place to the YMCA. This circulation system connects to the BCRD Wood River Trail multi-use path, commonly referred to as the bike path, to the west across Saddle Road through existing crosswalks.
		\boxtimes	17.96.060.B6	The City may approve and accept voluntary cash contributions in-lieu of
			Sidewalks	the above described improvements, which contributions must be
				segregated by the City and not used for any purpose other than the
				provision of these improvements. The contribution amount shall be one hundred ten percent (110%) of the estimated costs of concrete
				sidewalk and drainage improvements provided by a qualified
				contractor, plus associated engineering costs, as approved by the City
				Engineer. Any approved in-lieu contribution shall be paid before the
				City issues a certificate of occupancy.
			Commission	N/A. The Commission does not recommend a voluntary cash
			Findings	contribution in-lieu of improvements for this project.
\boxtimes			17.96.060.C1	All storm water shall be retained on site.
			Drainage Commission	All storm water shall be retained on site including water from roof
			Findings	drains. Preliminary drainage plans are indicated on Sheets C2.0 and
			T manigs	C3.0 of the Design Review submittal drawings. The proposed drainage
				plan includes a system of drywells and grass drainage swales.
				Prior to issuance of a Building Permit for the project, the applicant
	· ·			shall submit a final drainage plan indicating grading, catch basins,
				piping, and drywells (KMC §17.96.040.C.2b & KMC §17.96.060.C.1-4) prepared by a civil engineer licensed in the state to be submitted for
				review and approval by the City Engineer and Streets Department.
				See Table 2 for City Department comments including City Engineer
				and Streets Department conditions.
\boxtimes			17.96.060.C2	Drainage improvements constructed shall be equal to the length of the
			Drainage	subject property lines adjacent to any public street or private street.
			Commission	See above analysis for Ketchum Municipal Code §17.96.060C1. All
			Findings	drainage improvements are required to meet City standards.
				All drainage improvements shall be indicated on civil plans prepared
				by an Idaho licensed engineer and require review and approval from
				the City Engineer & Streets Department prior to issuance of a Building
				Permit for the project.

				See Table 2 for review comments and conditions from the City Engineer & Streets Department.
\boxtimes			17.96.060.C3	The City Engineer may require additional drainage improvements as
			Drainage	necessary, depending on the unique characteristics of a site.
			Commission	A final drainage plan prepared by a civil engineer licensed in the state
			Findings	of Idaho shall be submitted with the Building Permit application to be reviewed and approved by the City Engineer and the Streets
				Department. The City Engineer may require additional drainage
				improvements as necessary.
\boxtimes			17.96.060.C.4	Drainage facilities shall be constructed per City standards.
			Drainage	
			Commission	All drainage facilities within the project site and the public right-of-
			Findings	way shall meet City standards. Final drainage specifications must be
				included with the civil drawings submitted with the Building Permit
				application to be reviewed and approved by the City Engineer &
				Streets Department.
\boxtimes			17.96.060.D1	All utilities necessary for the development shall be improved and
			Utilities	installed at the sole expense of the applicant.
			Commission	Sheet C4.00 of the project plans show utility connections and
			Findings	locations. All utilities necessary for the fire station must be improved
				and installed at the sole expense of the applicant. Prior to issuance of
				a Building Permit, the applicant must secure a will-serve letter from
				Idaho Power. Final plans will be reviewed and approved by the
				Utilities Department prior to issuance of a Building Permit for the
				project. See Table 2 for review comments and conditions from the
				Utilities Department.
\boxtimes			17.96.060.D2	Utilities shall be located underground and utility, power, and
			Utilities	communication lines within the development site shall be concealed
				from public view.
			Commission	All utilities within the development site shall be underground and
			Findings	concealed from public view. See above analysis for Ketchum
				Municipal Code §17.96.060D1. The generator located at the
				northeast corner of the project site must be fully screened from public
			47.00.000.70	view.
\boxtimes	Ш		17.96.060.D3	When extension of utilities is necessary all developers will be required
			Utilities	to pay for and install two (2") inch SDR11 fiber optical conduit. The
				placement and construction of the fiber optical conduit shall be done in
				accordance with city of Ketchum standards and at the discretion of the
		<u> </u>		City Engineer.

		Commission Findings	The applicant is aware of this requirement to install services for high- speed internet to the site. The applicant will work with the City Engineer to identify the location of a fiber line to serve the project.
		17.96.060.E1 Compatibility of Design	The project's materials, colors and signing shall be complementary with the townscape, surrounding neighborhoods and adjoining structures.
		Commission Findings	The exterior elevations (Sheet A3.00) show the proposed materials, colors, and signage. The façade design alternates gray horizontal metal panels with brown vertical metal siding. Projecting towards Saddle Road, the four apparatus bays are distinguished from the rest of the fire station with black brick veneer and glass-panel garage doors. The modern building alludes to traditional firehouse design through red detailing framing the garage doors. Integrated with the architecture of the building, the Ketchum Fire Station 1 sign at the south elevation directs attention to the public entryway. In addition to the red firehouse doors, the 1 sign at the front elevation anchors the building as a fire station.
			Residential, commercial, and light industrial development border the project site and PUD. Most of the surrounding neighborhood is developed with the exception of a few vacant properties in the light industrial area. To the east of the project site, the light industrial buildings are characterized by more simple design styles that combine stucco, concrete, and brick. Directly north of the project site, the Northwood Place façade design uses stone veneer to differentiate from the horizontal siding. Across Saddle Road, buildings including the church and townhomes integrate river rock, stone veneer, stucco, and wood siding into the façade design. The alternation of brick veneer with board-and-batten siding provides visual interest to the YMCA building.
			The materials proposed for the fire station are compatible with the surrounding neighborhood and nearby buildings. The design approach refashions traditional materials combined with contemporary finishes to augment visual interest. The new fire station will add modern style to the eclectic buildings within the neighborhood. The adaptation of traditional materials like the brick complements the more conventional design styles in the neighborhood.
	\boxtimes	17.96.060.E2 Compatibility of Design	Preservation of significant landmarks shall be encouraged and protected, where applicable. A significant landmark is one which gives historical and/or cultural importance to the neighborhood and/or community.

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		Commission	N/A. No significant landmarks of historical or cultural importance
		Findings	have been identified on the property. The project site has been used
	 		for parking and snow storage.
	\boxtimes	17.96.060.E3	Additions to existing buildings, built prior to 1940, shall be
		Compatibility	complementary in design and use similar material and finishes of the
		of Design	building being added to.
		Commission	N/A This standard does not apply because the fire station is new
		Findings	construction.
		17.96.060.F1	Building(s) shall provide unobstructed pedestrian access to the nearest
		Architectural	sidewalk and the entryway shall be clearly defined.
		Commission Findings	The project plans include a path that borders the south side of fire station and directs pedestrians to the public entrance from the shared parking area. This pathway leads to the sidewalk that extends from Northwood Place to the YMCA. This internal circulation system will connect to the bike path across Saddle Road through existing crosswalks.
			The fire station accommodates diverse spaces from living quarters to fire truck storage to maintenance areas to administrative offices. These different fire station functions are separated within the building. The apparatus bays at the center of the station separate the administrative areas and firefighter living quarters from areas dedicated to emergency response operations, maintenance, and storage.
			The design of the entryway at the south elevation includes large windows and doors inviting the public into the facility. The entryway is distinguished from the rest of the fire station by brown metal siding and signage. The emergency response operations area incorporates with fewer windows and uses different materials combining the gray metal panels with the black brick.
\boxtimes		17.96.060.F2	The building character shall be clearly defined by use of architectural
		Architectural	features.
		Commission	The fire station is characterized by modern design elements with
		Findings	simple building forms and functional floor plans. The orientation and placement of rectangular building shapes with flat roofs at varying heights define the fire station's functional arrangement.
			Separating the operations and maintenance areas from the administrative offices and living quarters, the apparatus bays at the center of the station are defined by the glass-paneled garage doors. These windows will introduce natural light into the apparatus bays while providing pedestrians a unique view of the stored fire engines.

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				The southern portion of the building is distinguished from the rest of the fire station through its size, shape, and placement. With significant fenestration, the south façade design welcomes the public into the fire station. The pattern of material placement provides texture to the box building form. The vertical placement of the brown metal siding provides visual relief from the horizontal metal panels and black brick.
\boxtimes			17.96.060.F3	There shall be continuity of materials, colors and signing within the
			Architectural	project.
			Commission Findings	The exterior walls of the building utilize the same metal and brick materials and gray, block, and brown color scheme. Highlighting the apparatus bays, the use of the firehouse red is limited to the apparatus-bay garage doors. The consistent pattern of material placement and colors across all building walls connects the diverse functions of the fire station into one cohesive design.
\boxtimes			17.96.060.F4	Accessory structures, fences, walls and landscape features within the
			Architectural	project shall match or complement the principal building.
			Commission	Accessory Structures
			Findings	The 1,360 square foot carport at the southeast corner of the project
				site uses the same black brick material as the fire station. A row of
				rectangular windows at the carport's south elevation provides relief from the black brick veneer. The four parking spaces in the carport will be reserved for staff and command vehicles. A covered patio area will extend to the south of the carport. Utilizing the same material and color palette, the carport and patio match the fire station design theme.
				<u>Fences & Gates</u>
				In the 1990s, a 5-foot concrete retaining wall was constructed along the side property line to separate Tax Lot 6689 from the industrial area to the east. In addition to the existing CMU wall, the project includes a 4-foot tall patio fence, a 6-foot tall trellis, and a rolling gate (Sheets L1.00 & L1.50). The patio fence will not only enhance privacy, but also limits public access to the Fire Department operations area. Comprised of horizontal slats, the patio fence will match the color of the carport and covered patio. The trellis system separates the fire station from the Northwood Place apartments. Plants attach to panels so that the freestanding trellis will transform into a living fence. Multi-functional, the green trellis will enhance screening and soften the fires station's black, brown, and gray walls.
				<u>Landscape</u>

			The landscape plan is included on Sheets L1.00 and L1.500 of the project plans. Grass medians border Saddle Road and separate the northern driveway access from the apparatus-bay curb cut reserved for emergency response. Grasses and flowering plants are proposed along the front façade at either side of the center apparatus bays. Softening the building's hard edges, the plants invite and welcome the public into the fire station. Flowering plants and shrubs border the north side of the building softening the gray and brown metals panels. Boulders are incorporated throughout the landscape design providing visual interest.
\boxtimes		17.96.060.F5	Building walls shall provide undulation/relief, thus reducing the
		Architectural	appearance of bulk and flatness.
		Commission Findings	The fire station design uses rectangular shapes in different forms to reduce the flatness of building walls. The gray metal panels, black brick, brown metal siding, and window openings are all unique rectangular elements in different sizes and orientations. For example, the gray metal panels are placed horizontally and the brown metal siding is aligned vertically. This contrast of rectangular shapes provides visual interest to the box-shaped building. In addition to this rectangular arrangement, color variation and multiple windows and doors to breathe life into the fire station. The varying roof heights define the separate areas of the building. Projecting beyond the rest of the building, the firehouse red detailing highlight framing the glass panels focuses attention to the apparatus bays.
\boxtimes		17.96.060.F6 Architectural	Building(s) shall orient towards their primary street frontage.
		Commission	The front façade of the building orients towards Saddle Road.
	(Findings	, in the same of t
\boxtimes	П	17.96.060.F7	Garbage storage areas and satellite receivers shall be screened from
<u> </u>		Architectural	public view and located off alleys.
		Commission	The concrete trash enclosure is located at the southeast corner of the
		Findings	project site. In addition to the concrete trash enclosure, the carport
			and fenced patio further screen the dumpster from public view.
			Prior to issuance of a Building Permit for the project, the applicant
			shall submit a will serve letter from Clear Creek Disposal to the
			Planning & Building Department.
			The project plans do not include any satellite receivers.

		17.96.060.F8 Architectural	Building design shall include weather protection which prevents water to drip or snow to slide on areas where pedestrians gather and circulate or onto adjacent properties.
		Commission Findings	Enhancing weather protection, the flat roof form will prevent water from dripping or snow from sliding from the building. At the main entrance, the second floor cantilevers beyond the first floor to cover the pedestrian pathway.
		17.96.060.G1 Circulation Design	Pedestrian, equestrian and bicycle access shall be located to connect with existing and anticipated easements and pathways.
		Commission Findings	The project plans include a path that directs pedestrians to the public entrance from the shared parking area. This pathway leads to the sidewalk that extends from Northwood Place to the YMCA. This internal circulation system connects to the bike path across Saddle Road through existing crosswalks.
	\boxtimes	17.96.060.G2	Awnings extending over public sidewalks shall extend five (5') feet or more across the public sidewalk but shall not extend within two (2') feet of parking or travel lanes within the right of way.
		Circulation Design	N/A. No awnings are proposed to extend across the public sidewalk.
		17.96.060.G3 Circulation Design Commission Findings	Traffic shall flow safely within the project and onto adjacent streets. Traffic includes vehicle, bicycle, pedestrian and equestrian use. Consideration shall be given to adequate sight distances and proper signage. Neighboring Highway 75, Saddle Road, and Warm Springs Road, the fire station site is centrally located with easy access to main routes to all service delivery areas. A driveway access off Saddle Road at the northwest corner of the site will facilitate two-way traffic to and from the fire station. The curb cut along the four apparatus bays will be reserved for emergency response. Sight line windows are
			incorporated into the building design that allow emergency responders to view any pedestrians or bicyclists approaching the station on the sidewalk and any obstructions in front of the apparatus bays. The City has engaged a traffic engineering firm to identify safety concerns and circulation conflicts between neighborhood traffic and Fire Department emergency response operations and identify any mitigation measures. These mitigation measures may include warning signals, traffic control devices, and alert systems. If the traffic study identifies circulation conflicts, the City will implement any

			mitigation measures necessary to ensure the safety of pedestrians, bicyclists, and drivers in the area. Prior to issuance of a Building Permit for the project, the City Engineer and Streets Department shall review the civil drawings to ensure adequate sight distances and proper signage for the proposed driveway access.
		17.96.060.G4 Circulation Design	Curb cuts and driveway entrances shall be no closer than twenty (20') feet to the nearest intersection of two or more streets, as measured along the property line adjacent to the right of way. Due to site conditions or current/projected traffic levels or speed, the City Engineer may increase the minimum distance requirements.
		Commission Findings	The project site is located over 250 ft from Saddle Road's intersection with Park Circle and over 400 ft from the Saddle Road and Warm Springs Road intersection. Clear sight lines are provided to the north and south of the fire station driveways. Prior to issuance of a Building Permit for the project, the City Engineer
			and Streets Department shall review the civil drawings to ensure adequate sight distances and proper signage for the proposed parking access.
		17.96.060.G5 Circulation Design Commission Findings	Unobstructed access shall be provided for emergency vehicles, snowplows, garbage trucks and similar service vehicles to all necessary locations within the proposed project. Clear sight lines are provided to the north and south of the fire station driveways. Sight line windows are incorporated into the building design that allow emergency responders to view any pedestrians or bicyclists approaching the station on the sidewalk and any obstructions in front of the apparatus bays. The north driveway access facilitates two-way traffic for staff vehicles to enter and exit the station. The curb cut at the apparatus bays is reserved for emergency response. Garbage trucks will access the trash enclosure from the shared parking area to the south of the station. As the circulation areas will include a snowmelt system, snowplows will not need to remove snow from the site.
	\boxtimes	17.96.060.H1 Snow Storage	Snow storage areas shall not be less than thirty percent (30%) of the improved parking and pedestrian circulation areas.
		Commission Findings	As permitted by KMC §17.96.060.H4, the traffic and pedestrian circulation areas will include a snowmelt system instead of a snow storage area.

			17.96.060.H2 Snow Storage	Snow storage areas shall be provided on-site.
			Commission	N/A. As indicated on Sheet C2.00 of the project plans, the fire station
			Findings	site will be snow-melted as permitted pursuant to KMC
			, ,, willigs	\$17.96.060.H4.
		\boxtimes	17.96.060.H3	A designated snow storage area shall not have any dimension less than
			Snow Storage	five (5') feet and shall be a minimum of twenty-five (25) square feet.
			Commission	As permitted by KMC §17.96.060.H4, the project site will include a
			Findings	snowmelt system instead of a snow storage area.
\boxtimes			17.96.060.H4	In lieu of providing snow storage areas, snow melt and hauling of snow
_	_		Snow Storage	may be allowed.
			Commission	The fire station paved circulation areas will include a snowmelt
			Findings	system instead of snow storage. Snow-melting all circulation areas
			_	will enhance Fire Department operations and emergency response.
\boxtimes			17.96.060.11	Landscaping is required for all projects.
			Landscaping	
			Commission	The landscape plan is included on Sheets L1.00 and L1.50 of the
			Findings	project plans. The grasses, flowering plants, and shrubs complement
				the fire station's modern design.
\boxtimes			17.96.060.12	Landscape materials and vegetation types specified shall be readily
			Landscaping	adaptable to a site's microclimate, soil conditions, orientation and
				aspect, and shall serve to enhance and complement the neighborhood
				and townscape.
			Commission	The landscape materials and vegetation types shall be readily
			Findings	adaptable to the site's microclimate, soil conditions, orientation, and
				aspect. The proposed landscaping will soften the fire station's hard
	4			lines and rectangular mass. Bordering the front property line, the tall
	'			grasses and flowering plants augment the welcoming entryway to the
				fire station.
\boxtimes			17.96.060.I3	All trees, shrubs, grasses and perennials shall be drought tolerant.
			Landscaping	Native species are recommended but not required.
			Commission	All proposed landscape materials and vegetation types shall be
			Findings	drought tolerant. The applicant is encouraged to select native species.
\boxtimes			17.96.060.14	Landscaping shall provide a substantial buffer between land uses,
			Landscaping	including, but not limited to, structures, streets and parking lots. The
				development of landscaped public courtyards, including trees and
				shrubs where appropriate, shall be encouraged.
			Commission	The proposed landscaping is appropriate for the fire station project.
			Findings	The living trellis buffers the fire station from the Northwood Place
				apartments. An existing retaining wall separates the project site from
				the light industrial area.

Ketchum Fire Station Design Review
Planning & Zoning Commission Meetings of February 10 & 24, 2020
Findings of Fact, Conclusions of Law, and Decision
City of Ketchum Planning & Building Department

			17.96.060.J1 Public Amenities	Where sidewalks are required, pedestrian amenities shall be installed. Amenities may include, but are not limited to, benches and other seating, kiosks, bus shelters, trash receptacles, restrooms, fountains, art, etc. All public amenities shall receive approval from the Public Works Department prior to design review approval from the Commission.
			Commission Findings	The project will realign the existing sidewalk that extends from Northwood Place to the YMCA. The width does not provide sufficient clearance to allow public amenities within the sidewalk design while still maintaining a clear path of travel as required by ADA. Further, sight constraints limit available locations to install amenities as any obstruction would conflict with vehicle ingress and egress into the site. Due to associated site constraints and potential conflicts with Fire Department operations, the fire station project does not propose any exterior public amenities such as benches. The community room and public restrooms provided within the fire station satisfy the public amenity requirement.

CONCLUSIONS OF LAW

- 1. The City of Ketchum is a municipal corporation established in accordance with Article XII of the Constitution of the State of Idaho and Title 50 Idaho Code and is required and has exercised its authority pursuant to the Local Land Use Planning Act codified at Chapter 65 of Title 67 Idaho Code and pursuant to Chapters 3, 9 and 13 of Title 50 Idaho Code to enact the Ordinances and regulations, which Ordinances are codified in the Ketchum City Code ("KMC") and are identified in the Findings of Fact and which are herein restated as Conclusions of Law by this reference and which City Ordinances govern the Applicant's Mountain Overlay Design Review Application for the development and use of the project site.
- 2. The Commission has authority to hear the applicant's Design Review Application pursuant to Chapter 17.96 of Ketchum Code Title 17.
- 3. The City of Ketchum Planning Department provided adequate notice for the review of this application.
- 2. The Design Review application is governed under Ketchum Municipal Code Chapters 17.96, 17.124, 17.08, 17.12, 17.18, and 17.128.
- 3. The Design Review application for the fire station meets the standards of approval under Title 17 of KMC subject to conditions of approval.

DECISION

THEREFORE, the Ketchum Planning and Zoning Commission **approves** this Design Review application this Monday, February 24th, 2020 subject to the following conditions:

CONDITIONS OF APPROVAL

Ketchum Fire Station Design Review
Planning & Zoning Commission Meetings of February 10 & 24, 2020
Findings of Fact, Conclusions of Law, and Decision
City of Ketchum Planning & Building Penantment

- 1. This Design Review approval is subject to all comments and conditions as described in the City Department Comments (Table 2), the Zoning and Dimensional Standards Analysis including the off-street parking requirements subject to existing agreements between the City and the YMCA (Table 3), and the Design Review Standards Analysis (Table 4).
- 2. This Design Review approval is based on the plans and information presented and approved at the meeting on the date noted herein. Building Permit plans for all on-site improvements must conform to the approved Design Review plans unless otherwise approved in writing by the Planning and Zoning Commission or Administrator. Any building or site discrepancies which do not conform to the approved plans will be subject to removal.
- 3. All governing ordinances, requirements, and regulations of the Fire Department (2012 International Fire Code and local Fire Protection Ordinance No.1125), Building Department (2012 International Building Code, the 2012 International Residential Code, and Title 15 of Ketchum Municipal Code), Utilities Department, Street Department (Title 12 of Ketchum Municipal Code), and the City Engineer shall be met prior to Certificate of Occupancy.
- 4. The applicant shall submit final civil drawings prepared by an engineer registered in the State of Idaho to include specification for the ROW, utilities, and drainage improvements to be reviewed and approved by the City Engineer, Streets, and Utilities departments prior to issuance of a Building Permit for the project.
- 5. The term of Design Review approval shall be twelve (12) months from the date that the Findings of Fact, Conclusions of Law, and Decision are adopted by the Commission or upon appeal, the date the approval is granted by the Council subject to changes in zoning regulations (KMC §17.96.090).
- 6. All Design Review elements shall be completed prior to issuance of a Certificate of Occupancy for the building.
- 7. All exterior lighting on the property shall be in compliance with Ketchum Municipal Code, Chapter 17.132, Dark Skies, and shall be inspected by Planning Staff and approved prior the issuance of a Certificate of Occupancy for the building.
- 8. The project shall comply with the requirements of §17.124.040 Development Standards as adopted on the date a Building Permit is submitted for the project.
- 9. Prior to issuance of a Building Permit for the project, the applicant shall submit a construction management plans, which addresses each of the standards as set forth in Ketchum Municipal Code, Chapter 15.06 Construction Activity Standards.
- 10. In addition to the requirements set forth in this Design Review approval, this project shall comply with all applicable local, state, and federal laws.
- 11. OPTIONAL Planning & Zoning Commission recommendations to Ketchum City Council regarding the traffic and circulation study and safety treatments.

Findings of Fact **adopted** this 24th day of February, 2020.

Neil Morrow, Chair City of Ketchum Planning and Zoning Commission

