

City of Ketchum Planning & Building

STAFF REPORT KETCHUM PLANNING AND ZONING COMMISSION SPECIAL MEETING ON NOVEMBER 8, 2022

PROJECT:	691 N Spruce Avenue Residence
FILE NUMBER:	P22-042
APPLICATION:	Pre-Application Mountain Overlay Design Review
PROPERTY OWNER:	Spruce and 6 th LLC
REPRESENTATIVE:	Jake Watkins, Roger Ferris + Partners (Architect)
LOCATION:	691 N Spruce Avenue (Ketchum Townsite: Block 91: Lots 7 & 8)
ZONING:	Limited Residential (LR)
OVERLAY:	Mountain Overlay
REVIEWER:	Abby Rivin - Senior Planner

Introduction and Background

The applicant, property owner 6th and Spruce LLC represented by architect Jake Watkins, has submitted a Pre-Application Mountain Overlay Design Review for the development of a new-single family residence and associated site improvements located at 691 N Spruce Avenue (Ketchum Townsite: Block 91: Lots 7 & 8) within the Limited Residential (LR) Zoning District and the Mountain Overlay.


Pursuant to Ketchum Municipal Code (KMC) §17.104.050, Design Review is required for new development within the Mountain Overlay. Pre-Application is not required for projects in the Mountain Overlay but may be requested by the applicant pursuant to KMC §17.104.060.A. The Pre-Application is an opportunity for the Commission to give the applicant feedback on the proposed project. This preliminary review allows the Commission to ask questions, identify code compliance issues or design concerns, and provide recommendations to the applicant.

The following analysis provides an overview of the project, assesses the proposed development in relation to Mountain Overlay Design Review criteria and standards, identifies outstanding action items that the applicant must resolve for the final Mountain Overlay Design Review application, and highlights key issues for the Commission's consideration and further discussion with the applicant.

Analysis


Project Site

The property located at 691 N Spruce Avenue is comprised of separate Ketchum Townsite lots as shown in Figure 1. The property is developed with an existing single-family home that was constructed in 1977. The City issued the building permit for the construction of the original home (Application File No. 77-29) on both lots without requiring consolidation of the development parcel. The building permit was issued prior to the City's adoption Ordinance No. 316 in 1979 that implemented subdivision standards for boundary modifications between existing lots. Prior to 1979, lot line the City's subdivision regulations (Ordinance No. 252).

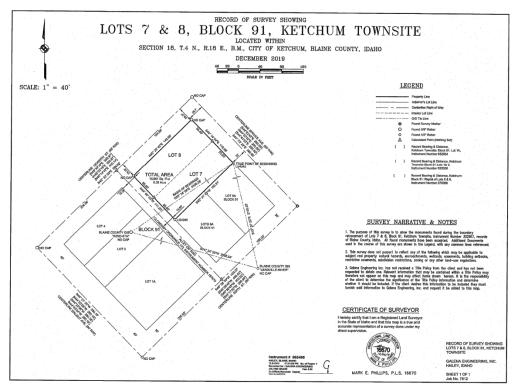

adjustments were exempt from Figure 1: Survey Showing Lots 7 & 8, Block 91, Ketchum Townsite

The existing home's building footprint, driveway, and site improvements are contained on Lot 7 (See Figure 2). The grading for the construction of the original home encroached slightly over the north side property line disturbed a portion of Lot 8.

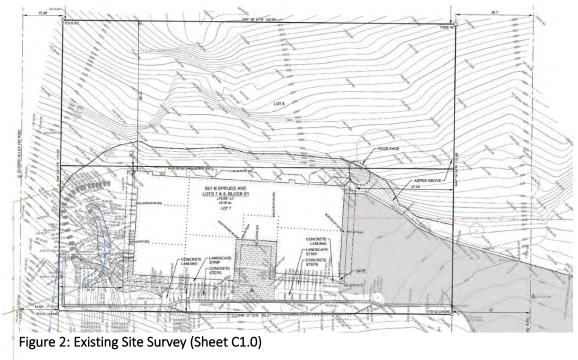

The existing home was developed prior to the City's establishment of the Mountain Overlay Zoning District in 1989 and does not comply with current hillside development standards. Current code requires new building to be constructed in areas that have less than 25% slope (KMC §16.04.020). The topographical survey shows 25% and greater slopes surrounding the limits of disturbance of the existing nonconforming home. The contours of the site and the adjacent undisturbed hillside show that the original natural slope of the development parcel was exceeded 25% slope prior to the construction of the existing nonconforming home in 1977.

Additionally, the existing home and structures, including retaining walls, encroach within the front, rear, and side yard setback areas and are nonconforming with the dimensional standards required in the LR Zone. The existing nonconforming home is proposed to be demolished. Since the existing nonconforming home is proposed to be demolished, the new development, including all existing and proposed site improvements, must comply with all current code standards.

The existing site survey on Sheet C1.0 shows that the existing nonconforming home encroaches within required setback areas—the home is setback only 1.78 feet from the north interior side property line adjacent to Lot 8. The applicant has proposed consolidating the two lots so that the new home will comply with the setbacks required in the LR Zone. The lot consolidation must comply with all subdivision design and development standards specified in KMC §16.04.040. Building envelopes are required to be established on lots that contain areas of 25% or greater slope based on natural contours. These building envelopes must be established outside of hillsides greater than 25% (KMC §16.04.040.F2). A waiver to this standard may only be considered for lot line shifts of parcels that are entirely within slopes of 25% or greater to create a reasonable building envelope provided that the project complies with Mountain Overlay Design Review standards and all other City requirements.

Should the Commission support the project proposed with the Pre-Application, the subdivision application for the lot consolidation preliminary plat and associated waiver request will be considered concurrently with the final Mountain Overlay Design Review application.

Zoning Code Interpretation 22-001

The Planning and Zoning Commission considered the question of whether nonconforming properties on hillsides of 25% and greater slope would be permitted to be redeveloped if the existing nonconforming home were to be demolished during their special meeting on February 15th, 2022. The Planning and Zoning Commission Zoning Code Interpretation 22-001 is attached to the staff report as Exhibit B.

The Commission determined that existing nonconforming properties may be redeveloped under the following conditions:

- A. If the property configuration is proposed to be modified (lot line adjustment, lot consolidation etc.), then the new property configuration must establish a building envelope on the lowest portion of the property. Existing non-conforming building footprints are not permitted to be redeveloped outright. If a more compliant alternative at a lower elevation on the hillside property exists, then the new home must be sited in the more suitable area for redevelopment.
- B. If the property configuration is not being altered or changed, then a new home may be constructed at the Commission's discretion through Mountain Overlay Design Review provided

that the project does not exceed the height or limits of disturbance of the existing nonconforming home. The building footprint shall conform as close as possible to the existing building.

The 691 N Spruce Avenue Residence project proposes to configure the property by consolidating Lot 7 and Lot 8. The proposed building envelope has been established at the lower elevation of the development parcel and to comply with the minimum setbacks required in the LR Zone. Mountain Overlay Design Review criteria KMC §17.104.070.A10 directs the Commission to consider if there are other sites on the parcel more suitable for the proposed development in order to carry out the purposes of the Mountain Overlay. The new home is sited within the most suitable area for development at the lower elevation of the parcel. The building envelope conforms to the building footprint of the existing nonconforming home.

Limits of Disturbance

The site survey on Sheet C1.0 of the project plans attached as Exhibit A show the limits of disturbance of the existing nonconforming development. The total area of existing site disturbance is 8,469 square feet. The construction of the existing nonconforming development in 1977 disturbed a majority of Lot 7 except for a small area at the northeast corner of the property. The site photos on Sheets EX003 and EX004 of the project plans show the existing disturbed areas on the development parcel. Driveway improvements and retaining walls disturbed the natural hillside within the front (east/Spruce Ave) setback area. Drystack retaining walls, landscape steps, a paver patio, and a drainage swale disturbed the natural hillside within the rear setback area (See Figure 3). Grading improvements and the construction of railroad tie retainage and a tall concrete retaining wall disturbed the natural hillside within the south (interior) side yard setback area (See Figure 4).



Figure 3: Existing Rear Yard Disturbance (Sheet EX004)



Figure 4: Existing South Side Yard Disturbance (Sheet EX004)

The building footprint of the existing nonconforming home is setback less than 2 feet from the north (interior) property line disturbing a majority of the natural hillside within the side yard setback area adjacent to Lot 8. The remainder of the north side yard setback area has been graded and improved with gravel. The gravel grading improvements extend slightly over the shared property line onto Lot 8. The existing site survey on Sheet C1.0 shows that the existing disturbance extends slightly beyond the gravel grading improvements into the areas of 25% and greater slope on Lot 8. The applicant has indicated that grading required for the construction of the original home disturbed the natural hillside on Lot 8. The existing limits of disturbance indicated on Sheet L1.0 of the project plans does not match the civil site survey. The existing landscape conditions on Sheet L1.0 indicate that the existing limits of disturbance is survey (Sheet C1.0) and the existing landscaping conditions (Sheet L1.0) on the project plans submitted with the final Mountain Overlay Design Review application. In addition to resolving this discrepancy, the applicant must submit more material documenting the existing disturbance that extends onto Lot 8 as well as the area to the north of the driveway retaining wall on Lot 7.

Sheet C1.1 shows that the disturbance proposed for the new home does not exceed the existing limits of disturbance on the site. The proposed limits of disturbance indicated on Sheet C1.1 includes the gravel grading improvements bordering the north property line separating the two lots but does not extend into the 25% and greater slope area on Lot 8.

The maximum height of the proposed home is 33 feet, which is 1.22 feet less than the maximum height of the existing nonconforming home. The total building coverage of the existing nonconforming home is 4,084 square feet. The proposed development's building coverage is 2,478 square feet, which is 1,606 square feet less than existing. Sheet C1.1 shows the building footprint of the existing home overlayed onto the site plan for the proposed residence. The proposed building envelope is contained within the footprint of the existing nonconforming home.

Driveway Improvements

The applicant has proposed regrading and resurfacing the existing driveway access and installing a snowmelt system. The proposed improvements decrease the width of the driveway slightly from 25' to 23'-4''. The grade of the existing driveway slopes uphill towards the garage from its access along Spruce Avenue. The applicant has proposed lowering the finished grade of driveway and sloping the driveway down 7.6% towards the garage from its access along Spruce Avenue (See Figure 5).

Retaining walls border the north and south sides of the existing driveway. These existing driveway retaining walls encroach within the front and side yard setback areas and are required to be removed. Staff asked the applicant to explain how the slope of the hillside will be stabilized with the removal of the existing retaining walls and proposed driveway improvements. The applicant responded: *The retaining walls will be removed in areas where the grade is already stabilized due to the existence of exposed ledge. In areas where ledge is not present, we have introduced a sloped grade that will be permanently stabilized by banked slopes with vegetative cover.* The applicant has submitted a civil grading and drainage plan prepared by an Idaho-licensed engineer included on Sheet C1.1 of the project plans. Sheet C1.1 does not provide sufficient detail for the proposed driveway improvements and adjacent hillside stabilization. The applicant is required to submit engineered plans that provide sufficient detail for all proposed grading improvements on the development parcel as well as

engineered structural drawings for the building foundation with the final Mountain Overlay Design Review application.

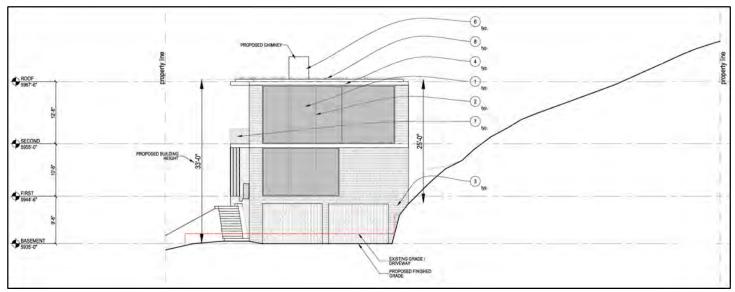


Figure 3: Existing and Proposed Driveway Grade (Sheet A201)

Landscaping and Revegetation on Hillsides

Pursuant to KMC §17.104.070.A9, all cuts and fills shall be concealed with landscaping, revegetation, and/or natural stone materials. Revegetation with a clear zone of 30 feet around all structures is recommended, should include low combustible irrigated vegetation with appropriate species, and should be harmonious with the surrounding hillside. The landscape plan on Sheet L2.0 indicates that the rear yard setback area and south interior side yard setback area will be restored and revegetated with native grasses and sage brush. New proposed vegetation includes enhancing the existing aspen tree groves on the property and the installation of new serviceberry and snowberry plantings. Adjustments to the landscape plan on Sheet L2.0 would be required if the Commission recommends a 30-foot-clear zone around the new home. In addition to the recommended 30-foot-clear zone, Fire Protection Ordinance No. 1217 requires that: (1) tree crowns extending within 10 feet of any structure shall be pruned to maintain a minimum horizontal clearance of 10 feet, (2) tree crowns within 30 feet of any structure shall be pruned to remove limbs less than 6 feet above the ground surface adjacent to trees, and (3) non-fire resistive vegetation or growth shall be kept clear of buildings and structures in order to provide a clear area for fire suppression operations. The new landscaping proposed in the rear (west) and south side yard setback area must be modified and setback sufficiently to comply with Fire Department requirements.

Staff Recommendation

After considering the project plans attached as Exhibit A, the applicant's presentation, and any public comment received, staff recommends the Commission provide feedback to the applicant and move to advance the 691 N Spruce Ave Residence project to final Mountain Overlay Design Review.

Exhibits:

- A. 691 N Spruce Ave Residence Pre-Application Mountain Overlay Design Review Submittal
- B. Planning and Zoning Commission Zoning Code Interpretation 22-001

Exhibit A 691 N Spruce Ave Residence Pre-Application Mountain Overlay Design Review Submittal



City of Ketchum Planning & Building



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Mountain Overlay Design Review Application

OWNER INFORMATION			
Project Name: RESIDENCE - 691 N	IORTH SPRUCE AVENUE		
Owner Name: SPRUCE AND 6TH			
Mailing Address: ATTN: INEZ D'A	RCANGELO 611 NORTH ST, GREEN	WICH, CT 06830	
Phone: SEE REPRESENTATIVE		·	
Email: SEE REPRESENTATIVE			
PROJECT INFORMATION			
Architect/Representative: ROGE	R FERRIS + PARTNERS		
Phone: 203.222.4848			
Mailing Address: 11 WILTON ROA	D, WESTPORT, CT 06880		
Email: WATKINS@FERRISARCH.CO	OM (JAKE WATKINS)		
Engineer of Record: GALENA ENG			
Engineer Email: SFLYNN@GALEN	A-ENGINEERING.COM (SEAN FLYN	N)	
Legal Land Description: LOTS 7 &	BOF BLOCK 91 - CITY OF KETCHUN	I, BLAINE COUNTY, IDAHO - R	PK0000091007A
Project Address: 691 NORTH SPRI	JCE AVENUE		
Lot Area: 16,681 SF			
Zoning District: LR - LIMITED RESI			
Anticipated Use: SINGLE FAMILY	DWELLING		
Number of Residential Units: 1			
TYPE OF CONSTRUCTION			
X New	Remodel	□ Addition	Other, please explain:
TOTAL FLOOR AREA			
Propo	sed		Existing
Basement: 527 g	ross SF		1,020 gross SF
1 st Floor: 2,750	gross SF		1,508 gross SF
2 nd Floor: 2,419	gross SF		2,324 gross SF
3 rd Floor: -			-
Decks: 297 S	F		394 SF
Mezzanine: -			
Total: 5,696			4,852 SF
Building Coverage: 2,881 SF	17.2 % (224 SF reduction)	Curb Cut: 24 LF 🕅	21.5 % (no change)
PROPOSED SETBACKS			
Front: 41.6' (4.3' reduction)	Side: 12.2' (3.5' reduction)	Side: 58.7' (1.3' reductio	n) Rear: 28.2' (3.9' reduction)
ADDITIONAL INFORMATION			
Building Height: 33'-6"		Parking Spaces Provided: 2	
Will Fill or Excavation Be Required			
If Yes, Amount in Cubic Yards	Fill: 35 Excavati	on: 90	
Will Existing Trees or Vegetation	Be Removed? Yes NoX		

Applicant agrees in the event of a dispute concerning the interpretation or enforcement of the Mountain Overlay Design Review Application, in which the City of Ketchum is the prevailing party, to pay reasonable attorney fees, including attorney fees on appeal, and expenses of the City of Ketchum. I, the undersigned, certify that all information submitted with and upon this application form is true and accurate to the best of my knowledge and belief.

Signature of Owner/Representative

MAY 10, 2022

Date

City of Ketchum Planning & Building Department Mountain Overlay Design Review Application

Residence

691 North Spruce Ave. Ketchum, ID 83340

Pre-Application - Mountain Overlay Design Review - Revision #3 October 11, 2022





Residence -Ketchum, ID Master Drawing I

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Residence 691 North Spruce Ave. Ketchum, ID 83340

Architect **Roger Ferris + Partners** 11 Wilton Road • Westport, Connecticut 06880 tel. 203.222.4848 • www.ferrisarch.com

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Landscape Architect BYLA Landscape Architects 323 Lewis Street, Suite N • Ketchum, ID 83340 tel. 208.726.5907 • www.byla.us

ARCHITECT'S SEAL LICENSED ARCHITECT AR 98698 STATE OF IDAH

KEY PLAN

PROJECT PHASE - PERMITTING

REVISIONS

NO.	DESCRIPTION	DATE	ISSUED TO
1	PRE-APP - MODR	MAY 10, 2022	CITY
2	MODR - REV #1	JUNE 16, 2022	CITY
3	MODR - REV #2	AUGUST 26, 2022	CITY
4	MODR - REV #3	OCTOBER 6, 2022	CITY
5	MODR - REV#4	OCTOBER 11, 2022	CITY

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Vicinity Map





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5	MODR - REV#4	OCTOBER 11, 2022	CITY

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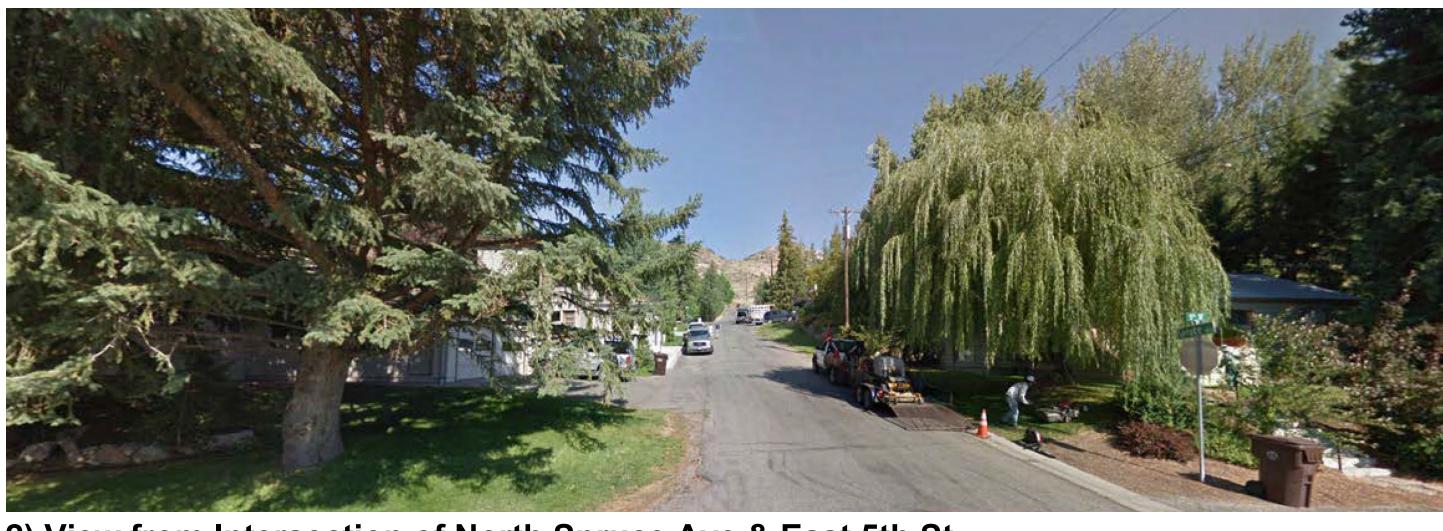




Vantage Points



1) View from North Spruce Ave




2) View from Intersection of North Spruce Ave & East 5th St



3) View from North Walnut Ave



4) View from intersection of North Walnut Ave & East 6th St

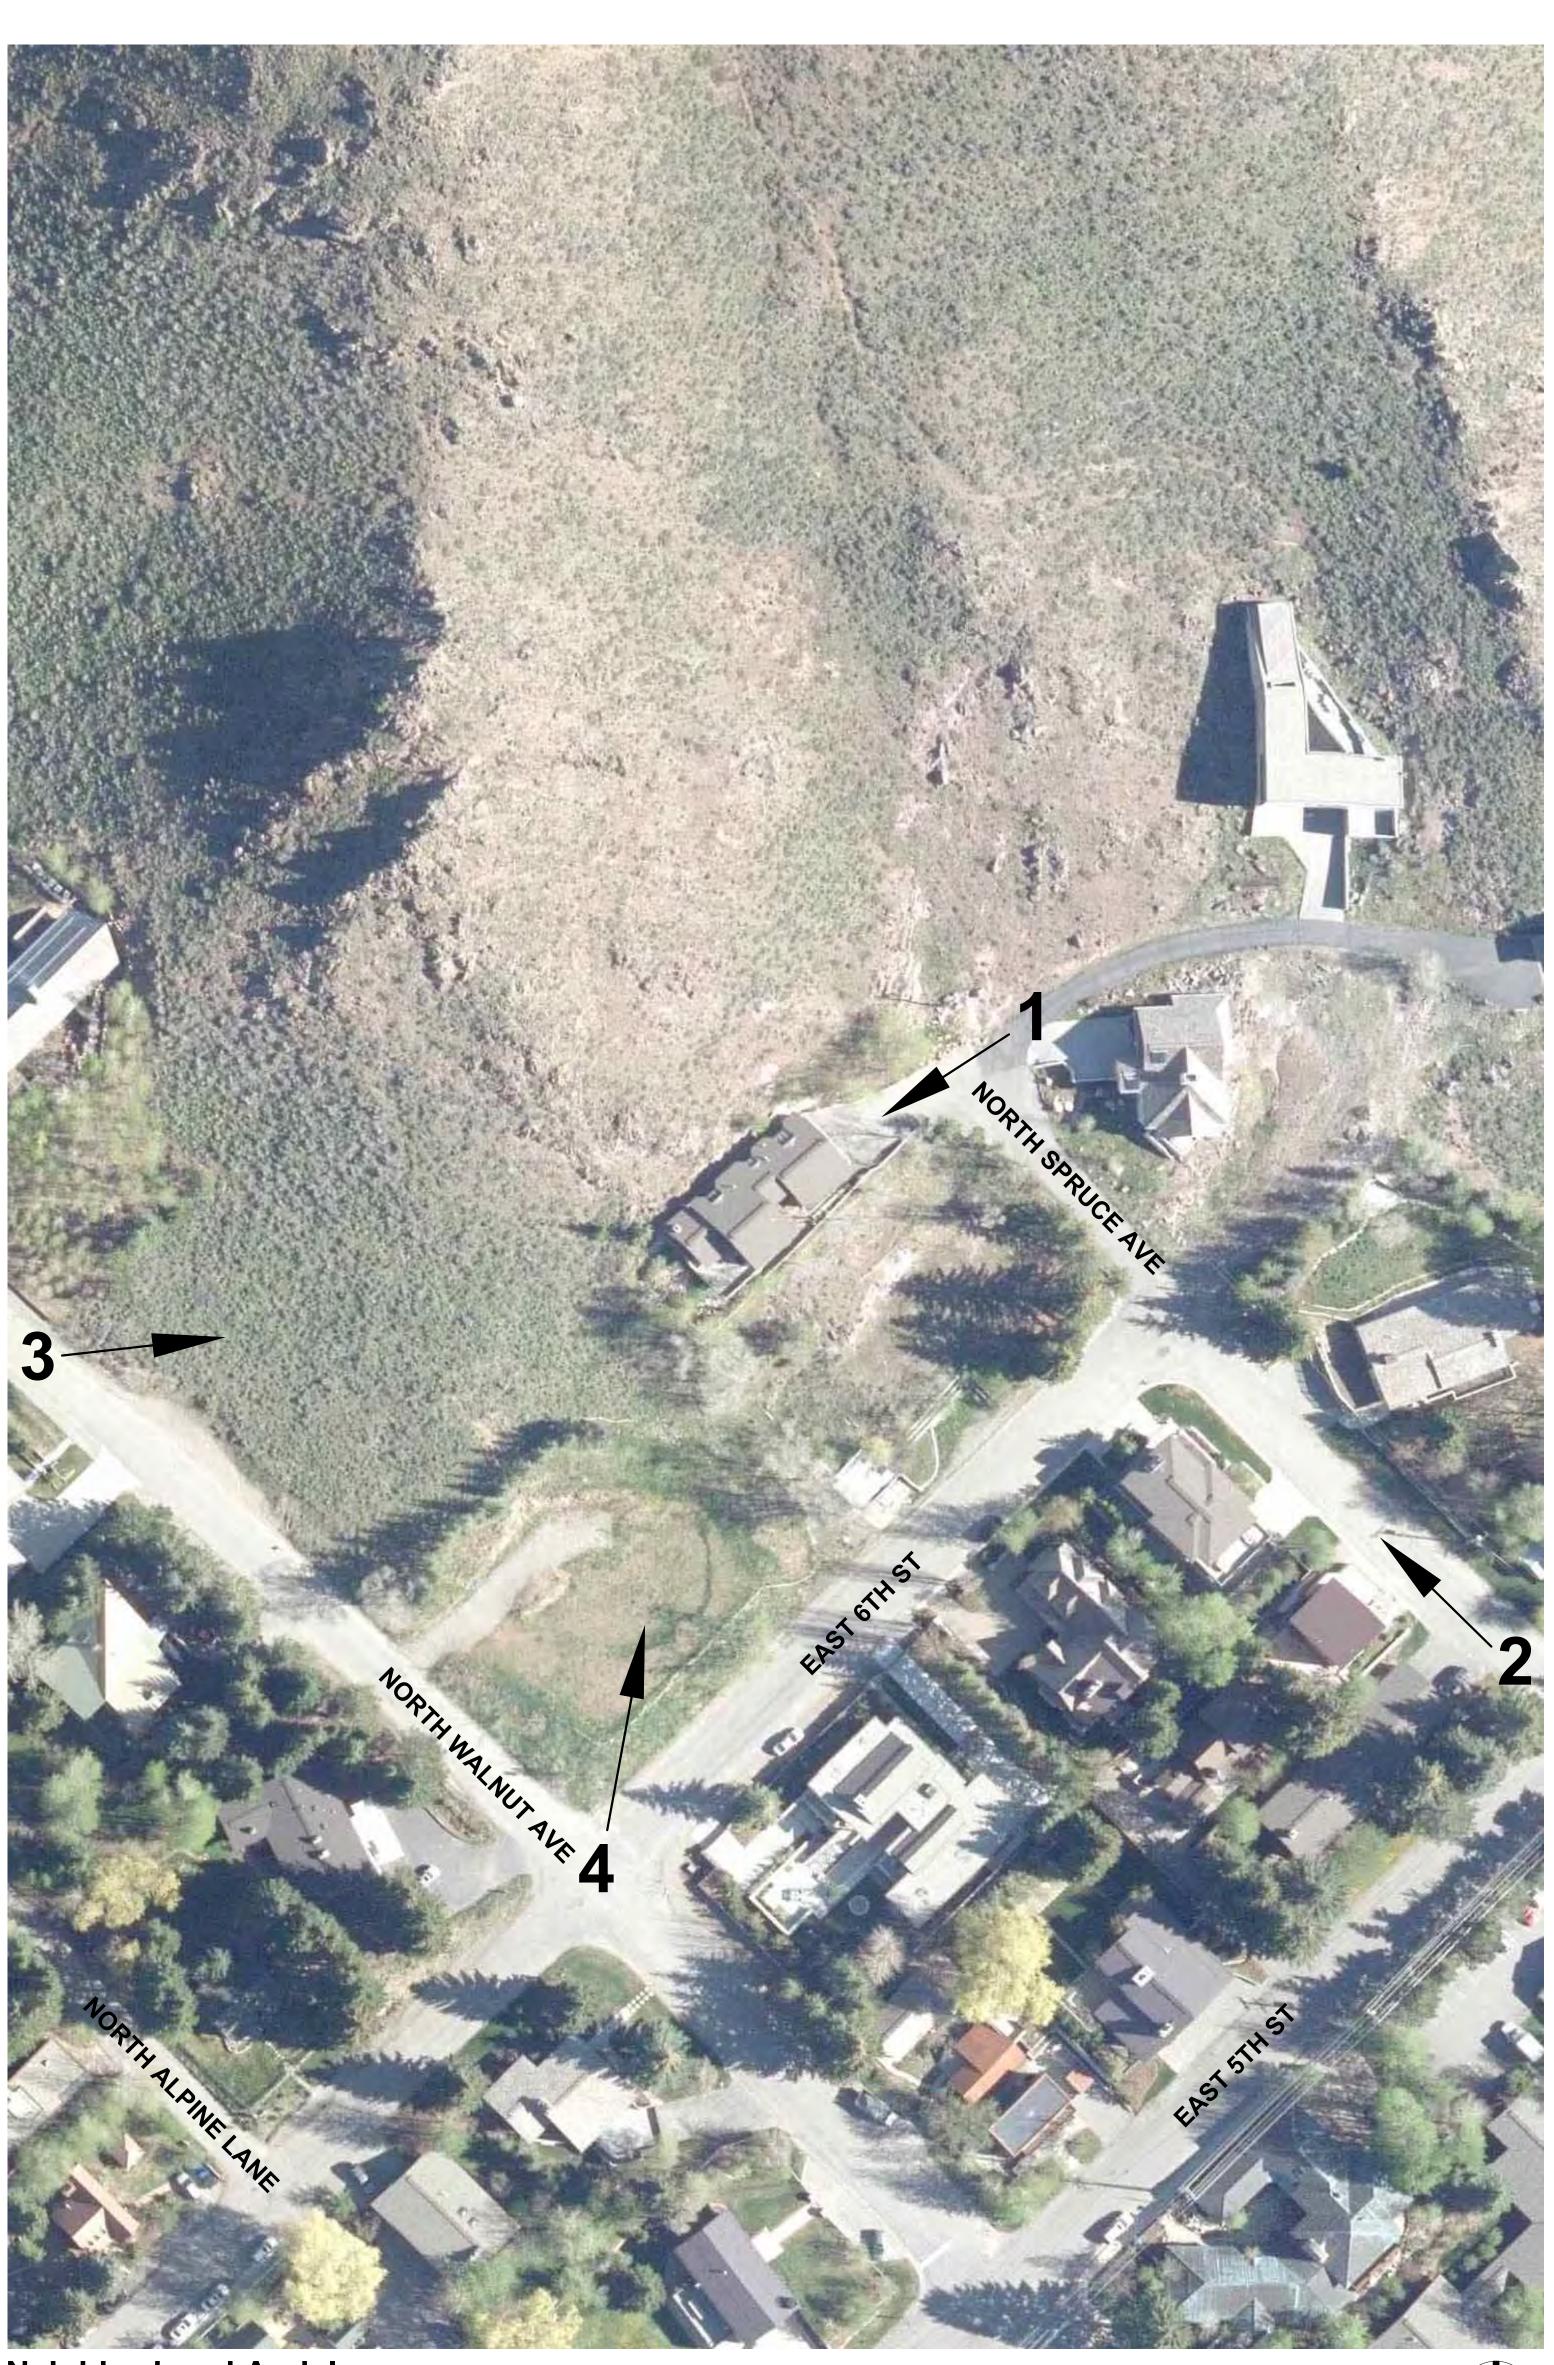

Neighborhood Aerial

Residence 691 North Spruce Ave. Ketchum, ID 83340

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KEY PLAN


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VANTAGE POINTS








Existing Site Photos

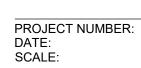

1) View at back of existing house



2) View from driveway

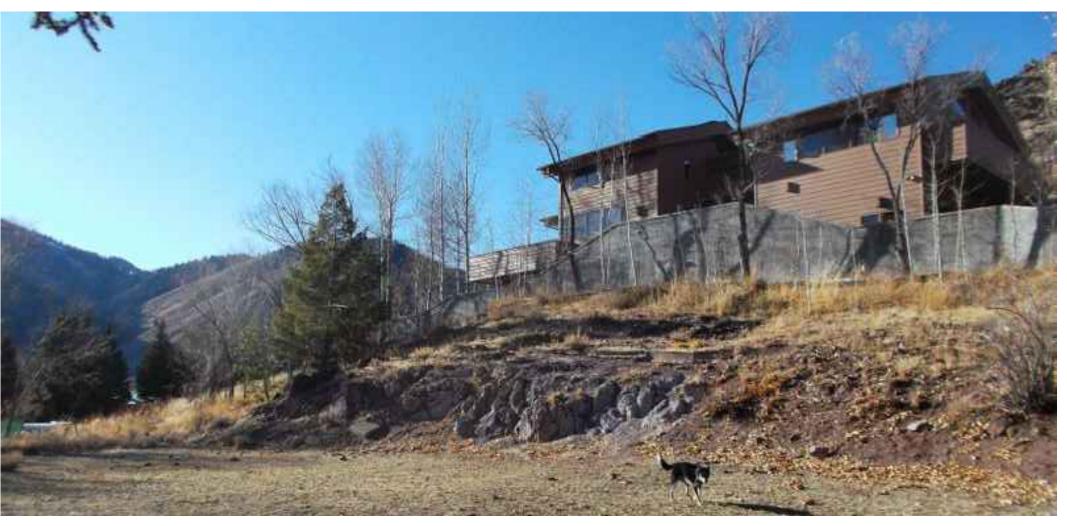


3) View from 671 East 6th St



4) View from 671 East 6th St



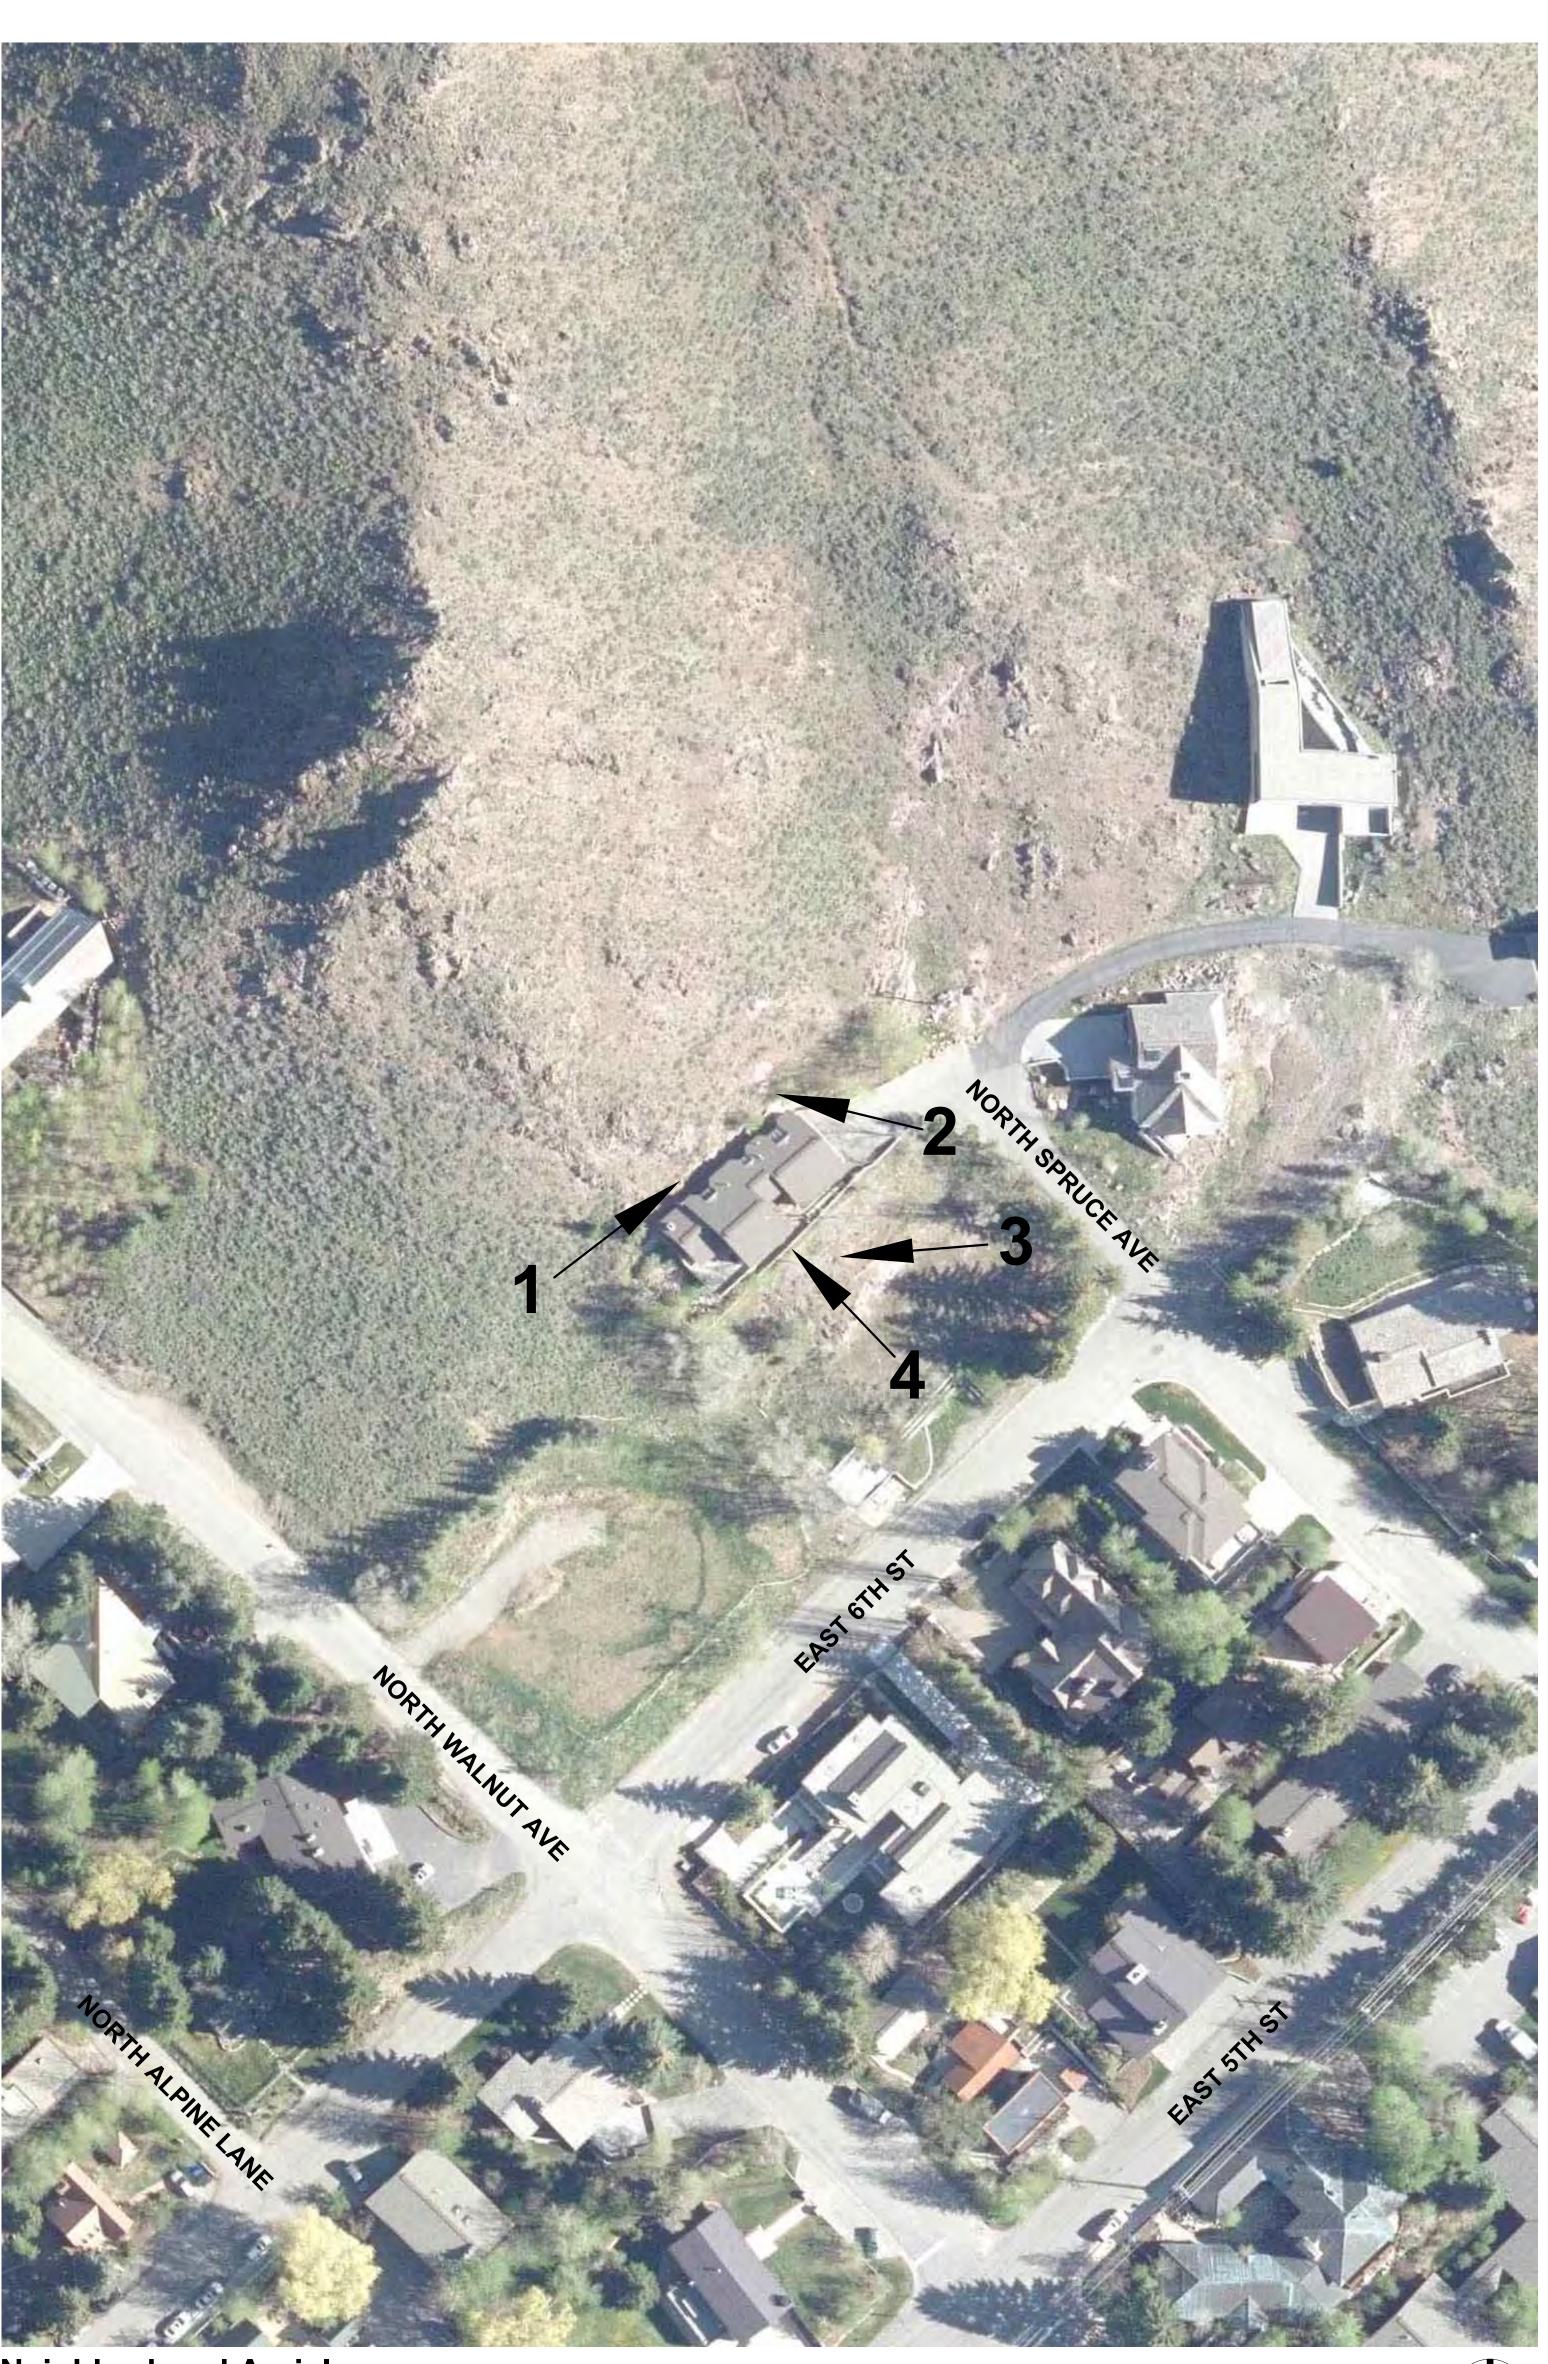

Neighborhood Aerial

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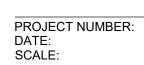
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SHEET NAME

EXISTING SITE PHOTOS



21-002 JULY 14, 2021 N/A



Existing Site Photos









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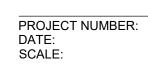
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EXISTING SITE PHOTOS



21-002 JULY 14, 2021 N/A



Existing Site Photos















Residence 691 North Spruce Ave. Ketchum, ID 83340

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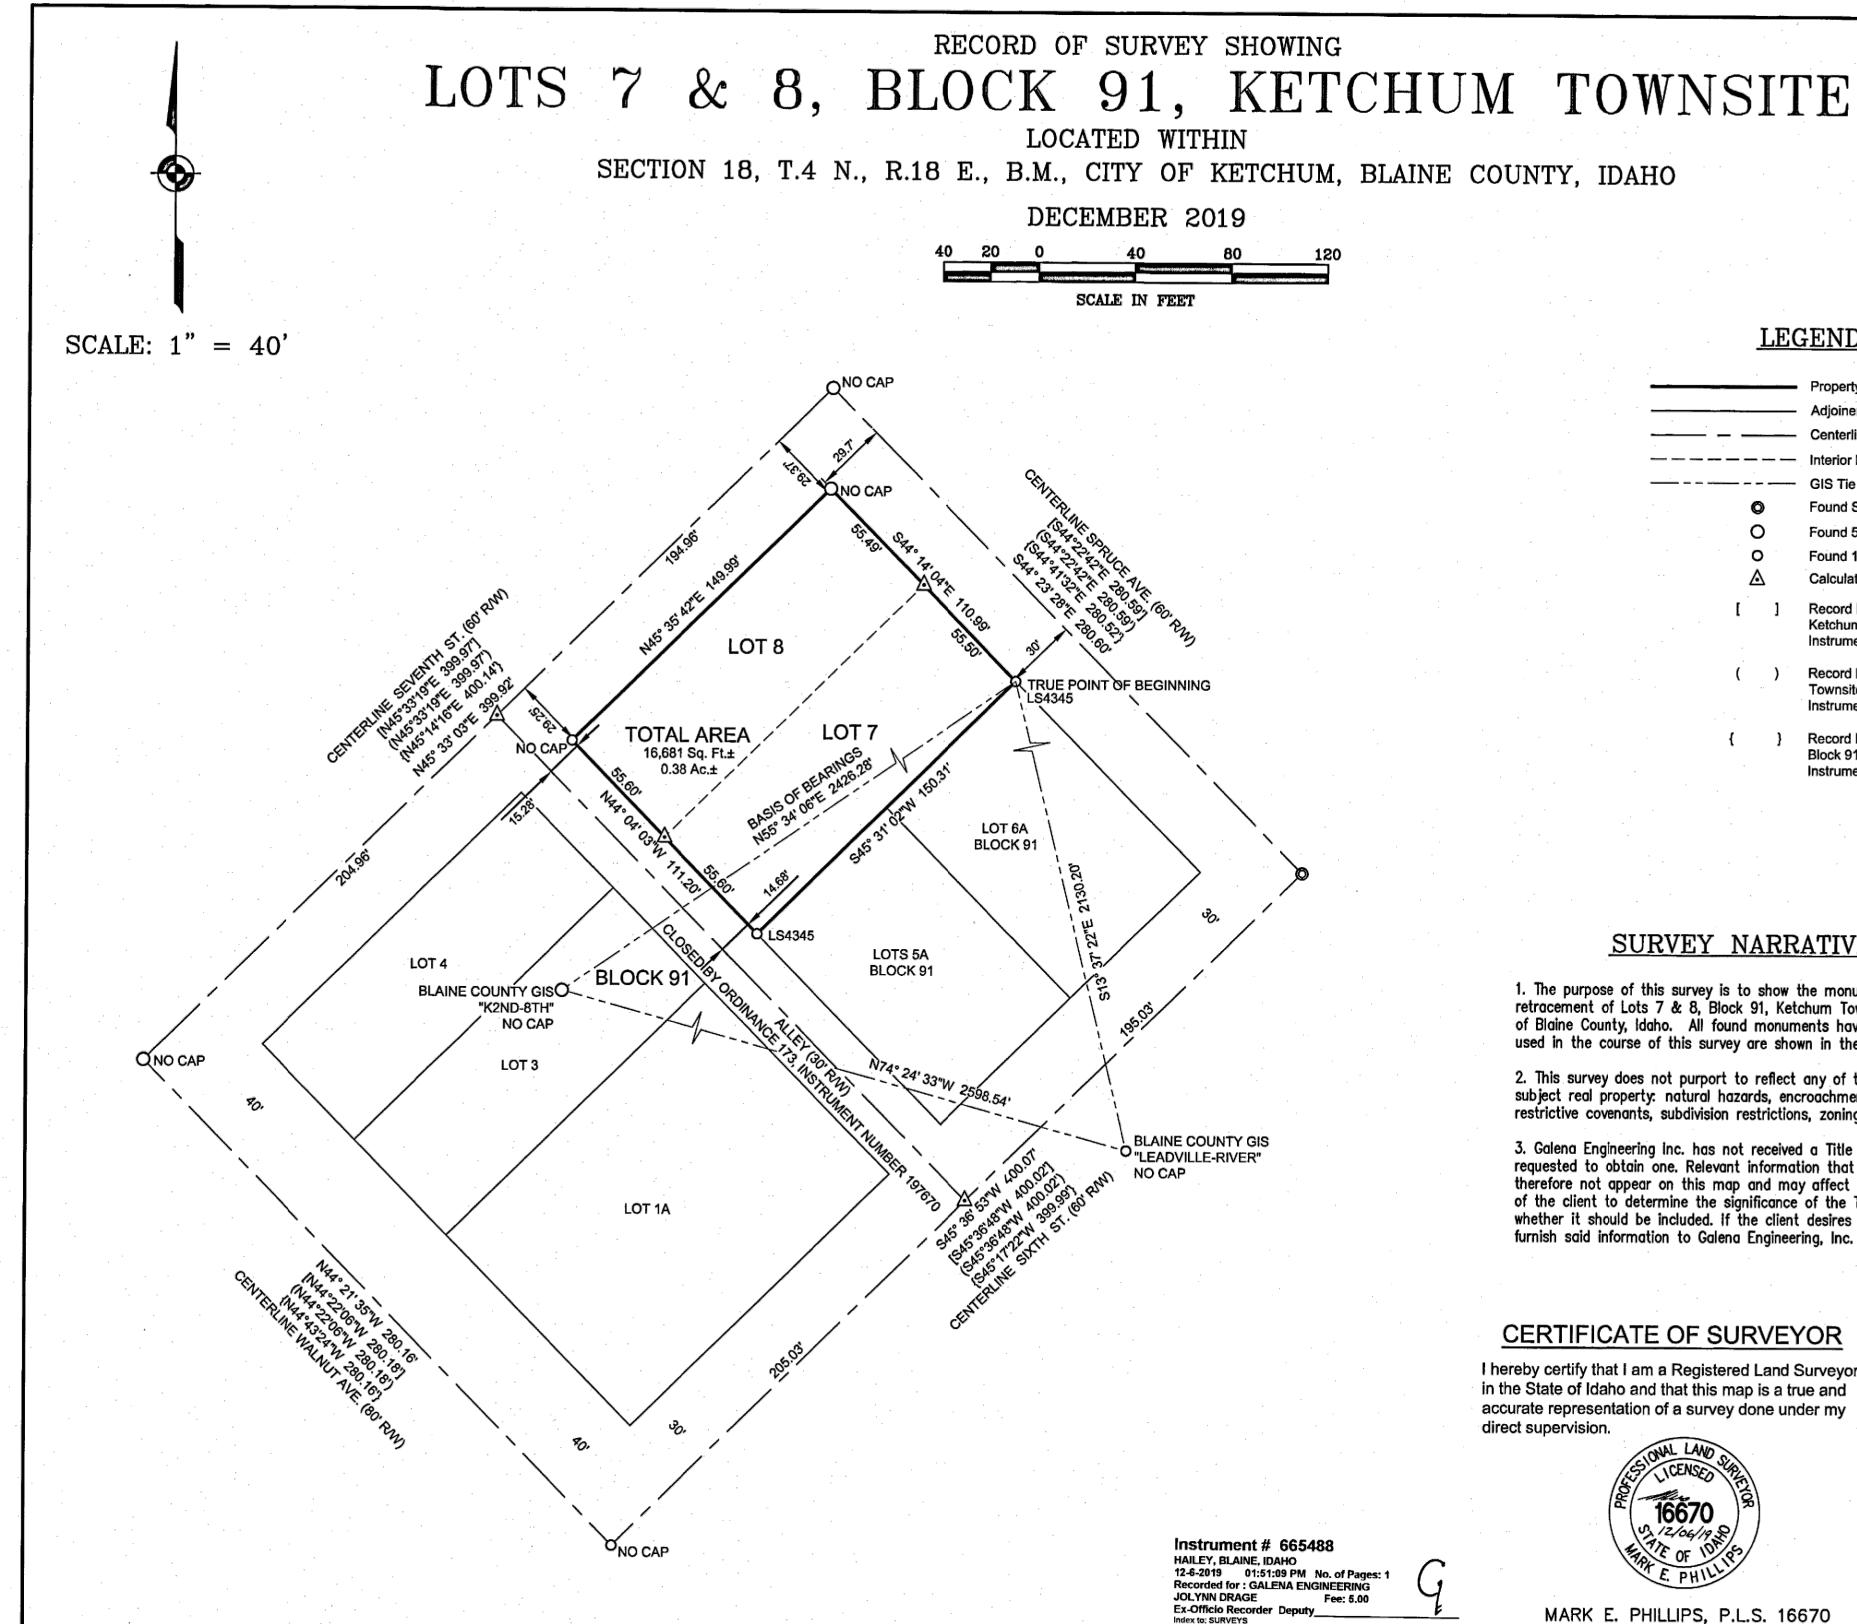
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EXISTING SITE PHOTOS

PROJECT NUMBER: DATE: SCALE:

21-002 JULY 14, 2021 N/A






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BLAINE COUNTY GIS 'LEADVILLE-RIVER'

LEGEND

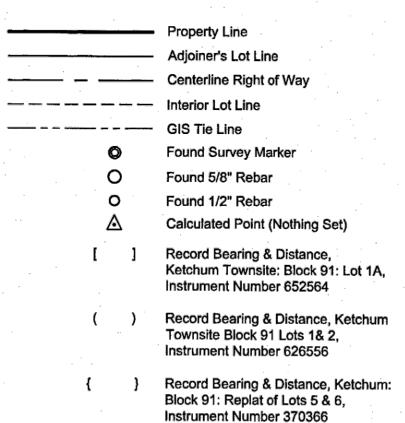

SURVEY NARRATIVE & NOTES

1. The purpose of this survey is to show the monuments found during the boundary retracement of Lots 7 & 8, Block 91, Ketchum Townsite, Instrument Number 302967, records of Blaine County, Idaho. All found monuments have been accepted. Additional Documents used in the course of this survey are shown in the Legend, with any common lines referenced.

2. This survey does not purport to reflect any of the following which may be applicable to subject real property: natural hazards, encroachments, wetlands, easements, building setbacks, restrictive covenants, subdivision restrictions, zoning or any other land—use regulations.

3. Galena Engineering Inc. has not received a Title Policy from the client and has not been requested to obtain one. Relevant information that may be contained within a Title Policy may therefore not appear on this map and may affect items shown hereon. It is the responsibility of the client to determine the significance of the Title Policy information and determine whether it should be included. If the client desires this information to be included they must furnish said information to Galena Engineering, Inc. and request it be added to this map.

CERTIFICATE OF SURVEYOR

I hereby certify that I am a Registered Land Surveyor in the State of Idaho and that this map is a true and accurate representation of a survey done under my direct supervision.




RECORD OF SURVEY SHOWING LOTS 7 & 8, BLOCK 91, KETCHUM TOWNSITE

GALENA ENGINEERING, INC. HAILEY, IDAHO


SHEET 1 OF 1 Job No. 7812

Instrument # 665488 HAILEY, BLAINE, IDAHO 12-6-2019 01:51:09 PM No. of Pages: 1 Recorded for : GALENA ENGINEERING JOLYNN DRAGE Fee: 5.00 Ex-Officio Recorder Deputy

MARK E. PHILLIPS, P.L.S. 16670

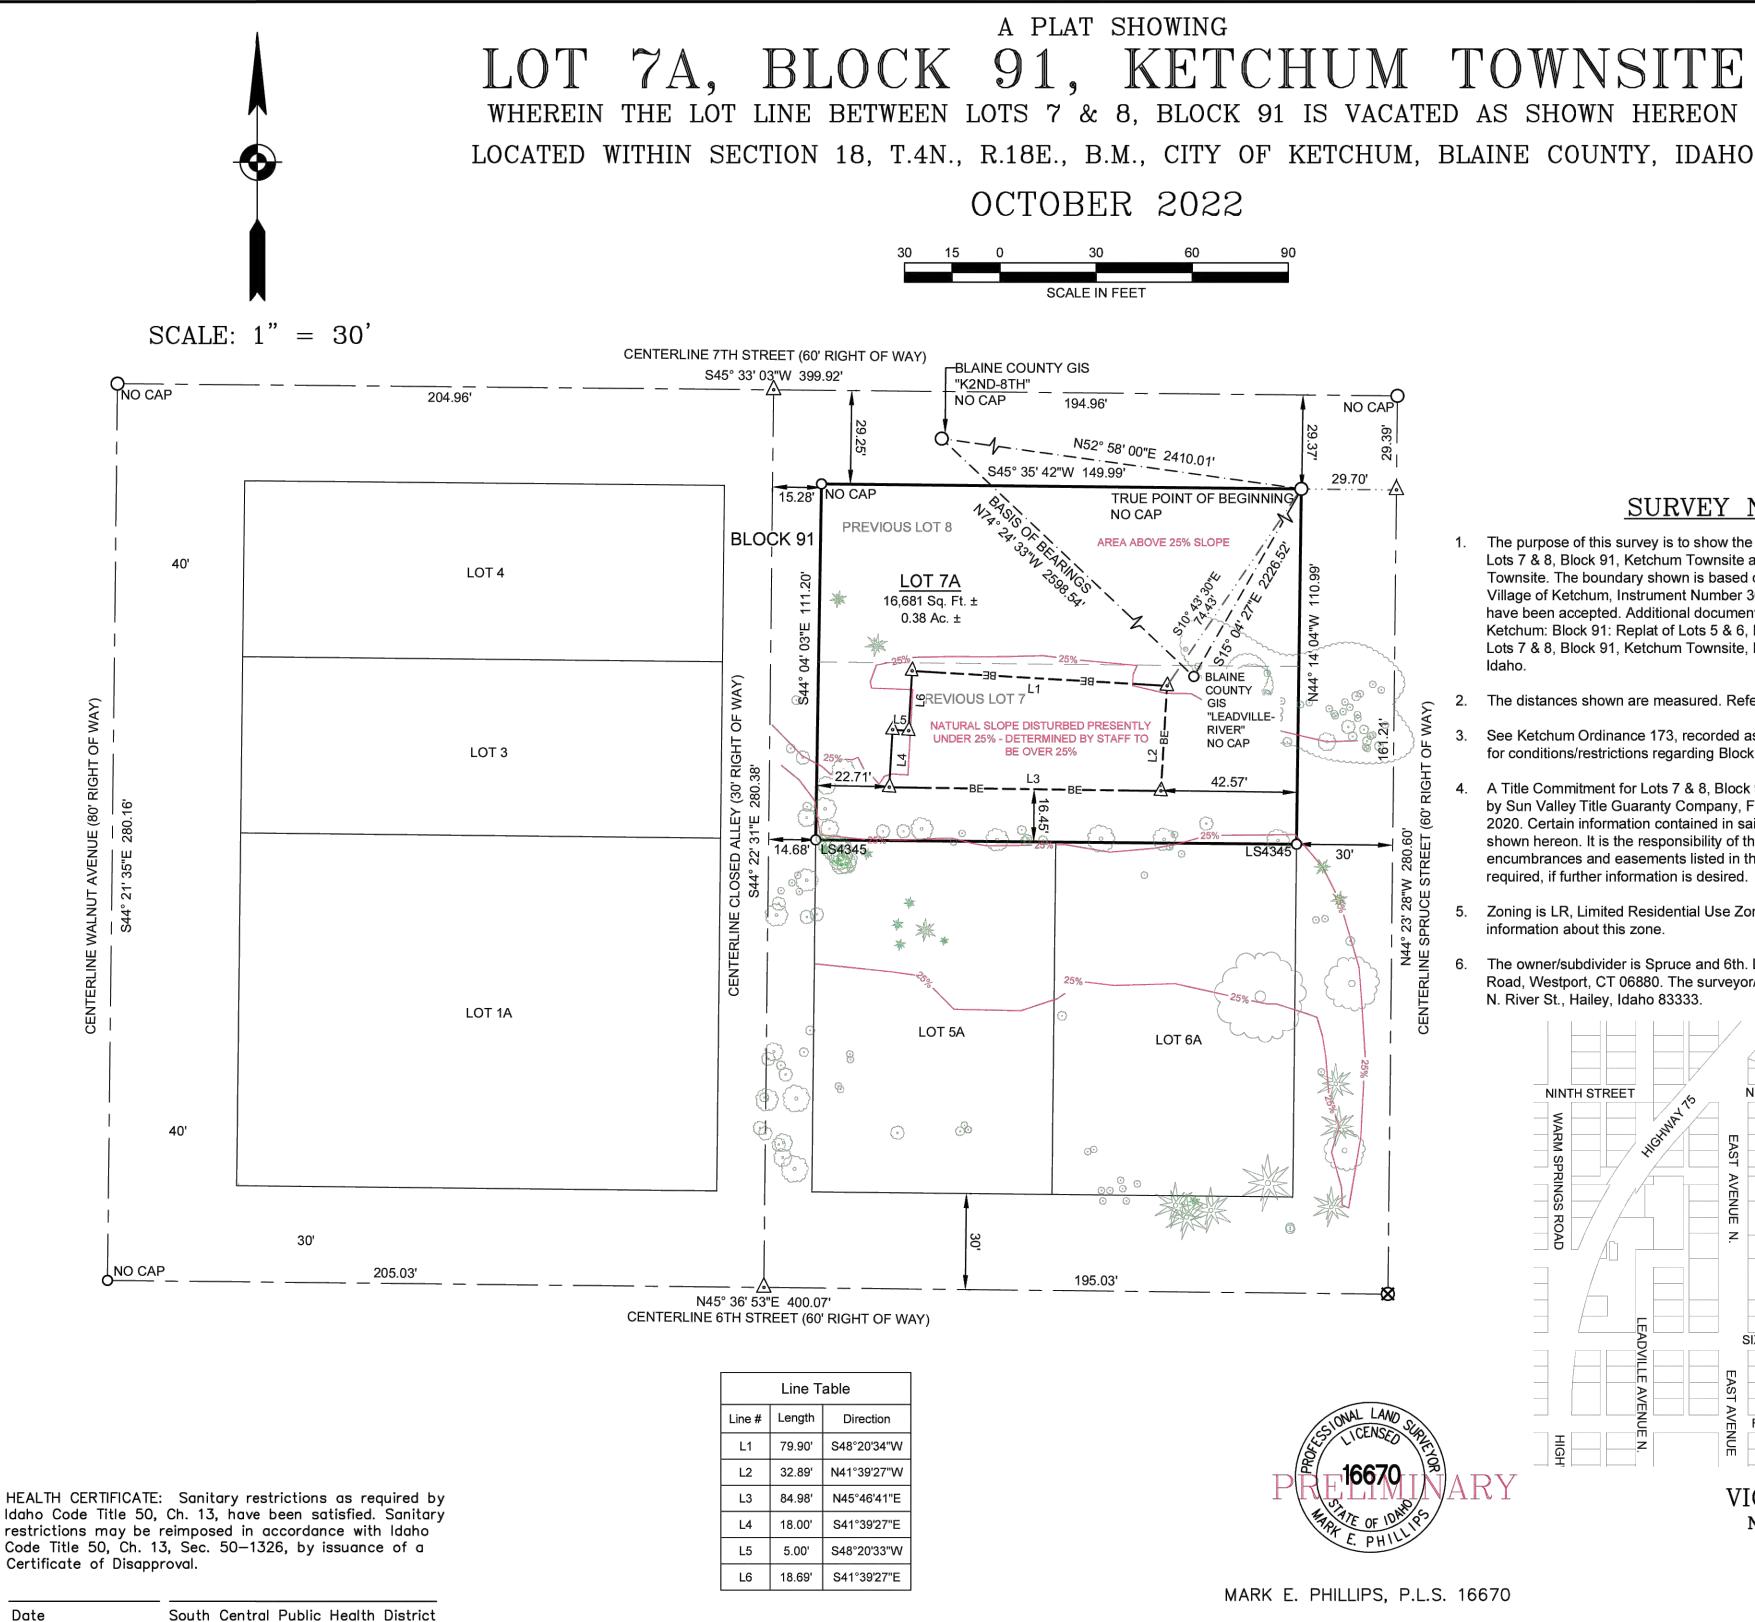


LEGEND

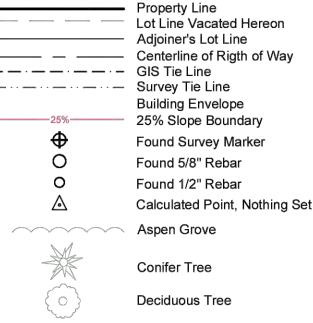


SURVEY NARRATIVE & NOTES

- 1. The purpose of this survey is to show the monuments found and set during the boundary retracement of Lots 7 & 8, Block 91, Ketchum Townsite and vacate the interior line creating Lot 7A, Block 91, Ketchum Townsite. The boundary shown is based on found lot corner monuments and the Official Map of the Village of Ketchum, Instrument Number 302967, records of Blaine County, Idaho. All found monuments have been accepted. Additional documents used during the course of this survey include the Plat of Ketchum: Block 91: Replat of Lots 5 & 6, Instrument Number 370366 and the Record of Survey showing Lots 7 & 8. Block 91. Ketchum Townsite. Instrument Number 665488. both records of Blaine County. Idaho.
- The distances shown are measured. Refer to the above referenced documents for previous record data.
- See Ketchum Ordinance 173, recorded as Instrument Number 197670, records of Blaine County, Idaho for conditions/restrictions regarding Block 91 Alley.
- A Title Commitment for Lots 7 & 8, Block 91, Village of Ketchum, Blaine County, Idaho, has been issued by Sun Valley Title Guaranty Company, File Number 19349503, with a Date of Guarantee of May 29, 2020. Certain information contained in said title policy may not appear on this map or may affect items shown hereon. It is the responsibility of the owner or agent to review said title policy. All plottable encumbrances and easements listed in the title report are shown hereon. Review of specific documents is required, if further information is desired.
- Zoning is LR, Limited Residential Use Zone. Refer to City of Ketchum Zoning Ordinance for more specific information about this zone.
- The owner/subdivider is Spruce and 6th. L.L.C., c/o Jake Watkins at Roger Ferris Partners, 11 Wilton Road, Westport, CT 06880. The surveyor/representative is Mark E. Phillips, Galena Engineering, Inc., 317 N. River St., Hailey, Idaho 83333.

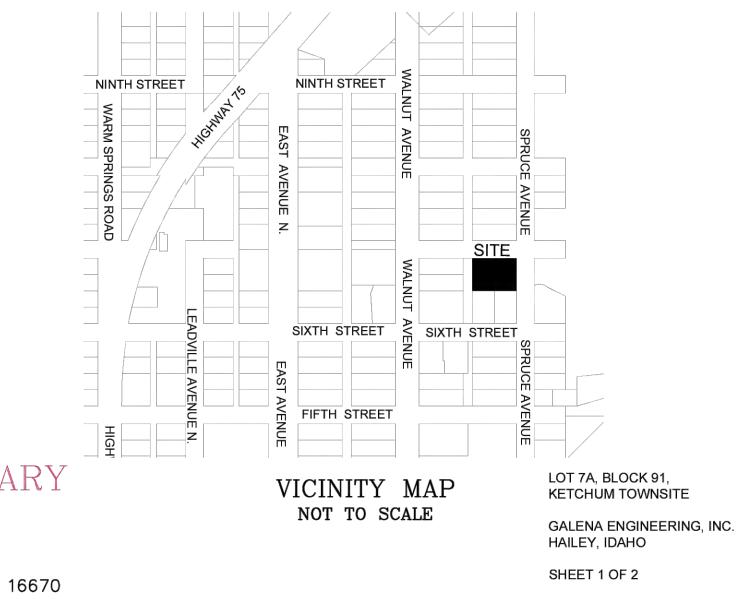

Job No. 7932

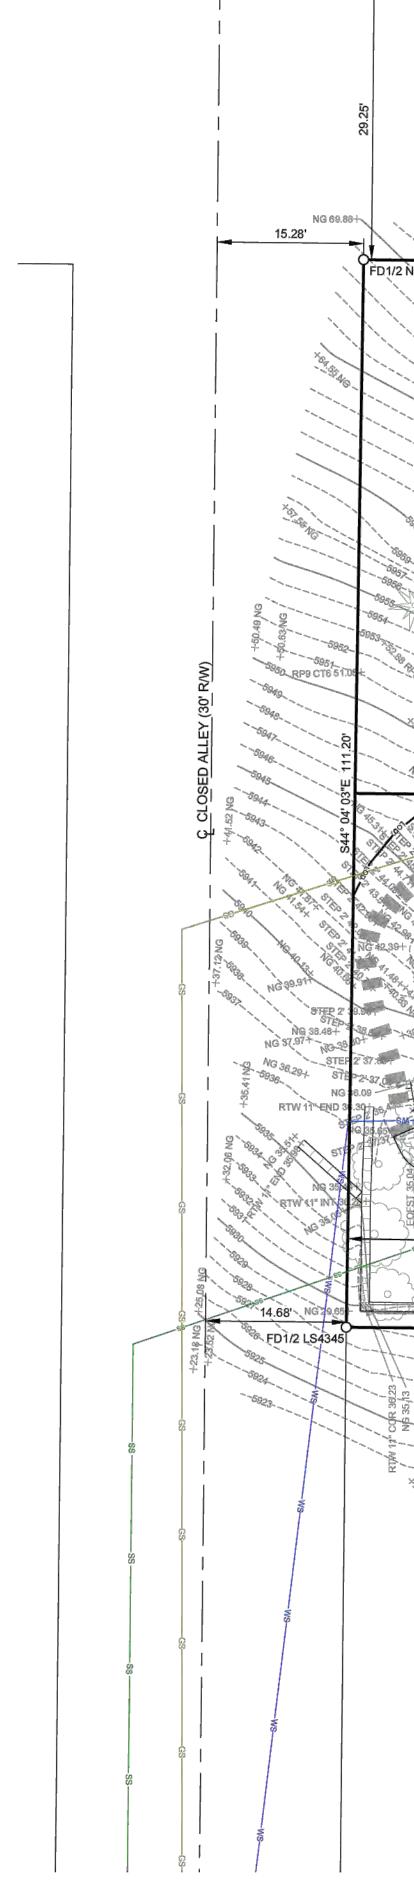

LEGEND

Property Line

Adjoiner's Lot Line

Pavers

Edge of Asphalt

Flat Stone Pavers

DT = Deciduous Tree

GMTR = Gas Meter

AP = Angle Point

BEG = Beginning BOW = Back of Walk

CMP = Corrugated Metal Pipe

EOA = Edge of Asphalt EOC = Edge of Concrete

EOP = Edge of Pavers

FF = Finished Floor GB = Grade Break

INT = Intersection

RP = Reference Point

RR TIE = Railroad Tie TA = Top of Asphalt

TOE = Toe of Slope TOP = Top of Slope TW = Top of Wall

THRESH = Threshold of Door

WTR TOP = Top of Water Fall

NC = No Cap NG = Natural Ground PVC = Polyvinyl Chloride Pipe

EOFST = Edge of Flat Stone

GFF = Garage Finished Floor

Approximate Gas Service

FNDGEAR = Found Gear Survey Marker

FD5/8 = Found 5/8" Rebar

FD1/2 = Found 1/2" Rebar CP / CNTRL = Survey Control

	Centerline
O	FNDGEAR = Found G
0	FD5/8 = Found 5/8" Re
0	FD1/2 = Found 1/2" Re
\triangle	CP / CNTRL = Survey
	5' Contour Interval
and states and	1' Contour Interval
	FL = Flow Line
	Limits of Disturbance
	Building
	Above Ground Deck

----- Roof Outline EOA -ECA-RECRECKE RTW = Concrete Retaining Wall


Drystack or Railroad Tie Retaining Wall AAAAAAAAA Rock Face Aspen Grove

200 CT = Conifer Tree

Landscape Steps ĠM ------ Buried Power Line -O- PP = Power Pole GUY = Guywire

CB = Catch Basin Culvert

<u>Ç 7TH ST. (60' R/W)</u>

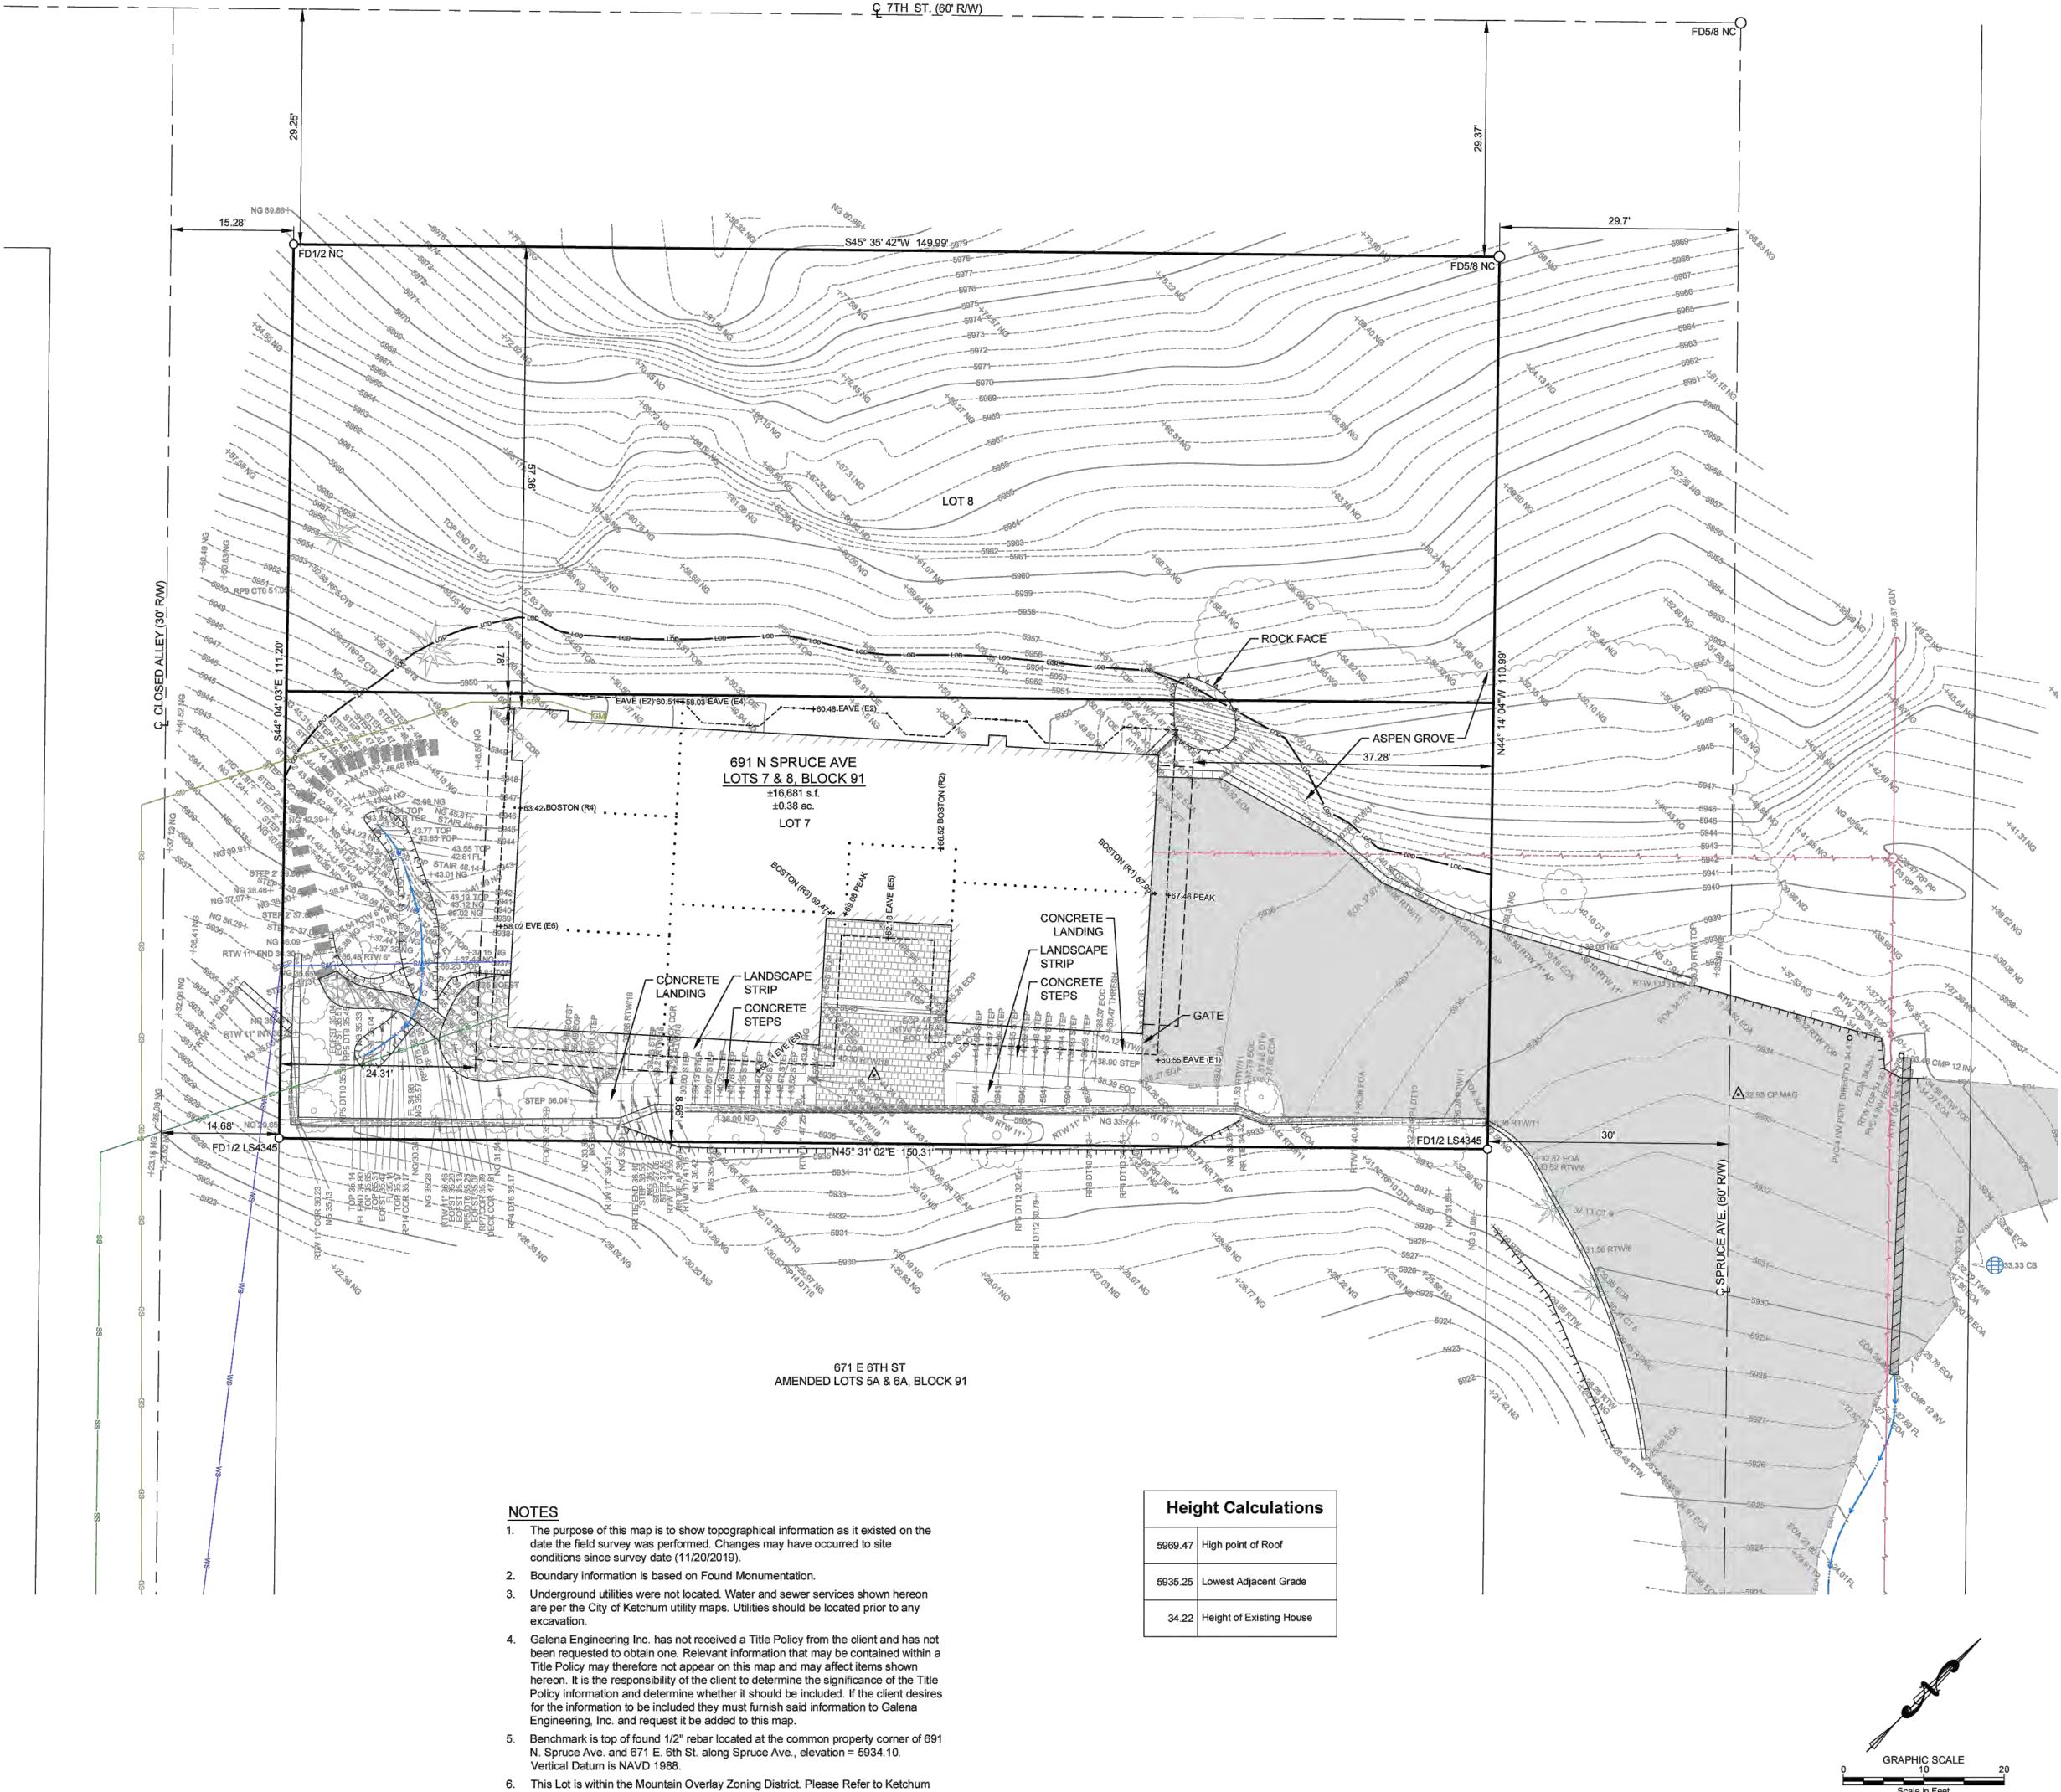

- This Lot is within the Mountain Overlay Zoning District. Please Refer to Ketchum Zoning Ordinance 17.104 for use conditions and restrictions.

Height Calculations		
5969.47	High point of Roof	
5935.25	Lowest Adjacent Grade	



LEGEND EXISTING ITEMS

Property Line ------ Centerline of Right of Way Existing House Footprint Existing Deck Footprint 5' Contour Interval --- 1' Contour Interval

Adjoiner's Lot Line

Flow Line

Asphalt

Aspen Grove Conifer Tree

Deciduous Tree Gas Meter Gas Marker GAS Telephone Riser _____ Power Box Power Pole Guywire Sewer Main Sewer Service 0 Sewer Manhole Catch Basin Culvert Water Main Water Service 4.4% Existing Grade

PROPOSED ITEMS 1' Contour Interval

----- Building Setback ----- Interior Lot Line to be Abandoned Asphalt

Landscape Drywell Trench Drain French Drain • Spot Elevations 4.4% Proposed Grade

----- New Building Envelope





SITE IMPROVEMENT KEY NOTES - - - SO1 SAWCUT EXISTING ASPHALT TO PROVIDE FOR A CLEAN VERTICAL EDGE.

S02 CONSTRUCT ASPHALT DRIVEWAY. SEE DETAIL 1 / C1.2. (S03) INSTALL LANDSCAPE DRYWELL. SEE DETAIL 3 / C1.2.

a. RIM = 5932.5 +/- (6" under driveway)

S04 INSTALL TRENCH DRAIN. SEE DETAIL 2 / C1.2. -SD-SO5 INSTALL 6"Ø D3034 PVC PIPE @ S=2.0% MIN. 3.0" MINIMUM COVER. SEE DETAIL 4 / C1.2. ----- S06 INSTALL FRENCH DRAIN

GRADING AND DRAINAGE NOTES 1. ALL DRAINAGE IS TO BE RETAINED ONSITE.

2. GRADE AWAY FROM FOUNDATION AT 5%.


Calculations

Existing Site Disturbance

Proposed Site Disturbance Existing Bldg. Coverage -House

> -Deck 1 -Deck 2 -Front Stair -Front Wall -Back Wall

Proposed Bldg. Coverage -House -AC Pad

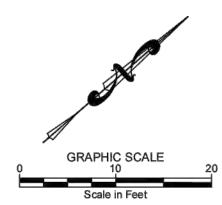



8,469 SF no change 4,084 SF 2,711 SF 254 SF 140 SF 783 SF 157 SF 39 SF 2,748 SF 2,663 SF 85 SF




CONSTRUCTION NOTES

- 1. ALL CONSTRUCTION SHALL BE IN CONFORMANCE WITH THE MOST CURRENT EDITION OF THE "IDAHO STANDARDS FOR PUBLIC WORKS CONSTRUCTION" (ISPWC) AND CITY OF KETCHUM STANDARDS. THE CONTRACTOR SHALL BE RESPONSIBLE FOR OBTAINING AND KEEPING A COPY OF THE ISPWC AND CITY OF KETCHUM STANDARDS ON SITE DURING CONSTRUCTION.
- 2. THE LOCATION OF EXISTING UNDERGROUND UTILITIES ARE SHOWN ON THE PLANS IN AN APPROXIMATE WAY. THE CONTRACTOR SHALL BE RESPONSIBLE FOR LOCATING EXISTING UTILITIES PRIOR TO COMMENCING AND DURING THE CONSTRUCTION. THE CONTRACTOR AGREES TO BE FULLY RESPONSIBLE FOR ANY AND ALL DAMAGES WHICH RESULT FROM HIS FAILURE TO ACCURATELY LOCATE AND PRESERVE ANY AND ALL UNDERGROUND UTILITIES. CONTRACTOR SHALL CALL DIGLINE (1-800-342-1585) TO LOCATE ALL EXISTING UNDERGROUND UTILITIES A MINIMUM OF 48 HOURS IN ADVANCE OF EXCAVATION.
- 3. CONTRACTOR SHALL COORDINATE RELOCATIONS OF DRY UTILITY FACILITIES (POWER, CABLE, PHONE, TV) WITH THE APPROPRIATE UTILITY FRANCHISE.
- 4. THE CONTRACTOR SHALL CLEAN UP THE SITE AFTER CONSTRUCTION SO THAT IT IS IN A CONDITION EQUAL TO OR BETTER THAN THAT WHICH EXISTED PRIOR TO CONSTRUCTION.
- 5. THE CONTRACTOR SHALL OBTAIN ALL NECESSARY PERMITS PRIOR TO CONSTRUCTION (THIS MAY INCLUDE ENCROACHMENT PERMITS AND NATIONAL POLLUTANT DISCHARGE ELIMINATION SYSTEM (NPDES) CONSTRUCTION GENERAL PERMIT (CGP) PERMIT COVERAGE).
- 6. ALL CLEARING & GRUBBING SHALL CONFORM TO ISPWC SECTION 201.
- 7. ALL EXCAVATION & EMBANKMENT SHALL CONFORM TO ISPWC SECTION 202. SUBGRADE SHALL BE EXCAVATED AND SHAPED TO LINE, GRADE, AND CROSS-SECTION SHOWN ON THE PLANS. THE SUBGRADE SHALL BE COMPACTED TO 95% OF MAXIMUM DENSITY AS DETERMINED BY ASTM D-698. THE CONTRACTOR SHALL WATER OR AERATE SUBGRADE AS NECESSARY TO OBTAIN OPTIMUM MOISTURE CONTENT. IN-LIEU OF DENSITY MEASUREMENTS, THE SUBGRADE MAY BE PROOF-ROLLED TO THE APPROVAL OF THE ENGINEER.
- PROOF-ROLLING: AFTER EXCAVATION TO THE SUBGRADE ELEVATION AND PRIOR TO PLACING COURSE GRAVEL, THE CONTRACTOR SHALL PROOF ROLL THE SUBGRADE WITH A 5-TON SMOOTH DRUM ROLLER, LOADED WATER TRUCK, OR LOADED DUMP TRUCK, AS ACCEPTED BY THE ENGINEER. THE CONTRACTOR SHALL IMMEDIATELY NOTIFY THE ENGINEER OF UNSUITABLE SUBGRADE MATERIAL AREAS, AND/OR AREAS NOT CAPABLE OF COMPACTION ACCORDING TO THESE SPECIFICATIONS. UNSUITABLE OR DAMAGED SUBGRADE IS WHEN THE SOIL MOVES, PUMPS AND/OR DISPLACES UNDER ANY TYPE OF PRESSURE INCLUDING FOOT TRAFFIC LOADS.
- IF, IN THE OPINION OF THE ENGINEER, THE CONTRACTOR'S OPERATIONS RESULT IN DAMAGE TO, OR PROTECTION OF, THE SUBGRADE, THE CONTRACTOR SHALL, AT HIS OWN EXPENSE, REPAIR THE DAMAGED SUBGRADE BY OVER-EXCAVATION OF UNSUITABLE MATERIAL TO FIRM SUBSOIL, LINE EXCAVATION WITH GEOTEXTILE FABRIC, AND BACKFILL WITH PIT RUN GRAVEL.
- 8. ALL 2" MINUS GRAVEL SHALL CONFORM TO ISPWC 802, TYPE II (ITD STANDARD 703.04, 2"), SHALL BE PLACED IN CONFORMANCE WITH ISPWC SECTION 801 AND COMPACTED PER SECTION 202. MINIMUM COMPACTION OF PLACED MATERIAL SHALL BE 90% OF MAXIMUM LABORATORY DENSITY AS DETERMINED BY AASHTO T-99.
- 9. ALL 3/4" MINUS CRUSHED GRAVEL SHALL CONFORM TO ISPWC 802, TYPE I (ITD STANDARD 703.04, 3/4" B), SHALL BE PLACED IN CONFORMANCE WITH ISPWC SECTION 802 AND COMPACTED PER SECTION 202. MINIMUM COMPACTION OF PLACED MATERIAL SHALL BE 95% OF MAXIMUM LABORATORY DENSITY AS DETERMINED BY AASHTO T-99 OR ITD T-91.
- 10. ALL ASPHALTIC CONCRETE PAVEMENT WORK SHALL CONFORM TO ISPWC SECTION(S) 805, 810, AND 811 FOR CLASS II PAVEMENT. ASPHALT AGGREGATE SHALL BE 1/2" (13MM) NOMINAL SIZE CONFORMING TO TABLE 803B IN ISPWC SECTION 803. ASPHALT BINDER SHALL BE PG 58-28 CONFORMING TO TABLE A-1 IN **ISPWC SECTION 805.**
- 11. ASPHALT SAWCUTS SHALL BE AS INDICATED ON THE DRAWINGS, OR 24" INCHES FROM EDGE OF EXISTING ASPHALT, IF NOT INDICATED OTHERWISE SO AS TO PROVIDE A CLEAN PAVEMENT EDGE FOR MATCHING. NO WHEEL CUTTING SHALL BE ALLOWED.
- 12. ALL CONCRETE WORK SHALL CONFORM TO ISPWC SECTIONS 701, 703, AND 705. ALL CONCRETE SHALL BE 3,000 PSI MINIMUM, 28 DAY, AS DEFINED IN ISPWC SECTION 703, TABLE 1. IMMEDIATELY AFTER PLACEMENT PROTECT CONCRETE BY APPLYING MEMBRANE-FORMING CURING COMPOUND, TYPE 2, CLASS A PER ASTM C 309-94. APPLY CURING COMPOUND PER MANUFACTURER'S INSTRUCTIONS AND SPECIFICATIONS.
- 13. PER IDAHO CODE § 55-1613, THE CONTRACTOR SHALL RETAIN AND PROTECT ALL MONUMENTS, ACCESSORIES TO CORNERS, BENCHMARKS AND POINTS SET IN CONTROL SURVEYS; ALL MONUMENTS, ACCESSORIES TO CORNERS, BENCHMARKS AND POINTS SET IN CONTROL SURVEYS THAT ARE LOST OR DISTURBED BY CONSTRUCTION SHALL BE REESTABLISHED AND RE-MONUMENTED, AT THE EXPENSE OF THE AGENCY OR PERSON CAUSING THEIR LOSS OR DISTURBANCE AT THEIR ORIGINAL LOCATION OR BY SETTING OF A WITNESS CORNER OR REFERENCE POINT OR A REPLACEMENT BENCHMARK OR CONTROL POINT. BY OR UNDER THE DIRECTION OF A PROFESSIONAL LAND SURVEYOR.

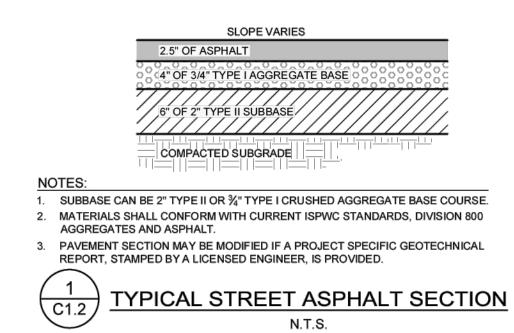

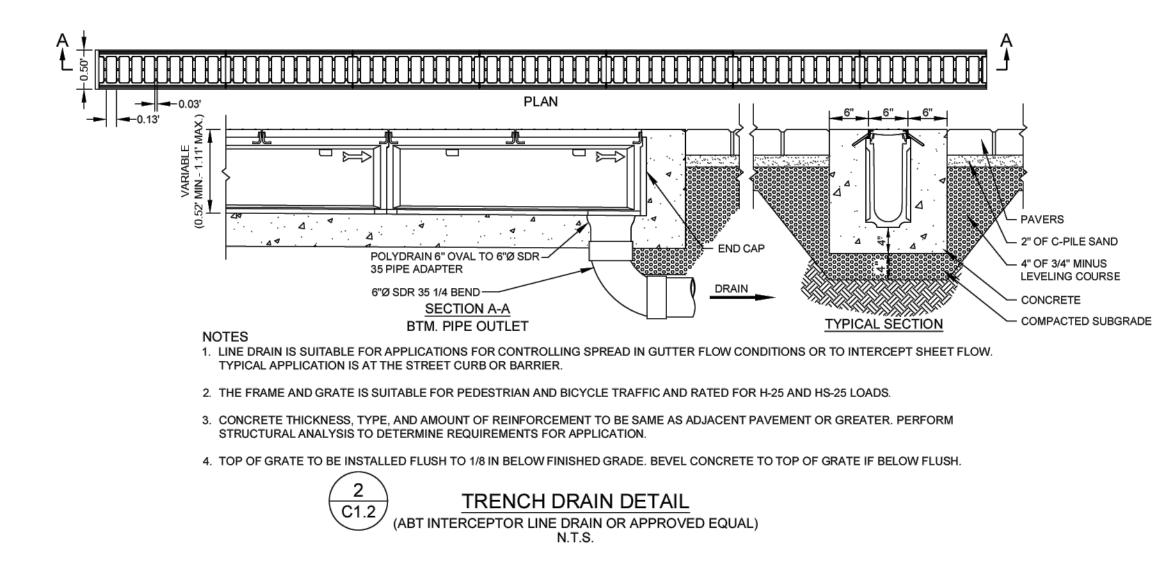

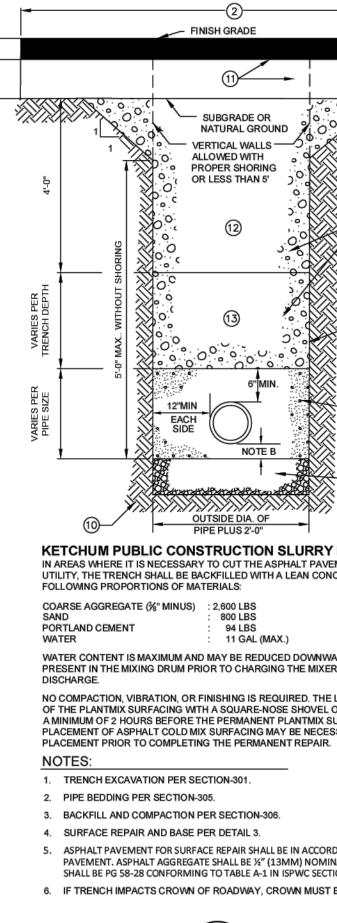

- FINISH GRADE

(1)

SUBGRADE OR

— VERTICAL WALLS —

ALLOWED WITH

PROPER SHORING

OR LESS THAN 5'

(12)

800 LE

94 I BS

NATURAL GROUND



6. IF TRENCH IMPACTS CROWN OF ROADWAY, CROWN MUST BE MAINTAINED AND POSITIVE DRAINAGE PROVIDED.

5. ASPHALT PAVEMENT FOR SURFACE REPAIR SHALL BE IN ACCORDANCE WITH PLANS AND ISPWC SECTIONS 805, 810, AND 811 FOR CLASS II PAVEMENT. ASPHALT AGGREGATE SHALL BE 1/2" (13MM) NOMINAL SIZE CONFORMING TO TABLE 803B IN ISPWC SECTION 803. ASPHALT BINDER SHALL BE PG 58-28 CONFORMING TO TABLE A-1 IN ISPWC SECTION 805.

NO COMPACTION, VIBRATION, OR FINISHING IS REQUIRED. THE LEAN CONCRETE MIX SHALL BE STRUCK OFF AT OR BELOW THE ELEVATION OF THE PLANTMIX SURFACING WITH A SQUARE-NOSE SHOVEL OR SIMILAR HAND TOOL. THE BACKFILL MIX SHALL BE ALLOWED TO SET FOR OF 2 HOURS BEFORE THE PERMANENT PLANTMIX SURFACING IS PLACED TO COMPLETE PLACEMENT OF ASPHALT COLD MIX SURFACING MAY BE NECESSARY TO ACCOMMODATE TRAFFIC WITHIN THE FIRST 2 HOURS OF BACKFILL

11 GAL (MAX.) WATER CONTENT IS MAXIMUM AND MAY BE REDUCED DOWNWARD. CARE SHALL BE TAKEN TO ASSURE THAT EXCESS WATER IS NOT PRESENT IN THE MIXING DRUM PRIOR TO CHARGING THE MIXER WITH MATERIALS. THOROUGH MIXING WILL BE REQUIRED PRIOR TO

NOTE o o o OUTSIDE DIA. OF
 PIPE PLUS 2'-0" KETCHUM PUBLIC CONSTRUCTION SLURRY REQUIREMENT IN AREAS WHERE IT IS NECESSARY TO CUT THE ASPHALT PAVEMENT AND DIG A TRENCH FOR BURIAL OF CONDUIT CABLE OR OTHER CITY UTILITY, THE TRENCH SHALL BE BACKFILLED WITH A LEAN CONCRETE MIX TO THE BOTTOM OF FINISH SURFACE MATERIAL WITH THE

8) PIPE BEDDING PER SECTION-305 (SEE SD-302). 10) UNDISTURBED SOIL (TYP). PEPAIRED SURFACE, SEE DETAIL 5, SEE "KETCHUM PUBLIC CONSTRUCTION SLURRY REQUIREMENT" BELOW IF LOCATED WITHIN PUBLIC RIGHT-OF-WAY. 12 UPPER COMPACTION ZONE; SEE "KETCHUM PUBLIC CONSTRUCTION SLURRY REQUIREMENT" BELOW IF LOCATED WITHIN PUBLIC RIGHT-OF-WAY. (13) LOWER COMPACTION ZONE

FOUNDATION STABILIZATION MAY VARY PER SOIL TYPE AND STABILITY (PER SECTION-304).

7) VERTICAL TRENCH WALLS SHORING PER O.S.H.A.

6 TRENCH BACKFILL PER SECTION-306, OR SEE "KETCHUM PUBLIC CONSTRUCTION SLURRY REQUIREMENT" BELOW IF LOCATED WITHIN PUBLIC RIGHT-OF-WAY.

) EXISTING BASE. TRENCH BACK SLOPE PER O.S.H.A. OR SUITABLE


) SURFACE REPAIR WIDTH, 4' MINIMUM. SEE NOTE 5.) EXISTING SURFACE.

EGEND 2' REQUIRED BOTH SIDES, SAWCUT REQUIRED.


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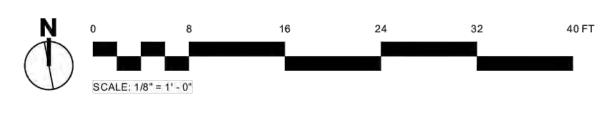



MĪN. °o 00 0 LANDSCAPE DRYWELI




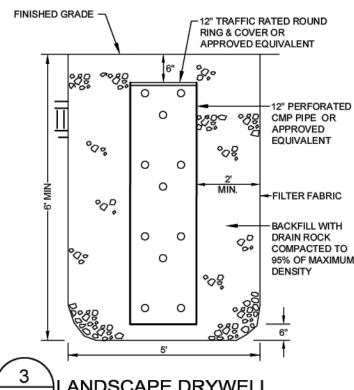




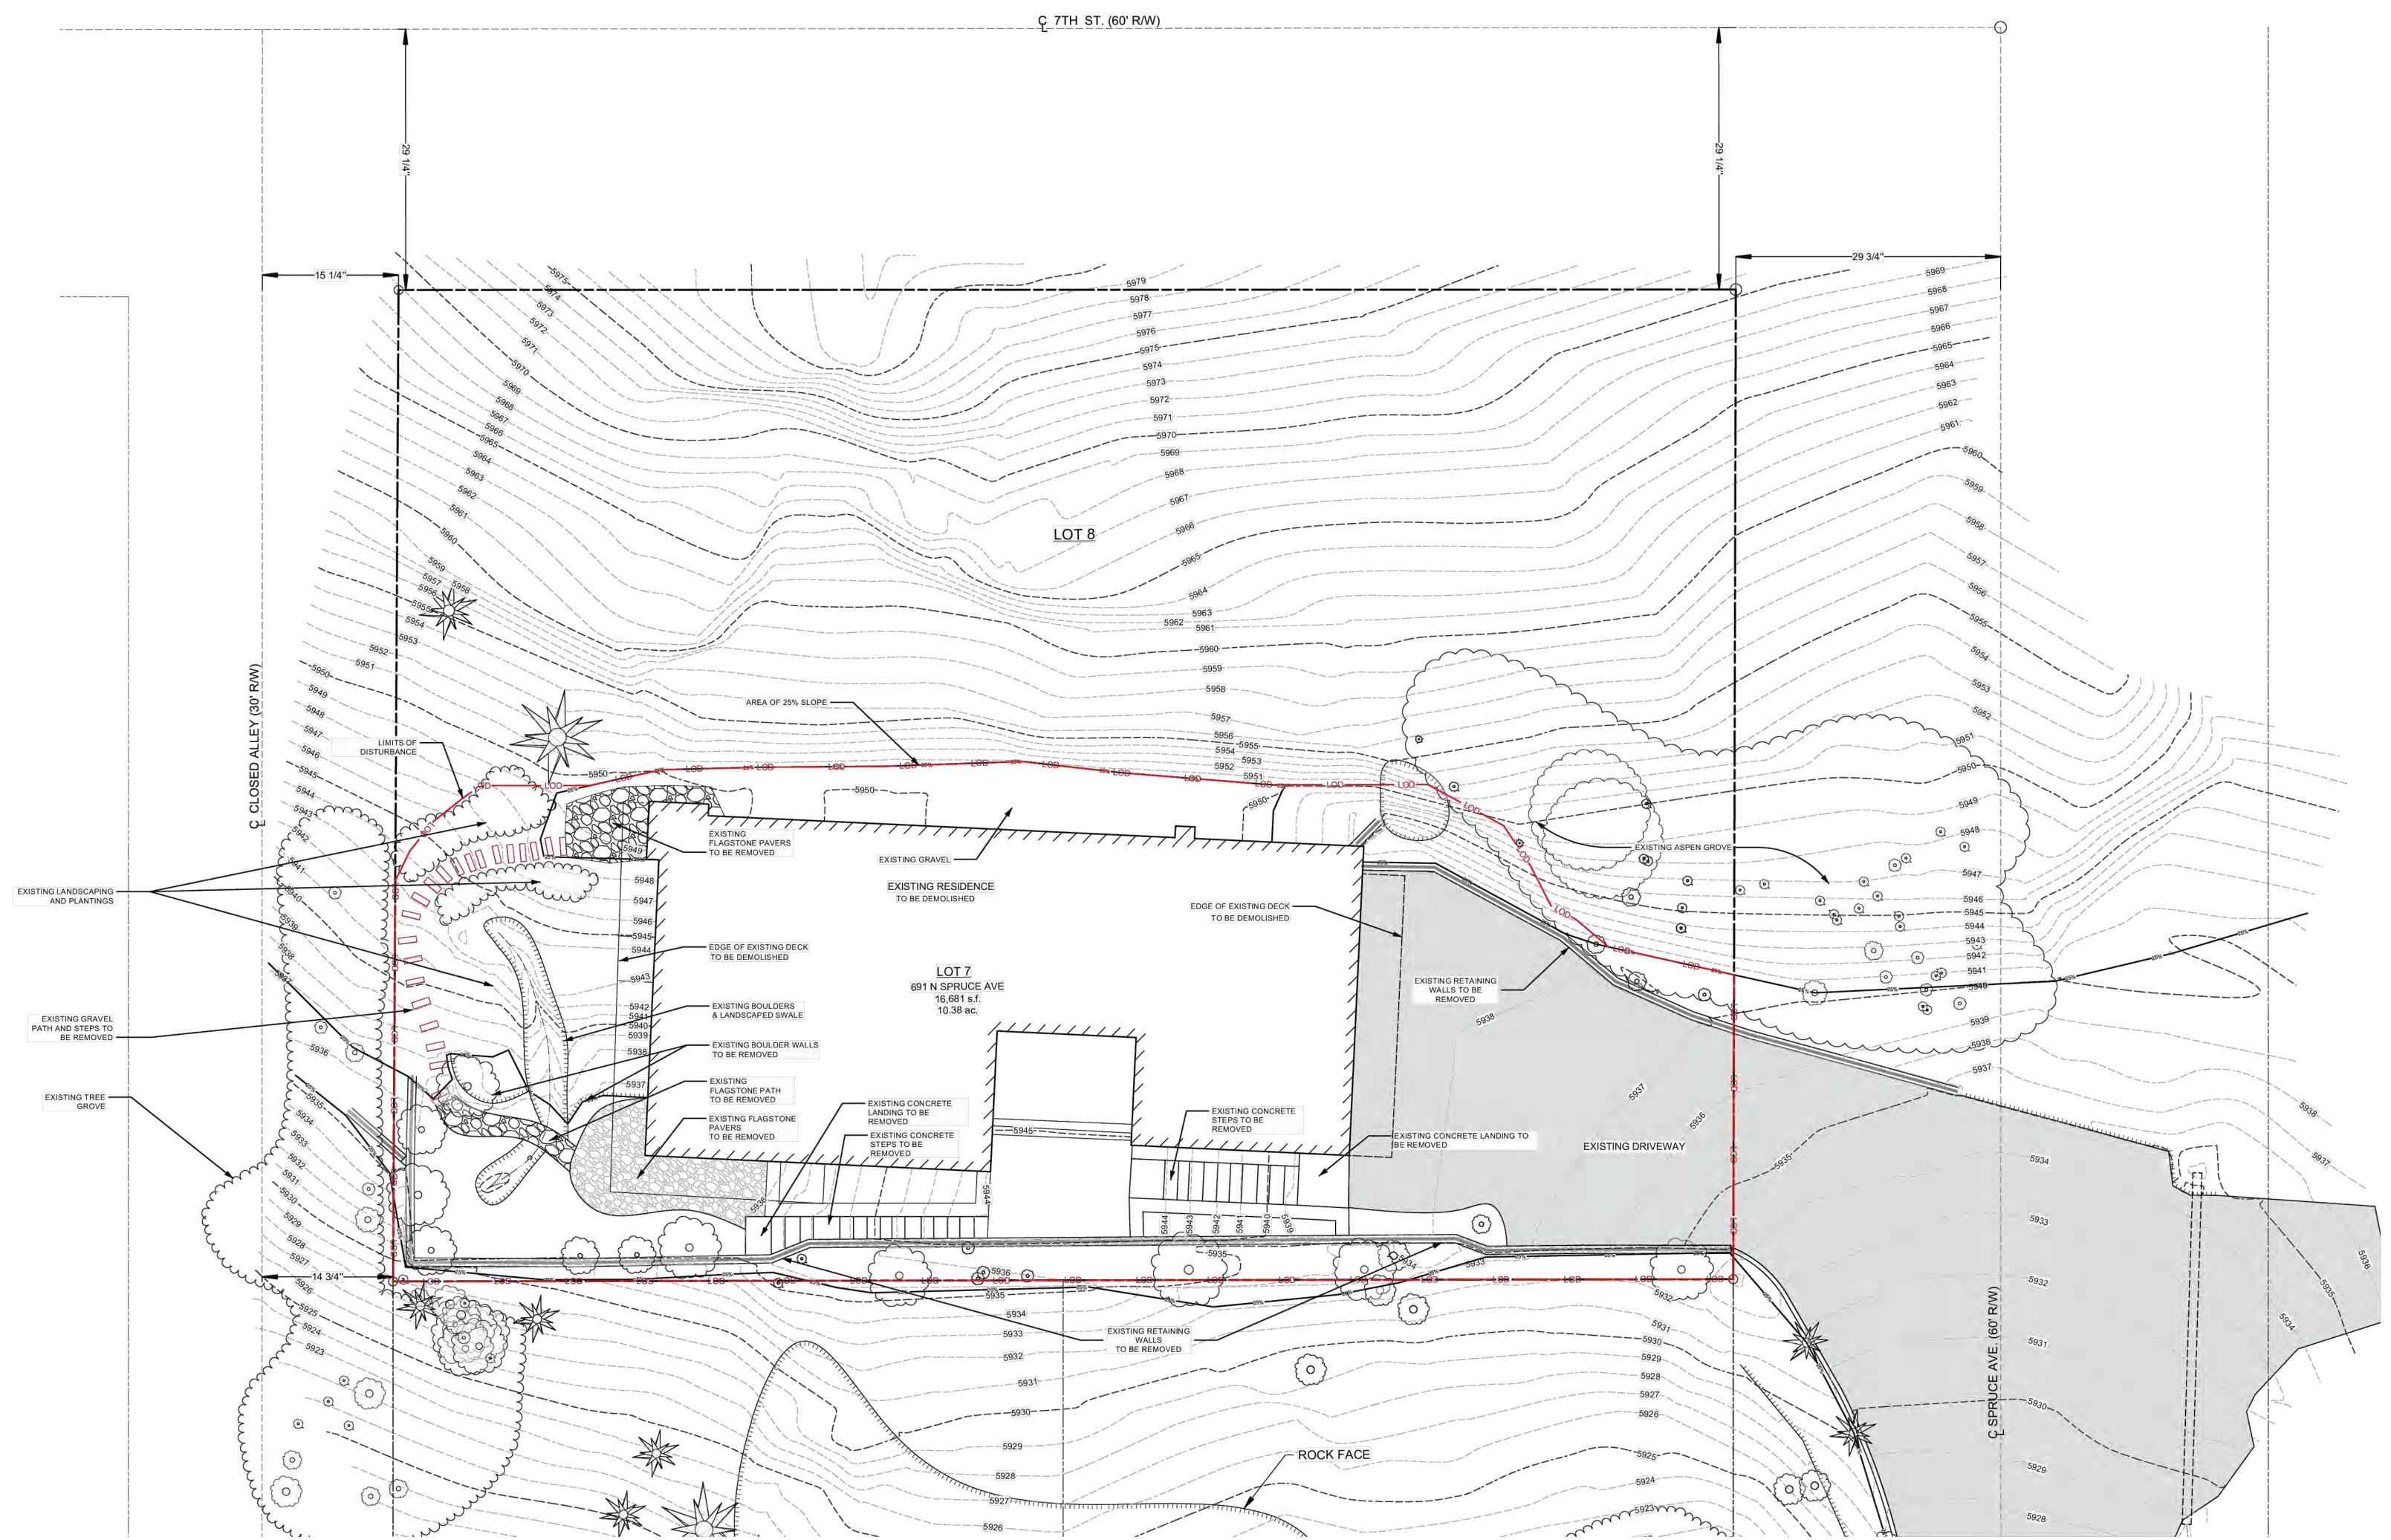

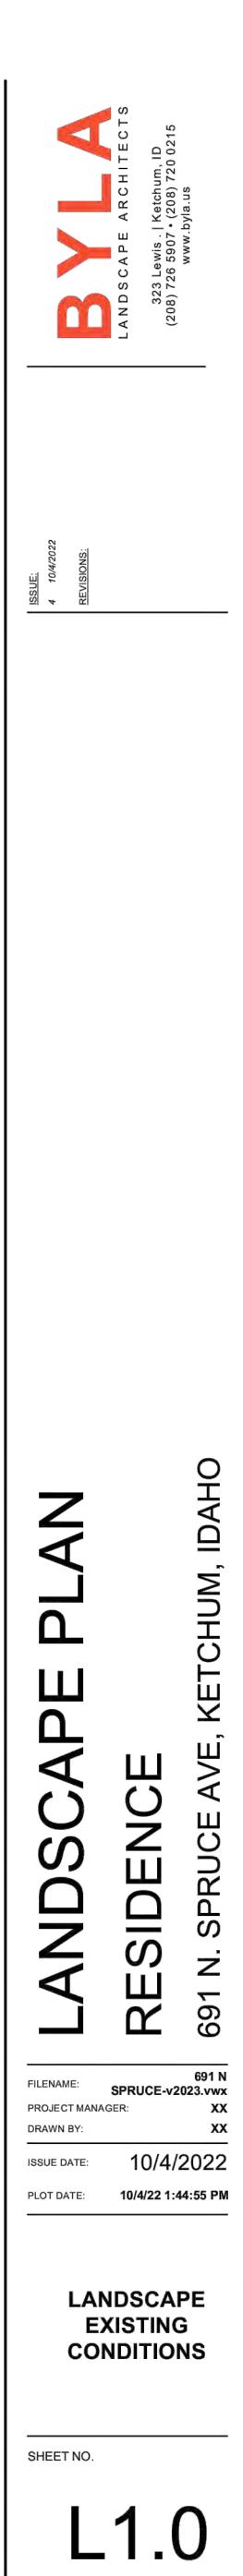

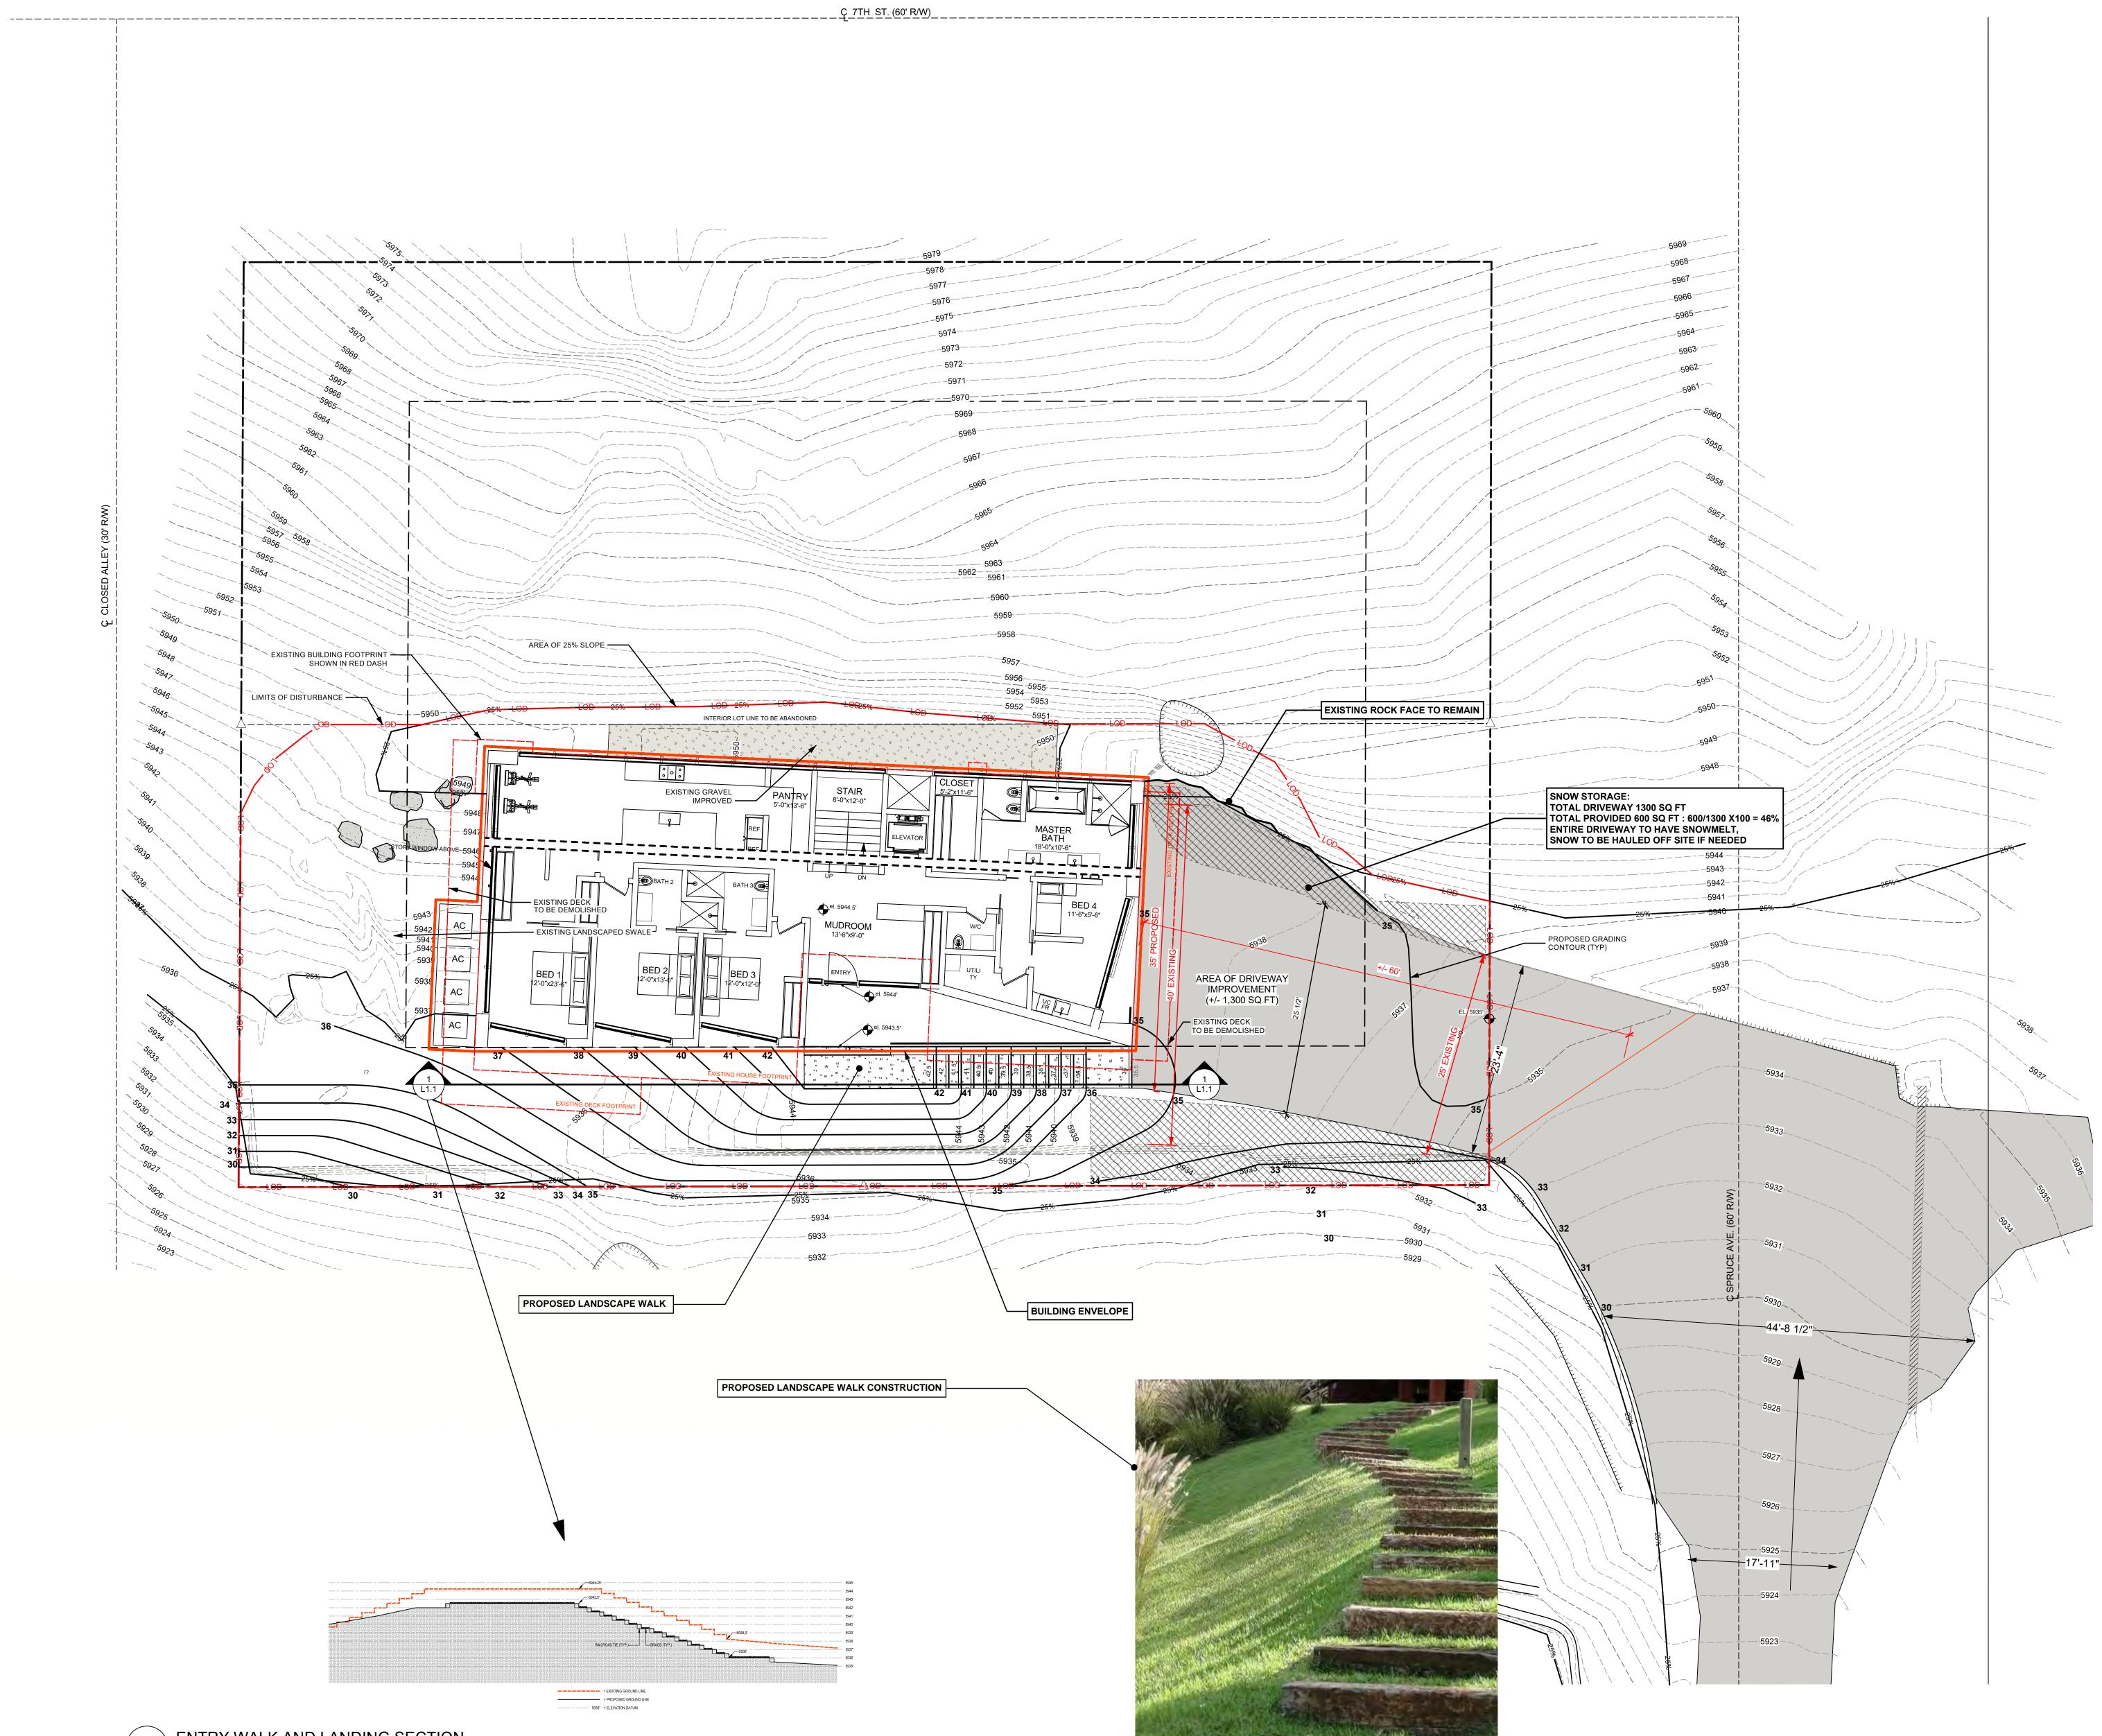

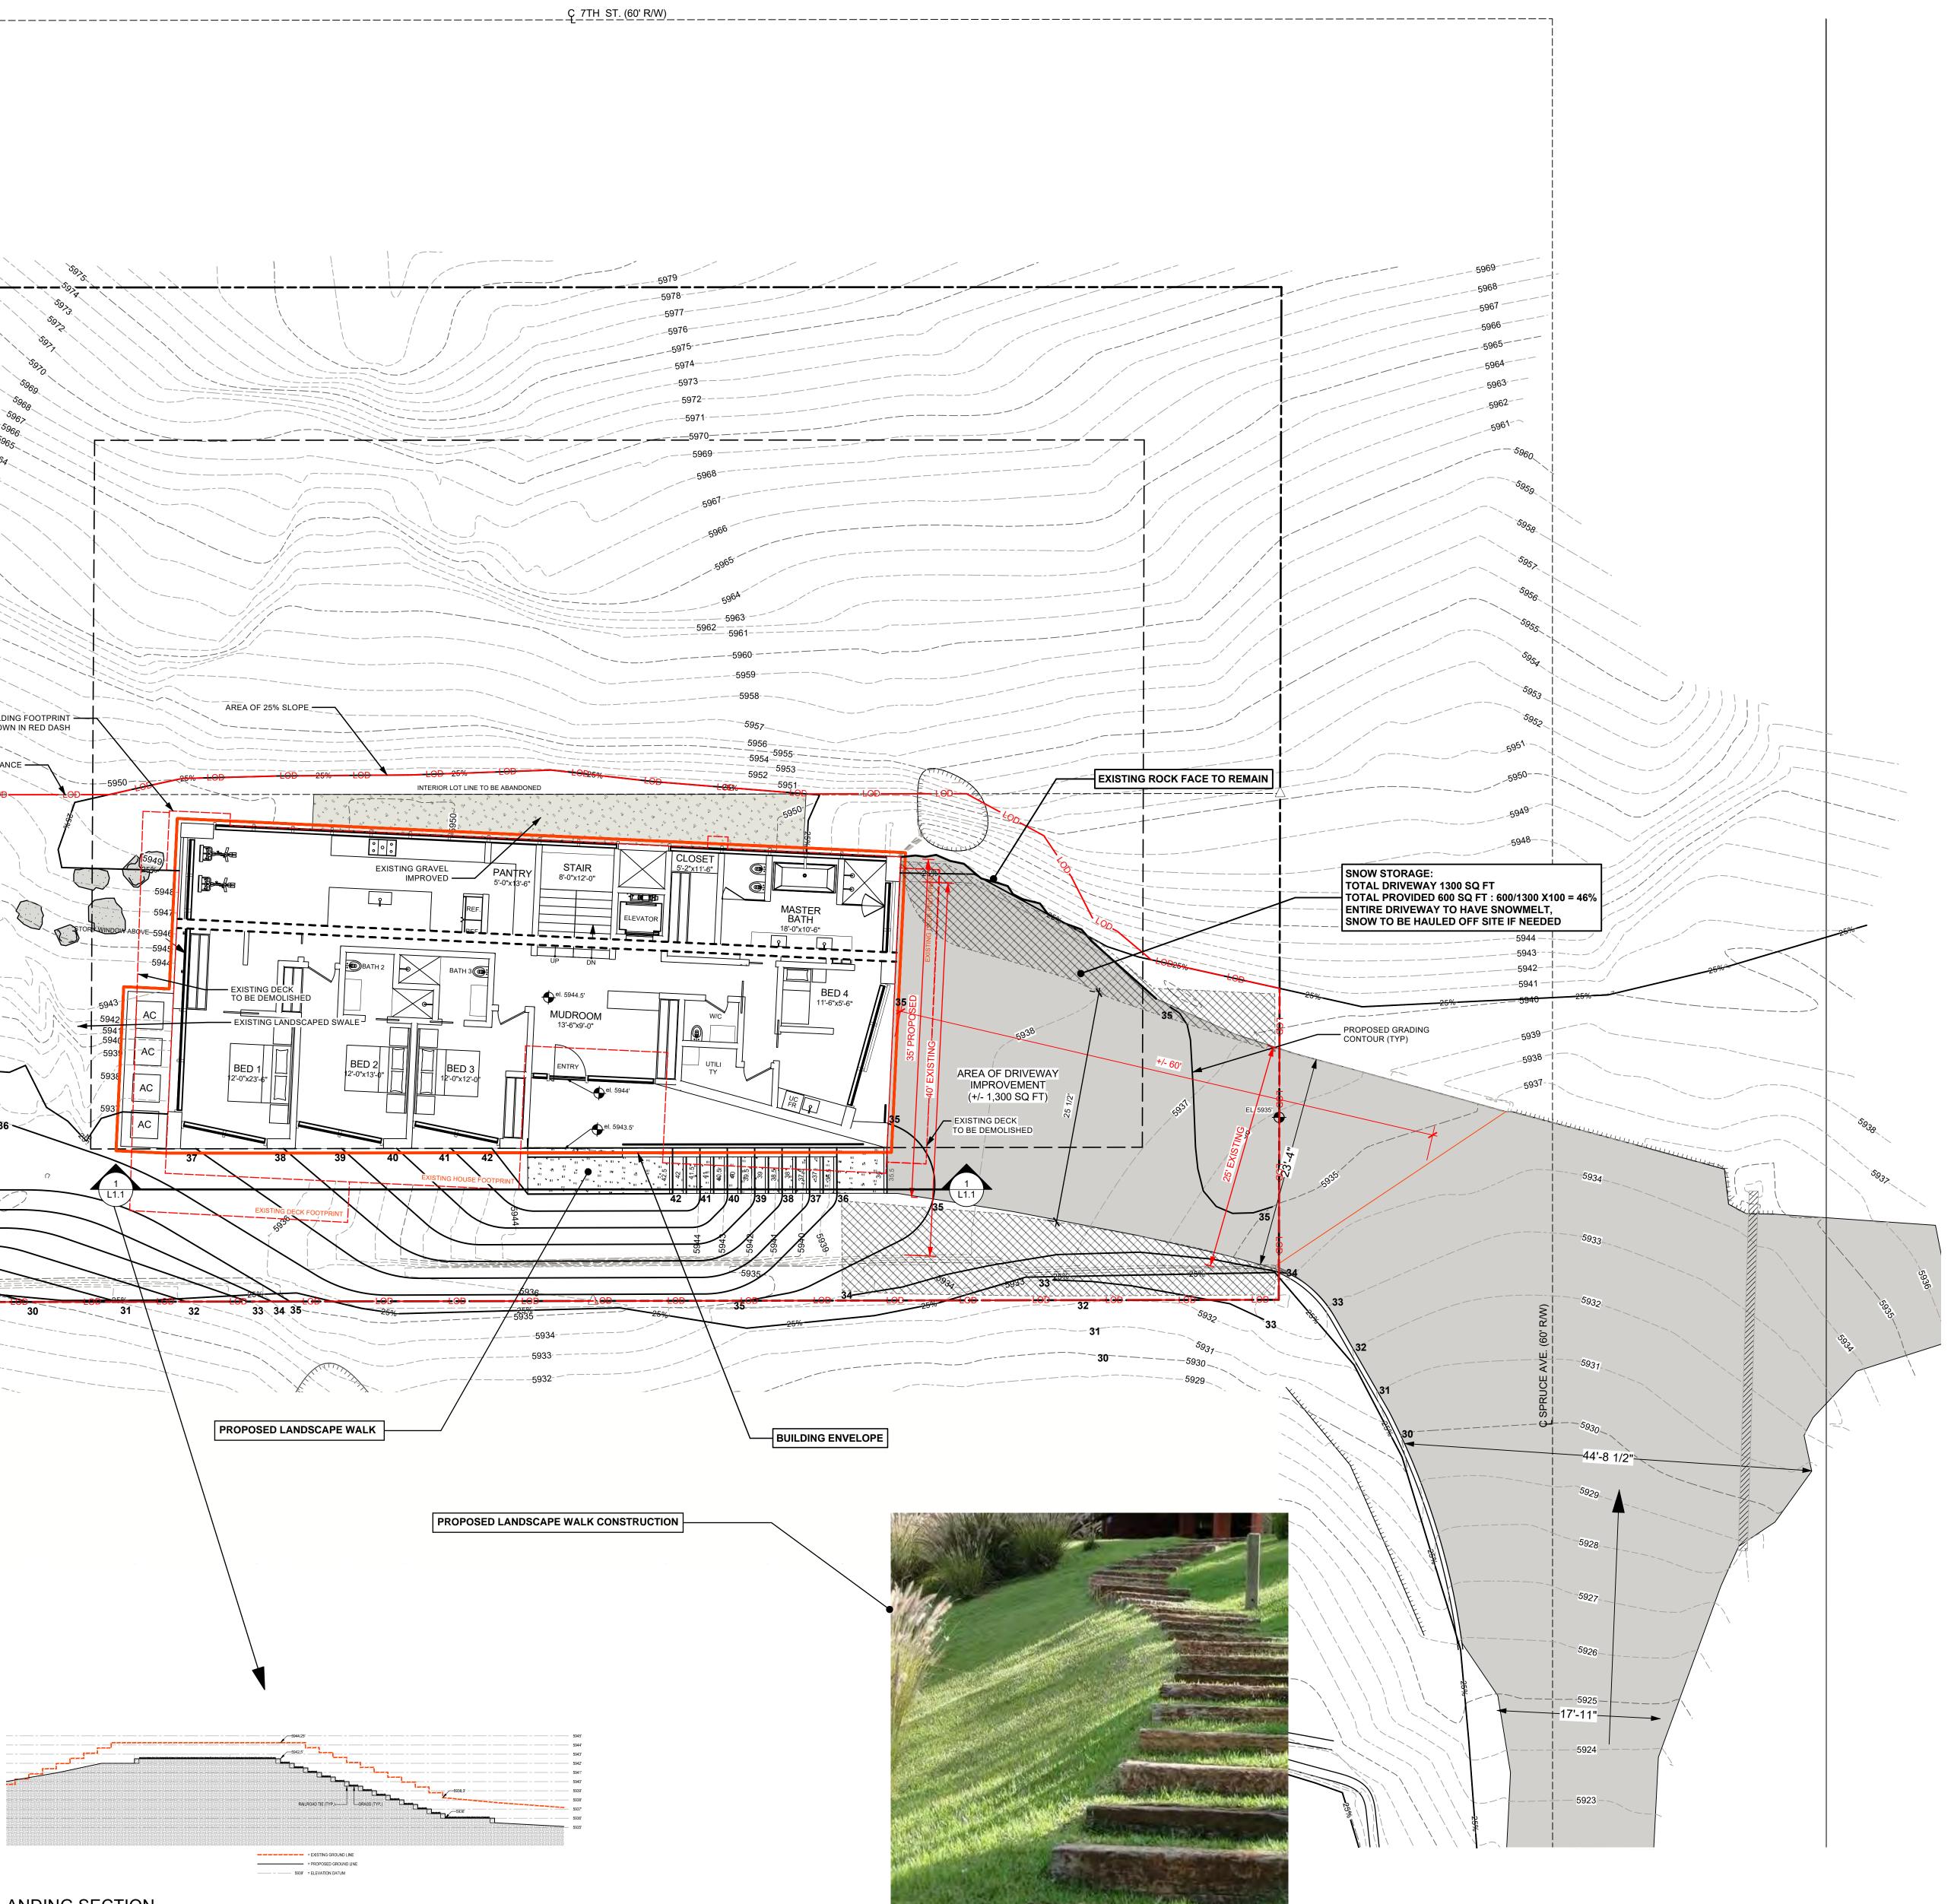


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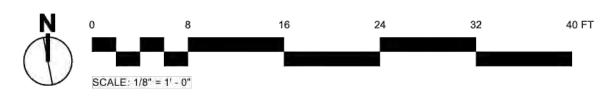
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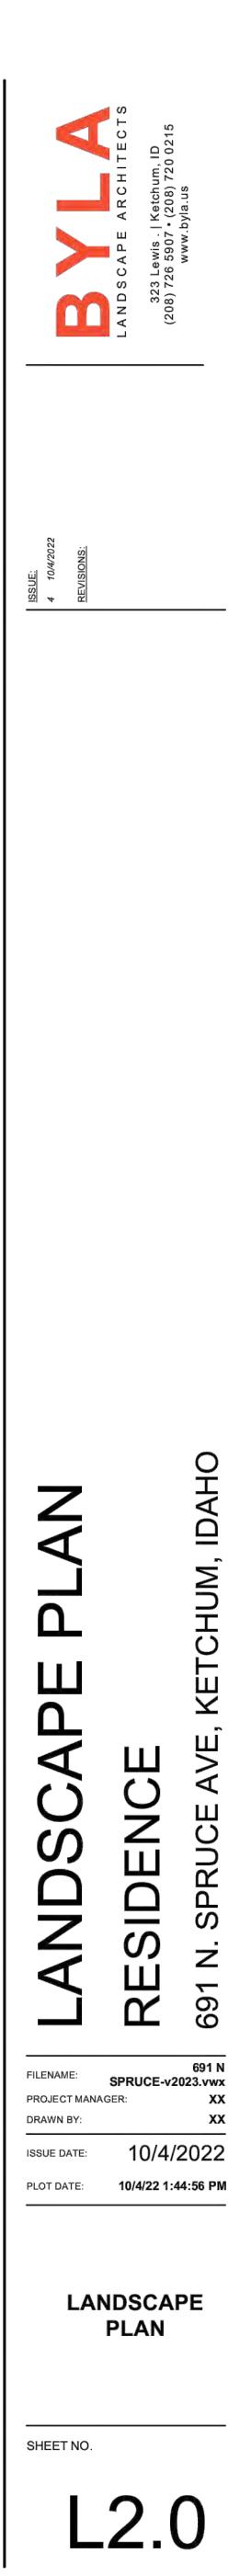



32

40 FT







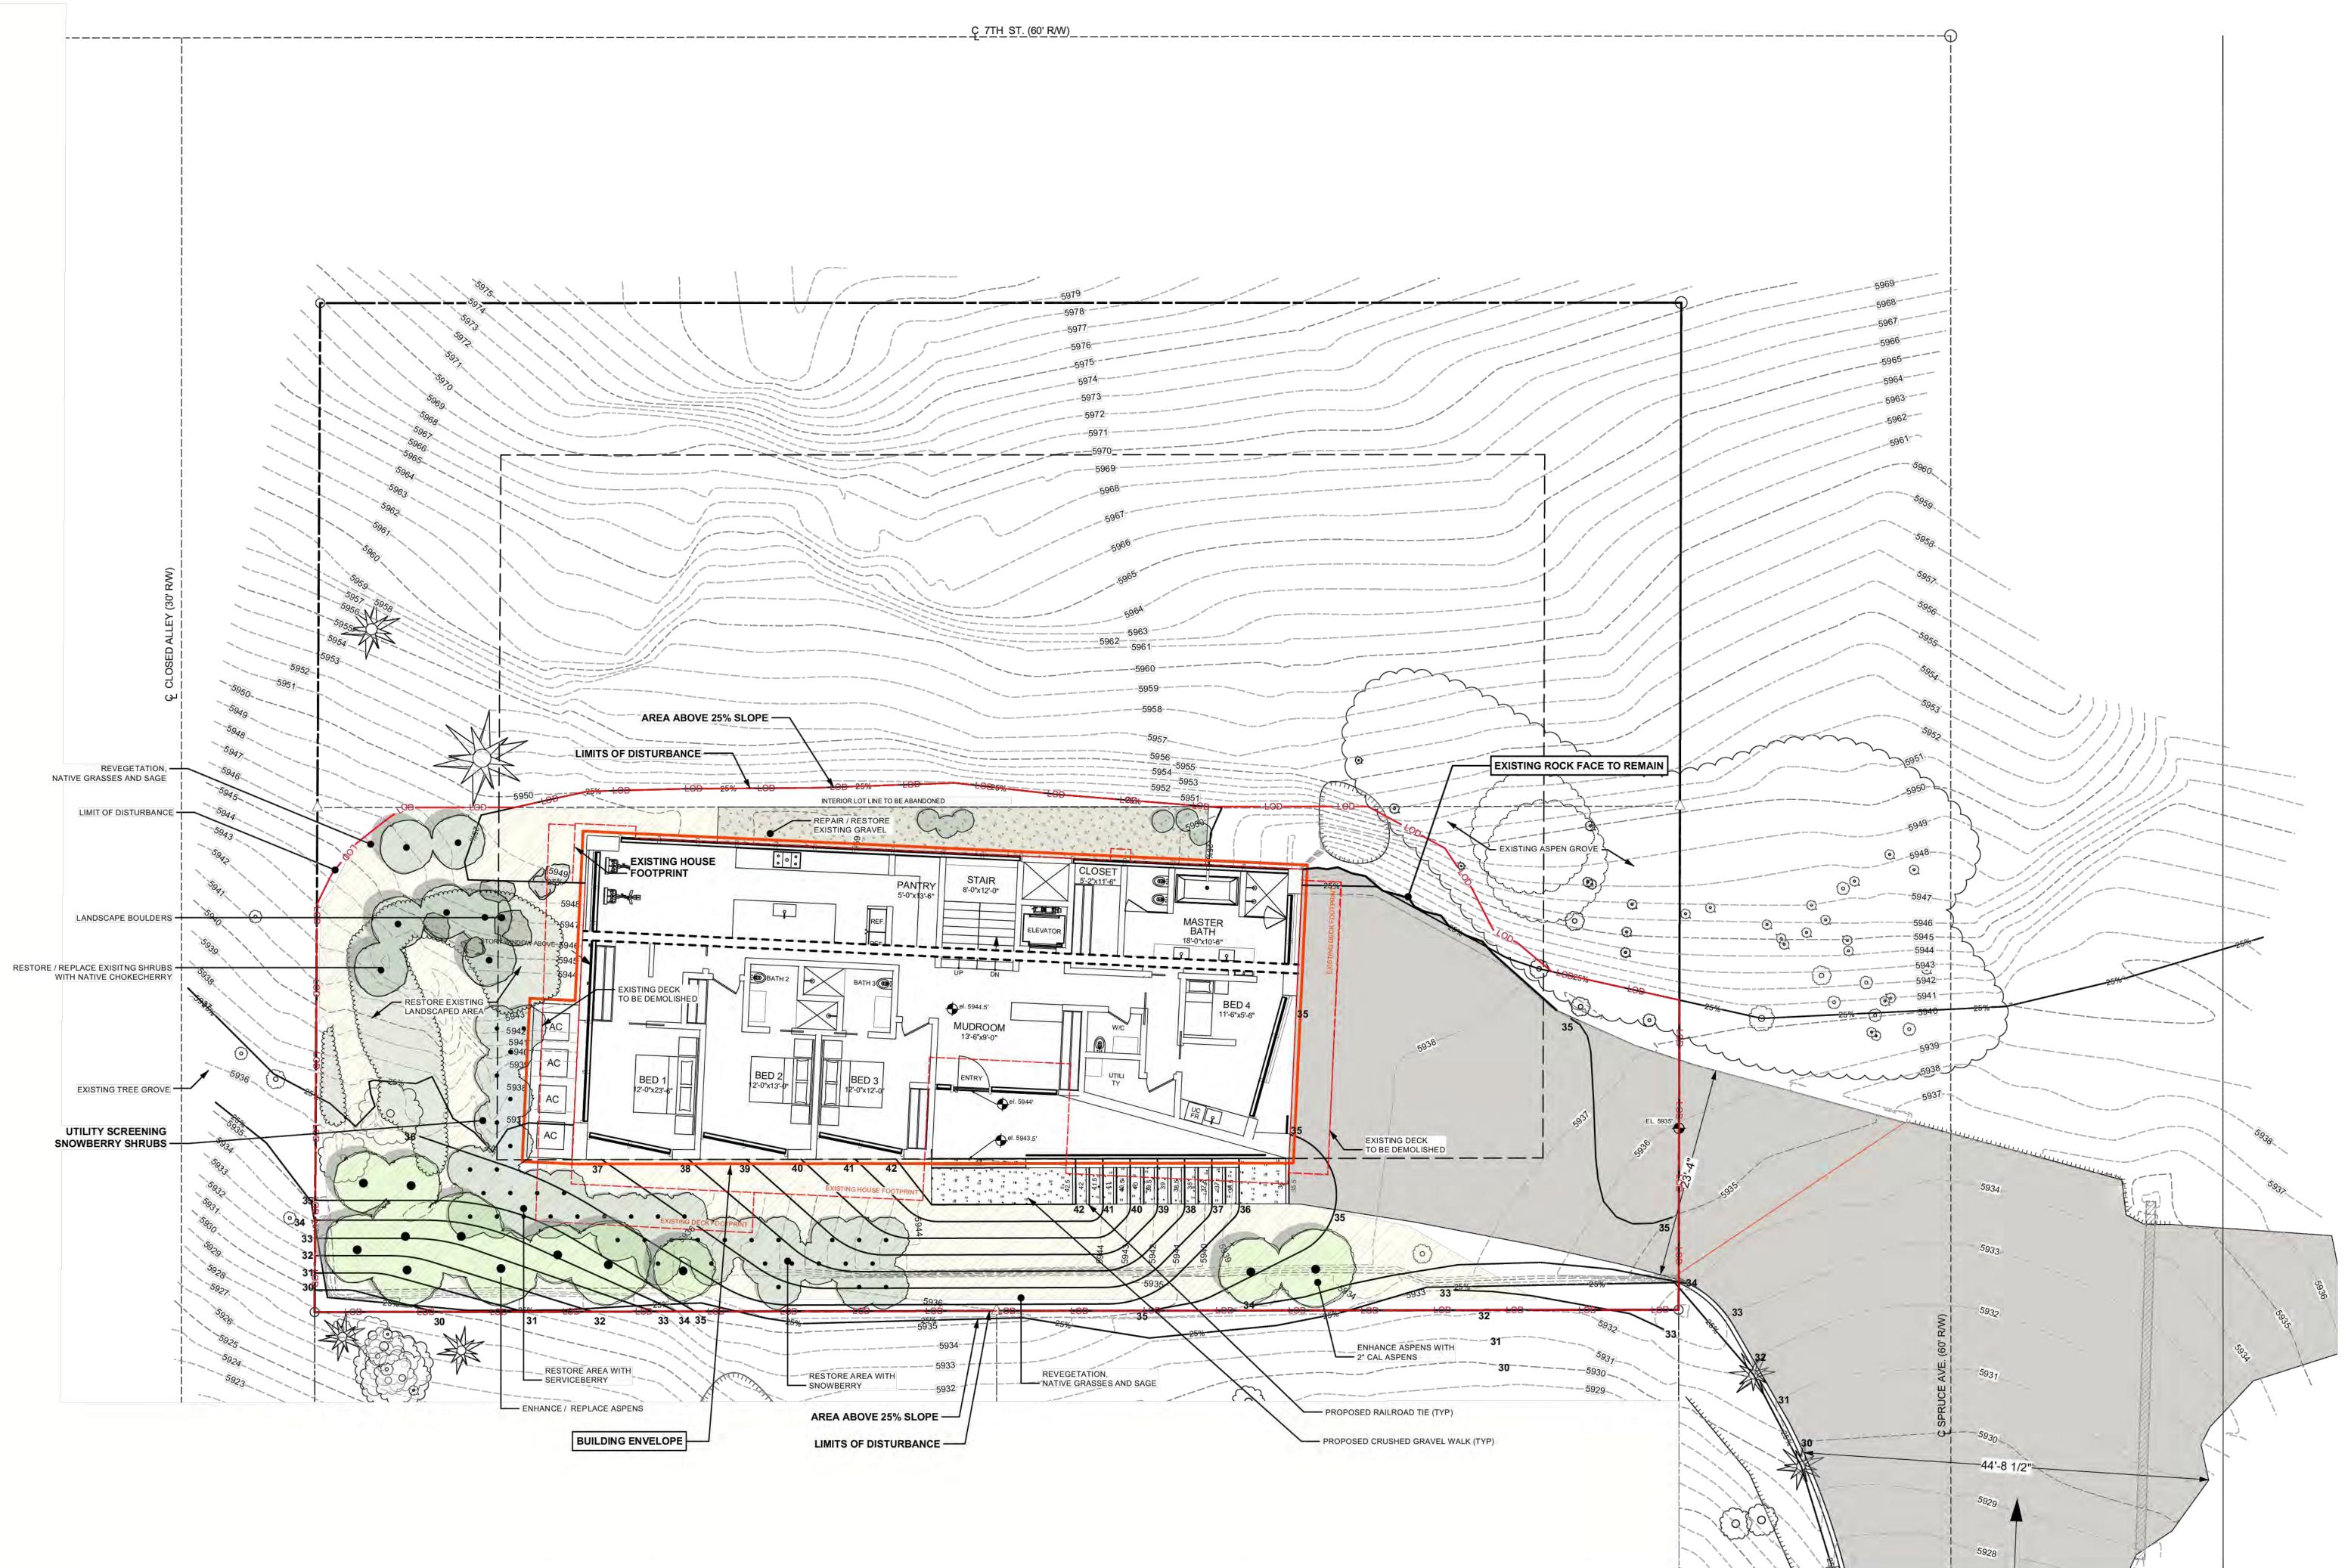

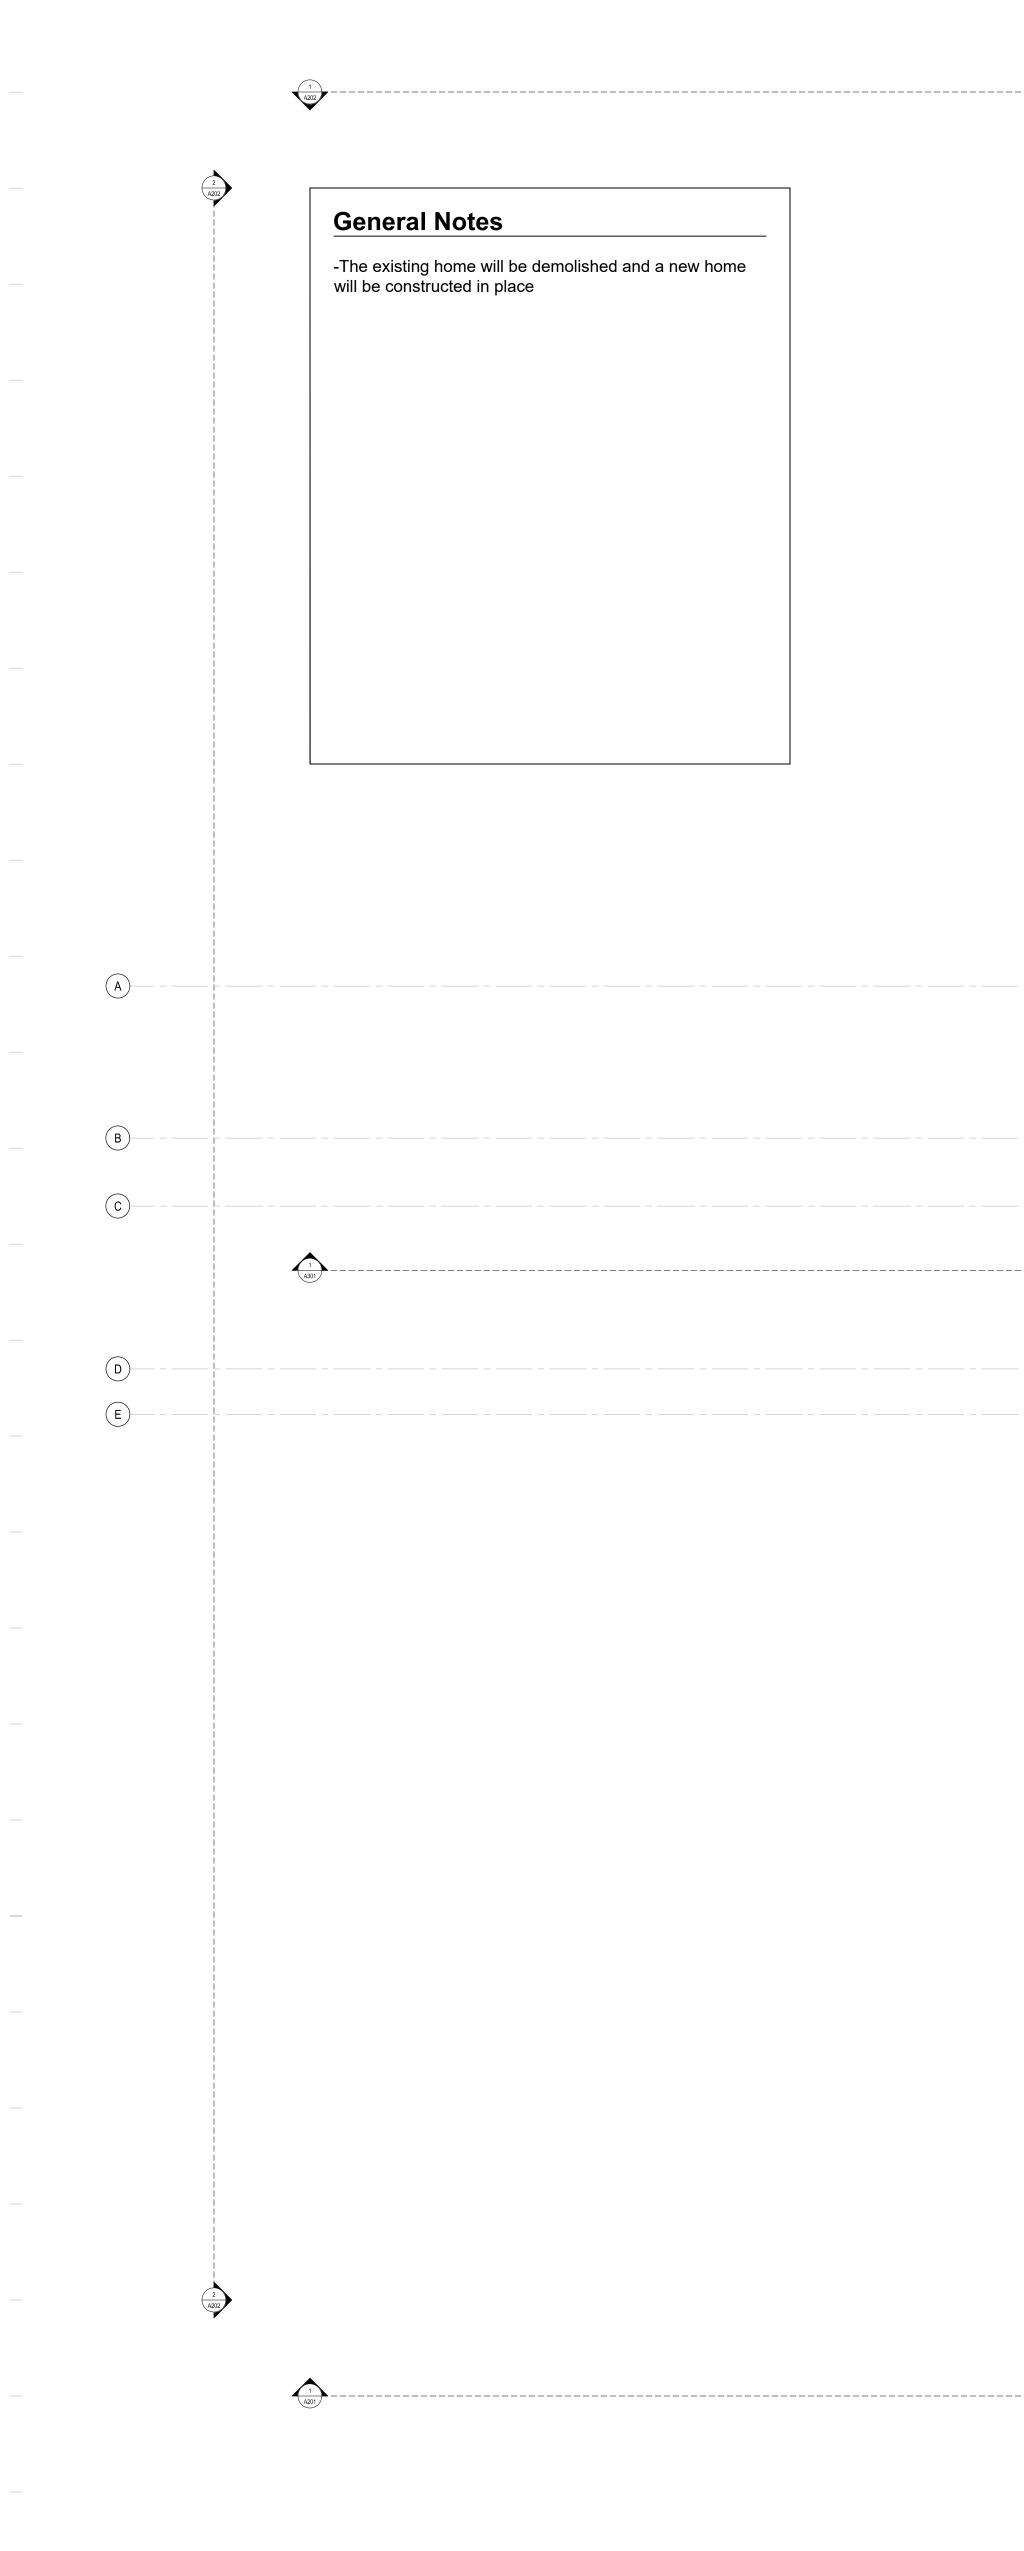


1 Basement Plan

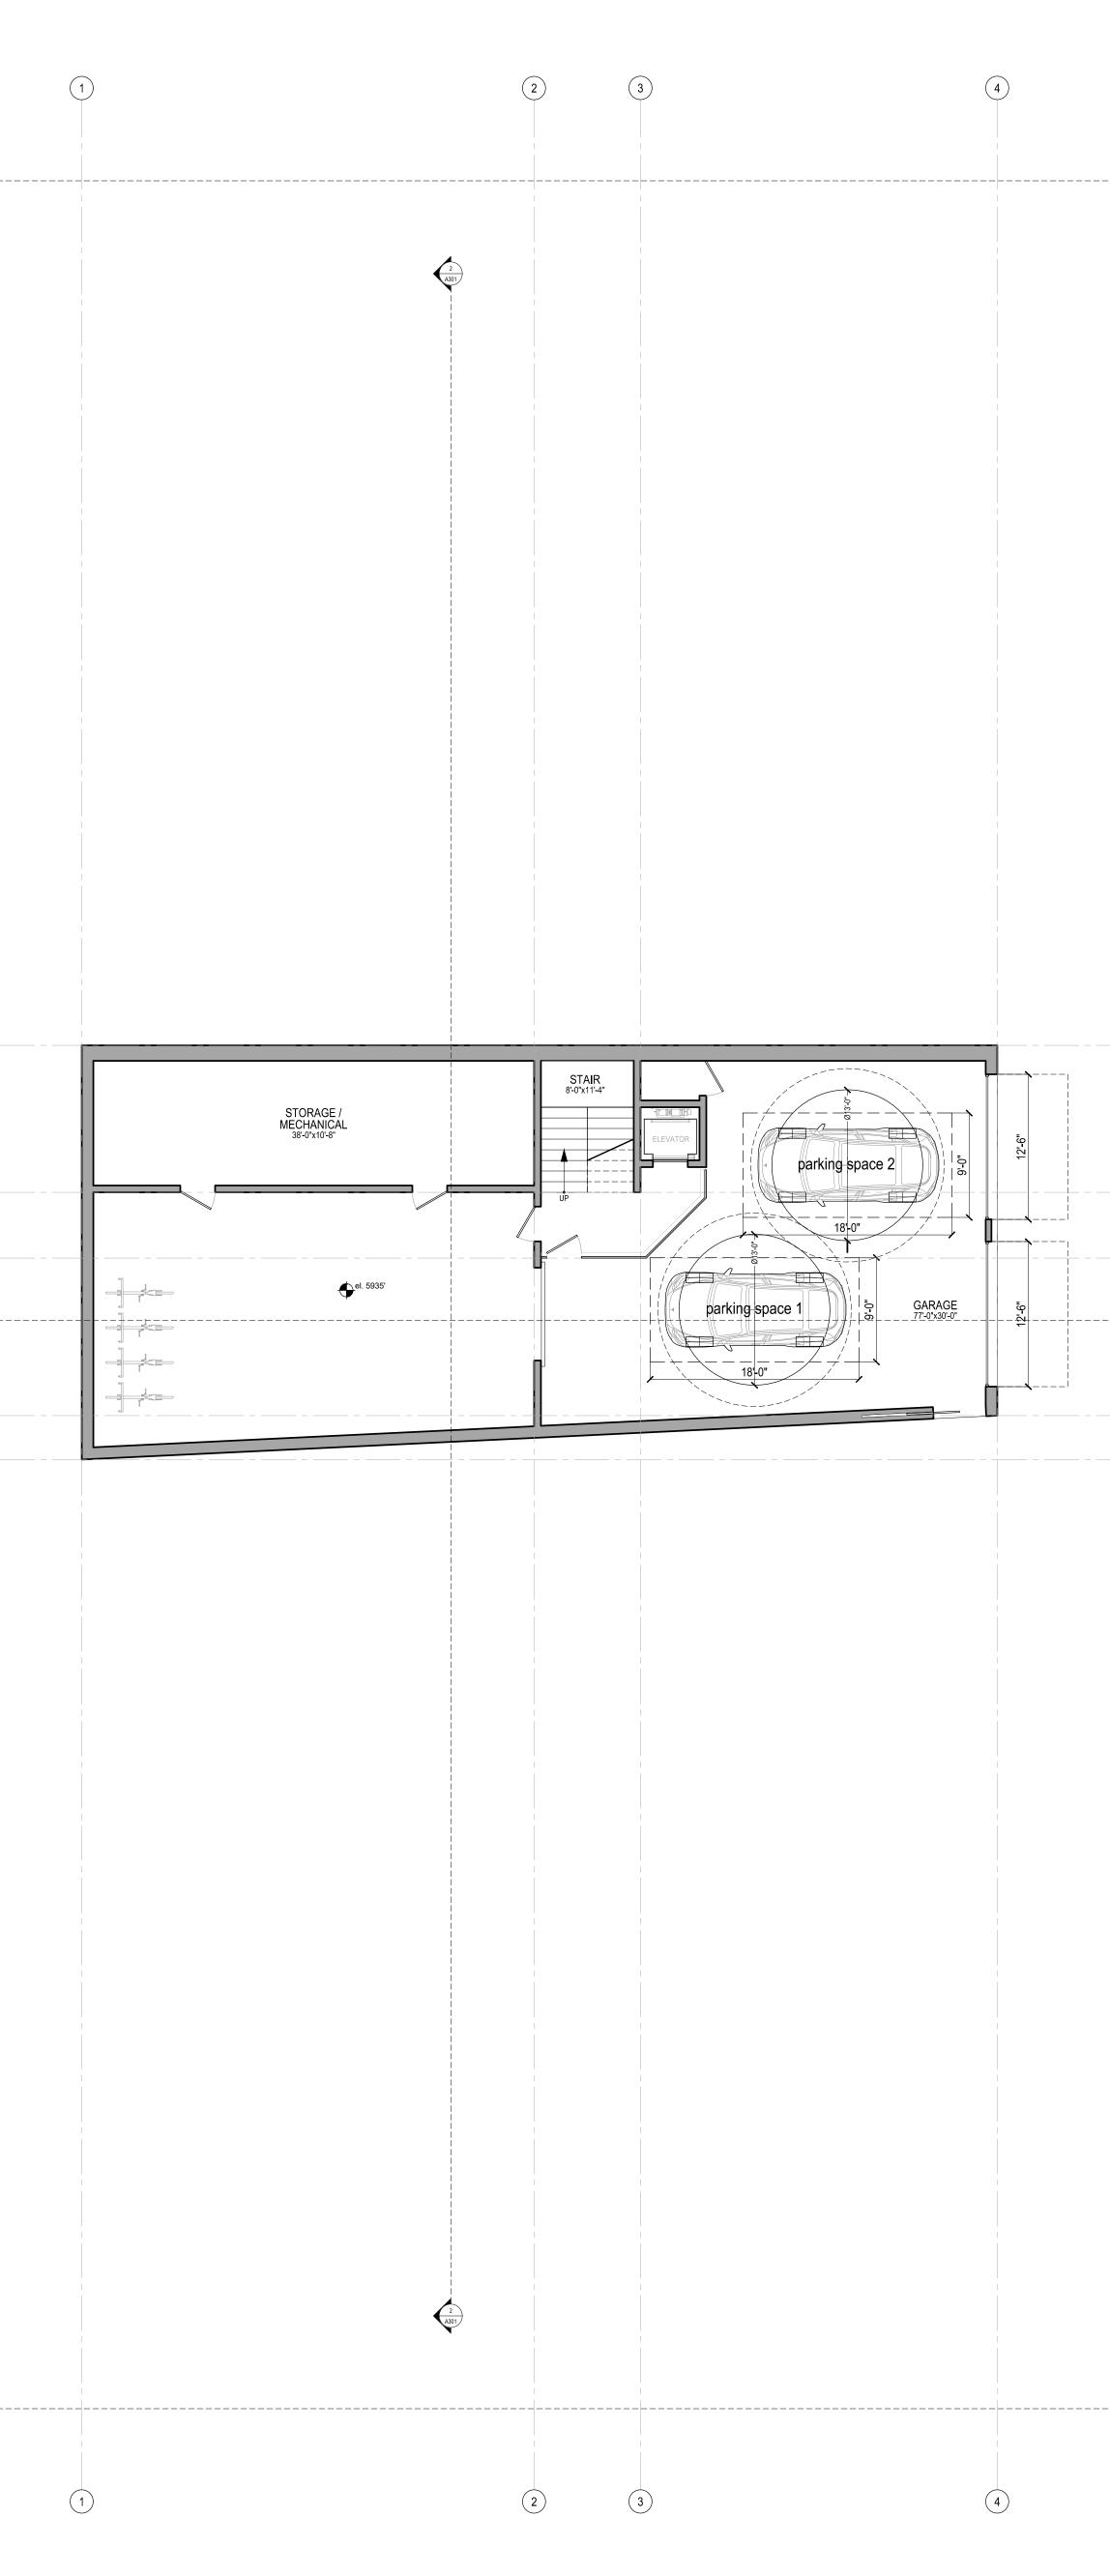

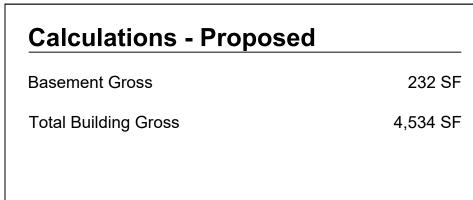

- 1 A202

 $\left(\begin{array}{c} 2\\ A201 \end{array}\right)$

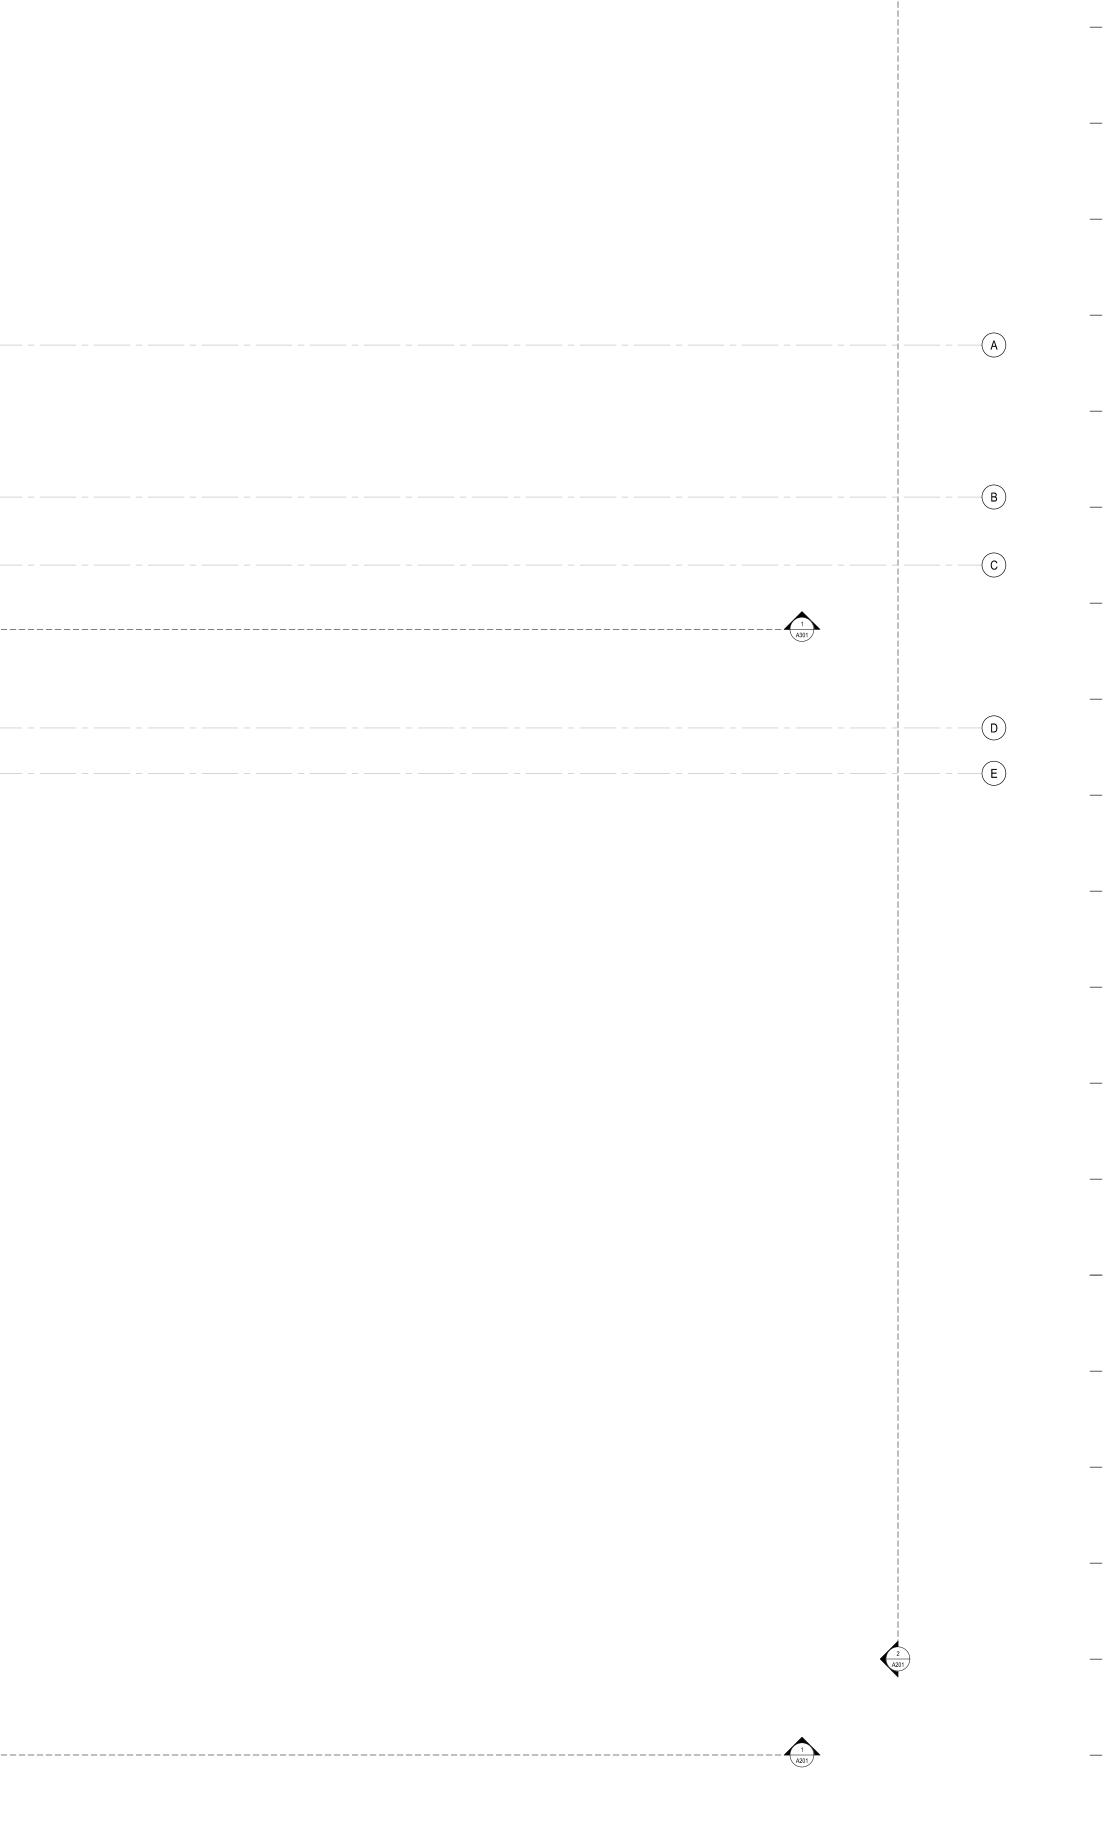

56'

40'

24'

16' 2

Residence 691 North Spruce Ave. Ketchum, ID 83340

—

Architect **Roger Ferris + Partners** 11 Wilton Road • Westport, Connecticut 06880 tel. 203.222.4848 • www.ferrisarch.com

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Landscape Architect BYLA Landscape Architects 323 Lewis Street, Suite N • Ketchum, ID 83340 tel. 208.726.5907 • www.byla.us

ARCHITECT'S SEAL LICENSED ARCHITECT AR 986985 OGER P FERRI STATE OF IDAHO

KEY PLAN

PROJECT PHASE - PERMITTING


REVISIONS

NO.	DESCRIPTION	DATE	ISSUED TO
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2	MODR - REV #1	JUNE 16, 2022	CITY
3	MODR - REV #2	AUGUST 26, 2022	CITY
4	MODR - REV #3	OCTOBER 6, 2022	CITY
5	MODR - REV#4	OCTOBER 11, 2022	CITY


SHEET NAME

BASEMENT PLAN


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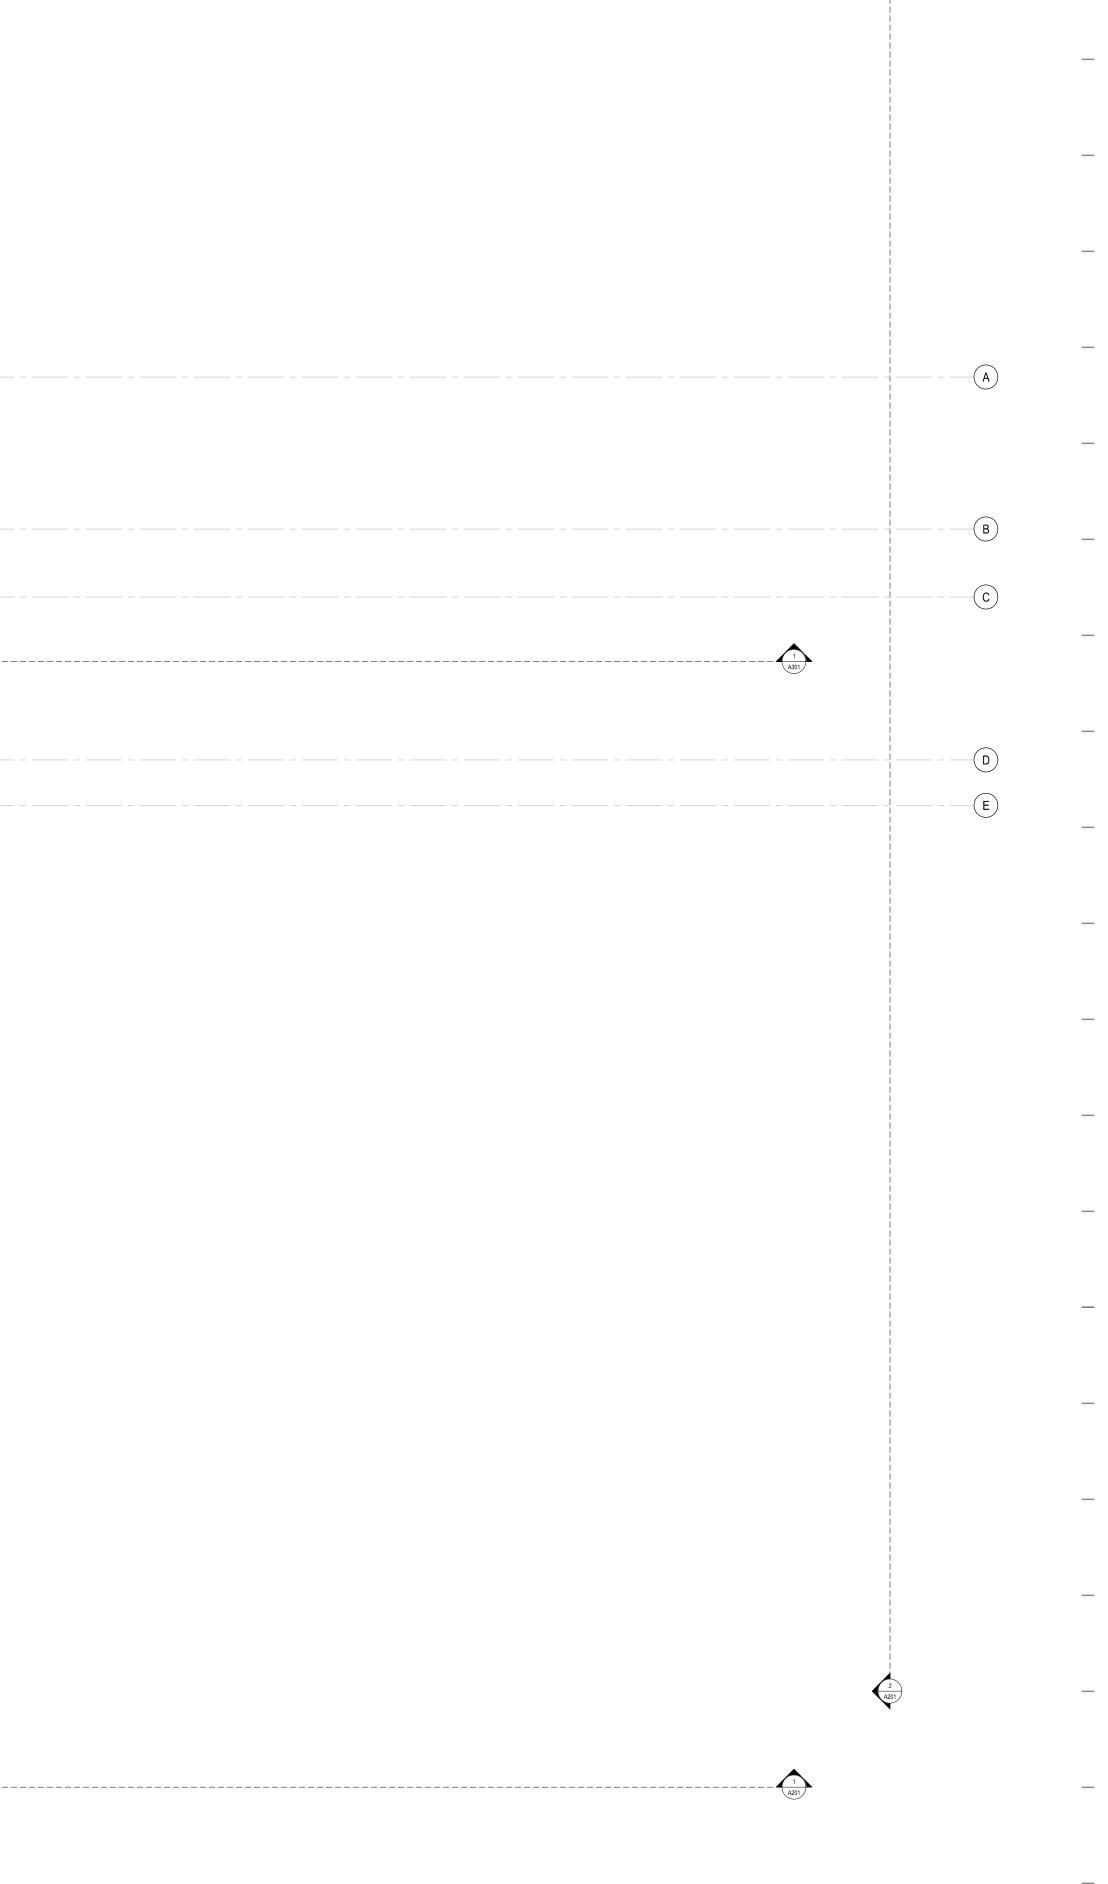


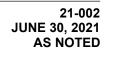

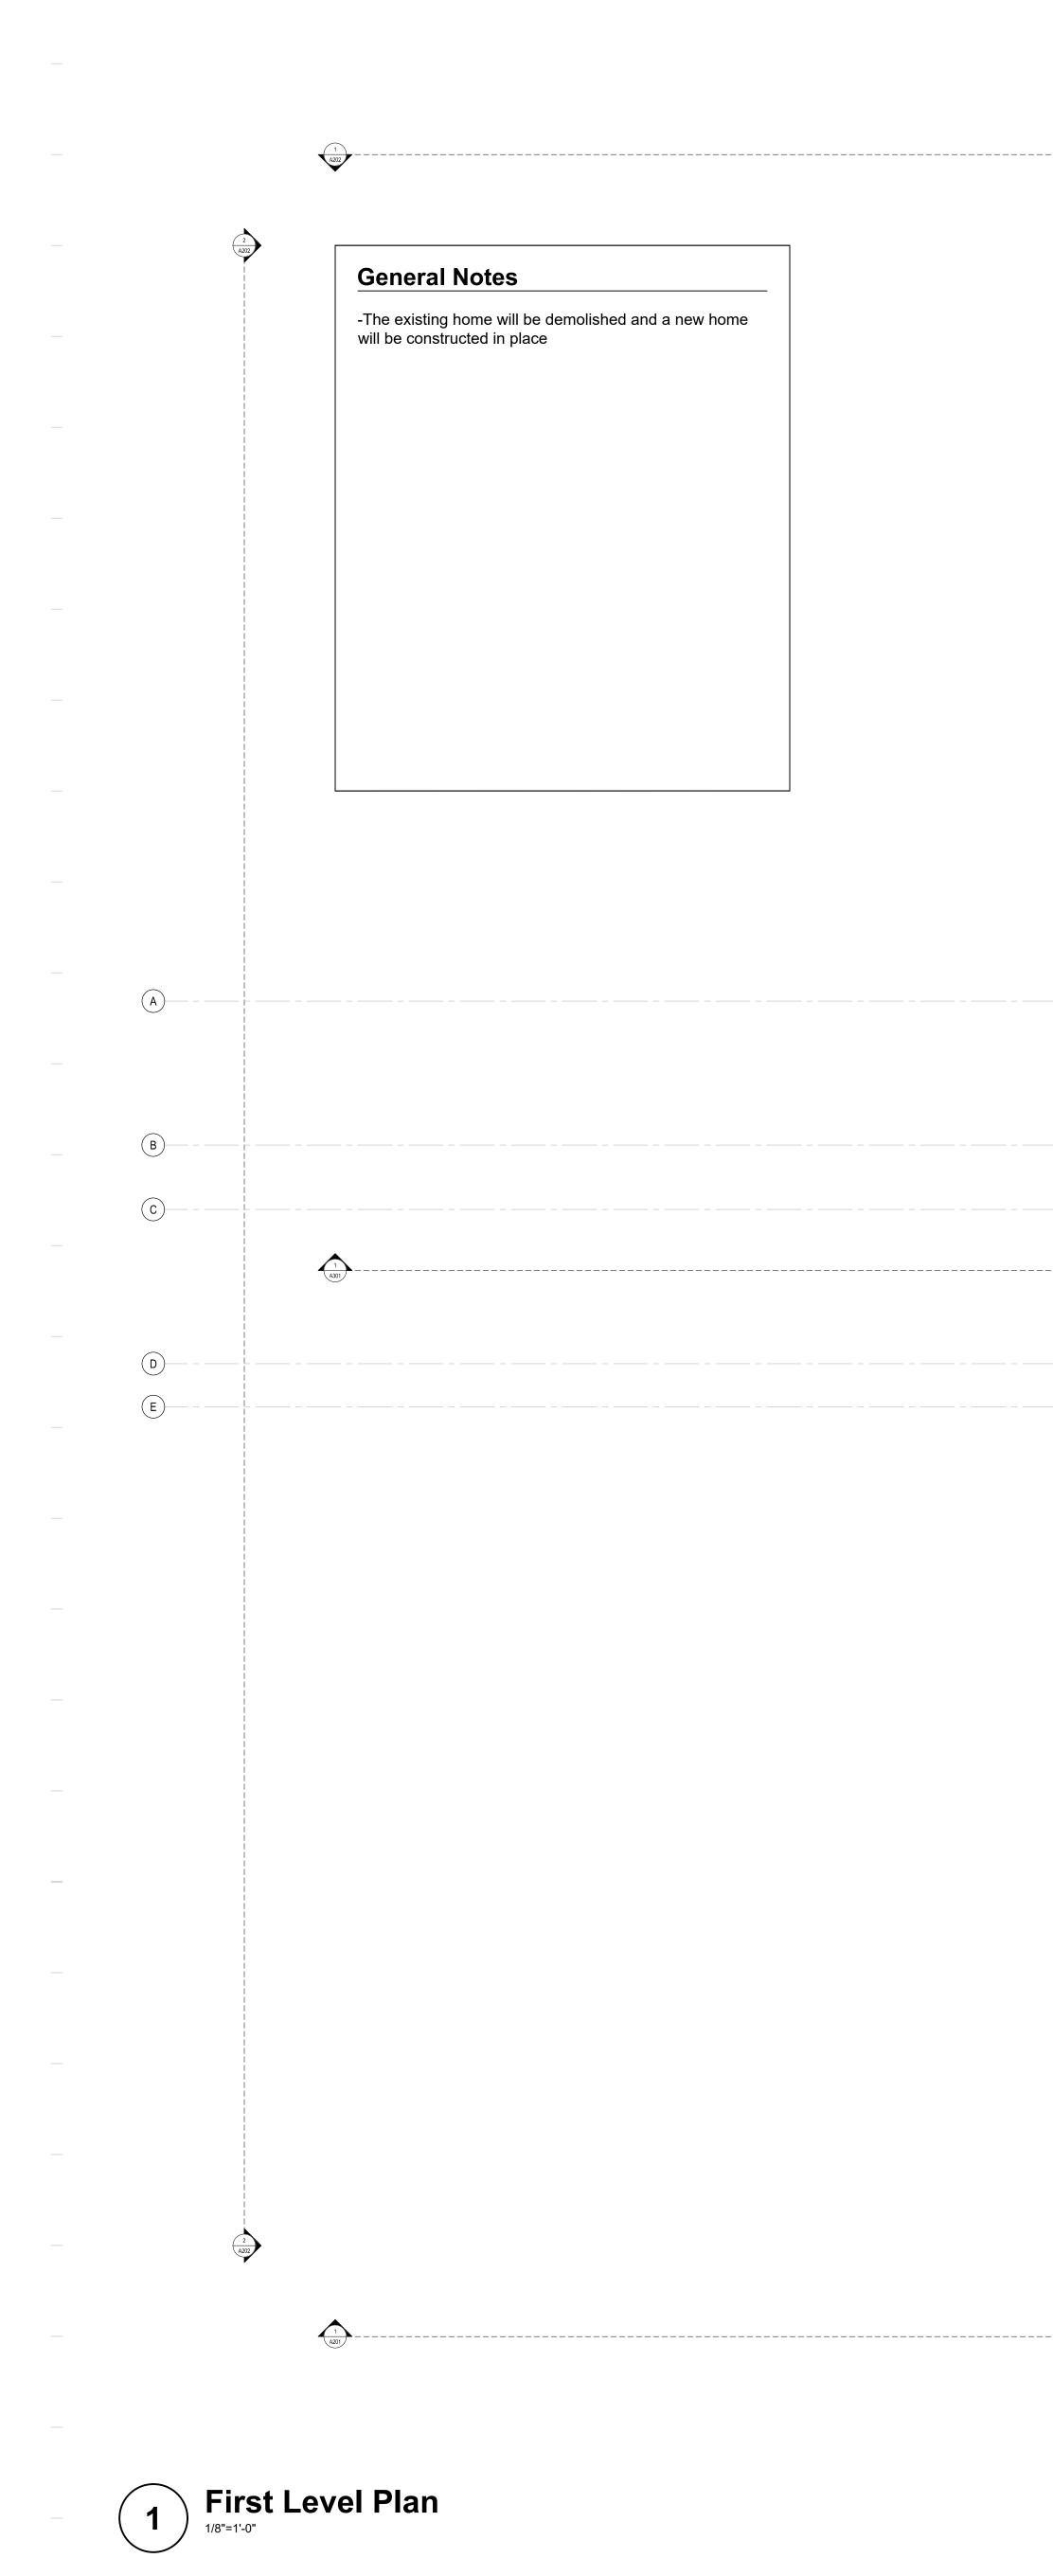

- 1 A202

 $\left(\begin{array}{c}2\\A201\end{array}\right)$

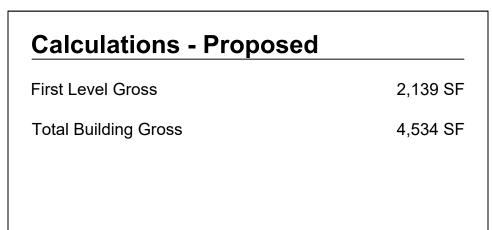

•

40'

16' 24'

Residence 691 North Spruce Ave. Ketchum, ID 83340

—

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ARCHITECT'S SEAL LICENSED ARCHITECT AR 986985 OGER P FER STATE OF IDAHC

KEY PLAN

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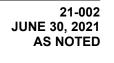
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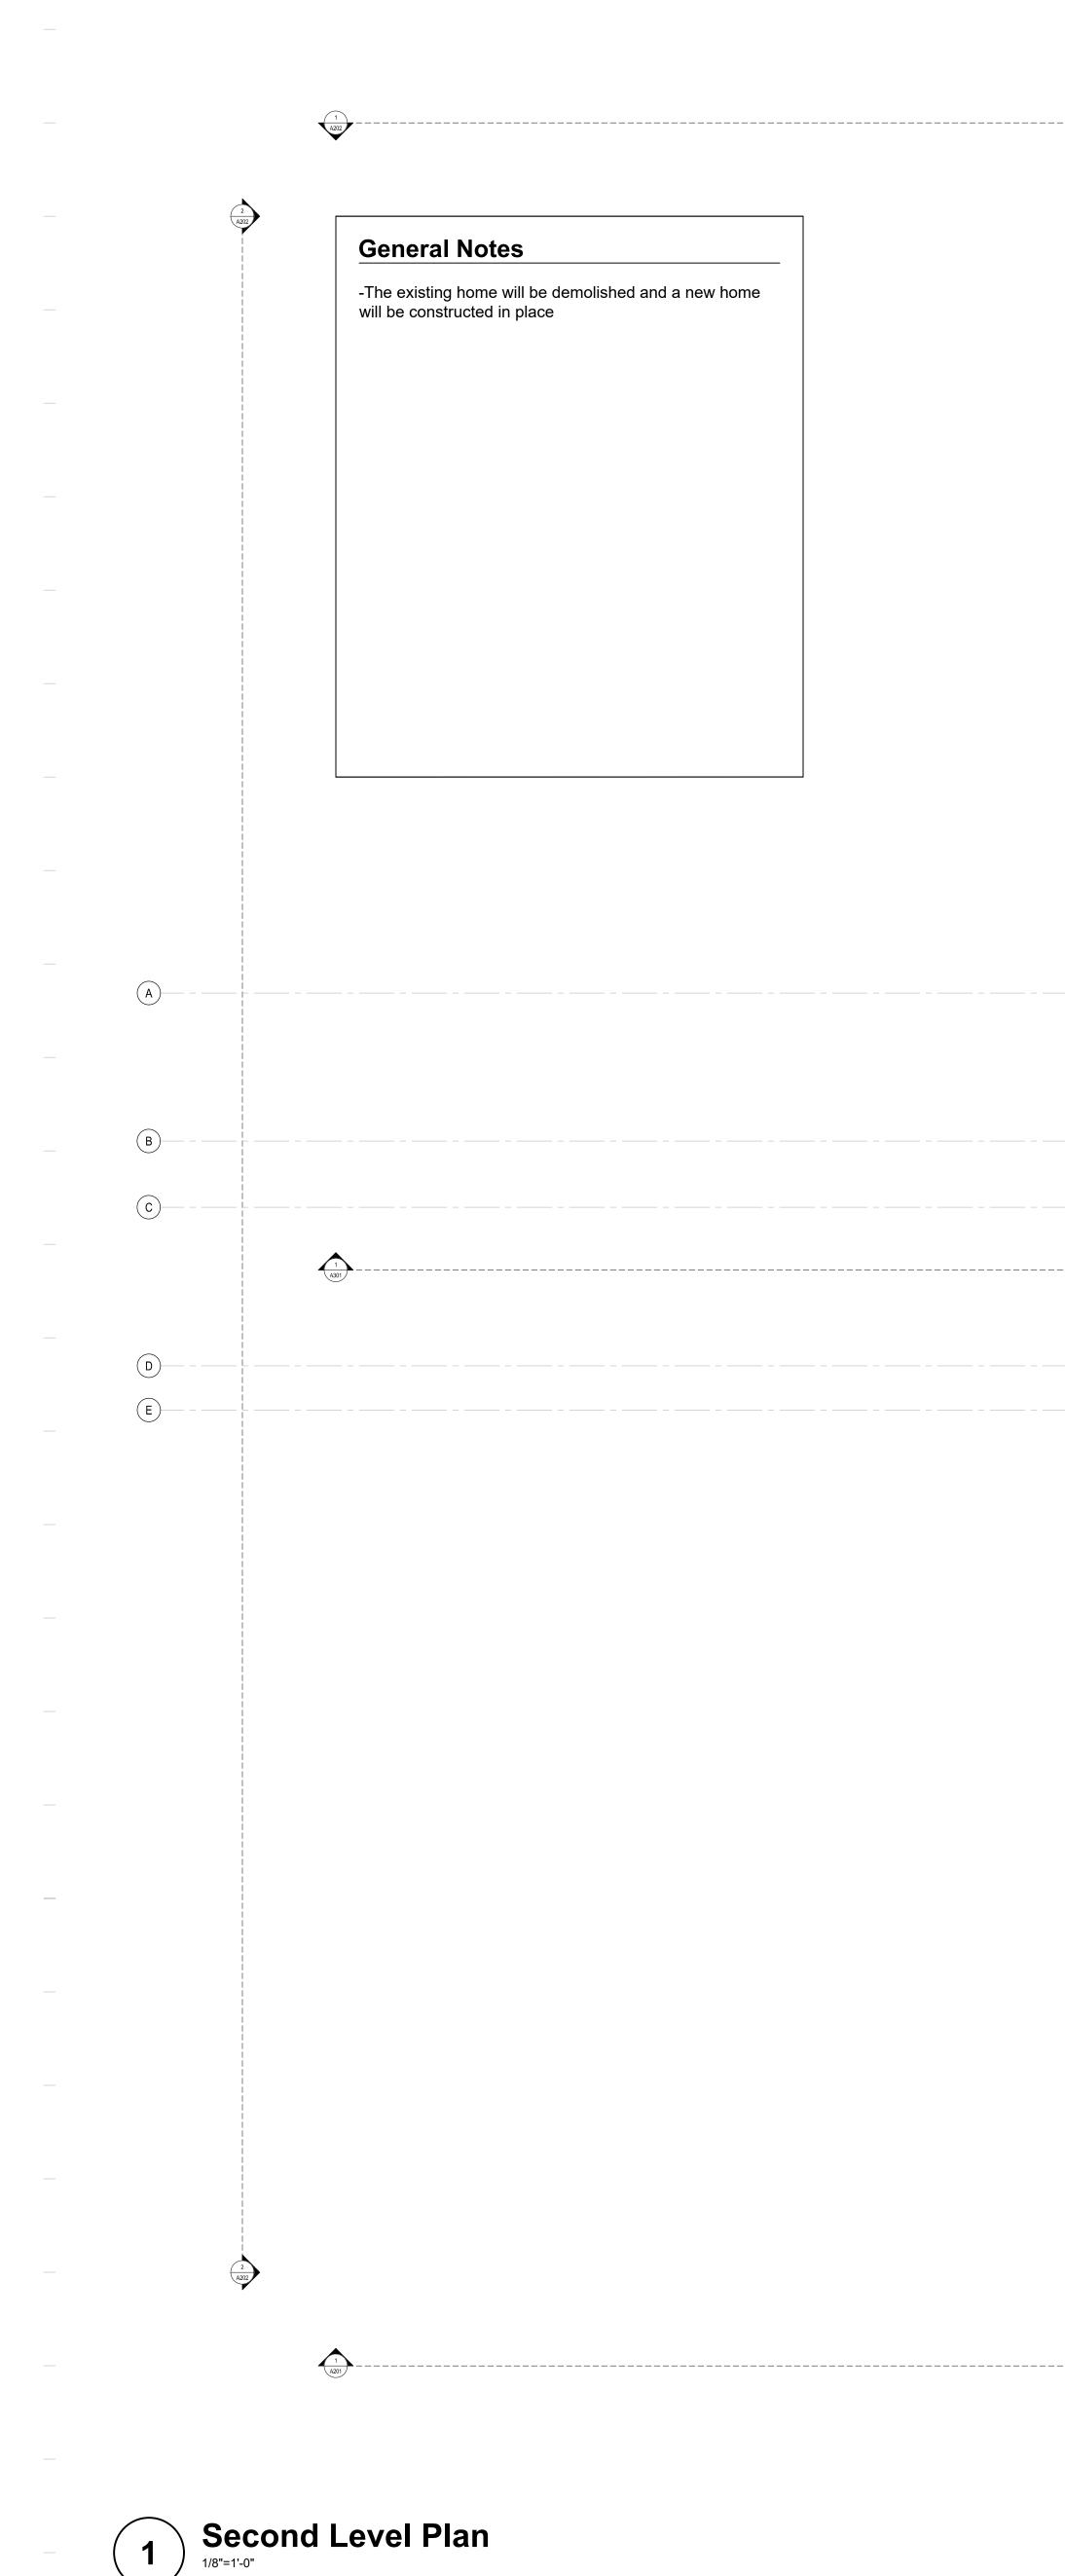
SHEET NAME

FIRST LEVEL PLAN


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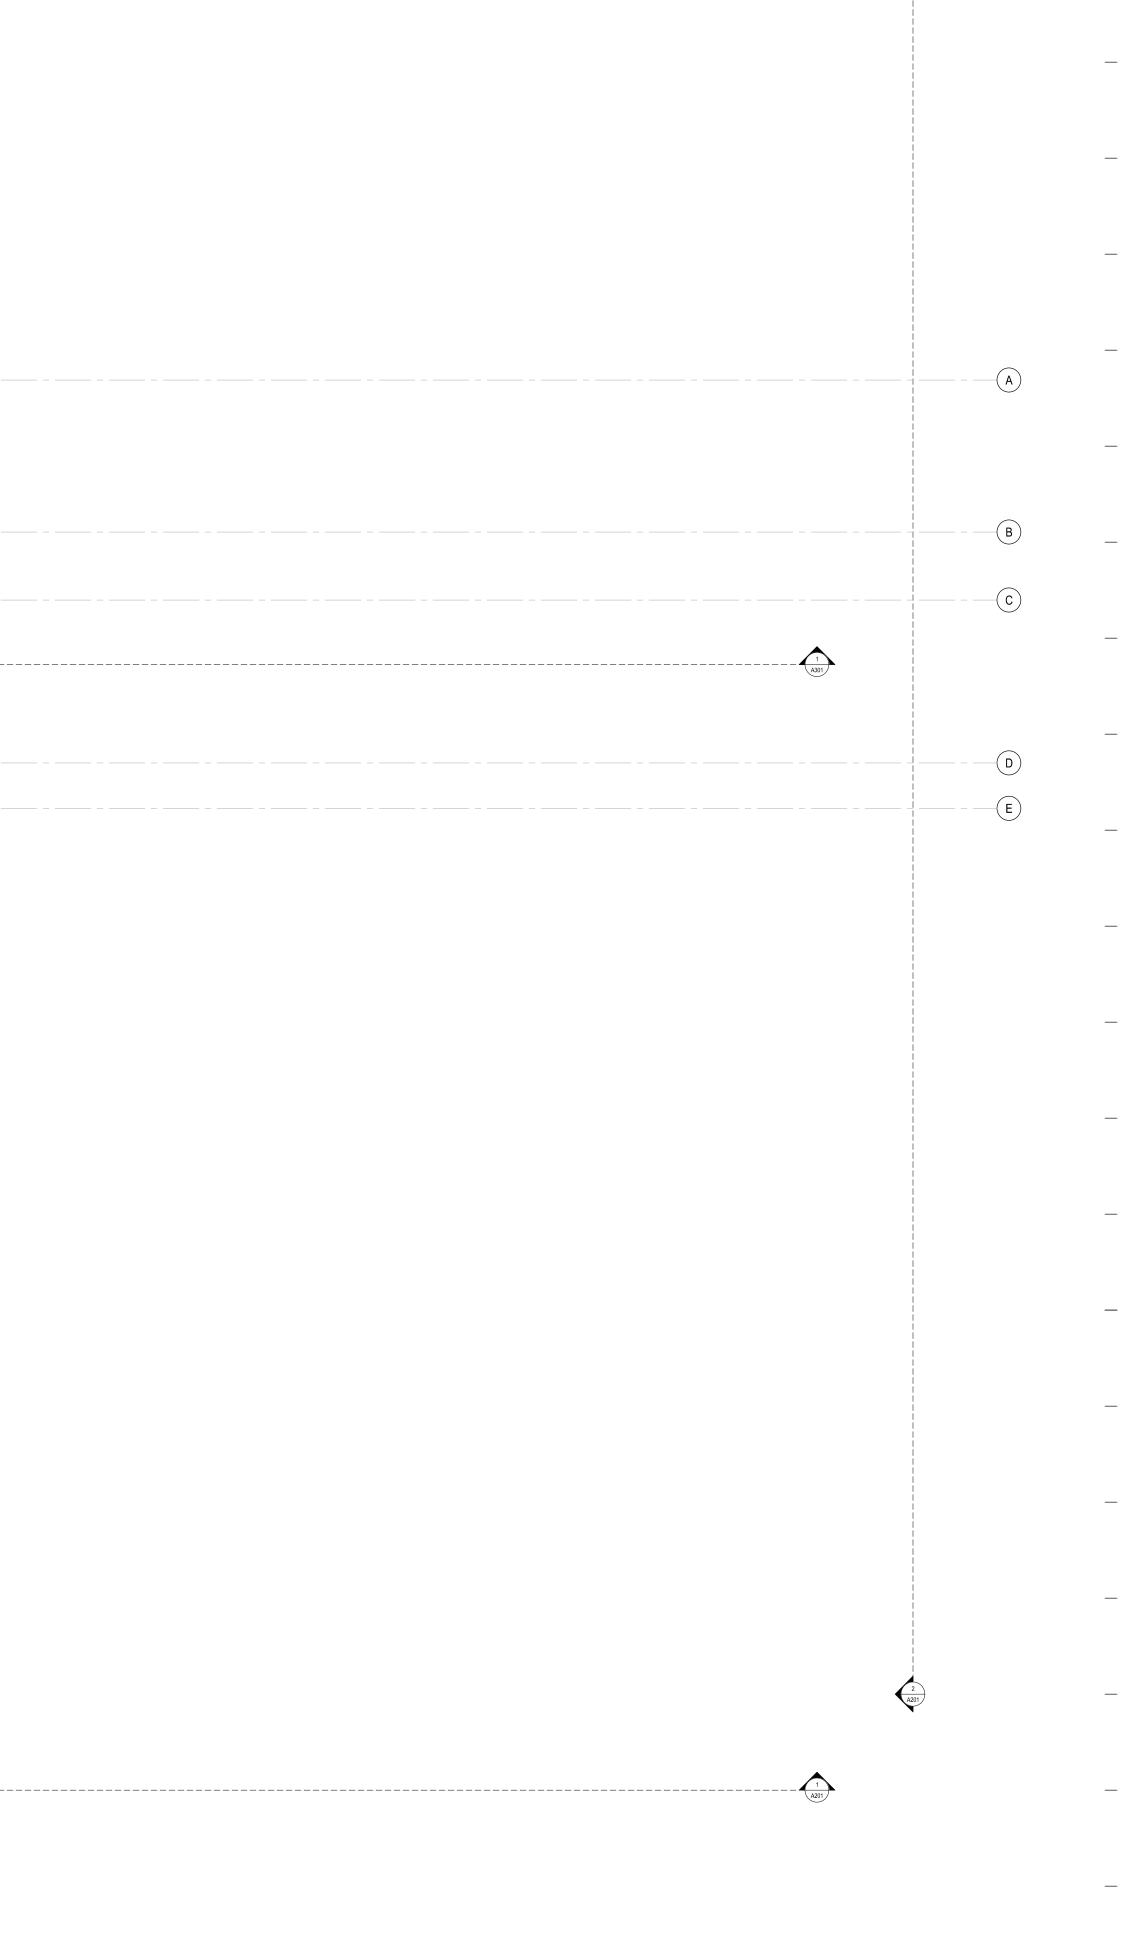







- 1 A202

 $\left(\begin{array}{c}2\\A201\end{array}\right)$

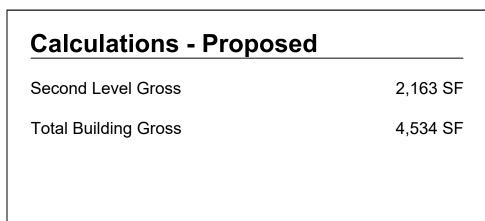

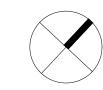

56'

40'

16' 24'

Residence 691 North Spruce Ave. Ketchum, ID 83340

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KEY PLAN

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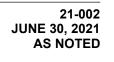
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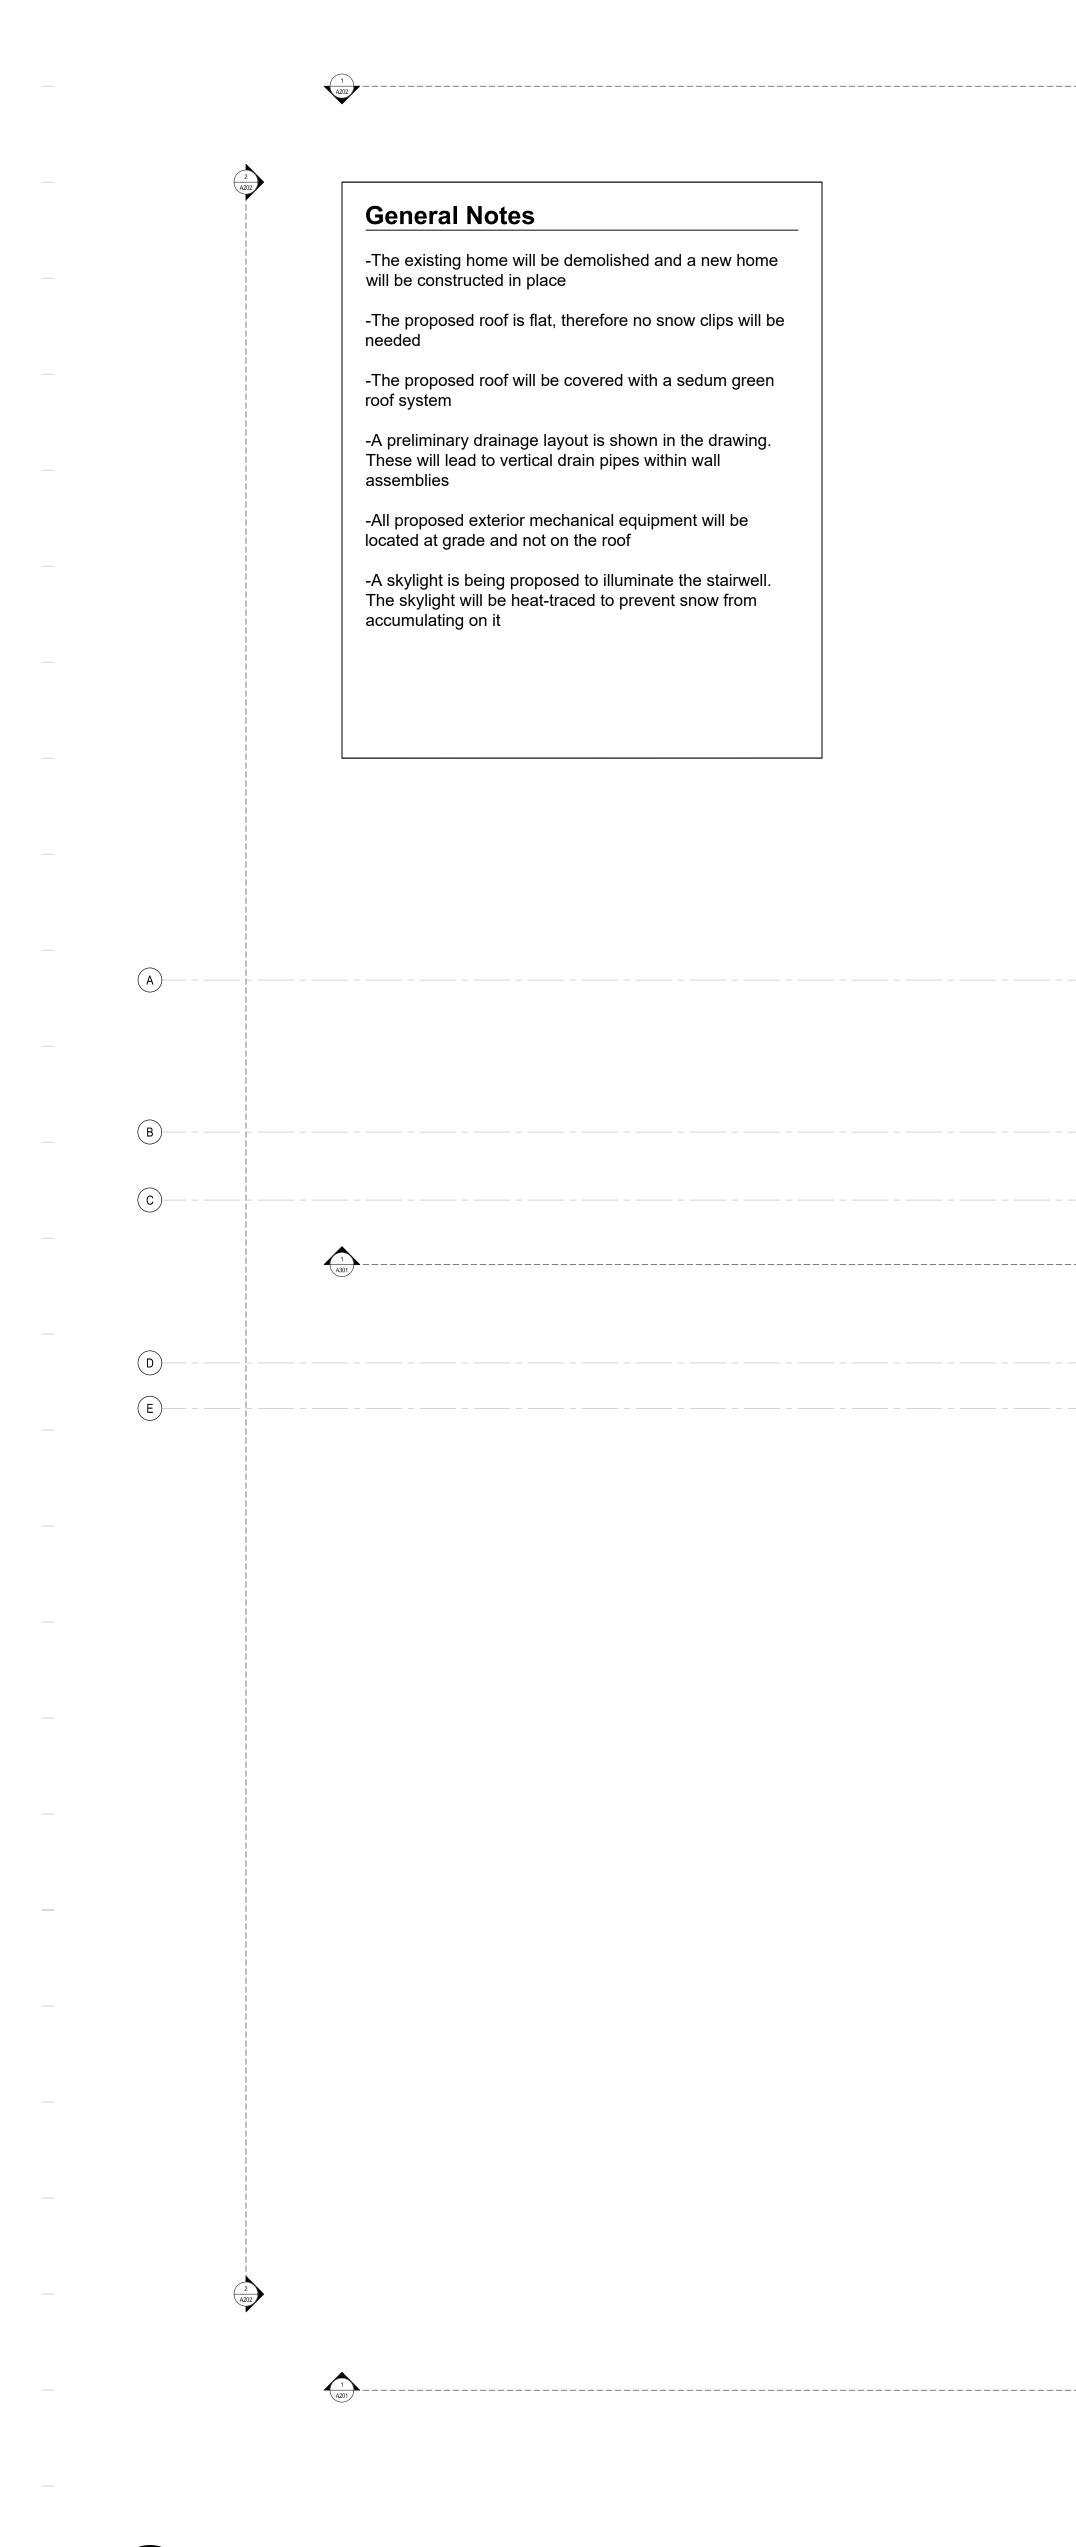
SHEET NAME

SECOND LEVEL PLAN


PROJECT NUMBER: DATE: SCALE:









1 Roof Plan

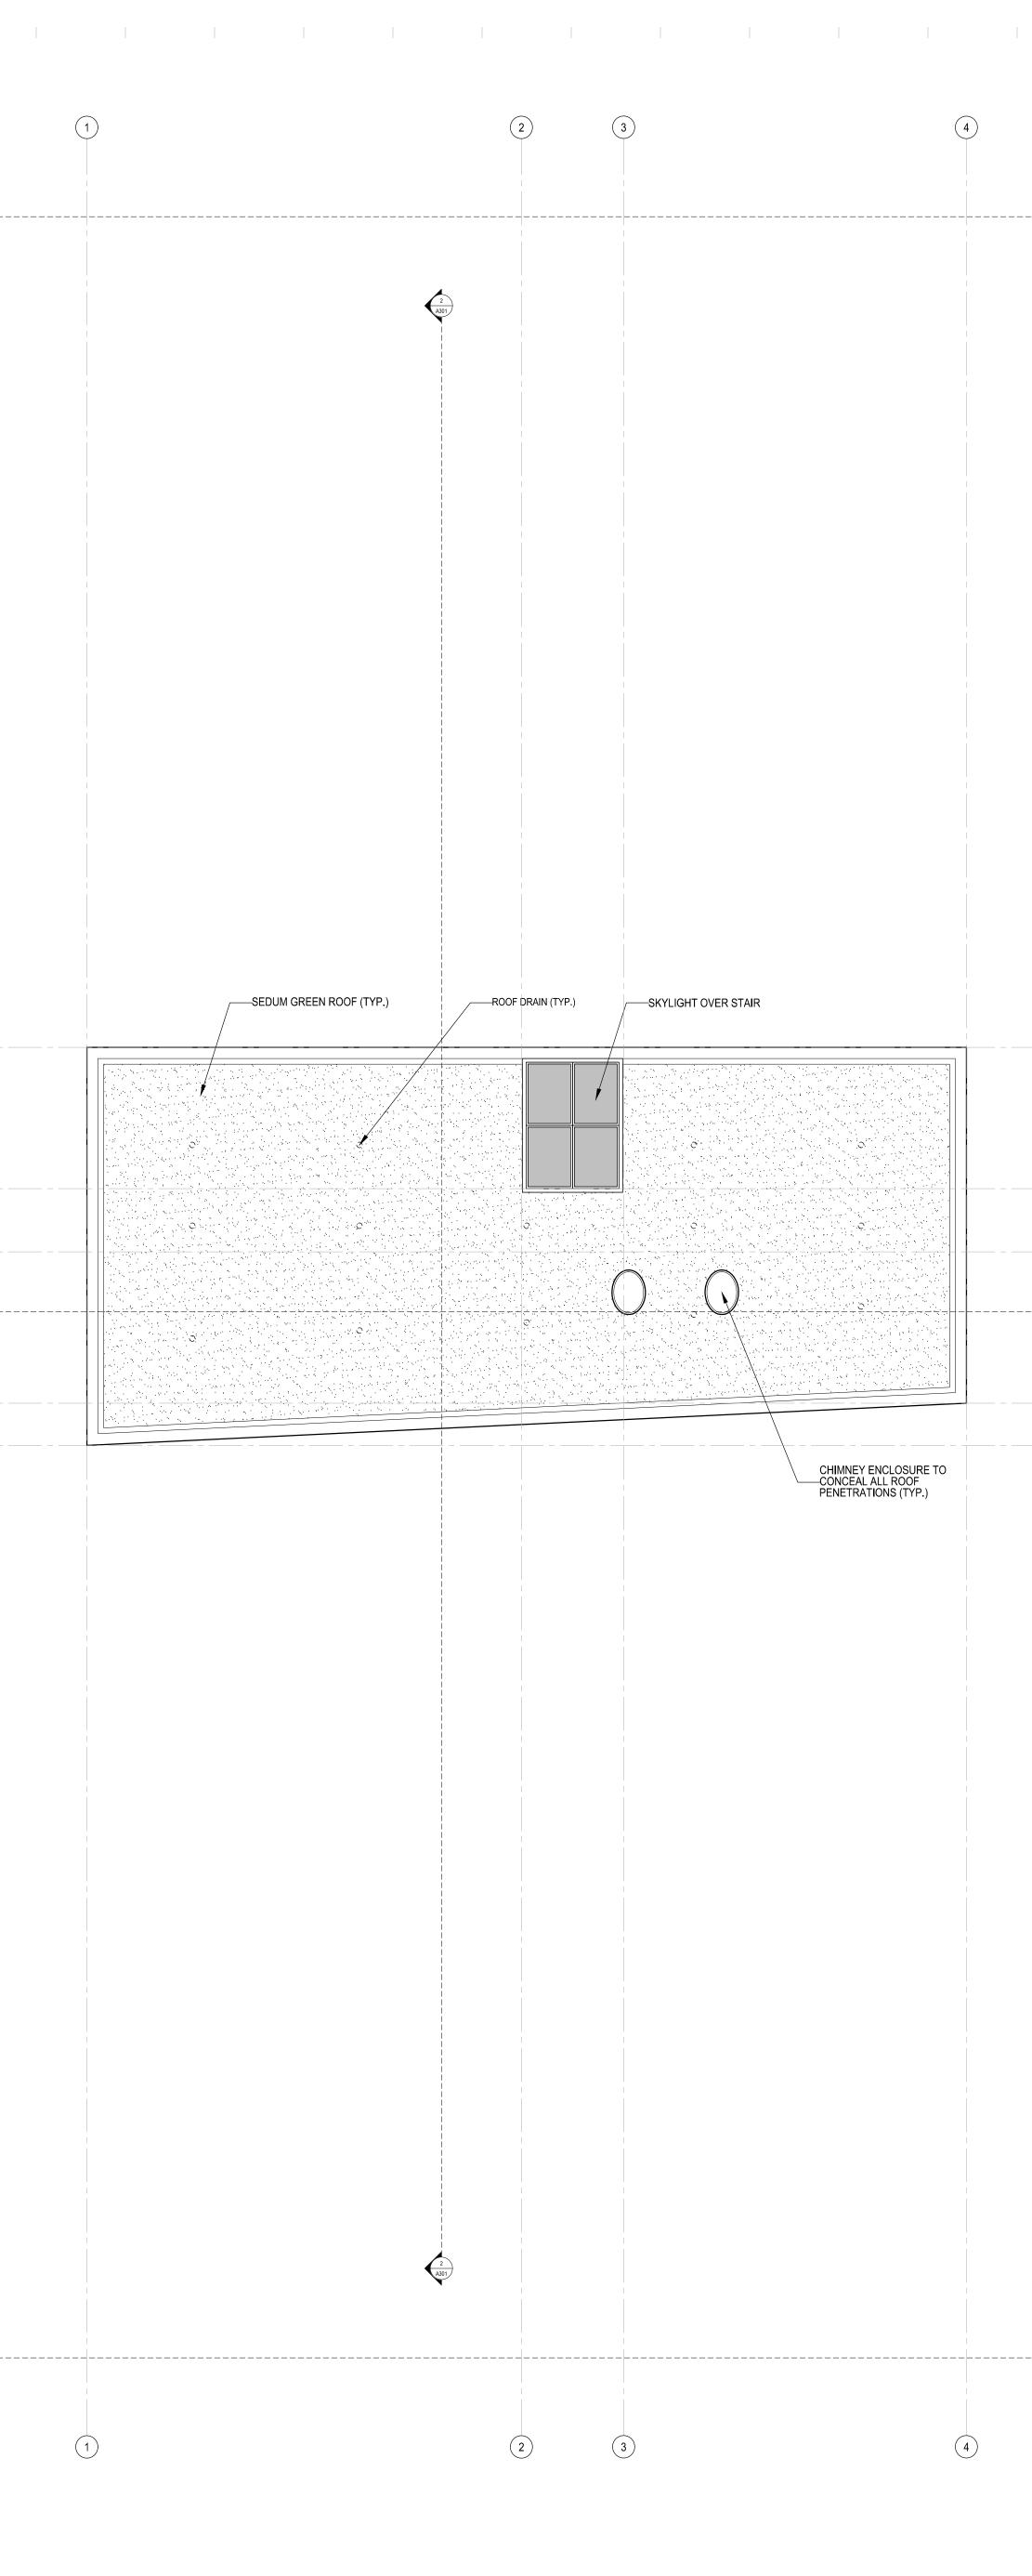

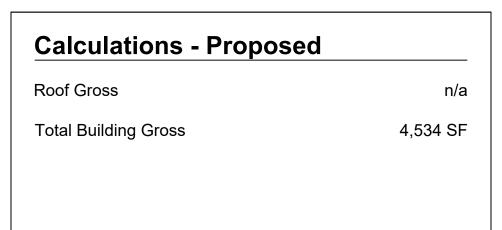

- 1 A202

 $\begin{pmatrix} 2 \\ A201 \end{pmatrix}$

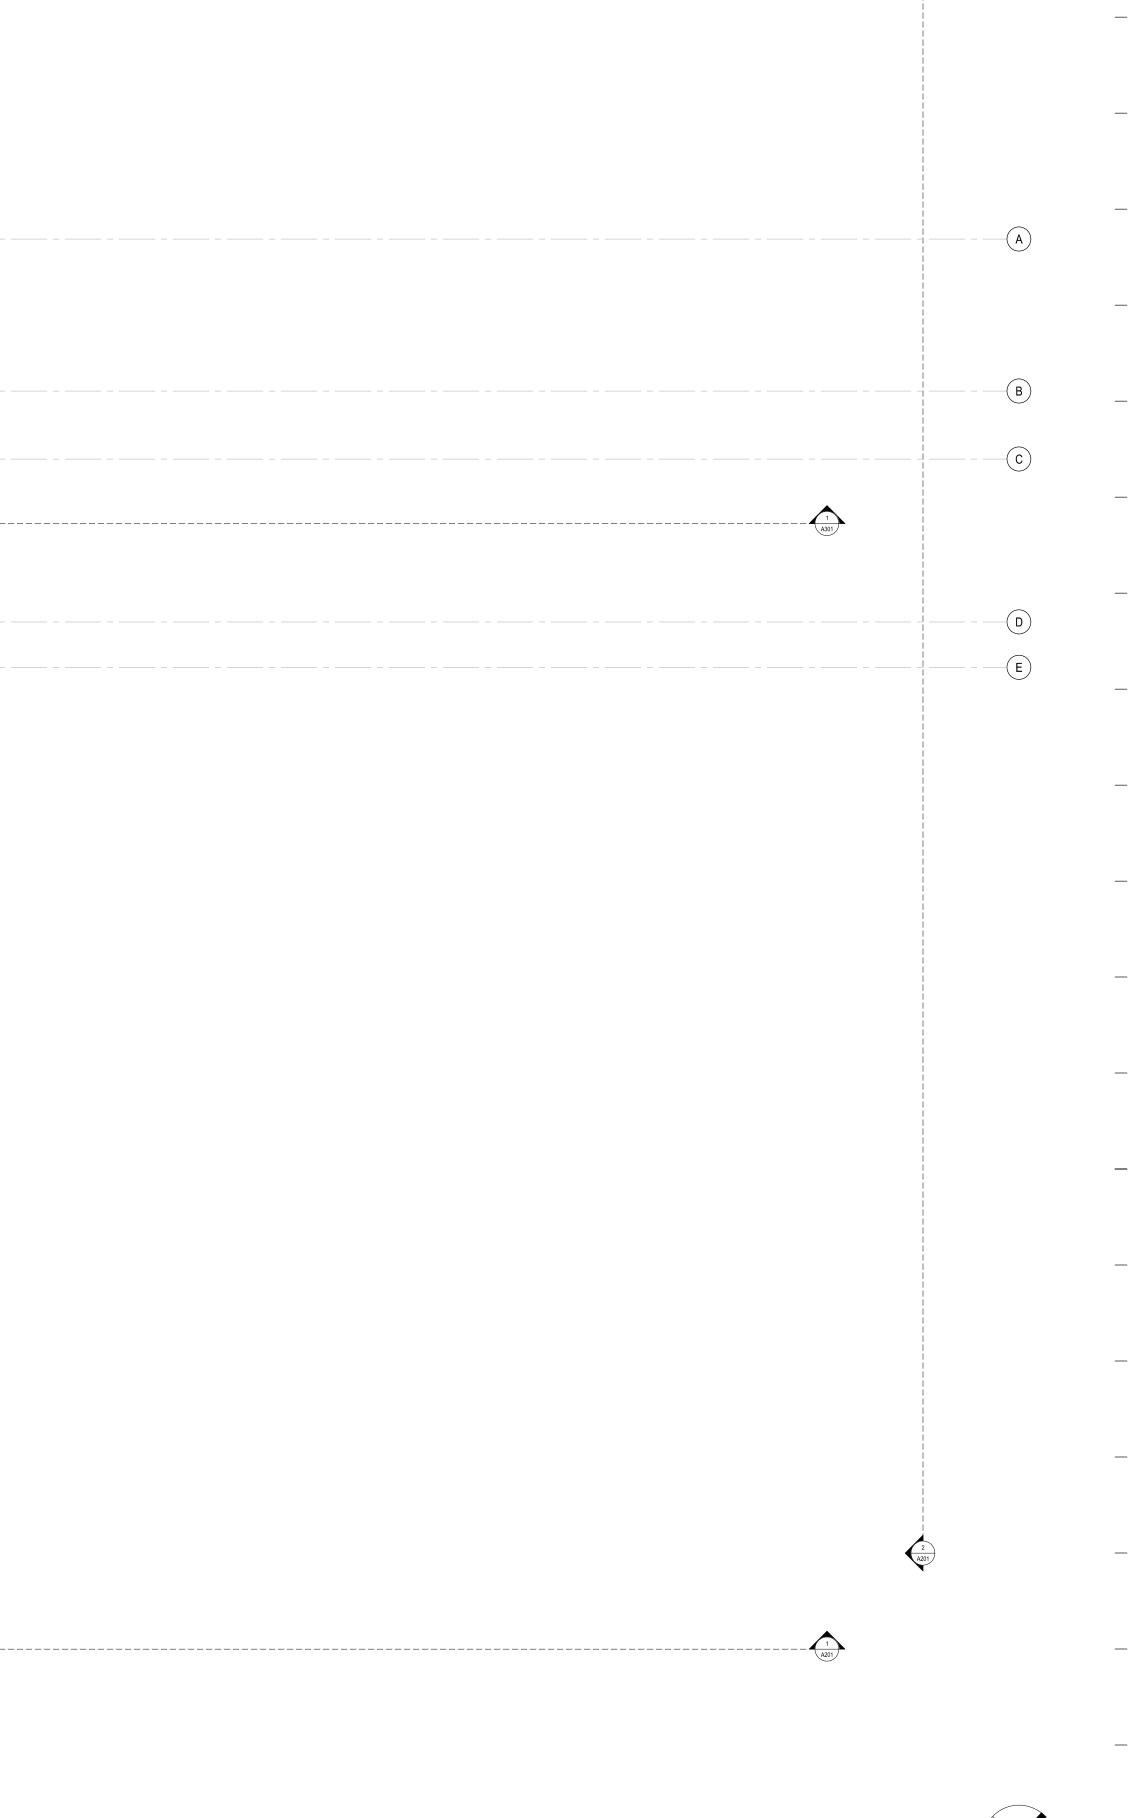

56'

40'

16' 24'

Residence 691 North Spruce Ave. Ketchum, ID 83340

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ARCHITECT'S SEAL LICENSED ARCHITECT AR 986985 OGER P FERRI STATE OF IDAHO

KEY PLAN

PROJECT PHASE - PERMITTING


REVISIONS

NO.	DESCRIPTION	DATE	ISSUED TO
1	MODR - REV #1	JUNE 16, 2022	CITY
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3	MODR - REV #3	OCTOBER 6, 2022	CITY
4	MODR - REV#4	OCTOBER 11, 2022	CITY

SHEET NAME


ROOF PLAN


PROJECT NUMBER: DATE: SCALE:

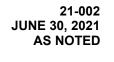





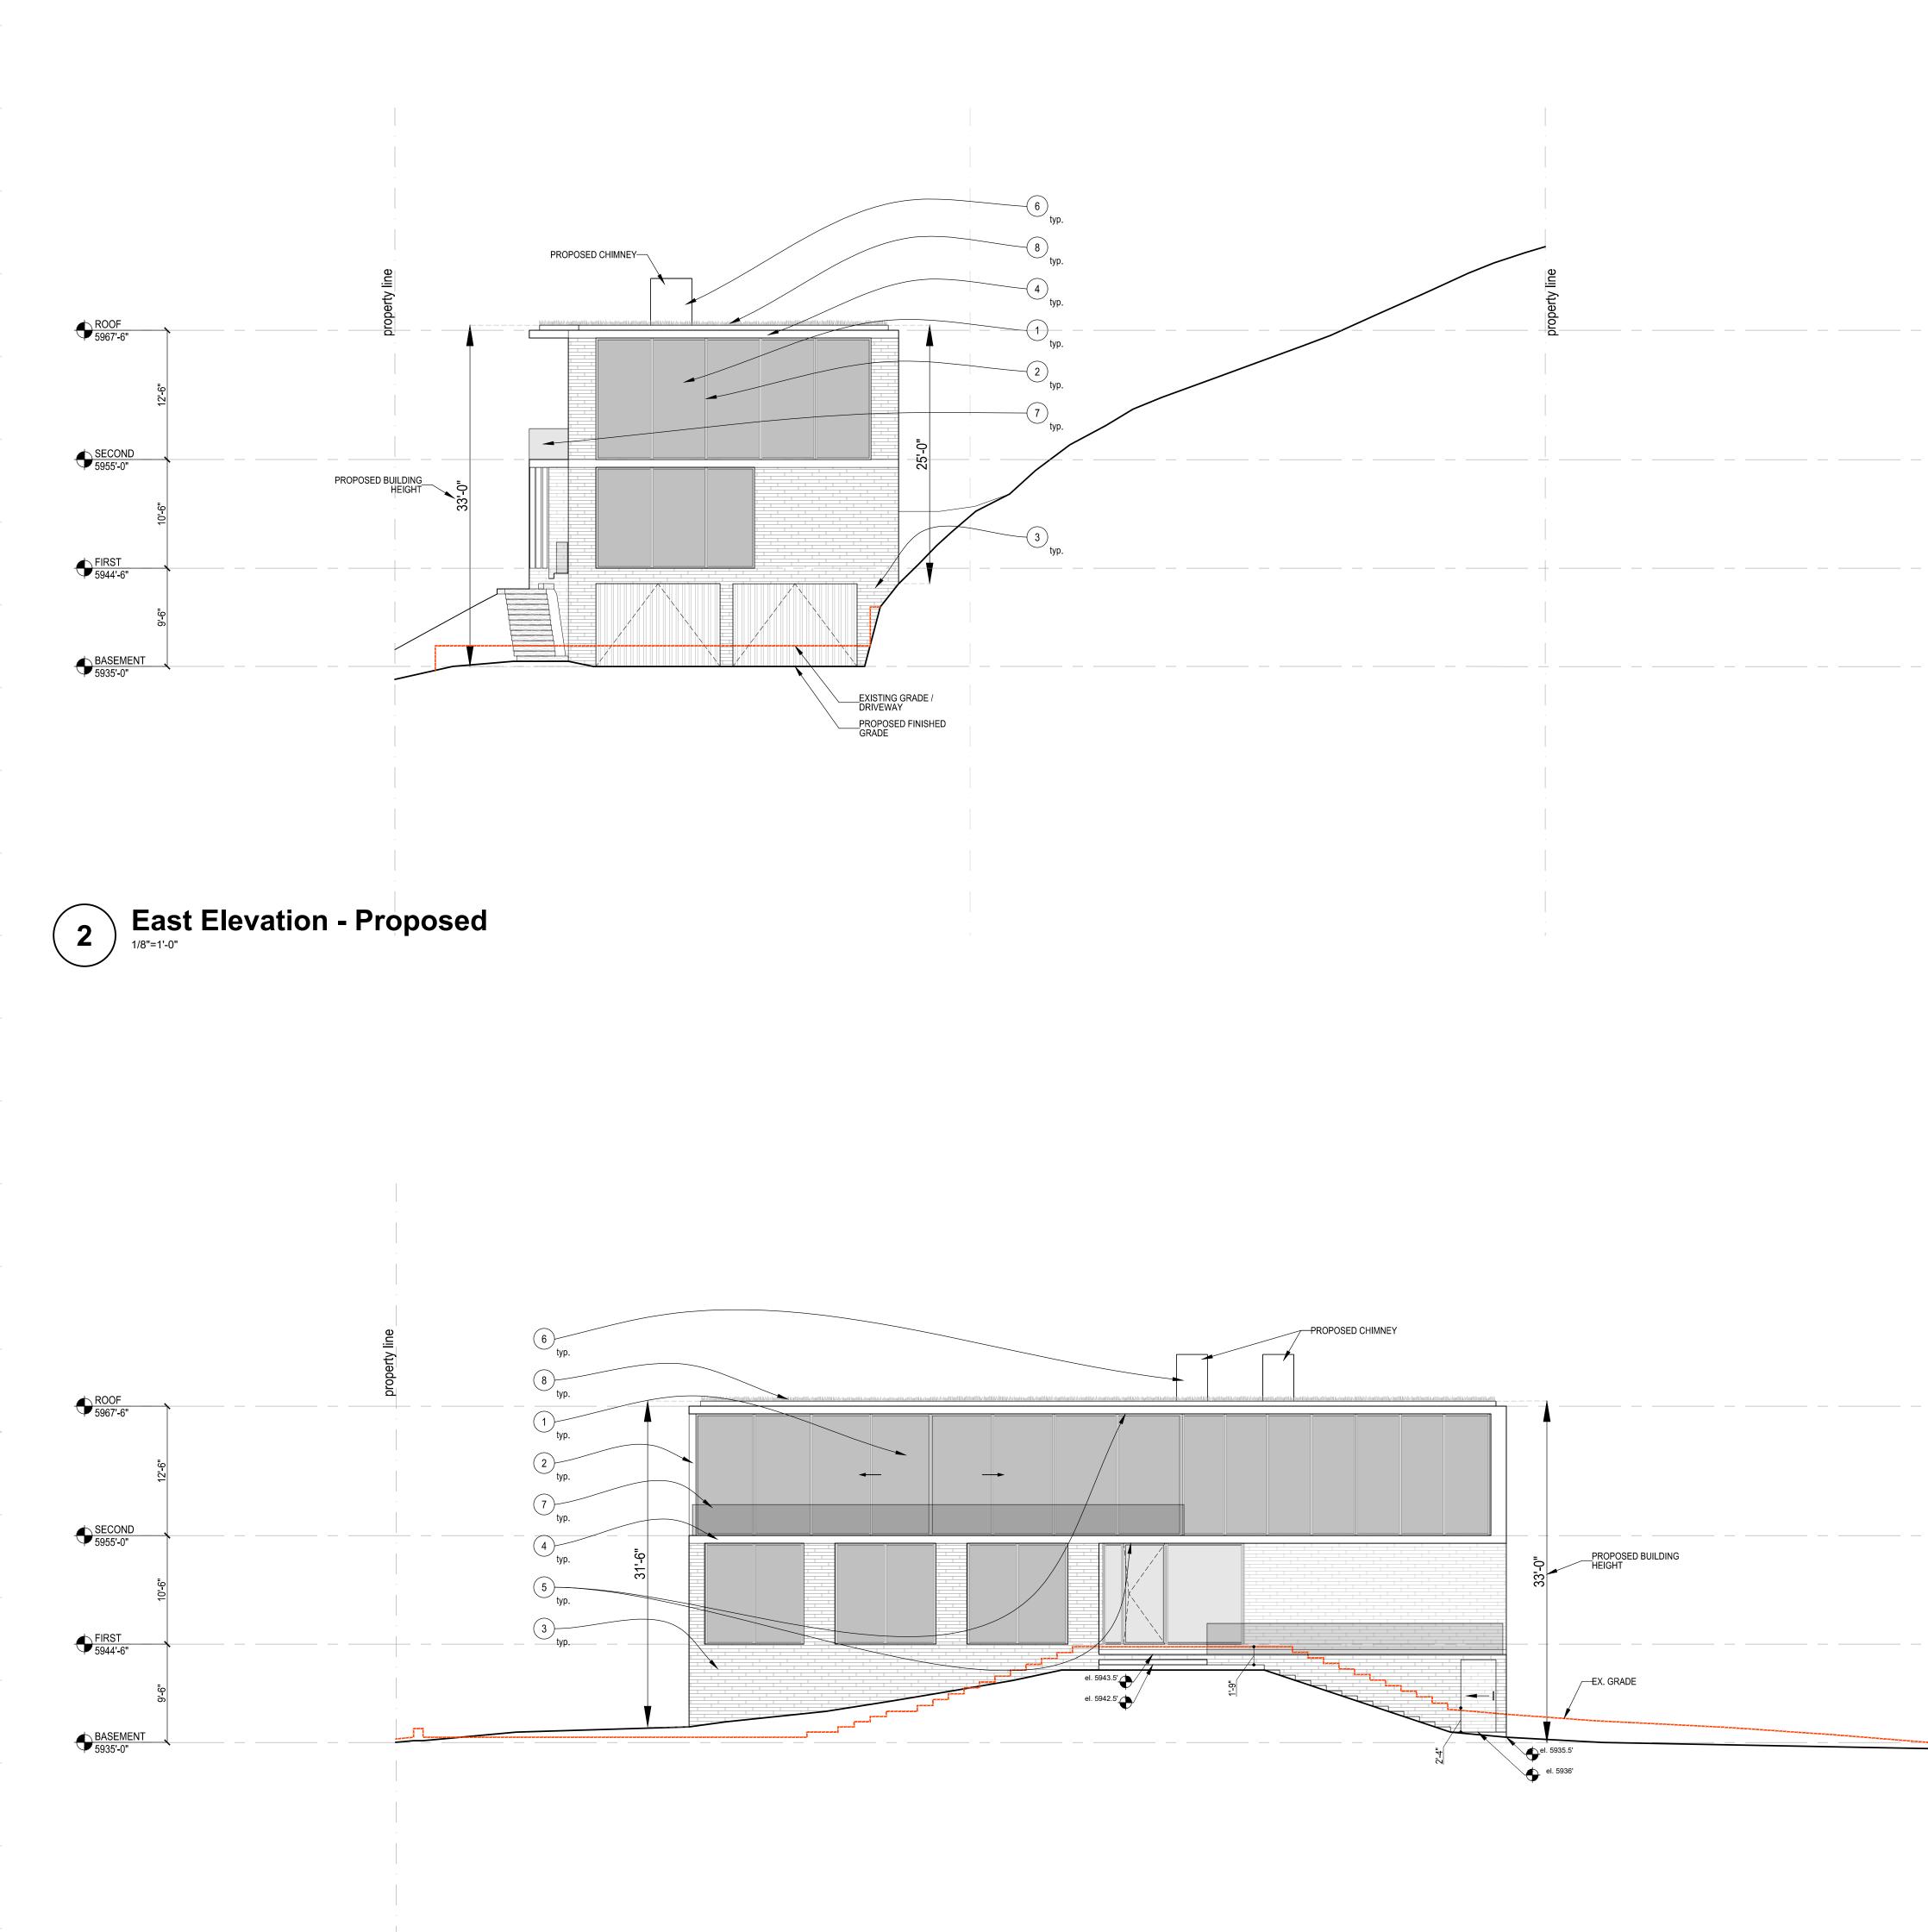

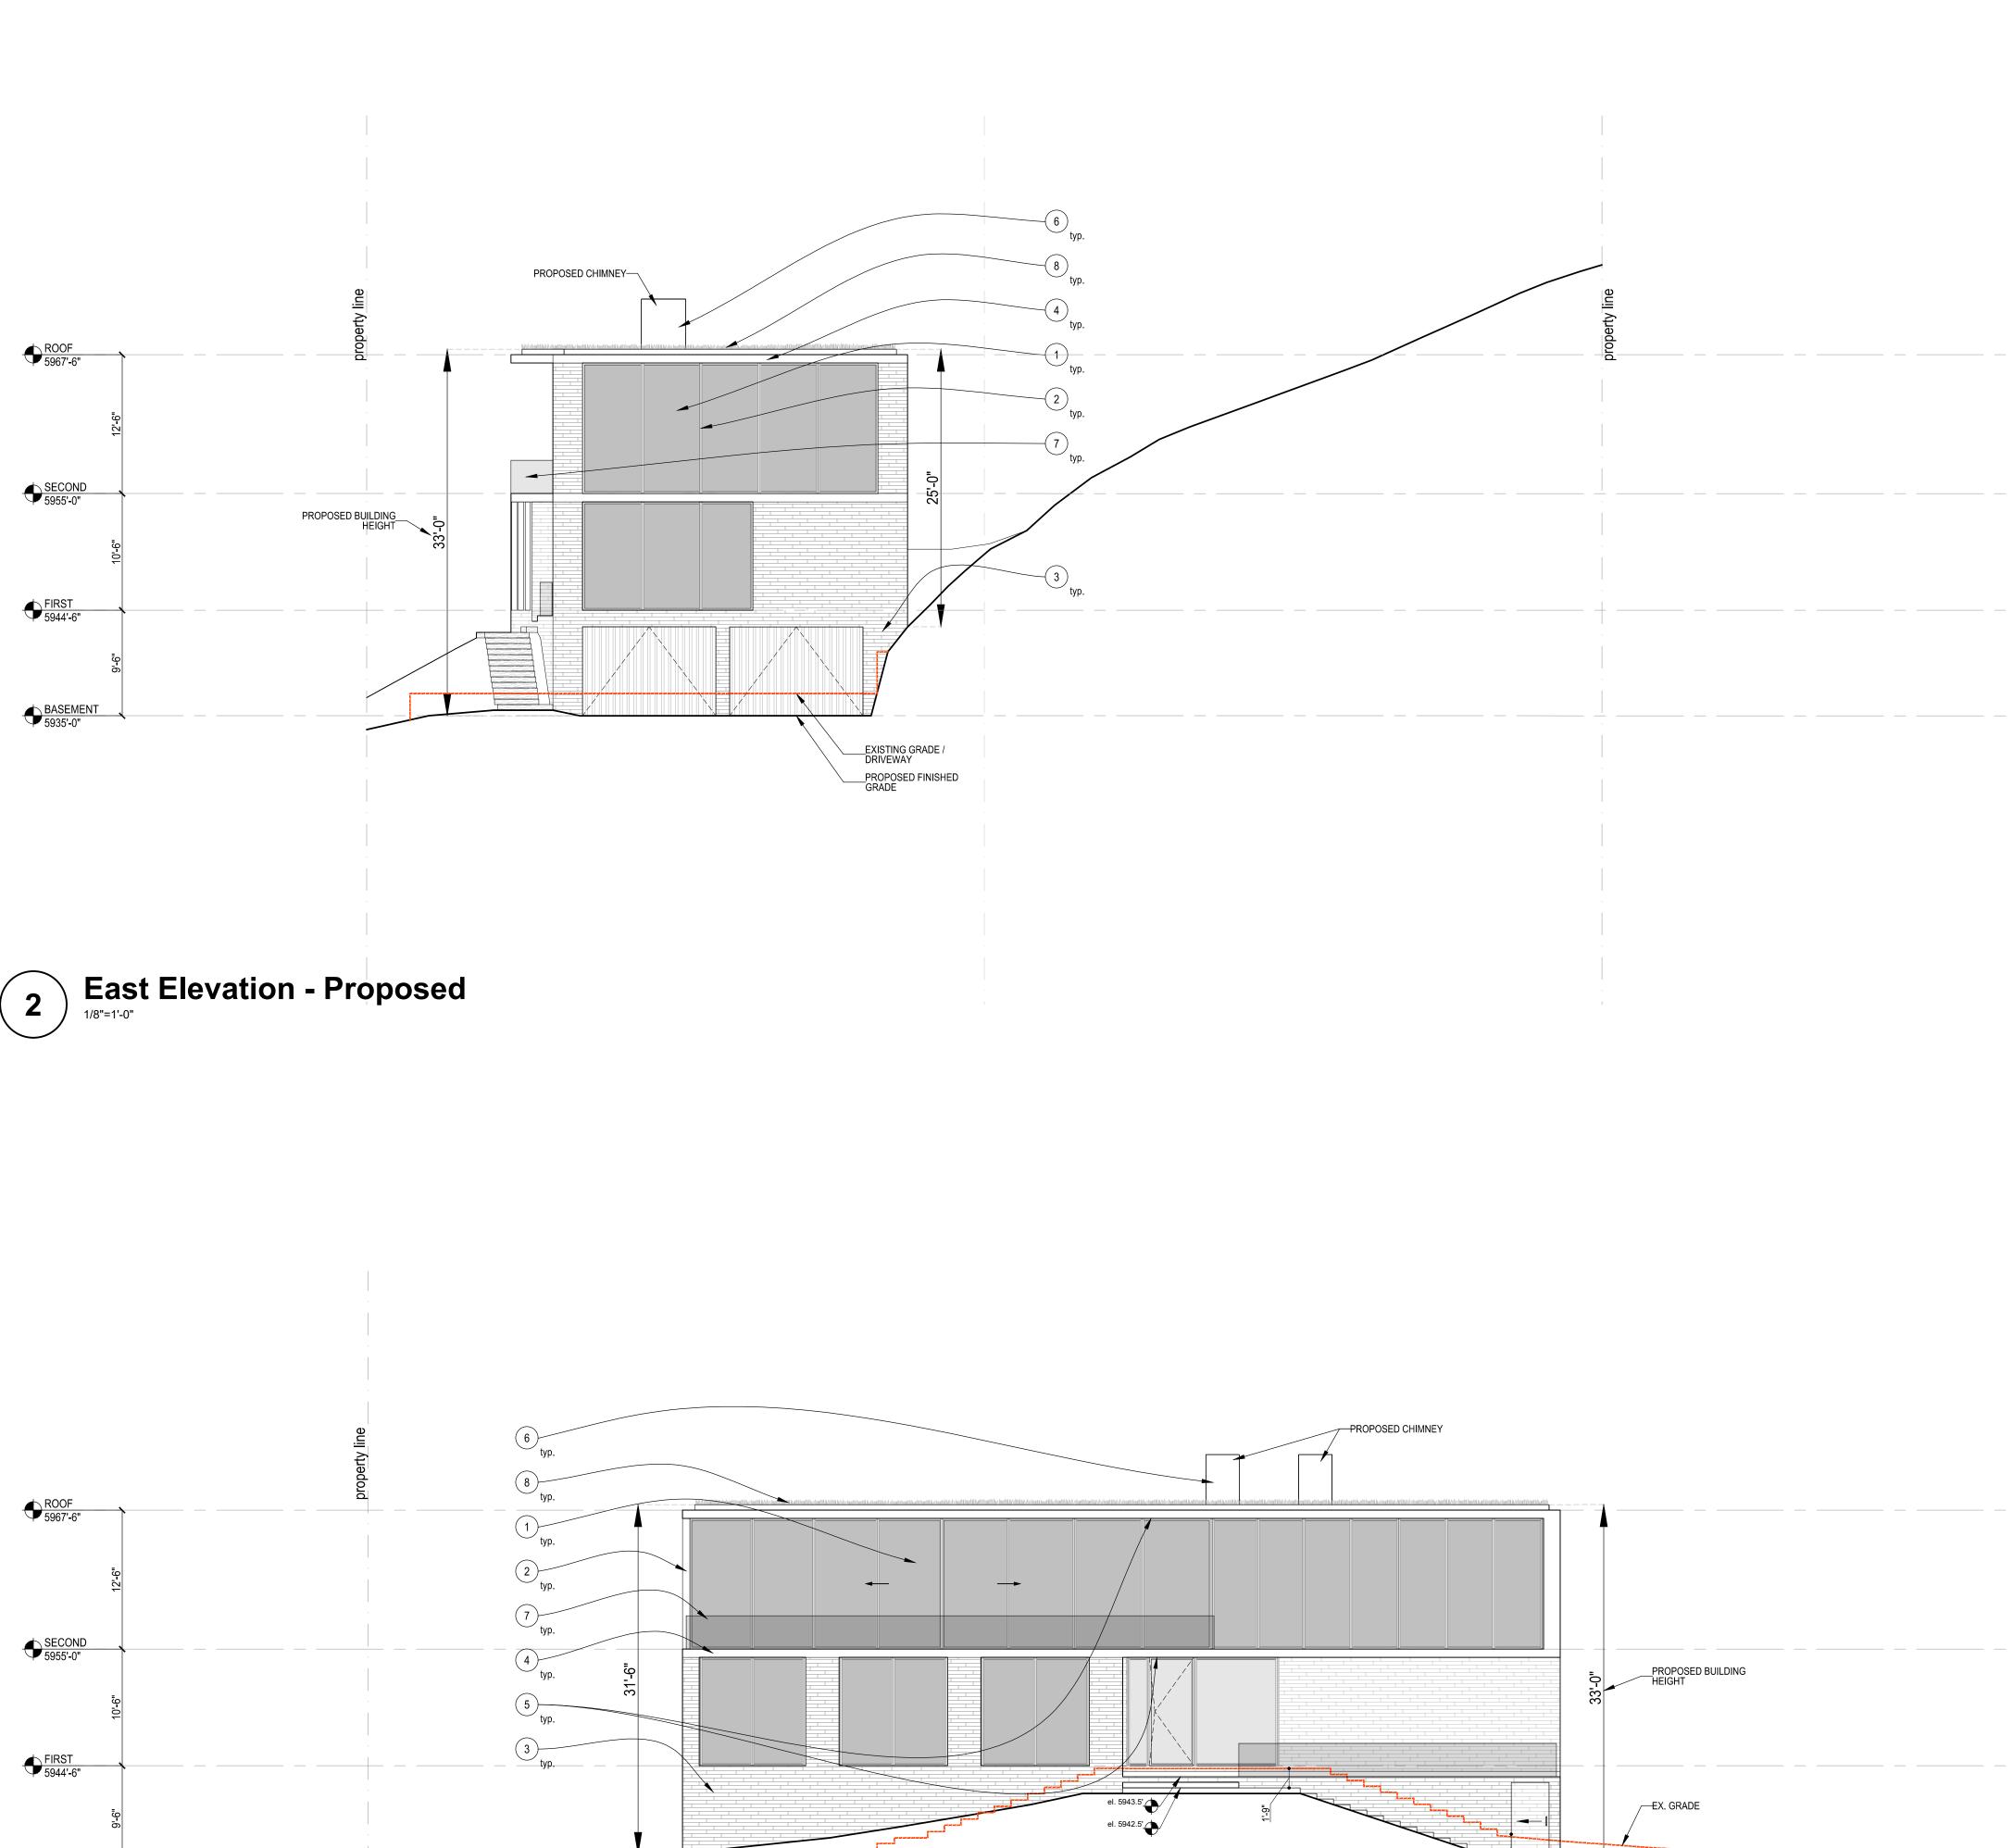

Material Legend

- 1) Wood Windows & Doors 2) Wood Louvers
- 3) Stone Cladding 4) Stone Fascias
- 5) Wood Soffits

- 6) Zinc Chimney 7) Glass Guardrail 8) Green Roof

See Proposed Material Palette

Residence 691 North Spruce Ave. Ketchum, ID 83340

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4	MODR - REV #3	OCTOBER 6, 2022	CITY
5	MODR - REV#4	OCTOBER 11, 2022	CITY

SHEET NAME ELEVATIONS


56'

40'


24'


16'

PROJECT NUMBER: DATE: SCALE:

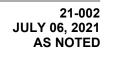



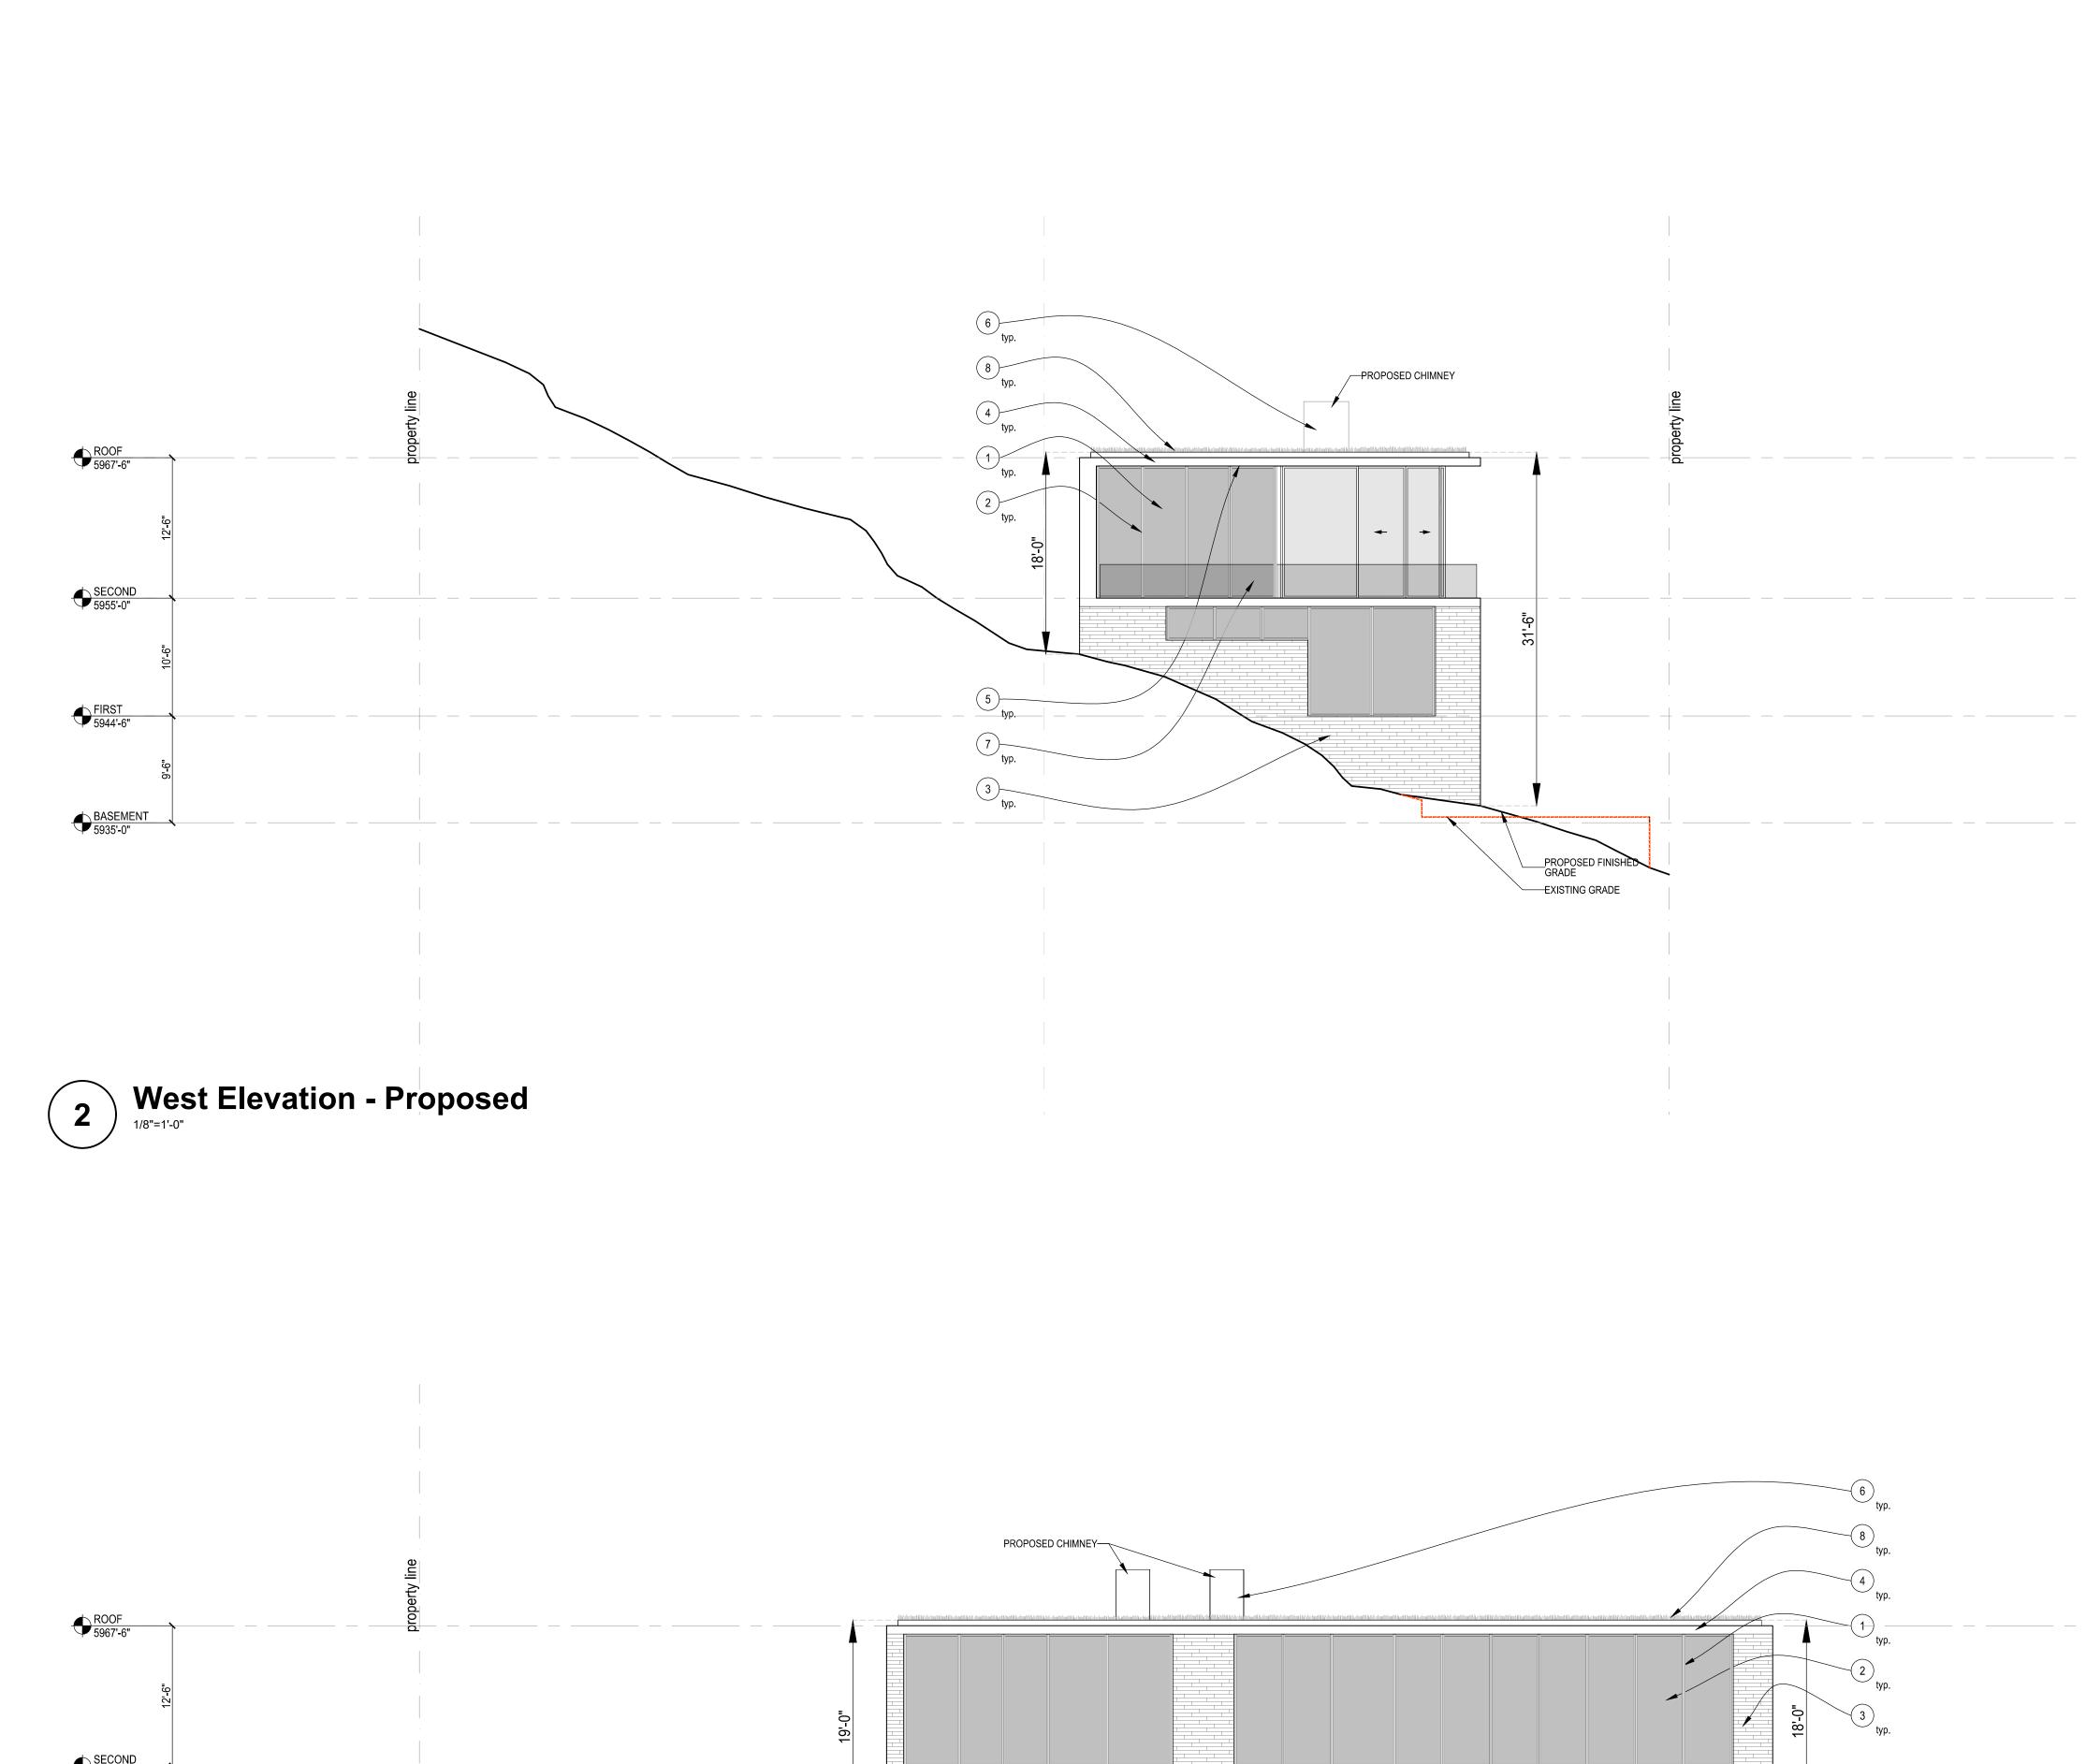

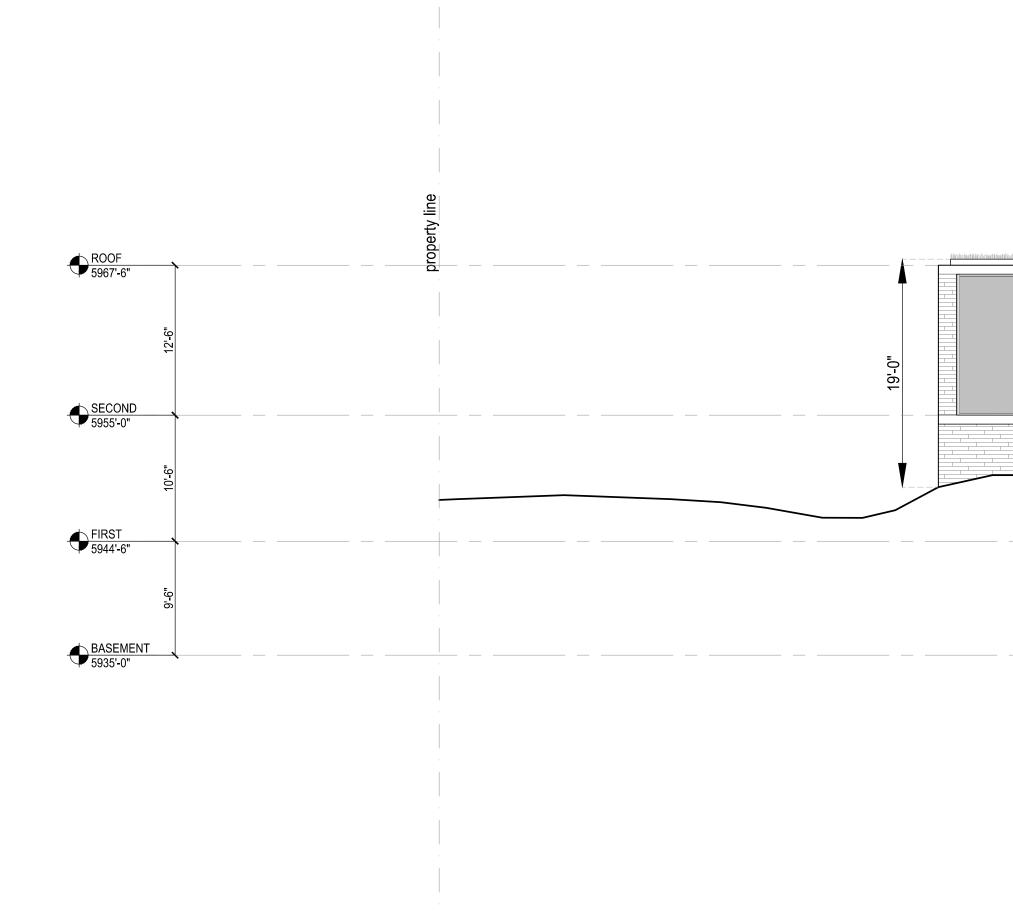

1 North Elevation - Proposed

Material Legend

- 1) Wood Windows & Doors
- 2) Wood Louvers
- 3) Stone Cladding 4) Stone Fascias

- 5) Wood Soffits
- 6) Zinc Chimney 7) Glass Guardrail 8) Green Roof

See Proposed Material Palette

Residence 691 North Spruce Ave. Ketchum, ID 83340

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SHEET NAME

56'


40'

24'


16'

ELEVATIONS


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MODR - REV#4	OCTOBER 11, 2022	CITY
	PRE-APP - MODR MODR - REV #1 MODR - REV #2 MODR - REV #3	PRE-APP - MODR MAY 10, 2022 MODR - REV #1 JUNE 16, 2022 MODR - REV #2 AUGUST 26, 2022 MODR - REV #3 OCTOBER 6, 2022

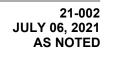
SHEET NAME

FIRST LEVEL REFLECTED CEILING PLAN

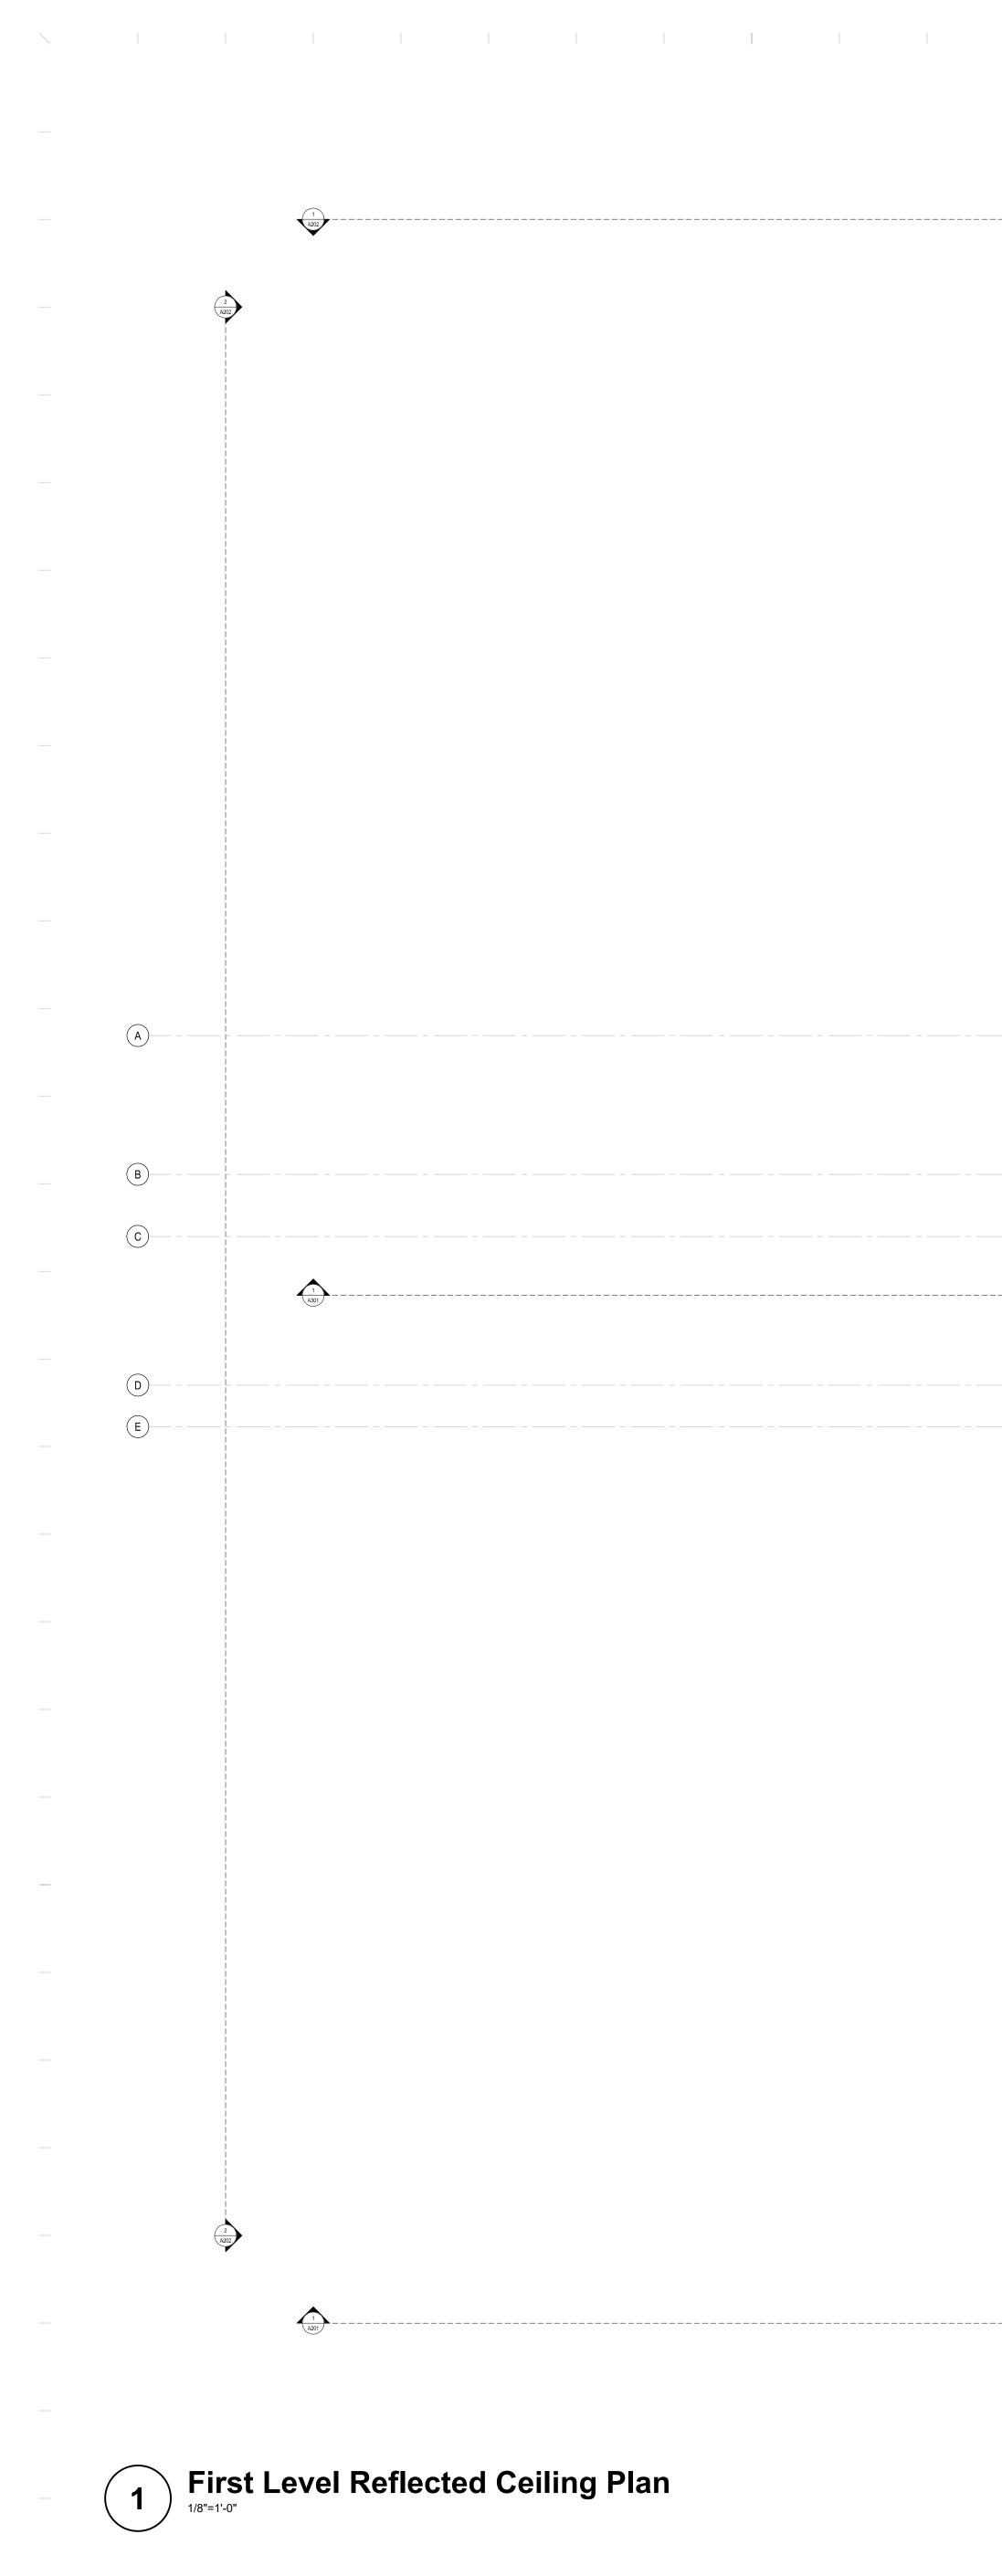
PROJECT NUMBER: DATE: SCALE:

21-002 JUNE 30, 2021 AS NOTED

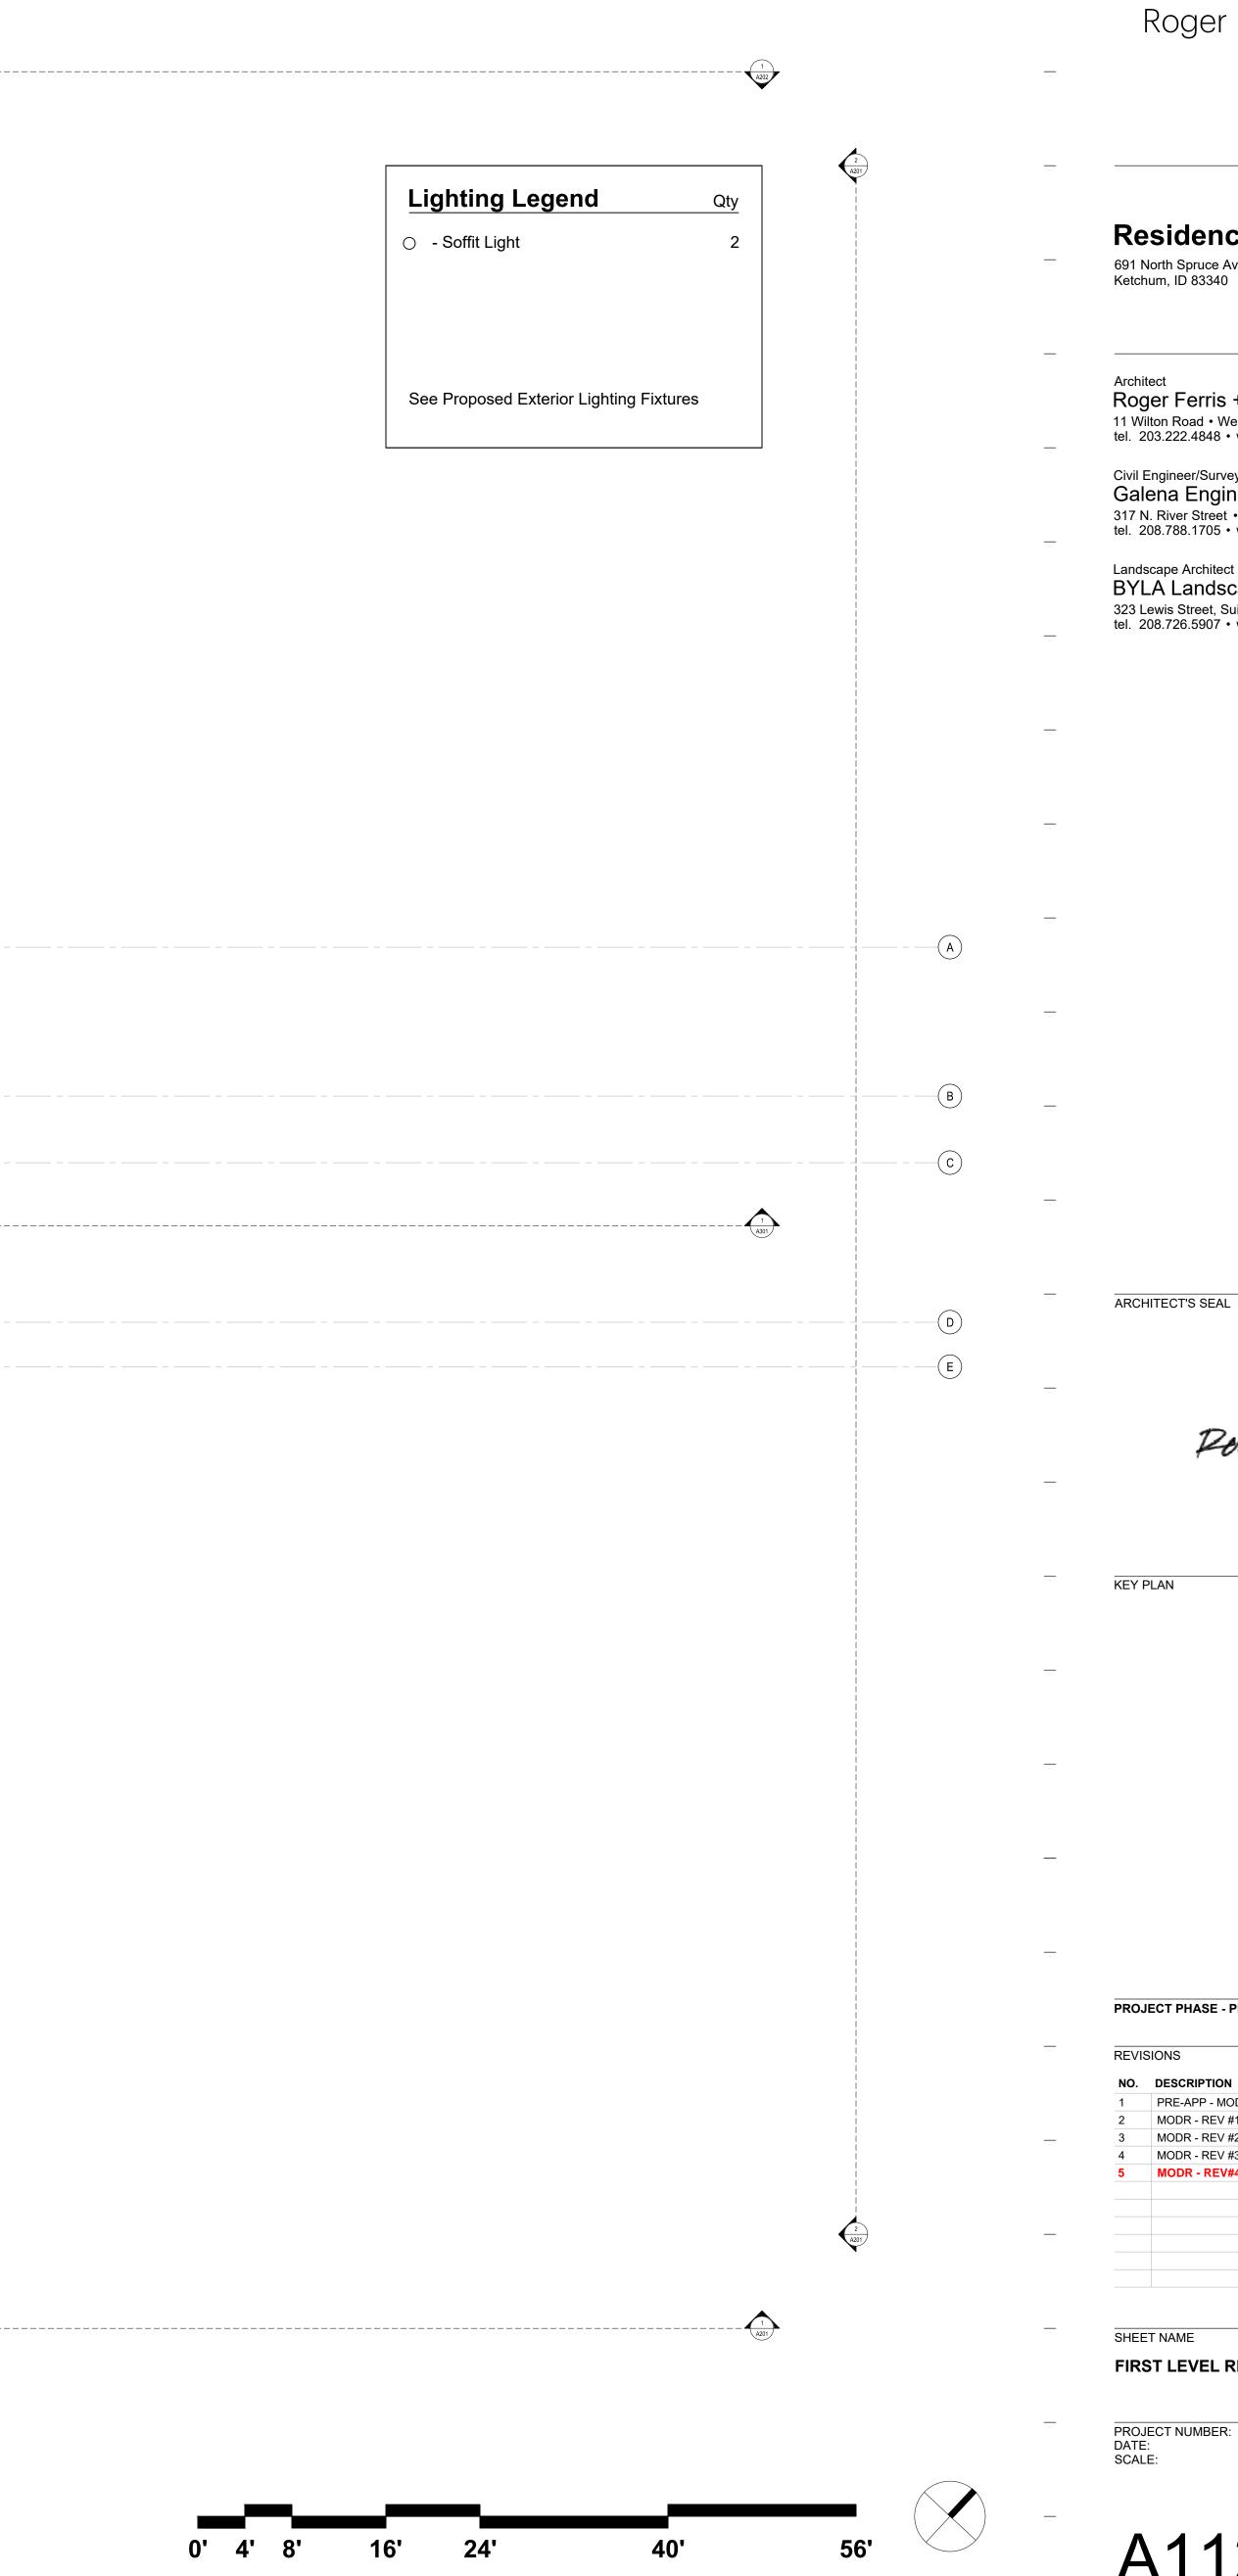

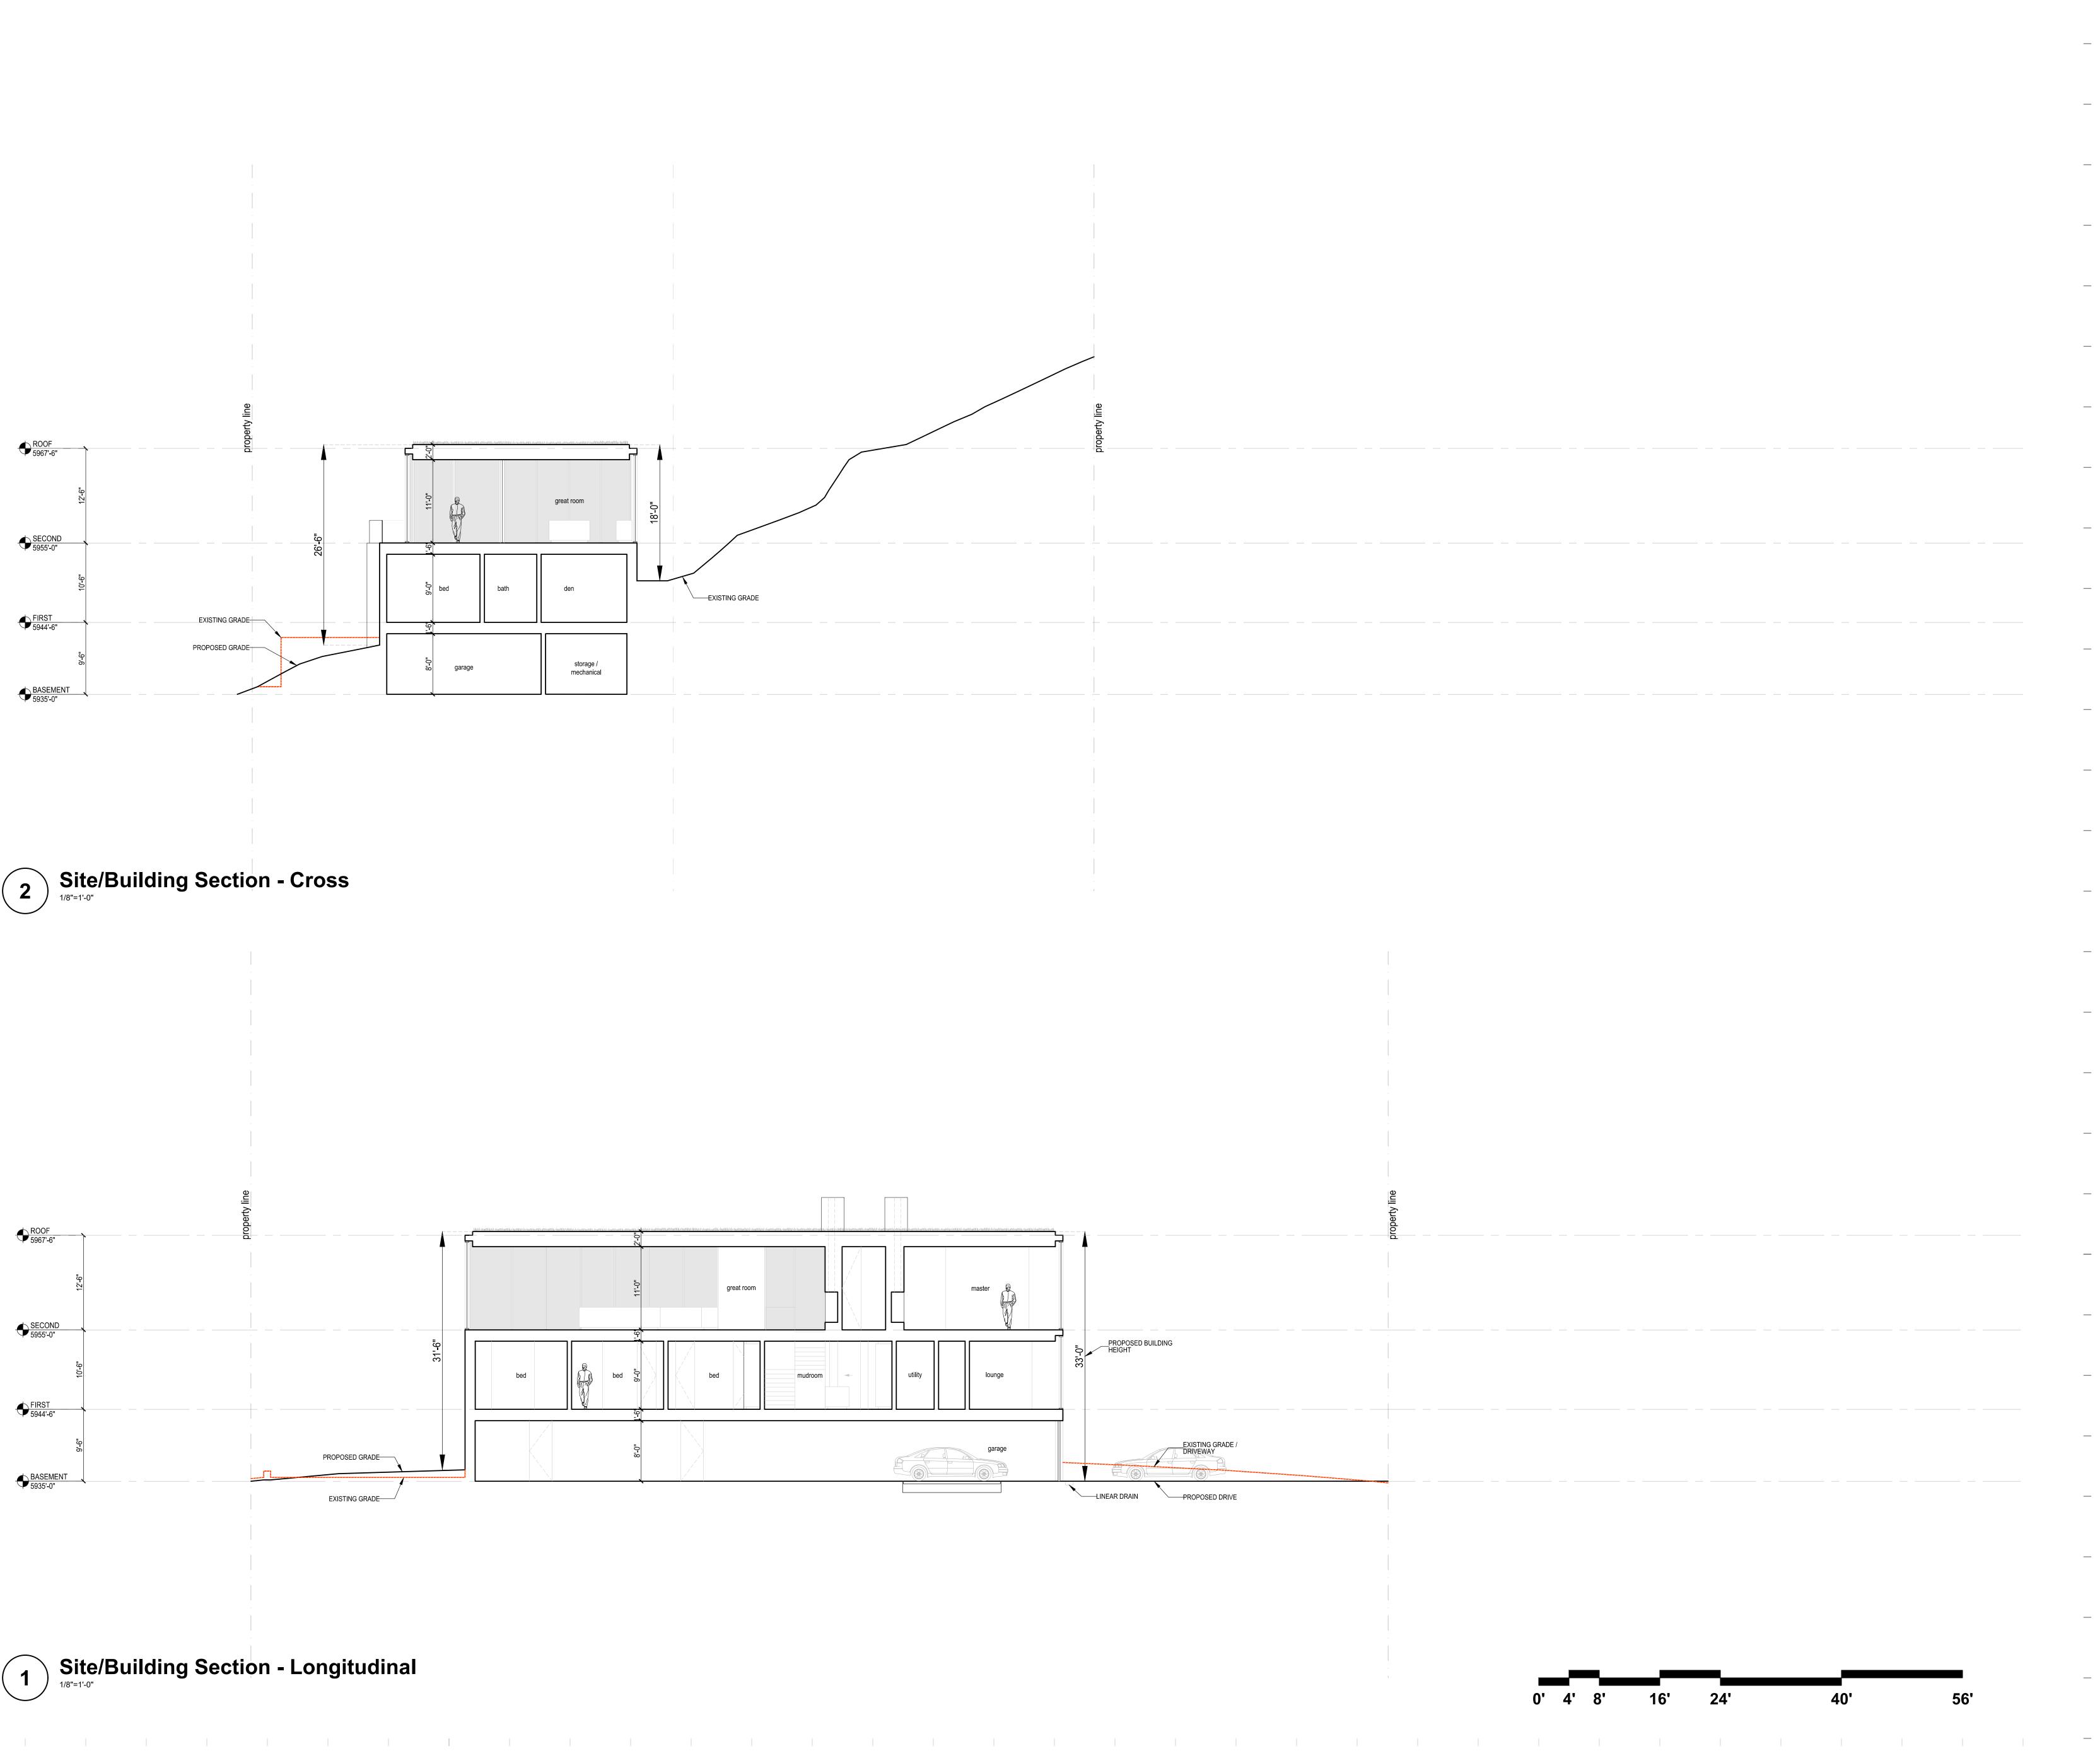



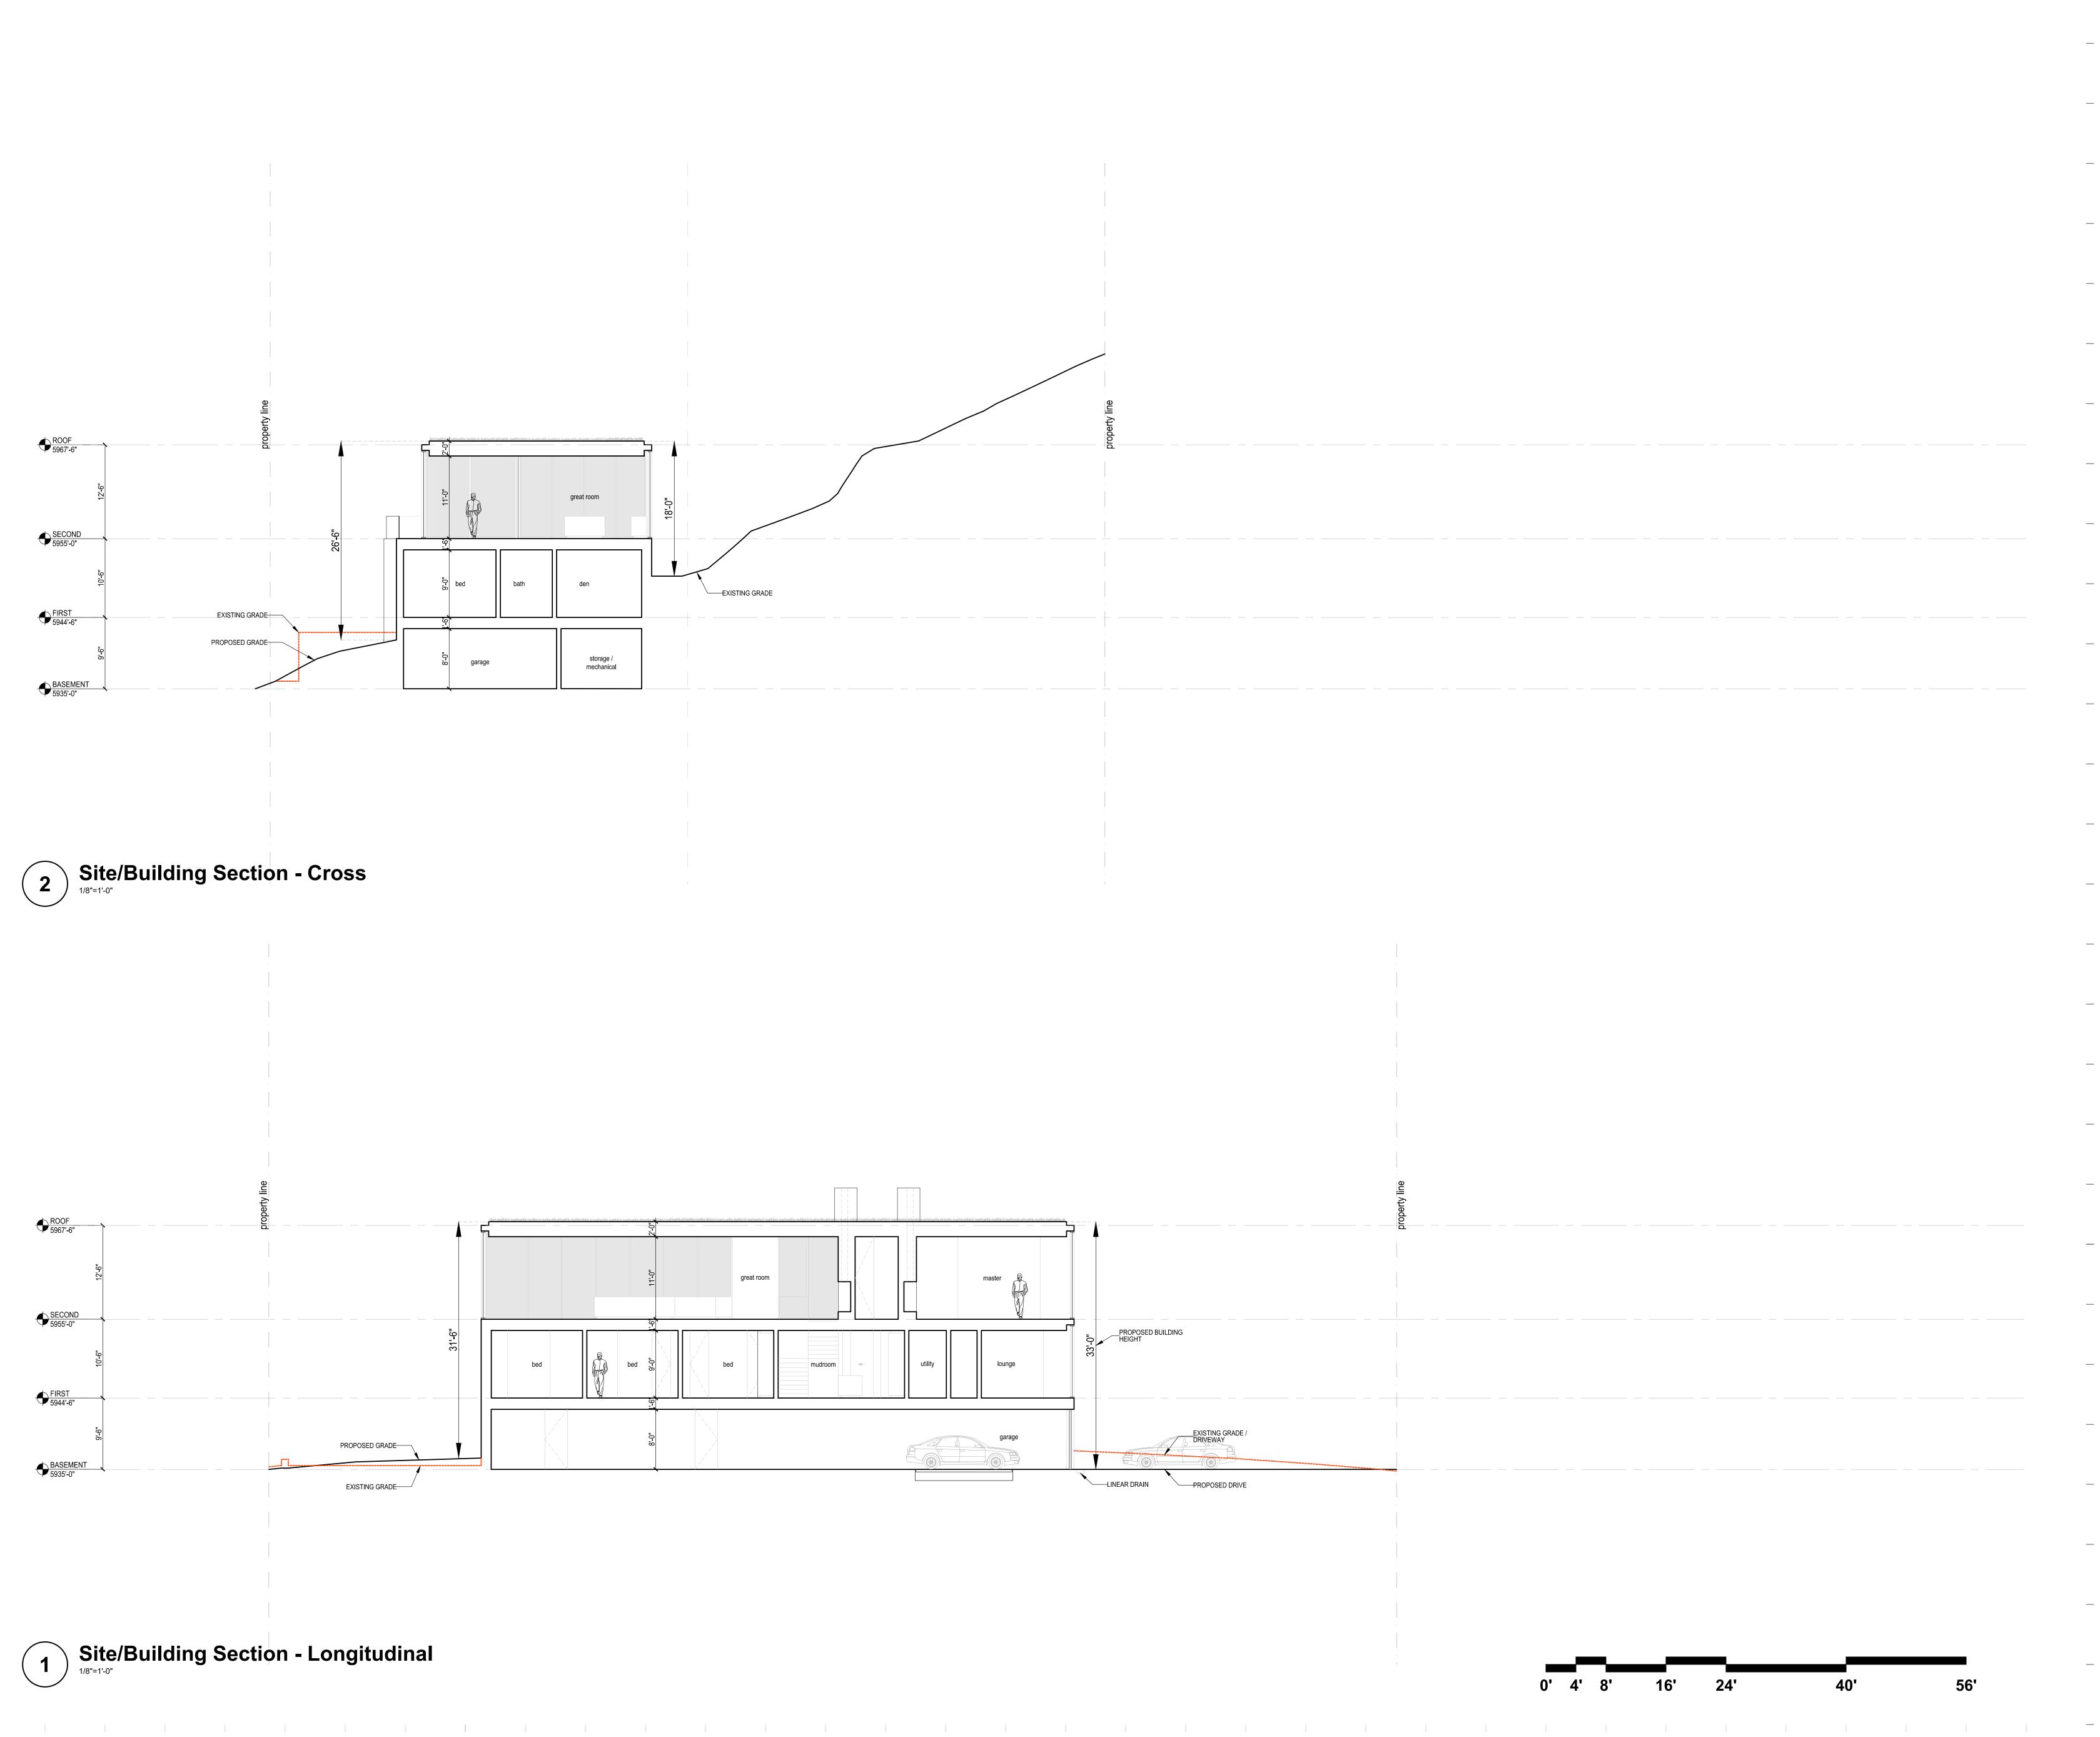

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PROJECT PHASE - PERMITTING


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5	MODR - REV#4	OCTOBER 11, 2022	CITY

SHEET NAME

SITE/BUILDING SECTION

PROJECT NUMBER: DATE: SCALE:



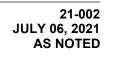


Proposed Exterior Lighting Fixtures & Photometric Plan

All fixtures to comply with City of Ketchum Dark Sky Ordinance - Chapter 17.132



Lighting Fixture - Soffit Light

Recessed 2700K Color Temperature

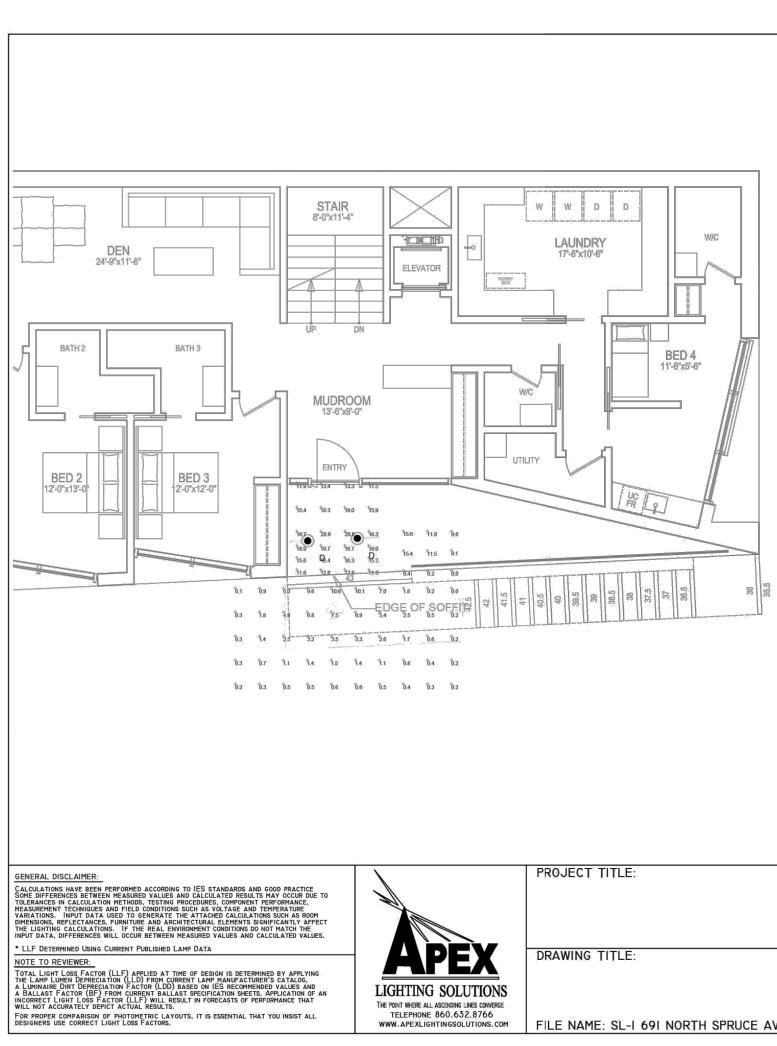

Qty	aire Sched	Arrangement	Lumens	Tinput	t Watts	LŰF	BUG	Rating		Description			
2	D	Single	1386	13		0.850	B1-U0	<u>.</u>				VI60 / RECES	SED IN CA
		ŀ	1				1.			L			
Calcul	lation Sum	mary											
Label				Grid Height	t	Avg	Ma	lax	Min	Avg/N	lin D	Max/Min	
GROL	JND_Plana	ı,		-0		2.31	10.	0.6	0.0	N.A.	1	N.A.	
STEP	1			0.625		12.25	12.	2.8	11.6	1.06	1	1.10	
STEP	2			1.25		15,88	16.	6.4	15.2	1.04	4	1.08	
STEP	3			1.875		19.33	19.	9.7	18.9	1.02	1	1.04	
TOP L	ANDING			2.5		16.37	20	0.9	11.5	1.42		1.82	

CT TITLE:	SCALE : 1/8"=1'-0"
691 NORTH SPRUCE AVE	DATE: 8/11/22
NG TITLE:	DRAWN BY: LED
EXTERIOR LIGHTING	SHEET:
PHOTOMETRIC CALCULATIONS	
AME: SL-I 69I NORTH SPRUCE AVE 08-II-2022 LED.DWG	

Residence 691 North Spruce Ave. Ketchum, ID 83340

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KEY PLAN

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SHEET NAME

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PROPOSED EXTERIOR LIGHTING FIXTURES

PROJECT NUMBER: DATE: SCALE:






Proposed Material Palette



1) Wood Windows & Doors At exterior glazing locations

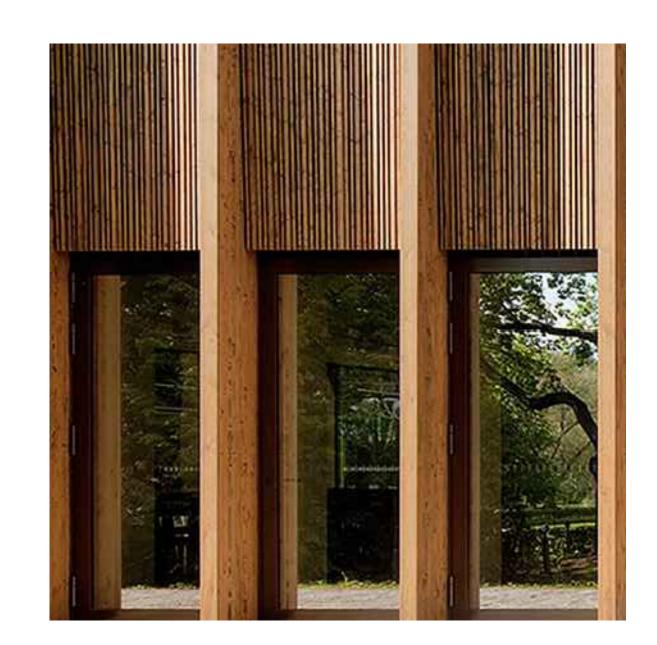






5) Wood Soffits At exterior soffit locations

6) Zinc

2) Wood Louvers At exterior glazed locations

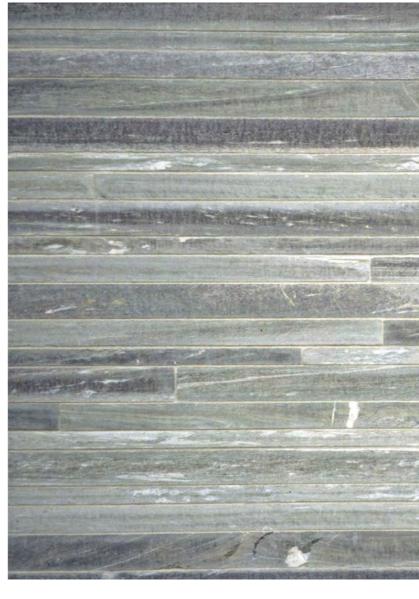

3) Stone Cladding At exterior walls

At chimneys & parapet caps



7) Glass Guardrail At exterior terraces





4) Stone Slabs At exterior terraces & fascias



8) Green Roof Sedum green roof w/native vegetation (TBD by Landscape Architect) Residence 691 North Spruce Ave. Ketchum, ID 83340

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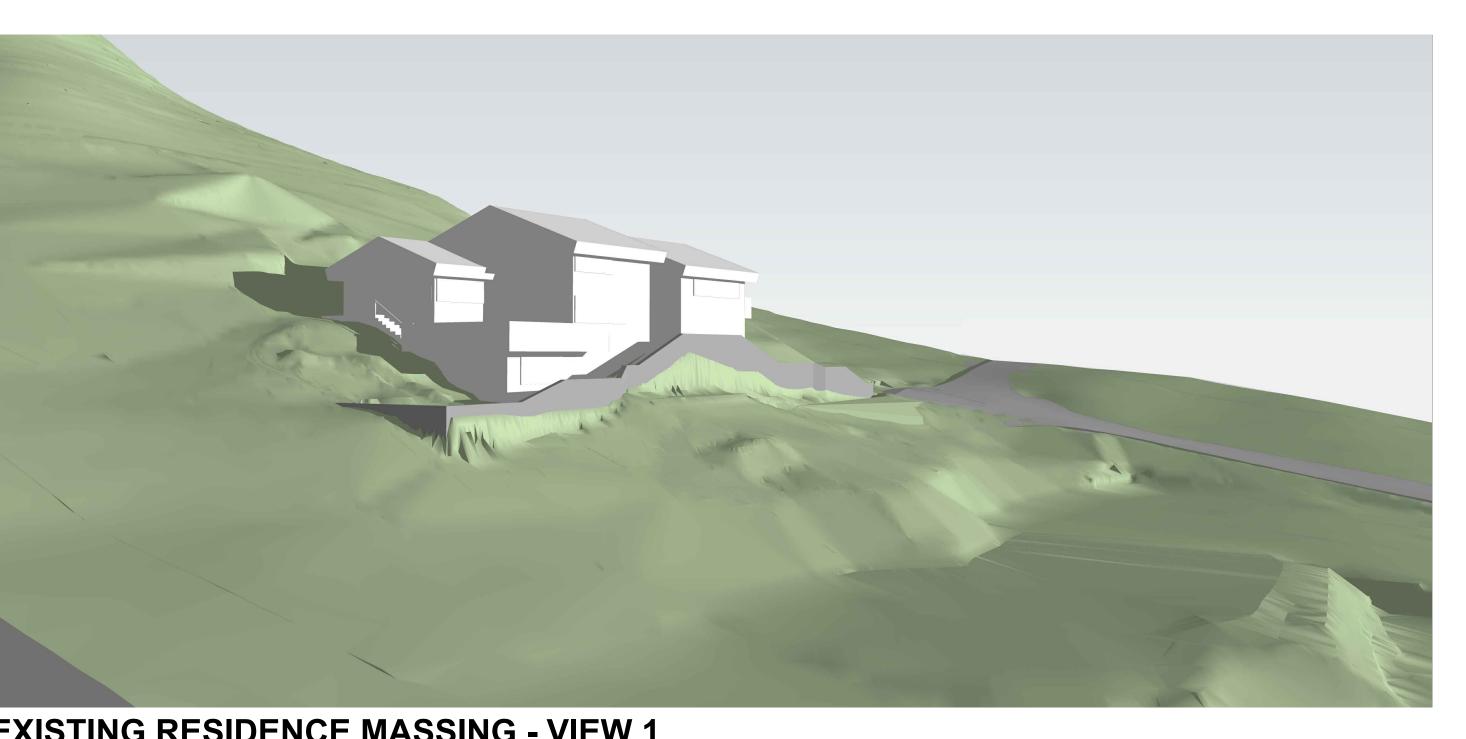
PROPOSED MATERIAL PALETTE

PROJECT NUMBER: DATE: SCALE:






3D Comparison



EXISTING RESIDENCE MASSING - VIEW 1

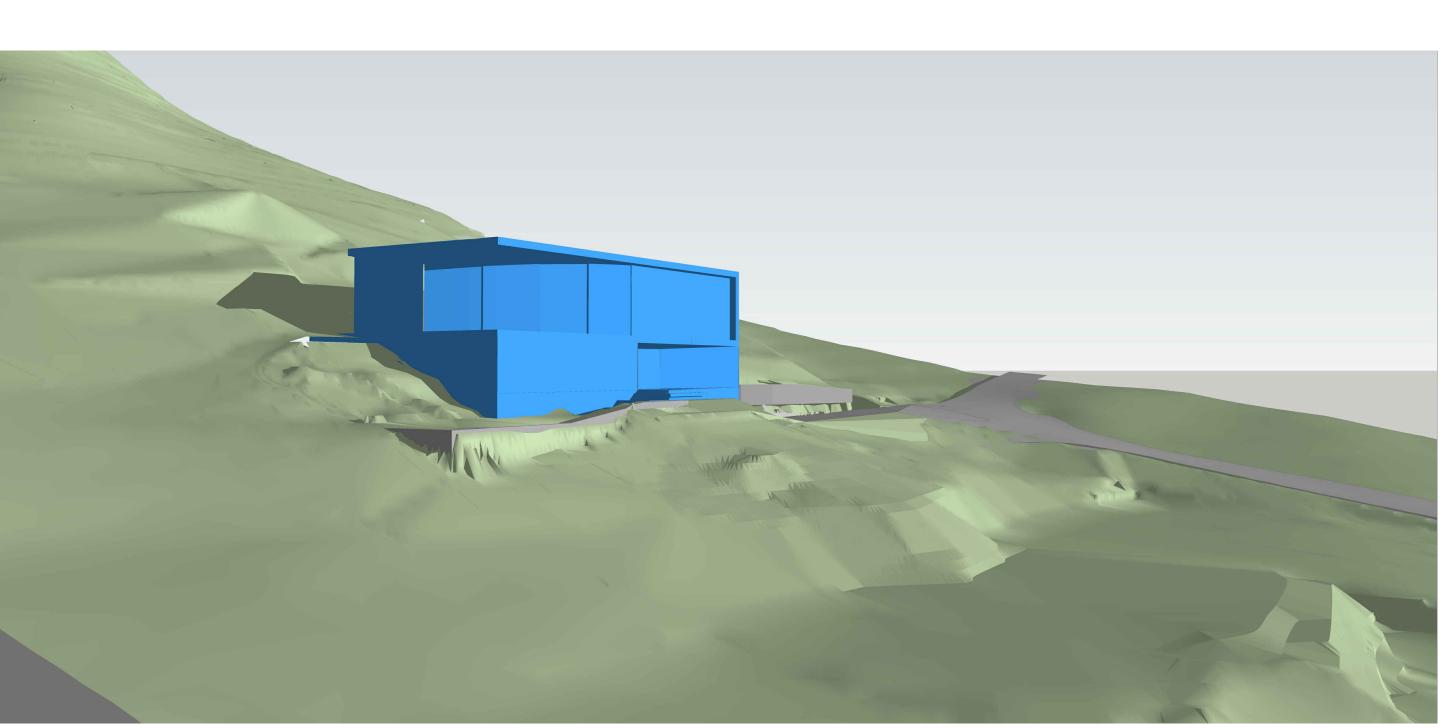

PROPOSED RESIDENCE MASSING - VIEW 1




PROPOSED RESIDENCE MASSING OVERLAYED ON EXISTING MASSING - VIEW 1

PROPOSED RESIDENCE MASSING OVERLAYED ON EXISTING MASSING - VIEW 2



PROPOSED RESIDENCE MASSING - VIEW 2

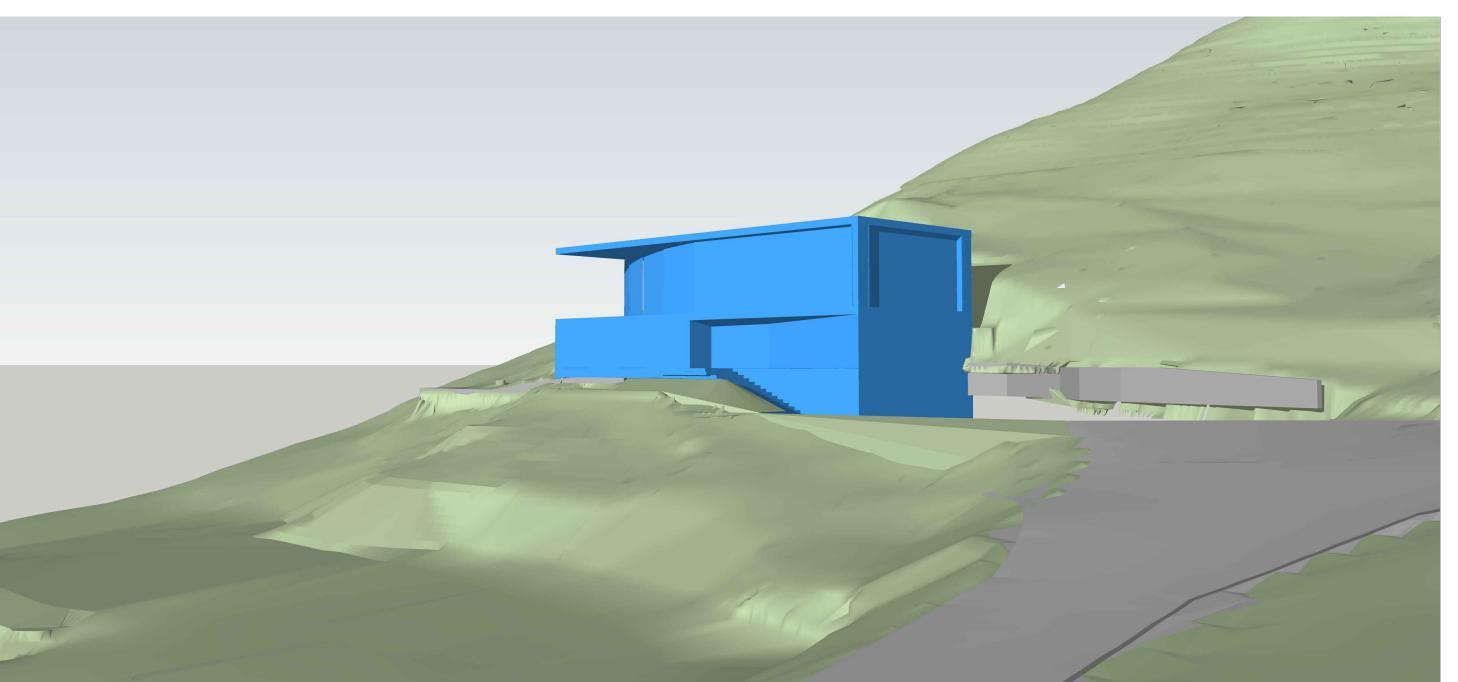

EXISTING RESIDENCE MASSING - VIEW 2



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3D Comparison


PROJECT NUMBER: DATE: SCALE:





CONSTRUCTION STAGING PLAN CONSTRUCTION FENCE NG 69.88+ 5.28' DUMPSTER

LEGEND

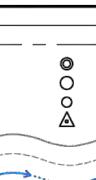

N N

AAAAAAAA Rock Face Aspen Grove

127

Culvert

oiner's Lot Line

Property Line

FNDGEAR = Found Gear Surv FD5/8 = Found 5/8" Rebar FD1/2 = Found 1/2" Rebar CP / CNTRL = Survey Control 5' Contour Interval 1' Contour Interval FL = Flow Line

Above Ground Deck Edge of Asphalt Flat Stone Pavers

RTW = Concrete Retaining W Drystack or Railroad Tie Retaining Wall

CT = Conifer Tree

DT = Deciduous Tree

Landscape Steps GMTR = Gas Meter **Overhead Power Line** PP = Power Pole GUY = Guywire SS = Sewer Service CB = Catch Basin


AP = Angle Point

> BEG = Beginning BOW = Back of Walk CMP = Corrugated Metal Pipe EOA = Edge of Asphalt EOC = Edge of Concrete EOP = Edge of Pavers EOFST = Edge of Flat Stone FF = Finished Floor GB = Grade Break GFF = Garage Finished Floor INT = Intersection NC = No Cap NG = Natural Ground PVC = Polyvinyl Chloride Pipe RP = Reference Point RR TIE = Railroad Tie TA = Top of Asphalt THRESH = Threshold of Door TOE = Toe of Slope TOP = Top of Slope


TW = Top of Wall WTR TOP = Top of Water Fall



AREA OF **DEMOLITION &** CONSTRUCTION

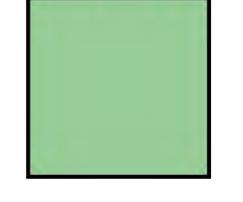



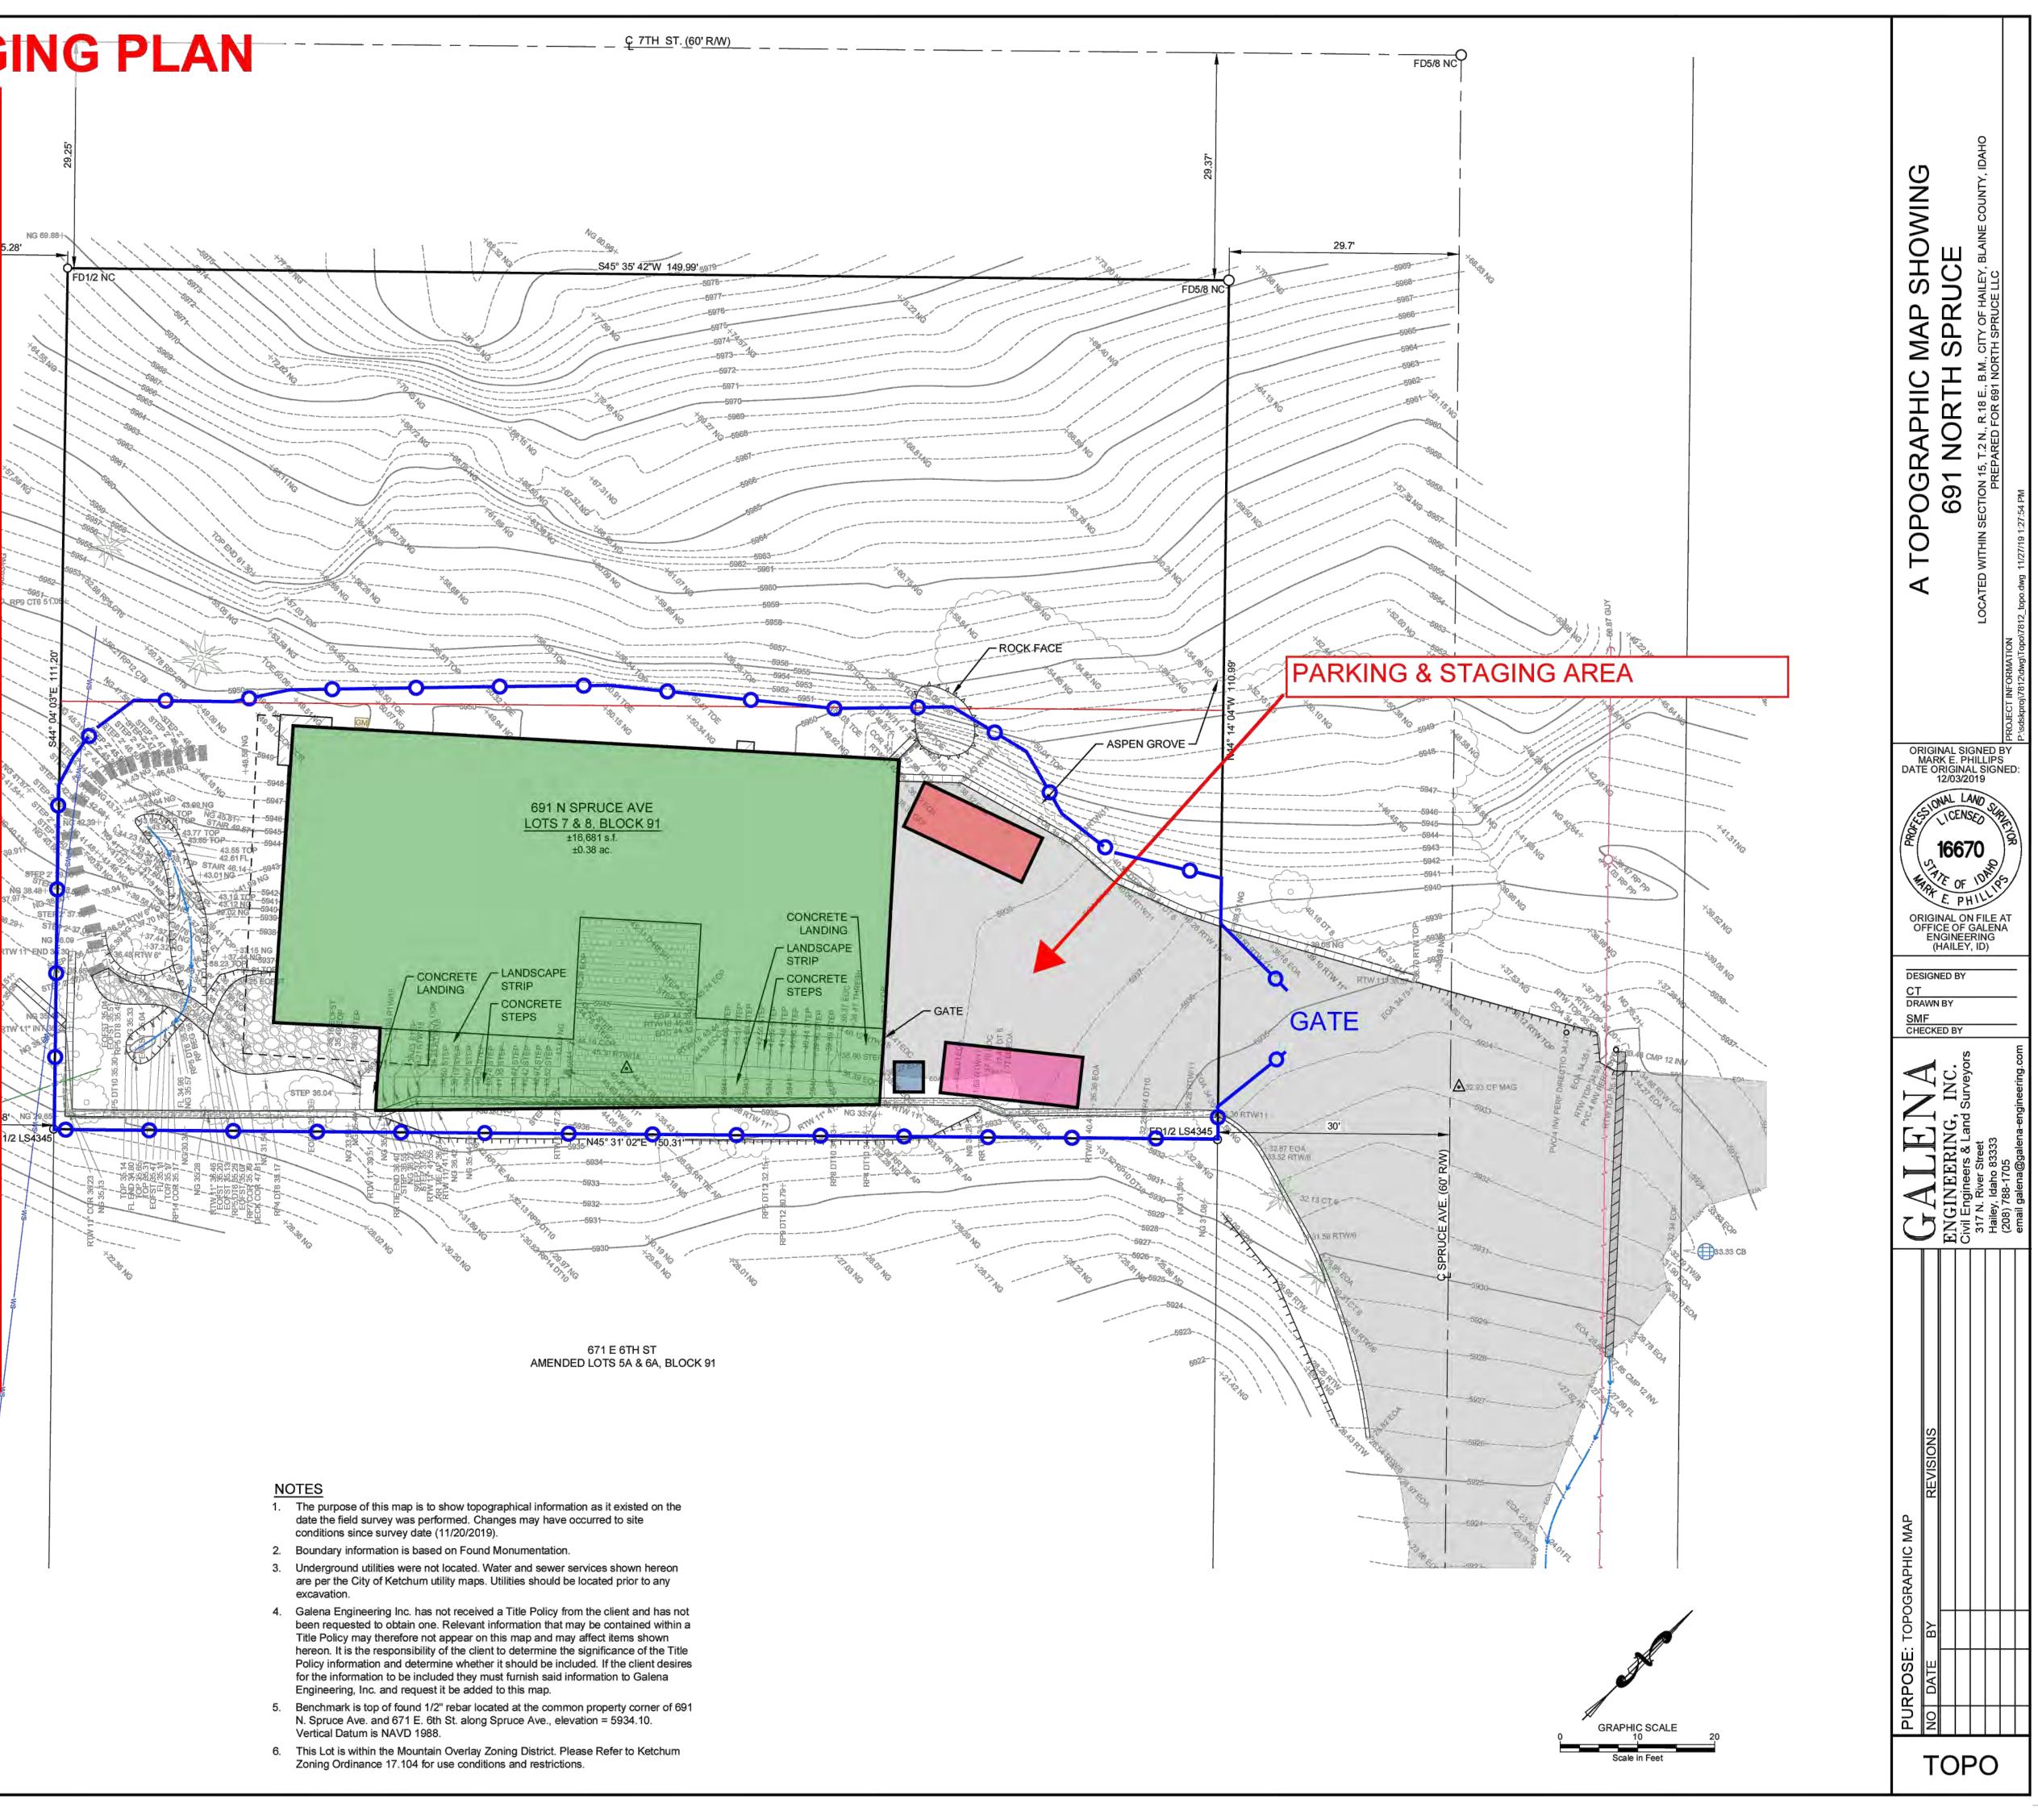

August 26, 2022

Abby Rivin, AICP Senior Planner City of Ketchum Department of Planning and Building

Re: 691 N Spruce Ave Residence Pre-Application Mountain Overlay Design Review–Completeness Review

Dear Abby,

We have prepared this document in response to #18 on the list of comments issued by the City Planning Staff. This document explains how the project complies with all Mountain Overlay Design Review standards. Our responses are indicated with red, italicized font.

17.104.070 - Mountain Overlay Design Review

Design review applications shall be made and processed according to the regulations contained in <u>chapter 17.96</u> of this title and as follows:

Α.

Criteria and standards. The following list of criteria and those contained in <u>chapter 17.96</u> of this title must be considered and addressed by each applicant seeking design review approval. The Commission will use this list of design review criteria along with that contained in <u>chapter</u> <u>17.96</u> of this title as a basis to determine whether a project is to be approved, approved with conditions or denied:

1.

There shall be no building on ridges or knolls which would have a material visual impact on a significant skyline visible from a public vantage point entering the City or within the City. "Material", as the term is used herein, shall be construed in light of the magnitude of the negative impact on the objectives of this section;

The proposed home is shorter and smaller than the existing home. The home cannot be seen from beyond it's immediate neighborhood. It can only be seen from N Spruce Ave (north of East 5th St only), East 6th St (from N Spruce Ave to the Walnut Ave intersection only) and Walnut Ave (around the East 6th St intersection only).

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2.

Building, excavating, filling and vegetation disturbance on hillsides which would have a material visual impact visible from a public vantage point entering the City or within the City shall be minimized. "Material", as the term is used herein, shall be construed in light of the magnitude of the negative impact on the objectives of this section;

The limit of disturbance will not go beyond the existing limit of disturbance.

3.

Driveway standards as well as other applicable standards contained in <u>title 12, chapter 12.04</u> of this Code shall be met;

The proposed project will be accessed via a new driveway which will fall within the footprint of the existing driveway. The proposed driveway will be less steep, will better address fire safety standards and will contain drainage on site.

4.

All development shall have access for fire and other emergency vehicles to within 150 feet of the furthest exterior wall of any building;

The proposed project was reviewed with Assistant Fire Chief, Seth Martin, who stated that the project was an improvement by providing emergency access along with a parking area for the fire apparatus. Additionally, the proposed project will include a fire sprinkler system, further reducing the risk of fire.

5.

Significant rock outcroppings shall not be disturbed;

No significant rock outcroppings will be disturbed.

6.

International Building Code (IBC) and International Fire Code (IFC) and Ketchum Fire Department requirements shall be met;

The proposed project will be designed in accordance with all currently adopted codes.

7.

Public water and sewer service shall comply with the requirements of the City;

The proposed project will include a new water service and an updated sewer system that will comply with all applicable codes.

8.

Drainage shall be controlled and maintained to not adversely affect other properties;

The proposed project will include drainage measures to ensure that it will not adversely impact other properties. All drainage will be contained on site and all drainage systems will comply with all applicable codes.

9.

Cuts and fills allowed for roadways shall be minimized; lengths of driveways allowed shall be minimized; all cuts and fills shall be concealed with landscaping, revegetation and/or natural stone materials. Revegetation on hillsides with a clear zone of 30 feet around all structures is recommended. Said clear zone shall include low combustible irrigated vegetation with appropriate species, on file with the Ketchum Planning Department. Revegetation outside of this clear zone should be harmonious with the surrounding hillsides;

The driveway for the proposed project will be in the same location as the existing driveway, minimizing the need for additional earthwork on the site. All landscaping and civil work needed to complete the construction of the proposed driveway will comply with all applicable codes.

10.

Are there other sites on the parcel more suitable for the proposed development in order to carry out the purposes of this section;

The proposed structure is located entirely within the boundary of the currently disturbed zone of the existing house.

11.

Access traversing 25 percent or greater slopes does not have significant impact on drainage, snow and earthslide potential and erosion as it relates to the subject property and to adjacent properties;

The proposed project does not introduce any new site access that traverse's slopes of 25% or greater.

12.

Utilities shall be underground;

The proposed project will include all underground utilities.

13.

Limits of disturbance shall be established on the plans and protected by fencing on the site for the duration of construction;

The proposed project plans delineate a limit of disturbance line. This entire area will be enclosed by fencing for the duration of construction.

14.

Excavations, fills and vegetation disturbance on hillsides not associated with the building construction shall be minimized; and

Excavation, fill and vegetation disturbance on hillsides not associated with the building construction will be minimized. Additionally, the proposed project will restore the currently scarred site back to a more natural state. This will primarily be achieved by removing many large site walls and introducing minimal grading. The landscape architect will revegetate all areas disrupted during construction and the final design will feature native species, aiming to blend the proposed structure into its natural surroundings.

15.

Preservation of significant landmarks shall be encouraged and protected, where applicable. A significant landmark is one which gives historical and/or cultural importance to the neighborhood and/or community.

No significant landmarks have been identified on this site.

16.

Encroachments of below grade structures into required setbacks are subject to subsection 17.128.020.K of this title and shall not conflict with any applicable easements, existing

underground structures, sensitive ecological areas, soil stability, drainage, other sections of this Code or other regulating codes such as adopted International Code Council Codes, or other site features concerning health, safety, and welfare.

No encroachments of below grade structures into setbacks are proposed.

Please do not hesitate to contact us with any questions.

Best,

Jake Watkins, AIA

Exhibit B Planning and Zoning Commission Zoning Code Interpretation 22-001

City of Ketchum Planning & Building



KETCHUM PLANNING AND ZONING COMMISSION ZONING CODE INTERPRETATION 22-001 NONCONFORMING BUILDING FOOTPRINTS IN MOUNTAIN OVERLAY

INTERPRETATION QUESTION

This zoning code interpretation addresses redeveloping nonconforming properties within the Mountain Overlay. Current code requires new buildings to be constructed in areas that have less than 25% slope (Ketchum Municipal Code §16.04.020) and building envelopes on new parcels to be located outside of a 25% slope. Existing homes on hillsides that were developed prior to the City's establishment of the Mountain Overlay Zoning District in 1989 may not comply with current development standards. These homes are considered non-conforming buildings and may be maintained in their current condition. Nonconforming buildings and uses are governed under Chapter 17.136 of Ketchum Municipal Code. If a non-conforming structure is demolished, or a new parcel is created, then the new building and parcel must comply with all current development standards. Certain non-conforming building footprints and properties can not be brought into compliance with code. The fundamental question before the Commission was whether these non-conforming properties may be developed with a new home or if these nonconforming properties would not be permitted to be redeveloped if the existing non-conforming home were to be demolished. If redevelopment was prohibited, property owners would only be able to repair, maintain, and enlarge their existing nonconforming homes in accordance with the standards specified in Chapter 17.136 of Ketchum Municipal Code.

MOUNTAIN OVERLAY PURPOSE

Hillside development standards protect the community character and health and safety by ensuring the adequate provision of public services and facilities, including fire protection. The Mountain Overlay standards prohibit the detrimental alteration of hillside that would adversely impact existing soils, drainage, and vegetation. The undeveloped hillsides surrounding Ketchum are one of Ketchum's character-defining features. The Mountain Overlay Zoning District ensures the preservation of these hills, ridgelines, and natural features. The standards minimize the visual impact of development by directing building sites away from higher elevations and keeping hillsides open and unobstructed.

ZONING NONCONFORMITIES

Nonconformities are existing uses, buildings, lots, or site features that were legally established at the time they were created but no longer comply with current zoning code regulations. When land use regulations change, existing developments may not comply with the amended zoning code standards. Requiring owners to immediately bring their non-conforming buildings and uses into compliance following land use regulation changes would be a hardship. To mitigate this hardship, zoning codes set specific standards to address nonconformities. These standards generally allow owners to maintain nonconformities in their current condition but prohibit or limit substantial modifications and expansions. This approach assumes all nonconformities will

be phased out over time. Standards regulating zoning nonconformities balance the community's interests in new land use objectives with private property interests in existing development.

ZONING CODE INTERPRETATION IMPLICATIONS: HILLSIDE DISTURBANCE

Redeveloping nonconforming building footprints may result in even more disturbance to the hillside. New single-family homes in Ketchum have trended towards replacing existing, smaller buildings with larger structures, which would have a greater impact on the hillside. Redeveloping these nonconforming properties to comply with current City building, fire, zoning, and streets standards could result in more hillside disturbance. For example, widening an existing street that accesses a nonconforming property would result in significantly more disturbance to the hillside.

ZONING CODE INTERPRETATION IMPLICATIONS: VISIBILITY ON HILLSIDES

Many non-conforming buildings in the Mountain Overlay are sited on prominent ridgelines and hilltops and are highly visible. Allowing these non-conforming building footprints to be redeveloped with new homes would perpetuate a condition that is no longer allowed.

PLANNING AND ZONING COMMISSION INTERPRETATION

The Commission determined that the redevelopment of existing non-conforming properties may be redeveloped under the following conditions:

- A. If the property configuration is proposed to be modified (lot line adjustment, lot consolidation etc.), then the new property configuration must establish a building envelope on the lowest portion of the property. Existing non-conforming building footprints are not permitted to be redeveloped outright. If a more compliant alternative at a lower elevation on the hillside property exists, the new home must be sited in the more suitable area for redevelopment.
- B. If the property configuration is not being altered or changed, then a new home may be constructed at the Commission's discretion through Mountain Overlay Design Review provided that the project does not exceed the height or limits of disturbance of the existing non-conforming home. The building footprint shall conform as close as possible to the existing building.

This determination will apply to all existing non-conforming properties in hillside areas.

Zoning Code Interpretation adopted this 8th day of March 2022.

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Neil Morrow, Chair City of Ketchum Planning and Zoning Commission

Zoning Code Interpretation 22-001 Nonconforming Building Pads in Mountain Overlay Planning & Zoning Commission Meeting of March 8th, 2022 **City of Ketchum Planning & Building Department**