

STAFF REPORT KETCHUM PLANNING AND ZONING COMMISSION REGULAR MEETING OF FEBRUARY 28, 2023

PROJECT: The 208 Condos

FILE NUMBER: P22-035 and P22-035A

APPLICATION TYPE: Final Design Review and Subdivision – Condominium Preliminary Plat

APPLICANT: Nicole Ramey, Medici Architects (Architect)

PROPERTY OWNER: 755 S Broadway, LLC

REQUEST: Final Design Review and Condominium Preliminary Plat application for the

development of a new, 10,856 square foot, three-story mixed-use building

LOCATION: 200 N Leadville Avenue - Ketchum Townsite: Block 23: Lot 1

ZONING: Community Core – Subdistrict 2 – Mixed Use (CC-2)

REVIEWER: Morgan R. Landers, AICP – Senior Planner

NOTICE: A public hearing notice for the project was mailed to all owners of property within 300

feet of the project site and all political subdivisions on November 7, 2022. The public hearing notice was published in the Idaho Mountain Express on November 9, 2022. A notice was posted on the project site and the city's website on November 7, 2022. Story poles were verified on the subject property on November 22, 2022. The project was heard at the November 29, 2022 meeting of the Planning and Zoning Commission (the "Commission") and continued to a special meeting on December 20, 2022. The project was heard again on December 20, 2023, and continued to the January 10, 2023 meeting of the Commission. The applicant, siting the need for additional time to respond to Commission's comments, requested the January 10, 2023 hearing be continued to the February 28, 2023 meeting of the Commission. No information was presented or reviewed at the January 10, 2023 meeting and no public comment was

taken.

I. EXECUTIVE SUMMARY:

As noted above, the Commission has reviewed the proposed application two previous times. Once at their November 29, 2022 hearing and again on December 20, 2022. Staff and Commission comments at the November 29, 2022 hearing were addressed by the applicant at the December 20, 2022 hearing with the exception of the north façade wall. The Commission discussed design review criteria related to the bulk and flatness of the building and commented that the bulk and flatness of the north façade wall was significant and that additional articulation should be considered. The Commission requested the applicant evaluate stepping back the third floor and applying varied materials and architectural detailing to achieve a reduced bulk and

flatness. The Commission also requested a 3D model/rendering of what the building will look like in context with the surrounding neighborhood.

The applicant has provided a revised development proposal included as (Attachment A). The applicant has indicated that the 3D model/rendering will be provided during the applicant presentation portion of the meeting. The following changes are proposed:

- The third floor is stepped back on the Leadville Ave side approximately 4 feet from the ground floor façade wall for a total of 6 feet 10 inches from the property line on Leadville Ave.
- The third-floor deck has been extended to the north end of the building
- The building has been pulled away from the north property line 7 inches to allow for additional brick detailing and architectural treatments on the north façade including a wrap of the dark wood paneling on the ground floor and bricked in windows on the upper floors
- The parapet wall on the rear portion of the building has been raised 1 foot 4 inches to accommodate an elevator tower on the alley side of the building
- A metal railing has been added to the east end of the façade along 2nd Street
- A wall trellis on the north façade has been added to facilitate climbing vines from the ground floor to the rooftop deck

Staff recommends the Commission review the proposed changes to determine if the Commission's concerns and requests have been addressed satisfactorily.

II. CONFORMANCE WITH ZONING AND DESIGN REVIEW STANDARDS:

Per Ketchum Municipal Code (KMC) §17.96.010.A – *Applicability*, design review is required for all new mixed-use buildings. Before granting Design Review approval, the Commission must determine that the application meets two criteria: (1) the project doesn't jeopardize the health, safety, or welfare of the public, and (2) the project conforms to all Design Review standards and zoning regulations (KMC §17.96.050.A).

Criteria #1: Health, Safety, and Welfare of the Public

The 2014 Comprehensive Plan outlines 10 core values that drive our vision for the future including a strong and diverse economy, vibrant downtown, community character, and a variety of housing options. The built environment within the downtown plays a key role in materializing these values to achieve the city's vision. The 2014 Comprehensive Plan designates the future land use for the subject property as "mixed-use commercial" where, according to the plan, "New structures in existing mixed-use areas should be oriented to streets and sidewalks and contain a mix of activities. Mixed-use development should contain common public space features that provide relief to the density and contribute to the quality of the street." Primary uses include offices, medical facilities, health/wellness-related services, recreation, government, residential, and services.

Policy CD-1.3 of Chapter 4 of the comprehensive plan states that "Infill and redevelopment projects should be contextually appropriate to the neighborhood and development in which they occur. Context refers to the natural and manmade features adjoining a development site; it does not imply a certain style." The transition between buildings is a key design element and has the potential to impact the perceived cohesiveness of the downtown and can impact the way residents and visitors experience a place.

Staff believes the project meets many of the goals and policies of the plan. The project proposes a variety of sizes of residential units and provides desirable retail square footage on the ground floor. The project is set back from the property line on both the Leadville Ave and 2nd Street sides, with awnings that invite and protect pedestrians. Benches at the corner and thoughtful landscape elements create common public space that engages with the uses in the building and the adjacent sidewalk. The Commission has expressed concerns related to the project's context with the neighborhood and adjacent development. As further discussed below, the bulk and flatness of the north façade is the most concerning aspect of the development. If the Commission

determines that the revisions to the building effectively reduce the bulk and flatness of the building, the project could be found to conform to Policy CD-1.3 of the comprehensive plan.

Criteria #2: Applicable Standards and Criteria

Conformance with Zoning Regulations

The proposed changes do not impact the project's conformance with the zoning regulations, including dimensional standards, applicable to the project. The project remains in conformance with all zoning requirements.

Conformance with Design Review Improvements and Standards

Staff believes that most design review criteria are met with the proposed project, particularly as it relates to the changes made between the November 29th and December 20th hearings. Based on discussions at the December 20th hearing, the remaining concern for the Commission is design review criteria 17.96.060.F.5, which outlines that "Building walls shall provide undulation/relief, thus reducing the appearance of bulk and flatness". Staff believes that many of the changes proposed are a positive improvement from what was proposed at the December 20th hearing. The applicant has revised the plan set to show the existing adjacent trees for context. The applicant has not provided the 3D model/rendering of the surrounding buildings as requested by the Commission as part of the plan set, however, the model will be presented at the hearing for consideration. Sheet A4.4 shows the north façade elevation with the trellis, more articulated brick detailing, bricked in windows, and wood treatment that wraps the corner at the ground floor. It also shows the step back of the third floor from the front façade. No step backs of the third floor have been made on the sides or the rear of the building. Sheet A4.3 shows the same elevation but with the existing vegetation.

The renderings on Sheet A4.5 show how the step back of the third floor changes the appearance of the building. For comparison, Figures 1 and 2 below show comparison renderings between the December 20th proposal and what is proposed today.

Figure 1: Corner Rendering of 2nd and Leadville Comparison (December 20th on Left)





Figure 2: Corner Rendering of Leadville Ave Comparison (December 20th on Left)





The revised renderings depict what exists today with vegetation on adjacent properties. For reference, Sheet A4.4 shows what the elevation would look like if the vegetation did not exist.

III. STAFF RECOMMENDATION

Staff requests the Commission review the Design Review application and provided feedback to the applicant on the proposed revisions.

ATTACHMENTS:

A. Application Materials – Revised Design Review Plan Set



ATTACHMENT A: Application Materials – Revised Design Review Plan Set

THE 208



NOTE: 3D RENDERINGS ARE FOR ILLUSTRATIVE PURPOSES ONLY. NOT TO BE USED FOR CONSTRUCTION.

ZONING REQUIREMENTS

JURISDICTION: CITY OF KETCHUM, ID

CC COMMUNITY CORE, **ZONING:** SUBDISTRICT 2-MIXED USE

RPK00000230010 PARCEL ASSESSOR'S #:

LOT SIZE: 5,504 SF = 0.13 ACRE

LEGAL DESCRIPTION:

LOT 1, BLOCK 23 OF THE VILLAGE OF KETCHUM, BLAINE COUNTY, IDAHO, ACCORDING TO THE OFFICIAL PLAT THEREOF, RECORDED AS INSTRUMENT NO. 302967, RECORDS OF BLAINE COUNTY, IDAHO.

MAX. FAR: 2.25 WITH INCLUSIONARY HOUSING INCENTIVE -REFER TO SHEET A0.3 MAX. BUILDING COVERAGE: 75% (SF)

SETBACKS:

5' AVERAGE -FRONT AND STREET SIDE -ADJACENT TO ALLEYWAY -NON-HABITABLE STRUCTURES

CODE INFORMATION

LOCATED ON BUILDING ROOF-TOPS

MAX. HEIGHT: 42' ABOVE ABE

ALL MATERIALS, WORKMANSHIP, DESIGN AND CONSTRUCTION SHALL CONFORM TO THE DRAWINGS, SPECIFICATIONS, AND THE FOLLOWING APPLICABLE CODES USED IN THIS DESIGN FOR CITY OF KETCHUM.

10'

2018 INTERNATIONAL BUILDING CODE (IBC)

2018 INTERNATIONAL FIRE CODE -INCLUDING AMENDMENTS PER KETCHUM ORDINANCE

2018 INTERNATIONAL ENERGY CONSERVATION CODE (IECC) -INCLUDING AMENDMENTS BY THE IDAHO BUILDING CODE BOARD

2018 INTERNATIONAL FIRE CODE (IFC) -INCLUDING ADMENDMENTS PER KETCHUM ORDINANCE

2018 CITY OF KETCHUM MUNICIPAL CODE

-INCLUDING KETCHUM GREEN BUILDING CODE 2018 INTERNATIONAL FUEL GAS CODE (IFGC)

2018 INTERNATIONAL MECHANICAL CODE (IMC)

2018 NATIONAL ELECTRIC CODE (NEC) 2018 IDAHO STATE PLUMBIONG CODE (ISPC)

ACCESSIBLE UNITS

PROJECT CONTAINS (4) UNITS TOTAL: (3)TYPE B UNITS PROVIDED, PER IBC CHAPTER 11

PARKING: RETAIL:

EXEMPT LESS THAN 5,500 SF 0 SPACES **RESIDENTIAL:** 4 SPACES

DESIGN REVIEW APPLICATION REQUIREMENTS

TITLE 17 - CHAPTER 17.96 DESIGN REVIEW:

17.96.040.C.2.f: FLOOR PLAN. LIST GROSS AND NET SQUARE FOOTAGE FOR EACH FLOOR. LIST OCCUPANCY CLASSIFICATION AND TYPE OF CONSTRUCTION.

OCCUPANCY CLASSIFICATION:

M MERCANTILE (RETAIL AREAS)

R-2 RESIDENTIAL S-2 PARKING AREAS

TYPE OF CONSTRUCTION:

NOTE: METHOD FOR MEASURING FLOOR AREA (GROSS) PER CHAPTER 17.08

ARE NOT INCLUDED IN THE GROSS FLOOR AREA CALCULATION.

DEFINITIONS: THE SUM OF HORIZONTAL AREA OF THE BUILDING MEASURED ALONG THE OUTSIDE WALLS OF EACH FLOOR OF A BUILDING OR PORTION OF A BUILDING, INCLUDING STAIR TOWERS AND ELEVATORS ON THE GROUND FLOOR ONLY, AND 50 PERCENT OF ATRIUMS OVER 18 FEET PLATE HEIGHT, BUT NOT INCLUDING BASEMENTS, UNDERGROUND PARKING AREAS OR OPEN UNENCLOSED DECKS. PARKING AREAS COVERED BY A ROOF OR PORTION OF THE BUILDING AND ENCLOSED ON THREE OR MORE SIDES BY BUILDING WALLS ARE INCLUDED. FOUR PARKING STALLS FOR DEVELOPMENTS ON SINGLE KETCHUM TOWN SITE LOTS OF 5,600 SF IN SIZE OR LESS

NOTE: METHOD FOR MEASURING FLOOR AREA (NET) PER CHAPTER 17.08 DEFINITIONS: THE SUM OF HORIZONTAL AREAS OF ALL FLOORS IN A BUILDING INCLUDING BASEMENTS BUT NOT INCLUDING OPEN UNENCLOSED DECKS. INTERIOR OR EXTERIOR CIRCULATION, MECHANICAL EQUIPMENT ROOMS, PARKING AREAS, COMMON AREAS, PUBLIC BATHROOMS OR STORAGE AREAS IN BASEMENTS.

DESIGNER:

PROJECT NEW CONSTRUCTION OF **DESCRIPTION:** MIXED USE AND COMMERCIAL BUILDING

2667 SOUTH TACOMA WAY

E:MIKEC@PERFORMANCERADIATOR.COM

ARCHITECT: MEDICI ARCHITECTS

KETCHUM, ID 83340

FRIDAY HARBOR, WA 98250

GALENA ENGINEERING, INC CIVIL ENGINEER: 317 N. RIVER STREET SURVEYOR:

P: 208.788.1705

LYON LANDSCAPE ARCHITECTS LANDSCAPE

> HAILEY, IDAHO 83333 P:253.209.4053

CONRAD BROTHERS

KETCHUM, IDAHO 83340 P:208.309.1200

ELECTRICAL ABOSSEIN ENGINEERING **ENGINEER:** 18465 NE 68TH STREET #22

P:425.462.9441

CITY OF THE MH COMPANIES

BOISE, IDAHO 83704 CONSULTANT:

GRID LINES

PROJECT BASE POINT

PROPERTY CORNER

PROPERTY LINE

CENTER LINE

N 90 00' 00" E

Distance

〈4 A1.0

REFERENCE ELEVATION

TOP OF WALL ELEVATION

PROPERTY LINE TAG

SECTIONS FOUND

DETAIL SECTION FOUND

INTERIOR ELEVATION

FOUND ON SHEET A1.0

ON SHEET A101

ON SHEET A101

EXIT DIRECTION

SMOKE DETECTOR

SMOKE & CARBON

DOOR TAG NUMBER

10'-0"x12'-0" DOOR SIZE

MONOXIDE DETECTOR

WINDOWS TAG NUMBER

DRAWING REVISION

WALL TAG ASSEMBLY

WHOLE HOUSE FAN

2995 N COLE RD SUITE 115 P:208.609.3722

PROJECT DATA

OWNER: MICHAEL, CARR

> TACOMA, WA 98409 P:206.423.3121

200 WEST RIVER STREET #301

P: 208.726.0194 E: EMILY@MEDICIARCHITECTS.COM

EXECUTIVE DESIGN SERVICES SHERMAN, JONATHAN

P:206.383.4526

E:JONATHANDESIGN0007@GMAIL.COM

HAILEY, IDAHO 83333

E:GALENA@GALENA-ENGINEERING.COM

ARCHITECT: 126 SOUTH MAIN STREET, SUITE B1

E:MOGHAN@LYONLA.COM

CONTRACTOR: 105 LEWIS ST SUITE 101

E:PAUL@CONRADBROTHERSCONSTRUCTION.COM

REDMOND, WA 98052

E:CSERVICE@ABOSSEIN.COM

KETCHUM LIGHTING

E:CARSON@MHLIGHTING.COM

PROJECT LOCATION **VICINITY MAP**

PICT PICTURE

QTY QUANTITY

REQ'D REQUIRED

REV REVISION

R RISER

RM ROOM

SIM

STD

PLAM PLASTIC LAMINATE

PL PROPERTY LINE

REF REFRIGERATOR

RO ROUGH OPENING

SIMILAR

SOG SLAB ON GRADE

SPEC SPECIFICATION

SS STAINLESS STEEL

STEEL

SD STORM DRAIN

SUP SUPPLEMENTAL

TV TELEVISION

TEMP TEMPORARY

TOW TOP OF WALL

TREAD

TB TOWEL BAR

TO TOP OF

TYP TYPICAL

STOR STORAGE

STANDARD

SAFETY GLASS

SINGLE HUNG

SQUARE FOOT

T&G TONGUE & GROOVE

TPZ TREE PROTECTION ZONE

VAPOR BARRIER

VTOS VENT TO OUTSIDE

VIF VERIFY IN FIELD

VG VERTICAL GRAIN

WC WATER CLOSET

WH WATER HEATER

WHF WHOLE HOUSE FAN

WP WATER PROOFING

VERT VERTICAL

W WASHER

WIN WINDOW

W/O WITHOUT

W/ WITH

YD YARD

UNO UNLESS NOTED OTHERWISE

WRB WATER RESISTANT BARRIER

TOILET PAPER DISPENSER

PSF POUNDS PER SQUARE FOOT

PSI POUNDS PER SQUARE INCH

PNA PROTECTED NATURAL AREA

MEDICI ARCHITECTS

1/4" = 1'-0"

11661 SE 1ST STREET, SUITE 200 BELLEVUE, WASHINGTON 98005 TEL: (425) 453-9298 FAX: (425) 452-8448 **REGISTRATION:**

NICOLE C. RAMEY STATE OF IDAHO 02/22/23 INTAKE DATE: **REVISIONS:** DATE:

PROJECT / CLIENT:

THE 208 BUILDING

CARR, MICHAEL

JOB ADDRESS: 200 N LEADVILLE KETCHUM IDAHO, 83340 PARCEL #RPK00000230010

SYMBOL LEGEND EXISTING WALL

EXISTING WALL TO

FOUNDATION WALL

CONCRETE SURFACE

CAST IN PLACE

STRUCTURAL POST

SIZE AND TYPE PER

STRUCTURAL PLAN

CONCRETE

GAS OUTLET

GAS METER

HOSE BIB

DOWNSPOUT

ELECTRICAL METER

ELECTRICAL PANEL

COMPACTED FILL

RIGID OR SPRAY

BIBS BLOWN-IN

BATT INSULATION

VENT TO OUTSIDE

WATER METER

ELEVATION CHANGE

STEP DOWN /

KEY NOTES

EXHAUST FAN

INSULATION

INSULATION

UNDISTURBED EARTH

2X WALLS

ABBREVIATIONS AFF ABOVE FINISH FLOOR A/C AIR CONDITIONING AHU AIR HANDLING UNIT ALT ALTERNATE ALUM ALUMINUM ANOD ANODIZED BSMT BASEMENT BLK BLOCK BS BOTH SIDES BLDG BUILDING CAB CABINET CB CATCH BASIN CLG CEILING CLR CLEAR CL CLOSET CONC CONCRETE CONT CONTINUOUS

CMU CONCRETE MASONRY UNIT CJ CONTROL JOINT CPT CARPET CSMT CASEMENT CF CUBIC FOOT DIA DIAMETER

DBH DIAMETER BREAST HEIGHT DIM DIMENSION DW DISHWASHER DOUBLE HUNG

DOWN DOWNSPOUT DRYER EA EACH ELEC ELECTRICAL EP ELECTRICAL PANEL

ELEV ELEVATOR EQ EQUAL EXT EXTERIOR EXIST EXISTING FFE FINISH FLOOR ELEVATION FRD FIRE RATE DOOR FRW FIRE RATE WINDOW FXD FIXED

FIXT FIXTURE FAR FLOOR AREA RATIO FTG FOOTING FAU FORCED AIR UNIT FDN FOUNDATION FURN FURNACE GFA GROSS FLOOR AREA HDWD HARDWOOD HDR HEADER HVAC HEATING, VENTILATION & A/C

HORZ HORIZONTAL HR HOUR INCL INCLUDE (ED)(ING) INT INTERIOR LED LIGHT EMITTING DIODE LOD LIMIT OF DISTURBANCE LF LINEAR FEET MANUF MANUFACTURER MAX MAXIMUM MECH MECHANICAL MED MEDIUM

HT HEIGHT

MIN MINIMUM MISC MISCELLANEOUS NIC NOT IN CONTRACT NTS NOT TO SCALE NO NUMBER OC ON CENTER PERF PERFORATED

DRAWING NAME: TITLE SHEET

> Drawn By: MS Checked By: NR

Owner Approval:

PHASE:

CONSTRUCTION DRAWINGS


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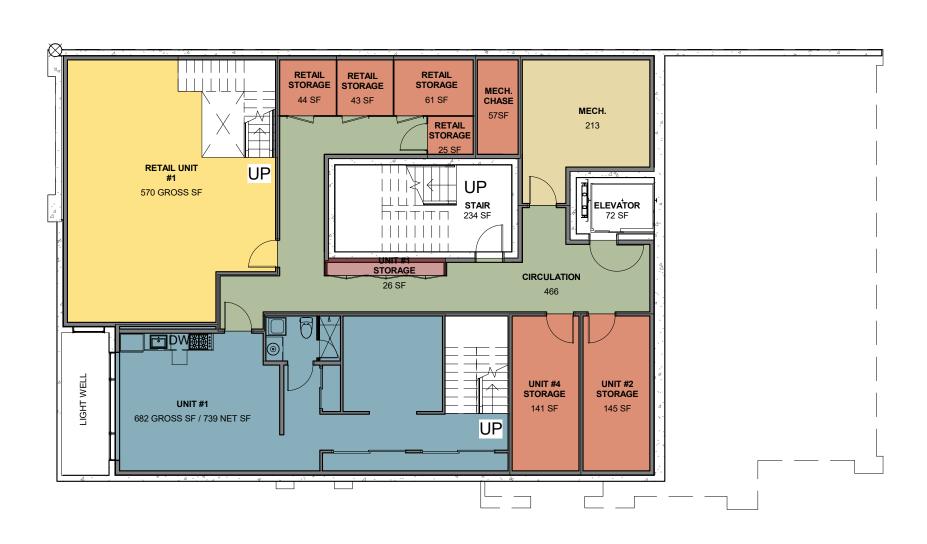
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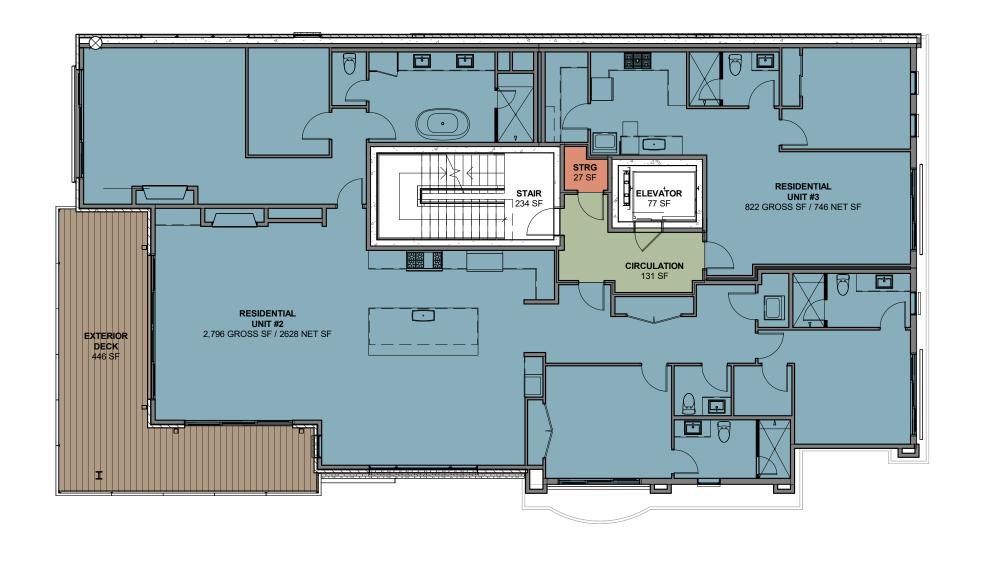
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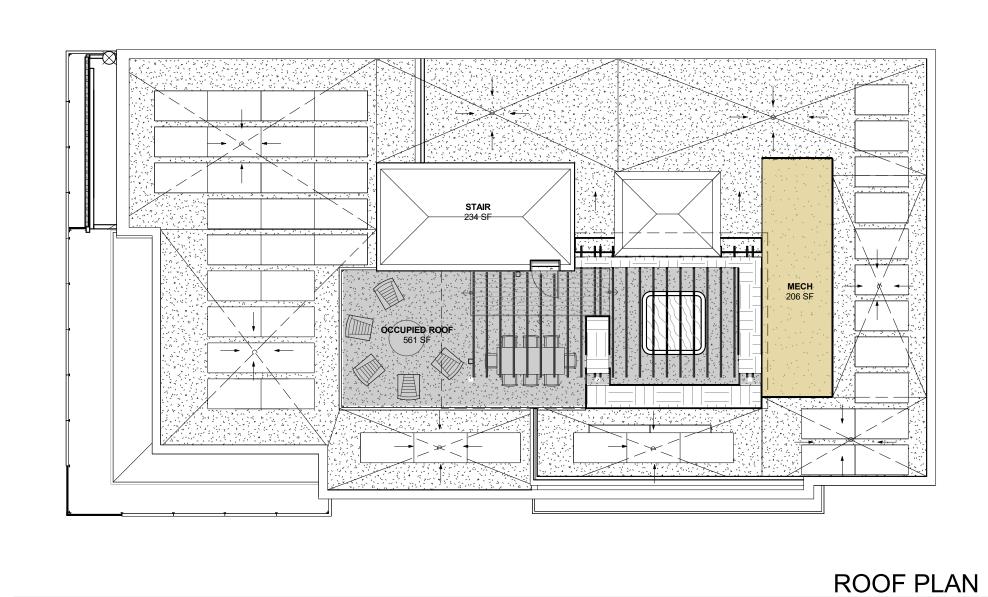



LOWER LEVEL PLAN
3/32" = 1'-0"




2ND FLOOR PLAN 3/32" = 1'-0"


3/32" = 1'-0"

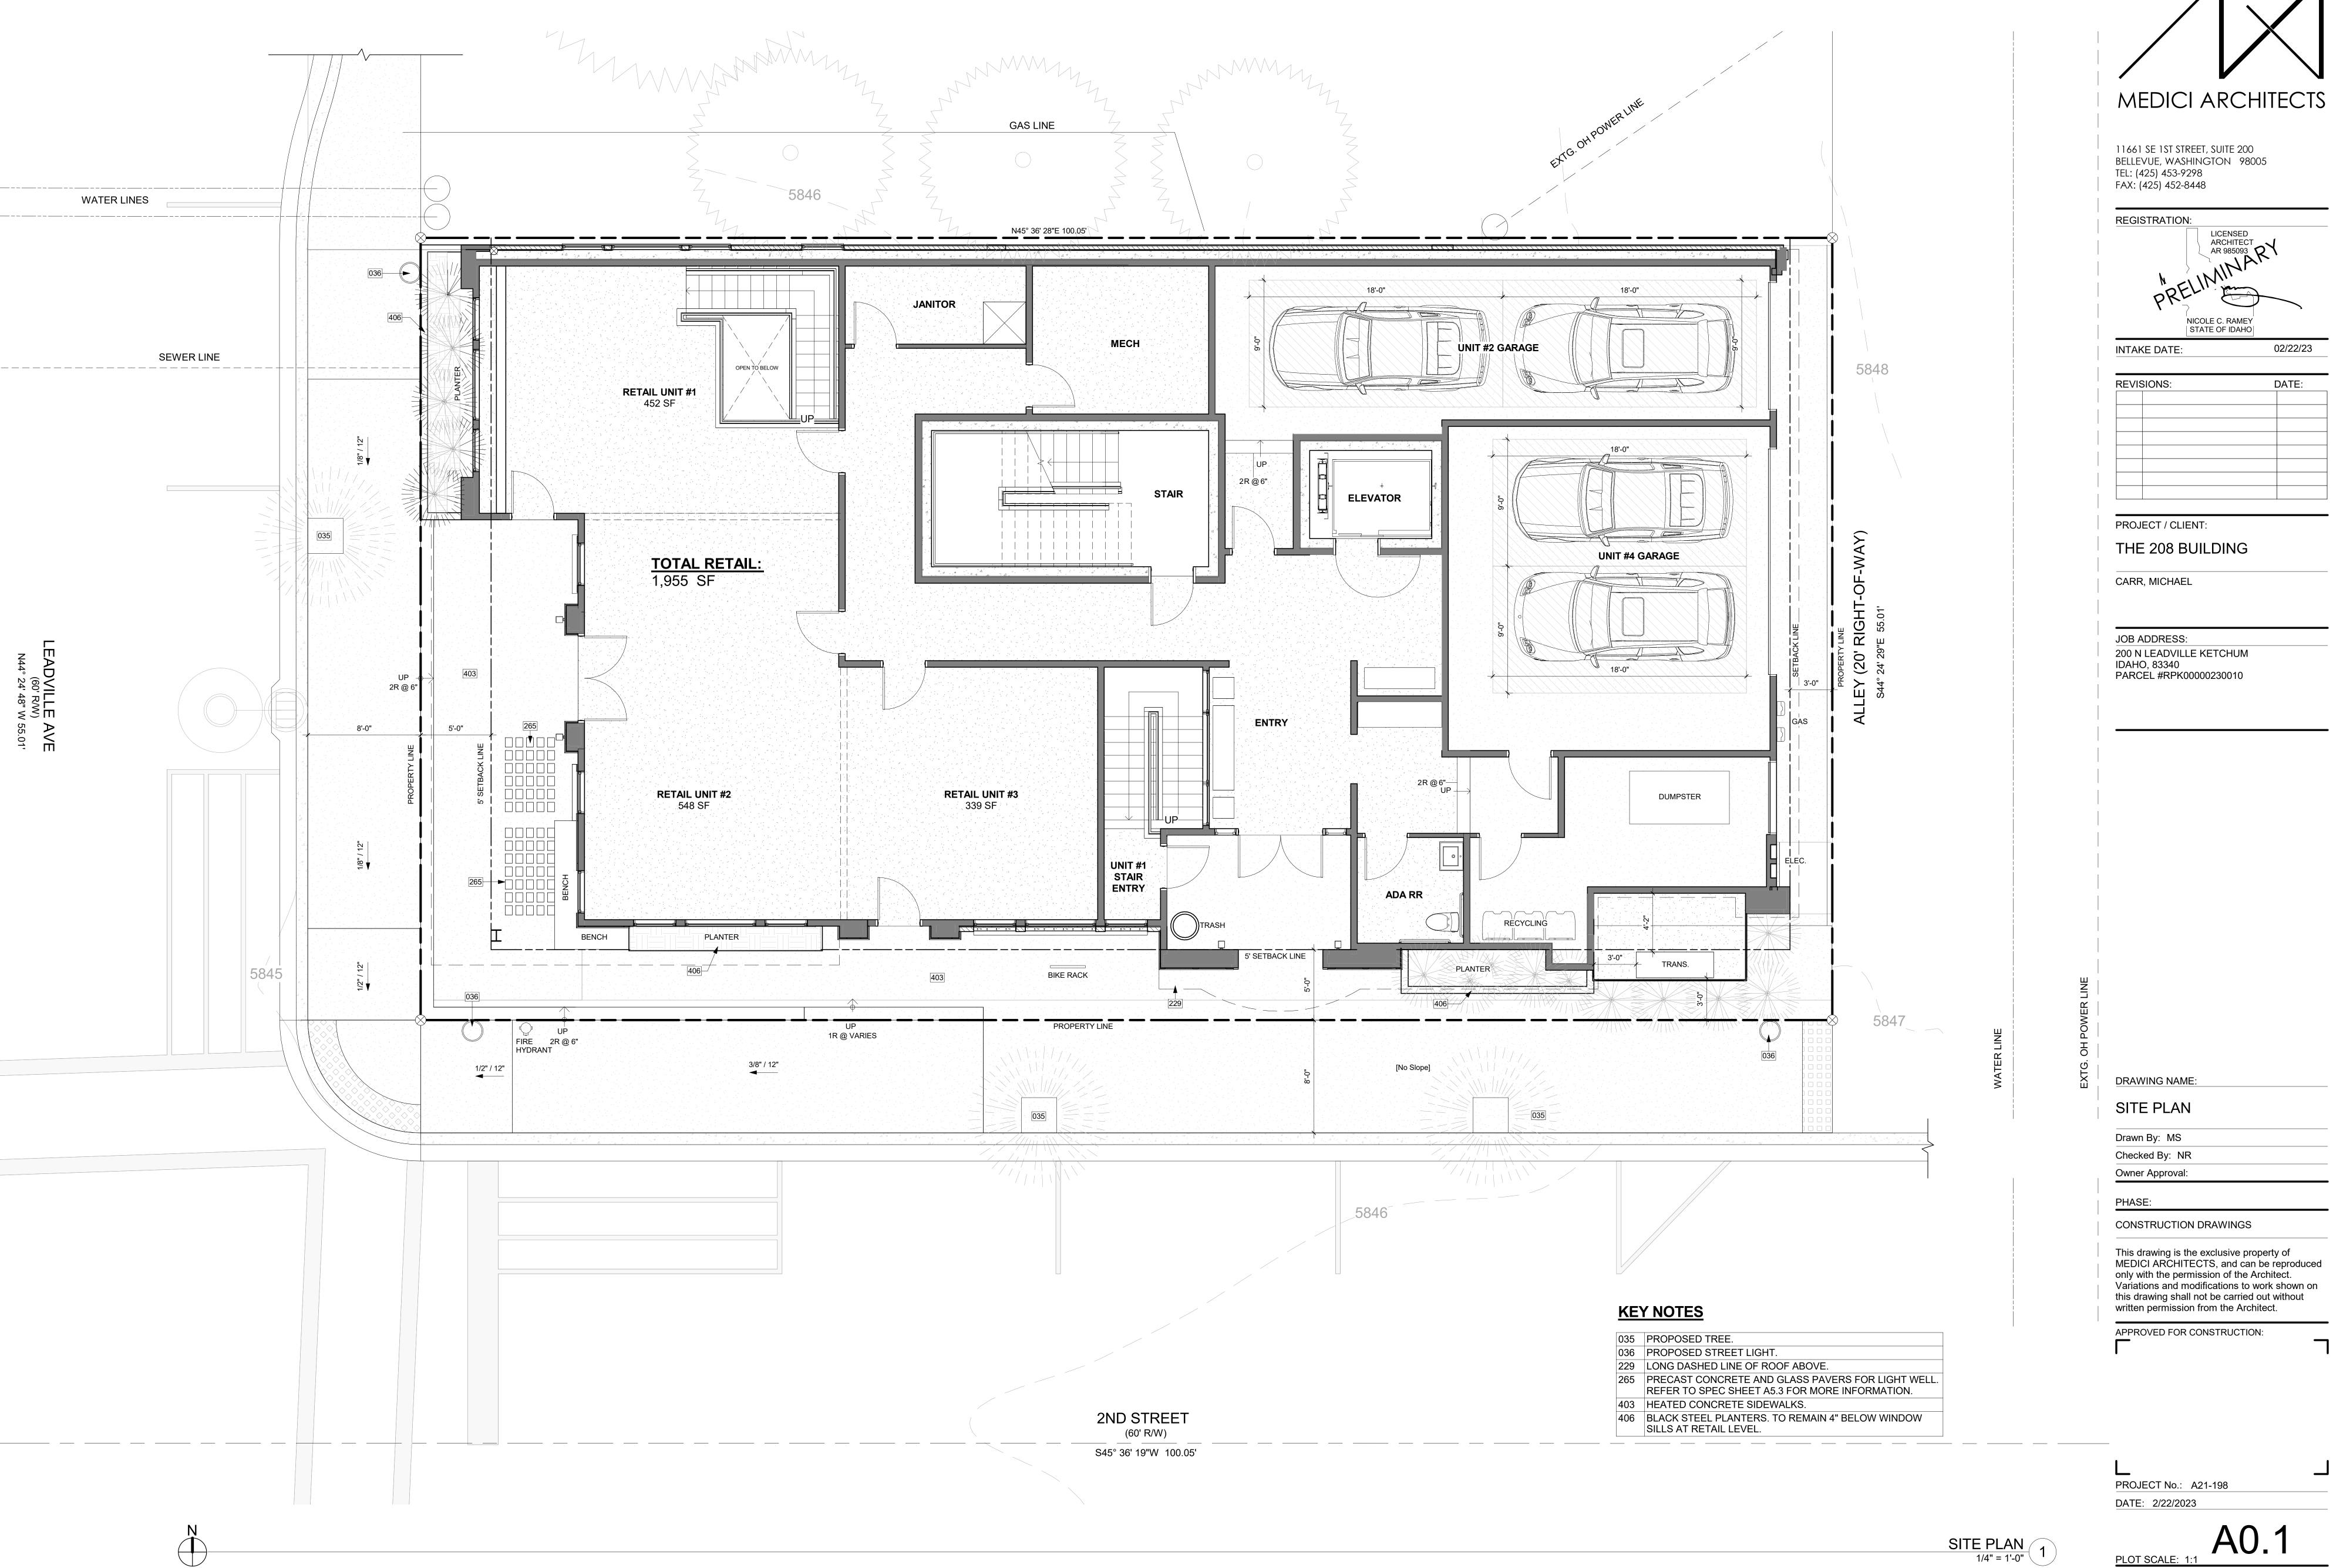

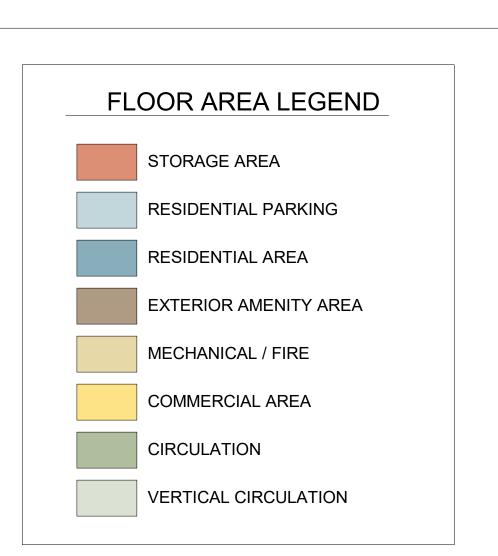

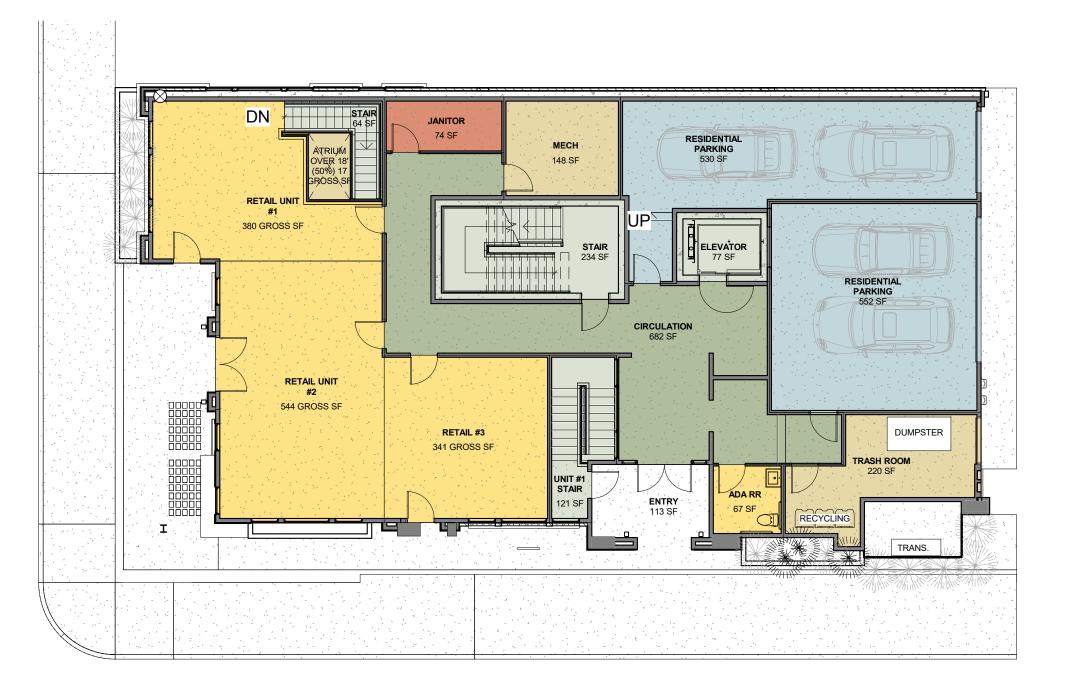

1ST FLOOR PLAN 3/32" = 1'-0"

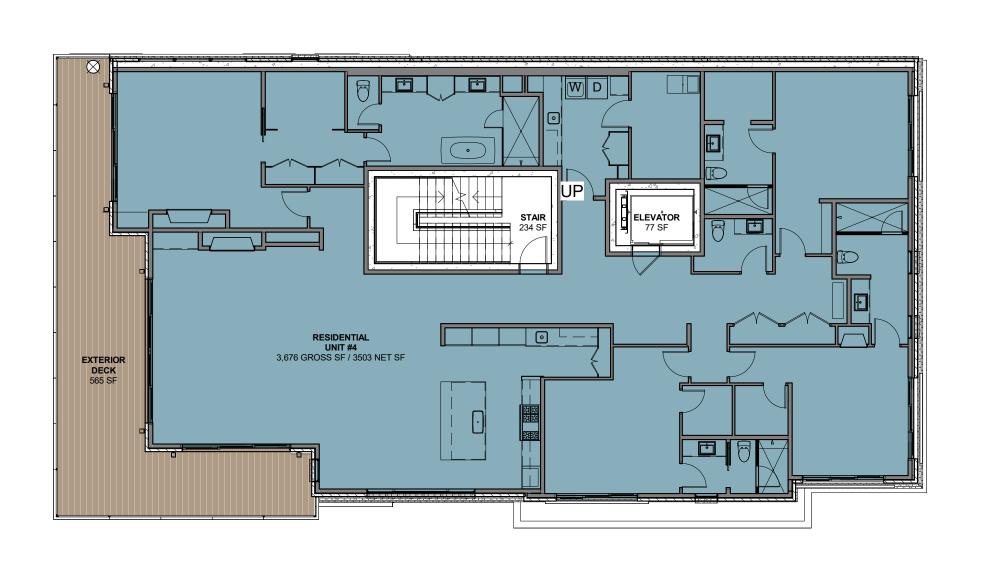

3RD FLOOR PLAN 3/32" = 1'-0"

| | BUILDING AREA SQUARE FOOTAGES | | | | | |
|-------------|-------------------------------|-------------------------|-------------|---------------|--|--|
| FLOOR PLAN | AREA USE | GROSS AREA SF | NET AREA SF | EXCLUDED AREA | | |
| | RESIDENTIAL UNIT #1 | 682 SF | 639 SF | 682 | | |
| | STORAGE UNIT #4 | 141 SF | | 14 | | |
| | STORAGE UNIT #1 | 26 SF | | 20 | | |
| | STORAGE UNIT #2 | 145 SF | | 14: | | |
| LOWER LEVEL | RETAIL UNIT #1 | 570 SF | | 57 | | |
| | MECH / FIRE RISER ROOM | 213 SF | | 21 | | |
| | CIRCULATION | 466 SF | | 46 | | |
| | STAIR | 234 SF | | 23 | | |
| TOTALS: | ELEVATOR | 72 SF 2549 SF | 639 SF | 7. | | |
| | | | | 254 | | |
| FLOOR PLAN | AREA USE | GROSS AREA SF | NET AREA SF | EXCLUDED AREA | | |
| | RETAIL UNIT #1 | 380 SF | | | | |
| | RETAIL UNIT #1 STAIR | 121 SF | | | | |
| | ATRIUM (50% over 18') | 34 SF | | 1 | | |
| | RETAIL UNIT #2 | 544 SF | | | | |
| | RETAIL UNIT #3 RESTROOM | 341 SF 67 SF | | | | |
| | RESIDENTIAL UNIT#1 STAIR | 33 SF | | | | |
| 1ST FLOOR | RESIDENTIAL PARKING | 530 SF | | 32 | | |
| | RESIDENTIAL PARKING | 552 SF | | 32 | | |
| | JANITOR | 74 SF | | 02 | | |
| | MECHANICAL | 148 SF | | | | |
| | CIRCULATION | 682 SF | | | | |
| | STAIR | 234 SF | | | | |
| | ELEVATOR | 77 SF | | | | |
| | TRASH ROOM | 220 SF | | | | |
| TOTALS: | | 4069 SF | 0 SF | 66 | | |
| FLOOR PLAN | AREA USE | GROSS AREA SF | NET AREA SF | EXCLUDED AREA | | |
| | RESIDENTIAL UNIT #2 | 2796 SF | 2628 SF | | | |
| | RESIDENTIAL UNIT #3 | 822 SF | 746 SF | | | |
| | STORAGE | 27 SF | | | | |
| 2ND FLOOR | EXTERIOR DECK | 446 SF | | 44 | | |
| | CIRCULATION | 131 SF | | | | |
| | STAIR | 234 SF | | 23 | | |
| TOTALC | ELEVATOR | 77 SF | 2274.05 | | | |
| TOTALS: | | 4533 SF | 3374 SF | 75 | | |
| FLOOR PLAN | AREA USE | GROSS AREA SF | NET AREA SF | EXCLUDED AREA | | |
| | RESIDENTIAL UNIT #4 | 3676 SF | 3503 SF | | | |
| 3RD FLOOR | EXTERIOR DECK | 565 SF | | 56 | | |
| | STAIR | 234 SF | | 23 | | |
| TOTALS: | ELEVATOR | 77 SF 4552 SF | 3503 SF | | | |
| | | | | | | |
| FLOOR PLAN | AREA USE | GROSS AREA SF | NET AREA SF | EXCLUDED AREA | | |
| ROOF DECK | OCCUPIED ROOF | 561 SF | | 56 | | |
| | MECHANICAL | 206 SF | | 20 | | |
| TOTALS: | STAIR | 234 SF 1001 SF | 0SF | 23 100 | | |
| | | | | | | |
| | | | | | | |
| | | GROSS AREA SF | NET AREA SF | EXCLUDED AREA | | |

TOTAL BUILDING: 16,704 SF 7516 SF 5,848

FAR:

GROSS AREA SF

10,856 SF

BUILDING FOOTPRINT

4309 SF = 78.33% OF SITE AREA

LEADVILLE AVE SETBACK
919 SF / 55 = 10.887_AVG. SETBACK

SETBACKS

1200 SF = 21.67% OF SITE AREA

2 YO SETBACK

1100 SF / 100° = 11.07_AVG. SETBACK

This drawing is the exclusive pro

DESIGN REVIEW FLOOR

DRAWING NAME:

Drawn By: MS

Checked By: NR

Owner Approval:

PHASE:

AREA DIAGRAM

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MEDICI ARCHITECTS

NICOLE C. RAMEY STATE OF IDAHO

02/22/23

DATE:

11661 SE 1ST STREET, SUITE 200 BELLEVUE, WASHINGTON 98005

TEL: (425) 453-9298 FAX: (425) 452-8448

REGISTRATION:

INTAKE DATE:

REVISIONS:

PROJECT / CLIENT:

CARR, MICHAEL

JOB ADDRESS:

FAR

1.97

SITE AREA SF

5504 SF


THE 208 BUILDING


200 N LEADVILLE KETCHUM IDAHO, 83340 PARCEL #RPK00000230010

APPROVED FOR CONSTRUCTION:

PROJECT No.: A21-198

DATE: 2/22/2023

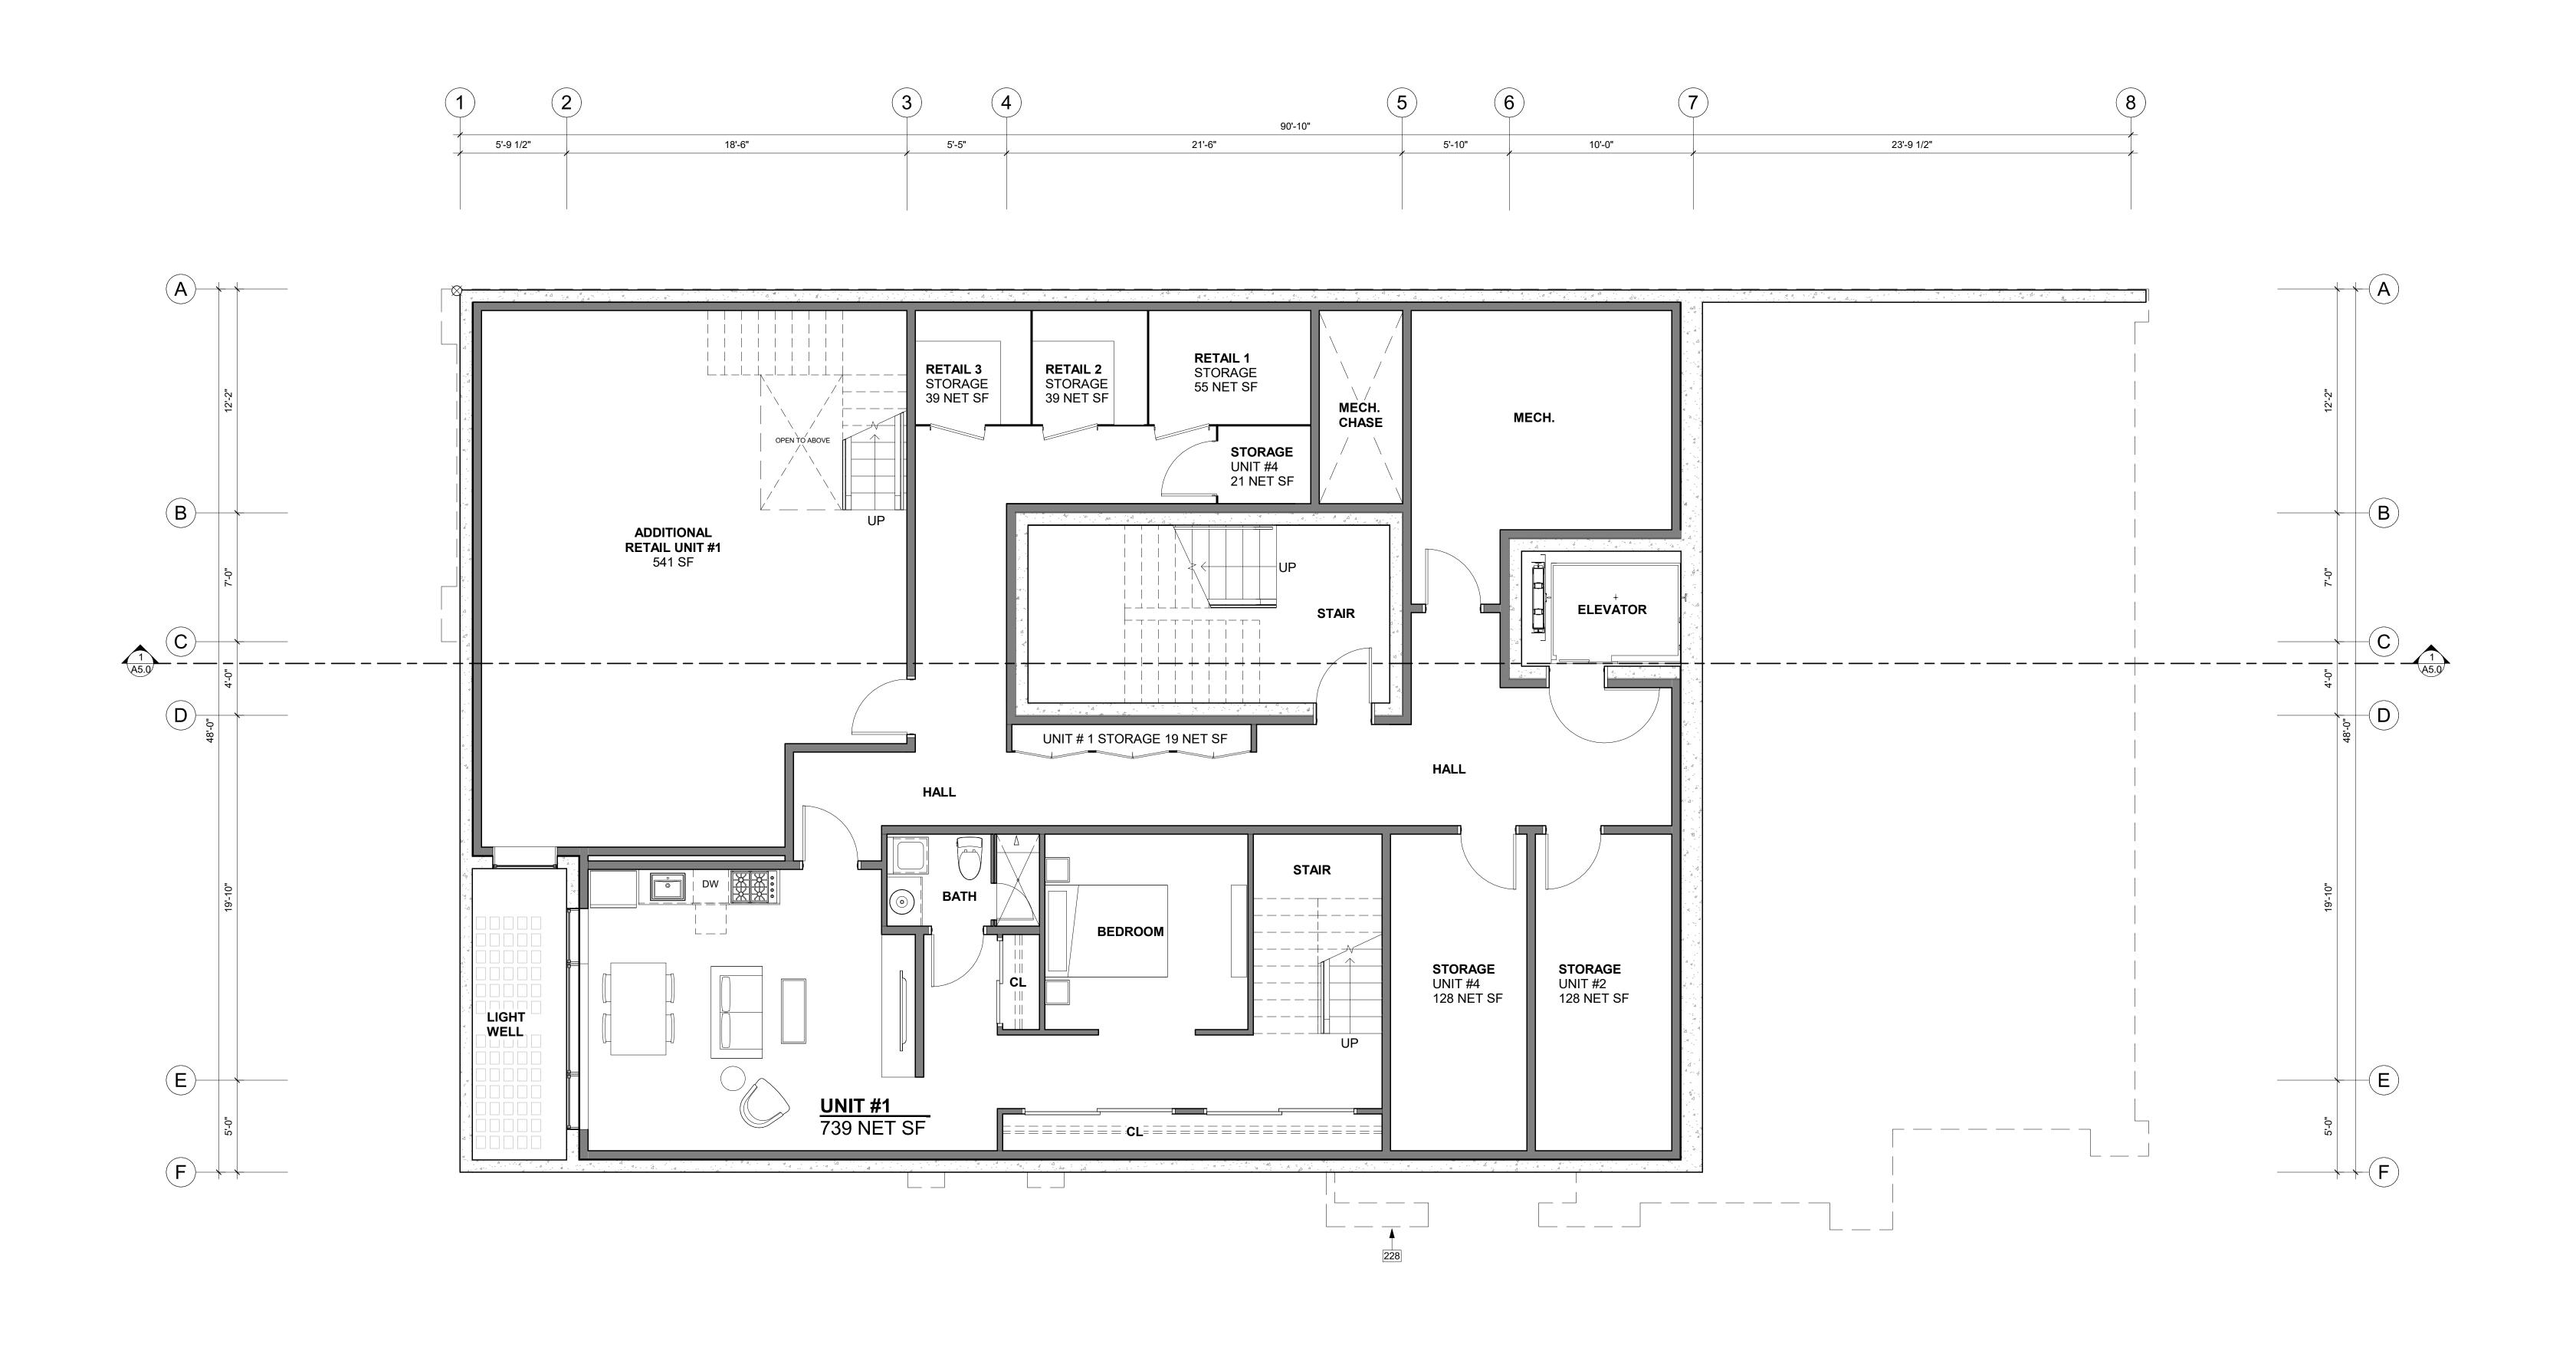

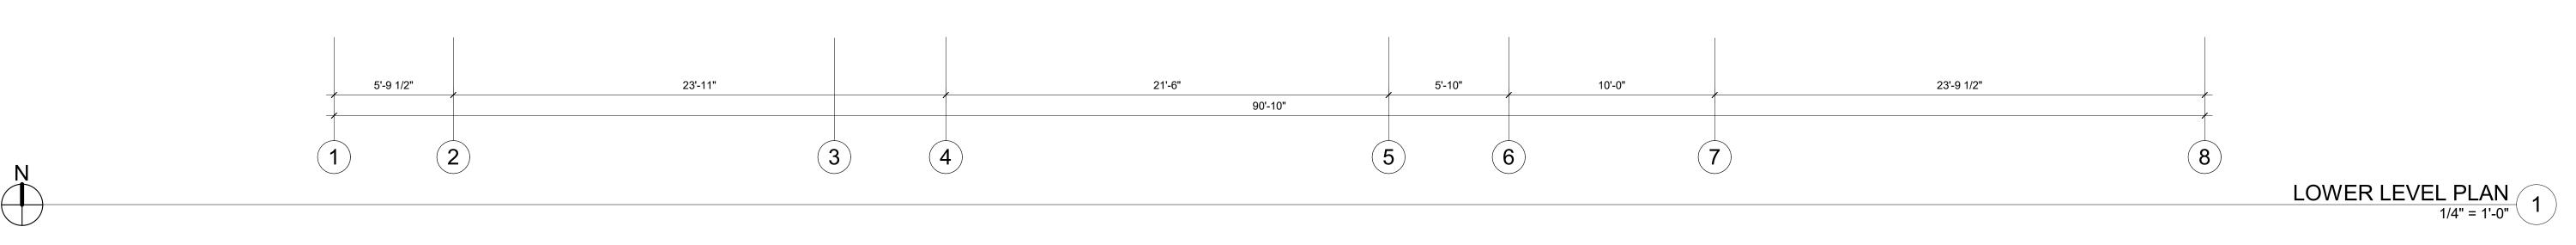


KEY NOTES

228 DASHED LINE OF BUILDING ABOVE.



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REGISTRATION:

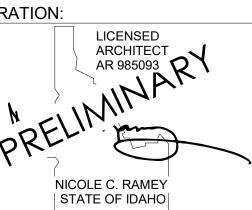

REVISIONS: DATE:

PROJECT / CLIENT:

THE 208 BUILDING

CARR, MICHAEL

JOB ADDRESS:

200 N LEADVILLE KETCHUM
IDAHO, 83340
PARCEL #RPK00000230010

DRAWING NAME:

LOWER LEVEL PLAN

Drawn By: MS
Checked By: NR
Owner Approval:

PHASE:

CONSTRUCTION DRAWINGS

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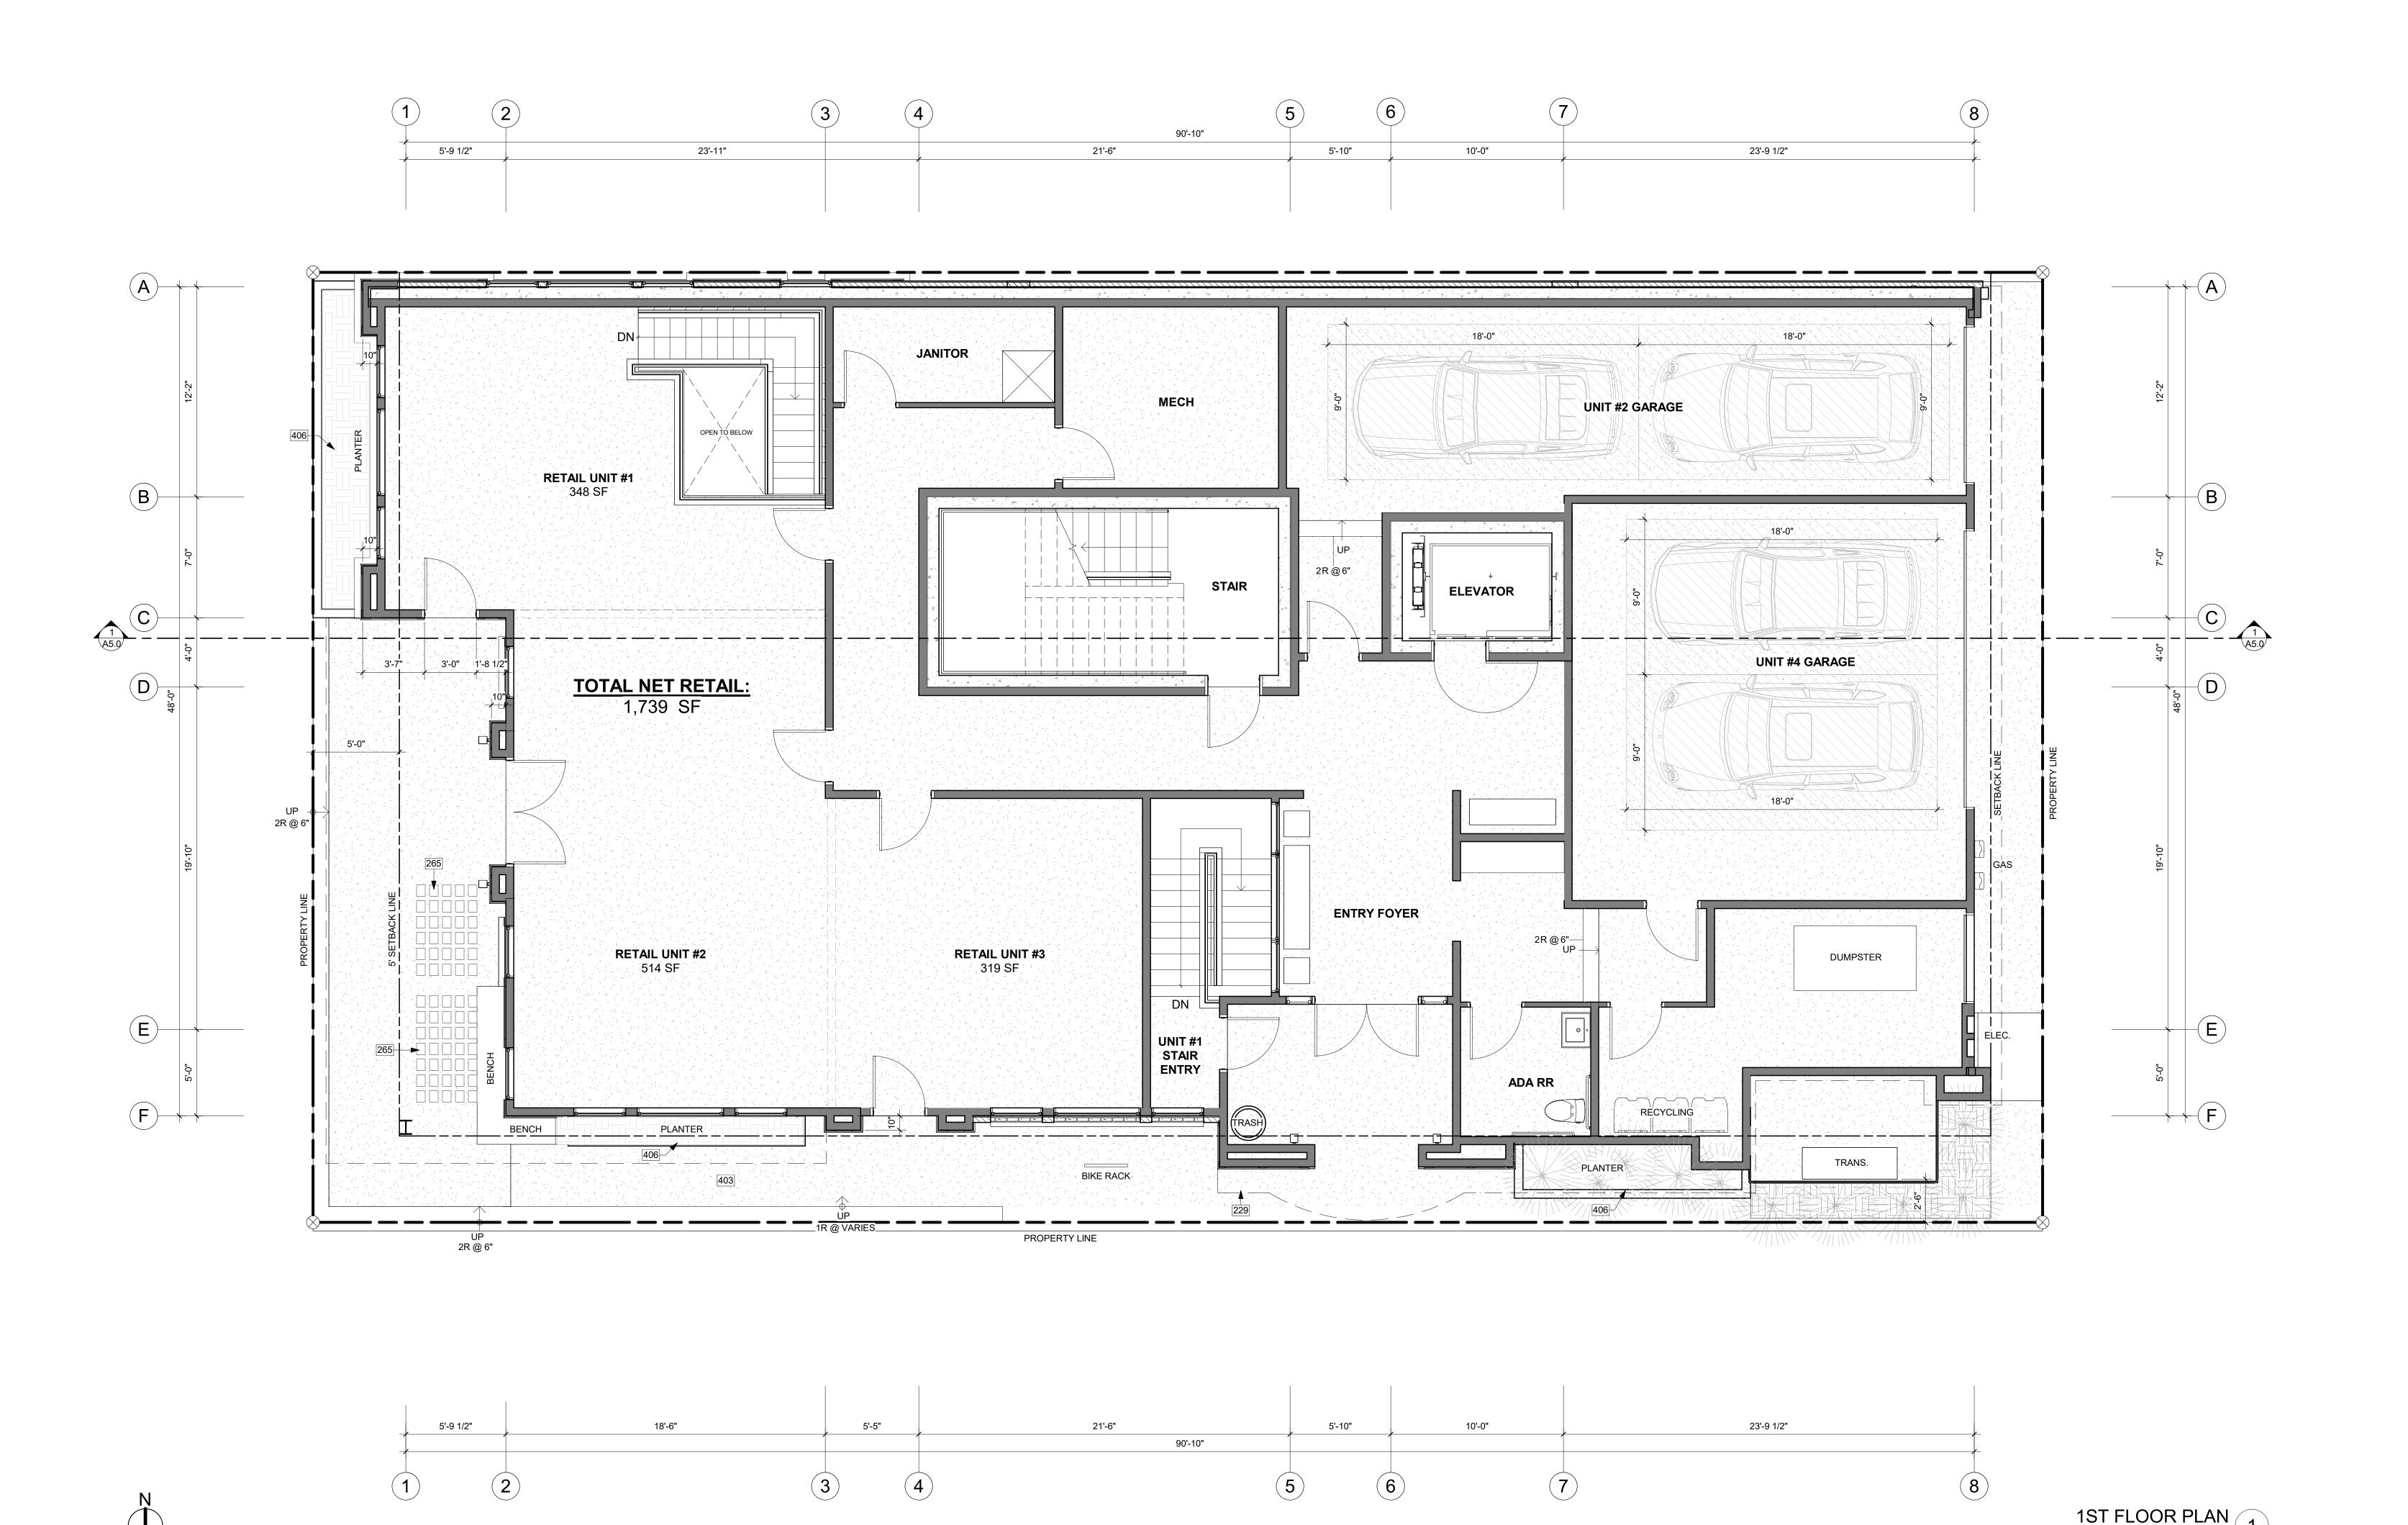
APPROVED FOR CONSTRUCTION:

PROJECT No.: A21-198

DATE: 2/22/2023

A2.0

T SCALE: 1:1




KEY NOTES

- 229 LONG DASHED LINE OF ROOF ABOVE.
- 265 PRECAST CONCRETE AND GLASS PAVERS FOR LIGHT WELL. REFER TO SPEC SHEET A5.3 FOR MORE
- INFORMATION.
- 403 HEATED CONCRETE SIDEWALKS.
- 406 BLACK STEEL PLANTERS. TO REMAIN 4" BELOW WINDOW SILLS AT RETAIL LEVEL.



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REGISTRATION:

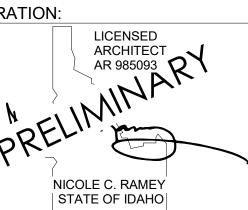

INTAKE DATE:

REVISIONS:

DATE:

PROJECT / CLIENT:

THE 208 BUILDING

CARR, MICHAEL

JOB ADDRESS:

200 N LEADVILLE KETCHUM
IDAHO, 83340
PARCEL #RPK00000230010

DRAWING NAME:

1ST FLOOR PLAN

Drawn By: MS
Checked By: NR
Owner Approval:

PHASE:

CONSTRUCTION DRAWINGS


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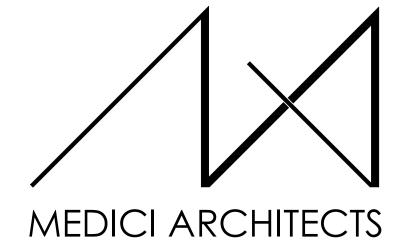
APPROVED FOR CONSTRUCTION:

PROJECT No.: A21-198

DATE: 2/22/2023

A2.1
PLOT SCALE: 1:1



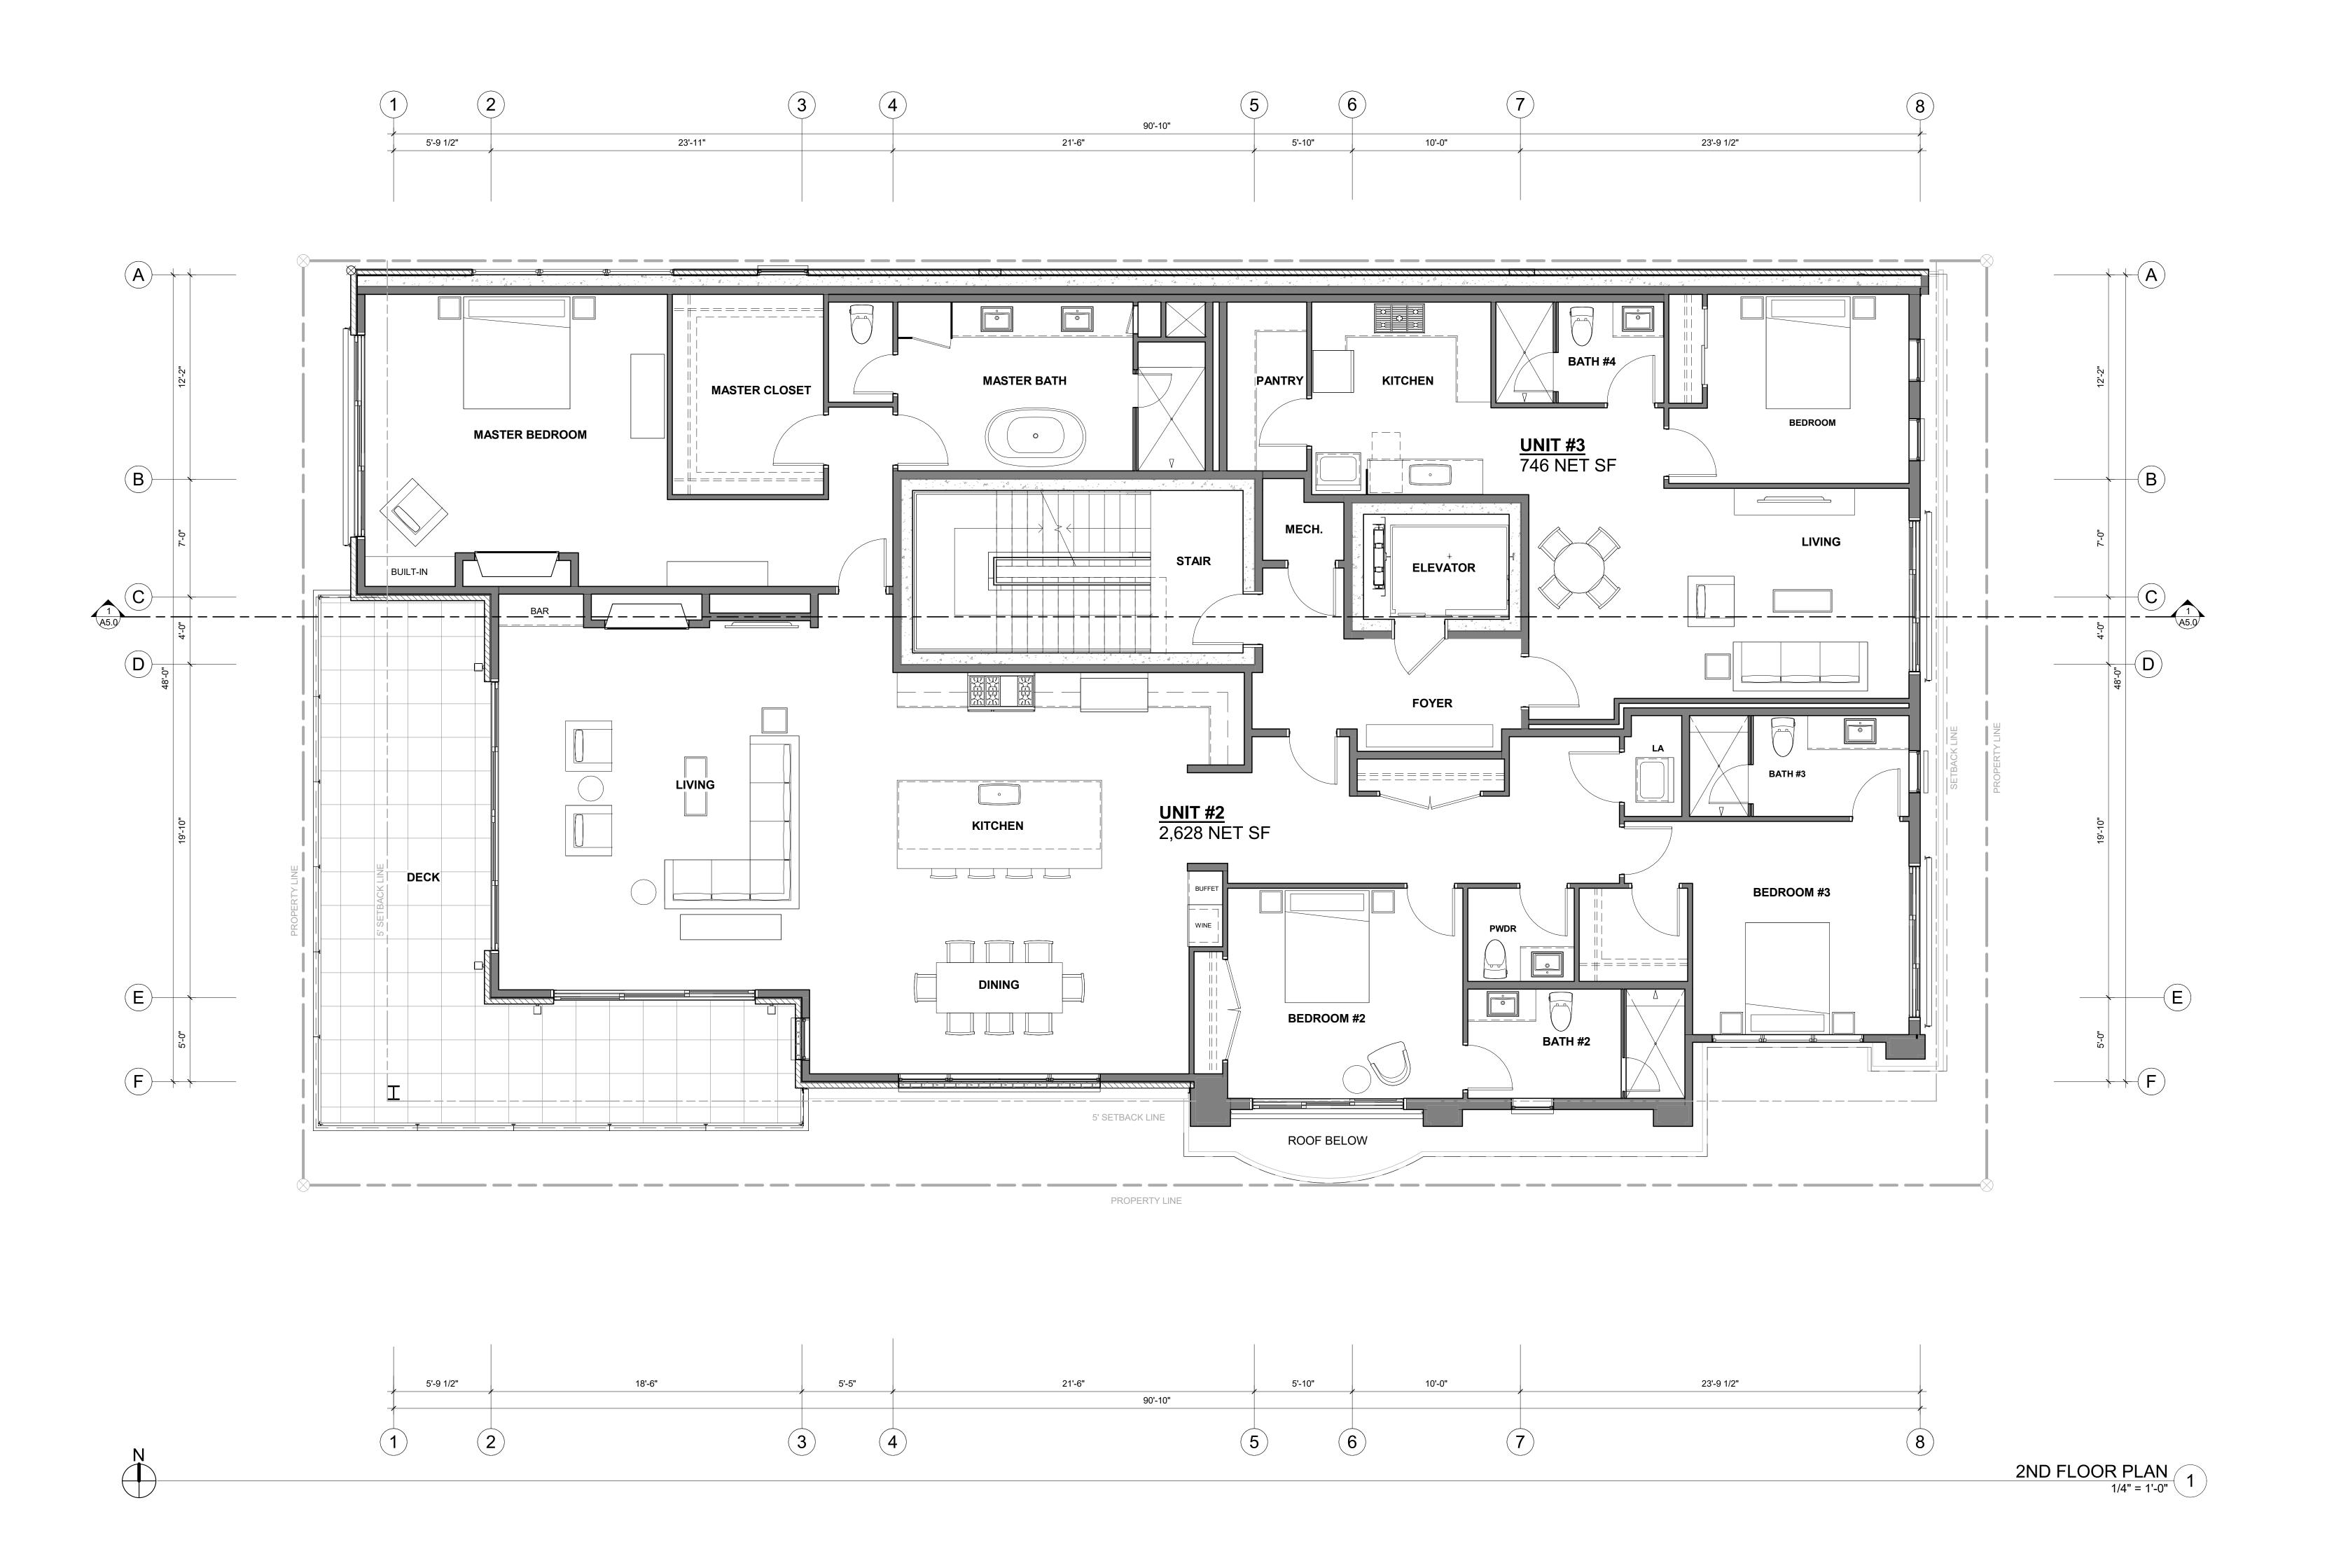

REGISTRATION:

RATION:

LICENSED
ARCHITECT
AR 985093

NICOLE C. RAMEY
STATE OF IDAHO

REVISIONS: DATE:

PROJECT / CLIENT:
THE 208 BUILDING

CARR, MICHAEL

JOB ADDRESS:

200 N LEADVILLE KETCHUM
IDAHO, 83340
PARCEL #RPK00000230010

DRAWING NAME:

2ND FLOOR PLAN

Drawn By: MS
Checked By: NR
Owner Approval:

PHASE:

CONSTRUCTION DRAWINGS


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APPROVED FOR CONSTRUCTION:

PROJECT No.: A21-198


DATE: 2/22/2023

A2.2



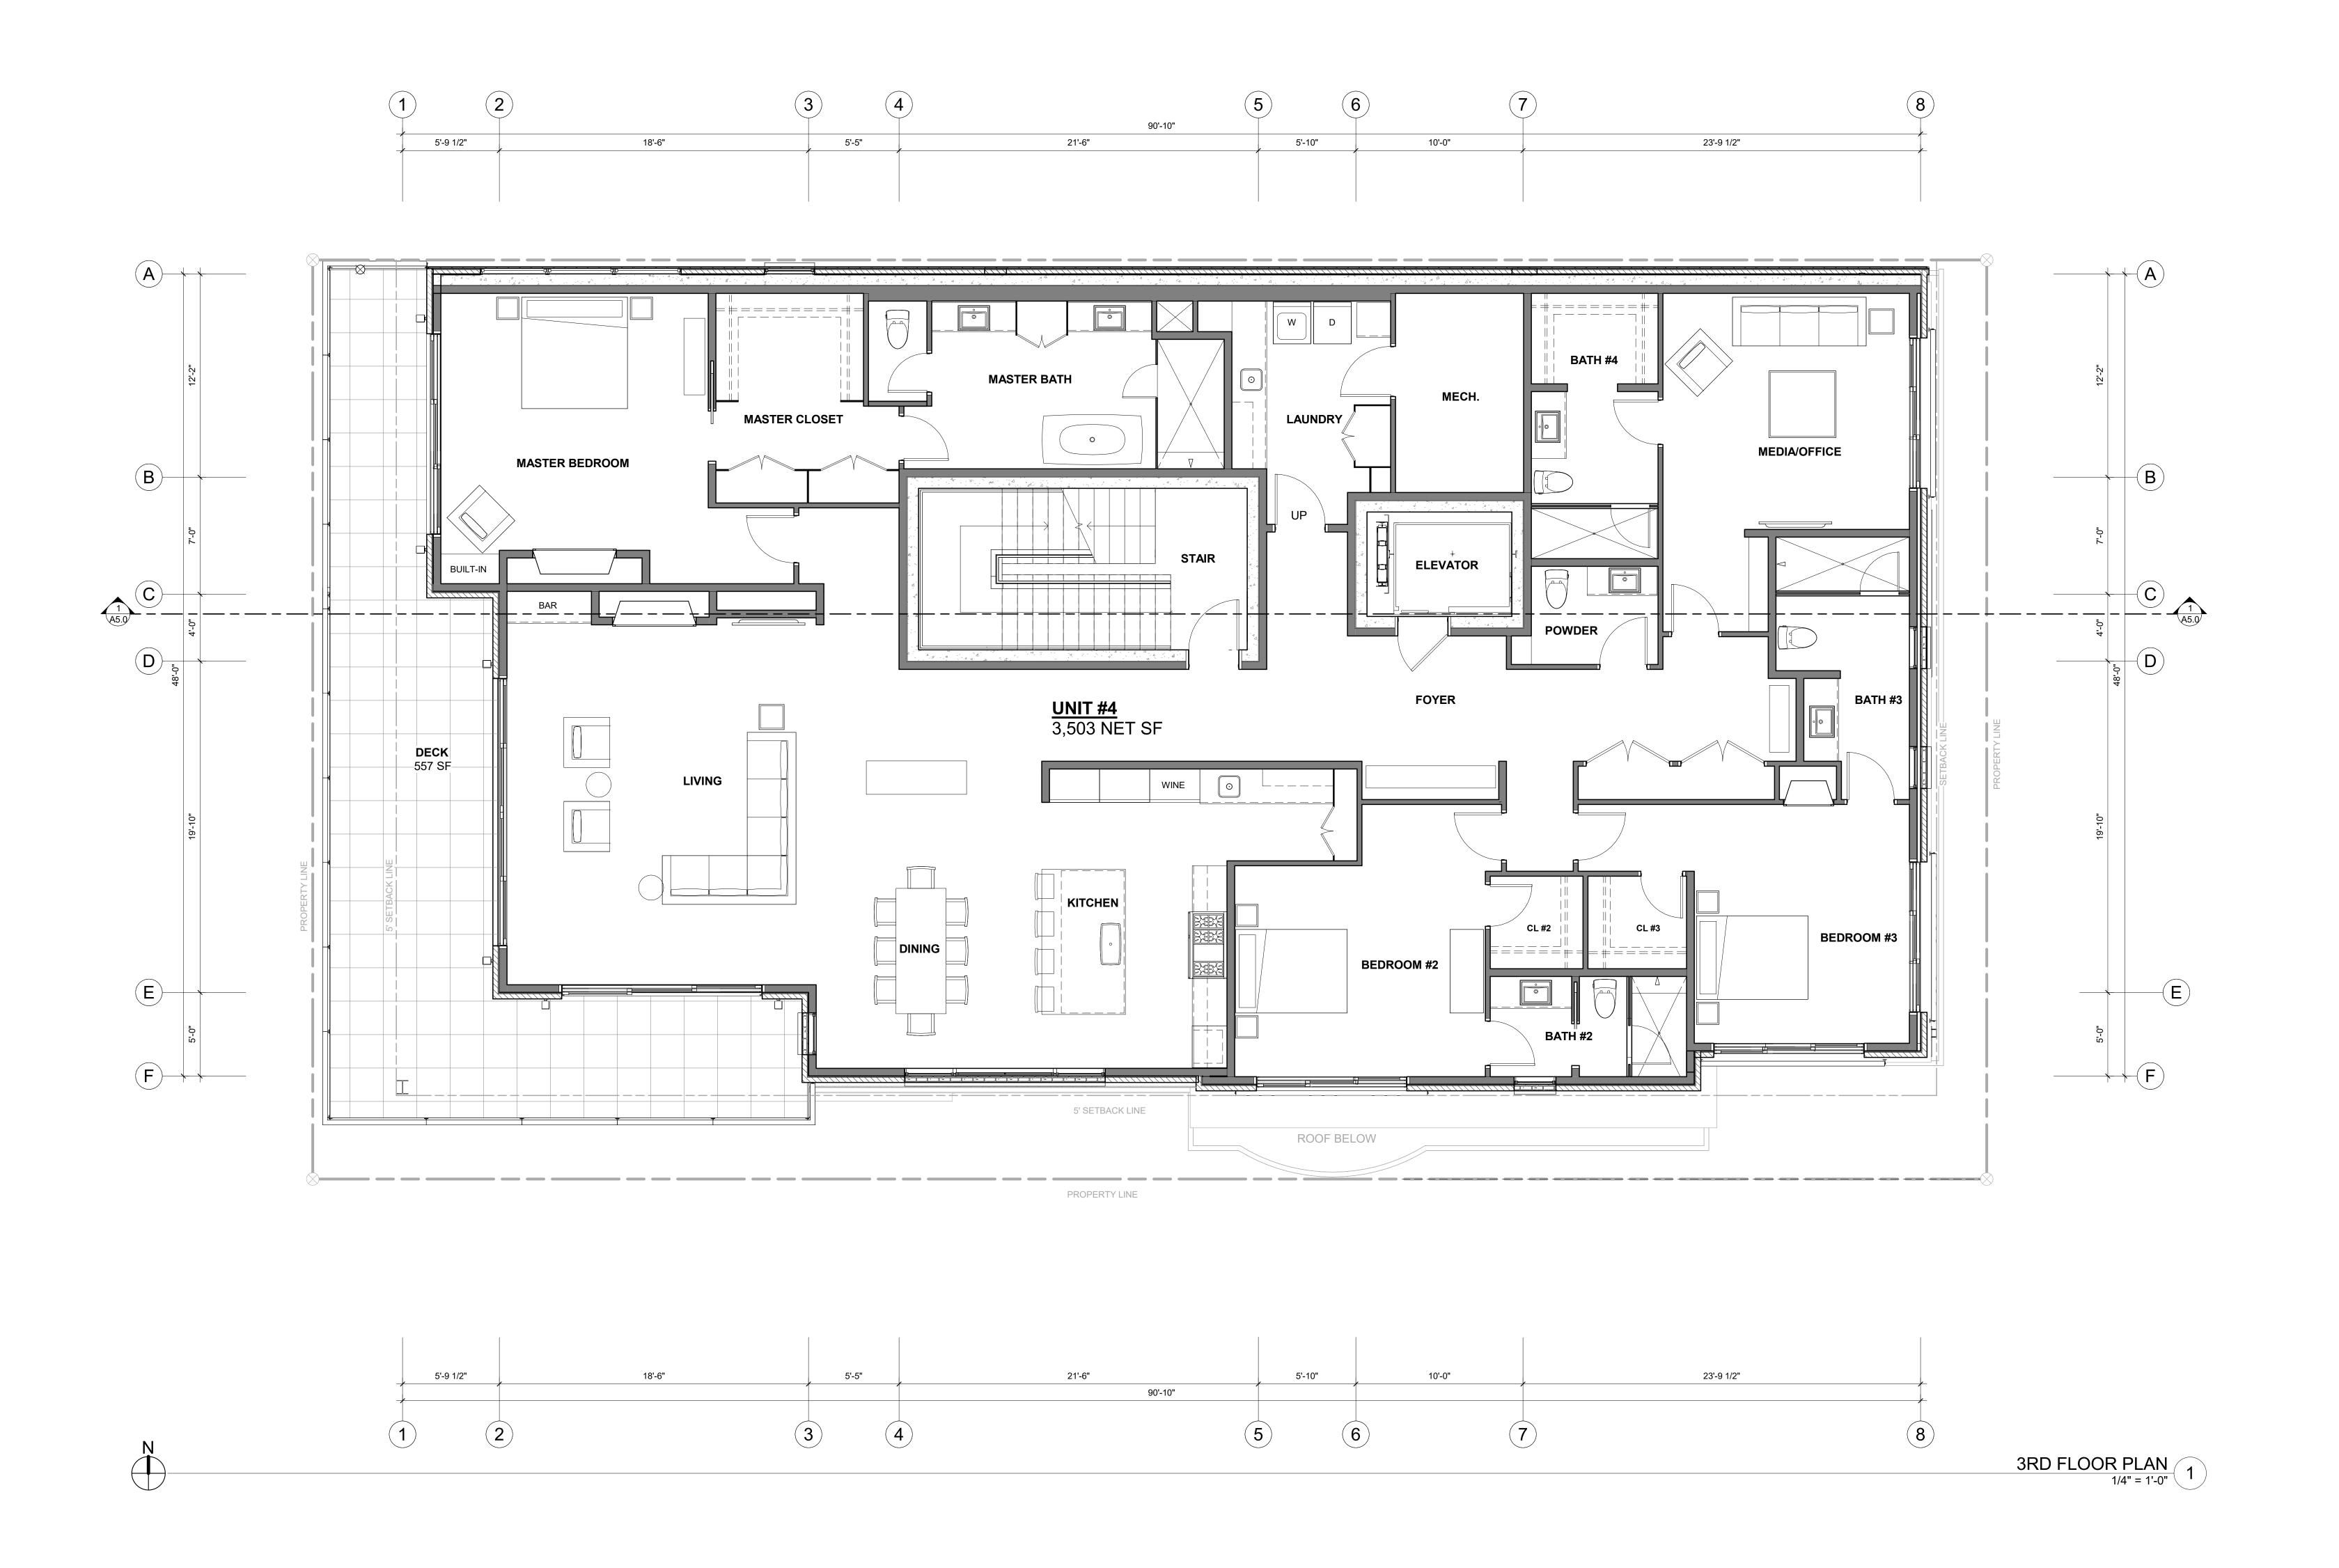

REGISTRATION:

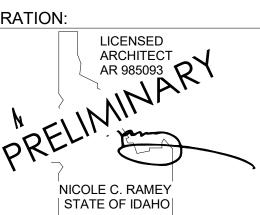

REVISIONS: DATE:

PROJECT / CLIENT:
THE 208 BUILDING

CARR, MICHAEL

JOB ADDRESS:

200 N LEADVILLE KETCHUM
IDAHO, 83340
PARCEL #RPK00000230010

DRAWING NAME:

3RD FLOOR PLAN

Drawn By: MS
Checked By: NR
Owner Approval:

PHASE:

CONSTRUCTION DRAWINGS


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APPROVED FOR CONSTRUCTION:

PROJECT No.: A21-198

DATE: 2/22/2023

SCALE: 1:1



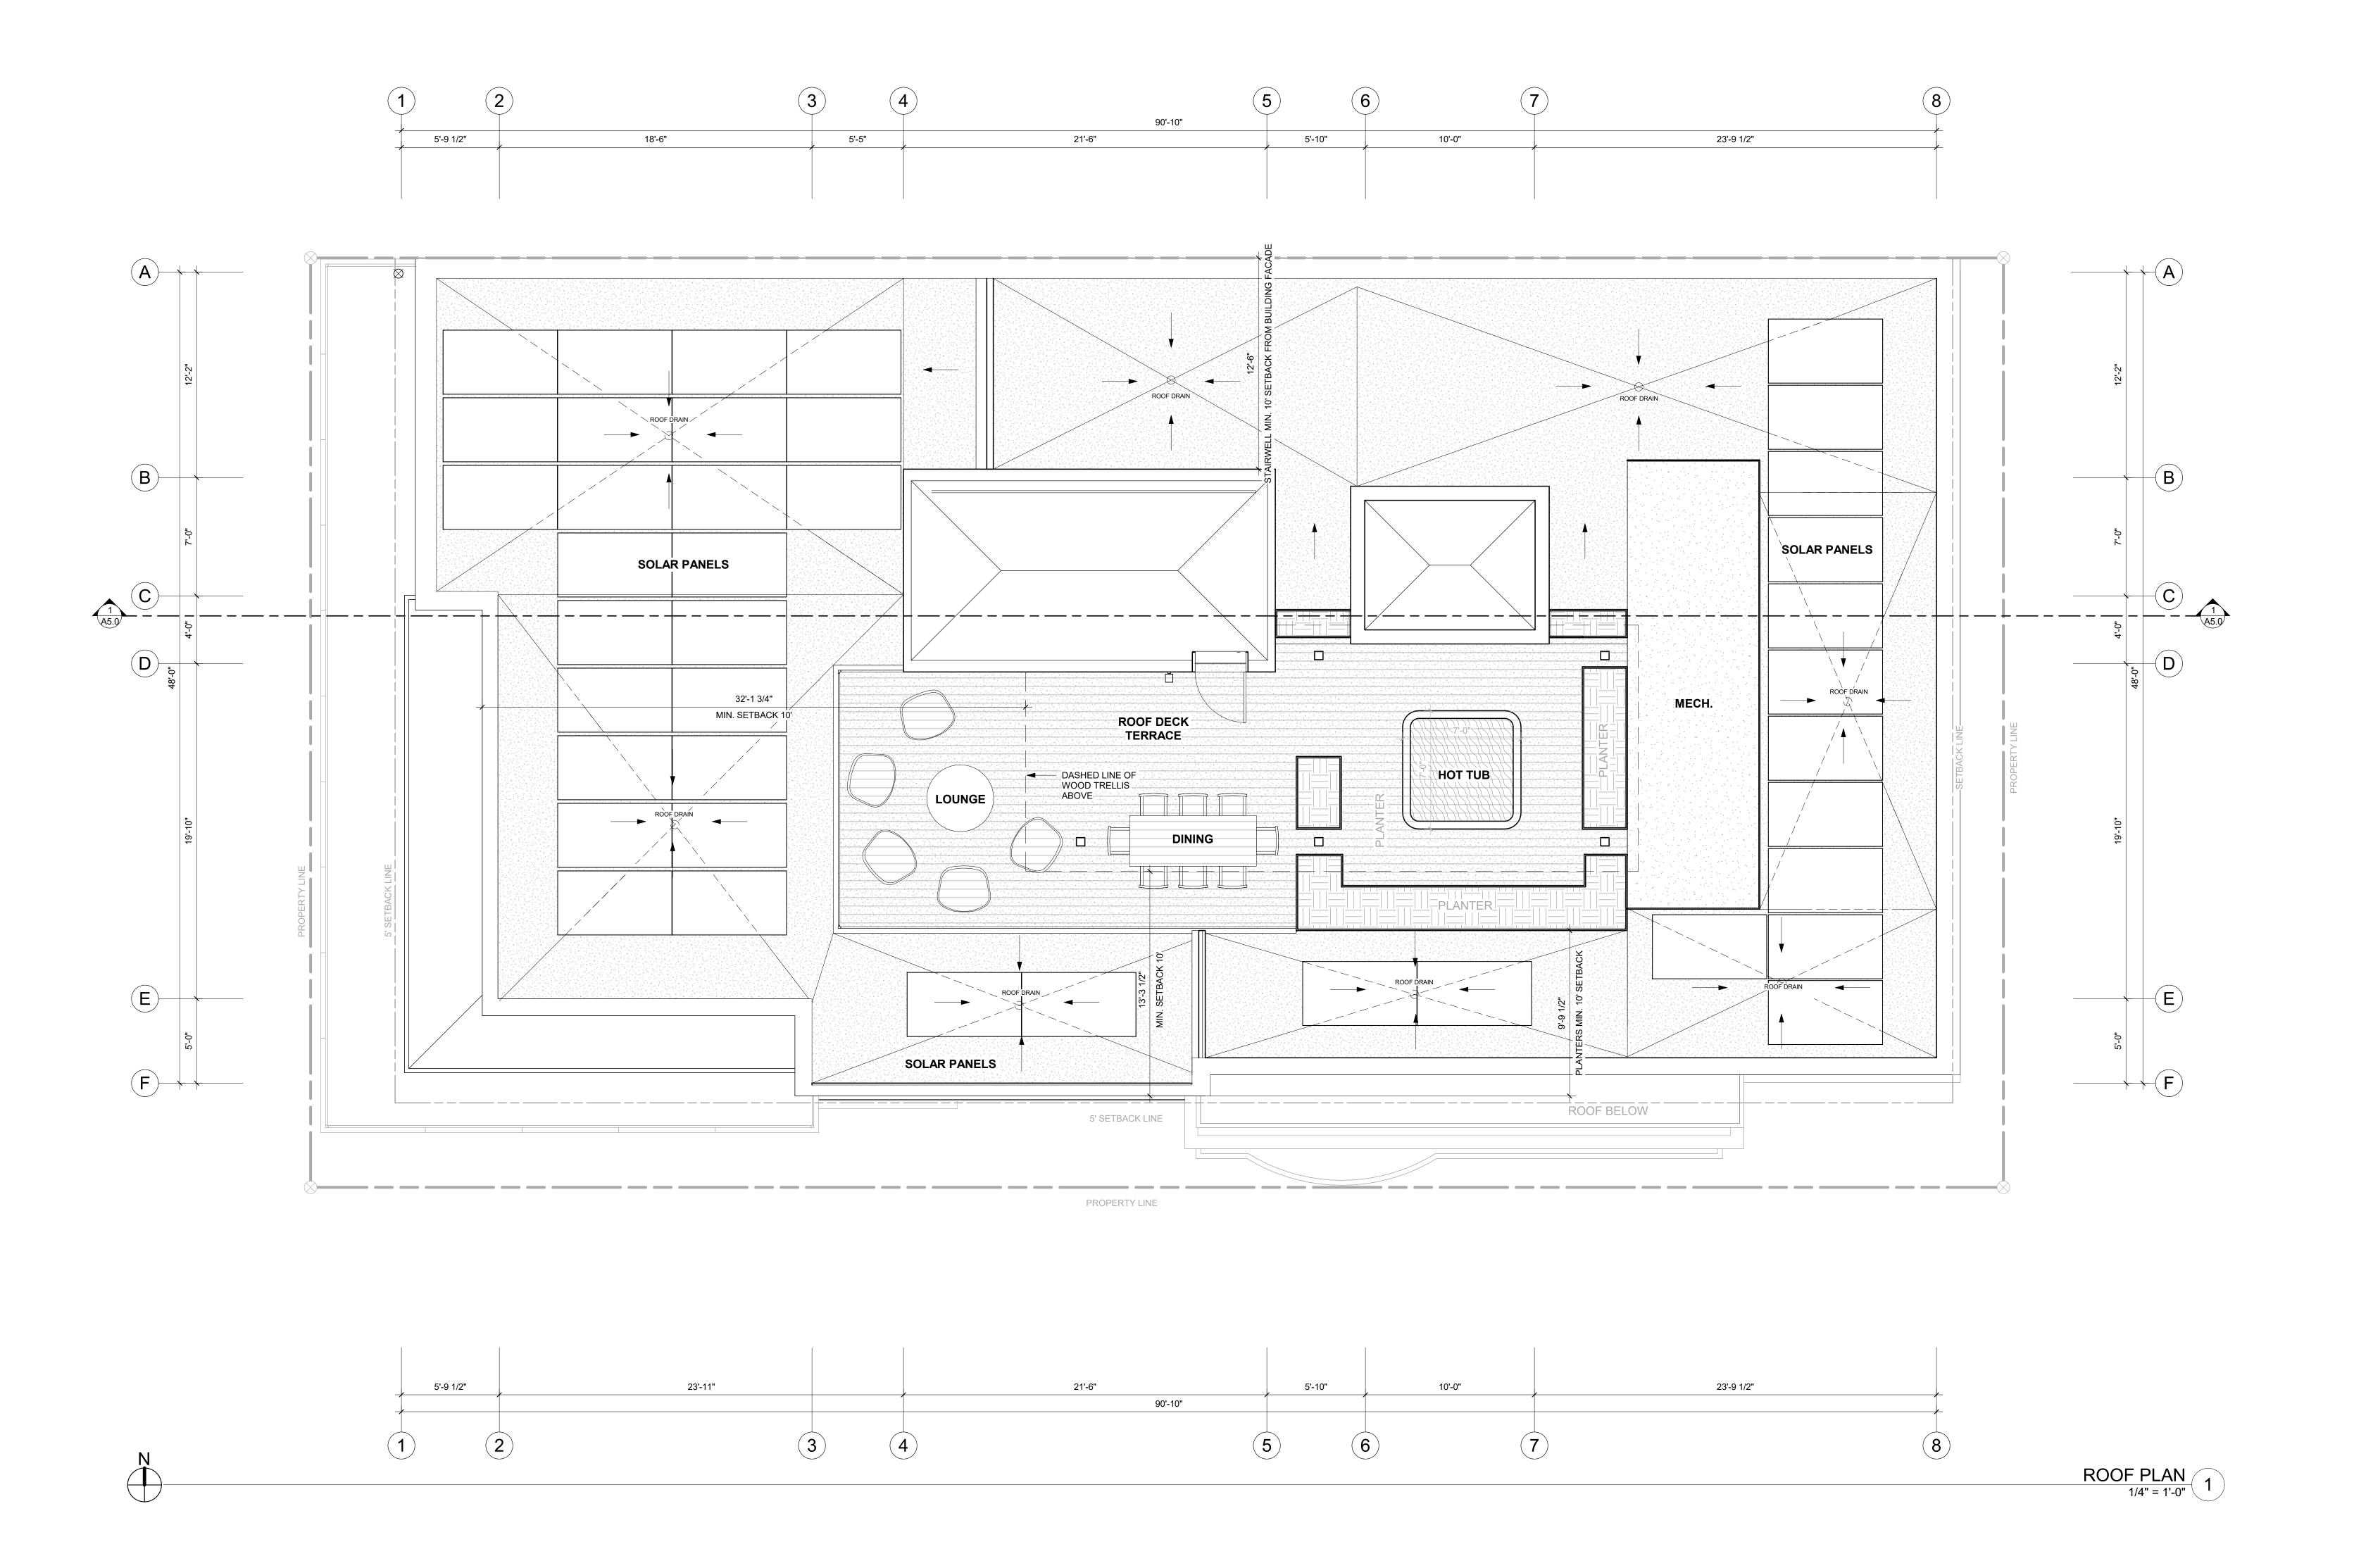

REGISTRATION:

RATION:

LICENSED
ARCHITECT
AR 985093

NICOLE C. RAMEY
STATE OF IDAHO

INTAKE DATE: 02/22/23

REVISIONS: DATE:

PROJECT / CLIENT:
THE 208 BUILDING

CARR, MICHAEL

JOB ADDRESS: 200 N LEADVILLE KETCHUM IDAHO, 83340 PARCEL #RPK00000230010

DRAWING NAME:

ROOF PLAN

Drawn By: MS
Checked By: NR
Owner Approval:

PHASE:

CONSTRUCTION DRAWINGS

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APPROVED FOR CONSTRUCTION:

PROJECT No.: A21-198

DATE: 2/22/2023


A3.0



SOUTH ELEVATION
1/4" = 1'-0"
1


KEY NOTES

- 400 NATURAL STONE VENEER.
- 401 BRICK VENEER.
- 404 WOOD SIDING.
- 405 BLACK STEEL C-CHANNEL. 406 BLACK STEEL PLANTERS. TO REMAIN 4" BELOW WINDOW
- SILLS AT RETAIL LEVEL.
- 408 BLACK STEEL GUARD. MIN. 75% TRANSPARENT AT ROOFTOP.
- 407 METAL MESH SCREEN.
- 409 BLACK METAL COPING OVER PARAPET WALL. 410 METAL CLAD WOOD WINDOWS AND DOORS.
- 411 PRE CAST CONCRETE LINTEL.

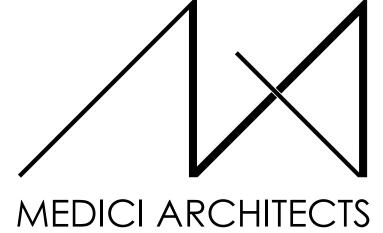


11661 SE 1ST STREET, SUITE 200 BELLEVUE, WASHINGTON 98005 TEL: (425) 453-9298 FAX: (425) 452-8448

REGISTRATION:

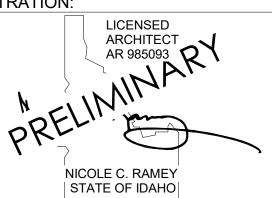

02/22/23 INTAKE DATE:

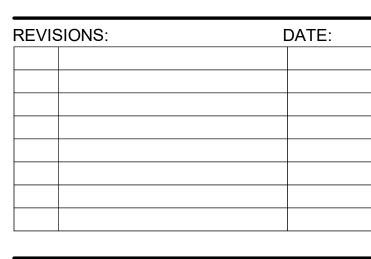

PROJECT / CLIENT: THE 208 BUILDING

CARR, MICHAEL

JOB ADDRESS: 200 N LEADVILLE KETCHUM IDAHO, 83340 PARCEL #RPK00000230010

DRAWING NAME:

ELEVATIONS

Drawn By: MS Checked By: NR Owner Approval:

PHASE:

CONSTRUCTION DRAWINGS


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APPROVED FOR CONSTRUCTION:

PROJECT No.: A21-198


DATE: 2/22/2023




WEST ELEVATION
1/4" = 1'-0"
2

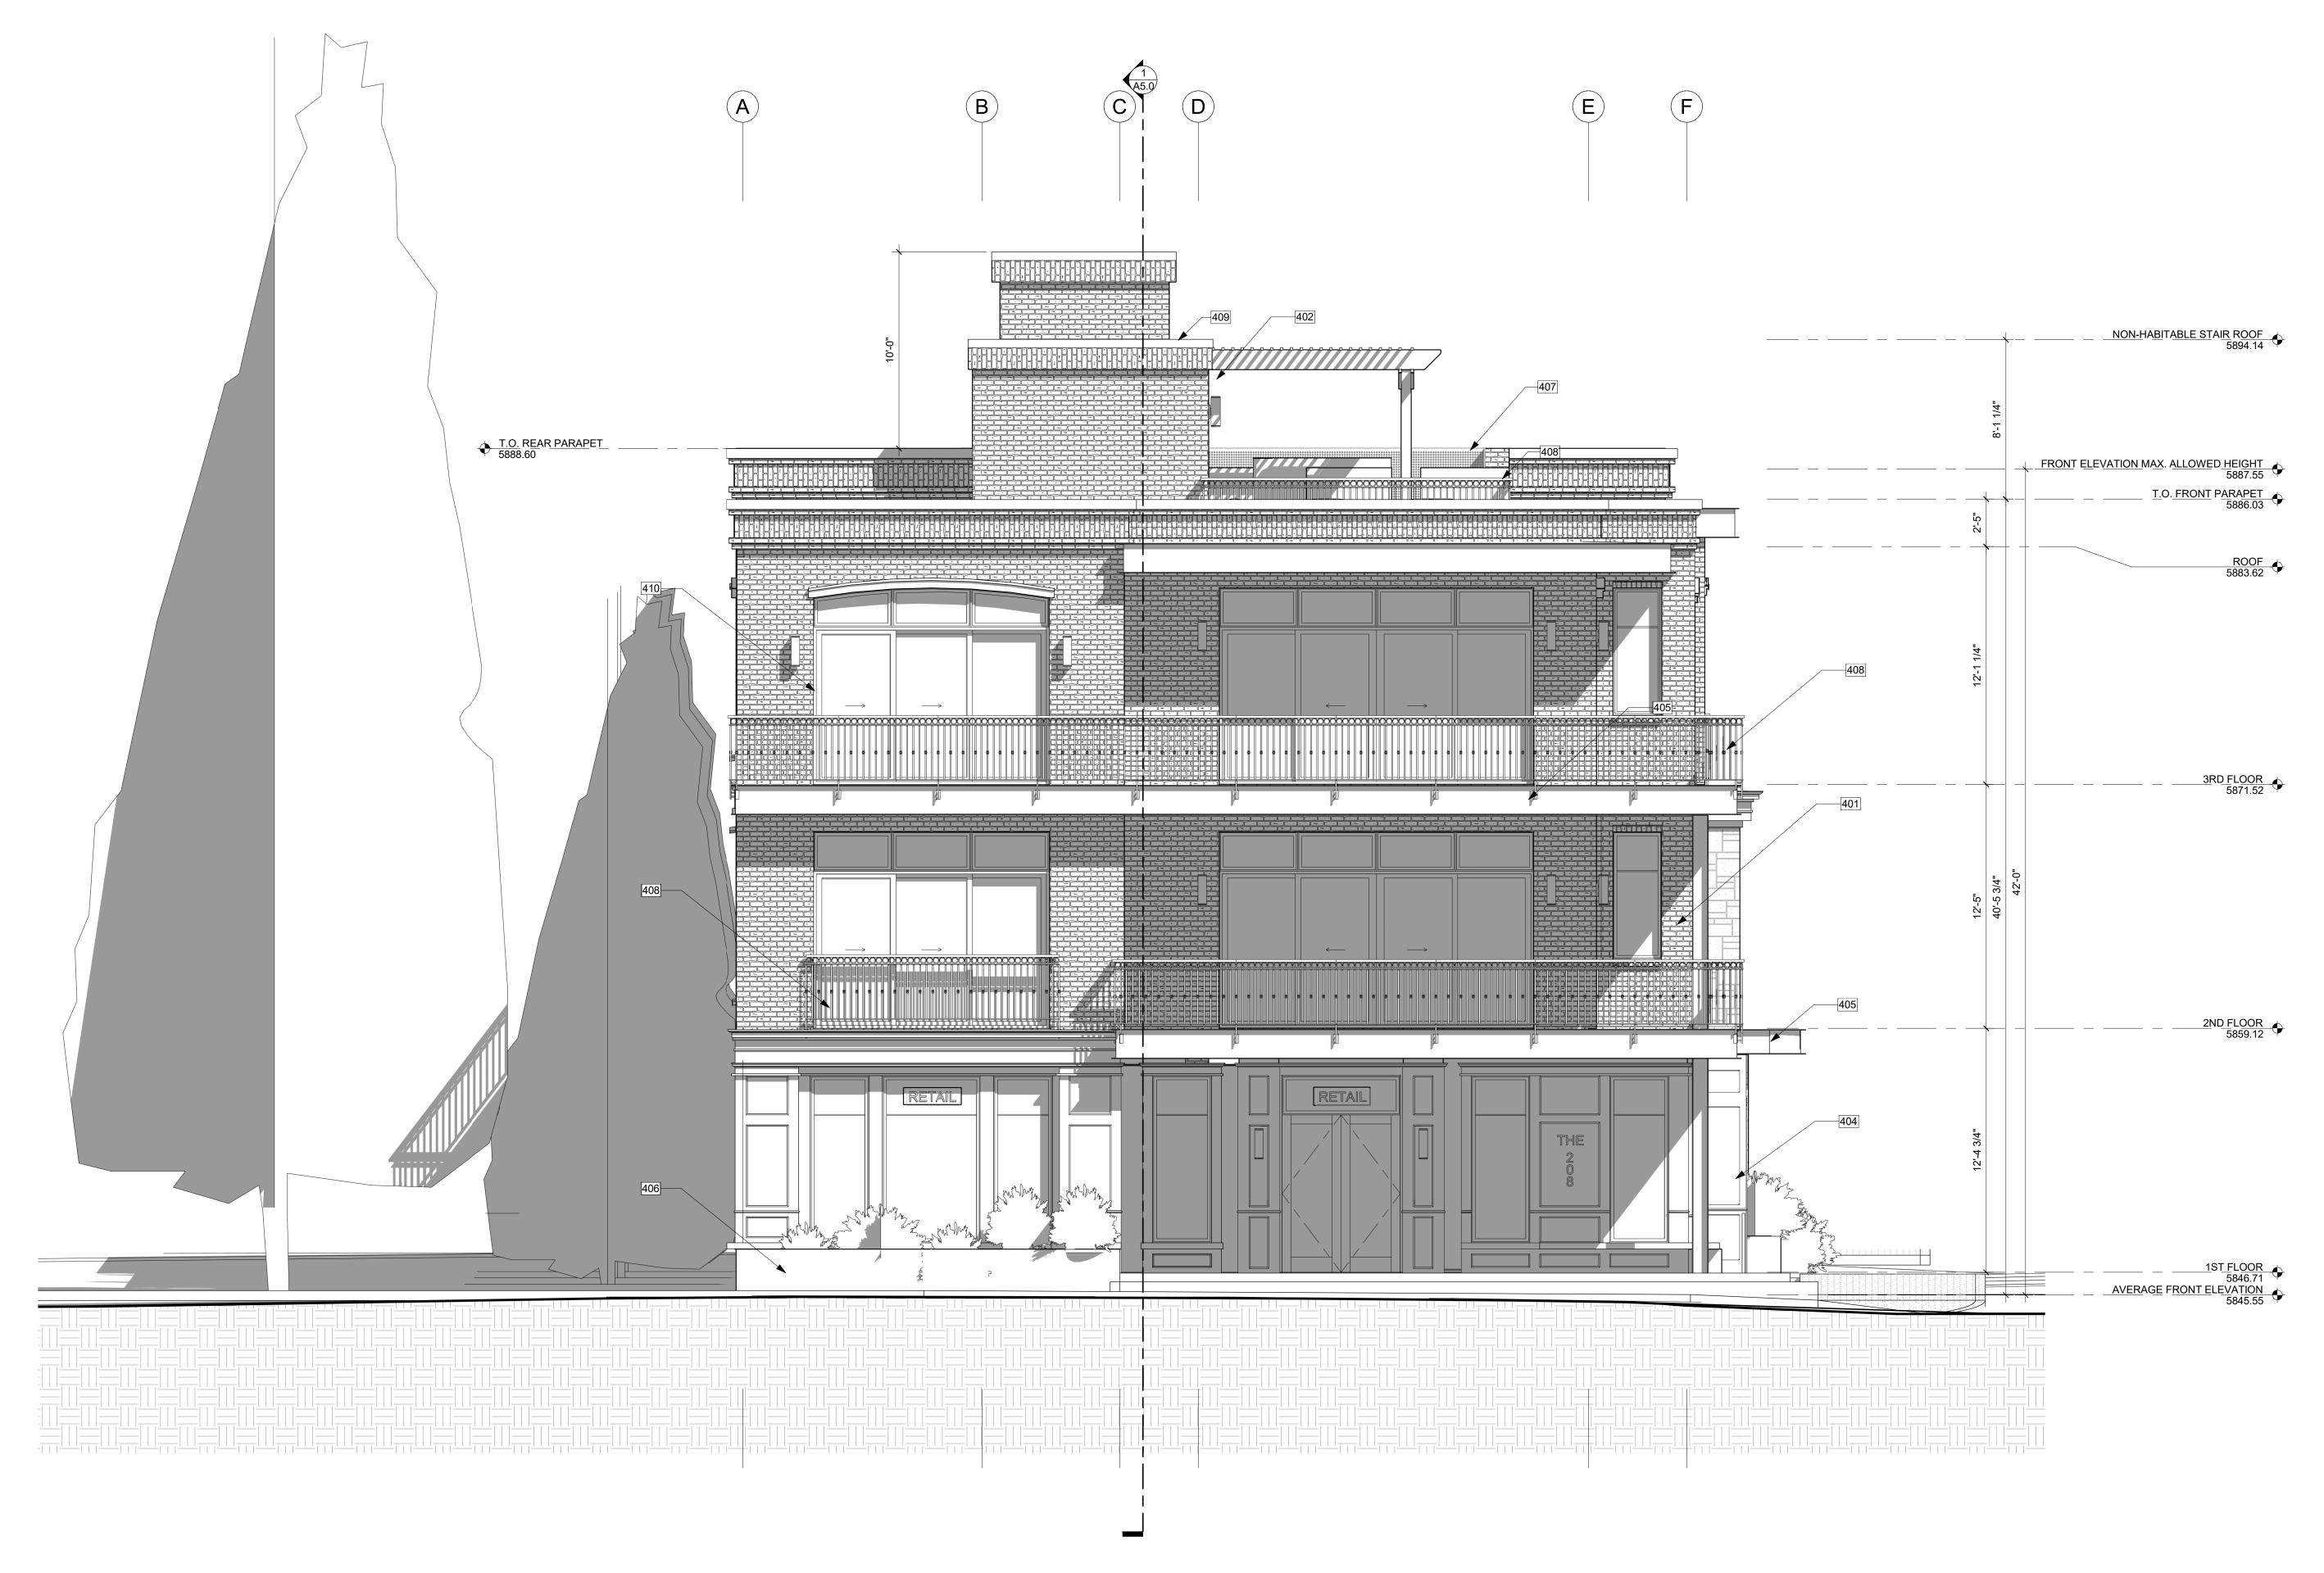KEY NOTES

| 401 | BRICK VENEER. |
|-----|---|
| 402 | LIGHTING @ ALL EXTERIOR DOORS INSTALLED PER MANUFACTURER, TYP. REFER TO SHEET A5.2 FOR LIGTHING SPECS. ALL LIGHTS SHALL COMPLY WITH CITY OF KETCHUM MUNICIPAL CODE 17.132. |
| 404 | WOOD SIDING. |
| 405 | BLACK STEEL C-CHANNEL. |
| 406 | BLACK STEEL PLANTERS. TO REMAIN 4" BELOW WINDOW SILLS AT RETAIL LEVEL. |
| 407 | METAL MESH SCREEN. |
| 408 | BLACK STEEL GUARD. MIN. 75% TRANSPARENT AT ROOFTOP. |
| 409 | BLACK METAL COPING OVER PARAPET WALL. |
| 410 | METAL CLAD WOOD WINDOWS AND DOORS. |

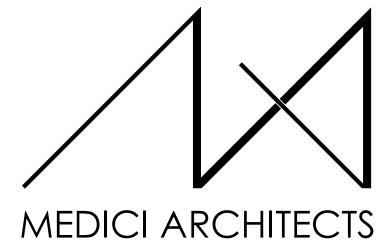

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02/22/23 INTAKE DATE:
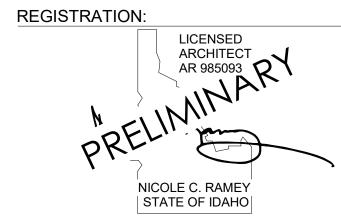
| REVISIONS: | DATE: | |
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PROJECT / CLIENT:

THE 208 BUILDING

CARR, MICHAEL

JOB ADDRESS: 200 N LEADVILLE KETCHUM IDAHO, 83340 PARCEL #RPK00000230010

DRAWING NAME:

ELEVATIONS

Drawn By: MS Checked By: NR Owner Approval:


PHASE:

CONSTRUCTION DRAWINGS

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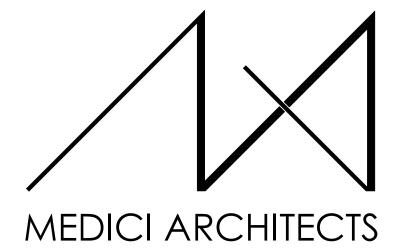
APPROVED FOR CONSTRUCTION:

PROJECT No.: A21-198

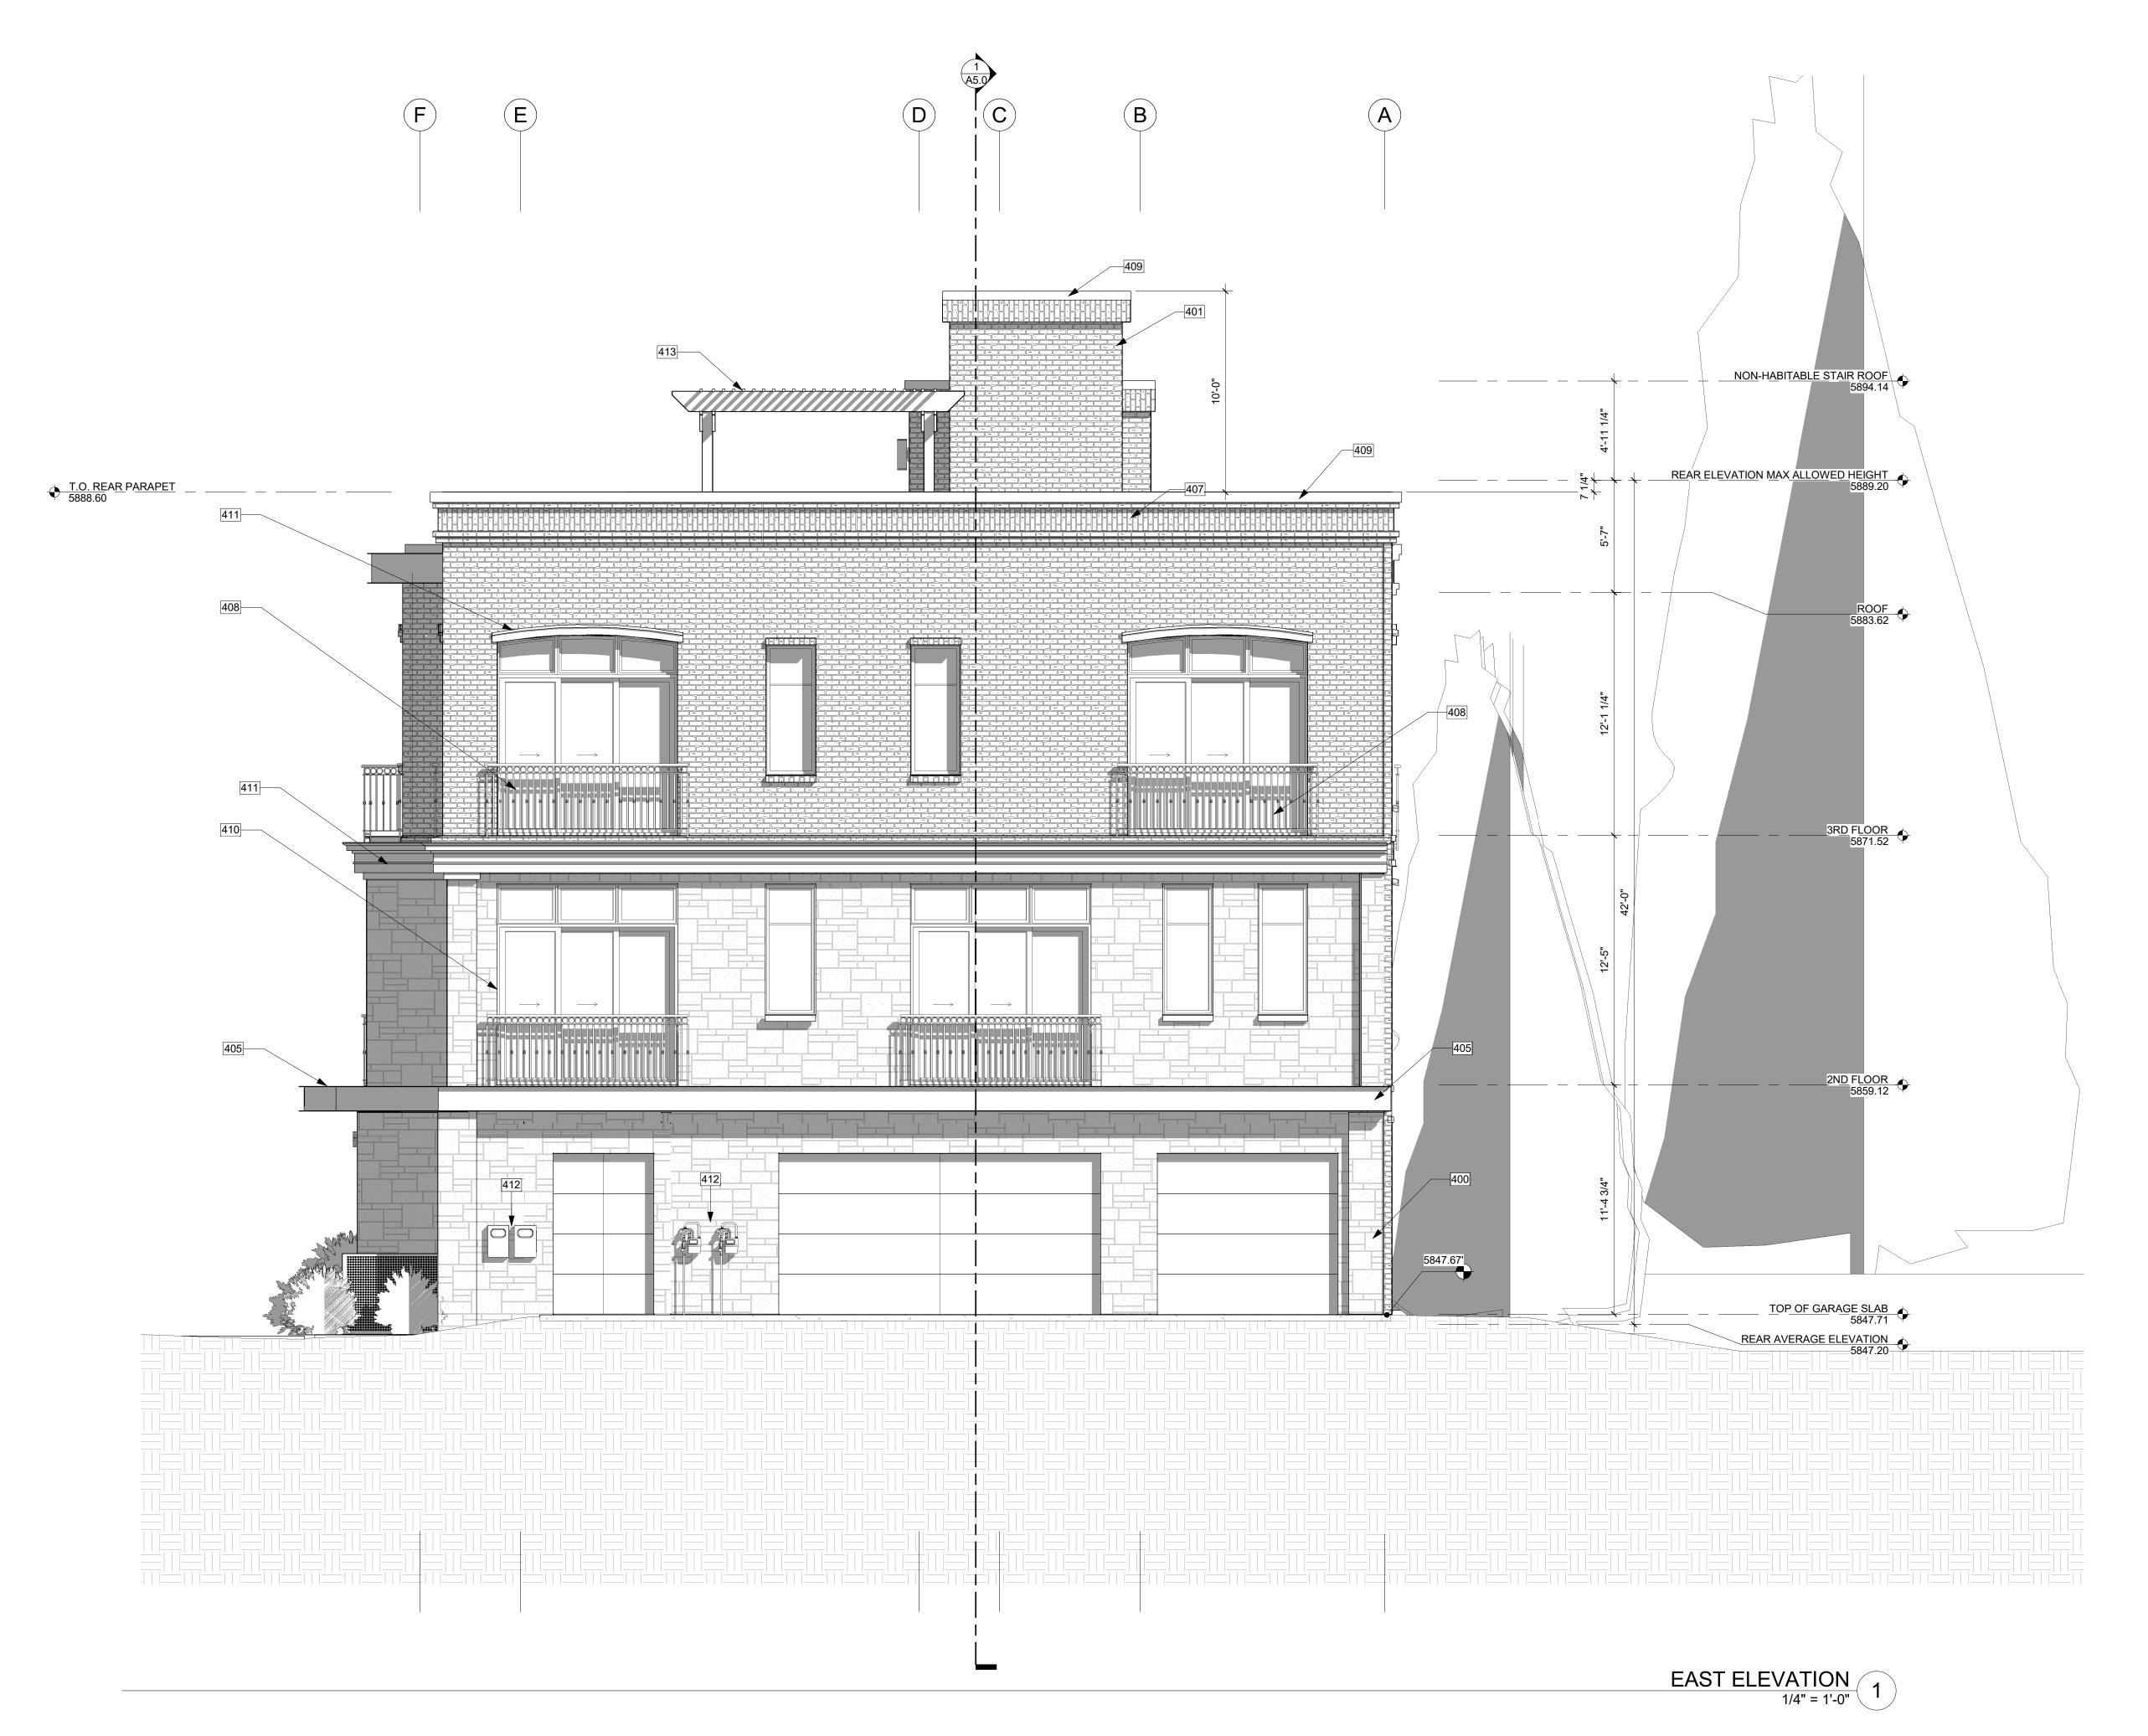


KEY NOTES

- 400 NATURAL STONE VENEER.
- 401 BRICK VENEER.
- 405 BLACK STEEL C-CHANNEL.
- 407 METAL MESH SCREEN. 408 BLACK STEEL GUARD. MIN. 75% TRANSPARENT AT
- ROOFTOP. 409 BLACK METAL COPING OVER PARAPET WALL.
- 410 METAL CLAD WOOD WINDOWS AND DOORS.
- 411 PRE CAST CONCRETE LINTEL.
- 412 ELECTRICAL/ GAS METERS.
- 413 BLACK STEEL FRAMED TRELLIS W/ BLACK STAINED WOOD CANOPY.



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02/22/23 INTAKE DATE:
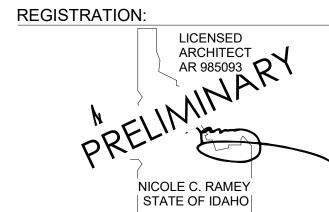
| REVISIONS: | DATE: | |
|------------|-------|--|
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PROJECT / CLIENT:

THE 208 BUILDING

CARR, MICHAEL

JOB ADDRESS: 200 N LEADVILLE KETCHUM IDAHO, 83340 PARCEL #RPK00000230010

DRAWING NAME:

ELEVATIONS

Drawn By: MS Checked By: NR Owner Approval:

PHASE:


CONSTRUCTION DRAWINGS

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APPROVED FOR CONSTRUCTION:

PROJECT No.: A21-198

DATE: 2/22/2023

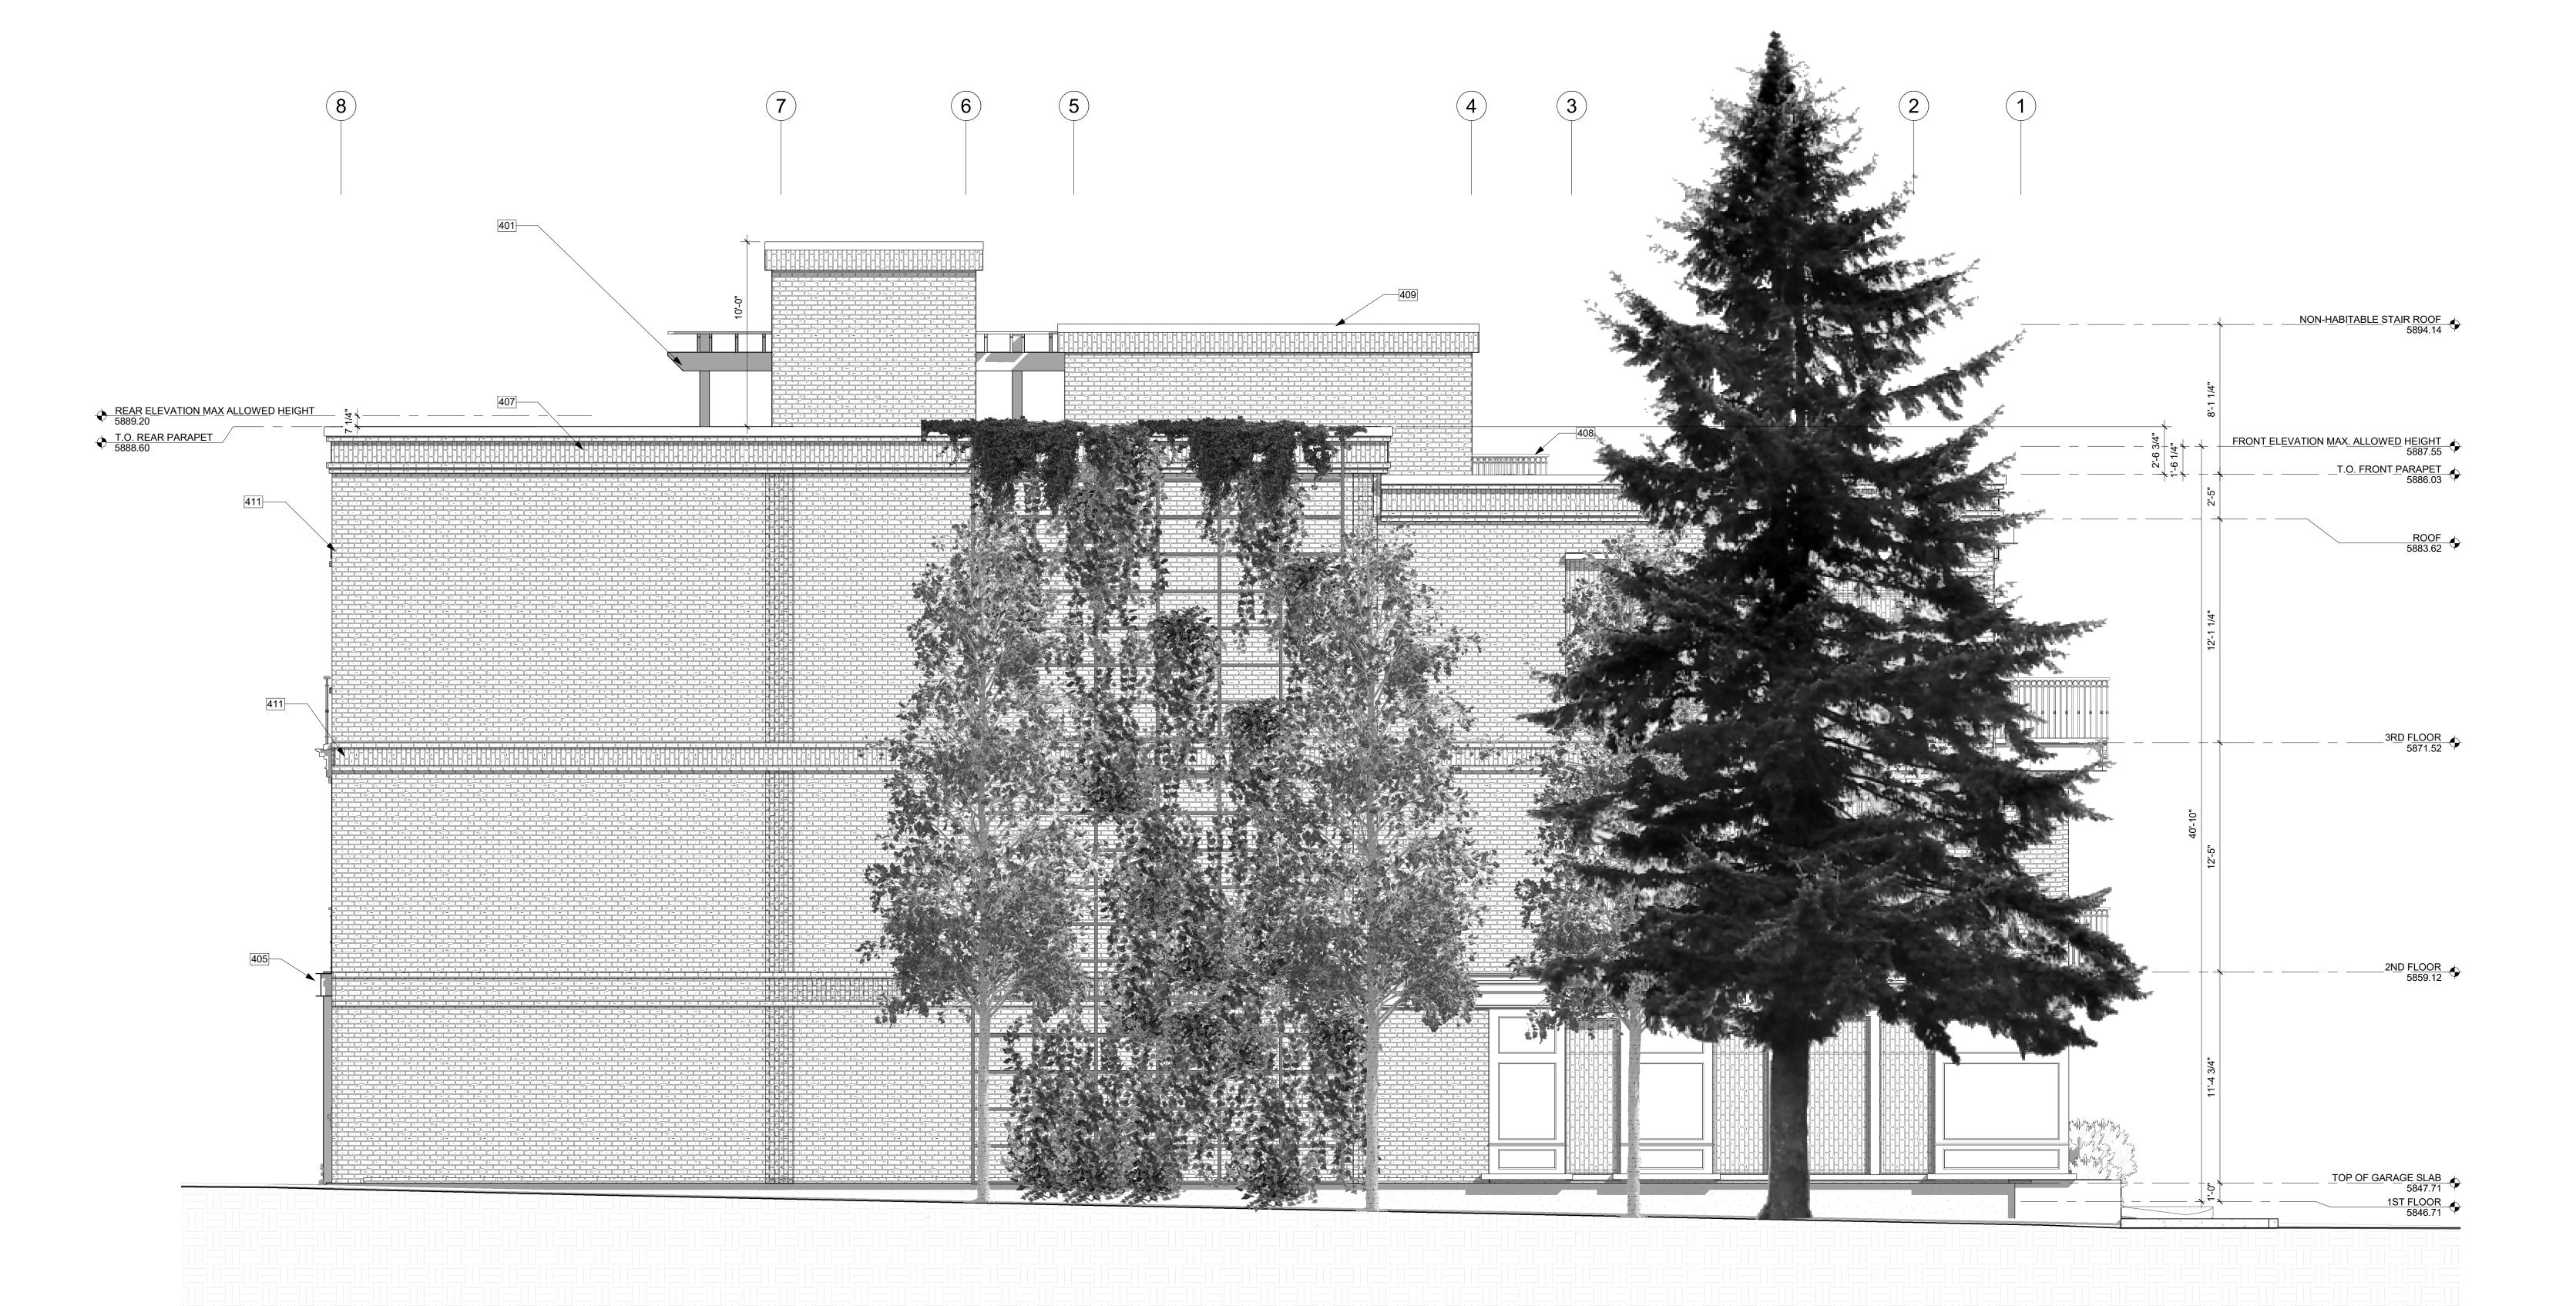

NORTH ELEVATION
1/4" = 1'-0"
1


KEY NOTES

- 401 BRICK VENEER.405 BLACK STEEL C-CHANNEL.
- 407 METAL MESH SCREEN.
- 408 BLACK STEEL GUARD. MIN. 75% TRANSPARENT AT ROOFTOP.
- 409 BLACK METAL COPING OVER PARAPET WALL. 411 PRE CAST CONCRETE LINTEL.

MEDICI ARCHITECTS

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REGISTRATION:

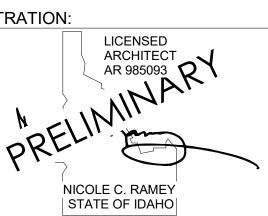

INTAKE DATE: 02/22/23 **REVISIONS**:

PROJECT / CLIENT: THE 208 BUILDING

CARR, MICHAEL

JOB ADDRESS: 200 N LEADVILLE KETCHUM IDAHO, 83340 PARCEL #RPK00000230010

DRAWING NAME:

ELEVATIONS


Drawn By: MS Checked By: EB Owner Approval:

CONSTRUCTION DRAWINGS

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APPROVED FOR CONSTRUCTION:

PROJECT No.: A21-198 DATE: 2/22/2023

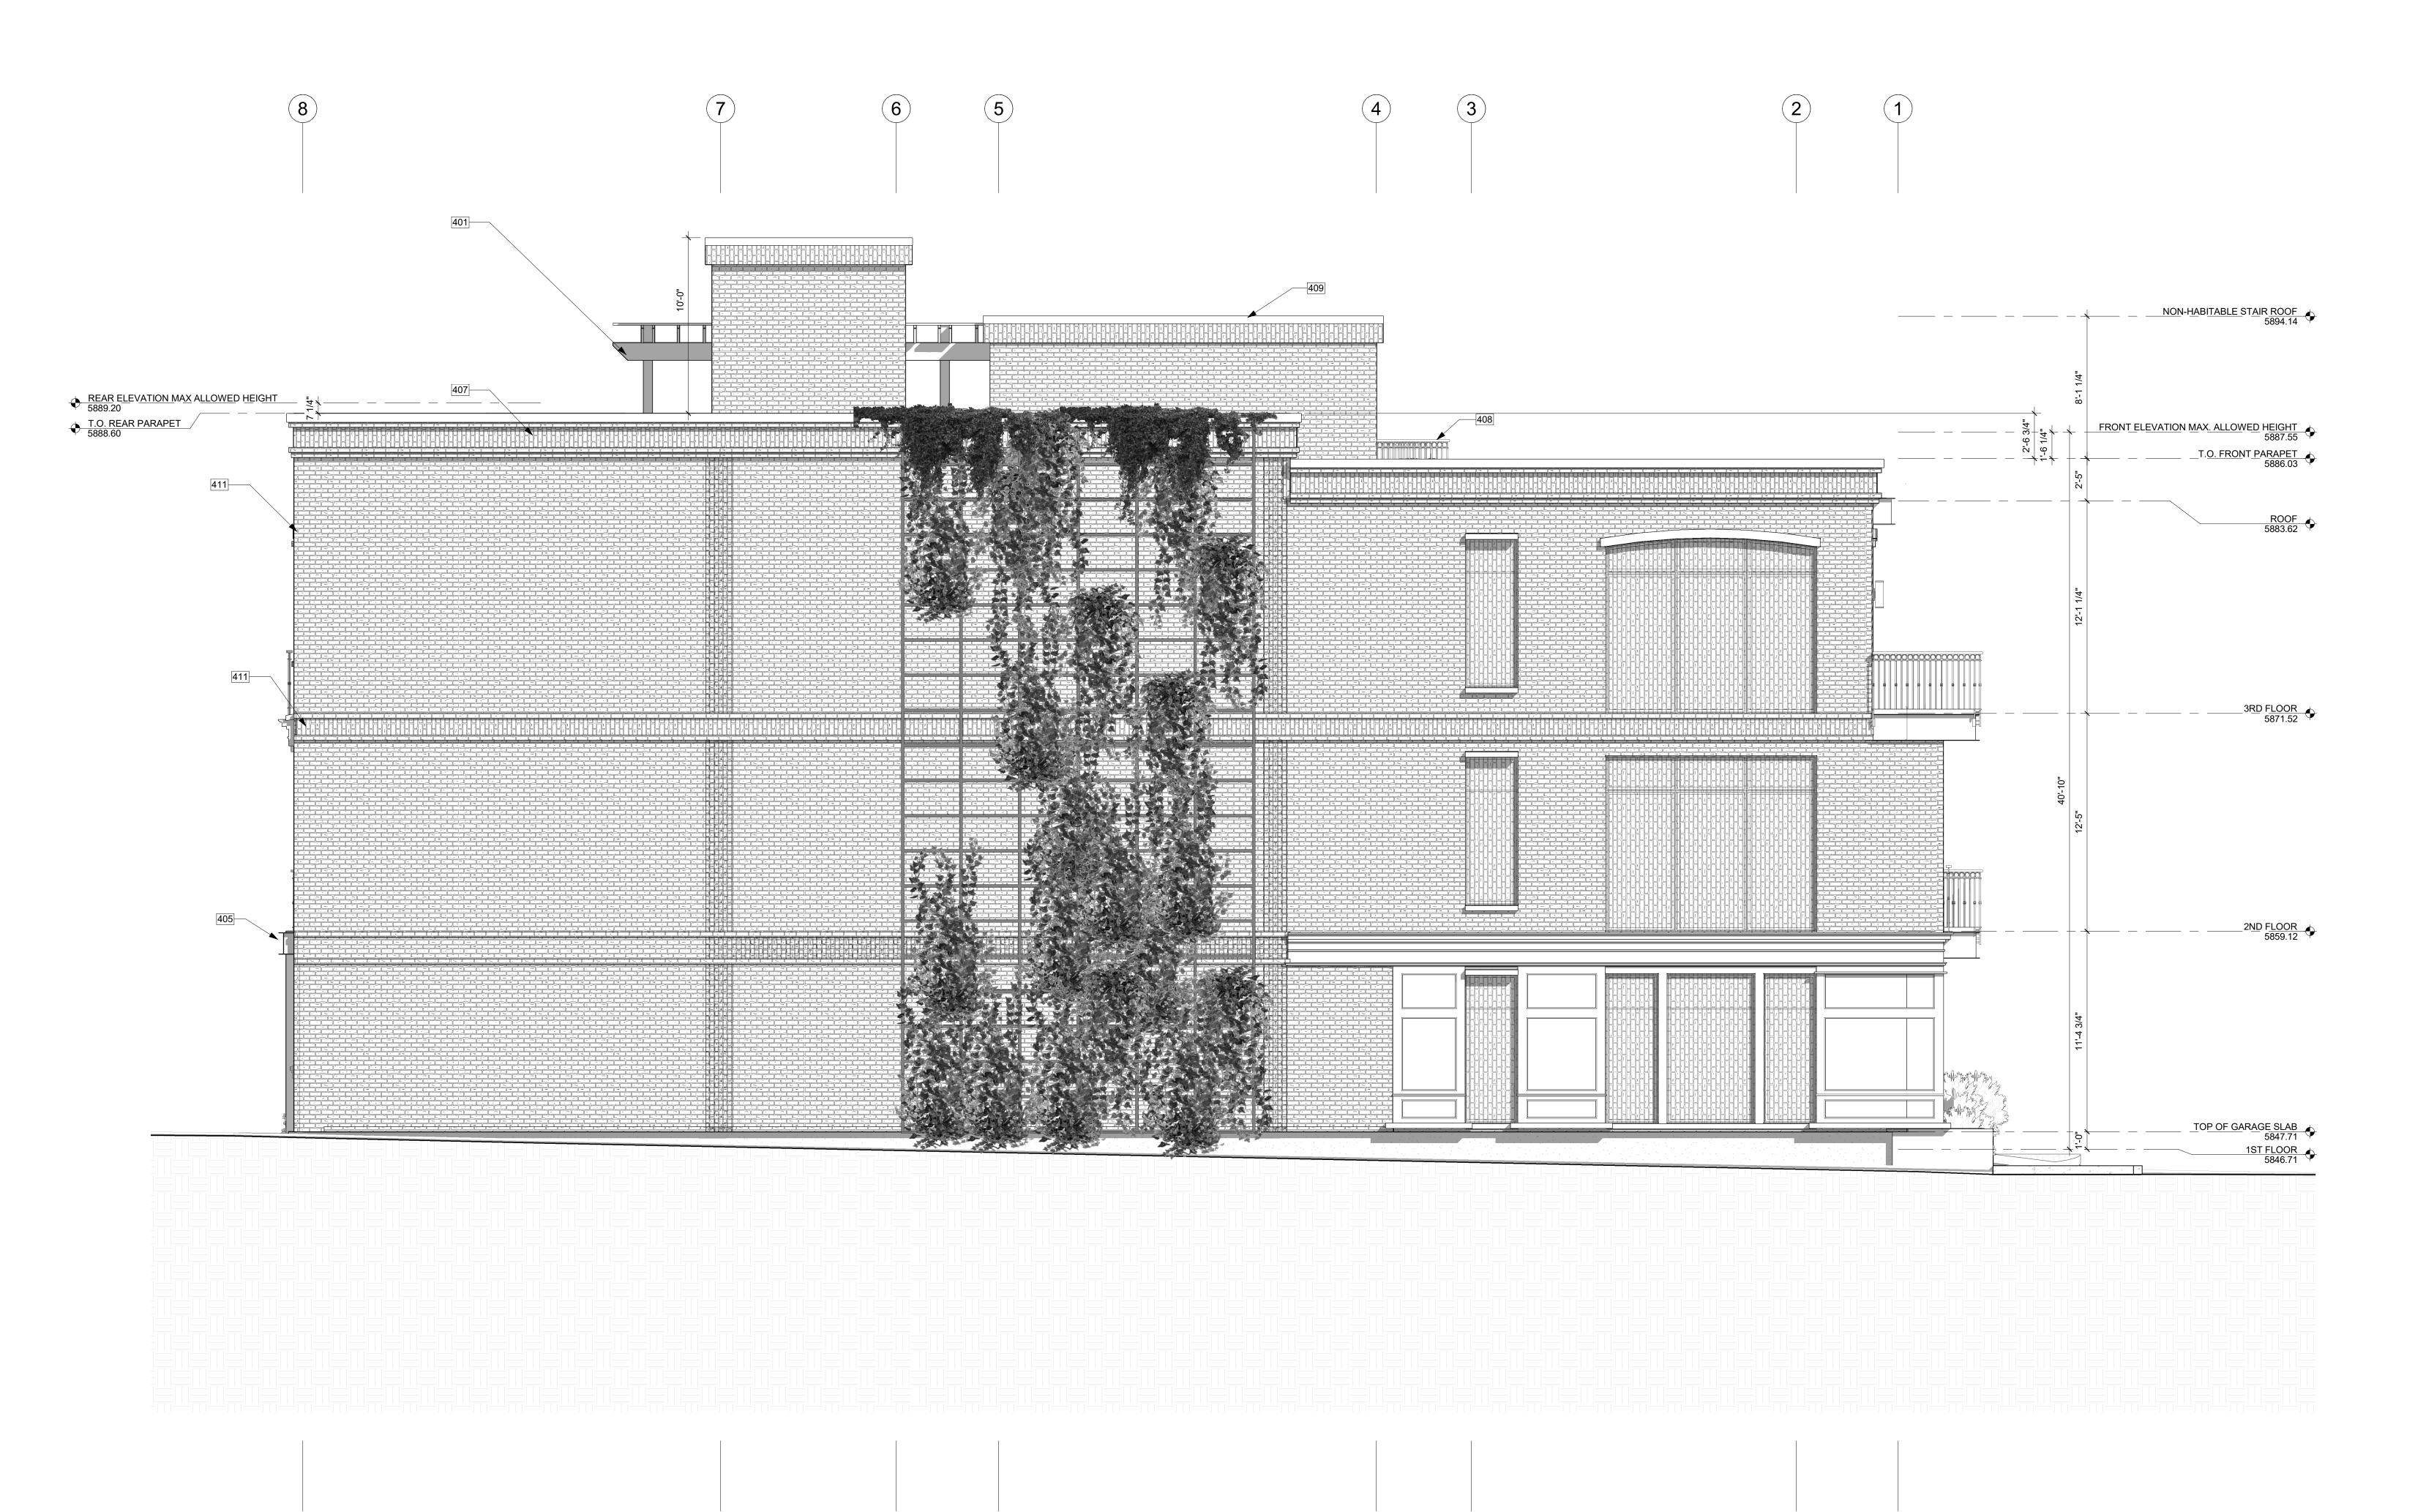

NORTH ELEVATION
1/4" = 1'-0"
1


KEY NOTES

- 401 BRICK VENEER.
- 405 BLACK STEEL C-CHANNEL.
- 407 METAL MESH SCREEN.
- 408 BLACK STEEL GUARD. MIN. 75% TRANSPARENT AT
- ROOFTOP.
- 409 BLACK METAL COPING OVER PARAPET WALL. 411 PRE CAST CONCRETE LINTEL.

MEDICI ARCHITECTS

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REGISTRATION:

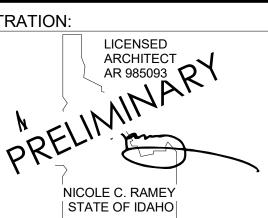

02/22/23 INTAKE DATE: **REVISIONS**: DATE:

PROJECT / CLIENT: THE 208 BUILDING

CARR, MICHAEL

JOB ADDRESS: 200 N LEADVILLE KETCHUM IDAHO, 83340 PARCEL #RPK00000230010

DRAWING NAME:

ELEVATIONS

Drawn By: Author Checked By: Checker Owner Approval:

PHASE:

CONSTRUCTION DRAWINGS

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APPROVED FOR CONSTRUCTION:

PROJECT No.: A21-198

DATE: 2/22/2023

NOTE: 3D RENDERINGS ARE FOR ILLUSTRATIVE PURPOSES ONLY. NOT TO BE USED FOR CONSTRUCTION.






MEDICI ARCHITECTS

11661 SE 1ST STREET, SUITE 200 BELLEVUE, WASHINGTON 98005 TEL: (425) 453-9298 FAX: (425) 452-8448

REGISTRATION:

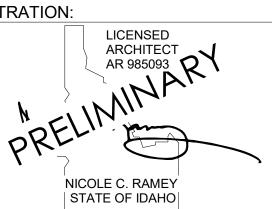

REVISIONS: DATE:

PROJECT / CLIENT:
THE 208 BUILDING

CARR, MICHAEL

NORTH EAST PERSPECTIVE

JOB ADDRESS:
200 N LEADVILLE KETCHUM
IDAHO, 83340
PARCEL #RPK00000230010



SOUTH WEST PERSPECTIVE

SOUTH EAST PERSPECTIVE

DRAWING NAME:

PERSPECTIVES

Drawn By: MS
Checked By: NR
Owner Approval:

HASE:

CONSTRUCTION DRAWINGS


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APPROVED FOR CONSTRUCTION:

PROJECT No.: A21-198

DATE: 2/22/2023

A4.5

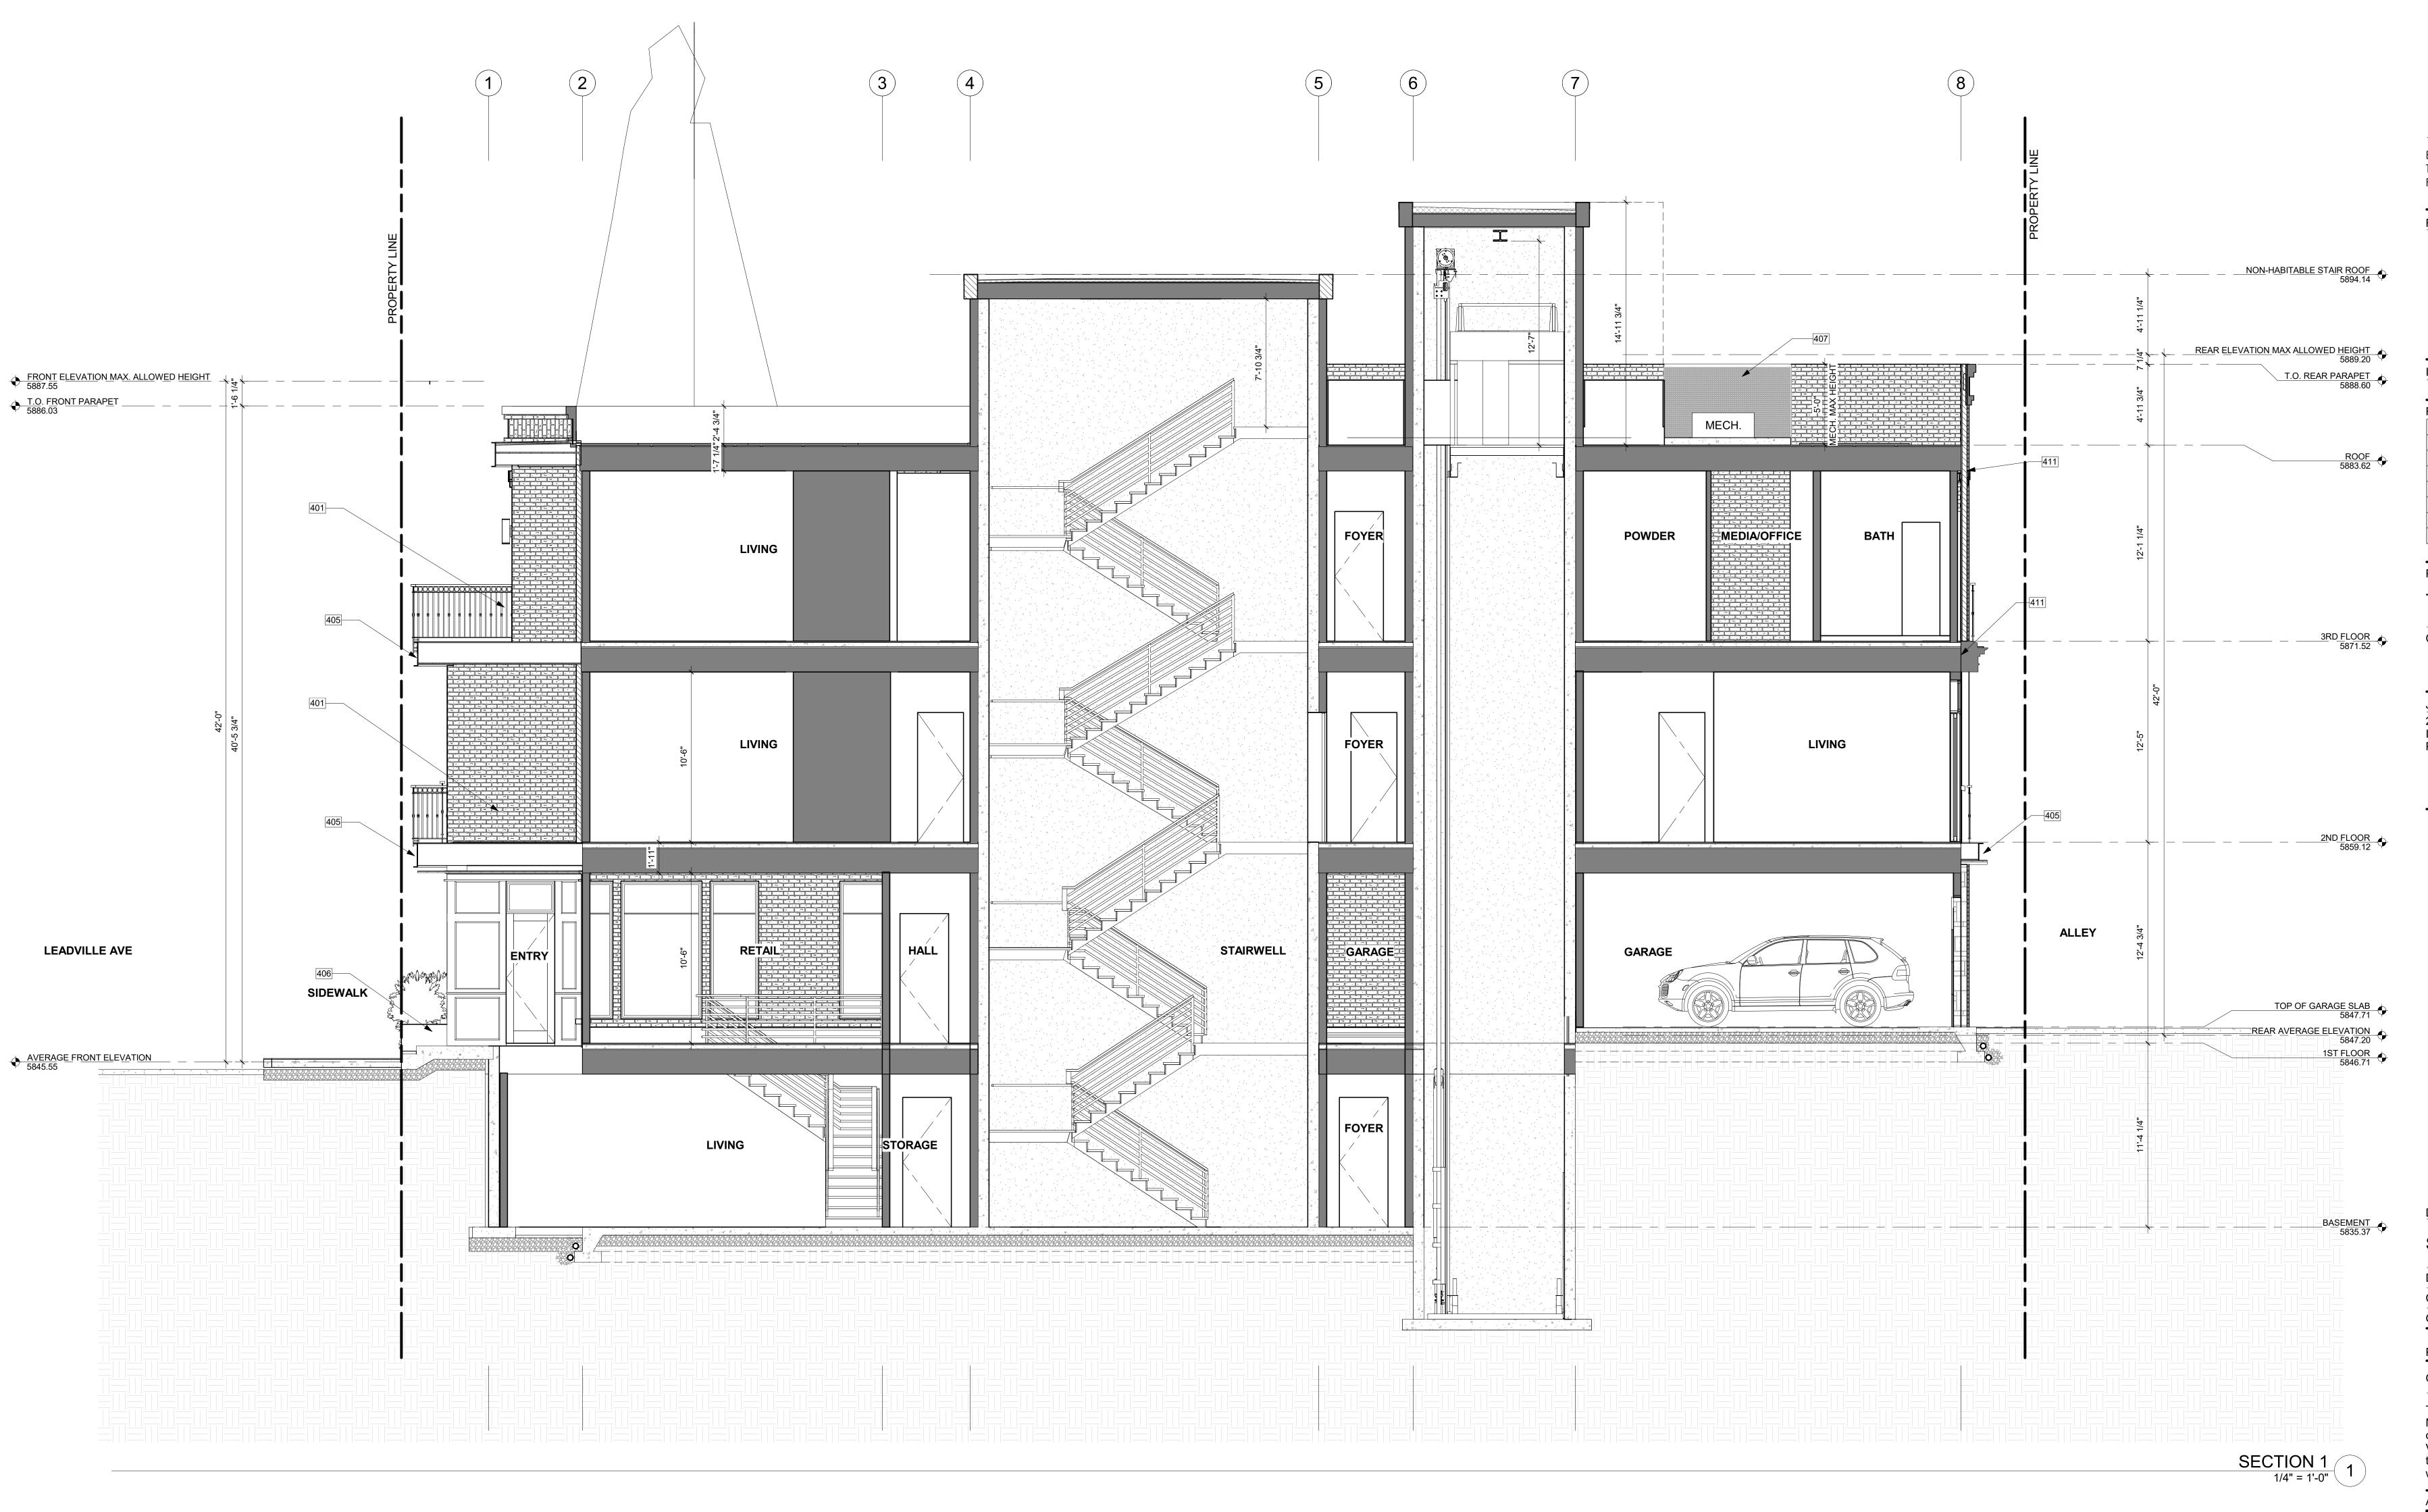

KEY NOTES

- 401 BRICK VENEER. 405 BLACK STEEL C-CHANNEL.
- 406 BLACK STEEL PLANTERS. TO REMAIN 4" BELOW WINDOW SILLS AT RETAIL LEVEL.
- 407 METAL MESH SCREEN.
- 411 PRE CAST CONCRETE LINTEL.

MEDICI ARCHITECTS

11661 SE 1ST STREET, SUITE 200 BELLEVUE, WASHINGTON 98005 TEL: (425) 453-9298 FAX: (425) 452-8448

REGISTRATION:

NICOLE C. RAMEY STATE OF IDAHO

02/22/23 INTAKE DATE:

REVISIONS:

PROJECT / CLIENT: THE 208 BUILDING

CARR, MICHAEL

JOB ADDRESS: 200 N LEADVILLE KETCHUM IDAHO, 83340 PARCEL #RPK00000230010

DRAWING NAME:

SECTIONS

Drawn By: MS Checked By: NR Owner Approval:

PHASE:

CONSTRUCTION DRAWINGS

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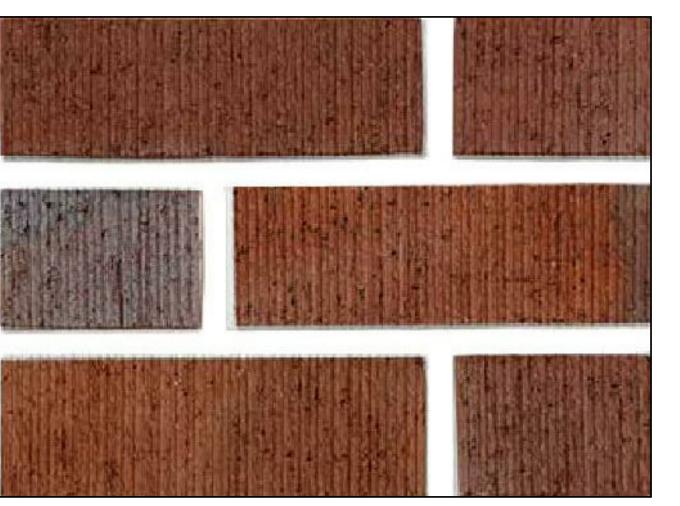
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PROJECT No.: A21-198

DATE: 2/22/2023





BRICK VENEER
MOUNTAIN BLEND WITH RUG TEXTURE




SILVERTIP STACK




WOOD SOFFIT
ALASKAN YELLOW CEDAR VG



STEEL BLACK STEEL

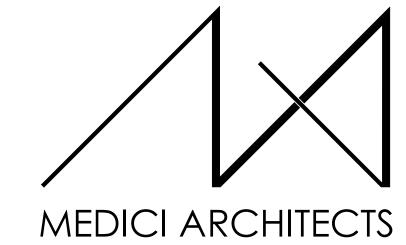

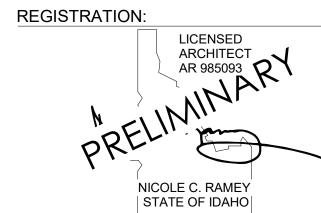

02/22/23 INTAKE DATE: **REVISIONS**:

PROJECT / CLIENT: THE 208 BUILDING

CARR, MICHAEL

JOB ADDRESS: 200 N LEADVILLE KETCHUM IDAHO, 83340 PARCEL #RPK00000230010

DRAWING NAME:

EXTERIOR MATERIALS

Drawn By: MS Checked By: NR Owner Approval:

PHASE:


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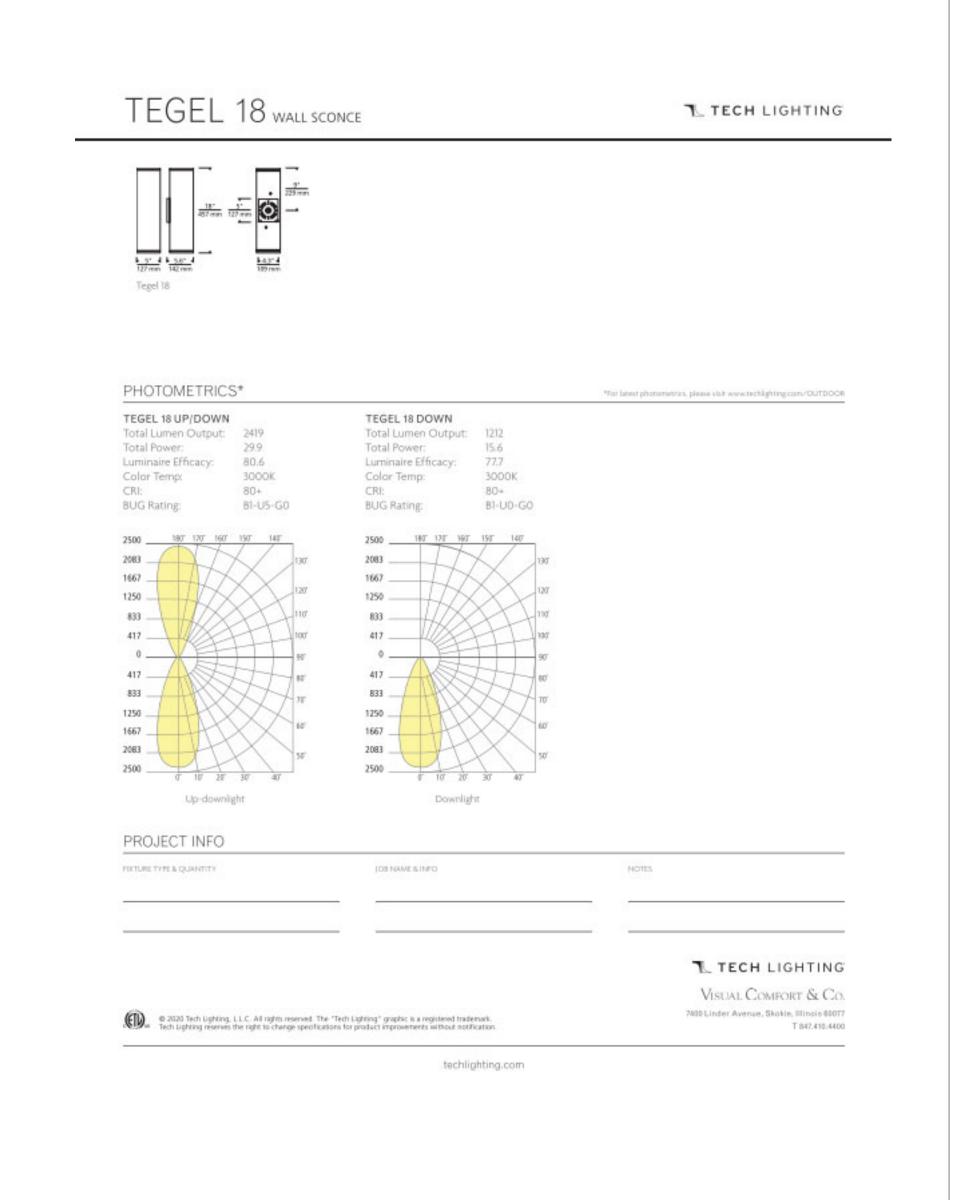
APPROVED FOR CONSTRUCTION:


PROJECT No.: A21-198

DATE: 2/22/2023



В

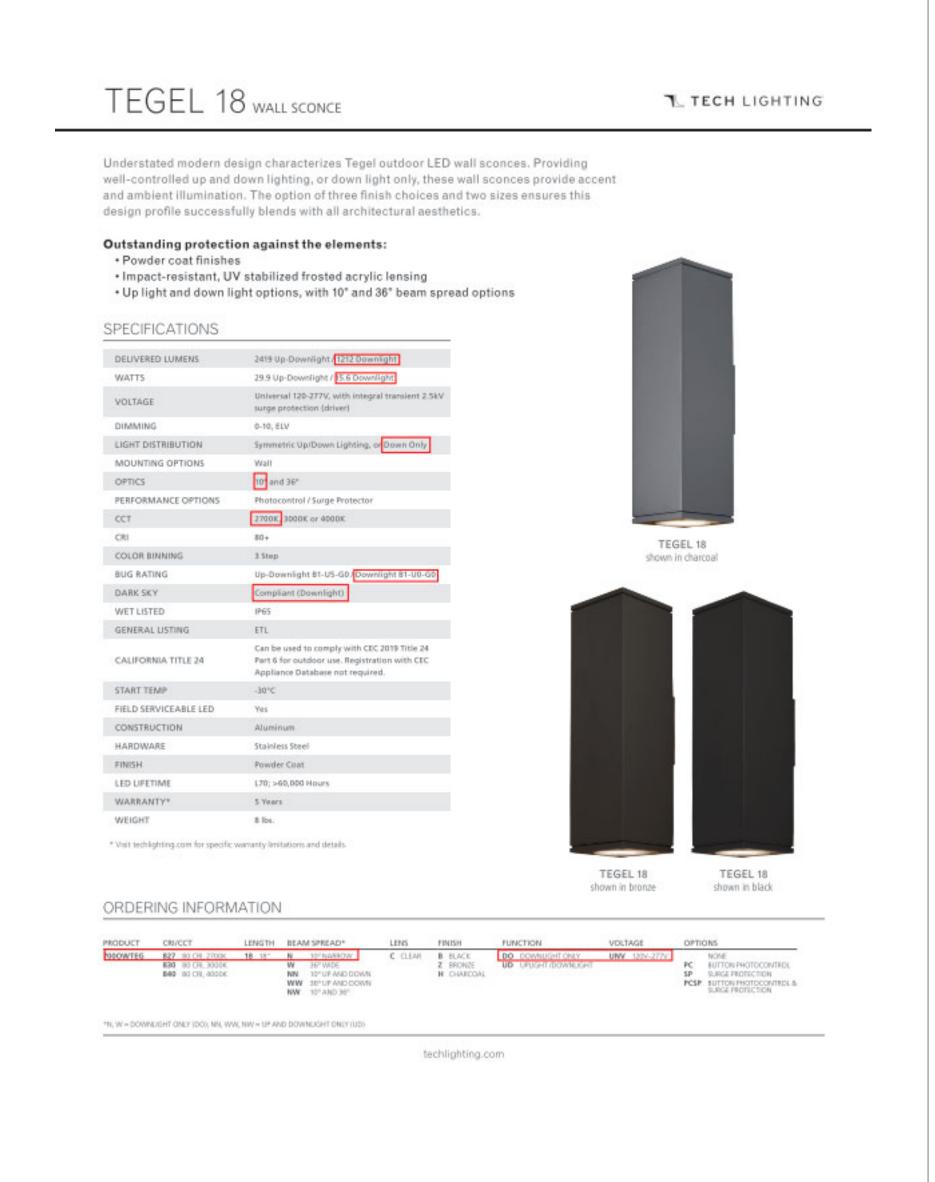

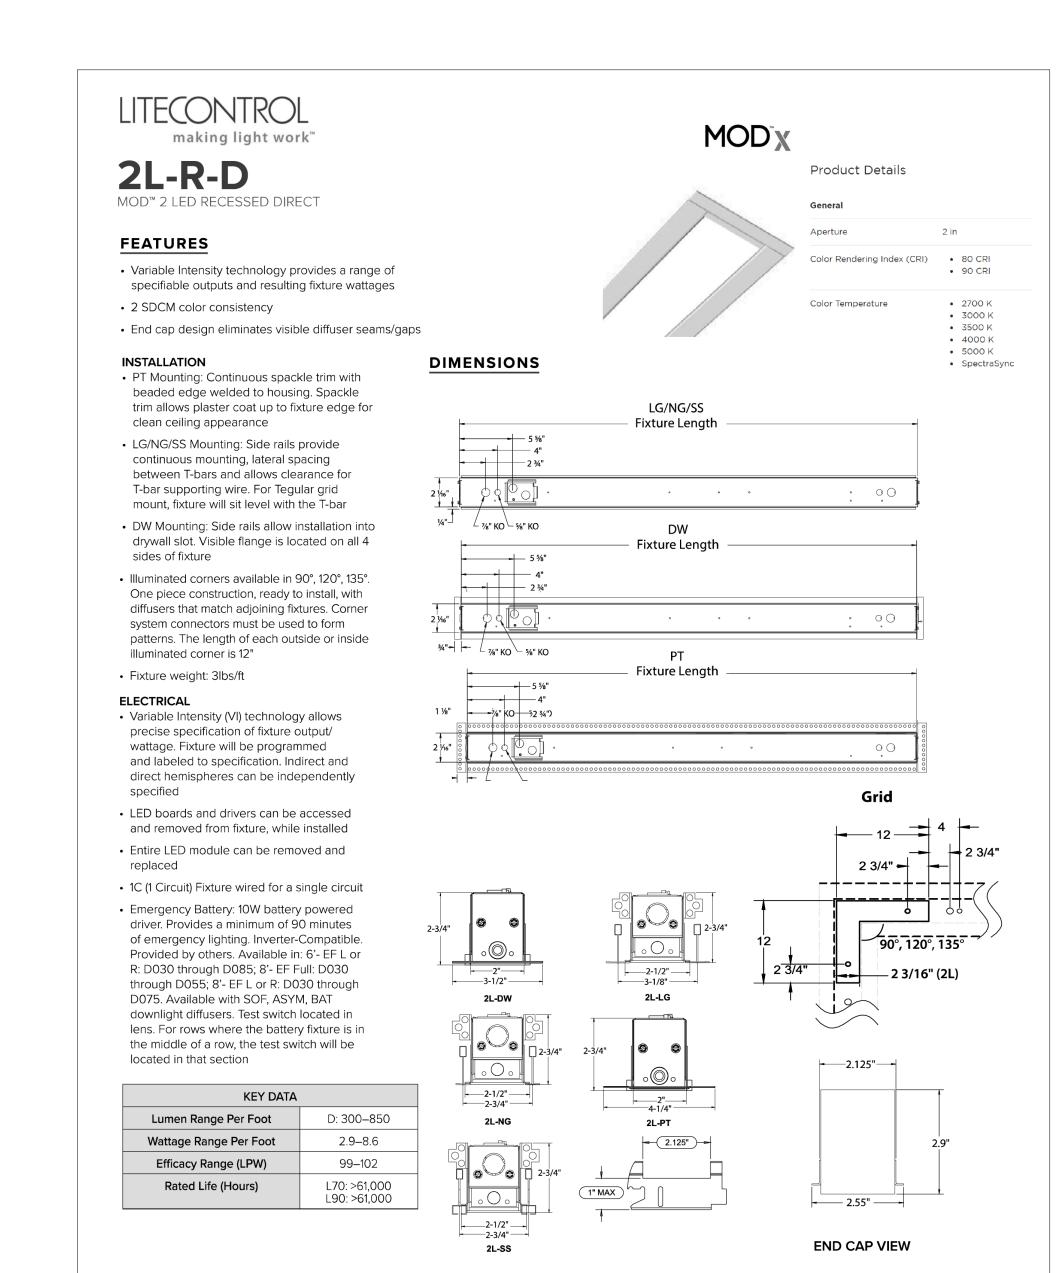

ROUND POLE-MOUNTED OCCUPANCY

• Sensor up to 30'. Select voltage and finish

Round Pole-Mounted Occupancy Sensor: up to

30' - an outdoor occupancy sensor with 0-10V

interface dimming control that mounts directly

to the pole. Wide 360° pattern. Module colors

is cut for round pole mounting. Pole diameter

is needed upon order. Poles to be drilled

in the field will be provided with installation

Ordering Example: SCH-R4⁴/277²/BL³

SQUARE POLE-MOUNTED OCCUPANCY

Sensor up to 30'. Select voltage and finish color.

Square Pole-Mounted Occupancy Sensor: up to

30' - an outdoor occupancy sensor with 0-10V

interface dimming control that mounts directly

to the pole. Wide 360° pattern. Module colors

is cut for round pole mounting. Pole diameter

is needed upon order. Poles to be drilled in the field will be provided with installation

AstroDIM provides multi-stage night-time

power reduction based on an internal timer

referenced to the power on/off time. There is

no need for an external control infrastructure.

reference to the midpoint, which is calculated

The unit automatically performs a dimming

profile based on the predefined scheduled

based on the power on/off times.

Ordering Example: SCH-S/277²/BL³

are available in Black, Gray, and White. Module

instructions.

SCH-S

ASTRODIM

are available in Black, Gray, and White. Module

Ouro

Post Top

PTSA23/24/34

Flush Mount

FMSA33/34

ISOFOOT CANDLE PLOT

1

4 3 2 1 0 1 2 3 4

FMSA33/PTSA23

FMSA34, PTSA24, PTSA34

KIMLIGHTING®

ARCHITECTURAL AREA/SITE

SiteSync™ wireless control options

Fixtures must be grounded in accordance

• Universal voltage, 120 through 277V with

a ±10% tolerance. Driver is Underwriters

High voltage configurations, 347/480. Driver

illumination options. Driver is Underwriters

• "Thermal Shield", secondary side, thermistor

LED module and electronic components

• Drivers shall have greater than a 0.9 power

factor, less than 20% harmonic distortion,

and be suitable for operation in -40°C to

• Luminaire shall be capable of operating at

100% brightness in a 40°C environment. Both

driver and optical array have integral thermal

detection of temperatures in excess of 85°C.

protection that will dim the luminaire upon

• Wiring: No. 18AWM rated 105°C, wet rating.

KEY DATA

2694 - 16874

25 - 150

95 – 133

L70/>60,000

35 lbs – 15.8 Kg

0.608

• Surge protection: 10,000k in parallel,

Lumen Range

Wattage Range

Efficacy Range (LPW)

Reported Life (Hours)

Weight

DIMENSIONS

20,000k in series

40°C ambient environments.

provides protection for the sustainable life of

has a 0-10V dimming interface for multi-level

Failure to do so may result in serious

with national, state and/or local electrical codes.

• 20" size in single/dual arm post top, pole and wall mount • High performance optics up to 16,874 delivered lumens

• UL/cUL listed for wet locations, IP66 and 4G/1.5G vibration rated

UR20

FEATURES

 Elegant form factor Diffusion lens option


INSTALLATION

personal injury.


Laboratories listed.


Laboratories listed.

ELECTRICAL

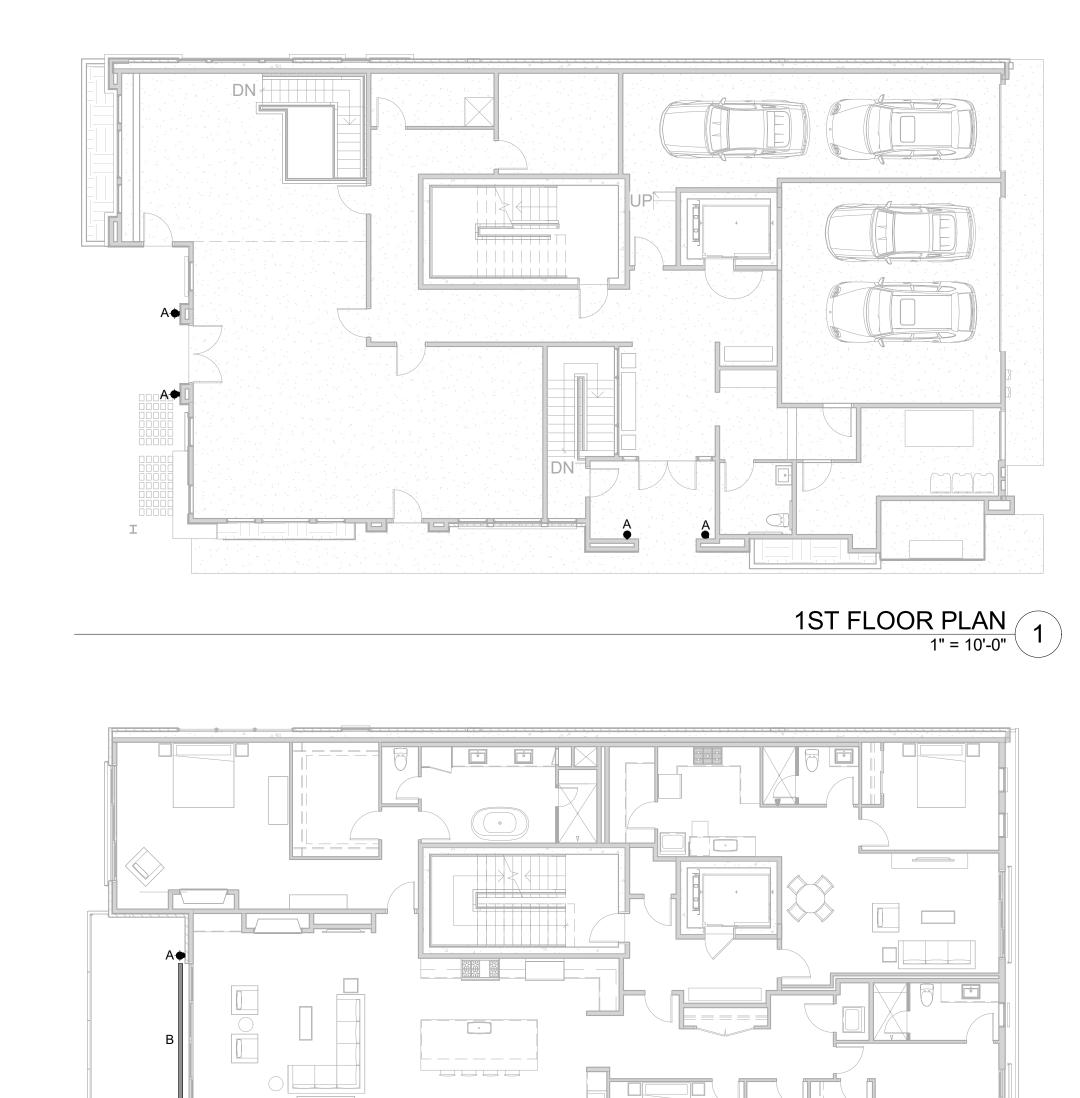

В

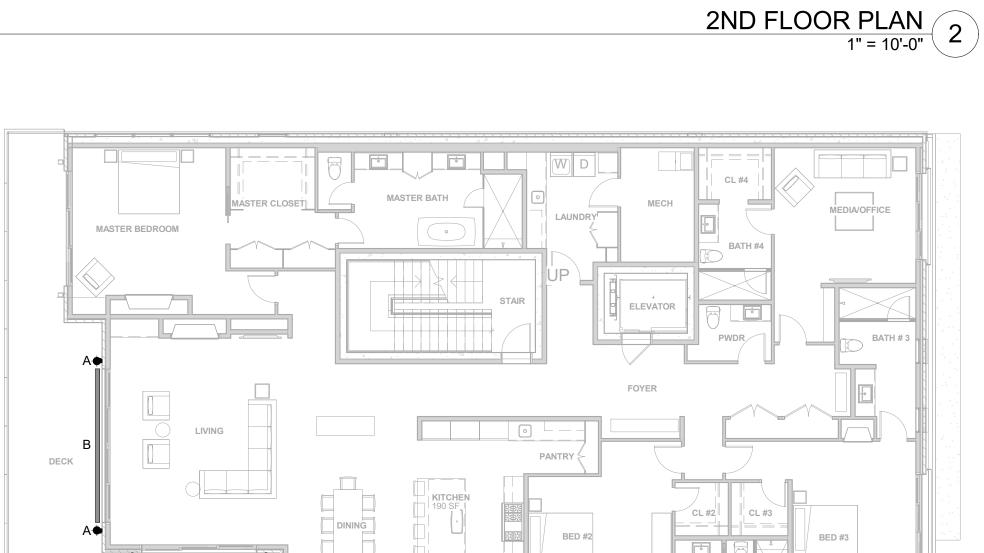

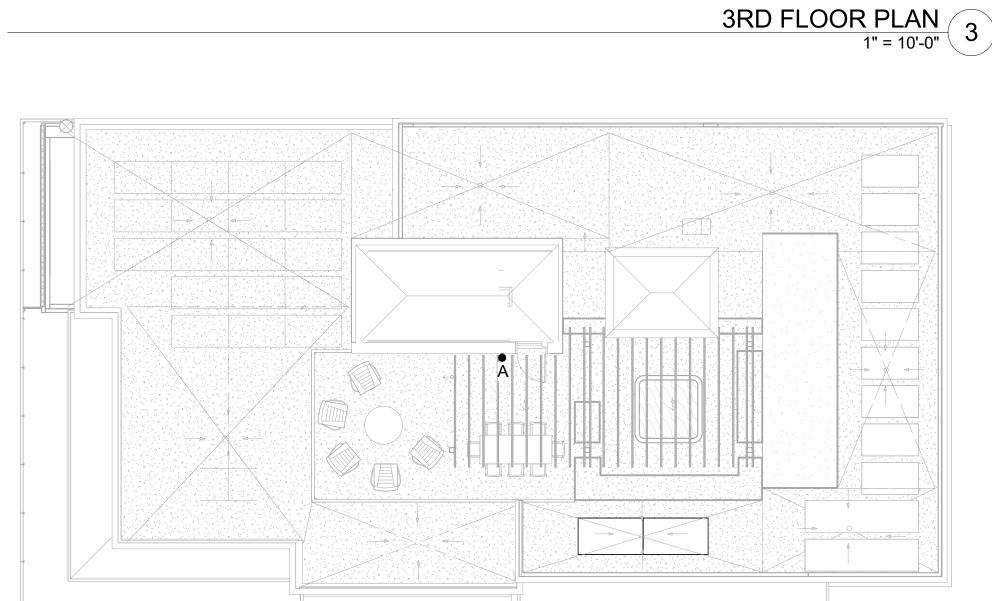



TEL: (425) 453-9298 FAX: (425) 452-8448 **REGISTRATION:**

NICOLE C. RAMEY STATE OF IDAHO

02/22/23 INTAKE DATE: **REVISIONS:** DATE:

PROJECT / CLIENT:

THE 208 BUILDING

CARR, MICHAEL

JOB ADDRESS: 200 N LEADVILLE KETCHUM IDAHO, 83340 PARCEL #RPK00000230010

DRAWING NAME: EXTERIOR LIGHTING PLANS AND FIXTURES

Drawn By: MS Checked By: NR Owner Approval:

PHASE:


CONSTRUCTION DRAWINGS


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APPROVED FOR CONSTRUCTION:

PROJECT No.: A21-198 DATE: 2/22/2023

ROOF PLAN 1" = 10'-0" 4




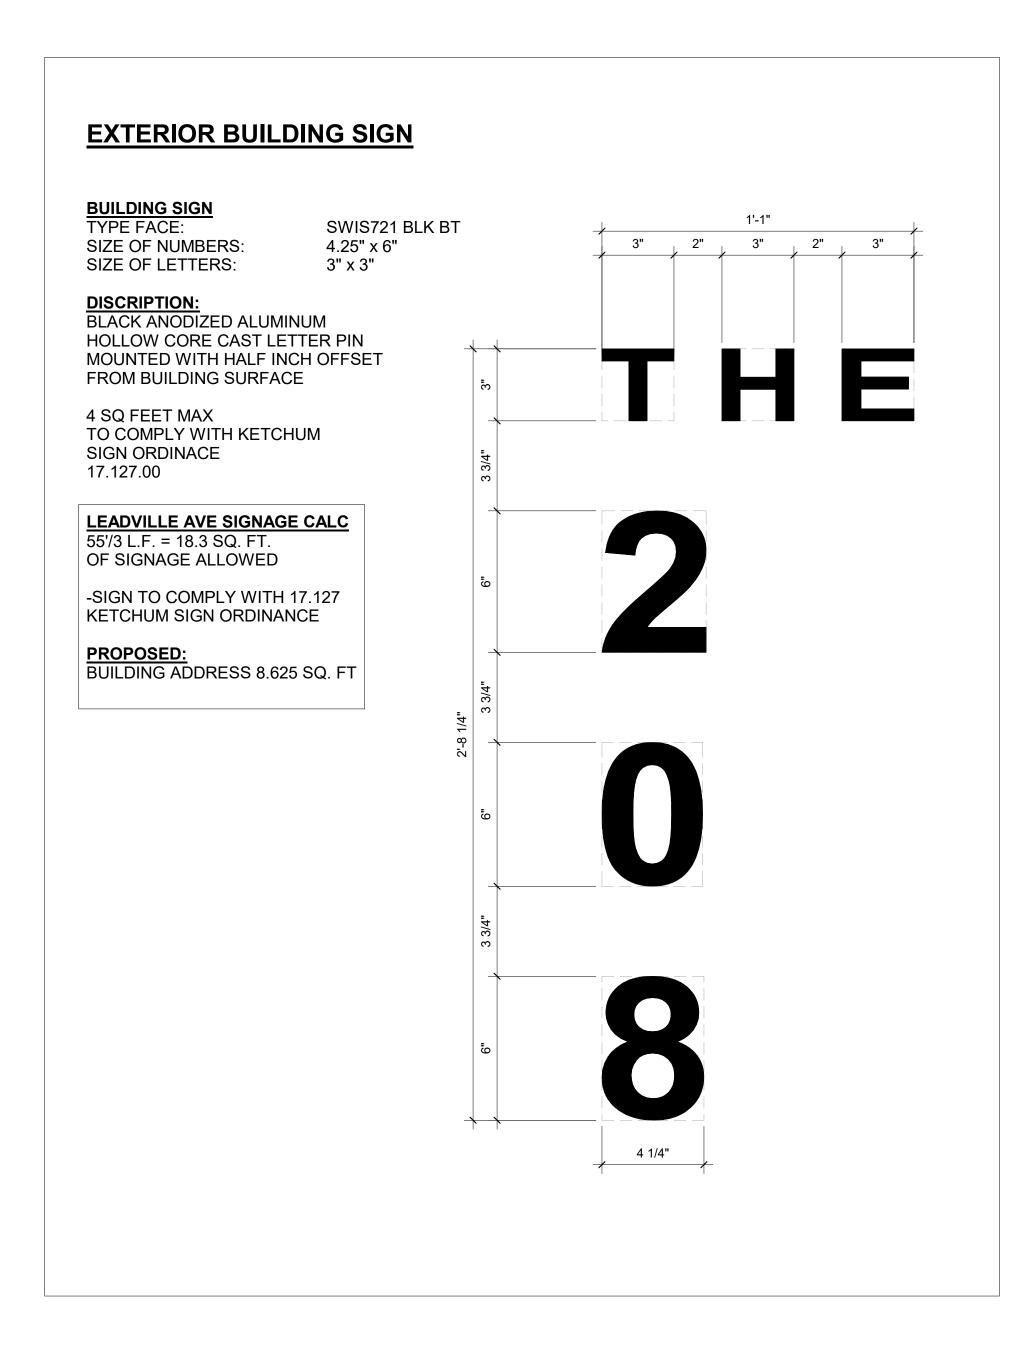


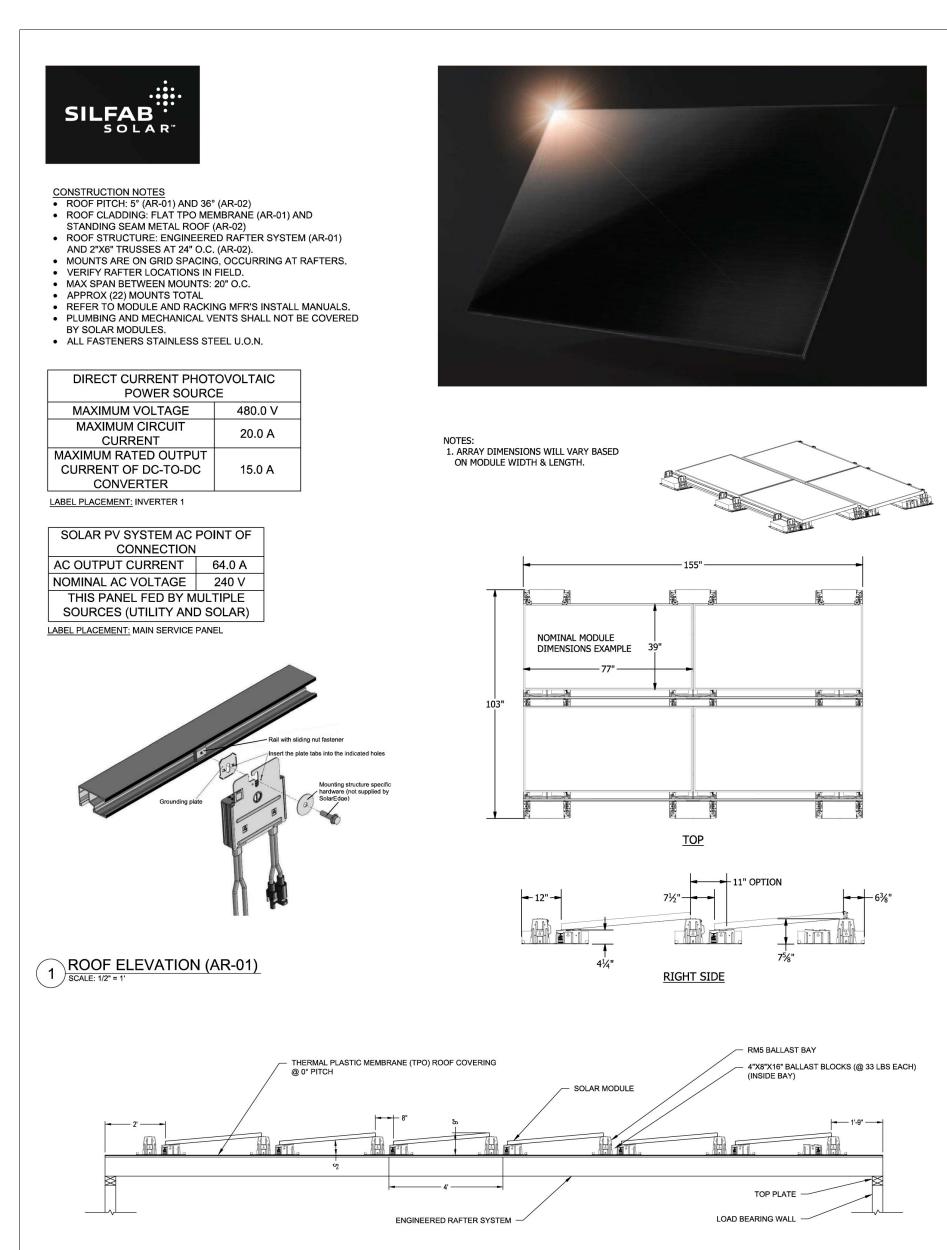
-4SQ FT MAX

EXTERIOR SIGN



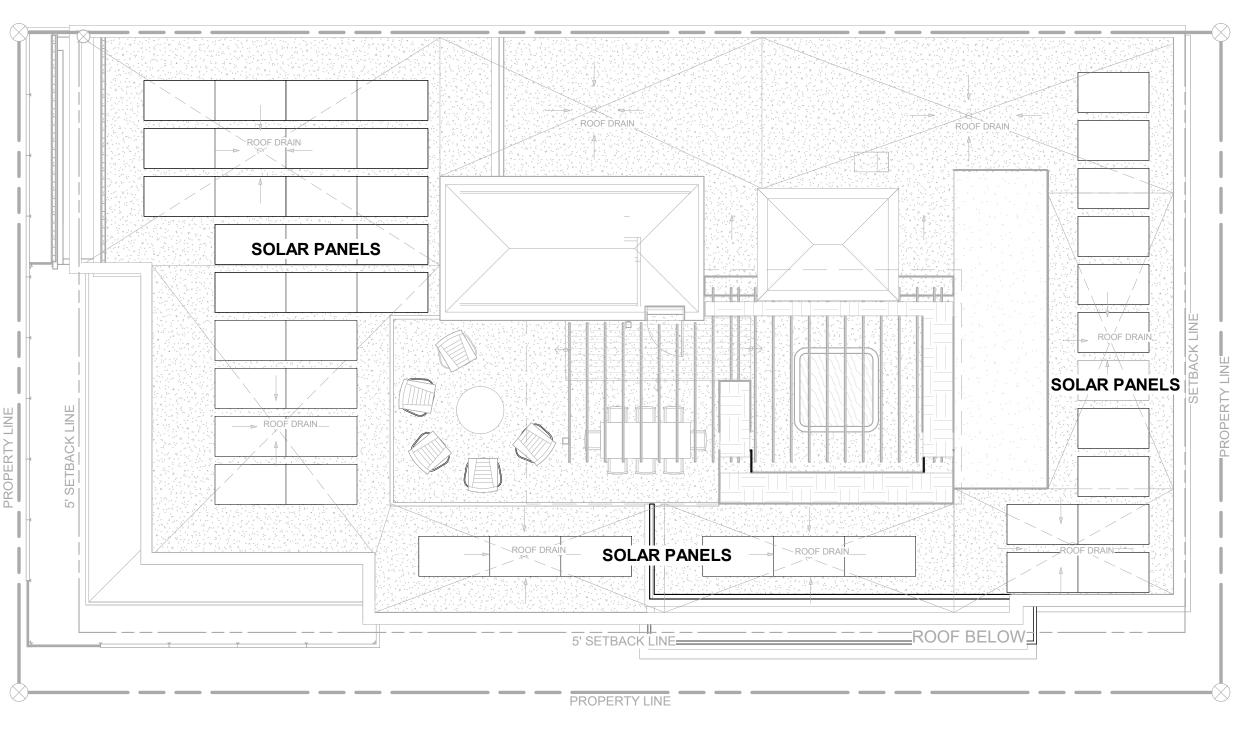


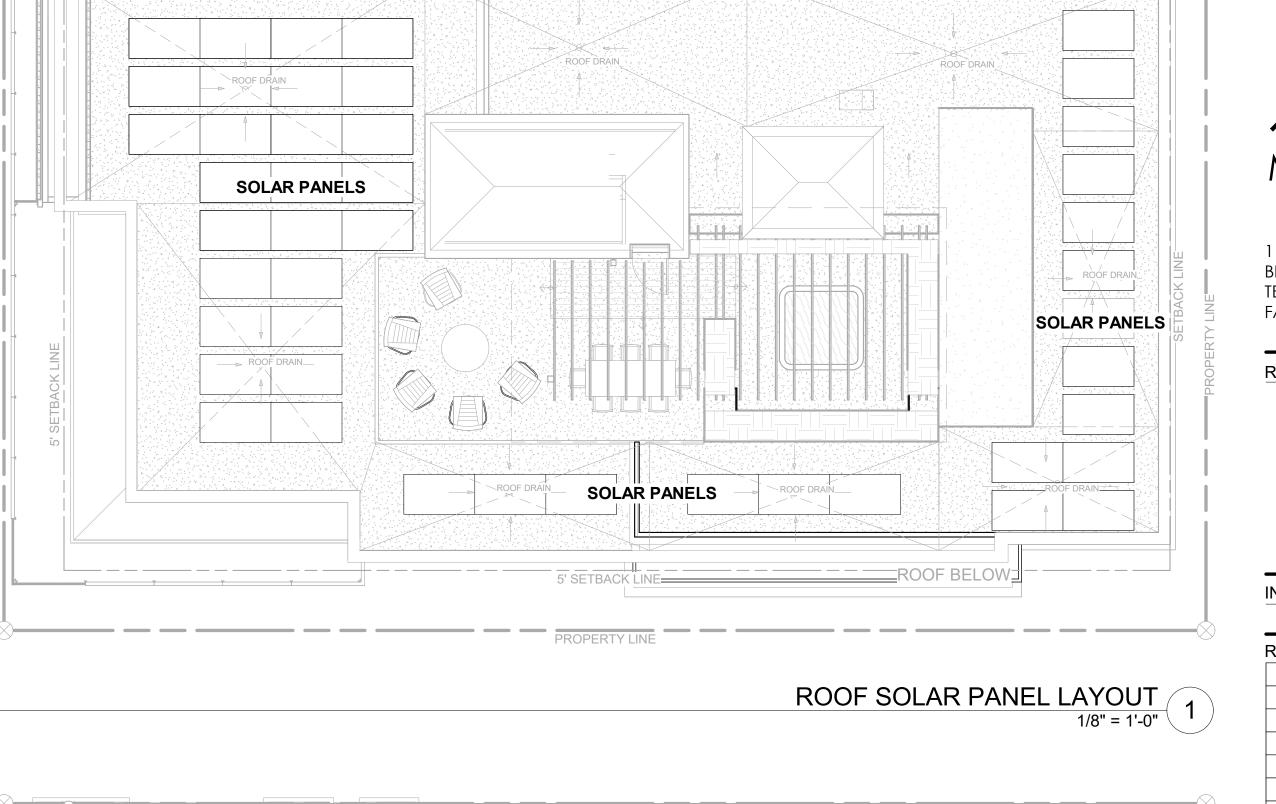

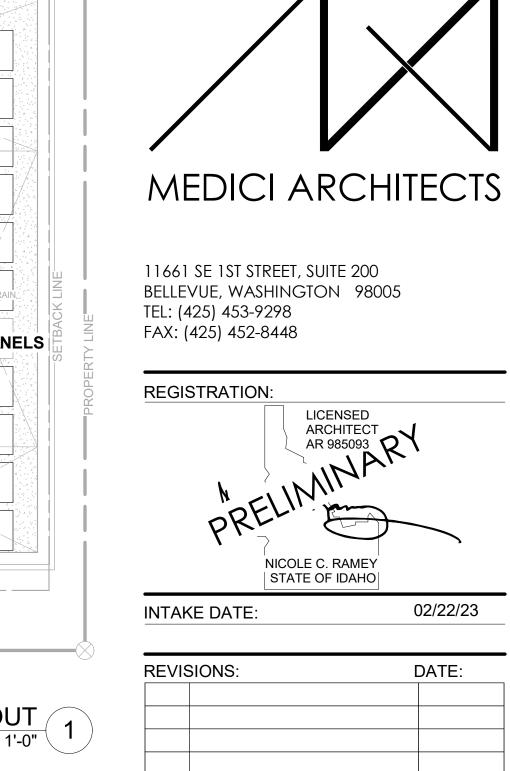

PROJECT / CLIENT: THE 208 BUILDING CARR, MICHAEL

> JOB ADDRESS: 200 N LEADVILLE KETCHUM IDAHO, 83340 PARCEL #RPK00000230010

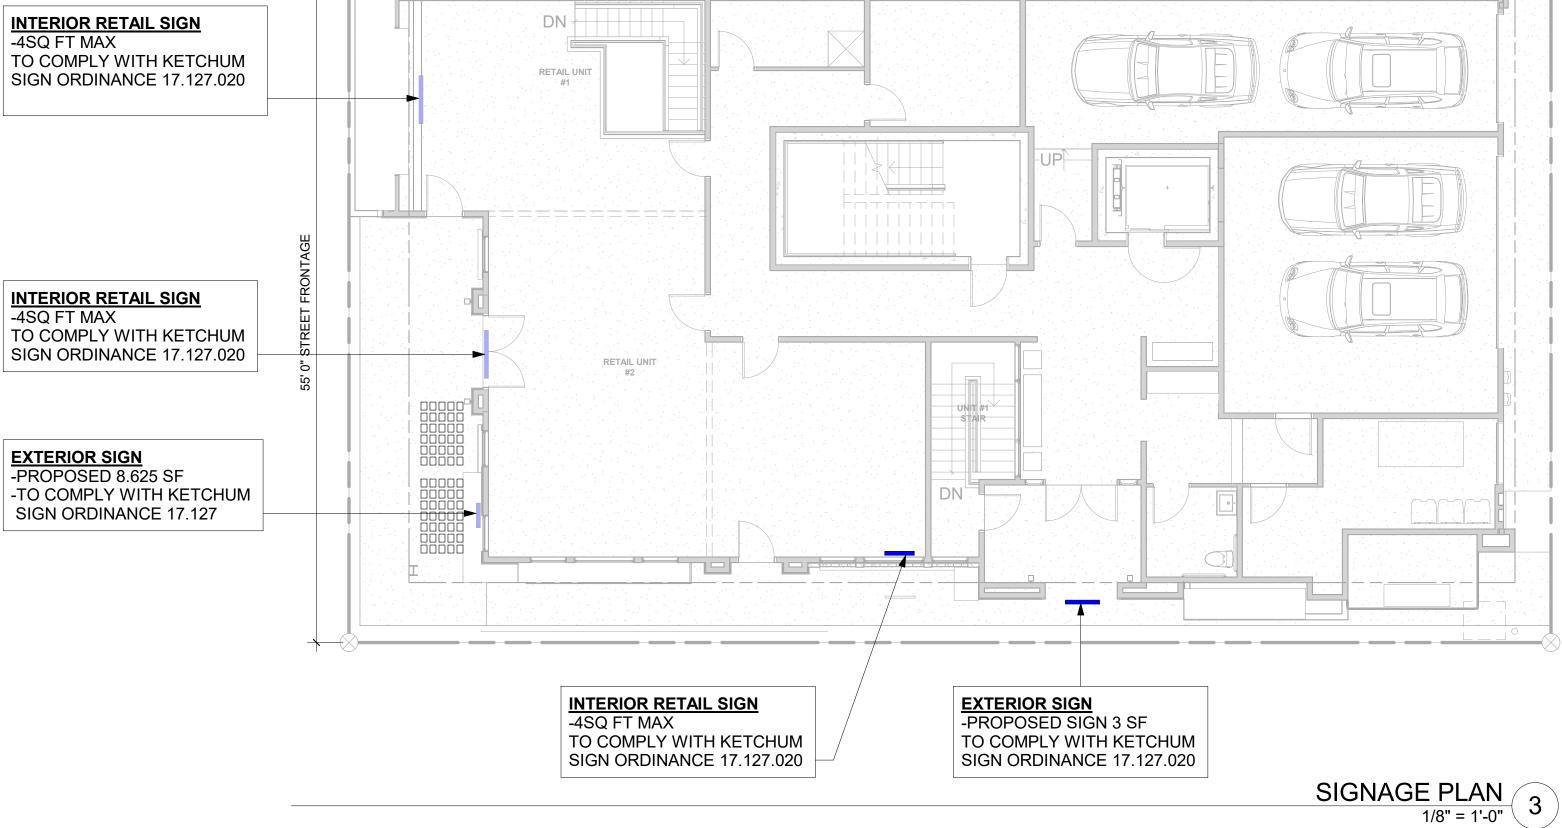

DRAWING NAME:

SPEC SHEET

Drawn By: MS Checked By: NR Owner Approval:

PHASE:

CONSTRUCTION DRAWINGS


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PROJECT No.: A21-198 DATE: 2/22/2023







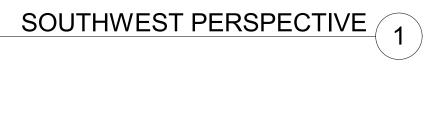

SOUTH PERSPECTIVE 3




SOUTHEAST PERSPECTIVE 2

MEDICI ARCHITECTS

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REGISTRATION:

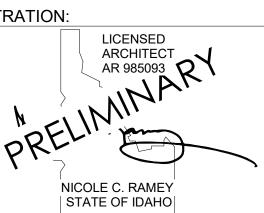

02/22/23 INTAKE DATE:

REVISIONS:

PROJECT / CLIENT:

THE 208 BUILDING

CARR, MICHAEL

JOB ADDRESS: 200 N LEADVILLE KETCHUM IDAHO, 83340 PARCEL #RPK00000230010

DRAWING NAME:

PERSPECTIVES

Drawn By: MS Checked By: NR Owner Approval:

PHASE:

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APPROVED FOR CONSTRUCTION:

PROJECT No.: A21-198 DATE: 2/22/2023