N RE:	
	)
120 N East Avenue Addition	) KETCHUM PLANNING AND ZONING COMMISSION
Design Review	) FINDINGS OF FACT, CONCLUSIONS OF LAW, AND
Application File Number: P24-074	) DECISION
•	)
	, )
Date: May 27, 2025	)

**PROJECT:** 120 N East Ave Addition

**APPLICATION TYPE:** Design Review

FILE NUMBER: P24-074

**PROPERTY OWNER:** 120 East LLC

**REPRESENTATIVE:** Mike Brunelle, Brunelle Architects

LOCATION: 120 N East Avenue (Ketchum Townsite: Block 42: Lot 2)

**ZONING:** Mixed-Use Subdistrict of the Community Core (CC-2 Zone)

OVERLAY: None

#### **RECORD OF PROCEEDINGS**

The Planning and Zoning Commission (the "Commission") considered the 120 N East Avenue Addition Design Review Application File No. P24-074 during their special meeting on May 7, 2025. A public hearing notice for the project was mailed to all owners of property within 300 feet of the project site on April 16, 2025. The public hearing notice was published in the Idaho Mountain Express on April 16, 2025. A notice was posted on the project site on April 30, 2025 and on the city's website on April 22, 2025. After considering Staff's analysis, the applicant's presentation, and public comment, the Commission approved Design Review Application File No. P24-074 subject to conditions.

#### **FINDINGS OF FACT**

The Commission having reviewed the entire project record, provided notice, and conducted the required public hearing does hereby make and set forth these Findings of Fact, Conclusions of Law, and Decision as follows:

The applicant is proposing a 2,279-square-foot addition to the existing commercial building located at 120 N East Avenue (the "subject property") in the Mixed-Use Subdistrict of the Community Core ("CC-

2 Zone"). The proposed 2,279 square-foot addition will accommodate a remodel of the existing commercial area, a new attached garage, and two new multi-family dwelling units. The proposed mixed-use building has a total FAR is 0.99 and with a maximum height of 39′-7″. The project plans are included as Exhibit A.

The proposed addition is subject to Design Review pursuant to Ketchum Municipal Code ("KMC") §17.96.010.A4, which requires Design Review for substantially altering the exterior of commercial and mixed-use buildings. The Planning and Zoning Commission (the "Commission") has the authority to review and approve the applicant's Design Review request pursuant to KMC §17.96.030.B. As conditioned, the Commission finds that the project complies with all zoning code requirements and Design Review standards.

#### Findings Regarding Conformance with Zoning and Design Review Standards

Pursuant to KMC §17.96.050.A, the Commission shall determine the following before granting Design Review approval:

- 1. The project does not jeopardize the health, safety or welfare of the public.
- 2. The project generally conforms with the goals, policies, and objectives of the adopted comprehensive plan.
- 3. The project conforms to all applicable standards and criteria as set forth in this chapter, this title, and any other standards as adopted or amended by the City of Ketchum from time to time.

#### <u>Criteria 1 & Criteria 2: Public Health, Safety, and Welfare & Comprehensive Plan Conformance</u> Future Land Use

The subject property is designated as Mixed-Use Commercial on the future land use map of the 2104 Comprehensive Plan ("2014 Plan"). The Mixed-Use Commercial promotes a wide range of commercial and residential uses and mixed-use development. The 2014 Plan supports redevelopment and the intensification of land uses downtown. Goal LU-1 promotes, "a functional, compact, and mixed-use pattern that integrates and balances residential and non-residential land uses." Goal LU-2 supports, "infill and redevelopment in the downtown, major activity areas and specific areas that can take advantage of proximity to services and transportation" (page 71). As noted in the 2014 Plan, redevelopment, "means the more intensive use of existing or underused buildings and sites or the replacement of buildings with larger buildings" (page 71). Policy LU-2.1 supports the intensification of land uses on appropriate redevelopment sites downtown (page 71).

The project will expand the existing commercial space in the 120 N East Ave building and add two new housing units. By intensifying the existing commercial use and adding residential use, the project meets the 2014 Plan policies supporting a mixture of uses and the intensification of land uses through redevelopment downtown.

#### Housing

The 2014 Plan identifies downtown as an appropriate place for housing density due to its proximity to jobs and transportation options. Policy H-1.4 of the comprehensive plan states that, "housing should be integrated into the downtown core" (page 20), and Policy H-3.1 encourages the siting of housing in new developments near public transportation and retail districts (page 21). The project will provide

two new housing units located within the downtown core within walking distance to the Mountain Rides bus stop Visitor Center on Sun Valley Road, which provides access to all major transit routes connecting riders to other areas of Ketchum and the Wood River Valley.

#### Compatibility with Surrounding Neighborhood

The 2014 Plan provides the following policies regarding design and compatibility with the surrounding neighborhood:

- Policy CD-1.3: "Infill and redevelopment projects should be contextually appropriate to the neighborhood and development in which they occur. Context refers to the natural and manmade features adjoining a development site; it does not imply a certain style" (page 26).
- Policy CD-1.4: "Each new project should be well-designed and attractive, and should complement surrounding land uses and existing neighborhood character" (page 26).

While infill and redevelopment has intensified downtown, this area has not experienced the same degree of change. The proposed three-story mixed-use building has maximum height of 38'-5", is 8,134 gross square feet, and has a total Floor Area Ratio (FAR) of 0.99. The natural materials and earthtone colors will complement the adjacent buildings and surrounding buildings. Staff believes the project provides a high-quality design that complements adjacent buildings and is contextually appropriate for this area of downtown.

#### Criteria 3: Conformance with Applicable Standards and Criteria

The 120 N East Ave Addition Design Review project complies with all zoning code regulations, dimensional standards required for buildings in the CC-2 Zone, Design Review standards, and Community Core project requirements.

#### FINDINGS REGARDING COMPLIANCE WITH ZONING REGULATIONS

17.12.020 – District Use Matrix	Conformance
Zone District: Mixed-Use Subdistrict of the Community Core (CC-2)	YES
Staff Analysis: The mixed-use development includes commercial offices and two multi-family	
dwelling units, which are permitted in the CC-2 Zone pursuant to KMC §17.12.020.	

17.12.040 – Dimensional Standards. CC District Matrix	Conformance
Minimum Lot Size	YES
Staff Analysis: Required: 5,500 square feet	
Lot 2 Area: 8,250 square feet	

17.12.040 – Dimensional Standards. CC District Matrix	Conformance
Minimum Lot Width	YES
Staff Analysis:	
Required: Minimum lot width of an average of 55 feet is required in the CC-2 zone district.	
Existing Nonconforming Lot Width: 55 feet	

17.12.040 – Dimensional Standards. CC District Matrix	Conformance
Minimum Building Setbacks	YES

#### Staff Analysis:

#### Required:

Front (East Avenue/west): 5' average

Side (interior/north): 0' Side (interior/south): 0' Rear (alley/east): 3'

Non-habitable structures, permanently affixed deck amenities, solar panels visible above roof ridge or parapet, and mechanical equipment and screening affixed to a roof from all building

facades: 10 feet

#### Proposed:

Setbacks for Mixed-Use Building

Front (East Avenue/west): 11'-1" average

Side (interior/north): 10" Side (interior/south): 7" Rear (alley/east): 68'-6"

#### Rooftop Structures

N/A—no rooftop solar or mechanical units are proposed to be installed on the roof.

17.12.040 – Dimensional Standards. CC District Matrix	Conformance
Maximum Building Heights	YES

Permitted: 42 feet

Height of building/CC District: The greatest vertical distance of a building in the community core district measured by determining the average elevation of the front property line and rear property line. Draw a line from the average front or rear elevation up to the maximum building height allowed, and then draw a line at that height parallel to the front or rear property line. The resulting line establishes the highest elevation of the front or rear facade. The front or rear facade shall not extend above this line. Side facades may be stepped up or down to transition from the highest elevation of the front facade height to the highest elevation of the rear facade. One or multiple steps along the side facades are allowed, except no step shall occur within 40 feet of the front elevation or within 35 feet of the rear facade. The City shall establish the elevation points used to calculate the average elevation of the front and rear property lines (see illustration A on file in the office of the City Clerk).

#### Proposed:

Maximum Height of Front Façade: 38'-7" Maximum Height of Rear Façade: 33'-6"

17.124.040 – Floor Area Ratios and Community Housing	Conformance
1 27122 110 10 11001 7 1100 110100 dilla committatille, illocatille	000

All new buildings and alterations to existing buildings in the GR-H, T, T-3000	YES
and CC zoning districts, unless otherwise specified in this title, shall be subject	
to the maximum floor area ratio (FAR) described below.	

#### Required

Permitted FAR: 1.0

Permitted FAR with Community Housing: 2.25

#### Proposed:

The FAR calculation is provided on Sheet A-002 of the project plans.

Total Gross Floor Area: 8,134 square feet

Lot Area: 8,250 square feet

FAR: 0.99

17.125.030 - Off Street Parking and Loading 17.125.040 - Off Street Parking and Loading Calculations 17.125.050 - Community Core District Off Street Parking and Loading Calculations	Conformance
Pursuant to Ketchum Municipal Code 17.125.020.A1, all new development	YES
must comply with the off street vehicle parking requirements.	

#### Permitted:

#### Required (KMC §17.125.040)

Multi-Family Dwelling Units in CC Zone

Units 750 square feet or less: 0 parking spaces

Units 751 square feet to 2,000 square feet: 1 parking space

Units 2,001 square feet and above: 2 parking spaces

Non-residential: 1 parking space per 1,000 gross square feet (refer to definition of gross floor area with additional exclusion of common and public areas)

#### Exemptions in CC Zone

- Community housing
- Food service
- The first 5,500 gross square feet of retail trade
- The first 5,500 gross square feet of assembly uses
- The first 5,500 square feet of office and personal service uses

#### Project Parking Demand

Office (4,139 gross sq ft): Exempt

#### Multi-Family Dwelling Units:

- Second-Floor Dwelling Unit Net Floor Area: 574 square feet—0 parking required
- Third-Floor Dwelling Unit Net Floor Area: 2,185 square feet—2 parking spaces required

#### Total Parking Demand:

2 Parking Spaces

#### Proposed

The applicant has provided 7 parking spaces—2 parking spaces are proposed within the attached garage and 5 parking spaces are proposed for the surface parking area.

Conformance
YES

#### Finding:

<u>Required:</u> 1 bike rack, accommodating at least two bicycles, is required based on the project parking demand.

<u>Proposed:</u> 1 bike rack accommodating two bicycles is provided on site.

17.127 – Signage	Conformance
Master Signage Plan for New Construction	YES
Finding: The master signage plan is specified on sheet L-100.	

17.132 – Dark Skies	Conformance
Compliance with Section 17.132 – Dark Skies.	YES
Finding. The outerior lighting plan is provided on sheets A 002 and A 004. The proposed	

**Finding**: The exterior lighting plan is provided on sheets A-003 and A-004. The proposed exterior lighting complies with the Dark Skies Ordinance.

#### FINDINGS REGARDING COMPLIANCE WITH DESIGN REVIEW STANDARDS

17.96.060.A.1 - Streets	Conformance
The applicant shall be responsible for all costs associated with providing a	YES
connection from an existing City street to their development.	Condition #4

**Finding:** The City Engineer has conducted a review of the project plans and believes the proposed right-of-way improvements comply with city standards. The applicant shall submit final civil drawings prepared by an engineer registered in the State of Idaho that provide specifications for all right-of-way improvements, including sidewalks, alley asphalt, streetlights, utilities, and drainage facilities, for review and approval by the City Engineer, Streets Department, Utilities Department, and Planning Department prior to issuance of a building permit for the project pursuant to condition of approval #4.

17.96.060.A.2 - Streets	Conformance
All street designs shall be approved by the City Engineer.	YES
	Condition #4

**Finding**: No new streets or changes to the travel lanes or street designs are proposed with this project. Final civil drawings for all associated right-of-way improvements shall be submitted with the building permit application to be verified, reviewed, and approved by the City Engineer and Streets Department. Final review of all right-of-way improvements will be completed prior to issuance of a building permit for the project pursuant to condition of approval #4.

17.96.060.B.1 - Sidewalks	Conformance
All projects under subsection 17.96.010.A of this chapter that qualify as a "substantial improvement" shall install sidewalks as required by the Public Works Department.	YES
"substantial improvement" shall install sidewalks as required by the Public	YES

**Finding**: Ketchum Municipal Code 17.124.140 outlines the zone districts where sidewalks are required when substantial improvements are made, which include the CC, all tourist zone districts, and all light industrial districts. As the project is within the CC-2 zone district, sidewalks are required and included in the project plans. The applicant has proposed to install new 8-foot-wide sidewalk along 2<sup>nd</sup> Street.

17.96.060.B.2 - Sidewalks	Conformance
Sidewalk width shall conform to the City's right-of-way standards, however the	YES
City Engineer may reduce or increase the sidewalk width and design standard	Condition
requirements at their discretion.	#4

**Finding**: The applicant has proposed installing a new 8-foot-wide, concrete sidewalk along East Avenue. The City Engineer, Streets Department, and City Arborist have conducted a review of the project plans and believe the proposed right-of-way improvements comply with city standards.

The applicant shall submit final civil drawings prepared by an engineer registered in the State of Idaho that provide specifications for all right-of-way improvements, including sidewalks, alley asphalt, streetlights, utilities, and drainage facilities, for review and approval by the City Engineer, Streets Department, Utilities Department, and Planning Department prior to issuance of a building permit for the project pursuant to condition of approval #4.

17.96.060.B.3 - Sidewalks	Conformance
Sidewalks may be waived if one of the following criteria is met:	N/A
a) The project comprises an addition of less than 250 square feet of conditioned space.	
b) The City Engineer finds that sidewalks are not necessary because of existing geographic limitations, pedestrian traffic on the street does not warrant a sidewalk, or if a sidewalk would not be beneficial to the general welfare and safety of the public.	

**Finding**: N/A. Sidewalks are required for the project. The applicant has not requested, nor has the City Engineer granted, a waiver to the sidewalk requirement for the project.

17.96.060.B.4 - Sidewalks	Conformance
The length of sidewalk improvements constructed shall be equal to the length of the subject property line(s) adjacent to any public street or private street.	YES
Finding: The proposed sidewalk improvements are equal to the length of the sub	ject property's

**Finding**: The proposed sidewalk improvements are equal to the length of the subject property's frontage along East Avenue.

17.96.060.B.5 – Sidewalks	Conformance
New sidewalks shall be planned to provide pedestrian connections to any existing or future sidewalks adjacent to the site. In addition, sidewalks shall be constructed to provide safe pedestrian access to and around a building.	YES
Finding: The new sidewalk will connect to the existing sidewalk to the north and south along	

17.96.060.B.6 - Sidewalks	Conformance
The City may approve and accept voluntary cash contributions in lieu of the above described improvements, which contributions must be segregated by the City and not used for any purpose other than the provision of these improvements. The contribution amount shall be 110 percent of the estimated costs of concrete sidewalk and drainage improvements provided by a qualified contractor, plus associated engineering costs, as approved by the City Engineer. Any approved in lieu contribution shall be paid before the City issues a certificate of occupancy.	N/A

**Finding**: N/A. The applicant has not requested relief from the requirement to construct sidewalks nor has the City granted any such request.

17.96.060.C.1 - Drainage	Conformance
All stormwater shall be retained on site.	YES
	Condition #4

#### Finding:

East Avenue.

On-site stormwater drainage will be directed through internal roof drains to on-site drywells. The roof plan on revised sheet A-104 includes a note stating that the EDPM roofing will be sloped to an internal drain system. Specifications for the roof drainage submitted must be provided with the project plans submitted with the building permit application for final review and approval by the City Engineer.

Pursuant to condition of approval #4, the applicant shall submit final civil drawings prepared by an engineer registered in the State of Idaho that provide specifications for all drainage improvements, for review and approval by the City Engineer and Streets Department prior to issuance of a building permit for the project.

17.96.060.C.2 - Drainage	Conformance
Drainage improvements constructed shall be equal to the length of the subject	YES
property lines adjacent to any public street or private street.	Condition #4

**Finding**: The project proposes to construct drainage improvements along the length of the subject property, including curb and gutter, along East Avenue. All drainage improvements are required to be constructed to comply with city standards. Pursuant to condition of approval #4, the applicant shall submit final civil drawings prepared by an engineer registered in the State of Idaho that provide specifications for all drainage improvements, for review and approval by the City Engineer and Streets Department prior to issuance of a building permit for the project.

17.96.060.C.3 - Drainage	Conformance
The City Engineer may require additional drainage improvements as	YES
necessary, depending on the unique characteristics of a site.	Condition #4

**Finding**: The City Engineer will determine if the drainage improvements for the public right-of-way and surface parking area are sufficient after reviewing the final civil drawings submitted with the building permit application. The City Engineer may require additional drainage improvements if necessary. Pursuant to condition of approval #4, the applicant shall submit final civil drawings prepared by an engineer registered in the State of Idaho that provide specifications for all drainage improvements, for review and approval by the City Engineer and Streets Department prior to issuance of a building permit for the project.

17.96.060.C.4 - Drainage	Conformance
Drainage facilities shall be constructed per City standards.	YES
	Condition #4

#### Finding:

The City Engineer and Streets Department have conducted a review of the project plans and believe the proposed right-of-way improvements comply with city standards. Pursuant to condition of approval #4, the applicant shall submit final civil drawings prepared by an engineer registered in the State of Idaho that provide specifications for all drainage improvements, for review and approval by the City Engineer and Streets Department prior to issuance of a building permit for the project.

17.96.060.D.1 - Utilities	Conformance
All utilities necessary for the development shall be improved and installed at the sole expense of the applicant.	YES
the sole expense of the applicant.	

**Finding**: All project costs associated with the development, including the installation of utilities, are the responsibility of the applicant. The applicant has not made requests for funding to the city for utility improvements. No funds have been provided by the city for the project.

17.96.060.D.2 - Utilities	Conformance
Utilities shall be located underground and utility, power, and communication	YES
lines within the development site shall be concealed from public view.	

**Finding**: Sheet L-100 shows the siting of the new transformer required to serve the project. The proposed transformer is located at northeast corner of the property by the alley and is not visible from public view along the East Avenue street frontage. The revised submittal included a letter dated January 17, 2025 confirming that they have reviewed the design and siting of the proposed transformer. The gas meters will be located within an alcove along the south interior façade.

17.96.060.D.3 - Utilities	Conformance
When extension of utilities is necessary all developers will be required to pay	N/A
for and install two-inch SDR11 fiber optical conduit. The placement and	

construction of the fiber optical conduit shall be done in accordance with City of Ketchum standards and at the discretion of the City Engineer.

**Finding**: N/A. The location of the subject property is already served by fiber optic cable and therefore no conduit is required in this location.

17.96.060.E.1 – Compatibility of Design	Conformance
The project's materials, colors and signing shall be complementary with the	YES
townscape, surrounding neighborhoods and adjoining structures.	

#### Finding:

The proposed exterior materials include unpainted sealed steel panels, metal cladding, bonderized metal paneling, board-formed concrete, stucco painted dark brown (Benjamin Moore Deep River 1582), wood siding and soffit material in a natural light brown color (Resawn Abodo Vulcan Cladding "Straw"), and wood siding in a dark brown color (Resawn Abodo Vulcan Cladding "Nero"). The proposed sign is comprised of steel beams and plates with colors that match the metal and steel panels proposed for the building. The natural materials and earthtone colors will complement the adjacent buildings and surrounding buildings. The project provides a high-quality design that complements adjacent buildings and is contextually appropriate for this area of downtown.

17.96.060.E.2 – Compatibility of Design	Conformance
Preservation of significant landmarks shall be encouraged and protected, where applicable. A significant landmark is one which gives historical and/or cultural importance to the neighborhood and/or community.	N/A
<b>Finding</b> : The subject property is not listed as a historical or cultural landmark on t Ketchum's Historical Building/Site List, therefore this standard does not apply.	he city of

17.96.060.E.3 – Compatibility of Design	Conformance
Additions to existing buildings, built prior to 1940, shall be complementary in design and use similar material and finishes of the building being added to.	N/A
Finding: N/A. The existing commercial building was constructed in 1985.	

Conformance
YES

**Finding**: The primary building entrance is along East Avenue. The existing building entrance borders the south side property line. The existing building entrance connects to the East Avenue sidewalk through an uncovered pathway and uncovered steps. The project proposes to improve the existing building entrance. The entrance will remain in the same location but is proposed to be further defined by a flat roof projection that covers a portion of the pathway. The flat roof covering will provide weather protection for pedestrians accessing the building. The proposed building entrance is well defined and provide unobstructed access to the sidewalk.

17.96.060.F.2 – Architectural	Conformance
The building character shall be clearly defined by use of architectural features.	YES

Finding: The building character is defined by architectural features, including horizontal bands at the top of each floor level. These horizontal bands provide a distinct base, middle, and top along the front façade. The third-floor is setback from the lower levels, which softens the visual presence of the addition along East Avenue and helps to distinguish the building's interior program externally. The project includes different roof styles, including the flat roof covering proposed for the building entrance along East Avenue as well as flat and sloped roof elements at different heights on the third floor addition. The different roof styles and heights help break up the building's bulk and mass and provide visual interest. The front facade includes large windows that break up the solid surfaces. The horizontal bands capping the top of each floor level is comprised of light brown wood siding that is placed vertically. The third floor is comprised of darker brown wood siding that is placed horizontally. The placement and pattern of the light and dark brown wood siding provide visual interest that helps animate the façade. The open space on the subject property along East Avene includes a bench and provides a space for pedestrian gathering. The proposed signage is pedestrian oriented, complements the design of the building, and integrates with the streetscape.

17.96.060.F.3 – Architectural	Conformance
There shall be continuity of materials, colors and signing within the project.	YES

Finding: The project uses an integrated palette of high-quality exterior materials. The proposed exterior materials include unpainted sealed steel panels, metal cladding, bonderized metal paneling, board-formed concrete, stucco painted dark brown (Benjamin Moore Deep River 1582), wood siding and soffit material in a natural light brown color (Resawn Abodo Vulcan Cladding "Straw"), and wood siding in a dark brown color (Resawn Abodo Vulcan Cladding "Nero"). The proposed sign is comprised of steel beams and plates with colors that match the metal and steel panels proposed for the building. The natural materials and earthtone colors will complement the adjacent buildings and surrounding buildings. The project provides a high-quality design that complements adjacent buildings and is contextually appropriate for this area of downtown.

Conformance
YES

**Finding**: The existing site includes shrubs planted along the East Avenue street frontage and aspen trees that border the south interior property line. New board-formed concrete walls are proposed to border the pathway to the building entrance. The existing landscape features and board-formed concrete walls math and complement the principal building.

17.96.060.F.5 – Architectural	Conformance
Building walls shall provide undulation/relief, thus reducing the appearance	YES
of bulk and flatness.	

Finding: All building walls provide either undulation through projections/recessions in building mass or visual relief through exterior material differentiation. The horizontal bands that cap the top of each floor level define the character of the building and provide a distinct base, middle, and top along the front façade. The third-floor is setback from the lower levels, which softens the visual presence of the addition along East Avenue and helps to distinguish the building's interior program externally. The project includes different roof styles, including the flat roof covering proposed for the building entrance along East Avenue as well as flat and sloped roof elements at different heights on the third floor addition. The different roof styles and heights help break up the building's bulk and mass and provide visual interest. The front facade includes large windows that break up the solid surfaces. The East Avenue and alley façades are designed with both solid surfaces and window openings and employ consistent architectural elements, exterior materials, and colors.

The majority of the north interior side façade and a portion of the south interior side facade are setback less than 1 foot from the side property line. Windows have been incorporated into portions of the south interior façade that are setback more than 5 feet from the interior lot line. The north side façade and the portion of south façade setback less than 1 foot from the side property line are characterized by exterior materials differentiation. The first two floors are comprised of stucco painted brown, the horizontal bands that cap the top of each floor level are comprised of light brown wood siding, the third floor is comprised of dark brown wood siding. The light brown siding is placed vertically and the dark brown siding is placed horizontally. The exterior material differentiation as well as the pattern and placement of the light and dark brown wood siding provide visual interest that helps animate the side façades..

17.96.060.F.6 – Architectural	Conformance
Building(s) shall orient toward their primary street frontage.	YES

Finding: The building orients towards East Avenue. The primary building entrance is along East Avenue. The existing building entrance borders the south side property line. The existing building entrance connects to the East Avenue sidewalk through an uncovered pathway and uncovered steps. The project proposes to improve the existing building entrance. The entrance will remain in the same location but is proposed to be further defined by a flat roof projection that covers a portion of the pathway. The flat roof covering will provide weather protection for pedestrians accessing the building. The proposed building entrance is well defined and provide unobstructed access to the sidewalk.

17.96.060.F.7 – Architectural	Conformance
Garbage storage areas and satellite receivers shall be screened from public view and located off alleys.	YES
Finding: The dumpster is located at the rear of the lot by the alley and screened by an	
enclosure. No satellite receivers are proposed.	

17.96.060.F.8 – Architectural	Conformance
Building design shall include weather protection which prevents water to drip	YES
or snow to slide on areas where pedestrians gather and circulate or onto	
adjacent properties.	

Finding: The roof plan on revised sheet A-104 includes a note stating that the EDPM roofing will be sloped to an internal drain system. Specifications for the roof drainage submitted must be provided with the project plans submitted with the building permit application for final review and approval by the City Engineer. The proposed flat roof covering the pathway that connects the East Avenue sidewalk to the building entrance will provide weather protection for pedestrians.

17.96.060.G.1 – Circulation Design	Conformance
Pedestrian, equestrian and bicycle access shall be located to connect with existing and anticipated easements and pathways.	YES
existing and anticipated easements and pathways.	

**Finding**: The new sidewalk will connect to the existing concrete sidewalks along East Avenue. The proposed sidewalk connects to pathways on the project site providing safe pedestrian access to and around the building.

17.96.060.G.2 – Circulation Design	Conformance
Awnings extending over public sidewalks shall extend five feet or more across the public sidewalk but shall not extend within two feet of parking or travel lanes within the right-of-way.	N/A

**Finding**: N/A. All projecting flat roof elements terminate at the property line and no awnings are proposed to extend over the property line.

17.96.060.G.3 – Circulation Design	Conformance
Traffic shall flow safely within the project and onto adjacent streets. Traffic includes vehicle, bicycle, pedestrian and equestrian use. Consideration shall be given to adequate sight distances and proper signage.	YES

**Finding**: Access to the project is provided along East Avenue and the alley. Access to the surface parking area and garage are accessed off the block 42 alleyway. The proposed alley access allows traffic to flow safely within the project. The new sidewalk will connect to walkways on the subject property providing safe pedestrian access to and around the building.

17.96.060.G.4 – Circulation Design	Conformance
Curb cuts and driveway entrances shall be no closer than 20 feet to the nearest intersection of two or more streets, as measured along the property line adjacent to the right-of-way. Due to site conditions or current/projected traffic levels or speed, the City Engineer may increase the minimum distance requirements.	N/A

**Finding**: N/A. No curb cuts or driveway entrances are proposed along East Avenue. Access to the surface parking area and garage are accessed off the block 42 alleyway.

17.96.060.G.5 – Circulation Design	Conformance
Unobstructed access shall be provided for emergency vehicles, snowplows, garbage trucks and similar service vehicles to all necessary locations within the proposed project.	YES

**Finding**: Unobstructed access for emergency vehicles, snowplows, garbage trucks, and similar service vehicles is provided to the project from East Avenue and the alley.

17.96.060.H.1 – Snow Storage	Conformance
Snow storage areas shall not be less than 30 percent of the improved parking	YES
and pedestrian circulation areas.	Condition #2

**Finding**: Based on the areas listed on revised sheet L-100, the total parking and pedestrian circulation area is 4,122 square feet. 1,237 square feet of snow storage is required based on parking and pedestrian circulation area. Only 471 square feet of snow storage is provided on the subject property. The remaining snow storage requirement is proposed to be satisfied through hauling of snow off site, which is permitted pursuant to KMC 17.96.060.H4.

17.96.060.H.2 – Snow Storage	Conformance
Snow storage areas shall be provided on site.	YES
	Condition #2

**Finding**: Based on the areas listed on revised sheet L-100, the total parking and pedestrian circulation area is 4,122 square feet. 1,237 square feet of snow storage is required based on parking and pedestrian circulation area. Only 471 square feet of snow storage is provided on the subject property. The remaining snow storage requirement is proposed to be satisfied through hauling of snow off site, which is permitted pursuant to KMC 17.96.060.H4.

17.96.060.H.3 – Snow Storage	Conformance
A designated snow storage area shall not have any dimension less than five feet and shall be a minimum of 25 square feet.	YES Condition #2
Finding: The proposed snow storage area is 471 square feet with a minimum dimension of 5	

**Finding**: The proposed snow storage area is 471 square feet with a minimum dimension of 5 feet.

17.96.060.H.4 – Snow Storage	Conformance
In lieu of providing snow storage areas, snowmelt and hauling of snow may be	YES
allowed.	Condition #2

**Finding**: The applicant has indicated that the owners have an existing agreement with the adjacent property owner to the south to store snow but intend to utilize Joe's Backhoe Service to haul snow off-site once the surface parking area improvements are complete. Pursuant to condition #2, prior to issuance of a building permit, the applicant shall submit a copy of the snow hauling agreement with a contractor who provides snow hauling services to ensure compliance with the snow storage standards specified in KMC §17.96.060.H1.

17.96.060.I.1 – Landscaping	Conformance
Landscaping is required for all projects.	YES

**Finding**: Existing landscaping is proposed to be retained on site. Existing landscaping includes aspen trees and shrubs along East Avenue.

17.96.060.I.2 – Landscaping	Conformance
Landscape materials and vegetation types specified shall be readily adaptable to a site's microclimate, soil conditions, orientation and aspect, and shall serve to enhance and complement the neighborhood and townscape.	YES
Finding: The existing aspen trees and shrubs are proposed to be retained and cor	nplement the

**Finding**: The existing aspen trees and shrubs are proposed to be retained and complement the neighborhood.

17.96.060.I.3 – Landscaping	Conformance
All trees, shrubs, grasses and perennials shall be drought tolerant. Native species are recommended but not required.	YES
Finding: The existing landscaping is proposed to be retained on site.	

17.96.060.I.4 – Landscaping	Conformance
Landscaping shall provide a substantial buffer between land uses, including,	YES
but not limited to, structures, streets and parking lots. The development of	
landscaped public courtyards, including trees and shrubs where appropriate,	
shall be encouraged.	
<b>Finding</b> : The existing landscaping is proposed to be retained. The existing shrubs	along East

17.96.060.J.1 – Public Amenities	Conformance
Where sidewalks are required, pedestrian amenities shall be installed.	YES
Amenities may include, but are not limited to, benches and other seating,	
kiosks, bus shelters, trash receptacles, restrooms, fountains, art, etc. All public	
amenities shall receive approval from the Public Works Department prior to	
design review approval from the Commission	

**Finding**: The applicant will provide a bench and two bike racks on the subject property by the East Avenue sidewalk.

17.96.060.K.1 – Underground Encroachments	Conformance
Encroachments of below grade structures into required setbacks are subject to subsection 17.128.020.K of this title and shall not conflict with any applicable easements, existing underground structures, sensitive ecological areas, soil stability, drainage, other sections of this Code or other regulating codes such as adopted International Code Council Codes, or other site features concerning	N/A
health, safety, and welfare.	
<b>Finding</b> : N/A. The basement does not encroach into required setback areas.	

Avenue help beautify the street frontage.

17.96.060.K.2 – Underground Encroachments	Conformance
No below grade structure shall be permitted to encroach into the riparian setback.	N/A
Finding: N/A. The basement does not encroach into required setbacks.	

#### FINDINGS REGARDING CONFORMANCE WITH COMMUNITY CORE PROJECT REQUIREMENTS

17.96.070.A.1 – Streets	Conformance
Street trees, streetlights, street furnishings, and all other street improvements	YES
shall be installed or constructed as determined by the Public Works	Condition
Department.	#4

Finding: The project will construct right-of-way improvements, including a new sidewalk along East Avenue, drainage facilities, and streetlights in accordance with city standards. No street trees are proposed. A bench and two bike racks are proposed to be sited on the subject property along the East Avenue frontage. The applicant shall submit final civil drawings prepared by an engineer registered in the State of Idaho that provide specifications for all right-of-way improvements, including sidewalks, alley asphalt, streetlights, utilities, and drainage facilities, for review and approval by the City Engineer prior to issuance of a building permit for the project pursuant to condition of approval #4.

17.96.070.A.2 – Streets	Conformance
Street trees with a minimum caliper size of three inches, shall be placed in tree grates.	N/A
Finding: N/A. No street trees are proposed or required to be installed for the proj	ect.

17.50.070.A.5 Streets	Comormance
Due to site constraints, the requirements of this subsection A may be modified	N/A
by the Public Works Department.	
Finding: N/A. The subject property is not characterized by site constraints that wa	arrant
modification to the requirements of KMC §17.96.060.A. The City Engineer and St	reets
Department have conducted a preliminary review of the project plans and believ	e the
proposed right-of-way improvements comply with city standards	

17 96 070 A 3 - Streets

17.96.070.B.1 - Architectural	Conformance
Facades facing a street or alley or located more than five feet from an interior	YES
side property line shall be designed with both solid surfaces and window	
openings to avoid the creation of blank walls and employ similar architectural	
elements, materials, and colors as the front facade.	

**Finding**: The East Avenue and alley façades are designed with both solid surfaces and window openings and employ consistent architectural elements, exterior materials, and colors. The majority of the north interior side façade and a portion of the south interior side facade are setback less than 1 foot from the side property line. Windows have been incorporated into portions of the south interior façade that are setback more than 5 feet from the interior lot

Conformance

line. The north side façade and the portion of south façade setback less than 1 foot from the side property line are characterized by exterior materials differentiation. The first two floors are comprised of stucco painted brown, the horizontal bands that cap the top of each floor level are comprised of light brown wood siding, the third floor is comprised of dark brown wood siding. The light brown siding is placed vertically and the dark brown siding is placed horizontally. The exterior material differentiation as well as the pattern and placement of the light and dark brown wood siding provide visual interest that helps animate the side façades.

17.96.070.B.2 - Architectural	Conformance
For nonresidential portions of buildings, front building facades and facades	YES
fronting a pedestrian walkway shall be designed with ground floor storefront	
windows and doors with clear transparent glass. Landscaping planters shall be	
incorporated into facades fronting pedestrian walkways.	

**Finding**: The placement of windows on the first two floors of the front façade matches the existing window configuration. The window configuration of the existing office building includes a significant amount of glazing. The existing shrubs that front the East Avenue sidewalk are proposed to be retained. Sheet L-100 shows that new steel planter is proposed to be installed along the front façade by the East Avenue sidewalk.

17.96.070.B.3 - Architectural	Conformance
For nonresidential portions of buildings, front facades shall be designed to	YES
not obscure views into windows.	

**Finding:** The design of the existing and proposed front façade is designed so that views into windows are not obscured. The existing shrubs along East Avenue that are proposed to be retained do not impede views into the first-floor windows.

17.96.070.B.4 - Architectural	Conformance
Roofing forms and materials shall be compatible with the overall style and character of the structure. Reflective materials are prohibited.	YES
character of the structure. Reflective materials are prombled.	

**Finding**: The new angled roof and flat roof proposed for the third-floor addition are compatible with the overall style and character of the remodeled structure. Reflective roofing material is not proposed.

17.96.070.B.5 - Architectural	Conformance
All pitched roofs shall be designed to sufficiently hold all snow with snow	YES
clips, gutters, and downspouts.	Condition #4

**Finding**: The roof plan on revised sheet A-104 includes a note stating that the EDPM roofing will be sloped to an internal drain system. Specifications for the roof drainage submitted must be provided with the project plans submitted with the building permit application for final review and approval by the City Engineer. The applicant shall submit final civil drawings prepared by an engineer registered in the State of Idaho that provide specifications for all drainage improvements, including roof drainage, for review and approval by the City Engineer prior to issuance of a building permit for the project pursuant to condition of approval #4.

17.96.070.B.6 - Architectural	Conformance
Roof overhangs shall not extend more than three feet over a public sidewalk. Roof overhangs that extend over the public sidewalk shall be approved by the Public Works Department.	N/A

**Finding**: N/A. All roof overhangs and projections are contained on the subject property and do not extend over the property lines.

17.96.070.B.7 - Architectural	Conformance
Front porches and stoops shall not be enclosed on the ground floor by permanent or temporary walls, windows, window screens, or plastic or fabric materials.	N/A
<b>Finding</b> : N/A. The project does not include front porches or stoops on the front fa	acade of the

**Finding**: N/A. The project does not include front porches or stoops on the front façade of the building.

17.96.070.C.1 – Service Areas and Mechanical/Electrical Equipment	Conformance
Trash disposal areas and shipping and receiving areas shall be located within parking garages or to the rear of buildings. Trash disposal areas shall not be located within the public right-of-way and shall be screened from public views.	YES
<b>Finding</b> : The dumpster is located at the rear of the property along the alley and is be screened within an enclosure.	proposed to

17.96.070.C.2 – Service Areas and Mechanical/Electrical Equipment	Conformance
Roof and ground mounted mechanical and electrical equipment shall be fully	YES
screened from public view. Screening shall be compatible with the overall	
building design.	

**Finding**: Sheet L-100 shows the siting of the new transformer required to serve the project. The proposed transformer is located at northeast corner of the property by the alley and is not visible from public view along the East Avenue street frontage. The revised submittal included a letter dated January 17, 2025 confirming that they have reviewed the design and siting of the proposed transformer. The gas meters are located in an alcove along the south side façade. The project does not propose to install any roof-mounted mechanical or electrical equipment.

17.96.070.D.1 - Landscaping	Conformance
When a healthy and mature tree is removed from a site, it shall be replaced with a new tree. Replacement trees may occur on or off site.	N/A
<b>Finding</b> : N/A. All existing healthy and mature trees are proposed to be retained or property.	on the subject

17.96.070.D.2 - Landscaping	Conformance
Trees that are placed within a courtyard, plaza, or pedestrian walkway shall be placed within tree wells that are covered by tree grates.	N/A
Finding: N/A. No trees are proposed in courtyard plazas or within pedestrian walkways.	

17.96.070.D.3 - Landscaping	Conformance
The City arborist shall approve all parking lot and replacement trees.	N/A
Finding: N/A. All existing healthy and mature trees are proposed to be retained on the subject property, so no replacement trees are required per KMC \$17.96.070.D1	

17.96.070.E.1 – Surface Parking Lots	Conformance
Surface parking lots shall be accessed from off the alley and shall be fully screened from the street.	YES
<b>Finding</b> : The surface parking area is located at the rear of the lot and accessed from the alley. The surface parking lot is fully screened from East Avenue by the mixed-use building.	

17.96.070.E.2 – Surface Parking Lots	Conformance
Surface parking lots shall incorporate at least one tree and one additional	N/A
tree per ten on site parking spaces. Trees shall be planted in landscaped	
planters, tree wells and/or diamond shaped planter boxes located between	
parking rows. Planter boxes shall be designed so as not to impair vision or site	
distance of the traveling public.	

**Finding**: The existing 6 aspen trees located along the south side of the parking lot are proposed to be retained. The surface parking area is comprised of only one row of parking with 5 parking spaces oriented towards the north side property line. The remainder of the parking area is the aisle providing access to these parking spaces from the alley. Since the surface parking area contains less than 10 parking spaces (5 total parking spaces are proposed), this requirement is not applicable.

17.96.070.E.3 – Surface Parking Lots	Conformance
Ground cover, low lying shrubs, and trees shall be planted within the planters	N/A
and planter boxes. Tree grates or landscaping may be used in tree wells	
located within pedestrian walkways.	
Finding: N/A as no new ground cover, low lying shrubs, or trees are proposed to	be installed in
the surface parking area.	

17.96.070.F.1 – Bicycle Parking	Conformance
One bicycle rack, able to accommodate at least two bicycles, shall be provided	YES
for every four parking spaces as required by the proposed use. At a minimum,	
one bicycle rack shall be required per development.	

**Finding**: The project has a total parking of two spaces. One bike rack is required for the development. The project proposes to install two bike racks, accommodating two bicycles, on the subject property adjacent to the entrance to the building along East Avenue.

17.96.070.F.2 – Bicycle Parking	Conformance
When the calculation of the required number of bicycle racks called for in this section results in a fractional number, a fraction equal to or greater than one-half shall be adjusted to the next highest whole number.	YES
Finding: One bike rack is required for the proposed development.	

17.96.070.F.3 – Bicycle Parking	Conformance
Bicycle racks shall be clearly visible from the building entrance they serve and not mounted less than 50 feet from said entrance or as close as the nearest non-ADA parking space, whichever is closest. Bicycle racks shall be located to achieve unobstructed access from the public right-of-way and not in areas requiring access via stairways or other major obstacles.	YES
<b>Finding</b> : The project proposes to install one bike rack, accommodating two bicy to the entrance to the building along the alley.	cles, adjacent

#### **CONCLUSIONS OF LAW**

- 1. The City of Ketchum is a municipal corporation established in accordance with Article XII of the Constitution of the State of Idaho and Title 50 Idaho Code and is required and has exercised its authority pursuant to the Local Land Use Planning Act codified at Chapter 65 of Title 67 Idaho Code and pursuant to Chapters 3, 9 and 13 of Title 50 Idaho Code to enact the ordinances and regulations, which ordinances are codified in the Ketchum Municipal Code ("KMC") and are identified in the Findings of Fact and which are herein restated as Conclusions of Law by this reference and which City Ordinances govern the applicant's Design Review application for the development and use of the project site.
- 2. The Commission has authority to hear the applicant's Design Review Application pursuant to Chapter 17.96 of Ketchum Municipal Code Title 17.
- 3. The City of Ketchum Planning Department provided notice for the review of this application in accordance with Ketchum Municipal Code §17.96.080.
- 4. The Design Review application is governed under Ketchum Municipal Code Chapters 17.96, 17.124, 17.08, 17.12, 17.18, and 17.128.
- 5. The 120 N East Ave Addition Design Review Application File No. P24-074 meets all applicable standards specified in Title 17 of Ketchum Municipal Code.

#### **DECISION**

**THEREFORE,** the Ketchum Planning and Zoning Commission **approves** this Design Review Application File No. P24-074 this Tuesday, May 27, 2025 subject to the following conditions of approval.

#### CONDITIONS OF APPROVAL

- 1. This Design Review approval is based on the plans dated February 6, 2025 and the information presented and approved at the May 7, 2025 Planning and Zoning Commission Special Meeting included as Exhibit A. The building permit plans must conform to the approved Design Review plans unless otherwise approved in writing by the Planning and Zoning Commission or Administrator. Any building or site discrepancies which do not conform to the approved plans will be subject to removal.
- 2. Prior to issuance of a building permit, the applicant shall submit a copy of the snow hauling agreement with a contractor who provides snow hauling services to ensure compliance with the snow storage standards specified in KMC §17.96.060.H1.
- 3. At time of building permit, the applicant shall submit final civil drawings prepared by an engineer registered in the State of Idaho that provide specifications for all right-of-way improvements, including sidewalks, alley asphalt, streetlights, utilities, and drainage facilities, for final review and approval by the City Engineer, Streets Department, Utilities Department, and Planning Department.
- 4. Pursuant to Ketchum Municipal Code §17.127.030.B, separate sign permits shall be required for all new signs prior to installation.
- 5. The term of Design Review approval shall be twelve (12) months from the date that the Findings of Fact, Conclusions of Law, and Decision are adopted by the Planning and Zoning Commission or upon appeal, the date the approval is granted by the Council subject to changes in zoning regulations. Any extension shall comply with KMC §17.96.090.
- 6. In addition to the requirements set forth in this Design Review approval, this project shall comply with all applicable local, state, and federal laws.

Findings of Fact **adopted** this 27<sup>th</sup> day of May 2025.

Neil Morrow, Chair City of Ketchum Planning and Zoning Commission

# Exhibit A

<u>Contractor</u> Peak Venture Group, LLC

Galena-Benchmark Engineering

Cody Colombo 120 N. Leadville

208/481-1189

P.O. Box 733

208/726-9512 208/481-8287


Ketchum, ID 83340


cody@peakvg.com

**Civil Engineering** 

Contact - David Patrie

Ketchum, ID 83340

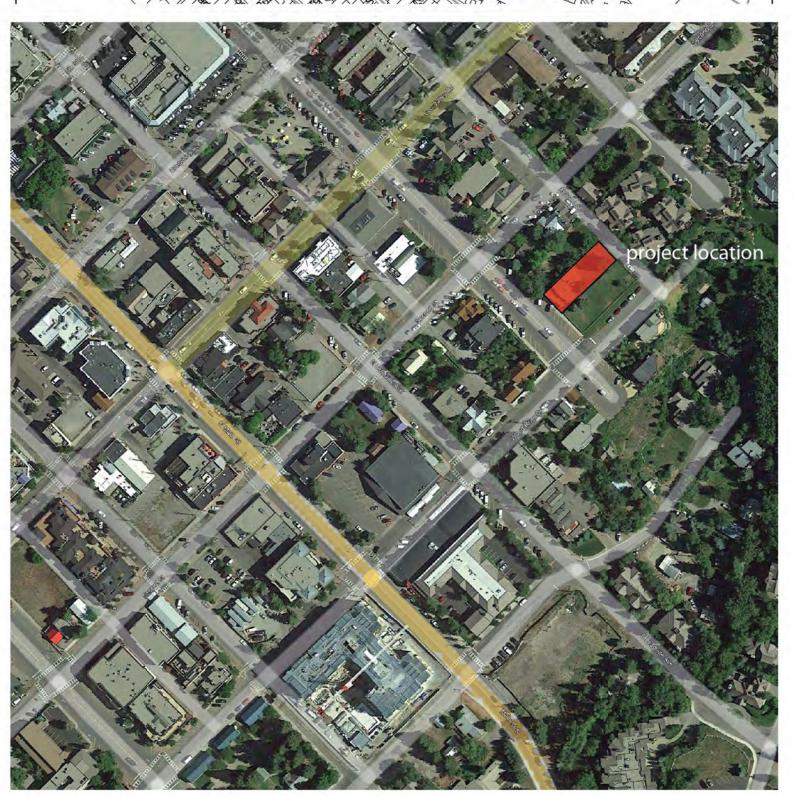

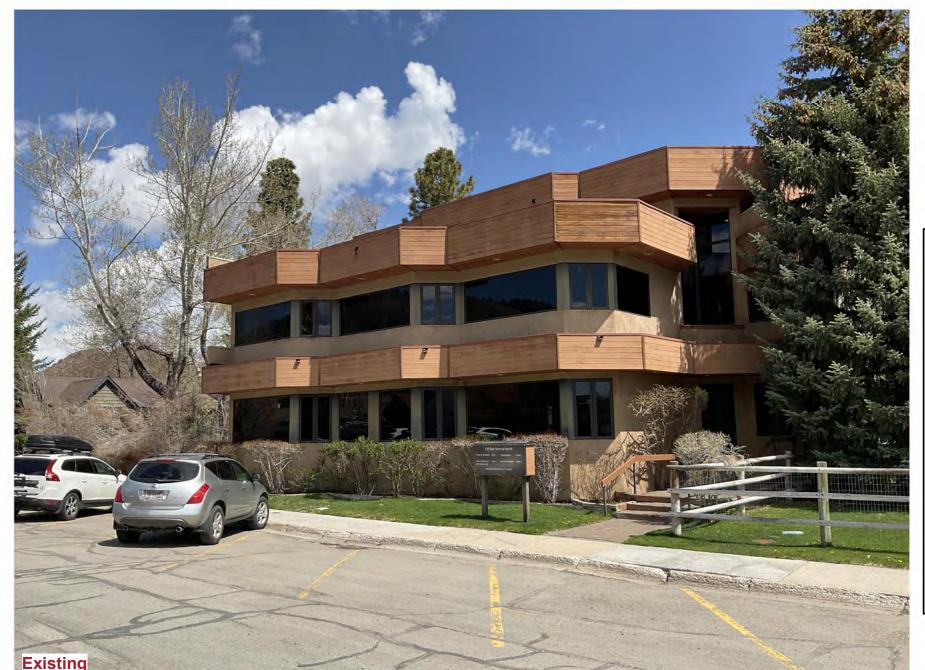



## Project Team

<u>Owner</u> 120 N East LLC 120 N East Avenue Ketchum, ID 83340

**Brunelle Architects** 

Mike Brunelle 190 Cranbrook Rd P.O. Box 3204 Hailey, ID 83333 208/589-0771 mike@brunellearchitects.com

**Structural Engineer** Maxwell Structural Design Studio dave@galena-benchmark.com Craig Maxwell P.E. 105 Lewis Street, Unit 205 Ketchum, ID 83340

P.O. Box 1911 Sun Valley, ID 83353 208/721-2171 craig@maxwellsds.com

**Index of Drawings** cover sheet Survey Site Improvement Plan Site Plan as-builts images site panoramas as-builts project/FAR information photometric study - building photometric study - roadway floor plan - basement floor plan - 1st floor floor plan - 2nd floor floor plan - 3rd floor roof plan elevations elevations elevations elevations electrical

190 Cranbrook Rd PO BOX 3204 Hailey Idaho 83333-3204 p 208.589.0771

120 N East LLC

120 N East Ave Ketchum, Idaho 83340

02/06/2025 Permit Set: **Construction Set:** xx/xx/xx REVISION


120 N East LLC

120 N East Ave Ketchum, Idaho 83340

BRUNELLE ARCHITECTS, INC

MIKE BRUNELLE 190 CRANBROOK RD PO BOX 3204 HAILEY, IDAHO 83333 P. 208.589.0771 MIKE@BRUNELLEARCHITECTS.COM

cover sheet

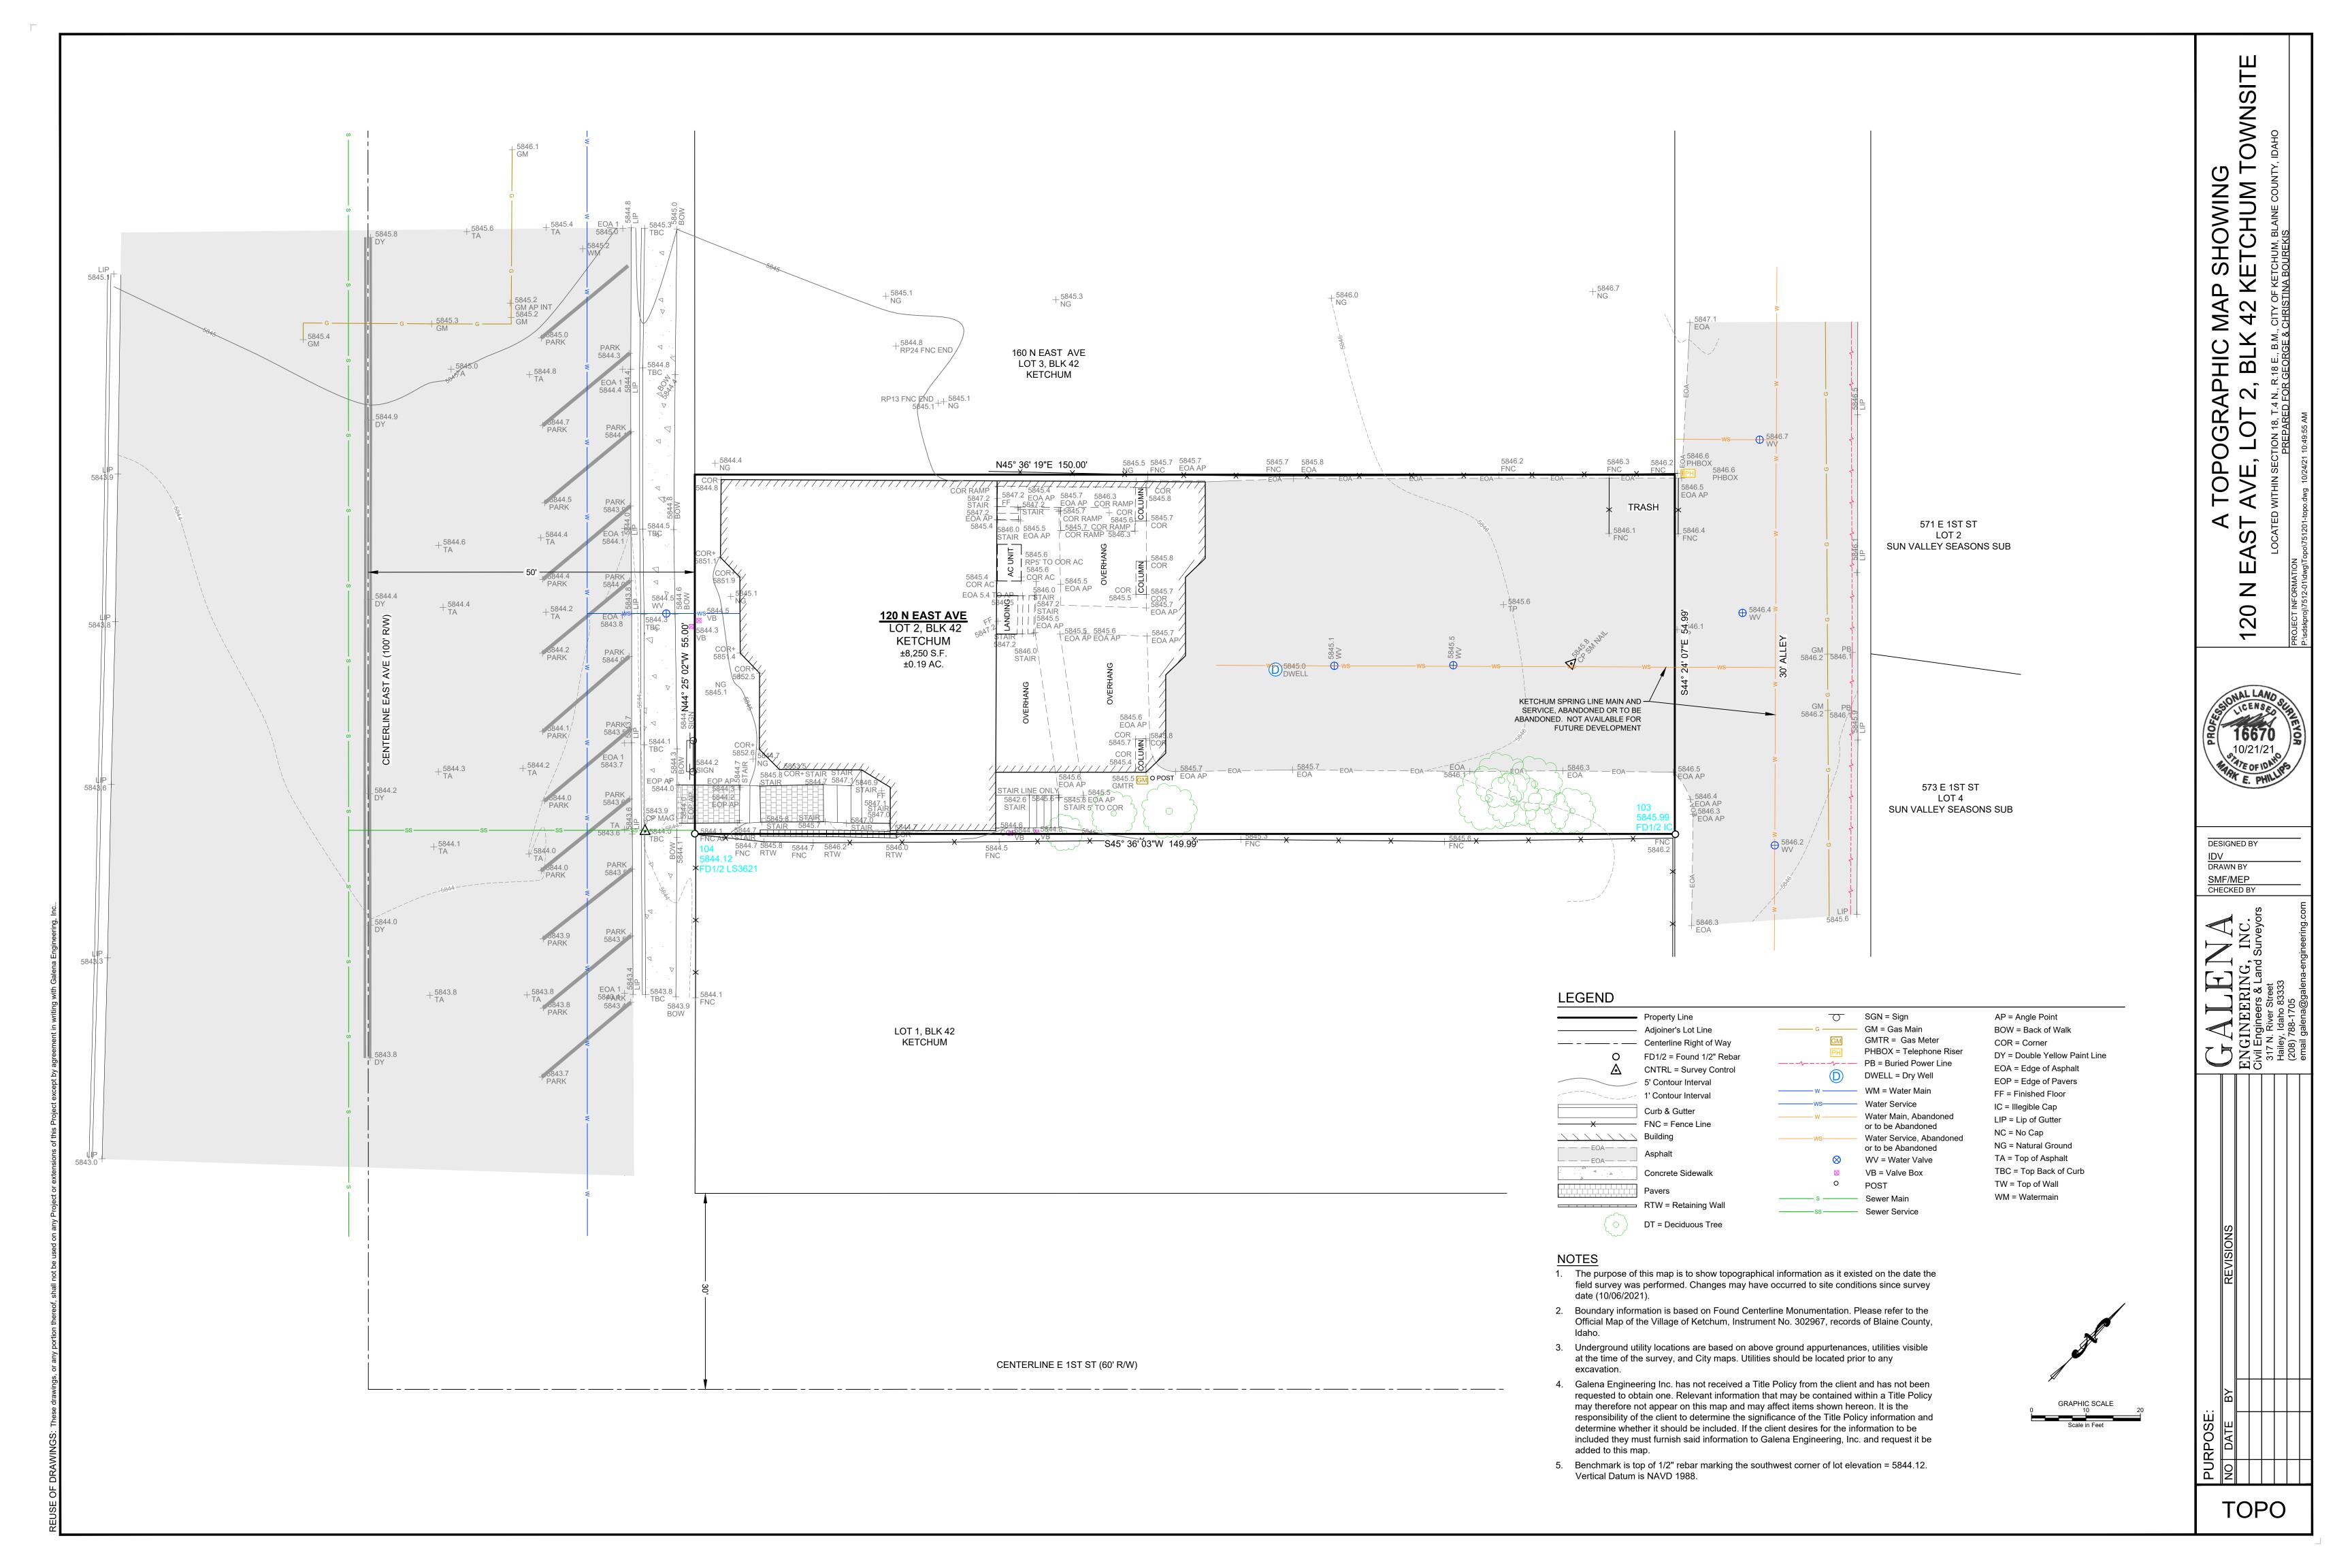


### **GENERAL CONSTRUCTION NOTES**


- 1. ALL CONSTRUCTION SHALL BE IN CONFORMANCE WITH THE MOST CURRENT EDITION OF THE "IDAHO STANDARDS FOR PUBLIC WORKS CONSTRUCTION" (ISPWC) AND CITY OF KETCHUM STANDARDS. THE CONTRACTOR SHALL BE RESPONSIBLE FOR OBTAINING AND KEEPING A COPY OF THE ISPWC AND CITY OF KETCHUM STANDARDS ON SITE DURING CONSTRUCTION
- 2. THE LOCATION OF EXISTING UNDERGROUND UTILITIES ARE SHOWN ON THE PLANS IN AN APPROXIMATE WAY. THE CONTRACTOR SHALL BE RESPONSIBLE FOR LOCATING EXISTING UTILITIES PRIOR TO COMMENCING AND DURING THE CONSTRUCTION. THE CONTRACTOR AGREES TO BE FULLY RESPONSIBLE FOR ANY AND ALL DAMAGES WHICH RESULT FROM HIS FAILURE TO ACCURATELY LOCATE AND PRESERVE ANY AND ALL UNDERGROUND UTILITIES. CONTRACTOR SHALL CALL DIGLINE (1-800-342-1585) TO LOCATE ALL EXISTING UNDERGROUND UTILITIES A MINIMUM OF 48 HOURS IN ADVANCE OF EXCAVATION.
- 3. CONTRACTOR SHALL COORDINATE RELOCATIONS OF DRY UTILITY FACILITIES (POWER, CABLE, PHONE, TV) WITH THE APPROPRIATE UTILITY FRANCHISE.
- 4. THE CONTRACTOR SHALL CLEAN UP THE SITE AFTER CONSTRUCTION SO THAT IT IS IN A CONDITION EQUAL TO OR BETTER THAN THAT WHICH EXISTED PRIOR TO CONSTRUCTION.
- 5. THE CONTRACTOR SHALL OBTAIN ALL NECESSARY PERMITS PRIOR TO CONSTRUCTION (THIS MAY INCLUDE ENCROACHMENT PERMITS AND NATIONAL POLLUTANT DISCHARGE ELIMINATION SYSTEM (NPDES) CONSTRUCTION GENERAL PERMIT (CGP) PERMIT COVERAGE).
- 6. ALL CLEARING & GRUBBING SHALL CONFORM TO ISPWC SECTION 201.
- ALL EXCAVATION & EMBANKMENT SHALL CONFORM TO ISPWC SECTION 202. SUBGRADE SHALL BE EXCAVATED AND SHAPED TO LINE, GRADE, AND CROSS-SECTION SHOWN ON THE PLANS. THE SUBGRADE SHALL BE COMPACTED TO 95% OF MAXIMUM DENSITY AS DETERMINED BY ASTM D-698. THE CONTRACTOR SHALL WATER OR AERATE SUBGRADE AS NECESSARY TO OBTAIN OPTIMUM MOISTURE CONTENT. IN-LIEU OF DENSITY MEASUREMENTS, THE SUBGRADE MAY BE PROOF-ROLLED TO THE APPROVAL OF THE ENGINEER.

- PROOF-ROLLING: AFTER EXCAVATION TO THE SUBGRADE ELEVATION AND PRIOR TO PLACING COURSE GRAVEL, THE CONTRACTOR SHALL PROOF ROLL THE SUBGRADE WITH A 5-TON SMOOTH DRUM ROLLER, LOADED WATER TRUCK, OR LOADED DUMP TRUCK, AS ACCEPTED BY THE ENGINEER. THE CONTRACTOR SHALL IMMEDIATELY NOTIFY THE ENGINEER OF UNSUITABLE SUBGRADE MATERIAL AREAS, AND/OR AREAS NOT CAPABLE OF COMPACTION ACCORDING TO THESE SPECIFICATIONS. UNSUITABLE OR DAMAGED SUBGRADE IS WHEN THE SOIL MOVES, PUMPS AND/OR DISPLACES UNDER ANY TYPE OF PRESSURE INCLUDING FOOT TRAFFIC LOADS.
- IF, IN THE OPINION OF THE ENGINEER, THE CONTRACTOR'S OPERATIONS RESULT IN DAMAGE TO, OR PROTECTION OF, THE SUBGRADE, THE CONTRACTOR SHALL, AT HIS OWN EXPENSE, REPAIR THE DAMAGED SUBGRADE BY OVER-EXCAVATION OF UNSUITABLE MATERIAL TO FIRM SUBSOIL, LINE EXCAVATION WITH GEOTEXTILE FABRIC, AND BACKFILL WITH PIT RUN GRAVEL.
- 8. ALL 2" MINUS GRAVEL SHALL CONFORM TO ISPWC 802, TYPE II (ITD STANDARD 703.04, 2"), SHALL BE PLACED IN CONFORMANCE WITH ISPWC SECTION 801 AND COMPACTED PER SECTION 202. MINIMUM COMPACTION OF PLACED MATERIAL SHALL BE 90% OF MAXIMUM LABORATORY DENSITY AS DETERMINED BY AASHTO T-99.
- 9. ALL 3/4" MINUS CRUSHED GRAVEL SHALL CONFORM TO ISPWC 802, TYPE I (ITD STANDARD 703.04, 3/4" B), SHALL BE PLACED IN CONFORMANCE WITH ISPWC SECTION 802 AND COMPACTED PER SECTION 202. MINIMUM COMPACTION OF PLACED MATERIAL SHALL BE 95% OF MAXIMUM LABORATORY DENSITY AS DETERMINED BY AASHTO T-99 OR ITD T-91.
- 10. ALL ASPHALTIC CONCRETE PAVEMENT WORK SHALL CONFORM TO ISPWC SECTION(S) 805, 810, AND 811 FOR CLASS II PAVEMENT. ASPHALT AGGREGATE SHALL BE 1/2" (13MM) NOMINAL SIZE CONFORMING TO TABLE 803B IN ISPWC SECTION 803. ASPHALT BINDER SHALL BE PG 58-28 CONFORMING TO TABLE A-1 IN ISPWC SECTION 805.
- 11. ASPHALT SAWCUTS SHALL BE AS INDICATED ON THE DRAWINGS, OR 24" INCHES FROM EDGE OF EXISTING ASPHALT, IF NOT INDICATED OTHERWISE SO AS TO PROVIDE A CLEAN PAVEMENT EDGE FOR MATCHING. NO WHEEL CUTTING SHALL BE ALLOWED. PRIOR TO REPLACING ASPHALT, THE UNDERLYING SURFACE INCLUDING VERTICAL SAWCUT JOINTS SHALL BE CLEANED OF ALL DEBRIS AND A TACK COAT SHALL BE APPLIED TO ALL CURBS, SAWCUTS, OR OVERLAY SURFACES.

- 12. THE CONTRACTOR SHALL BE RESPONSIBLE FOR PROVIDING A TRAFFIC CONTROL PLAN FOR APPROVAL BY THE CITY OF KETCHUM PRIOR TO CONSTRUCTION. THE TRAFFIC CONTROL PLAN SHALL BE PER THE CURRENT EDITION OF THE US DEPARTMENT OF TRANSPORTATION MANUAL OF UNIFORM TRAFFIC CONTROL DEVICES (MUTCD).
- 13. ALL CONCRETE WORK SHALL CONFORM TO ISPWC SECTIONS 701, 703, AND 705, ALL CONCRETE SHALL BE 3,000 PSI MINIMUM, 28 DAY, AS DEFINED IN ISPWC SECTION 703, TABLE 1. IMMEDIATELY AFTER PLACEMENT PROTECT CONCRETE BY APPLYING MEMBRANE-FORMING CURING COMPOUND, TYPE 2, CLASS A PER ASTM C 309-94. APPLY CURING COMPOUND PER MANUFACTURER'S INSTRUCTIONS AND SPECIFICATIONS.
- 14. PER IDAHO CODE § 55-1613, THE CONTRACTOR SHALL RETAIN AND PROTECT ALL MONUMENTS, ACCESSORIES TO CORNERS, BENCHMARKS AND POINTS SET IN CONTROL SURVEYS; ALL MONUMENTS, ACCESSORIES TO CORNERS, BENCHMARKS AND POINTS SET IN CONTROL SURVEYS THAT ARE LOST OR DISTURBED BY CONSTRUCTION SHALL BE REESTABLISHED AND RE-MONUMENTED, AT THE EXPENSE OF THE AGENCY OR PERSON CAUSING THEIR LOSS OR DISTURBANCE AT THEIR ORIGINAL LOCATION OR BY SETTING OF A WITNESS CORNER OR REFERENCE POINT OR A REPLACEMENT BENCHMARK OR CONTROL POINT, BY OR UNDER THE DIRECTION OF A PROFESSIONAL LAND SURVEYOR.
- 15. THE CONTRACTOR SHALL BE RESPONSIBLE FOR HIRING A MATERIALS TESTING COMPANY DURING CONSTRUCTION TO VERIFY ALL COMPACTION AND MATERIAL PLAN AND SPECIFICATION REQUIREMENTS ARE MET. QUALITY CONTROL DOCUMENTATION OF TESTING FOR WORK IN RIGHT-OF-WAY MEETING CITY OF KETCHUM CODE SECTION 12.04.040 (CONCRETE, AGGREGATE BASE COMPACTION, ASPHALT COMPACTION) WILL BE NECESSARY FOR CERTIFICATE OF OCCUPANCY.
- NO SNOWMELT INSTALLATIONS ARE TO OCCUR WITHIN CITY OF KETCHUM ROW.
- 17. BOUNDARY INFORMATION AND TOPOGRAPHIC DATA SHOWN HEREON ARE PER A SURVEY CONDUCTED BY GALENA ENGINEERING 10/06/2021. SITE CONDITIONS MAY HAVE CHANGED SINCE THE DATE OF SURVEY. CONTRACTOR TO NOTIFY ENGINEER OF ANY DISCREPANCIES THAT AFFECT THE SCOPE OF WORK.

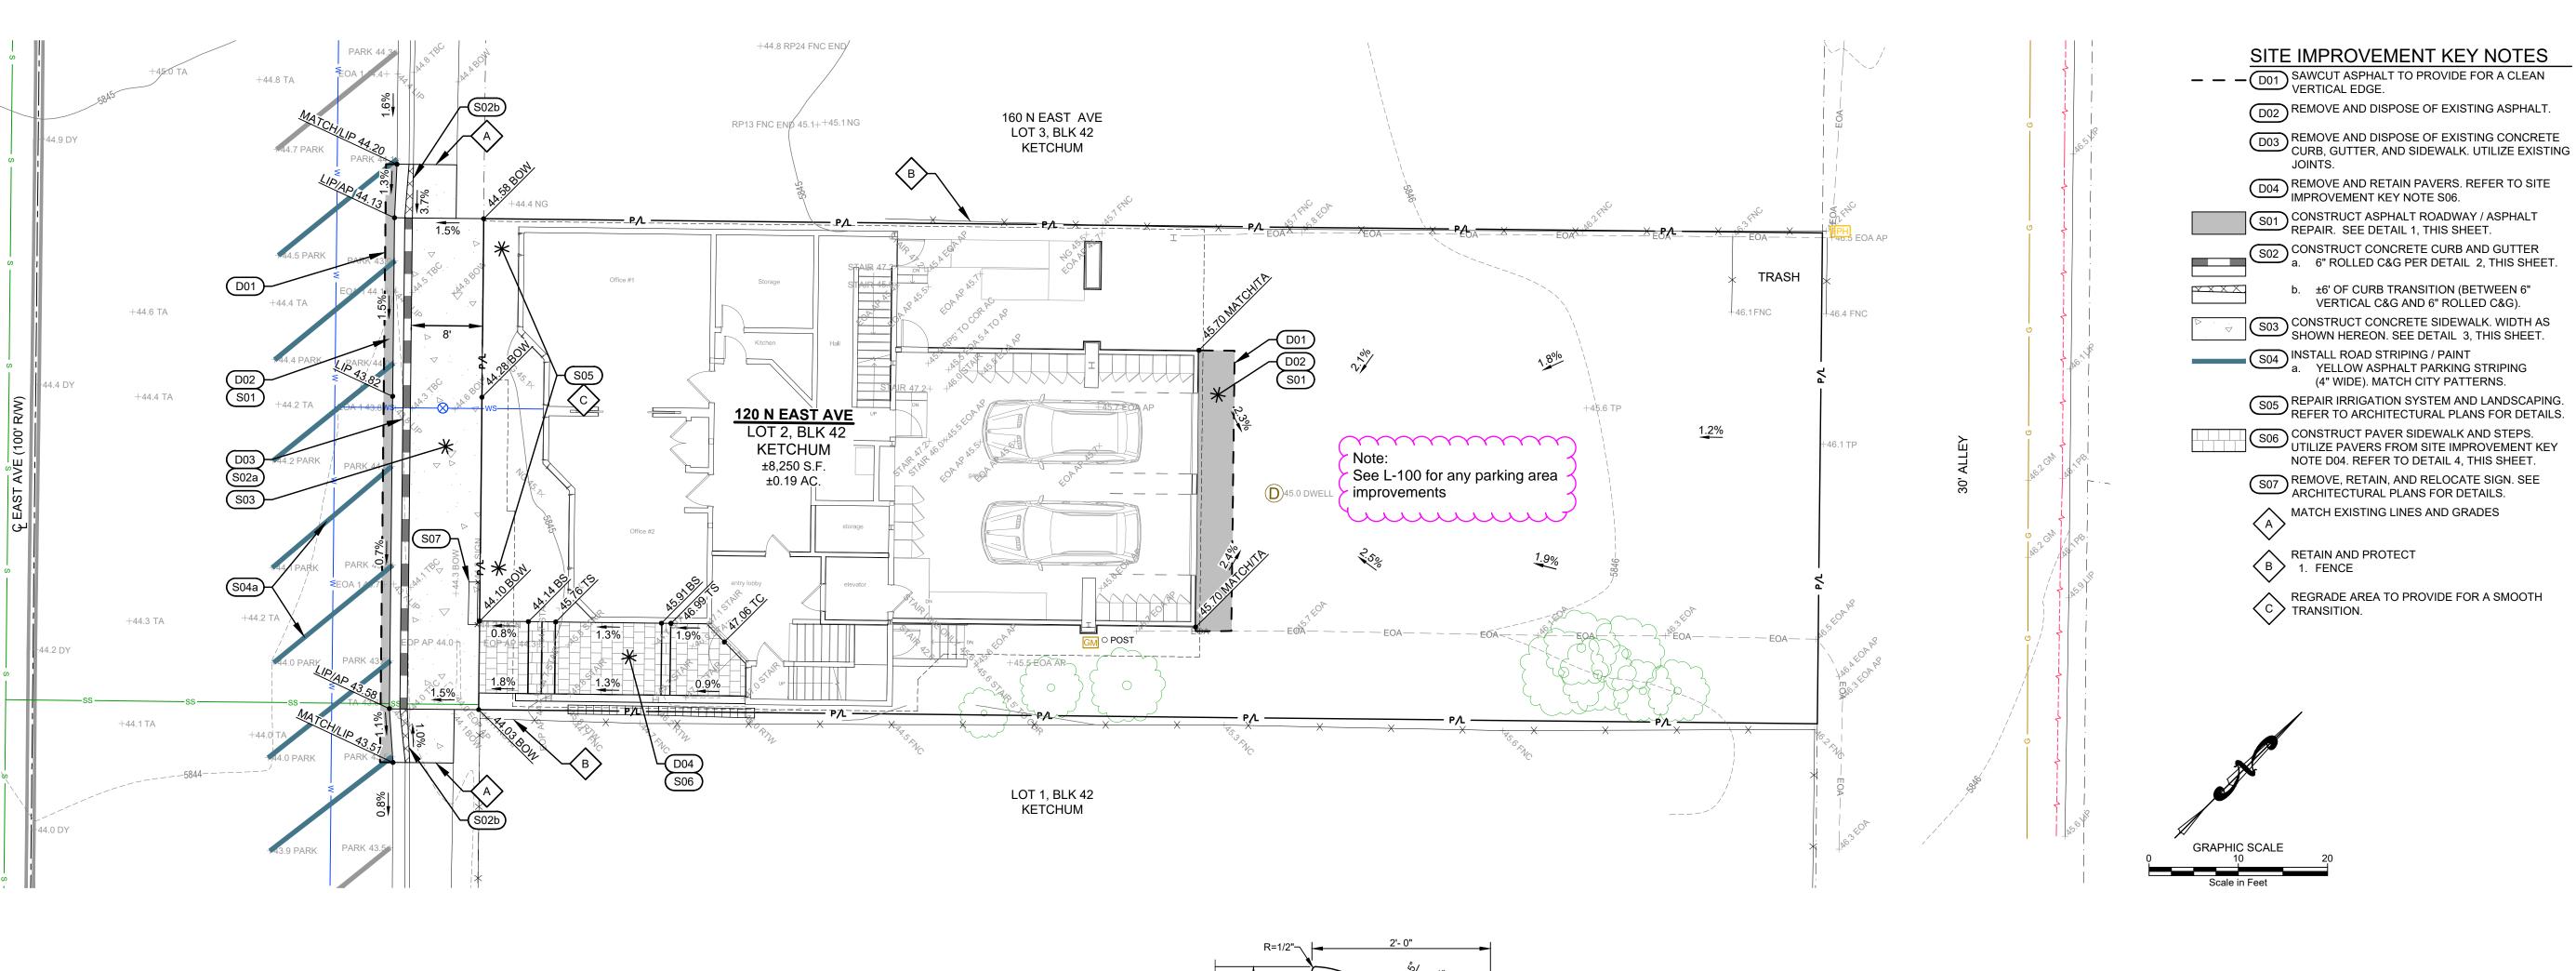

## LEGEND

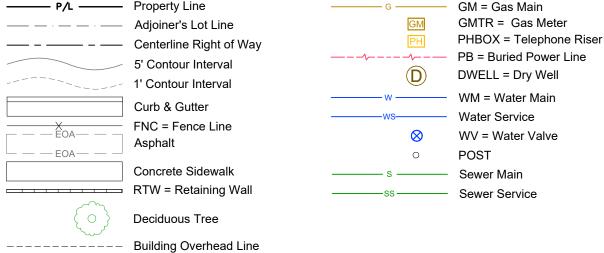

NC = No Cap

### ABBREVIATIONS

AP = Angle Point BOW = Back of Walk BS = Bottom of Step COR = Corner DY = Double Yellow Paint Line EOA = Edge of Asphalt EOP = Edge of Pavers

LIP = Lip of Gutter

NG = Natural Ground TA = Top of Asphalt TBC = Top Back of Curb TC = Top of Concrete TS = Top of Step TW = Top of Wall FF = Finished Floor WM = Watermain IC = Illegible Cap


## SLOPE VARIES 3" OF ASPHALT 3 4" OF 3/4" MINUS AGGREGATE LEVELING COURSE OMPACTED SUBGRADE

### 1. SUBBASE CAN BE 2" TYPE II OR ¾" TYPE I CRUSHED AGGREGATE

- 2. MATERIALS SHALL CONFORM WITH CURRENT ISPWC STANDARDS, DIVISION 800 AGGREGATES AND ASPHALT.
- 3. PAVEMENT SECTION MAY BE MODIFIED IF A PROJECT SPECIFIC GEOTECHNICAL REPORT, STAMPED BY A LICENSED ENGINEER, IS



PROVIDED.

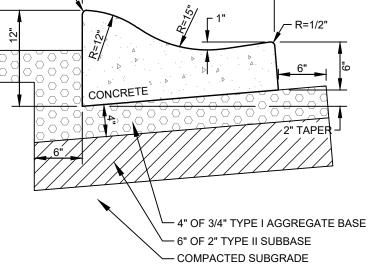


## SUBBASE CAN BE 2" TYPE II OR ¾" TYPE I CRUSHED AGGREGATE BASE COURSE.

- 2. MATERIALS SHALL CONFORM WITH CURRENT ISPWC STANDARDS, DIVISION 800 AGGREGATES AND ASPHALT.
- 3. PAVEMENT SECTION MAY BE MODIFIED IF A PROJECT SPECIFIC GEOTECHNICAL REPORT. STAMPED BY A LICENSED ENGINEER, IS PROVIDED. 4. 1/2-INCH PREFORMED EXPANSION JOINT MATERIAL (AASHTO M 213) AT TERMINAL POINTS
- 5. CONTINUOUS PLACEMENT PREFERRED, SCORE INTERVALS 10-FEET MAXIMUM SPACING



6" CONCRETE ROLLED CURB & GUTTER

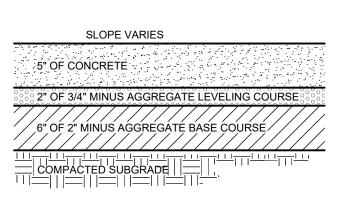


## SUBBASE CAN BE 2" TYPE II OR ¾" TYPE I CRUSHED AGGREGATE BASE COURSE.

- 2. MATERIALS SHALL CONFORM WITH CURRENT ISPWC STANDARDS, DIVISION 800 AGGREGATES AND ASPHALT.
- 3. PAVEMENT SECTION MAY BE MODIFIED IF A PROJECT SPECIFIC GEOTECHNICAL REPORT, STAMPED BY A LICENSED ENGINEER, IS PROVIDED.
- 4. 1/2-INCH PREFORMED EXPANSION JOINT MATERIAL (AASHTO M 213) AT TERMINAL POINTS
- 5. CONTINUOUS PLACEMENT PREFERRED, SCORE INTERVALS 10-FEET MAXIMUM SPACING (8-FEET W/SIDEWALK).



TYPICAL CONCRETE SIDEWALK SECTION N.T.S.

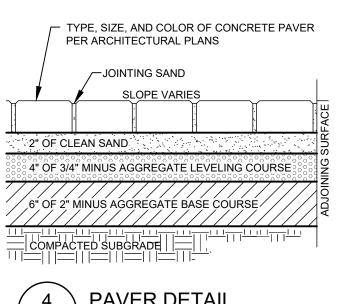



**PAVER DETAIL** 


0 <u>₹</u>


DESIGNED BY: RAWN BY HECKED BY SURVEY DATE:


C1.00

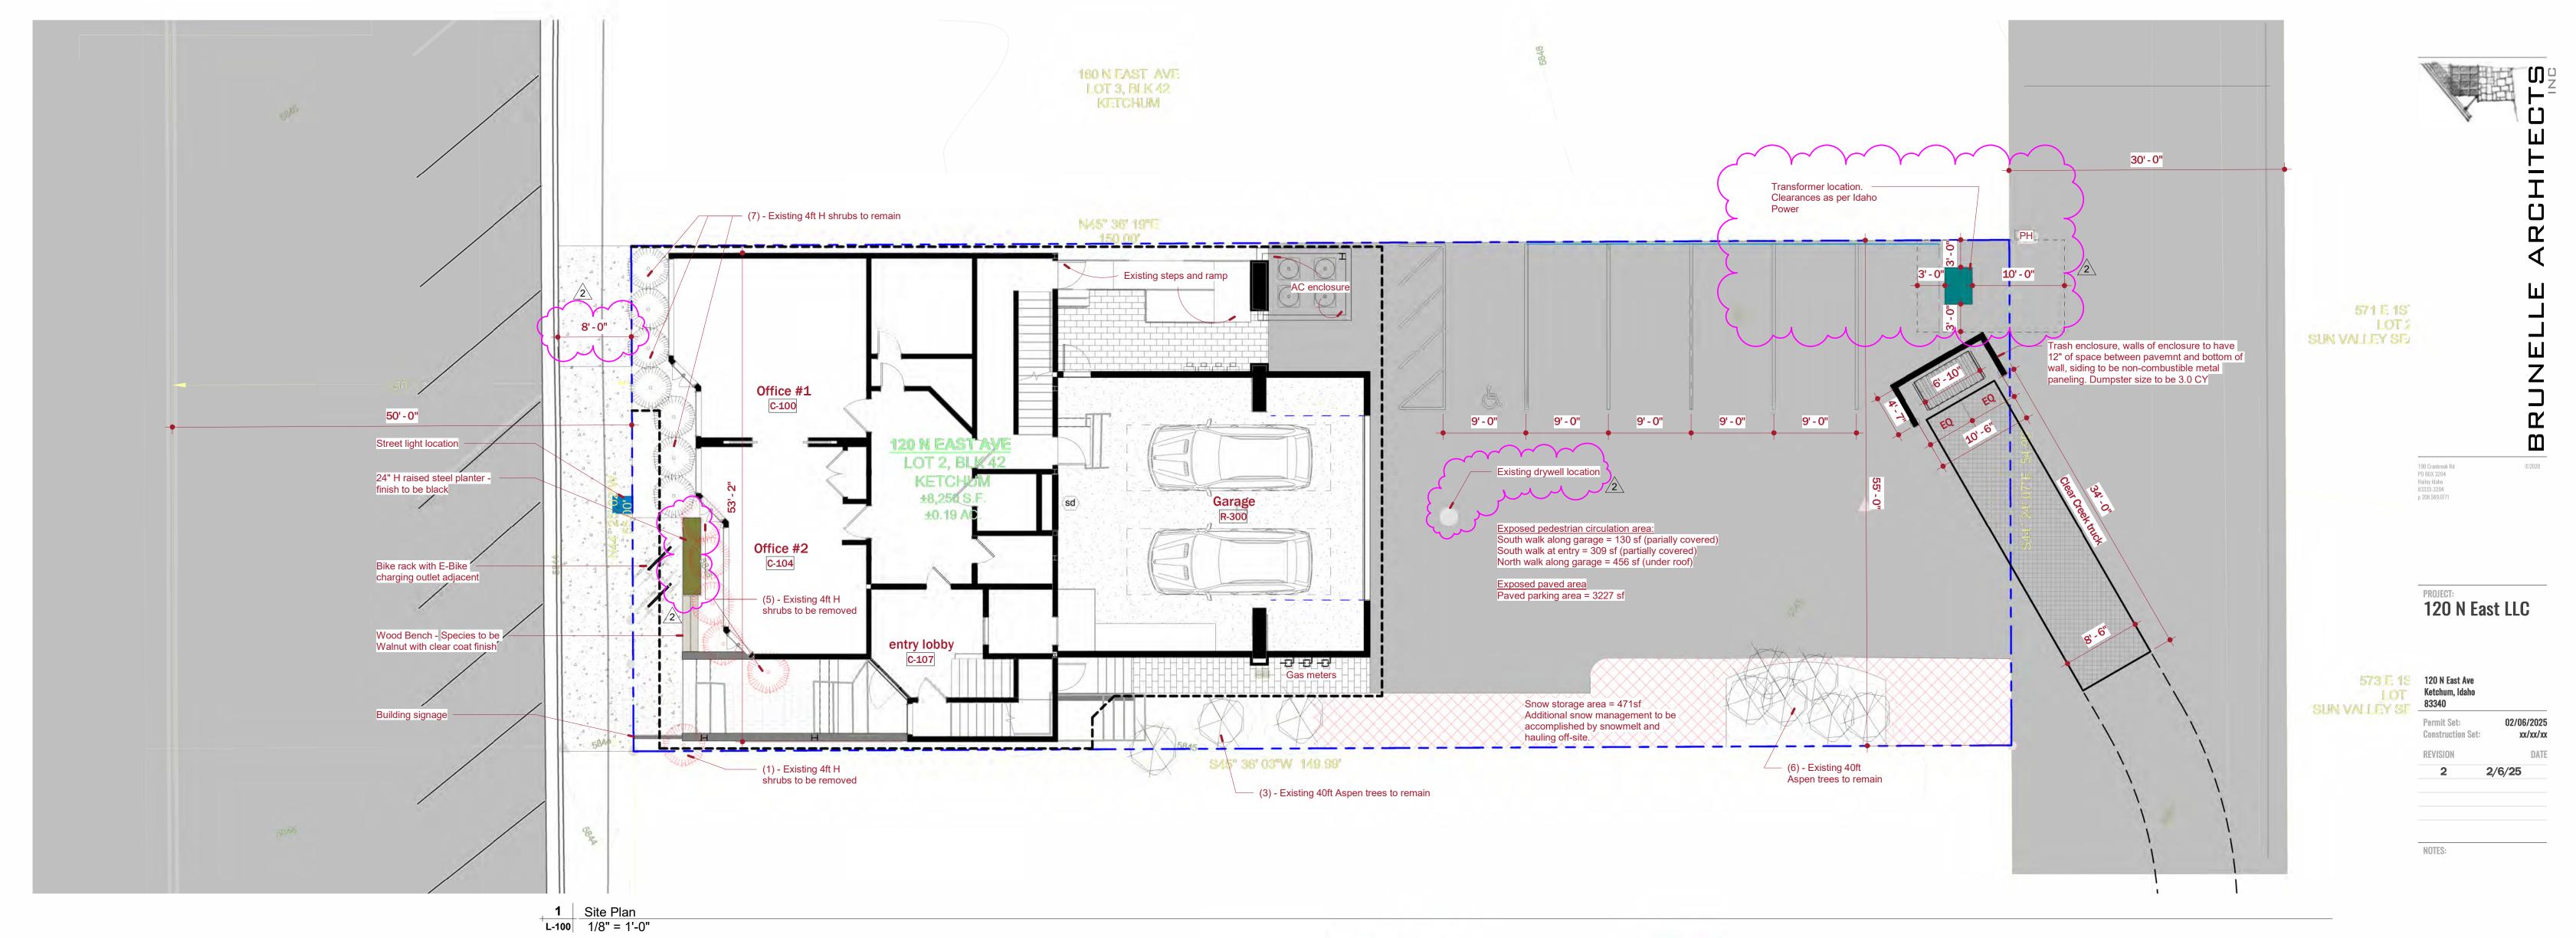

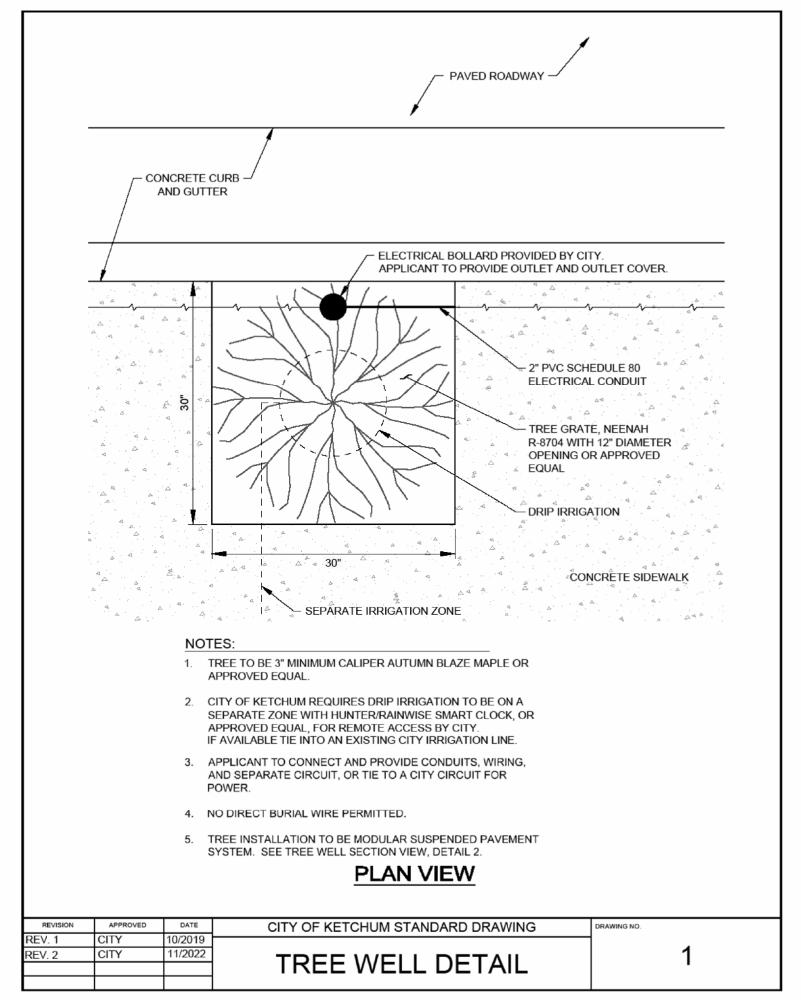

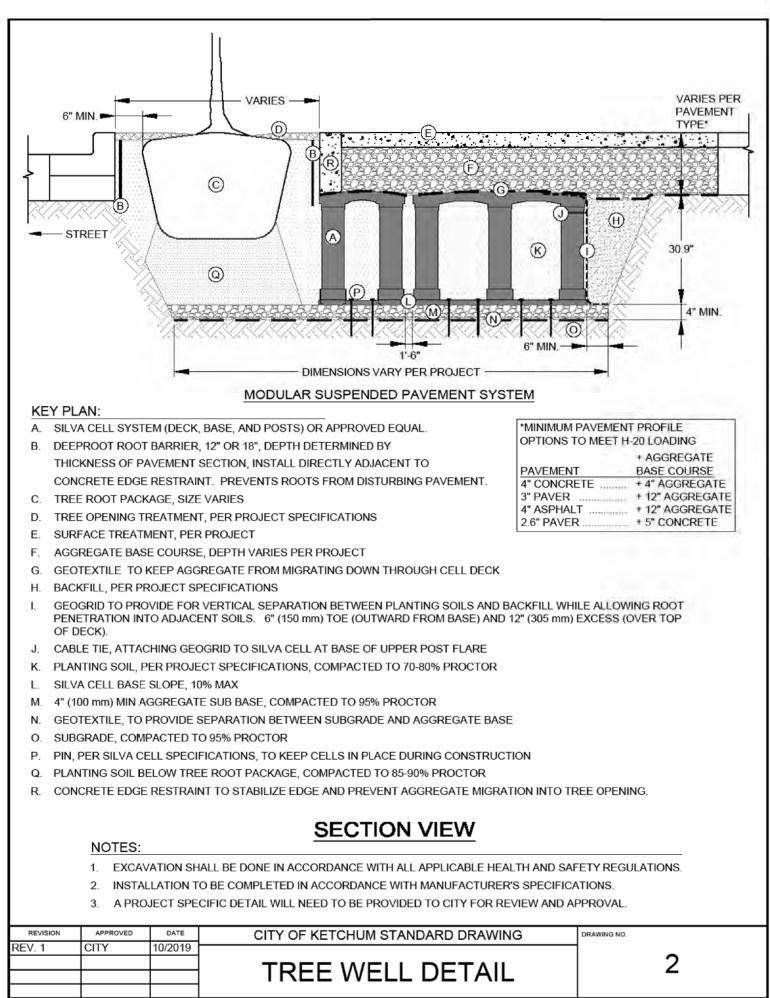

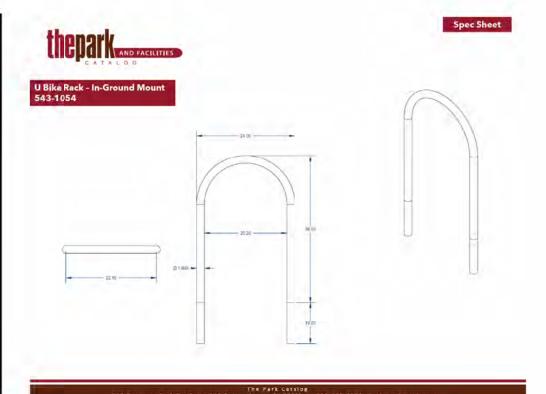

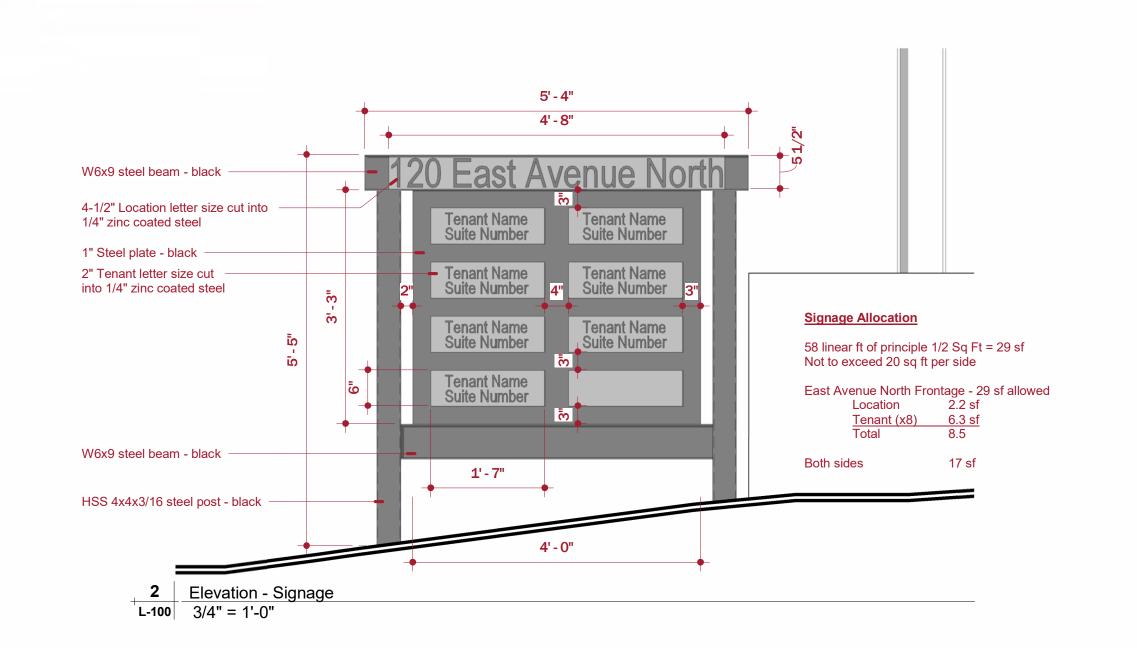



Site Plan

CALE: As indicated

L-100

DRAWN BY: Author

Plot Date: 2/6/2025 3:59:35 PM














20 N East Ave Ketchum, Idaho 13340	
ermit Set: onstruction Set:	02/06/2025 xx/xx/xx
EVISION	DATE





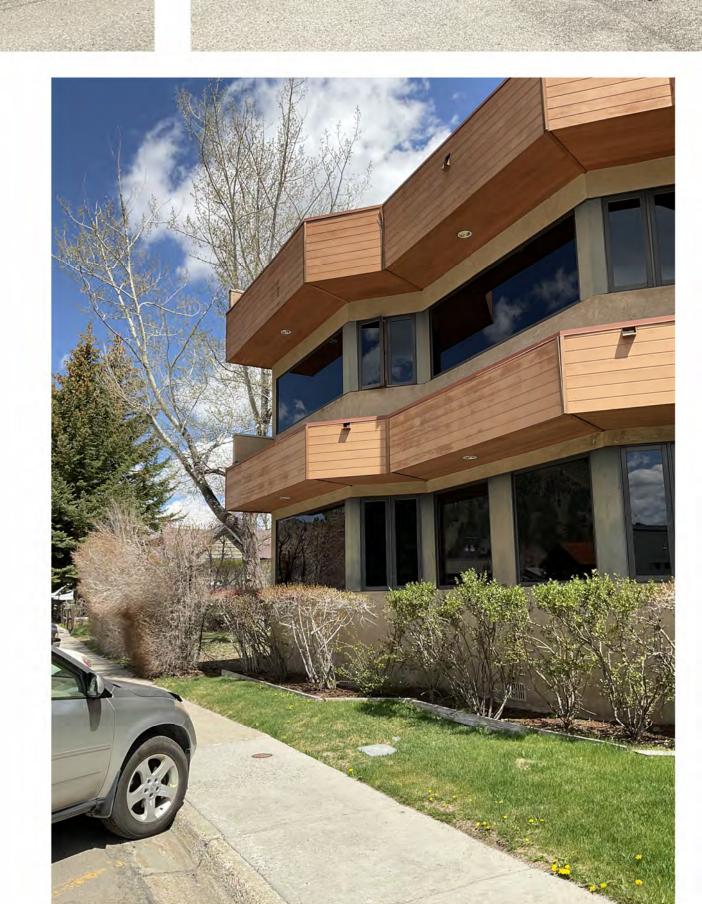


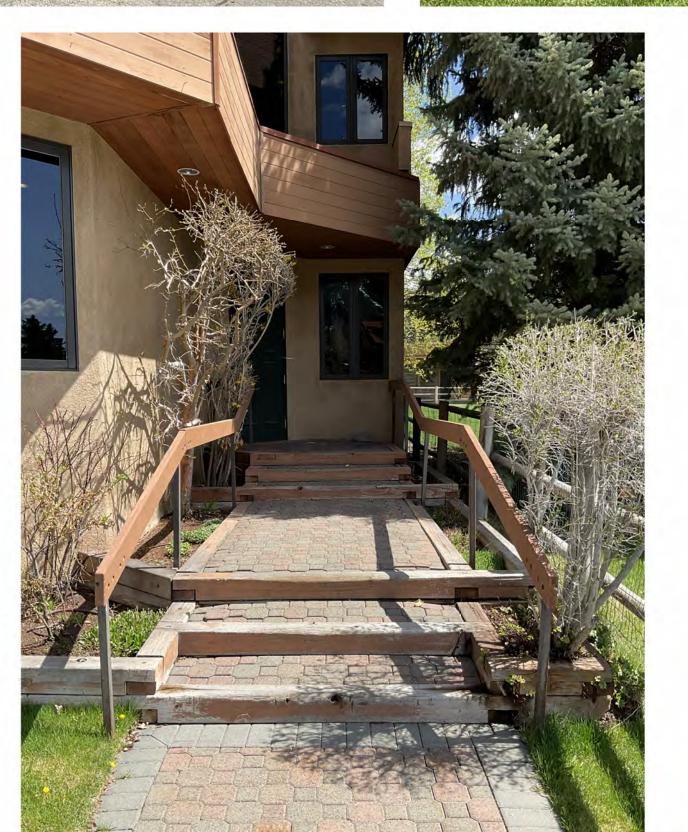

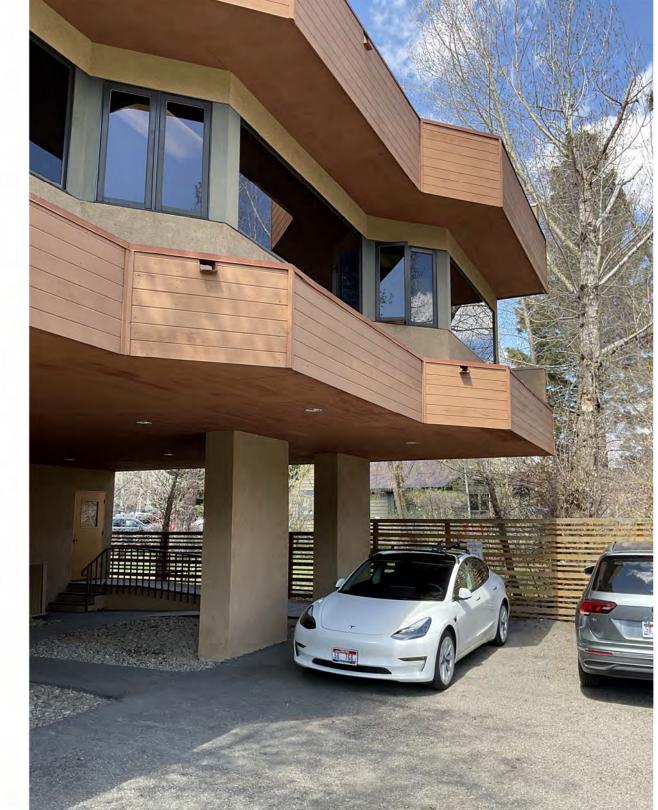






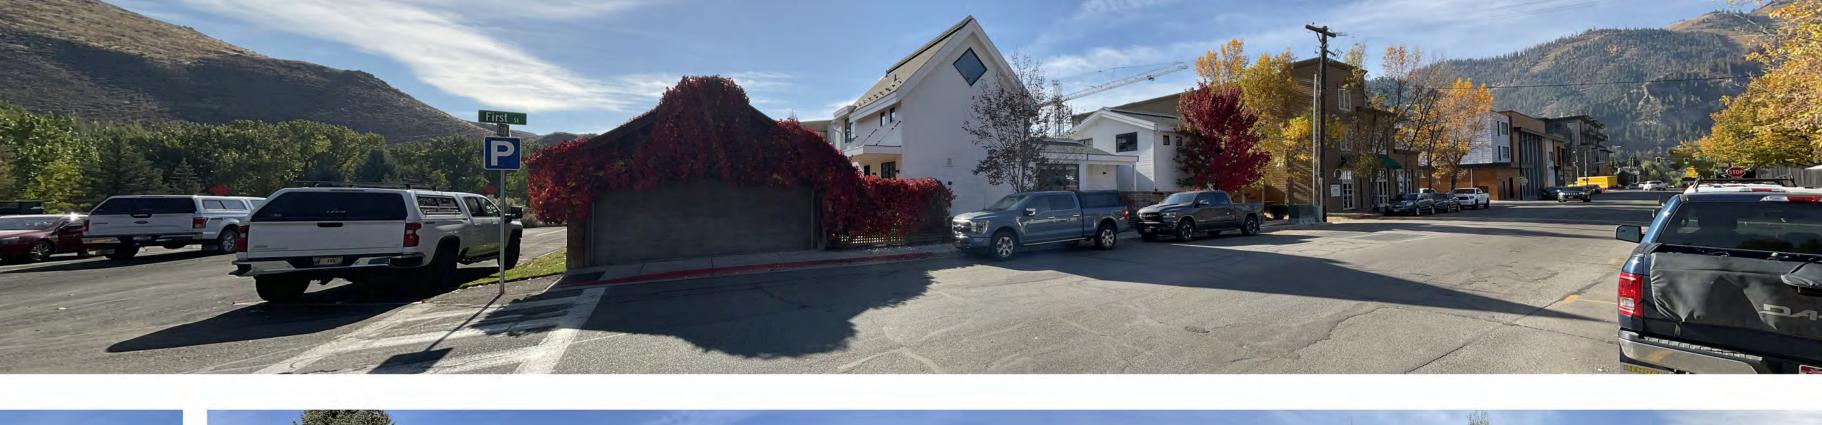





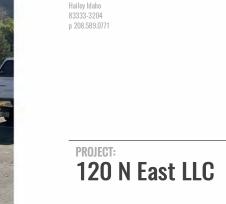


33340	
Permit Set: Construction Set:	02/06/2025 xx/xx/xx
REVISION	DATE



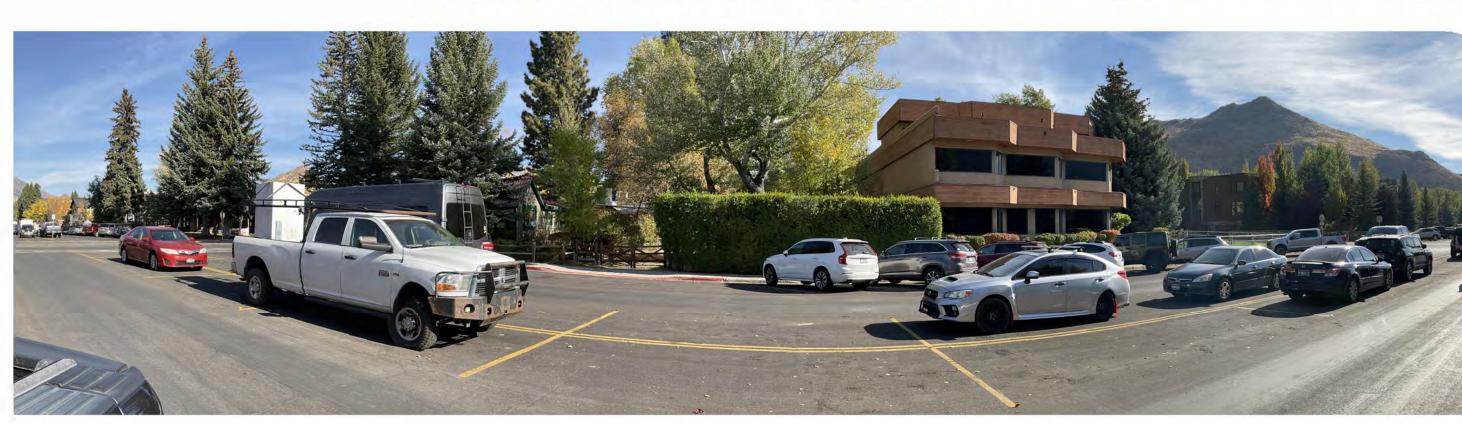


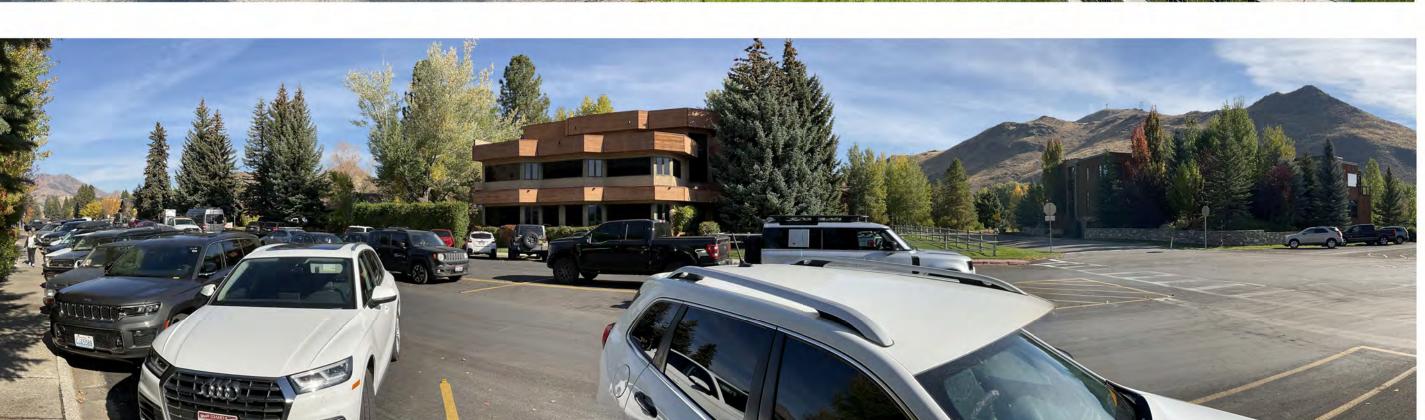




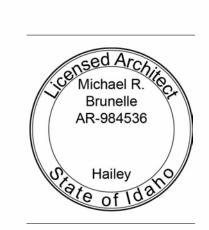



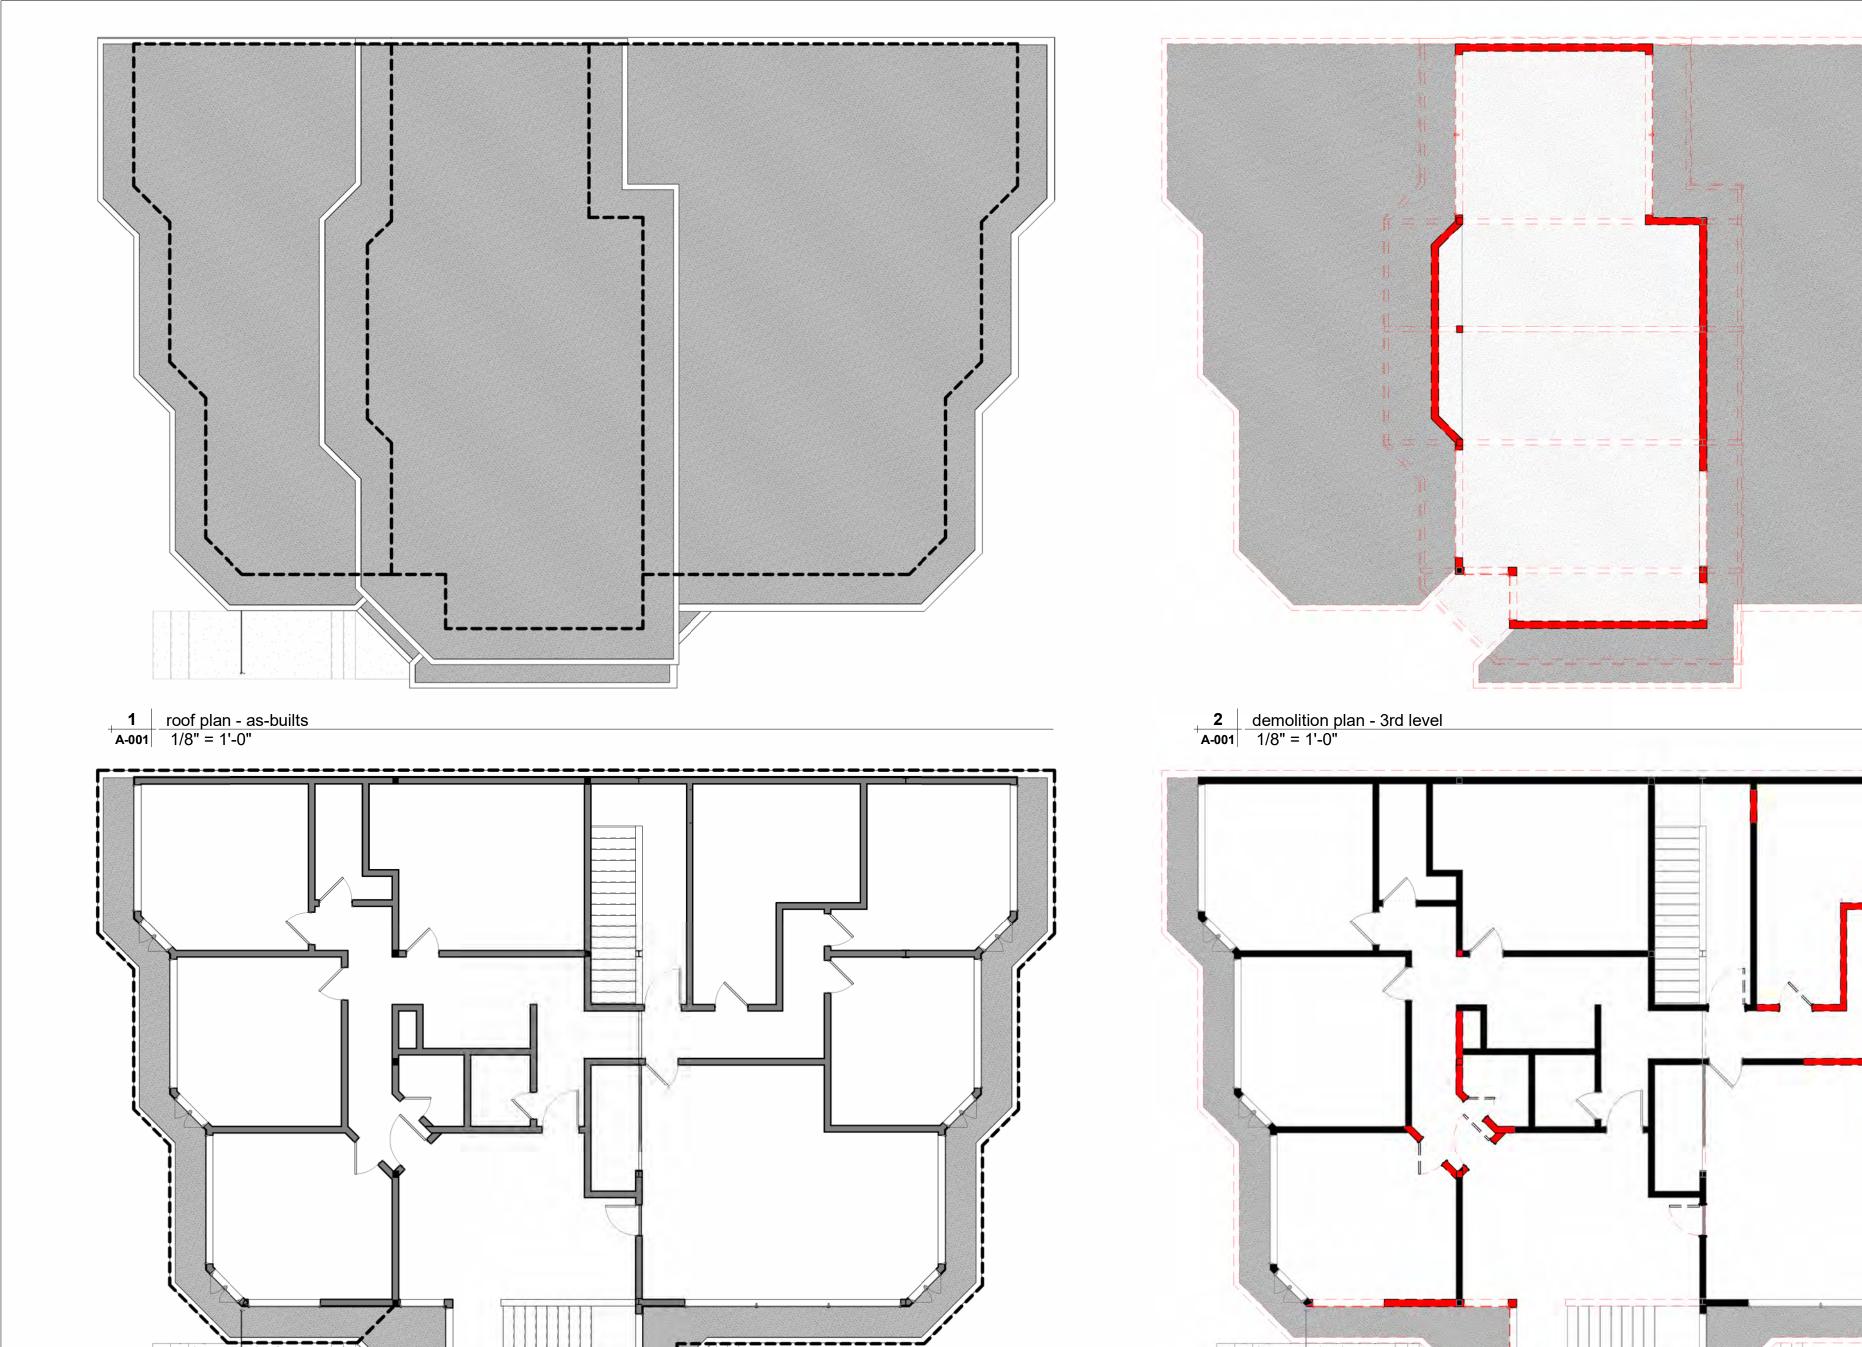

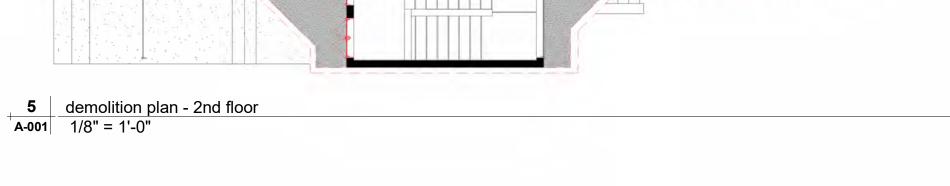





PROJECT:
120 N East LLC

02/06/2025 xx/xx/xx

120 N East Ave Ketchum, Idaho 83340 Permit Set:

Construction Set:


Michael R. Brunelle AR-984536

as-builts

1/8" = 1'-0"


SCALE:



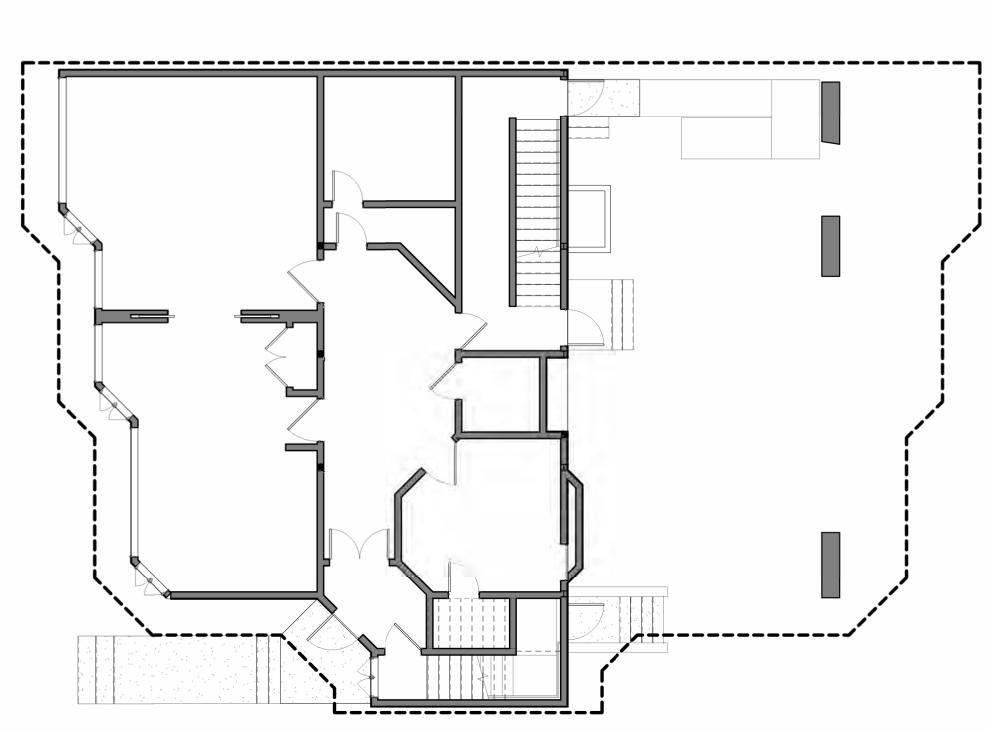


7 | floor plan - 1st level - as-builts | 1/8" = 1'-0"

4 | floor plan - 2nd level - as-builts | 1/8" = 1'-0"

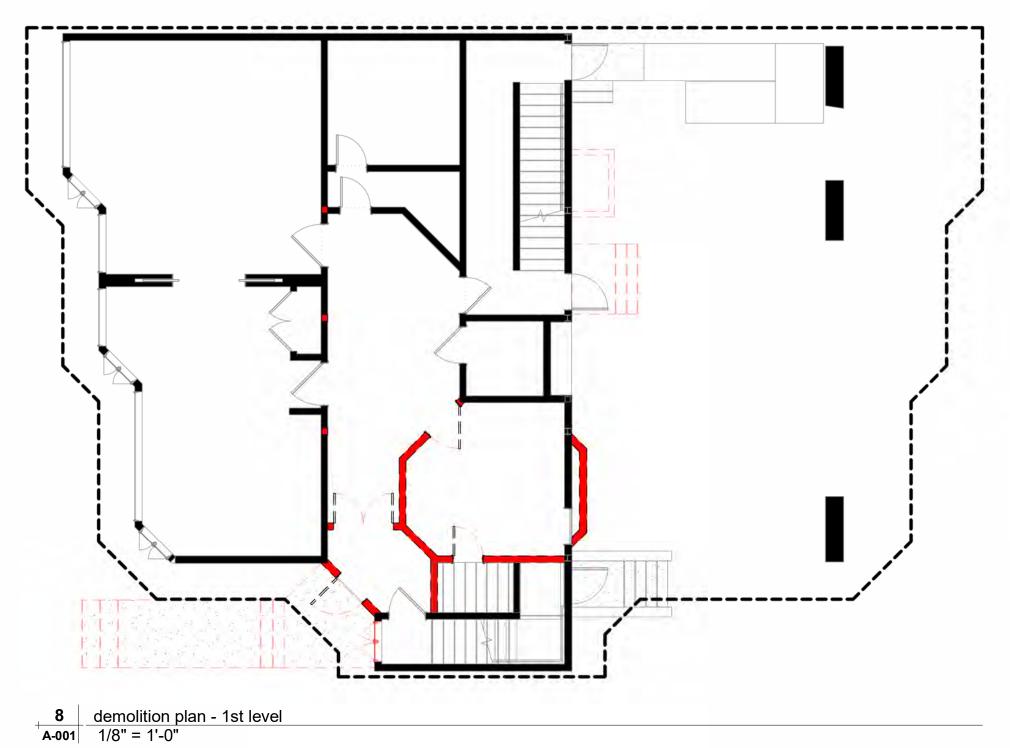

DRAWN BY: Plot Date: 2/6/2025 3:59:47 PM

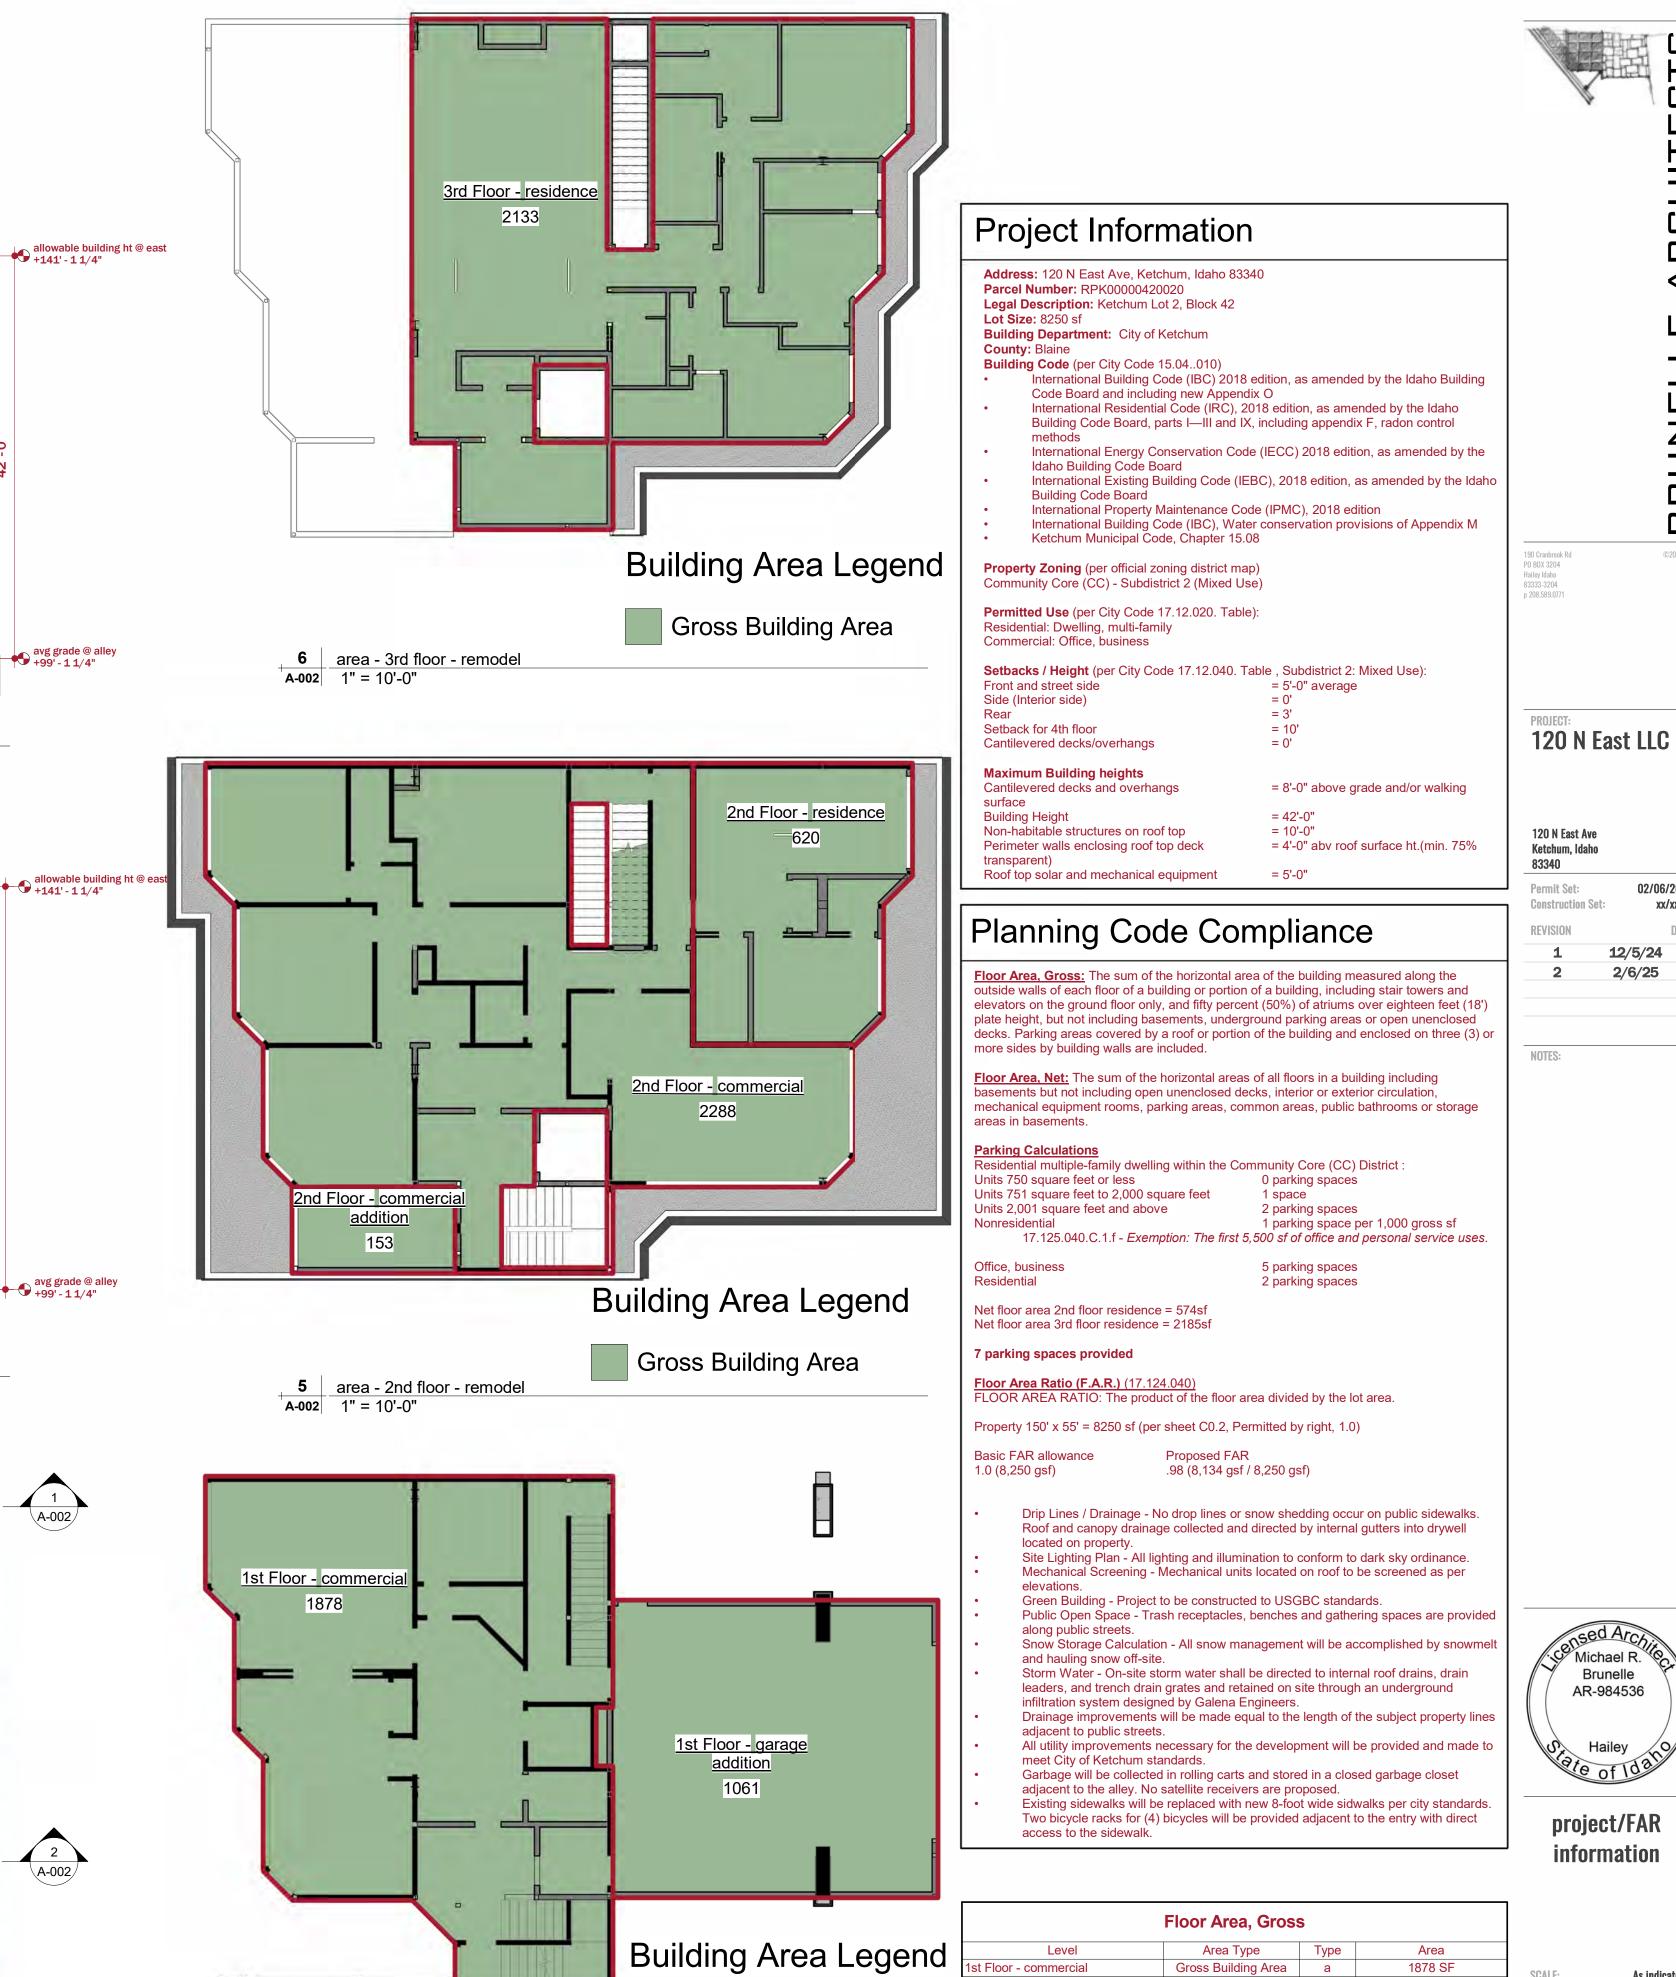

Gross Building Area

4 area - 1st floor - remodel

A-002 1" = 10'-0"

40' - 0"

40' Setback

A-002 Section - Setback Section - North

1" = 10'-0"

22' - 5"

10' - 1"

A-002 1" = 10'-0"

3 Setback Diagram

A-002 1" = 10'-0"

25' - 7"

2 Section - Setback Section - South

N East setback

Blue hatch area indicates actual setback to

face of finish along N east avenue frontage,

including patios less than 30 inches above

adjacent grade and fences/walls less than 6 feet above adjacent greade = 610 sf

1st floor - 610 sf / 55'-0" = 11'-1"

2nd floor - 451 sf / 55'-0" = 8'-2" 3rd floor - 1433 sf / 55'-0" = 26'-0" **B2** (C)

building footprint

**B2** (C)

40' - 0"

40' Setback

38' - 4"

+139' - 13/4"

allowable building ht @ west +139' - 1 3/4"

avg grade @ N East

75' - 3 5/8"

**Building Step Allowed** 

75' - 3 5/8"

**Building Step Allowed** 

**E B**3

(E B3

E B3

102' - 3"

102' - 3"

103' - 9"

69' - 6"

68' - 9"

72' - 6"

81' - 2"

75' - 6"

74' - 9"

68' - 6"

69' - 11"

78' - 6"

78' - 6"

68' - 6"

35' - 0"

35' Setback

35' - 0"


35' Setback

Blue hatch area indicates actual setback to

face of finish along alley frontage, including patios less than 30 inches above adjacent

grade and fences/walls less than 6 feet above adjacent greade = 4534 sf

alley setback 4534 sf / 55'-0" = 82'-5"

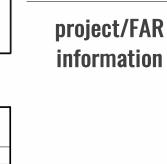

Brunelle

AR-984536

02/06/2025

12/5/24

2/6/25

	Floor Area, Gross	S	
Level	Area Type	Туре	Area
1st Floor - commercial	Gross Building Area	а	1878 SF
1st Floor - garage addition	Gross Building Area	а	1061 SF
2nd Floor - commercial	Gross Building Area	а	2288 SF
2nd Floor - commercial addition	Gross Building Area	а	153 SF
2nd Floor - residence	Gross Building Area	а	620 SF
3rd Floor - residence	Gross Building Area	а	2133 SF
			8134 SF

120 N East LLC

Brunelle AR-984536

photometric study -

Luminaire Luminaire Total

Watts

13.2

Watts

8

79.2


Lumens

0.900 70

1.000 844

1/4" = 1'-0"

Plot Date: 2/6/2025 3:59:55 PM

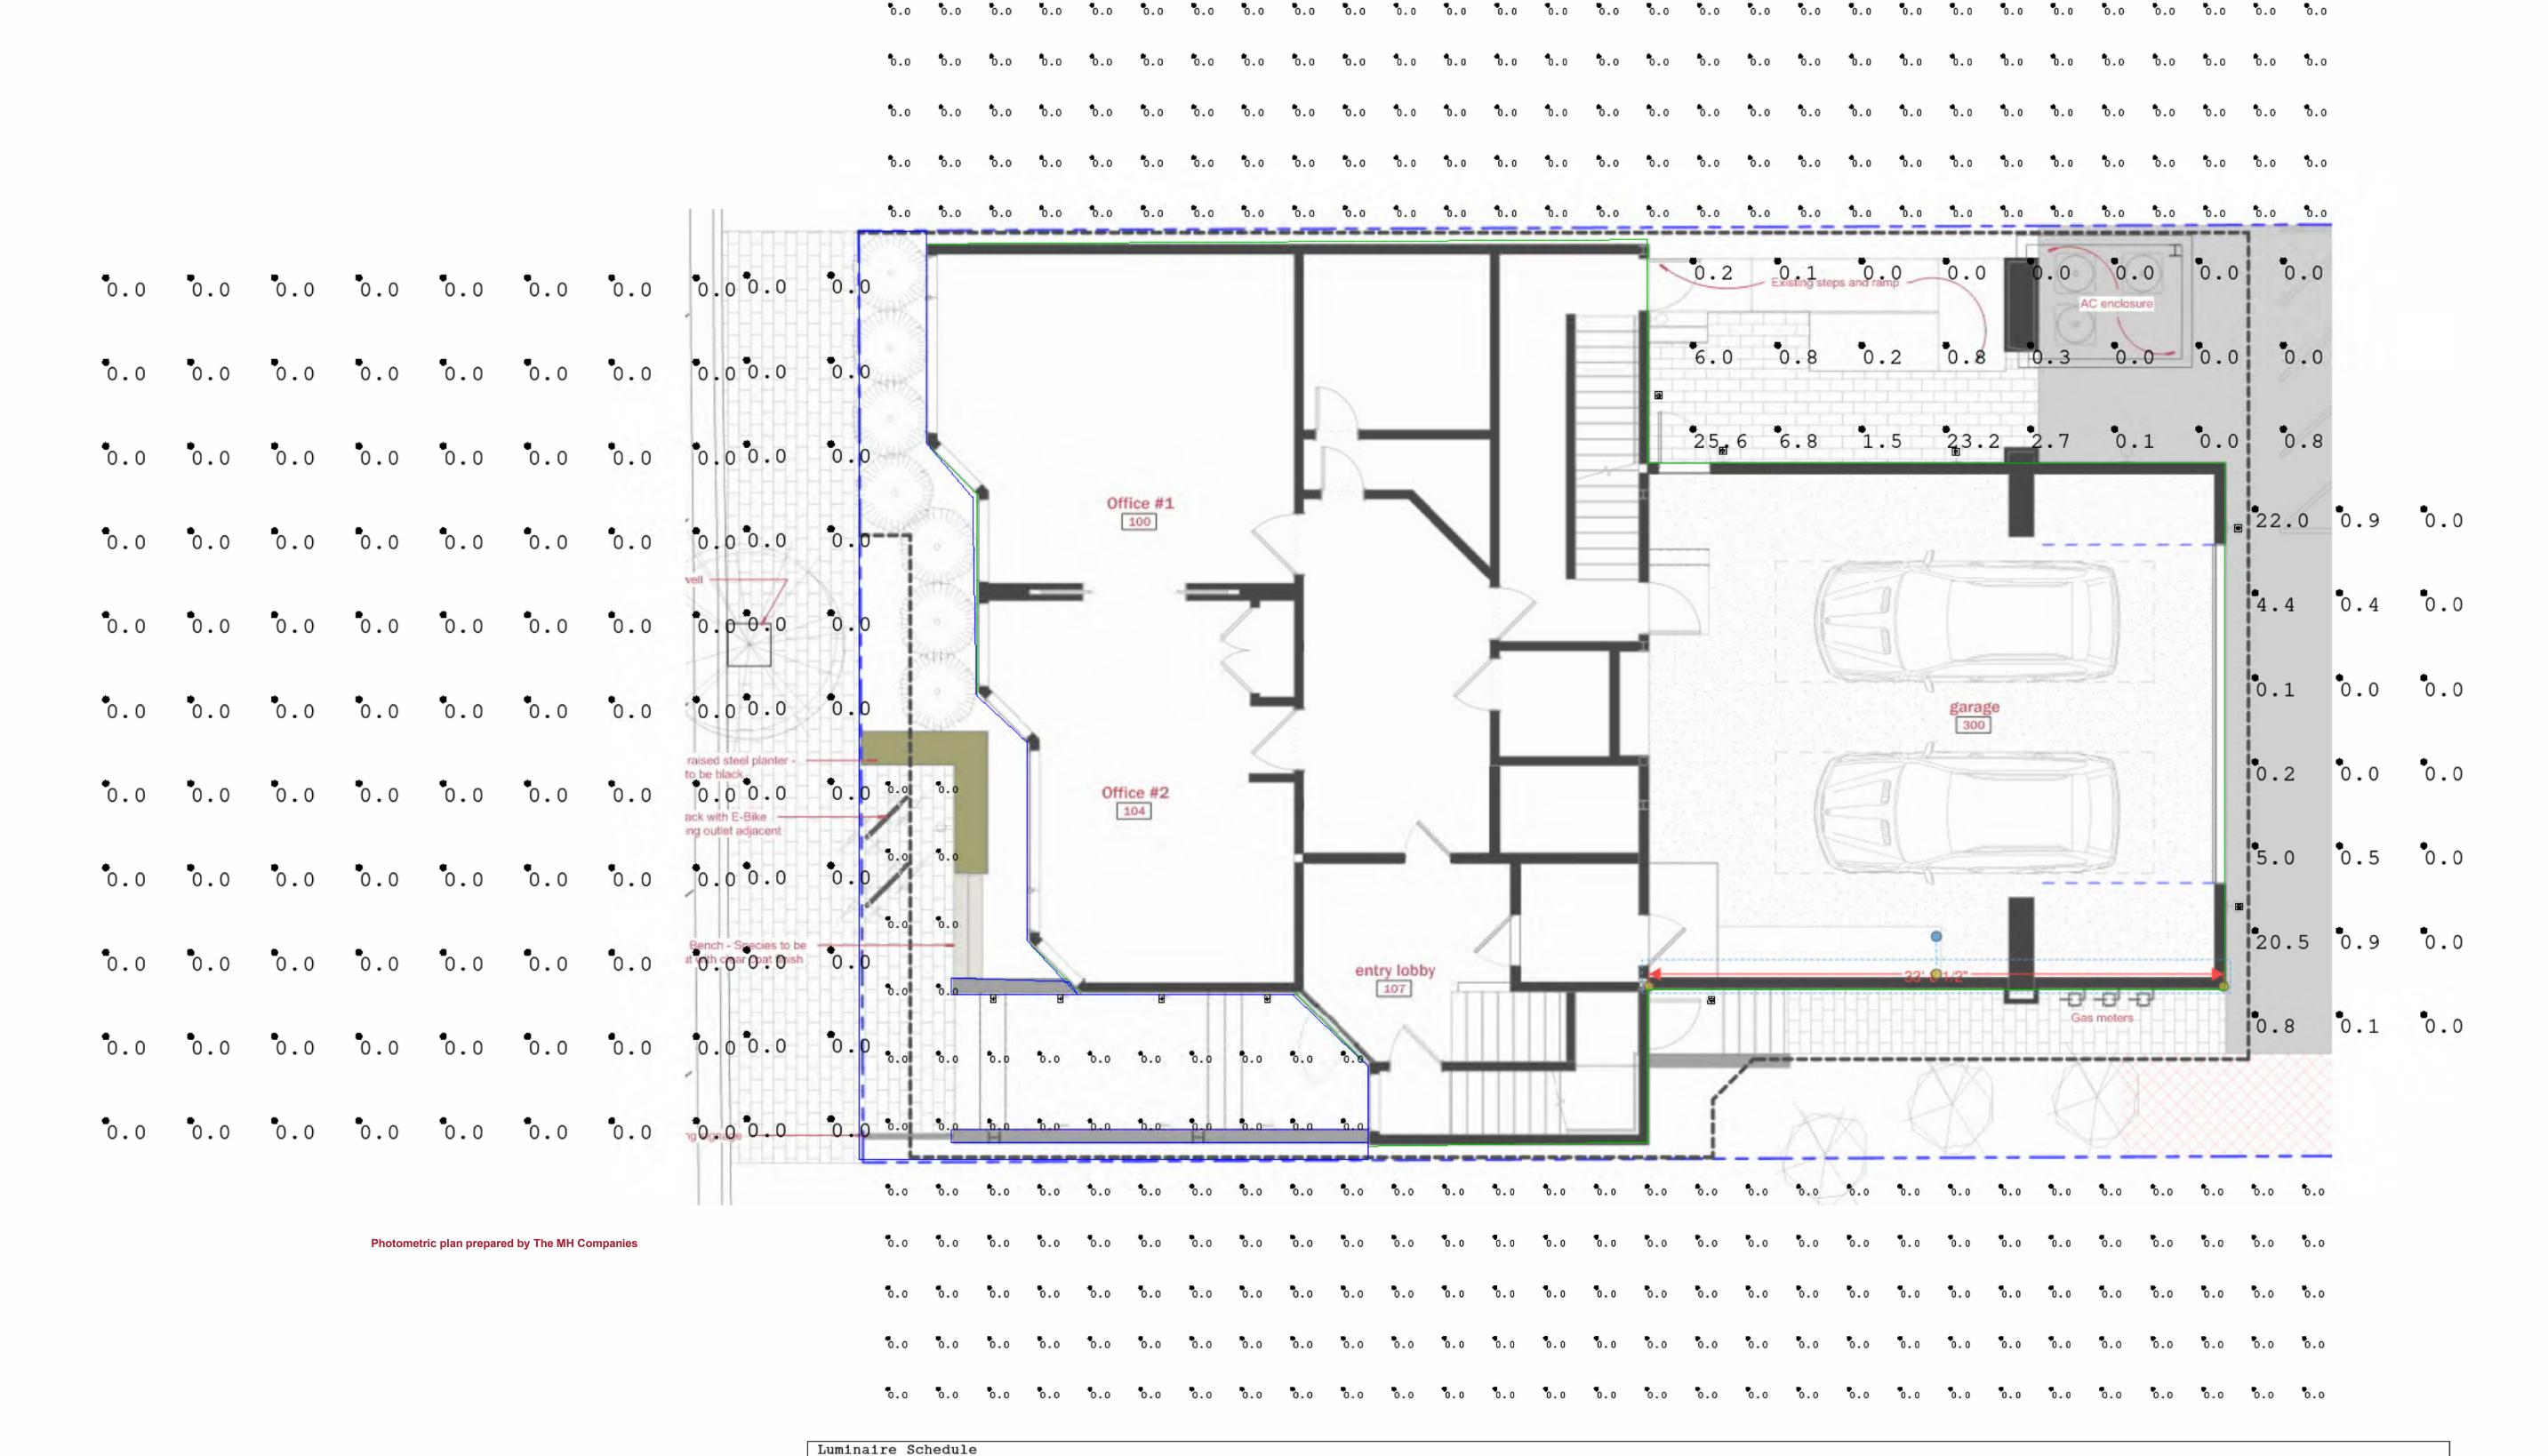

Description

CCT\_ 2986K, CRI\_ 82\_0Ra

Arrangement

Single


Single


Qty Label


4 B Ferona


6 WCED3D-13W-830-W

_ 1	photometric stud
A-003	1/4" = 1'-0"

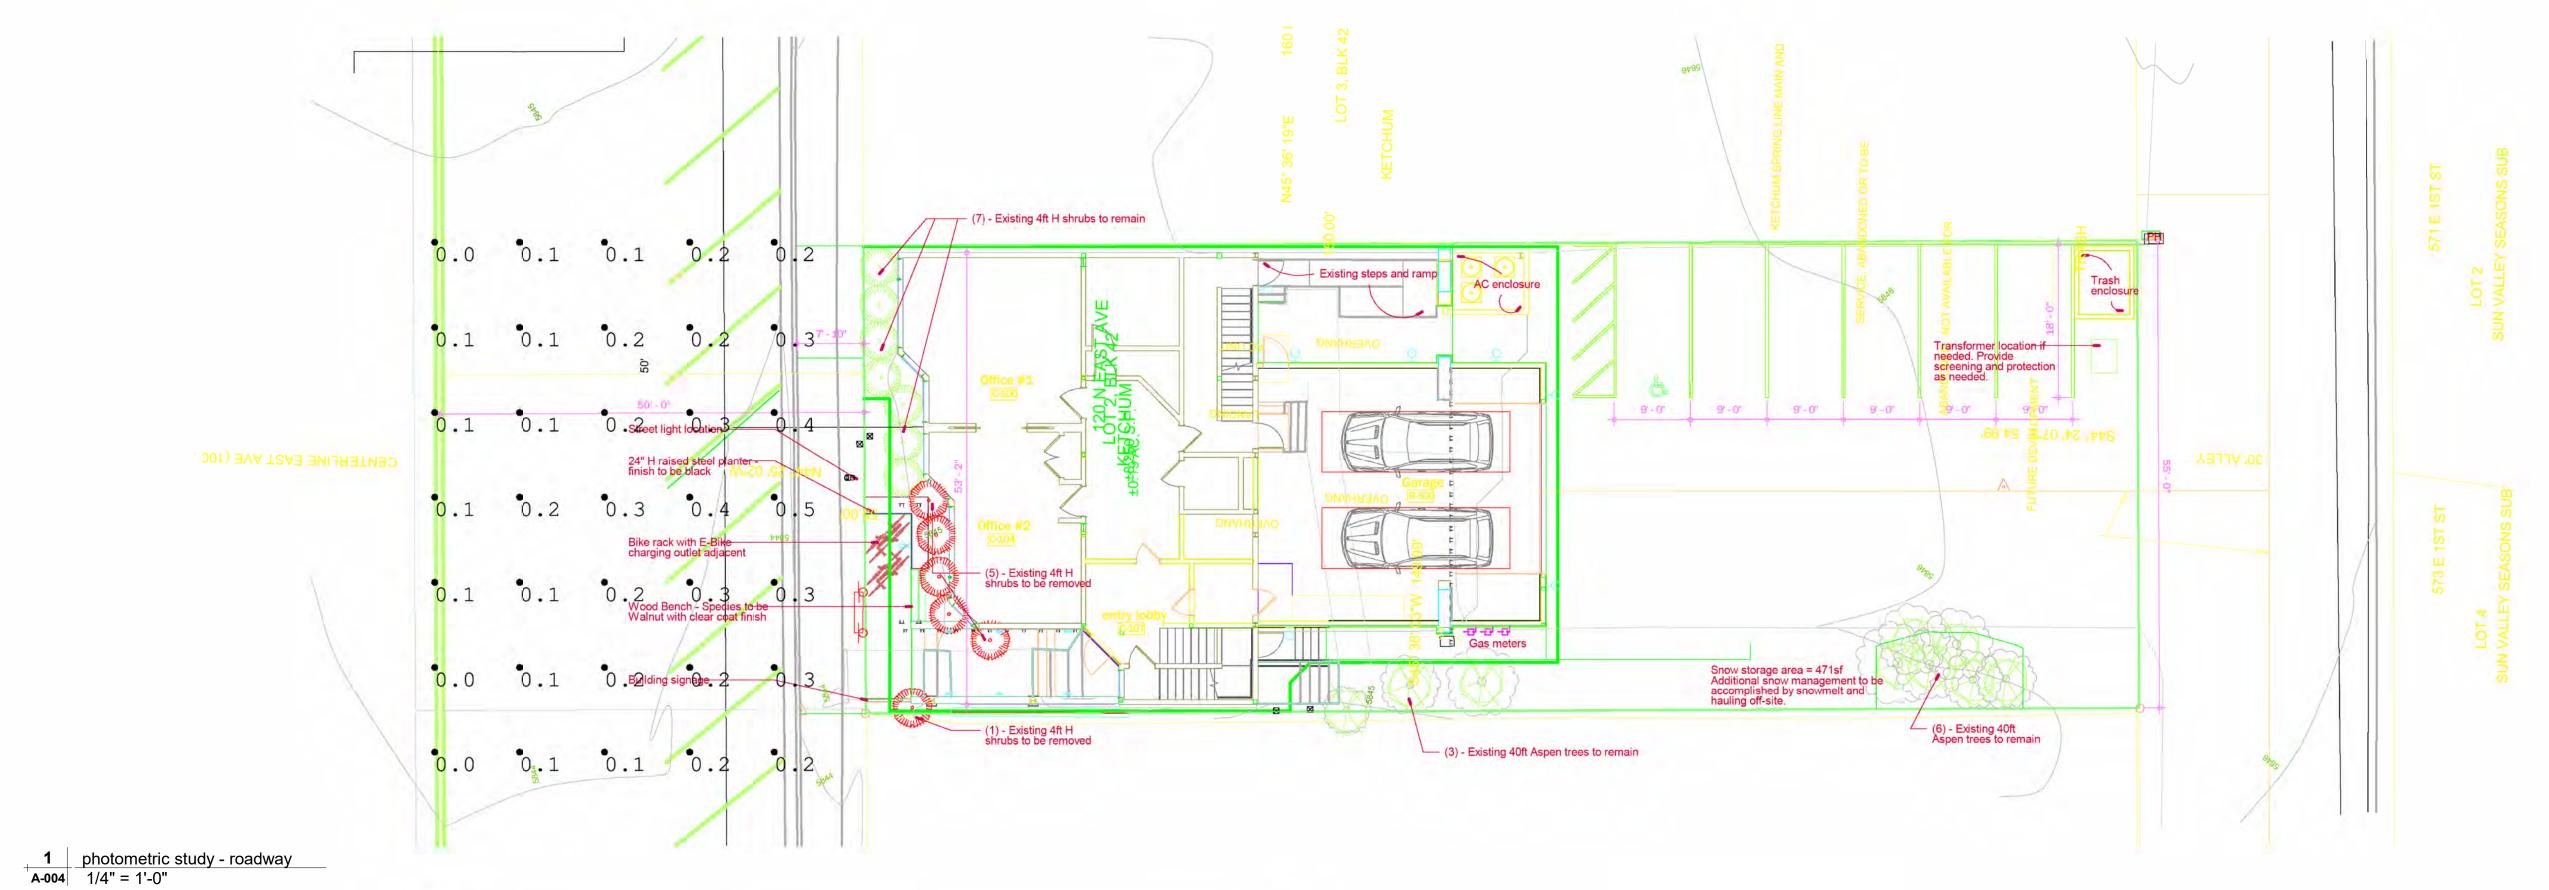

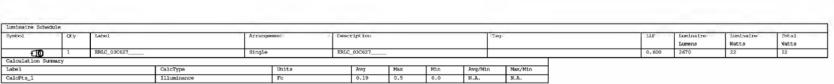

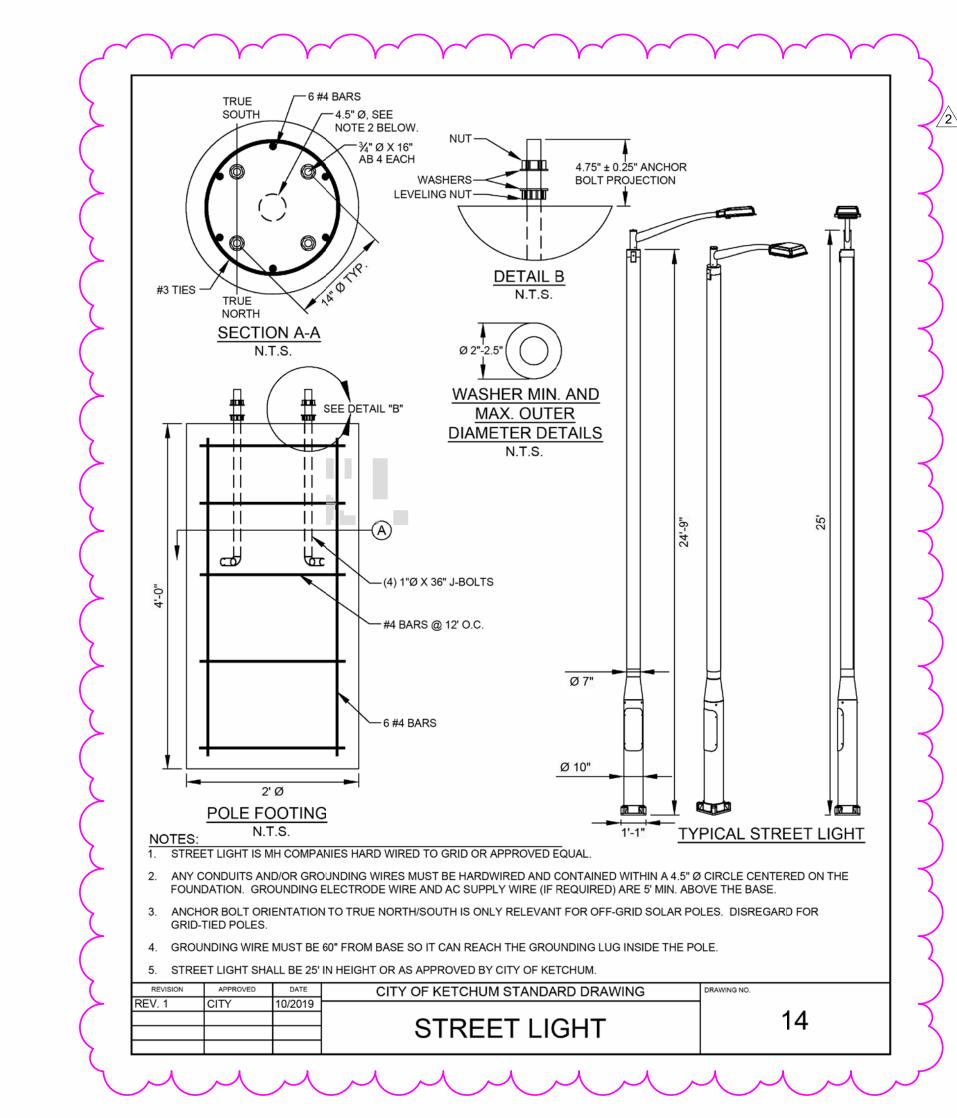

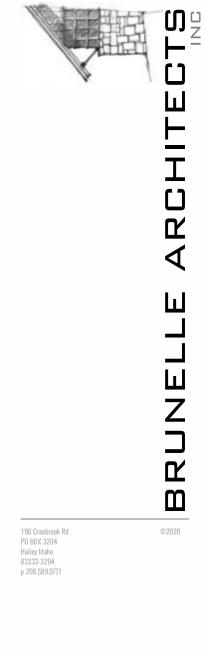


PROJECT:
120 N East LLC

#### 120 N East Ave Ketchum, Idaho 83340

Permit Set: Construction Set:	02/06/20: xx/xx/
REVISION	DA
2	2/6/25

NOTES:

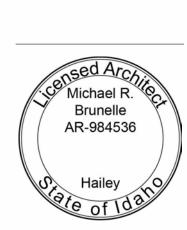


photometric study roadway

SCALE: 1/4" = 1'-0"

A-004

DRAWN BY: Author

Plot Date: 2/6/2025 3:59:57 PM

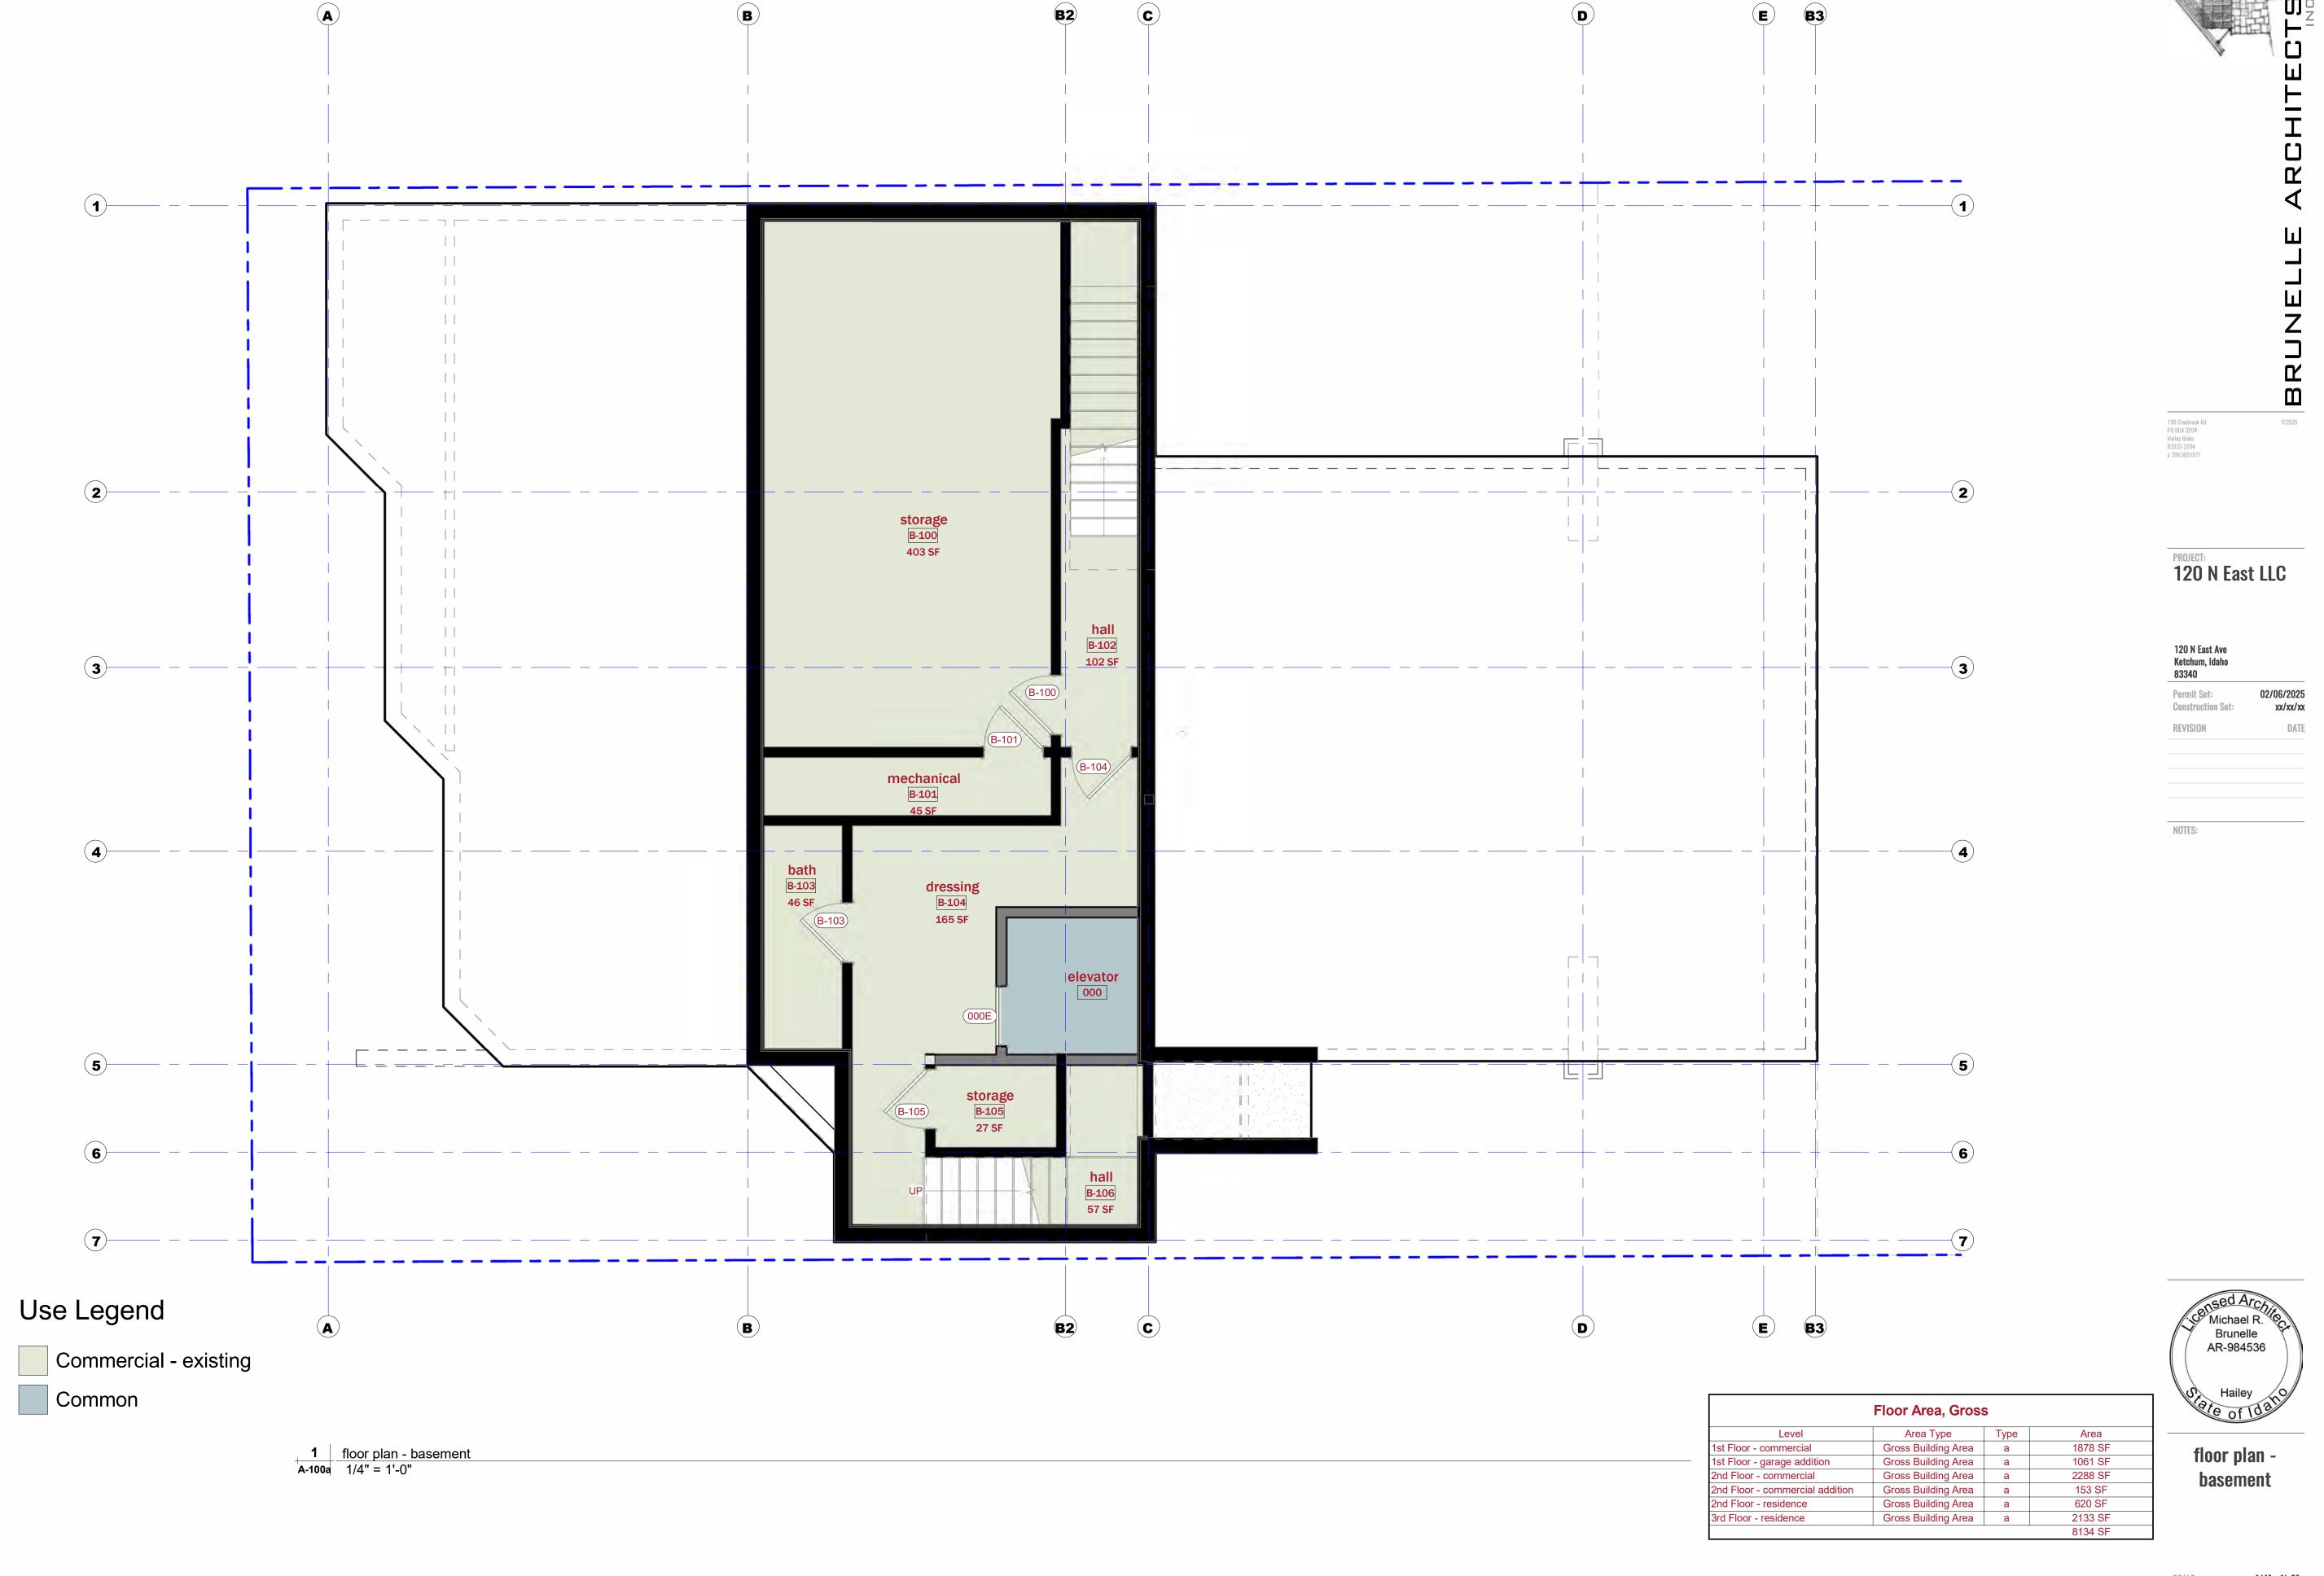

SCALE: 1/4" = 1'-0"



| DRAWN BY: Author | Plot Date: 2/6/2025 4:00:00 PM



A-101a

 DRAWN BY:
 Author

 Plot Date:
 2/6/2025 4:00:07 PM



SCALE: 1/4" = 1'-0"



SCALE: 1/4" = 1'-0"

DRAWN BY: Author

Plot Date: 2/6/2025 4:00:19 PM


**E B3** 



roof plan

1/4" = 1'-0"

Plot Date: 2/6/2025 4:00:24 PM

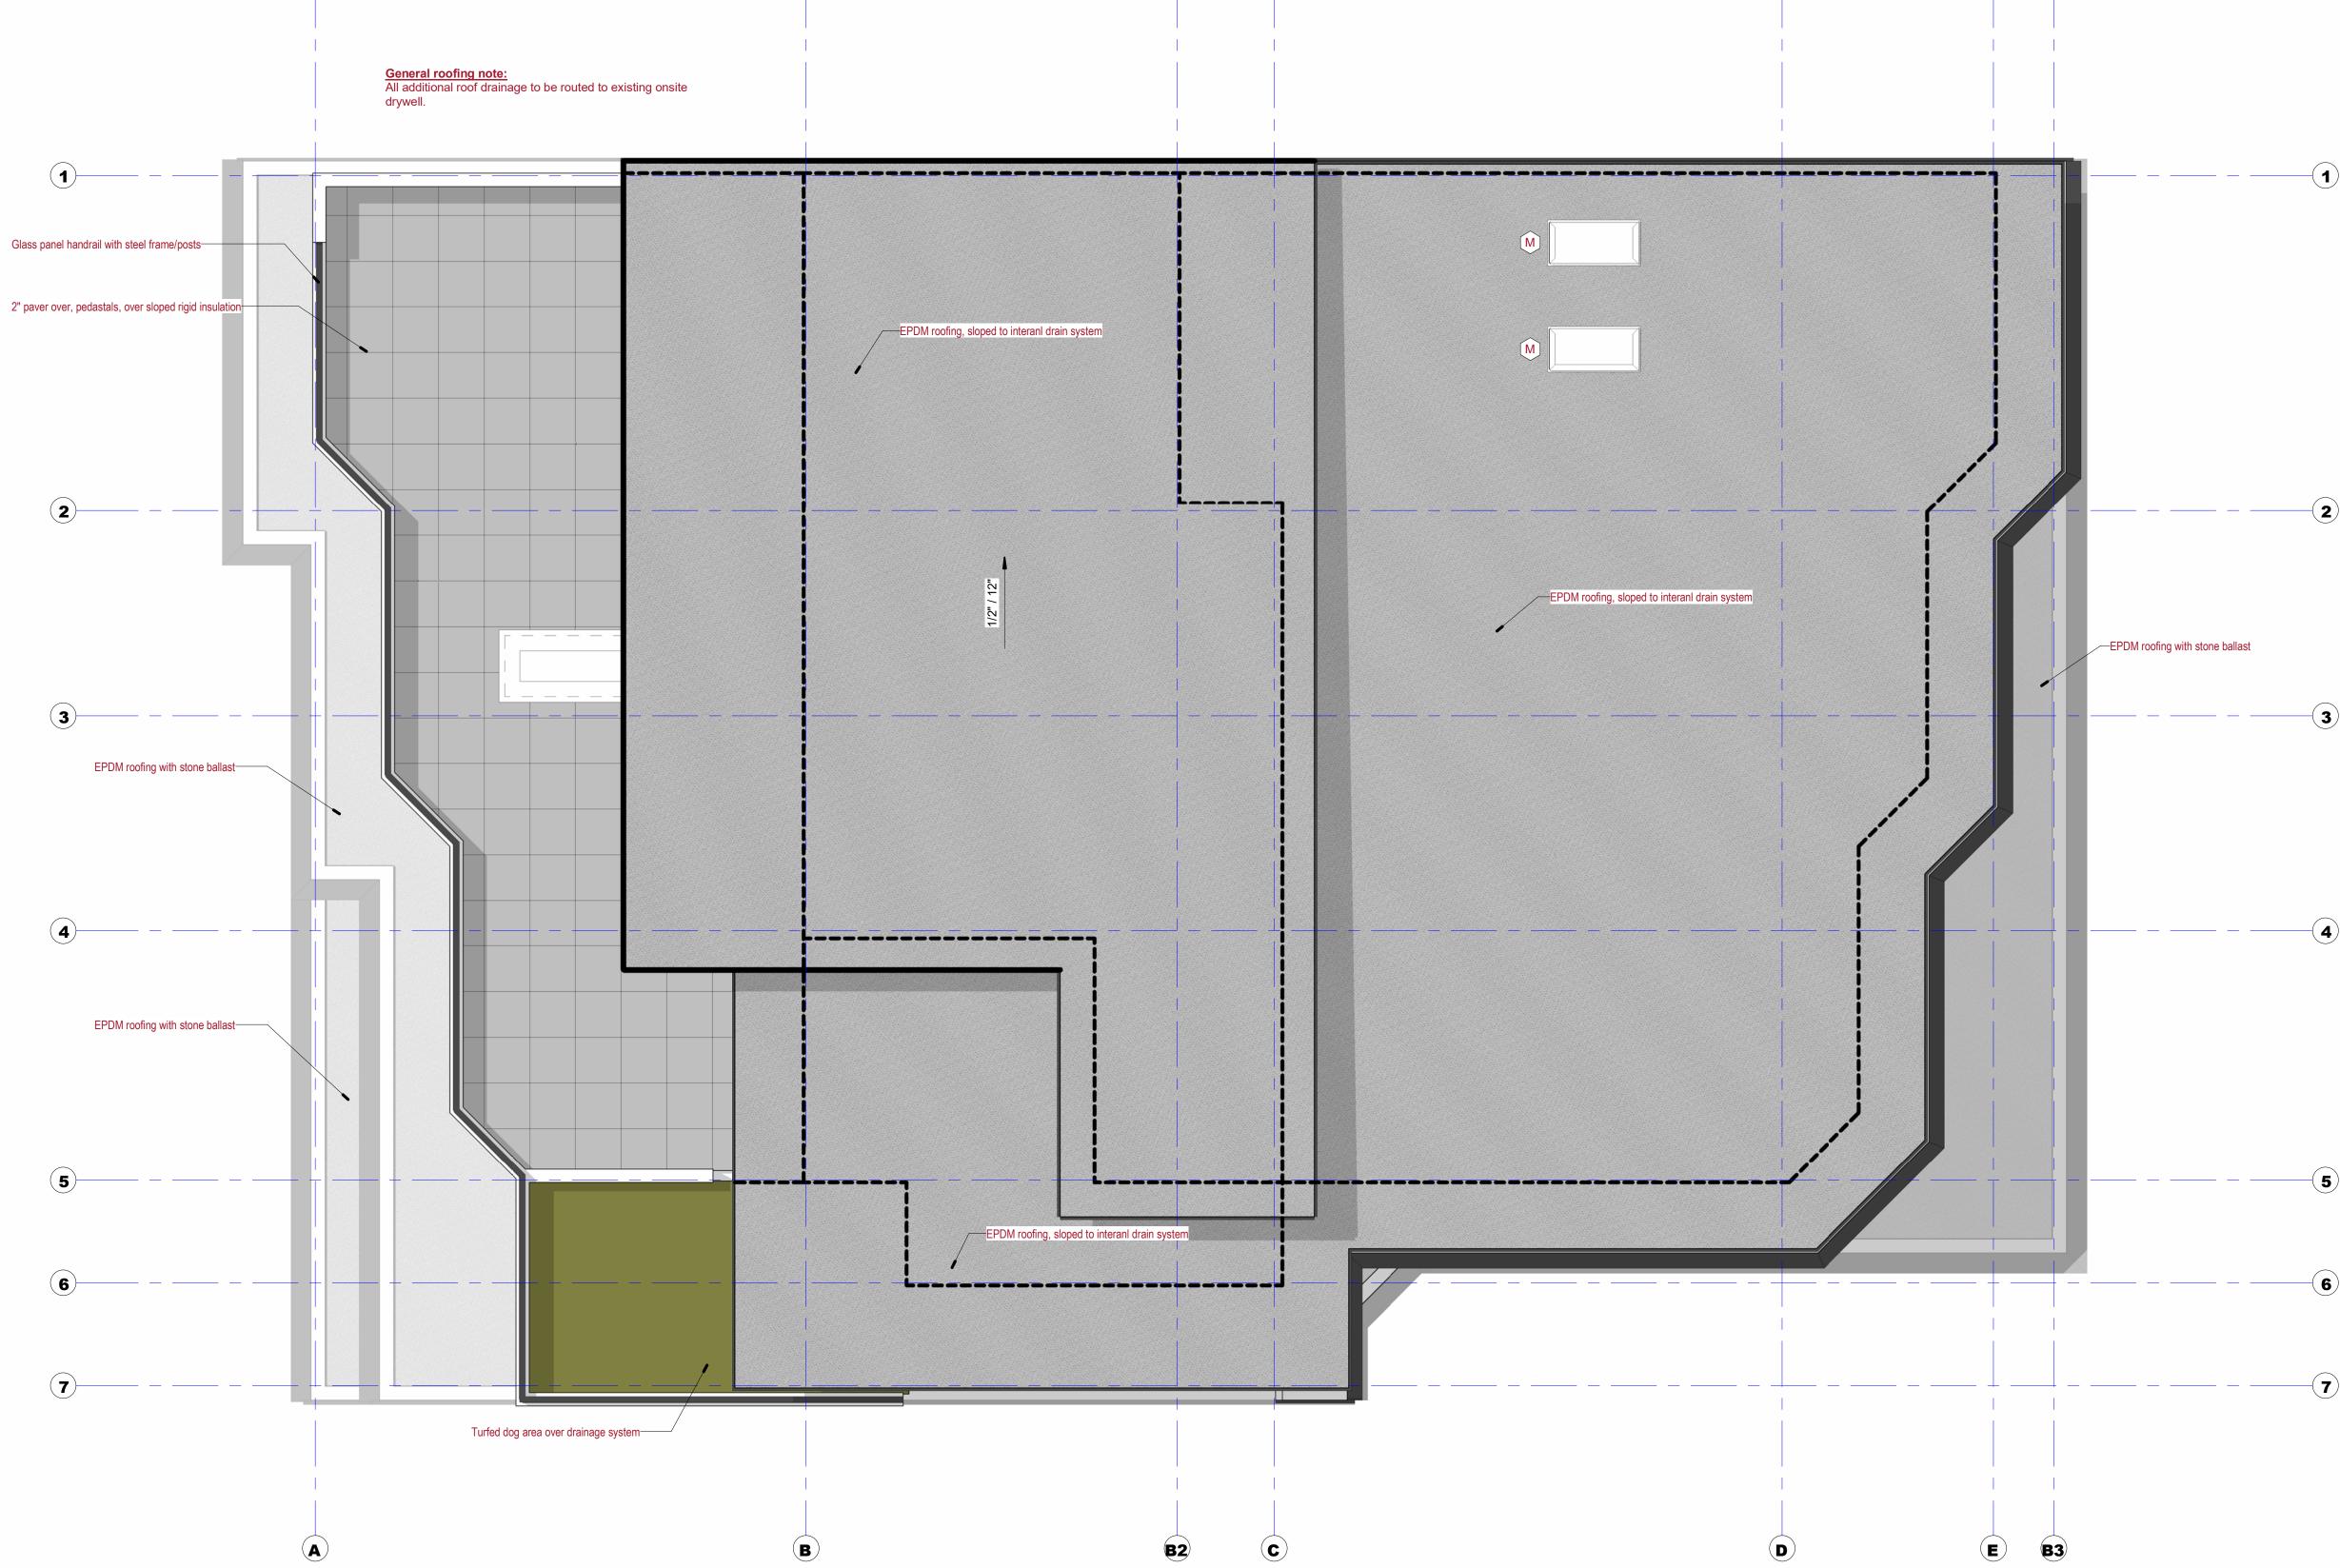


1 roof plan A-104 1/4" = 1'-0"



3 West Perspective 12" = 1'-0"



4 SW Perspective 12" = 1'-0"

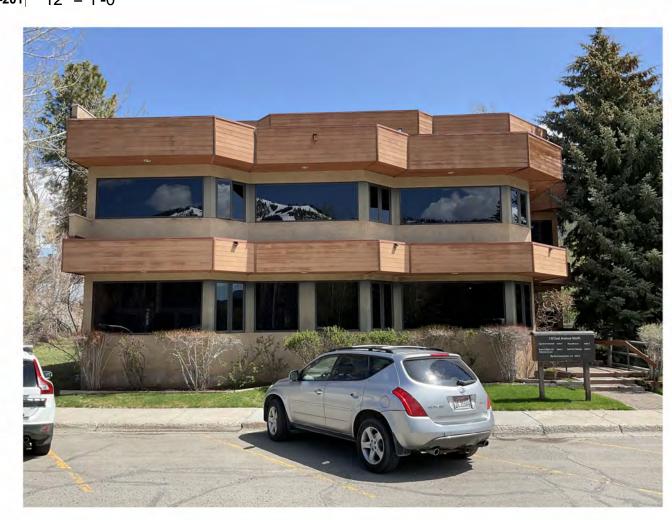



unpainted, sealed steel concrete

MAT 5 - Wood siding, MAT 6 - Roofing -

reSawn Abodo Vulcan stone ballasted Cladding - "Nero"

MAT 1 - Metal - MAT 2 - Board formed MAT 3 - Stucco -





Handrail posts





MAT 3 - Stucco Benjamin Moore paint Deep River 1582


MAT 4 - Wood siding/soffit,
reSawn Abodo Vulcan
Cladding - "Straw"




Flashing






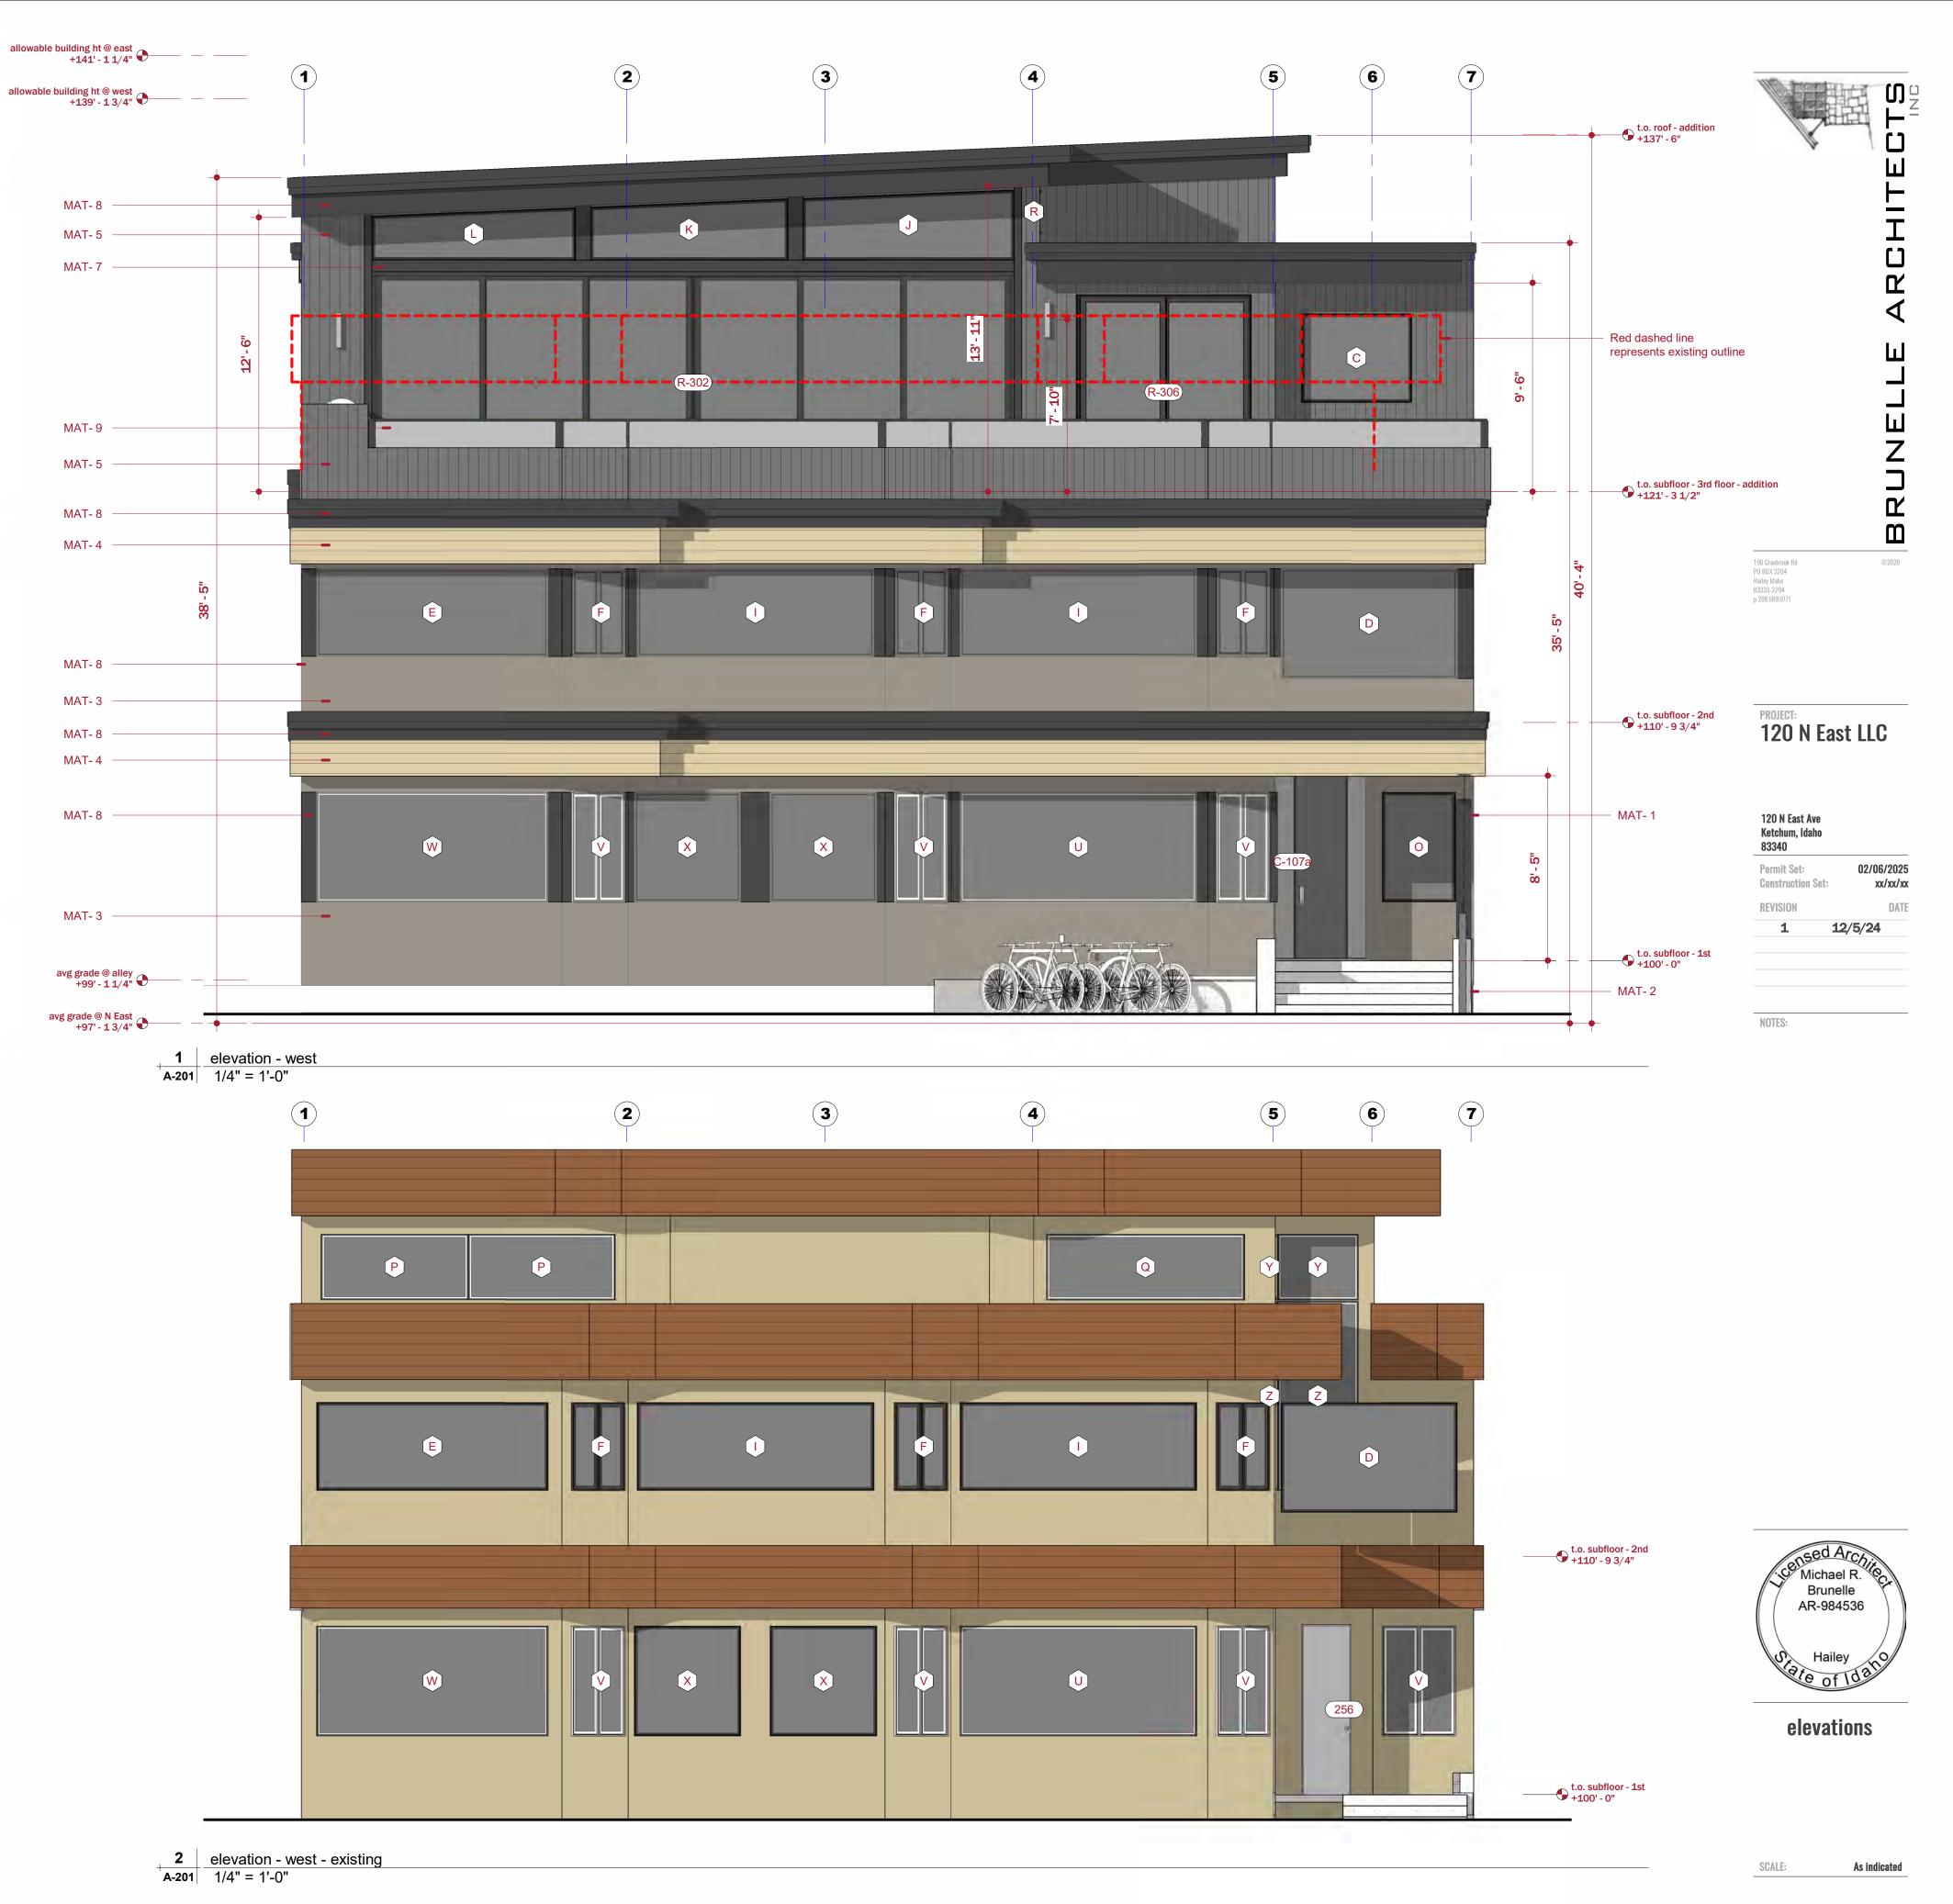

DRAWN BY: Plot Date: 2/6/2025 4:00:44 PM

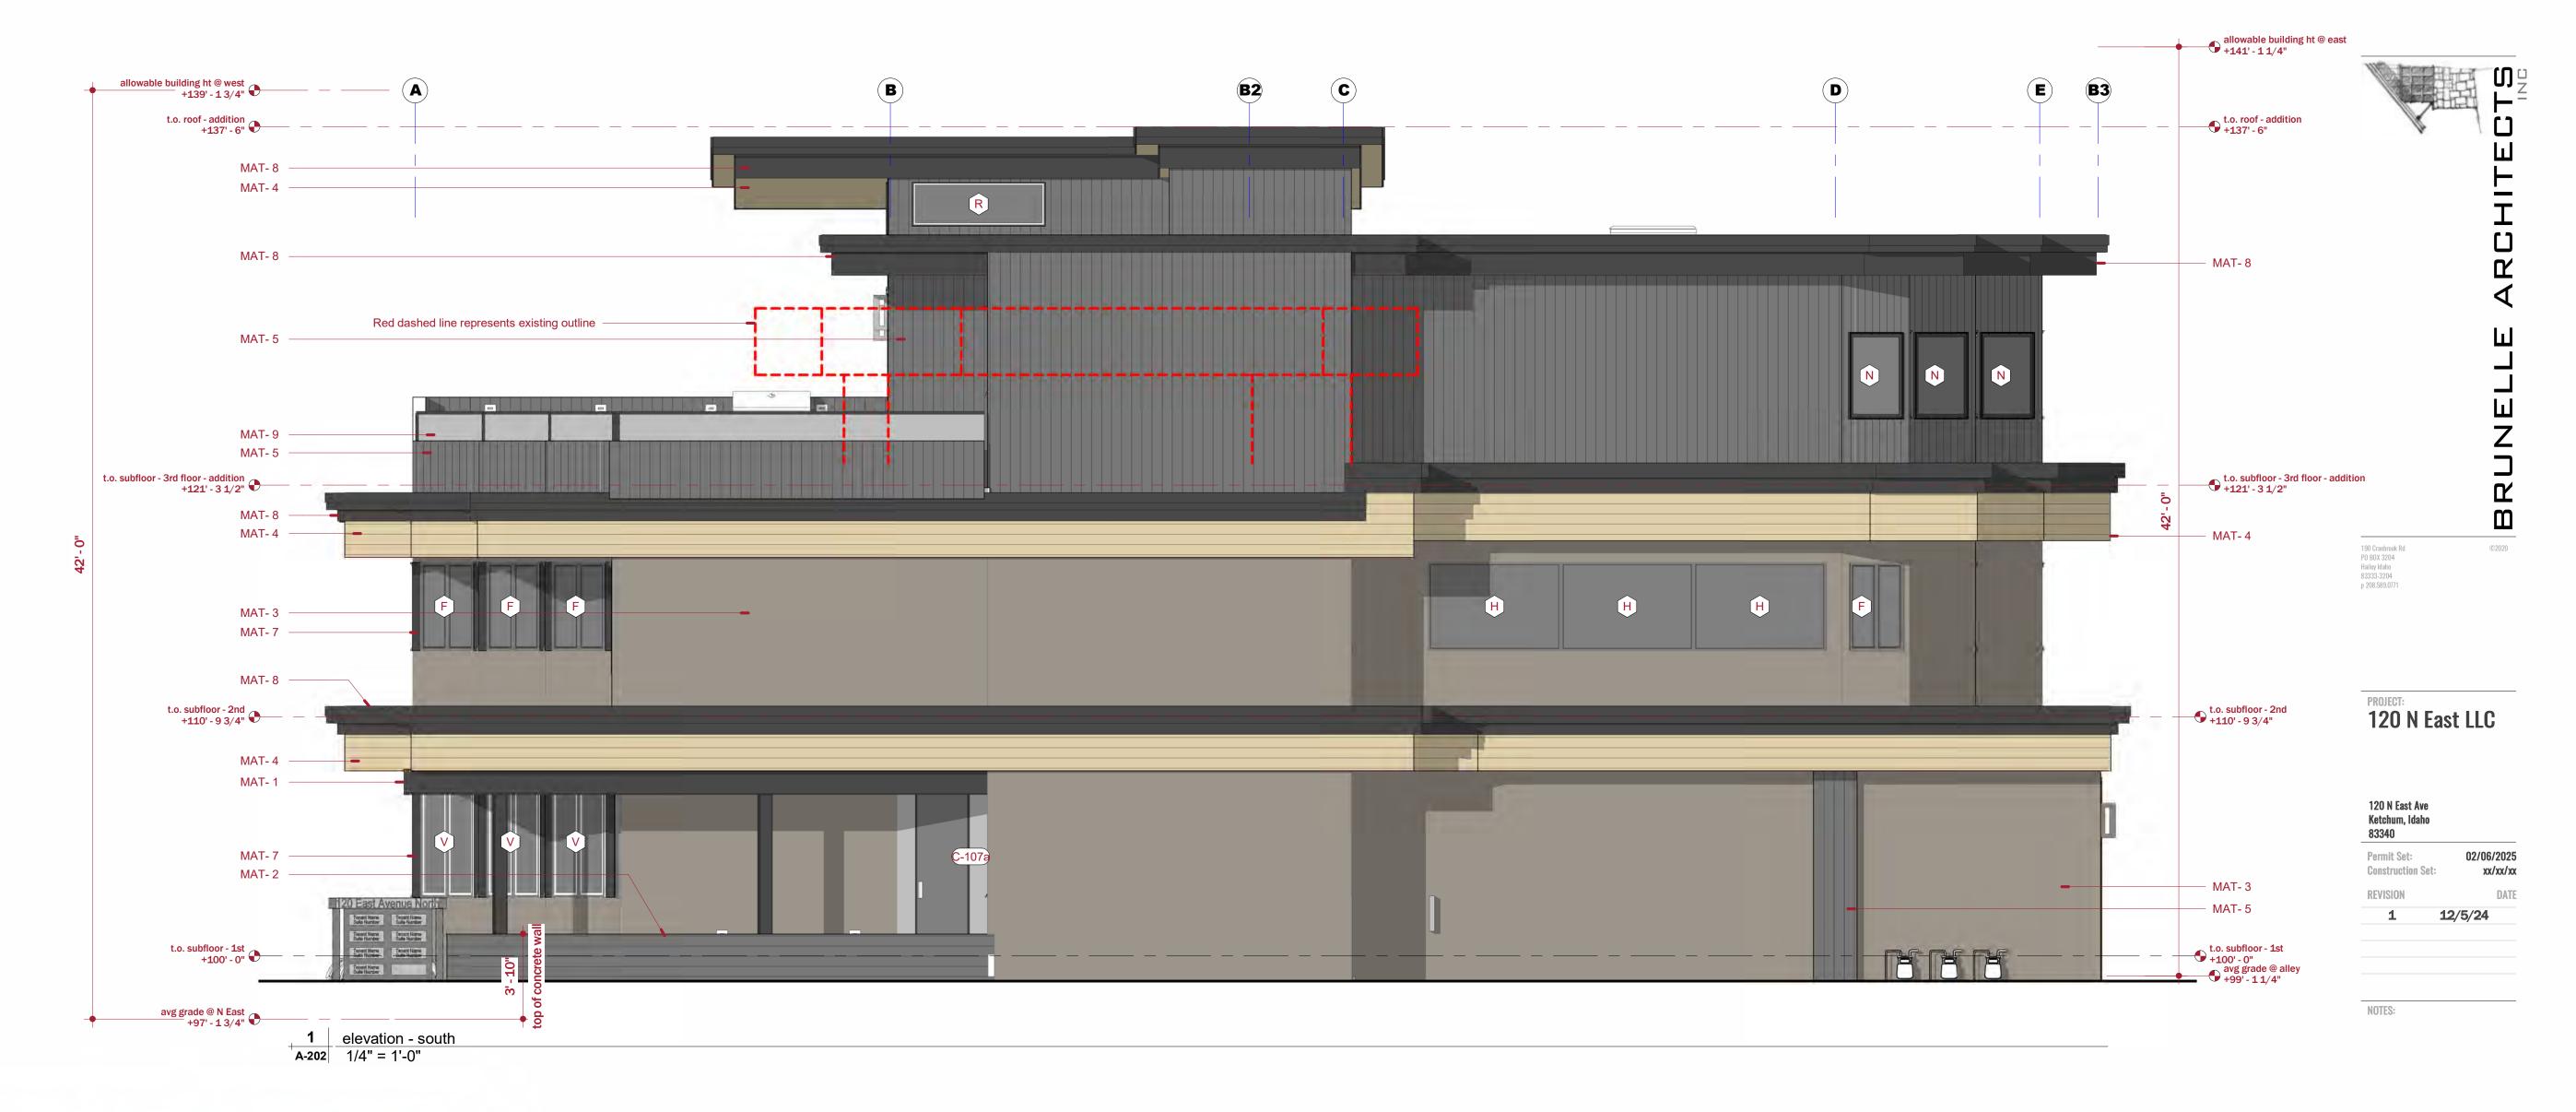




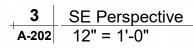



unpainted, sealed steel concrete



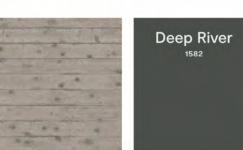



















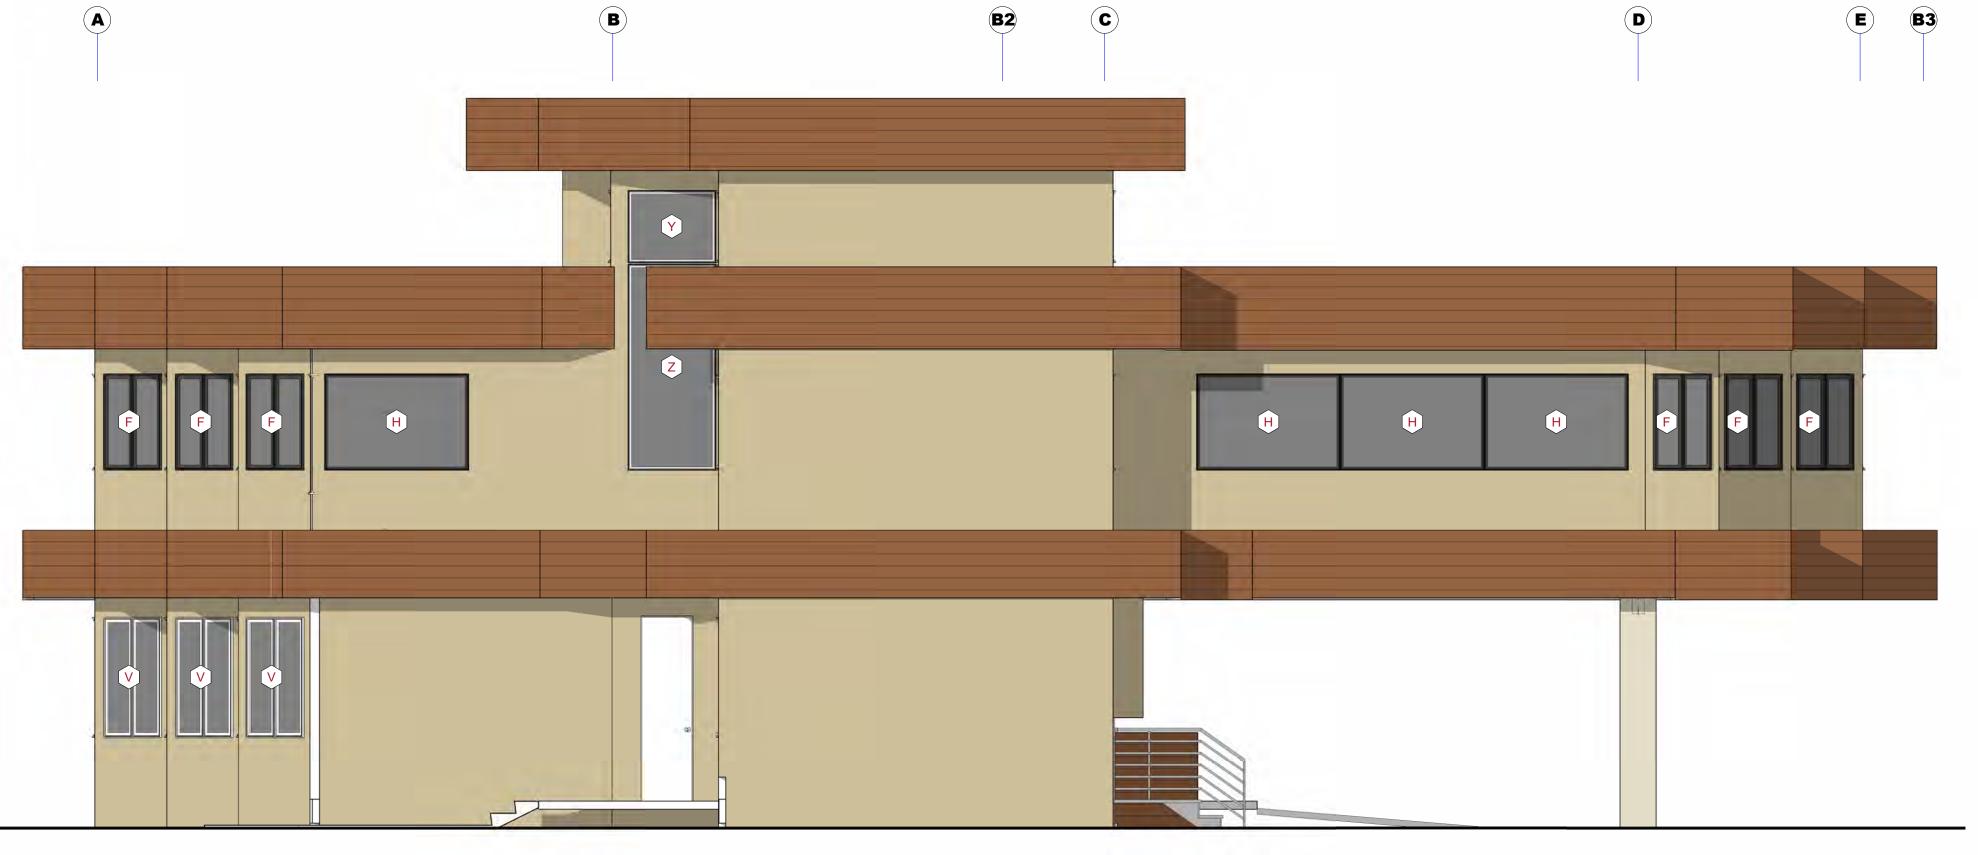

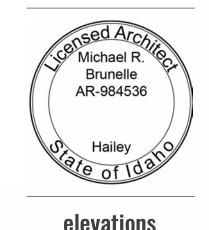

elevations

As indicated

DRAWN BY: Plot Date: 2/6/2025 4:01:04 PM

2 elevation - south - existing 1/4" = 1'-0"

MAT 5 - Wood siding, MAT 6 - Roofing reSawn Abodo Vulcan stone ballasted Cladding - "Nero"

Handrail posts

MAT 7 - Metal cladding, MAT 8 - Metal match existing paneling, Bonderized (windows and doors), Metal - Fascia / Flashing



SE Perspective
12" = 1'-0"



4 NE Perspective 12" = 1'-0"




Existing tree conditions, South Elevation



Existing tree conditions, South Elevation



MAT 1 - Metal unpainted, sealed steel concrete

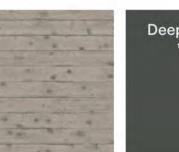

MAT 2 - Board formed MAT 3 - Stucco -





MAT 3 - Stucco Benjamin Moore paint Deep River 1582

MAT 4 - Wood siding/soffit,
reSawn Abodo Vulcan
Cladding - "Straw"



MAT 5 - Wood siding, MAT 6 - Roofing reSawn Abodo Vulcan stone ballasted Cladding - "Nero"



MAT 7 - Metal cladding, MAT 8 - Metal match existing paneling, Bonderized (windows and doors), Metal - Fascia /

Handrail posts





Flashing



MAT 9 - Glass handrail with steel posts



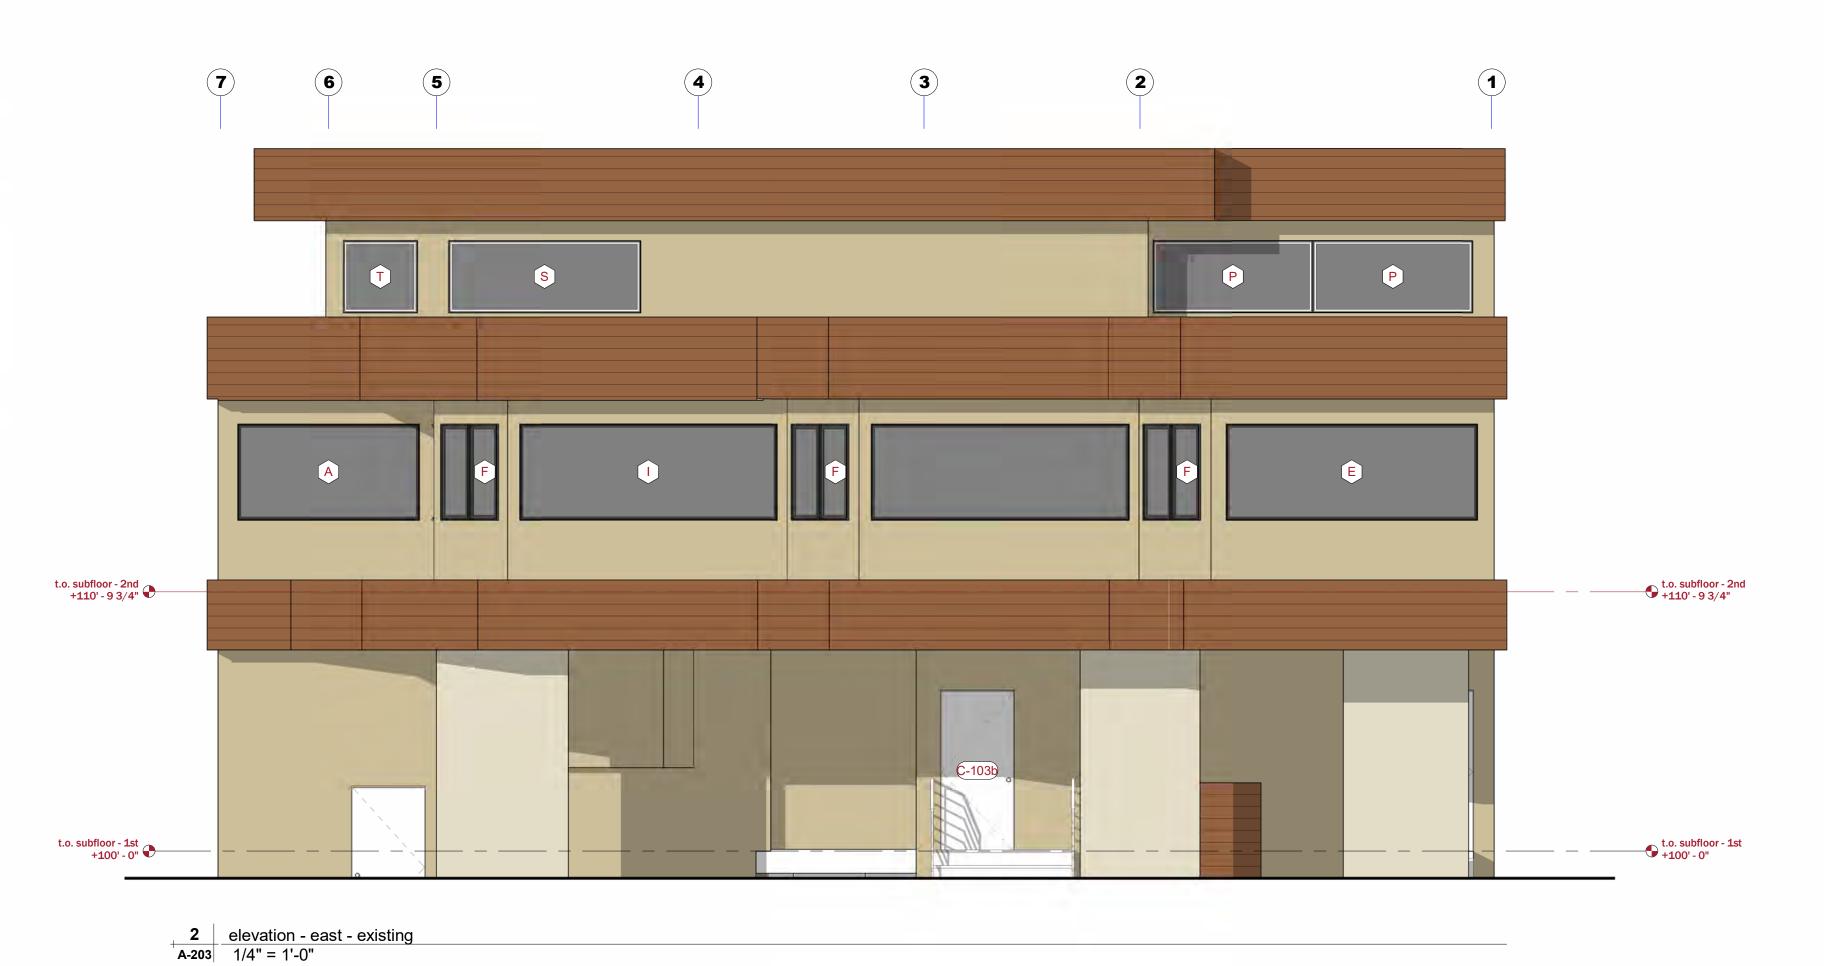

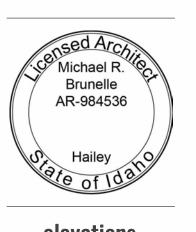

120 N East Ave Ketchum, Idaho 83340

Permit Set:

**Construction Set:** 

02/06/2025


12/5/24


2/6/25


xx/xx/xx


elevations

DRAWN BY:

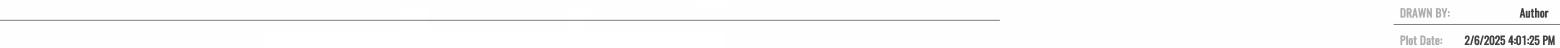

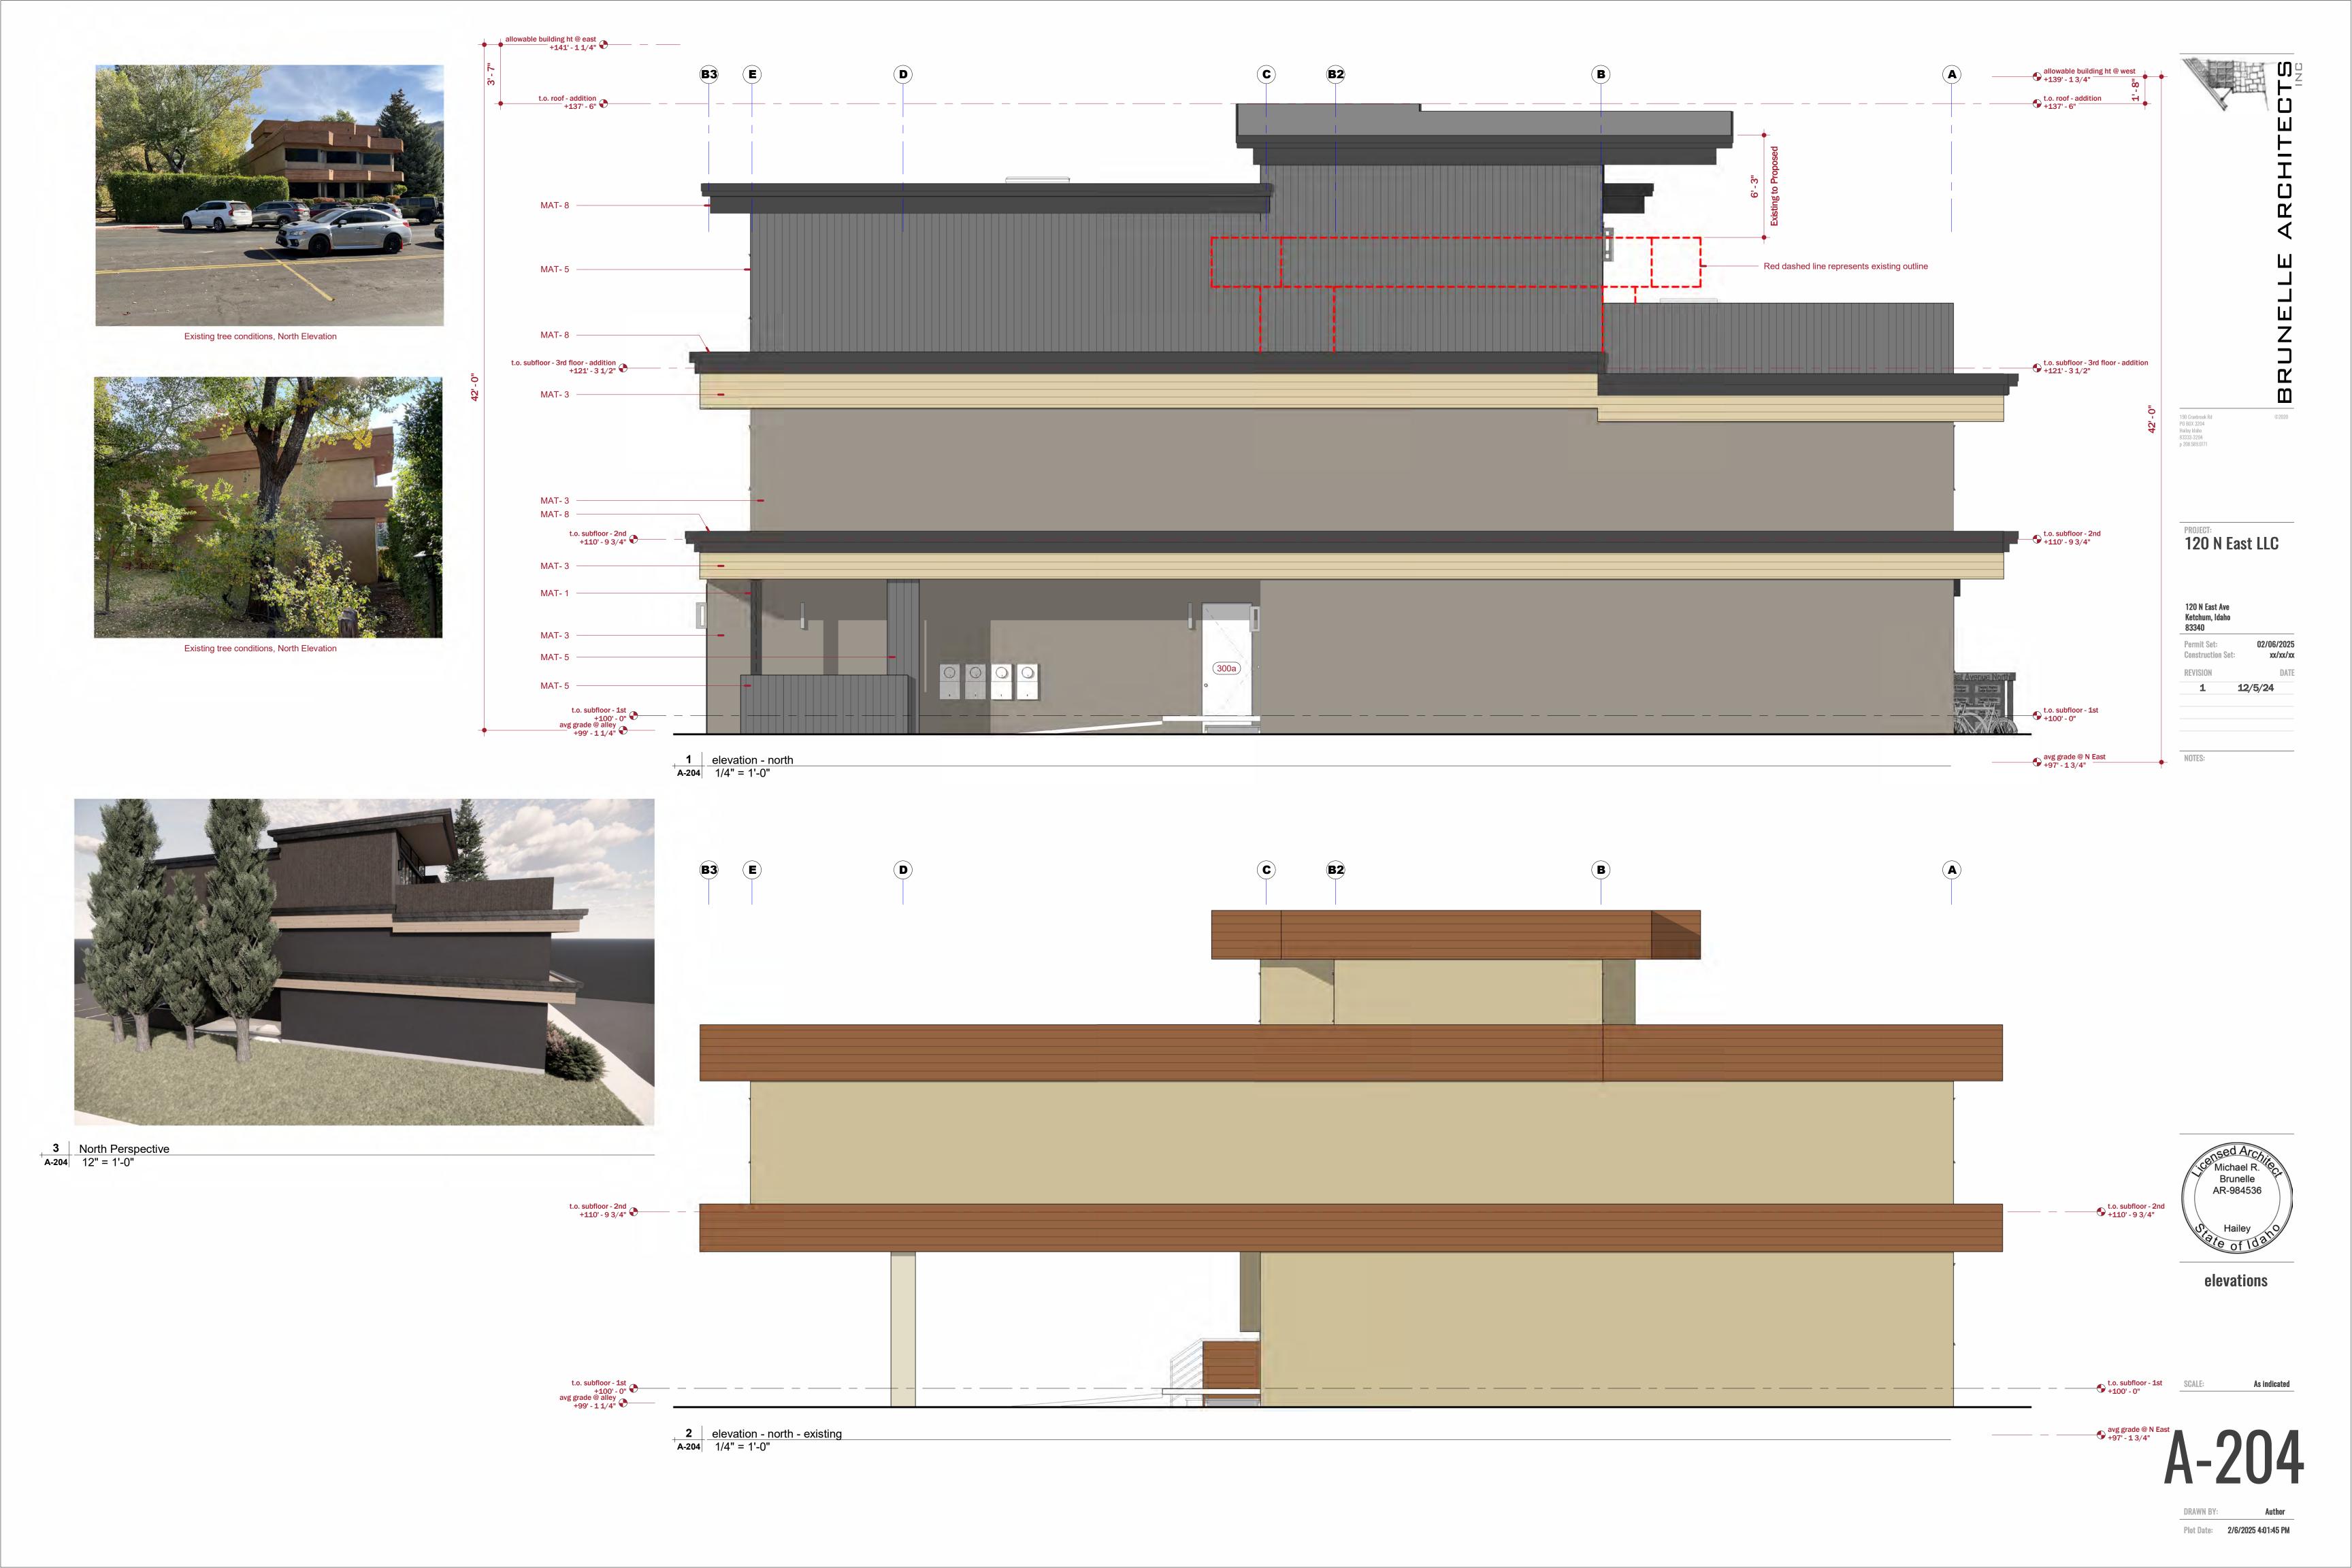

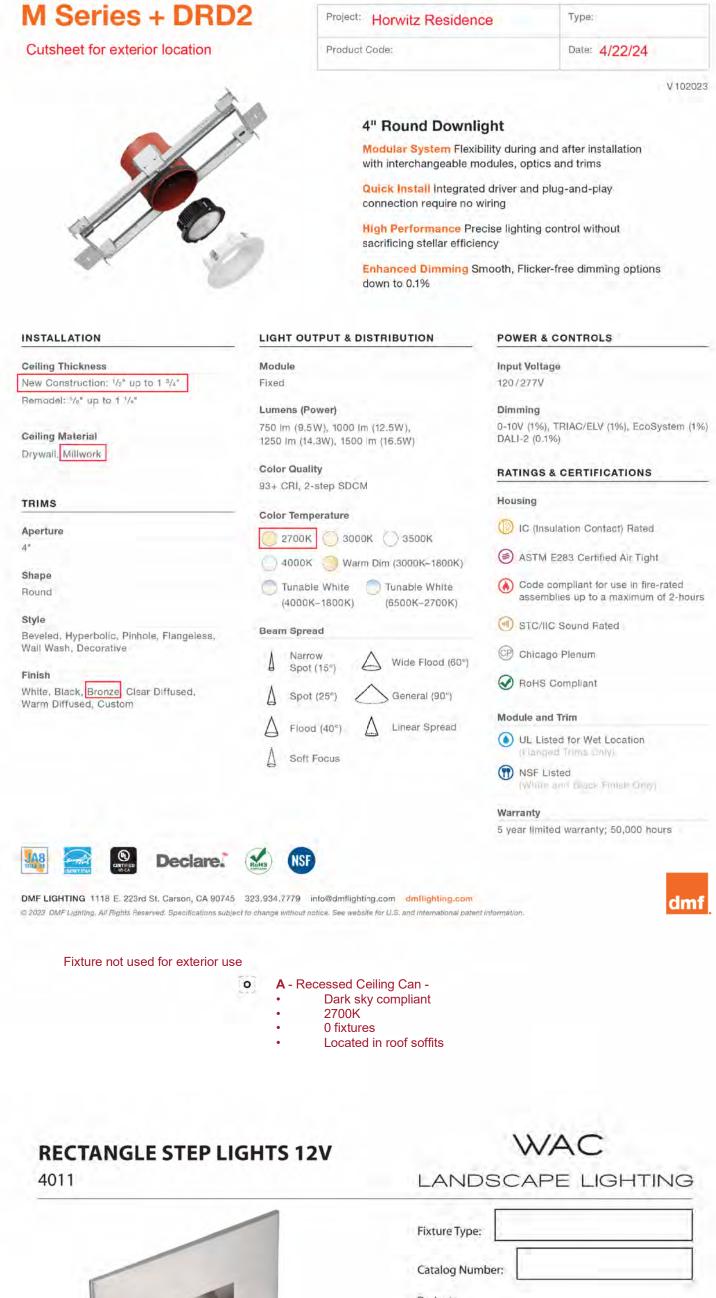

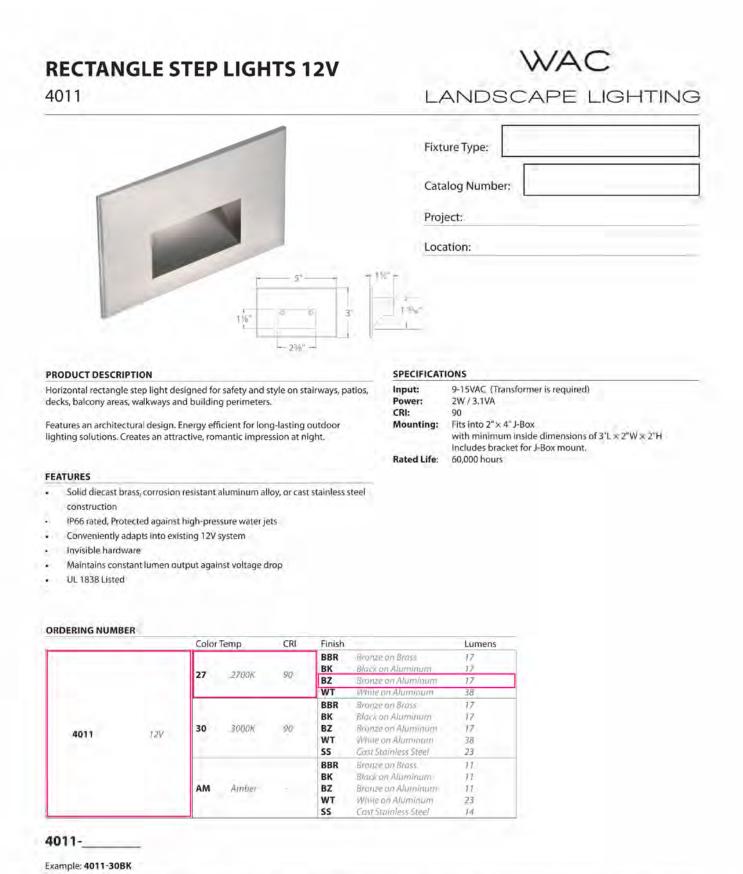

Central Distribution Center

1600 Distribution Ct

Patio/Entry walls, 12" above pavers
Upper patio cabinets, 40" above pavers

WAC Lighting retains the right to modify the design of our products at any time as part of the company's continuous improvement program. JUL 2016

Dark sky compliant CRI 2700K 16 fixtures

**B** - Step Louvre -

Lithia Springs, GA 30122

Western Distribution Center

1750 Archibald Avenue

Ontario, CA 91760

Headquarters/Eastern Distribution Center


44 Harbor Park Drive

Port Washington, NY 11050

waclighting.com

Phone (800) 526.2588

Fax (800) 526.2585

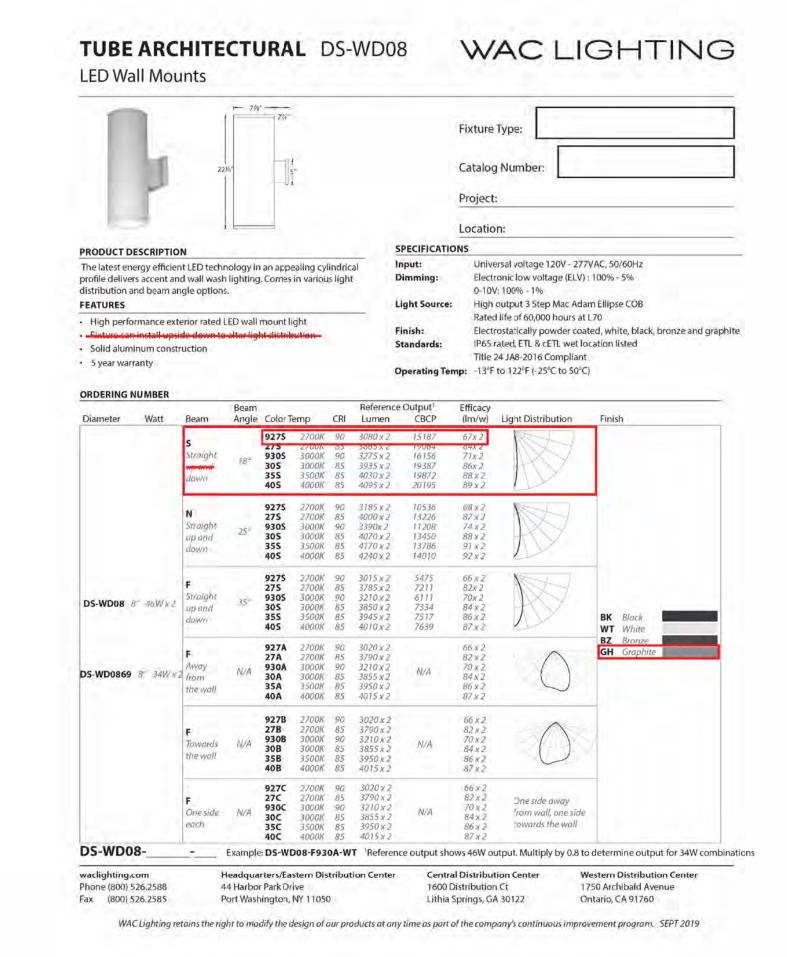


C - Wall sconce Dark sky compliant
CRI 2700K
Situres
Garage/Entry - 8ft high
Upper Level Patio - 8ft high




\*Low end of this range is determined by output current which may not directly translate to the perceived light output

WAC Lighting fixtures are compatible with a variety of dimmers. For your convenience we have included a compatibility chart showing dimmers which have been tested with our products. The recommended list below is based upon testing conducted in a lab, and the results can vary in certain field applications due to a number of factors. Exclusion from the list does not imply incompatibility, just that it has not been tested by WAC Lighting. Please reference the dimmer manufacturer's instructions for installation, or contact a WAC lighting professional at 800-526-2588.

Corridors / Hally	ways	Stairs - Wall Mount	S	Stairs - Step Mount	
					Ď
				1	
36"	□ 36* □	12" 8		1	
12"- 18"		1	i i	Nount in center of stair as apper tread as possible. Fo one light per step for steps	r best results use

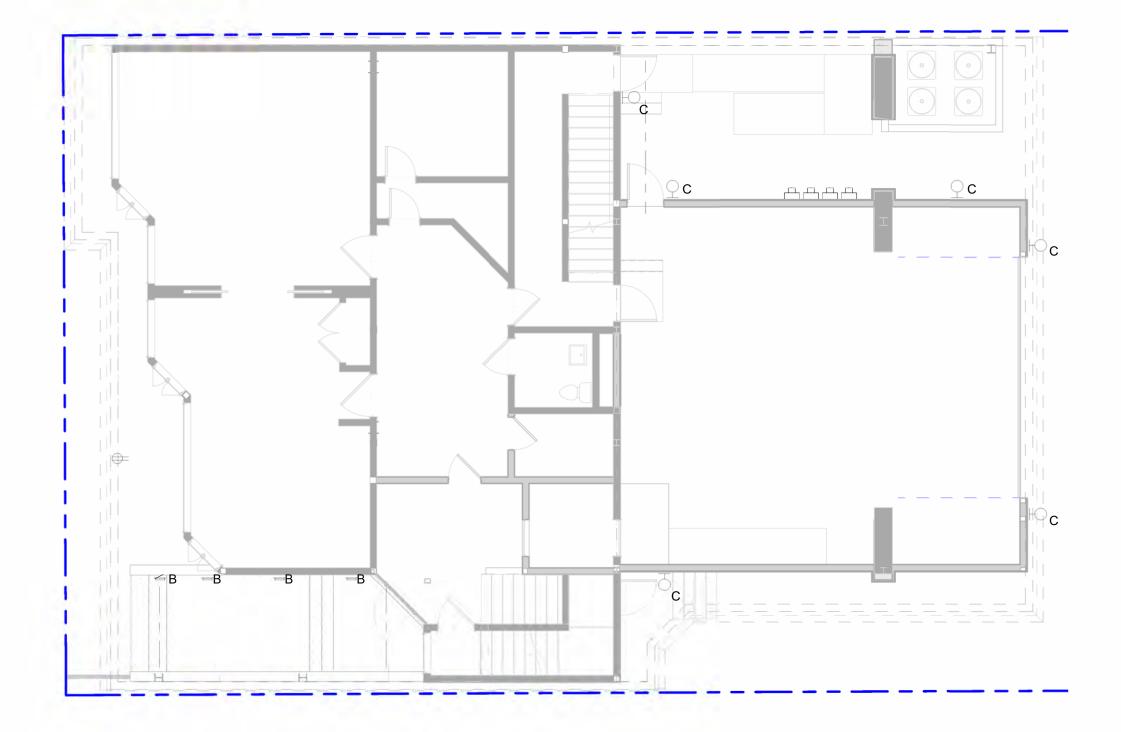

exterior lighting plan - 1st floor
1/8" = 1'-0"

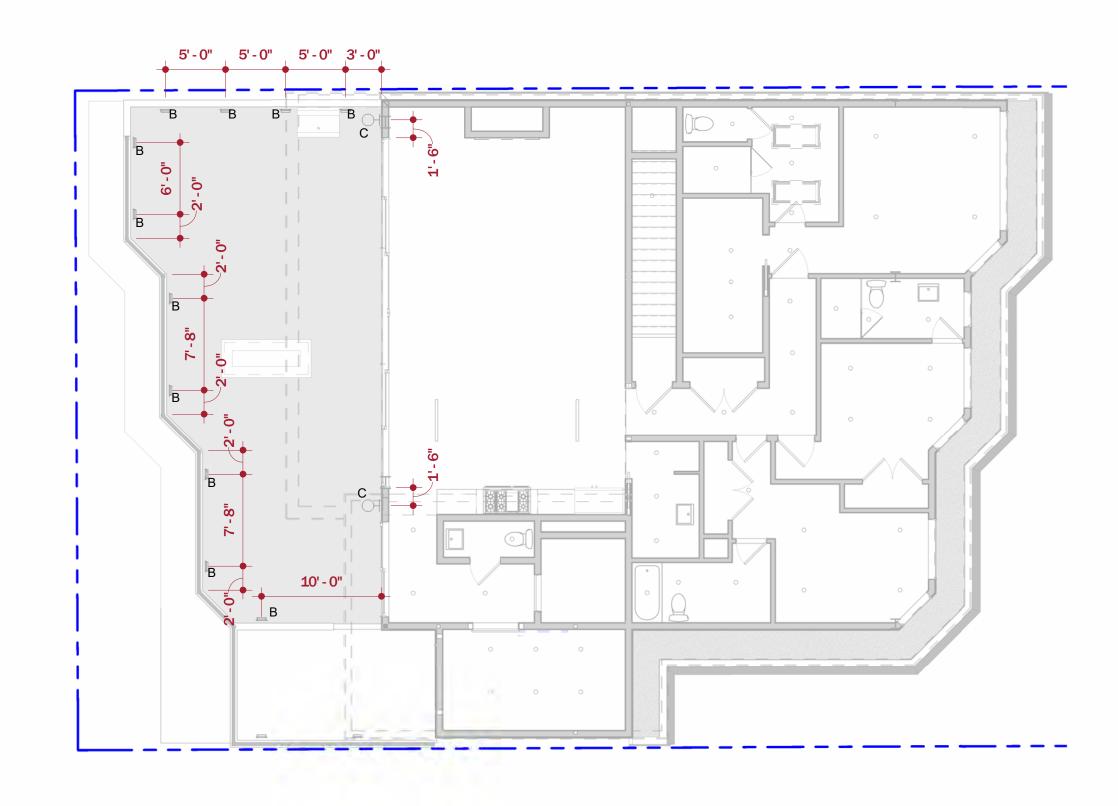

exterior lighting plan - 3rd floor
1/8" = 1'-0"



190 Cranbrook Rd PO 80X 3204 Hailey Idaho 83333-3204 p 208.589.0771

### PROJECT: 120 N East LLC

120 N East Ave

REVISION DATE

NOTES:



SCALE: As indicated

E-100

 DRAWN BY:
 Author

 Plot Date:
 2/6/2025 4:01:50 PM