

City of Ketchum

June 2, 2021

Mayor Bradshaw and City Councilors City of Ketchum Ketchum, Idaho

Mayor Bradshaw and City Councilors:

#### Recommendation To Approve Change Order #5 to Contract 20454

#### Recommendation and Summary

Staff is recommending the council provide authorization to the Mayor to sign Change Order #6 to Contract 20454 with CORE | Headwaters LLC:

"I move to approve Change Order #5 decreasing Contract 20454 from \$9,370,779 to \$9,328,712; a decrease of \$42,067.00 in Contract 20454 with CORE | Headwaters LLC; and authorize the Mayor to sign the Change Order."

The reasons for the recommendation are as follows:

• The City and the project team have made certain project value engineering changes, which will reduce the cost, but not reduce the overall function of the fire station. These include:

- Reducing the heat demand and need for two of the boilers.
- Removed redundant IT room cooling.
- Included wiring for future security systems, but eliminated equipment until needed.
- Added lights and drywall where needed.

#### Introduction and History

The City of Ketchum approved the construction of a fire station on November 5, 2020. Since that time, the project team has worked to bring the project to construction. Change Order #5 was developed by the project team to eliminate some redundancy that was engineering in or had duplicate vendors assigned.

#### <u>Analysis</u>

Change Order #5 will provide for a building with lower cost and the same useability as determined by the project team with input from the Ketchum Fire Department.

#### Sustainability Impact

Re-engineering the heating system will reduce electrical and gas usage. Reducing some electrical duplication will also provide a slight reduction in electrical use.

#### Financial Impact

This change order will be funded from project contingency.

Attachments

• Attachment A: Change Order #5 Contract 20454

Project Description: Fire Station CM/GC

Change Order #:005

Effective Date: June 7 2021

Additional Time Granted:0 days

New Contract End Date: Unchanged

#### **Contract Price Impact**

Original Contract Price: \$9,320,940.00

Total of Prior Change Orders: \$49,839.00

Contract Price Prior to this Change Order: \$9,370,779.00

Increase / (Decrease) of this Change Order: \$ (42,067.00)

Contract Price Incorporating this Change Order: \$ 9,328,712.00

#### Acceptance

Neil Bradshaw, Mayor City of Ketchum

# MAIA® Document G701™ – 2017

#### **Change Order**

<b>PROJECT</b> : <i>(name and address)</i> Ketchum Fire Station #1	<b>CONTRACT INFORMATION:</b> Contract For: Ketchum Fire Station #1	CHANGE ORDER INFORMATION: Change Order Number: 005
107 Saddle Road, Ketchum, ID	Date:	Date: June 2, 2021
OWNER: (name and address)	ARCHITECT: (name and address)	CONTRACTOR: (name and address)
City of Ketchum, Idaho	Cole Architects, PLLC	CORE Headwaters, LLC
480 E. Ave. N., PO Box 2315	1008 W. Main St.	900 Jet Stream Drive
Ketchum, ID 83340	Boise, ID 83702	Rexburg, ID 83440

#### THE CONTRACT IS CHANGED AS FOLLOWS:

(Insert a detailed description of the change and, if applicable, attach or reference specific exhibits. Also include agreed upon adjustments attributable to executed Construction Change Directives.)

See attached spreadsheet of nine items.

The origina	al Contract Su	n was	\$	9,320,940.00
The net cha	ange by previously aut	horized Change Orders	\$	49,839.00
The	Contract Sum	prior to this Change Order was	\$	9,370,779.00
The	Contract Sum	will be decreased by this Change Order in the amount o	f \$	(42,067.00)
The new	Contract Sum	, including this Change Order, will be	\$	9,328,712.00
The Contra	ct Time will be unch	inged by (0) days.		

The new date of Substantial Completion will be

NOTE: This Change Order does not include adjustments to the Contract Sum or Guaranteed Maximum Price, or the Contract Time, that have been authorized by Construction Change Directive until the cost and time have been agreed upon by both the Owner and Contractor, in which case a Change Order is executed to supersede the Construction Change Directive.

NOT VALID UNTIL SIGNED BY THE ARCHITECT, CONTRACTOR AND OWNER.

CORE Headwaters, LLC	City of Ketchum, Idaho
CONTRACTOR (Firm name)	OWNER (Firm name)
lander	
SIGNATURE	SIGNATURE
Chris Schratwieser/Senior PM	
PRINTED NAME AND TITLE	PRINTED NAME AND TITLE
6/02/2021	
DATE	DATE
	CONTRACTOR (Firm name) SIGNATURE Chris Schratwieser/Senior PM PRINTED NAME AND TITLE 6/02/2021

AIA Document G701<sup>™</sup> – 2017. Copyright © 1979, 1987, 2000, 2001 and 2017 by The American Institute of Architects. All rights reserved. WARNING: This AIA<sup>®</sup> Document is protected by U.S. Copyright Law and International Treaties. Unauthorized reproduction or distribution of this AIA<sup>®</sup> Document, or any portion of it, may result in severe civil and criminal penalties, and will be prosecuted to the maximum extent possible under the law. This document was created on 06/02/2021 18:39:09 under the terms of AIA Documents-on-Demand<sup>™</sup> Order No. 2010723434, and is not for resale. This document is licensed by The American Institute of Architects for one-time use only, and may not be reproduced prior to its completion.

1	ASI-09 Delete CCTV & Security Equipment	\$ (18,845.00)
2	RFI-144 Reduced the Number of Boilers and Associated Piping & Electrical	\$ (22,375.00)
3	RFI-160 Remove Fan Redundancy at both IT Rooms	\$ (13,560.00)
4	RFI-180 Install Hard Lid Ceilings at App Bay Alcoves	\$ 969.00
5	ASI-07 & RFI-167 Revised Casework & Lockers	\$ 8,793.00
6	ASI-08 and RFI-186R Added & Revised Restroom Accessories & Details	\$ 1,884.00
7	Northwood Heated Walkway	\$ 3,200.00
	Northwood Heated Walkway (Contractor's Contingency)	\$ (3,200.00)
8	RFI-163R Added Wall Packs at Doors 102B & 106C	\$ 2,936.00
9	ASI-12 Delete Alerting System Cabling and Conductors	\$ (1,869.00)
	Total:	\$ (42,067.00)



Building. Growing. Leading. ...Since 1937.

### Budget Evolution Item Summary City of Ketchum Fire Station #1

Change from CFCI to OFOI CCTV & PA system Equipment

Date:

5/5/2021

Description: CCTV & PA Equipment to be furnished and installed by Owner

SCOPE	SUBCONTRACTOR	AMC	UNT
CCTV & PA Equipment to be OFOI	Magic Valley Electric	\$	(17,688.00
		\$	-
SUBTOTAL:		\$	(17,688.00
SUBTOTAL reflects direct costs only on t	he presumption that costs will co		( )
allowances. If costs are reimbursed by (			s the
, SUBTOTAL with add of agreed upon mai	-		
		_	0
Bond and Insurance	CORE	\$	(370.00
CMAR FEE	CORE	\$	(787.00
Sales Tax	CORE	\$	-
TOTAL AMOUNT:		\$	(18,845.00

ELECTE 395 Railway St. Jerome,	The Powe	r To Do	o It Right	1 39 Je	: Valley Ele 5 Railway erome, Id 8 ice: 208.94	33338
SU	BCONTRACTOR CH	IANGE	E ORDE	R REQU	EST	
					Date:	4/23/2021
SUBCONTRACTOR:	Magic Valley Electric		PRO	JECT NAME:	Ketchum Fire	e station
		_				
	Jimmy Gyorfy	_			_	
ADDRESS:	395 Railway Street	_	PROJEC	T ADDRESS:		
1	Jerome, ID 83338	_			Ketchum, ID	
PHONE:	208-944-4931	TH	IIS IS IN RES	SPONSE TO:		hris S.
				Bulletin #:		
	Core Construction	_		ASI #:		
	Chris Schratwieser	VE	ERBAL REQU	JEST FROM:		
ADDRESS:	777 North 4th Street	_				
	Boise, ID 83702		SUBCONTRA	ACTOR CO#:	#7	
PHONE:	702-794-0550					
	Deduction change and a of DA	<u></u>	automont or			
DESCRIPTION:	Deduction change order of PA	system E	quipment ar	Id CCTV Syst	em Equipme	ent
LOCATION:						
DRAWINGS:						
DIAMINOS.	Trade Description	Hours	Labor Amt.			Total Cost
LABOR:	Journeyman					0.00
	Apprentice					0.00
						0.00
						0.00
						0.00
	Description	QTY	Unit Price	Sub-Total	Taxes	Total Cost
MATERIAL:	CCTV Camera Equipment	1	9,611.43	9,611.43	0.00	9,611.43
	PA System Equipment	1	8,077.05	8,077.05	0.00	8,077.05
			-,	0.00	0.00	0.00
				0.00	0.00	0.00
				0.00	0.00	0.00
	Description	QTY	Unit Price	Sub-Total	Taxes	Total Cost
EQUIPMENT:				0.00	0.00	0.00
				0.00	0.00	0.00
				0.00	0.00	0.00
				0.00	0.00	0.00
				0.00	0.00	0.00
				0.00	0.00	0.00
SUBTOTAL:						17,688.48
GRAND TOTAL:				Total Amour	nt	\$17,688.48
NOTES:						
	Authorized Signature		Date			



Building. Growing. Leading. ...Since 1937.

### Budget Evolution Item Summary City of Ketchum Fire Station #1

Wetside Mechanical Downsize RFI-144

Date:

4/1/2021

Description: Reduce the Nur	mber of Boilers and assocaited	piping & ele	ctrical
SCOPE	SUBCONTRACTOR	AMC	UNT
delete boilers and reduce piping size	Evans	\$	(20,545.00)
Reduce electrical with Boiler reduction	Magic Valley Electric	\$	(456.00)
SUBTOTAL:		\$	(21,001.00)
SUBTOTAL reflects direct costs only on the	presumption that costs will co	me from	
allowances. If costs are reimbursed by Cha	ange Order, TOTAL AMOUNT b	elow reflects	s the
SUBTOTAL with add of agreed upon marku	ip in accordance with the chang	ge order prio	ing.
Bond and Insurance	CORE	\$	(439.00)
CMAR FEE	CORE	\$	(935.00)
Sales Tax	CORE	\$	-
TOTAL AMOUNT:		\$	(22,375.00)

## **Change Request Proposal**

Project: (name and address)	203600 / CoK FS No. 1 107 Saddle Road Ketchum, ID 83340	Change request number: Description:	14 RFI 144 Wetside Mechanical Downsizing
Customer:	CORE   Headwaters, LLC		
Notice to Proc	eed	Status:	Proposed
Submitted date: Received date: Rough order of m	agnitude: 0.00	Origination date:	03/08/21
Quotation			
Submitted date: Due date:	03/10/21		
Submitted amoun	t: -20,545.29		
Requested days of	delay: 0		
Notes			
Per RFI 144, rec	luce the number of wetside mechanical boilers from 8	to 6, and reduce the main pipe size from	4" to 2".
Revenue Detai	1		
Billing Iter	n Description		Revenue
	original mech equip credit		-102,751.77
	revised mech equip cost original boiler piping credit		86,826.33 -6,144.27
	revised boiler piping credit		2,244.42
	labor credit -9hrs		-720.00
		Total Revenue For CR	14 -20,545.29
		Approvals	
Customer: COR Authorized Repre	E   Headwaters, LLC sentative:	Contractor: Evans Plumbin	g, Inc.
Ву:		Ву:	
Date:		Date:	

- F	Lochinvar	MARLEY 7	Bell & Gossett	Metraflex	
GRITI	TON & ASSO	CIATES, INC.	Quota	tion No. 2	2021-2-4-15:19
		EW AVENUE D 83704	BID DATE:	2/11/2021	
	· · · · ·	02-5887		2/11/2021	
			TERMS:	NET 30 DA	AYS
	Main	of Mech equi	ment F.O.B	Factory Fre	eight Allowed
TO:	0	V.	JOB:	Ketchum F	ire Station
ATTN:			ENGINEER:	None Sele	cted
			SALESMAN:	Brandon K	arren

We are pleased to quote you on the following equipment for the above job subject to approval. Quantities listed are not guaranteed and should be verified. Prices will be adjusted accordingly. This quotation is subject to change without notice and void after 30 days unless otherwise stated below. All Contracts or Orders are subject to acceptance by the Company and are contingent upon non-occurrence of strikes or other delays beyond their control. In addition to prices named herein, you are to pay any applicable sales taxes.

For complete terms and conditions of sales visit www.gritton.com/termsofsale or send written request for complete terms and conditions.

Qty	Description & Tag	Net Price Ea.	Total Net Price
8	Tag: B-1~8 Lochinvar Knight Wall Mount Boiler WHB-399N modulating 5:1 gas fired 399 MBH Input, factory-tested, 439 stainless steel fire- tube condensing boiler. AHRI 94.4% Eff., 80 psi, ASME H, 30# PRV. Factory installed SMART SYSTEM <sup>™</sup> control, Multi- Colored Graphic LCD display with Navigation Dial and Soft Keys for, password security, three loop temperature setpoints with outdoor air reset curves, pump delay with freeze protection, pump exercise, DHW prioritization and USB PC port connection. Includes cascade control of up to eight boilers with sequencing options for "lead lag" or "efficiency optimized" modulation logic, with both capable of rotation. Ship wt. 213# Supply voltage shall be 120 volt / 60 hertz / 1 ph. 5K SCCR rating. Water: 1-1/2" Inlet/Outlet, Gas Inlet 3/4" Req. 4-14" w.c. for NG, Req. 8-14"	\$7,116.00	\$56,928.00
	<ul> <li>w.c. for LP Direct Vent CAT IV Venting, maximum 100 ft. TEL with 4" Air, 4" Vent.</li> <li>Includes shipped loose with each boiler for field installation/wiring by contractor: - Lochinvar Boiler Pump 120/60/1, Outdoor temp sensor, T&amp;P gauge, air vent,</li> </ul>		

	Condensate trap asesmbly and misc. boiler connection fittings. Quoted per scheduled conditions. Note: Venting & combustion air intake by others.		
8	Tag: B-1~8 1813C29K 2PSI Gas Regulator, 1" NPT, 9/16" orifice, yellow spring, 5.5-8.5" WC, good up to 500 MBH	\$125.00	\$1,000.00
8	Tag: B-1~8 Low Water Cut-Off w/ Manual Reset	\$96.00	\$768.00
1	Start-up by factory authorized Gritton technician. Contractor shall be responsible for, and must confirm, pre start-up preparation. Gritton is not responsible for external controls or incoming utilities. Site utilities must be purged, tested & connected to system prior to start-up visit. Installing contractor must be present and system load available to properly fire boiler(s). Pre-start-up forms must be returned to Gritton. Site conditions outside of our control which require a second trip or additional day of start-up service will be billed at \$180.00 per hour. Start-up requires combustion/CO2 testing, adjust and documentation by qualified technician as per Boiler IOM. Install & Maintenance responsibility is by others. Warranty requires written record of start-up testing and regular maintenance as outlined within IOM. Start-Up may be performed by qualified contractor or is available as stated above. Boiler Notes & Exclusions: Local air quality regulations may require source testing of certain gas fired appliances in order to obtain an operating permit and assure compliance with local emission regulations. The owners or their representative are responsible for meeting all codes and regulations regarding the installation and operation of this equipment. Gritton is not providing source testing with this quotation. Excludes all combustion air piping, flue venting, fuel piping, control and sensor mounting, wiring or connection unless stated otherwise. Price does not include any seismic calculations or supports, coatings other than factory standard or Low NOx requirements unless stated otherwise. Gas train sized for 1/2 psi unless stated otherwise. Burner voltage and site gas pressure to be confirmed at time of order. An approved submittal is required prior to order release. Exposed piping may require field insulation installed to comply with local safety codes. Insulation cannot be factory installed.	\$2,050.00	\$2,050.00
8	Tag: B-1~8 Condensate Neutralization Kits	\$132.00	\$1,056.00
8	Tag: B-1~8 4" Sidewall Vent Kit 100157611	\$95.00	\$760.00

14	Thermometers 9" Adj Alum 30-240	\$35.34	\$494.76
8	B&G CB-1-1/2S, Circuit Setter, Lead-Free brass body with 1-1/2" SWT ends	\$118.00	\$944.00
2	B&G CB-4 Circuit Setter, 4" 125# cast iron valve, Flanged	\$1,560.00	\$3,120.00
2	Tag: HWP-1,2 B&G In-Line Pump Series e-90, Model 2 AAC, BF, 3 HP, 3600 RPM, with 4.25" Impeller, E.P.R. SiC-SiC Seal, U.S. Motors, TEFC, Premium Efficient, 208-230/460/3/60 Motor, 120 GPM, 55 FT TDH	\$1,272.00	\$2,544.00
2	Tag: SMP-1,2 B&G In-Line Pump Series e-90, Model 2 AAC, BF, 3 HP, 3600 RPM, with 4.375" Impeller, E.P.R. SiC-SiC Seal, U.S. Motors, TEFC, Premium Efficient, 208-230/460/3/60 Motor, 150 GPM, 55 FT TDH	\$1,272.00	\$2,544.00
4	Tag: VFD-1-4 ABB VFD 3 HP 208/3	\$1,432.00	\$5,728.00
4	Metraflex model CVOSS904 4" globe style check valve 125#	\$775.00	\$3,100.00
8	Metraflex model BSN0150 1-1/2" Bronze Check Valve	\$85.00	\$680.00
8	Metraflex Double sphere DSEE0400, EPDM body, 4" 150# flanged, less tie rods.	\$175.00	\$1,400.00
10	Metraflex BL03EDINC04, 4" cast iron lug pattern butterfly valve, bronze disc, stainless steel stem, 10 position lever operator	\$130.00	\$1,300.00
4	Metraflex BL03EDINC03, 3" cast iron lug pattern butterfly valve, bronze disc, stainless steel stem, 10 position lever operator	\$98.00	\$392.00
2	Tag: SRS-1,2 B&G SRS-4F Sediment Removal Separator 4 IN. Flange	\$1,530.00	\$3,060.00
	Tag: ET-1,2		

2	Wessels NTA-120 Expansion Tank 70 Gallon	\$1,229.00	\$2,458.00
4	B&G #107A High Capacity Air Vent Cast Iron	\$110.86	\$443.44
2	Tag: CPF-1,2 GTP FB5 Chemical Feeder 5 Gallon	\$400.21	\$800.43
1	Tag: GT-1 GTP GP100-DE4-1 100GL, 1/3 HP 1.3GPM Industrial glycol feed package (30" x 30" x 65") Dual pump system with controls and manifolds	\$5,365.00	\$5,365.00
	Total		\$96,935.63

Note: As no specifications were provided for the following material, we reserve the right to requote once written documentation is provided to us.  $\frac{16\%}{5,816.14}$  $\frac{102,751.77}{7}$ 

Lochinyar	MARLEY 7	Bell & Gossett	Metra lex Lakos
ON & ASSC	CIATES, INC.	Quot	ation No. 2021-2-4-15:19
		<b>BID DATE</b>	: 2/24/2021
(208) 20	)2-5887	DATE	: 2/24/2021 3:29:12 PM
		TERMS	: NET 30 DAYS
•	A malea	F.O.E	8 Factory Freight Allowed
revise	e mech. cqu	JOB	: Ketchum Fire Station
			: None Selected : Brandon Karren
	ON & ASSC 9476 FAIRVI BOISE, I (208) 20	ON & ASSOCIATES, INC. 9476 FAIRVIEW AVENUE BOISE, ID 83704 (208) 202-5887	ON & ASSOCIATES, INC. Quot 9476 FAIRVIEW AVENUE BID DATE BOISE, ID 83704 (208) 202-5887 DATE TERMS F.O.E F.O.E F.O.E JOB ENGINEER

We are pleased to quote you on the following equipment for the above job subject to approval. Quantities listed are not guaranteed and should be verified. Prices will be adjusted accordingly. This quotation is subject to change without notice and void after 30 days unless otherwise stated below. All Contracts or Orders are subject to acceptance by the Company and are contingent upon non-occurrence of strikes or other delays beyond their control. In addition to prices named herein, you are to pay any applicable sales taxes.

For complete terms and conditions of sales visit www.gritton.com/termsofsale or send written request for complete terms and conditions.

Qty	Description & Tag	Net Price Ea.	Total Net Price
6	Tag: B-1~8 Lochinvar Knight Wall Mount Boiler WHB-399N modulating 5:1 gas fired 399 MBH Input, factory-tested, 439 stainless steel fire- tube condensing boiler. AHRI 94.4% Eff., 80 psi, ASME H, 30# PRV. Factory installed SMART SYSTEM™" control, Multi- Colored Graphic LCD display with Navigation Dial and Soft Keys for, password security, three loop temperature setpoints with outdoor air reset curves, pump delay with freeze protection, pump exercise, DHW prioritization and USB PC port connection. Includes cascade control of up to eight boilers with sequencing options for "lead lag" or "efficiency optimized" modulation logic, with both capable of rotation. Ship wt. 213# Supply voltage shall be 120 volt / 60 hertz / 1 ph. 5K SCCR rating. Water: 1-1/2" Inlet/Outlet, Gas Inlet 3/4" Req. 4-14" w.c. for NG, Req. 8-14" w.c. for LP Direct Vent CAT IV Venting, maximum 100 ft. TEL with 4" Air, 4" Vent. Includes shipped loose with each boiler for field installation/wiring by contractor: - Lochinvar Boiler Pump 120/60/1, Outdoor temp sensor, T&P gauge, air vent,	\$7,116.00	\$42,696.00

	Condensate trap asesmbly and misc. boiler connection fittings. Quoted per scheduled conditions. Note: Venting & combustion air intake by others.		
6	Tag: B-1~8 1813C29K 2PSI Gas Regulator, 1" NPT, 9/16" orifice, yellow spring, 5.5-8.5" WC, good up to 500 MBH	\$125.00	\$750.00
6	Tag: B-1~8 Low Water Cut-Off w/ Manual Reset	\$96.00	\$576.00
1	Start-up by factory authorized Gritton technician. Contractor shall be responsible for, and must confirm, pre start-up preparation. Gritton is not responsible for external controls or incoming utilities. Site utilities must be purged, tested & connected to system prior to start-up visit. Installing contractor must be present and system load available to properly fire boiler(s). Pre-start-up forms must be returned to Gritton. Site conditions outside of our control which require a second trip or additional day of start-up service will be billed at \$180.00 per hour. Start-up requires combustion/CO2 testing, adjust and documentation by qualified technician as per Boiler 10M. Install & Maintenance responsibility is by others. Warranty requires written record of start-up testing and regular maintenance as outlined within 10M. Start-Up may be performed by qualified contractor or is available as stated above. Boiler Notes & Exclusions: Local air quality regulations may require source testing of certain gas fired appliances in order to obtain an operating permit and assure compliance with local emission regulations. The owners or their representative are responsible for meeting all codes and regulations regarding the installation and operation of this equipment. Gritton is not providing source testing with this quotation. Excludes all combustion air piping, flue venting, fuel piping, control and sensor mounting, wiring or connection unless stated otherwise. Price does not include any seismic calculations or supports, coatings other than factory standard or Low NOx requirements unless stated otherwise. Gas train sized for 1/2 psi unless stated otherwise. Exposed piping may require field insulation installed to comply with local safety codes. Insulation cannot be factory installed.	\$2,050.00	\$2,050.00
6	Tag: B-1~8 Condensate Neutralization Kits	\$132.00	\$792.00
6	Tag: B-1~8 4" Sidewall Vent Kit 100157611	\$95.00	\$570.00

14	Thermometers 9" Adj Alum 30-240	\$35.34	\$494.76
6	B&G CB-1-1/2S, Circuit Setter, Lead-Free brass body with 1-1/2" SWT ends	\$118.00	\$708.00
1	B&G CB-4 Circuit Setter, 4" 125# cast iron valve, Flanged	\$1,560.00	\$1,560.00
1	B&G CB-2S Circuit Setter, Lead-Free brass body with 2" SWT ends	\$150.00	\$150.00
2	Tag: HWP-1,2 B&G In-Line Pump Series e-90, Model 1.25 AAB, BF, 2 HP, 3600 RPM, with 4" Impeller, Standard Seal, , U.S. Motors, TEFC, Premium Efficient, 208-230/460/3/60 Motor, 30 gpm, 55 ft	\$1,110.00	\$2,220.00
2 .	Tag: SMP-1,2 B&G In-Line Pump Series e-90, Model 2 AAC, BF, 3 HP, 3600 RPM, with 4.375" Impeller, E.P.R. SiC-SiC Seal, U.S. Motors, TEFC, Premium Efficient, 208-230/460/3/60 Motor, 150 GPM, 55 FT TDH	\$1,272.00	\$2,544.00
2	Tag: VFD-1-2 ABB VFD 2 HP 208/3	\$1,432.00	\$2,864.00
2	Tag: VFD-3-4 ABB VFD 3 HP 208/3	\$1,432.00	\$2,864.00
2	Metraflex model CVOSS904 4" globe style check valve 125#	\$775.00	\$1,550.00
2	Metraflex model BSN0200 2" Bronze Check Valve	\$147.00	\$294.00
6	Metraflex model BSN0150 1-1/2" Bronze Check Valve	\$85.00	\$510.00
4	Metraflex Double sphere DSEE0400, EPDM body, 4" 150# flanged, less tie rods.	\$175.00	\$700.00
4	Metraflex Double sphere DSEE0200, EPDM body, 2" 150# flanged, less tie rods.	\$110.00	\$440.00
5	Metraflex BL03EDINC04, 4" cast iron lug pattern butterfly	\$130.00	\$650.00

	valve, bronze disc, stainless steel stem, 10 position lever operator		
4	Metraflex BL03EDINC03, 3" cast iron lug pattern butterfly valve, bronze disc, stainless steel stem, 10 position lever operator	\$98.00	\$392.00
1	Tag: SRS-2 B&G SRS-4F Sediment Removal Separator 4 IN. Flange	\$1,530.00	\$1,530.00
1	Tag: SRS-1 B&G EAS-2 Enhanced Air Separator 2 IN. NPT	\$575.00	\$575.00
2	Tag: ET-1,2 Wessels NTA-120 Expansion Tank 70 Gallon	\$1,229.00	\$2,458.00
4.	B&G #107A High Capacity Air Vent Cast Iron	\$110.86	\$443.44
2	Tag: CPF-1,2 GTP FB5 Chemical Feeder 5 Gallon	\$400.21	\$800.43
2	Tag: GT-1 GTP GP100-DE4-1 100GL, 1/3 HP 1.3GPM Industrial glycol feed package (30" x 30" x 65") Dual pump system with controls and manifolds	\$5,365.00	\$10,730.00
	Total		\$81,911.63

Note: As no specifications were provided for the following material, we reserve the right to requote once written documentation is provided to us.

+ 6% tox \$4,914.70 \$86,826.33

#FERGU	SON <sup>®</sup> WOLSELEY INDUSTRIAL GROUP	FEL #3057 2150 ELDRIDGE AVE TWIN FALLS, ID 83301-0000	From	ver To: 5122 n: Jess nments:	9 Sy Lawre	ence	
		Phone: 208-733-3770 Fax: 208-736-7248					
12:52:23 MA	R 08 2021	Phone: 208	ERPRISES #3007 uotation 3-733-3770 736-7248	aigi	na)	beiler	Page 1 of 2
Bid No: Bid Date: Quoted By:	B562336 03/08/21 ST		Cust Phone: Terms:	208-726-5 NET 10TH		x	
Customer:	EVANS PLUMBING KETCHUM FIRE STATIO COMMERICAL JOB AC 111 GULF STREAM LAI HAILEY, ID 83333	COUNT	Ship To:	EVANS PL KETCHUM COMMER 111 GULF HAILEY, II	I FIRE ICAL J( STRE/	STATION OB ACCOUNT AM LANE	
Cust PO#:	COPPER ADDS	а. 8	Job Name:	KETCHUM	I FIRE	STATION	
ltem	Description		Quantity	Net Price	UM	Total	
СТММЈ	3X3X1-1/2 WR0	DT CXCXC TEE	8	45,630	EA	365.04	
CCAPM	FROM OUR DIS 3 WROT COP C FROM OUR DIS	CAP 3-1/8 OD	2	21.370	EA	42,74	
C9M	3 WROT CXC 9		6	30.130	EA	180.78	
FNWX411CM		2PC SWT FP BV	2	157.998	EA	316.00	
CTMMF	3X3X3/4 WROT	UR DISTRO CENTER CXCXC TEE DISTRO CENTER	4	45.630	EA	182.52	
FNW421P	LIMITED STOC	S 600# WOG SWT 2PC FP K @ OUR DISTRO CNTR	2	329.425	EA	658.85	
CTPPM C9P	4X4X3 WROT C AVAIL @ OUR   4 WROT CXC 9	DISTRO CENTER	2	90.300 66.000	EA EA	180.60 264.00	
		DISTRO CENTER	80	2452 220		1062.59	

Net Total: Tax: Freight: Total:

2453.220 C

4108.440 C

80

40

\$5796.49 \$347.78 \$0.00 \$6144.27

1962.58

1643.38



3 X 20 L HARD COP TUBE

FROM OUR PIPE DISTRO

4 X 20 L HARD COP TUBE

FROM OUR PIPE DISTRO

LHARDM20

LHARDP20

HOW ARE WE DOING? WE WANT YOUR FEEDBACK! Scan the QR code or use the link below to complete a survey about your bids:

https://survey.medallia.com/?bidsorder&fc=3149&on=1234752

# FERGU	SON WOLSELEY	FERGUSON ENTERPRISES #3680 318 6TH STREET N NAMPA, ID 83687-3009 Phone: 208-466-8907 Fax: 208-466-8900	From	rer To: 51229 n: Tre Kohler ments:
14:02:04 MA	R 08 2021	FERGUSON ENTER Price Quot Phone: 208-4 Fax: 208-46	ation 66-8907	revised beiler piping Page 1 of 1
Bid No: Bid Date: Quoted By:	B562943 03/08/21 TCK		Cust Phone: Terms:	208-726-5261 NET 10TH PROX
Customer:	EVANS PLUMBING KETCHUM FIRE STATIC COMMERICAL JOB ACC 111 GULF STREAM LAN HAILEY, ID 83333	COUNT	Ship To:	EVANS PLUMBING KETCHUM FIRE STATION COMMERICAL JOB ACCOUNT 111 GULF STREAM LANE HAILEY, ID 83333
Cust PO#:	KETCHUM FIRE STATIC	DN .	Job Name:	KETCHUM FIRE STATION
ltem	Description		Quantity	Net Price UM Total

Item	Description	Quantity	Net Price	UM	Total
СТККЈ	2X2X1-1/2 WROT CXCXC TEE	8	28,782	EA	230.26
CCAPK	2 WROT COP CAP 2-1/8 OD	2	10.262	EA	20.52
C9K	2 WROT CXC 90 ELL 2-1/8 OD	6	20.934	EA	125.60
FNWX411CK	LF 2 BRS 600# 2PC SWT FP BV	4	51.118	EA	204.47
СТК	2 WROT CXCXC TEE 2-1/8 OD	2	36.954	EA	73.91
LHARDK20	2 X 20 L HARD COP TUBE BID GOOD FOR 30 DAYS SUBJECT TO PRIOR SALE LEAD TIMES VARY SUBJECT TO FRT CHARGESE	120	1218.840	С	1462.61

Net Total:	\$2117.37
Tax:	\$127.05
Freight:	\$0.00
Total:	\$2244.42

Quoted prices are based upon receipt of the total quantity for immediate shipment (48 hours). SHIPMENTS BEYOND 48 HOURS SHALL BE AT THE PRICE IN EFFECT AT TIME OF SHIPMENT UNLESS NOTED OTHERWISE. QUOTES FOR PRODUCTS SHIPPED FOR RESALE ARE NOT FIRM UNLESS NOTED OTHERWISE.

CONTACT YOUR SALES REPRESENTATIVE IMMEDIATELY FOR ASSISTANCE WITH DBE/MBE/WBE/SMALL BUSINESS REQUIREMENTS.

Seller not responsible for delays, lack of product or increase of pricing due to causes beyond our control, and/or based upon Local, State and Federal laws governing type of products that can be sold or put into commerce. This Quote is offered contingent upon the Buyer's acceptance of Seller's terms and conditions, which are incorporated by reference and found either following this document, or on the web at https://www.ferguson.com/content/website-info/terms-of-sale Govt Buyers: All items are open market unless noted otherwise.

LEAD LAW WARNING: It is illegal to install products that are not "lead free" in accordance with US Federal or other applicable law in potable water systems anticipated for human consumption. Products with \*NP in the description are NOT lead free and can only be installed in non-potable applications. Buyer is solely responsible for product selection.



#### HOW ARE WE DOING? WE WANT YOUR FEEDBACK! Scan the QR code or use the link below to

complete a survey about your bids: https://survey.medallia.com/?bidsorder&fc=3149&on=1234752



#### The Power To Do It Right!

Magic Valley Electric, LLC 395 Railway Street Jerome, Id 83338 Office: 208.944.4931

### SUBCONTRACTOR CHANGE ORDER REQUEST

					Date:	3/25/2021
SUBCONTRACTOR:	Magic Valley Electric	_	PROJ	ECT NAME:	Ketchum Fire	e station
CONTACT:	Jimmy Gyorfy					
ADDRESS:	395 Railway Street	-	PROJECT	ADDRESS:	107 Saddle R	Road
	Jerome, ID 83338	-			Ketchum, ID	
PHONE:	208-944-4931	Th	IS IS IN RES	PONSE TO:	RFI#CC-144F	
		•		Bulletin #:	·	
CONTRACTOR:	Core Construction	ASI #:				
CONTACT:	Chris Schratwieser	VE	ERBAL REQU	IEST FROM:		
ADDRESS:	777 North 4th Street	-				
	Boise, ID 83702	<u> </u>	SUBCONTRA	CTOR CO#:		
PHONE:	702-794-0550	-				
DESCRIPTION:	Remove all electrical connection	is to Bo	ile <u>r #3</u> & #4, (	down size co	onductors to	HWP-1
	and HWP-2 from #10 to #12 wire,			rs 2-3pole 30	amp to 2-3pc	ole 20amp
	Ketchum Fire Station/Mechanica	Il Room				
DRAWINGS:	E4.03 Dated 2/23/21	<u></u>			Π	
	Trade Description	Hours	Labor Amt.			Total Cost
LABOR:	Journeyman	8	70.00		ļ	560.00
	Apprentice	8	60.00		ļ (	480.00
					ļ (	0.00
l						0.00
						0.00
	Description	QTY	Unit Price	Sub-Total	Taxes	Total Cost
MATERIAL:	conduit, boxes, & devices	1	168.37	168.37	10.10	178.47
	Breakers from 30amp to 20amp	2	(375.00)	(750.00)	· · · ·	(795.00)
	changing wire #10 to wire #12	280	0.11	30.80	1.85	32.65
				0.00	0.00	0.00
				0.00	0.00	0.00
	Description	QTY	Unit Price	Sub-Total	Taxes	Total Cost
EQUIPMENT:				0.00	0.00	0.00
				0.00	0.00	0.00
				0.00	0.00	0.00
				0.00	0.00	0.00
				0.00	0.00	0.00
		+		0.00	0.00	0.00
SUBTOTAL: GRAND TOTAL:				Total Amou		456.12
GRAND TOTAL.	CREDIT BACK			Total Amou	nt	\$456.12
NOTES						
NOTES:						
	Authorized Signature		Date			
	Addionzed Olghadare		Dute			





Regional office for CORE NV company 777 N 4th St Bosie, Idaho 83702 Project: 90-20-01-006 - CoK - City of Ketchum Fire Station 107 Saddle Road Ketchum, Idaho 83340

### **Opportunity to Remove Boiler from Mech Rm**

TO:	Alex Goedhart (Cole Architects) Crystal McColly (Cole Architects)	FROM:	JT Brown <b>(CORE Construction - Las Vegas)</b> 777 N Fourth St Boise, Idaho 83702	
DATE INITIATED:	02/17/2021		Doise, Idano 00702	
LOCATION:		STATUS:	Open	
PROJECT STAGE:	Course of Construction	DUE DATE:	02/24/2021	
COST IMPACT:		COST CODE:		
DRAWING NUMBER:	M1.02, M1.05, M7.00	SCHEDULE IMPACT:		
LINKED DRAWINGS:		SPEC SECTION:		
		REFERENCE:		

#### RECEIVED FROM: Vic Hulett (Evans Plumbing Incorporated (EPI))

#### COPIES TO:

Eric Bertovich (City of Ketchum), JT Brown (CORE Construction - Las Vegas), Cary Goldberg (DPPM Project Management), C.J. Gorringe (Thornton Heating & Sheetmetal), Jimmy Gyorfy (Magic Valley Electric), Lex Howard (Magic Valley Electric), Vic Hulett (Evans Plumbing Incorporated (EPI)), Bill McLaughlin (City of Ketchum), Dennis Potts (DPPM Project Management), Chris Schratwieser (CORE Construction - Las Vegas), Matt Sylvester (CORE Construction - Las Vegas), Brett Traylor (Evans Plumbing Incorporated (EPI))

#### Question from JT Brown (CORE Construction - Las Vegas) at 07:05 AM on 02/17/2021

In the Apparatus Bay the Supply Fan SF-1 was changed to a Penthouse Fan PH-1 in ASI #2, however the Hot Water Coil HWC-1 was not deleted. Please confirm the HSC-1 is not required with the PH-1 and if it can be deleted does the hot water demand go down enough to delete a boiler (one of Boiler1-4) from the mechanical room?

#### Awaiting an Official Response

Yes, HWC-1 can be removed as part of ASI#2. While reviewing the Radiant Floor system it was discovered that HWC-1 made up a majority of the heating and flow requirements in that system. Now that HWC-1 is gone we have reduced the number of boilers used, downsized the supply pumps and reduced pipe size. We have omitted boilers 3 and 4 from the project (along with pumps BP-3 and BP-4) and we have reselected HWP-1 and HWP-2 to provide 30 gpm at 55' of head along with reducing the main pipe sizing from a 4"Ø to a 2"Ø. Please see the updated sheets attached with changes to the Radiant Floor Hot Water Piping Schematic, updated Boiler and Pump schedules along with the removal of the schedule for the removed hot water coil.

Contractor is to present all changes as a cost savings to the owner.

See attached updated sheets M2.00 - Hydronic Piping Schematics & M4.03 - HVAC Schedules.

Austin Hall Musgrove Engineering 2/24/2021


Electrical Response (see attached drawings):

E4.03 - Removed electrical connections to Boilers #3 and #4. Changed wires sizes for HWP-1 and HWP-2 from #10's to #12's.

E9.02 - Changed circuit breakers (2,4,6) and (8,10,12) from 30A/3P to 20A/3P.

Greg Bartholomew Musgrove Engineering 3/15/2021

ΒY

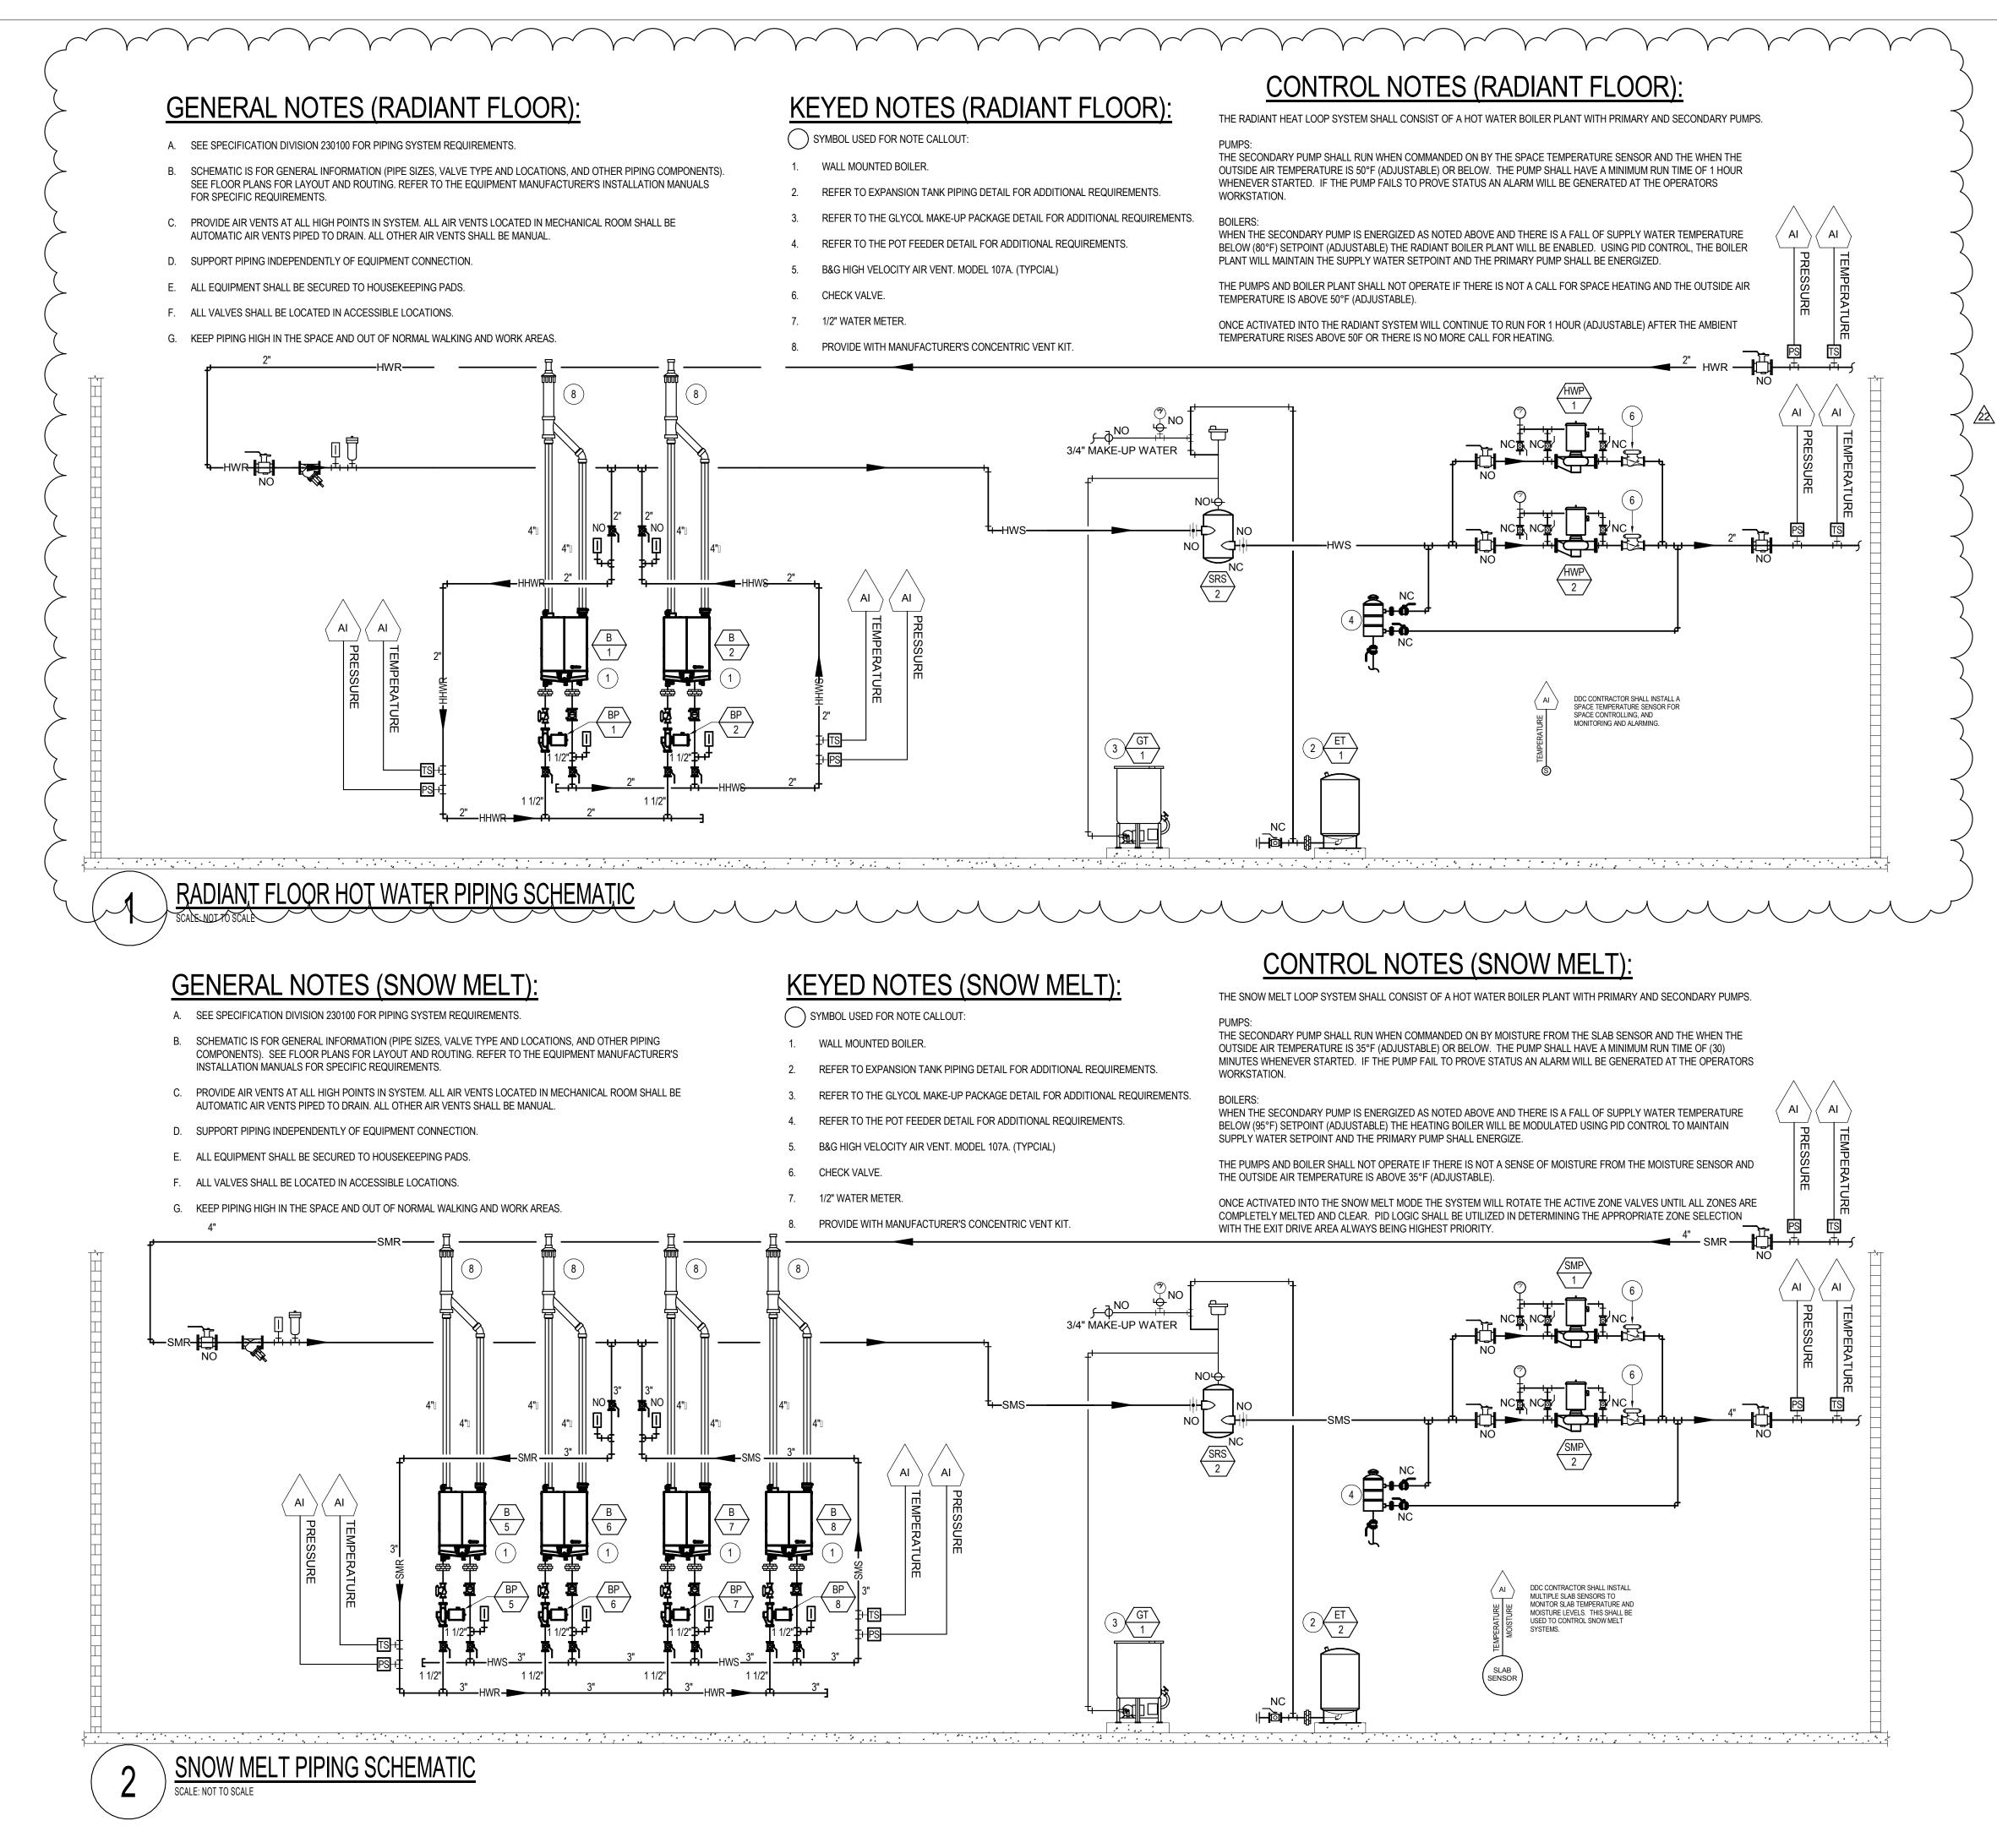

<section-header><text><text><text><text></text></text></text></text></section-header>
CONSULTANT   Image: Consultant
KETCHUM FIRE         STATION         107 SADDLE ROAD, KETCHUM ID 83353         ISSUES         PHASE       CONSTRUCTION SE         DATE       6/19/202         JOB NUMBER       18-02         MARK       DATE         Q/23/21       RFI #144
SHEET NAME HYDRONIC PIPING SCHEMATICS SHEET NUMBER

**M2.00** 

Γ	CONDENSING HOT WATER BOILER SCHEDULE											
.  =											-	
	SYMBOL	AREA SERVED	THERMAL EFFICIENCY	FUEL	EWT (°F)	LWT (°F)	BOILER FLOW (GPM)	MAX P.D. (FT HQ)	INPUT MBH	OUTPUT MBH	MANUFACTURER AND MODEL	REMARKS
	<u>B-1</u>	APPARATUS BAY	96	NATURAL GAS	90	110	38	14	399	349	ХРАК 398А	1,2,3,4,5
	<u>B-2</u>	APPARATUS BAY	96	NATURAL GAS	90	110	38	14	399	349	XPAK 398A	1,2,3,4,5
	<u>B-5</u>	SNOW MELT SYSTEM	96	NATURAL GAS	80	100	38	14	399	349	XPAK 398A	1,2,3,4,5
	<u>B-6</u>	SNOW MELT SYSTEM	96	NATURAL GAS	80	100	38	14	399	349	XPAK 398A	1,2,3,4,5
	<u>B-7</u>	SNOW MELT SYSTEM	96	NATURAL GAS	80	100	38	14	399	349	XPAK 398A	1,2,3,4,5
	<u>B-8</u>	SNOW MELT SYSTEM	96	NATURAL GAS	80	100	38	14	399	349	XPAK 398A	1,2,3,4,5

#### REMARKS:

1. APPROVED ALTERNATE MANUFACTURERS: FULTON, LOCHINVAR, CLEAVER BROOKS CLEARFIRE, BUDERUS LOGANO, VIESSMANN VITOCROSSAL 300, LAARS, AERCO BENCHMARK, NTI.

2. PROVIDE BOILER VENTING KIT, NEUTRALIZING KIT, COMBUSTION AIR INTAKE KIT, LOW WATER CUT-OFF, FLOW SWITCH, MODULATING GAS BURNER, CONDENSATE TRAP, 316L STAINLESS STEEL COMBUSTION CHAMBER, EXHAUST PIPE, CSD-1 AND OSA RESET. 3. BOILER SHALL BE PROVIDED W/FACTORY START-UP, START-UP IS NOT COMPLETE UNTIL ALL BURNERS AND BLOWER ARE CALIBRATED FOR PEAK PERFORMANCE AND AT COMPLETION OF PROJECT ALL BURNERS, BLOWERS, HEAT EXCHANGERS, AND OTHER INTERNAL PARTS SHALL BE THOROUGHLY CLEANED OF CONSTRUCTION DEBRIS.

4. PROVIDE WITH TACO 0012, 1/8 HP PRIMARY PUMP. 120V CONNECTION PROVIDED BY ELECTRICAL.

		$\langle \rangle$	$\sim$	$\langle \! \! \! \! \! \! \! \! \! \! \! \! \! \! \! \! \! \! \!$	$\sim$								
					PU	IMP S	CHE	DULE					
			CAPA	CITY			MOTOR		SUCTION	TRIPLE	OPERATING		
SYSTEM SERVED	TYPE	FLOW (GPM)	HEAD (FT)	EWT (°F)	MIN EFF	HP	RPM	V/Ø	DIFFUSER	DUTY VALVE	WEIGHT (LBS)	MANUFACTURER AND MODEL	REMARKS
IANT FLOOR SYSTEM	INLINE MOUNTED	30	55	110	56	2	3600	208/3	N/A	N/A	85	B&G SERIES E-90	1,2,4
ANT FLOOR SYSTEM	INLINE MOUNTED	30	55	110	56	2	3600	208/3	N/A	N/A	85	B&G SERIES E-90	1 , 2 , 4
VMELT BOILER SYSTEM	INLINE MOUNTED	150	55	70	64	3	1750	208/3	N/A	N/A	85	B&G SERIES E-90	1 , 2 , 4
MELT BOILER SYSTEM	INLINE MOUNTED	150	55	70	64	3	1750	208/3	N/A	N/A	85	B&G SERIES E-90	1,2,4
BOILER PUMP	INLINE MOUNTED	N/A	N/A	N/A	N/A	1/8	3250	120/1	N/A	N/A	13	TACO 0012	5
DOILEINT OWN	INLINE MOUNTED	N/A	N/A	N/A	N/A	1/8	3250	120/1	N/A	N/A	13	TACO 0012	5
BOILER PUMP		N/A	N/A	N/A	N/A	1/8	3250	120/1	N/A	N/A	13	TACO 0012	5
	INLINE MOUNTED			N1/A	N/A	1/8	3250	120/1	N/A	N/A	13	TACO 0012	5
BOILER PUMP	INLINE MOUNTED	N/A	N/A	N/A									
BOILER PUMP BOILER PUMP		N/A N/A	N/A N/A	N/A N/A	N/A	1/8	3250	120/1	N/A	N/A	13	TACO 0012	5

		$\sim$	*	*	*			*			$\frown$	$\sim$		
				CAP	ACITY			MOTOR						
IBOL	SYSTEM SERVED	ТҮРЕ	FLOW (GPM)	HEAD (FT)	EWT (°F)	MIN EFF	HP	RPM	V/Ø	SUCTION DIFFUSER	TRIPLE DUTY VALVE	OPERATING WEIGHT (LBS)	MANUFACTURER AND MODEL	REMARKS
<u>P-1</u>	RADIANT FLOOR SYSTEM	INLINE MOUNTED	30	55	110	56	2	3600	208/3	N/A	N/A	85	B&G SERIES E-90	1,2,4
/P-2	RADIANT FLOOR SYSTEM	INLINE MOUNTED	30	55	110	56	2	3600	208/3	N/A	N/A	85	B&G SERIES E-90	1,2,4
<u>1P-1</u>	SNOWMELT BOILER SYSTEM	INLINE MOUNTED	150	55	70	64	3	1750	208/3	N/A	N/A	85	B&G SERIES E-90	1,2,4
<u>MP-2</u>	SNOWMELT BOILER SYSTEM	INLINE MOUNTED	150	55	70	64	3	1750	208/3	N/A	N/A	85	B&G SERIES E-90	1,2,4
<u>3P-1</u>	BOILER PUMP	INLINE MOUNTED	N/A	N/A	N/A	N/A	1/8	3250	120/1	N/A	N/A	13	TACO 0012	5
	BOILER PUMP	INLINE MOUNTED	N/A	N/A	N/A	N/A	1/8	3250	120/1	N/A	N/A	13	TACO 0012	5
<u>BP-2</u>	BOILER PUMP	INLINE MOUNTED	N/A	N/A	N/A	N/A	1/8	3250	120/1	N/A	N/A	13	TACO 0012	5
			N1/A	N/A	N/A	N/A	1/8	3250	120/1	N/A	N/A	13	TACO 0012	5
<u>3P-5</u>	BOILER PUMP	INLINE MOUNTED	N/A						1	1			1	
<u>BP-2</u> <u>BP-5</u> <u>BP-6</u> <u>BP-7</u>		INLINE MOUNTED	N/A N/A	N/A	N/A	N/A	1/8	3250	120/1	N/A	N/A	13	TACO 0012	5

1. APPROVED ALTERNATE MANUFACTURERS: ARMSTRONG, GRUNDFOS, TACO, WILO, PACO, PEERLESS, PATTERSON.


2. PROVIDE UNIT WITH PREMIUM EFFICIENCY MOTOR.

3. NOT USED.

4. PUMP SELECTION MADE BASED ON 30% PROPYLENE GLYCOL AND 70% WATER.

5. 120V CONNECTION PROVIDED BY ELECTRICAL.

<section-header>         COOLES         1008 W Main St         Boise, Idaho 83702         208.345.1800         Colearchitects.net         Copyright © 2020 Cole Architects, PLLC         T         Copyright © 2020 Cole Architects, PLLC         ARCHITECTURE + PLANNING + DESIGN         6211 Roosevelt Way NE         Seattle, WA 98115         206.522.3820         STAMP</section-header>
CONSULTANT
MUSGROVE ENGINEERING, P.A.
234 S. WHISPERWOOD WAY
BOISE, IDAHO 83709 (208) 384-0585 PROJECT #19-366
PROJECT INFORMATION
KETCHUM
<b>KETCHUM FIRE</b>
<b>STATION</b> 107 SADDLE ROAD, KETCHUM ID 83353
ISSUES
PHASECONSTRUCTION SETDATE6/19/2020
JOB NUMBER     18-022       MARK     DATE       DESCRIPTION
MARK         DATE         DESCRIPTION           2         8/17/20         ASI #2           22         2/23/21         RFI #144
HVAC SCHEDULES
M4.03

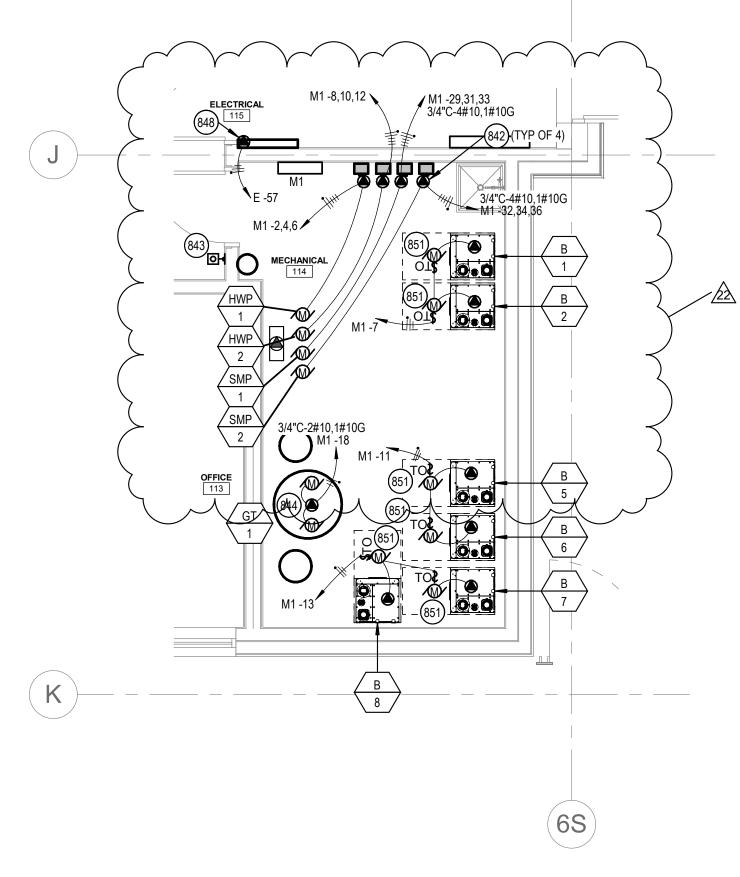

 $\rightarrow$ 

ENLARGED MECH ROOM MECH POWER PLAN - LEVEL 01 1/4" = 1'-0"



# SYMBOL USED FOR CALLOUT

- 842 VFD FURNISHED AND INSTALLED BY MECHANICAL CONTRACTOR AND TERMINATED BY ELECTRICAL CONTRACTOR. FURNISH AND INSTALL CONDUIT AND CONDUCTORS NOTED FROM THE PUMP TO THE VFD AND THEN TO THE PANELBOARD AND CIRCUITS NOTED. COORDINATE WITH MECHANICAL CONTRACTOR AND MECHANICAL DRAWINGS FOR ADDITIONAL INFORMATION. FURNISH AND INSTALL ALL ELECTRICAL REQUIRED FOR A COMPLETE AND FUNCTIONING SYSTEM.
- 843 FURNISH AND INSTALL A WALL MOUNTED MUSHROOM BUTTON FOR BOILER SHUTDOWN. THE MUSHROOM BUTTON SHALL BE PUSH TO STOP, PULL TO START WITH 40MM RED BUTTON. PROVIDE A NON-LOCKABLE PLEXIGLASS, HINGED COVER. PROVIDE A RED, MACHINE PRINTED LABLE ABOVE THE COVER THAT READS "EMERGENCY BOILER SHUTDOWN". ROUTE BOILER CIRCUITS THROUGH PUSHBUTTON AND CONNECT AS REQUIRED, COORDINATE WITH BOILER CONTRACTOR PRIOR TO BEGINNING WORK. COORDINATE WITH OWNER AND LOCAL AUTHORITY HAVING JURISDICTION FOR REQUIRED LOCATION PRIOR TO BEGINNING ROUGH-IN.
- 844 FURNISH AND INSTALL ELECTRICAL SHOWN TO GT-1 AND ALL ASSOCIATED EQUIPMENT AND PUMPS. COORDINATE WITH PLUMBING CONTRACTOR FOR ADDITIONAL INFORMATION PRIOR TO BEGINNING WORK. FURNISH AND INSTALL ALL ELECTRICAL REQUIRED FOR A COMPLETE AND FUNCTIONING SYSTEM.
- 848 FURNISH AND INSTALL ELECTRICAL CONNECTION TO DDC CONTROL PANEL. COORDINATE WITH MECHANICAL CONTRACTOR FOR ADDITIONAL INFORMATION.
- 851 FURNISH AND INSTALL ELECTRICAL CONNECTION TO BOILER AND ASSOCIATED PUMP. COORDINATE WITH BOILER INSTALLER AND SUPPLIER PRIOR TO BEGINNING WORK.



234 S. WHISPERWOOD WAY BOISE, IDAHO 83709 (208) 384-0585 PROJECT #19-366

PROJECT INFORMATION



### KETCHUM FIRE STATION

107 SADDLE ROAD, KETCHUM ID 83353

ISSUES

PHASECONSTRUCTION SETDATE6/19/2020JOB NUMBER18-022MARKDATEDESCRIPTION1110/21/2ASI #400

0 22 2/23/21 RFI #144


SHEET NAME

ENLARGED MECHANICAL ROOM PLAN - LEVEL 01



	Branch Panel: N								
	Location: Sp Supply From: MS Mounting: Su	BB				Volts: Phases: Wires:	-	ye	
	Enclosure: Ty	pe 1		$\frown$	$\frown$	$\frown$	$\frown$	$\frown$	
	DE PANEL WITH INDIVIDUAL BRANC ORING TO THE DDC CONTROL SYS							POWER AN	
СКТ	<b>Circuit Description</b>	Trip	Potes		A		В	(	;
1	BS-2,FC-105 THRU 111, 113, 114	15 A	2	837 VA	901 VA				
3			(			837 VA	901 VA		
5	EF-5	20 A	Y					1376 VA	
7	BOILER 1, 2	20 A		760 VA	901 VA	-			
9			L (				901 VA		
11	BOILER 5, 6	20 A	Y					760 VA	
13	BOILER 7, 8	20 A		760 VA	0 VA		ļ		L
15	Spare	20 A	1	$ \  \  \  \  \  \  \  \  \  \  \  \  \ $	$\searrow$	OVA	O VA	$\bigvee$	
17	Spare	20 A	1					0 VA	;
19	BS-4, FC-112	15 A	2	167 VA	377 VA	-			
21						167 VA	377 VA		
23	WH-2	70 A	3					6000 VA	
25				6000 VA	6000 VA				
27						6000 VA	6000 VA		
29	SMP-1	30 A	3	1071114	4074344			1274 VA	(
31				1274 VA	1274 VA	4074144	4074144		+
33						1274 VA	1274 VA	0.1/4	
35	Spare	20 A	1	0.1/4	0.1/4			0 VA	Ľ
37	Spare	20 A	1	0 VA	0 VA	0.1/4	0.1/4		
39	Spare	20 A	1			0 VA	0 VA	0.1/4	
41	Spare	20 A	1	0 VA	0 VA			0 VA	
43	Spare	20 A	1	UVA	UVA	0.1/4	0.1/4		-
45 47	Spare Spare	20 A 20 A	1			0 VA	0 VA	0 VA	
47	Spare	20 A	1	0 VA	0 VA			UVA	
49 51	Spare	20 A	1	UVA	UVA	0 VA	0 VA		
53	Spare	20 A	1			5 77		0 VA	
55	Spare	20 A	1	0 VA	0 VA			5 771	
57	Spare	20 A	1	<i>• •/</i> •	0 171	0 VA	0 VA		
59	Spare	20 A	1					0 VA	
	<b>-</b>		al Load:	1925	50 VA	1773	SO VA	2164	ـــــــــــــــــــــــــــــــــــــ
			I Amps:		2 A		8 A	182	

	Branch Panel: M Location: Spa Supply From: MSI Mounting: Rec Enclosure: Typ	Volts: 120/208 Wye Phases: 3 Wires: 4							A.I.C. Rating: 65K Mains Type: MLO Mains Rating: 600 A MCB Rating: 600 A				
	DE PANEL WITH INDIVIDUAL BRANCI ORING TO THE DDC CONTROL SYST						FEGRATED	POWER AN	ND ENERG		R WITH	MODBUS INTERFACE. CONNECT T	HE
скт	Circuit Description	Trip	Poles		A		В	C		Poles	Trip	Circuit Description	скт
1	HP-3	80 A	3	9187 VA	7302 VA					3	70 A	HP-1	2
3						9187 VA	7302 VA						4
5								9187 VA	7302 VA				6
7	HP-3	80 A	3	9187 VA	10016 VA					3	90 A	HP-2	8
9						9187 VA	10016 VA						10
11								9187 VA	10016 VA				12
13	HEAT PUMP HEAT TAPE	20 A	2	1100 VA	550 VA					2	20 A	HEAT PUMP HEAT TAPE	14
15						1100 VA	550 VA						16
17	REC-ROOFTOP	20 A	1					720 VA	7686 VA	3	70 A	ERU-2	18
19	EF-1	20 A	3	793 VA	7686 VA								20
21						793 VA	7686 VA						22
23								793 VA					24
25	BS-3, FC-201 THRU 209	15 A	2	671 VA	360 VA					1		DF-1, 2, 3, 4, 5 & 6	26
27						671 VA	500 VA			1	20 A		28
29	EF-2	20 A	1					104 VA	125 VA	2	15 A	BS-5, FC-210	30
31	Spare	20 A	1	0 VA	125 VA								32
33	Spare	20 A	1			0 VA	0 VA			1	20 A	Spare	34
35	Spare	20 A	1					0 VA	0 VA	1	20 A		36
37	Spare	20 A	1	0 VA	0 VA					1	20 A	Spare	38
39	Spare	20 A	1			0 VA	0 VA			1		Spare	40
41	Spare	20 A	1					0 VA	0 VA	1	20 A	Spare	42
43	Spare	20 A	1	0 VA	0 VA					1	20 A	Spare	44
45	Spare	20 A	1			0 VA	0 VA			1	20 A		46
47	Spare	20 A	1					0 VA	0 VA	1	20 A	Spare	48
49	Spare	20 A	1	0 VA	0 VA					1	20 A	Spare	50
51	Spare	20 A	1			0 VA	0 VA			1	20 A	Spare	52
53	Spare	20 A	1					0 VA	0 VA	1	20 A	Spare	54
55	Spare	20 A	1	0 VA	0 VA					1	20 A	Spare	56
57	Spare	20 A	1			0 VA	0 VA			1	20 A	-	58
59	Spare	20 A	1					0 VA	0 VA	1	20 A	Spare	60
			I Load:		75 VA		0 VA	4511					
		Total	Amps:	30	94 A	39	4 A	376	5 A				

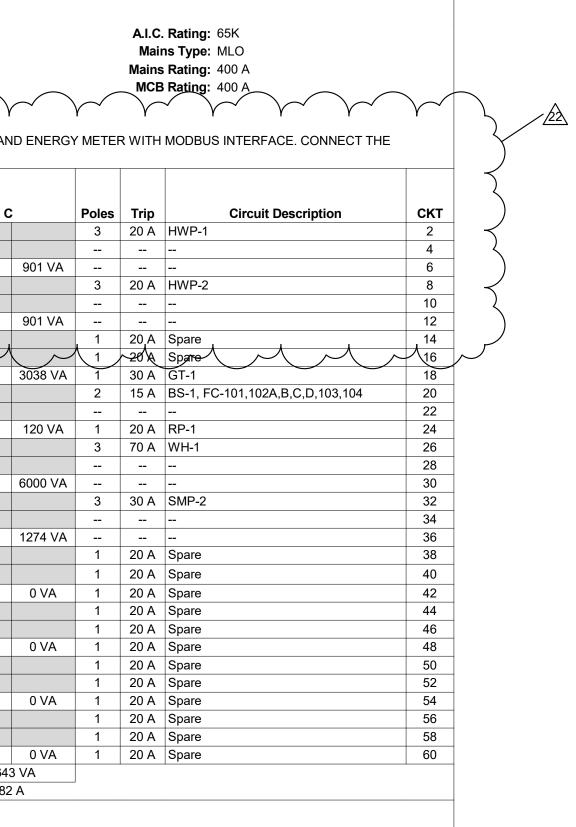

A.I.C. Rating:	65K
Mains Type:	MLO
Mains Rating:	600 A
MCB Rating	600 A

Branch Panel: E

Supply From: MSB Mounting: Surface

Location: Space 62 Enclosure: Type 1

Notes: PROVIDE PANEL WITH INDIVIDUAL BRANCH CIRCUIT MONITORING FOR ALL CIRCUITS AND INTEGRATED POWER AND ENERGY METER WITH MODBUS INTERFACE. CONNECT THE MONITORING TO THE DDC CONTROL SYSTEM. PROVIDE SECT 1 WITH FEED THROUGH LUGS. MAINTAIN SPECIFIED CONDUIT AND FEEDER SIZE FROM SECTION 1 TO SECTION 2. 

Wires: 4

скт	Circuit Description	Trip	Poles		Α	I	3	C	;	Poles	Trip	Circuit Description	СКТ
1	DCU-1 DFC-1	25 A	2	1872 VA	1000 VA					1		RH-4 RH-5	2
3						1872 VA	1160 VA	4070 \/A	700 \ / A	1		RH-2 RH-3	4
5	DCU-2 DFC-2	25 A 	2	1872 VA	360 VA			1872 VA	720 VA	1	20 A	REC-RADIO ROOM REC-RADIO ROOM	6 8
9	CONDENSATE PUMP	20 A	1	1072 17	000 1/1	800 VA	720 VA			1		REC-RADIO ROOM	10
11	REC-RADIO ROOM	20 A	1				-	360 VA	360 VA	1	20 A	REC-MONITOR RADIO ROOM	12
13	REC-IT 109	20 A	1	720 VA	720 VA					1	20 A	REC-REFRIGERATOR EMS/ALS	14
15	REC-IT 109	20 A	1			360 VA	720 VA			1		REC-REFRIGERATOR EMS/ALS	16
17	REC-IT 217	20 A	1					720 VA	1500 VA	1		REC-IT 217 UPS	18
19	REC-IT 217	20 A	1	360 VA	360 VA	E 40 \ /A	E 40 \ /A			1	20 A	REC-IT 217	20
21 23	REC-APPARATUS BAY REC-APPARATUS BAY	20 A 20 A	1			540 VA	540 VA	720 VA	360 VA	1	20 A	REC-APPARATUS BAY REC-APPARATUS BAY	22 24
25	REC-APPARATUS BAY	20 A	1	540 VA	540 VA			720 VA	300 VA	1		REC-APPARATUS BAY	24
27	REC-APPARATUS BAY	20 A	1			540 VA	540 VA			1	20 A	REC-APPARATUS BAY	28
29	OVERHEAD DOOR	20 A	1					1200 VA	1200 VA	1	20 A	OVERHEAD DOOR	30
31	OVERHEAD DOOR	20 A	1	1200 VA	1200 VA					1	20 A	OVERHEAD DOOR	32
33	FOUR FOLD DOOR	20 A	3			420 VA	420 VA			3	20 A	FOUR FOLD DOOR	34
35				400.000	400.000			420 VA	420 VA				36
37				420 VA	420 VA	400.141	400.545						38
39	FOUR FOLD DOOR	20 A	3			420 VA	420 VA	400.1/1	400.1/1	3	20 A	FOUR FOLD DOOR	40
41 43				420 VA	420 VA			420 VA	420 VA				42 44
43	 VEF-1	 60 A		420 VA	420 VA	2906 VA	500 VA				 20 A	 VEHICLE EXHAUST CONTROL PANEL	44
47						2000 VA	300 VA	2906 VA	43 VA	1		LTG-POLE LIGHT	48
49				2906 VA	436 VA					1	20 A	LTG-HALL 106/RADIO/EMS STOR	50
51	LTG-SHOP/TECH/COMP/LOCKER/DEC	20 A	1			894 VA	1250 VA			1	20 A	LTG-APPARATUS BAY	52
53	LTG-KITCHEN/DAY USE	20 A	1					772 VA	1250 VA	1	20 A		54
55	LTG-HALL 203/SHOWER/DORM	20 A	1	707 VA	201 VA					1		LTG-BLDG EXTERIOR	56
57	DDC PANEL	20 A	1			500 VA	0 VA	4000.144	4040344	1		ALARM PANEL	58
59	EH-1	20 A	2	1000 \/A	1500 \/A			1000 VA	1610 VA	1		REC-HOSE WASHER REC-RAM AIR GEAR DRYER	60
61 63	 EH-5	 20 A	2	1000 VA	1500 VA	750 VA	1000 VA			1		EH-2	62 64
65						750 VA	1000 VA	750 VA	1000 VA				66
67	EH-9	20 A	2	1000 VA	1000 VA			100 111		2		EH-8	68
69						1000 VA	1000 VA						70
71	EH-7	20 A	2					750 VA	750 VA	2	20 A	EH-6	72
73				750 VA	750 VA								74
75	EH-4	20 A	2			750 VA	750 VA			2		EH-3	76
77				1440 \/A	900 VA			750 VA	750 VA	 1		 REC-RECEPTION 133	78 80
79 81	REC-FIRE MARSHAL 111 REC-OFFICE 113	20 A 20 A	1	1440 VA	900 VA	1440 VA	1440 VA			1		REC-OFFICE 112	80
83	BBQ GAS SOLENOID VALVE	20 A	1					500 VA	750 VA	1		FIRE ALARM CONTROL PANEL	84
85	ACCESS CONTROL SYSTEM	20 A	1	1250 VA	500 VA					1		ACCESS CONTROL SYSTEM IT ROOMS	
87	SF-1	20 A	3			901 VA	120 VA			1		MOTORIZED DAMPER	88
89								901 VA	220 VA	1		HWC-1 & DAMPER	90
91				901 VA	500 VA					1		GAS DETECTION PANEL	92
93	EH-12	20 A	2			750 VA	750 VA	750.14	750.14	2		EH-13	94
95 97	 EH 11			750 VA	750 VA			750 VA	750 VA		 20 A	 EH-10	96 98
97	EH-11	20 A 	2	750 VA	7 50 VA	750 VA	750 VA			2	20 A		98 100
101	 RH-1	 20 A	1			100 VA	7.50 VA	660 VA	600 VA	1		FIRE SMOKE DAMPERS	100
101	REC-IT 109 UPS	20 A	1	1500 VA	360 VA					1		REC-IT 217	102
105	Spare	20 A	1			0 VA	0 VA			1		Spare	106
107	Spare	20 A	1					0 VA	0 VA	1		Spare	108
109	Spare	20 A	1	0 VA	0 VA					1		Spare	110
	Spare	20 A	1			0 VA	0 VA	0.111	0.111	1		Spare	112
113	Spare Spare	20 A	1	0.1/4	0.1/4			0 VA	0 VA	1		Spare Spare	114
115 117	Spare Spare	20 A 20 A	1	0 VA	0 VA	0 VA	0 VA			1		Spare Spare	116 118
	Spare	20 A 20 A	1			UVA	UVA	0 VA	0 VA	1		Spare	120
	- F		al Load:	3146	64 VA	2763	1 VA	2811		· ·	,	- F	
			Amps:		3 A		0 A	235		L			
Legend	l:												
1													

Volts: 120/208 Wye Phases: 3

#### A.I.C. Rating: 65K Mains Type: MLO Mains Rating: 400 A MCB Rating: 400 A

<section-header>         COOLES         COORES         Coore</section-header>
STAMP
CONSULTANT
MUSGROVE ENGINEERING, P.A.
234 S. WHISPERWOOD WAY BOISE, IDAHO 83709
(208) 384-0585 PROJECT #19-366
PROJECT INFORMATION
KETCHUM
KETCHUM FIRE
<b>STATION</b> 107 SADDLE ROAD, KETCHUM ID 83353
ISSUES PHASE CONSTRUCTION SET
PHASE         CONSTRUCTION SE           DATE         6/19/2020           JOB NUMBER         18-022
MARKDATEDESCRIPTION222/23/21RFI #144
ELECTRICAL SCHEDULES
SHEET NUMBER
E9.02



Building. Growing. Leading. ...Since 1937.

### Budget Evolution Item Summary City of Ketchum Fire Station #1

RFI-160 Delete Redundant Fans @ IT Rooms

Date:

5/12/2021

Description: As	equested, Delete redundant fans at both IT Re	ooms	
SCOPE	SUBCONTRACTOR	AMC	
Delete redundant fans	Thornton	\$	(11,440.00
Delete associated Electric	Magic Valley Electric	\$	(1,288.00)
		+	
		+	
		+	
SUBTOTAL:		Ś	(12,728.00
	only on the presumption that costs will come		( ,
	ursed by Change Order, TOTAL AMOUNT belo		s the
	upon markup in accordance with the change of		
Bond and Insurance	CORE	\$	(266.00)
CMAR FEE	CORE	\$	(566.00)
Sales Tax	CORE	\$	-
TOTAL AMOUNT:		\$	(13,560.00



Regional office for CORE NV company 777 N 4th St Bosie, Idaho 83702 Project: 90-20-01-006 - CoK - City of Ketchum Fire Station 107 Saddle Rd. Ketchum, Idaho 83340

### IT Room Fan Redundancy

то:	Bill Carter (Musgrove Engineering, PA) Alex Goedhart (Cole Architects) Crystal McColly (Cole Architects)	FROM:	JT Brown <b>(CORE Construction - Las Vegas)</b> 777 N Fourth St Boise, Idaho 83702
DATE INITIATED:	03/31/2021	STATUS:	Open
LOCATION:		DUE DATE:	04/07/2021
PROJECT STAGE:	Course of Construction	COST CODE:	
COST IMPACT:		SCHEDULE IMPACT:	
DRAWING NUMBER:	M1.00, M1.01	SPEC SECTION:	
LINKED DRAWINGS:		REFERENCE:	
RECEIVED FROM:	C.J. Gorringe (Thornton Heating & Sheetmetal)		

COPIES TO:

JT Brown (CORE Construction - Las Vegas), Cary Goldberg (DPPM Project Management), C.J. Gorringe (Thornton Heating & Sheetmetal), Jimmy Gyorfy (Magic Valley Electric), Bill McLaughlin (City of Ketchum), Dennis Potts (DPPM Project Management), Chris Schratwieser (CORE Construction - Las Vegas), Matt Sylvester (CORE Construction - Las Vegas), Brett Traylor (Evans Plumbing Incorporated (EPI))

#### Question from JT Brown (CORE Construction - Las Vegas) at 12:46 PM on 03/31/2021

The owner is opting to remove the redundancy of fan coil units in the IT rooms. Please confirm the equipment that is to be removed from the scope of the project so that a credit can be provided. IT 109 has FC 112 fed from the VRF and DFC/DCU 1. IT Room 217 has FC 210 fed from the VRF and DFC/DCU 2.

Awaiting an Official Response

#### See attached updated drawings and narrative.

M1.00 – HVAC PLAN- LEVEL 01 M1.01 – HVAC PLAN- LEVEL 02 M1.04 – HVAC ROOF PLAN M4.00– HVAC SCHEDULES P3.00 – CONDENSATE PIPING PLAN – LEVEL 01 P3.01 – CONDENSATE PIPING PLAN – LEVEL 02 E4.01 – MECHANICAL POWER PLAN - LEVEL 01 E4.02 – MECHANICAL POWER PLAN - LEVEL 02 E8.00 – ELECTRICAL PLAN - ROOF

Crystal McColly Cole Architects 4/13/21

BY



OVER 35 YEARS OF ENGINEERING EXCELLENCE

### RFI#CC-160

#### (Electrical, Mechanical and Plumbing)

Date:	4.12.2021	To:	Cole Architects
Job Number:	19-366		1008 W Main St,
Prepared By:	Austin Hall, Greg Bartholomew		Boise, ID 83702
Sheet:	1 of 2	Attention:	Crystal McColly
I		I	, ,

#### Project: <u>Ketchum Fire Station</u>

#### **Mechanical Plan Revisions**

- 1. M1.00 HVAC PLAN- LEVEL 01
  - a. Removed <u>DFC-1</u> and associated thermostat.
- 2. M1.01 HVAC PLAN- LEVEL 02
  - a. Removed <u>DFC-2</u> and associated thermostat.
- 3. M1.04 HVAC ROOF PLAN
  - a. Removed <u>DCU-1</u> and DCU-2.
  - b. Removed keyed note 230.
- 4. M4.00– HVAC SCHEDULES
  - a. Removed Ductless Split System Air Conditioning Unit Schedule.

#### Plumbing Plan Revisions

- 1. P3.00 CONDENSATE PIPING PLAN LEVEL 01
  - a. Removed condensate piping serving removed <u>DFC-1</u>.
- 2. P3.01 CONDENSATE PIPING PLAN LEVEL 02
  - a. Removed condensate piping serving removed DFC-2.

#### **Electrical Plan Revisions**

- 1. E4.01 MECHANICAL POWER PLAN LEVEL 01
  - a. Removed electrical connections to DFC-1 and associated notes.
- 2. E4.02 MECHANICAL POWER PLAN LEVEL 02
  - a. Removed electrical connections to DFC-2 and associated notes.
- 3. E8.00 ELECTRICAL PLAN ROOF
  - a. Removed electrical connections to DCU-1 and DCU-2 and associated notes. Change these circuit breakers to spare in the panelboard schedule.
  - b. Removed rooftop mounted receptacle adjacent to the DCU-1 and DCU-2.




234 S. Whisperwood Way Boise, ID 83709 Phone: 208,384,0585 Fax: 208,384,0765 www.musgrovepa.com

OVER 35 YEARS OF ENGINEERING EXCELLENCE

#### Attachments:

210412 RFI#CC-160 Mechanical 210412 RFI#CC-160 Electrical

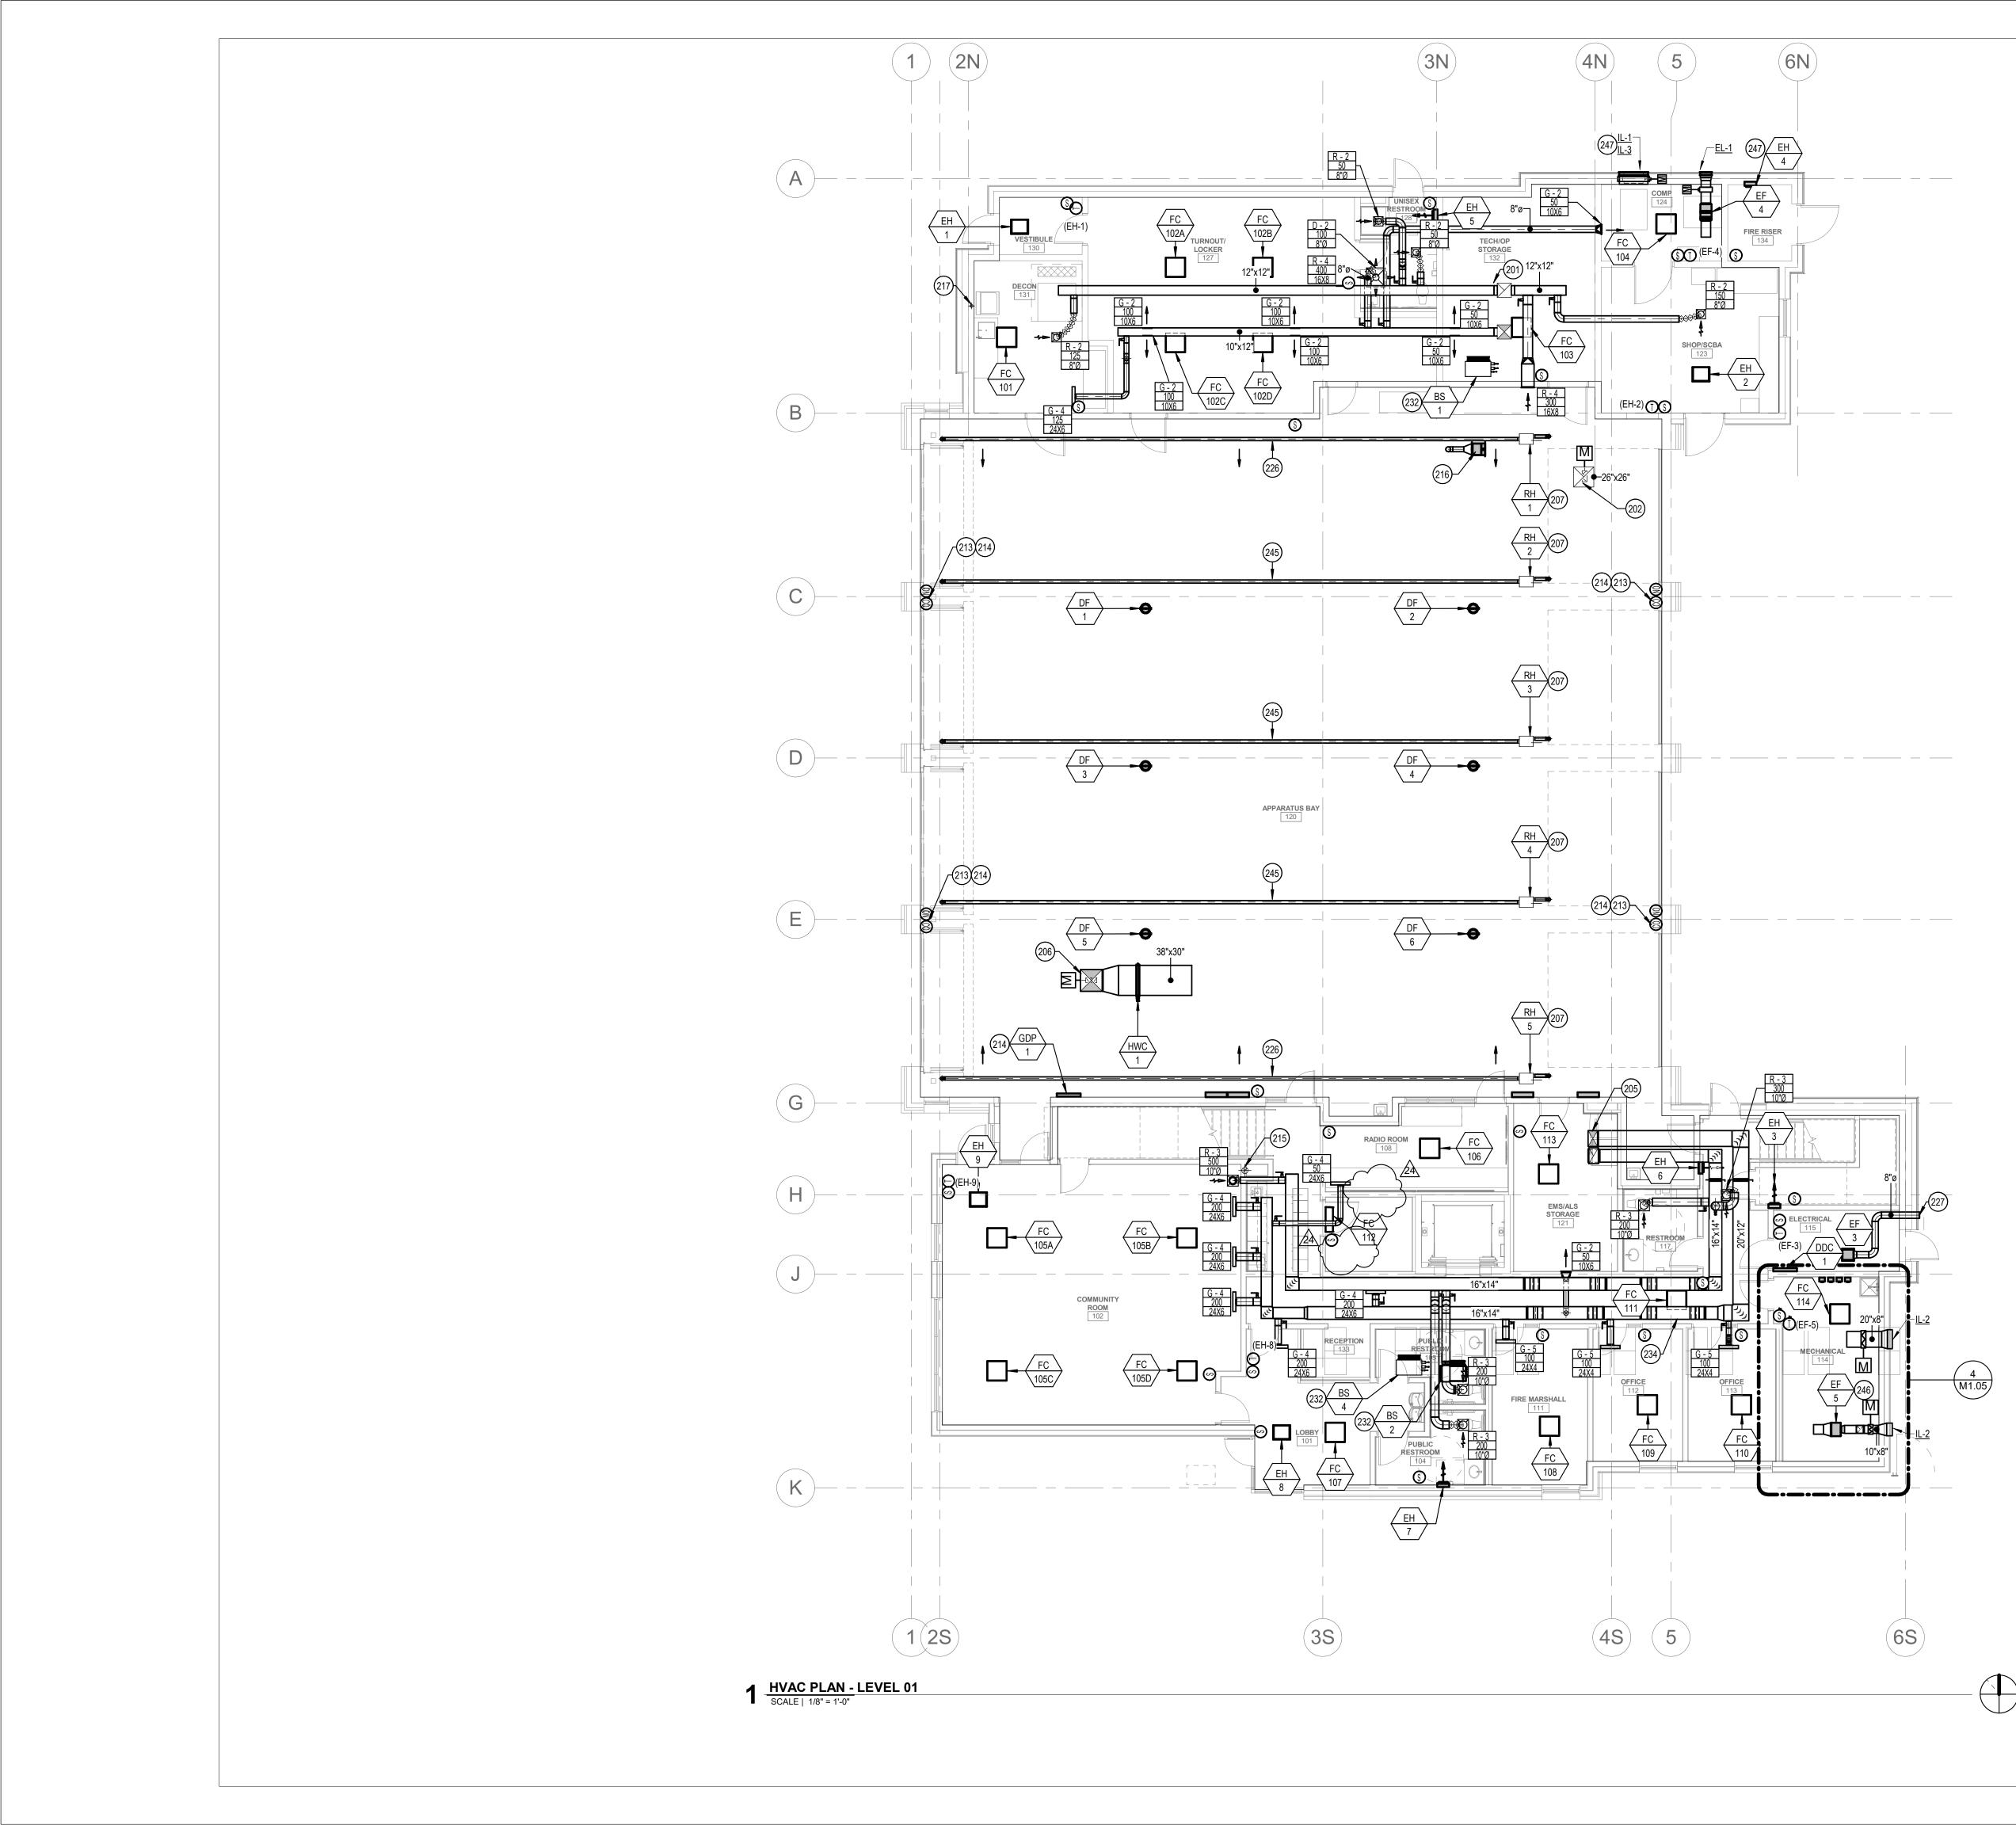

## KEYED NOTES:

(#) SYMBOL USED FOR CALLOUT

- 201 SUPPLY AND EXHAUST DUCT UP THROUGH ROOF TO ENERGY RECOVERY UNIT. TRANSITION DUCTWORK AS REQUIRED TO MATCH UNIT OPENINGS. REFER TO HVAC ROOF PLAN FOR CONTINUATION.
- 202 ROUTE EXHAUST DUCT DOWN FROM EXHAUST FAN ON ROOF, FULL SIZE. TERMINATE 6" BELOW ROOF AND COVER OPENING WITH EXPANDED METAL SCREEN (MIN. OF 1" OPENINGS). PROVIDE 120V/1ø LOW LEAKAGE MOTORIZED DAMPER.
- 205 ROUTE SUPPLY AND EXHAUST DUCT UP THROUGH FLOOR IN CHASE ABOVE TO 2ND FLOOR CEILING SPACE. REFER TO 2ND FLOOR HVAC PLAN FOR CONTINUATION.
- 206 ROUTE SUPPLY DUCT DOWN FROM SUPPLY FAN ON ROOF, FULL SIZE. ROUTE BETWEEN JOISTS AND COVER OPENING WITH EXPANDED METAL SCREEN (MIN. OF 1" OPENINGS). PROVIDE 120V/1ø LOW LEAKAGE MOTORIZED DAMPER.
- 207 GAS-FIRED RADIANT TUBE HEATER TO BE INSTALLED PER MANUFACTURER'S RECOMMENDATIONS. ROUTE 4"Ø COMBUSTION AIR INTAKE UP THROUGH ROOF AS REQUIRED. REFER TO STRUCTURAL PLANS FOR CONNECTIONS TO STRUCTURAL MEMBERS. CONTRACTOR TO FULLY COORDINATE RADIANT HEATER LOCATION WITH LIGHTING BELOW.
- 213 PROVIDE AND INSTALL WALL-MOUNTED CO AND NO2 SENSORS AT MANUFACTURER'S RECOMMENDED ELEVATIONS.
- 214 PROVIDE TOXIC GAS DETECTION SYSTEM. PROVIDE WITH WALL MOUNTED DUAL GAS SENSORS FOR C02 AND NO2. STAGE 1 AUDIO ALARM SET TO 200 PPM FOR CO1 AND 0.2 PPM FOR NO2 (ADJUSTABLE). COORDINATE SENSOR HEIGHT WITH MANUFACTURER.
- 215 PROVIDE RADON EXHAUST SYSTEM FOR ENTIRE SLEEPING AREA OF BUILDING (SOUTH SIDE). SEE DETAIL.
- 216 OWNER FURNISHED, CONTRACTOR INSTALLED PLYMOVENT VEHICLE EXHAUST SYSTEM AND RACK. COORDINATE ANY FACILILTIES IN THIS AREA WITH OWNER. VEHICLE EXHAUST CONTROLS PROVIDED BY CONTRACTOR. EXHAUST FAN SHOWN FOR COORDINATION PURPOSES ONLY. MECHANICAL CONTRACTOR SHALL ROUTE 6"Ø TYPE 'B' DOUBLE WALL VENT UP THROUGH ROOF FOR EXHAUSTING OF VEHICLE EXHAUST SYSTEM. COORDINATE WITH OWNER FOR EXACT LOCATION AND FOR FURTHER REQUIREMENTS. REFER TO HVAC ROOF PLAN FOR CONTINUATION.
- 217 4" DIAMETER SPIRAL GALVANIZED DRYER VENT. ROUTE UP TO CEILING SPACE. DUCT SHALL NOT BE CONNECTED OR INSTALLED USING SHEET METAL SCREWS OR OTHER FASTENERS THAT WILL OBSTRUCT THE EXHAUST FLOW. PROVIDE CELANOUT IN VERTICAL RISER. ROUTE DRYER VENT TO ROOF. PROVIDE OUTLET WITH BOOSTER FAN AND BACKDRAFT DAMPER. SCREENS SHALL NOT BE INSTALLED AT THE DUCT TERMINATION. SEE DETAIL.
- 226 SHIELD FOR GAS-FIRED RADIANT TUBE HEATER TO BE INSTALLED AT A 45 DEGREE ANGLE.
- 227 ROUTE EXHAUST DUCT THROUGH WALL AND TERMINATE WITH WALL CAP.
- 232 BRANCH SELECTOR BOX. INSTALL PER MANUFACTURER'S GUIDELINES. SEE PIPING PLAN FOR REFRIGERANT LINE ROUTING.
- 234 DUCTWORK TO BE ROUTED AROUND STRUCTURAL MEMBERS. IT IS THE CONTRACTOR'S RESPONSIBILITY TO FULLY COORDINATE ALL DUCT ELBOWS, ROUTING, AND TRANSITIONS TO AVOID STRUCTURAL MEMBERS.
- 245 SHIELD FOR GAS-FIRED RADIANT TUBE HEATER TO BE INSTALLED AT A 0 DEGREE ANGLE.
- 246 EXHAUST FAN INSTALLED ABOVE HYDRONIC PIPING. CONTRACTOR TO COORDINATE ALL EXHAUST FAN AND DAMPER ACCESS WITH PIPING, BOILERS, VALVES, AND EQUIPMENT.
- 247 MOUNT BOTTOM OF IL-3 AT 16" AFF. MOUNT TOP OF IL-1 AND EL-1 AT 11' 2".



Boise, Idaho 83702 208.345.1800 **colearchitects.net** Copyright © 2020 Cole Architects, PLLC



**ARCHITECTURE + PLANNING + DESIGN** 6211 Roosevelt Way NE

6211 Roosevelt Way NE Seattle, WA 98115 206.522.3820

STAMP

#### CONSULTANT



234 S. WHISPERWOOD WAY BOISE, IDAHO 83709 (208) 384-0585 PROJECT #19-366

**PROJECT INFORMATION** 



### KETCHUM FIRE STATION

107 SADDLE ROAD, KETCHUM ID 83353

#### ISSUES

PHASECONSTRUCTION SETDATE6/19/2020JOB NUMBER18-022MARKDATEDESCRIPTION1110/21/2ASI #40

 0


 12
 11/4/20
 RFI #97R1

 24
 4/12/21
 RFI #CC-160

SHEET NAME

HVAC PLAN - LEVEL 01



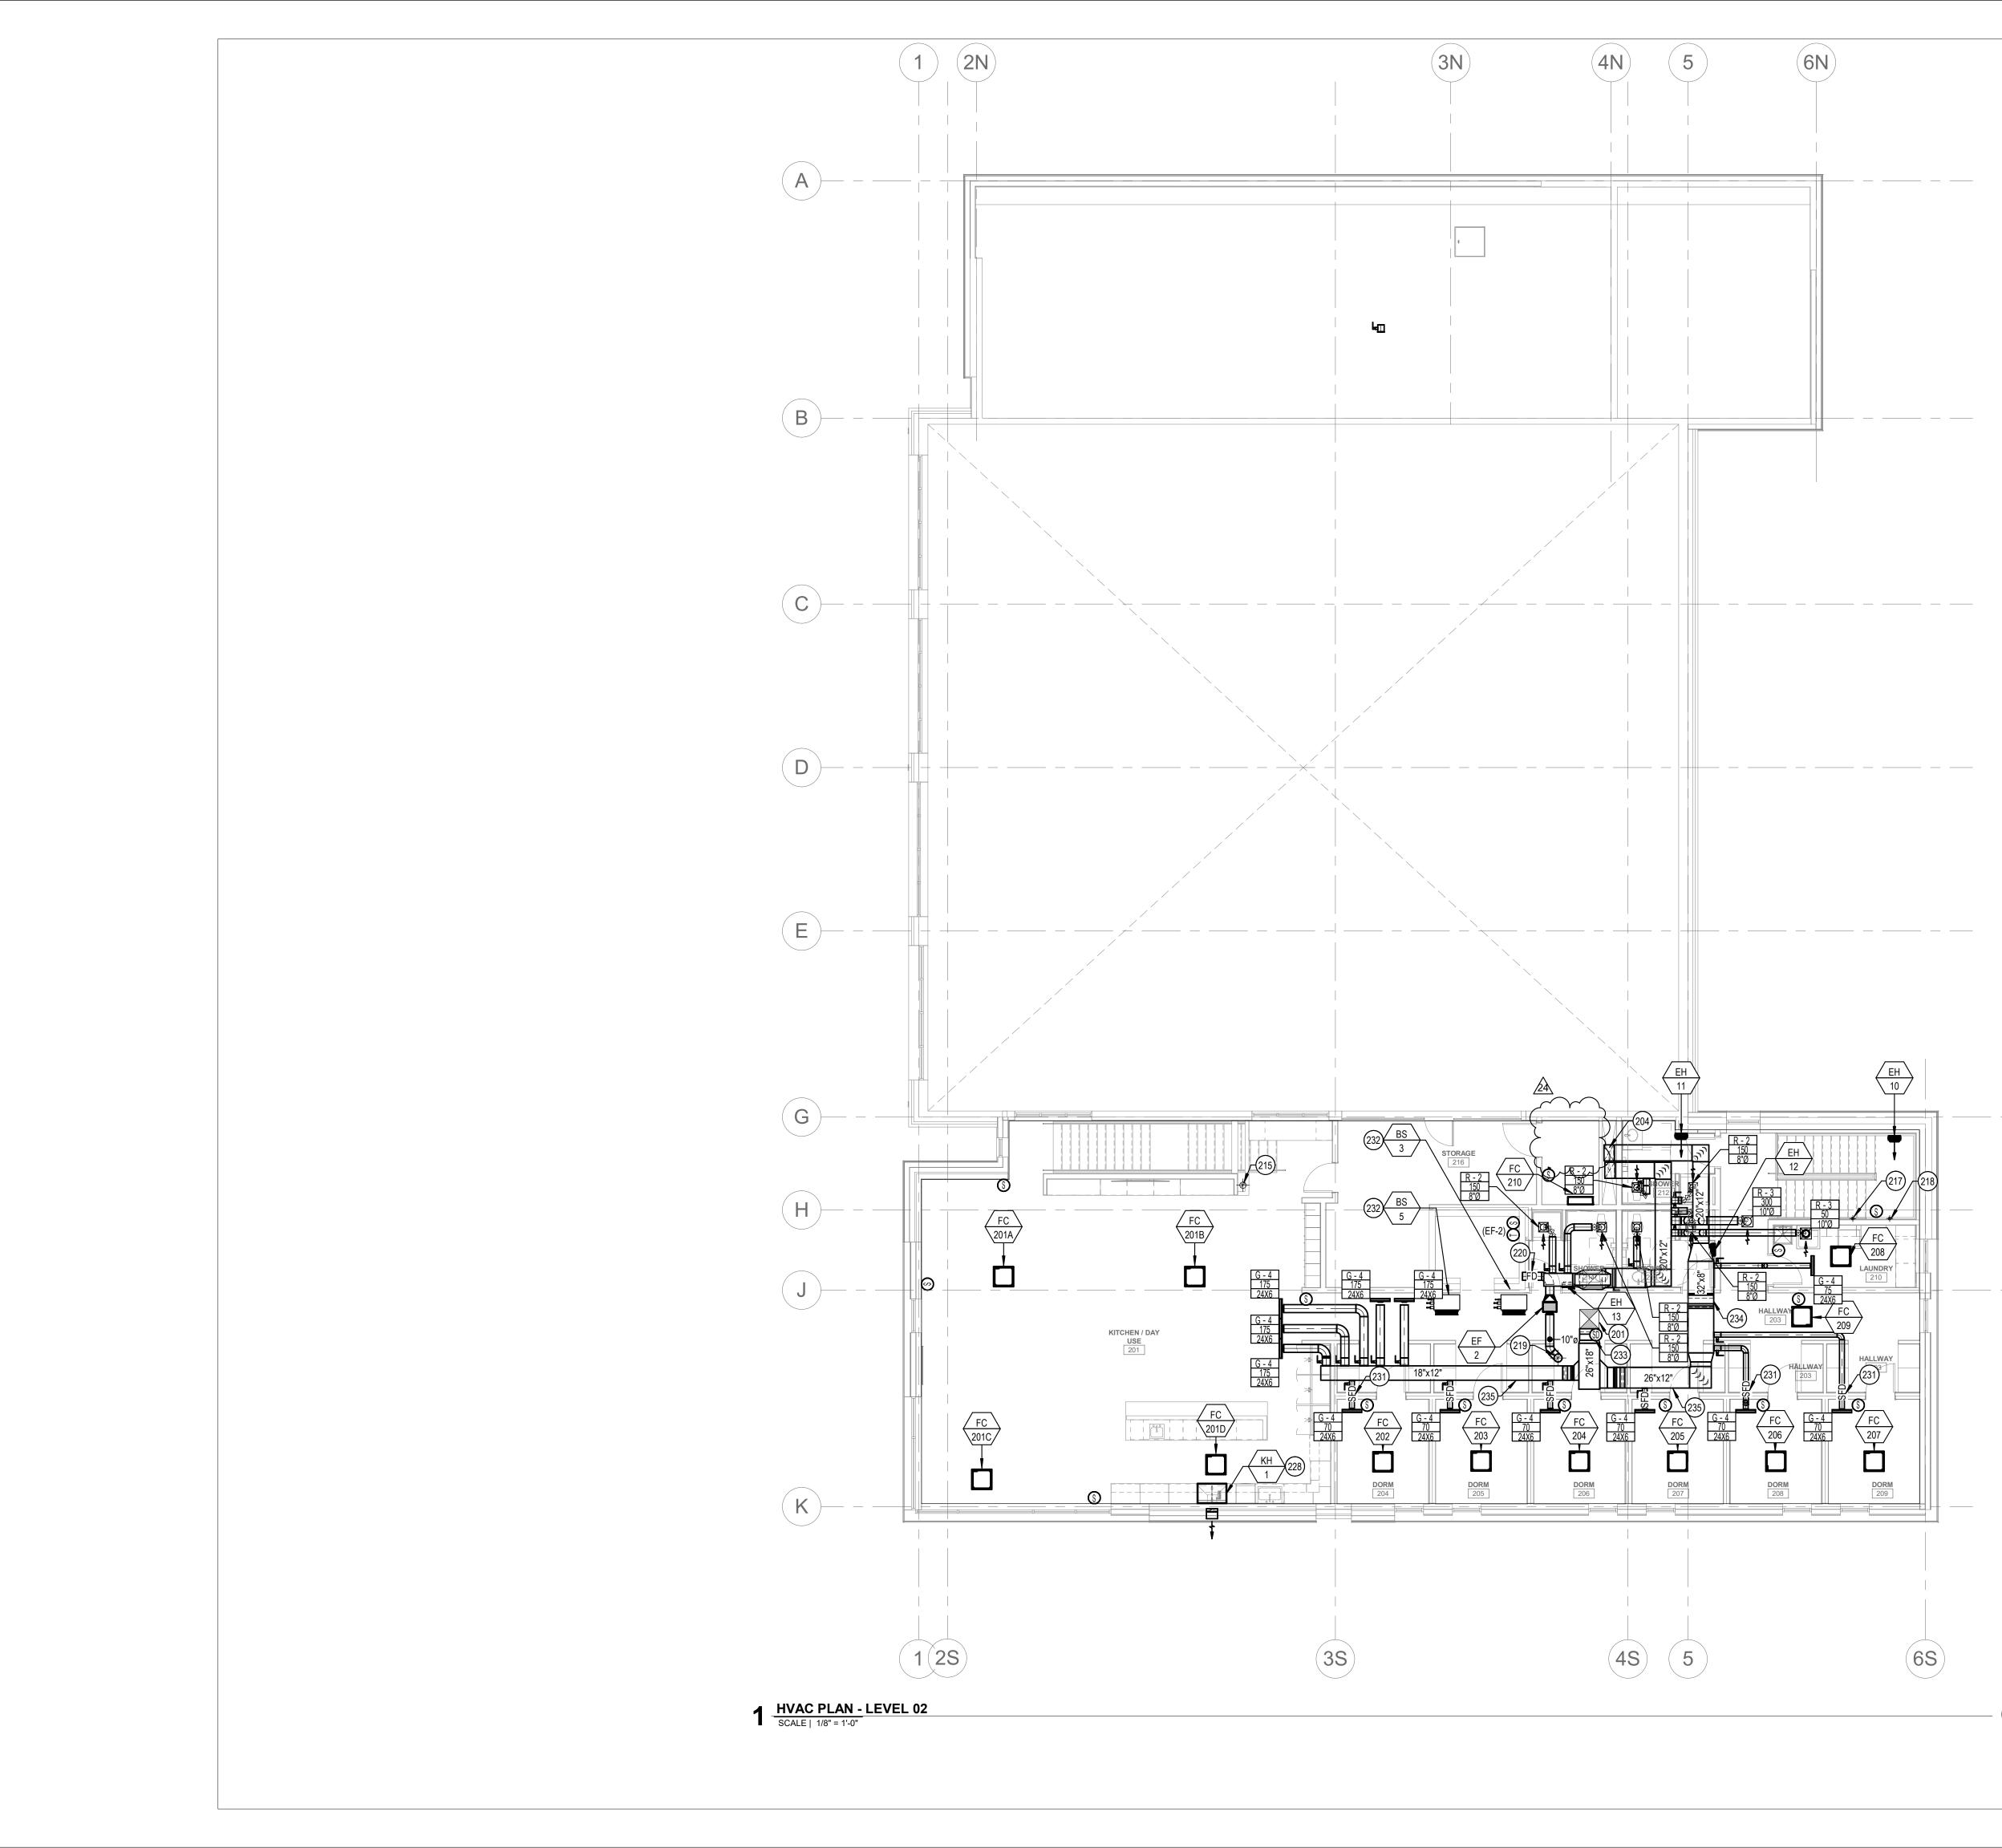

## KEYED NOTES:

- # SYMBOL USED FOR CALLOUT
- 201 SUPPLY AND EXHAUST DUCT UP THROUGH ROOF TO ENERGY RECOVERY UNIT. TRANSITION DUCTWORK AS REQUIRED TO MATCH UNIT OPENINGS. REFER TO HVAC ROOF PLAN FOR CONTINUATION.
- 204 SUPPLY AND EXHAUST DUCT DOWN IN CHASE TO FIRST FLOOR CEILING SPACE. REFER TO 1ST FLOOR HVAC PLAN FOR CONTINUATION.
- 215 PROVIDE RADON EXHAUST SYSTEM FOR ENTIRE SLEEPING AREA OF BUILDING (SOUTH SIDE). SEE DETAIL.
- 217 4" DIAMETER SPIRAL GALVANIZED DRYER VENT. ROUTE UP TO CEILING SPACE. DUCT SHALL NOT BE CONNECTED OR INSTALLED USING SHEET METAL SCREWS OR OTHER FASTENERS THAT WILL OBSTRUCT THE EXHAUST FLOW. PROVIDE CELANOUT IN VERTICAL RISER. ROUTE DRYER VENT TO ROOF. PROVIDE OUTLET WITH BOOSTER FAN AND BACKDRAFT DAMPER. SCREENS SHALL NOT BE INSTALLED AT THE DUCT TERMINATION. SEE DETAIL.
- 218 4" DRYER DUCT ROUTED UP THROUGH ROOF TO BE PROVIDED FOR FUTURE DRYER.
- 219 EXHAUST DUCT UP THROUGH ROOF. REFER TO HVAC ROOF PLAN FOR CONTINUATION.
- 220 PROVIDE FIRE DAMPER.
- 228 ROUTED 3-1/4"X14" EXHAUST DUCT THROUGH EXTERIOR WALL AND TERMINATE WITH WALL CAP.
- 231 PROVIDE FIRE/SMOKE DAMPER.
- 232 BRANCH SELECTOR BOX. INSTALL PER MANUFACTURER'S GUIDELINES. SEE PIPING PLAN FOR REFRIGERANT LINE ROUTING.
- 233 PROVIDE SUPPLY DUCT MOUNTED SMOKE DETECTOR FOR UNIT SHUTDOWN.
- 234 DUCTWORK TO BE ROUTED AROUND STRUCTURAL MEMBERS. IT IS THE CONTRACTOR'S RESPONSIBILITY TO FULLY COORDINATE ALL DUCT ELBOWS, ROUTING, AND TRANSITIONS TO AVOID STRUCTURAL MEMBERS.
- 235 DUCTWORK ROUTED THROUGH VIERENDEEL OPENINGS IN TRUSSES. COORDINATE EXACT SIZES AND ROUTING WITH TRUSS MANUFACTURER AND STRUCTURAL ENGINEER.



Boise, Idaho 83702 208.345.1800 **colearchitects.net** Copyright © 2020 Cole Architects, PLLC



ARCHITECTURE + PLANNING + DESIGN

6211 Roosevelt Way NE Seattle, WA 98115 206.522.3820

STAMP

### CONSULTANT



234 S. WHISPERWOOD WAY BOISE, IDAHO 83709 (208) 384-0585 PROJECT #19-366

PROJECT INFORMATION



# KETCHUM FIRE

107 SADDLE ROAD, KETCHUM ID 83353

#### ISSUES

PHASE	CONSTRUCTION SET
DATE	6/19/2020
JOB NUMBER	18-022

 MARK
 DATE
 DESCRIPTION

 24
 4/12/21
 RFI #CC-160


SHEET NAME


HVAC PLAN - LEVEL

SHEET NUMBER

M1.01



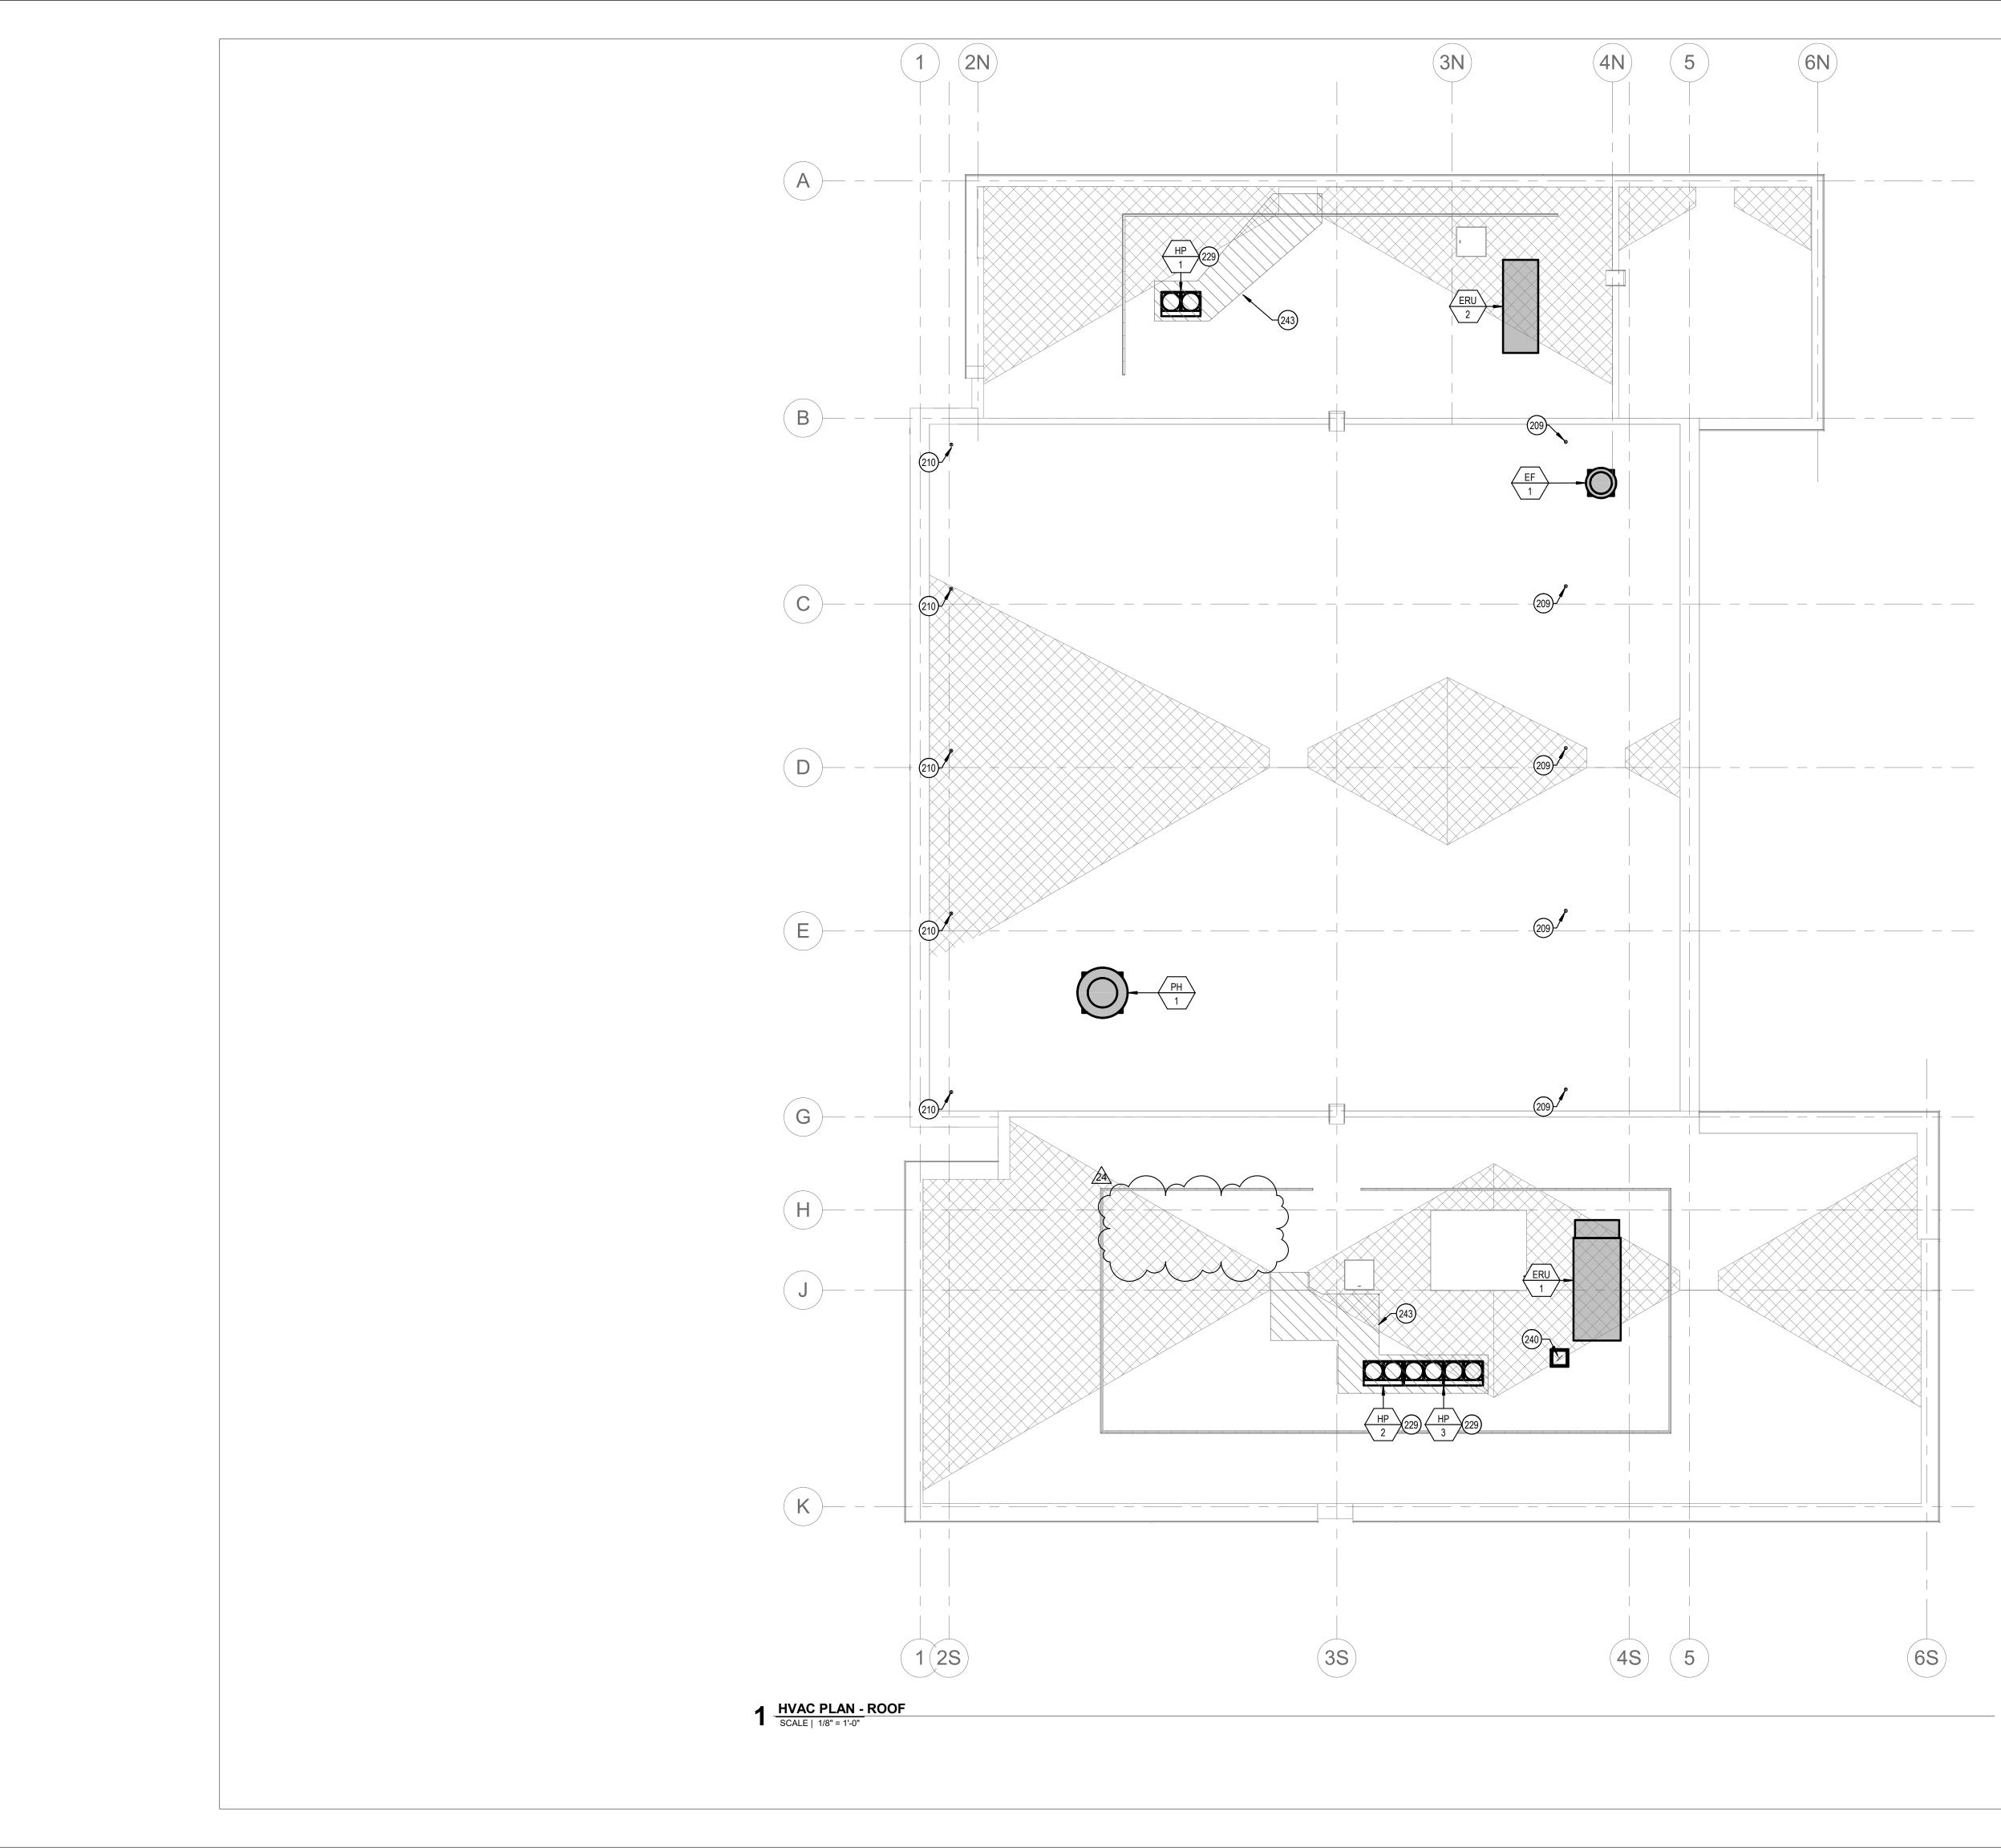

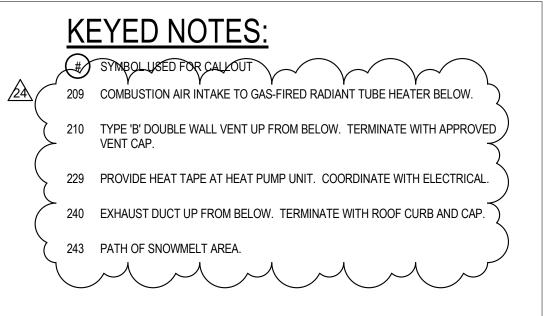





VRF HVAC SYSTEM SCHEDULE
--------------------------

							OUTDC		S								
		COOLING REQUIRED AT 80°F EDB, 67°F EWB		HEATING REQUIRED AT 70°F EAT	ELECTRICAL					OPERATING	MANUFACTURER AND						
	SYMBOL		AREA SERVED	TONS	UNIT TYPE	TOTAL MBH	SENSIBLE MBH	TOTAL MBH	MCA	MOCP	V/Ø		UM EER	R WEIGHT (LBS) MODEL		REMARKS	
	<u>HP-1</u>		NORTH	6	HEAT RECOVERY	56	44	45.9	60.8	70	208/3	1:	3.7	730	DAIKIN RELQ72TATJA	1,2,4,6,	
	<u>HP-2</u>		SOUTH 1ST FLOOR	10	HEAT RECOVERY	116	95	76.5	83.4	90	208/3	12	2.4	795	DAIKIN RELQ120TATJ	ATJ 1,2,4,6,9	
	<u>HP-3</u>		SOUTH 2ND FLOOR	16	HEAT RECOVERY	149	115	128.9	76.5 76.5	80 80	208/3 208/3	12.5 DAIKIN REL		DAIKIN RELQ192TATJA	1,2,4,6,		
						INE	OOR FA			S							
HEAT PUMP	BRANCH SELECT.	COIL AREA SERVED		NOMINAL	UNIT TYPE	SUPPLY FAN	COOLING	HEATING		ELECTRICAL	ELECTRICAL	SOUND	OPERATING WEIGHT	MANUFACTURER AND	REMARKS		
YMBOL	SYMBOL	SYMBOL		TONS		CFM	МВН	МВН	MCA	MOCP	V/Ø	(dBA)		(LBS)	MODEL	KEMAKKS	
		<u>FC-101</u>	DECON 131	0.6	4-WAY CASSETTE	307	6.4	6.4	0.3	15	208/1	125	32	35.3	DAIKIN MODEL FXZQ07TAVJU	1,3,5,6	
		FC-102A	TURNOUT/LOCKER 127	0.75	4-WAY CASSETTE	317	7.8	7.1	0.3	15	208/1		33	35.3	DAIKIN MODEL FXZQ09TAVJU	1,3,5,6	
<u>HP-1</u> <u>BS-1</u>		<u>FC-102B</u>	TURNOUT/LOCKER 127	0.75	4-WAY CASSETTE	317	7.8	7.1	0.3	15	208/1	400	33	35.3	DAIKIN MODEL FXZQ09TAVJU	1,3,5,6	
	<u>BS-1</u>	FC-102C	TURNOUT/LOCKER 127	0.75	4-WAY CASSETTE	317	7.8	7.1	0.3	15	208/1	- 400	33	35.3	DAIKIN MODEL FXZQ09TAVJU	1,3,5,	
		FC-102D	TURNOUT/LOCKER 127	0.75	4-WAY CASSETTE	317	7.8	7.1	0.3	15	208/1		33	35.3	DAIKIN MODEL FXZQ09TAVJU	1,3,5,	
		<u>FC-103</u>	TECH/OP STORAGE 132	0.6	4-WAY CASSETTE	307	6.4	6.4	0.3	15	208/1	100	32	35.3	DAIKIN MODEL FXZQ07TAVJU	1,3,5,	
		<u>FC-104</u>	COMP 124	1.5	4-WAY CASSETTE	742	14.8	14.8	0.6	15	208/1	100	36	50.7	DAIKIN MODEL FZFQ18TVJU	1,3,5,	
		<u>FC-105A</u>	COMMUNITY ROOM 102	1	4-WAY CASSETTE	742	10	13.6	0.4	15	208/1		34	36	DAIKIN MODEL FZFQ12TVJU	1,3,5,	
		FC-105B	COMMUNITY ROOM 102	1.5	4-WAY CASSETTE	742	14.8	14.8	0.6	15	208/1		36	50.7	DAIKIN MODEL FZFQ18TVJU	1,3,5,	
		FC-105C	COMMUNITY ROOM 102	1	4-WAY CASSETTE	742	10	13.6	0.4	15	208/1	600	34	36	DAIKIN MODEL FZFQ12TVJU	1,3,5,	
		FC-105D	COMMUNITY ROOM 102	1.5	4-WAY CASSETTE	742	14.8	14.8	0.6	15	208/1		36	50.7	DAIKIN MODEL FZFQ18TVJU	1,3,5,	
		<u>FC-106</u>	RADIO ROOM 108	0.6	4-WAY CASSETTE	307	6.4	6.4	0.3	15	208/1	50	32	35.3	DAIKIN MODEL FXZQ07TAVJU	1,3,5,	
	<u>BS-2</u>	<u>FC-107</u>	LOBBY 101	2.0	4-WAY CASSETTE	777	19.8	19.8	0.7	15	208/1	200	36	50.7	DAIKIN MODEL FXFQ24TVJU	1,3,5,	
<u>HP-2</u>		<u>FC-108</u>	FIRE MARSHAL 111	0.6	4-WAY CASSETTE	307	6.4	6.4	0.3	15	208/1	100	32	35.3	DAIKIN MODEL FXZQ07TAVJU	1,3,5,	
		<u>FC-109</u>	OFFICE 112	0.6	4-WAY CASSETTE	307	6.4	6.4	0.3	15	208/1	100	32	35.3	DAIKIN MODEL FXZQ07TAVJU	1,3,5,	
		<u>FC-110</u>	OFFICE 113	0.6	4-WAY CASSETTE	307	6.4	6.4	0.3	15	208/1	100	32	35.3	DAIKIN MODEL FXZQ07TAVJU	1,3,5,	
		<u>FC-111</u>	HALLWAY 116	0.75	4-WAY CASSETTE	317	7.8	7.1	0.3	15	208/1	200	33	35.3	DAIKIN MODEL FXZQ09TAVJU	1,3,5,	
	<u>BS-4</u>	FC-112	IT 109	1.5	HIGH WALL	500	15.2	21.0	0.4	15.0	208/1	0	43	31	DAIKIN MODEL FXAQ18PVJU	1,3,5,	
	_	<u>FC-113</u>	EMS/ALS STORAGE 121	0.6	4-WAY CASSETTE	307	6.4	6.4	0.3	15	208/1	50	32	35.3	DAIKIN MODEL FXZQ07TAVJU	1,3,5,	
	<u>BS-2</u>	<u>FC-114</u>	MECHANICAL 114	1.5	4-WAY CASSETTE	742	14.8	14.8	0.6	15	208/1	0	36	50.7	DAIKIN MODEL FZFQ18TVJU	1,3,5,	

	INDOOR FAN COIL UNITS																	
HEAT	JMP SELECT. COIL AREA SERVED			NOMINAL		SUPPLY FAN	COOLING	HEATING		ELECTRICAL	-	054	SOUND	OPERATING	MANUFACTURER AND			
SYMBOL		TONS	UNIT TYPE	CFM	MBH	MBH	MCA	USA	(dBA)	WEIGHT (LBS)	MODEL	REMARKS						
		FC-201A	KITCHEN/DAY USE 201	1.5	4-WAY CASSETTE	742	14.8	14.8	0.6	15	208/1	36	50.7	DAIKIN MODEL FZFQ18TVJU	1,3,5,6			
		FC-201B	KITCHEN/DAY USE 201	1.5	4-WAY CASSETTE	742	14.8	14.8	0.6	15	208/1	-	36	50.7	DAIKIN MODEL FZFQ18TVJU	1,3,5,6		
		FC-201C	KITCHEN/DAY USE 201	1.5	4-WAY CASSETTE	742	14.8	14.8	0.6	15	208/1	530	36	50.7	DAIKIN MODEL FZFQ18TVJU	1,3,5,6		
		FC-201D	KITCHEN/DAY USE 201	1.5	4-WAY CASSETTE	742	14.8	14.8	0.6	15	208/1		36	50.7	DAIKIN MODEL FZFQ18TVJU	1,3,5,6		
		<u>FC-202</u>	DORM 204	0.6	4-WAY CASSETTE	307	6.4	6.4	0.3	15	208/1	70	32	35.3	DAIKIN MODEL FXZQ07TAVJU	1,3,5,6		
	<u>BS-3</u> –	<u>FC-203</u>	DORM 205	0.6	4-WAY CASSETTE	307	6.4	6.4	0.3	15	208/1	70	32	35.3	DAIKIN MODEL FXZQ07TAVJU	1,3,5,6		
<u>HP-3</u>		<u>FC-204</u>	DORM 206	0.6	4-WAY CASSETTE	307	6.4	6.4	0.3	15	208/1	70	32	35.3	DAIKIN MODEL FXZQ07TAVJU	1,3,5,6		
			<u>FC-205</u>	DORM 207	0.6	4-WAY CASSETTE	307	6.4	6.4	0.3	15	208/1	70	32	35.3	DAIKIN MODEL FXZQ07TAVJU	1,3,5,6	
			<u>FC-206</u>	DORM 208	0.6	4-WAY CASSETTE	307	6.4	6.4	0.3	15	208/1	70	32	35.3	DAIKIN MODEL FXZQ07TAVJU	1,3,5,6	
		<u>FC-207</u>	<u>FC-207</u>	<u>FC-207</u>	DORM 209	0.6	4-WAY CASSETTE	307	6.4	6.4	0.3	15	208/1	70	32	35.3	DAIKIN MODEL FXZQ07TAVJU	1,3,5,6
		<u>FC-208</u>	LAUNDRY 210	0.6	4-WAY CASSETTE	307	6.4	6.4	0.3	15	208/1	75	32	35.3	DAIKIN MODEL FXZQ07TAVJU	1,3,5,6		
		<u>FC-209</u>	HALLWAY 203	2.0	4-WAY CASSETTE	777	19.8	19.8	0.7	15	208/1	350	36	50.7	DAIKIN MODEL FXFQ24TVJU	1,3,5,6		
	<u>BS-5</u>	<u>FC-210</u>	IT 217	1.5	HIGH WALL	500	15.2	21.0	0.4	15.0	208/1	0	43	31	DAIKIN MODEL FXAQ18PVJU	1,3,5,6		
REMARKS	EWARKS																	

REMARKS:

24

1. APPROVED ALTERNATE MANUFACTURERS: MITSUBISHI, PANASONIC, LG, CARRIER, OR APPROVED EQUAL.

2. PROVIDE MANUFACTURER'S CRANKCASE HEATER, REFRIGERATION LINE SET AND TEES, AND TAMPER PROOF PORT CAPS.

3. CONTROL UNIT TROUGH INTELLIGENT TOUCH MANAGEMENT (ITM) CONTROL SYSTEM WITH BACNET INTERFACE OPTION. ALL SPACE SENSORS SHALL BE MANUFACTURER'S HARD-WIRED WALL MOUNTED THERMOSTATS. CONFIRM WITH OWNER AND ARCHITECT AS TO FINAL LOCATION OF CENTRAL CONTROL PANEL..

4. PROVIDE WITH MIRO INDUSTRIES HEAVY DUTY MECHANICAL GALVANIZED ROOF SUPPORT WITH ADJUSTABLE SUPPORT LEGS. SUPPORT SHALL EXTEND A MINIMUM OF 2" BEYOND EQUIPMENT IN EACH DIRECTION. BOLT EQUIPMENT TO MECHANICAL SUPPORT. PROVIDE HEAT TAPE ON PLATFORM TO NEAREST DRAIN.

5. PROVIDE WITH LITTLE GIANT MINI CONDENSATE PUMP. FOR HIGH WALL APPLICATIONS, CONCEAL PUMP BEHIND UNIT WITHIN MOUNTING BRACKET ASSEMBLY.

6. ELECTRICAL TO PROVIDE DISCONNECT.

7. PROVIDE MANUFACTURER'S FILTER BOX AND FILTER.

8. PROVIDE MANUFACTURER'S FINAL ACCEPTANCE AND WARRANTY LETTER AT REFRIGERANT PIPING ROUGH IN AND FINAL INSTALLATION STAGES. MANUFACTURER'S LETTER SHALL BE BY CERTIFIED MANUFACTURER'S REP.

9 COOLING BTU VALUES SHALL BEAT 86.5°F AMBIENT, HEATING BTU VALUES SHALL BEAT -20°F AMBIENT.



Boise, Idaho 83702 208.345.1800 colearchitects.net Copyright © 2020 Cole Architects, PLLC



ARCHITECTURE + PLANNING + DESIGN 6211 Roosevelt Way NE Seattle, WA 98115

STAMP

206.522.3820

#### CONSULTANT



234 S. WHISPERWOOD WAY BOISE, IDAHO 83709 (208) 384-0585 PROJECT #19-366

PROJECT INFORMATION



### **KETCHUM FIRE** STATION

107 SADDLE ROAD, KETCHUM ID 83353

#### ISSUES

PHASE	CONSTRUCTION SET
DATE	6/19/2020
JOB NUMBER	18-022
	10.02


DESCRIPTION 
 MARK
 DATE
 DESCR

 24
 4/12/21
 RFI #CC-160

SHEET NAME

### HVAC SCHEDULES



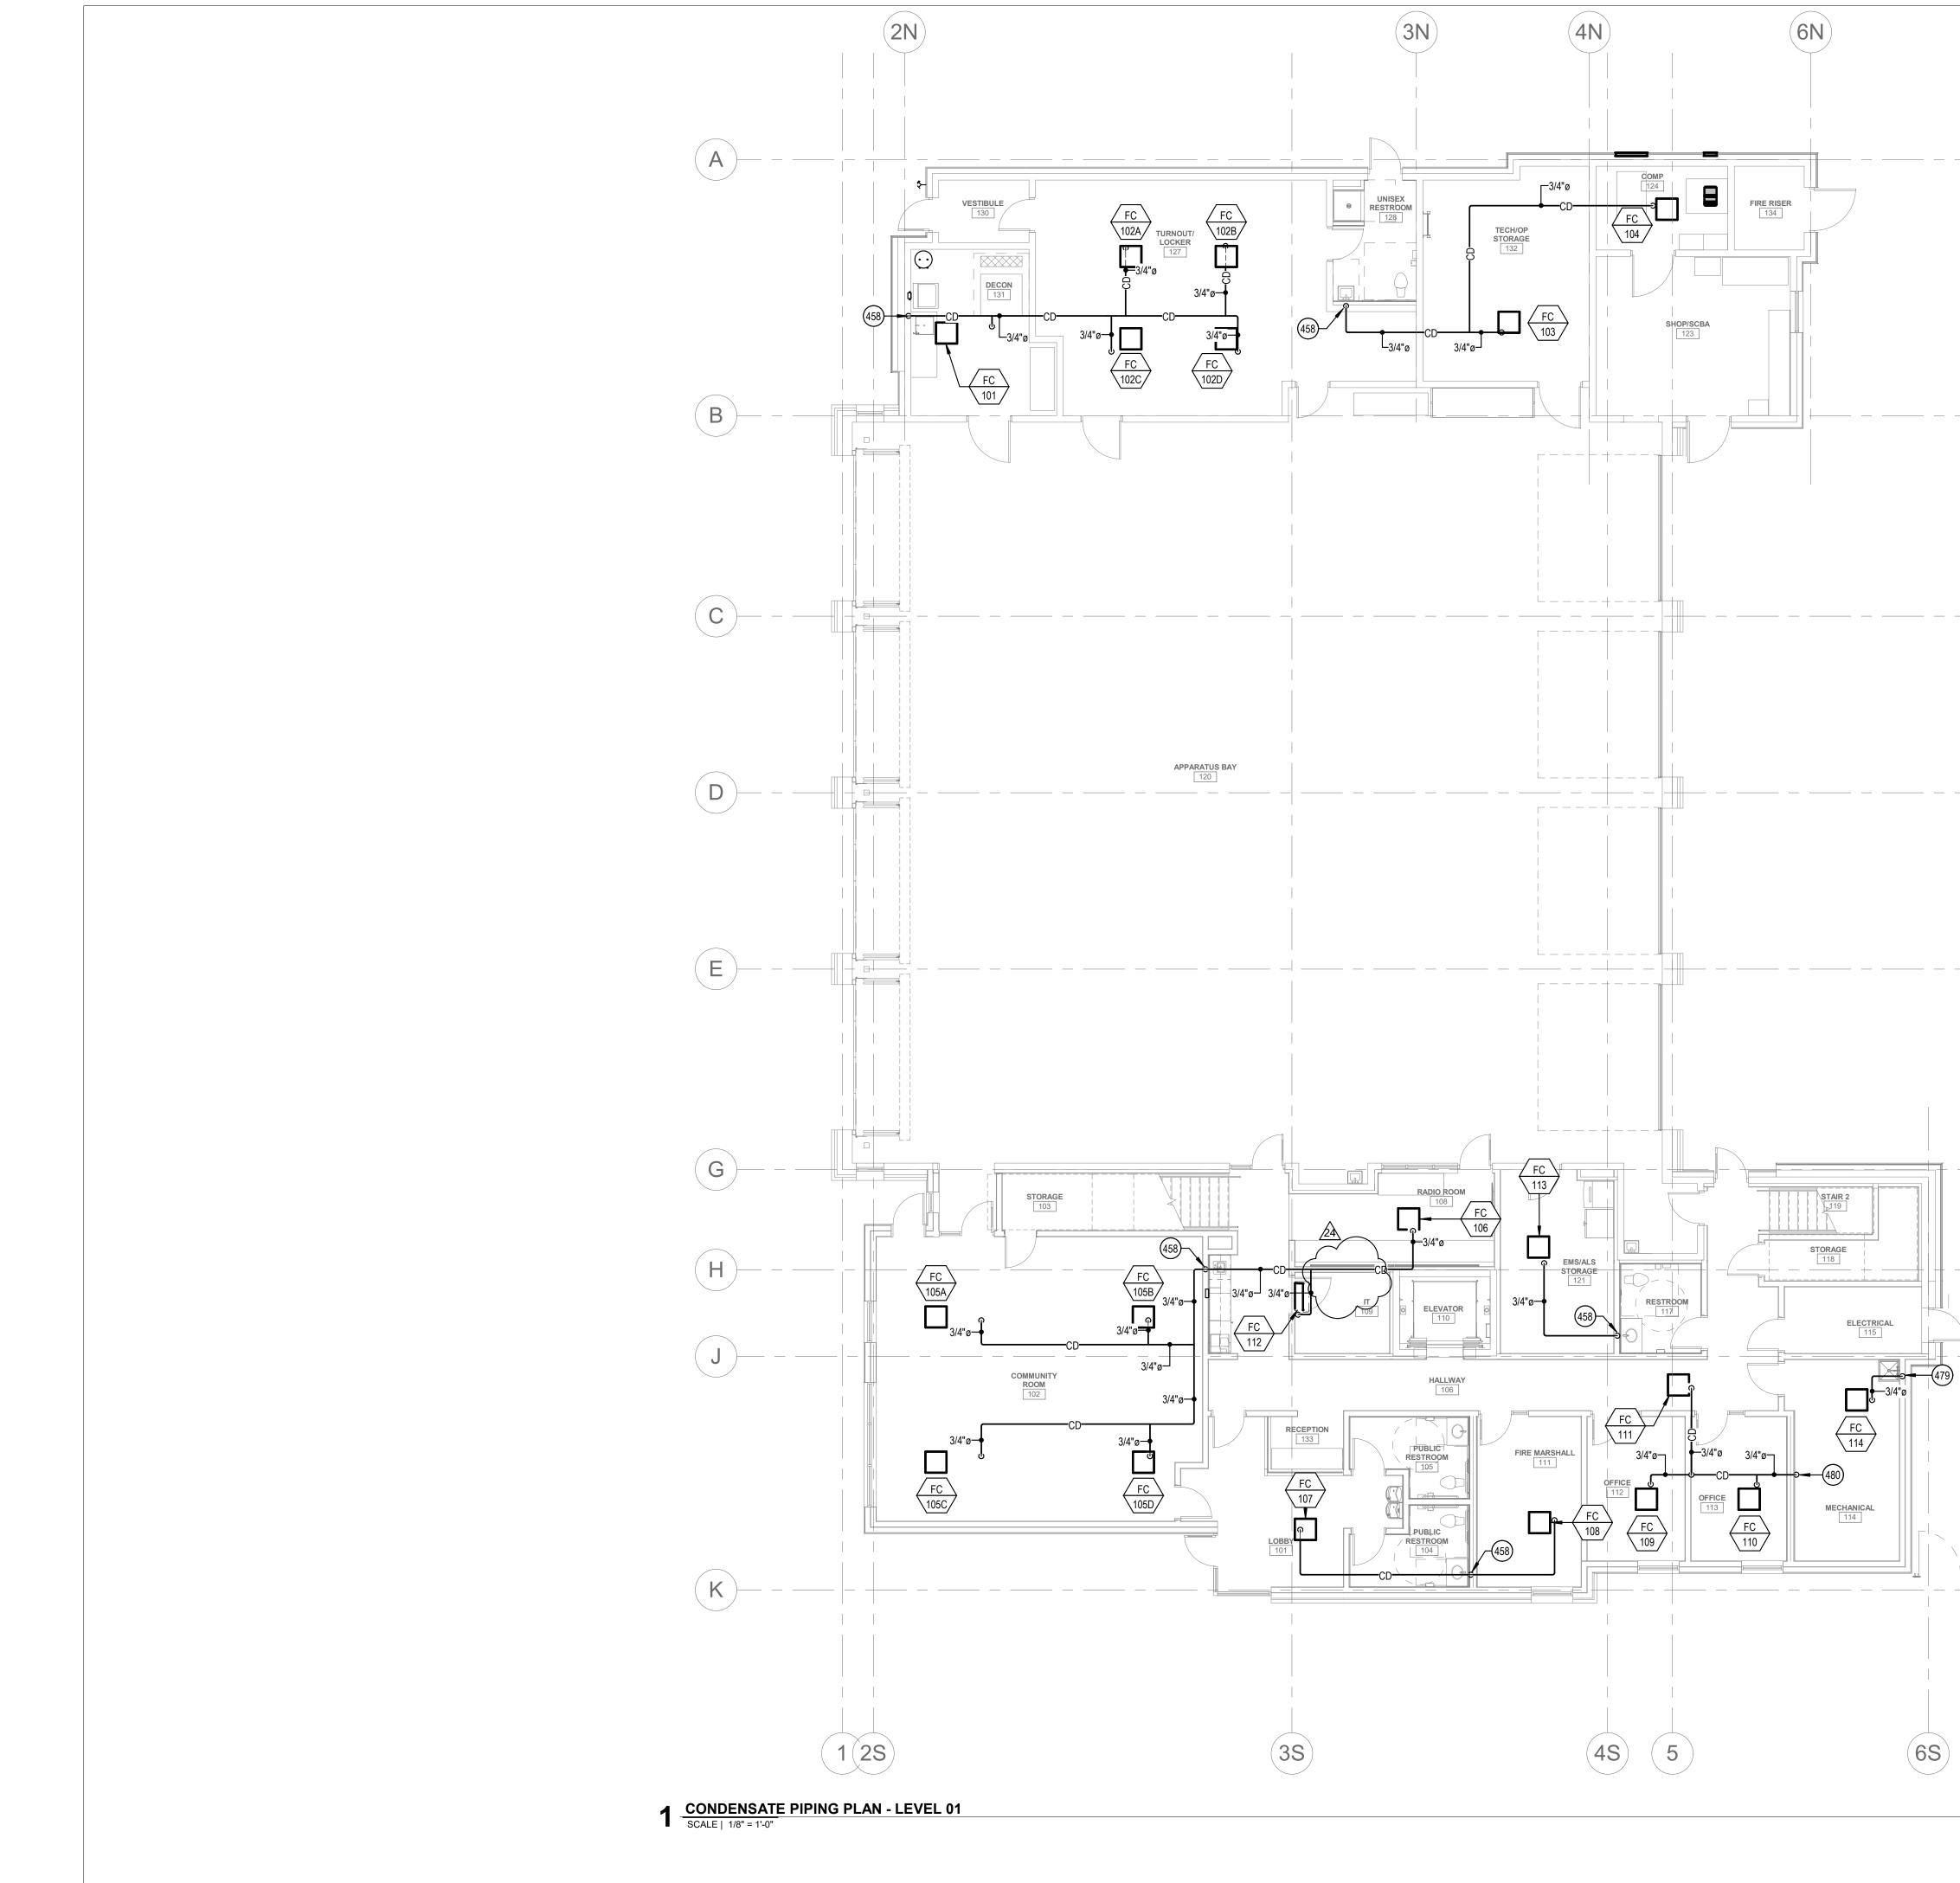

## KEYED NOTES:

# SYMBOL USED FOR CALLOUT

6S

- 458 ROUTE CONDENSATE PIPING FULL SIZE TO NEAREST SINK TAILPIECE. REFER TO SINK/LAVATORY TAILPIECE CONDENSATE DETAIL.
- 479 ROUTE CONDENSATE PIPING FULL SIZE DOWN IN WALL AND TERMINATE 6" ABOVE SERVICE SINK.
- 480 ROUTE CONDENSATE PIPING FULL SIZE DOWN IN WALL AND TERMINATE 6" ABOVE FLOOR SINK.



1008 W Main St Boise, Idaho 83702 208.345.1800 colearchitects.net Copyright © 2020 Cole Architects, PLLC



ARCHITECTURE + PLANNING + DESIGN 6211 Roosevelt Way NE Seattle, WA 98115 206.522.3820

STAMP

### CONSULTANT



234 S. WHISPERWOOD WAY BOISE, IDAHO 83709 (208) 384-0585 PROJECT #19-366

**PROJECT INFORMATION** 



### **KETCHUM FIRE** STATION

107 SADDLE ROAD, KETCHUM ID 83353

ISSUES

PHASE CONSTRUCTION SET 6/19/2020 DATE JOB NUMBER 18-022


 MARK
 DATE
 DESCRIPTION

 24
 4/12/21
 RFI #CC-160

SHEET NAME

CONDENSATE PIPING PLAN -LEVEL 01



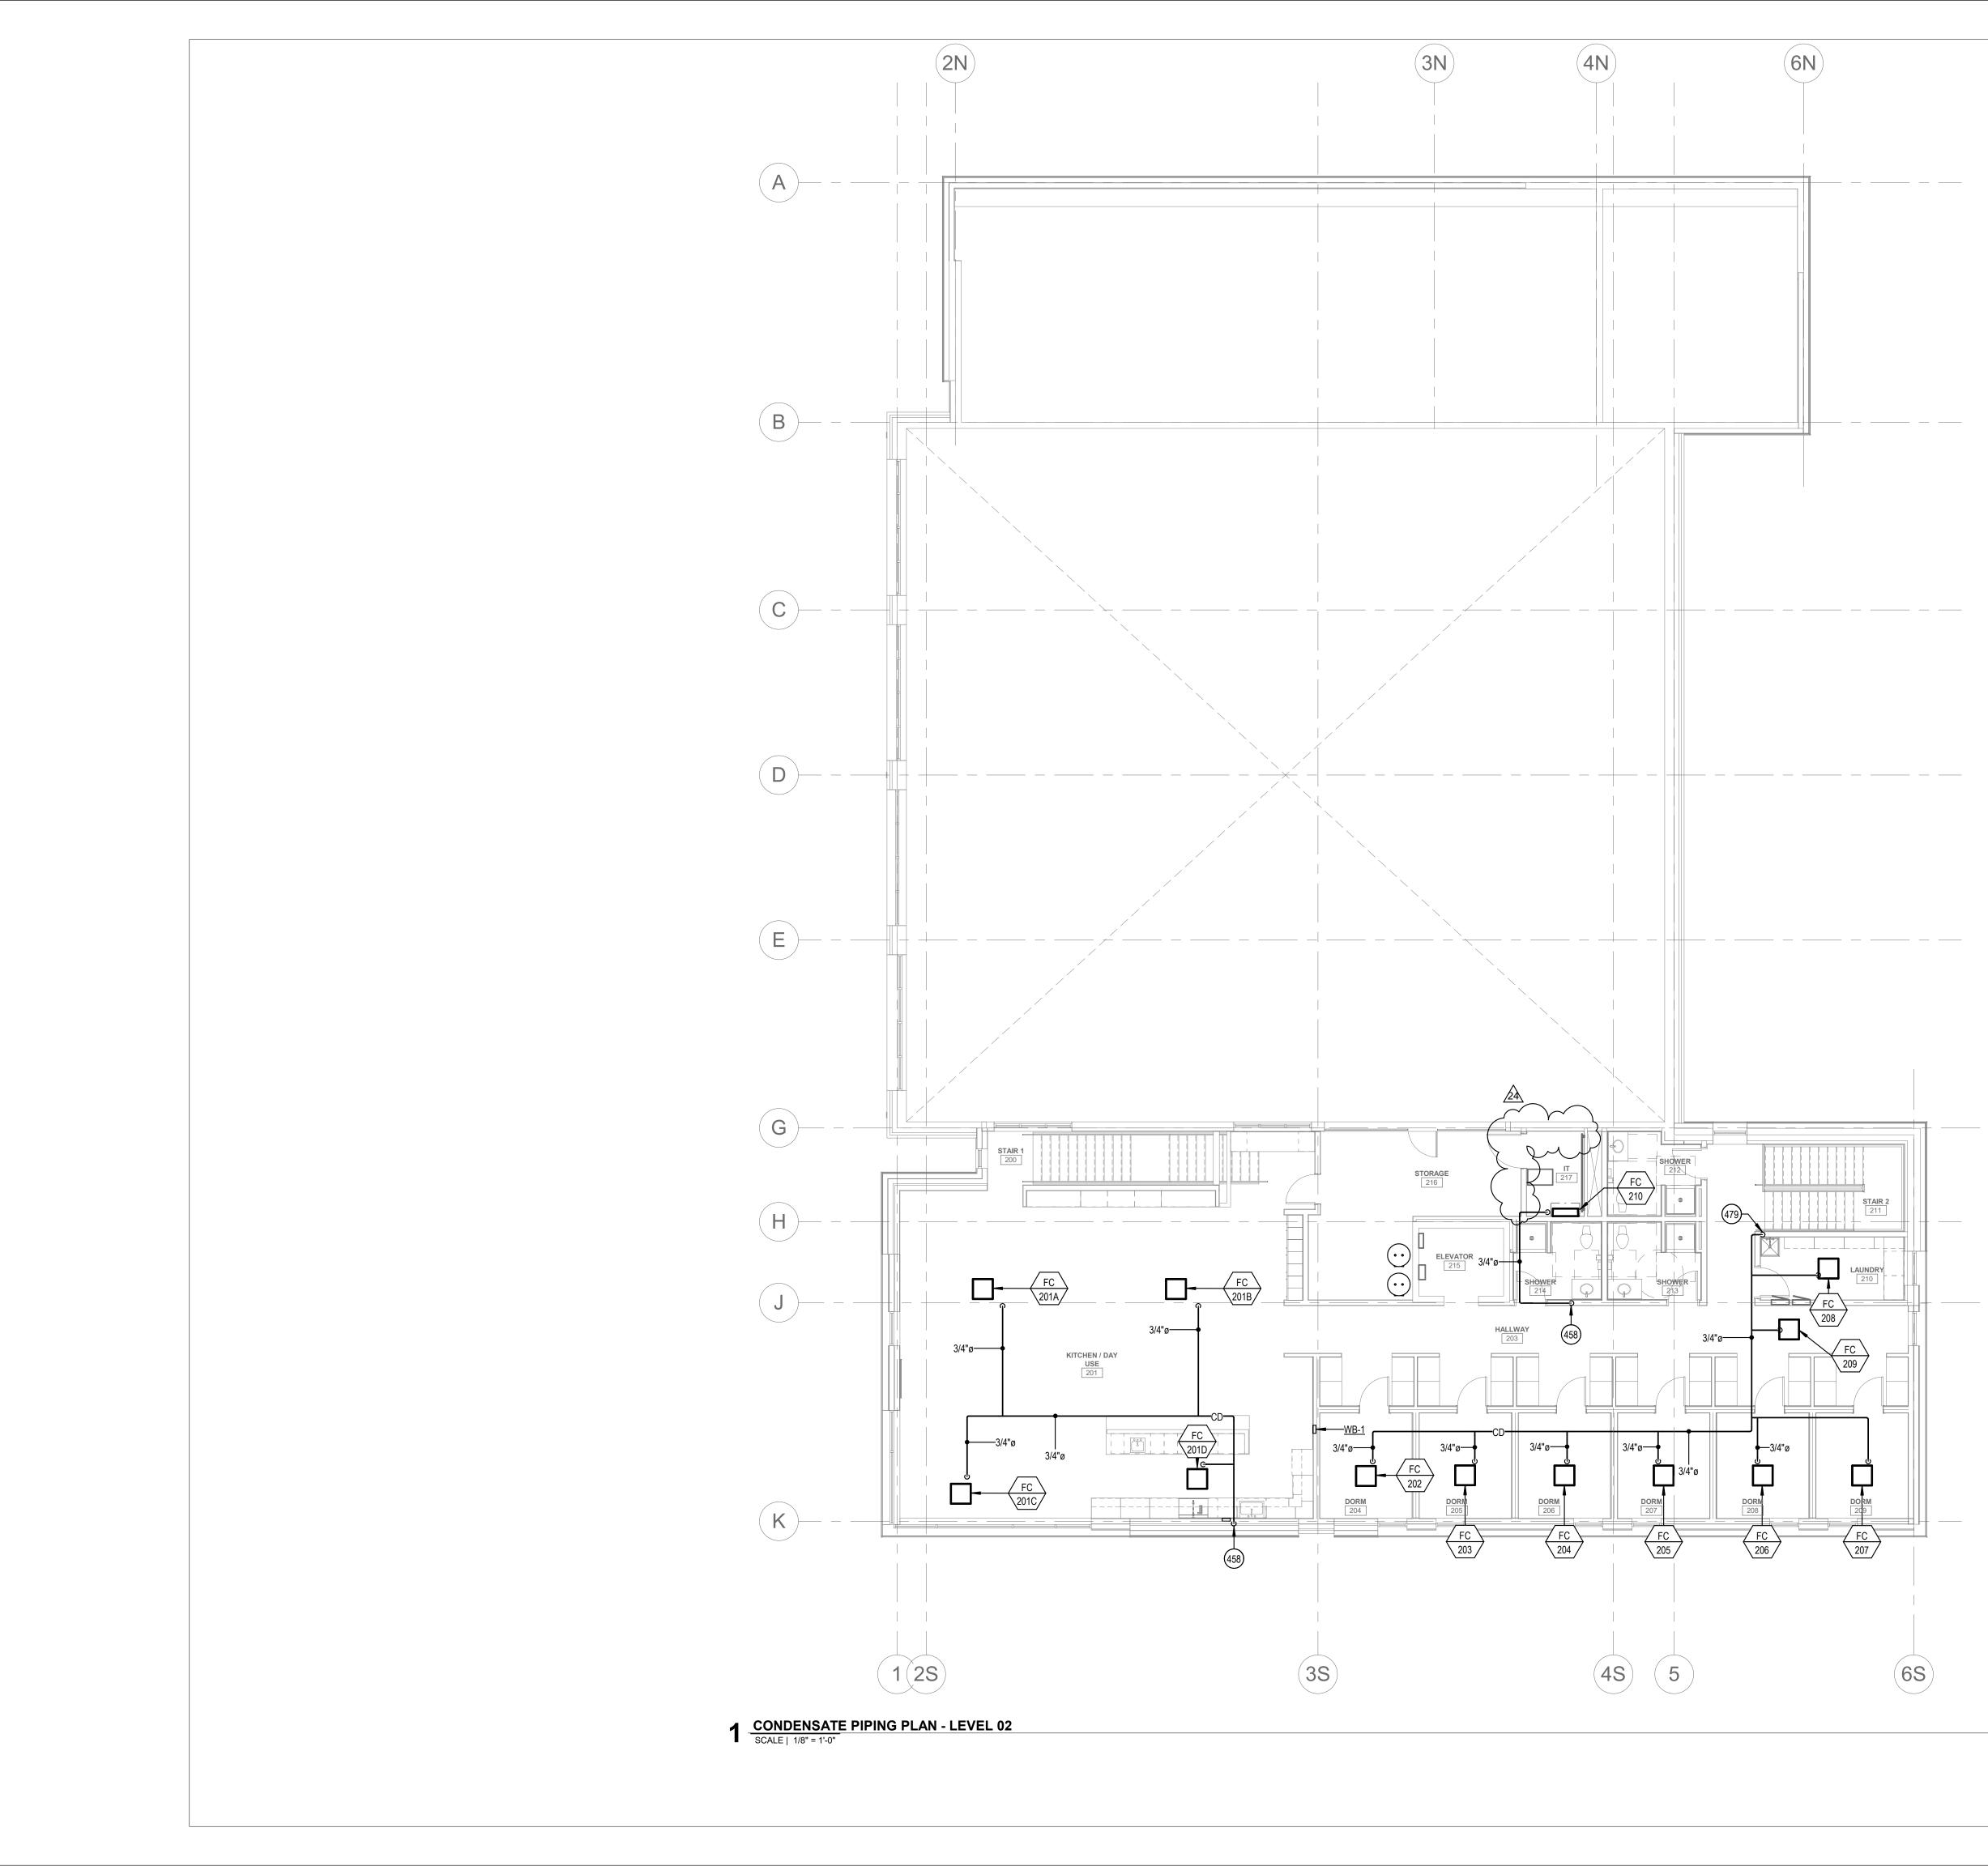

## KEYED NOTES:

# SYMBOL USED FOR CALLOUT

- 458 ROUTE CONDENSATE PIPING FULL SIZE TO NEAREST SINK TAILPIECE. REFER TO SINK/LAVATORY TAILPIECE CONDENSATE DETAIL.
- 479 ROUTE CONDENSATE PIPING FULL SIZE DOWN IN WALL AND TERMINATE 6" ABOVE SERVICE SINK.



STAMP

### CONSULTANT



234 S. WHISPERWOOD WAY BOISE, IDAHO 83709 (208) 384-0585 PROJECT #19-366

PROJECT INFORMATION



# KETCHUM FIRE

107 SADDLE ROAD, KETCHUM ID 83353

ISSUES

PHASECONSTRUCTION SETDATE6/19/2020JOB NUMBER18-022

 MARK
 DATE
 DESCRIPTION


 24
 4/12/21
 RFI #CC-160

SHEET NAME

CONDENSATE PIPING PLAN -LEVEL 02

SHEET NUMBER

P3.01

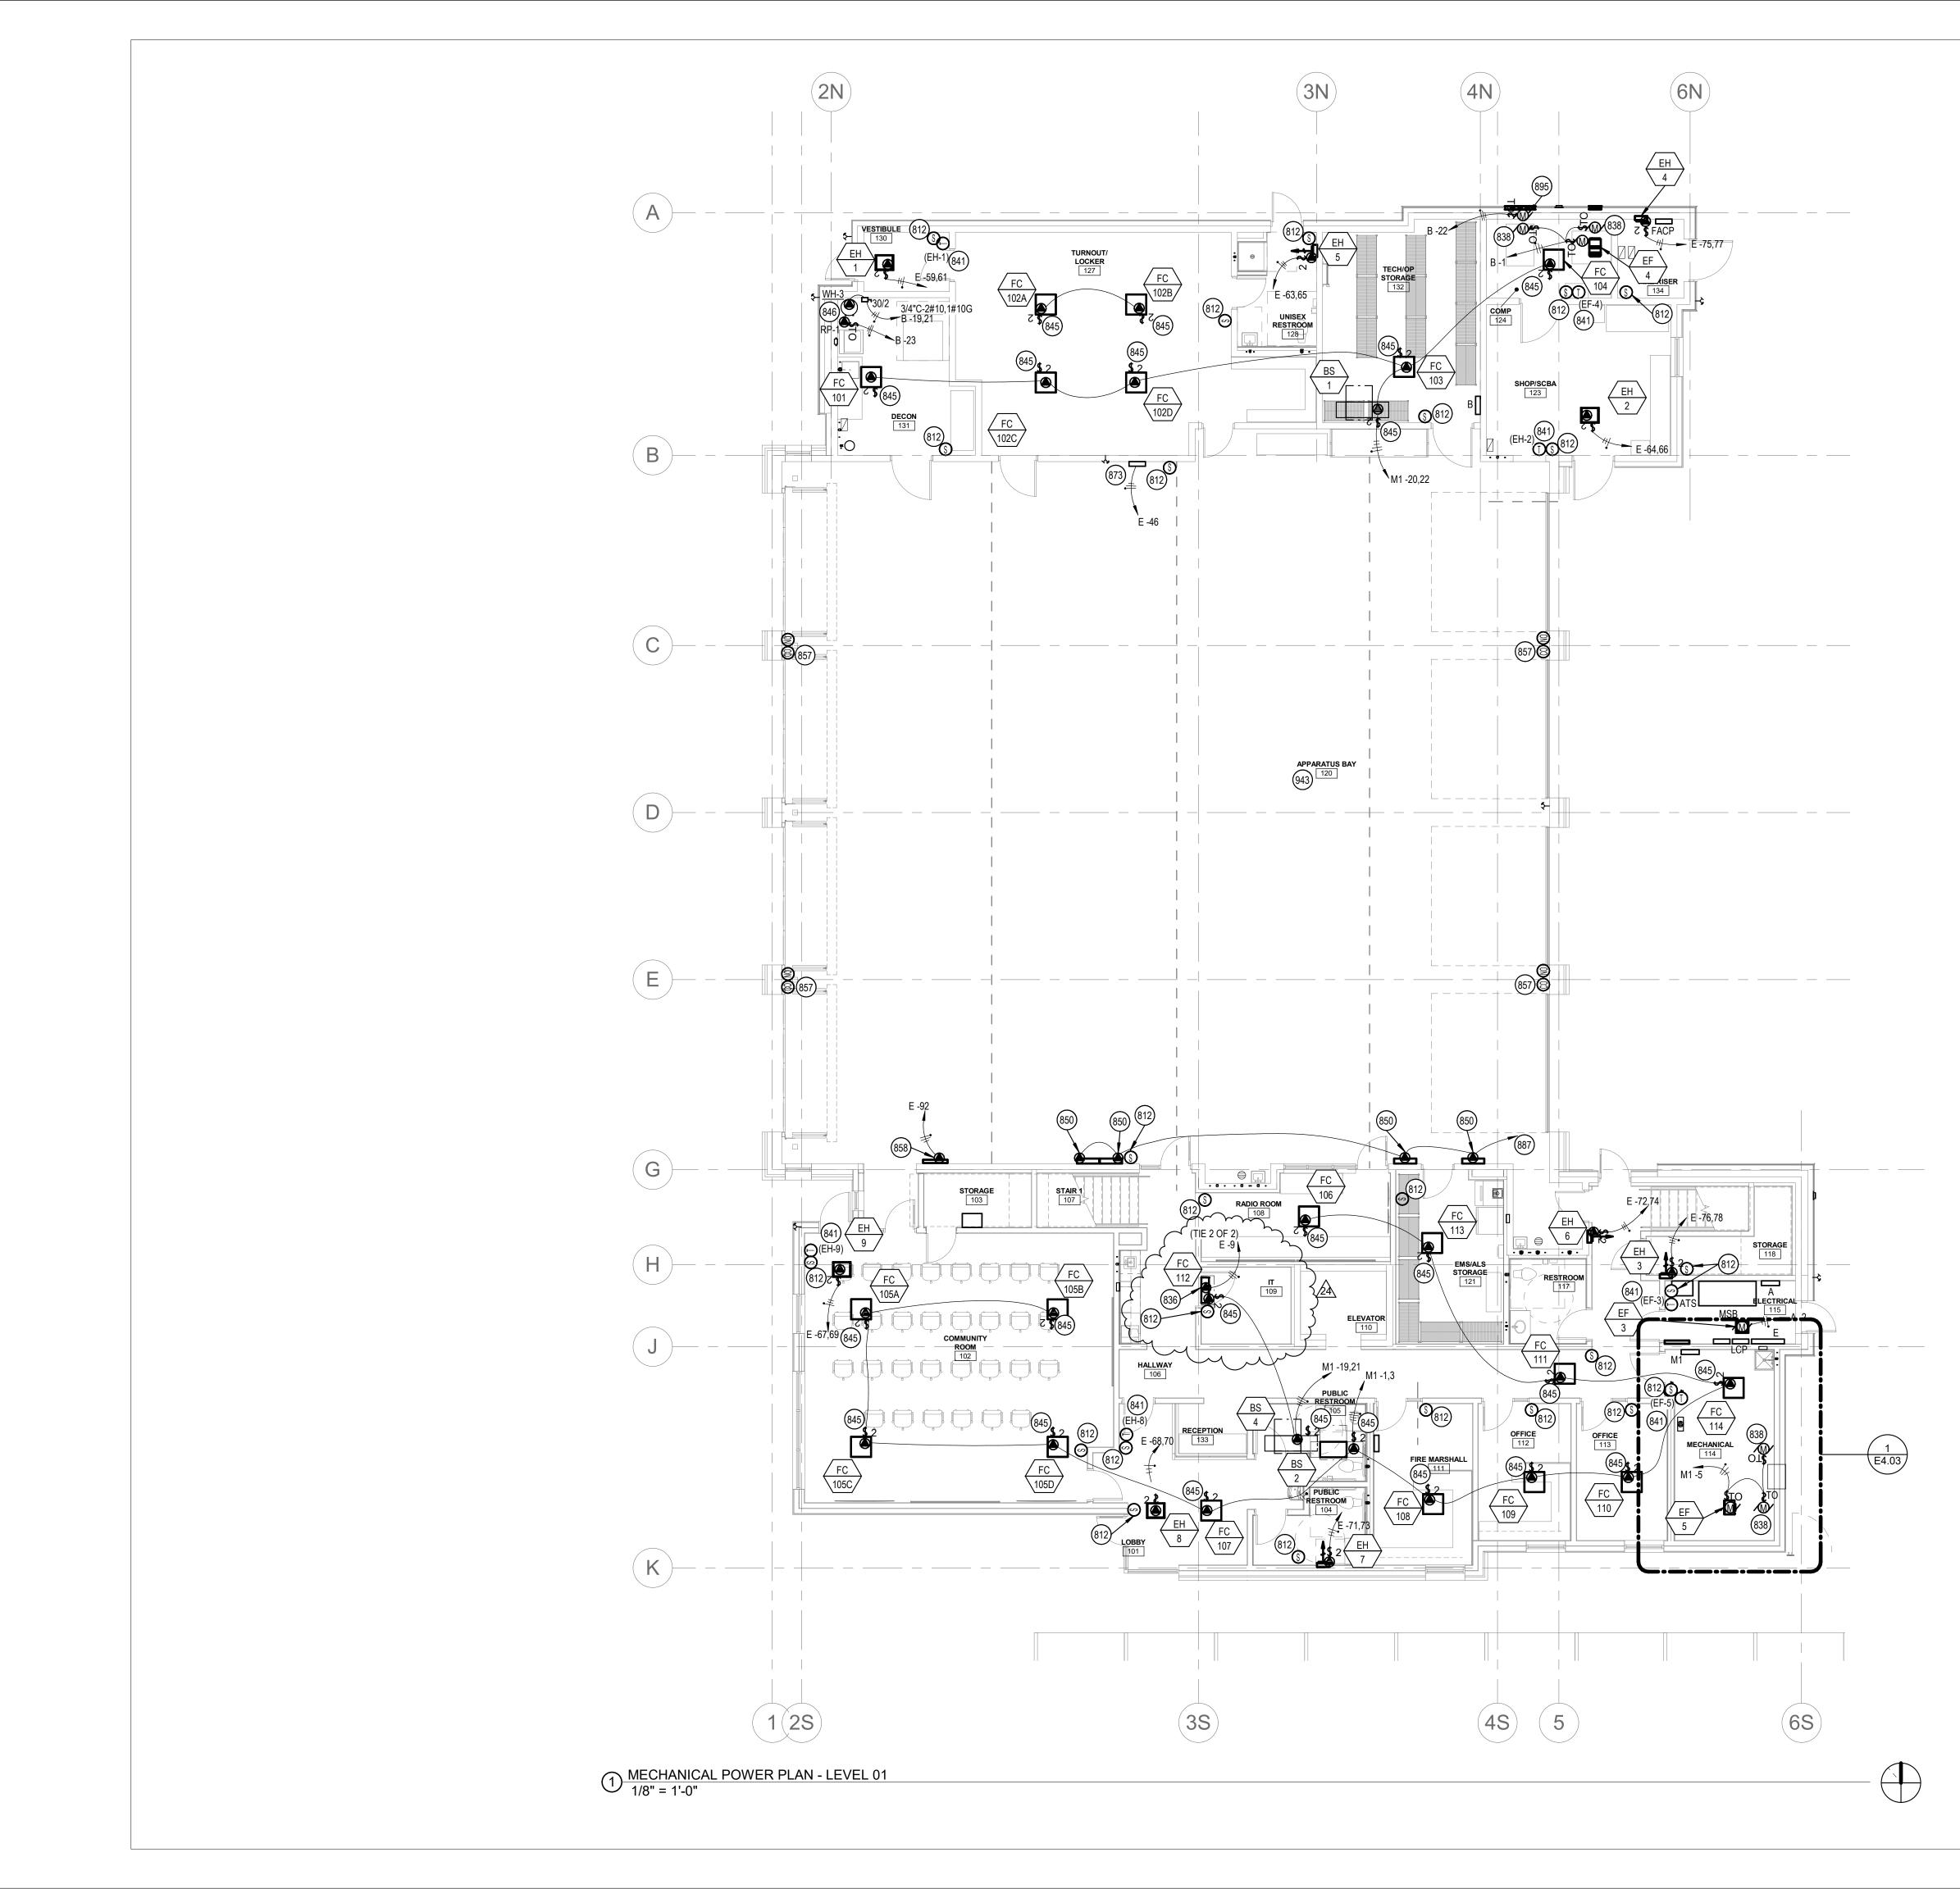



(#) SYMBOL USED FOR CALLOUT

- 812 1/2" CONDUIT TO THE DDC CONTROL PANEL. BOX AND CONDUIT TO BE PROVIDED BY ELECTRICAL CONTRACTOR. MECHANICAL CONTRACTOR TO MAKE FINAL CONNECTIONS. COORDINATE BOX SIZE WITH MECHANICAL CONTRACTOR. COORDINATE EXACT LOCATION WITH MECHANICAL CONTRACTOR.
- 836 FURNISH AND INSTALL ELECTRICAL CONNECTION FOR CONDENSATE PUMP. COORDINATE WITH MECHANICAL CONTRACTOR FOR ADDITIONAL INFORMATION. PROVIDE ALL ELECTRICAL REQURIED FOR A COMPLETE AND FUNCTIONING SYSTEM.
- 838 CONNECTION FOR UPPER MOTORIZED LOUVER/DAMPER. PROVIDE ICE-CUBE TYPE RELAY IN A NEMA 1 ENCLOSURE FOR CONTROL BY ASSOCIATED DEVICE. INTERLOCK WITH ASSOCIATED EXHAUST FAN #4 AS REQUIRED, COORDINATE COIL VOLTAGE AND ELECTRICAL INFORMATION WITH MECHANICAL CONTRACTOR.
- 841 LINE VOLTAGE HEAT RISE T-STAT. 1/2" CONDUIT TO ASSOCIATED MECHANICAL UNIT. BOX, CONDUIT, AND CONDUCTORS TO BE PROVIDED AND INSTALLED BY ELECTRICAL CONTRACTOR. COORDINATE WITH MECHANICAL CONTRACTOR PRIOR TO BEGINNING WORK.
- 845 FURNISH AND INSTALL DISCONNECT SWITCH, COORDINATE LOCATION WITH HVAC EQUIPMENT AND MECHANICAL CONTRACTOR TO MAINTAIN ALL REQUIRED CLEARANCES. IN ADDITION TO THE POWER CIRCUIT SHOWN, THE ELECTRICAL CONTRACTOR SHALL FURNISH AND INSTALL 1/2" EMPTY CONDUIT WITH PULLSTRING AND DAISY-CHAIN BETWEEN ALL HVAC UNITS ON THIS CIRCUIT FOR CONTROL WIRING. WIRING FURNISHED AND INSTALLED BY MECHANICAL CONTRACTOR. REFER TO THE MECHANICAL DRAWINGS FOR SCHEMATICS AND ADDITIONAL INFORMATION. COORDINATE WITH MECHANICAL CONTRACTOR PRIOR TO BEGINNING WORK. FURNISH AND INSTALL ALL ELECTRICAL REQUIRED FOR A COMPLETE AND FUNCTIONING SYSTEM.
- 846 FURNISH AND INSTALL ELECTRICAL CONNECTION TO WATER HEATER. COORDINATE DISCONNECT LOCATION WITH OTHER TRADES TO MAINTAIN REQUIRED CLEARANCES. CONNECT ALL EQUIPMENT ASSOCIATED WITH WATER HEATER.
- 850 FURNISH AND INSTALL 3/4" CONDUIT TO SNOW MELT CONTROLS AT SNOW MANIFOLD. COORDINATE LOCATION AND REQUIREMENTS WITH EQUIPMENT INSTALLER PRIOR TO BEGINNING WORK.
- 857 1/2" CONDUIT TO CORRESPONDING GAS DETECTION PANEL. BOX, CONDUIT, AND CONDUCTORS TO BE PROVIDED BY ELECTRICAL CONTRACTOR. LEAVE 12" SLACK AT BOX AND MECHANICAL UNIT. MECHANICAL CONTRACTOR TO MAKE FINAL CONNECTIONS. COORDINATE BOX SIZE AND QUANTITY OF CONDUCTOR(S) WITH MECHANICAL CONTRACTOR. COORDINATE EXACT LOCATION WITH MECHANICAL CONTRACTOR.
- 858 GAS DETECTION PANEL, COORDINATE EXACT LOCATION AND ELECTRICAL REQUIREMENTS WITH MECHANICAL CONTRACTOR.
- 873 VEHICLE EXHAUST CONTROL PANEL. COORDINATE ELECTRICAL CONNECTION AND WITH EQUIPMENT.
- 887 ROUTE 3/4" CONDUIT TO THE DDC CONTROL PANEL.
- 895 CONNECTION FOR LOWER MOTORIZED LOUVER/DAMPER. PROVIDE ICE-CUBE TYPE RELAY IN A NEMA 1 ENCLOSURE FOR CONTROL BY ASSOCIATED DEVICE. INTERLOCK WITH ASSOCIATED BREATHING AIR COMPRESSOR AS REQUIRED, COORDINATE COIL VOLTAGE AND ELECTRICAL INFORMATION WITH MECHANICAL CONTRACTOR.
- 943 ALL LOW-VOLTAGE CONDUCTORS AND CABLING ROUTED IN OR THROUGH THE APPARATUS BAY SHALL BE ROUTED IN CONDUIT, NO EXCEPTIONS. ROUTE CONDUIT UP AS HIGH AS POSSIBLE AND TIGHT TO STRUCTURE. COORDINATE WITH OTHER TRADES PRIOR TO BEGINNING WORK.



#### Boise, Idaho 83702 208.345.1800 colearchitects.net Copyright © 2020 Cole Architects, PLLC



ARCHITECTURE + PLANNING + DESIGN 6211 Roosevelt Way NE

Seattle, WA 98115 206.522.3820

STAMP

#### CONSULTANT



234 S. WHISPERWOOD WAY BOISE, IDAHO 83709 (208) 384-0585 PROJECT #19-366

**PROJECT INFORMATION** 



# KETCHUM FIRE

107 SADDLE ROAD, KETCHUM ID 83353

#### ISSUES

 PHASE
 CONSTRUCTION SET

 DATE
 6/19/2020

 JOB NUMBER
 18-022

 MARK
 DATE
 DESCRIPTION

 14
 10/01/0
 10/01/0

 
 11
 10/21/2 0
 ASI #4

 12
 11/4/20
 RFI #97R1

 24
 4/12/21
 RFI #CC-160

SHEET NAME

MECHANICAL POWER PLAN -LEVEL 01





### **KEYED NOTES:**

(#) SYMBOL USED FOR CALLOUT

- 812 1/2" CONDUIT TO THE DDC CONTROL PANEL. BOX AND CONDUIT TO BE PROVIDED BY ELECTRICAL CONTRACTOR. MECHANICAL CONTRACTOR TO MAKE FINAL CONNECTIONS. COORDINATE BOX SIZE WITH MECHANICAL CONTRACTOR. COORDINATE EXACT LOCATION WITH MECHANICAL CONTRACTOR.
- 835 COORDINATE DISCONNECT SWITCH AND DISCONNECT MOUNTING AND LOCATION WITH HVAC CONTRACTOR PRIOR TO BEGINNING ROUGH-IN.
- 836 FURNISH AND INSTALL ELECTRICAL CONNECTION FOR CONDENSATE PUMP. COORDINATE WITH MECHANICAL CONTRACTOR FOR ADDITIONAL INFORMATION. PROVIDE ALL ELECTRICAL REQURIED FOR A COMPLETE AND FUNCTIONING SYSTEM.
- 838 CONNECTION FOR UPPER MOTORIZED LOUVER/DAMPER. PROVIDE ICE-CUBE TYPE RELAY IN A NEMA 1 ENCLOSURE FOR CONTROL BY ASSOCIATED DEVICE. INTERLOCK WITH ASSOCIATED EXHAUST FAN #4 AS REQUIRED, COORDINATE COIL VOLTAGE AND ELECTRICAL INFORMATION WITH MECHANICAL CONTRACTOR.
- 839 FURNISH AND INSTALL ELECTRICAL CONNECTION TO DESTRATIFICATION FAN AS REQUIRED. COORDINATE DISCONNECT AND ELECTRICAL CONNECTION TO CONTROL TRANSFORMER AND OTHER ELECTRICAL CONNECTIONS WITH MECHANICAL CONTRACTOR PRIOR TO BEGINNING WORK. FURNISH AND INSTALL ALL ELECTRICAL WIRING AND EQUIPMENT REQUIRED FOR A COMPLETE AND FUNCTIONING SYSTEM.
- 840 FURNISH AND INSTALL DISCONNECT AND ELECTRICAL CONNECTION TO EQUIPMENT SHOWN AND COORDINATE WITH MECHANICAL CONTRACTOR PRIOR TO BEGINNING WORK.
- 841 LINE VOLTAGE HEAT RISE T-STAT. 1/2" CONDUIT TO ASSOCIATED MECHANICAL UNIT. BOX, CONDUIT, AND CONDUCTORS TO BE PROVIDED AND INSTALLED BY ELECTRICAL CONTRACTOR. COORDINATE WITH MECHANICAL CONTRACTOR PRIOR TO BEGINNING WORK.
- 845 FURNISH AND INSTALL DISCONNECT SWITCH, COORDINATE LOCATION WITH HVAC EQUIPMENT AND MECHANICAL CONTRACTOR TO MAINTAIN ALL REQUIRED CLEARANCES. IN ADDITION TO THE POWER CIRCUIT SHOWN, THE ELECTRICAL CONTRACTOR SHALL FURNISH AND INSTALL 1/2" EMPTY CONDUIT WITH PULLSTRING AND DAISY-CHAIN BETWEEN ALL HVAC UNITS ON THIS CIRCUIT FOR CONTROL WIRING. WIRING FURNISHED AND INSTALLED BY MECHANICAL CONTRACTOR. REFER TO THE MECHANICAL DRAWINGS FOR SCHEMATICS AND ADDITIONAL INFORMATION. COORDINATE WITH MECHANICAL CONTRACTOR PRIOR TO BEGINNING WORK. FURNISH AND INSTALL ALL ELECTRICAL REQUIRED FOR A COMPLETE AND FUNCTIONING SYSTEM.
- 846 FURNISH AND INSTALL ELECTRICAL CONNECTION TO WATER HEATER. COORDINATE DISCONNECT LOCATION WITH OTHER TRADES TO MAINTAIN REQUIRED CLEARANCES. CONNECT ALL EQUIPMENT ASSOCIATED WITH WATER HEATER.
- 847 FURNISH AND INSTALL ELECTRICAL CONNECTION TO RECIRC PUMP. COORDINATE DISCONNECT LOCATION WITH OTHER TRADES TO MAINTAIN REQUIRED CLEARANCES. CONNECT ALL EQUIPMENT ASSOCIATED WITH RECIRC PUMP.
- 849 FURNISH AND INSTALL ELECTRICAL CONNECTION TO CONTROL TRANSFORMER FOR EQUIPMENT SHOWN. CONTROLS TRANSFORMER SHALL BE FURNISHED AND INSTALLED BY MECHANICAL CONTRACTOR. COORDINATE WITH MECHANICAL CONTRACTOR FOR ADDITIONAL INFORMATION.
- 881 ROUTE CIRCUIT THROUGH THE GAS DETECTION PANEL AS REQUIRED. COORDINATE WITH THE MECHANICAL CONTRACTOR FOR ADDITIONAL INFORMATION. FURNISH AND INSTALL ALL ELECTRICAL CONNECTIONS AND ELECTRICAL EQUIPMENT REQUIRED FOR A COMPLETE AND FUNCTIONING SYSTEM.
- 883 ROUTE 3/4" EMPTY CONDUIT WITH PULLSTRING FROM HVAC EQUIPMENT SHOWN TO THE DDC CONTROL PANEL FOR CONTROL WIRING. CONTROL WIRING FURNISH AND INSTALLED BY CONTROLS CONTRACTOR. COORDINATE WITH CONTROL CONTRACTOR PRIOR TO BEGINNING WORK.
- 888 RADON FAN LOCATED IN ATTIC IN THIS APPROXIMATE AREA. PROVIDE ALL ELECTRICAL CONNECTIONS REQUIRED, COORDINATE WITH MECHANICAL CONTRACTOR PRIOR TO BEGINNING WORK.



Boise, Idaho 83702 208.345.1800 colearchitects.net Copyright © 2020 Cole Architects, PLLC



ARCHITECTURE + PLANNING + DESIGN 6211 Roosevelt Way NE

Seattle, WA 98115 206.522.3820

STAMP

### CONSULTANT



234 S. WHISPERWOOD WAY BOISE, IDAHO 83709 (208) 384-0585 PROJECT #19-366

**PROJECT INFORMATION** 



### **KETCHUM FIRE** STATION

107 SADDLE ROAD, KETCHUM ID 83353

#### ISSUES


CONSTRUCTION SET PHASE 6/19/2020 DATE JOB NUMBER 18-022 MARK DATE DESCRIPTION 11 10/21/2 ASI #4 0


24 4/12/21 RFI #CC-160

SHEET NAME

MECHANICAL POWER PLAN -LEVEL 02




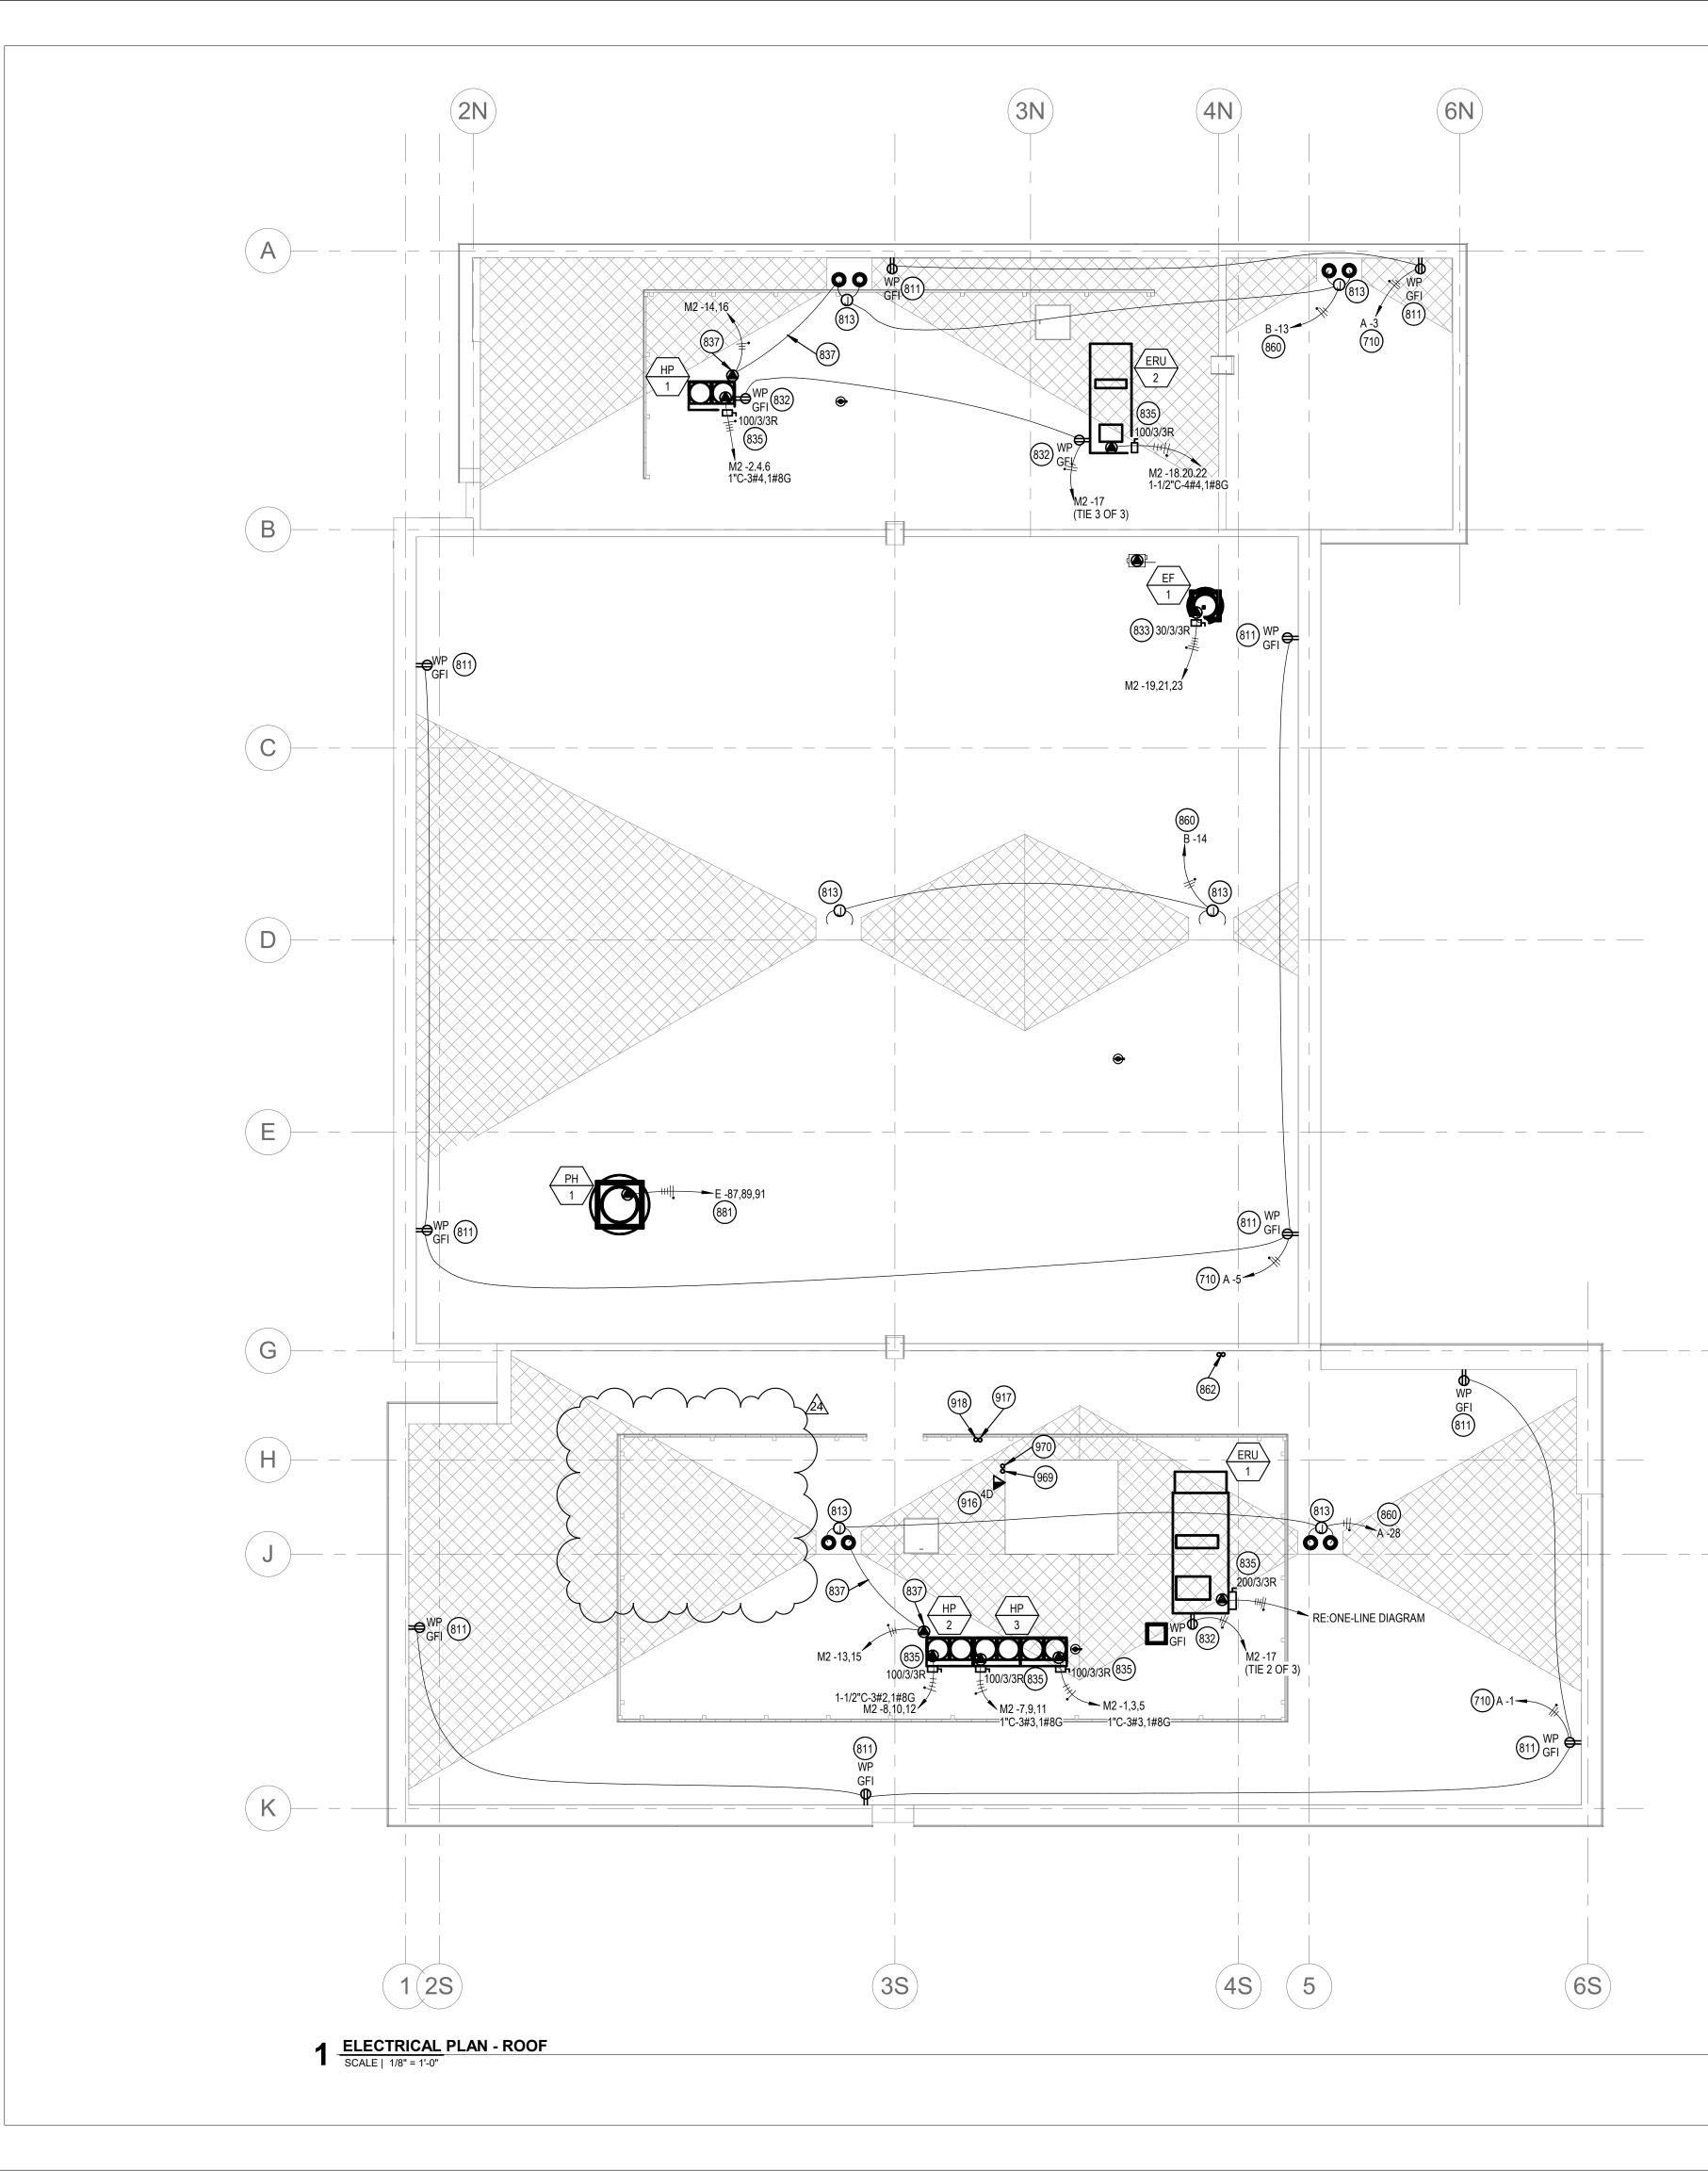

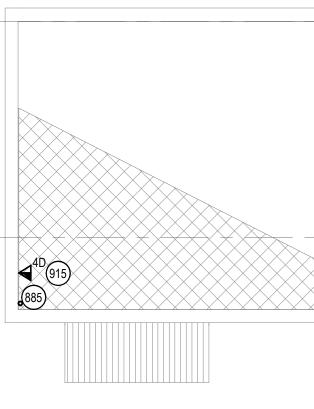

## KEYED NOTES:

- (#) SYMBOL USED FOR CALLOUT
- 710 ROUTE CIRCUIT THROUGH THE LIGHTING CONTROL PANEL. REFER TO THE LIGHTING CONTROL PANEL SCHEDULE FOR ADDITIONAL INFORMATION.
- 811 RECEPTACLE FOR FUTURE CHRISTMAS LIGHTS. MOUNT RECEPTACLE ON ROOF PARAPET. COORDINATE MOUNTING WITH ARCHITECTURAL DRAWINGS AND OTHER TRADES PRIOR TO BEGINNING ROUGH-IN. ROUTE CIRCUIT THROUGHT THE LIGHTING CONTROL PANEL.
- 813 HEAT TAPE LOCATED ON ROOF. VERIFY EXACT LOCATION WITH OWNER. WRAP HEAT TAPE AROUND ROOF DRAIN AND OVERFLOW DRAIN DOWNSPOUT. EXTEND HEAT TAPE 4' DOWN THE DRAINPIPE. MAKE ALL CONNECTIONS. RE:HEAT TAPE DETAIL
- 832 MOUNT RECEPTACLE ON RIGID CONDUIT 12" ABOVE ROOF DECK OR ON MECHANICAL UNIT WHERE APPLICABLE.
- 833 FIELD COORDINATE DISCONNECT AND HVAC EQUIPMENT LOCATION WITH MECHANICAL CONTRACTOR TO MAINTAIN ALL REQUIRED CLEARANCES.
- 835 COORDINATE DISCONNECT SWITCH AND DISCONNECT MOUNTING AND LOCATION WITH HVAC CONTRACTOR PRIOR TO BEGINNING ROUGH-IN.
- 837 FURNISH AND INSTALL HEAT AROUND HEAT PUMP BASES AND FROM HEAP PUMP BASE TO ROOF DRAIN. HEAT TAPE SHALL WRAP AROUND THE BASE OF THE UNIT(S), COORDINATE WITH MECHANICAL CONTRACTOR. UTILIZE RAYCHEM ICESTOP 12W/FT, 208 VOLTS OR APPROVED EQUAL. INSTALL PENTAIR DIGITRACE AMC-1A OR EQUAL THERMOSTAT CONTROL FOR EACH CIRCUIT. PROVIDE GROUND-FAULT EQUIPMENT PROTECTION FOR CIRCUIT NOTED. COORDINATE ALL WORK AND INSTALLATION WITH MECHANICAL CONTRACTOR PRIOR TO BEGINNING WORK. FURNISH AND INSTALL ALL ELECTRICAL EQUIPMENT AND WIRING REQUIRED FOR A COMPLETE AND FUNCTIONING SYSTEM.
- 860 PROVIDE GFEP TYPE CIRCUIT BREAKER FOR CIRCUIT NOTED.
- 862 ROUTE (2) 4" EMPTY CONDUITS FROM THE ELECTRICAL ROOM, OVER TO MECHANICAL CHASE AND UP THROUGH ROOF FOR FUTURE SOLAR PANELS. INSTALL CAP ON CONDUITS AND MAKE WATER-TIGHT. COORDINATE ROUTING WITH OTHER TRADES PRIOR TO BEGINNING WORK.
- 881 ROUTE CIRCUIT THROUGH THE GAS DETECTION PANEL AS REQUIRED. COORDINATE WITH THE MECHANICAL CONTRACTOR FOR ADDITIONAL INFORMATION. FURNISH AND INSTALL ALL ELECTRICAL CONNECTIONS AND ELECTRICAL EQUIPMENT REQUIRED FOR A COMPLETE AND FUNCTIONING SYSTEM.
- 885 (1) 4" EMPTY CONDUITS WITH PULLSTRING FROM THE APPARATUS STORAGE BUILDING TO THIS APPROXIMATE LOCATION FOR FUTURE SOLAR SYSTEM. CAP AND MARK LOCATIONS.
- 915 MOUNT DEVICE ON ROOF IN THIS APPROXIMATE LOCATION FOR FUTURE PV SYSTEM CONTROL PANEL. COORDINATE MOUNTING AND LOCATION WITH ARCHITECTURAL DRAWINGS AND OTHER TRADES PRIOR TO BEGINNING WORK. FURNISH AND INSTALL WEATHERPROOF COVER.
- 916 MOUNT DEVICE ON ROOF ON ELEVATOR HOISTWAY STRUCTURE ROUTED THROUGH ROOF AT THIS APPROXIMATE LOCATION FOR FUTURE PV SYSTEM CONTROL PANEL. COORDINATE MOUNTING AND LOCATION WITH ARCHITECTURAL DRAWINGS AND OTHER TRADES PRIOR TO BEGINNING WORK. FURNISH AND INSTALL WEATHERPROOF COVER.
- 917 ROUTE (2)1-1/2" CONDUITS FROM ROOF DOWN TO THE RADIO RACK IN THE IT ROOM ON LEVEL 1 FOR RADIO ANTENNA CABLING. REFER TO THE ROOF PENETRATION DETAIL FOR ADDITIONAL INFORMATION. COORDINATE ROUTING WITH OTHER TRADES.
- 918 ROUTE (1)1" CONDUIT FROM ROOF DOWN TO THE GROUNDING BUS IN THE IT ROOM ON LEVEL 1 FOR RADIO ANTENNA GROUNDING CONDUCTORS. REFER TO THE ROOF PENETRATION DETAIL FOR ADDITIONAL INFORMATION. COORDINATE ROUTING WITH OTHER TRADES.
- 969 ROUTE (1)1" CONDUIT THROUGH ROOF AND STUB INTO STRUCTURE BELOW FOR FUTURE PV CONTROL PANEL CABLING. REFER TO THE ROOF PENETRATION DETAIL FOR ADDITIONAL INFORMATION. COORDINATE ROUTING WITH OTHER TRADES.
- 970 ROUTE (1)1" CONDUIT FROM ROOF DOWN TO THE IT ROOM ON LEVEL 1 FOR SATELLITE DISH CONDUCTORS. REFER TO THE ROOF PENETRATION DETAIL FOR ADDITIONAL INFORMATION. COORDINATE ROUTING WITH OTHER TRADES.

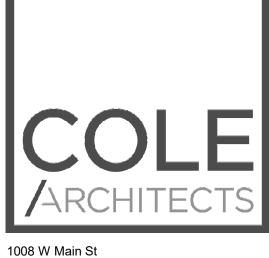

Boise, Idaho 83702 208.345.1800 **colearchitects.net** Copyright © 2020 Cole Architects, PLLC



**ARCHITECTURE + PLANNING + DESIGN** 6211 Roosevelt Way NE

Seattle, WA 98115 206.522.3820

STAMP

### CONSULTANT



234 S. WHISPERWOOD WAY BOISE, IDAHO 83709 (208) 384-0585 PROJECT #19-366

**PROJECT INFORMATION** 



## KETCHUM FIRE STATION

107 SADDLE ROAD, KETCHUM ID 83353

## ISSUES

PHASE		CONSTRUCTION SET
DATE		6/19/2020
JOB NUMBER 18-		18-022
MARK	DATE	DESCRIPTION
20	1/20/21	ASI #5

 21
 1/26/21
 ASI #6

 24
 4/12/21
 RFI #CC-160

SHEET NAME

ELECTRICAL PLAN -



Thornton Heating & Sheetmetal, INC.

P.O.Box 242 Ketchum, Idaho 83340 208-726-5520

## **Credit Memo**

Date	Credit No.
4/15/2021	47845

Customer		
Core Construction 777 N. 4th. St. Boise, ID. 83702		
Boise, ID. 83702		

		P.O. No.	Project
		Ketchum Fire	Ketchum Fire
Description	Qty	Rate	Amount
CREDIT FOR MINI SPLITS Credit for mini splits Restocking fee		14,300.00 -2,860.00	-14,300.00 2,860.00
		Total	-\$11,440.00
		Invoices	\$0.00
		Balance Cre	dit -\$11,440.00

The second secon	<b>IIC</b> Ine Power	To Do	o It Right	1 39 J	c Valley Ele 95 Railway erome, Id 8 fice: 208.94	Street 33338
SU	BCONTRACTOR CHA	ANGE	E ORDE	R REQU	IEST	
					Date:	5/6/2021
SUBCONTRACTOR:	Magic Valley Electric		PRO	JECT NAME:	Ketchum Fire	e station
CONTACT	Jimmy Gyorfy					
					107 Saddle F	Dood
ADDRESS.	395 Railway Street Jerome, ID 83338		PROJECT	I ADDRESS.		
	208-944-4931			SPONSE TO:	Ketchum, ID	03333
FIIONE.	200-944-4931			Bulletin #:		
CONTRACTOR.	Core Construction			ASI #:		
	Chris Schratwieser			JEST FROM:		
				JEST FROM.		
ADDRESS:	777 North 4th Street			ACTOR CO#:		
	Boise, ID 83702 702-794-0550		SUDUUNIRA			
THOME.						
DESCRIPTION:	Deduction change order on remo	ovina el	ectrical con	nections to F	C's in I.T. ro	oms on
	1st and 2nd floor as well as elect					
LOCATION:	Ketchum Fire Station					
DRAWINGS:	RFI response 160 pages E4.01, E	4.02, ar	nd E8.00			
	Trade Description	Hours	Labor Amt.			Total Cost
LABOR:	Journeyman	8.35	70.00			584.50
	Apprentice	8.35	60.00			501.00
						0.00
						0.00
						0.00
	Description	QTY	Unit Price	Sub-Total	Taxes	Total Cost
MATERIAL:	30 amp disconnects(not retunable)	2	-	0.00	0.00	0.00
	#10 wire	840	0.17	142.80	8.57	151.37
	Misc material(flex, bell box, GFCI)	1	48.66	48.66	2.92	51.58
				0.00	0.00	0.00
				0.00	0.00	0.00
	Description	QTY	Unit Price	Sub-Total	Taxes	Total Cost
EQUIPMENT:				0.00	0.00	0.00
				0.00	0.00	0.00
				0.00	0.00	0.00
				0.00	0.00	0.00
				0.00	0.00	0.00
				0.00	0.00	0.00
SUBTOTAL:						1,288.45
GRAND TOTAL:				Total Amou	nt	\$1,288.45
NOTES:						
			Data			
	Authorized Signature		Date			

Б



Building. Growing. Leading. ...Since 1937.

## Budget Evolution Item Summary City of Ketchum Fire Station #1

RFI-180 App Bay Alcove Ceilings

Date:

5/5/2021

Description: Add non com	busable ceilings to North & South	h App Bay Alco	oves
SCOPE	SUBCONTRACTOR	AMOU	INT
Add ceilings to alcoves	Interior Contractors	\$	910.00
Painting already included this area	Roe Painting	\$	-
SUBTOTAL:		\$	910.00
SUBTOTAL reflects direct costs only on t			
allowances. If costs are reimbursed by 0	Change Order, TOTAL AMOUNT be	elow reflects t	he
SUBTOTAL with add of agreed upon mar	kup in accordance with the chang	ge order pricir	ng.
Bond and Insurance	CORE	\$	19.00
CMAR FEE	CORE	\$	40.00
Sales Tax	CORE	\$	-
TOTAL AMOUNT:		\$	969.00





Regional office for CORE NV company 777 N 4th St Bosie, Idaho 83702 Project: 90-20-01-006 - CoK - City of Ketchum Fire Station 107 Saddle Rd. Ketchum, Idaho 83340

## Ceilings @ App Bay Alcoves

TO:	Alex Goedhart (Cole Architects) Crystal McColly (Cole Architects)	FROM:	JT Brown (CORE Construction - Las Vegas) 777 N Fourth St Baise, Idebs 90700
DATE INITIATED:	04/29/2021		Boise, Idaho 83702
LOCATION:	Ketchum Fire Station	STATUS:	Open
PROJECT STAGE:	Course of Construction	DUE DATE:	05/06/2021
COST IMPACT:	Yes (Unknown)	COST CODE:	
DRAWING NUMBER:	A2.61	SCHEDULE IMPACT:	TBD
LINKED DRAWINGS:		SPEC SECTION:	
		REFERENCE:	

#### **RECEIVED FROM:**

#### COPIES TO:

John Allen (Interior Contractors), JT Brown (CORE Construction - Las Vegas), Tyler Brown (Interior Contractors), Robert Fowers (Commercial Fire Protection), Cary Goldberg (DPPM Project Management), Bill McLaughlin (City of Ketchum), Dennis Potts (DPPM Project Management), Chris Schratwieser (CORE Construction - Las Vegas), Matt Sylvester (CORE Construction - Las Vegas)

#### Question from JT Brown (CORE Construction - Las Vegas) at 01:18 PM on 04/29/2021

On the North side of the apparatus bay the wall jogs in for equipment to be placed with a masonry header out flush. Please confirm that the design intent is to finish the area with an acoustical ceiling (ACT-1). We would suggest having the ceiling height 1" above the masonry header. Also confirm the boot wash area at the southside of the app bay will also finish with an acoustical ceiling (ACT-1). See exact location on attached reflected ceiling plan.

Attachments:

A2.61\_ REFLECTED CEILING PLAN - LEVEL 01 Rev.1 markup.pdf

Awaiting an Official Response

The design intent is to finish both areas with mold-resistant gypsum board. Having the ceiling height 1" above the masonry header is acceptable.

Provide mold-resistant gypsum board with moisture and mold resistant core and paper surfaces. Core: 5/8", Type X.

It is our understanding that both of these areas are non-combustible construction and are therefore not required to be fire sprinkled. Confirm with Fire Marshall that these areas do not need to be sprinkled.

Crystal McColly Cole Architects 4/30/21

BY

DATE

## **INTERIOR CONTRACTORS, INC.**

PO. BOX 3873 HAILEY, ID 83333

## **ESTIMATE**

Date	Estimate #	
5/5/2021	2565	
PUBLIC WORKS #002879-B-4 RCE-24255		

## Name / Address

CORE CONSTRUCTION CO.

			Project
			ID-COK FIRE STA
	Description		Total
PER RFI #CC-180 CEILINGS @ APPAR	ATUS BAY ALCOVES		910.00
Thank you for your bu	siness.	Total	\$910.00
Phone #	E-mail	•	
1 208 481- 0311	john.incon@gmail.com		



Building. Growing. Leading. ...Since 1937.

## Budget Evolution Item Summary City of Ketchum Fire Station #1

ASI-07/RFI-167 Revised Casework

Date: 6

6/1/2021

SCOPE	SUBCONTRACTOR	AMOU	JNT
Casework & locker revisions revised	Gary's Woodworking	\$	8,632.00
Delete install of OFCI Lockers	Office Environment Co.	\$	(378.00
SUBTOTAL:		\$	8,254.00
SUBTOTAL reflects direct costs only on th	ne presumption that costs will com	e from	
allowances. If costs are reimbursed by C	-		
SUBTOTAL with add of agreed upon mark	kup in accordance with the change	order prici	ng.
Bond and Insurance	CORE	\$	172.00
CMAR FEE	CORE	\$	367.00
Sales Tax	CORE	\$	-
TOTAL AMOUNT:		\$	8,793.00

OFFICE ENVIRONMENT COMPANY Americana Blvd | Boise, ID 83702 | w: 208-385-0507 | www.oecworks.com



#### **CoK Locker Deduction Change Order Proposal**

Change Ord	er Deduct #1
Date:	6/1/21
То:	Core Construction
Attn:	Chris Schratwieser
Email:	chrisschratwieser@coreconstruction.com

#### Change Order Description:

Credit for installation cost of the seven owner furnished contractor installed lockers per ASI-07 and sheet A5.02

Scope of Work Description & Clarifications	
10 51 00 - Lockers Quantity: 7 Note; Includes credit for installation of 7 lockers	(\$378)
Total Change Order Amount (Deduct from Base Bid)	(\$378

	Proposal Acceptance & Agreement
Ian Phillips	The undersigned hereby accepts, agrees to and Acknowledges OEC's proposal
iphillips@oecworks.com	Signature:
248-933-8891	Printed Name:
623 S. Americana Blvd	Title:
Boise, ID 83702	Date:



Ph: (208) 734-6121 Fax: (208) 734-7177 Email: garyswoodworking@gmail.com

## Change order

05-24-2021 RE: Ketchum Fire Station RFI #CC-167 ASI 07

Reception 133 Add bottom and edge band.4-casters and laminate one end and top. Add lock

518.00

Work stations 202

Add 18 laminated lockers with locks and handles. Is laminate burnished black oak? Add bottom and edge band. 8-casters to the two cabinets and laminate remaining sides. Laminate tops Install locks on bottom drawer one additional support bracket

> 6540.00 lockers 916.00 2 roll out cabinets

<u>Coffee/copy west</u> Re-design update dimensions

<u>Kitchen 201 Island</u> Add bottom and edge band. 4-casters and laminated both sides and top. Add 1 lock

658.00

Total

8632.00



Regional office for CORE NV company 777 N 4th St Bosie, Idaho 83702 Project: 90-20-01-006 - CoK - City of Ketchum Fire Station 107 Saddle Rd. Ketchum, Idaho 83340

## Food Lockers Change from Metal to Plastic Laminate

FROM:

TO:	Alex Goedhart (Cole Architects) Crystal McColly (Cole Architects)
DATE INITIATED:	04/07/2021
LOCATION:	
PROJECT STAGE:	Course of Construction
COST IMPACT:	
DRAWING NUMBER:	A2.02, 2/A5.02
LINKED DRAWINGS:	

STATUS: DUE DATE: COST CODE: SCHEDULE IMPACT: SPEC SECTION: REFERENCE: JT Brown **(CORE Construction - Las Vegas)** 777 N Fourth St Boise, Idaho 83702 Open 04/14/2021

#### **RECEIVED FROM:**

#### COPIES TO:

JT Brown (CORE Construction - Las Vegas), Cary Goldberg (DPPM Project Management), Andy Henning (Garys Woodworking), Bill McLaughlin (City of Ketchum), Dennis Potts (DPPM Project Management), Chris Schratwieser (CORE Construction - Las Vegas), Matt Sylvester (CORE Construction - Las Vegas)

#### Question from JT Brown (CORE Construction - Las Vegas) at 12:30 PM on 04/07/2021

As discussed, the metal lockers shown in the Day Use Room 201 detail 2/A5.02 are to be changed to Plastic Laminate. Please confirm layout and finish for the plastic laminate.

Awaiting an Official Response

## See attached floor plan and interior elevation sketches of the updated Kitchen/ Day Use locker layout.

Lockers to be PL-1.


Each of the 18 lockers to have a keyed lock.

Cabinet pulls to match other Kitchen casework.


Crystal McColly Cole Architects 4/21/21

DATE

BY

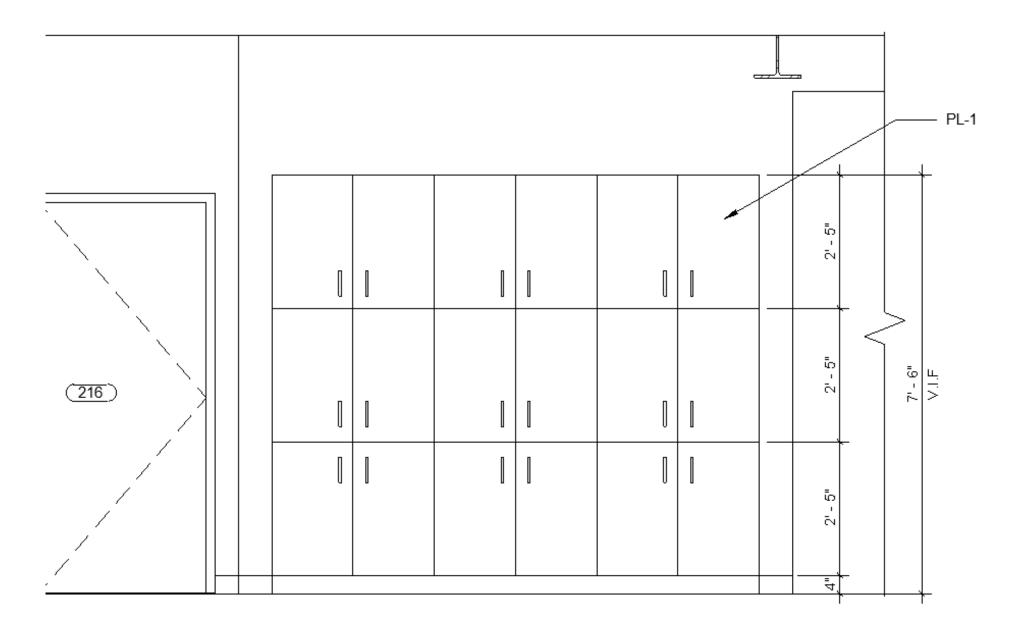

KITCHEN/DAY USE LOCKER LAYOUT INTERIOR ELEVATION RFI #CC-167 KETCHUM FIRE STATION #1 4/21/21

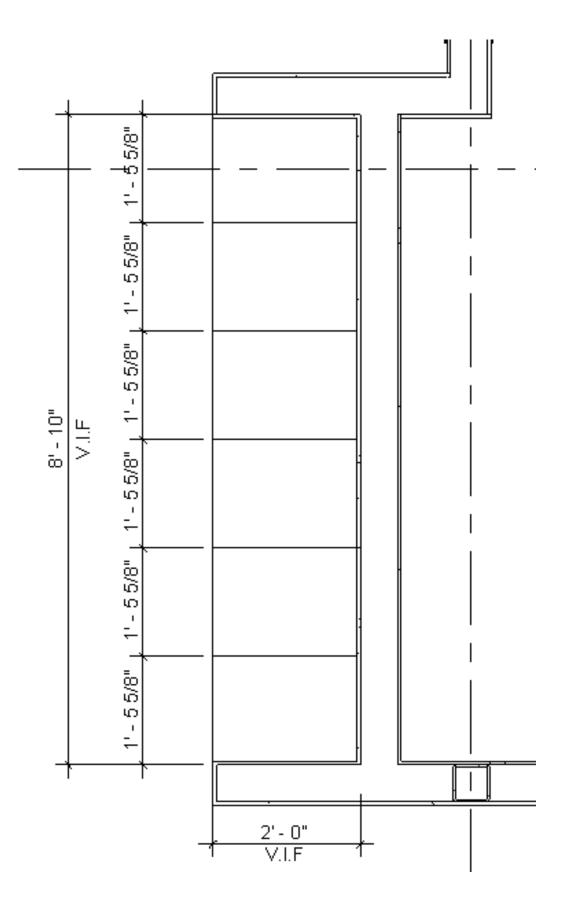

KITCHEN/DAY USE LOCKER LAYOUT FLOOR PLAN RFI #CC-167 KETCHUM FIRE STATION #1 4/21/21

# COLE/ARCHITECTS

ARCHITECTURE / PLANNING / INTERIOR DESIGN

## ASI 07

PROJECT NAME	KETCHUM FIRE STATION #1
PROJECT NUMBER	18-022
DATE	5/3/2021
CONSTRUCTION COMPANY	CORE CONSTRUCTION

THE WORK SHALL BE CARRIED OUT IN ACCORDANCE WITH THE FOLLOWING SUPPLEMENTAL INSTRUCTIONS ISSUED IN ACCORDANCE WITH THE CONTRACT.

#### **DESCRIPTION OF CHANGES:**

#### DRAWINGS:

#### ARCHITECTURAL:

- A2.02 FLOOR PLAN LEVEL 02

   Updated metal Kitchen lockers to be 18 built-in casework lockers.
- 2) A2.22 DIMENSIONS PLAN LEVEL 02
  - a) Updated metal Kitchen lockers to be 18 built-in casework lockers.
- 3) A5.01 INTERIOR ELEVATIONS
  - a) Added Keynote #28.
  - b) #2 RECEPTION 133 SOUTH
    - i) Added casters to cabinet and finished the remaining sides of the rolling cabinet.
    - ii) Added keynote #28.
    - iii) Added reference detail 12/A5.21.
  - c) #4-COFFEE/COPY-WEST
    - i) Updated dimensions of the trash/recycle pull-out and microwave alcove.
  - d) #11 KITCHEN/DAY USE 201 ISLAND NORTH
    - i) Reduced three base cabinets from 2'-9" to 2'-8" to enlarge the three trash/recycle pull outs.

#### 4) A5.02 – INTERIOR ELEVATIONS

- a) #2 WORK STATIONS 202 EAST
  - i) Updated metal Kitchen lockers to be 18 built-in casework lockers, per RFI #CC-167 response.
  - ii) Updated keynote #15 and noted to add keyed lock to each of the lockers.
  - iii) Added reference detail 12/A5.21.
- b) #3 WORK STATIONS 202 NORTH
  - i) Added casters to the two under counter drawers and finished the remaining sides of the rolling cabinet.
  - ii) Added keynote #20 to add keyed lock to one of the drawers.
  - iii) Add additional support bracket underneath the built-in countertop.
- 5) A5.21 INTERIOR DETAILS
  - a) Added detail #12 BASE CABINET W/DRAWERS & CASTERS.

Page 1 of 2

# COLE/ARCHITECTS

ARCHITECTURE / PLANNING / INTERIOR DESIGN


#### **ATTACHMENTS:**

#### **DRAWINGS**:

- A2.02 FLOOR PLAN LEVEL 02
- A2.22 DIMENSIONS PLAN LEVEL 02
- A5.01 INTERIOR ELEVATIONS
- A5.02 INTERIOR ELEVATIONS
- A5.21 INTERIOR DETAILS

END OF ASI

Page **2** of **2** 

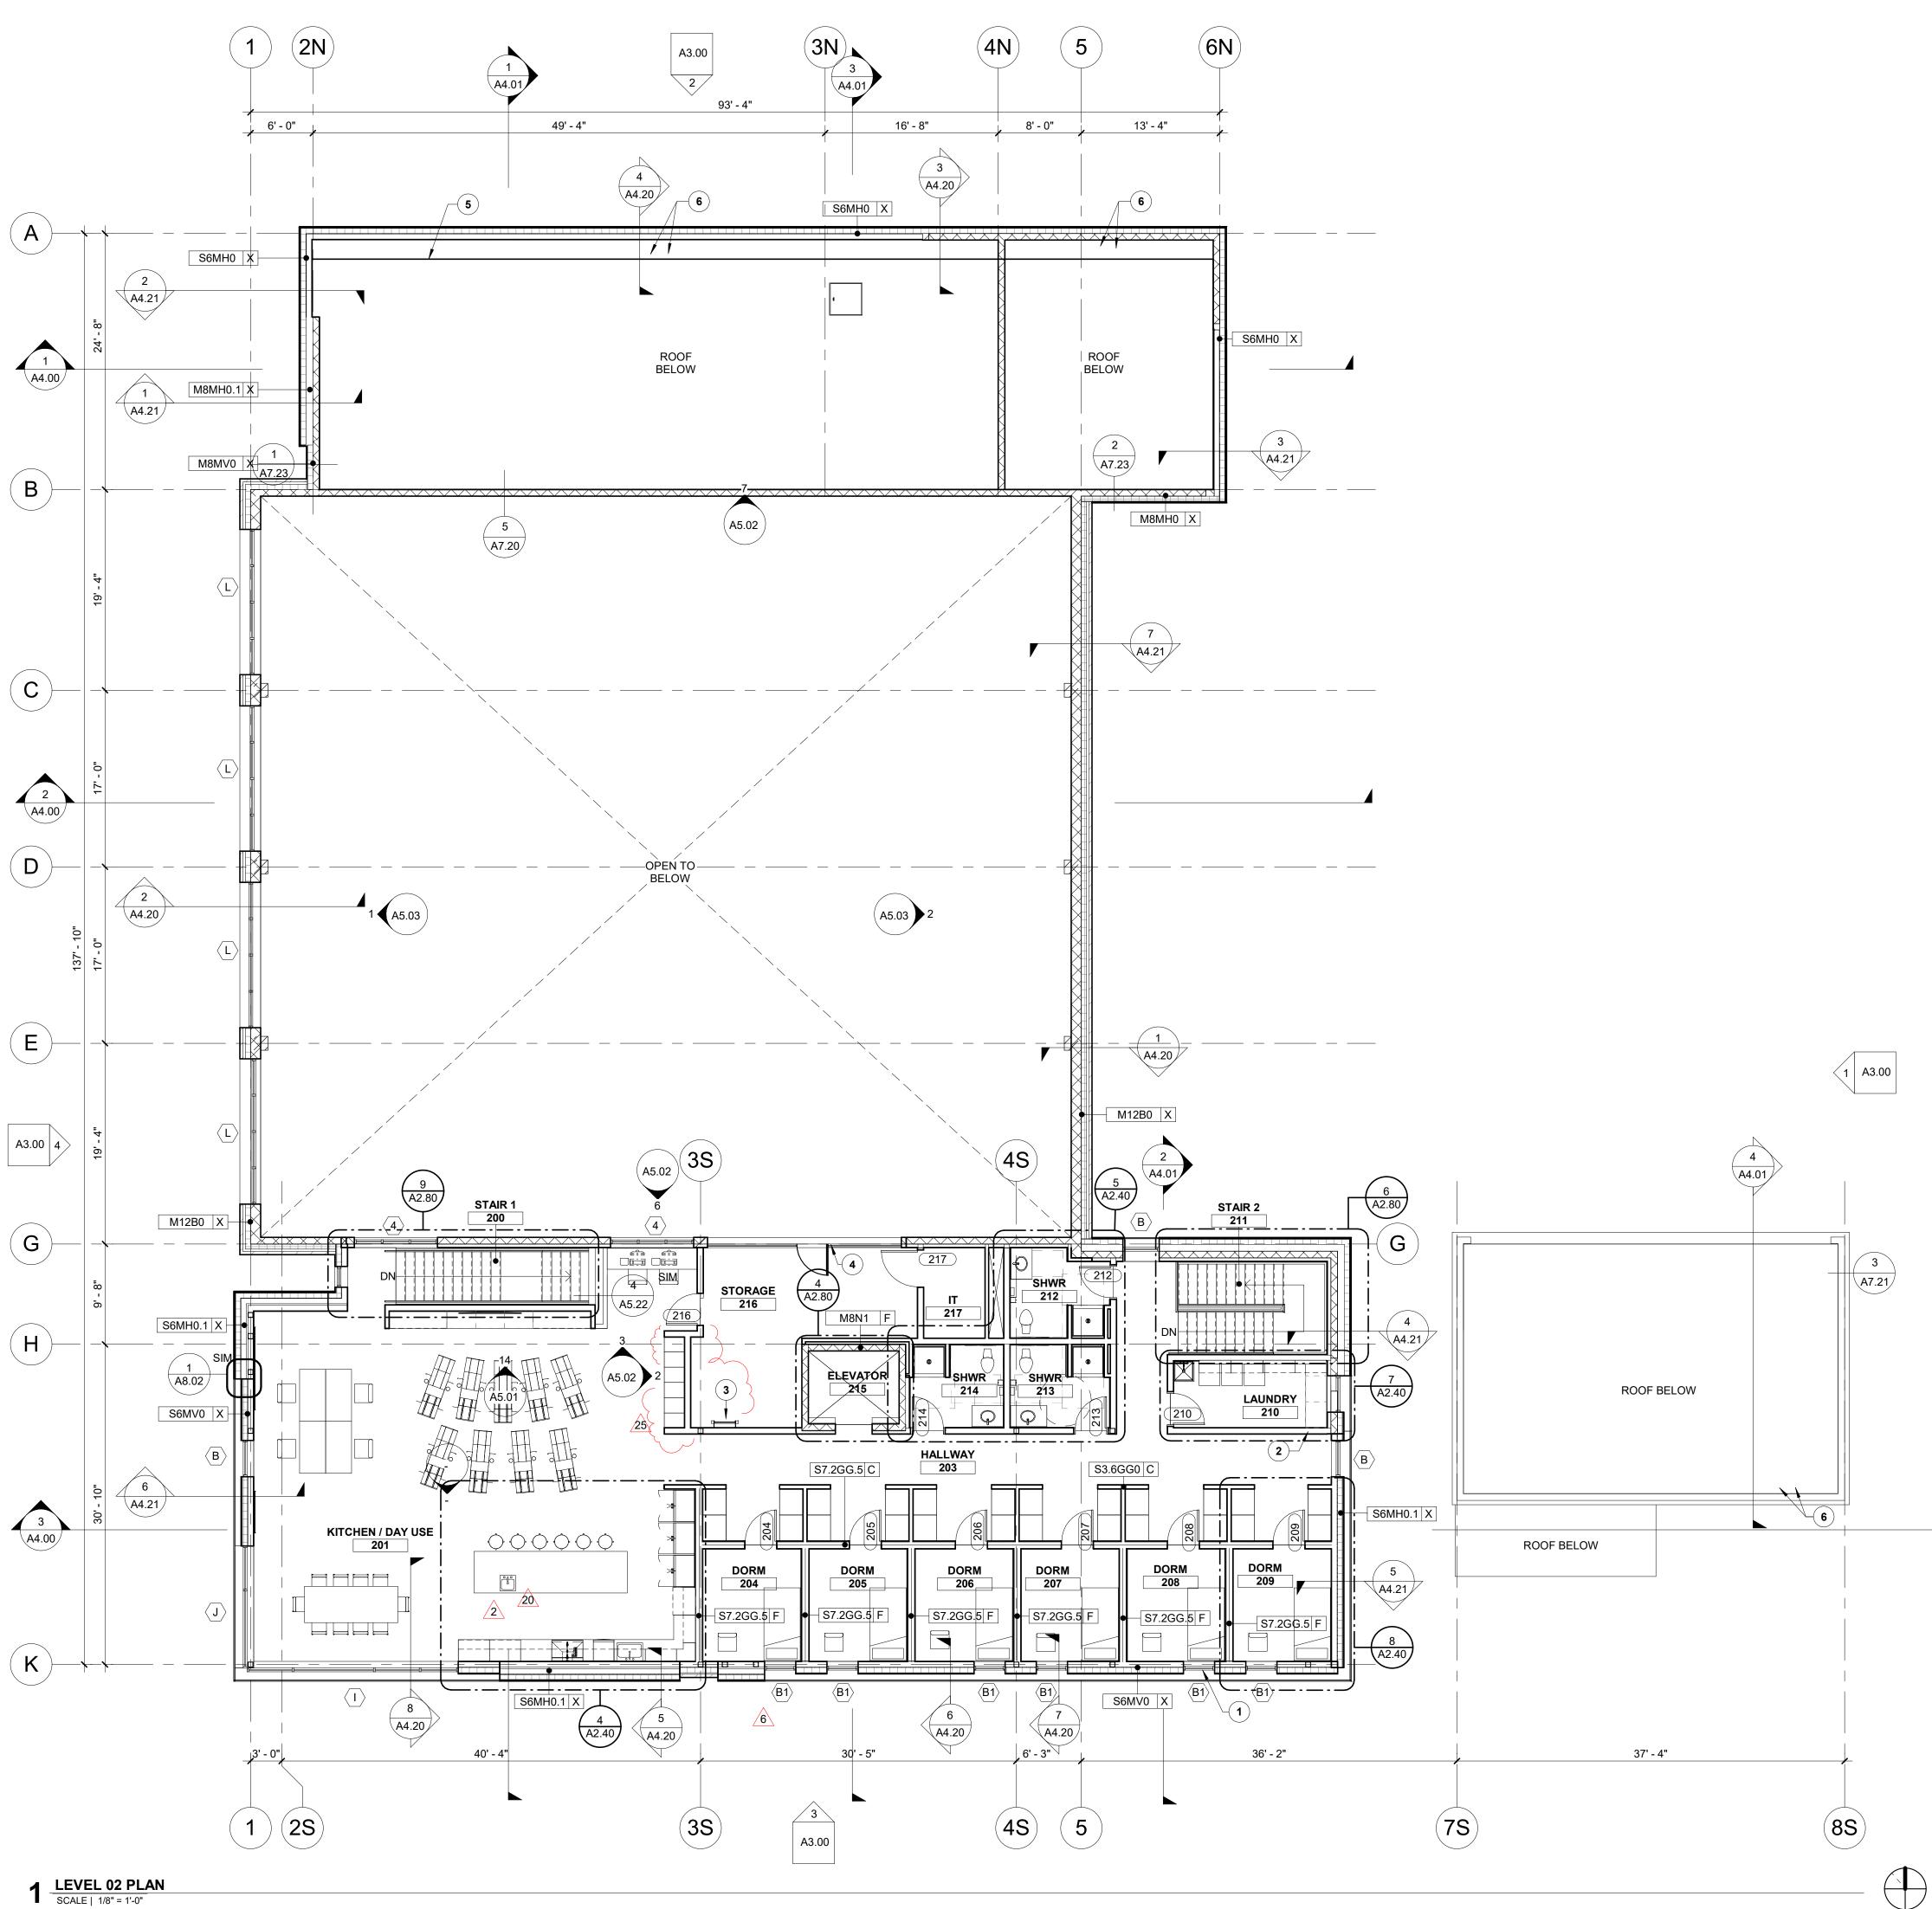

## **GENERAL NOTES**

- A. FIELD VERIFY ALL DIMENSIONS AND EXISTING CONDITIONS. NOTIFY ARCHITECT IMMEDIATELY IF ANY CONFLICTS OR DISCREPANCIES OCCUR BEFORE PROCEEDING WITH WORK.
- B. CROSS REFERENCES SHOWN ON DRAWINGS DO NOT NECESSARILY INDICATE ALL LIKE CONDITIONS AND DO NOT LIMIT APPLICATION OF ANY DRAWING OR DETAIL. WHERE SPECIFIC DIMENSIONS, DETAILS, OR DESIGN INTENT CANNOT BE DETERMINED, CONSULT THE ARCHITECT PRIOR TO PROCEEDING WITH WORK. IF DESIGN INTENT REMAINS UNCLEAR THEN PROVIDE MOST EXPENSIVE OPTION IN BID.
- C. PROVIDE SOLID BLOCKING IN WALLS FOR ALL WALL HUNG EQUIPMENT. BLOCKING TO MEET OR EXCEED MANUFACTURER'S RECOMMENDATIONS. FASTEN EQUIPMENT TO WALLS PER MANUFACTURER'S RECOMMENDATIONS. PROVIDE BLOCKING FOR, BUT NOT LIMITED TO THE FOLLOWING: MILLWORK, RAILING, FIRE EXTINGUISHER ACCESSORIES, WALL MOUNTED PLUMBING FIXTURES, SHELVING, ELECTRICAL EQUIPMENT, RESTROOM ACCESSORIES AND DISPLAY ITEMS.
- D. CAULK ALL COUNTERTOPS, BACKSPLASHES AND CABINETS AT LOCATIONS WHERE THEY MEET WALLS. SEAL ALL CUT-OUTS IN COUNTERTOPS.
- E. ERECT DUST PROOF PARTITIONS AS REQUIRED BY OWNER TO PROTECT ADJACENT AREAS.
- F. ALL PARTITIONS ARE TYPE "S6GG0-F" UNLESS OTHERWISE NOTED.
- G. SEAL AROUND ALL MECHANICAL AND ELECTRICAL EQUIPMENT PENETRATIONS AT WALLS. AT RATED WALLS USE A U.L. APPROVED FIRE-STOPPING MATERIAL. APPROPRIATE FOR FIRE RATING REQUIREMENTS.
- H. PROVIDE 4" DOOR JAMBS FROM FACE-OF-FINISH AT ADJACENT WALLS ON THE HINGE SIDE OR UNLESS OTHERWISE INDICATED.
- I. DIMENSIONS ARE TO GRID LINE OR FACE OF STRUCTURAL MEMBER UNLESS OTHERWISE NOTED. DOOR & WINDOW OPENING DIMENSIONS ARE TO ROUGH OPENING OR CENTERLINE OF OPENING. CONCRETE AND BRICK DIMENSIONS ARE GIVEN TO THE FACE OF CONCRETE OR MASONRY AND TO THE FACE OF ROUGH OPENINGS.

## **KEYNOTES** (#)

- EGRESS WINDOWS, TYP. AT DORMS STRUCTURAL COLUMN, SEE STRUCTURAL
- ROOF ACCESS LADDER. 4. BLACK POWDER COATED METAL SAFETY RAILING WITH LATCHING
- ACCESS GATE.
- 5. EQUIPMENT SCREEN, RE: TO ROOF PLAN 6. ROOF DRAINS, RE: TO ROOF PLAN




1008 W Main St Boise, Idaho 83702 208.345.1800 colearchitects.net Copyright © 2020 Cole Architects, PLLC



ARCHITECTURE + PLANNING + DESIGN 6211 Roosevelt Way NE Seattle, WA 98115 206.522.3820

BIDDERS ARE INSTRUCTED TO CAREFULLY REVIEW THE CONSTRUCTION DOCUMENTS AND THE SITE CONDITIONS. INFORMATION REGARDING THE COMPLETE WORK OF SPECIFIC TRADES IS DISPERSED THROUGHOUT THE ENTIRE DOCUMENT SET AND CANNOT BE ACCURATELY DETERMINED BY REFERENCE TO OTHER THAN COMPLETE DOCUMENT SETS.



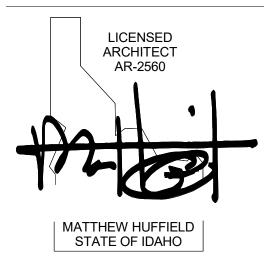

CONSULTANT

**PROJECT INFORMATION** 



## **KETCHUM FIRE STATION NO. 1**


107 SADDLE ROAD, KETCHUM, ID 83353


ISSUES				
PHASE		CONSTRUCTION SET		
DATE		JUNE 19, 2020		
JOB NU	JMBER	18-022		
MARK	DATE	DESCRIPTION		
25	5/3/21	ASI 07		
24	TBD	RFI #CC-178		
20	1/20/21	ASI 05		
6	8/17/20	ASI 2		
2	7/17/20	ASI 1		

SHEET NAME

FLOOR PLAN -LEVEL 02



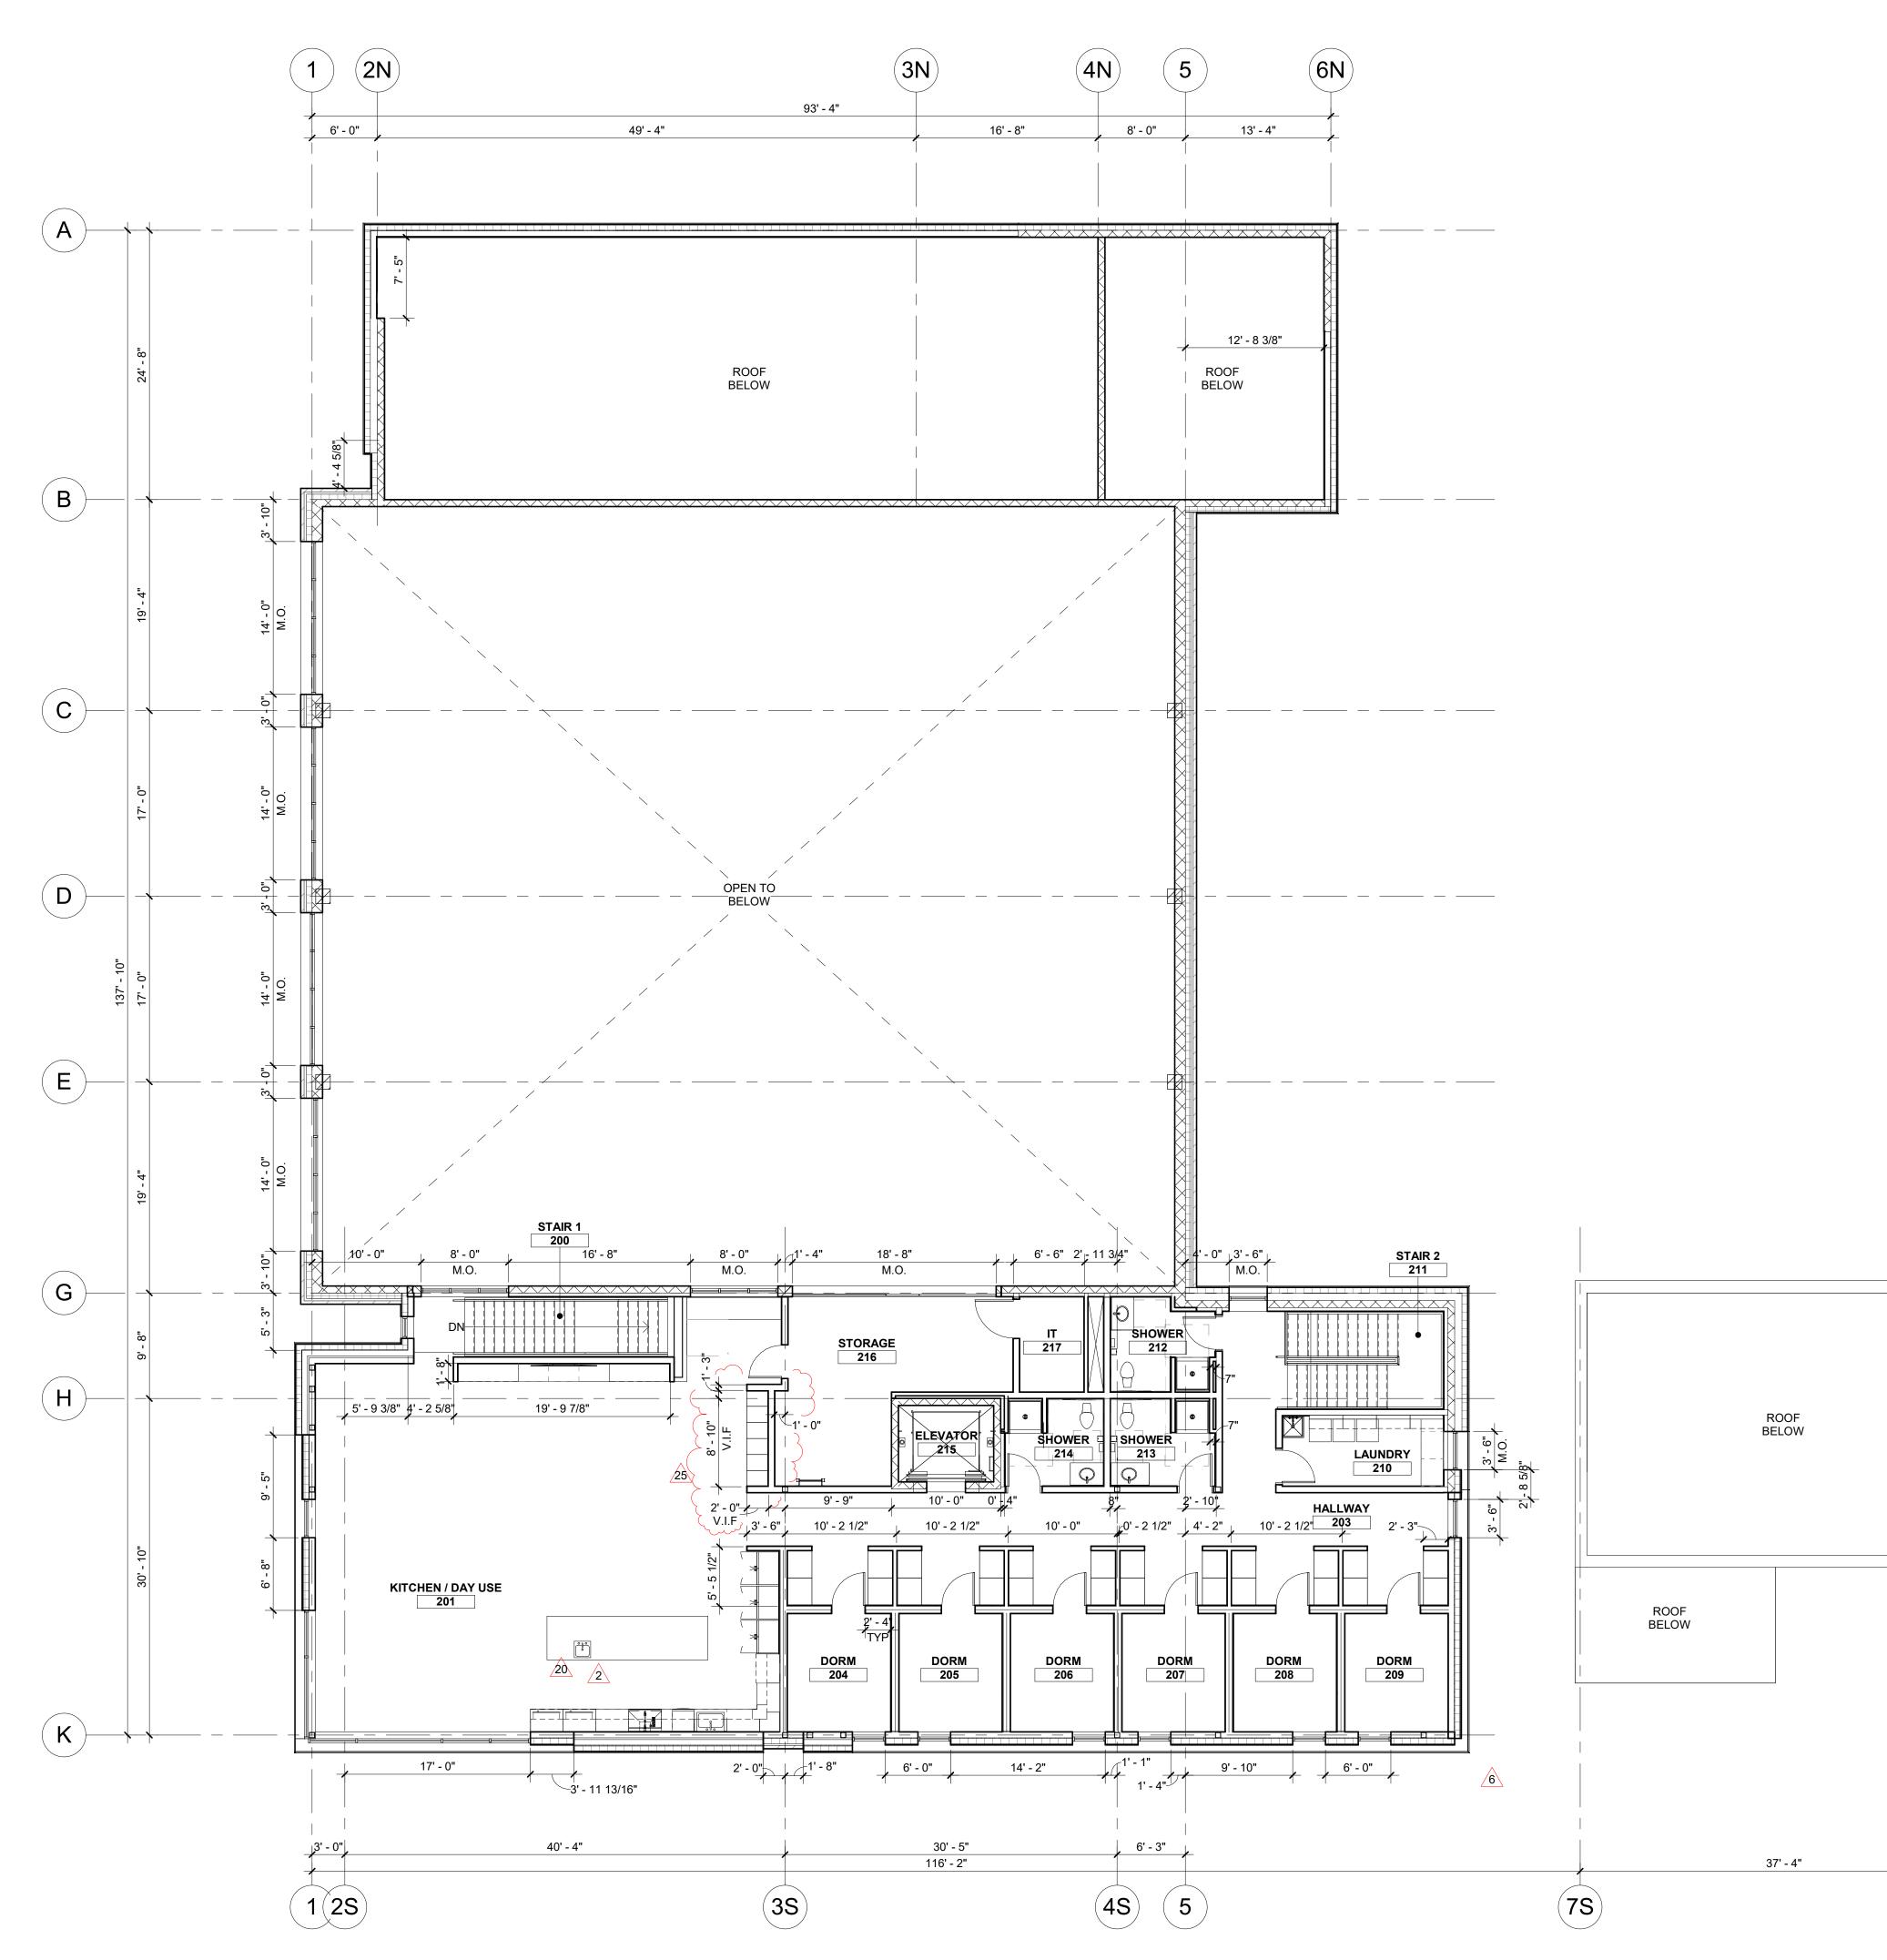


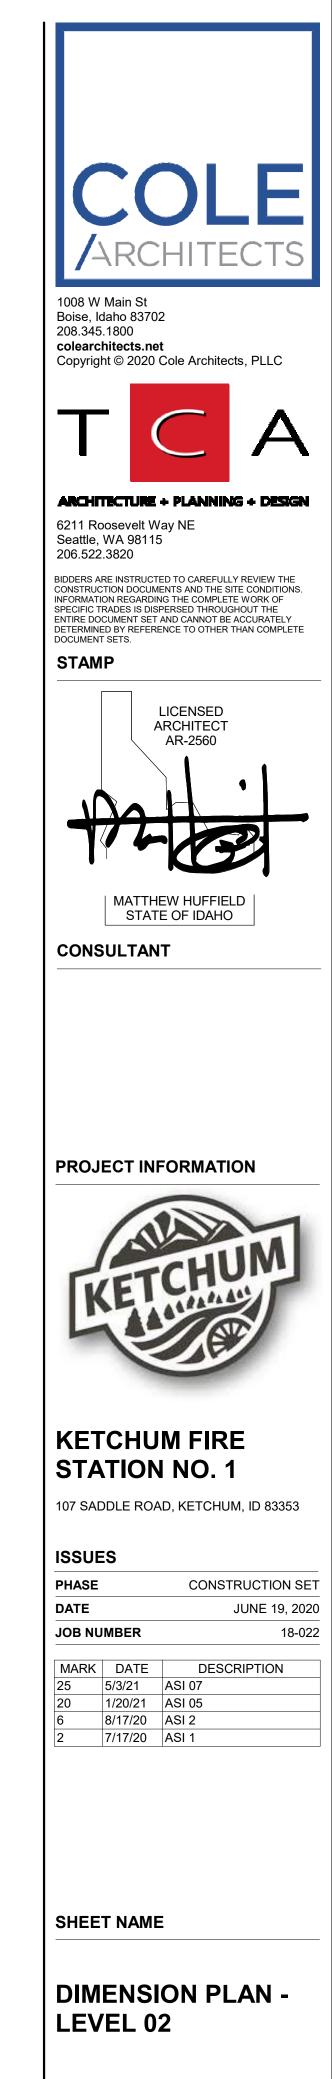



SHEET NUMBER

**8S** 



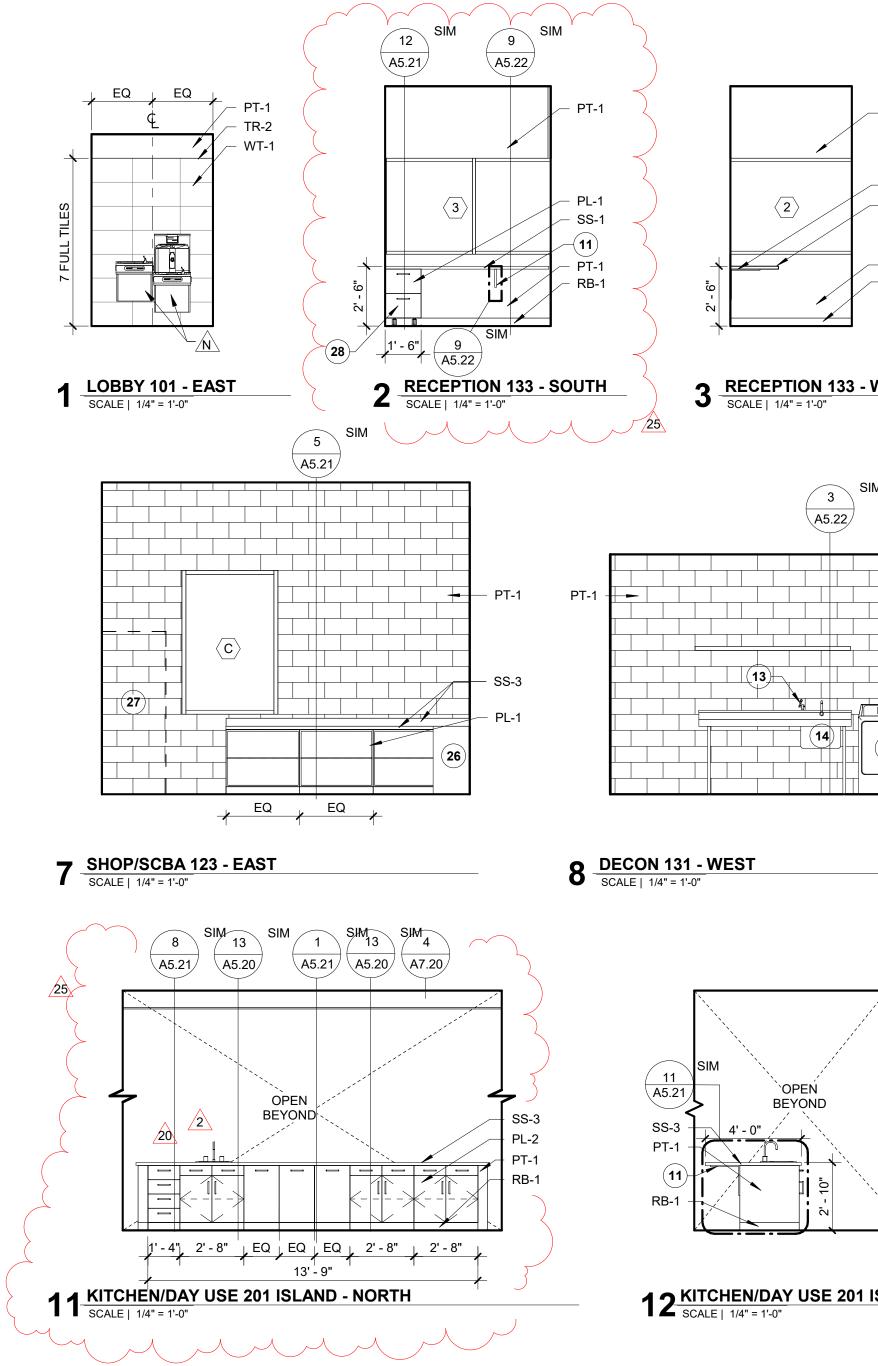

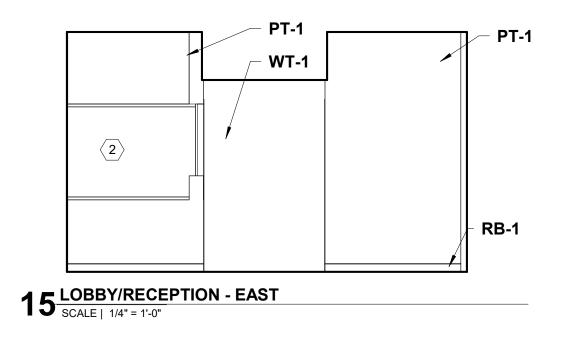

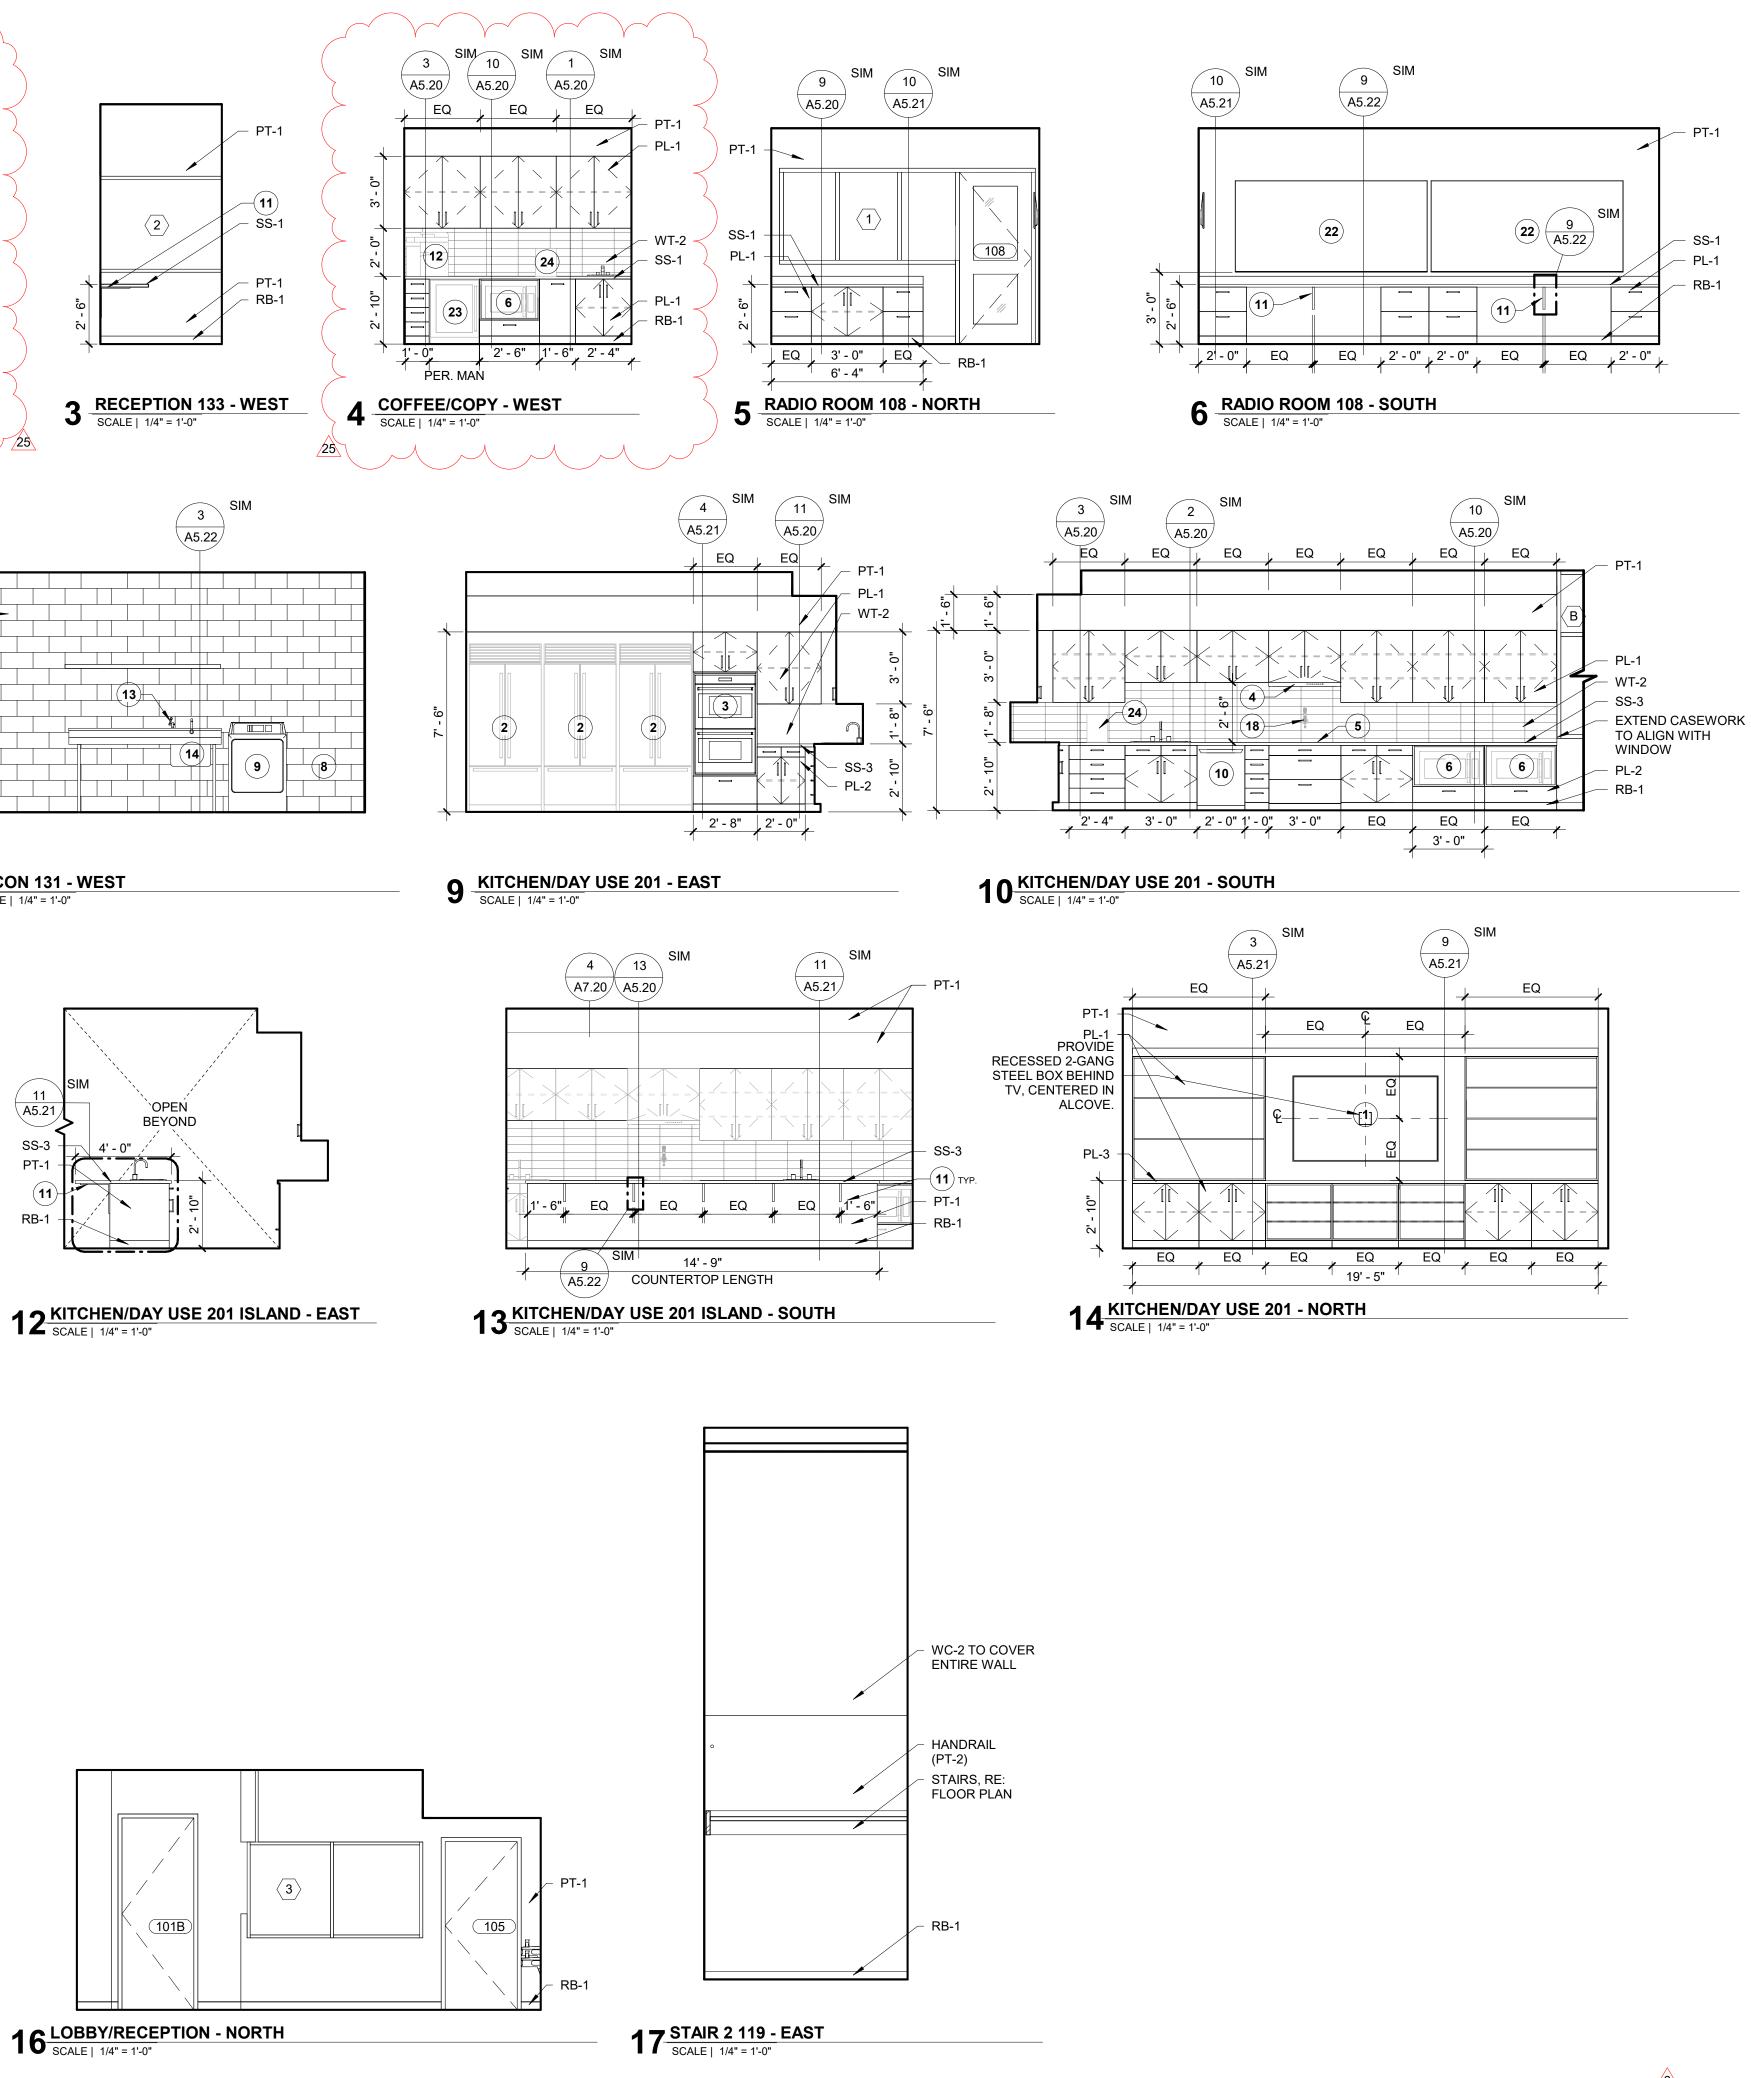

# **GENERAL NOTES**

- A. REFER TO ARCHITECTURAL FLOOR, ELEVATION AND FINISH PLANS. CONTRACTOR SHALL CLARIFY ANY QUESTIONS CONCERNING FINISHES, LOCATION, OR DESIGN INTENT WITH DESIGNER PRIOR TO ORDERING OF MATERIALS.
- B. AT ROOMS WITH NEW EXPOSED CEILING, PAINT WALLS TO UNDERSIDE OF STRUCTURE ABOVE.
- C. SEE REFLECTED CEILING PLAN FOR GYPSUM BOARD SOFFIT LOCATIONS. REFER TO REFLECTED CEILING PLAN AND INTERIOR FINISH SCHEDULE FOR FINISH, AS SCHEDULED.
- D. PROVIDE A THIN, CLEAR, SILICONE BEAD (1/8") AT PERIMETER OF ALL DOOR FRAMES AND BORROWED GLASS LITES AFTER INSTALLATION OF SCHEDULED WALL COVERINGS. DOOR FRAMES ON PAINTED WALLS SHOULD RECEIVE THIN, PAINTABLE SILICONE BEAD (1/8") AT PERIMETER PRIOR TO PAINTING, ONLY WHERE THE FRAME DOES NOT MEET THE WALL.
- E. ALL INTERIOR FINISHES MUST BE INSTALLED BY A CERTIFIED INSTALLER / SUBCONTRACTOR PER MANUFACTURER'S INSTRUCTIONS. USE MANUFACTURER'S APPROVED ADHESIVES AND SEAM SEALERS.
- F. ALL FLOORING TRANSITIONS OCCUR UNDER THE CENTER OF THE DOOR UNLESS OTHERWISE NOTED. FLOOR TRANSITION HEIGHTS NOT TO EXCEED 1/4" MAXIMUM. PROVIDE APPROPRIATE SCHLUTER TRANSITION STRIP IN ANODIZED ALUMINUM FINISH AT EACH LOCATION WHERE FLOOR FINISH MATERIAL CHANGES. UNLESS NOTED OTHERWISE.
- G. PROVIDE WINDOW COVERINGS AT ALL WINDOW LOCATIONS. SEE INTERIOR FINISH SPECIFICATIONS FOR ROLLER SHADE SPECIFICATION.
- H. ALL CABINET HARDWARE AT CASEWORK LOCATIONS TO BE RICHELIEU CONTEMPORARY STEEL PULL - 205 TO BE 6 5/16" LONG IN BRUSHED NICKEL FINISH (OR APPROVED EQUAL WITH SIMILAR FINISH).
- I. ALL WINDOW SILLS TO BE SOLID SURFACE (SS-1) UNLESS NOTED OTHERWISE.
- J. PROVIDE SOLID BLOCKING OR OTHER SUITABLE BACKING AT LOCATIONS INCLUDING, BUT NOT LIMITED TO, THE FOLLOWING: EDGES WHERE FINISH MATERIALS CHANGE, GRAB BARS, TOILET PARTITIONS, DOOR STOPS, SHELF BRACKETS, HANDRAILS AND ALL MOUNTED EQUIPMENT, INCLUDING EQUIPMENT FURNISHED BY OWNER. PROVIDE STEEL BACKING FOR GRAB BARS ATTACHED TO PARTITIONS. EXTEND BACKING 6" BEYOND OUTLINE OF EQUIPMENT.
- K. REFERENCE PLUMBING/MECHANICAL DRAWINGS, ELECTRICAL DRAWINGS AND SPECIFICATIONS FOR ADDITIONAL PRODUCT INFORMATION. IF CONFLICT EXISTS NOTIFY ARCHITECT AND PRICE MOST EXPENSIVE OPTION.

## **KEY NOTES**

- TV/MONITOR. RE: EQUIPMENT PLANS & SCHEDULE.
   REFRIGERATOR. RE: EQUIPMENT PLANS & SCHEDULE.
- BUILT-IN DOUBLE OVEN. RE: EQUIPMENT PLANS & SCHEDULE.
   RANGE HOOD. RE: EQUIPMENT PLANS & SCHEDULE.
- 5. RANGE. RE: EQUIPMENT PLANS & SCHEDUL 5. RANGE. RE: EQUIPMENT PLANS & SCHEDULE.
- MICROWAVE. RE: EQUIPMENT PLANS & SCHEDULE.
   MOP SERVICE BASIN WITH FAUCET.
- MOP SERVICE BASIN WITTH ACCELL.
   WASHER TOP LOAD. RE: EQUIPMENT PLANS & SCHEDULE.
   DRYER. RE: EQUIPMENT PLANS & SCHEDULE.
- DISHWASHER. RE: EQUIPMENT PLANS & SCHEDULE.
   PROVIDE COUNTERTOP SUPPORTS AS REQUIRED. SUPPORT
- PROVIDE COUNTERTOF SUPPORTS AS REQUIRED. SUPPORT BRACKETS TO BE WHITE. RE: SPECIFICATIONS.
   PRINTER TO BE OWNER SUPPLIED, CONTRACTOR INSTALLED. COORDINATE PRINTER SIZE PRIOR TO CABINET FABRICATION AND INSTALLATION TO ACCOMMODATE HEICHT, RE: EQUIPMENT PLANS
- INSTALLATION TO ACCOMMODATE HEIGHT. RE: EQUIPMENT PLANS & SCHEDULE.
  13. EMERGENCY EYE WASH STATION. RE: EQUIPMENT PLANS & SCHEDULE
- SCHEDULE. 14. SERVICE SINK.
- FOOD LOCKERS. RE: EQUIPMENT PLANS & SCHEDULE.
   RUB RAIL. 7'-0" LONG X 6" HIGH.
- ROB RAIL. 7-0 LONG X 6 HIGH.
   PROVIDE METAL 24" X 24" WORKSTATION WALL BRACKET FACTORY PAINTED WHITE, TYP. RE: SPECIFICATIONS.
   WALL MOUNT BOT FULLER CONTRACTOR EURNISHED. CONTRACTOR
- WALL MOUNT POT FILLER. CONTRACTOR FURNISHED, CONTRACTOR INSTALLED.
   FLAMABLE LIQUIDS CABINET. RE: EQUIPMENT PLANS & SCHEDULE.
- FLAMABLE LIQUIDS CABINET. RE: EQUIPMENT PL/
   BOOTWASH STATION WITH 17" x 15" SINK.
- 21. BIKE HOOKS. RE: EQUIPMENT PLANS & SCHEDULE.
- 22. WHITE BOARD. RE: EQUIPMENT PLANS & SCHEDULE.
  23. UNDERCOUNTER MINATURE REFRIGERATOR. RE: EQUIPMENT PLANS
- & SCHEDULE. 24. LOCATION OF PLUMBED, COUNTER TOP COFFEE MAKER. RE:
- EQUIPMENT PLANS & SCHEDULE. 25. STAINLESS STEEL SHELF.
- 26. FLAMMABLE LIQUIDS CABINET. RE: FINISH & FURNITURE PLANS &

SCHEDULE. 27. CLYINDER STORAGE, RE: FINISH & FURNITURE PLANS & SCHEDULE. 28. ADD KEYED LOCK TO LOWER DRAWER.




#### 1008 W Main St Boise, Idaho 83702 208.345.1800 **colearchitects.net** Copyright © 2020 Cole Architects, PLLC



**ARCHITECTURE + PLANNING + DESIGN** 6211 Roosevelt Way NE Seattle, WA 98115 206.522.3820

BIDDERS ARE INSTRUCTED TO CAREFULLY REVIEW THE CONSTRUCTION DOCUMENTS AND THE SITE CONDITIONS. INFORMATION REGARDING THE COMPLETE WORK OF SPECIFIC TRADES IS DISPERSED THROUGHOUT THE ENTIRE DOCUMENT SET AND CANNOT BE ACCURATELY DETERMINED BY REFERENCE TO OTHER THAN COMPLETE DOCUMENT SETS.

STAMP

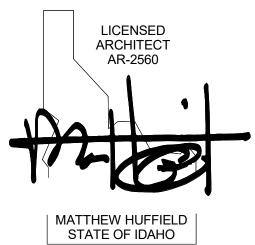

CONSULTANT

## PROJECT INFORMATION



## KETCHUM FIRE STATION NO. 1


107 SADDLE ROAD, KETCHUM, ID 83353

# ISSUES PHASE CONSTRUCTION SET DATE JUNE 19, 2020 JOB NUMBER 18-022 MARK DATE DESCRIPTION 25 5/3/21 ASI 07 20 1/20/21 ASI 05 6 8/17/20 ASI 2 2 7/17/20 ASI 1

SHEET NAME

INTERIOR ELEVATIONS




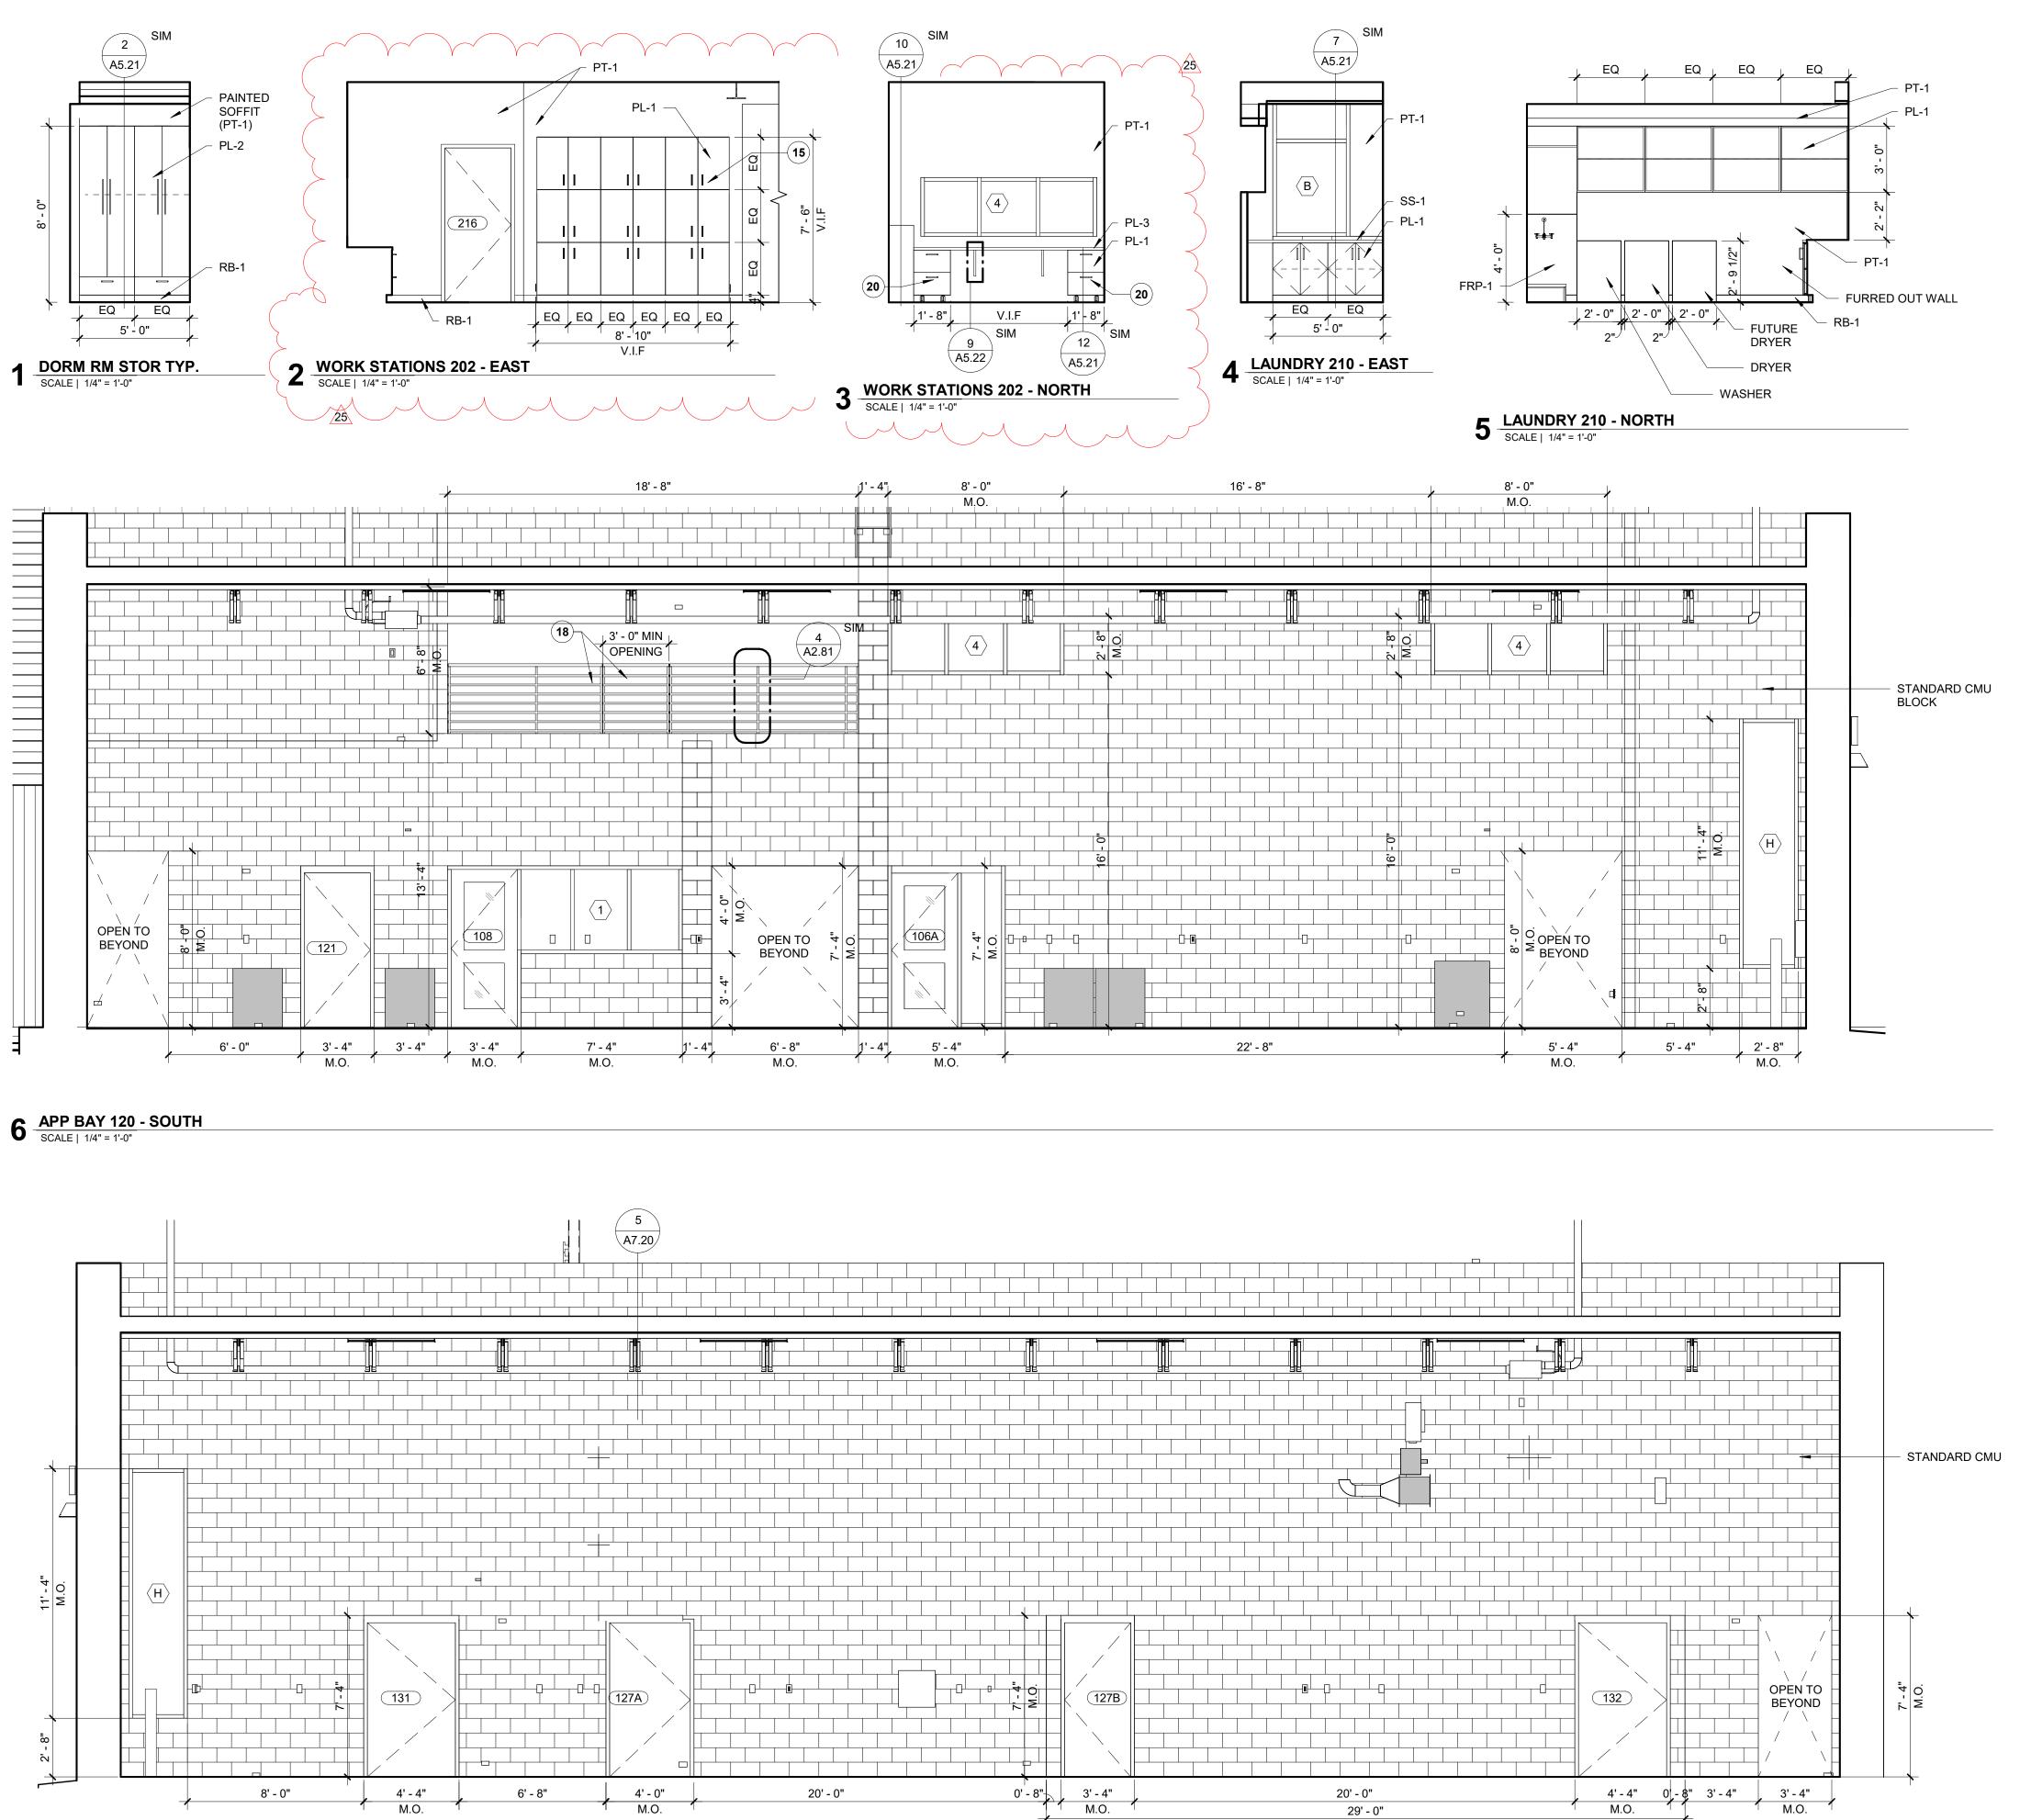





**7** APP BAY 120 - NORTH SCALE | 1/4" = 1'-0"

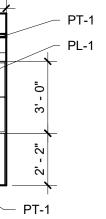

# **GENERAL NOTES**

- A. REFER TO ARCHITECTURAL FLOOR, ELEVATION AND FINISH PLANS. CONTRACTOR SHALL CLARIFY ANY QUESTIONS CONCERNING FINISHES, LOCATION, OR DESIGN INTENT WITH DESIGNER PRIOR TO ORDERING OF MATERIALS.
- B. AT ROOMS WITH NEW EXPOSED CEILING, PAINT WALLS TO UNDERSIDE OF STRUCTURE ABOVE.
- C. SEE REFLECTED CEILING PLAN FOR GYPSUM BOARD SOFFIT LOCATIONS. REFER TO REFLECTED CEILING PLAN AND INTERIOR FINISH SCHEDULE FOR FINISH, AS SCHEDULED.
- D. PROVIDE A THIN, CLEAR, SILICONE BEAD (1/8") AT PERIMETER OF ALL DOOR FRAMES AND BORROWED GLASS LITES AFTER INSTALLATION OF SCHEDULED WALL COVERINGS. DOOR FRAMES ON PAINTED WALLS SHOULD RECEIVE THIN, PAINTABLE SILICONE BEAD (1/8") AT PERIMETER PRIOR TO PAINTING, ONLY WHERE THE FRAME DOES NOT MEET THE WALL.
- E. ALL INTERIOR FINISHES MUST BE INSTALLED BY A CERTIFIED INSTALLER / SUBCONTRACTOR PER MANUFACTURER'S INSTRUCTIONS. USE MANUFACTURER'S APPROVED ADHESIVES AND SEAM SEALERS.
- F. ALL FLOORING TRANSITIONS OCCUR UNDER THE CENTER OF THE DOOR UNLESS OTHERWISE NOTED. FLOOR TRANSITION HEIGHTS NOT TO EXCEED 1/4" MAXIMUM. PROVIDE APPROPRIATE SCHLUTER TRANSITION STRIP IN ANODIZED ALUMINUM FINISH AT EACH LOCATION WHERE FLOOR FINISH MATERIAL CHANGES. UNLESS NOTED OTHERWISE.
- G. PROVIDE WINDOW COVERINGS AT ALL WINDOW LOCATIONS. SEE INTERIOR FINISH SPECIFICATIONS FOR ROLLER SHADE SPECIFICATION.
- H. ALL CABINET HARDWARE AT CASEWORK LOCATIONS TO BE RICHELIEU CONTEMPORARY STEEL PULL - 205 TO BE 6 5/16" LONG IN BRUSHED NICKEL FINISH (OR APPROVED EQUAL WITH SIMILAR FINISH).
- I. ALL WINDOW SILLS TO BE SOLID SURFACE (SS-1) UNLESS NOTED OTHERWISE.
- J. PROVIDE SOLID BLOCKING OR OTHER SUITABLE BACKING AT LOCATIONS INCLUDING, BUT NOT LIMITED TO, THE FOLLOWING: EDGES WHERE FINISH MATERIALS CHANGE, GRAB BARS, TOILET PARTITIONS, DOOR STOPS, SHELF BRACKETS, HANDRAILS AND ALL MOUNTED EQUIPMENT, INCLUDING EQUIPMENT FURNISHED BY OWNER, PROVIDE STEEL BACKING FOR GRAB BARS ATTACHED TO PARTITIONS. EXTEND BACKING 6" BEYOND OUTLINE OF EQUIPMENT.
- K. REFERENCE PLUMBING/MECHANICAL DRAWINGS, ELECTRICAL DRAWINGS AND SPECIFICATIONS FOR ADDITIONAL PRODUCT INFORMATION. IF CONFLICT EXISTS NOTIFY ARCHITECT AND PRICE MOST EXPENSIVE OPTION.

# **KEY NOTES**

- 1. TV/MONITOR. CONTRACTOR FURNISHED, CONTRACTOR INSTALLED. 2. REFRIGERATOR. CONTRACTOR FURNISHED, CONTRACTOR INSTALLED. REFER TO INTERIOR SPECIFICATIONS.
- 3. BUILT-IN DOUBLE OVEN. CONTRACTOR FURNISHED, CONTRACTOR INSTALLED. REFER TO INTERIOR SPECIFICATIONS. 4. RANGE HOOD. CONTRACTOR FURNISHED, CONTRACTOR INSTALLED.
- 5. RANGE. CONTRACTOR FURNISHED, CONTRACTOR INSTALLED. 6. MICROWAVE. CONTRACTOR FURNISHED, CONTRACTOR INSTALLED.
- . MOP SERVICE BASIN WITH FAUCET. 8. WASHER TOP LOAD. SEE SPECIFICATIONS.
- 9. DRYER. SEE SPECIFICATIONS. 10. DISHWASHER. CONTRACTOR FURNISHED, CONTRACTOR INSTALLED. 11. PROVIDE COUNTERTOP SUPPORTS AS REQUIRED. SUPPORT BRACKETS TO BE WHITE.
- 12. PRINTER TO BE OWNER SUPPLIED, CONTRACTOR INSTALLED. COORDINATE PRINTER SIZE PRIOR TO CABINET FABRICATION AND INSTALLATION TO ACCOMMODATE HEIGHT. 13. EMERGENCY EYE WASH STATION.
- $\widehat{\phantom{a}}$ 14. SERVICE SINK. ~ 25 15. 18 BUILT-IN CASEWORK LOCKERS. CABINET PULLS TO MATCH REST OF CASEWORK. PROVIDE A KEYED LOCK FOR EACH OF THE 18
- LOCKERS. 🗸 16. RUB RAIL. 7'-0" LONG X 6" HIGH. 17. PROVIDE METAL 24" X 24" WORKSTATION WALL BRACKET FACTORY
- PAINTED WHITE, TYP. 18. BLACK POWDER COATED METAL SAFETY RAILING WITH LATCHING ACCESS GATE.
- 19. CLOTHING ROD. CONTRACTOR FURNISHED, CONTRACTOR SINSTALLED.

25 20. ADD KEYED LOCK TO LOWER DRAWER. 




1008 W Main St Boise, Idaho 83702 208.345.1800 colearchitects.net Copyright © 2020 Cole Architects, PLLC



ARCHITECTURE + PLANNING + DESIGN 6211 Roosevelt Way NE Seattle, WA 98115 206.522.3820

BIDDERS ARE INSTRUCTED TO CAREFULLY REVIEW THE CONSTRUCTION DOCUMENTS AND THE SITE CONDITIONS. INFORMATION REGARDING THE COMPLETE WORK OF SPECIFIC TRADES IS DISPERSED THROUGHOUT THE ENTIRE DOCUMENT SET AND CANNOT BE ACCURATELY DETERMINED BY REFERENCE TO OTHER THAN COMPLETE DOCUMENT SETS.

STAMP

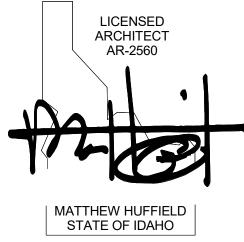

CONSULTANT

## **PROJECT INFORMATION**



## **KETCHUM FIRE STATION NO. 1**

107 SADDLE ROAD, KETCHUM, ID 83353


## ISSUES


PHASE		CONSTRUCTION SE JUNE 19, 202		
DATE				
JOB NU	JMBER	18-0		
MARK	DATE	DESCRIPTION		
25	5/3/21	ASI 07		
24	TBD	RFI #CC-178		
6	8/17/20	ASI 2		
3	7/29/20	RFI CC#19 - R1		


SHEET NAME

## INTERIOR **ELEVATIONS**




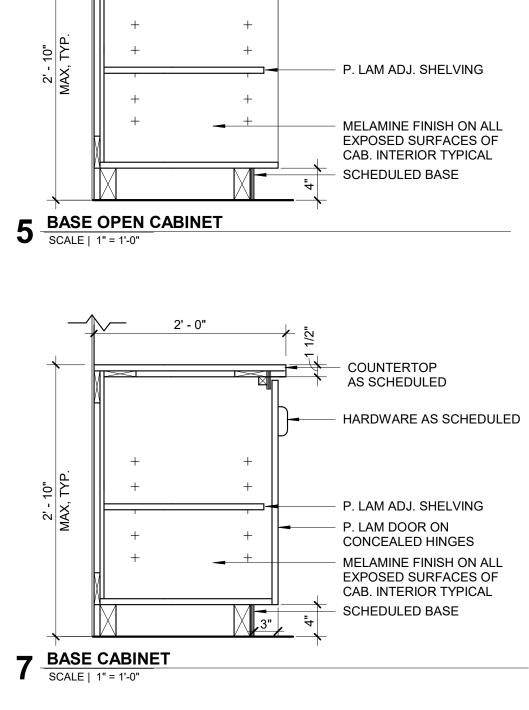


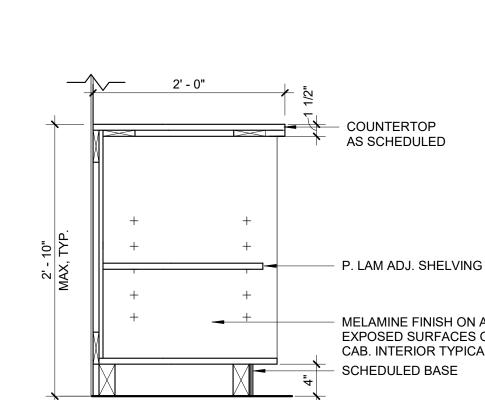

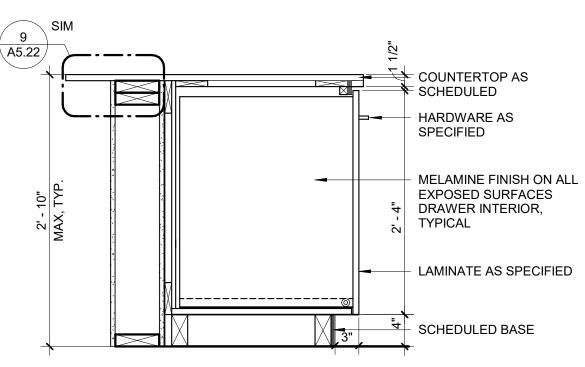


1 BASE CABINET DRAWER @ KITCHEN ISLAND SCALE | 1" = 1'-0"

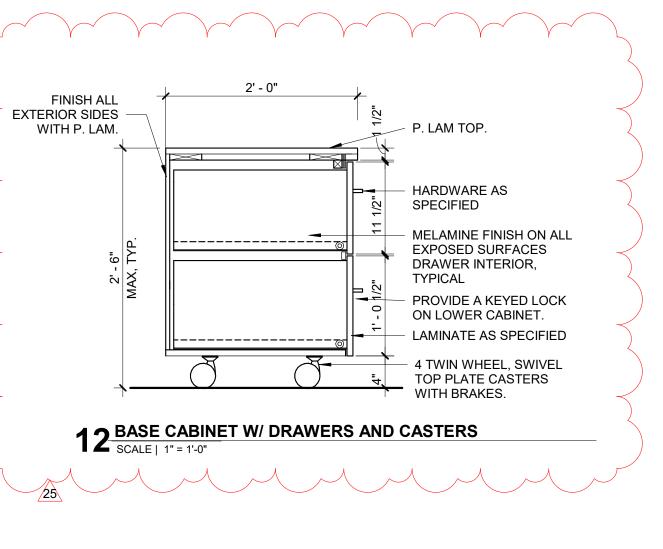

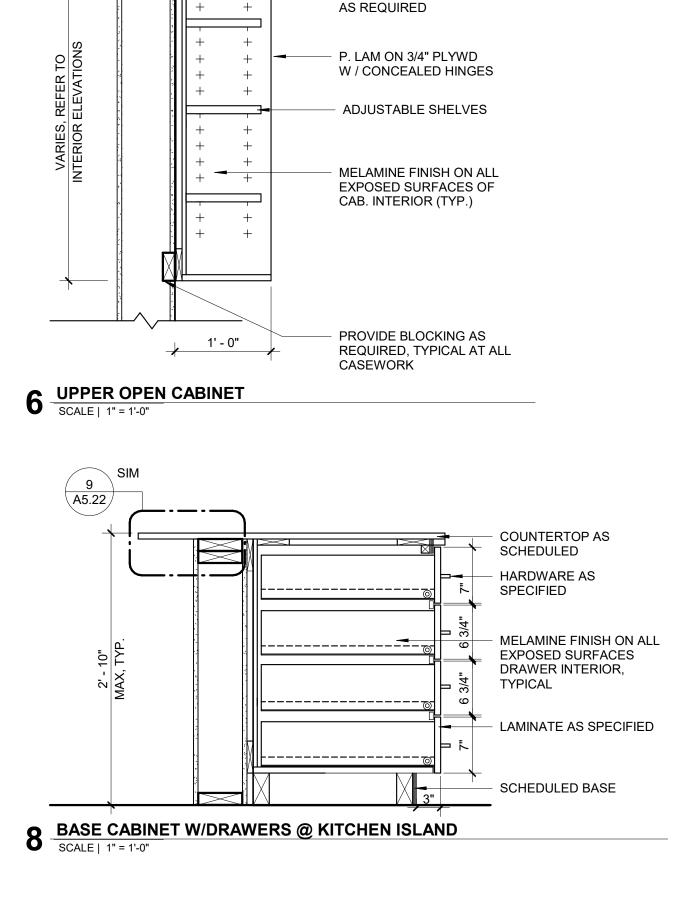



FUR DOWN TO EXTEND TO TOP OF UPPER CABINET

BLOCKING

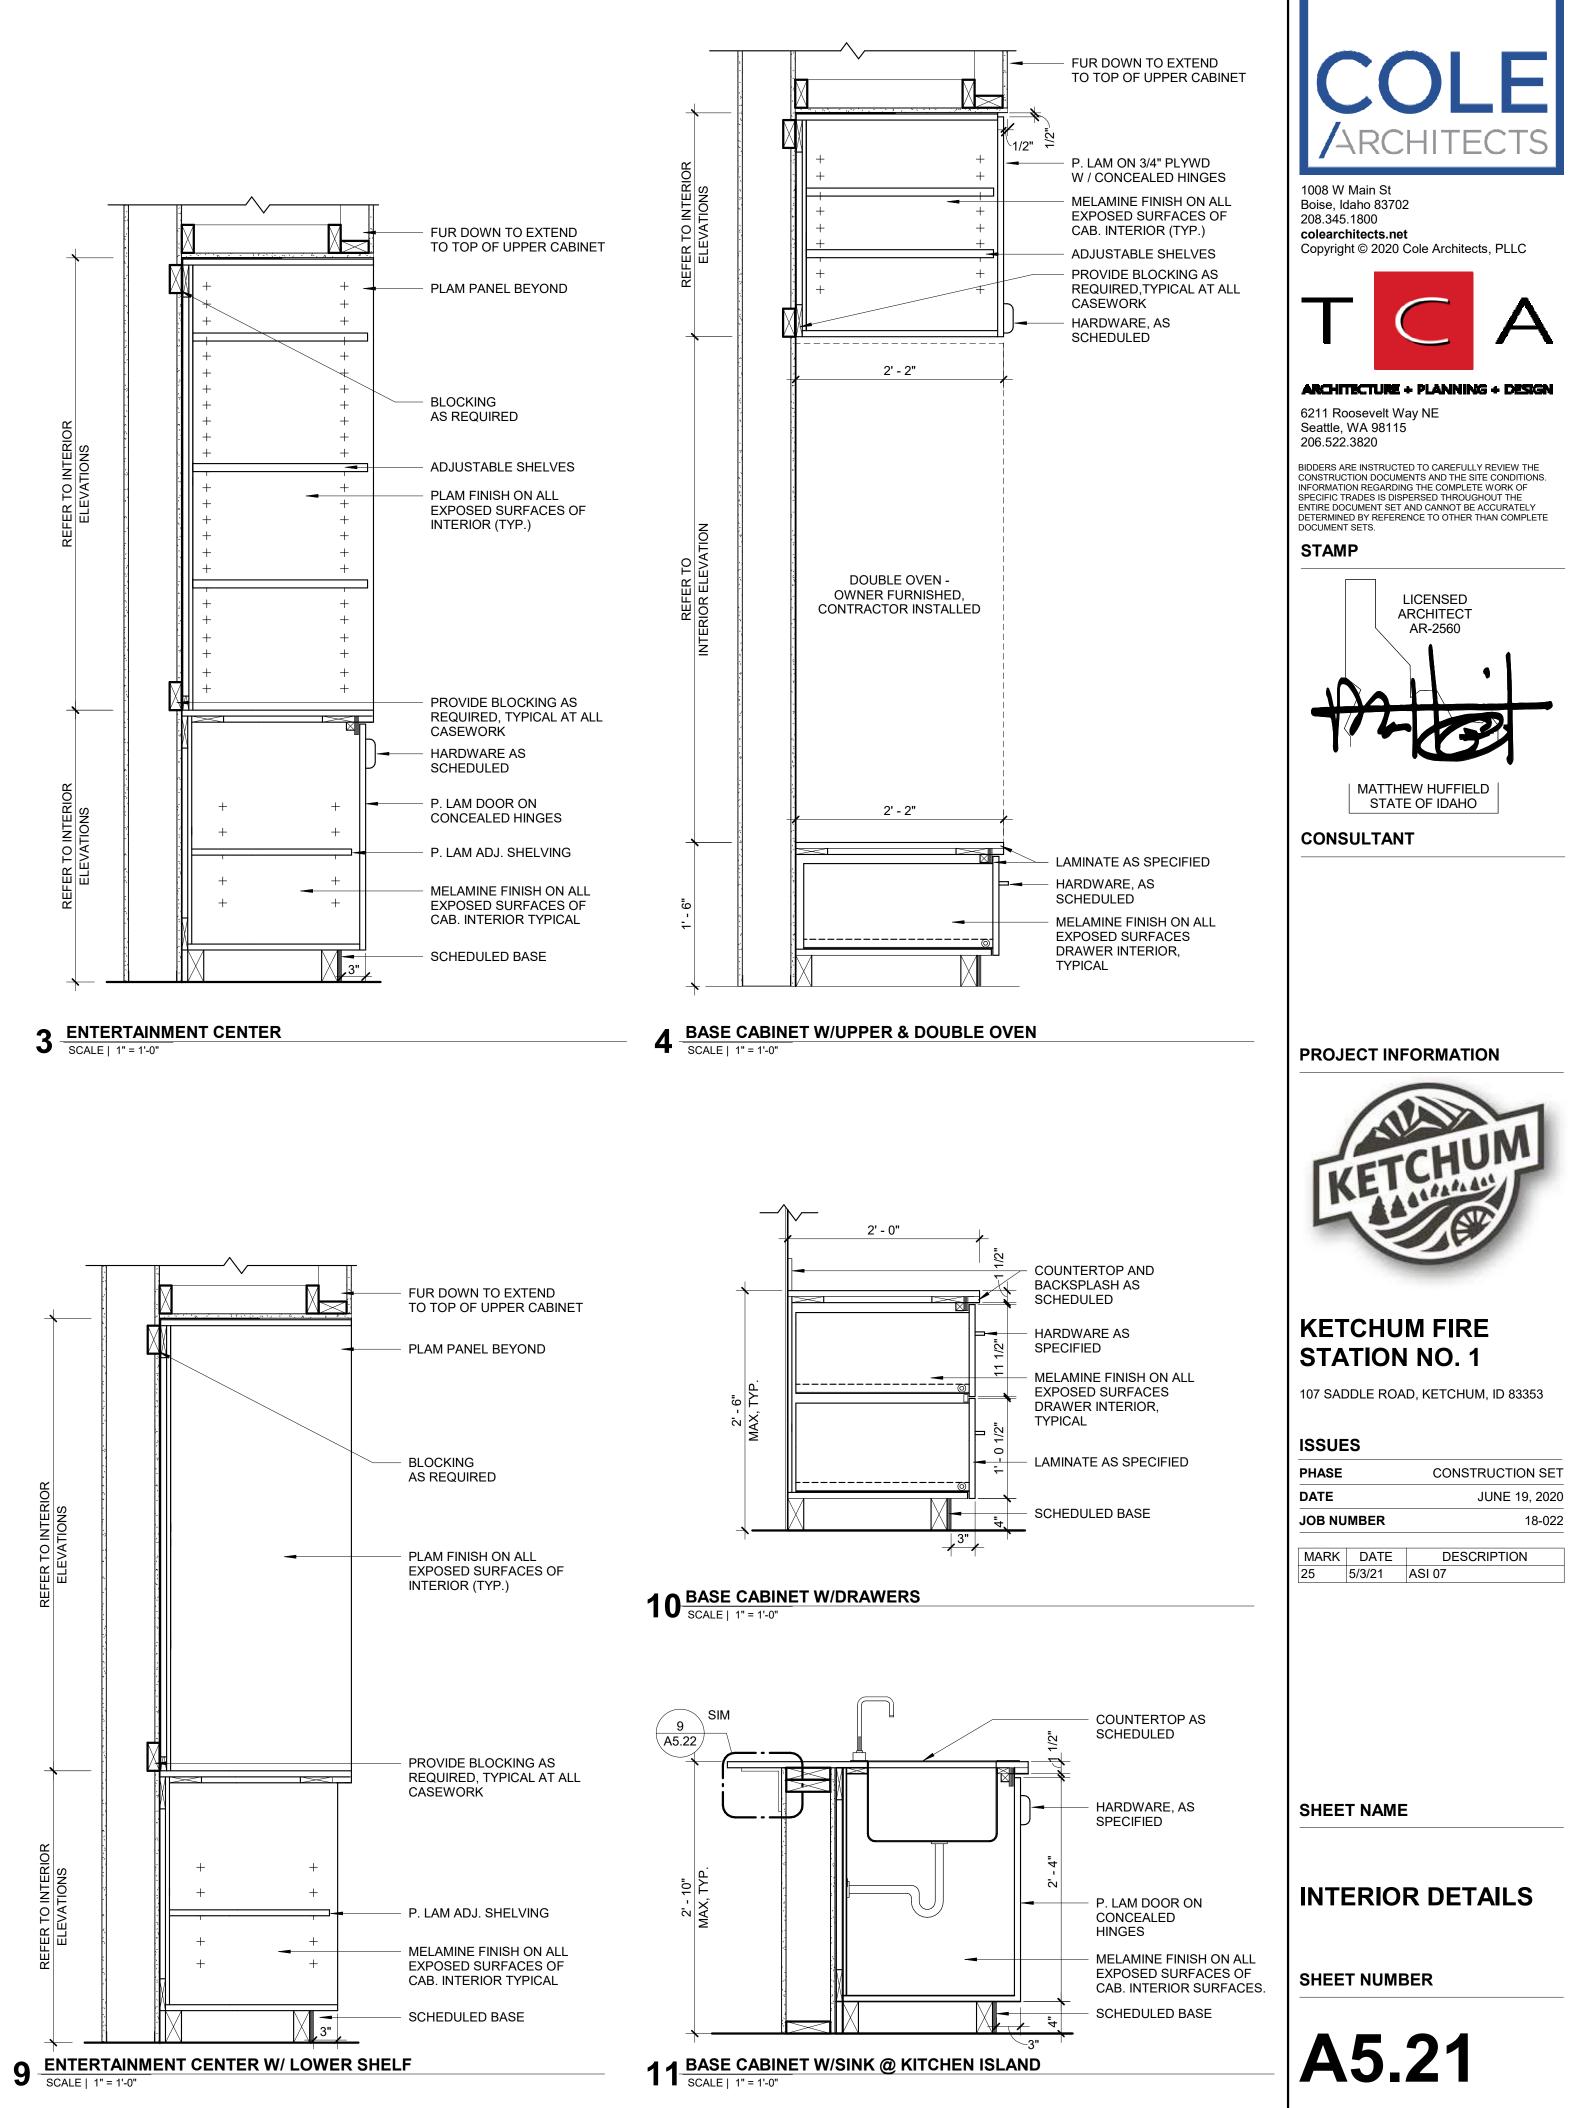

## 2 DORM CLOSET CASEWORK SCALE | 1" = 1'-0"

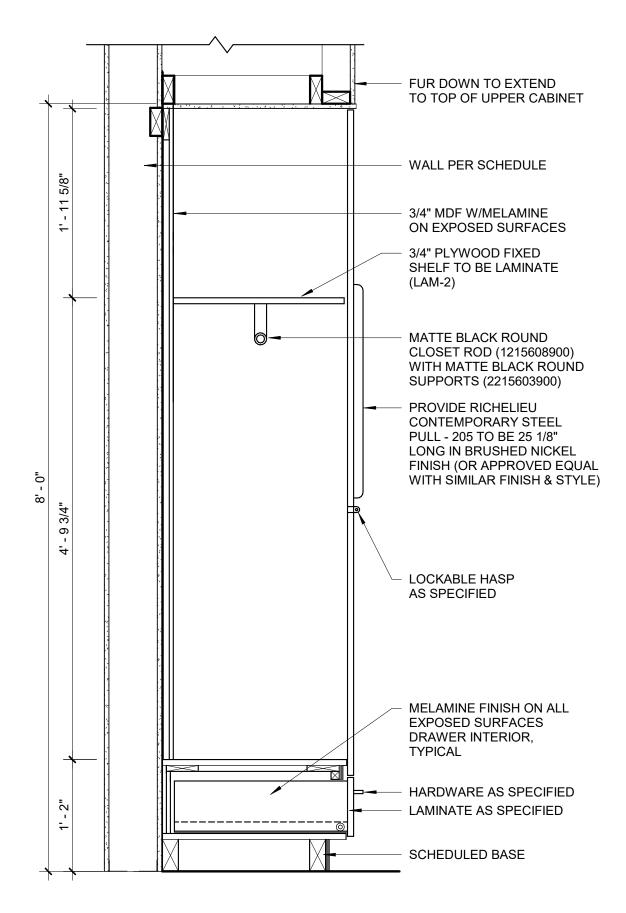

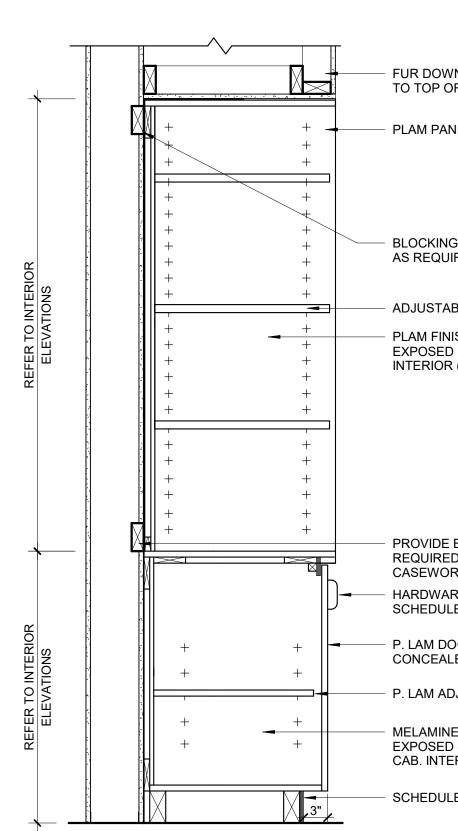



Building. Growing. Leading. ...Since 1937.

## Budget Evolution Item Summary City of Ketchum Fire Station #1

ASI-08/RFI-186 Revised Accessories

Date:

5/26/2021

SCOPE	SUBCONTRACTOR	AMOL	JNT
Wall revisions and repairs	Interior Contractors	\$	541.00
Wall Accesory adjustments per RFI-186r	Office Environment Co.	\$	1,227.00
		_	
SUBTOTAL:		\$	1,768.00
SUBTOTAL reflects direct costs only on the	presumption that costs will com	e from	
allowances. If costs are reimbursed by Cha			
SUBTOTAL with add of agreed upon marku	p in accordance with the change	order prici	ng.
Bond and Insurance	CORE	\$	37.00
CMAR FEE	CORE	\$	79.00
Sales Tax	CORE	\$	-
TOTAL AMOUNT:		\$	1,884.00

## **INTERIOR CONTRACTORS, INC.**

PO. BOX 3873 HAILEY, ID 83333

## Invoice

Date	Invoice #
5/25/2021	5103

Bill To		
CORE CONSTRUCTION CO		

		Terms	Project
		Due on receipt	ID-COK FIRE STA.
	Description		Amount
PER INCON CO #002 PER INCON CO #002	24 43		320.00 221.00
Thank you for your bus	siness.	Total	\$541.0
Phone #	E-mail		

5/25/2021

20892.jpeg

Interior Contractors, Inc. PC Box 3073 Halley, ID 80333 . CHANGE ORDER 208-481-0311 70 love construction 00224 inge(s) speci for real come 212, 213, and 214 paper towal disputer and track : my on add per core and hr=6 4- 10FTX 35/8 metal studs - 20 gunse 2- 10FTX 35/8 metal studs - 20 gunse NOTE: This Change Order becomes part of and in conformance with the existing contract. WE AGREE hereby to make the change(s) specified above at this price 🖒 MALL: 5/25/21 \$ PREVIOUS CONTRACT AMOUNT JAN COM \$ REVISED CONTRACT TOTAL \$ 320 00 ACCEPTED — The above prices and specifications of this Change Order are satisfactory and are hereby accepted. All work to be performed under same terms and conditions as specified in original contract unless otherwise stipulated. Date of acceptance Signature (OVINE III)

5/25/2021

20891.jpeg

0 Interior Contractors, Inc. . PO Box 3873 Haitey, ID 83333 .... CHANGE ORDER 208-481-0311 70 Love construction 00243 S. 2. S. Later We hereby agree to make the change(s) specified below 13+ floor welling toll and 105 Second paper tous dispose and these This was an add per love and DATE OF EXCILANCE Fatal hr : \$4 2- 10 FT 35/8 metal studs - 20 gume 1-10 FT 35/8 matel track = 20 gume NOTE: This Change Order becomes part of and in conformance with the existing contract WE AGREE hereby to make the change(s) specified above at this price ⇔ 5 25/24 \$ July 3 PREVIOUS CONTRACT AMOUNT GNATURE (CONTRACTOR) S REVISED CONTRACT TOTAL \$ 221 00 ACCEPTED - The above prices and specifications of this Change Order are satisfactory and are hereby accepted. All work to be performed under same terms Date of acceptance and conditions as specified in original contract unless otherwise stipulated. Signature \_\_\_\_ (CARER)

OFFICE ENVIRONMENT COMPANY S. Americana Blvd | Boise, ID 83702 | w: 208-385-0507 | www.oecworks.com



#### **CoK Fire Station Project Change Order Proposal**

Change Order	Request #	3
Date:	5/21/21	

**Core Construction** To: John Brown Attn: Email: johnbrown@coreconstruction.com

#### **Change Order Description:**

Supply and Install additional Items per approved submittal. Provide Credit for removed items from approved submittal.

Scope of Work Description & Clarifications	Amount	
10 28 00 Supply and Install of added items: -Recessed automatic paper towel dispencer and waste receptacle combo unit ; <b>Additional 2</b> (B-39747) -Counter mounted automatic soap dispenser; <b>Additional 3</b> (B-824)	\$2,315.67	
10 28 00 Credit for Removed Items: -Stainless steel shelf; <b>Removed 1</b> (B-295) -Double coat hook; <b>Removed all 12</b> (B-549) -Recessed paper towel dispenser; <b>Removed 3</b> (B-35903)	-\$1,088.73	
Total Change Order Amount	\$1,226.95	

Proposa	Acceptance	& Agreement
---------	------------	-------------

lan Phillips	The undersigned hereby accepts, agrees to and Acknowledges OEC's propos
<u>iphillips@oecworks.com</u>	Signature:
248-933-8891	Printed Name:
623 S. Americana Blvd	Title:
Boise, ID 83702	Date:



#### **Bobrick Washroom Equipment, Inc.**

Washroom Accessory Submittal

Quote No: USJZC000064-1 Quote Date: 6/12/2020 Job Name: Ketchum Fire O E C SOLUTIONS 623 S AMERICANA BLVD BOISE, ID 837026732

Item		Description	Qty	
4288 🗸		Contura Surf Mtd Tp Disp	$\checkmark$	7
4221 🗸		Contura Seat Cover Dispenser	$\checkmark$	7
270 🗸		Contura Surf Mtd Napkin Disp	$\checkmark$	7
39747 🗸	(+2)	Rec Roll Towel Disp W/18 Gal (68L) Waste	<u>6</u> X	1
239X34 🗸		Shelf And Mop Holder-34 In	$\checkmark$	1
824 🗸	(+3)	Automatic No Touch Liquid Soap Series C	7	4
6806.99X18 🗸		Straight Grab Bar 18" (457Mm) Peened	<b>_</b>	2
6806.99X36 🗸		Straight Grab Bar 36" (914Mm) Peened	$\checkmark$	2
6806.99X42 🗸		Straight Grab Bar 42" (1067Mm) Peened	$\checkmark$	2
КВ200-00 🗸		Bcs Horz <del>Gream</del> Wm Provide color 'Grey"	$\checkmark$	2
295X18 🧹 🤇	(-1)	Shelf 5W By 18 Long	<mark>3</mark>	4
549 (-	-12)	Double Hook Not Required, Provide Credit		12
35903 🧹	(-3)	Paper Towel Dispenser 2	×-	-5-


Wall mounted paper towel dispenser, similar to model 35903. - Quantity : 3-





#### RFI #CC-186: ASI-08 Added Paper Towel Dispenser @ Restroom 214


Status	Open		
То	Alex Goedhart (Cole Architects) Crystal McColly (Cole Architects)	From	JT Brown (CORE Construction - Las Vegas) 777 N Fourth St Boise, Idaho 83702
Date Initiated	May 12, 2021	Due Date	May 19, 2021
Location	Ketchum Fire Station>Fire Station>2nd Floor>214 Shower (SW)	Project Stage	Course of Construction
Cost Impact	Yes (Unknown)	Schedule Impact	TBD
Spec Section		Cost Code	
Drawing Number	A5.00	Reference	
Linked Drawings			
Received From	Tyler Brown (Interior Contractors)		
Copies To	(Office Environment Company), Cary Goldberg (DP	PM Project Manageme	as), Tyler Brown (Interior Contractors), Karal Comer ent), Bill McLaughlin (City of Ketchum), Levi Newsom hris Schratwieser (CORE Construction - Las Vegas),
Activity			
Question	Question from JT Brown CORE Construction -	Las Vegas on Wednes	sday, May 12, 2021 at 01:39 PM MDT
		hed-in and drywalled.	wever the location shown at Restroom 214 conflicts Please confirm a surface mounted paper towel/trash
	Awaiting an Official Response		
All Replies	Response from Customer Support on Monday,	May 17, 2021 at 10:08	AM MDT
	emailed from: ["crystal@colearchitects.com"] See Crystal McColly, AIA, LEED AP BD+C	attached response.	
	COLE/ARCHITECTS Project Architect		
	p 208.345.1800 / d 208.605.3404 / c 208.731.903	1	
	Attachments RFI #CC-186 - ASI-08 Added Paper Towel Dispen	ser @ Restroom 214 -	Response.pdf
See	attached updated sheet A5.00 - INTERIOR	ELEVATIONS - R	ESTROOMS.
- #20 - R - #21 - A	of Sheet Changes: ) - SHOWER 214 - EAST emoved recessed paper towel dispenser (E - SHOWER 214 - SOUTH dded recessed paper towel dispenser (Bob		
	tal McColly Architects		

Cole Architects 5/25/21

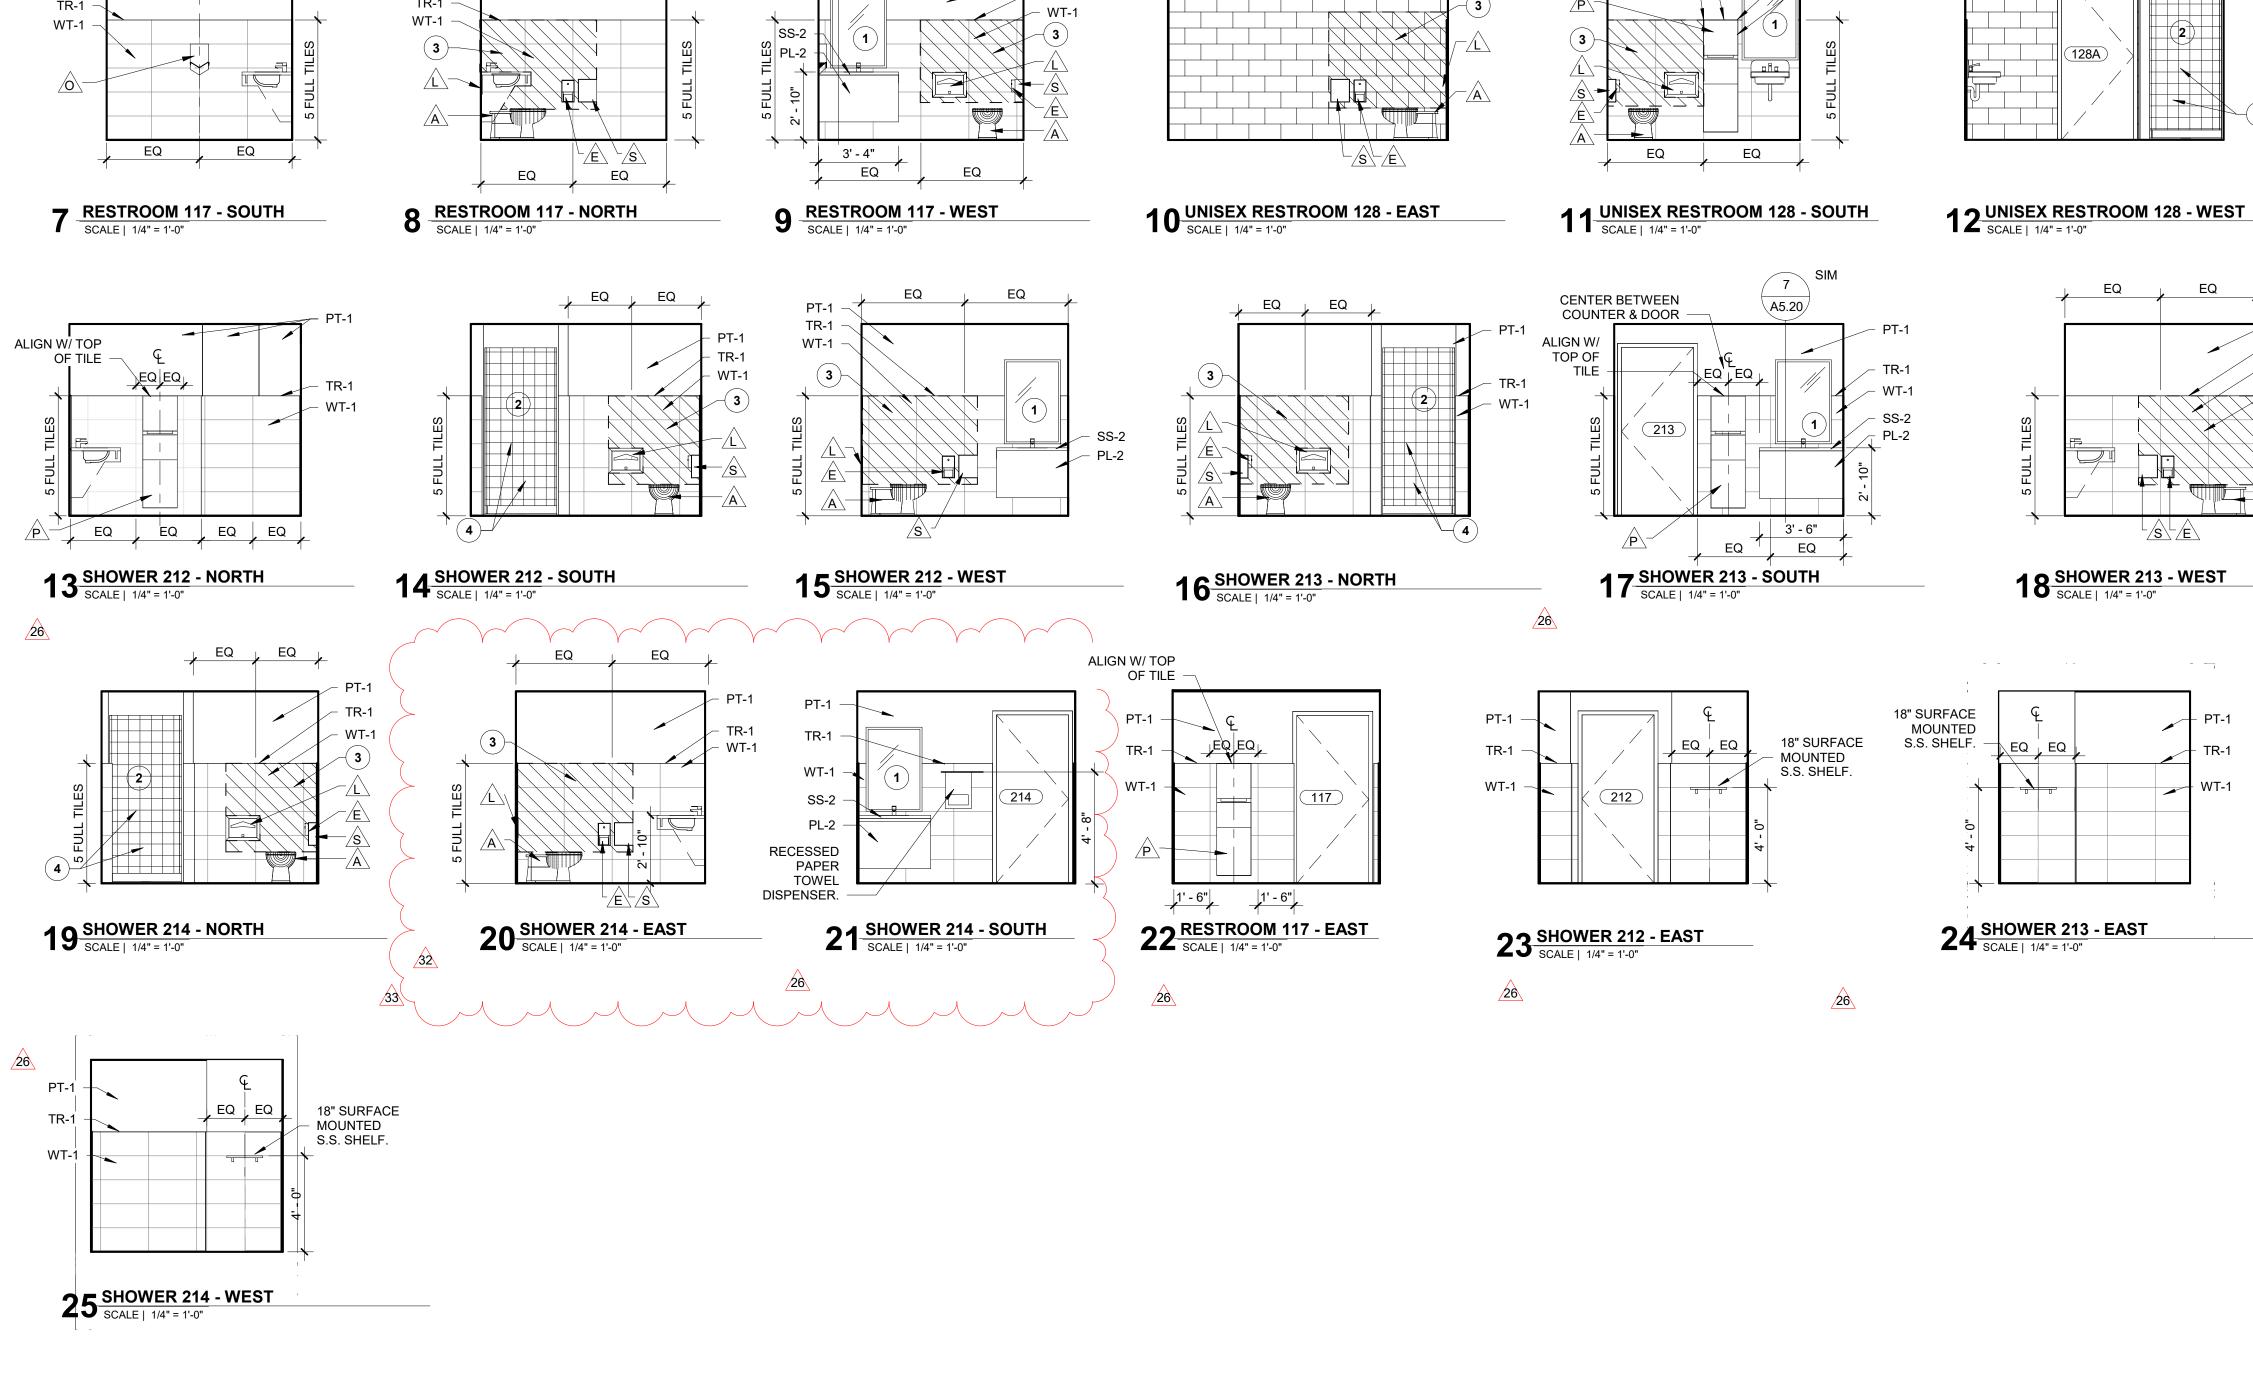

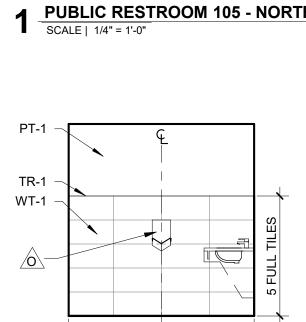

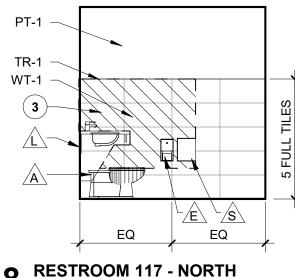


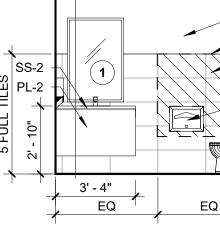


SIM

7 `


A5.20/

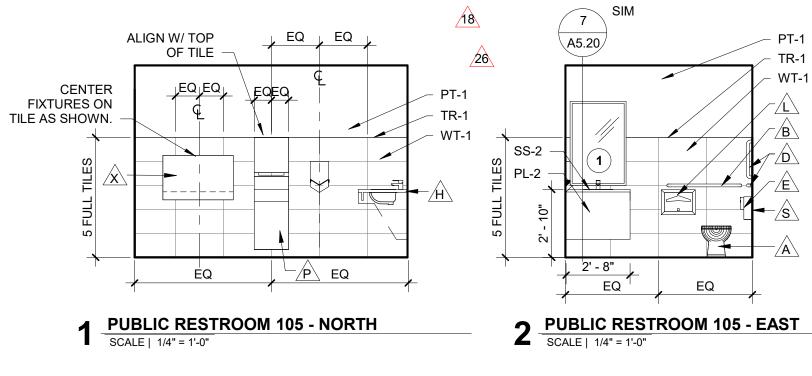

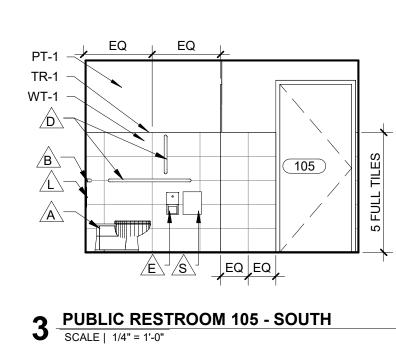


PT-1

TR-1

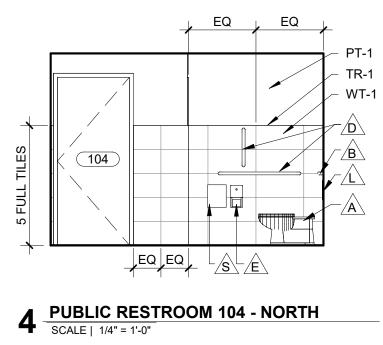

– PT-1

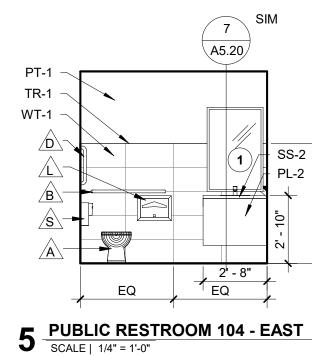

- PT-1

TR-1


WT-1

26

ALIGN W/ TOP OF TILE


ALIGN W/ EDGE OF TILE




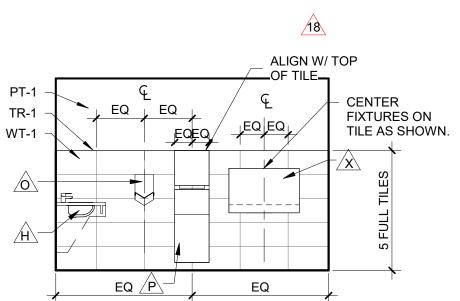


26

<u>/</u>2

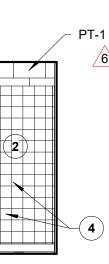

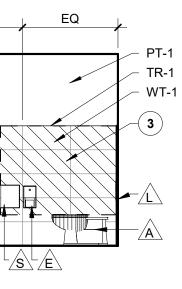

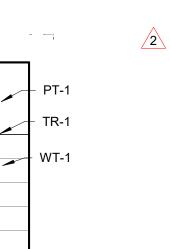


# **GENERAL NOTES**

- A. REFER TO ARCHITECTURAL FLOOR, ELEVATION AND FINISH PLANS. CONTRACTOR SHALL CLARIFY ANY QUESTIONS CONCERNING FINISHES, LOCATION, OR DESIGN INTENT WITH DESIGNER PRIOR TO ORDERING OF MATERIALS.
- B. AT ROOMS WITH NEW EXPOSED CEILING, PAINT WALLS TO UNDERSIDE OF STRUCTURE ABOVE.
- C. SEE REFLECTED CEILING PLAN FOR GYPSUM BOARD SOFFIT LOCATIONS. REFER TO REFLECTED CEILING PLAN AND INTERIOR FINISH SCHEDULE FOR FINISH, AS SCHEDULED.
- D. PROVIDE A THIN, CLEAR, SILICONE BEAD (1/8") AT PERIMETER OF ALL DOOR FRAMES AND BORROWED GLASS LITES AFTER INSTALLATION OF SCHEDULED WALL COVERINGS. DOOR FRAMES ON PAINTED WALLS SHOULD RECEIVE THIN, PAINTABLE SILICONE BEAD (1/8") AT PERIMETER PRIOR TO PAINTING, ONLY WHERE THE FRAME DOES NOT MEET THE WALL.
- E. ALL INTERIOR FINISHES MUST BE INSTALLED BY A CERTIFIED INSTALLER / SUBCONTRACTOR PER MANUFACTURER'S INSTRUCTIONS. USE MANUFACTURER'S APPROVED ADHESIVES AND SEAM SEALERS.
- F. ALL FLOORING TRANSITIONS OCCUR UNDER THE CENTER OF THE DOOR UNLESS OTHERWISE NOTED. FLOOR TRANSITION HEIGHTS NOT TO EXCEED 1/4" MAXIMUM. PROVIDE APPROPRIATE SCHLUTER TRANSITION STRIP IN ANODIZED ALUMINUM FINISH AT EACH LOCATION WHERE FLOOR FINISH MATERIAL CHANGES. UNLESS NOTED OTHERWISE
- G. PROVIDE WINDOW COVERINGS AT ALL WINDOW LOCATIONS. SEE INTERIOR FINISH SPECIFICATIONS FOR ROLLER SHADE SPECIFICATION.
- H. ALL CABINET HARDWARE AT CASEWORK LOCATIONS TO BE RICHELIEU CONTEMPORARY STEEL PULL - 205 TO BE 6 5/16" LONG IN BRUSHED NICKEL FINISH (OR APPROVED EQUAL WITH SIMILAR FINISH).
- I. ALL WINDOW SILLS TO BE SOLID SURFACE (SS-1) UNLESS NOTED OTHERWISE.
- J. PROVIDE SOLID BLOCKING OR OTHER SUITABLE BACKING AT LOCATIONS INCLUDING, BUT NOT LIMITED TO, THE FOLLOWING: EDGES WHERE FINISH MATERIALS CHANGE, GRAB BARS, TOILET PARTITIONS, DOOR STOPS, SHELF BRACKETS, HANDRAILS AND ALL MOUNTED EQUIPMENT, INCLUDING EQUIPMENT FURNISHED BY OWNER. PROVIDE STEEL BACKING FOR GRAB BARS ATTACHED TO PARTITIONS. EXTEND BACKING 6" BEYOND OUTLINE OF EQUIPMENT.
- K. REFERENCE PLUMBING/MECHANICAL DRAWINGS, ELECTRICAL DRAWINGS AND SPECIFICATIONS FOR ADDITIONAL PRODUCT INFORMATION. IF CONFLICT EXISTS NOTIFY ARCHITECT AND PRICE MOST EXPENSIVE OPTION.
- .. PROVIDE COUNTER-MOUNTED AUTOMATIC, TOP-FILL BULK LIQUID SOAP DISPENSER IN ALL RESTROOMS (104, 105, 117, 128, 212, 213 & 214).

## **KEY NOTES**

- 1. MIRROR TO BE 2'-4" WIDE X 3'-6" HIGH WITH A 1" BLACK METAL FRAME. INSTALL CENTERED ABOVE SINK.
- 2. ADA ADAPTABLE SHOWER INSERT. REFER TO SPECIFICATIONS. 3. ADA ADAPTABLE RESTROOM, PROVIDE BLOCKING IN WALL TO ALLOW FOR FUTURE MOUNTING OF ALL ADA REQUIRED FIXTURES AND
- HARDWARE AND AT REQUIRED MOUNTING HEIGHTS. 4. SHOWER INSERT TO HAVE NO GRAB BARS OR SEAT INSTALLED.
- SHOWER INSERT TO HAVE REQUIRED BLOCKING TO BE ADA ADAPTABLE AND ALLOW FOR FUTURE ADA GRAB BARS AND SEAT.

## **MOUNTING HEIGHTS**

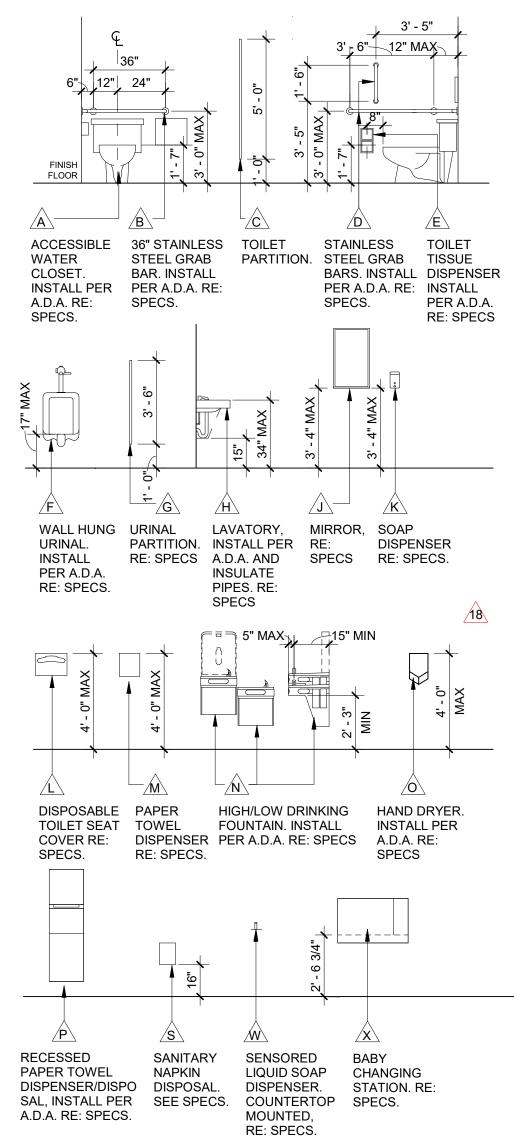




#### 1008 W Main St Boise, Idaho 83702 208.345.1800 colearchitects.net Copyright © 2020 Cole Architects, PLLC



ARCHITECTURE + PLANNING + DESIGN 6211 Roosevelt Way NE Seattle, WA 98115 206.522.3820

BIDDERS ARE INSTRUCTED TO CAREFULLY REVIEW THE CONSTRUCTION DOCUMENTS AND THE SITE CONDITIONS. INFORMATION REGARDING THE COMPLETE WORK OF SPECIFIC TRADES IS DISPERSED THROUGHOUT THE ENTIRE DOCUMENT SET AND CANNOT BE ACCURATELY DETERMINED BY REFERENCE TO OTHER THAN COMPLETE DOCUMENT SETS.

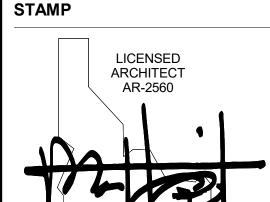



CONSULTANT

**PROJECT INFORMATION** 



## **KETCHUM FIRE STATION NO. 1**

107 SADDLE ROAD, KETCHUM, ID 83353

ISSUE	-0	
PHASE		CONSTRUCTION SET
DATE		JUNE 19, 2020
JOB NU	JMBER	18-022
MARK	DATE	DESCRIPTION
33	5/25/21	RFI #CC-186R1
32	5/17/21	RFI #CC-186
26	5/3/21	ASI 08
18	12/30/20	RFI #CC-125
6	8/17/20	ASI 2
2	7/17/20	ASI 1

SHEET NAME

## INTERIOR **ELEVATIONS -**RESTROOMS



# COLE/ARCHITECTS

ARCHITECTURE / PLANNING / INTERIOR DESIGN

## ASI 08

PROJECT NAME	KETCHUM FIRE STATION #1
PROJECT NUMBER	18-022
DATE	5/3/2021
CONSTRUCTION COMPANY	CORE CONSTRUCTION

THE WORK SHALL BE CARRIED OUT IN ACCORDANCE WITH THE FOLLOWING SUPPLEMENTAL INSTRUCTIONS ISSUED IN ACCORDANCE WITH THE CONTRACT.

#### **DESCRIPTION OF CHANGES:**

#### **DRAWINGS:**

#### ARCHITECTURAL:

- A2.01 FLOOR PLAN LEVEL 01

   ADDED INTERIOR ELEVATION 18/A5.01 COFFEE/COPY NORTH.
- 2) A2.40 ENLARGED PLANS
  - a) #5 ENLARGED PLAN DORM SHOWERS
    - i) ADDED #23 SHOWER 212 EAST.
    - ii) ADDED #24 SHOWER 213 EAST.
    - iii) ADDED #25 SHOWER 214 WEST.
  - b) #6 ENLARGED PLAN OFFICE RESTROOM
    - i) ADDED INTERIOR ELEVATION #22.
- 3) A5.00 INTERIOR ELEVATIONS RESTROOMS
  - a) ADDED GENERAL NOTE 'L'. "PROVIDE COUNTER-MOUNTED AUTOMATIC, TOP-FILL BULK LIQUID SOAP DISPENSER IN ALL RESTROOMS (104, 105, 117, 128, 212, 213 & 214)."
  - b) #1 PUBLIC RESTROOM 105 NORTH
    - i) ADDED RECESSED PAPER TOWEL DISPENSER AND WASTE RECEPTACLE.
    - ii) ADDED WALL MOUNTED BABY CHANGNING STATION.
  - c) #6 PUBLIC RESTROOM 104 SOUTH
    - i) ADDED RECESSED PAPER TOWEL DISPENSER AND WASTE RECEPTACLE.
    - ii) ADDED WALL MOUNTED BABY CHANGNING STATION.
  - d) #11 UNISEX RESTROOM 128 SOUTH
    - i) UPDATED LOCATION OF RECESSED PAPER TOWEL DISPENSER & WASTE RECEPTACLE.
  - e) #13 SHOWER 212 NORTH
    - i) ADDED RECESSED PAPER TOWEL DISPENSER AND WASTE RECEPTACLE.
  - f) #17 SHOWER 213 SOUTH
    - i) ADDED RECESSED PAPER TOWEL DISPENSER AND WASTE RECEPTACLE.
  - g) #21 SHOWER 214 SOUTH
  - i) ADDED RECESSED PAPER TOWEL DISPENSER AND WASTE RECEPTACLE.
  - h) ADDED #22 RESTROOM 117 EAST
    - i) ADDED RECESSED PAPER TOWEL DISPENSER AND WASTE RECEPTACLE.
  - i) ADDED #23 SHOWER 212 EAST

/

# COLE/ARCHITECTS

ARCHITECTURE / PLANNING / INTERIOR DESIGN


- i) ADDED SURFACE MOUNTED SHELF.
- j) ADDED #24 SHOWER 213 EAST
- i) ADDED SURFACE MOUNTED SHELF.
- k) ADDED #25 SHOWER 214 WEST
  - i) ADDED SURFACE MOUNTED SHELF.
- 4) A5.01 INTERIOR ELEVATIONS
  - a) ADDED #18 COFFEE/COPY NORTH
    - i) ADDED RECESSED PAPER TOWEL DISPENSER.
  - b) ADDED GENERAL NOTE 'L'. "PROVIDE COUNTER-MOUNTED AUTOMATIC, TOP-FILL BULK LIQUID SOAP DISPENSER IN ALL RESTROOMS (104, 105, 117, 128, 212, 213 & 214)."

#### **ATTACHMENTS:**

#### DRAWINGS:

- A2.01 FLOOR PLAN LEVEL 01
- A2.40 ENLARGED PLANS
- A5.00 INTERIOR ELEVATIONS RESTROOMS
- A5.01 INTERIOR ELEVATIONS

END OF ASI

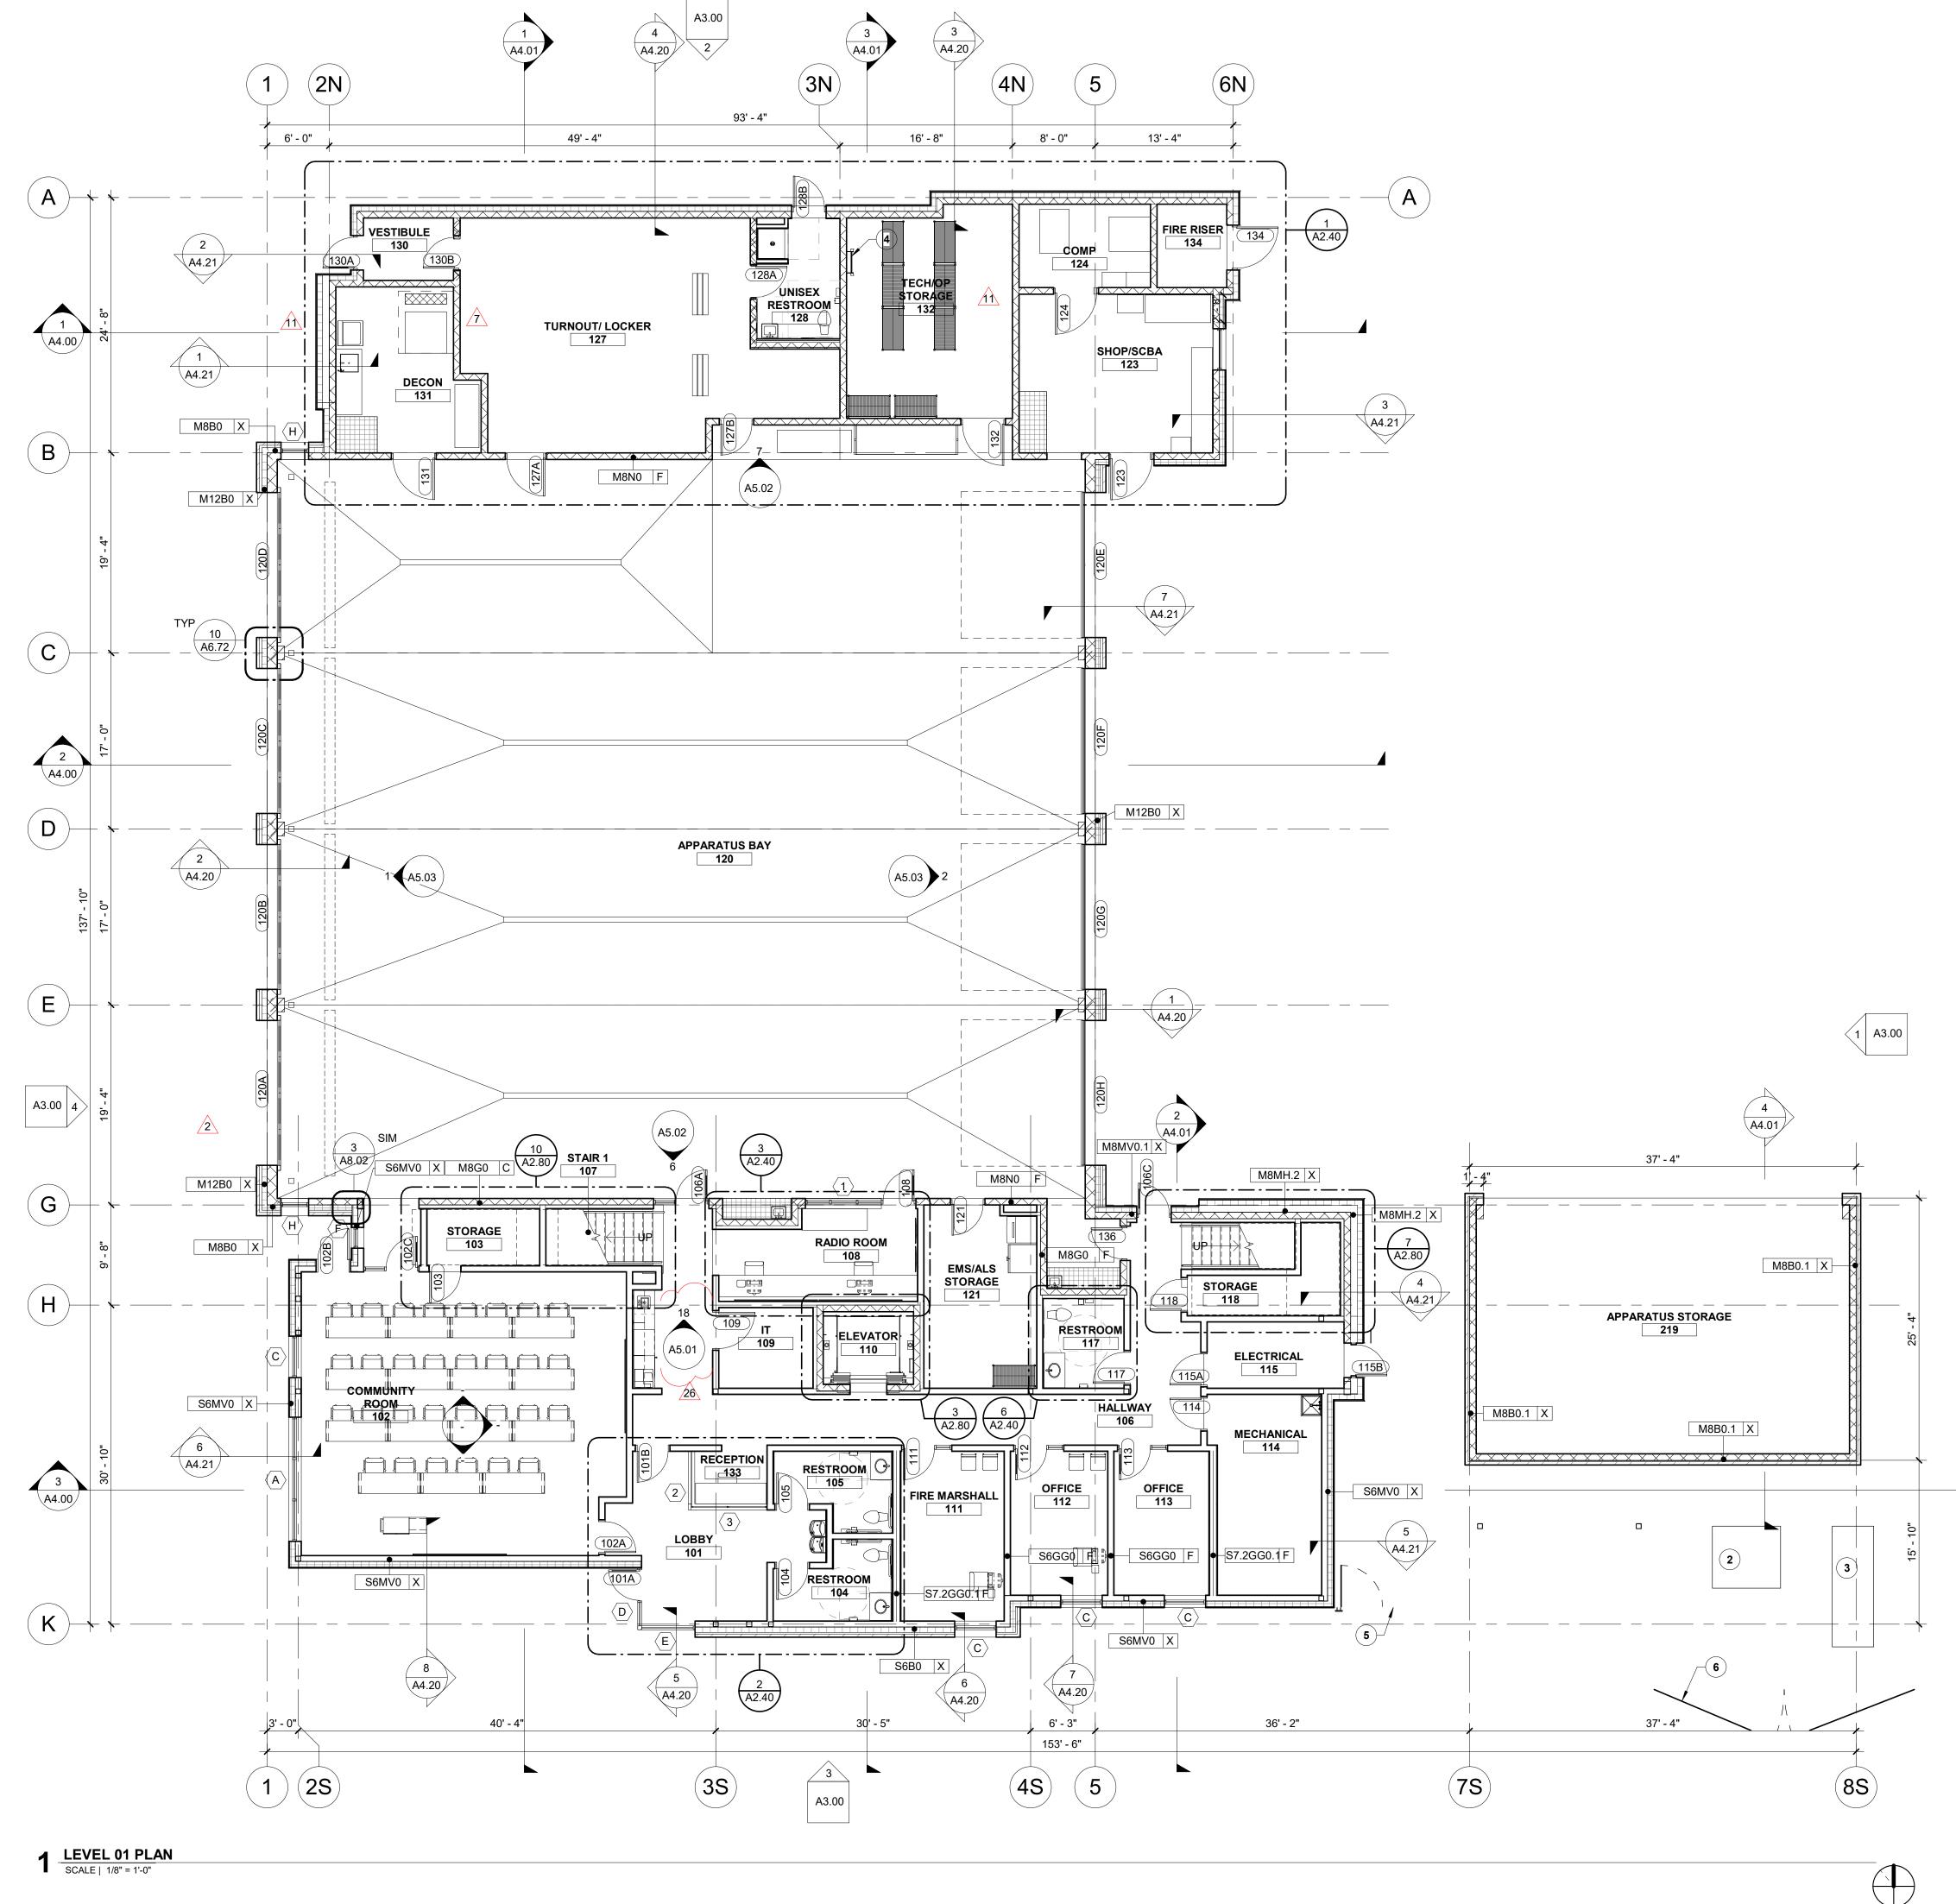

## **GENERAL NOTES**

- A. FIELD VERIFY ALL DIMENSIONS AND EXISTING CONDITIONS. NOTIFY ARCHITECT IMMEDIATELY IF ANY CONFLICTS OR DISCREPANCIES OCCUR BEFORE PROCEEDING WITH WORK.
- B. CROSS REFERENCES SHOWN ON DRAWINGS DO NOT NECESSARILY INDICATE ALL LIKE CONDITIONS AND DO NOT LIMIT APPLICATION OF ANY DRAWING OR DETAIL. WHERE SPECIFIC DIMENSIONS, DETAILS, OR DESIGN INTENT CANNOT BE DETERMINED, CONSULT THE ARCHITECT PRIOR TO PROCEEDING WITH WORK. IF DESIGN INTENT REMAINS UNCLEAR THEN PROVIDE MOST EXPENSIVE OPTION IN BID.
- C. PROVIDE SOLID BLOCKING IN WALLS FOR ALL WALL HUNG EQUIPMENT. BLOCKING TO MEET OR EXCEED MANUFACTURER'S RECOMMENDATIONS. FASTEN EQUIPMENT TO WALLS PER MANUFACTURER'S RECOMMENDATIONS. PROVIDE BLOCKING FOR, BUT NOT LIMITED TO THE FOLLOWING: MILLWORK, RAILING, FIRE EXTINGUISHER ACCESSORIES, WALL MOUNTED PLUMBING FIXTURES, SHELVING, ELECTRICAL EQUIPMENT, RESTROOM ACCESSORIES AND DISPLAY ITEMS.
- D. CAULK ALL COUNTERTOPS, BACKSPLASHES AND CABINETS AT LOCATIONS WHERE THEY MEET WALLS. SEAL ALL CUT-OUTS IN COUNTERTOPS.
- E. ERECT DUST PROOF PARTITIONS AS REQUIRED BY OWNER TO PROTECT ADJACENT AREAS.
- F. ALL PARTITIONS ARE TYPE "S6GG0-F" UNLESS OTHERWISE NOTED.
- G. SEAL AROUND ALL MECHANICAL AND ELECTRICAL EQUIPMENT PENETRATIONS AT WALLS. AT RATED WALLS USE A U.L. APPROVED FIRE-STOPPING MATERIAL. APPROPRIATE FOR FIRE RATING REQUIREMENTS.
- H. PROVIDE 4" DOOR JAMBS FROM FACE-OF-FINISH AT ADJACENT WALLS ON THE HINGE SIDE OR UNLESS OTHERWISE INDICATED.
- I. DIMENSIONS ARE TO GRID LINE OR FACE OF STRUCTURAL MEMBER UNLESS OTHERWISE NOTED. DOOR & WINDOW OPENING DIMENSIONS ARE TO ROUGH OPENING OR CENTERLINE OF OPENING. CONCRETE AND BRICK DIMENSIONS ARE GIVEN TO THE FACE OF CONCRETE OR MASONRY AND TO THE FACE OF ROUGH OPENINGS.

## **KEYNOTES** (#)

- STRUCTURAL COLUMN, SEE STRUCTURAL NEW TRANSFORMER, SEE ELECTRICAL
- GENERATOR, SEE ELECTRICAL
- ROOF ACCESS LADDER. FENCE, SEE LANDSCAPE
- 6. GATE, SEE LANDSCAPE




1008 W Main St Boise, Idaho 83702 208.345.1800 colearchitects.net Copyright © 2020 Cole Architects, PLLC



ARCHITECTURE + PLANNING + DESIGN 6211 Roosevelt Way NE Seattle, WA 98115 206.522.3820

BIDDERS ARE INSTRUCTED TO CAREFULLY REVIEW THE CONSTRUCTION DOCUMENTS AND THE SITE CONDITIONS. INFORMATION REGARDING THE COMPLETE WORK OF SPECIFIC TRADES IS DISPERSED THROUGHOUT THE ENTIRE DOCUMENT SET AND CANNOT BE ACCURATELY DETERMINED BY REFERENCE TO OTHER THAN COMPLETE DOCUMENT SETS.

#### STAMP

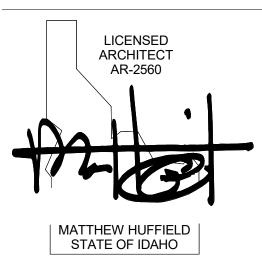

CONSULTANT

## **PROJECT INFORMATION**



## **KETCHUM FIRE STATION NO. 1**


107 SADDLE ROAD, KETCHUM, ID 83353

## ISSUES


PHASE		CONSTRUCTION SET
DATE		JUNE 19, 2020
JOB NU	JMBER	18-022
MARK	DATE	DESCRIPTION
26	5/3/21	ASI 08
11	10/22/20	ASI 04
7	9/2/20	RFI #CC-62
2	7/17/20	ASI 1
SHEE	T NAME	≣

LEVEL 01




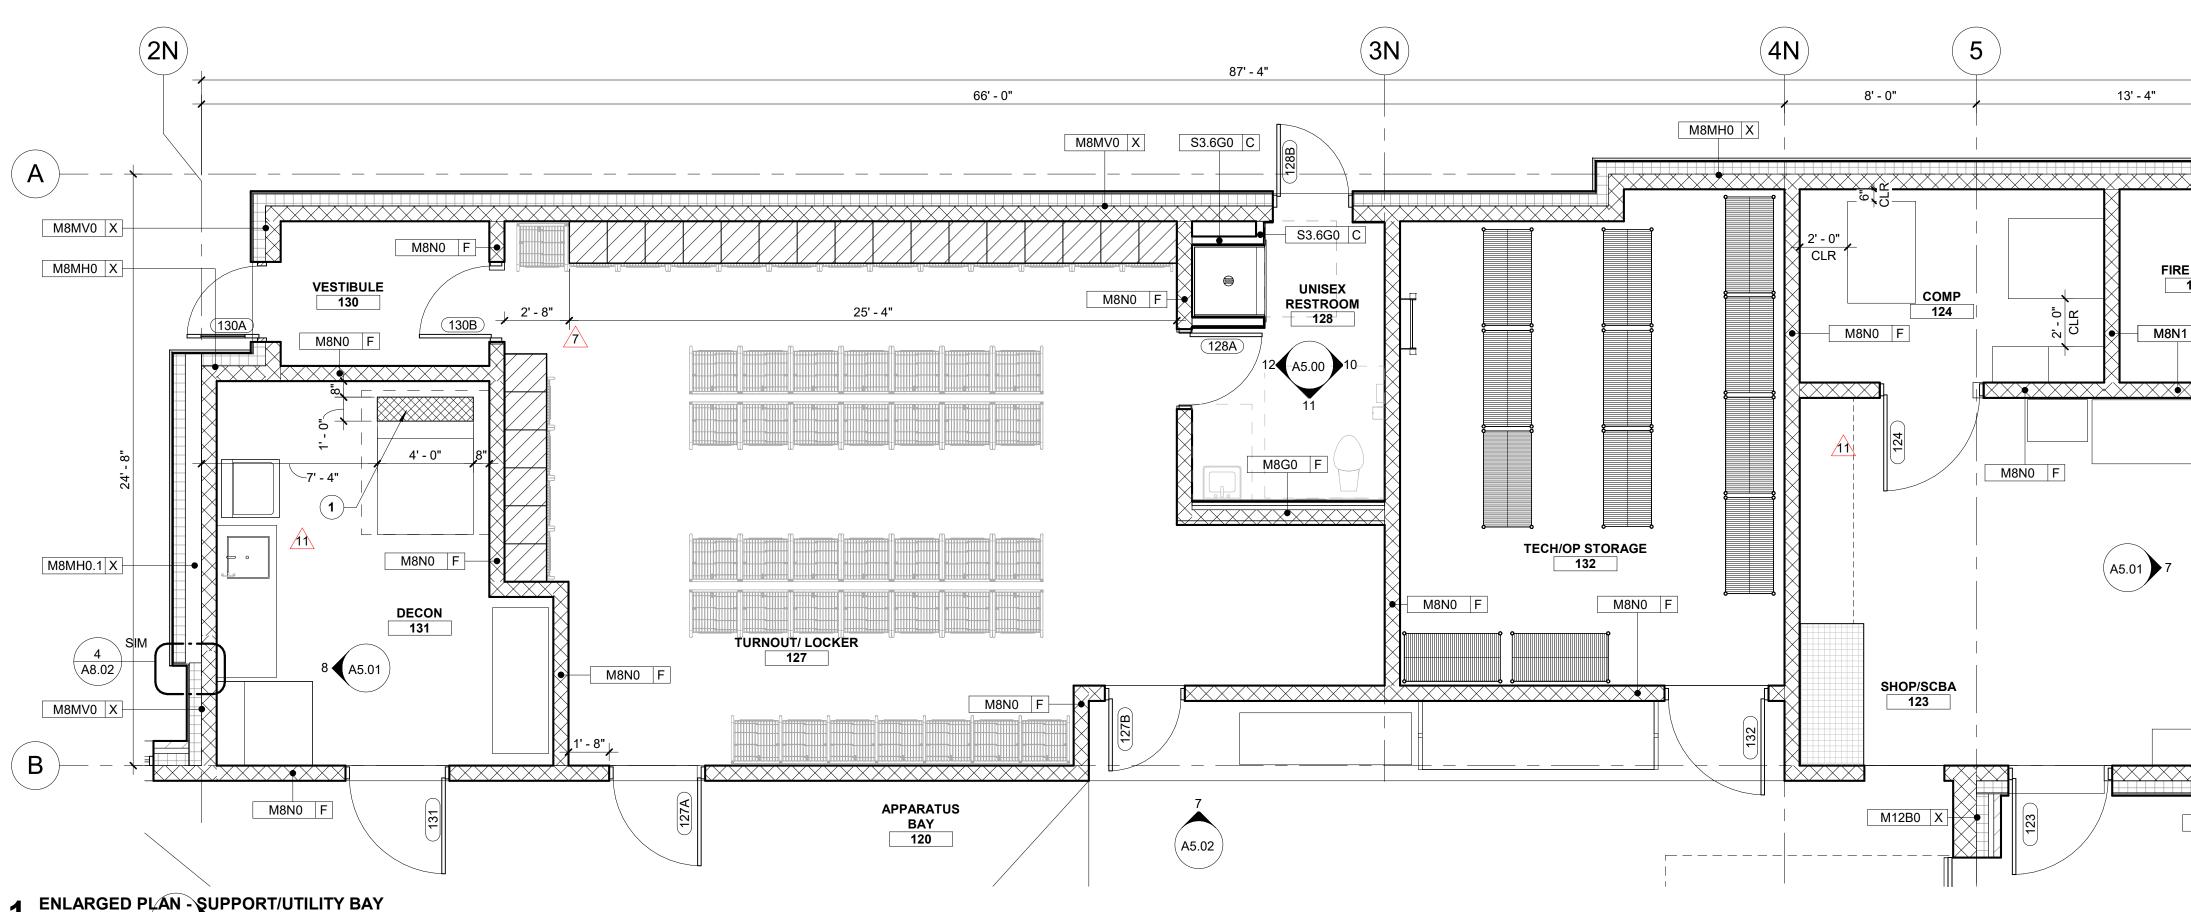


1 ENLARGED PLAN - SUPPORT/UTILITY BAY SCALE | 1/4" = 1'-0" (A5.03) 2

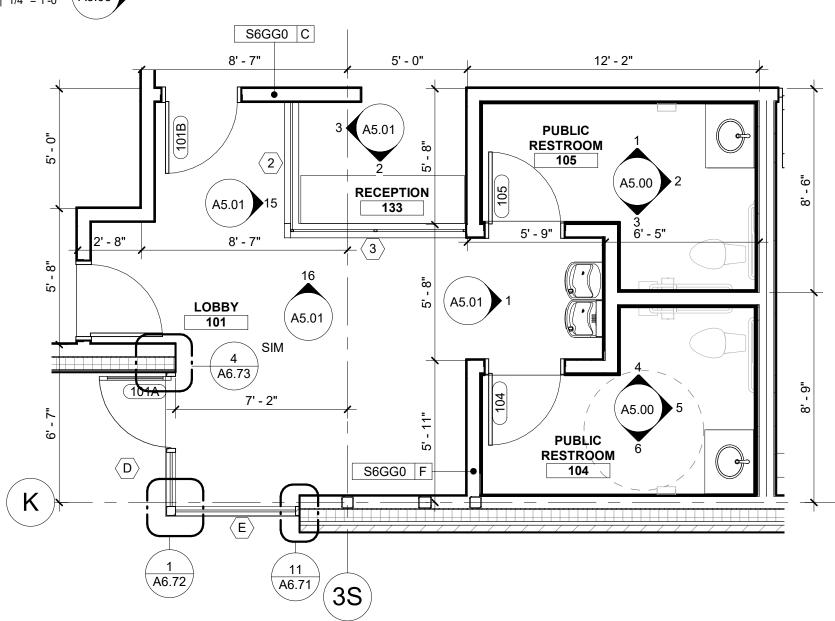



2 ENLARGED PLAN - LOBBY SCALE | 1/4" = 1'-0"

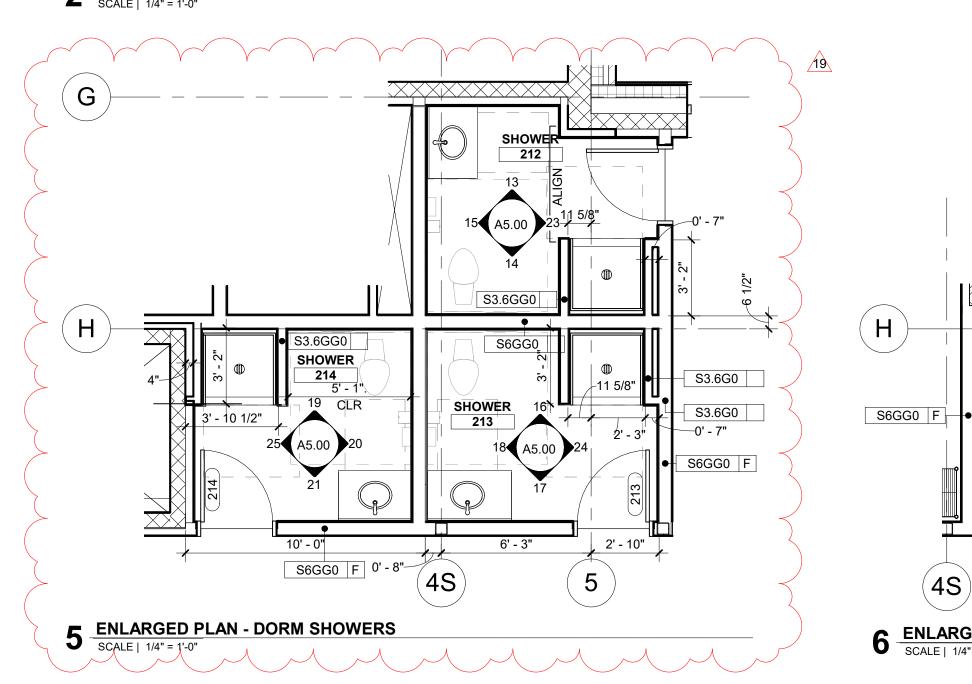

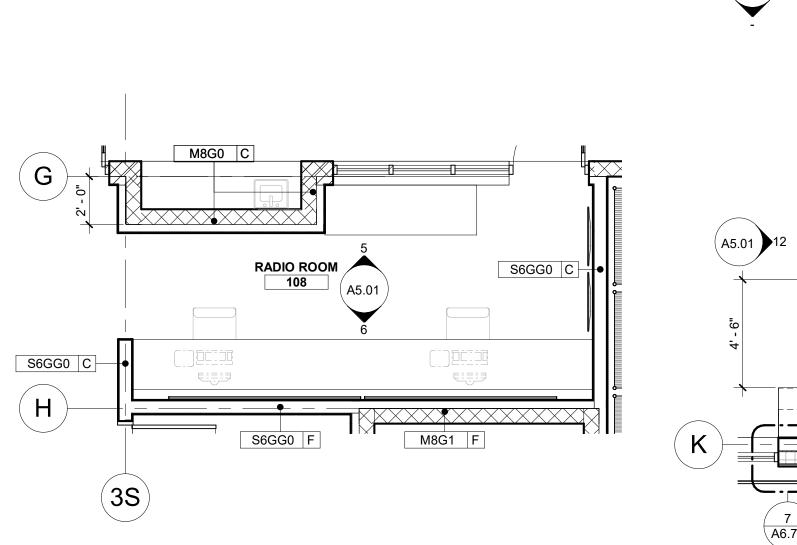





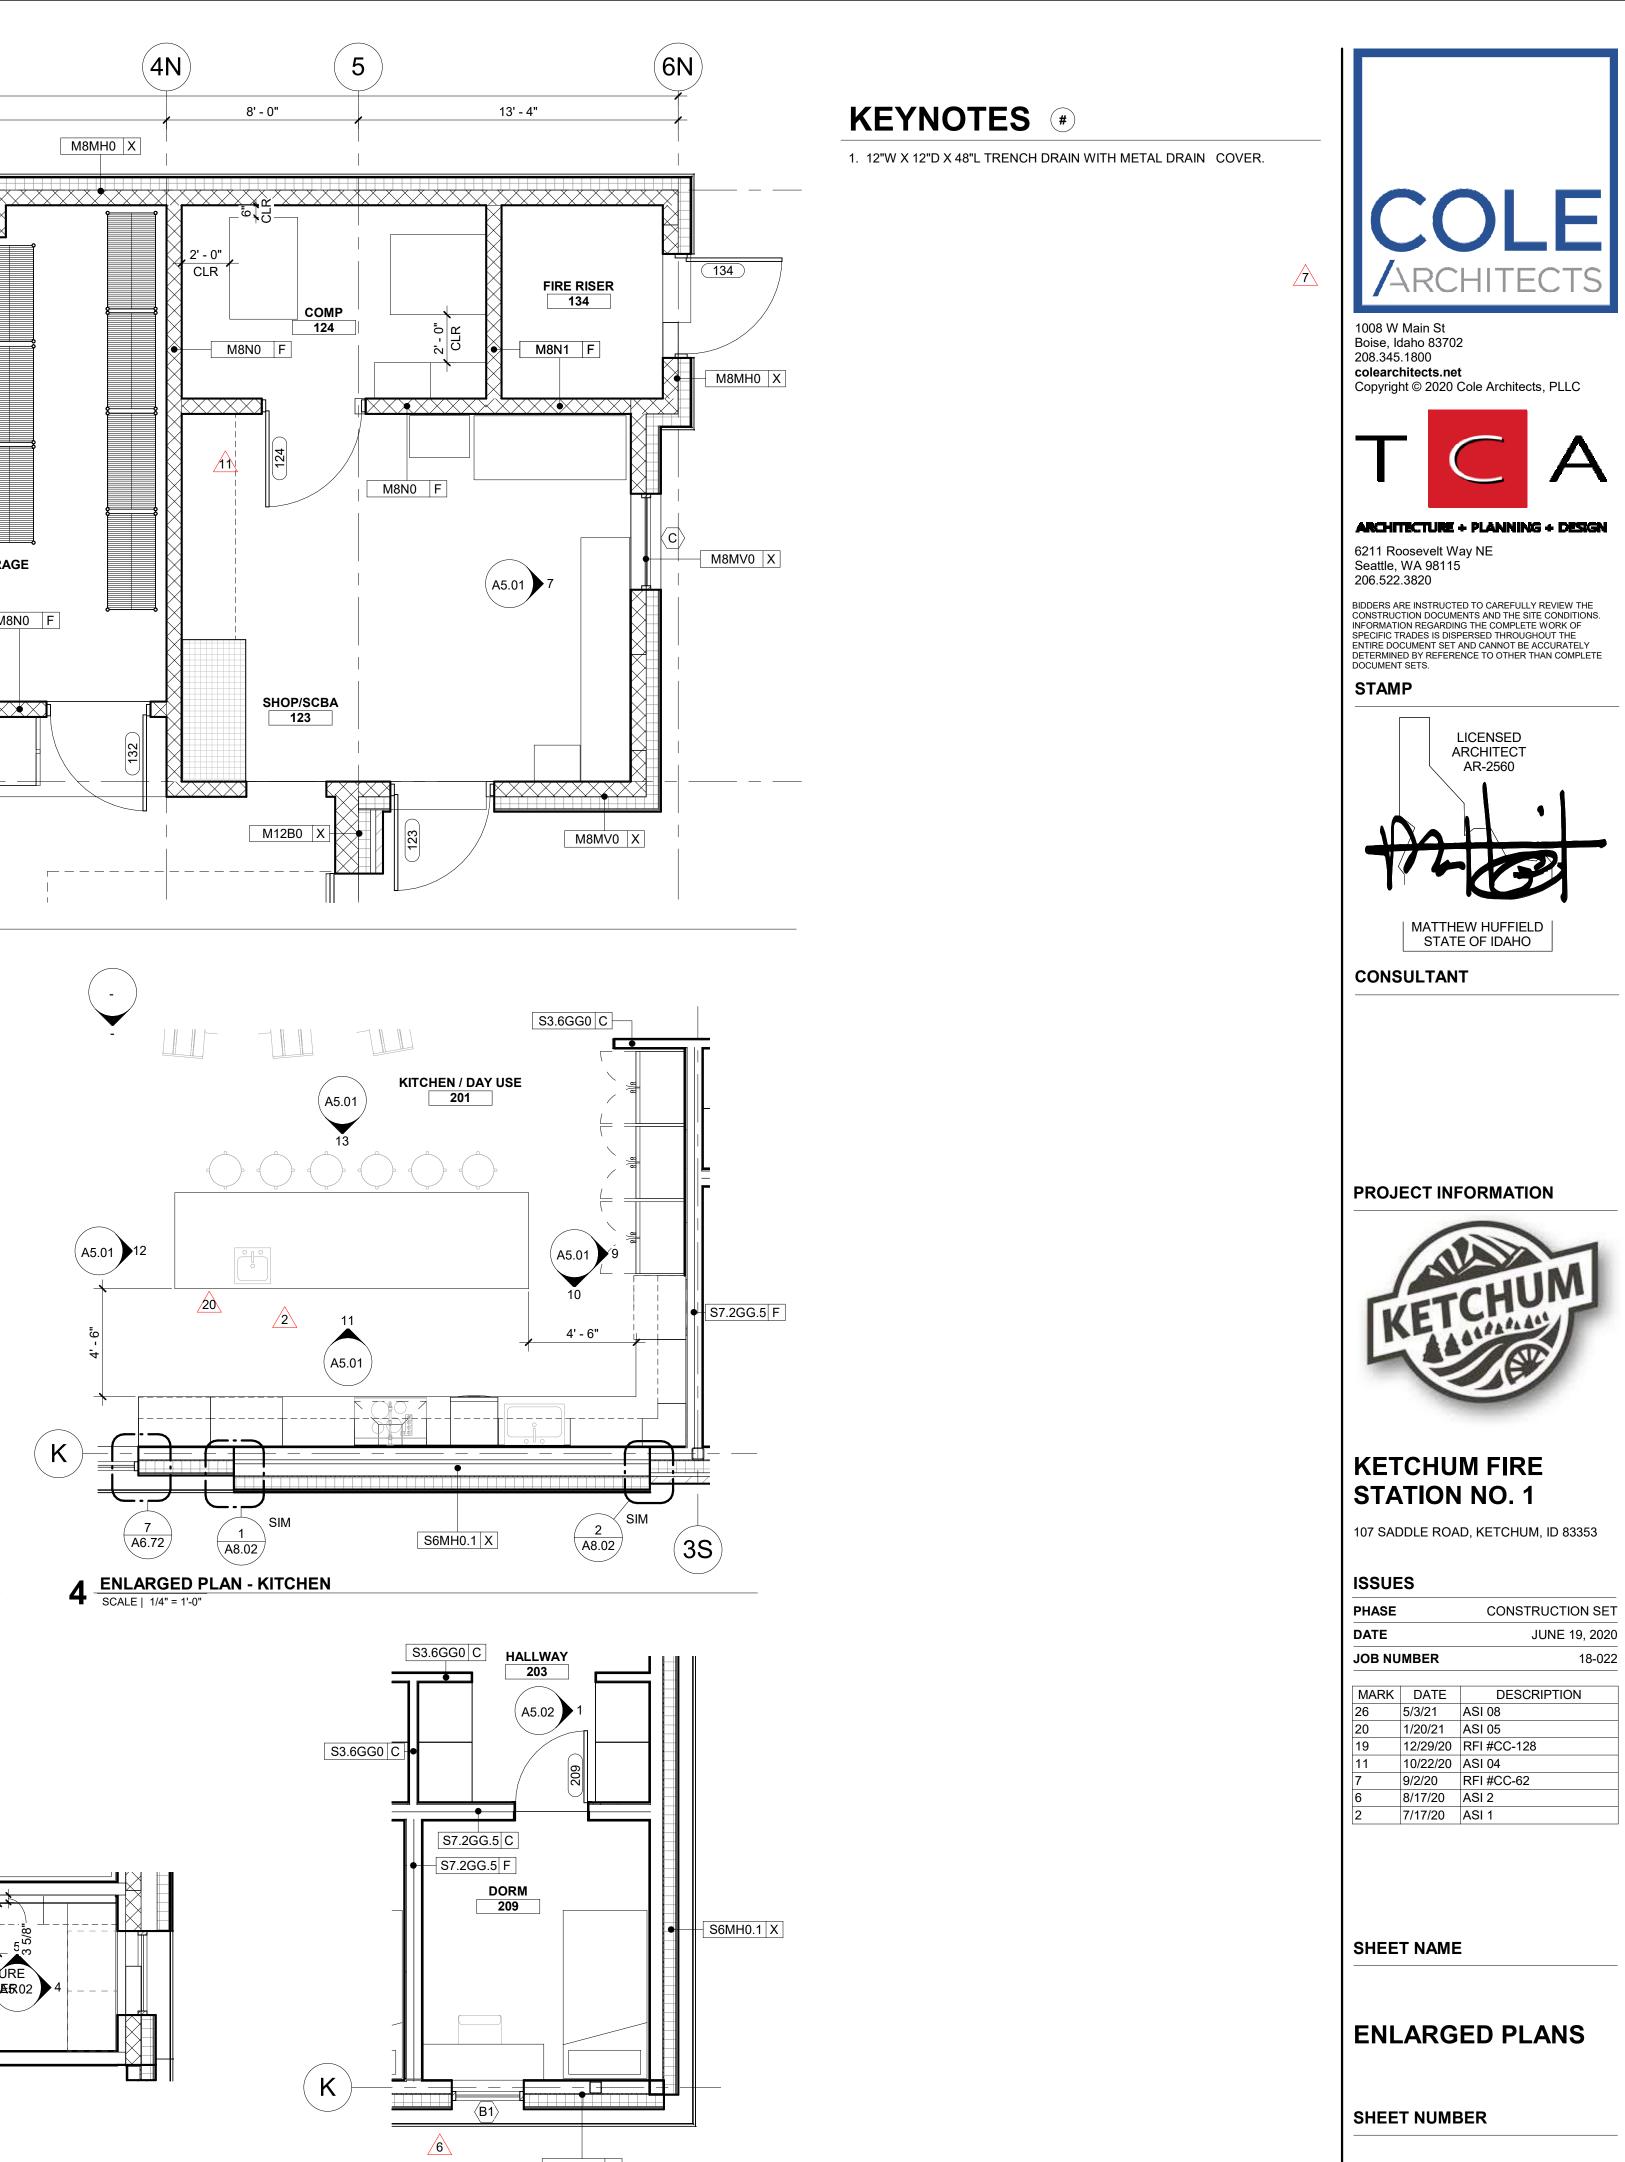

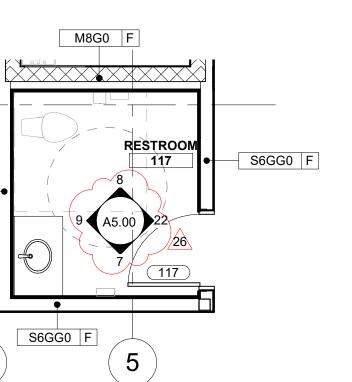

6 ENLARGED PLAN - OFFICE RESTROOM SCALE | 1/4" = 1'-0"

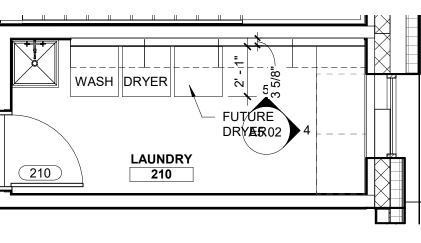

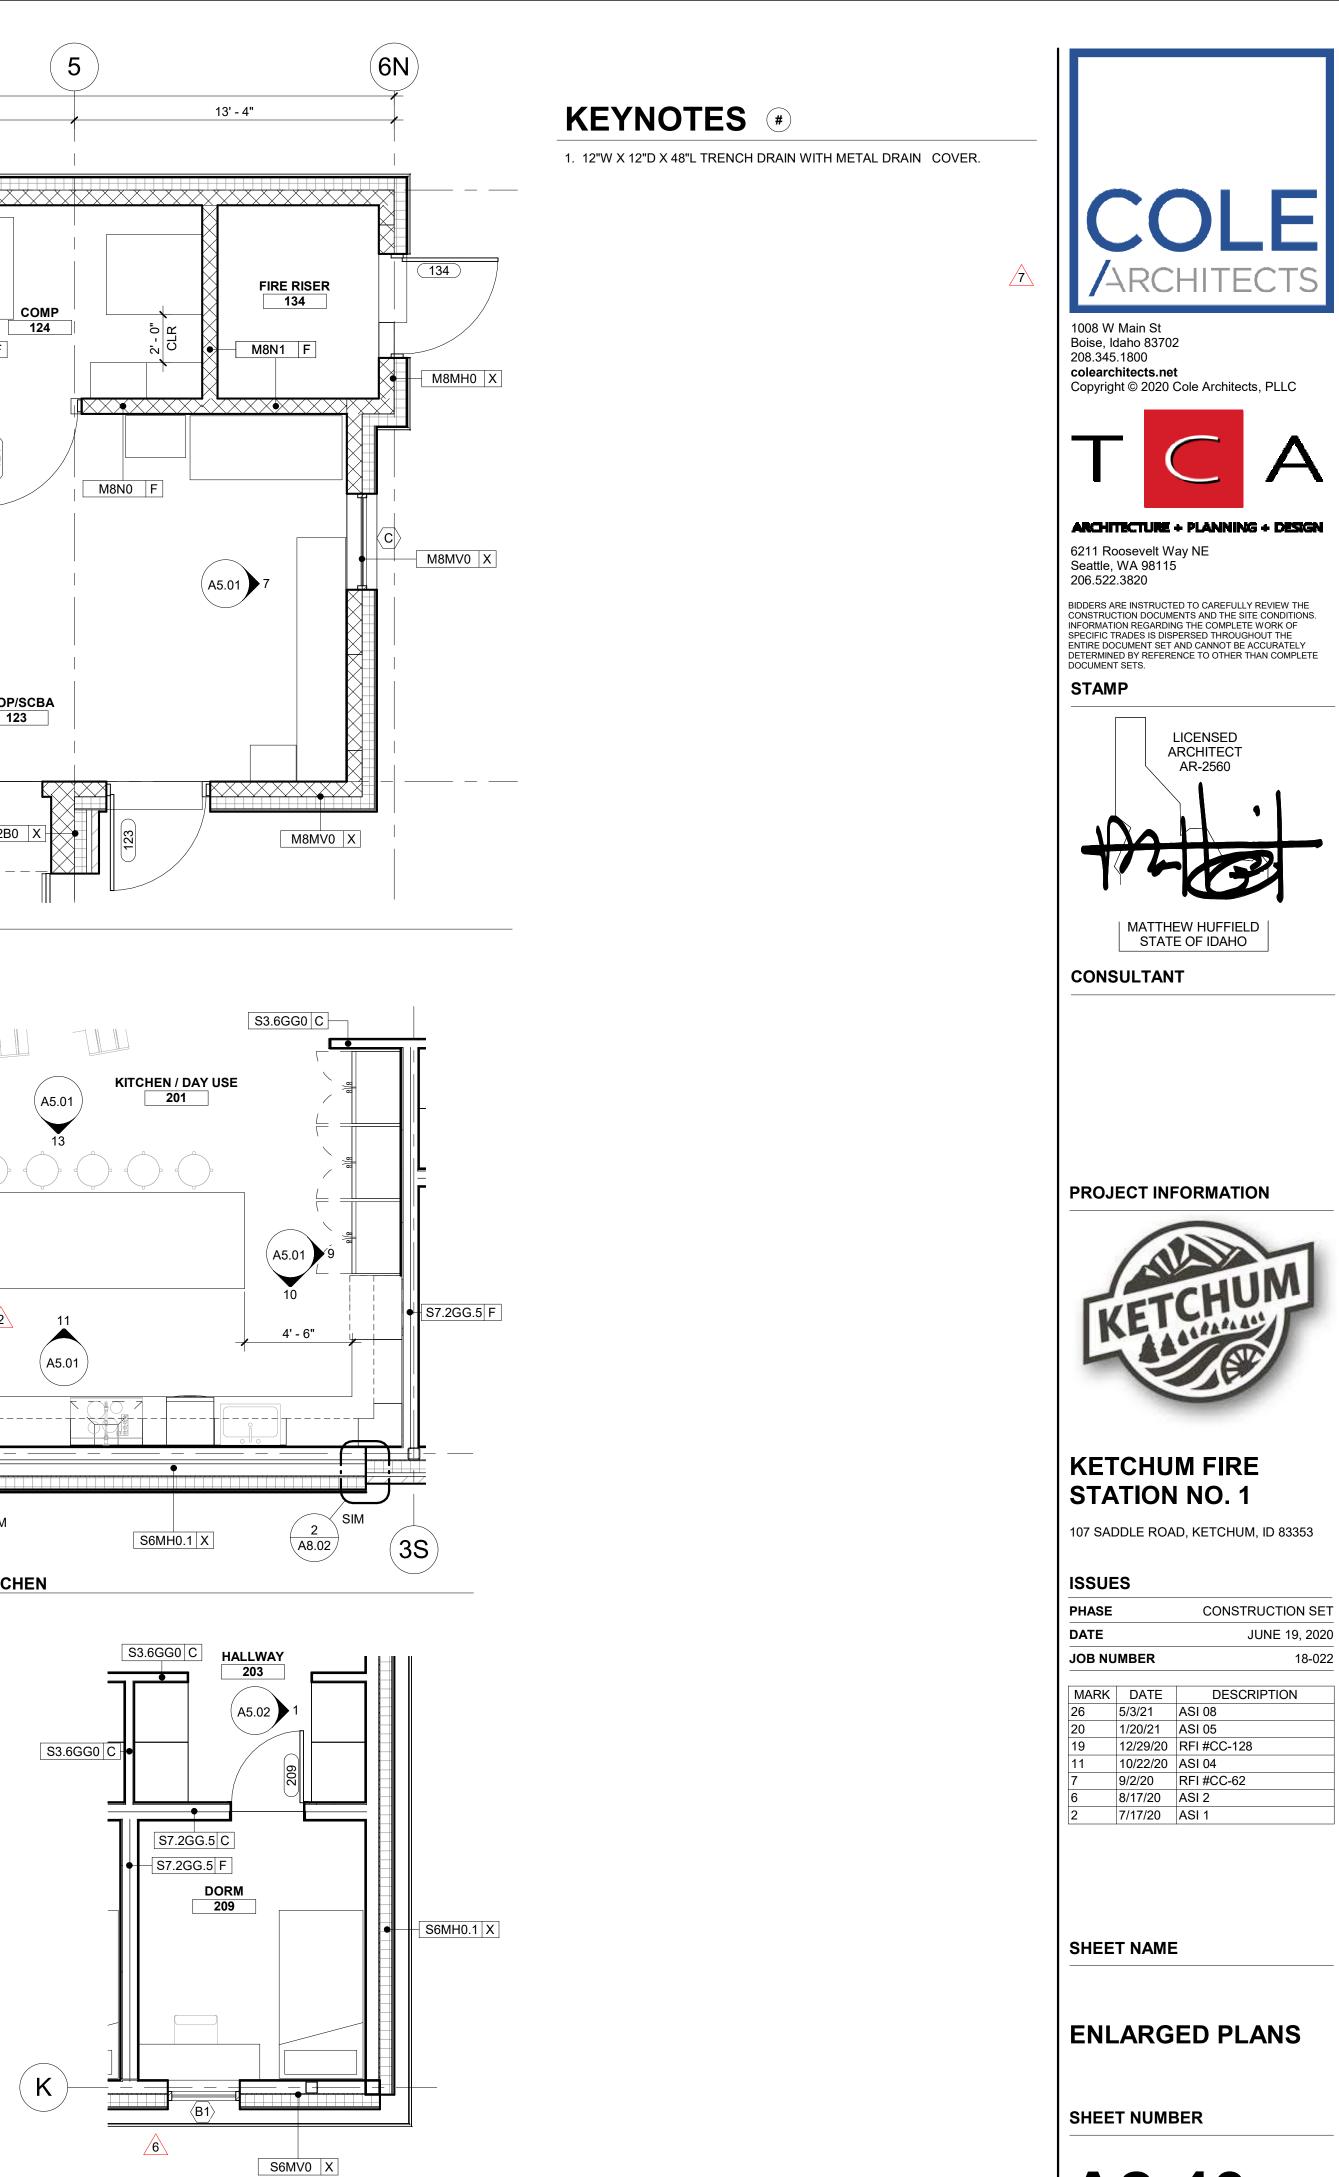

A2.40



# **GENERAL NOTES**

- E. ALL INTERIOR FINISHES MUST BE INSTALLED BY A CERTIFIED INSTALLER /
- ALL FLOORING TRANSITIONS OCCUR UNDER THE CENTER OF THE DOOR STRIP IN ANODIZED ALUMINUM FINISH AT EACH LOCATION WHERE FLOOR

- J. PROVIDE SOLID BLOCKING OR OTHER SUITABLE BACKING AT LOCATIONS BACKING FOR GRAB BARS ATTACHED TO PARTITIONS. EXTEND BACKING
- INFORMATION. IF CONFLICT EXISTS NOTIFY ARCHITECT AND PRICE MOST




#### 1008 W Main St Boise, Idaho 83702 208.345.1800 colearchitects.net Copyright © 2020 Cole Architects, PLLC



ARCHITECTURE + PLANNING + DESIGN 6211 Roosevelt Way NE Seattle, WA 98115 206.522.3820

BIDDERS ARE INSTRUCTED TO CAREFULLY REVIEW THE CONSTRUCTION DOCUMENTS AND THE SITE CONDITIONS. INFORMATION REGARDING THE COMPLETE WORK OF SPECIFIC TRADES IS DISPERSED THROUGHOUT THE ENTIRE DOCUMENT SET AND CANNOT BE ACCURATELY DETERMINED BY REFERENCE TO OTHER THAN COMPLETE DOCUMENT SETS.

## STAMP

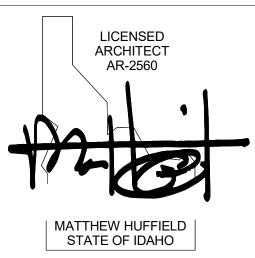

CONSULTANT

**PROJECT INFORMATION** 



## **KETCHUM FIRE STATION NO. 1**


107 SADDLE ROAD, KETCHUM, ID 83353

PHASE		CONSTRUCTION SET
DATE		JUNE 19, 2020
JOB NU	JMBER	18-022
MARK	DATE	DESCRIPTION
26	5/3/21	ASI 08
18	12/30/20	RFI #CC-125
6	8/17/20	ASI 2
2	7/17/20	ASI 1


## SHEET NAME


INTERIOR **ELEVATIONS** -RESTROOMS




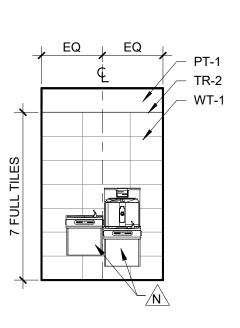



7 <u>SHOP/SCBA 123 - EAST</u> SCALE | 1/4" = 1'-0"

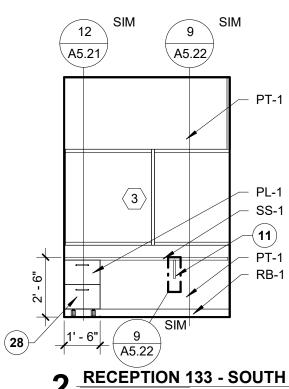


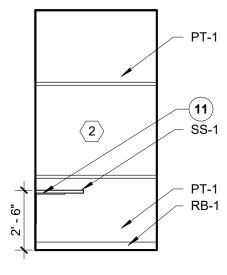


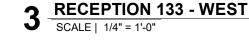


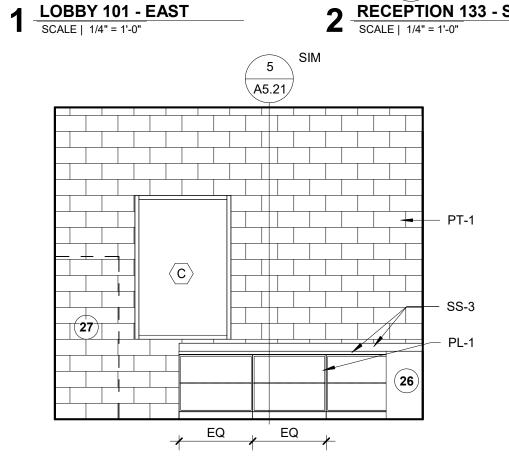

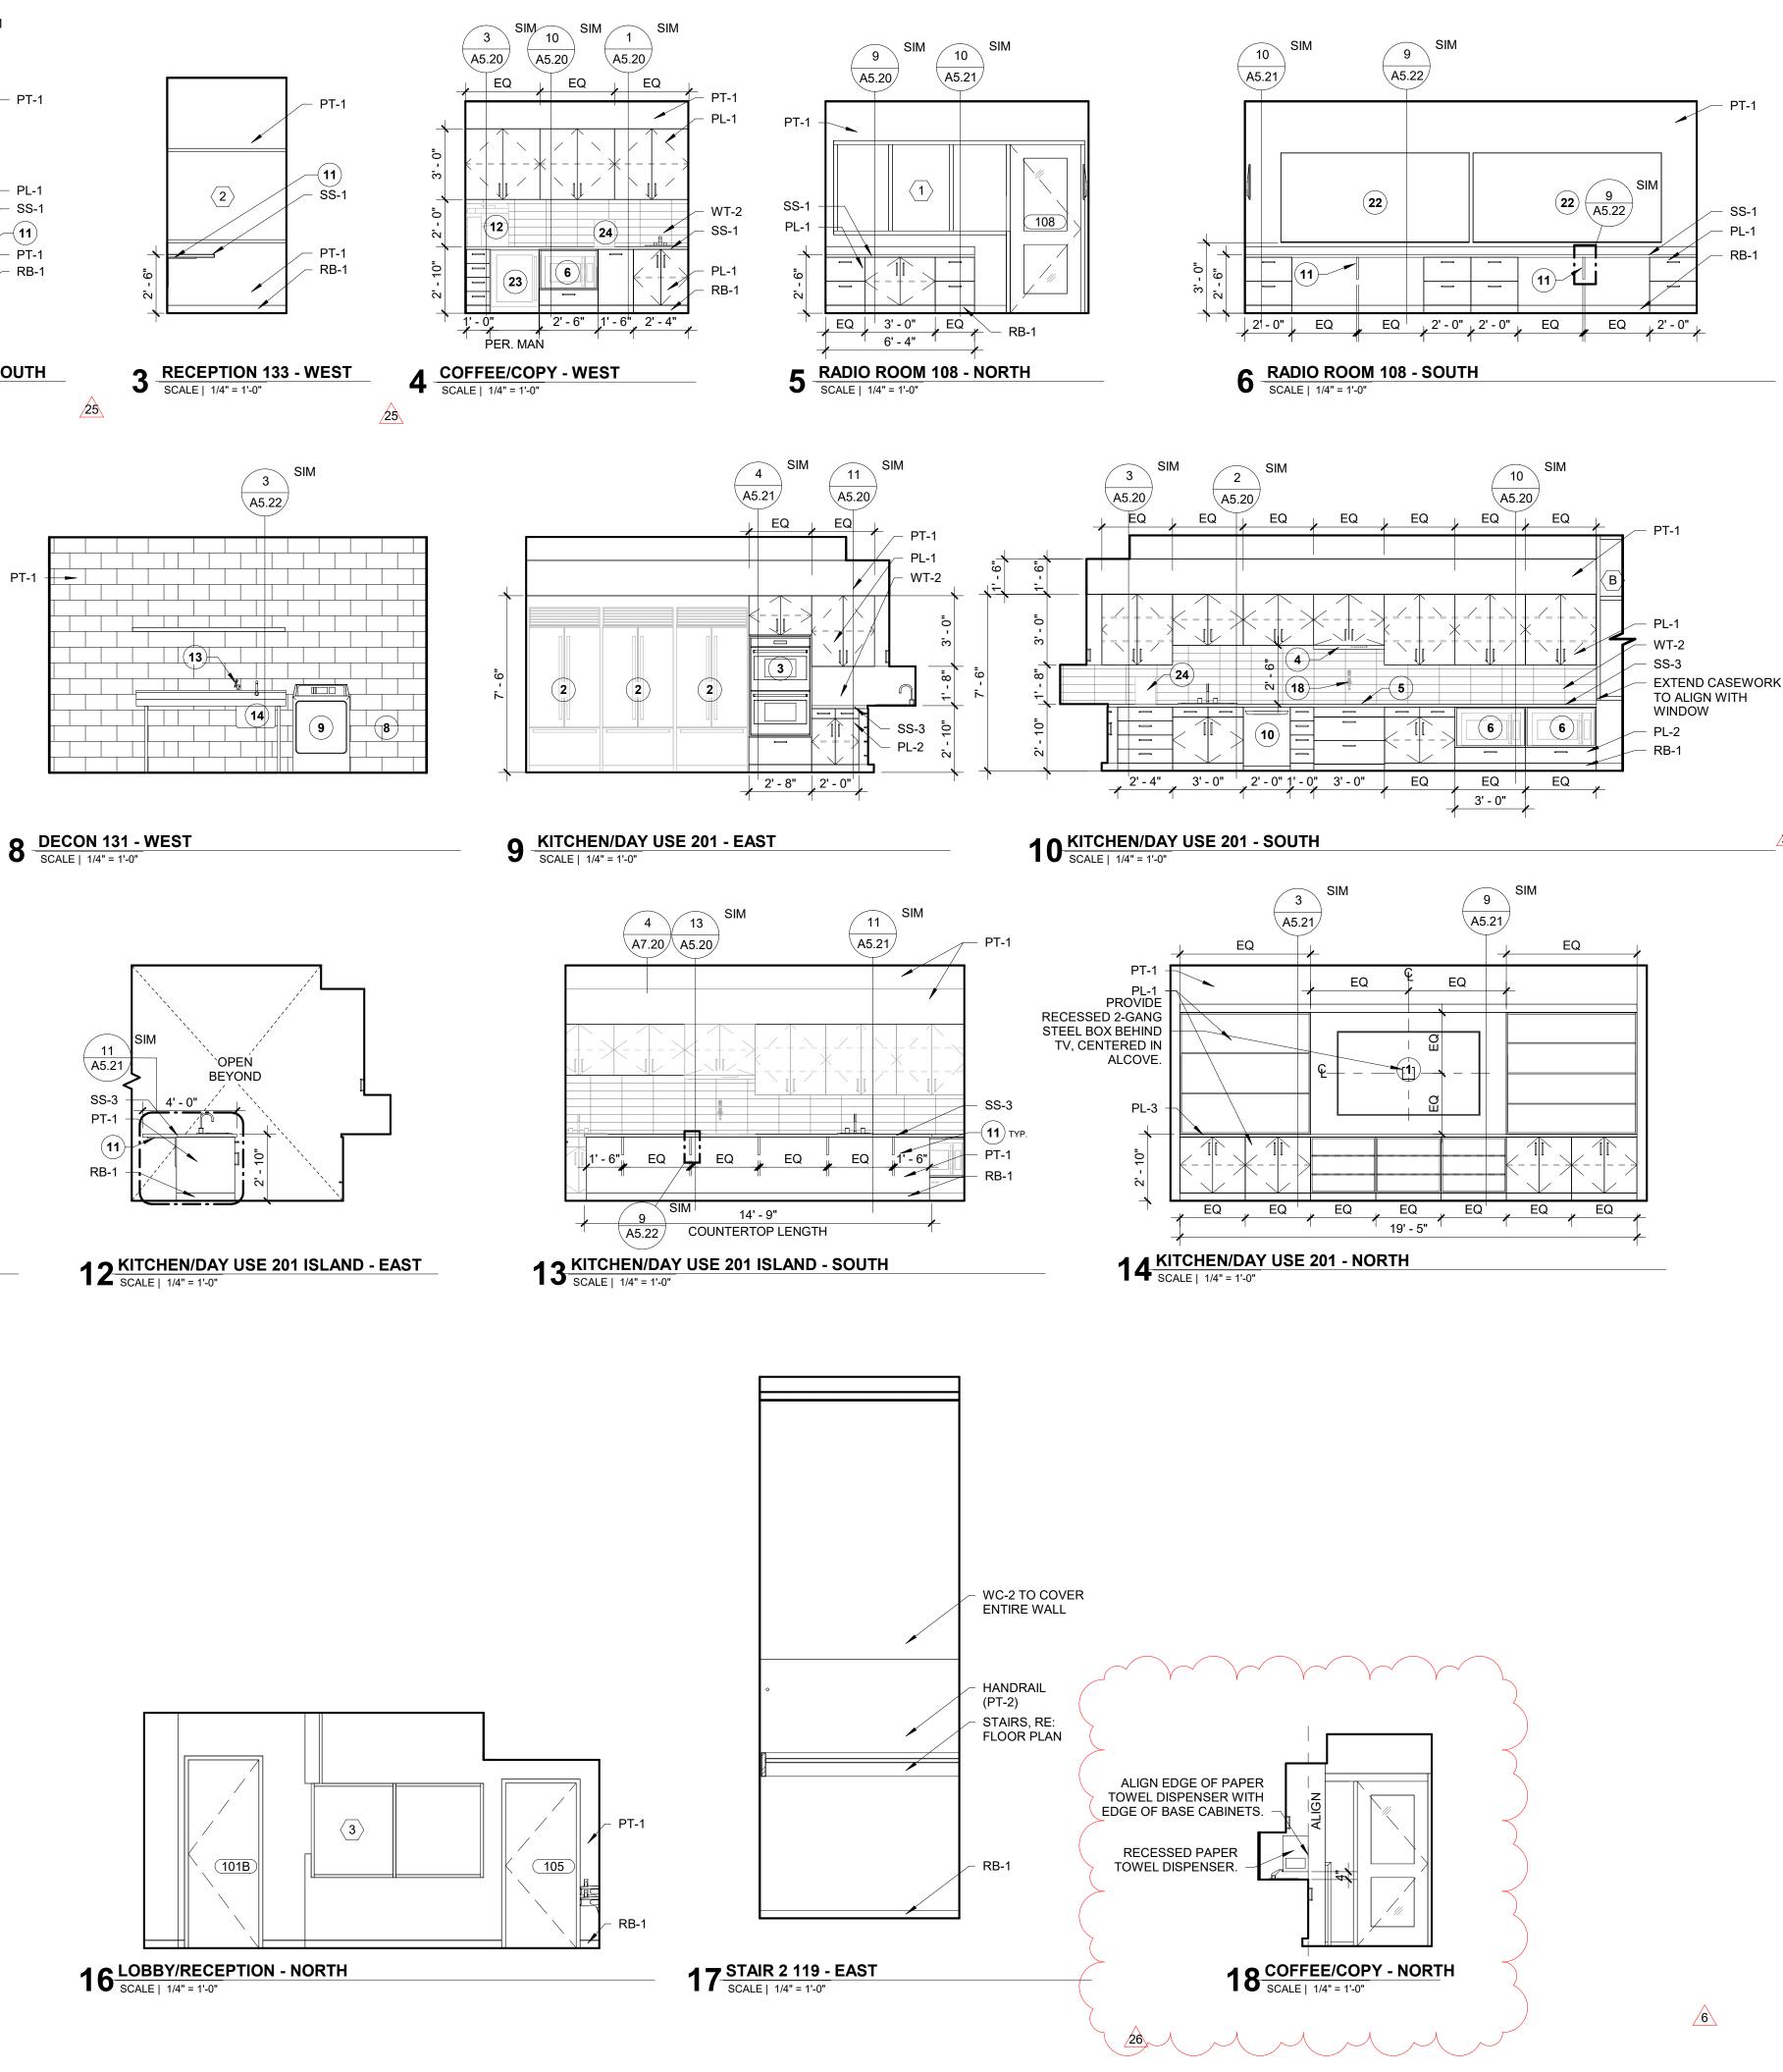


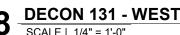


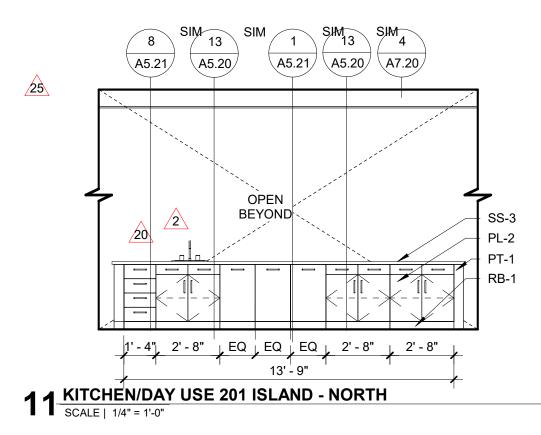

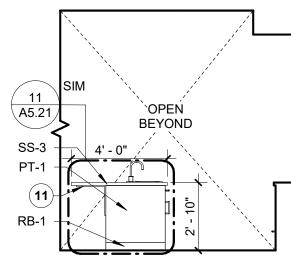



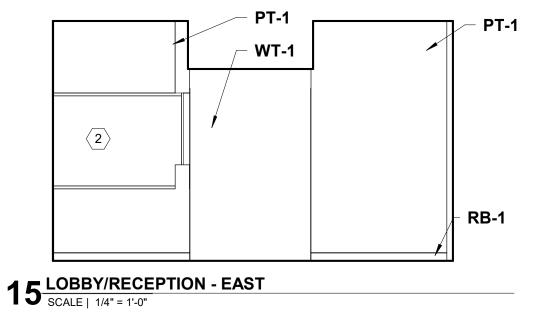

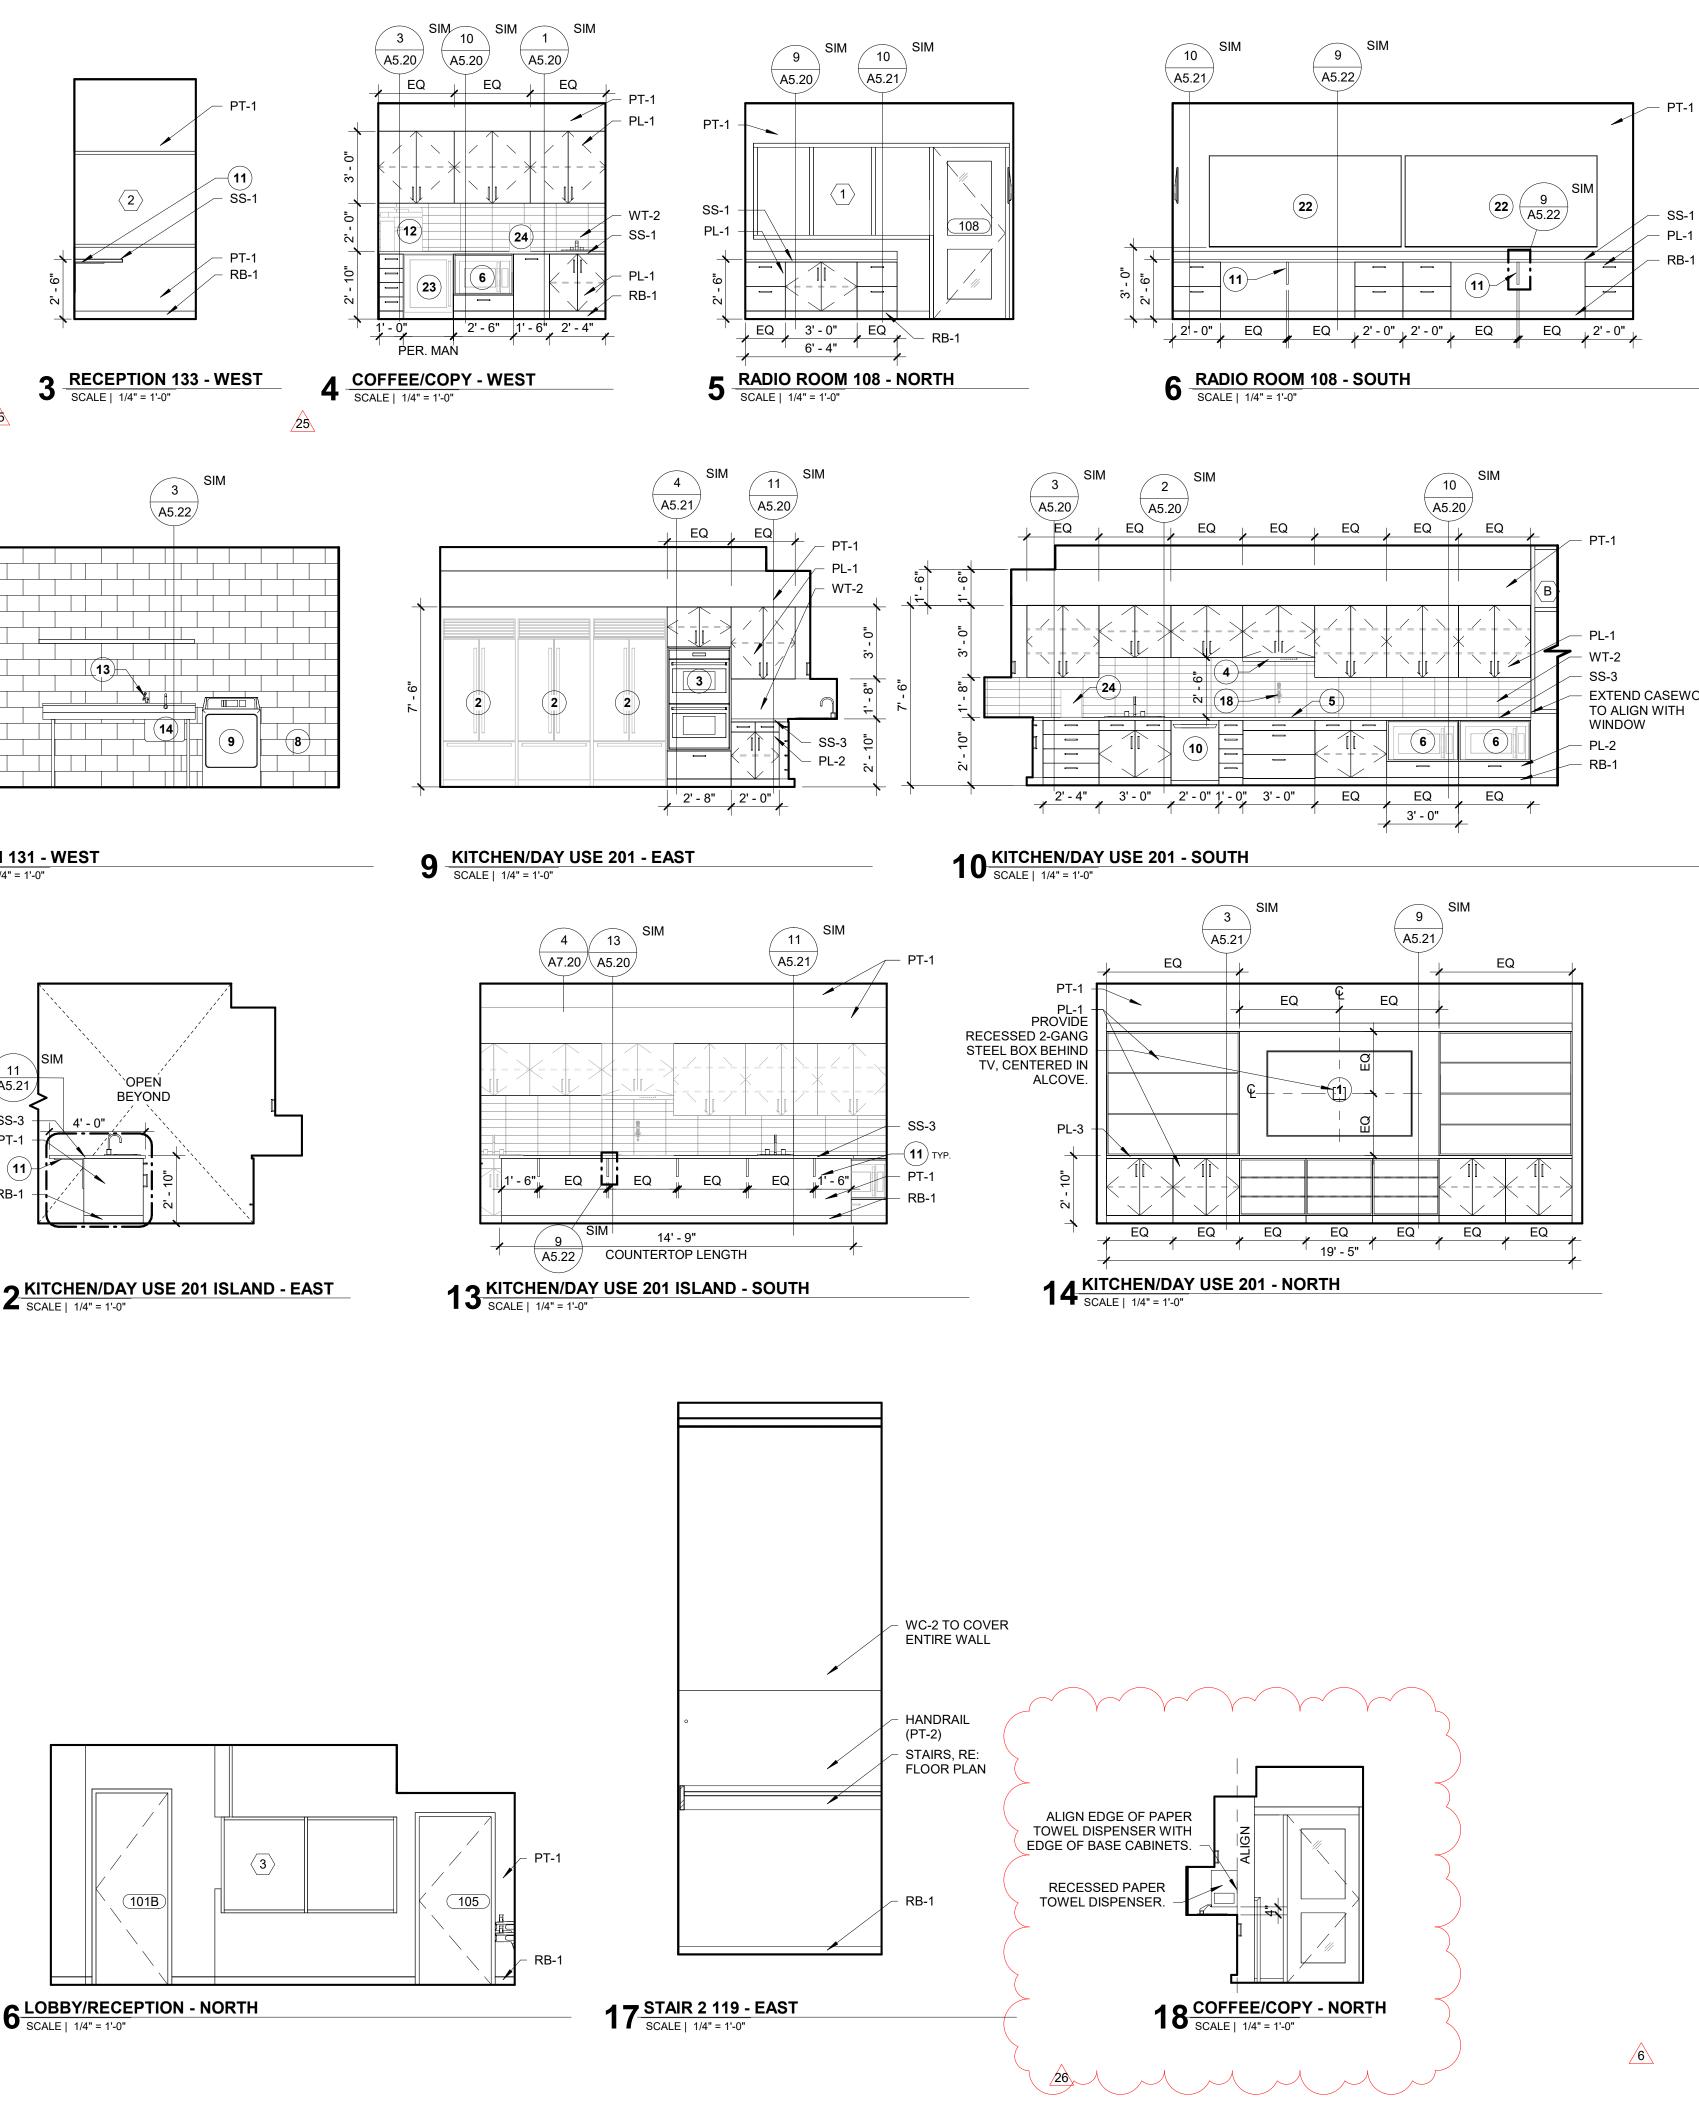

## **GENERAL NOTES**

- A. REFER TO ARCHITECTURAL FLOOR, ELEVATION AND FINISH PLANS. CONTRACTOR SHALL CLARIFY ANY QUESTIONS CONCERNING FINISHES, LOCATION, OR DESIGN INTENT WITH DESIGNER PRIOR TO ORDERING OF MATERIALS.
- B. AT ROOMS WITH NEW EXPOSED CEILING, PAINT WALLS TO UNDERSIDE OF STRUCTURE ABOVE.
- C. SEE REFLECTED CEILING PLAN FOR GYPSUM BOARD SOFFIT LOCATIONS REFER TO REFLECTED CEILING PLAN AND INTERIOR FINISH SCHEDULE FOR FINISH, AS SCHEDULED.
- PROVIDE A THIN, CLEAR, SILICONE BEAD (1/8") AT PERIMETER OF ALL DOOR FRAMES AND BORROWED GLASS LITES AFTER INSTALLATION OF SCHEDULED WALL COVERINGS. DOOR FRAMES ON PAINTED WALLS SHOULD RECEIVE THIN, PAINTABLE SILICONE BEAD (1/8") AT PERIMETER PRIOR TO PAINTING, ONLY WHERE THE FRAME DOES NOT MEET THE WALL.
- E. ALL INTERIOR FINISHES MUST BE INSTALLED BY A CERTIFIED INSTALLER SUBCONTRACTOR PER MANUFACTURER'S INSTRUCTIONS. USE MANUFACTURER'S APPROVED ADHESIVES AND SEAM SEALERS.
- F. ALL FLOORING TRANSITIONS OCCUR UNDER THE CENTER OF THE DOOR UNLESS OTHERWISE NOTED. FLOOR TRANSITION HEIGHTS NOT TO EXCEED 1/4" MAXIMUM. PROVIDE APPROPRIATE SCHLUTER TRANSITION STRIP IN ANODIZED ALUMINUM FINISH AT EACH LOCATION WHERE FLOOR FINISH MATERIAL CHANGES. UNLESS NOTED OTHERWISE.
- G. PROVIDE WINDOW COVERINGS AT ALL WINDOW LOCATIONS. SEE INTERIOR FINISH SPECIFICATIONS FOR ROLLER SHADE SPECIFICATION.
- H. ALL CABINET HARDWARE AT CASEWORK LOCATIONS TO BE RICHELIEU CONTEMPORARY STEEL PULL - 205 TO BE 6 5/16" LONG IN BRUSHED NICKEL FINISH (OR APPROVED EQUAL WITH SIMILAR FINISH).
- I. ALL WINDOW SILLS TO BE SOLID SURFACE (SS-1) UNLESS NOTED OTHERWISE.
- J. PROVIDE SOLID BLOCKING OR OTHER SUITABLE BACKING AT LOCATIONS INCLUDING, BUT NOT LIMITED TO, THE FOLLOWING: EDGES WHERE FINISH MATERIALS CHANGE, GRAB BARS, TOILET PARTITIONS, DOOR STOPS, SHELF BRACKETS, HANDRAILS AND ALL MOUNTED EQUIPMENT, INCLUDING EQUIPMENT FURNISHED BY OWNER. PROVIDE STEEL BACKING FOR GRAB BARS ATTACHED TO PARTITIONS. EXTEND BACKING 6" BEYOND OUTLINE OF EQUIPMENT.
- K. REFERENCE PLUMBING/MECHANICAL DRAWINGS, ELECTRICAL DRAWINGS AND SPECIFICATIONS FOR ADDITIONAL PRODUCT INFORMATION. IF CONFLICT EXISTS NOTIFY ARCHITECT AND PRICE MOST EXPENSIVE OPTION.

PROVIDE COUNTER-MOUNTED AUTOMATIC, TOP-FILL BULK LIQUID SOAP DISPENSER IN ALL RESTROOMS (104, 105, 117, 128, 212, 213 & 214). MMM **KEY NOTES** 

- 1. TV/MONITOR. RE: EQUIPMENT PLANS & SCHEDULE. **REFRIGERATOR. RE: EQUIPMENT PLANS & SCHEDULE**
- BUILT-IN DOUBLE OVEN. RE: EQUIPMENT PLANS & SCHEDULE. 4. RANGE HOOD. RE: EQUIPMENT PLANS & SCHEDULE.
- RANGE. RE: EQUIPMENT PLANS & SCHEDULE.
- MICROWAVE. RE: EQUIPMENT PLANS & SCHEDULE. MOP SERVICE BASIN WITH FAUCET.
- WASHER TOP LOAD. RE: EQUIPMENT PLANS & SCHEDULE.
- 9. DRYER. RE: EQUIPMENT PLANS & SCHEDULE. 10. DISHWASHER. RE: EQUIPMENT PLANS & SCHEDULE.
- 11. PROVIDE COUNTERTOP SUPPORTS AS REQUIRED. SUPPORT BRACKETS TO BE WHITE. RE: SPECIFICATIONS. 12. PRINTER TO BE OWNER SUPPLIED. CONTRACTOR INSTALLED.
- COORDINATE PRINTER SIZE PRIOR TO CABINET FABRICATION AND INSTALLATION TO ACCOMMODATE HEIGHT. RE: EQUIPMENT PLANS & SCHEDULE.
- 13. EMERGENCY EYE WASH STATION. RE: EQUIPMENT PLANS & SCHEDULE.
- 14. SERVICE SINK.
- 15. FOOD LOCKERS. RE: EQUIPMENT PLANS & SCHEDULE. 16. RUB RAIL. 7'-0" LONG X 6" HIGH.
- 17. PROVIDE METAL 24" X 24" WORKSTATION WALL BRACKET FACTORY PAINTED WHITE, TYP. RE: SPECIFICATIONS. 18. WALL MOUNT POT FILLER. CONTRACTOR FURNISHED, CONTRACTOR
- INSTALLED. FLAMABLE LIQUIDS CABINET. RE: EQUIPMENT PLANS & SCHEDULE.
   BOOTWASH STATION WITH 17" x 15" SINK.
- 21. BIKE HOOKS. RE: EQUIPMENT PLANS & SCHEDULE.
- 22. WHITE BOARD. RE: EQUIPMENT PLANS & SCHEDULE.
- 23. UNDERCOUNTER MINATURE REFRIGERATOR. RE: EQUIPMENT PLANS & SCHEDULE. 24. LOCATION OF PLUMBED, COUNTER TOP COFFEE MAKER. RE:
- EQUIPMENT PLANS & SCHEDULE.
- 25. STAINLESS STEEL SHELF.
- 26. FLAMMABLE LIQUIDS CABINET. RE: FINISH & FURNITURE PLANS & SCHEDULE.
- 27. CLYINDER STORAGE, RE: FINISH & FURNITURE PLANS & SCHEDULE. 25 28. ADD KEYED LOCK TO LOWER DRAWER.




1008 W Main St Boise, Idaho 83702 208.345.1800 colearchitects.net Copyright © 2020 Cole Architects, PLLC



ARCHITECTURE + PLANNING + DESIGN 6211 Roosevelt Way NE Seattle, WA 98115 206.522.3820

BIDDERS ARE INSTRUCTED TO CAREFULLY REVIEW THE CONSTRUCTION DOCUMENTS AND THE SITE CONDITIONS INFORMATION REGARDING THE COMPLETE WORK OF SPECIFIC TRADES IS DISPERSED THROUGHOUT THE ENTIRE DOCUMENT SET AND CANNOT BE ACCURATELY DETERMINED BY REFERENCE TO OTHER THAN COMPLETE DOCUMENT SETS.

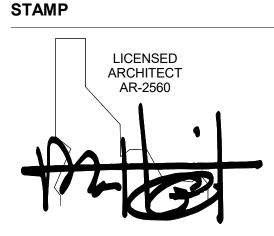

MATTHEW HUFFIELD STATE OF IDAHO

CONSULTANT

## **PROJECT INFORMATION**



## **KETCHUM FIRE** STATION NO. 1

107 SADDLE ROAD, KETCHUM, ID 83353

ISSUE	ES	
PHASE		CONSTRUCTION SET
DATE		JUNE 19, 2020
JOB NU	JMBER	18-022
MARK 26	DATE 5/3/21	DESCRIPTION ASI 08
25	5/3/21	ASI 07
20	1/20/21	ASI 05
6	8/17/20	ASI 2
2	7/17/20	ASI 1

SHEET NAME

## INTERIOR **ELEVATIONS**





Building. Growing. Leading. ...Since 1937.

## Budget Evolution Item Summary City of Ketchum Fire Station #1

Northwood Sidewalk Snowmelt

Date:

6/2/2021

SCOPE	SUBCONTRACTOR	AMOUNT
Install snowmelt at Sidewalk north	Red Hawk Plumbing	\$ 3,200.00
CM/GC Contingency usage	CORE	\$ (3,200.00
SUBTOTAL:		\$ -
SUBTOTAL reflects direct costs only on the	· ·	
allowances. If costs are reimbursed by C	_	
SUBTOTAL with add of agreed upon mar	kup in accordance with the chang	ge order pricing.
Bond and Insurance	CORE	\$-
CMAR FEE	CORE	\$ -
Sales Tax	CORE	\$ -
TOTAL AMOUNT:		\$-

## Invoice





425626	05/03/2021	\$3,200.00	05/13/2021	NET 10	
INVOICE #	DATE	TOTAL DUE	DUE DATE	TERMS	ENCLOSED
	Core Construction	2	20-01-006		

#### P.O. NUMBER

Sidewalk Snow Melt Ketchum Fire

SALES REP Dave/Aaron

DATE	ACTIVITY	DESCRIPTION	QTY	RATE	AMOUNT
	PARTS & LABOR	Steel mesh, reflective snowmelt insulation, five eights snowmelt tubing, glycol, permit and inspection fees, and adapters.	1	3,200.00	3,200.00
DISCLAIME	ER: Fixtures not provided by	Red Hawk Plumbing, BALANCE DUE			\$3,200,00

LLC shall be warranted by the provider.

	CONSTRUCTI	ION	
Buildin	ng. Growing. LeadingSince	1937	
	dget Evolution Item Su		,
	•	•	
City C	of Ketchum Fire Station	#1	
RFI-163 Added Wall Packs @ Drs	102B & 106C	Date:	5/17/2021
Description: Per RF	-I-163 add Wall packs above doors 102	B and 106C	
SCOPE	SUBCONTRACTOR	AMO	UNT
Added Wall Packs	Magic Valley Electric	\$	4,637.00
Owner retains original fixtures for	с ,		,
	Stock		
			4.627.00
		\$	4,637.00
	nly on the presumption that costs will c		4,637.00
SUBTOTAL reflects direct costs or	· · ·	ome from	
SUBTOTAL reflects direct costs or allowances. If costs are reimburs	sed by Change Order, TOTAL AMOUNT	ome from below reflects	the
SUBTOTAL reflects direct costs or allowances. If costs are reimburs	sed by Change Order, TOTAL AMOUNT	ome from below reflects	the
SUBTOTAL reflects direct costs or allowances. If costs are reimburs	· · ·	ome from below reflects	the
SUBTOTAL reflects direct costs or allowances. If costs are reimburs SUBTOTAL with add of agreed up	sed by Change Order, TOTAL AMOUNT for markup in accordance with the char	ome from below reflects nge order prici	the ng.
SUBTOTAL reflects direct costs or allowances. If costs are reimburs SUBTOTAL with add of agreed up Bond and Insurance	sed by Change Order, TOTAL AMOUNT for markup in accordance with the chan CORE	ome from below reflects nge order prici \$	the ing. 97.00
allowances. If costs are reimburs SUBTOTAL with add of agreed up Bond and Insurance CMAR FEE	eed by Change Order, TOTAL AMOUNT for markup in accordance with the chan CORE CORE	ome from below reflects nge order prici \$ \$	the ng.
SUBTOTAL reflects direct costs or allowances. If costs are reimburs SUBTOTAL with add of agreed up Bond and Insurance	sed by Change Order, TOTAL AMOUNT for markup in accordance with the chan CORE	ome from below reflects nge order prici \$	the ing. 97.00



Regional office for CORE NV company 777 N 4th St Bosie, Idaho 83702 Project: 90-20-01-006 - CoK - City of Ketchum Fire Station 107 Saddle Rd. Ketchum, Idaho 83340

## Soffit Light Fixture over Doors 102B, 106C

TO:	Alex Goedhart (Cole Architects) Crystal McColly (Cole Architects)	FROM:	JT Brown (CORE Construction - Las Vegas) 777 N Fourth St Date: John 20200
DATE INITIATED:	04/02/2021		Boise, Idaho 83702
LOCATION:		STATUS:	Open
PROJECT STAGE:	Course of Construction	DUE DATE:	04/09/2021
COST IMPACT:		COST CODE:	
	E3.01	SCHEDULE IMPACT:	
		SPEC SECTION:	
LINKED DRAWINGS:		REFERENCE:	

#### **RECEIVED FROM:** Jimmy Gyorfy (Magic Valley Electric)

#### COPIES TO:

Eric Abrego (Signature Roofing), John Allen (Interior Contractors), JT Brown (CORE Construction - Las Vegas), Tyler Brown (Interior Contractors), Dustin Campbell (Signature Roofing), Alex Goedhart (Cole Architects), Cary Goldberg (DPPM Project Management), Jimmy Gyorfy (Magic Valley Electric), Lex Howard (Magic Valley Electric), Bill McLaughlin (City of Ketchum), Dennis Potts (DPPM Project Management), Chris Schratwieser (CORE Construction - Las Vegas), Matt Sylvester (CORE Construction - Las Vegas)


#### Question from JT Brown (CORE Construction - Las Vegas) at 02:35 PM on 04/02/2021

The RL-8 fixture is shown to be installed in the soffit outside community room door 102B and hallway door 106C on E3.01. The RL8 fixture has an 11"x14"base that is 4"deep. The soffit in these areas are basically 6" of insulation wrapped sim to 2/A4.01. Please confirm the RL-8 is to installed or if we need to switch to a wall pack.

#### Awaiting an Official Response

Switch these (2) fixtures to wall packs. Provide battery backup for both fixtures. The wall packs will be the same fixtures as used on the rest of the building. See attached product spec sheet for reference.

Crystal McColly Cole Architects 4/20/21

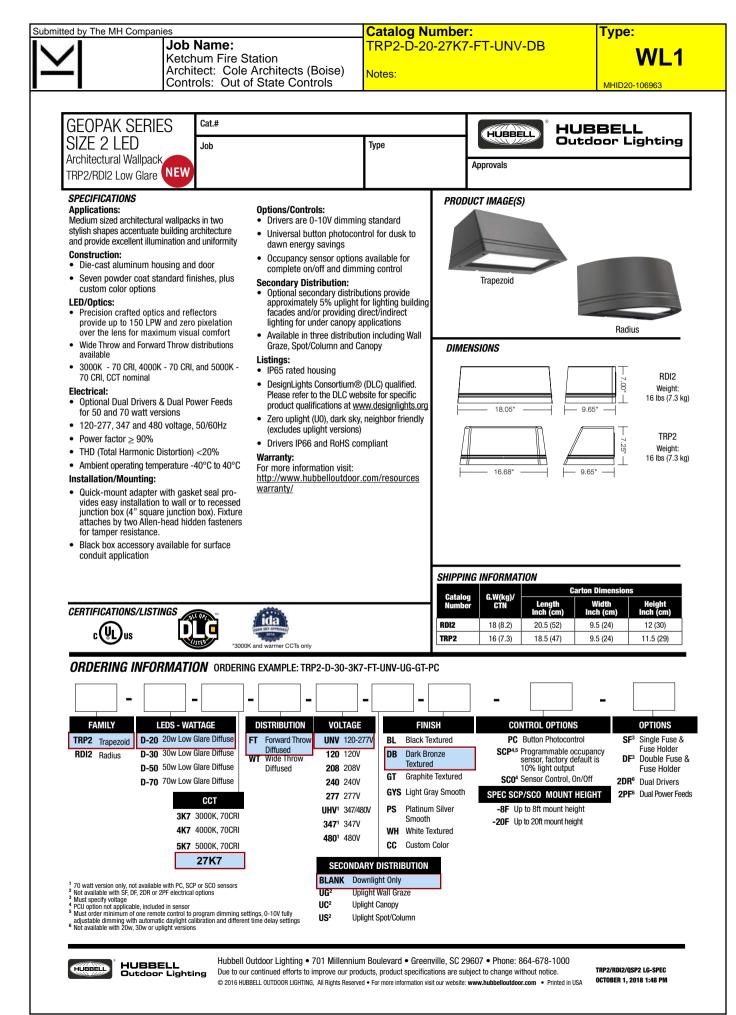


I by The M⊢ I	I Companies	s Job Nar	ne:				_ <mark>Ca</mark> _TR	talc P2-	<b>g Nur</b> D-20-2	nber: 27K7-	FT-I	JNV.	-DB		Ту	pe:		
	A	Architect	Fire Sta Cole A Out of	rchitects	s (Bois	se)	Not	Notes:					MH	ID20-1		-		
•			0000													<u>1020-1</u>	00903	
ACCESSORII Catalog Nu	E <b>S -</b> Order se mber	parately					D	escri	otion									
SCP-REMOTE BB-GEO-XX			SCP option. 1/2" threade								-		k Bron	ze "DB"				
adjustable dimmin	num of one remote ng with automatic da ith SiteSync, one of	control to progra aylight calibration	m dimming setti n and different tir	ıgs, 0-10V fully ne delay settings	3.	BB-GE				2"	,		-	-				
ordered separately	y. Each option conta ditional Bridge Node	ins the SiteSync	License, GUI and	Bridge Node.		DD-UL	U-77											
	-																	
									R			To Wall						
	-	=	<u>^</u>						1									
BB	-GEO-XX – Mour	nted to luminai	ire		Fi	ixture gask	ket	4 - 1/2	' conduit entri	es l	Wall gask	et						
	ER CONSUMI	-																
# OF LEDS	VERSION	1:	<b>LTAGE (V)</b> 20		<b>T (Amps)</b> 18	) S	YSTEM	POWE 21	R (w)									
			77 20		.08 .28			<u>21</u> 33										
	Downlight		77 20		.12 .41			33 49										
	Only	2	77	0.	. <u>18</u> .52			49 62										
		2	77	0.	.22			62										
180			47 80		. <u>18</u> .13			62 62										
100			20 77		. <u>18</u> .08	_		<u>22</u> 22										
		1:	20	0.	29			35										
	With Unlight		77 20		. <u>13</u> .43			<u>35</u> 52										
	With Uplight	2	77 20	0.	19 55			52 66										
		2	77	0.	.24			66										
			47 80		.19 .14			66 66										
PERFORMAN	NCE DATA - L	.OW GLARE	Ŧ			5K					4K					3K		
SECONDARY			MAIN DISTR		000K nor		Í			000K nor					000K noi			
DISTRIBUTIO	N WATTS D-20	<b>WATTS</b> 21.0	TYPE FT	LUMENS 3,082	LPW 147	<b>B</b>	U 0	G 1	LUMENS 3,067	146	<b>B</b>	U 0	<b>G</b>	LUMENS 2,883	LPW 137	B 1	U 0	
	D-30	33.4	WT FT	3,195 4,995	152 150	1	0	0 1	3,179 4,970	151 149	1	0	0	2,988 4,672	142 140	1	0	F
None			WT FT	5,178 7,094	155 146	1	0	1 1	5,152 7,058	154 145	1	0	1	4,843 6,635	145 136	1	0	╞
	D-50	48.7	WT FT	7,353	151 140	1	0	1	7,316	150 140	1	0	1	6,877 8,108	141 131	1	0	F
	D-70	61.8	WT	8,986	145	1	0	1	8,941	145	1	0	1	8,405	136	1	0	F
	D-20	22.3	FT WT	2,991 3,325	134 149	1	3 3	1	2,976 3,309	133 148	1	3	1	2,798 3,110	125 139	1	3	F
UC	D-30	35.5	FT WT	<u>4,847</u> 5,389	137 152	1	3	1 1	4,823 5,362	1 <u>36</u> 151	1	3	1	4,534 5,040	<u>128</u> 142	1	3	╞
(Canopy)	D-50	51.7	FT WT	6,884 7,653	1 <u>33</u> 148	1	3	1	6,850 7,615	1 <u>32</u> 147	1	3	1	6,439 7,158	125 138	1	3	F
	D-70	65.7	FT	8,413	128	1	3	1	8,371	127	1	3	1	7,869	120	1	3	F
	D-20	22.3	WT FT	9,353 2,966	142 133	1	3	1	9,306 2,952	142 132	1	3	1	8,748 2,774	133 124	1	3	F
	D-30	35.5	WT FT	3,302	148 135	1	3	0	3,286 4,784	147 135	1	3	0	3,089 4,497	139 127	1	3	╞
UG (Wall Graze)		51.7	WT FT	5,352 6,827	151 132	1	3	1	5,325 6,793	150 131	1	3	1	5,006 6,386	141 124	1	3	╞
	D-70	65.7	WT FT	7,600 8,344	147 127	1	3	1	7,562 8,302	146 126	1	3	1	7,109 7,804	137 119	1	3	╞
		+ +	WT FT	9,288 3,156	141 142	1	3	1	9,242 3,140	141 141	1	3	1	8,687 2,952	132 132	1	3	╞
	D-20	22.3	WT FT	3,316 5,114	149 144	1	3	0	3,300 5,089	148 143	1	3	0	3,102 4,784	139 135	1	3	F
US (Spot/	D-30	35.5	WT	5,375	151	1	3	1	5,348	151	1	3	1	5,027	142	1	3	F
0.1	D-50	51.7	FT	7,263	140	1	3	<u>1</u> 1	7,227	140	1	3	1	6,793 7,140	<u>131</u> 138	1	3	1
Column)	D-50	0	WT FT	7,633	148 135	1	3	1	7,595 8,832	147 134		3	1	8,302	126	1	3	L

HUBBELL

HUBBELL Outdoor Lighting • 701 Millennium Boulevard • Greenville, SC 29607 • Phone: 864-678-1000 Due to our continued efforts to improve our products, product specifications are subject to change without notice. © 2016 HUBBELL OUTDOOR LIGHTING, All Rights Reserved • For more information visit our website: www.hubbelloutdoor.com • Printed in USA

TRP2/RDI2/QSP2 LG-SPEC OCTOBER 1, 2018 1:48 PM

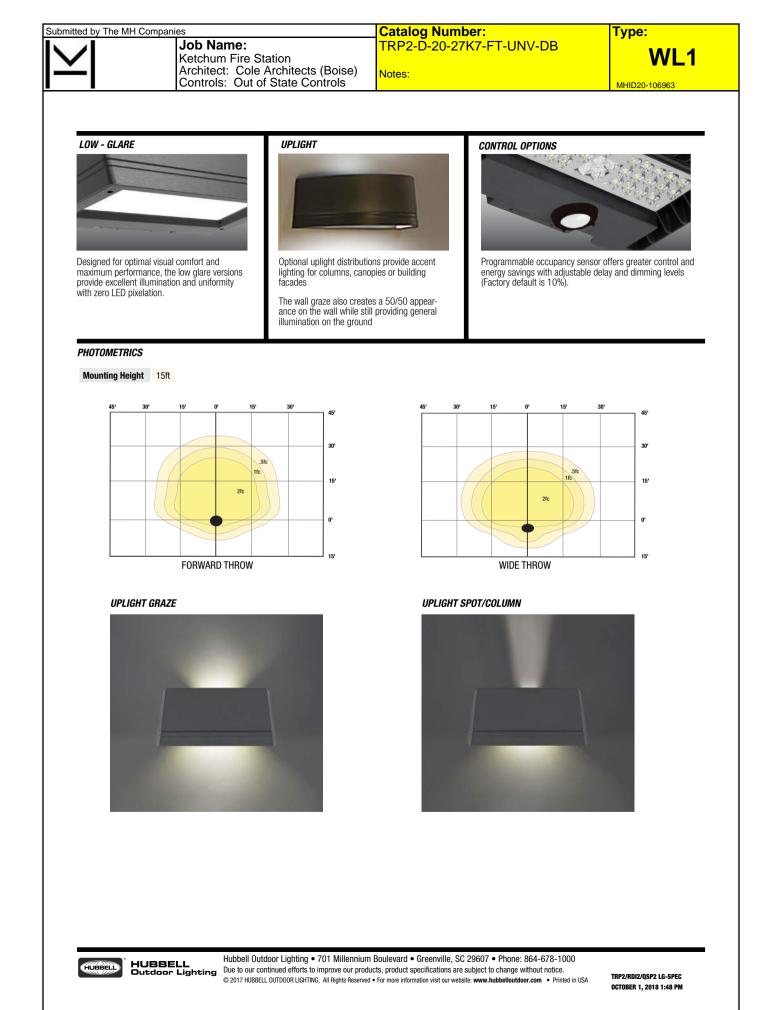

#### Submitted by The MH Companies

Job Name: Ketchum Fire Station Architect: Cole Architects (Boise) Controls: Out of State Controls


Catalog Number: LPS32-S RTSLP

Notes:

MHID20-106963

## LIGHTPOWER<sup>®</sup> LPS Series

Central Lighting Micro Inverters

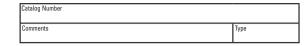

#### **FEATURES**

#### Application

Designed for indoor installation in commercial or industrial applications, LIGHTPOWER<sup>™</sup> Series micro inverter systems provide sinusoidal Emergency AC power to lighting fixtures equipped with incandescent, linear fluorescent, compact fluorescent or LED lamps between 20 and 55 watts. The lighting load can be installed at a distance of up to 1.000 feet from the LIGHTPOWER<sup>™</sup> micro inverter. Observe all required AC conductor sizing requirements. Ceiling T-Grid mount models approved for use in City of Chicago.

#### Operation

When normal utility supplied power is interrupted, the LIGHTPOWER<sup>™</sup> Series unit will automatically transfer to emergency mode in less than 1-second and begin supplying pure sinusoidal AC power to the load for 90 minutes. The unit is capable of operating normally on, normally off, or switched loads. A low voltage battery disconnect circuit will prevent "deep discharge" damage to the battery. AC lockout prevents battery discharge prior to initial unit power-up. The charging circuit will bring the batteries to full recharge within UL time standards. A "brownout" circuit will automatically transfer the unit to emergency power if the utility voltage falls to a predetermined "low line" limit.

#### Construction

The LIGHTPOWER<sup>™</sup> enclosure and cover are constructed of heavy-duty, 20 gauge steel with a white powder-coat paint finish.

#### Compliances


UL 924 (Emergency Lighting) UL 2043 (Plenum Air Handling Spaces) and City of Chicago (CCEA) for T-Grid Models Life Safety Code (NFPA 101) National Electrical Code (NFPA 70) OSHA, State and Local Code compliant

#### Warrantv

Unit and Electronics: 3 years full\* Batteries: SLA Lead Calcium: 3 years full, 7 years pro-rata Nickel Cadmium: 2 years full, 13 years pro-rata \* excludes fuses

Batteries must be connected to an energized charging circuit within 90 days from date of shipment or warranty is void.

#### **ORDERING GUIDE**

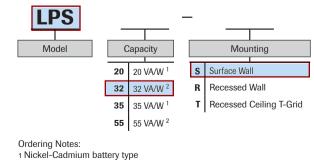

2 Lead Calcium battery type

### RTSLP Remote Test Switch for LPS

ACCESSORIES (order separately)







Recessed Wall Mount Mode



Recessed Ceiling Mount T-Grid Model

Submitted On: Aug 24, 2020

Index Page

Submitted by The MH Companies



Job Name: Ketchum Fire Station Architect: Cole Architects (Boise) Controls: Out of State Controls Catalog Number: LPS32-S RTSLP

Notes:

MHID20-106963

	R
	I ITE )
DUAL	

### LIGHTPOWER<sup>®</sup> LPS Series Central Lighting Micro Inverters

#### **SPECIFICATIONS**

#### **Electronics**

Input/Output: 120/120VAC or 277/277VAC, 60 Hz

Input/Output Connections: Terminal block

Operating Temperature Range: 20°C to 30°C (68°F to 86°F)

Charger Type: Temperature compensated, dual-mode

AC Lockout: Prevents battery discharge following installation when branch circuit AC power is not present.

Low Voltage Battery Disconnect: Protects the battery from damaging "deep discharge" conditions during prolonged power failures.

Brownout Protection: Automatically transfers to emergency power

when utility voltage drops to a point that would cause fluorescent lamps to extinguish.

 $\mbox{Overload}$  and  $\mbox{Short}$  Circuit Protection: AC and DC protection provided by fuses and automatic shut down.

Test Means: Manual "TEST" button.


LED Indicators: "AC-ON" (red), "Charging-ON" (green), "Inverter-ON" (amber).

#### **Batteries**

LPS32/LPS55: SLA lead calcium with 10 year rated life. LPS20/LPS35: Nickel-Cadmium with 15 year rated life.

	LPS32	LPS55	LPS20	LPS35		
Power Rating (VA/W)	32	55	20	35		
Power Factor Range						
Temp Range (°C)	20-30					
Weight (lb) with batteries	14	18	11	12		
Maximum Input Current (A)	120 VAC: 0.34 A 277 VAC: 0.15 A	120 VAC: 0.54 A 277 VAC: 0.23 A	120 VAC: 0.25 A 277 VAC: 0.11 A	120 VAC: 0.37 A 277 VAC: 0.16 A		
System DC Voltage		12				
Recharge Time (Hr)		96				

#### DIMENSIONS

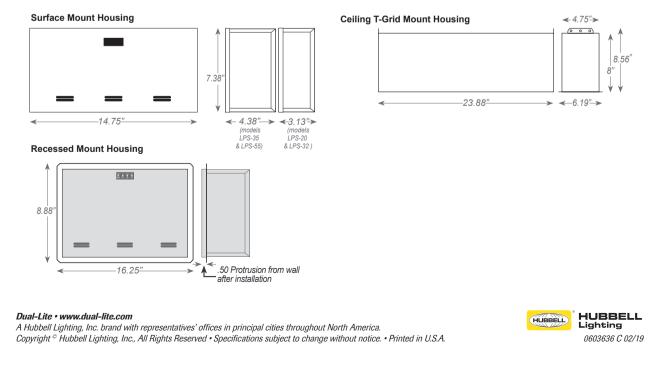

ELECTE 395 Railway St. Jerome,	The Powe	r To De	o It Right	1 39 Jo	: Valley Ele 5 Railway erome, Id 8 ice: 208.94	Street 33338
SU	BCONTRACTOR CH	ANGE	E ORDE	R REQU	EST	
					Date:	5/17/2021
SUBCONTRACTOR:	Magic Valley Electric		PRO.	JECT NAME:	Ketchum Fire	e station
		_			-	
	Jimmy Gyorfy	_	<b>DD</b> 0 ( <b>D</b> 0			
ADDRESS:	395 Railway Street	_	PROJEC	T ADDRESS:		
BUONE	Jerome, ID 83338	,			Ketchum, ID	83353
PHONE:	208-944-4931	_ //	115 IS IN RES	SPONSE TO:		
	Coro Construction			Bulletin #: ASI #:		
	Core Construction Chris Schratwieser			JEST FROM:		
	777 North 4th Street					
ADDINESS.	Boise, ID 83702	- ,		ACTOR CO#:		
PHONE:	702-794-0550	- `	JODOONII	101 011 00#.		
		_				
DESCRIPTION:	New WL-1E fixtures one above	Door 102	B and one a	bove door 1	06C	
	Ketchum Fire Station					
DRAWINGS:				1		<b>T</b> ( 10 )
	Trade Description	Hours	Labor Amt.			Total Cost
LABOR:	Journeyman	2	70.00			140.00
	Apprentice	2	60.00			120.00
						0.00
						0.00
	Description	QTY	Unit Price	Sub-Total	Taxes	Total Cost
MATERIAL:		2	1,752.02	3,504.04	210.24	3,714.28
	Shipping charge	1	250.00	250.00	15.00	265.00
		•	200.00	0.00	0.00	0.00
				0.00	0.00	0.00
				0.00	0.00	0.00
	Description	QTY	Unit Price	Sub-Total	Taxes	Total Cost
EQUIPMENT:				0.00	0.00	0.00
				0.00	0.00	0.00
				0.00	0.00	0.00
				0.00	0.00	0.00
				0.00	0.00	0.00
				0.00	0.00	0.00
SUBTOTAL:						4,239.28
OH & Profit Material@1						397.93
GRAND TOTAL:				Total Amou	nt	\$4,637.21
NOTES:	Authorized Signature		Date			
			2410			

	C	CONSTRUC			
	Budget Ev	ng. LeadingSind volution Item num Fire Statio	Sumn	nary	
ASI-12 Alerting Cabling	]		Date:		5/27/2021
Description:	Per ASI-12 Delete	Alerting system Cabling	and condu	uctors O	FOI
			5		
SCOPE Delete Cabling and Cond		SUBCONTRACTOR Magic Valley Electric		AMOL	JNT
SUBTOTAL:				\$	(1,754.00)
SUBTOTAL: SUBTOTAL reflects direct allowances. If costs are i SUBTOTAL with add of a	reimbursed by Chang	ge Order, TOTAL AMOU	NT below r	om eflects 1	the
SUBTOTAL reflects direct allowances. If costs are a	reimbursed by Chang	ge Order, TOTAL AMOU	NT below r	om eflects 1	the
SUBTOTAL reflects direct allowances. If costs are SUBTOTAL with add of a	reimbursed by Chang	ge Order, TOTAL AMOU n accordance with the	NT below r	om eflects t er pricir	the ng.

THE STREET STREET	The Power			! 39 J. Off	c Valley Ele 95 Railway erome, Id 8 fice: 208.94	Street 33338
SU	BCONTRACTOR CH	ANGE	ORDE	R REQU	IEST	
					Date:	5/27/2021
SUBCONTRACTOR:	Magic Valley Electric	_	PRO	JECT NAME:	Ketchum Fire	e station
CONTACT	Jimmy Gyorfy	-				
	395 Railway Street	-			107 Saddle F	Poad
ADDRESS.		-	PROJECT	ADDRESS.		
	Jerome, ID 83338 208-944-4931	- 		SPONSE TO:	Ketchum, ID	03333
FHONE.	208-944-4931	- //		Bulletin #:		
CONTRACTOR.	Coro Construction			ASI #:		
	Core Construction	-		IEST FROM:		
	Chris Schratwieser 777 North 4th Street		TOAL KEYU	EST PRUM:		
ADDRESS.	Boise, ID 83702					
	702-794-0550	-	SUDUUNIRA	CTOR CO#:		
THOME.		-				
DESCRIPTION:	Deduction Change order for del	etina ca	ble for came	ras.		
				-		
LOCATION:	Ketchum Fire station					
DRAWINGS:						
	Trade Description	Hours	Labor Amt.			Total Cost
LABOR:	Journeyman		70.00			0.00
	Apprentice		60.00			0.00
						0.00
						0.00
						0.00
	Description	QTY	Unit Price	Sub-Total	Taxes	Total Cost
MATERIAL:	decution of Cable from Sub cont.	1	1,654.93	1,654.93	99.30	1,754.23
				0.00	0.00	0.00
				0.00	0.00	0.00
				0.00	0.00	0.00
				0.00	0.00	0.00
	Description	QTY	Unit Price	Sub-Total	Taxes	Total Cost
EQUIPMENT:				0.00	0.00	0.00
				0.00	0.00	0.00
				0.00	0.00	0.00
				0.00	0.00	0.00
				0.00	0.00	0.00
				0.00	0.00	0.00
SUBTOTAL:						1,754.23
GRAND TOTAL:				Total Amou	nt	\$1,754.23
NOTES:		_				
	Authorized Signature		Date			

## COLE/ARCHITECTS

ARCHITECTURE / PLANNING / INTERIOR DESIGN

## ASI 12

PROJECT NAME	KETCHUM FIRE STATION #1			
PROJECT NUMBER	PROJECT NUMBER 18-022			
DATE	5/13/2021			
CONSTRUCTION COMPANY	L CORE CONSTRUCTION			

THE WORK SHALL BE CARRIED OUT IN ACCORDANCE WITH THE FOLLOWING SUPPLEMENTAL INSTRUCTIONS ISSUED IN ACCORDANCE WITH THE CONTRACT.

#### **DESCRIPTION OF CHANGES:**

#### **DRAWINGS:**

#### ELECTRICAL:

- 1) E7.01 SECURITY & ALERTING PLAN LEVEL 01
  - a) ALERTING SYSTEM CABLING AND CONDUCTORS WILL BE INSTALLED BY THE ALERTING SYSTEM CONTRACTOR. REMOVED REFERENCE IN THE KEYED NOTES FOR ELECTRICAL CONTRACTOR TO PROVIDE AND INSTALL CABLING AND CONDUCTORS. ELECTRICAL CONTRACTOR WILL STILL BE REQUIRED TO INSTALL J-HOOKS ABOVE ACCESSIBLE CEILING AND CONDUITS FOR ALERTING SYSTEM EQUIPMENT AND CABLING. REFER TO THE ATTACHED DRAWINGS FOR ADDITIONAL INFORMATION.
- 2) E7.02 SECURITY & ALERTING PLAN LEVEL 02
  - a) ALERTING SYSTEM CABLING AND CONDUCTORS WILL BE INSTALLED BY THE ALERTING SYSTEM CONTRACTOR. REMOVED REFERENCE IN THE KEYED NOTES FOR ELECTRICAL CONTRACTOR TO PROVIDE AND INSTALL CABLING AND CONDUCTORS. ELECTRICAL CONTRACTOR WILL STILL BE REQUIRED TO INSTALL J-HOOKS ABOVE ACCESSIBLE CEILING AND CONDUITS FOR ALERTING SYSTEM EQUIPMENT AND CABLING. REFER TO THE ATTACHED DRAWINGS FOR ADDITIONAL INFORMATION.


#### ATTACHMENTS:

#### **DRAWINGS**:

- E7.01 SECURITY & ALERTING PLAN LEVEL 01
- E7.02 SECURITY & ALERTING PLAN LEVEL 02

#### END OF ASI

Page 1 of 1

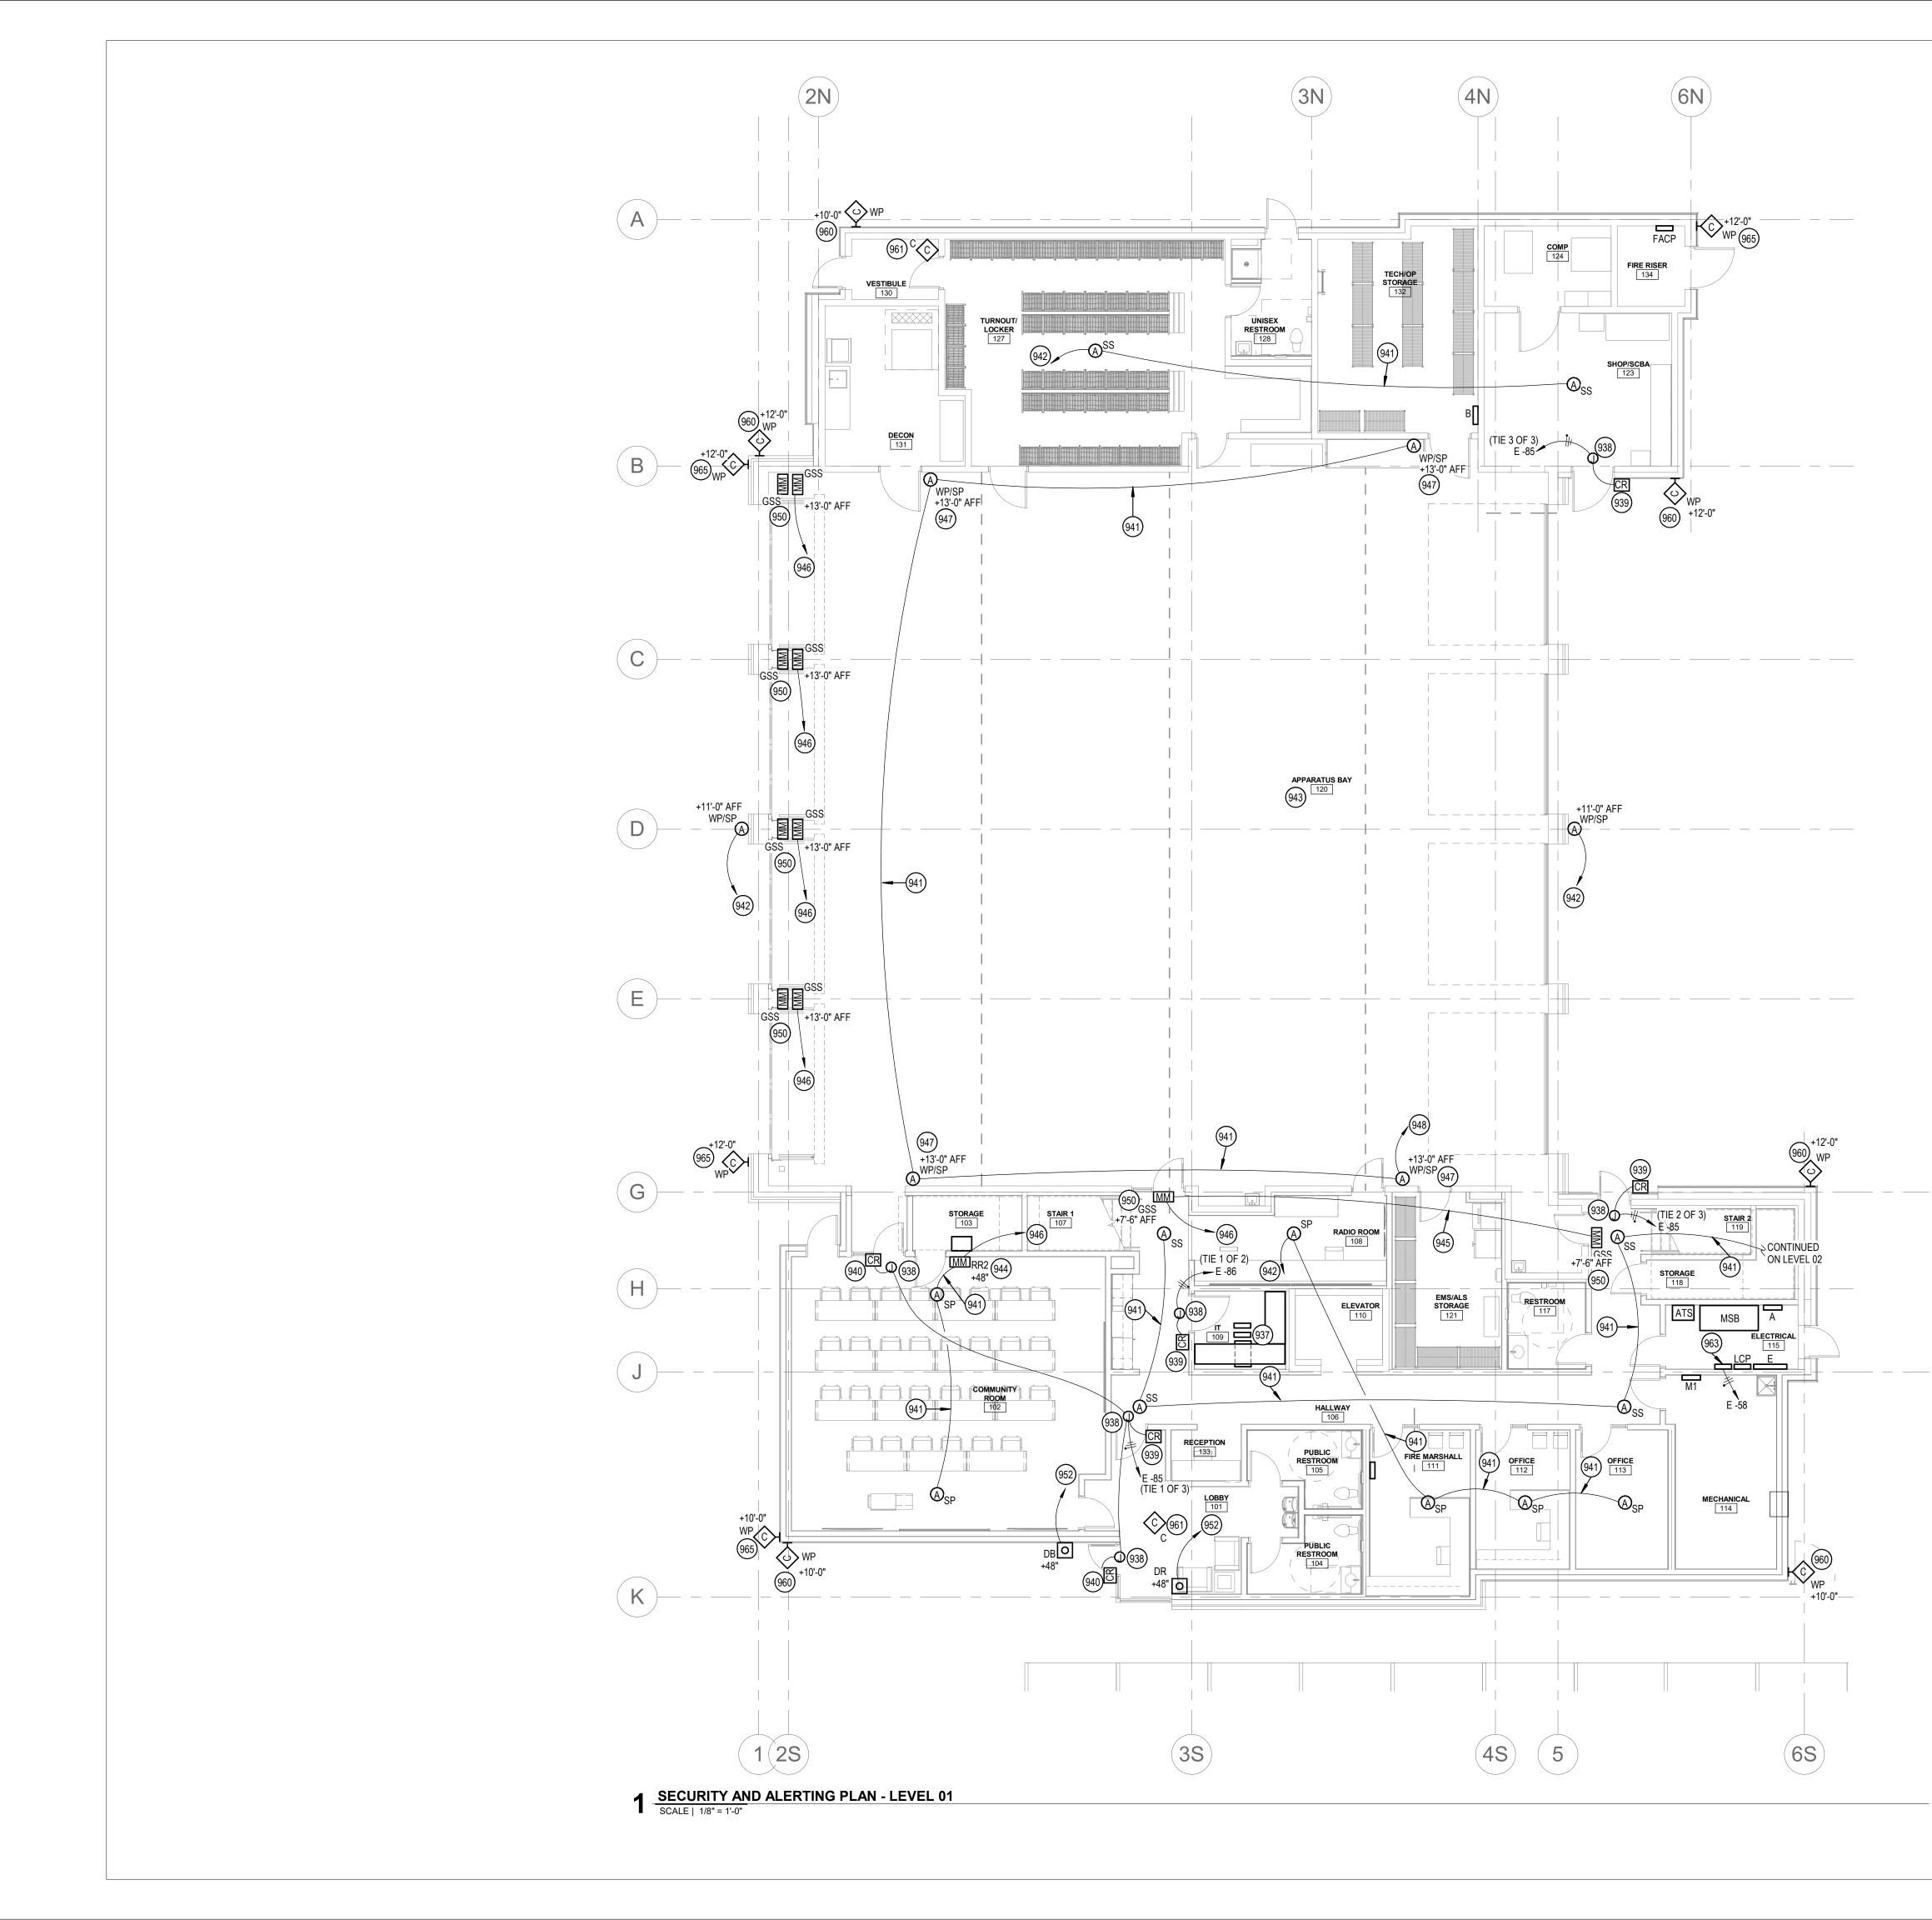



(#) SYMBOL USED FOR CALLOUT

- 937 G2 ATX STATION CONTROLLER, G2 UNINTERRUPTIBLE POWER SUPPLY, OEM AMPLIFIER FURNISHED AND INSTALLED BY THE ALERTING SYSTEM CONTRACTOR.
- 938 JUNCTION BOX LOCATED ABOVE ACCESSIBLE CEILING OR FLUSH MOUNTED 24" ABOVE TOP OF DOOR. COORDINATE LOCATION WITH ARCHTITECTURAL DRAWINGS PRIOR TO BEGINNING ROUGH-IN. ROUTE 1/2" CONDUIT TO DOOR MULLION AND 1/2" CONDUIT TO TO CARD READER. REFER TO THE DOOR CARD ACCESS DETAIL FOR ADDITIONAL INFORMATION.
- 939 FURNISH AND INSTALL JUNCTION BOX FOR CARD READER. PROVIDE 1/2" CONDUIT(S) FROM DOOR MULLION TO JUNCTION BOX(ES) AS SHOWN. REFER TO THE DOOR CARD ACCESS DETAIL FOR ADDITIONAL INFORMATION.
- 940 CARD READER TO BE MOUNTED ON MULLION. PROVIDE 1/2" CONDUIT(S) FROM MULLION TO JUNCTION BOX(ES) AS SHOWN. REFER TO THE DOOR CARD ACCESS DETAIL FOR ADDITIONAL INFORMATION.
- 941 ALERTING SYSTEM CONDUCTORS SHALL BE FURNISH AND INSTALLED BY ALERTING SYSTEM CONTRACTOR. ELECTRICAL CONTRACTOR SHALL INSTALL J-HOOKS ABOVE ACCESSIBLE CEILINGS AND 3/4" CONDUIT FOR ALERT SYSTEM CONDUCTORS WHEN ROUTED THROUGH OPEN TO STRUCTURE SPACES OR ABOVE HARD LIDS. INSTALL PULLSTRING IN CONDUITS AND TERMINATE WITH INSULATED THROAT BUSHINGS. COORDINATE CONDUIT ROUTING WITH OTHER TRADES AND ALERTING SYSTEM CONTRACTOR PRIOR TO BEGINNING WORK.
- 942 ALERTING SYSTEM CONDUCTORS SHALL BE FURNISH AND INSTALLED BY ALERTING SYSTEM CONTRACTOR. ROUTE 3/4" CONDUIT WITH PULLSTRING TO THE ALERTING SYSTEM EQUIPMENT IN THE IT ROOM 109. COORDINATE WITH ALERTING SYSTEM CONTRACTOR FOR ADDITIONAL INFORMATION PRIOR TO BEGINNING WORK.
- ALL LOW-VOLTAGE CONDUCTORS AND CABLING ROUTED IN OR THROUGH THE APPARATUS BAY SHALL BE ROUTED IN CONDUIT, NO EXCEPTIONS. ROUTE CONDUIT UP AS HIGH AS POSSIBLE AND TIGHT TO STRUCTURE. COORDINATE WITH OTHER TRADES PRIOR TO BEGINNING WORK.
- 944 FURNISH AND INSTALL 4-GANG BOX WITH ROUGH OPENING OF 2-3/4" H x 7-3/8" W
- 945 ROUTE 3/4" CONDUIT WITH PULLSTRING BETWEEN EQUIPMENT SHOWN. COORDINATE WITH ALERTING SYSTEM CONTRACTOR FOR ADDITIONAL INFORMATION PRIOR TO BEGINNING WORK.
- 946 ALERTING SYSTEM CONDUCTORS SHALL BE FURNISH AND INSTALLED BY ALERTING SYSTEM CONTRACTOR. ROUTE 3/4" CONDUIT WITH PULLSTRING TO THE ALERTING SYSTEM EQUIPMENT IN THE IT ROOM 109. COORDINATE WITH ALERTING SYSTEM CONTRACTOR FOR ADDITIONAL INFORMATION PRIOR TO BEGINNING WORK.
- PROVIDE 4" METAL J-BOX WITH MUD RING AND COVER AT SPEAKER. PROVIDE 3/4" DIA. HOLE CENTERED IN J-BOX COVER WITH HEYCO #2840 BUSHING FOR SPEAKER CABLE. MOUNT AT HEIGHT NOTED.
- 948 ALERTING SYSTEM CONDUCTORS SHALL BE FURNISH AND INSTALLED BY ALERTING SYSTEM CONTRACTOR. ROUTE 3/4" CONDUIT WITH PULLSTRING TO THE ALERTING SYSTEM EQUIPMENT IN THE IT ROOM 109. COORDINATE WITH ALERTING SYSTEM CONTRACTOR FOR ADDITIONAL INFORMATION PRIOR TO BEGINNING WORK.
- PROVIDE 4" METAL J-BOX WITH MUD RING AT HEIGHT NOTE FOR MESSAGE SIGN AT HEIGHT NOTED. ORIENT MUD RING OPENING HORIZONTALLY. PROVIDE DUPLEX STAINLESS STEEL J-BOX COVER WITH 3/4" DIA. HOLE CENTERED IN THE COVER WITH A HEYCO #2840 BUSHING.
- 952 ALERTING SYSTEM CONDUCTORS SHALL BE FURNISH AND INSTALLED BY ALERTING SYSTEM CONTRACTOR. ROUTE 3/4" CONDUIT WITH PULLSTRING FROM DEVICE SHOWN TO THE ALERTING SYSTEM EQUIPMENT IN THE IT ROOM 109. -COORDINATE WITH ALERTING SYSTEM CONTRACTOR FOR ADDITIONAL INFORMATION PRIOR TO BEGINNING WORK.
- FURNISH AND INSTALL WEATHERPROOF JUNCTION BOX HEIGHT NOTED FOR FUTURE SECURITY CAMERA. ROUTE 3/4" CONDUIT WITH PULLSTRING FROM JUNCTION BOX AND STUB ABOVE NEAREST ACCESSIBLE CEILING. TERMINATE WITH INSULATED THROAT BUSHING.
- 961 FURNISH AND INSTALL JUNCTION BOX IN CEILING FOR FUTURE SECURITY CAMERA. ROUTE 3/4" CONDUIT WITH PULLSTRING FROM JUNCTION BOX AND STUB ABOVE NEAREST ACCESSIBLE CEILING. TERMINATE WITH INSULATED THROAT BUSHING.
- 963 ALARM INTERFACE PANEL, REFER TO THE ALARM INTERFACE PANEL DETAIL FOR ADDITIONAL INFORMATION.
- 965 FURNISH AND INSTALL WEATHERPROOF JUNCTION BOX HEIGHT NOTED FOR FUTURE SECURITY CAMERA. ROUTE 3/4" CONDUIT WITH PULLSTRING FROM JUNCTION BOX AND STUB ABOVE NEAREST ACCESSIBLE CEILING. TERMINATE WITH INSULATED THROAT BUSHING.



Boise, Idaho 83702 208.345.1800 colearchitects.net Copyright © 2020 Cole Architects, PLLC



ARCHITECTURE + PLANNING + DESIGN

6211 Roosevelt Way NE Seattle, WA 98115 206.522.3820

STAMP



## CONSULTANT



234 S. WHISPERWOOD WAY BOISE, IDAHO 83709 (208) 384-0585 PROJECT #19-366

**PROJECT INFORMATION** 



## KETCHUM FIRE

107 SADDLE ROAD, KETCHUM ID 83353

## ISSUES


PHASE		CONSTRUCTION SET
DATE		6/19/2020
JOB NU	MBER	18-022
MARK	DATE	DESCRIPTION
28	5/13/21	ASI 09
31	5/13/21	ASI 12


SHEET NAME

SECURITY & ALERTING PLAN -LEVEL 01

SHEET NUMBER



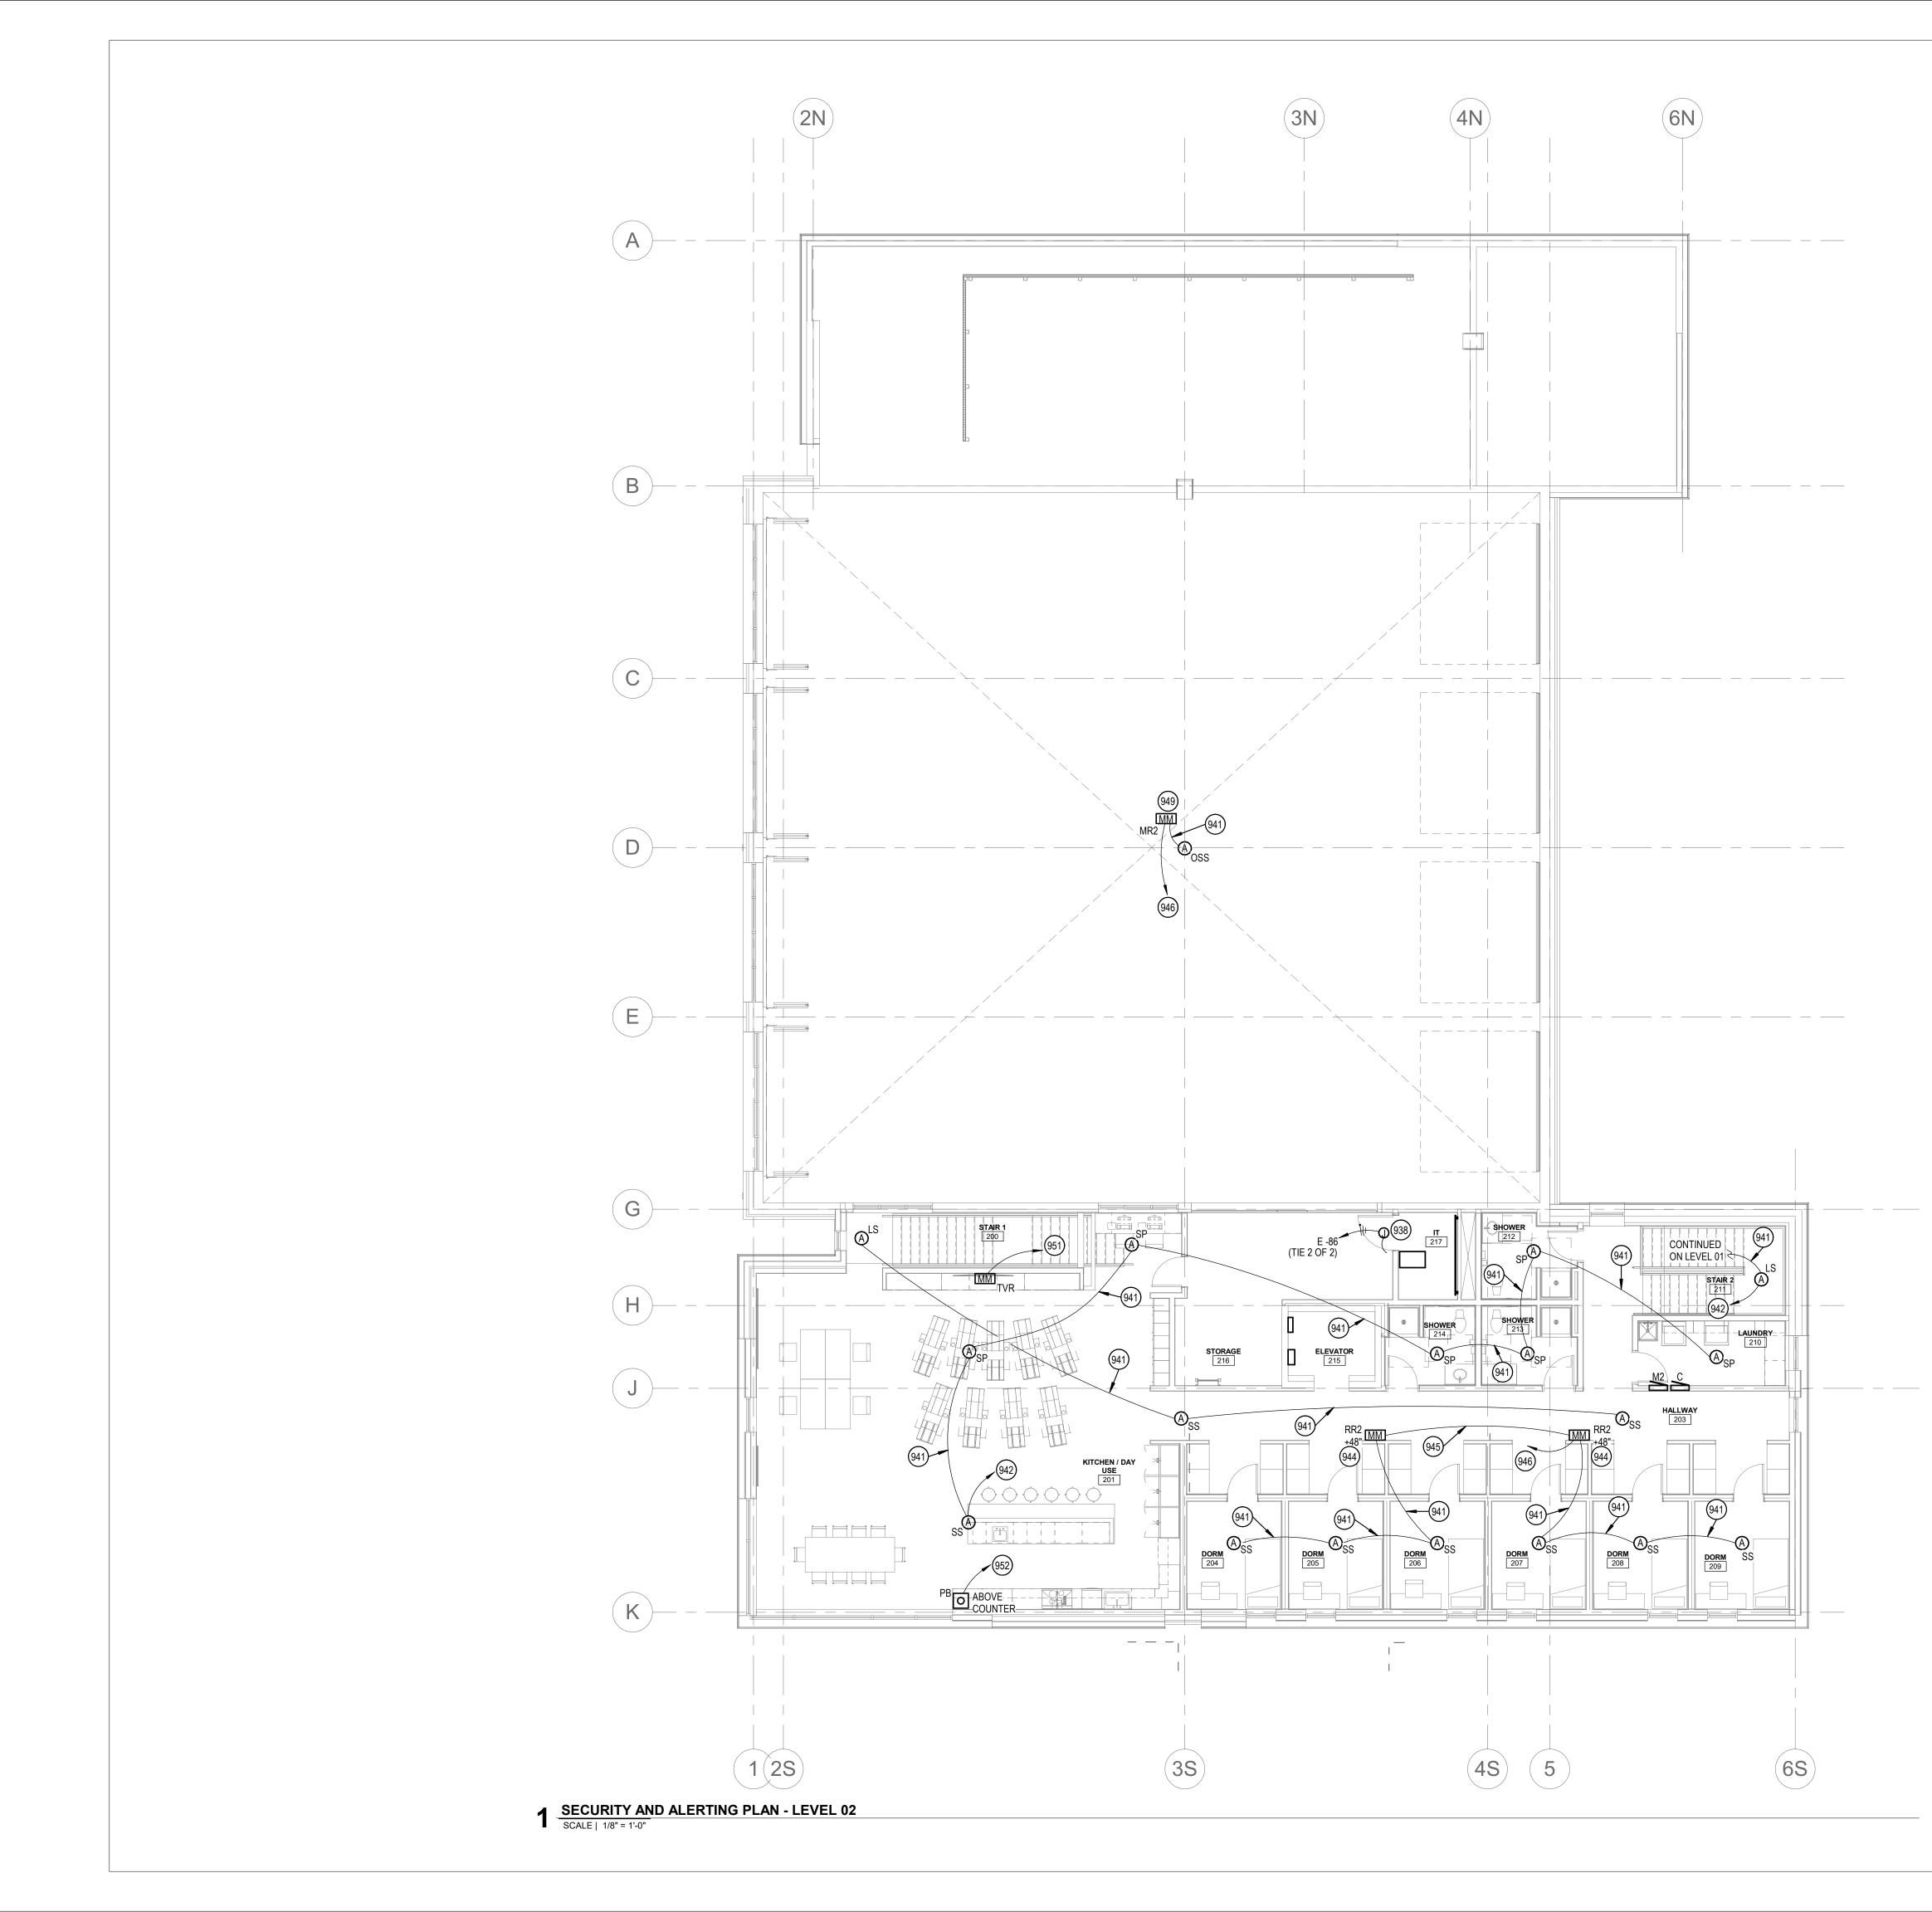

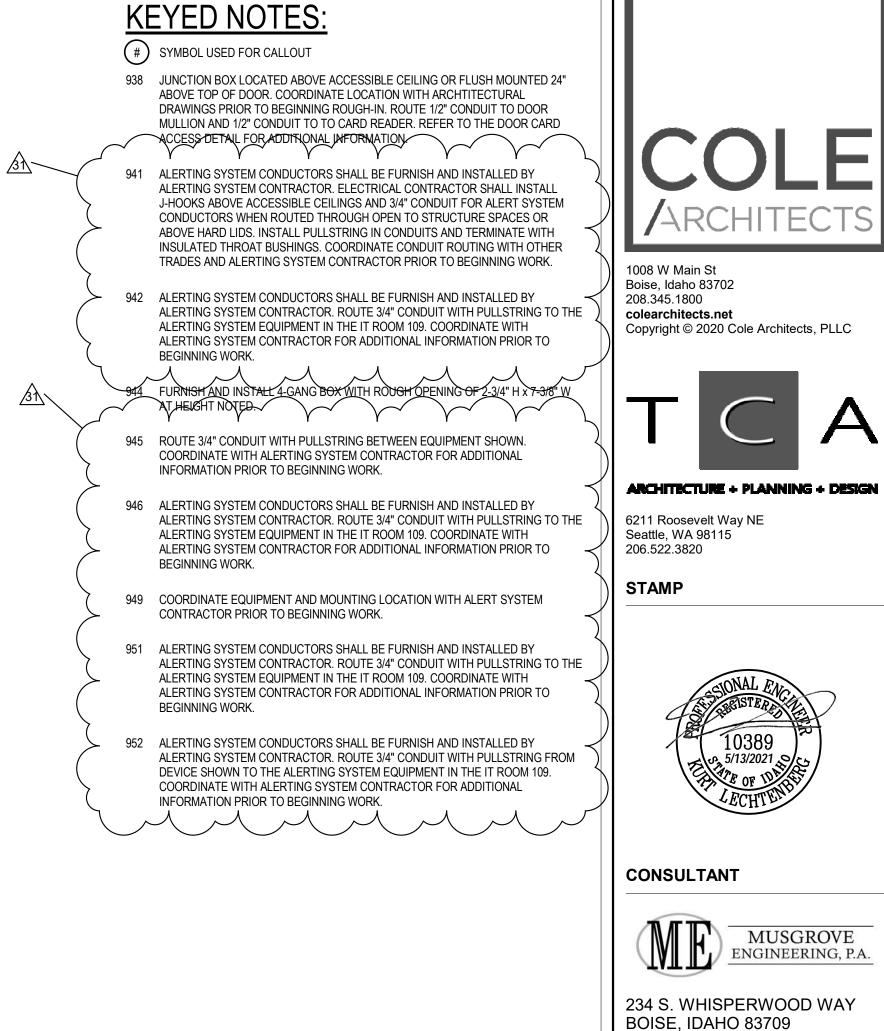

BOISE, IDAHO 83709 (208) 384-0585 PROJECT #19-366

PROJECT INFORMATION



# KETCHUM FIRE

107 SADDLE ROAD, KETCHUM ID 83353

## ISSUES

PHASECONSTRUCTION SETDATE6/19/2020JOB NUMBER18-022

MARKDATEDESCRIPTION315/13/21ASI 12

SHEET NAME

SECURITY & ALERTING PLAN -LEVEL 02

SHEET NUMBER

