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The 208 Condos	)	KETCHUM PLANNING AND ZONING COMMISSION
Design Review	)	FINDINGS OF FACT, CONCLUSIONS OF LAW, AND
Date: April 11, 2023	)	DECISION
	)	
File Number: P22-035	)	

**PROJECT:** The 208 Condos

**APPLICATION TYPE:** Design Review

FILE NUMBER: P22-035

**ASSOCIATED APPLICATIONS**: Condominium Subdivision Preliminary Plat (P22-035A)

**REPRESENTATIVE:** Nicole Ramey, Medici Architects (Architect)

**OWNER:** 755 S Broadway, LLC

**LOCATION:** 200 N Leadville Ave – Lot 1 Block 23, Ketchum Townsite

**ZONING:** Community Core – Subdistrict 2 – Mixed Use (CC-2)

OVERLAY: None

### **RECORD OF PROCEEDINGS**

The City of Ketchum received the application for Final Design Review and condominium preliminary plat on July 1, 2022. The Final Design and Preliminary Plat applications have been reviewed concurrently and were deemed complete on October 14, 2022. Department comments were provided to the applicant on July 27, 2022, and additional comments provided on October 14, 2022. Following receipt of the complete application, staff routed the application materials to all city departments for review. All department comments have been addressed satisfactorily through applicant revision of project plans or conditions of approval.

A public hearing notice for the project was mailed to all owners of property within 300 feet of the project site and all political subdivisions on November 7, 2022. The public hearing notice

was published in the Idaho Mountain Express on November 9, 2022. A notice was posted on the project site and the city's website on November 7, 2022. Story poles were verified on the subject property on November 22, 2022. The project was heard at the November 29, 2022 meeting of the Planning and Zoning Commission (the "Commission") and continued to a special meeting on December 20, 2022. The project was heard again on December 20, 2022, and continued to the January 10, 2023 meeting of the Commission. The applicant, citing the need for additional time to respond to Commission's comments, requested the January 10, 2023 hearing be continued to the February 28, 2023 meeting of the Commission. No information was presented or reviewed at the January 10, 2023 meeting and no public comment was taken.

The Planning and Zoning Commission (the "Commission") conducted their final consideration of the Design Review (Application No. P22-035) and the Condominium Subdivision Preliminary Plat (Application No. P22-035A) applications concurrently at their February 28, 2023 hearing, and the associated public hearings were combined in accordance with Idaho Code §67-6522. After considering staff's analysis, the applicant's presentation, and public comment, the Commission approved the Design Review application with a vote of 3-2 and recommended approval of the Condominium Subdivision Preliminary Plat application to the City Council with a vote of 3-2.

### **BACKGROUND**

The Applicant is proposing an 10,856 square foot three-story mixed-use development known as The 208 Condominiums (the "project"), located at 200 N Leadville Avenue (the "subject property"). The development is not subject to the interim ordinance as the applications were deemed complete prior to the effective date of the ordinance. The subject property is a vacant corner lot zoned Community Core - Subdistrict 2 - Mixed Use (CC-2) just southeast of the Kneadery and VP Companies offices, across from Vintage restaurant and another vacant lot on the opposite corner.

As proposed, the project includes 1,306 square feet of ground floor retail, and four residential dwelling units as follows:

- One dwelling unit in the basement 639 net square feet (NSF)
- Two dwelling units on the second floor 746 NSF and 2,628 NSF
- One dwelling unit on the third floor 3,503 NSF

Based on the size of the units, a total of 4 parking spaces are required for the residential units. The project proposes two two-car garages. The retail space and the two residential units less than 750 net square feet are exempt from parking requirements.

The project proposes to take advantage of the Floor Area Ratio (FAR) bonus in exchange for community housing, mitigating the additional floor area by making a community housing contribution. The total FAR for the project is 1.97, where 1.0 is permitted by right.

The project will construct improvements to the right-of-way per the City of Ketchum improvement standards including, three streetlights, asphalt alley, curb and gutter, and 8-foot sidewalks. The project proposes to snowmelt the sidewalks adjacent to the project. The city engineer and streets department has conducted a preliminary review all improvements and believes the improvements to meet the city's standards. Final review of all improvements to the right-of-way will be conducted by the City Engineer

and Streets Department prior to issuance of a building permit. An encroachment permit approved by the City Council will be required for the snow melt system and pavers.

### FINDINGS OF FACT

The Commission, having reviewed the entire project record, provided notice, and conducted the required public hearing, does hereby find that the project does not jeopardize the health, safety, and welfare of the public and conforms to all applicable standards and criteria as set forth in Chapter 17.96 – *Design Review* and Title 17 – *Zoning Regulations*. Therefore, the Commission does hereby make and set forth these Findings of Fact, Conclusions of Law, and Decision as follows:

### FINDINGS REGARDING HEALTH, SAFETY, AND WELFARE

The 2014 Comprehensive Plan outlines 10 core values that drive the city's vision for the future including a strong and diverse economy, vibrant downtown, community character, and a variety of housing options. The built environment within the downtown plays a key role in materializing these values to achieve the city's vision. The 2014 Comprehensive Plan designates the future land use for the subject property as "mixed-use commercial" where, according to the plan, "New structures in existing mixed-use areas should be oriented to streets and sidewalks and contain a mix of activities. Mixed-use development should contain common public space features that provide relief to the density and contribute to the quality of the street." Primary uses include offices, medical facilities, health/wellness-related services, recreation, government, residential, and services.

Policy CD-1.3 of Chapter 4 of the comprehensive plan states that "Infill and redevelopment projects should be contextually appropriate to the neighborhood and development in which they occur. Context refers to the natural and manmade features adjoining a development site; it does not imply a certain style." The transition between buildings is a key design element and has the potential to impact the perceived cohesiveness of the downtown and can impact the way residents and visitors experience a place.

The Commission discussed the project's conformance with the future land use designation and found that the proposed project met the vision of the future land use designation as there are both residential and commercial uses proposed in the project. All of the proposed uses are listed as acceptable primary uses in the comprehensive plan. The Commission also found that the proposed uses and design of the building provided an active ground floor street frontage that supports the goals of creating a vibrant downtown. The building is set back from the property line with pedestrian amenities such as landscape planters and benches. This design creates spaces for pedestrians to congregate at the corner of the building where there are opportunities to window shop. The building design also includes floor to ceiling storefront windows that provide interest for pedestrians traveling along Leadville Ave and 2<sup>nd</sup> Street. The

building is oriented towards the corner of Leadville Ave and 2<sup>nd</sup> Street with vertical and horizontal architectural elements and storefront windows on the ground level.

The Commission also discussed the project and whether it was contextually appropriate to the neighborhood. The Commission acknowledged that the building was larger than the immediately adjacent one-story structures but acknowledged that there are two- and three-story structures within one block of the subject property. The subject property is one block from Sun Valley Rd and one block from Main Street. Both roads are heavily trafficked by pedestrians and vehicles and are the locations of many larger buildings within the community core. Ultimately, the Commission found that the context of the neighborhood should be measured not by the immediately adjacent structures, but by the broader surroundings. The Commission also acknowledged that the changes proposed by the applicant throughout the design review process improved the building's perceived height and addressed concerns related to bulk and flatness.

Therefore, the Commission found that the project is in general conformance with the comprehensive plan and does not jeopardize the health, safety, or welfare of the public.

### FINDINGS REGARDING COMPLIANCE WITH ZONING REGULATIONS

	Zoning and Dimensional Standards Analysis			
Co	Compliant Ketchum Municipal Code Standards and Staff Comments			
Yes	No	N/A	KMC §	Standards and Staff Comments
$\boxtimes$			17.12.030	Minimum Lot Area
			Staff	Permitted: 5,500 square feet
			Comments	
				Proposed: 5,504 square feet
$\boxtimes$			17.12.030	FAR or Lot Coverage
			Staff	Permitted FAR: 1.0
			Comments	Permitted FAR with Community Housing: 2.25
				Floor Area, Gross: The sum of the horizontal area of the building measured along the outside walls of each floor of a building or portion of a building, including stair towers and elevators on the ground floor only, and 50 percent of atriums over 18 feet plate height, but not including basements, underground parking areas or open unenclosed decks. Parking areas covered by a roof or portion of the building and enclosed on three or more sides by building walls are included. Four parking stalls for developments on single Ketchum Town Site lots of 5,600 square feet in size or less are not included in the gross floor area calculation.  Proposed:

			10.0505/5.01.110.00
			Gross Square Footage – 10,856 SF (Per Sheet A0.0)
			Total Lot Area – 5,504 SF
			FAR – 1.97
			Community Housing Mitigation Calculation:
			Permitted Gross Square Feet (1.0 FAR): 5,504 SF
			Proposed Gross Square Feet: 10,856 SF
			Increase Above Permitted FAR: 5,352 SF
			20% of Increase: 1,070 SF
			Net Livable (15% Reduction): 910 SF
$\boxtimes$		17.12.030	Minimum Building Setbacks
		Staff	Permitted:
		Comments	Front (N Leadville Ave/west): 5 feet average
			Side (Interior/north): 0 feet
			Side (Street Side/2 <sup>nd</sup> Street): 5 feet average as this frontage is considered
			"street side"
			Rear (Alley/east): 3 feet
			Real (Alley/east). 5 leet
			To calculated the average setback for front and street sides, the length of the
			façade at each level is measured and multiplied by five to determine the
			minimum required square footage of setback for the façade at that level. To
			calculate compliance with the minimum requirement, the total square footage
			of proposed setback for the same facade is measured.
			0 feet - Cantilevered decks and overhangs
			10 feet - Non-habitable structures, fixed amenities, solar and mechanical
			equipment affixed to a roof from all building facades for all projects except for
			projects where 100% of the residential units are community or workforce
			housing.
			Proposed:
			Front (N Leadville Ave/west): 16.71-foot average
			Side (Interior/north): 6-inch setback
			Side (Street Side/south): 11-foot average
			Rear (Alley/east): 11-foot average
			Theat (Time 1) east). II foot average
			Rooftop planters, trellis, mechanical equipment, elevator and stair tower are
			all set back 10 feet from the façade wall. Solar panels are flush with the roof
			and do not require being set back. The final placement of solar panels must
			meet all fire code requirements.
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		17.12.030	Building Height

$\boxtimes$		Staff	Permitted: 42 feet
		Comments	Height of building/CC District: The greatest vertical distance of a building in the
		Comments	community core district measured by determining the average elevation of the
			front property line and rear property line. Draw a line from the average front
			or rear elevation up to the maximum building height allowed, and then draw a
			line at that height parallel to the front or rear property line. The resulting line
			establishes the highest elevation of the front or rear facade. The front or rear
			facade shall not extend above this line. Side facades may be stepped up or
			down to transition from the highest elevation of the front facade height to the
			highest elevation of the rear facade. One or multiple steps along the side
			facades are allowed, except no step shall occur within 40 feet of the front
			elevation or within 35 feet of the rear facade. The City shall establish the
			elevation points used to calculate the average elevation of the front and rear
			property lines (see illustration A on file in the office of the City Clerk).
			Cantilevered decks and overhangs: 8 feet above walking surface
			Non-habitable structures located on building roof tops: 10 feet max
			Perimeter walls enclosing roof top deck and structures: 4 feet above roof
			surface height if it projects above the maximum height limit
			Roof top solar and mechanical equipment above roof surface: 5 feet
			Proposed:
			As shown on Sheets A4.0 and A4.1, the total building height in the
			rear is 41.4 feet. The total building height in the front (Leadville
			side) is 40.5 feet.
			Cantilevered decks and overhangs: 12 feet 4 inches to the top of the
			cantilevered decks and overhangs
			Non-habitable structures located on building roof tops: stair and trellis are 10
			feet or less from the top of the roof
			Roof top solar and mechanical equipment above roof surface: 5 feet
			Perimeter walls enclosing rooftop deck and structures: does not exceed the
			maximum building height therefore the max height does not apply
$\boxtimes$		17.125.030H	Curb Cut
		Staff	Permitted:
		Comments	A maximum of thirty five percent (35%) of the linear footage of any street
			frontage may be devoted to access off street parking.
			<b>Proposed:</b> The subject property has two street frontages, one along N
			Leadville Ave and the other along 2nd Street. All access to proposed off street
			parking is being accessed from an alley and therefore no street frontage is
			devoted to access off street parking.

$\boxtimes$		17.125.040	Parking Spaces
		Staff	Permitted: For residential multi-family dwelling units in the Community Core
		Comments	Units 750 net SF or less – 0 spaces
			Units 751 SF to 2,000 net SF – minimum of 1 space
			Units 2,001 net SF and above – minimum of 2 spaces
			Retail spaces less than 5,500 SF are exempt from parking requirements in the Community Core
			The project proposes a total of 4 dwelling units:
			One dwelling unit in the basement – 639 net square feet (NSF) – no parking required
			<ul> <li>Two dwelling units on the second floor – 746 NSF and 2,628</li> <li>NSF – two spaces required</li> </ul>
			One dwelling unit on the third floor – 3,503 NSF – two spaces required
			A total of 4 off-street parking spaces are required for the project.
			Bicycle parking: One bicycle parking space for two bicycles is required.
			Proposed:
			As shown on Sheet A2.1, the project proposes a total of four parking spaces,
			two tandem parking spaces for Unit #2 and a side-by-side 2 car garage for Unit #4.

### FINDINGS REGARDING COMPLIANCE WITH DESIGN REVIEW STANDARDS

17.96.060.A.1 - Streets	Conformance
The applicant shall be responsible for all costs associated with providing a connection	YES
from an existing City street to their development.	

**Finding:** The development is at the corner of N Leadville Ave and 2<sup>nd</sup> Street, two existing public rights-of-way. The development proposes to bring both rights-of-way up to city standards by replacing the existing nonconforming sidewalks, provide curb and gutter, and improve the alley to meet standards and provide for adequate drainage. The development proposes walkways the full length of the building from the property line to ensure direct pedestrian access from all building entrances to the sidewalks. All improvements to the right-of-way and walkways to the right-of-way improvements are at the expense of the applicant.

17.96.060.A.2 - Streets	Conformance
All street designs shall be approved by the City Engineer.	YES
	Condition #3

**Finding**: No new streets are proposed for the project, however, all improvements to the right-of-way as shown on the project plans has been reviewed by the City Engineer. Final review of all improvements to the right-of-way will be completed prior to issuance of a building permit for the project per condition of approval #3.

17.96.060.B.1 - Sidewalks	Conformance
All projects under subsection 17.96.010.A of this chapter that qualify as a "substantial	YES
improvement" shall install sidewalks as required by the Public Works Department.	

**Finding**: KMC 17.124.140 outlines the zone districts where sidewalks are required when substantial improvements are made, which include the CC, all tourist zone districts, and all light industrial districts. As the project is within the CC-2 zone district, sidewalks are required and proposed.

17.96.060.B.2 - Sidewalks	Conformance
Sidewalk width shall conform to the City's right-of-way standards, however the City	YES
Engineer may reduce or increase the sidewalk width and design standard	Condition #3
requirements at their discretion.	

**Finding**: The project plans provided the details of the sidewalks for review by the City Engineer. Preliminary review of the project plans indicates that all city right-of-way standards for width and construction are met. Final review of all improvements to the right-of-way will be completed prior to issuance of a building permit for the project per condition of approval #3.

17.96.060.B.3 - Sidewalks	Conformance
Sidewalks may be waived if one of the following criteria is met:	N/A
<ul> <li>a) The project comprises an addition of less than 250 square feet of conditioned space.</li> </ul>	
b) The City Engineer finds that sidewalks are not necessary because of existing geographic limitations, pedestrian traffic on the street does not warrant a sidewalk, or if a sidewalk would not be beneficial to the general welfare and safety of the public.	

**Finding**: The applicant has not requested, nor has the City Engineer granted a waiver to the sidewalk requirement for the project.

17.96.060.B.4 - Sidewalks	Conformance
The length of sidewalk improvements constructed shall be equal to the length of the	YES
subject property line(s) adjacent to any public street or private street.	

**Finding**: As shown on the project plans, the project proposes new sidewalks to be placed the full length of the subject property along N Leadville Ave and 2<sup>nd</sup> Street.

17.96.060.B.5 – Sidewalks	Conformance
New sidewalks shall be planned to provide pedestrian connections to any existing or	YES
future sidewalks adjacent to the site. In addition, sidewalks shall be constructed to	
provide safe pedestrian access to and around a building.	

**Finding**: There are existing sidewalks along the subject property connecting to existing sidewalks to the north and east. The development proposes to replace the existing nonconforming 5-foot sidewalks on both N Leadville Ave and 2<sup>nd</sup> Street. The new 8-foot sidewalks will taper and connect to the existing sidewalks to the north and east. There will be direct pedestrian access from the entrances and exits to the building to the new sidewalks as shown in the project plans.

17.96.060.B.6 - Sidewalks	Conformance
The City may approve and accept voluntary cash contributions in lieu of the above described improvements, which contributions must be segregated by the City and not used for any purpose other than the provision of these improvements. The contribution amount shall be 110 percent of the estimated costs of concrete sidewalk and drainage improvements provided by a qualified contractor, plus associated engineering costs, as approved by the City Engineer. Any approved in lieu contribution	N/A
shall be paid before the City issues a certificate of occupancy.	

**Finding**: The applicant has not requested relief from the requirement to construct sidewalks nor has the City granted any such request.

17.96.060.C.1 - Drainage	Conformance
All stormwater shall be retained on site.	YES

**Finding**: The project proposes a series of roof drains, drywells, and catch basins to manage onsite stormwater. Per the project plans, all stormwater is being retained on site.

17.96.060.C.2 - Drainage	Conformance
Drainage improvements constructed shall be equal to the length of the subject	YES
property lines adjacent to any public street or private street.	Condition #3

**Finding**: As shown on the project plans, all stormwater is retained on-site. The project proposes to construct right-of-way improvements the length of the subject property, including curb and gutter and other drainage infrastructure, along N Leadville Ave and 2<sup>nd</sup> Street. The project also proposes drainage infrastructure in the alley behind the subject property for the full length of the subject property. Final design of drainage infrastructure will be reviewed and approved by the City Engineer prior to building permit issuance per condition #3.

17.96.060.C.3 - Drainage	Conformance
The City Engineer may require additional drainage improvements as necessary, depending on the unique characteristics of a site.	N/A

**Finding**: The City Engineer did not identify any additional drainage improvements during department review. The characteristics of the site do not warrant additional drainage improvements.

17.96.060.C.4 - Drainage	Conformance
Drainage facilities shall be constructed per City standards.	YES
	Condition #3

**Finding**: Based on review of the project plans by the City Engineer during department review, all drainage facilities meet city standards. Final design of drainage facilities will be reviewed and approved by the city engineer prior to issuance of a building permit per condition #3.

17.96.060.D.1 - Utilities	Conformance
All utilities necessary for the development shall be improved and installed at the sole expense of the applicant.	YES
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**Finding**: All project costs associated with the development, including installation of utilities, are the responsibility of the applicant. The applicant has not made requests for funding to the City, and no funds have been provided by the city for the project. The subject property was previously served by an above ground power line to a power pole on-site. At the owner's expense, the overhead line and power pole have already been removed. The development will be served by power from below grade power lines to an on-site transformer as shown on the project plans.

17.96.060.D.2 - Utilities	Conformance
Utilities shall be located underground and utility, power, and communication lines within the development site shall be concealed from public view.	YES

**Finding**: Per the project plans, all necessary utilities are underground. As shown on Sheet A0.1, a single-phase transformer is located on the southeast corner of the property adjacent to the alley and the pedestrian sidewalk along 2<sup>nd</sup> Street. The transformer is proposed to be screened with perforated metal paneling and landscaping as shown on the sheet. The Idaho Power will serve letter is dated October 24, 2022 and references a previous version of the site plan. As outlined in condition of approval #3, an updated service letter from Idaho Power shall be provided with the building permit application to ensure all screening and access is adequate. Any changes in transformer size and location may require an amendment to the design review approval. As conditioned, this standard is met.

17.96.060.D.3 - Utilities	Conformance
When extension of utilities is necessary all developers will be required to pay for and	N/A
install two-inch SDR11 fiber optical conduit. The placement and construction of the	

fiber optical conduit shall be done in accordance with City of Ketchum standards and at the discretion of the City Engineer.

**Finding**: The location of the subject property is already served by fiber optical and therefore no conduit is required in this location.

17.96.060.E.1 – Compatibility of Design	Conformance
The project's materials, colors and signing shall be complementary with the	YES
townscape, surrounding neighborhoods and adjoining structures.	

**Finding**: The surrounding neighbors and adjoining structures have a wide variety of materials and colors. Most of the structures adjacent to the subject property, or directly across the street, are one-story single-family residence type buildings with pitched roofs and white or lightly colored horizontal siding. However, further north along N Leadville Ave on the same block, the materials and color palette shift to brick, darker accent colors such as red or green, and flat roofs such as the building with the Cellar Pub. The building at the corner of N Leadville and Sun Valley Rd has brick, light colored stucco, and red accents. Although the proposed development does not mimic the light-colored horizontal materials of immediately adjacent properties, the proposed materials of darker brick, and black metal accents on the balconies are complementary to the buildings on N Leadville Ave. The building also includes a lighter colored accent wall along 2<sup>nd</sup> Street that ties the building's color palette to the surrounding properties and lightens the buildings feel where there are no windows.

17.96.060.E.2 – Compatibility of Design	Conformance
Preservation of significant landmarks shall be encouraged and protected, where applicable. A significant landmark is one which gives historical and/or cultural importance to the neighborhood and/or community.	N/A
Finding: The subject property is vacant therefore this standard does not apply.	

17.96.060.E.3 – Compatibility of Design	Conformance
Additions to existing buildings, built prior to 1940, shall be complementary in design and use similar material and finishes of the building being added to.	N/A
Finding: The subject property is vacant therefore this standard does not apply.	

17.96.060.F.1 - Architectural	Conformance
Building(s) shall provide unobstructed pedestrian access to the nearest sidewalk and the entryway shall be clearly defined.	YES

**Finding**: The project includes primary entrances to the retail on both N Leadville Ave and 2<sup>nd</sup> Street. Additionally, there are entrances to the residential units on 2<sup>nd</sup> Street. All entrances have direct access to the sidewalk. All entrances are identifiable with architectural elements, particularly the elements on 2<sup>nd</sup> Street where there is a

recessed entrance to the upper floor units and a single entrance articulated with architectural detailing around the door for the basement residence.

17.96.060.F.2 – Architectural	Conformance
The building character shall be clearly defined by use of architectural features.	YES

**Finding**: The building character mimics that of historic brick buildings with balconies that stretch for a significant length of the building. The windows have a subtle curvature at the top which is also a characteristic of more ornate historic brick buildings. Some examples in Ketchum include the buildings where Enoteca, Sun Valley Cullinary, and the Sawtooth Club are located.

17.96.060.F.3 – Architectural	Conformance
There shall be continuity of materials, colors and signing within the project.	YES

**Finding**: The project uses a consistent set of materials including multiple shades of brick, black metal accents, and lighter wood siding under the balconies. The signage for the project is minimal and does not deter from the architectural characteristics of the building. Signage is primarily wall mounted signage and window decals as shown on the elevations in the project plans.

17.96.060.F.4 – Architectural	Conformance
Accessory structures, fences, walls and landscape features within the project shall	YES
match or complement the principal building.	

**Finding**: The proposed balconies are of a material that contrasts but compliments the two tones of brick on the facades of the building. The rooftop deck proposes a wood pergola and metal landscape planters that complement the other materials of the building.

17.96.060.F.5 – Architectural	Conformance
Building walls shall provide undulation/relief, thus reducing the appearance of bulk and flatness.	YES

**Finding**: The development implements a variety of features that successfully minimize the appearance of bulk and flatness on the primary facades of the building. Features include setback facades with cantilevered balconies, setback roof projection above the third floor balcony on N Leadville Ave, three dimensional trim features at each floor of the building, and material changes from the base of the building to the top on the 2<sup>nd</sup> Street side of the building. The only wall with limited undulation and material variation is the north façade which is located on an interior lot line but not set back more than 5 feet. As shown on Sheet A4.4, the development proposes horizontal brick banding, indentions of the wall façade to create "bricked in" windows, wrapping of ground floor architectural materials, and a vertical trellis with climbing vines. All of these treatments serve to avoid the creation of blank walls and are consistent with the other materials and treatments of the front façade. Additionally, the third floor façade on the N Leadville Ave side of the building is set back from the lower floors

which provides additional undulation and relief to the north façade. This setback, combined with the façade treatments, serve to adequately reduce the appearance of bulk and flatness of the building.

Conformance
YES

**Finding**: The subject properties' primary street frontage is N Leadville Ave, however, as a corner lot, the building should orient to both N Leadville and  $2^{nd}$  Street. The development orients to N Leadville Ave very effectively with cantilevered balconies, main entrances to the retail space, and landscape planters that anchor the building. Additionally, the ground floor retail space includes storefront windows along N Leadville Ave that extend around the corner to the  $2^{nd}$  Street side.

17.96.060.F.7 – Architectural	Conformance
Garbage storage areas and satellite receivers shall be screened from public view and located off alleys.	YES

**Finding**: As shown on the project plans, the garbage area is in the rear of the building, in an enclosed storage room with a roll up door for access and service.

17.96.060.F.8 – Architectural	Conformance
Building design shall include weather protection which prevents water to drip or snow	YES
to slide on areas where pedestrians gather and circulate or onto adjacent properties.	

**Finding**: As shown on the project plans, the roof plan for the project includes flat roofs at an angle that causes water to drain toward a series of roof drains along the interior of the roof. Cantilevered decks integrate with roof drain systems for any water or snow accumulation. Based on the design of drainage facilities and roof design, no water or snow will enter onto adjacent properties.

17.96.060.G.1 – Circulation Design	Conformance
Pedestrian, equestrian and bicycle access shall be located to connect with existing and anticipated easements and pathways.	YES
Finding: The project is fully connected by crosswalks with the existing sidewalk system. There are no regional	
trails, other anticipated easements, or pathways other than the sidewalk system	

17.96.060.G.2 – Circulation Design	Conformance
Awnings extending over public sidewalks shall extend five feet or more across the public sidewalk but shall not extend within two feet of parking or travel lanes within the right-of-way.	N/A
<b>Finding</b> : The development does not propose any awnings over public sidewalks.	

17.96.060.G.3 – Circulation Design	Conformance
Traffic shall flow safely within the project and onto adjacent streets. Traffic includes vehicle, bicycle, pedestrian and equestrian use. Consideration shall be given to adequate sight distances and proper signage.	YES

**Finding**: Vehicle traffic accesses the site from the alley between N Leadville Ave and East Ave. Following required improvements to the alley, the access will be adequate to enter or exit the project safely. Bicycle and pedestrian circulation will primarily be in and out of the front of the project along 2<sup>nd</sup> Street.

17.96.060.G.4 – Circulation Design	Conformance
Curb cuts and driveway entrances shall be no closer than 20 feet to the nearest	N/A
intersection of two or more streets, as measured along the property line adjacent to	
the right-of-way. Due to site conditions or current/projected traffic levels or speed, the	
City Engineer may increase the minimum distance requirements.	

**Finding**: The subject property is a corner lot, however, alley access points for garages in the Community Core are not considered curb cuts or driveways, therefore this standard does not apply.

17.96.060.G.5 – Circulation Design	Conformance
Unobstructed access shall be provided for emergency vehicles, snowplows, garbage	YES
trucks and similar service vehicles to all necessary locations within the proposed	
project.	

**Finding**: With the right-of-way improvements proposed, access for emergency vehicles, snowplows, and garbage trucks will be enhanced as access to the property will be achievable from all sides. The enclosed garages and garbage handling area is such that vehicles will not overhang into the alley and garbage receptacles will be returned to their storage area immediately following service. There is direct access to the building from the alley, N Leadville Ave, and 2<sup>nd</sup> Street in case of emergencies.

17.96.060.H.1 – Snow Storage	Conformance
Snow storage areas shall not be less than 30 percent of the improved parking and pedestrian circulation areas.	N/A
<b>Finding</b> : The project proposes heated pavers for the pedestrian areas between the buildi sidewalks per the project plans, therefore, no on-site snow storage is required.	ng and pedestrian

17.96.060.H.2 – Snow Storage	Conformance
Snow storage areas shall be provided on site.	N/A
Finding: As discussed above, no on-site snow storage is required as snowmelt is proposed	d.

17.96.060.H.3 – Snow Storage	Conformance
A designated snow storage area shall not have any dimension less than five feet and shall be a minimum of 25 square feet.	N/A
Finding: As discussed above, no on-site snow storage is required as snowmelt is proposed	d.

17.96.060.H.4 – Snow Storage	Conformance
In lieu of providing snow storage areas, snowmelt and hauling of snow may be allowed.	N/A
Finding: As discussed above, no on-site snow storage is required as snowmelt is propose	d.

17.96.060.I.1 – Landscaping	Conformance
Landscaping is required for all projects.	YES

**Finding**: The development proposes landscaping for the project as shown on the project plans including landscape planter beds and street trees.

17.96.060.I.2 – Landscaping	Conformance
Landscape materials and vegetation types specified shall be readily adaptable to a	YES
site's microclimate, soil conditions, orientation and aspect, and shall serve to enhance	
and complement the neighborhood and townscape.	

**Finding**: The landscape plan includes street trees and planter boxes with low lying shrubs and tall grasses, primarily on the west and south facing sides of the building. The landscape plan adds interest to the street by providing autumn blaze maples which are vibrant during the fall. These vegetation types are found in many areas of the community core including 4<sup>th</sup> Street, Sun Valley Rd, and East Ave. Having similar streetscape throughout the community core provides visitors with a sense of place reinforcing where they are in the community.

17.96.060.I.3 – Landscaping	Conformance
All trees, shrubs, grasses and perennials shall be drought tolerant. Native species are recommended but not required.	YES
Finding: All proposed plantings are drought tolerant and common for the area.	

Landscaping shall provide a substantial buffer between land uses, including, but not	
limited to, structures, streets and parking lots. The development of landscaped public courtyards, including trees and shrubs where appropriate, shall be encouraged.	YES

**Finding**: The proposed land uses are complimentary to the surrounding area, therefore substantial buffer between the proposed development and surrounding properties is not encouraged. The development does not

include any surface parking lots that need screening with vegetation. The building is setback 5 feet from the property boundary which expands the pedestrian realm. This area is where the landscape planters are proposed which enhances the pedestrian experience and creates a softening of the building.

Conformance
YES

**Finding**: The development proposes street trees which have been approved by the Public Works Director. Trash receptacles, benches, and bike racks are proposed on the subject property, not within the right-of-way.

17.96.060.K.1 – Underground Encroachments	Conformance
Encroachments of below grade structures into required setbacks are subject to subsection 17.128.020.K of this title and shall not conflict with any applicable easements, existing underground structures, sensitive ecological areas, soil stability, drainage, other sections of this Code or other regulating codes such as adopted International Code Council Codes, or other site features concerning health, safety, and welfare.	N/A

**Finding**: As noted in 17.128.020.G, the provisions of 17.128.020.K do not apply to the Community Core district of which the subject property is located. Therefore, this standard is not applicable.

17.96.060.K.2 – Underground Encroachments	Conformance
No below grade structure shall be permitted to encroach into the riparian setback.	N/A

**Finding**: The subject property is not adjacent to any bodies of water; therefore, no riparian setback exists for the property.

### FINDINGS REGARDING DESIGN REVIEW STANDARDS - COMMUNITY CORE

17.96.070.A.1 – Streets	Conformance
Street trees, streetlights, street furnishings, and all other street improvements shall be	YES
installed or constructed as determined by the Public Works Department.	Condition #3

**Finding**: The development includes benches, bike racks, and trash receptacles on the subject property. Within the right-of-way, the development proposes street trees along N Leadville Ave and 2<sup>nd</sup> Street, snowmelt sidewalks, a new fire hydrant, and three streetlights. Final review and approval of all right-of-way improvements will be conducted at the time of building permit review per condition #3.

17.96.070.A.2 – Streets	Conformance
Street trees with a minimum caliper size of three inches, shall be placed in tree grates.	YES

**Finding**: As shown in the project plans, street trees proposed are 3" caliper, include tree grates, and will be installed using Silva Cell installation requirements.

17.96.070.A.3 – Streets	Conformance
Due to site constraints, the requirements of this subsection A may be modified by the Public Works Department.	YES

**Finding**: No modifications to these requirements have been made. The Public Works Department has provided directions as to the location of improvements in the right-of-way.

17.96.070.B.1 - Architectural	Conformance
Facades facing a street or alley or located more than five feet from an interior side property line shall be designed with both solid surfaces and window openings to avoid the creation of blank walls and employ similar architectural elements, materials, and colors as the front facade.	YES

**Finding**: As outlined above, the development employs a variety of architectural materials and features to avoid the creation of blank walls and reduce bulk and mass. The only wall with limited undulation and material variation is the north façade which is located on an interior lot line but not set back more than 5 feet. As shown on Sheet A4.4, the development proposes horizontal brick banding, indentions of the wall façade to create "bricked in" windows, wrapping of ground floor architectural materials, and a vertical trellis with climbing vines. All of these treatments serve to avoid the creation of blank walls and are consistent with the other materials and treatments of the front façade.

17.96.070.B.2 - Architectural	Conformance
For nonresidential portions of buildings, front building facades and facades fronting a	YES
pedestrian walkway shall be designed with ground floor storefront windows and doors	
with clear transparent glass. Landscaping planters shall be incorporated into facades	
fronting pedestrian walkways.	

**Finding**: The development includes ground floor retail that fronts N Leadville Ave and 2<sup>nd</sup> Street. The building includes significant storefront windows on the N Leadville Ave frontage that wrap around the first half of the building on the 2<sup>nd</sup> Street side. One landscape planter is located on N Leadville Ave with two more on 2<sup>nd</sup> Street.

17.96.070.B.3 - Architectural	Conformance
For nonresidential portions of buildings, front facades shall be designed to not obscure views into windows.	YES

**Finding**: The development does not include features that would obscure views into windows. On the N Leadville side of the building, the landscape planter includes low lying shrubs and grasses as an accent to the windows rather than an obstruction.

17.96.070.B.4 - Architectural	Conformance
Roofing forms and materials shall be compatible with the overall style and character of the structure. Reflective materials are prohibited.	YES

**Finding**: The roof form and material is like that of the rest of the building. The roof form is flat, compatible with the horizontal cantilevered decks. The roof soffit is proposed to be a lighter color wood siding which will be a nice complement to the lighter tones in the brick. No reflective materials are proposed.

17.96.070.B.5 - Architectural	Conformance
All pitched roofs shall be designed to sufficiently hold all snow with snow clips, gutters, and downspouts.	N/A
Finding: The project does not include pitched roofs.	•

17.96.070.B.6 - Architectural	Conformance
Roof overhangs shall not extend more than three feet over a public sidewalk. Roof overhangs that extend over the public sidewalk shall be approved by the Public Works Department.	N/A
Finding: Roof overhangs are not proposed to encroach into the public right-of-way or over the sidewalk.	

17.96.070.B.7 - Architectural	Conformance
Front porches and stoops shall not be enclosed on the ground floor by permanent or temporary walls, windows, window screens, or plastic or fabric materials.	YES

**Finding**: The building does not have a traditional front porch or stoop, however, due to the topography of the site, the finished floor of the building is slightly higher than the sidewalk on the N Leadville Ave side, creating a stepped entrance to the building that somewhat functions like a stoop. The stepped-up area is not enclosed by any walls, fences, or other screening materials.

17.96.070.C.1 – Service Areas and Mechanical/Electrical Equipment	Conformance
Trash disposal areas and shipping and receiving areas shall be located within parking	YES
garages or to the rear of buildings. Trash disposal areas shall not be located within the	
public right-of-way and shall be screened from public views.	

**Finding**: The trash disposal area for the project is located in the rear of the building within a fully enclosed portion of the building not visible by the public. The dumpster is located on an automatic roller which enters the alley during trash servicing and retracts to its original location within the building once the servicing is complete.

17.96.070.C.2 – Service Areas and Mechanical/Electrical Equipment	Conformance
Roof and ground mounted mechanical and electrical equipment shall be fully screened	YES
from public view. Screening shall be compatible with the overall building design.	Condition #5

**Finding**: As shown on the project plans, the roof mounted mechanical equipment and solar panels are setback from the roof parapet as required by the Ketchum Municipal Code. Mechanical equipment on the roof will be screened with a 5-foot max perforated metal screen. The same screen is proposed to screen the ground mounted transformer at the rear of the property on 2<sup>nd</sup> Street at the alley. As shown on Sheet A0.1, a single-phase transformer is located on the southeast corner of the property adjacent to the alley and the pedestrian sidewalk along 2<sup>nd</sup> Street. The transformer is proposed to be screened with perforated metal paneling and landscaping as shown on the sheet. The Idaho Power will serve letter is dated October 24, 2022 and references a previous version of the site plan. As outlined in condition of approval #5, an updated service letter from Idaho Power shall be provided with the building permit application to ensure all screening and access is adequate. Any changes in transformer size and location may require an amendment to the design review approval. As conditioned, this standard is met.

17.96.070.D.1 - Landscaping	Conformance
When a healthy and mature tree is removed from a site, it shall be replaced with a new tree. Replacement trees may occur on or off site.	N/A
<b>Finding</b> : No trees exist on the subject property therefore replacement trees are not required.	

17.96.070.D.2 - Landscaping	Conformance
Trees that are placed within a courtyard, plaza, or pedestrian walkway shall be placed within tree wells that are covered by tree grates.	YES
<b>Finding</b> : All street trees proposed are within tree grates and must be installed using Silva requirements.	Cell installation

17.96.070.D.3 - Landscaping	Conformance
The City arborist shall approve all parking lot and replacement trees.	N/A
<b>Finding</b> : No replacement trees or parking lot trees are proposed for the development the does not apply.	refore this standard

17.96.070.E.1 – Surface Parking Lots	Conformance
Surface parking lots shall be accessed from off the alley and shall be fully screened from the street.	N/A
Finding: The development does not propose surface parking lots therefore this standard	does not apply.

17.96.070.E.2 – Surface Parking Lots	Conformance
Surface parking lots shall incorporate at least one tree and one additional tree per ten	N/A
on-site parking spaces. Trees shall be planted in landscaped planters, tree wells	
and/or diamond shaped planter boxes located between parking rows. Planter boxes	
shall be designed so as not to impair vision or site distance of the traveling public.	
<b>Finding</b> : The development does not propose surface parking lots therefore this standard	does not apply.

17.96.070.E.3 – Surface Parking Lots	Conformance
Ground cover, low lying shrubs, and trees shall be planted within the planters and planter boxes. Tree grates or landscaping may be used in tree wells located within pedestrian walkways.	N/A

17.96.070.F.1 – Bicycle Parking	Conformance
One bicycle rack, able to accommodate at least two bicycles, shall be provided for every four parking spaces as required by the proposed use. At a minimum, one bicycle rack shall be required per development.	YES

**Finding**: As shown on the project plans, one bicycle rack is proposed between the entrance to the basement residential unit and the main entrance to the building on 2<sup>nd</sup> Street.

17.96.070.F.2 – Bicycle Parking	Conformance
When the calculation of the required number of bicycle racks called for in this section results in a fractional number, a fraction equal to or greater than one-half shall be adjusted to the next highest whole number.	YES

**Finding**: The development requires four parking spaces, therefore only one bicycle rack is required. The required bicycle rack is provided between the entrance to the basement residential unit and the main entrance to the building on  $2^{nd}$  Street.

17.96.070.F.3 – Bicycle Parking	Conformance
Bicycle racks shall be clearly visible from the building entrance they serve and not mounted less than 50 feet from said entrance or as close as the nearest non-ADA parking space, whichever is closest. Bicycle racks shall be located to achieve unobstructed access from the public right-of-way and not in areas requiring access via stairways or other major obstacles.	YES

**Finding**: The required bicycle rack is provided between the entrance to the basement residential unit and the main entrance to the building on 2<sup>nd</sup> Street. This location is clearly visible for most visitors to the building and within 50 feet of the entrance on the N Leadville Ave side of the building.

### **CONCLUSIONS OF LAW**

- 1. The City of Ketchum is a municipal corporation established in accordance with Article XII of the Constitution of the State of Idaho and Title 50 Idaho Code and is required and has exercised its authority pursuant to the Local Land Use Planning Act codified at Chapter 65 of Title 67 Idaho Code and pursuant to Chapters 3, 9 and 13 of Title 50 Idaho Code to enact the ordinances and regulations, which ordinances are codified in the Ketchum Municipal Code ("KMC") and are identified in the Findings of Fact and which are herein restated as Conclusions of Law by this reference and which City Ordinances govern the applicant's Design Review application for the development and use of the project site.
- 2. The Commission has authority to hear the applicant's Design Review Application pursuant to Chapter 17.96 of Ketchum Municipal Code Title 17.
- 3. The City of Ketchum Planning Department provided notice for the review of this application in accordance with Ketchum Municipal Code §17.96.080.
- 4. The Design Review application is governed under Ketchum Municipal Code Chapters 17.96, 17.124, 17.08, 17.12, 17.18, and 17.128.
- 5. The Design Review application meets all applicable standards specified in Title 17 of Ketchum Municipal Code.

### **DECISION**

**THEREFORE,** the Commission **approves** this Design Review Application File No. P22-035 this Tuesday, April 11, 2023, subject to the following conditions of approval.

### **CONDITIONS OF APPROVAL**

- This Design Review approval is based on the architectural plan set presented at the February 28, 2023 Planning and Zoning Commission meeting, included as Exhibit A to these findings. Building Permit Plans must conform to the approved Design Review plans unless otherwise approved in writing by the Commission or the Planning and Zoning Administrator. Any building or site discrepancies which do not conform to the approved plans will be subject to removal.
- 2. The Civil and Landscape Drawings included in Exhibit B are preliminary only and must be revised to match the approved design review plan set prior to building permit application.
- 3. Final civil drawings prepared by an engineer registered in the State of Idaho which include specifications for right-of-way, utilities, and drainage improvements shall be submitted for review and approval by the City Engineer, Streets, and Utilities departments prior to issuance of a building permit for the project.

- 4. Final landscape drawings shall be submitted for review and approval by the Planning and Building, City Engineer, Streets, and Utilities departments prior to issuance of a building permit for the project.
- 5. A letter from Idaho Power confirming the final transformer size, location, and approval of the proposed screening and landscaping shall be submitted with the building permit application. Any changes in the size, location, or screening constitute an amendment to the design review and must be reviewed and approved by the Administrator or the Commission per the requirements of Chapter 17.96 *Design Review*.
- 6. Prior to issuance of a building permit for the project, the City Council shall review and approve an encroachment agreement for the installation and maintenance of the paver sidewalk and snowmelt within the public rights-of-way.
- 7. In exchange for an increase in FAR, a voluntary community housing contribution of 910 square feet is required. Payment-in-lieu contributions for community housing are required prior to issuance of a building permit for the project.
- 8. Prior to issuance of a building permit for the project, an Encroachment Agreement shall be approved by the City Council addressing the paver sidewalks and snowmelt within the right-of-way.
- 9. The term of Design Review approval shall be twelve (12) months from the date that the Findings of Fact, Conclusions of Law, and Decision are adopted by the Commission or upon appeal, the date the approval is granted by the Council subject to changes in zoning regulations.
- 10. In addition to the requirements set forth in this Design Review approval, this project shall comply with all applicable local, state, and federal laws.

Findings of Fact adopted this 11th day of April 2023.

Neil Morrow, Chair City of Ketchum Planning and Zoning Commission



# Exhibit A: 200 N Leadville Ave - Design Review Plan Set

# **THE 208**



NOTE: 3D RENDERINGS ARE FOR ILLUSTRATIVE PURPOSES ONLY. NOT TO BE USED FOR CONSTRUCTION.

**ZONING REQUIREMENTS** 

JURISDICTION: CITY OF KETCHUM, ID

CC COMMUNITY CORE, **ZONING:** SUBDISTRICT 2-MIXED USE

RPK00000230010 PARCEL ASSESSOR'S #:

**LOT SIZE:** 5,504 SF = 0.13 ACRE

**LEGAL DESCRIPTION:** 

LOT 1, BLOCK 23 OF THE VILLAGE OF KETCHUM, BLAINE COUNTY, IDAHO, ACCORDING TO THE OFFICIAL PLAT THEREOF, RECORDED AS INSTRUMENT NO. 302967, RECORDS OF BLAINE COUNTY, IDAHO.

MAX. FAR: 2.25 WITH INCLUSIONARY HOUSING INCENTIVE -REFER TO SHEET A0.3 MAX. BUILDING COVERAGE: 75% (SF)

**SETBACKS:** 

5' AVERAGE -FRONT AND STREET SIDE -ADJACENT TO ALLEYWAY -NON-HABITABLE STRUCTURES

**CODE INFORMATION** 

LOCATED ON BUILDING ROOF-TOPS

MAX. HEIGHT: 42' ABOVE ABE

ALL MATERIALS, WORKMANSHIP, DESIGN AND CONSTRUCTION SHALL CONFORM TO THE DRAWINGS, SPECIFICATIONS, AND THE FOLLOWING APPLICABLE CODES USED IN THIS DESIGN FOR CITY OF KETCHUM.

2018 INTERNATIONAL BUILDING CODE (IBC)

2018 INTERNATIONAL FIRE CODE -INCLUDING AMENDMENTS PER KETCHUM ORDINANCE

2018 INTERNATIONAL ENERGY CONSERVATION CODE (IECC) -INCLUDING AMENDMENTS BY THE IDAHO BUILDING CODE BOARD

2018 INTERNATIONAL FIRE CODE (IFC) -INCLUDING ADMENDMENTS PER KETCHUM ORDINANCE

2018 CITY OF KETCHUM MUNICIPAL CODE

-INCLUDING KETCHUM GREEN BUILDING CODE 2018 INTERNATIONAL FUEL GAS CODE (IFGC)

2018 INTERNATIONAL MECHANICAL CODE (IMC)

2018 NATIONAL ELECTRIC CODE (NEC) 2018 IDAHO STATE PLUMBIONG CODE (ISPC)

# **ACCESSIBLE UNITS**

PROJECT CONTAINS (4) UNITS TOTAL: (3)TYPE B UNITS PROVIDED, PER IBC CHAPTER 11

PARKING: RETAIL:

EXEMPT LESS THAN 5,500 SF 0 SPACES **RESIDENTIAL:** 4 SPACES

### **DESIGN REVIEW APPLICATION REQUIREMENTS**

TITLE 17 - CHAPTER 17.96 DESIGN REVIEW:

17.96.040.C.2.f: FLOOR PLAN. LIST GROSS AND NET SQUARE FOOTAGE FOR EACH FLOOR. LIST OCCUPANCY CLASSIFICATION AND TYPE OF CONSTRUCTION.

OCCUPANCY CLASSIFICATION:

M MERCANTILE (RETAIL AREAS)

R-2 RESIDENTIAL S-2 PARKING AREAS

**TYPE OF CONSTRUCTION:** 

NOTE: METHOD FOR MEASURING FLOOR AREA (GROSS) PER CHAPTER 17.08

ARE NOT INCLUDED IN THE GROSS FLOOR AREA CALCULATION.

**DEFINITIONS:** THE SUM OF HORIZONTAL AREA OF THE BUILDING MEASURED ALONG THE OUTSIDE WALLS OF EACH FLOOR OF A BUILDING OR PORTION OF A BUILDING, INCLUDING STAIR TOWERS AND ELEVATORS ON THE GROUND FLOOR ONLY, AND 50 PERCENT OF ATRIUMS OVER 18 FEET PLATE HEIGHT, BUT NOT INCLUDING BASEMENTS, UNDERGROUND PARKING AREAS OR OPEN UNENCLOSED DECKS. PARKING AREAS COVERED BY A ROOF OR PORTION OF THE BUILDING AND ENCLOSED ON THREE OR MORE SIDES BY BUILDING WALLS ARE INCLUDED. FOUR PARKING STALLS FOR DEVELOPMENTS ON SINGLE KETCHUM TOWN SITE LOTS OF 5,600 SF IN SIZE OR LESS

NOTE: METHOD FOR MEASURING FLOOR AREA (NET) PER CHAPTER 17.08 DEFINITIONS: THE SUM OF HORIZONTAL AREAS OF ALL FLOORS IN A BUILDING INCLUDING BASEMENTS BUT NOT INCLUDING OPEN UNENCLOSED DECKS. INTERIOR OR EXTERIOR CIRCULATION, MECHANICAL EQUIPMENT ROOMS, PARKING AREAS, COMMON AREAS, PUBLIC BATHROOMS OR STORAGE AREAS IN BASEMENTS.

**PROJECT** NEW CONSTRUCTION OF **DESCRIPTION:** MIXED USE AND COMMERCIAL BUILDING

ARCHITECT:

SHERMAN, JONATHAN

317 N. RIVER STREET

LYON LANDSCAPE ARCHITECTS LANDSCAPE ARCHITECT:

P:253.209.4053

**CONRAD BROTHERS** 

P:208.309.1200

**ELECTRICAL** ABOSSEIN ENGINEERING **ENGINEER:** 

P:425.462.9441

BOISE, IDAHO 83704

DESIGNER:

2667 SOUTH TACOMA WAY TACOMA, WA 98409

E:MIKEC@PERFORMANCERADIATOR.COM

P: 208.726.0194

**EXECUTIVE DESIGN SERVICES** 

FRIDAY HARBOR, WA 98250

P:206.383.4526

GALENA ENGINEERING, INC CIVIL ENGINEER: SURVEYOR:

HAILEY, IDAHO 83333

E:MOGHAN@LYONLA.COM

CONTRACTOR: 105 LEWIS ST SUITE 101

18465 NE 68TH STREET #22

E:CSERVICE@ABOSSEIN.COM

KETCHUM 2995 N COLE RD SUITE 115

P:208.609.3722 CONSULTANT: E:CARSON@MHLIGHTING.COM

**GRID LINES** 

PROJECT BASE POINT

PROPERTY CORNER

PROPERTY LINE

CENTER LINE

N 90 00' 00" E

Distance

〈4 A1.0

REFERENCE ELEVATION

TOP OF WALL ELEVATION

PROPERTY LINE TAG

SECTIONS FOUND

DETAIL SECTION FOUND

INTERIOR ELEVATION

FOUND ON SHEET A1.0

ON SHEET A101

ON SHEET A101

EXIT DIRECTION

SMOKE DETECTOR

SMOKE & CARBON

DOOR TAG NUMBER

10'-0"x12'-0" DOOR SIZE

MONOXIDE DETECTOR

WINDOWS TAG NUMBER

DRAWING REVISION

WALL TAG ASSEMBLY

WHOLE HOUSE FAN

# **PROJECT DATA**

OWNER: MICHAEL, CARR

P:206.423.3121

MEDICI ARCHITECTS

200 WEST RIVER STREET #301 KETCHUM, ID 83340

E: EMILY@MEDICIARCHITECTS.COM

E:JONATHANDESIGN0007@GMAIL.COM

HAILEY, IDAHO 83333 P: 208.788.1705

E:GALENA@GALENA-ENGINEERING.COM

126 SOUTH MAIN STREET, SUITE B1

KETCHUM, IDAHO 83340

E:PAUL@CONRADBROTHERSCONSTRUCTION.COM

REDMOND, WA 98052

CITY OF THE MH COMPANIES


LIGHTING

PROJECT LOCATION

**VICINITY MAP** 

1/4" = 1'-0"

MEDICI ARCHITECTS 11661 SE 1ST STREET, SUITE 200 BELLEVUE, WASHINGTON 98005 TEL: (425) 453-9298 FAX: (425) 452-8448 **REGISTRATION:** 

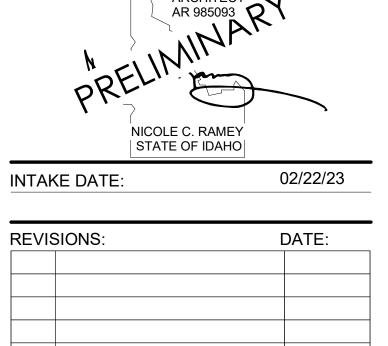

PROJECT / CLIENT:

THE 208 BUILDING

CARR, MICHAEL

JOB ADDRESS: 200 N LEADVILLE KETCHUM IDAHO, 83340 PARCEL #RPK00000230010

### SYMBOL LEGEND EXISTING WALL

2X WALLS

**FOUNDATION WALL** 

CONCRETE SURFACE

CAST IN PLACE

STRUCTURAL POST

SIZE AND TYPE PER

STRUCTURAL PLAN

CONCRETE

GAS OUTLET

**GAS METER** 

HOSE BIB

DOWNSPOUT

**ELECTRICAL METER** 

ELECTRICAL PANEL

COMPACTED FILL

RIGID OR SPRAY

**BIBS BLOWN-IN** 

BATT INSULATION

VENT TO OUTSIDE

WATER METER

**ELEVATION CHANGE** 

STEP DOWN /

**KEY NOTES** 

EXHAUST FAN

INSULATION

INSULATION

UNDISTURBED EARTH



BLK BLOCK BS BOTH SIDES BLDG BUILDING CAB CABINET CB CATCH BASIN CLG CEILING

CLR CLEAR CL CLOSET CONC CONCRETE CMU CONCRETE MASONRY UNIT CONT CONTINUOUS

CJ CONTROL JOINT CPT CARPET CSMT CASEMENT CF CUBIC FOOT

DIA DIAMETER DBH DIAMETER BREAST HEIGHT DIM DIMENSION DW DISHWASHER DOUBLE HUNG

DOWN DOWNSPOUT DRYER EA EACH ELEC ELECTRICAL EP ELECTRICAL PANEL

ELEV ELEVATOR EQ EQUAL EXT EXTERIOR EXIST EXISTING FFE FINISH FLOOR ELEVATION FRD FIRE RATE DOOR FRW FIRE RATE WINDOW FXD FIXED FIXT FIXTURE

FAR FLOOR AREA RATIO FTG FOOTING FAU FORCED AIR UNIT FDN FOUNDATION FURN FURNACE GFA GROSS FLOOR AREA HDWD HARDWOOD HDR HEADER HVAC HEATING, VENTILATION & A/C

HORZ HORIZONTAL HR HOUR INCL INCLUDE (ED)(ING) INT INTERIOR LED LIGHT EMITTING DIODE LOD LIMIT OF DISTURBANCE LF LINEAR FEET MANUF MANUFACTURER MAX MAXIMUM

HT HEIGHT

MECH MECHANICAL MED MEDIUM MIN MINIMUM MISC MISCELLANEOUS NIC NOT IN CONTRACT NTS NOT TO SCALE NO NUMBER

OC ON CENTER

PERF PERFORATED

# AFF ABOVE FINISH FLOOR

**ABBREVIATIONS** 

PICT PICTURE PLAM PLASTIC LAMINATE PSF POUNDS PER SQUARE FOOT PSI POUNDS PER SQUARE INCH PL PROPERTY LINE PNA PROTECTED NATURAL AREA QTY QUANTITY

REF REFRIGERATOR REQ'D REQUIRED REV REVISION R RISER RM ROOM RO ROUGH OPENING

SAFETY GLASS SIM SIMILAR SINGLE HUNG SOG SLAB ON GRADE SPEC SPECIFICATION SQUARE FOOT

SS STAINLESS STEEL STANDARD STD STEEL STOR STORAGE

SD STORM DRAIN SUP SUPPLEMENTAL TV TELEVISION TEMP TEMPORARY TOILET PAPER DISPENSER T&G TONGUE & GROOVE

TO TOP OF TOW TOP OF WALL TB TOWEL BAR TREAD TPZ TREE PROTECTION ZONE TYP TYPICAL

YD YARD

UNO UNLESS NOTED OTHERWISE VAPOR BARRIER VTOS VENT TO OUTSIDE VIF VERIFY IN FIELD VERT VERTICAL VG VERTICAL GRAIN WC WATER CLOSET

WH WATER HEATER WRB WATER RESISTANT BARRIER W WASHER WHF WHOLE HOUSE FAN WIN WINDOW W/ WITH W/O WITHOUT WP WATER PROOFING

> PHASE: CONSTRUCTION DRAWINGS

DRAWING NAME:

TITLE SHEET

Drawn By: MS

Checked By: NR

Owner Approval:


This drawing is the exclusive property of MEDICI ARCHITECTS, and can be reproduced only with the permission of the Architect. Variations and modifications to work shown on this drawing shall not be carried out without written permission from the Architect.


APPROVED FOR CONSTRUCTION:

PROJECT No.: A21-198


DATE: 2/22/2023

PLOT SCALE: 1:1

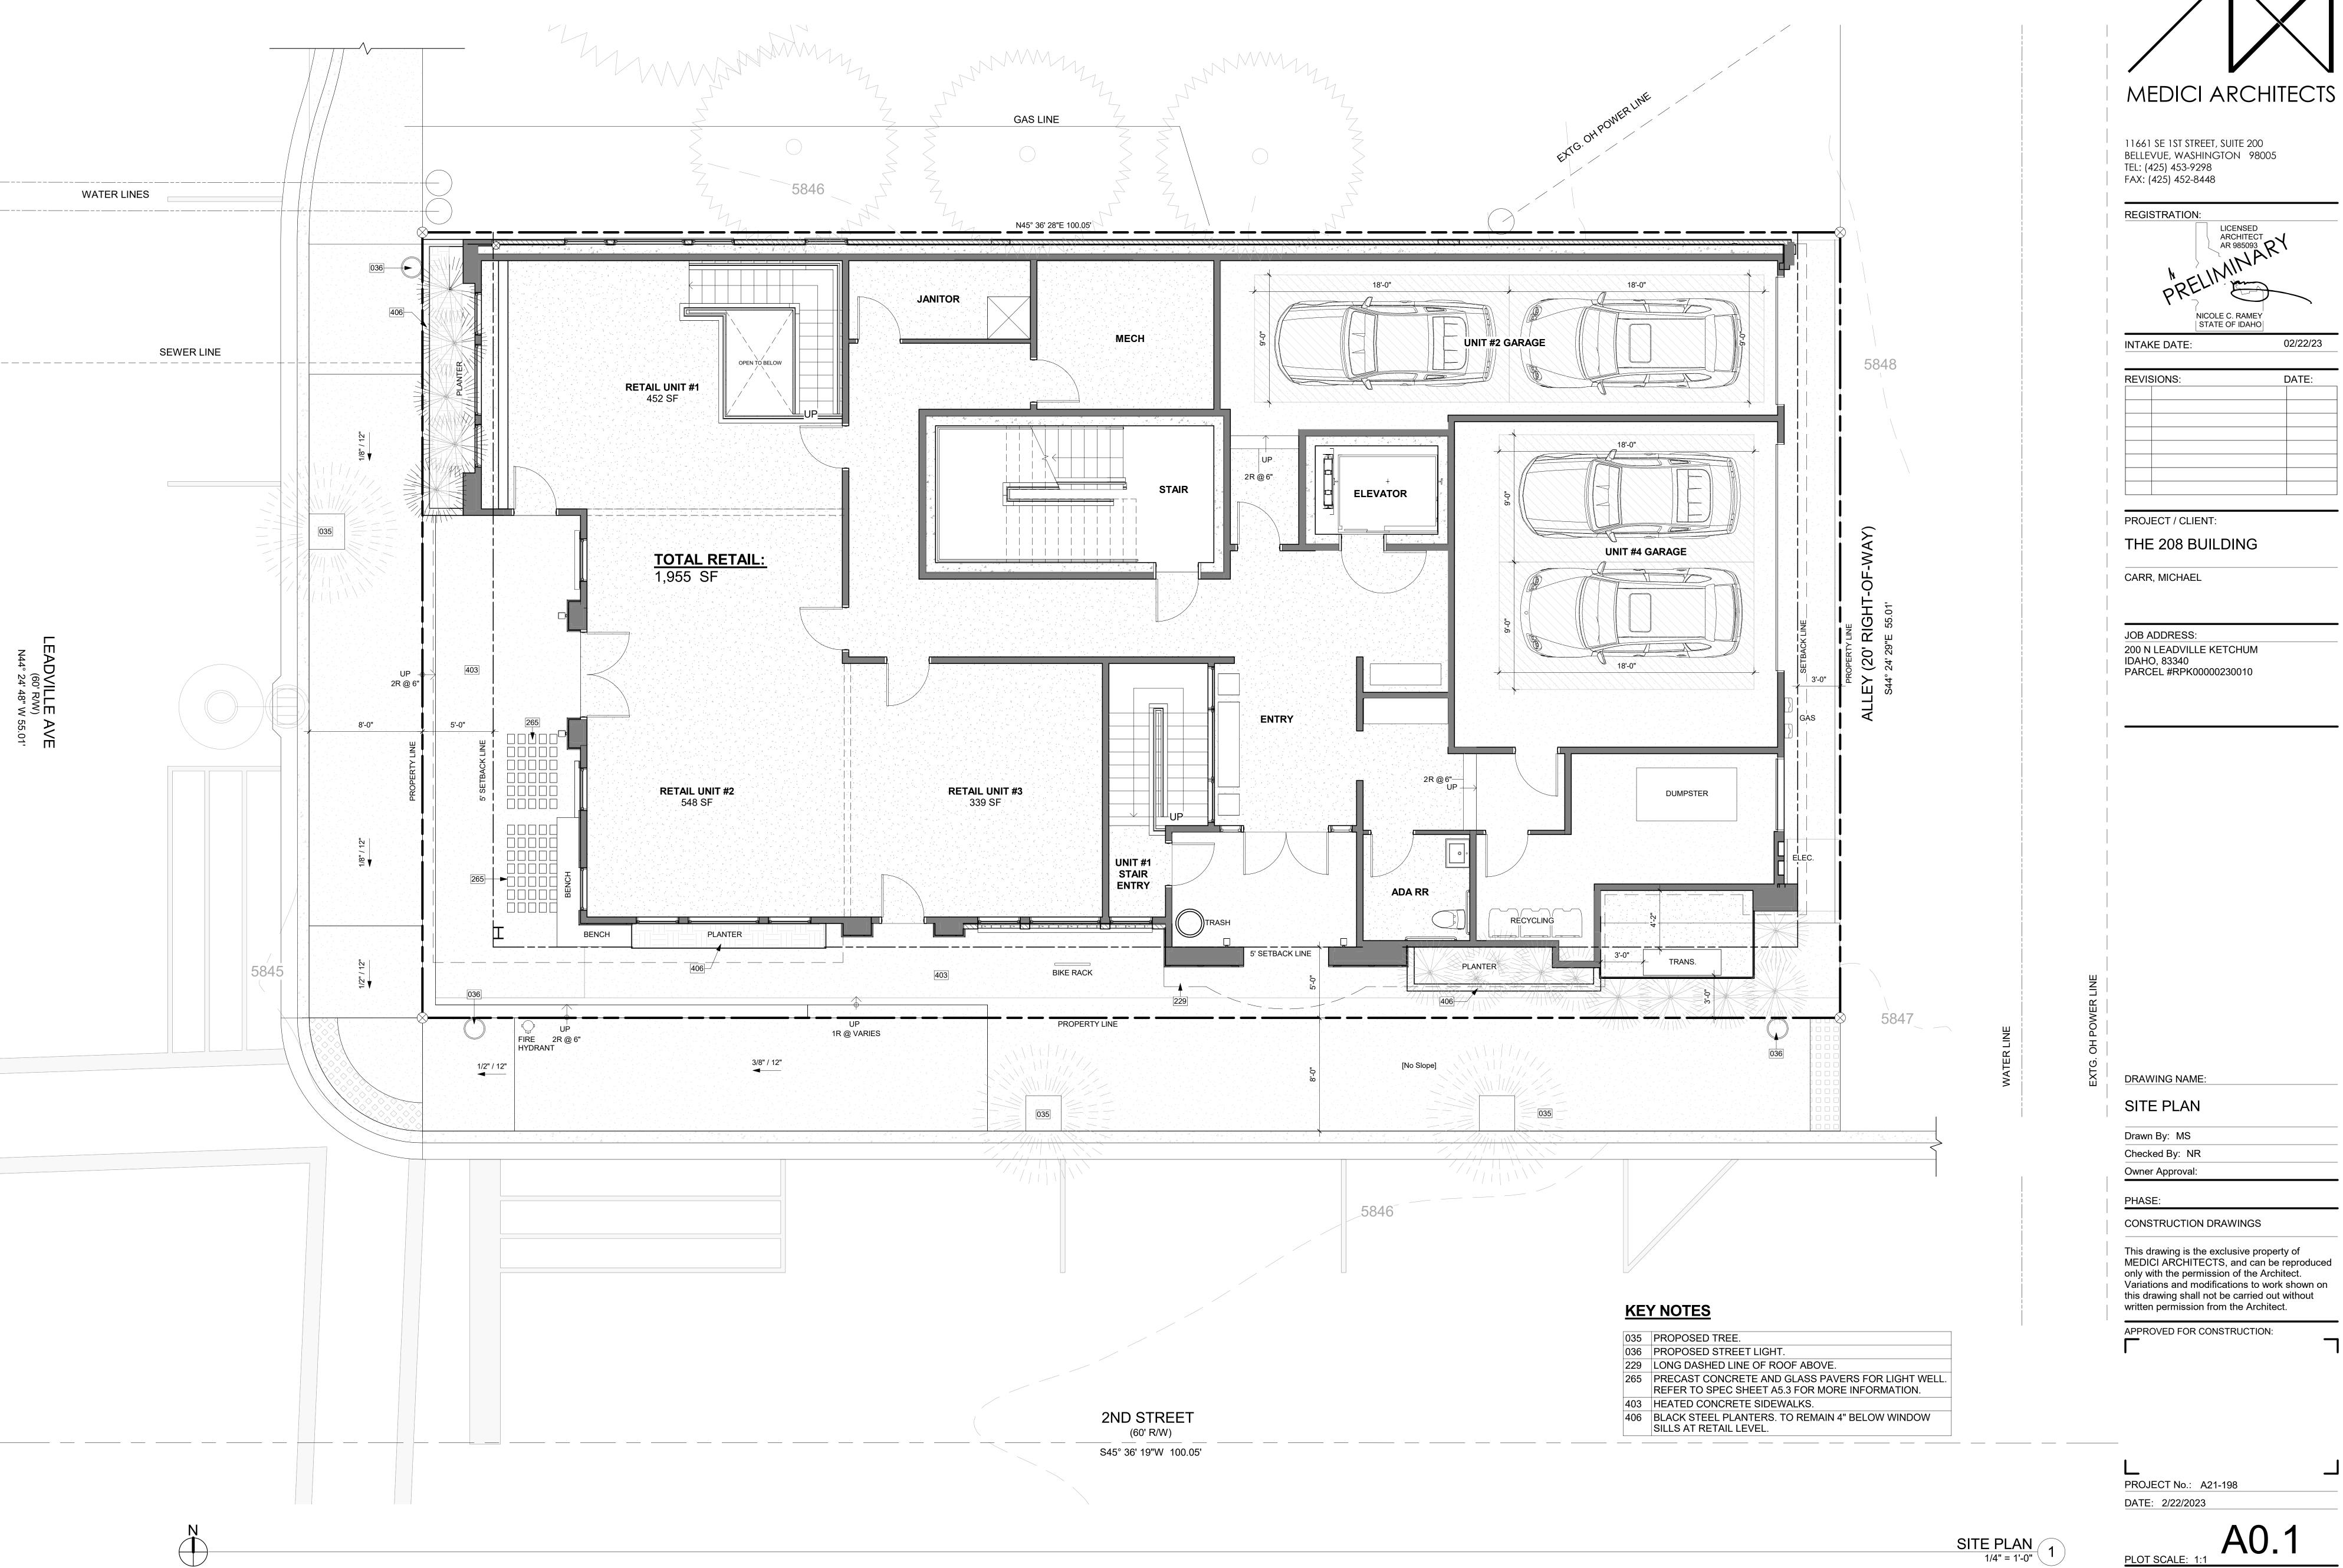

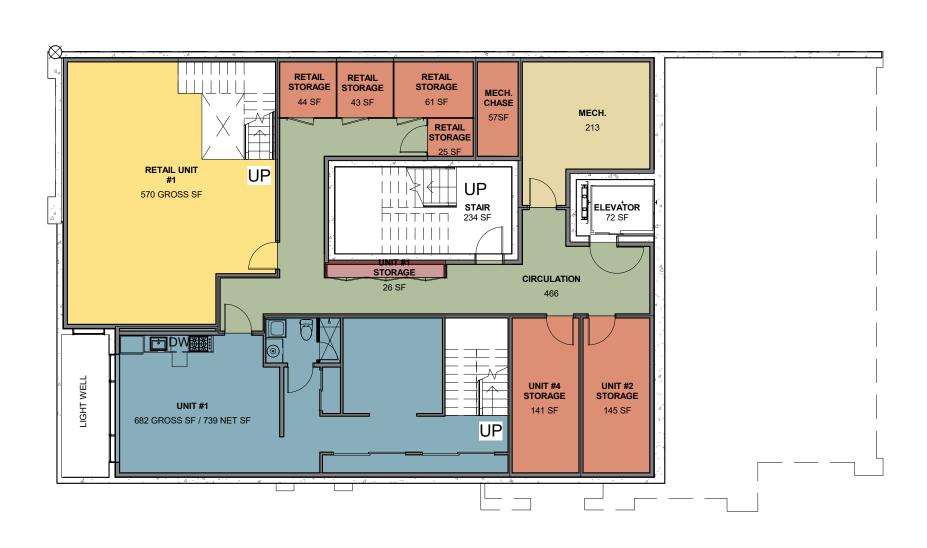



LOWER LEVEL PLAN 3/32" = 1'-0"

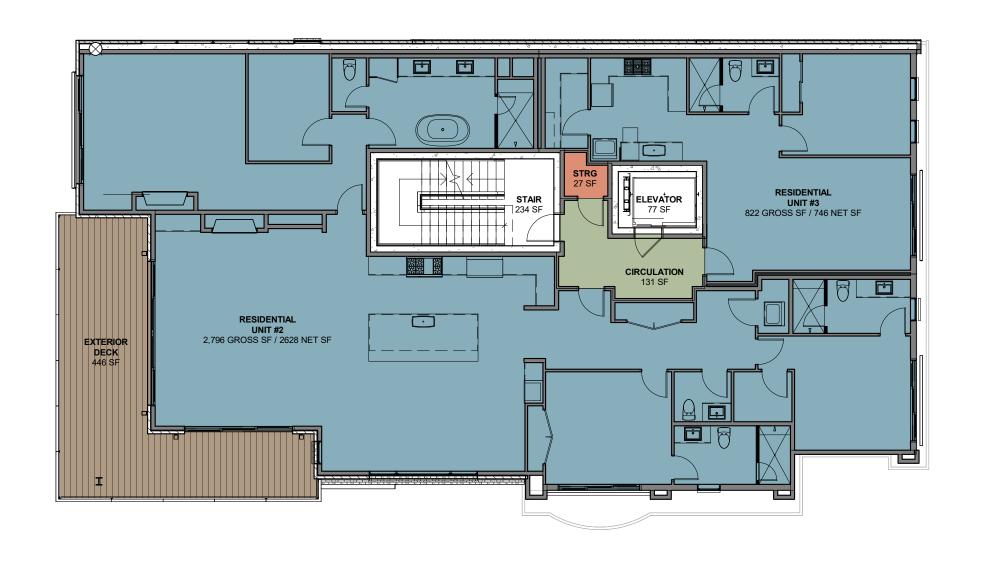


2ND FLOOR PLAN 3/32" = 1'-0"


3/32" = 1'-0"

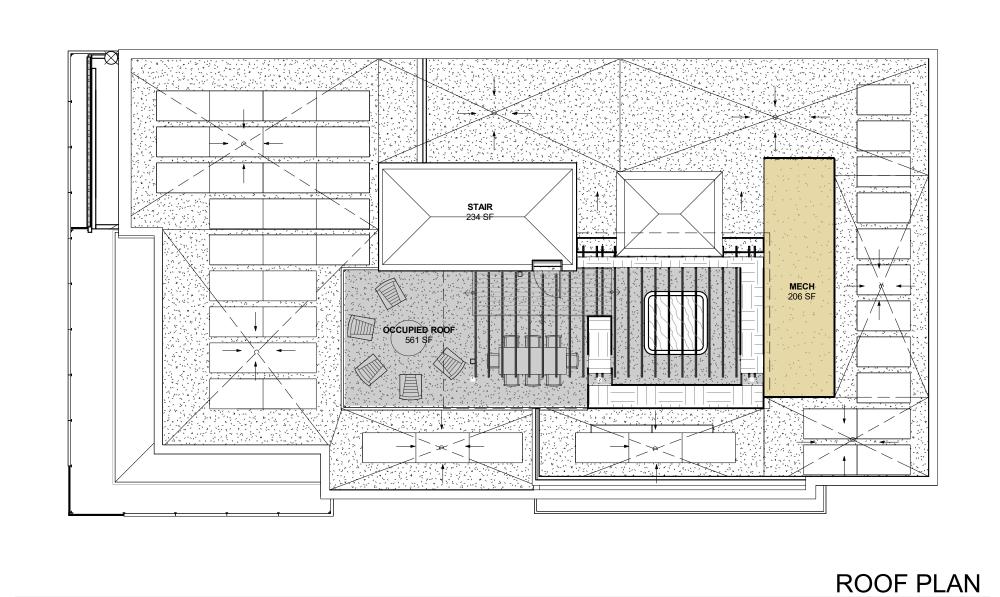

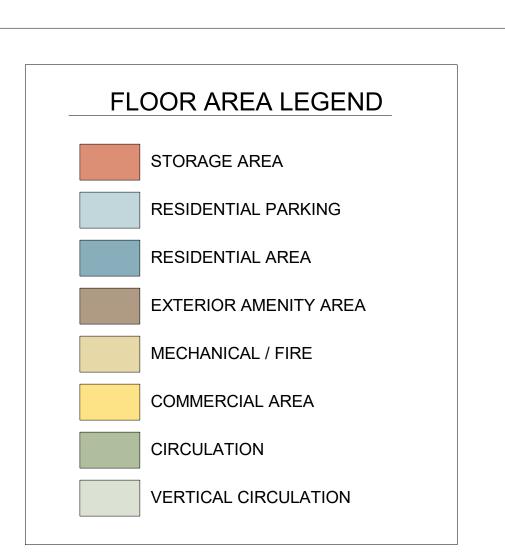

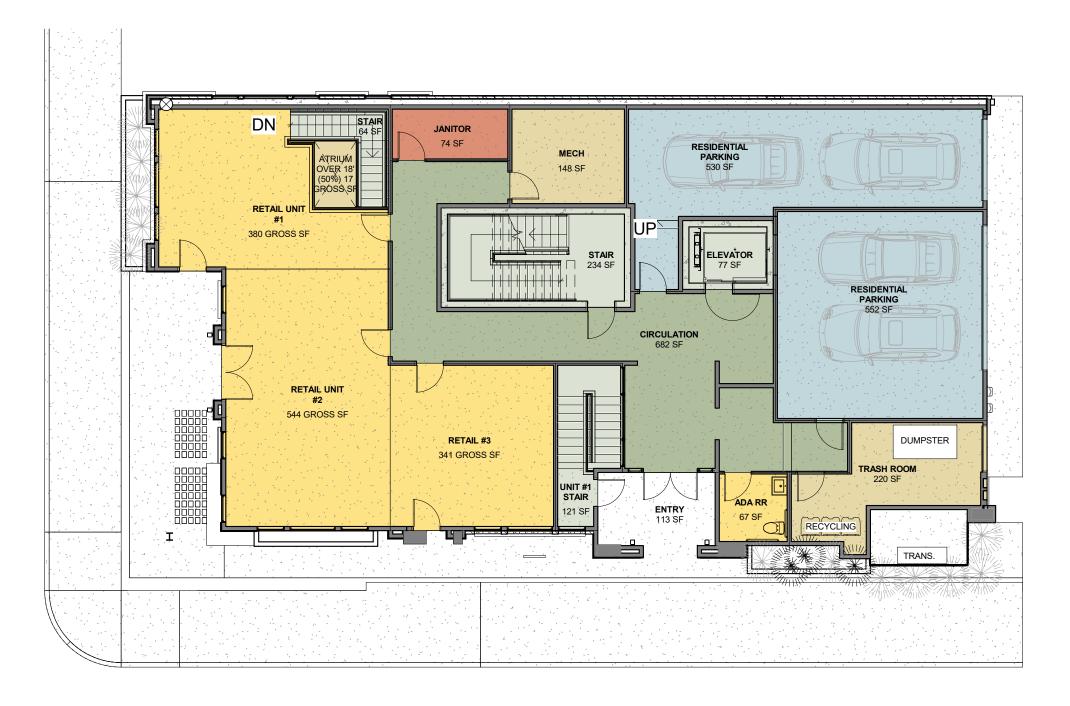


1ST FLOOR PLAN 3/32" = 1'-0"

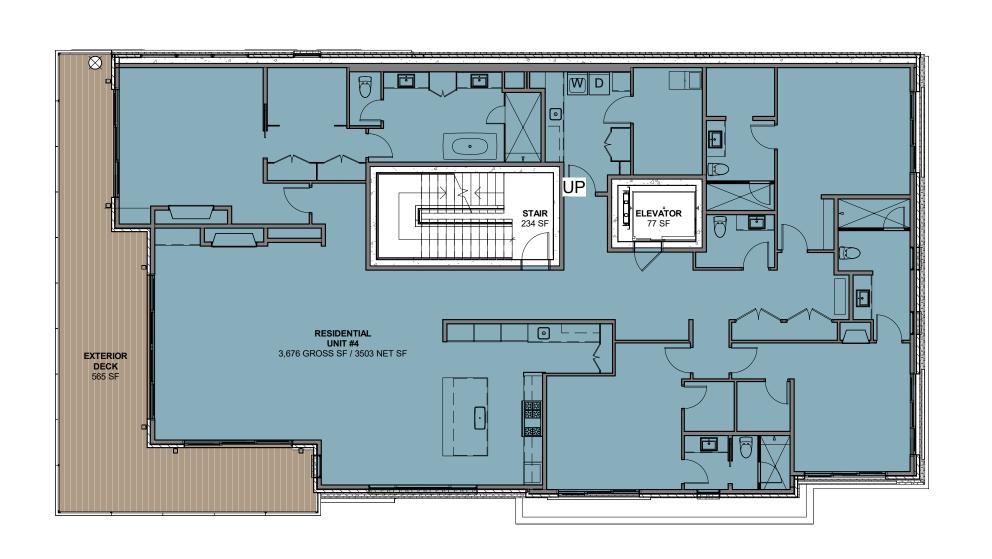

3RD FLOOR PLAN 3/32" = 1'-0"

	<b>BUILDING A</b>	REA SQUARE FO	OOTAGES	
FLOOR PLAN	AREA USE	GROSS AREA SF	NET AREA SF	EXCLUDED AREA
LOWER LEVEL	RESIDENTIAL UNIT #1	682 SF	639 SF	68
	STORAGE UNIT #4	141 SF		14
	STORAGE UNIT #1	26 SF		
	STORAGE UNIT #2	145 SF		14
	RETAIL UNIT #1	570 SF		5
	MECH / FIRE RISER ROOM	213 SF		2
	CIRCULATION	466 SF		46
	STAIR	234 SF		23
	ELEVATOR	72 SF		7
TOTALS	:	2549 SF	639 SF	254
FLOOR PLAN	AREA USE	GROSS AREA SF	NET AREA SF	EXCLUDED AREA
	RETAIL UNIT #1	380 SF		
	RETAIL UNIT #1 STAIR	121 SF		
	ATRIUM (50% over 18')	34 SF		
	RETAIL UNIT #2	544 SF		
	RETAIL UNIT #3	341 SF		
	RESTROOM	67 SF		
1ST FLOOR	RESIDENTIAL UNIT#1 STAIR	33 SF		
	RESIDENTIAL PARKING	530 SF		32
	RESIDENTIAL PARKING	552 SF		32
	JANITOR	74 SF		
	MECHANICAL	148 SF		
	CIRCULATION	682 SF		
	STAIR	234 SF		
	ELEVATOR	77 SF		
	TRASH ROOM	220 SF		
TOTALS	:	4069 SF	0 SF	66
FLOOR PLAN	AREA USE	GROSS AREA SF	NET AREA SF	EXCLUDED AREA
	RESIDENTIAL UNIT #2	2796 SF	2628 SF	
	RESIDENTIAL UNIT #3	822 SF	746 SF	
	STORAGE	27 SF		
2ND FLOOR	EXTERIOR DECK	446 SF		44
	CIRCULATION	131 SF		
	STAIR	234 SF		23
	ELEVATOR	77 SF		
TOTALS	:	4533 SF	3374 SF	7!
FLOOR PLAN	AREA USE	GROSS AREA SF	NET AREA SF	EXCLUDED AREA
	RESIDENTIAL UNIT #4	3676 SF	3503 SF	
3RD FLOOR	EXTERIOR DECK	565 SF		56
	STAIR	234 SF		23
	ELEVATOR	77 SF		
TOTALS	:	4552 SF	3503 SF	87
FLOOR PLAN	AREA USE	GROSS AREA SF	NET AREA SF	EXCLUDED AREA
	OCCUPIED ROOF	561 SF		56
ROOF DECK	MECHANICAL	206 SF		20
	STAIR	234 SF		23
TOTALS	:	1001 SF	0SF	10
		GROSS AREA SF	NET AREA SF	EXCLUDED AREA
TOTAL BUILDI	NC:	16,704 SF	7516 SF	5,84

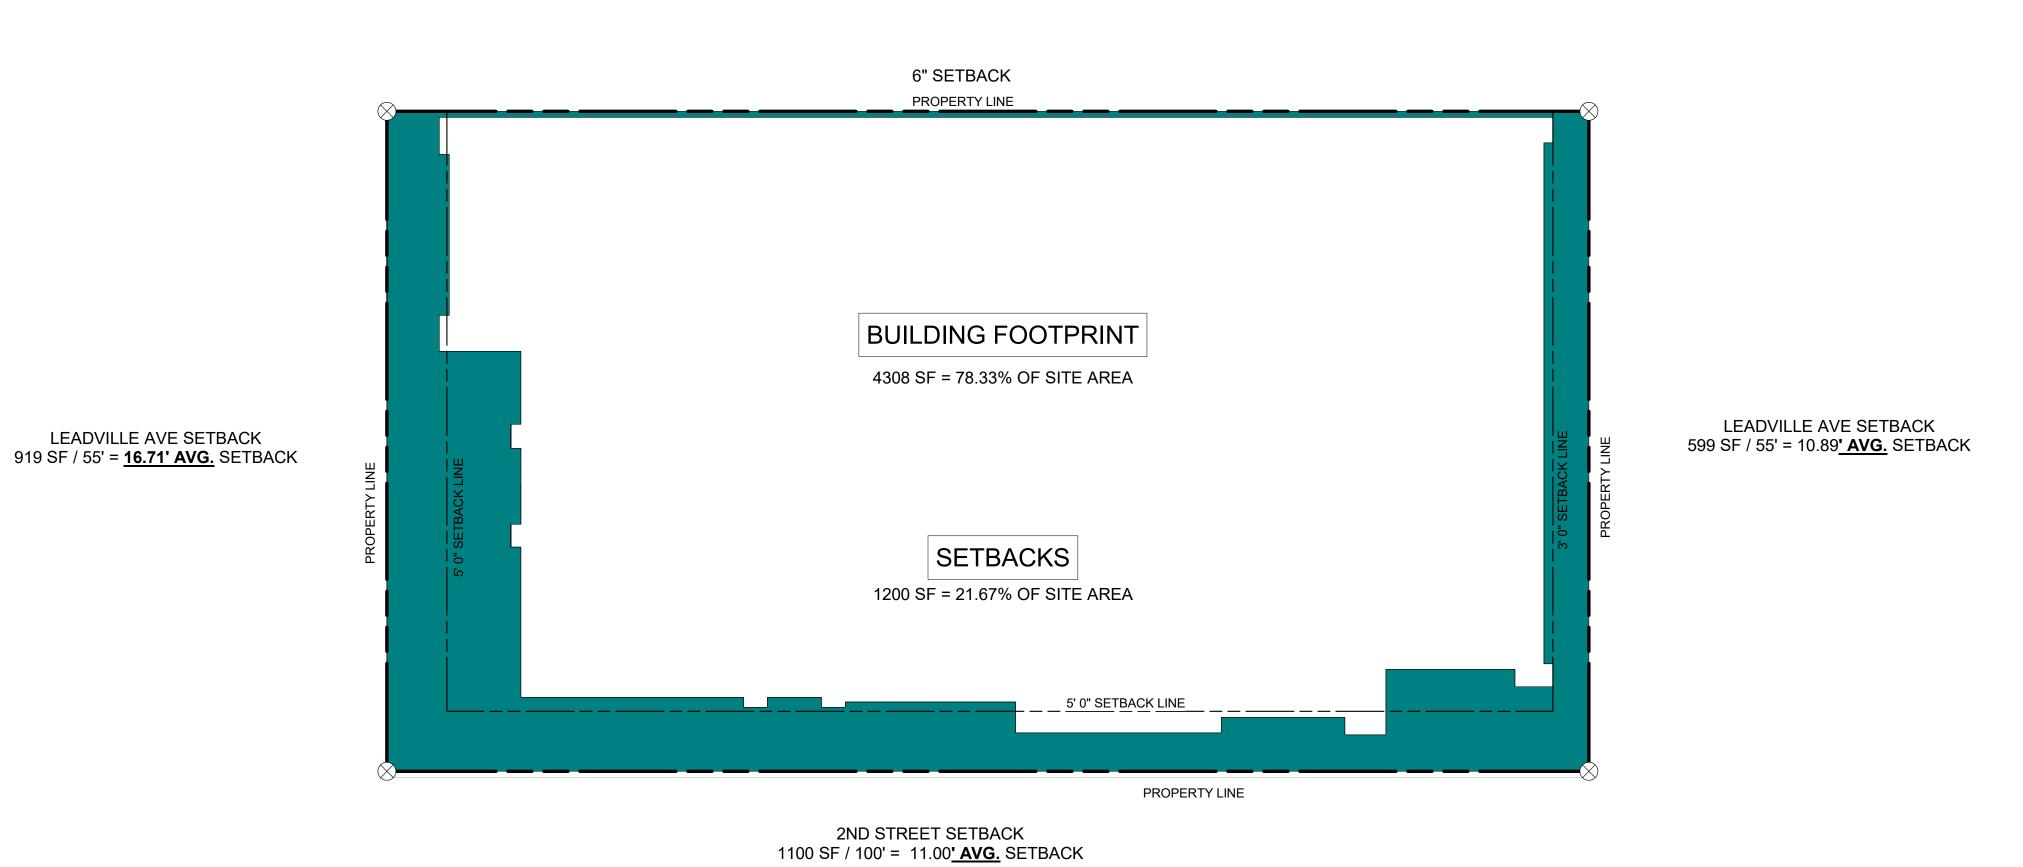

AVE SETBACK .89**' AVG.** SETBACK PHASE:

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DESIGN REVIEW FLOOR

MEDICI ARCHITECTS

NICOLE C. RAMEY STATE OF IDAHO

02/22/23

DATE:

11661 SE 1ST STREET, SUITE 200 BELLEVUE, WASHINGTON 98005

TEL: (425) 453-9298 FAX: (425) 452-8448

REGISTRATION:

INTAKE DATE:

**REVISIONS:** 

PROJECT / CLIENT:

CARR, MICHAEL

JOB ADDRESS:

THE 208 BUILDING

200 N LEADVILLE KETCHUM IDAHO, 83340 PARCEL #RPK00000230010

APPROVED FOR CONSTRUCTION:

CONSTRUCTION DRAWINGS

DRAWING NAME:

Drawn By: MS

Checked By: NR


Owner Approval:


AREA DIAGRAM

PROJECT No.: A21-198

DATE: 2/22/2023


PLOT SCALE: 1:1

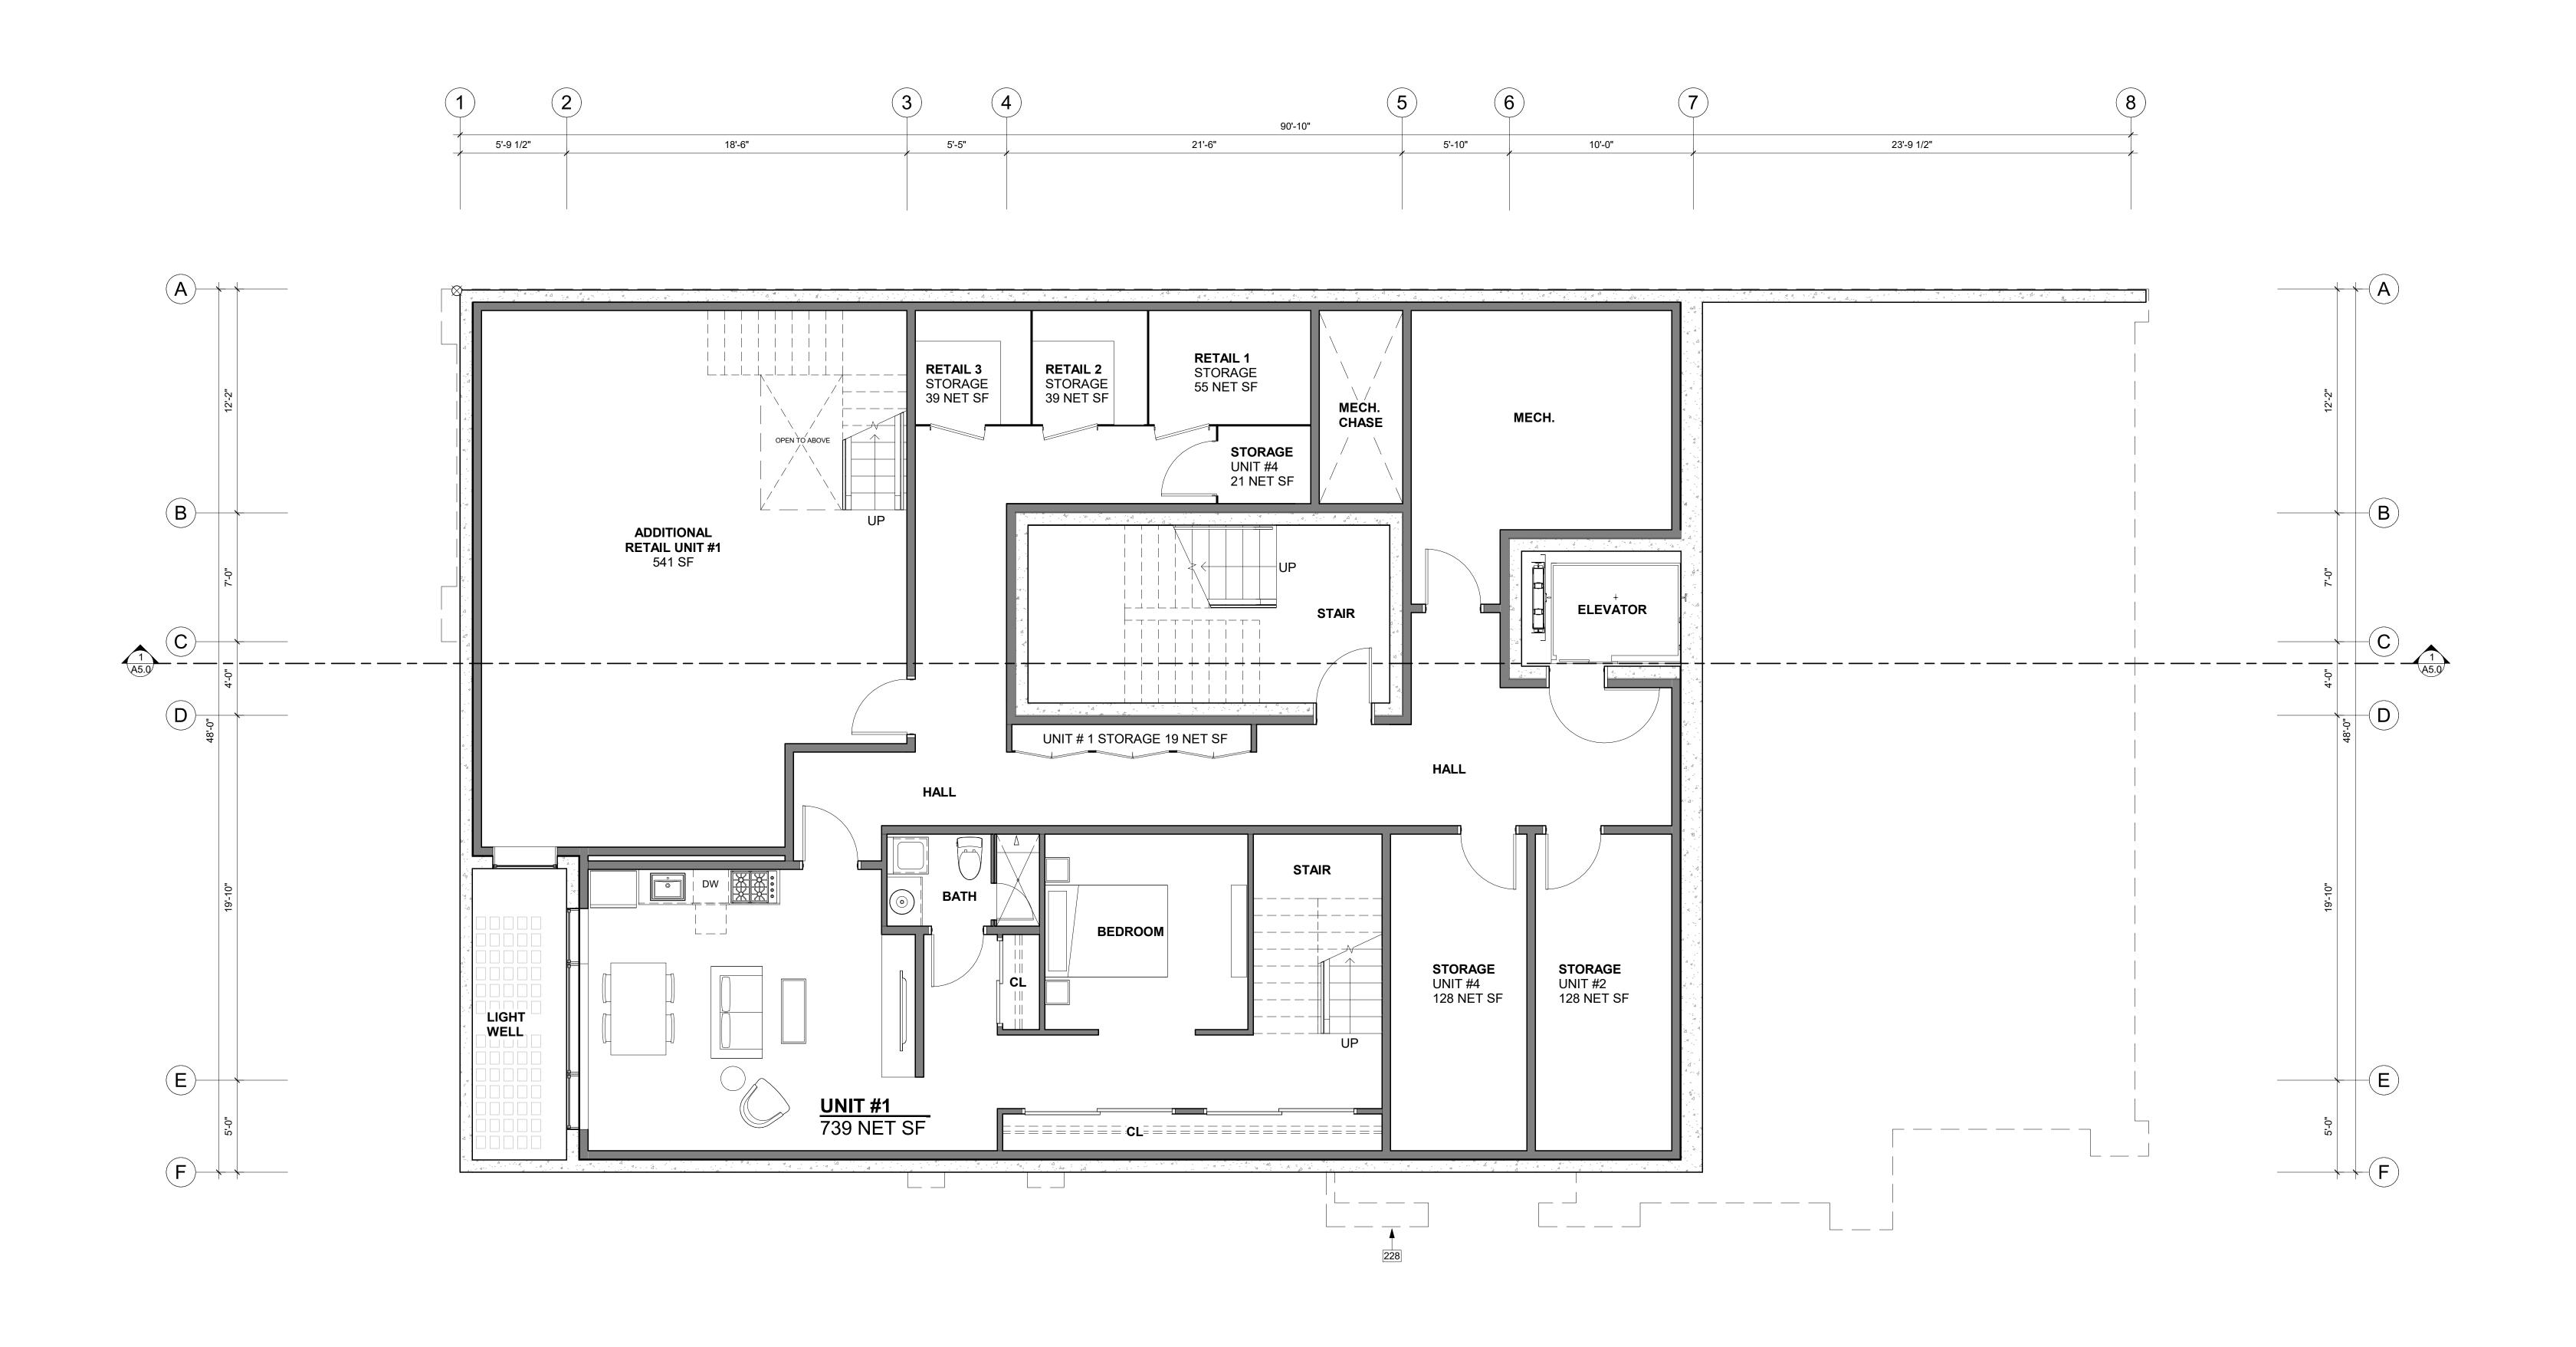

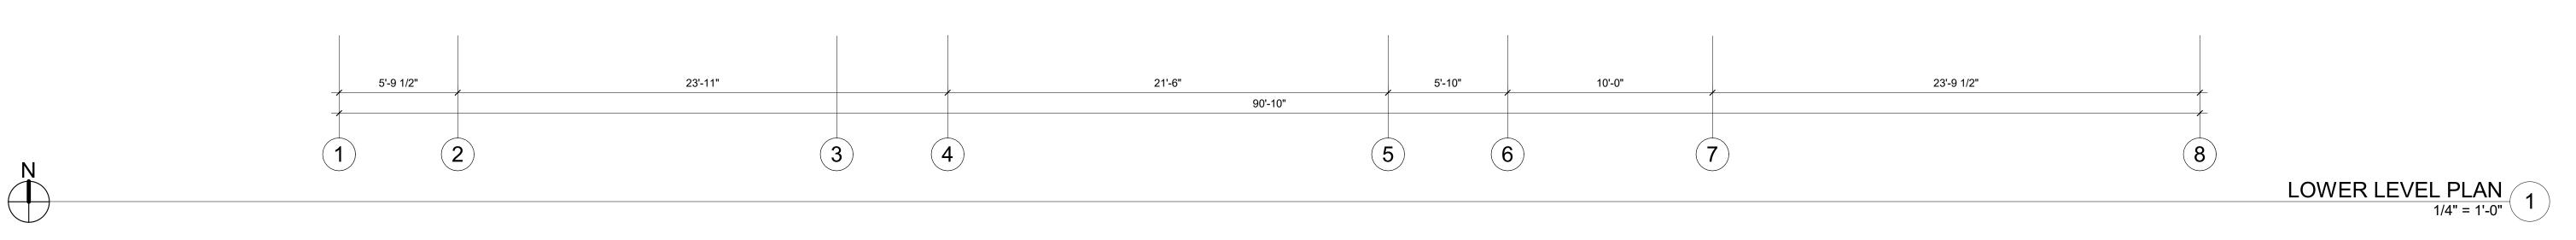


# **KEY NOTES**

228 DASHED LINE OF BUILDING ABOVE.

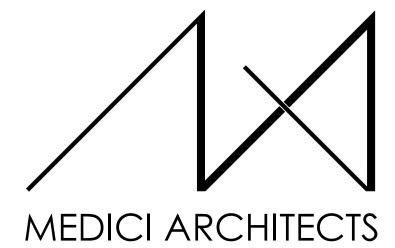

11661 SE 1ST STREET, SUITE 200 BELLEVUE, WASHINGTON 98005 TEL: (425) 453-9298 FAX: (425) 452-8448

REGISTRATION:

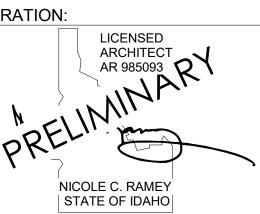

REVISIONS: DATE:

PROJECT / CLIENT:

THE 208 BUILDING

CARR, MICHAEL

JOB ADDRESS:

200 N LEADVILLE KETCHUM
IDAHO, 83340
PARCEL #RPK00000230010

DRAWING NAME:

### LOWER LEVEL PLAN

Drawn By: MS
Checked By: NR
Owner Approval:

PHASE:

CONSTRUCTION DRAWINGS


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PROJECT No.: A21-198


DATE: 2/22/2023

OT SCALE: 1:1



# **KEY NOTES**

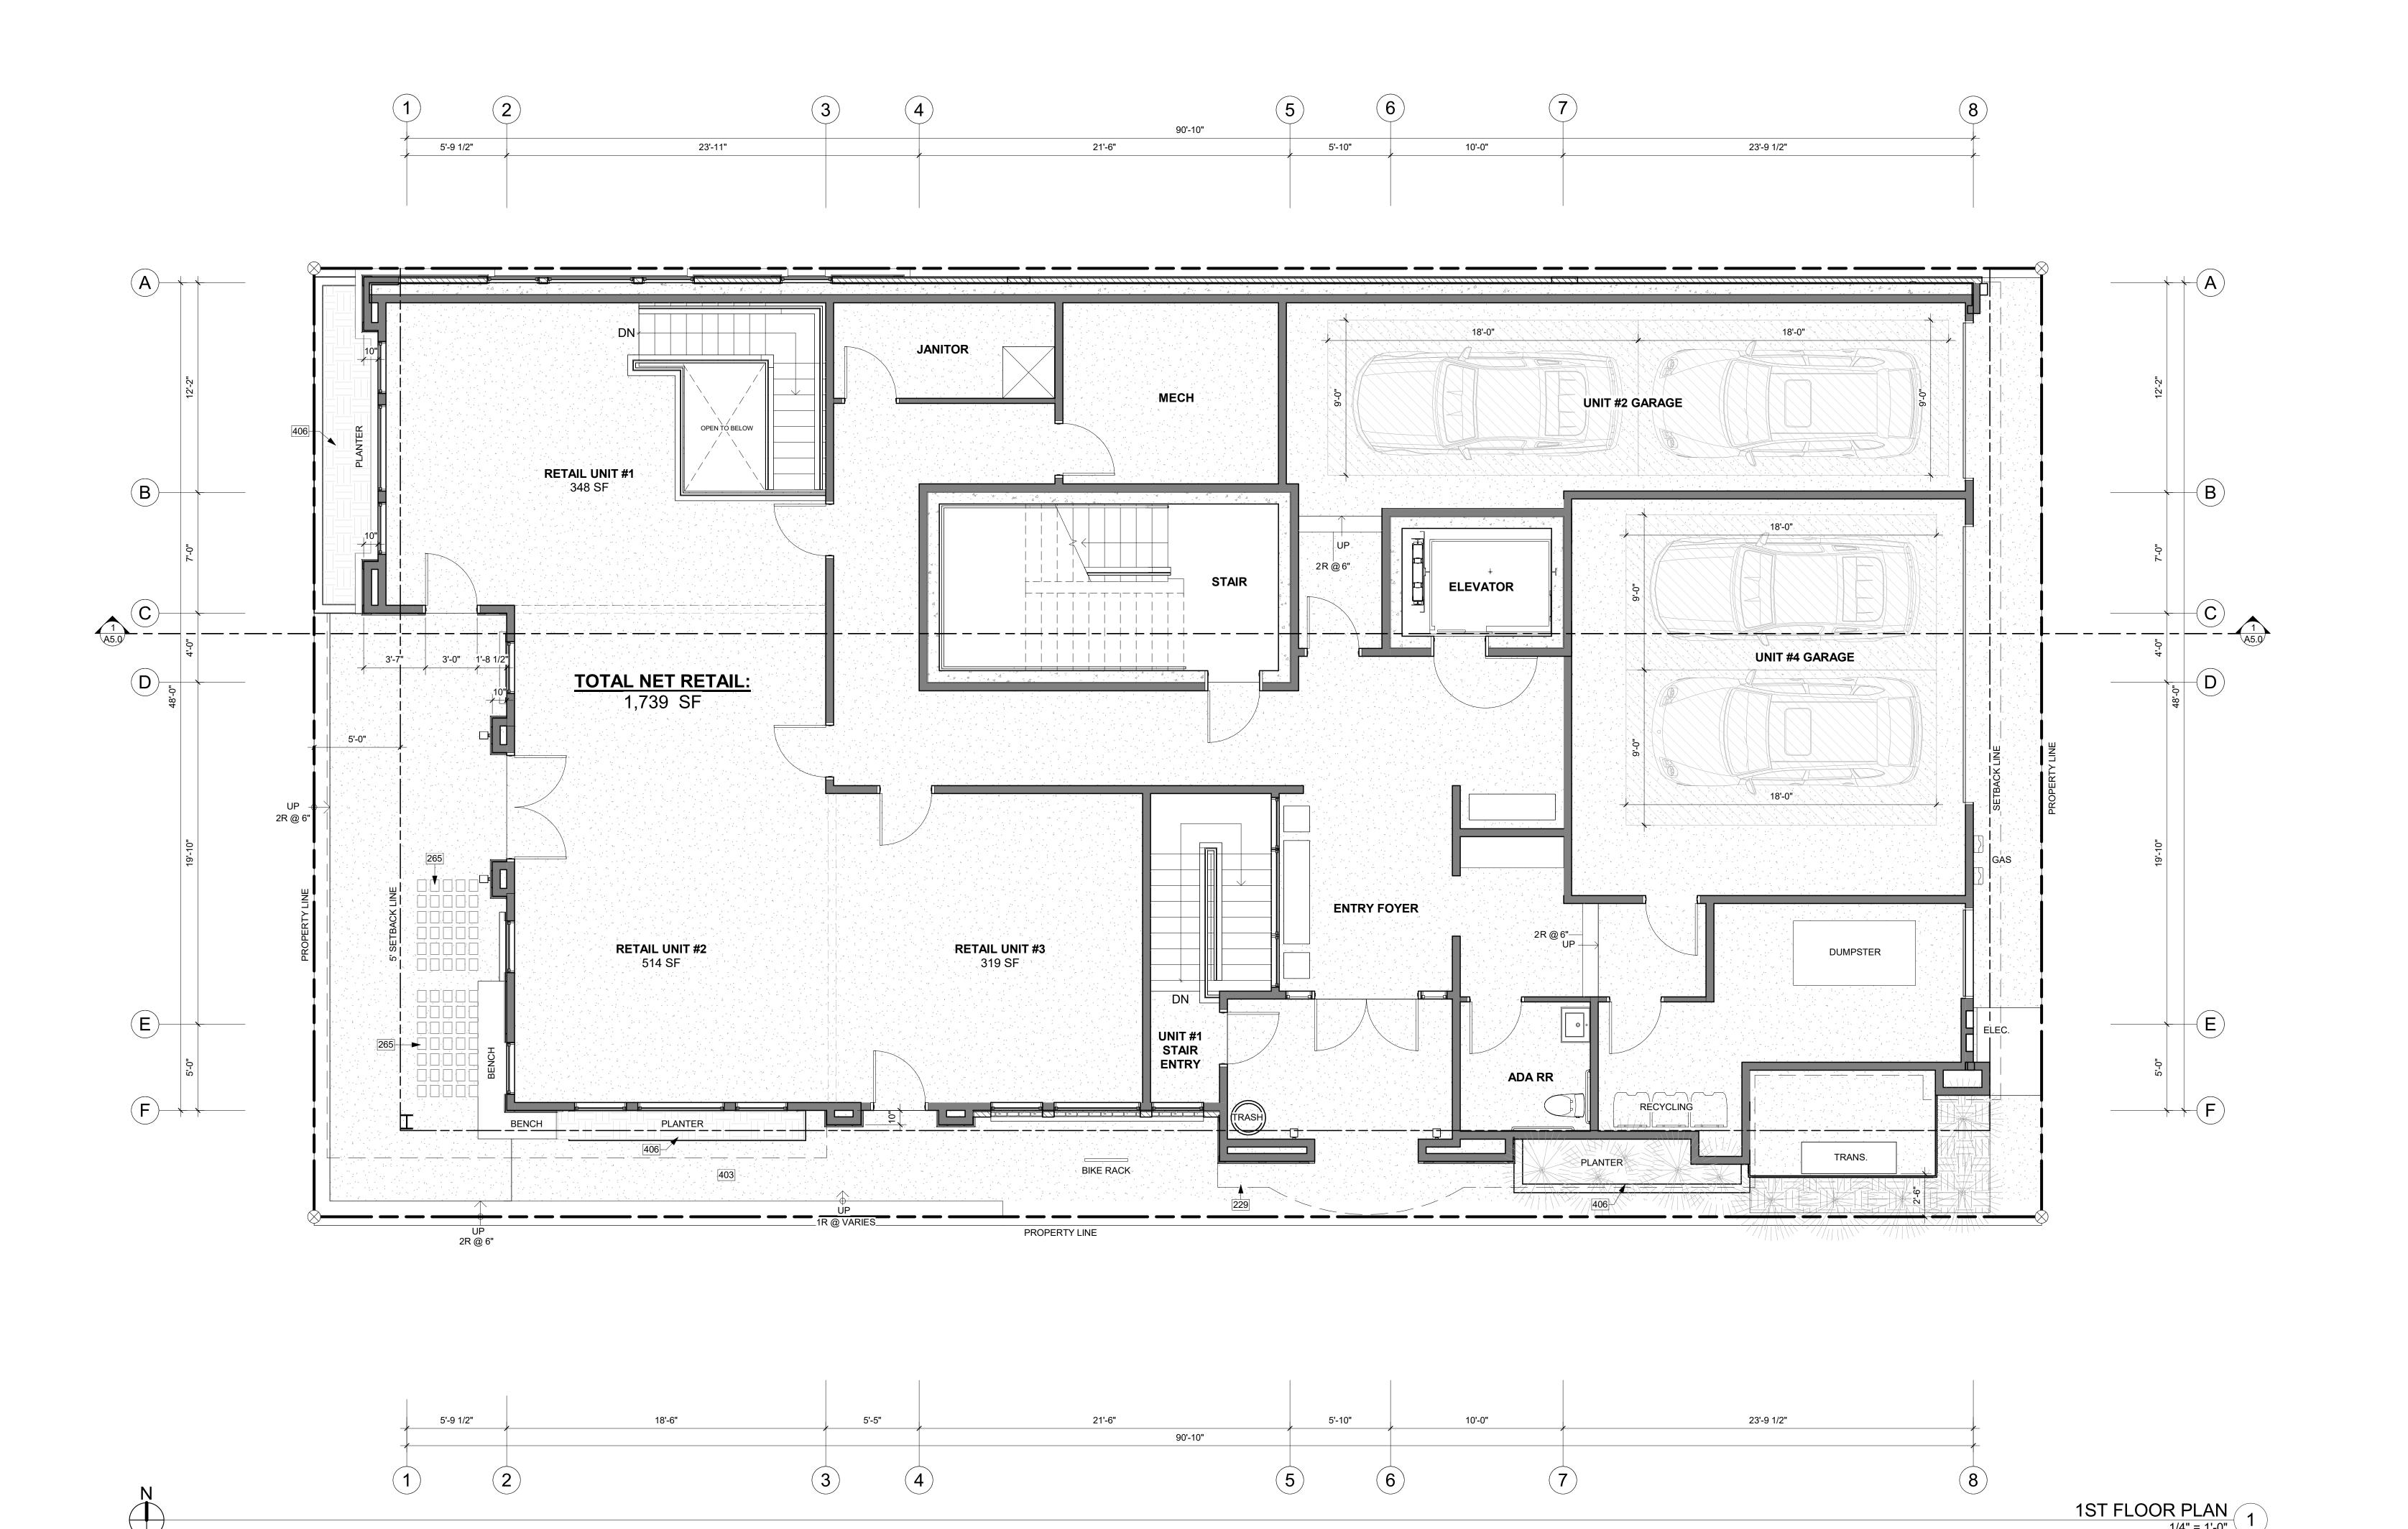- 229 LONG DASHED LINE OF ROOF ABOVE.
- 265 PRECAST CONCRETE AND GLASS PAVERS FOR LIGHT
- WELL. REFER TO SPEC SHEET A5.3 FOR MORE INFORMATION.
- 403 HEATED CONCRETE SIDEWALKS.
- 406 BLACK STEEL PLANTERS. TO REMAIN 4" BELOW WINDOW SILLS AT RETAIL LEVEL.

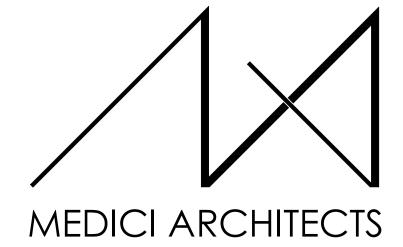

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REGISTRATION:

NICOLE C. RAMEY STATE OF IDAHO

02/22/23 INTAKE DATE: DATE:

**REVISIONS**: PROJECT / CLIENT:

THE 208 BUILDING

CARR, MICHAEL

JOB ADDRESS: 200 N LEADVILLE KETCHUM IDAHO, 83340 PARCEL #RPK00000230010

DRAWING NAME:

**1ST FLOOR PLAN** 

Drawn By: MS Checked By: NR Owner Approval:

PHASE:

CONSTRUCTION DRAWINGS


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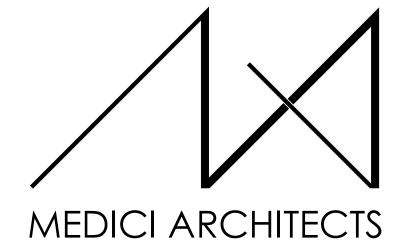
APPROVED FOR CONSTRUCTION:

PROJECT No.: A21-198

DATE: 2/22/2023

PLOT SCALE: 1:1



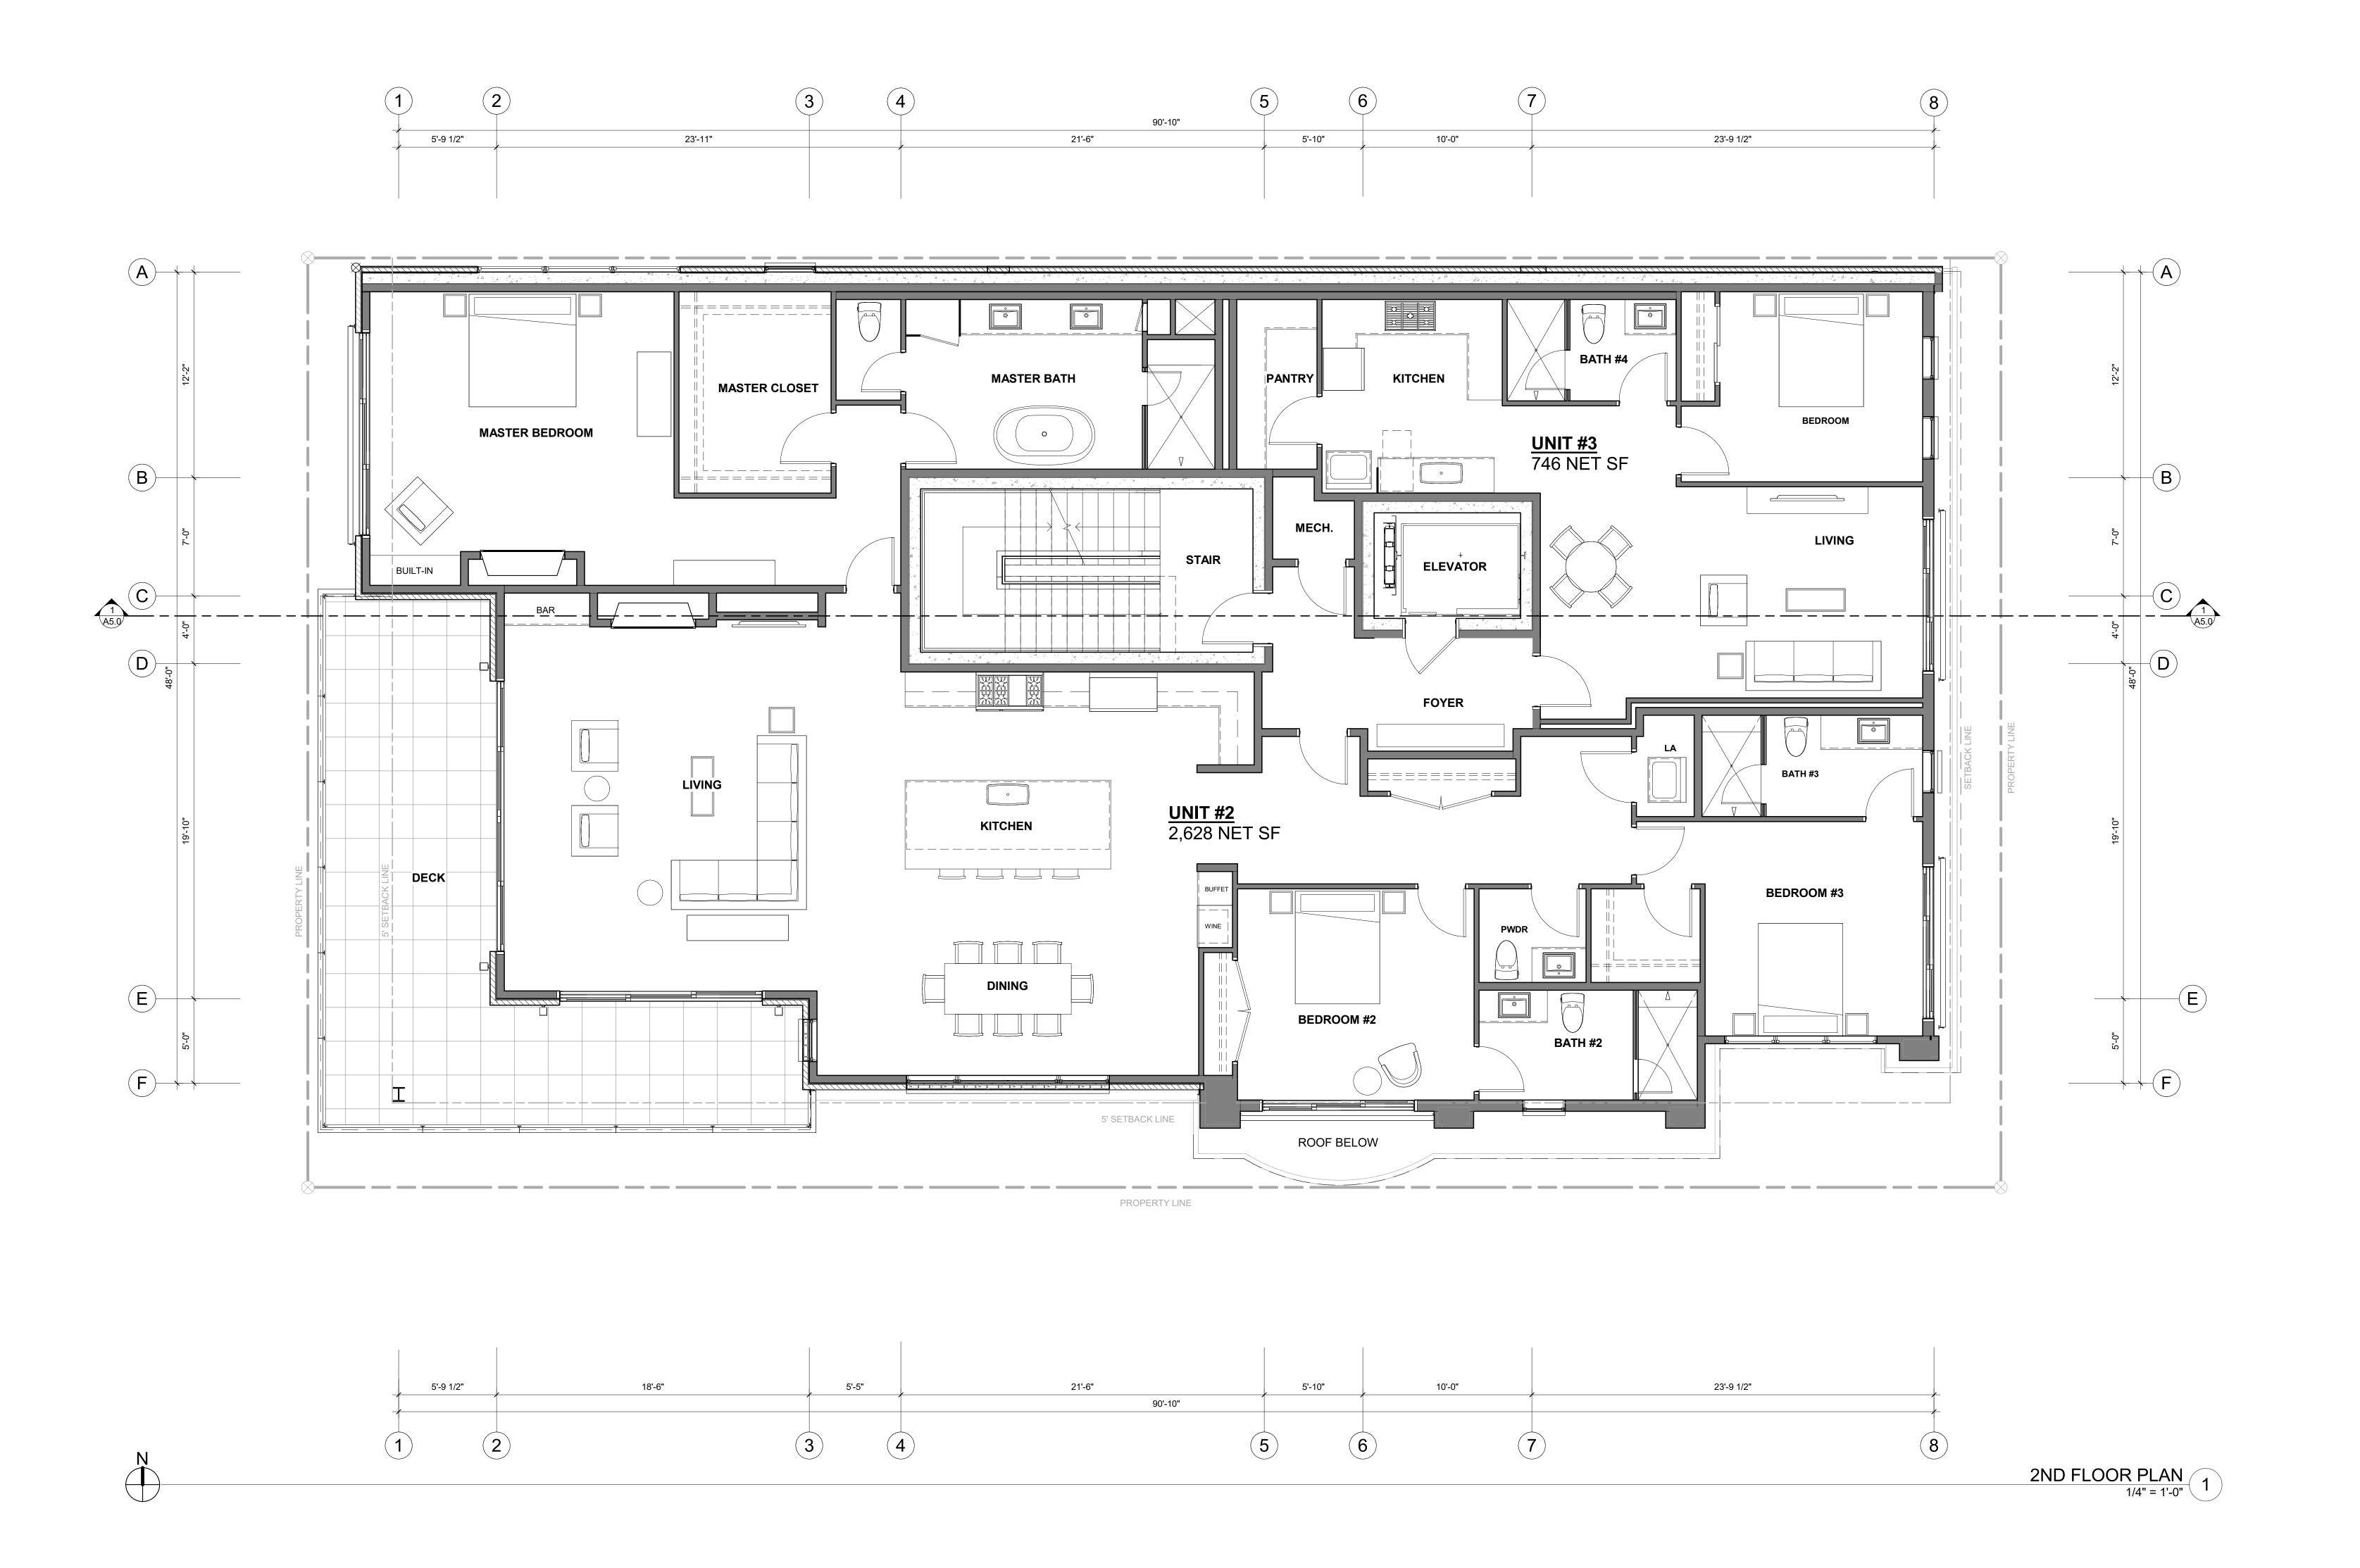

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REGISTRATION:

NICOLE C. RAMEY
STATE OF IDAHO

REVISIONS: DATE:

PROJECT / CLIENT:

THE 208 BUILDING

CARR, MICHAEL

JOB ADDRESS:

200 N LEADVILLE KETCHUM
IDAHO, 83340
PARCEL #RPK00000230010

DRAWING NAME:

2ND FLOOR PLAN

Drawn By: MS
Checked By: NR
Owner Approval:

PHASE:

CONSTRUCTION DRAWINGS


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PROJECT No.: A21-198

DATE: 2/22/2023


A2.2



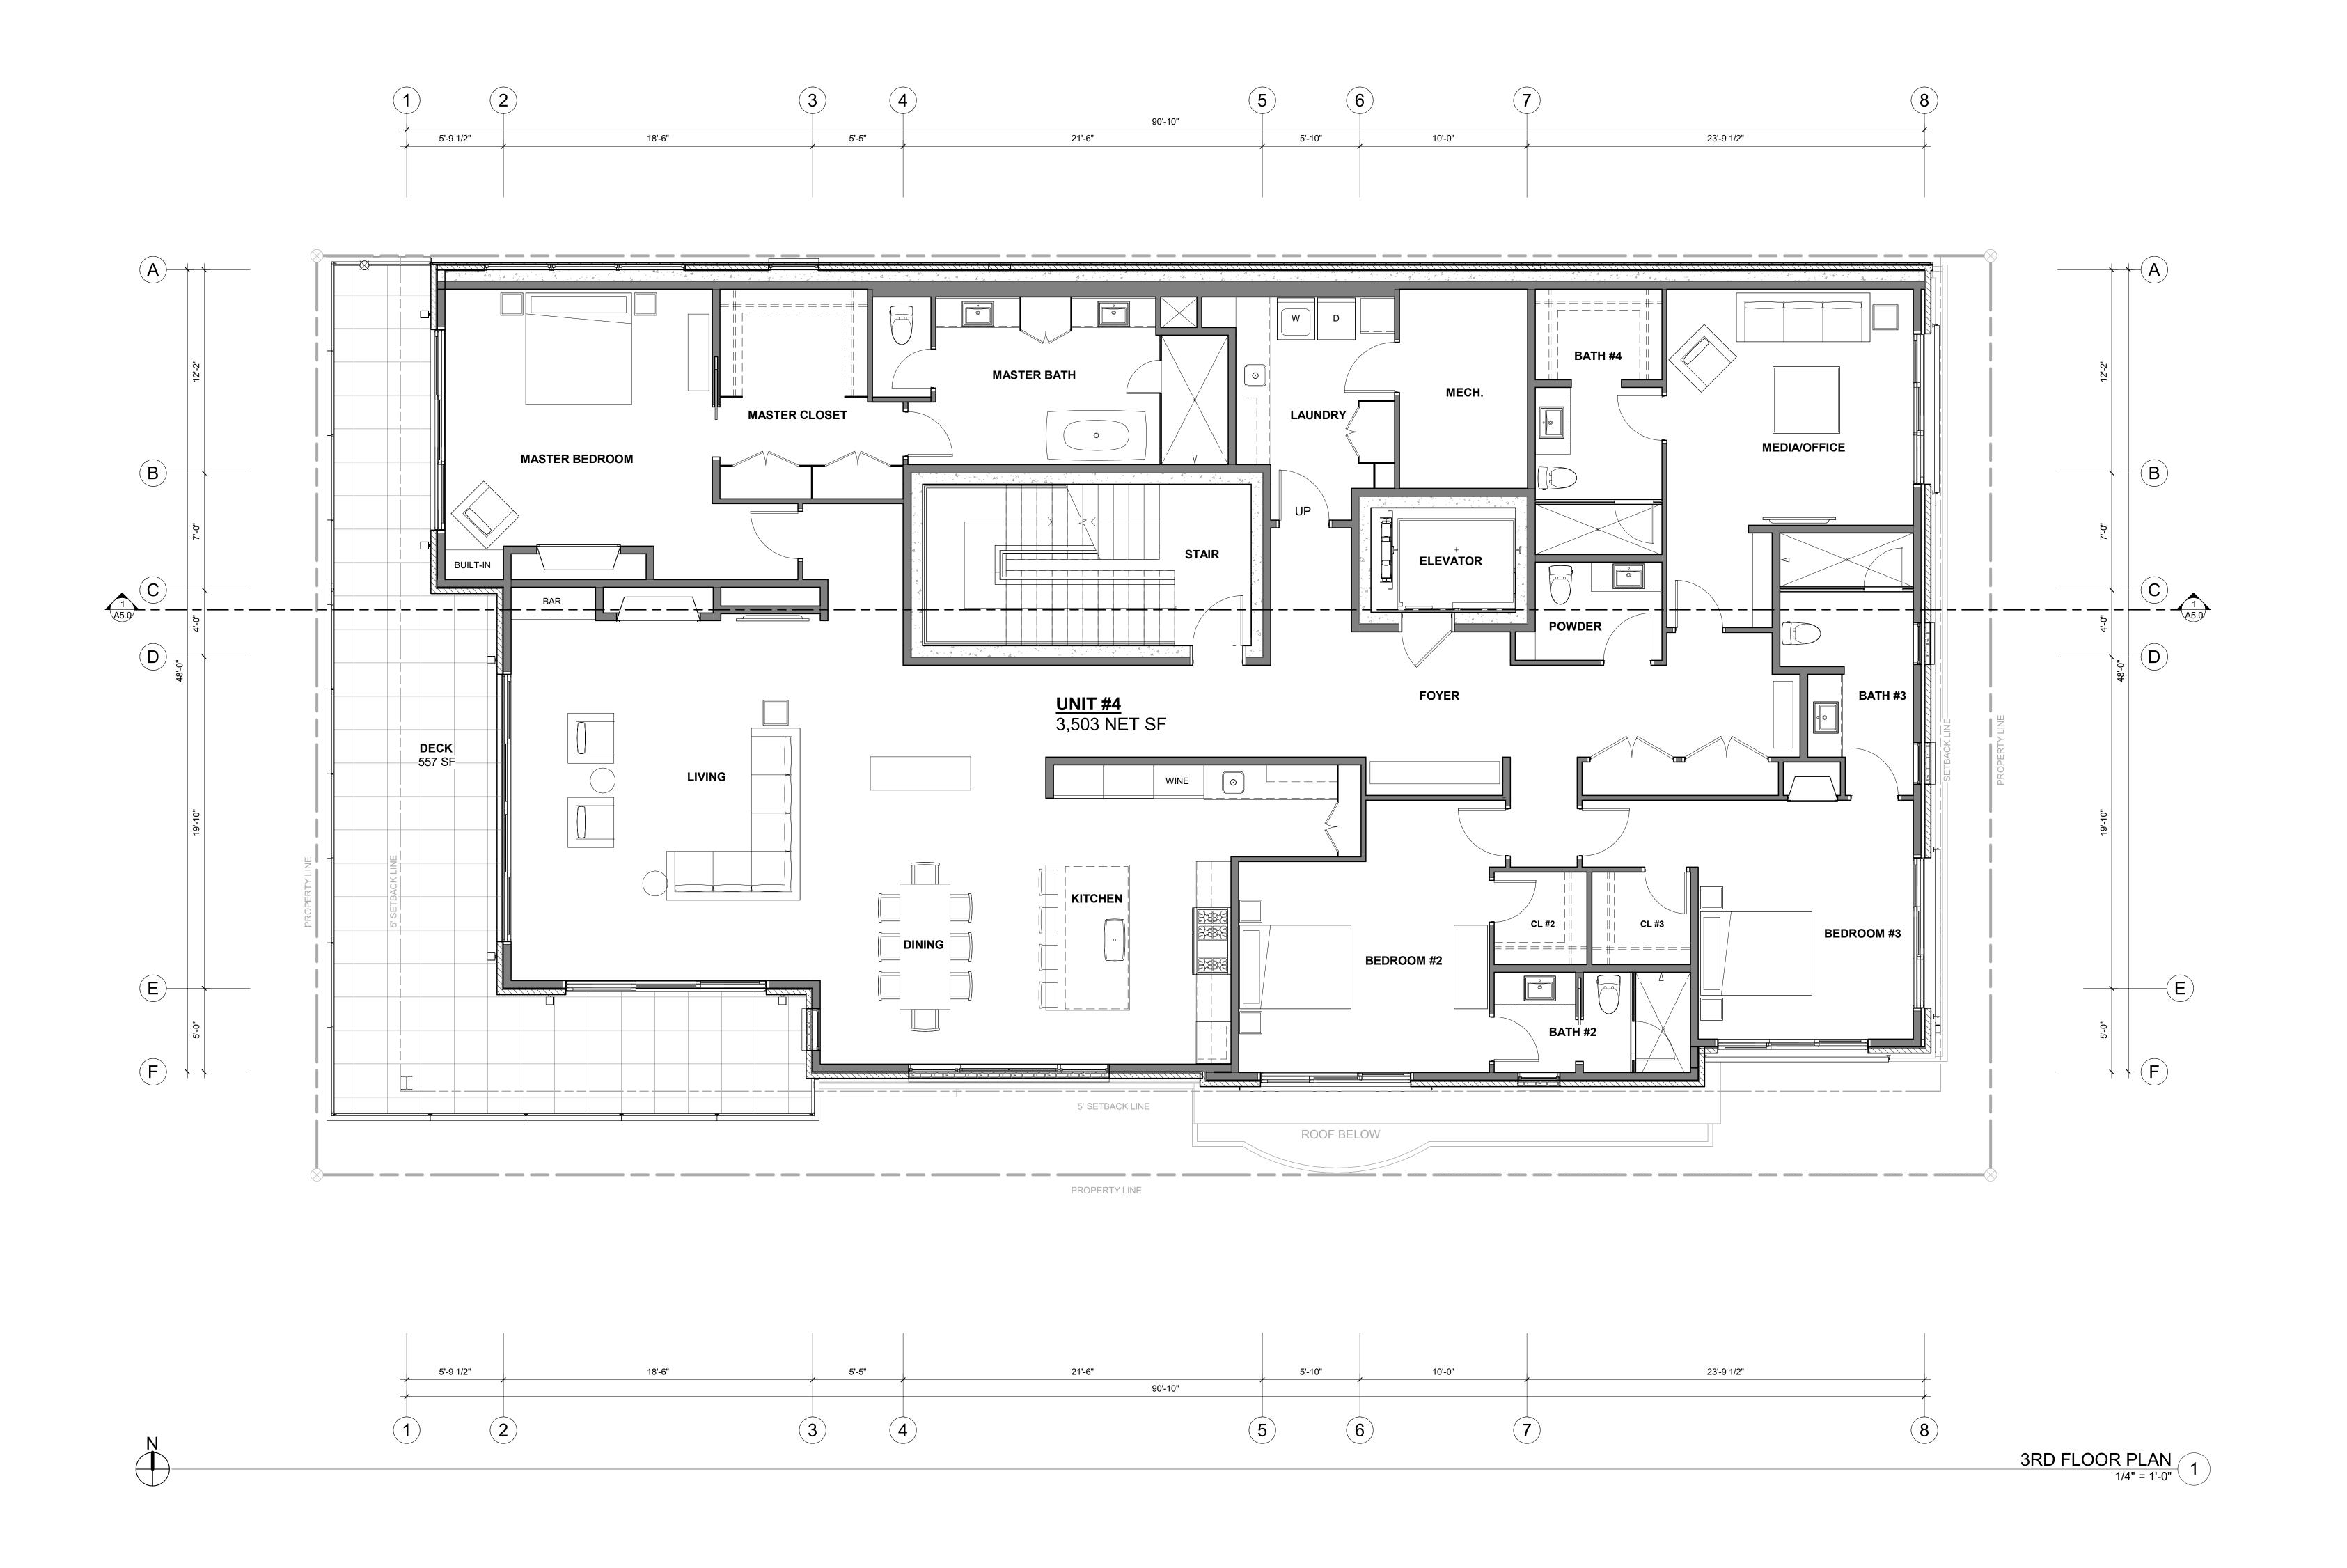

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REGISTRATION:

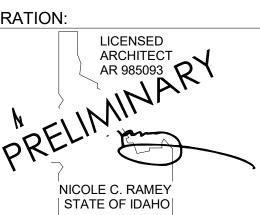

REVISIONS: DATE:

PROJECT / CLIENT:

THE 208 BUILDING

CARR, MICHAEL

JOB ADDRESS:
200 N LEADVILLE KETCHUM
IDAHO, 83340
PARCEL #RPK00000230010

DRAWING NAME:

3RD FLOOR PLAN

Drawn By: MS
Checked By: NR
Owner Approval:

PHASE:

CONSTRUCTION DRAWINGS


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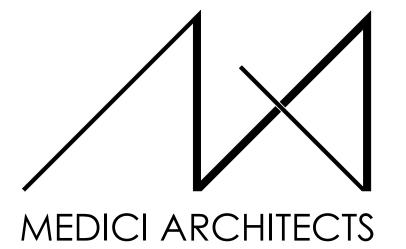
APPROVED FOR CONSTRUCTION:

PROJECT No.: A21-198

DATE: 2/22/2023

A2.3



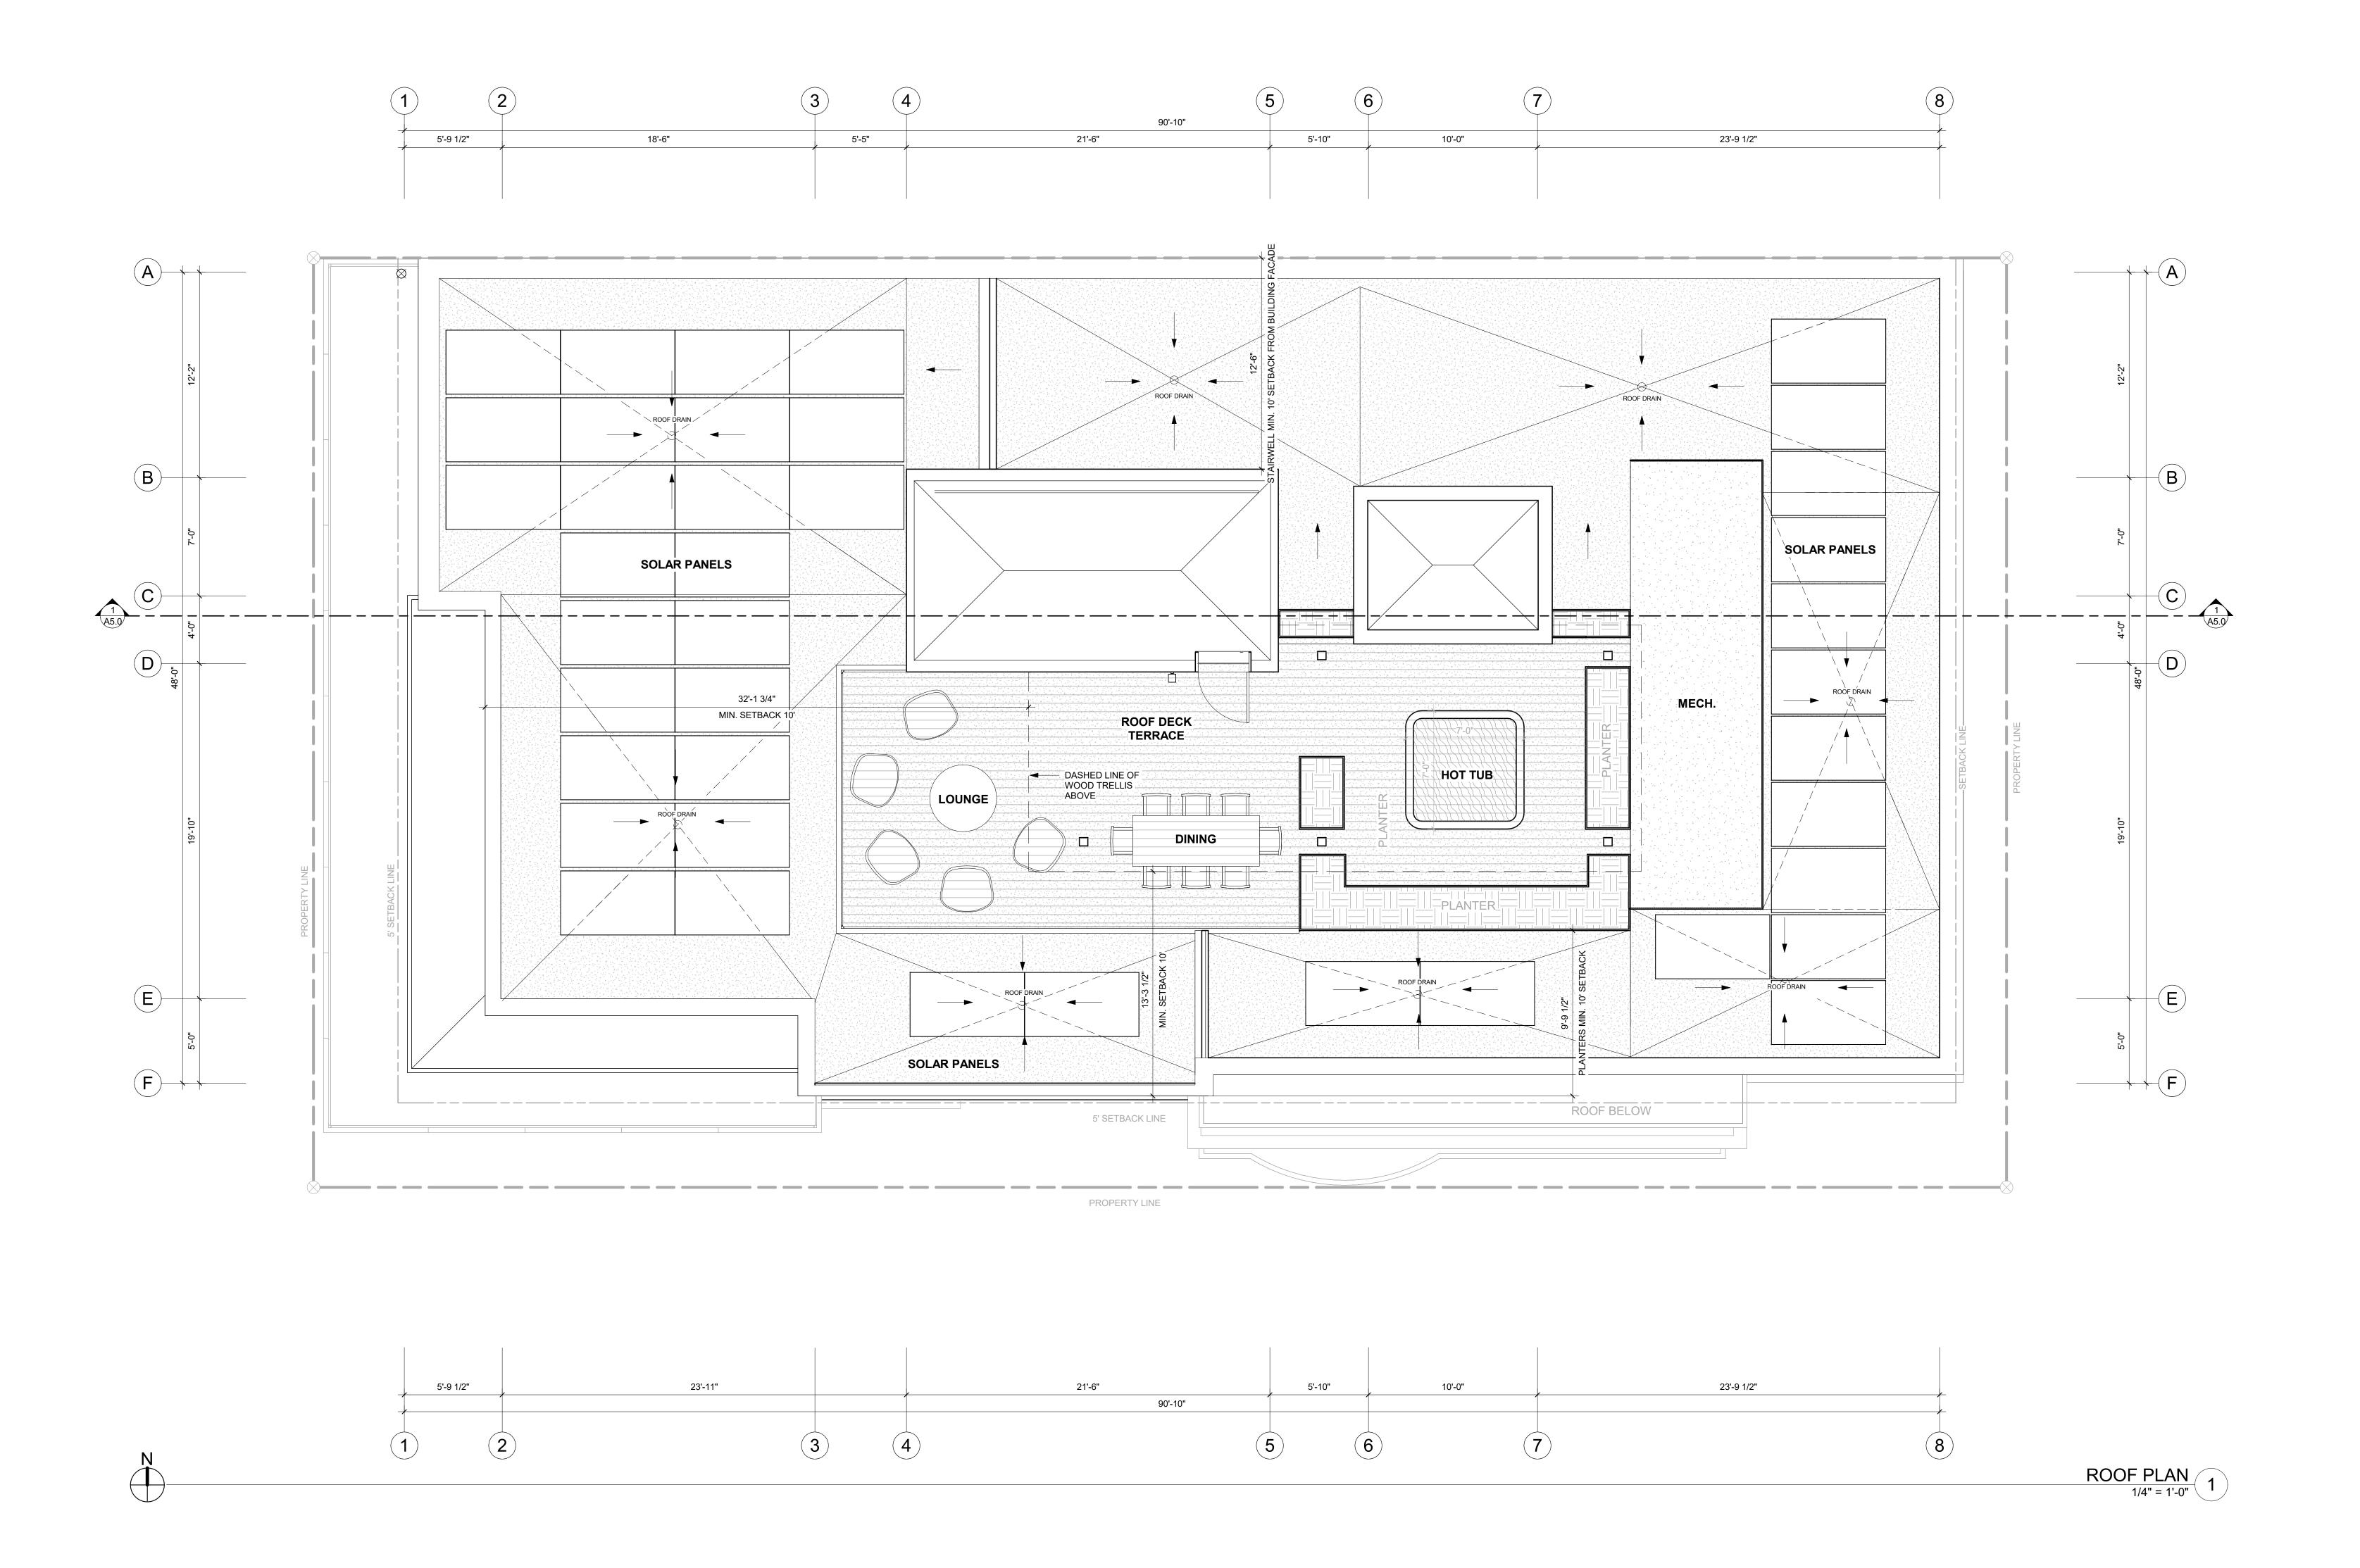

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REGISTRATION:

NICOLE C. RAMEY STATE OF IDAHO

INTAKE DATE: 02/22/23 **REVISIONS**: DATE:

PROJECT / CLIENT:

THE 208 BUILDING

CARR, MICHAEL

JOB ADDRESS: 200 N LEADVILLE KETCHUM IDAHO, 83340 PARCEL #RPK00000230010

DRAWING NAME:

**ROOF PLAN** 

Drawn By: MS Checked By: NR Owner Approval:

PHASE:

CONSTRUCTION DRAWINGS

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APPROVED FOR CONSTRUCTION:


PROJECT No.: A21-198 DATE: 2/22/2023



SOUTH ELEVATION
1/4" = 1'-0"
1


# **KEY NOTES**

- 400 NATURAL STONE VENEER.
- 401 BRICK VENEER.
- 404 WOOD SIDING.
- 405 BLACK STEEL C-CHANNEL. 406 BLACK STEEL PLANTERS. TO REMAIN 4" BELOW WINDOW
- SILLS AT RETAIL LEVEL.
- 407 METAL MESH SCREEN.
- 408 BLACK STEEL GUARD. MIN. 75% TRANSPARENT AT ROOFTOP.
- 409 BLACK METAL COPING OVER PARAPET WALL.
- 410 METAL CLAD WOOD WINDOWS AND DOORS.
- 411 PRE CAST CONCRETE LINTEL.

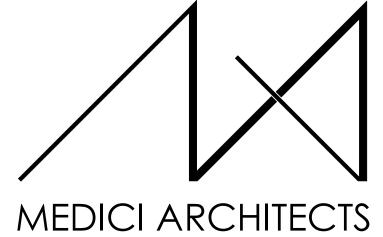

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REGISTRATION:

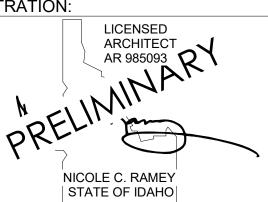

02/22/23 INTAKE DATE:

**REVISIONS**: DATE:

PROJECT / CLIENT: THE 208 BUILDING

CARR, MICHAEL

JOB ADDRESS:

200 N LEADVILLE KETCHUM IDAHO, 83340 PARCEL #RPK00000230010

DRAWING NAME:

### **ELEVATIONS**

Drawn By: MS Checked By: NR Owner Approval:

PHASE:

CONSTRUCTION DRAWINGS

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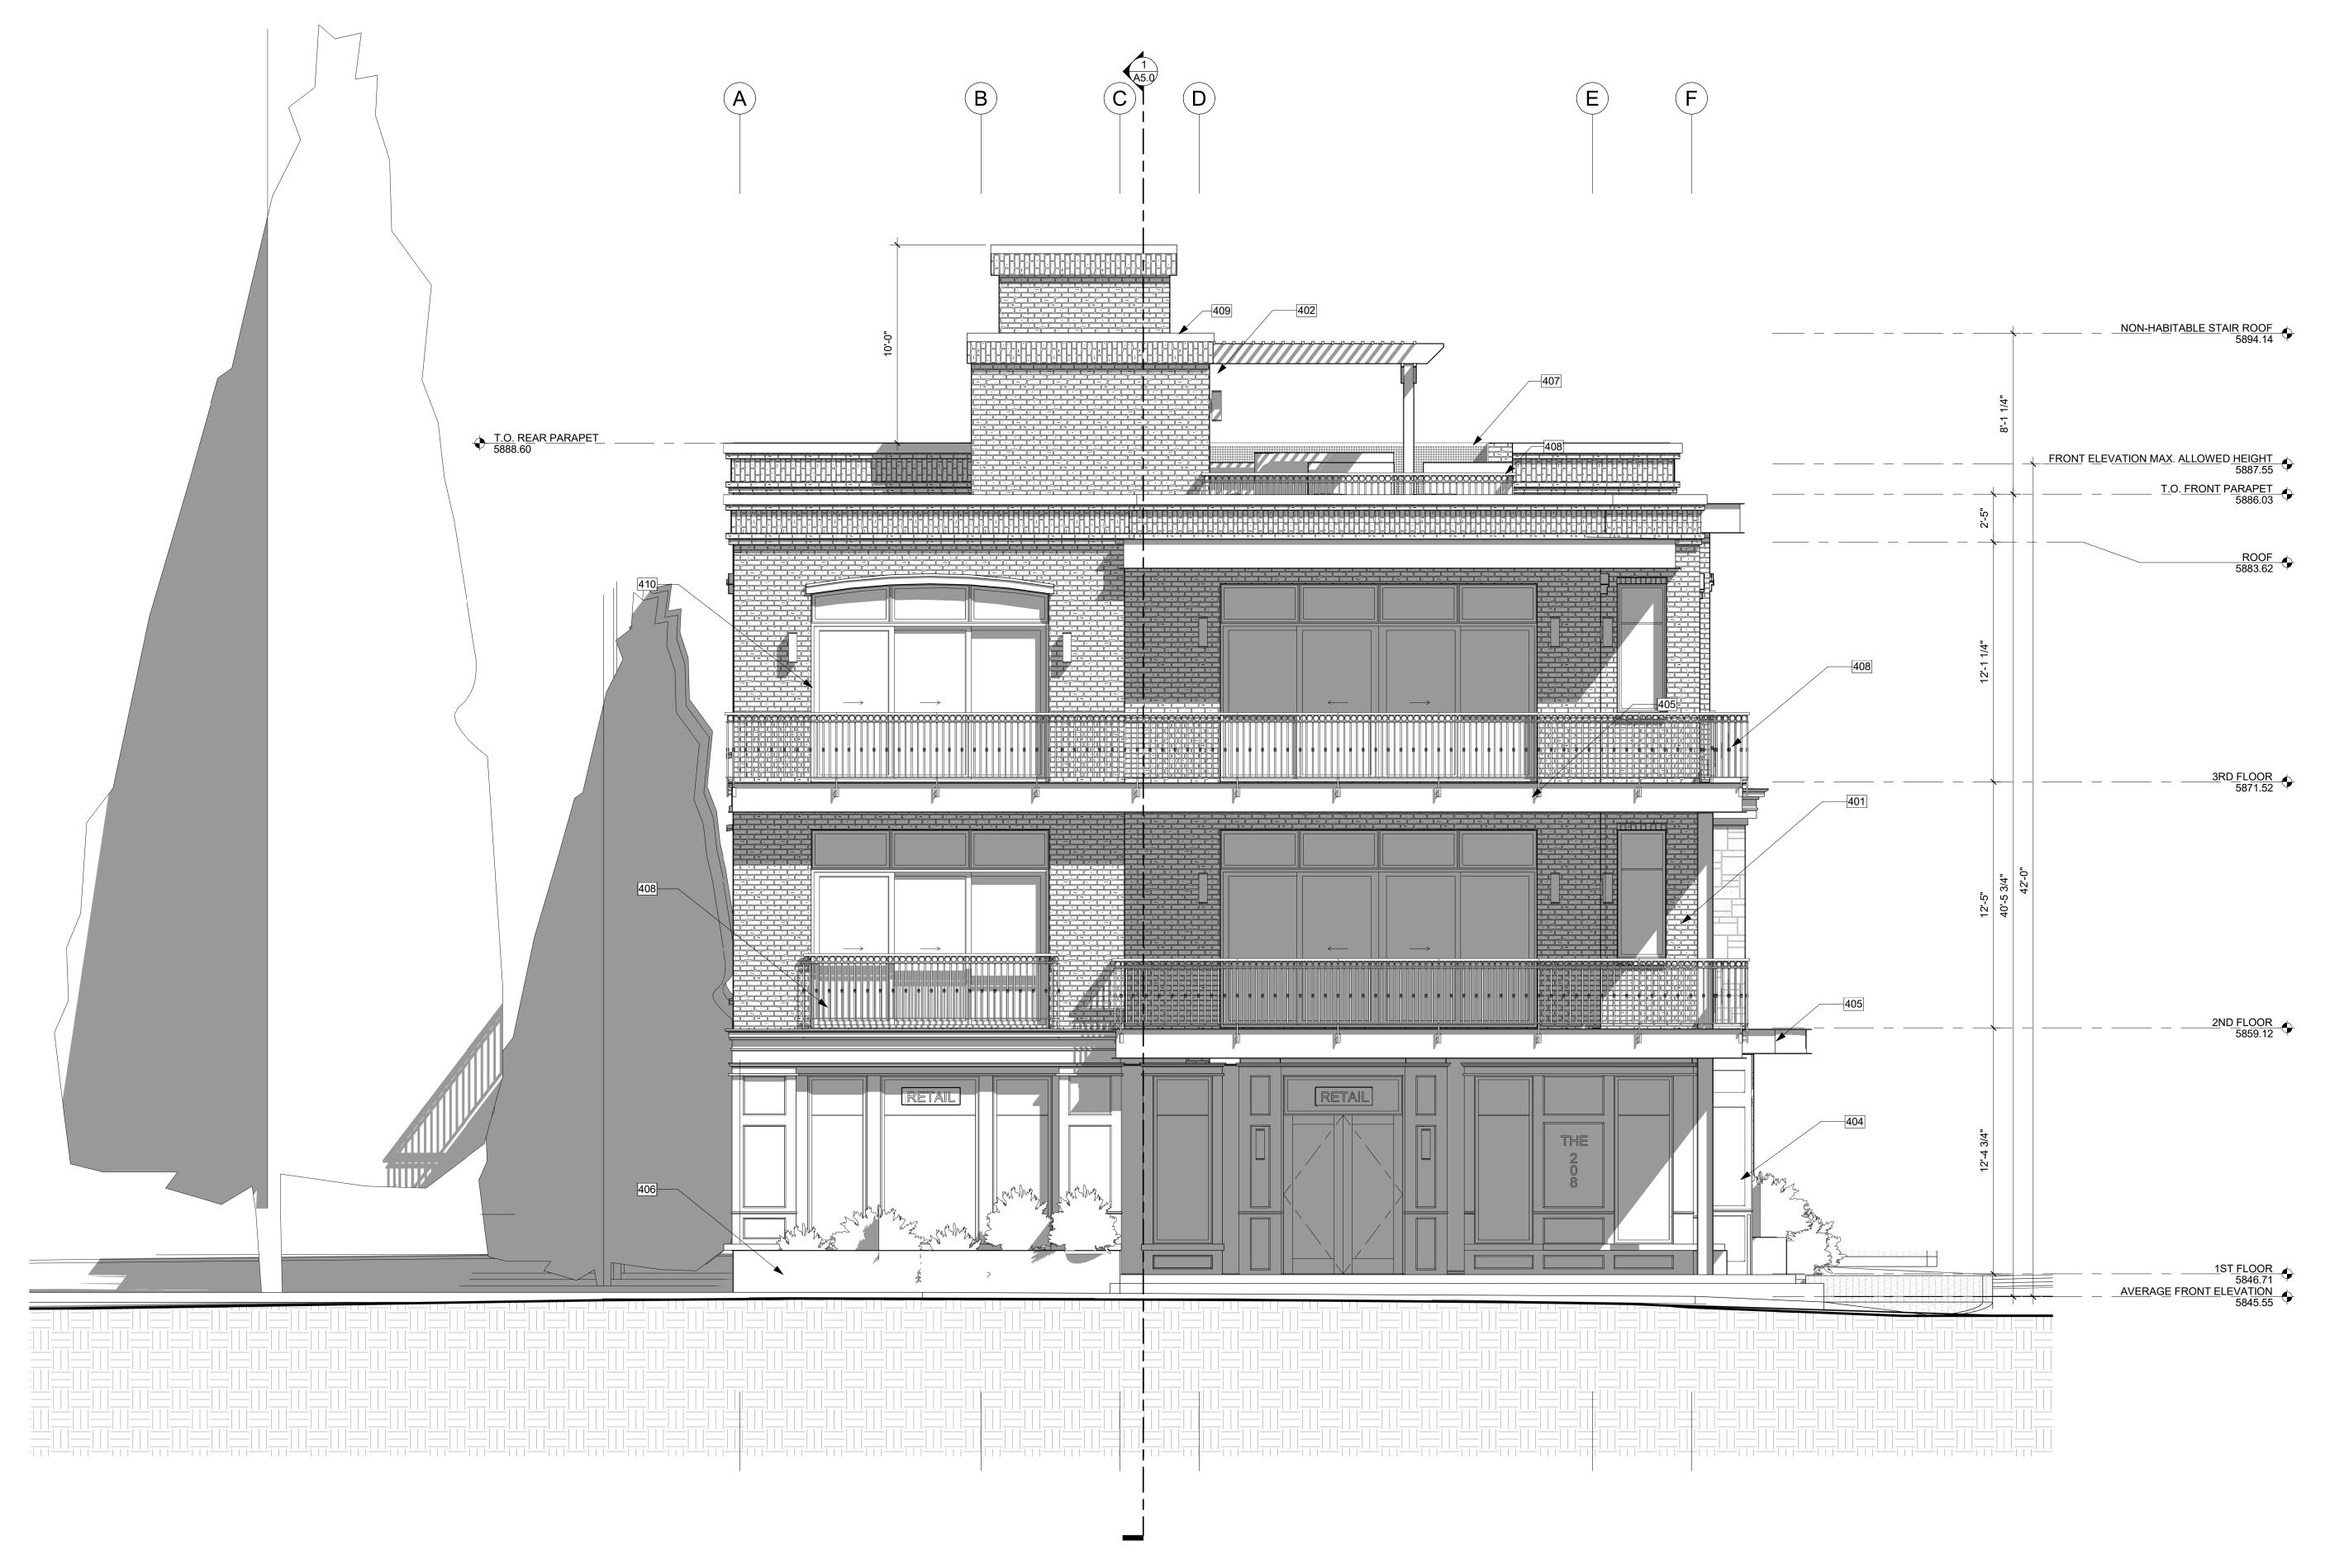
Variations and modifications to work shown on this drawing a half not be a corried out with out. this drawing shall not be carried out without written permission from the Architect.

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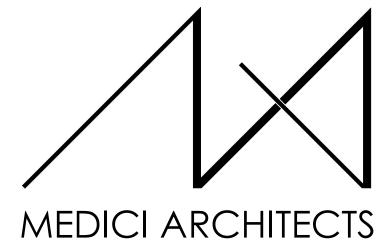
PLOT SCALE: 1:1




WEST ELEVATION
1/4" = 1'-0"
2

# **KEY NOTES**


401	BRICK VENEER.
402	LIGHTING @ ALL EXTERIOR DOORS INSTALLED PER MANUFACTURER, TYP. REFER TO SHEET A5.2 FOR LIGTHING SPECS. ALL LIGHTS SHALL COMPLY WITH CITY OF KETCHUM MUNICIPAL CODE 17.132.
404	WOOD SIDING.
405	BLACK STEEL C-CHANNEL.
406	BLACK STEEL PLANTERS. TO REMAIN 4" BELOW WINDOW SILLS AT RETAIL LEVEL.
407	METAL MESH SCREEN.
408	BLACK STEEL GUARD. MIN. 75% TRANSPARENT AT ROOFTOP.
409	BLACK METAL COPING OVER PARAPET WALL.
410	METAL CLAD WOOD WINDOWS AND DOORS.



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02/22/23 INTAKE DATE:

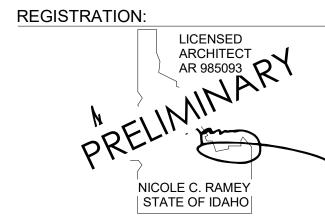

PROJECT / CLIENT:

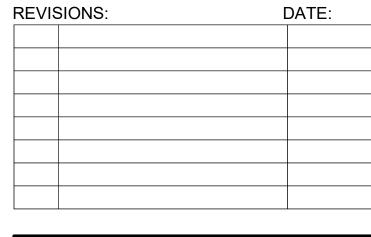THE 208 BUILDING

CARR, MICHAEL

JOB ADDRESS: 200 N LEADVILLE KETCHUM IDAHO, 83340 PARCEL #RPK00000230010

DRAWING NAME:

### **ELEVATIONS**

Drawn By: MS Checked By: NR Owner Approval:


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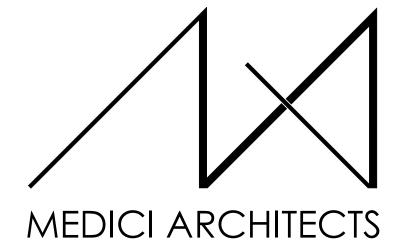
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PROJECT No.: A21-198




# **KEY NOTES**

- 400 NATURAL STONE VENEER.
- 401 BRICK VENEER.
- 405 BLACK STEEL C-CHANNEL.
- 407 METAL MESH SCREEN. 408 BLACK STEEL GUARD. MIN. 75% TRANSPARENT AT
- ROOFTOP. 409 BLACK METAL COPING OVER PARAPET WALL.
- 410 METAL CLAD WOOD WINDOWS AND DOORS.
- 411 PRE CAST CONCRETE LINTEL.
- 412 ELECTRICAL/ GAS METERS.
- 413 BLACK STEEL FRAMED TRELLIS W/ BLACK STAINED WOOD CANOPY.

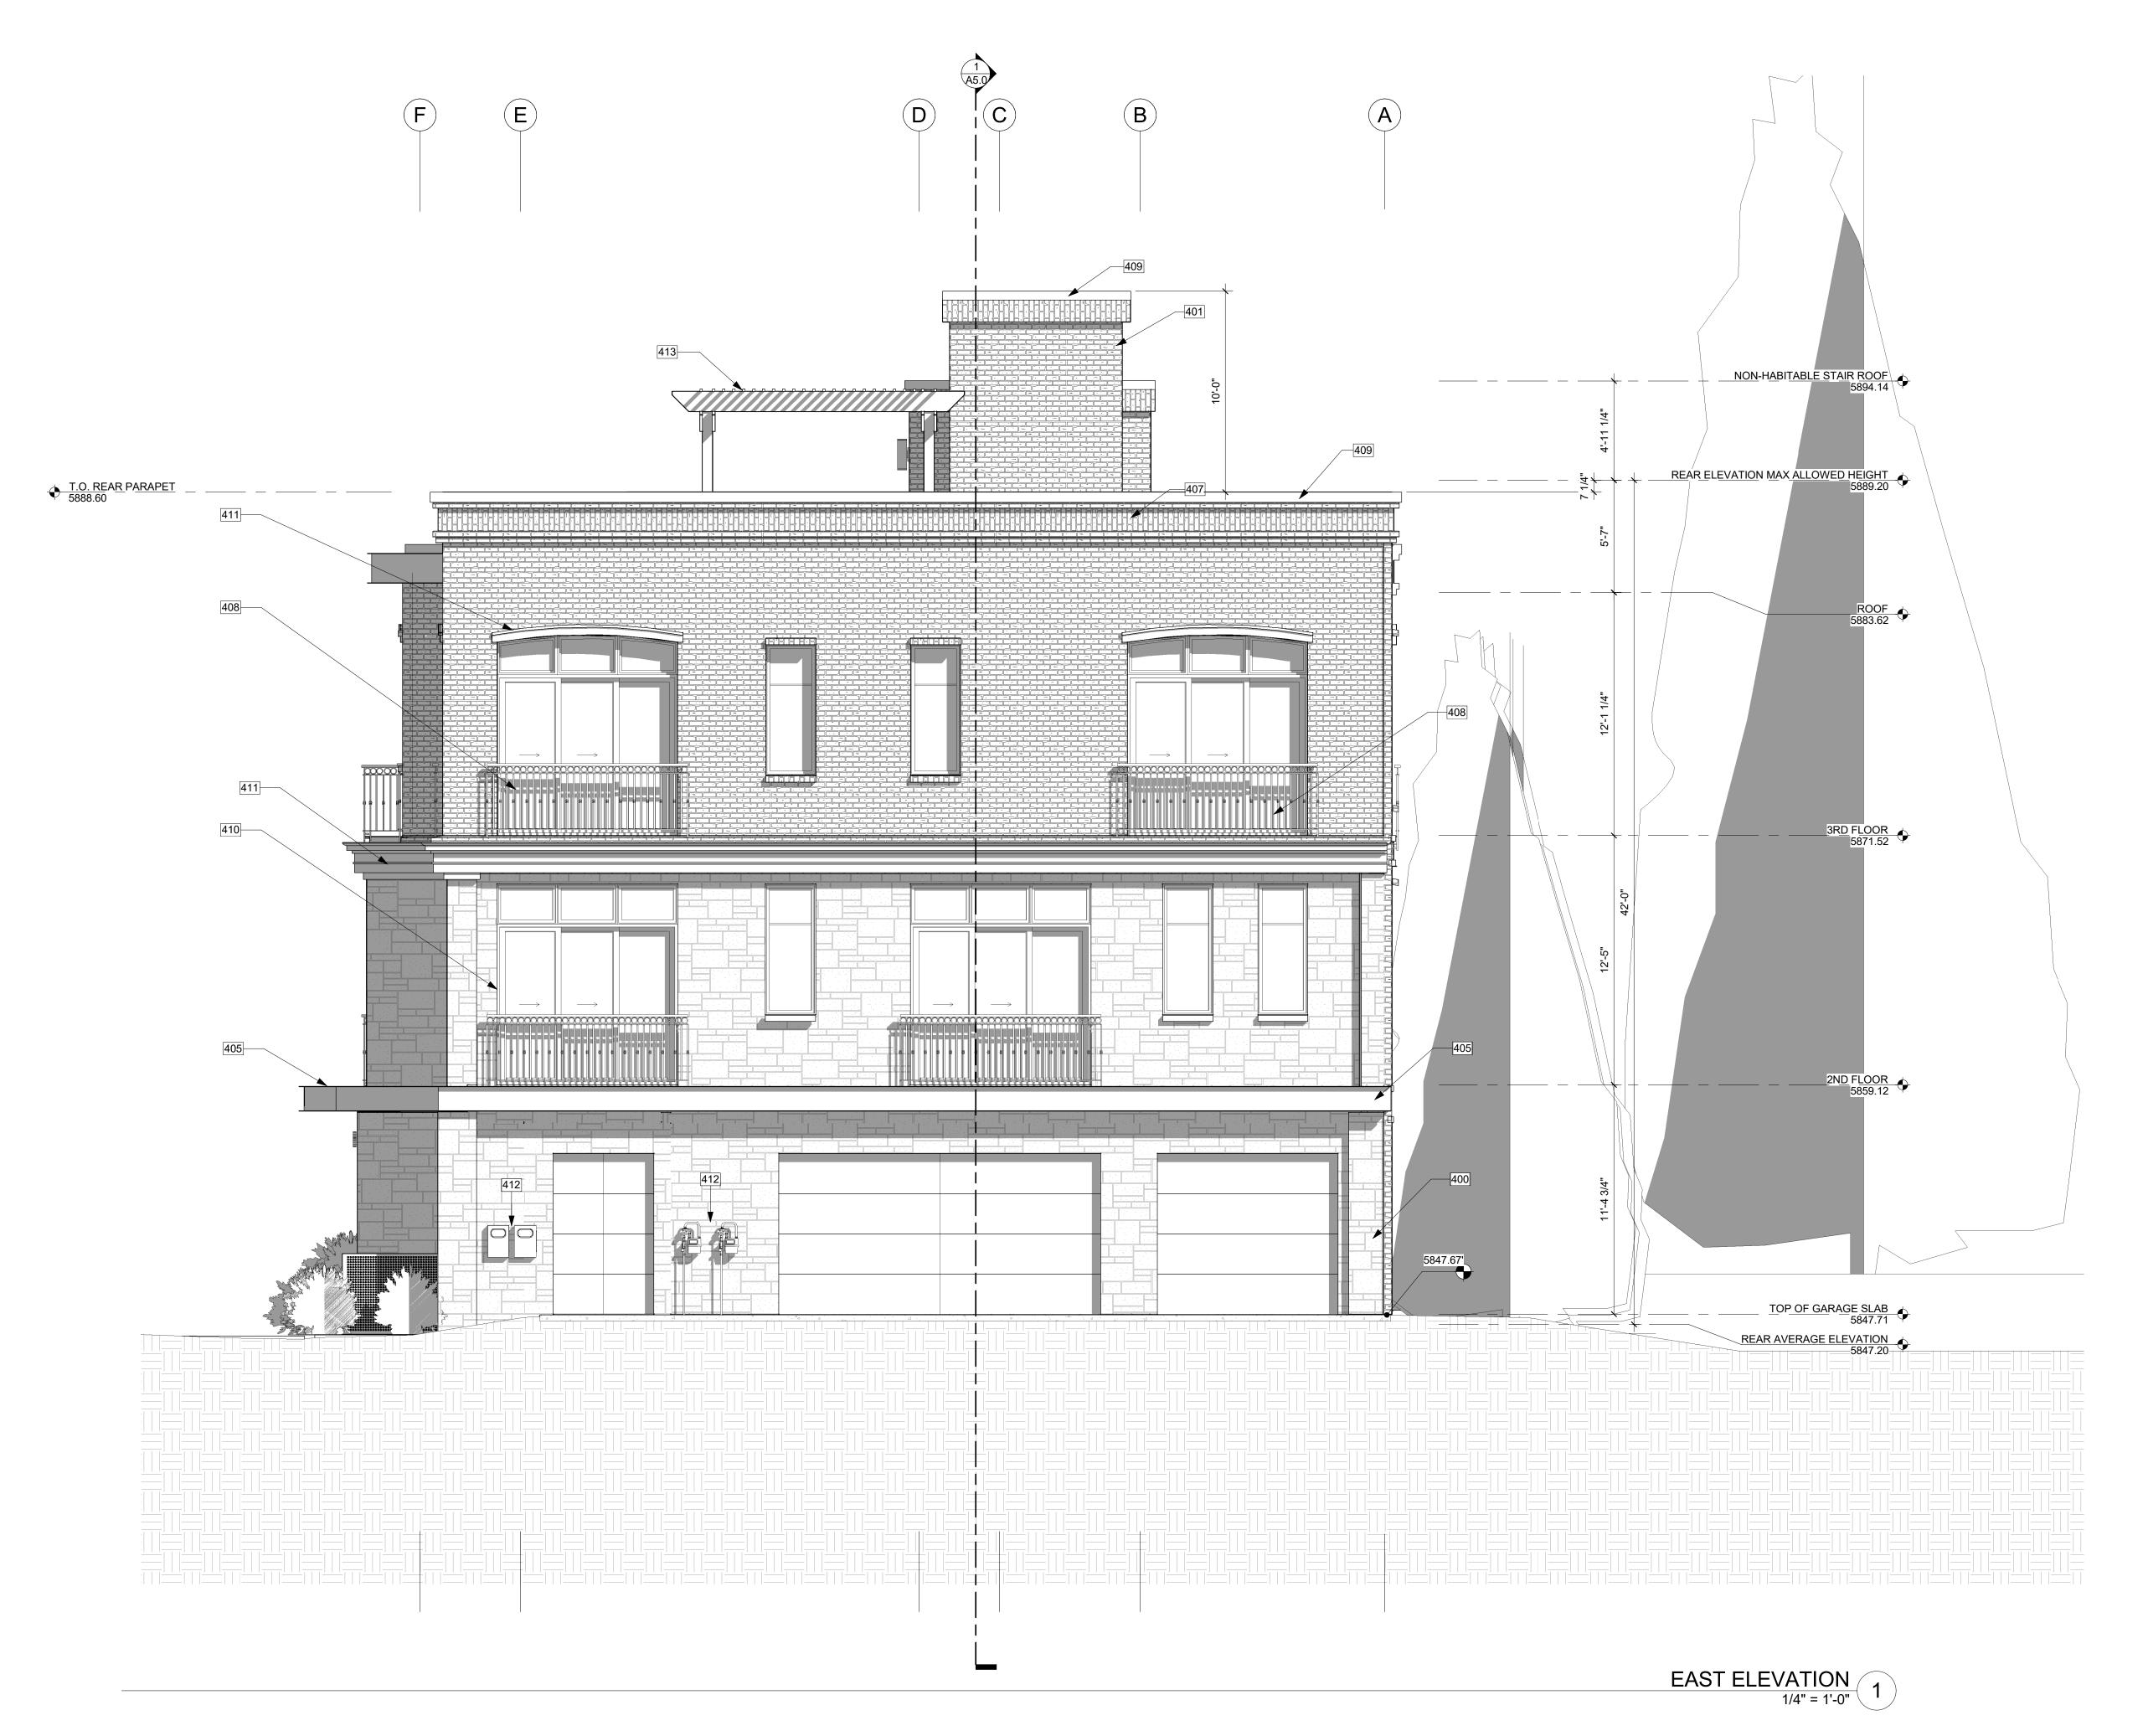

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INTAKE DATE: 02/22/23

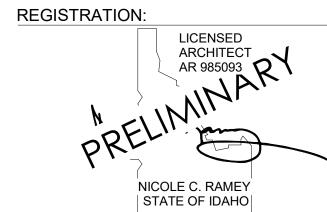REVISIONS:	DATE:

PROJECT / CLIENT:

THE 208 BUILDING

CARR, MICHAEL

JOB ADDRESS: 200 N LEADVILLE KETCHUM IDAHO, 83340 PARCEL #RPK00000230010

DRAWING NAME:

### **ELEVATIONS**

Drawn By: MS Checked By: NR Owner Approval:

PHASE:

CONSTRUCTION DRAWINGS


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APPROVED FOR CONSTRUCTION:

PROJECT No.: A21-198

DATE: 2/22/2023

PLOT SCALE: 1:1

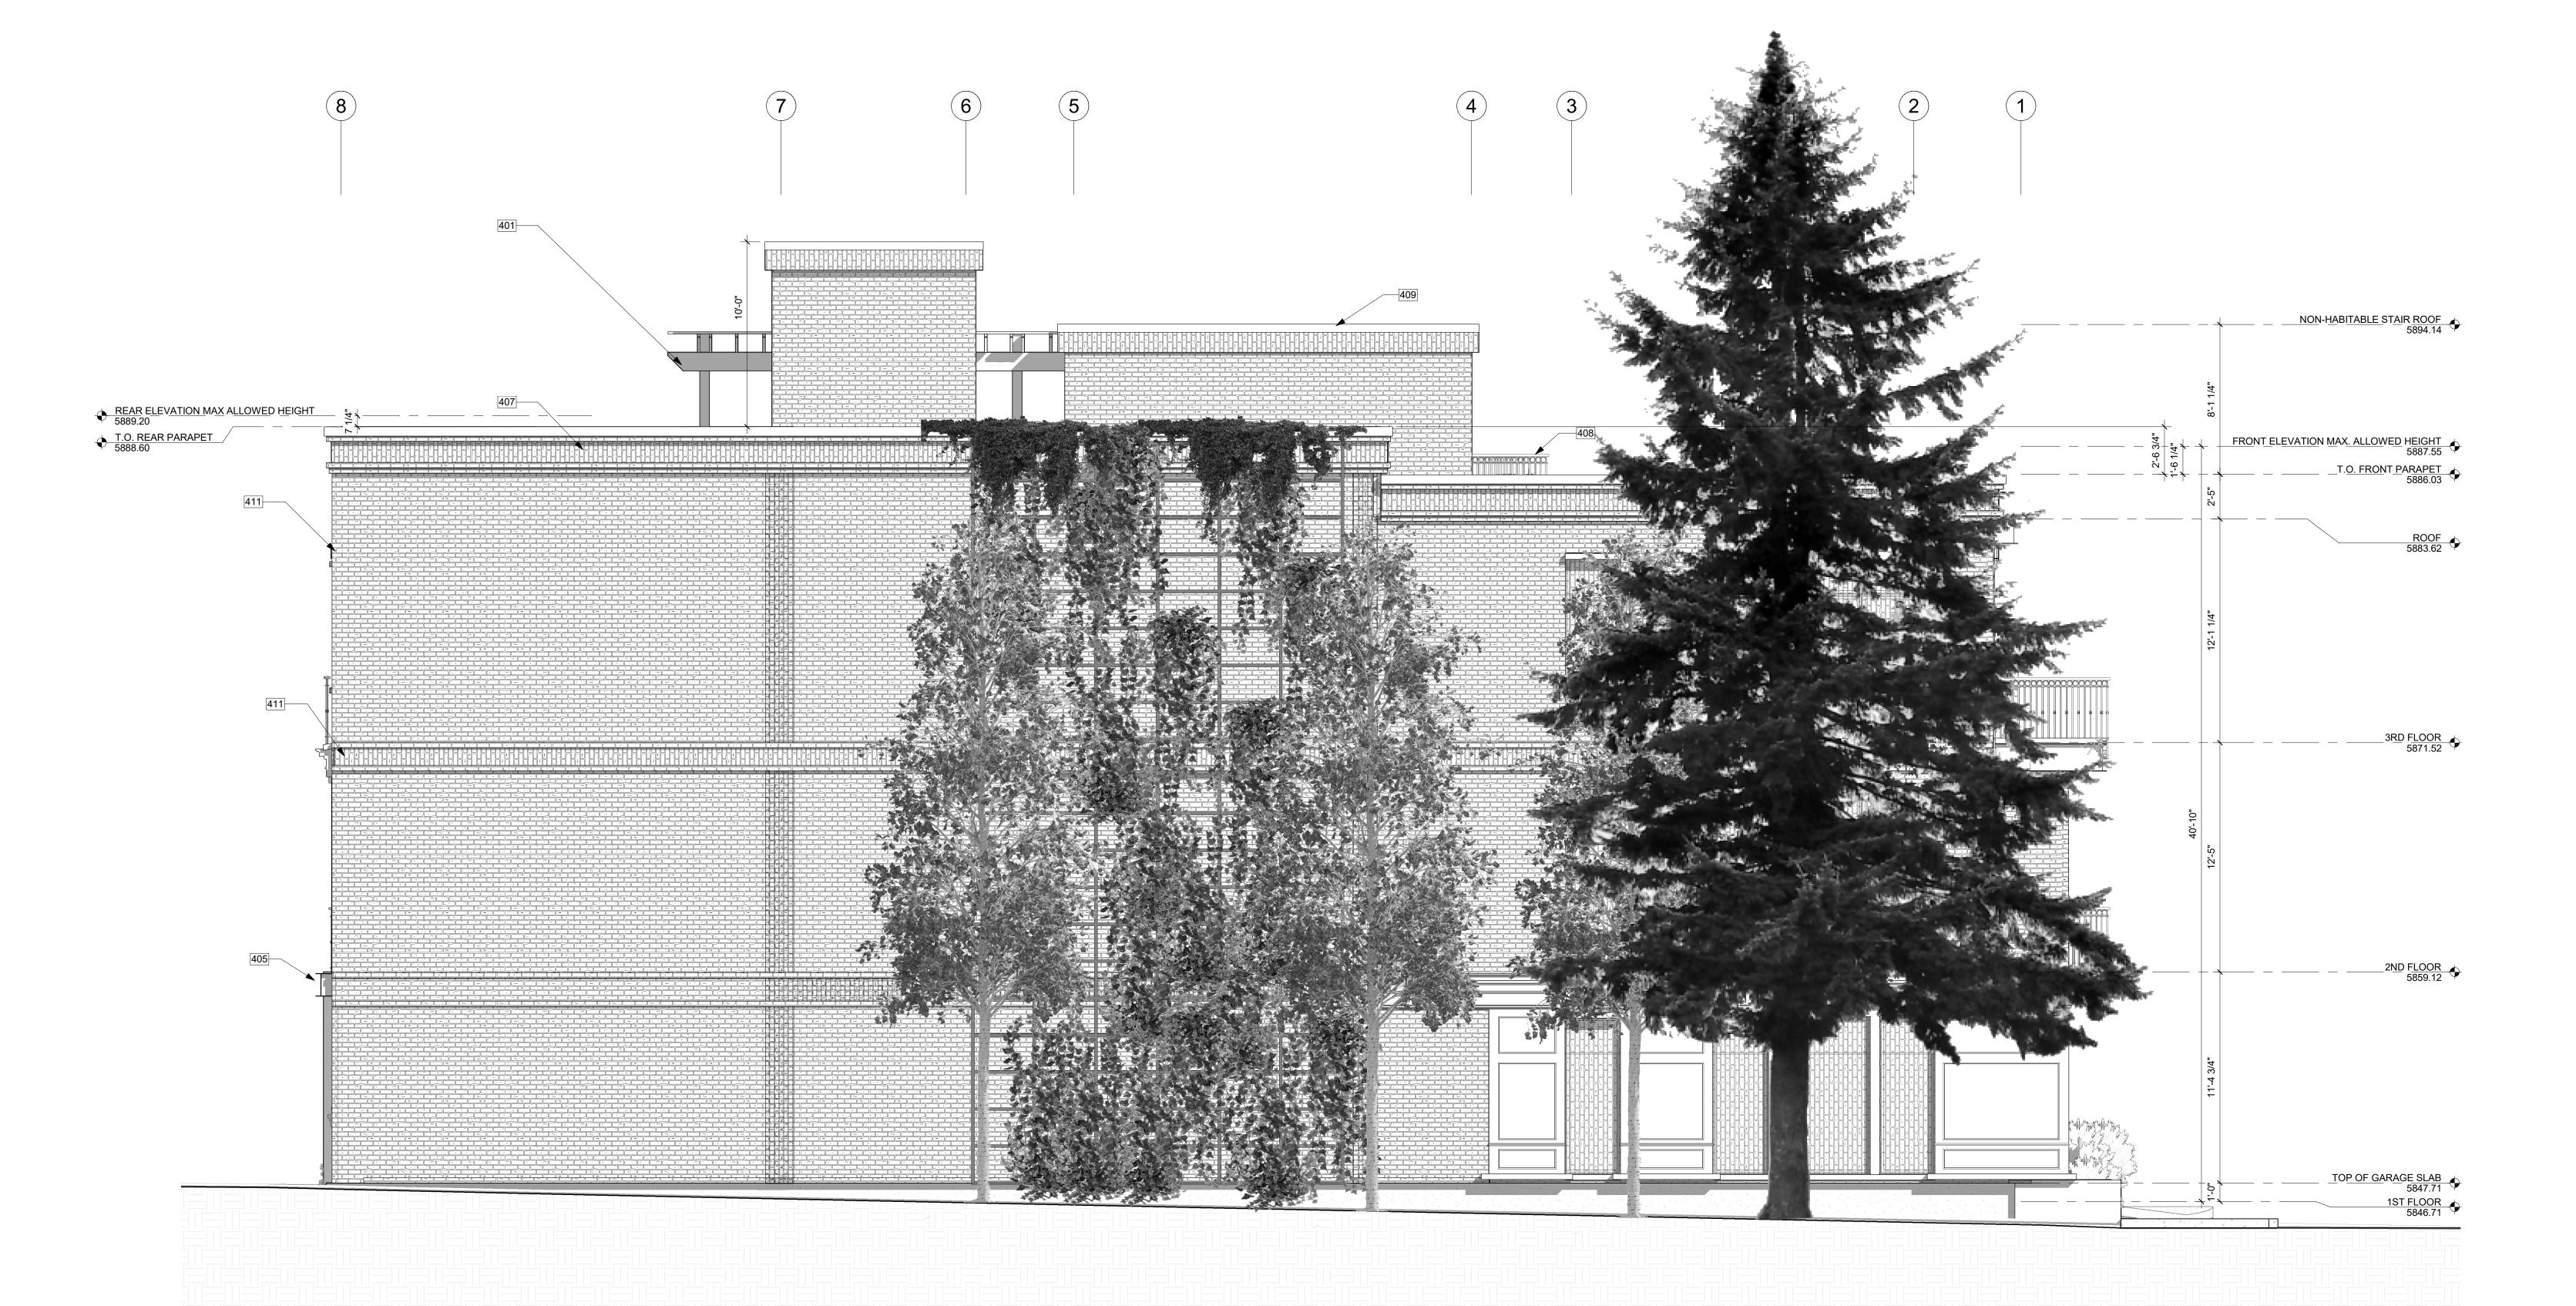

NORTH ELEVATION
1/4" = 1'-0"
1

# **KEY NOTES**


- 401 BRICK VENEER.405 BLACK STEEL C-CHANNEL.
- 407 METAL MESH SCREEN.
- 408 BLACK STEEL GUARD. MIN. 75% TRANSPARENT AT ROOFTOP.

409 BLACK METAL COPING OVER PARAPET WALL. 411 PRE CAST CONCRETE LINTEL.

MEDICI ARCHITECTS

11661 SE 1ST STREET, SUITE 200 BELLEVUE, WASHINGTON 98005 TEL: (425) 453-9298 FAX: (425) 452-8448

REGISTRATION:

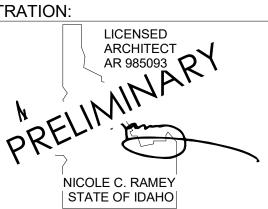

INTAKE DATE: 02/22/23 **REVISIONS**:

PROJECT / CLIENT: THE 208 BUILDING

CARR, MICHAEL

JOB ADDRESS: 200 N LEADVILLE KETCHUM IDAHO, 83340 PARCEL #RPK00000230010

DRAWING NAME:

## **ELEVATIONS**

Drawn By: MS Checked By: EB Owner Approval:

PHASE:


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PROJECT No.: A21-198

DATE: 2/22/2023




NORTH ELEVATION
1/4" = 1'-0"
1

# **KEY NOTES**

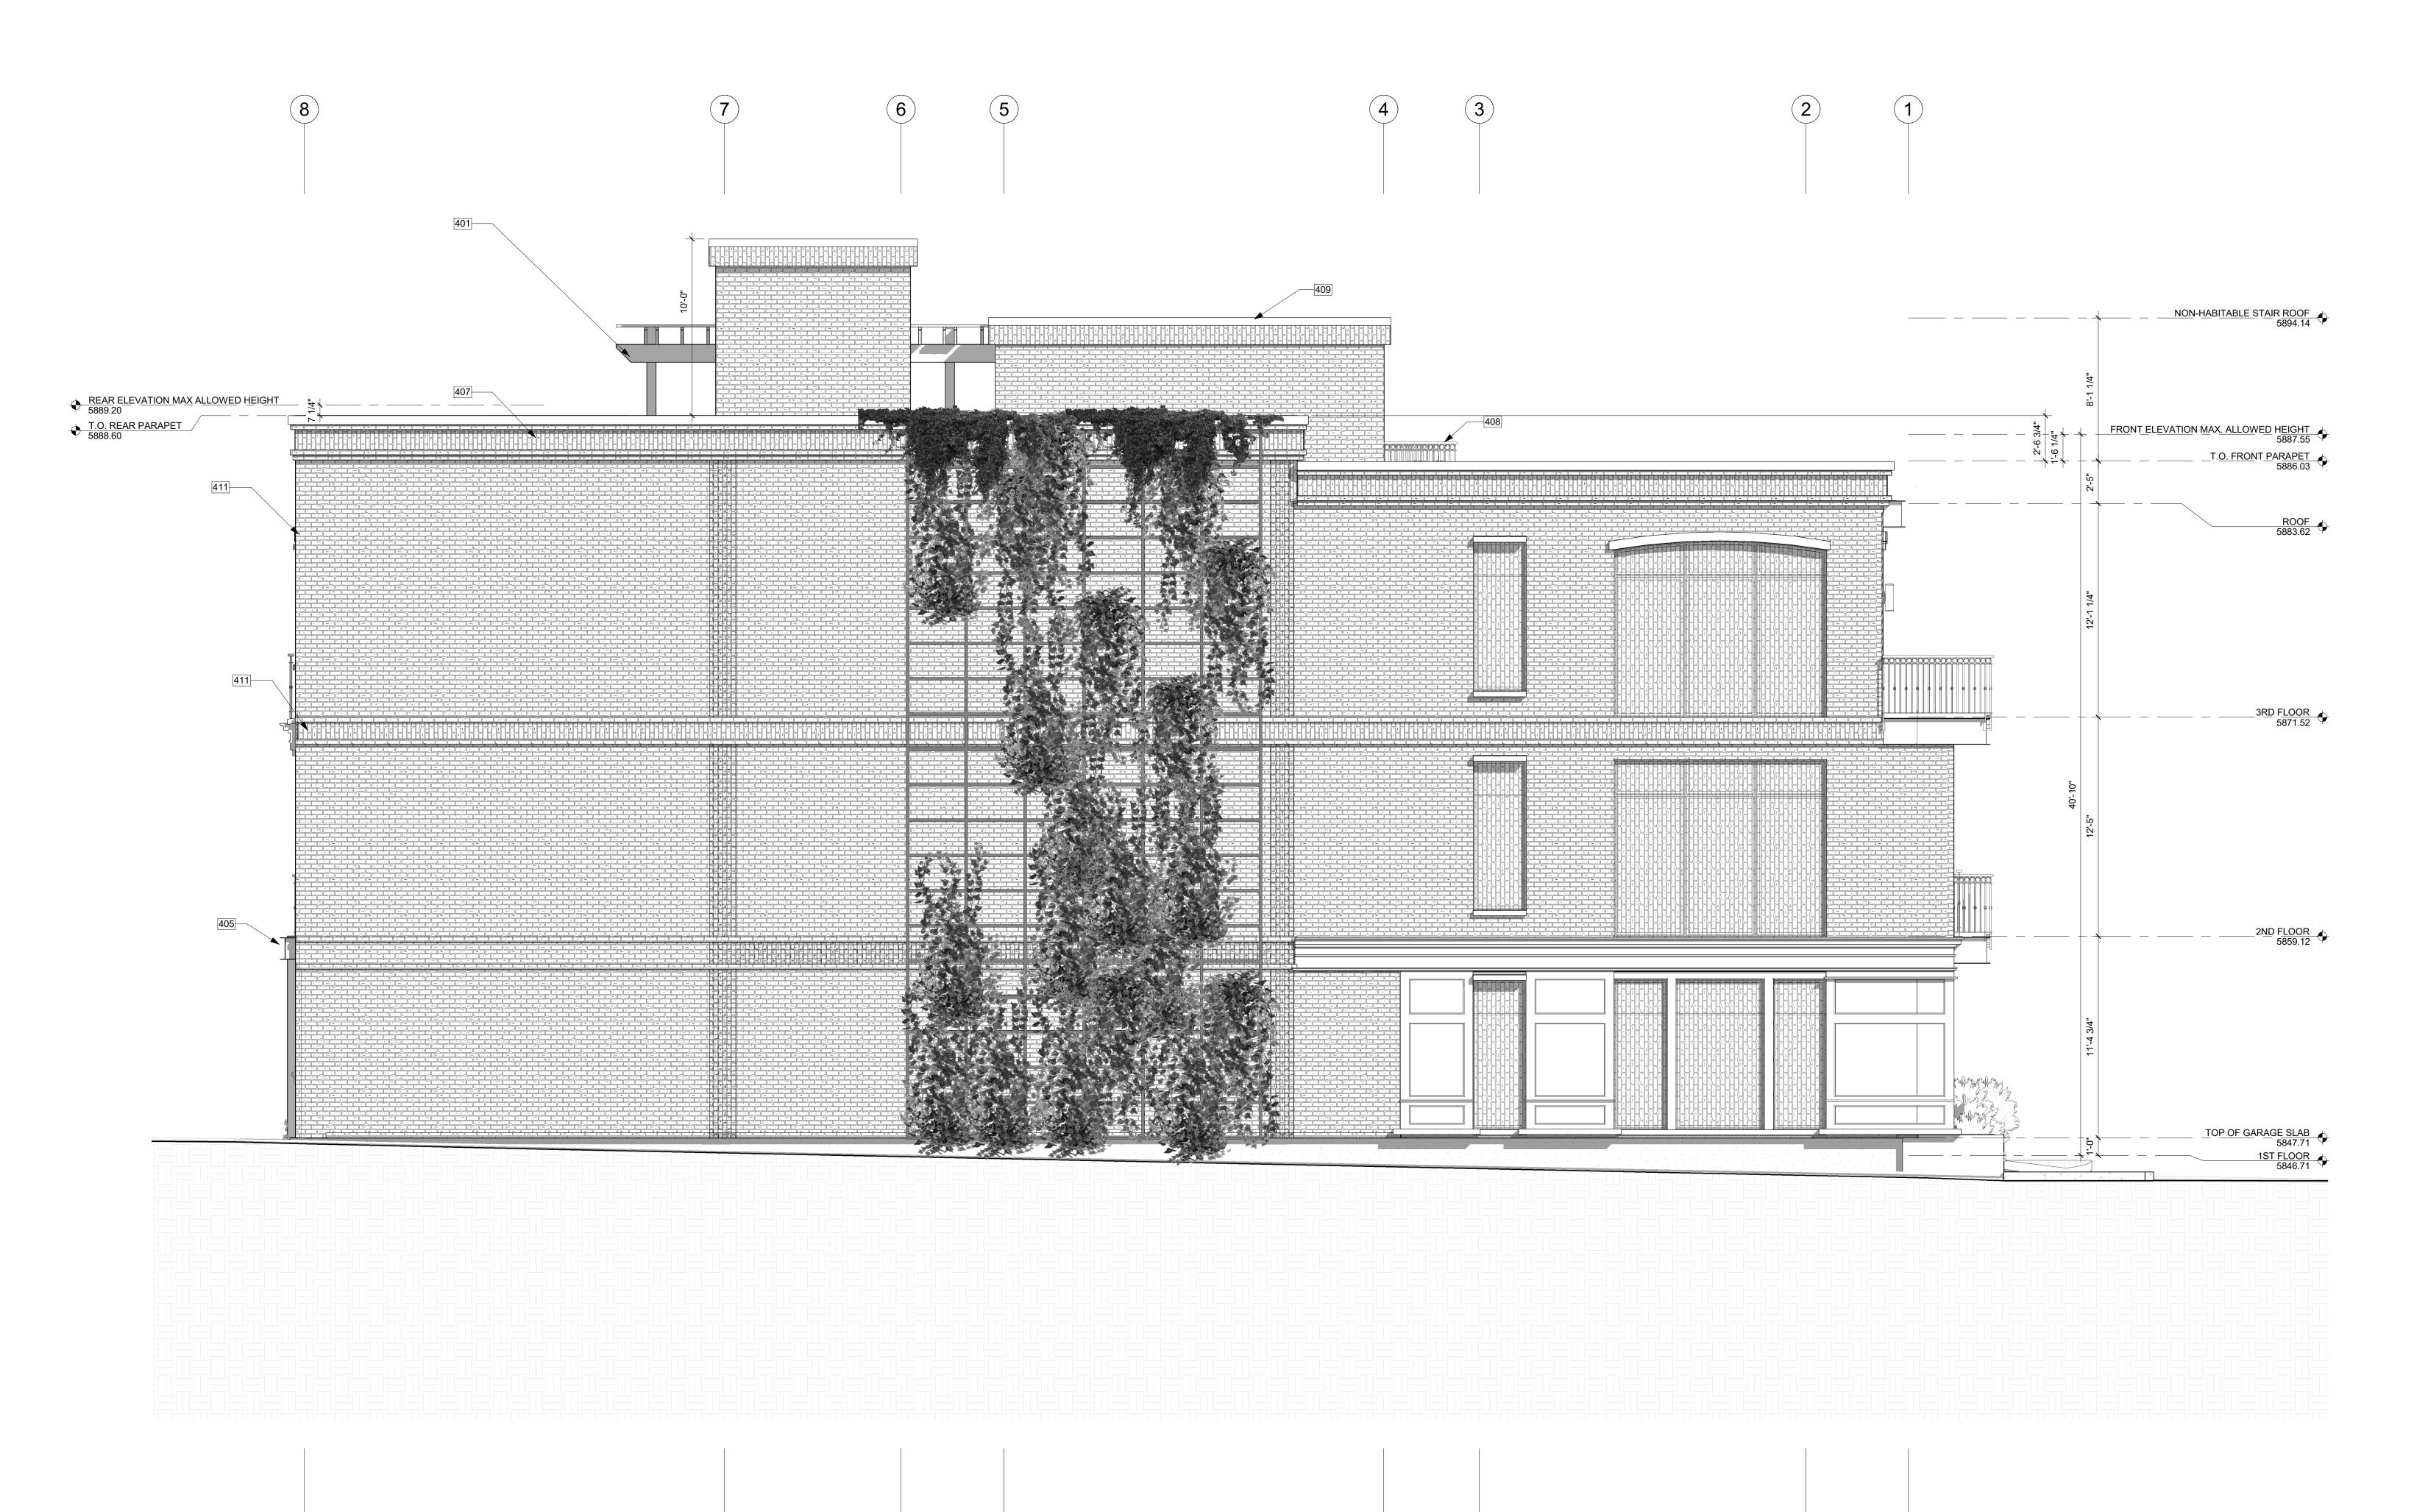- 401 BRICK VENEER.
- 405 BLACK STEEL C-CHANNEL.
- 407 METAL MESH SCREEN.
- 408 BLACK STEEL GUARD. MIN. 75% TRANSPARENT AT
  - ROOFTOP.
- 409 BLACK METAL COPING OVER PARAPET WALL. 411 PRE CAST CONCRETE LINTEL.

MEDICI ARCHITECTS

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02/22/23 INTAKE DATE: **REVISIONS**: DATE:

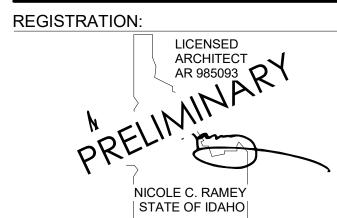PROJECT / CLIENT: THE 208 BUILDING

CARR, MICHAEL

JOB ADDRESS: 200 N LEADVILLE KETCHUM IDAHO, 83340 PARCEL #RPK00000230010

DRAWING NAME:

## **ELEVATIONS**

Drawn By: Author Checked By: Checker Owner Approval:

PHASE:

CONSTRUCTION DRAWINGS

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PROJECT No.: A21-198


DATE: 2/22/2023

NOTE: 3D RENDERINGS ARE FOR ILLUSTRATIVE PURPOSES ONLY. NOT TO BE USED FOR CONSTRUCTION.






SOUTH EAST PERSPECTIVE NORTH EAST PERSPECTIVE

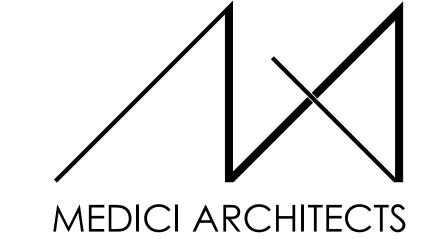

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REGISTRATION:

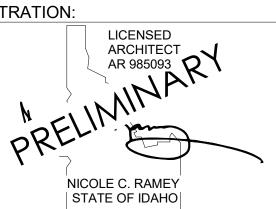

02/22/23 INTAKE DATE: **REVISIONS:** 

PROJECT / CLIENT: THE 208 BUILDING

CARR, MICHAEL

JOB ADDRESS: 200 N LEADVILLE KETCHUM IDAHO, 83340 PARCEL #RPK00000230010



SOUTH WEST PERSPECTIVE

DRAWING NAME:

## PERSPECTIVES


Drawn By: MS Checked By: NR Owner Approval:

CONSTRUCTION DRAWINGS

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APPROVED FOR CONSTRUCTION:

PROJECT No.: A21-198 DATE: 2/22/2023

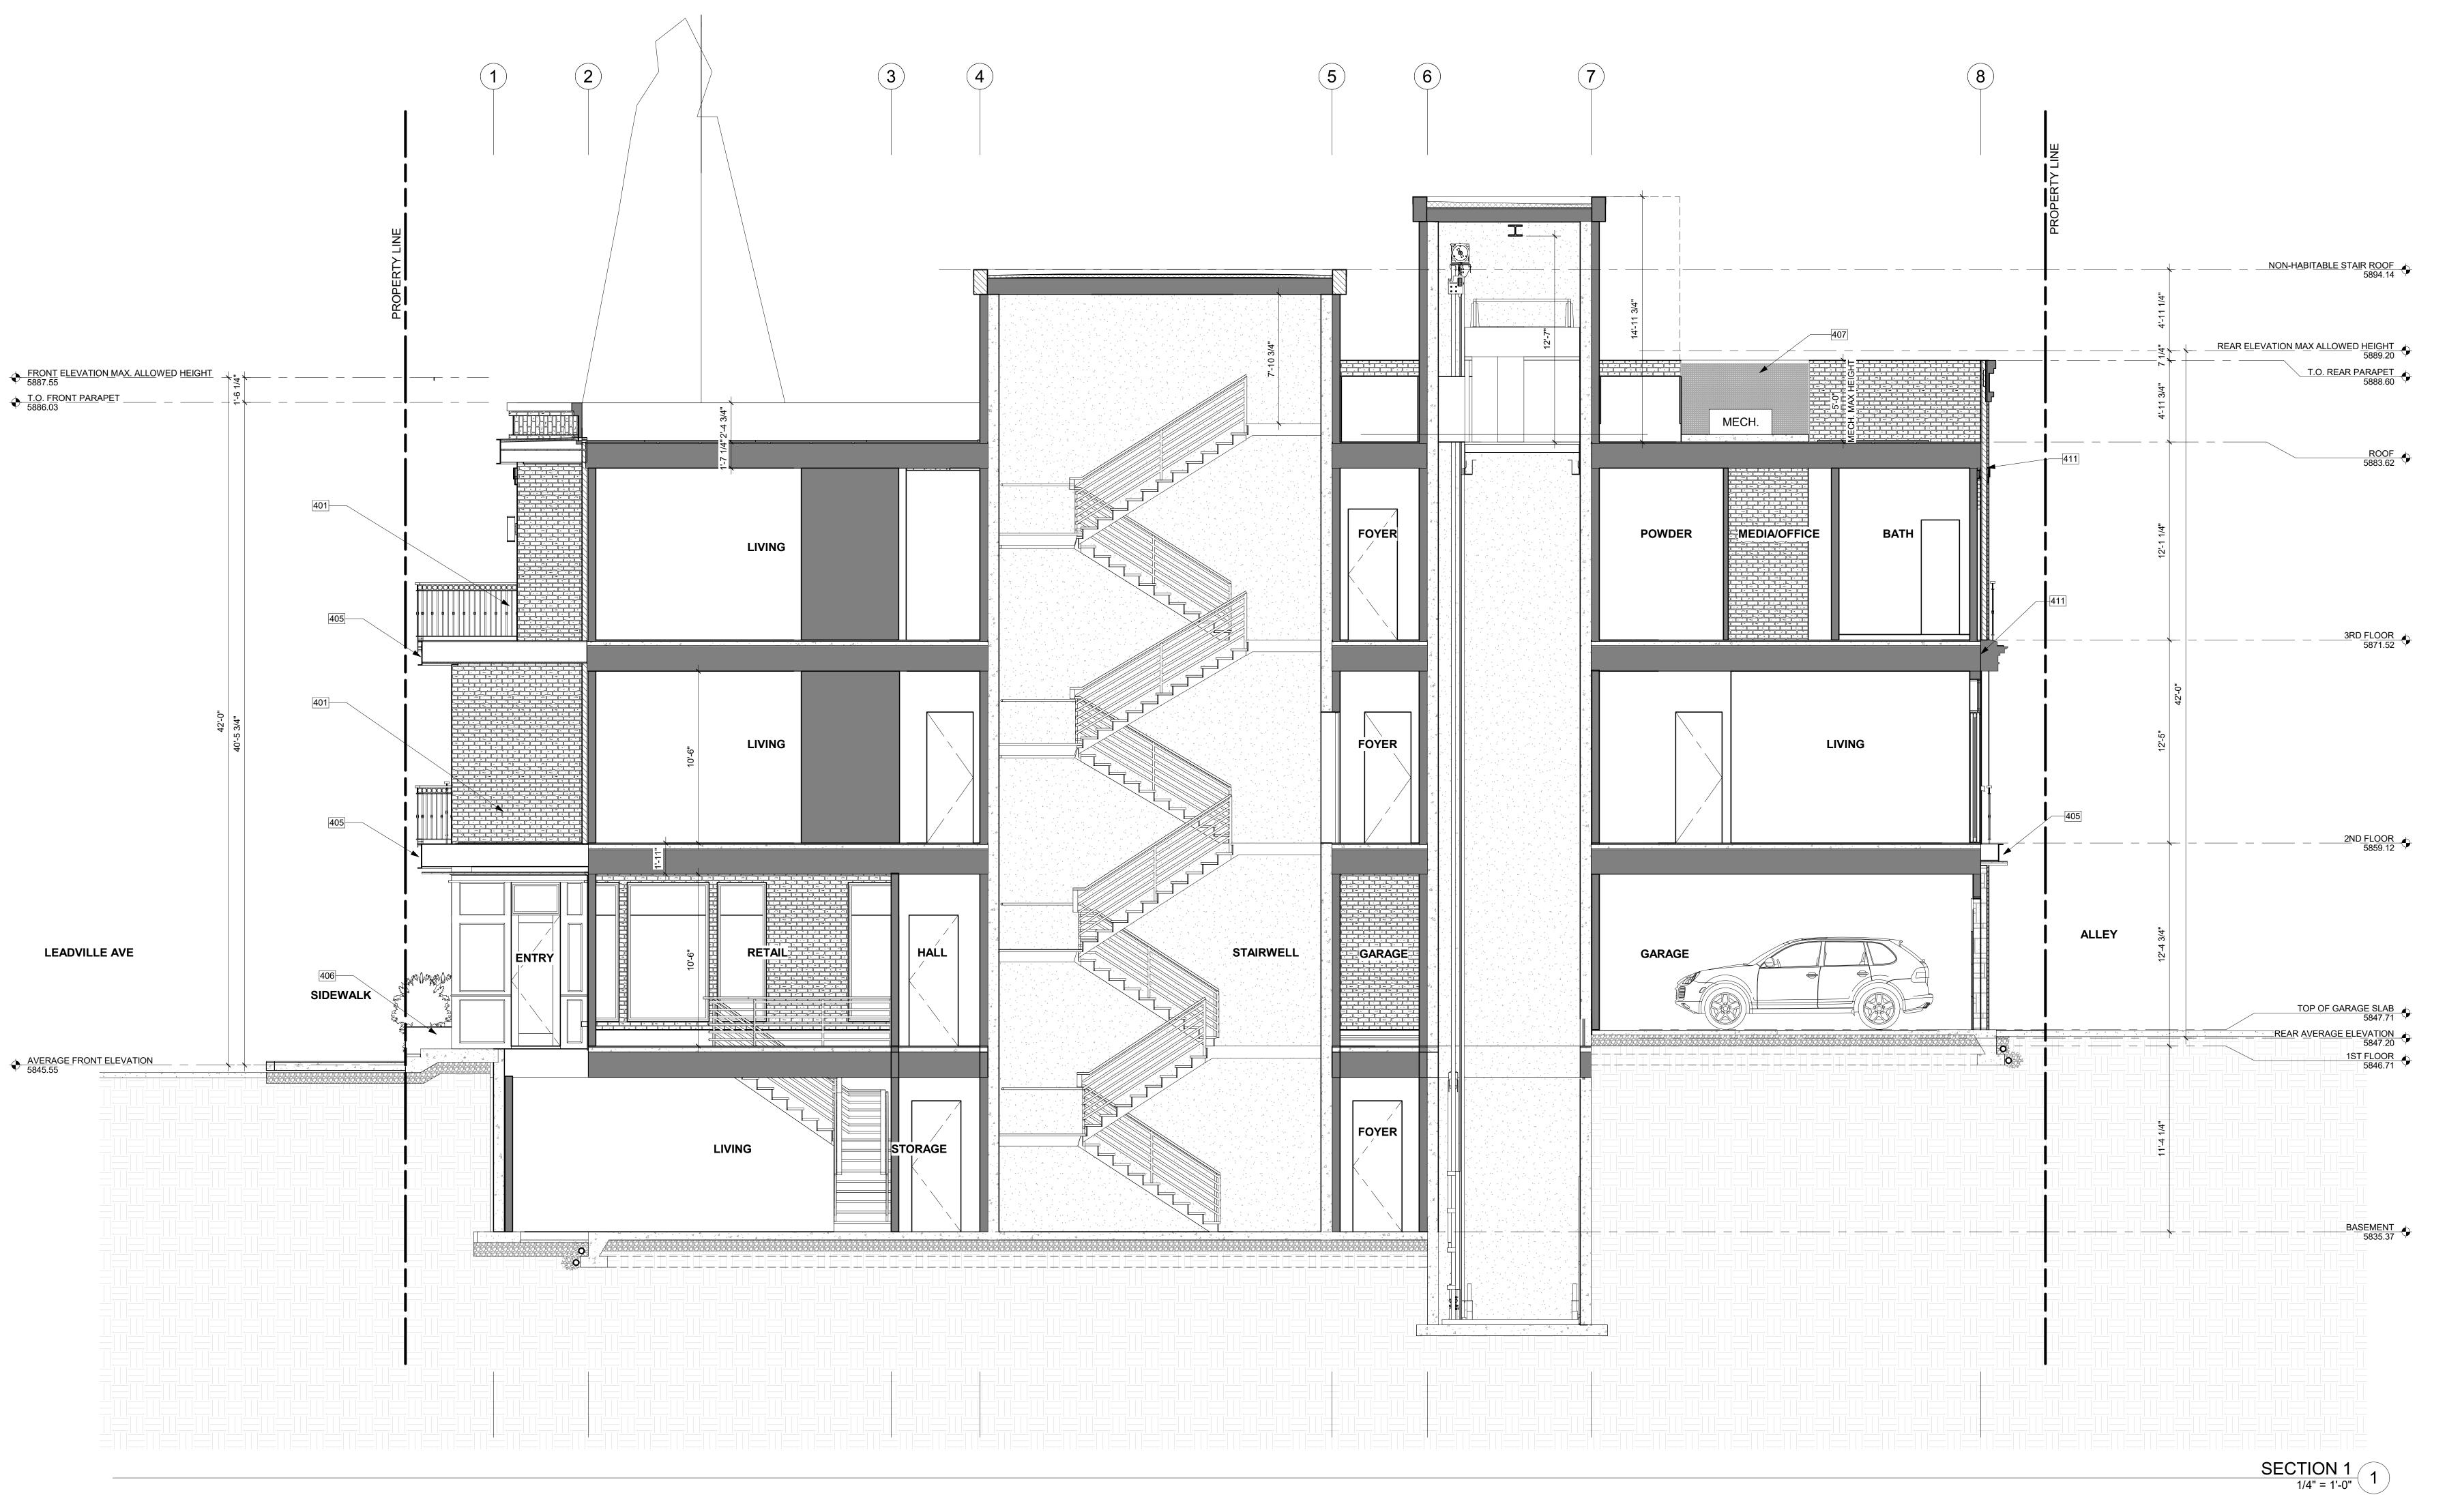

# **KEY NOTES**


- 401 BRICK VENEER.
- 405 BLACK STEEL C-CHANNEL.
- 406 BLACK STEEL PLANTERS. TO REMAIN 4" BELOW WINDOW SILLS AT RETAIL LEVEL.
- 407 METAL MESH SCREEN.

411 PRE CAST CONCRETE LINTEL.

MEDICI ARCHITECTS

11661 SE 1ST STREET, SUITE 200 BELLEVUE, WASHINGTON 98005 TEL: (425) 453-9298 FAX: (425) 452-8448

REGISTRATION:

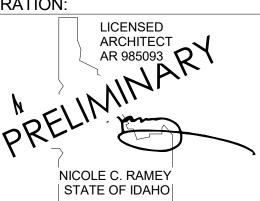

02/22/23 INTAKE DATE:

**REVISIONS**:

PROJECT / CLIENT: THE 208 BUILDING

CARR, MICHAEL

JOB ADDRESS: 200 N LEADVILLE KETCHUM IDAHO, 83340 PARCEL #RPK00000230010

DRAWING NAME:

# SECTIONS

Drawn By: MS Checked By: NR Owner Approval:

PHASE:

CONSTRUCTION DRAWINGS

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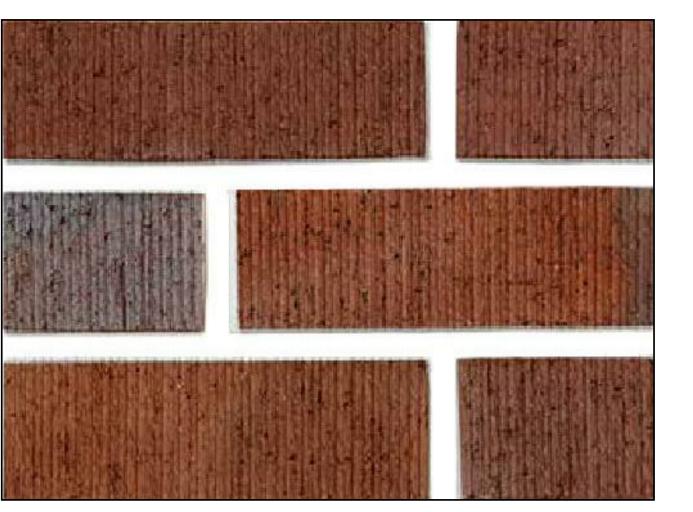
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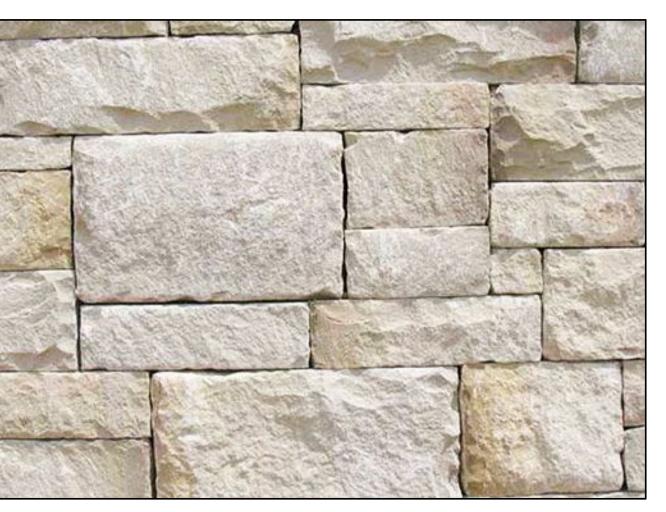
PROJECT No.: A21-198

DATE: 2/22/2023






BRICK VENEER
MOUNTAIN BLEND WITH RUG TEXTURE




SILVERTIP STACK



WOOD SOFFIT
ALASKAN YELLOW CEDAR VG

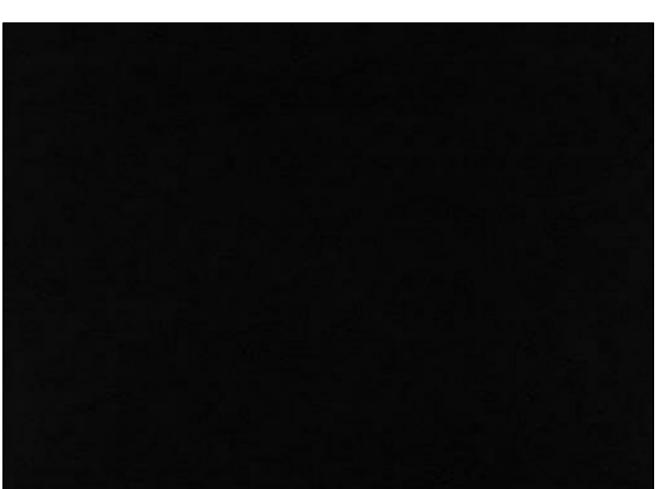


STEEL BLACK STEEL

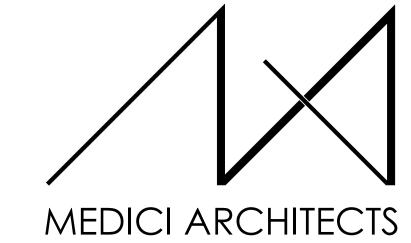

11661 SE 1ST STREET, SUITE 200 BELLEVUE, WASHINGTON 98005 TEL: (425) 453-9298 FAX: (425) 452-8448

REGISTRATION:

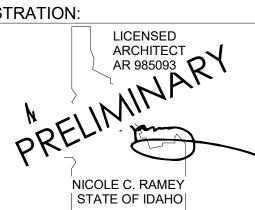

REVISIONS: DATE:

PROJECT / CLIENT:
THE 208 BUILDING

CARR, MICHAEL

JOB ADDRESS:
200 N LEADVILLE KETCHUM
IDAHO, 83340
PARCEL #RPK00000230010

DRAWING NAME:

## **EXTERIOR MATERIALS**

Drawn By: MS
Checked By: NR
Owner Approval:

PHASE:

CONSTRUCTION DRAWINGS


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APPROVED FOR CONSTRUCTION:


PROJECT No.: A21-198


DATE: 2/22/2023

A5.1

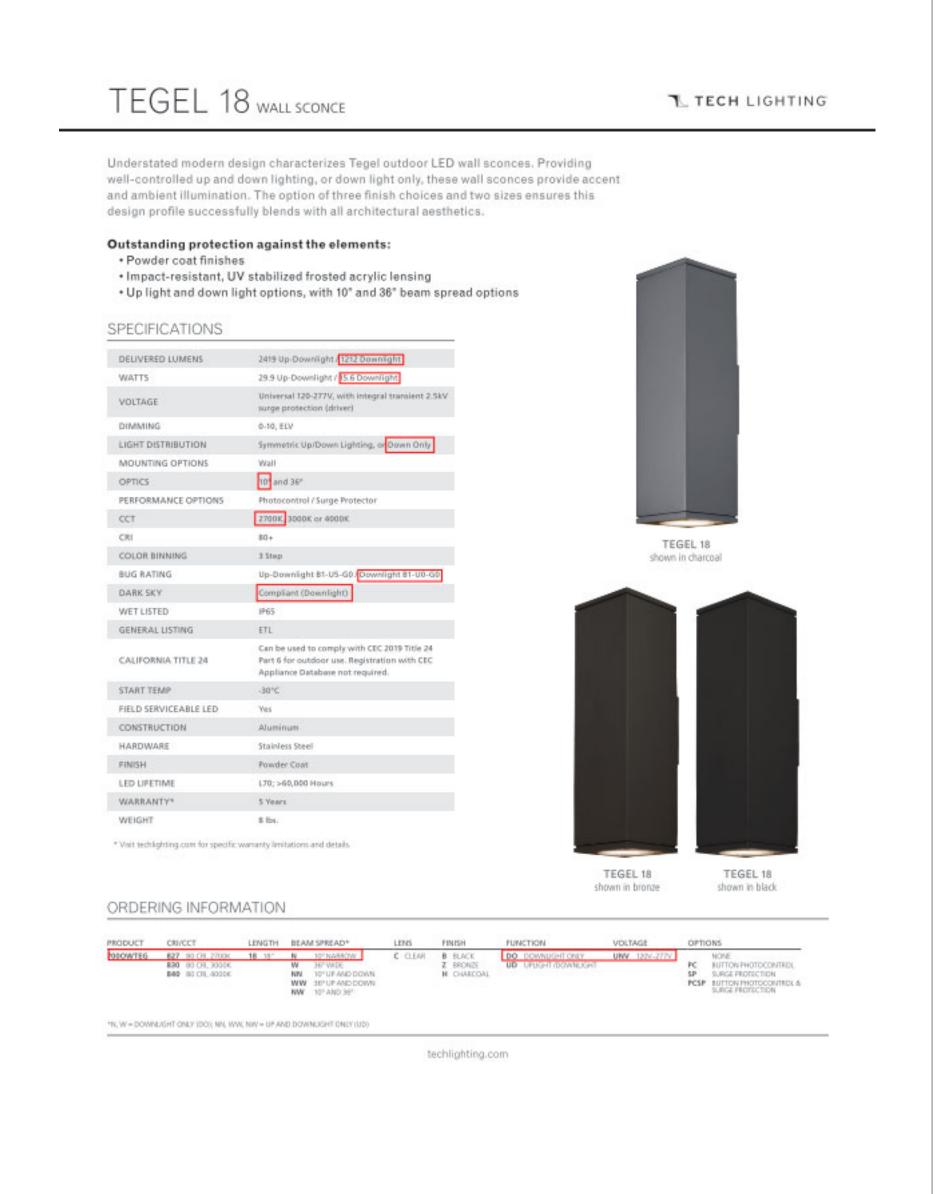

В

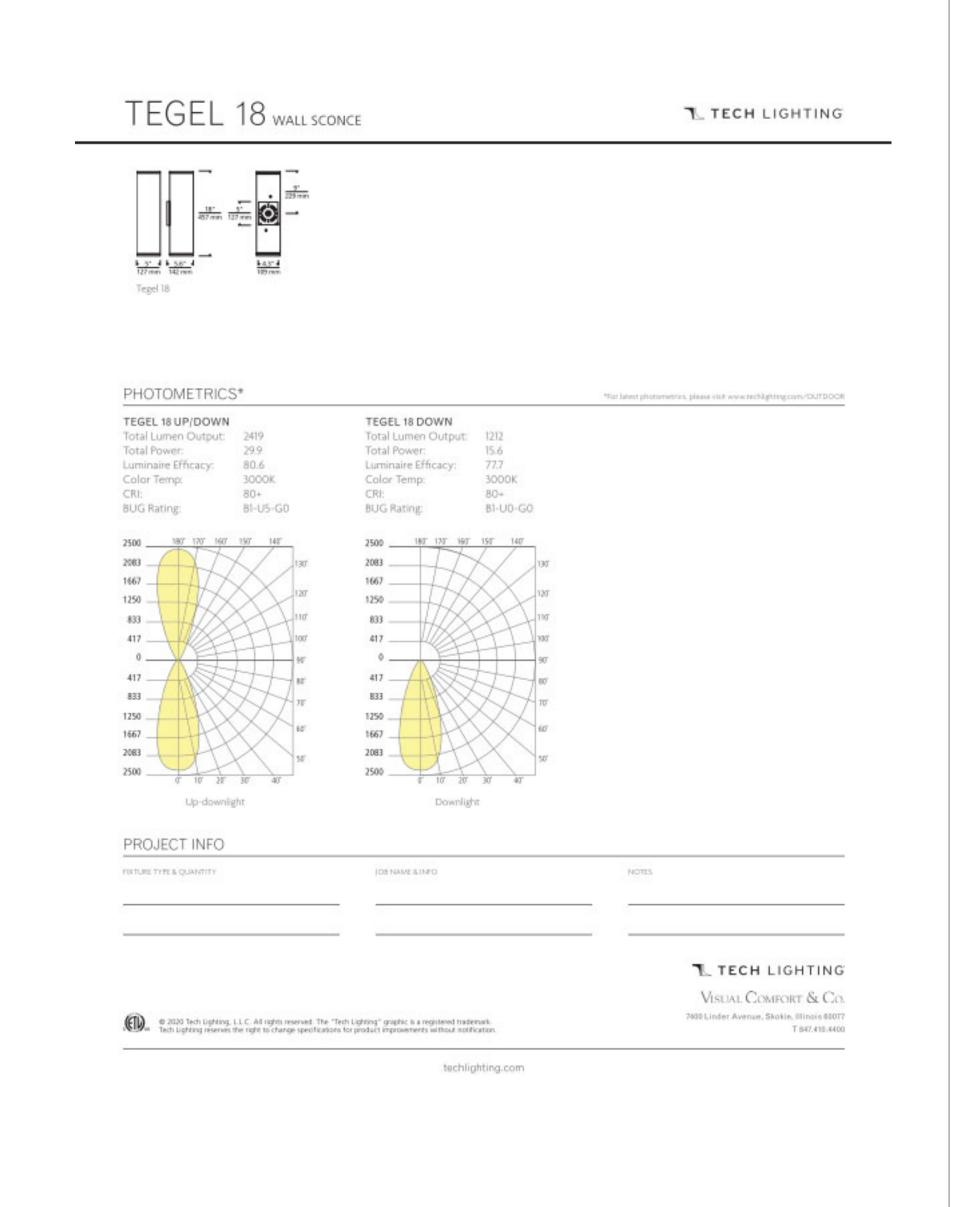


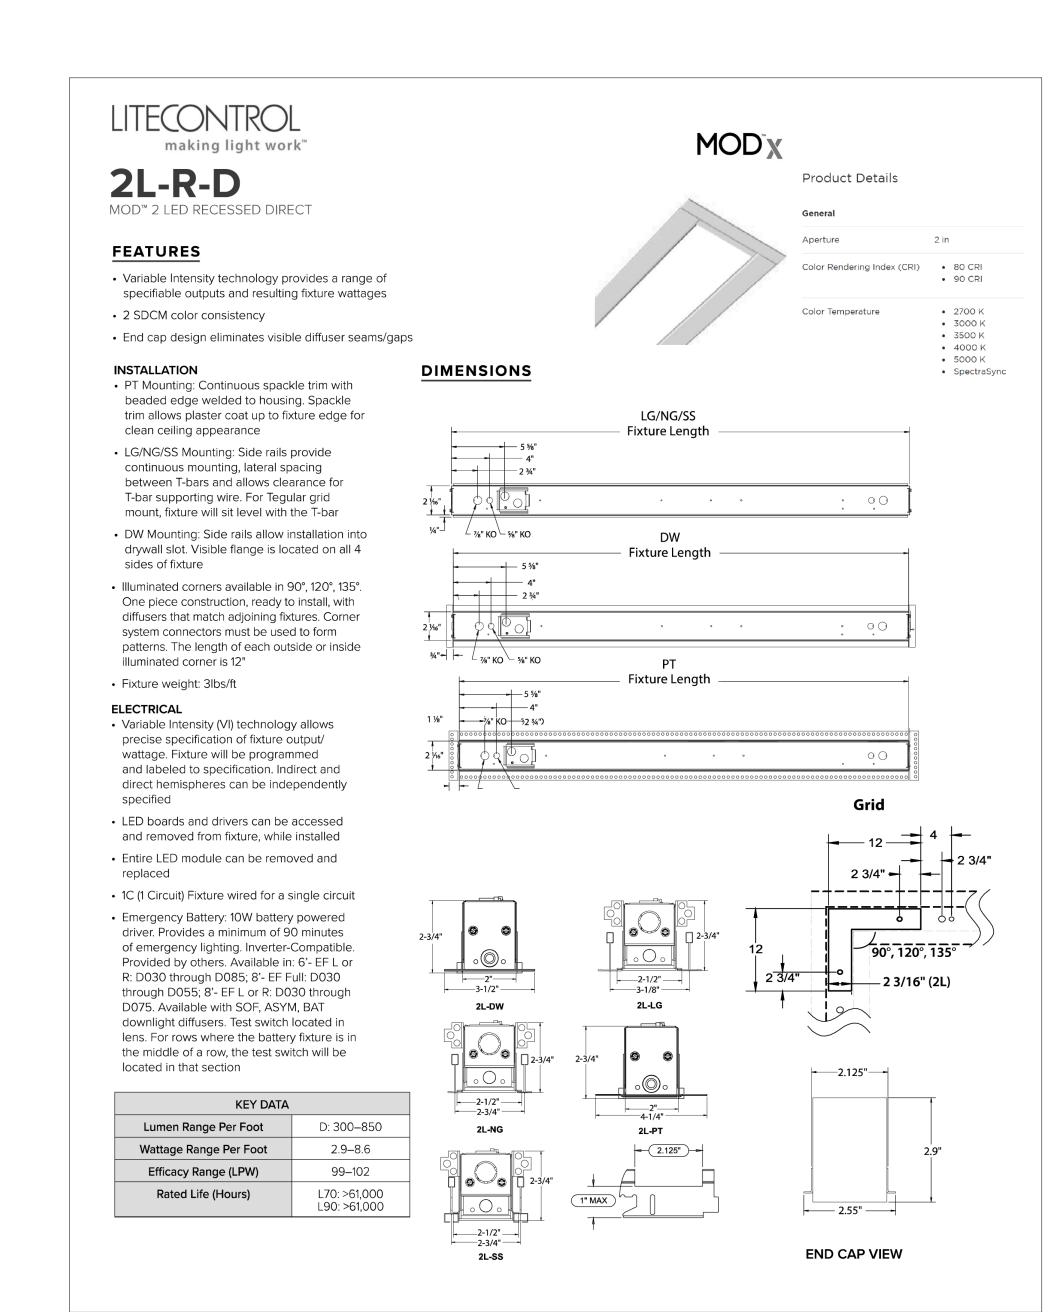








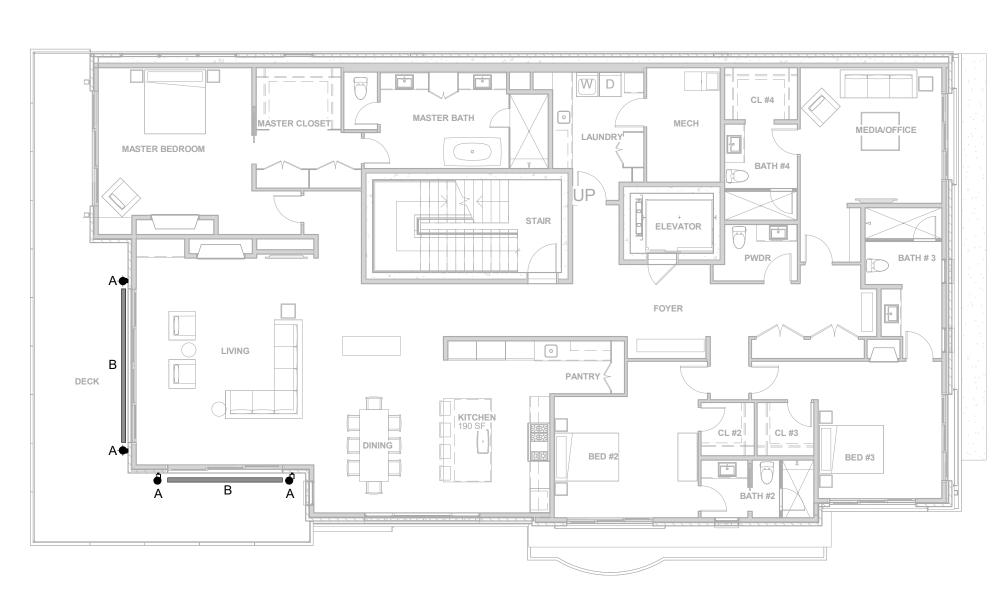

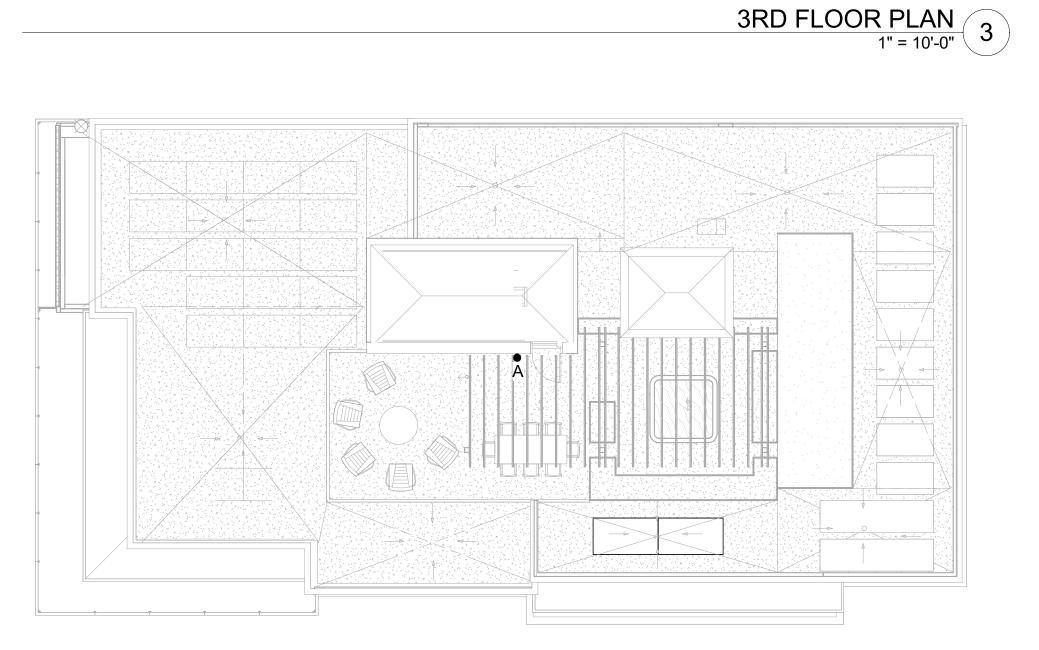






11661 SE 1ST STREET, SUITE 200 BELLEVUE, WASHINGTON 98005 TEL: (425) 453-9298 FAX: (425) 452-8448

**REGISTRATION:** 

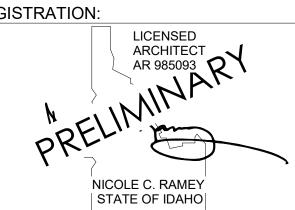

02/22/23 INTAKE DATE: **REVISIONS:** DATE:

PROJECT / CLIENT: THE 208 BUILDING

CARR, MICHAEL

JOB ADDRESS: 200 N LEADVILLE KETCHUM IDAHO, 83340 PARCEL #RPK00000230010

DRAWING NAME: EXTERIOR LIGHTING PLANS AND FIXTURES

Drawn By: MS Checked By: NR Owner Approval:

PHASE:


CONSTRUCTION DRAWINGS


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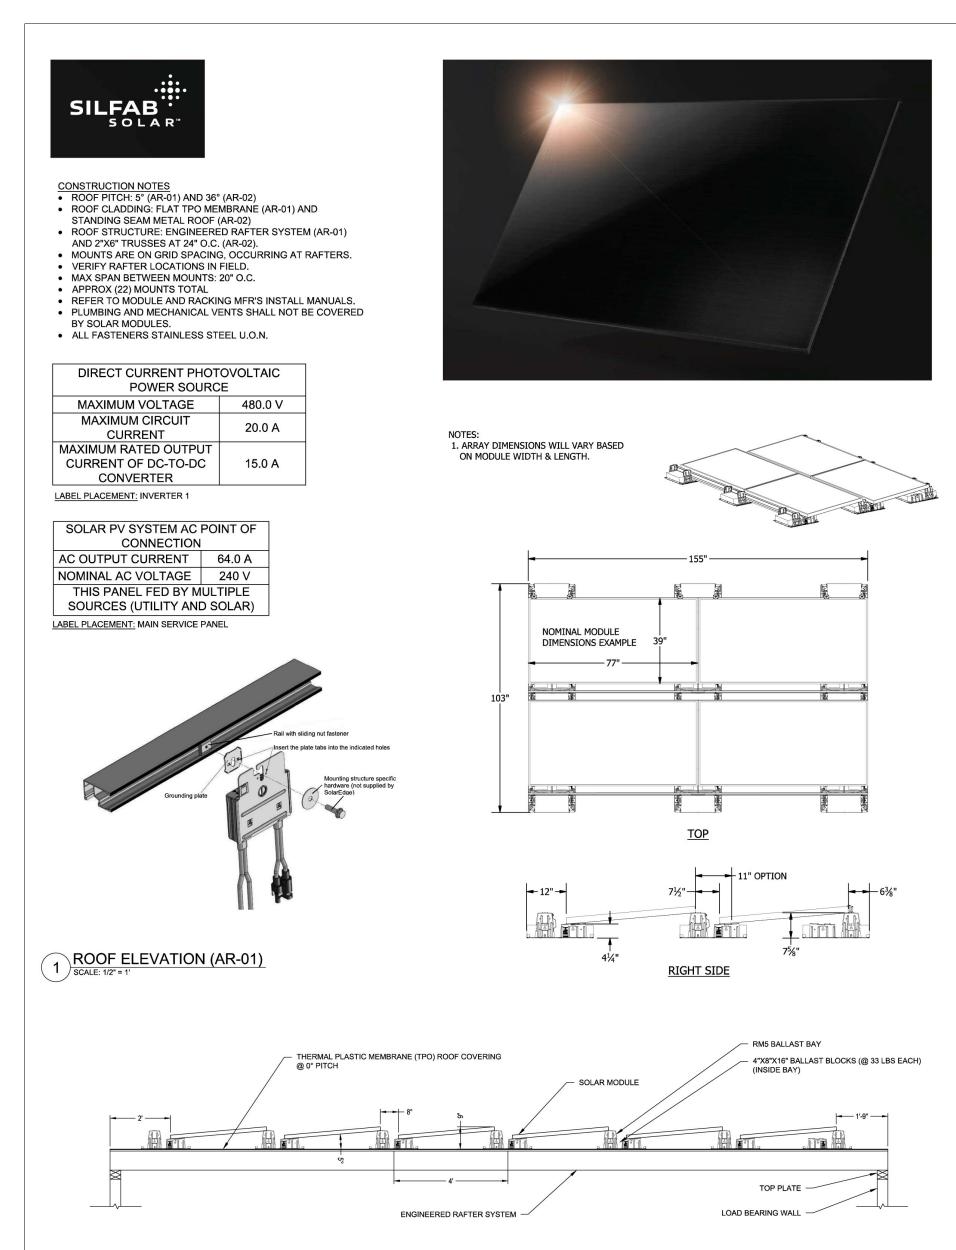
APPROVED FOR CONSTRUCTION:


PROJECT No.: A21-198


DATE: 2/22/2023




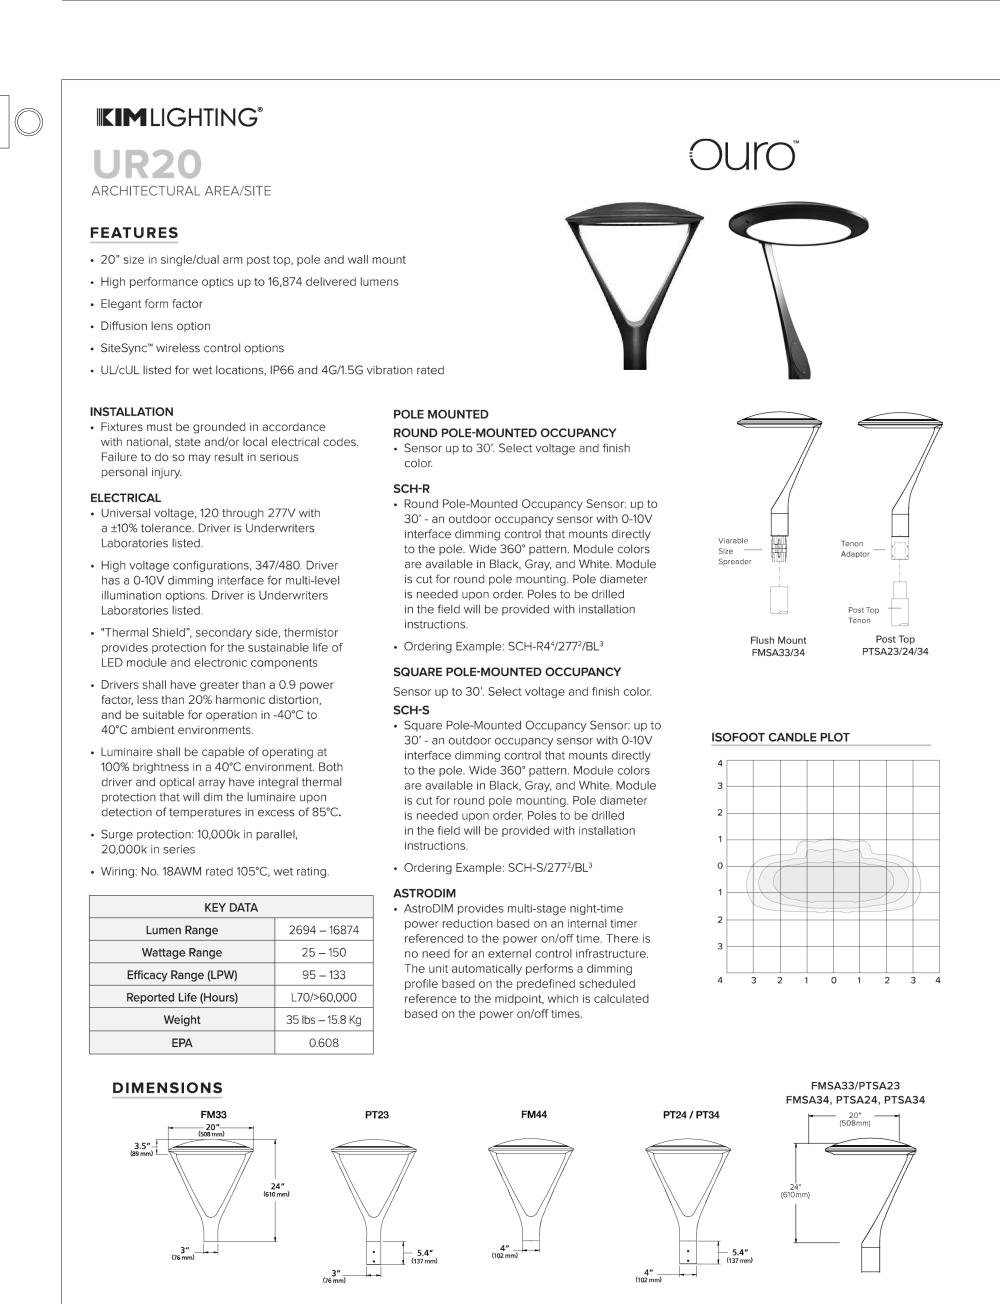

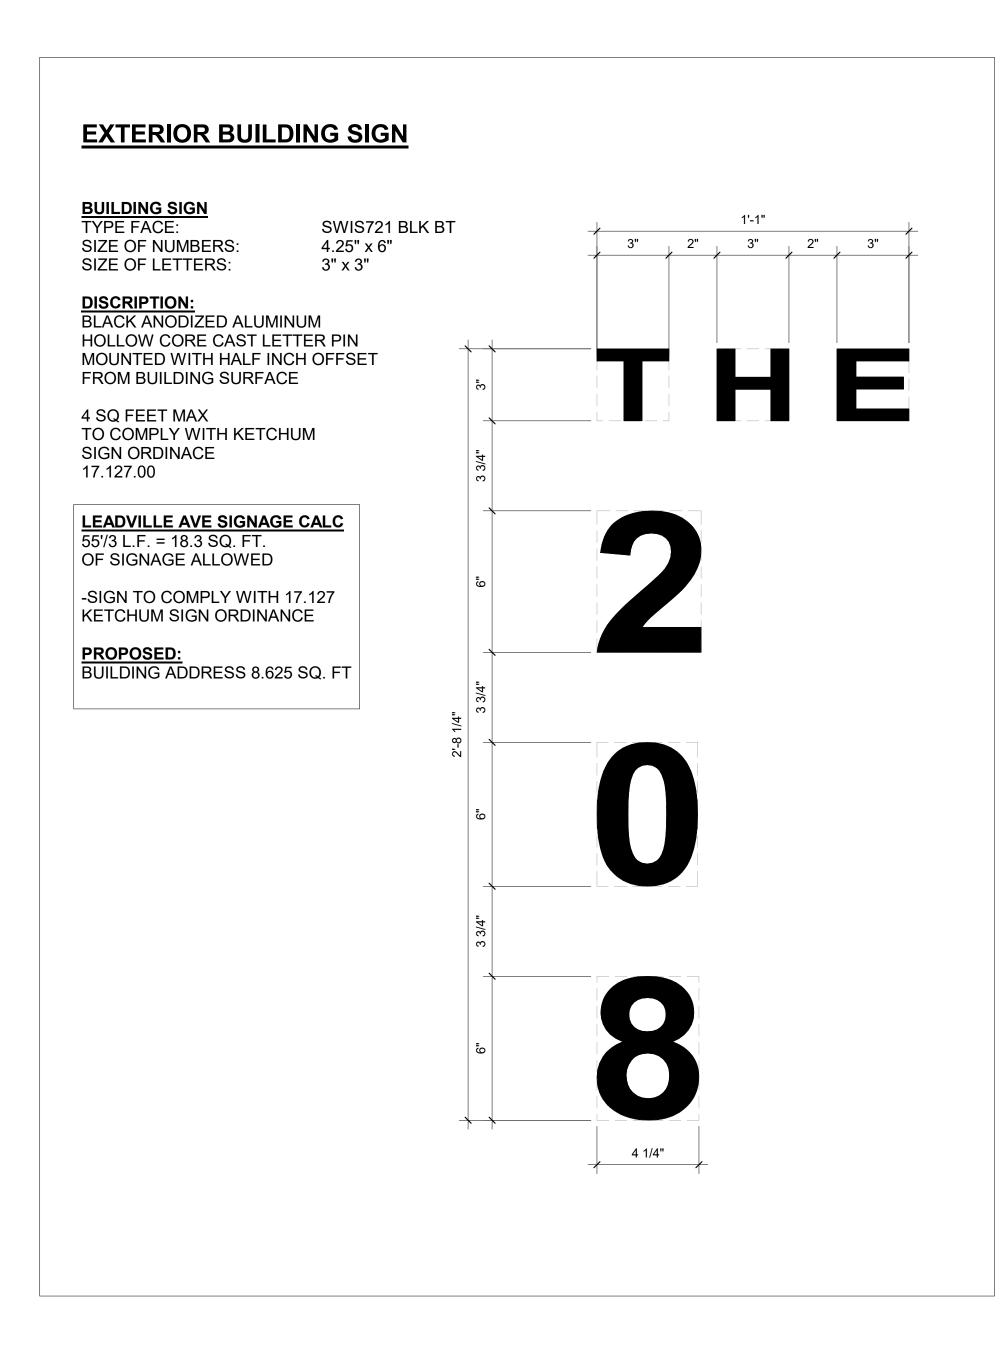

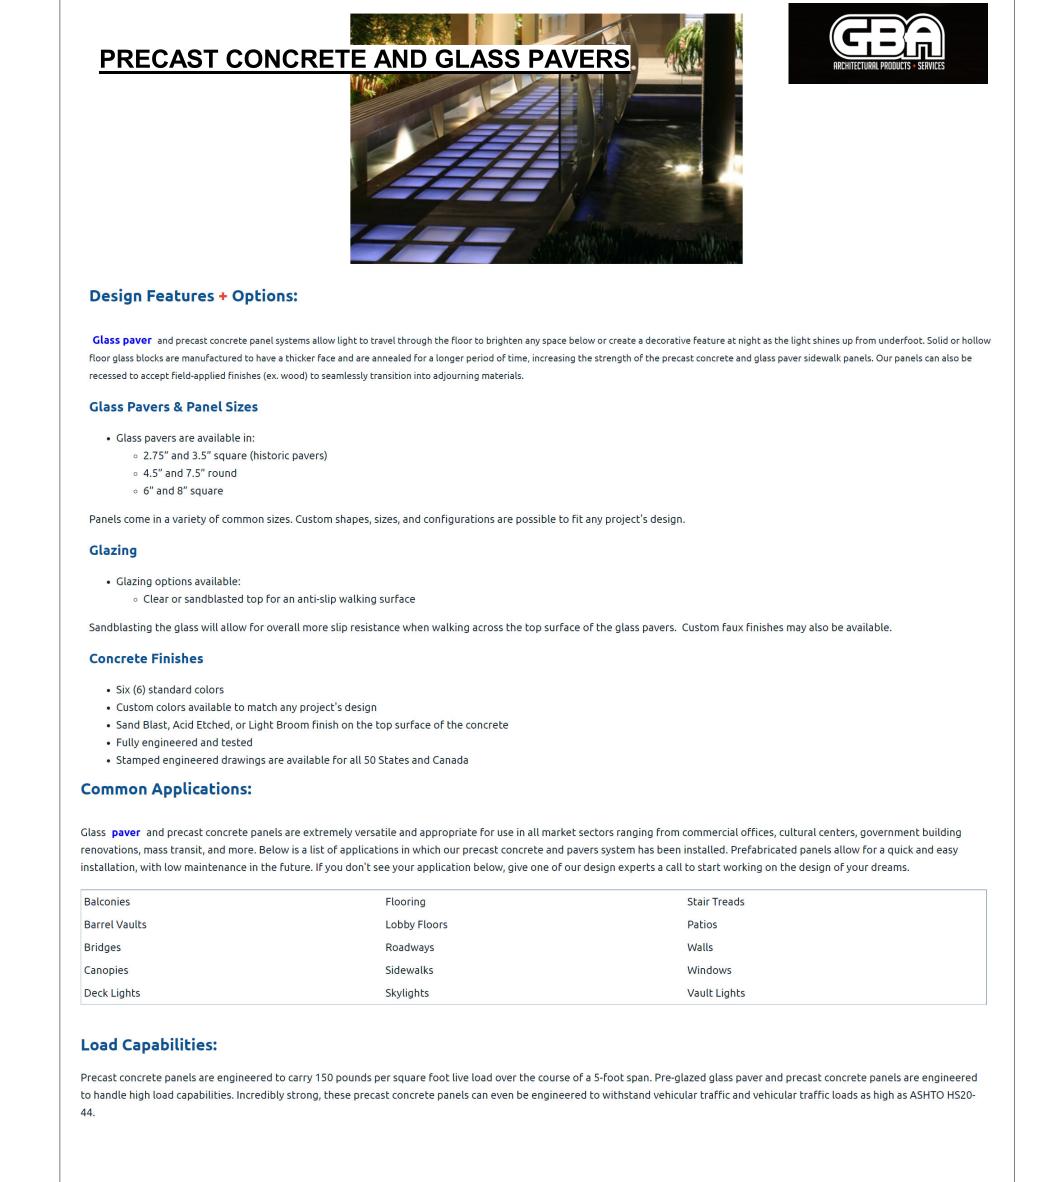

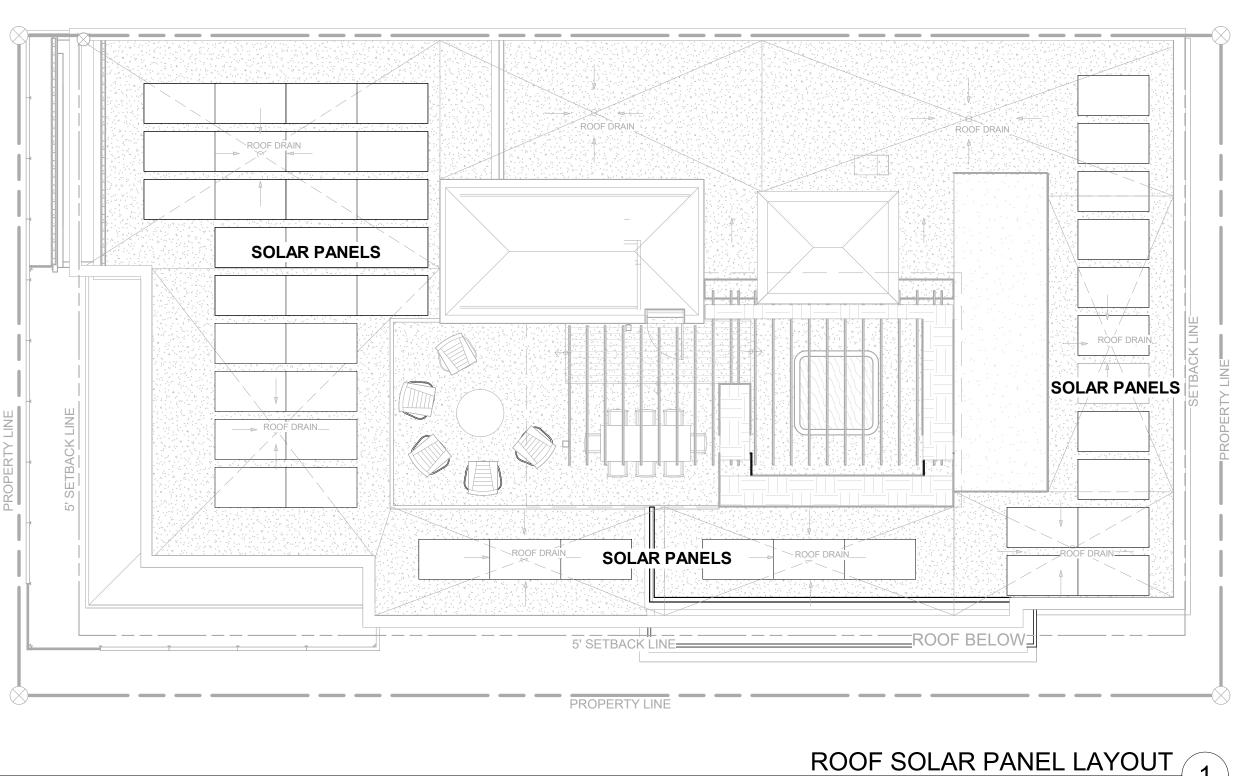

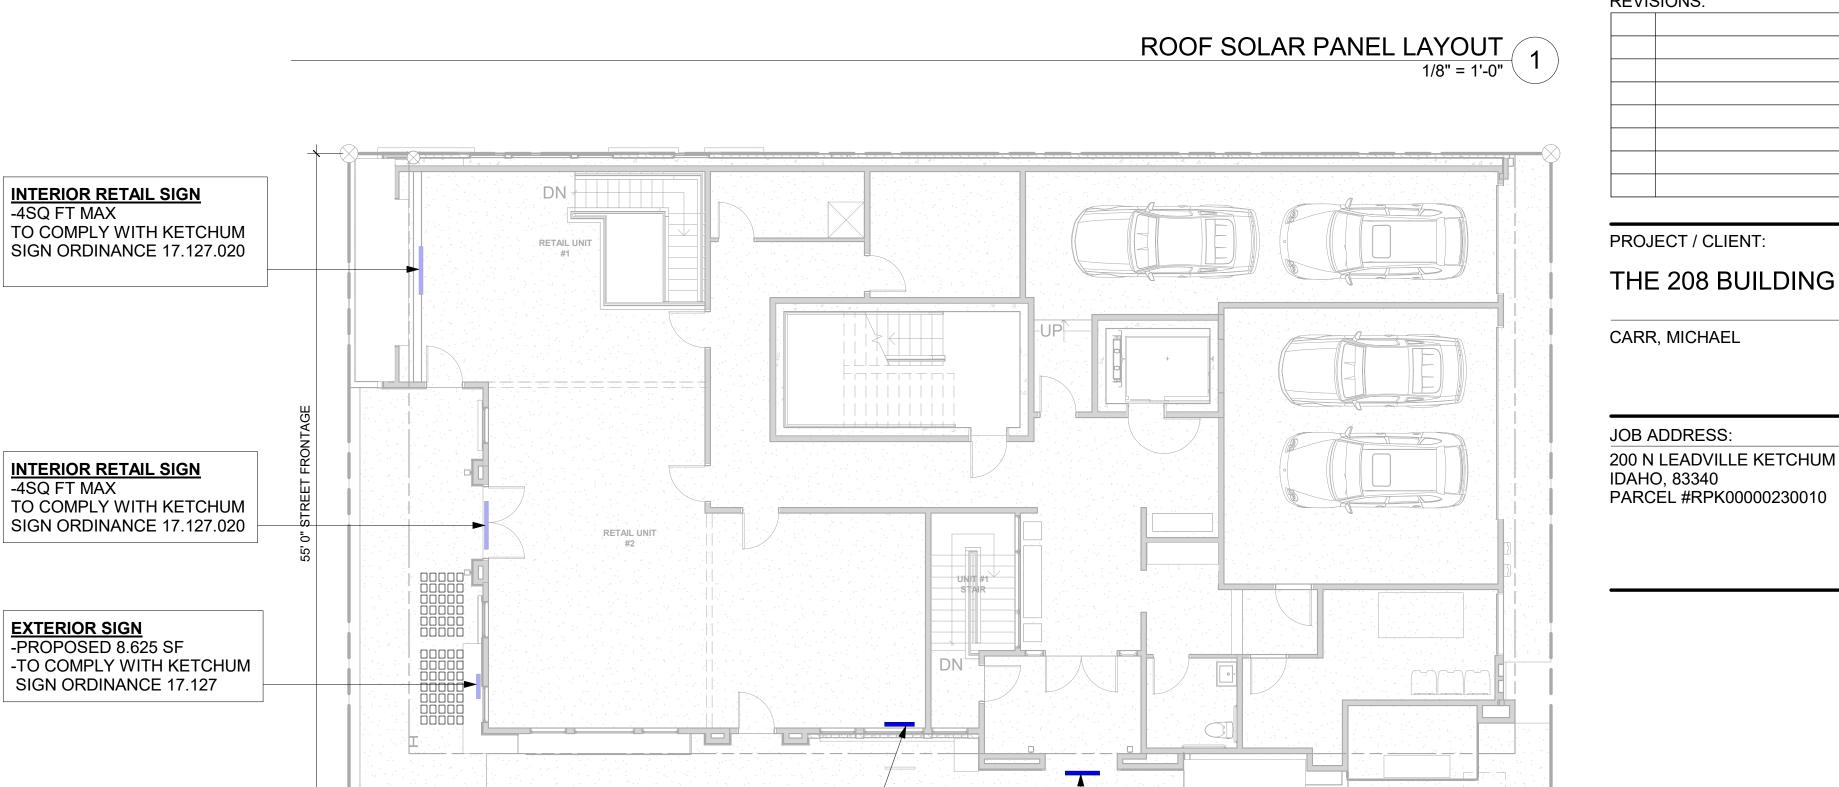


EXTERIOR SIGN -PROPOSED SIGN 3 SF

TO COMPLY WITH KETCHUM

SIGN ORDINANCE 17.127.020


INTERIOR RETAIL SIGN -4SQ FT MAX

TO COMPLY WITH KETCHUM SIGN ORDINANCE 17.127.020

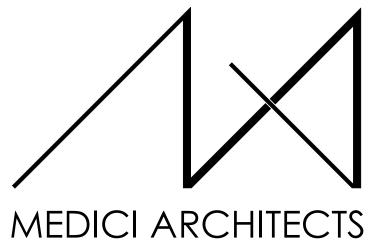

11661 SE 1ST STREET, SUITE 200 BELLEVUE, WASHINGTON 98005 TEL: (425) 453-9298 FAX: (425) 452-8448

**REGISTRATION:** 

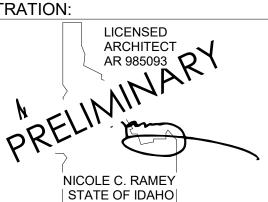

02/22/23 INTAKE DATE:

DATE: **REVISIONS:** 

PROJECT / CLIENT:

200 N LEADVILLE KETCHUM

DRAWING NAME:

SIGNAGE PLAN
1/8" = 1'-0"
3

## SPEC SHEET

Drawn By: MS Checked By: NR Owner Approval:

PHASE:


CONSTRUCTION DRAWINGS


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APPROVED FOR CONSTRUCTION:

PROJECT No.: A21-198

DATE: 2/22/2023



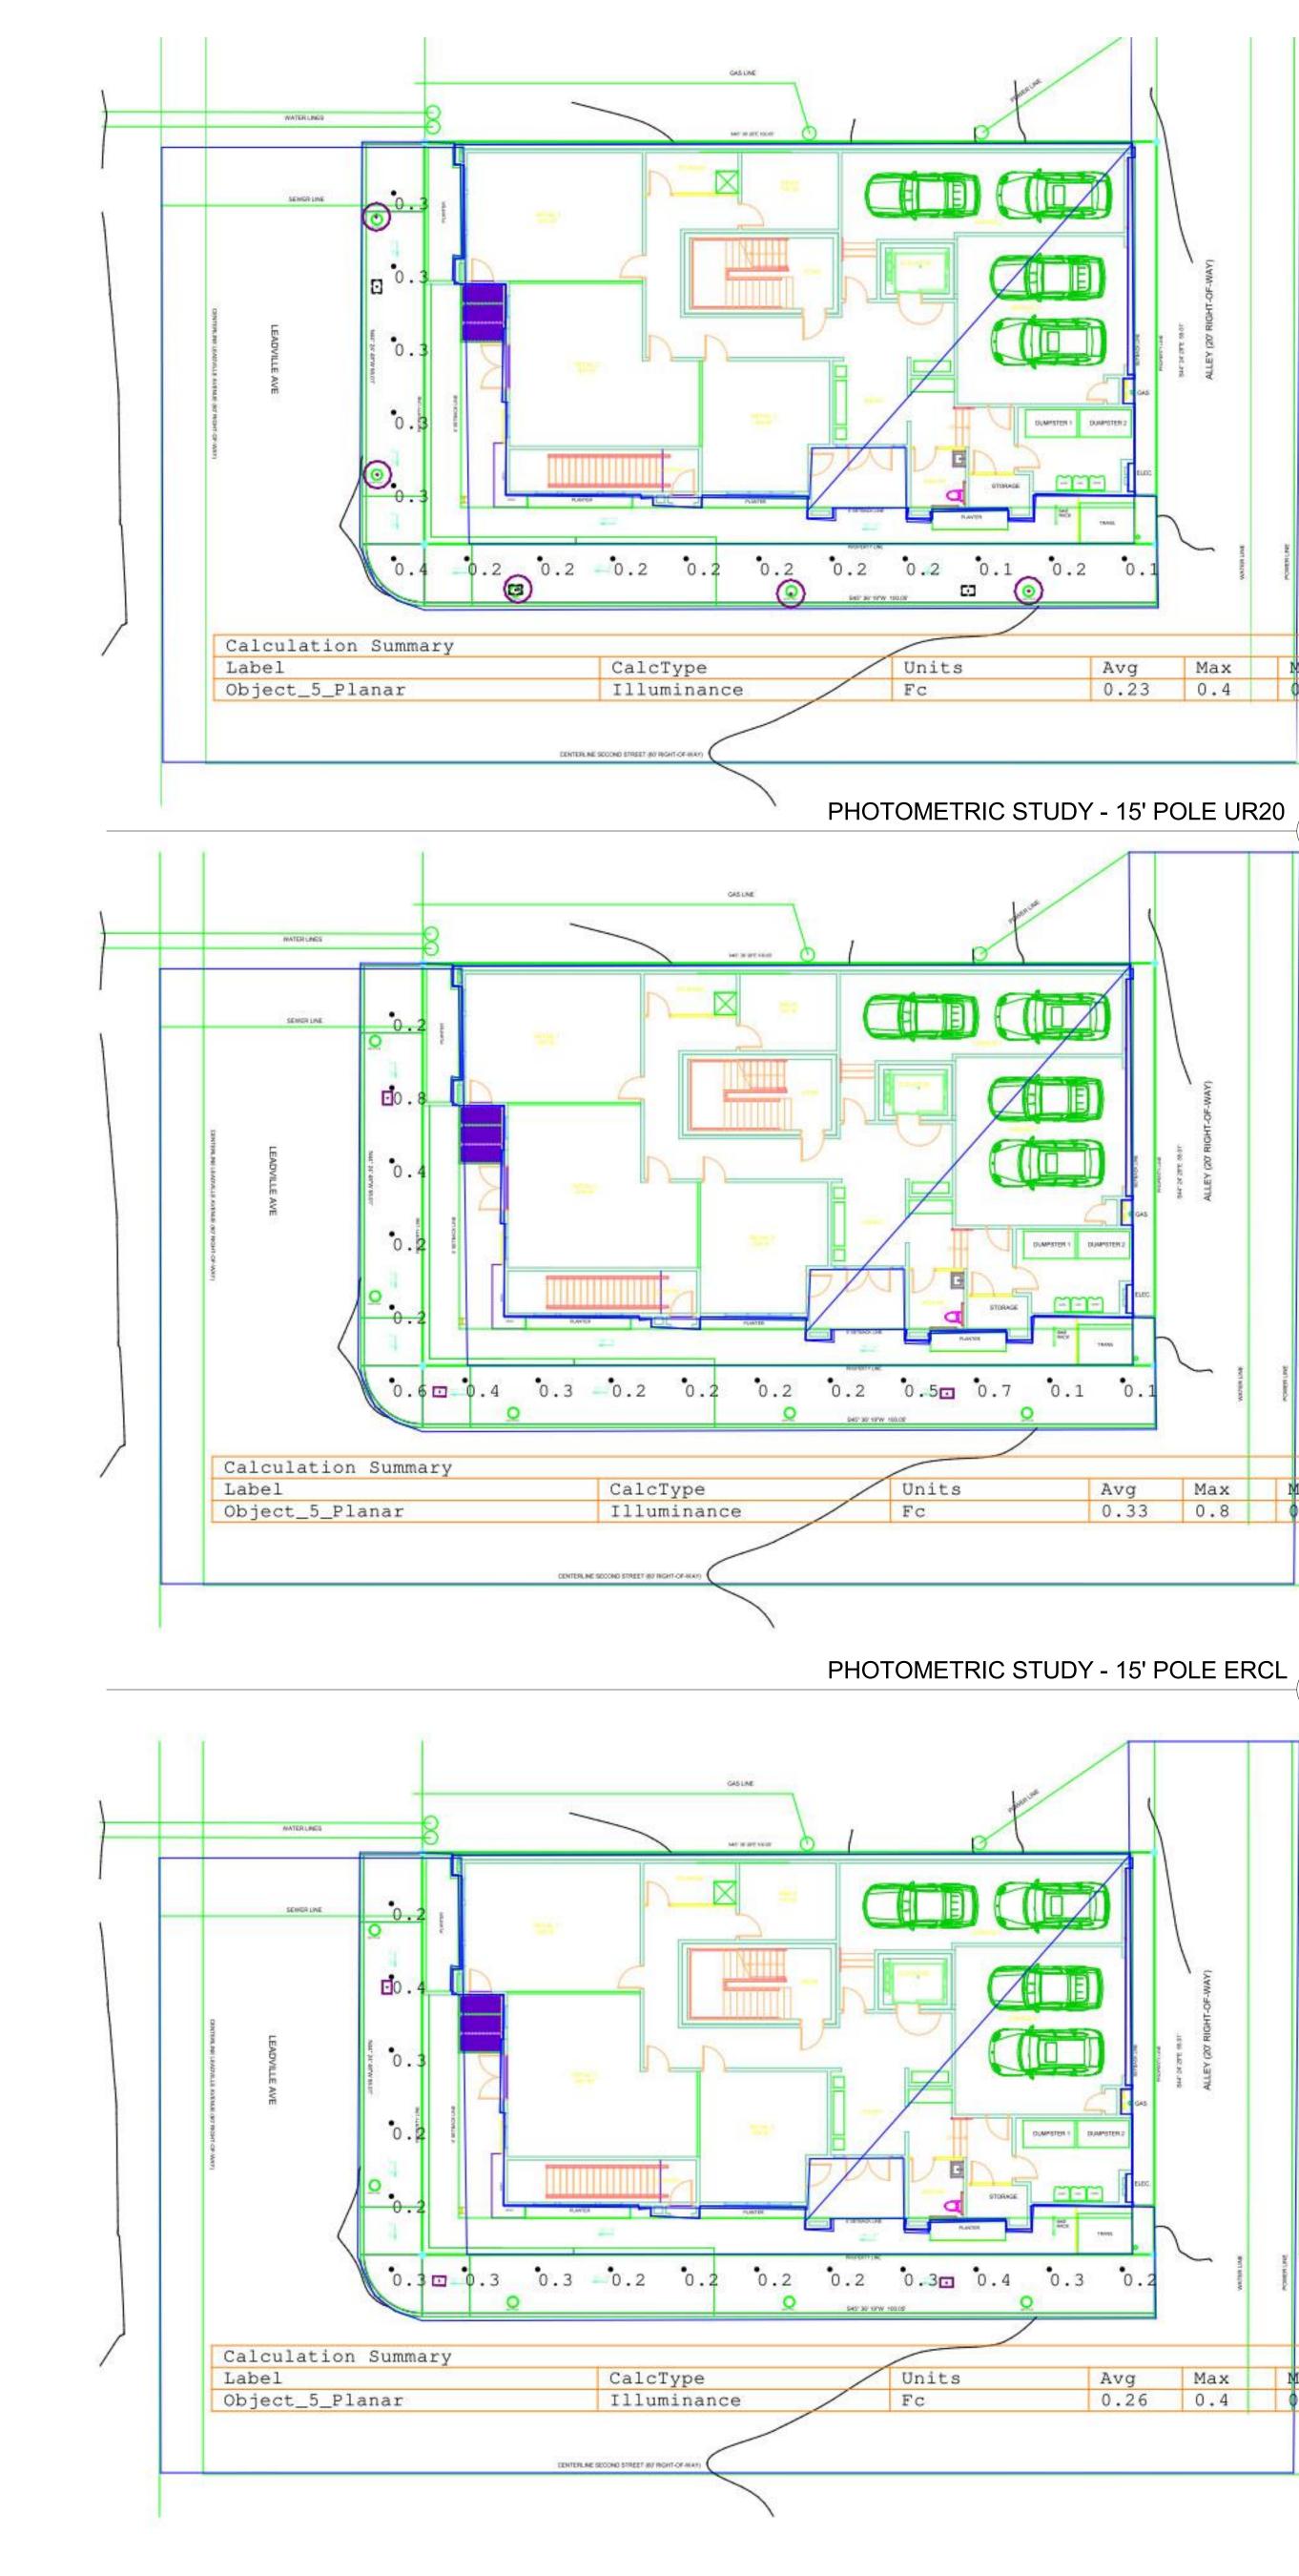

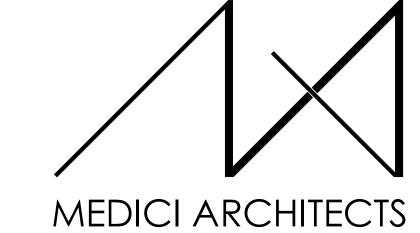11711 SE 8TH STREET 200 W. RIVER ST. SUITE 100 SUITE 301
BELLEVUE, WA 98005 KETCHUM, ID 83340
TEL: (425) 453-9298 TEL: (208) 726-0194

REGISTRATION:

REVISIONS: DATE:

PROJECT / CLIENT:

THE 208 BUILDING

CARR, MICHAEL

JOB ADDRESS:

200 N LEADVILLE KETCHUM IDAHO, 83340
PARCEL #RPK00000230010

DRAWING NAME:

# PHOTOMETRIC STUDIES

Drawn By: NR/AR
Checked By: EB
Owner Approval:

PHASE:

CONSTRUCTION DRAWINGS

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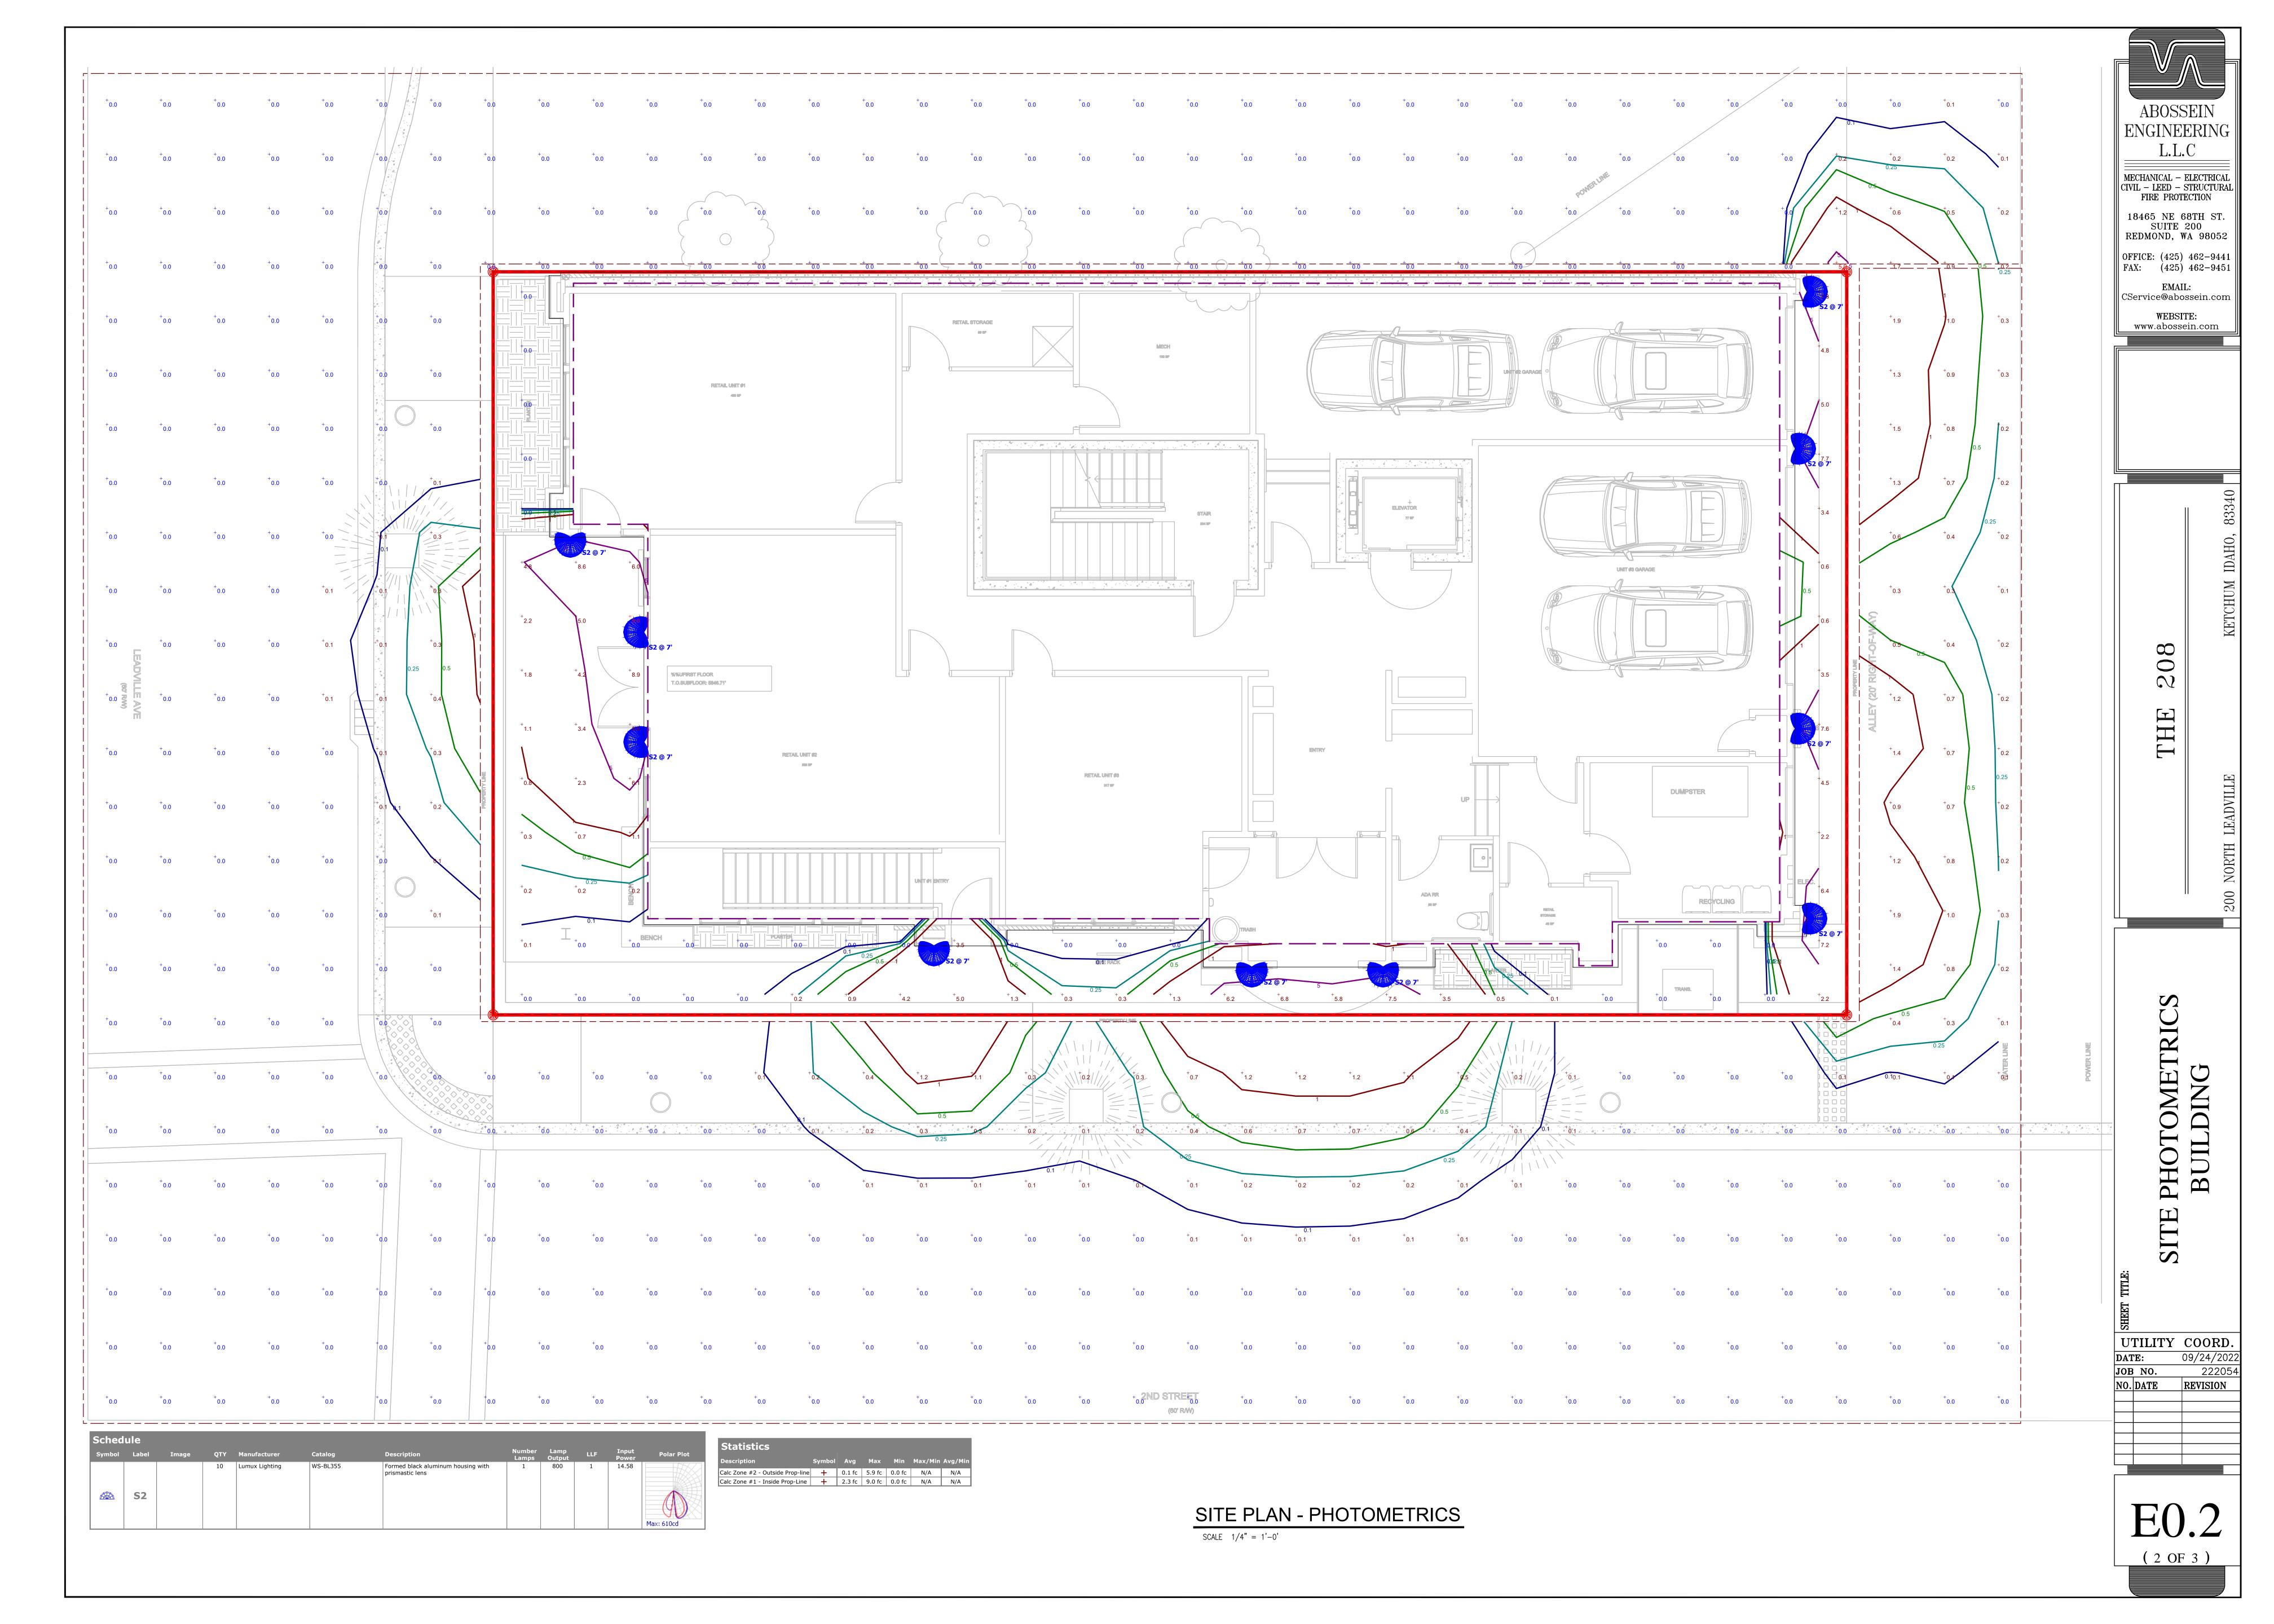
APPROVED FOR CONSTRUCTION:

PROJECT No.: A21-198

DATE: 10/12/2022 1:21:19 PM

PLOT SCALE: 1:1

PHOTOMETRIC STUDY - 25' POLE ERCL







SOUTHWEST PERSPECTIVE 1









SOUTHEAST PERSPECTIVE 2

NICOLE C. RAMEY STATE OF IDAHO

11661 SE 1ST STREET, SUITE 200 BELLEVUE, WASHINGTON 98005 TEL: (425) 453-9298 FAX: (425) 452-8448

REGISTRATION:

MEDICI ARCHITECTS

02/22/23 INTAKE DATE:

**REVISIONS:** 

PROJECT / CLIENT:

THE 208 BUILDING

CARR, MICHAEL

JOB ADDRESS: 200 N LEADVILLE KETCHUM IDAHO, 83340 PARCEL #RPK00000230010

DRAWING NAME:

## PERSPECTIVES

Drawn By: MS Checked By: NR Owner Approval:

PHASE:

CONSTRUCTION DRAWINGS

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APPROVED FOR CONSTRUCTION:

PROJECT No.: A21-198 DATE: 2/22/2023



# Exhibit B:

# 200 N Leadville Ave -Preliminary Civil and Landscape Drawings


# 200 N. LEADVILLE AVENUE - THE 208 BUILDING

# KETCHUM, IDAHO OCTOBER 2022

#### **CONSTRUCTION NOTES**

- 1. ALL CONSTRUCTION SHALL BE IN CONFORMANCE WITH THE MOST CURRENT EDITION OF THE "IDAHO REGULATIONS FOR PUBLIC DRINKING WATER SYSTEMS," THE CURRENT EDITION OF THE "IDAHO STANDARDS FOR PUBLIC WORKS CONSTRUCTION" (ISPWC),
- SHALL BE RESPONSIBLE FOR LOCATING EXISTING UTILITIES PRIOR TO COMMENCING AND DURING THE CONSTRUCTION. THE CONTRACTOR AGREES TO BE FULLY RESPONSIBLE FOR ANY AND ALL DAMAGES WHICH RESULT FROM HIS FAILURE TO ACCURATELY LOCATE AND PRESERVE ANY AND ALL UNDERGROUND UTILITIES. CONTRACTOR SHALL CALL DIGLINE

- STANDARDS FOR PUBLIC WORKS CONSTRUCTION (ISPWC), IDAPA 58.01.08, IDAHO RULES FOR PUBLIC DRINKING WATER SYSTEMS
- STANDARDS FOR PUBLIC WORKS CONSTRUCTION (ISPWC), AMERICAN WATER WORKS ASSOCIATION (AWWA) STANDARDS, AND
- 8. ALL WATER SUPPLY FIXTURES, FITTINGS, PIPING, AND ALL RELATED APPURTENANCES SHALL COMPLY WITH THE LOW LEAD ACT
- 9. THE CONTRACTOR SHALL USE ANSI/NSF STANDARD 60 CHEMICALS AND COMPOUNDS DURING INSTALLATION & DISINFECTION OF
- 10. CONTRACTOR SHALL COORDINATE LOCATIONS OF DRY UTILITY FACILITIES (POWER, CABLE, PHONE, TV) NOT SHOWN ON THE
- 11. ALL CLEARING & GRUBBING SHALL CONFORM TO ISPWC SECTION 201
- 12. ALL EXCAVATION & EMBANKMENT SHALL CONFORM TO ISPWC SECTION 202. EXCAVATED SUBGRADE SHALL BE COMPACTED AND
- 14. ALL 3/4" MINUS CRUSHED GRAVEL SHALL CONFORM TO ISPWC 802, TYPE I (ITD STANDARD 703.04, 3/4" B), SHALL BE PLACED IN CONFORMANCE WITH ISPWC SECTION 802 AND COMPACTED PER SECTION 202. MINIMUM COMPACTION OF PLACED MATERIAL
- 15. ALL ASPHALTIC CONCRETE PAVEMENT WORK SHALL CONFORM TO ISPWC SECTION(S) 805, 810, AND 811 FOR CLASS II PAVEMENT. ASPHALT AGGREGATE SHALL BE 1/2" (13MM) NOMINAL SIZE CONFORMING TO TABLE 803B IN ISPWC SECTION 803. ASPHALT BINDER SHALL BE PG 58-28 CONFORMING TO TABLE A-1 IN ISPWC SECTION 805.
- 16. ALL EDGES OF EXISTING ASPHALT PAVING SHALL BE SAW CUT 24" TO PROVIDE A CLEAN PAVEMENT EDGE FOR MATCHING. NO WHEEL CUTTING SHALL BE ALLOWED.
- 17. THE CONTRACTOR SHALL BE RESPONSIBLE FOR PROVIDING TRAFFIC CONTROL PER THE CURRENT EDITION OF THE US DEPARTMENT OF TRANSPORTATION MANUAL OF UNIFORM TRAFFIC CONTROL DEVICES (MUTCD).
- 18. ALL CONCRETE FORM WORK SHALL SHALL CONFORM TO ISPWC SECTION 701 AND 703. ALL CONCRETE SHALL BE 3,000 PSI MINIMUM, 28 DAY, AS DEFINED IN ISPWC SECTION 703, TABLE 1.C.
- 19. ALL TRENCHING SHALL CONFORM TO ISPWC STANDARD DRAWING SD-301. TRENCHES SHALL BE BACKFILLED AND COMPACTED TO A MINIMUM OF 95% OF MAXIMUM DENSITY AS DETERMINED BY AASHTO T-99.
- 20. TOPOGRAPHIC, SITE, AND BOUNDARY SURVEYS SHOWN HEREON WERE CONDUCTED BY GALENA ENGINEERING, INC., 5/04/2021. REFER TO TOPOGRAPHIC MAP FOR NOTES.
- 21. PER IDAHO CODE § 55-1613, THE CONTRACTOR SHALL RETAIN AND PROTECT ALL MONUMENTS, ACCESSORIES TO CORNERS, BENCHMARKS AND POINTS SET IN CONTROL SURVEYS; ALL MONUMENTS, ACCESSORIES TO CORNERS, BENCHMARKS AND POINTS SET IN CONTROL SURVEYS THAT ARE LOST OR DISTURBED BY CONSTRUCTION SHALL BE REESTABLISHED AND RE-MONUMENTED, AT THE EXPENSE OF THE AGENCY OR PERSON CAUSING THEIR LOSS OR DISTURBANCE AT THEIR ORIGINAL LOCATION OR BY SETTING OF A WITNESS CORNER OR REFERENCE POINT OR A REPLACEMENT BENCHMARK OR CONTROL POINT, BY OR UNDER THE DIRECTION OF A PROFESSIONAL LAND SURVEYOR.

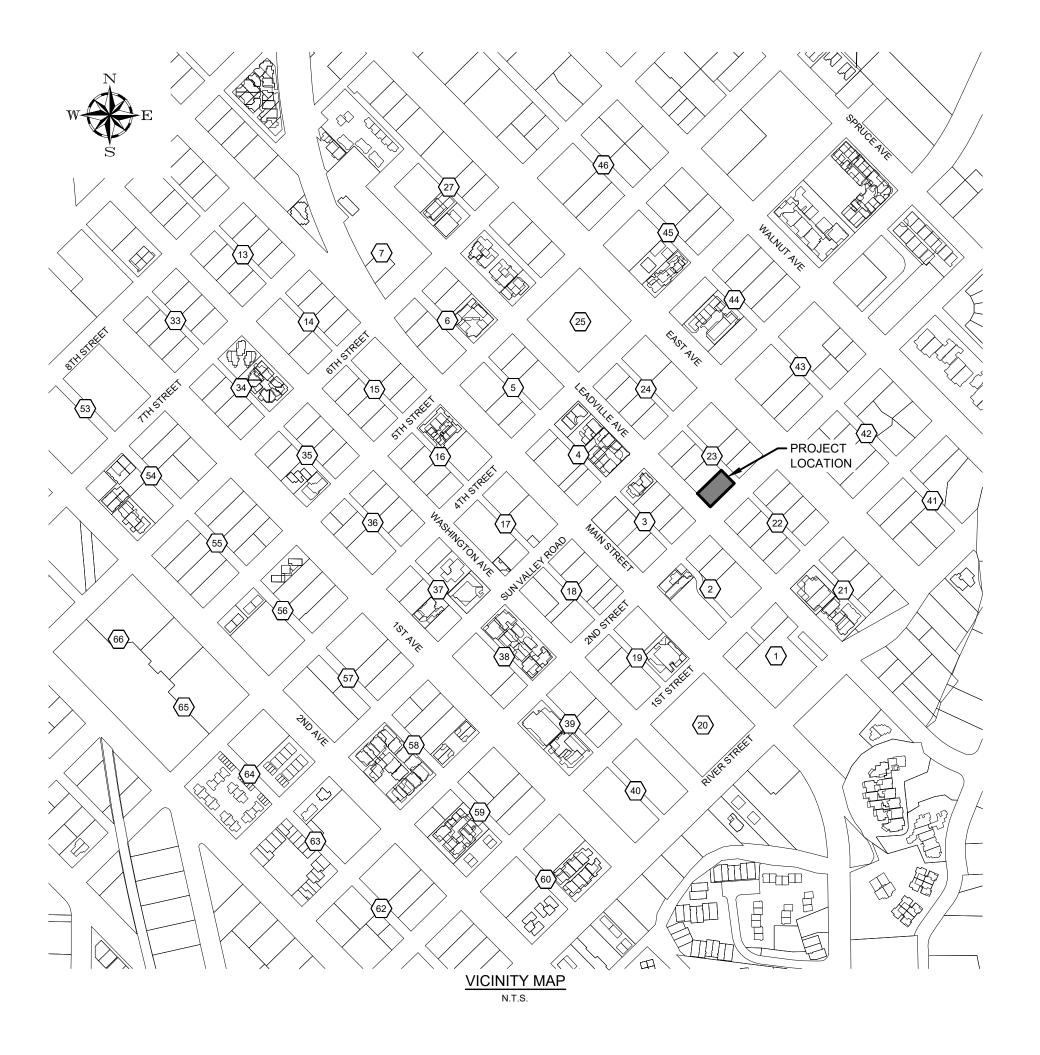

# SHEET INDEX

DESCRIPTION **COVER SHEET EXISTING SITE CONDITIONS** 

SITE GEOMETRY PLAN

SITE GRADING, DRAINAGE, AND UTILITY PLAN

C2.10 **DETAIL SHEET** C2.11

**DETAIL SHEET** 

DESIGNED BY DRAWN BY

CHECKED BY

SURVEY NARRATIVE & NOTES

- 1. Galena Engineering, Inc., makes no representations as to the existence of any other record documents that may affect this parcel other than those shown in the exceptions of Schedule B-2 as shown hereon.
- 2. The purpose of this survey is to show the monuments found during the boundary retracement of Lot 1, Block 23, Ketchum Townsite. The boundary shown is based on found lot corner monuments and the Amended Record of Survey of Lot 1, Block 23, Ketchum Townsite, Instrument Number 682212, records of Blaine County, Idaho. All found monuments have been accepted. As listed in the Survey Narrative & Notes on said Record of Survey and previously recorded survey under Instrument Number 673065, the missing lot corner monuments were set by block breakdown and proportioning record distances. Vertical Datum is NAVD 1988. Additional documents used in the course of this survey include the plat of the Village of Ketchum, Instrument Number 302967, records of Blaine County, Idaho.
- 3. The bearings and distances shown are measured. Refer to the above referenced documents for previous record information.
- 4. This map makes no assumptions as to any unwritten rights that may exist by and between the adjoining land owners.
- 5. The Surveyor did not abstract property. Survey is based on the Legal Description above.
- 6. Nothing in this survey is intended to express an opinion regarding ownership or title.
- 7. The word "Certify" is understood to be an expression of Professional judgement by the surveyor, which is based on his best knowledge, information and belief.
- 8. This survey is certified for this transaction only.
- 9. The findings and opinions of Galena Engineering, Inc., reflected hereon are privileged, confidential and intended for the use of the individual or entity for whom the work was prepared, it is understood that the use of, reliance on, or reproduction of same, in whole or in part, by others without the express written consent of Galena Engineering, Inc., is prohibited and without warranty, express or implied. Galena Engineering, Inc., shall be held harmless against damages or expenses resulting from such unauthorized use, reliance or reproduction. Copyright 2021. All rights reserved.
- 10. Utility locations shown hereon are based on above ground appurtenances, City of Ketchum utility maps, and Magic Valley Utility Locating. Digline services should be called prior to any excavation.
- 11. Evidence of earth moving work was observed in the process of conducting the fieldwork. A building within the property was demolished in October of 2020. It appears that Utility services have been installed within the last few months, however, the specific date is unknown. No evidence of building construction was observed in the process of conducting the fieldwork.
- 12. No markers indicating a field delineation of wetlands by a qualified specialist were observed in the process of conducting the fieldwork.
- 13. No evidence of cemeteries or burial grounds were observed during the course of the survey work.
- 14. The property has access along N. Leadville Avenue, Second Street, and the Alley within Block 23. There are currently no curb cuts along N Leadville and 2nd Street and the main access is from the alley. Approximate pavement widths are shown hereon.
- 15. No Delineated parking spaces currently exist on the site. There are 2 parking spaces within the Leadville Road Right of Way and 2 parking spaces within the 2nd Street Right of Way and are shown hereon.
- 16. At the time of this survey there is no evidence of recent street or sidewalk construction or repairs.
- 17. The current Zoning is CC Community Core, Subdistrict 2-Mixed Use. No zoning report or letter was provided to the surveyor by the client.
- 18. The property described hereon is the same as the property described in the title policy provided by TitleOneCorporation dba Sun Valley Title, authorized agent for Steward Title Guaranty Company, issuing office file number 20378964, commitment date of August 31, 2020, and that all easements, covenants and restrictions referenced in said title commitment are apparent from a physical inspection of the site or otherwise known to me have been plotted hereon or otherwise noted as to their effect on the subject property.
- 19. No visible evidence of the location of any underground or above ground storage tanks, wells, railroad tracks, spur tracks or sidings were observed during the course of the survey work.
- 20. During the course of this survey, it was observed that the water valve for the water service to Lot 1 is within Lot 2 as shown hereon. Additionally, it has been observed that the gas service line for Lot 1 is within Lot 2 as shown hereon and the overhead power line to Lot 1 also passes over Lot 2 as shown hereon.

#### TITLE INFORMATION AND LIST OF EXCEPTIONS

This survey does not constitute a title search by the Surveyor. All information regarding record easements and other documents that might affect the quality of title to parcel shown hereon was gained from issuing office file number 20378964, issued by TitleOneCorporation dba Su Valley Title, authorized agent for Steward Title Guaranty Company, commitment date of August 31, 2020.

The following exceptions are per title policy provided by TitleOneCorporation dba Sun Valley Title, issuing office file number 20378964, Commitment Date: August 31, 2020, Schedule B, Part II Exceptions:

- 1. Any defect, lien, encumbrance, adverse claim, or other matter that appears for the first time in the Public Records or is created, attaches, or is disclosed between the Commitment Date and the date on which all of the Schedule B, Part I—Requirements are met. AFFECTS PROPERTY, NOT PLOTTABLE.
- 2. Rights or claims of parties in possession not shown by the public records. AFFECTS PROPERTY, NOT PLOTTABLE. NOT OBSERVED WITHIN SURVEYED BOUNDARY AT TIME OF SURVEY.
- 3. Any encroachment, encumbrance, violation, variation, or adverse circumstance affecting the Title that would be disclosed by an accurate and complete land survey of the Land, and that is not shown by the Public Records.. AFFECTS PROPERTY, NOT PLOTTABLE. NOT OBSERVED WITHIN SURVEYED BOUNDARY AT TIME OF SURVEY.
- 4. Easements, or claims of easements, not shown by the public records. AFFECTS PROPERTY, NOT PLOTTABLE.
- 5. Any lien, or right to a lien, for services, labor, or materials heretofore or hereafter furnished, imposed by law and not shown by the public records. AFFECTS PROPERTY, NOT PLOTTABLE.
- 6. (a) Unpatented mining claims; (b) reservations or exceptions in patents or in Acts authorizing the issuance thereof; (c) water rights, claims to title to water, whether or not the matters excepted under (a), (b), or (c) are shown by the public records. AFFECTS PROPERTY, NOT PLOTTABLE. NOT OBSERVED WITHIN SURVEYED BOUNDARY AT TIME OF SURVEY.
- 7. Taxes or special assessments which are not shown as existing liens by the records of any taxing authority that levies taxes or assessments on real property or by the public records. Proceedings by a public agency which may result in taxes or assessments, or notices to such proceedings whether or not shown by the records of such agency, or by the public records.. AFFECTS PROPERTY, NOT PLOTTABLE.
- 8. Taxes for the year 2019 are paid in full.
  Parcel Number: RPK00000230010
  Original Amount: \$5,449.28
  Without homeowner's exemption AFFECTS PROPERTY, NOT PLOTTABLE.
- Taxes, including any assessments collected therewith, for the year 2020 which are a lien not yet due and payable AFFECTS
- PROPERTY, NOT PLOTTABLE.
- 10. Water and sewer charges, if any, for the City of Ketchum.- AFFECTS PROPERTY, NOT PLOTTABLE.
- Easements, reservations, restrictions, and dedications as shown on the official plat of Ketchum Townsite. AFFECTS PROPERTY, NOT PLOTTABLE.
- 12. Reservations and exceptions in a United States Patent, and in the act authorizing the issuance thereof, recorded April 12, 1937 as Instrument No. 75052. AFFECTS PROPERTY, NOT PLOTTABLE.
- 13. Right of way for ditches, tunnels, telephone, and distribution lines constructed by authority of the United States, as granted to the United States under the provisions of Section 58-604 Idaho Code. AFFECTS PROPERTY, NOT PLOTTABLE.

### SURVEY CERTIFICATION:

### To: 755 S Broadway LLC

This is to certify that this map or plat and the survey on which it is based were made in accordance with the 2021 Minimum Standard Detail Requirements for ALTA/NSPS Land Title Surveys, jointly established and adopted by ALTA and NSPS, and includes Items 1, 8, 11, and 14 of Table A thereof. The field work was completed on 04/10/2021.

Date of Map: 05/04/2021 Mark E. Phillips Professional Land Surveyor No. 16670 State of Idaho 16670 05/04/2021

MARK E. PHILLIPS, P.L.S. 16670

 PURPOSE:
 ΚΕVISIONS
 ENGISTOR

 NO DATE BY
 REVISIONS
 ENGISTOR


 Aniley, (208) 78 email 9
 (208) 78 email 9

**ALTA** 

CHECKED BY

SUR HUM


A/NSI 7, BI

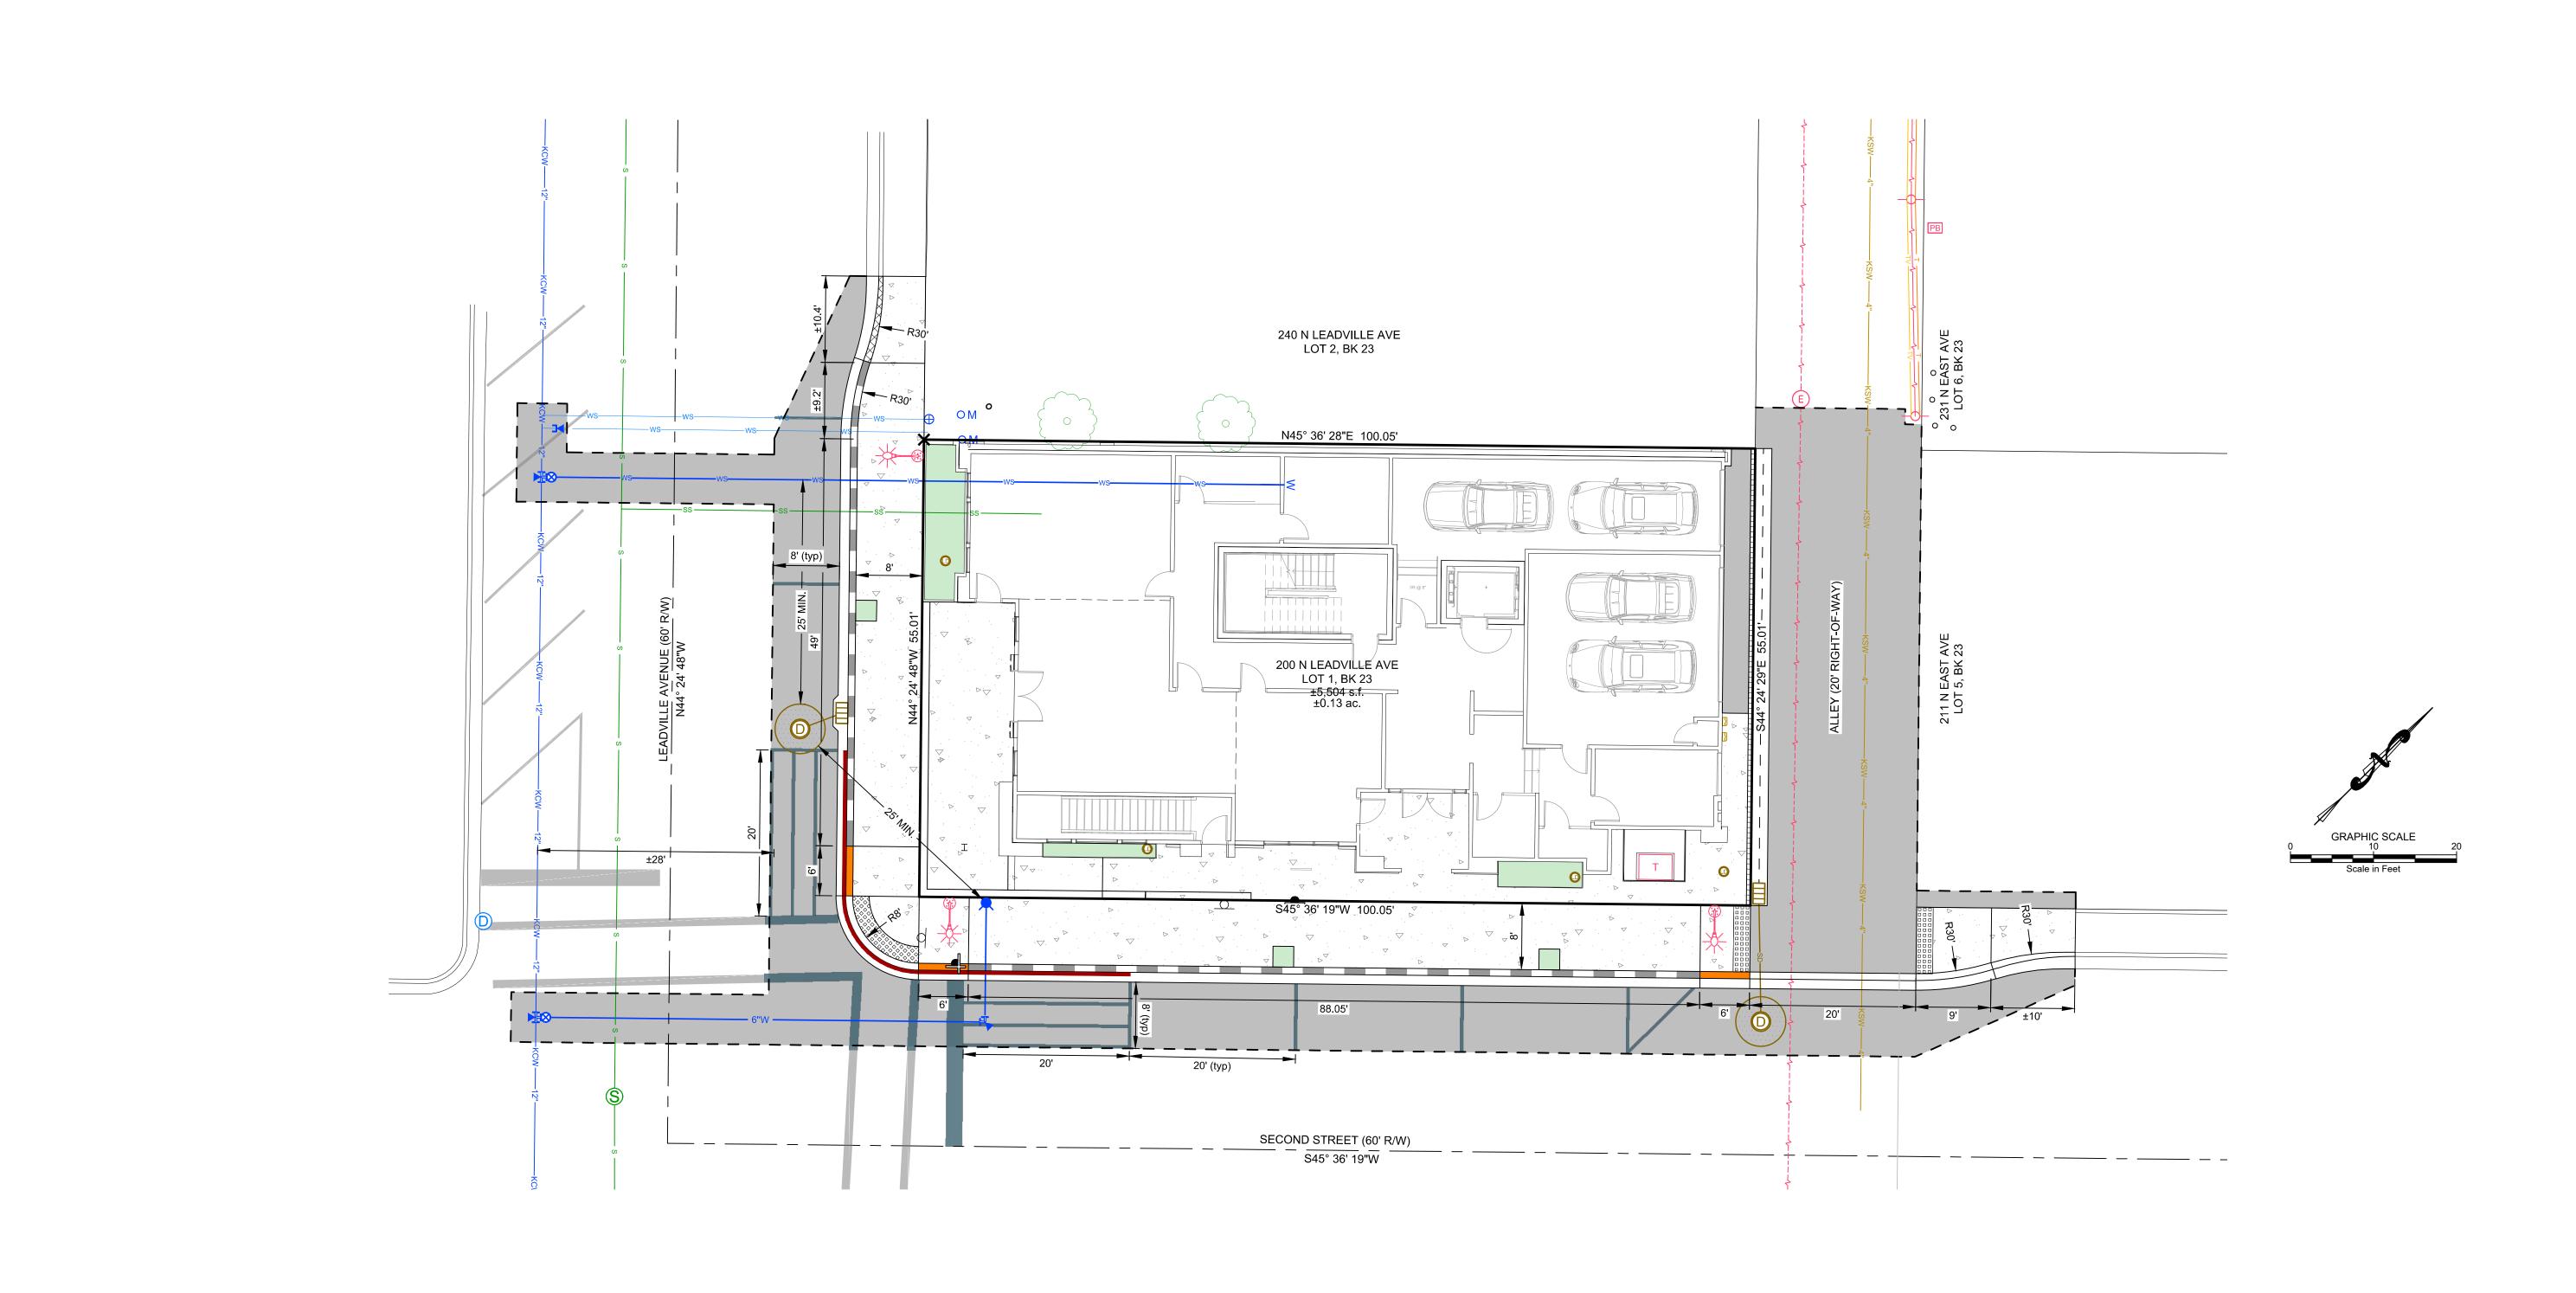


GEOMETRY PLAN 200 N. LEADVILLE AVENUE THE 208 BUILDING

DESIGNED BY CT DRAWN BY JCL CHECKED BY

C1.00

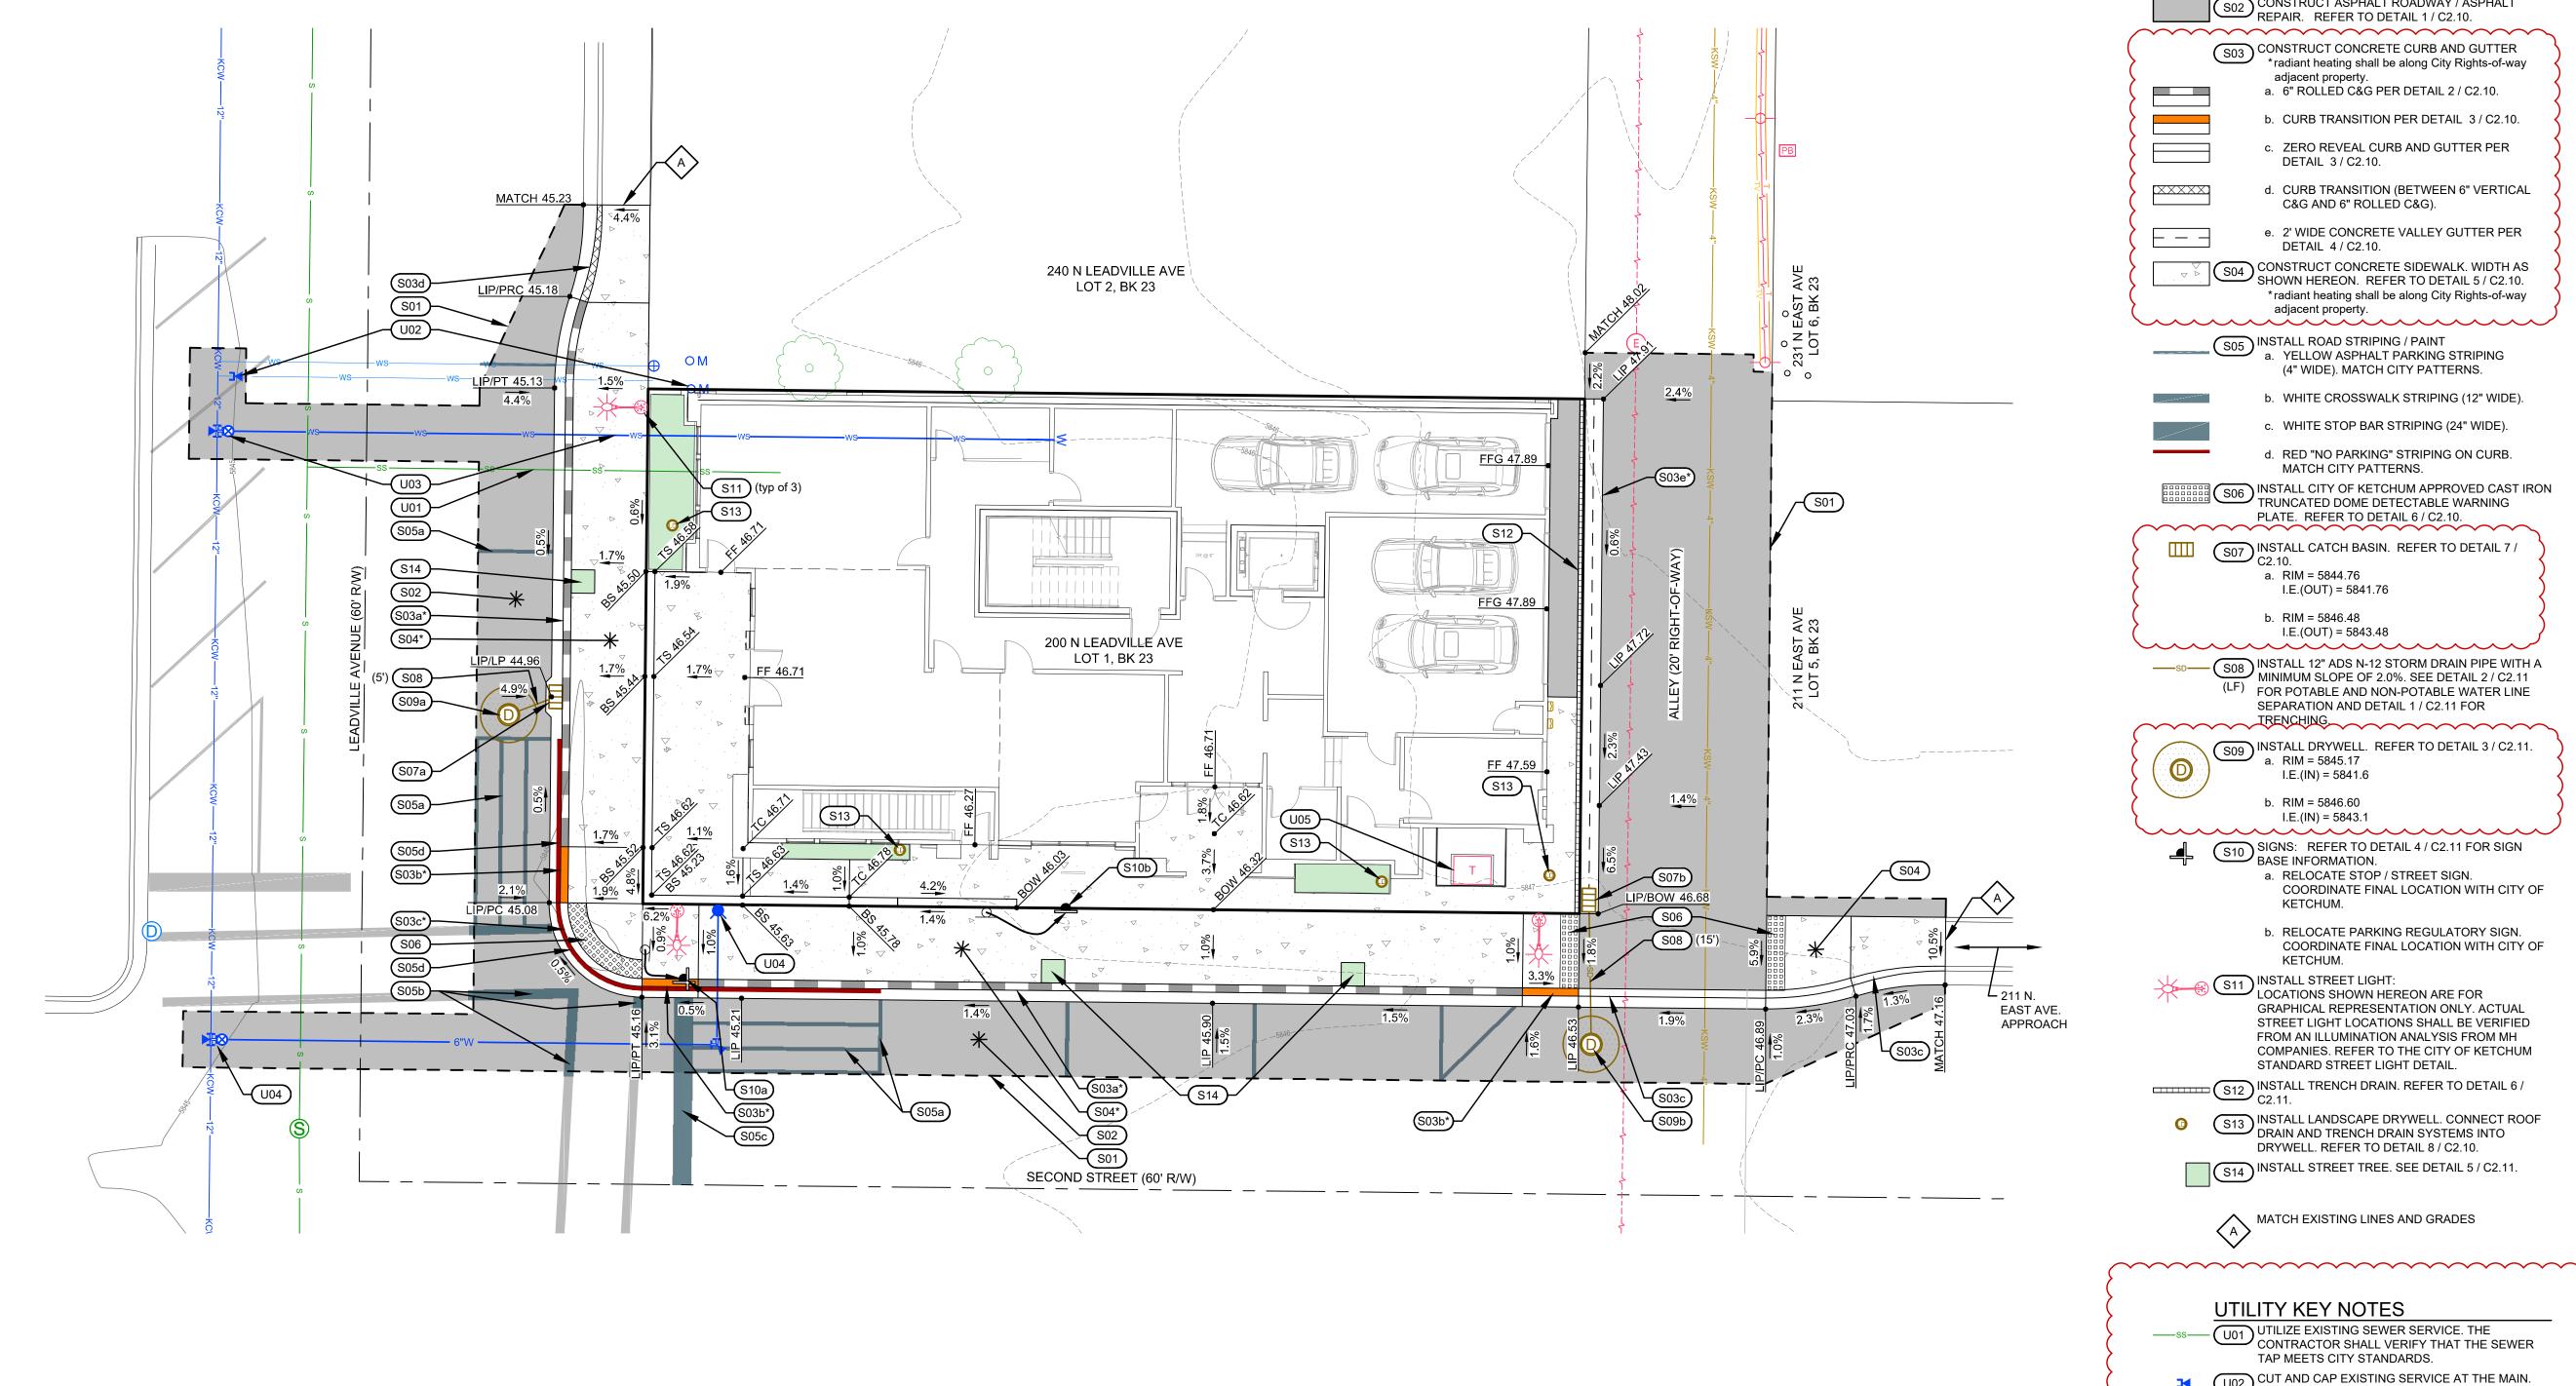

**ABBREVIATIONS** BOW = Back of Walk BS = Bottom of Steps FF = Finished Floor Elevation FG = Finished Grade GFF = Garage Finished Floor LIP = Lip of Gutter LP = Low Point PC = Point of Curvature PRC = Point of Reverse Curb PT = Point of Tangent TC = Top of Concrete TS = Top of Steps

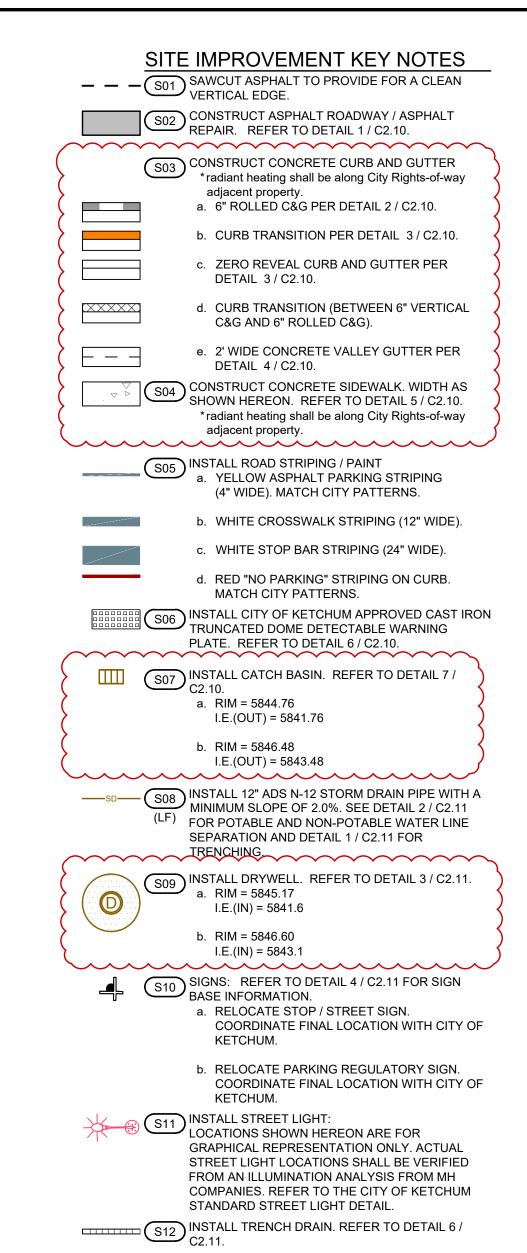

DRYWELL. REFER TO DETAIL 8 / C2.10. S14 INSTALL STREET TREE. SEE DETAIL 5 / C2.11.

(S13) INSTALL LANDSCAPE DRYWELL. CONNECT ROOF DRAIN AND TRENCH DRAIN SYSTEMS INTO

UTILITY KEY NOTES U01 UTILIZE EXISTING SEWER SERVICE. THE CONTRACTOR SHALL VERIFY THAT THE SEWER

TAP MEETS CITY STANDARDS. CUT AND CAP EXISTING SERVICE AT THE MAIN. REMOVE METER BOX.

MATCH EXISTING LINES AND GRADES


INSTALL NEW FIRE LINE WITH STAINLESS STEEL TAPPING SADDLE, GATE VALVE, AND THRUST BLOCKING. PLUMB DOMESTIC OFF NEW FIRE LINE IN RISER ROOM. INSTALL 1 METER FOR COMMERCIAL AND 1 METER FOR RESIDENTIAL. REFER TO PLUMBING PLAN FOR WATER LINE SIZING DATA. REFER TO DETAIL 2 / C2.11 FOR POTABLE / NON-POTABLE WATER LINE SEPARATION AND DETAIL 7 / C2.11 FOR THRUST BLOCK REQUIREMENTS.

INSTALL FIRE HYDRANT ASSEMBLY (SEE DETAIL 9 / C2.10). INSTALL 12"X6" STAINLESS STEEL TAPPING SADDLE

6" GATE VALVE 6" 90° D.I. BEND W/ THRUST BLOCKS

±68 L.F. OF 6" PVC WATER MAIN. CITY TO PROVIDE MOUNTAIN EXTENSION. CONTRACTOR TO COORDINATE WITH WATER AND FIRE DEPARTMENTS. REFER TO DETAIL 2 / C2.11 FOR POTABLE / NON-POTABLE WATER LINE SEPARATION AND DETAIL 7 / C2.11 FOR THRUST BLOCK REQUIREMENTS.

U05 INSTALL POWER TRANSFORMER. REFER TO ARCHITECTURAL AND ELECTRICAL PLANS FOR DETAILS.

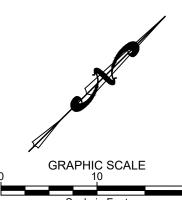


DIN( 200

DESIGNED BY

JCL CHECKED BY

DRAWN BY

C2.00

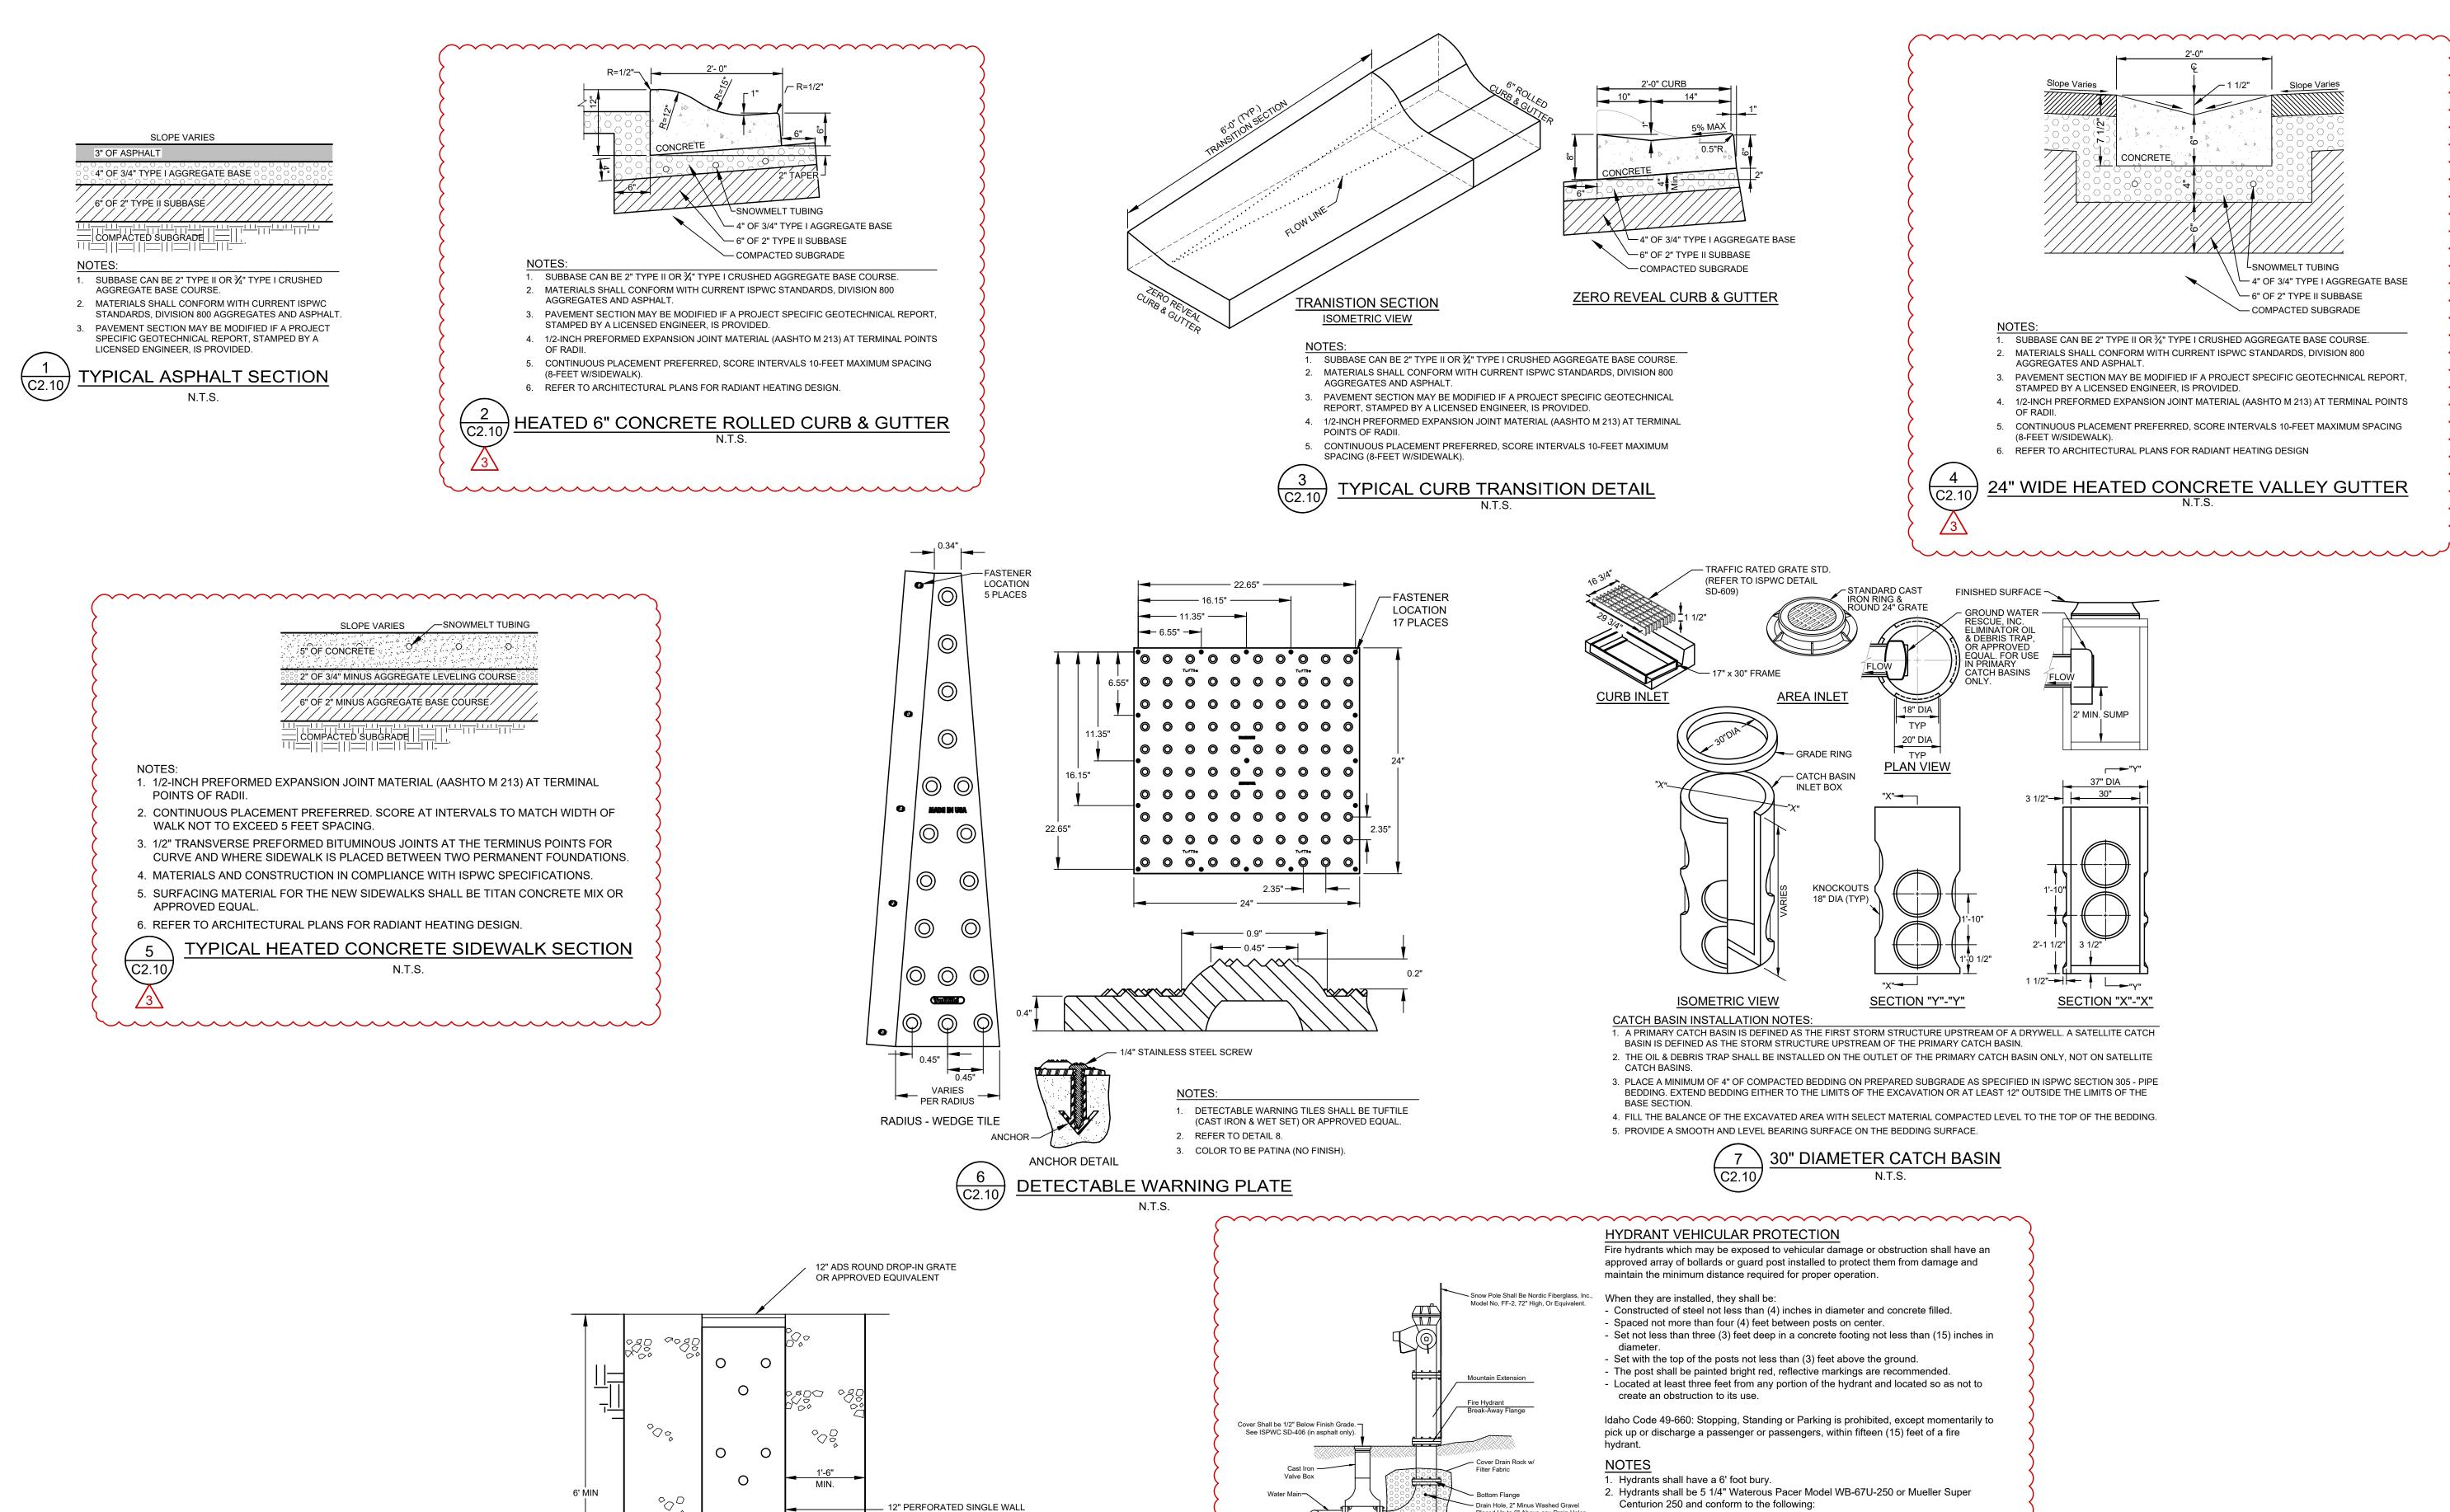

CORRUGATED ADS PIPE OR

- BACKFILL WITH DRAIN ROCK

COMPACTED TO 95% OF MAXIMUM

APPROVED EQUIVALENT

■ FILTER FABRIC

LANDSCAPE DRYWELL


 Drain Hole, 2" Minus Washed Gravel
 Placed Up to 6" Above any Drain Holes Centurion 250 and conform to the following: - Traffic "breakaway" design - 2 ea.. 2-1/2" NST threaded nozzles - 1 ea.. 4-1/2" NST threaded nozzles - 250 PSI rated - Dry Barrel type 6" barrel UL Listed Cast Iron M.J. x Flange -- Red in color - Main valve size 5-1/4" - Minimum of 1/2 C.Y. of 2" Uncrushed Aggregate 3. Mechanical Restraints shall be used. Restraints shall be Romac Industries per ISPWC Section 801 - Uncrushed Aggregate
Placed 1.5' Under Lowest Part of Hydrant and Up to
6" Above any Drain Holes (Precast or Cast in Place) RomaGrip or approved equivalent. No lug or set screw type restraints are to be used on PVC pipe. 4. City shall approve location and elevation of all Fire Hydrants. 5. Auxiliary Gate Valve shall meet AWWA C509 (Total rubber encapsulated, resilient seat, waterous series or approved equal). 6. Valve Box shall be Tyler 664A or approved equal. 7. Hydrant break away flange elevation equal to street centerline or 4" to 8" above finished grade as approved. 8. Fire hydrant assemblies located on the opposite side of the roadway from the watermain shall have 2" Dow Board installed over the pipeline leading to the hydrant. The Dow Board shall extend from auxiliary gate valve to the hydrant. FIRE HYDRANT ASSEMBL` 


C2.10


DESIGNED BY

CHECKED BY

DRAWN BY

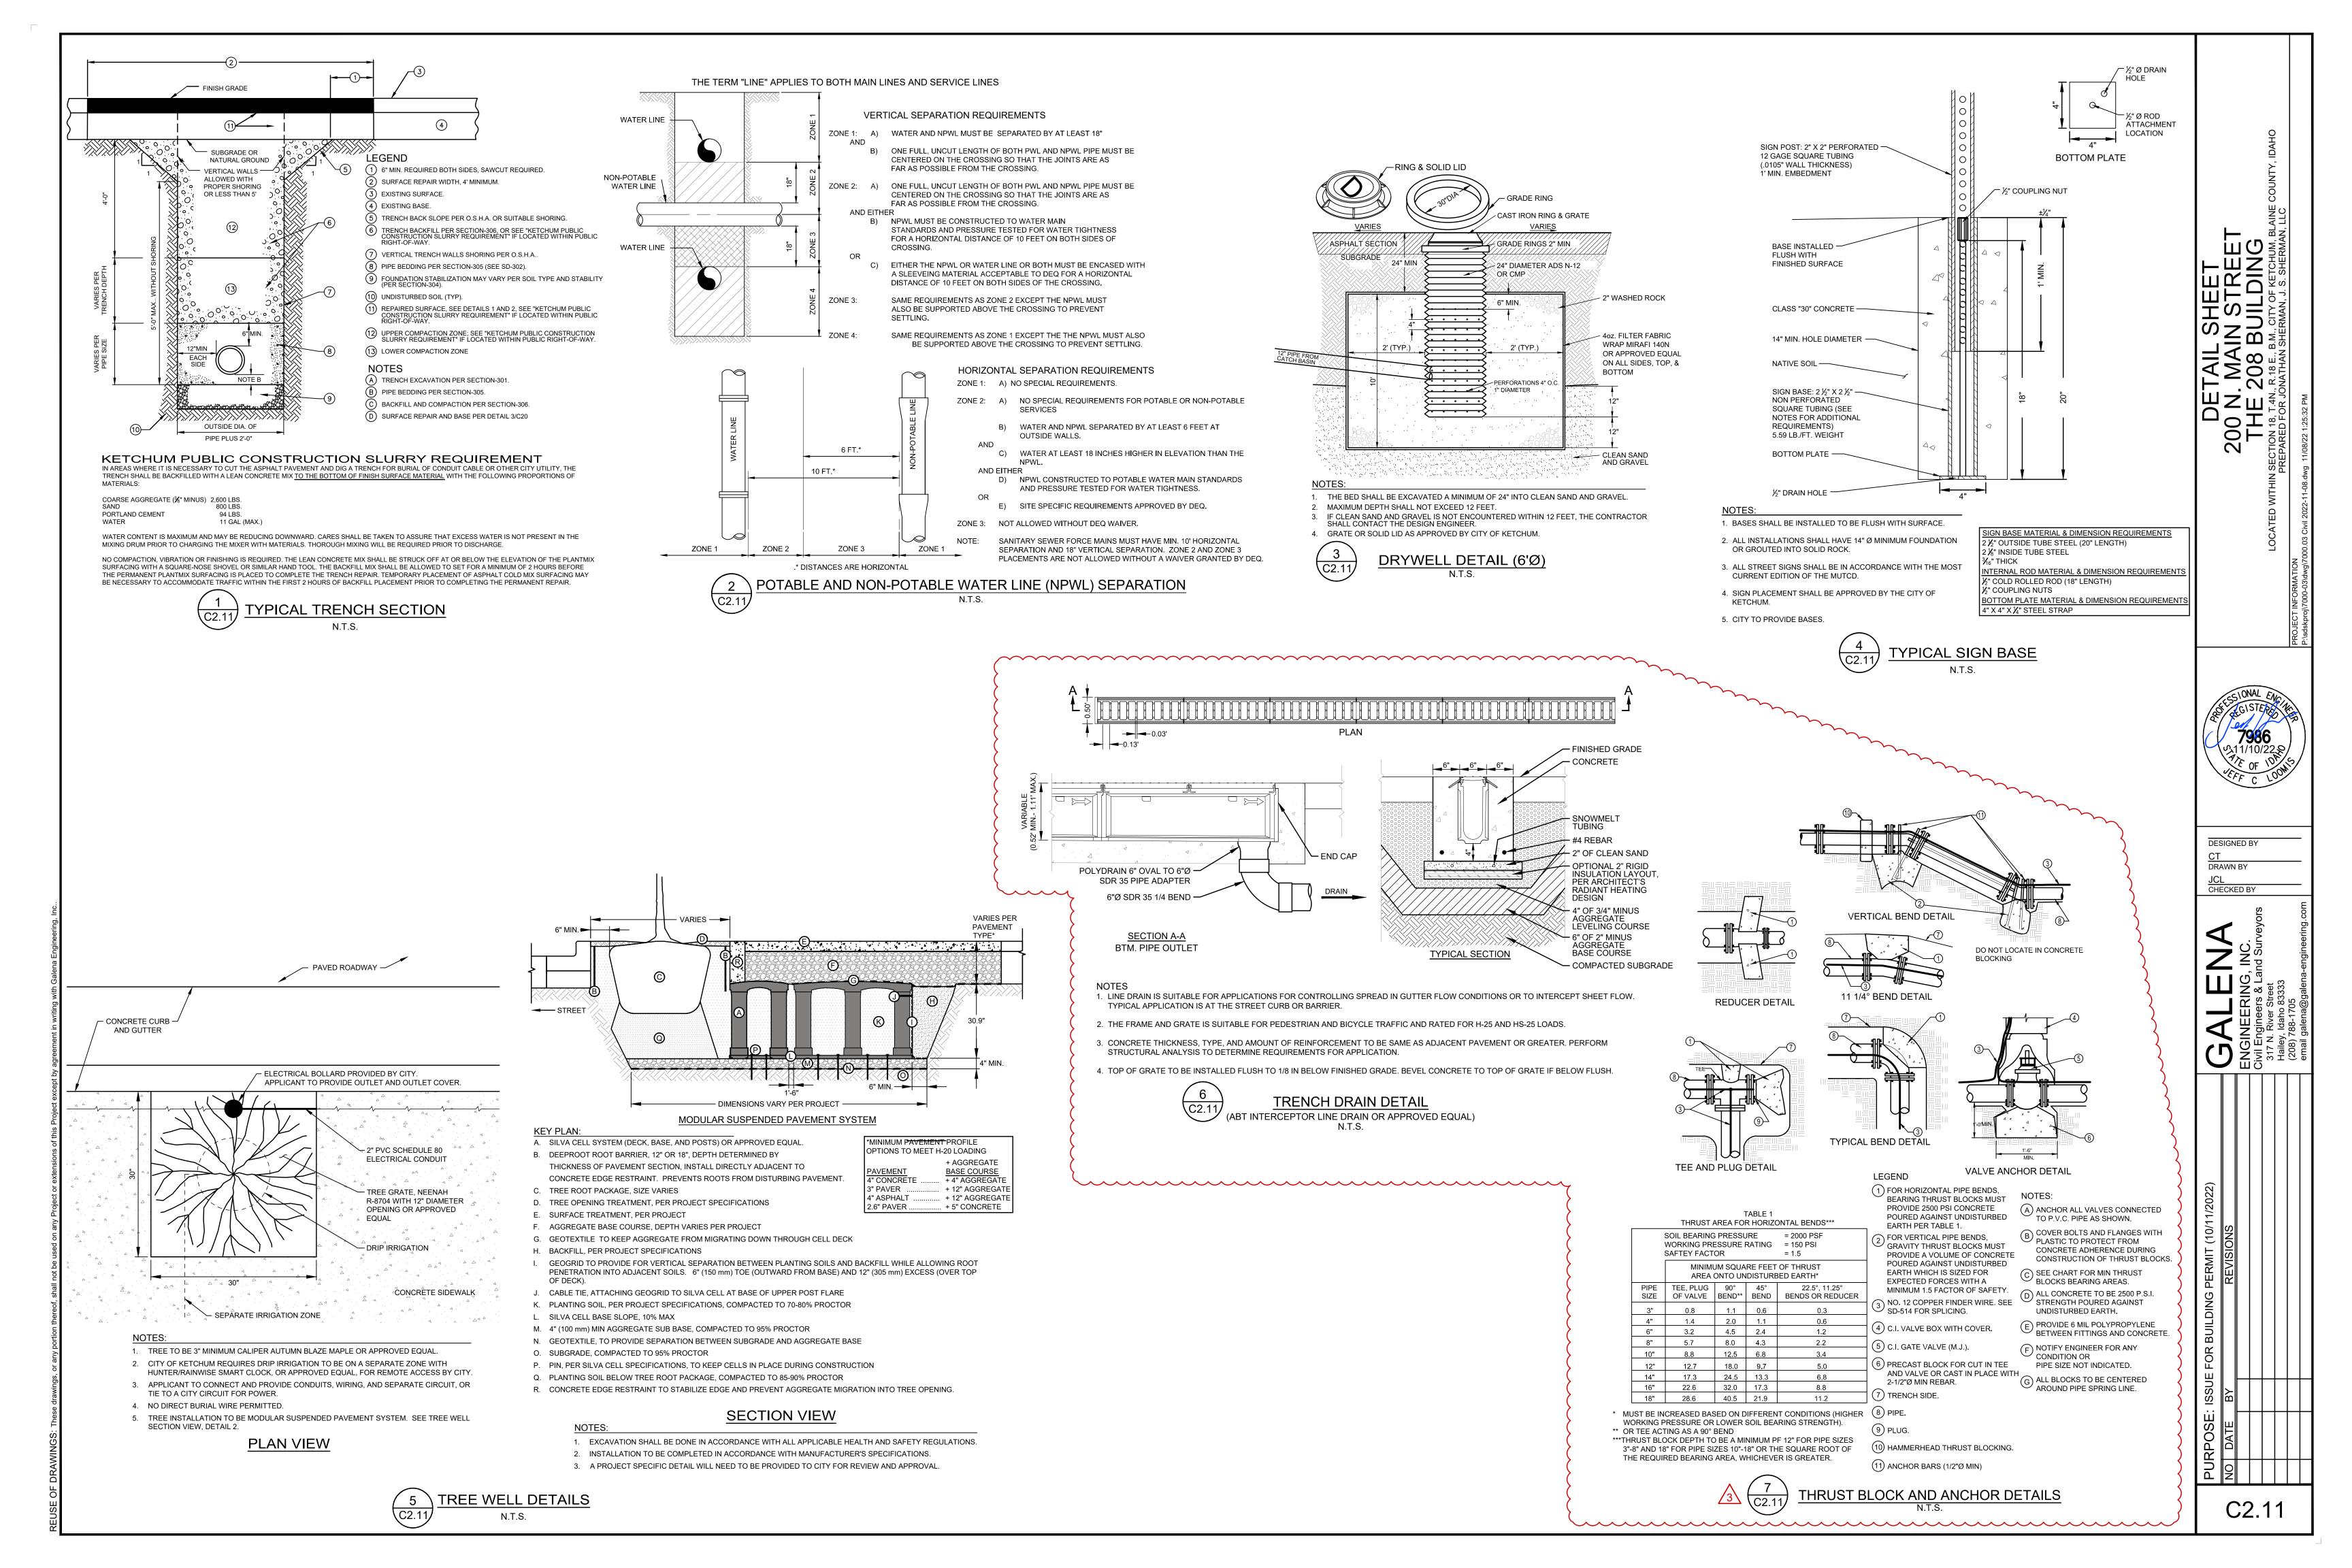

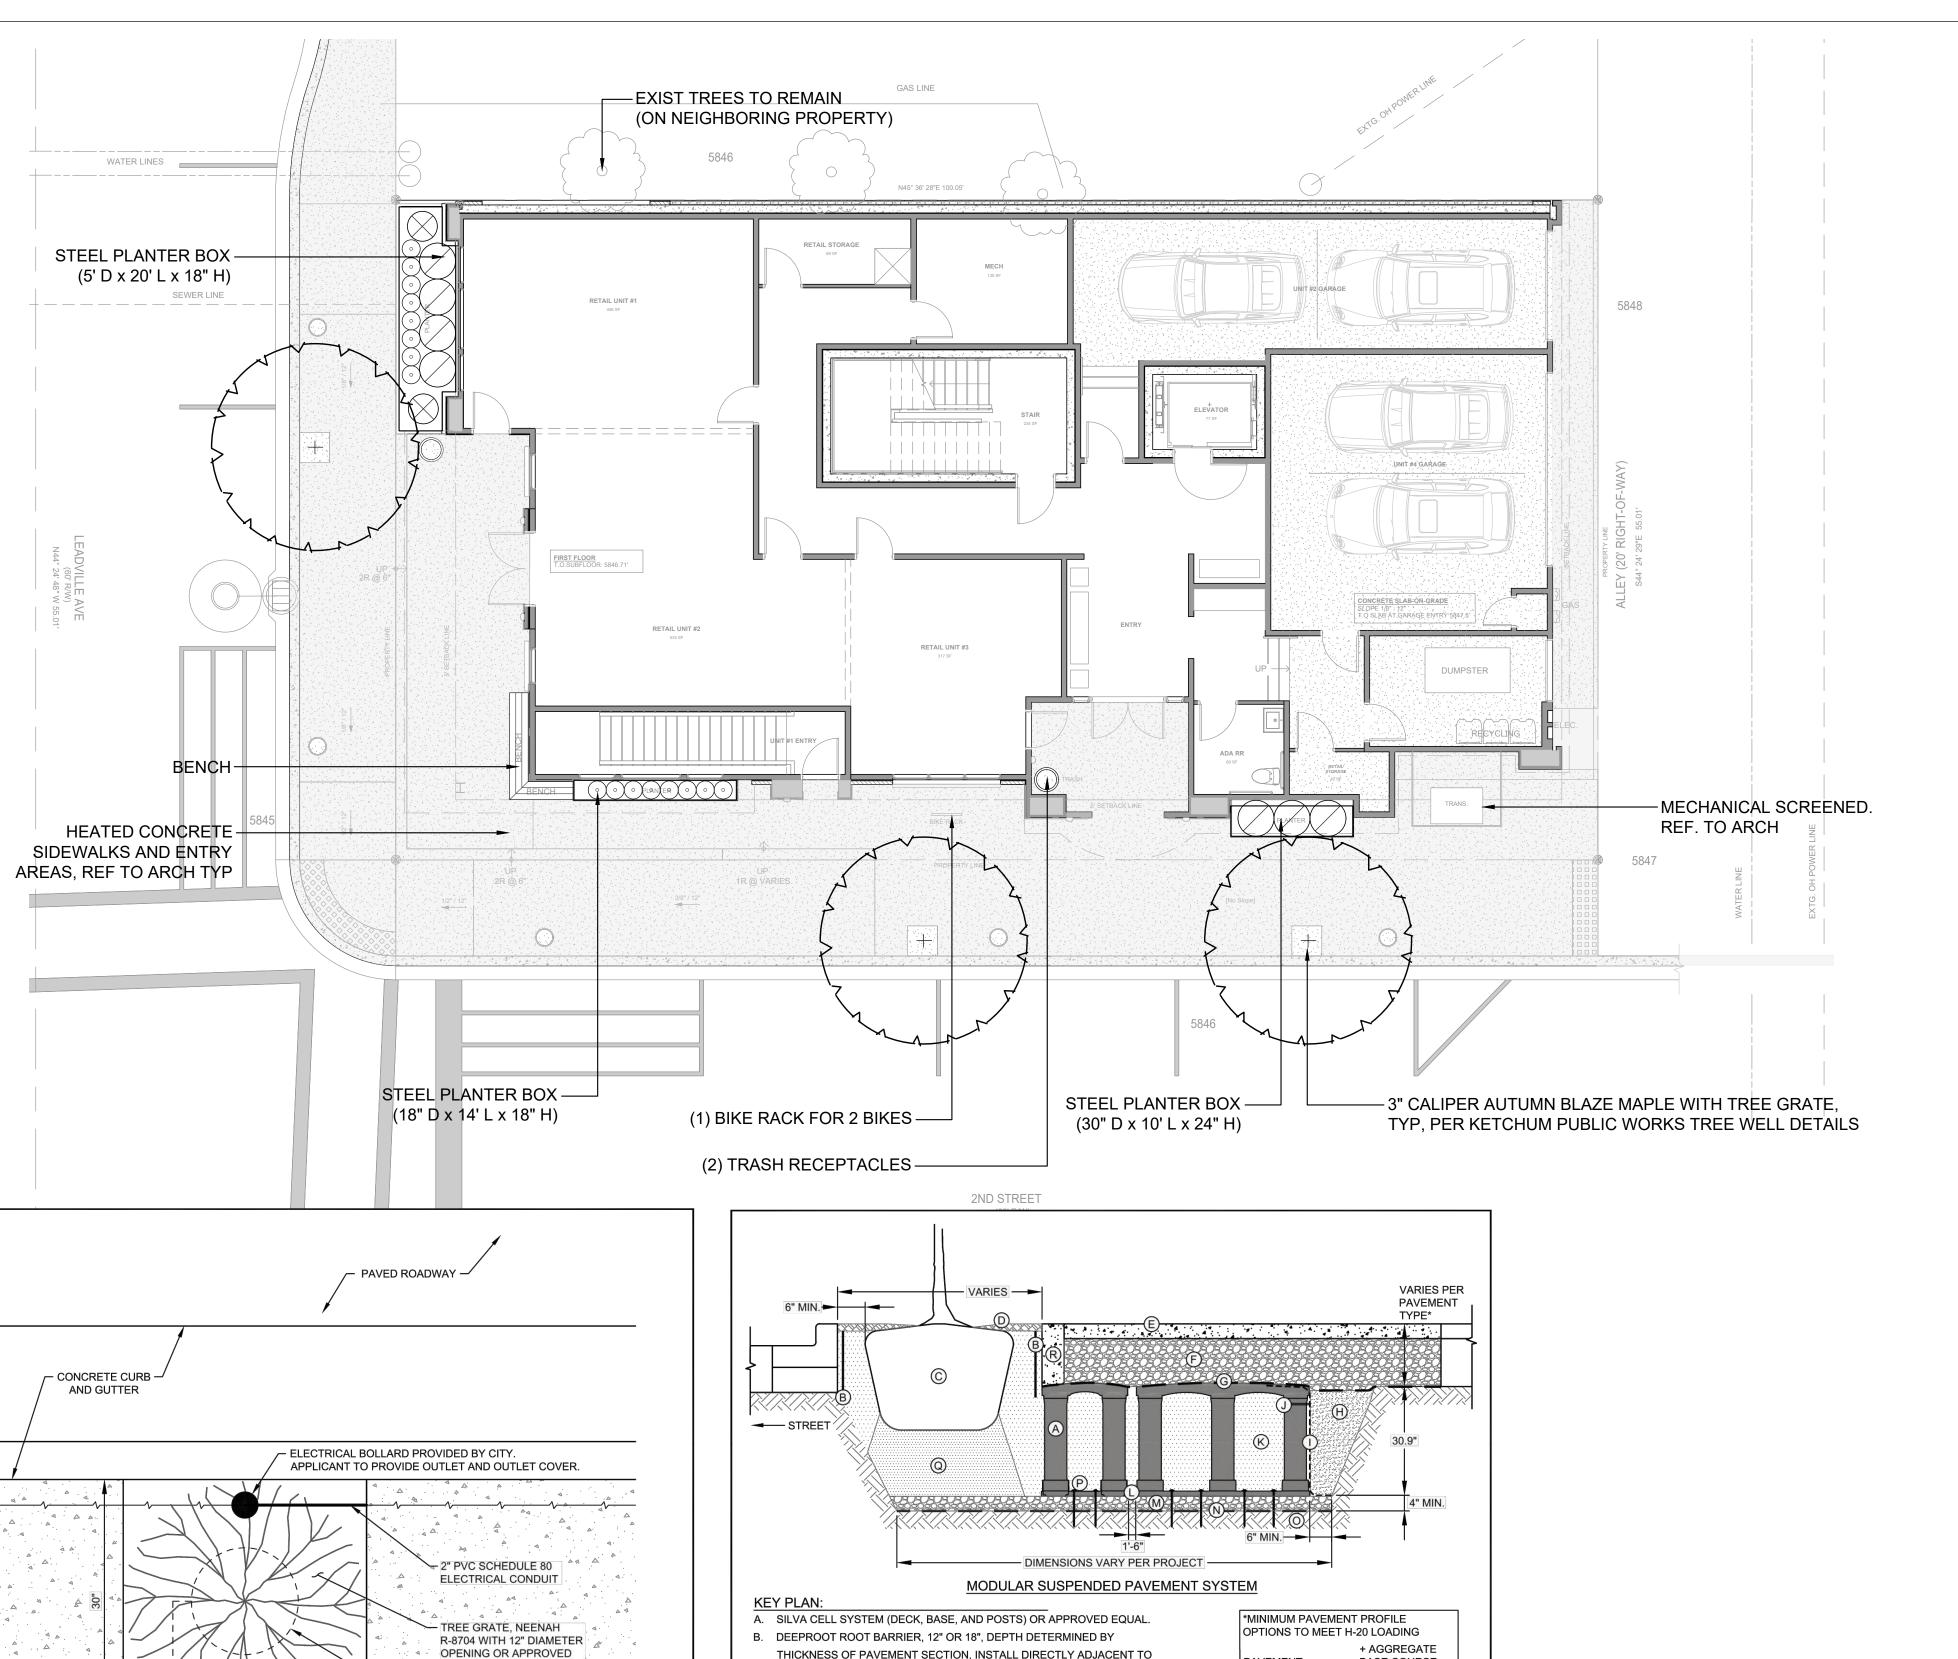

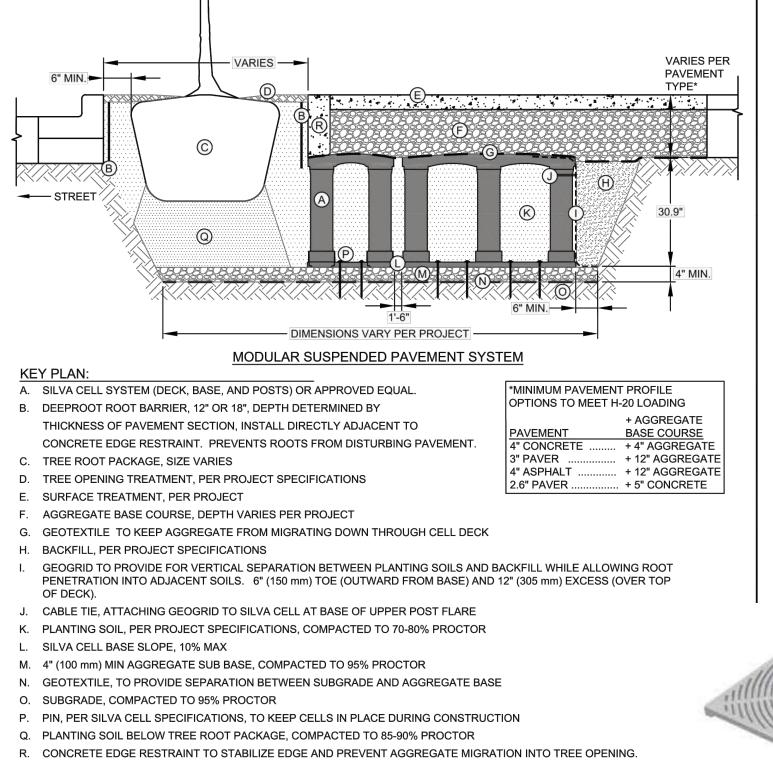

**SECTION VIEW** 

1. EXCAVATION SHALL BE DONE IN ACCORDANCE WITH ALL APPLICABLE HEALTH AND SAFETY REGULATIONS.

CITY OF KETCHUM STANDARD DRAWING

TREE WELL DETAIL

2. INSTALLATION TO BE COMPLETED IN ACCORDANCE WITH MANUFACTURER'S SPECIFICATIONS. 3. A PROJECT SPECIFIC DETAIL WILL NEED TO BE PROVIDED TO CITY FOR REVIEW AND APPROVAL. NEENAH R-8704 TREE GRATE

CONCRETE SIDEWALK

1. TREE TO BE 3" MINIMUM CALIPER AUTUMN BLAZE MAPLE OR

2. CITY OF KETCHUM REQUIRES DRIP IRRIGATION TO BE ON A SEPARATE ZONE WITH HUNTER/RAINWISE SMART CLOCK, OR

3. APPLICANT TO CONNECT AND PROVIDE CONDUITS, WIRING, AND SEPARATE CIRCUIT, OR TIE TO A CITY CIRCUIT FOR

5. TREE INSTALLATION TO BE MODULAR SUSPENDED PAVEMENT

PLAN VIEW

CITY OF KETCHUM STANDARD DRAWING

TREE WELL DETAIL

SYSTEM. SEE TREE WELL SECTION VIEW, DETAIL 2.

APPROVED EQUAL, FOR REMOTE ACCESS BY CITY.

APPROVED EQUAL.

NO DIRECT BURIAL WIRE PERMITTED.

#### LANDSCAPE LEGEND

TRASH RECEPTACLE

**BIKE RACK** 

INTEGRATED BENCHES

HEATED CONCRETE SIDEWALKS

#### LANDSCAPE NOTES

#### STREET TREES

1 STREET TREE / 40 LF OF STREET FRONTAGE

• 100' LF OF FRONTAGE / 40 LF = 3 (2.5) STREET TREES REQUIRED

#### **BIKE RACKS**

• 1 BIKE RACK PROVIDED FOR 4 PARKING SPACES

• INVERTED U SHAPE FOR 2 BIKES

#### BENCHES & TRASH

 1 BENCH AND 1 TRASH RECEPTACLE PROVIDED ALONG EACH FRONTAGE OF 2ND ST AND LEADVILLE AVE

#### **SNOW STORAGE**


• HEATED CONCRETE SIDEWALKS AND ENTRY AREAS PROVIDED, ELIMINATING REQUIREMENT FOR SNOW STORAGE






LANDSCAPE FORMS GENERATION 50 BENCH AND TRASH RECEPTACLE

#### INVERTED U BIKE RACK

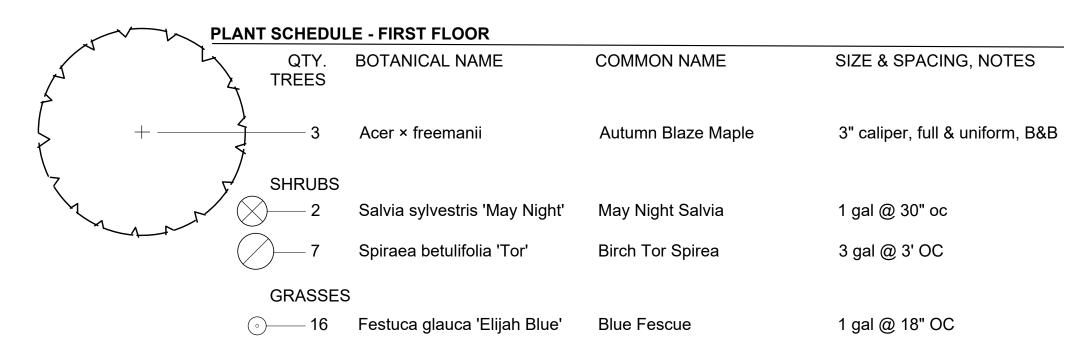

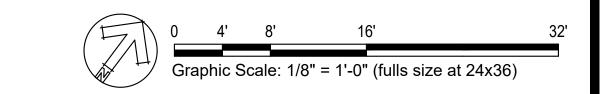

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3.18.22 Pre-Application Submittal 5.31.22 Design Review Submittal

PROJECT ADDRESS:

208

DRAWN: ML

CHECKED: EW DATE: September 28, 2022 PROJECT: 200 Leadville

NUMBER: LLA0292.21

LANDSCAPE SITE PLAN

Revie


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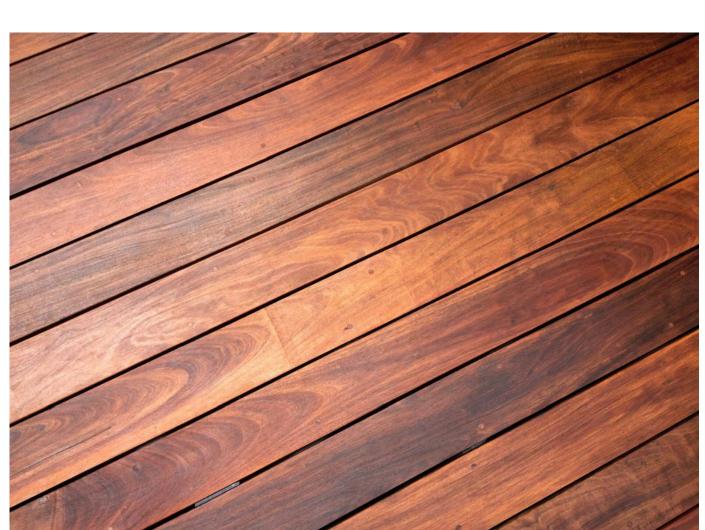
208

DESIGN: ML DRAWN: ML CHECKED: EW

ROOFTOP

LAYOUT PLAN



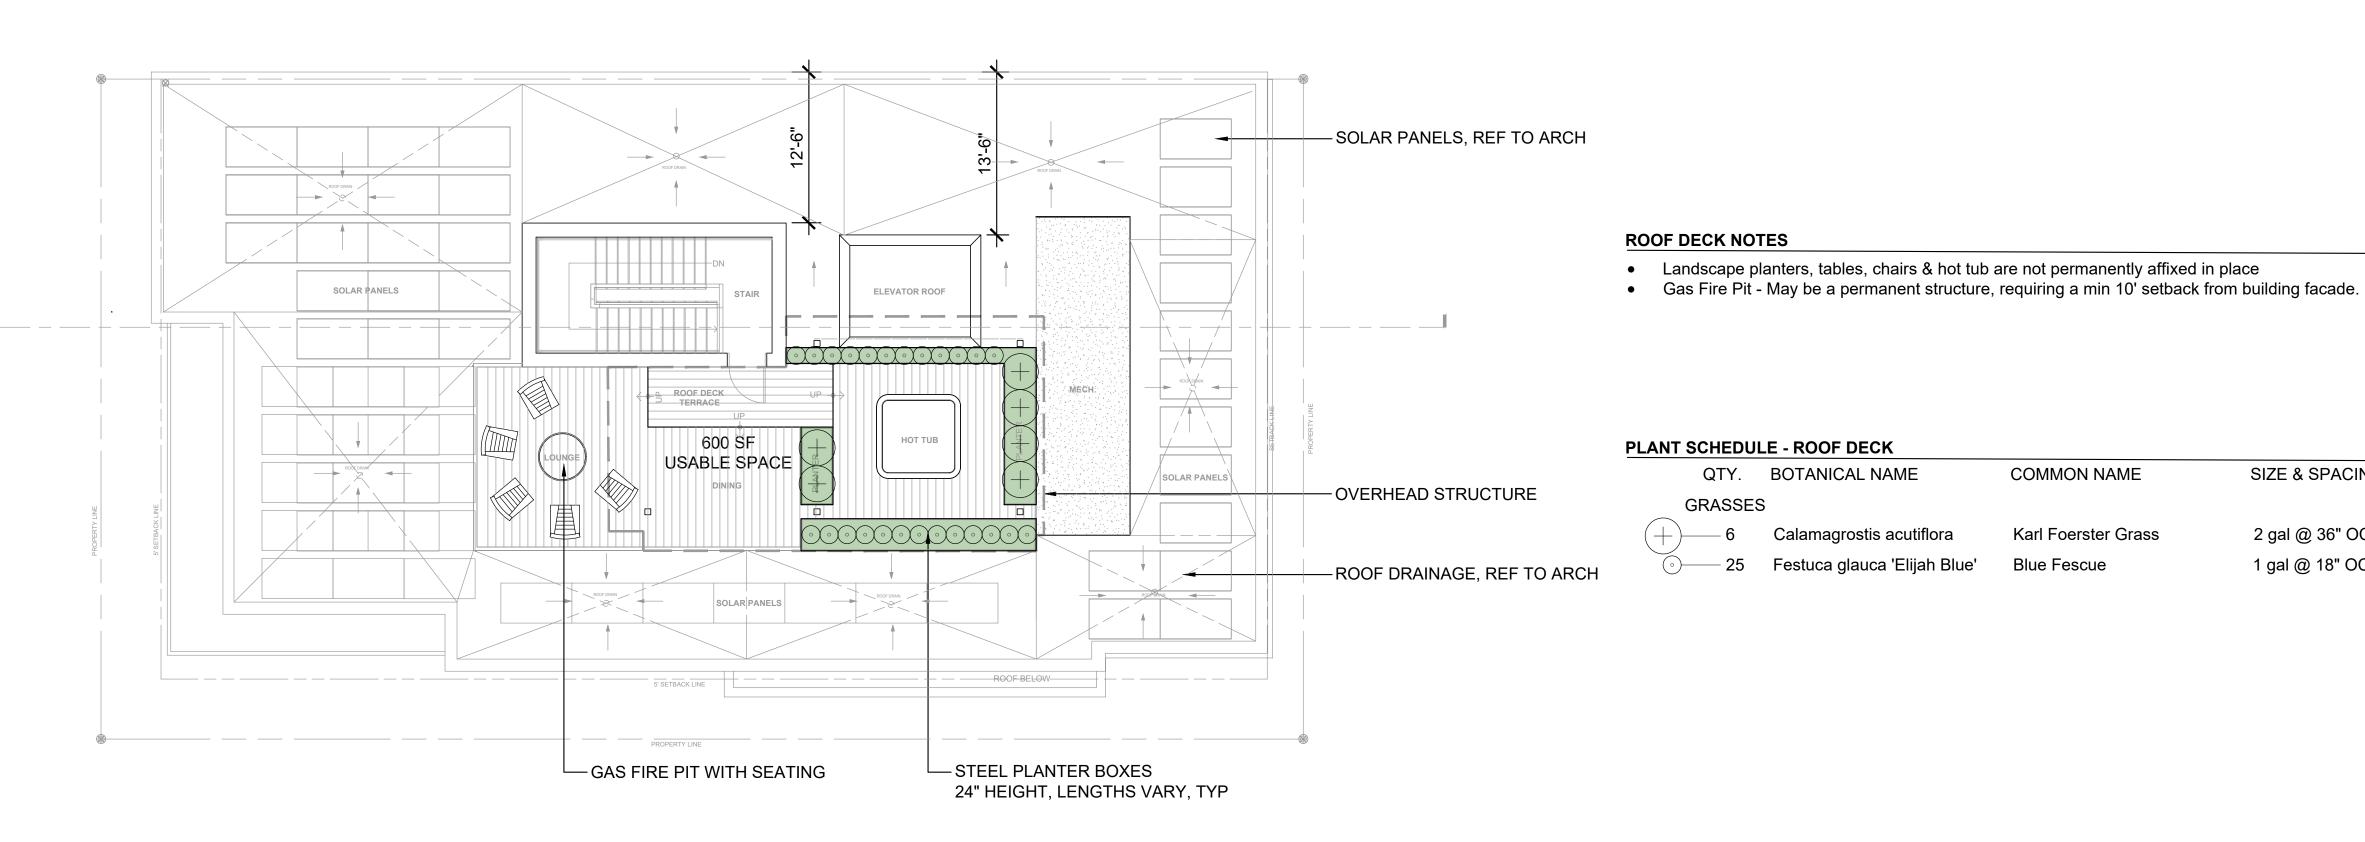



METAL MESH SCREENING OF UTILITIES



ROOFTOP & AT GRADE STEEL PLANTERS

ROOFTOP DECKING MATERIAL

SIZE & SPACING, NOTES

2 gal @ 36" OC

1 gal @ 18" OC

COMMON NAME

Karl Foerster Grass

Blue Fescue