

City of Ketchum

March 15, 2020

Mayor Bradshaw and City Councilors City of Ketchum Ketchum, Idaho

Mayor Bradshaw and City Councilors:

Recommendation To Approve Change Order #4 to Contract 20454

Recommendation and Summary

Staff is recommending the council provide authorization to the Mayor to sign Change Order #4 to Contract 20454 with CORE | Headwaters LLC:

"I move to approve Change Order #4 in an amount of \$35,811, to Contract 20454 with CORE | Headwaters LLC and authorize the Mayor to sign the Change Order."

The reasons for the recommendation are as follows:

• The City and the project team have made certain project changes, primarily to windows and doors, that have had a cost impact.

Introduction and History

The City of Ketchum approved the construction of a fire station on November 5, 2020. Since that time, the project team has worked to bring the project to construction. Change Order #4 was developed by the project team to address certain building usability issues that have arisen during the construction phase.

<u>Analysis</u>

Change Order #4 will provide for a building with increased usability as determined by the project team with input from the Ketchum Fire Department.

Sustainability Impact

There is no sustainability impact arising from this action.

Financial Impact

This change order will be funded from project contingency.

Attachments

• Attachment A: Change Order #4 Contract 20454

Project Description: Fire Station CM/GC

Change Order #:004

Effective Date:3/15/2021

Additional Time Granted:0 days

New Contract End Date: Unchanged

Contract Price Impact

Original Contract Price: \$9,320,940.00

Total of Prior Change Orders: \$ 14,028.00

Contract Price Prior to this Change Order: \$9,334,968.00

Increase / (Decrease) of this Change Order: \$ 35,811

Contract Price Incorporating this Change Order: \$ 9,370,779.00

Acceptance

Neil Bradshaw, Mayor City of Ketchum



Change Order

PROJECT: (name and address) Ketchum Fire Station #1 107 Saddle Road, Ketchum, ID OWNER: (name and address)

City of Ketchum, Idaho 480 E. Ave. N., PO Box 2315

Ketchum, ID 83340

CONTRACT INFORMATION:

Contract For: Ketchum Fire Station #1

ARCHITECT: (name and address)

Cole Architects, PLLC 1008 W. Main Street

Boise, ID 83702

CHANGE ORDER INFORMATION:

Change Order Number: 004

Date: March 9, 2021

CONTRACTOR: (name and address)

CORE Headwaters, LLC 900 Jet Stream Drive Rexburg, ID 83440

THE CONTRACT IS CHANGED AS FOLLOWS:

(Insert a detailed description of the change and, if applicable, attach or reference specific exhibits. Also include agreed upon adjustments attributable to executed Construction Change Directives.)

See attached spreadsheet of ten items.

The origina	al Contract Su	ım	was			\$ 9,320,940.00
The net cha	ange by previously au	thorized C	hange Orde	rs		\$ 14,028.00
The	Contract Sum	prior to	this Change	e Order was		\$ 9,334,968.00
The	Contract Sum	will be	increased	by this Chang	ge Order in the amount of	\$ 35,811.00
The new	Contract Sum	, in	cluding this	Change Orde	r, will be	\$ 9,370,779.00
The Contra	act Time will be unch	anged by		(0) days.	
The new da	ate of Substantial Con	npletion wi	ill be			

NOTE: This Change Order does not include adjustments to the Contract Sum or Guaranteed Maximum Price, or the Contract Time, that have been authorized by Construction Change Directive until the cost and time have been agreed upon

	hich case a Change Order is executed to s	0 1
NOT VALID UNTIL SIGNED BY THE ARC	HITECT, CONTRACTOR AND OWNER.	
Cole Architects, PLLC	CORE Headwaters, LLC	City of Ketchum, Idaho
ARCHITECT (Firm name)	CONTRACTOR (Firm name)	OWNER (Firm name)
Cupital M'Celly	Gen Xall	
SIGNATURE ()	SIGNATURE	SIGNATURE
Crystal McColly, Architect	Chris Schratwieser Senior PM	
PRINTED NAME AND TITLE	PRINTED NAME AND TITLE	PRINTED NAME AND TITLE
3/9/21	3/09/2021	
DATE	DATE	DATE

1	Change OFCI to CFCI for Dorm Shades	\$	1,204.00
2	ASI #4 - Relocate Equipment	\$	17,866.00
3	RFI 75R1 - Revise polish flooring finishes level	\$	(4,135.00)
4	Office GWB & Laundry Furring	\$	941.00
5	ASI #5 - Electric	\$	5,324.00
6	ASI #6 - Hand Dryers, Satellite Dish	\$	5,942.00
7	RFI 62 - Decon Room Revisions not in ASI-03	\$	4,321.00
8	RFI 94 - Revised Apparatus Storage Structure	\$	(3,692.00)
9	Add Back S-3 Sink	\$	2,492.00
10	RFI 77R1 and 115 - Change Sinks & Faucets, Relocated Drain	\$	5,548.00
		\$	35,811.00
	Including CO #001 through CO #003	\$9,	334,968.00
	New Contract Sum	\$9,	370,779.00



Building. Growing. Leading. ... Since 1937.

Budget Evolution Item Summary City of Ketchum Fire Station #1

Change OFCI to CFCI for Dorm Sha	ades	Date:	3/1/2021
Description: Change	e OFCI Dorm Blackout Shades to CFCI		
SCOPE	SUBCONTRACTOR	AMOU	
Provide Dorm Black out Shades x 6	6 OEC	\$	1,130.00
		\longrightarrow	
			
		+	
		+	
		+-	
			
		+	
			
			
			
	- 	- 	
SUBTOTAL:		\$	1,130.00
SUBTOTAL reflects direct costs onl	ly on the presumption that costs will	come from	
allowances. If costs are reimburse	ed by Change Order, TOTAL AMOUNT	below reflects	the
SUBTOTAL with add of agreed upc	on markup in accordance with the cha	ange order prici	ng.
Bond and Insurance	CORE	\$	24.00
CMAR FEE	CORE	\$	50.00
Sales Tax	CORE	\$	
TOTAL AMOUNT:		\$	1.204.00



OFFICE ENVIRONMENT COMPANY 623 S. Americana Blvd | Boise, ID 83702 | w: 208-385-0507 | www.oecworks.com

CoK dorms **2000062**

Change Order Request # 1

Date: 12/1/20	
Change Order Description: Furnish 6 Mecho Urban manual Black Out shades	
Scope of Work Description & Clarifications	Amount
Pricing is based on Furnishing 6 Mecho Urban manual Shade Dorm Black out	\$1,130
Installation was part of original scope.	
Exclusions: Wall patching, painting and Backing	
Total Change Order Amount	\$1,130



Building. Growing. Leading. ... Since 1937.

Budget Evolution Item Summary City of Ketchum Fire Station #1

ASI #4 Relocate Equipment	Dat	e:	12/8/2020
Description: Revise Equipment	t layout Decon, Move Heaters t	o Second I	loor
Description. Revise Equipment	t layout Decoil, Move Heaters t	o secona i	1001
SCOPE	SUBCONTRACTOR	AMO	UNT
Change Filters to MERV 13 from MERV 8	Thornton	\$	5,426.00
MERV 13 from MERV 8 Spec Clarification	CM/GC Contingency	\$	(5,426.00)
Move Water Heaters, Add WH-3, ET-2, RP-1	Evans Plumbing	\$	6,419.00
Move and Add Electrical for ASI-4	Magic Valley Electric	\$	10,351.00
	<u> </u>		
SUBTOTAL:		\$	16,770.00
SUBTOTAL reflects direct costs only on the p	•		
allowances. If costs are reimbursed by Chan	•		
SUBTOTAL with add of agreed upon markup	in accordance with the change	order pric	ing.
Bond and Insurance	CORE	\$	350.00
CMAR FEE	CORE	\$	746.00
Sales Tax	CORE	\$	-
TOTAL AMOUNT:	T	\$	17,866.00

Thornton Heating & Sheetmetal, INC. P.O.Box 242 Ketchum, Idaho 83340 208-726-5520

Estimate

Date	Estimate #	
10/29/2020	932	

Name / Address	
Core Construction 777 N. 4th. St. Boise, ID. 83702	

Terms	Sales Rep
Net 15	GC
Job N	lame

Quantity	Description		Cost	Total
	Change order #1			
1	ERU #1 - Upgrade to Merv 13 filters (40 total filters)		3,617.00	3,617.00
1	ERU #2 - Ugrade to MERV 13 filters (20 total filters)		1,809.00	1,809.00
	thorntonheating@hotmail.com	Total		\$5,426.00

Terms: All material is guaranteed to be as specified. All work to be completed in a professional manner according to standard practices. Any alteration or deviation from the original bid will be an extra charge above the original figure. Estimates are good for 30 days. Any bid constitutes a firm price for work to be done. Budget numbers will be billed on time and material and can exceed or fall short of estimated price.

Signature	 ALL CREDIT CARD PAYMENTS WILL HAVE A 3% PROCESSING FEE AS OF
Date:	 5/04/2020.

Chris Schratwieser

From: CJ <cj@thornton-heating.com>
Sent: Tuesday, October 20, 2020 7:55 AM

To: Chris Schratwieser
Cc: Matt Sylvester

Subject: FW: Ketchum FS - MERV Filter Item

From: Mike Devine <mdevine@techairprod.com>

Sent: Tuesday, October 20, 2020 8:32 AM

To: CJ <cj@thornton-heating.com>

Subject: RE: Ketchum FS - MERV Filter Item

CJ, see the highlighted comment below. There are (2) ERU's on the job, but I'm confused how they are coming up with only (8) filters on the job. The submittals show the following filters for each unit (MERV 8 is what we designed the units to have per the original specification).

ERU-1

Supply air filters (8) 16x25x2 Return air filters (4) 16x25x2 Outside air filters (4) 16x25x2

ERU-2

Supply air filters (4) 20x20x2
Return air filters (2) 20x25x2
Outside air filters (2) 20x25x2

Mike Devine President

Office: 208-377-2071 Fax: 208-378-8265 1410 E. Iron Eagle Drive Eagle, Idaho 83616



From: CJ <<u>cj@thornton-heating.com</u>>
Sent: Tuesday, October 06, 2020 10:10 AM

To: Hadlock, Scott <<u>shadlock@siglers.com</u>>; Mike Devine <<u>mdevine@techairprod.com</u>>

Subject: FW: Ketchum FS - MERV Filter Item

From: Chris Schratwieser < chrisschratwieser@coreconstruction.com

Sent: Tuesday, October 6, 2020 10:09 AM

To: CJ <cj@thornton-heating.com>

Cc: Matt Sylvester <mattsylvester@coreconstruction.com>

Subject: FW: Ketchum FS - MERV Filter Item

CJ,

Please review the below and provide a narrative

Chris Schratwieser, LEED AP

Senior Project Manager

CORE Construction | West

C: 702-715-2200 | W: COREconstruction.com

From: Chris Schratwieser

Sent: Friday, September 25, 2020 6:36 AM

To: cj@thornton-heating.com

Cc: John Brown < johnbrown@coreconstruction.com >; Matt Sylvester (mattsylvester@coreconstruction.com)

<<u>mattsylvester@coreconstruction.com</u>> **Subject:** FW: Ketchum FS - MERV Filter Item

CJ.

Please review and respond at your earliest opportunity. The quantities she lists contradicts what you have submitted on. Need your reply on that as well.

Thanks

Chris Schratwieser, LEED AP

Senior Project Manager

CORE Construction | West

C: 702-715-2200 | W: COREconstruction.com

From: Crystal McColly < Crystal@colearchitects.net>

Sent: Thursday, September 24, 2020 5:17 PM

To: Bill McLaughlin < BMcLaughlin@ketchumfire.org >; Grant Gager < ggager@ketchumidaho.org >; Cary Goldberg

- <cgoldberg@dppmllc.com>; Dennis Potts <dpotts@dppmllc.com>; Chris Schratwieser
- <chrisschratwieser@coreconstruction.com>; Kate Kelly <Kate.Kelly@brightworks.net>; Kanika Golani
- < kanika.golani@brightworks.net >; Matt Sylvester < mattsylvester @coreconstruction.com >; John Brown
- <johnbrown@coreconstruction.com>; Matt Huffield <Matt@colearchitects.net>; Bill Carter <BillC@musgrovepa.com>;

James Siefert < <u>jamess@musgrovepa.com</u>>

Subject: Ketchum FS - MERV Filter Item

Good afternoon Team,

This email is intended is to summarize and clarify the MERV filter item discussion and to clarify what needs to be priced by Core.

- Currently, we have MERV 13 filters in the project as this is a requirement for indoor air quality LEED point we are pursuing and counting on. These filters will need to be in the project in order to achieve the LEED point. If it decided to go to MERV 8 filters or to change to MERV 8 filters in the future, then we cannot pursue this point. We have confirmed with Brightworks, LEED does not require any replacement terms of the MERV filters.
- There are only two mechanical units in the project that have these filters and each unit will have four MERV 13 filters each. This means there are (8) MERV 13 filters total in the project.
- Cary has asked Core to provide pricing on adding two differential gauges. The gauging is to see whether the filter needs replacement. The idea is that they can replace the filters only when they need to and not on a set schedule. According to the mechanical engineer, this could save on cost, but with only (8) MERV 13 filters, they don't see it being a huge cost savings.

Chris – Could you provide pricing on what the (8) MERV 13 filters cost? And could you also provide pricing on adding two differential gauges?

Please let me know if you have any questions.

Thank you,

Crystal McColly, AIA, NCARB | COLE/ARCHITECTS Project Architect **p** 208.345.1800 / **d** 208.605.3404 / **c** 208.731.9031

Change Request Proposal

203600 / CoK FS No. 1 Change request number: 07 Project: 107 Saddle Road (name and Description: ASI 04 - Relocation of Water Heaters Ketchum, ID 83340 address) Customer: CORE | Headwaters, LLC Notice to Proceed Status: Proposed Origination date: 11/04/20 Submitted date: Received date: Rough order of magnitude: 0.00 Quotation Submitted date: 11/04/20 Due date: Submitted amount: 6,419.27 Requested days delay: 0 Notes Per ASI 04 - Move 2 water heaters from COMP 124 to STORAGE 216. Add WH-3, ET-2 and RP-1 in DECON 131. Add FS-2 in STORAGE 124 Revenue Detail **Billing Item** Description Revenue Labor - 10 hrs 800.00 Original Rough-In Mtrl Credit -2,354.81 Revised Rough-In Mtrl Add 5,176.83 WH-3, FS-2 and ET-2 Fixtures 2,064.30 M/U on Mtrl Difference (15%) 732.95 **Total Revenue For CR 07** 6,419.27

Approvals			
Customer: CORE Headwaters, LLC Authorized Representative:	Contractor: Evans Plumbing, Inc.		
Ву:	Ву:		
Date:	Date:		

Print Date: 11/04/20 Page 1 of 1



QUOTE #BPLB20200200000940

		Quoted By:	Michael Fisher
Job Name:	Ketchum FD	Bid Date:	04/17/2020
		Expires:	05/17/2020
Location:	Ketchum, ID, USA		

Quoted prices are based upon receipt of the total quantity for immediate shipment (48 hours). SHIPMENTS BEYOND 48 HOURS SHALL BE AT THE PRICE IN

EFFECT AT TIME OF SHIPMENT UNLESS NOTED OTHERWISE. Seller not responsible for delays, lack of product or increase of pricing due to causes beyond our control, and/or based upon Local, State and Federal laws governing type of products that can be sold or put into commerce. This Quote is offered contingent upon the Buyer's acceptance of Seller's terms and conditions, which are incorporated by reference and found either following this document, or on the web at http://wolseleyna.com/terms_conditionsSale.html. Govt Buyers: All items quoted are open market unless noted otherwise.

QUOTES FOR PRODUCTS SHIPPED

FOR RESALE ARE NOT FIRM UNLESS NOTED OTHERWISE. CONTACT YOUR SALES REPRESENTATIVE IMMEDIATELY FOR ASSISTANCE WITH DBE/MBE/WBE/SMALL BUSINESS REQUIREMENTS.

Ferguson - Boise

586 North Locust Grove Road Meridian, ID 83642 Phone: (208) 376-6660

FOR ASSISTANCE WITH DBE/MBE/WBE/SMALL BUSINESS REQUIREMENTS.		Phone: (208) 376-6660					
ITEM#	MFC	DESCRIPTION	P- QTY	U/M	P-UNIT PRICE	EXT QTY	EXT PRICE
		SECTION 301 TARIFFS: PLEASE SEE THE FULL FERGUSON LETTER AT THE END OF THIS QUOTE. THE ANNOUNCED INCREASED TARIFFS WILL RESULT IN PRICE INCREASES. AT THIS TIME, OUR VENDORS ARE UNCLEAR WHEN/IF AND AT WHAT RATE THESE TARIFFS WILL BE IMPOSED. HERE ARE THE STEPS WE WILL TAKE GIVEN THE INFORMATION WE HAVE TODAY: 1) PRICING ON ALL PRODUCTS IMPORTED FROM CHINA ON OPEN AND FUTURE QUOTES WILL EXPIRE 30 DAYS AFTER THE BID DATE. 2) WE WILL CONTINUE TO COMPETITIVELY QUOTE THESE PRODUCTS BASED ON OUR COST. IF THE TARIFFS ARE IMPOSED, WE WILL HAVE NO CHOICE BUT TO PASS THESE COSTS ON TO THE MARKET. 3) TO BE CLEAR, IF/WHEN THE TARIFFS ARE IMPOSED, FERGUSON WILL BE FORCED TO PRICE THESE PRODUCTS BASED ON THE COST AT THE TIME OF SHIPMENT.					
BLE250S33NC ZZ	BRADFORD WHITE	WH-3 WATER HEATER CCY 50G 4.5KW 208V 3PH COMMERCIAL ELECTRIC WATER HEATER	1	EA	\$1,525.26	1	\$1,525.26
AST12	AMTROL	ET-2 EXPANSION TANK 4.4 GAL TANK VOL THERM-X-TROL THERMAL EXPANSION TANK NON-ASME	1	EA	\$56.58	1	\$56.58
		FS-2 FLOOR SINK					
ZZN19104NHP 232 ZZN19103NHP	ZURN ZURN	8" X 8" A.R.E. SANI-FLOR RECEPTOR, 6" SUMP DEPTH, N.B. FRAME AND GRATE - 4" NO HUB , TRAP PRIMER CONNECTION, 1/2 GRATE, ALUMINUM DOME STRAINER 8" X 8" A.R.E. SANI-FLOR RECEPTOR, 6" SUMP DEPTH, N.B.	1	EA EA	\$482.46 \$482.46	1	\$482.46 \$482.46
232 ZZN19102NHP 232	ZURN	FRAME AND GRATE - 3" NO HUB , TRAP PRIMER CONNECTION, 1/2 GRATE, ALUMINUM DOME STRAINER 8" X 8" A.R.E. SANI-FLOR RECEPTOR, 6" SUMP DEPTH, N.B. FRAME AND GRATE - 2" NO HUB , TRAP PRIMER CONNECTION, 1/2 GRATE, ALUMINUM DOME STRAINER	1	EA	\$482.46	1	\$482.46



March 20, 2020

Re: Bid activity

Dear valued customer,

The World Health Organization has declared COVID-19 a global pandemic, and Ferguson's priority continues to be the health of our associates, our customers and the communities in which we live and work. In addition to ensuring all our locations are equipped with and using proper sanitization products and techniques, any Ferguson associate who is not feeling well or is at high risk for contracting the virus is being asked to protect themselves and others by staying home.

Efforts to prevent the spread of COVID-19 have the potential to impact the global supply chain across many industries. Ferguson's Supply Chain, Procurement and Business Continuity teams are continually evaluating our supply chain from both sourcing and distribution perspectives and do not anticipate any significant disruptions based on information currently available. We are working together to plan for and mitigate any potential disruption so that we may quickly and effectively implement measures to keep business moving as usual.

Ferguson is committed to fulfilling requests for all bids as quoted – including pricing and inventory availability. Bid products and pricing are based on current knowledge at the time of the quote and have the potential to change.

We are committed to sharing additional information as it becomes available. In the meantime, should you have any questions, please reach out to your Sales associate directly.

Thank you for your business and support.



To our valued customers,

In December 2018, the U.S. Trade Representative (USTR) modified the 301-tariff schedule to allow for negotiations between the U.S. and China. The Trump Administration has decided to increase the current 10% tariff by an additional 15% on certain Chinese-made imports due to dissatisfaction with **China's Commitment to address U.S. concerns**. The tariff increase took effect on May 10, 2019.

Tariffs are taxes that cannot be negotiated, therefore Ferguson must implement timely price increases to cover additional costs in totality. While we cannot give manufacturer-specific price increases at this time, we will immediately follow manufacturer price changes as we receive them.

Ferguson does not anticipate any shortages of material. However, increased tariffs will result in price increases. To better support you, we are proactively contacting all our vendor partners to understand how they will manage price increases including existing job contracts.

Here are the steps we will take given the information we have today:

- 1) Unless otherwise noted on seller's quotation, all prices are subject to change at any time.
- 2) We will continue to competitively quote these products based on our costs. If the additional tariffs are imposed, we will have no choice but to pass these costs on to the market.
- 3) To be clear, if/when the additional tariffs are imposed, Ferguson will be forced to price these products based on the costs at the time of shipment.

Our priority is to provide you with access to products at a competitive price, with no disruption in supply. We appreciate your loyalty and understanding as we manage this changing business environment. If you have questions concerning upcoming jobs or existing quotes, please speak with your Ferguson sales associate to help plan your business.

Thank you for your continued support and partnership.

Ferguson Enterprises

Update: Section 301 Tariffs

Background

The President announced the third round of tariffs in the Section 301 action, imposing 10% tariffs on Chinese imports valued at \$200B, effective September 24, 2018. Tariffs were scheduled to increase to 25% on January 1, 2019, but the President suspended this deadline for 90-days to allow for negotiations between the US and China.

Timeline of Section 301 Tariff Measures

May 29, 2018 The President issues a statement, invoking his authority under Section 301 of the U.S. Trade Act of 1974 to combat China's burdensome trade practices on U.S. interests. He instructed the Office of the U.S. Trade Representative (USTR) to release by June 15 a list of Chinese imports valued at \$50B that would be subject to an additional 25% tariff.

July 6, 2018 Effective date of 25% tariffs on Chinese imports valued at \$34B. (List #1)

July 10, 2018 USTR releases notice of intent and initiation of the public comment period to impose additional 25% tariffs on a third list of Chinese imports valued at \$200B. (List #3)

August 23, 2018 Effective date of 25% tariffs on Chinese imports valued at \$16B. (List #2)

September 17, 2018 President announces decision to impose 10% tariffs on Chinese imports valued at \$200B. (List #3). Tariffs to increase to 25% on January 1, 2019. President also announces additional tariffs on \$267B of Chinese imports if China retaliates against the U.S.

September 18, 2018 China initiates retaliation against the U.S., moving to impose tariffs on \$60B of U.S. goods imported into China, increasing likelihood of fourth round of tariffs imposed by the U.S.

September 24, 2018 Effective date of 10% tariffs on Chinese imports valued at \$200B. Scheduled to increase to 25% on January 1, 2019. (List #3).

December 19, 2018 - President announces a 90-day suspension of the January 1, 2019 deadline. List #3 tariffs to increase to 25% on March 2, 2019 if negotiations do not result in China meeting US demands.

May 10, 2019 President announces decision to increase tariffs to 25% on List #3. Increase to take effect May 10, 2019.

For additional information, visit USTR.gov.

Company:	evans
Job Name:	Ketchum Fire Station PEX []
Material Set:	Factor #1
Labor Set:	Factor #1 (Quote)
Run Date:	11-05-2020 @ 10:12:39
Sort Key:	By Family/Matl Group

			Price
Family/Matl Group		Qty	Total
Pipe - Copper Tube		501.88	\$ 1,601.25
Fitting - Wrot Copper Fittings		19	\$ 46.57
Valve - Ball Valves		2	\$ 40.65
Hanger - Bolts		210	\$ 22.05
Hanger - Hangers		735	\$ 630.08
Hanger - Miscellaneous		210	\$ 6.30
Joint - Miscellaneous		44	\$ 7.92
TOTALS:		1,721.88	\$ 2,354.81

Company: evans

Job Name: Ketchum Fire Station PEX []

Material Set: Factor #1

Labor Set: Factor #1 (Quote)

Run Date: 11-05-2020 @ 10:12:39

Sort Key: By Family/Matl Group

			Price		
Family/Matl Group		Qty	Total		
Pipe - Copper Tube		336.15	\$	1,973.68	
Pipe - PVC DWV Pipe		74.41	\$	65.52	
Fitting - PVC DWV Fittings		13	\$	44.14	
Fitting - Wrot Copper Fittings		37	\$	212.80	
Valve - Ball Valves		5	\$	124.15	
Hanger - Hangers		440	\$	364.95	
Hanger - Miscellaneous		128	\$	3.84	
RP-1 Recirc Pump		1	\$	420.11	
RPBP BACKFLOW		1	\$	1,967.64	
TOTALS:		1,033.56	\$	5,176.83	



The Power To Do It Right!

Magic Valley Electric, LLC 395 Railway Street Jerome, Id 83338 Office: 208.944.4931

SUBCONTRACTOR CHANGE ORDER REQUEST

					Date:	11/4/2020
SUBCONTRACTOR:	Magic Valley Electric	_	PRO.	JECT NAME:	Ketchum Fire	e station
CONTACT:	Jimmy Gyorfy					
	395 Railway Street	_	PROJECT	TADDRESS:	107 Saddle F	Road
	Jerome, ID 83338	_			Ketchum, ID	
PHONE:	208-944-4931	 TF	IS IS IN RES	SPONSE TO:	,	
		_		Bulletin #:		
CONTRACTOR:	Core Construction			ASI #:	4	
CONTACT:	Chris Schratwieser	VE	RBAL REQU	JEST FROM:		
ADDRESS:	777 North 4th Street	_				
	Boise, ID 83702	_	SUBCONTRA	ACTOR CO#:		
PHONE:	702-794-0550	_				
DECODIDEION	A014 44 11- 124/11 0 1 D1	. 471.0-				
DESCRIPTION:	ASI-4. 14.a. added WH-3 and RF	² , 17.b&c	. moved con	npressor and	added comp	oressor.
I OCATION:	Ketchum Fire Station					
DRAWINGS:						
21.0.01.000	Trade Description	Hours	Labor Amt.			Total Cost
LABOR:	Journeyman	86	70.00			6,020.00
						0.00
						0.00
						0.00
						0.00
	Description	QTY	Unit Price	Sub-Total	Taxes	Total Cost
MATERIAL:	WH-3 Disconnect	1	306.87	306.87	18.41	325.28
	Conduit, & Supports	1	2,206.38	2,206.38	132.38	2,338.76
	Wire	1	1,573.03	1,573.03	94.38	1,667.41
				0.00	0.00	0.00
				0.00	0.00	0.00
	Description	QTY	Unit Price	Sub-Total	Taxes	Total Cost
EQUIPMENT:				0.00	0.00	0.00
				0.00	0.00	0.00
				0.00	0.00	0.00
				0.00	0.00	0.00
				0.00	0.00	0.00
SUBTOTAL:				0.00	0.00	0.00 10,351.46
GRAND TOTAL:				Total Amou	nt	\$10,351.46
ORARD TOTAL.				Total Alliou	ı	Ψ10,331.40
NOTES:						
110120.						
	Authorized Signature		Date			
	•					



Building. Growing. Leading. ... Since 1937.

Budget Evolution Item Summary City of Ketchum Fire Station #1

Polished Concrete floor-RFI-75R.1	L	Date:	2/9/2021
Doccrintian: Povice nelich	ned floor finishes level per RFI 75	ED1	
Description: Revise polish	ed floor fiffishes level per KF1 /2	2KT	
SCOPE	SUBCONTRACTOR	AMC	DUNT
Revise Polish floor grit finish level	Floor Tech	\$	(3,518.00)
Delete Entry Mat Lobby 101	Dillabaugh Flooring Ame	rica \$	(363.00)
		\Rightarrow	
			
		=	
		$\overline{}$	
		\Box	
	 		
SUBTOTAL:		\$	(3,881.00)
SUBTOTAL reflects direct costs only on t	the presumption that costs will	come from	
allowances. If costs are reimbursed by 0	Change Order, TOTAL AMOUNT	below reflects	s the
SUBTOTAL with add of agreed upon ma	rkup in accordance with the cha	inge order prid	ing.
Bond and Insurance	CORE	\$	(81.00)
CMAR FEE	CORE	\$	(173.00)
Sales Tax	CORE	\$	-
TOTAL AMOUNT:		\$	(4,135.00)



Regional office for CORE NV company 777 N 4th St Bosie, Idaho 83702 Project: 5-20-01-006 - CoK - City of Ketchum Fire Station 107 Saddle Road Ketchum, Idaho 83353

JT Brown (CORE Construction - Las Vegas)

Apparatus Bay 120 VA: Change to Sealed Concrete

TO: Alex Goedhart (Cole Architects)

Crystal McColly (Cole Architects)

777 N Fourth St

Boise, Idaho 83702

DATE INITIATED: 09/09/2020

LOCATION:
PROJECT STAGE: Cou

STATUS: Open

DUE DATE: 10/07/2020

Course of Construction

COST CODE:

FROM:

COST IMPACT:
DRAWING NUMBER: A6.01, A6.03

SCHEDULE IMPACT: SPEC SECTION:

LINKED DRAWINGS:

REFERENCE:

RECEIVED FROM:

JT Brown (CORE Construction - Las Vegas)

COPIES TO:

SUB JOB:

Kepa Bengoa (Floor Tech, Inc), JT Brown (CORE Construction - Las Vegas), Grant Gager (City of Ketchum), Alan Gelet (Garrett Construction, Inc), Cary Goldberg (DPPM Project Management), Bill McLaughlin (City of Ketchum), Dennis Potts (DPPM Project Management), Chris Schratwieser (CORE Construction - Las Vegas), Matt Sylvester (CORE Construction - Las Vegas)

Question from JT Brown (CORE Construction - Las Vegas) at 04:00 PM on 09/08/2020

Per the VA Log the option to remove the polished concrete and change to sealed concrete has been accepted at the Apparatus Bay 120, see attached marked up A6.01, Please provide confirmation.

Attachments:

A6.01 FINISH & FURNITURE FLOOR PLAN -LEVEL 01 Rev.2.pdf

Awaiting an Official Response

See attached updated sheets A6.01 and A6.02.

Walk off carpet removed from project. Contractor providing credit. 10'-0" surface mats to be provided by owner to meet LEED requirements.

Provide pricing for the following two options for owner to review:

Option 1: All polished concrete to be 800 grit, as per spec and updated drawings.

Option 2: Polished concrete to be 400 grit in only the App Bay 120 and Turnout/Locker Room 127. The rest of the rest of the polished concrete to be 800 grit.

Crystal McColly Cole Architects 11/4/20

ВУ	DATE	COPIES TO

	NUMBER	ROOM	TAG	DESCRIPTION
	101	LOBBY	1	ROCKWELL CLUB CHAIR
	101 101	LOBBY LOBBY	3	ROCKWELL OCCASIONAL TAB WALK OFF MAT
	102	COMMUNITY ROOM COMMUNITY ROOM	4	TRAINING TABLE VERY SIDE TRAINING CHAIR
	102 102	COMMUNITY ROOM	5 7	WHITE BOARD
	102 102	COMMUNITY ROOM COMMUNITY ROOM	8 38	PODIUM ROLLER SHADES
	106	COFFEE/COPY NOOK	9	WASTE/RECYCLING CONTAINE
	108 112	RADIO ROOM OFFICE	12 13	WHITE BOARD SOJI TASK CHAIR
	112	OFFICE	14	DESK SYSTEM - X SERIES + STORAGE
	112	OFFICE	15	VERY SIDE GUEST CHAIR
	120 120	APPARATUS BAY APPARATUS BAY	6 10	HOSE DRYING RACK ROLLING HOSE RACK
	121	EMS/ALS STORAGE EMS/ALS STORAGE	16 17	WIRE SHELVES SUPPLY CART
FIRE RISER	121 121	EMS/ALS STORAGE	28	MEDICAL SAFE
COMP 124	123 123	SHOP SHOP	18 19	FLAMABLE LIQUIDS CABINET BIKE STORAGE
THE PART OF THE PA	123 127	SHOP TURNOUT/LOCKER ROOM	11 20	SCBA STORAGE RACK LOCKER BENCH
RESTROOM 1	127	TURNOUT/LOCKER ROOM	21	LOCKERS
TURNOUT/ LOCKER	127 132	TURNOUT/LOCKER ROOM TECH/OP STORAGE	22	GEAR LOCKERS WIRE SHELVES
	201	DAY USE	24	LA-Z-BOY RECLINERS
DECON TECH/OP STORAGE	201 201	DAY USE DAY USE	25 26	DESK JIVE TABLE HAWTHORN VERY TASK CHAIF
131 132 23 TYP	201 201	DAY USE DAY USE	27 29	FOOD LOCKERS WHITE BOARD
SHOP/SCBA 18\7	201	DAY USE	30	WASTE/RECYCLING CONTAINE
dg-1 cg-1	201 201	DAY USE KITCHEN	31 32	BULLETIN BOARD BAR STOOLS
GG-1	201	KITCHEN	33	DINING TABLE
	201 204	KITCHEN DORM	34 35	CHAIRS BED
	204 204	DORM DORM	36 37	DESK JIVE TABLE BLACK OUT SHADES
	20 T	1	<u> </u>	
ÂPPARÂTUS BAY				
	\sim \wedge			
	13			
STAIR 1 107	_			
CG-4 CG-1 4 CG-1				 1
STORAGE 103 STORAGE EMS/ALS				
108 13 108 STORAGE STORAGE 121				
ASTYP. 118 TYP. 118 TYP.				
H 4 4 4 4 1 4 1 5 1 1 1 1 1 1 1 1 1 1 1 1				
ELEVATOR 1109 ELEVATOR 1110 1117 117 117 117 118				
CG-1 CG-1 HALLWAY				
RECEP. RECEP.		××××××××××××××××××××××××××××××××××××××	<u> </u>	××××××××××××××××××××××××××××××××××××××
PUBLIC RESTROOM RESTROOM OFFICE 15 OFFICE 15 OFFICE 15		, , , , , , , , , , , , , , , , , , , ,	<i>i</i>	
8 COMMUNITY ROOM 114 OFFICE MECH 114				

PUBLIC RESTROOM



MECHOSHADE

GENERAL NOTES

6

NEW

CFCI

- A. REFER TO ARCHITECTURAL FLOOR, ELEVATION AND FINISH PLANS. CONTRACTOR SHALL CLARIFY ANY QUESTIONS CONCERNING FINISHES, LOCATION, OR DESIGN INTENT WITH DESIGNER PRIOR TO ORDERING OF MATERIALS.
- B. AT ROOMS WITH NEW EXPOSED CEILING, PAINT WALLS TO UNDERSIDE OF STRUCTURE ABOVE.
- C. SEE REFLECTED CEILING PLAN FOR GYPSUM BOARD SOFFIT LOCATIONS. REFER TO REFLECTED CEILING PLAN AND INTERIOR FINISH SCHEDULE FOR FINISH, AS SCHEDULED.
- D. PROVIDE A THIN, CLEAR, SILICONE BEAD (1/8") AT PERIMETER OF ALL DOOR FRAMES AND BORROWED GLASS LITES AFTER INSTALLATION OF SCHEDULED WALL COVERINGS. DOOR FRAMES ON PAINTED WALLS SHOULD RECEIVE THIN, PAINTABLE SILICONE BEAD (1/8") AT PERIMETER PRIOR TO PAINTING, ONLY WHERE THE FRAME DOES NOT MEET THE WALL.
- E. ALL INTERIOR FINISHES MUST BE INSTALLED BY A CERTIFIED INSTALLER / SUBCONTRACTOR PER MANUFACTURER'S INSTRUCTIONS. USE MANUFACTURER'S APPROVED ADHESIVES AND SEAM SEALERS.
- F. ALL FLOORING TRANSITIONS OCCUR UNDER THE CENTER OF THE DOOR UNLESS OTHERWISE NOTED. FLOOR TRANSITION HEIGHTS NOT TO EXCEED 1/4" MAXIMUM. PROVIDE APPROPRIATE SCHLUTER TRANSITION STRIP IN ANODIZED ALUMINUM FINISH AT EACH LOCATION WHERE FLOOR FINISH MATERIAL CHANGES. UNLESS NOTED OTHERWISE.
- G. PROVIDE WINDOW COVERINGS AT ALL WINDOW LOCATIONS. SEE INTERIOR FINISH SPECIFICATIONS FOR ROLLER SHADE SPECIFICATION.
- H. ALL CABINET HARDWARE AT CASEWORK LOCATIONS TO BE RICHELIEU CONTEMPORARY STEEL PULL - 205 TO BE 6 5/16" LONG IN BRUSHED NICKEL FINISH (OR APPROVED EQUAL WITH SIMILAR FINISH).
- I. ALL WINDOW SILLS TO BE SOLID SURFACE (SS-1) UNLESS NOTED OTHERWISE.
- J. PROVIDE SOLID BLOCKING OR OTHER SUITABLE BACKING AT LOCATIONS INCLUDING, BUT NOT LIMITED TO, THE FOLLOWING: EDGES WHERE FINISH MATERIALS CHANGE, GRAB BARS, TOILET PARTITIONS, DOOR STOPS, SHELF BRACKETS, HANDRAILS AND ALL MOUNTED EQUIPMENT, INCLUDING EQUIPMENT FURNISHED BY OWNER. PROVIDE STEEL BACKING FOR GRAB BARS ATTACHED TO PARTITIONS. EXTEND BACKING 6" BEYOND OUTLINE OF EQUIPMENT.
- K. REFERENCE PLUMBING/MECHANICAL DRAWINGS, ELECTRICAL DRAWINGS AND SPECIFICATIONS FOR ADDITIONAL PRODUCT INFORMATION. IF CONFLICT EXISTS NOTIFY ARCHITECT AND PRICE MOST EXPENSIVE OPTION.

KEY NOTES

1. PROVIDE SCHLUTER TRANSITION STRIP (TR-1) BETWEEN CONCRETE TO CARPET TRANSITION. REFER TO INTERIOR FINISH SCHEDULE AND INTERIOR FINISH DETAILS.

FLOORING

POLISHED CONCRETE (CON-1) 4 - 4 3 4 - 4 4 SEALED CONCRETE (CON-2) LUXURY VINYL TILE (LVT-1)

TILE (T-1) **BOOT WASH GRATE**

SHEET NUMBER





6211 Roosevelt Way NE Seattle, WA 98115 206.522.3820

CONSTRUCTION DOCUMENTS AND THE SITE CONDITIONS. INFORMATION REGARDING THE COMPLETE WORK OF SPECIFIC TRADES IS DISPERSED THROUGHOUT THE ENTIRE DOCUMENT SET AND CANNOT BE ACCURATELY DETERMINED BY REFERENCE TO OTHER THAN COMPLETE DOCUMENT SETS. STAMP

LICENSED ARCHITECT AR-2560

> MATTHEW HUFFIELD STATE OF IDAHO

CONSULTANT

PROJECT INFORMATION



KETCHUM FIRE STATION NO. 1

107 SADDLE ROAD, KETCHUM, ID 83353

ISSUES

PHASE CONSTRUCTION SET DATE JUNE 19, 2020 **JOB NUMBER** 18-022

MARK DATE DESCRIPTION 11/4/20 RFI #CC-75 7/17/20 ASI 1

SHEET NAME

FINISH & **FURNITURE FLOOR** PLAN - LEVEL 01

FLOOR FINISH PLAN - LEVEL 01 SCALE | 1/8" = 1'-0"


ROOM						QUANTIT	EXISTING/N CON	NSTURCTI				
NUMBER	ROOM	TAG	DESCRIPTION	MANUFACTURER	ITEM#	Y	EW	ON	W	D	Н	LEVE
101	LOBBY	1	ROCKWELL CLUB CHAIR	KNOLL		2	NEW	OFOI	2' - 9"	2' - 3"	2' - 5"	1
01	LOBBY	2	ROCKWELL OCCASIONAL TABLE	KNOLL		1		OFOI	1' - 10"	1' - 10"	1' - 8"	1
101	LOBBY	3	WALK OFF MAT			1	NEW	OFOI	3' - 0"	10' - 0"		1
102	COMMUNITY ROOM	4	TRAINING TABLE	HAWTHORN		15	NEW	OFOI	2' - 0"	6' - 0"	2' - 5"	1
02	COMMUNITY ROOM	5	VERY SIDE TRAINING CHAIR	HAWTHORN		30	NEW	OFOI	1' - 11 1/2"	1' - 10"	2' - 9 29/32"	1
102	COMMUNITY ROOM	7	WHITE BOARD	ULINE	H-2757	2	NEW	OFCI	8' - 0"	0' - 0 1/2"	4' - 0"	1
102	COMMUNITY ROOM	8	PODIUM	ULINE	H-7825	1	NEW	OFOI	2' - 2"	1' - 9"	3' - 11"	1
102	COMMUNITY ROOM	38	ROLLER SHADES	MECHOSHADE		3						
06	COFFEE/COPY NOOK	9	WASTE/RECYCLING CONTAINERS	ULINE	S-13527GR	2	NEW	OFOI	1' - 3"	0' - 11"	1' - 8"	1
08	RADIO ROOM	12	WHITE BOARD	ULINE	H-2757	2	NEW	OFCI	8' - 0"	0' - 0 1/2"	4' - 0"	1
12	OFFICE	13	SOJI TASK CHAIR	HAWTHORN		4		OFOI	2' - 4"	2' - 3"	3' - 8"	1
12	OFFICE	14	DESK SYSTEM - X SERIES + STORAGE	HAWTHORN		2	NEW	OFOI	1' - 0"	1' - 6"	6' - 0"	1
12	OFFICE	15	VERY SIDE GUEST CHAIR	HAWTHORN		4	NEW	OFOI	23' - 6"	1' - 10"	2' - 9 29/32"	1
20	APPARATUS BAY	6	HOSE DRYING RACK	READY RACK	MHD-80		NEW	OFCI	6' - 0 13/16"	0' - 3 1/2"	3' - 6"	1
20	APPARATUS BAY	10	ROLLING HOSE RACK	READY RACK	HC-64-3T	1	NEW	OFCI	10' - 0"	2' - 10"	5' - 0"	1
21	EMS/ALS STORAGE	16	WIRE SHELVES	GLOBAL INDUSTRIES	236614	6	NEW	OFCI	4' - 0"	2' - 0"	6' - 2"	1
21	EMS/ALS STORAGE	17	SUPPLY CART	ULINE	H-6787	1	NEW	OFOI	4' - 0"	1' - 6"	3' - 5"	1
21	EMS/ALS STORAGE	28	MEDICAL SAFE	ADIRMED	999-04-WHI	1	NEW	OFCI	1' - 4"	0' - 6"	1' - 9"	1
23	SHOP	18	FLAMABLE LIQUIDS CABINET	GLOBAL INDUSTRIAL		1	NEW	OFCI				1
23	SHOP	19	BIKE STORAGE	DELTA	RS4000	4	NEW	OFCI	0' - 3"	0' - 5"	0' - 11"	1
23	SHOP	11	SCBA STORAGE RACK	READY RACK	SOS2432-C	1	NEW	OFOI	6' - 4"	2' - 8"	6' - 9"	1
27	TURNOUT/LOCKER ROOM	20	LOCKER BENCH	READY RACK	RRB-48	2	NEW	OFOI	4' - 0"	0' - 9 1/2"	1' - 5"	1
27	TURNOUT/LOCKER ROOM	21	LOCKERS				EXISTING	OFCI				1
27	TURNOUT/LOCKER ROOM	22	GEAR LOCKERS			49	EXISTING	OFCI				1
32	TECH/OP STORAGE	23	WIRE SHELVES	GLOBAL INDUSTRIES	236614	12	NEW	OFCI	4' - 0"	2' - 0"	6' - 2"	1
.01	DAY USE	24	LA-Z-BOY RECLINERS	LA-Z-BOY		9	NEW	OFOI				2
.01	DAY USE	25	DESK JIVE TABLE	HAWTHORN	TCRA-3054	4	NEW	OFOI	4' - 6"	2' - 6"	2' - 5"	2
01	DAY USE	26	HAWTHORN VERY TASK CHAIR	HAWTHORN		12	NEW	OFOI	2' - 3"	2' - 2"	3' - 3"	2
.01	DAY USE	27	FOOD LOCKERS	HADRIAN	GLADIATOR DOUBLE TIER	7	NEW	OFCI	1' - 3"	1' - 6"	6' - 0"	2
01	DAY USE	29	WHITE BOARD	ULINE	H-2757	1	NEW	OFCI	8' - 0"		4' - 0"	2
201	DAY USE	30	WASTE/RECYCLING CONTAINERS	ULINE	S-13527GR	3	NEW	OFOI	1' - 3"	0' - 11"	1' - 8"	2
.01	DAY USE	31	BULLETIN BOARD	ULINE	H-3946	1	NEW	OFCI	4' - 0"		3' - 0"	2
.01	KITCHEN	32	BAR STOOLS	FS FURNITURE		6	NEW	OFOI	1' - 5"	1' - 6"	3' - 6 1/4"	2
201	KITCHEN	33	DINING TABLE			1	NEW	OFOI				2
201	KITCHEN	34	CHAIRS	FS FURNITURE		10	NEW	OFOI	1' - 4 1/2"	1' - 5"	2' - 8 1/4"	2
204	DORM	35	BED	FS FURNITURE	TWIN XL	6	NEW	OFOI	3' - 1"	7' - 0"	3' - 3"	2
204	DORM	36	DESK JIVE TABLE	HAWTHORN	TCRA-1854	6	NEW	OFOI	4' - 6"	1' - 6"	2' - 5"	2
204	DORM	37	BLACK OUT SHADES	MECHOSHADE	0800	6	NEW	CFCI				2


GENERAL NOTES

- A. REFER TO ARCHITECTURAL FLOOR, ELEVATION AND FINISH PLANS. CONTRACTOR SHALL CLARIFY ANY QUESTIONS CONCERNING FINISHES, LOCATION, OR DESIGN INTENT WITH DESIGNER PRIOR TO ORDERING OF MATERIALS.
- B. AT ROOMS WITH NEW EXPOSED CEILING, PAINT WALLS TO UNDERSIDE OF STRUCTURE ABOVE.
- C. SEE REFLECTED CEILING PLAN FOR GYPSUM BOARD SOFFIT LOCATIONS. REFER TO REFLECTED CEILING PLAN AND INTERIOR FINISH SCHEDULE FOR FINISH, AS SCHEDULED.
- D. PROVIDE A THIN. CLEAR. SILICONE BEAD (1/8") AT PERIMETER OF ALL DOOR FRAMES AND BORROWED GLASS LITES AFTER INSTALLATION OF SCHEDULED WALL COVERINGS. DOOR FRAMES ON PAINTED WALLS SHOULD RECEIVE THIN, PAINTABLE SILICONE BEAD (1/8") AT PERIMETER PRIOR TO PAINTING, ONLY WHERE THE FRAME DOES NOT MEET THE WALL.
- E. ALL INTERIOR FINISHES MUST BE INSTALLED BY A CERTIFIED INSTALLER / SUBCONTRACTOR PER MANUFACTURER'S INSTRUCTIONS. USE MANUFACTURER'S APPROVED ADHESIVES AND SEAM SEALERS.
- F. ALL FLOORING TRANSITIONS OCCUR UNDER THE CENTER OF THE DOOR UNLESS OTHERWISE NOTED. FLOOR TRANSITION HEIGHTS NOT TO EXCEED 1/4" MAXIMUM. PROVIDE APPROPRIATE SCHLUTER TRANSITION STRIP IN ANODIZED ALUMINUM FINISH AT EACH LOCATION WHERE FLOOR FINISH MATERIAL CHANGES. UNLESS NOTED OTHERWISE.
- G. PROVIDE WINDOW COVERINGS AT ALL WINDOW LOCATIONS. SEE INTERIOR FINISH SPECIFICATIONS FOR ROLLER SHADE SPECIFICATION.
- H. ALL CABINET HARDWARE AT CASEWORK LOCATIONS TO BE RICHELIEU CONTEMPORARY STEEL PULL - 205 TO BE 6 5/16" LONG IN BRUSHED NICKEL FINISH (OR APPROVED EQUAL WITH SIMILAR FINISH).
- I. ALL WINDOW SILLS TO BE SOLID SURFACE (SS-1) UNLESS NOTED OTHERWISE.
- J. PROVIDE SOLID BLOCKING OR OTHER SUITABLE BACKING AT LOCATIONS INCLUDING, BUT NOT LIMITED TO, THE FOLLOWING: EDGES WHERE FINISH MATERIALS CHANGE, GRAB BARS, TOILET PARTITIONS, DOOR STOPS, SHELF BRACKETS, HANDRAILS AND ALL MOUNTED EQUIPMENT, INCLUDING EQUIPMENT FURNISHED BY OWNER. PROVIDE STEEL BACKING FOR GRAB BARS ATTACHED TO PARTITIONS. EXTEND BACKING 6" BEYOND OUTLINE OF EQUIPMENT.
- K. REFERENCE PLUMBING/MECHANICAL DRAWINGS, ELECTRICAL DRAWINGS AND SPECIFICATIONS FOR ADDITIONAL PRODUCT INFORMATION. IF CONFLICT EXISTS NOTIFY ARCHITECT AND PRICE MOST EXPENSIVE OPTION.

KEY NOTES

1. PROVIDE SCHLUTER TRANSITION STRIP (TR-1) BETWEEN CONCRETE TO LUXURY VINYL TILE TRANSITION AND TILE TO LUXURY VINYL TILE TRANSITION. REFER TO INTERIOR FINISH SCHEDULE AND INTERIOR FINISH DETAILS.

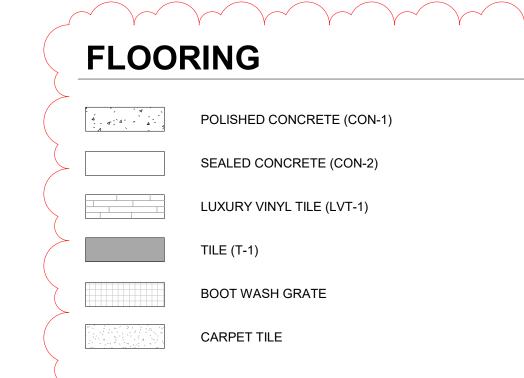

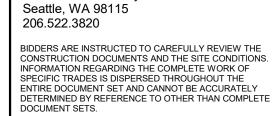


6211 Roosevelt Way NE

Copyright © 2020 Cole Architects, PLLC

ARCHITECTURE + PLANNING + DESIGN

1008 W Main St Boise, Idaho 83702 208.345.1800 colearchitects.net

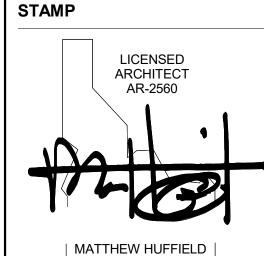

STATE OF IDAHO

CONSULTANT



KETCHUM FIRE STATION NO. 1

107 SADDLE ROAD, KETCHUM, ID 83353

ISSUES

PHASE CONSTRUCTION SET JUNE 19, 2020 DATE **JOB NUMBER** 18-022


MARK DATE DESCRIPTION 11/4/20 RFI #CC-75 7/17/20 ASI 1

SHEET NAME

FINISH & **FURNITURE FLOOR** PLAN - LEVEL 02

SHEET NUMBER

A6.02

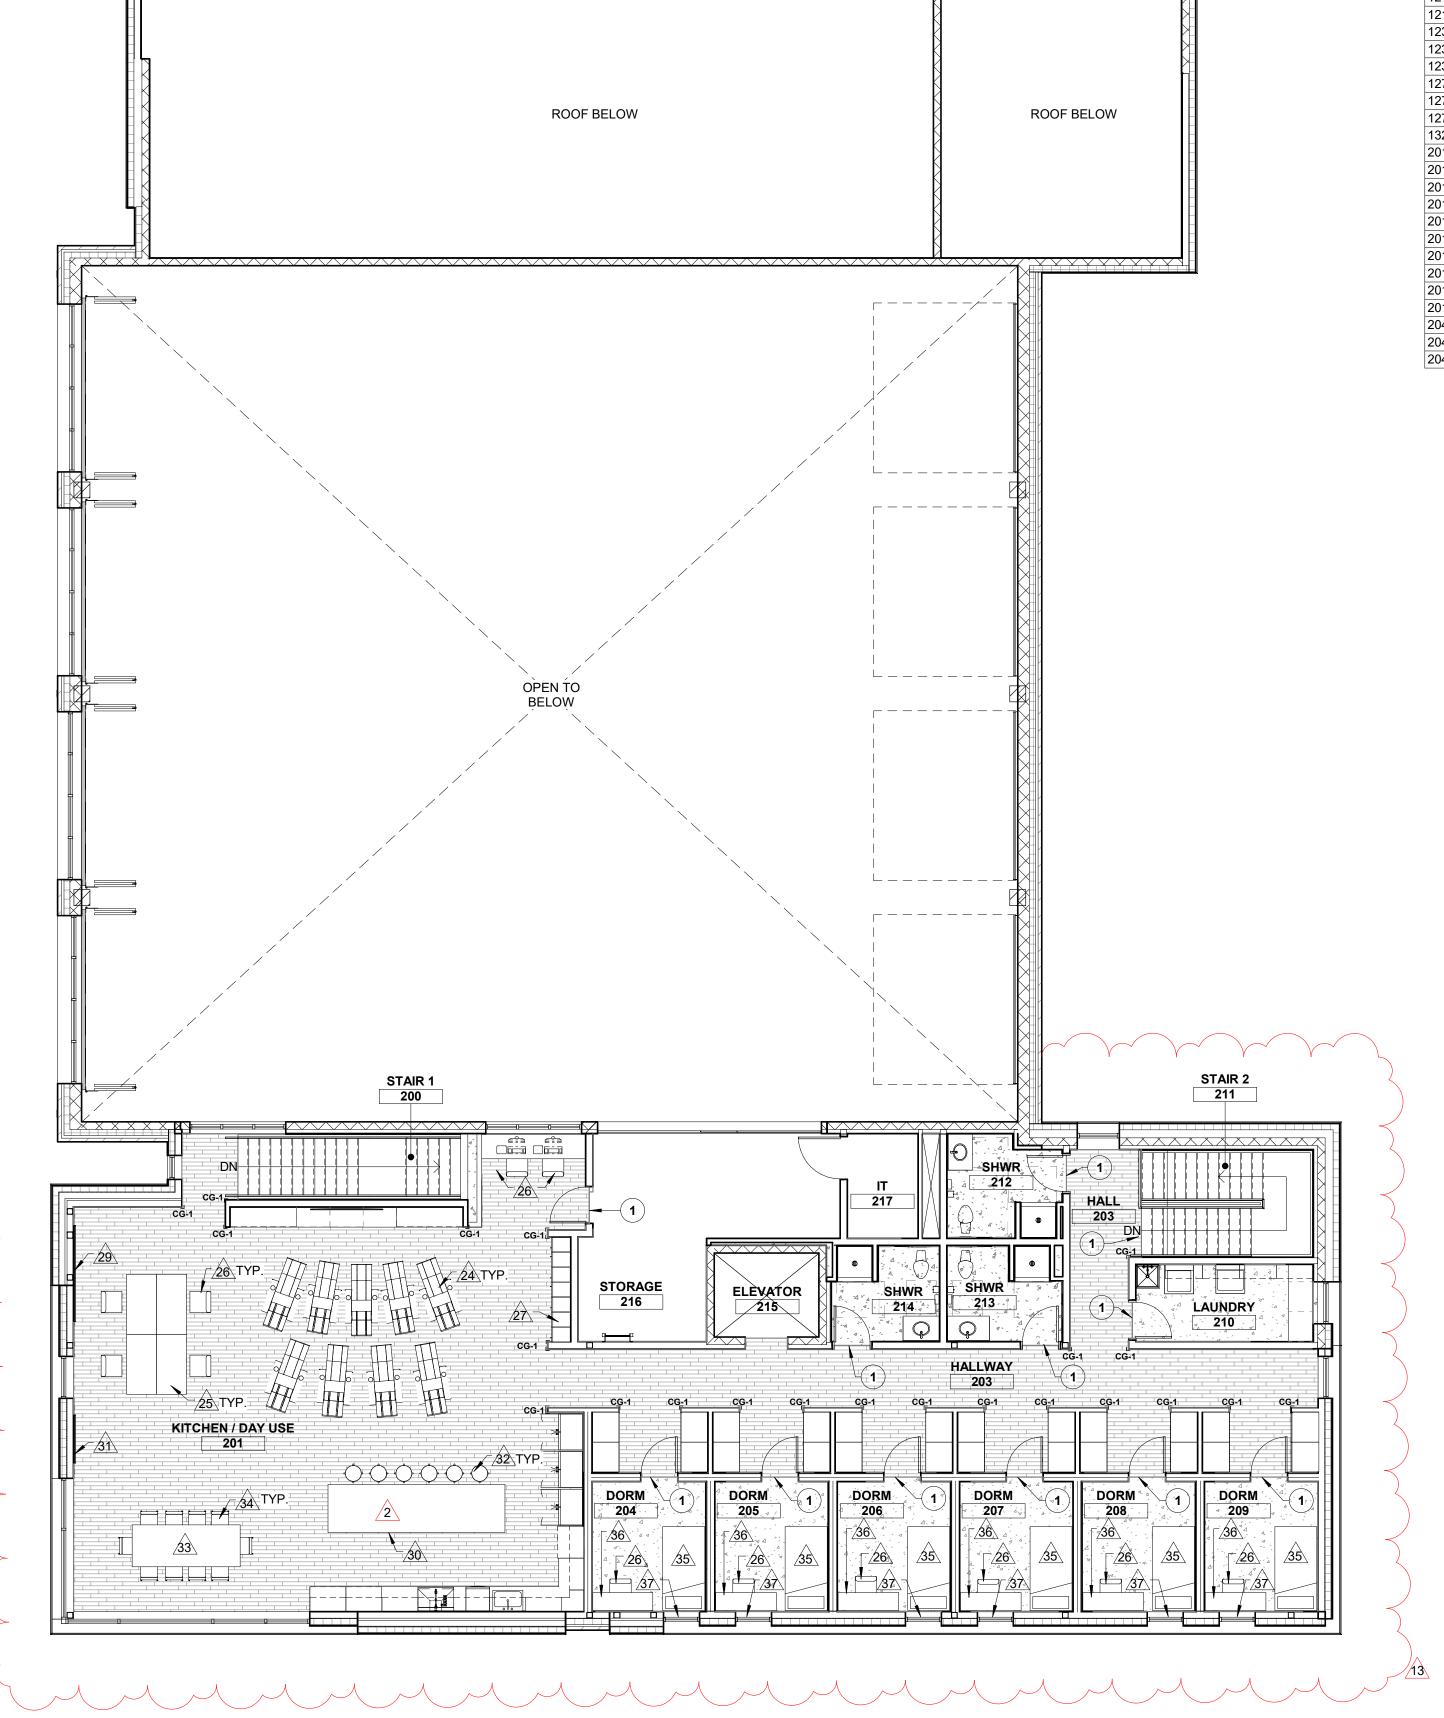

ROOF BELOW

Chris Schratwieser

From: kepa@gofloortech.com

Sent: Friday, November 6, 2020 7:20 AM

To: Chris Schratwieser

Subject: RE: CoK Fire Station #1- Concrete floor finish

Gotcha, in that case, based on the numbers discussed previously looks like option 1 would be the original bid, \$42,975.75 (Plus sealed concrete) while option 2 would be \$39,457.95 (plus sealed concrete).

Thanks! Change order credit is \$3,518.00



Kepa Bengoa
Office Manager, Floor Tech, Inc.
O (208) 462-5207 | C (208) 859-1229
www.gofloortech.com

From: Chris Schratwieser <chrisschratwieser@coreconstruction.com>

Sent: Thursday, November 05, 2020 3:17 PM

To: kepa@gofloortech.com

Cc: Matt Sylvester <mattsylvester@coreconstruction.com> **Subject:** RE: CoK Fire Station #1- Concrete floor finish

No stain. Only change from spec is to grind at 400 grit in lieu of 800 grit. All other processes to remain the same as the specifications.

Thanks

Chris Schratwieser, LEED AP

Senior Project Manager

CORE Construction | West

C: 702-715-2200 | W: COREconstruction.com

From: kepa@gofloortech.com <kepa@gofloortech.com>

Sent: Thursday, November 5, 2020 1:02 PM

To: Chris Schratwieser < chrisschratwieser@coreconstruction.com

Subject: RE: CoK Fire Station #1- Concrete floor finish

Clarifying question. It looks like the documentation doesn't list whether the 400 areas are the 400 with stain or 400 without stain option, however I'm guessing that since it is not mentioned, it is without stain.

For now I'll work on the numbers based on without stain, but let me know if this is incorrect.

Thanks.

Chris Schratwieser

From: Matt Sylvester

Sent: Tuesday, November 3, 2020 1:27 PM

To: Chris Schratwieser
Cc: John Brown

Subject: FW: Estimated materials cost

Matthew Sylvester

Assistant Project Manager

CORE Construction | West

C: 702-416-7677 | W: coreconstruction.com

From: Emilio Bengoa < Emilio B@flooringamericaboise.com >

Sent: Tuesday, November 3, 2020 1:26 PM

To: Matt Sylvester < mattsylvester@coreconstruction.com>

Subject: Re: Estimated materials cost

Hello Matt,

Great chatting with you today. Regarding the credit for the walk off carpet installation it's \$363.00.

Thank you

Emilio Bengoa

Commercial Project Manager

EmilioB@flooringamericaboise.com

208-695-9155

From: Matt Sylvester < mattsylvester@coreconstruction.com >

Sent: Tuesday, November 3, 2020 11:20 AM

To: Emilio Bengoa < Emilio B@flooringamericaboise.com >

Cc: Chris Schratwieser < com; John Brown < johnbrown@coreconstruction.com>

Subject: RE: Estimated materials cost

Emilio,

This shouldn't be an issue. First we need to wait for approval of your submittals. There are requirements that will need to be followed for stored materials for insurance purposes, and you will need to provide invoices from the manufacturers. But we will cross this bridge once your submittals get approved.

Thank you,

Matthew Sylvester

Assistant Project Manager

CORE Construction | West

C: 702-416-7677 | W: coreconstruction.com



Building. Growing. Leading. ... Since 1937.

Budget Evolution Item Summary City of Ketchum Fire Station #1

Office GWB & Laundry Furring		Date:	2/19/2021
Description: Added GW	VB at Offices & Laundry Wall Furi	ring for Plumhing	
Description. Added GV	b at Offices & Lauriury Warr Lari	IIIg IOI FIUIIIDIIIg	,
SCOPE	SUBCONTRACTOR	AMO	UNT
Added GWB & Wall furring	Interiors	\$	884.00
		=	
			
		二	
SUBTOTAL:		\$	884.00
SUBTOTAL reflects direct costs only o	n the presumption that costs wi	'	
allowances. If costs are reimbursed b	·		the
SUBTOTAL with add of agreed upon n			
Bond and Insurance	CORE	\$	18.00
CMAR FEE	CORE	\$	39.00
Sales Tax	CORE	\$	-
TOTAL AMOUNT:		\$	941.00

INTERIOR CONTRACTORS, INC.

PO. BOX 3873 HAILEY, ID 83333

Phone #

1 208 481- 0311

Name / Address	
CORE CONSTRUCTION CO.	

E-mail


john.incon@gmail.com

ESTIMATE


Date	Estimate #
2/10/2021	2500

PUBLIC WORKS #002879-B-4 RCE-24255

	Project
	ID-COK FIRE STA
Description	Total
ADDED FURRING @ LAUNDRY ROOM ADDED DRYWALL @ ROOMS 112 & 113	385.0
Chank you for your business.	Total \$884.0

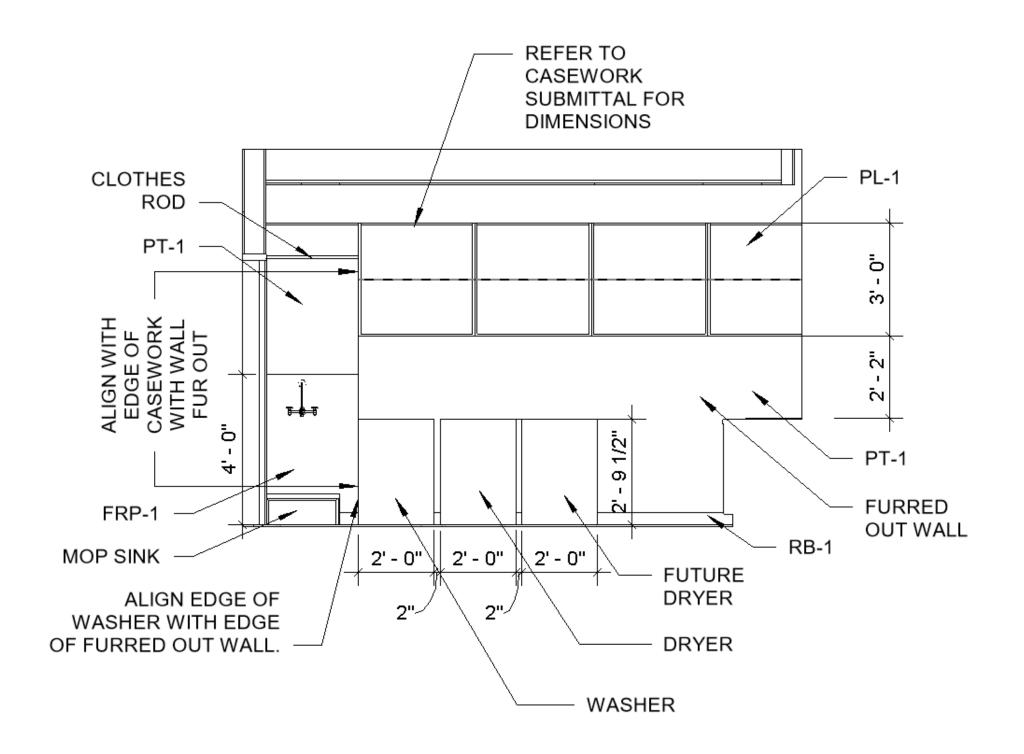

INTERIOR ELEVATION - LAUNDRY 210 - NORTH

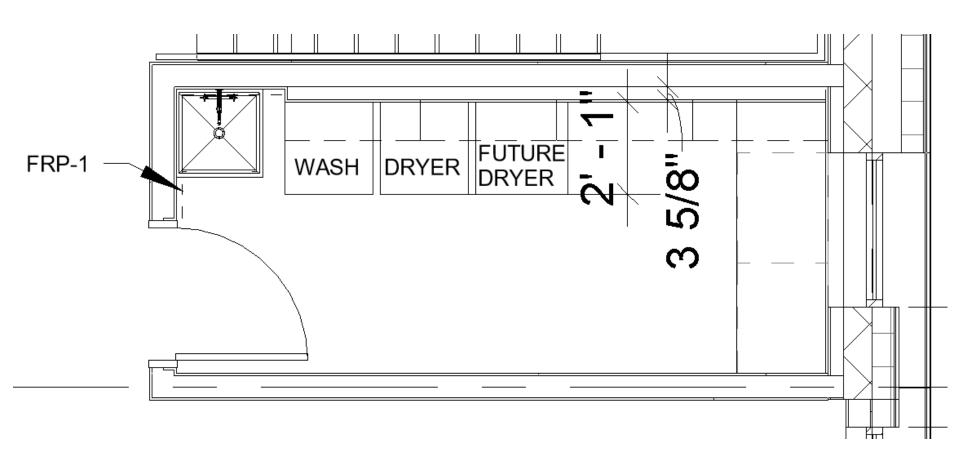

INTERIOR ELEVATION - LAUNDRY 210 - NORTH

Chris Schratwieser

From: Crystal McColly <crystal@colearchitects.com>

Sent: Tuesday, January 26, 2021 3:53 PM **To:** Chris Schratwieser; Matt Sylvester


Cc: John Brown; Dennis Potts; Cary Goldberg; Bill McLaughlin; Grant Gager; Kate Kelly;

Kanika Golani

Subject: Ketchum FS - Additional GWB for LEED Acoustic Rating

Good afternoon Chris,

In order to meet the LEED acoustic STC rating, we will need to have an extra layer of gyp board between the offices 111, 112 & 113, highlighted in the image below. Could you please provide a price for what this additional material would cost? For reference, each of the highlighted walls is approximately 14'-0" long by 12'-0" high.

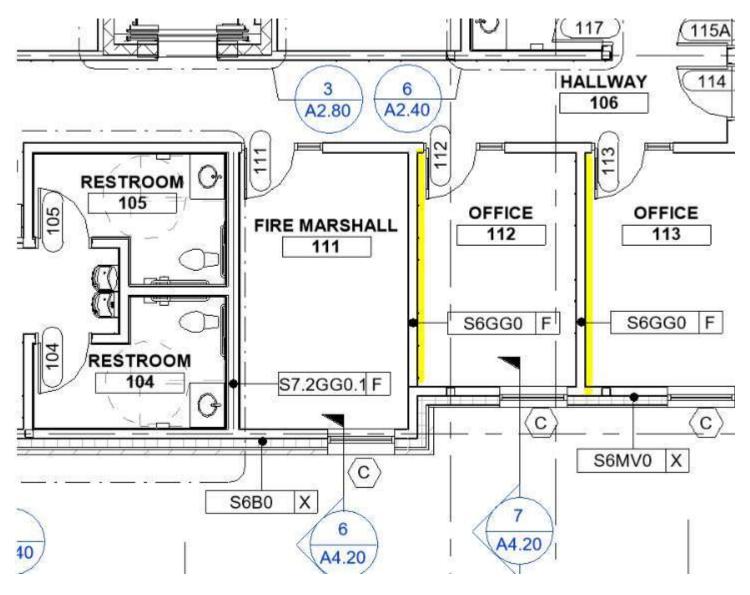

Thank you,



Building. Growing. Leading. ... Since 1937.

Budget Evolution Item Summary City of Ketchum Fire Station #1

ASI #5 Electric		Date:	2/9/2021
•	er for Gear Dryer. Relocate and ad	d Antennas at r	oof,
•	e conduit for future PV array		
SCOPE	SUBCONTRACTOR	AMO	
Provide electric changes per ASI #5	Magic Valley Electric	\$	4,998.00
			
			
			
			
			
		+	
SUBTOTAL:		\$	4,998.00
SUBTOTAL reflects direct costs only of	on the presumption that costs will		1,000.01
allowances. If costs are reimbursed			the
SUBTOTAL with add of agreed upon			
Bond and Insurance	CORE	\$	104.00
CMAR FEE	CORE	\$	222.00
Sales Tax	CORE	\$	-
TOTAL AMOUNT:		\$	5,324.00



ASI 05

PROJECT NAME	KETCHUM FIRE STATION #1
PROJECT NUMBER	18-022
DATE	1/20/2021
CONSTRUCTION COMPANY	CORE CONSTRUCTION

THE WORK SHALL BE CARRIED OUT IN ACCORDANCE WITH THE FOLLOWING SUPPLEMENTAL INSTRUCTIONS ISSUED IN ACCORDANCE WITH THE CONTRACT.

DESCRIPTION OF CHANGES:

DRAWINGS:

ARCHITECTURAL:

- 1) A2.02 FLOOR PLAN LEVEL 02
 - a) Added sink back into the kitchen island in Kitchen/Day Use 201.
- 2) A2.22 DIMENSION PLAN LEVEL 02
 - a) Added sink back into the kitchen island in Kitchen/Day Use 201.
- 3) A2.40 ENLARGED PLANS
 - a) #4 ENLARGED PLAN KITCHEN
 - i) Added sink back into the kitchen island in Kitchen/Day Use 201.
- 4) A5.01 INTERIOR ELEVATIONS
 - a) #11 KITCHEN/DAY USE 201 ISLAND NORTH
 - i) Added sink back into the kitchen island in Kitchen/Day Use 201.
- 5) A7.00 ROOF PLAN
 - a) Added dimensions to roof ladder location per response to RFI #CC-133.

PLUMBING:

- 6) P1.01 PLUMBING WASTE AND VENT PLAN LEVEL 02
 - a) Added S-5 and associated water piping.
- 7) P2.01 PLUMBING WATER AND GAS PLAN LEVEL 02
 - a) Added S-5 and associated water piping.
- 8) P6.00 PLUMBING FIXTURE SCHEDULE
 - a) Added S-5 to the plumbing fixture schedule.

ELECTRICAL:



ARCHITECTURE / PLANNING / INTERIOR DESIGN

- 9) E5.01 POWER PLAN LEVEL 01
 - a) Install electrical connection for future gear dryer.
 - b) Route 1"C-4#8,1#10G from future gear dryer outlet to panelboard 'B'. Coordinate with owner for plug configuration prior to beginning work.

10) E8.00 - ELECTRICAL ROOF PLAN

- a) Moved conduits for Antenna to stub up adjacent to screen wall.
- b) Added 1" conduit for future PV controller. Stub conduit into structure space below.

11) E9.01 – ELECTRICAL SCHEDULES


a) Added 3-Pole, 35 Amp circuit breaker in panelboard 'B' for future gear dryer. Electrical information has been provided by the owner.

ATTACHMENTS:

DRAWINGS:

- A2.02 FLOOR PLAN LEVEL 02
- A2.22 DIMENSION PLAN LEVEL 02
- A2.40 ENLARGED PLANS
- A5.01 INTERIOR ELEVATIONS
- A7.00 ROOF PLAN
- P1.01 PLUMBING WASTE AND VENT PLAN LEVEL 02
- P2.01 PLUMBING WATER AND GAS PLAN LEVEL 02
- P6.00 PLUMBING FIXTURE SCHEDULE
- E5.01 POWER PLAN LEVEL 01
- E8.00 ELECTRICAL ROOF PLAN
- E9.01 ELECTRICAL SCHEDULES

END OF ASI

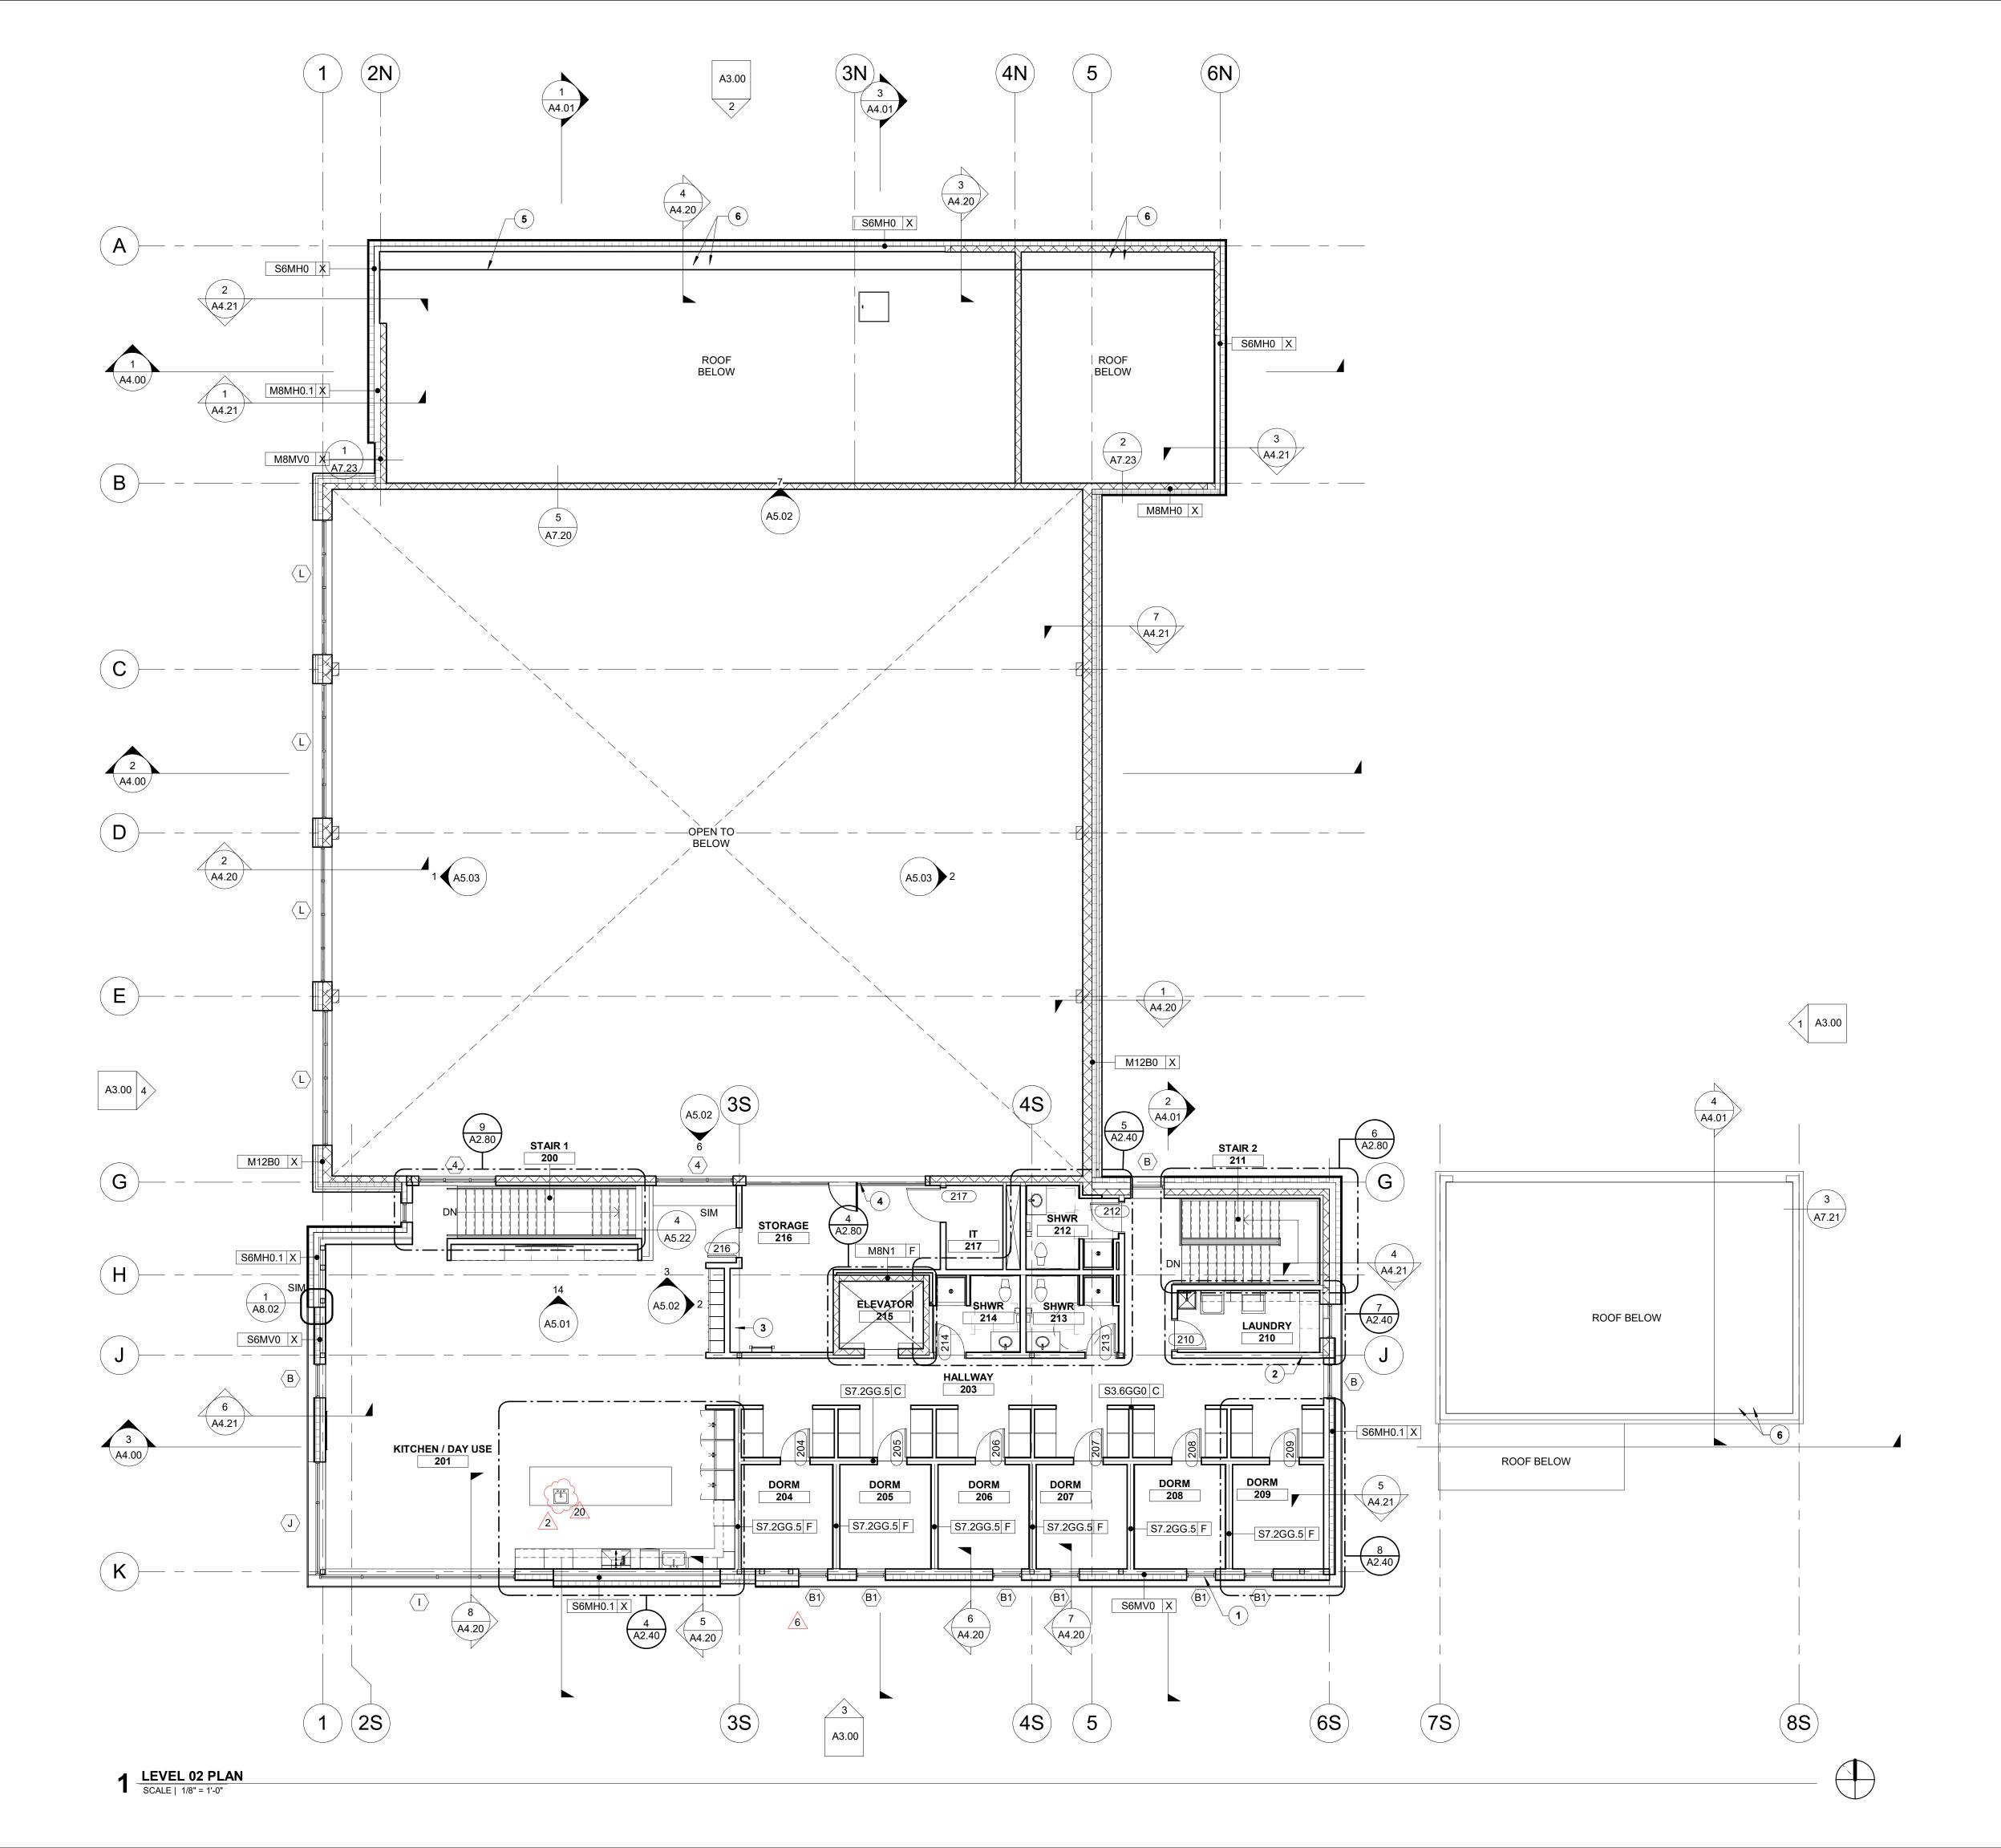

GENERAL NOTES

- A. FIELD VERIFY ALL DIMENSIONS AND EXISTING CONDITIONS. NOTIFY ARCHITECT IMMEDIATELY IF ANY CONFLICTS OR DISCREPANCIES OCCUR BEFORE PROCEEDING WITH WORK.
- B. CROSS REFERENCES SHOWN ON DRAWINGS DO NOT NECESSARILY INDICATE ALL LIKE CONDITIONS AND DO NOT LIMIT APPLICATION OF ANY DRAWING OR DETAIL. WHERE SPECIFIC DIMENSIONS, DETAILS, OR DESIGN INTENT CANNOT BE DETERMINED, CONSULT THE ARCHITECT PRIOR TO PROCEEDING WITH WORK. IF DESIGN INTENT REMAINS UNCLEAR THEN PROVIDE MOST EXPENSIVE OPTION IN BID.
- C. PROVIDE SOLID BLOCKING IN WALLS FOR ALL WALL HUNG EQUIPMENT. BLOCKING TO MEET OR EXCEED MANUFACTURER'S RECOMMENDATIONS. FASTEN EQUIPMENT TO WALLS PER MANUFACTURER'S RECOMMENDATIONS. PROVIDE BLOCKING FOR, BUT NOT LIMITED TO THE FOLLOWING: MILLWORK, RAILING, FIRE EXTINGUISHER ACCESSORIES, WALL MOUNTED PLUMBING FIXTURES, SHELVING, ELECTRICAL EQUIPMENT, RESTROOM ACCESSORIES AND DISPLAY ITEMS.
- D. CAULK ALL COUNTERTOPS, BACKSPLASHES AND CABINETS AT LOCATIONS WHERE THEY MEET WALLS. SEAL ALL CUT-OUTS IN COUNTERTOPS.
- E. ERECT DUST PROOF PARTITIONS AS REQUIRED BY OWNER TO PROTECT ADJACENT AREAS.
- F. ALL PARTITIONS ARE TYPE "S6GG0-F" UNLESS OTHERWISE NOTED.
- G. SEAL AROUND ALL MECHANICAL AND ELECTRICAL EQUIPMENT PENETRATIONS AT WALLS. AT RATED WALLS USE A U.L. APPROVED FIRE-STOPPING MATERIAL. APPROPRIATE FOR FIRE RATING REQUIREMENTS.
- H. PROVIDE 4" DOOR JAMBS FROM FACE-OF-FINISH AT ADJACENT WALLS ON THE HINGE SIDE OR UNLESS OTHERWISE INDICATED.
- I. DIMENSIONS ARE TO GRID LINE OR FACE OF STRUCTURAL MEMBER UNLESS OTHERWISE NOTED. DOOR & WINDOW OPENING DIMENSIONS ARE TO ROUGH OPENING OR CENTERLINE OF OPENING. CONCRETE AND BRICK DIMENSIONS ARE GIVEN TO THE FACE OF CONCRETE OR MASONRY AND TO THE FACE OF ROUGH OPENINGS.

KEYNOTES

- EGRESS WINDOWS, TYP. AT DORMS
- STRUCTURAL COLUMN, SEE STRUCTURAL ROOF ACCESS LADDER.
- 4. BLACK POWDER COATED METAL SAFETY RAILING WITH LATCHING
- ACCESS GATE.
 5. EQUIPMENT SCREEN, RE: TO ROOF PLAN
- 6. ROOF DRAINS, RE: TO ROOF PLAN



1008 W Main St Boise, Idaho 83702 208.345.1800 **colearchitects.net** Copyright © 2020 Cole Architects, PLLC




ARCHITECTURE + PLANNING + DESIGN

6211 Roosevelt Way NE Seattle, WA 98115 206.522.3820

BIDDERS ARE INSTRUCTED TO CAREFULLY REVIEW THE CONSTRUCTION DOCUMENTS AND THE SITE CONDITIONS. INFORMATION REGARDING THE COMPLETE WORK OF SPECIFIC TRADES IS DISPERSED THROUGHOUT THE ENTIRE DOCUMENT SET AND CANNOT BE ACCURATELY DETERMINED BY REFERENCE TO OTHER THAN COMPLETE DOCUMENT SETS.

STAMP

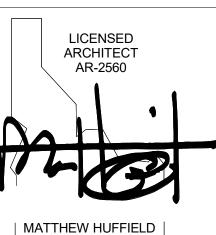

STATE OF IDAHO

CONSULTANT

PROJECT INFORMATION



KETCHUM FIRE STATION NO. 1

107 SADDLE ROAD, KETCHUM, ID 83353

ISSUES

PHASE CONSTRUCTION SET

DATE JUNE 19, 2020

JOB NUMBER 18-022

ARK DATE DESCRIPTION

01/20/21 ASI 05

8/17/20 ASI 2


7/17/20 ASI 1

SHEET NAME

FLOOR PLAN -LEVEL 02

SHEET NUMBER

A2.02

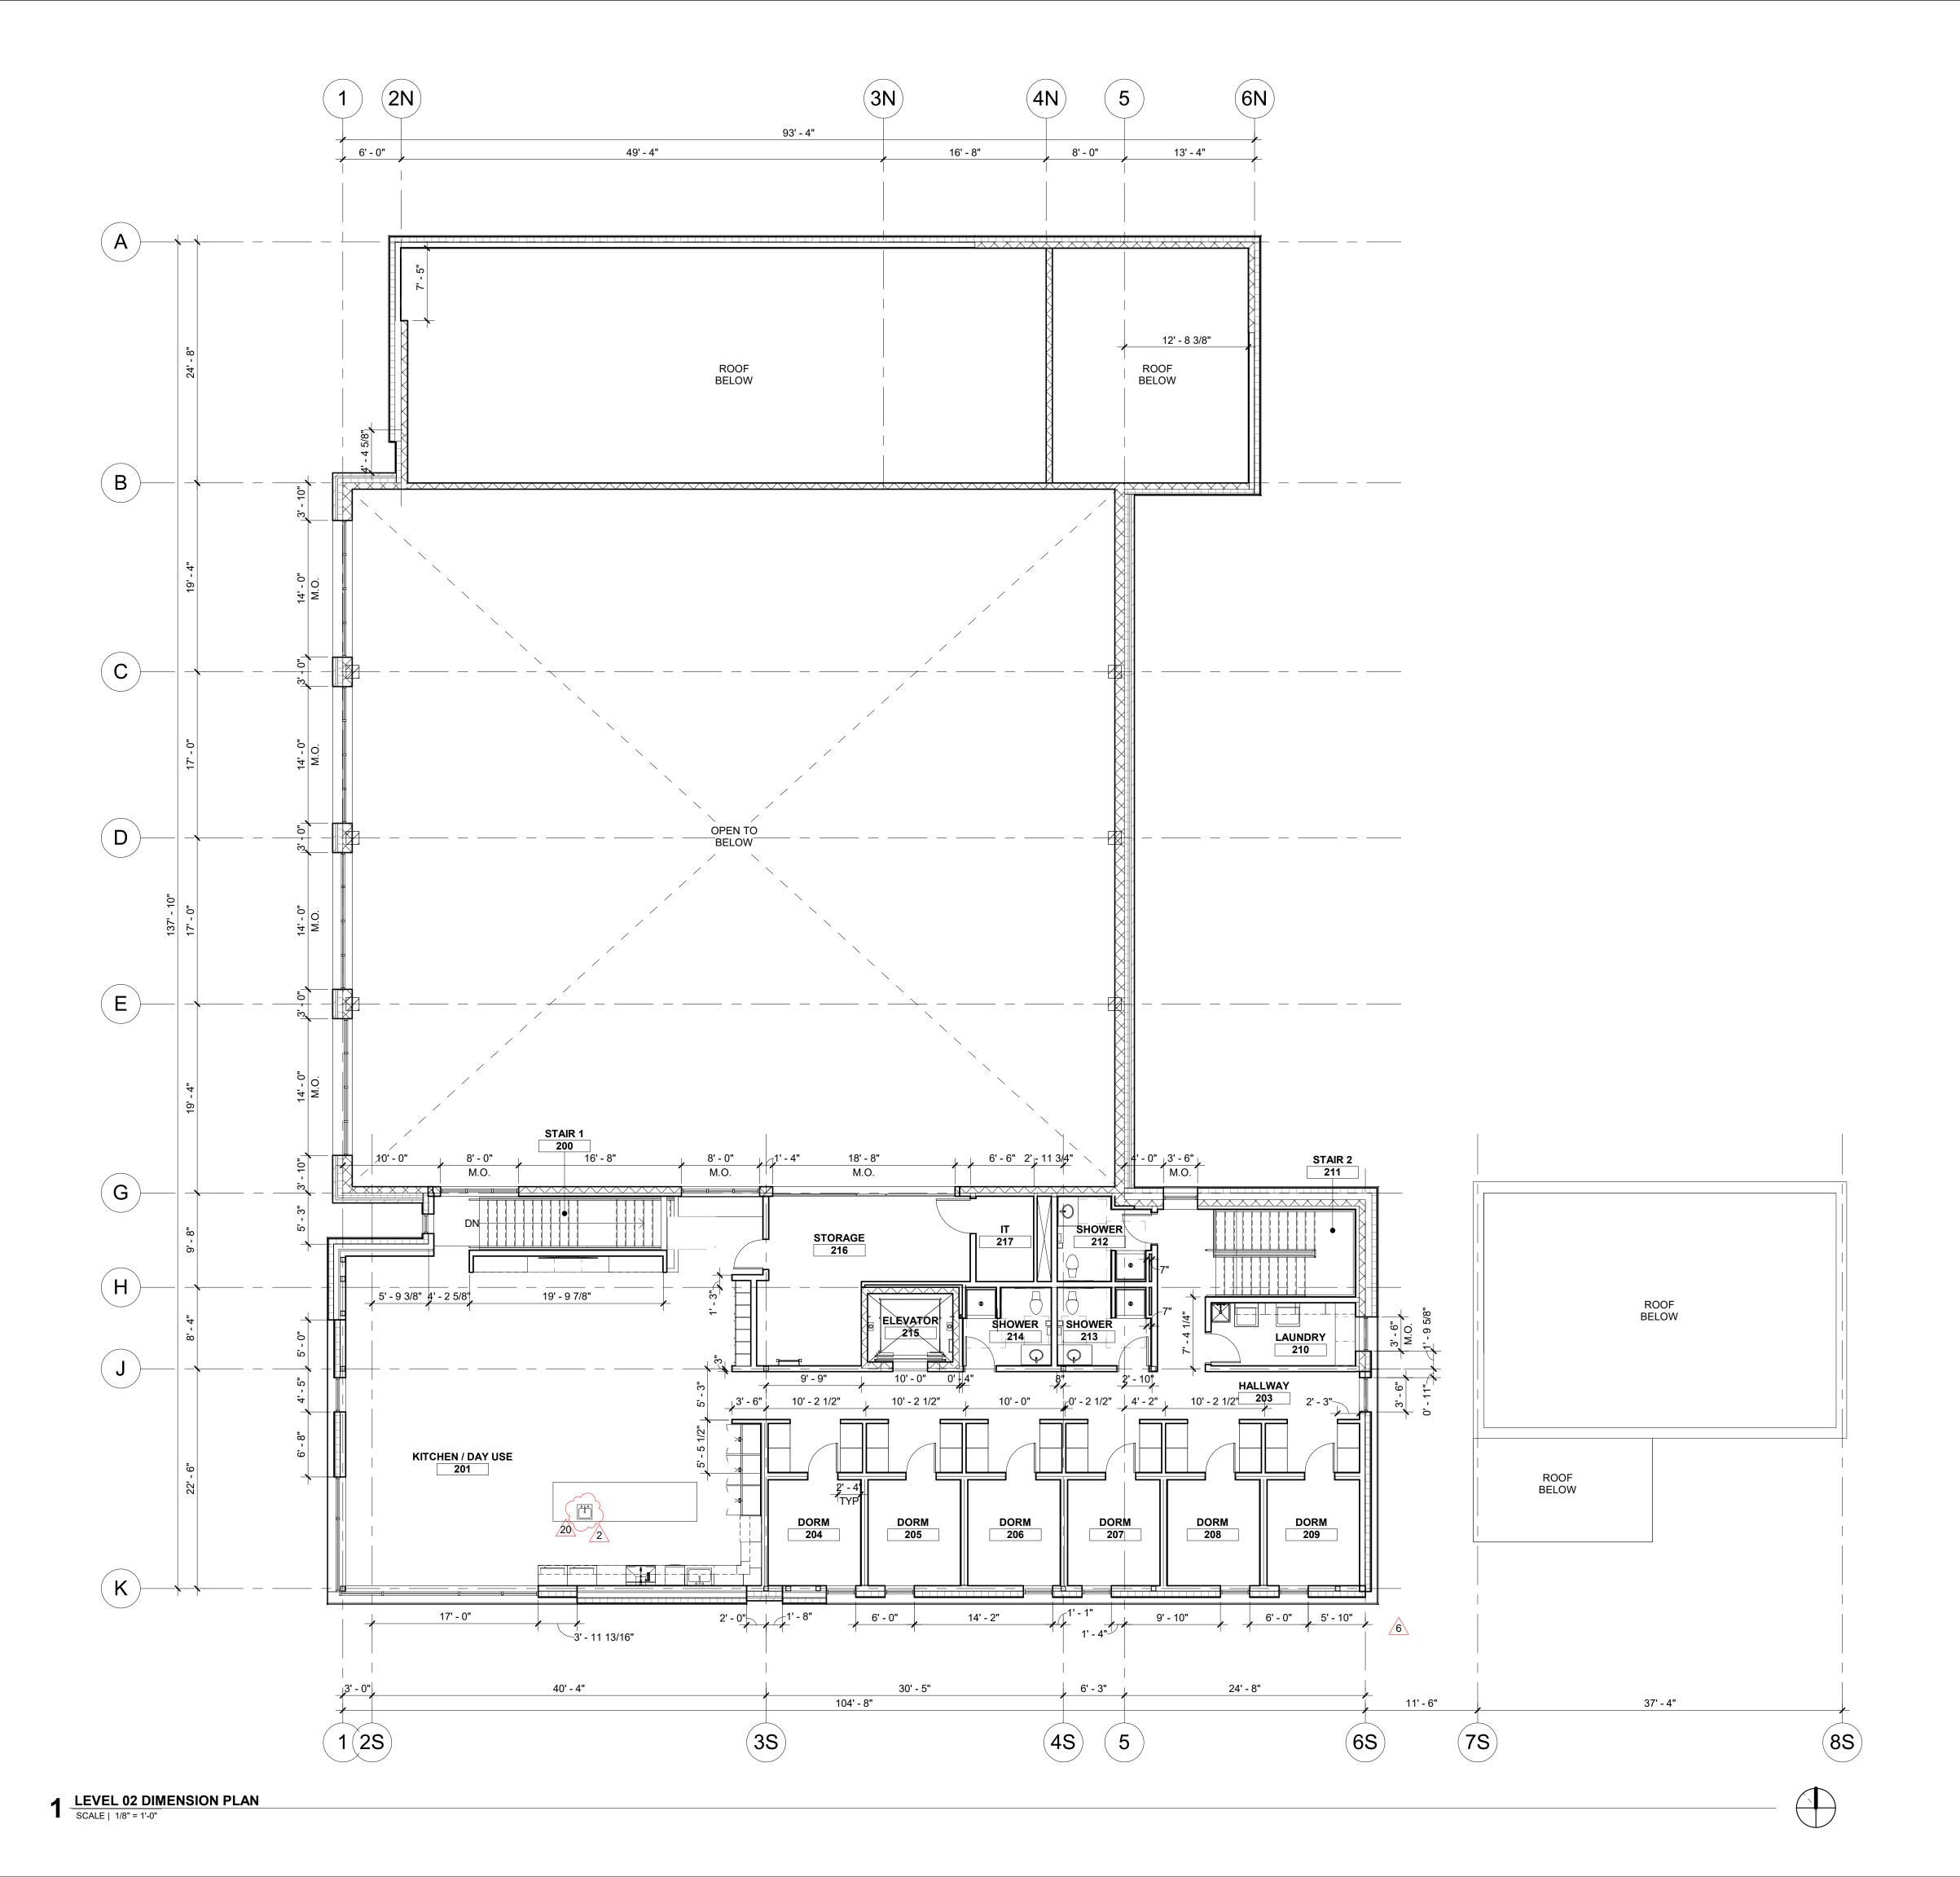




Boise, Idaho 83702 208.345.1800 colearchitects.net Copyright © 2020 Cole Architects, PLLC



ARCHITECTURE + PLANNING + DESIGN

6211 Roosevelt Way NE Seattle, WA 98115 206.522.3820

BIDDERS ARE INSTRUCTED TO CAREFULLY REVIEW THE CONSTRUCTION DOCUMENTS AND THE SITE CONDITIONS. INFORMATION REGARDING THE COMPLETE WORK OF SPECIFIC TRADES IS DISPERSED THROUGHOUT THE ENTIRE DOCUMENT SET AND CANNOT BE ACCURATELY DETERMINED BY REFERENCE TO OTHER THAN COMPLETE DOCUMENT SETS.

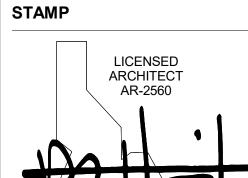

MATTHEW HUFFIELD STATE OF IDAHO

CONSULTANT

PROJECT INFORMATION



KETCHUM FIRE STATION NO. 1

107 SADDLE ROAD, KETCHUM, ID 83353

PHASE	CONSTRUCTION
DATE	JUNE 19,
JOB NUMBER	1


MARK	DATE	DESCRIPTION
20	01/20/21	ASI 05
6	8/17/20	ASI 2
2	7/17/20	ASI 1

SHEET NAME

DIMENSION PLAN -LEVEL 02

SHEET NUMBER

A2.22

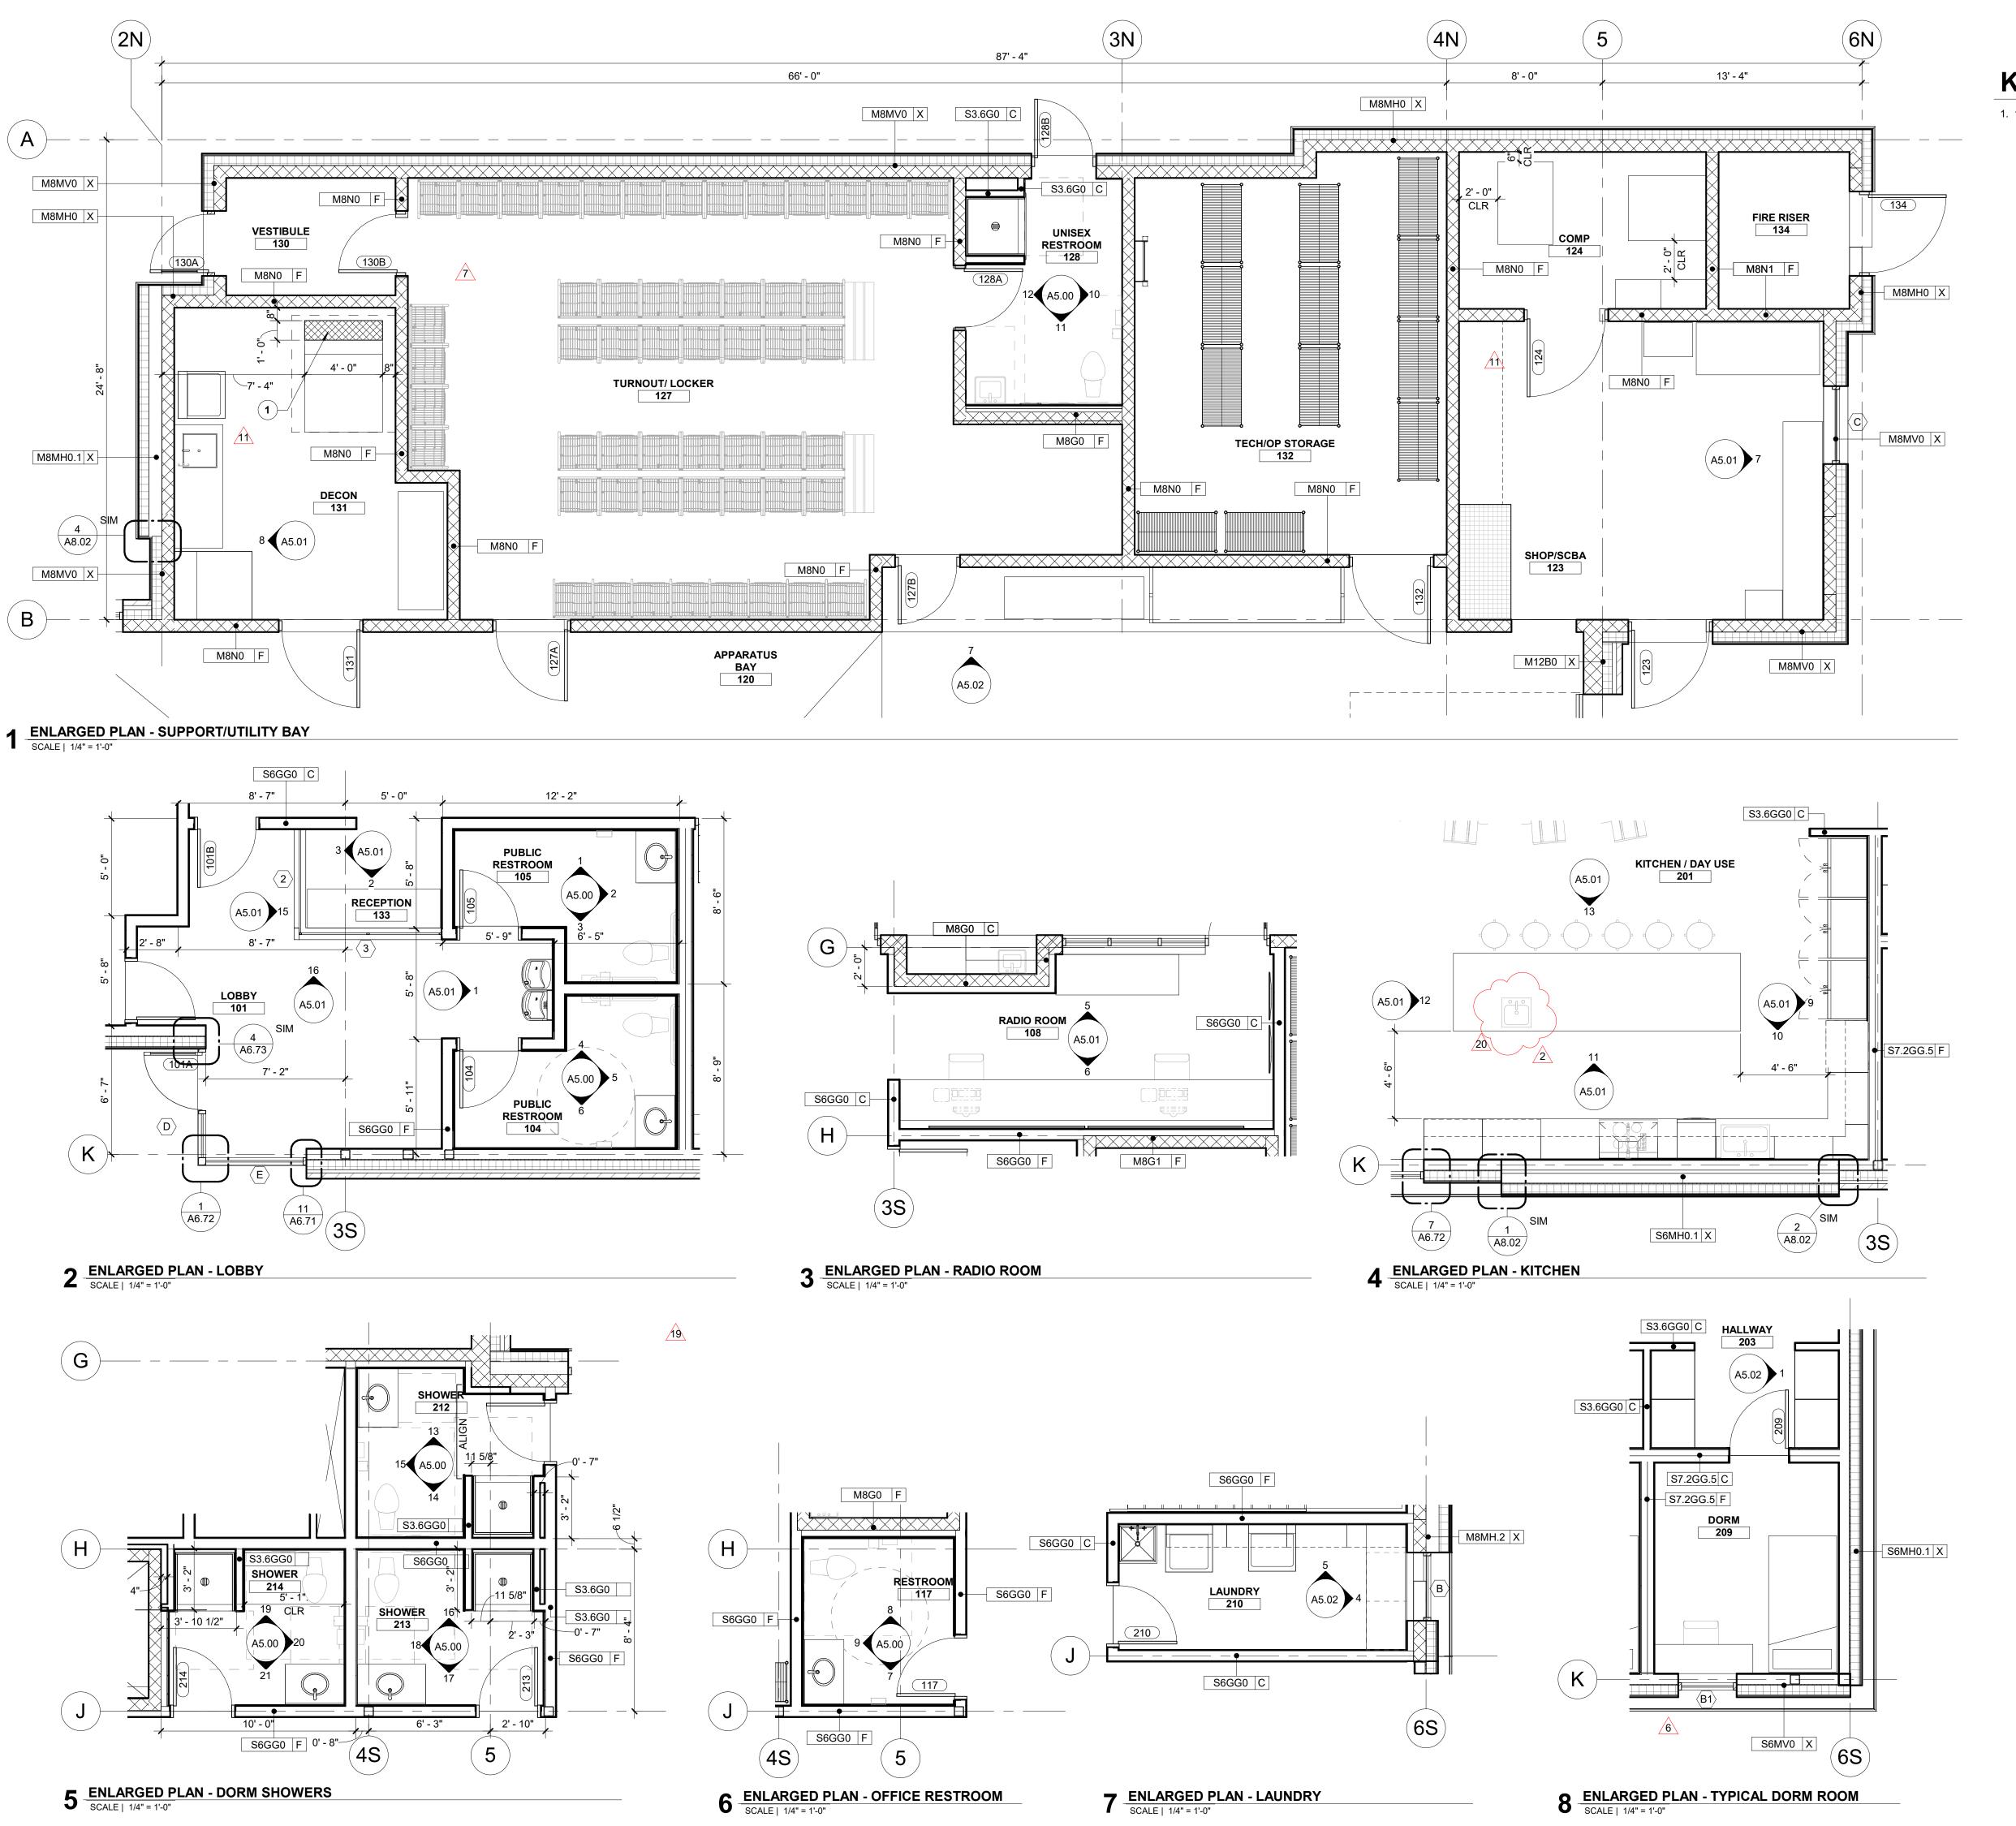

KEYNOTES

1. 12"W X 12"D X 48"L TRENCH DRAIN WITH METAL DRAIN COVER.




1008 W Main St Boise, Idaho 83702 208.345.1800 **colearchitects.net** Copyright © 2020 Cole Architects, PLLC



6211 Roosevelt Way NE Seattle, WA 98115 206.522.3820

BIDDERS ARE INSTRUCTED TO CAREFULLY REVIEW THE CONSTRUCTION DOCUMENTS AND THE SITE CONDITIONS. INFORMATION REGARDING THE COMPLETE WORK OF SPECIFIC TRADES IS DISPERSED THROUGHOUT THE ENTIRE DOCUMENT SET AND CANNOT BE ACCURATELY DETERMINED BY REFERENCE TO OTHER THAN COMPLETE DOCUMENT SETS.

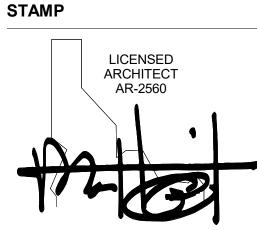

MATTHEW HUFFIELD STATE OF IDAHO

CONSULTANT

PROJECT INFORMATION



KETCHUM FIRE STATION NO. 1

107 SADDLE ROAD, KETCHUM, ID 83353

ISSUES

PHASE	CONSTRUCTION SE
DATE	JUNE 19, 202
JOB NUMBER	18-02
MARK DATE	DESCRIPTION

ARK DATE DESCRIPTION

0 01/20/21 ASI 05

12/29/20 RFI #CC-128

10/22/20 ASI 04

9/2/20 RFI #CC-62

8/17/20 ASI 2


7/17/20 ASI 1

SHEET NAME

ENLARGED PLANS

SHEET NUMBER

A2.40

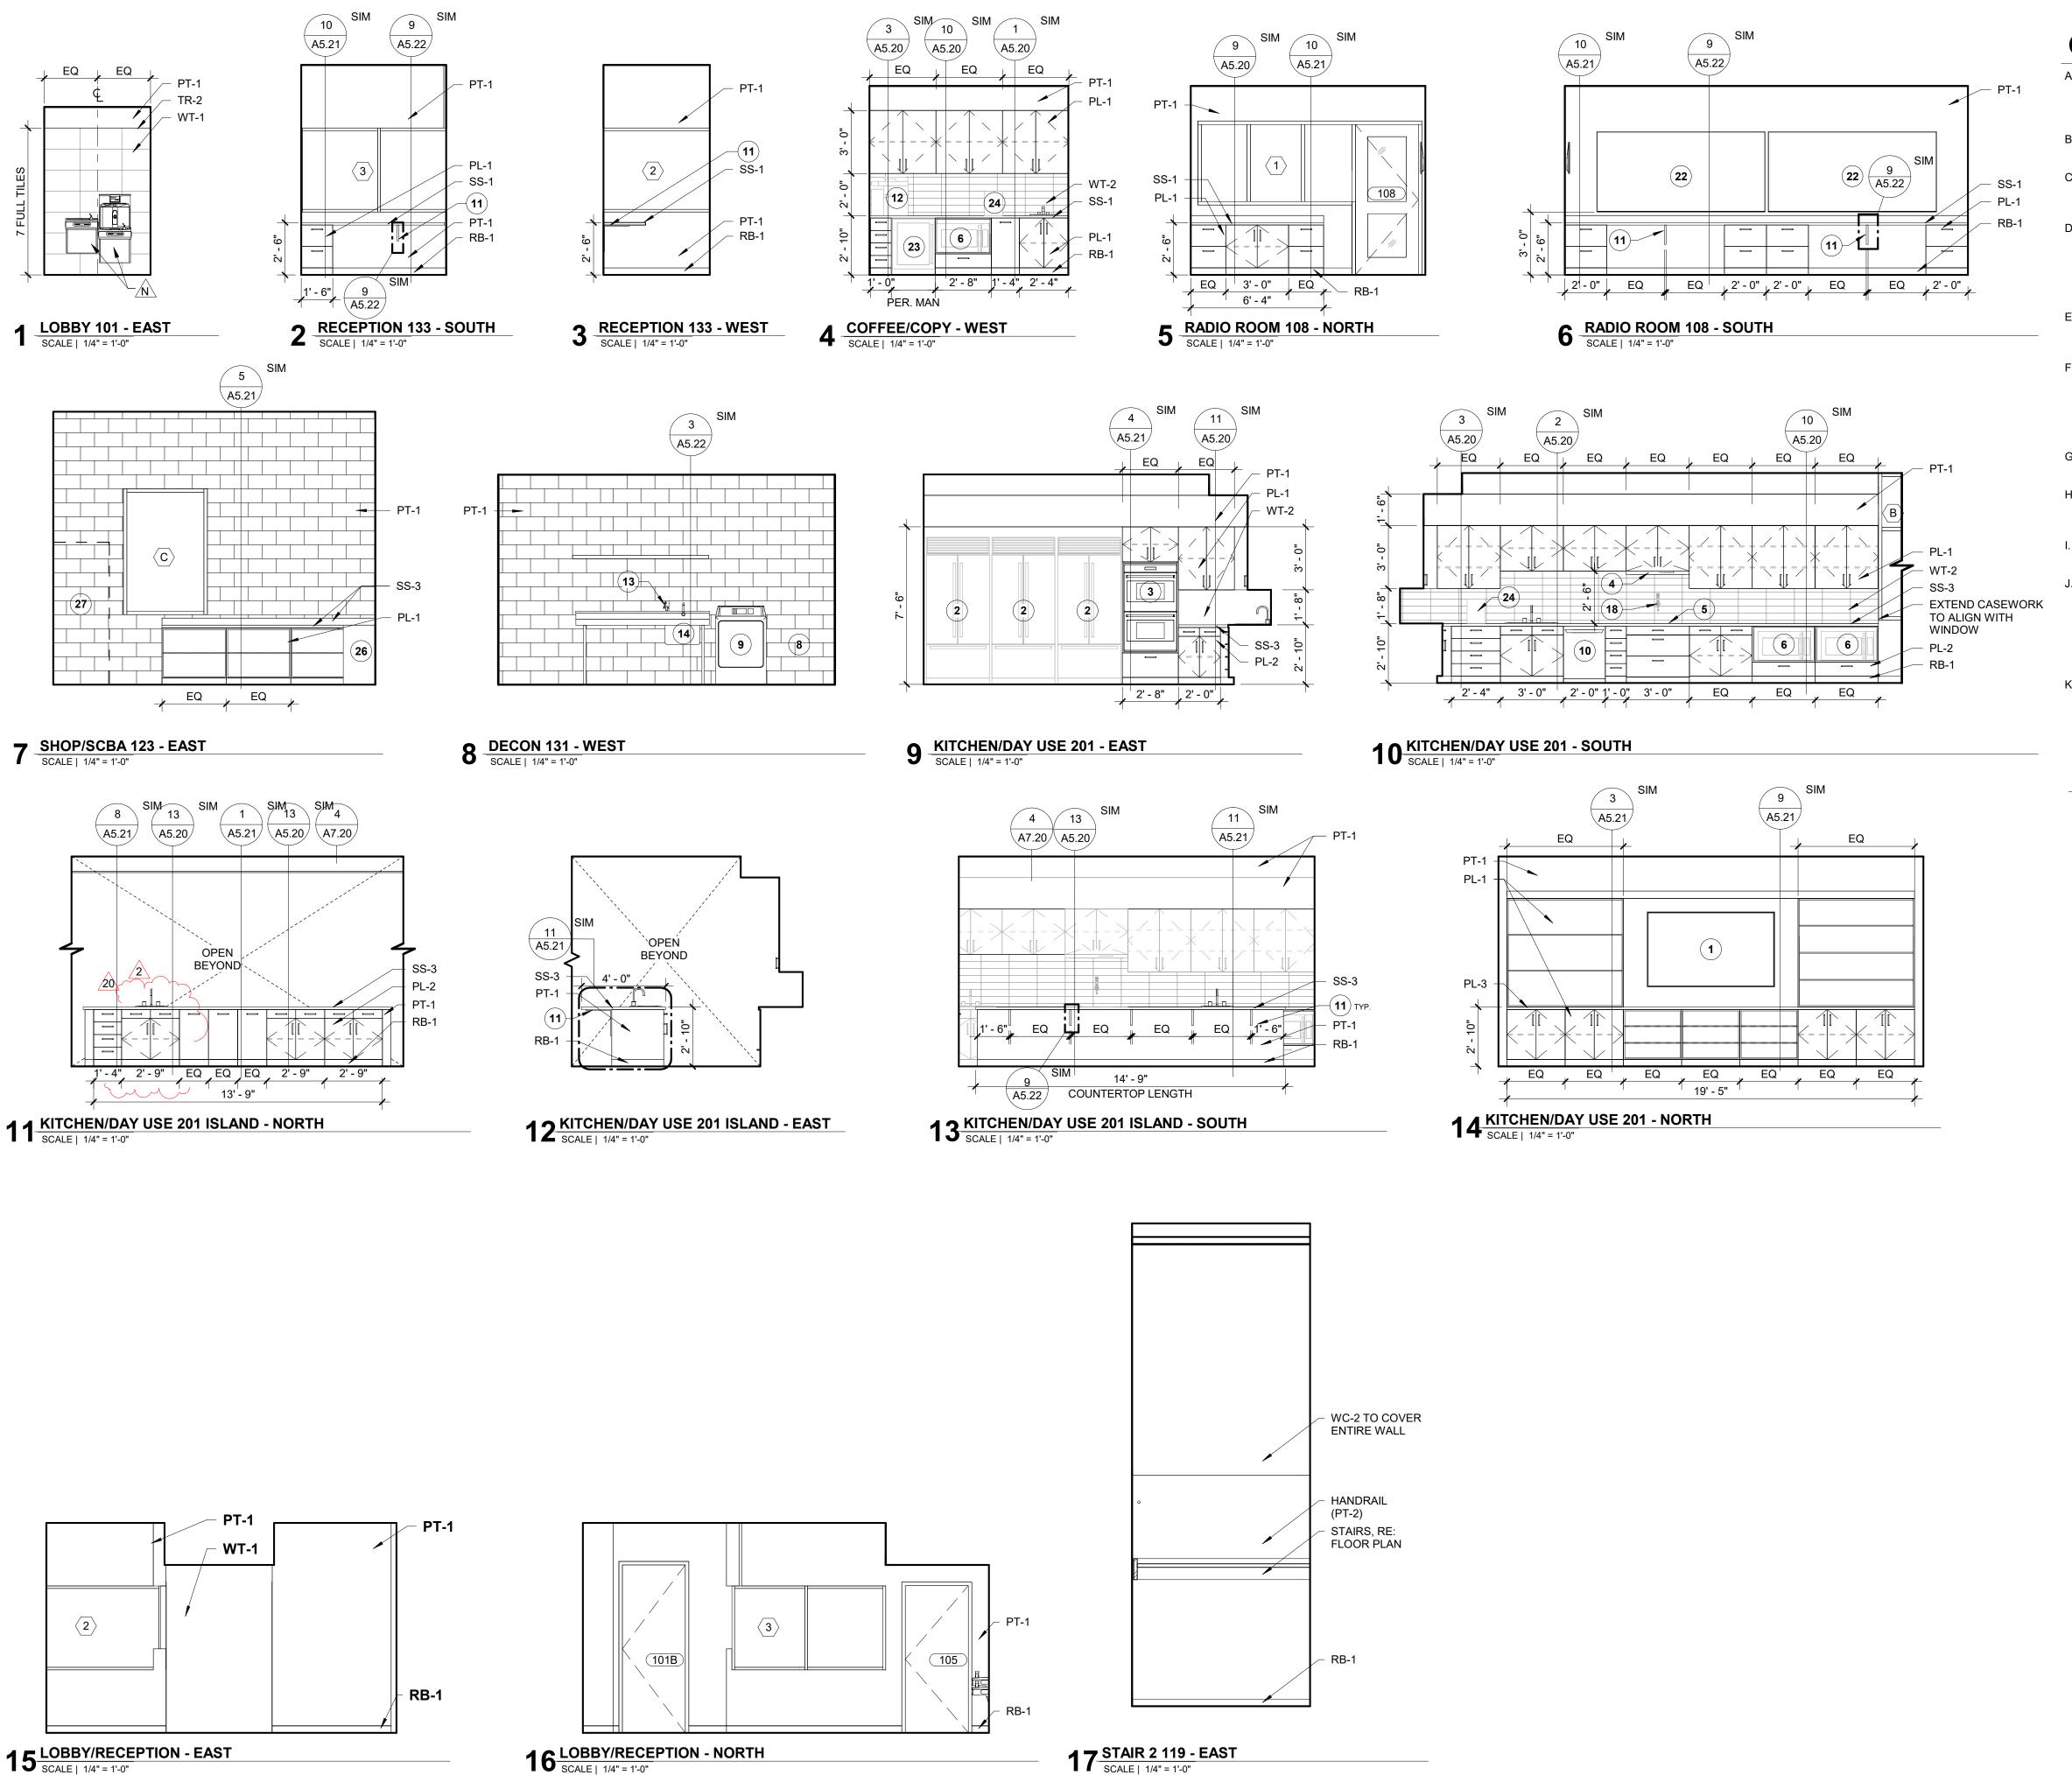

GENERAL NOTES

SCHEDULE FOR FINISH, AS SCHEDULED.

- A. REFER TO ARCHITECTURAL FLOOR, ELEVATION AND FINISH PLANS. CONTRACTOR SHALL CLARIFY ANY QUESTIONS CONCERNING FINISHES, LOCATION, OR DESIGN INTENT WITH DESIGNER PRIOR TO ORDERING OF MATERIALS.
- B. AT ROOMS WITH NEW EXPOSED CEILING, PAINT WALLS TO UNDERSIDE OF STRUCTURE ABOVE.
- C. SEE REFLECTED CEILING PLAN FOR GYPSUM BOARD SOFFIT LOCATIONS. REFER TO REFLECTED CEILING PLAN AND INTERIOR FINISH
- D. PROVIDE A THIN, CLEAR, SILICONE BEAD (1/8") AT PERIMETER OF ALL DOOR FRAMES AND BORROWED GLASS LITES AFTER INSTALLATION OF SCHEDULED WALL COVERINGS. DOOR FRAMES ON PAINTED WALLS SHOULD RECEIVE THIN, PAINTABLE SILICONE BEAD (1/8") AT PERIMETER PRIOR TO PAINTING, ONLY WHERE THE FRAME DOES NOT MEET THE WALL
- E. ALL INTERIOR FINISHES MUST BE INSTALLED BY A CERTIFIED INSTALLER / SUBCONTRACTOR PER MANUFACTURER'S INSTRUCTIONS. USE MANUFACTURER'S APPROVED ADHESIVES AND SEAM SEALERS.
- F. ALL FLOORING TRANSITIONS OCCUR UNDER THE CENTER OF THE DOOR UNLESS OTHERWISE NOTED. FLOOR TRANSITION HEIGHTS NOT TO EXCEED 1/4" MAXIMUM. PROVIDE APPROPRIATE SCHLUTER TRANSITION STRIP IN ANODIZED ALUMINUM FINISH AT EACH LOCATION WHERE FLOOR FINISH MATERIAL CHANGES. UNLESS NOTED OTHERWISE
- G. PROVIDE WINDOW COVERINGS AT ALL WINDOW LOCATIONS. SEE INTERIOR FINISH SPECIFICATIONS FOR ROLLER SHADE SPECIFICATION.
- H. ALL CABINET HARDWARE AT CASEWORK LOCATIONS TO BE RICHELIEU CONTEMPORARY STEEL PULL 205 TO BE 6 5/16" LONG IN BRUSHED NICKEL FINISH (OR APPROVED EQUAL WITH SIMILAR FINISH).
- I. ALL WINDOW SILLS TO BE SOLID SURFACE (SS-1) UNLESS NOTED OTHERWISE.
- J. PROVIDE SOLID BLOCKING OR OTHER SUITABLE BACKING AT LOCATIONS INCLUDING, BUT NOT LIMITED TO, THE FOLLOWING: EDGES WHERE FINISH MATERIALS CHANGE, GRAB BARS, TOILET PARTITIONS, DOOR STOPS, SHELF BRACKETS, HANDRAILS AND ALL MOUNTED EQUIPMENT, INCLUDING EQUIPMENT FURNISHED BY OWNER. PROVIDE

STEEL BACKING FOR GRAB BARS ATTACHED TO PARTITIONS. EXTEND

K. REFERENCE PLUMBING/MECHANICAL DRAWINGS, ELECTRICAL DRAWINGS AND SPECIFICATIONS FOR ADDITIONAL PRODUCT INFORMATION. IF CONFLICT EXISTS NOTIFY ARCHITECT AND PRICE MOST EXPENSIVE OPTION.

KEY NOTES

1. TV/MONITOR. RE: EQUIPMENT PLANS & SCHEDULE.

BACKING 6" BEYOND OUTLINE OF EQUIPMENT.

- REFRIGERATOR. RE: EQUIPMENT PLANS & SCHEDULE.
 BUILT-IN DOUBLE OVEN. RE: EQUIPMENT PLANS & SCHEDULE.
 RANGE HOOD. RE: EQUIPMENT PLANS & SCHEDULE.
- RANGE. RE: EQUIPMENT PLANS & SCHEDULE.
 MICROWAVE. RE: EQUIPMENT PLANS & SCHEDULE.
 MOP SERVICE BASIN WITH FAUCET.
- 8. WASHER TOP LOAD. RE: EQUIPMENT PLANS & SCHEDULE.
- DRYER. RE: EQUIPMENT PLANS & SCHEDULE.
 DISHWASHER. RE: EQUIPMENT PLANS & SCHEDULE.
- PROVIDE COUNTERTOP SUPPORTS AS REQUIRED. SUPPORT BRACKETS TO BE WHITE. RE: SPECIFICATIONS.
- 12. PRINTER TO BE OWNER SUPPLIED, CONTRACTOR INSTALLED. COORDINATE PRINTER SIZE PRIOR TO CABINET FABRICATION AND INSTALLATION TO ACCOMMODATE HEIGHT. RE: EQUIPMENT PLANS &
- SCHEDULE.

 13. EMERGENCY EYE WASH STATION. RE: EQUIPMENT PLANS & SCHEDULE.
- 14. SERVICE SINK.
- 15. FOOD LOCKERS. RE: EQUIPMENT PLANS & SCHEDULE. 16. RUB RAIL. 7'-0" LONG X 6" HIGH.
- 17. PROVIDE METAL 24" X 24" WORKSTATION WALL BRACKET FACTORY PAINTED WHITE, TYP. RE: SPECIFICATIONS.
- 18. WALL MOUNT POT FILLER. CONTRACTOR FURNISHED, CONTRACTOR
- INSTALLED.

 19. FLAMABLE LIQUIDS CABINET. RE: EQUIPMENT PLANS & SCHEDULE.
- 20. BOOTWASH STATION WITH 17" x 15" SINK.
 21. BIKE HOOKS. RE: EQUIPMENT PLANS & SCHEDULE.
- 22. WHITE BOARD. RE: EQUIPMENT PLANS & SCHEDULE.23. UNDERCOUNTER MINATURE REFRIGERATOR. RE: EQUIPMENT PLANS
- & SCHEDULE.

 24. LOCATION OF PLUMBED, COUNTER TOP COFFEE MAKER. RE:
- EQUIPMENT PLANS & SCHEDULE.
- 25. STAINLESS STEEL SHELF.26. FLAMMABLE LIQUIDS CABINET. RE: FINISH & FURNITURE PLANS &
- SCHEDULE.
 27. CLYINDER STORAGE, RE: FINISH & FURNITURE PLANS & SCHEDULE.

COLE

1008 W Main St Boise, Idaho 83702 208.345.1800 **colearchitects.net** Copyright © 2020 Cole Architects, PLLC




ARCHITECTURE + PLANNING + DESIGN

6211 Roosevelt Way NE Seattle, WA 98115 206.522.3820

CONSTRUCTION DOCUMENTS AND THE SITE CONDITIONS. INFORMATION REGARDING THE COMPLETE WORK OF SPECIFIC TRADES IS DISPERSED THROUGHOUT THE ENTIRE DOCUMENT SET AND CANNOT BE ACCURATELY DETERMINED BY REFERENCE TO OTHER THAN COMPLETE DOCUMENT SETS.

STAMP

CONSULTANT

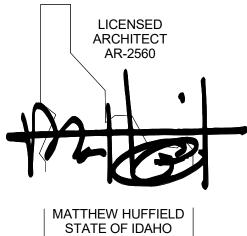

PROJECT INFORMATION



KETCHUM FIRE STATION NO. 1

107 SADDLE ROAD, KETCHUM, ID 83353

ISSUES

PHASECONSTRUCTION SETDATEJUNE 19, 2020JOB NUMBER18-022

 MARK
 DATE
 DESCRIPTION

 20
 01/20/21
 ASI 05

 6
 8/17/20
 ASI 2


 2
 7/17/20
 ASI 1

SHEET NAME

INTERIOR ELEVATIONS

SHEET NUMBER

A5.01

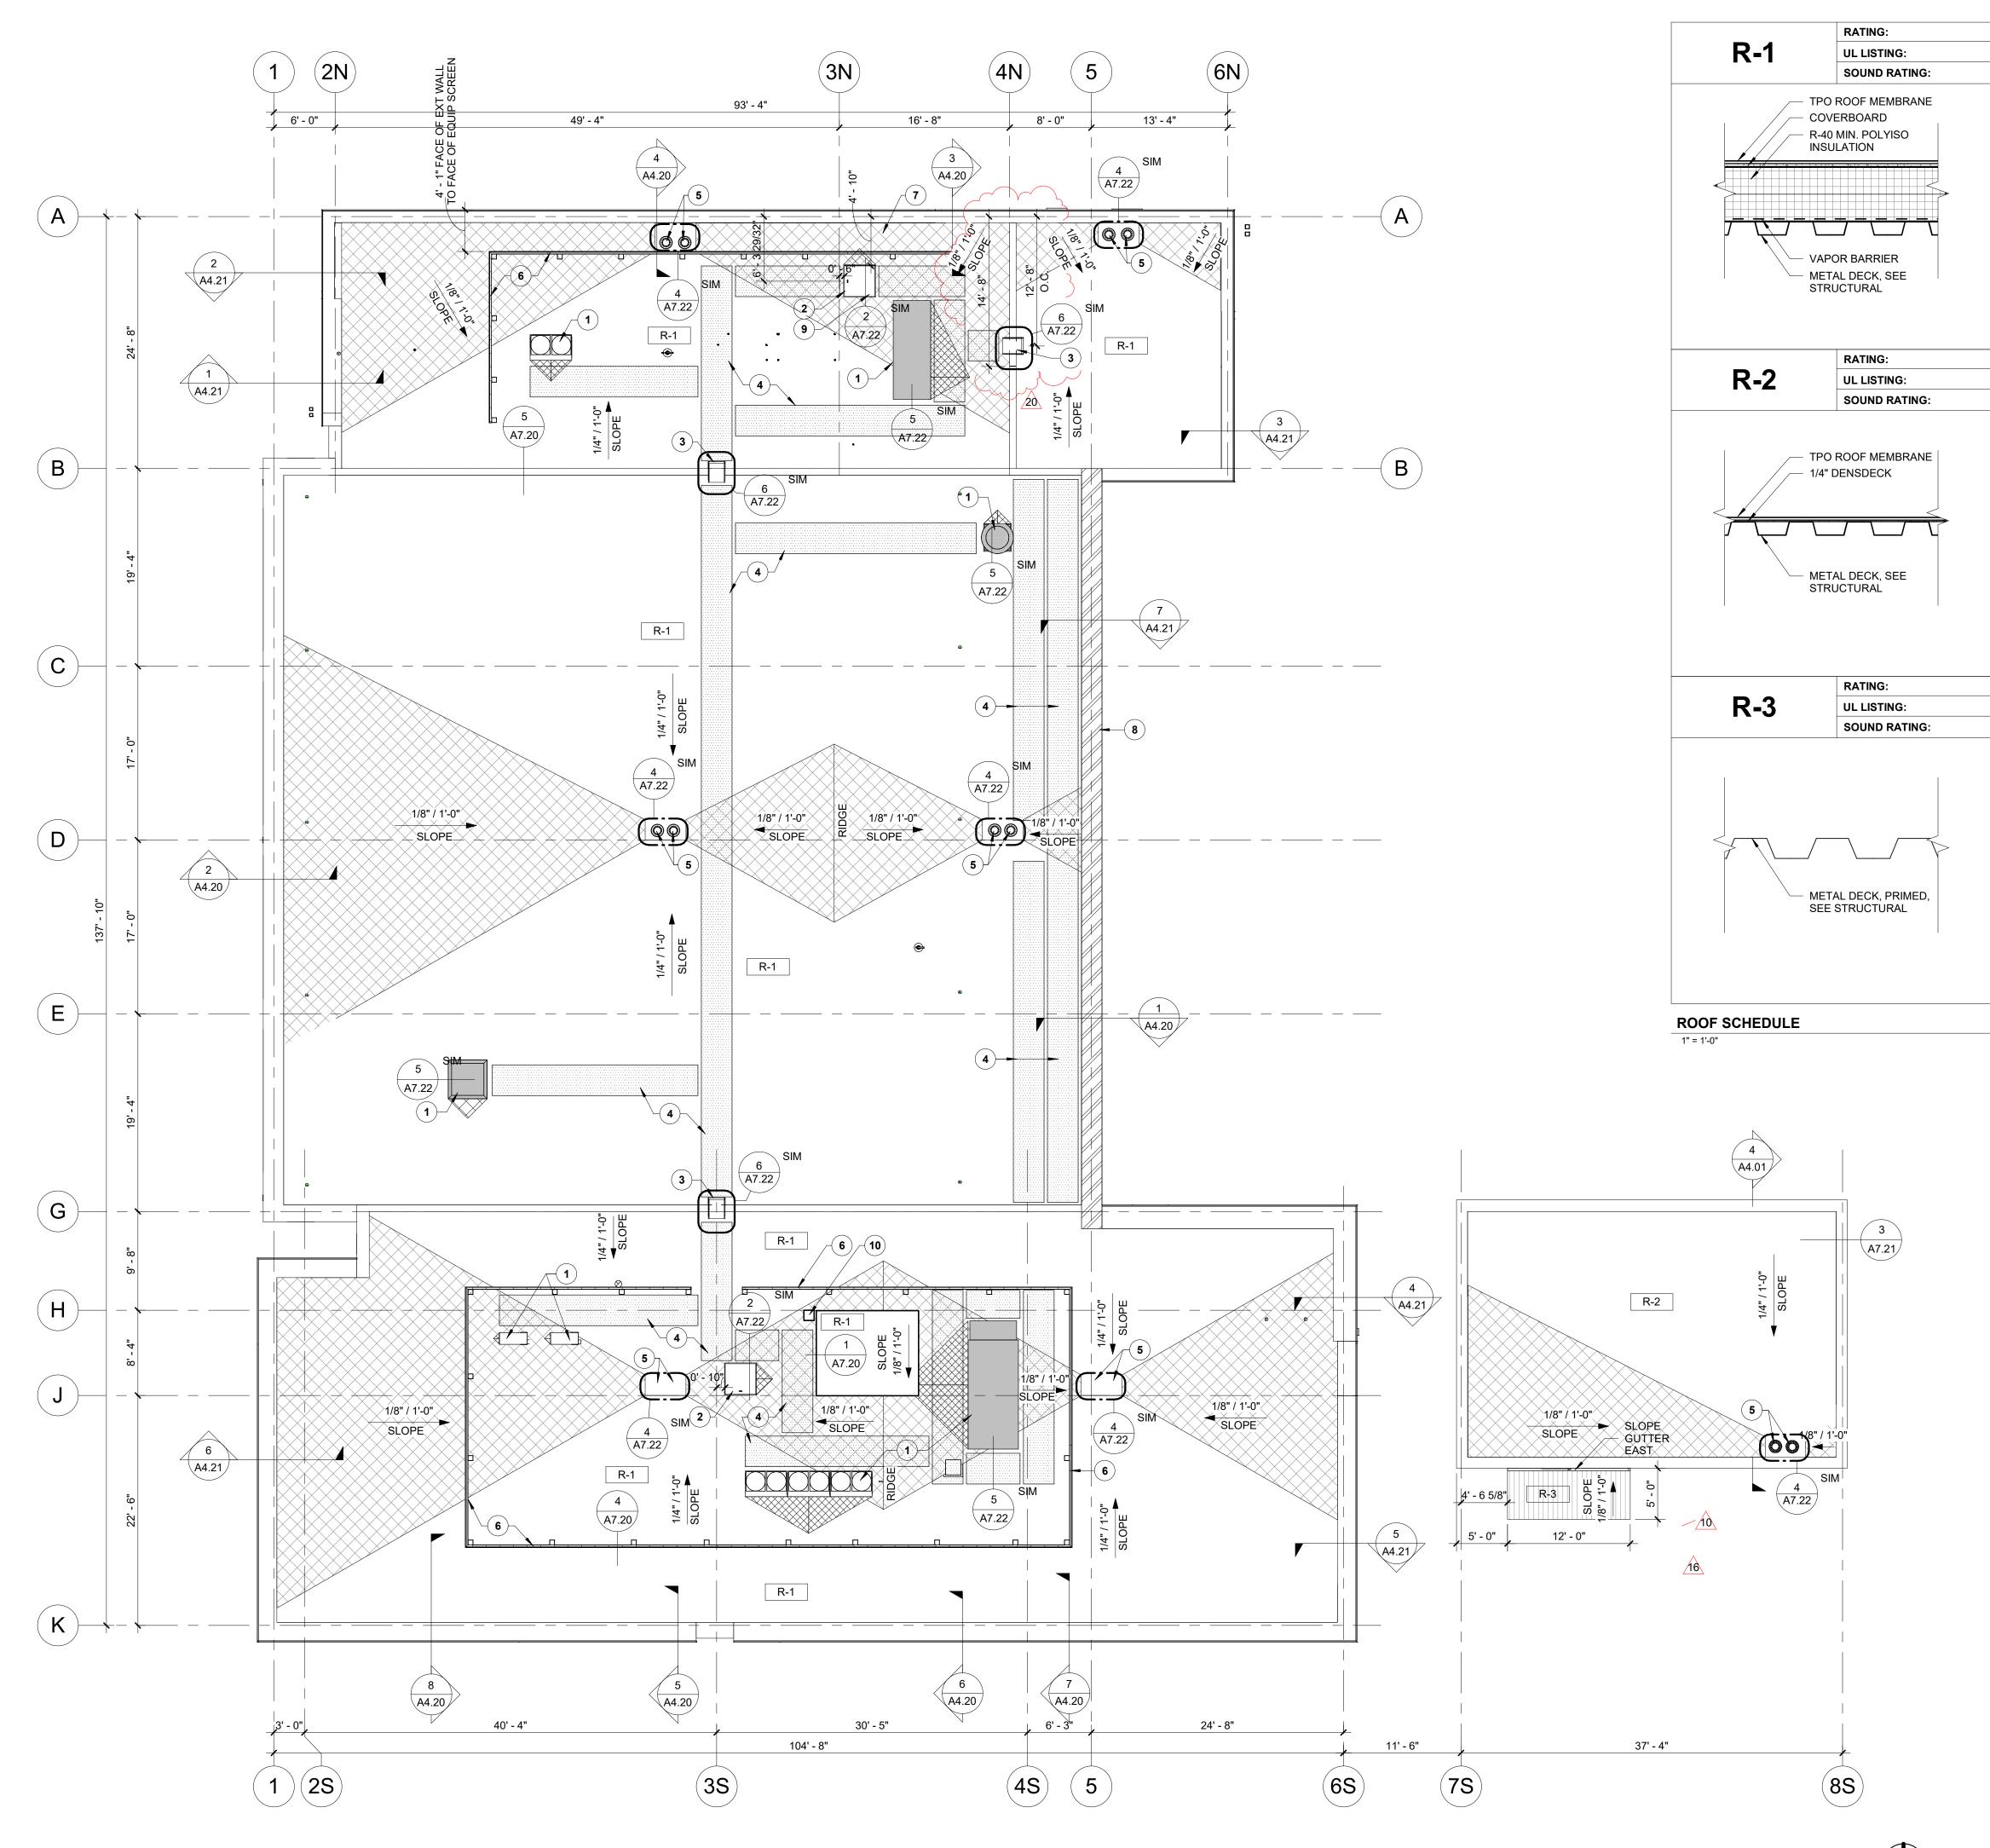

GENERAL NOTES

RECOMMENDATIONS.

- A. COORDINATE INSTALLATION OF ROOFING WITH OTHER TRADES. REPORT ANY CONFLICTS WITH ITEMS INSTALLED BY OTHER TRADES TO ARCHITECT.
- B. ALL ROOF CURBS FOR NEW ROOFTOP EXHAUST FANS, HVAC UNITS AND CONDENSING UNITS SHALL HAVE CURB HEIGHTS THAT WILL ALLOW FOR A MINIMUM OF 8" BASE FLASHING HEIGHTS FOR THE
- C. ALL PLUMBING VENTS SHALL EXTEND ABOVE THE FINISHED SURFACE OF THE ROOF SYSTEM AS REQUIRED TO PROVIDE FOR A MINIMUM OF 8" BASE FLASHING. PROVIDE FLASHING AROUND VENTS AND ROOF PENETRATIONS PER ROOFING MANUFACTURER
- D. PROVIDE 36" WIDE WALK PADS AROUND PERIMITER OF ALL MECHANICAL EQUIPMENT. PROVIDE 36" WIDE WALK PADS AROUND ALL ROOF HATCHES & 72"X72" PADS AT LADDERS.
- E. UNLESS NOTED OTHERWISE PROVIDE FIRESTONE UNI-CLAD KYNAR 500/HYLAR 5000 PRE-FINISHED GALVALUME STEEL (24 GA) ARCHITECTURE SHEET AND COIL FOR ALL COPINGS, FLASHING & TRIM PIECES. SUBMIT STANDARD COLOR SELECTION TO ARCHITECT FOR APPROVAL. ALL CLEATS TO BE CONTINUOUS.
- F. ALL GUTTERS TO BE PREFINISHED SMACNA APPROVED 'K' STYLE CONTINUOUS ALUMINUM GUTTERS SIZED FOR QUANTITY OF WATER FLOW. PROVIDE STAINLESS STEEL SCREENS FOR GUTTERS. UNO PROVIDE HEAT CABLE IN GUTTER. UNO SUBMIT STANDARD COLOR SELECTION TO ARCHITECT FOR APPROVAL.
- G. ALL DOWNSPOUTS TO BE PRE-FINISHED SMACNA APPROVED RECTANGULAR ALUMINUM DOWNSPOUT SIZED FOR QUANTITY OF WATER FLOW. PROVIDE ALUMINUM ATTACHMENT CLIPS AT MAX 4' INTERVALS. UNO PROVIDE HEAT CABLE IN DOWNSPOUT AND EXTEND INTO GROUND. UNO SUBMIT STANDARD COLOR SELECTION TO ARCHITECT FOR APPROVAL. SEE EXTERIOR ELEVATIONS OR ROOF PLAN FOR LOCATIONS.
- H. PROVIDE PAINTED 4' TALL CAST ALUM. DOWNSPOUT BOOTS @ ALL DOWN SPOUTS, TIE INTO SUB-GRADE DRAINAGE, RE: CIVIL.
- I. TAPERED INSULATION TO BE 1/4" PER FOOT MIN SLOPE TO DRAIN. ROOF PLAN SHOWS TAPERED INSULATION FOR GRAPHIC REPRESENTATION ONLY. CONTRACTOR TO VERIFY INSULATION REQUIRED TO SLOPE PRIOR TO MEMBRANE INSULATION.
- J. PROVIDE TAPERED INSULATION CRICKETS 1/4" PER FOOT MIN. SLOPE @ HIGH SIDE OF ALL MECHANICAL UNITS AND ROOF HATCHES, TO SHED WATER AROUND AND MAINTAIN POSITIVE ROOF DRAINAGE.
- K. VERIFY ELEVATION OF ROOF DRAIN RELATIVE TO OVERFLOW SCUPPER PRIOR TO INSTALLATION OF SCUPPER.

L. PROVIDE SELF-ADHERING VAPOR RETARDER BETWEEN DECK AND

- INSULATION, SEE ROOF SCHEDULE AND ROOF DETAILS. UNO PROVIDE CARLISLE AIR & VAPOR BARRIER TR725. PROVIDE AIR TIGHT SEAL AROUND ALL DECK PENETRATIONS AND DECK PERIMITER PRIOR TO INSTALLING VAPOR BARRIER.
- M. ALL WOOD NAILER AND BLOCKING TO BE TREATED. SECURE NAILERS PER FM GLOBAL 1-49 PERIMETER FLASHING
- N. INSTALL MANUFACTURE'S RECOMENDED PRESSURE-SENSITIVE RUSS STRIP ALONG ENTIRE ROOF PERIMITER AND AT PERIMITER OF ALL ROOF CURBS.
- O. WHEN APPLICABLE UNLESS NOTED OTHERWISE, USE CDX PLYWOOD FOR EXTERIOR APPLICATIONS AND BCD PLYWOOD FOR INTERIOR APPLICATIONS.

KEYNOTES

- ROOF MOUNTED MECHANICAL UNIT, SEE MECHANICAL DRAWINGS.
 3' x 3' ROOF ACCESS HATCH.
 ROOF ACCESS LADDER.
 WALKING PAD.
- 5. ROOF DRAIN AND OVERFLOW DRAIN, SEE ARCH ROOF DETAILS AND PLUMBING DRAWINGS.
- 6. EQUIPMENT SCREEN.
- 7. FALL ARREST SYSTEM, SEE SPECIFICATIONS SECTION 118129. 8. REINFORCED PARAPET CAP FOR LADDER TRAINING SHOWN
- HATCHED.
- 9. GUARD RAIL ATTACHED TO ROOF HATCH.10. ROOF ANTENNA.

ROOF PLAN LEGEND

ROOF WALK PADS. REFER TO SPECIFICATIONS

TAPERED INSULATION CRICKET

REINFORCED WALL CAP FOR LADDER TRAINING



1008 W Main St Boise, Idaho 83702 208.345.1800 colearchitects.net Copyright © 2020 Cole Architects, PLLC




ARCHITECTURE + PLANNING + DESIGN

6211 Roosevelt Way NE Seattle, WA 98115 206.522.3820

BIDDERS ARE INSTRUCTED TO CAREFULLY REVIEW THE CONSTRUCTION DOCUMENTS AND THE SITE CONDITIONS. INFORMATION REGARDING THE COMPLETE WORK OF SPECIFIC TRADES IS DISPERSED THROUGHOUT THE ENTIRE DOCUMENT SET AND CANNOT BE ACCURATELY DETERMINED BY REFERENCE TO OTHER THAN COMPLETE DOCUMENT SETS.

STAMP

CONSULTANT

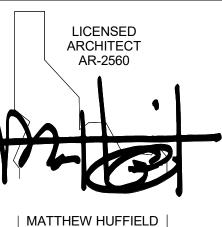

STATE OF IDAHO



KETCHUM FIRE STATION NO. 1

107 SADDLE ROAD, KETCHUM, ID 83353

ISSUES

PHASE CONSTRUCTION SET DATE JUNE 19, 2020 **JOB NUMBER** 18-022


DESCRIPTION MARK DATE 01/20/21 ASI 05 12/15/20 RFI #CC-94 10 10/14/20 ASI 03

SHEET NAME

ROOF PLAN

SHEET NUMBER

A7.00

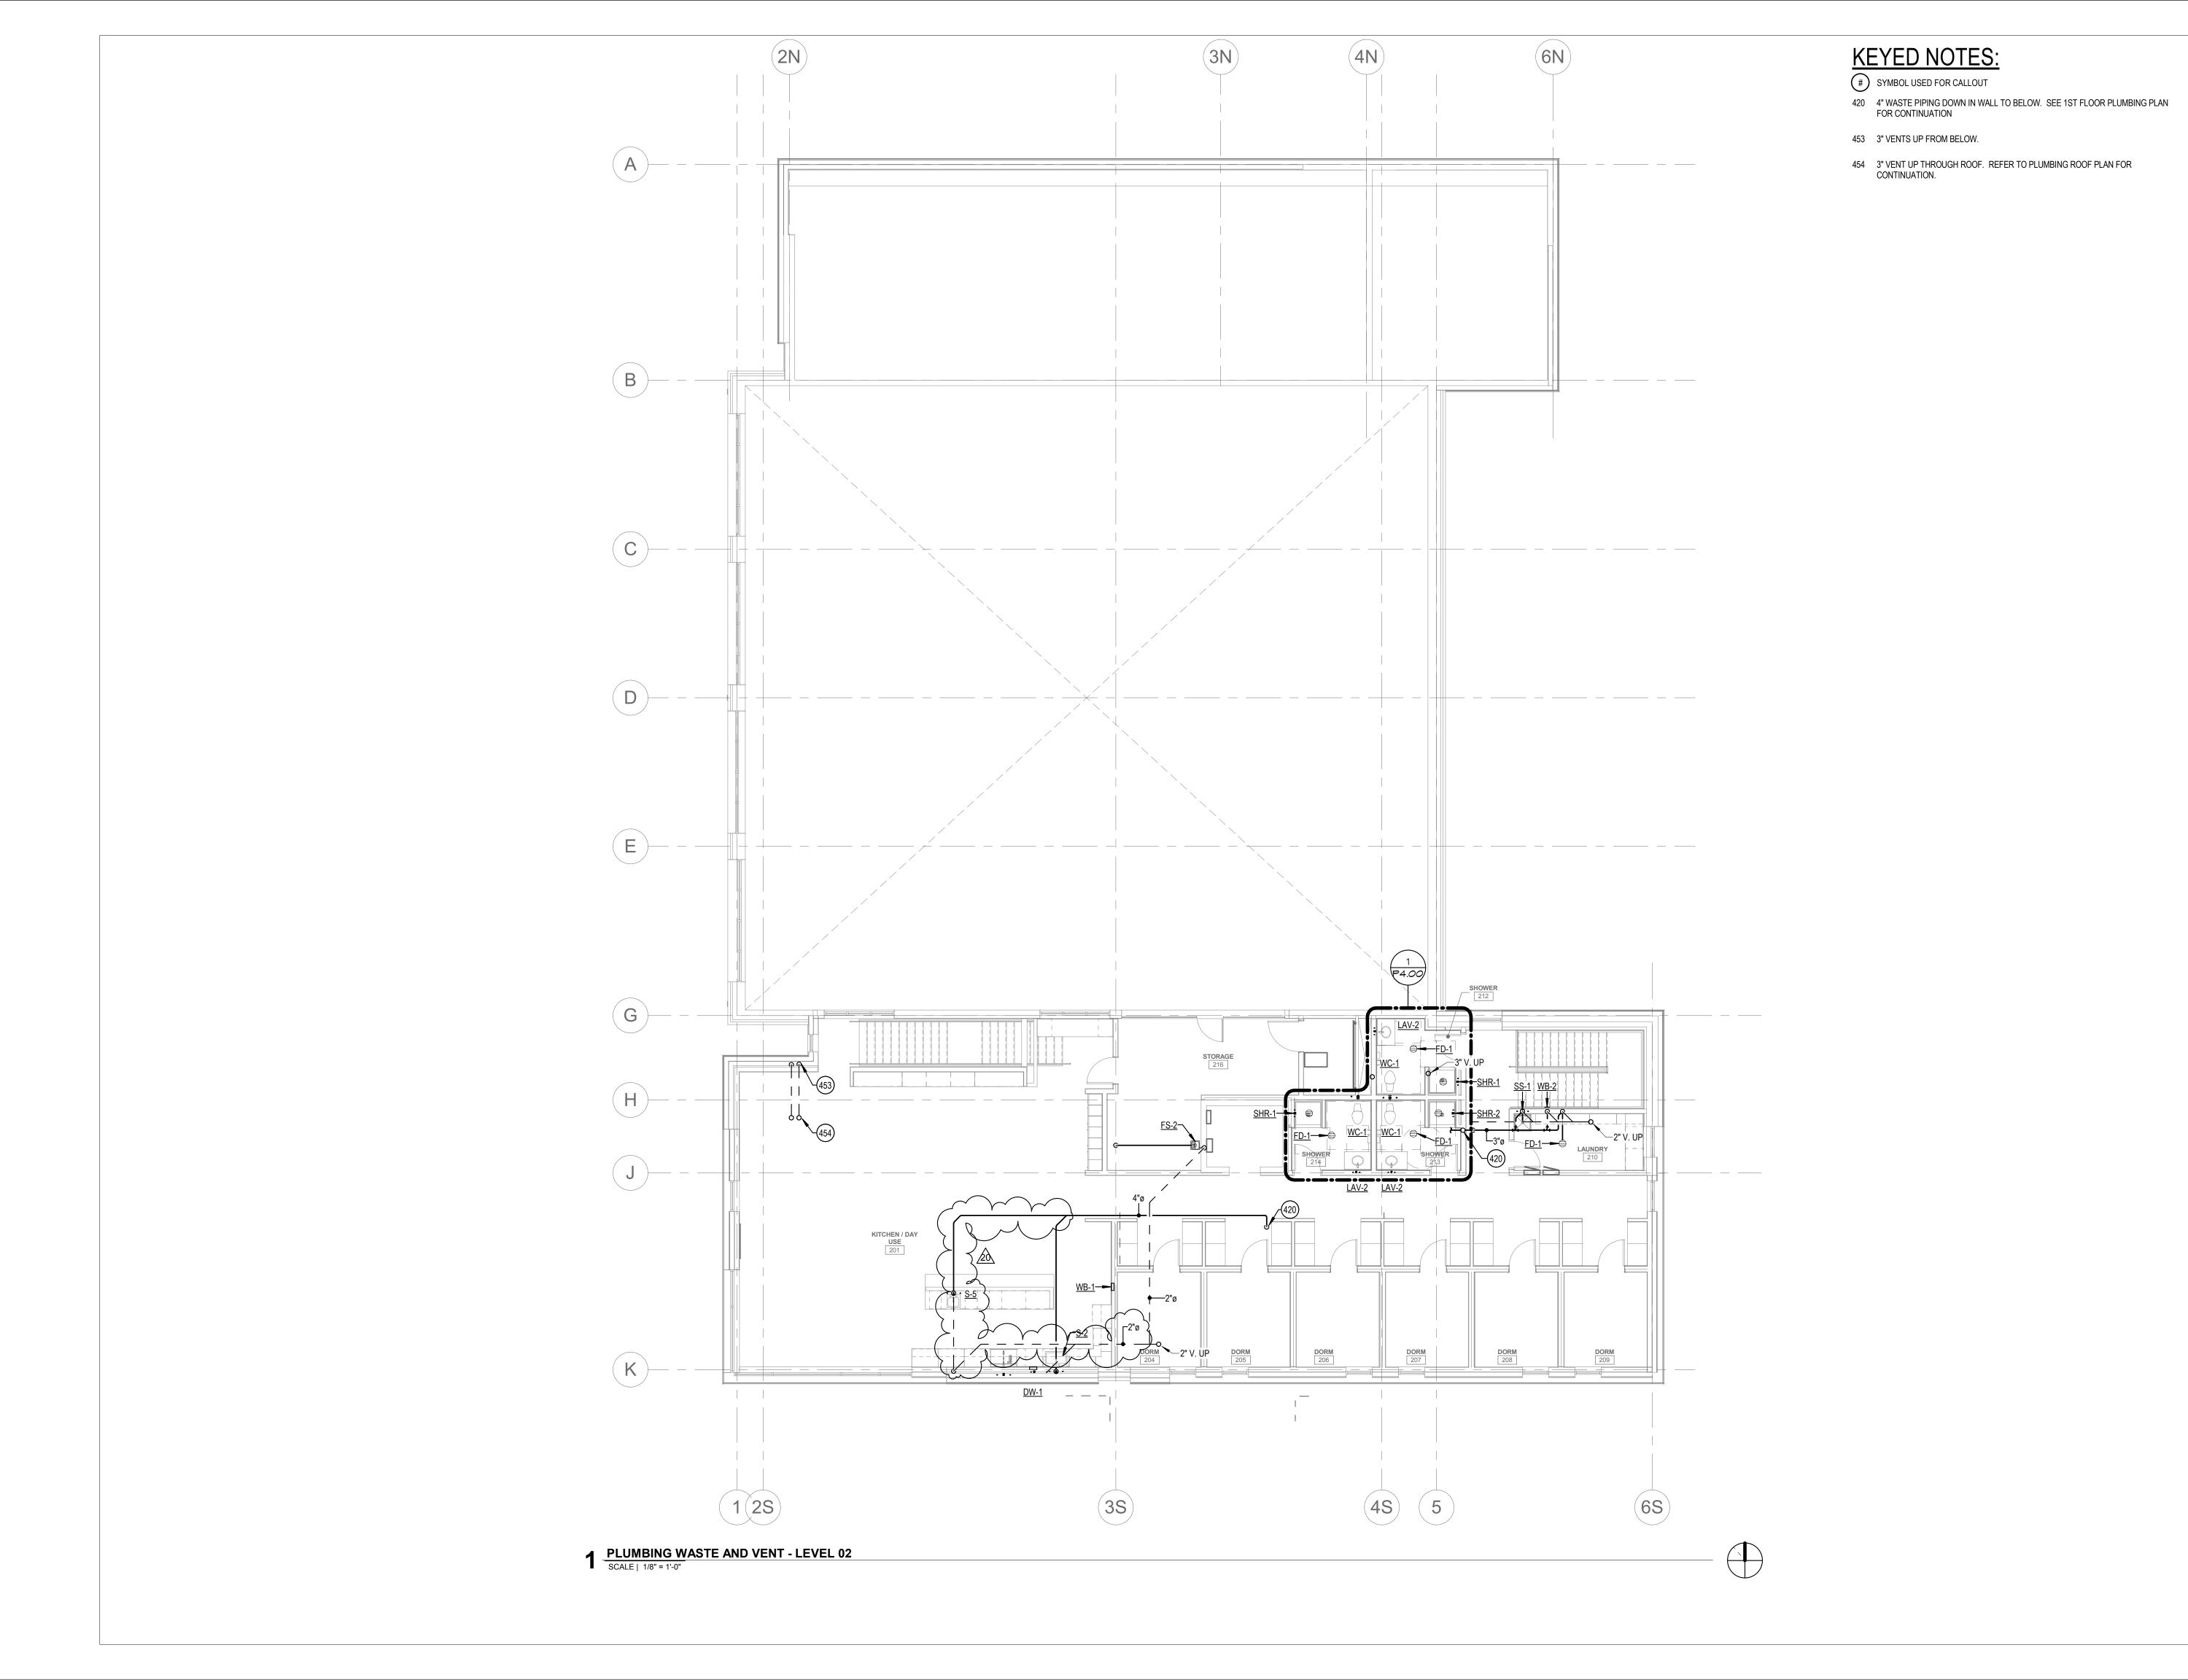





6211 Roosevelt Way NE Seattle, WA 98115 206.522.3820

STAMP



CONSULTANT



234 S. WHISPERWOOD WAY BOISE, IDAHO 83709 (208) 384-0585 PROJECT #19-366

PROJECT INFORMATION



KETCHUM FIRE STATION

107 SADDLE ROAD, KETCHUM ID 83353

ISSUES

PHASECONSTRUCTION SETDATE6/19/2020JOB NUMBER18-022


MARK DATE DESCRIPTION
1 7/17/20 ASI #1
11 10/21/2 ASI #4
0
20 1/20/21 ASI #5

SHEET NAME

PLUMBING WASTE AND VENT PLAN -LEVEL 02

SHEET NUMBER

P1.01

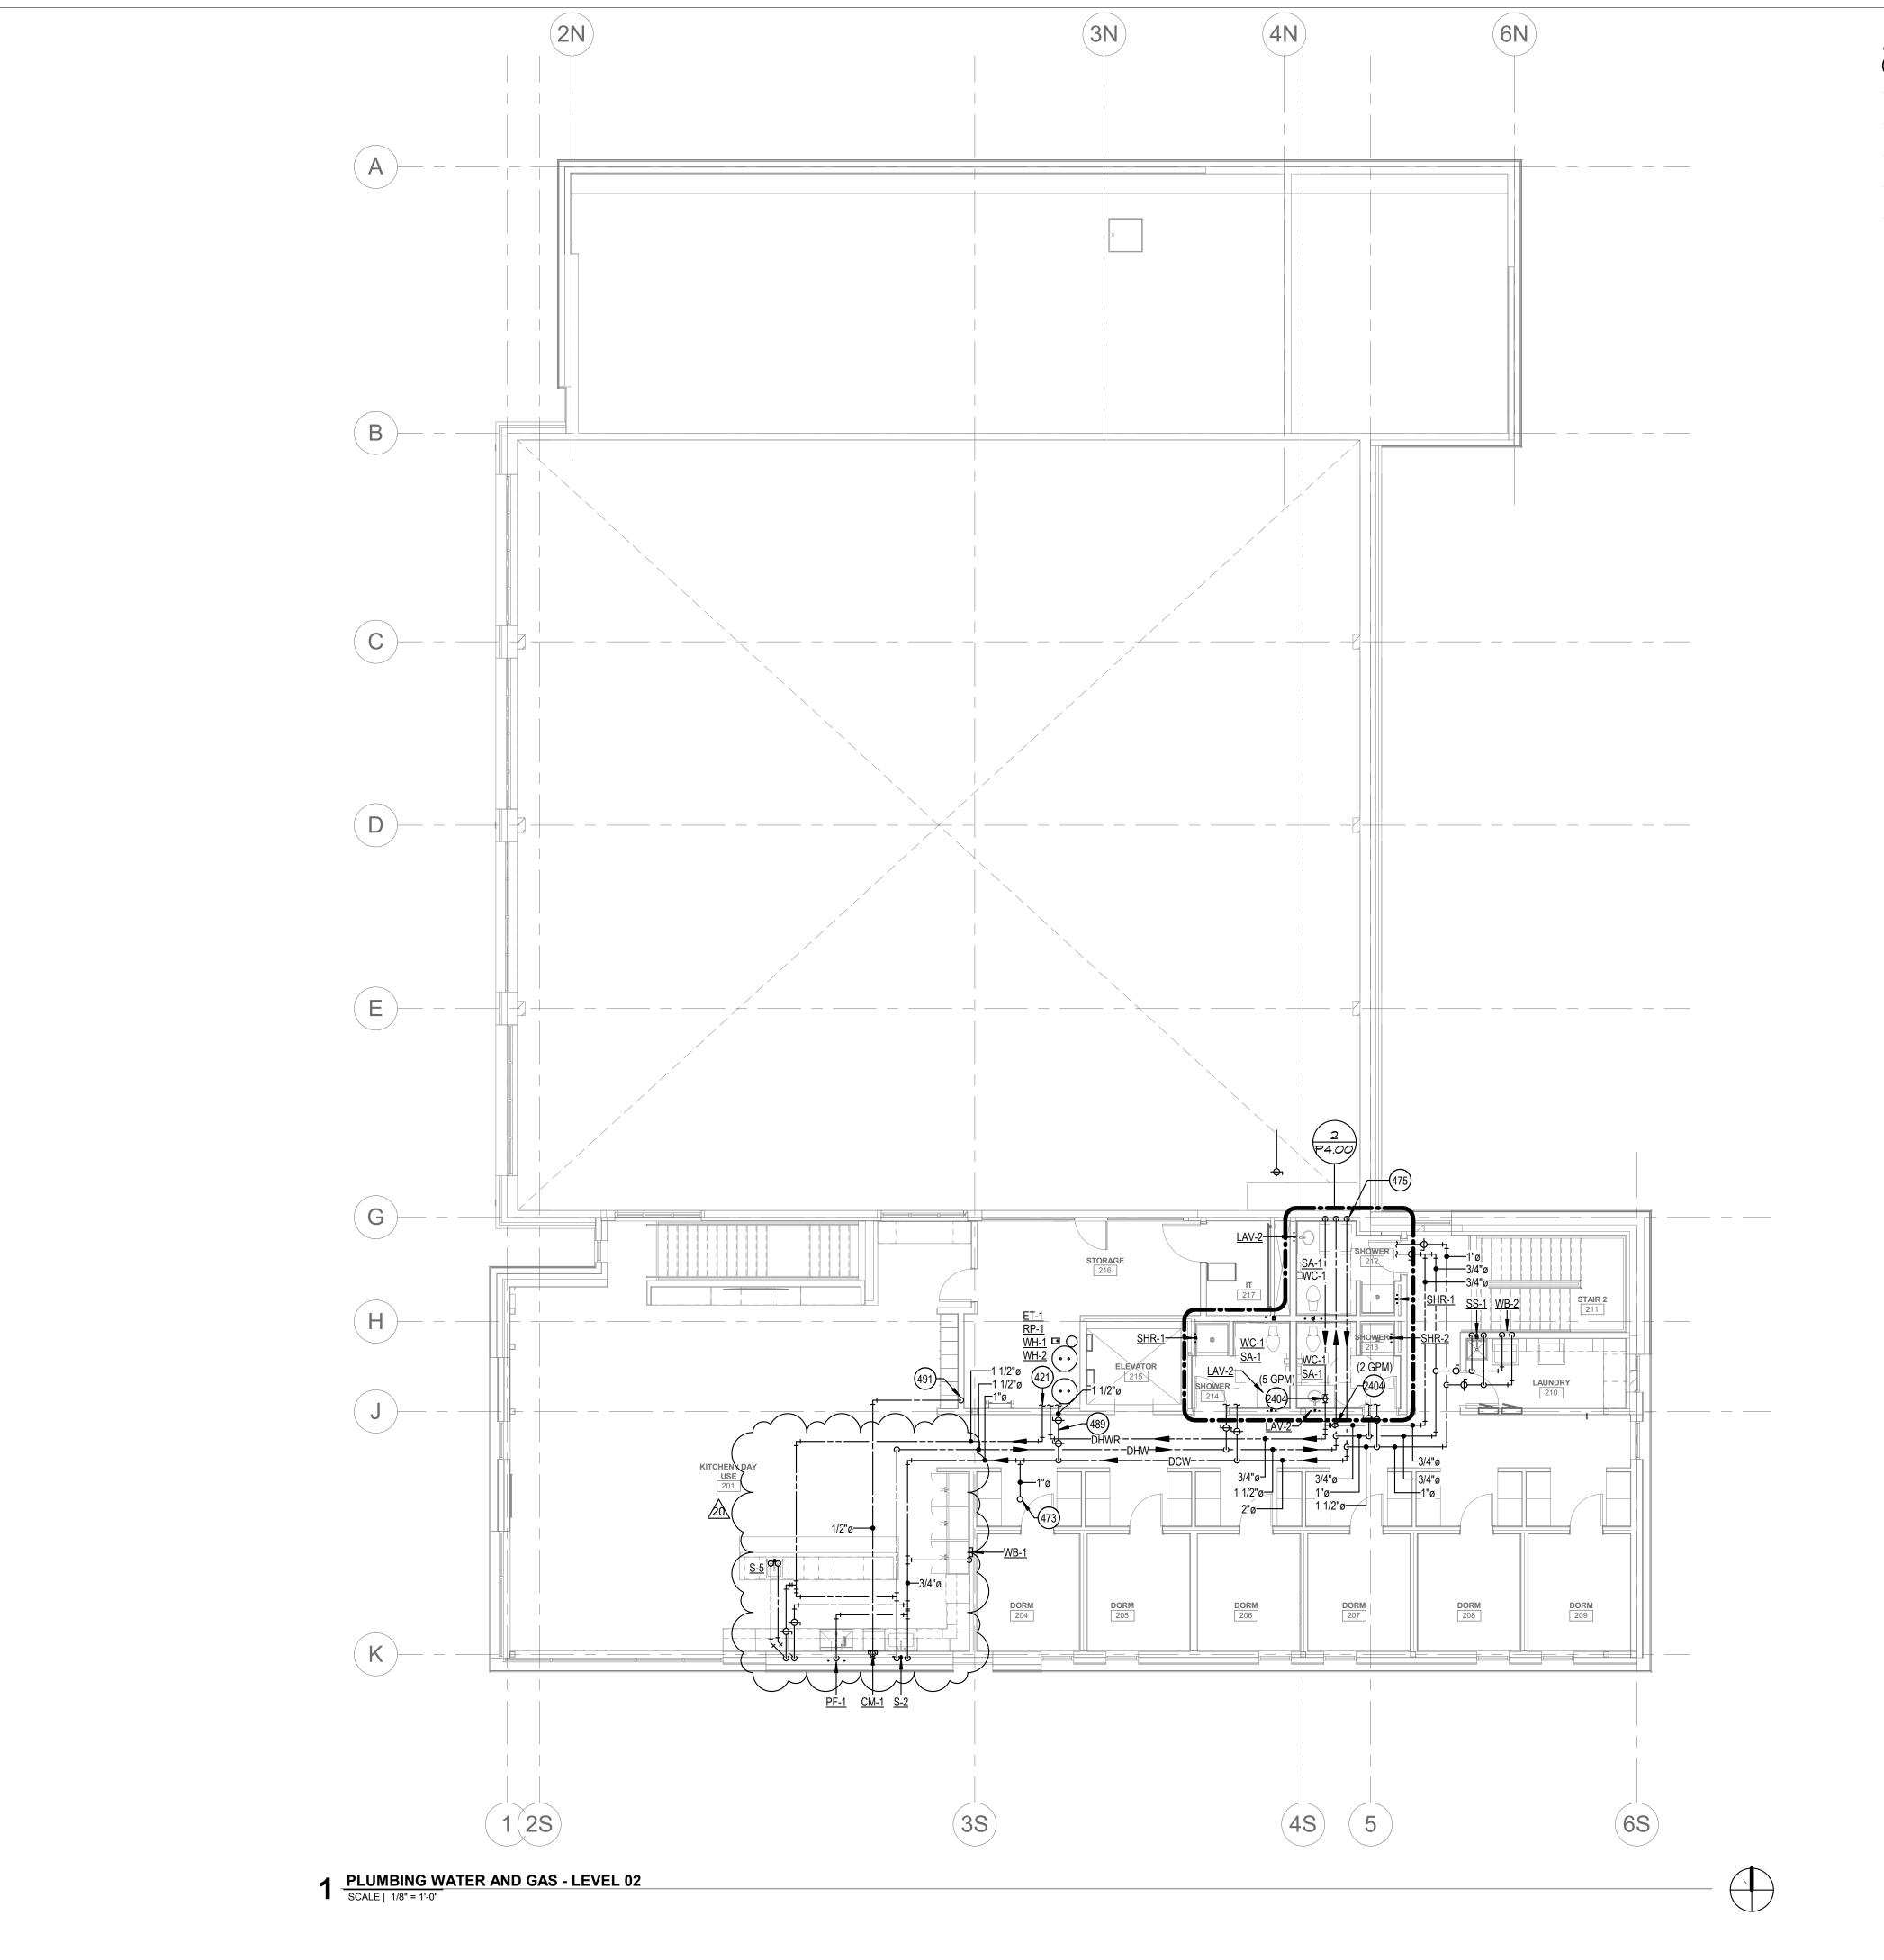

KEYED NOTES:

- # SYMBOL USED FOR CALLOUT
- 421 REFER TO WATER HEATER PIPING DETAIL WITH TWO WATER HEATERS.
- 473 1" CW LINE ROUTED UP TO ROOF HYDRANT.
- 475 2" CW, 1 1/2" HW, AND 3/4" HWR UP FROM BELOW.
- 489 PROVIDE 1-1/2" SUB-METER ON THE DOMESTIC HOT WATER SYSTEM.
- 491 1/2" CW LINE UP FROM BELOW.
- 2404 BALANCE TO SPECIFICED GPM.



1008 W Main St Boise, Idaho 83702 208.345.1800 **colearchitects.net** Copyright © 2020 Cole Architects, PLLC



ARCHITECTURE + PLANNING + DESIGN
6211 Roosevelt Way NE
Seattle, WA 98115
206.522.3820

STAMP



CONSULTANT



234 S. WHISPERWOOD WAY BOISE, IDAHO 83709 (208) 384-0585 PROJECT #19-366

PROJECT INFORMATION



KETCHUM FIRE STATION

107 SADDLE ROAD, KETCHUM ID 83353

ISSUES

PHASE CONSTRUCTION SET

DATE 6/19/2020

JOB NUMBER 18-022

 MARK
 DATE
 DESCRIPTION

 1
 7/17/20
 ASI #1

 11
 10/21/2
 ASI #4

 0
 0

 20
 1/20/21
 ASI #5

SHEET NAME

PLUMBING WATER AND GAS PLAN -LEVEL 02

SHEET NUMBER

P2.01

	Γ	1				1/\ I U	RE SCHEDULE
SYMBOL	FIXTURE DESCRIPTION	WASTE	VENT	NNECTION S TRAP	IZE CW	HW	MANUFACTURER / MODEL NUMBER / DESCRIPTION / ADDITIONAL COMMENTS
<u>CM-1</u>	WALL BOX (WATER SUPPLY TO COFFEE MAKER)				1/2		PROVIDED BY OTHERS, INSTALLED BY CONTRACTOR. PROVIDE REDUCED PRESSURE BACKFLOW PREVENTER ON SUPPLY LINE.
<u>D-1</u>	DISPOSER	2	1 1/2	1 1/2			PROVIDED BY OTHERS, INSTALLED BY CONTRACTOR.
<u>DF-1</u>	DRINKING FOUNTAIN WITH BOTTLE FILLING STATION (INTERIOR DUAL BUBBLERS) (ELECTRIC WATER COOLER) (ADA COMPLIANT) (HIGH/LOW)	1 1/2	1 1/2	1 1/2	1/2		ELKAY MODEL LZSTL8WSLK,HIGH/LOW COOLER WITH BOTTLE FILLING STATION WITH FLEXI-GUARD STREAMSAVER BUBBLER. OPERATED BY FRONT OR SIDE PUSH BARS AND BOTTLE FILLING STATION OPERATED BY SENSOR ACTIVATION WITH AUTOMATIC 30-SECOND SHUT-OFF TIMER. 115 VOLT, 4.5 AMP, 6 HERTZ, AND FILTER. PROVIDE WITH JAY R. SMITH 0834 FLOOR MOUNTED SUPPORT CARRIER.
<u>DN-1</u>	DOWN SPOUT NOZZLE (CAST IRON)	SEE PLANS					JAY R. SMITH FIGURE NUMBER 1770-NB CAST IRON NOZZLE WITH WALL FLANGE, NICKEL-BRONZE FINISH.
<u>DW-1</u> <u>ET-1</u>	DISHWASHER EXPANSION TANK				3/4	1/2	PROVIDED BY OTHERS, CONNECT WASTE TO DISPOSAL. SEE DETAIL SHEET P2.00. AMTROL THERM-X-TROL ST-25V, OR APPROVED EQUAL, NON ASME SERIES THERMAL EXPANSION ABSORBER, ANTIMICROBIAL LINER, AND 5 YEAR WARRANTY.
<u>ET-2</u>	EXPANSION TANK				3/4		AMTROL THERM-X-TROL ST-12, OR APPROVED EQUAL, NON ASME SERIES THERMAL EXPANSION ABSORBE ANTIMICROBIAL LINER, AND 5 YEAR WARRANTY.
<u>ES-1</u>	EMERGENCY EYE WASH/ SHOWER COMBINATION (FLOOR MOUNTED) (ADA COMPLIANT)	1 1/2	1 1/2	1 1/2	1 1/4	1-1/4	ACORN MODEL S2310 BARRIER FREE COMBINATION SHOWER AND EYE WASH, WITH PULL ROPE AND PUSH FLAG. ABS SHOWERHEAD AND EYE/FACE WASH. PROVIDE WITH DUST COVER AND UNIVERSAL SIGN. PROVIDE WITH FD-1 AND ACORN MODEL ET71 LEAD FREE, THERMOSTATIC MIXING VALVE OR EQUAL. 1-1/4" TEMPERED WATER.
<u>EYE-1</u>	EMERGENCY EYE WASH (WALL MOUNTED)				1/2	1/2	ACORN SAFETY MODEL S0406-CH12-BFP, WALL MOUNTED WITH DUAL 45° ANGLED HEADS AND RECOIL HO PROVIDE WITH FLIP TOP DUST COVERS, UNIVERSAL EMERGENCY SIGN, DOUBLE CHECK BACKFLOW, STAINLESS STEEL 90° WITH SHEET NIPPLE, AND ACORN MODEL ET71 THERMOSTATIC MIXING VALVE OR EQUAL, LEAD FREE, WITH TEMPERATURE GAUGE ON OUTLET.
<u>FCO</u>	FLOOR CLEANOUT	SEE PLANS					JAY R. SMITH 4020 SERIES WITH ADJUSTABLE TOP AND ABS PLUG. PROVIDE WITH FIGURE NUMBER 9912 F HEIGHT ADJUSTMENT AFTER CONCRETE POUR.
FD-1	FLOOR DRAIN (CONCRETE FLOOR)	2	2	2			JAY R. SMITH FIGURE NUMBER 2005Y-A05NB: NO-HUB OUTLET, 5" ROUND, NICKEL BRONZE FINISH, WITH ADJUSTABLE STRAINER AND TRAP PRIMER. INSTALL TOP OF DRAIN 1/8" BELOW FINISH FLOOR AND CAULK EDGE.
<u>FD-2</u>	FLOOR DRAIN (CONCRETE FLOOR)	4	2	4			JAY R. SMITH FIGURE NUMBER 2005Y-A08NB: NO-HUB OUTLET, 8" ROUND, NICKEL BRONZE FINISH, WITH ADJUSTABLE STRAINER AND TRAP PRIMER. INSTALL TOP OF DRAIN 1/8" BELOW FINISH FLOOR AND CAULK
FILL-1	FLUSH CONNECTION				3		EDGE. BUILDING CONNECTIONS MODEL 152 2.5" WALL MOUNT FLUSH OUTLET. INSTALL WITH MODEL 164 CONTROVALVE.
<u>FS-1</u>	FLOOR SINK (HALF GRATE) (10" DEEP)	4	2	4	-		JAY R. SMITH FIGURE NUMBER 3160Y-12: CAST IRON RECEPTOR, ALUMINUM DOME STRAINER, NICKEL BRONZE GRATE, AND TRAP PRIMER. INSTALL TOP OF SINK 1/8" BELOW FINISH FLOOR AND CAULK EDGE.
<u>FS-2</u>	(FOOT TRAFFIC RATED) FLOOR SINK (6" DEEP)	2	2	2			JAY R. SMITH FIGURE NUMBER 3100Y-12, CAST IRON RECEPTOR, ALUMINUM DOME STRAINER, NICKEL
GCO	(HALF GRATE, FOOT TRAFFIC RATED) GRADE CLEANOUT (NON-PAVED AREAS)	SEE PLANS					BRONZE GRATE, AND TRAP PRIMER. INSTALL TOP OF SINK 1/8" BELOW FINISH FLOOR AND CAULK EDGE. JAY R. SMITH 4220 SERIES WITH ABS PLUG.
GCO	GRADE CLEANOUT (PAVED AREAS)	SEE PLANS					JAY R. SMITH 4250 SERIES, ROUND FLANGED HOUSING WITH HEAVY DUTY CAST IRON COVER. FURNISH WITH ABS PLUG. COVER TO BE INSCRIBED "SAN".
HB-1	(VEHICULAR TRAFFIC) HOSE BIBB (EXTERIOR)				3/4		WOODFORD MODEL 67 - EXPOSED STYLE WITH MODEL 50HA BACKFLOW PREVENTER, 3/4" INLET, AND CHROME PLATED. PROVIDE WITH TEE KEY AND INSTALL AT 18" ABOVE FINISH GRADE.
HB-2	(NON-FREEZE) HOSE BIBB				3/4		WOODFORD MODEL 26 - EXPOSED STYLE WITH 3/4" INLET, AND CHROME PLATED. PROVIDE WITH METAL
<u>LAV-1</u>	(INTERIOR) LAVATORY (WALL MOUNTED) (ADA COMPLIANT)	1 1/2	1 1/2	1 1/4	1/2	1/2	WHEEL HANDLE AND WOODFORD MODEL 50HF BACKFLOW PREVENTER. KOHLER KINGSTON MODEL K-2005: VITREOUS CHINA, WALL MOUNTED, HOLES ON 4" CENTERS, AND GRID STRAINER. CHICAGO FAUCETS MODEL 420-E39VPABCP: 3-3/4" LONG, SINGLE LEVER FAUCET WITH 0.35 G AERATOR. PROVIDE WITH JAY R. SMITH FIGURE NUMBER 0700-Z SUPPORT WITH CONCEALED ARMS AND WATTS SERIES USG-B THERMOSTATIC MIXING VALVE, ASSE STANDARD 1070 LISTED, BRONZE BODY, INTEGRAL CHECK VALVES, AND SELECTABLE TEMPERATURE RANGE FROM 80°F TO 120°F. PROVIDE WITH LS-1 LAV SHIELD.
LAV-2	LAVATORY (COUNTERTOP / CABINET MOUNTED) (ADA COMPLIANT)	1 1/2	1 1/2	1 1/4	1/2	1/2	KOHLER PENNINGTON MODEL K-2196-4 VITREOUS CHINA, COUNTERTOP-MOUNTED SINK WITH HOLES ON 4 CENTERS, AND GRID STRAINER. CHICAGO FAUCETS MODEL 420-E39VPABCP: 3-3/4" LONG, SINGLE LEVER FAUCET WITH 0.35 GPM AERATOR. PROVIDE WITH WATTS SERIES LFUSG-B THERMOSTATIC MIXING VALVE ASSE STANDARD 1070 LISTED, LEAD-FREE BRASS BODY, INTEGRAL CHECK VALVES, AND SELECTABLE TEMPERATURE RANGE FROM 80°F TO 120°F. PROVIDE WITH PIPING INSULATION, TRUEBRO LAV GUARD, PLUMBEREX HANDI-SHIELD, OR EQUAL.
<u>LS-1</u>	LAVATORY SHIELD (WALL MOUNTED SHIELD FOR CONCEALING PIPING, VALVES, AND INSTANTANEOUS WATER HEATERS)						TRUEBRO "LAV SHIELD" ADA COMPLIANT, TOTAL ENCLOSURE. SINGLE-PIECE CONSTRUCTION, SLOAN OPTISHIELD ETF-529, OR APPROVED EQUAL.
<u>OD-1</u>	OVERFLOW ROOF DRAIN (LOW PROFILE DOME STYLE) (METAL GRATE)						JAY R. SMITH FIGURE NUMBER 1070Y-R-C-RS-CID WITH CAST IRON DOME GRATE AND RAIN SHIELD.
<u>OI-1</u>	OIL AND SAND INTERCEPTOR (1500 GALLONS)	4	3				PRE-CAST CONCRETE, 1500 GALLON CAPACITY, OIL AND SAND INTERCEPTOR. SEE DRAWING FOR DETAIL NO SPLIT DESIGN VAULTS WITH GASKETS BELOW FLUID LEVEL ALLOWED.
<u>PF-1</u>	POT FILLER ROOF DRAIN				1/2	1/2	PROVIDED BY OTHERS, INSTALLED BY CONTRACTOR.
<u>RD-1</u>	(LOW PROFILE DOME STYLE) (METAL GRATE)						JAY R. SMITH FIGURE NUMBER 1010Y-R-C-CID WITH CAST IRON DOME GRATE.
RH-1	ROOF HYDRANT (NON FREEZE)				1		WOODFORD MODEL RHY2-MS. NON-FREEZE STYLE WITH 3/4" HOSE CONNECTION AND INTEGRAL DOUBLE CHECK BACKFLOW PREVENTER. REQUIRES 1/8" DRAIN HOLE TO BE PIPED TO A DRAIN LOCATION.
<u>RP-1</u>	RECIRCULATION PUMP (HOT WATER RETURN SYSTEM)					3/4	BELL AND GOSSETT BRONZE MODEL NBF-22, 115 VOLT, 0.8 AMPS, 92 WATTS, AND SHALL PROVIDE 7 GPM. 10 FEET HEAD. INCLUDE 7-DAY PROGRAMMABLE ELECTRONIC TIME CLOCK WITH BATTERY BACKUP, INTERMATIC MODEL CAMBOLYE RD89. APPROVED ALTERNATE: APMSTRONIC TACO GRUNDEOS.
RPBP-1	REDUCED PRESSURE BACKFLOW PREVENTER		INDIRECT	<u> </u>			INTERMATIC MODEL GM40AVE-RD89. APPROVED ALTERNATE: ARMSTRONG, TACO, GRUNDFOS. WATTS SERIES LF009 REDUCED PRESSURE ZONE ASSEMBLY WITH QUARTER TURN BALL VALVES, BRONZ STRAINER, AND AIR GAP. BRONZE BODY CONSTRUCTION - 1/2" THRU 2", PROVIDE WITH STRAINER. LEAD FREE. 2 1/2" THRU 10" 957 SERIES. SEE NOTE 6.
<u>S-1</u>	SINK - SINGLE COMPARTMENT (17" X 20" X 6 1/2") (ADA COMPLIANT)	2	1 1/2	1 1/2	1/2	1/2	ELKAY LUSTERTONE MODEL LRAD-1720: 6-1/2" DEEP STAINLESS STEEL SINK. ELKAY MODEL LK-3001 SING LEVER FAUCET WITH 1.5 GPM AERATOR, SWING SPOUT, AND HOSE SPRAY. PROVIDE WITH ELKAY MODEL LK-35 CHROME PLATED TAILPIECE AND STAINLESS STEEL BASKET, AND WATTS SERIES USG-B THERMOSTATIC MIXING VALVE, ASSE STANDARD 1070 LISTED, BRONZE BODY, INTEGRAL CHECK VALVES, AND SELECTABLE TEMPERATURE RANGE FROM 80°F TO 120°F.
<u>S-2</u>	KITCHEN SINK - DOUBLE COMPARTMENT (14" X 14" X 6 1/2" - EACH) (ADA COMPLIANT)	2	1 1/2	1 1/2	1/2	1/2	ELKAY LUSTERTONE MODEL LRAD-3319: 6-1/2" DEEP STAINLESS STEEL SINK. ELKAY MODEL LK-3001 SINGL LEVER FAUCET WITH 1.5 GPM AERATOR, SWING SPOUT, AND HOSE SPRAY. PROVIDE WITH ELKAY MODEL LK-35 CHROME PLATED TAILPIECE AND STAINLESS STEEL BASKET, AND WATTS SERIES USG-B THERMOSTATIC MIXING VALVE, ASSE STANDARD 1070 LISTED, BRONZE BODY, INTEGRAL CHECK VALVES, AND SELECTABLE TEMPERATURE RANGE FROM 80°F TO 120°F.
<u>S-3</u>	PREP SINK - SINGLE COMPARTMENT (15" X 15" X 7")	2	1 1/2	1 1/2	1/2	1/2	ELKAY LUSTERTONE MODEL BLR150C: 7" DEEP, STAINLESS STEEL SINK WITH ELKAY MODEL LKD2223, DL HANDLE MIXING FAUCET WITH HIGH GOOSENECK SPOUT AND 1.5 GPM AERATOR. PROVIDE ELKAY MODEL LK-35 CHROME PLATED TAILPIECE AND STAINLESS STEEL BASKET.
<u>\$4</u>	BOOT WASH HAND SINK (17" X 15"/X 5-1/2")	2	1/2	11/2	1/2	7/2	REGENCY 600HS17: 17"X15", STAINLESS STEEL SINK WITH INTEGRATED GOOSENECK FAUCET. PROVIDE CHROME PLATED TAIL PIECE AND STAINLESS STEEL BASKET
<u>S-5</u>	PREP SINK - SINGLE COMPARTMENT (15" X 15" X 7")	2	1 1/2	1 1/2	1/2	1/2	ELKAY LUSTERTONE MODEL BLR150C: 7" DEEP, STAINLESS STEEL SINK WITH ELKAY MODEL LKD2223, DL HANDLE MIXING FAUCET WITH HIGH GOOSENECK SPOUT AND 1.5 GPM AERATOR. PROVIDE ELKAY MODEL LK-35 CHROME PLATED TAILPIECE AND STAINLESS STEEL BASKET.
							BEST BATH SYSTEMS MODEL LCS4238A5T, WITH A 1/2" THRESHOLD, ONE PIECE CLASSIC TILE FINISH, SHOWER MODULE SHALL BE CONSTRUCTED OF GELCOAT/FIBERGLASS WITH FULL INTEGRAL PLYWOOD
SHR-1	SHOWER (42" X 38" X 79") (INSERT STYLE) (ADA COMPLIANT)	2	1 1/2	2	1/2	1/2	BACKING IN ALL THE WALLS FOR STRENGTH AND CUSTOMIZED INSTALLATION OF ACCESSORIES. PRE-LEVELED FLOOR FOR EASY INSTALLATION. NOTE LOW THRESHOLD DESIGN REQUIRES 8" X 8" BLOCK OUT CENTERED AT DRAIN PIPE LOCATION. ACCESSORIES: (1) 12" S.S. GRAB BAR, (1) 24" S.S. GRAB BAR, (1) 27" S.S. GRAB BAR, (1) SURFACE MOUNTE SOAP DISH (1) SIOUX CHIEF CAULKLESS BRASS DRAIN #827-2B WITH CHROME SCREEN, (1) TWS COLLAPSIBLE 'T' SHAPED WATER RETAINER. ALSO INCLUDE MOEN MODEL 8346EP15, 1.5 GPM ECO-PERFORMANCE
							HANDHELD SHOWER SYSTEM, POSI-TEMP, WITHOUT VOLUME CONTROL, ADJUSTABLE TEMPERATURE LIN STOP, 1/4 TURN STOPS, 4 PORT CYCLING VALVE, HANDHELD SHOWER, 69" DOUBLE SWIVEL HOSE ASSEM 30" SLIDE BAR, VACUUM BREAKER, DROP ELL, AND STAINLESS STEEL CURTAIN ROD. PROVIDE TAPE-WEIGHTED SHOWER CURTAIN.

			CC	NNECTION S	IZE		
SYMBOL	FIXTURE DESCRIPTION	WASTE	VENT	TRAP	CW	HW	MANUFACTURER / MODEL NUMBER / DESCRIPTION / ADDITIONAL COMMENTS
SHR-2	SHOWER (42" X 38" X 79") (INSERT STYLE) (ADA COMPLIANT)	2	1 1/2	2	1/2	1/2	BEST BATH SYSTEMS MODEL LCS4238A5T, WITH A 1/2" THRESHOLD, ONE PIECE CLASSIC TILE FINISH, SHOWER MODULE SHALL BE CONSTRUCTED OF GELCOAT/FIBERGLASS WITH FULL INTEGRAL PLYWOOD BACKING IN ALL THE WALLS FOR STRENGTH AND CUSTOMIZED INSTALLATION OF ACCESSORIES. PRE-LEVELED FLOOR FOR EASY INSTALLATION. NOTE LOW THRESHOLD DESIGN REQUIRES 8" X 8" BLOCK OUT CENTERED AT DRAIN PIPE LOCATION. ACCESSORIES: (1) 12" S.S. GRAB BAR, (1) 24" S.S. GRAB BAR, (1) 27" S.S. GRAB BAR, (1) 32"X16" PHENOLIC LAB, ADA COMPLIANT, SWING-DOWN SEAT WITH LEGS, (1) SURFACE MOUNTED SOAP DISH (1) SIOUX CHIEF CAULKLESS BRASS DRAIN #827-2B WITH CHROME SCREEN, (1) TWS COLLAPSIBLE 'T' SHAPED WATER RETAINER. ALSO INCLUDE MOEN MODEL 8346EP15, 1.5 GPM ECO-PERFORMANCE HANDHELD SHOWER SYSTEM, POSI-TEMP, WITHOUT VOLUME CONTROL, ADJUSTABLE TEMPERATURE LIMIT STOP, 1/4 TURN STOPS, 4 PORT CYCLING VALVE, HANDHELD SHOWER, 69" DOUBLE SWIVEL HOSE ASSEMBLY, 30" SLIDE BAR, VACUUM BREAKER, DROP ELL, AND STAINLESS STEEL CURTAIN ROD. PROVIDE TAPE-WEIGHTED SHOWER CURTAIN.
<u>SS-1</u>	SERVICE SINK (24" X 24" X 10") (FLOOR MOUNTED)	3	2	3	1/2	1/2	ACORN TERRAZZO-WARE MODEL TRH-242410: PROVIDE AND INSTALL WITH STAINLESS STEEL BUMPER GUARD, DRAIN GASKET, CHROME FAUCET, 36" HOSE AND WALL HANGER, MOP HANGER, AND 2 SIDE STAINLESS STEEL WALL GUARD.
<u>TD-1</u>	TRENCH DRAIN (10" WIDE) (HEAVY TRAFFIC RATED)	4	2	4	-		JAY R. SMITH FIGURE NUMBER 9812 10" WIDE TRENCH DRAIN SYSTEM. SLOPE DRAIN SYSTEM WITH INTEGRAL METAL RAIL, PROVIDE WITH END CAPS, OUTLETS, CATCH BASIN (9812G-880-CB24-BP), AND HEAVY DUTY (CLASS C) GALVANIZED STEEL BAR GRATE (MODEL 9812-G). REFER TO ARCHITECTURAL PLAN FOR EXACT LENGTH REQUIREMENTS.
<u>TP-1</u>	TRAP PRIMER (PRESSURE ACTIVATED) (1 TO 4 TRAPS)				1/2"		PRECISION PLUMBING PRODUCTS MODEL CPO-500 WITH DU DISTRIBUTION UNIT IF REQUIRED FOR SERVING MORE THAN ONE TRAP. APPROVED ALTERNATES: MIFAB, SIOUX CHIEF, SLOAN, AND ZURN
<u>TP-1</u>	TRAP PRIMER (FLUSH VALVE PRIMER) (1 TRAP)				1/2"		PRECISION PLUMBING PRODUCTS MODEL FVP-1VB WITH VACUUM BREAKER. TRAP PRIMER TUBING SHALL BE INSTALLED OFF BACK OF FLUSH VALVE. APPROVED ALTERNATES: MIFAB, SIOUX CHIEF, SLOAN, AND ZURN
<u>TP-1</u>	TRAP PRIMER (LAVATORY TAILPIECE PRIMER) (1 TRAP)				1/2"		DEARBORN BRASS 1-1/2" TRAP PRIMER TAILPIECE WITH COMPRESSION CONNECTION.
<u>UF-1</u>	UTILITY FAUCET				1/2	1/2	ACORN UTILITY FAUCET OPTION KFC: BRASS CONSTRUCTION WITH ROUGH CHROME FINISH, TWO HANDLES 8" CENTERSET, WALL MOUNTED, PAIL HOOK WITH 9-1/4" REACH, WALL BRACE, VACUUM BREAKER, AND 3/4" THREADED SPOUT.
UF-2	UTILITY FAUCET				3/4	3/4	T&S BRASS AND BRONZE WORKS MV-0771-11N MIXING VALVE. CHROME PLATED WITH TWO HANDLES, 6" CENTER SET, WALL MOUNTED, PAIL HOOK WITH 9-1/4" REACH, WALL BRACE, VACUUM BREAKER, AND 3/4" THREADED SPOUT. PROVIDE WITH 50' HOSE, REAR TRIGGER STAINLESS STEEL WATER GUN & HOSE RACK.
<u>US-1</u>	UTILITY SINK (23" X 21" X 13") (FLOOR MOUNTED)	2	1 1/2	1 1/2	1/2	1/2	FIAT MOLDED STONE MODEL FL-1. PROVIDE WITH A-1 DECK CHROME FAUCET, DRAIN WITH STOPPER, AND EASY LEVELING LEGS.
<u>WB-1</u>	WALL BOX (WATER SUPPLY TO ICE MAKER)		-		1/2		OATEY FIREMASTER MODEL 39121 WITH FACEPLATE, ADJUSTABLE METAL SUPPORT BRACKET, AND WATER HAMMER ARRESTOR. FIRE-RATED, LOW LEAD, OR APPROVED EQUAL.
<u>WB-2</u>	WALL BOX (SUPPLY TO AND DRAIN FROM WASHING MACHINE)	2	1 1/2	2	1/2	1/2	OATEY FIREMASTER MODEL 38478 WITH ADJUSTABLE METAL SUPPORT BRACKET, AND WATER HAMMER ARRESTORS. FIRE RATED, OR APPROVED EQUAL.
<u>WC-1</u>	WATER CLOSET (DUAL FLUSH TANK) (FLOOR MOUNTED) (COMFORT HEIGHT / ADA)	4	2	INT.	1/2		KOHLER HIGHLINE MODEL K-3989, DUAL FLUSH, FLOOR MOUNTED, GRAVITY FLUSH TANK WITH ELONGATED BOWL, 1.6 GPF OR 1.1 GPF. PROVIDE KOHLER LUSTRA MODEL K-4650 ELONGATED, OPEN FRONT SEAT WITH CHECK HINGE AND COVER.
WCO	WALL CLEANOUT	SEE PLANS	-				JAY R. SMITH 4472T SERIES WITH CAST BRONZE TAPER THREAD PLUG, STAINLESS STEEL ROUND COVER, AND A STAINLESS STEEL VANDAL PROOF SCREW.
<u>WH-1</u>	WATER HEATER (119 GALLON UPRIGHT MODEL) (208V-3Ø ELECTRIC)				SEE PLANS	SEE PLANS	BRADFORD WHITE MODEL E32-120R-3, SIMULTANEOUS TRIPLE ELEMENTS, (3) 6 KW, 208V/3Ø, 28" DIAMETER, 63" TALL, WITH TOP CONNECTIONS. PROVIDE WITH WALL BRACKET SUPPORT AND SEISMIC STRAP.
<u>WH-2</u>	WATER HEATER (119 GALLON UPRIGHT MODEL) (208V-3Ø ELECTRIC)				SEE PLANS	SEE PLANS	BRADFORD WHITE MODEL E32-120R-3, SIMULTANEOUS TRIPLE ELEMENTS, (3) 6 KW, 208V/3Ø, 28" DIAMETER, 63" TALL, WITH TOP CONNECTIONS. PROVIDE WITH WALL BRACKET SUPPORT AND SEISMIC STRAP.
<u>WH-3</u>	WATER HEATER (50 GALLON UPRIGHT MODEL) (208V-1Ø ELECTRIC)				SEE PLANS	SEE PLANS	BRADFORD WHITE MODEL LE250S3-1NCZZ, NON-SIMULTANEOUS DUAL ELEMENTS, (2) 4.5 KW, 208V/1Ø, 22" DIAMETER, 47" TALL, WITH TOP CONNECTIONS. PROVIDE WITH WALL BRACKET SUPPORT AND SEISMIC STRAP.
NOTES:						<u> </u>	
1.	ALL ADA COMPLIANT FIXTURES MUST COM	PLY WITH ICO	C/ANSI A117.	1. SEE ARCH	HITECTURAL	PLANS FOR	HANDICAPPED FIXTURE DESIGNATIONS, LOCATIONS, CLEARANCES, AND MOUNTING HEIGHTS.
2.	ALL EXPOSED HW PIPING, CW PIPING, AND MOLDED CLOSED CELL VINYL INSULATION				IES AND ALL	ADA COMPL	IANT SINKS MUST BE INSULATED TO PREVENT INJURY. REFER TO ARCHITECTURAL PLANS. INSULATE WITH
3.	PROVIDE P-TRAP PRIMERS FOR ALL FLOOF	R DRAINS ANI	D FLOOR SIN	IKS. PROVIE	DE A BALL TY	PE SHUT-OF	F VALVE UPSTREAM OF PRIMER VALVE. SEE SPECIFICATIONS.
4.	SEE SPECIFICATIONS FOR ALTERNATE APP	PROVED MAN	UFACTURER	RS.			

GAS	SIZING CH	ART (METE	R #1)					
SYMBOL	INPUT (MBH)	RUNOUT SIZE (2-PSI) (INCHES)	EQUIPMENT CONNECTION SIZES (7" WC) (INCHES)					
B-5 (RADIANT FLOOR SYSTEM)	399.0	1/2	3/4					
B-6 (RADIANT FLOOR SYSTEM)	399.0	1/2	3/4					
B-7 (RADIANT FLOOR SYSTEM)	399.0	1/2	3/4					
B-8 (RADIANT FLOOR SYSTEM)	399.0	1/2	3/4					
RADIANT HEATERS 200.0 MBH (X5)	1000.0	1/2 (EACH)	3/4					
GAS GENERATOR	1511.0	1	1					
TOTAL	4107.0	EQUIVALENT LENGTH = 150 FT PRESSURE = 2-PSI MAIN SIZE = 1-1/2"Ø						

COFFEE MAKER ICE MAKER

EVAPORATIVE COOLER NON-POTABLE LOOP AT APPARATUS BAY

NOTE: GAS SIZES TO EQUIPMENT ARE AS NOTED IN SCHEDULE ABOVE. ROUTE NOTED (2-PSI) GAS LINE TO GAS EQUIPMENT. PROVIDE GAS COCK AND PRESSURE REGULATOR (2-PSI - 7" WC) SIZED FOR GAS LOAD AT EACH PIECE OF EQUIPMENT. VENT TO ATMOSPHERE PER MANUFACTURERS RECOMMENDATIONS. ROUTE NOTED (7" WC) GAS LINE TO GAS FIRED EQUIPMENT WITH GAS COCK AND FLEX CONNECTOR AT UNIT.

GAS	GAS SIZING CHART (METER #2)											
SYMBOL	INPUT (MBH)	RUNOUT SIZE (2-PSI) (INCHES)	EQUIPMENT CONNECTION SIZES (7" WC) (INCHES)									
B-1 (SNOW MELT SYSTEM)	399.0	1/2	3/4									
B-2 (SNOW MELT SYSTEM)	399.0	1/2	3/4									
B-3 (SNOW MELT SYSTEM)	399.0	1/2	3/4									
(SNOW MELT SYSTEM)	399.0	1/2	3/4									
TOTAL	1596.0	EQUIVALENT LENGTH = 50 FT PRESSURE = 2-PSI MAIN SIZE = 1"Ø										

NOTE: GAS SIZES TO EQUIPMENT ARE AS NOTED IN SCHEDULE ABOVE. ROUTE NOTED (2-PSI) GAS LINE TO GAS EQUIPMENT. PROVIDE GAS COCK AND PRESSURE REGULATOR (2-PSI - 7" WC) SIZED FOR GAS LOAD AT EACH PIECE OF EQUIPMENT. VENT TO ATMOSPHERE PER MANUFACTURERS RECOMMENDATIONS. ROUTE NOTED (7" WC) GAS LINE TO GAS FIRED EQUIPMENT WITH GAS COCK AND FLEX CONNECTOR AT UNIT. SEE GAS CONNECTION DETAILS ON SHEET



1008 W Main St Boise, Idaho 83702 208.345.1800 **colearchitects.net** Copyright © 2020 Cole Architects, PLLC



6211 Roosevelt Way NE Seattle, WA 98115 206.522.3820

STAMP



CONSULTANT



234 S. WHISPERWOOD WAY BOISE, IDAHO 83709 (208) 384-0585 PROJECT #19-366

PROJECT INFORMATION



KETCHUM FIRE STATION

107 SADDLE ROAD, KETCHUM ID 83353

ISSUES

PHASE	CONSTRUCTION S
DATE	6/19/20
JOB NUMBER	18-0


MARK	DATE	DESCRIPTION
2	8/17/20	ASI #2
9	12/28/2	RFI #77R1
	0	
11	10/21/2	ASI #4
	0	
20	1/20/21	ASI #5

SHEET NAME

PLUMBING FIXTURE SCHEDULE

SHEET NUMBER

P6.00

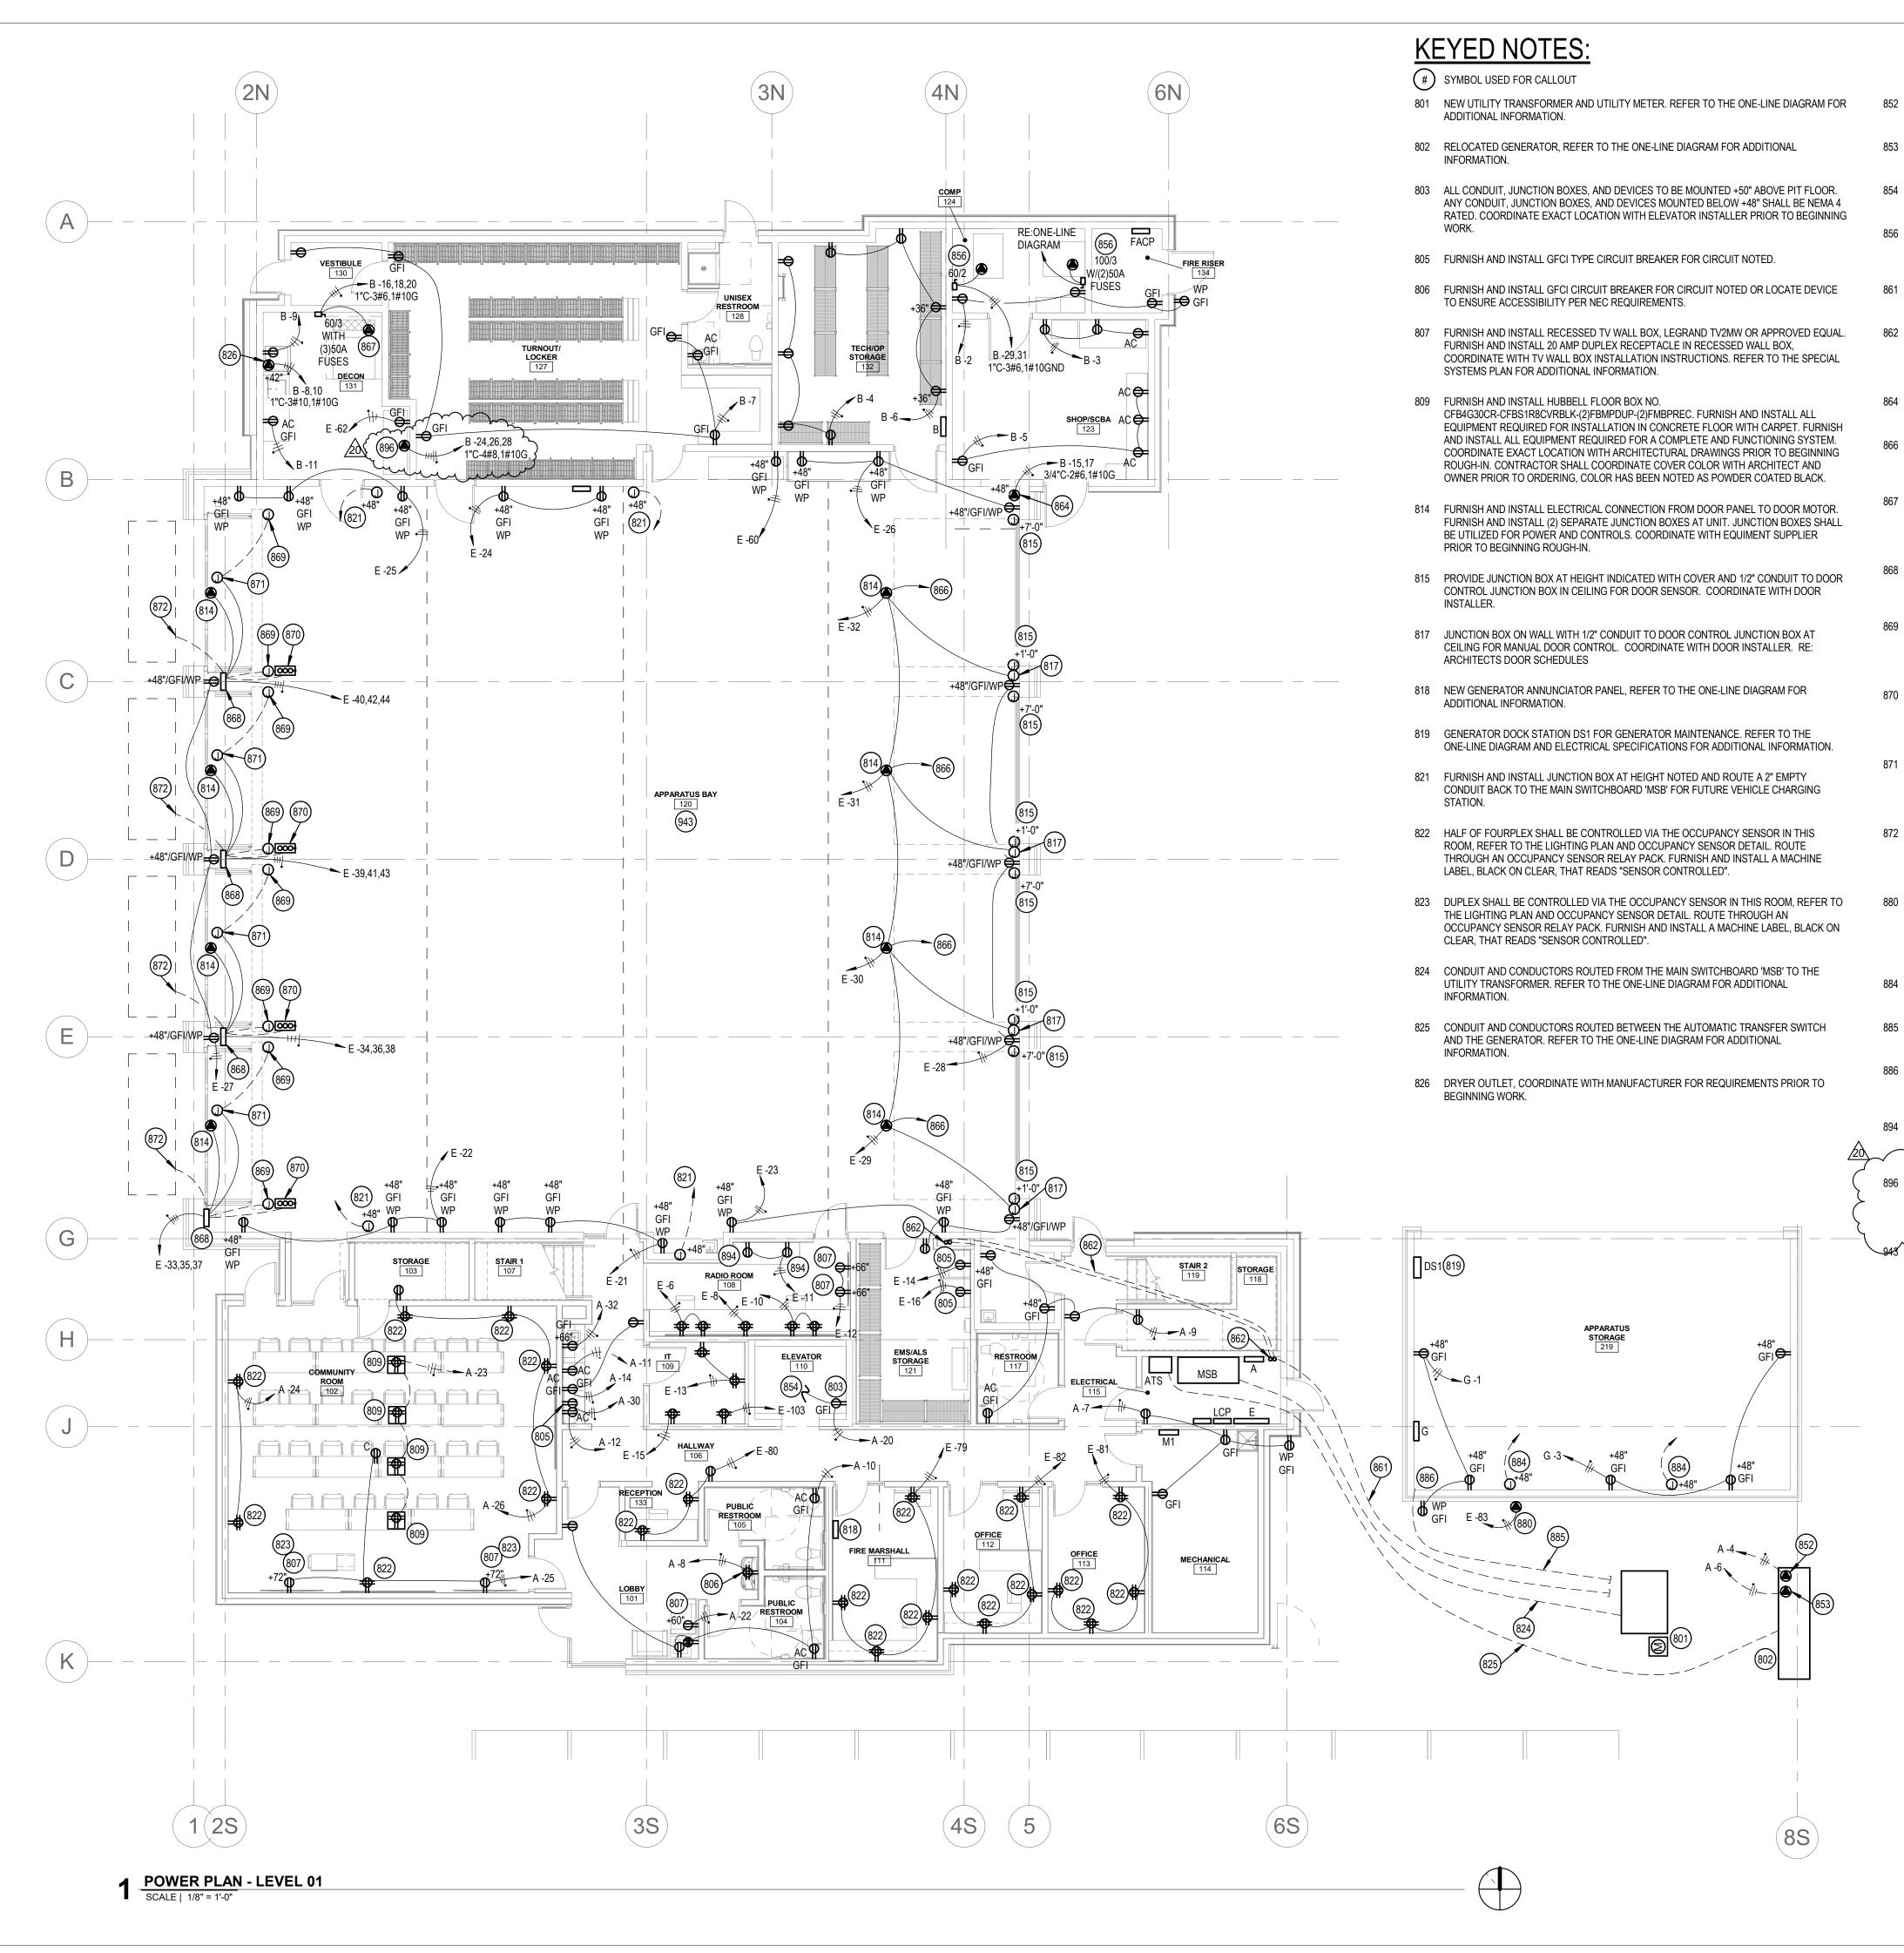

- 852 ELECTRICAL CONNECTION FOR GENERATOR BATTERY CHARGER. COORDINATE WITH THE EXISTING EQUIPMENT PRIOR TO BEGINNING WORK.
- 853 ELECTRICAL CONNECTION FOR THE GENERATOR HEATER. COORDINATE WITH THE EXISTING EQUIPMENT PRIOR TO BEGINNING WORK.
- 854 EXTEND AND CONNECT TO ELEVATOR HOISTWAY LIGHTS AND RECEPTACLES. REFER TO POWER PLANS AND LIGHTING PLANS FOR CONTINUATION.
- 856 FURNISH AND INSTALL ELECTRICAL CONNECTION FOR COMPRESSOR. COORDINATE DISCONNECT LOCATION WITH EQUIPMENT INSTALLER TO MAINTAIN REQUIRED
- 861 (2) 4" EMPTY CONDUITS WITH PULLSTRING FROM ELECTRICAL ROOM TO THIS APPROXIMATE LOCATION FOR FUTURE SOLAR SYSTEM. CAP AND MARK LOCATIONS.
- ROUTE (2) 4" EMPTY CONDUITS FROM THE ELECTRICAL ROOM, OVER TO MECHANICAL CHASE AND UP THROUGH ROOF FOR FUTURE SOLAR PANELS. INSTALL CAP ON CONDUITS AND MAKE WATER-TIGHT. COORDINATE ROUTING WITH OTHER TRADES PRIOR TO
- FURNISH AND INSTALL NEMA 6-50R RECEPTACLE FOR PORTABLE WELDER AT HEIGHT NOTED. COORDINATE PLUG CONFIGURATION WITH OWNER PRIOR TO BEGINNING WORK.
- FURNISH AND INSTALL 3/4" CONDUIT FROM CONTROL JUNCTION BOX TO VEHICLE EXHAUST SYSTEM CONTROL BOX. COORDAINTE WITH EQUIPMENT AND EQUIPMENT INSTALLER PRIOR TO BEGINNING WORK.
- 867 FURNISH AND INSTALL ELECTRICAL CONNECTION FOR EXTRACTOR. COORDINATE WITH OWNER AND EQUIPMENT SUPPLIER FOR EXACT ELECTRICAL REQUIREMENTS PRIOR TO BEGINNING WORK. FURNISH AND INSTALL ALL ELECTRICAL REQUIRED FOR A COMPLETE AND FUNCTIONING SYSTEM.
- FURNISH AND INSTALL ELECTRICAL CONNECTION TO MAIN FOUR FOLD DOOR PANEL.

 COORDINATE EXACT LOCATION AND REQUIREMENTS WITH EQUIPMENT SUPPLIER PRIOR

 TO BEGINNING WORK.
- 869 FURNISH AND INSTALL 1/2" CONDUIT FROM DOOR PANEL TO PHOTOSENSOR. PHOTO SENSOR MOUNTED ON METAL PEDESTAL. REFER TO THE ARCHITECTURAL DRAWINGS FOR METAL PEDESTAL LOCATION. COORDINATE EXACT LOCATION AND REQUIREMENTS WITH EQUIPMENT SUPPLIER PRIOR TO BEGINNING WORK.
- 870 FURNISH AND INSTALL 1/2" CONDUIT FROM DOOR PANEL TO OPEN/CLOSE/STOP PUSHBUTTON. PUSHBUTTON MOUNTED ON METAL PEDESTAL. REFER TO THE ARCHITECTURAL DRAWINGS FOR METAL PEDESTAL LOCATION. COORDINATE EXACT LOCATION AND REQUIREMENTS WITH EQUIPMENT SUPPLIER PRIOR TO BEGINNING WORK.
- FURNISH AND INSTALL 1/2" CONDUIT FROM DOOR PANEL TO DOOR SENSOR. DOOR SENSOR MOUNTED ABOVE DOORS. REFER TO THE ARCHITECTURAL DRAWINGS FOR METAL PEDESTAL LOCATION. COORDINATE EXACT LOCATION AND REQUIREMENTS WITH EQUIPMENT SUPPLIER PRIOR TO BEGINNING WORK.
- FURNISH AND INSTALL 3/4" CONDUIT FROM DOOR PANEL TO EXTERIOR FLOOR LOOP MODULE AND EXTERIOR FLOOR LOOP. COORDINATE EXACT LOCATION AND REQUIREMENTS WITH EQUIPMENT SUPPLIER PRIOR TO BEGINNING WORK. FURNISH AND INSTALL ALL EQUIPMENT AND WIRING FOR A COMPLETE AND FUNCTIONING SYSTEM.
- 880 FURNISH AND INSTALL ELECTRICAL CONNECTION TO GAS SOLENOID VALVE FOR SHUT DOWN OF GAS TO BBQ UPON SIGNAL FROM THE ALARM INTERFACE PANEL. COORDINATE LOCATION WITH PLUMBING CONTRACTOR. ROUTE CIRCUIT THROUGH THE ALARM INTERFACE PANEL. REFER TO THE ALARM INTERFACE PANEL DETAIL FOR ADDITIONAL INFORMATION
- FURNISH AND INSTALL JUNCTION BOX AT HEIGHT NOTED AND ROUTE A 1-1/2" EMPTY CONDUIT BACK TO PANELBOARD 'G' FOR FUTURE VEHICLE CHARGING STATION.
- 885 (1) 4" EMPTY CONDUITS WITH PULLSTRING FROM THE APPARATUS STORAGE BUILDING TO THIS APPROXIMATE LOCATION FOR FUTURE SOLAR SYSTEM. CAP AND MARK LOCATIONS.
- ROUTE (1) 4" EMPTY CONDUIT FROM THE APPARATUS STORAGE BUILDING UP THROUGH ROOF FOR FUTURE SOLAR PANELS. INSTALL CAP ON CONDUITS AND MAKE WATER-TIGHT COORDINATE ROUTING WITH OTHER TRADES PRIOR TO BEGINNING WORK.
- 4 MOUNT RECEPTACLE ABOVE COUNTER AND HORIZONTALLY TO FIT BETWEEN WINDOW AND MILLWORK. COORDINATE WITH ARCHITECTURAL DRAWINGS AND ELEVATIONS PRIOR
- Y Y Y Y Y Y Y Y Y Y Y Y 896 FURNISH AND INSTALL OUTLET FOR FUTURE GEAR DRYER. COORDINATE EXACT LOCATION AND EQUIPMENT CONNECTION WITH OWNER PRIOR TO BEGINNING WORK.
 - ALL LOW-VOLTAGE CONDUCTORS AND CABLING ROUTED IN OR THROUGH THE APPARATUS BAY SHALL BE ROUTED IN CONDUIT, NO EXCEPTIONS. ROUTE CONDUIT UP AS HIGH AS POSSIBLE AND TIGHT TO STRUCTURE. COORDINATE WITH OTHER TRADES PRIOR TO BEGINNING WORK.

FURNISH AND INSTALL ALL ELECTRICAL REQUIRED FOR A COMPLETE AND FUNCTIONING



1008 W Main St Boise, Idaho 83702 208.345.1800 **colearchitects.net** Copyright © 2020 Cole Architects, PLLC



ARCHITECTURE + PLANNING + DESIGN

6211 Roosevelt Way NE Seattle, WA 98115 206.522.3820

STAMP



CONSULTANT



234 S. WHISPERWOOD WAY BOISE, IDAHO 83709 (208) 384-0585 PROJECT #19-366

PROJECT INFORMATION



KETCHUM FIRE STATION

107 SADDLE ROAD, KETCHUM ID 83353

ISSUES

PHASECONSTRUCTION SETDATE6/19/2020JOB NUMBER18-022

MARK DATE DESCRIPTION

11 10/21/2 ASI #4
0


20 1/20/21 ASI #5

SHEET NAME

POWER PLAN -LEVEL 01

SHEET NUMBER

E5.01

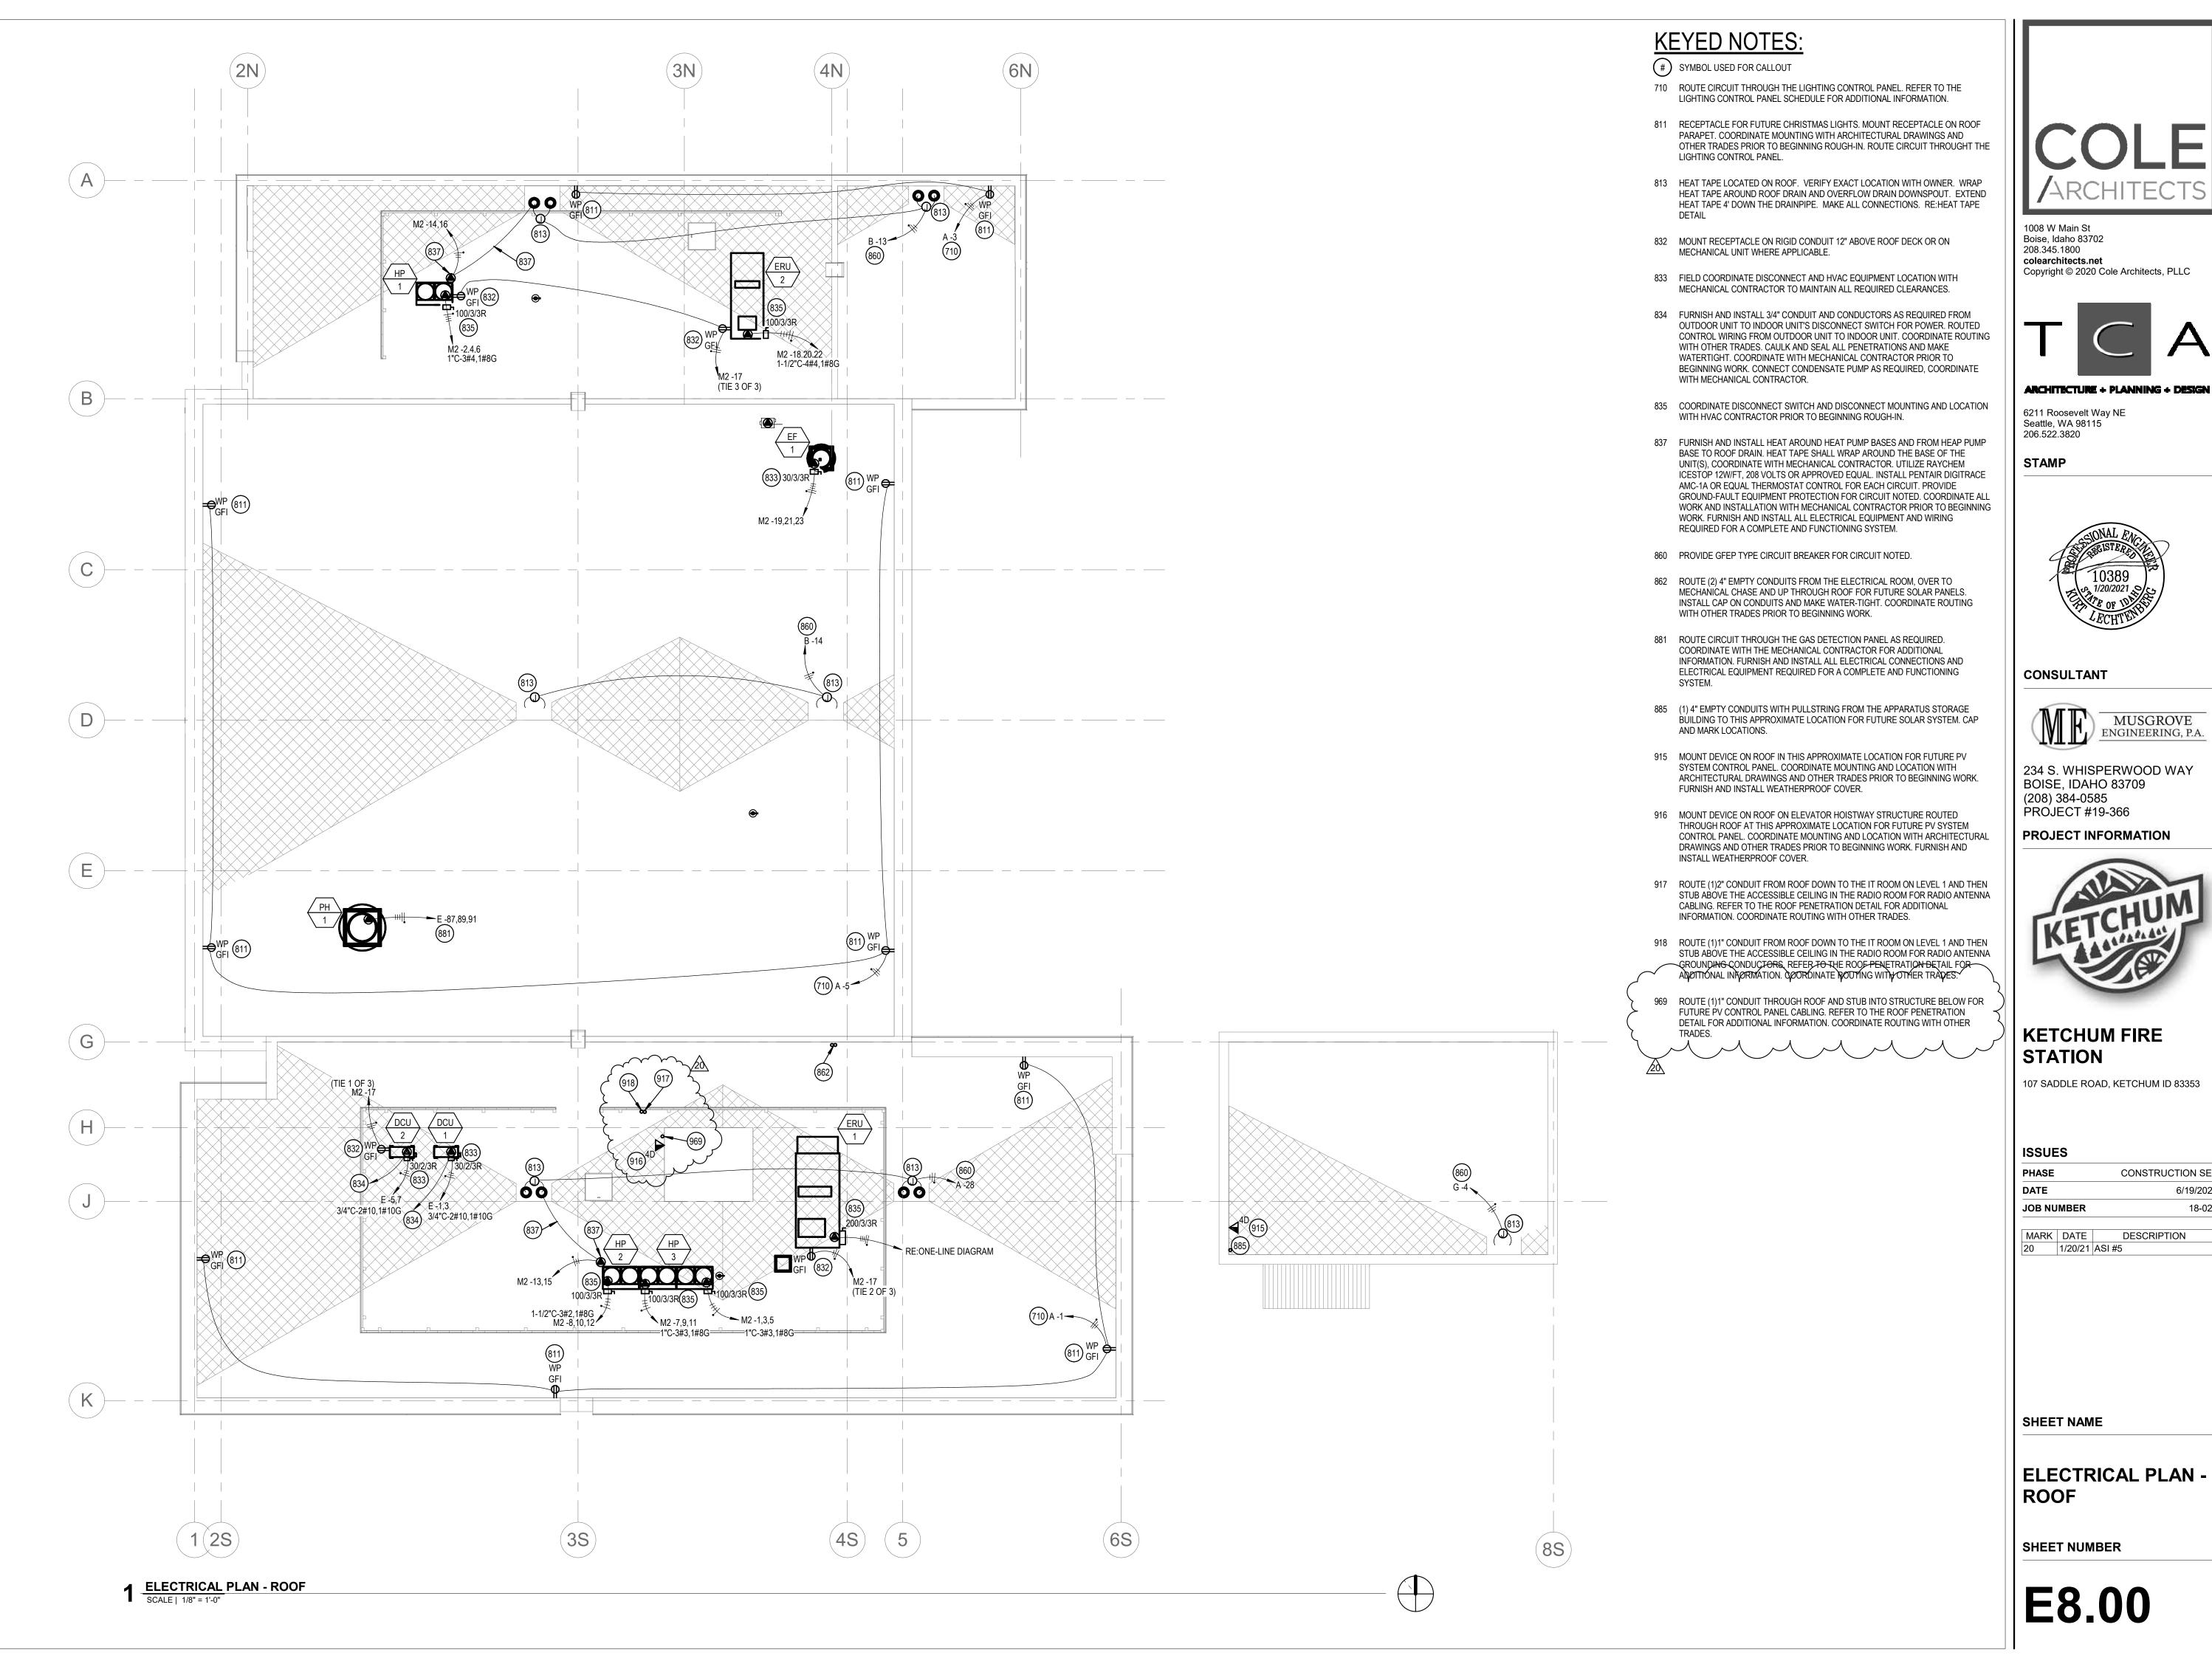



CONSULTANT



234 S. WHISPERWOOD WAY BOISE, IDAHO 83709 (208) 384-0585 PROJECT #19-366

PROJECT INFORMATION



KETCHUM FIRE STATION

107 SADDLE ROAD, KETCHUM ID 83353

ISSUES

PHASE	CONSTRUCTION SE
DATE	6/19/202
JOB NUMBER	18-02

MARK DATE DESCRIPTION

SHEET NAME

ELECTRICAL PLAN -ROOF

SHEET NUMBER

E8.00

Branch Panel: A

Location: Space 62 Supply From: MSB Mounting: Surface Enclosure: Type 1

Volts: 120/208 Wye Phases: 3 Wires: 4

A.I.C. Rating: 65K Mains Type: MLO Mains Rating: 200 A MCB Rating: 200 A

Notes: PANELBOARD SHALL BE SINGLE SECTION

PROVIDE PANEL WITH INDIVIDUAL BRANCH CIRCUIT MONITORING FOR ALL CIRCUITS AND INTEGRATED POWER AND ENERGY METER WITH MODBUS INTERFACE. CONNECT THE MONITORING TO THE DDC CONTROL SYSTEM. PROVIDE SINGLE SECTION PANELBOARD.

СКТ	Circuit Description	Trip	Poles		A	E	3	C	;	Poles	Trip	Circuit Description	СКТ
1	REC-ROOFTOP	20 A	1	720 VA	100 VA			_		1	20 A	EF-3	2
3	REC-ROOFTOP	20 A	1			360 VA	600 VA			1	20 A	GENERATOR BATTERY CHARGER	4
5	REC-ROOFTOP	20 A	1					720 VA	500 VA	1	20 A	GENERATOR HEATER	6
7	REC-ELECT, MECH	20 A	1	720 VA	960 VA					1	20 A	REC-EWC	8
9	REC-STOR, RESTROOMS	20 A	1			900 VA	900 VA			1	20 A	REC-PUBLIC RR, LOBBY	10
11	REC-KEURIG COFFEE MAKER	20 A	1					1400 VA	1200 VA	1	20 A	REC-PRINTER	12
13	AMPLIFIER	20 A	1	500 VA	360 VA					1	20 A	REC-HALLWAY COUNTER	14
15	REC-DAY USE FLOOR BOX	20 A	1			360 VA	540 VA			1	20 A	REC-FLRBOX DAY USE	16
17	REC-DAY USE FLOOR BOX	20 A	1					360 VA	360 VA	1	20 A	REC-FLRBOX DAY USE	18
19	ELEVATOR BUSSMAN MODULE	20 A	1	500 VA	483 VA					1	20 A	REC LTS ELEVATOR HOISTWAY	20
21	ELEVATOR EQUIPMENT ELEV REC &	20 A	1			600 VA	180 VA			1	20 A	REC-MONITOR	22
23	REC-FLRBOX COMMUNITY	20 A	1					1440 VA	720 VA	1	20 A	REC-COMMUNITY ROOM	24
25	REC-COMMUNITY ROOM	20 A	1	900 VA	1620 VA					1	20 A	REC-COMMUNITY ROOM	26
27	LTG-ELEC/OFFICE/RR/LOBBY	20 A	1			586 VA	1500 VA			1	20 A	ROOF HEAT TAPE	28
29	LTG-COMMUNITY RM/STOR	20 A	1					588 VA	720 VA	1	20 A	REC-UNDERCOUNTER REFRIG	30
31	LCP	20 A	1	360 VA	1440 VA					1	20 A	REC-MICROWAVE	32
33	Spare	20 A	1			0 VA	0 VA			1	20 A	Spare	34
35	Spare	20 A	1					0 VA	0 VA	1	20 A	Spare	36
37	Spare	20 A	1	0 VA	0 VA					1	20 A	Spare	38
39	Spare	20 A	1			0 VA	0 VA			1	20 A	Spare	40
41	Spare	20 A	1					0 VA	0 VA	1	20 A	Spare	42
43	Spare	20 A	1	0 VA	0 VA					1	20 A	Spare	44
45	Spare	20 A	1			0 VA	0 VA			1	20 A	Spare	46
47	Spare	20 A	1					0 VA	0 VA	1	20 A	Spare	48
49	Spare	20 A	1	0 VA	0 VA					1	20 A	Spare	50
51	Spare	20 A	1			0 VA	0 VA			1	20 A	Spare	52
53	Spare	20 A	1					0 VA	0 VA	1	20 A	Spare	54
55	Spare	20 A	1	0 VA	0 VA					1	20 A	Spare	56
57	Spare	20 A	1			0 VA	0 VA			1	20 A	Spare	58
59	Spare	20 A	1					0 VA	0 VA	1	20 A	Spare	60
		Tota	l Load:	866	2 VA	6500) VA	7981	VA				4
		Total Amps:			1 A	54	68 A						

Branch Panel: C

Supply From: MSB Mounting: Recessed Enclosure: Type 1

Volts: 120/208 Wye Phases: 3 Wires: 4

Mains Type: MLO Mains Rating: 400 A MCB Rating: 400 A

PROVIDE PANEL WITH INDIVIDUAL BRANCH CIRCUIT MONITORING FOR ALL CIRCUITS AND INTEGRATED POWER AND ENERGY METER WITH MODBUS INTERFACE. CONNECT THE MONITORING TO THE DDC CONTROL SYSTEM. PROVIDE SINGLE SECTION PANELBOARD.

CKT	Circuit Description	Trip	Poles		A		3	C	;	Poles	Trip	Circuit Description	CKT
1	DRYER	30 A	2	1260 VA	1260 VA					2	30 A	DRYER	2
3						1260 VA	1260 VA						4
5	REC-WASHER	20 A	1					900 VA	1080 VA	1	20 A	REC-HALLWAY, LAUNDRY	6
7	REC- SHOWERS	20 A	1	540 VA	1080 VA					1	20 A	REC-DORM 208, 209	8
9	REC-WORK STATION	20 A	1			540 VA	1080 VA			1	20 A	REC-DORM 204, 205	10
11	REC-WORK STATION	20 A	1					900 VA	1080 VA	1	20 A	REC-DORM 206, 207	12
13	REC-KITCHEN COUNTER	20 A	1	360 VA	1440 VA					1	20 A	REC-MICROWAVE	14
15	REC-KITCHEN COUNTER	20 A	1			540 VA	1440 VA			1	20 A	REC-MICROWAVE	16
17	DISHWASHER	20 A	1					1200 VA	1175 VA	1	20 A	DISPOSAL	18
19	REC-KITCHEN COUNTER	20 A	1	540 VA	720 VA					1	20 A	REC-REFRIGERATOR	20
21	REC-DAYROOM, TV	20 A	1			540 VA	720 VA			1	20 A	REC-REFRIGERATOR	22
23	TRUCK POWER BLOCK HEATERS	30 A	1					2400 VA	720 VA	1	20 A	REC-REFRIGERATOR	24
25	TRUCK POWER BLOCK HEATERS	30 A	1	2400 VA	720 VA					1	20 A	REC-DAYROOM	26
27	TRUCK POWER BLOCK HEATERS	30 A	1			2400 VA	540 VA			1	20 A	REC-STORAGE	28
29	TRUCK POWER BLOCK HEATERS	30 A	1					2400 VA	170 VA	1	20 A	LTG-STORAGE/LAUNDRY	30
31	TRUCK POWER BLOCK HEATERS	30 A	1	2400 VA	4160 VA					2	50 A	RANGE	32
33	TRUCK POWER BLOCK HEATERS	30 A	1			2400 VA	4160 VA						34
35	TRUCK POWER BLOCK HEATERS	30 A	1					2400 VA	0 VA	1	20 A	Spare	36
37	TRUCK POWER BLOCK HEATERS	30 A	1	2400 VA	0 VA					1	20 A	Spare	38
39	WALL OVEN	50 A	2			3900 VA	1400 VA			1	20 A	REC-KEURIG COFFEE MAKER	40
41								3900 VA	0 VA	1	20 A	Spare	42
43	ATTIC RADON FAN	20 A	1	500 VA	0 VA					1	20 A	Spare	44
45	Spare	20 A	1			0 VA	0 VA			1	20 A	Spare	46
47	Spare	20 A	1					0 VA	0 VA	1	20 A	Spare	48
49	Spare	20 A	1	0 VA	0 VA					1	20 A	Spare	50
51	Spare	20 A	1			0 VA	0 VA			1	20 A	Spare	52
53	Spare	20 A	1					0 VA	0 VA	1	20 A	Spare	54
55	Spare	20 A	1	0 VA	0 VA					1	20 A	Spare	56
57	Spare	20 A	1			0 VA	0 VA			1	20 A	Spare	58
59	Spare	20 A	1					0 VA	0 VA	1	20 A	Spare	60
	1 -	Tota	I Load:	1978	80 VA	2218	0 VA	1831	6 VA		1	1	
		Total	Amps:	16	7 A	187 A		153 A		1			

Branch Panel: B

Location: Space 27 Supply From: MSB Mounting: Surface Enclosure: Type 1

Volts: 120/208 Wye Phases: 3 Wires: 4

A.I.C. Rating: 22K Mains Type: MLO Mains Rating: 200 A MCB Rating: 200 A

PROVIDE PANEL WITH INDIVIDUAL BRANCH CIRCUIT MONITORING FOR ALL CIRCUITS AND INTEGRATED POWER AND ENERGY METER WITH MODBUS INTERFACE. CONNECT THE MONITORING TO THE DDC CONTROL SYSTEM. PROVIDE SINGLE SECTION PANELBOARD.

(T	Circuit Description	Trip	Poles		A		В	C	;	Poles	Trip	Circuit Description	CKT
1	EF-4 & UPPER MOTORIZED LOUVERS	20 A	1	1376 VA	720 VA					1		REC-COMP, FIRE RISER	2
3	REC-SHOP/SCBA	20 A	1			540 VA	720 VA			1		REC-TECH/OP STORAGE	4
5	REC-SHOP/SCBA	20 A	1					720 VA	720 VA	1		REC-TECH/OP STORAGE	6
7	REC-TURNOUT/LOCKER, VEST, RR	20 A	1	1080 VA	1260 VA					2	30 A	DRYER	8
9	REC-WASHER	20 A	1			900 VA	1260 VA						10
11	REC-DECON	20 A	1					180 VA	500 VA	1	20 A	IRRIGATION CONTROLLER	12
13	ROOF HEAT TAPE	20 A	1	1500 VA	1500 VA					1	20 A	ROOF HEAT TAPE	14
15	PORTABLE WELDER	50 A	2			4160 VA	5167 VA			3	60 A	EXTRACTOR	16
17								4160 VA	5167 VA				18
19	WH-3	30 A	2	2250 VA	5167 VA								20_
21						2250 VA	100 VA			1	/20 A	LOWER MOTORIZED LOUVER	22
23	RP-1	20 A	1					120 VA	336/3 VA	3	35 A	GEAR DRYER	24
25	Spare	20 A	1	0 VA	3363 VA								26
27	Spare	20 A	1			0 VA	3363 VA		7				28
29	AIR COMPRESSOR	50 A	2					4160 VA	0 VA	1		Spare ,	30
31				4160 VA	0 VA					_1/_	20 A	Spare	32/
33	Spare	20 A	1			0 VA	0 VA			1	20 A	Spare	34
35	Spare	20 A	1					0 VA	0 VA	1	20 A	Spare	36
37	Spare	20 A	1	0 VA	0 VA					1	20 A	Spare	38
39	Spare	20 A	1			0 VA	0 VA			1	20 A	Spare	40
41	Spare	20 A	1					0 VA	0 VA	1	20 A	Spare	42
43	Spare	20 A	1	0 VA	0 VA					1	20 A	Spare	44
45	Spare	20 A	1			0 VA	0 VA			1	20 A	Spare	46
47	Spare	20 A	1					0 VA	0 VA	1	20 A	Spare	48
49	Spare	20 A	1	0 VA	0 VA					1	20 A	Spare	50
51	Spare	20 A	1			0 VA	0 VA			1	20 A	Spare	52
53	Spare	20 A	1					0 VA	0 VA	1	20 A	Spare	54
55	Spare	20 A	1	0 VA	0 VA					1	20 A	Spare	56
57	Spare	20 A	1			0 VA	0 VA			1		Spare	58
59	Spare	20 A	1					0 VA	0 VA	1		Spare	60
	1 *	Tota	Load:	2237	75 VA	1845	59 VA	1908	9 VA		1	1 .	_ I
			Amps:		7 A		4 A	160 A		I			

Branch Panel: G

Location: APPARATUS STORAGE 219 Supply From: MSB Mounting: Surface

Enclosure: Type 1

Phases: 3 Wires: 4 A.I.C. Rating: 42K Mains Type: MLO Mains Rating: 200 A MCB Rating: 200 A

PROVIDE PANEL WITH INDIVIDUAL BRANCH CIRCUIT MONITORING FOR ALL CIRCUITS AND INTEGRATED POWER AND ENERGY METER WITH MODBUS INTERFACE. CONNECT THE MONITORING TO THE DDC CONTROL SYSTEM.

						В С						скт	
СКТ	Circuit Description	Trip	Poles		A			С		Poles	Trip		Circuit Description
1	REC-APPARATUS STORAGE	20 A	1	540 VA	128 VA					1	20 A	LTG-APPARATUS STORAGE	2
3	REC-APPARATUS STORAGE	20 A	1			180 VA	500 VA			1	20 A	ROOF HEAT TAPE	4
5	LTG-BBQ AREA	20 A	1					42 VA	0 VA	1	20 A	Spare	6
7	Spare	20 A	1	0 VA	0 VA					1	20 A	Spare	8
9	Spare	20 A	1			0 VA	0 VA			1	20 A	Spare	10
11	Spare	20 A	1					0 VA	0 VA	1	20 A	Spare	12
13	Spare	20 A	1	0 VA	0 VA					1	20 A	Spare	14
15	Spare	20 A	1			0 VA	0 VA			1	20 A	Spare	16
17	Spare	20 A	1					0 VA	0 VA	1	20 A	Spare	18
19	Spare	20 A	1	0 VA	0 VA					1	20 A	Spare	20
21	Spare	20 A	1			0 VA	0 VA			1	20 A	Spare	22
23	Spare	20 A	1					0 VA	0 VA	1	20 A	Spare	24
		Tota	l Load:	663	3 VA	680	VA	42	VA				•
		Total	Amps:	6	S A	6	Α	0	A	_			



1008 W Main St Boise, Idaho 83702 208.345.1800 colearchitects.net Copyright © 2020 Cole Architects, PLLC



6211 Roosevelt Way NE Seattle, WA 98115 206.522.3820

STAMP



CONSULTANT



234 S. WHISPERWOOD WAY BOISE, IDAHO 83709 (208) 384-0585 PROJECT #19-366

PROJECT INFORMATION



KETCHUM FIRE STATION

107 SADDLE ROAD, KETCHUM ID 83353

ISSUES

PHASE	CONSTRUCTION SET
DATE	6/19/2020
JOB NUMBER	18-022

MARK DATE DESCRIPTION 11 10/21/2 ASI #4 0 12 11/4/20 RFI #97R1

SHEET NAME

20 1/20/21 ASI #5

ELECTRICAL SCHEDULES

SHEET NUMBER

E9.01

SU	BCONTRACTOR C	HANG	E ORDE	R REQU	<u>EST</u>			
SUBCONTRACTOR:	MAGIC VALLEY ELECTRIC		PRO	JECT NAME:	Ketchum Fire	station		
	Jimmy Gyorfy							
	395 Railway Street		PROJEC	T ADDRESS:	: 107 Saddle Road			
	Jerome, ID 83338				Ketchum, ID			
	208-944-4931			•	,			
		— ТН	HIS IS IN RE	SPONSE TO:				
		• • • • • • • • • • • • • • • • • • • •		Bulletin #:				
CONTRACTOR:	Core Construction			ASI #:		5		
	Chris Schratwieser		FRBAL REQU	UEST FROM:				
0011171011	777 North 4th Street							
	Boise, ID 83702		SUBCONTR	ACTOR CO#:				
	702-794-0550		OODOONIIO	101011011.				
DESCRIPTION:	Gear Dryer-Installing conduit,	wire, supp	orts, discor	nect & Break	er from pane	 el В.		
			·		•			
	Antenna conduit relocation &	added PV	Controller of	conduit per k	eyed notes			
	917 & 918							
	Ketchum Fire Station							
DRAWINGS:	From ASI-5 Dated 1/20/21							
	Trade Description	Hours	Labor Amt.			Total Cost		
LABOR:	Journeyman	24	70.00			1,680.00		
	Apprentice	24	60.00			1,440.00		
						0.00		
						0.00		
						0.00		
	Description	QTY	Unit Price	Sub-Total	Taxes	Total Cost		
MATERIAL:	35A Breaker	1	325.00	325.00	19.50	344.50		
	Misc.	1	831.63	831.63	49.90	881.53		
				0.00	0.00	0.00		
				0.00	0.00	0.00		
				0.00	0.00	0.00		
	Description	QTY	Unit Price	Sub-Total	Taxes	Total Cost		
EQUIPMENT:				0.00	0.00	0.00		
				0.00	0.00	0.00		
				0.00	0.00	0.00		
				0.00	0.00	0.00		
				0.00	0.00	0.00		
				0.00	0.00	0.00		
SUBTOTAL:						4,346.03		
OH & Profit@15%						651.90		
GRAND TOTAL:				Total Amour	nt	\$4,997.93		
NOTES:					\$4,	998.00		
	Authorized Signature		Date:	1/28/21				



Building. Growing. Leading. ... Since 1937.

Budget Evolution Item Summary City of Ketchum Fire Station #1

ASI #6 Hand Dryers, Satellite	Dish		Date:	2/9/2021
December 2014			· C · · · · · · · · · · · · · · · · ·	
•	•	r Hand Dryers. Add Satellite		
	nged cond	uits for low voltage system	_	
SCOPE		SUBCONTRACTOR		10UNT
Provide electric changes per AS	31 #6	Magic Valley Electric	\$	5,577.00
				
				
				
		+		
				
				
		+		
		$\overline{}$		
		 		
		 		
	•			
SUBTOTAL:			\$	5,577.00
SUBTOTAL reflects direct costs		· ' ' ' ' ' ' ' ' ' ' ' ' ' ' ' ' ' ' '		
allowances. If costs are reimbu				
SUBTOTAL with add of agreed	upon mark	up in accordance with the	change order p	ricing.
Bond and Insurance		CORE	\$	117.00
CMAR FEE		CORE	\$	248.00
Sales Tax		CORE	\$	-
TOTAL AMOUNT:			\$	5,942.00



ASI 06

PROJECT NAME	KETCHUM FIRE STATION #1
PROJECT NUMBER	18-022
DATE	1/20/2021
CONSTRUCTION COMPANY	CORE CONSTRUCTION

THE WORK SHALL BE CARRIED OUT IN ACCORDANCE WITH THE FOLLOWING SUPPLEMENTAL INSTRUCTIONS ISSUED IN ACCORDANCE WITH THE CONTRACT.

DESCRIPTION OF CHANGES:

DRAWINGS:

ELECTRICAL:


- 1) E5.01 POWER PLAN LEVEL 01
 - a) Added electrical connections for (3) hand dryers.
- 2) E8.00 ELECTRICAL ROOF PLAN
 - a. Modified Keyed Notes 917 and 918 for conduit routing and stub locations. Conduits are to be stubbed into the IT Room on Level 1.
 - b. Added 1" conduit for Satellite Dish, stub into the IT Room on Level 1.
- 3) E9.01 ELECTRICAL SCHEDULES
 - a) Added hand dryer circuits to panelboard 'A'.

ATTACHMENTS:

DRAWINGS:

- E5.01 POWER PLAN LEVEL 01
- E8.00 ELECTRICAL ROOF PLAN
- E9.01 ELECTRICAL SCHEDULES

END OF ASI

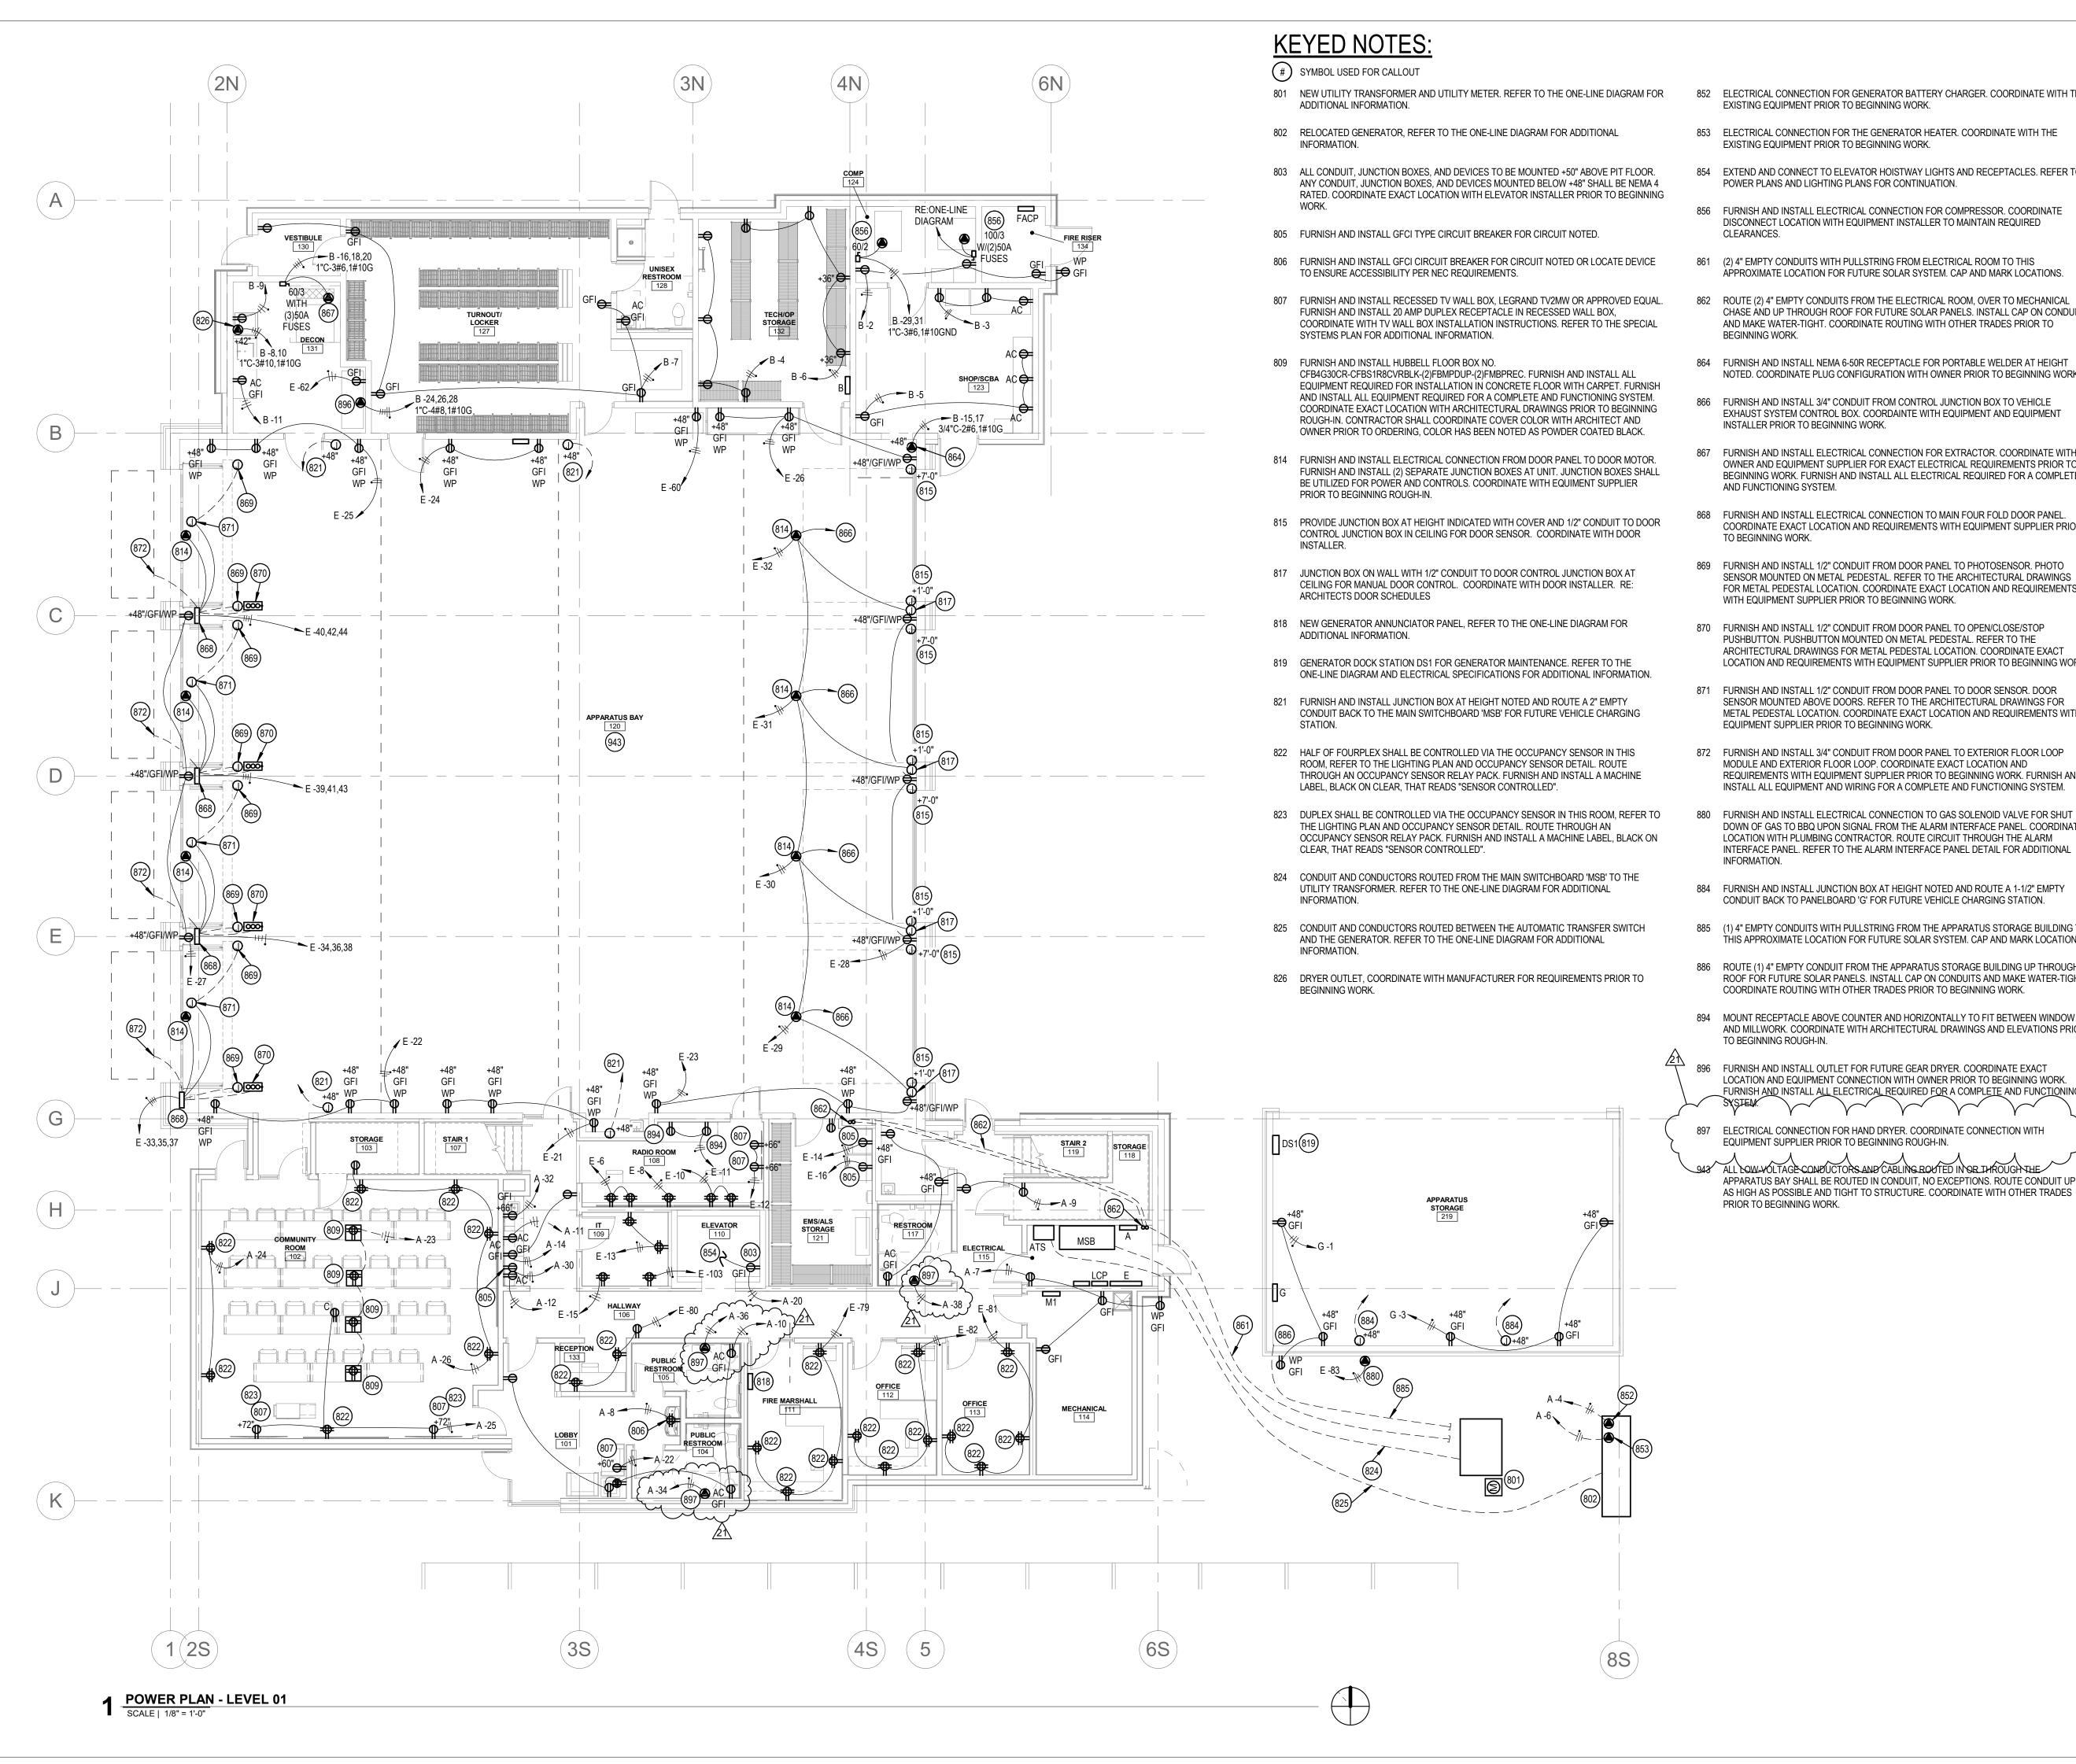

- 852 ELECTRICAL CONNECTION FOR GENERATOR BATTERY CHARGER. COORDINATE WITH THE EXISTING EQUIPMENT PRIOR TO BEGINNING WORK.
- 853 ELECTRICAL CONNECTION FOR THE GENERATOR HEATER. COORDINATE WITH THE EXISTING EQUIPMENT PRIOR TO BEGINNING WORK.
- 854 EXTEND AND CONNECT TO ELEVATOR HOISTWAY LIGHTS AND RECEPTACLES. REFER TO
- POWER PLANS AND LIGHTING PLANS FOR CONTINUATION. 856 FURNISH AND INSTALL ELECTRICAL CONNECTION FOR COMPRESSOR. COORDINATE
- 861 (2) 4" EMPTY CONDUITS WITH PULLSTRING FROM ELECTRICAL ROOM TO THIS
- 862 ROUTE (2) 4" EMPTY CONDUITS FROM THE ELECTRICAL ROOM, OVER TO MECHANICAL CHASE AND UP THROUGH ROOF FOR FUTURE SOLAR PANELS. INSTALL CAP ON CONDUITS AND MAKE WATER-TIGHT. COORDINATE ROUTING WITH OTHER TRADES PRIOR TO
- 864 FURNISH AND INSTALL NEMA 6-50R RECEPTACLE FOR PORTABLE WELDER AT HEIGHT NOTED. COORDINATE PLUG CONFIGURATION WITH OWNER PRIOR TO BEGINNING WORK.
- 866 FURNISH AND INSTALL 3/4" CONDUIT FROM CONTROL JUNCTION BOX TO VEHICLE EXHAUST SYSTEM CONTROL BOX. COORDAINTE WITH EQUIPMENT AND EQUIPMENT INSTALLER PRIOR TO BEGINNING WORK.
- 867 FURNISH AND INSTALL ELECTRICAL CONNECTION FOR EXTRACTOR. COORDINATE WITH OWNER AND EQUIPMENT SUPPLIER FOR EXACT ELECTRICAL REQUIREMENTS PRIOR TO BEGINNING WORK. FURNISH AND INSTALL ALL ELECTRICAL REQUIRED FOR A COMPLETE AND FUNCTIONING SYSTEM.
- 868 FURNISH AND INSTALL ELECTRICAL CONNECTION TO MAIN FOUR FOLD DOOR PANEL. COORDINATE EXACT LOCATION AND REQUIREMENTS WITH EQUIPMENT SUPPLIER PRIOR TO BEGINNING WORK.
- 869 FURNISH AND INSTALL 1/2" CONDUIT FROM DOOR PANEL TO PHOTOSENSOR. PHOTO SENSOR MOUNTED ON METAL PEDESTAL. REFER TO THE ARCHITECTURAL DRAWINGS FOR METAL PEDESTAL LOCATION. COORDINATE EXACT LOCATION AND REQUIREMENTS WITH EQUIPMENT SUPPLIER PRIOR TO BEGINNING WORK.
- 870 FURNISH AND INSTALL 1/2" CONDUIT FROM DOOR PANEL TO OPEN/CLOSE/STOP PUSHBUTTON. PUSHBUTTON MOUNTED ON METAL PEDESTAL. REFER TO THE ARCHITECTURAL DRAWINGS FOR METAL PEDESTAL LOCATION. COORDINATE EXACT LOCATION AND REQUIREMENTS WITH EQUIPMENT SUPPLIER PRIOR TO BEGINNING WORK.
- 871 FURNISH AND INSTALL 1/2" CONDUIT FROM DOOR PANEL TO DOOR SENSOR. DOOR SENSOR MOUNTED ABOVE DOORS. REFER TO THE ARCHITECTURAL DRAWINGS FOR METAL PEDESTAL LOCATION. COORDINATE EXACT LOCATION AND REQUIREMENTS WITH EQUIPMENT SUPPLIER PRIOR TO BEGINNING WORK.
- FURNISH AND INSTALL 3/4" CONDUIT FROM DOOR PANEL TO EXTERIOR FLOOR LOOP MODULE AND EXTERIOR FLOOR LOOP. COORDINATE EXACT LOCATION AND REQUIREMENTS WITH EQUIPMENT SUPPLIER PRIOR TO BEGINNING WORK. FURNISH AND INSTALL ALL EQUIPMENT AND WIRING FOR A COMPLETE AND FUNCTIONING SYSTEM.
- 880 FURNISH AND INSTALL ELECTRICAL CONNECTION TO GAS SOLENOID VALVE FOR SHUT DOWN OF GAS TO BBQ UPON SIGNAL FROM THE ALARM INTERFACE PANEL. COORDINATE LOCATION WITH PLUMBING CONTRACTOR. ROUTE CIRCUIT THROUGH THE ALARM INTERFACE PANEL. REFER TO THE ALARM INTERFACE PANEL DETAIL FOR ADDITIONAL
- 884 FURNISH AND INSTALL JUNCTION BOX AT HEIGHT NOTED AND ROUTE A 1-1/2" EMPTY CONDUIT BACK TO PANELBOARD 'G' FOR FUTURE VEHICLE CHARGING STATION.
- (1) 4" EMPTY CONDUITS WITH PULLSTRING FROM THE APPARATUS STORAGE BUILDING TO THIS APPROXIMATE LOCATION FOR FUTURE SOLAR SYSTEM. CAP AND MARK LOCATIONS.
- 886 ROUTE (1) 4" EMPTY CONDUIT FROM THE APPARATUS STORAGE BUILDING UP THROUGH ROOF FOR FUTURE SOLAR PANELS. INSTALL CAP ON CONDUITS AND MAKE WATER-TIGHT COORDINATE ROUTING WITH OTHER TRADES PRIOR TO BEGINNING WORK.
- 894 MOUNT RECEPTACLE ABOVE COUNTER AND HORIZONTALLY TO FIT BETWEEN WINDOW AND MILLWORK. COORDINATE WITH ARCHITECTURAL DRAWINGS AND ELEVATIONS PRIOR
- FURNISH AND INSTALL OUTLET FOR FUTURE GEAR DRYER. COORDINATE EXACT LOCATION AND EQUIPMENT CONNECTION WITH OWNER PRIOR TO BEGINNING WORK.
- ELECTRICAL CONNECTION FOR HAND DRYER. COORDINATE CONNECTION WITH EQUIPMENT SUPPLIER PRIOR TO BEGINNING ROUGH-IN.
- APPARATUS BAY SHALL BE ROUTED IN CONDUIT, NO EXCEPTIONS. ROUTE CONDUIT UP



107 SADDLE ROAD, KETCHUM ID 83353

ISSUES

1008 W Main St Boise, Idaho 83702

colearchitects.net

6211 Roosevelt Way NE

Seattle, WA 98115

CONSULTANT

MUSGROVE

ENGINEERING, P.A.

234 S. WHISPERWOOD WAY

BOISE, IDAHO 83709

PROJECT INFORMATION

(208) 384-0585 PROJECT #19-366

206.522.3820

STAMP

Copyright © 2020 Cole Architects, PLLC

ARCHITECTURE + PLANNING + DESIGN

208.345.1800

PHASE CONSTRUCTION SET DATE 6/19/2020 **JOB NUMBER** 18-022

DESCRIPTION MARK DATE 10/21/2 ASI #4 1/20/21 ASI #5


SHEET NAME

21 1/26/21 ASI #6

POWER PLAN -LEVEL 01

SHEET NUMBER

E5.01

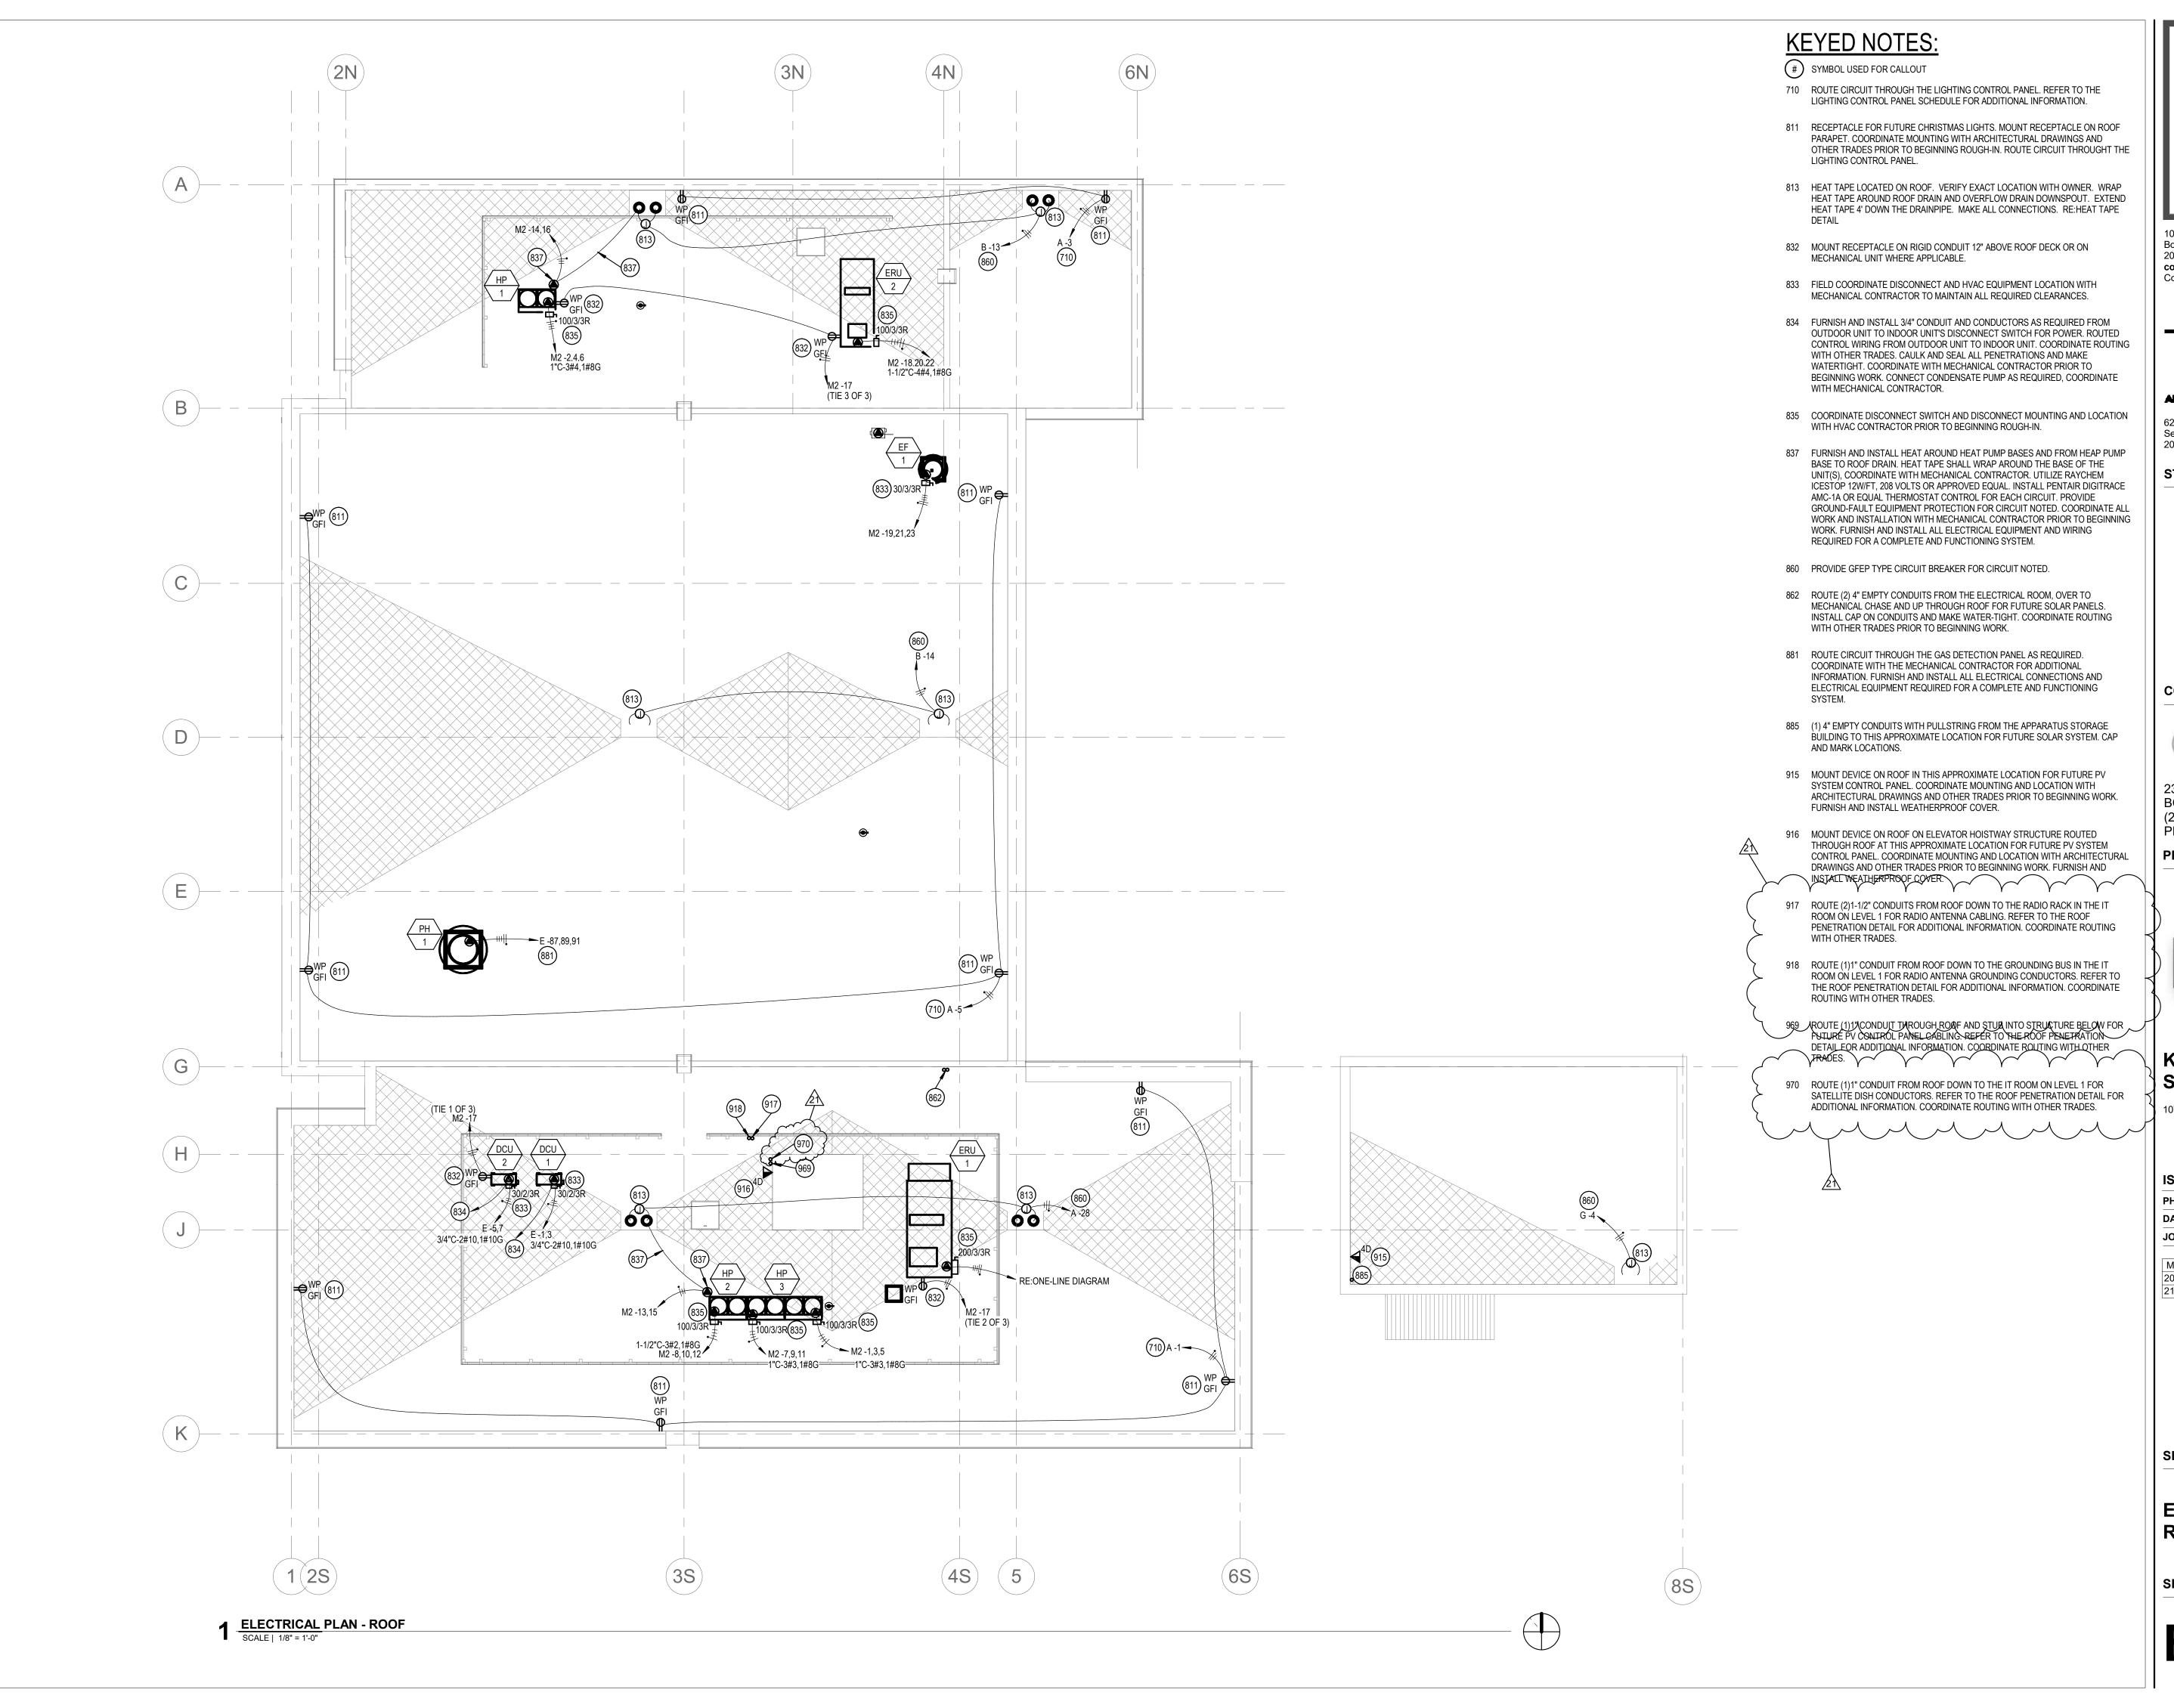





ON | CO44 B-----

6211 Roosevelt Way NE Seattle, WA 98115 206.522.3820

STAMP



CONSULTANT



234 S. WHISPERWOOD WAY BOISE, IDAHO 83709 (208) 384-0585 PROJECT #19-366

PROJECT INFORMATION



KETCHUM FIRE STATION

107 SADDLE ROAD, KETCHUM ID 83353

ISS	U	ES	;

HASE	CONSTRUCTION SE
ATE	6/19/20
OB NUMBER	18-0

 MARK
 DATE
 DESCRIPTION

 20
 1/20/21
 ASI #5

 21
 1/26/21
 ASI #6

SHEET NAME

ELECTRICAL PLAN -

SHEET NUMBER

E8.00

Branch Panel: A

Location: Space 62 Supply From: MSB Mounting: Surface Enclosure: Type 1

Volts: 120/208 Wye Phases: 3 Wires: 4

A.I.C. Rating: 65K Mains Type: MLO Mains Rating: 200 A MCB Rating: 200 A

Notes: PANELBOARD SHALL BE SINGLE SECTION

PROVIDE PANEL WITH INDIVIDUAL BRANCH CIRCUIT MONITORING FOR ALL CIRCUITS AND INTEGRATED POWER AND ENERGY METER WITH MODBUS INTERFACE. CONNECT THE MONITORING TO THE DDC CONTROL SYSTEM. PROVIDE SINGLE SECTION PANELBOARD.

CKT	Circuit Description	Trip	Poles		A	i	В	C	;	Poles	Trip	Circuit Description	СКТ
1	REC-ROOFTOP	20 A	1	720 VA	100 VA					1	20 A	EF-3	2
3	REC-ROOFTOP	20 A	1			360 VA	600 VA			1	20 A	GENERATOR BATTERY CHARGER	4
5	REC-ROOFTOP	20 A	1					720 VA	500 VA	1	20 A	GENERATOR HEATER	6
7	REC-ELECT, MECH	20 A	1	720 VA	960 VA					1	20 A	REC-EWC	8
9	REC-STOR, RESTROOMS	20 A	1			900 VA	900 VA			1	20 A	REC-PUBLIC RR, LOBBY	10
11	REC-KEURIG COFFEE MAKER	20 A	1					1400 VA	1200 VA	1	20 A	REC-PRINTER	12
13	AMPLIFIER	20 A	1	500 VA	360 VA					1	20 A	REC-HALLWAY COUNTER	14
15	REC-DAY USE FLOOR BOX	20 A	1			360 VA	540 VA			1	20 A	REC-FLRBOX DAY USE	16
17	REC-DAY USE FLOOR BOX	20 A	1					360 VA	360 VA	1	20 A	REC-FLRBOX DAY USE	18
19	ELEVATOR BUSSMAN MODULE	20 A	1	500 VA	483 VA					1	20 A	REC LTS ELEVATOR HOISTWAY	20
21	ELEVATOR EQUIPMENT ELEV REC &	20 A	1			600 VA	180 VA			1	20 A	REC-MONITOR	22
23	REC-FLRBOX COMMUNITY	20 A	1					1440 VA	720 VA	1	20 A	REC-COMMUNITY ROOM	24
25	REC-COMMUNITY ROOM	20 A	1	900 VA	1620 VA					1	20 A	REC-COMMUNITY ROOM	26
27	LTG-ELEC/OFFICE/RR/LOBBY	20 A	1			586 VA	1500 VA			1	20 A	ROOF HEAT TAPE	28
29	LTG-COMMUNITY RM/STOR	20 A	1					_588VA	720 VA	~/		REG-UNDERCOUNTER REFRIG	36
31	LCP	20 A	كملر	360 VA	1440 V X	Υ	Υ	Υ	Υ	1	20 A	REC-MICROWAVE Y	Y 32
33	Spare	20 A	(1			0 VA	1000 VA			1	20 A	HAND DRYER	34
35	Spare	20 A	\ 1					0 VA	1000 VA	1	20 A	HAND DRYER	36
37	Spare	20 A	71	0 VA	1000 VA					1	20 A	HAND DRYER	38
39	Spare	20 A	77	J	٨	0 VA _A	0 VA _A	,	ا لم	1	20 A	Spare, , ,	40
41	Spare	20 A	1)VA	OVA \	1/	20 A	8pare	42
43	Spare	20 A	1	0 VA	0 VA					1	20 A	Spare	44
45	Spare	20 A	1			0 VA	0 VA			1	20 A	Spare	46
47	Spare	20 A	1					0 VA	0 VA	1	20 A	Spare	48
49	Spare	20 A	1	0 VA	0 VA					1	20 A	Spare	50
51	Spare	20 A	1			0 VA	0 VA			1	20 A	Spare	52
53	Spare	20 A	1					0 VA	0 VA	1	20 A	Spare	54
55	Spare	20 A	1	0 VA	0 VA					1	20 A	Spare	56
57	Spare	20 A	1			0 VA	0 VA			1	20 A	Spare	58
59	Spare	20 A	1					0 VA	0 VA	1	20 A	Spare	60
		Tota	I Load:	966	2 VA	7499	9 VA	8980	VA				
		Total	Amps:	8:	2 A	62	2 A	77	A				

Branch	Panel: C	
---------------	----------	--

Location: Space 85 Supply From: MSB Mounting: Recessed Enclosure: Type 1

Volts: 120/208 Wye Phases: 3 Wires: 4

Mains Type: MLO Mains Rating: 400 A MCB Rating: 400 A

PROVIDE PANEL WITH INDIVIDUAL BRANCH CIRCUIT MONITORING FOR ALL CIRCUITS AND INTEGRATED POWER AND ENERGY METER WITH MODBUS INTERFACE. CONNECT THE MONITORING TO THE DDC CONTROL SYSTEM. PROVIDE SINGLE SECTION PANELBOARD.

CKT	Circuit Description	Trip	Poles		A		3	(;	Poles	Trip	Circuit Description	CKT
1	DRYER	30 A	2	1260 VA	1260 VA					2	30 A	DRYER	2
3						1260 VA	1260 VA						4
5	REC-WASHER	20 A	1					900 VA	1080 VA	1	20 A	REC-HALLWAY, LAUNDRY	6
7	REC- SHOWERS	20 A	1	540 VA	1080 VA					1	20 A	REC-DORM 208, 209	8
9	REC-WORK STATION	20 A	1			540 VA	1080 VA			1	20 A	REC-DORM 204, 205	10
11	REC-WORK STATION	20 A	1					900 VA	1080 VA	1	20 A	REC-DORM 206, 207	12
13	REC-KITCHEN COUNTER	20 A	1	360 VA	1440 VA					1	20 A	REC-MICROWAVE	14
15	REC-KITCHEN COUNTER	20 A	1			540 VA	1440 VA			1	20 A	REC-MICROWAVE	16
17	DISHWASHER	20 A	1					1200 VA	1175 VA	1	20 A	DISPOSAL	18
19	REC-KITCHEN COUNTER	20 A	1	540 VA	720 VA					1	20 A	REC-REFRIGERATOR	20
21	REC-DAYROOM, TV	20 A	1			540 VA	720 VA			1	20 A	REC-REFRIGERATOR	22
23	TRUCK POWER BLOCK HEATERS	30 A	1					2400 VA	720 VA	1	20 A	REC-REFRIGERATOR	24
25	TRUCK POWER BLOCK HEATERS	30 A	1	2400 VA	720 VA					1	20 A	REC-DAYROOM	26
27	TRUCK POWER BLOCK HEATERS	30 A	1			2400 VA	540 VA			1	20 A	REC-STORAGE	28
29	TRUCK POWER BLOCK HEATERS	30 A	1					2400 VA	170 VA	1	20 A	LTG-STORAGE/LAUNDRY	30
31	TRUCK POWER BLOCK HEATERS	30 A	1	2400 VA	4160 VA					2	50 A	RANGE	32
33	TRUCK POWER BLOCK HEATERS	30 A	1			2400 VA	4160 VA						34
35	TRUCK POWER BLOCK HEATERS	30 A	1					2400 VA	0 VA	1	20 A	Spare	36
37	TRUCK POWER BLOCK HEATERS	30 A	1	2400 VA	0 VA					1	20 A	Spare	38
39	WALL OVEN	50 A	2			3900 VA	1400 VA			1	20 A	REC-KEURIG COFFEE MAKER	40
41								3900 VA	0 VA	1	20 A	Spare	42
43	ATTIC RADON FAN	20 A	1	500 VA	0 VA					1	20 A	Spare	44
45	Spare	20 A	1			0 VA	0 VA			1	20 A	Spare	46
47	Spare	20 A	1					0 VA	0 VA	1	20 A	Spare	48
49	Spare	20 A	1	0 VA	0 VA					1	20 A	Spare	50
51	Spare	20 A	1			0 VA	0 VA			1	20 A	Spare	52
53	Spare	20 A	1					0 VA	0 VA	1	20 A	Spare	54
55	Spare	20 A	1	0 VA	0 VA					1	20 A	Spare	56
57	Spare	20 A	1			0 VA	0 VA			1	20 A	Spare	58
59	Spare	20 A	1					0 VA	0 VA	1	20 A	Spare	60
		Tota	l Load:	1978	30 VA	2218	0 VA	1831	6 VA		•		
		Total	Amps:	16	7 A	18	7 A	153	B A	-			

Branch Panel: B

Location: Space 27 Supply From: MSB Mounting: Surface Enclosure: Type 1

Volts: 120/208 Wye Phases: 3 Wires: 4

A.I.C. Rating: 22K Mains Type: MLO Mains Rating: 200 A MCB Rating: 200 A

PROVIDE PANEL WITH INDIVIDUAL BRANCH CIRCUIT MONITORING FOR ALL CIRCUITS AND INTEGRATED POWER AND ENERGY METER WITH MODBUS INTERFACE. CONNECT THE MONITORING TO THE DDC CONTROL SYSTEM. PROVIDE SINGLE SECTION PANELBOARD.

CKT	Circuit Description	Trip	Poles		A	į į	3	C	<u> </u>	Poles	Trip	Circuit Description	CKT
1	EF-4 & UPPER MOTORIZED LOUVERS	20 A	1	1376 VA	720 VA					1	20 A	REC-COMP, FIRE RISER	2
3	REC-SHOP/SCBA	20 A	1			540 VA	720 VA			1	20 A	REC-TECH/OP STORAGE	4
5	REC-SHOP/SCBA	20 A	1					720 VA	720 VA	1	20 A	REC-TECH/OP STORAGE	6
7	REC-TURNOUT/LOCKER, VEST, RR	20 A	1	1080 VA	1260 VA					2	30 A	DRYER	8
9	REC-WASHER	20 A	1			900 VA	1260 VA						10
11	REC-DECON	20 A	1					180 VA	500 VA	1	20 A	IRRIGATION CONTROLLER	12
13	ROOF HEAT TAPE	20 A	1	1500 VA	1500 VA					1	20 A	ROOF HEAT TAPE	14
15	PORTABLE WELDER	50 A	2			4160 VA	5167 VA			3	60 A	EXTRACTOR	16
17								4160 VA	5167 VA				18
19	WH-3	30 A	2	2250 VA	5167 VA								20
21						2250 VA	100 VA			1	20 A	LOWER MOTORIZED LOUVER	22
23	RP-1	20 A	1					120 VA	3363 VA	3	35 A	GEAR DRYER	24
25	Spare	20 A	1	0 VA	3363 VA								26
27	Spare	20 A	1			0 VA	3363 VA						28
29	AIR COMPRESSOR	50 A	2					4160 VA	0 VA	1	20 A	Spare	30
31				4160 VA	0 VA					1	20 A	Spare	32
33	Spare	20 A	1			0 VA	0 VA			1	20 A	Spare	34
35	Spare	20 A	1					0 VA	0 VA	1	20 A	Spare	36
37	Spare	20 A	1	0 VA	0 VA					1	20 A	Spare	38
39	Spare	20 A	1			0 VA	0 VA			1	20 A	Spare	40
41	Spare	20 A	1					0 VA	0 VA	1	20 A	Spare	42
43	Spare	20 A	1	0 VA	0 VA					1	20 A	Spare	44
45	Spare	20 A	1			0 VA	0 VA			1	20 A	Spare	46
47	Spare	20 A	1					0 VA	0 VA	1	20 A	Spare	48
49	Spare	20 A	1	0 VA	0 VA					1	20 A	Spare	50
51	Spare	20 A	1			0 VA	0 VA			1	20 A	Spare	52
53	Spare	20 A	1					0 VA	0 VA	1	20 A	Spare	54
55	Spare	20 A	1	0 VA	0 VA					1	20 A	Spare	56
57	Spare	20 A	1			0 VA	0 VA			1	20 A	Spare	58
59	Spare	20 A	1					0 VA	0 VA	1	20 A	Spare	60
	1 2	Tota	l Load:	2237	'5 VA	1845	9 VA	19089	9 VA			-	
			Amps:		7 A	15	4 A	160		1			

Branch Panel: G

Location: APPARATUS STORAGE 219 Supply From: MSB Mounting: Surface

Enclosure: Type 1

Phases: 3 Wires: 4 A.I.C. Rating: 42K Mains Type: MLO Mains Rating: 200 A MCB Rating: 200 A

PROVIDE PANEL WITH INDIVIDUAL BRANCH CIRCUIT MONITORING FOR ALL CIRCUITS AND INTEGRATED POWER AND ENERGY METER WITH MODBUS INTERFACE. CONNECT THE MONITORING TO THE DDC CONTROL SYSTEM.

CKT	Circuit Description	Trip	Poles		Α		В	(Poles	Trip	Circuit Description	CKT
1	REC-APPARATUS STORAGE	20 A	1	540 VA	128 VA					1	20 A	LTG-APPARATUS STORAGE	2
3	REC-APPARATUS STORAGE	20 A	1			180 VA	500 VA			1	20 A	ROOF HEAT TAPE	4
5	LTG-BBQ AREA	20 A	1					42 VA	0 VA	1	20 A	Spare	6
7	Spare	20 A	1	0 VA	0 VA					1	20 A	Spare	8
9	Spare	20 A	1			0 VA	0 VA			1	20 A	Spare	10
11	Spare	20 A	1					0 VA	0 VA	1	20 A	Spare	12
13	Spare	20 A	1	0 VA	0 VA					1	20 A	Spare	14
15	Spare	20 A	1			0 VA	0 VA			1	20 A	Spare	16
17	Spare	20 A	1					0 VA	0 VA	1	20 A	Spare	18
19	Spare	20 A	1	0 VA	0 VA					1	20 A	Spare	20
21	Spare	20 A	1			0 VA	0 VA			1	20 A	Spare	22
23	Spare	20 A	1					0 VA	0 VA	1	20 A	Spare	24
		Tota	l Load:	66	3 VA	680	VA	42	VA				•
		Total	Amps:	6	6 A	6	Α	0	A	_			
Legend	l:												



1008 W Main St Boise, Idaho 83702 208.345.1800 colearchitects.net Copyright © 2020 Cole Architects, PLLC



ARCHITECTURE + PLANNING + DESIGN

6211 Roosevelt Way NE Seattle, WA 98115 206.522.3820

STAMP



CONSULTANT



234 S. WHISPERWOOD WAY BOISE, IDAHO 83709 (208) 384-0585 PROJECT #19-366

PROJECT INFORMATION



KETCHUM FIRE STATION

107 SADDLE ROAD, KETCHUM ID 83353

ISSUES

PHASE	CONSTRUCTION
DATE	6/19/2
JOB NUMBER	18-

IVIARN	DATE	DESCRIPTION
11	10/21/2	ASI #4
	0	
12	11/4/20	RFI #97R1
20	1/20/21	ASI #5
21	1/26/21	ASI #6

SHEET NAME

ELECTRICAL SCHEDULES

SHEET NUMBER

E9.01

SU	BCONTRACTOR CI	HANGE	ORDE	R REQU	EST		
SUBCONTRACTOR:	MAGIC VALLEY ELECTRIC		PRO	JECT NAME:	Ketchum Fire	station	
	Jimmy Gyorfy						
OONTAOT.	395 Railway Street		PPO IEC	T ADDRESS:	107 Saddla E	Pood	
	•	_	PROJEC	I ADDRESS.			
	Jerome, ID 83338				Ketchum, ID	03333	
	208-944-4931						
		TF	HIS IS IN RE	SPONSE TO:			
				Bulletin #:		6	
	Core Construction						
CONTACT:	Chris Schratwieser	VERBAL REQUEST FROM:					
	777 North 4th Street						
	Boise, ID 83702	<u> </u>	SUBCONTRA	ACTOR CO#:			
	_702-794-0550						
DESCRIPTION:	ASI-6-Added electrical connec	tion for (3) hand dryer	s including b	reakers.		
	Route keyed notes 917 & 918 c	conduit to	IT Rm. Add	1" conduit fo	r satellite to	IT Rm.	
	Ketchum Fire Station						
LOCATION	Ketchum Fire Station						
DRAWINGS:	From ASI-6 Dated 1/20/21	Hours	Lohor Amt			Total Cost	
LADOD	Trade Description	Hours	Labor Amt.				
LABUR:	Journeyman	29	70.00			2,030.00	
	Apprentice	29	60.00			1,740.00	
						0.00	
						0.00	
						0.00	
	Description	QTY	Unit Price	Sub-Total	Taxes	Total Cost	
MATERIAL:	20A Breaker	3	50.00	150.00	9.00	159.00	
	Misc.	1	868.42	868.42	52.11	920.53	
				0.00	0.00	0.00	
				0.00	0.00	0.00	
				0.00	0.00	0.00	
	Description	QTY	Unit Price	Sub-Total	Taxes	Total Cost	
EQUIPMENT:	· ·			0.00	0.00	0.00	
				0.00	0.00	0.00	
				0.00	0.00	0.00	
				0.00	0.00	0.00	
				0.00	0.00	0.00	
				0.00	0.00	0.00	
SUBTOTAL:				0.00	0.00		
						4,849.53	
OH & Profit@15% GRAND TOTAL:	T			T-4-1 A	- 4	727.43	
GRAND TOTAL:				Total Amour	nt	\$5,576.95	
NOTES:		,			\$	5,577.00	
	Authorized Signature		Date:	1/28/21			



Building. Growing. Leading. ... Since 1937.

Budget Evolution Item Summary City of Ketchum Fire Station #1

RFI-62 Decon Room Revisions not in ASI-03		Date:	2/19/2021
Description: Revised Comme	ercial Laundry (Decon) pip	ing	
SCOPE	SUBCONTRACTOR	AMOL	JNT
Install plbg w/Valves to Decon Laundry	Evans Plumbing	\$	2,697.00
Added Grate & Frame @ DECON room	Rule Steel	\$	1,359.00
	Ţ		
SUBTOTAL:		\$	4,056.00
SUBTOTAL reflects direct costs only on the	<u> </u>		
allowances. If costs are reimbursed by Cha			
SUBTOTAL with add of agreed upon marku	p in accordance with the	change order prici	ng.
Bond and Insurance	CORE	\$	85.00
CMAR FEE	CORE	\$	180.00
Sales Tax	CORE	\$	-
TOTAL AMOUNT:		\$	4,321.00

Change Request Proposal

Customer: CORE | Headwaters, LLC

Authorized Representative:

Date:

203600 / CoK FS No. 1 Change request number: 09 Project: 107 Saddle Road RFI 62 Commercial Laundry Piping (name and Description: Ketchum, ID 83340 address) Customer: CORE | Headwaters, LLC Notice to Proceed Status: Proposed Origination date: 02/12/21 Submitted date: Received date: Rough order of magnitude: 0.00 Quotation Submitted date: 02/12/21 Due date: Submitted amount: 2,697.35 Requested days delay: 0 Notes Per RFI 62, drawing P5.01 detail 6, install hot and cold water mains down to commercial laundry with check valves, filters and air cushion risers. Revenue Detail Billing Item Description Revenue 640.00 Labor - 8 hrs Materials - see supplier quote 1,789.00 Material Markup (15%) 268.35 **Total Revenue For CR 09** 2,697.35 **Approvals**

Contractor: Evans Plumbing, Inc.

Ву:

Date:

Print Date: 02/12/21 Page 1 of 1





FEL #3057 2150 ELDRIDGE AVE TWIN FALLS, ID 83301-0000

Phone: 208-733-3770 Fax: 208-736-7248

Deliver To:

From: **Matthew Quintana**

Comments:

Page 1 of 2

11:06:01 FEB 10 2021

FERGUSON ENTERPRISES #3007

Price Quotation Phone: 208-733-3770 Fax: 208-736-7248

Bid No:

B523070

Bid Date:

02/10/21 Quoted By: MBQ

Customer:

EVANS PLUMBING

SERVICE ACCOUNT 111 GULF STREAM LANE

HAILEY, ID 83333

Cust Phone: 208-726-5261

Terms:

NET 10TH PROX

Ship To:

EVANS PLUMBING

SERVICE ACCOUNT

111 GULF STREAM LANE

HAILEY, ID 83333

Cust PO#:

RFI62

Job Name: 203600

Item	Description	Quantity	Net Price	UM	Total
LHARDK20	2 X 20 L HARD COP TUBE	60	1274.784		764.87
CTKKG	2X2X1 WROT CXCXC TEE	2	25.840	EA	51.68
CTK	2 WROT CXCXC TEE 2-1/8 OD	2	33.176	EA	66.35
CRCKJ	2X1-1/2 WROT CXC RED COUP	2	13.983	EA	27.97
CRCKF	2X3/4 WROT CXC RED COUP	2	15.329	EA	30.66
C9J	1-1/2 WROT CXC 90 ELL 1-5/8 OD	4	10.315	EA	41.26
LHARDJ20	1-1/2 X 20 L HARD COP TUBE	20	803.737	С	160.75
CRCJF	1-1/2X3/4 WROT CXC RED COUP	1	9.218	EA	9.22
CTJ	1-1/2 WROT CXCXC TEE 1-5/8 OD	3	20.863	EA	62.59
FNWX10PG	LF 1 COMM WTR HAMM ARRST	2	46.473	EA	92.95
PFX31J	LF 1-1/2 BRS 125# THRD SWG CHK VLV	2	49.298	EA	98.60
FNWX415J	LF 1-1/2 BRS 600 WOG THRD 2PC BV	2	33.555	EA	67.11
GBRNJM	LF 1-1/2X3 BRS NIP GBL	4	8.206	EA	32.82
GBRNFM	LF 3/4X3 BRS NIP GBL	2	3.226	EA	6.45
PFX75FC	LFN 3/4 BRS MIP BLR DRN	2	6.900	EA	13.80
FNW7816Y0162	1-5/8 OD PLTD CUSH TUBE STRUT CLMP	4	8.520	EA	34.08
IBRLFRCMK	LF 3X2 BRS RED COUP	2	51.578	EA	103.16
IBRLFBKJ	LF 2X1-1/2 BRS BUSH	2	11.698	EA	23.40

Net Total:

Tax:

Freight: Total:

\$1687.72 \$101.28

\$0.00 \$1789.00



Scan the QR code or use the link below to complete a survey about your bids: https://survey.medallia.com/?bidsorder&fc=3003&on=1095924

Change Order Request Summary

Project: Ketchum Fire Station 1 Subcontractor: Rule Steel
Date: November 24, 2020 Reference: RFI #CC-62R1

C/O Req. No.: 07R1

Description: RFI #CC-62R1 Grate and frame in Decon Room

Material:

Item Description	Quantity	Unit Price	Extended
WF (in)		\$0.78	\$ -
WF (out)		\$0.78	\$ -
C (in)		\$0.90	\$ -
C (out)		\$0.90	\$ -
MC (in)		\$1.14	\$
MC (out)		\$1.14	\$ -
PL (in)		\$0.78	\$ -
PL (out)		\$0.78	\$ -
FB (in)		\$0.78	\$ -
FB (out)		\$0.78	\$
L (in)	18	\$0.78	\$ 14.04
L (out)		\$0.78	\$ -
HSS (in)		\$0.84	\$ -
HSS (out)		\$0.84	\$
Pipe (in)		\$1.02	\$
Pipe (out)		\$1.02	\$
Rod (in)		\$0.78	\$ -
Rod (out)		\$0.78	\$
Hardware (in)		lump	\$ 18.00
Hardware (out)		lump	\$
Paint Material (in)		lump	\$ -
Paint Material (out)		lump	\$ -
	18	Total Mat.	\$ -

Shop Hours (net):
Detailing (net) include field meas.
Painting Labor (net):
Blasting Labor (net):
Freight (net):

Hours	Rate/Hr		Extended
1.50	\$	70.00	\$ 105.00
1.00	\$	75.00	\$ 75.00
	\$	60.00	\$ -
	\$	115.00	\$ -
	lur		\$ 110.00
	Tot	al Shop	\$ 290.00

Subcontractor

<u>Suppliers</u>

Subcontractor	Work Description	Quo	ote Amount
DMS (COR #004)	Erection	\$	660.00
	Work Description	Quo	ote Amount
Peterson Grating	Grating	\$	260.00
Valmont	Galvanizing	\$	36.00
Wooster	Nosings	\$	-
	Sub Total	\$	956.00
	10% mkup	\$	95.60
Tota	al Subcontractor/Supplier	\$	1,051.60

Change Order Request Amount
Sales Tax 6% (on material and suppliers)

Additional Bond Cost

Total Change Order Request - Rounded Added time to schedule - working days

\$ 1,341.60
\$ 17.76
\$ -
\$ 1,359.00

Change Order Request

<u>Donahue - McNamara Steel LLC.</u>					
P.O. Box 1250,	CHANGE ORDER REQUEST #004				
Sun Valley, ID 83353	DATE: November 19, 2020 JOB #				
208-720-0977 fax 208-788-2575	PROJECT: Ketchum Fire Station #1	•			
To: Rule Steel	JOB PHONE				
	CONTRACT#	-			
Attn: Ron Allen	CONTRACT DATE				
We agree to make the change(s) specified below;					
Added Grating at Extractor Trench in Deco	on Room Per RFI CC-62R1				
DMS will install shelf angles and Grating in 1 location p					
Please reference RFIs CC-62R1					
Labor					
(8) Ironworker hr(s) @ \$75.00/hr.					
Equipment N/A					
<u>Material</u>					
By Rule Steel					
	10% OH	&P \$	60.00		
NOTE: This change order becomes part of and in conformance with the	e existing contract.				
	gree to hereby to make the change(s)				
-	ied above at this price	\$	660.00		
DATE 11/19/2020	PREVIOUS CONTRACT				
$\overline{\Omega}$	AMOUNT	\$			
Doug Drussel	REVISED CONTRACT	•			
SIGNATURE BY DONAHUE~MCNAMARA STEEL	AMOUNT	\$			
ACCEPTED - The above prices and specifications of th	- · · · · · · · · · · · · · · · · · · ·				
hereby accepted. All work shall be performed under the	e same terms and conditions as specified				
in the original contract unless otherwise stipulated.					
SIGNATURE BY GENERAL CONTRACTOR, OWNER, OR HIS AC	GENT DATE				



RFI #CC-62R1
REVISED

Regional office for CORE NV company 777 N 4th St Bosie, Idaho 83702 Project: 5-20-01-006 - CoK - City of Ketchum Fire Station 107 Saddle Road Ketchum, Idaho 83353

JT Brown (CORE Construction - Las Vegas)

Extractor and Extractor Trench in Decon Rm 131

TO: Alex Goedhart (Cole Architects)

Crystal McColly (Cole Architects)

777 N Fourth St

Boise, Idaho 83702

DATE INITIATED: 08/21/2020

Ketchum Fire Station>Fire Station>1st Floor>131

Decon

STATUS: Open **DUE DATE:** 08/28/2020

PROJECT STAGE: Cours

Course of Construction

COST CODE:

FROM:

SUB JOB: COST IMPACT:

LOCATION:

SCHEDULE IMPACT:

SPEC SECTION:

DRAWING NUMBER: A6.21, P1.00, P2.00, S2.01a

REFERENCE:

LINKED DRAWINGS:

RECEIVED FROM:

Brett Traylor (Evans Plumbing Incorporated (EPI))

COPIES TO:

JT Brown (CORE Construction - Las Vegas), Grant Gager (City of Ketchum), Cary Goldberg (DPPM Project Management), Bill McLaughlin (City of Ketchum), Dennis Potts (DPPM Project Management), Chris Schratwieser (CORE Construction - Las Vegas), Matt Sylvester (CORE Construction - Las Vegas), Brett Traylor (Evans Plumbing Incorporated (EPI))

Question from JT Brown (CORE Construction - Las Vegas) at 12:46 PM on 08/21/2020

On the equipment plan A6.21 item 22-Extractor and Item 14-Extractor Trough Drain are shown to be OFCI items installed in the Decontamination (Decon) Rm 131, however waste nor water is specifically shown on the plumbing plans P1.00 and P2.00 respectively. Please include waste/drain and water requirements for these fixtures on P1.00 and P2.00. The size of the extractor trench drain is not clearly shown and will need to be blocked out in the slab when the SOG is poured and may require a structural detail not shown on S2.01a. Attached to this RFI is a spec sheet on the extractor called out with a 8.4 cu ft capacity and the trough drain is required to have a minimum 4" min blockout bigger than the drain and placed after the original SOG.

Attachments:

EH060A-OPL.pdf

Awaiting an Official Response

See attached for water and trench drain information. Changes will be included in ASI 3.

See attached updated sheet P1.00.

James Siefert Musgrove Engineering 08/31/20 Crystal McColly Cole Architects 9/15/20

KPFF(9-1-20):


SEE ATTACHED STRUCTURAL PAGES, CHANGES TO BE ISSUED IN FORTHCOMING ASI-03.

ADAM STICKA, KPFF

The extractor trough drain will not be provided. Provide a 12"W X 12"D x 48"L cast in place trench drain with metal cover. See the attached updated sheets: S2.01a, S4.03, A2.01, A2.40, A6.21, P1.00, P2.00 & P5.01.

Crystal McColly Cole Architects 9/2/20

BY	DATE	COPIES TO

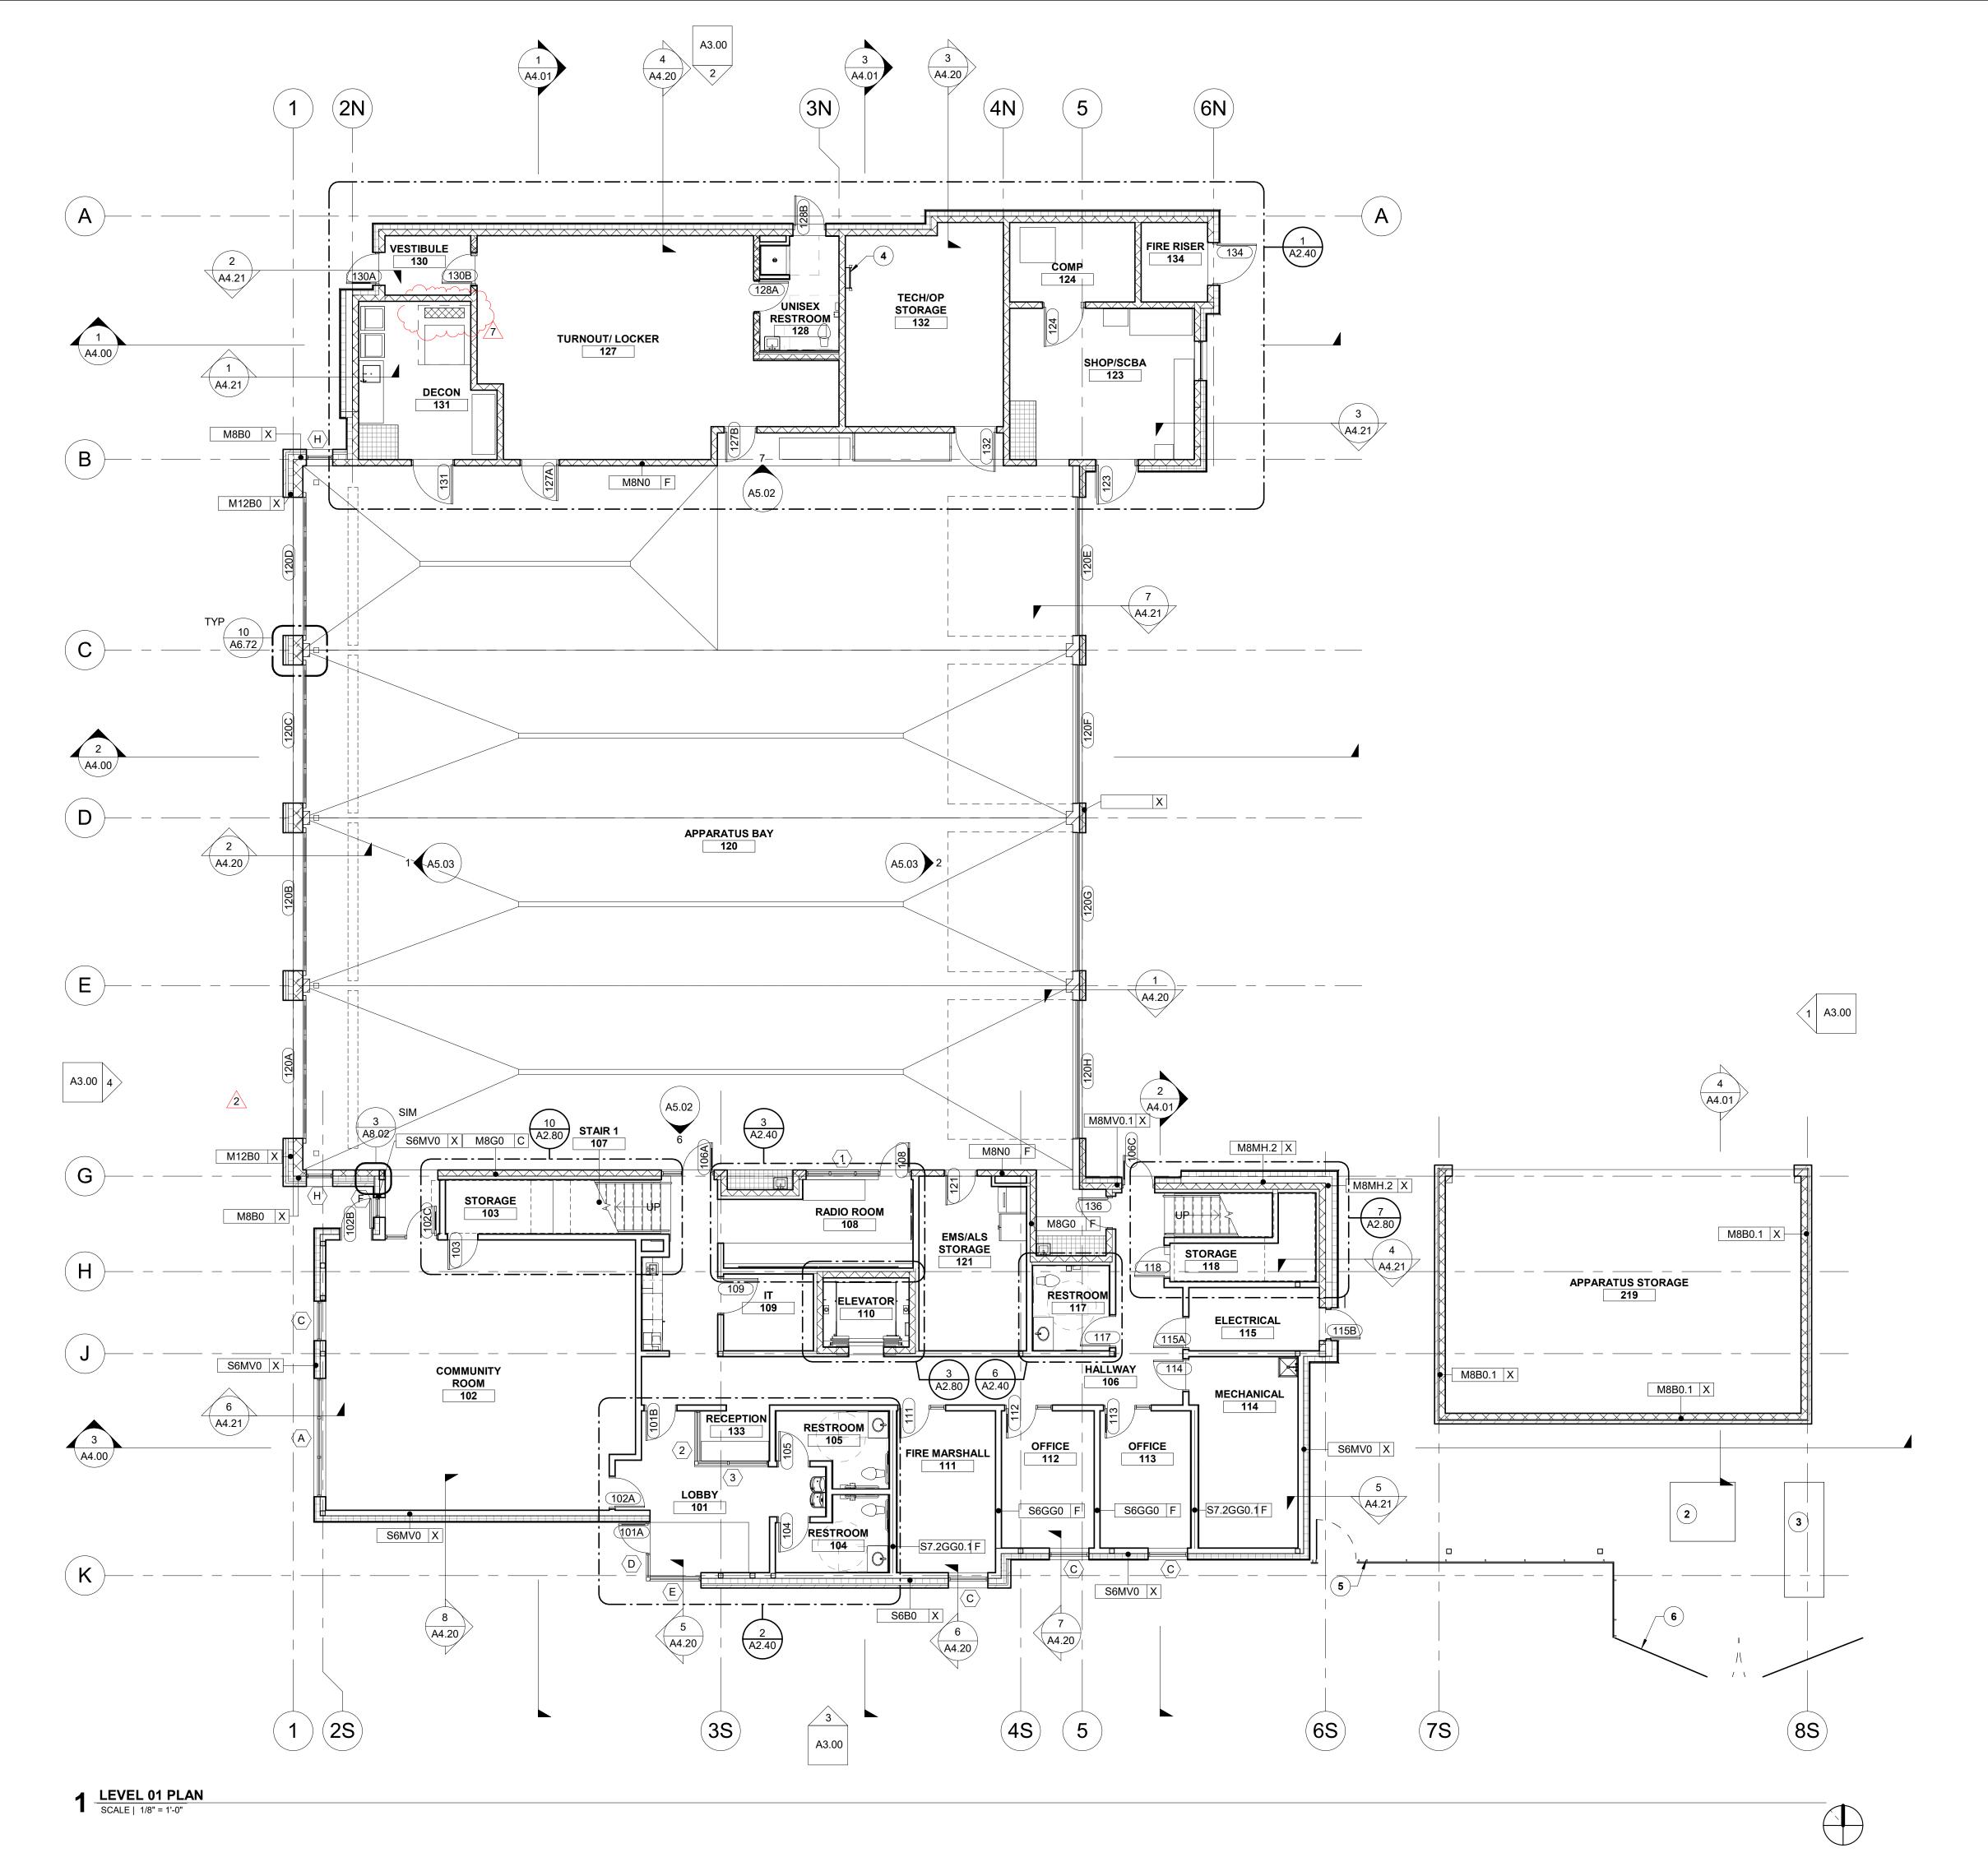

GENERAL NOTES

- A. FIELD VERIFY ALL DIMENSIONS AND EXISTING CONDITIONS. NOTIFY ARCHITECT IMMEDIATELY IF ANY CONFLICTS OR DISCREPANCIES OCCUR BEFORE PROCEEDING WITH WORK.
- B. CROSS REFERENCES SHOWN ON DRAWINGS DO NOT NECESSARILY INDICATE ALL LIKE CONDITIONS AND DO NOT LIMIT APPLICATION OF ANY DRAWING OR DETAIL. WHERE SPECIFIC DIMENSIONS, DETAILS, OR DESIGN INTENT CANNOT BE DETERMINED, CONSULT THE ARCHITECT PRIOR TO PROCEEDING WITH WORK. IF DESIGN INTENT REMAINS UNCLEAR THEN PROVIDE MOST EXPENSIVE OPTION IN BID.
- C. PROVIDE SOLID BLOCKING IN WALLS FOR ALL WALL HUNG EQUIPMENT. BLOCKING TO MEET OR EXCEED MANUFACTURER'S RECOMMENDATIONS. FASTEN EQUIPMENT TO WALLS PER MANUFACTURER'S RECOMMENDATIONS. PROVIDE BLOCKING FOR, BUT NOT LIMITED TO THE FOLLOWING: MILLWORK, RAILING, FIRE EXTINGUISHER ACCESSORIES, WALL MOUNTED PLUMBING FIXTURES, SHELVING, ELECTRICAL EQUIPMENT, RESTROOM ACCESSORIES AND DISPLAY ITEMS.
- D. CAULK ALL COUNTERTOPS, BACKSPLASHES AND CABINETS AT LOCATIONS WHERE THEY MEET WALLS. SEAL ALL CUT-OUTS IN COUNTERTOPS.
- E. ERECT DUST PROOF PARTITIONS AS REQUIRED BY OWNER TO PROTECT ADJACENT AREAS.
- F. ALL PARTITIONS ARE TYPE "S6GG0-F" UNLESS OTHERWISE NOTED.
- G. SEAL AROUND ALL MECHANICAL AND ELECTRICAL EQUIPMENT PENETRATIONS AT WALLS. AT RATED WALLS USE A U.L. APPROVED FIRE-STOPPING MATERIAL. APPROPRIATE FOR FIRE RATING REQUIREMENTS.
- H. PROVIDE 4" DOOR JAMBS FROM FACE-OF-FINISH AT ADJACENT WALLS ON THE HINGE SIDE OR UNLESS OTHERWISE INDICATED.
- I. DIMENSIONS ARE TO GRID LINE OR FACE OF STRUCTURAL MEMBER UNLESS OTHERWISE NOTED. DOOR & WINDOW OPENING DIMENSIONS ARE TO ROUGH OPENING OR CENTERLINE OF OPENING. CONCRETE AND BRICK DIMENSIONS ARE GIVEN TO THE FACE OF CONCRETE OR MASONRY AND TO THE FACE OF ROUGH OPENINGS.

KEYNOTES

- . STRUCTURAL COLUMN, SEE STRUCTURAL
- NEW TRANSFORMER, SEE ELECTRICAL
 GENERATOR, SEE ELECTRICAL
- ROOF ACCESS LADDER.
- 5. FENCE, SEE LANDSCAPE6. GATE, SEE LANDSCAPE

COLE /ARCHITECTS

1008 W Main St Boise, Idaho 83702 208.345.1800 **colearchitects.net** Copyright © 2020 Cole Architects, PLLC




ARCHITECTURE + PLANNING + DESIGN

6211 Roosevelt Way NE Seattle, WA 98115 206.522.3820

BIDDERS ARE INSTRUCTED TO CAREFULLY REVIEW THE CONSTRUCTION DOCUMENTS AND THE SITE CONDITIONS. INFORMATION REGARDING THE COMPLETE WORK OF SPECIFIC TRADES IS DISPERSED THROUGHOUT THE ENTIRE DOCUMENT SET AND CANNOT BE ACCURATELY DETERMINED BY REFERENCE TO OTHER THAN COMPLETE DOCUMENT SETS.

STAMP

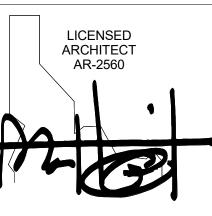

MATTHEW HUFFIELD STATE OF IDAHO

CONSULTANT

PROJECT INFORMATION



KETCHUM FIRE STATION NO. 1

107 SADDLE ROAD, KETCHUM, ID 83353

ISSUES

PHASECONSTRUCTION SETDATEJUNE 19, 2020JOB NUMBER18-022


MARK DATE DESCRIPTION
9/2/20 RFI #CC-62
7/17/20 ASI 1

SHEET NAME

FLOOR PLAN -LEVEL 01

SHEET NUMBER

A2.01

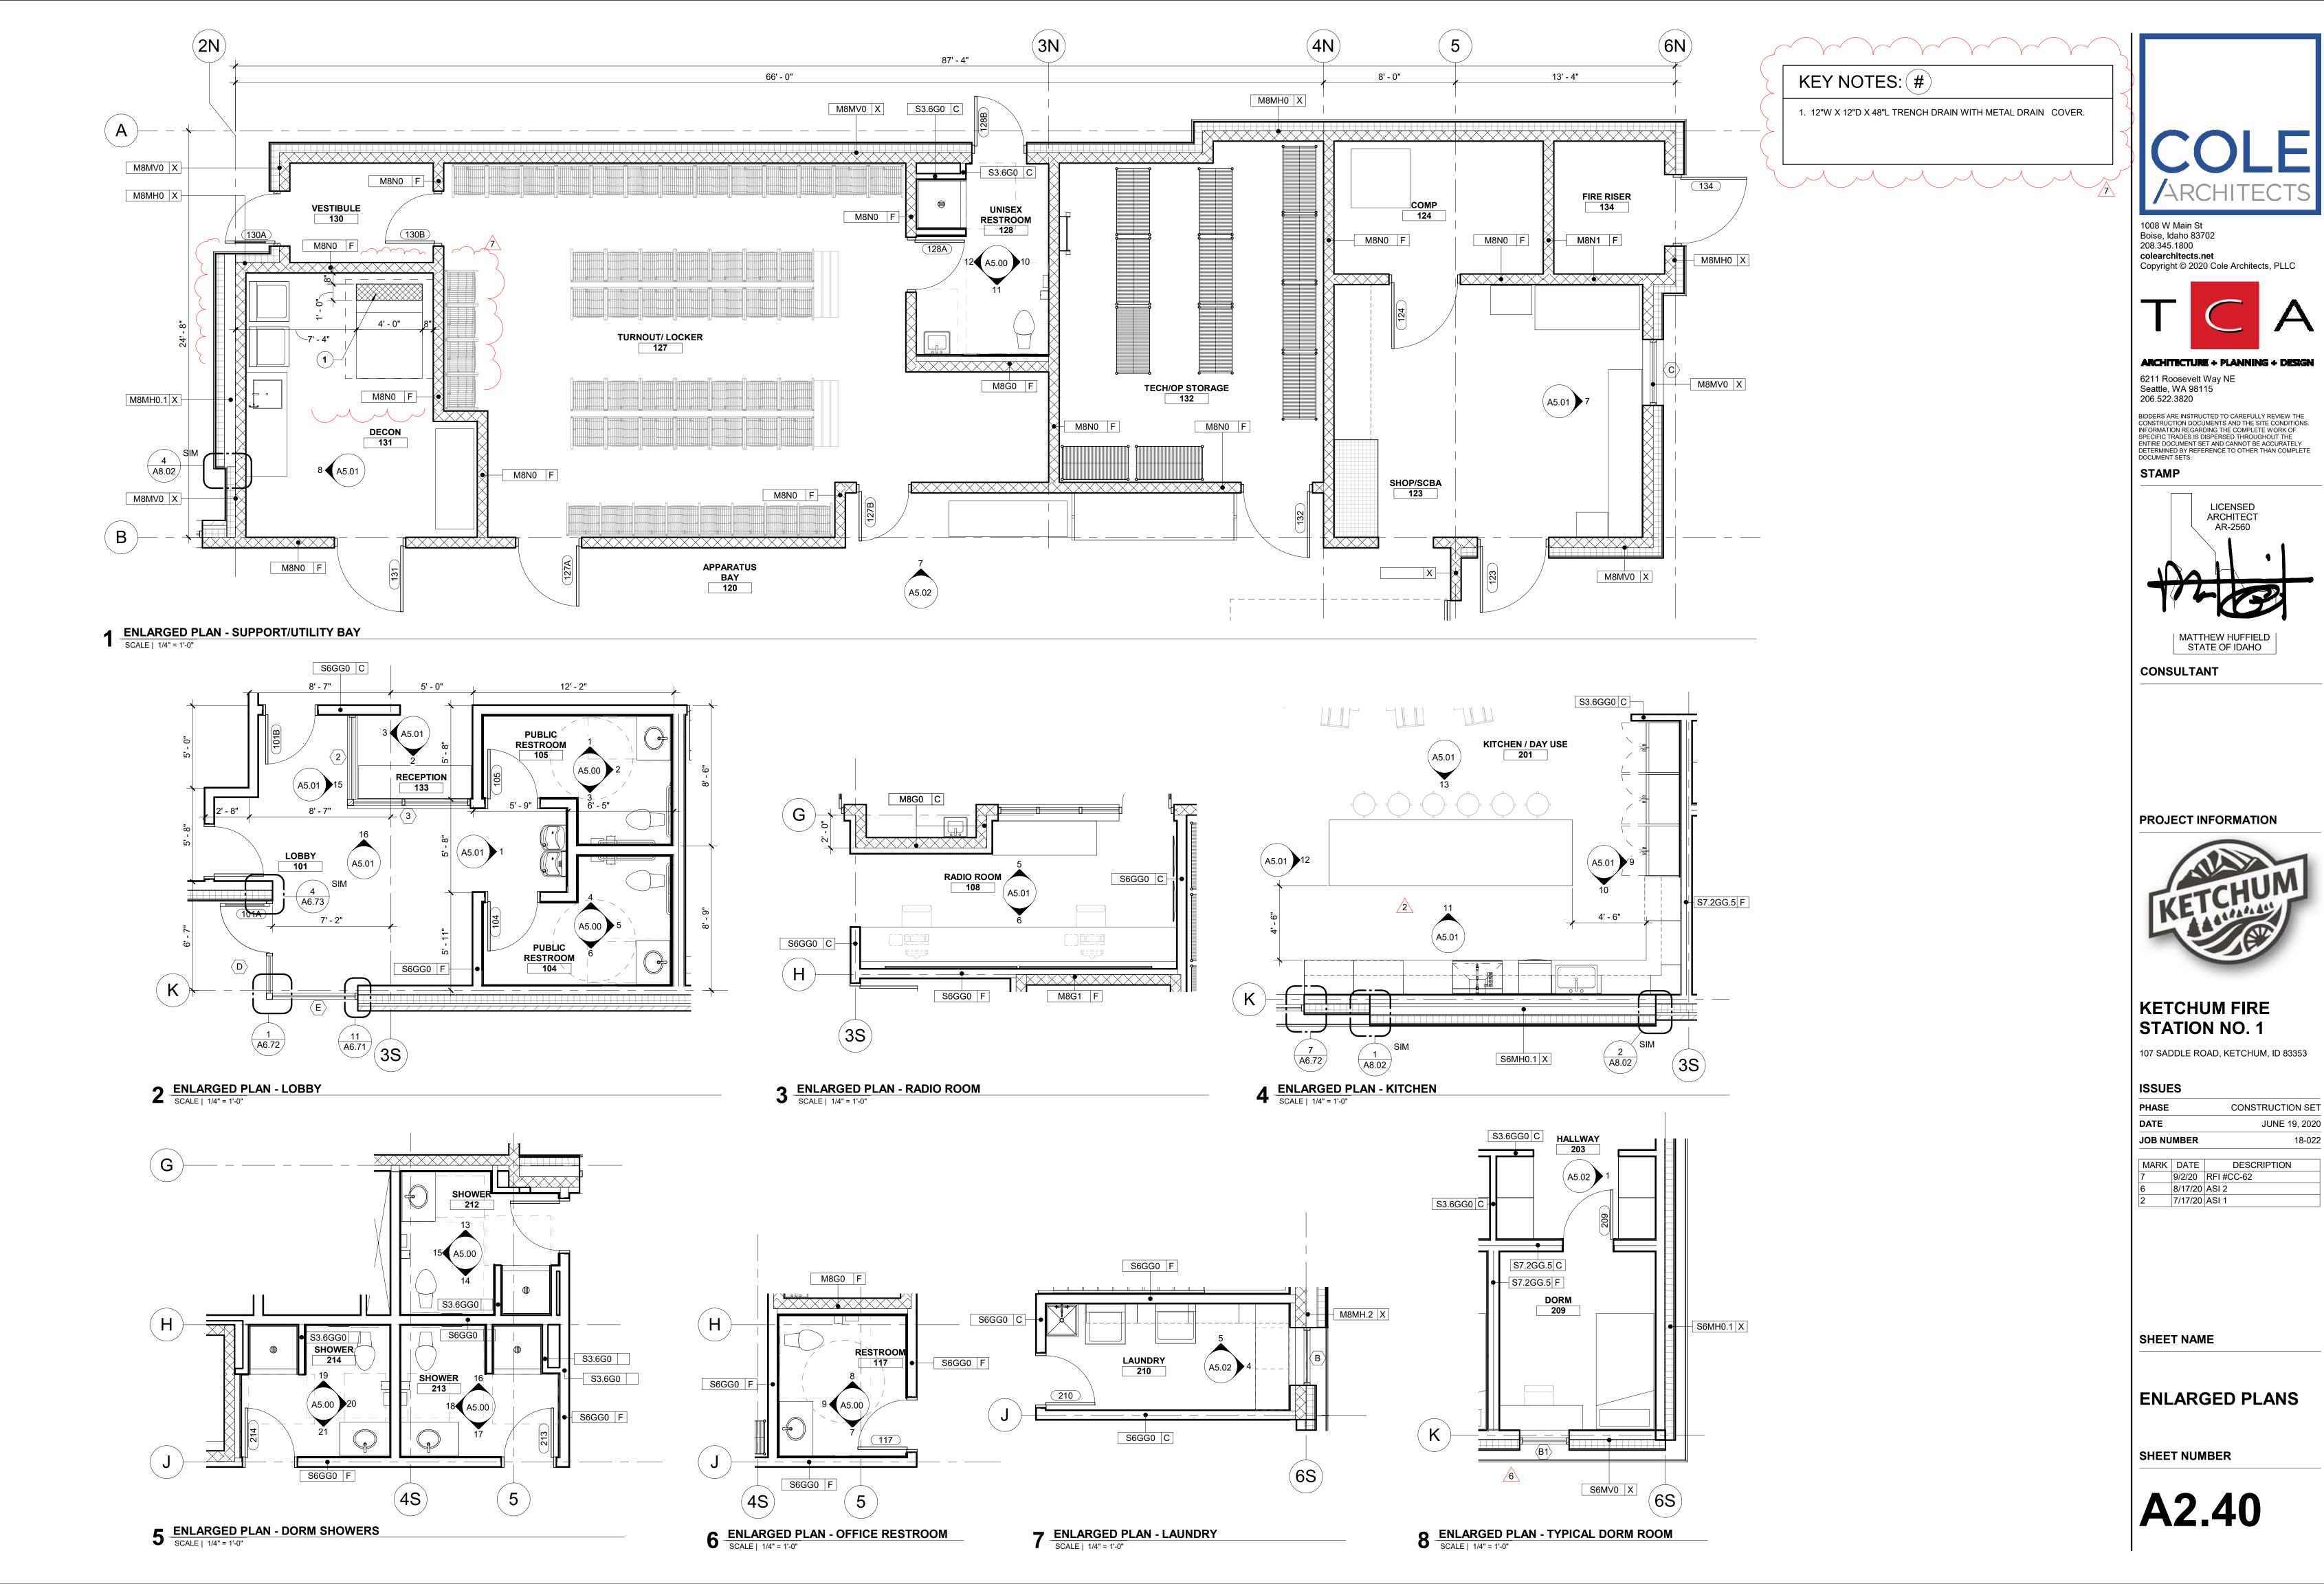

18-022


ROOM NUMBER	ROOM	TAG	DESCRIPTION	MANUFACTURER	ITEM#	QUANTIT Y	EXISTING/NE W	CONSTRUCTI ON	w	D	Н	LEVEL
D1	LOBBY	1	EMERGENCY PHONE	TBD		1	NEW	OFCI				1
02	COMMUNITY ROOM	8	WALL MOUNTED TV	LG	43UN7300PUF	2	NEW	OFCI	6' - 0 13/16"	0' - 3 1/2"	3' - 6"	1
06	COFFEE/COPY NOOK	2	COPY MACHINE	HP	1MR66A#A2L	1	NEW	OFOI	1' - 7 17/32"	1' - 2 27/32"	1' - 7 1/4"	1
06	COFFEE/COPY NOOK	3	UNDER COUNTER BEVERAGE REFRIDGERATOR	GE	GVS04BQNSS	1	NEW	OFCI	1' - 7"	1' - 11"	2' - 9"	1
)6	COFFEE/COPY NOOK	4	MICROWAVE	KITCHENAID	KMCS3022GSS	1	NEW	OFCI	2' - 0"	1' - 8"	1' - 1"	1
06	COFFEE/COPY NOOK	5	COFFEE MAKER	KEURIG	GMT20143	1	NEW	OFOI	0' - 10 13/32"	1' - 2"	1' - 1 29/32"	2
8	RADIO ROOM	6	RADIO CHARGING STATION	TBD		1	NEW	OFCI				1
)8	RADIO ROOM	10	32" WALL MOUNTED MONITOR	SAMSUNG	UN32N5300AFXZA	2	NEW	OFCI	2' - 4 29/32"	0' - 3 3/32"	1' - 5 5/16"	1
0	APPARATUS BAY	9	ROTOJET HOSE WASHER	ROTOJET	Series 100A	1	NEW	OFCI	7' - 2"	2' - 2"	4' - 1"	1
1	STORAGE	12	ICE MACHINE	MANITOWOC	SM-50A	1	NEW	OFCI	2' - 2"	2' - 4 1/2"	2' - 8 1/2"	1
1	STORAGE	13	REFRIGERATOR	LG	LRFCS2503S	1	NEW	OFOI	2' - 9"	2' - 5"	5' - 9 7/8"	1
:3	SHOP	7	SCBA FILL STATION	BAUER COMPRESSORS	CFS5.5-2S	1	NEW	OFCI	2' - 6"	1' - 9"	4' - 5"	1
3	SHOP	15	LOW PRESSURE COMPRESSOR	TBD		1	NEW	OFOI				1
4	COMPRESSOR	18	COMPRESSOR WITH CO MONITOR	HUSH AIR CONNECT 7500	8004553	1	NEW	OFCI	3' - 7"	3' - 7"	5' - 3"	1
1	DECONTAMINATION	21	RAM TURNOUT GEAR DRYER	RAM AIR	TG-4	1	NEW	OFCI	6' - 1"	2' - 4"	6' - 6"	1
31	DECONTAMINATION	22	EXTRACTOR	CONTINENTIAL GIRBAU	EH060	1	NEW	OFCI	3' - 2 13/32"	4' - 0 3/16"	4' - 10 3/32"	1
31	DECONTAMINATION	23	WASHER	LG	WM3700HVA	1	NEW	OFCI	2' - 3"	2' - 6 1/4"	3' - 3"	1
31	DECONTAMINATION	25	EMERGENCY SHOWER/EYE WASH	ULINE	H-5457	1	NEW	CFCI				1
1	DECONTAMINATION	24	DRYER	BOSCH	WTG86400UC	1 _	NEW	OFCI	1' - 11 1/2"	2' - 1"	2' - 9 1/4"	2
11	DECONTAMINATION	14	EXTRACTOR DRAINAGE TRENCH	HIGH MARK MANUFACTURING	ABS DRAIN TROUGH	1	NEW	OFCI)			1
1	DAY USE	11	WALL MOUNTED TV	LG	43UN7300PUF	1	NEW	OFCI	3' - 2 5/16"	0' - 3 5/16"	1' - 10 1/2"	2
1	KITCHEN	26	36" BURNER ELECTRIC INDUCTION COOKTOP	KITCHENAID	KICU569X	1	NEW	OFCI	3' - 0 5/16"	1' - 9 5/16"	0' - 3 1/8"	2
1	KITCHEN	27	HOOD	LG	LSHD3680ST	1	NEW	OFCI	2' - 11 3/8"	1' - 7 11/16"	3' - 9"	2
1	KITCHEN	28	DOUBLE WALL OVEN	LG	LWD3063063ST	1	NEW	OFCI	2' - 6"	2' - 0 3/4"	4' - 2 7/16"	2
1	KITCHEN	29	MICROWAVE	LG	LMC2075BD	2	NEW	OFCI	2' - 0 7/16"	1' - 7 5/8"	1' - 1 5/8"	2
1	KITCHEN	30	DISHWASHER	BOSCH	SHX3AR75UC	1	NEW	OFCI	2' - 0"	2' - 0 1/4"	2' - 9 3/4"	2
1	KITCHEN	20	REFRIGERATOR	LG	LRFCS2503S	3	NEW	OFOI	2' - 9"	2' - 5"	5' - 9 7/8"	2
1	KITCHEN	19	COFFEE MAKER	KEURIG	GMT20143	1	NEW	OFOI	0' - 10 13/32"	1' - 2"	1' - 1 29/32"	2
0	LAUNDRY	17	DRYER	LG	DLEX9000V	1	NEW	OFCI	2' - 5"	2' - 9 3/8"	3' - 4 7/8"	1
0	LAUNDRY	16	WASHER	LG	WM3700HVA	1	NEW	OFCI	2' - 3"	2' - 6 1/4"	3' - 3"	2





6211 Roosevelt Way NE Seattle, WA 98115 206.522.3820

BIDDERS ARE INSTRUCTED TO CAREFULLY REVIEW THE CONSTRUCTION DOCUMENTS AND THE SITE CONDITIONS. INFORMATION REGARDING THE COMPLETE WORK OF SPECIFIC TRADES IS DISPERSED THROUGHOUT THE ENTIRE DOCUMENT SET AND CANNOT BE ACCURATELY DETERMINED BY REFERENCE TO OTHER THAN COMPLETE DOCUMENT SETS.

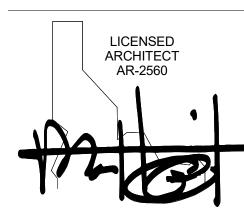

MATTHEW HUFFIELD STATE OF IDAHO

CONSULTANT

PROJECT INFORMATION



KETCHUM FIRE STATION NO. 1

107 SADDLE ROAD, KETCHUM, ID 83353

ISSUES

PHASECONSTRUCTION SETDATEJUNE 19, 2020JOB NUMBER18-022


MARK DATE DESCRIPTION
7 9/2/20 RFI #CC-62


SHEET NAME

EQUIPMENT PLAN -LEVEL 01

SHEET NUMBER

A6.21

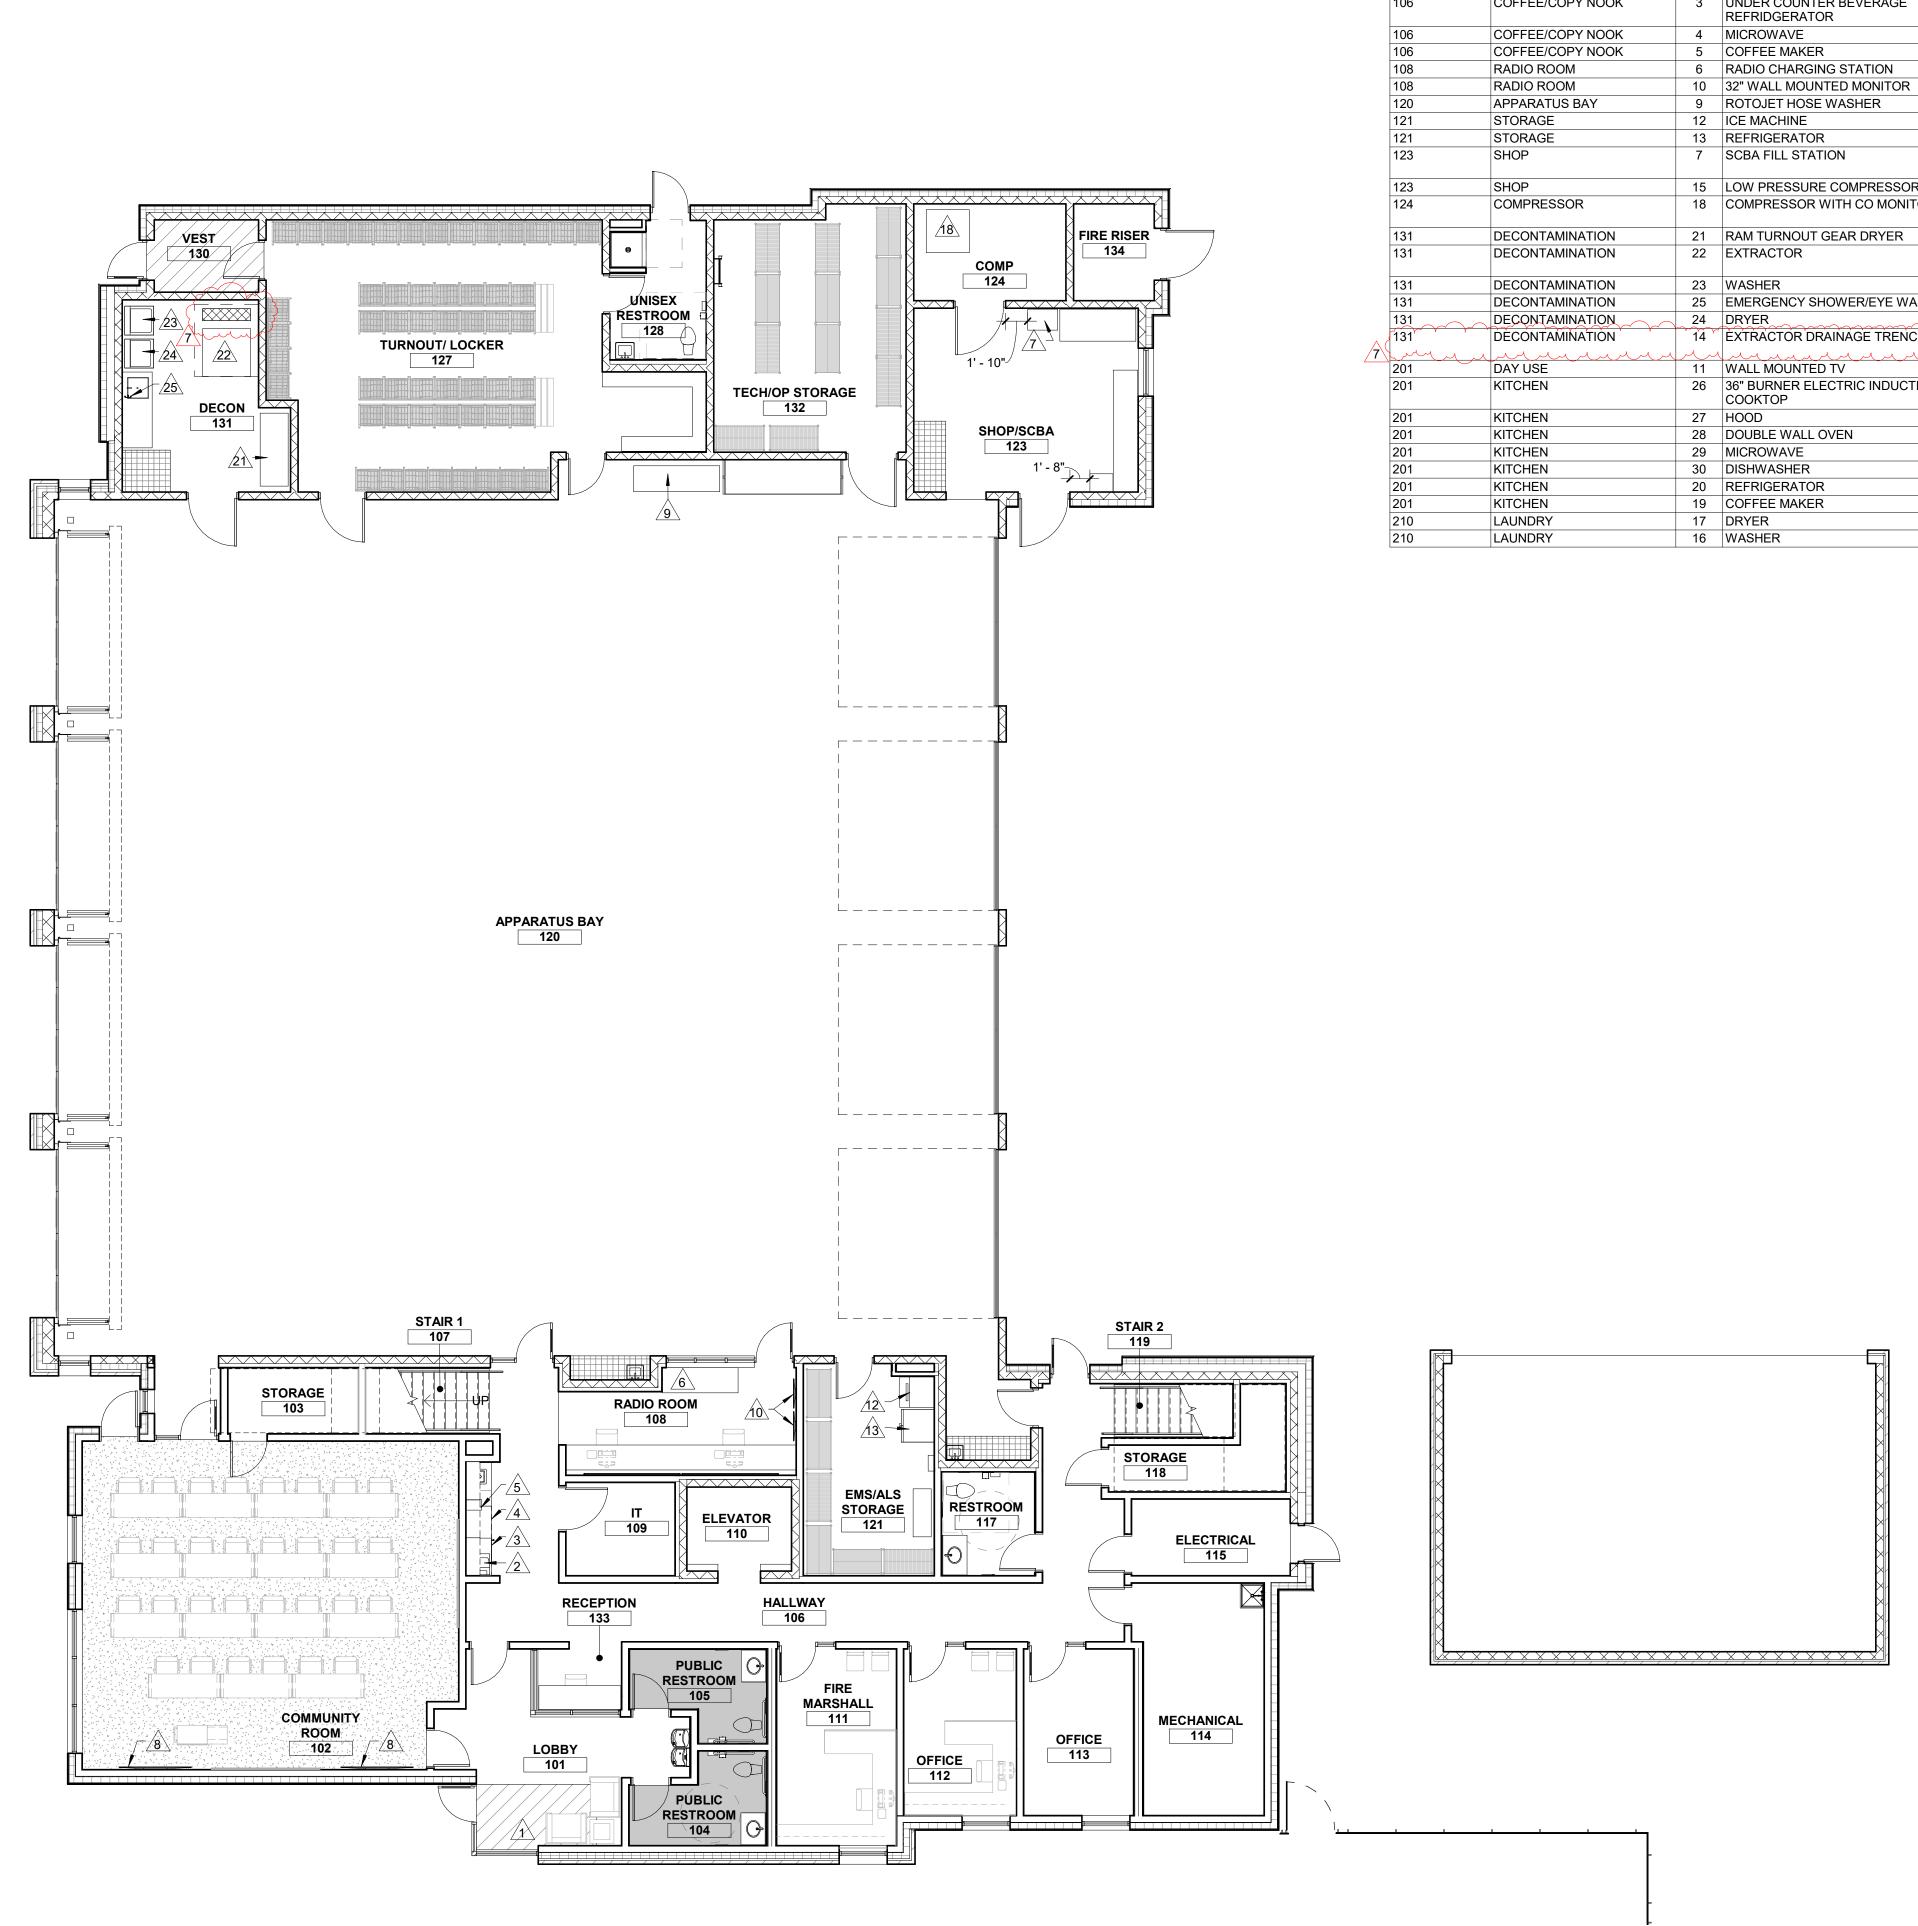

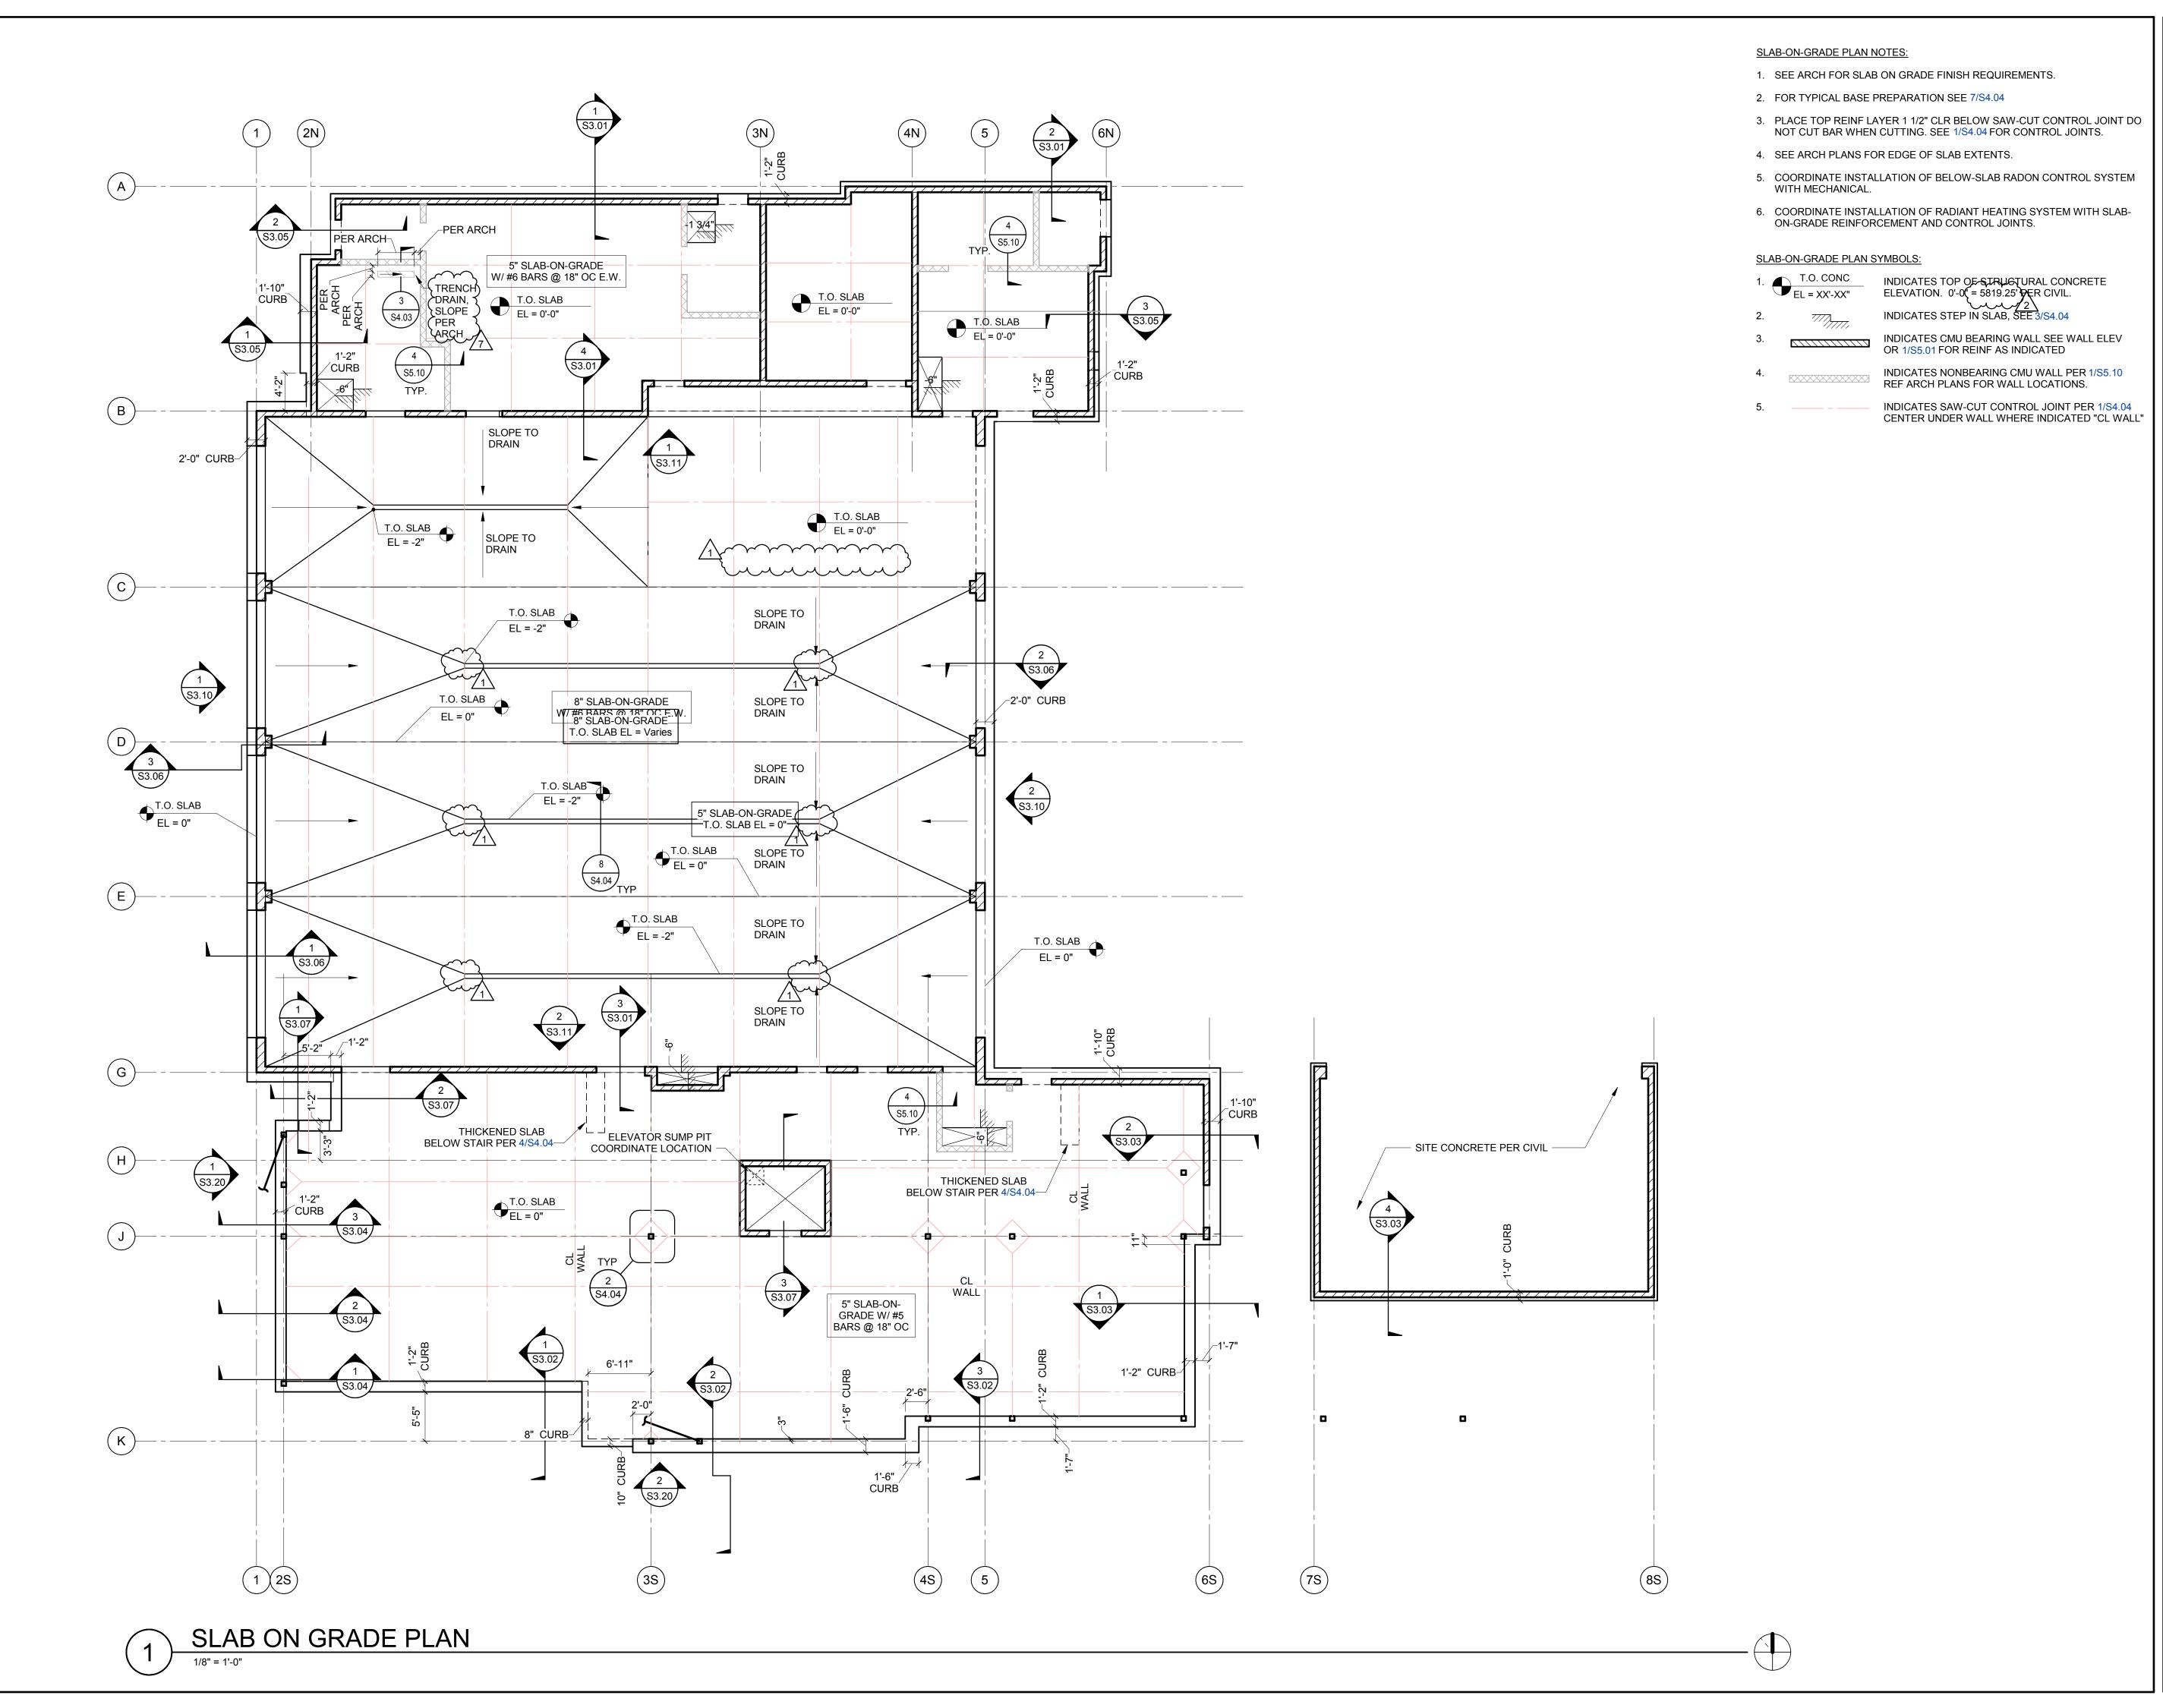





STAMP

Seattle, WA 98115 206.522.3820

6211 Roosevelt Way NE

CONSULTANT



PROJECT INFORMATION



KETCHUM FIRE STATION

SADDLE ROAD KETCHUM, ID 83353

ISSUES


PHASE		CONSTRUCTION SET		
DATE	DATE 6/19			
JOB NU	IMBER	1021190017		
MARK	DATE	DESCRIPTION		
1	7/17/2020	ASI #1		
7	9/2/20	REI#CC-62		


SHEET NAME


SLAB ON GRADE PLAN

SHEET NUMBER


S2.01a

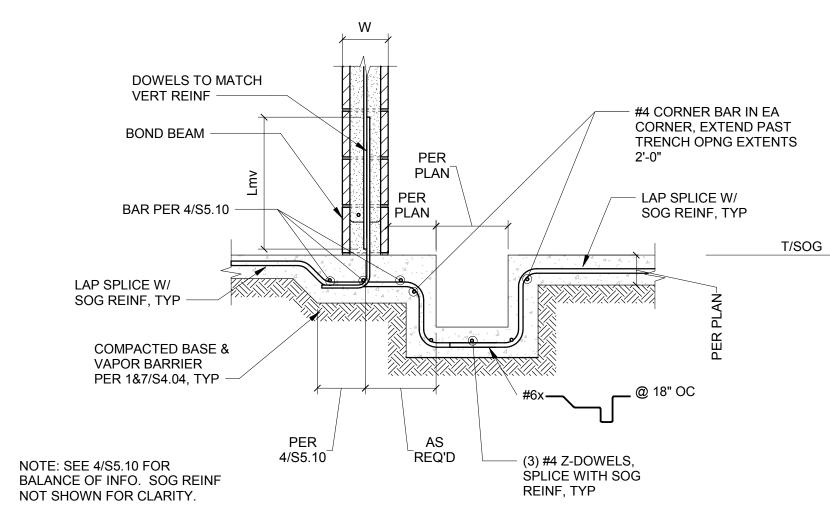

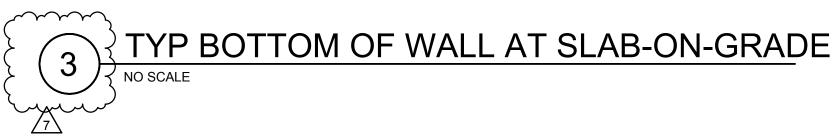

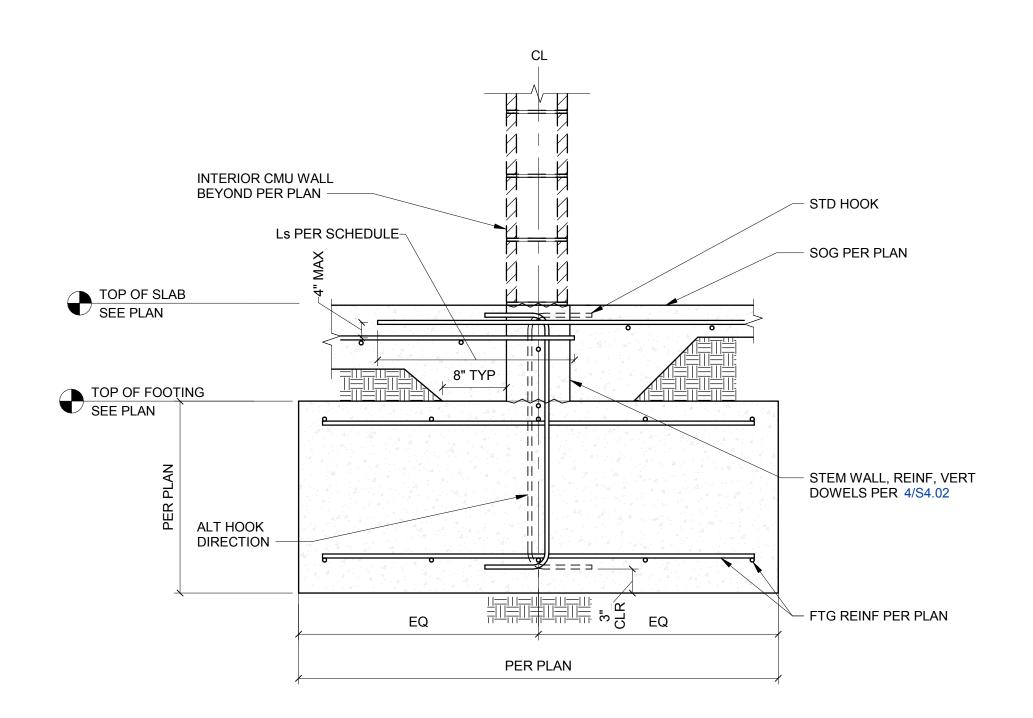

FOOTING AT INTERIOR CMU WALL AT WALL OPENING

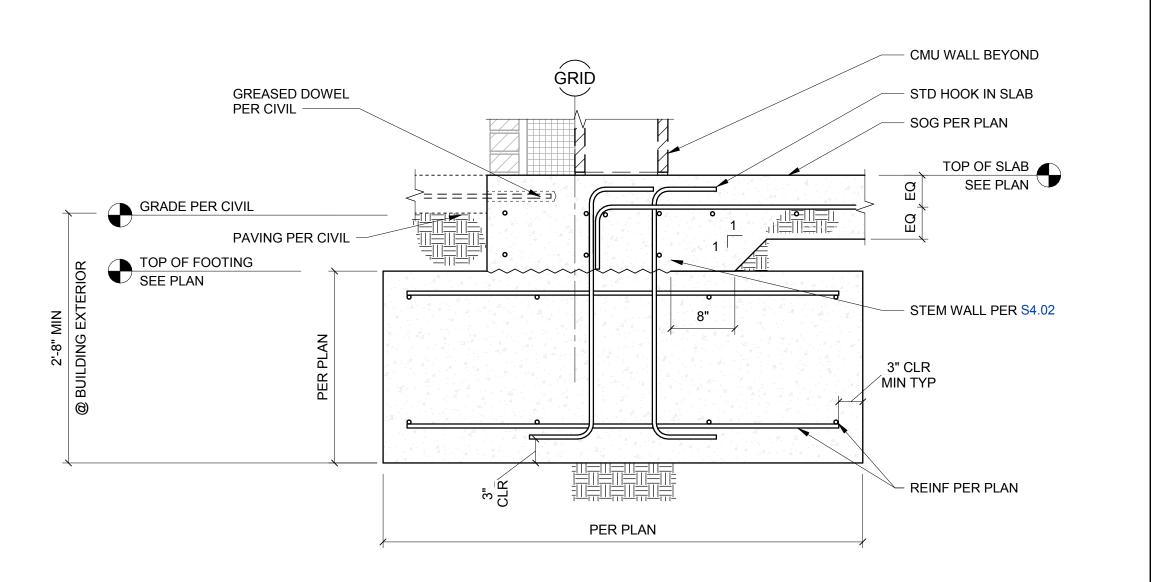

EDGE OF SLAB ON GRADE AT WALL OPENINGS 1" = 1'-0"



1008 W Main St Boise, Idaho 83702 208.345.1800 colearchitects.net Copyright © 2020 Cole Architects, PLLC



6211 Roosevelt Way NE Seattle, WA 98115 206.522.3820

STAMP

CONSULTANT





KETCHUM FIRE STATION

SADDLE ROAD KETCHUM, ID 83353

ISSUES


PHASE		CONSTRUCTION SET
DATE		6/19/20
JOB NUMBER		1021190017
MARK	DATE	DESCRIPTION
7	9/2/20	RFI#CC-62

SHEET NAME

TYPICAL CONCRETE DETAILS

SHEET NUMBER

S4.03

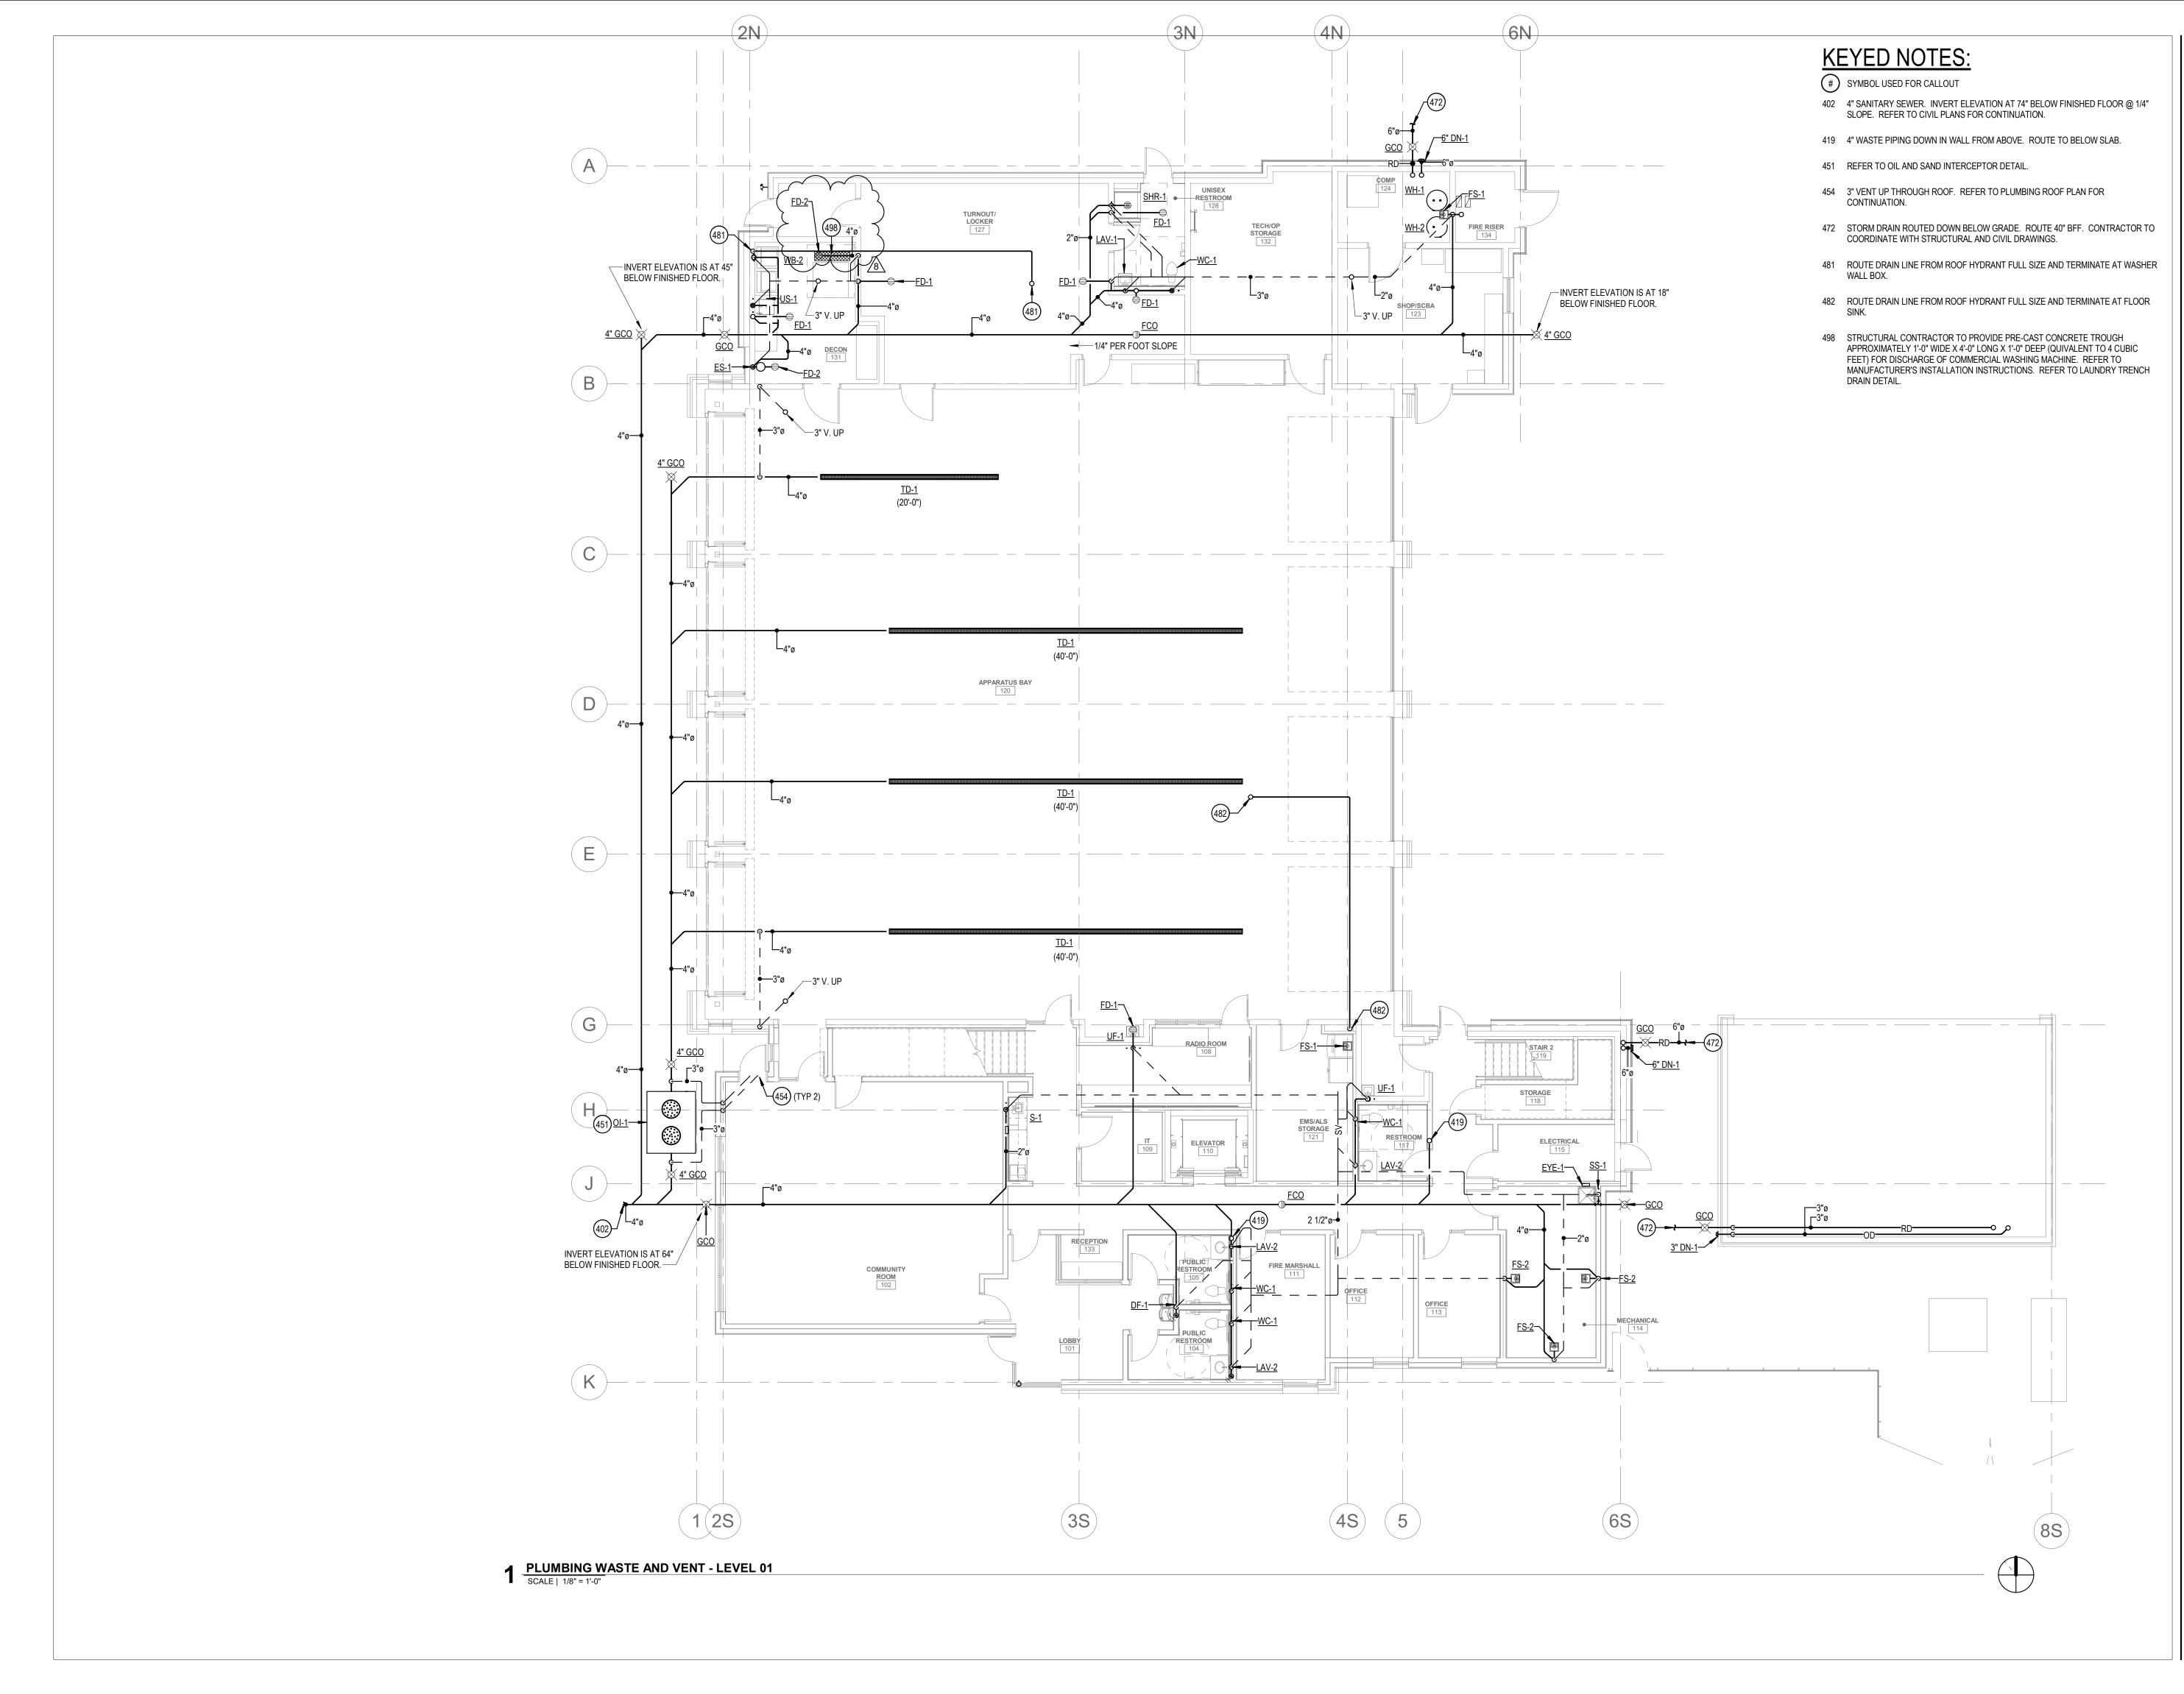





ARCHITECTURE + PLANNING + DESIGN
6211 Page 2014 Way NE

6211 Roosevelt Way NE Seattle, WA 98115 206.522.3820

STAMP

CONSULTANT



234 S. WHISPERWOOD WAY BOISE, IDAHO 83709 (208) 384-0585 PROJECT #19-366

PROJECT INFORMATION



KETCHUM FIRE STATION

107 SADDLE ROAD, KETCHUM ID 83353

ISSUES

PHASE	CONSTRUCTION SE
DATE	6/19/202
JOB NUMBER	18-02

 MARK
 DATE
 DESCRIPTION

 1
 7/17/20
 ASI #1

 7
 8/31/20
 RFI #CC-62


 8
 9/03/20
 RFI #CC-62R1

SHEET NAME

PUMBING WASTE AND VENT PLAN -LEVEL 01

SHEET NUMBER

P1.00

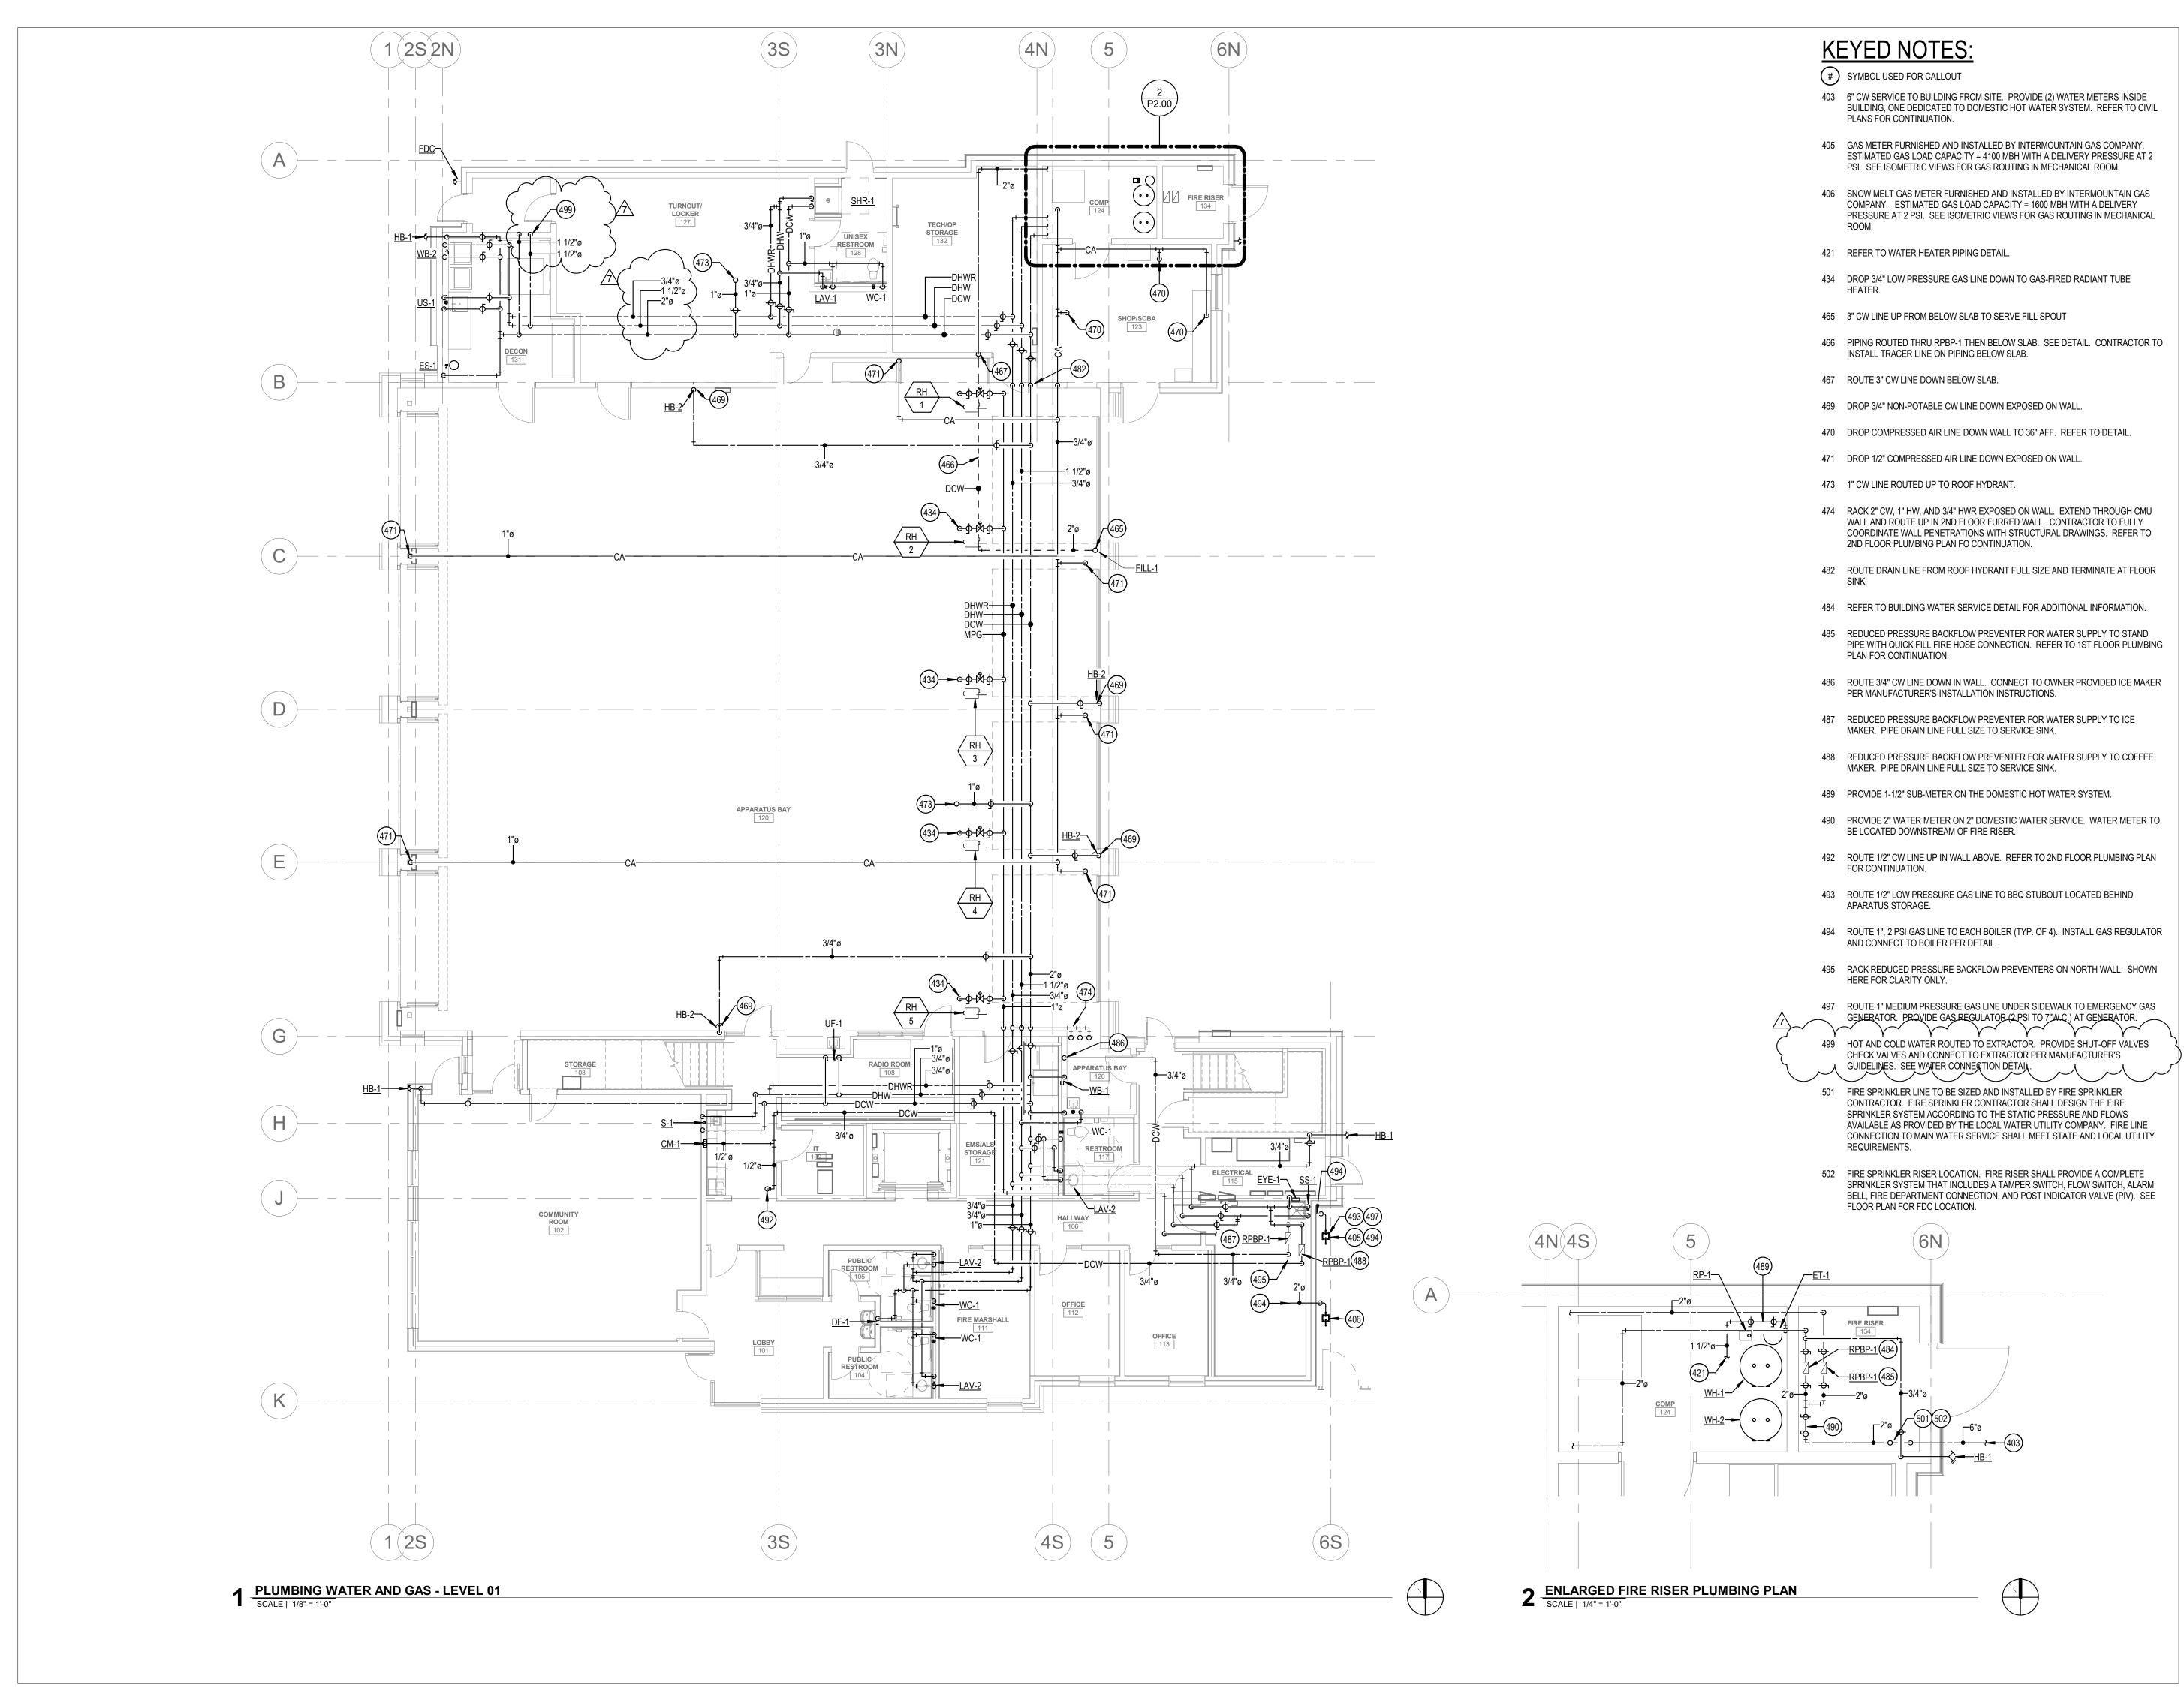





ARCHITECTURE + PLANNING + DESIGN

6211 Roosevelt Way NE Seattle, WA 98115 206.522.3820

STAMP

CONSULTANT



234 S. WHISPERWOOD WAY BOISE, IDAHO 83709 (208) 384-0585 PROJECT #19-366

PROJECT INFORMATION



KETCHUM FIRE STATION

107 SADDLE ROAD, KETCHUM ID 83353

SUES

PHASE CONSTRUCTION SET

DATE 6/19/2020

JOB NUMBER 18-022

 MARK
 DATE
 DESCRIPTION

 6
 8/17/20
 ASI #2


 7
 9/2/20
 RFI #CC-62

SHEET NAME


PLUMBING WATER AND GAS PLAN -LEVEL 01


SHEET NUMBER


P2.00

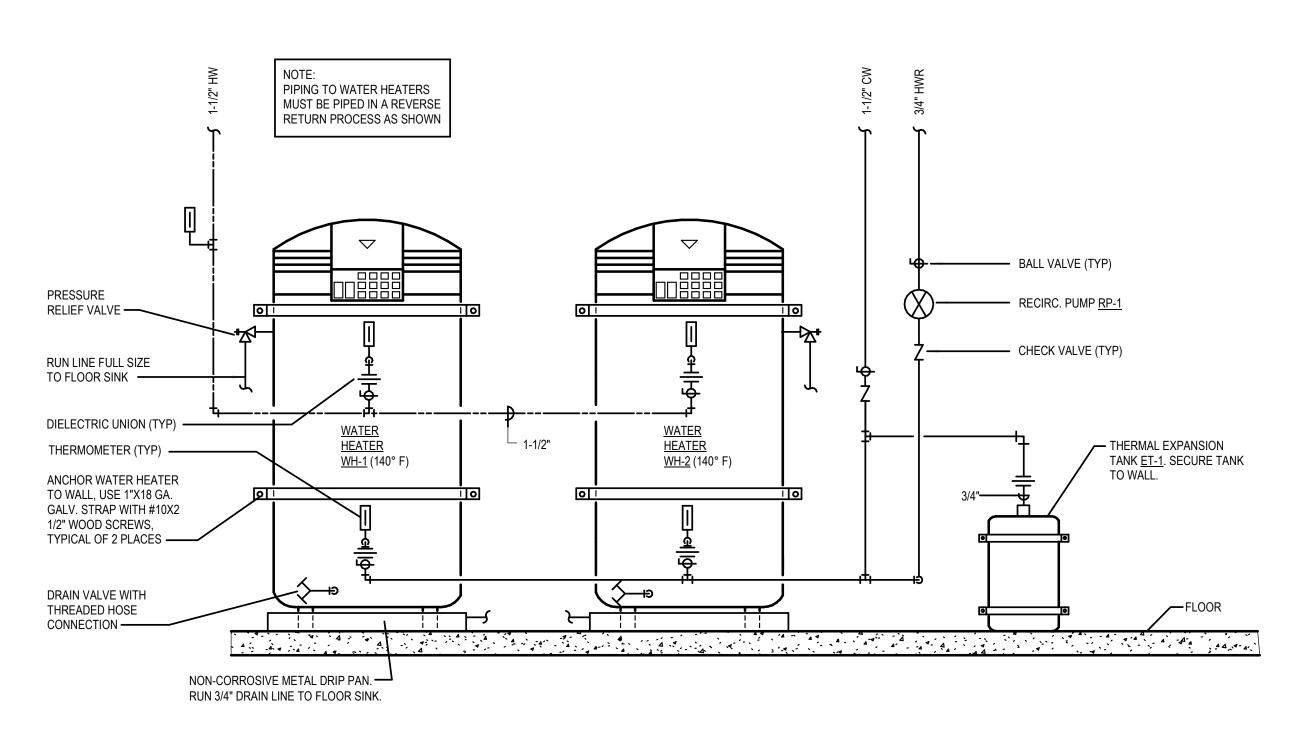

1 ELECTRIC GAS WATER HEATER PIPING DETAIL SCALE | NTS

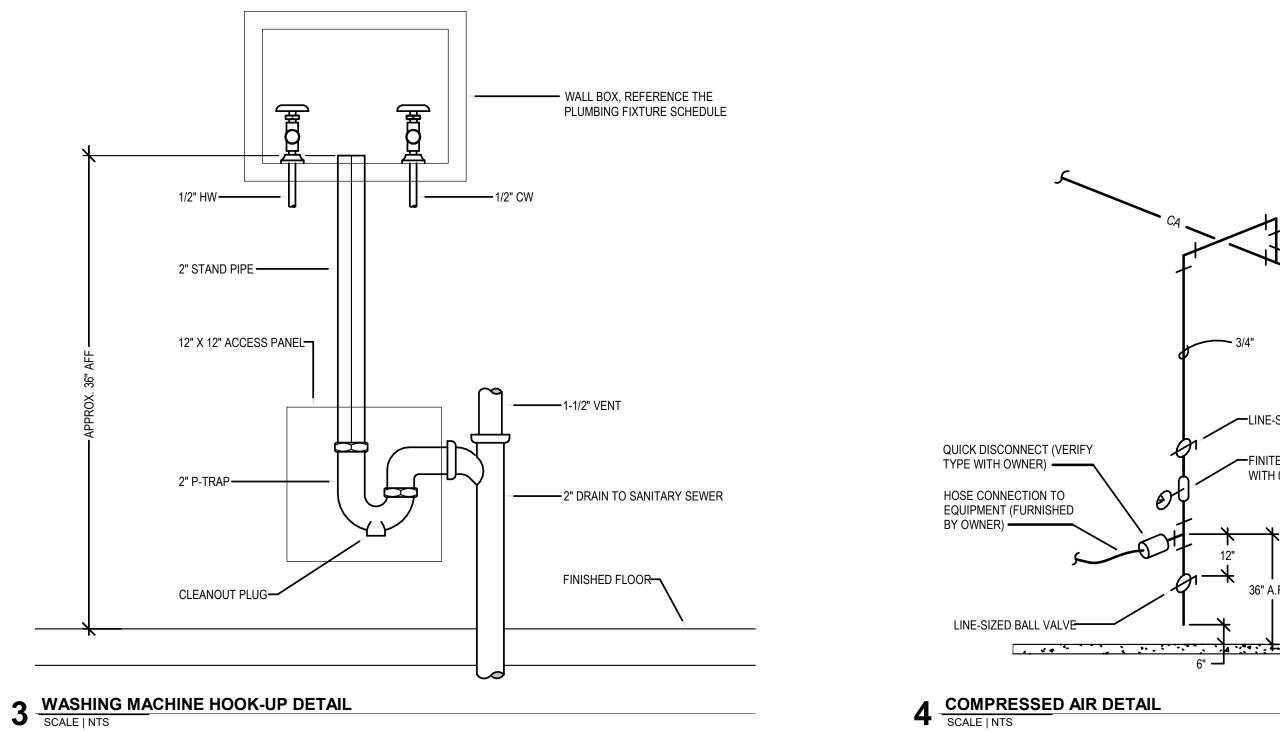


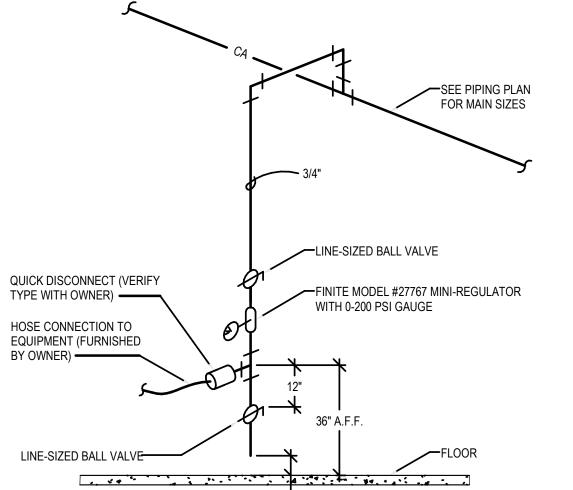

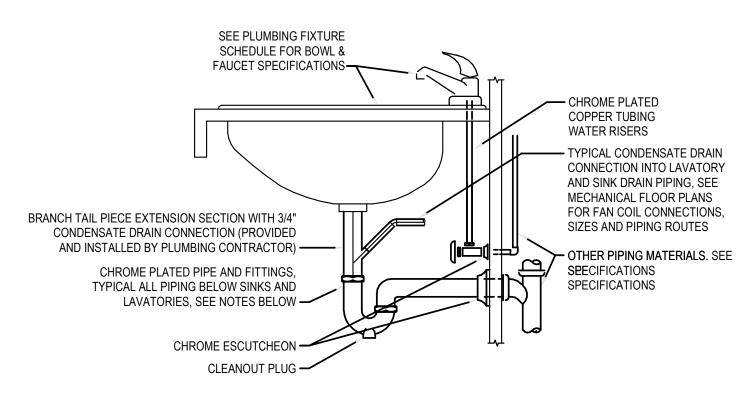

1. INTERIOR EXPOSED PIPE, VALVES AND FIXTURE TRIM, INCLUDING TRIM BEHIND CASEWORK DOORS, SHALL BE CHROME PLATED.

- 2. ALL PIPING PENETRATIONS THROUGH FINISHED WALLS SHALL BE PROVIDED WITH CHROME ESCUTCHEONS.
- 3. ALL SINK AND LAVATORY TRAPS SHALL BE PROVIDED WITH A CLEANOUT PLUG IN THE BOTTOM OF THE TRAP.
- 4. ALL PLUMBING FIXTURES SHALL BE CAULKED AND SEALED TO SURROUNDING SURFACES.
- 5. PLUMBING CONTRACTOR SHALL VERIFY THE LOCATION OF ALL LAVATORIES AND SINKS THAT NEED TO BE INSTALLED WITH THE BRANCH TAIL PIECE SECTION WITH 3/4" DRAIN CONNECTION. THE PLUMBING CONTRACTOR WILL BE RESPONSIBLE TO VERIFY THE PLUMBING

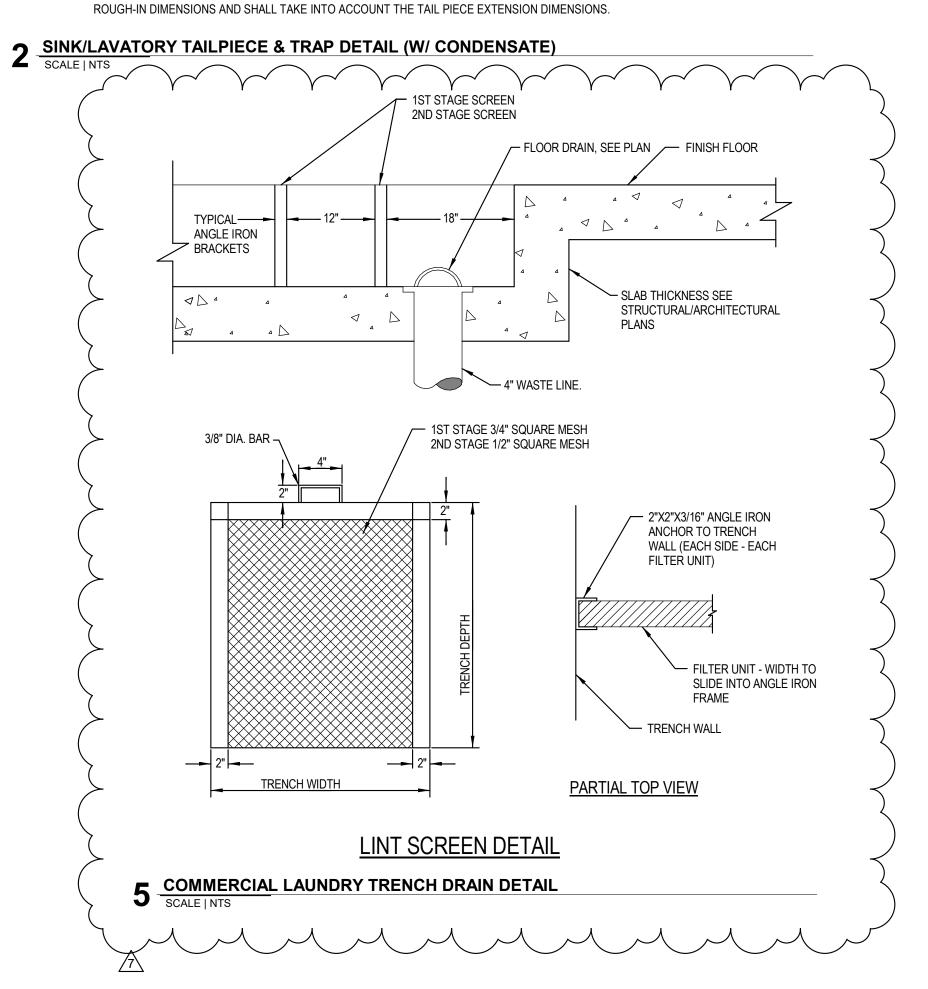

1008 W Main St Boise, Idaho 83702 208.345.1800 colearchitects.net Copyright © 2020 Cole Architects, PLLC



6211 Roosevelt Way NE Seattle, WA 98115 206.522.3820

STAMP

CONSULTANT



234 S. WHISPERWOOD WAY BOISE, IDAHO 83709 (208) 384-0585 PROJECT #19-366

PROJECT INFORMATION



KETCHUM FIRE STATION

107 SADDLE ROAD, KETCHUM ID 83353

ISSUES

PHASE	CONSTRUCTION SE
DATE	6/19/202
JOB NUMBER	18-02


MARK DATE DESCRIPTION 9/2/20 RFI #CC-62

SHEET NAME

PLUMBING DETAILS

SHEET NUMBER

P5.01

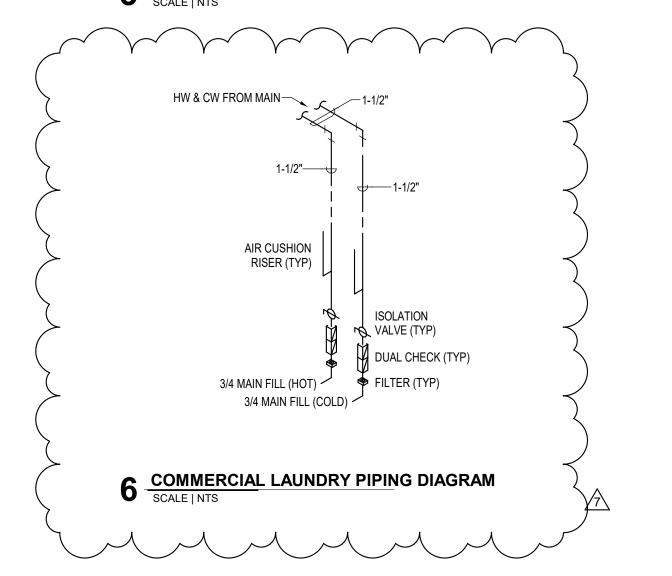



Building. Growing. Leading. ... Since 1937.

Budget Evolution Item Summary City of Ketchum Fire Station #1

RFI-94 App Storage Structure	Revisions	Date:	2/22/2021
Description: Rev	rised Apparatus Storage Structu	re	
SCOPE	SUBCONTRACT	OR AM	DUNT
Revised footings and SOG	Garrett Concre		(575.00)
Revised App Storage Steel	Rule Steel	\$	(2,891.00)
Neviseu App Storage Steel	Rule Steel	۶	(2,891.00)
SUBTOTAL:		\$	(3,466.00)
	only on the presumption that o	· · · · · · · · · · · · · · · · · · ·	(3,400.00)
	ursed by Change Order, TOTAL		s the
	upon markup in accordance wit		
Bond and Insurance	CORE	\$	(72.00)
CMAR FEE	CORE	\$	(154.00)
Sales Tax	CORE	\$	-
TOTAL AMOUNT:	i	\$	(3.692.00

Chris Schratwieser

From: Pat Garrett < garrettpat1963@gmail.com>

Sent: Friday, February 19, 2021 2:25 PM

To: Chris Schratwieser

Subject: Parking Co

Value of org bid \$23,703.11

Value of the new structure \$23,127.76

Credit \$ 575.35

if you need work sheets please let me know

Change Order Request Summary

Project: Ketchum Fire Station 1 Subcontractor: Rule Steel
Date: January 7, 2021 Reference: RFI #CC-94

C/O Req. No.: 12

Description: Rev'd patio canopy from a column supported frame to a cable supported frame.

Material:

Item Description	Quantity	Unit Price	Extended
WF (in)		\$0.78	\$ -
WF (out)		\$0.78	\$ -
C (in)		\$0.90	\$ -
C (out)		\$0.90	\$ -
MC (in)		\$1.14	\$ -
MC (out)		\$1.14	\$ -
PL (in)	504	\$0.78	\$ 393.12
PL (out)	(1164)	\$0.78	\$ (907.92)
FB (in)		\$0.78	\$ -
FB (out)		\$0.78	\$ -
L (in)		\$0.78	\$ -
L (out)	(260)	\$0.78	\$ (202.80)
HSS (in)	760	\$0.84	\$ 638.40
HSS (out)	(2546)	\$0.84	\$ (2,138.64)
Pipe (in)		\$1.02	\$ -
Pipe (out)		\$1.02	\$ -
Rod (in)		\$0.78	\$ -
Rod (out)		\$0.78	\$ -
Hardware (in)		lump	\$ 451.95
Hardware (out)		lump	\$ (62.20)
Paint Material (in)		lump	\$ -
Paint Material (out)		lump	\$ -
	(2,706)	Total Mat.	\$ (1,828.09)

Shop Hours (net):
Detailing (net) include field meas.
Painting Labor (net):
Blasting Labor (net):
Freight (net):

Hours	Rate/Hr		Extended
-3.00	\$	70.00	\$ (210.00)
0.00	\$	75.00	\$ -
0.00	\$	60.00	\$ -
0.00	\$	115.00	\$ -
	lump		\$ 50.00
Total Shop			\$ (160.00)

Subcontractor

Suppliers

Subcontractor	Work Description	Quote Amount	
DMS	No Credit	\$	-
Suppliers	Work Description	Quo	te Amount
SEI	Deck/Joists	\$	(217.50)
Valmont	Galvanizing	\$	(465.89)
Wooster	Nosings	\$	-
	Sub Total	\$	(683.39)
	10% mkup	\$	(68.34)
	Total Subcontractor/Supplier	\$	(751.72)

Change Order Request Amount
Sales Tax 6% (on material and suppliers)
Additional Bond Cost

\$ (2,739.81)
\$ (150.69)
\$ -

Total Change Order Request - Rounded Added time to schedule - working days

\$ (2,891.00)

Notes:

- 1) Canopy was reduced in size.
- 2) No credit for Erection The added tie rods cancel out the removed columns
- 3)
- 4)



Regional office for CORE NV company 777 N 4th St Bosie, Idaho 83702

Project: 5-20-01-006 - CoK - City of Ketchum Fire Station 107 Saddle Road Ketchum, Idaho 83353

Patio Columns per ASI 3

TO: FROM: JT Brown (CORE Construction - Las Vegas) Alex Goedhart (Cole Architects) Crystal McColly (Cole Architects)

777 N Fourth St Boise, Idaho 83702

DATE INITIATED: 10/22/2020

> STATUS: Open

DUE DATE: 10/29/2020 **PROJECT STAGE:** Course of Construction

> COST CODE: Yes (Unknown)

SCHEDULE IMPACT: Yes (Unknown) DRAWING NUMBER: 1/A1.01, S2.01

SPEC SECTION: **LINKED DRAWINGS:** REFERENCE:

RECEIVED FROM: JT Brown (CORE Construction - Las Vegas)

COPIES TO:

LOCATION:

COST IMPACT:

Ron Allen (Rule Steel), JT Brown (CORE Construction - Las Vegas), Grant Gager (City of Ketchum), Grady Garrett (Garrett Construction, Inc), Pat Garrett (Garrett Construction, Inc), Alan Gelet (Garrett Construction, Inc), Cary Goldberg (DPPM Project Management), Jimmy Gyorfy (Magic Valley Electric), Jonathan Lunceford (Lunceford Excavation, Inc), Bill McLaughlin (City of Ketchum), Dennis Potts (DPPM Project Management), Billy Salts (Magic Valley Electric), Chris Schratwieser (CORE Construction - Las Vegas), Matt Sylvester (CORE Construction - Las Vegas)

Question from JT Brown (CORE Construction - Las Vegas) at 01:51 PM on 10/22/2020

Per ASI 3 the patio columns were not eliminated but moved closer to the Covered Parking (Apparatus Storage) Building. The high voltage conduits coming off of the transformer and the low voltage conduit coming off the pedestals next to the transformer angled north and then entered the building as shown in the attached sketch. Please confirm if the conduits need to be moved or if the columns can be moved. A suggestion would be to move both columns south 2 feet and the east column west 5' and the footings should clear the conduits.

Attachments:

Patio Columns per ASI- Sketch.pdf

Awaiting an Official Response

See attached updated structural and architectural sheets showing the exterior canopy updates including structure, dimensions and details.

S2.01 - FOUNDATION PLAN

S2.02 - LEVEL 2 - FRAMING PLAN

S3.03 - WALL SECTIONS

S6.04 - TYPICAL STEEL DETAILS

A1.01 - ARCHITECTURAL SITE DETAILS - Updated Details 3 & 8. Details 4 & 6 not used.

A3.00 - EXTERIOR ELEVATIONS


A4.00 - BUILDING SECTIONS

A7.00 - ROOF PLAN

The updated design will have no columns and not conflict with the underground conduits.

Crystal McColly **Cole Architects** 12/15/20

ВУ	DATE	COPIES TO

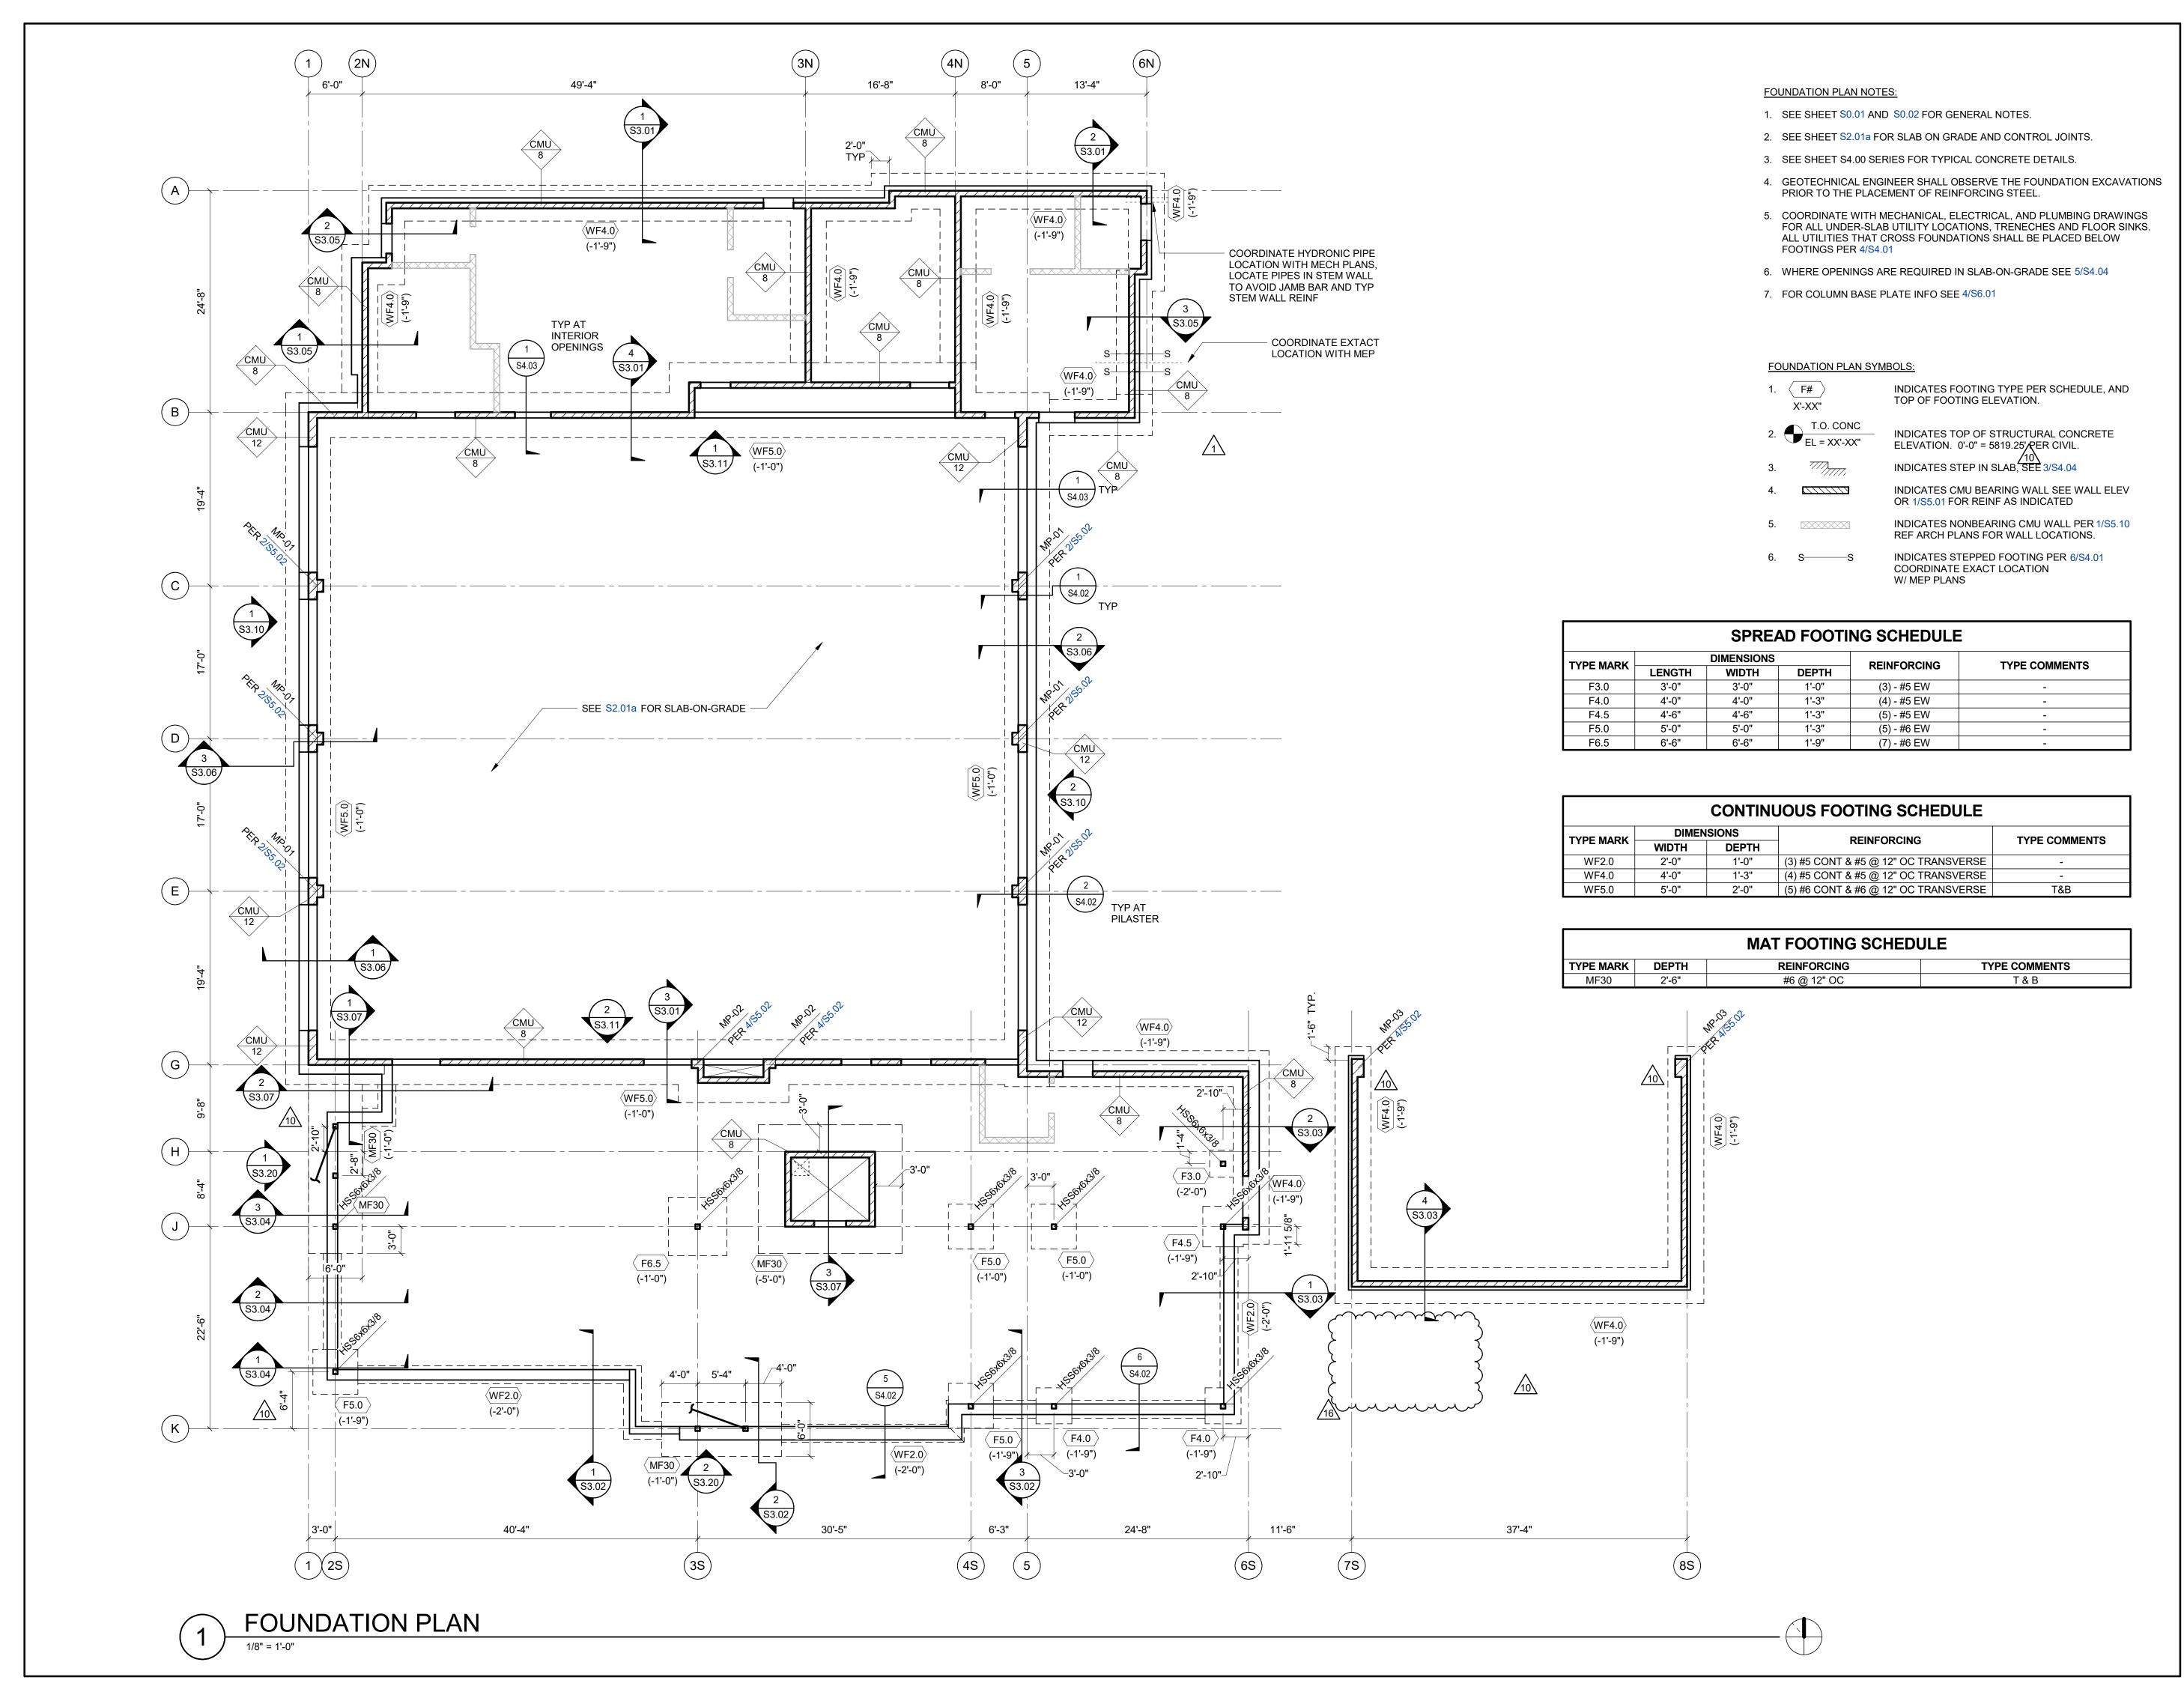





ARCHITECTURE + PLANNING + DESIGN
6211 Roosevelt Way NE
Seattle, WA 98115

206.522.3820

STAMP

P-14922

CONSULTANT





KETCHUM FIRE STATION

SADDLE ROAD KETCHUM, ID 83353

ISSUES


	CONSTRUCTION SET
	6/19/20
MBER	10211900175
DATE	DESCRIPTION
7/17/2020	ASI #1
10/8/2020	ASI #3
12/15/20	RFI CC#94
	DATE 7/17/2020 10/8/2020

SHEET NAME

FOUNDATION PLAN

SHEET NUMBER

S2.01

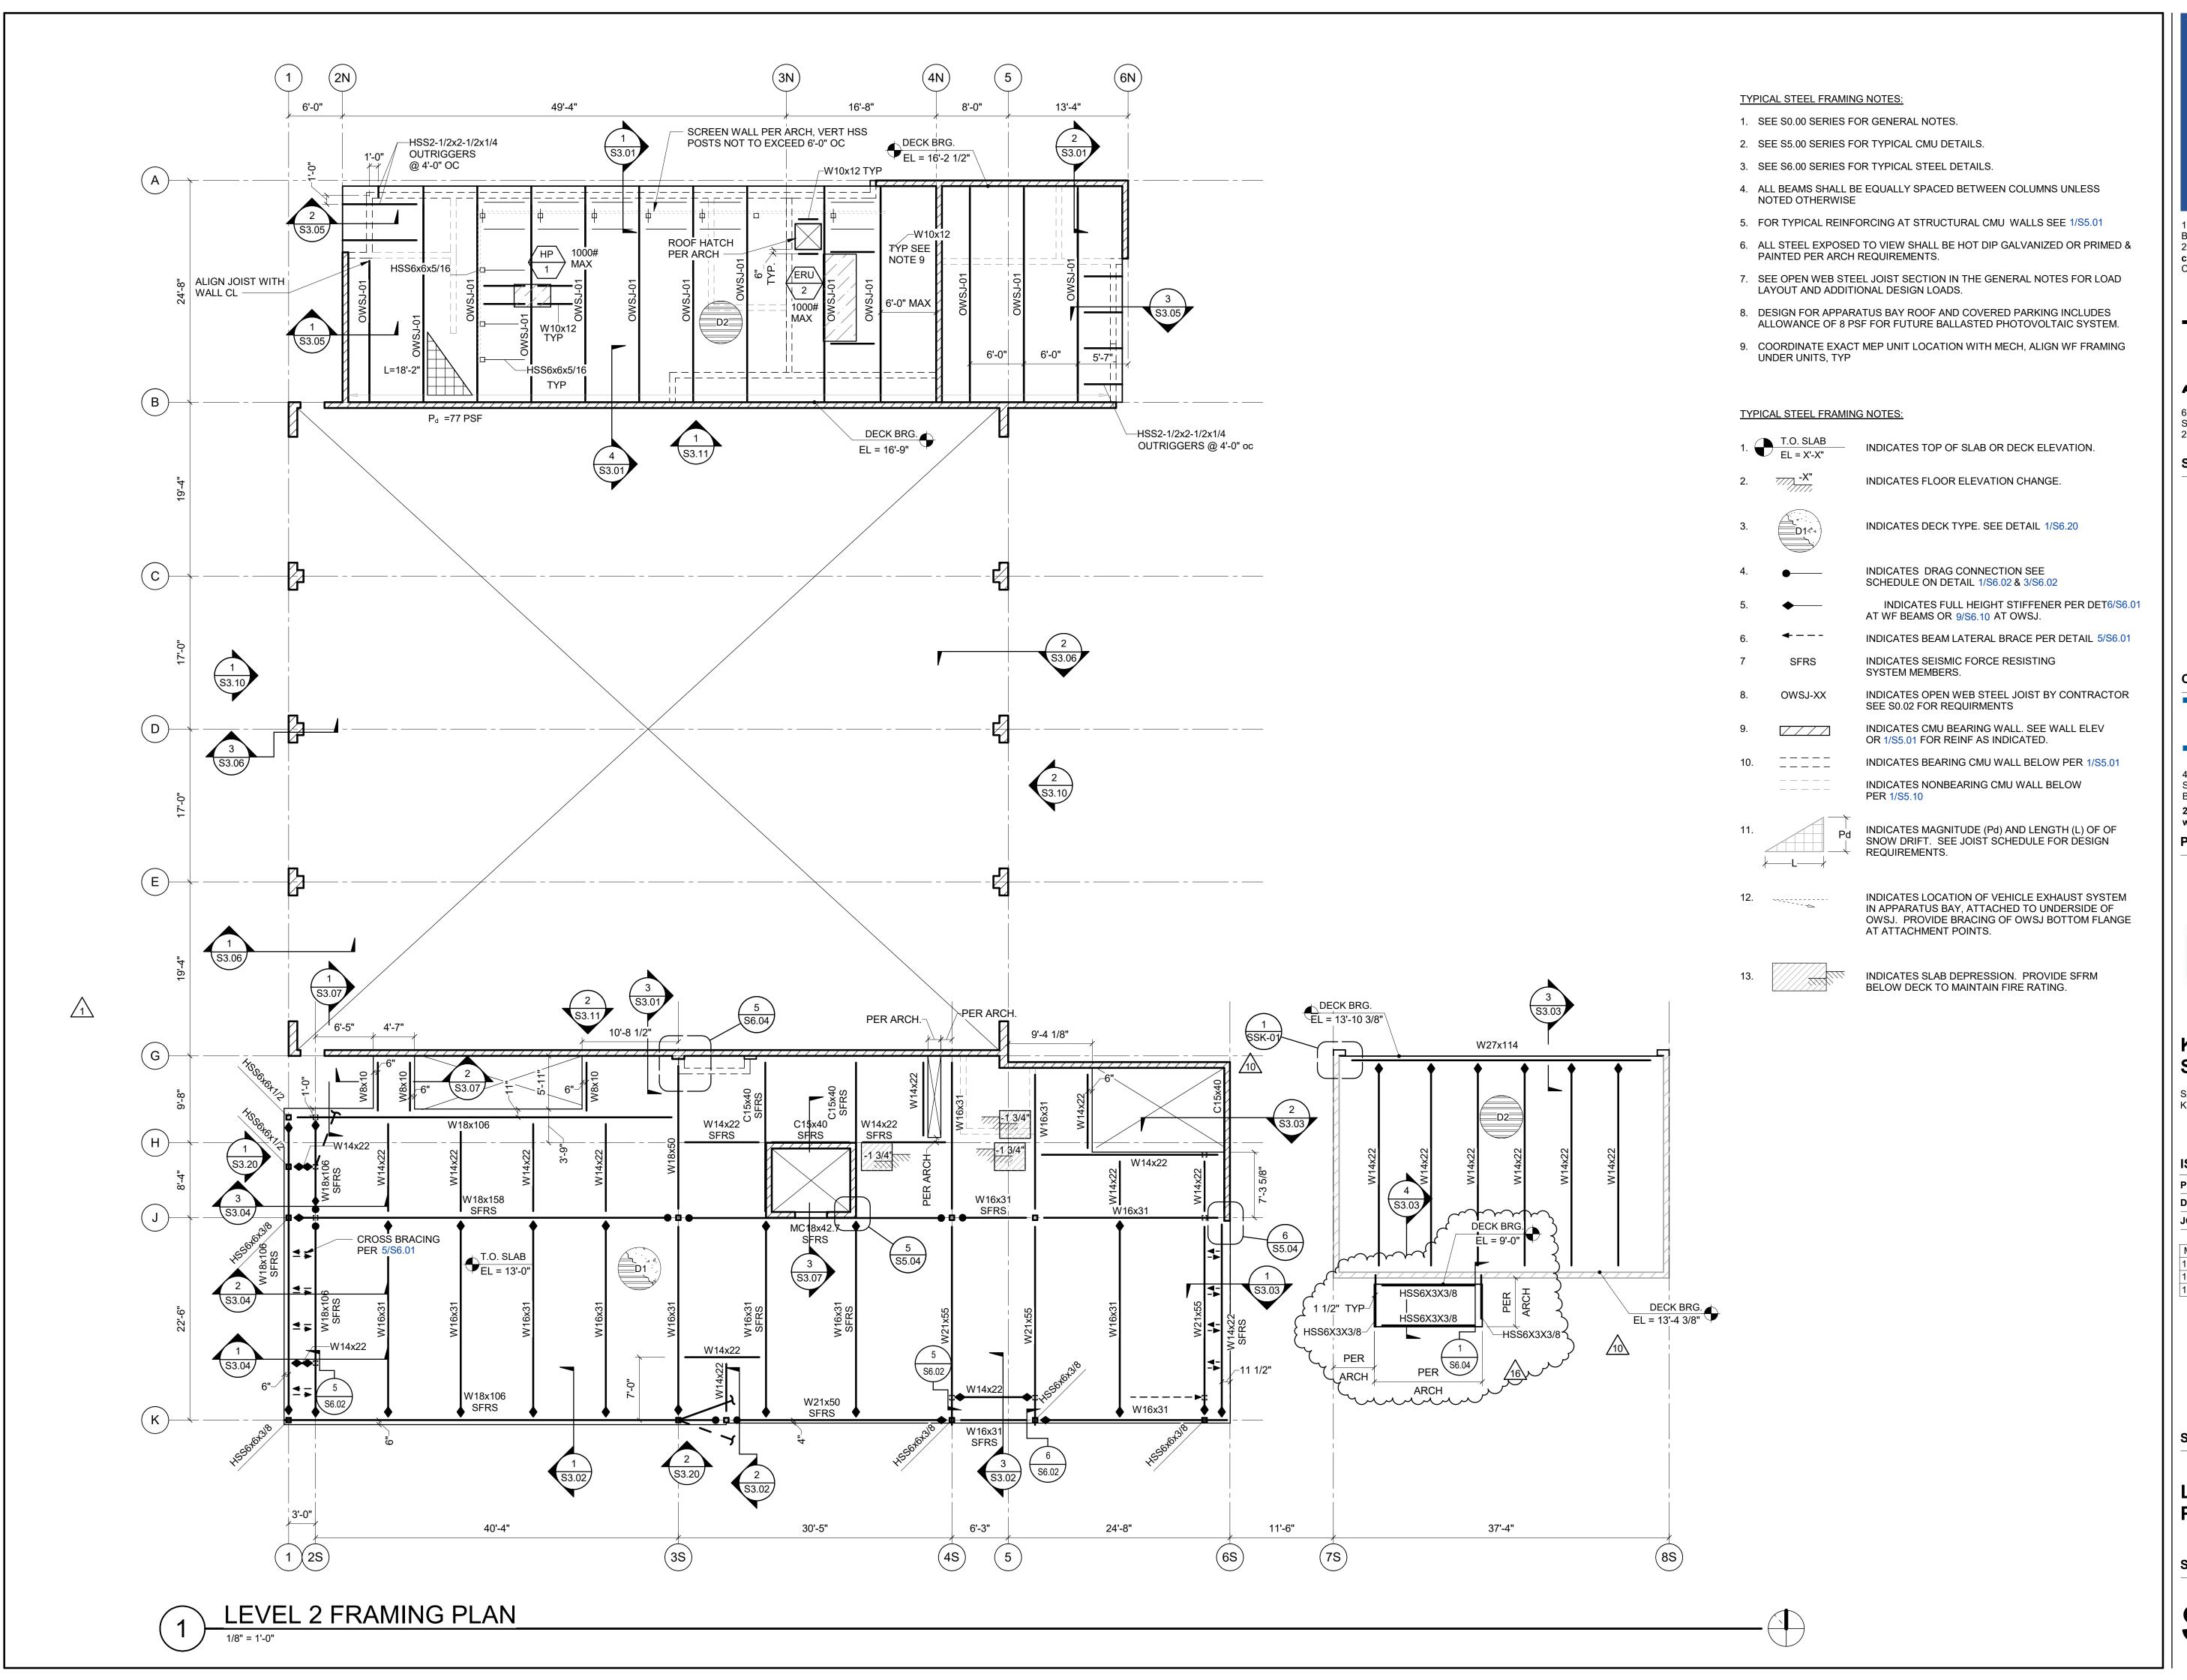



ARCHITECTURE + PLANNING + DESIGN

6211 Roosevelt Way NE Seattle, WA 98115 206.522.3820

STAMP



CONSULTANT

412 E. Parkcenter Blvd. Suite 200 Boise, ID 84010 208.336.6985 www.kpff.com

www.kpff.com
PROJECT INFORMATION



KETCHUM FIRE STATION

SADDLE ROAD KETCHUM, ID 83353

ISSUES

 PHASE
 CONSTRUCTION SET

 DATE
 6/19/20

 JOB NUMBER
 10211900175

 MARK
 DATE
 DESCRIPTION

 1
 7/17/2020
 ASI #1

 10
 10/8/2020
 ASI #3


 16
 12/15/20
 RFI CC#94


SHEET NAME

LEVEL 2 FRAMING PLAN

SHEET NUMBER

S2.02

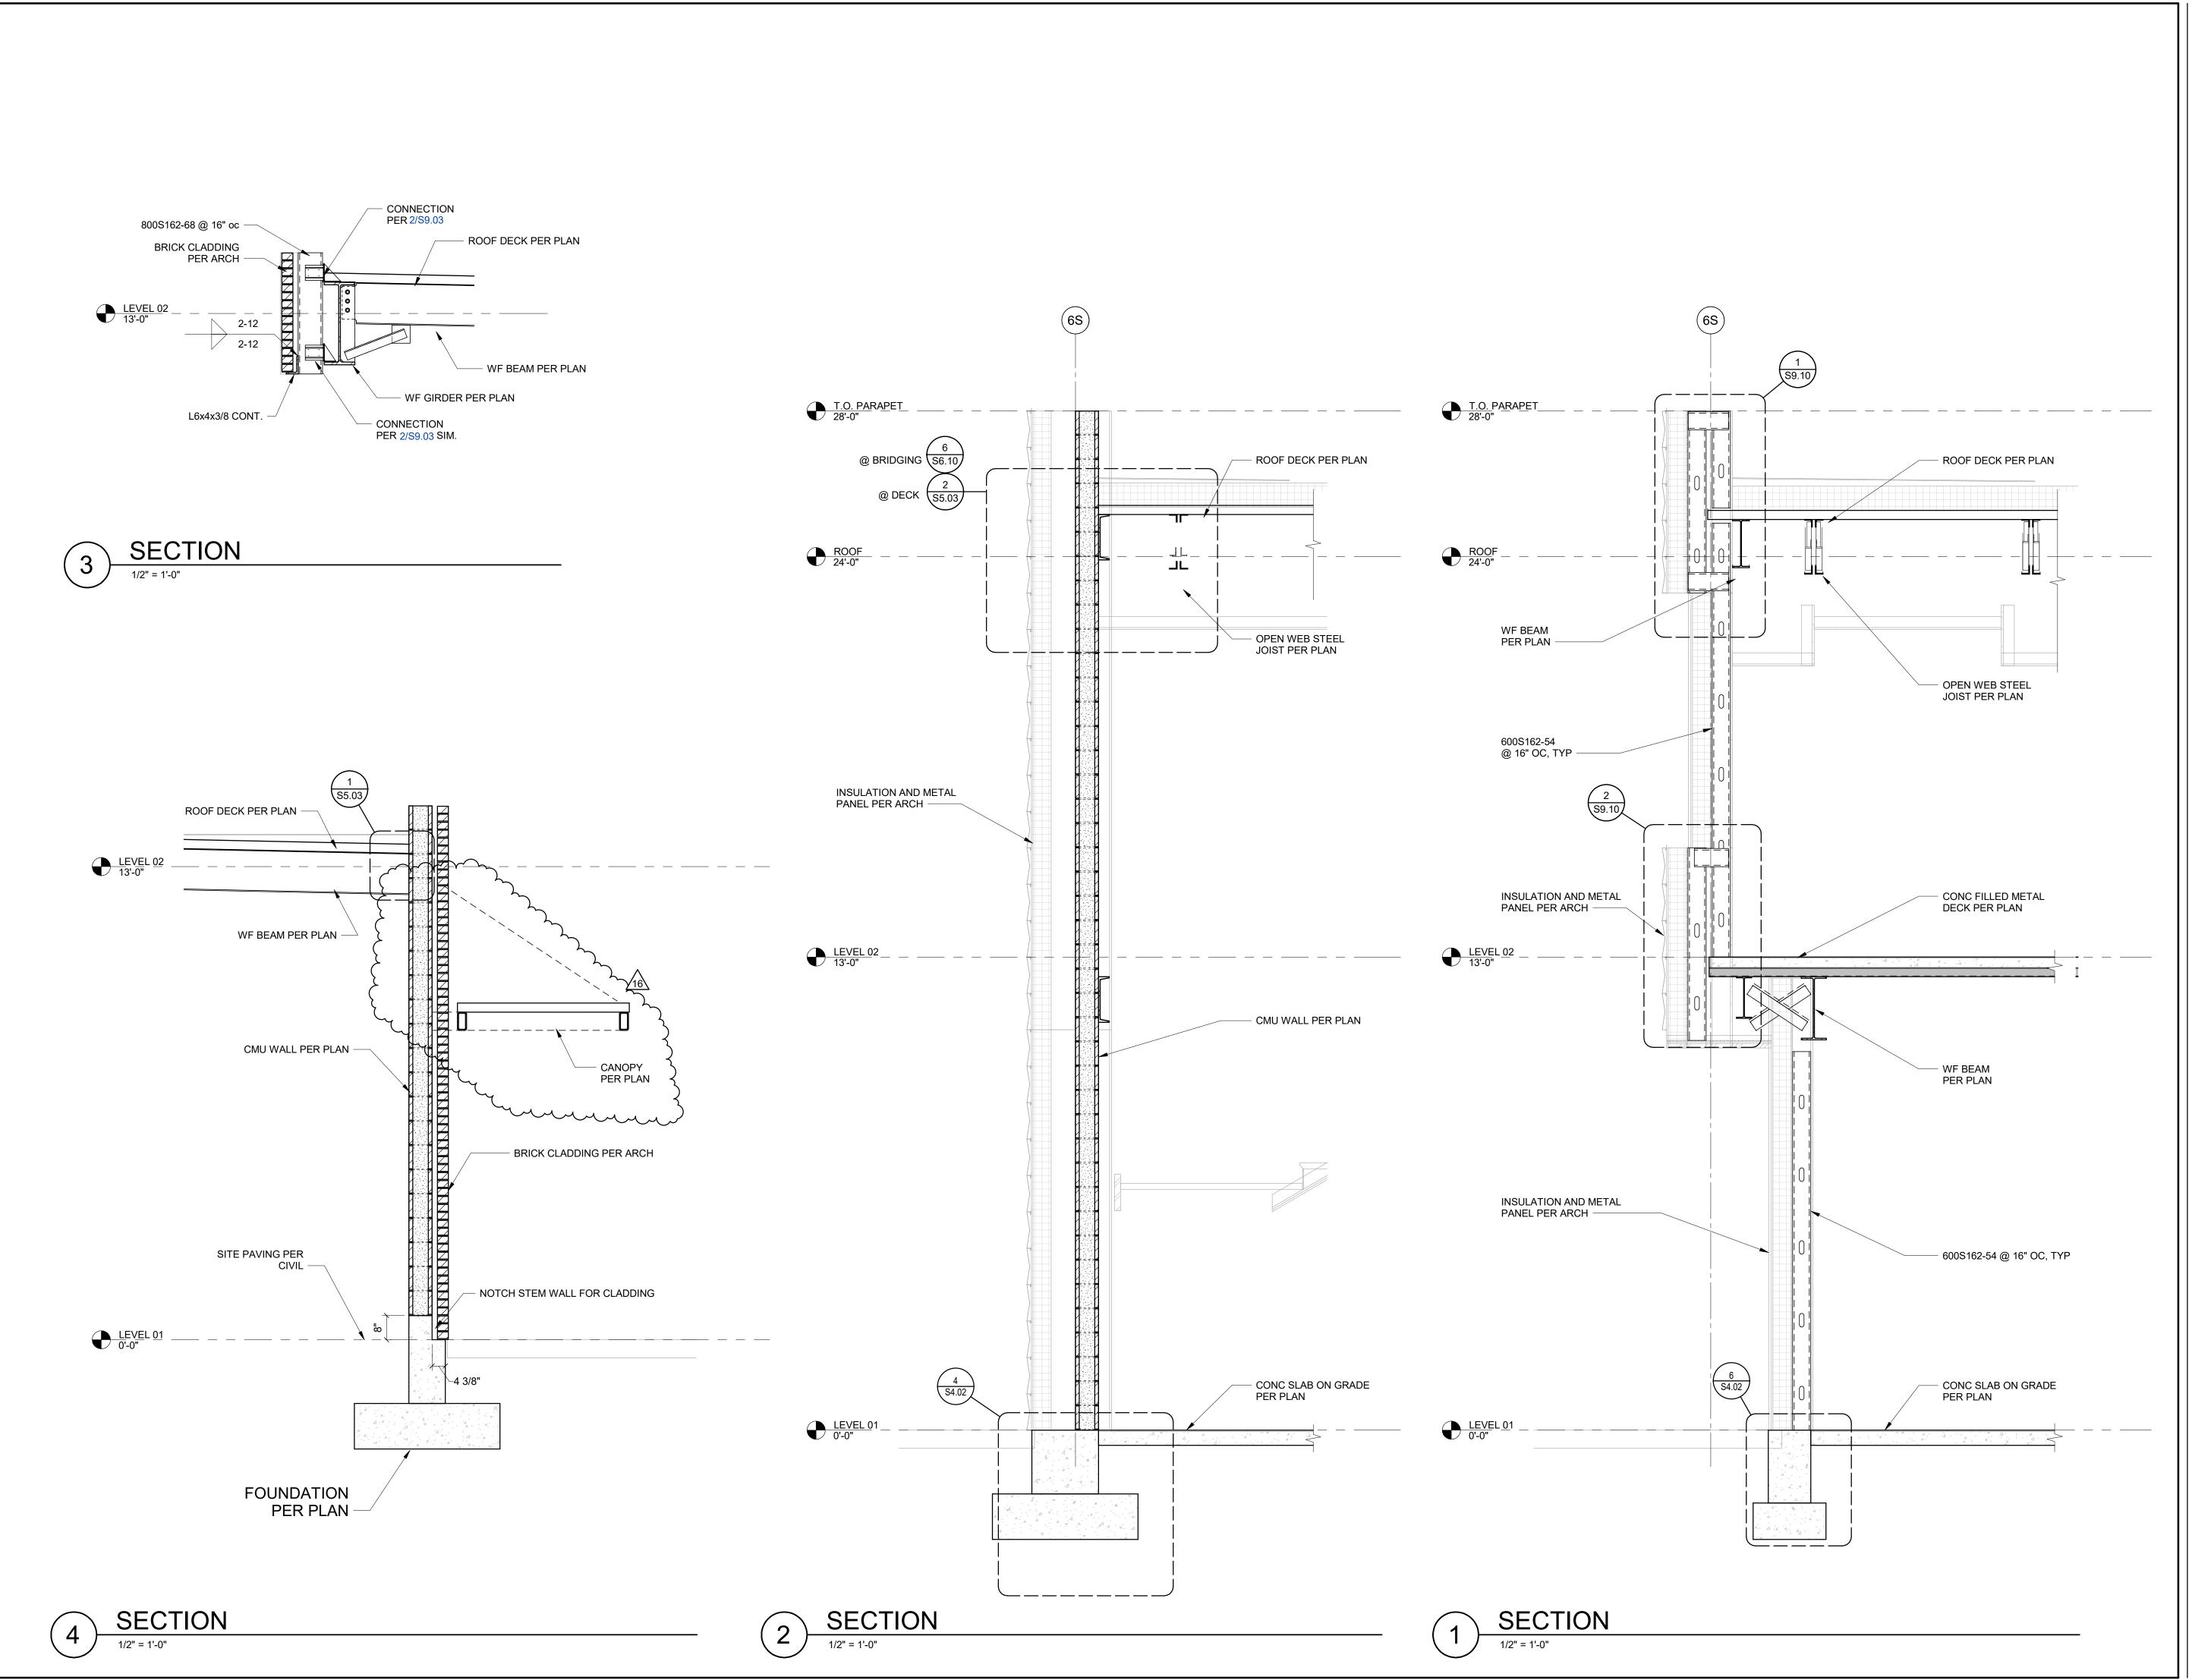

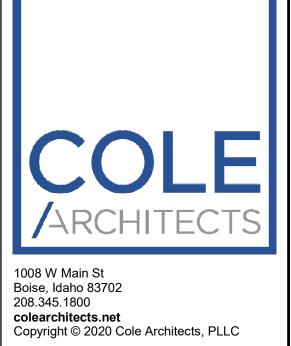


TCA

ARCHITECTURE + PLANNING + DESIGN

6211 Roosevelt Way NE
Seattle, WA 98115
206.522.3820

STAMP

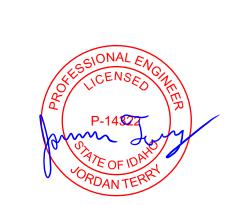

CONSULTANT





KETCHUM FIRE STATION

SADDLE ROAD KETCHUM, ID 83353

ISSUES

	CONSTRUCTION SET
	6/19/20
MBER	1021190017
DATE	DESCRIPTION
12/15/20	RFI CC#94
	DATE


, 10.13.00

SHEET NAME

| WALL SECTIONS

SHEET NUMBER

S3.03

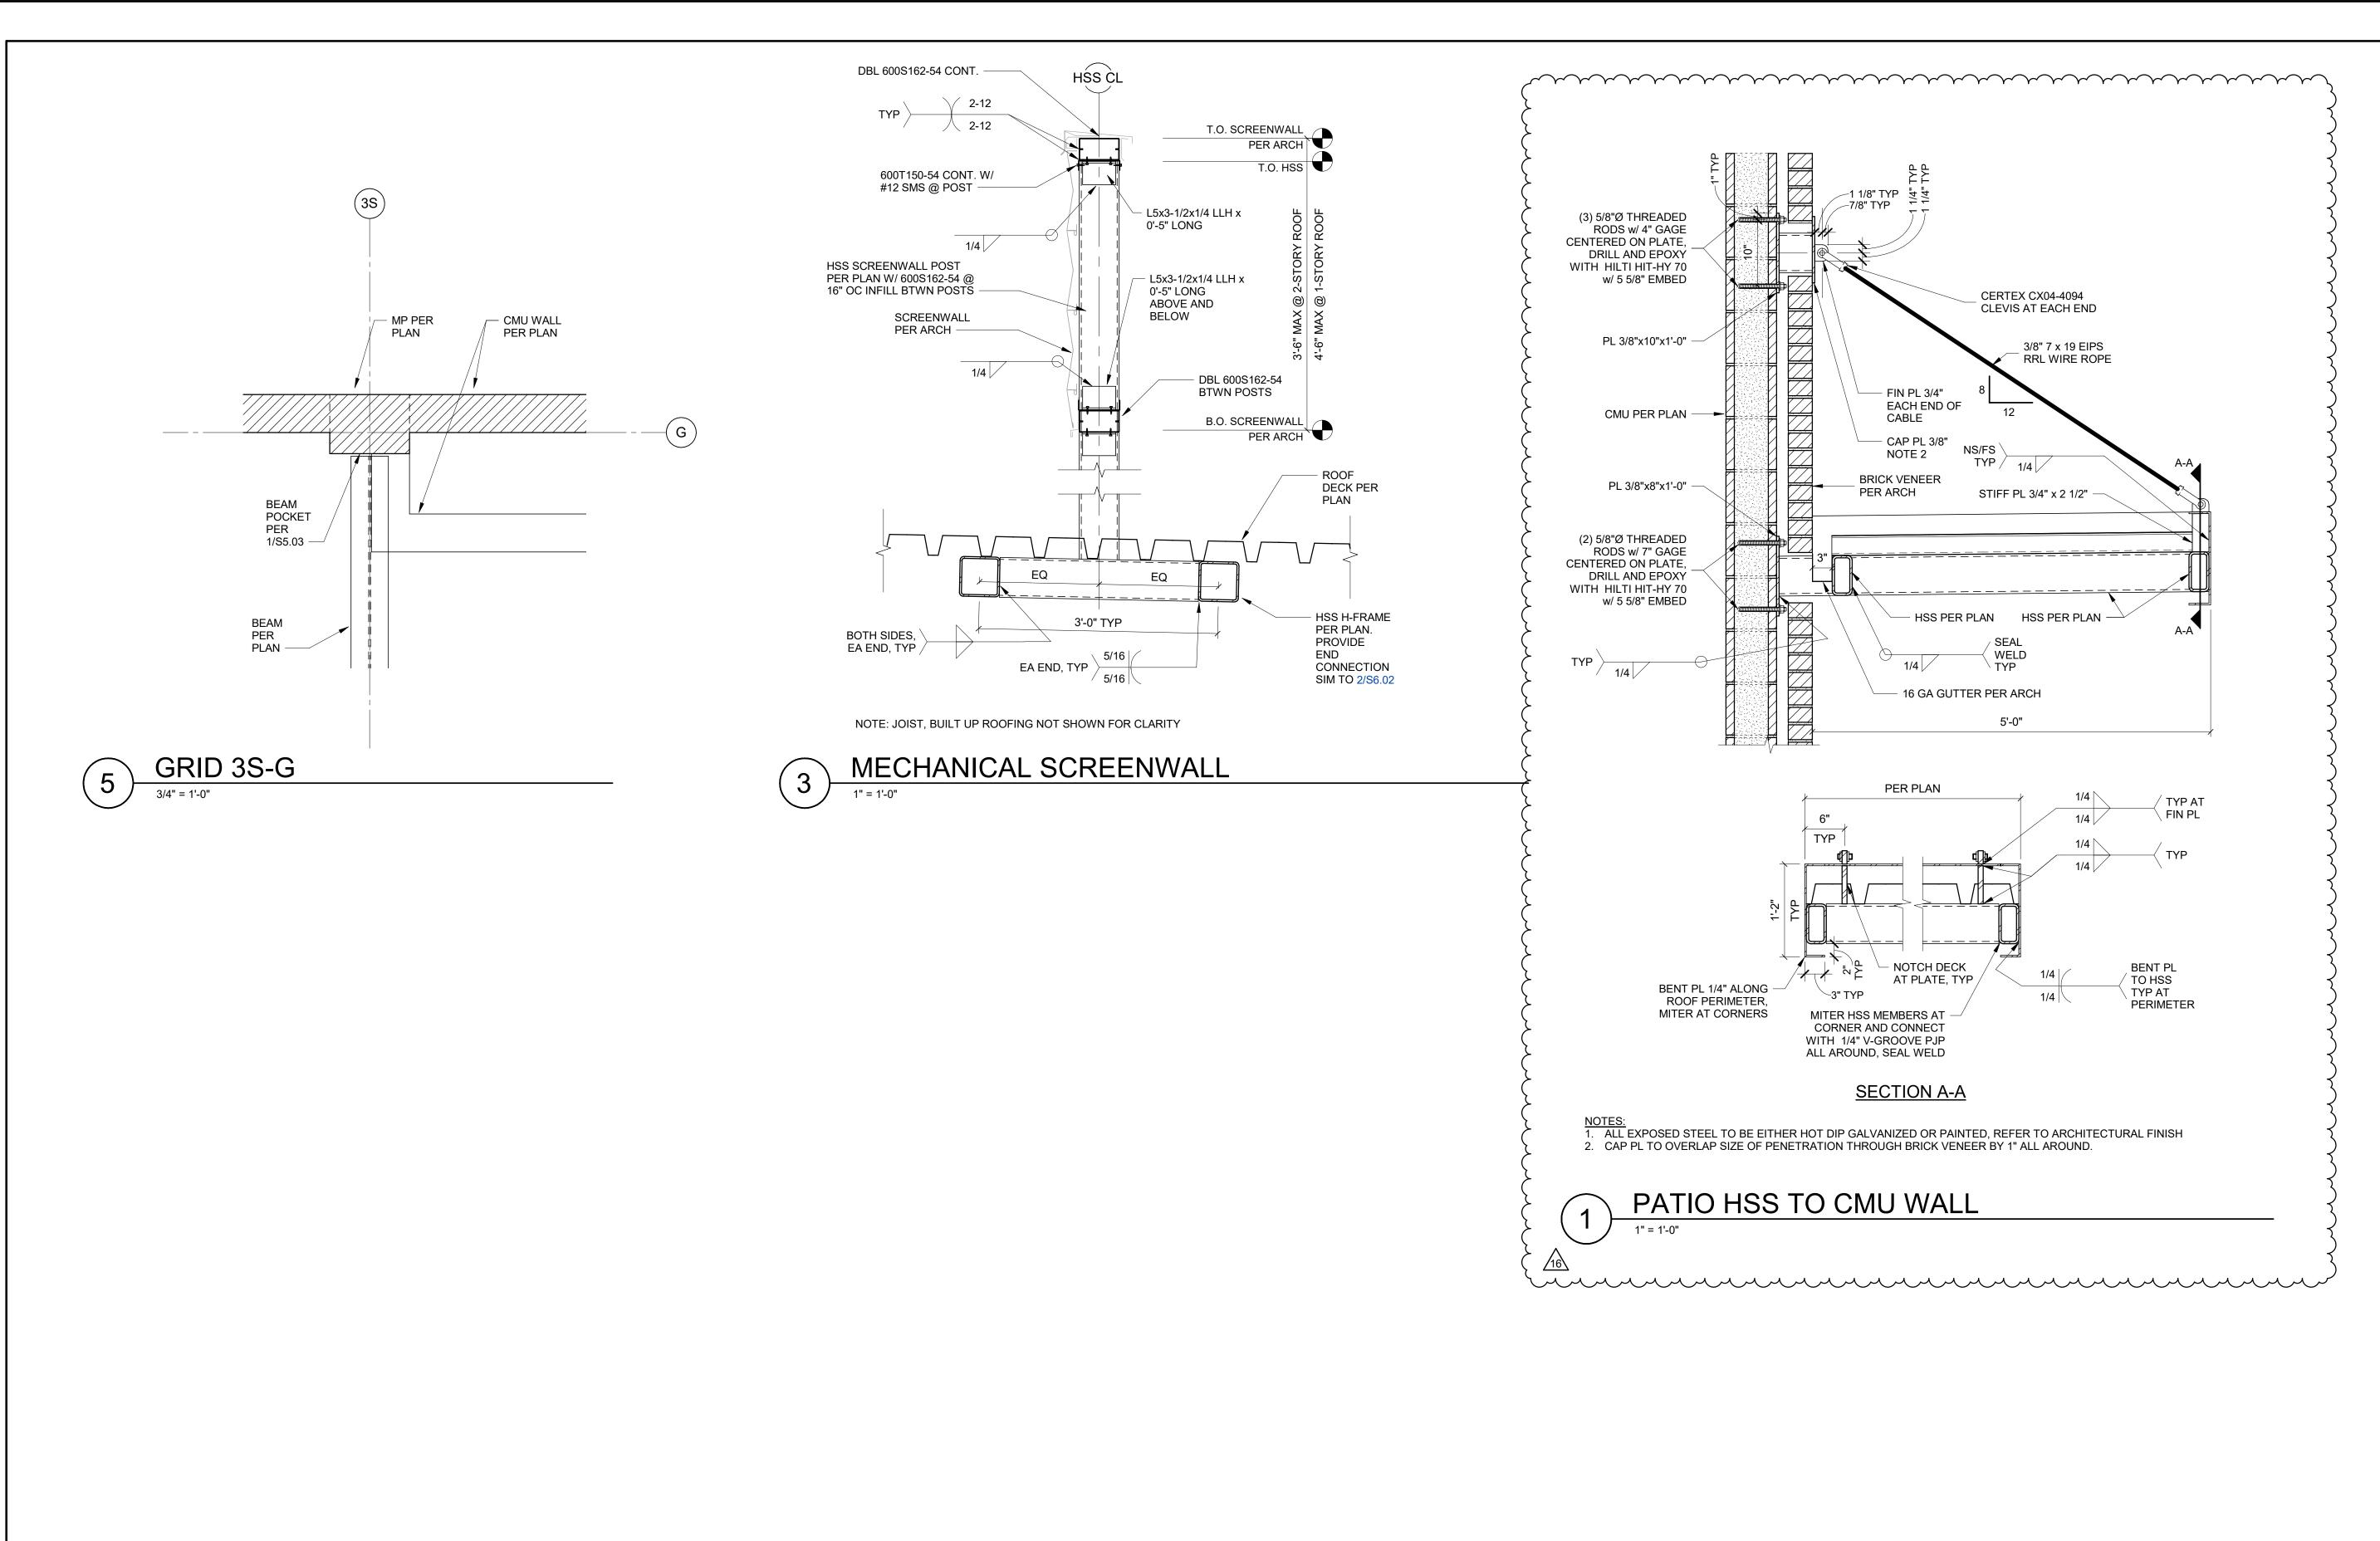






STAMP

206.522.3820

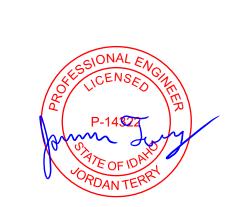





KETCHUM FIRE STATION

SADDLE ROAD KETCHUM, ID 83353

ISSUES


PHASE		CONSTRUCTION SE		
DATE		6/19/2		
JOB NU	IMBER	102119001		
MARK	DATE	DESCRIPTION		
MARK 10	DATE 10/8/2020	DESCRIPTION ASI #3		

SHEET NAME

TYPICAL STEEL **DETAILS**

SHEET NUMBER

S6.04

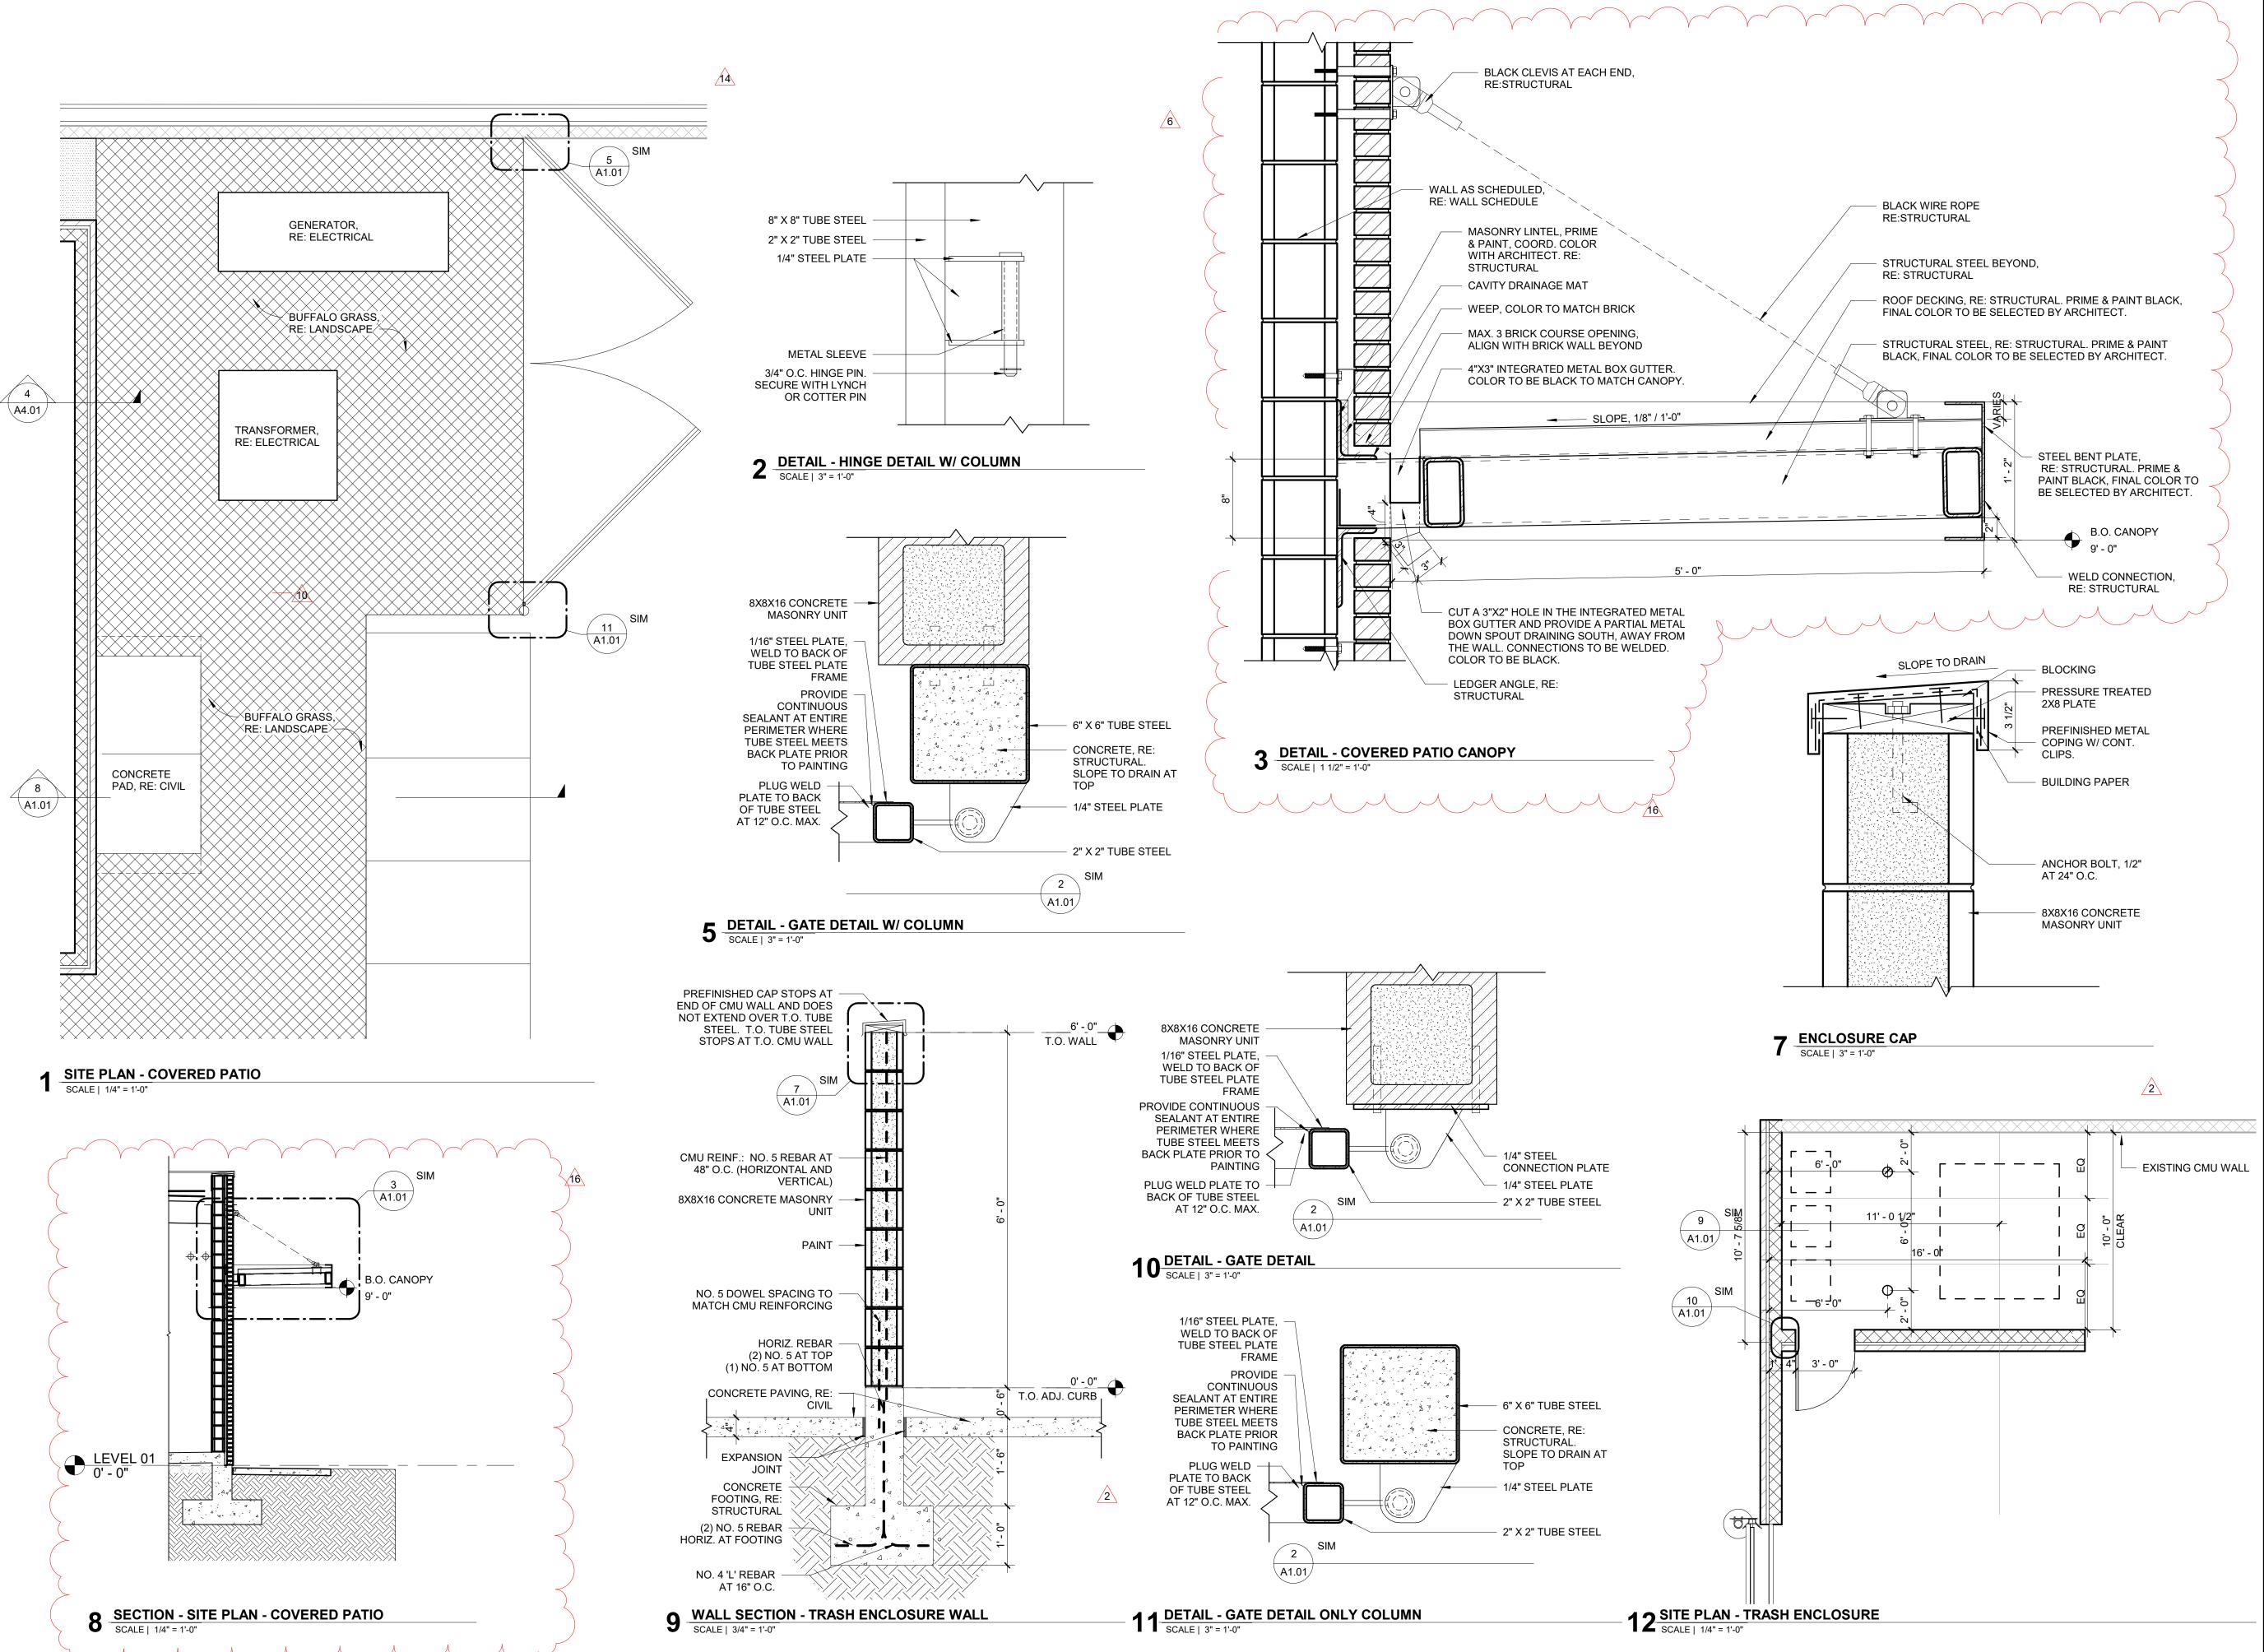






ARCHITECTURE + PLANNING + DESIGN

6211 Roosevelt Way NE Seattle, WA 98115 206.522.3820

BIDDERS ARE INSTRUCTED TO CAREFULLY REVIEW THE CONSTRUCTION DOCUMENTS AND THE SITE CONDITIONS. INFORMATION REGARDING THE COMPLETE WORK OF SPECIFIC TRADES IS DISPERSED THROUGHOUT THE ENTIRE DOCUMENT SET AND CANNOT BE ACCURATELY DETERMINED BY REFERENCE TO OTHER THAN COMPLETE DOCUMENT SETS.

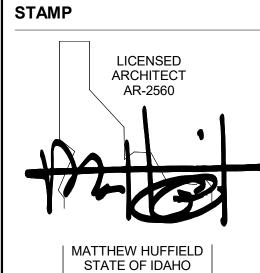

OTATE OF IDAI

CONSULTANT

PROJECT INFORMATION



KETCHUM FIRE STATION NO. 1

107 SADDLE ROAD, KETCHUM, ID 83353

ISSUES


ALL	PHASE		CONSTRUCTION SET
	DATE		JUNE 19, 2020
	JOB NU	IMBER	18-022
	MARK	DATE	DESCRIPTION
	4.0	40/45/00	DEL //00 04

SHEET NAME

ARCHITECTURAL SITE DETAILS

SHEET NUMBER

A1.01

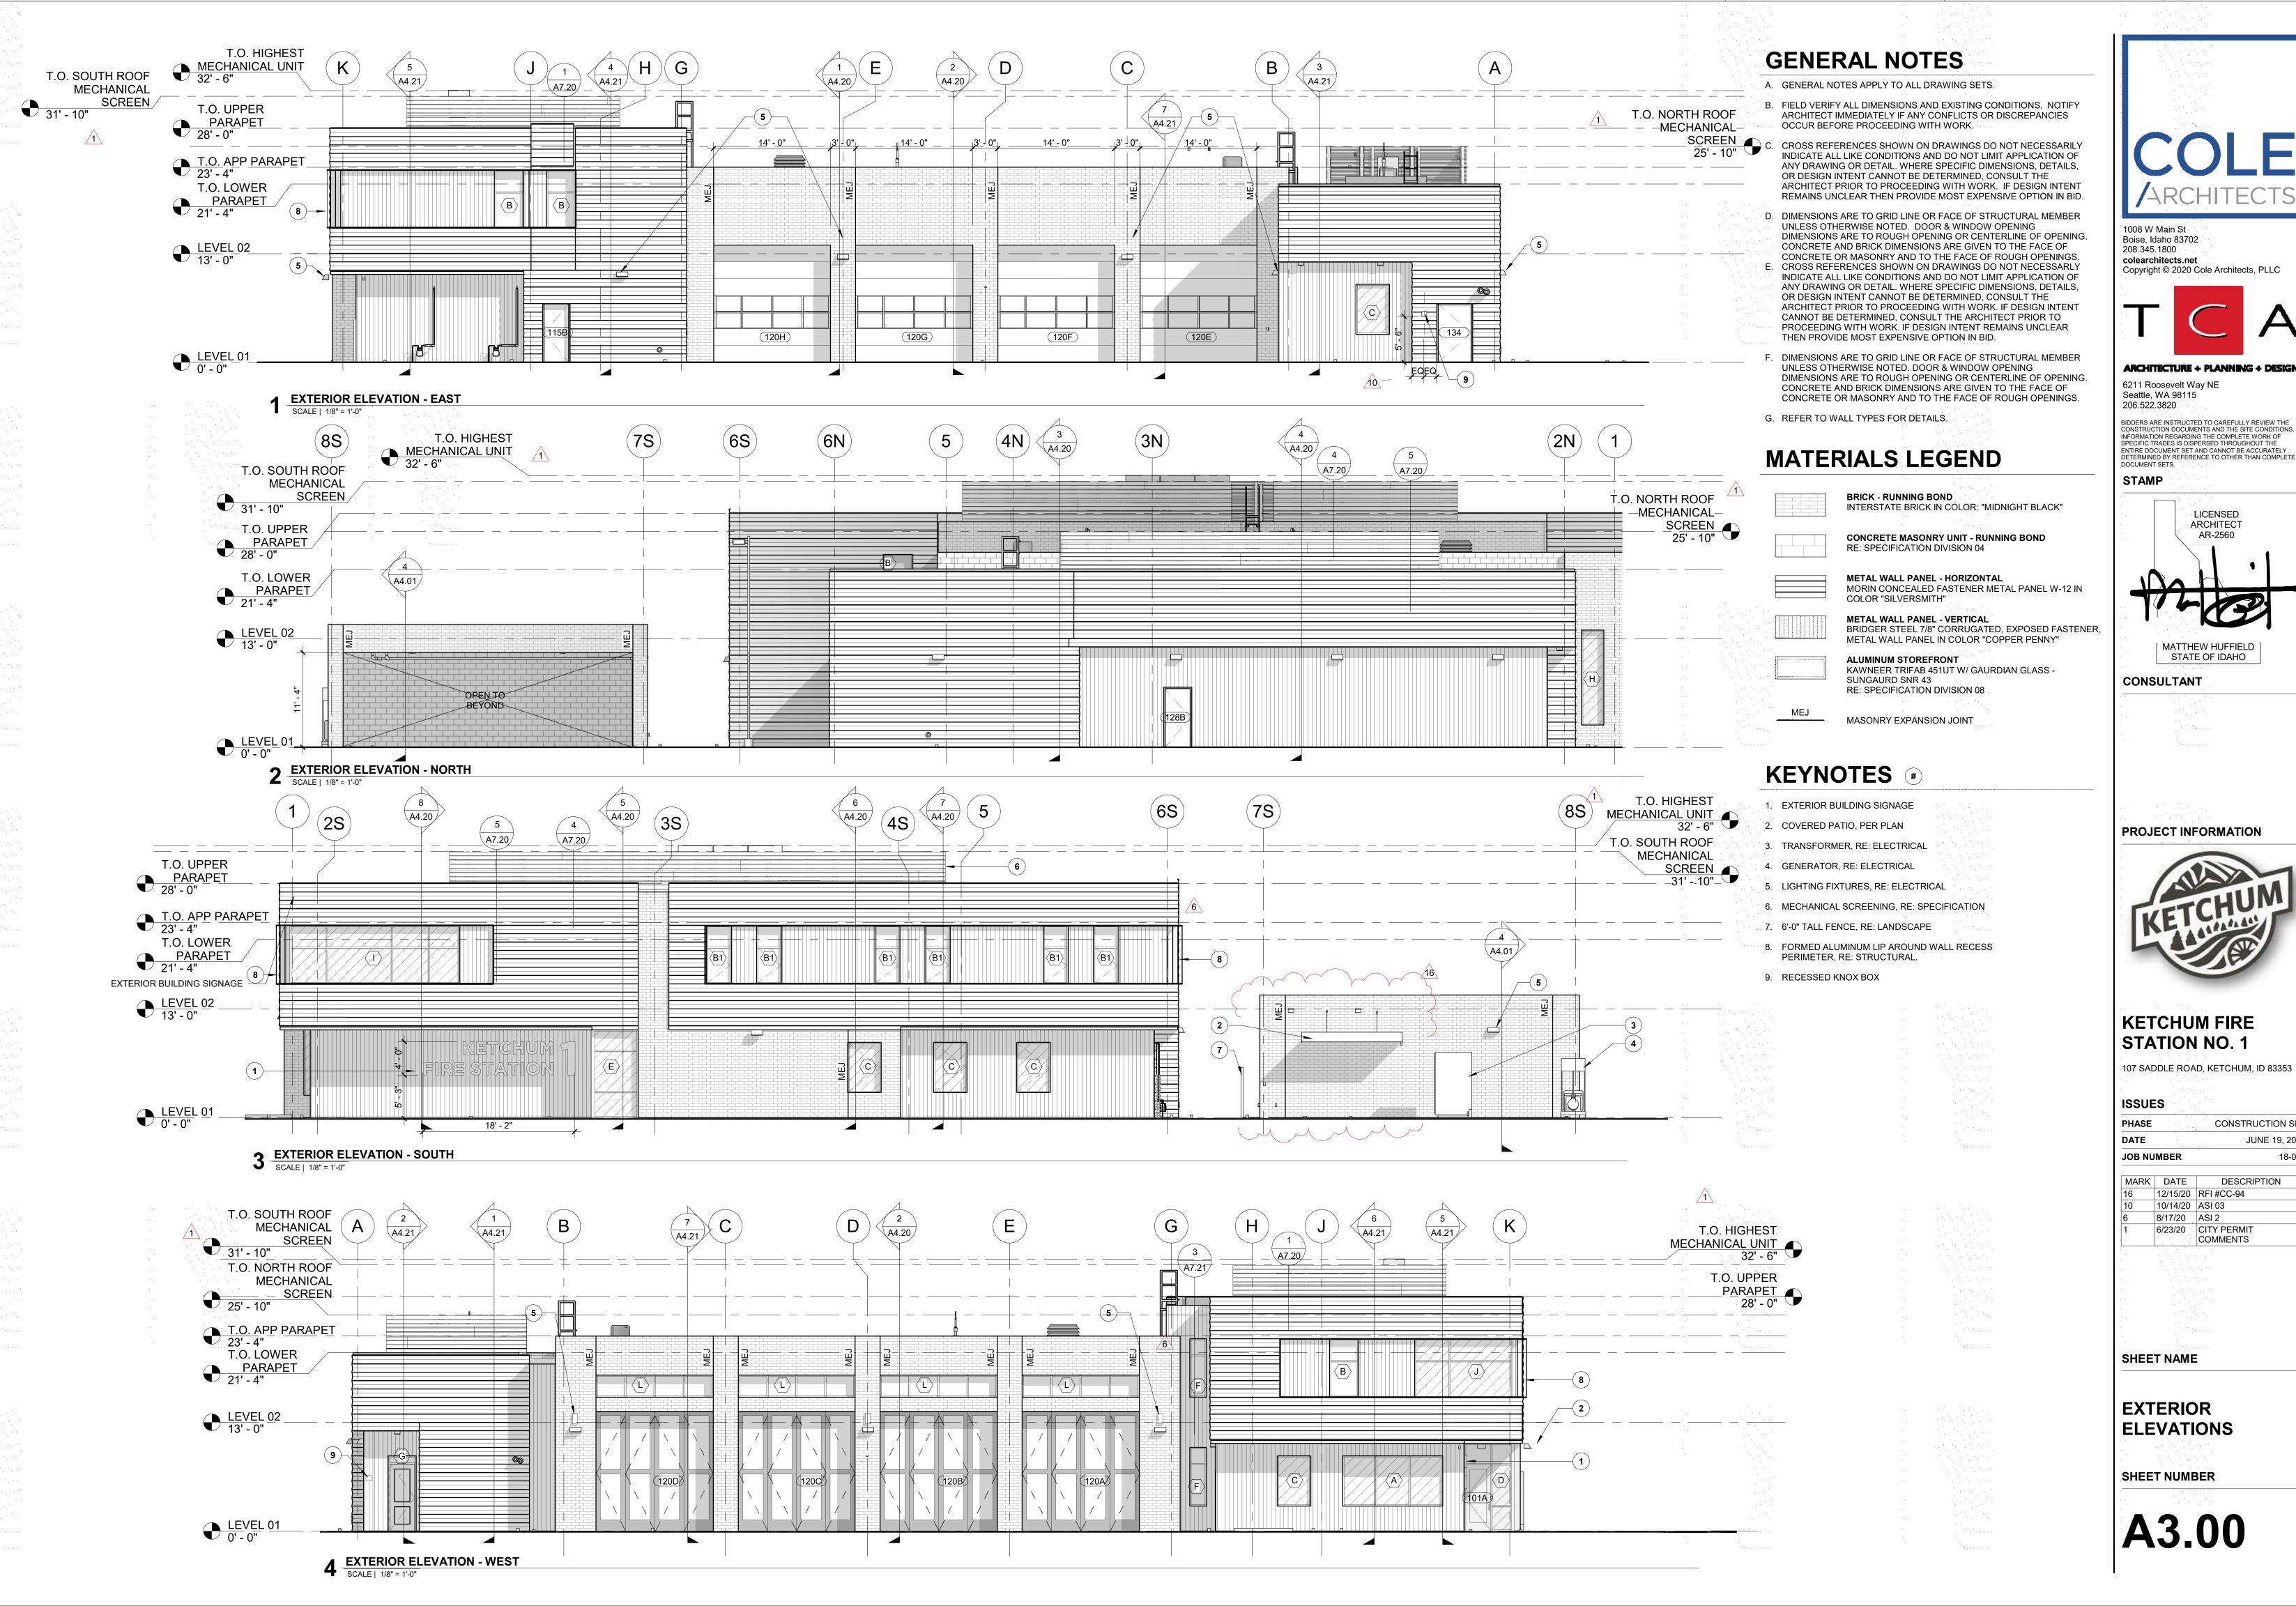


CONSTRUCTION SET


DESCRIPTION


JUNE 19, 2020

18-022

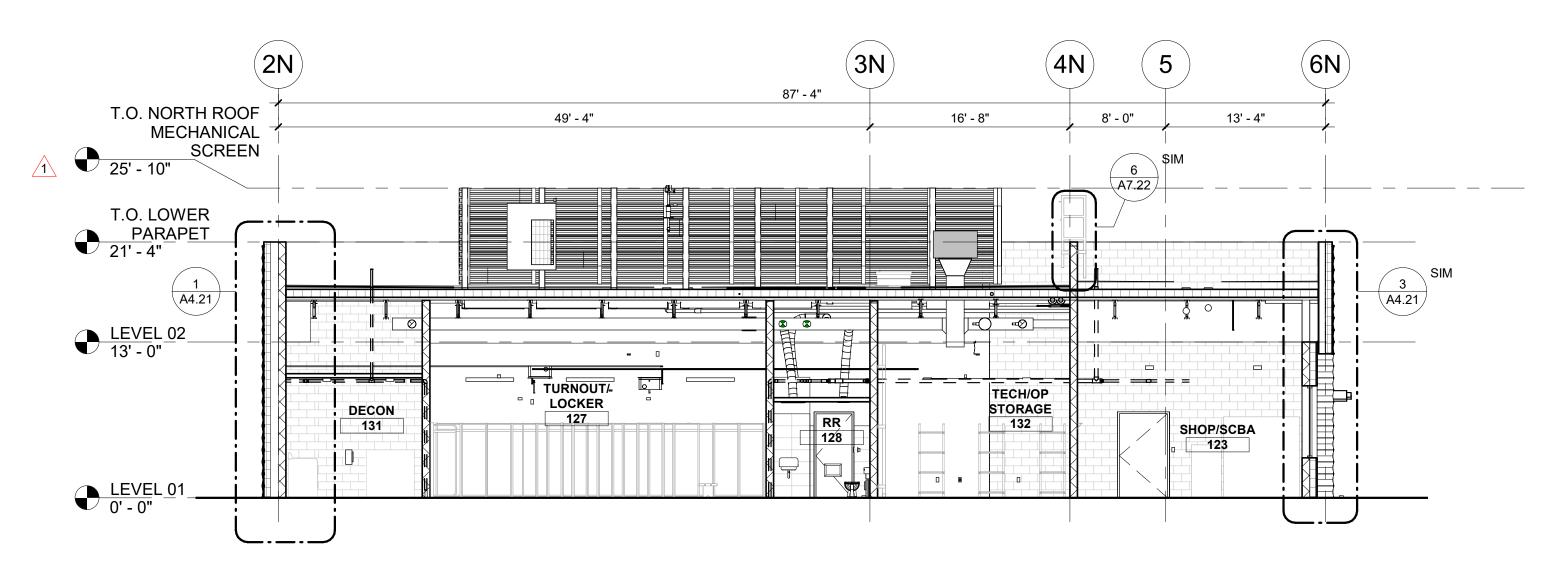


▲ BUILDING SECTION - SUPPORT/UTILITY BAY SCALE | 1/8" = 1'-0"

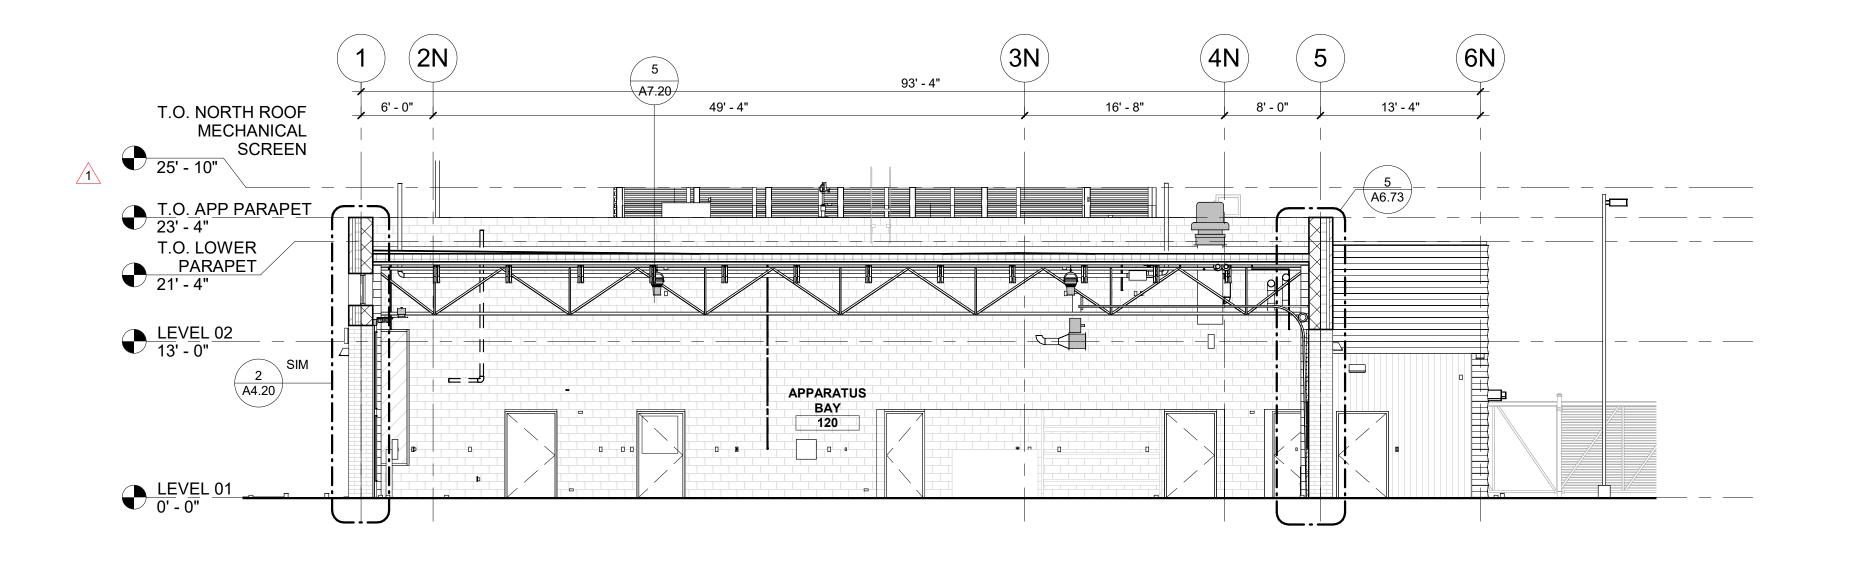

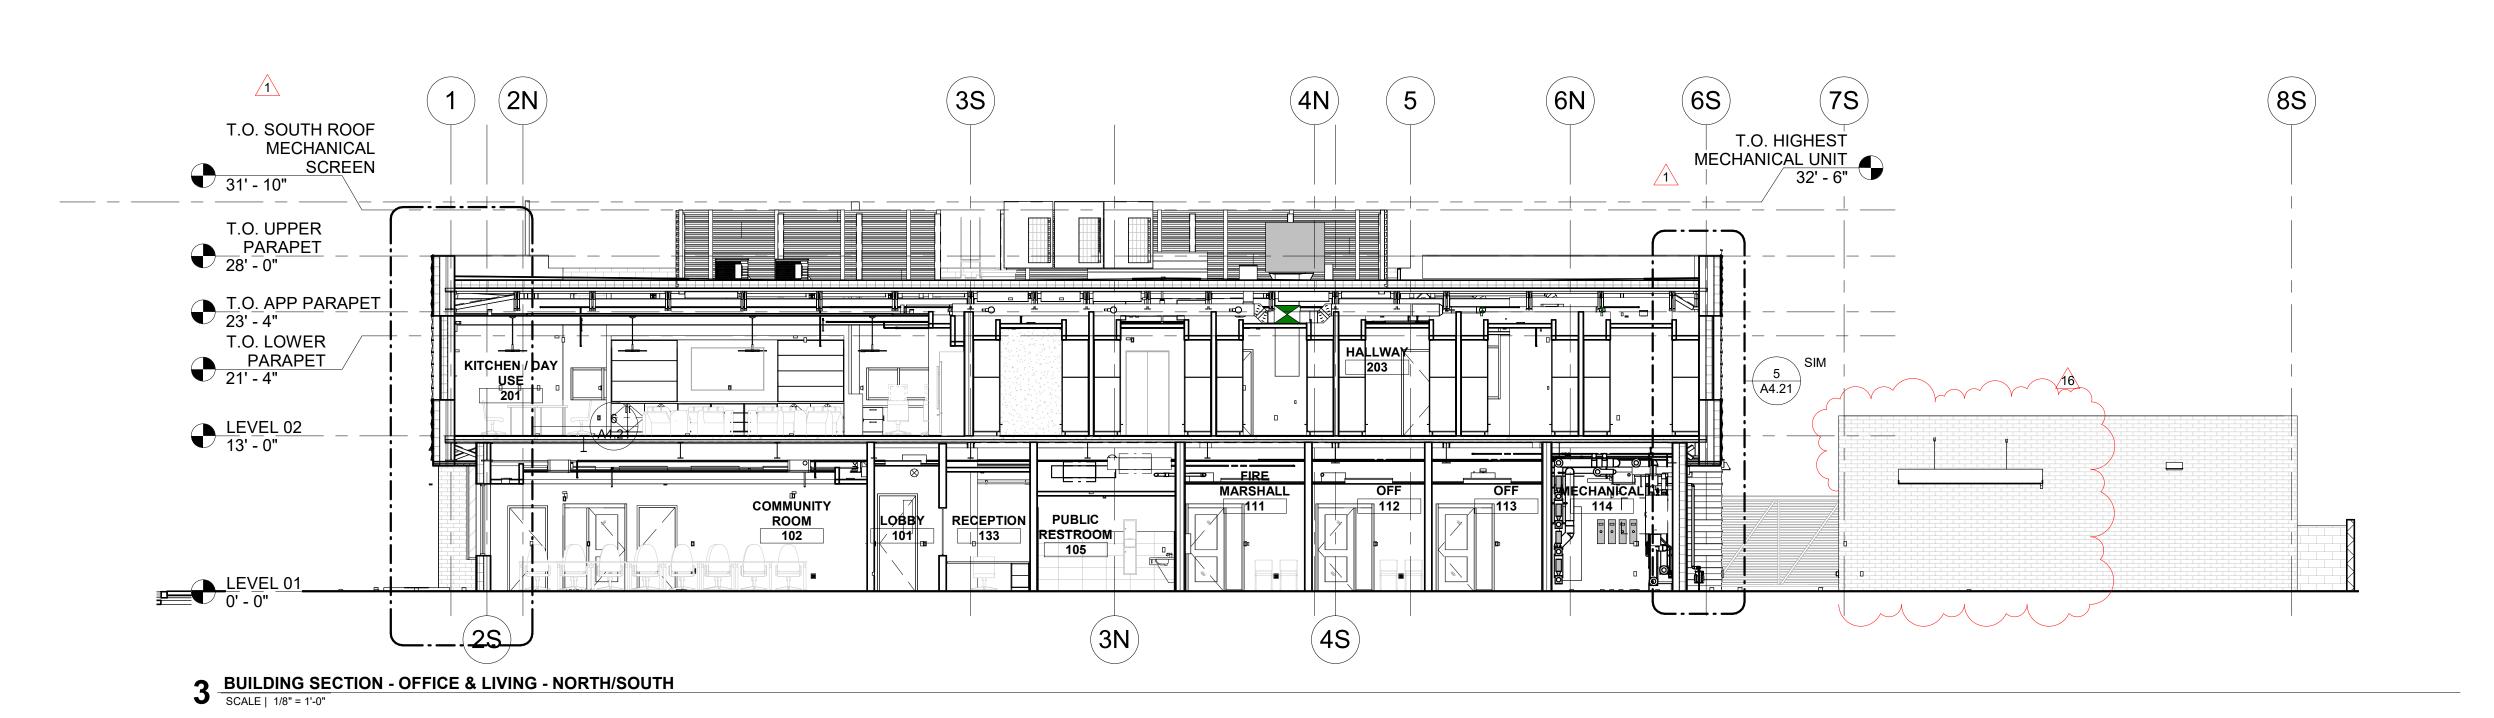

2 BUILDING SECTION - APPARATUS BAY

SCALE | 1/8" = 1'-0"

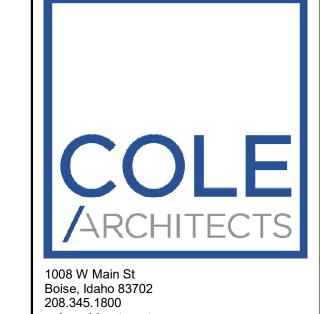


colearchitects.net Copyright © 2020 Cole Architects, PLLC

ARCHITECTURE + PLANNING + DESIGN 6211 Roosevelt Way NE Seattle, WA 98115

206.522.3820

BIDDERS ARE INSTRUCTED TO CAREFULLY REVIEW THE CONSTRUCTION DOCUMENTS AND THE SITE CONDITIONS. INFORMATION REGARDING THE COMPLETE WORK OF SPECIFIC TRADES IS DISPERSED THROUGHOUT THE ENTIRE DOCUMENT SET AND CANNOT BE ACCURATELY DETERMINED BY REFERENCE TO OTHER THAN COMPLETE DOCUMENT SETS.

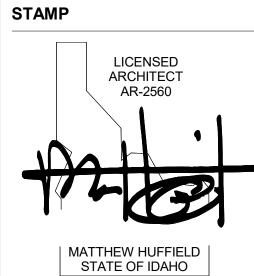

CONSULTANT

PROJECT INFORMATION



KETCHUM FIRE STATION NO. 1

107 SADDLE ROAD, KETCHUM, ID 83353

ISSUES

CONSTRUCTION SET JUNE 19, 2020 DATE 18-022 JOB NUMBER


DESCRIPTION 12/15/20 RFI #CC-94 6/23/20 CITY PERMIT COMMENTS

SHEET NAME

BUILDING **SECTIONS**

SHEET NUMBER

A4.00

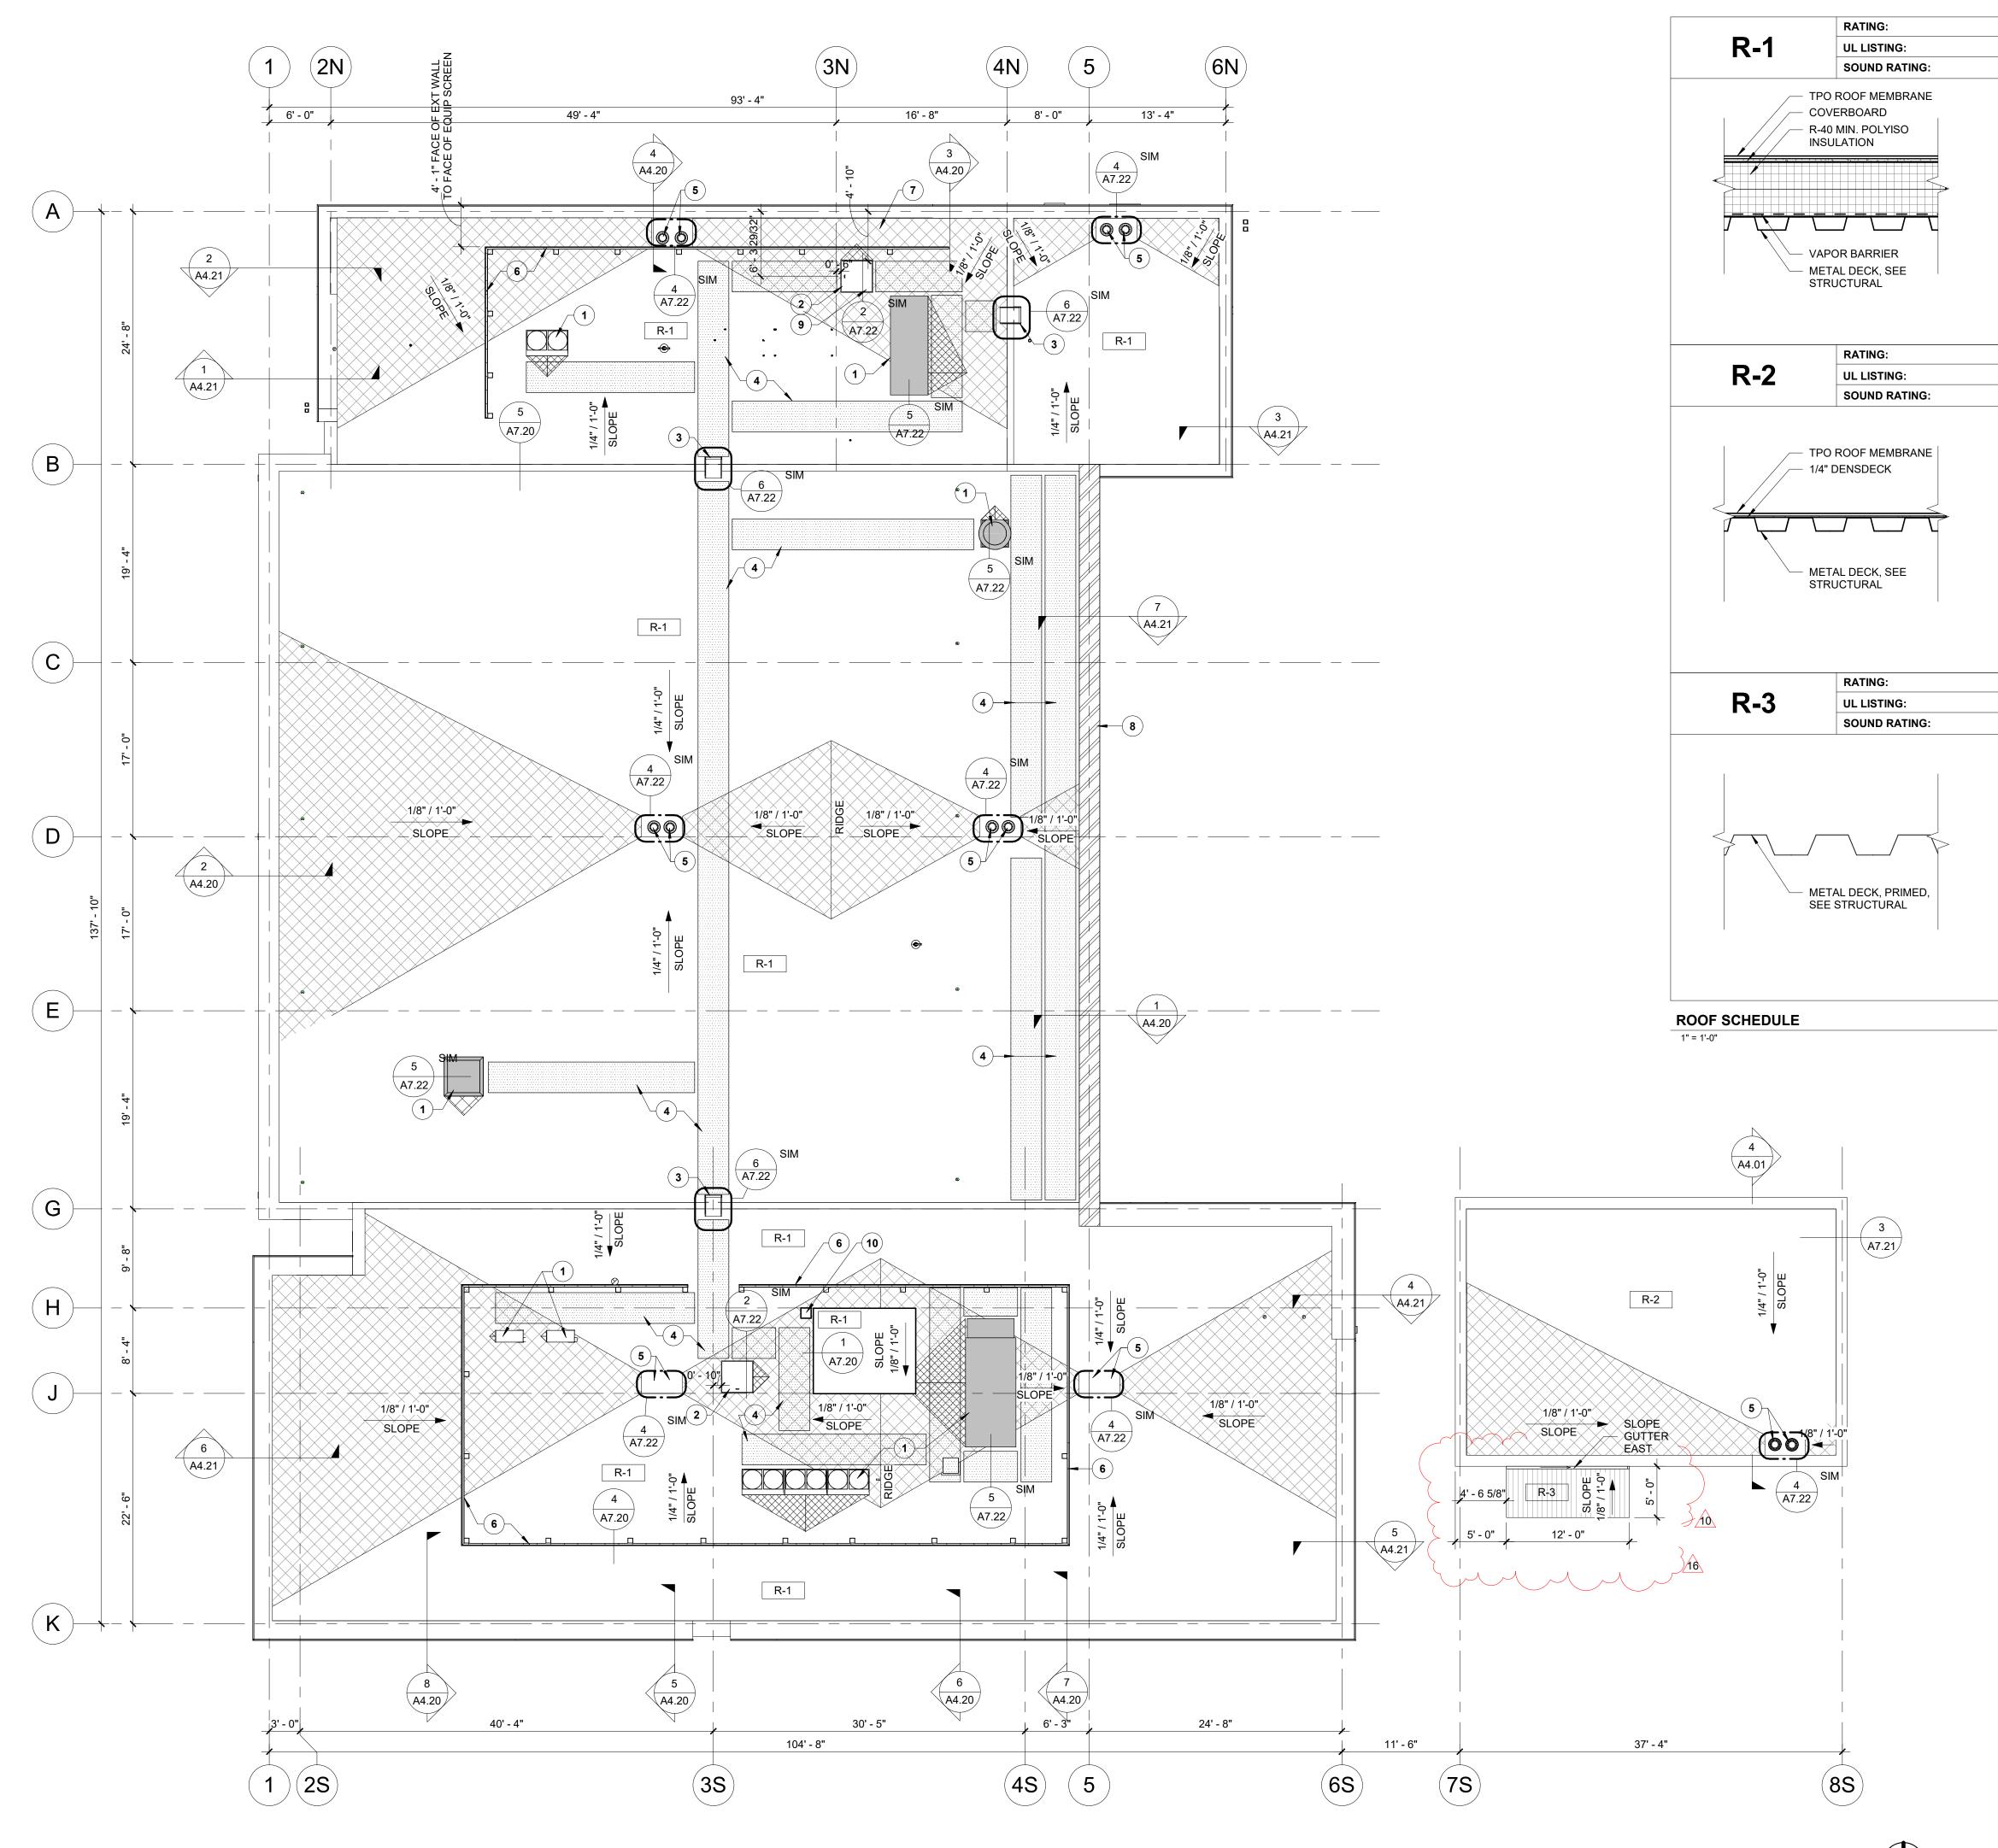

GENERAL NOTES

- A. COORDINATE INSTALLATION OF ROOFING WITH OTHER TRADES. REPORT ANY CONFLICTS WITH ITEMS INSTALLED BY OTHER TRADES TO ARCHITECT.
- B. ALL ROOF CURBS FOR NEW ROOFTOP EXHAUST FANS, HVAC UNITS AND CONDENSING UNITS SHALL HAVE CURB HEIGHTS THAT WILL ALLOW FOR A MINIMUM OF 8" BASE FLASHING HEIGHTS FOR THE ROOF SYSTEM.
- C. ALL PLUMBING VENTS SHALL EXTEND ABOVE THE FINISHED SURFACE OF THE ROOF SYSTEM AS REQUIRED TO PROVIDE FOR A MINIMUM OF 8" BASE FLASHING. PROVIDE FLASHING AROUND VENTS AND ROOF PENETRATIONS PER ROOFING MANUFACTURER RECOMMENDATIONS.
- D. PROVIDE 36" WIDE WALK PADS AROUND PERIMITER OF ALL MECHANICAL EQUIPMENT. PROVIDE 36" WIDE WALK PADS AROUND ALL ROOF HATCHES & 72"X72" PADS AT LADDERS.
- E. UNLESS NOTED OTHERWISE PROVIDE FIRESTONE UNI-CLAD KYNAR 500/HYLAR 5000 PRE-FINISHED GALVALUME STEEL (24 GA) ARCHITECTURE SHEET AND COIL FOR ALL COPINGS, FLASHING & TRIM PIECES. SUBMIT STANDARD COLOR SELECTION TO ARCHITECT FOR APPROVAL. ALL CLEATS TO BE CONTINUOUS.
- F. ALL GUTTERS TO BE PREFINISHED SMACNA APPROVED 'K' STYLE CONTINUOUS ALUMINUM GUTTERS SIZED FOR QUANTITY OF WATER FLOW. PROVIDE STAINLESS STEEL SCREENS FOR GUTTERS. UNO PROVIDE HEAT CABLE IN GUTTER. UNO SUBMIT STANDARD COLOR SELECTION TO ARCHITECT FOR APPROVAL.
- G. ALL DOWNSPOUTS TO BE PRE-FINISHED SMACNA APPROVED RECTANGULAR ALUMINUM DOWNSPOUT SIZED FOR QUANTITY OF WATER FLOW. PROVIDE ALUMINUM ATTACHMENT CLIPS AT MAX 4' INTERVALS. UNO PROVIDE HEAT CABLE IN DOWNSPOUT AND EXTEND INTO GROUND. UNO SUBMIT STANDARD COLOR SELECTION TO ARCHITECT FOR APPROVAL. SEE EXTERIOR ELEVATIONS OR ROOF PLAN FOR LOCATIONS.
- H. PROVIDE PAINTED 4' TALL CAST ALUM. DOWNSPOUT BOOTS @ ALL DOWN SPOUTS, TIE INTO SUB-GRADE DRAINAGE, RE: CIVIL.
- I. TAPERED INSULATION TO BE 1/4" PER FOOT MIN SLOPE TO DRAIN. ROOF PLAN SHOWS TAPERED INSULATION FOR GRAPHIC REPRESENTATION ONLY. CONTRACTOR TO VERIFY INSULATION REQUIRED TO SLOPE PRIOR TO MEMBRANE INSULATION.
- J. PROVIDE TAPERED INSULATION CRICKETS 1/4" PER FOOT MIN. SLOPE @ HIGH SIDE OF ALL MECHANICAL UNITS AND ROOF HATCHES, TO SHED WATER AROUND AND MAINTAIN POSITIVE ROOF
- K. VERIFY ELEVATION OF ROOF DRAIN RELATIVE TO OVERFLOW SCUPPER PRIOR TO INSTALLATION OF SCUPPER.
- L. PROVIDE SELF-ADHERING VAPOR RETARDER BETWEEN DECK AND INSULATION, SEE ROOF SCHEDULE AND ROOF DETAILS. UNO PROVIDE CARLISLE AIR & VAPOR BARRIER TR725. PROVIDE AIR TIGHT SEAL AROUND ALL DECK PENETRATIONS AND DECK PERIMITER PRIOR TO INSTALLING VAPOR BARRIER.
- M. ALL WOOD NAILER AND BLOCKING TO BE TREATED. SECURE NAILERS PER FM GLOBAL 1-49 PERIMETER FLASHING REQUIREMENTS.
- N. INSTALL MANUFACTURE'S RECOMENDED PRESSURE-SENSITIVE RUSS STRIP ALONG ENTIRE ROOF PERIMITER AND AT PERIMITER OF ALL ROOF CURBS.
- O. WHEN APPLICABLE UNLESS NOTED OTHERWISE, USE CDX PLYWOOD FOR EXTERIOR APPLICATIONS AND BCD PLYWOOD FOR INTERIOR APPLICATIONS.

KEYNOTES

- ROOF MOUNTED MECHANICAL UNIT, SEE MECHANICAL DRAWINGS.
 3' x 3' ROOF ACCESS HATCH.
 ROOF ACCESS LADDER.
 WALKING PAD.
 ROOF DRAIN AND OVERFLOW DRAIN, SEE ARCH ROOF DETAILS AND PLUMBING DRAWINGS.
 EQUIPMENT SCREEN.
 FALL APPEST SYSTEM, SEE SPECIFICATIONS SECTION 118130.
- 7. FALL ARREST SYSTEM, SEE SPECIFICATIONS SECTION 118129. 8. REINFORCED PARAPET CAP FOR LADDER TRAINING SHOWN
- HATCHED. 9. GUARD RAIL ATTACHED TO ROOF HATCH.
- 10. ROOF ANTENNA.

ROOF PLAN LEGEND

ROOF WALK PADS. REFER TO SPECIFICATIONS

REINFORCED WALL CAP FOR LADDER TRAINING

TAPERED INSULATION CRICKET



1008 W Main St Boise, Idaho 83702 208.345.1800 colearchitects.net Copyright © 2020 Cole Architects, PLLC




ARCHITECTURE + PLANNING + DESIGN

6211 Roosevelt Way NE Seattle, WA 98115 206.522.3820

BIDDERS ARE INSTRUCTED TO CAREFULLY REVIEW THE CONSTRUCTION DOCUMENTS AND THE SITE CONDITIONS. INFORMATION REGARDING THE COMPLETE WORK OF SPECIFIC TRADES IS DISPERSED THROUGHOUT THE ENTIRE DOCUMENT SET AND CANNOT BE ACCURATELY DETERMINED BY REFERENCE TO OTHER THAN COMPLETE DOCUMENT SETS.

STAMP

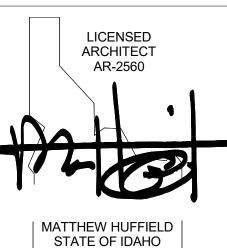

CONSULTANT



KETCHUM FIRE STATION NO. 1

107 SADDLE ROAD, KETCHUM, ID 83353

ISSUES

PHASE CONSTRUCTION SET JUNE 19, 2020 DATE JOB NUMBER 18-022

DESCRIPTION MARK DATE 12/15/20 RFI #CC-94 10 10/14/20 ASI 03

SHEET NAME

ROOF PLAN

SHEET NUMBER

A7.00



Building. Growing. Leading. ... Since 1937.

Budget Evolution Item Summary City of Ketchum Fire Station #1

Add Back S-3 Sink		Date:	11/18/2020
Description: As request	ed by Owner add back sink S-3 to	Kitchen area	
SCOPE	SUBCONTRACTOR	AMO	UNT
Provide S-3 Sink deleted in VA	Evans Plumbing	\$	2,200.00
SUBTOTAL:		\$	2,200.00
SUBTOTAL reflects direct costs only or	<u> </u>		
allowances. If costs are reimbursed b	•		
SUBTOTAL with add of agreed upon m	narkup in accordance with the ch	ange order prici	ng.
Bond and Insurance	CORE	\$	46.00
CMAR FEE	CORE	\$	98.00
Sales Tax	CORE	\$	148.00
TOTAL AMOUNT:		\$	2,492.00

Change Request Proposal

203600 / CoK FS No. 1 Change request number: 80 Project: (name and 107 Saddle Road S-3 in Kitchen Description: Ketchum, ID 83340 address) Customer: CORE | Headwaters, LLC Notice to Proceed Status: Proposed Origination date: 11/12/20 Submitted date: Received date: Rough order of magnitude: 0.00 Quotation Submitted date: 11/12/20 Due date: Submitted amount: 2,200.00 Requested days delay: Notes Addition of S-3 back into the Kitchen. Revenue Detail Billing Item Description Revenue 1,000.00 Labor Material 1,200.00 **Total Revenue For CR 08** 2,200.00 **Approvals** Customer: CORE | Headwaters, LLC Contractor: Evans Plumbing, Inc. Authorized Representative: By: Date: Date:

Print Date: 11/12/20 Page 1 of 1



BID PROPOSAL

Public Works PWC-C-15343-AAA-4 Plumbing- PLB-C-035960 HVAC- HVC-C-2728

111 Gulf Stream Ln Hailey, ID 83333 2188 4th Ave, East Twin Falls, ID 83301
(P)208-726-5261 (F)208-788_8176 (P)208-329-7900

June 23, 2020

Core Construction Attn Jeff Jerome

Ketchum Fire Station No 1 Plumbing VE suggestions.

We have put together the following VE suggestions for the plumbing scope on the Ketchum Fire Station No 1.

- Use Space Age under slab insulation in leu of the specified R-5 for the snow melt system. Subject to approval from engineer and code officials.Deduct (11,500.00)
- Use PEX for domestic water piping less than 2" for all non exposed water piping. All exposed water piping will be Copper as specified........................Deduct (13,500.00)
- Reduce the total lineal footage of the trench drains by 60 ft leaving 40 ft runs in place of the 60 ft runs shown in each of the 3 bays.......Deduct (12,000.00)
- ***** Remove S-3 from the island sink in the kitchen area....Deduct (2,200.00)

Total of 4 accepted VO items: \$39,200.00



Building. Growing. Leading. ... Since 1937.

Budget Evolution Item Summary City of Ketchum Fire Station #1

Change Sinks & Faucets, Relocate Drain		Date: 3/9/2	021
Description: Change Faucets	s UF-2 Add Sinks S-4, Adde	d drain P-trap-boot wash	
coor	SUBCONTRACTOR	AA AQUINIT	
SCOPE	SUBCONTRACTOR	AMOUNT	
Add Boot wash p-trap drain	Evans	\$ 342.	.00
Change Faucets from UF-1 to UF-2 and			
add S-4 sinks	Evans	\$ 4,865.	.00
			_
SUBTOTAL:		\$ 5,207.	.00
SUBTOTAL reflects direct costs only on the	presumption that costs w	vill come from	
allowances. If costs are reimbursed by Cha	ange Order, TOTAL AMOU	NT below reflects the	
SUBTOTAL with add of agreed upon marku	up in accordance with the	change order pricing.	
Bond and Insurance	CORE	\$ 109.	00
CMAR FEE	CORE	\$ 232.	.00
Sales Tax	CORE	\$ -	-
TOTAL AMOUNT:		\$ 5.548.	.00



RFI #CC-77R1
REVISED

Regional office for CORE NV company 777 N 4th St Bosie, Idaho 83702 **Project:** 5-20-01-006 - CoK - City of Ketchum Fire Station 107 Saddle Road Ketchum, Idaho 83353

JT Brown (CORE Construction - Las Vegas)

Printed On: 11/18/2020 10:31 AM

777 N Fourth St

Open

09/23/2020

Boise, Idaho 83702

Boot Wash Area Revision

FROM:

STATUS:

DUE DATE:

COST CODE: SCHEDULE IMPACT:

SPEC SECTION:

REFERENCE:

TO: Jordan Terry (KPFF) (Response Required)

Course of Construction

Alex Goedhart (Cole Architects)

Crystal McColly (Cole Architects)

09/16/2020

LOCATION:

PROJECT STAGE:

DATE INITIATED:

DRAWING NUMBER: LINKED DRAWINGS:

RECEIVED FROM:

JT Brown (CORE Construction - Las Vegas)

COPIES TO:

Ron Allen (Rule Steel), JT Brown (CORE Construction - Las Vegas), Grant Gager (City of Ketchum), Pat Garrett (Garrett Construction, Inc), Alan Gelet (Garrett Construction, Inc), Cary Goldberg (DPPM Project Management), Vic Hulett (Evans Plumbing Incorporated (EPI)), Bill McLaughlin (City of Ketchum), Dennis Potts (DPPM Project Management), Chris Schratwieser (CORE Construction - Las Vegas), Matt Sylvester (CORE Construction - Las Vegas), Brett Traylor (Evans Plumbing Incorporated (EPI))

Question from JT Brown (CORE Construction - Las Vegas) at 01:24 PM on 09/16/2020

This RFI is to confirm direction given to date including RFI-62R1 and acknowledge structural field conditions.

- 1) Please confirm location of the drains at the 3 depressed slab locations is acceptable due to structural constraints.
- 2) The added drain at the alcove next to the apparatus bay has a conflict with the structural footing and the depression will need to be reduced to 3" with drain centered.
- 3) The SCBA room 123 the added floor drain depression can not be centered because of the structural footing and will be offset seven (7) inches as indicated on attached.
- 4) At the boot wash area 136 Southeast of the App Bays, we are installing per revised RFI-62R1 and attached drawing.

Attachments:

S2.01a SLAB ON GRADE PLAN Rev.2 markup (8).pdf

Official Response: Customer Support () responded on Wednesday, November 4th, 2020 at 8:51AM MST

emailed from: ["crystal@colearchitects.com"] See attached response.

Crystal McColly, AIA, NCARB

COLE/ARCHITECTS

Project Architect

p 208.345.1800 / d 208.605.3404 / c 208.731.9031

Attachments:

RFI #CC-77 - Boot Wash Area Revision - Response.pdf

It is structurally acceptable to trench or chip down into the footing a maximum of 4" to install the p-trap for this drain. The maximum size of the trench should be 6" wide x 16" long. Locate the trench to minimize bars that are cut. One bar maximum may be cut for this trench.

Jordan Terry, KPFF - 11/20/20

ВҮ	DATE	COPIES TO



Regional office for CORE NV company 777 N 4th St Bosie, Idaho 83702

Project: 5-20-01-006 - CoK - City of Ketchum Fire Station 107 Saudle Road Ketchum, Idaho 83353

Boot Wash Area Revision

FROM: TO: Alex Goedhart (Cole Architects) JT Brown (CORE Construction - Las Vegas) Crystal McColly (Cole Architects)

777 N Fourth St

Boise, Idaho 837 DATE INITIATED: 09/16/2020

STATUS: Open LOCATION:

DUE DATE: 09/23/2020 PROJECT STAGE: Course of Construction

COST CODE: SUB JOB: **SCHEDULE IMPACT: COST IMPACT:** SPEC SECTION: **DRAWING NUMBER:** REFERENCE:

RECEIVED FROM:

LINKED DRAWINGS:

COPIES TO:

Ron Allen (Rule Steel), JT Brown (CORE Construction - Las Vegas), Grant Gager (City of Kotchum), Pat Garrett (Garrett Construction, Inc), Alan Gelet (Garrett Construction, Inc), Cary Goldberg (DPPM Project Management), Vic Hulett (Evans Plumbing Incorporated (EPI)), Bill McLaughlin (City of Ketchum), Dennis Potts (DPPM Project Management), Chris Schratwieser (CORE Construction - Las Vegas), Matt Sylvester (CORE Construction - Las Vegas), Brett Traylor (Evans Plumbing Incorporated (EPI))

Question from JT Brown (CORE Construction - Las Vegas) at 🕰:24 PM on 09/16/2020

This RFI is to confirm direction given to date including RFI-62R1 and acknowledge structural field conditions.

- 1) Please confirm location of the drains at the 3 depressed slab locations is acceptable due to structural constraints.
 2) The added drain at the alcove next to the apparatus bay has a conflict with the structural footing and the depression will need to be reduced to 3" with drain centered.
- 3) The SCBA room 123 the added floor drain depression can not be centered because of the structural footing and will be offset seven (7) inches as indicated on attached.
- 4) At the boot wash area 136 Southeast of the App Bays, we are in alling per revised RFI-62R1 and attached drawing.

Attachments:

S2.01a SLAB ON GRADE PLAN Rev.2 markup (8).pdf

Awaiting an Official Response


All Replies:

See attached marked up slab on grade

- 1) Drain locations are acceptable. Waintain required slope for adequate drainage.
- 2) 3" depressed slab will be too shallow to provide adequate drainage and allow for the recessed grate. Structural to provide direction to cut slab to meet required depth.
- 3) Drain location is acceptable. Maintain required slope for adequate drainage.
- 4) Maintain 2'-0" widt

Crystal McColly Cole Architects 11/4/20

BY /	DATE	COPIES TO

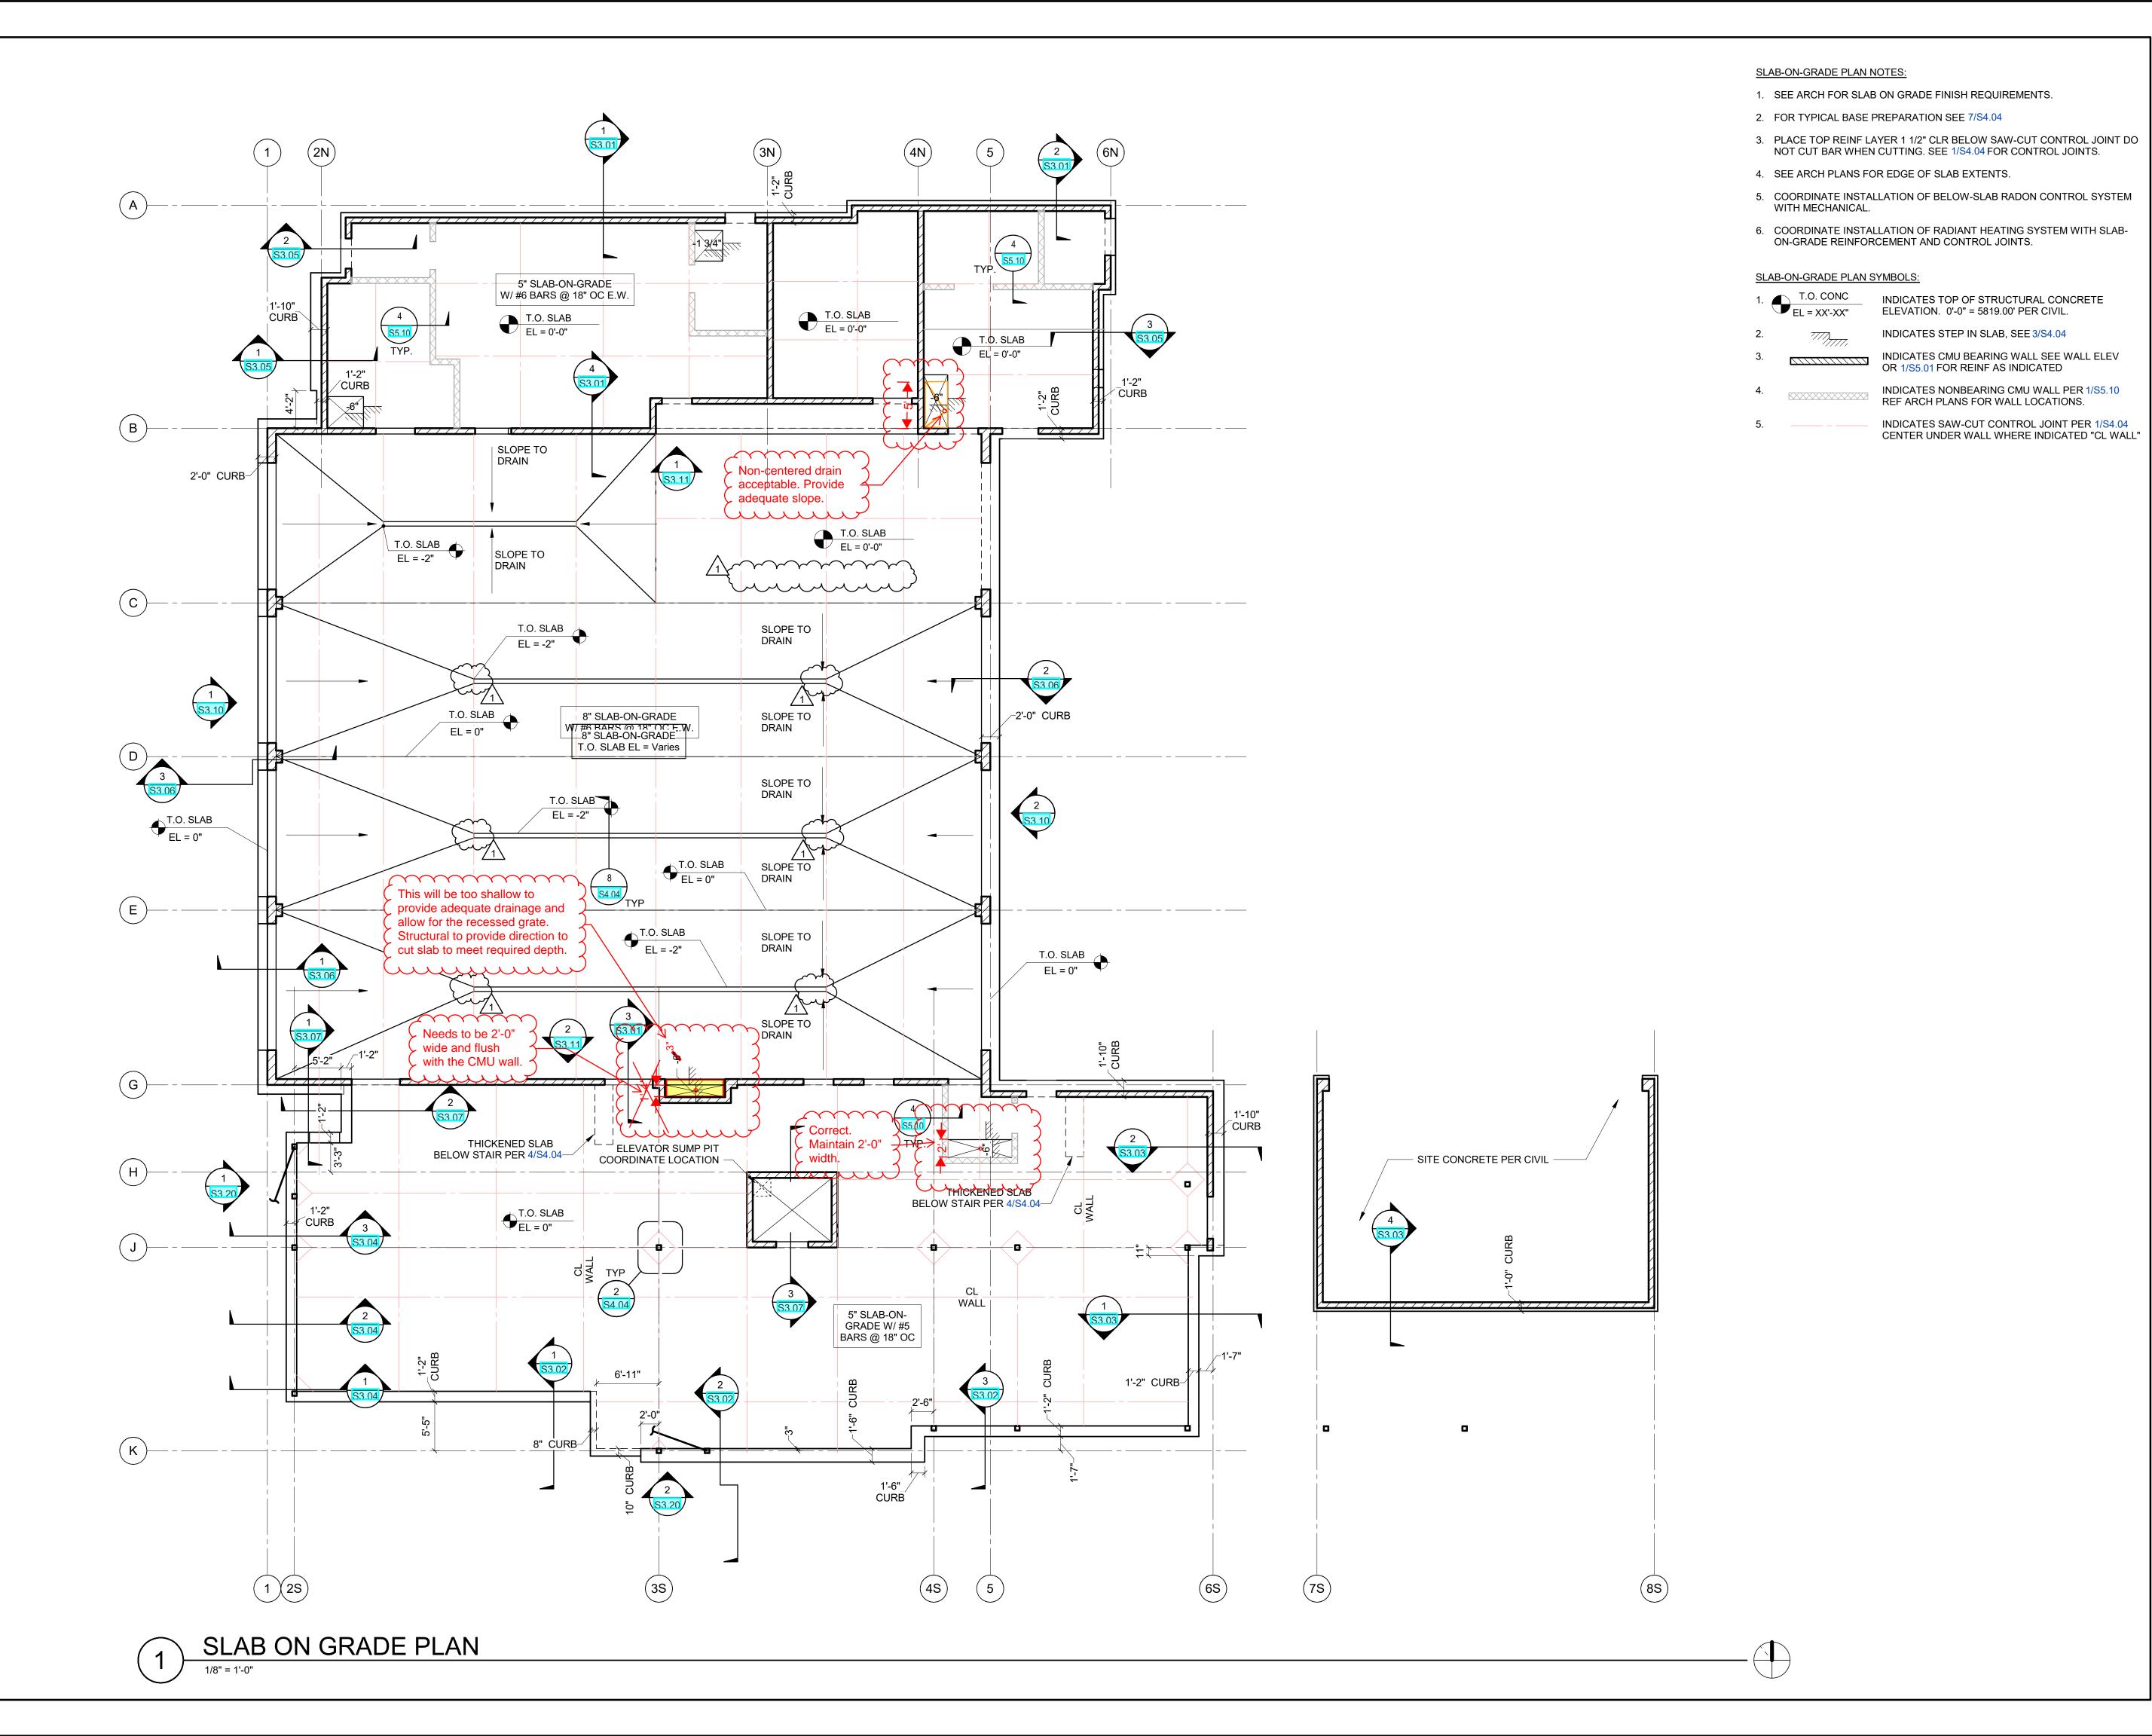



ARCHITECTURE + PLANNING + DESIGN

6211 Roosevelt Way NE Seattle, WA 98115

STAMP

206.522.3820



CONSULTANT



PROJECT INFORMATION



KETCHUM FIRE STATION

SADDLE ROAD KETCHUM, ID 83353

ISSUES

PHASE		CONSTRUCTION SET 6/19/20		
DATE				
JOB NUM	BER	10211900175		
MARK	DATE	DESCRIPTION		


7/17/2020 ASI #1

SHEET NAME

SLAB ON GRADE PLAN

SHEET NUMBER

S2.01a

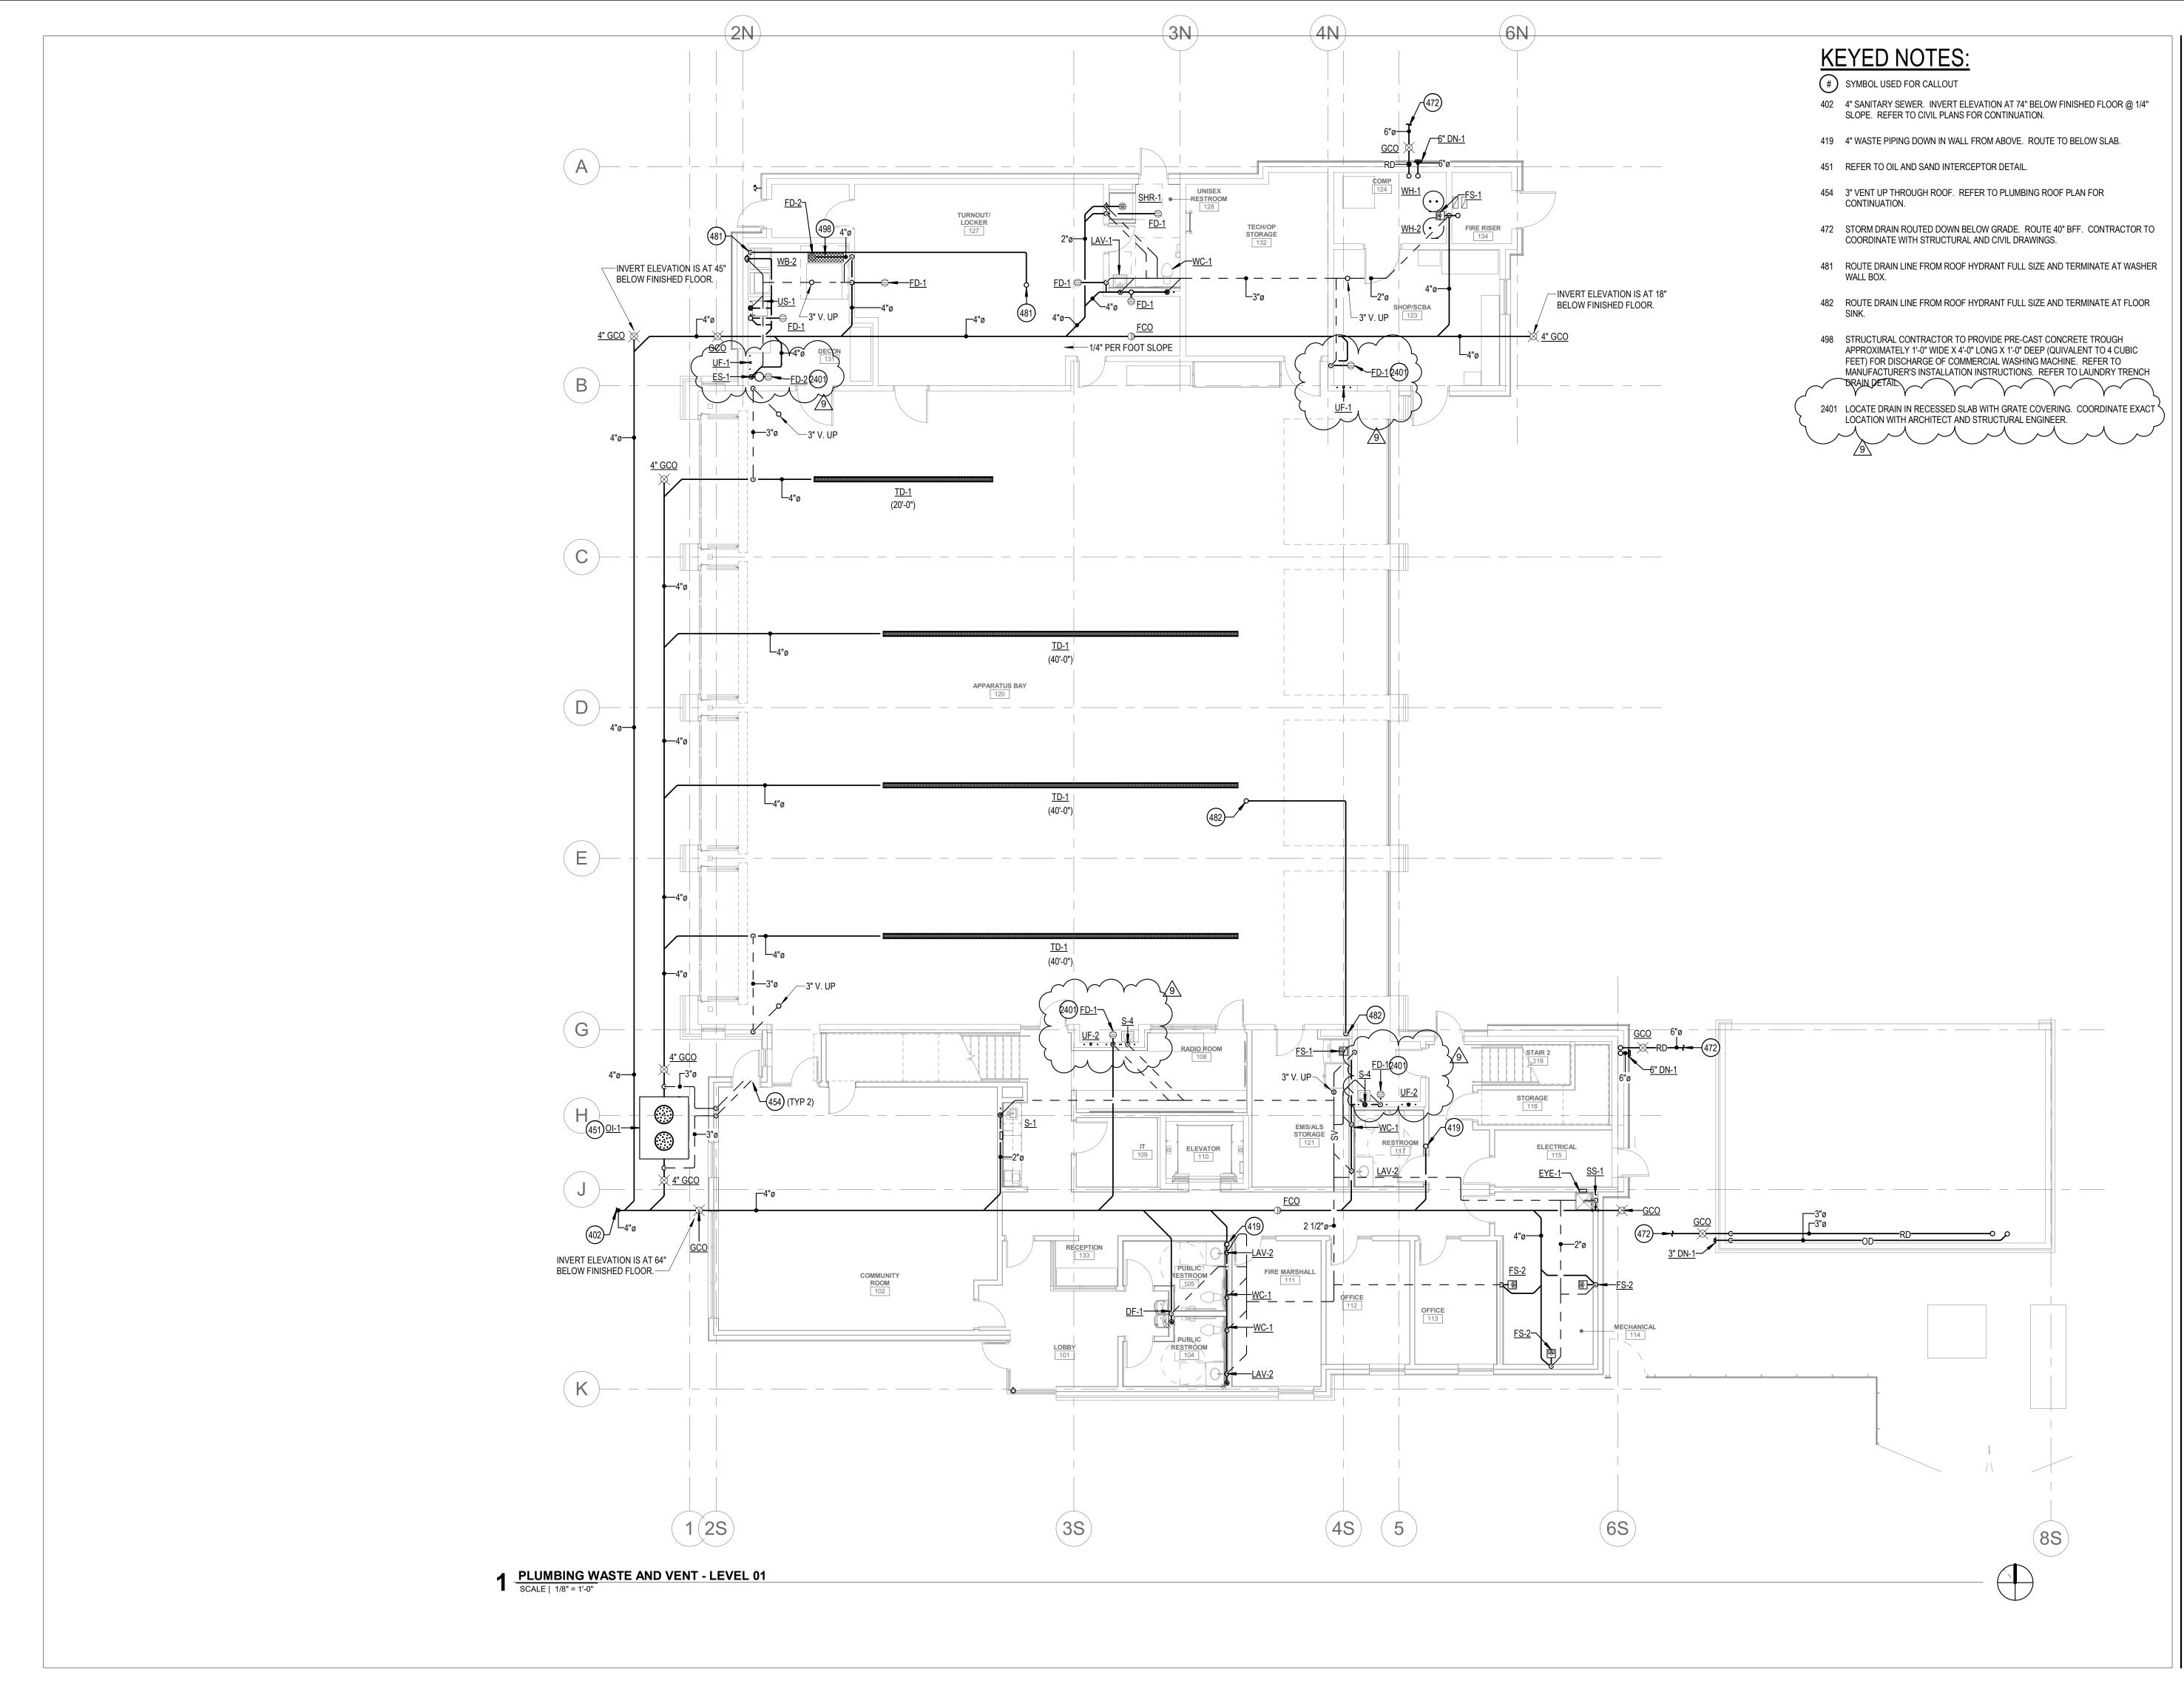





ARCHITECTURE + PLANNING + DESIGN
6211 Roosevelt Way NE
Seattle, WA 98115

206.522.3820

STAMP

CONSULTANT



234 S. WHISPERWOOD WAY BOISE, IDAHO 83709 (208) 384-0585 PROJECT #19-366

PROJECT INFORMATION



KETCHUM FIRE STATION

107 SADDLE ROAD, KETCHUM ID 83353

ISSUES

PHASECONSTRUCTION SETDATE6/19/2020JOB NUMBER18-022

 MARK
 DATE
 DESCRIPTION

 1
 7/17/20
 ASI #1

 7
 8/31/20
 RFI #CC-62

 8
 9/03/20
 RFI #CC-62R1

 9
 09/21/2
 RFI #CC-77


 0
 RFI #CC-77

SHEET NAME

PUMBING WASTE AND VENT PLAN -LEVEL 01

SHEET NUMBER

P1.00

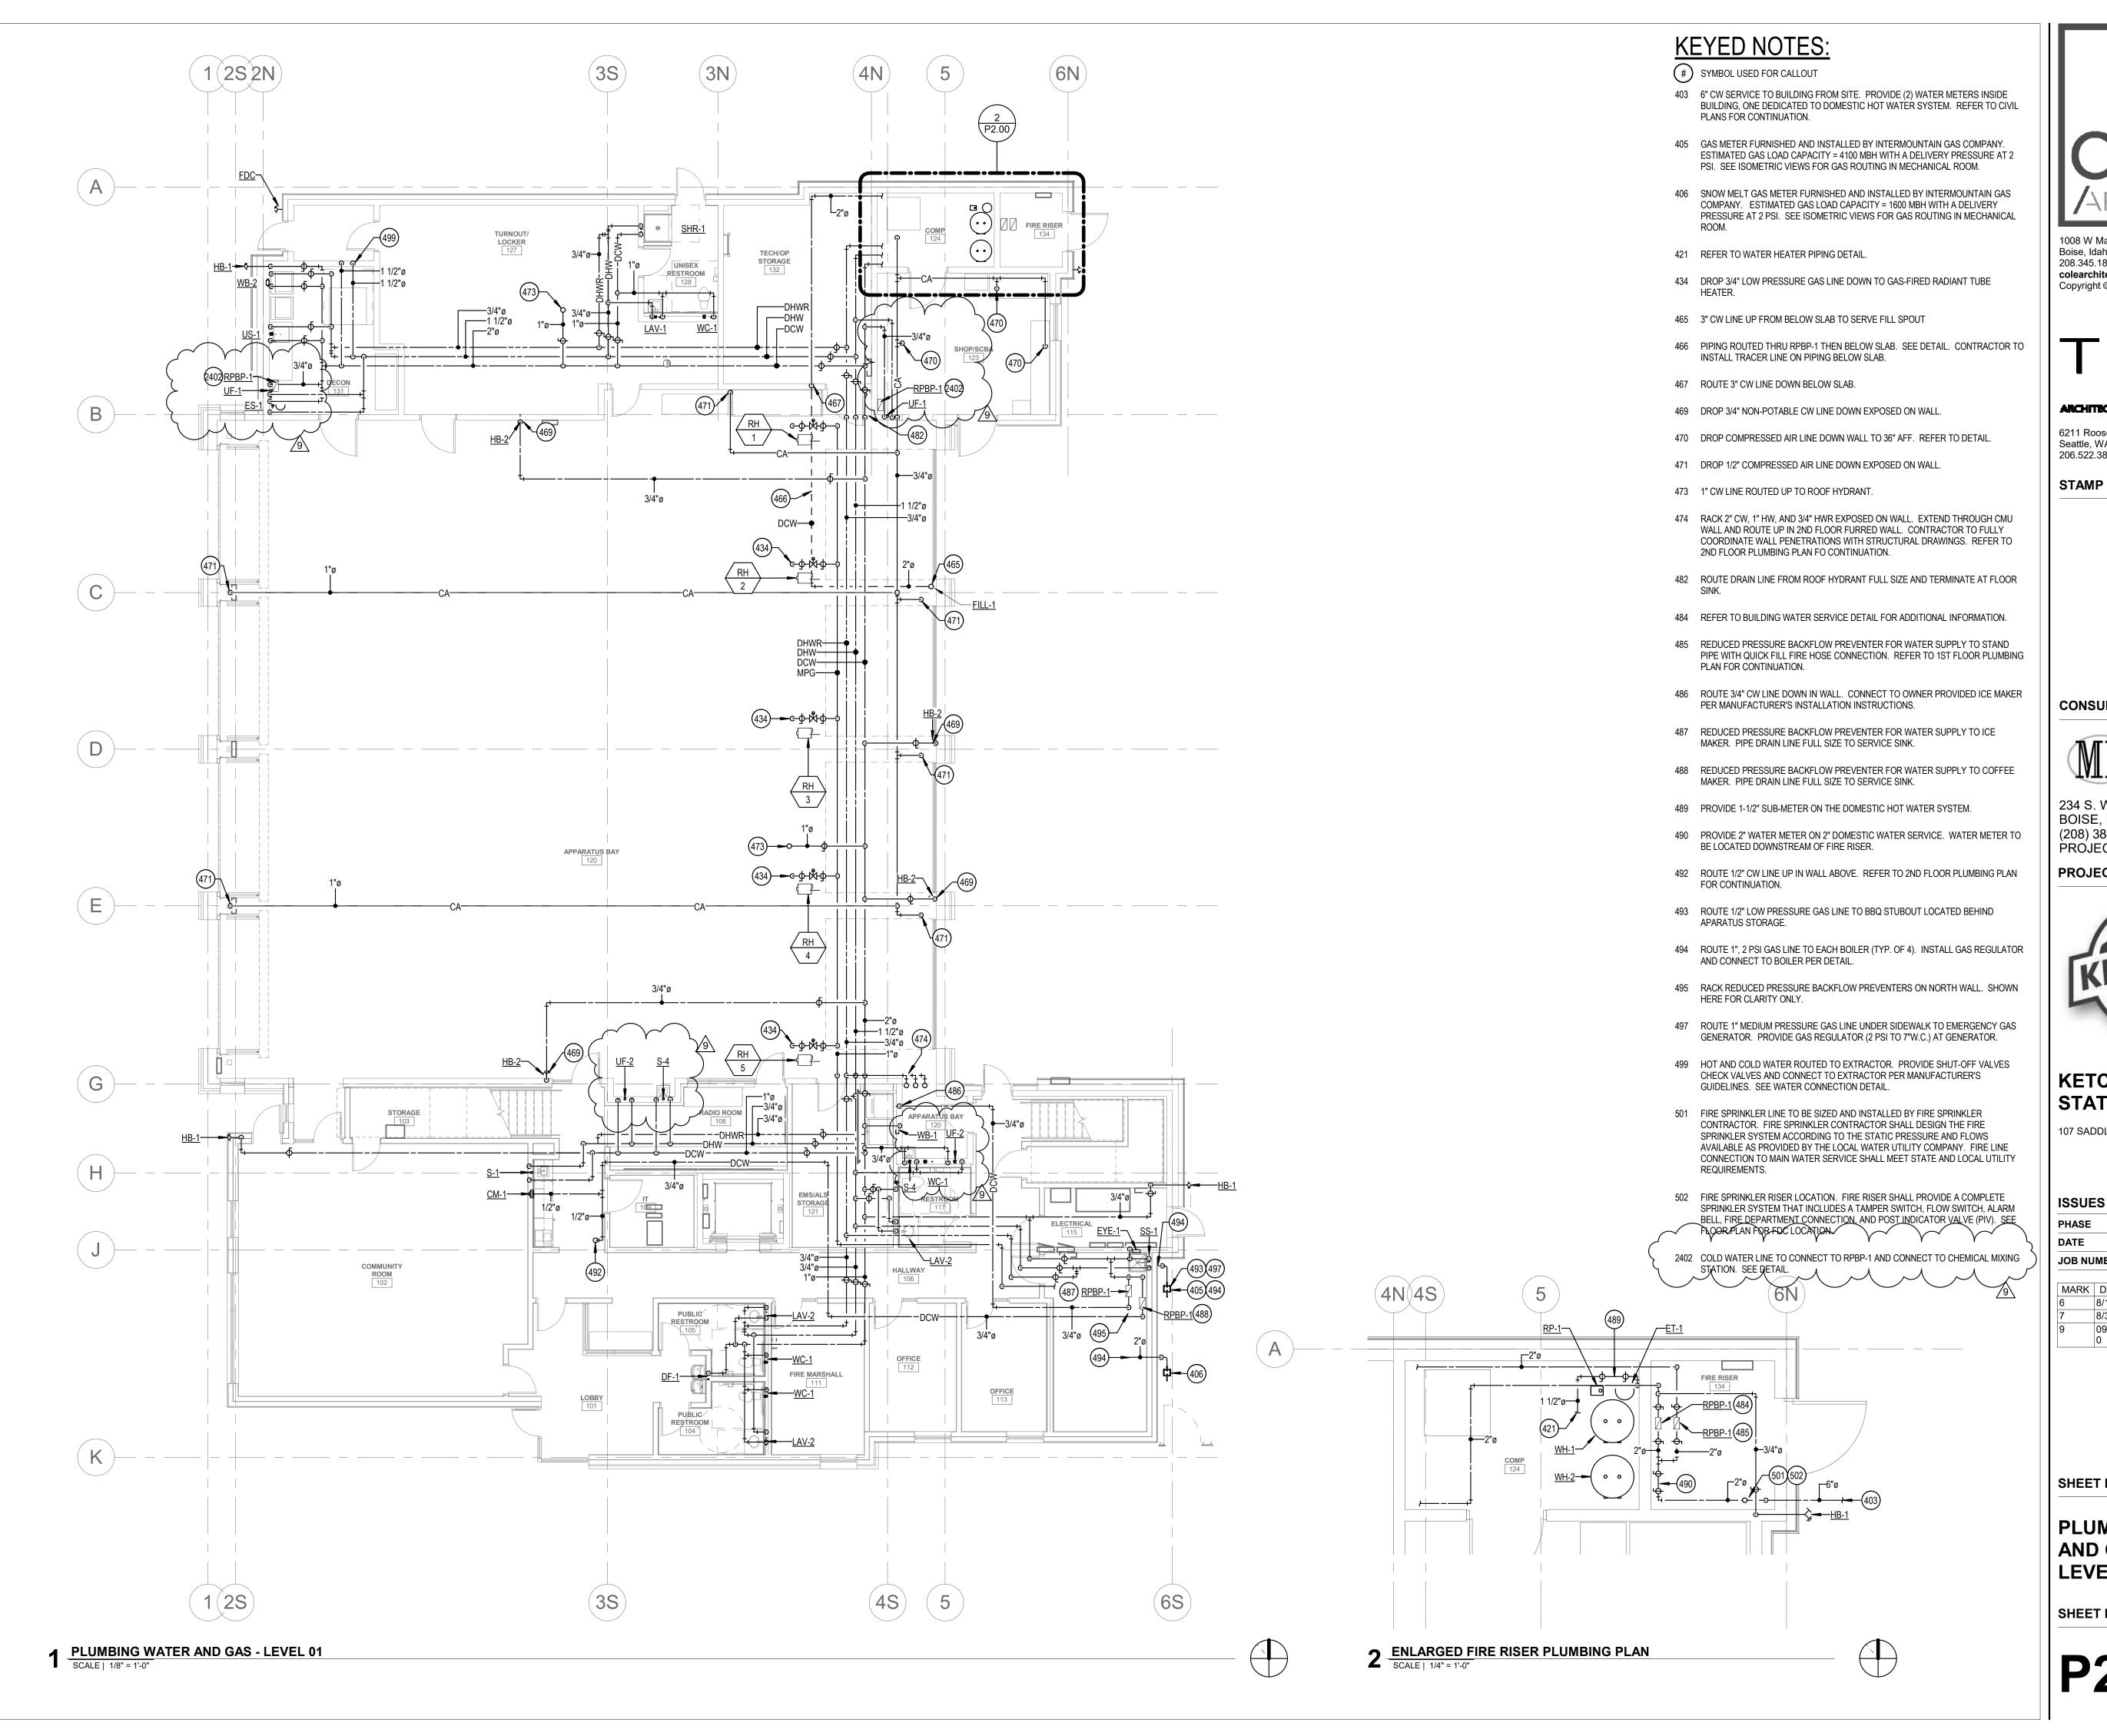





ARCHITECTURE + PLANNING + DESIGN 6211 Roosevelt Way NE

206.522.3820

Seattle, WA 98115

CONSULTANT



234 S. WHISPERWOOD WAY BOISE, IDAHO 83709 (208) 384-0585 PROJECT #19-366

PROJECT INFORMATION



KETCHUM FIRE STATION

107 SADDLE ROAD, KETCHUM ID 83353

ISSUES

PHASE CONSTRUCTION SET DATE 6/19/2020 **JOB NUMBER** 18-022


DESCRIPTION MARK DATE 8/17/20 ASI #2 8/31/20 RFI #CC-62 09/21/2 RFI #CC-77

SHEET NAME

PLUMBING WATER AND GAS PLAN -LEVEL 01

SHEET NUMBER

P2.00

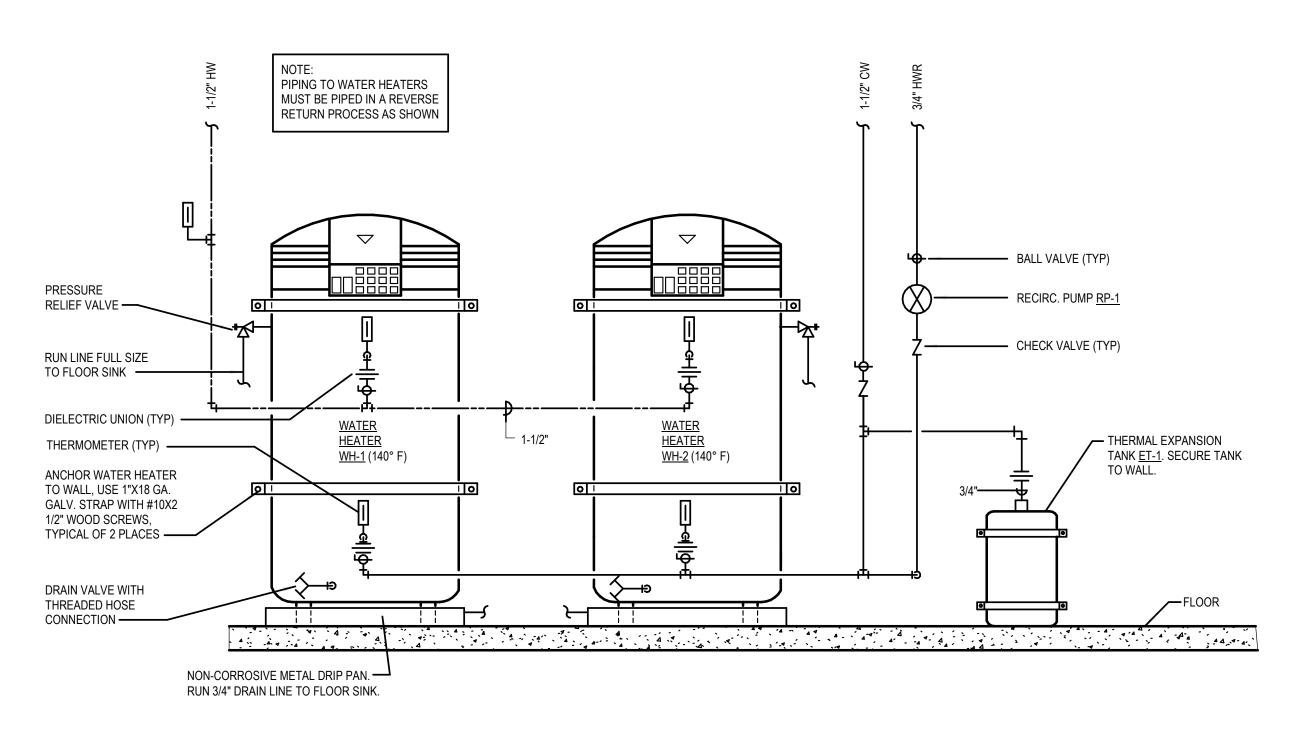

ELECTRIC GAS WATER HEATER PIPING DETAIL

1-1/2"---

AIR CUSHION

RISER (TYP)

3/4 MAIN FILL (COLD) /

6 COMMERCIAL LAUNDRY PIPING DIAGRAM


----1-1/2"

ISOLATION

DUAL CHECK (TYP)

VALVE (TYP)

FILTER (TYP)

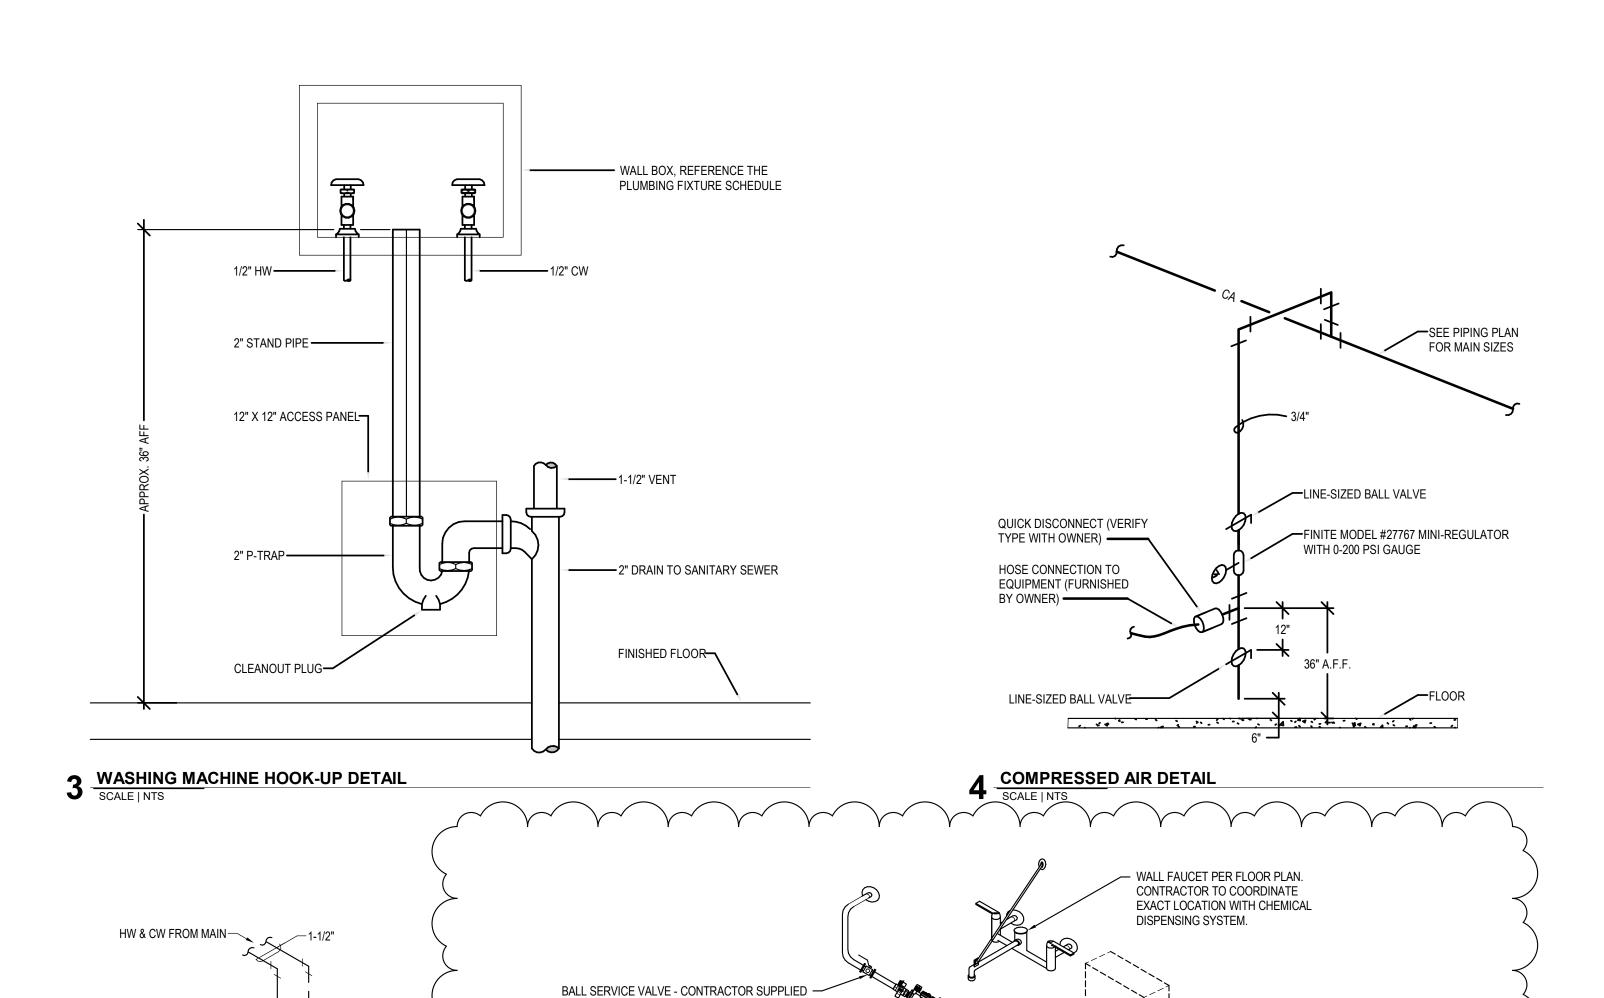

<u>RPBP-1</u> -

PIPE ANCHOR —

- CHEMICAL DISPENSING SYSTEM

FLOW PREVENTION. SYSTEM

FURNISHED BY OWNER.

─3/4-INCH GATE VALVE WITH A 3/4-INCH MALE HOSE NOZZLE. PROVIDE

WITH ANTI-SIPHON CHECK VALVE AND

ATMOSPHERIC VENT.


THAT MEETS ASSE 1055-B BACK

(TYPICAL)

TERMINATE INDIRECTLY -


CHEMICAL MIXING STATION DETAIL

AT TRENCH DRAIN

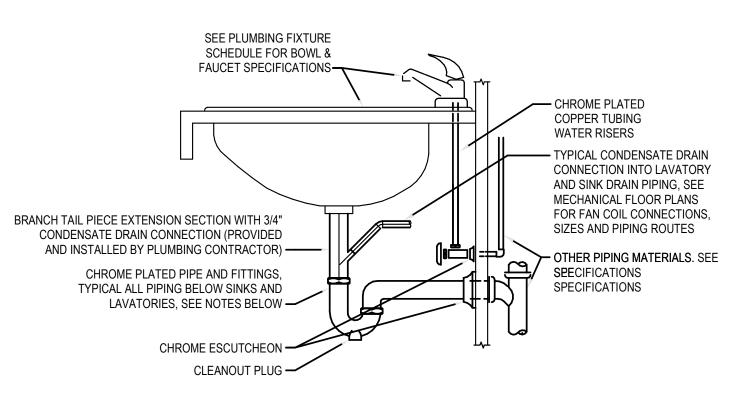

- 1. INTERIOR EXPOSED PIPE, VALVES AND FIXTURE TRIM, INCLUDING TRIM BEHIND CASEWORK DOORS, SHALL BE CHROME PLATED.
- 2. ALL PIPING PENETRATIONS THROUGH FINISHED WALLS SHALL BE PROVIDED WITH CHROME ESCUTCHEONS.
- 3. ALL SINK AND LAVATORY TRAPS SHALL BE PROVIDED WITH A CLEANOUT PLUG IN THE BOTTOM OF THE TRAP.
- 4. ALL PLUMBING FIXTURES SHALL BE CAULKED AND SEALED TO SURROUNDING SURFACES.
- 5. PLUMBING CONTRACTOR SHALL VERIFY THE LOCATION OF ALL LAVATORIES AND SINKS THAT NEED TO BE INSTALLED WITH THE BRANCH TAIL PIECE SECTION WITH 3/4" DRAIN CONNECTION. THE PLUMBING CONTRACTOR WILL BE RESPONSIBLE TO VERIFY THE PLUMBING ROUGH-IN DIMENSIONS AND SHALL TAKE INTO ACCOUNT THE TAIL PIECE EXTENSION DIMENSIONS.

2 SINK/LAVATORY TAILPIECE & TRAP DETAIL (W/ CONDENSATE) SCALE | NTS

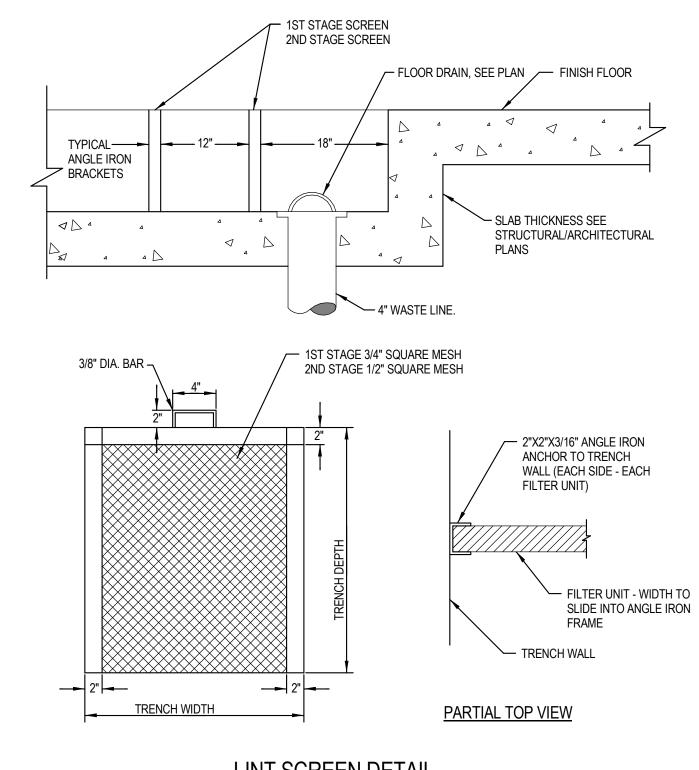

LINT SCREEN DETAIL

5 COMMERCIAL LAUNDRY TRENCH DRAIN DETAIL SCALE | NTS



1008 W Main St Boise, Idaho 83702 208.345.1800 colearchitects.net Copyright © 2020 Cole Architects, PLLC



ARCHITECTURE + PLANNING + DESIGN 6211 Roosevelt Way NE Seattle, WA 98115

206.522.3820

STAMP

CONSULTANT



234 S. WHISPERWOOD WAY BOISE, IDAHO 83709 (208) 384-0585 PROJECT #19-366

PROJECT INFORMATION



KETCHUM FIRE STATION

107 SADDLE ROAD, KETCHUM ID 83353

ISSUES

6/19/202
18-02

DESCRIPTION MARK DATE 8/31/20 RFI #CC-62 09/21/2 RFI #CC-77

SHEET NAME

PLUMBING DETAILS

SHEET NUMBER

P5.01

			^^	NNECTION S	IZF		
SYMBOL	FIXTURE DESCRIPTION	WASTE	VENT	TRAP	CW	HW	MANUFACTURER / MODEL NUMBER / DESCRIPTION / ADDITIONAL COMMENTS
<u>CM-1</u>	WALL BOX (WATER SUPPLY TO COFFEE MAKER)				1/2		PROVIDED BY OTHERS, INSTALLED BY CONTRACTOR. PROVIDE REDUCED PRESSURE BACKFLOW PREVENTER ON SUPPLY LINE.
<u>D-1</u>	DISPOSER DRINKING FOUNTAIN WITH BOTTLE	2	1 1/2	1 1/2			PROVIDED BY OTHERS, INSTALLED BY CONTRACTOR.
<u>DF-1</u>	FILLING STATION (INTERIOR DUAL BUBBLERS) (ELECTRIC WATER COOLER) (ADA COMPLIANT) (HIGH/LOW)	1 1/2	1 1/2	1 1/2	1/2		ELKAY MODEL LZSTL8WSLK,HIGH/LOW COOLER WITH BOTTLE FILLING STATION WITH FLEXI-GUARD STREAMSAVER BUBBLER. OPERATED BY FRONT OR SIDE PUSH BARS AND BOTTLE FILLING STATION OPERATED BY SENSOR ACTIVATION WITH AUTOMATIC 30-SECOND SHUT-OFF TIMER. 115 VOLT, 4.5 AMF HERTZ, AND FILTER. PROVIDE WITH JAY R. SMITH 0834 FLOOR MOUNTED SUPPORT CARRIER.
<u>DN-1</u>	DOWN SPOUT NOZZLE (CAST IRON)	SEE PLANS					JAY R. SMITH FIGURE NUMBER 1770-NB CAST IRON NOZZLE WITH WALL FLANGE, NICKEL-BRONZE FINISI
<u>DW-1</u>	DISHWASHER EXPANSION TANK					1/2	PROVIDED BY OTHERS, CONNECT WASTE TO DISPOSAL. SEE DETAIL SHEET P2.00. AMTROL THERM-X-TROL ST-25V, OR APPROVED EQUAL, NON ASME SERIES THERMAL EXPANSION
<u>ET-1</u>	EXPANSION TANK EMERGENCY EYE WASH/				3/4		ABSORBER, ANTIMICROBIAL LINER, AND 5 YEAR WARRANTY. ACORN MODEL S2310 BARRIER FREE COMBINATION SHOWER AND EYE WASH, WITH PULL ROPE AND PU
<u>ES-1</u>	SHOWER COMBINATION (FLOOR MOUNTED) (ADA COMPLIANT)	1 1/2	1 1/2	1 1/2	1 1/4	1-1/4	FLAG. ABS SHOWERHEAD AND EYE/FACE WASH. PROVIDE WITH DUST COVER AND UNIVERSAL SIGN. PROVIDE WITH FD-1 AND ACORN MODEL ET71 LEAD FREE, THERMOSTATIC MIXING VALVE OR EQUAL. 1-1/4" TEMPERED WATER. ACORN SAFETY MODEL S0406-CH12-BFP, WALL MOUNTED WITH DUAL 45° ANGLED HEADS AND RECOIL
<u>EYE-1</u>	EMERGENCY EYE WASH (WALL MOUNTED)				1/2	1/2	PROVIDE WITH FLIP TOP DUST COVERS, UNIVERSAL EMERGENCY SIGN, DOUBLE CHECK BACKFLOW, STAINLESS STEEL 90° WITH SHEET NIPPLE, AND ACORN MODEL ET71 THERMOSTATIC MIXING VALVE OF EQUAL, LEAD FREE, WITH TEMPERATURE GAUGE ON OUTLET.
<u>FCO</u>	FLOOR CLEANOUT	SEE PLANS					JAY R. SMITH 4020 SERIES WITH ADJUSTABLE TOP AND ABS PLUG. PROVIDE WITH FIGURE NUMBER 991 HEIGHT ADJUSTMENT AFTER CONCRETE POUR. JAY R. SMITH FIGURE NUMBER 2005Y-A05NB: NO-HUB OUTLET, 5" ROUND, NICKEL BRONZE FINISH, WITH
<u>FD-1</u>	FLOOR DRAIN (CONCRETE FLOOR)	2	2	2			ADJUSTABLE STRAINER AND TRAP PRIMER. INSTALL TOP OF DRAIN 1/8" BELOW FINISH FLOOR AND CALEDGE.
FD-2	FLOOR DRAIN (CONCRETE FLOOR)	4	2	4			JAY R. SMITH FIGURE NUMBER 2005Y-A08NB: NO-HUB OUTLET, 8" ROUND, NICKEL BRONZE FINISH, WITH ADJUSTABLE STRAINER AND TRAP PRIMER. INSTALL TOP OF DRAIN 1/8" BELOW FINISH FLOOR AND CAUEDGE. BUILDING CONNECTIONS MODEL 152 2.5" WALL MOUNT FLUSH OUTLET. INSTALL WITH MODEL 164 CONT
FILL-1	FLUSH CONNECTION FLOOR SINK				3		VALVE.
<u>FS-1</u>	(HALF GRATE) (10" DEEP) (FOOT TRAFFIC RATED)	4	2	4			JAY R. SMITH FIGURE NUMBER 3160Y-12: CAST IRON RECEPTOR, ALUMINUM DOME STRAINER, NICKEL BRONZE GRATE, AND TRAP PRIMER. INSTALL TOP OF SINK 1/8" BELOW FINISH FLOOR AND CAULK EDGE
GCO	GRADE CLEANOUT (NON-PAVED AREAS)	SEE PLANS					JAY R. SMITH 4220 SERIES WITH ABS PLUG.
<u>GCO</u>	GRADE CLEANOUT (PAVED AREAS) (VEHICULAR TRAFFIC)	SEE PLANS					JAY R. SMITH 4250 SERIES, ROUND FLANGED HOUSING WITH HEAVY DUTY CAST IRON COVER. FURNISH WITH ABS PLUG. COVER TO BE INSCRIBED "SAN".
<u>HB-1</u>	HOSE BIBB (EXTERIOR) (NON-FREEZE)				3/4		WOODFORD MODEL 67 - EXPOSED STYLE WITH MODEL 50HA BACKFLOW PREVENTER, 3/4" INLET, AND CHROME PLATED. PROVIDE WITH TEE KEY AND INSTALL AT 18" ABOVE FINISH GRADE.
<u>HB-2</u>	HOSE BIBB (INTERIOR)				3/4		WOODFORD MODEL 26 - EXPOSED STYLE WITH 3/4" INLET, AND CHROME PLATED. PROVIDE WITH META WHEEL HANDLE AND WOODFORD MODEL 50HF BACKFLOW PREVENTER.
LAV-1	LAVATORY (WALL MOUNTED) (ADA COMPLIANT)	1 1/2	1 1/2	1 1/4	1/2	1/2	KOHLER KINGSTON MODEL K-2005: VITREOUS CHINA, WALL MOUNTED, HOLES ON 4" CENTERS, AND GESTRAINER. CHICAGO FAUCETS MODEL 420-E39VPABCP: 3-3/4" LONG, SINGLE LEVER FAUCET WITH 0.35 AERATOR. PROVIDE WITH JAY R. SMITH FIGURE NUMBER 0700-Z SUPPORT WITH CONCEALED ARMS AN WATTS SERIES USG-B THERMOSTATIC MIXING VALVE, ASSE STANDARD 1070 LISTED, BRONZE BODY, INTEGRAL CHECK VALVES, AND SELECTABLE TEMPERATURE RANGE FROM 80°F TO 120°F. PROVIDE W LS-1 LAV SHIELD.
LAV-2	LAVATORY (COUNTERTOP / CABINET MOUNTED) (ADA COMPLIANT)	1 1/2	1 1/2	1 1/4	1/2	1/2	KOHLER PENNINGTON MODEL K-2196-4 VITREOUS CHINA, COUNTERTOP-MOUNTED SINK WITH HOLES C CENTERS, AND GRID STRAINER. CHICAGO FAUCETS MODEL 420-E39VPABCP: 3-3/4" LONG, SINGLE LEV FAUCET WITH 0.35 GPM AERATOR. PROVIDE WITH WATTS SERIES LFUSG-B THERMOSTATIC MIXING VAI ASSE STANDARD 1070 LISTED, LEAD-FREE BRASS BODY, INTEGRAL CHECK VALVES, AND SELECTABLE TEMPERATURE RANGE FROM 80°F TO 120°F. PROVIDE WITH PIPING INSULATION, TRUEBRO LAV GUARI PLUMBEREX HANDI-SHIELD, OR EQUAL.
<u>LS-1</u>	LAVATORY SHIELD (WALL MOUNTED SHIELD FOR CONCEALING PIPING, VALVES, AND INSTANTANEOUS WATER HEATERS)						TRUEBRO "LAV SHIELD" ADA COMPLIANT, TOTAL ENCLOSURE. SINGLE-PIECE CONSTRUCTION, SLOAN OPTISHIELD ETF-529, OR APPROVED EQUAL.
<u>OD-1</u>	OVERFLOW ROOF DRAIN (LOW PROFILE DOME STYLE) (METAL GRATE)						JAY R. SMITH FIGURE NUMBER 1070Y-R-C-RS-CID WITH CAST IRON DOME GRATE AND RAIN SHIELD.
<u>OI-1</u>	OIL AND SAND INTERCEPTOR (1500 GALLONS)	4	3				PRE-CAST CONCRETE, 1500 GALLON CAPACITY, OIL AND SAND INTERCEPTOR. SEE DRAWING FOR DET NO SPLIT DESIGN VAULTS WITH GASKETS BELOW FLUID LEVEL ALLOWED.
<u>PF-1</u>	POT FILLER ROOF DRAIN				1/2	1/2	PROVIDED BY OTHERS, INSTALLED BY CONTRACTOR.
<u>RD-1</u>	(LOW PROFILE DOME STYLE) (METAL GRATE)						JAY R. SMITH FIGURE NUMBER 1010Y-R-C-CID WITH CAST IRON DOME GRATE.
RH-1	ROOF HYDRANT (NON FREEZE)				1		WOODFORD MODEL RHY2-MS. NON-FREEZE STYLE WITH 3/4" HOSE CONNECTION AND INTEGRAL DOUB CHECK BACKFLOW PREVENTER. REQUIRES 1/8" DRAIN HOLE TO BE PIPED TO A DRAIN LOCATION.
<u>RP-1</u>	RECIRCULATION PUMP (HOT WATER RETURN SYSTEM)					3/4	BELL AND GOSSETT BRONZE MODEL NBF-22, 115 VOLT, 0.8 AMPS, 92 WATTS, AND SHALL PROVIDE 7 GF 10 FEET HEAD. INCLUDE 7-DAY PROGRAMMABLE ELECTRONIC TIME CLOCK WITH BATTERY BACKUP, INTERMATIC MODEL GM40AVE-RD89. APPROVED ALTERNATE: ARMSTRONG, TACO, GRUNDFOS.
RPBP-1	REDUCED PRESSURE BACKFLOW PREVENTER		INDIRECT				WATTS SERIES LF009 REDUCED PRESSURE ZONE ASSEMBLY WITH QUARTER TURN BALL VALVES, BRO STRAINER, AND AIR GAP. BRONZE BODY CONSTRUCTION - 1/2" THRU 2", PROVIDE WITH STRAINER. LE. FREE. 2 1/2" THRU 10" 957 SERIES. SEE NOTE 6.
<u>S-1</u>	SINK - SINGLE COMPARTMENT (17" X 20" X 6 1/2") (ADA COMPLIANT)	2	1 1/2	1 1/2	1/2	1/2	ELKAY LUSTERTONE MODEL LRAD-1720: 6-1/2" DEEP STAINLESS STEEL SINK. ELKAY MODEL LK-3001 SI LEVER FAUCET WITH 1.5 GPM AERATOR, SWING SPOUT, AND HOSE SPRAY. PROVIDE WITH ELKAY MOD LK-35 CHROME PLATED TAILPIECE AND STAINLESS STEEL BASKET, AND WATTS SERIES USG-B THERMOSTATIC MIXING VALVE, ASSE STANDARD 1070 LISTED, BRONZE BODY, INTEGRAL CHECK VALVE
<u>S-2</u>	KITCHEN SINK - DOUBLE COMPARTMENT (14" X 14" X 6 1/2" - EACH) (ADA COMPLIANT)	2	1 1/2	1 1/2	1/2	1/2	AND SELECTABLE TEMPERATURE RANGE FROM 80°F TO 120°F. ELKAY LUSTERTONE MODEL LRAD-3319: 6-1/2" DEEP STAINLESS STEEL SINK. ELKAY MODEL LK-3001 SIN LEVER FAUCET WITH 1.5 GPM AERATOR, SWING SPOUT, AND HOSE SPRAY. PROVIDE WITH ELKAY MODEL LK-35 CHROME PLATED TAILPIECE AND STAINLESS STEEL BASKET, AND WATTS SERIES USG-B THERMOSTATIC MIXING VALVE, ASSE STANDARD 1070 LISTED, BRONZE BODY, INTEGRAL CHECK VALVE
<u>S-3</u>	PREP SINK - SINGLE COMPARTMENT (15" X 15" X 7")	2	1 1/2	1 1/2	1/2	1/2	AND SELECTABLE TEMPERATURE RANGE FROM 80°F TO 120°F. ELKAY LUSTERTONE MODEL BLR150C: 7" DEEP, STAINLESS STEEL SINK WITH ELKAY MODEL LKD2223, HANDLE MIXING FAUCET WITH HIGH GOOSENECK SPOUT AND 1.5 GPM AERATOR. PROVIDE ELKAY MO
<u>S-4</u>	BOOT WASH HAND SINK	2	1 1/2	1 1/2	1/2	1/2	REGENCY 600HS17: 17"X15", STAINLESS STEEL SINK WITH INTEGRATED GOOSENECK FAUCET. PROVIDENCE OF THE PRO
	(17" X 15" X 5-1/2")						CHROME PLATED TAILPIECE AND STAINLESS STEEL BASKET. BEST BATH SYSTEMS MODEL LC 94238ABT, WITH A 1/2 THRESHOLD, ONE PIECE CLASSIC TILE FINISH, SHOWER MODULE SHALL BE CONSTRUCTED OF GELCOAT/FIBERGLASS WITH FULL INTEGRAL PLYWOOD
OLID 4	SHOWER (42" X 38" X 79")		4.4/0		410	4/0	BACKING IN ALL THE WALLS FOR STRENGTH AND CUSTOMIZED INSTALLATION OF ACCESSORIES. PRE-LEVELED FLOOR FOR EASY INSTALLATION. NOTE LOW THRESHOLD DESIGN REQUIRES 8" X 8" BLOOUT CENTERED AT DRAIN PIPE LOCATION. ACCESSORIES: (1) 12" S.S. GRAB BAR, (1) 24" S.S. GRAB BAR, (1) 27" S.S. GRAB BAR, (1) SURFACE MOUN
SHR-1	(INSERT STYLÉ) (ADA COMPLIANT)	2	1 1/2	2	1/2	1/2	SOAP DISH (1) SIOUX CHIEF CAULKLESS BRASS DRAIN #827-2B WITH CHROME SCREEN, (1) TWS COLLAPSIBLE 'T' SHAPED WATER RETAINER. ALSO INCLUDE MOEN MODEL 8346EP15, 1.5 GPM ECO-PERFORMANCE HANDHELD SHOWER SYSTEM, POSI-TEMP, WITHOUT VOLUME CONTROL, ADJUSTABLE TEMPERATURE STOP, 1/4 TURN STOPS, 4 PORT CYCLING VALVE, HANDHELD SHOWER, 69" DOUBLE SWIVEL HOSE ASSE 30" SLIDE BAR, VACUUM BREAKER, DROP ELL, AND STAINLESS STEEL CURTAIN ROD. PROVIDE
							TAPE-WEIGHTED SHOWER CURTAIN. BEST BATH SYSTEMS MODEL LCS4238A5T, WITH A 1/2" THRESHOLD, ONE PIECE CLASSIC TILE FINISH,
SHR-2	SHOWER (42" X 38" X 79") (INSERT STYLE) (ADA COMPLIANT)	2	1 1/2	2	1/2	1/2	SHOWER MODULE SHALL BE CONSTRUCTED OF GELCOAT/FIBERGLASS WITH FULL INTEGRAL PLYWOO BACKING IN ALL THE WALLS FOR STRENGTH AND CUSTOMIZED INSTALLATION OF ACCESSORIES. PRE-LEVELED FLOOR FOR EASY INSTALLATION. NOTE LOW THRESHOLD DESIGN REQUIRES 8" X 8" BLCOUT CENTERED AT DRAIN PIPE LOCATION. ACCESSORIES: (1) 12" S.S. GRAB BAR, (1) 24" S.S. GRAB BAR, (1) 27" S.S. GRAB BAR, (1) 32"X16" PHENOL LAB, ADA COMPLIANT, SWING-DOWN SEAT WITH LEGS, (1) SURFACE MOUNTED SOAP DISH (1) SIOUX C CAULKLESS BRASS DRAIN #827-2B WITH CHROME SCREEN, (1) TWS COLLAPSIBLE 'T' SHAPED WATER RETAINER. ALSO INCLUDE MOEN MODEL 8346EP15, 1.5 GPM ECO-PERFORMANCE HANDHELD SHOWER

	Τ	<u> </u>	CC	NNECTION S			
SYMBOL	FIXTURE DESCRIPTION	WASTE	VENT	TRAP	CW	HW	MANUFACTURER / MODEL NUMBER / DESCRIPTION / ADDITIONAL COMMENTS
<u>SS-1</u>	SERVICE SINK (24" X 24" X 10") (FLOOR MOUNTED)	3	2	3	1/2	1/2	ACORN TERRAZZO-WARE MODEL TRH-242410: PROVIDE AND INSTALL WITH STAINLESS STEEL BUMPER GUARD, DRAIN GASKET, CHROME FAUCET, 36" HOSE AND WALL HANGER, MOP HANGER, AND 2 SIDE STAINLESS STEEL WALL GUARD.
<u>TD-1</u>	TRENCH DRAIN (10" WIDE) (HEAVY TRAFFIC RATED)	4	2	4			JAY R. SMITH FIGURE NUMBER 9812 10" WIDE TRENCH DRAIN SYSTEM. SLOPE DRAIN SYSTEM WITH INTEGRAL METAL RAIL, PROVIDE WITH END CAPS, OUTLETS, CATCH BASIN (9812G-880-CB24-BP), AND HEAVY DUTY (CLASS C) GALVANIZED STEEL BAR GRATE (MODEL 9812-G). REFER TO ARCHITECTURAL PLAN FOR EXACT LENGTH REQUIREMENTS.
<u>TP-1</u>	TRAP PRIMER (PRESSURE ACTIVATED) (1 TO 4 TRAPS)				1/2"		PRECISION PLUMBING PRODUCTS MODEL CPO-500 WITH DU DISTRIBUTION UNIT IF REQUIRED FOR SERVING MORE THAN ONE TRAP. APPROVED ALTERNATES: MIFAB, SIOUX CHIEF, SLOAN, AND ZURN
<u>TP-1</u>	TRAP PRIMER (FLUSH VALVE PRIMER) (1 TRAP)				1/2"		PRECISION PLUMBING PRODUCTS MODEL FVP-1VB WITH VACUUM BREAKER. TRAP PRIMER TUBING SHALL BE INSTALLED OFF BACK OF FLUSH VALVE. APPROVED ALTERNATES: MIFAB, SIOUX CHIEF, SLOAN, AND ZURN
<u>TP-1</u>	TRAP PRIMER (LAVATORY TAILPIECE PRIMER) (1 TRAP)				1/2"	-	DEARBORN BRASS 1-1/2" TRAP PRIMER TAILPIECE WITH COMPRESSION CONNECTION.
UF-1	UTILITY FAUCET	-			1/2	1/2	ACORN UTILITY FAUCET OPTION KFC: BRASS CONSTRUCTION WITH ROUGH CHROME FINISH, TWO HANDLES 8" CENTERSET, WALL MOUNTED, PAIL HOOK WITH 9-1/4" REACH, WALL BRACE, VACUUM BREAKER, AND 3/4" THREADED SPOUT
UF-2	UTILITY FAUCET				3/4	3/4	T&S BRASS AND BRONZE WORKS MV-0771-11N MIXING VALVE. CHROME PLATED WITH TWO HANDLES, 6" CENTER SET, WALL MOUNTED, PAIL HOOK WITH 9-1/4" REACH, WALL BRACE, VACUUM BREAKER, AND 3/4" THREADED SPOUT. PROVIDE WITH 50' HOSE, REAR TRIGGER STAINLESS STEEL WATER GUN & HOSE RACK.
<u>US-1</u>	UTILITY SINK (23" X 21" X 13") (FLOOR MOUNTED)	2	1 1/2	1 1/2	1/2	1/2	FIAT MOLDED STONE MODEL FL-1. PROVIDE WITH A-1 DECK CHROME FAUCET, DRAIN WITH STOPPER, AND EASY LEVELING LEGS.
<u>WB-1</u>	WALL BOX (WATER SUPPLY TO ICE MAKER)				1/2		OATEY FIREMASTER MODEL 39121 WITH FACEPLATE, ADJUSTABLE METAL SUPPORT BRACKET, AND WATER HAMMER ARRESTOR. FIRE-RATED, LOW LEAD, OR APPROVED EQUAL.
<u>WB-2</u>	WALL BOX (SUPPLY TO AND DRAIN FROM WASHING MACHINE)	2	1 1/2	2	1/2	1/2	OATEY FIREMASTER MODEL 38478 WITH ADJUSTABLE METAL SUPPORT BRACKET, AND WATER HAMMER ARRESTORS. FIRE RATED, OR APPROVED EQUAL.
<u>WC-1</u>	WATER CLOSET (DUAL FLUSH TANK) (FLOOR MOUNTED) (COMFORT HEIGHT / ADA)	4	2	INT.	1/2		KOHLER HIGHLINE MODEL K-3989, DUAL FLUSH, FLOOR MOUNTED, GRAVITY FLUSH TANK WITH ELONGATED BOWL, 1.6 GPF OR 1.1 GPF. PROVIDE KOHLER LUSTRA MODEL K-4650 ELONGATED, OPEN FRONT SEAT WITH CHECK HINGE AND COVER.
WCO	WALL CLEANOUT	SEE PLANS					JAY R. SMITH 4472T SERIES WITH CAST BRONZE TAPER THREAD PLUG, STAINLESS STEEL ROUND COVER, AND A STAINLESS STEEL VANDAL PROOF SCREW.
<u>WH-1</u>	WATER HEATER (119 GALLON UPRIGHT MODEL) (208V-3Ø ELECTRIC)				SEE PLANS	SEE PLANS	BRADFORD WHITE MODEL E32-120R-3, SIMULTANEOUS TRIPLE ELEMENTS, (3) 6 KW, 208V/3Ø, 28" DIAMETER, 63" TALL, WITH TOP CONNECTIONS. PROVIDE WITH WALL BRACKET SUPPORT AND SEISMIC STRAP.
<u>WH-2</u>	WATER HEATER (119 GALLON UPRIGHT MODEL) (208V-3Ø ELECTRIC)				SEE PLANS	SEE PLANS	BRADFORD WHITE MODEL E32-120R-3, SIMULTANEOUS TRIPLE ELEMENTS, (3) 6 KW, 208V/3Ø, 28" DIAMETER, 63" TALL, WITH TOP CONNECTIONS. PROVIDE WITH WALL BRACKET SUPPORT AND SEISMIC STRAP.
NOTES:							
							HANDICAPPED FIXTURE DESIGNATIONS, LOCATIONS, CLEARANCES, AND MOUNTING HEIGHTS.
2.	ALL EXPOSED HW PIPING, CW PIPING, AND MOLDED CLOSED CELL VINYL INSULATION				IES AND ALL	ADA COMPL	LIANT SINKS MUST BE INSULATED TO PREVENT INJURY. REFER TO ARCHITECTURAL PLANS. INSULATE WITH
3.	PROVIDE P-TRAP PRIMERS FOR ALL FLOOP	R DRAINS AND	FLOOR SIN	KS. PROVID	DE A BALL TY	PE SHUT-OF	F VALVE UPSTREAM OF PRIMER VALVE. SEE SPECIFICATIONS.

GAS	GAS SIZING CHART (METER #1)									
SYMBOL	INPUT (MBH)	RUNOUT SIZE (2-PSI) (INCHES)	EQUIPMENT CONNECTION SIZES (7" WC) (INCHES)							
B-5 (RADIANT FLOOR SYSTEM)	399.0	1/2	3/4							
B-6 (RADIANT FLOOR SYSTEM)	399.0	1/2	3/4							
B-7 (RADIANT FLOOR SYSTEM)	399.0	1/2	3/4							
B-8 (RADIANT FLOOR SYSTEM)	399.0	1/2	3/4							
RADIANT HEATERS 200.0 MBH (X5)	1000.0	1/2 (EACH)	3/4							
GAS GENERATOR	1511.0	1	1							
TOTAL	4107.0	EQUIVALENT LE PRESSUF MAIN SIZE	RE = 2-PSI							

EQUIPMENT: COFFEE MAKER ICE MAKER

EVAPORATIVE COOLER

NON-POTABLE LOOP AT APPARATUS BAY

NOTE: GAS SIZES TO EQUIPMENT ARE AS NOTED IN SCHEDULE ABOVE. ROUTE NOTED (2-PSI) GAS LINE TO GAS EQUIPMENT. PROVIDE GAS COCK AND PRESSURE REGULATOR (2-PSI - 7" WC) SIZED FOR GAS LOAD AT EACH PIECE OF EQUIPMENT. VENT TO ATMOSPHERE PER MANUFACTURERS RECOMMENDATIONS. ROUTE NOTED (7" WC) GAS LINE TO GAS FIRED EQUIPMENT WITH GAS COCK AND FLEX CONNECTOR AT UNIT.

GAS SIZING CHART (METER #2)								
SYMBOL	INPUT (MBH)	RUNOUT SIZE (2-PSI) (INCHES)	EQUIPMENT CONNECTION SIZES (7" WC) (INCHES)					
B-1 (SNOW MELT SYSTEM)	399.0	1/2	3/4					
(SNOW MELT SYSTEM)	399.0	1/2	3/4					
B-3 (SNOW MELT SYSTEM)	399.0	1/2	3/4					
(SNOW MELT SYSTEM)	399.0	1/2	3/4					
TOTAL	1596.0	EQUIVALENT LENGTH = 50 FT PRESSURE = 2-PSI MAIN SIZE = 1"Ø						

NOTE: GAS SIZES TO EQUIPMENT ARE AS NOTED IN SCHEDULE ABOVE. ROUTE NOTED (2-PSI) GAS LINE TO GAS EQUIPMENT. PROVIDE GAS COCK AND PRESSURE REGULATOR (2-PSI - 7" WC) SIZED FOR GAS LOAD AT EACH PIECE OF EQUIPMENT. VENT TO ATMOSPHERE PER MANUFACTURERS RECOMMENDATIONS. ROUTE NOTED (7" WC) GAS LINE TO GAS FIRED EQUIPMENT WITH GAS COCK AND FLEX CONNECTOR AT UNIT. SEE GAS CONNECTION DETAILS ON SHEET



1008 W Main St Boise, Idaho 83702 208.345.1800 colearchitects.net Copyright © 2020 Cole Architects, PLLC



6211 Roosevelt Way NE Seattle, WA 98115 206.522.3820

STAMP

CONSULTANT



234 S. WHISPERWOOD WAY BOISE, IDAHO 83709 (208) 384-0585 PROJECT #19-366

PROJECT INFORMATION



KETCHUM FIRE STATION

107 SADDLE ROAD, KETCHUM ID 83353

ISSUES

	PHASE	CONSTRUCTION SE
	DATE	6/19/20
	JOB NUMBER	18-0

MARK DATE DESCRIPTION 8/17/20 ASI #2 09/21/2 RFI #CC-77

SHEET NAME

PLUMBING FIXTURE SCHEDULE

SHEET NUMBER

P6.00



Regional office for CORE NV company 777 N 4th St Bosie, Idaho 83702

Project: 5-20-01-006 - CoK - City of Ketchum Fire Station 107 Saddle Road Ketchum, Idaho 83353

Chris Schratwieser (CORE Construction - Las

Printed On: 11/20/2020 11:26 PM

Added Plumbing Fixtures in ASI-04 Drawing not Included in Narrative

Alex Goedhart (Cole Architects)

Crystal McColly (Cole Architects)

DATE INITIATED: 11/19/2020

LOCATION:

PROJECT STAGE: Course of Construction

COST IMPACT: Yes (Unknown)

LINKED DRAWINGS:

DRAWING NUMBER: P2.00 FROM:

7150 Cascade Valley Court Las Vegas, Nevada 89128

STATUS: Open **DUE DATE:** 11/26/2020

COST CODE:

SCHEDULE IMPACT: SPEC SECTION:

REFERENCE:

RECEIVED FROM: JT Brown (CORE Construction - Las Vegas)

COPIES TO:

JT Brown (CORE Construction - Las Vegas), Grant Gager (City of Ketchum), Cary Goldberg (DPPM Project Management), Bill McLaughlin (City of Ketchum), Dennis Potts (DPPM Project Management), Chris Schratwieser (CORE Construction - Las Vegas), Matt Sylvester (CORE Construction - Las Vegas), Brett Traylor (Evans Plumbing Incorporated (EPI))

Question from Chris Schratwieser (CORE Construction - Las Vegas) at 12:25 PM on 11/19/2020

Upon further review of the plumbing drawing P2.00 issued as part of ASI-4 various items were not included in the narrative that effect the function of the plumbing system. Please confirm design intent and added scope:

- 1) At the App Bay 120 Alcove located in the southeast corner of the app bay along the south wall of the alcove there is a UF-2 and S-4 fixture callout that did not previously exist.
- 2) At Shop/SCBA 123 keynote 2402 was added referencing the added RPBP-1. UF-1 was also added, both are in the Southwest corner of that room 3) At Decon Room 131 in the Southwest corner UF-1 and RPBP-1 with keynote 2402 were added.

Awaiting an Official Response

The following sheets were not formally issued with a narrative to RFI #CC-77 response as intended.

Please see attached sheets P1.00, P2.00, P5.01 & P6.00 and attached narrative in response to design intent and scope. All revisions are clouded with delta 9.

Crystal McColly Cole Architects 12/30/20

ВҮ	DATE	COPIES TO

NARRATIVE: RFI #CC-77R1

P1.00:

- •Added note 2401.
- •Shop/SCBA 123 added waste piping, FD-1, UF-1, bubble 2401.
- •Decon 131 added waste piping, UF-1, bubble 2401.
- •Boot wash area moved FD-1, added UF-2, S-4, bubble 2401.
- •Corner of App Bay new restroom 117 extended waste piping, removed UF-1, added UF-2, S-4, FD-1, bubble 2401.

P2.00:


- •Added note 2402.
- •Decon 131 added water lines, RBPB-1, UF-1, bubble 2402.
- •Shop/SCBA 123 added water lines, UF-1, RBPB-1, bubble 2402.
- •Boot wash area added water lines, UF-2, S-4.
- •Corner of App Bay new restroom 117 added water lines, removed UF-1, added UF-2, S-4.

P5.01:

•Added detail 7.

P6.00:

- •Added S-4
- •Added UF-2.

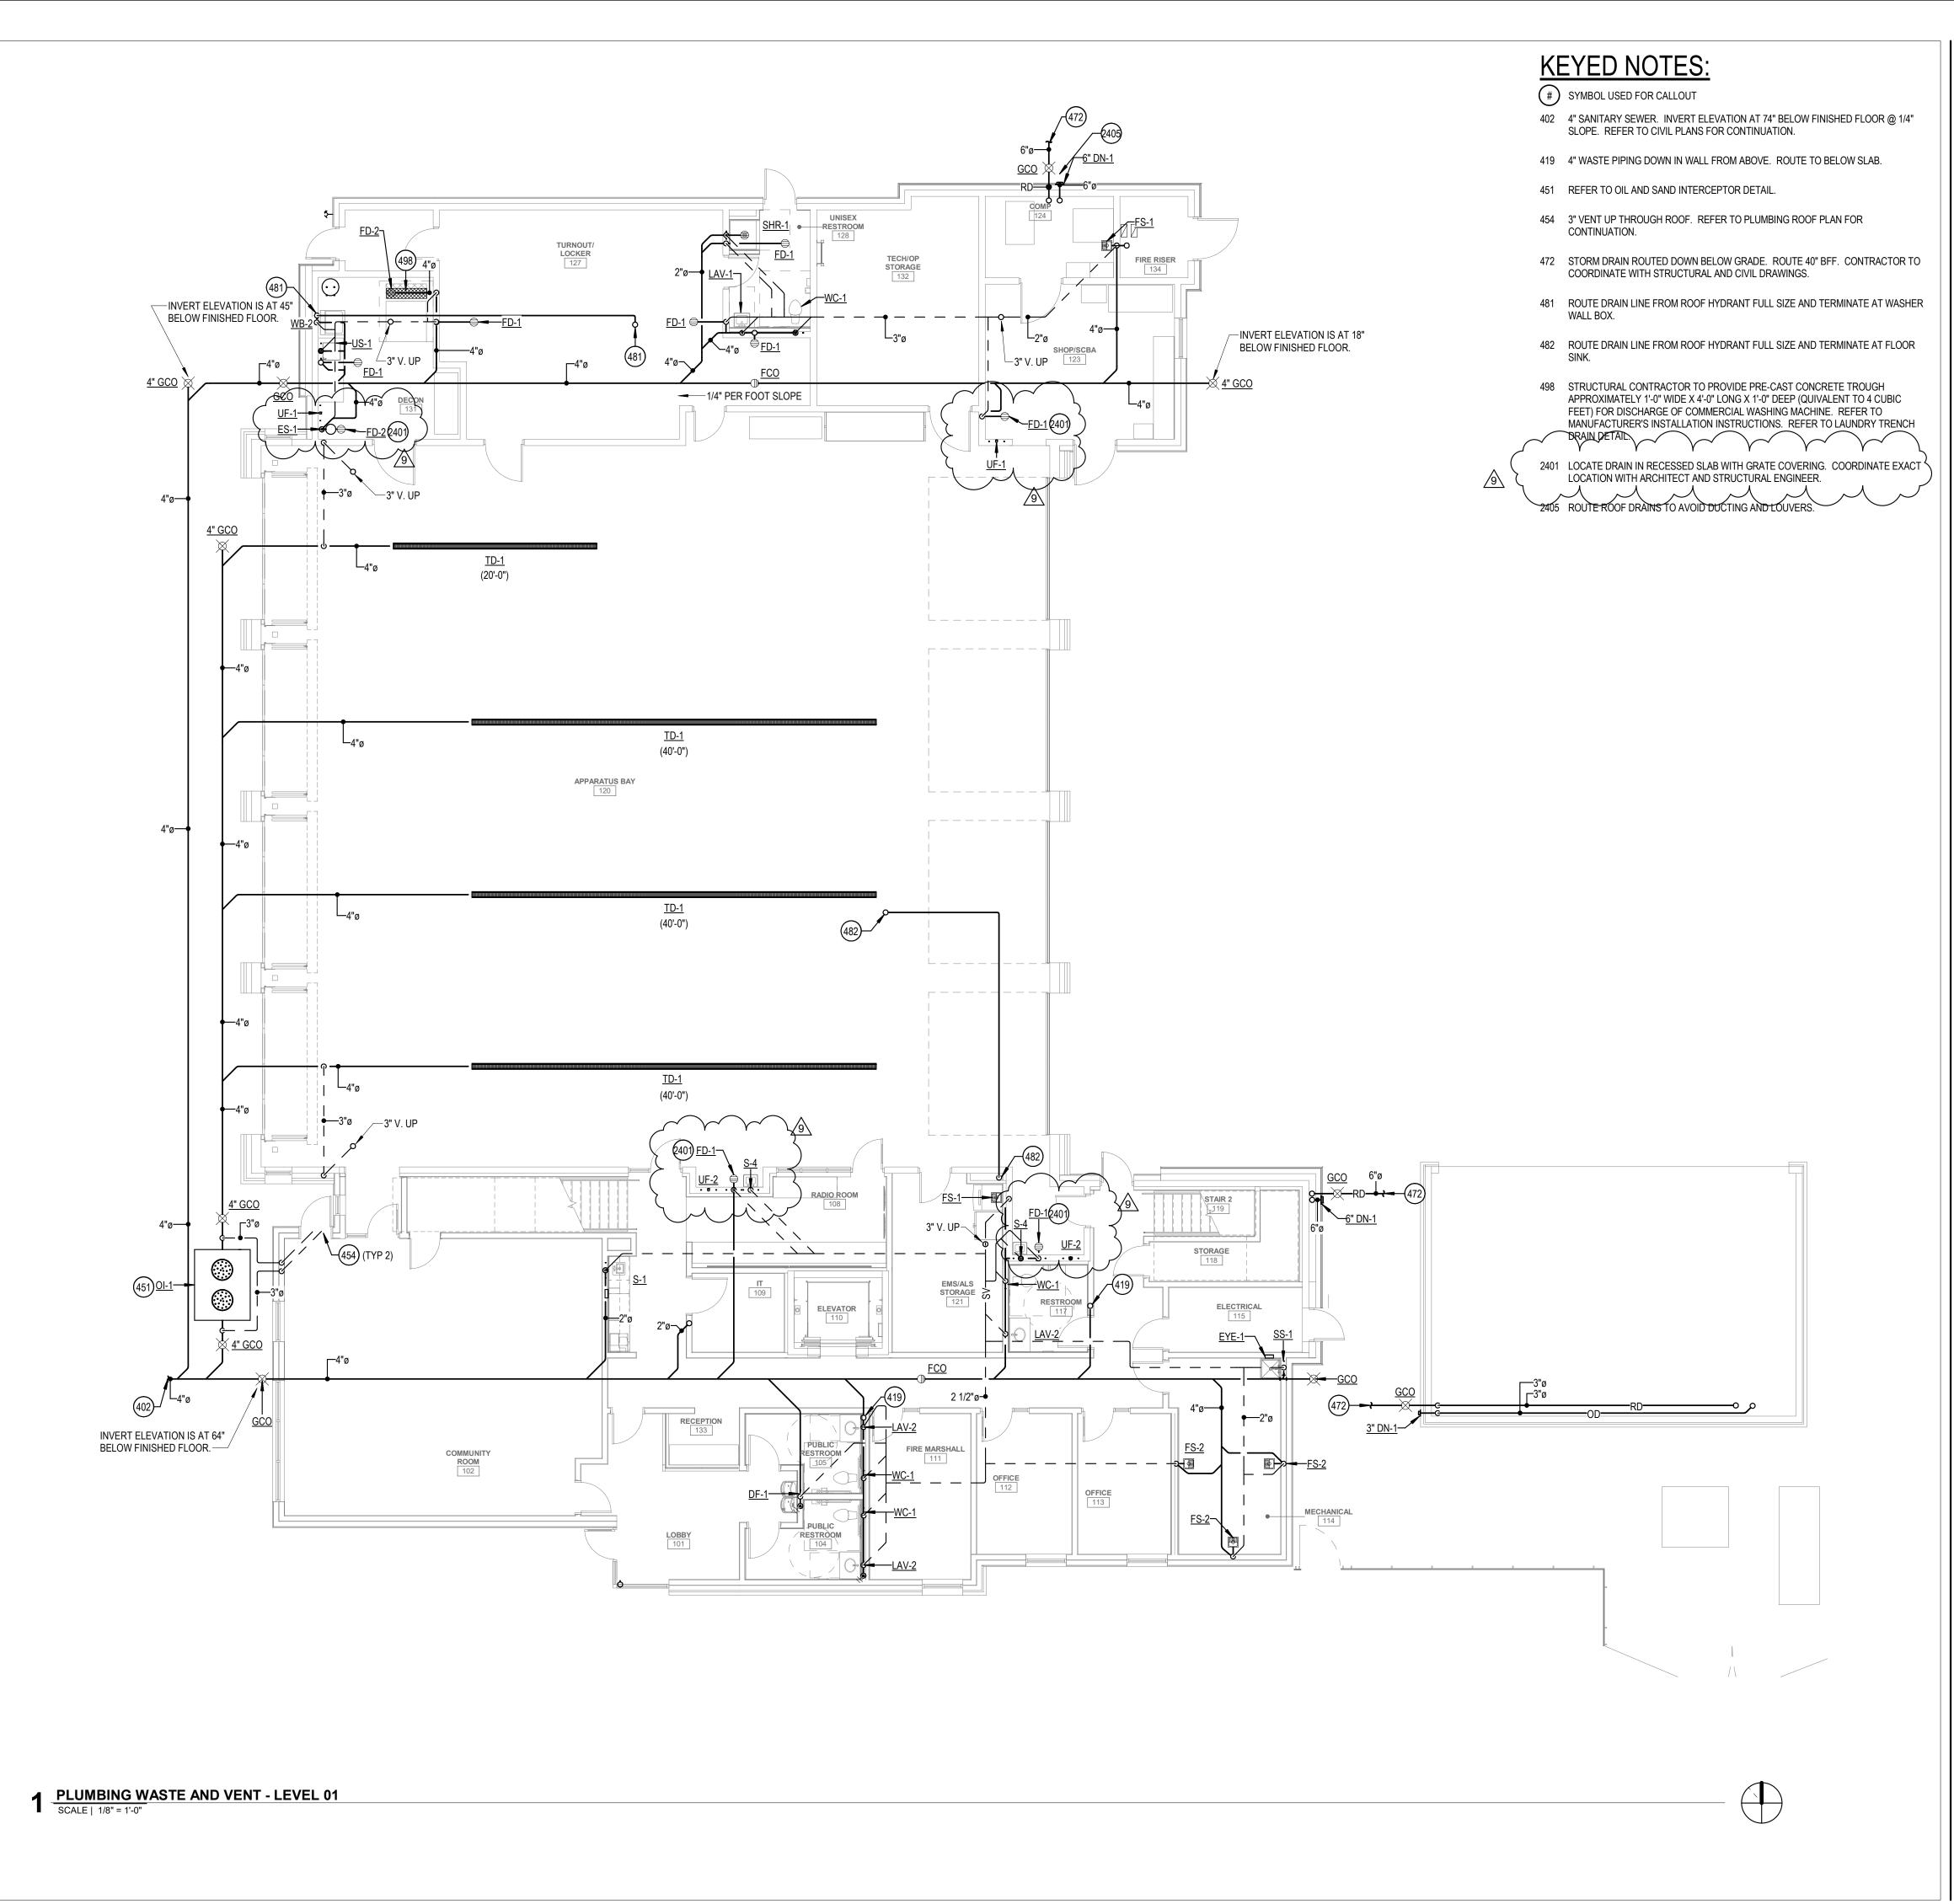





ARCHITECTURE + PLANNING + DESIGN

6211 Roosevelt Way NE Seattle, WA 98115 206.522.3820

STAMP



CONSULTANT



234 S. WHISPERWOOD WAY BOISE, IDAHO 83709 (208) 384-0585 PROJECT #19-366

PROJECT INFORMATION



KETCHUM FIRE STATION

107 SADDLE ROAD, KETCHUM ID 83353

ISSUES

PHASE	CONSTRUCTION SET	
DATE	6/19/2020	
JOB NUMBER	18-022	


MARK	DATE	DESCRIPTION
1	7/17/20	ASI #1
3	8/31/20	RFI #CC-62
4	9/03/20	RFI #CC-62R1
9	12/28/2 0	RFI #77R1
11	10/21/2 0	ASI #4
12	11/4/20	RFI #97R1

SHEET NAME

PUMBING WASTE AND VENT PLAN -LEVEL 01

SHEET NUMBER

P1.00

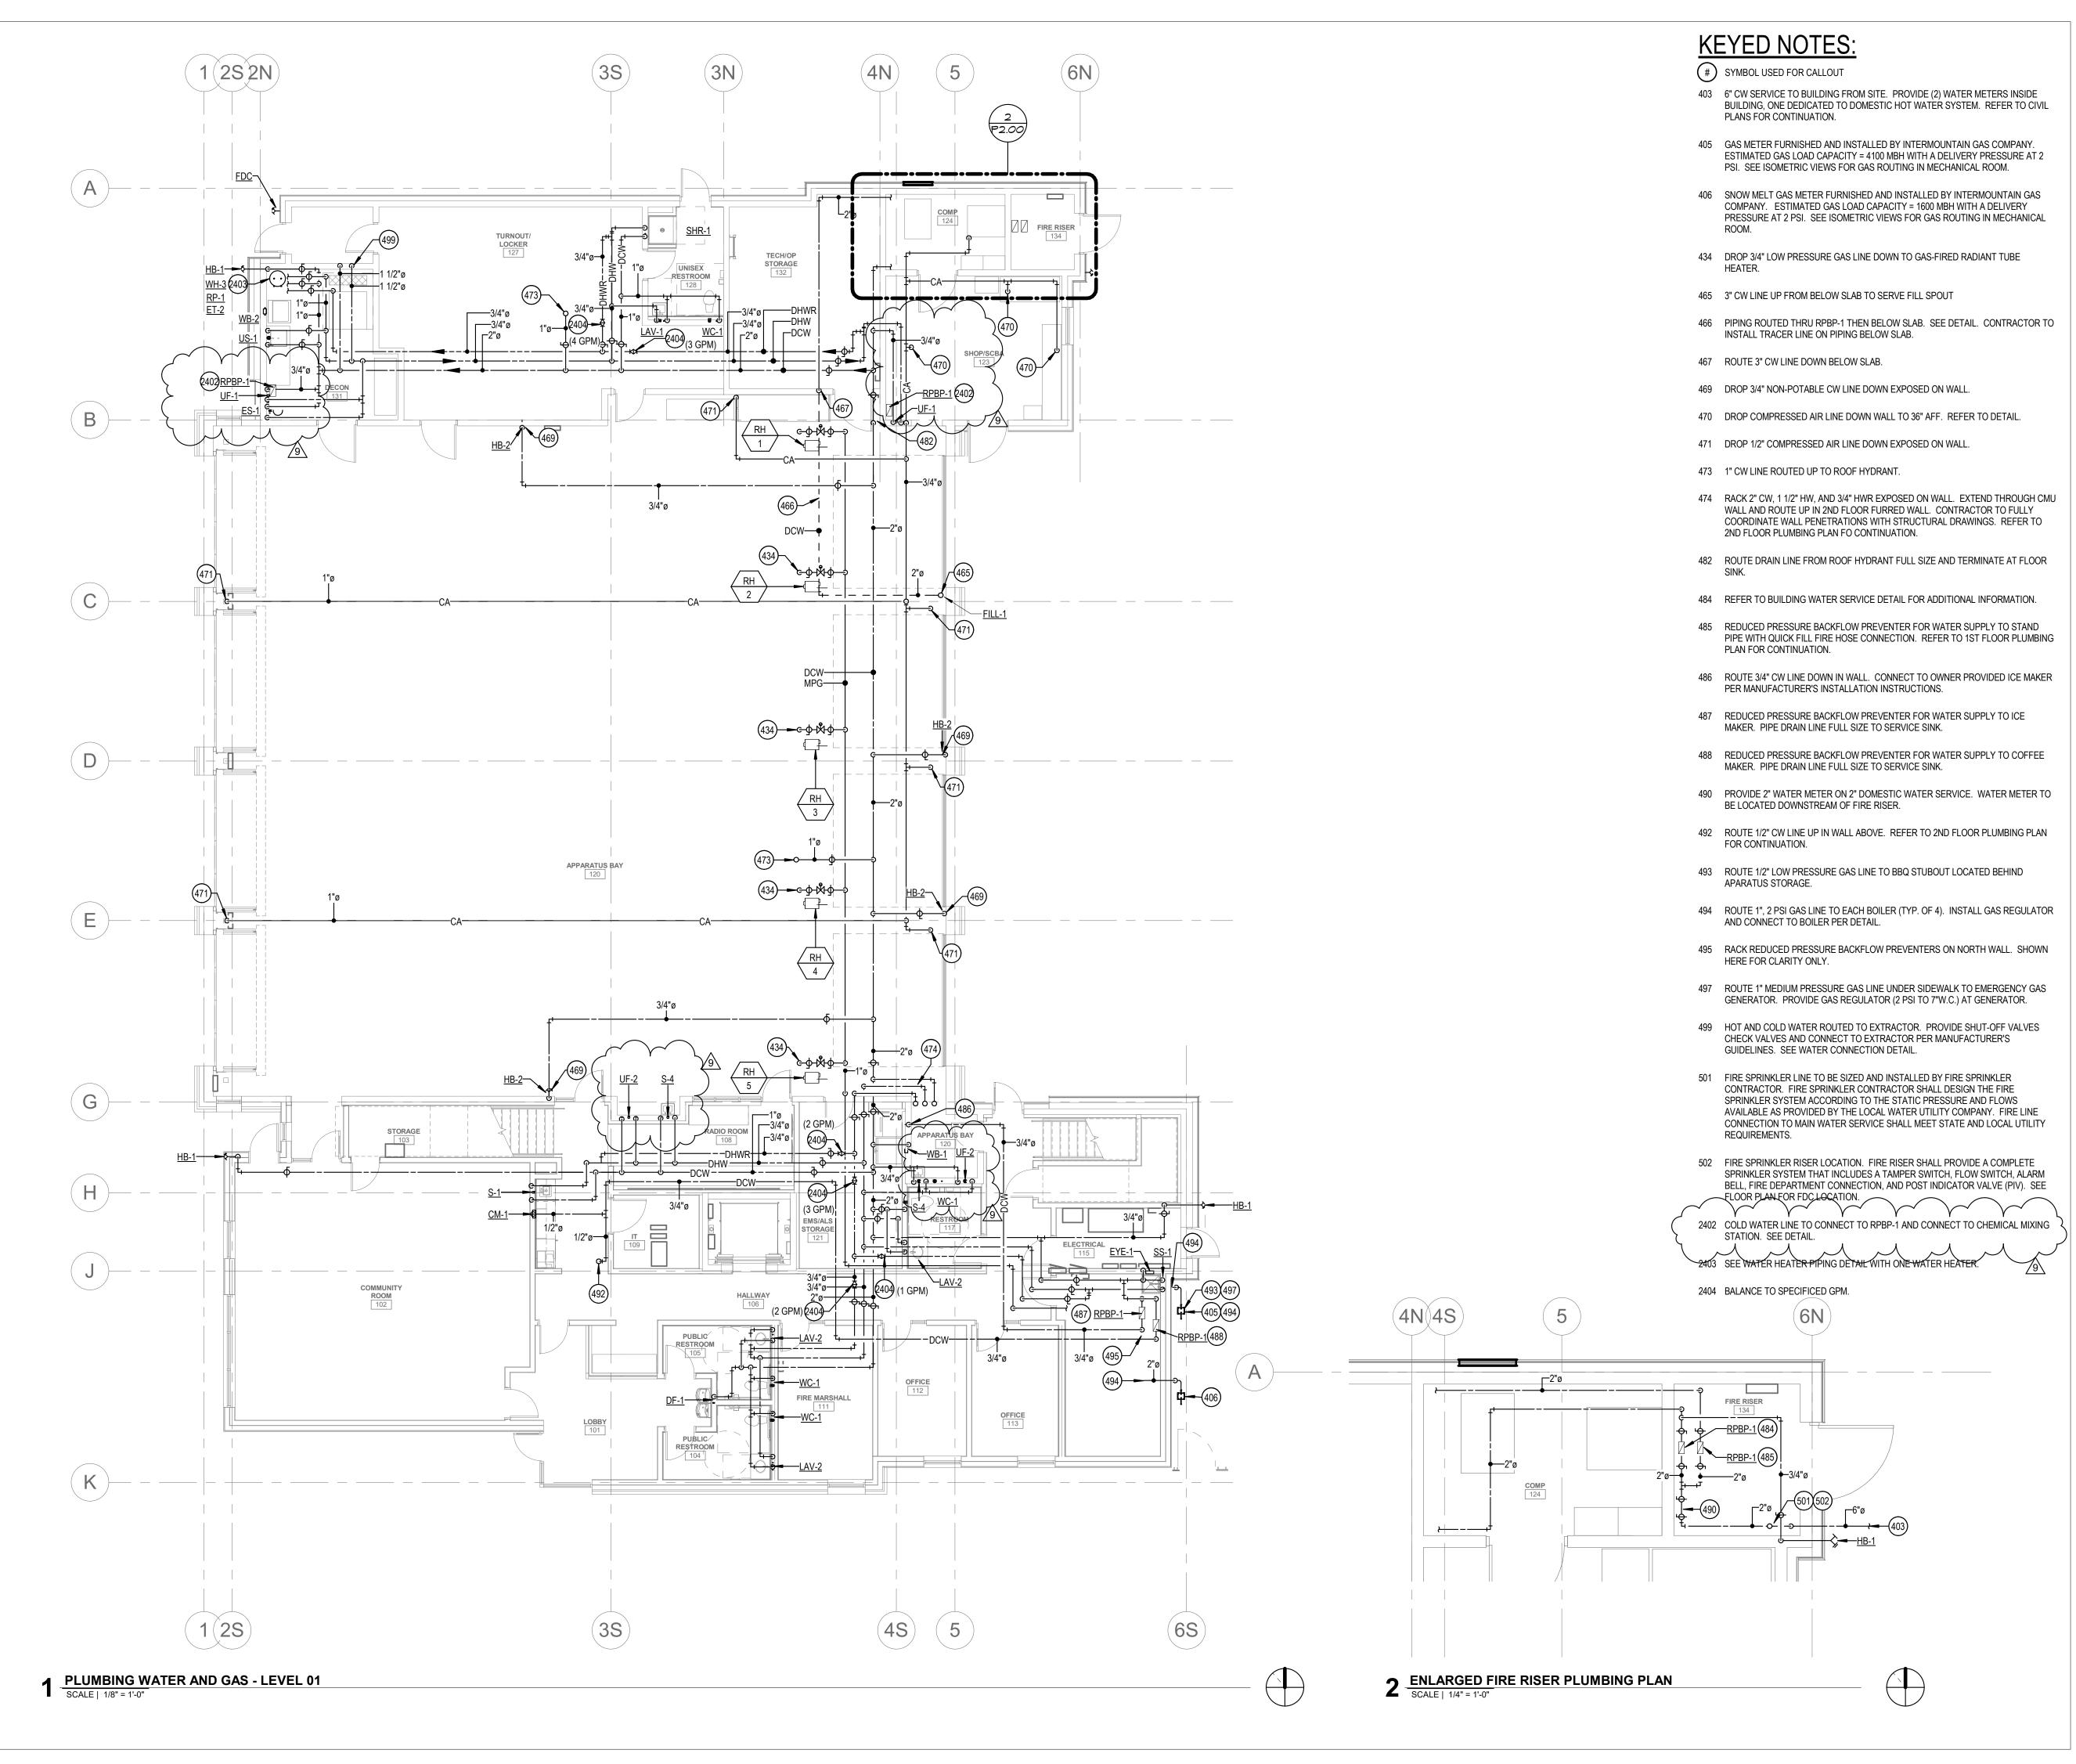





ARCHITECTURE + PLANNING + DESIGN

6211 Roosevelt Way NE Seattle, WA 98115 206.522.3820

STAMP



CONSULTANT



234 S. WHISPERWOOD WAY BOISE, IDAHO 83709 (208) 384-0585 PROJECT #19-366

PROJECT INFORMATION



KETCHUM FIRE STATION

107 SADDLE ROAD, KETCHUM ID 83353

ISSUES

PHASE	CONSTRUCTION SE		
DATE	6/19/202		
JOB NUMBER	18-02		
,			


MARK	DATE	DESCRIPTION
2	8/17/20	ASI #2
3	8/31/20	RFI #CC-62
9	12/28/2	RFI #77R1
	0	
11	10/21/2	ASI #4
	0	

SHEET NAME

PLUMBING WATER AND GAS PLAN -LEVEL 01

SHEET NUMBER

P2.00

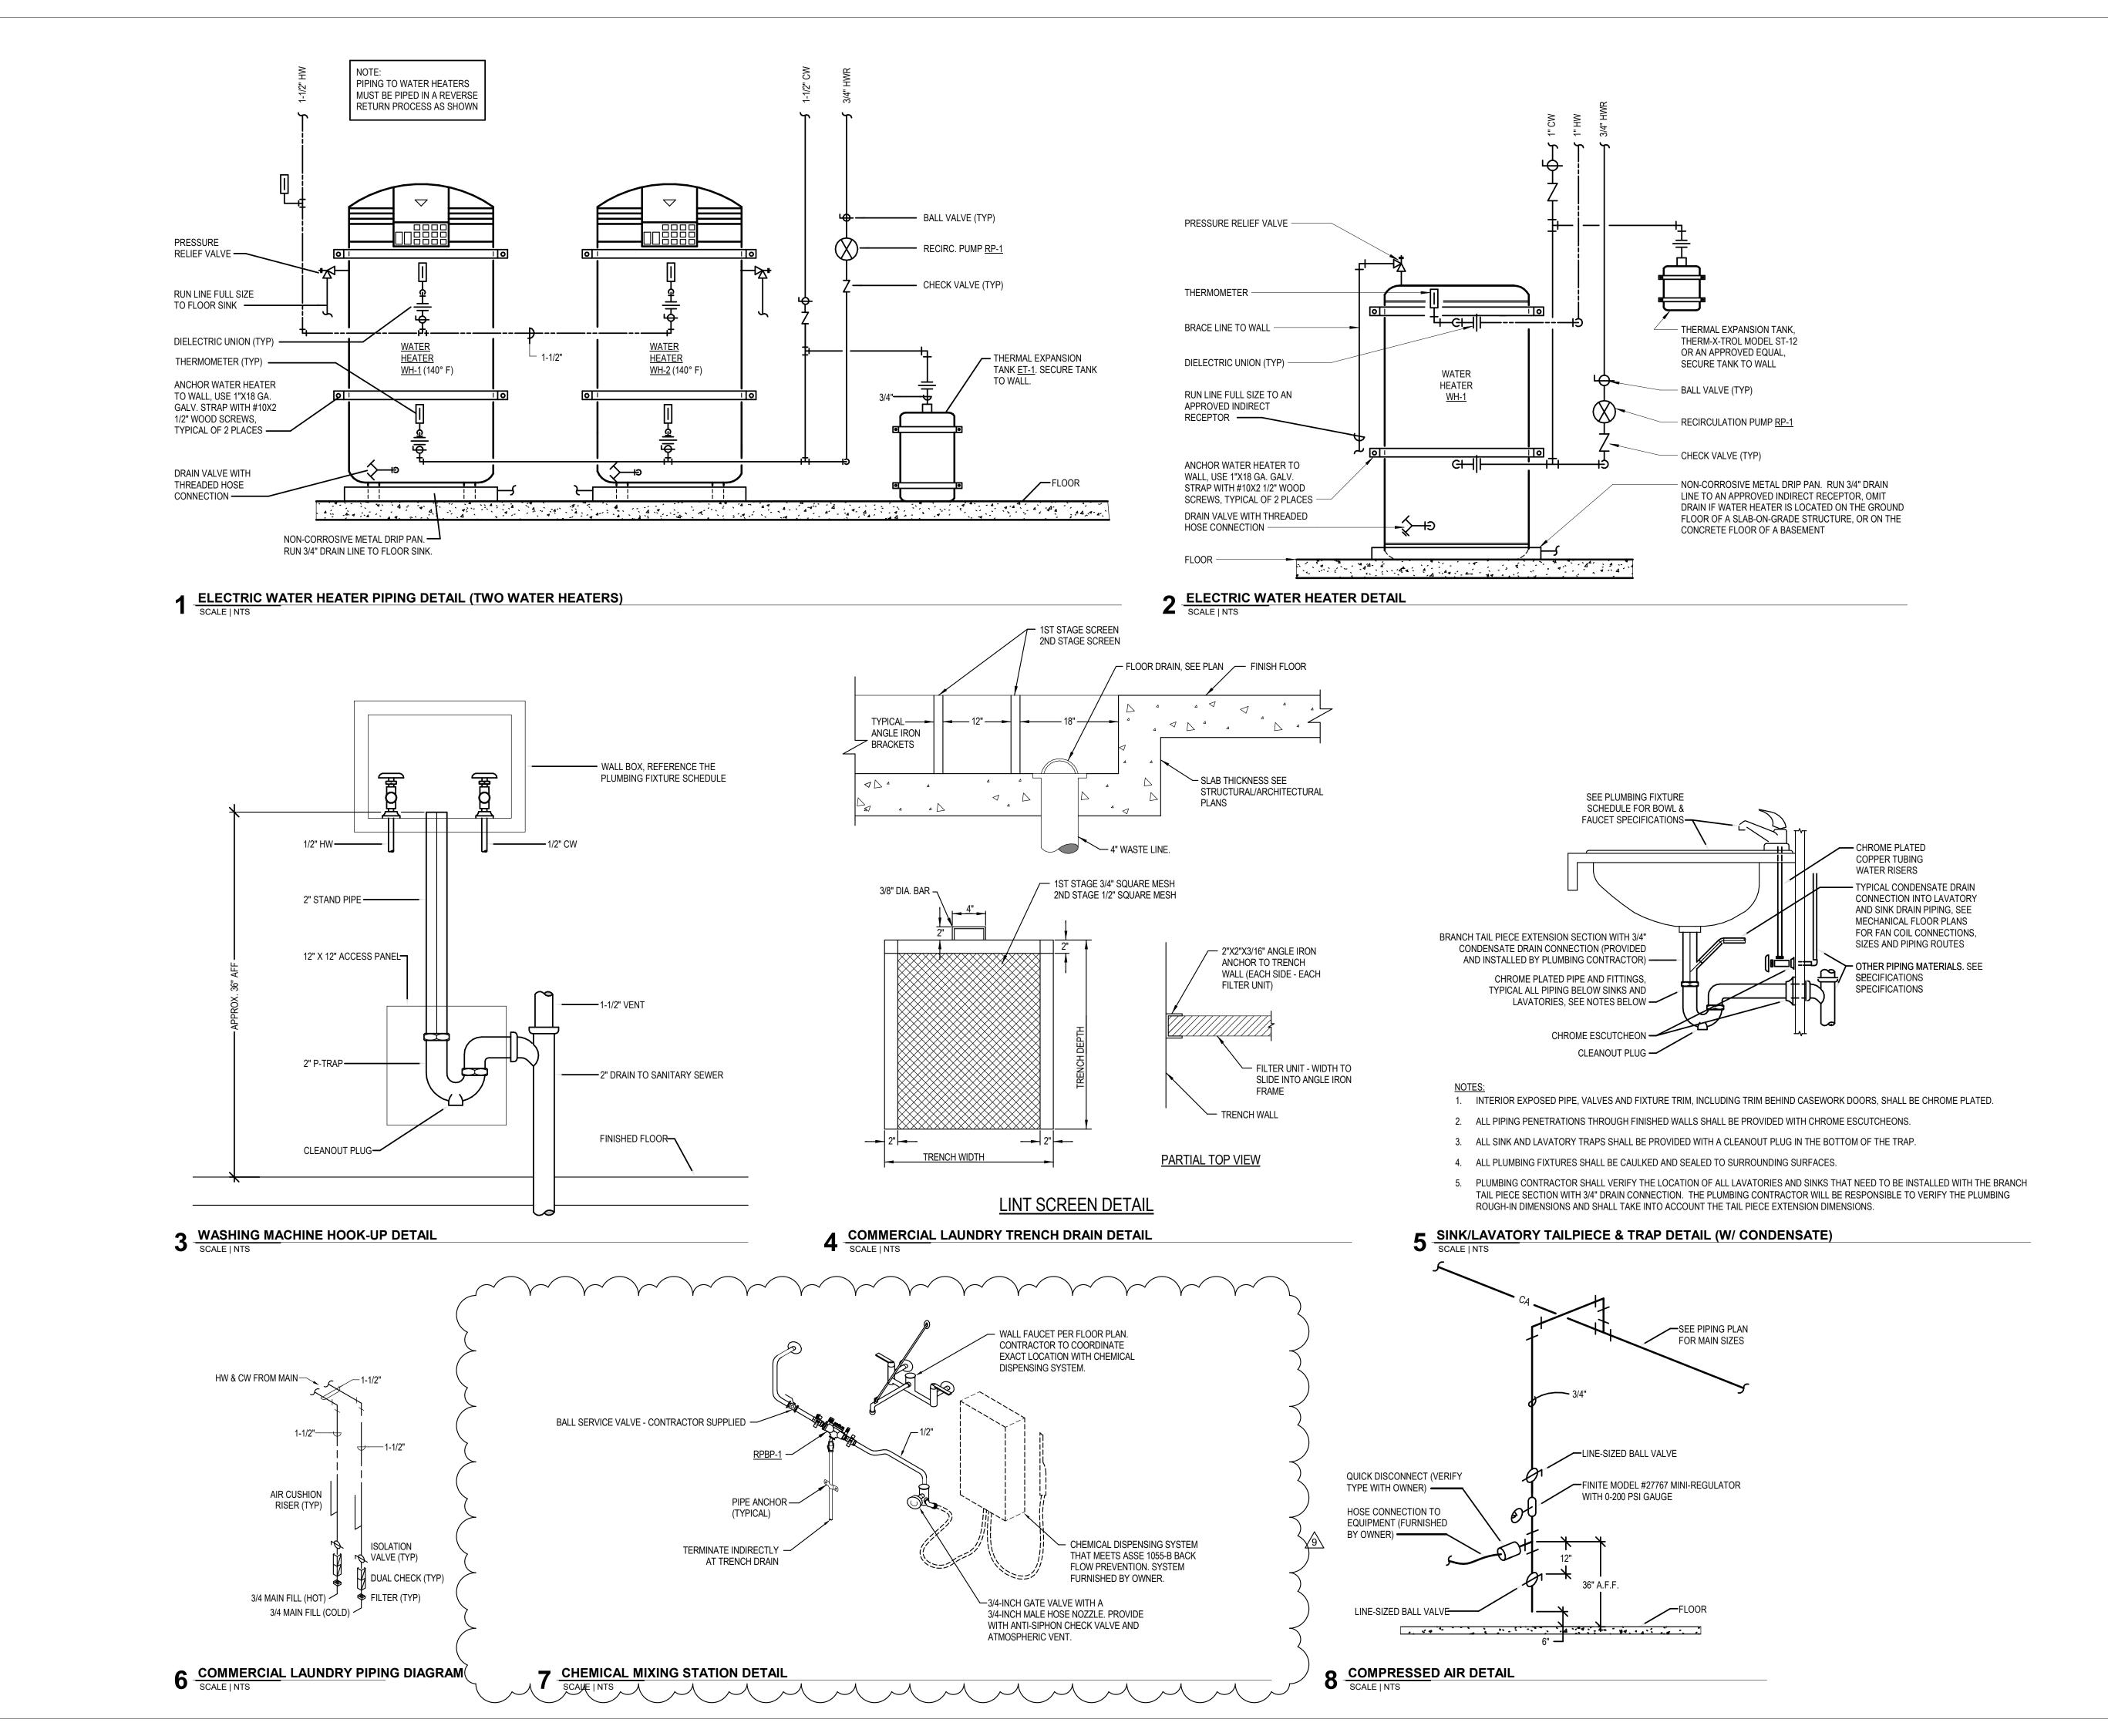





ARCHITECTURE + PLANNING + DESIGN
6211 Page availt Way NE

6211 Roosevelt Way NE Seattle, WA 98115 206.522.3820

STAMP



CONSULTANT



234 S. WHISPERWOOD WAY BOISE, IDAHO 83709 (208) 384-0585 PROJECT #19-366

PROJECT INFORMATION



KETCHUM FIRE STATION

107 SADDLE ROAD, KETCHUM ID 83353

ISSUES

	PHASE	CONSTRUCTION SET		
	DATE	6/19/2020		
	JOB NUMBER	18-022		

	MARK	DATE	DESCRIPTION			
	3	8/31/20	RFI #CC-62			
	9	12/28/2	RFI #77R1			
		0				
	11	10/21/2	ASI #4			

SHEET NAME

PLUMBING DETAILS

SHEET NUMBER

P5.01

	1	Г					IRE SCHEDULE	
SYMBOL	FIXTURE DESCRIPTION	WASTE	CC VENT	NNECTION S	IZE CW	l _{HW}	MANUFACTURER / MODEL NUMBER / DESCRIPTION / ADDITIONAL COMMENTS	
<u>CM-1</u>	WALL BOX (WATER SUPPLY TO COFFEE MAKER)				1/2		PROVIDED BY OTHERS, INSTALLED BY CONTRACTOR. PROVIDE REDUCED PRESSURE BACKFLOW PREVENTER ON SUPPLY LINE.	
<u>D-1</u>	DISPOSER	2	1 1/2	1 1/2			PROVIDED BY OTHERS, INSTALLED BY CONTRACTOR.	
<u>DF-1</u>	DRINKING FOUNTAIN WITH BOTTLE FILLING STATION (INTERIOR DUAL BUBBLERS) (ELECTRIC WATER COOLER) (ADA COMPLIANT) (HIGH/LOW)	1 1/2	1 1/2	1 1/2	1/2		ELKAY MODEL LZSTL8WSLK,HIGH/LOW COOLER WITH BOTTLE FILLING STATION WITH FLEXI-GUARD STREAMSAVER BUBBLER. OPERATED BY FRONT OR SIDE PUSH BARS AND BOTTLE FILLING STATION OPERATED BY SENSOR ACTIVATION WITH AUTOMATIC 30-SECOND SHUT-OFF TIMER. 115 VOLT, 4.5 AMP, HERTZ, AND FILTER. PROVIDE WITH JAY R. SMITH 0834 FLOOR MOUNTED SUPPORT CARRIER.	
<u>DN-1</u>	DOWN SPOUT NOZZLE (CAST IRON)	SEE PLANS					JAY R. SMITH FIGURE NUMBER 1770-NB CAST IRON NOZZLE WITH WALL FLANGE, NICKEL-BRONZE FINISH.	
<u>DW-1</u> ET-1	DISHWASHER EXPANSION TANK				3/4	1/2	PROVIDED BY OTHERS, CONNECT WASTE TO DISPOSAL. SEE DETAIL SHEET P2.00. AMTROL THERM-X-TROL ST-25V, OR APPROVED EQUAL, NON ASME SERIES THERMAL EXPANSION ADDRESS ANTIMICED PRODUCT OF THE PROPERTY OF THE PROP	
<u>ET-2</u>	EXPANSION TANK				3/4		ABSORBER, ANTIMICROBIAL LINER, AND 5 YEAR WARRANTY. AMTROL THERM-X-TROL ST-12, OR APPROVED EQUAL, NON ASME SERIES THERMAL EXPANSION ABSORBANTIMICROBIAL LINER, AND 5 YEAR WARRANTY.	
<u>ES-1</u>	EMERGENCY EYE WASH/ SHOWER COMBINATION (FLOOR MOUNTED) (ADA COMPLIANT)	1 1/2	1 1/2	1 1/2	1 1/4	1-1/4	ACORN MODEL S2310 BARRIER FREE COMBINATION SHOWER AND EYE WASH, WITH PULL ROPE AND PUS FLAG. ABS SHOWERHEAD AND EYE/FACE WASH. PROVIDE WITH DUST COVER AND UNIVERSAL SIGN. PROVIDE WITH FD-1 AND ACORN MODEL ET71 LEAD FREE, THERMOSTATIC MIXING VALVE OR EQUAL. 1-1/4" TEMPERED WATER.	
EYE-1	EMERGENCY EYE WASH (WALL MOUNTED)	-			1/2	1/2	ACORN SAFETY MODEL S0406-CH12-BFP, WALL MOUNTED WITH DUAL 45° ANGLED HEADS AND RECOIL H PROVIDE WITH FLIP TOP DUST COVERS, UNIVERSAL EMERGENCY SIGN, DOUBLE CHECK BACKFLOW, STAINLESS STEEL 90° WITH SHEET NIPPLE, AND ACORN MODEL ET71 THERMOSTATIC MIXING VALVE OR EQUAL, LEAD FREE, WITH TEMPERATURE GAUGE ON OUTLET.	
<u>FCO</u>	FLOOR CLEANOUT	SEE PLANS					JAY R. SMITH 4020 SERIES WITH ADJUSTABLE TOP AND ABS PLUG. PROVIDE WITH FIGURE NUMBER 9912 HEIGHT ADJUSTMENT AFTER CONCRETE POUR.	
<u>FD-1</u>	FLOOR DRAIN (CONCRETE FLOOR)	2	2	2			JAY R. SMITH FIGURE NUMBER 2005Y-A05NB: NO-HUB OUTLET, 5" ROUND, NICKEL BRONZE FINISH, WITH ADJUSTABLE STRAINER AND TRAP PRIMER. INSTALL TOP OF DRAIN 1/8" BELOW FINISH FLOOR AND CAUL EDGE.	
<u>FD-2</u>	FLOOR DRAIN (CONCRETE FLOOR)	4	2	4			JAY R. SMITH FIGURE NUMBER 2005Y-A08NB: NO-HUB OUTLET, 8" ROUND, NICKEL BRONZE FINISH, WITH ADJUSTABLE STRAINER AND TRAP PRIMER. INSTALL TOP OF DRAIN 1/8" BELOW FINISH FLOOR AND CAULEDGE.	
FILL-1	FLUSH CONNECTION				3		BUILDING CONNECTIONS MODEL 152 2.5" WALL MOUNT FLUSH OUTLET. INSTALL WITH MODEL 164 CONTRVALVE.	
<u>FS-1</u>	FLOOR SINK (HALF GRATE) (10" DEEP) (FOOT TRAFFIC RATED)	4	2	4			JAY R. SMITH FIGURE NUMBER 3160Y-12: CAST IRON RECEPTOR, ALUMINUM DOME STRAINER, NICKEL BRONZE GRATE, AND TRAP PRIMER. INSTALL TOP OF SINK 1/8" BELOW FINISH FLOOR AND CAULK EDGE.	
<u>FS-2</u>	FLOOR SINK (6" DEEP) (HALF GRATE, FOOT TRAFFIC RATED)	2	2	2			JAY R. SMITH FIGURE NUMBER 3100Y-12, CAST IRON RECEPTOR, ALUMINUM DOME STRAINER, NICKEL BRONZE GRATE, AND TRAP PRIMER. INSTALL TOP OF SINK 1/8" BELOW FINISH FLOOR AND CAULK EDGE	
<u>GCO</u>	GRADE CLEANOUT (NON-PAVED AREAS)	SEE PLANS					JAY R. SMITH 4220 SERIES WITH ABS PLUG.	
<u>GCO</u>	GRADE CLEANOUT (PAVED AREAS) (VEHICULAR TRAFFIC)	SEE PLANS					JAY R. SMITH 4250 SERIES, ROUND FLANGED HOUSING WITH HEAVY DUTY CAST IRON COVER. FURNISH WITH ABS PLUG. COVER TO BE INSCRIBED "SAN".	
<u>HB-1</u>	HOSE BIBB (EXTERIOR) (NON-FREEZE)				3/4		WOODFORD MODEL 67 - EXPOSED STYLE WITH MODEL 50HA BACKFLOW PREVENTER, 3/4" INLET, AND CHROME PLATED. PROVIDE WITH TEE KEY AND INSTALL AT 18" ABOVE FINISH GRADE.	
<u>HB-2</u>	HOSE BIBB (INTERIOR)				3/4		WOODFORD MODEL 26 - EXPOSED STYLE WITH 3/4" INLET, AND CHROME PLATED. PROVIDE WITH METAL WHEEL HANDLE AND WOODFORD MODEL 50HF BACKFLOW PREVENTER.	
<u>LAV-1</u>	LAVATORY (WALL MOUNTED) (ADA COMPLIANT)	1 1/2	1 1/2	1 1/4	1/2	1/2	KOHLER KINGSTON MODEL K-2005: VITREOUS CHINA, WALL MOUNTED, HOLES ON 4" CENTERS, AND GRI STRAINER. CHICAGO FAUCETS MODEL 420-E39VPABCP: 3-3/4" LONG, SINGLE LEVER FAUCET WITH 0.35 AERATOR. PROVIDE WITH JAY R. SMITH FIGURE NUMBER 0700-Z SUPPORT WITH CONCEALED ARMS AND WATTS SERIES USG-B THERMOSTATIC MIXING VALVE, ASSE STANDARD 1070 LISTED, BRONZE BODY, INTEGRAL CHECK VALVES, AND SELECTABLE TEMPERATURE RANGE FROM 80°F TO 120°F. PROVIDE WILS-1 LAV SHIELD.	
LAV-2	LAVATORY (COUNTERTOP / CABINET MOUNTED) (ADA COMPLIANT)	1 1/2	1 1/2	1 1/4	1/2	1/2	KOHLER PENNINGTON MODEL K-2196-4 VITREOUS CHINA, COUNTERTOP-MOUNTED SINK WITH HOLES ON CENTERS, AND GRID STRAINER. CHICAGO FAUCETS MODEL 420-E39VPABCP: 3-3/4" LONG, SINGLE LEVE FAUCET WITH 0.35 GPM AERATOR. PROVIDE WITH WATTS SERIES LFUSG-B THERMOSTATIC MIXING VALVA ASSE STANDARD 1070 LISTED, LEAD-FREE BRASS BODY, INTEGRAL CHECK VALVES, AND SELECTABLE TEMPERATURE RANGE FROM 80°F TO 120°F. PROVIDE WITH PIPING INSULATION, TRUEBRO LAV GUARD, PLUMBEREX HANDI-SHIELD, OR EQUAL.	
<u>LS-1</u>	LAVATORY SHIELD (WALL MOUNTED SHIELD FOR CONCEALING PIPING, VALVES, AND INSTANTANEOUS WATER HEATERS)						TRUEBRO "LAV SHIELD" ADA COMPLIANT, TOTAL ENCLOSURE. SINGLE-PIECE CONSTRUCTION, SLOAN OPTISHIELD ETF-529, OR APPROVED EQUAL.	
<u>OD-1</u>	OVERFLOW ROOF DRAIN (LOW PROFILE DOME STYLE) (METAL GRATE)						JAY R. SMITH FIGURE NUMBER 1070Y-R-C-RS-CID WITH CAST IRON DOME GRATE AND RAIN SHIELD.	
<u>Ol-1</u>	OIL AND SAND INTERCEPTOR (1500 GALLONS)	4	3				PRE-CAST CONCRETE, 1500 GALLON CAPACITY, OIL AND SAND INTERCEPTOR. SEE DRAWING FOR DETANO SPLIT DESIGN VAULTS WITH GASKETS BELOW FLUID LEVEL ALLOWED.	
<u>PF-1</u> RD-1	POT FILLER ROOF DRAIN (LOW PROFILE DOME STYLE)				1/2	1/2	PROVIDED BY OTHERS, INSTALLED BY CONTRACTOR. JAY R. SMITH FIGURE NUMBER 1010Y-R-C-CID WITH CAST IRON DOME GRATE.	
RH-1	(METAL GRATE) ROOF HYDRANT				4		WOODFORD MODEL RHY2-MS. NON-FREEZE STYLE WITH 3/4" HOSE CONNECTION AND INTEGRAL DOUBL	
	(NON FREEZE) RECIRCULATION PUMP					3/4	CHECK BACKFLOW PREVENTER. REQUIRES 1/8" DRAIN HOLE TO BE PIPED TO A DRAIN LOCATION. BELL AND GOSSETT BRONZE MODEL NBF-22, 115 VOLT, 0.8 AMPS, 92 WATTS, AND SHALL PROVIDE 7 GPN 10 FEET HEAD. INCLUDE 7-DAY PROGRAMMABLE ELECTRONIC TIME CLOCK WITH BATTERY BACKUP,	
<u>RP-1</u>	(HOT WATER RETURN SYSTEM) REDUCED PRESSURE BACKFLOW		INID/DESC			3/4	INTERMATIC MODEL GM40AVE-RD89. APPROVED ALTERNATE: ARMSTRONG, TACO, GRUNDFOS. WATTS SERIES LF009 REDUCED PRESSURE ZONE ASSEMBLY WITH QUARTER TURN BALL VALVES, BRON	
RPBP-1	PREVENTER		INDIRECT				STRAINER, AND AIR GAP. BRONZE BODY CONSTRUCTION - 1/2" THRU 2", PROVIDE WITH STRAINER. LEAFREE. 2 1/2" THRU 10" 957 SERIES. SEE NOTE 6. ELKAY LUSTERTONE MODEL LRAD-1720: 6-1/2" DEEP STAINLESS STEEL SINK. ELKAY MODEL LK-3001 SIN	
<u>S-1</u>	SINK - SINGLE COMPARTMENT (17" X 20" X 6 1/2") (ADA COMPLIANT)	2	1 1/2	1 1/2	1/2	1/2	LEVER FAUCET WITH 1.5 GPM AERATOR, SWING SPOUT, AND HOSE SPRAY. PROVIDE WITH ELKAY MODELLK-35 CHROME PLATED TAILPIECE AND STAINLESS STEEL BASKET, AND WATTS SERIES USG-B THERMOSTATIC MIXING VALVE, ASSE STANDARD 1070 LISTED, BRONZE BODY, INTEGRAL CHECK VALVES AND SELECTABLE TEMPERATURE RANGE FROM 80°F TO 120°F.	
<u>S-2</u>	KITCHEN SINK - DOUBLE COMPARTMENT (14" X 14" X 6 1/2" - EACH) (ADA COMPLIANT)	2	1 1/2	1 1/2	1/2	1/2	ELKAY LUSTERTONE MODEL LRAD-3319: 6-1/2" DEEP STAINLESS STEEL SINK. ELKAY MODEL LK-3001 SING LEVER FAUCET WITH 1.5 GPM AERATOR, SWING SPOUT, AND HOSE SPRAY. PROVIDE WITH ELKAY MODE LK-35 CHROME PLATED TAILPIECE AND STAINLESS STEEL BASKET, AND WATTS SERIES USG-B THERMOSTATIC MIXING VALVE, ASSE STANDARD 1070 LISTED, BRONZE BODY, INTEGRAL CHECK VALVES AND SELECTABLE TEMPERATURE RANGE FROM 80°F TO 120°F.	
<u>S-3</u>	PREP SINK - SINGLE COMPARTMENT (15" X 15" X 7")	2	1 1/2	1 1/2	1/2	1/2	ELKAY LUSTERTONE MODEL BLR150C: 7" DEEP, STAINLESS STEEL SINK WITH ELKAY MODEL LKD2223, L HANDLE MIXING FAUCET WITH HIGH GOOSENECK SPOUT AND 1.5 GPM AERATOR. PROVIDE ELKAY MODE LK-35 CHROME PLATED JAILPIECE AND STANLESS STEEL BASKET.	
S-4	BOOT WASH HAND SINK (17" X 15" X 5-1/2")	2	1 1/2	1 1/2	1/2	1/2	REGENCY 600HS17: 17"X15", STAINLESS STEEL SINK WITH INTEGRATED GOOSENECK FAUCET. PROVIDE CHROME PLATED TAILPIECE AND STAINLESS STEEL BASKET.	
SHR-1	SHOWER (42" X 38" X 79") (INSERT STYLE) (ADA COMPLIANT)	2	1 1/2	2	1/2	1/2	BEST BATH SYSTEMS MODEL LCS4238A5T, WINH A 1/2 THRESHOLD, ONE PIECE CLASSIC TILE FINISH, SHOWER MODULE SHALL BE CONSTRUCTED OF GELCOAT/FIBERGLASS WITH FULL INTEGRAL PLYWOOD BACKING IN ALL THE WALLS FOR STRENGTH AND CUSTOMIZED INSTALLATION OF ACCESSORIES. PRE-LEVELED FLOOR FOR EASY INSTALLATION. NOTE LOW THRESHOLD DESIGN REQUIRES 8" X 8" BLOCOUT CENTERED AT DRAIN PIPE LOCATION. ACCESSORIES: (1) 12" S.S. GRAB BAR, (1) 24" S.S. GRAB BAR, (1) 27" S.S. GRAB BAR, (1) SURFACE MOUNT SOAP DISH (1) SIOUX CHIEF CAULKLESS BRASS DRAIN #827-2B WITH CHROME SCREEN, (1) TWS COLLAPSIBLE 'T' SHAPED WATER RETAINER. ALSO INCLUDE MOEN MODEL 8346EP15, 1.5 GPM ECO-PERFORMANCE HANDHELD SHOWER SYSTEM, POSI-TEMP, WITHOUT VOLUME CONTROL, ADJUSTABLE TEMPERATURE LISTOP, 1/4 TURN STOPS, 4 PORT CYCLING VALVE, HANDHELD SHOWER, 69" DOUBLE SWIVEL HOSE ASSEN 30" SLIDE BAR, VACUUM BREAKER, DROP ELL, AND STAINLESS STEEL CURTAIN ROD. PROVIDE	

SYMBOL	FIXTURE DESCRIPTION		CO	NNECTION S	ZE		MANUFACTURER / MODEL NUMBER / DESCRIPTION / ADDITIONAL COMMENTS
JIDQL	. Strong Beoordi Hora	WASTE	VENT	TRAP	CW	HW	
SHR-2	SHOWER (42" X 38" X 79") (INSERT STYLE) (ADA COMPLIANT)	2	1 1/2	2	1/2	1/2	BEST BATH SYSTEMS MODEL LCS4238A5T, WITH A 1/2" THRESHOLD, ONE PIECE CLASSIC TILE FINISH, SHOWER MODULE SHALL BE CONSTRUCTED OF GELCOAT/FIBERGLASS WITH FULL INTEGRAL PLYWOOD BACKING IN ALL THE WALLS FOR STRENGTH AND CUSTOMIZED INSTALLATION OF ACCESSORIES. PRE-LEVELED FLOOR FOR EASY INSTALLATION. NOTE LOW THRESHOLD DESIGN REQUIRES 8" X 8" BLOCK OUT CENTERED AT DRAIN PIPE LOCATION. ACCESSORIES: (1) 12" S.S. GRAB BAR, (1) 24" S.S. GRAB BAR, (1) 27" S.S. GRAB BAR, (1) 32"X16" PHENOLIC LAB, ADA COMPLIANT, SWING-DOWN SEAT WITH LEGS, (1) SURFACE MOUNTED SOAP DISH (1) SIOUX CHIEF CAULKLESS BRASS DRAIN #827-2B WITH CHROME SCREEN, (1) TWS COLLAPSIBLE 'T' SHAPED WATER RETAINER. ALSO INCLUDE MOEN MODEL 8346EP15, 1.5 GPM ECO-PERFORMANCE HANDHELD SHOWER SYSTEM, POSI-TEMP, WITHOUT VOLUME CONTROL, ADJUSTABLE TEMPERATURE LIMIT STOP, 1/4 TURN STOPS, 4 PORT CYCLING VALVE, HANDHELD SHOWER, 69" DOUBLE SWIVEL HOSE ASSEMBLY, 30" SLIDE BAR VACUUM BREAKER, DROP ELL, AND STAINLESS STEEL CURTAIN ROD. PROVIDE TAPE-WEIGHTED SHOWER CURTAIN.
<u>SS-1</u>	SERVICE SINK (24" X 24" X 10") (FLOOR MOUNTED)	3	2	3	1/2	1/2	ACORN TERRAZZO-WARE MODEL TRH-242410: PROVIDE AND INSTALL WITH STAINLESS STEEL BUMPER GUARD, DRAIN GASKET, CHROME FAUCET, 36" HOSE AND WALL HANGER, MOP HANGER, AND 2 SIDE STAINLESS STEEL WALL GUARD.
<u>TD-1</u>	TRENCH DRAIN (10" WIDE) (HEAVY TRAFFIC RATED)	4	2	4		-	JAY R. SMITH FIGURE NUMBER 9812 10" WIDE TRENCH DRAIN SYSTEM. SLOPE DRAIN SYSTEM WITH INTEGRAL METAL RAIL, PROVIDE WITH END CAPS, OUTLETS, CATCH BASIN (9812G-880-CB24-BP), AND HEAVY DUTY (CLASS C) GALVANIZED STEEL BAR GRATE (MODEL 9812-G). REFER TO ARCHITECTURAL PLAN FOR EXACT LENGTH REQUIREMENTS.
<u>TP-1</u>	TRAP PRIMER (PRESSURE ACTIVATED) (1 TO 4 TRAPS)				1/2"		PRECISION PLUMBING PRODUCTS MODEL CPO-500 WITH DU DISTRIBUTION UNIT IF REQUIRED FOR SERVING MORE THAN ONE TRAP. APPROVED ALTERNATES: MIFAB, SIOUX CHIEF, SLOAN, AND ZURN
<u>TP-1</u>	TRAP PRIMER (FLUSH VALVE PRIMER) (1 TRAP)				1/2"		PRECISION PLUMBING PRODUCTS MODEL FVP-1VB WITH VACUUM BREAKER. TRAP PRIMER TUBING SHALL BE INSTALLED OFF BACK OF FLUSH VALVE. APPROVED ALTERNATES: MIFAB, SIOUX CHIEF, SLOAN, AND ZURN
<u>TP-1</u>	TRAP PRIMER (LAVATORY TAILPIECE PRIMER) (1 TRAP)				1/2"		DEARBORN BRASS 1-1/2" TRAP PRIMER TAILPIECE WITH COMPRESSION CONNECTION.
UF-1	UTILITY FAUCET		-		1/2	1/2	ACORN UTILITY FAUCET OPTION KFC: BRASS CONSTRUCTION WITH ROUGH CHROME FINISH, TWO HANDLE: 8" CENTERSET, WALL MOUNTED, PAIL HOOK WITH 9-1/4" REACH, WALL BRACE, VACUUM BREAKER, AND 3/4" THREADED SPOUT
UF-2	UTILITY FAUCET		-		3/4	3/4	T&S BRASS AND BRONZE WORKS MV-0771-11N MIXING VALVE. CHROME PLATED WITH TWO HANDLES, 6" CENTER SET, WALL MOUNTED, PAIL HOOK WITH 9-1/4" REACH, WALL BRACE, VACUUM BREAKER, AND 3/4" THREADED SPOUT. PROVIDE WITH 50' HOSE, REAR TRIGGER STAINLESS STEEL WATER GUN & HOSE RACK.
<u>US-1</u>	UTILITY SINK (23" X 21" X 13") (FLOOR MOUNTED)	2	1 1/2	1 1/2	1/2	1/2	FIAT MOLDED STONE MODEL FL-1. PROVIDE WITH A-1 DECK CHROME FAUCET, DRAIN WITH STOPPER, AND EASY LEVELING LEGS.
<u>WB-1</u>	WALL BOX (WATER SUPPLY TO ICE MAKER)				1/2		OATEY FIREMASTER MODEL 39121 WITH FACEPLATE, ADJUSTABLE METAL SUPPORT BRACKET, AND WATER HAMMER ARRESTOR. FIRE-RATED, LOW LEAD, OR APPROVED EQUAL.
<u>WB-2</u>	WALL BOX (SUPPLY TO AND DRAIN FROM WASHING MACHINE)	2	1 1/2	2	1/2	1/2	OATEY FIREMASTER MODEL 38478 WITH ADJUSTABLE METAL SUPPORT BRACKET, AND WATER HAMMER ARRESTORS. FIRE RATED, OR APPROVED EQUAL.
<u>WC-1</u>	WATER CLOSET (DUAL FLUSH TANK) (FLOOR MOUNTED) (COMFORT HEIGHT / ADA)	4	2	INT.	1/2		KOHLER HIGHLINE MODEL K-3989, DUAL FLUSH, FLOOR MOUNTED, GRAVITY FLUSH TANK WITH ELONGATED BOWL, 1.6 GPF OR 1.1 GPF. PROVIDE KOHLER LUSTRA MODEL K-4650 ELONGATED, OPEN FRONT SEAT WITH CHECK HINGE AND COVER.
<u>WCO</u>	WALL CLEANOUT	SEE PLANS					JAY R. SMITH 4472T SERIES WITH CAST BRONZE TAPER THREAD PLUG, STAINLESS STEEL ROUND COVER, AND A STAINLESS STEEL VANDAL PROOF SCREW.
<u>WH-1</u>	WATER HEATER (119 GALLON UPRIGHT MODEL) (208V-3Ø ELECTRIC)				SEE PLANS	SEE PLANS	BRADFORD WHITE MODEL E32-120R-3, SIMULTANEOUS TRIPLE ELEMENTS, (3) 6 KW, 208V/3Ø, 28" DIAMETER, 63" TALL, WITH TOP CONNECTIONS. PROVIDE WITH WALL BRACKET SUPPORT AND SEISMIC STRAP.
<u>WH-2</u>	WATER HEATER (119 GALLON UPRIGHT MODEL) (208V-3Ø ELECTRIC)				SEE PLANS	SEE PLANS	BRADFORD WHITE MODEL E32-120R-3, SIMULTANEOUS TRIPLE ELEMENTS, (3) 6 KW, 208V/3Ø, 28" DIAMETER, 63" TALL, WITH TOP CONNECTIONS. PROVIDE WITH WALL BRACKET SUPPORT AND SEISMIC STRAP.
<u>WH-3</u>	WATER HEATER (50 GALLON UPRIGHT MODEL) (208V-1Ø ELECTRIC)			-	SEE PLANS	SEE PLANS	BRADFORD WHITE MODEL LE250S3-1NCZZ, NON-SIMULTANEOUS DUAL ELEMENTS, (2) 4.5 KW, 208V/1Ø, 22" DIAMETER, 47" TALL, WITH TOP CONNECTIONS. PROVIDE WITH WALL BRACKET SUPPORT AND SEISMIC STRAP.
NOTES:		•					·
1.	ALL ADA COMPLIANT FIXTURES MUST COM	PLY WITH ICO	C/ANSI A117.	1. SEE ARCH	ITECTURAL	PLANS FOR	HANDICAPPED FIXTURE DESIGNATIONS, LOCATIONS, CLEARANCES, AND MOUNTING HEIGHTS.
2.	ALL EXPOSED HW PIPING, CW PIPING, AND MOLDED CLOSED CELL VINYL INSULATION				ES AND ALL	ADA COMPL	IANT SINKS MUST BE INSULATED TO PREVENT INJURY. REFER TO ARCHITECTURAL PLANS. INSULATE WITH
3.		· · · · · · · · · · · · · · · · · · ·			E A BALL TY	PE SHUT-OF	F VALVE UPSTREAM OF PRIMER VALVE. SEE SPECIFICATIONS.
4	SEE SPECIFICATIONS FOR ALTERNATE APP		I IEACTI IDED	<u> </u>			

GAS SIZING CHART (METER #1)								
SYMBOL	INPUT (MBH)	RUNOUT SIZE (2-PSI) (INCHES)	EQUIPMENT CONNECTION SIZES (7" WC) (INCHES)					
B-5 (RADIANT FLOOR SYSTEM)	399.0	1/2	3/4					
B-6 (RADIANT FLOOR SYSTEM)	399.0	1/2	3/4					
B-7 (RADIANT FLOOR SYSTEM)	399.0	1/2	3/4					
B-8 (RADIANT FLOOR SYSTEM)	399.0	1/2	3/4					
RADIANT HEATERS 200.0 MBH (X5)	1000.0	1/2 (EACH)	3/4					
GAS GENERATOR	1511.0	1	1					
TOTAL 4107.0 EQUIVALENT LENGTH = 150 FT PRESSURE = 2-PSI MAIN SIZE = 1-1/2"Ø								

COFFEE MAKER ICE MAKER

EVAPORATIVE COOLER
NON-POTABLE LOOP AT APPARATUS BAY

NOTE: GAS SIZES TO EQUIPMENT ARE AS NOTED IN SCHEDULE ABOVE. ROUTE NOTED (2-PSI) GAS LINE TO GAS EQUIPMENT. PROVIDE GAS COCK AND PRESSURE REGULATOR (2-PSI - 7" WC) SIZED FOR GAS LOAD AT EACH PIECE OF EQUIPMENT. VENT TO ATMOSPHERE PER MANUFACTURERS RECOMMENDATIONS. ROUTE NOTED (7" WC) GAS LINE TO GAS FIRED EQUIPMENT WITH GAS COCK AND FLEX CONNECTOR AT UNIT.

GAS SIZING CHART (METER #2)								
SYMBOL	INPUT (MBH)	RUNOUT SIZE (2-PSI) (INCHES)	EQUIPMENT CONNECTION SIZES (7" WC) (INCHES)					
B-1 (SNOW MELT SYSTEM)	399.0	1/2	3/4					
(SNOW MELT SYSTEM) 399.0		1/2	3/4					
B-3 (SNOW MELT SYSTEM)	399.0	1/2	3/4					
B-4 (SNOW MELT SYSTEM)	399.0	1/2	3/4					
TOTAL	1596.0	PRESSUF	ENGTH = 50 FT RE = 2-PSI ZE = 1"Ø					

NOTE: GAS SIZES TO EQUIPMENT ARE AS NOTED IN SCHEDULE ABOVE. ROUTE NOTED (2-PSI) GAS LINE TO GAS EQUIPMENT. PROVIDE GAS COCK AND PRESSURE REGULATOR (2-PSI - 7" WC) SIZED FOR GAS LOAD AT EACH PIECE OF EQUIPMENT. VENT TO ATMOSPHERE PER MANUFACTURERS RECOMMENDATIONS. ROUTE NOTED (7" WC) GAS LINE TO GAS FIRED EQUIPMENT WITH GAS COCK AND FLEX CONNECTOR AT UNIT. SEE GAS CONNECTION DETAILS ON SHEET



1008 W Main St Boise, Idaho 83702 208.345.1800 **colearchitects.net** Copyright © 2020 Cole Architects, PLLC



6211 Roosevelt Way NE Seattle, WA 98115 206.522.3820

STAMP



CONSULTANT



234 S. WHISPERWOOD WAY BOISE, IDAHO 83709 (208) 384-0585 PROJECT #19-366

PROJECT INFORMATION



KETCHUM FIRE STATION

107 SADDLE ROAD, KETCHUM ID 83353

ISSUES

PHASE	CONSTRUCTION
DATE	6/19/2
JOB NUMBER	18-

MARK	DATE	DESCRIPTION
2	8/17/20	ASI #2
9	12/28/2	RFI #77R1
	0	
11	10/21/2	ASI #4
	0	

SHEET NAME

PLUMBING FIXTURE SCHEDULE

SHEET NUMBER

P6.00

Change Request Proposal

203600 / CoK FS No. 1 Change request number: Project: (name and 12 107 Saddle Road RFI CC-77 Boot Wash Area Revision Description: Ketchum, ID 83340 address) Customer: CORE | Headwaters, LLC Notice to Proceed Status: Proposed Origination date: 03/05/21 Submitted date: Received date: Rough order of magnitude: 0.00 Quotation Submitted date: 03/05/21 Due date: Submitted amount: 341.53 Requested days delay: 0 Notes Relocate drain p-trap per RFI CC-77. Revenue Detail Billing Item Description Revenue Labor - 3 hrs 240.00 Materials 88.29 Material Markup (15%) 13.24 **Total Revenue For CR 12** 341.53

Approvals				
Customer: CORE Headwaters, LLC Authorized Representative: Contractor: Evans Plumbing, Inc.				
Ву:	By:			
Date:	Date:			

Print Date: 03/05/21 Page 1 of 1

Steve Evans

From: Andrew Marolf - 3149 NORTHWEST <andrew.marolf@ferguson.com>

Sent: Friday, March 5, 2021 3:18 PM

To: Steve Evans

Subject: Email Bid# B561335

Boot wash change request.

Price Quotation # B561335

FEL #3149

121 JETSTAR LANE HAILEY, ID 83333-0000

Phone: 208-788-3317 Fax: 208-788-4182

Bid No.....: B561335

Bid Date...: 03/05/21 Quoted By: ASM

Customer.: EVANS PLUMBING

KETCHUM FIRE STATION COMMERICAL JOB ACCOUNT 111 GULF STREAM LANE

HAILEY, ID 83333

Cust Phone: 208-726-5261

Terms......: NET 10TH PROX
Ship To......: EVANS PLUMBING

KETCHUM FIRE STATION
COMMERICAL JOB ACCOUNT

111 GULF STREAM LANE HAILEY, ID 83333

Cust PO#..: Job Name.: 203600/BOOT WASH

Item	Description	Quantity	Net Price	им	Total	Customer Code
P40FCPK20	2X20 PVC S40 FOAM CORE PIPE	60	101.334	С	60.80	
PDWVCK	2 PVC DWV COUP	3	0.657	EA	1.97	
PDWVYPPK	4X4X2 PVC DWV WYE	1	9.359	EA	9.36	
PDWV9K	2 PVC DWV 90 ELL	6	1.607	EA	9.64	
PDWVS4K	2 PVC DWV ST 45 ELL	1	1.520	EA	1.52	

Subtotal: \$83.29

Inbound Freight: \$0.00

Tax: \$5.00

Order Total: \$88.29

Quoted prices are based upon receipt of the total quantity for immediate shipment (48 hours). SHIPMENTS BEYOND 48 HOURS SHALL BE AT THE PRICE IN EFFECT AT TIME OF SHIPMENT UNLESS NOTED OTHERWISE. QUOTES FOR PRODUCTS SHIPPED FOR RESALE ARE NOT FIRM UNLESS NOTED OTHERWISE.

Change Request Proposal

203600 / CoK FS No. 1 Project: (name and 107 Saddle Road Ketchum, ID 83340 address)

Change request number: 11

Description:

Origination date:

Status:

RFI 115 Sink S-4, Faucet UF-2

Proposed

02/17/21

Customer: CORE | Headwaters, LLC

Notice to Proceed

Submitted date:

Received date: Rough order of magnitude: 0.00

Quotation

Submitted date:

03/03/21

Due date:

Submitted amount: 4,864.90 Requested days delay: 0

Notes

Per RFI 115, replace 2 UF-1 faucets with 2 UF-2 faucets and add 2 S-4 sinks.

Revenue Detail

Billing Item	Description	Revenue
	Additional Labor - 30 hrs	2,400.00
	credit 2 UF-1	-129.85
	add 2 UF-2, 2 S-4	1,599.33
	rough-in materials	500.00
	Markup on Difference (15%)	295.42
	Core Drilling - 10 holes	200.00

Total Revenue For CR 11 4,864.90

	Approvals			
Customer: CORE Headwaters, LLC Authorized Representative:	Contractor: Evans Plumbing, Inc.			
Ву:	By:			
Date:	Date:			

Print Date: 03/04/21 Page 1 of 1

#FERGUSON

Job Name:

Location:

QUOTE #BPLB20200200000940

 Ketchum FD
 Quoted By: Bid Date: 04/17/2020
 Michael Fisher 04/17/2020

 Expires: 05/17/2020

Quoted prices are based upon receipt of the total quantity for immediate shipment (48 hours). SHIPMENTS BEYOND 48 HOURS SHALL BE AT THE PRICE IN

EFFECT AT TIME OF SHIPMENT UNLESS NOTED OTHERWISE. Seller not responsible for delays, lack of product or increase of pricing due to causes beyond our control, and/or based upon Local, State and Federal laws governing type of products that can be sold or put into commerce. This Quote is offered contingent upon the Buyer's acceptance of Seller's terms and conditions, which are incorporated by reference and found either following this document, or on the web at http://wolseleyna.com/terms_conditionsSale.html. Govt Buyers: All items quoted are open market unless noted otherwise.

QUOTES FOR PRODUCTS SHIPPED

FOR RESALE ARE NOT FIRM UNLESS NOTED OTHERWISE. CONTACT YOUR SALES REPRESENTATIVE IMMEDIATELY FOR ASSISTANCE WITH DBE/MBE/WBE/SMALL BUSINESS REQUIREMENTS.

Ferguson - Boise

586 North Locust Grove Road Meridian, ID 83642 Phone: (208) 376-6660

	FUR ASSISTANC	E WITH DBE/MBE/WBE/SMALL BUSINESS REQUIREMENTS.	L		Holle. (20	0,010-00	700
ITEM#	MFC	DESCRIPTION	P- QTY	U/M	P-UNIT PRICE	EXT QTY	EXT PRICE
		SECTION 301 TARIFFS: PLEASE SEE THE FULL FERGUSON LETTER AT THE END OF THIS QUOTE. THE ANNOUNCED INCREASED TARIFFS WILL RESULT IN PRICE INCREASES. AT THIS TIME, OUR VENDORS ARE UNCLEAR WHEN/IF AND AT WHAT RATE THESE TARIFFS WILL BE IMPOSED. HERE ARE THE STEPS WE WILL TAKE GIVEN THE INFORMATION WE HAVE TODAY: 1) PRICING ON ALL PRODUCTS IMPORTED FROM CHINA ON OPEN AND FUTURE QUOTES WILL EXPIRE 30 DAYS AFTER THE BID DATE. 2) WE WILL CONTINUE TO COMPETITIVELY QUOTE THESE PRODUCTS BASED ON OUR COST. IF THE TARIFFS ARE IMPOSED, WE WILL HAVE NO CHOICE BUT TO PASS THESE COSTS ON TO THE MARKET. 3) TO BE CLEAR, IF/WHEN THE TARIFFS ARE IMPOSED, FERGUSON WILL BE FORCED TO PRICE THESE PRODUCTS BASED ON THE COST AT THE TIME OF SHIPMENT.					
TMV077111N	T&S BRASS	UF-1 -U-2 UTILITY FAUCET 1/2" MIXING VALVE ASSEMBLY, NATURAL FINISH	1	EA	\$615.73	1	\$615.73
R600HS17	REGENCY	<u>S-4 SINK</u> 17"X15", STAINLESS STEEL SINK WITH INTEGRATED GOOSENECK FAUCET	1	EA	\$138.67	1	\$138.67

2 UF-2 @ \$615,73	\$1231.46
2 54 2 \$ 138.67	\$ 277.34
Subtata	\$1,508.80
640 tox	\$ 90.53
total	\$ 1,599.33

#FERGUSON

QUOTE #BPLB20200200000940

Job Name:	Ketchum FD	Quoted By Bid Date	Michael Fisher 04/17/2020
		Expires:	05/17/2020
Location:	Ketchum ID USA		

Quoted prices are based upon receipt of the total quantity for immediate shipment (48 hours). SHIPMENTS BEYOND 48 HOURS SHALL BE AT THE PRICE IN

EFFECT AT TIME OF SHIPMENT UNLESS NOTED OTHERWISE. Seller not responsible for delays, lack of product or increase of pricing due to causes beyond our control, and/or based upon Local, State and Federal laws governing type of products that can be sold or put into commerce. This Quote is offered contingent upon the Buyer's acceptance of Seller's terms and conditions, which are incorporated by reference and found either following this document, or on the web at http://wolseleyna.com/terms_conditionsSale.html. Govt Buyers: All items quoted are open market unless noted otherwise. OUOTES FOR PRODUCTS SHIPPED

ARE NOT FIRM LINE FOR NOTED OF THE OUTER OUTER OF THE OUTER O

Ferguson - Boise

586 North Locust Grove Road Meridian, ID 83642

OR RESALE ARE		S NOTED OTHERWISE. CONTACT YOUR SALES REPRESENTATIVE IMMEDIATELY CE WITH DBE/MBE/MBE/SMALL BUSINESS REQUIREMENTS.	Phone: (208) 376-6660				
ITEM#	MFC	DESCRIPTION	P- QTY		P-UNIT PRICE		EXT PRICE
S3396075	SLOAN	VBF-72-A1 9 TRAP PRIMER	1	EA	\$46 77	1	\$46.77
		TP-1 TRAP PRIMER - LAVATORY TAILPIECE					
		NOTE: OFFERED SUBJECT TO APPROVAL: NO MODEL PROVIDED				and the second s	
DEA8321	DEARBORN	· 1-1/2 TRAP PRMR TAILPIECE CP	1.	EA	\$15 10	1 '	\$15.10
		UF-1 UTILITY FAUCET					
D28T9	DELTA	NOT FOR POTABLE USE 2 HANDLE CROSS WM SERVICE SINK FAUCET ROUGH CHROME	1	EA 2	\$61 25 UF-l E	9 61.7	\$61.25 5 4 133.50
		US-1 UTILITY SINK			6	to fox	\$ 7.35 \$ 129.85
		NOTE: WE OFFER THE FOLLOWING SUBJECT TO THE APPROVAL OF THE ARCHITECT, ENGINEER & OWNER					
M18F	MUSTEE	SINGLE FLOOR MOUNTING LAUNDRY TRAY SMTHTP	1			1	
M93600	MUSTEE	CCN POLISHED CHROME 4 LAUNDRY TRAY FAUCET	1			1	
PFPTB107	PROFLO	1-1/2 17GA P TRAP CP	1			1	
FXQAC32C	PROFLO	LF 5/8 OD X 3/8 OD QT ANG VALVE	2			2	
PFX146324	PROFLO	LEAD LAW COMPLIANT 3/8 C X 1/2 FIP 20 STAINLESS STEEL	2			2	
PFE7	PROFLO	SINK CONNECTOR 5/8" OD CP SHALLOW ESC FLANGE	2			2	
		SUBTOTAL	1	EA	\$126 40	1	\$126 40
		WD 4 WACHED DOV					
020404	CATEV	WB-1 WASHER BOX					
O39121	OATEY	LF FIR IMOB QT HAMM BV SWT	1 1	EA	\$64.00	1 1	\$64.00