

#### City of Ketchum Planning & Building

# STAFF REPORT KETCHUM PLANNING AND ZONING COMMISSION MEETING OF DECEMBER 15, 2020

**PROJECT:** Leadville Residences

FILE NUMBER: P20-077

APPLICATION TYPE: Pre-Application Design Review

**REPRESENTATIVE:** Mike Brunelle (Architect), Travis Jones (Realtor), & Layne Thompson (Magleby

Construction)

PROPERTY OWNER: Leadville South, LLC (GM Property Holdings LLC per Blaine County Assessor's

Office Data)

**REQUEST:** Pre-Application Design Review for the development of a new three-story, 50.5-

foot tall, 7,815-square-foot duplex

**LOCATION:** Northwest Corner of N Leadville Avenue & E 2<sup>nd</sup> Street (Ketchum Townsite:

Block 3: Lot 5)

**ZONING:** Mixed-Use Subdistrict of the Community Core (CC-2)

OVERLAY: None

#### NEW DUPLEX IN THE HEART OF DOWNTOWN

The Leadville Residences project proposes to develop a new three-story, 50.5-foot tall, 7,815-square-foot duplex on a vacant lot located at the corner of Leadville Avenue and 2<sup>nd</sup> Street. The property is located within the Mixed-Use Subdistrict of the Community Core (CC-2). Multi-family dwelling units are a permitted use in the CC-2 Zone, and unlike the Retail Core (CC-1), dwelling units may be sited on the ground floor. The duplex is comprised of two, attached townhome units with private decks, rooftop terraces, and garages accessed from the alley.



Figure 1: Street Corner Rendering (Project Plans Sheet A-003)

#### P&Z COMMISSION FEEDBACK

The Planning & Zoning Commission previously considered this Pre-Application Design Review during their meeting on September 15<sup>th</sup>. The Commission expressed concerns about the duplex's over-scaled size and the project's incompatibility with surrounding buildings and uses. Their recommendations focused on integrating the project within the neighborhood, enhancing the streetscape to create a walkable environment, and reducing the duplex's dominating mass and tall blank walls.

#### APPLICANT'S PROJECT PLAN UPDATES

The Pre-Application Design Review submittal (Exhibit A) includes updated project plans and a summary of proposed modifications. These changes include slight adjustments to building mass as well as new elevated entrances to create front stoops bordered by raised planters and benches along 2<sup>nd</sup> Street and Leadville Avenue. The applicant's proposed design updates are insufficient and fail to meaningfully address the Commission's recommendations.

#### **ANALYSIS**

The Leadville Residences is an infill project located on a vacant lot in the heart of downtown Ketchum. The property shares the alley with restaurants and bars fronting Main Street, including the Warfield and Casino. The neighborhood is characterized by smaller historic buildings, including Vintage Restaurant. This area of downtown Ketchum is vibrant with opportunities for people to connect with each other and the built environment. The neighborhood includes local stores, restaurants, and bars for the community to shop, eat, and party.



"The building with a lively building edge is connected, part of the social fabric, part of the town, part of the lives of all people who live and move around it."

A Pattern Language
 by Christopher Alexander,
 Sara Ishikawa, and Murray
 Silverstein

Figure 2: Birds Eye View Rendering (Project Plans Sheets CS & A-003)

Downtown is Ketchum's gathering place connecting locals, second homeowners, and tourists. These connections create community, and our community defines Ketchum's small-town character and sense of place. This luxury housing development does not fit in with downtown's authentic atmosphere—the duplex's lifelessness will decrease vibrancy.

#### Design Review Objectives (Ketchum Municipal Code §17.96.020)

The Leadville Residences project does not meet Design Review objectives or the community's vision for downtown.

#### Enhance Ketchum's Appearance, Character, Beauty, and Function

This project will diminish Ketchum's vibrant, small-town character. The proposed location undermines the community's vision to maintain downtown as Ketchum's vibrant commercial area where local businesses thrive and the community gathers together.

The Community Core Zone's purpose (Ketchum Municipal Code §17.18.130) is to:

- maintain town's compact and cohesive center of commerce and culture,
- create an attractive and safe pedestrian environment, which includes sidewalks, gathering spaces, streetscape amenities, and landscaping,
- retain Ketchum's unique small-town scale and character, and
- encourage buildings that respect local and historical context while offering design diversity.

Additional housing units would make this project more consistent with the community's vision and goals for downtown as detailed in the 2014 Comprehensive Plan. More residents would help activate the building by increasing opportunities for social interaction. Additional housing units would also increase the diversity of housing types and styles within Ketchum.

The architectural design emphasizes that the duplex is a private space for residential use. For example, the window placement is configured based on the residents' desire for mountain views and privacy. The facades along 2nd Street and Leadville Avenue are uninviting and cut off from the surrounding streetscape. Instead of interacting with the neighborhood and pedestrians outside, this building orients inward rendering the surrounding streetscape a lifeless dead zone.

#### Ensure New Development is Complementary to the Design of Existing Neighborhoods

This project ignores local context. Over-scaled, the three-story duplex is considerably larger than neighboring buildings. Massing models (Sheet-003) underscore the duplex's size—the building dominates the streetscape. The project lacks key features, like active storefronts and detailed building facades, that create inviting, sociable, interactive, and dynamic places.

#### Protect the Town's Economic Base

The duplex's rear façade includes large windows facing the alley shared with downtown's popular nightlife and bar scene. This design exacerbates the potential for conflict between the proposed low-density residential use and the surrounding commercial neighborhood. As the community has experienced in the light industrial area, commercial activity often conflicts with the quiet enjoyment of a residential home. The two-unit, high-end townhouse development's location neighboring Ketchum's nightlife and bar scene may jeopardize the operations of these longstanding commercial establishments.

#### STAFF RECOMMENDATION

Staff recommends the Commission provide feedback to the applicant regarding the updated project plans and either (a) continue review of the Pre-Application if the applicant is willing to collaborate with the P&Z Commission to workshop the project or (b) accept the applicant's request to proceed to final Design Review application if they're reluctant to continue the Pre-Application phase.

Leadville Residences Pre-Application Design Review Staff Report Planning & Zoning Commission Meeting of December 15<sup>th</sup>, 2020 City of Ketchum Planning & Ruilding Department

#### **EXHIBITS:**

- A. Leadville Residences Pre-Application Design Review Submittal
- B. Zoning & Dimensional Standards Analysis
- C. Staff Report: P&Z Commission Meeting of September 15<sup>th</sup>, 2020

# Exhibit A: Leadville Residences Pre-Application Design Review Submittal




#### City of Ketchum Planning & Building



### **Design Review Application**

OFFICIAL USE ONLY	1
File 1201-077	
Date Realived:1 - 20	
By: WP	
Pre-Application Qe Paid:	
Design Review Fee Paid:	
Approved Date:	
Denied Date:	
Ву:	
ADRE: Yes No 🗙	

APPLICANT INFORMATION					
Project Name: Leadville Residences	ect Name: Leadville Residences Phone: 208/720-5988				
Owner: Leadville South LLC	Mailing Address: 1		31 Antler Dr, Hailey, ID 83333		
Email: layne@collabeng.com	Email: layne@collabeng.com		o i / wider Bi, Flamey, ib 00000		
Architect/Representative: Mike Brunelle Pho		Phone: 208/589-0771			
Email: mike@brunellearchitects.com			OB 3204, Hailey, ID 83333		
Architect License Number: AR-984536		7	, , , , , , , , , , , , , , , , , , , ,		
Engineer of Record: TBD		Phone:			
Email: TBD		Mailing Address:			
Engineer License Number: TBD			ì		
	lic commercial projects, resid	lential buildings containing	more than four (4) dwelling units and development		
projects containing more than four (4) dwelling					
PROJECT INFORMATION					
Legal Land Description: Lot 5, Block 3, Ketchu	m Townsite				
Street Address: Leadville, 2nd Street					
Lot Area (Square Feet): 5500 sf					
Zoning District: CC-2					
Overlay District:	☐ Avalanche	□Mountain			
Type of Construction: ■New	□Addition	□Remodel □Other			
Anticipated Use: Residential		Number of Residential Units:2			
TOTAL FLOOR AREA					
	Proposed		Existing		
Basements	0	Sq. Ft.	Sq. Ft.		
1 <sup>st</sup> Floor	3402	Sq. Ft.	Sq. Ft.		
2 <sup>nd</sup> Floor	2954	Sq. Ft.	Sq. Ft.		
3 <sup>rd</sup> Floor	1800	Sq. Ft.	Sq. Ft.		
Mezzanine		Sq. Ft.	Sq. Ft.		
Total	8156	Sq. Ft.	Sq. Ft.		
FLOOR AREA RATIO					
Community Core: 1.4	Tourist:		General Residential-High:		
BUILDING COVERAGE/OPEN SPACE					
Percent of Building Coverage: 64.2					
DIMENSIONAL STANDARDS/PROPOS	ED SETBACKS				
Front: 5'-0" average	de: 5'-0" avg - street Side: 0'-0" - interior		Rear: 3'-0"		
Building Height: 42'-0"			·		
OFF STREET PARKING					
Parking Spaces Provided:8					
Curb Cut: Sq. Ft.	%				
WATER SYSTEM					

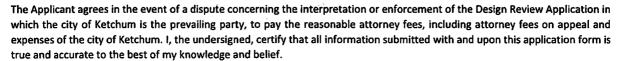

Mike Brunelle 08/10/20
Signature of Owner/Representative Date

#### **DESIGN REVIEW EVALUATION STANDARDS**

(May not apply to Administrative Design Review):

#### 17.96.060: IMPROVEMENTS AND STANDARDS FOR ALL PROJECTS

#### A. Streets:

- 1. The applicant shall be responsible for all costs associated with providing a connection from an existing city streets to their development.
- 2. All streets designs shall be in conformance with the right-of-way standards and approved by the Public Works Director.

#### B. Sidewalks:

- 1. All projects under 17.96.010(A) that qualify as a "Substantial Improvement" shall install sidewalks in conformance with the right-of-way standards. Sidewalk improvements may be waived for projects that qualify as a "Substantial Improvement" which comprise additions of less than 250 square feet of conditioned space.
- 2. The length of sidewalk improvements constructed shall be equal to the length of the subject property line(s) adjacent to any public street or private street.
- New sidewalks shall be planned to provide pedestrian connections to any existing or future sidewalks adjacent to the site. In addition, sidewalks shall be constructed to provide safe pedestrian access to and around a building.
- 4. The city may approve and accept voluntary cash contributions in-lieu of the above described improvements, which contributions must be segregated by the city and not used for any purpose other than the provision of these improvements. The contribution amount shall be one hundred ten percent (110%) of the estimated costs of concrete sidewalk and drainage improvements provided by a qualified contractor, plus associated engineering costs, as approved by the Public Works Director. Any approved in-lieu contribution shall be paid before the city issues a certificate of occupancy.

#### C. Drainage:

- 1. All storm water shall be retained on site.
- 2. Drainage improvements constructed shall be equal to the length of the subject property lines adjacent to any public street or private street.
- 3. The Public Works Director may require additional drainage improvements as necessary, depending on the unique characteristics of a site.



#### **Leadville Residences list of revisions – 2020-11-03**

#### Leadville Avenue

East Elevation, 1st floor

- North residence entrance elevated 3'-6" from sidewalk elevation with masonry stairs
- Steel plate planter raised to 2'-6", length revised
- Covered entrance roofs
  - o South unit to be 2'-6" from property line (was 6")
  - O North unit to be 9'-5" from property line (was 6'-6")
- East wall of North unit = 9'-5" from property line (was 8'-6")

East Elevation, 2<sup>nd</sup> floor

• Roof overhang omitted

#### 2<sup>nd</sup> Avenue

South Elevation, 1st floor

- South residence entrance elevated 3'-6" from sidewalk elevation with masonry stairs
- Stone wall revised
  - o Added stone to east end
  - o 9'-0" added stone to west end
  - Stone to have live wall metal screening to promote ivy growth during summer months
  - o Bench added to west end of stone wall
- 4'-6" x 12'-4" recess added with bench for sitting
- Metal paneled bump-out revised
  - o Lowered to ground level, top of paneling to be 26'-6" from sidewalk
  - o Original design had bump-out starting at 2<sup>nd</sup> floor extending to level of roof deck

South Elevation, 3<sup>rd</sup> floor

- South wall moved from property line 5'-9" (was 2'-0" & 0'-0" (at bump-out))
- Roof fascia extended to west to create horizontal break

South Elevation, 4<sup>th</sup> floor

- Handrail moved to be 5'-1" from property line (was 1'-6")
- Roof fascia/Handrail extends entire length of building to create horizontal break

#### **West Alley**

West Elevation, 2<sup>nd</sup> floor

- Solid 4'-0" wall added to open patio to reduce street sound from alley
  - o Wall to incorporate planter and sitting bench

West Elevation, 3<sup>rd</sup> floor

- Solid 4'-0" wall added to open patio to reduce street sound from alley
  - o Wall to incorporate planter and sitting bench
- West wall of bedroom moved west

#### **Property line, North**

North Elevation, 1<sup>st</sup> floor



- Stone wall revised
  - o Added stone to east end
  - o 9'-0" added stone to west end
- 4'-6" x 12'-4" recess added
- Metal paneled bump-out revised
  - o Lowered to ground level, top of paneling to be 26'-6" from sidewalk
  - o Original design had bump-out starting at 2<sup>nd</sup> floor extending to level of roof deck

#### North Elevation, 3<sup>rd</sup> floor

- South wall moved from property line 6'-9" (was 3'-0" & 1'-0" (at bump-out))
- Roof fascia extended to west to create horizontal break

#### North Elevation, 4<sup>th</sup> floor

- Handrail moved to be 6'-1" from property line (was 2'-6")
- Roof fascia/Handrail extends entire length of building to create horizontal break

Building separation wall reduced in height

= 4'-0" abv roof surface ht.(min. 75% transparent)

# Planning Code Compliance

Perimeter walls enclosing roof top deck

Roof top solar and mechanical equipment

FLOOR AREA, GROSS: The sum of the horizontal area of the building measured along the outside walls of each floor of a building or portion of a building, including stair towers and elevators on the ground floor only, and fifty percent (50%) of atriums over eighteen feet (18') plate height, but not including basements, underground parking areas or open unenclosed decks. Parking areas covered by a roof or portion of the building and enclosed on three (3) or more sides by building walls are included.

FLOOR AREA INCREASE: The gross and net floor area of a building allowed in addition to the permitted floor area in exchange for the provision of community housing units within the project, all of which are considered to be a public benefit. FLOOR AREA, NET: The sum of the horizontal areas of all floors in a building including basements but not including open inenclosed decks, interior or exterior circulation, mechanical equipment rooms, parking areas, common areas, public bathrooms or storage areas in basements Level 1 (ground level) Level 2 (second level) Level 3 (third level) 1660 sf 252 sf Level 4 (fourth level) Total By Use Residential multiple-family dwelling within the Community Core (CC) District: Units 750 square feet or less 0 parking spaces Units 751 square feet to 2,000 square feet Units 2,001 square feet and above 2 parking spaces 8 parking spaces provided FLOOR AREA RATIO: The product of the floor area divided by the lot area. Property 100' x 55' = 5500 sf (Permitted by right, 1.0) Community Core Housing incentive (2.25) = 5500 x 2.25 = 12,375 sf Proposed FAR Min. FAR allowed with inclusionary housing Basic FAR allowance 1.0 (5,500 gsf) Community Housing calculation 7815 asf - 648 sf (parking discount. (4)-9x18) = 7167 sf 7167 sf - 5500 sf = 1667 sf 333 sf - 15% (gross sf discount) = 283 sf (net sf (inside face of finish sf) Community Housing requirement) 283 sf (req. Community Housing) - 0 sf (provided Community Housing) = 283 sf In-lieu payment = \$238/sf x 283 sf = \$67,354 (inlieu payment) Drip Lines / Drainage - No drop lines or snow shedding occur on public sidewalks. Roof and canopy drainage collected and directed


# **Project Code Information**


Green Building - Project to be constructed to USGBC standards.


Site Lighting Plan - All lighting and illumination to conform to dark sky ordinance

Mechanical Screening - Mechanical units located on roof to be screened as per elevations.

Public Open Space - Trash receptacles, benches and gathering spaces are provided along public streets.

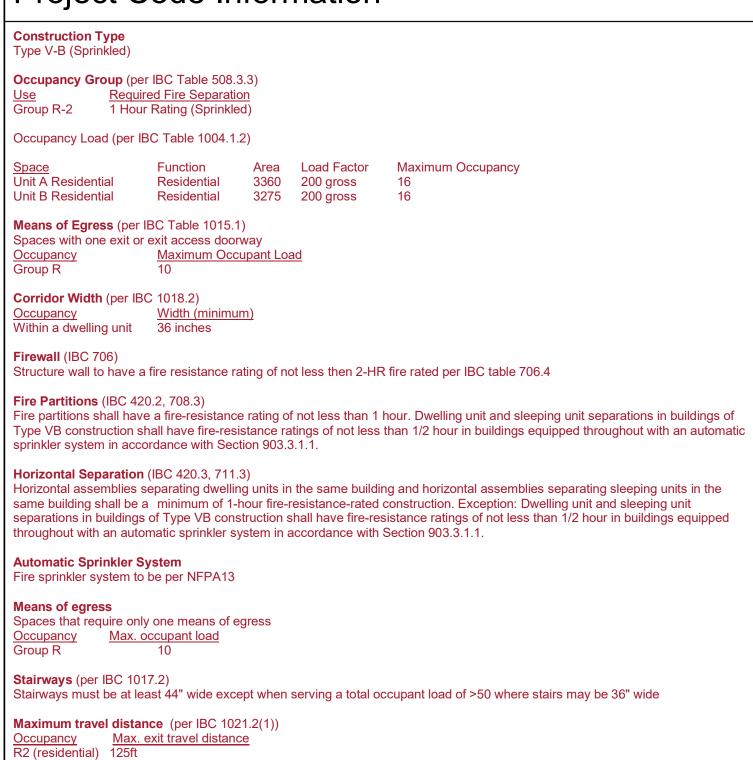

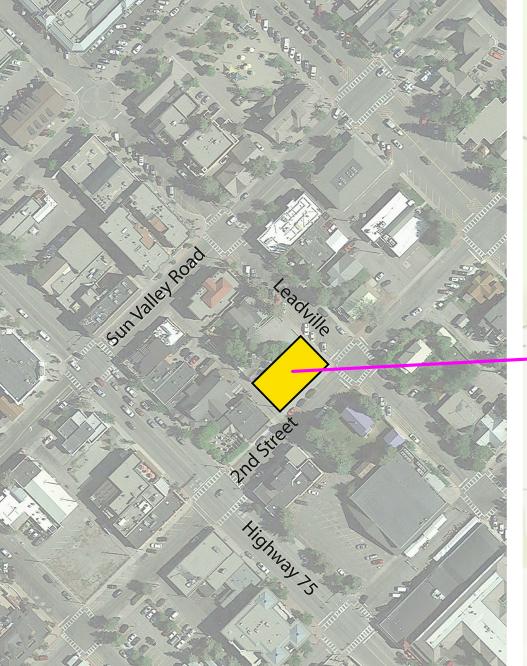

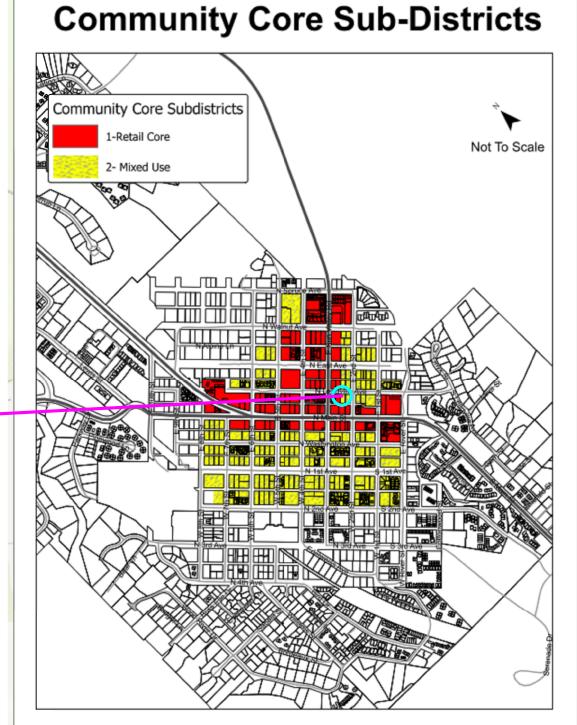



# Leadville Residences Lot 5, Block 3, Ketchum Townsite Ketchum, Idaho

OWNERSHIP OF DOCUMENTS: This document, and the ideas and designs incorporated herein as an instrument of professional service, is the property of Brunelle Architects, and is not to be used, in whole or in part, for any other project without the written authorization of Brunelle Architects, Inc.

# **Project Contacts**

**General Contractor** Magleby Construction Layne Thompson 511 East Ave, Suite 201 Ketchum, ID 83340 PO Box 494 Sun Valley, ID 83353 Ithompson@maglebyconstruction 208/806-1399

**Architect** 

Brunelle Architects, Inc. Mike Brunelle 190 Cranbrook Rd P.O. Box 3204 Hailey, ID 83333 208/589-0771 mike@brunellearchitects.com

Civil Engineer/Surveyor

Galena Engineering, INC Sean M. Flynn, PE 317 North River St Hailey, ID 83333 208/481-0306 sflynn@galena-engineering.com

Landscape Architect NS Consulting, PLLC. Nathan Schutte, ASLA 380 E Highway 26 Shoshone, ID 83352 208/320-2911

nathanwschutte@gmail.com

Structural Engineer

**Energy Consultation** 

City of Ketchum

Jim Lynch 480 East Avenue North P.O. Box 2315 Ketchum, ID 83340 208/726-7802 jlynch@ketchumidaho.com

Drawing List					
Sheet Number	Sheet Name				
CS	Cover				
TOPO	survey (existing)				
C1.0	Civil				
C2.0	Civil				
L1	Landscape Plan				
A-001	setback diagrams				
A-002	ketchum fabric				
A-003	3d massing				
A-101	floor plan				
A-102	floor plan				
A-103	floor plan				
A-104	floor plan				
A-105	roof plan				
A-201	elevations				
A-202	elevations				
A-203	elevations				
A-204	elevations				
A-301	sections				
A-302	sections				


# BRUNELLE ARCHITECTS, INC

MIKE BRUNELLE 190 CRANBROOK RD PO BOX 3204 HAILEY, IDAHO 83333 P. 208.589.0771 MIKE@BRUNELLEARCHITECTS.COM

Leadville Residences

Lot 5, Block 3, Ketchum Townsite

PROJECT NO

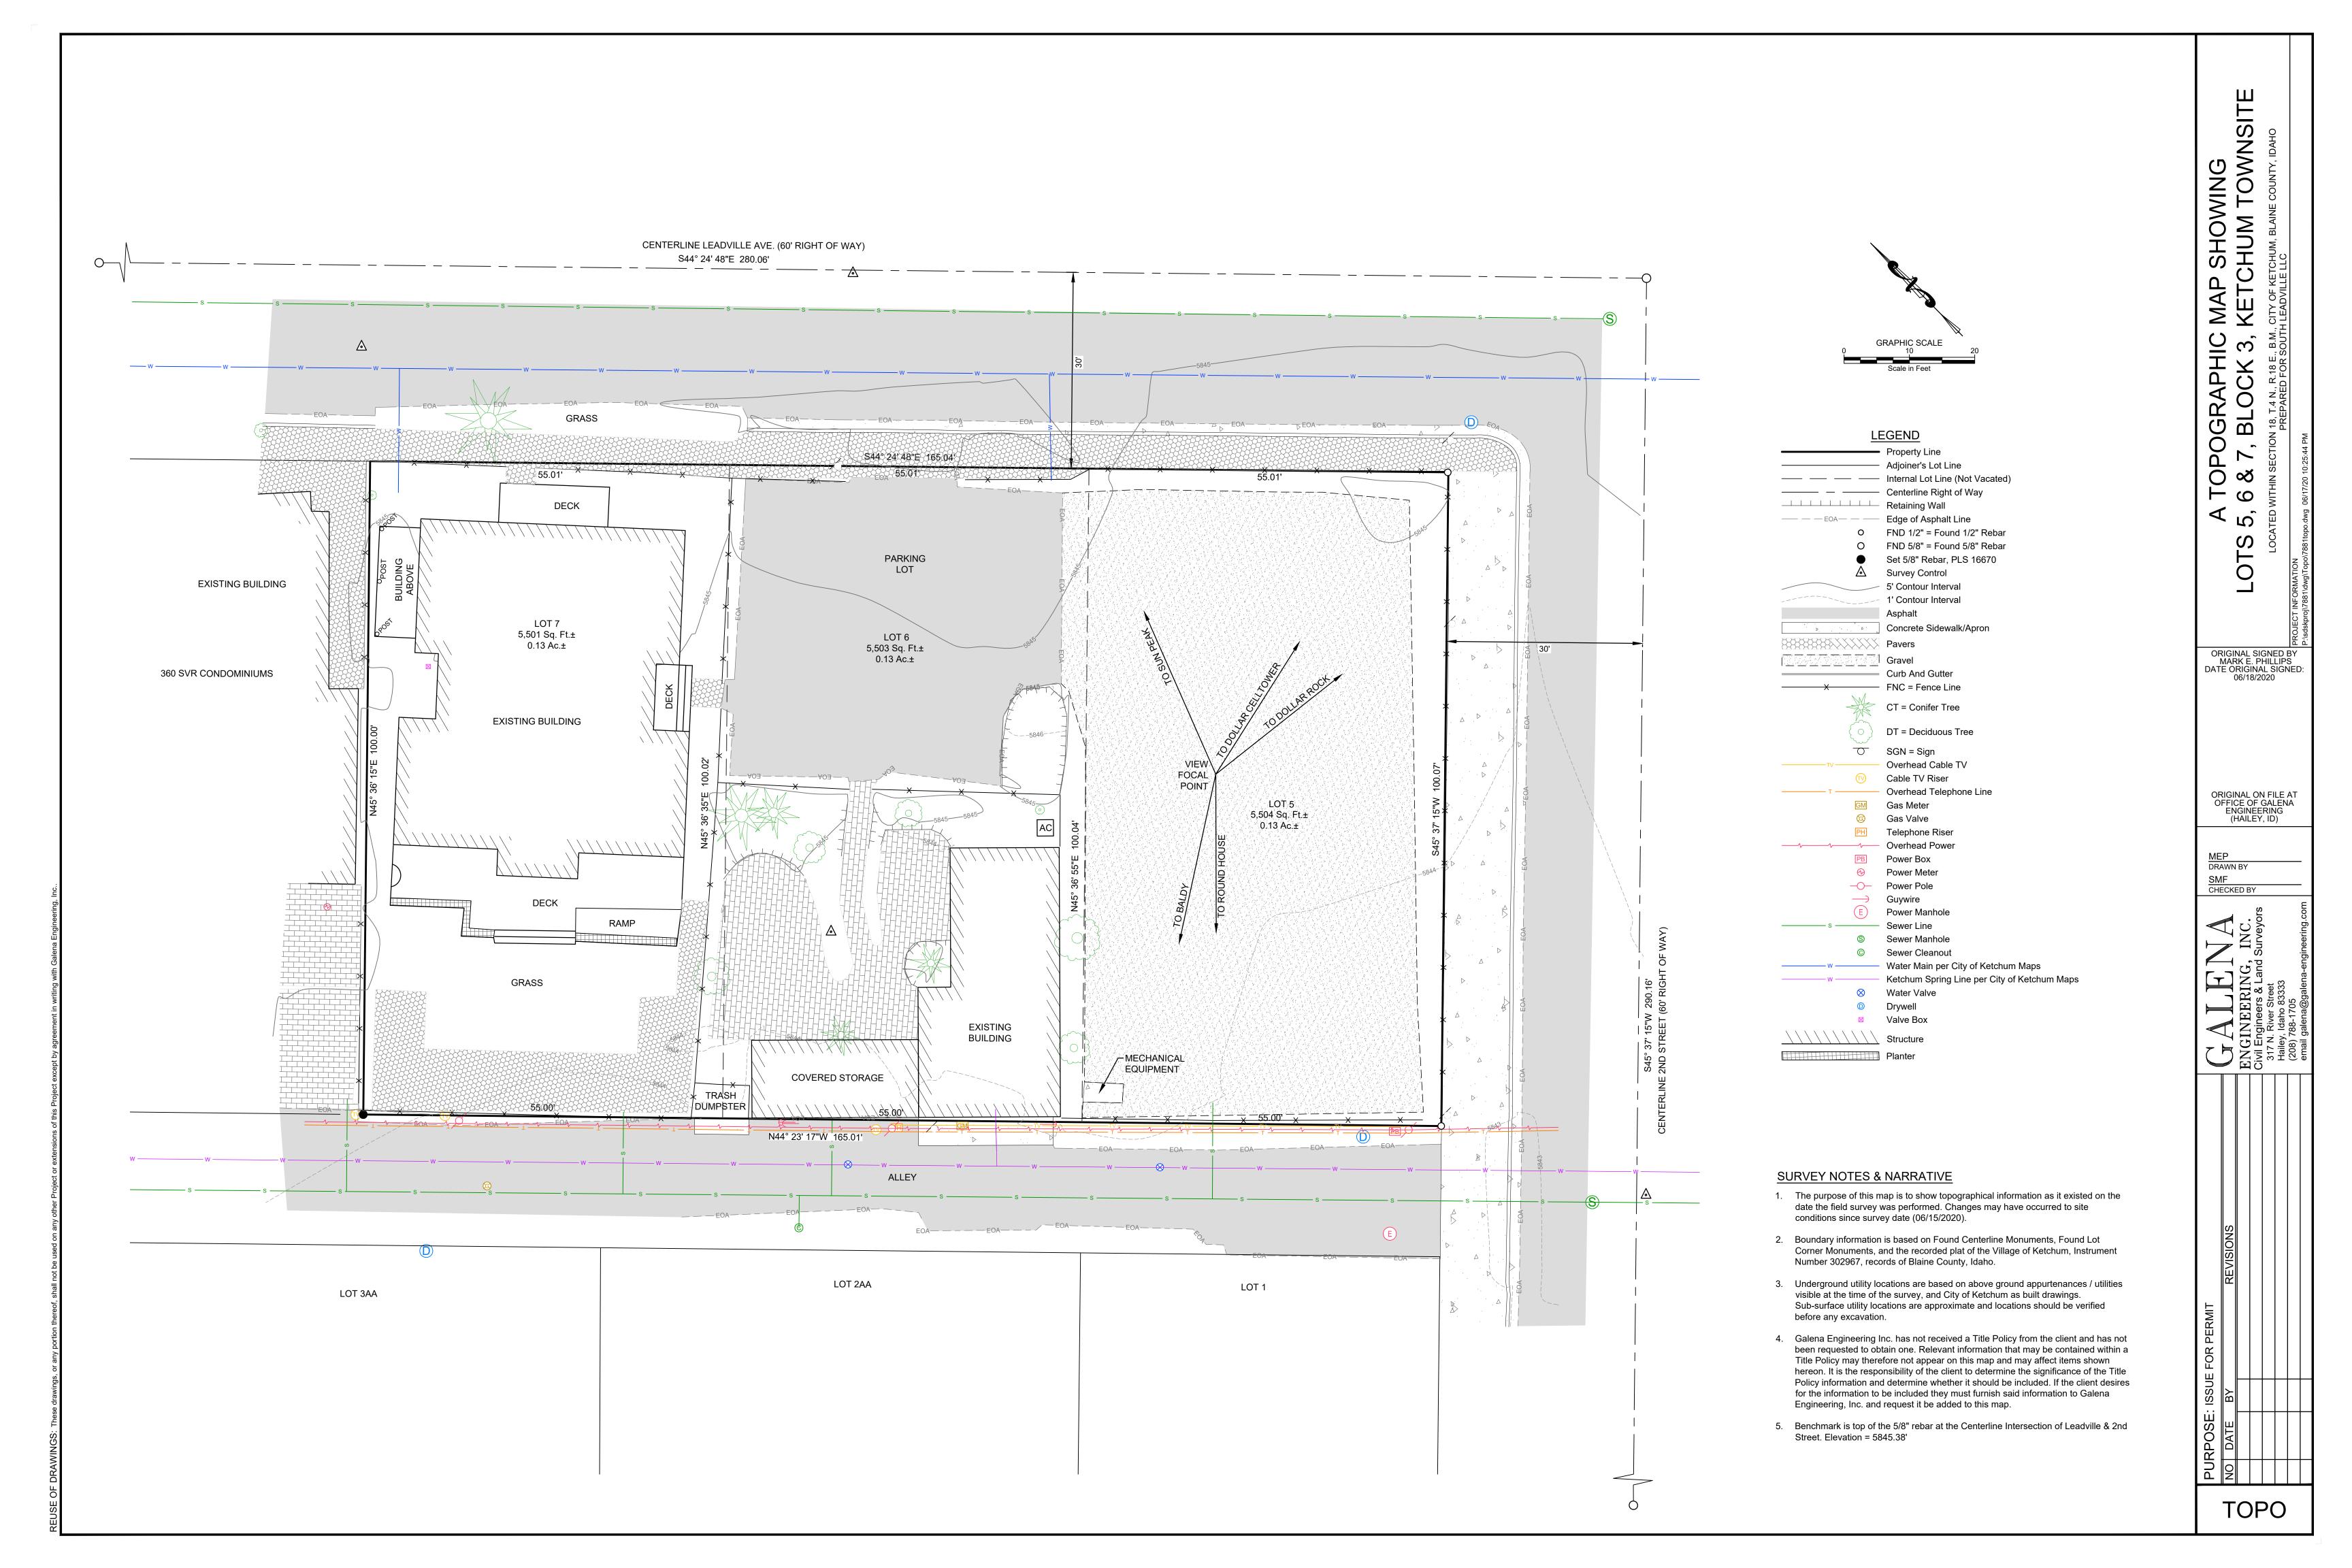

TBW 45.05 Spot Elevation

Telephone Riser Overhead Power

Power Box Power Pole

#### CONSTRUCTION KEYNOTES

#### SITE IMPROVEMENTS

Sawcut existing asphalt to provide for a clean vertical edge.

CONSTRUCT/ REPAIR ASPHALT . SEE DETAIL 1, SHEET C2.0.

## S03 CONSTRUCT CONCRETE CURB

- a. 6" CONCRETE VERTICAL CURB AND GUTTER PER DETAIL 2,
- b. ZERO REVEAL CURB AND GUTTER PER DETAIL 3, SHEET C2.0.
- c. CURB TRANSITION PER DETAIL 3, SHEET C2.0.
- d. 6" CONCRETE VERTICAL CURB PER DETAIL 4, SHEET C2.0. e. 2' WIDE CONCRETE VALLEY GUTTER PER DETAIL 11, SHEET
- INSTALL TRUNCATED DOME DETECTABLE WARNING INSERT. SEE DETAIL 9, SHEET C2.0. CONSTRUCT CONCRETE SIDEWALK. WIDTH AS SHOWN HEREON. SEE DETAIL 5, SHEET C2.0.
- S06 INSTALL PAVEMENT MARKINGS PER CITY OF KETCHUM STANDARDS
  - a. 4" WIDE YELLOW PARKING STRIPE b. 24" WIDE WHITE STOP BAR
  - c. NO PARKING ZONE (RED CURB)
  - d. WHITE CROSSWALK STRIPING (MATCH CITY PATTERNS)
- (S07) INSTALL SIGNS. CITY WILL PROVIDE SIGN BASES. SEE DETAIL 9, SHEET C2.0 FOR SIGN BASE DETAIL. a. RELOCATE STOP/STREET SIGN.
  - b. REGULATORY SIGN. COORDINATE TYPE AND FINAL LOCATION WITH CITY OF KETCHUM.
- (S08) INSTALL PAVERS PER ARCHITECTURAL PLANS.



PROPOSED STREET LIGHT LOCATION PER KETCHUM SIDEWALK IMPROVEMENT PLAN Q1-2 (NOT CONSTRUCTED).

#### UTILITY IMPROVEMENTS

TRENCH DRAIN WITH HEAT TAPE. SEE LANDSCAPE ARCHITECT DRAWINGS FOR DETAIL. INSTALL PER MANUFACTURERS SPECIFICATIONS.

- (U02) INSTALL DRYWELL PER DETAIL 12, SHEET C2.0. a. RIM ELEV = TBD (SOLID LID)
- CONNECT ROOF DRAINS PER ARCH. I.E. (IN) = TBD
- b. RIM ELEV = TBD (SOLID LID) IE (IN) = TBD
- c. RIM ELEV = TBD (RECTANGULAR GRATE) IE (IN) = TBD
- (U03) REMOVE AND DISPOSE OF DRYWELL.

## (PIPE LENGTH, LF) U04 INSTALL STORM DRAIN

a. 12"Ø D3034 PVC PIPE @ S=2.0% MIN. 3.0' MINIMUM COVER. b. 12" WATER QUALITY PIPE @ S=2.0% MIN. 3.0' MINIMUM COVER.

(U05) INSTALL NEW 1" WATER SERVICE.

a. RETAIN, PROTECT, UTILIZE EXISTING 4"Ø SEWER SERVICE.

b. INSTALL NEW 4"Ø PVC SEWER SERVICE. (U07) RELOCATE DRY UTILITIES PER ARCHITECTURAL PLANS.

(U08) INSTALL CATCH BASIN PER DETAIL 7, SHEET C2.0.

a. RIM ELEV = TBD (RECTANGULAR GRATE)

- I.E. (OUT) = TBD
- b. RIM ELEV = TBD (RECTANGULAR GRATE) IE(IN) = TBD
- IE (OUT) = TBD
- c. RIM ELEV = TBD (RECTANGULAR GRATE) IE (OUT) = TBD
- d. RIM ELEV = TBD (CIRCULAR GRATE) I.E. (OUT) = TBD
- (U09) REMOVE AND DISPOSE OF DRYWELL.

#### CONSTRUCTION NOTES

- 1. ALL CONSTRUCTION SHALL BE IN CONFORMANCE WITH THE MOST CURRENT EDITION OF THE "IDAHO REGULATIONS FOR PUBLIC DRINKING WATER SYSTEMS," THE CURRENT EDITION OF THE "IDAHO STANDARDS FOR PUBLIC WORKS CONSTRUCTION" (ISPWC), AND CITY OF KETCHUM STANDARDS. THE CONTRACTOR SHALL BE RESPONSIBLE FOR OBTAINING AND KEEPING A COPY OF THE ISPWC ON SITE DURING CONSTRUCTION.
- 2. THE LOCATION OF EXISTING UNDERGROUND UTILITIES ARE SHOWN ON THE PLANS IN AN APPROXIMATE WAY. THE CONTRACTOR SHALL BE RESPONSIBLE FOR LOCATING EXISTING UTILITIES PRIOR TO COMMENCING AND DURING THE CONSTRUCTION. THE CONTRACTOR AGREES TO BE FULLY RESPONSIBLE FOR ANY AND ALL DAMAGES WHICH RESULT FROM HIS FAILURE TO ACCURATELY LOCATE AND PRESERVE ANY AND ALL UNDERGROUND UTILITIES. CONTRACTOR SHALL CALL DIGLINE (1-800-342-1585) TO LOCATE ALL EXISTING UNDERGROUND
- 3. THE CONTRACTOR SHALL CLEAN UP THE SITE AFTER CONSTRUCTION SO THAT IT IS IN A CONDITION EQUAL TO OR BETTER THAN THAT WHICH EXISTED PRIOR TO CONSTRUCTION, INCLUDING BUT NOT LIMITED TO, EPA'S NPDES CONSTRUCTION GENERAL PERMIT.
- 4. THE CONTRACTOR SHALL OBTAIN ALL NECESSARY PERMITS PRIOR TO CONSTRUCTION.
- 5. CONSTRUCTION OF WATER MAINS AND ALL OTHER RELATED APPURTENANCES SHALL BE IN ACCORDANCE WITH THE IDAHO STANDARDS FOR PUBLIC WORKS CONSTRUCTION (ISPWC), IDAPA 58.01.08, IDAHO RULES FOR PUBLIC DRINKING WATER SYSTEMS AND THE CITY OF KETCHUM UTILITIES DEPARTMENT STANDARDS.
- 6. CONTRACTOR SHALL PRESSURE TEST, DISINFECT, AND CONDUCT BIOLOGICAL TESTING IN ACCORDANCE WITH THE IDAHO STANDARDS FOR PUBLIC WORKS CONSTRUCTION (ISPWC). AMERICAN WATER WORKS ASSOCIATION (AWWA) STANDARDS, AND THE PRESSURE TESTING, DISINFECTION, AND MICROBIOLOGICAL TESTING PROCEDURES.
- 7. ALL WATER SUPPLY FIXTURES, FITTINGS, PIPING, AND ALL RELATED APPURTENANCES SHALL BE ANSI/NSF STD. 61 COMPLIANT.
- 8. ALL WATER SUPPLY FIXTURES, FITTINGS, PIPING, AND ALL RELATED APPURTENANCES SHALL COMPLY WITH THE LOW LEAD ACT REQUIRING ALL MATERIALS TO HAVE A LEAD CONTENT EQUAL TO OR LESS THAT 0.25%.
- 9. THE CONTRACTOR SHALL USE ANSI/NSF STANDARD 60 CHEMICALS AND COMPOUNDS DURING INSTALLATION & DISINFECTION OF POTABLE WATER MAIN.
- 10. CONTRACTOR SHALL COORDINATE LOCATIONS OF DRY UTILITY FACILITIES (POWER, CABLE, PHONE, TV) NOT SHOWN ON THE DRAWING WITH IDAHO POWER.
- 11. ALL CLEARING & GRUBBING SHALL CONFORM TO ISPWC SECTION 201.
- 12. ALL EXCAVATION & EMBANKMENT SHALL CONFORM TO ISPWC SECTION 202. EXCAVATED SUBGRADE SHALL BE COMPACTED AND ALL UNSUITABLE SECTIONS REMOVED AND REPLACED WITH STRUCTURAL FILL AS DETERMINED BY THE ENGINEER. MINIMUM COMPACTION OF PLACED MATERIAL SHALL BE 95% OF MAXIMUM LABORATORY DENSITY AS DETERMINED BY AASHTO T-99 OR ITD T-91.
- 13. ALL 2" MINUS GRAVEL SHALL CONFORM TO ISPWC 802, TYPE II (ITD STANDARD 703.04, 2"), SHALL BE PLACED IN CONFORMANCE WITH ISPWC SECTION 801 AND COMPACTED PER SECTION 202. MINIMUM COMPACTION OF PLACED MATERIAL SHALL BE 90% OF MAXIMUM LABORATORY DENSITY AS DETERMINED BY AASHTO T-99.
- 14. ALL 3/4" MINUS CRUSHED GRAVEL SHALL CONFORM TO ISPWC 802, TYPE I (ITD STANDARD 703.04, 3/4" B), SHALL BE PLACED IN CONFORMANCE WITH ISPWC SECTION 802 AND COMPACTED PER SECTION 202. MINIMUM COMPACTION OF PLACED MATERIAL SHALL BE 95% OF MAXIMUM LABORATORY DENSITY AS DETERMINED BY AASHTO T-99 OR ITD T-91.
- 15. ALL ASPHALTIC CONCRETE PAVEMENT WORK SHALL CONFORM TO ISPWC SECTION(S) 805, 810, AND 811 FOR CLASS II PAVEMENT. ASPHALT AGGREGATE SHALL BE 1/2" (13MM) NOMINAL SIZE CONFORMING TO TABLE 803B IN ISPWC SECTION 803. ASPHALT BINDER SHALL BE PG 58-28 CONFORMING TO TABLE A-1 IN ISPWC SECTION 805.
- 16. ALL EDGES OF EXISTING ASPHALT PAVING SHALL BE SAW CUT 24" TO PROVIDE A CLEAN PAVEMENT EDGE FOR MATCHING, NO WHEEL CUTTING SHALL BE ALLOWED.
- 17. THE CONTRACTOR SHALL BE RESPONSIBLE FOR PROVIDING TRAFFIC CONTROL PER THE CURRENT EDITION OF THE US DEPARTMENT OF TRANSPORTATION MANUAL OF UNIFORM TRAFFIC CONTROL DEVICES (MUTCD).
- 18. ALL CONCRETE FORM WORK SHALL SHALL CONFORM TO ISPWC SECTION 701 AND 703. ALL CONCRETE SHALL BE 3,000 PSI MINIMUM, 28 DAY, AS DEFINED IN ISPWC SECTION 703, TABLE 1.
- 19. ALL TRENCHING SHALL CONFORM TO ISPWC STANDARD DRAWING SD-301. TRENCHES SHALL BE BACKFILLED AND COMPACTED TO A MINIMUM OF 95% OF MAXIMUM DENSITY AS DETERMINED BY AASHTO T-99.
- 20. TOPOGRAPHIC, SITE, AND BOUNDARY SURVEYS SHOWN HEREON WERE CONDUCTED BY ALPINE ENTERPRISES INC.
- 21.PER IDAHO CODE § 55-1613, THE CONTRACTOR SHALL RETAIN AND PROTECT ALL MONUMENTS, ACCESSORIES TO CORNERS, BENCHMARKS AND POINTS SET IN CONTROL SURVEYS; ALL MONUMENTS, ACCESSORIES TO CORNERS, BENCHMARKS AND POINTS SET IN CONTROL SURVEYS THAT ARE LOST OR DISTURBED BY CONSTRUCTION SHALL BE REESTABLISHED AND RE-MONUMENTED, AT THE EXPENSE OF THE AGENCY OR PERSON CAUSING THEIR LOSS OR DISTURBANCE AT THEIR ORIGINAL LOCATION OR BY SETTING OF A WITNESS CORNER OR REFERENCE POINT OR A REPLACEMENT BENCHMARK OR CONTROL POINT, BY OR UNDER THE DIRECTION OF A PROFESSIONAL LAND SURVEYOR.

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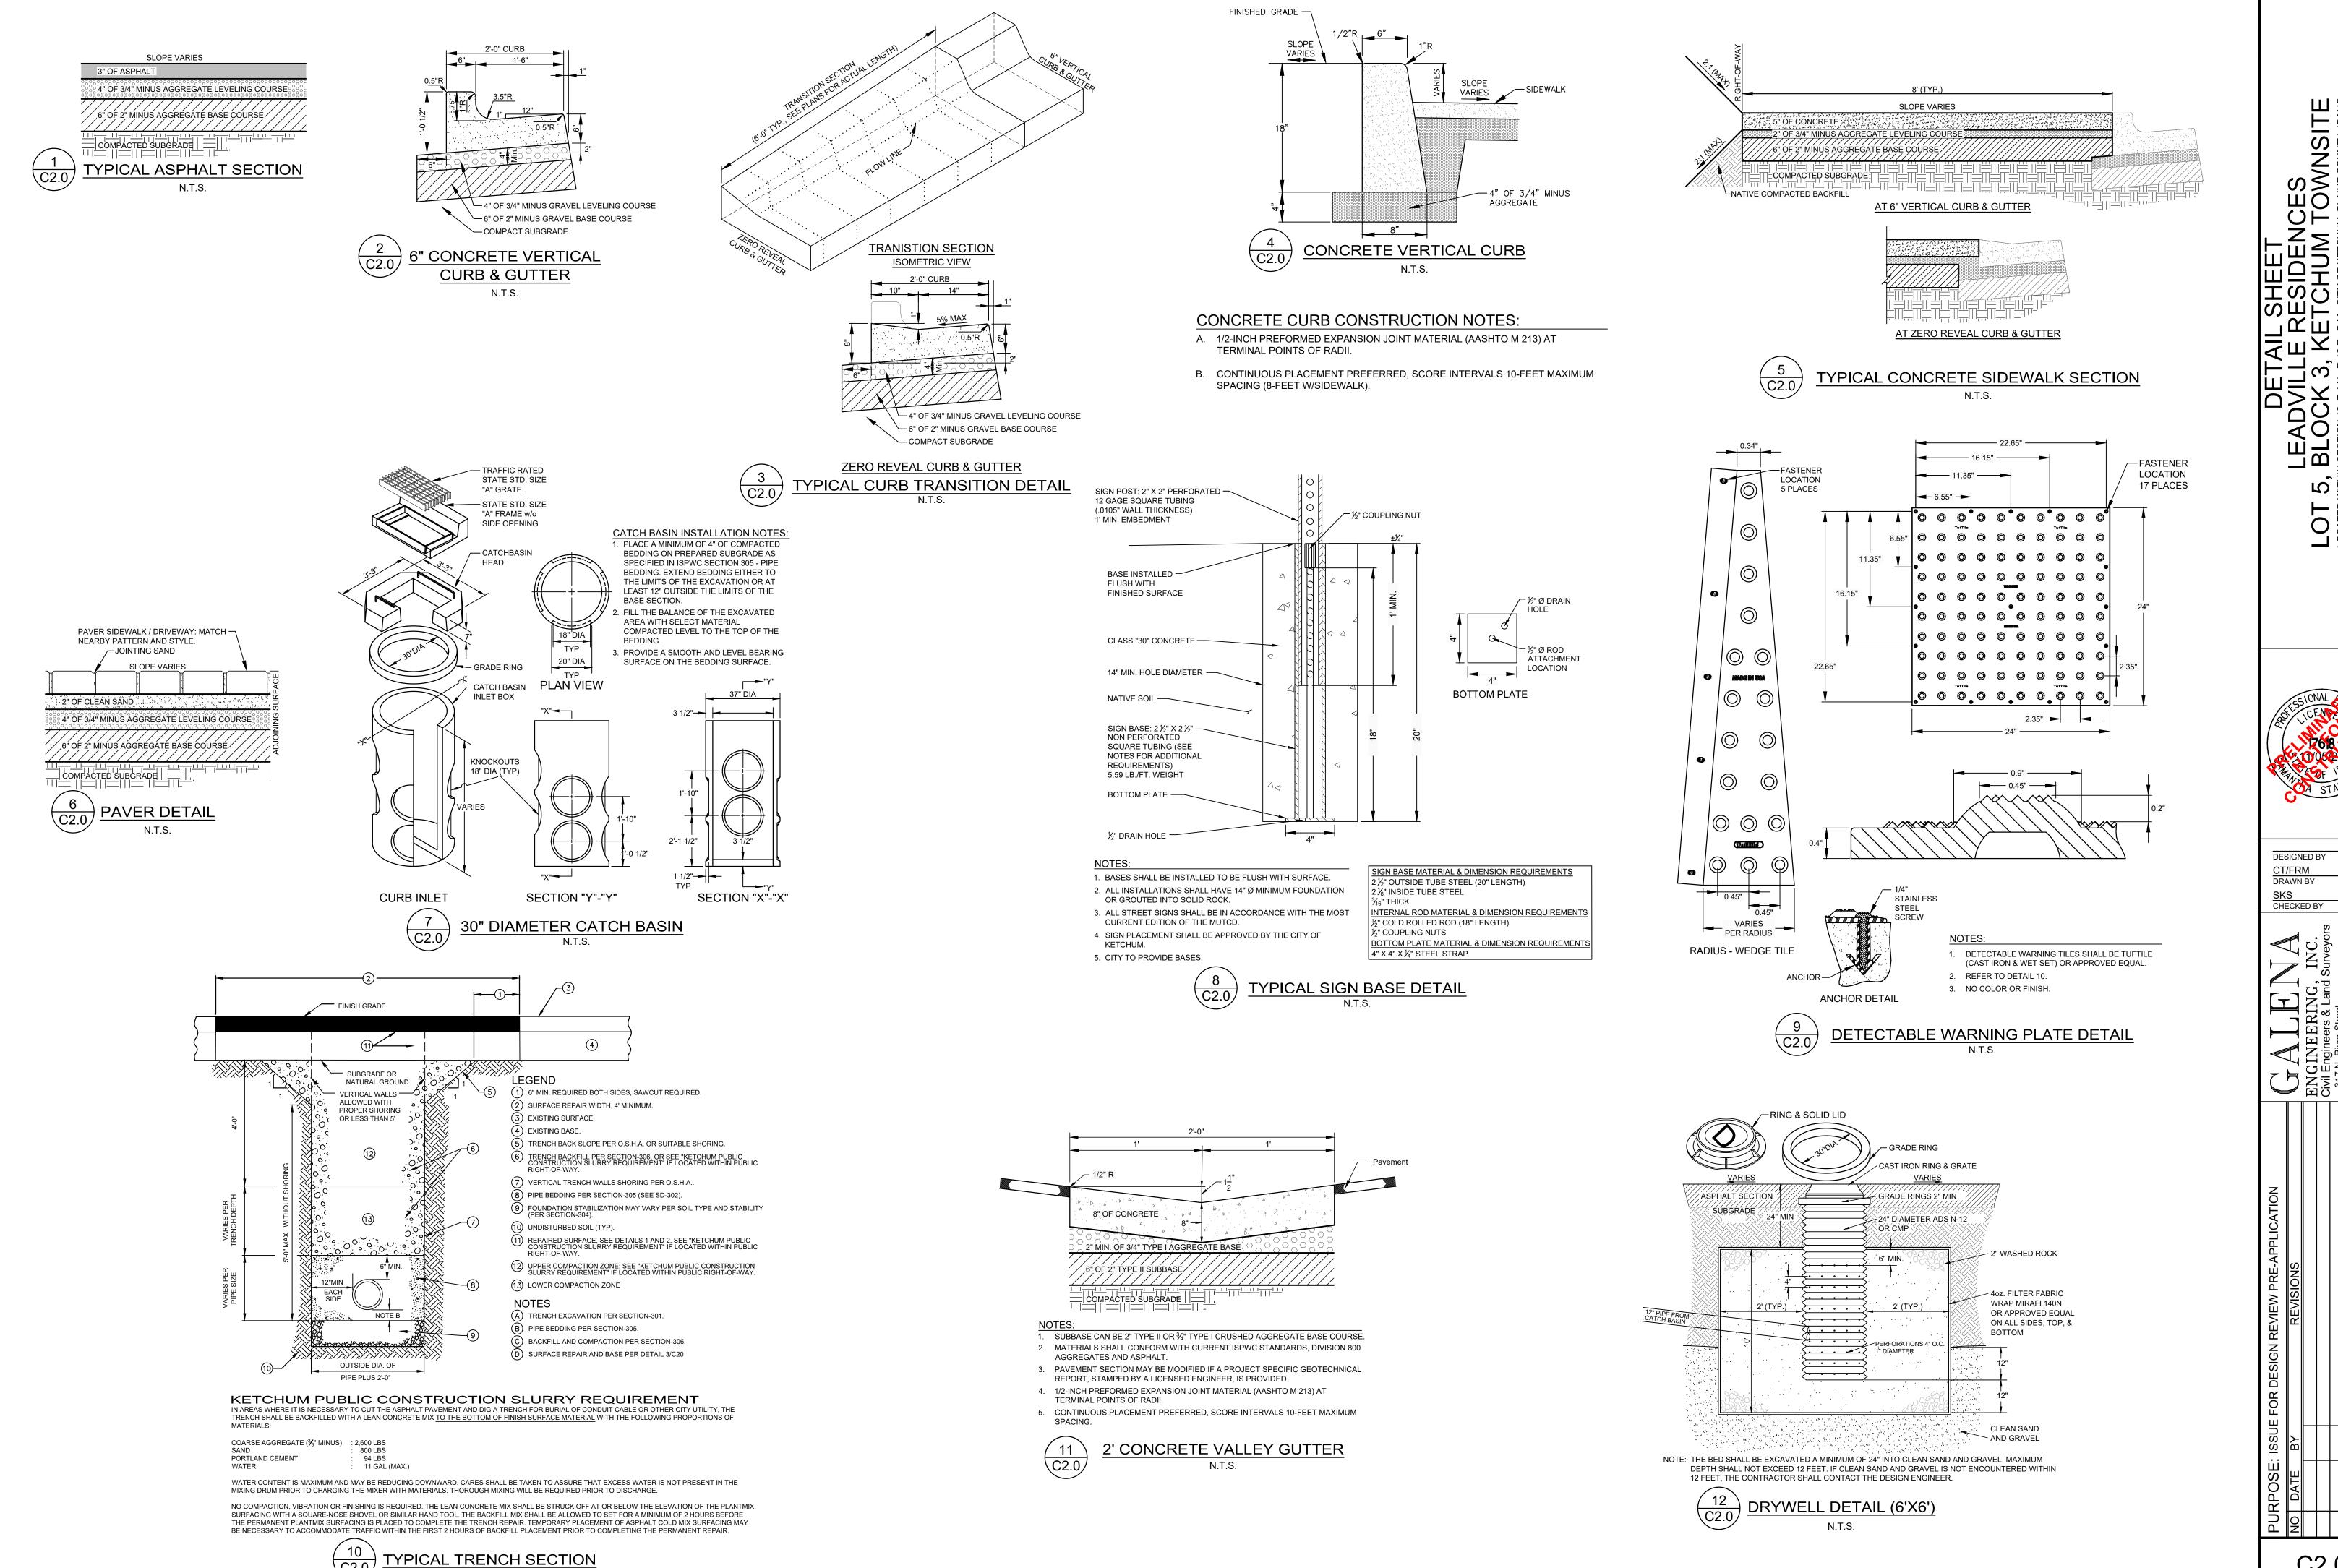
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CT/FRM DRAWN BY CHECKED BY

DESIGNED BY


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C1.0





## LANDSCAPE LEGEND

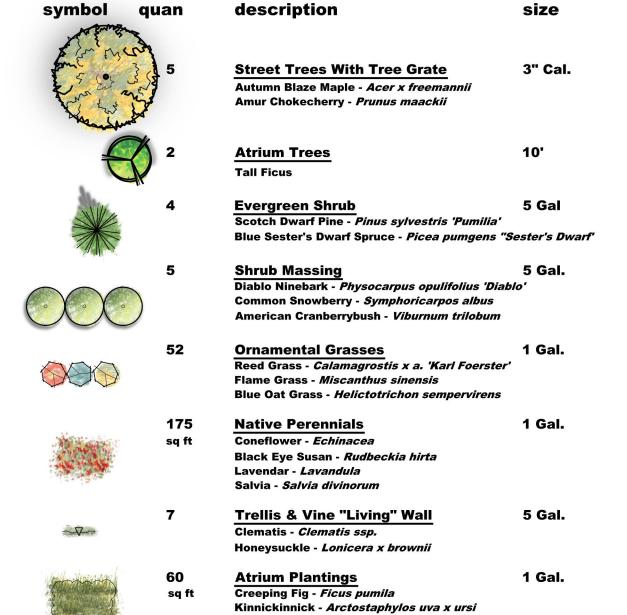


Vinca - *Vinca minor* 



## LANDSCAPE NOTES

- 1. All planting beds to have drip irrigation
- 2. All planting beds to have 3" cover of bark or compost

# **PLAN LEGEND**

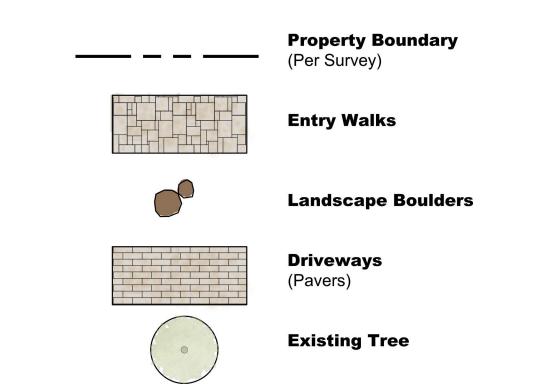



**CONSULTING** 

landscape architecture & drone mapping

E: nathanwschutte@gmail.com

The designs and concepts shown are the sole property of NS Consulting.

The drawings may not be used except

with the expressed written consent of

NS Consulting, PLLC.

380 E Highway 26 Shoshone, ID 83352 P: 208.320.2911

PROJECT

LEADVIL

Lot 5, BLOCK 3

Ketchum, Idaho

November 11, 2020


DRAWN BY
Nathan Schutte

REVISION


No. Date Remark

DESIGN REVIEW

LANDSCAPE PLAN

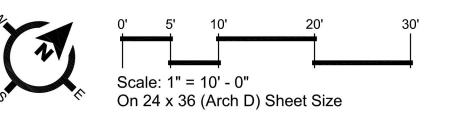

L1

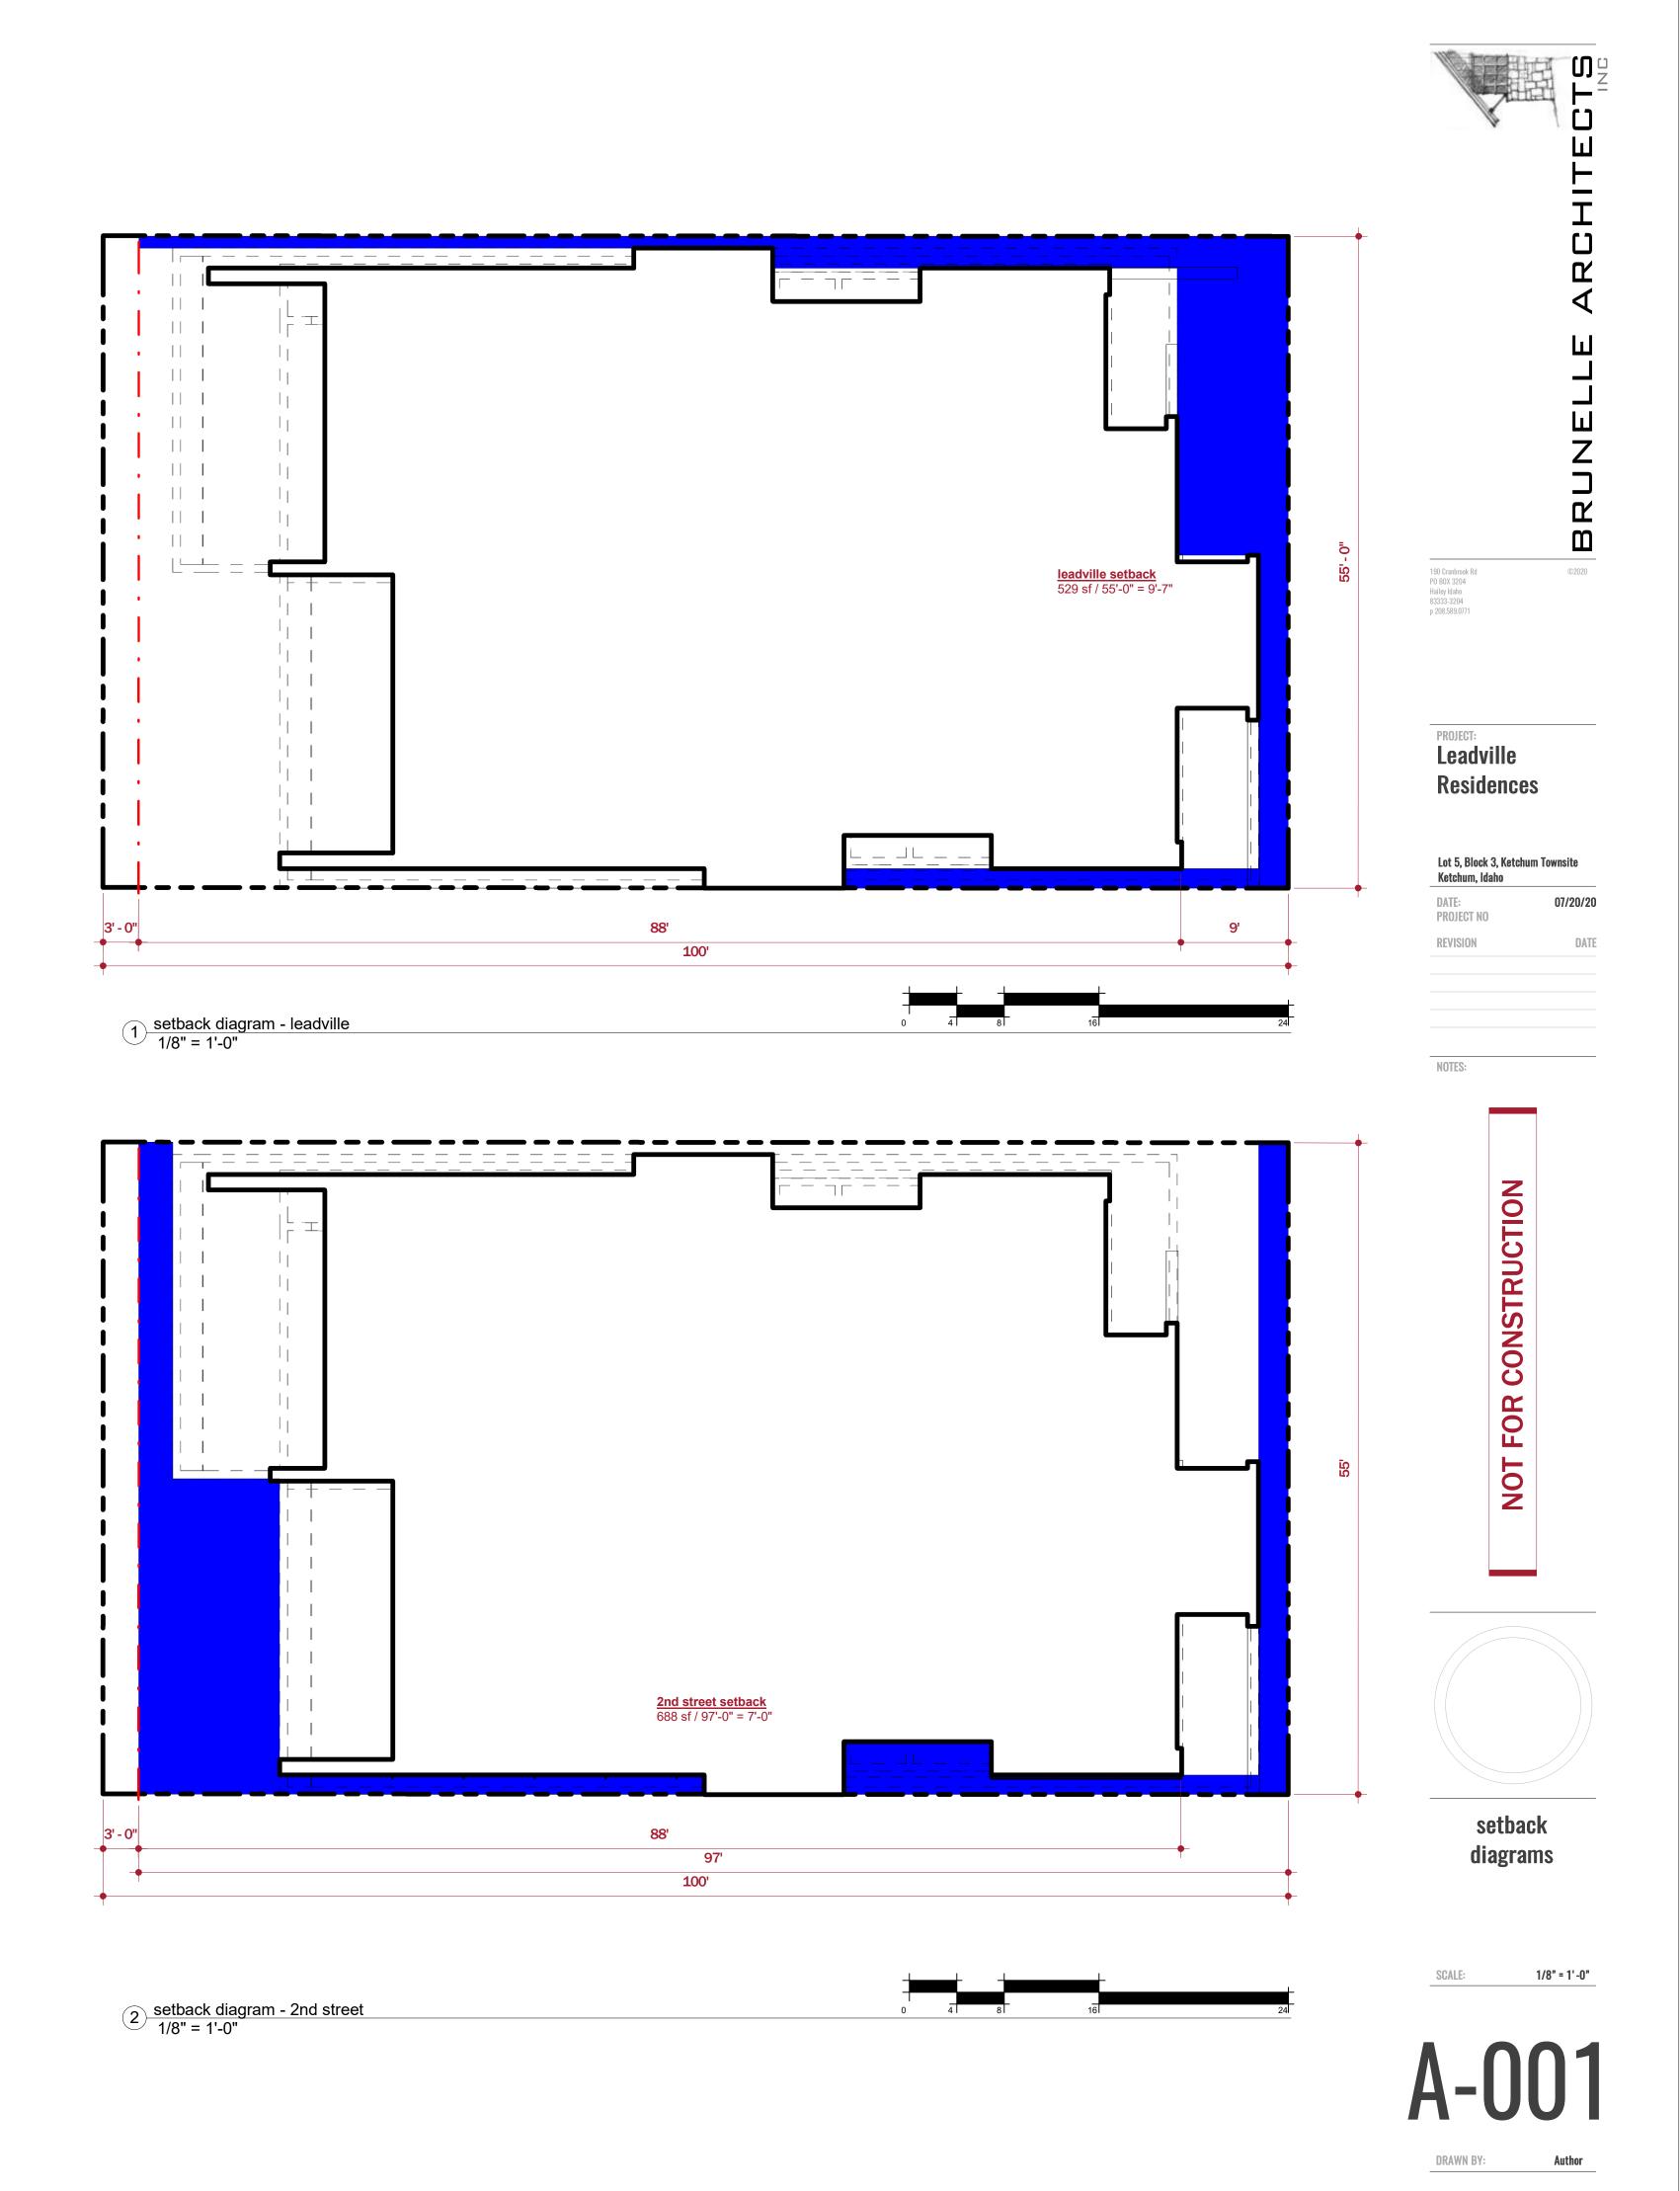

190 Cranbrook Rd PO BOX 3204 Hailey Idaho 83333-3204 p 208.589.0771

PROJECT: Leadville Residences

Lot 5, Block 3, Ketchum Townsite

DATE: Project no

NOTES:

roof above

roof above

8' - 0"

10' - 5"

new raised planter

setback diagrams

1/8" = 1'-0"

DRAWN BY:




190 Cranbrook Rd PO BOX 3204 Hailey Idaho 83333-3204 p 208.589.0771

NOTES:







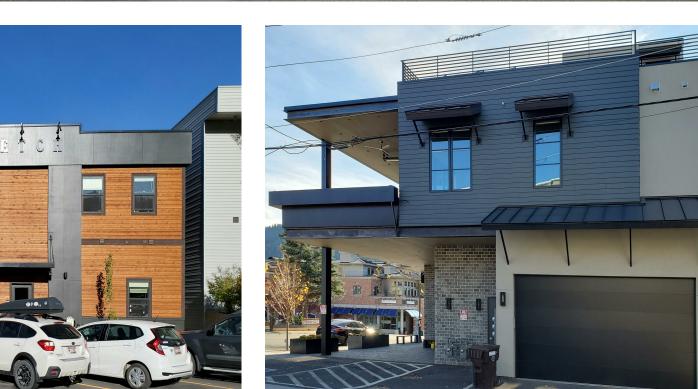















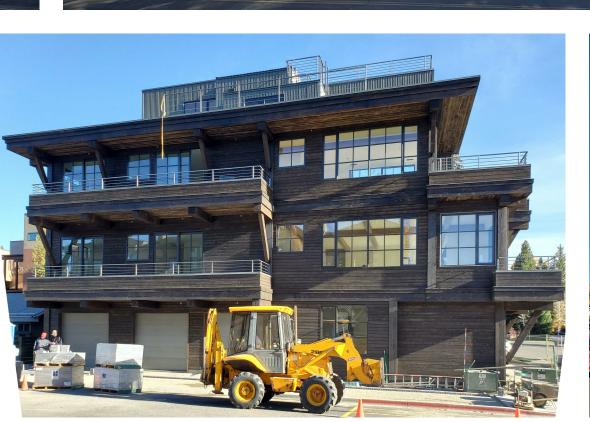

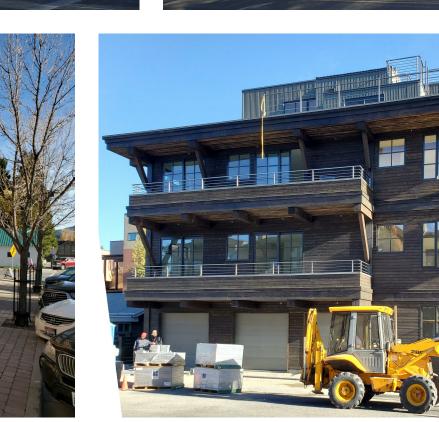

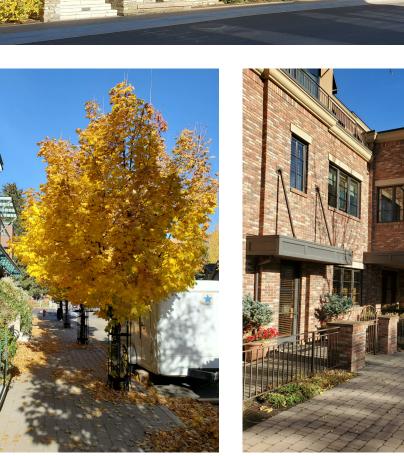

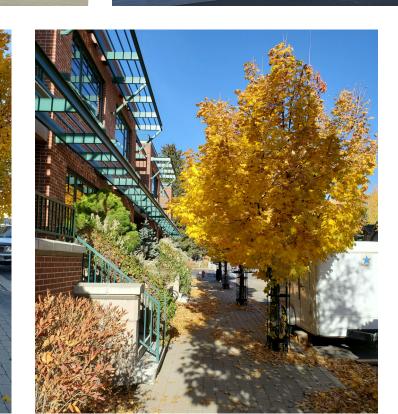















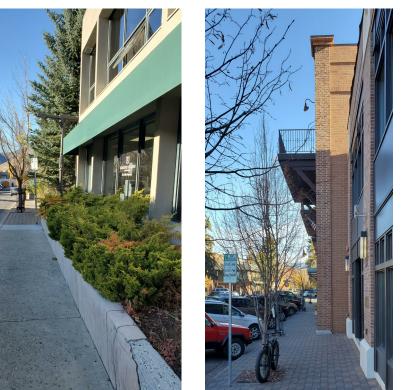




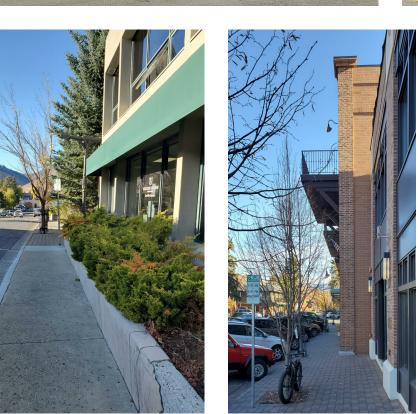






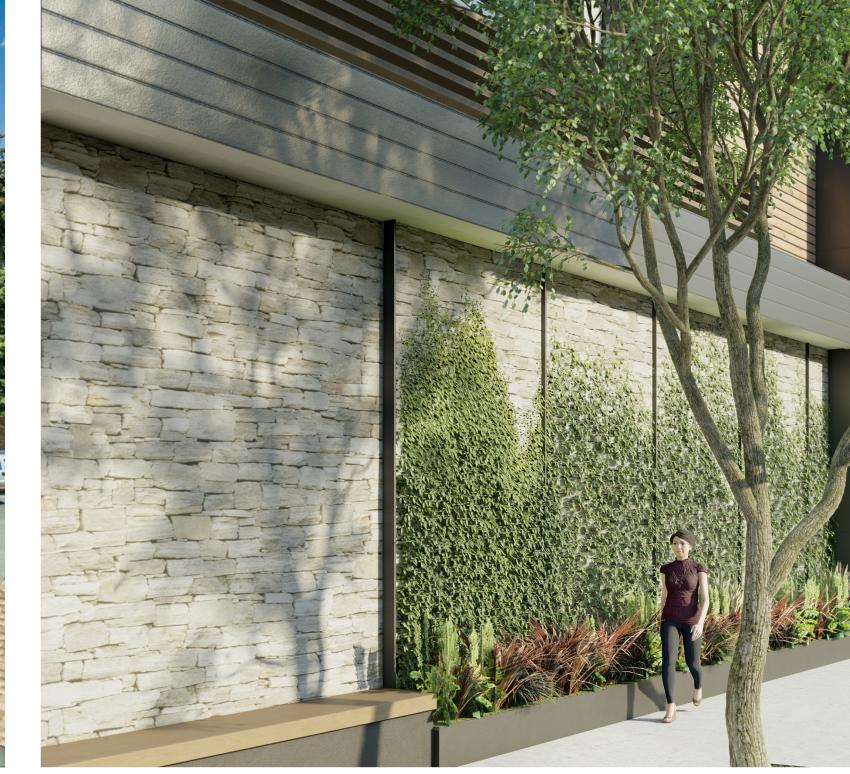









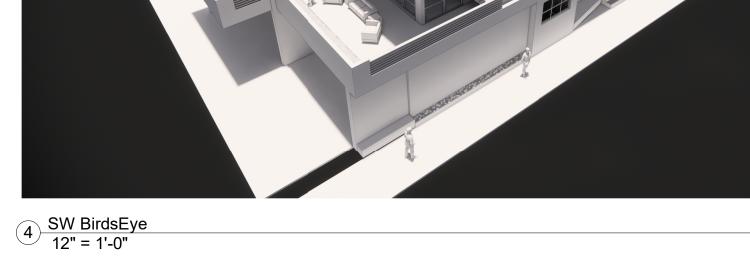




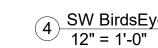

1 NE Perspective 12" = 1'-0"

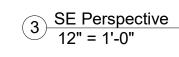


2 NW BirdsEye 12" = 1'-0"

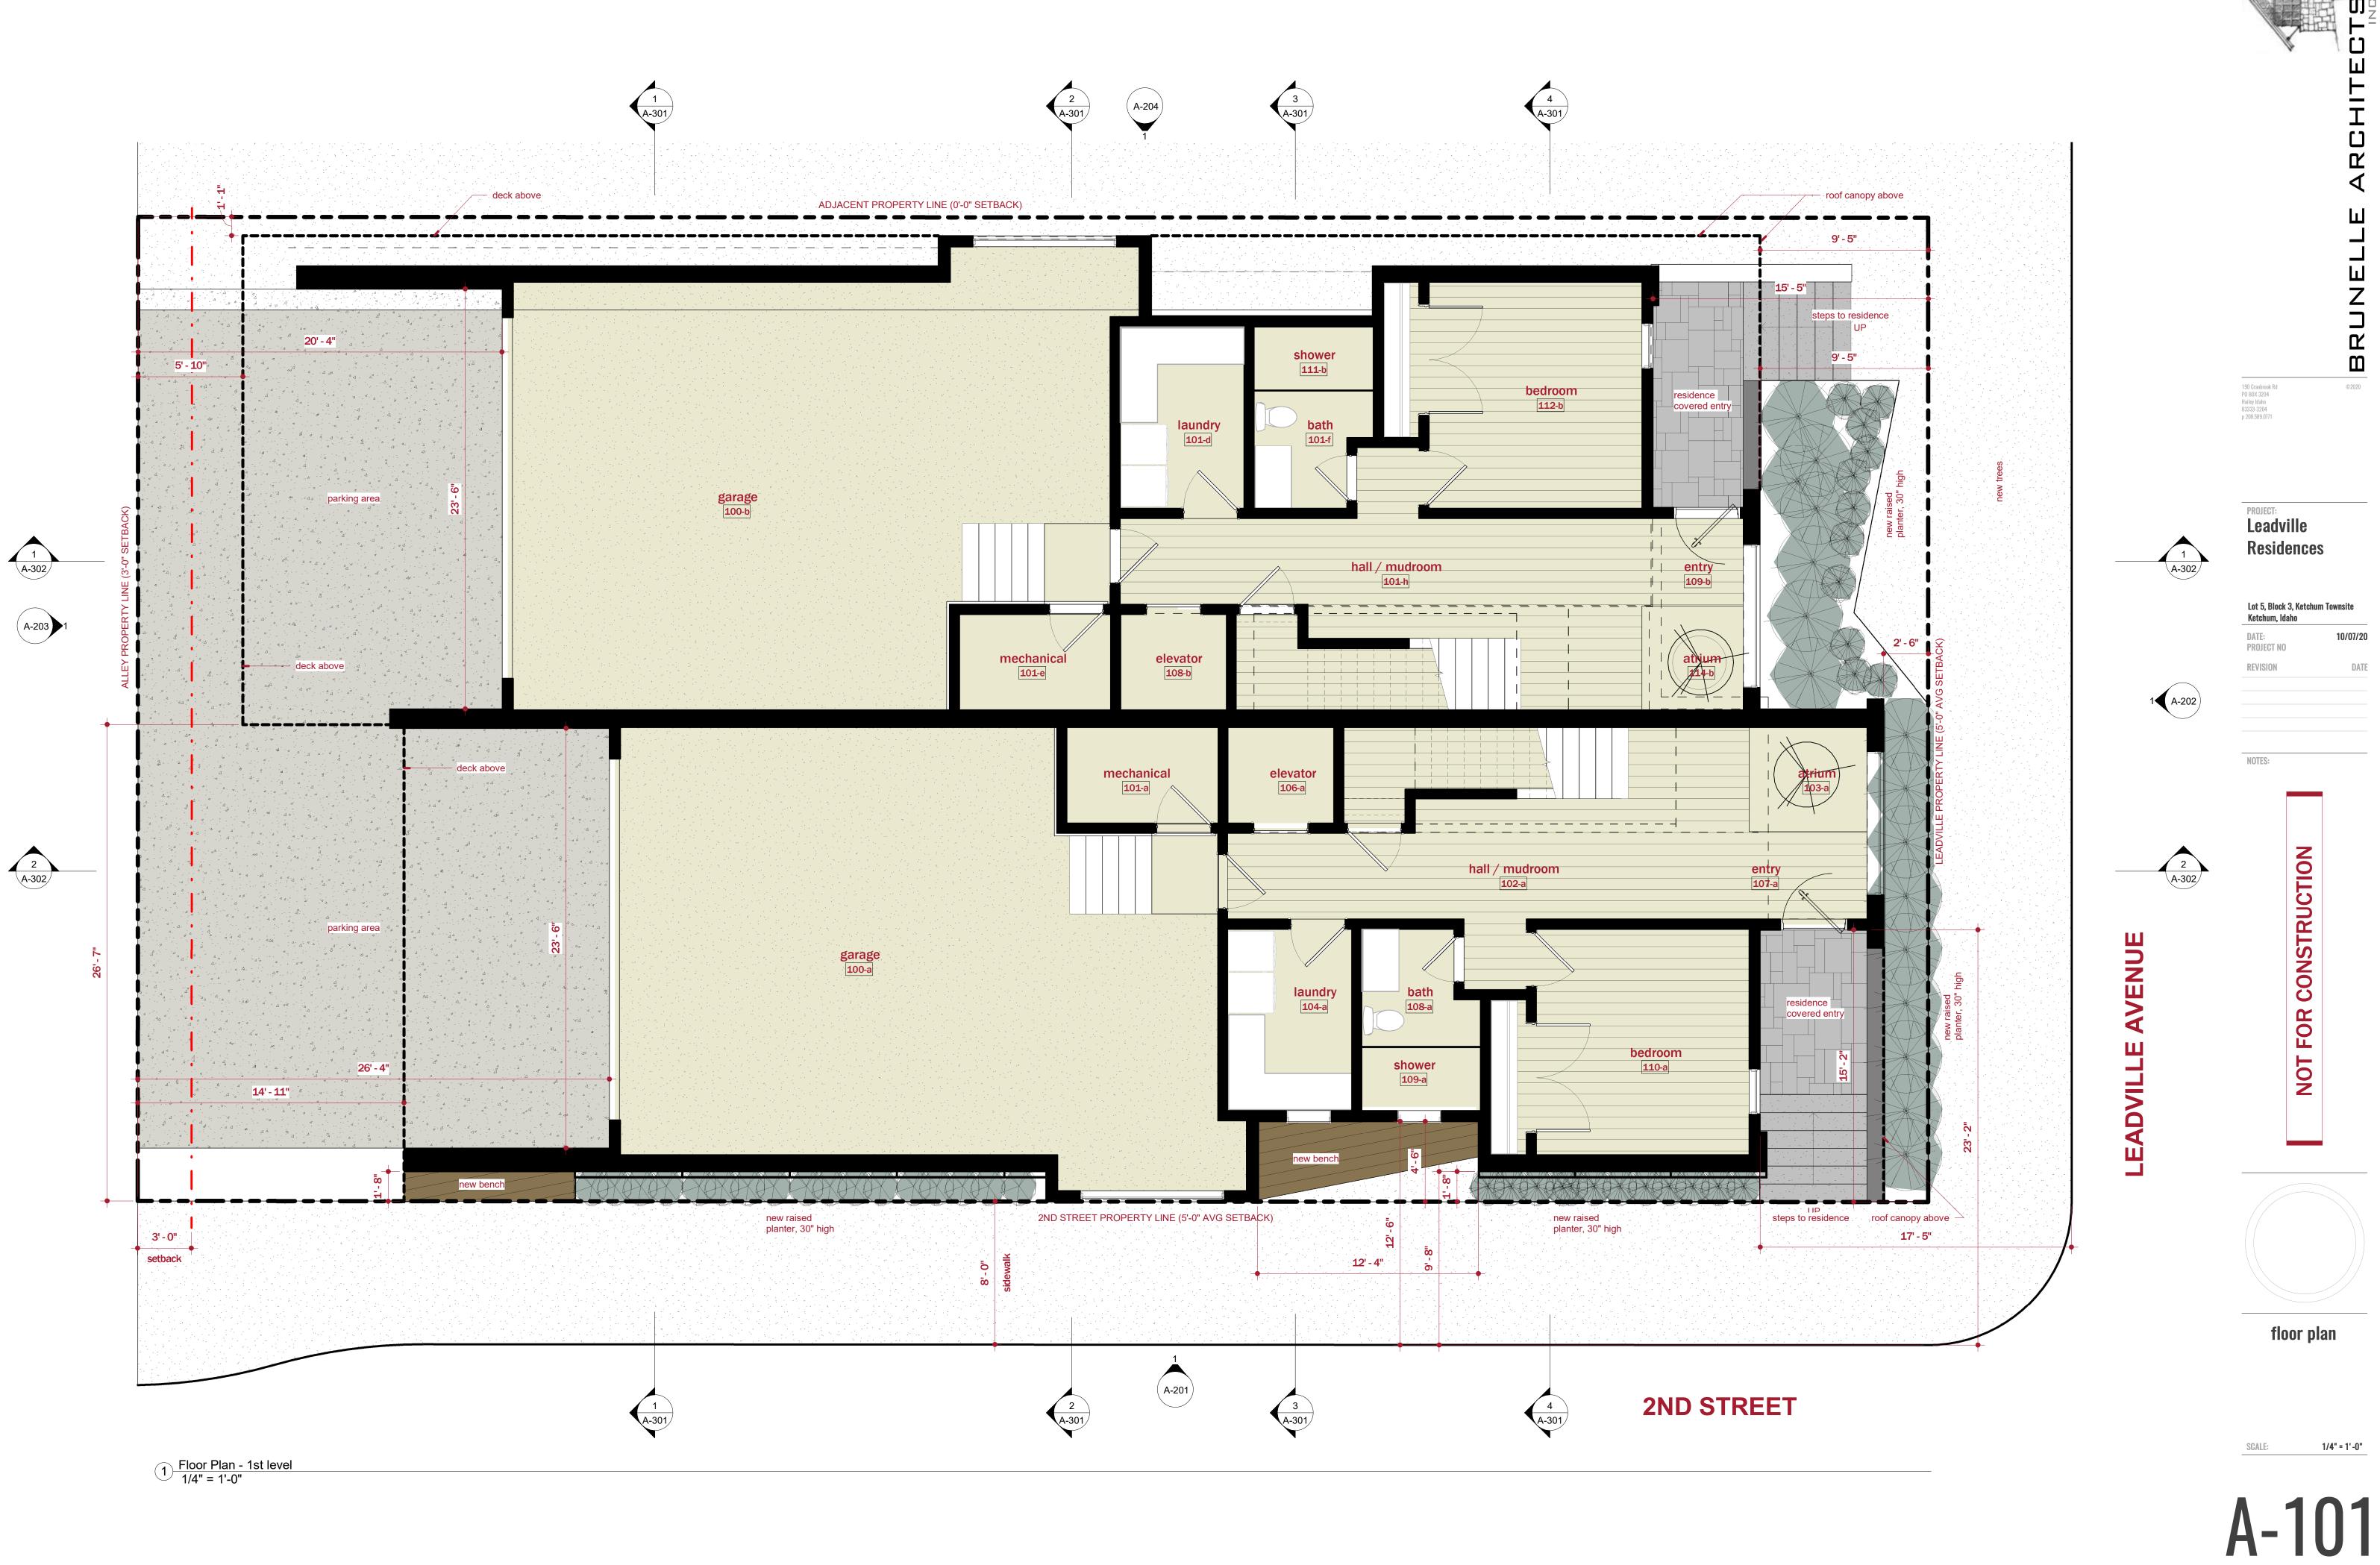



1/4" = 1'-0"

NOT FOR CONSTRUCTION

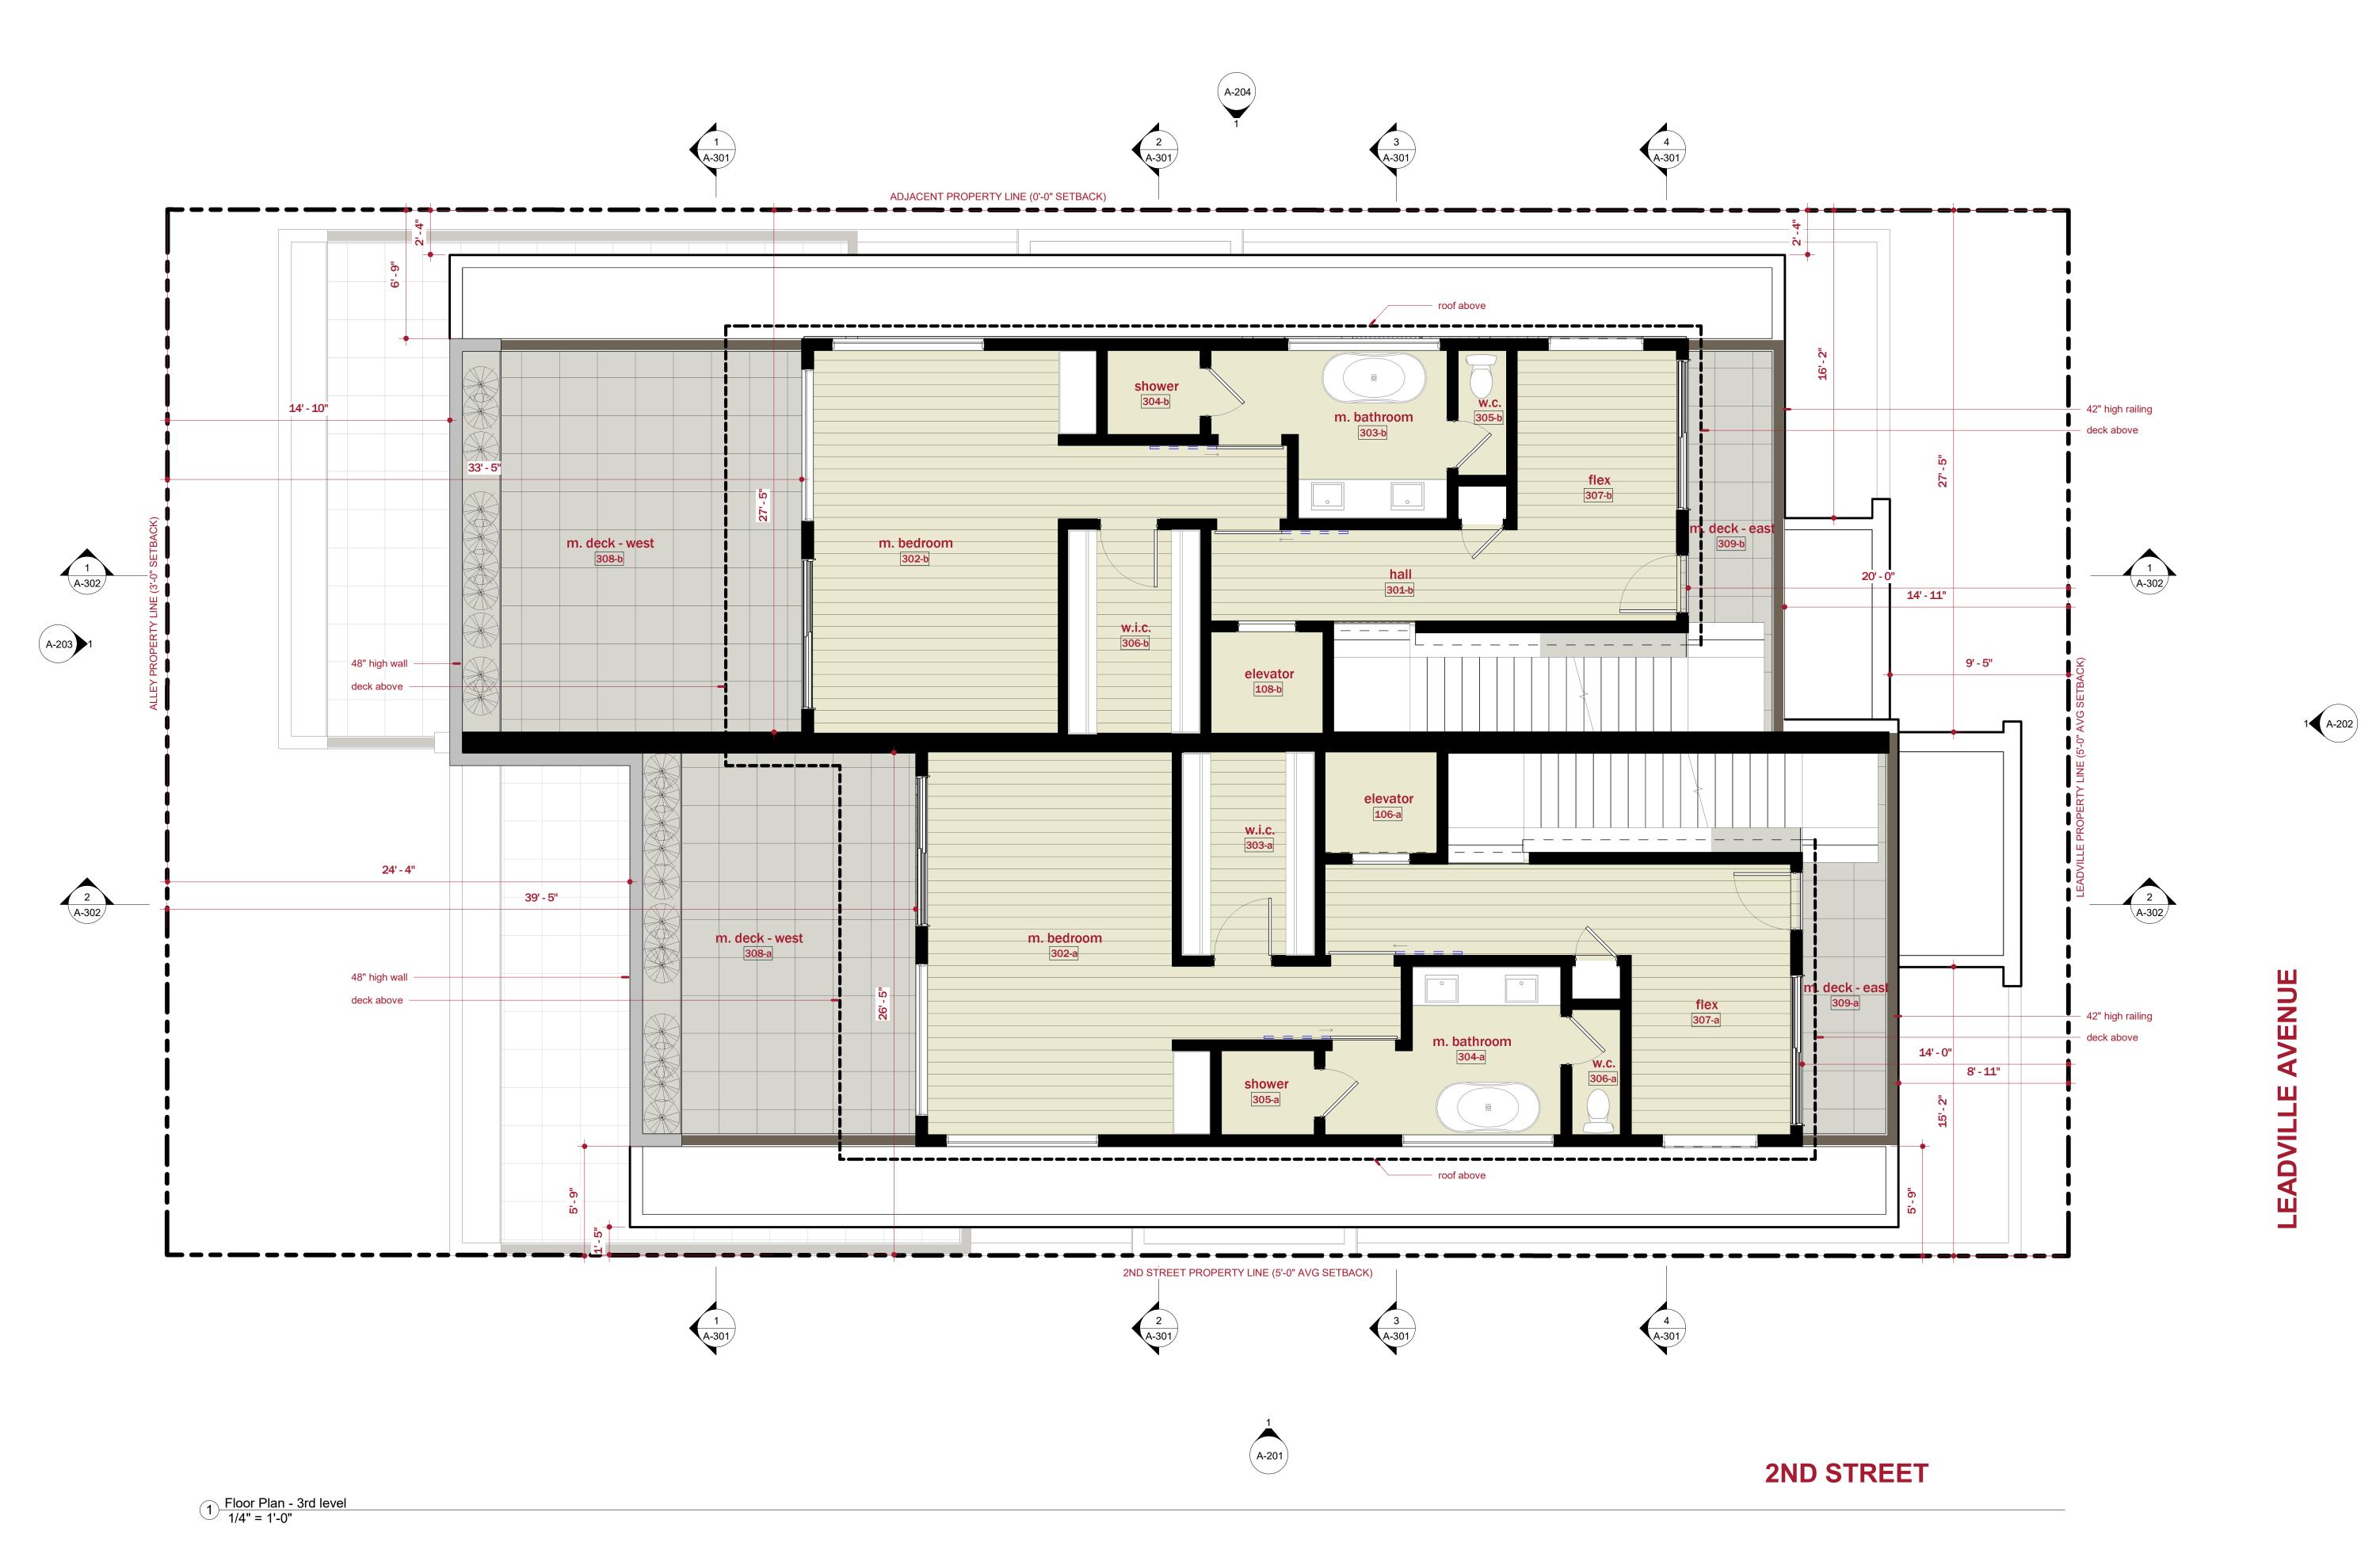

A-103

floor plan

190 Cranbrook Rd PO BOX 3204 Hailey Idaho 83333-3204 p 208.589.0771

PROJECT:


PROJECT NO

Leadville

Residences

Lot 5, Block 3, Ketchum Townsite

NOT FOR CONSTRUCTION

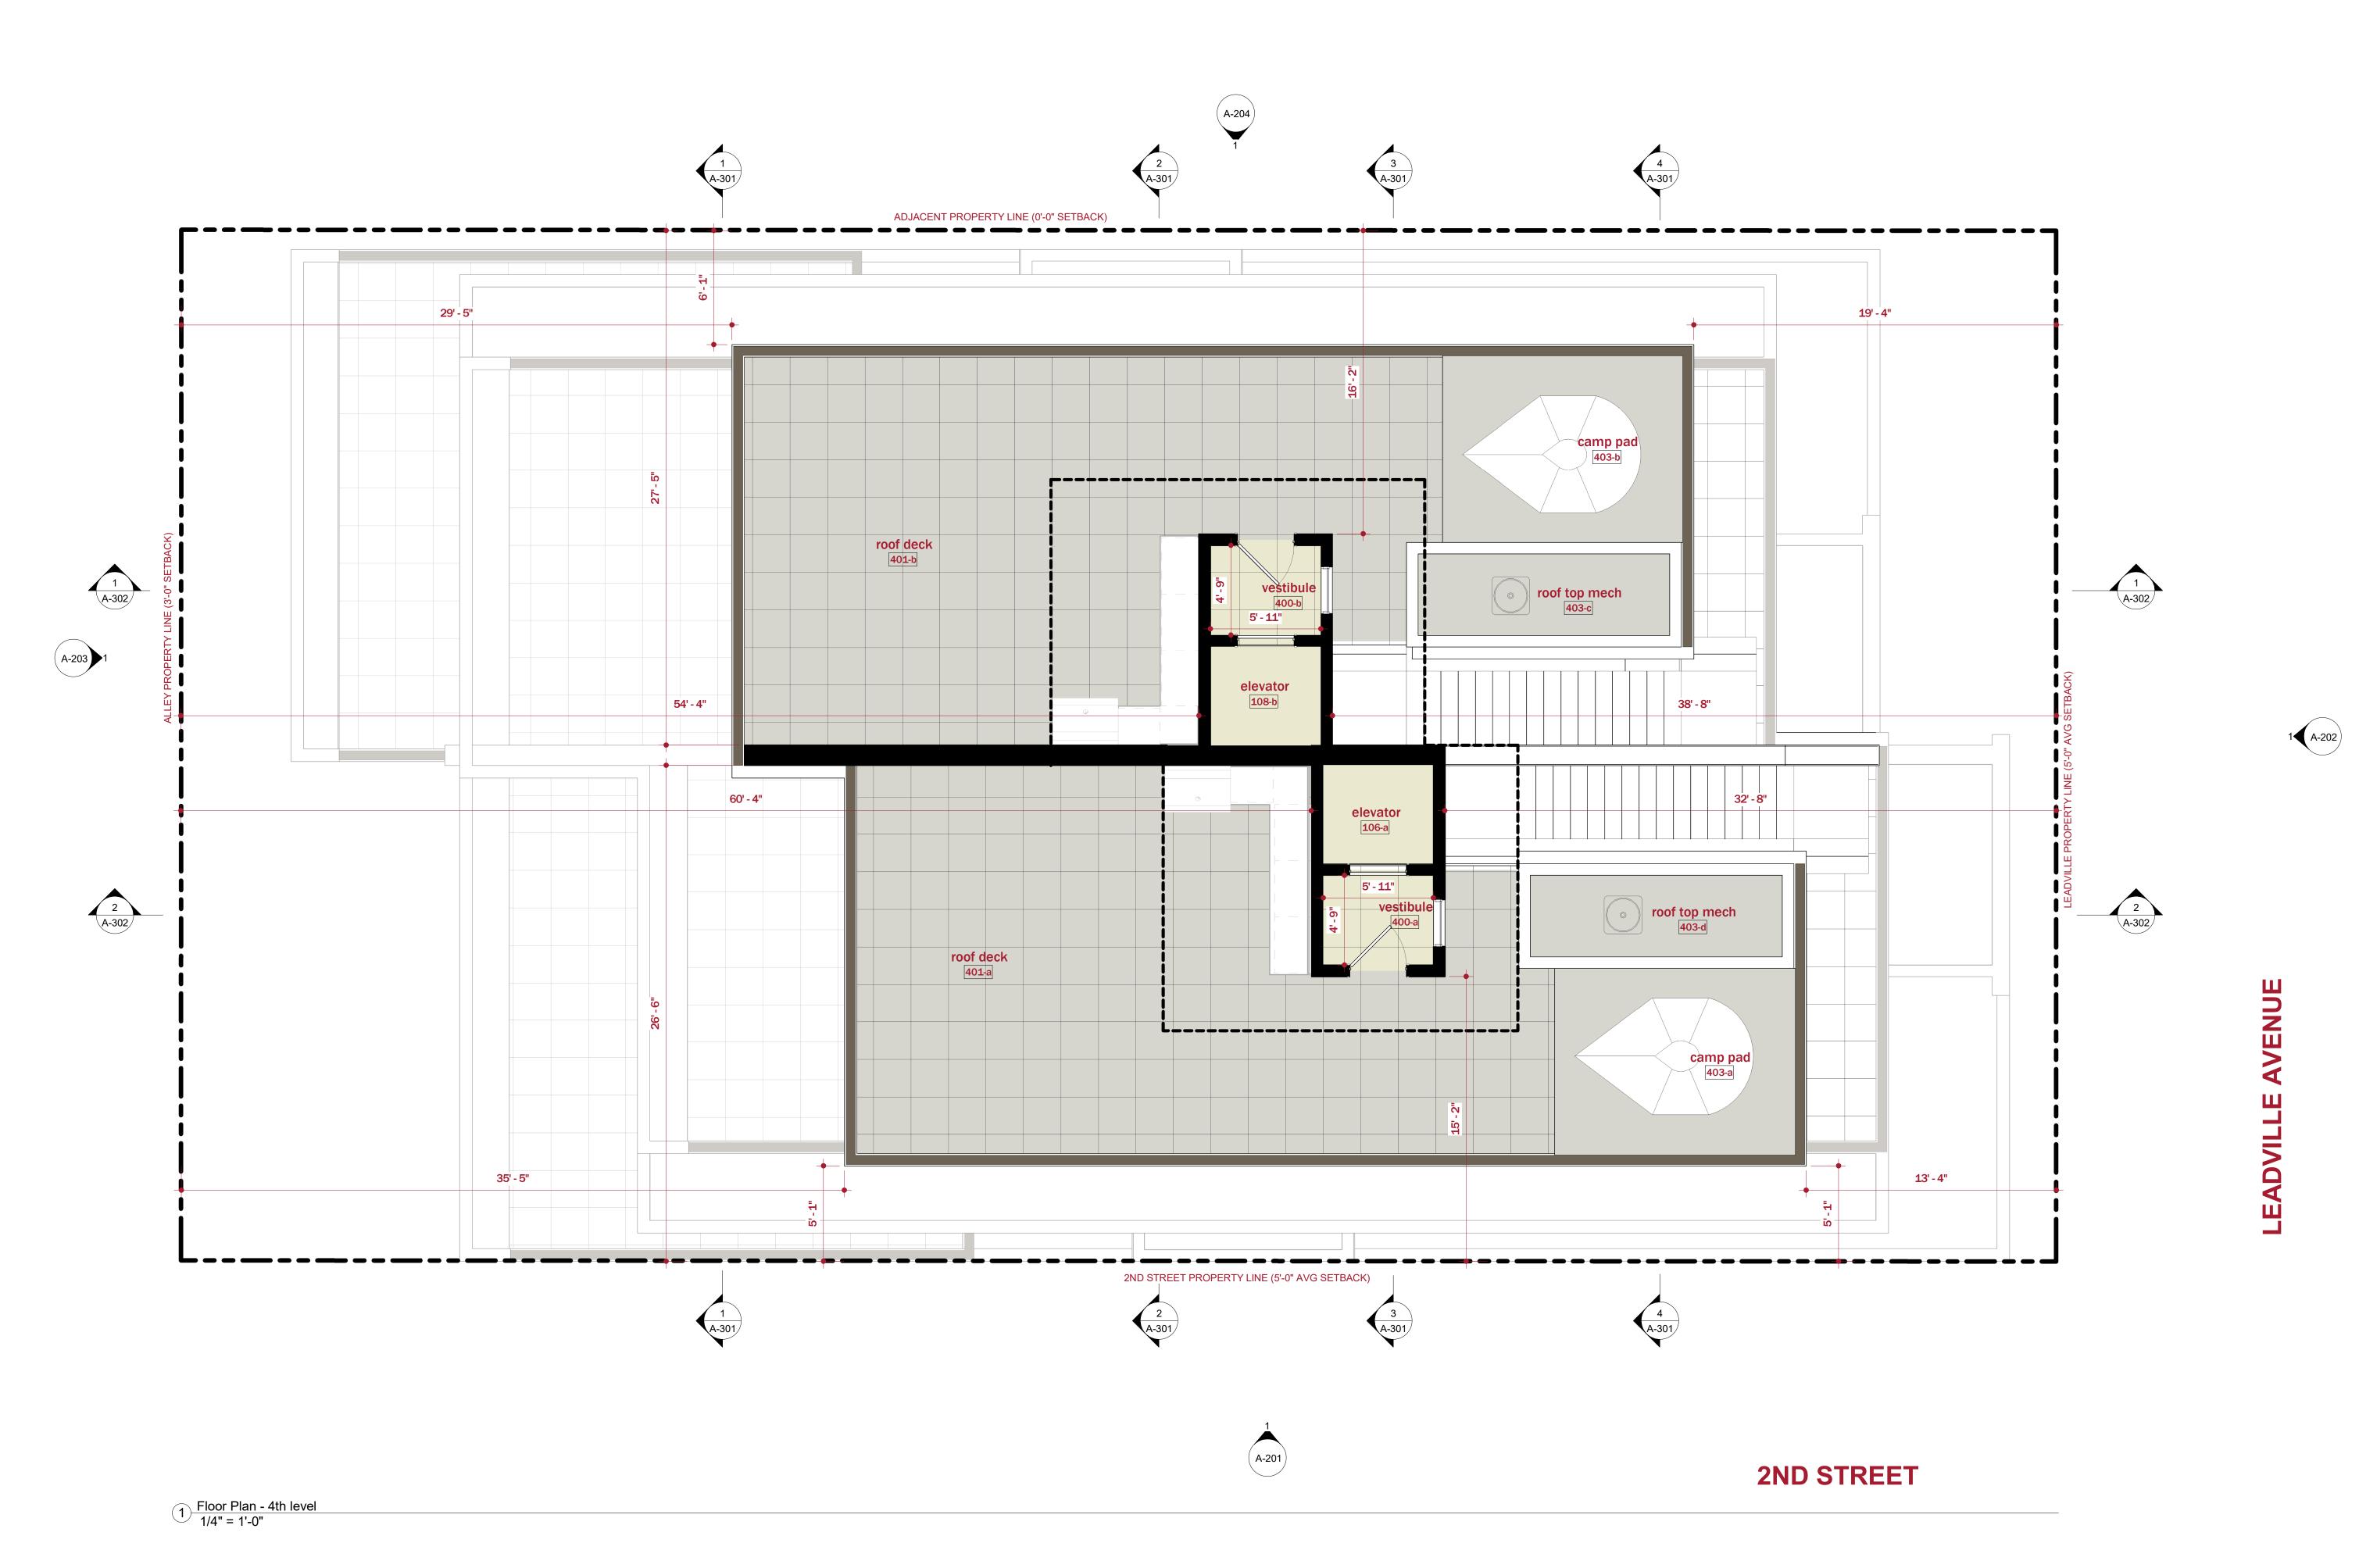

A-104

DRAWN BY: Author

floor plan

1/4" = 1'-0"


190 Cranbrook Rd PO BOX 3204 Hailey Idaho 83333-3204 p 208.589.0771

> PROJECT: Leadville


Residences

DATE: PROJECT NO

NOT FOR CONSTRUCTION

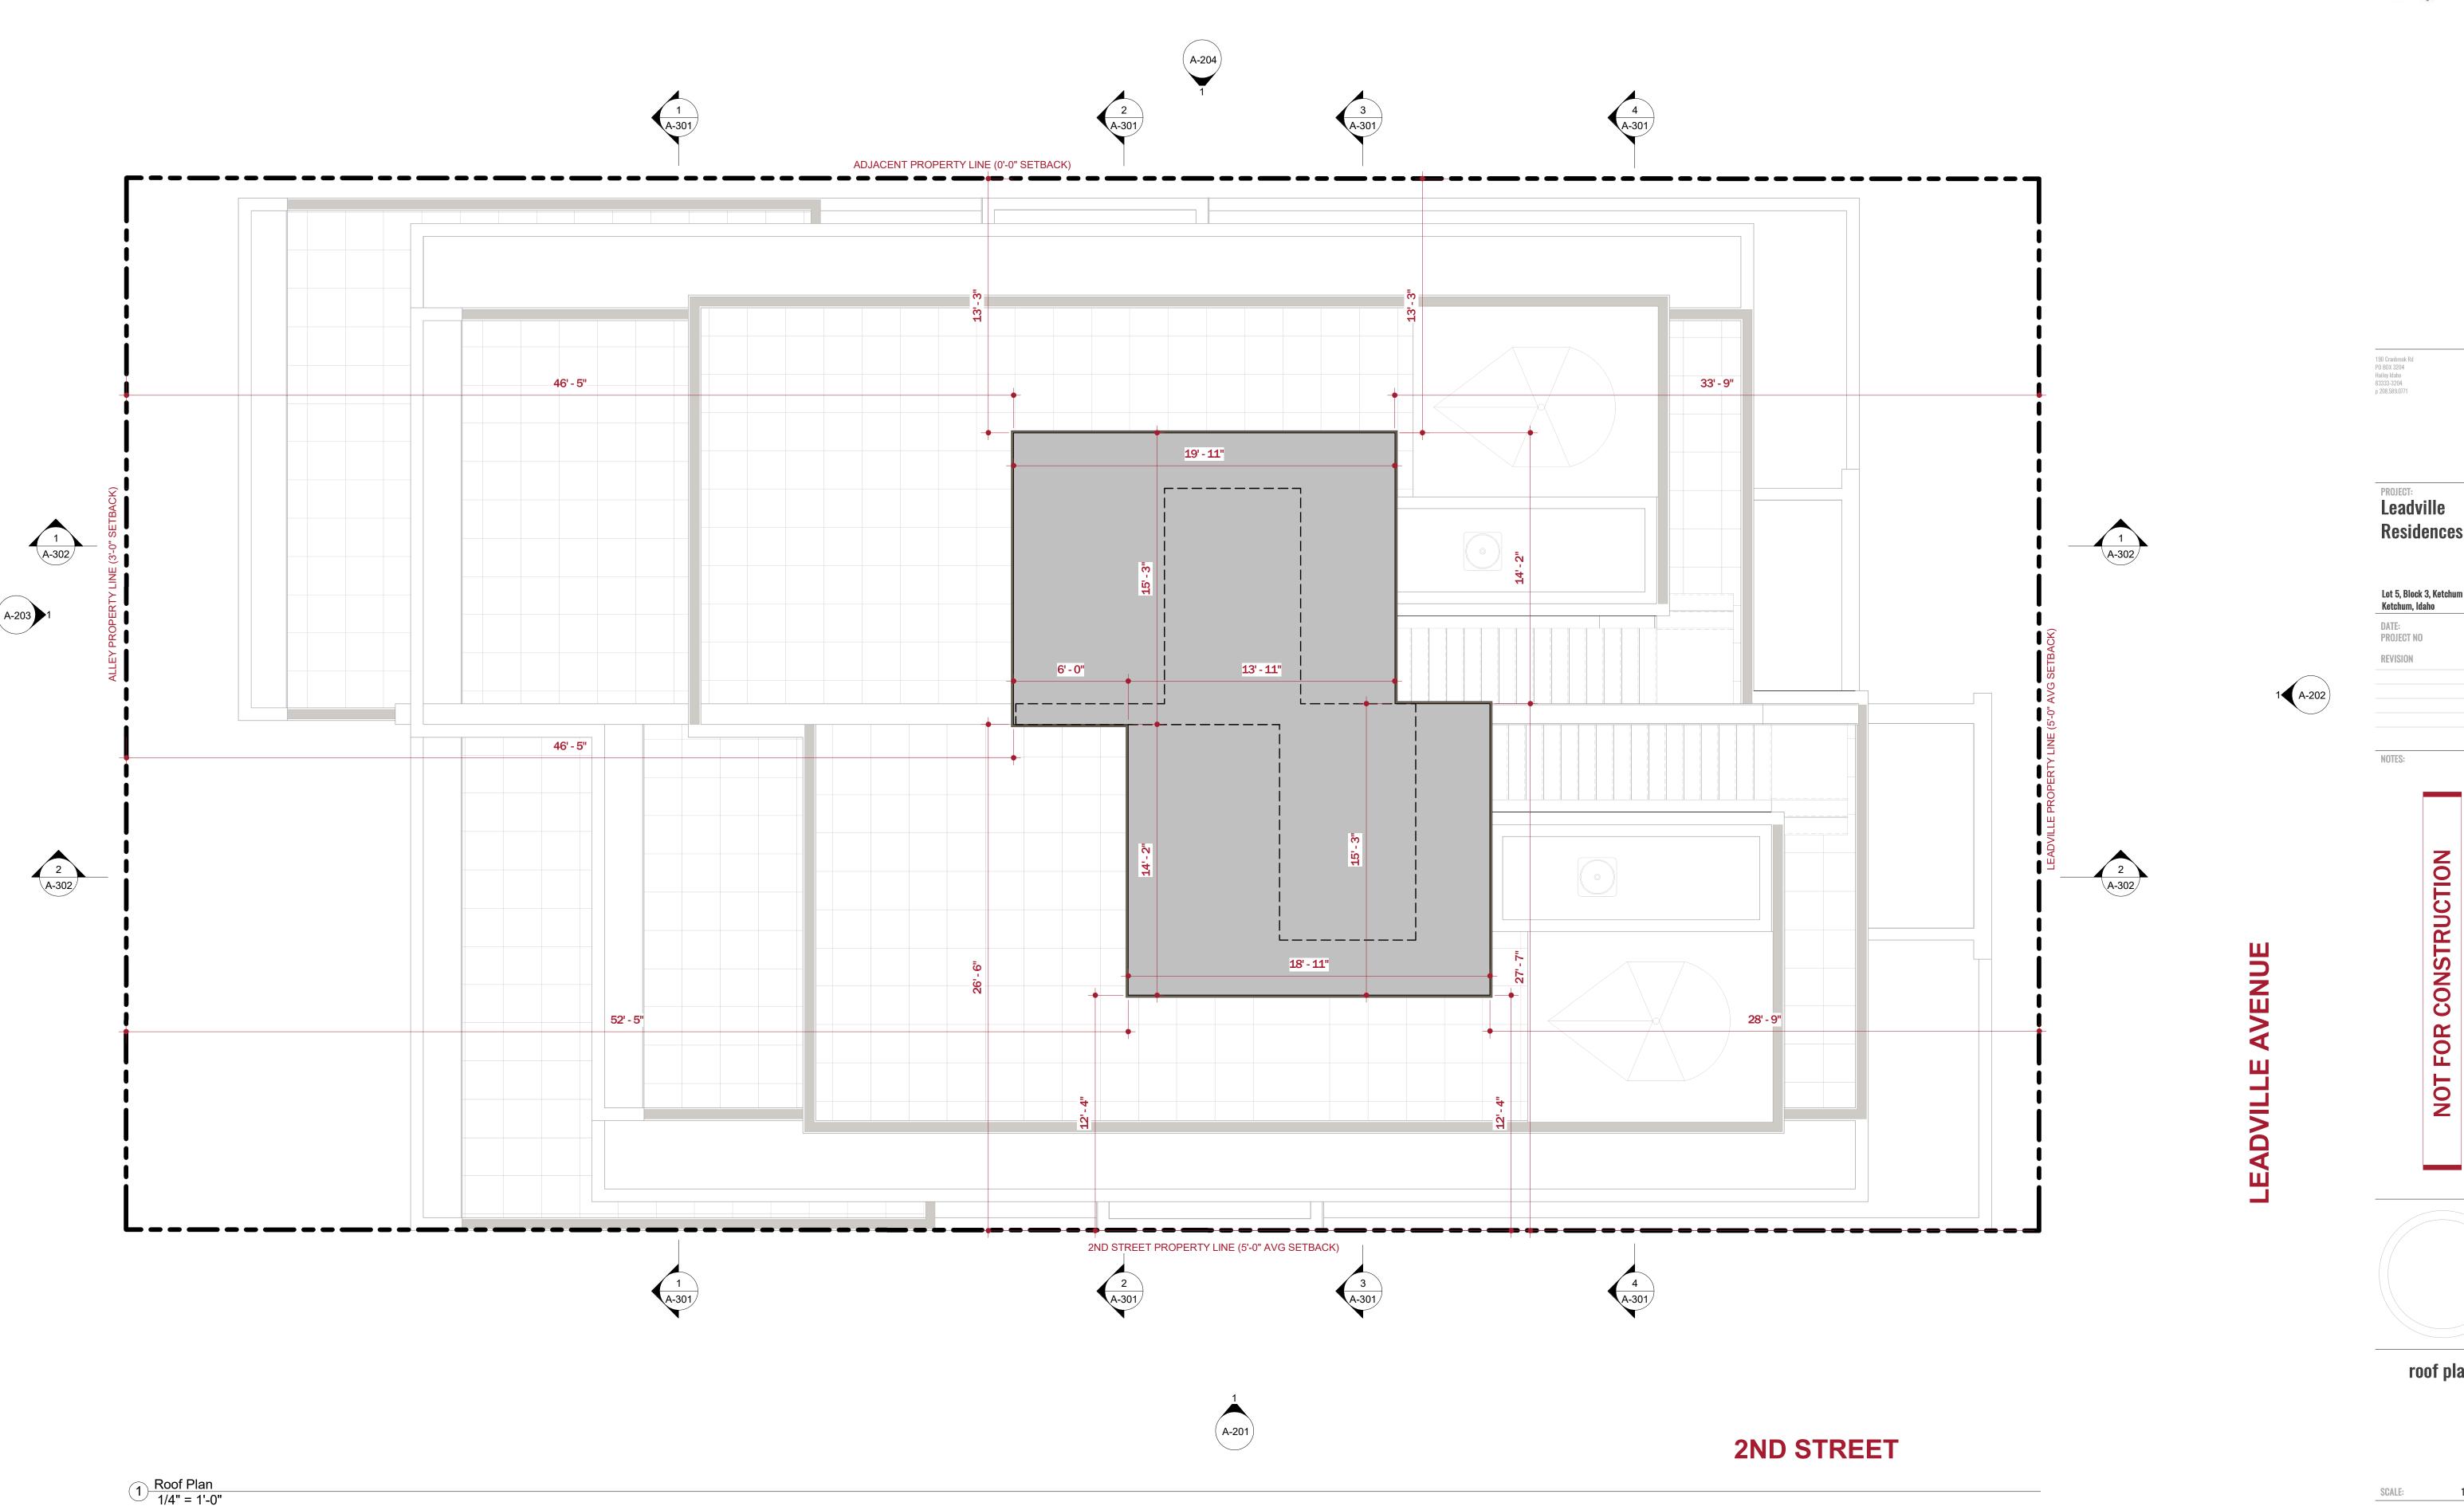



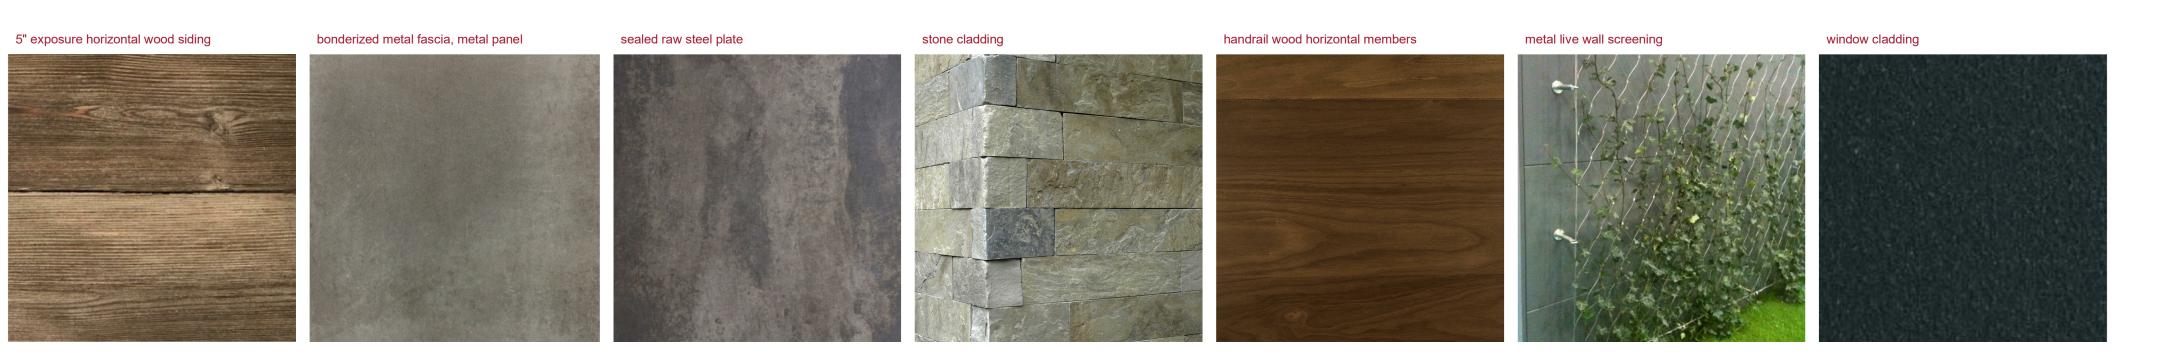

SCALE: As indicated

A-201

DRAWN BY:



DRAWN BY:

PROJECT: Leadville Residences Lot 5, Block 3, Ketchum Townsite Ketchum, Idaho DATE: Project no 10/19/20 REVISION NOT FOR CONSTRUCTION

elevations

DRAWN BY:

handrail wood horizontal members metal live wall screening window cladding



bonderized metal fascia, metal panel

5" exposure horizontal wood siding

sealed raw steel plate

stone cladding



SCALE: As indicated

A-204

DRAWN BY: Author


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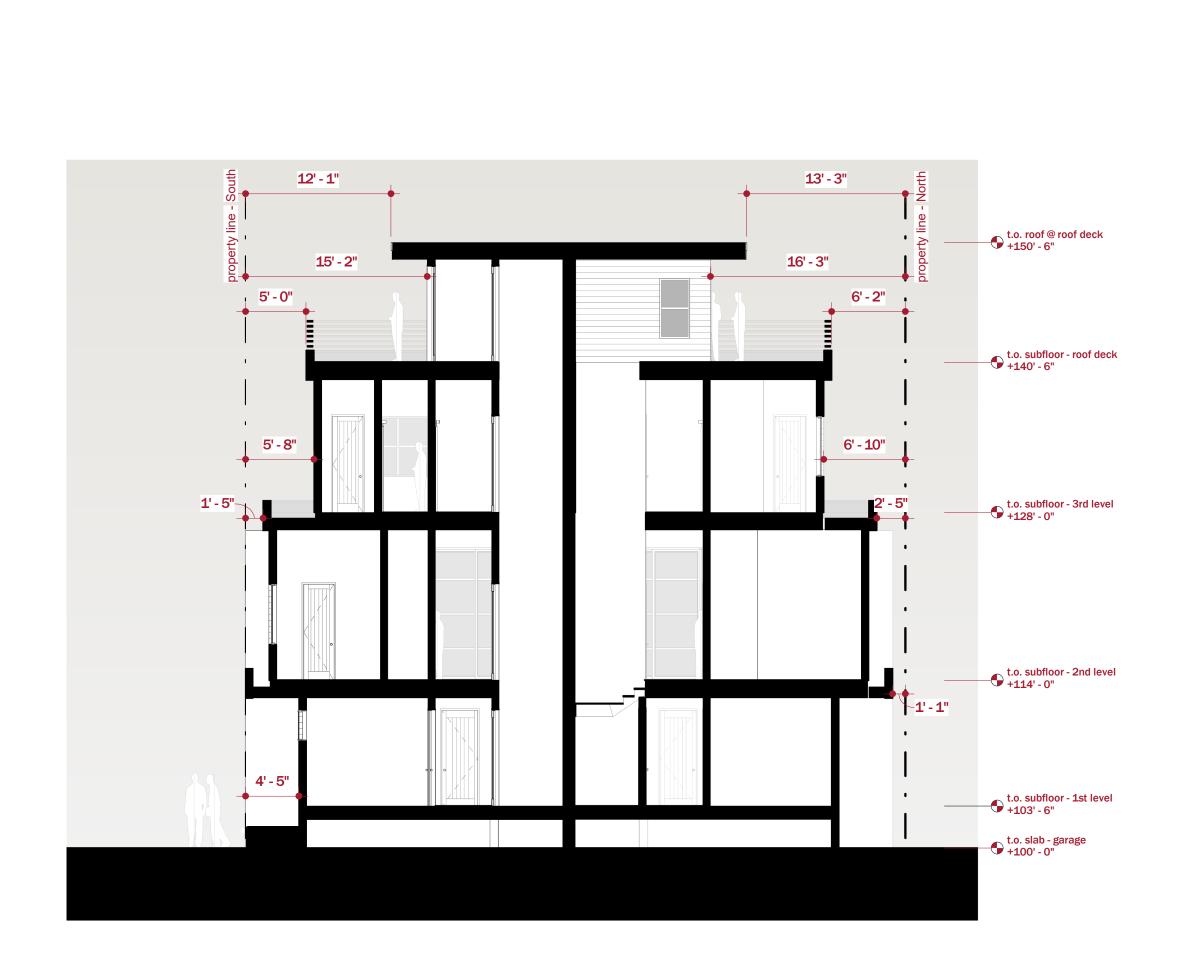
sections

DRAWN BY:

SCALE: 1/8" = 1'-0"

Author



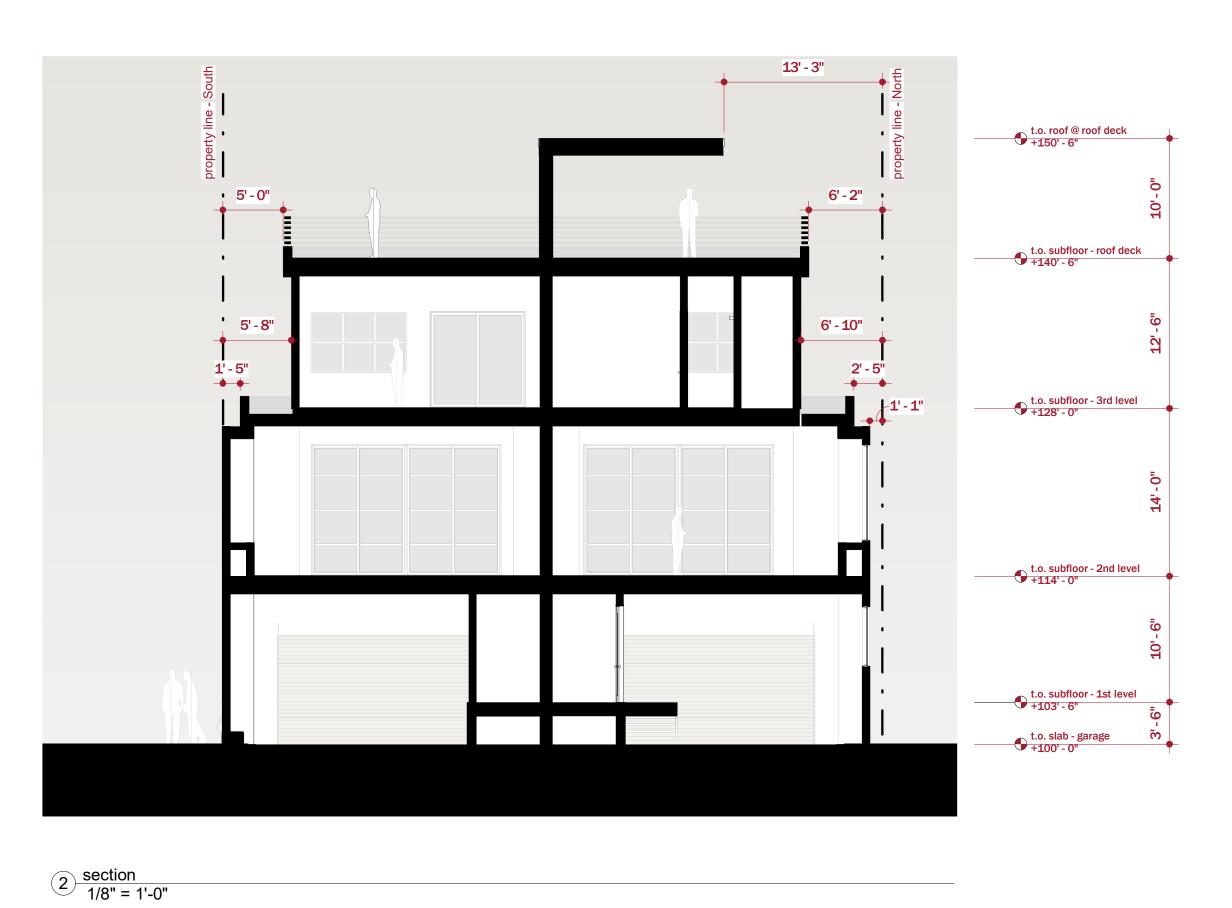

26' - 5"

26' - 6"

5' - 8"

1' - 5"

++

1'-8"

1 section 1/8" = 1'-0"

3 section 1/8" = 1'-0"

27' - 6"

6' - 10"

6' - 10"

t.o. roof @ roof deck +150' - 6"


t.o. subfloor - roof deck +140' - 6"

t.o. subfloor - 3rd level +128' - 0"

t.o. subfloor - 2nd level +114' - 0"

t.o. subfloor - 1st level +103' - 6"

t.o. slab - garage +100' - 0"

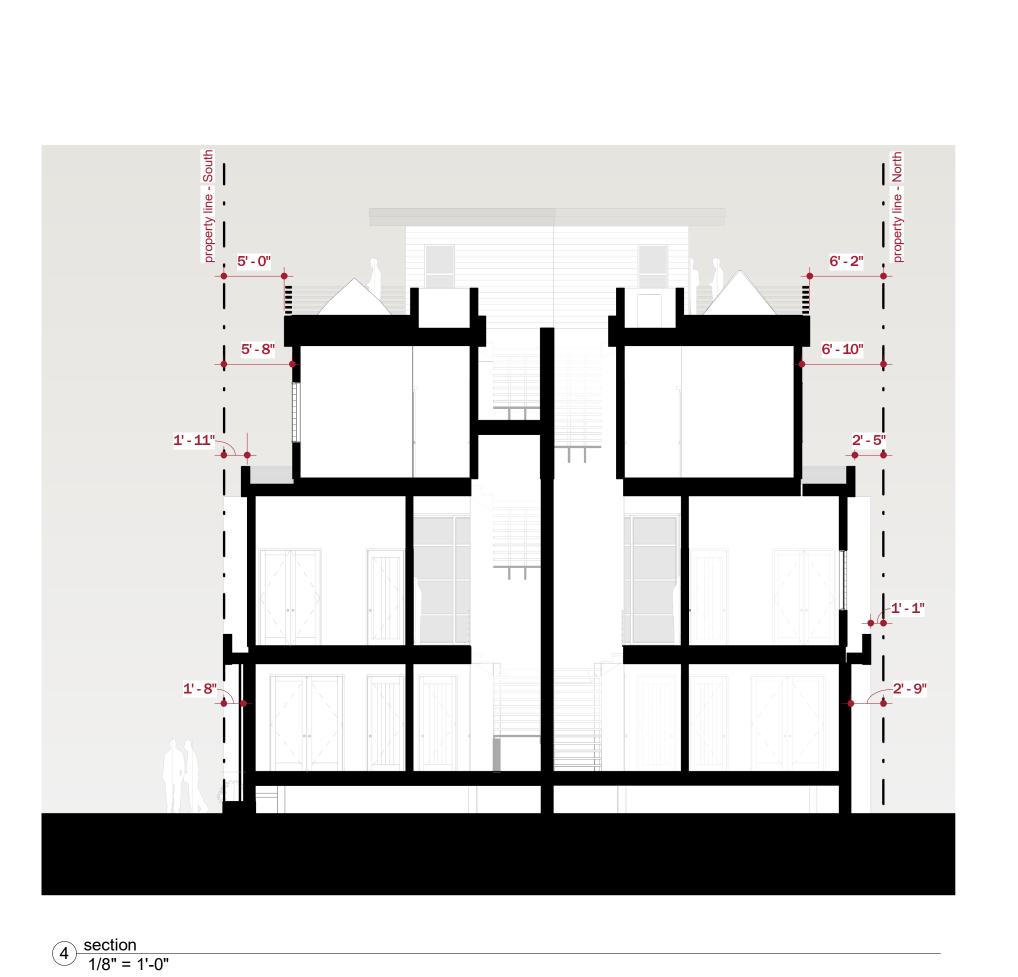

Lot 5, Block 3, Ketchum Townsite Ketchum, Idaho DATE: Project no 10/20/20 REVISION DATE

NOTES:

t.o. roof @ roof deck +150' - 6"


t.o. subfloor - roof deck +140' - 6"

t.o. subfloor - 3rd level +128' - 0"

t.o. subfloor - 2nd level +114' - 0"

t.o. subfloor - 1st level +103' - 6"

NOT FOR CONSTRUCTION

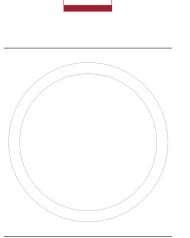


1/8" = 1'-0"

sections

SCALE:

DRAWN BY:

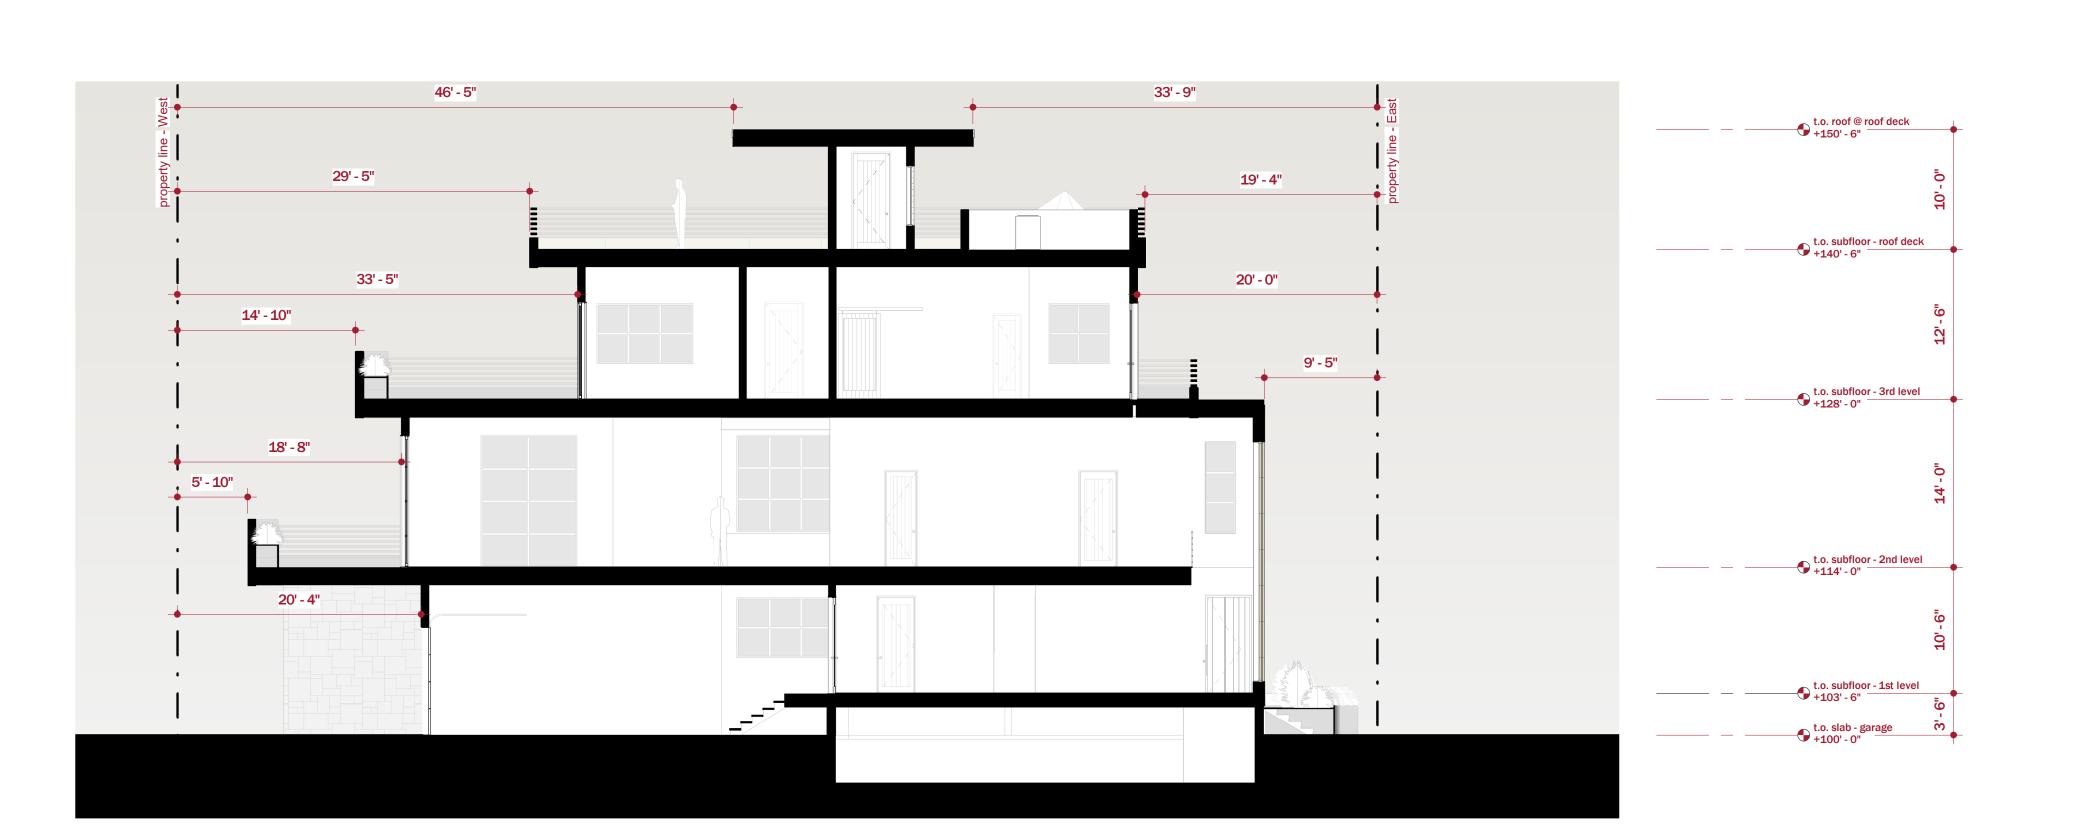



1 section 1/8" = 1'-0"

2 section 1/8" = 1'-0"



# Leadville Townhome Residences 2<sup>nd</sup> & Leadville

# City of Ketchum Construction Activity Plan – Design Review

#### **Construction Activities Project Overview**

The Leadville Townhome Residences consists of (2)  $\sim$  3500 SF single family residences in downtown Ketchum. General Contractor's site management representatives will be onsite for the duration of the project working from an onsite office located at the property. Proactive planning will be a paramount management tactic to minimize public impact while strictly following all City of Ketchum construction activity requirements.

#### **Public Safety and Site Security**

#### **Public Safety**

- <u>Traffic Control</u>: intermittent traffic control will be used to safely enter and exit the site throughout the project. No traffic revisions will be used during construction, TURP permits will be specifically submitted for ROW disturbance.
- <u>Sidewalks and ROW Parking Stalls:</u> The sidewalks and parking around the site will be closed for
  the duration of the project to ensure the fastest possible construction period and to protect
  right of way safety. Signage per the attached site markups will direct pedestrian traffic away
  from the site to adjacent sidewalk access. A full signage plan will be coordinated with Ketchum
  Streets Department and a formal plan from Road Work ahead will be submitted at time of
  building permit application.
  - ROW Parking Stalls closed for 12 14 month construction duration: 8 Total (4 on Leadville and 4 on 2<sup>nd</sup> Ave)
- OSHA Compliance: The construction activities will maintain, at minimum, full OSHA compliance; bi-monthly safety consultant audits will be ongoing throughout the duration of the project. All potential infractions in OSHA safety standards will be published to all trades and corrected immediately following safety consultant review. Proactive planning will be the site management focus on all safety matters.
- <u>Site Protection and Security:</u> The entire site will have 6' chain link fence protection to ensure public safety along with project personnel safety.
  - West Property Line (PL): The west property line at alley will be fenced with a privacy screen.
  - South PL: The south property line will also be fenced with privacy screen
  - East PL: The east site boundary is adjacent to Leadville will be fenced closing sidewalk and 3 parking stalls for the duration of project with Privacy screen up to the temporary stop sign section. No privacy screen will be placed on the fence at the corner of the project to create highest visibility for vehicular traffic through fencing.
  - North PL: The north property line is adjacent to Vintage Restaurant and will have 6' Construction fencing separating the two properties.

#### **Operating Procedures, Hours and (Approximate) Schedule Milestones**

#### **Operating Procedures:**

- General Contractor will have full time representative(s) onsite through the duration of the
  project. Site representatives will be onsite at all hours of operation when work is being
  conducted by trade personnel. GC site management personnel will coordinate, direct and hold
  all companies accountable for the City of Ketchum building standards and the approved CM Plan
  specific requirements.
- Each Trade Partner will receive a Construction Management Plan in their contract agreement documents. This ensures that all required CM Plan requirements are adopted by trade partner(s) project planning and execution.
- Hours of Operation: 7:30AM 7:00PM, except Saturdays and Sundays (Project will follow City of Ketchum Standards for weekend work)
- Job Site Office(s)/Dumpsters/Temp Toilets
  - o Job site office: Will be Located inside site fencing, see attachments.
  - Dumpsters: One 6 yard dumpsters will initially be onsite and will be accessed by Clear
     Creek Disposal via the construction access gates.
  - Temporary Toilets: The amount of toilets needed throughout the project will fluctuate.
     The toilets will be staged within the fenced staging area. 2 to 4 toilets with bi-weekly cleanings will be needed at the height of construction activities.

#### **Schedule Milestones:**

Breakground: Spring of 2021

Excavation/Utilities: April 2021

Cut: 655 CYDSFill: 300 CYDS

• Overhead power line to be undergrounded: May 2021

Below Grade Concrete: June 2021

Wood and Steel Structure: July – September 2021

Roof Dry-In: September 2021

• MEP Rough-in: September – November 2021

• Interiors: November 2021 – March 2022

Site Improvements: April - May 2022

Landscaping: June 2022

#### **Construction Mitigation Procedures:**

- Air Quality from Construction Activities
  - Dust Mitigation: During the excavation scopes of work all dust will be consistently sprayed down with water to ensure no excessive airborne particles are exposed to the general public and surrounding properties.
  - Noise: The site will abide by all City of Ketchum noise standards throughout the project.
     Additionally, no loud music will be allowed onsite, compressors and other loud equipment will be turned off each evening.
- Street Maintenance
  - o GC will provide regular street cleaning to ensure no site debris is tracked into public right of ways. Additionally, trucks leaving the site will be inspected and cleaned if dirty.

#### Site Maintenance

o GC will provide general labor and site coordination dedicated to keeping site clean and safe throughout the duration of the project.

#### **Truck Route:**

See attached trucking map for visual aid. The majority of trucking activities for the project will be limited to the initial demolition, excavation, concrete, steel and backfill phases, with ongoing "just in time" deliveries. The heaviest concentration being in the initial excavation/Concrete phase, lasting approximately 3-4 months. Backfill will be a short duration with periodic truck activity. During the concrete phase there will be established milestone days for placement of concrete and TURP permits will be submitted for any road closures or traffic alterations.

#### Hoisting:

Mobile cranes will be used through out the duration of the project and will primarily be set up and operated inside the fence boundaries of the project. Any crane set up and activity outside the construction fencing shown on attachments will be submitted for approval using the TURP permit application.

#### Parking:

All parking for the site personnel will be concentrated in the City of Ketchum's surface parking lot located on Washington and 1<sup>st</sup> Ave West. The project will be requesting the use of approximately 10 paid stalls for the duration of the project (approx. 12 -14 months). There will also be onsite parking in the staging area for work trucks needed to complete certain scopes of work. Additional offsite parking will be addressed with leased parking agreement.

#### Site Laydown yard and Staging:

A "just in time" delivery staging area has been identified for the site, the intention is to proactively plan all materials needed for the project and only deliver at the time needed to be installed. The project will utilize all staging within the fenced project. If additional staging/parking is needed we will rent a lot and provide a traffic plan to and from this location.


#### TURP:

All temporary use of right-of-way's outside the CM Plan initial ROW request will be submitted for formal request and approval. A site-specific traffic control plan will accompany formal permit requests. The City of Ketchum Public Works TURP Application guidelines will be followed for all requests.

#### **Construction Management Site Responsibility Matrix**

	General	Finish	PE	PM	Site Coordinator –	Contracted Trade
	Superintendent	Superintendent			General Labor	
Public Safety	X – Primary	Χ	Χ	Χ	X	X
Traffic Control	X					Trade Partner's
OHSA	Х	Х	Χ	Χ	Х	Х
Compliance						
Site Protection	X	X			X	
Security	Х	Х			Х	
Site Operations	X – Primary	Χ			Х	
Schedule	Х			Χ		
Construction	Х	Х			Х	X
Mitigation						

Trucking	Х				Х	X
Parking	Χ	X			X	X
TURP	Х			Х		
Public Notice	Х		Χ	Х		
Jobsite Office(s)	Х	Х	Х		Х	
Temp Toilets	Х				Х	Clear Creek Disposal
Dumpsters	Х				X	Clear Creek Disposal

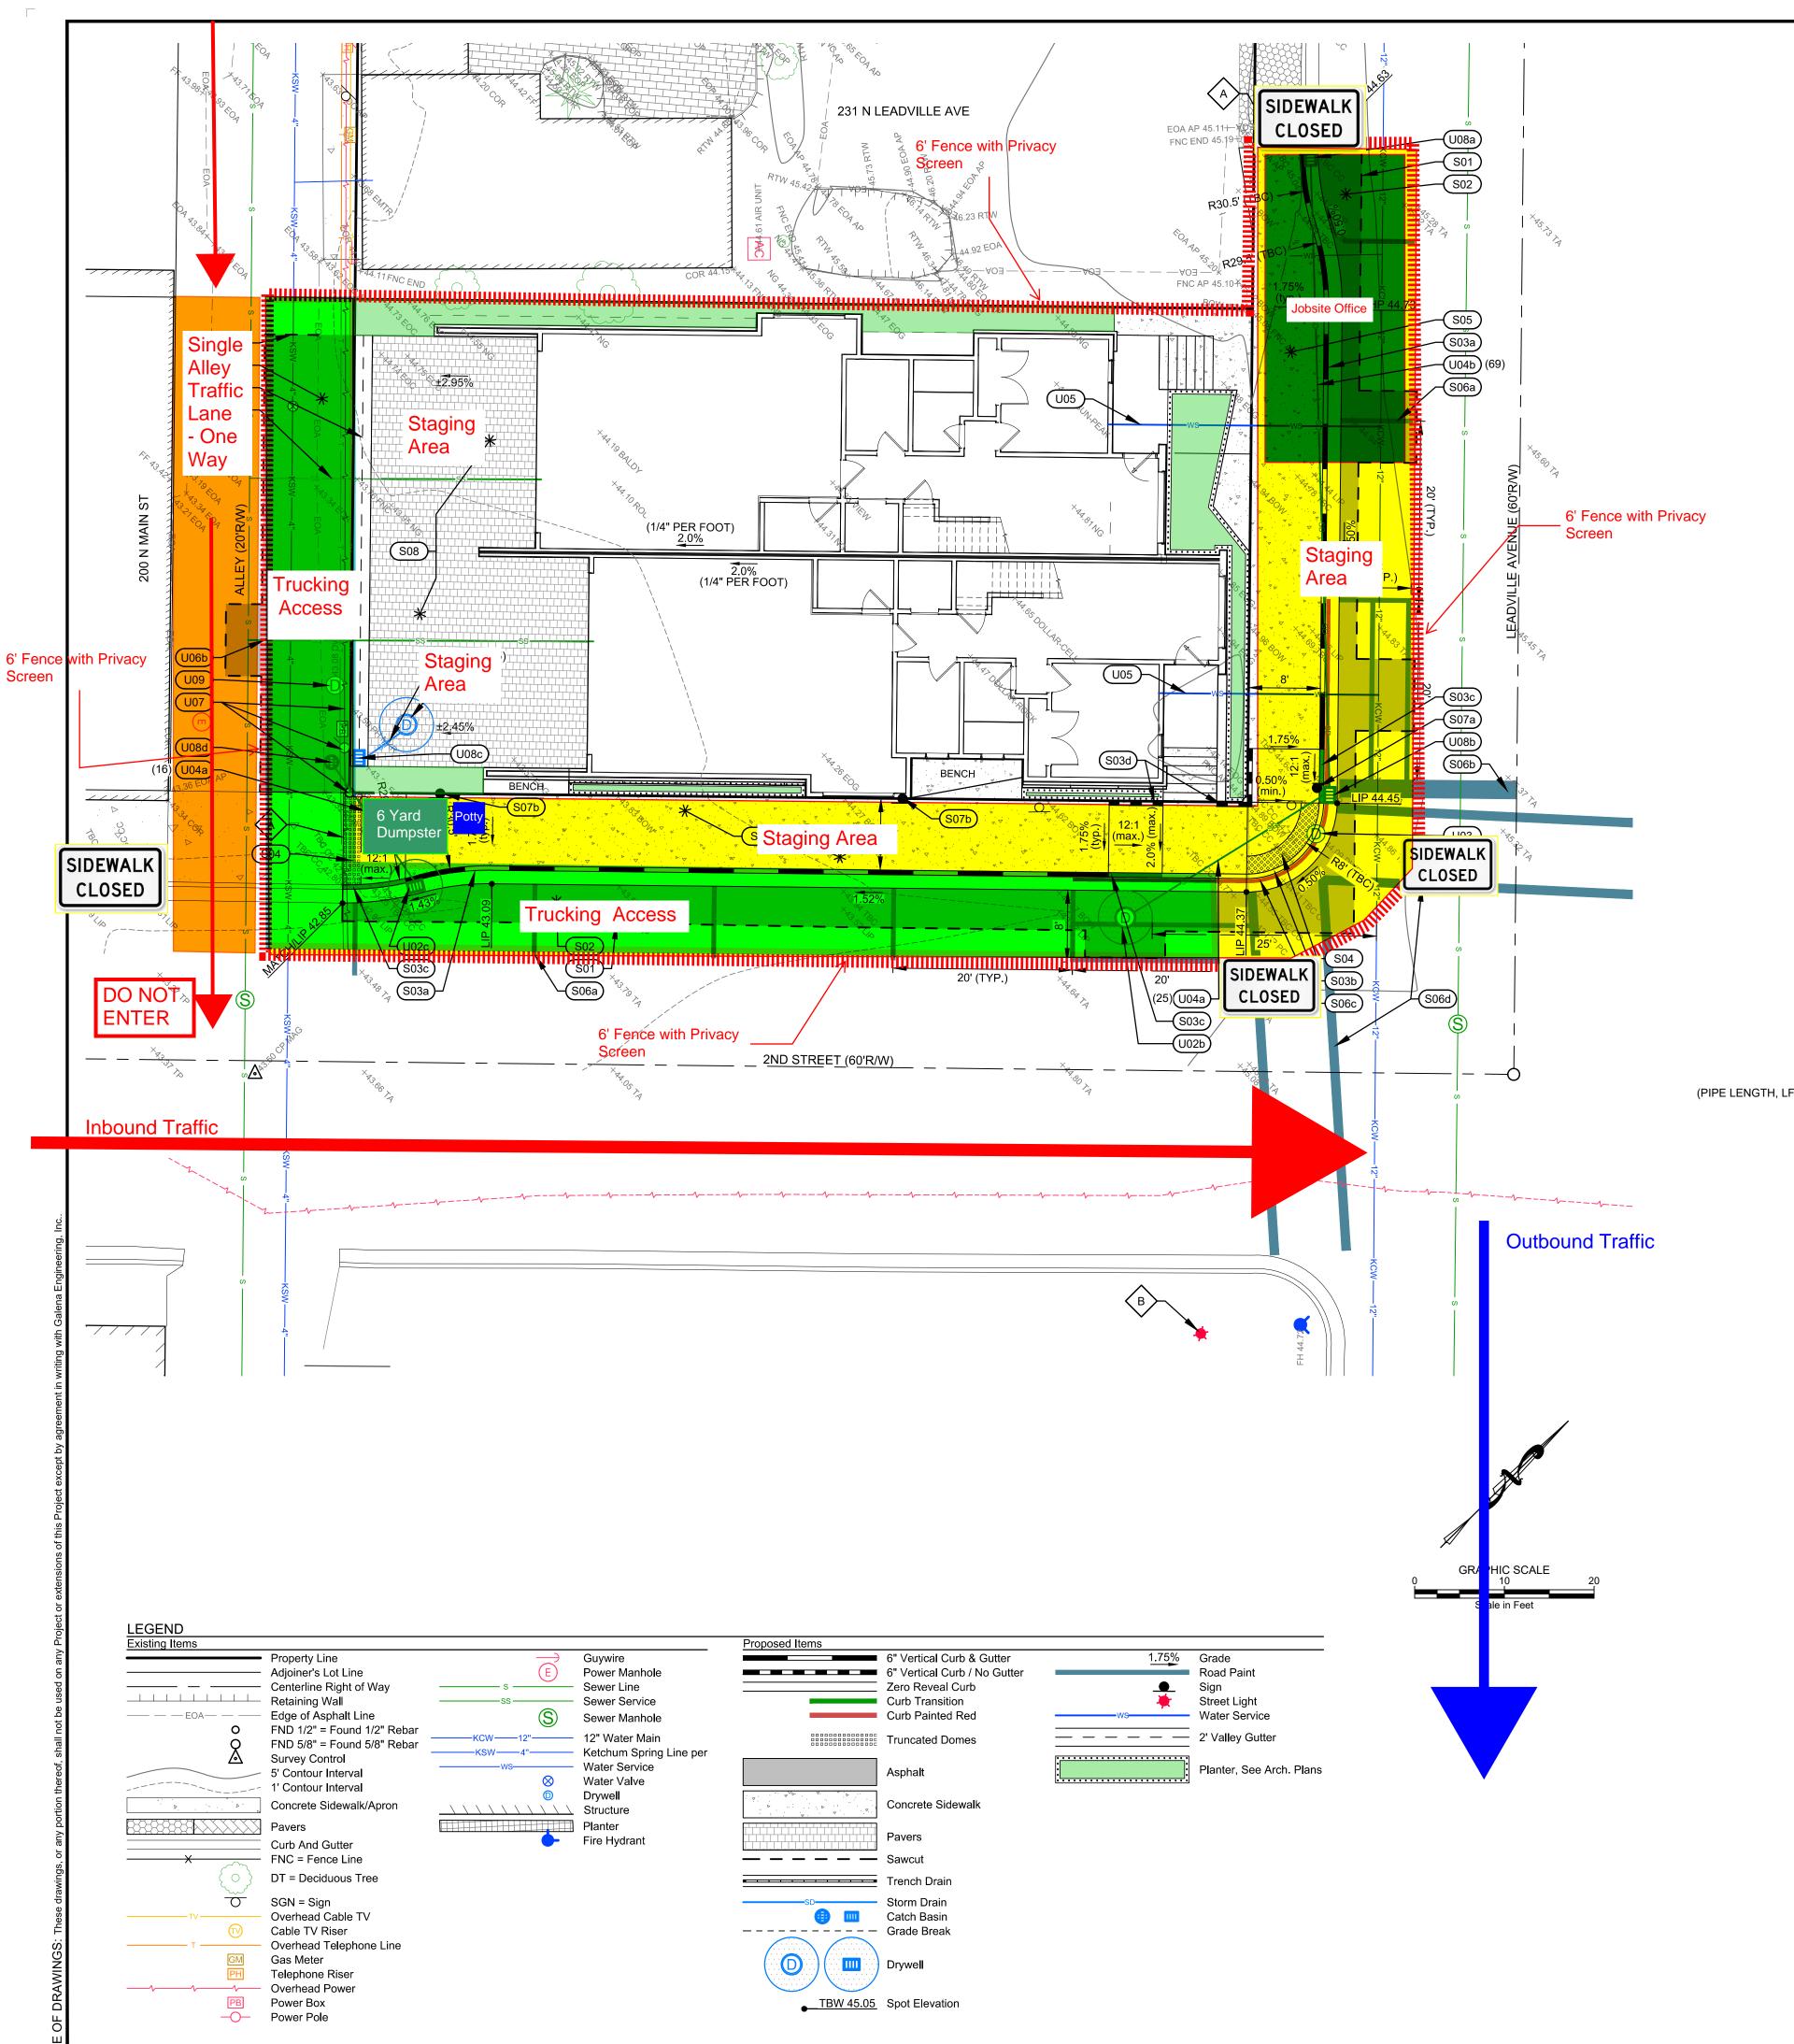

#### **CONSTRUCTION KEYNOTES**

#### SITE IMPROVEMENTS

Sawcut existing asphalt to provide for a clean vertical edge.

CONSTRUCT/ REPAIR ASPHALT . SEE DETAIL 1, SHEET C2.0.

# S03 CONSTRUCT CONCRETE CURB

- a. 6" CONCRETE VERTICAL CURB AND GUTTER PER DETAIL 2,
- b. ZERO REVEAL CURB AND GUTTER PER DETAIL 3, SHEET C2.0.
- c. CURB TRANSITION PER DETAIL 3, SHEET C2.0.
- d. 6" CONCRETE VERTICAL CURB PER DETAIL 4, SHEET C2.0.
- e. 2' WIDE CONCRETE VALLEY GUTTER PER DETAIL 11, SHEET
- INSTALL TRUNCATED DOME DETECTABLE WARNING INSERT. SEE DETAIL 9, SHEET C2.0.
- (S05) CONSTRUCT CONCRETE SIDEWALK. WIDTH AS SHOWN HEREON. SEE DETAIL 5, SHEET C2.0.
- S06 INSTALL PAVEMENT MARKINGS PER CITY OF KETCHUM STANDARDS a. 4" WIDE YELLOW PARKING STRIPE
  - b. 24" WIDE WHITE STOP BAR

a. RELOCATE STOP/STREET SIGN.

- c. NO PARKING ZONE (RED CURB)
- d. WHITE CROSSWALK STRIPING (MATCH CITY PATTERNS)
- (S07) INSTALL SIGNS. CITY WILL PROVIDE SIGN BASES. SEE DETAIL 9, SHEET C2.0 FOR SIGN BASE DETAIL.
  - b. REGULATORY SIGN. COORDINATE TYPE AND FINAL LOCATION WITH CITY OF KETCHUM.
- (S08) INSTALL PAVERS PER ARCHITECTURAL PLANS.

MATCH EXISTING LINES AND GRADES

PROPOSED STREET LIGHT LOCATION PER KETCHUM SIDEWALK B IMPROVEMENT PLAN Q1-2 (NOT CONSTRUCTED)

#### UTILITY IMPROVEMENTS

TRENCH DRAIN WITH HEAT TAPE. SEE LANDSCAPE ARCHITECT DRAWINGS FOR DETAIL. INSTALL PER MANUFACTURERS SPECIFICATIONS.

- (U02) INSTALL DRYWELL PER DETAIL 12, SHEET C2.0. a. RIM ELEV = TBD (SOLID LID)
- CONNECT ROOF DRAINS PER ARCH. I.E. (IN) = TBD
- b. RIM ELEV = TBD (SOLID LID)
- IE (IN) = TBD c. RIM ELEV = TBD (RECTANGULAR GRATE)
- IE(IN) = TBD
- (U03) REMOVE AND DISPOSE OF DRYWELL.

(PIPE LENGTH, LF) U04 INSTALL STORM DRAIN

a. 12"Ø D3034 PVC PIPE @ S=2.0% MIN. 3.0' MINIMUM COVER. b. 12" WATER QUALITY PIPE @ S=2.0% MIN. 3.0' MINIMUM COVER.

(U05) INSTALL NEW 1" WATER SERVICE.

- a. RETAIN, PROTECT, UTILIZE EXISTING 4"Ø SEWER SERVICE.
- b. INSTALL NEW 4"Ø PVC SEWER SERVICE.
- (U07) RELOCATE DRY UTILITIES PER ARCHITECTURAL PLANS.
- (U08) INSTALL CATCH BASIN PER DETAIL 7, SHEET C2.0.
- a. RIM ELEV = TBD (RECTANGULAR GRATE) I.E. (OUT) = TBD
- b. RIM ELEV = TBD (RECTANGULAR GRATE) IE(IN) = TBD
- IE (OUT) = TBD
- c. RIM ELEV = TBD (RECTANGULAR GRATE) IE (OUT) = TBD
- d. RIM ELEV = TBD (CIRCULAR GRATE) I.E. (OUT) = TBD
- (U09) REMOVE AND DISPOSE OF DRYWELL.

#### **CONSTRUCTION NOTES**

- 1. ALL CONSTRUCTION SHALL BE IN CONFORMANCE WITH THE MOST CURRENT EDITION OF THE "IDAHO REGULATIONS FOR PUBLIC DRINKING WATER SYSTEMS," THE CURRENT EDITION OF THE "IDAHO STANDARDS FOR PUBLIC WORKS CONSTRUCTION" (ISPWC), AND CITY OF KETCHUM STANDARDS. THE CONTRACTOR SHALL BE RESPONSIBLE FOR OBTAINING AND KEEPING A COPY OF THE ISPWC ON SITE DURING CONSTRUCTION.
- 2. THE LOCATION OF EXISTING UNDERGROUND UTILITIES ARE SHOWN ON THE PLANS IN AN APPROXIMATE WAY. THE CONTRACTOR SHALL BE RESPONSIBLE FOR LOCATING EXISTING UTILITIES PRIOR TO COMMENCING AND DURING THE CONSTRUCTION. THE CONTRACTOR AGREES TO BE FULLY RESPONSIBLE FOR ANY AND ALL DAMAGES WHICH RESULT FROM HIS FAILURE TO ACCURATELY LOCATE AND PRESERVE ANY AND ALL UNDERGROUND UTILITIES. CONTRACTOR SHALL CALL DIGLINE (1-800-342-1585) TO LOCATE ALL EXISTING UNDERGROUND UTILITIES.
- 3. THE CONTRACTOR SHALL CLEAN UP THE SITE AFTER CONSTRUCTION SO THAT IT IS IN A CONDITION EQUAL TO OR BETTER THAN THAT WHICH EXISTED PRIOR TO CONSTRUCTION, INCLUDING BUT NOT LIMITED TO, EPA'S NPDES CONSTRUCTION GENERAL PERMIT.
- 4. THE CONTRACTOR SHALL OBTAIN ALL NECESSARY PERMITS PRIOR TO CONSTRUCTION.
- 5. CONSTRUCTION OF WATER MAINS AND ALL OTHER RELATED APPURTENANCES SHALL BE IN ACCORDANCE WITH THE IDAHO STANDARDS FOR PUBLIC WORKS CONSTRUCTION (ISPWC), IDAPA 58.01.08, IDAHO RULES FOR PUBLIC DRINKING WATER SYSTEMS AND THE CITY OF KETCHUM UTILITIES DEPARTMENT STANDARDS.
- CONTRACTOR SHALL PRESSURE TEST, DISINFECT, AND CONDUCT BIOLOGICAL TESTING IN ACCORDANCE WITH THE IDAHO STANDARDS FOR PUBLIC WORKS CONSTRUCTION (ISPWC), AMERICAN WATER WORKS ASSOCIATION (AWWA) STANDARDS, AND THE PRESSURE TESTING, DISINFECTION, AND MICROBIOLOGICAL TESTING PROCEDURES.
- 7. ALL WATER SUPPLY FIXTURES, FITTINGS, PIPING, AND ALL RELATED APPURTENANCES SHALL BE ANSI/NSF STD. 61 COMPLIANT.
- 8. ALL WATER SUPPLY FIXTURES, FITTINGS, PIPING, AND ALL RELATED APPURTENANCES SHALL COMPLY WITH THE LOW LEAD ACT REQUIRING ALL MATERIALS TO HAVE A LEAD CONTENT EQUAL TO OR LESS THAT 0.25%.
- 9. THE CONTRACTOR SHALL USE ANSI/NSF STANDARD 60 CHEMICALS AND COMPOUNDS DURING INSTALLATION & DISINFECTION OF POTABLE WATER MAIN.
- 10. CONTRACTOR SHALL COORDINATE LOCATIONS OF DRY UTILITY FACILITIES (POWER, CABLE, PHONE, TV) NOT SHOWN ON THE DRAWING WITH IDAHO POWER
- 11. ALL CLEARING & GRUBBING SHALL CONFORM TO ISPWC SECTION 201.
- 12. ALL EXCAVATION & EMBANKMENT SHALL CONFORM TO ISPWC SECTION 202. EXCAVATED SUBGRADE SHALL BE COMPACTED AND ALL UNSUITABLE SECTIONS REMOVED AND REPLACED WITH STRUCTURAL FILL AS DETERMINED BY THE ENGINEER. MINIMUM COMPACTION OF PLACED MATERIAL SHALL BE 95% OF MAXIMUM LABORATORY DENSITY AS DETERMINED BY AASHTO T-99 OR ITD T-91.
- 13. ALL 2" MINUS GRAVEL SHALL CONFORM TO ISPWC 802, TYPE II (ITD STANDARD 703.04, 2"), SHALL BE PLACED IN CONFORMANCE WITH ISPWC SECTION 801 AND COMPACTED PER SECTION 202. MINIMUM COMPACTION OF PLACED MATERIAL SHALL BE 90% OF MAXIMUM LABORATORY DENSITY AS DETERMINED BY AASHTO T-99.
- 14. ALL 3/4" MINUS CRUSHED GRAVEL SHALL CONFORM TO ISPWC 802, TYPE I (ITD STANDARD 703.04, 3/4" B), SHALL BE PLACED IN CONFORMANCE WITH ISPWC SECTION 802 AND COMPACTED PER SECTION 202. MINIMUM COMPACTION OF PLACED MATERIAL SHALL BE 95% OF MAXIMUM LABORATORY DENSITY AS DETERMINED BY AASHTO T-99 OR ITD T-91.
- 15. ALL ASPHALTIC CONCRETE PAVEMENT WORK SHALL CONFORM TO ISPWC SECTION(S) 805, 810, AND 811 FOR CLASS II PAVEMENT. ASPHALT AGGREGATE SHALL BE 1/2" (13MM) NOMINAL SIZE CONFORMING TO TABLE 803B IN ISPWC SECTION 803. ASPHALT BINDER SHALL BE PG 58-28 CONFORMING TO TABLE A-1 IN ISPWC SECTION 805.
- 16. ALL EDGES OF EXISTING ASPHALT PAVING SHALL BE SAW CUT 24" TO PROVIDE A CLEAN PAVEMENT EDGE FOR MATCHING. NO WHEEL CUTTING SHALL BE ALLOWED.
- 17. THE CONTRACTOR SHALL BE RESPONSIBLE FOR PROVIDING TRAFFIC CONTROL PER THE CURRENT EDITION OF THE US DEPARTMENT OF TRANSPORTATION MANUAL OF UNIFORM TRAFFIC CONTROL DEVICES (MUTCD).
- 18. ALL CONCRETE FORM WORK SHALL SHALL CONFORM TO ISPWC SECTION 701 AND 703. ALL CONCRETE SHALL BE 3,000 PSI MINIMUM, 28 DAY, AS DEFINED IN ISPWC SECTION 703, TABLE 1.
- 19. ALL TRENCHING SHALL CONFORM TO ISPWC STANDARD DRAWING SD-301. TRENCHES SHALL BE BACKFILLED AND COMPACTED TO A MINIMUM OF 95% OF MAXIMUM DENSITY AS DETERMINED BY AASHTO T-99.
- 20. TOPOGRAPHIC, SITE, AND BOUNDARY SURVEYS SHOWN HEREON WERE CONDUCTED BY ALPINE ENTERPRISES INC.
- 21.PER IDAHO CODE § 55-1613, THE CONTRACTOR SHALL RETAIN AND PROTECT ALL MONUMENTS, ACCESSORIES TO CORNERS, BENCHMARKS AND POINTS SET IN CONTROL SURVEYS; ALL MONUMENTS, ACCESSORIES TO CORNERS, BENCHMARKS AND POINTS SET IN CONTROL SURVEYS THAT ARE LOST OR DISTURBED BY CONSTRUCTION SHALL BE REESTABLISHED AND RE-MONUMENTED, AT THE EXPENSE OF THE AGENCY OR PERSON CAUSING THEIR LOSS OR DISTURBANCE AT THEIR ORIGINAL LOCATION OR BY SETTING OF A WITNESS CORNER OR REFERENCE POINT OR A REPLACEMENT BENCHMARK OR CONTROL POINT, BY OR UNDER THE DIRECTION OF A PROFESSIONAL LAND SURVEYOR.

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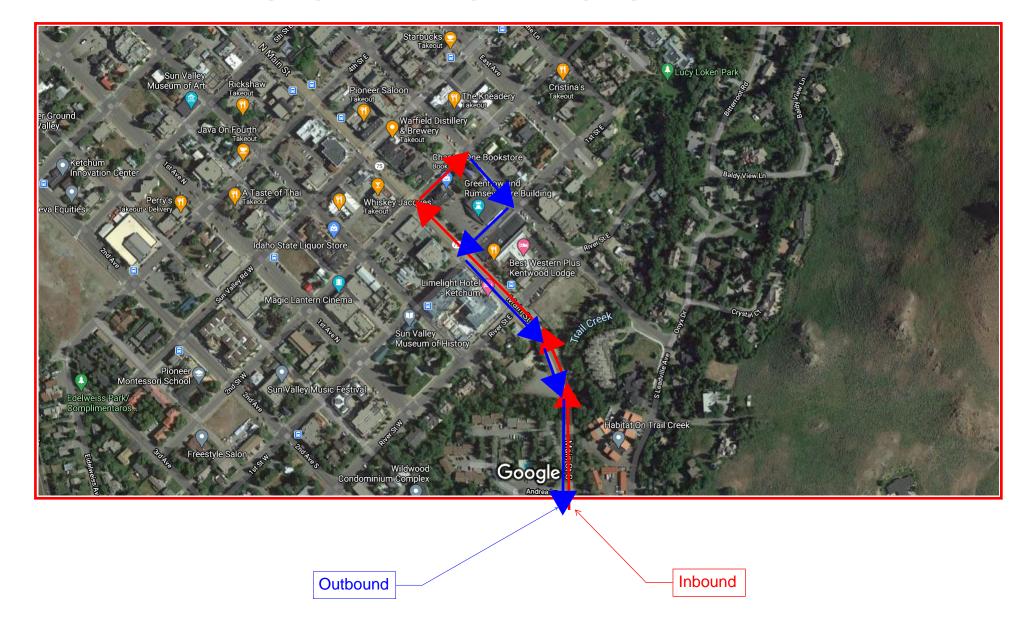
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# Construction Fencing for the project - 6' Foot with Privacy Screen



# TRUCKING ROUTE



# Exhibit B: Zoning & Dimensional Standards Analysis



## Leadville Residences Pre-Application Design Review EXHIBIT B: ZONING & DIMENSIONAL STANDARDS ANALYSIS

	Table 1: Zoning & Dimensional Standards Analysis						
Compliant		nt	Standards and Staff Comments				
Yes	No	N/	Ketchum	City Standards and Staff Comments			
		Α	Municipal				
			Code Section				
$\boxtimes$			§17.12.040	Minimum Lot Area			
			Staff	Required: 5,500 square feet minimum			
			Comments	Existing (Ketchum Townsite: Block 3: Lot 3): 5,500 square feet			
$\boxtimes$			§17.124.040	Floor Area Ratios and Community Housing			
			Staff	Permitted in Community Core Subdistrict 2(CC-2)			
			Comments	Permitted Gross FAR: 1.0			
				Permitted Gross FAR with Inclusionary Housing Incentive: 2.25			
				FLOOR AREA, GROSS: The sum of the horizontal area of the building			
				measured along the outside walls of each floor of a building or portion of			
				a building, including stair towers and elevators on the ground floor only,			
				and fifty percent (50%) of atriums over eighteen feet (18') plate height,			
				but not including basements, underground parking areas or open			
				unenclosed decks. Parking areas covered by a roof or portion of the			
				building and enclosed on three (3) or more sides by building walls are			
				included. Four (4) parking stalls for developments on single Ketchum			
				town site lots of five thousand six hundred (5,600) square feet in size or			
				less are not included in the gross floor area calculation (KMC			
				§17.08.020).			
				The permitted FAR in the Community Core Zone is 1.0. The Planning &			
				Zoning Commission may allow an increased FAR subject to Design Review			
				(Ketchum Municipal Code §17.124.040.B). Ketchum Municipal Code does			
				not guarantee 2.25 as the allowed FAR. New developments may be			
				permitted an increased FAR above 1.0 at the Commission's discretion			
				through Design Review. To receive more floor area, new buildings must			
				complement the scale and character of the surrounding neighborhood.			
				Dranasad			
				Proposed:			
				Duplex Gross Floor Area: 7,815 gross square feet			
				Ketchum Townsite Lot 3 Area: 5,500 sq ft FAR Proposed: 1.4 (7,815 gross sq ft/5,500 sq ft lot area)			
				FAN FIOPOSEU. 1.4 (7,013 BIOSS SY 11/3,300 SY 11 101 died)			
$\boxtimes$			§17.12.040	Minimum Building Setbacks			
			317.12.040	William Salian Poetsacio			

### Staff Comments

### Required:

Front & Street Side: 5' avg

Rear side not adjacent to an alleyway: 0'

Interior Side: 0'

Cantilevered decks and overhangs: 0'

Setbacks for 4<sup>th</sup> floors: 10 ft

Non-habitable structures, fixed amenities, solar and mechanical equipment affixed to the roof from all building facades: 10 ft

### Proposed:

The applicant has provided setback diagrams on Sheet A-001 of the project plans. Dimensioned Setbacks are also included on the first-floor plan (Sheet-101).

Front (East/Leadville Avenue): 9'-7" average

Building Setback Ranges from Minimum: 2'-6" to Maximum: 15'-1"

Interior Side (North/adjacent to Vintage Restaurant): 2'-8"

Street Side (South/2<sup>nd</sup> Street): 7'-0" average

Building Setback Ranges from Minimum: 0' to Maximum: ~25 ft

Rear Side Adjacent to Alleyway: 3'

The building footprint of Unit A's garage is setback 26'-4" from the rear property line and Unit B's garage is setback 20'-4'.

The second-floor decks extend past the garage building footprint towards the alley.

Second-Floor Deck Cantilever Setback from Rear Property Line

Unit A (south): 14'-11" Unit B (north): 5'-10"

Non-habitable structures, fixed amenities, solar and mechanical equipment affixed to the roof from all building facades:

The roof plan is indicated on Sheets A-104 and A-105. The rooftop terrace is accessed by exterior stairwells located at the third-floor fronting Leadville Avenue and elevators centered in the middle of the duplex building. The roof deck plan includes camp roof-mounted mechanical equipment, elevator shafts with associated vestibules, and camp pads.

Roof-Mounted Mechanical Equipment: >15 feet

Non-Habitable Structures (elevator and vestibule): >15 feet

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				Roof and ground mounted mechanical and electrical equipment shall be fully screened from public view. Screening shall be compatible with the overall building design (Ketchum Municipal Code §17.96.070.C2). The location of the new transformer as approved by Idaho Power must be included on the site plan submitted with the final Design Review
			0.5.00	application.
$\boxtimes$		Ш	§17.12.040	Building Height
			Staff	Permitted
			Comments	Maximum Building Height: 42 feet
				Non-habitable structures located on building roof tops: 10 feet
				Perimeter walls enclosing roof top deck and structures: 4 feet above roof
				surface height. Perimeter roof top walls are required to be at least 75%
				transparent.
				Rooftop solar and mechanical equipment above roof surface: 5 feet
				Proposed
				Maximum Building Height: 40'-6"
				Non-habitable structures located on building roof tops: 10'
				Perimeter walls enclosing roof top deck and structures: The rooftop
				terrace is enclosed by wood handrails. The project plans should specify
				the height of perimeter walls enclosing the roof deck. Perimeter walls
				enclosing the roof deck may extend 4 feet above the roof surface and
				must be 75% transparent.
				Rooftop solar and mechanical equipment above roof surface: The project
				plans must indicate the height of all rooftop solar and mechanical
				equipment extending above the roof surface. Roof and ground mounted
				mechanical and electrical equipment shall be fully screened from public
				view. Screening shall be compatible with the overall building design
				(Ketchum Municipal Code §17.96.070.C2).
		$\boxtimes$	§17.125.030.H	Curb Cut
			Staff	Required:
			Comments	A total of 35% of the linear footage of any street frontage can be
				devoted to access to off street parking. Corner lots that front two or
				more streets may select either or both streets as access but shall not
				devote more than 35% of the total linear footage of street frontage to
				access off street parking.
				Description At At A
				Proposed: N/A

			The two parking garages are accessed from the Block 3 alleyway.
$\boxtimes$		§17.125.40	Parking Spaces
		Staff	Required Residential Multiple-Family Dwelling within the Community
		Comments	Core (CC) District:
			Units 2,001 square feet and above: 2 parking spaces
			The duplex development generates a total parking demand of 4 spaces.
			Proposed: 4 parking spaces
			Each townhome unit includes an attached garage accessed from the
			Block 3 alleyway that may accommodate 2 parking spaces.
			The project plans must indicate the dimensions of the parking spaces
			within the enclosed garages.

Exhibit C:
Staff Report
P&Z Commission Meeting
of
September 15<sup>th</sup>, 2020



# STAFF REPORT KETCHUM PLANNING AND ZONING COMMISSION MEETING OF SEPTEMBER 15, 2020

**PROJECT:** Leadville Residences

FILE NUMBER: P20-077

**APPLICATION TYPE:** Pre-Application Design Review

**REPRESENTATIVE:** Mike Brunelle, Architect

PROPERTY OWNER: Leadville South, LLC (GM Property Holdings LLC per Blaine County Assessor's

Office Data as of 9/9/20)

**REQUEST:** Pre-Application Design Review for the development of a new three-story, 50.5-

foot tall, 7,600-square-foot duplex

**LOCATION:** Northwest Corner of N Leadville Avenue & E 2<sup>nd</sup> Street (Ketchum Townsite:

Block 3: Lot 5)

**ZONING:** Mixed-Use Subdistrict of the Community Core (CC-2)

**OVERLAY:** None

### **NEW DUPLEX**

### AT THE CORNER OF LEADVILLE AVENUE & 2nd STREET

The Leadville Residences project proposes to develop a new three-story, 50.5-foot tall, 7,600-square-foot duplex and associated site improvements on a vacant lot located at the corner of Leadville Avenue and 2<sup>nd</sup> Street. The property is located within the Mixed-Use Subdistrict of the Community Core (CC-2). Multi-family dwelling units are a permitted use in the CC-2 Zone, and unlike the Retail Core Subdistrict (CC-1), dwelling units may be sited on the ground floor. The duplex is comprised of two, attached townhome units with private decks and garages accessed from the Block 3 alleyway.



Figure 1. 3D Massing, Sheet DR-05, Project Plans

### DESIGN REVIEW MAINTAINS KETCHUM'S AUTHENTICITY & MOUNTAIN-TOWN CHARACTER

The Pre-Application facilitates an iterative and collaborative process between the Planning & Zoning Commission, developers and their design teams, and the community. This preliminary review allows

the Commission to identify design issues, offer constructive advice, and highlight opportunities to improve project. The Commission's feedback helps developers produce high-quality buildings and projects that enhance the character of downtown Ketchum.

### **ANALYSIS**

### **Project Location & Neighborhood Context**

The Leadville Residences is an infill project located on a vacant lot at the northwest corner of Leadville Avenue and 2<sup>nd</sup> Street. The subject property is currently used as a parking lot. The property shares the alley with restaurants and bars fronting Main Street, including the Warfield, Casino, and Rico's. The neighborhood is characterized by historic buildings, including:

- The Alonzo Price/Esther Fairman House located at 180 N Leadville Avenue, which is a 1.5-story, wood-framed private residence with a front-gable roof built in 1929. Alonzo Price was the son of William Price, who was the manager of the Philadelphia Smelter.
- The Griffith/Conger Compound located at 380 2<sup>nd</sup> Street—a two-story, wood-framed house built in 1929.
- The Sanger House located at 200 N Leadville Avenue is a 1.5-story, wood-framed house, which was built in 1929.
- The McCann, Daech, Fenton Realty Building (Albert Griffith Warehouse & Grocery Annex) located at 271 N Leadville is a 1.5-story, wood -framed duplex built in the early 1900s.



Figure 2. The Alonzo Price/Esther Fairman House

- The Vintage Restaurant is located within the Bert Cross Cabin, which was built in 1925.
- The Casino (Ketchum Kamp Hotel) is a 2-story, wood-frame building built in the early 1900s.
- The Warfield at Main Street and Sun Valley Road is a 2-story, brick building built in the 1930s.

The neighborhood's built environment reflects Ketchum's past. The architecture is defined by natural materials like wood and stone, simple geometrical designs, and Chalet-style features characteristic of alpinesettings.



Figure 3. The Casino (Source: The Community Library Regional History Department)

The subject property is designated as Mixed-Use Commercial on the Future Land Use Map of the 2014 Comprehensive Plan. The Mixed-Use Commercial designation is intended to promote a wide range of land uses. The Comprehensive Plan encourages mixed-use development that integrates different uses, like retail, restaurants, residential, offices, and cultural or civic facilities, within a single building. These mixed-use developments should also contain common public space and contribute to downtown's street life. Duplexes are designated as primary uses within the City's Low-Density Residential neighborhoods, not downtown. Multi-family dwelling units are a permitted use in the CC-2 Zone (KMC 17.12.020). Ketchum Municipal Code 17.08.020 defines multiple-family dwelling as a building under single or multiple ownership containing two or more dwelling units used for residential occupancy. Unlike the Retail Core, which limits ground-floor street frontage to commercial uses, residential uses may occupy the ground floor in the Mixed-Use Subdistrict.

### <u>Three-Story Luxury Duplex: Zoning & Dimensional Standards Analysis</u>

Staff's analysis of the project's compliance with CC-2 zoning and dimensional standards is detailed in Table 1.

	Table 1: Zoning & Dimensional Standards Analysis						
Compliant		nt	Standards and Staff Comments				
Yes	No	N/	Ketchum	City Standards and Staff Comments			
		Α	Municipal				
			Code §				
$\boxtimes$			17.12.040	Minimum Lot Area			
			Staff	Required: 5,500 square feet minimum			
			Comments	Existing (Ketchum Townsite: Block 3: Lot 3): 5,500 square feet			
$\boxtimes$			17.124.040	Floor Area Ratios and Community Housing			
			Staff	Permitted in Community Core Subdistrict 2(CC-2)			
			Comments	Permitted Gross FAR: 1.0			
				Permitted Gross FAR with Inclusionary Housing Incentive: 2.25			
				FLOOR AREA, GROSS: The sum of the horizontal area of the building			
				measured along the outside walls of each floor of a building or portion of			
				a building, including stair towers and elevators on the ground floor only,			
				and fifty percent (50%) of atriums over eighteen feet (18') plate height,			
				but not including basements, underground parking areas or open			
				unenclosed decks. Parking areas covered by a roof or portion of the			
				building and enclosed on three (3) or more sides by building walls are			
				included. Four (4) parking stalls for developments on single Ketchum town			
				site lots of five thousand six hundred (5,600) square feet in size or less are			
				not included in the gross floor area calculation (KMC §17.08.020).			
				Proposed:			
				Duplex Gross Floor Area: 7,600 gross square feet			
				Ketchum Townsite Lot 3 Area: 5,500 sq ft			
				FAR Proposed: 1.4 (7,600 gross sq ft/5,500 sq ft lot area)			
				Increase Above Permitted FAR: 2,100 sq ft			
				20% of Increase: 420 sq ft			
				Net Livable (15% Reduction): 357 sq ft			
				Community Housing In-Lieu Fee: \$84,966			
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				Pursuant to Ketchum Municipal Code (KMC) §17.124.040, the increase
				above the permitted 1.0 Gross FAR is subject to Design Review approval.
$\boxtimes$			17.12.040	Minimum Building Setbacks
			Staff	Required:
			Comments	Front & Street Side: 5' avg
				Rear side not adjacent to an alleyway: 0'
				Interior Side: 0' Cantilevered decks and overhangs: 0'
				Setbacks for 4 <sup>th</sup> floors: 10 ft
				Non-habitable structures, fixed amenities, solar and mechanical
				equipment affixed to the roof from all building facades: 10 ft
				Proposed:
				The applicant has provided setback diagrams on Sheet DR-01 of the
				project plans.
				Front (East/Leadville Avenue): 11'-11'' average
				Building Setback Ranges from Minimum: 2'-6" to Maximum: 15'-11¾"
				Interior Side (North/adjacent to Vintage Restaurant): 2'-8"
				Street Side (South/2 <sup>nd</sup> Street): 7'-2" average
				Building Setback Ranges from Minimum: 0' to Maximum: ~25 ft
				Rear Side Adjacent to Alleyway: > 3'
				The building footprint of Unit B's garage is setback 20'-4" from the rear
				property line. The applicant has indicated the overhang of the second-
				level deck extending over the driveway.
				The project plans must dimension the setbacks of cantilevered decks and
				roof overhangs from all property lines.
				Non-habitable structures, fixed amenities, solar and mechanical
				equipment affixed to the roof from all building facades:
				The roof plan is indicated on Sheets DR-02 and L1. The roof deck is
				accessed by an exterior stairwell located at the third-floor decks fronting
				Leadville Avenue. The roof deck is also accessed from an elevator
				centered in the middle of the duplex building. The roof deck plans include raised planters, camp pads, roof-mounted mechanical equipment, BBQ
				and kitchen facilities, and dining areas.
				The roof plans must indicate the cethody of non-behitable structures
				The roof plans must indicate the setback of non-habitable structures, fixed amenities, or mechanical equipment affixed to the roof from all
				building facades. Non-habitable structures, fixed amenities, solar and
				mechanical equipment affixed to the roof must be setback 10 feet from
				all building facades. Roof and ground mounted mechanical and electrical

			equipment shall be fully screened from public view. Screening shall be
			compatible with the overall building design (Ketchum Municipal Code
			§17.96.070.C2).
$\boxtimes$		17.12.040	Building Height
		Staff	Permitted
		Comments	Maximum Building Height: 42 feet
			Non-habitable structures located on building roof tops: 10 feet
			Perimeter walls enclosing roof top deck and structures: 4 feet above roof surface height. Perimeter roof top walls are required to be at least 75% transparent.
			Rooftop solar and mechanical equipment above roof surface: 5 feet
			Proposed The applicant has dimensioned the building and floor heights on Sheet DR-03 of the project plans.
			Maximum Building Height: 42 feet
			Non-habitable structures located on building roof tops: 8 feet-6 inches
			Perimeter walls enclosing roof top deck and structures: The elevations indicate that the roof deck railing and parapet wall extend above the 42-foot maximum building height. The project plans must dimension the height of perimeter walls enclosing the roof deck. Perimeter walls enclosing the roof deck may extend 4 feet above the roof surface and must be 75% transparent.
			Rooftop solar and mechanical equipment above roof surface: The roof plans indicated on Sheets DR-02 and L1 indicated roof-mounted mechanical equipment. The project plans must provide dimensions for the height of all rooftop solar and mechanical equipment extending above the roof surface. Roof and ground mounted mechanical and electrical equipment shall be fully screened from public view. Screening shall be compatible with the overall building design (Ketchum Municipal Code §17.96.070.C2).
	$\boxtimes$	17.125.030.H	Curb Cut
		Staff	Required:
		Comments	A total of 35% of the linear footage of any street frontage can be devoted
			to access to off street parking. Corner lots that front two or more streets may select either or both streets as access but shall not devote more than
			35% of the total linear footage of street frontage to access off street parking.
			Proposed: N/A

			The two parking garages are accessed from the Block 3 alleyway.
$\boxtimes$		17.125.40	Parking Spaces
		Staff	Required Residential Multiple-Family Dwelling within the Community Core
		Comments	(CC) District:
			Units 2,001 square feet and above: 2 parking spaces
			The duplex development generates a total parking demand of 4 spaces.
			Proposed: 4 parking spaces
			Each townhome unit includes an attached garage accessed from the Block
			3 alleyway that may accommodate 2 parking spaces.
			The project plans must indicate the dimensions of the parking spaces
			within the enclosed garages.

### Design Review Standards: Architectural Features and Compatibility of Design

The duplex is larger than the surrounding built environment along Leadville Avenue and 2<sup>nd</sup> Street. More meaningful scaling devices need to be integrated into the project plans to break up the building's bulk and mass. The project plans do not specify the proposed exterior materials. The elevations indicate material differentiation using window and door openings, rectangular panels, horizontal siding, and stone veneer. Two-story elements, like the atrium feature, provide visual interest to the front façade along Leadville Avenue.

Design Review helps our community achieve a more sustainable, vibrant, connected, and beautiful Ketchum. Downtown Ketchum is the soul of our small-town, mountain community. Downtown is a vibrant and walkable commercial area and the social center for gatherings with neighbors and visitors. Downtown brings locals, second homeowners, and tourists together to make us a connected community. How will this building enhance the character of downtown Ketchum and contribute to our mountain community?

### STAFF RECOMMENDATION

Staff recommends the Commission provide feedback to the applicant and move to <u>continue</u> review of the Pre-Application.

### **EXHIBITS:**

A. Leadville Residences Pre-Application Design Review Submittal & Project Plans