

# STAFF REPORT KETCHUM PLANNING AND ZONING COMMISSION MEETING OF FEBRUARY 11, 2024

**PROJECT:** Knob Hill Residence

FILE NUMBER: P24-087

**APPLICATION TYPE:** Pre-Application Mountain Overlay Design Review

**PROPERTY OWNER:** Knob Hill Properties LLC

**REPRESENTATIVES:** Peter Seidner & Hank Moore, Presidio Vista Properties

**ARCHITECT:** Zac Rockett, Architect, Ro Rockett Design

**REQUEST:** Pre-Application Mountain Overlay Design Review for the development

of a new three-story, 8,319-square-foot single-family residence and

associated site improvements

**LOCATION:** Ketchum Townsite—Block 91: Lots 3 & 4 (Parcel Numbers:

RPK0000091004A & RPK00000910030)

**ZONING:** Limited Residential (LR)

**OVERLAY:** Mountain Overlay

**REVIEWER:** Abby Rivin – Senior Planner

**NOTICE:** A courtesy public meeting notice was mailed to all property owners


within 300 feet of the project site on January 22, 2025. The notice was

published in the Idaho Mountain Express on January 22, 2025. A notice was posted on the city's website on January 22, 2025 and on


the project site on February 4, 2025.

#### **EXECUTIVE SUMMARY**

The applicant has submitted a Pre-Application Mountain Overlay Design Review for the development of a new three-story, 8,319-square-foot single-family residence (the "project", see Figure 1), located on two vacant lots on Walnut Avenue within the Knob Hill neighborhood (the "subject property"). The subject property is located within the city's Limited Residential (LR) Zone and the Mountain Overlay (MO) Zoning District. The project plans are included as Attachment A. Supplemental material submitted with the Pre-Application, including the applicant's Design Narrative and written response to MO Design Review standards, is included as Attachment B.

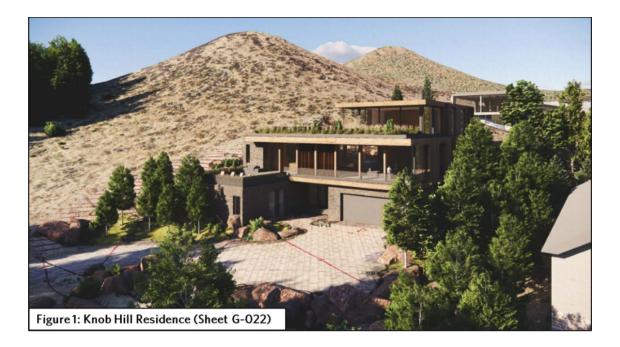


The subject property (see Figure 2) is comprised of two separate lots in Block 91 of Ketchum Townsite. Topography was not considered when the original Ketchum Townsite was established in 1948. The Knob Hill neighborhood contains platted blocks with vacant lots and unimproved rights-of-way that extend high up the hillside.

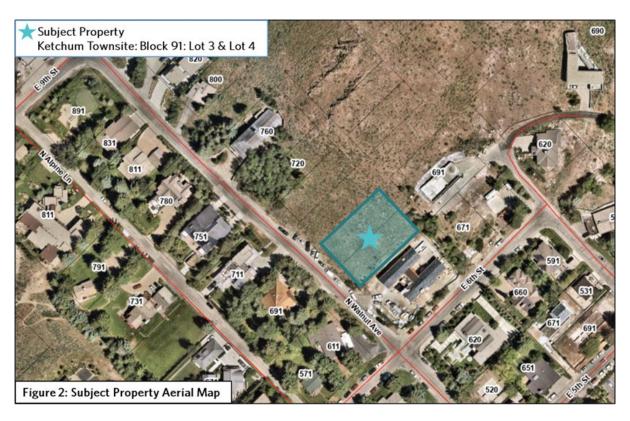

The slope exhibit in Figure 3 shows the subject property with areas of 25% and greater slope in red, areas of 20% slope in green, and areas of 15% slope in yellow. Most of the subject property contains hillsides of 25% and greater slope.

The subject property is constrained by a view corridor and landscape easement (recorded as Instrument No. 663131) that benefits the adjacent property to the south along Walnut Avenue (see Figure 4). The view corridor easement highlighted in yellow in Figure 4 is intended to preserve the views from the adjacent property over the southwest side of the subject property. The landscape easement highlighted in green in Figure 4 is intended to provide screening for privacy.



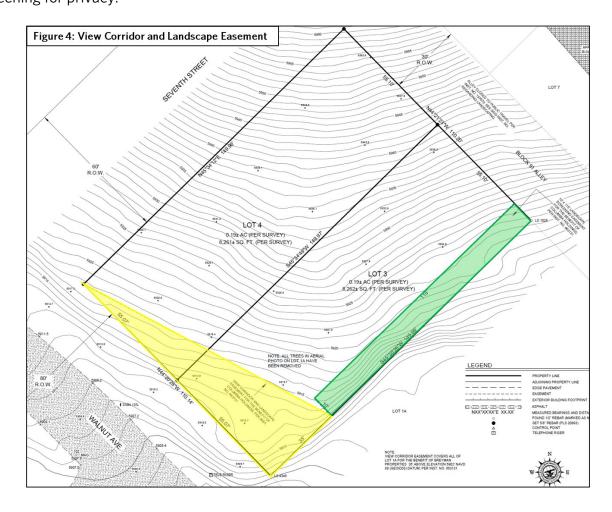

The project proposes consolidating the two lots to accommodate the development of the new home. Lot consolidations are permitted in the LR Zone subject to a waiver pursuant to Ketchum Municipal Code (KMC) \$16.04.030.C1a. KMC \$16.04.030.C4 requires that, "All preliminary plat applications for consolidation of lots must also demonstrate conformance with all applicable building permit and land use development approvals, all applicable rules and regulations in title 17, zoning regulations, and general conformance with the adopted comprehensive plan." In addition, the project will require a waiver to establish a reasonable building envelope within slopes of 25% and greater per KMC \$16.04.040.F2. The subdivision application for the lot consolidation preliminary plat and written waiver requests must be submitted concurrently with the final MO Design Review application.

The project is subject to Mountain Overlay Pre-Application Design Review pursuant to KMC \$17.96.010.D.1 as the subject property is greater than 11,000 square feet. Pre-Application Design Review is an opportunity for the Planning and Zoning Commission (the "Commission") to give the applicant feedback on the proposed project. This preliminary review allows the Commission to ask questions, identify code compliance issues or design concerns, and provide recommendations to the applicant. There is no formal staff recommendation and no motion or action for the Commission to take at this time. Staff recommends the Commission provide feedback to the applicant after reviewing the Knob Hill Residence Pre-Application MO Design Review submittal (Attachments A & B), the applicant's presentation, staff analysis, and public comment.

#### **BACKGROUND**

#### **Process to Date**

The Planning and Building Department received the Knob Hill Residence Pre-Application MO Design Review application on October 15, 2024. The Pre-Application was reviewed by all city departments and comments were provided to the applicant for review. Although not required for Pre-Application Design Review, the applicant revised the submittal in response to staff comments. All city department comments and feedback provided by the Commission must be addressed by the applicant upon submittal of the final Design Review application. Pursuant to KMC §17.96.010.D5, the applicant must file a complete Design Review application and pay all required fees within 180 calendars of the last Pre-Application Design Review meeting with the Commission, otherwise the Pre-Application will become null and void.

#### **ANALYSIS**

Pursuant to KMC \$17.96.050.A, the Commission shall determine the following prior to granting Design Review approval:

- 1. The project doesn't jeopardize the health, safety, or welfare of the public.
- 2. The project generally conforms with the goals, policies, and objectives of the adopted comprehensive plan.
- 3. The project conforms to all applicable standards and criteria as set forth in this chapter, this title, and any other standards as adopted or amended by the City of Ketchum from time to time.

# Criteria 1 & 2: Public Health, Safety, and Welfare & Comprehensive Plan Conformance Future Land Use

The subject property is designated as Low Density Residential on the Future Land Use Map of Ketchum's 2014 Comprehensive Plan (the "comprehensive plan"). The Low Density Residential future land use category promotes new housing within existing neighborhoods that are connected

to local streets and have access to parks, open space, schools, and other civic activities. Primary uses in the Low Density Residential future land use category include single-family residences, duplexes, and accessory dwelling units. This project aligns with the Low Density Residential future land use category as the applicant proposes to develop a new single-family within the Knob Hill neighborhood.

#### Hillside Protection & Compatibility with Surrounding Neighborhood

Ketchum's undeveloped hillsides define the character of our community. The comprehensive plan emphasizes the importance of protecting environmental quality and preserving natural resources to maintain Ketchum's economy, quality of life, and community identity. The comprehensive plan provides the following policies related to maintaining open space buffers, protecting hillsides, and preserving natural features:

- Policy OS-3.2—Open Space Community Separators: "Establish and maintain open space buffers in important scenic areas to maintain the community's separate identity from surrounding communities and to protect views and open space" (page 36).
- Policy CD-2.2—Mountain Overlay Zone: "Continue to protect hillsides within the City and the Area of City Impact from further development. Enforce and encourage strengthening of the Mountain Overlay standards of the City and County, by using a variety of techniques; such as clustering at lower elevations, creating conservation easements, or purchasing private property on hillsides" (page 26).
- Policy CD-2.4—Development Designed for Natural Feature Preservation: "Protect and incorporate natural features into newly developing areas. Conserve the natural patterns of streams, ridgelines, topography, riparian areas, and wildlife habitat areas" (page 27).

Infill development and redevelopment disturbs natural land features, topography, soils, and vegetation. Construction activities like excavation, grading, and vegetation removal can adversely impact natural hillside topography, soils, slope stability, drainage patterns, and wildlife habitat. Ketchum's Mountain Overlay standards referenced in Policy CD-2.2 of the comprehensive plan mitigate these adverse impacts by minimizing the disturbance associated with hillside development activity. These standards help preserve Ketchum's hillsides and wildlife habitat by prohibiting detrimental alterations to hilltops, rock outcroppings, knolls, and ridges. The Mountain Overlay protects scenic views and open space corridors by directing building sites to lower elevations and preserving our unobstructed hillsides.

In addition to our undeveloped hillsides, Ketchum's built environment, neighborhoods, and architectural design contribute to community character. The comprehensive plan encourages new development to be compatible with the character of the surrounding neighborhood. Policy CD-1.3 of the comprehensive plan states that, "Infill and redevelopment projects should be contextually appropriate to the neighborhood and development in which they occur. Context refers to the natural and manmade features adjoining a development site; it does not imply a certain style" (page 26). In addition, Policy CD-1.4 of the comprehensive plan states that, "Each new project should be well-designed and attractive, and should complement surrounding land uses and existing neighborhood character" (page 26).

Staff believes the proposed development is compatible with the character of surrounding residential homes in the Knob Hill neighborhood but recommends the applicant modify the design to further minimize hillside disturbance on the subject property. Please see the Mountain Overlay Design

Review Standards section of the staff report below and Attachment D for staff's analysis and recommendations to minimize hillside disturbance.

#### Criteria 3: Applicable Standards and Criteria

#### **LR Zoning and Dimensional Standards**


Staff reviewed the Pre-Application submittal for applicable zoning and dimensional standards, including setbacks, building height, building coverage, and parking. Planning staff's comprehensive analysis of all zoning and dimensional standards is provided in Attachment C. No code compliance issues were identified by staff based on the information provided in the Pre-Application submittal. Staff will review all zoning and dimensional standards again at final MO Design Review to ensure the project remains in compliance.

#### **Design Review Standards**

Landscaping (KMC §17.96.060.1)

The landscape plan on sheet L-5.00 proposes 5 Ponderosa Pine trees, 16 Quaking Aspen trees, 6 Common Chokecherry trees, and variety of shrubs as well as numerous landscape boulders. Some of these landscape boulders are retaining structures and others are solely ornamental. In the Design Narrative (see Attachment B), the applicant explains that the proposed retaining elements and landscape features are intended to echo the natural features of the surrounding hillsides and

provides exhibits to illustrate this approach (see Figure 5). Sheet L-1.00 of the project plans (see Attachment A) shows the proposed ornamental and retaining boulders with notes that state, "large native boulders to retain grade and match existing rock outcrops uphill" and "landscape boulders to match existing boulders on site and blend into native landscape character."

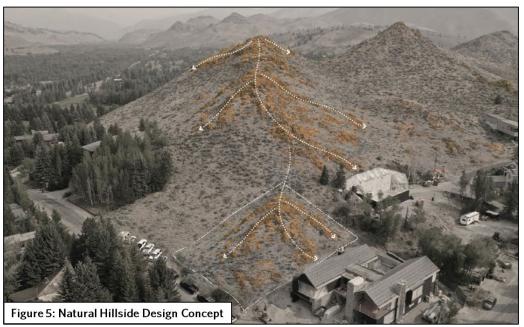


Pursuant to KMC \$17.96.060.12, "Landscape materials and vegetation types specified shall be readily adaptable to a site's microclimate, soil conditions, orientation and aspect, and shall serve to enhance and complement the neighborhood and townscape." Existing native vegetation in the Knob Hill neighborhood is comprised predominately of native sagebrush plant species. Staff recommends the applicant modify the landscape plan by removing some of the trees and boulders to complement the surrounding sage-covered hillside.

#### Mountain Overlay Design Review Standards

Hillside Disturbance

Pursuant to KMC §17.104.070.A14, "Excavations, fills and vegetation disturbance on hillsides not associated with the building construction shall be minimized." As shown on the lot disturbance

diagrams on sheet G-020 (see Figure 6), only a portion of the subject property along the rear property line is proposed to remain undisturbed. The total proposed undisturbed area is 1,660 square feet, which is only 10% of the subject property's total area. Hillside disturbance that is not associated with the building construction includes a small patio and hot tub at the northeast corner of the property as well as the driveway and fire apparatus access zone.

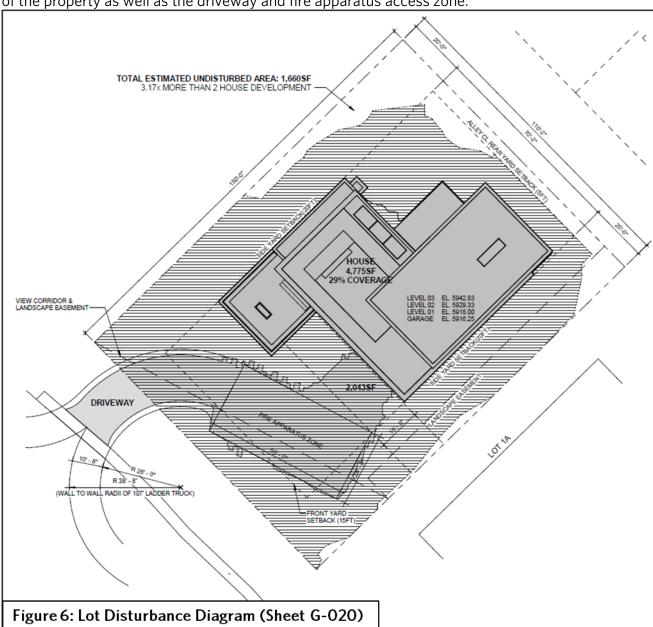

In the Design Narrative (see Attachment B), the applicant provides a summary of design changes made to the outdoor patio and hot tub area in response to Planning staff feedback to preserve more of the natural hillside. The applicant has significantly reduced the size outdoor patio area from the first iteration of the design drawings. Staff appreciates these changes and the applicant's thoughtful response to feedback, however, staff believes that removing the outdoor patio and hot tub would preserve even more of the natural hillside. Staff recommends the applicant remove the outdoor patio and hot tub to preserve more of the natural hillside area.

The proposed driveway improvements contribute to hillside disturbance not associated with building construction. The proposed driveway improvements are detailed on sheet C1.0 of the

project plans (see Attachment A). In the Design Narrative (see Attachment B), the applicant provides an analysis of the proposed driveway access. The applicant states:


Safety and integration into the hillside were primary factors under consideration as the design team set out to site the building and provide vehicular access. Using the existing topography of the site and entering as high as possible on Walnut Avenue, the driveway gently slopes up along the existing contours to provide direct access to a garage. This configuration allows safe vehicular egress from the property, accommodates the required fire safety apparatus, and avoids large collections of steep retaining structures that would otherwise be required.

In the written response to MO Design Review standards (see Attachment B), the applicant further explains:

The driveway accesses the site as high on Walnut Ave as possible to allow a more direct approach onto the site which results in less cut and fill as opposed to having a driveway perpendicular to Walnut Ave and further south on the subject property. Furthermore, the driveway follows the existing contours of the site to further limit cut and fill.

The applicant has revised the proposed driveway access based on Planning staff feedback and Fire Department requirements. These changes included reducing the size of the garage, relocating the garage to facilitate a shorter driveway, and reducing the length and width of the driveway to limit disturbance.

Pursuant to KMC \$17.104.070.A9, "lengths of driveways allowed shall be minimized." The proposed driveway access along Walnut Avenue is 20 feet wide and surfaced with asphalt. The driveway then extends to the fire apparatus zone that is surfaced with pavers. As shown in Figure 8, the fire apparatus zone is 50 feet long and 26 feet wide. The length of the asphalt portion of the driveway is 57 feet. The length of the portion of the driveway surfaced with pavers is 71 feet long. The total length of the driveway is 128 feet (see Figure 7).

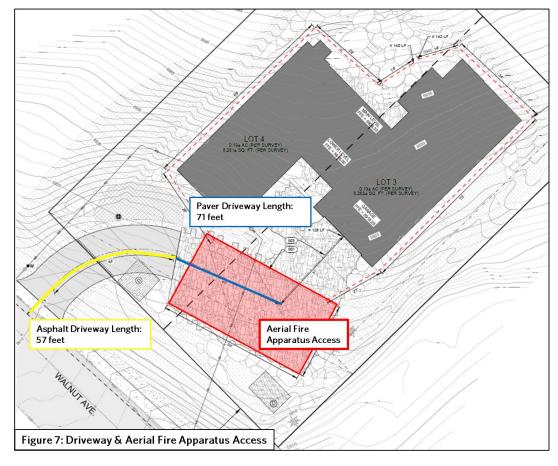

Pursuant to Fire Department requirements, aerial fire apparatus access is required where the vertical distance between the grade plane and the highest roof surface exceeds 30 feet. Aerial fire apparatus access roads must have a minimum unobstructed width of 26 feet and must be sited no closer than 15 feet and no further than 30 feet from the structure. Aerial fire apparatus access is required because the proposed height of the home is 38.5 feet from the lowest finished grade to the highest point of the roof. The proposed driveway and fire apparatus zone improvements push the home further up the hillside. The required setback from the front property line in the LR Zone is 15 feet. As a result of the driveway improvements, the home is setback 40'-7" from the front property line along Walnut Avenue, which is 25'-7" more than the minimum required.

If the height of the proposed home were reduced to less than 30 feet above grade, then the aerial fire apparatus access would not be required. Removing the aerial fire apparatus access would reduce the length of the driveway and allow the home to be sited at a lower elevation on the subject property. Staff believes this change would significantly reduce hillside disturbance. Staff recommends the applicant reduce the height of the home to less than 30 feet above grade by either reducing floor-to-ceiling heights or removing the third floor to remove the aerial fire apparatus access requirement, which would allow the home to be sited at the lower elevation of the subject property and minimize hillside disturbance.

#### STAFF RECOMMENDATION

At the Pre-Application stage, staff does not provide a recommendation, and no action is taken by the Commission. Staff requests the Commission provide feedback to the applicant on the proposed design, issues identified in the staff report, and any other items deemed relevant to the project.


#### **ATTACHMENTS:**

- A. Pre-Application MO Design Review Submittal: Project Plan Set
- B. Pre-Application MO Design Review Submittal: Application & Supplemental Materials
- C. LR Zoning and Dimensional Standards Evaluation
- D. Mountain Overlay Design Review Standards Analysis

Attachment A
Pre-Application
MO Design Review
Submittal:
Project Plan Set



# **MODR PRE-APPLICATION / 01.15.2025**

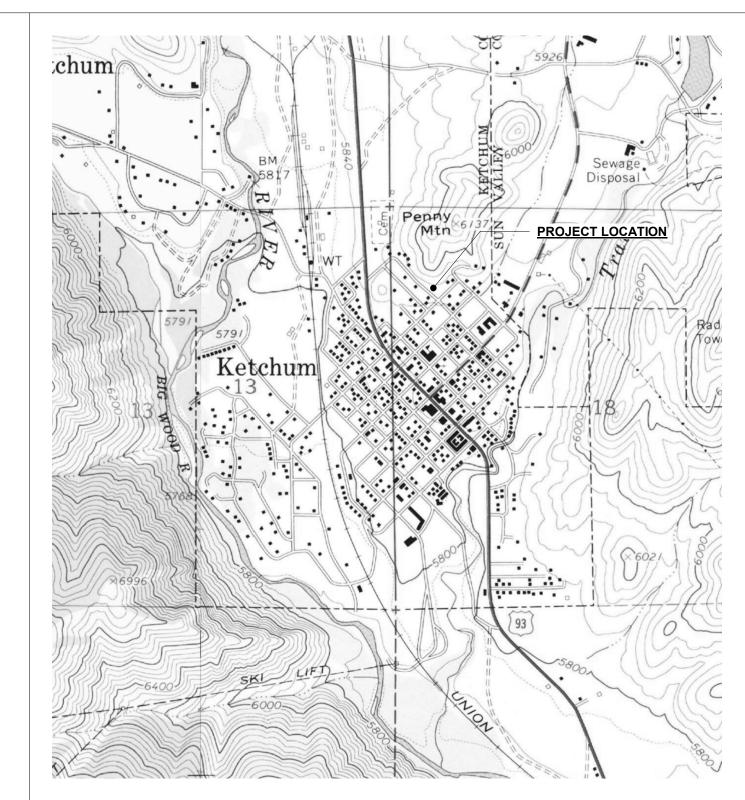

NTS

PROJECT LOCATION

- 1. THE CONTRACTOR SHALL BE RESPONSIBLE FOR ALL DRAWINGS, CALCULATIONS, GOVERNMENTAL AGENCY APPROVALS AND FEES TO COMPLETE THIS WORK. CONTRACTOR/SUBCONTRACTORS SHALL SUBMIT MECHANICAL, ELECTRICAL, COMMUNICATIONS AND PLUMBING DRAWINGS TO RO ROCKETT DESIGN FOR PREVIEW OF DEVICE TYPES, LOCATIONS AND QUANTITIES, HVAC ZONING/THERMOSTAT LOCATIONS, ETC. PRIOR TO SUBMITTING FOR PERMIT AND CONSTRUCTION.
- THESE DOCUMENTS ARE INTENDED TO INCLUDE ALL LABOR, MATERIALS, EQUIPMENT AND SERVICES REQUIRED TO COMPLETE ALL WORK DESCRIBED HEREIN. IT IS THE RESPONSIBILITY OF THE CONTRACTOR TO BRING TO THE ATTENTION OF THE ARCHITECT ANY CONDITIONS WHICH WILL NOT PERMIT CONSTRUCTION ACCORDING TO THE INTENTIONS OF THESE DOCUMENTS. IT IS THE RESPONSIBILITY OF THE ARCHITECT TO PROVIDE DETAILS AND/OR DIRECTIONS REGARDING DESIGN INTENT WHERE IT IS ALTERED BY EXISTING CONDITIONS OR WHERE NEGLECTED IN THE DOCUMENTS.
- . ANY MATERIALS PROPOSED FOR SUBSTITUTION OF THOSE SPECIFIED, OR CALLED OUT BY TRADE NAME, IN THESE DOCUMENTS SHALL BE PRESENTED TO THE ARCHITECT FOR REVIEW. THE CONTRACTOR SHALL SUBMIT SAMPLES WHEN REQUIRED BY THE ARCHITECT, AND ALL SUCH SAMPLES SHALL BE REVIEWED BY THE ARCHITECT BEFORE THE WORK IS PERFORMED. WORK MUST CONFORM TO THE REVIEWED SAMPLES. ANY WORK WHICH DOES NOT CONFORM SHALL BE REMOVED AND REPLACE WITH WORK WHICH CONFORMS AT THE CONTRACTOR'S EXPENSE. SUBCONTRACTORS SHALL SUBMIT REQUESTS AND SAMPLES FOR REVIEW THROUGH THE GENERAL CONTRACTOR WHEN WORK IS LET THROUGH HIM OR HER. REQUIRED VERIFICATIONS AND
- SUBMITTALS TO BE MADE IN ADEQUATE TIME AS NOT TO DELAY WORK IN PROGRESS. 4. SHOP DRAWINGS SHALL BE SUBMITTED TO THE ARCHITECT FOR HIS OR HER REVIEW WHERE CALLED FOR ANYWHERE IN THESE DOCUMENTS. REVIEW SHALL BE MADE BY THE ARCHITECT BEFORE WORK IS BEGUN, AND WORK SHALL CONFORM TO THE REVIEWED SHOP DRAWINGS, SUBJECT TO REPLACEMENT AS REQUIRED IN PARAGRAPH "E" ABOVE.
- 5. DO NOT SCALE DRAWINGS. CONTRACTOR SHALL VERIFY ALL DIMENSIONAL DISCREPANCIES WITH THE ARCHITECT.
- 6. CONTRACTOR SHALL VERIFY AND COORDINATE ALL OPENINGS THROUGH FLOORS, CEILINGS, AND WALLS WITH ALL ARCHITECTURAL, STRUCTURAL, MECHANICAL, PLUMBING AND ELECTRICAL
- 7. CONTRACTOR WILL ASSUME RESPONSIBILITY OF ITEMS REQUIRING COORDINATION AND RESOLUTION DURING THE BIDDING PROCESS.
- 8. BUILDING TO BE FULLY SPRINKLERED PER NFPA 13D. CONTRACTOR TO PROVIDE FIRE SPRINKLER

**PROJECT NOTES** 

NTS

SYSTEM DESIGN AND SHOP DRAWINGS TO COMFORM TO THESE STANDARDS. 9. USGS ELEVATION 5,918'-0" IS EQUIVALENT TO +100'-0" AS NOTED IN ALL ARCHITECTURAL & CONSULTANT DRAWINGS, U.N.O.

# <u>DESCRIPTION</u> NEW SINGLE FAMILY RESIDENCE ON AN UNIMPROVED SITE

PROJECT ADDRESS LOT 3&4, BLOCK 91

KETCHUM LOT 3 BLOCK 91, PARCEL NUMBER: RPK00000910030 & KETCHUM LOT 4 BLOCK 91, PARCEL NUMBER: RPK0000091004A CITY OF KETCHUM, BLAIN COUNTY, IDAHO, 83340

CURRENT CODE
2018 INTERNATIONAL BUILDING CODE\*

2018 INTERNATIONAL RESIDENTIAL CODE\* 2018 INTERNATIONAL ENERGY CONSERVATION CODE\* 2018 INTERNATIONAL FIRE CODE WITH LOCAL AMENDMENTS\* 2018 INTERNATIONAL SWIMMING POOL AND SPA CODE

2018 INTERNATIONAL EXISTING BUILDING CODE 2018 INTERNATIONAL PROPERTY MAINTENANCE CODE TITLE 15 KETCHUM MUNICIPAL CODE

NATIONAL GREEN BUILDING STANDARD [SILVER CERTIFICATION] APPENDIX M OF THE IBC AS AMENDED BY THE CITY OF KETCHUM ALL APPLICABLE COUNTY ORDINANCES

\*AS AMENDED BY THE IDAHO BUILDING CODE BOARD AND INCLUDING NOTED APPENDICES.

PARCEL IDENTIFICATION #: RPK00000910030 & RPK0000091004A LOT AREA: LOT 3=8,262SF(.19AC). LOT 4=8,261SF(.19AC), COMBINED=16,523SF(.38AC)

ZONING DISTRICT: LR OVERLAY DISTRICT:MOUNTAIN TYPE OF CONSTRUCTION: NEW, TYPE V ANTICIPATED USE: SINGLE FAMILY RESIDENTIAL

NO. RESIDENTIAL UNITS: 1

FRONT YARD: 15'-0", 40'-7" PROPOSED REAR YARD: 5'-0", 14'-1" PROPOSED SIDE YARD: 10'-0", 20'-0" PROPOSED

35'-0"(PROPERTIES WHICH STEP UP OR DOWN HILLSIDES MAY EXTEND 5FT ABOVE THE MAX HEIGHT.) 33'-6" PROPOSED(38'-6" OVERALL STEPPING UP HILLSIDE)

MAXIMUM BUILDING COVERAGE 35%, 29% PROPOSED (4,775SF / 16,523SF)

PROJECT DATA

NTS

OFF-STREET PARKING
PARKING SPACES PROVIDED: 2 (9' X 18' PER STALL)

CURB CUT: 35% MAXIMUM, 18% PROPOSED(20'-0" DRIVEWAY/110'-0" FRONTAGE)

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**KNOB HILL RESIDENCE** 

KNOB HILL PROPERTIES, LLC P.O. BOX 14001-174 KETCHUM, ID 83340

PROJECT ARCHITECT:

RO | ROCKETT DESIGN 1306 BRIDGEWAY, FLOOR 2 SAUSALITO, CA 94965 TEL: 415.289.0830

SURVEYOR:

BENCHMARK ASSOCIATES, P.A. P.O. BOX 733 - 100 BELL DRIVE KETCHUM, ID 83340 TEL: 208.726.9512

GEOTECHNICAL ENGINEER:

**BUTLER ASSOCIATES, INC.** P.O. BOX 1034 KETCHUM, ID 83340 TEL: 208.720.6432

CIVIL ENGINEER:

BENCHMARK ASSOCIATES, P.A. P.O. BOX 733 - 100 BELL DRIVE KETCHUM, ID 83340 TEL: 208.726.9512

LANDSCAPE ARCHITECT:

FIELD STUDIO 722 N ROUSE AVE BOZEMAN, MT 59715 TEL: 406.551.2098

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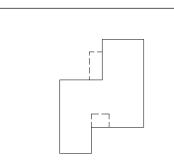
ambiguities, or conflicts which are alleged.

1 01.15.25 MODR PRE-APPLICATION

NO DATE ISSUE

PROJECT:

**KNOB HILL RESIDENCE** LOT 3&4, BLOCK 91



PROJECT NUMBER

DRAWING TITLE: **COVER SHEET** 

DRAWING NUMBER:

NOT FOR CONSTRUCTION

**LEGEND** ISSUED REVISED/ REISSUED 🕒 OMITTED 1-GENERAL G-000 COVER SHEET G-001 SHEET INDEX G-010 FAR & LOT COVERAGE SUMMARY G-011 **BUILDING HEIGHT** G-020 LOT DISTURBANCE DIAGRAMS G-021 MATERIAL PALETTE G-022 RENDERED PERSPECTIVES G-023 RENDERED ELEVATIONS RENDERED ELEVATIONS G-024 G-025 PHOTOGRAPHY EXHIBITS 2-SURVEY TOPOGRAPHIC SURVEY 1 OF 1. SLOPE EXHIBIT WORKSHEET 3-CIVIL C-1.0 GRADING, DRAINAGE & UTILITY PLAN C-1.1 DETAIL SHEET EXB FIRE TRUCK EXHIBIT 4-LANDSCAPE L-0.00 OVERALL SITE PLAN L-1.00 LAYOUT AND MATERIALS PLAN L-2.00 GRADING AND DRAINAGE PLAN L-5.00 PLANTING PLAN 5-ARCHITECTURAL A-100 SITE PLAN A-102 REFERENCE PLAN / LEVEL 01 A-103 REFERENCE PLAN / LEVEL 02 A-104 REFERENCE PLAN / LEVEL 03 A-105 REFERENCE PLAN / ROOF NTS SHEET INDEX

# **KNOB HILL RESIDENCE**

OWNER:

KNOB HILL PROPERTIES, LLC P.O. BOX 14001-174 KETCHUM, ID 83340

PROJECT ARCHITECT:

RO | ROCKETT DESIGN 1306 BRIDGEWAY, FLOOR 2 SAUSALITO, CA 94965 TEL: 415.289.0830

SURVEYOR:

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CIVIL ENGINEER:

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SEAL:

1 01.15.25 MODR PRE-APPLICATION
NO DATE ISSUE

PROJECT:

KNOB HILL RESIDENCE LOT 3&4, BLOCK 91

PROJECT NUMBER

2204


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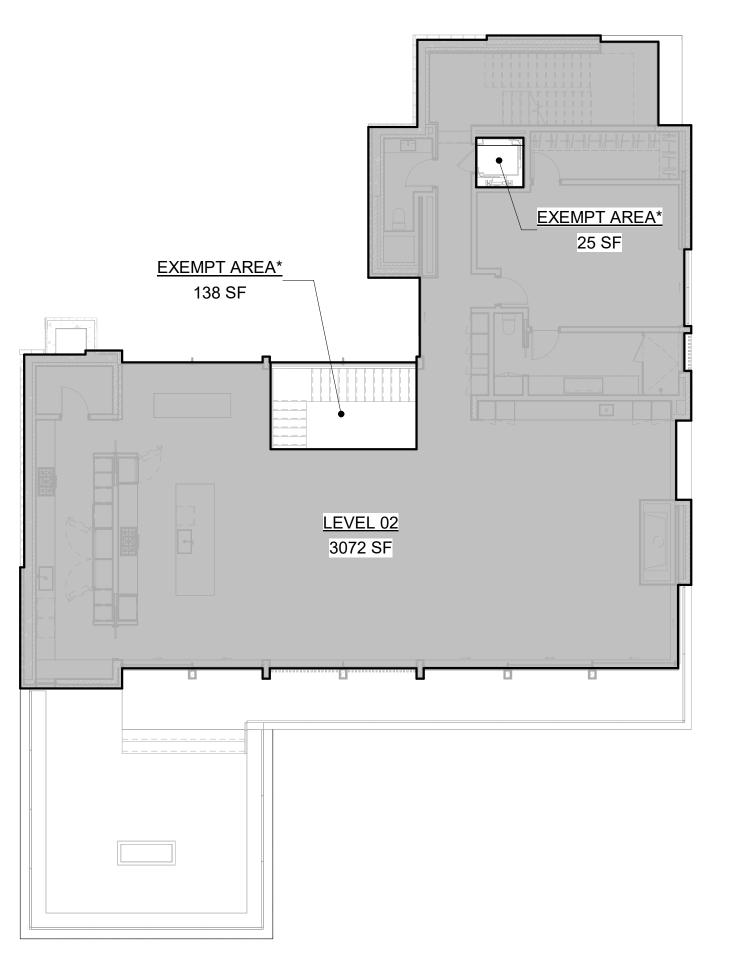
SHEET INDEX


DRAWING NUMBER:

G-001

NOT FOR CONSTRUCTION



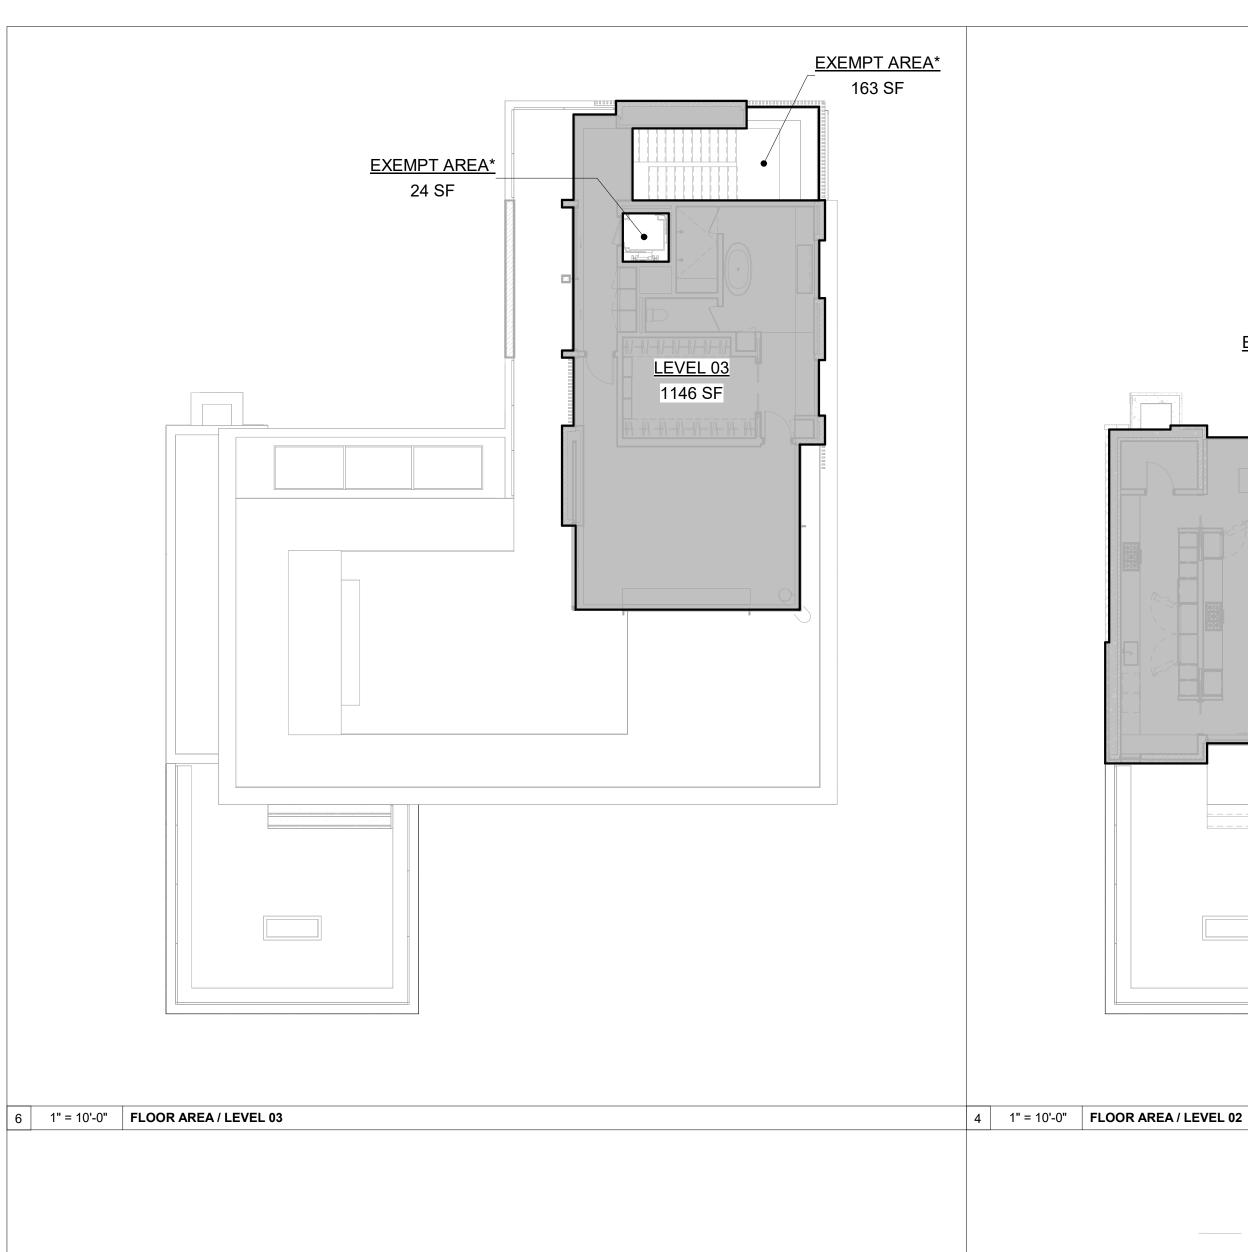

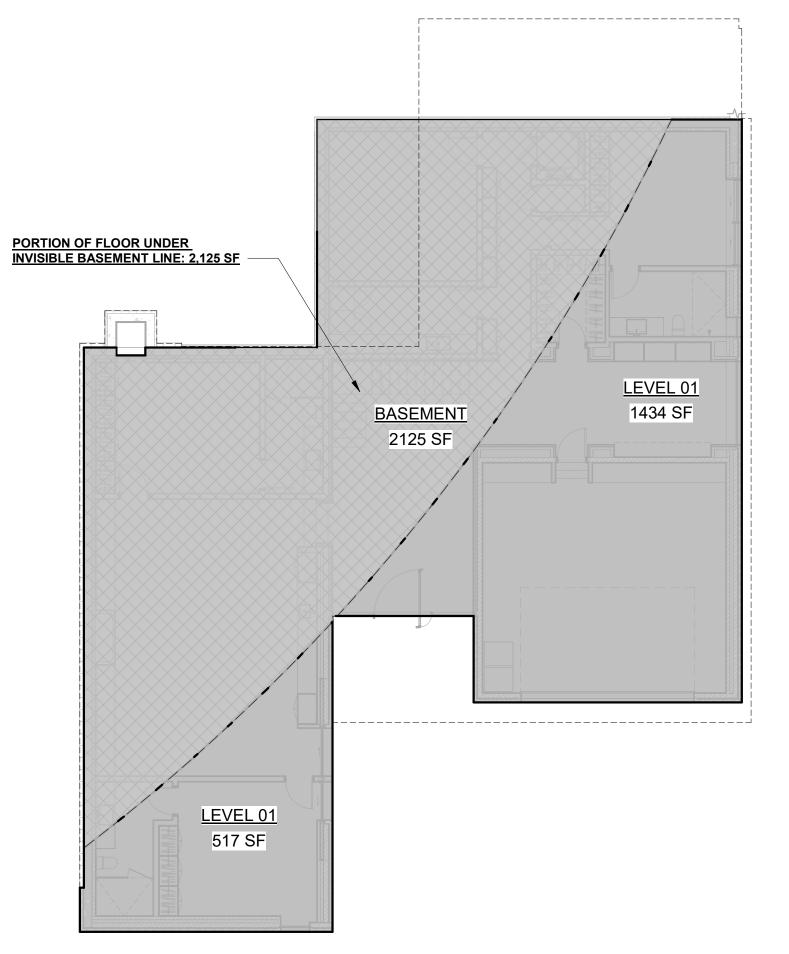

KNOB HILL PROPERTIES, LLC P.O. BOX 14001-174 KETCHUM, ID 83340

PROJECT ARCHITECT:

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LANDSCAPE ARCHITECT:

**FIELD STUDIO** 722 N ROUSE AVE BOZEMAN, MT 59715 TEL: 406.551.2098

2 1" = 10'-0" FLOOR AREA / LEVEL 01

PROPOSED FLOOR AREA CALCULATIONS

ZONING: LR

Are
1951 S
3072 S
1146 S
-

6169 SF

# EXEMPT FLOOR AREA

GROSS FLOOR AREA TOTAL

Name	Area
BASEMENT	2125 SF
EXEMPT AREA*	350 SF

\*STAIR TOWERS AND ELEVATORS ON THE GROUND FLOOR ONLY

# PROPOSED LOT COVERAGE CALCULATIONS

LOT AREA(PER SURVEY): 0.38 ACRES(16,523SF) PERMISSIBLE BUILDING COVERAGE(35% OF LOT AREA): 0.13 ACRES(5,783SF)	BUILDING COVERAGE	4775 SF	COMPLI
	,	,	

KMC §17.08.020

1 1/8" = 1'-0" PROPOSED FLOOR AREA CALCULATIONS

# FLOOR AREA, GROSS:

THE SUM OF THE HORIZONTAL AREA OF THE BUILDING MEASURED ALONG THE OUTSIDE WALLS OF EACH FLOOR OF A BUILDING OR PORTION OF A BUILDING, INCLUDING STAIR TOWERS AND ELEVATORS ON THE GROUND FLOOR ONLY, AND 50 PERCENT OF ATRIUMS OVER 18 FEET PLATE HEIGHT, BUT NOT INCLUDING BASEMENTS, UNDERGROUND PARKING AREAS OR OPEN UNENCLOSED DECKS. PARKING AREAS COVERED BY A ROOF OR PORTION OF THE BUILDING AND ENCLOSED ON THREE OR MORE SIDES BY BUILDING WALLS ARE INCLUDED.


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1 01.15.25 MODR PRE-APPLICATION NO DATE ISSUE

KNOB HILL RESIDENCE LOT 3&4, BLOCK 91



PROJECT NUMBER


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FAR & LOT COVERAGE SUMMARY

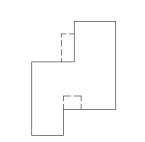
DRAWING NUMBER:

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3 1" = 20'-0" LOT COVERAGE



1/16" = 1'-0" ROOF PLAN / BUILDING HEIGHT

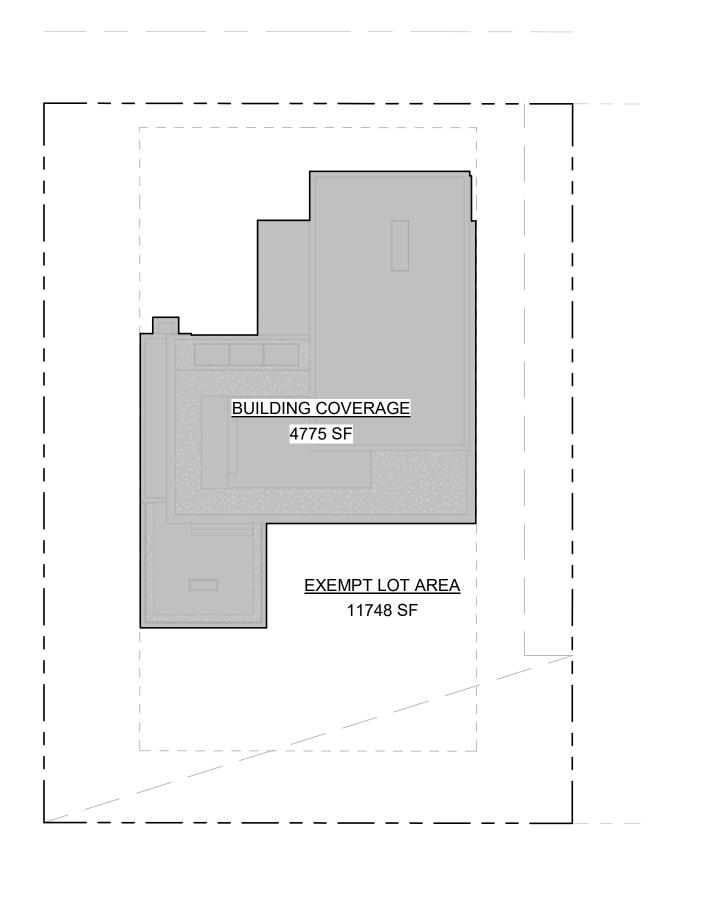**KNOB HILL RESIDENCE** 

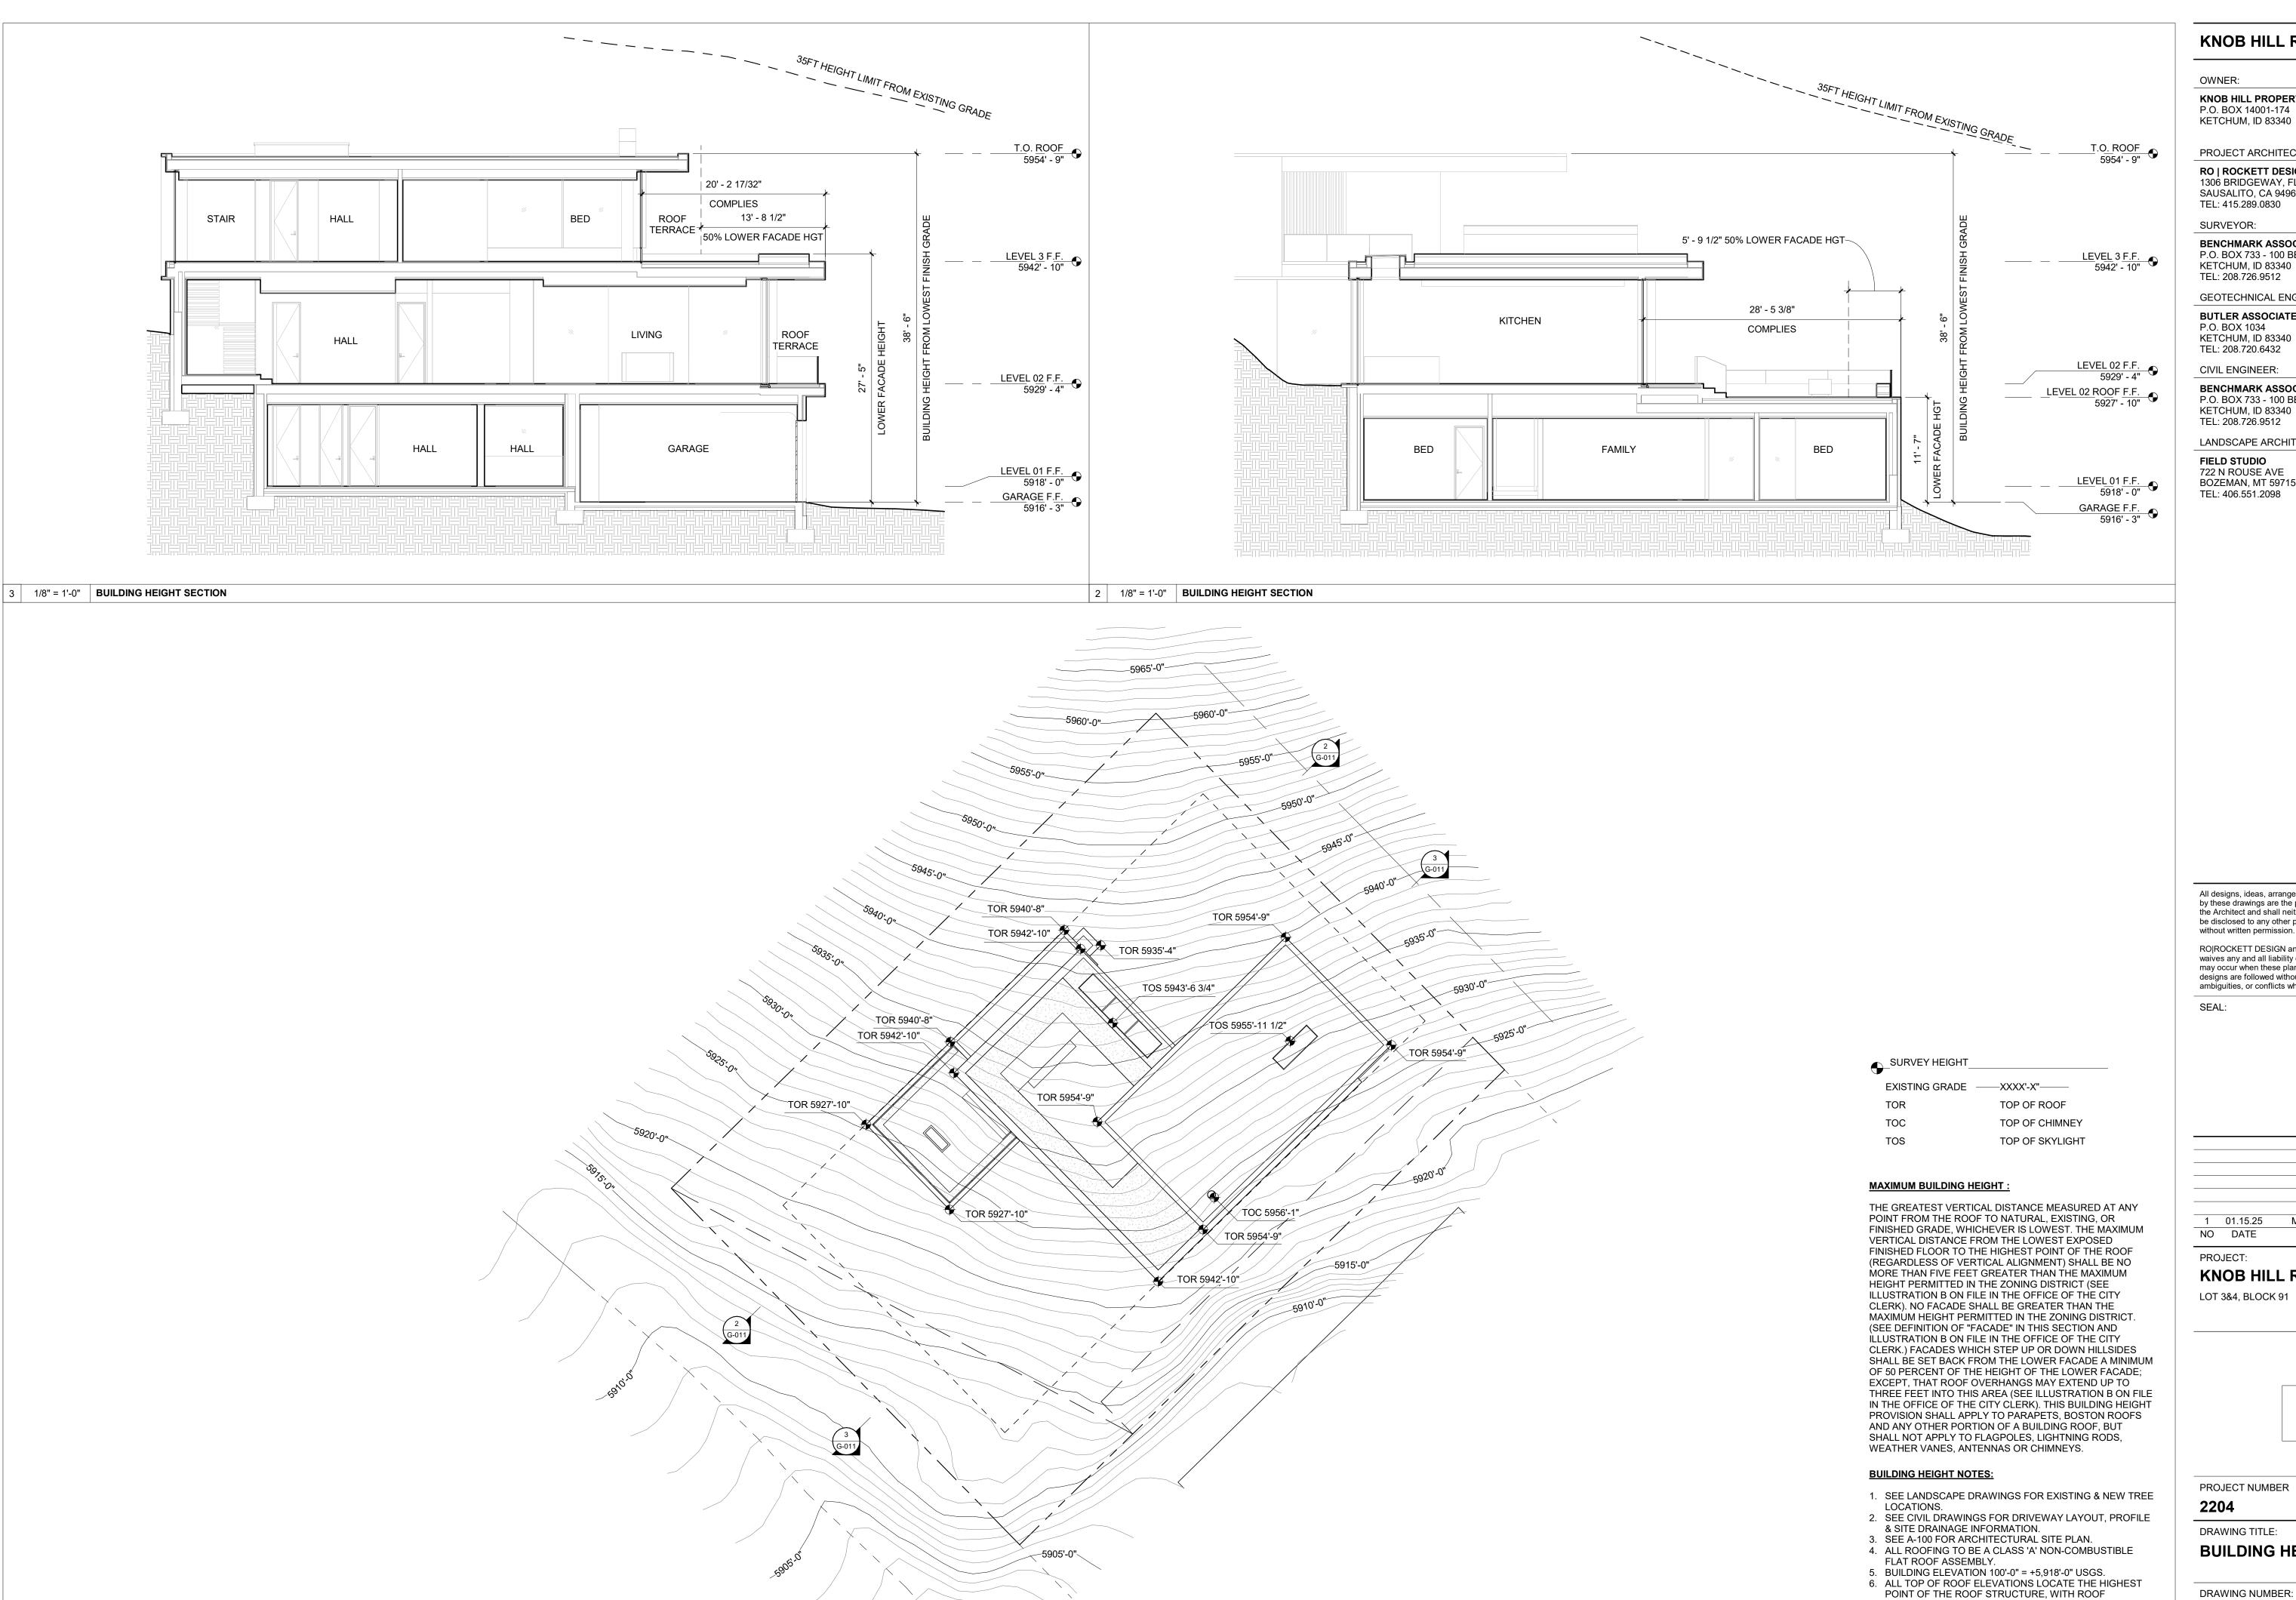OWNER:

KNOB HILL PROPERTIES, LLC P.O. BOX 14001-174 KETCHUM, ID 83340

PROJECT ARCHITECT:

RO | ROCKETT DESIGN 1306 BRIDGEWAY, FLOOR 2 SAUSALITO, CA 94965 TEL: 415.289.0830

SURVEYOR:

BENCHMARK ASSOCIATES, P.A. P.O. BOX 733 - 100 BELL DRIVE KETCHUM, ID 83340

GEOTECHNICAL ENGINEER:

BUTLER ASSOCIATES, INC. P.O. BOX 1034 KETCHUM, ID 83340

CIVIL ENGINEER:

**BENCHMARK ASSOCIATES, P.A.** P.O. BOX 733 - 100 BELL DRIVE KETCHUM, ID 83340 TEL: 208.726.9512

LANDSCAPE ARCHITECT:

**FIELD STUDIO** 722 N ROUSE AVE BOZEMAN, MT 59715 TEL: 406.551.2098

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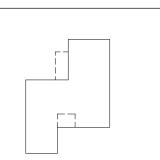
SEAL:

1 01.15.25 MODR PRE-APPLICATION

ISSUE

PROJECT:

KNOB HILL RESIDENCE



PROJECT NUMBER

DRAWING TITLE:


**BUILDING HEIGHT** 


DRAWING NUMBER:

ASSEMBLY SLOPING INWARDS TOWARDS INTERNAL ROOF DRAINS, WITH THE EXCEPTION OF THE T.O.

SKYLIGHTS AS NOTED.

NOT FOR CONSTRUCTION

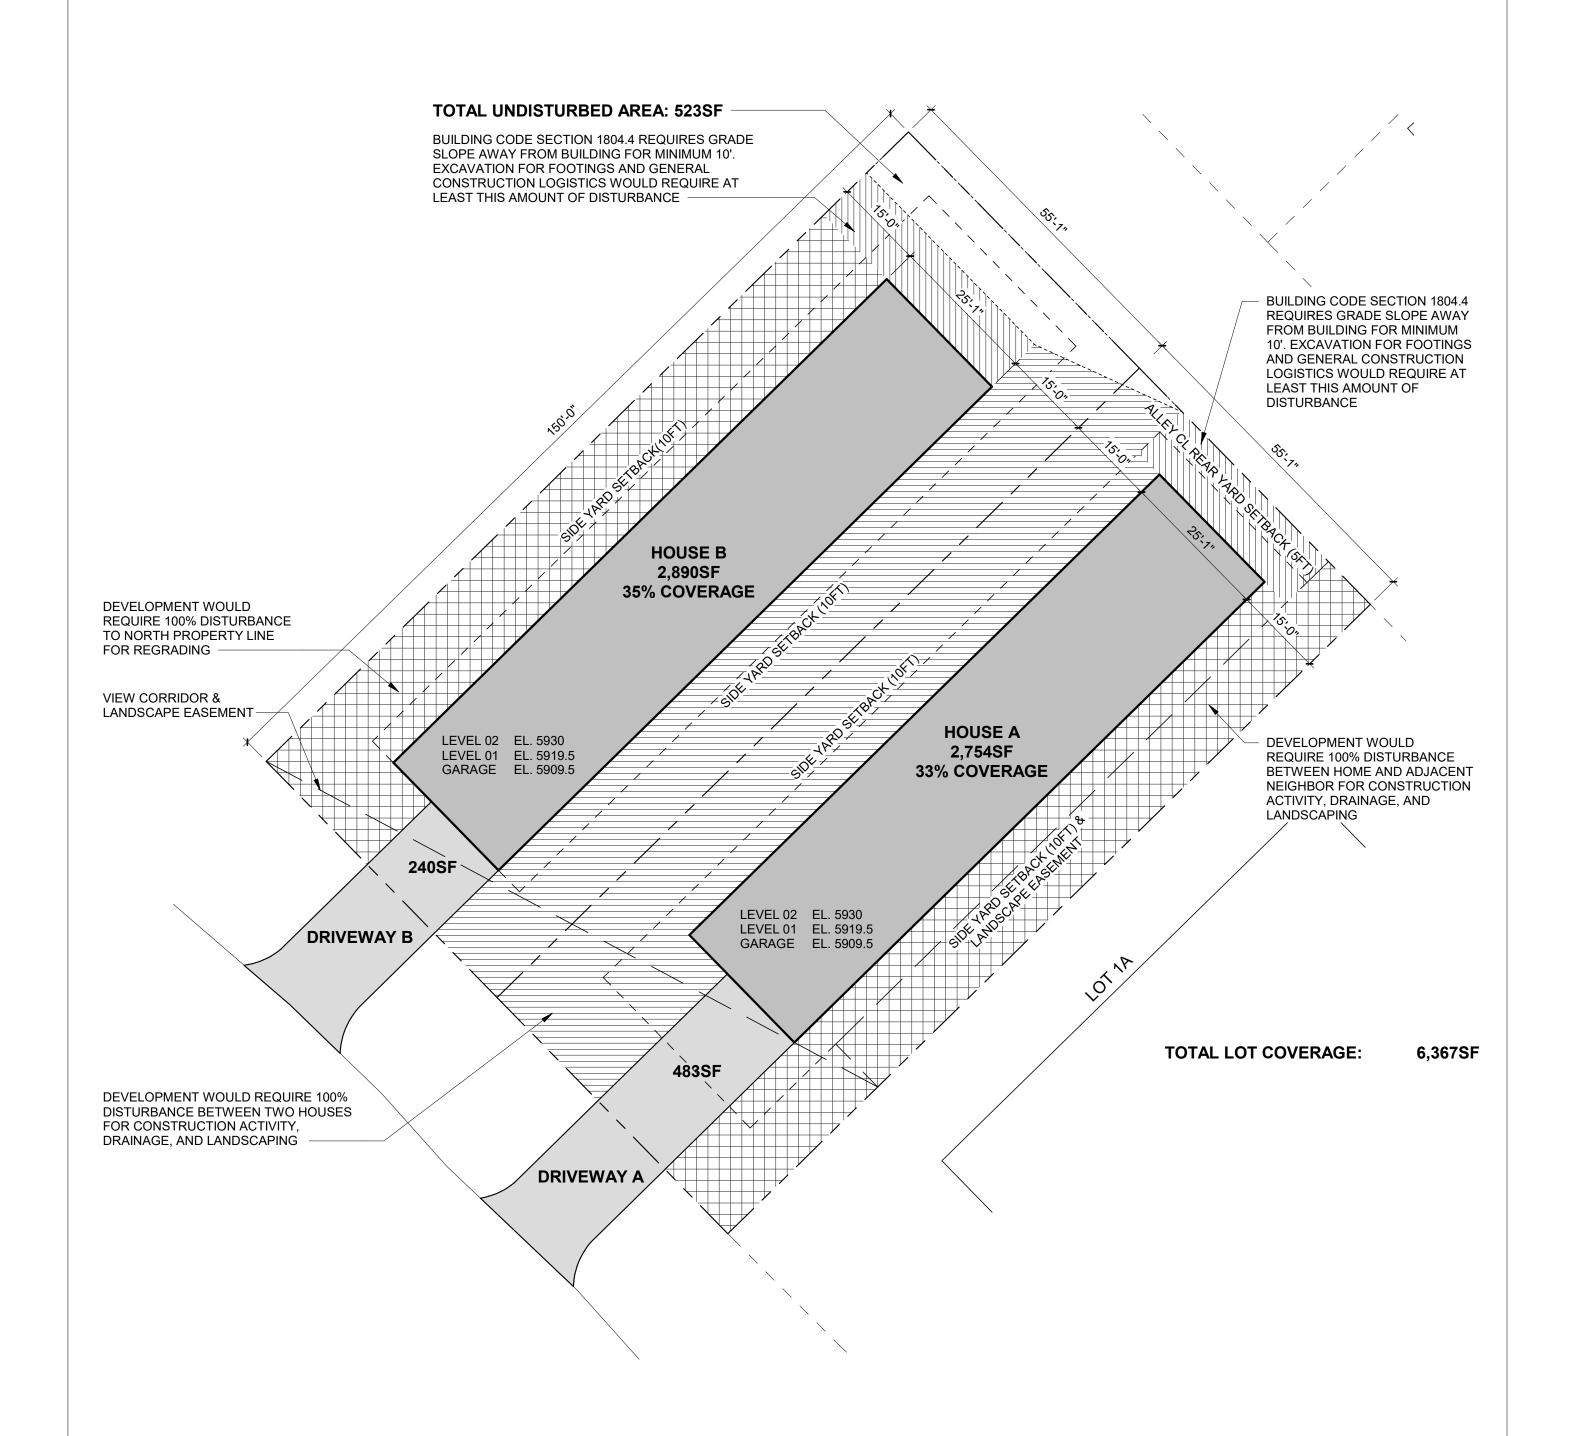

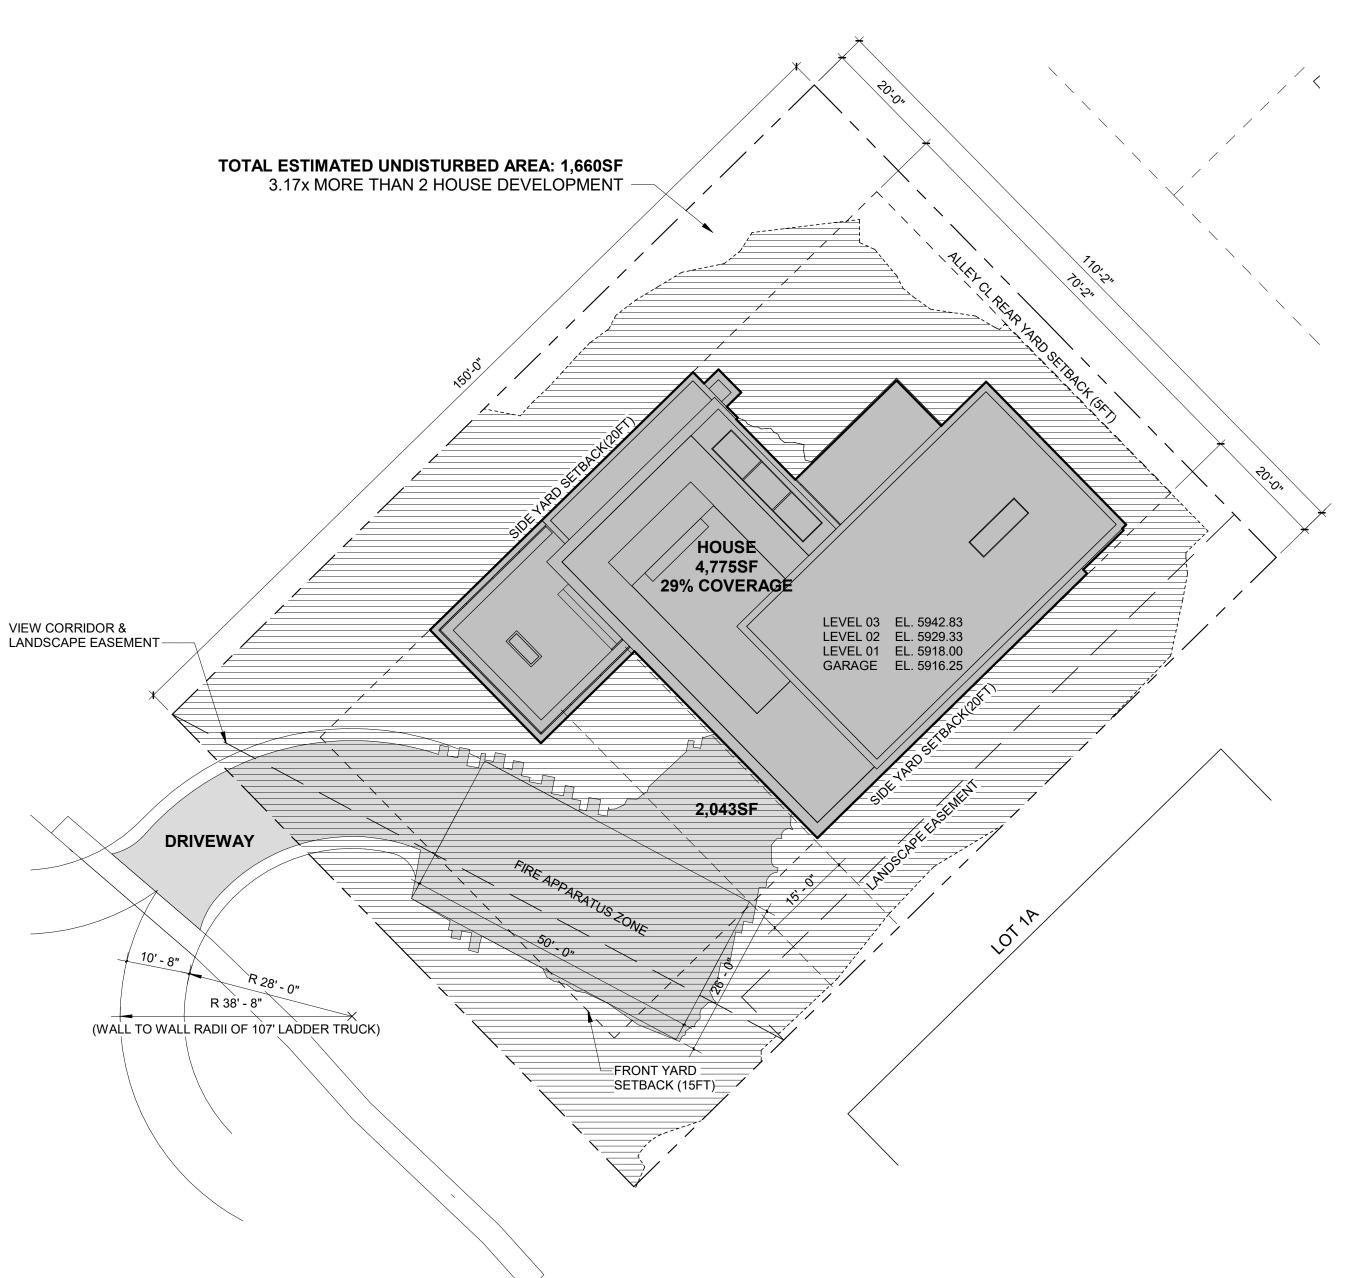

OWNER:

KNOB HILL PROPERTIES, LLC P.O. BOX 14001-174 KETCHUM, ID 83340

PROJECT ARCHITECT:

RO | ROCKETT DESIGN 1306 BRIDGEWAY, FLOOR 2 SAUSALITO, CA 94965 TEL: 415.289.0830

SURVEYOR:

BENCHMARK ASSOCIATES, P.A. P.O. BOX 733 - 100 BELL DRIVE KETCHUM, ID 83340 TEL: 208.726.9512

GEOTECHNICAL ENGINEER:

BUTLER ASSOCIATES, INC. P.O. BOX 1034 KETCHUM, ID 83340 TEL: 208.720.6432

CIVIL ENGINEER:

BENCHMARK ASSOCIATES, P.A. P.O. BOX 733 - 100 BELL DRIVE KETCHUM, ID 83340 TEL: 208.726.9512

LANDSCAPE ARCHITECT:

FIELD STUDIO 722 N ROUSE AVE BOZEMAN, MT 59715 TEL: 406.551.2098

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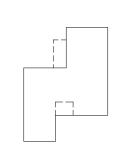
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SEAL:

1 01.15.25 MODR PRE-APPLICATION
NO DATE ISSUE

PROJECT:

KNOB HILL RESIDENCE LOT 3&4, BLOCK 91



PROJECT NUMBER

2204

DRAWING TITLE:

LOT DISTURBANCE DIAGRAMS

DRAWING NUMBER:


G-020

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2 1/16" = 1'-0" LOT DISTURBANCE DIAGRAM / DOUBLE LOT DEVELOPMENT

1 1/16" = 1'-0" LOT DISTURBANCE DIAGRAM / SINGLE LOT DEVELOPMENT



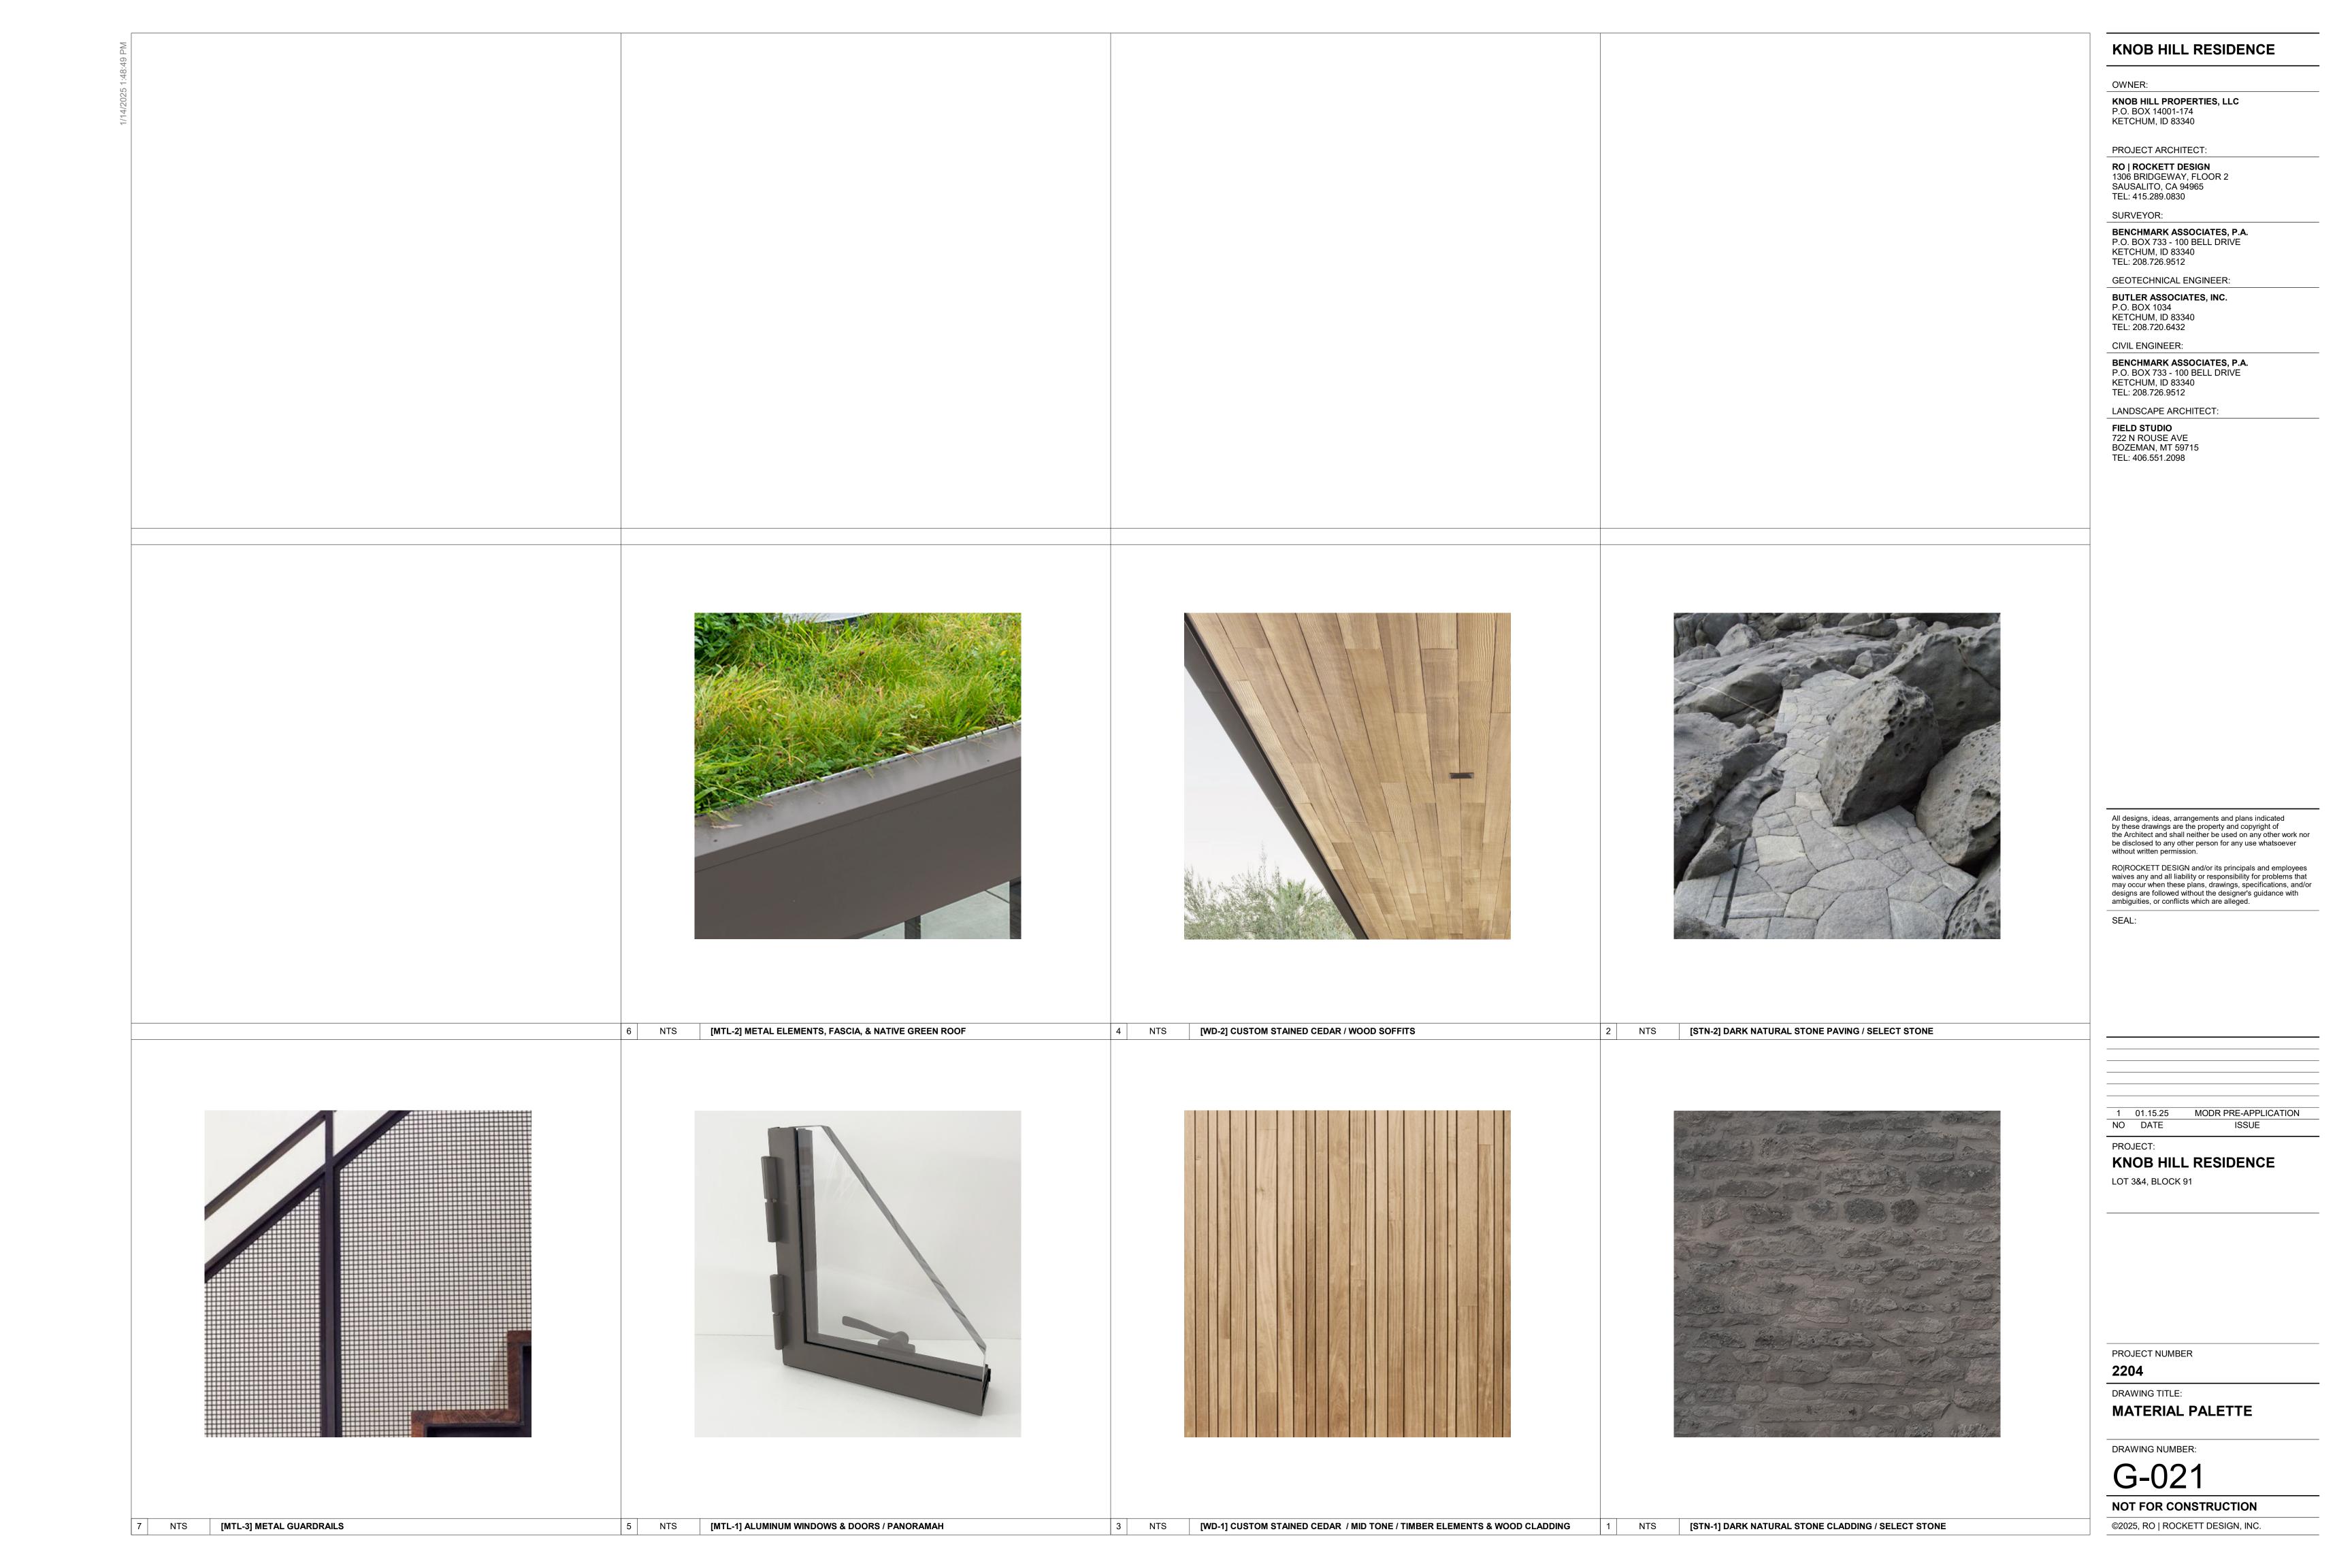

#### <u>NC</u>

REFER TO G-110 MATERIAL PALETTE FOR MATERIAL SPECIFICATIONS



# NOTF:

REFER TO G-110 MATERIAL PALETTE FOR MATERIAL SPECIFICATIONS

# **KNOB HILL RESIDENCE**

OWNER:

KNOB HILL PROPERTIES, LLC P.O. BOX 14001-174 KETCHUM, ID 83340

#### PROJECT ARCHITECT:

RO | ROCKETT DESIGN 1306 BRIDGEWAY, FLOOR 2 SAUSALITO, CA 94965 TEL: 415.289.0830

#### SURVEYOR:

BENCHMARK ASSOCIATES, P.A. P.O. BOX 733 - 100 BELL DRIVE KETCHUM, ID 83340 TEL: 208.726.9512

#### GEOTECHNICAL ENGINEER:

BUTLER ASSOCIATES, INC. P.O. BOX 1034 KETCHUM, ID 83340 TEL: 208.720.6432

#### CIVIL ENGINEER:

BENCHMARK ASSOCIATES, P.A. P.O. BOX 733 - 100 BELL DRIVE KETCHUM, ID 83340 TEL: 208.726.9512

### LANDSCAPE ARCHITECT:

FIELD STUDIO 722 N ROUSE AVE BOZEMAN, MT 59715 TEL: 406.551.2098

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\_\_\_\_\_

1 01.15.25 MODR PRE-APPLICATION
NO DATE ISSUE

# PROJECT:

KNOB HILL RESIDENCE LOT 3&4, BLOCK 91

PROJECT NUMBER

# 2204

DRAWING TITLE:

RENDERED PERSPECTIVES

DRAWING NUMBER:

G-022

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NTS PERSPECTIVE / STREET VIEW

NTS **PERSPECTIVE / BIRD'S EYE** 

REFER TO G-110 MATERIAL PALETTE FOR MATERIAL SPECIFICATIONS

[WD-1] CUSTOM STAINED CEDAR T.O. ROOF SCREEN DASHED LINE OF TREES LEVEL 03 F.F. 5942'-10" [WD-1] CUSTOM STAINED CEDAR SIDING [MTL-1] ALUMINUM WINDOWS & DOORS GUARDRAILS [STN-1] DARK NATURAL STONE CLADDING LEVEL 01 F.F. 5918'-0"

PROJECT NUMBER

NO DATE

PROJECT:

LOT 3&4, BLOCK 91

DRAWING TITLE: RENDERED ELEVATIONS

**KNOB HILL RESIDENCE** 

KNOB HILL PROPERTIES, LLC

BENCHMARK ASSOCIATES, P.A.

P.O. BOX 733 - 100 BELL DRÍVE

GEOTECHNICAL ENGINEER:

BUTLER ASSOCIATES, INC.

**BENCHMARK ASSOCIATES, P.A.** P.O. BOX 733 - 100 BELL DRIVE

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KNOB HILL RESIDENCE

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P.O. BOX 14001-174 KETCHUM, ID 83340

PROJECT ARCHITECT: RO | ROCKETT DESIGN 1306 BRIDGEWAY, FLOOR 2 SAUSALITO, CA 94965 TEL: 415.289.0830

SURVEYOR:

KETCHUM, ID 83340 TEL: 208.726.9512

P.O. BOX 1034

KETCHUM, ID 83340

KETCHUM, ID 83340

LANDSCAPE ARCHITECT:

TEL: 208.726.9512

**FIELD STUDIO** 722 N ROUSE AVE BOZEMAN, MT 59715 TEL: 406.551.2098

TEL: 208.720.6432 CIVIL ENGINEER:

OWNER:

DRAWING NUMBER:

G-023


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REFER TO G-110 MATERIAL PALETTE FOR MATERIAL SPECIFICATIONS NOT FOR CONSTRUCTION

2 1/8" = 1'-0" **ELEVATION / SOUTH** 

1/8" = 1'-0" **ELEVATION / EAST** 



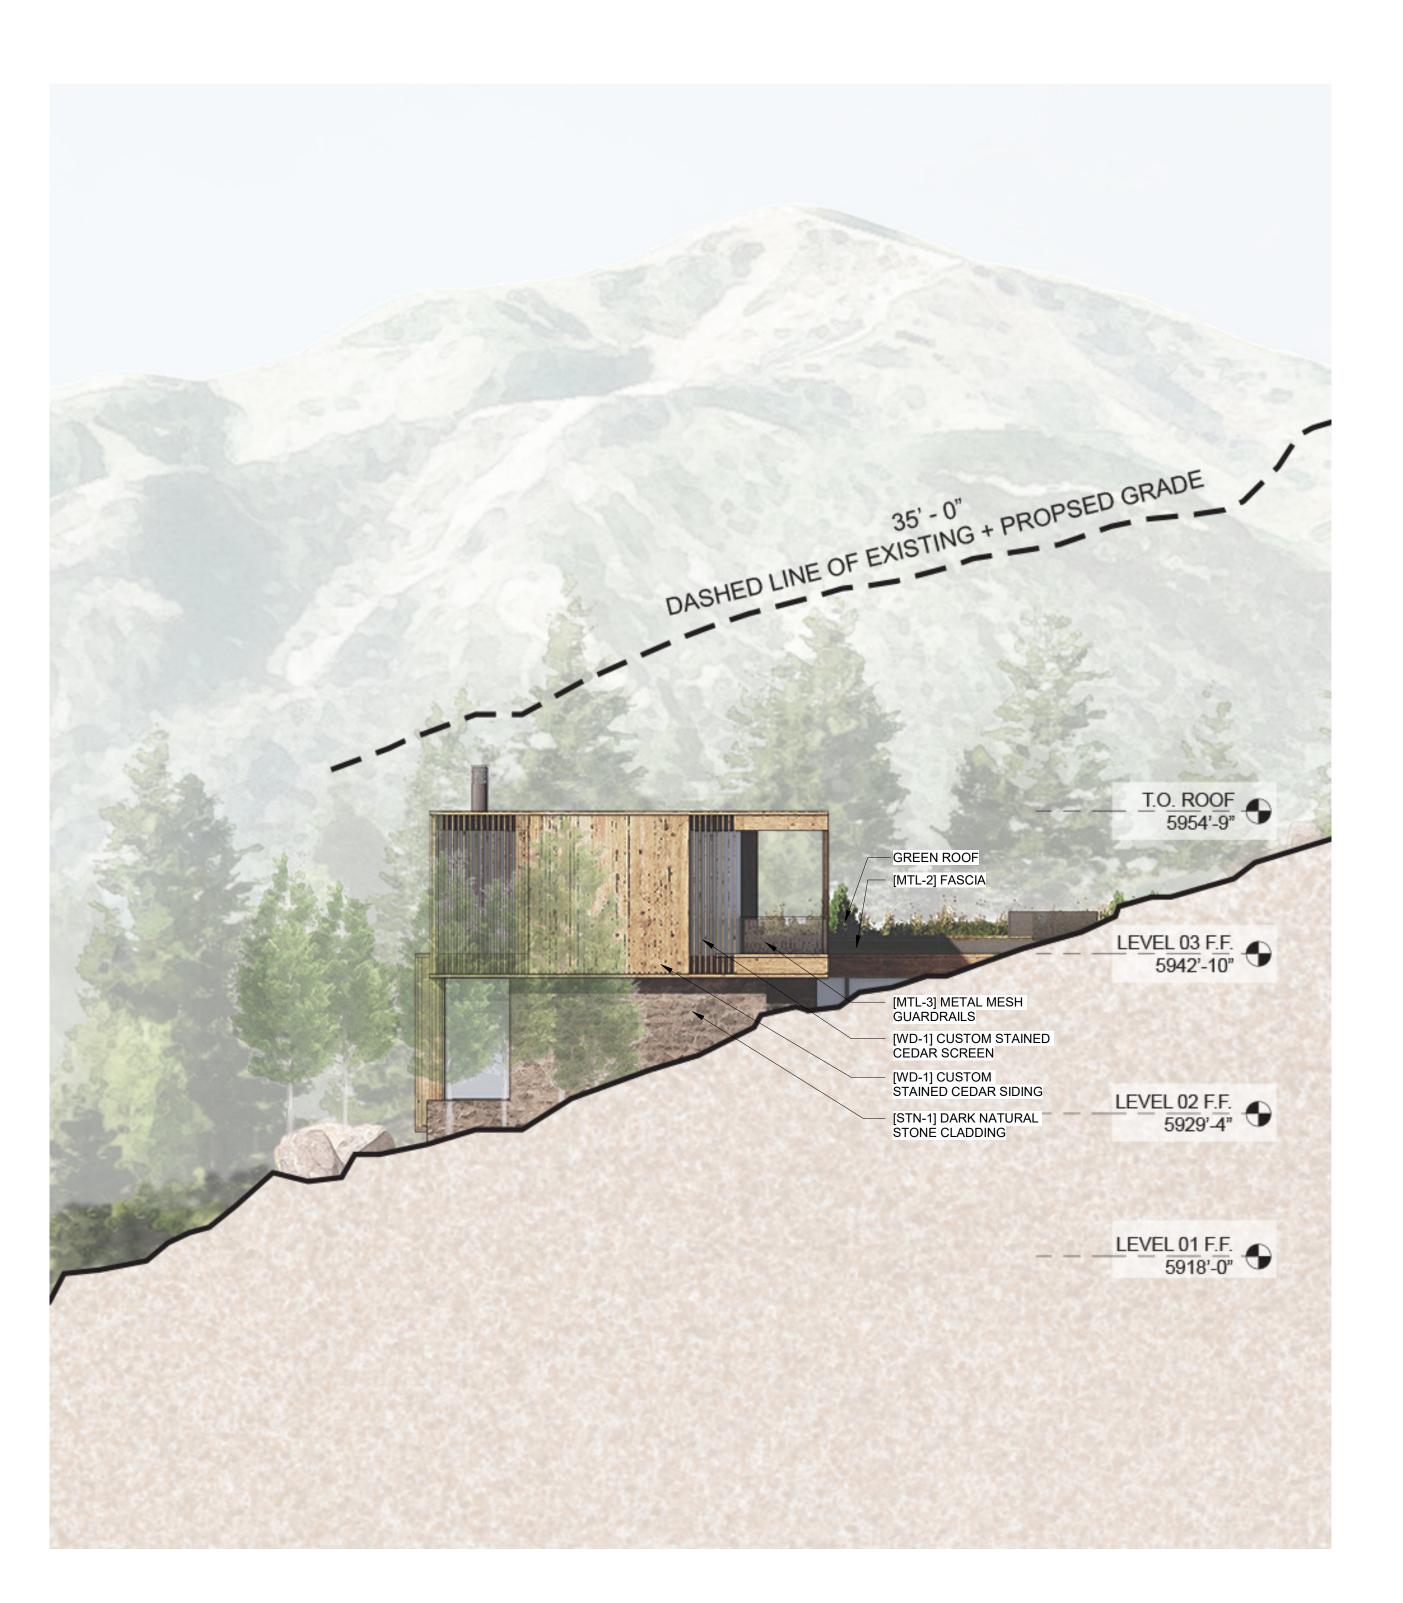

OWNER:

KNOB HILL PROPERTIES, LLC P.O. BOX 14001-174 KETCHUM, ID 83340

PROJECT ARCHITECT:

**RO | ROCKETT DESIGN** 1306 BRIDGEWAY, FLOOR 2 SAUSALITO, CA 94965 TEL: 415.289.0830

SURVEYOR:

**BENCHMARK ASSOCIATES, P.A.** P.O. BOX 733 - 100 BELL DRIVE KETCHUM, ID 83340 TEL: 208.726.9512

GEOTECHNICAL ENGINEER:

BUTLER ASSOCIATES, INC. P.O. BOX 1034 KETCHUM, ID 83340 TEL: 208.720.6432

CIVIL ENGINEER:

**BENCHMARK ASSOCIATES, P.A.** P.O. BOX 733 - 100 BELL DRIVE KETCHUM, ID 83340 TEL: 208.726.9512

LANDSCAPE ARCHITECT:

**FIELD STUDIO** 722 N ROUSE AVE BOZEMAN, MT 59715 TEL: 406.551.2098

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SEAL:

1 01.15.25 MODR PRE-APPLICATION NO DATE ISSUE

PROJECT:

KNOB HILL RESIDENCE LOT 3&4, BLOCK 91

PROJECT NUMBER

DRAWING TITLE: RENDERED ELEVATIONS

DRAWING NUMBER:

REFER TO G-110 MATERIAL PALETTE FOR MATERIAL SPECIFICATIONS

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REFER TO G-110 MATERIAL PALETTE FOR MATERIAL SPECIFICATIONS

2 1/8" = 1'-0" **ELEVATION / WEST** 

1 1/8" = 1'-0" **ELEVATION / NORTH** 

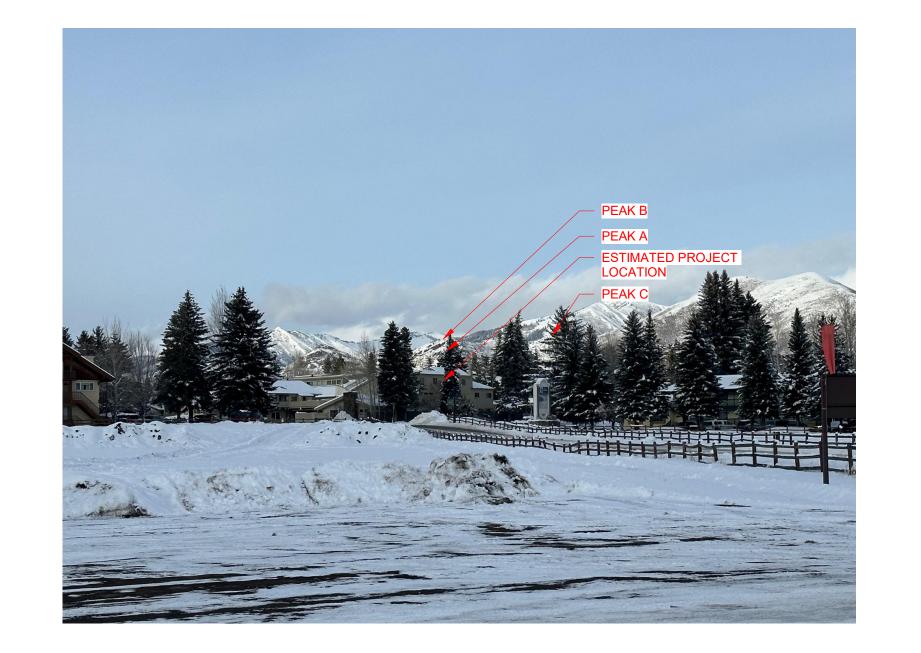


EXHIBIT F - VIEW FROM RIVER RUN PARKING LOT



EXHIBIT C - VIEW FROM 6TH STREET GRAVEL BIKE PATH CONNECTOR

EXHIBIT B - VIEW FROM TOWN SQUARE ICE CREAM SHED

**KNOB HILL RESIDENCE** 

OWN

KNOB HILL PROPERTIES, LLC P.O. BOX 14001-174 KETCHUM, ID 83340

PROJECT ARCHITECT:

RO | ROCKETT DESIGN 1306 BRIDGEWAY, FLOOR 2 SAUSALITO, CA 94965 TEL: 415.289.0830

SURVEYOR:

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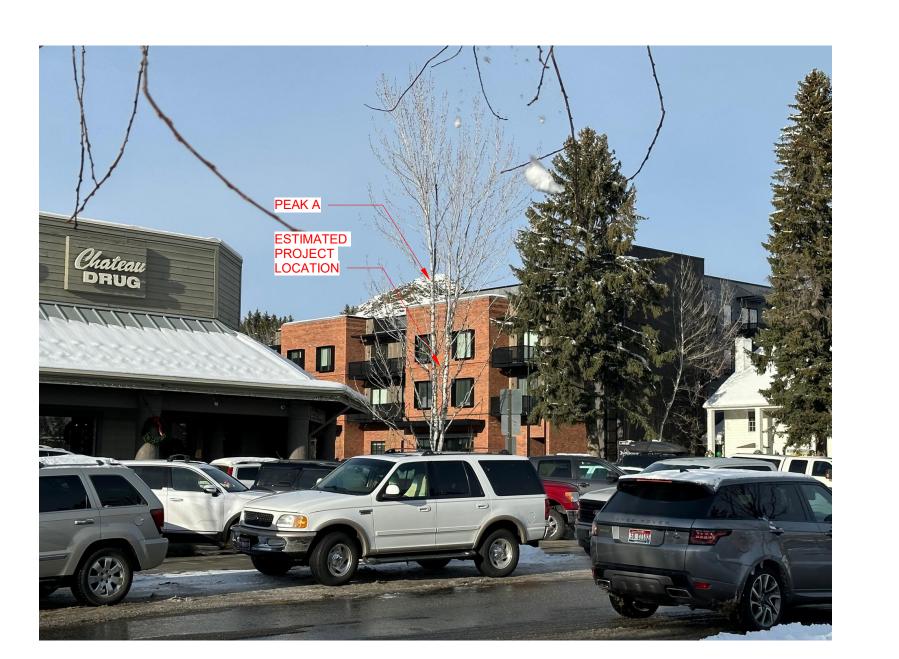
CIVIL ENGINEER:

BENCHMARK ASSOCIATES, P.A. P.O. BOX 733 - 100 BELL DRIVE KETCHUM, ID 83340 TEL: 208.726.9512

LANDSCAPE ARCHITECT:

FIELD STUDIO 722 N ROUSE AVE BOZEMAN, MT 59715 TEL: 406.551.2098





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SEAL:

PEAR C
PEAR B
PEAR A

PERCEPT SITE

EXHIBIT C

EXHIBIT C

PEAK B
PEAK A
ESTIMATED PROJECT
LOCATION
PEAK C

PEAK B
PEAK A
ESTIMATED
PROJECT
LOCATION

1 01.15.25 MODR PRE-APPLICATION
NO DATE ISSUE

PROJEC

KNOB HILL RESIDENCE LOT 3&4, BLOCK 91

PROJECT NUMBER

2204

DRAWING TITLE:

PHOTOGRAPHY EXHIBITS


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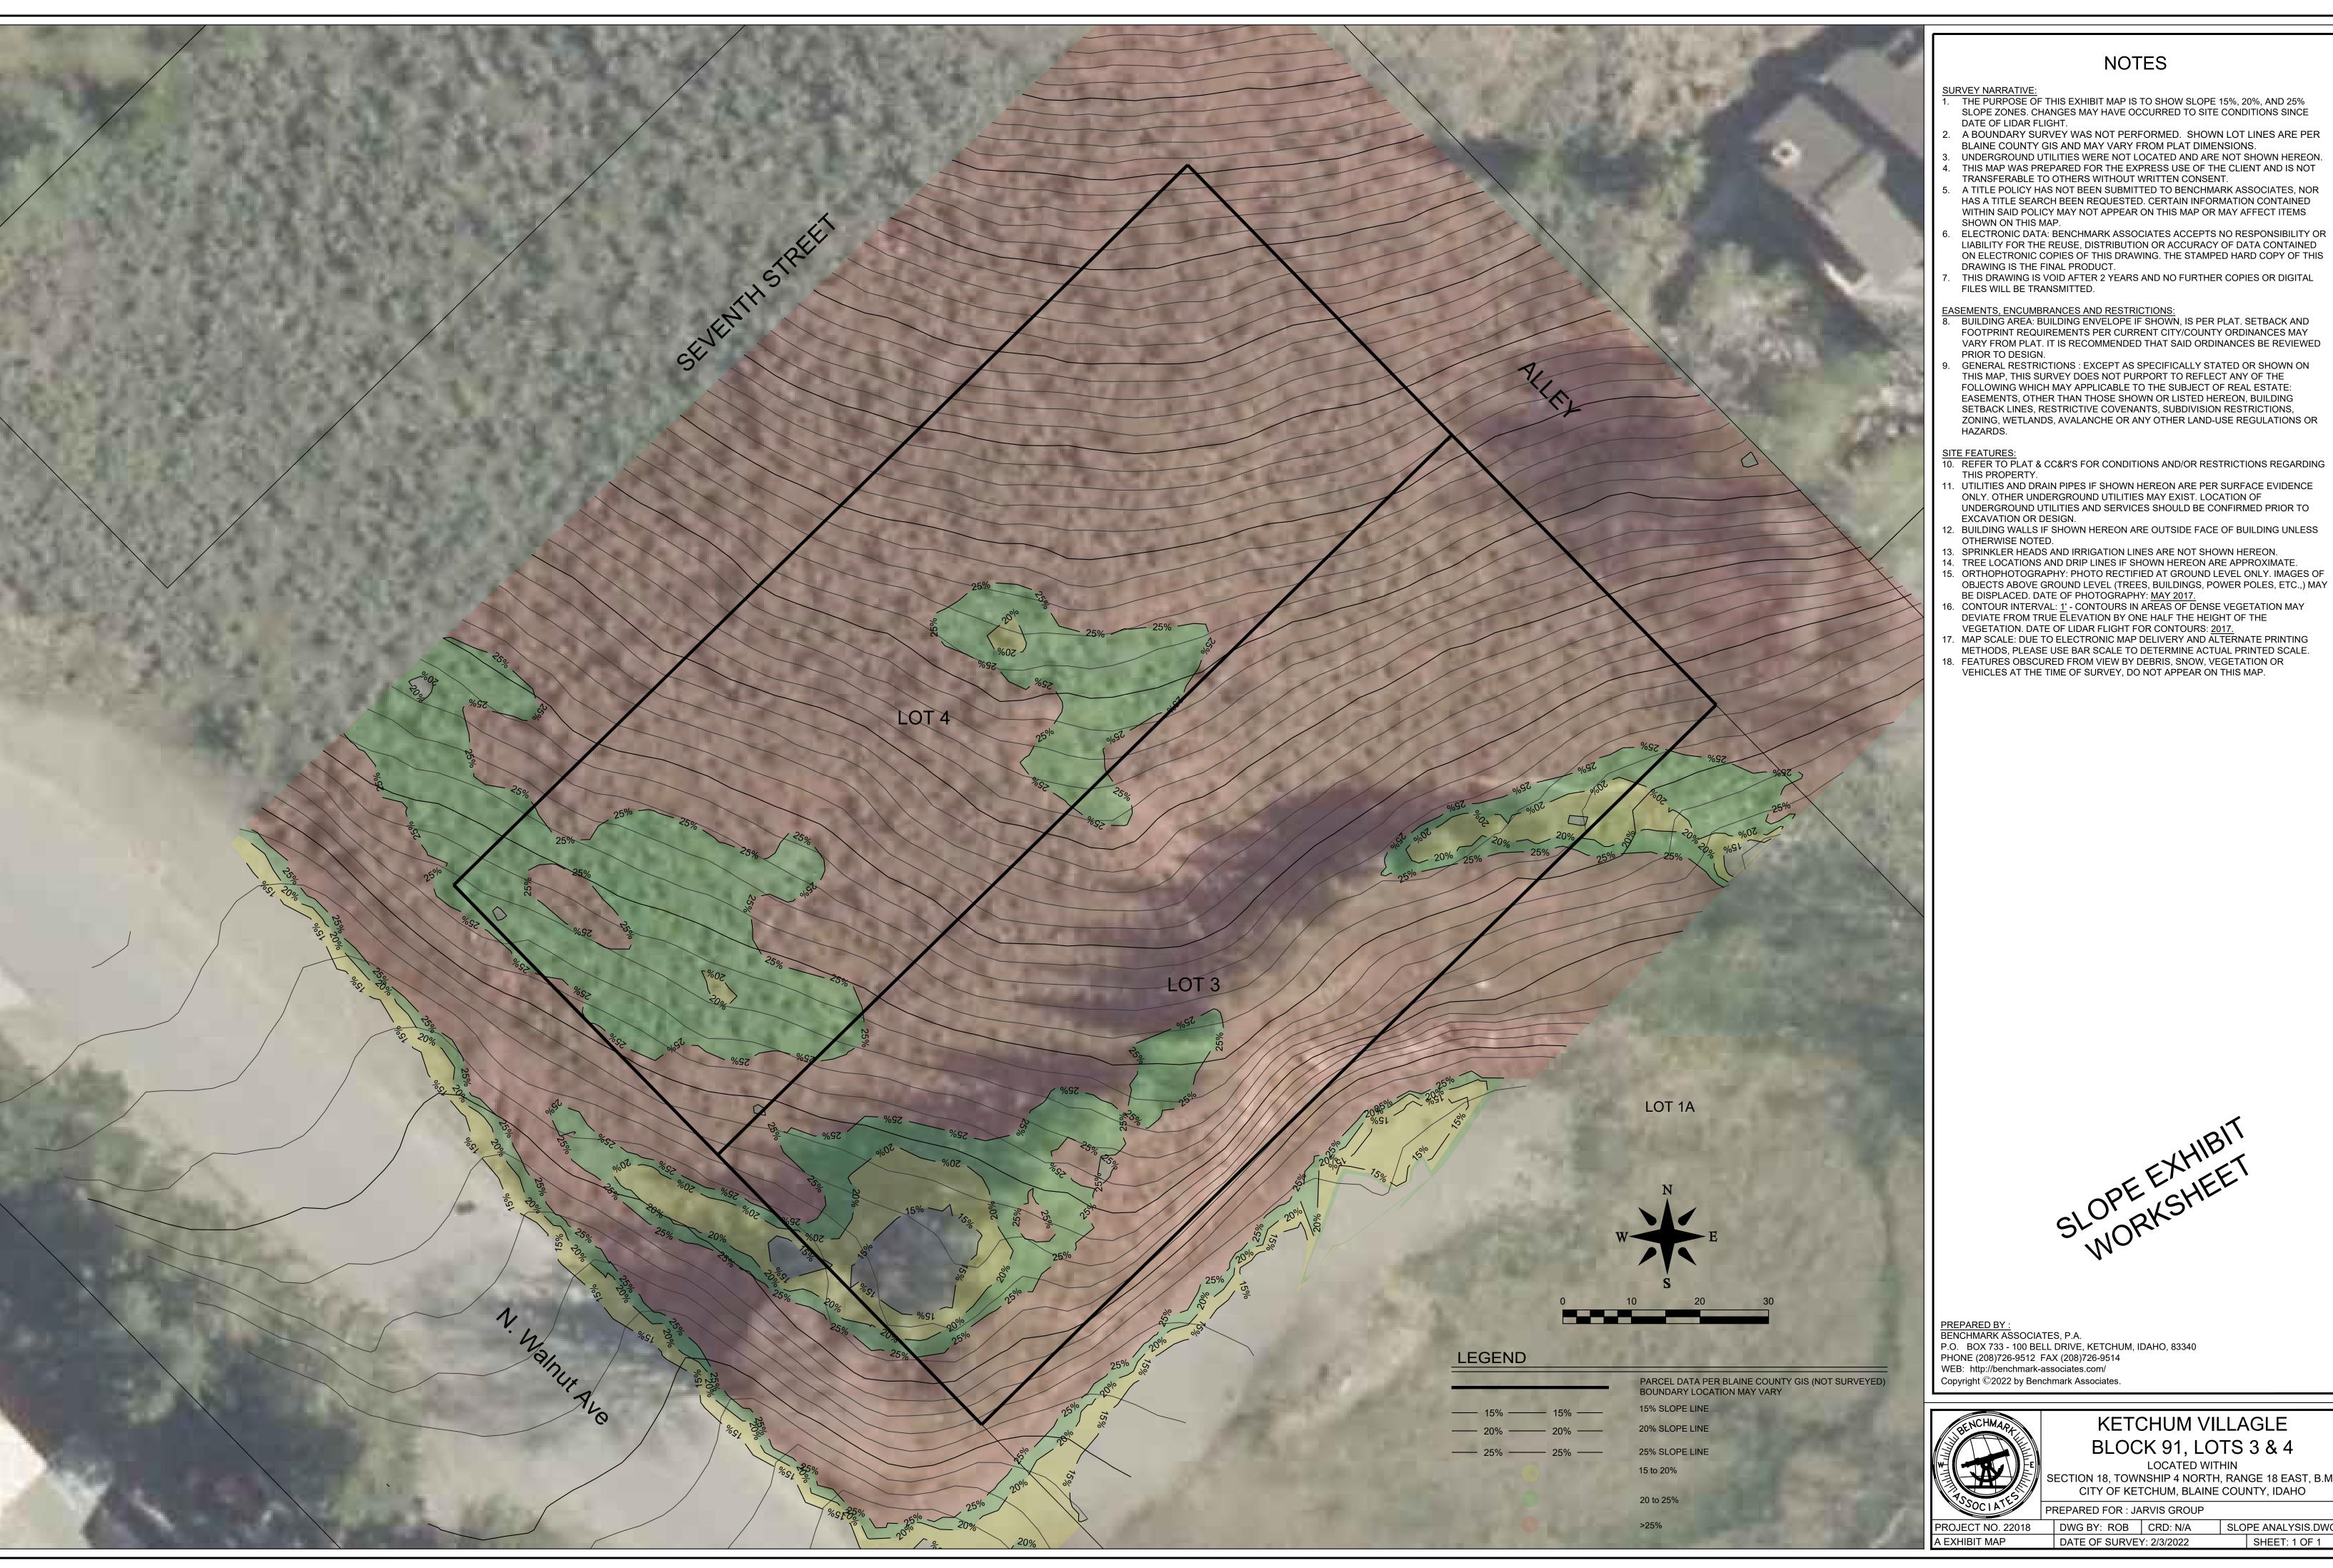
G-025

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NTS EXHIBIT KEY MAP 1 NTS EXHIBIT D - VIEW FROM BIKE PATH NEAR 6TH STREET 1 NTS EXHIBIT A - VIEW FROM TOWN SQUARE STARBUCKS





# **NOTES**

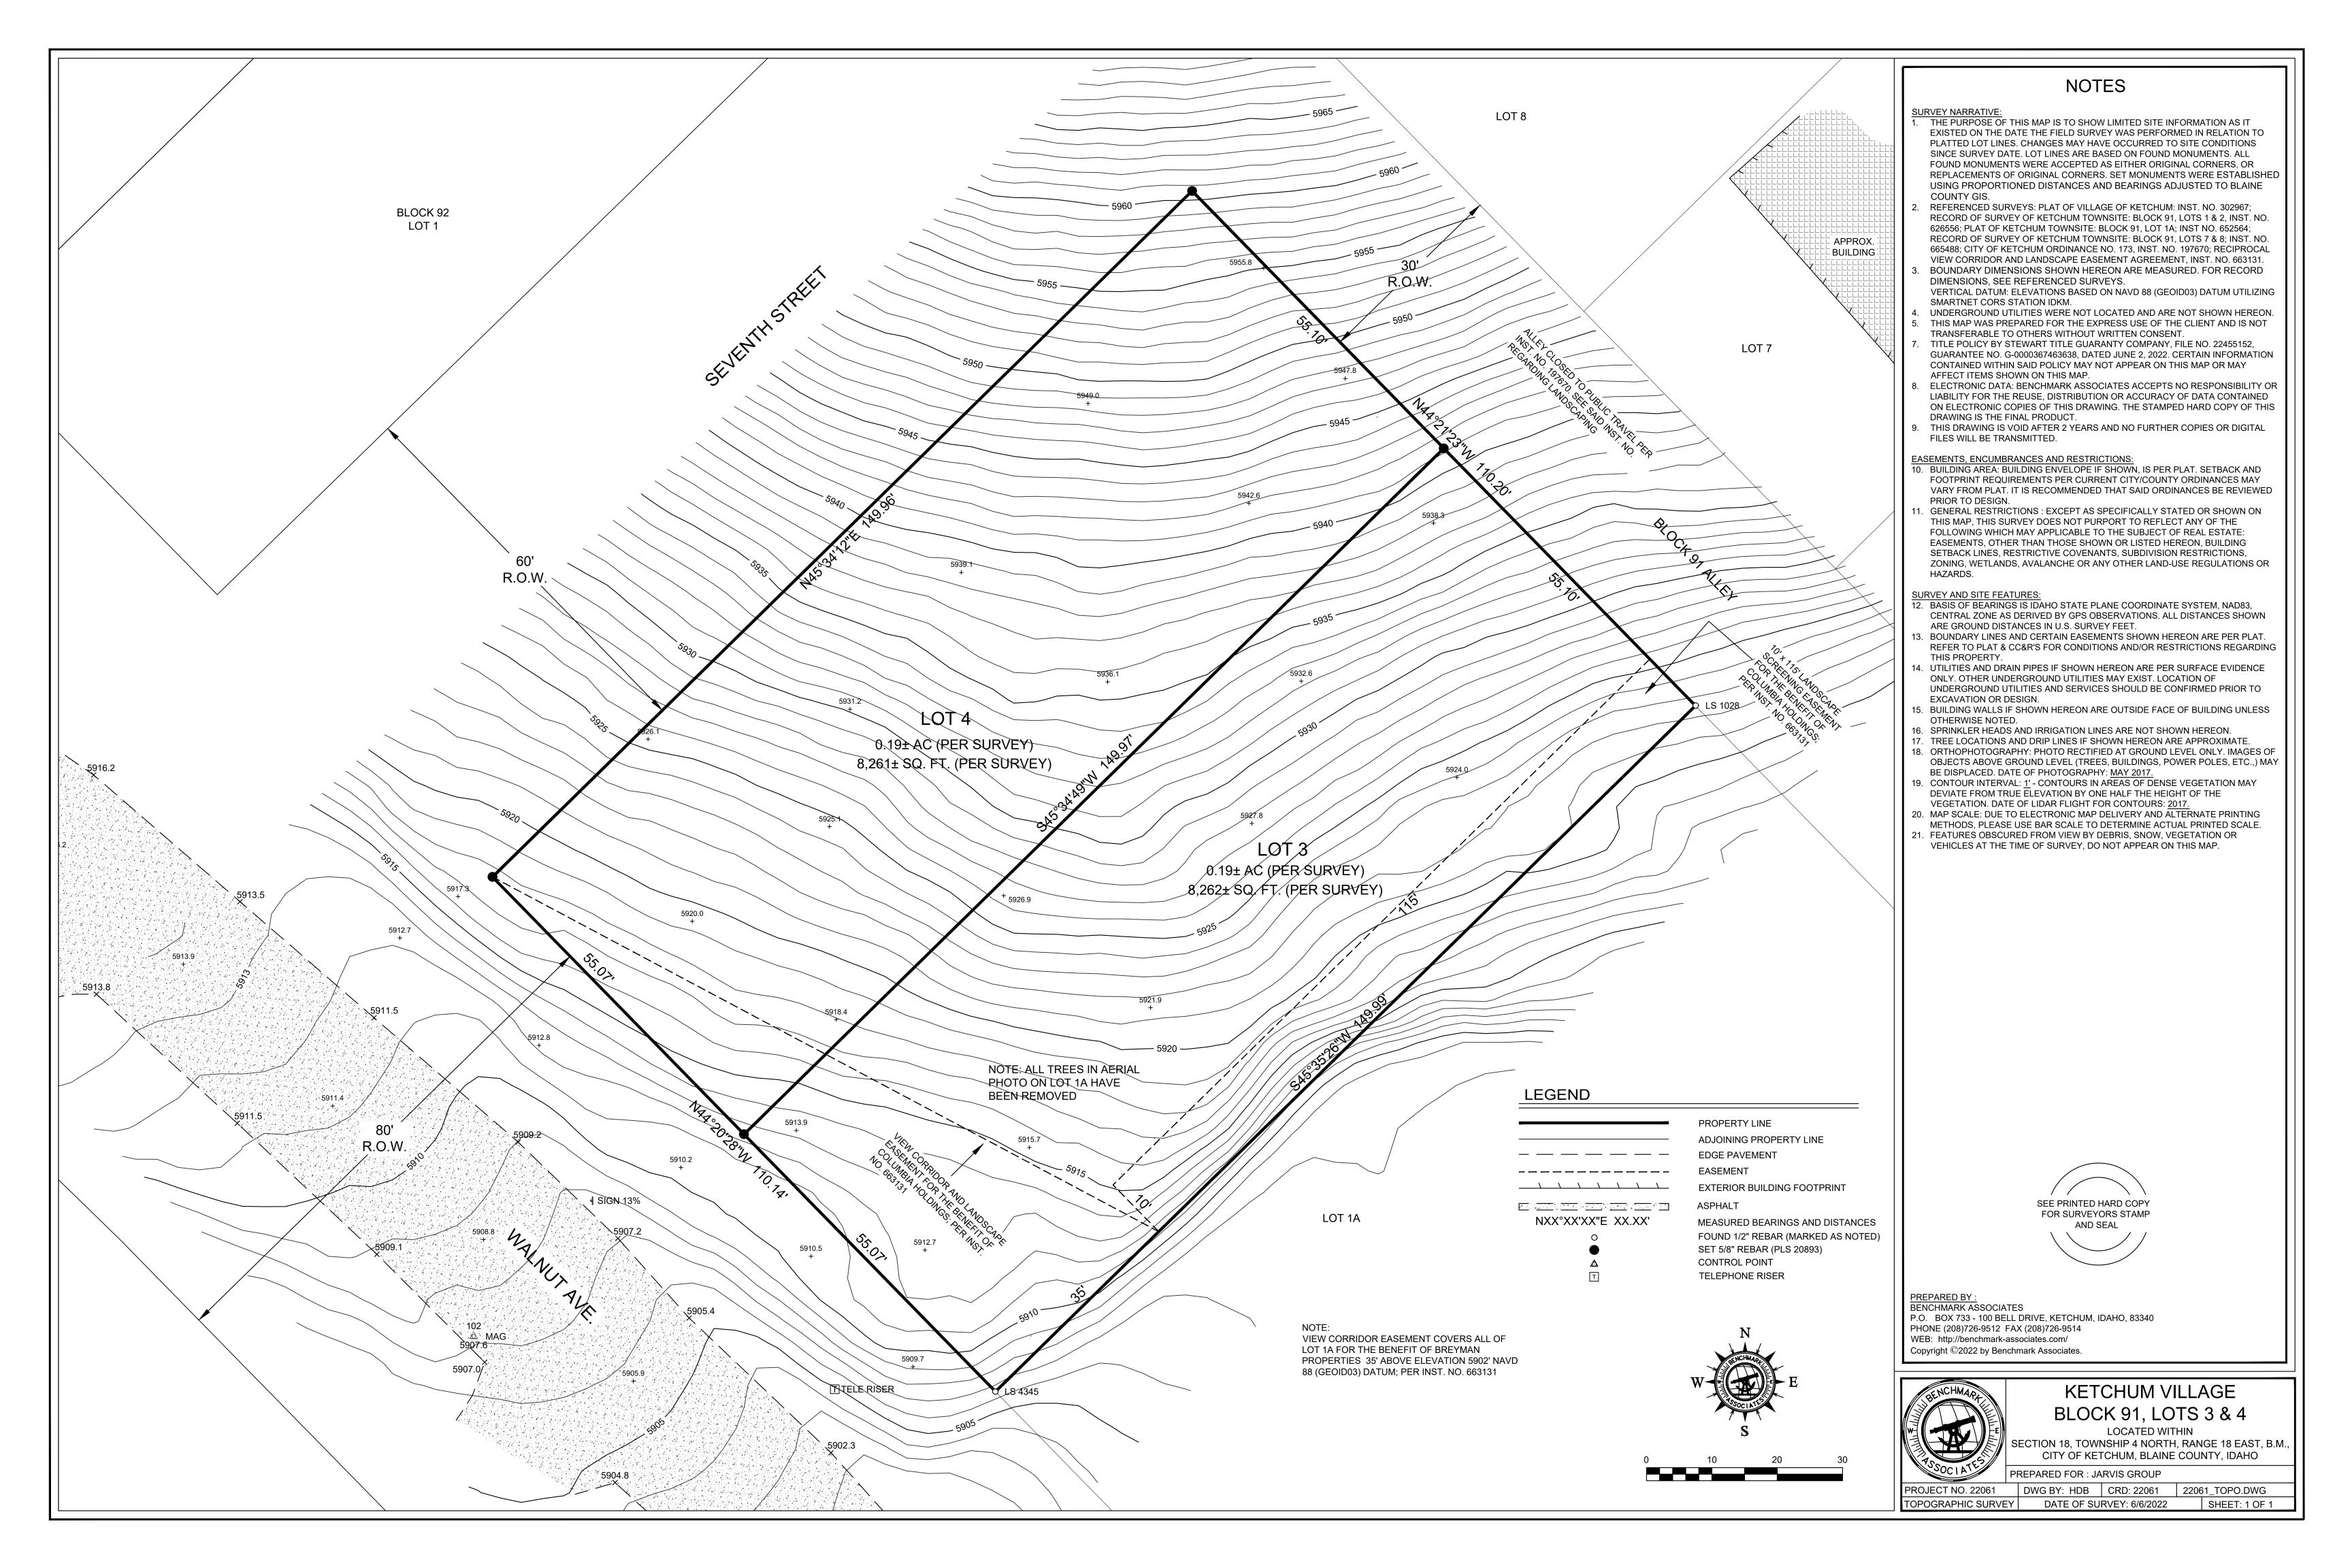THE PURPOSE OF THIS EXHIBIT MAP IS TO SHOW SLOPE 15%, 20%, AND 25% SLOPE ZONES. CHANGES MAY HAVE OCCURRED TO SITE CONDITIONS SINCE

- . A BOUNDARY SURVEY WAS NOT PERFORMED. SHOWN LOT LINES ARE PER BLAINE COUNTY GIS AND MAY VARY FROM PLAT DIMENSIONS.
- UNDERGROUND UTILITIES WERE NOT LOCATED AND ARE NOT SHOWN HEREON. THIS MAP WAS PREPARED FOR THE EXPRESS USE OF THE CLIENT AND IS NOT
- TRANSFERABLE TO OTHERS WITHOUT WRITTEN CONSENT. A TITLE POLICY HAS NOT BEEN SUBMITTED TO BENCHMARK ASSOCIATES, NOR HAS A TITLE SEARCH BEEN REQUESTED. CERTAIN INFORMATION CONTAINED
- WITHIN SAID POLICY MAY NOT APPEAR ON THIS MAP OR MAY AFFECT ITEMS SHOWN ON THIS MAP.
- ON ELECTRONIC COPIES OF THIS DRAWING. THE STAMPED HARD COPY OF THIS DRAWING IS THE FINAL PRODUCT.
- THIS DRAWING IS VOID AFTER 2 YEARS AND NO FURTHER COPIES OR DIGITAL FILES WILL BE TRANSMITTED.


FOOTPRINT REQUIREMENTS PER CURRENT CITY/COUNTY ORDINANCES MAY VARY FROM PLAT. IT IS RECOMMENDED THAT SAID ORDINANCES BE REVIEWED

GENERAL RESTRICTIONS: EXCEPT AS SPECIFICALLY STATED OR SHOWN ON THIS MAP, THIS SURVEY DOES NOT PURPORT TO REFLECT ANY OF THE FOLLOWING WHICH MAY APPLICABLE TO THE SUBJECT OF REAL ESTATE: EASEMENTS, OTHER THAN THOSE SHOWN OR LISTED HEREON, BUILDING SETBACK LINES, RESTRICTIVE COVENANTS, SUBDIVISION RESTRICTIONS, ZONING, WETLANDS, AVALANCHE OR ANY OTHER LAND-USE REGULATIONS OR

10. REFER TO PLAT & CC&R'S FOR CONDITIONS AND/OR RESTRICTIONS REGARDING

- 11. UTILITIES AND DRAIN PIPES IF SHOWN HEREON ARE PER SURFACE EVIDENCE ONLY. OTHER UNDERGROUND UTILITIES MAY EXIST. LOCATION OF UNDERGROUND UTILITIES AND SERVICES SHOULD BE CONFIRMED PRIOR TO
- 12. BUILDING WALLS IF SHOWN HEREON ARE OUTSIDE FACE OF BUILDING UNLESS
- 13. SPRINKLER HEADS AND IRRIGATION LINES ARE NOT SHOWN HEREON.
- 15. ORTHOPHOTOGRAPHY: PHOTO RECTIFIED AT GROUND LEVEL ONLY. IMAGES OF OBJECTS ABOVE GROUND LEVEL (TREES, BUILDINGS, POWER POLES, ETC.,) MAY BE DISPLACED. DATE OF PHOTOGRAPHY: MAY 2017.
- 16. CONTOUR INTERVAL: 1' CONTOURS IN AREAS OF DENSE VEGETATION MAY DEVIATE FROM TRUE ELEVATION BY ONE HALF THE HEIGHT OF THE VEGETATION. DATE OF LIDAR FLIGHT FOR CONTOURS: 2017.
- 7. MAP SCALE: DUE TO ELECTRONIC MAP DELIVERY AND ALTERNATE PRINTING METHODS, PLEASE USE BAR SCALE TO DETERMINE ACTUAL PRINTED SCALE.
- 18. FEATURES OBSCURED FROM VIEW BY DEBRIS, SNOW, VEGETATION OR VEHICLES AT THE TIME OF SURVEY, DO NOT APPEAR ON THIS MAP.

PREPARED BY:
BENCHMARK ASSOCIATES, P.A.
P.O. BOX 733 - 100 BELL DRIVE, KETCHUM, IDAHO, 83340
PHONE (208)726-9512 FAX (208)726-9514

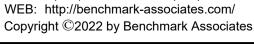



# KETCHUM VILLAGLE BLOCK 91, LOTS 3 & 4

LOCATED WITHIN CITY OF KETCHUM, BLAINE COUNTY, IDAHO


REPARED FOR : JARVIS GROUP


DWG BY: ROB | CRD: N/A SLOPE ANALYSIS.DWG DATE OF SURVEY: 2/3/2022 SHEET: 1 OF 1

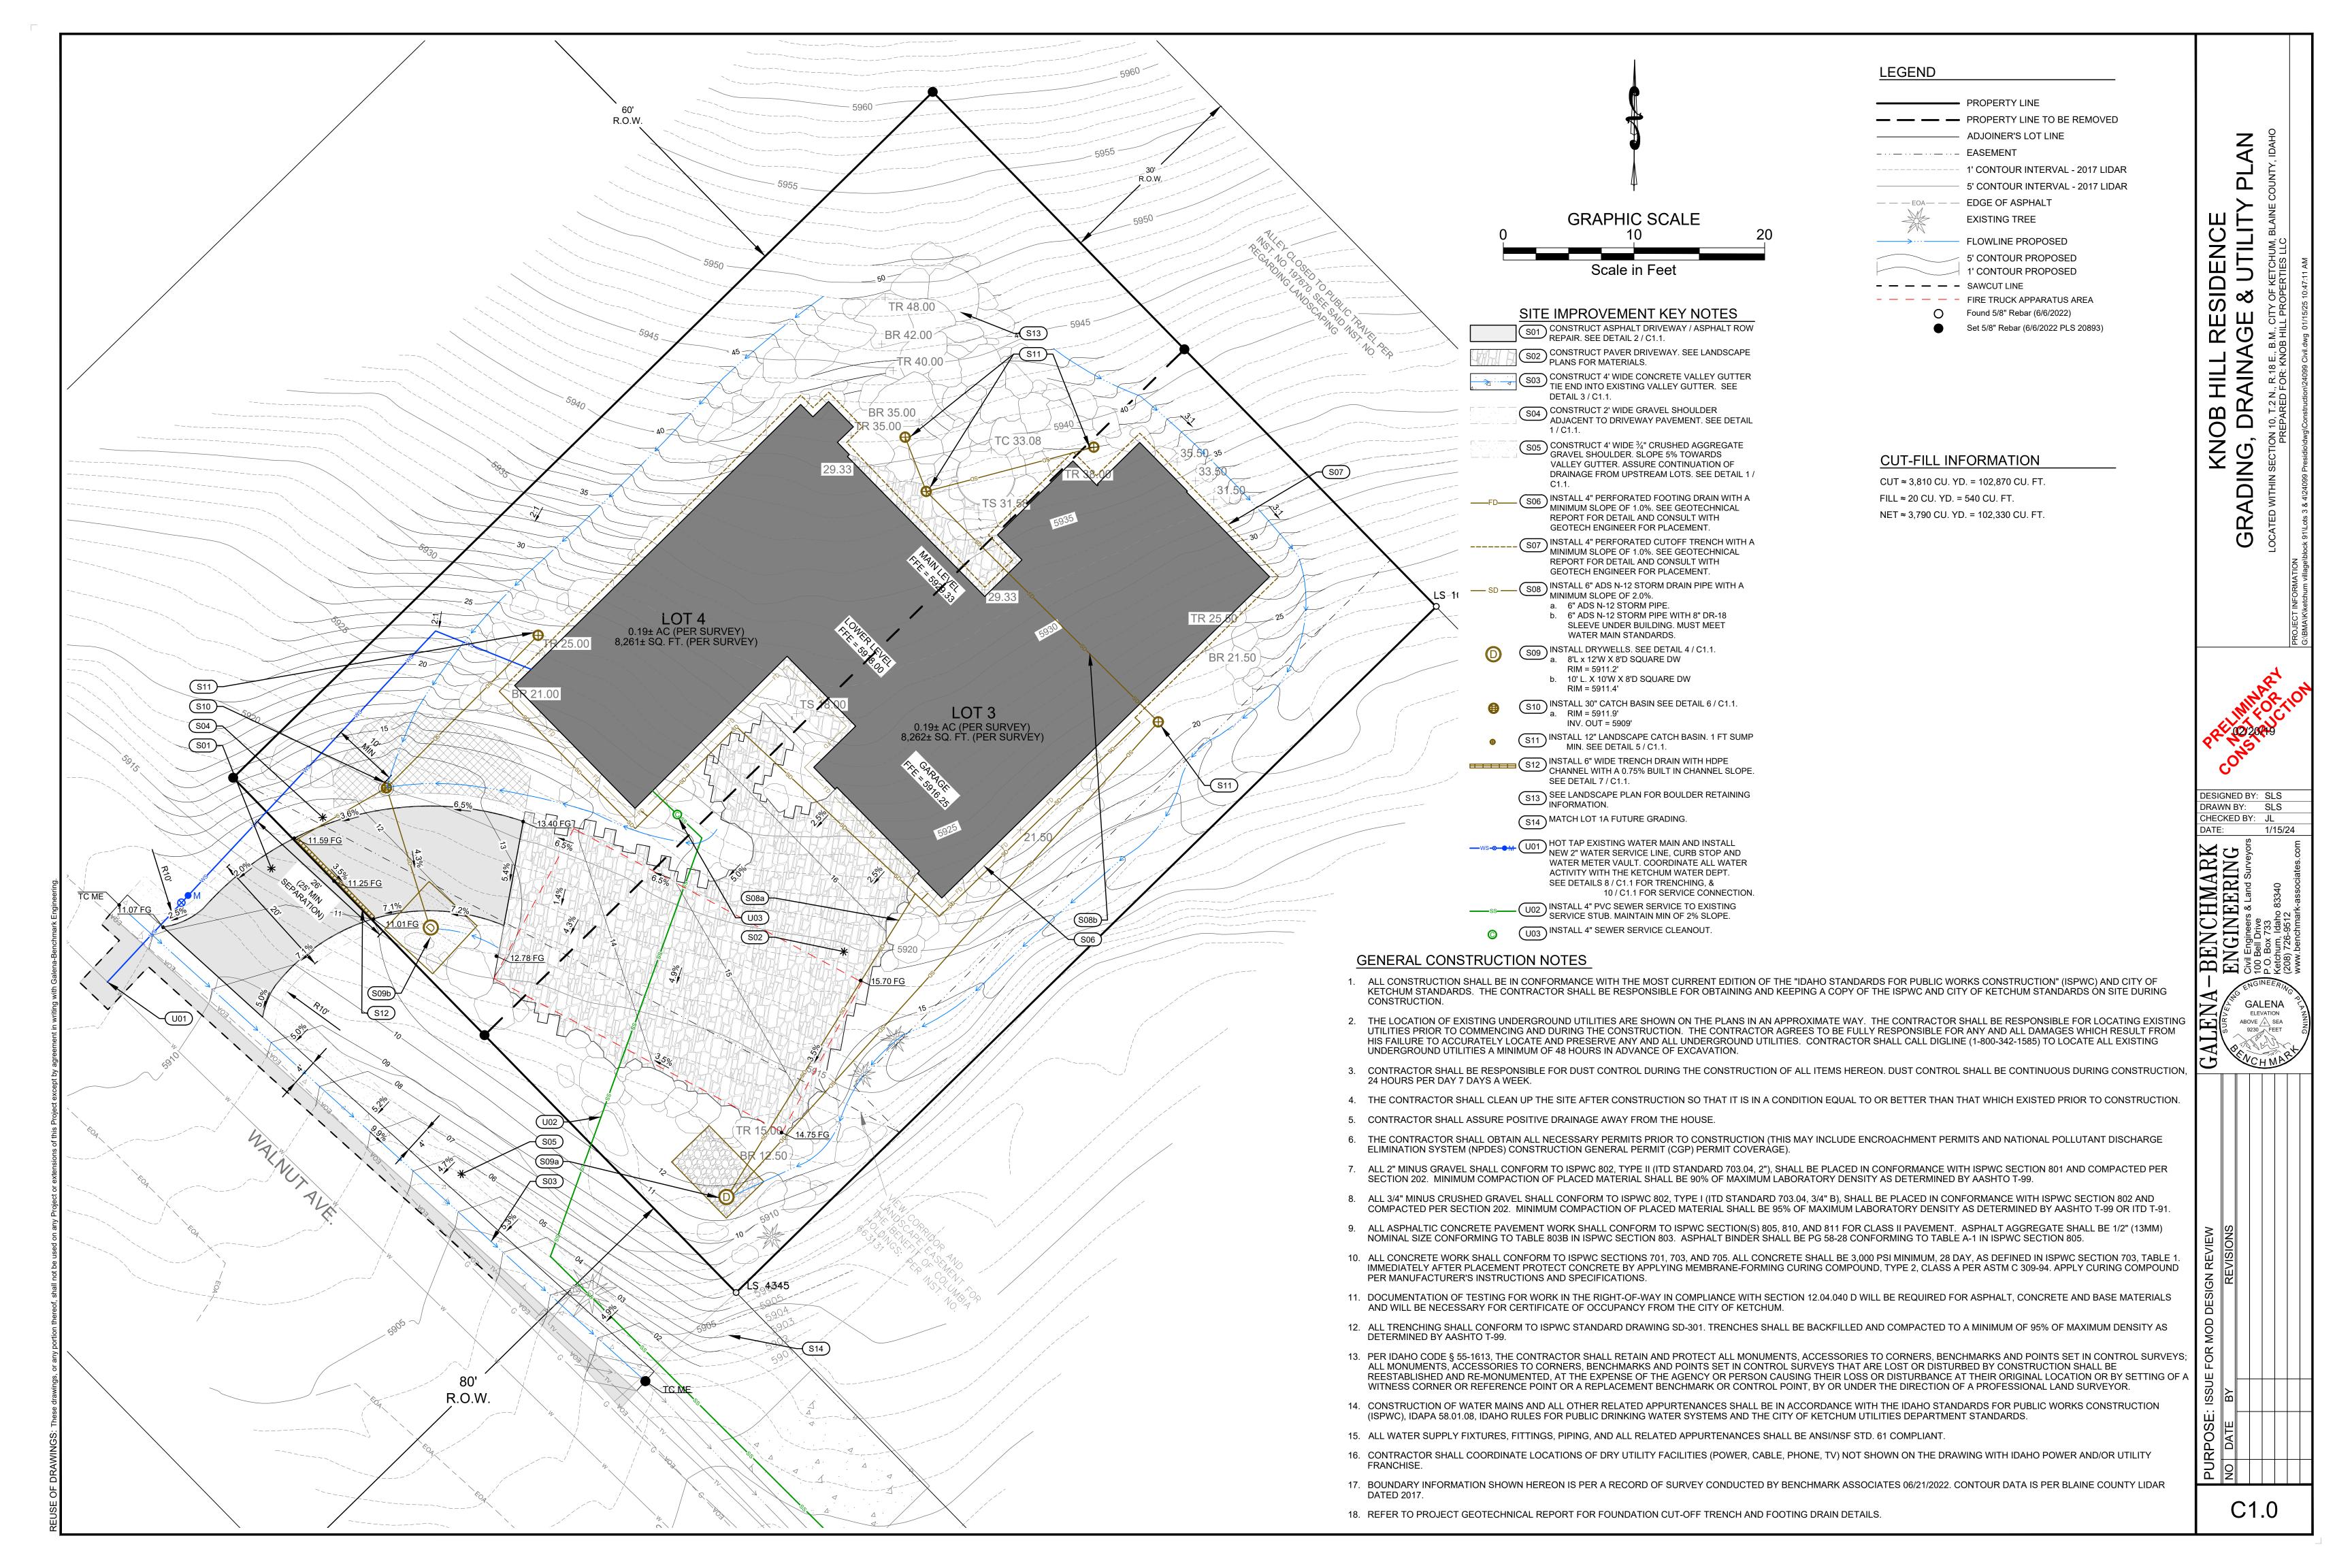


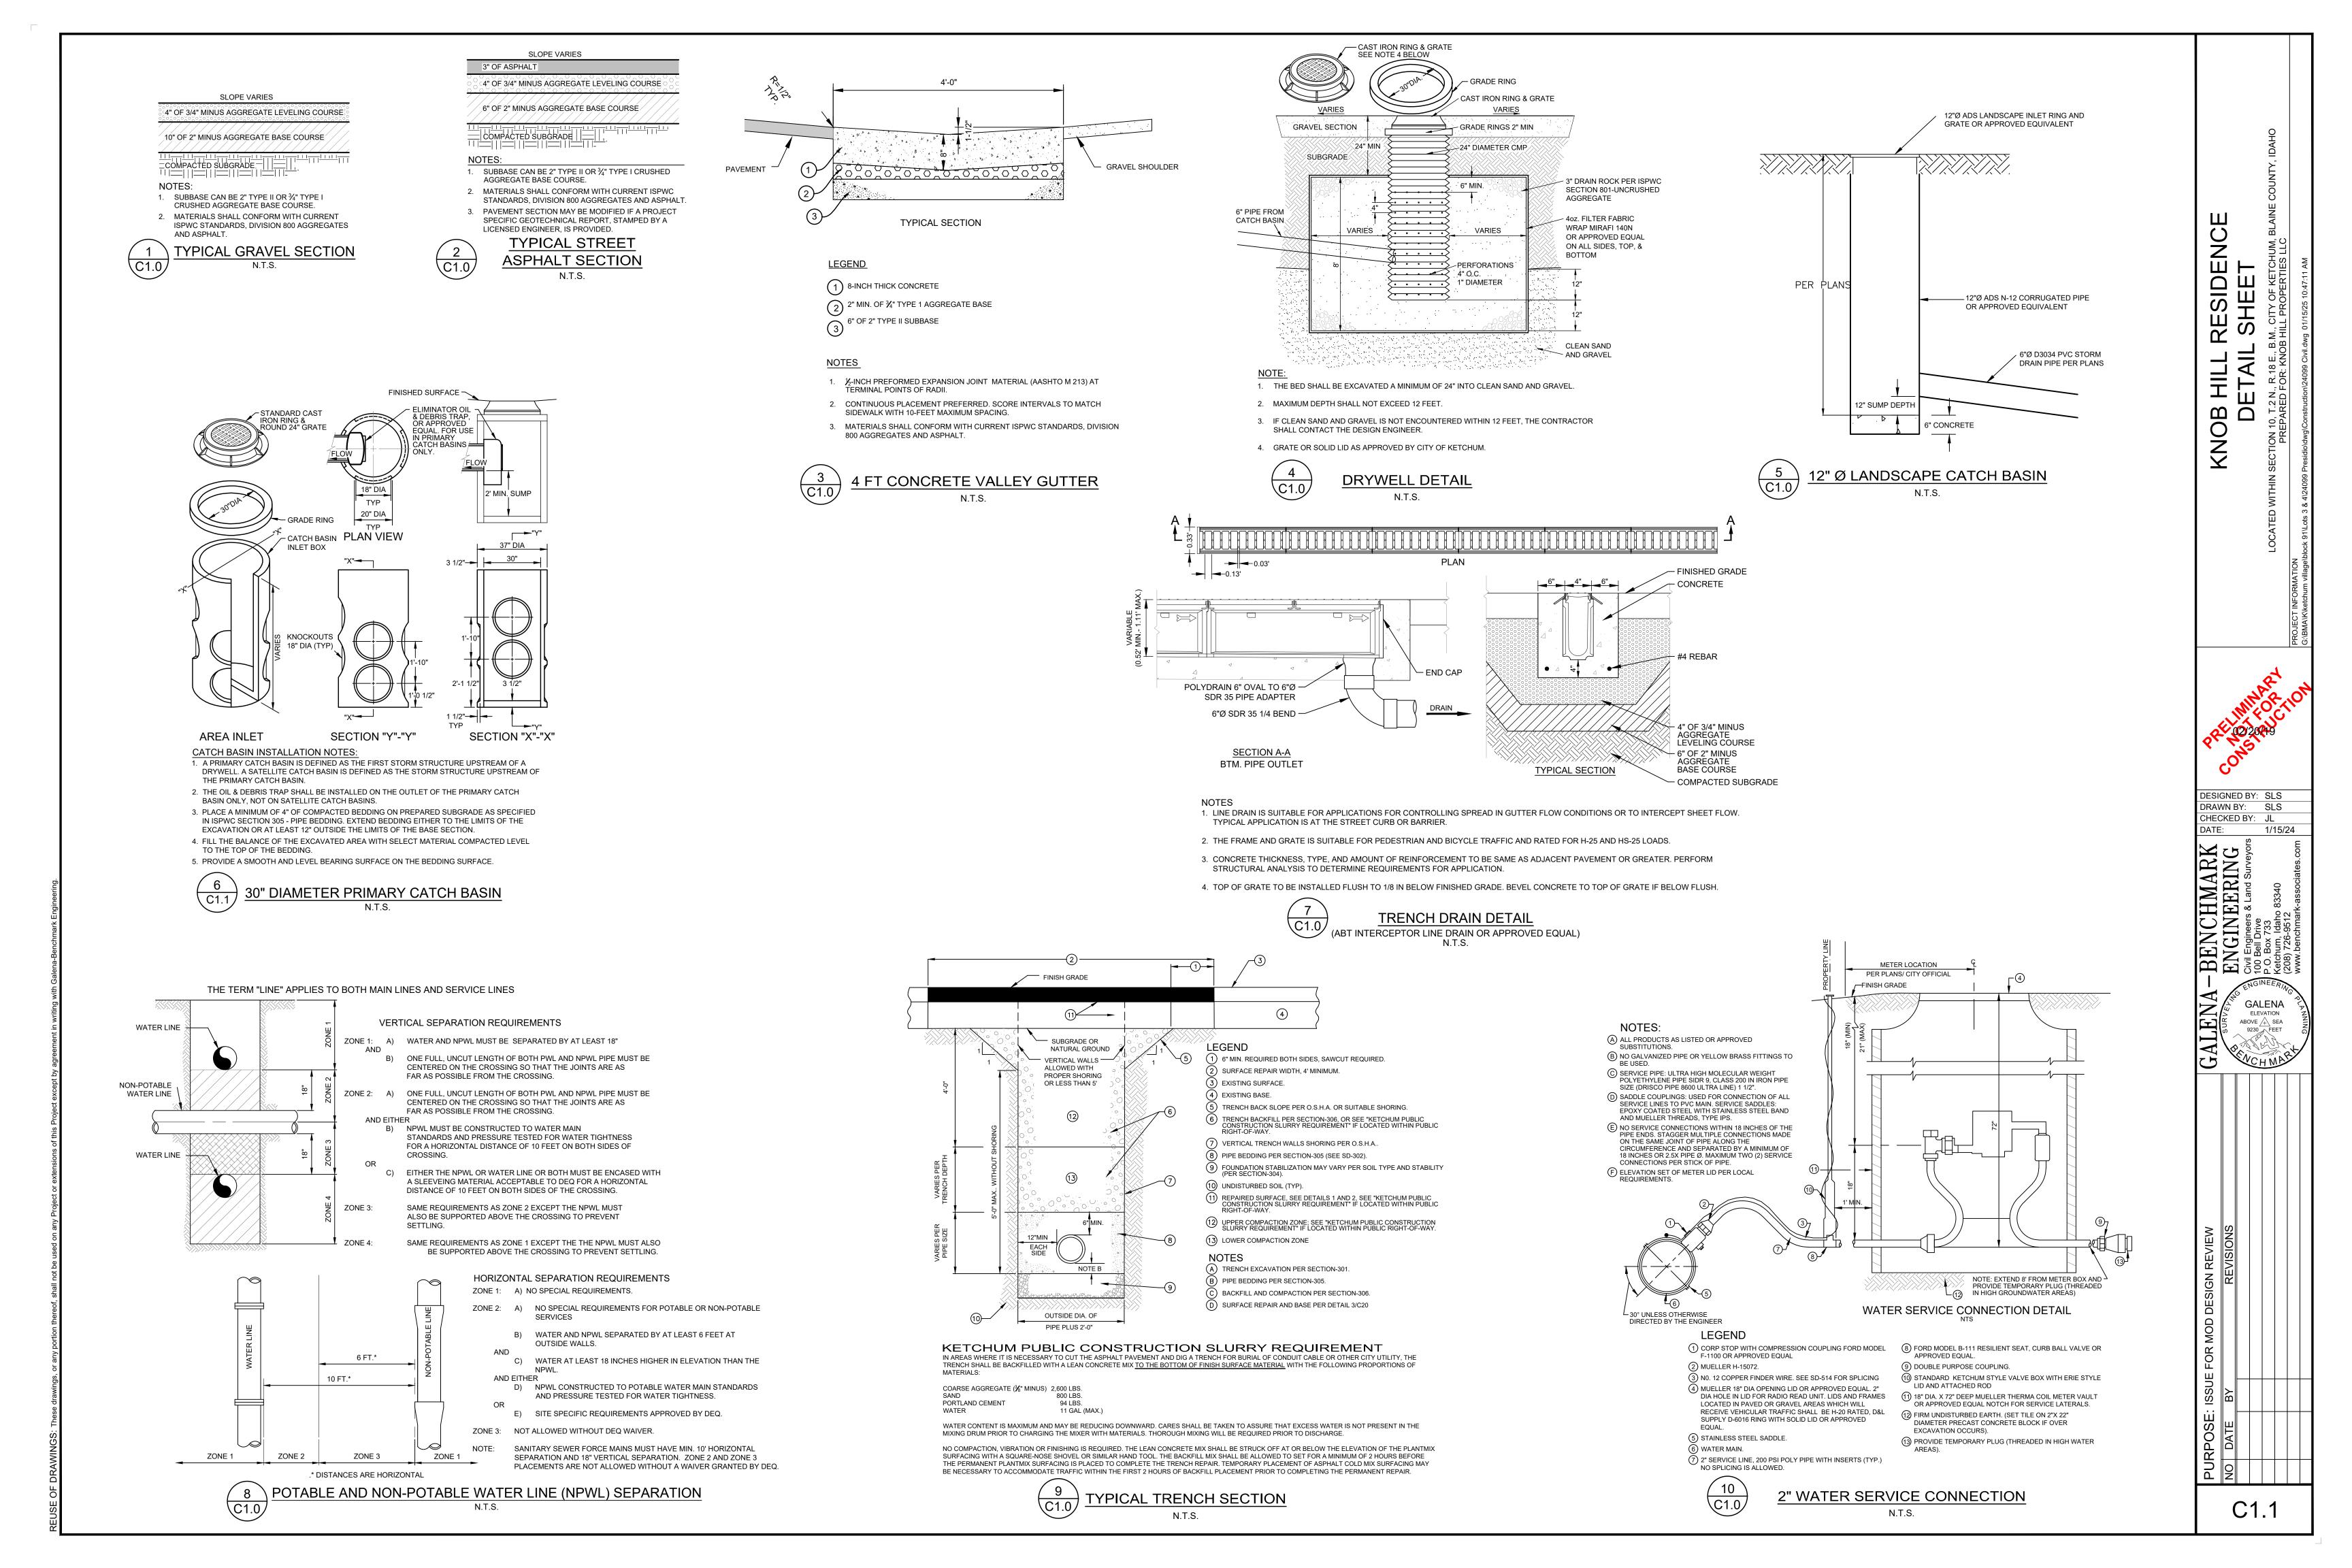



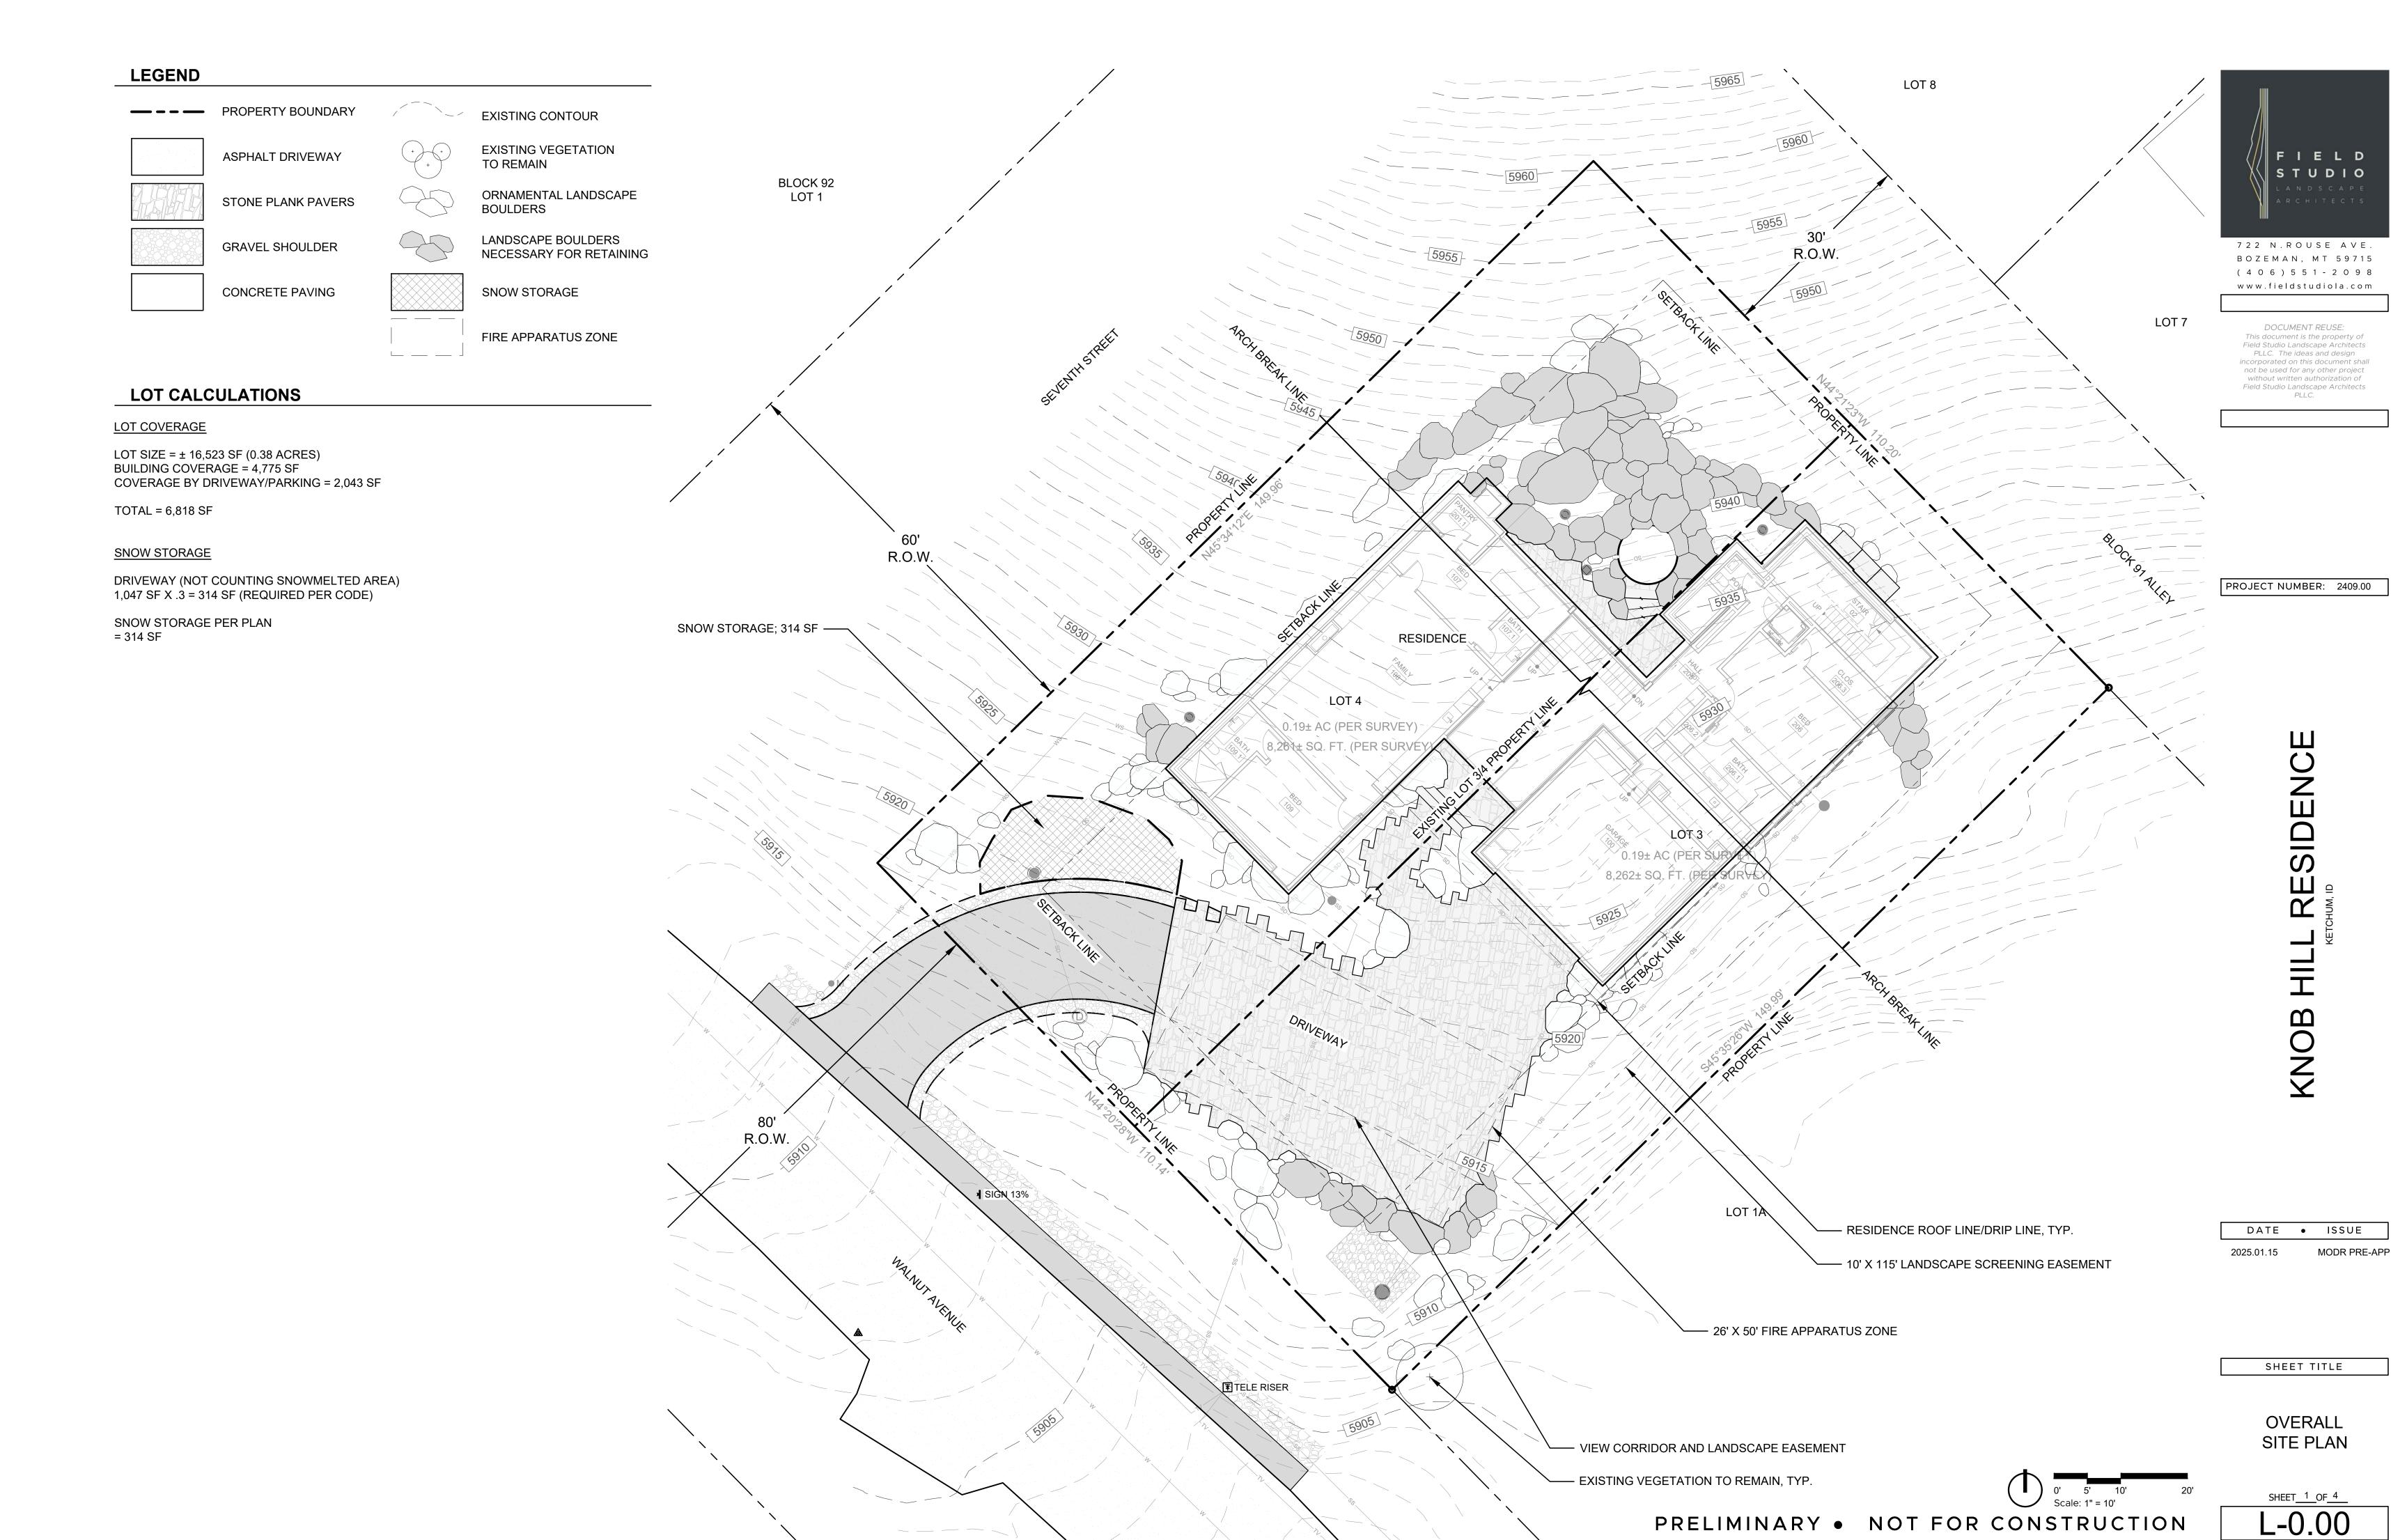

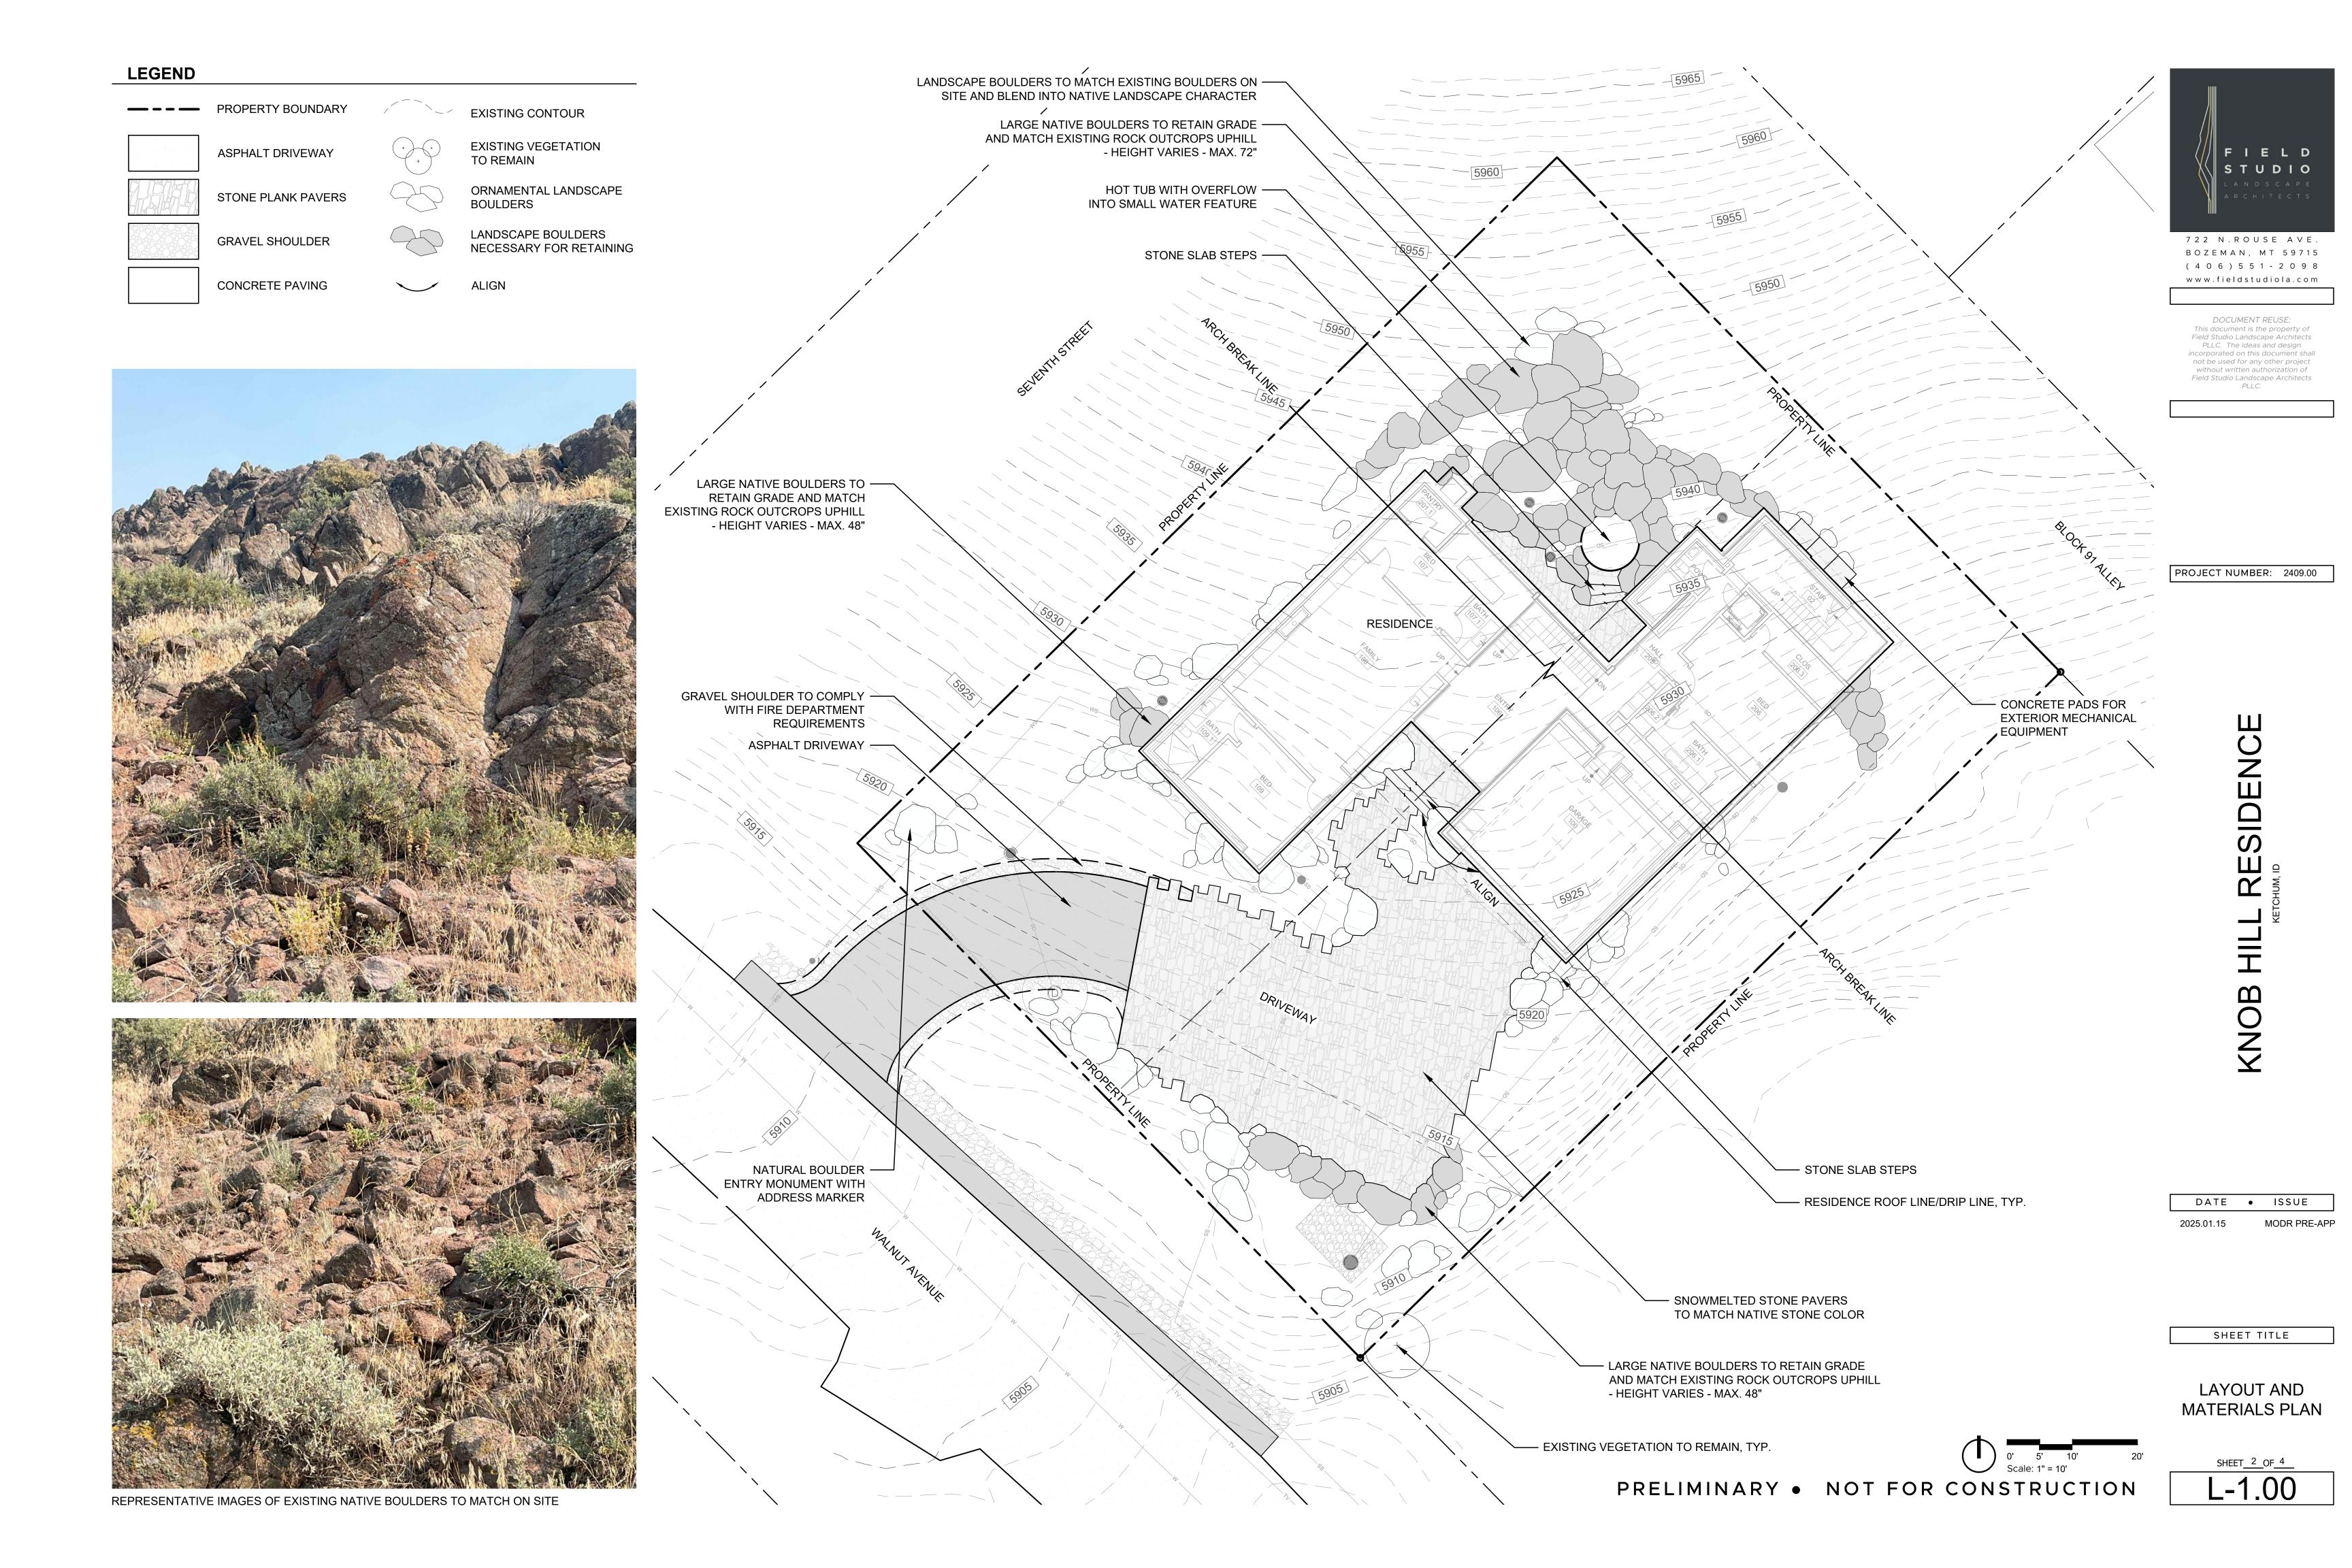

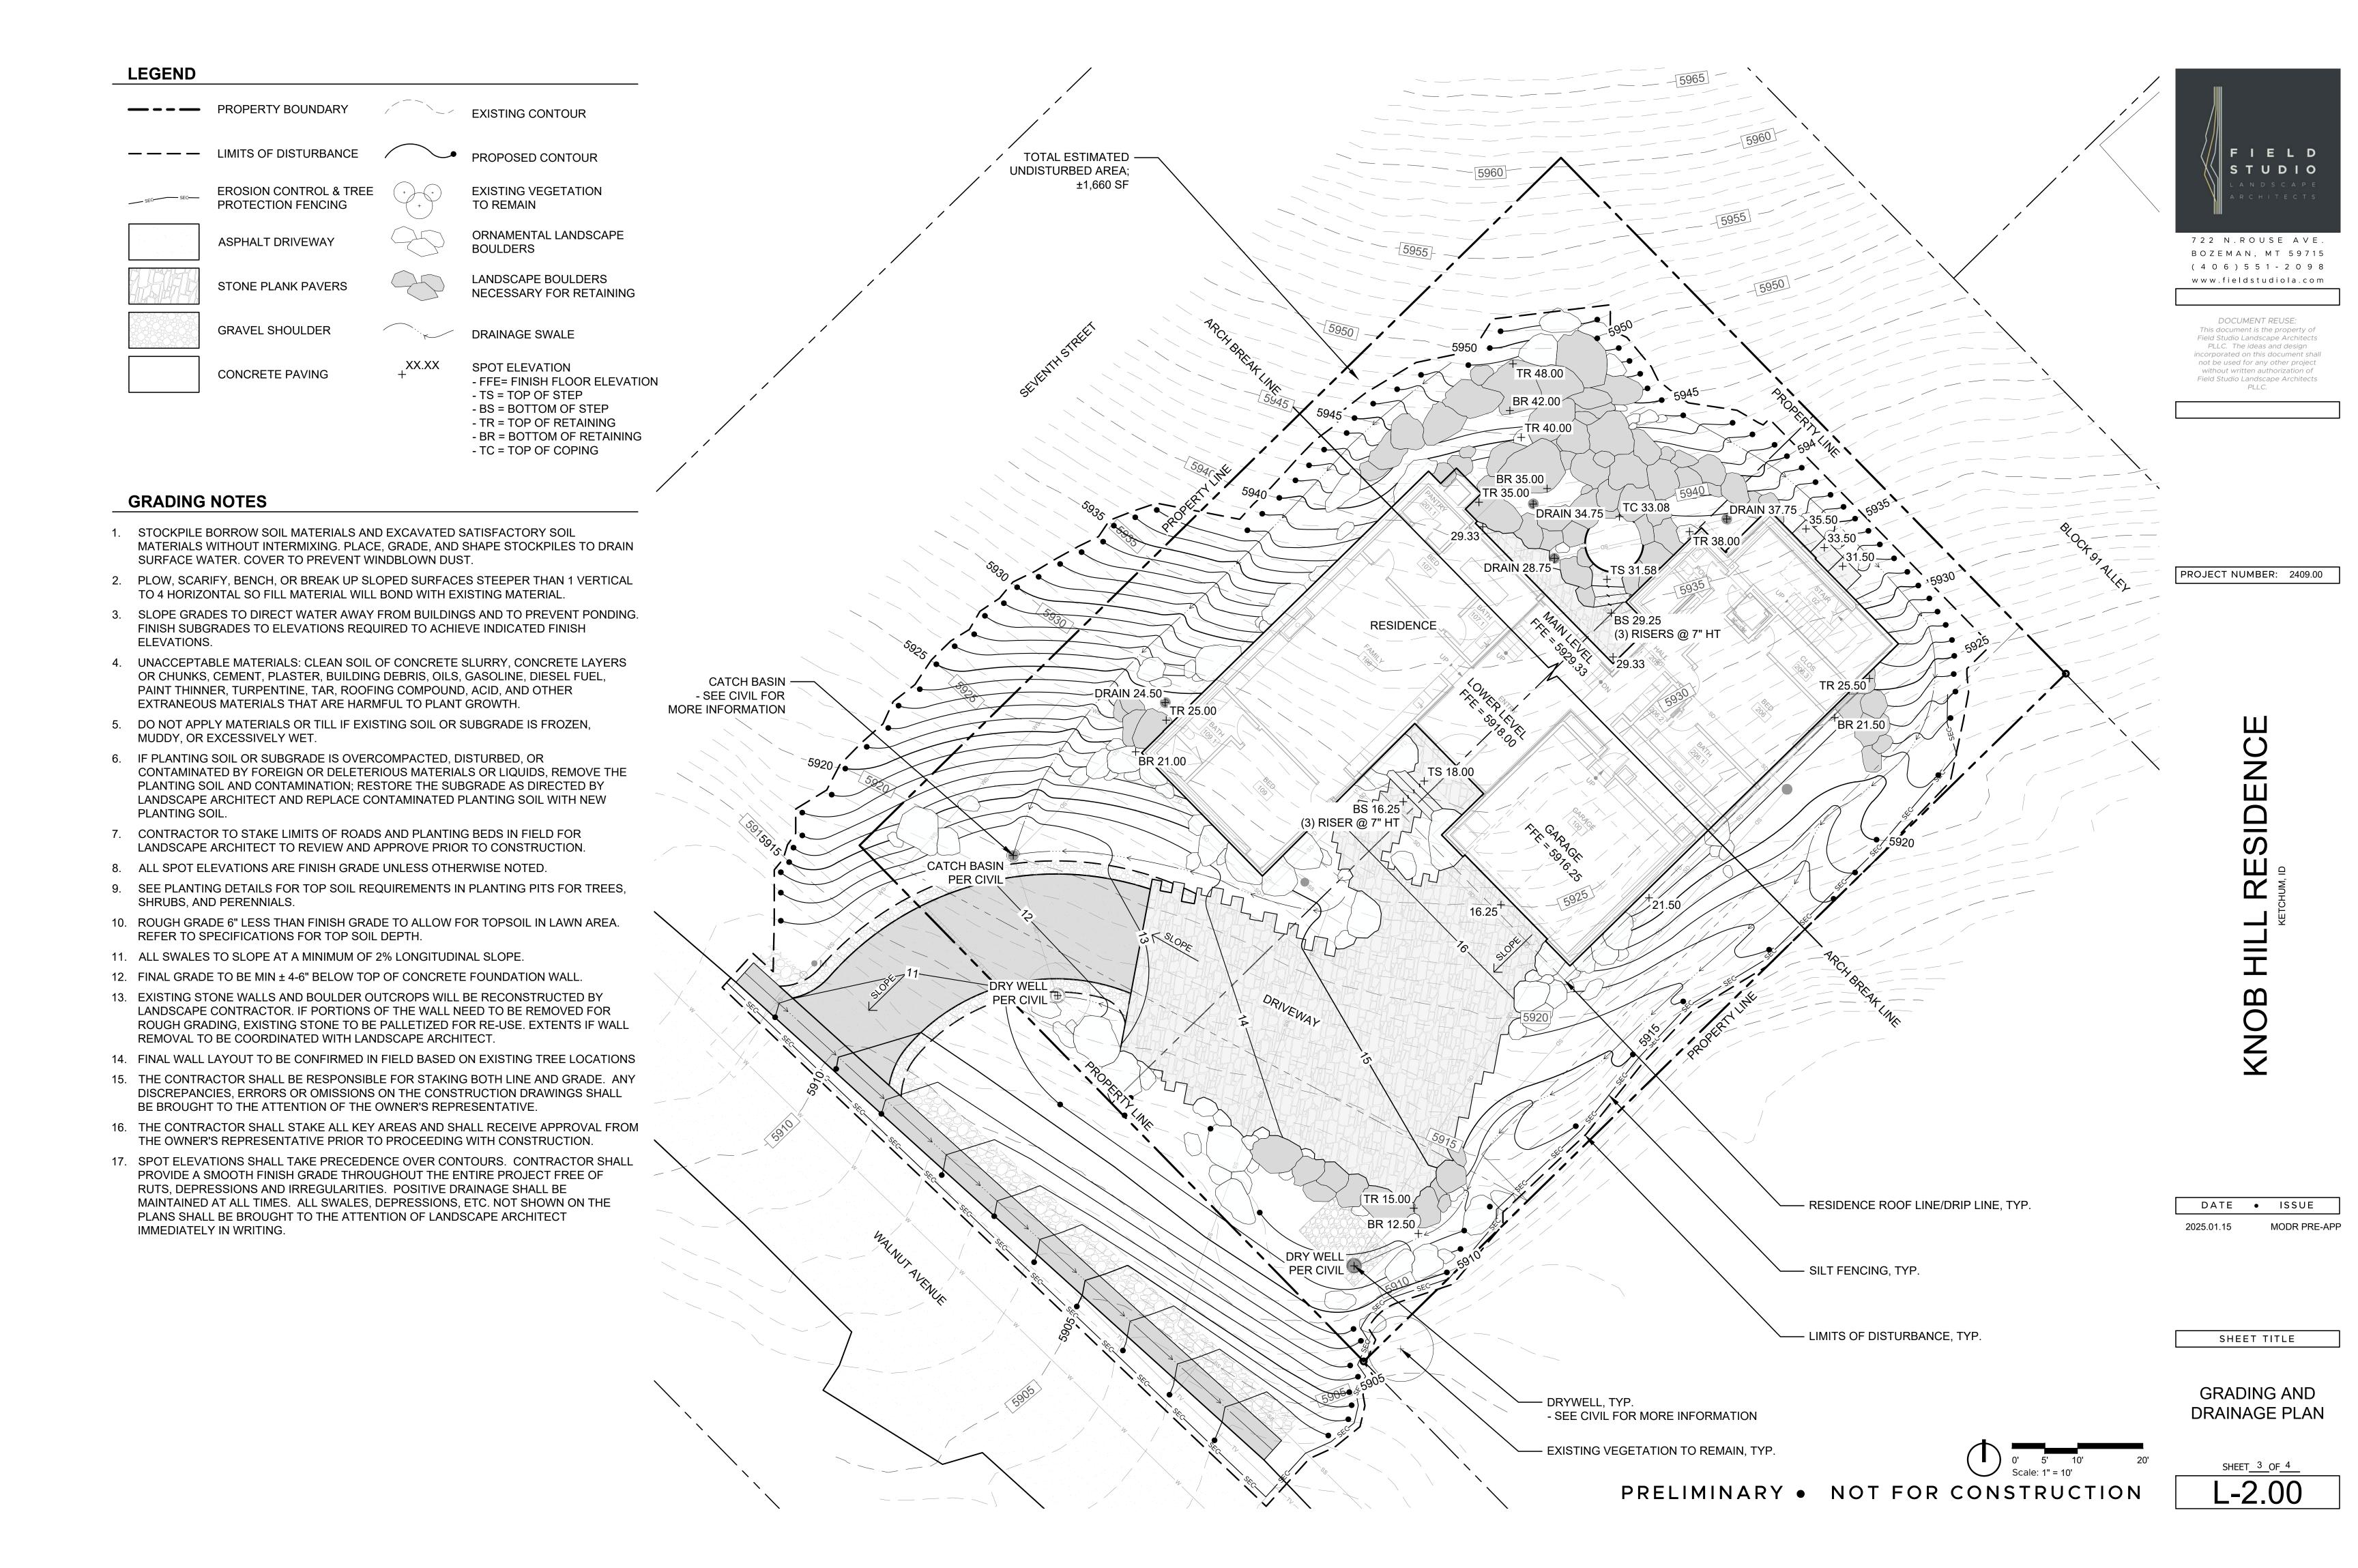


# **LEGEND** — – – PROPERTY BOUNDARY **EXISTING CONTOUR EXISTING VEGETATION** ASPHALT DRIVEWAY TO REMAIN ORNAMENTAL LANDSCAPE STONE PLANK PAVERS BOULDERS LANDSCAPE BOULDERS **GRAVEL SHOULDER** NECESSARY FOR RETAINING CONCRETE PAVING

# PLANTING SCHEDULE

TREES							
SYM.	KEY	QTY	BOTANIC NAME	COMMON NAME ROOT		SIZE	SPACING
	PP	5	Pinus ponderosa	Ponderosa Pine	B&B	14' HT	PER PLAN
0	PT	16	Populus tremulodes	Quaking Aspen	B&B	2" CAL.	PER PLAN
$\odot$	PV	6	Prunus virginiana	Common Chokecherry	#25	PER PLAN	
SHRU	IBS						
SYM.	KEY	QTY	BOTANIC NAME	COMMON NAME	ROOT	SIZE	SPACING
0	ACA	25	Artemisia cana	Silver Sagebrush CONT.		#2	PER PLAN
	ATD	27	Artemisia tridentata	Artemisia tridentata Big Sagebrush CONT.			
0	CNR	42	Chrysothamnus nauseosus	Chrysothamnus nauseosus Rabbitbrush CONT.			
۵	РТВ	11	Purshia tridentata	#5	PER PLAN		
0	SOC	32	Symphoricarpos occidentalis	horicarpos occidentalis   Western Snowberry   CONT.		#5	PER PLAN
SEED	MIX						
SYM.	ZONE SEED MIX		AREA				
	NATIVE GRASS AND FORB MIX  SPECIES  CANADIAN BLUEGRASS, Poa compressa SHEEP FESCUE, Festuca oviana IDAHO FESCUE, Festuca idahoensis BLUEBUNCH WHEATGRASS, Agropyron inerme ARROWLEAF BALSAMROOT, Balsamoriza sagittata SULFUR-FLOWER BUCKWHEAT, Eriogonum umbellatum			±7,2	50 SF		

NOTE:

1. VERIFY EXACT GRASS MIXTURE WITH LANDSCAPE ARCHITECT TO MATCH EXISTING CONDITIONS ON SITE PRIOR TO INSTALL.

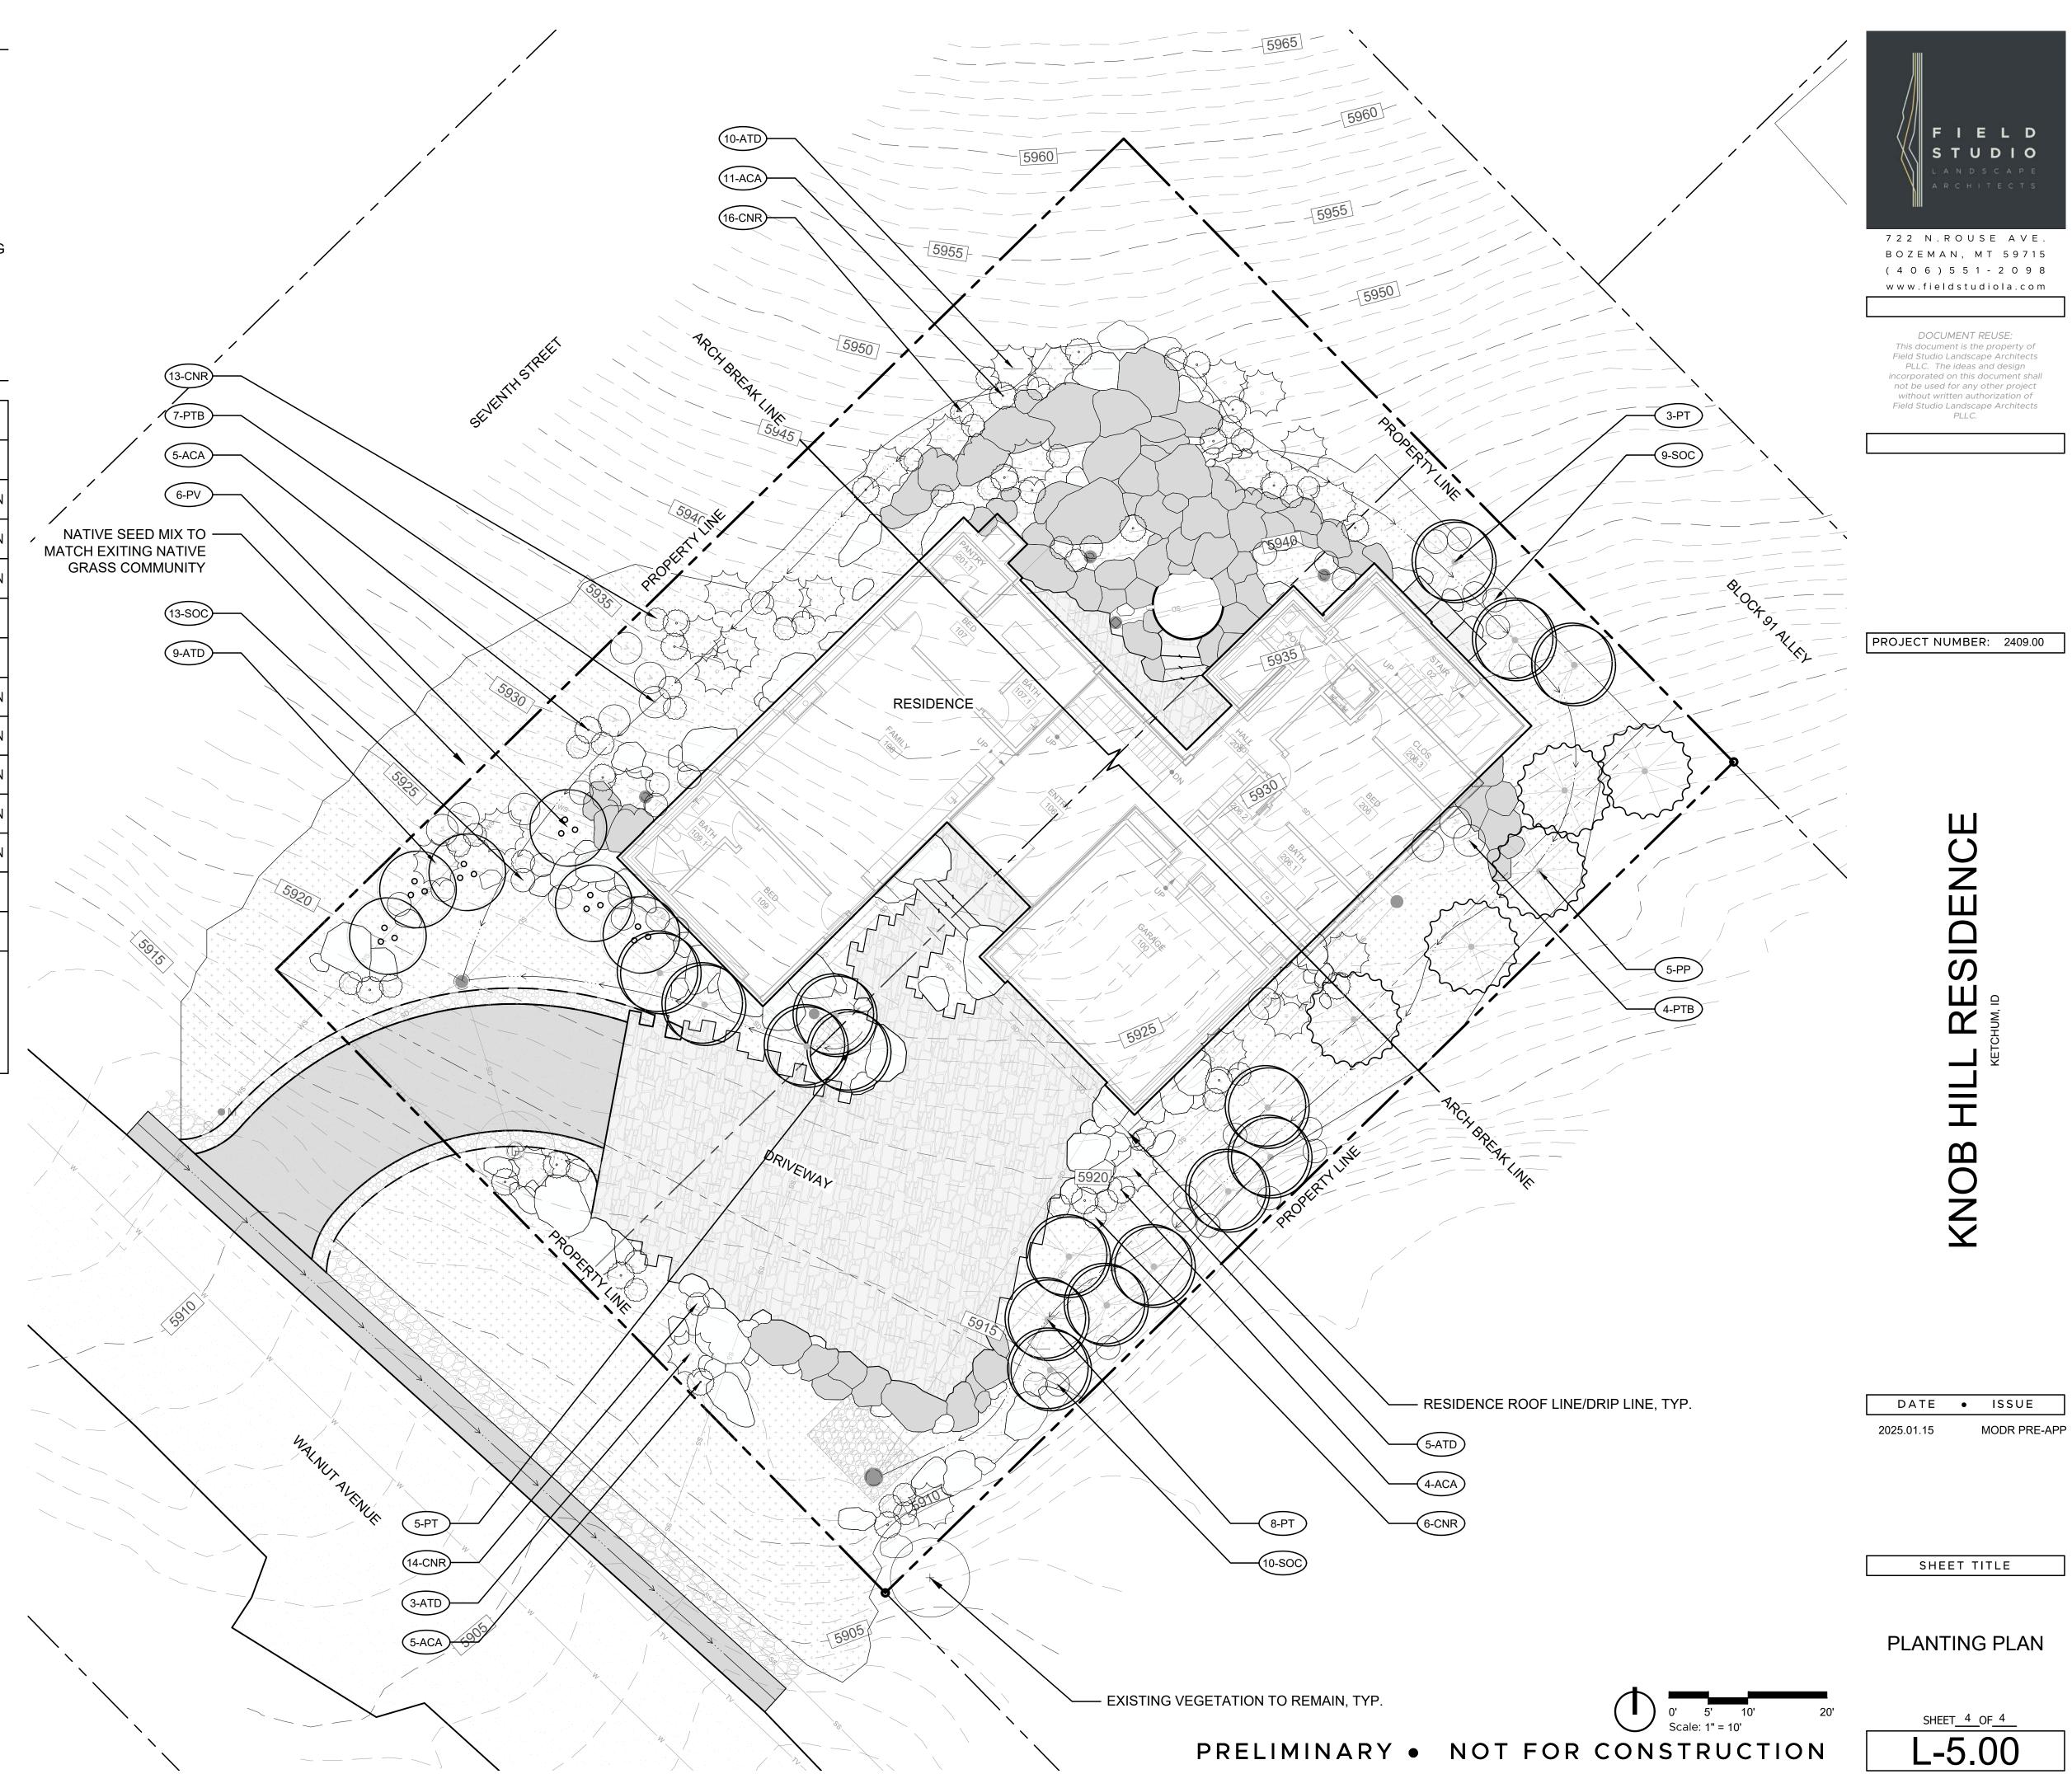

OWNER:

KNOB HILL PROPERTIES, LLC P.O. BOX 14001-174 KETCHUM, ID 83340

PROJECT ARCHITECT:

RO | ROCKETT DESIGN 1306 BRIDGEWAY, FLOOR 2 SAUSALITO, CA 94965 TEL: 415.289.0830

SURVEYOR:

BENCHMARK ASSOCIATES, P.A. P.O. BOX 733 - 100 BELL DRIVE KETCHUM, ID 83340 TEL: 208.726.9512

GEOTECHNICAL ENGINEER:

BUTLER ASSOCIATES, INC. P.O. BOX 1034 KETCHUM, ID 83340 TEL: 208.720.6432

CIVIL ENGINEER:

BENCHMARK ASSOCIATES, P.A. P.O. BOX 733 - 100 BELL DRIVE KETCHUM, ID 83340 TEL: 208.726.9512

LANDSCAPE ARCHITECT:

**FIELD STUDIO** 722 N ROUSE AVE BOZEMAN, MT 59715 TEL: 406.551.2098

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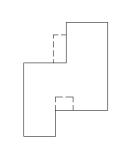
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SEAL:

1 01.15.25 MODR PRE-APPLICATION NO DATE ISSUE

PROJECT:

KNOB HILL RESIDENCE LOT 3&4, BLOCK 91



PROJECT NUMBER

DRAWING TITLE:

SITE PLAN

**SITE PLAN NOTES:** 

SEE LANDSCAPE PLAN FOR (E) & (N)TREE LOCATIONS
 SEE CIVIL DRAWINGS FOR DRIVEWAY LAYOUT, PROFILE & SITE DRAINAGE INFORMATION.

DRAWING NUMBER:

NOT FOR CONSTRUCTION

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1 1" = 10'-0" | **SITE PLAN** 

OWNER:

KNOB HILL PROPERTIES, LLC P.O. BOX 14001-174 KETCHUM, ID 83340

PROJECT ARCHITECT:

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FIELD STUDIO 722 N ROUSE AVE BOZEMAN, MT 59715 TEL: 406.551.2098

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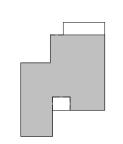
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SEAL:

1 01.15.25 MODR PRE-APPLICATION
NO DATE ISSUE

PROJECT:

KNOB HILL RESIDENCE LOT 3&4, BLOCK 91



PROJECT NUMBER

4

DRAWING TITLE:

REFERENCE PLAN NOTES:

 SEE LANDSCAPE DRAWINGS FOR PLANTING AND LANDSCAPE INFORMATION
 SEE CIVIL DRAWING FOR DRIVEWAY AND SITE

DRAINAGE INFORMATION

3. USGS ELEVATION +5,918'-0" IS NOTED AS +100'-0" IN
SUBSEQUENT ARCHITECTURAL DRAWINGS

4. COORDINATE STARTPOINT WITH CIVIL

 SEE G-200 FOR MORE INFORMATION REGARDING ROOF ASSEMBLIES REFERENCE PLAN / LEVEL 01

DRAWING NUMBER:

**A-102** 

NOT FOR CONSTRUCTION

1/8" = 1'-0" **REFERENCE PLAN / LEVEL 02** 

# KNOB HILL RESIDENCE

OWNER:

KNOB HILL PROPERTIES, LLC P.O. BOX 14001-174 KETCHUM, ID 83340

PROJECT ARCHITECT:

RO | ROCKETT DESIGN 1306 BRIDGEWAY, FLOOR 2 SAUSALITO, CA 94965 TEL: 415.289.0830

SURVEYOR:

BENCHMARK ASSOCIATES, P.A. P.O. BOX 733 - 100 BELL DRIVE KETCHUM, ID 83340 TEL: 208.726.9512

GEOTECHNICAL ENGINEER:

BUTLER ASSOCIATES, INC. P.O. BOX 1034 KETCHUM, ID 83340 TEL: 208.720.6432

CIVIL ENGINEER:

BENCHMARK ASSOCIATES, P.A. P.O. BOX 733 - 100 BELL DRIVE KETCHUM, ID 83340 TEL: 208.726.9512

LANDSCAPE ARCHITECT:

**FIELD STUDIO**722 N ROUSE AVE
BOZEMAN, MT 59715
TEL: 406.551.2098

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SEVI:

without written permission.


1 01.15.25 MODR PRE-APPLICATION

ISSUE

PROJECT:

NO DATE

KNOB HILL RESIDENCE LOT 3&4, BLOCK 91

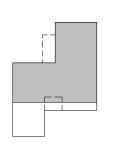

PROJECT NUMBER

•

DRAWING TITLE:

**REFERENCE PLAN NOTES:** 

 SEE LANDSCAPE DRAWINGS FOR PLANTING AND LANDSCAPE INFORMATION
 SEE CIVIL DRAWING FOR DRIVEWAY AND SITE

SUBSEQUENT ARCHITECTURAL DRAWINGS
4. COORDINATE STARTPOINT WITH CIVIL

DRAINAGE INFORMATION
3. USGS ELEVATION +5,918'-0" IS NOTED AS +100'-0" IN

 SEE G-200 FOR MORE INFORMATION REGARDING ROOF ASSEMBLIES REFERENCE PLAN / LEVEL 02

DRAWING NUMBER:

\-103

NOT FOR CONSTRUCTION

OWNER:

KNOB HILL PROPERTIES, LLC P.O. BOX 14001-174 KETCHUM, ID 83340

PROJECT ARCHITECT:

RO | ROCKETT DESIGN 1306 BRIDGEWAY, FLOOR 2 SAUSALITO, CA 94965 TEL: 415.289.0830

SURVEYOR:

BENCHMARK ASSOCIATES, P.A. P.O. BOX 733 - 100 BELL DRIVE KETCHUM, ID 83340 TEL: 208.726.9512

GEOTECHNICAL ENGINEER:

BUTLER ASSOCIATES, INC. P.O. BOX 1034 KETCHUM, ID 83340 TEL: 208.720.6432

CIVIL ENGINEER:

BENCHMARK ASSOCIATES, P.A. P.O. BOX 733 - 100 BELL DRIVE KETCHUM, ID 83340 TEL: 208.726.9512

LANDSCAPE ARCHITECT:

FIELD STUDIO 722 N ROUSE AVE BOZEMAN, MT 59715 TEL: 406.551.2098

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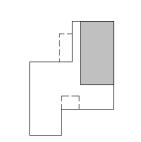
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SEVI:

1 01.15.25 MODR PRE-APPLICATION
NO DATE ISSUE

PROJECT:

KNOB HILL RESIDENCE LOT 3&4, BLOCK 91



PROJECT NUMBER

DRAWING TITLE:

**REFERENCE PLAN NOTES:** 

 SEE LANDSCAPE DRAWINGS FOR PLANTING AND LANDSCAPE INFORMATION
 SEE CIVIL DRAWING FOR DRIVEWAY AND SITE

SUBSEQUENT ARCHITECTURAL DRAWINGS
4. COORDINATE STARTPOINT WITH CIVIL

DRAINAGE INFORMATION
3. USGS ELEVATION +5,918'-0" IS NOTED AS +100'-0" IN


5. SEE G-200 FOR MORE INFORMATION REGARDING ROOF ASSEMBLIES

REFERENCE PLAN / LEVEL 03

DRAWING NUMBER:

<del>\</del>-104

NOT FOR CONSTRUCTION

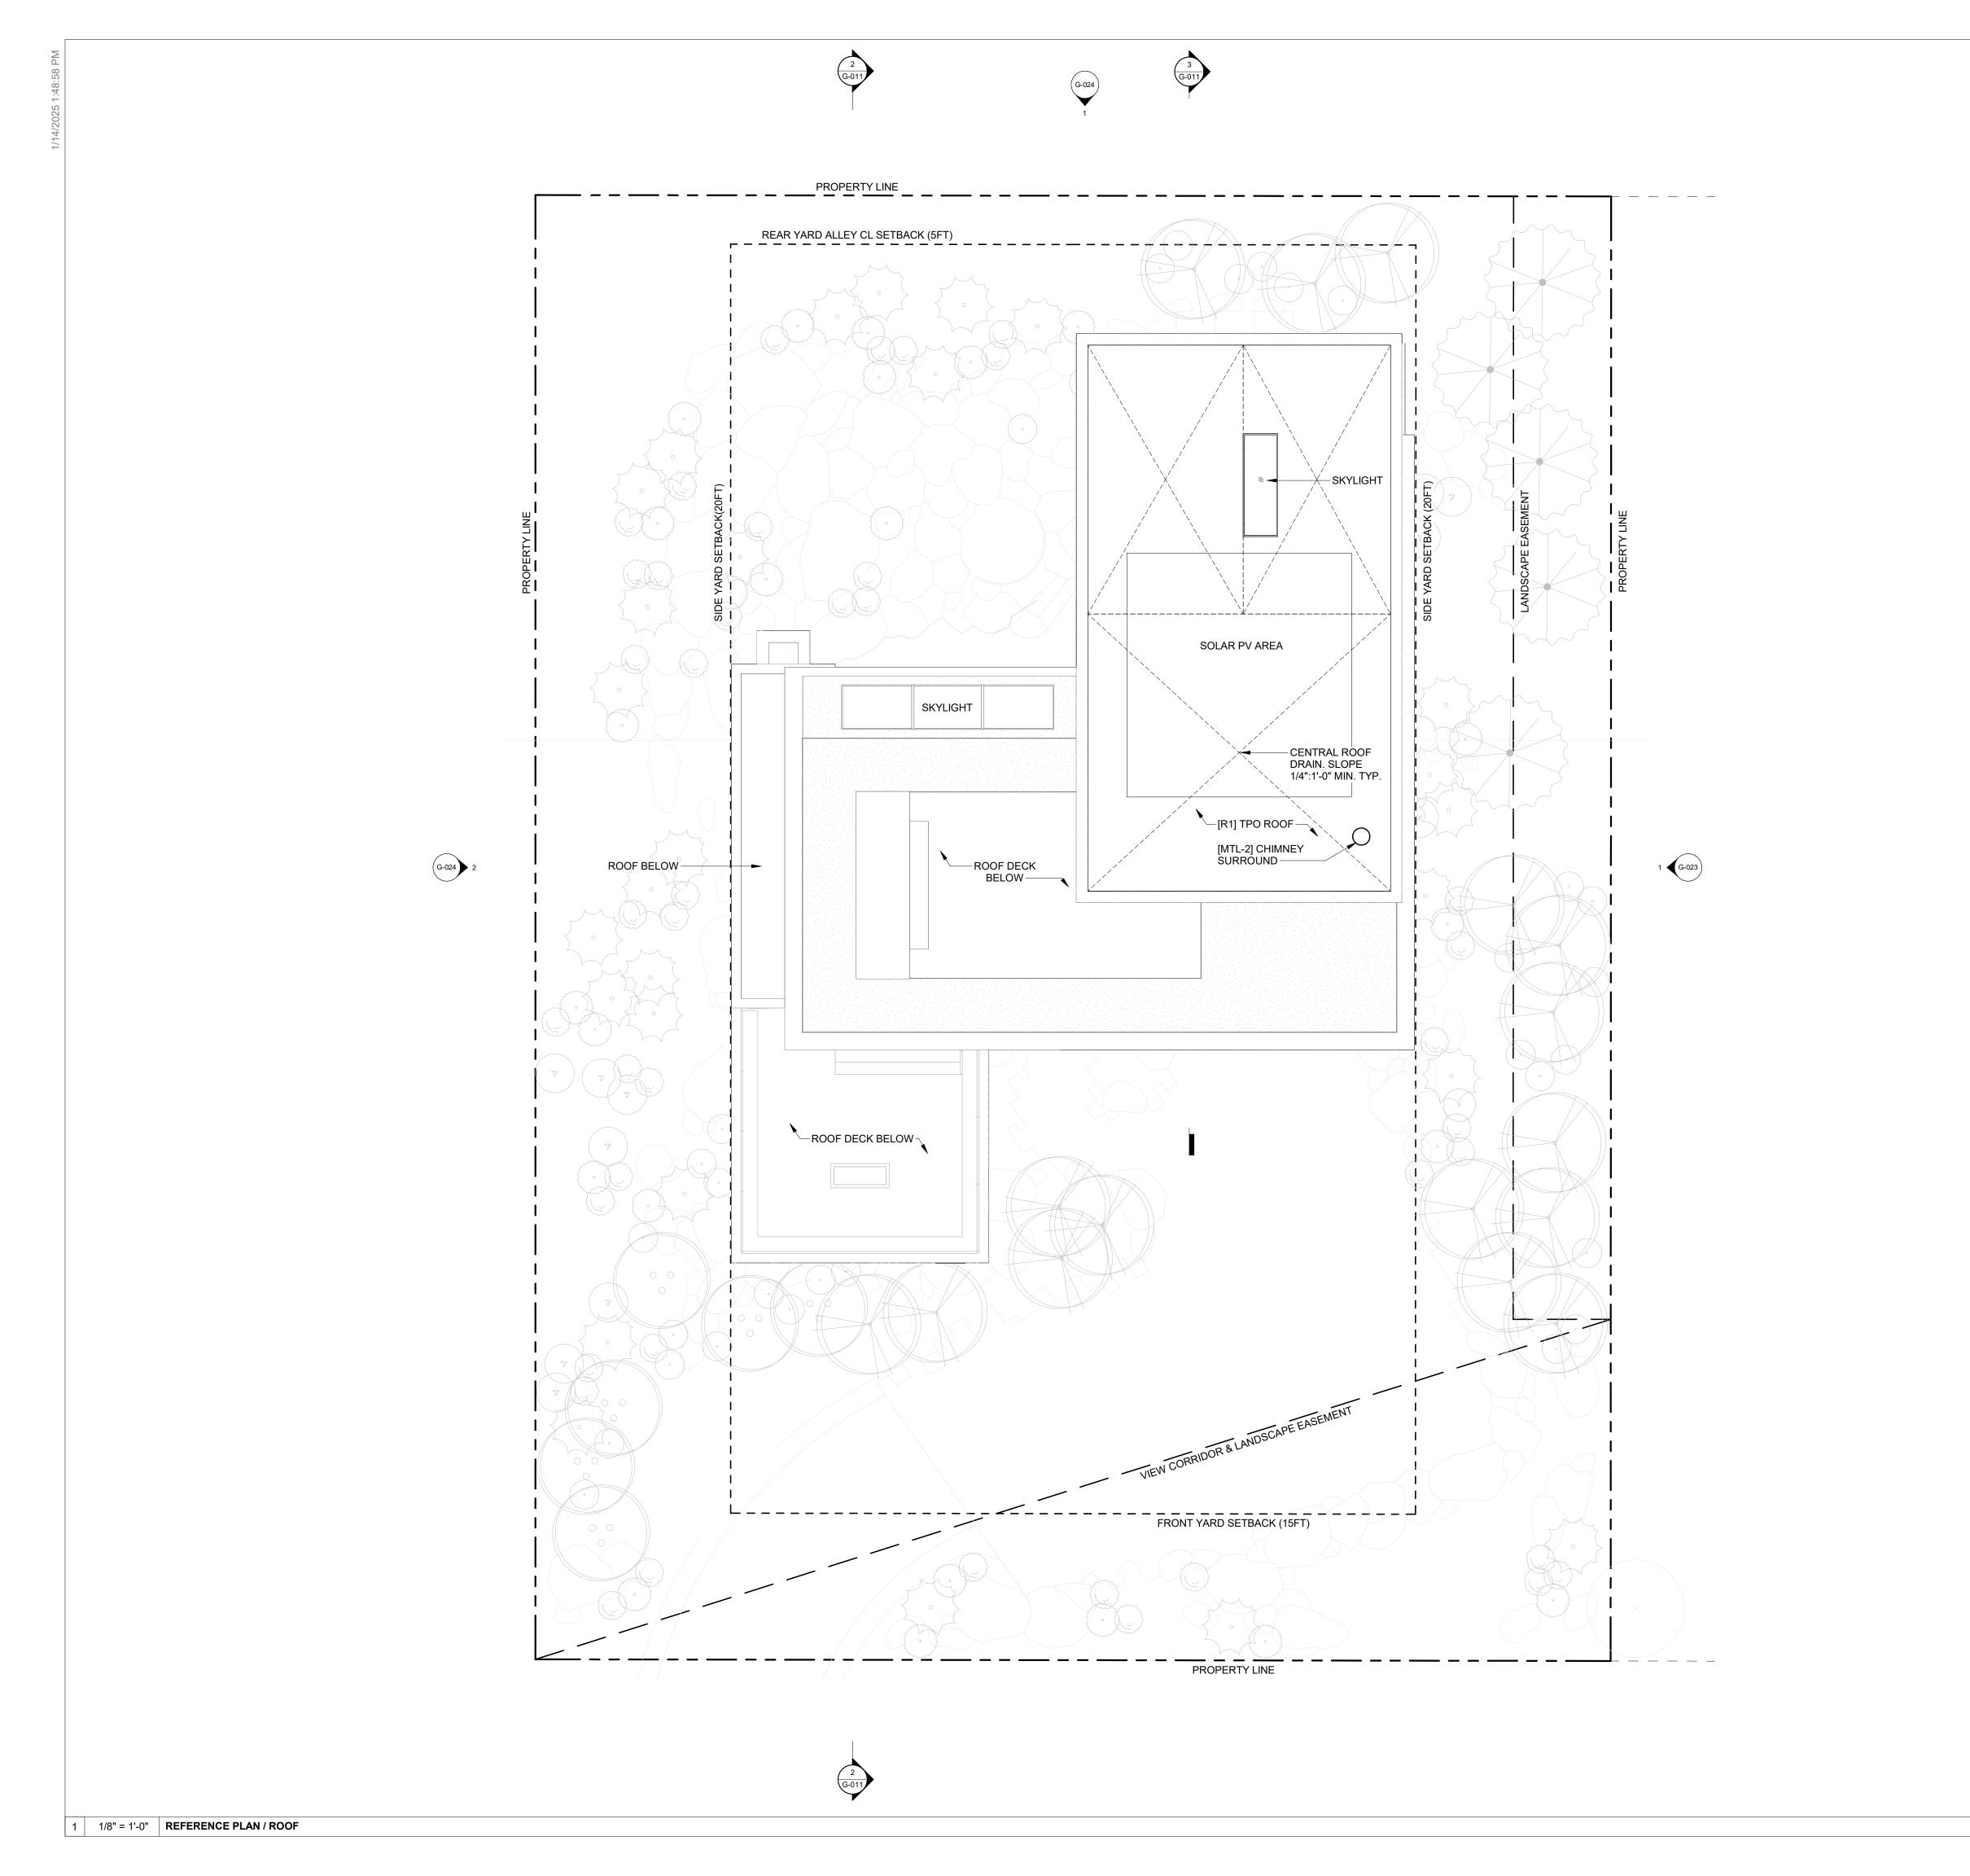

OWNER:

KNOB HILL PROPERTIES, LLC P.O. BOX 14001-174 KETCHUM, ID 83340

PROJECT ARCHITECT:

RO | ROCKETT DESIGN 1306 BRIDGEWAY, FLOOR 2 SAUSALITO, CA 94965 TEL: 415.289.0830

SURVEYOR:

BENCHMARK ASSOCIATES, P.A. P.O. BOX 733 - 100 BELL DRIVE KETCHUM, ID 83340 TEL: 208.726.9512

GEOTECHNICAL ENGINEER:

BUTLER ASSOCIATES, INC. P.O. BOX 1034 KETCHUM, ID 83340 TEL: 208.720.6432

CIVIL ENGINEER:

BENCHMARK ASSOCIATES, P.A. P.O. BOX 733 - 100 BELL DRIVE KETCHUM, ID 83340 TEL: 208.726.9512

LANDSCAPE ARCHITECT:

FIELD STUDIO 722 N ROUSE AVE BOZEMAN, MT 59715 TEL: 406.551.2098

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SEVI .


1 01.15.25 MODR PRE-APPLICATION

ISSUE

PROJECT:

NO DATE

KNOB HILL RESIDENCE LOT 3&4, BLOCK 91

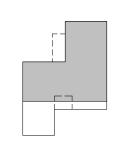

PROJECT NUMBER

DRAWING TITLE:

**REFERENCE PLAN NOTES:** 

 SEE LANDSCAPE DRAWINGS FOR PLANTING AND LANDSCAPE INFORMATION
 SEE CIVIL DRAWING FOR DRIVEWAY AND SITE DRAINAGE INFORMATION
 USGS ELEVATION +5,918'-0" IS NOTED AS +100'-0" IN

5. SEE G-200 FOR MORE INFORMATION REGARDING ROOF ASSEMBLIES

SUBSEQUENT ARCHITECTURAL DRAWINGS
4. COORDINATE STARTPOINT WITH CIVIL

REFERENCE PLAN / ROOF

DRAWING NUMBER:

A-105

NOT FOR CONSTRUCTION

Attachment B
Pre-Application
MO Design Review
Submittal:
Application
&
Supplemental Materials



### City of Ketchum Planning & Building

OFFICIAL USE ONLY
File Number: P24-087
Date Received: 10/15/24
By: GB
Pre-Application Fee Paid: \$4300
Design Review Fee Paid:
By:

#### **Pre-Application Mountain Overlay Design Review**

Submit completed application and documentation to <a href="mailto:planningandbuilding@ketchumidaho.org">planningandbuilding@ketchumidaho.org</a>. If you have questions, please contact the Planning and Building Department at (208) 726-7801. Design Review criteria, zoning regulations, and development standards are specified in Title 17 of Ketchum Municipal Code, which may be viewed by clicking the link <a href="mailto:here">here</a>. You will be contacted and invoiced once your application package is complete.

APPLICANT INFORMATION							
Project Name: Knob Hill Residence	Phone:	949	-554-5137	7			
Owner: Knob Hill Properties, LLC		Mailing Address:					
Email: peter@presidiovistaproperties.com			Keto	chum, ID	83340		
Architect/Representative: Ro Rockett Des	ign	Phone:	415	-289-0830	)		
Email: zrockett@rorockettdesign.com		Mailing Address:	1306	6 Bridgev	vay, Floor 2		
Architect License Number: AR-987275			Sau	salito, C	A 94965		
Engineer of Record: Galena Benchmark As	sociates	Phone:		-726-9512			
Email: phoebe@galena-benchmark.com		Mailing Address:	100	Bell Driv	e, Suite C		
Engineer License Number: 17661			Keto	chum, ID	83340		
Primary Contact Name and Phone Numbe	r: Nick Kunkle 415-2	89-0830 x206					
PROJECT INFORMATION							
Legal Land Description: Ketchum Lot 3&4		Street Address:	Lot				
Lot Area (Square Feet):16,523sf Combined	Zoning District: LR			RPK #:	00000910030 & 0000091004A	1	
Overlay District:     Floodplain	□ Avalanche	<b>⊠</b> Mountain		None			
Type of Construction:   New	□Addition	□Remodel		Other			
Anticipated Use: Single Family Residential		Number of Residential Units: 1					
GROSS FLOOR AREA							
	Proposed			Existing	B		
Basements	2,145	Sq.	Ft.	N/A		Sq. Ft.	
1 <sup>st</sup> Floor	1,951	Sq.	Ft.	N/A		Sq. Ft.	
2 <sup>nd</sup> Floor	3,091	Sq.	Ft.	N/A		Sq. Ft.	
3 <sup>rd</sup> Floor	1,173	Sq.	Ft.	N/A		Sq. Ft.	
Mezzanine	N/A	Sq.	Ft.	N/A		Sq. Ft.	
Total	6,215	Sq.	Ft.	N/A		Sq. Ft.	
FLOOR AREA RATIO							
Community Core: N/A Tourist: N/A				Genera	l Residential-High: <b>N/A</b>		
BUILDING COVERAGE/OPEN SPACE							
Percent of Building Coverage: 29%(4,775sf/16,523sf)							
DIMENSIONAL STANDARDS/PROPOSED SETBACKS							
Front: 15'/40'-7" PROPOSED Side: 10'/20' PROPOSED Side: 10'/20' PROPOSED Rear: 5'/14'-1" PROPOSED							
Building Height: 35'/33'-6" PROPOSED(38'-6" OVERALL STEPPING UP HILLSIDE; SEE ATTACHED ELEVATIONS)							
OFF STREET PARKING							
Parking Spaces Provided: 2 Curb Cut: 20'-0" Sq. Ft. 467SF % 18							
The Applicant agrees in the event of a dispute concerning the interpretation or enforcement of the Design Review Application in which the city of Ketchum							

The Applicant agrees in the event of a dispute concerning the interpretation or enforcement of the Design Review Application in which the city of Ketchum is the prevailing party, to pay the reasonable attorney fees, including attorney fees on appeal and expenses of the city of Ketchum. I, the undersigned, certify that all information submitted with and upon this application form is true and accurate to the best of my knowledge and belief.

10.11.2024

Signature of Owner/Representative

Date

#### PRE-APPLICATION MOUNTAIN OVERLAY DESIGN REVIEW SUBMITTAL CHECKLIST

A Pre-Application Design Review submittal shall include, but <u>are</u> not limited to, the materials listed in the following table in digital format. Please fill out the checklist in the table below and include the sheet number(s) where the required submittal material may be found in the project plan set. The applicant may elect to provide more details, additional plan sheets, and other supplemental materials not listed in the checklist at their discretion.

PRE-APPLICATION DESIGN REVIEW SUBMITTAL CHECKLIST				
Submitted				
by	Sheet	Pre-Application Required Materials		
Applicant	Number(s)	Pre-Application Required Materials		
Applicant	Number (3)	Project Narrative: A project narrative describing the approach and		
	D	concept of the project and how the project meets the applicable design		
X	Page 8, and 9 of PDF	review criteria. (narrative shall include a response to each applicable		
		criteria)		
		Conceptual Site Plan: A conceptual site plan showing proposed on and off-		
x	A-100, L-0.00,	site improvements. Site plan shall include conceptual landscaping and		
	L-1.00	public amenities. Detailed plant list not required.		
		Conceptual Elevations and Floor Plans: Elevations and floor plans for all		
x	G-111,G-112 A-102, A-103,	facades and all levels shall be provided. Elevations shall depict materiality,		
	A-102, A-103, A-104, A-105,	however, colored renderings not required.		
		Conceptual Materials and Color Palette: Materials and colors sample		
		board shall be provided for all facades. Photos of materials,		
X	G-110	representative imagery, and other digital representation of concept is		
		acceptable. Specifications of materials and colors are not required.		
		3D Perspectives: A minimum of two perspectives, one from a street view		
		and one from bird's eye view, showing the massing of the proposed		
X	G-110	project within the context of the surrounding neighborhood. Adjacent		
		properties and structures must be included. Full color renderings or		
		photo-realistic perspectives are not required.		
X	L-2.00, C-1.0	Topography of sufficient detail to represent slope of land		
X	L-2.00, C-1.0	Significant rock outcrops, cuts and fills required and similar features		
	-	Elevations of proposed building pads and public streets providing access,		
X	L-2.00, C-1.0	private access drives		
X	C-2.0	Preliminary utility extension plans		
X	L-2.00, C-1.0	Drainage plans and driveway plans		
X	N/A	Description of proposed blasting, if any		
	1			

#### **MODR Pre-Application**

#### **Design Narrative**

Site Design Approach & Methodology Knob Hill Residence (Application File No. P24-087)

\_

1/15/25

City of Ketchum Planning & Building P.O. Box 2315, 191 5<sup>th</sup> Street West Ketchum, ID 83340

CC: Abby Rivin

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#### **Natural Hillside Concept**

With the proposed project's location at the base of Penny Mountain, landscape design and preservation of the natural hillside are key components of the project's success. As you will see in the following exhibits, any required retaining or landscape elements are intended to mimic the natural features of Penny Mountain. The goal of this approach is to seamlessly blend the project into the hillside and minimize the disturbance required to build the project.

Exhibit 1

Project Location:


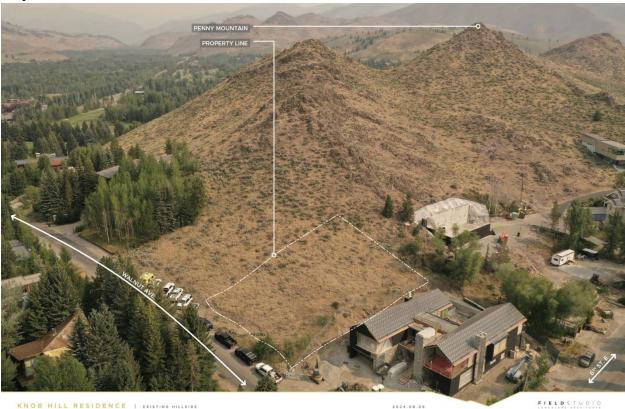


Exhibit 2

#### Natural Hillside Features:



Exhibit 3 **Design Concept:** 

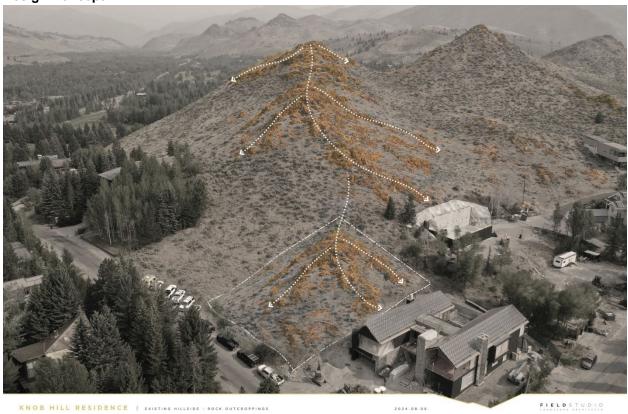

#### **Building Siting & Vehicular Access**

Safety and integration into the hillside were primary factors under consideration as the design team set out to site the building and provide vehicular access. Using the existing topography of the site and entering as high as possible on Walnut Avenue, the driveway gently slopes up along the existing contours to provide direct access to a garage. This configuration allows safe vehicular egress from the property, accommodates the required fire safety apparatus, and avoids large collections of steep retaining structures that would otherwise be required.

The proposed driveway and garage location is the result of multiple internal studies, planning department feedback, and specific requirements outlined by the fire department. The exhibits below show notable revisions made by the design team based on planning department feedback, including but not limited to a reduction in the size of the garage from 3-cars to 2-cars, the relocation of the garage to opposite side of the property to accommodate a shorter driveway, the length and width of the driveway were reduced to limit site coverage, and the inclusion of a 26ft x 50ft area for required fire apparatus access.



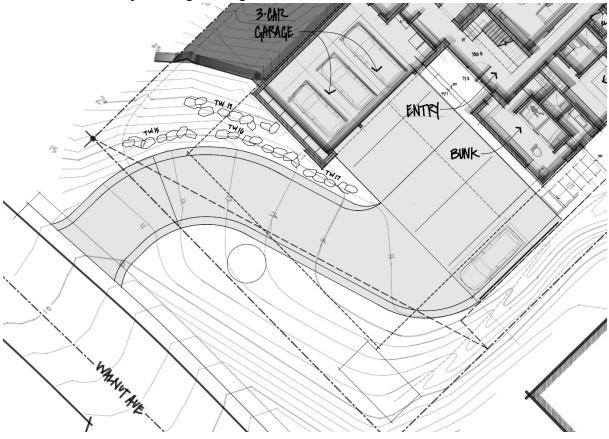


Exhibit 5

6/13 - Fire Apparatus Requirements:

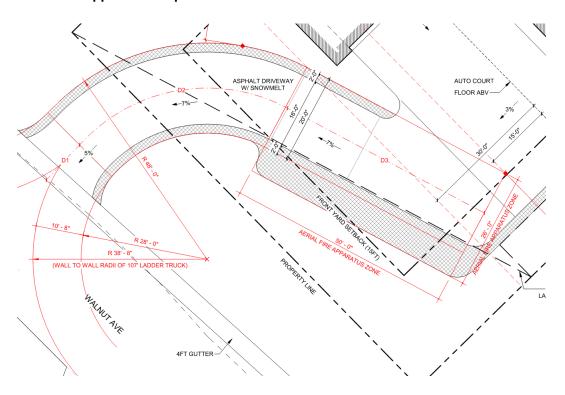


Exhibit 6 8/16 - Alternate Driveway & Garage Configuration:


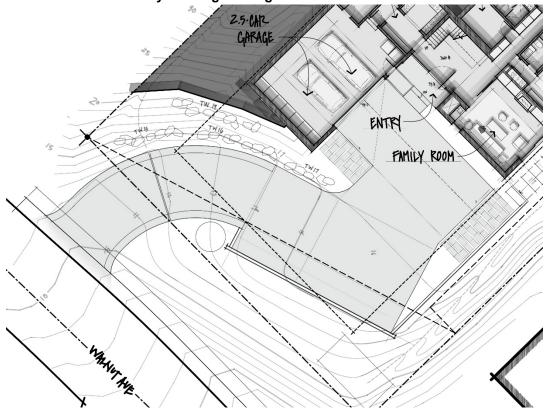


Exhibit 7



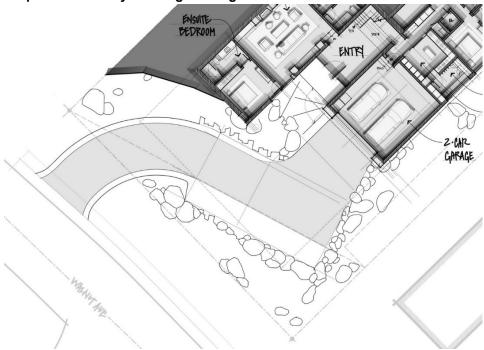

#### **Minimizing Hillside Disturbance**

The design team has shown in our drawing package (Sheet G-020) that combining lots 3 & 4 for the development of a single home, rather than two homes, will increase the overall undisturbed hillside area by over 3x. The total amount of undisturbed hillside has also increased dramatically over the course of several months while working with the planning department. Compared to the initial plans for the residence, which included a larger outdoor program at the rear of the house, the proposed design limits rear yard access to a small patio and outdoor spa while bringing natural light and ventilation into an otherwise opaque side of the house. In the following exhibits you will see a progression that followed guidance provided by the planning department and preserves more of the natural hillside.

Exhibit 8 5/29 - Initial Rear Yard Landscape Design:

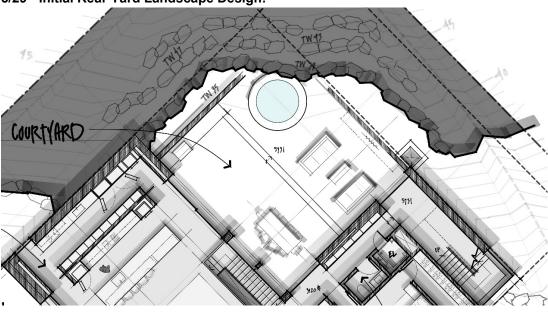


Exhibit 9

8/16 - Revised Rear Yard Landscape Design:

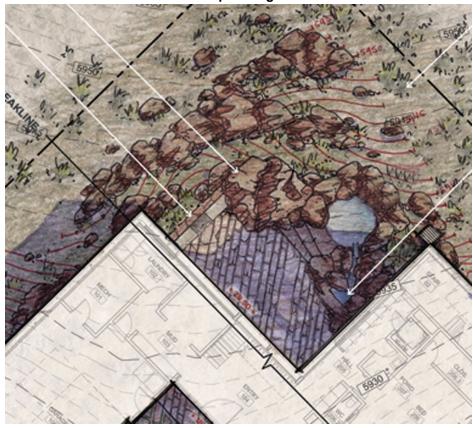


Exhibit 10
Proposed Rear Yard Landscape Design:



Los Angeles: 1031 W. Manchester Blvd. Unit 6 | Inglewood, CA | 213 784 0014 San Francisco: 1306 Bridgeway, Flr. 2 | Sausalito, CA | 415 289 0830 Aspen: 115 Boomerang Road, Unit 5101A | Aspen, CO | 970 977 9002

#### **Compatibility of Design**

The design team has also carefully considered the surrounding neighborhood context while developing the proposed project. The design incorporates a similar mix of materials (natural wood and stone), massing (two-story volumes stepping back and up the hillside), and architectural features (timber columns and overhangs). With the feedback of the planning department, the design team has introduced undulation and relief along the façade, maintained continuity of materials, and created a building character that aligns with both the requirements and the spirit of the Mountain Overlay Design Review District. We believe the proposed project will blend seamlessly into the area and will not have an adverse impact.

Exhibit 11 **600 Walnut Avenue:** 





Exhibit 12

#### 760 Walnut Avenue:



Exhibit 13 711 Walnut Avenue:



Exhibit 14

#### 691 Spruce Avenue:



Exhibit 15: **880 Walnut Avenue:** 



#### Exhibit 16:

#### 900 Walnut Avenue:



Exhibit 17:
Proposed Design Bird's Eye View:



Exhibit 18:

#### **Proposed Design Street View:**



#### **Building Height**

The design team has also carefully considered the surrounding neighborhood context while defining the height of the building. We have made a proactive decision to keep the height 1'-6" lower than the maximum façade and overall building height allowed; 33'-6" rather than 35'-0" and 38'-6" rather than 40'-0" respectively.

Exhibit 19: **Proposed Building Elevation:** 



#### **Conclusion**

Thank you for reviewing our design narrative. We hope the design team's efforts to increase the undisturbed hillside area, provide direct and safe vehicular access, and complement the surrounding context were clearly communicated. The planning department has positively influenced the proposed design with respect to the Mountain Overlay District's guidelines, especially in comparison to our initial intentions for the project.

We look forward to discussing our project further at our upcoming P&Z hearing on February 11th.

#### **MODR Pre-Application**

#### Mountain Overlay Design Review Standards Narrative

Knob Hill Residence (Application File No. P24-087)

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1/15/25

City of Ketchum Planning & Building P.O. Box 2315, 191 5<sup>th</sup> Street West Ketchum, ID 83340

CC: Abby Rivin

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#### Mountain Overlay Design Review Criteria & Standards

**17.104.070.A.1**: There shall be no building on ridges or knolls which would have a material visual impact on a significant skyline visible from a public vantage point entering the City or within the City. "Material", as the term is used herein, shall be construed in light of the magnitude of the negative impact on the objectives of this section;

**Response:** As shown on sheet G-025, the project is not sited on a ridge or knoll that would have a material visual impact on a significant skyline visible from a public vantage point entering or within the city.

**17.104.070.A.2**: Building, excavating, filling and vegetation disturbance on hillsides which would have a material visual impact visible from a public vantage point entering the City or within the City is minimized. Material, as the term is used herein, shall be construed in light of the magnitude of the negative impact on the objectives of this Ordinance.

**Response:** As shown on sheet G-025, the project size or disturbance is not located in a way that would have a material visual impact on a significant skyline visible from a public vantage point entering or within the city.

**17.104.070.A.3**: Driveway standards as well as other applicable standards contained in Street Standards Chapter 12.04 are met.

**Response:** As shown on sheet C-1.0, the proposed driveway improvements comply with all applicable standards for a private driveway specified in Ketchum Municipal Code §12.03.030.L.

**17.104.070.A.4**: All development shall have access for fire and other emergency vehicles to within one hundred fifty feet (150') of the furthest exterior wall of any building.

**Response:** As shown on sheet EXB, sufficient access is provided for fire and other emergency vehicles to reach within 150 feet of the furthest exterior wall of the building.

17.104.070.A.5: Significant rock outcroppings are not disturbed.

**Response:** There are no significant rock outcroppings within the property boundary of the subject property. Rock outcroppings further up the hillside are not blocked from view by the proposed residence.

**17.104.070.A.6**: International Building Code (IBC) and International Fire Code (IFC) and Ketchum Fire Department requirements shall be met.

**Response:** The project will comply with the 2018 International Residential Code, the 2018 International Fire Code, all local amendments specified in Title 15 of Ketchum Municipal Code, and Ketchum Fire Department requirements.

17.104.070.A.7: Public water and sewer service comply with the requirements of the City.

**Response:** As shown on C1.0 of the project plans, the project proposes connecting to the municipal water and sewer systems from existing lines within Walnut Ave. All requirements and specifications for the water and sewer connections set by the Utilities Department will be met.

17.104.070.A.8: Drainage is controlled and maintained to not adversely affect other properties.

**Response:** Pursuant to KMC §17.96.060.C.1, all storm water drainage shall be retained on site. Drainage improvements are specified on Sheet C1.0 of the project plans. The drainage improvements include the installation of a trench drain at the driveway. A combination of drywells and catch basins will be installed to collect stormwater from the rest of the property.

**17.104.070.A.9**: Cuts and fills allowed for roadways shall be minimized; lengths of driveways allowed shall be minimized; all cuts and fills shall be concealed with landscaping, revegetation and/or natural stone materials.

Revegetation on hillsides with a clear zone of thirty feet (30') around all structures is recommended. Said clear zone shall include low combustible irrigated vegetation with appropriate species, on file with the Ketchum planning department. Revegetation outside of this clear zone should be harmonious with the surrounding hillsides.

**Response:** The driveway accesses the site as high on Walnut Ave as possible to allow a more direct approach onto the site which results in less cut and fill as opposed to having a driveway perpendicular to Walnut Ave and further south on the subject property. Furthermore, the driveway follows the existing contours of the site to further limit cut and fill.

The landscape plan proposes a variety of trees, shrubs, grasses, and boulders that will conceal any proposed cuts and fills and blend the proposed project into the native hillside landscape.

**17.104.070.A.10**: There are not other sites on the parcel more suitable for the proposed development in order to carry out the purposes of this Ordinance.

**Response:** The location of the proposed residence allows for the building to be tucked into the hillside and step up with the cross slope, resulting in the project not having a material visual impact.

**17.104.070.A.11**: Access traversing 25% or greater slopes does not have significant impact on drainage, snow and earth slide potential and erosion as it relates to the subject property and to adjacent properties.

**Response:** A majority of the driveway traverse sections of the property over 25% slope. The proposed driveway access does not have significant impact on drainage, snow and earth slide potential and erosion on the subject property and adjacent properties.

17.104.070.A.12: Utilities shall be underground.

**Response:** The utility improvements are indicated on Sheet C1.0 of the project plans. All utility improvements will be underground.

**17.104.070.A.13**: Limits of disturbance shall be established on the plans and protected by fencing on the site for the duration of construction.

**Response:** Sheet L-2.00 shows the proposed limits of disturbance on the subject property for the proposed residence. A construction management plan that addresses all construction activity standards specified in Ketchum Municipal Code §15.06.030 will be submitted with the building permit application.

**17.104.070.A.14**: Excavations, fills and vegetation disturbance on hillsides not associated with the building construction shall be minimized.

**Response:** The project minimizes excavation and disturbance on the site not associated with building construction as seen on Sheet L-2.00. The proposed cut and fill quantities are specified on Sheet C1.0. The total estimated volume of the proposed cut is 3,810 cubic yards. The estimated proposed fill comes out to 20 cubic yards. Areas disturbed will be revegetated with native plantings upon completion of construction.

**17.104.070.A.15**: Preservation of significant landmarks shall be encouraged and protected, where applicable. A significant landmark is one which gives historical and/or cultural importance to the neighborhood and/or community.

**Response:** No significant landmarks have been identified on-site. The significant landmark uphill of the property will not be negatively impacted by the proposed development.

**17.104.070.A.16**: Encroachments of below grade structures into required setbacks are subject to subsection 17.128.020.K of this title and shall not conflict with any applicable easements, existing underground structures, sensitive ecological areas, soil stability, drainage, other sections of this Code or other regulating codes such as adopted International Code Council Codes, or other site features concerning health, safety, and welfare.

**Response:** This standard is not applicable as the project does not propose below-grade structures that encroach into required setbacks.

# Attachment C LR Zoning and Dimensional Standards Evaluation



## KNOB HILL RESIDENCE PRE-APPLICATION MOUNTAIN OVERLAY DESIGN REVIEW ZONING & DIMENSIONAL STANDARDS EVALUATION

LR Zoning and Dimensional Standards Evaluation				
Co	Compliant Standards and Staff Analysis			
Yes	No	N/	Ketchum	City Standards and Staff Analysis
		Α	Municipal	
			Code	
$\boxtimes$			17.12.030	Minimum Lot Area
			Staff Analysis	Required: 9,000 square feet minimum
				Existing (Ketchum Townsite—Block 91: Lots 3 & 4):
				16,523 square feet (0.38 acres)
$\boxtimes$			17.12.030	Building Coverage
			Staff Analysis	Permitted: 35%
				Proposed:
				Sheets G-010 and L-0.00 of the project plans provides building coverage
				information.
				29% (4,775 square feet / 16,523 square feet lot area)
$\boxtimes$			17.12.030	Minimum Building Setbacks
			Staff Analysis	Minimum Required Setbacks:
			-	Front: 15'
				Side: > of 1' for every 2' in building height, or 10' (19'-3'' required)
				Rear: 20'
				KMC §17.128.020.D: In measuring the rear yard of a principal building
				where the rear lot line abuts an alley, measurement may be made to the
				centerline of the alley, provided no building is located within the right-of-
				way of the alley.
				Proposed:
				Setback dimensions are specified on Sheet A-100 of the project plans.
				Front (Walnut Avenue Avenue): 40'-7"
				Side (north): 20'
				Side (south): 20'
				Rear (east property line): 14'-1"
				Rear (centerline of Block 91 alleyway): 29'-1"
$\boxtimes$			17.12.030	Building Height
			Staff Analysis	Height of Building (KMC §17.08.020)
				Height of Building: The greatest vertical distance measured at any point
				from the roof to natural, existing, or finished grade, whichever is lowest.
				The maximum vertical distance from the lowest exposed finished floor to
				the highest point of the roof (regardless of vertical alignment) shall be no
				more than five feet greater than the maximum height permitted in the
				zoning district (see illustration B on file in the office of the City Clerk). No

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			facade shall be greater than the maximum height permitted in the zoning district. (See definition of "facade" in this section and illustration B on file in the office of the City Clerk.) Facades which step up or down hillsides shall be set back from the lower facade a minimum of 50 percent of the height of the lower facade; except, that roof overhangs may extend up to three feet into this area (see illustration B on file in the office of the City Clerk). This building height provision shall apply to parapets, Boston roofs and any other portion of a building roof, but shall not apply to flagpoles, lightning rods, weather vanes, antennas or chimneys.
			Maximum Building Height Permitted: 35'
			Proposed: Elevations for finished floor and roof are specified in the building height section on sheet G-011 of the project plans.  • Lowest Exposed Finished Floor Elevation: 5916'-3"  • Highest Point of the Roof Elevation: 5954'-9"  • Maximum Vertical Distance (Regardless of Vertical Alignment): 38'-6"  • Lower Façade Height (35' max): 27'-5"  • Façade Setback (minimum of 50% lower façade height = 13'-9"): 13'-9"  • Maximum Façade Height: 33'-6"
$\boxtimes$		17.125.030.I	Driveway Width
		Staff Analysis	Required:  Minimum: The unobstructed, all weather surface of a private driveway shall not be less than 12 feet.  Maximum: The unobstructed, all weather surface of a private driveway shall not be greater than 35 percent of the linear footage of any street

			frontage or 30 feet, whichever is less, unless otherwise approved by the City Engineer.  Proposed: 20-foot-wide driveway 19% of Walnut Ave Street Frontage (20-foot-wide driveway/110 feet of Walnut Ave frontage)
$\boxtimes$		17.125.020.A. 2 & 17.125.040.B	Parking Spaces
		Staff Analysis	Off-street parking standards of this chapter apply to any new development and to any new established uses.  Required: One-Family Dwelling Units in all Zoning Districts: 2 parking spaces per dwelling unit.  Proposed: As shown on sheet A-102 of the project plans, two parking spaces are provided within the attached garage.

# Attachment D Mountain Overlay Design Review Standards Analysis



## KNOB HILL RESIDENCE PRE-APPLICATION MOUNTAIN OVERLAY DESIGN REVIEW MOUNTAIN OVERLAY DESIGN REVIEW STANDARDS EVALUATION

Mountain Overlay Design Review Standards (KMC §17.107.070.A)		
Ketchum Municipal	Mountain Overlay Standards & Staff Analysis	
Code		
17.104.070.A1	There shall be no building on ridges or knolls which would have a material	
	visual impact on a significant skyline visible from a public vantage point	
	entering the City or within the City. "Material", as the term is used herein,	
	shall be construed in light of the magnitude of the negative impact on the	
	objectives of this section.	
Staff Analysis	The project is not sited on a ridge or knoll that would have a material visual	
	impact on a significant skyline visible from a public vantage point entering or	
	within the city. The applicant has provided photography exhibits on Sheet G-	
	025 of the project plans shows the estimated project location from different	
	locations in the city. Based on the information provided in the Pre-Application	
	submittal, staff does not believe the proposed home will have a material visual	
	impact from any public vantage point within the city. When story poles are installed at final MO Design Review, staff will check public vantage points to	
	further assess whether the project has a material impact.	
17.104.070.A2	Building, excavating, filling and vegetation disturbance on hillsides which	
17.104.070.72	would have a material visual impact visible from a public vantage point	
	entering the City or within the City is minimized. Material, as the term is	
	used herein, shall be construed in light of the magnitude of the negative	
	impact on the objectives of this section.	
Staff Analysis	As noted in the analysis for KMC §17.104.070A2 above, staff does not	
	believe the project will have a material visual impact visible from a public	
	vantage point in the city. The subject property is located at the lower	
	elevation of the Penny Mountain hillside.	
17.104.070.A3	Driveway standards as well as other applicable standards contained in	
	Street Standards Chapter 12.04 are met.	
Staff Analysis	Please see staff analysis for KMC §17.104.070.A9 for an analysis of the	
	proposed driveway length. The civil drawings on sheet C1.0 and C1.1 specify	
	the proposed driveway improvements. The proposed driveway is 20 feet	
	wide and has a slope of about 7%. The site plan on sheet A-100 shows that	
	the full extent of the asphalt driveway and the stone paver driveway are	
	proposed to include snowmelt. The Fire Department requires snowmelt for	
	driveways or portions of driveways with 7-10% slope. The portion of the	
	driveway within the Walnut Avenue public right-of-way is 7.1% slope. As of	
	April 3, 2023, the City Council no longer approves Right-of-Way (ROW)	
	Encroachment Permits for residential snowmelt systems, unless the	

	snowmelt system is required by the Fire or Streets departments. The Fire Department requires snowmelt for the portion of the driveway in the Walnut Avenue public ROW as the slope slightly exceeds 7%. The portion of the heated driveway that encroaches into the public ROW along Walnut Avenue will require a ROW Encroachment Permit and final review and approval by the City Council.  The proposed driveway improvements shown in the Pre-Application submittal have been reviewed by the City Engineer, Streets Department, and Fire Department and city department comments were transmitted to the
	applicant. At final MO Design Review, city departments will conduct another code compliance review to ensure that all comments have been addressed and that the project complies with all requirements.
17.104.070.A4	All development shall have access for fire and other emergency vehicles to within one hundred fifty feet (150') of the furthest exterior wall of any building.
Staff Analysis	Sufficient access is provided for fire and other emergency vehicles to reach within 150 feet of the furthest exterior wall of the building. As shown on sheet EXH, access for fire and other emergency vehicles is provided from the fire apparatus zone at the southwest corner of the subject property to within 150 feet of the furthest exterior wall of the proposed home.
17.104.070.A5	Significant rock outcroppings are not disturbed.
Staff Analysis	As shown on the topographic survey included in the project plans, the subject property does not contain any significant rock outcroppings.
17.104.070.A6	International Building Code (IBC) and International Fire Code (IFC) and Ketchum Fire Department requirements shall be met.
Staff Analysis	The project must comply with the 2018 International Residential Code, the 2018 International Fire Code, all local amendments specified in Title 15 of Ketchum Municipal Code, and Ketchum Fire Department requirements. All building code and Fire Department requirements will be verified for compliance by the Building and Fire departments prior to building permit issuance.
17.104.070.A7	Public water and sewer service comply with the requirements of the City.
Staff Analysis	As shown on C1.0 of the project plans and detailed in notes U01 and U02, the project will tap into the existing water main and utilize the existing sewer line tap along Walnut Avenue. The Water and Wastewater departments will conduct an additional review of the project plans submitted with the final MO Design Review to confirm compliance with all complaints.
17.104.070.A8	Drainage is controlled and maintained to not adversely affect other properties.
Staff Analysis	Pursuant to KMC §17.96.060.C.1, all storm water drainage shall be retained on site. Drainage improvements are specified on sheets C1.0 and C1.1 of the project plans. The drainage improvements in the public right-of-way include constructing a new valley gutter that will connect to the existing valley gutter.

	Drainage improvements on the subject property include a system of catch basins and drywells as well as trench drain across the width of the driveway along the front property line. The City Engineer reviewed the drainage improvements shown in the Pre-Application submittal and comments were transmitted to the applicant. The City Engineer requested the applicant submit a geotechnical report and drainage calculations for the zing of drywells with the final MO Design Review submittal.
17.104.070.A9	Cuts and fills allowed for roadways shall be minimized; lengths of driveways allowed shall be minimized; all cuts and fills shall be concealed with landscaping, revegetation and/or natural stone materials.  Revegetation on hillsides with a clear zone of thirty feet (30') around all structures is recommended. Said clear zone shall include low combustible
	irrigated vegetation with appropriate species, on file with the Ketchum planning department. Revegetation outside of this clear zone should be harmonious with the surrounding hillsides.
Staff Analysis	In the Design Narrative, the applicant provides a summary of design changes made to the outdoor patio and hot tub area in response to Planning staff feedback to preserve more of the natural hillside. The applicant has significantly reduced the size outdoor patio area from the first iteration of the design drawings. Staff appreciates these changes and the applicant's thoughtful response to feedback, however, staff believes that removing the outdoor patio and hot tub would preserve even more of the natural hillside. Staff recommends the applicant remove the outdoor patio and hot tub to preserve more of the natural hillside area.
	In the Design Narrative, the applicant provides an analysis of the proposed driveway access. The applicant states:
	Safety and integration into the hillside were primary factors under consideration as the design team set out to site the building and provide vehicular access. Using the existing topography of the site and entering as high as possible on Walnut Avenue, the driveway gently slopes up along the existing contours to provide direct access to a garage. This configuration allows safe vehicular egress from the property, accommodates the required fire safety apparatus, and avoids large collections of steep retaining structures that would otherwise be required.
	In the written response to MO Design Review standards, the applicant further explains:  The driveway accesses the site as high on Walnut Ave as possible to allow a more direct approach onto the site which results in less cut and fill as opposed to having a driveway perpendicular to Walnut Ave and further

south on the subject property. Furthermore, the driveway follows the existing contours of the site to further limit cut and fill.

The landscape plan proposes a variety of trees, shrubs, grasses, and boulders that will conceal any proposed cuts and fills and blend the proposed project into the native hillside landscape.

The applicant has revised the proposed driveway access based on Planning staff feedback and Fire Department requirements. These changes included reducing the size of the garage, relocating the garage to facilitate a shorter driveway, and reducing the length and width of the driveway to limit disturbance. The proposed driveway access along Walnut Avenue is 20 feet wide and surfaced with asphalt. The driveway then extends to the fire apparatus zone that is surfaced with pavers. The fire apparatus zone is 50 feet long and 26 feet wide. The length of the asphalt portion of the driveway is 57 feet. The length of the portion of the driveway surfaced with pavers is 71 feet long. The total length of the driveway is 128 feet.

Pursuant to Fire Department requirements, aerial fire apparatus access is required where the vertical distance between the grade plane and the highest roof surface exceeds 30 feet. Aerial fire apparatus access roads must have a minimum unobstructed width of 26 feet and must be sited no closer than 15 feet and no further than 30 feet from the structure. Aerial fire apparatus access is required because the proposed height of the home is 38.5 feet from the lowest finished grade to the highest point of the roof. The proposed driveway and fire apparatus zone improvements push the home further up the hillside. The required setback from the front property line in the LR Zone is 15 feet. As a result of the driveway improvements, the home is setback 40'-7" from the front property line along Walnut Avenue, which is 25'-7" more than the minimum required.

If the height of the proposed home were reduced to less than 30 feet above grade, then the aerial fire apparatus access would not be required. Removing the aerial fire apparatus access would reduce the length of the driveway and allow the home to be sited at a lower elevation on the subject property. Staff believes this change would significantly reduce hillside disturbance. Staff recommends the applicant reduce the height of the home to less than 30 feet above grade by either reducing floor-to-ceiling heights or removing the third floor to remove the aerial fire apparatus access requirement, which would allow the home to be sited at the lower elevation of the subject property and minimize hillside disturbance.

17.104.070.A10

There are not other sites on the parcel more suitable for the proposed development in order to carry out the purposes of this section.

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Staff Analysis	Please see analysis for KMC §17.104.070.A9 and KMC §17.104.070.A14. Staff believes that the area where the proposed aerial fire apparatus access is located in the front yard may be a more suitable site from the proposed development. Aerial fire apparatus access is required because the proposed height of the home is 38.5 feet from the lowest finished grade to the highest point of the roof. If the height of the proposed home were reduced to less than 30 feet above grade, then the aerial fire apparatus access would not be required. Removing the aerial fire apparatus access would reduce the length of the driveway and allow the home to be sited at a lower elevation on the subject property. Staff believes this change would significantly reduce hillside disturbance. Staff recommends the applicant reduce the height of the home to less than 30 feet above grade by either reducing floor-to-ceiling heights or removing the third floor to remove the aerial fire apparatus access requirement, which would allow the home to be sited at the lower elevation of the subject property and minimize hillside disturbance.
17.104.070.A11	Access traversing 25% or greater slopes does not have significant impact
17.104.070.7(11	on drainage, snow and earth slide potential and erosion as it relates to the
	subject property and to adjacent properties.
Staff Analysis	The majority of the proposed driveway traverses slopes of 25% and greater. The City Engineer reviewed the proposed driveway improvements shown in the Pre-Application submittal and provided comments to the applicant related to the drainage improvements. The City Engineer will review the civil drawings submitted with the final MO Design Review submittal to assess whether the proposed driveway will have any significant impacts on drainage, snow, earth-slide potential, or erosion on the subject property or adjacent properties.
17.104.070.A12	· ·
Staff Analysis	Utilities shall be underground.  The utilities information provided on Sheet C1.0 of the project plans are
·	limited to water and sewer improvements. The utilities plan submitted with the final MO Design Review submittal must show the location and size of all utilities, including gas, electric, TV, and phone. All utilities shall be underground pursuant to KMC §17.104.070.A12. Pursuant to KMC §17.96.060.D2, "Utilities shall be located underground and utility, power, and communication lines within the development site shall be concealed from public view." In addition, the applicant must provide will-serve letters from Idaho Power Company and Clear Creek Disposal.
17.104.070.A13	Limits of disturbance shall be established on the plans and protected by
	fencing on the site for the duration of construction.
Staff Analysis	The proposed limits of disturbance is shown on sheet L-2.00 of the project plans. A construction management plan that addresses all construction activity standards specified in KMC §15.06.030 will be required to be submitted with the building permit application. KMC §15.06.030.J4 requires that, "Projects in the Mountain Overlay Zoning District or containing slopes greater than 25 percent shall be fenced pursuant to the design review

#### conditions of approval." City departments will conduct a comprehensive review of the proposed construction management plan during plan review at time of building permit. Excavations, fills and vegetation disturbance on hillsides not associated 17.104.070.A14 with the building construction shall be minimized. Staff Analysis Cut and fill information is provided on sheet C1.0 of the project plans. Excavation for the entirety of project will remove 3,810 cubic yards of soil. The total proposed amount of fill is 20 cubic yards. As shown on the lot disturbance diagrams on sheet G-020, only a portion of the subject property along the rear property line is proposed to remain undisturbed. The total proposed undisturbed area is 1,660 square feet, which is only 10% of the subject property's total area. Hillside disturbance that is not associated with the building construction includes a small patio and hot tub at the northeast corner of the property as well as the driveway and fire apparatus access zone. In the Design Narrative, the applicant provides a summary of design changes made to the outdoor patio and hot tub area in response to Planning staff feedback to preserve more of the natural hillside. The applicant has significantly reduced the size outdoor patio area from the first iteration of the design drawings. Staff appreciates these changes and the applicant's thoughtful response to feedback, however, staff believes that removing the outdoor patio and hot tub would preserve even more of the natural hillside. Staff recommends the applicant remove the outdoor patio and hot tub to preserve more of the natural hillside area. Pursuant to KMC \$17.104.070.A9, "lengths of driveways allowed shall be minimized." In the Design Narrative, the applicant provides an analysis of the proposed driveway access. The applicant states: Safety and integration into the hillside were primary factors under consideration as the design team set out to site the building and provide vehicular access. Using the existing topography of the site and entering as high as possible on Walnut Avenue, the driveway gently slopes up along the existing contours to provide direct access to a garage. This configuration allows safe vehicular egress from the property, accommodates the required fire safety apparatus, and avoids large collections of steep retaining structures that would otherwise be required. In the written response to MO Design Review standards, the applicant further explains: The driveway accesses the site as high on Walnut Ave as possible to allow a more direct approach onto the site which results in less cut and fill as opposed to having a driveway perpendicular to Walnut Ave and further

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#### 17.104.070.A.15

Preservation of significant landmarks shall be encouraged and protected, where applicable. A significant landmark is one which gives historical and/or cultural importance to the neighborhood and/or community.

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Staff Analysis	Ordinance No. 996 adopted in 2006 amended the Mountain Overlay
	boundaries and designated properties in the Knob Hill neighborhood as a
	significant landmark. Pursuant to KMC §17.104.030.B, "The area within these
	boundaries, northeast of the alley bisecting Walnut Avenue and Spruce
	· · · · · · · · · · · · · · · · · · ·
	Avenue consisting of lots 5, 6, 7 and 8, block 94, lots 5, 6, 7 and 8, block 93,
	lots 5, 6, 7 and 8, block 92, lots 5A, 6A, 7 and 8, block 91, lots 3 and 4, block
	97, Ketchum Town Site, and all properties within the Kinderhorn Subdivision,
	along with the rock outcropping within block 29, Ketchum Town Site, is
	hereby designated as a significant landmark within the City of Ketchum as
	denoted in the map, a true and correct copy of which is attached to ordinance
	996 as exhibit B and which is incorporated herein by this reference." The
	subject property is located west of and downhill from the four lots in Block 91
	designated as a significant landmark per KMC §17.104.030.B. Staff does not
	believe the significant landmark uphill of the subject property will be
	negatively impacted by the proposed development.
17.104.070.A.16	Encroachments of below grade structures into required setbacks are
	subject to subsection 17.128.020.K of this title and shall not conflict with
	any applicable easements, existing underground structures, sensitive
	ecological areas, soil stability, drainage, other sections of this Code or
	other regulating codes such as adopted International Code Council
	Codes, or other site features concerning health, safety, and welfare.
Staff Analysis	This standard is not applicable as the project does not propose below-grade
	structures that encroach into required setbacks.