PROJECT LOCATION MAP



PROJECT ADDRESS: Kaukauna Municipal Pool, 607 Dodge Street, Kaukauna, WI 54130

PROJECT OVERVIEW



SITE LOCATION PLAN NTS

CIVIL ENGINEER: PARKITECTURE + PLANNING 901 DEMING WAY, SUITE 102 MADISON, WI 53717 608.438.4253

LANDSCAPE ARCHITECT:

PARKITECTURE + PLANNING 901 DEMING WAY, SUITE 102 MADISON, WI 53717 608.886.6808

ARCHITECT:

ONE DESIGN & ENGINEERING, LLC 202 ASH STREET CAMBRIDGE, WI 53523 608.577.0443

MECHANICAL, PLUMBING, ELECTRICAL: HEIN ENGINEERING GROUP 17 APPLEGATE COURT, SUITE 200 MADISON, WI 53713

608.288.9260

KAUKAUNA POOL RENOVATION CITY OF KAUKAUNA KAUKAUNA, WI

PROJECT NUMBER 21.039



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C110 EXISTING POOL PLANS - EXISTING BUILDING C111 EXISTING POOL PLANS - POOL VESSEL

T100 TITLE SHEET

C100 EXISTING CONDITIONS PLAN

C101 EXISTING SITE PHOTOS C102 EXISTING SITE PHOTOS


A311	BUILDING ELEVATIONS - MATERIALS
A320	EXTERIOR RENDERINGS
A321	EXTERIOR RENDERINGS
A400	BUILDING SECTIONS
A401	BUILDING SECTIONS
A410	WALL SECTIONS
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A600	ENLARGED LOCKER ROOM PLAN
A601	ENLARGED LOCKER ROOM ELEVATIONS
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A603	ENLARGED RESTROOM PLANS
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KAUKAUNA POOL RENOVATION 607 Dodge Street Kaukauna, WI 54130

21.039 Project #: Review 3/13/2023 Issued For: Date:

T100



SITE LAYOUT NOTES

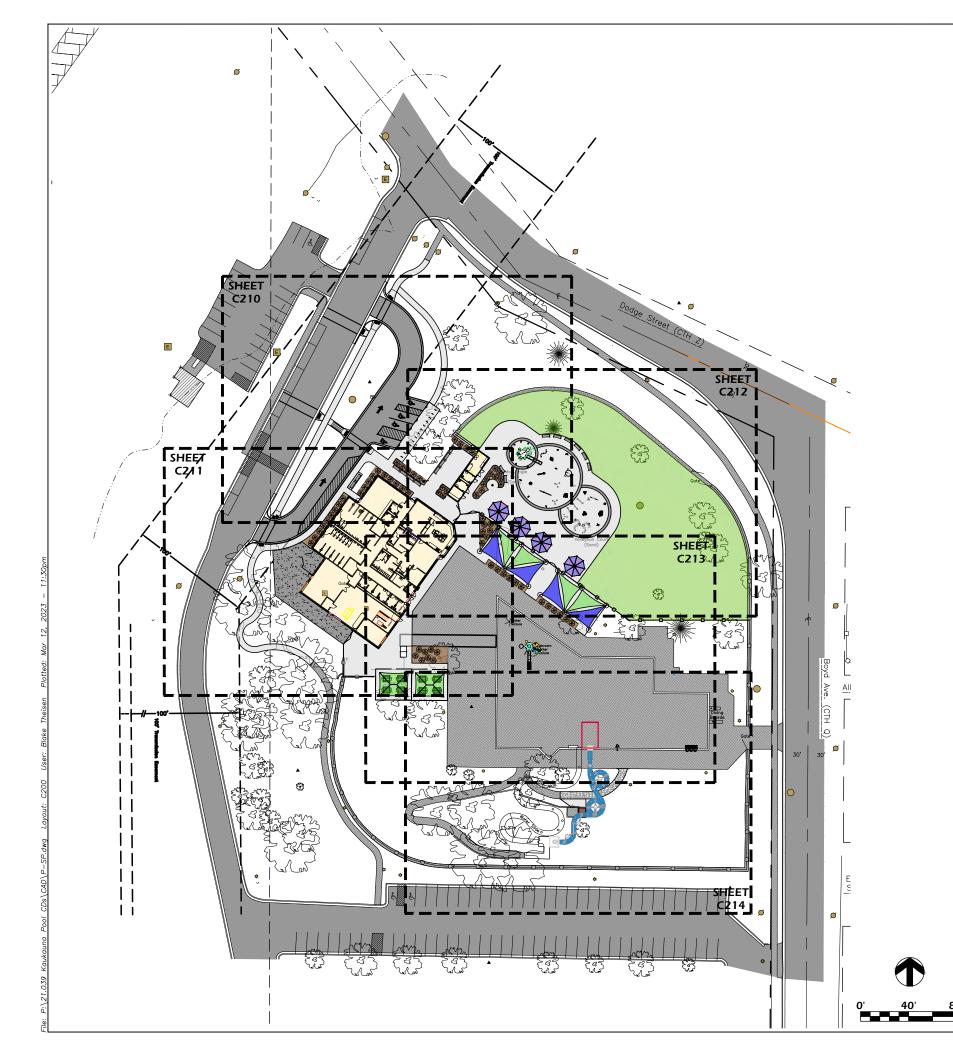- CONTACT DIGGER'S HOTLINE 5 WORKING DAYS PRIOR TO THE START OF CONSTRUCTION.
- ALL PROPOSED DIMENSIONS ARE REFERENCED PARALLEL OR PERPENDICULAR TO THE PROPOSED FEATURES SHOWN. WRITTEN DIMENSIONS SUPERSEDE ANY SCALED DIMENSIONS.
- PROPOSED GRADE AND LEVEL SHALL BE PERIODICALLY REVIEWED IN THE FIELD BY THE OWNER
- CONCRETE JOINTING IS SHOWN FOR DESIGN INTENT. FINAL SCORING PLANS SHALL BE SUBMITTED TO THE A/E FOR REVIEW AS A SHOP SUBMITTAL.
- CONTRACTOR TO IMPORT SOIL AS NEEDED TO PREPARE TURF AREAS. CONTRACTOR TO FINE GRADE ALL AREAS TO FINISH GRADE.
- ANY EXISTING STRUCTURES AND/OR UTILITIES NOT SHOWN ON THESE DOCUMENTS WHICH NEED TO BE REMOVED, RELOCATED, AND OR ADJUSTED SHALL BE THE RESPONSIBILITY OF THE SITE CONTRACTOR AND INCLUDED IN THE BASE BID.
- CONTRACTOR SHALL BE RESPONSIBLE FOR SITE STAKING. DIGITAL PLAN FILES MAY BE AVAILABLE FROM THE A/E.

LANDSCAPE AND RESTORATION NOTES

- CONTRACTOR SHALL MEET EXISTING GRADE AT GRADING LIMITS WITH A SMOOTH AND CONTINUOUS TRANSITION.
- SEED/SOIL PLACEMENT SHALL EXTEND TO THE LIMITS OF CONSTRUCTION DISTURBANCE.
- ALL GENERAL LANDSCAPE AREAS DISTURBED DURING CONSTRUCTION SHALL BE RESTORED WITH 4" MINIMUM TOPSOIL DEPTH AND SEEDED IN ACCORDANCE WITH THE SPECIFICATIONS. THIS SHALL INCLUDE ANY AREAS OUTSIDE OF THE PROJECT LIMITS THAT ARE DISTURBED BY CONTRACTOR ACTIVITY. WATERING SHALL BE BY CITY.



ENGINEERING

RENOVATION

ONE DESIGN

OVERVIEW

KAUKAUNA POOL 607 Dodge Street Kaukauna, WI 54130 SITE LAYOUT PLAN


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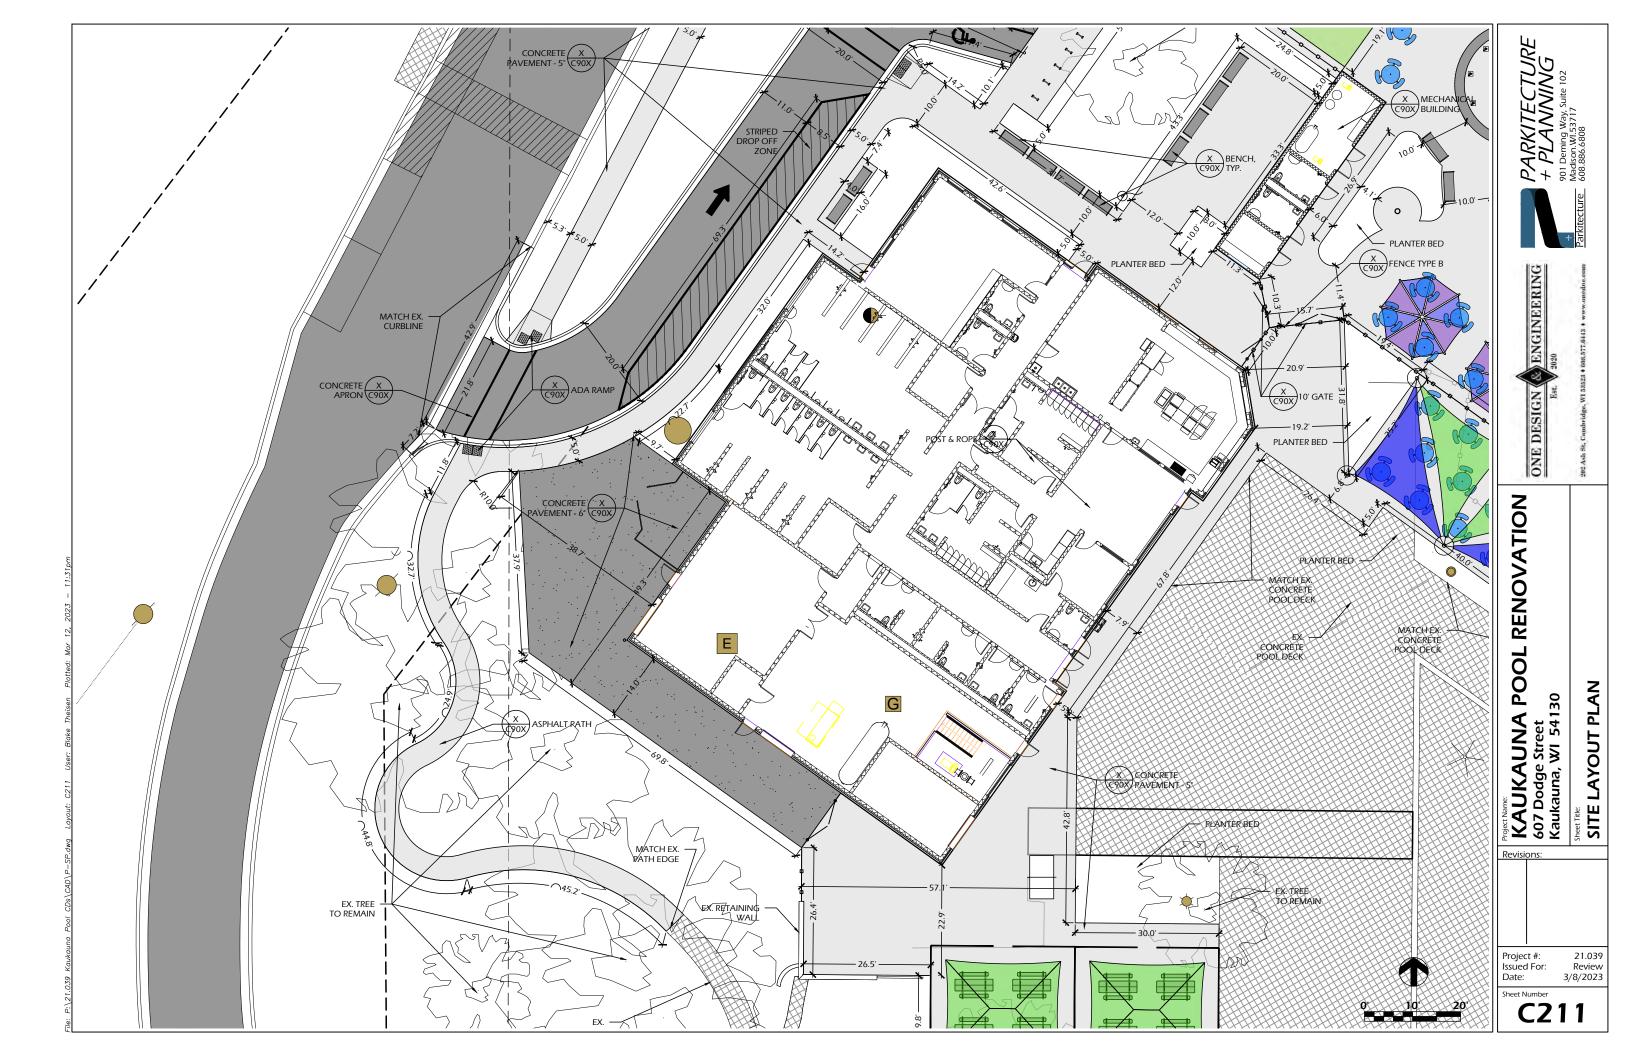
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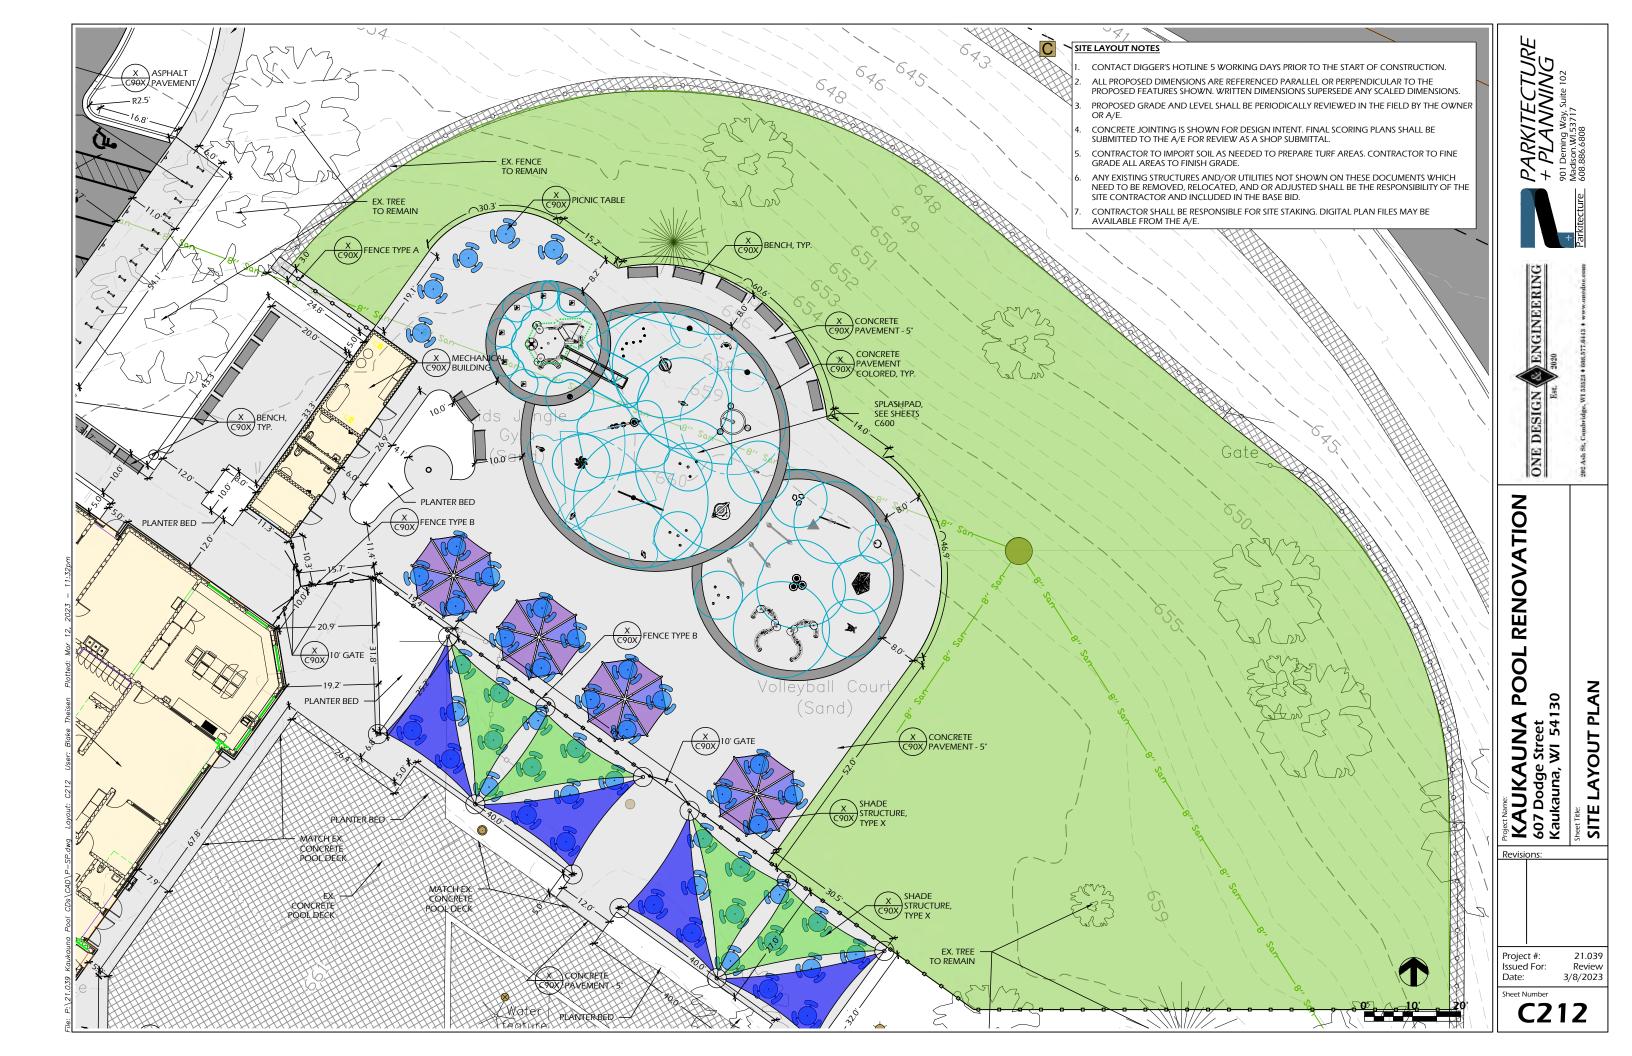
C200


21.039


Review 3/8/2023






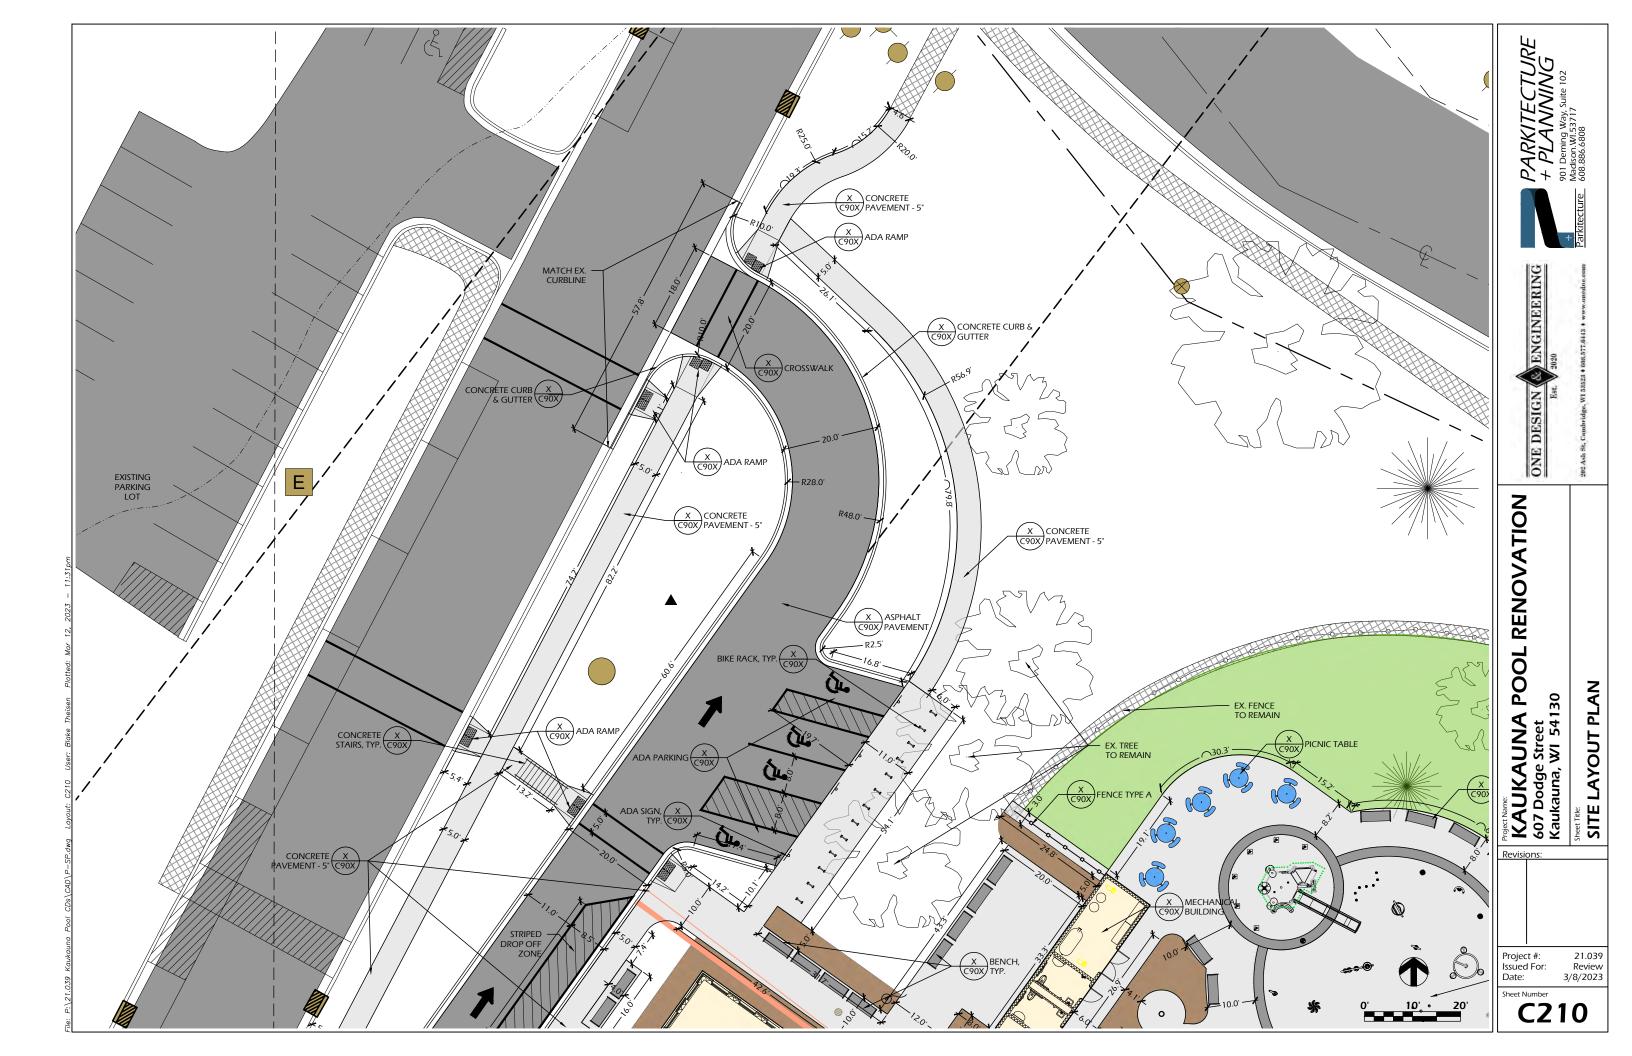

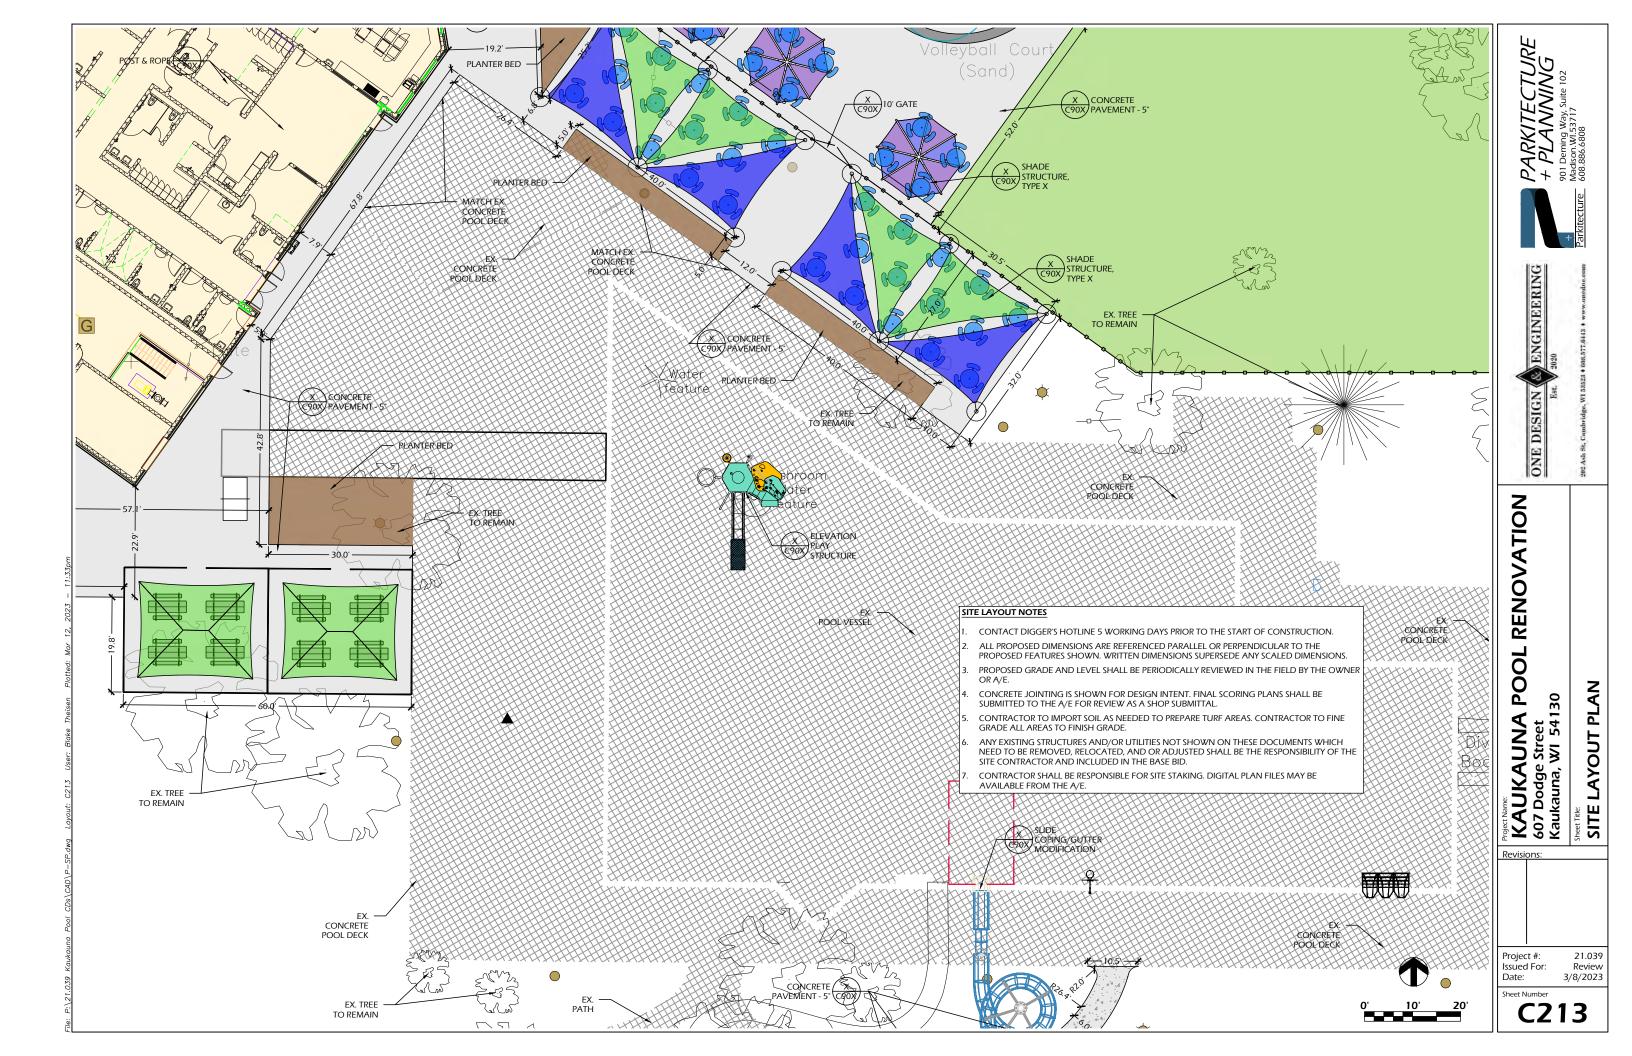

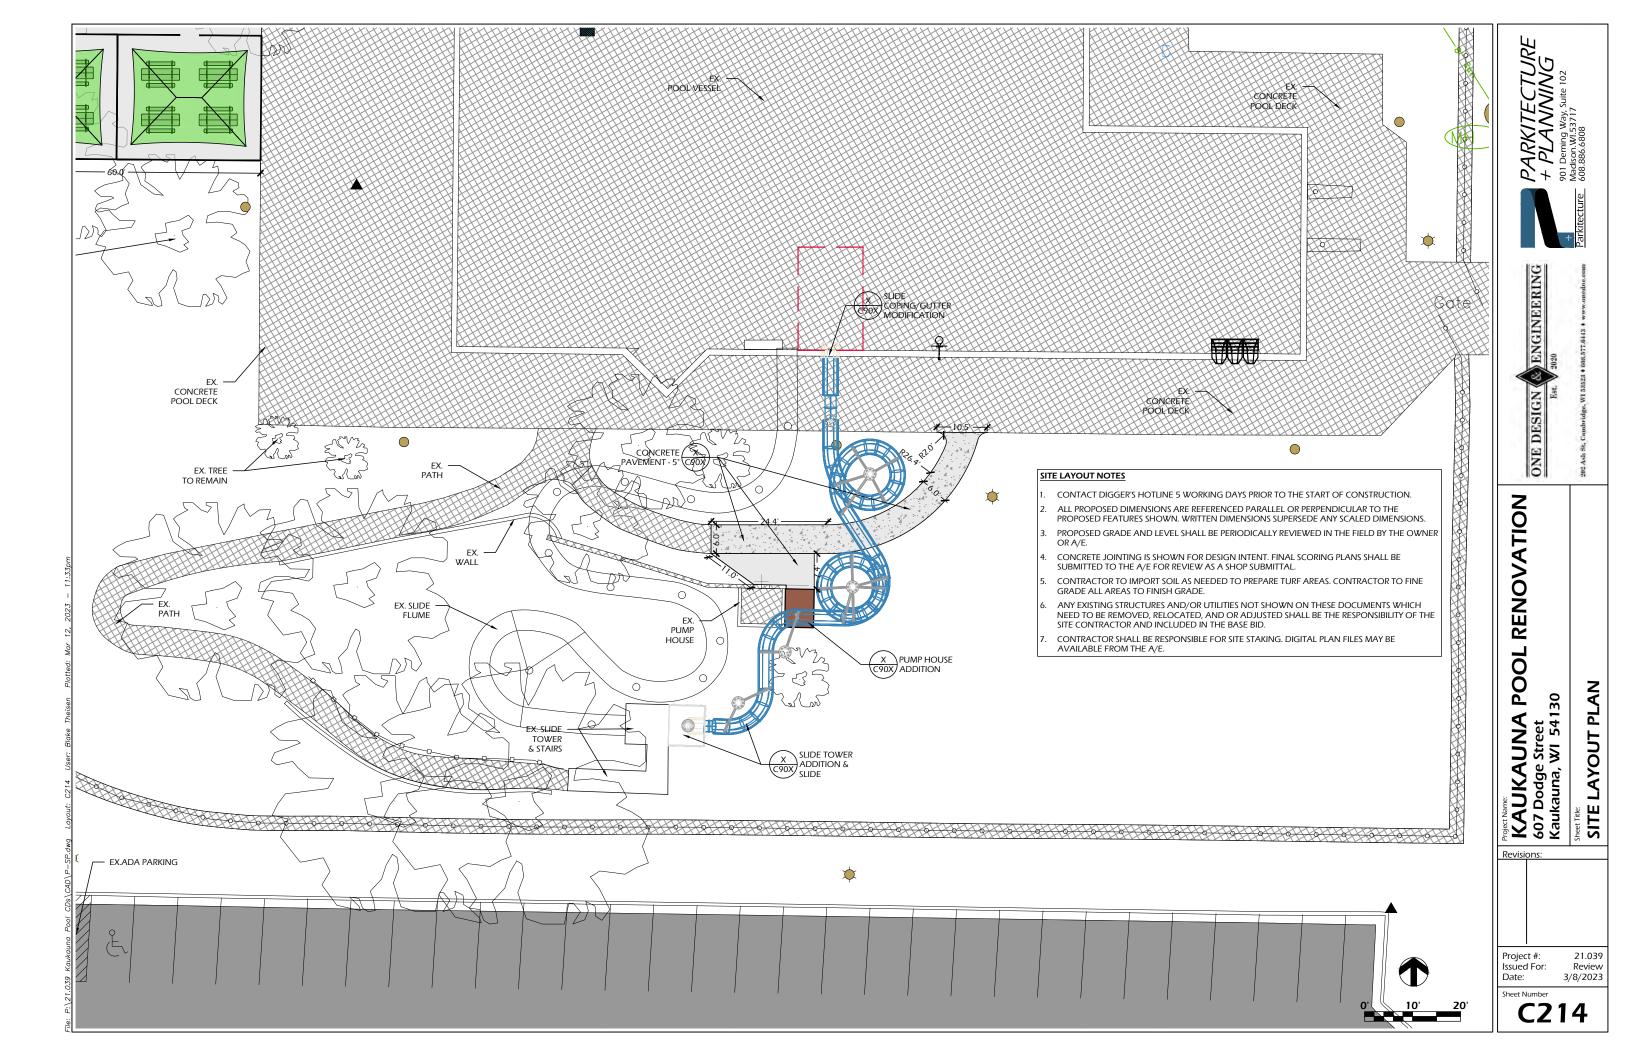

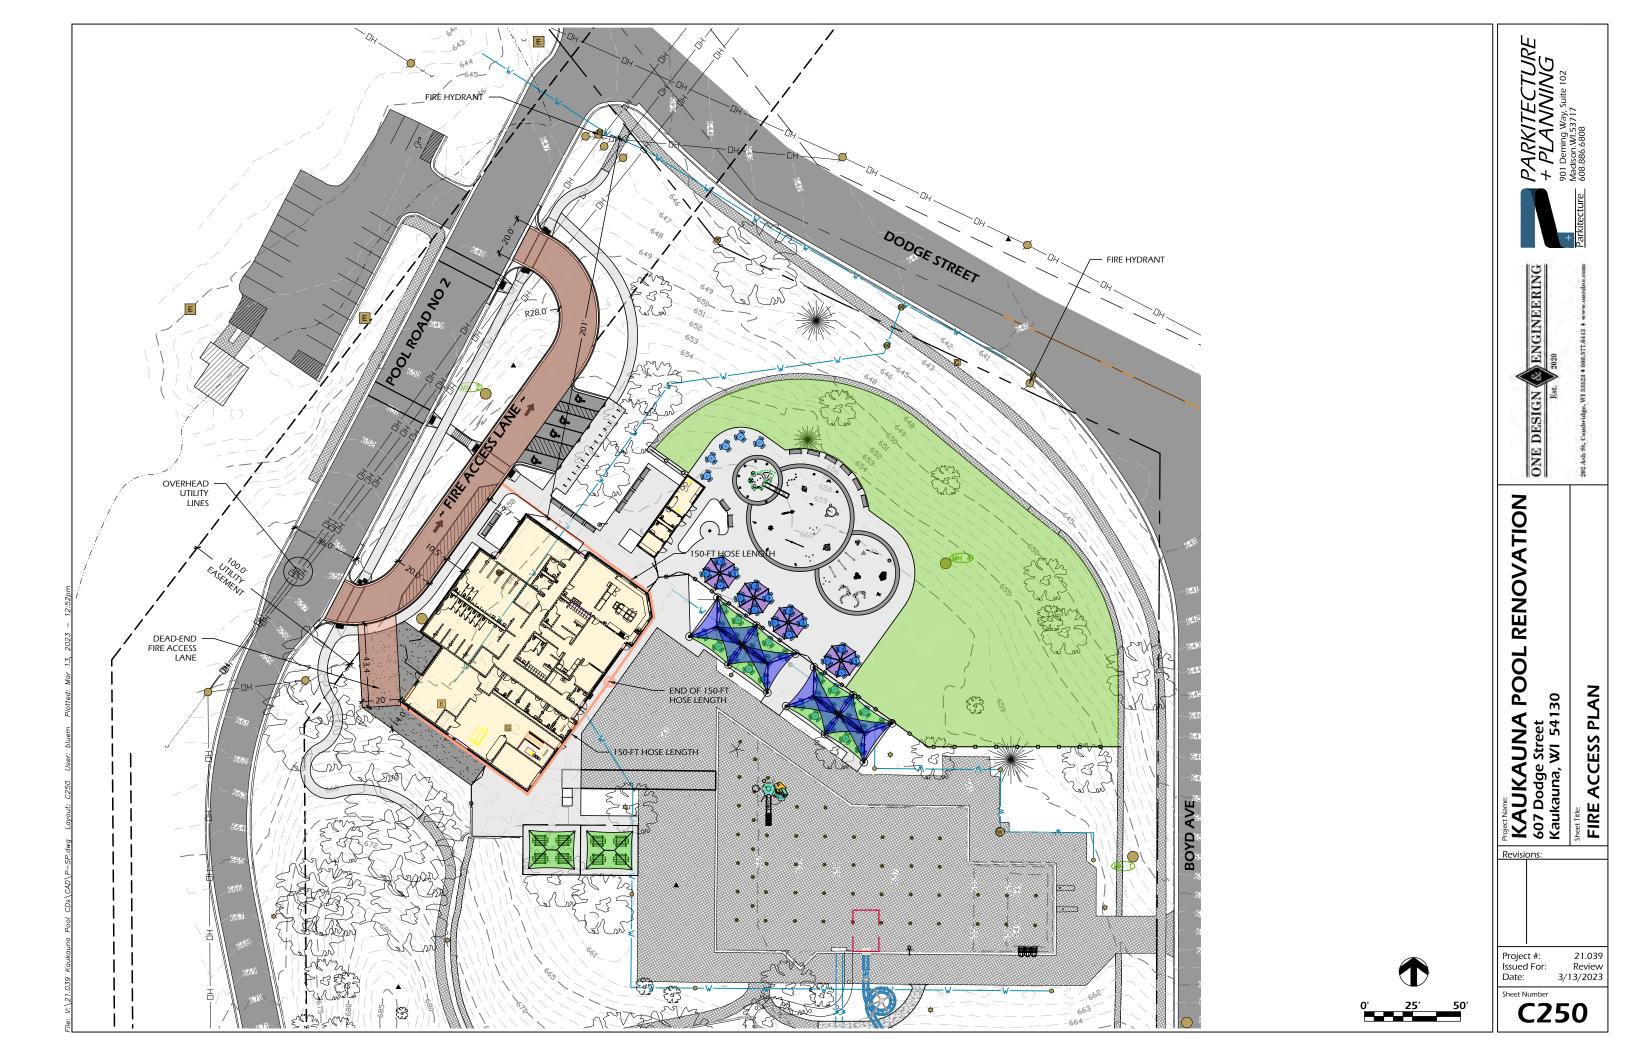

SPLASHPAD DIMENSION

TOTAL AREA: 387 m² 4166 ft²


SPRAY AREA: 3516 ft² 327 m²

GRID SIZE: $10 \times 10 \text{ ft}$ 3 x 3m

PRODUCT LEGEND

REF	PRODUCT	QTY	GPM	LPM
Α	Spray Loop VOR 0519	3	22.5	85.1
В	Spiroo VOR 7799	1	4	15.1
С	Activator N°3 VOR 0611	2	0	0
D	Foaming Geyser N°2 VOR 8084	2	28	105.8
E	Playsafe Drain N°4 VOR 1004	3		
F	Spraylink Jet N°2 VOR 3001	6	30	1 13.4
G	Spraylink Funnel VOR 3008	3	21	79.4
Н	Spraylink Team N°1 VOR 3059	1	11	41.6
I	Spraylink Team №3 VOR 3061	1	11	41.6
J	Spraylink Quad N°2 VOR 3063	1	17.5	66.2
K	Alto №2 VOR 7131	1	12.5	47.3
L	Hop №1 VOR 7133	1	10	37.8
М	Luna Nº1 VOR 7230	1	13.5	51
N	Bobble N°2 VOR 7233	1	21.5	81.3
0	Helio N°3 VOR 7238	1	3	11.3
P	Helio Nº6 VOR 7241	1	13	49.1
Q	Twinsplash VOR 7242	1	12	45.4
R	Cascade Rainforest VOR 7251	1	26	98.3
s	Loop N°2 VOR 7553	2	10	37.8
Т	Waterbug N°2 VOR 7581	1	6	22.7
U	Astra N°2 VOR 7698	1	7.5	28.4
V	Loop N°1 VOR 7719	1	5	18.9
W	Silhouette N°1 VOR 7772	1	32.5	122.9
х	Bamboo Twin Cannon VOR 7786	1	3.5	13.2
Υ	Bamboo Ring VOR 7787	1	2	7.6
z	Helico VOR 7790	1	17	64.3
AA	Butterfly N°1 VOR 7792	1	6.5	24.6
вв	Helico Nano VOR 7798	1	12.5	47.3
CC	Standard Elevation L2-450B	1	162	613.1
		QTY	GPM	LPM
_	TOTAL			

43 521 1970.5

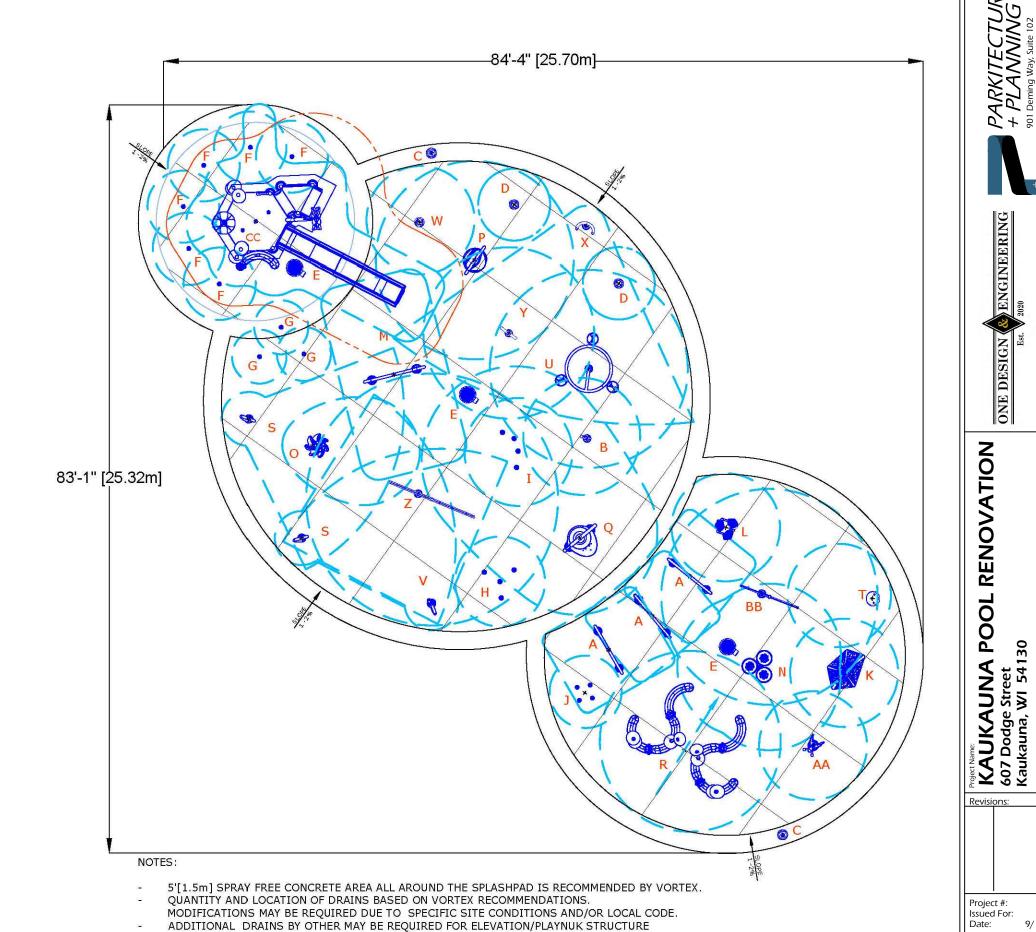

ONE DESIGN

SPLASHPAD FEATURE LAYOUT

21.039

Review 9/14/2022

Sheet Number

C501





KAUKAUNA POOL RENOVATION 607 Dodge Street Kaukauna, WI 54130

SPLASHPAD RENDERINGS

21.039 Review 9/14/2022 Project #: Issued For: Date:

Sheet Number

CX01

ENGINEERING

ONE DESIGN

KAUKAUNA POOL RENOVATION 607 Dodge Street Kaukauna, WI 54130

SPLASHPAD RENDERINGS

Project #: Issued For: Date:

21.039 Review 9/14/2022

Sheet Number CX02





ENGINEERING

ONE DESIGN (

KAUKAUNA POOL RENOVATION 607 Dodge Street Kaukauna, WI 54130

SPLASHPAD RENDERINGS

21.039 Review 9/14/2022 Project #: Issued For: Date:

Sheet Number CX03



ONE DESIGN

KAUKAUNA POOL RENOVATION 607 Dodge Street Kaukauna, WI 54130

SPLASHPAD RENDERINGS

Project #: Issued For: Date:

21.039 Review 9/14/2022

Sheet Number CX04



ONE DESIGN & ENGINEERING

KAUKAUNA POOL RENOVATION 607 Dodge Street Kaukauna, WI 54130


MINIATURE GOLF - CONCEPTUAL PLAN

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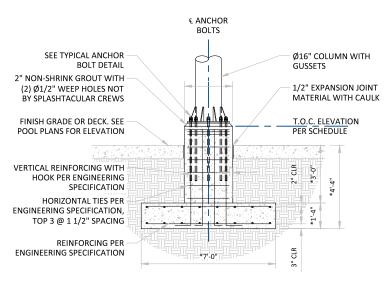
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EXHIBIT



* NOTE: FOOTING SIZE, DEPTH, AND CONFIGURATION SHOWN ARE APPROXIMATE, AND ARE USED FOR ESTIMATING PURPOSES ONLY. ACTUAL DIMENSIONS ARE SUBJECT TO FINAL DESIGN, SITE SPECIFIC SOIL CONDITIONS, AND RIDE CONFIGURATION.

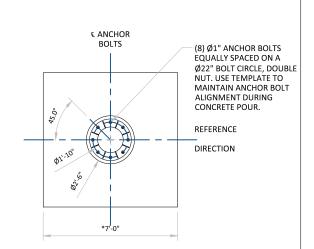


PIER DETAIL

SCALE: N.T.S




WATERSLIDE PERSPECTIVE C600

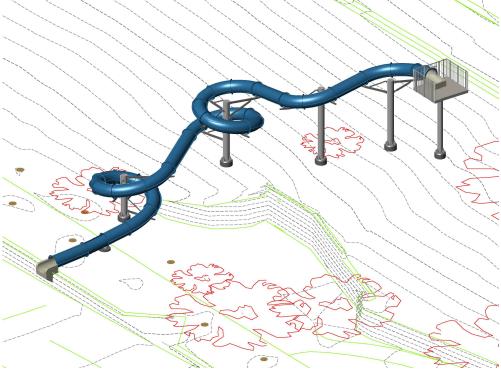

WATERSLIDE PERSPECTIVE

MARK	SLIDE TYPE	GPM	HEIGHT (ft)	LENGTH (ft)
Α	32" ENCLOSED BODY SLIDE	300-500	29.70'	190.66'
	TOTAL LENGTH:			190.66'

Slide height is from finished pool/runout deck to finished start deck. Water level is assumed to be (6) inches BELOW finished pool deck.

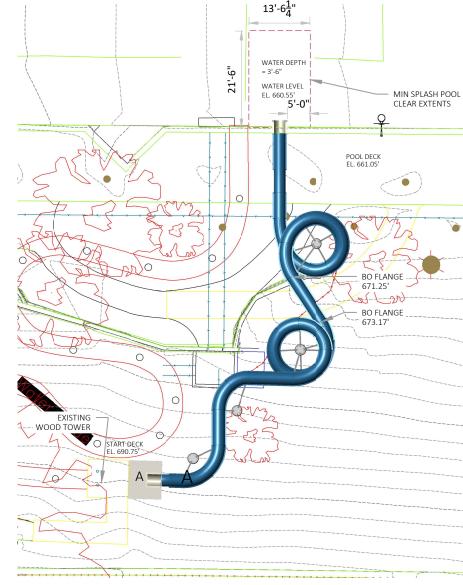

WATERSLIDE PLAN VIEW

Sheet Number

Issued For: Date:

C600

3/13/2023

ENGINEERING

ONE DESIGN

RENOVATION

0

PO

WATERSLIDE PLAN

- EXCESS SOCK MATERIAL TO BE DRAWN IN AND TIED OFF TO STAKE AT BOTH ENDS CHECK DAM SIZED TO SUIT CONDITIONS 8" TO 18" TYPICAL < FLO₩ 2"X2"X36" WOODEN STAKES PLACED 5' O.C.

8'-0" POST SPACING ALLOWED

IF A WOVEN GEOTEXTILE

FABRIC IS USED.

SEDIMENT SOCK NOTES:

1. ALL MATERIAL TO MEET SPECIFICATIONS.

WORK AREA

WORK AREA

- SEDIMENT SHOULD BE REMOVED FROM BEHIND CHECK DAM ONCE THE ACCUMULATED HEIGHT HAS REACHED ½ THE HEIGHT OF THE CHECK DAM.
- CHECK DAM CAN BE DIRECT SEEDED AT THE TIME OF INSTALLATION.
 FILTER MEDIA FILL TO MEET APPLICATION REQUIREMENTS.
- COMPOST MATERIAL TO BE DISPERSED ON SITE. AS DETERMINED BY ENGINEER.

2"X2"X36" WOODEN STAKES

SEDIMENT SOCK (12" TYPICAL)

SEDIMENT SOCK (12" TYPICAL)

AREA TO BE PROTECTED

PLACED 10' O.C.

MANY MANY MANY MANY MAN

SECTION

PROTECTED

- 2"X2"X36" WOODEN STAKES PLACED 10' O.C.

PLAN

SEDIMENT SOCK

SILT FENCE GENERAL NOTES

TRENCH DETAIL

FXCESS

GEOTEXTILE FABRIC

FLOW DIRECTION

EXCAVATED SOIL

GEOTEXTILE FABRIC ONLY

FOR MANUAL INSTALLATIONS THE TRENCH SHALL BE A MINIMUM OF 4" WIDE & 6" DEEP TO BURY AND ANCHOR THE GEOTEXTILE FABRIC. FOLD MATERIAL TO FIT TRENCH AND BACKFILL & COMPACT TRENCH WITH EXCAVATED SOIL.

SILT FENCE


ATTACH THE FABRIC TO

THE POSTS WITH WIRE STAPLES OR WOODEN


LATH AND NAILS

- 2. WOOD POSTS SHALL BE A MINIMUM SIZE OF 3' LENGTH OF OAK OR HICKORY
- 3. ADDITIONAL POST DEPTH OR TIE BACKS MAY BE REQUIRED IN UNSTABLE SOILS
- DETAILS OF CONSTRUCTION NOT SHOWN ON THIS DRAWING SHALL CONFORM TO THE PERTINENT REQUIREMENTS OF THE SPECIFICATIONS.
- 5. 8" OF FENCE FABRIC REQUIRED BELOW GRADE IN TRENCH PER DNR TECH STD. 1056
- MANUFACTURED ALTERNATIVES APPROVED AND LISTED ON THE WISDOT PRODUCT ACCEPTABILITY LIST (PAL) MAY BE SUBSTITUTED.
- FINISHED SIZE, INCLUDING FLAP POCKETS WHERE REQUIRED, SHALL EXTEND A MINIMUM OF 10" AROUND THE PERIMETER TO FACILITATE MAINTENANCE OR REMOVAL
- 8. FLAP POCKETS SHALL BE LARGE ENOUGH TO ACCEPT WOOD 2"X4"


- 9. EROSION CONTROL SHALL BE PROVIDED IN ACCORDANCE WITH WDNR TECHNICAL STANDARD AND TECHNICAL SPECIFICATIONS.
- 10. CROSS BRACE WITH 2" X 4" WOODEN FRAME OR EQUIVALENT AT TOP OF POSTS AS DIRECTED
- 11. MINIMUM 14 GAUGE WIRE REQUIRED, FOLD FABRIC 3" OVER THE WIRE AND STAPLE OR PLACE WIRE RINGS ON 12" C.C.
- 12. WIRE SUPPORT FENCE SHALL BE 14 GAUGE MINIMUM WOVEN WIRE WITH A MAXIMUM MESH SPACING OF 6". SECURE TOP OF GEOTEXTILE FABRIC TO TOP OF FENCE WITH STAPLES OR
- 13. GEOTEXTILE FABRIC SHALL BE REINFORCED WITH AN INDUSTRIAL POLYPROPYLENE NETTING WITH A MAXIMUM MESH SPACING OF 3/4" OR EQUAL. A HEAVY DUTY NYLON TOP SUPPORT CORD OR EQUIVALENT IS REQUIRED. (TYPE A)
- 14. STEEL POSTS SHALL BE STUDDED "TEE" OR "U" TYPE WITH A MINIMUM WEIGHT OF 1.28 LBS./LIN. FT. IWITHOUT ANCHOR! FIN ANCHORS SUFFICIENT TO RESIST POST MOVEMENT ARE REQUIRED. WOOD POSTS SHALL BE A MINIMUM SIZE OF 1 1/8" X 1 1/8" OF OAK OR HICKORY.
- CONSTRUCT SILT FENCE FROM A CONTINUOUS ROLL, IF POSSIBLE, BY CUTTING LENGTHS TO AVOID JOINTS. IF A JOINT IS NECESSARY, USE ONE OF THE FOLLOWING TWO METHODS: A.J TWIST METHOD - OVERLAP THE END POSTS AND TWIST, OR ROTATE, AT LEAST 180 DEGREES, B:) HOOK METHOD - HOOK THE END OF EACH SILT FENCE LENGTH.

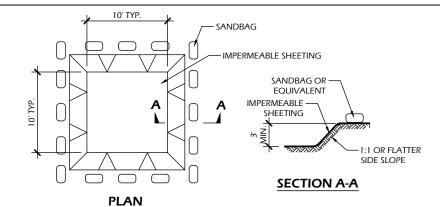

EXCAVATED WASHOUT STRUCTURE

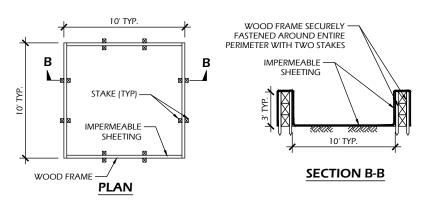

WASHOUT STRUCTURE WITH WOOD PLANKS

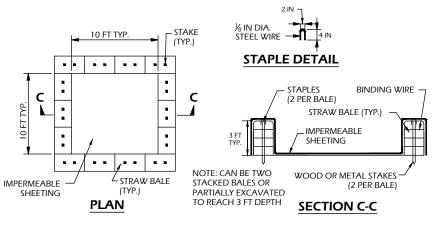

WASHOUT STRUCTURE WITH STRAW BALES

CONSTRUCTION SPECIFICATIONS

- TEMPORARY CONCRETE WASHOUT STRUCTURE SHALL BE USED TO WASH DOWN CONCRETE TRUCK CHUTES AND OTHER EQUIPMENT AFTER USE TO PREVENT WASHDOWN WATER FROM POLLUTING THE SITE.
- 2. LOCATE WASHOUT STRUCTURE A MINIMUM OF 50 FEET AWAY FROM OPEN CHANNELS, STORM DRAIN INLETS, SENSITIVE AREAS, WETLANDS, BUFFERS AND WATER COURSES AND AWAY FROM CONSTRUCTION
- 3. SIZE WASHOUT STRUCTURE FOR VOLUME NECESSARY TO CONTAIN WASH WATER AND SOLIDS AND MAINTAIN AT LEAST 4 INCHES OF FREEBOARD. TYPICAL DIMENSIONS ARE 10 FEET X 10 FEET X 3 FEET DEEP.
- 4. PREPARE SOIL BASE FREE OF ROCKS OR OTHER DEBRIS THAT MAY CAUSE TEARS OR HOLES IN THE LINER. FOR LINER, USE 10 MIL OR THICKER UV RESISTANT, IMPERMEABLE SHEETING, FREE OF HOLES AND TEARS OR OTHER DEFECTS THAT COMPROMISE IMPERMEABILITY OF THE MATERIAL.
- 5. PROVIDE A SIGN FOR THE WASHOUT IN CLOSE PROXIMITY TO THE FACILITY
- KEEP CONCRETE WASHOUT STRUCTURE WATER TIGHT. REPLACE IMPERMEABLE LINER IF DAMAGED (E.G., RIPPED OR PUNCTURED). EMPTY OR REPLACE WASHOUT STRUCTURE THAT IS 75 PERCENT FULL, AND DISPOSE OF ACCUMULATED MATERIAL PROPERLY. DO NOT REUSE PLASTIC LINER. WET-VACUUM STORED LIQUIDS THAT HAVE NOT EVAPORATED AND DISPOSE OF IN AN APPROVED MANNER. PRIOR TO FORECASTED RAINSTORMS, REMOVE LIQUIDS OR COVER STRUCTURE TO PREVENT OVERFLOWS. REMOVE HARDENED SOLIDS, WHOLE OR BROKEN UP, FOR DISPOSAL OR RECYCLING. MAINTAIN RUNOFF DIVERSION AROUND EXCAVATED WASHOUT STRUCTURE UNTIL STRUCTURE IS REMOVED.



CONCRETE WASHOUT STRUCTURE (TEMP)



OVATION REN **AUKAUNA POOL**

DETAIL

CONSTRUCTION

21.039 Issued For: Reviev Date: 3/13/2023


Sheet Number

C900

C900

SILT FENCE OR SEDIMENT SOCK

SCALE: NTS

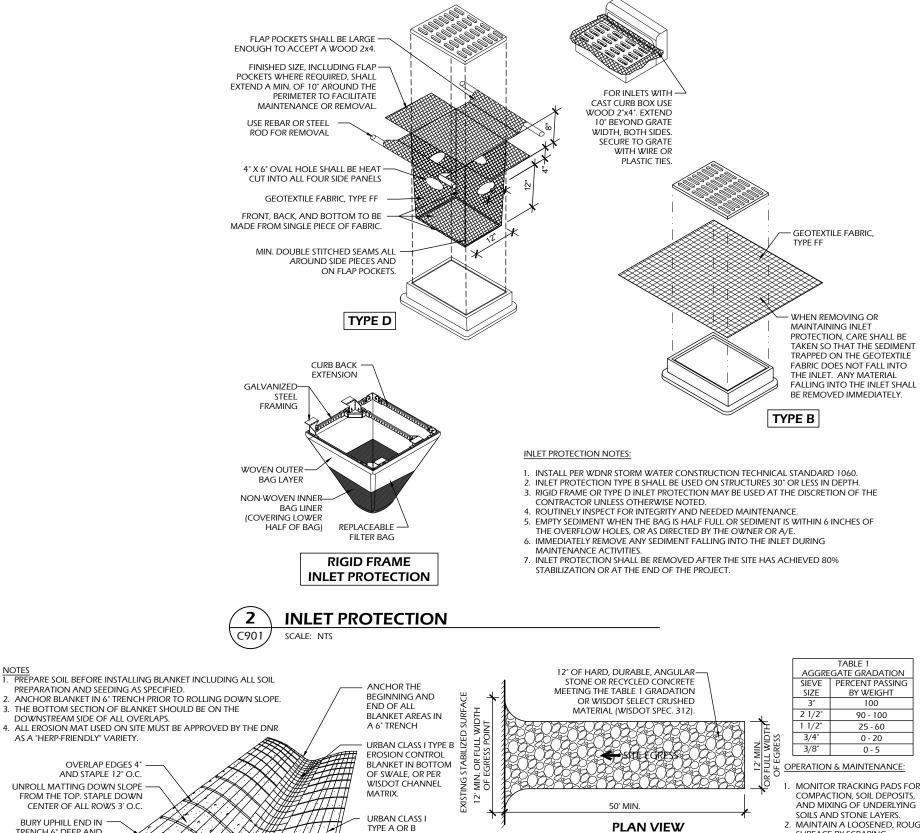

EROSION

CONTROL BLANKET ON

SIDE SLOPES

STAPLE CLASS I

INTERVALS: AND

AT ALL OVERLAP

JOINTS 24" O.C.

VARIES

BLANKET AT 20 FT.

EXISTING

STABILIZED

SURFACE

— CULVERT AS NEEDED

GEOTEXTILE FABRIC LINER (AS NEEDED) SELECT FABRIC TYPE BASED ON SOIL

SCALE: NTS

CONDITIONS & VEHICLE LOADING

PROFILE VIEW

AS A "HERP-FRIENDLY" VARIETY.

UNROLL MATTING DOWN SLOPE

BURY UPHILL END IN

STAPLE 12" O.C.

SCALE: NTS

TRENCH 6" DEEP AND

STEEL

STAPLE

C901

FROM THE TOP. STAPLE DOWN CENTER OF ALL ROWS 3' O.C

OVERLAP EDGES 4"

EROSION MAT

VARIES

AND STAPLE 12" O.C.

- COMPACTION, SOIL DEPOSITS, AND MIXING OF UNDERLYING 2. MAINTAIN A LOOSENED, ROUGH SURFACE BY SCRAPING,
- LOOSENING, OR TOP-DRESSING WITH ADDITIONAL AGGREGATE REPLACE GEOTEXTILE AND STONE IF LESS-INTENSIVE MAINTENANCE EFFORTS FAIL TO REESTABLISH EFFECTIVENESS. ADD STONE AS NEEDED TO MAINTAIN THE MINIMUM PAD
- THICKNESS 5. REPLACE DAMAGED OR CRUSHED CULVERTS UNDER

Date:

Project #:

Issued For:

ONE DESIGN

AUKAUNA POOL RENOVATION

DETAIL!


CONSTRUCTION


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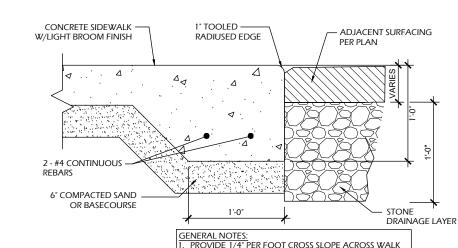
Review

3/13/2023

Sheet Number TRACKING PAD. STONE TRACKING PAD C901



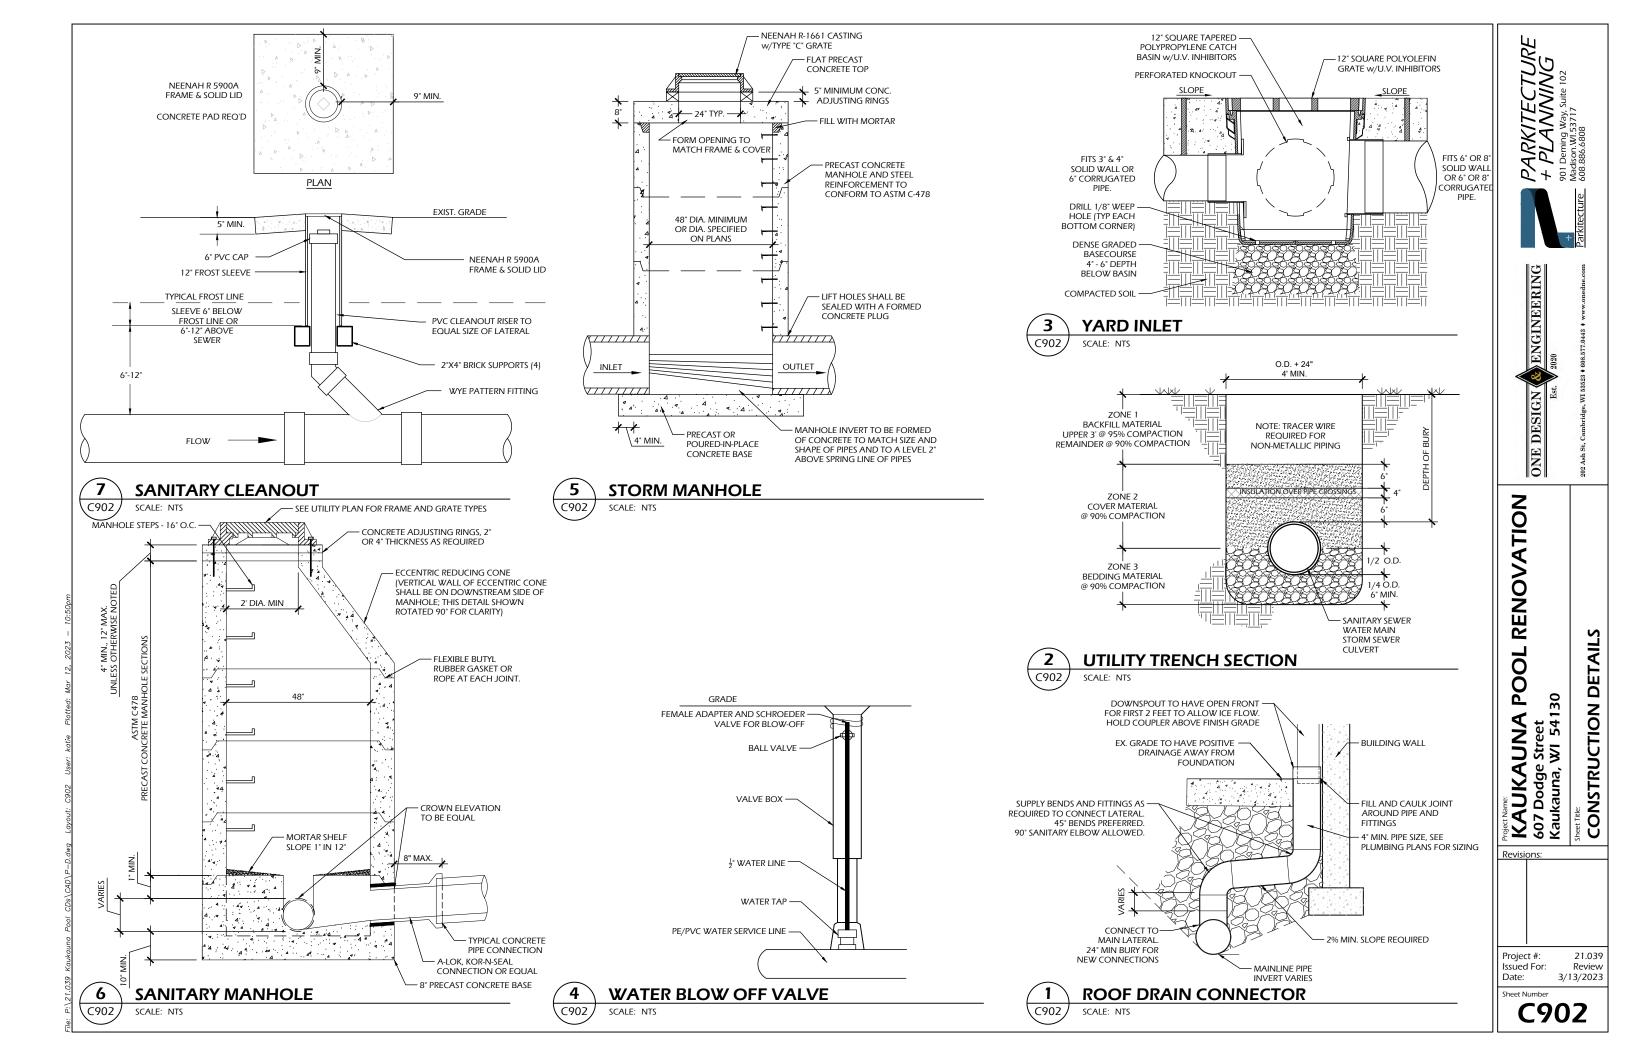


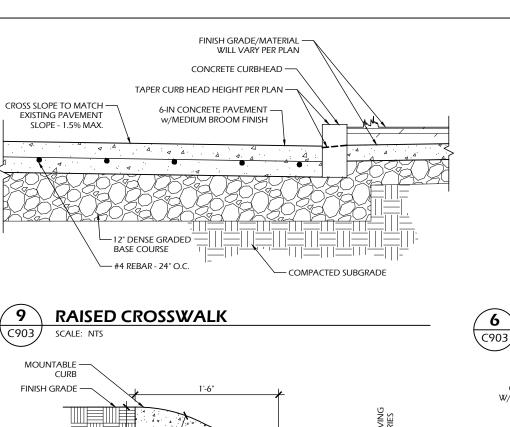

18-IN CONCRETE CURB & GUTTER

SCALE: NTS



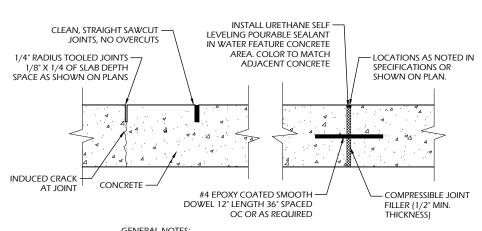

- SAWCUT ALL JOINTS FOR SPLASHPAD AREA OVERCUTS SHALL NOT BE ACCEPTED PROVIDE JOINTS PER JOINTING PLAN DOWEL BETWEEN ALL SEPARATE POURS (SPLASHPAD & STREET) ALL JOINTS SHALL BE STRAIGHT AND CONTINUOUS

- APPLIES TO EXCESS STONE BEYOND 12" AT BACK OF CURB.


 PAVING CONTRACTOR SHALL PROVIDE FLUSH BITUMINOUS TO CONCRETE CURB. IF BITUMINOUS IS RAISED AFTER PAVING, PAVING CONTRACTOR SHALL HEAT UP, REMOVE AND COMPACT EXCESS PAVEMENT.

30-IN CONCRETE CURB & GUTTER C903 SCALE: NTS


CONCRETE JOINTS

C903

CONCRETE PAVEMENT SCALE: NTS

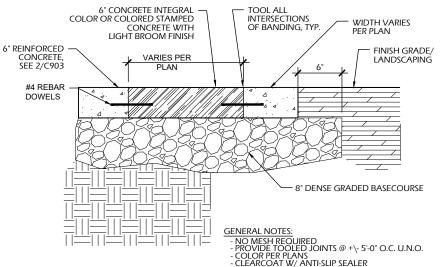


COLORED CONCRETE PAVEMENT C903 SCALE: NTS

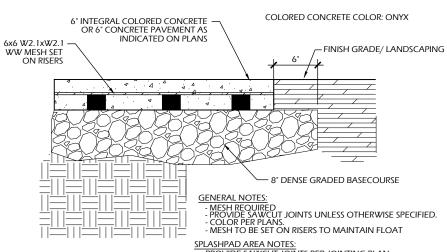

SPLASHPAD AREA NOTES:
- PROVIDE SAWCUT JOINTS PER JOINTING PLAN
- COLOR PER PLANS. CLEARCOAT W/ ANTI-SLIP SEALER NO EPOXY ON MESH IF USED AS PART OF BONDING GRID

REINFORCED CONCRETE PAVEMENT C903 SCALE: NTS

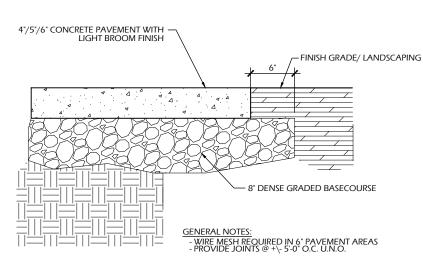

RENOVATION CONSTRUCTION DETAILS

POOL KAUKAUNA

ENGINEERING

ONE DESIGN

21.039 Project #: Issued For:

Review 3/13/2023 Date:

Sheet Number C903

FULL HEIGHT CURB HEAD FINISH GRADE

LEVELING BASE FOR CLIRB AND GLITTER

SCALE: NTS

GENERAL NOTES:

1. SEE TOP OF GRADING PLAN TO DETERMINE LOCATIONS OF HOLDING OR REJECT CURBS

IF SIDEWALK ABUTS CURB, BACK OF CURB TO BE "STRING LINE" STRAIGHT & RUBBED CLEAN

PROVIDE CONTROL JOINTS 10± O.C. PROVIDE BITUMINOUS EXPANSION JOINTS 50* O.C.
 EARTHWORK CONTRACTOR TO SUBGRADE AND STONE 12" BEYOND BACK OF CURB TO PROVIDE COMPACTED

EARTHWORK CONTRACTOR TO REMOVE ALL EXCESS STONE BEHIND BACK OF CURB IN LANDSCAPE ISLANDS. THIS APPLIES TO EXCESS STONE BEYOND 12" AT BACK OF CURB.

PAVING CONTRACTOR SHALL PROVIDE FLUSH BITUMINOUS TO CONCRETE CURB. IF BITUMINOUS IS RAISED AFTER PAVING, PAVING CONTRACTOR SHALL HEAT UP, REMOVE AND COMPACT EXCESS PAVEMENT.

18-IN MOUNTABLE CONCRETE CURB & GUTTER

8" DENSE GRADED BASE COURSE COMPACTED SUBGRADE

C903

GENERAL NOTES:

1. SEE TOP OF GRADING PLAN TO DETERMINE LOCATIONS OF HOLDING OR REJECT CURBS.

. IF SIDEWALK ABUTS CURB, BACK OF CURB TO BE "STRING LINE" STRAIGHT & RUBBED CLEAN.


PROVIDE CONTROL JOINTS 10°± O.C. PROVIDE BITUMINOUS EXPANSION JOINTS 50° O.C.

EARTHWORK CONTRACTOR TO SUBGRADE AND STONE 12" BEYOND BACK OF CURB TO PROVIDE COMPACTED LEVELING BASE FOR CURB AND GUTTER.

EARTHWORK CONTRACTOR TO REMOVE ALL EXCESS STONE BEHIND BACK OF CURB IN LANDSCAPE ISLANDS. THIS

C903

SCALE: NTS

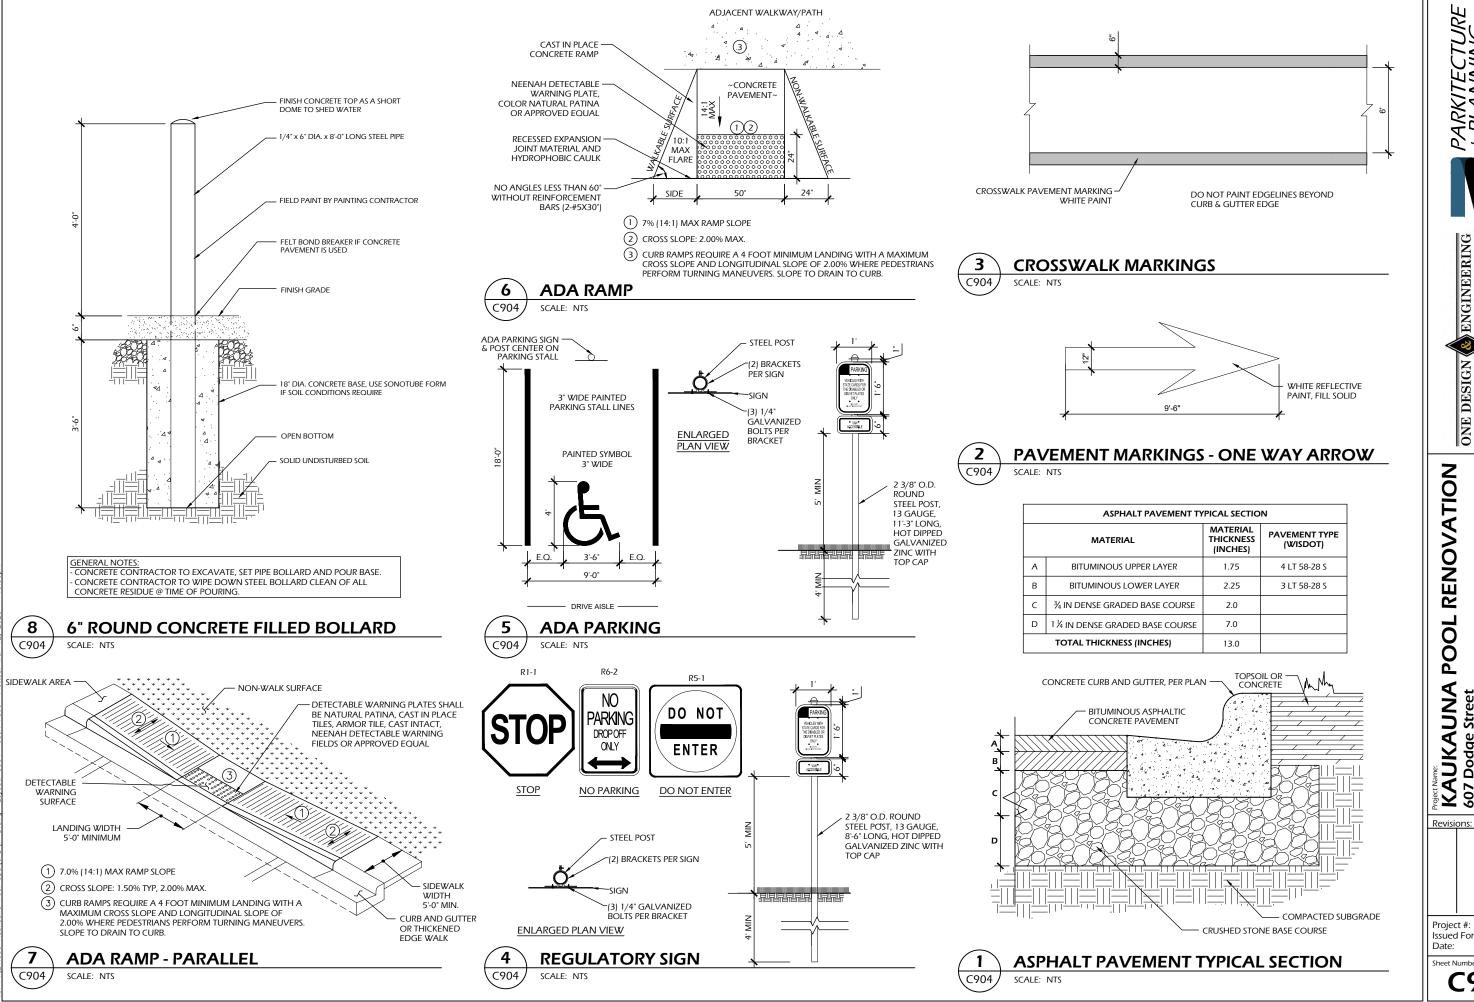

CONSTRUCTION DETAILS


Project #: Issued For: 3/13/2023


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21.039

Review



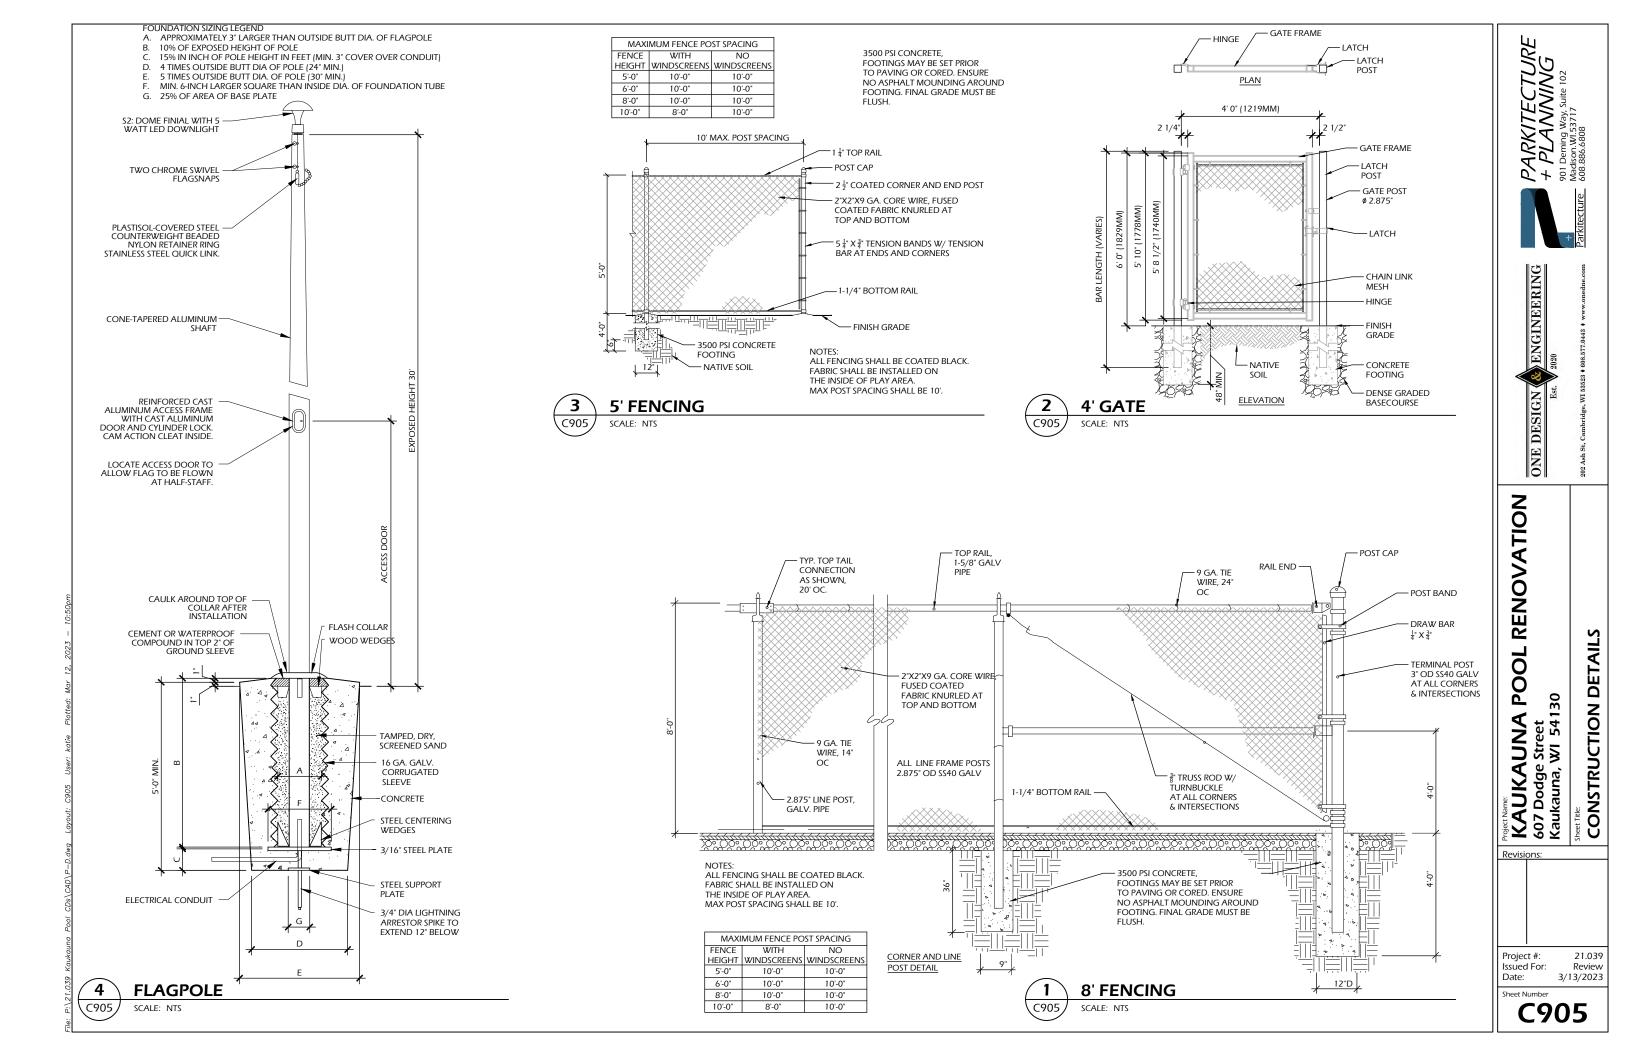



KAUKAUNA POOL RENOVATION 607 Dodge Street Kaukauna, WI 54130

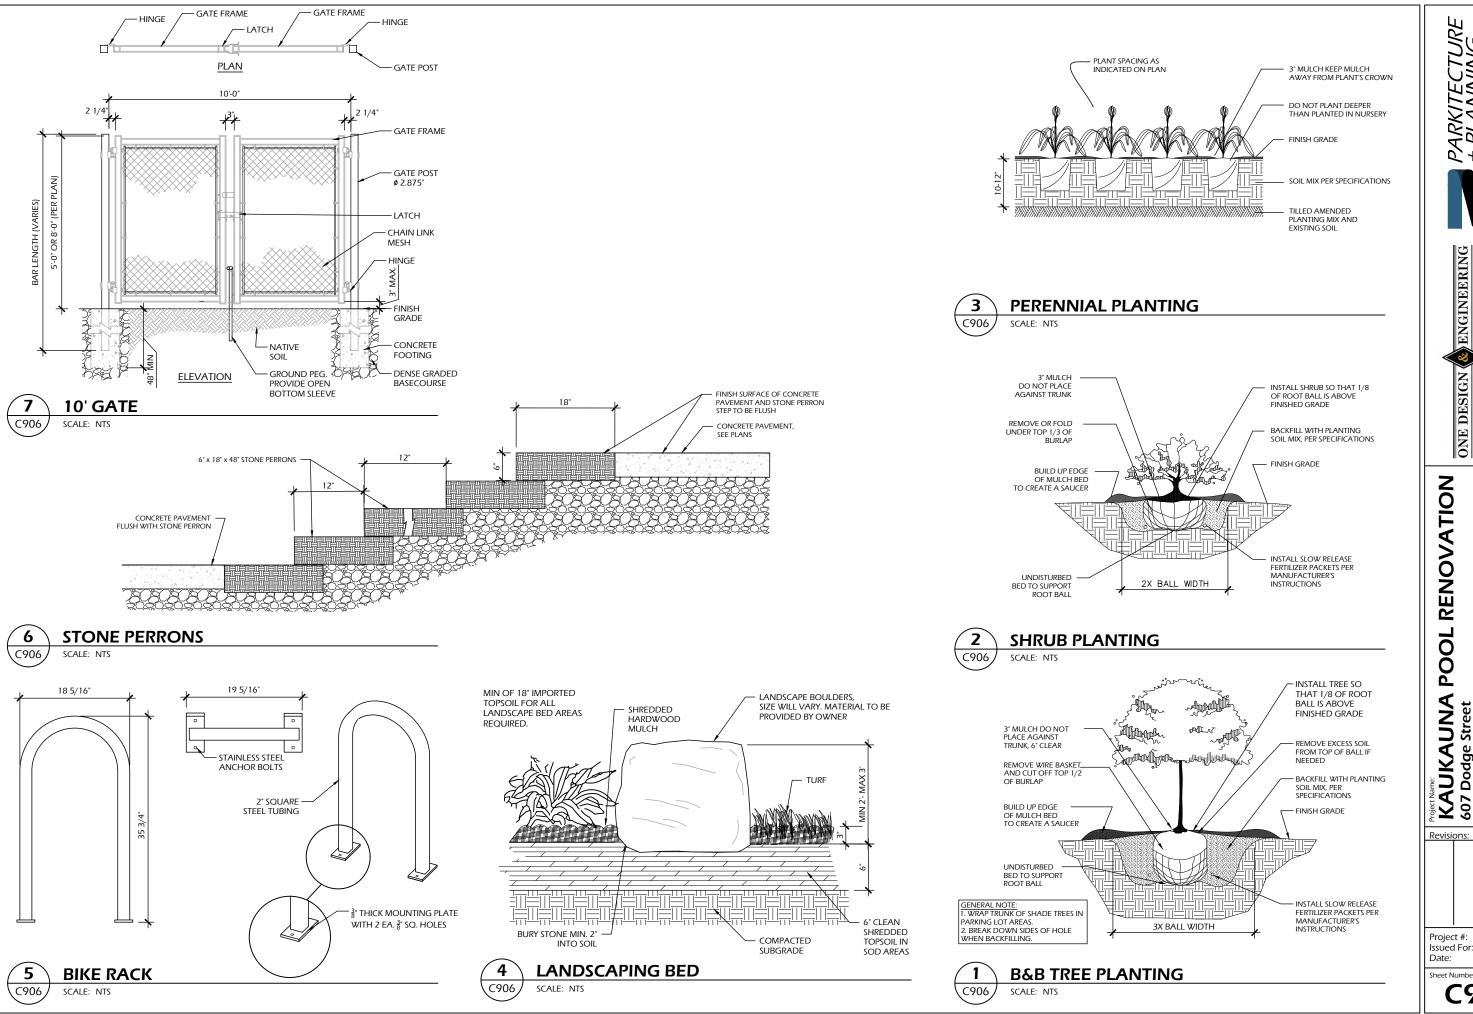CONSTRUCTION DETAILS


21.039 Review 3/13/2023 Issued For:

Sheet Number **C906**

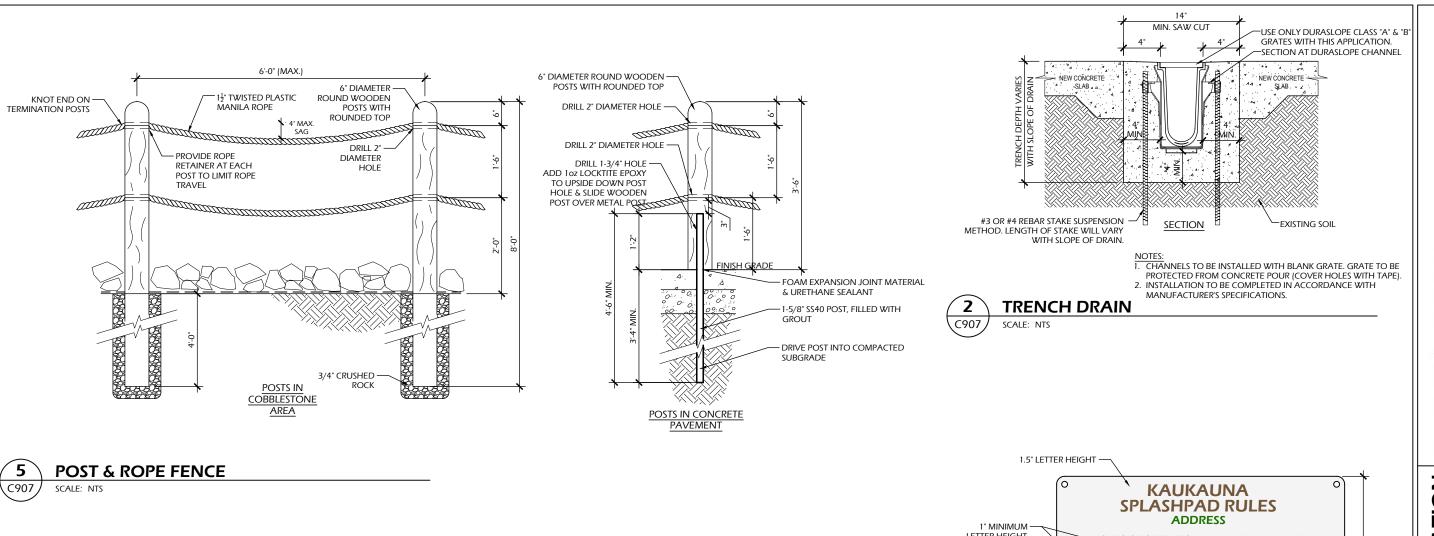

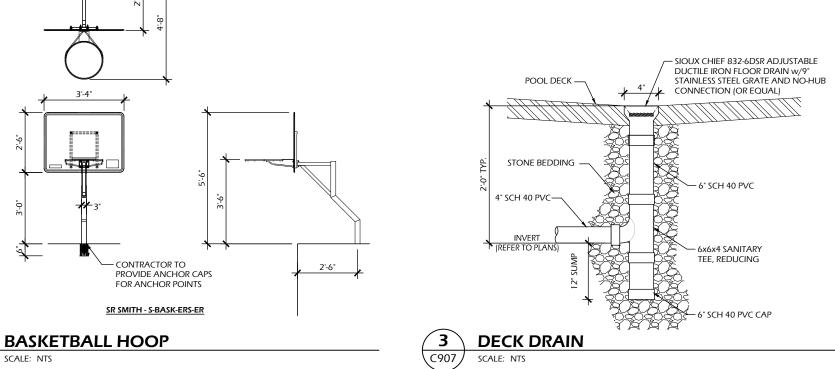

C907

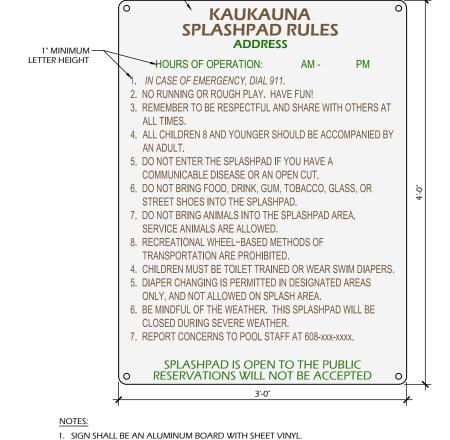

2. MOUNT TO RIGID METAL POLES WITH TAMPERPROOF FASTENERS.

KAUKAUNA POOL RENOVATION 607 Dodge Street Kaukauna, WI 54130 CONSTRUCTION DETAILS Revisions 21.039 Project #: Issued For: Review 3/13/2023 Date: Sheet Number C907

ENGINEERING

ONE DESIGN


3. SIGN SHALL BE LEVEL.
4. FINAL LOCATION TO BE APPROVED BY OWNER AND A/E DURING SUBMITTALS.
5. COLORS SHALL BE DETERMINED BY OWNER AND A/E DURING SUBMITTALS.

SPLASHPAD RULES SIGN

(907) SCALE: NTS

3. SIGN SHALL BE LEVEL.
4. FINAL LOCATION TO BE APPROVED BY OWNER AND A/E DURING SUBMITTALS.
5. COLORS SHALL BE DETERMINED BY OWNER AND A/E DURING SUBMITTALS.

(907) SCALE: NTS

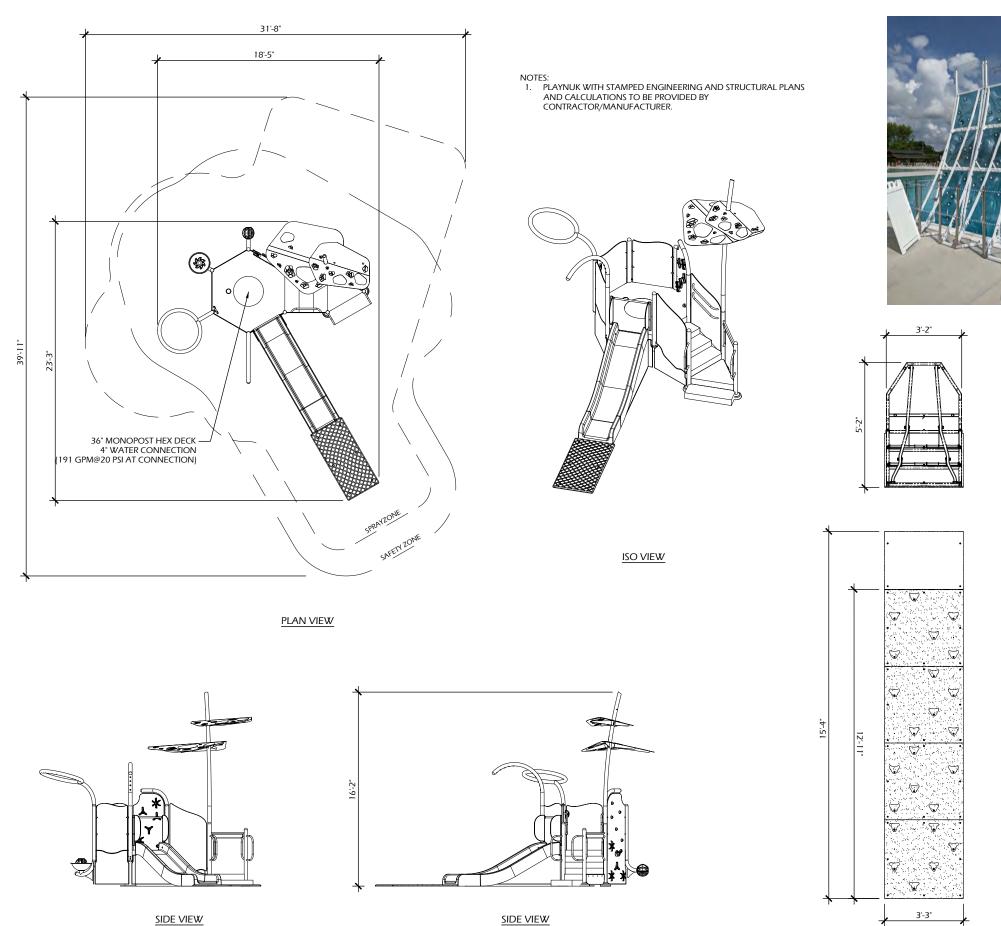

POOL PLAY STRUCTURE


C908

SCALE: NTS





- NOTES:
 1. INSTALL PER MANUFACTURER'S DETAILS.
- 2. CONTRACTOR TO PROVIDE EQUIPOTENTIAL BONDING POINTS PER ELECTRICAL PLANS.

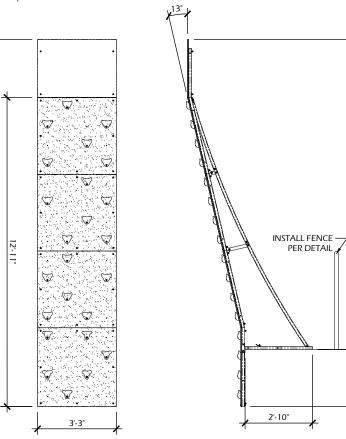

C908

CLIMBING WALL SCALE: NTS

Sheet Number

Project #: Issued For: Date:

ONE DESIGN & ENGINEERING


KAUKAUNA POOL RENOVATION 607 Dodge Street Kaukauna, WI 54130

CONSTRUCTION DETAILS

21.039

Review 3/13/2023


C908

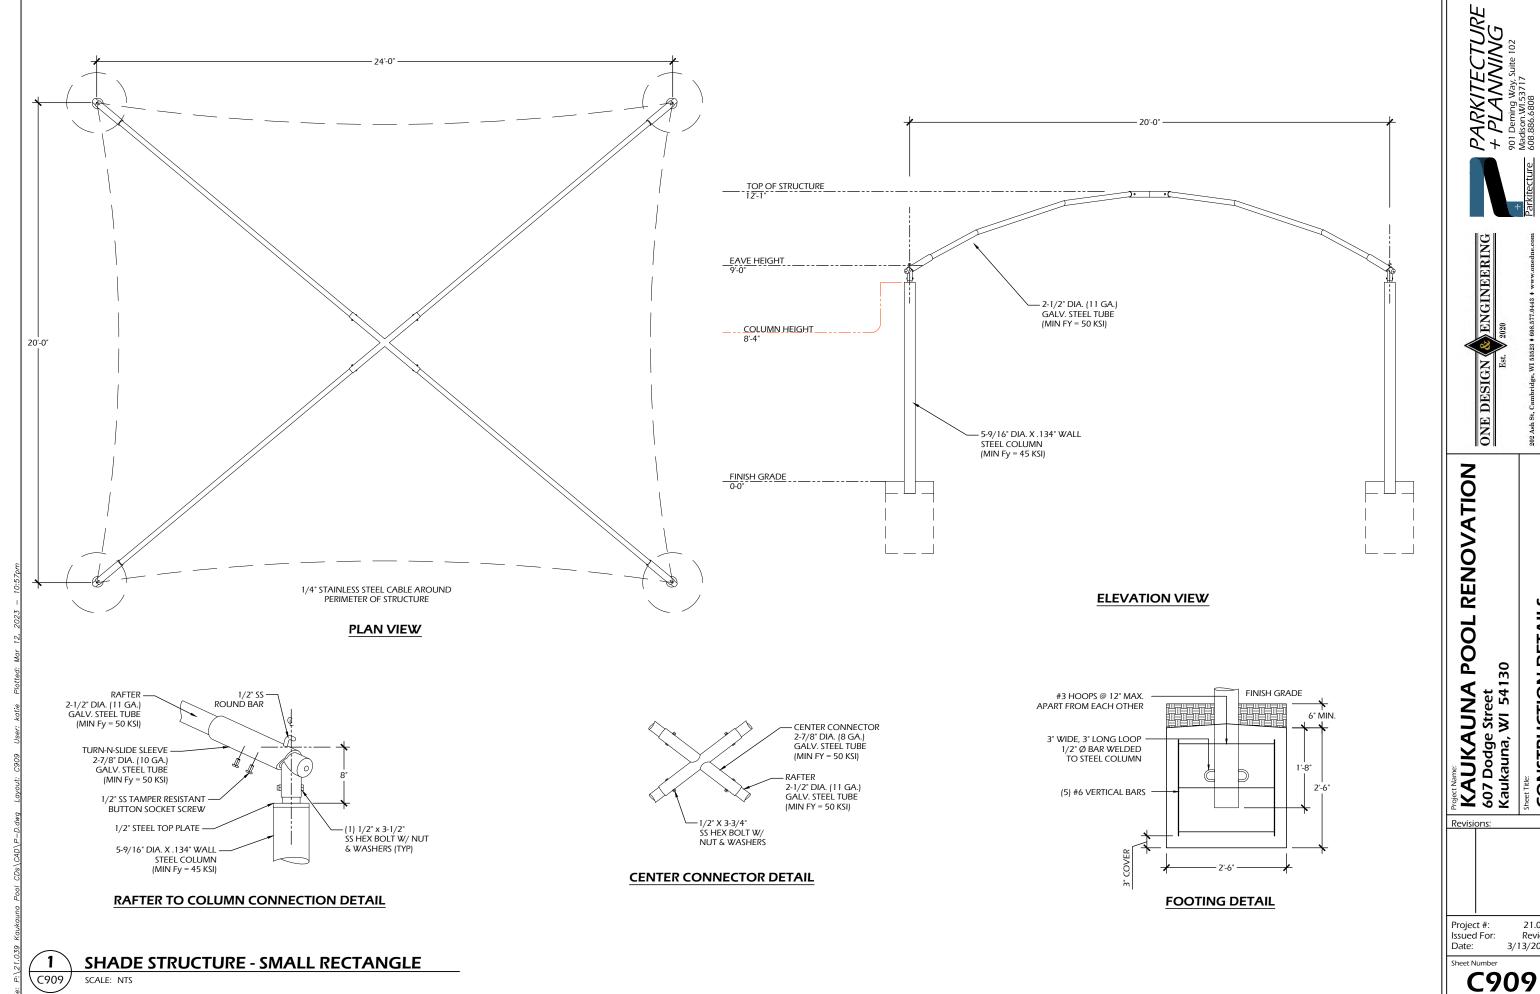

CONSTRUCTION DETAILS

21.039 Review 3/13/2023

SCALE: NTS

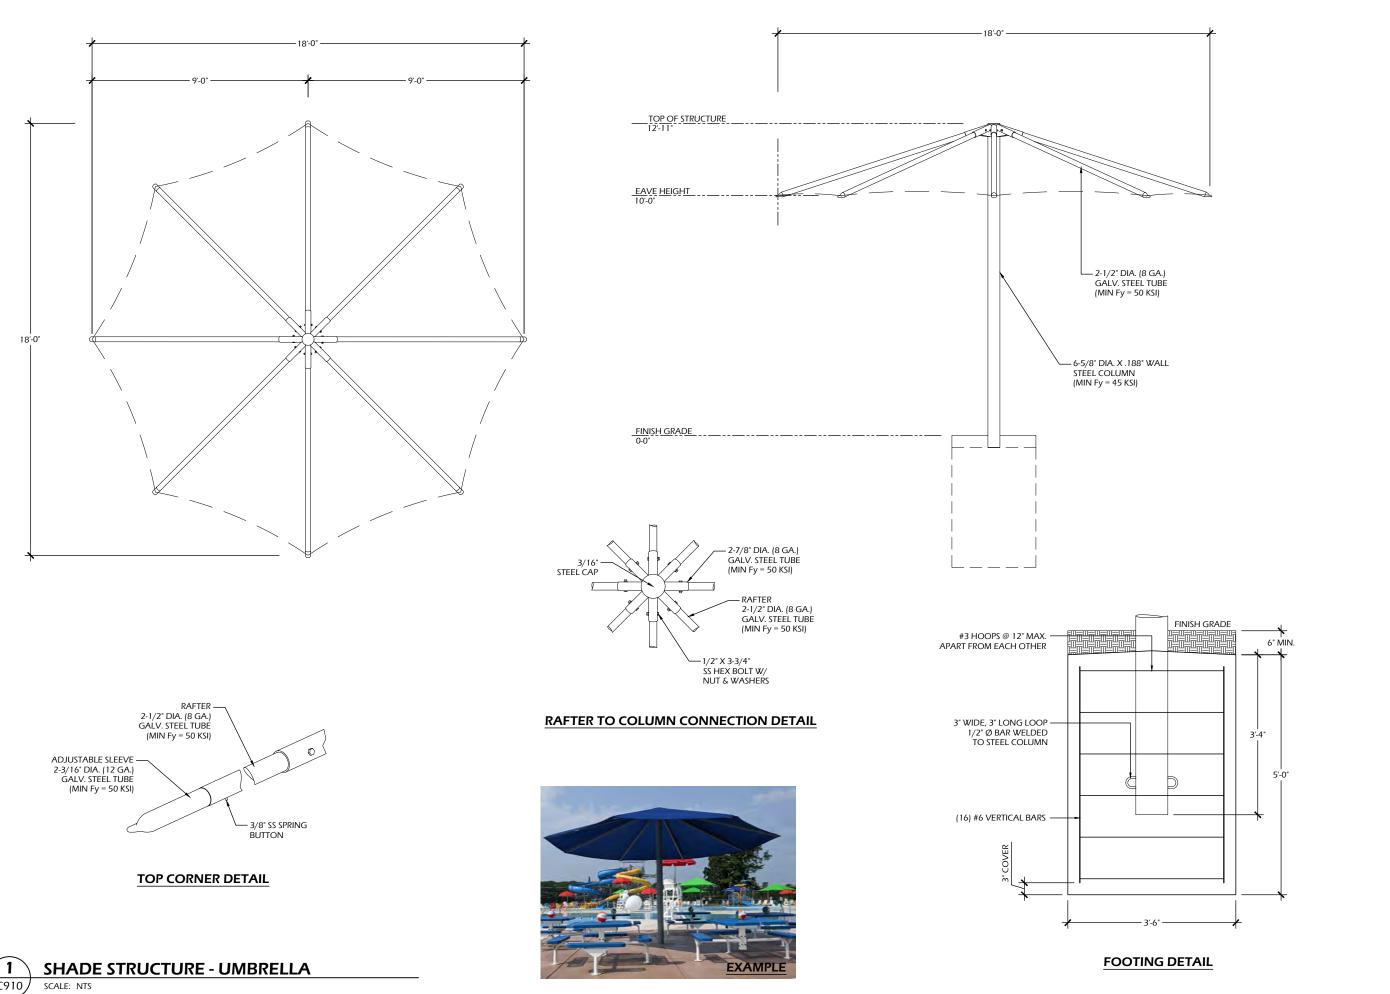

ONE DESIGN


KAUKAUNA POOL RENOVATION 607 Dodge Street Kaukauna, WI 54130

CONSTRUCTION DETAILS

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Sheet Number C910

C910

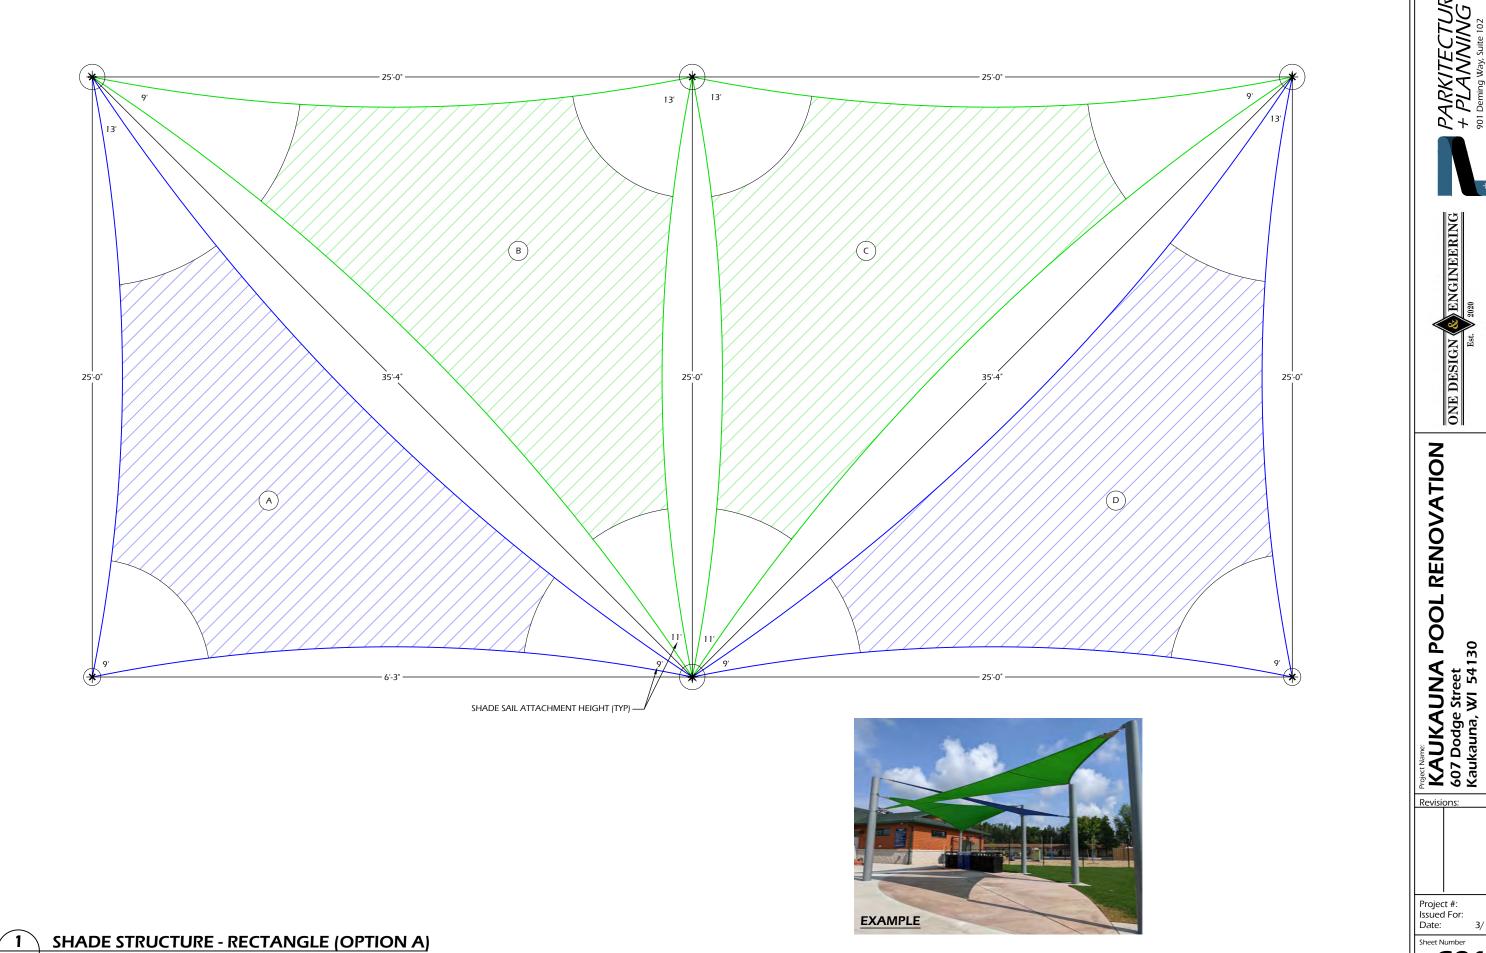


SCALE: NTS

Sheet Number C911

CONSTRUCTION DETAILS

21.039 Review 3/13/2023

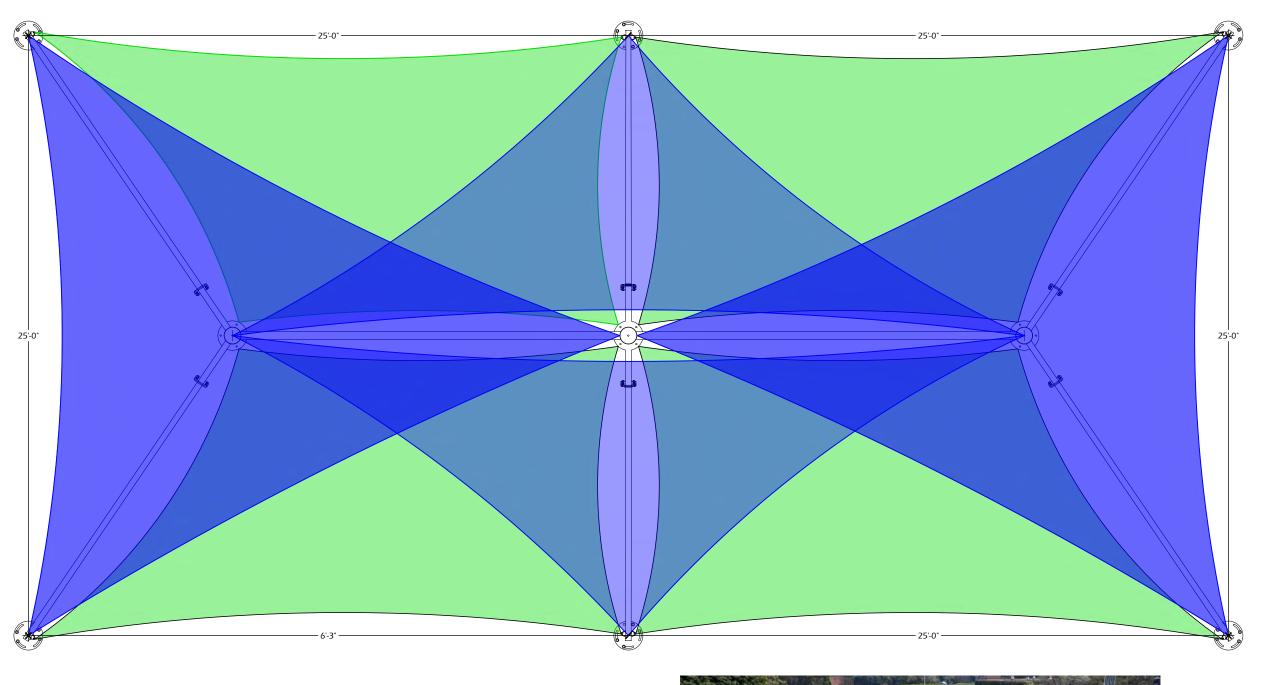



SHADE STRUCTURE - RECTANGLE (OPTION B)


SCALE: NTS

ONE DESIGN & ENGINEERING KAUKAUNA POOL RENOVATION 607 Dodge Street Kaukauna, WI 54130

CONSTRUCTION DETAILS


21.039 Review 3/13/2023 Project #: Issued For: Date:


Sheet Number C912

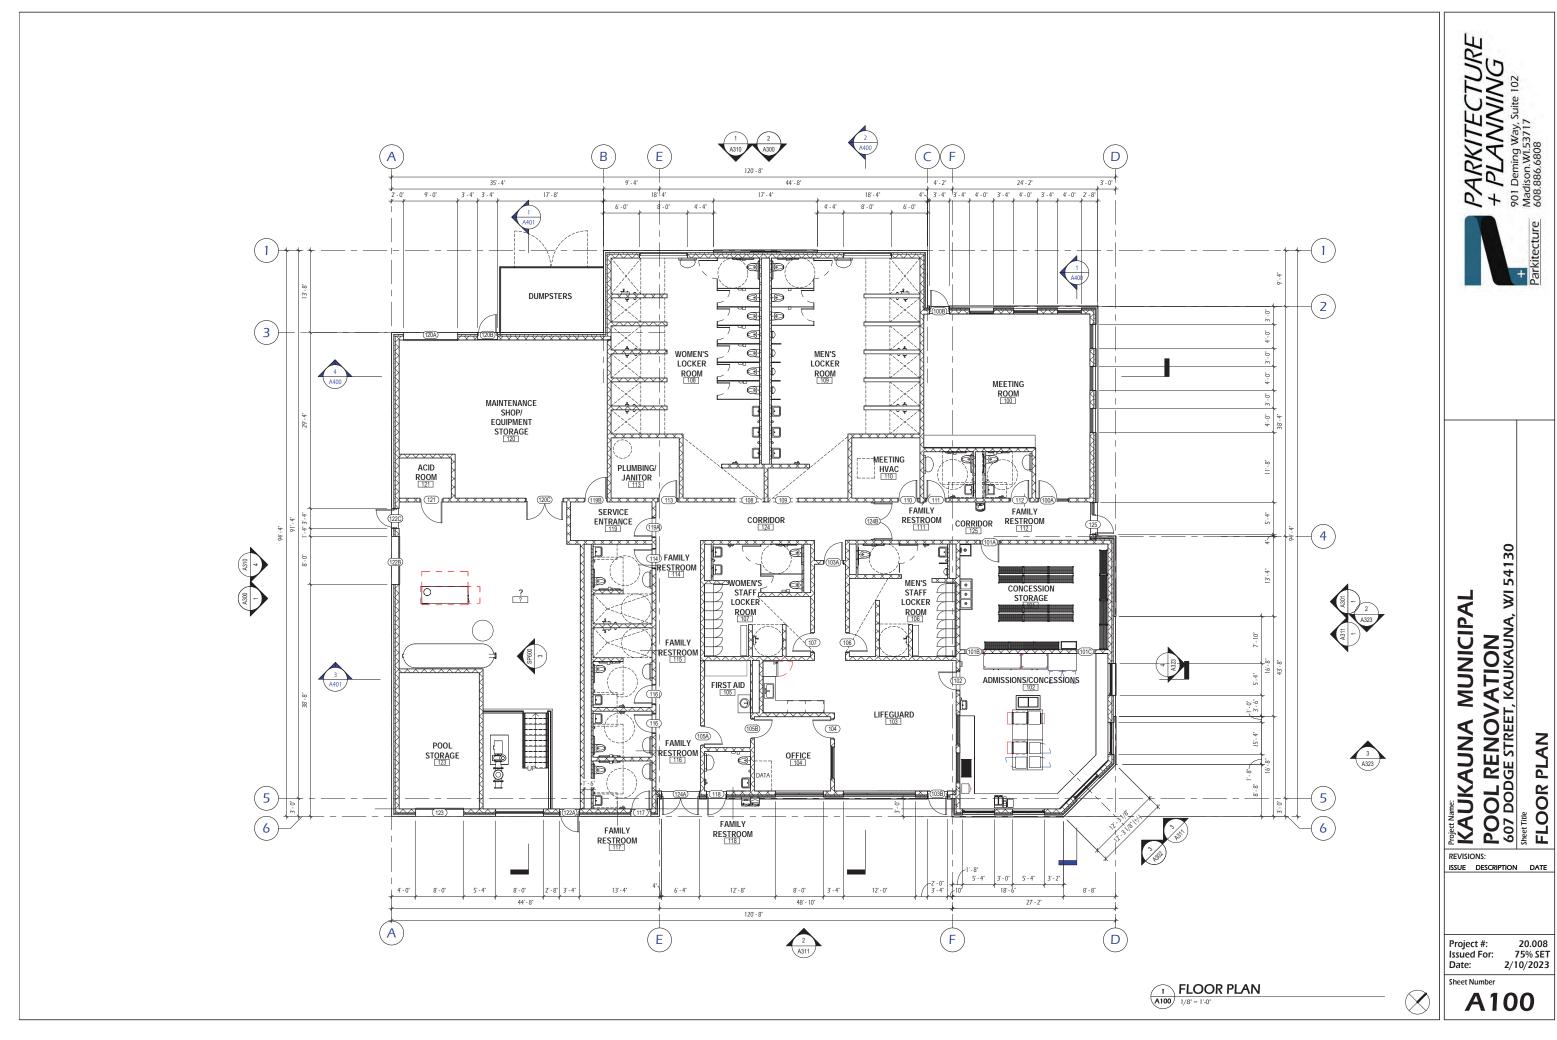



20.008 75% SET 2/10/2023

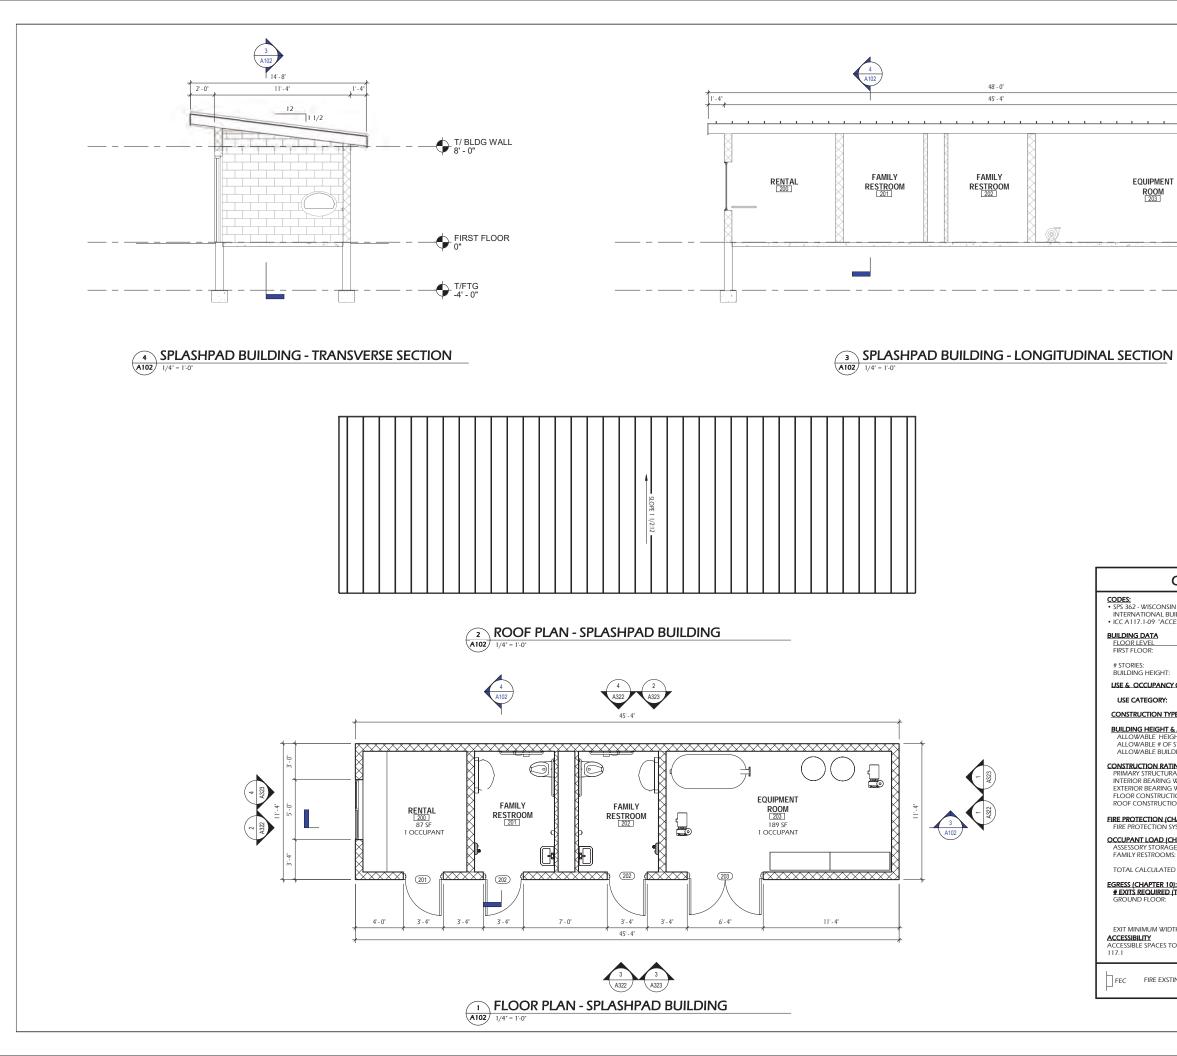

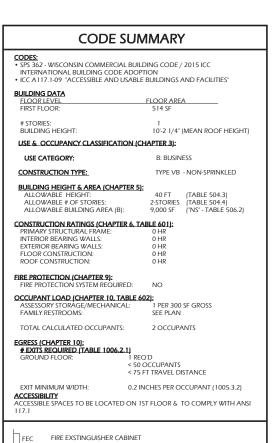

EQUIPMENT

ROOM 203



KAUKAUNA MUNICIPAL

ROOL RENOVATION
607 DODGE STREET, KAUKAUNA, WI 54130

SPLASHPAD BUILDING PLANS REVISIONS: ISSUE DESCRIPTION DATE


20.008 75% SET 2/10/2023

A102



FIRST FLOOR



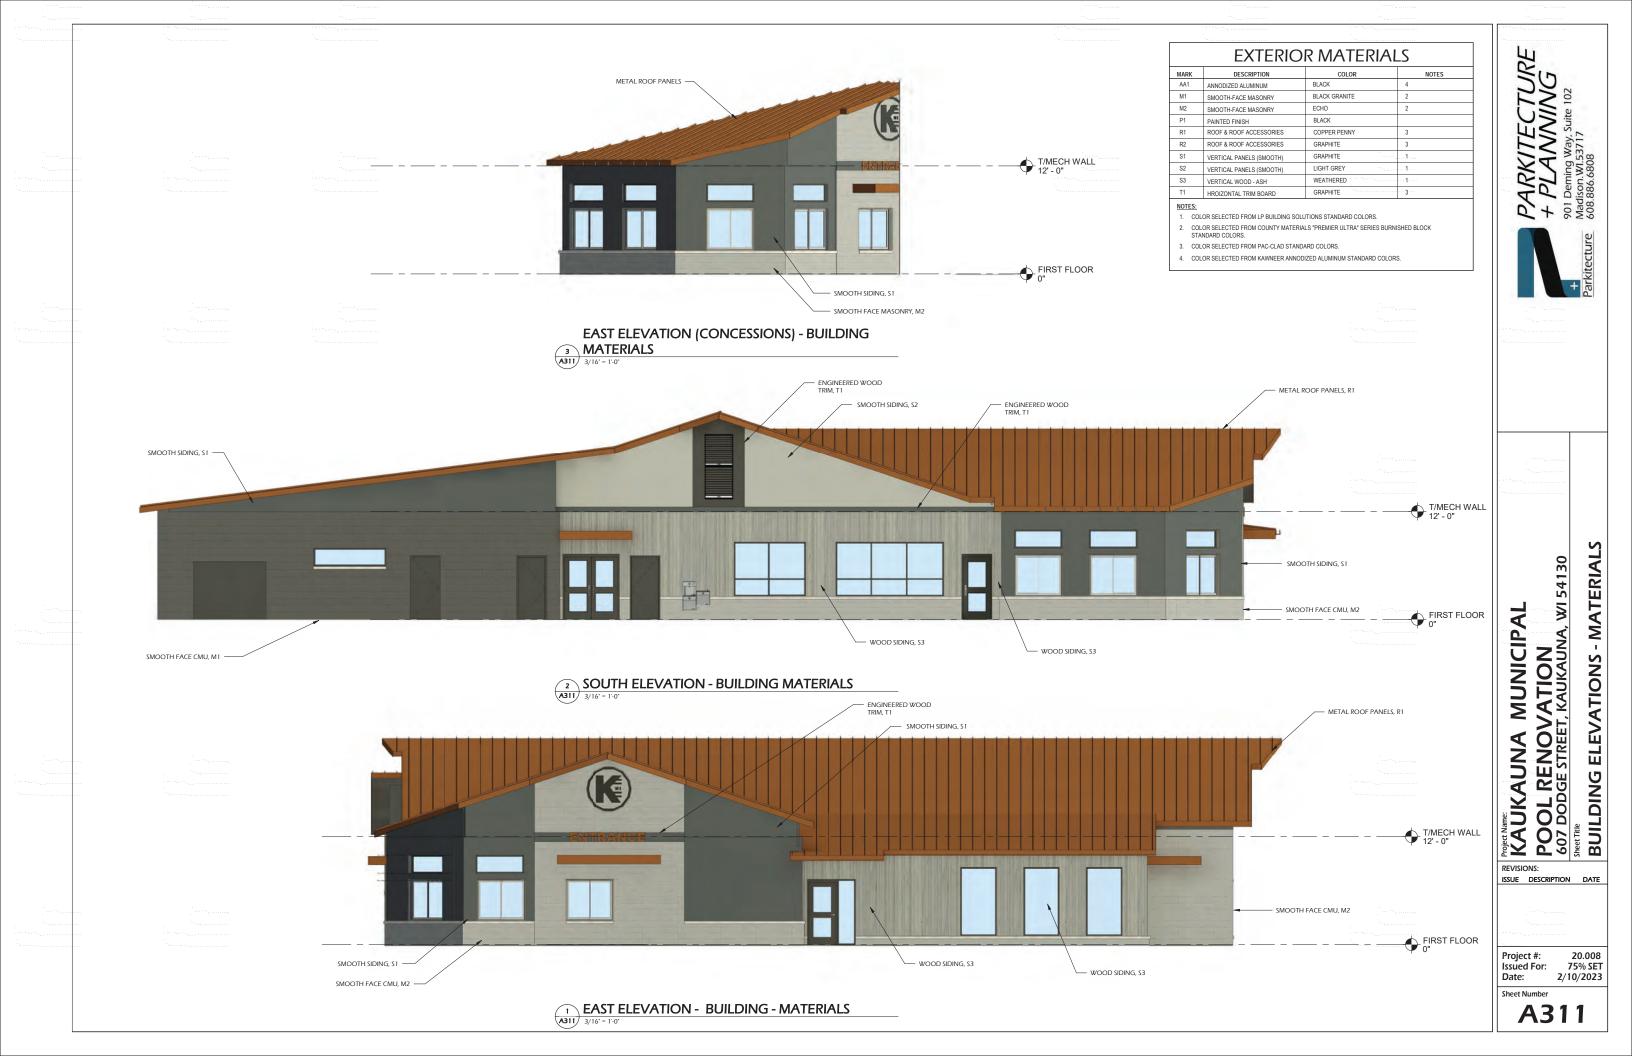



NORTHWEST ELEVATION



NORTHEAST ELEVATION



KAUKAUNA MUNICIPAL
POOL RENOVATION
607 DODGE STREET, KAUKAUNA, WI 54130

EXTERIOR RENDERINGS REVISIONS: ISSUE DESCRIPTION DATE

20.008 : 75% SET 2/10/2023

Project #: Issued For: Date: Sheet Number



SOUTH ELEVATION










MASONRY (M-2) (ECHO)


EXTERIOR MATERIALS								
MARK	DESCRIPTION	COLOR	NOTES					
AA1	ANNODIZED ALUMINUM	BLACK	4					
M1	SMOOTH-FACE MASONRY	BLACK GRANITE	2					
M2	SMOOTH-FACE MASONRY	ECHO	2					
P1	PAINTED FINISH	BLACK						
R1	ROOF & ROOF ACCESSORIES	COPPER PENNY	3					
R2	ROOF & ROOF ACCESSORIES	GRAPHITE	3					
S1	VERTICAL PANELS (SMOOTH)	GRAPHITE	1					
S2	VERTICAL PANELS (SMOOTH)	LIGHT GREY	1					
S3	VERTICAL WOOD - ASH	WEATHERED	1					
T1	HROIZONTAL TRIM BOARD	GRAPHITE	3					

- 1. COLOR SELECTED FROM LP BUILDING SOLUTIONS STANDARD COLORS.
- COLOR SELECTED FROM COUNTY MATERIALS "PREMIER ULTRA" SERIES BURNISHED BLOCK STANDARD COLORS.
- 3. COLOR SELECTED FROM PAC-CLAD STANDARD COLORS.
- 4. COLOR SELECTED FROM KAWNEER ANNODIZED ALUMINUM STANDARD COLORS.

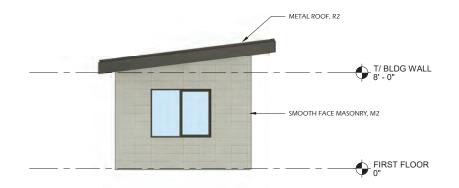





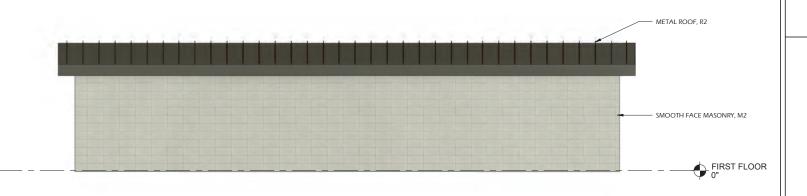


NORTH ELEVATION - MATERIALS SPLASHPAD

2 BUILDING A323 1/4" = 1'-0"



SOUTH ELEVATION - MATERIALS SPLASHPAD 3 BUILDING
1/4* = 1:0*

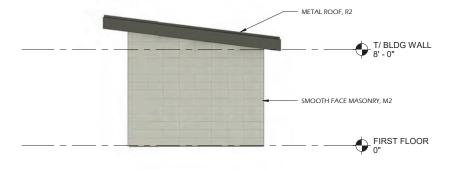

EAST ELEVATION - MATERIALS (SPLASHPAD BUILDING)

A323 1/4" - 1'0"



KAUKAUNA MUNICIPAL
POOL RENOVATION
607 DODGE STREET, KAUKAUNA, WI 54130
Sheet Title
BUILDING ELEVATIONS - MATERIALS

REVISIONS:

ISSUE DESCRIPTION DATE

20.008 75% SET 2/10/2023 Project #: Issued For: Date:

Sheet Number

A323