## DSPS CODE COMPLIANCE NOTES:

1) APPLICABLE BUILDING CODES:

2015 WISCONSIN BUILDING CODE (2015 WBC)

2015 INTERNATIONAL ENERGY CONSERVATION CODE

2015 INTERNATIONAL FUEL GAS CODE 2018 WISCONSIN PLUMBING CODE

2015 INTERNATIONAL MECHANICAL CODE

2015 INTERNATIONAL FIRE CODE

2017 NATIONAL ELECTRIC CODE OF WISCONSIN

2) BUILDING USE AND OCCUPANCY:

S-2, COMMERCIAL VEHICLE STORAGE

3) OCCUPANT LOAD

PER TABLE 1004.1.2 (PARKING GARAGE)= 200 S.F. PER PERSON (S-2 OCCUPANCY)

CALCULATED OCCUPANT LOAD: 4,950 SF/200 S.F. PER PERSON = 25 PERSONS

ACTUAL/DESIGN OCCUPANT LOAD = 14 (SECTION 1004.1.2, EXCEPTION)

4) CONSTRUCTION TYPE:

CONSTRUCTION TYPE = VB, NON-SPRINKLED

5) HEIGHT AND AREA LIMITATIONS:

PER TABLE 506.2 ALLOWABLE AREA, NON-SPRINKLED = 13,500 S.F.

PER IBC 705.3, EXCEPTION 1, BOTH BUILDINGS ON THE SAME LOT ARE BEING USED AREA PER TABLE 506.2 = 13,500 SF. THEREFORE NO FIRE RATING IS REQUIRED FOR

AREA OF BOTH BUILDINGS COMBINED = 7,350 S.F. WHICH IS LESS THAN ALLOWABLE FLOOR AREA OF 13,500 S.F., THEREFORE NO SEPARATION DISTANCE OR FIRE RATED CONSTRUCTION BETWEEN STRUCTURES IS REQUIRED.

6) THERMAL PERFORMANCE

COMCHECK ENVELOPE COMPLIANCE SOFTWARE HAS BEEN UTILIZED TO DEMONSTRATE COMPLIANCE WITH THE WISCONSIN ENERGY CONSERVATION CODE.

7) EXIT TRAVEL DISTANCE

NON-SPRINKLED, S-2 = 300 FEET (TABLE 1017.2)

MAXIMUM COMMON PATH OF TRAVEL = 100 FEET (TABLE 1006.2.1)

8) EGRESS WIDTH/NUMBER OF EXITS

BASED ON OCCUPANT LOAD OF 25 PERSONS 25 PERSON x0.2" PER PERSON = 5" REQUIRED

(2) - 36" WIDE DOORS = 72" PROVIDED THEREFORE GOOD

PER TABLE 1006.2.1: TWO (2) EXIT DOORS REQUIRED, TWO (2) ARE PROVIDED

OCCUPANCY = S-2, MAX OCCUPANT <29 PERSONS

9) MEANS OF EGRESS ILLUMINATION

MEANS OF EGRESS ILLUMINATION SHALL COMPLY WITH THE 2015 WBC, SECTION 1008.

MIN. ILLUMINATION LEVEL = 1.0 FOOT CANDLES, MAINTAINED ON AN UNINTERRUPTED POWER SUPPLY

10) ACCESSIBLE MEANS OF EGRESS: PER SECTION 1009.1 TWO (2) ACCESSIBLE MEANS OF EGRESS IS REQUIRED.

11) FIRE SUPPRESSION SYSTEM:

FIRE SUPPRESSION SYSTEM IS NOT REQUIRED PER 903.2.10.1 BUILDING

AREA/FIRE AREA IS <5,000 S.F.

12) PLUMBING FIXTURES

PER SECTION 2902.2, EXCEPTION 2: SEPARATE FACILITIES FOR EACH SEX

ARE NOT REQUIRED WHEN TOTAL OCCUPANT LOAD <16 PERSONS

ONE (1) UNISEX TOILET ROOM IS PROVIDED. DOOR SHALL BE EQUIPPED WITH PRIVACY LOCK.

PER TABLE 2902.1 ONE (1) TOILET, ONE (1) LAVATORY, ONE (1) DRINKING FOUNTAIN, AND ONE (1) SERVICE/MOP SINK REQUIRED

13) HAND HELD FIRE EXTINGUISHERS:

PROVIDE HAND HELD FIRE EXTINGUISHERS PER NFPA 10 AND 2015 WBC,


SECTION 906. MAX TRAVEL DISTANCE TO NEAREST FIRE EXTINGUISHER

SHALL NOT EXCEED 75 FEET

14) WOOD FRAMING DESIGN BY BUILDING SUPPLIER. BUILDING SUPPLIER SHALL SUBMIT SHOP DRAWING FOR ARCHITECT'S REVIEW. WOOD FRAMING / BUILDING DESIGNER SHALL SUBMIT COMPONENT DRAWINGS TO THE STATE FOR PLAN REVIEW AND PAY ALL RELATED FEES. SEE NOTE 8 ON SHEET A-3 FOR ADDITIONAL INFORMATION.

## GE CONTRACTING LLC

## VEHICLE STORAGE GARAGE

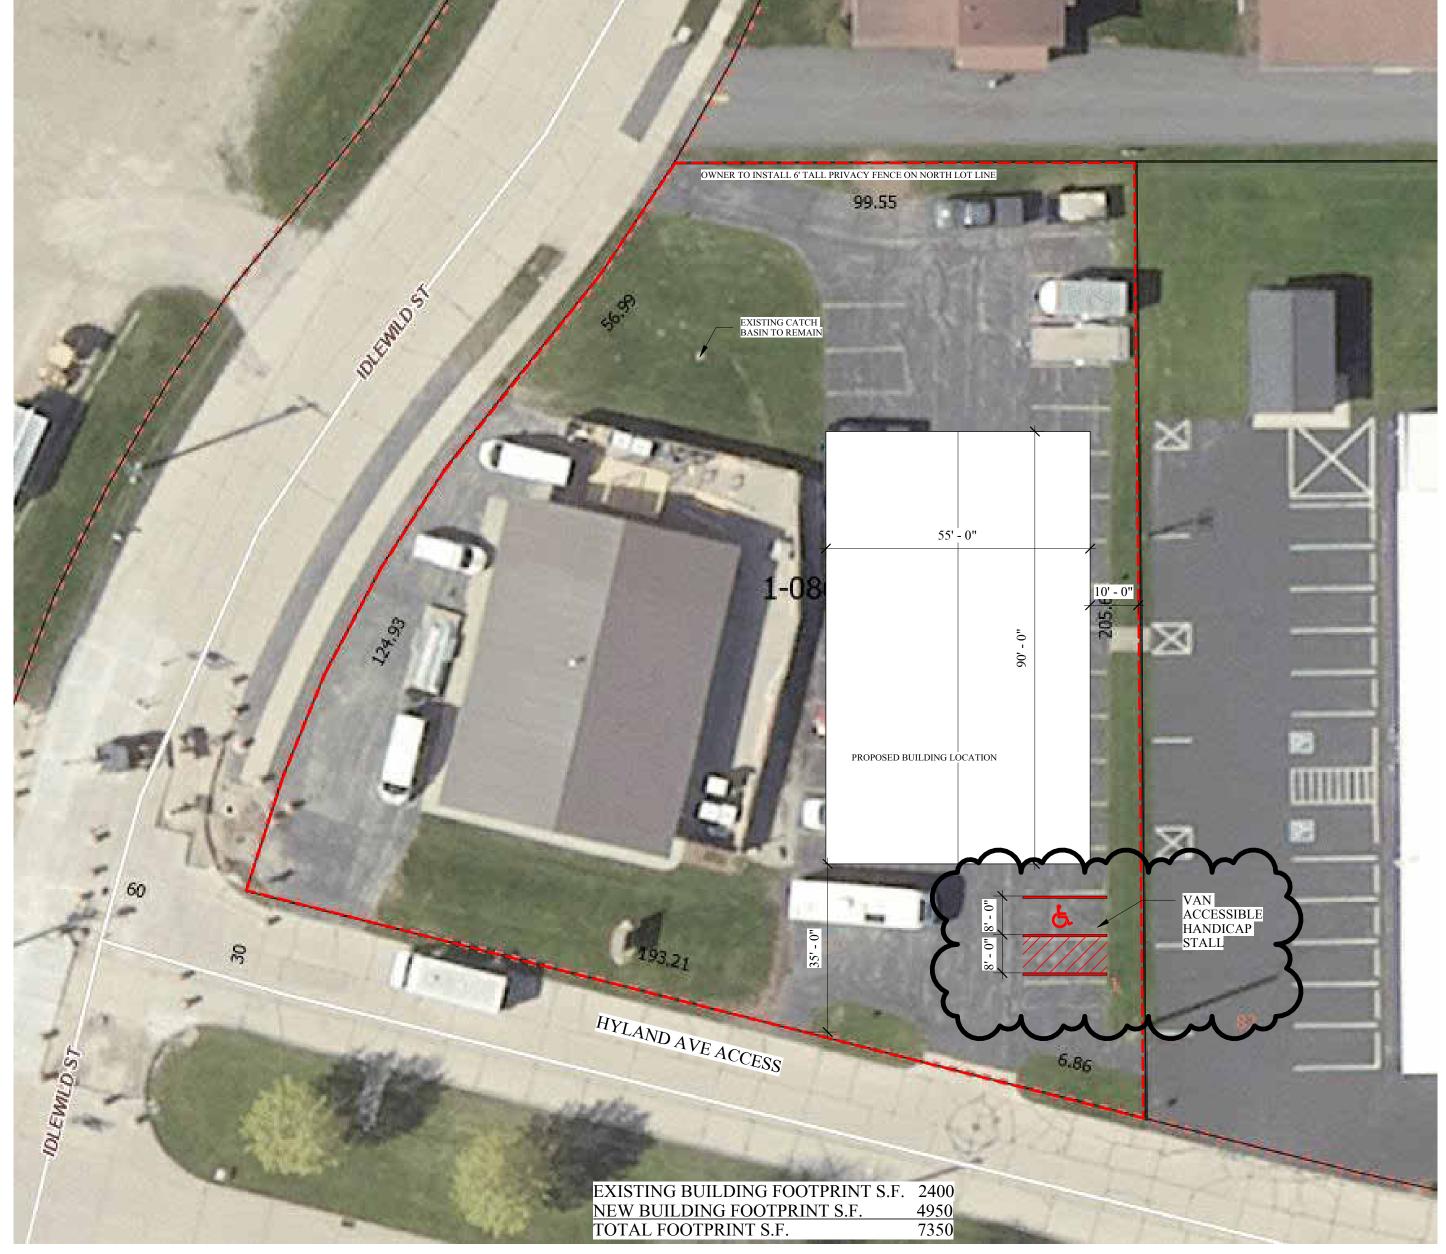

LOT SIZE = 28,664 S.F. LOT COVERAGE = 7,350 S.F. / 28,664 S.F. = 0.25

1 SITE PLAN

SCALE: 1" = 20'-0"



>	INDEX TO DRAWINGS	
_	SHEET NUMBER	DESCRIPTION
	A-1	COVER SHEET, INDEX & SITE PLAN
_	A-2	FOUNDATION PLAN
	A-3	FLOOR PLAN & TYP. BUILDING SECTION
>	A-4	EXTERIOR BUILDING ELEVATIONS

## **DESIGN LOADS**

ROOF LIVE LOAD	20 PSF
ROOF SNOW LOAD	
GROUND SNOW LOAD, Pg	40 PSF
SNOW EXPOSURE FACTOR, Ce	1.0
SNOW IMPORTANCEFACTOR, Is $$	1.0
THERMAL FACTOR, Ct	1.0
RAIN ON SNOW SURCHARGE, Prs	0 PSF
WIND DESIGN DATA	
BASIC WIND SPEED, ASCE 7-10 (3 SEC. GUST) $$	115 MPH
WIND IMPORTANCE FACTOR, IW	1.0
WIND EXPOSURE	
FLOOD DESIGN	N/A

07:36:30-05'00' ST.AUBIN A-6984 KAUKAUNA

809 HYLAND AVE. P.O. BOX 440

KAUKAUNA, WI 54130

PHONE: (920)-766-3521

FAX: (920)-766-0670

**VERIFY EXISTING SITE** 


DATA

ALTHOUGH EVERY EFFORT HAS BEEN MADE IN PREPARING THESE PLANS AND CHECKING THEM FOR ACCURACY, THE CONTRACTOR / BUILDER MUST CHECK ALL STRUCTURAL DETAILS AND DIMENSIONS AND BE RESPONSIBLE FOR THE SAME.



SITE MAP

As indicated SCALE: PROJECT: 2022-081 9-7-2022 DRAWN BY:

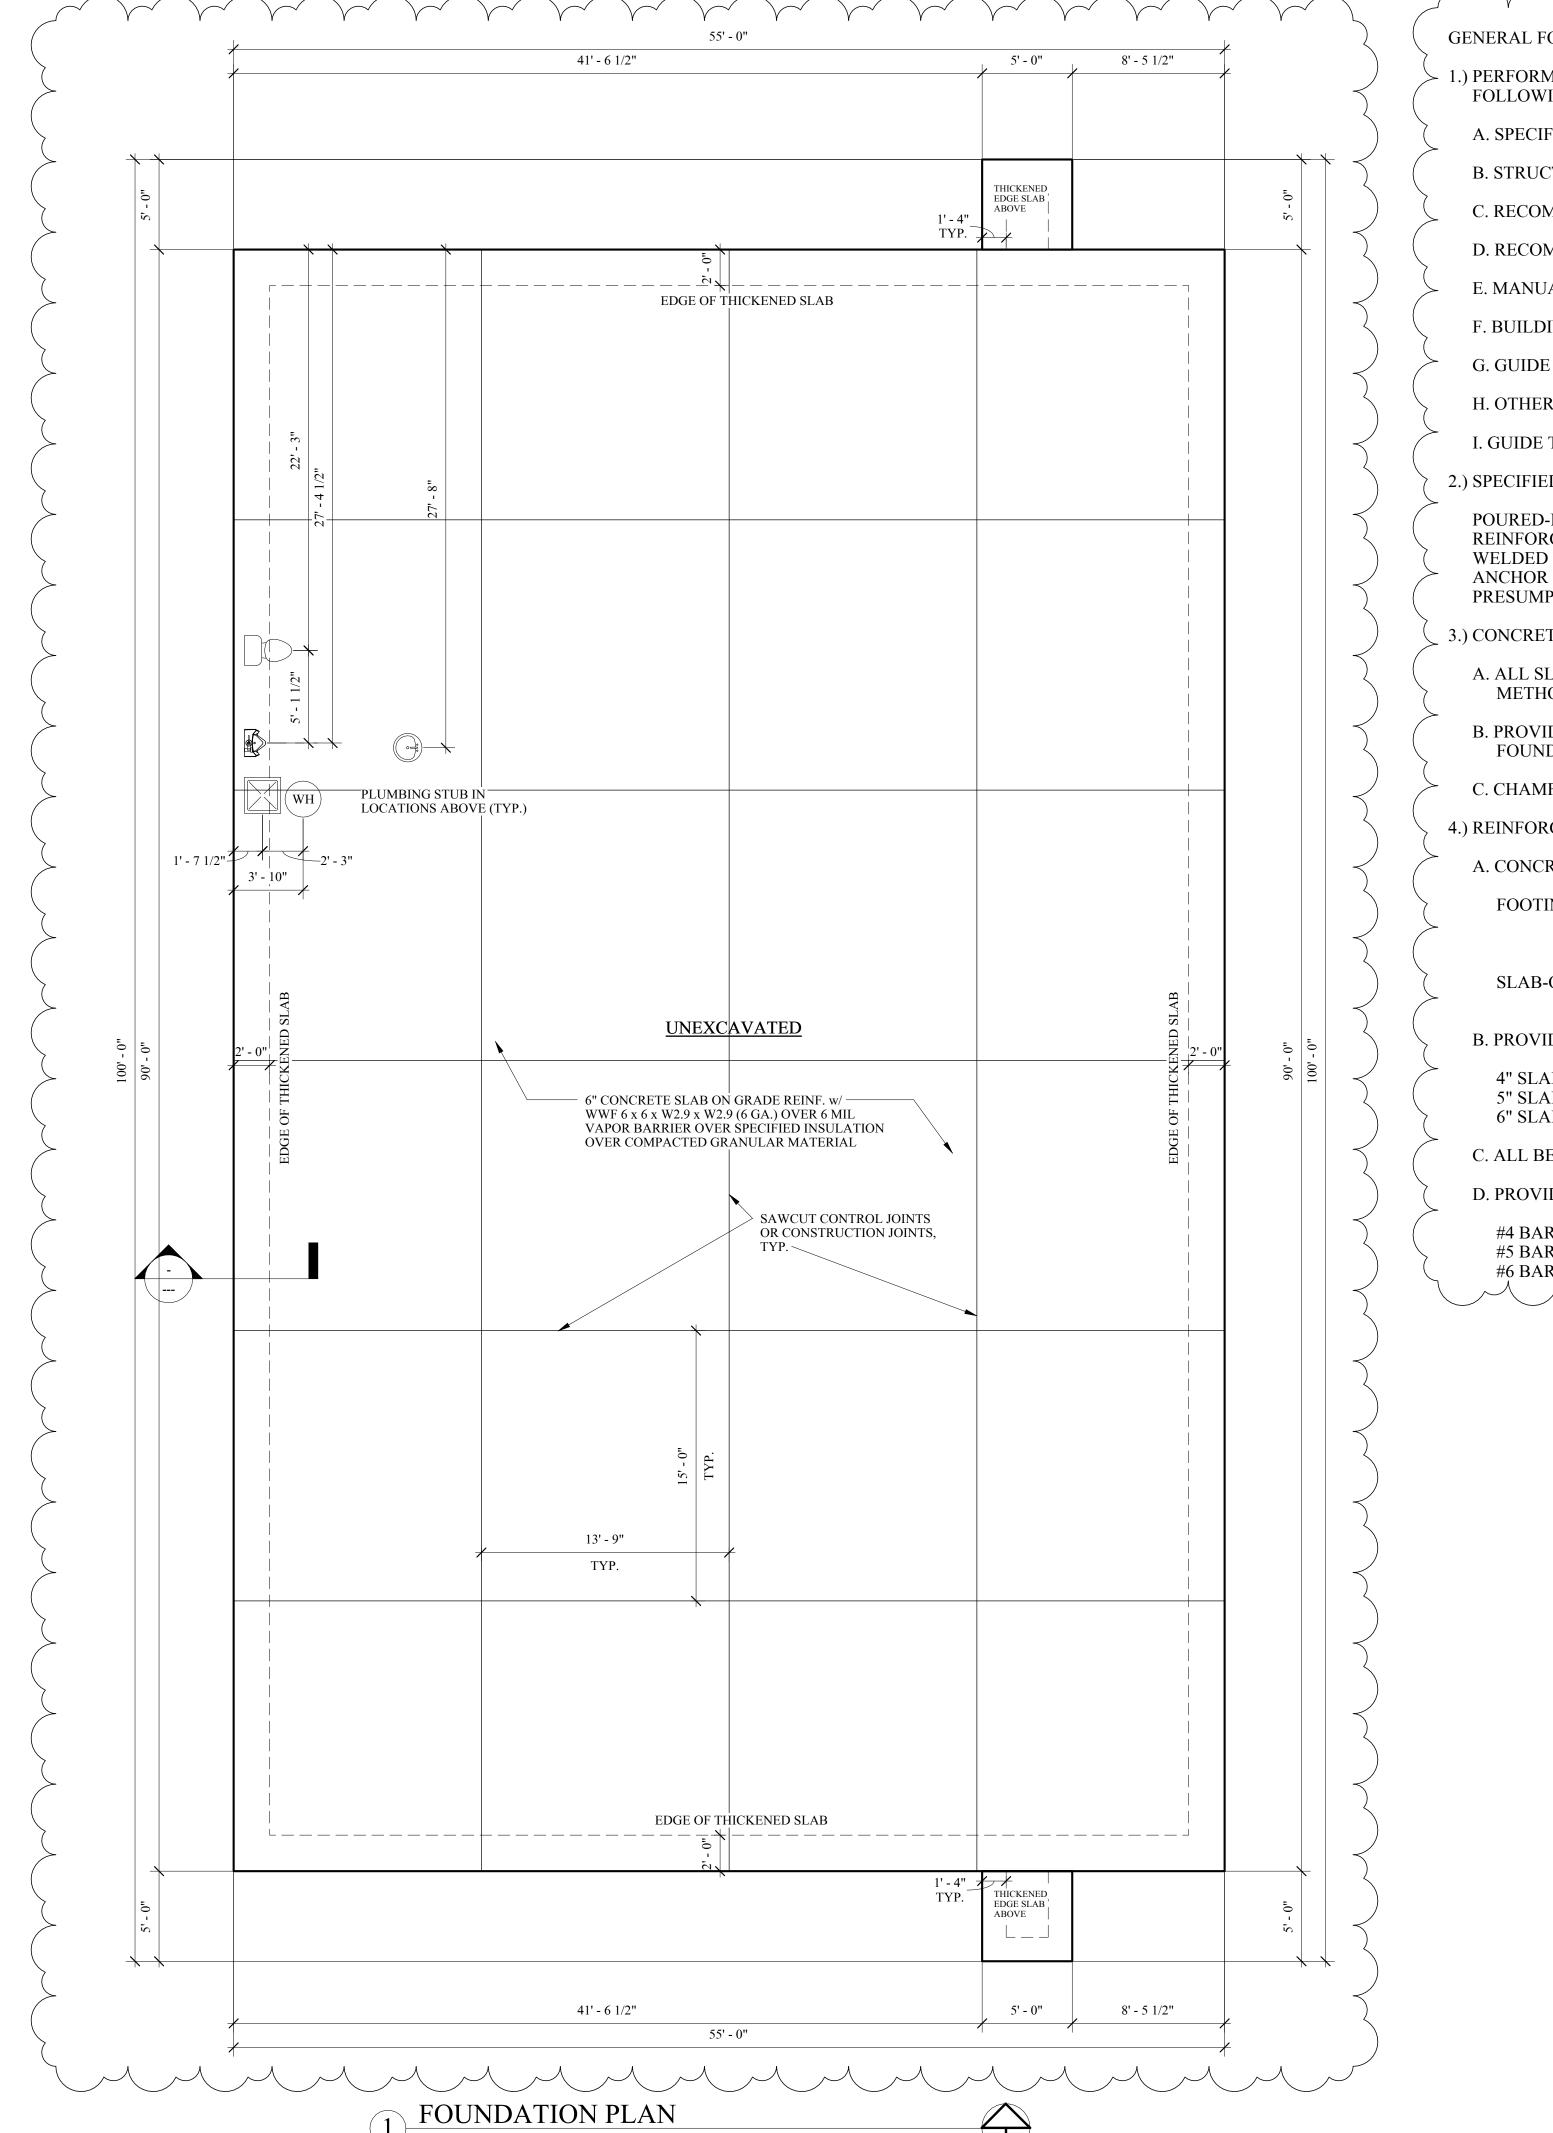

GENERAL FOUNDATION NOTES:

1.) PERFORM ALL WORK INDICATED OR REASONABLY IMPLIED, IN ACCORDANCE WITH THE LATEST EDITIONS OF THE

A. SPECIFICATION FOR TOLERANCES FOR CONCRETE CONSTRUCTION AND MATERIALS AND COMMENTARY, (ACI -117)

B. STRUCTURAL CONCRETE FOR BUILDINGS, (ACI-301)

C. RECOMMENDED PRACTICE FOR HOT WEATHER CONCRETING, (ACI-305)

D. RECOMMENDED PRACTICE FOR COLD WEATHER CONCRETING, (ACI-306)

E. MANUAL OF STNADARD PRACTICE FOR DETAILING REINFORCED CONCRETE STRUCTURES, (ACI-315)

F. BUILDING CODE REQUIREMENTS FOR REINFORCED CONCRETE, (ACI-318)

G. GUIDE TO FORMWORK FOR CONCRETE, (ACI 347)

H. OTHER GOVERNING LOCAL, STATE, AND FEDERAL CODES

I. GUIDE TO CONCRETE FLOOR AND SLAB CONSTRUCTION, (ACI 302.1R)

2.) SPECIFIED MATERIAL STRENGTHS:

POURED-IN-PLACE CONCRETE f'c ----- 4000 PSI AT 28 DAYS REINFORCING STEEL ------ ASTM A615, GRADE 60 WELDED WIRE FABRIC ----- ASTM A185 ANCHOR BOLTS ----- ASTM A307 PRESUMPTIVE SOIL BEARING PRESSURE - - - - 1,500 PSF

3.) CONCRETE

A. ALL SLABS ON GRADE WITH WELDED WIRE FABRIC REINFORCING SHALL BE MADE WITH THE "TWO POUR" METHOD.

B. PROVIDE SAWCUT CONTROL JOINTS IN EACH DIRECTION FOR ALL SLABS ON GRADE AND AS SHOWN ON THE FOUNDATION PLAN.

C. CHAMFER ALL EXPOSED CONCRETE EDGES 3/4".

4.) REINFORCING STEEL

A. CONCRETE COVER FOR REINFORCING STEEL, UNLESS OTHERWISE SHOWN, SHALL BE AS FOLLOWS:

FOOTINGS ----- 3" CLEAR FROM BOTTOM AND SIDES 2" CLEAR FROM TOP

SLAB-ON-GRADE ----- 1/3 SLAB THICKNESS FROM TOP, BUT NOT LESS THAN 3/4", NOR GREATER THAN 2"

B. PROVIDE THE FOLLOWING REINFORCEMENT UNLESS OTHERWISE NOTED FOR SLABS ON GRADE

4" SLAB - - - - - - WWF 6 x 6 x W2.0 x W2.0 (8 GA.) 5" SLAB ----- WWF 6 x 6 x W2.0 x W2.0 (8 GA.) 6" SLAB ----- WWF 6 x 6 x W2.9 x W2.9 (6 GA.)

C. ALL BENDS AND HOOKS IN REINFORCING SHALL BE MADE IN ACCORDANCE WITH ACI-318.

D. PROVIDE THE FOLLOWING LAP LENGTHS (INCHES) FOR SPLICES IN REINFORCING STEEL

#4 BARS - - - - 20" #5 BARS - - - - 26" #6 BARS - - - - 31"


F WISCONSIN ST. 2MOUR, WI 54165

LUMBER

Baisch **ENGINEERING** BAISCH ENGINEERING INC 809 HYLAND AVE. P.O. BOX 440 KAUKAUNA, WI 54130 PHONE: (920)-766-3521 FAX: (920)-766-0670

**VERIFY EXISTING SITE** DATA

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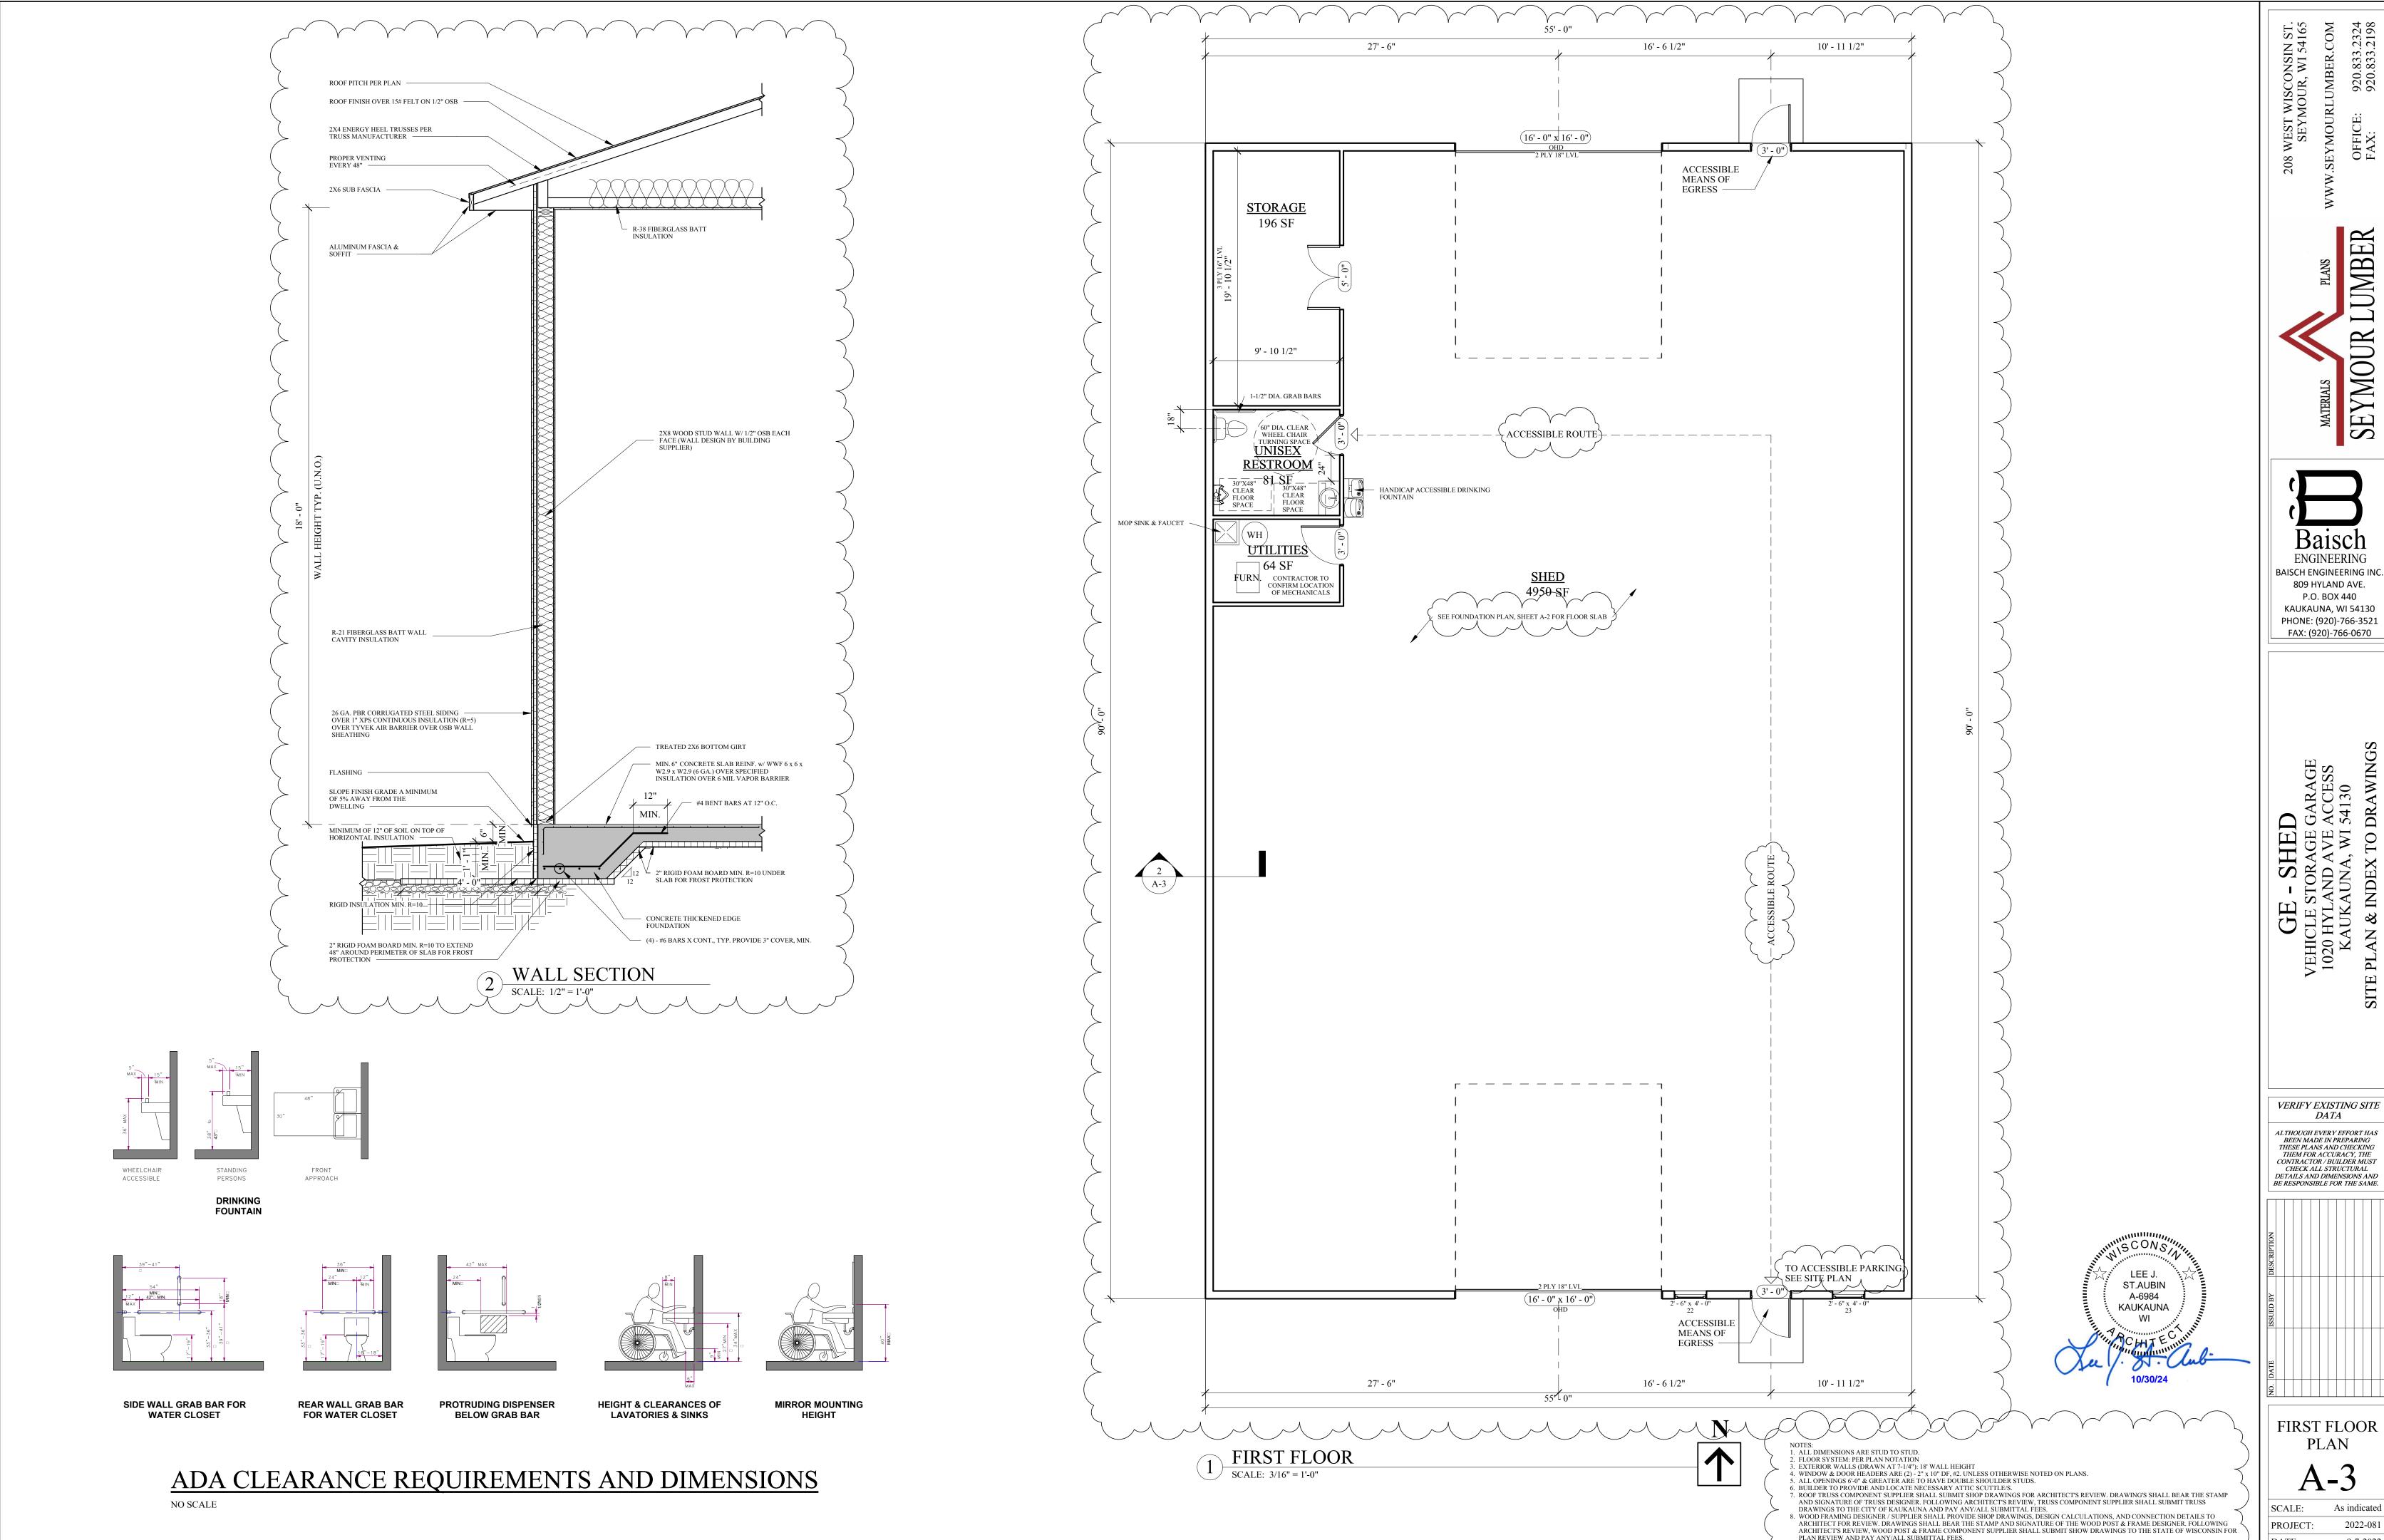
FOUNDATION **PLAN** 

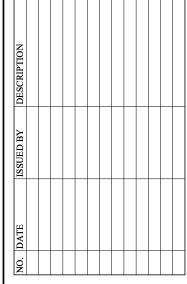ST.AUBIN

KAUKAUNA

As indicated SCALE: 2022-081 PROJECT: DATE: 9-7-2022

DRAWN BY: TA




PHONE: (920)-766-3521



2022-081 9-7-2022 DRAWN BY: TA


PLAN REVIEW AND PAY ANY/ALL SUBMITTAL FEES.

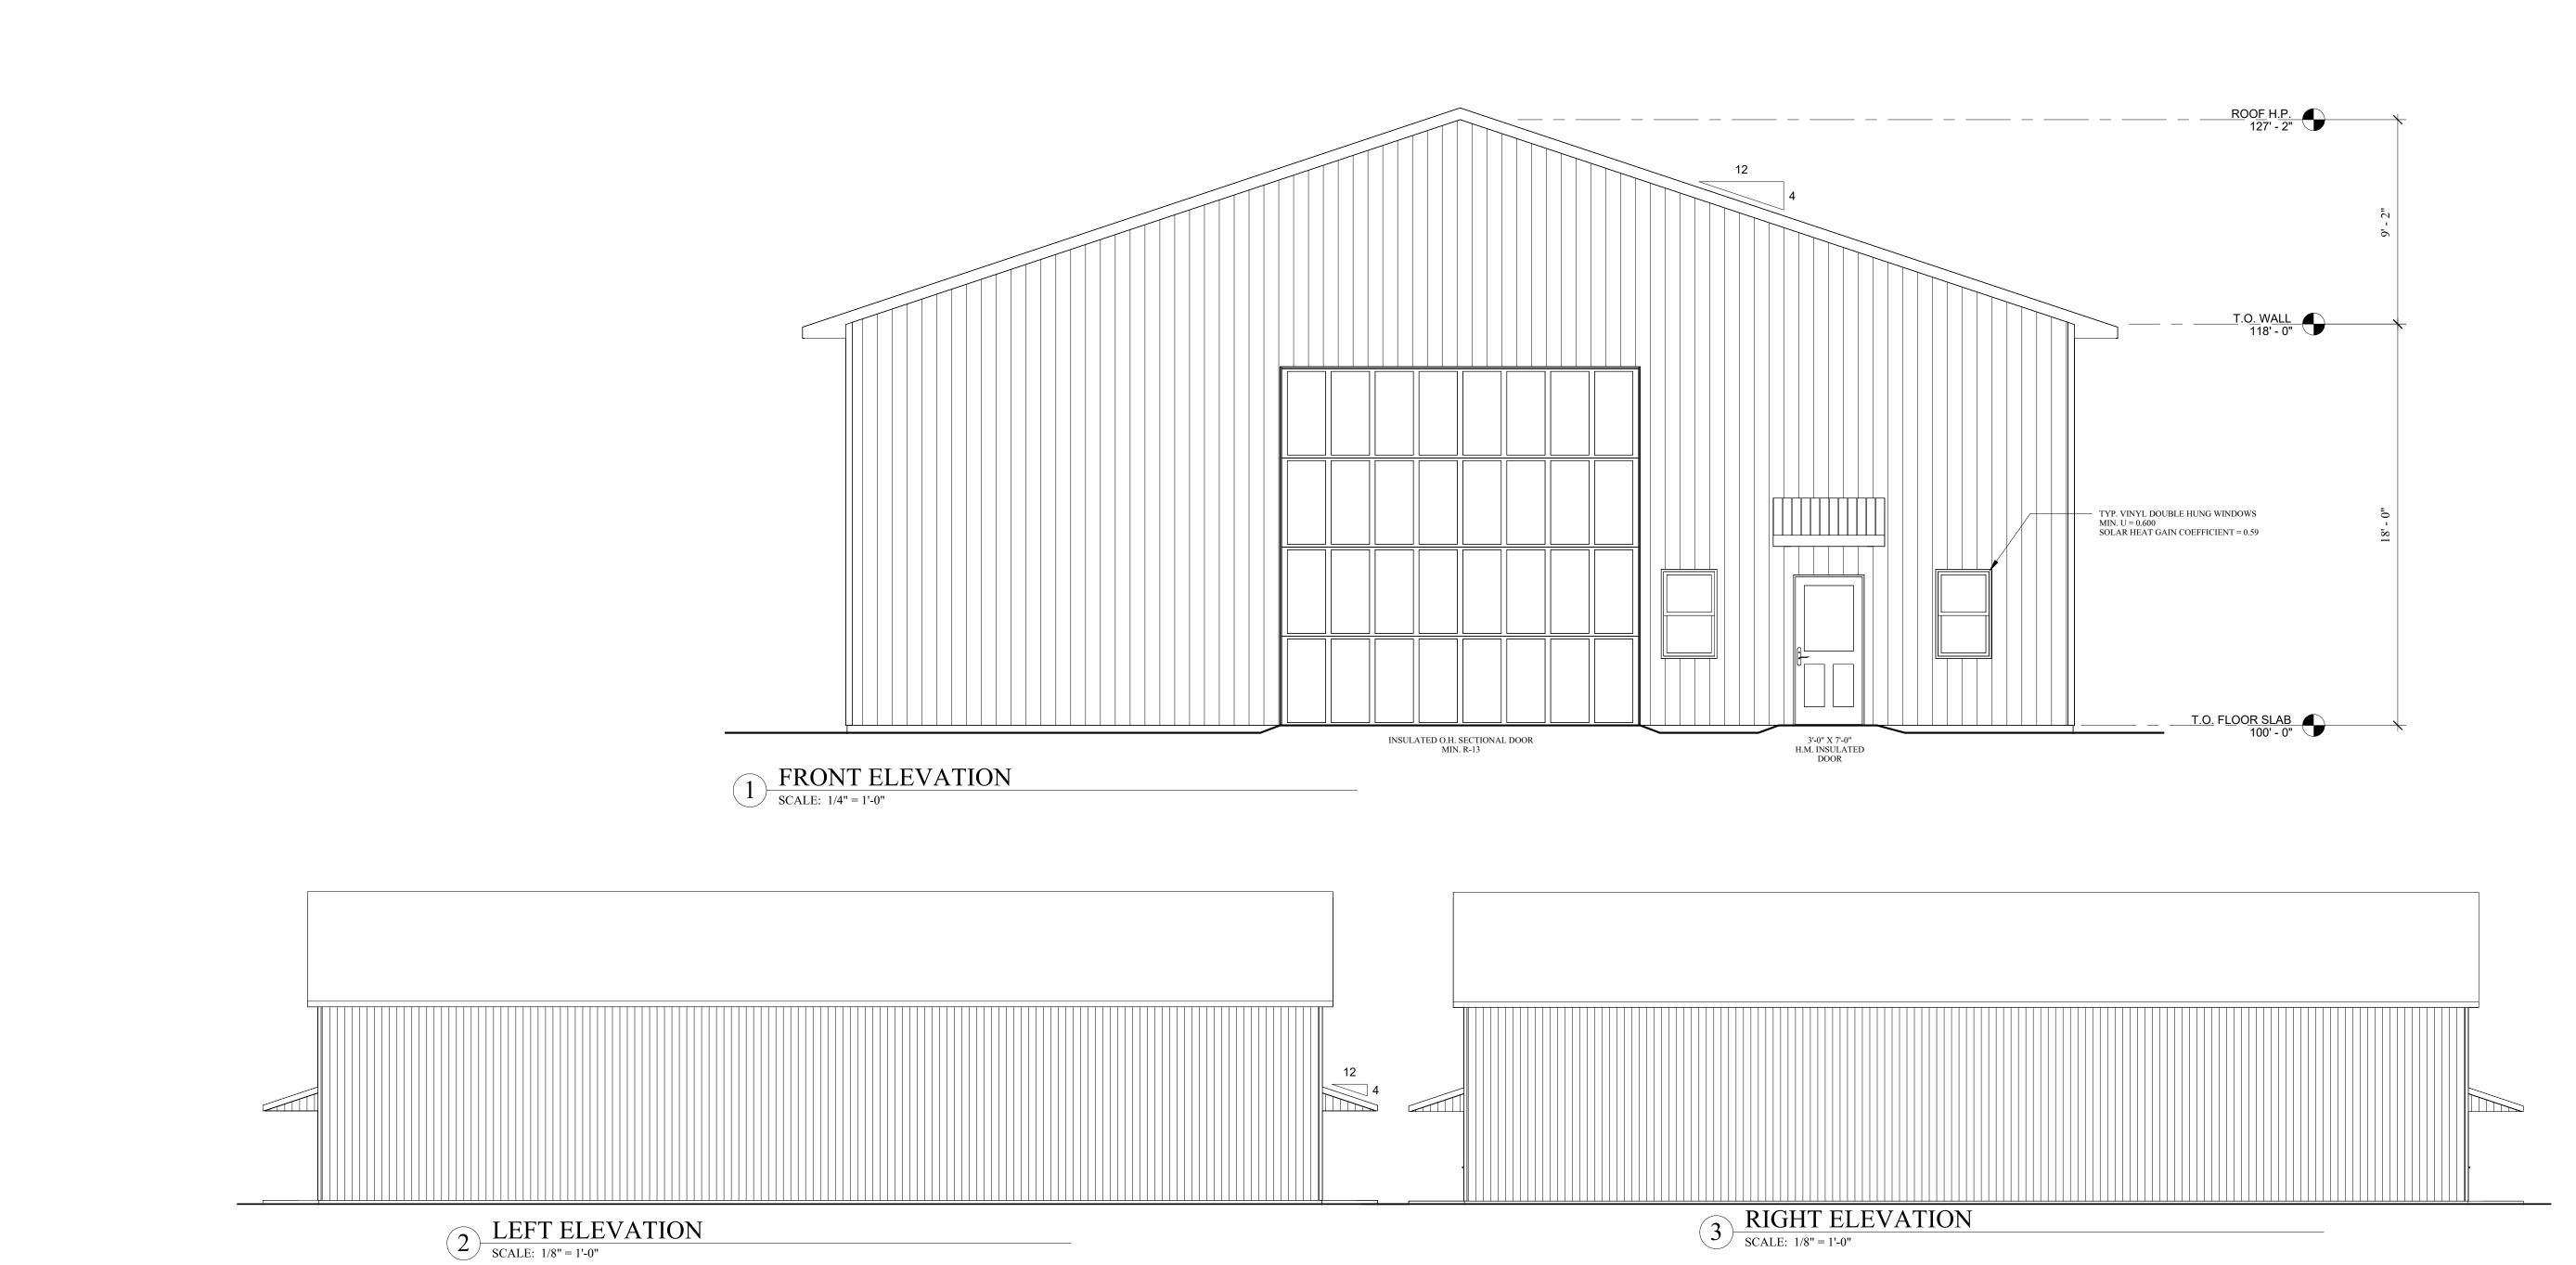

3'-0" X 7'-0" H.M. INSULATED DOOR

BACK ELEVATION

SCALE: 1/4" = 1'-0"

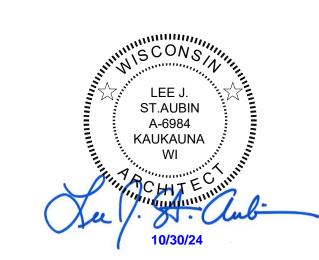

208 WEST WISCONSIN ST. SEYMOUR, WI 54165 W.SEYMOURLUMBER.COM 920.833.2324 920.833.2198


SEYMOUR LUMBER

Baisch

BAISCH ENGINEERING INC. 809 HYLAND AVE. P.O. BOX 440 KAUKAUNA, WI 54130 PHONE: (920)-766-3521 FAX: (920)-766-0670

VERIFY EXISTING SITE DATA

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**EXTERIOR** ELEVATIONS

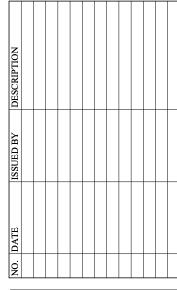SCALE: As indicated PROJECT: 2022-081 DATE: 9-7-2022 DRAWN BY: TA