Anax Yaa Andagan Yé Daakahídi Cultural Center: "Where the Sun Rays Touch First"

DOUGLAS INDIAN ASSOCIATION AND TRIBAL GOVERNMENT

35% COORDINATION SET

OWNER ARCHITECT MECHANICAL ELECTRICAL STRUCTURAL CIVIL LANDSCAPE LAND SURVEY

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PROJECT DESCRIPTION

SCOPE OF WORK DESCRIBED BELOW IS INCLUSIVE OF ALL ASSOCIATED ARCHITECTURAL, MECHANICAL AND ELECTRICAL WORK WITHIN, OR REQUIRED TO SUPPORT THE AREAS

THE WORK OF PROJECT IS DEFINED BY THE CONTRACT DOCUMENT DRAWINGS AND SPECIFICATIONS IS FOR THE CONSTRUCTION OF A NEW BUILDING. BASE BID AND DESIGN ALTERNATES AND CONSISTS OF THE FOLLOWING:

PHASE ONE SITE DEVELOPMENT. REMOVE OVERBURDEN MATERIAL DESCRIBED IN STRUCTURAL DRAWINGS AND PROVIDE ENGINEERED FILL TO DEPTH OF LOWER-LEVEL FOUNDATION. EXTEND LITILITIES AS REQUIRED TO COMPLETE THE PHASE 2. WORK. ANTICIPATE MATERIAL REMOVAL 4,800 CUBIC YARDS. ANTICIPATED PHASE 1 ENGINEERED FILL 3 500 CUBIC YARDS INCLUSIVE WITH PHASE 1 WORK IS PROVISION OF THE LOWER "HANNA BLOCK" SITE RETAINING STRUCTURE AS WELL AS THE ELECTRICAL UTILITY POWER LINE EXTENSION. ANTICIPATING CONSTRUCTION LATE SUMMER 2023

PHASE 2 BUILDING AND SITE CONSTRUCTION: WORK WILL INCLUDE CONSTRUCTION OF 2600 SE, TWO STORY BUILDING AND ALL OTHER FEATURES DEFINED IN THESE DOCUMENTS, INCLUDING CONSTRUCTION OF THE UPPER SITE RETAINAGE RAMPS, RAILINGS EXTERIOR ACCESS STAIRS, AND INSTALLATION OF HARDSCAPES AND LANDSCAPE FINISHING. ANTICIPATING CONSTRUCTION STARTING FALL 2023, EXTENDING THOUGH 2024 THE FF&E AND MOVE-IN EARLY IN 2025

GENERAL NOTES

SHEET INDEX

A10.0 3D VIEWS GENERAL

COVER SHEET G0.1 ABBREVIATIONS & LEGEND G1.0 SITE PLAN

CIVIL CIVIL SITE PLAN C1.0 C2.0 SECTION VIEWS

ARCHITECTURAL

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ROOF PLAN A2 4

A2.5 REFLECTED CEILING PLAN - LEVEL 0 A2.6 REFLECTED CEILING PLAN - LEVEL 1 EXTERIOR ELEVATIONS EXTERIOR ELEVATIONS BUILDING SECTIONS

BUILDING SECTIONS A5.0 ENLARGED SECTIONS A6.0

ENLARGED PLANS & INTERIOR ELEVATIONS A6.1 **ENLARGED PLANS & INTERIOR ELEVATIONS**

STRUCTURAL

GENERAL NOTES & ABBREVIATIONS

FOUNDATION PLAN FIRST FLOOR FRAMING PLAN ROOF FRAMING PLAN SECTION

SECTION SECTION

MECHANICAL SCHEDULES

COVER SHEET

SHEET#

G0.0


PLOT DATE: 06/05/2023 pound or number

CUR	cubical curtain	GB	grab bar
CW	curtain wall	GEN	general
CWB	cement board	GFCI	government furnish/contract
D	deep, depth	GI	galvanized iron
DBL	double	GL	glass
DEB	dry erase board	GND	ground
DEMO	demolish, demolition	GRD	grade
DEPT	department	GT	glass tile
DET	detail	GWB	gypsum wall board
DF	drinking fountain	GYP	gypsum
DIA.	diameter	H2O	water cooler
DIM	dimension	HB	hose bibb
DIV	division	HC	hollow core
DN	down	HDG	hot dipped galvanized
DP	dampproof(ing)	HDR	header
DR	door	HDWD	hardwood
DS	downspout	HDWE	hardware
DW	dishwasher	HM	hollow metal
DWG	drawing	HMT	hollow metal thermal break
DWR	drawer	HORIZ	horizontal
E	east	HR	hour
EA	each	HT	height
EF	exhaust fan	HTG	heating
EJ	expansion joint	HTR	heater
EL	elevation	HVC	heating/ventilating/cooling
ELEC	electrical	HWH	hot water heater
ELEV	elevator	ID	inside diameter
EM	entry mat	IG	insulated glass
EMER	emergency	IHM	insulated hollow metal
ENCL	enclosure	INCL	include
EP	electrical panelboard	INSUL	insulation
EPX	ероху	INT	interior
EQ	equal	IPS	interior paint system
EQUIP	equipment	JAN	janitor
EXH	exhaust	JST	joist
EXIST	existing	JT	joint
EXP	exposed	KD	knock down
EXPAN	expansion	KIT	kitchen
EXT	exterior/extend	КО	knock out
F	factory finish	L	length, long
FA	fire alarm	LAB	laboratory
FAB	fabricate	LAM	laminate
FAF	fluid applied flooring	LB	lock box (telephone)
FBCT	folding baby changing table	LH	left hand
FD	floor drain, file drawer	LIN	linoleum flooring
FDC	fire department connection	LKR	locker
FDN	foundation	LM	laminated glass
FE	fire extinguisher	LT	light
FEC	fire extinguisher cabinet	LWC	linear wood ceiling
FFL	finished floor line	M&E	mechanical and electrical
FG	fiberglass	MACH	machine
FH	fire hydrant	MATL	material
FHD	feminine hygiene disposal	MAX	maximum
FIN	finish	MBD	marker board
FLASH	flashing	MC	medicine cabinet
FLR	floor	MCP	metal ceiling panel
F0	face of	MCS	metal ceiling system
FOC	face of concrete	MECH	mechanical
FOF	face of finish	MEMB	membrane
FOS	face of studs	MET	metal
FP	fireproof	MFR	manufacturer
FRMG	framing	MGO	magnesium oxide
FRIVIG	fiberglass reinforced panels	MH	manhole
	fire retardant treated	MIL	millimeter
FRP		MIN	minimum
FRP FRT	full size		mirror
FRP FRT FS	full size folding shower seat	MIR	
FRP FRT FS FSS	folding shower seat	MIR	
FRP FRT FS FSS FT	folding shower seat foot, feet	MPI	Master Painter's Institute
FRP FRT FS FSS FT FTG	folding shower seat foot, feet footing	MPI MR	Master Painter's Institute moisture resistant
FRP FRT FS FSS FT FTG FURR	folding shower seat foot, feet footing furring	MPI MR MRGB	Master Painter's Institute moisture resistant moisture resistant gypsum I
FRP FRT FS FSS FT FTG FURR FUT	folding shower seat foot, feet footing furring future	MPI MR MRGB MSB	Master Painter's Institute moisture resistant moisture resistant gypsum I mop service basin
FRP FRT FS FSS FT	folding shower seat foot, feet footing furring	MPI MR MRGB	Master Painter's Institute moisture resistant moisture resistant gypsum I

GB	grab bar	MUL
GEN	general	MWP
GFCI	government furnish/contract install	N
GI	galvanized iron	N/A
GL	glass	NIC
GND	ground	NO
GRD	grade	NOM
	0	NSMF
GT	glass tile	
GWB	gypsum wall board	NTS
GYP	gypsum	OC
H2O	water cooler	OD
HB	hose bibb	OFCI
HC	hollow core	OFOI
HDG	hot dipped galvanized	ОН
HDR	header	OPNG
HDWD	hardwood	OPP
HDWE	hardware	OPO
HM	hollow metal	ORD
		_
HMT	hollow metal thermal break	PC
HORIZ	horizontal	PCR
HR	hour	PCT
HT	height	PERF
HTG	heating	PKG
HTR	heater	PL
HVC	heating/ventilating/cooling	PLAM
HWH	hot water heater	PLUM
ID	inside diameter	PLYWD
IG	insulated glass	PNL
IHM	insulated hollow metal	PR
INCL	include	PREFA
INSUL	insulation	PREFIN
INT	interior	PSF
IPS	interior paint system	PSI
JAN	janitor	PT
		PTD
JST	joist	
JT	joint	PTDR
KD	knock down	PTN
KIT	kitchen	PTR
KO	knock out	PVMT
L	length, long	QT
LAB	laboratory	RB
LAM	laminate	RCP
LB	lock box (telephone)	RD
LH	left hand	RE:
LIN	linoleum flooring	REBAR
LKR	locker	REF
LM	laminated glass	REFL
LT	light	REFR
LWC	linear wood ceiling	REINF
M&E	mechanical and electrical	REQD
MACH	machine	RESIL
MATL	material	RFEC
MAX	maximum	RH
MBD	marker board	RM
MC MRD		RO
	medicine cabinet	
MCP	metal ceiling panel	RP
MCS	metal ceiling system	RRS
MECH	mechanical	RSB
MEMB	membrane	RTD
MET	metal	RWL
MFR	manufacturer	SA
MGO	magnesium oxide	SASW
	-	
MH	manhole	SB
MIL	millimeter	SCHED
MIN	minimum	SCO
MIR	mirror	SD
MPI	Master Painter's Institute	SDT
MR	moisture resistant	SECT
MRGB	moisture resistant gypsum board	SH
MSB	mop service basin	SHTG
MTD	mounted	SHV
MTL	metal	SHWR

MUL	mullion	SLR
MWP	metal wall panel	SPEC
N	north	SQ
N/A	not applicable	SR
NIC	not in contract	SS
NO.	number	SSK
NOM NSMF	nominal	SSM
NTS	non-structural metal framing not to scale	STA
OC .	on center	STD
OD	outside diameter	STL
OFCI	owner furnish/contractor install	STN
OFOI	owner furnish/owner install	STRUC
OH	overhead	SUSP
OPNG	opening	SYM
OPP	opposite	SYS
OPQ ORD	opaque	T T&G
PC	overflow roof drain pre-cast	T.O.
PCR	proximity card reader	TB
PCT	porcelain tile	TBD
PERF	perforated	TBM
PKG	parking	TEL
PL	property line	TEMP
PLAM	plastic laminate	TFF
PLUM	plumb, plumbing	TG
PLYWD	plywood	THK
PNL PR	panel	TKBD TOB
PREFAB	pair prefabricated	TOC
PREFIN	prefinish(ed)	TOP
PSF	pounds per square foot	TOS
PSI	pounds per square inch	TOW
PT	paint	TPN
PTD	paper towel dispenser	TSCD
PTDR	paper towel dispenser and receptacle	TSPN
PTN PTR	partition	TTD
PVMT	paper towel receptacle pavement	TWF
QT	quarry tile	TYP
RB	resilient/rubber base	UL
RCP	reflected ceiling plan	UNFIN
RD	roof drain	UNO
RE:	regarding (see)	UR
REBAR	reinforcing bar	VB
REF REFL	reference reflected	VCT VERT
REFR	refrigerator	VEST
REINF	reinforc(ed)(ing)	VIF
REQD	required	VR
RESIL	resilient	W
RFEC	recessed fire extinguisher cabinet	W/
RH	robe hook, right hand	W/O
RM	room	WB
RO	rough opening	WC
RP	resin panel resilient rubber sheet	WCS WCV
RRS RSB	rubber self cove base	WD
RTD	rated	WDG
RWL	rain water leader	WDP
SA	self-adhered	WDW
SASW	self-adhered sheet waterproofing	WDWT
SB	shower bench	WH
SCHED	schedule	WOC
SCO	seat cover	WOM
SD	soap dispenser	WP
SDT SECT	static dissipative tile section	WR WS
SH	shelf	WSCT
SHTG	sheeting	WT
SHV	sheet vinyl	WWF
SHWR	shower	Σ
SIM	similar	≈

SLR	sealer	
SPEC	specification	
SQ	square	
SR	slip resistent	
SS	stainless steel	
SSK	service sink	
ST	solid surface material stain	
STA	station	
STD	standard	
STL	steel	
STN	stone	
STRUCT	structural	
SUSP	suspended	
SYM	symmetrical	
SYS	system	
T&G	perpendicular tongue and groove	_
T.O.	tongue and groove	_
TB	thermal break	_
TBD	to be determined	
TBM	tack board (modular)	
TEL	telephone	
TEMP	temporary	
TFF	troweled floor finish	
TG	tempered glass	
THK	thick	
TKBD TOB	tackboard top of beam	
TOC	top of concrete, top of curb	
TOP	top of concrete, top of curb	
TOS	top of steel	
TOW	top of wall	
TPN	toilet partition TS tube steel	
TSCD	toilet seat cover dispenser	
TSPN	transparent	
TTD	toilet tissue dispenser	
TV TWF	television	_
TYP	troweled wall finish typical	_
UL	Underwriters Laboratories, Inc.	
UNFIN	unfinished	
UNO	unless noted otherwise	
UR	urinal	
VB	vapor barrier	
VCT	vinyl composition tile	
VERT	vertical	
VEST	vestibule	
VIF VR	verify in field	
W	vapor retarder west, wide, width	_
W/	with	
W/O	without	
WB	window blind	
WC	water closet	
WCS	wood ceiling system	
WCV	wall covering	
WD	wood	
WDG	wood grille	
WDP	wood panel	
WDWT	window treatment	
WH	window treatment wall hung	
WOC	wall nung walkoff carpet	_
WOM	walkoff mat	_
WP	waterproof	
WR	water resistent/waste receptical	
WS	window shade	
WSCT	wainscot	
WT	window treatment	
WWF	woven wire fence	
Σ		
Σ	summation approximately	

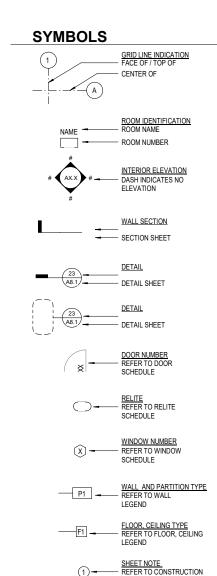

HEIGHT MARKER



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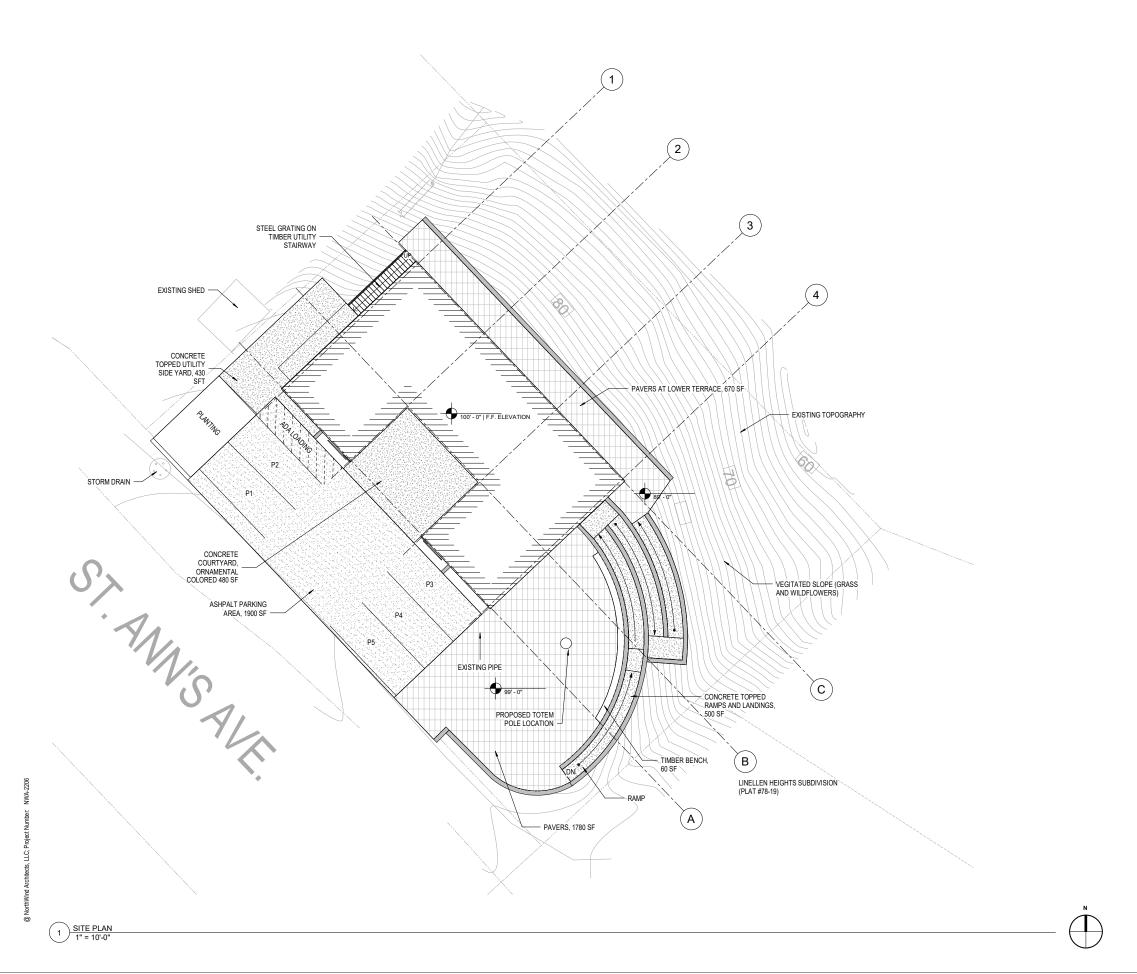
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Center **AYAYD** Cultural

SHEET TITLE: ABBREVIATIONS & LEGEND

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> **G0.1** SHEET#



1.
PARKING NOTES:

1.
SHEET NOTES:





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→1° ACTUAL

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ST, ANNS AVENUE DOUGLAS, ALASKA


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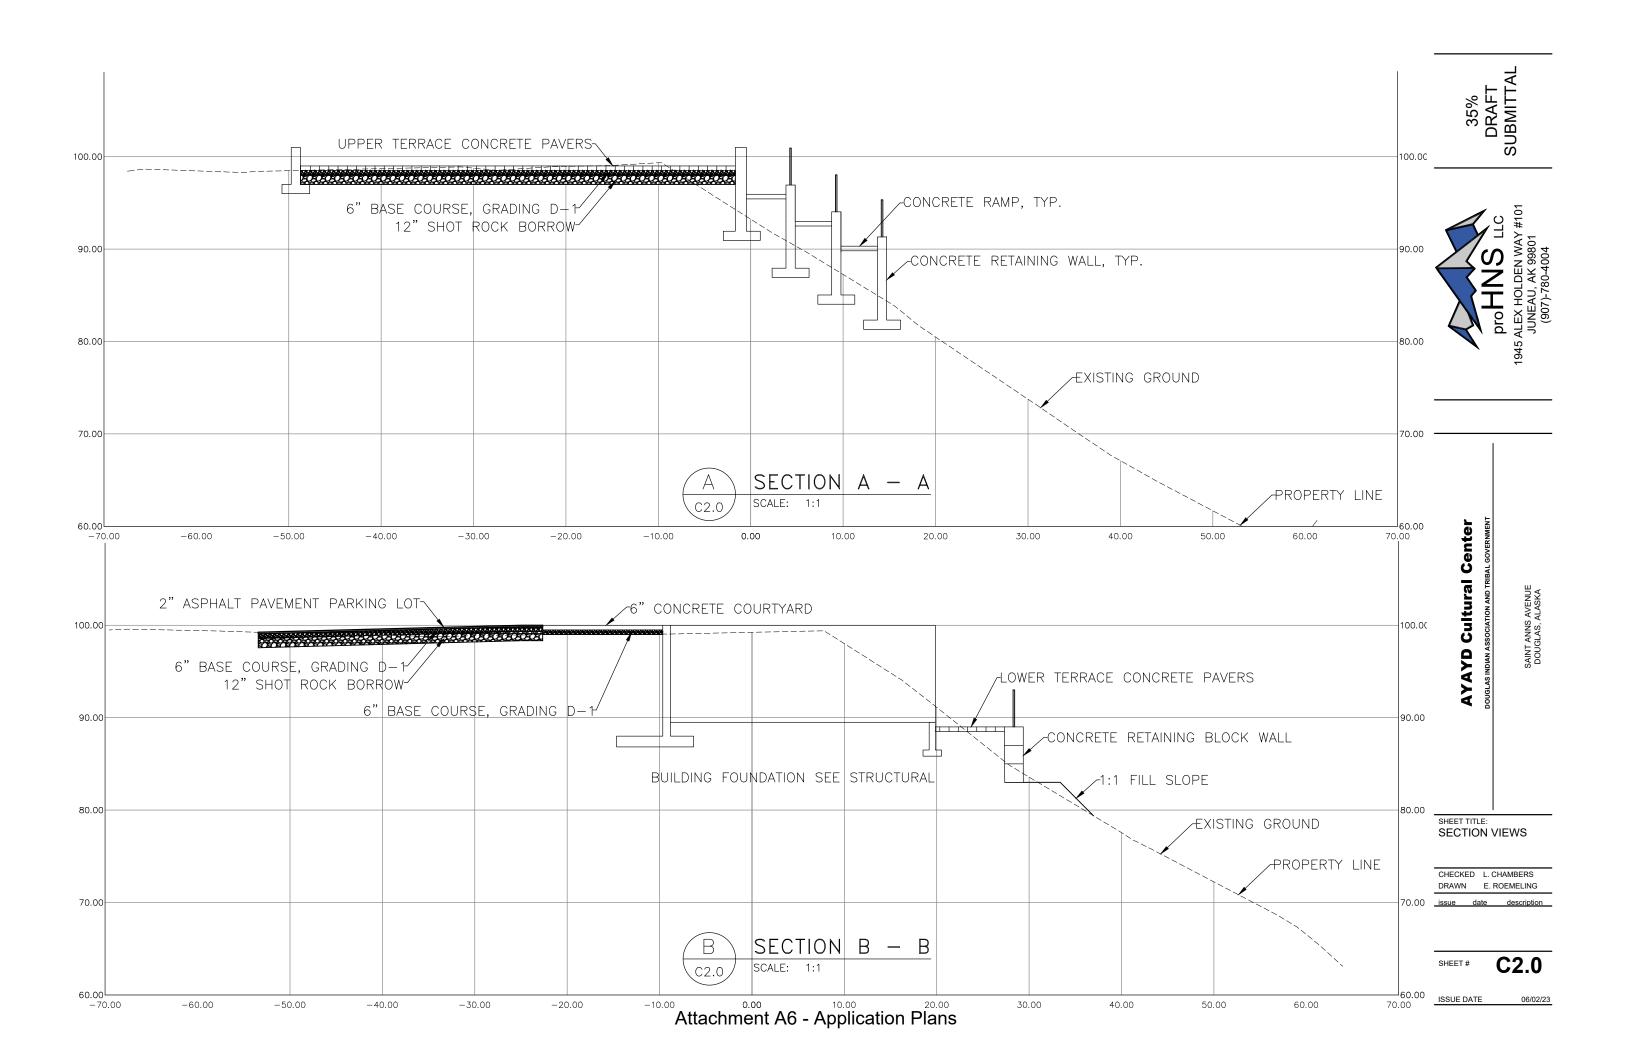
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SITE PLAN


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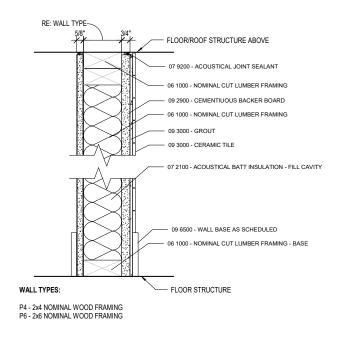
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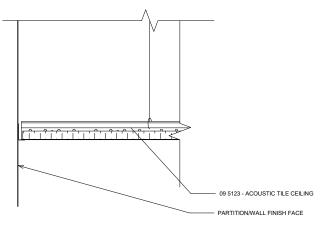







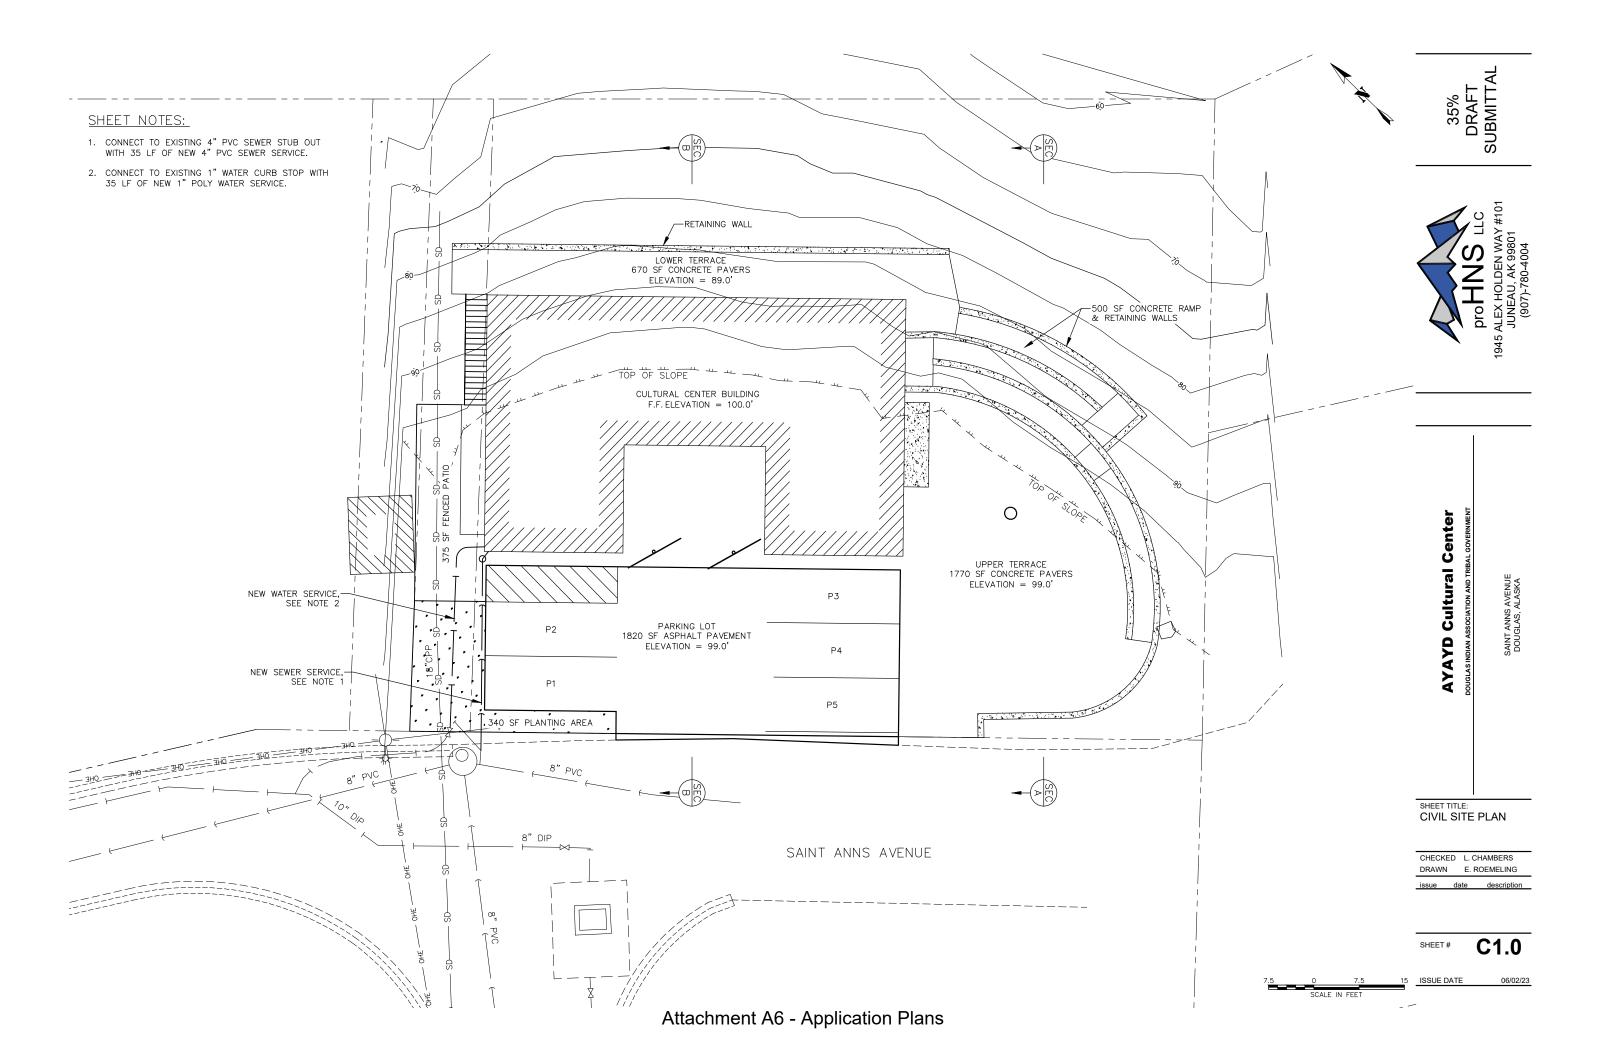

4 P()-CT - INTERIOR WOOD FRAMED PARTITION WITH CERAMIC TILE

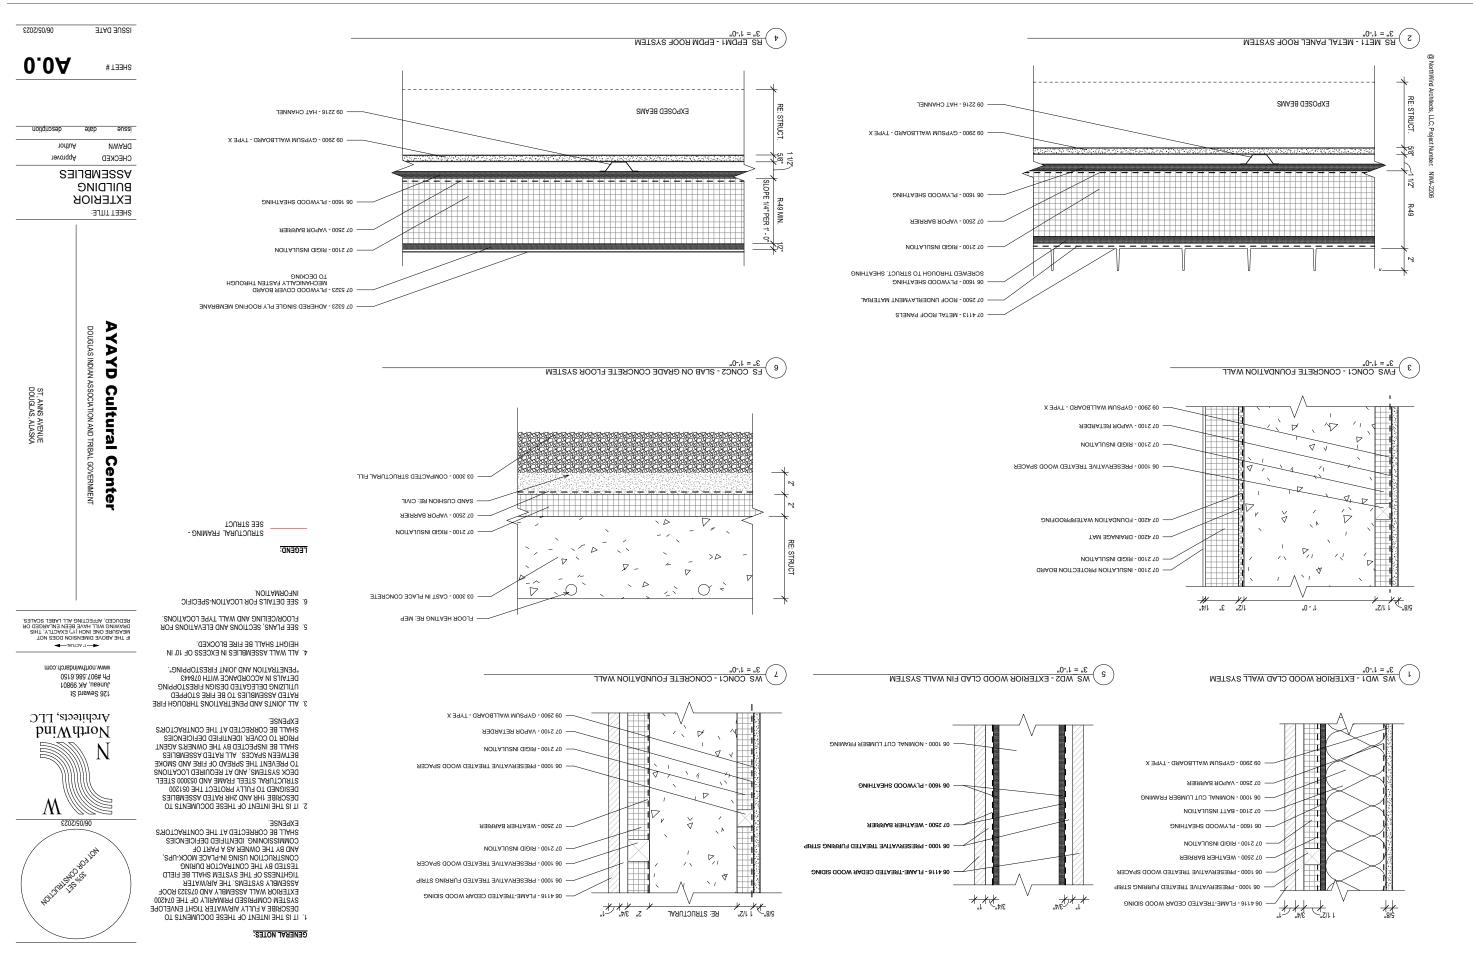

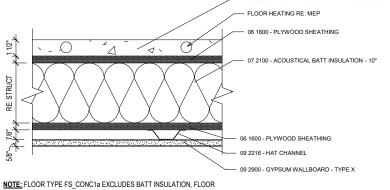

NOTE: FLOOR TYPE FS_CONC1a EXCLUDES BATT INSULATION, FLOOR HEATING, AND GYPSUM WALL BOARD. BOTTOM FACE IS CLAD WITH CEDAR SOFFIT PANELS

6 FS CONC1 - CONCRETE FLOOR & CEILING SYSTEM

GENERAL NOTES:


- IT IS THE INTENT OF THESE DOCUMENTS TO DESCRIBE A FULLY AIR/WATER TIGHT ENVELOPE SYSTEM COMPRISED PRIMARILY OF THE 074200 EXTERIOR WALL ASSEMBLY AND 075323 ROOF ASSEMBLY SYSTEMS. THE AIR/WATER ASSEMBLY STSTEMS. THE ANYWHER TIGHTNESS OF THE SYSTEM SHALL BE FIELD TESTED BY THE CONTRACTOR DURING CONSTRUCTION USING IN-PLACE MOCK-UPS, AND BY THE OWNER AS A PART OF COMMISSIONING. IDENTIFIED DEFICIENCIES SHALL BE CORRECTED AT THE CONTRACTOR'S
- IT IS THE INTENT OF THESE DOCUMENTS TO DESCRIBE 1HR AND 2HR RATED ASSEMBLIES DESIGNED TO FULLY PROTECT THE 051200 STRUCTURAL STEEL FRAME AND 053000 STEEL DECK SYSTEMS, AND AT REQUIRED LOCATIONS TO PREVENT THE SPREAD OF FIRE AND SMOKE BETWEEN SPACES. ALL RATED ASSEMBLIES SHALL BE INSPECTED BY THE OWNER'S AGENT PRIOR TO COVER. IDENTIFIED DEFICIENCIES SHALL BE CORRECTED AT THE CONTRACTOR'S
- 3. ALL JOINTS AND PENETRATIONS THROUGH FIRE RATED ASSEMBLIES TO BE FIRE STOPPED UTILIZING DELEGATED DESIGN FIRESTOPPING DETAILS IN ACCORDANCE WITH 078443
- 4. ALL WALL ASSEMBLIES IN EXCESS OF 10' IN HEIGHT SHALL BE FIRE BLOCKED.
- 5. SEE PLANS, SECTIONS AND ELEVATIONS FOR FLOOR/CEILING AND WALL TYPE LOCATIONS.
- 6. SEE DETAILS FOR LOCATION-SPECIFIC


LEGEND:

STRUCTURAL FRAMING -SEE STRUCT

RE: WALL TYPE FLOOR/ROOF STRUCTURE ABOVE 07 9200 - ACOUSTICAL JOINT SEALANT 09 2900 - GYPSUM WALLBOARD - TYPE X 06 1000 - NOMINAL CUT LUMBER FRAMING 07 2100 - ACOUSTICAL BATT INSULATION - FILL CAVITY 9 6500 - WALL BASE AS SCHEDULED 06 1000 - NOMINAL CUT LUMBER FRAMING - BASE - FLOOR STRUCTURE P4 - 2x4 NOMINAL WOOD FRAMING P6 - 2x6 NOMINAL WOOD FRAMING



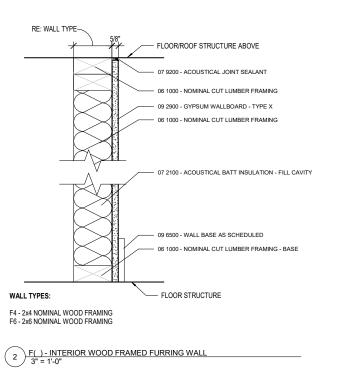

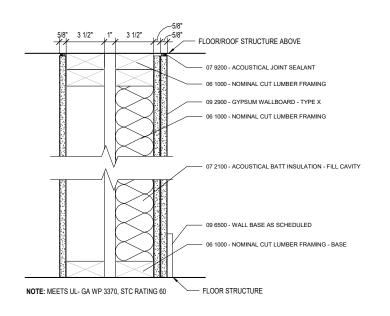

3 SW1 - INTERIOR WOOD FRAMED ELEVATOR SHAFT WALL PARTITION

06/05/2023



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SHEET TITLE:

INTERIOR BUILDING **ASSEMBLIES**

CHECKED Approver DRAWN Author date description issue

SHEET#

A0.1

1. SUBMITTALS: PROVIDE SUBMITTALS, INCLUDING SHOP DRAWINGS, PRODUCTLITERATURE, COLORPATTERN SELECTIONS, AND PROPOSED SUBSTITUTION POR CONSULTANT AND CLERK TREVIEW AND APPROVE PRIOR TO PROCUREMENT. DIGITAL SUBMITTALS FORMATTED TO STREAMLINE REVIEW PREFERRED. ANTICIPATE 10 DAY SUBMITTAL TURNAROUND BY A/E TEAM.
2. CONTRACTOR IS RESPONSIBLE FOR COORDINATION AND ASSEMBLY OF ALL COMPONENTS OF THE WORK.

/ISION 03 - CONCRETE E STRUCTURAL AND CIVIL SPECIFICATION

<u>JIVISION 05 - METALS:</u> SEE ALSO STRUCTURAL SPECIFICATION

SECTION 05 50 00 - METAL FABRICATIONS

1. OPEN FRAMING OF INTERIOR STARWAY (FAINTED)

2. OPEN PRAMING OF INTERIOR STARWAY.

2. STANKLESS STEEL PIEF HANDRAILS AT INTERIOR STARWAYS.

3. STANKLESS STEEL PIEF HANDRAILS AT INTERIOR STARWAYS.

4. HOT DIPPE GALVANIZED GUARDRAIL ASSEMBLY AT LANDSCAPE RAMP.

5. HOT DIPPED GALVANIZED GUARDRAIL ASSEMBLY AT LANDSCAPE.

6. HOT DIPPED GALVANIZED GUARDRAIL ASSEMBLY AT LANDSCAPE.

6. HOT DIPPED GALVANIZED GUARDRAIL ASSEMBLY AT LANDSCAPE.

RAMP AND STAR
GUNANZED STEEL GRANG STIR TREADS AT LANDSCAPE STARWAY.
316 ALLOY STANLESS STEEL CABLE NET INFILL PANELS AT
LANDSCAPE RAMP RAILING
STEEL PHOT POISTS FOR WOOD PANELS IN COURTYARD (PAINTED)
HOT DIPPED GALVANIZED STEEL TOTEMPOLE BASE ARMATURE IN
COURTYARD

SECTION 06 10 00 - ROUGH CARPENTRY

SEE ALSO STRUCTURAL SPECIFICATION

1. DIMENSION FRAMING LUMBER, WOOD BLOCKING AND NAILERS - FOR DIVISION 06 - WOOD, PLASTICS, & COMPOSITES:

SECTION 06 20 23 - INTERIOR FINISH CARPENTRY
1. INTERIOR WOOD TRIM:

INTERIOR MISCELLANEOUS BACKING USE: LOCATIONS AND THICKNESS PER DRAWINGS, GRADE ACX

A. INTERIOR TRIM FOR TRANSPARENT FINISH
a. SOLID SAWIN WOOD, PREMIUM, HEM.OCK, 37 MINIMUM,
B. INTERIOR FRAMES AND JAMBS FOR TRANSPARENT FINISH
a. SOLID SAWIN WOOD, PREMIUM CVG, HEMLOCK, 37 MINIMUM.

SECTION 06 20 30 - EXTERIOR FINISH CARPENTRY A. 2" THICK CEDAR SLABS GANGED TO GETHER IN TWO 10" X 10" CARVABLE PANELS - ICYS STRAIGHT LUMBER SUPPLIED (HOONAH)
B. SOLD 3" CEDAR IMBERS FOR CONFIGURATION AS CURVED SITE
BENCHALONG RETAINING WALL (SEE SITE PLAN), APPOXIMATELY
30 LF X 16" DEEP MOUNTED TO CAST CONCRETE SITE WALL.

SECTION 06 41 14 - PLASTIC LAMINATE FACED ARCHITECTURAL CABINETS E: PREMIUM

B. TYPE OF CONSTRUCTION: FRAMELESS
C. DOOR AND DRAWER-FRONT STYLE: 1/2" REVEAL OVERLAY
D. ADA KIWME SPACE AT VEGTABLE SINK IN TEACHING KITCHEN, AND
AT WASH SINK IN STAFF KITCHENETTE.
E. LAMINATE CLADDING: HIGH-PRESSURE DECORATIVE LAMINATE:
NEMA LD 3
a. BASIS OF DESIGN MANUFACTURER: FORMICA
b. COLOR: BLOND CEDAR 8576

CORNERS.

B. FASTENERS. INSTALL VERTICAL PLANK SIDING WITH
STAINLESS STEEL 3D RING SHANK NAILS, EVENLY
STAINLESS STEEL 3D RING SHANK NAILS, EVENLY
SPACED OVER HORIXONTAL 3M" X 3-1/2" PRESERVATIVE
TREATED OR CEDAR FURRING STRIPS, SPACES 16" O.C.

B. COLOR: BLOND CEDAR 8576
2. SOLID SUFFACE COUNTERTOPS:
A. SSM-1, FORMICA. - BIANCO MINERAL 758
3. STANKLESS STEEL COUNTERTOP AT KITCHEN: CUSTOM-FORMED
166A 316 ALLOY WITH SQUAARE EDGE AND WELDED CORNERS.
A. ISLAND TOP INTEGRATES STAINLESS STEEL VEGTABLE WASH
SINK, FINISHED ON 4 SIDES.
B. TOPS FLANKING RANGE FINISHED ON 2 SIDES, WITH INTEGRAL 6°
TALL STAINLESS STEEL BACKSPLASH.

O75200 SHEET METAL FLASHING, COPING, GUTTERS:

A CCESSORY SHEETMETAL TO MATCH: SLOPED ROOF FASCIA WRAP, ROOFING PERMETER FLASHINGS, GUTTERS AND DOWNSPOUTS, FLASHINGS, AT FENESTRATION.

COPINGS AND FLASHINGS. 24GA PVDF COATED STEEL SHEET, MITAL, COLOR:

A AT RENOVATE BUILDING THE EAVE AND RAKE WRAPS AND ATTERS TO BE WHITE. LLASHINGS AT

072500 WEATHER BARRIERS:

A T EXTERIOR WALLS:

1. WRB-1: SELF ADHERING, VAPOR PERMEABLE, WATER
RESISTIVE AIR BARRIER

A. VAPROSHELD - WALL SHIELD SA (GREEN).

FLEXIBLE FLASHING AND PRE-FORMED FLEXIBLE FLASHING INSIDE AND JUTISIDE CONNERS AND END DAMS:

1. BUTYL RUBBER FLASHING: COMPOSITE, SELF ADHESIVE, FLASHING PRODUCT CONISTING OF A PLIABLE, BUTYL RUBBER COMPOUND, BONCED TO A HIGH-DENSITY POLYETHYLENE FLM, ALUMINUM FOIL, OR SPUNBONDED POLYOLERIN

2. WEATHER BARRIER TAPE: USE WRB-1 WEATHER BARRIER TAPE AS FLEXIBLE FLASHING FOR ALL INSTANCES WHERE FLEXIBLE FLASHING IS NDICATED TO SEAL WRB-1 AND WRB-2 TO ITSELF OR TO ANY OTHER SUBSTRATE.

07260 VAPOR BARRIERS:

AT INSIDE FACE OF STUDS, UNDER FLOOR SLAB, OVER GRADE
AT EXISTING CRAWILSPACE:

1. VB-1. HIGH DENSITY POLYETHYLENE SHEET VAPOR

A 10 MIL MINIMUM, CLEAR
B. SEAL ALL LAPS AND PERIMETERS.
A TUNSERSIDE OF ROOF INSULATION, SLOPED AND FLAT ROOFS.

1. VB-2: LAMINATE WOVEN POLYETHYLENE, NONSUP, UV-PROTECTED BACKING LAYER ON 10% BUTYL RUBBER, SELF-ADHERING BASE LAYERS SUITABLE FOR APPLICATION IN FULLY ADHERED ROOFING SYSTEM:
A 30 MIL MINIMUM, 250 PSI, .05 PERMS

075419 SINGLE-PLY MEMBRANE ROOFING:

1. AT ROOF: 60 MILS HEAT WELDED PVC, FULLY ADHERED;

DOVERBOARD PLYWOOD WI FULL ADHESION TO UPLIFT, DESIGN BY ROOFING MANUFACTURER - MECHANICALLY FORTIENED POLYST TREENE INSULATION + MERRED EPS INSULATION KIT FOR 1/2" = 1' SLOPE TO

C. VAPOR RETARDER: ICE AND WATERSHIELD APPLIED TO FLAT STRUCTURAL DECK TO SERVE AS TEMPORARY WEATHER PROTECTION PRIOR TO INSTALLATION OF TAPER KIT AND ROOF DRAINS COMMERCIAL ROOF AND OVERFLOW DRAIN WITH DIBRIS SCREENS. SIZE FOR ROOF AREA, INSUALTE ALL ROOF DRAINLINES.

2. AT DECKIBALCONY: HEAT WELDED PYC TEXTURED TRAFFIC MEMBRANE. FULLY ADHERED: DURADECK ULTRA SURCOSEAL GREY, CONTACT: DURADECK NORTHWEST 1-800-442-9315

3. CEMENTITIOUS COVERBOARD PLYWOOD WI FASTENERS
TO UPLIFT, DESIGN BY ROOFING MANUFACTURER. TRIM FRAMING: TO SLOPE 1/4:17 AWAY FROM BUILDING TO RAILING.

074200 EXTERIOR WALL AND ROOF ASSEMBLIES:

WOOD CLADDING AND SOFFITS:

1. SIDING BOARDS. VERTICALLY ORIENTED FLAME-CHAR TREATED CVG CEDAR

A. ALTERNATING 5/4" X 8" AND X6, FLUSH T8G. TERNATING 5/4" X 8" AND X6, FLUSH T&G.
PENETRATING SEALER ON ALL FACES AND CUT) SPLICING OR SCARFING IN AN INSTALLED URSE. ALIGN COURSING. MITER OUTSIDE

METAL ROOFING:
1. STANDING SEAM, CONCEALED FASTENER 24 GA PVDF
COATED METAL ROOF PAVILLS,
A. BASIS OF DESIGN: MBCI BATTENLOK HS 12" PAN
FORMED METAL ROOF, CHARCOAL GREY.
2. PROVIDE CLAMP RAILING TYPE SNOW STOPS AT ALL
EAVES.

SECTION 07 21 00 - INSULATION

A PARTITION AND FLOOR ASSEMBLIES: GLASS FIBER BLANKET INSULATION.

B. UNFACED, TYPE I, ASTM C665, WITH MAXIMUM FLAME-SPREAD AND SMOKE-DEVELOPED INDEXES OF 25 AND 50, RESPECTIVELY, PER ASTM E88; PASSEM, ASTM E136 FOR COMBUSTION CHARACTERISTICS. THICKNESS AS INDICATED

AND GUTTERS TO BE WHITE. ILASHINGS AT FENESTRATIONS TO BE SELECTED BY ARCHITECT.

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ON DRAWINGS
ON DRAWINGS
ON DRAWINGS
RIGID INSULTION #1: ROXUL 1.5" MINERAL WOOL BOARD, MEDIUM
DENSITY, FOR USE UNDER WOOD SIDING,
RIGID INSULATION #2: TYPE XXX PEPS FOR USE IN ROOF ASSEMBLY
AND ON WARM SIDE OF CONCRETIE STURCTURE.
RIGID INSULATION TYPE #3: TYPE XXX PS FOR SUBGRADE USE,
UNDER CONCRETIE SLABS AND EXTIONR SIDE OF FOUNDATION

HIBERGLASS BATT WALL INSULATION
MINERAL WOOL BOARD INSULATION
ACCESSORY INSULATION FOR MISCELLANEOUS VOIDS: MINERAL
FIBER AND SPRAY FOAM INSULATION AS REQUIRED

1 WINDOWS, BASIS OF DESIGN MANUFACTURER: CASCADIA
2 BASIS OF DESIGN PRODUCTS:
A FIXED AND AWNING WINDOWS; UNIVERSAL SERIES
B STOREFRONT: UNIVERSAL SERIES STOREFRONT
C ENTRYJEXT DOORS, SWINGING AND OF THE PROPERTY. ENTRY/EXIT DOORS, SWINGING AND SLIDING: UNIVERSAL SERIES PATIO DOORS WITH FRAMES INTEGRATED INTO STOREFRONT.

(COUBLE CAZED)

EXT & MITERIOR FRAME FINISH: CHARCOAL GREY
HARDWARE: CORROSION RESISTANT FINISH ON HINGE
COMPONENTS AND STAINLESS STEEL MULTI-POINT LOCK
BACK, STAINLESS STEEL LOCKING KEEPERS, AND STAINLESS
STEEL ROTARY CRANK OPERATOR WITH FOLDING HANDLE.

087100 INTERIOR DOORS AND FRAMES:
1. DOORS: FACTORY CLEAR-FINISHED FIVE OR SEVEN PLY LUMBER

SECTION 10 28 00 - TOILET, BATH, AND LAUNDRY ACCESSORIES 1. PRODUCTS: BASIS OF DESIGN

DIVISION 10 - SPECIALITIES

NDRICAL LOCKSETS WITH ADA COMPLIANT LEVERS, ALL

დ. →

GASKETS AND SWEEPS: PENKO
PROVIDE CONTINUOUS WEATHERSTRIPPING AT EACH EDGE
OF EVERY EXTERIOR DOOR LEAF
SILENCERS AT INTERIOR DOORS: TIMELY
BRUSHED CHROME HARDWARE FINISH.

SECTION 088000 - GLAZING

EXTERIOR: COORDINATE WITH EXTERIOR FENESTRATION SUPPLIER; TRANSPARENT INSULATING GLASS. TEMPERED

WHERE REQUIRED.

B. INTERIOR TRANSPARENT GLAZING

a. CLEAR SAFETY GLASS

b. OVERALL THICKNESS: 3/8" NOMINAL

DIVISION 09 - FINISHES:

992900 GYPSUM BOARD:

1. 58° TYPE X. ASTM C1398/C1398M AT WALLS, CELLINGS
A. PROVIDE METAL CORNER TRIMS AND J.MOLDINGS, AND VINYL
EXPANSION JOINTS.
B. PROVIDE ALL DRYWALL MUDS AND TAPES, TEXTURES TO MATCH
EXISTING, PAINT OUT AS REQUIRED TO BLEND WITH

SURROUNDING.
MOISTURE RATED GYPSUM BOARD ASTM D3273 AT BATHROOM.
CEMENT BOARD BEHIND CERAMIC/PORCELAIN TILE.

BATHROOM WALLS: WET WALLS: CERAMIC TILE WAISCOT TO 50" AFF. ALL OTHERS: SCRUBBABLE WALL PAINT.

095100 ACOUSTIC CEILING TILE AND GRID:
1. ACT 1 - ASAIS OF DESIGN: ARMSTROUG ULTIMA 24X24 15/16"
18. KELED TEGLUAR, GRID "SILHOUETTE 1/4" RRVEAL, WHITE
2. SPECIAL SUBMITTAL: SEISMIC BRACING BY MANUFCTURER.

Attachment A6 - Application Plans

DIVISION 08 - OPENINGS:

INISHES AND HARDWARE
S: LOW-E COATED, INSULATED GLAZING UNITS

ORE WOOD DOORS.
A THICKNESS: 1-34"
B. FACING SELECTION: PLAIN SLICED, BOOK MATCH
C. FACE SPECIES TBD BY ARCHITECT.
D. STILE AND RAILS ARE BONDED TO CORE, THEN ENTIRE UNIT IS
ABRASINE PLANED BEFORE VENEERING.
2. FRAMES AND TRIM.
A SOLID SAWNLLIMBER, CLEAR FINISH TO MATCH DOOR FACES.
3. LITE OPENINGS.

A. FRAMESOLID SAWN LUMBER
A. FRAMESOLID SAWN LUMBER
B. GLAZING: FACTORY INSTALLED GLAZING IN DOORS INDICATED
TO BE FACTORY FUNSHED. COMPLY WITH REQUIREMENTS IN
SECTION 08800 "GLAZING"
1. SPECIAL DOOR - BETWEEN TEACHING KITCHEN AND EDUCATION
SPACE. WE WILL HAVE A 12" WIDE X 9" TALL NANAWALL 4 PANELS
WITH ONE PANEL CONFIGURED AS A SWING DOOR FOR DAILY USE
WHEN THE OTHERS ARE CLOSED. THIS SYSTEM WILL BE COPPED
TO THE TEACHING KITCHEN ISLAND COUNTERTOP AND WILL BE
WEATHER SEALED TO SEPARATE SOUND AND KITCHEN SMELLS
AND SOUNDS FROM THE ECOUCATION SPACE. FINISHES TO MATCH
OTHER DOOR AND FINISHES IN FACILITY.
5. DOOR HARDWARE
A. STANLEY-BEST OR ASSA ABLOY COMMERCIAL HARDWARE
A. STANLEY-BEST OR ASSA ABLOY COMMERCIAL HARDWARE
A. STANLEY-BEST OR ASSA ABLOY COMMERCIAL HARDWARE
A. STANLEY-BEST ALL DOORS

C. WALL OR FLOOR STOPS, HOLDERS AT ALL DOORS.
d. ADA CLOSERS WITH CONSEALED OVERHEAD STOPS ON
EXTERIOR DOORS, PROVIDED PARALLEL ARMS FOR ALL
OVERHEAD CLOSERS, UON.
e. PROTECTION PLATES. ROCKWOOD
• SIZES: FABRICATE PROTECTION PLATES (ARMOR, KICK OR
MOP) NOT MORE THAN 2" LESS THAN DOOR WIDTH ON
STOP SIDE AND NOT MORE THAN 1" LESS THAN DOOR
WIDTH ON PULL SIDE. X THE HEIGHT NIDICATED.
• METAL PLATES: STAINLESS STEEL, 18 GAUGE (0.050)
THICK, SATIN FINISH (US32D, 630), BEVELED FOUR EDGES

SECTION 101423 - ROOM - IDENTIFICATION PANEL SIGNAGE

SECTION 104400 - FIRE PROTECTION SPECIALTIES
A. FIRE PROTECTION EXTINGUISHERS & CABINETS
a. BASIS OF DESIGN; LL INDUSTRIES 2033F100
• SURFACE MOUNTED
• UP TO 20 LB FIRE EXTINGUISHERS
• #4 STANLESS STEEL
• FULL GLASS DOOR - CLEAR ACRYLIC GLAZING W/ "FIRE EXTINGUISHER"

DIE CAST "FIRE" HANDLE

SECTION 113100 - RESIDENTIAL APPLIANCES
A. DISHWASHER DIVISION 11 - EQUIPMENT

a. BASIS OF DESIGN:

• ADA COMPLIANT

• FINGERPRINT - RESISTANT STAINLESS STEEL

• 35 34" X 70" H X 25 38"D

B. MICROWAVE

B. MICROWAVE

BASIS OF DESIGN:

9.00 LIFT, 1500W

STAINLESS STEEL FACE

C. REFRIGERATOR WITH FREEZE AND ICE MAKER

BASIS OF DESIGN: GE CXX

CLEANSTEEL/STAINLESS STEEL

33.7/8" H X 19.3/4" W X 21 1/4" D

SECTION 11400 - COMMERCIAL KICHEN EQUIPMENT AND APPLIANCES
(EQUIPMENT, WILL BE COORDINATED WITH MECHANICAL:

A 48" WIDE 6-BURNER COMMERCIAL ELECTRIC RANGE WITH INTEGRATED OVEN.

B. TYPE 1 RANGE HOOD AND SUPPORTING EQUIPMENT
C. HIGH TEMPERATURE UNDERCOUNTER DISHWASHER
D. UPRIGHT SIDE BY SIDE COMMERCIAL REFRIGERATOR AND FREEZER, TOP
MOUNTED COMPRESSORS
E. 6'STANLESS STEEL WORK COUNTER ON STAINLESS STEEL LEGS,
INDERSEMBLESS

DRAWN

Approver Author

date

description

SHECKED

SPECIFICATIONS

SHEET TITLE:

6 HANGING PAN RACK OVE WORK COUNTER 3-WELL COMMERCIAL SINK ON STAINLESS STEEL LEGS W/ WASHER HOSE AND DRAINING SIDE APRONS, FLOOR MOUNTED GREASE INTECEPTOR.

096005 FLOORING SPECIALTIES - RUBBER BASE, STAIR NOSING AND TRANSITIONS:
BASIS OF DESIGN: THERMOSET RUBBER BY ROPE OR JOHNSONITE. 4" COVE BASE

AND WALKING SURFACE TRANSITIONS COLOR TO BE COORDINIED WITH FLOORING SELECTION. RUBBER BASE INSTALL LOCATIONS AS SCHEDULED.

086500 LUXURY VINYL TILE (LYT) FLOORING: 1. LVT: UPSTAIRS EDUCATION SPACE, DOWNSTIAR CIRCULATION SPACE, AND UPSTAIRS. LOBBY

UPSTAIRS LOBBY A. GLUE-DOWN TYPE, 30-YEAR BY ARMSTRONG

096516 - RESILIENT SHEET FLOORING

1. RESILIENT FLOORING, KITCHEN AND UTILTIY SPACES
A. MANUFACTURER: TARKETT
B. STYLE: OPTIMA
C. COLOR: SILVER BELLS 0872

08680 COMMERCIAL CAPPET:

1. WALK OFF CARPET TILE: 75X*IN FRONT OF EACH UPSTAIRS LOBBY AND DOWNSTAIRS LOUNGE DOORS.

1. WALK OFF CARPET TILE: 10X*IN FRONT OF EACH UPSTAIRS LOUNGE DOORS.

2. BROADLOMO KAPPET IN OFFICES SMALL MEETING ROOM

2. BROADLOMO KAPPET IN OFFICES SMALL MEETING ROOM

3. BASIS OF DESIGN: GOOD WILL-BC528 BY MOHAWK GROUP

089123 INTERIOR PAINTING:

1. INTERIOR DESIGN-BUILD COORDINATION WITH OWNER:

A AT INTERIOR CYPSUM WALLBOARD SURFACES PREP AND PAINT WITH ONE

A COAT PA PRIMER AND COAT'S REQUIRED TO COVER OF EGGSHELL LATEX

DANT

SECTION 09 77 13 - ACOUSTICAL FABRIC WRAPPED PANELS 1. PRODUCTS: PAINT.
PAINT OR CLEAR FINISH ALL INTERIOR WOOD DOORS, FRAM AND AND TRIM THAT IS A PART OF THE WORK.

SUSPENDED FABRIC WRAPPED PANELS, DOWNSTAIRS HALLWAY, LOUNG E AND
KITCHEN, UPSTAIRS BETIVEEN BEAMS IN CLASSROOM.

a. MANUFACTURER: FABRITACK
b. STYLE: GEO TRAK SYSTEM
c. SYSTEM: TERRACORE POLY
d. THOKNESS: T
d. THOKNESS: TO BE SELECTED BY ARCHITECT

321216 ASPHALT PAVING 3" ASPHALT PAVING OVER COMPACTED D1 BASE AND COMPACTED NSF SUB-BASE. PROVIDE PAINTED PARKING AND ACCESSIBILITY STRIPING DIVISION 32 - HARDSCAPE - COORDINATE WITH CIVIL DRAWINGS

GARMENT HOOK (GH); BOBRICK B-682, STANLESS STEEL SATIN FINISH
TOLET PAPER DISPENSER (TPD); BOBRICK B-340, STANLESS STEEL SATIN FINISH
GARAB BAR (GB); BOBRICK B-5806, STAINLESS STEEL SATIN FINISH, DIMENSIONS PER DRAWNINGS
DIAPER-CHANGING STATION (BCS); BOBRICK KB310-SSRE, STAINLESS STEEL
PAPER TOWLE DISPENSER (PTD); OFOI
PAPER TOWLE DISPENSER (PTD); OFOI
PAPER TOWLE DISPENSER (MS);
LIQUID-SOP DISPENSER (MSD); OFOI
HAND SAMITZER DISPENSER (MSD); OFOI
HAND SAMITZER DISPENSER (MSD); OFOI
MIRROR UNIT (MIR); BOBRICK B-165 2430, STAINLESS STEEL SATIN FINISH
MIRROR UNIT (MIR); BOBRICK B-165 2430, STAINLESS STEEL SATIN FINISH 321400 UNIT PAVERS LINEAR PRECAST CONC PATTERN OVER COMP 4" REINFORCED CONCRETE SIDEWALKS OVER COMPACTED D1 BASE. PROVIDE CONTROL JOINTS AT NO MORE THAN 6" CENTERS. WASHED AGGREGATE SURFACE FINISH.

LINEAR PRECAST CONCRETE UNIT PAVERS, 4"X4"X 24" TYP. BASKET WEAVE PATTERN OVER COMPACTED D1 BASE. 8000 PSI MINMUM CONCRETE, SANDBLASTED FINISH. WWW.MODERNPAVERS.NET

PROVIDE METAL POST MOUNTED ACCESSIBLE VAN PARKING SIGNAGE PER LOCAL REQUIREMENTS.

PROVIDE BUILING ADRESS NUMBERS 6" TALL CAST ALUMINUM "1021".

DE OWNER ORGANIZATION SIGNAGE PRINTED ON,2 TALL X 5 WIDE ICK ALUMNUM SHEET ON TWO 3 XX" ALUMNUM TUBES SET INFO ICK ALUMNUM TUBES SET INFO ICK ALUMNUM TUBES SET INFO ICK-ALE WHERE INDICATED, COORDINATE SIGNAGE LED SITE INFO ICH DALECTRICAL DRAWINGS. BACK OF SIGN AND SUPPORT TO BE PAINTED DARK BROWN. COORDINATE SIGNAGE DESIGN WITH TECT AND OWNER.

DIVISION 12 - FURNISHINGS

SECTION 122413 - ROLLER WINDOW SHADES
1. SUBMITTALS: PRODUCT DATA
2. PRODUCTS:

LER WINDOW SHADE, RS-1: ANUFACTURER: DRAPER

6. COLOR: WHITE PLATINUM
6. COLOR: WHITE PLATINUM
6. COLOR: WHITE PLATINUM
6. ROLLER WINDOW SHADE, RS2:
a. MANUFACTURER: MECHO SHADE
b. STYLE: CHELSEA BLACKOUT
6. COLOR: TO BE SELECTED BY ARCHITECT FROM MANUFACTURES
FULL RANGE OF COLORS
d. VALANCE: CLEAR ANODIZED ALUMINUM FASCIA

 \leq

DIVISION 21-25. MECHANICAL/HYAC/PLUMBING
REFER TO MECHANICAL AND PLUMBING DRAWINGS AND SHEET
SPECIFICATIONS.

DIVISION 26-28 - ELECTRICALREFER TO ELECTRICAL DRAWINGS AND SHEET SPECIFICATIONS.

DIVISION 31 - EARTHWORK

1. COORDINATE WITH CIVIL AND LANDSCAPE DRAWINGS. AS REQUIRED TO ONDELTE THE WORK REPAIR SOILS AND PLANTING IN AREAS OF SITE DISTURBANCE. ALL FINISH GRADE SURFACES TO DRAIN AWAY FROM BUILDING.

2. COORDINATE WITH ARCHITECTURAL SITE PLANS AND LANDSCAPE DRAWINGS AND SPECIFICATIONS.

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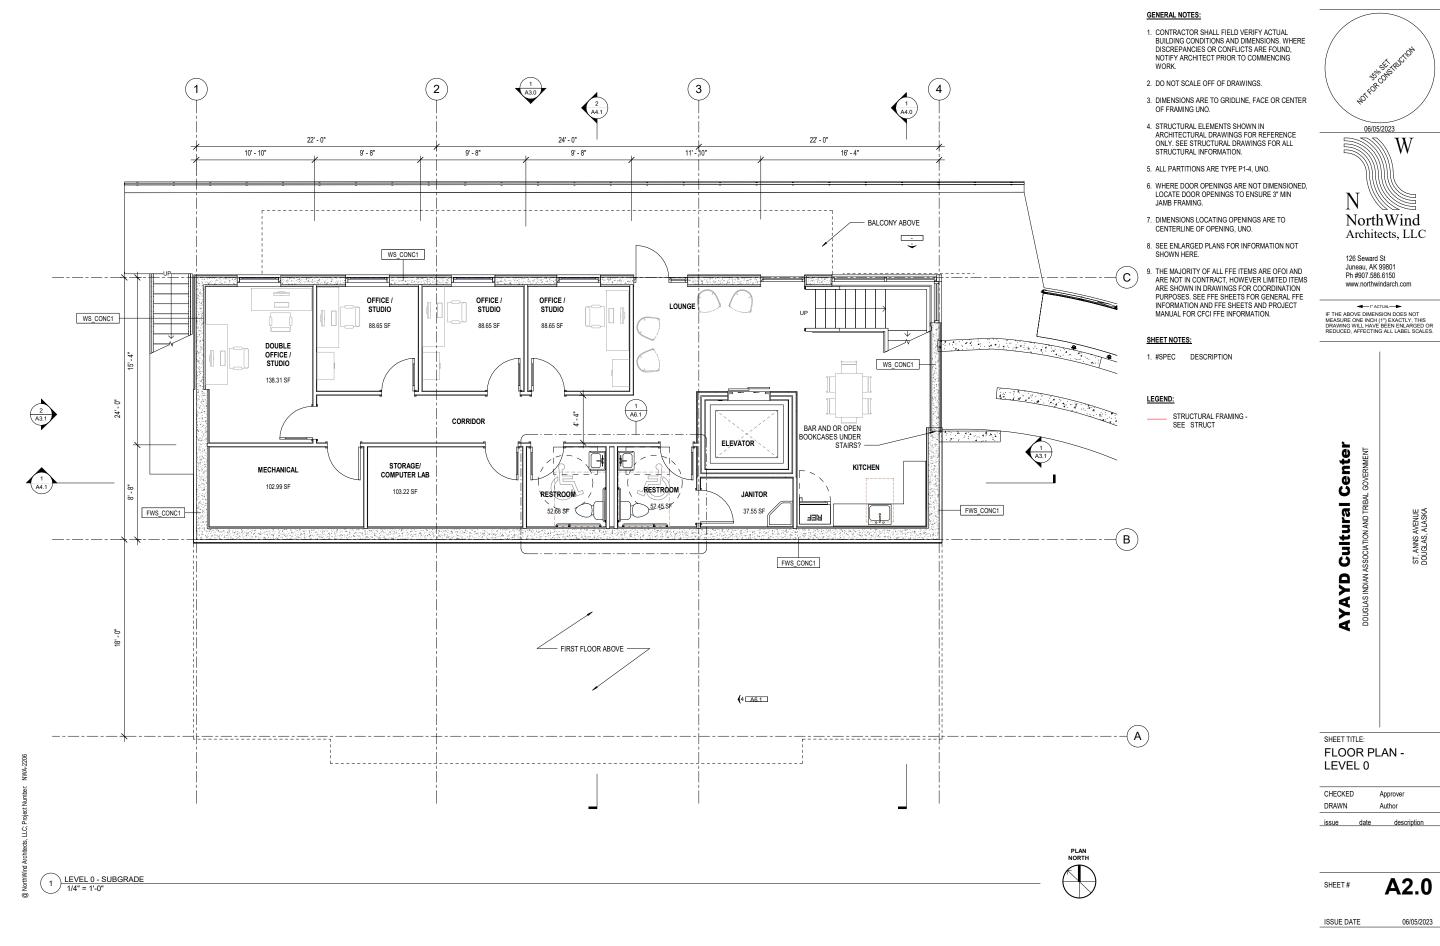
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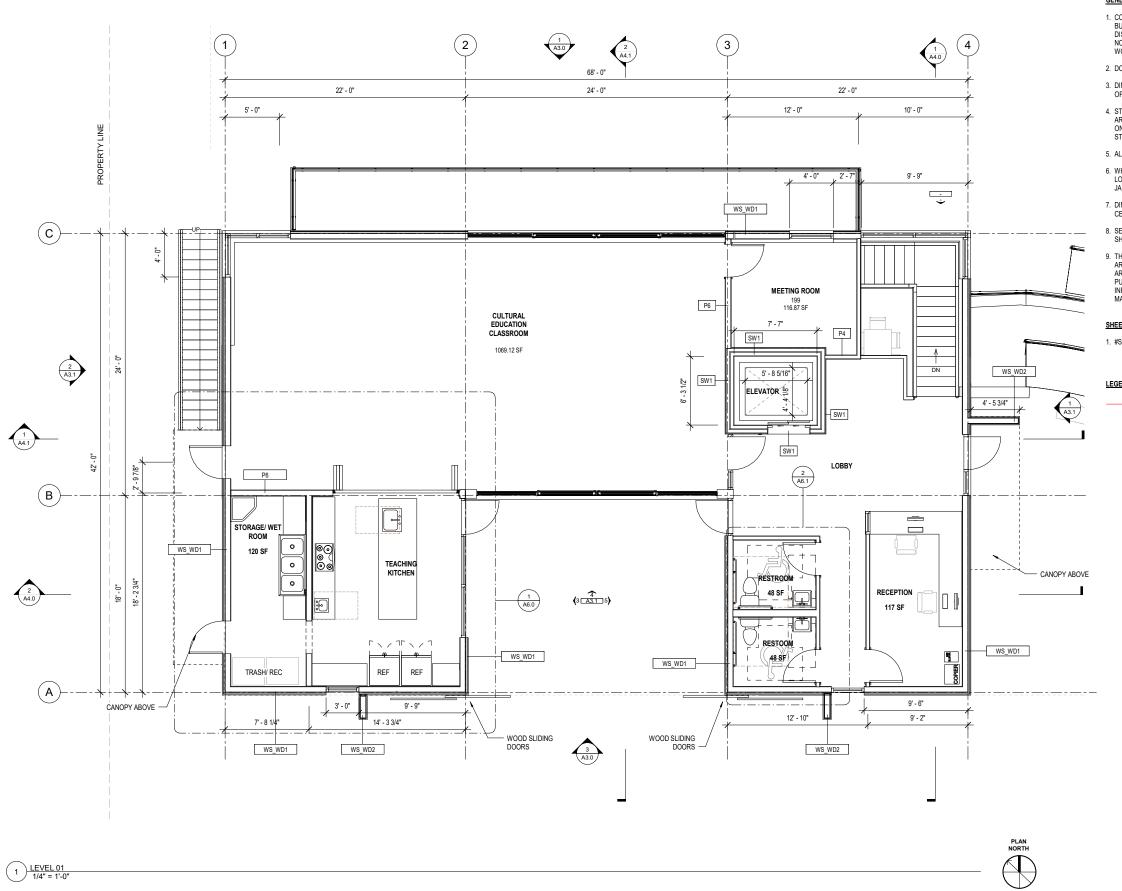
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- CONTRACTOR SHALL FIELD VERIFY ACTUAL BUILDING CONDITIONS AND DIMENSIONS. WHERE DISCREPANCIES OR CONFLICTS ARE FOUND, NOTIFY ARCHITECT PRIOR TO COMMENCING
- 2. DO NOT SCALE OFF OF DRAWINGS.
- 3. DIMENSIONS ARE TO GRIDLINE, FACE OR CENTER OF FRAMING UNO.
- STRUCTURAL ELEMENTS SHOWN IN ARCHITECTURAL DRAWINGS FOR REFERENCE ONLY. SEE STRUCTURAL DRAWINGS FOR ALL STRUCTURAL INFORMATION.
- 5. ALL PARTITIONS ARE TYPE P1-4, UNO.
- WHERE DOOR OPENINGS ARE NOT DIMENSIONED, LOCATE DOOR OPENINGS TO ENSURE 3" MIN JAMB FRAMING.
- 7. DIMENSIONS LOCATING OPENINGS ARE TO CENTERLINE OF OPENING, UNO.
- 8. SEE ENLARGED PLANS FOR INFORMATION NOT SHOWN HERE.
- 9. THE MAJORITY OF ALL FFE ITEMS ARE OFOI AND ARE NOT IN CONTRACT, HOWEVER LIMITED ITEMS ARE SHOWN IN DRAWINGS FOR COORDINATION PURPOSES. SEE FFE SHEETS FOR GENERAL FFE INFORMATION AND FFE SHEETS AND PROJECT MANUAL FOR CFCI FFE INFORMATION.

SHEET NOTES:

1. #SPEC DESCRIPTION

LEGEND:

STRUCTURAL FRAMING -SEE STRUCT





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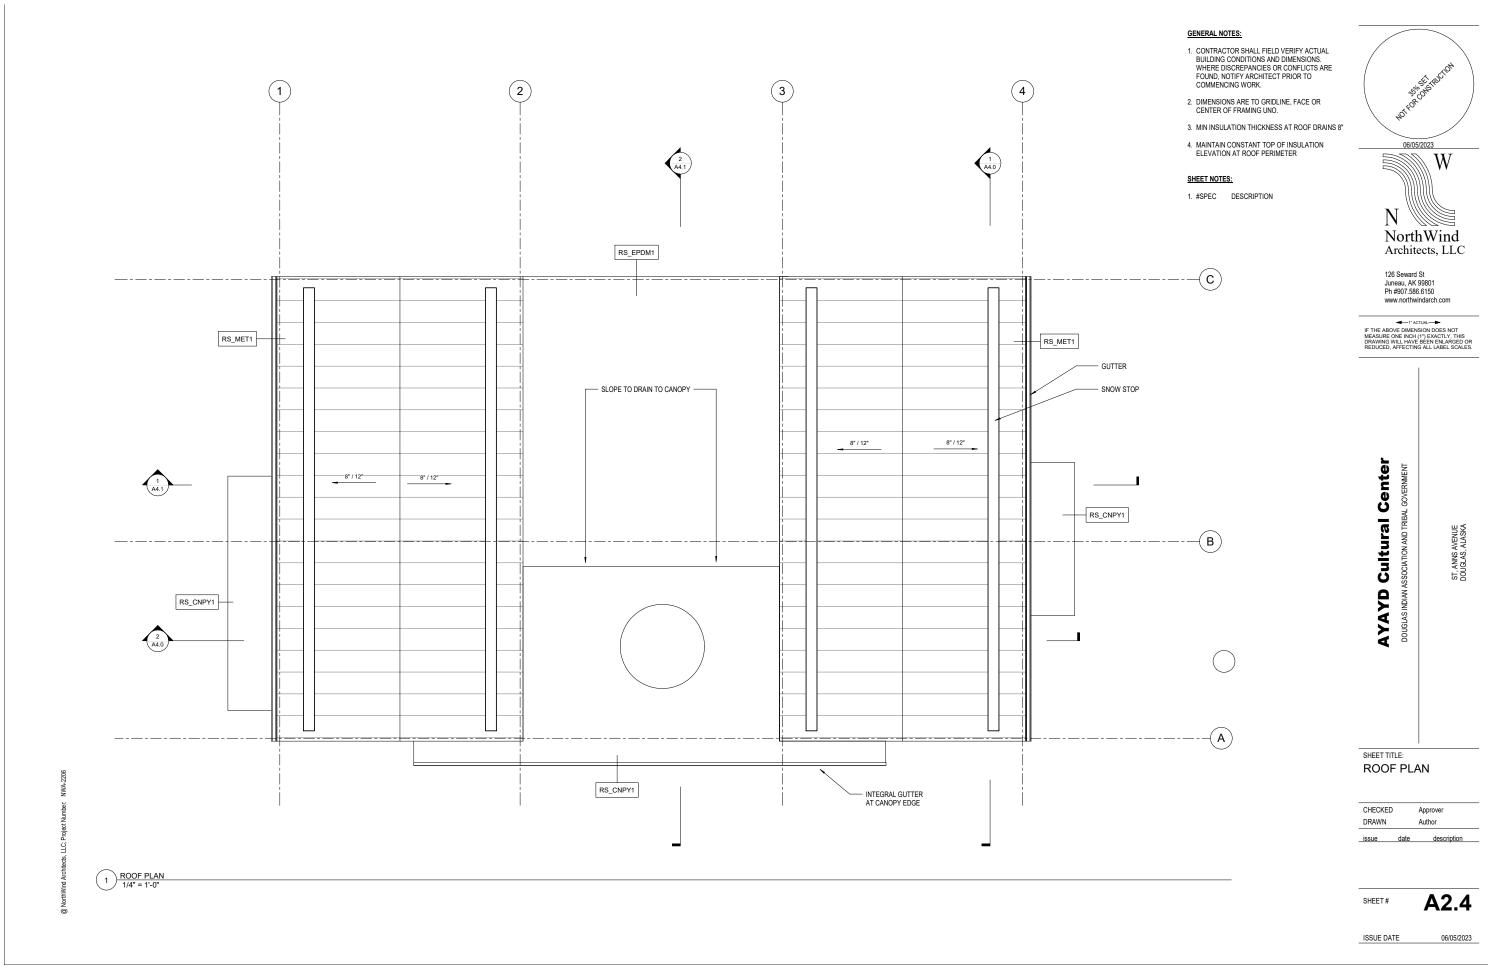
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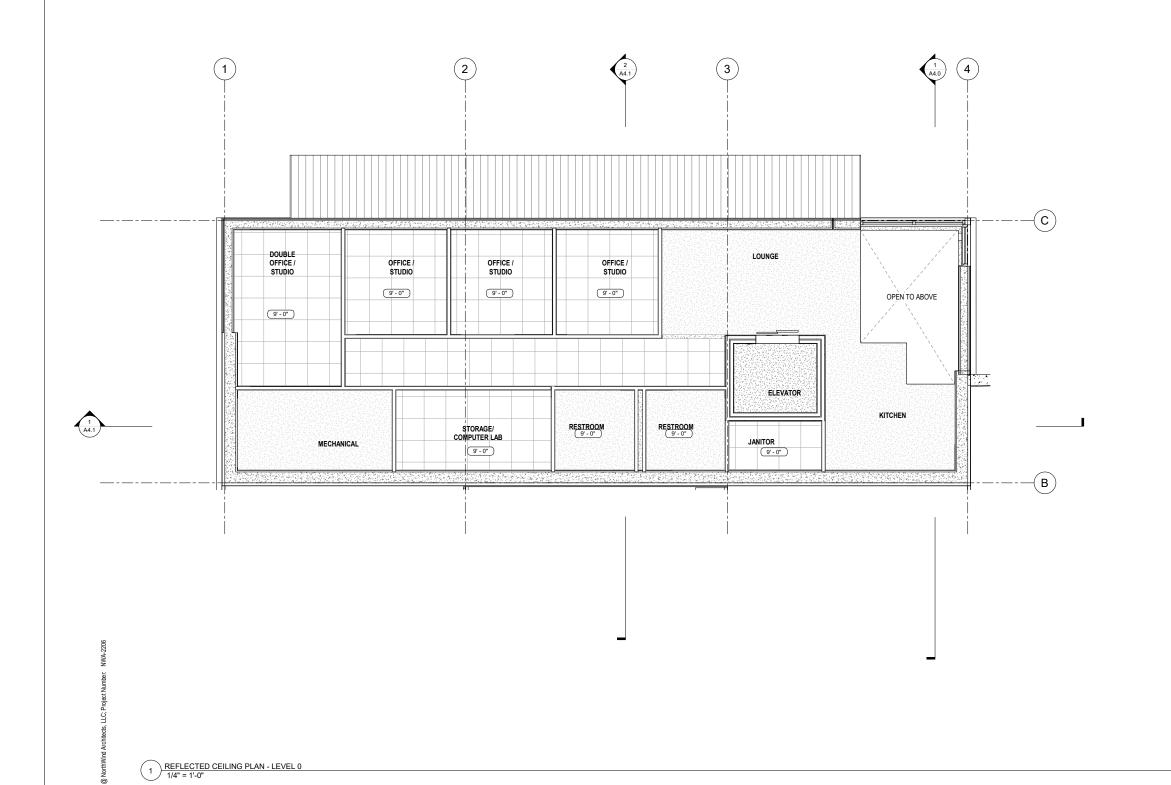
SHEET TITLE: FLOOR PLAN -LEVEL 1

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SHEET#

A2.1





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- 2. DO NOT SCALE OFF OF DRAWINGS
- 3. ALL CEILING HEIGHTS ARE 9' 0" AFF, UNO.
- 4. COORDINATE LOCATION OF ALL MEP ITEMS WITH
- MEP.
 5. CENTER MEP ITEMS INCLUDING SPRINKLER HEADS IN CEILING TILES.
- LINEWORK DEPICTING CEILING TILES IS TO SHOW EXTENT ONLY. POSITION GRID SUCH THAT NO EDGE TILES IS LESS THAN 6" IN WIDTH. CENTER GRID IN SPACES WHEREVER POSSIBLE.
- 7. LINEWORK DEPICTING CEILING PENETRATIONS ARE SHOWN FOR REFERENCE ONLY. SEE MEP.

SHEET NOTES:

1. #SPEC DESCRIPTION

LEGEND:





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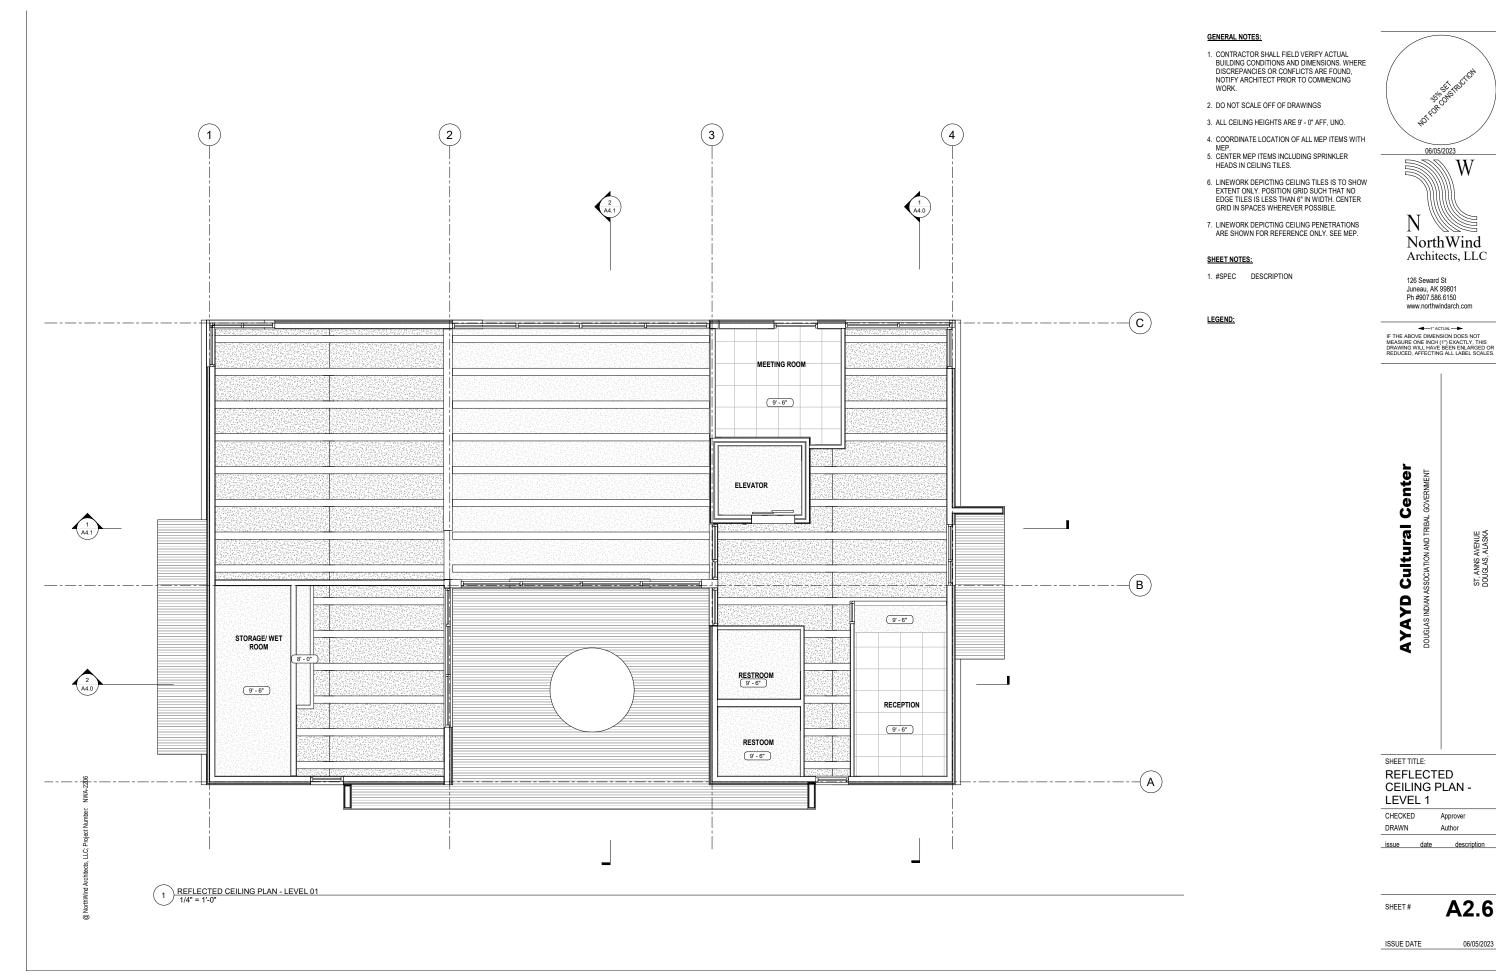
SHEET TITLE: REFLECTED CEILING PLAN -LEVEL 0

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issue date description

SHEET#

A2.5



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Author


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- 5. SECTION DRAWINGS FOR REFERENCE ONLY IDENTIFY DATUM AND DETAILS. NOT FOR CONSTRUCTION.
- 6. TAPERED INSULATION SLOPES NOT SHOWN FOR

SHEET NOTES:

1. #SPEC DESCRIPTION



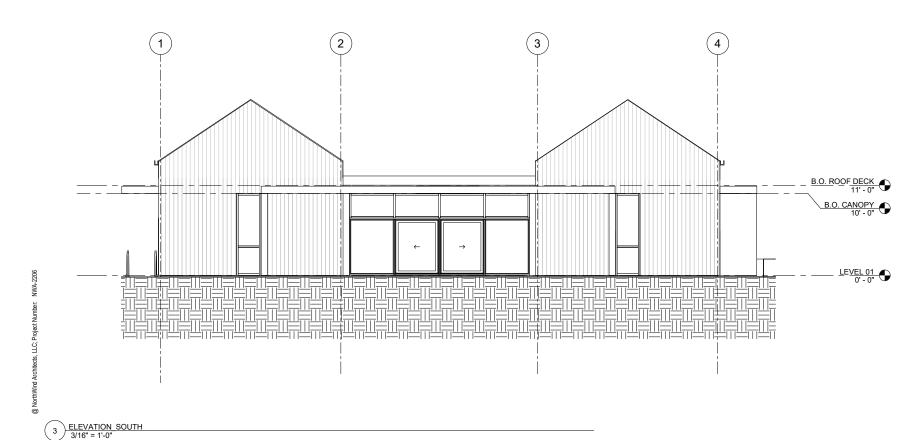

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SHEET TITLE:

EXTERIOR


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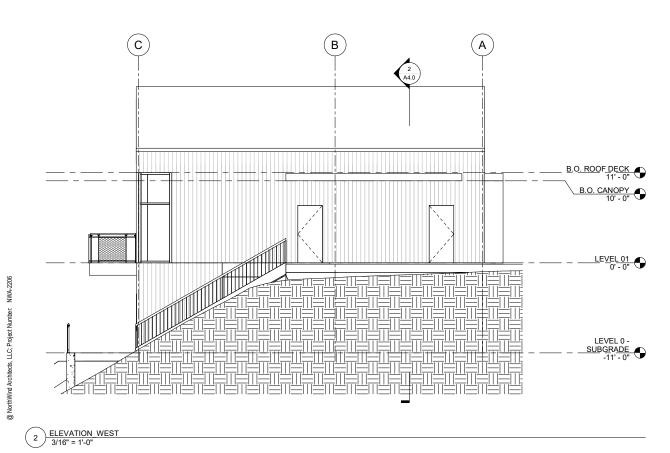
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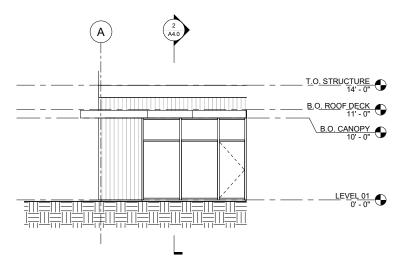
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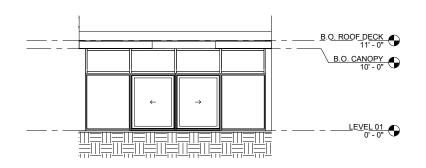
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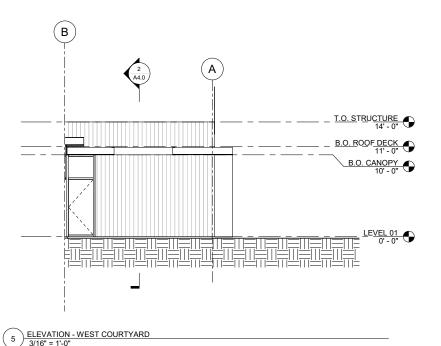




3 ELEVATION - EAST COURTYARD
3/16" = 1'-0"



4 ELEVATION - SOUTH COURTYARD
3/16" = 1'-0"

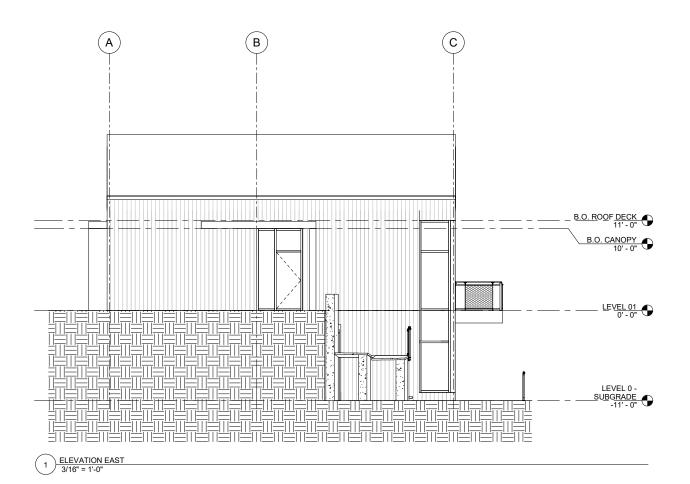

GENERAL NOTES:

- CONTRACTOR SHALL FIELD VERIFY ACTUAL
 BUILDING CONDITIONS AND DIMENSIONS. WHERE
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- 3. DIMENSIONS ARE TO GRIDLINE, FACE OR CENTER OF FRAMING UNO.
- STRUCTURAL ELEMENTS SHOWN IN
 ARCHITECTURAL DRAWINGS FOR REFERENCE
 ONLY, SEE STRUCTURAL DRAWINGS FOR ALL
 STRUCTURAL INFORMATION.
- 5. SECTION DRAWINGS FOR REFERENCE ONLY IDENTIFY DATUM AND DETAILS. NOT FOR CONSTRUCTION.
- 6. TAPERED INSULATION SLOPES NOT SHOWN FOR

SHEET NOTES:

1. #SPEC DESCRIPTION





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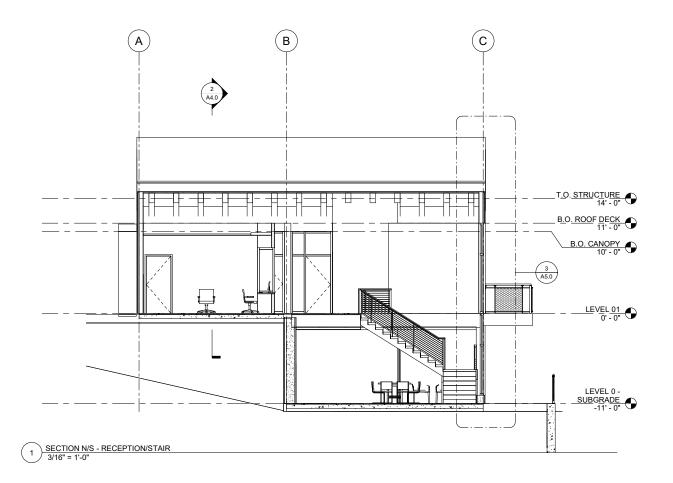
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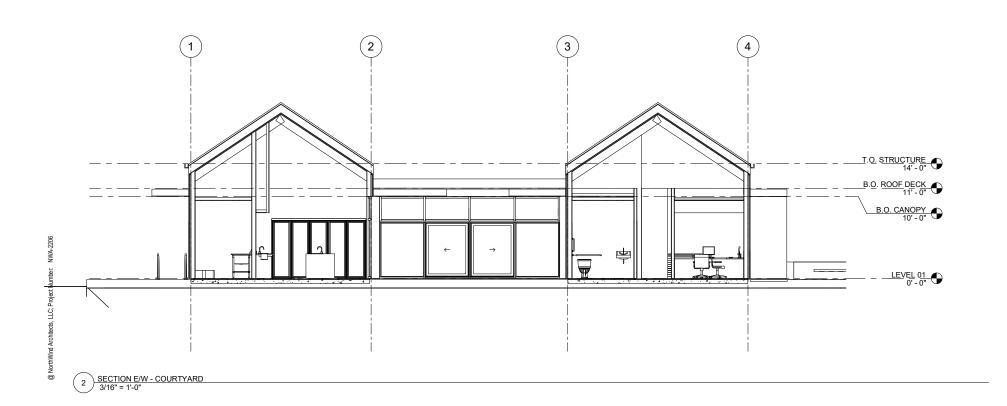
EXTERIOR

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- 3. DIMENSIONS ARE TO GRIDLINE, FACE OR CENTER OF FRAMING UNO.
- STRUCTURAL ELEMENTS SHOWN IN ARCHITECTURAL DRAWINGS FOR REFERENCE ONLY. SEE STRUCTURAL DRAWINGS FOR ALL STRUCTURAL INFORMATION.
- SECTION DRAWINGS FOR REFERENCE ONLY IDENTIFY DATUM AND DETAILS. NOT FOR CONSTRUCTION.
- 6. TAPERED INSULATION SLOPES NOT SHOWN FOR CLARITY.

SHEET NOTES:

1. #SPEC DESCRIPTION





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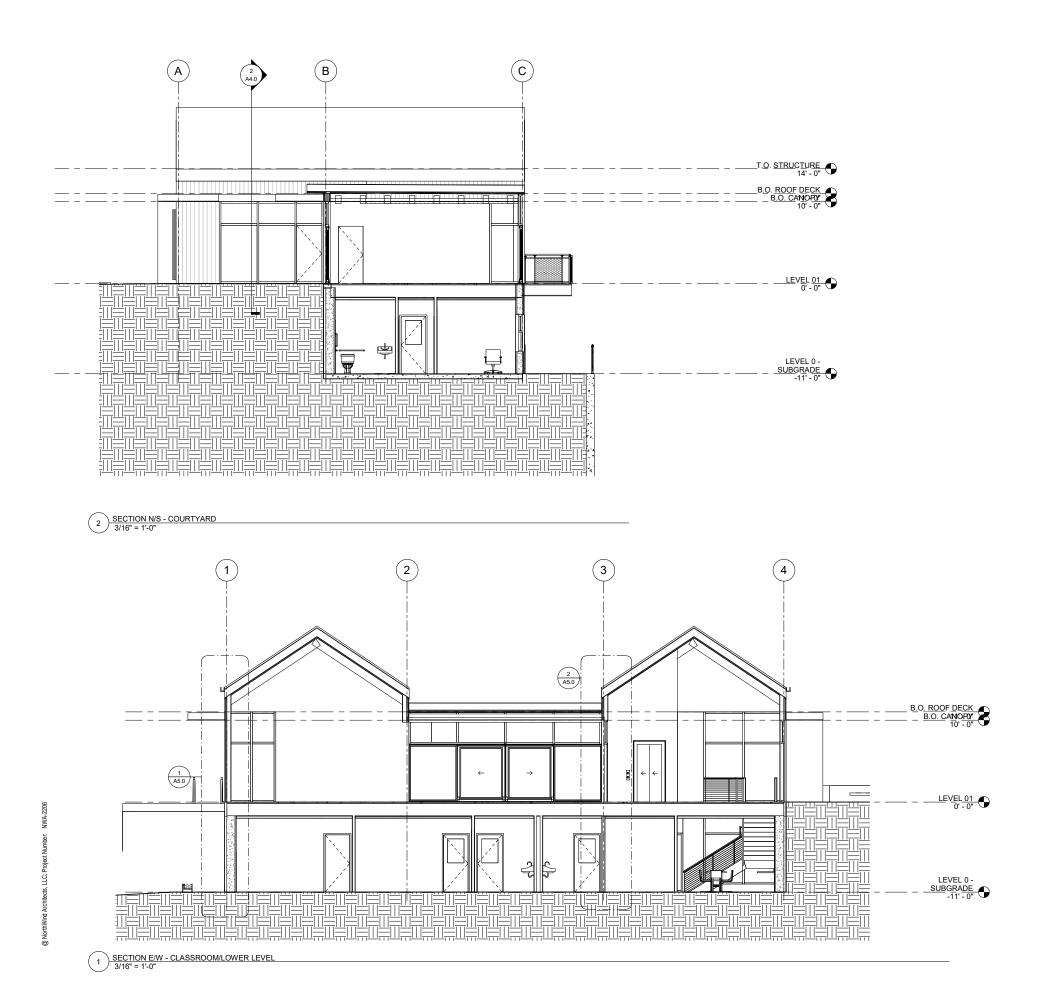
SHEET TITLE:
BUILDING
SECTIONS

CHECKED Approver
DRAWN Author

issue date description

SHEET#

A4.0



GENERAL NOTES:

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 BUILDING CONDITIONS AND DIMENSIONS. WHERE DISCREPANCIES OR CONFLICTS ARE FOUND, NOTIFY ARCHITECT PRIOR TO COMMENCING
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SHEET NOTES:

1. #SPEC DESCRIPTION





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WALL SECTION INTERIOR WALL AT GABLED ROOF TYP. 1/2" = 1'-0"

WALL SECTION FOUNDATION WALL TO EXTERIOR WALL SECTION TYP. 1/2" = 1'-0"


LEVEL 0 -SUBGRADE -11' - 0"

FS_CONC2

FS_CONC2

@ NorthWind Architects, LLC; Project Number: NWA-2206

SW1

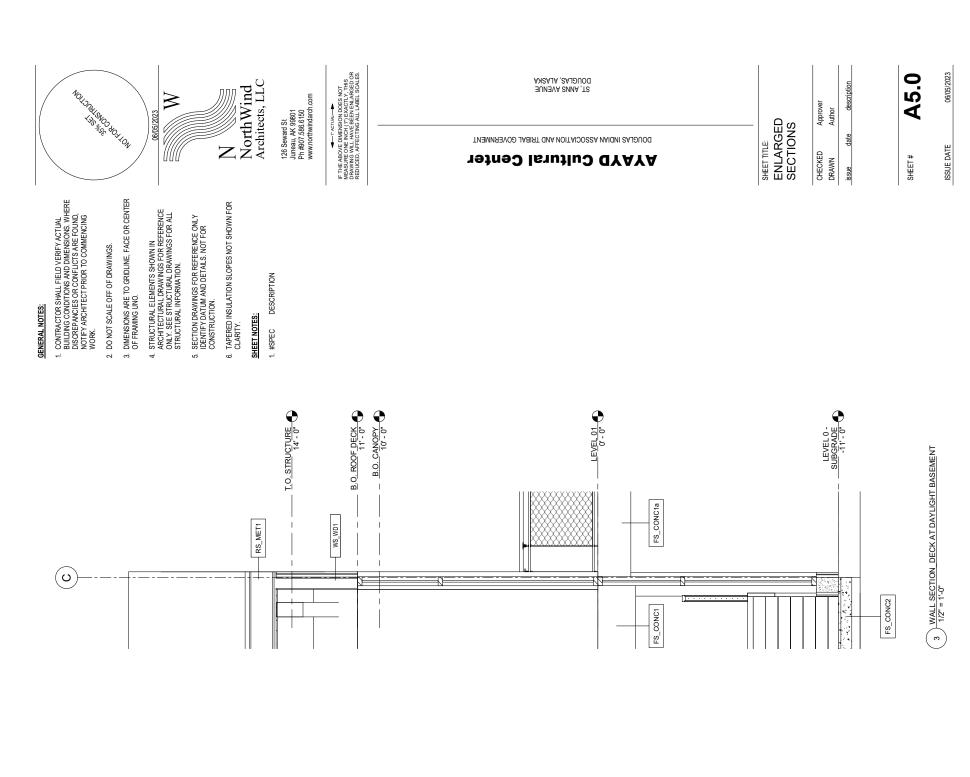

LEVEL 01 O

FS_CONC1

FS_CONC1

WS_WD1

00

_ T.O. STRUCTURE _

T.O. STRUCTURE 14'-0"

B.O. ROOF DECK 11'- 0"

RS_MET1


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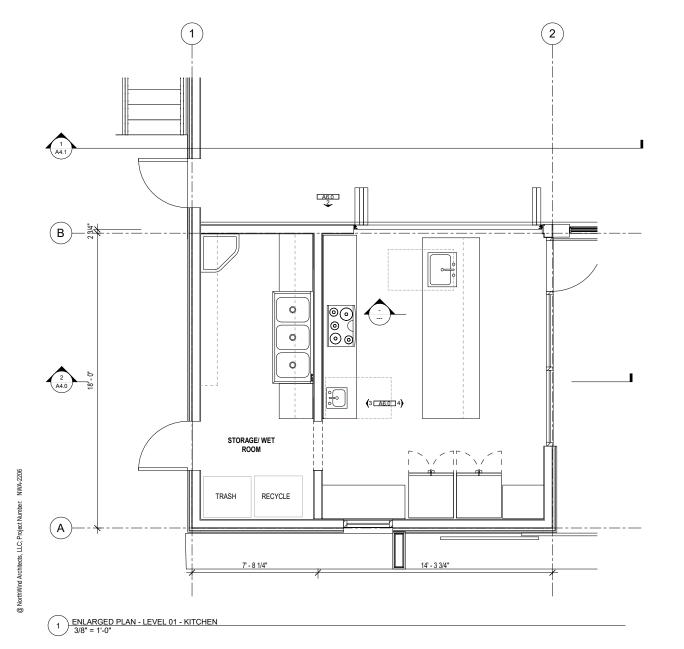
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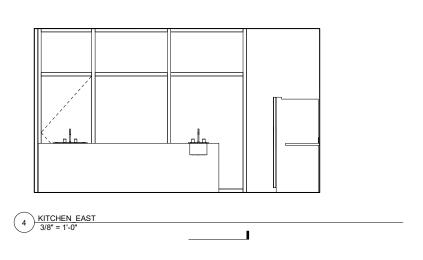
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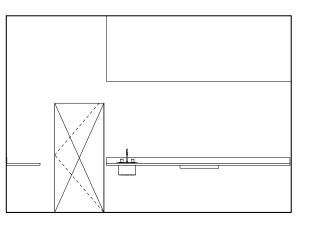
B.O. ROOF DECK 111 - 0" B.O. CANOPY 10' - 0"

WS_WD1







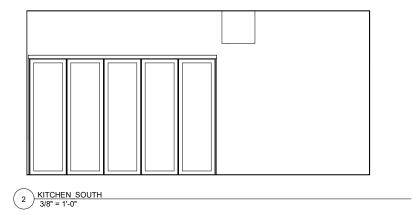


3 KITCHEN WEST 3/8" = 1'-0"

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- 5. CORNER GUARDS AND WALL PROTECTION NOT SHOWN FOR EVERY LOCATION. SEE FINISH PLANS AND ELEVATIONS FOR LOCATIONS.
- 6. THE MAJORITY OF ALL FFE ITEMS ARE OFOI AND ARE NOT IN CONTRACT, HOWEVER LIMITED ITEMS ARE SHOWN IN DRAWINGS FOR COORDINATION PURPOSES. SEE FFE SHEETS FOR GENERAL FFE INFORMATION AND FFE SHEETS AND PROJECT MANUAL FOR CFCI FFE INFORMATION

SHEET NOTES:

1. #SPEC DESCRIPTION

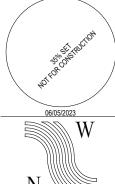

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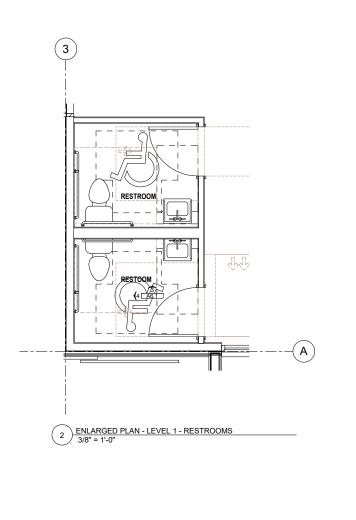
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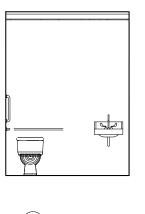
ST, ANNS AVENUE DOUGLAS, ALASKA

SHEET TITLE: ENLARGED PLANS & INTERIOR **ELEVATIONS**


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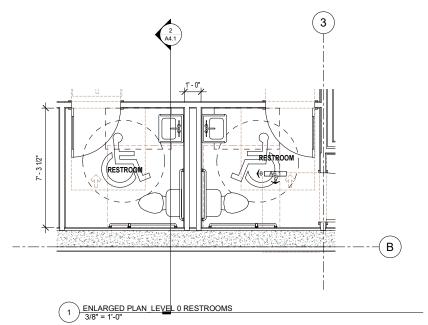










4 LEVEL 1 RESTROOM_WEST
3/8" = 1'-0"

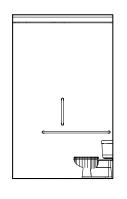

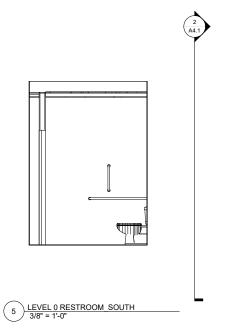

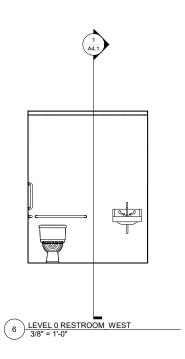

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→

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AYAYD Cultural Center DOUGLAS INDIAN ASSOCIATION AND TRIBAL GOVERNMENT

ST. ANNS AVENUE

SHEET TITLE:
3D VIEWS

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issue	date	description

SHEET# **A10.0**

DESIGN CRITERIA:

- 1. CODE: 2021 INTERNATIONAL BUILDING CODE
- 2. FLAT ROOF SNOW LOAD: 50 PSF
- 3. BASIC WIND SPEED: 140 MPH (3 SEC. GUST) EXPOSURE D
- 4. SEISMIC DESIGN CRITERIA:

SITE CLASS: D RISK CATEGORY: II SEISMIC DESIGN CATEGORY: D S_{DS} = 0.480

5. FLOOR LIVE LOADS: FLOORS: 100 PSF DECKS: 100 PSF

GENERAL NOTES:

- THE PLANS AND SPECIFICATIONS ARE A GUIDE ONLY AND DO NOT DEPICT OR
 CALL OUT EVERY COMPONENT NECESSARY FOR COMPLETION OF THE PROJECT.
- ENGINEER'S OBLIGATION AND/OR LIABILITY FOR ERRORS OR OMISSIONS SHALL BE LIMITED TO REDESIGNING AND REDRAWING THESE DRAWINGS TO CORRECT THE SITUATION.
- 3. PRIOR TO SUBMITTAL TO BUILDING DEPARTMENT, THE DESIGNER SHALL REVIEW THE STRUCTURAL DRAWINGS AND DETAILS FOR DIMENSIONAL ACCURACY.
- 4. IT IS THE CONTRACTOR'S RESPONSIBILITY TO VERIFY THAT ALL DIMENSIONS ARE EQUIVALENT ON STRUCTURAL AND ARCHITECTURAL DRAWINGS. ANY DISCREPANCIES SHALL IMMEDIATELY BE BROUGHT TO THE ATTENTION OF THE DESIGNER AND ENGINEER FOR RESOLUTION PRIOR TO CONSTRUCTION.
- 5. AT EACH PHASE OF WORK, THE CONTRACTOR SHALL VERIFY ALL RELEVANT GRADES, DIMENSIONS, MEMBER SIZES, CONNECTIONS, AND CONDITIONS PRIOR TO ORDERING ANY MATERIALS OR COMMENCING ANY WORK.
- 6. IT IS THE CONTRACTOR'S RESPONSIBILITY TO PROVIDE ADEQUATE SHORING, BRACING, FORMWORK, ETC., AS REQUIRED FOR THE PROTECTION OF LIFE AND PROPERTY DURING CONSTRUCTION.
- STRUCTURAL OBSERVATION OR FIELD INSPECTION IS NOT THE RESPONSIBILITY OF TIMBERLINE ENGINEERING LLC.

FOUNDATION:

- NO GEOTECHNICAL REPORT OR SOILS REPORT WAS PREPARED FOR THIS PROJECT.
- CONTRACTOR TO VERIFY THAT THE UNDISTURBED SOILS AT THE BOTTOM OF EXCAVATION HAVE A MINIMUM BEARING CAPACITY OF 2,000 PSF (WELL-GRADED SAND OR GRAVEL).
- 3. ORGANIC AND/OR WEAK SOILS ENCOUNTERED DURING EXCAVATION SHALL BE REMOVED AND REPLACED WITH WELL-COMPACTED, NON-FROST SUSCEPTIBLE STRUCTURAL FILL.
- 4. EXTERIOR FOOTINGS SHALL BEAR 2'-8" MINIMUM BELOW FINISHED GRADE OR ON NON-FROST SUSCEPTIBLE, FREE-DRAINING SOIL.
- CONCRETE COMPRESSIVE STRENGTH SHALL BE 3,000 PSI MIN. FOR STEMWALLS, AND FOOTINGS.
- 6. AIR ENTRAINING AGENT (3% 6%) SHALL BE USED IN ALL CONCRETE EXPOSED TO WEATHER
- 7. ALL MATERIALS AND PROCEDURES SHALL BE IN CONFORMANCE WITH ACI 318 AND OTHER APPLICABLE BUILDING CODES.
- 8. REINFORCING STEEL SHALL CONFORM TO ASTM A615. FOR #3 BARS AND SMALLER USE GRADE 40. FOR #4 BARS AND LARGER USE GRADE 60.
- 9. LAP SPLICE ALL BARS NO LESS THAN 40 BAR DIAMETERS U.N.O.
- 10. REBAR CONCRETE COVER:

E'AFOR CONCRETE CAST AGAINST AND PERMANENTLY EXPOSED TO COLUMNS NOT EXPOSED TO WEATHER.
1-1/2" FOR CONCRETE EXPOSED TO EARTH OR WEATHER, AND BEAMS AND

3/4" FOR SLABS AND WALLS NOT EXPOSED TO EARTH OR WEATHER.

- 11. HOLDOWN ANCHOR BOLTS SHALL BE GALV. ASTM F1554 GRADE 36 THREADED ROD WITH 22"-EMBEDMENT AND NUT & WASHER ON EMBEDDED END, U.N.O.
- 12. CONTROL JOINT SPACING SHALL BE 15' O.C. MAXIMUM IN ALL SLABS. LOCATION TO BE DETERMINED BY CONTRACTOR. SAW CUT JOINTS TO BE MADE 12 TO 24 HOURS AFTER CONCRETE PLACEMENT.
- 13. 1/2" EXPANSION JOINTS SHALL BE PLACED AT ALL SLAB BOUNDARIES AND SEALED WITH ELASTOMERIC CAULKING.

FRAMING NOTES:

- ALL MATERIALS, FASTENERS AND PROCEDURES SHALL BE IN CONFORMANCE WITH THE 2012 NDS, AND SHOULD BE INSTALLED PER THE MANUFACTURER'S SPECIFICATIONS. NAILS SHALL BE COMMON U.N.O.
- 2. ALL ROOF & FLOOR SHEATHING SHALL BE INSTALLED WITH THE LONG DIRECTION RUNNING PERPENDICULAR TO THE FRAMING MEMBERS.
- 3. ALL SAWN LUMBER MEMBERS SHALL BE DF-L(N)#2 U.N.O.
- 4. ALL HARDWARE SHALL BE SIMPSON STRONG TIE, OR APPROVED EQUAL, AND SHALL BE INSTALLED WITH THE MANUFACTURER'S SPECIFIED FASTENERS.
- 5. MOISTURE CONTENT OF WALL AND FLOOR FRAMING MEMBERS SHALL BE VERIFIED PRIOR TO ENCLOSURE. FRAMING MEMBERS SHALL NOT BE ENCLOSED IF THE MOISTURE CONTENT EXCEEDS 19%.
- 6. ALL WOOD IN CONTACT WITH CONCRETE SHALL BE PRESSURE TREATED.
- 7. SOLID 2x BLOCKING SHALL BE PROVIDED AT ENDS AND AT ALL INTERMEDIATE SUPPORTS OF JOISTS AND TRUSSES
- 8. PROVIDE THRU-FLOOR SOLID BLOCKING AT ALL COLUMN LOCATIONS FOR A CONTINUOUS LOAD PATH TO THE FOUNDATION.
- 9. ALL JOISTS, BEAMS, AND RAFTERS SHALL BE PLACED WITH CAMBER UP.
- 10. ALL HARDWARE IN CONTACT WITH PRESSURE-TREATED WOOD OR EXPOSED TO WEATHER OR SOIL SHALL HAVE A CORROSION RESISTANT COATING.
- 11. ATTACH RAFTERS, RIM JOISTS AND PERIMETER FLOOR/ROOF BLOCKING TO TOP PLATES W/ 16d T.N. @ 6" O.C., U.N.O.
- 12. TOP PLATES SHALL HAVE 48" MIN. LAP AT SPLICES WITH (16) STAGGERED 16d NAILS PER CONNECTION.
- 13. ALL GLULAM BEAMS SHALL BE DF/DF 24F-V4.
- 14. ALL GLULAM POSTS SHALL BE DF L2D.



JUNEAU, ALASKA 907-635-1433 JAGRAVES77@GMAIL.COM

1" ACTUAL

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AS INDIAN ASSOCIATION AND TRIBAL GOVERNN ST. ANN'S AVENUE, DOUGLAS, ALASKA

DOUGLAS INDIAN ASSOCIATION TRIBAL GOVERNMENT CULTURAL C

SHEET TITLE:
GENERAL NOTES
& ABBREVIATIONS

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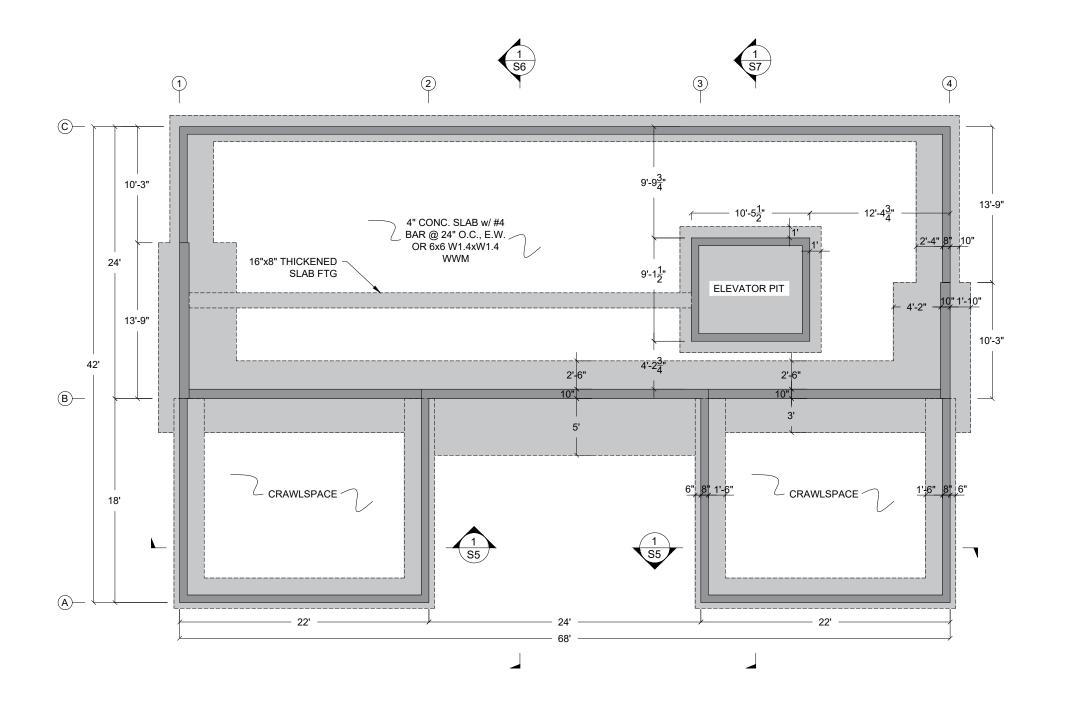
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FULL SIZE: 22"x34" ISSUE DATE

ABBREVIATIONS:

AB	ANCHOR BOLT	HD	HOLDDOWN	PSF	POUNDS PER SQUARE FOOT
ACI	AMERICAN CONCRETE INSTITUTE	HDR	HEADER	PSI	POUNDS PER SQUARE INCH
ARCH	ARCHITECT	HF	HEM-FIR	PT	PRESSURE TREATED
AYC	ALASKA YELLOW CEDAR	HORIZ.	HORIZONTAL	PWD	PLYWOOD
BCI	BOISE CASCADE	HT	HEIGHT	RO	ROUGH OPENING
ВМ	BEAM	IBC	INTERNATIONAL BUILDING CODE	RS	ROUGH SAWN
ВТМ	воттом	KS	KING STUD	SIM.	SIMILAR
COL	COLUMN	LAG	STANDARD HEX LAG SCREW	SQ	SQUARE
CONC	CONCRETE	LONG.	LONGITUDINAL	TN	TOE-NAILED
CONT	CONTINUOUS	MAX.	MAXIMUM	TP	TOP PLATE
DIA (Ø)	DIAMETER	MIN.	MINIMUM	TR.	TRIMMER STUDS
DBL	DOUBLE	MTE	MATCH TO EXISTING	TRANS.	TRANSVERSE
DF	DOUGLAS-FIR (NORTH)	NDS	NATIONAL DESIGN SPECIFICATION	TYP.	TYPICAL
EA	EACH	NFS	NON-FROST SUSCEPTIBLE	T&B	TOP & BOTTOM
EW	EACH WAY	NTS	NOT TO SCALE	T&G	TONGUE & GROOVE
FTG	FOOTING	O.C.	ON CENTER	UNO	UNLESS NOTED OTHERWISE
GALV.	GALVANIZED	OSB	ORIENTED STRAND BOARD	VERT.	VERTICAL
GLB	GLULAM	PLY	PLYWOOD	VL	VERSA-LAM







SHEET TITLE: FOUNDATION PLAN

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FOUNDATION PLAN
1/4" = 1'-0"

S2 SHEET#



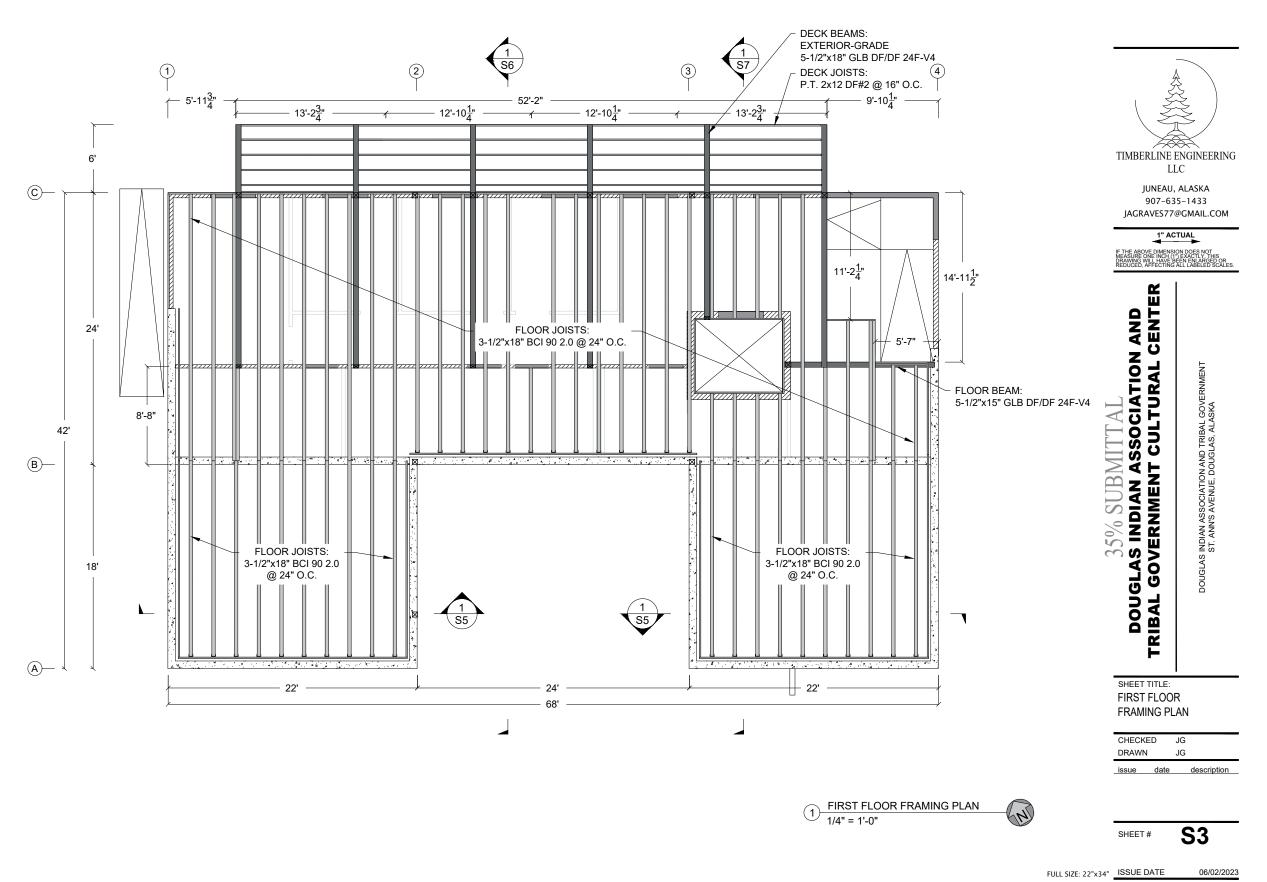

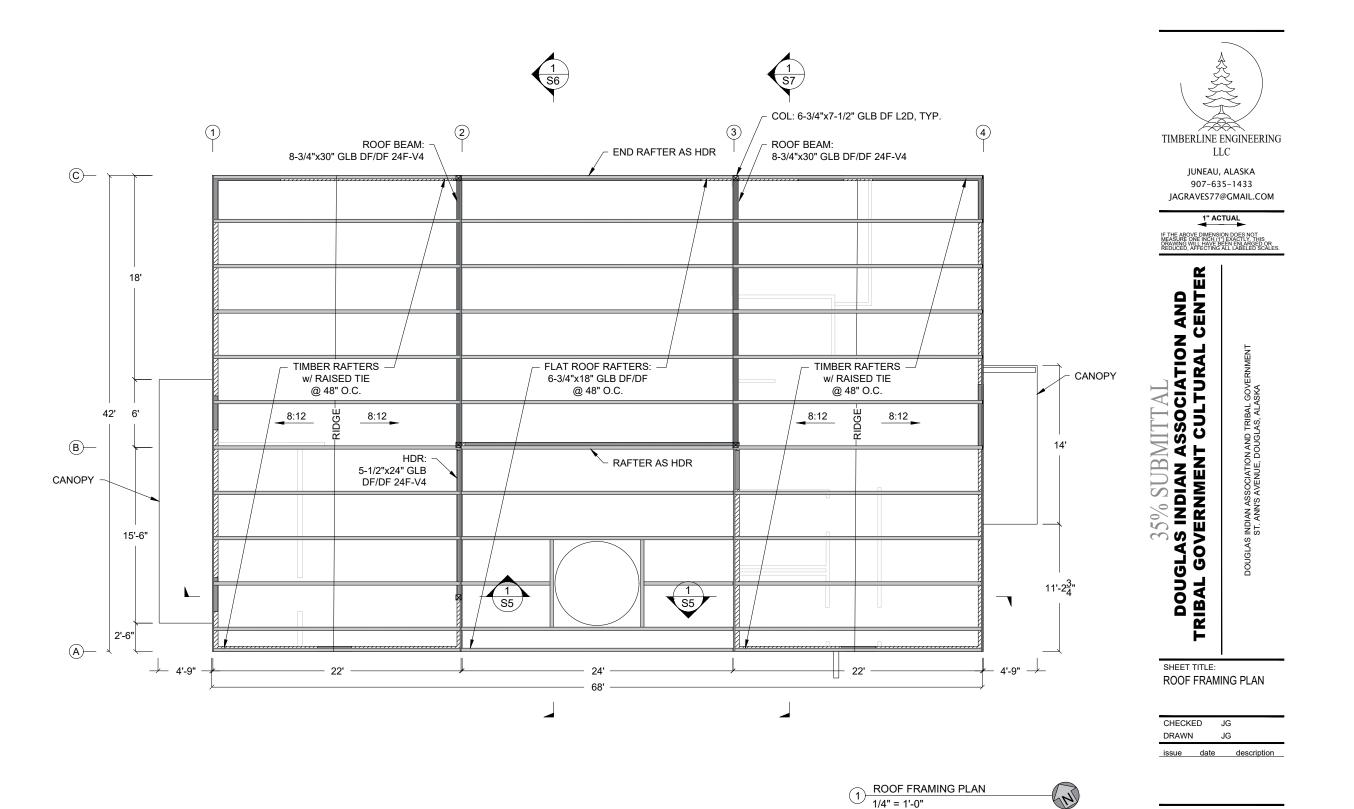
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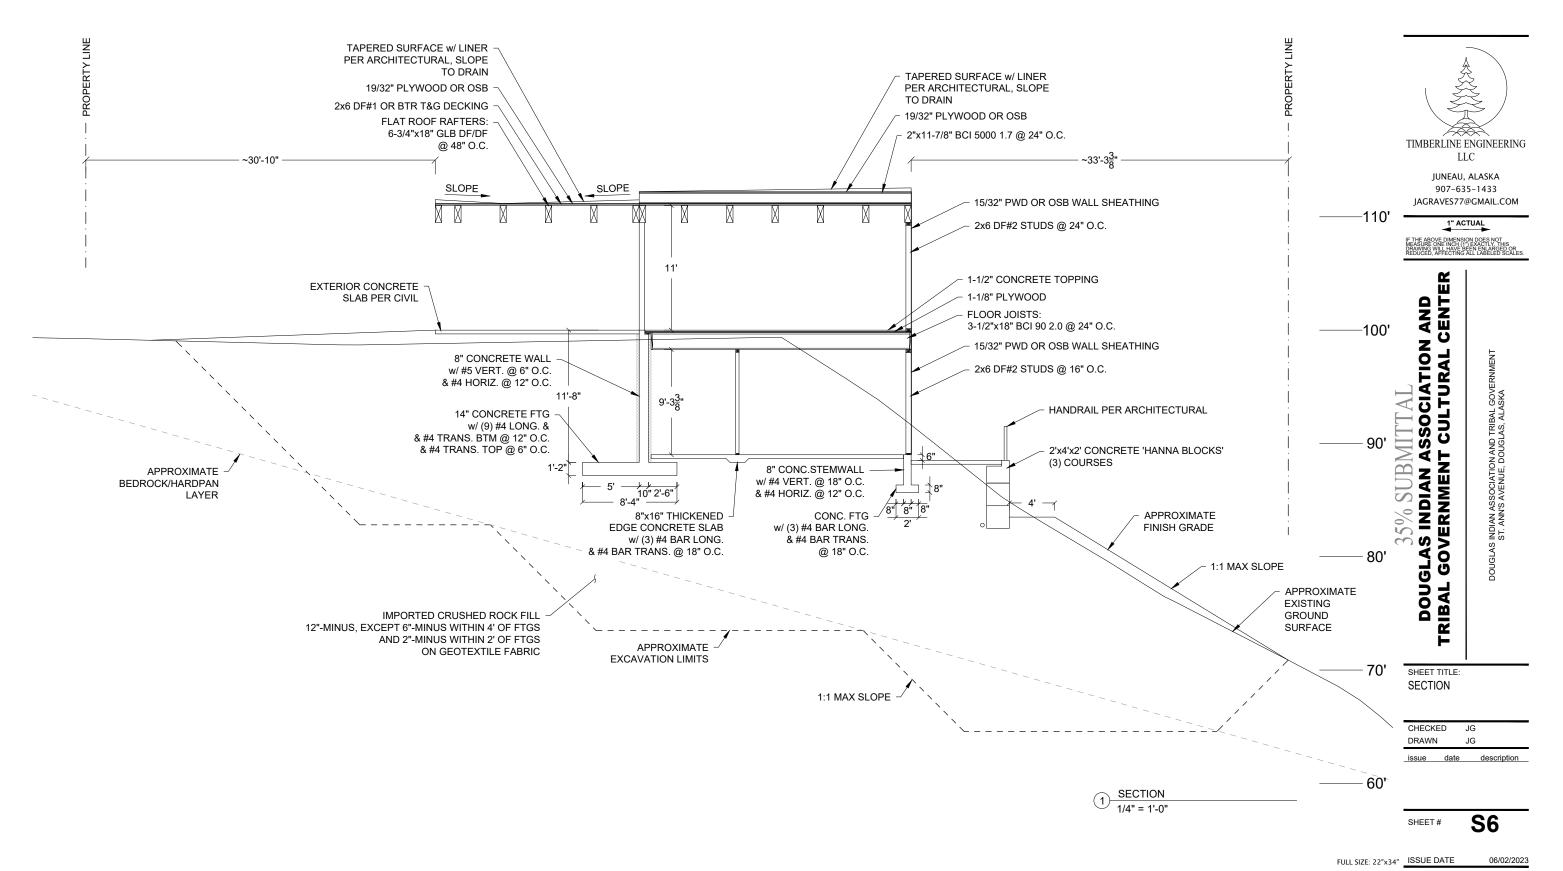
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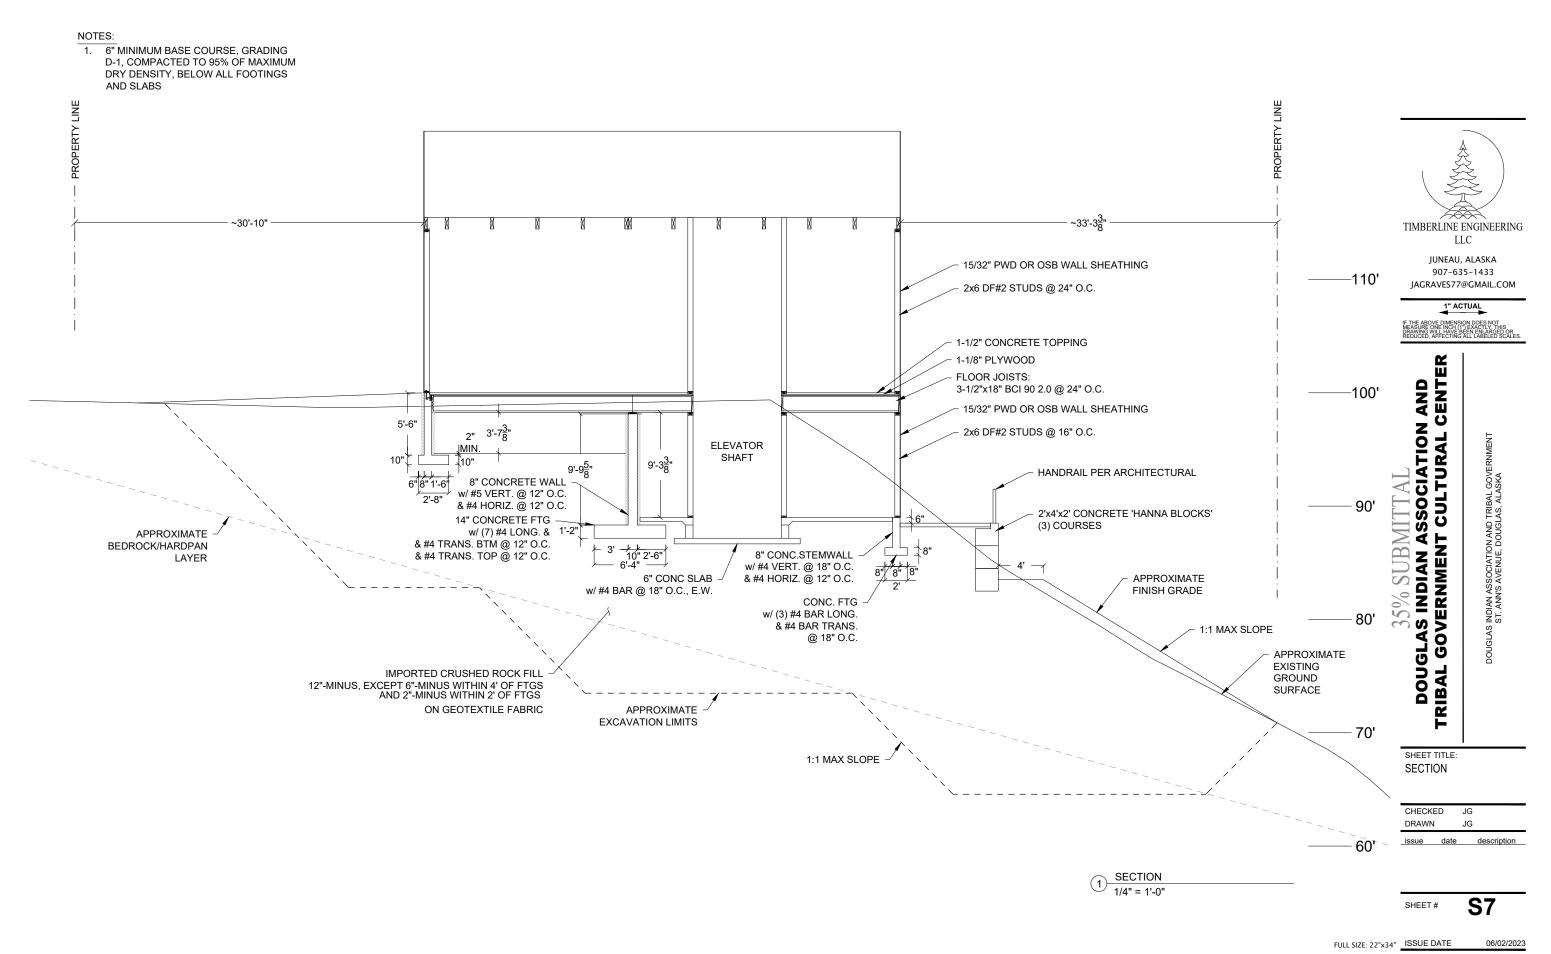
NOTES:

. 6" MINIMUM BASE COURSE, GRADING D-1, COMPACTED TO 95% OF MAXIMUM DRY DENSITY, BELOW ALL FOOTINGS AND SLABS



 6" MINIMUM BASE COURSE, GRADING D-1, COMPACTED TO 95% OF MAXIMUM DRY DENSITY, BELOW ALL FOOTINGS AND SLABS

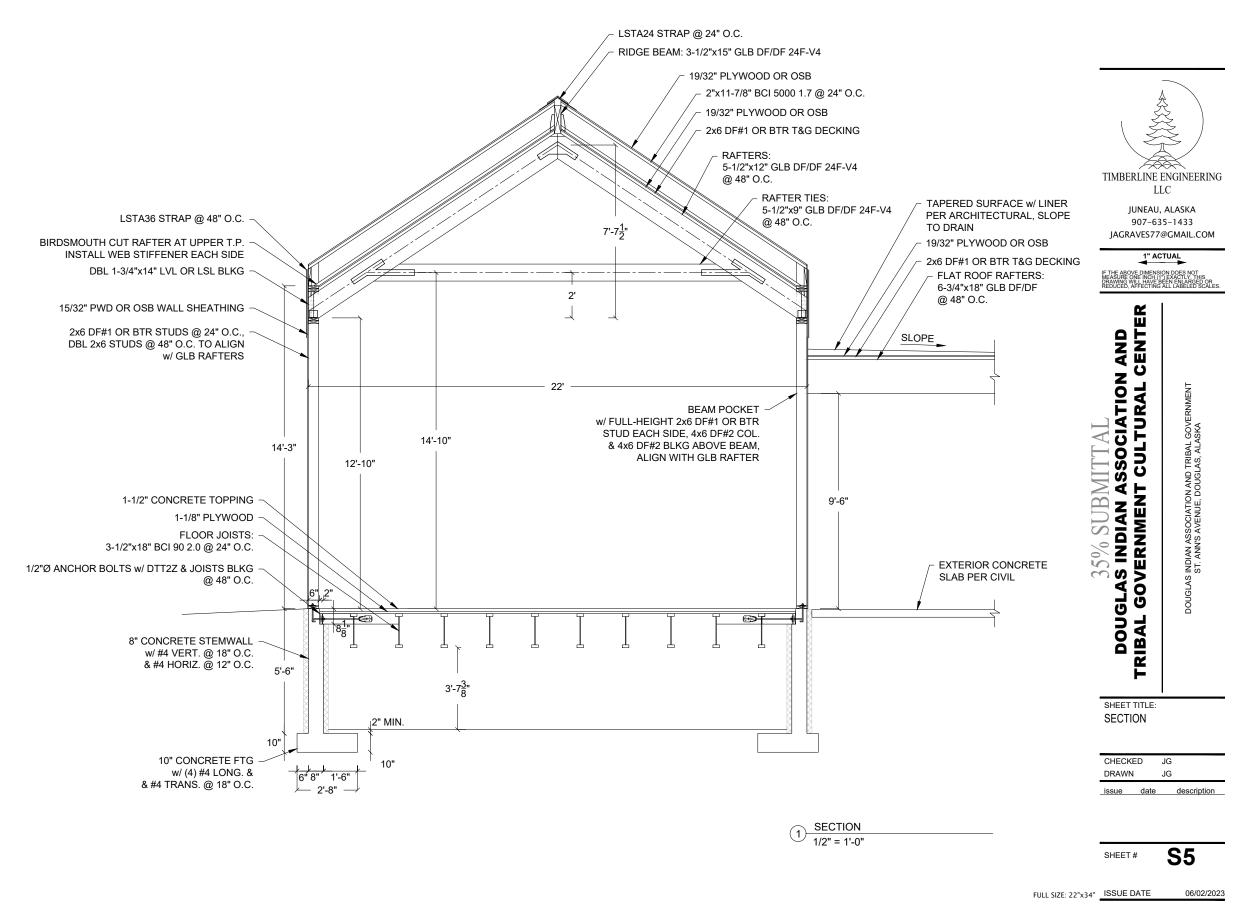





DRAWING WILL HAVE BEEN ENLARGED OR REDUCED, AFFECTING ALL LABEL SCALES.

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TRIBAL

description DKB RDH CHECKED

SCHEDNLES

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S.0M

06/02/2023

ISSUE DATE

8.9FLA ECM EXHAUST FAN, PROVIDE WITH INSULATED VENTED PITCHED ROOF CURB. 1559 1.3" W.C. 800 CEW COMBUSTIBLES ON BACK AND TOP OF HOOD. 1207 0.58" W.C. 800 CEW KITCHEN KEH-1 LIGHTS CONTROL PANEL, 15 AMP CIRCUIT, FIRE SUPPRESSION AND CONTROL CABINET ON RIGHT, ZERO CLEARANCE TO 138AJ dН ٨ ESP XAM DRIVE **МАИ** ИРАСТОВЕК LOCATION SAMA WODEL **WOJJ RIA** ELECTRICAL **BYSIS OF DESIGN** КІТСНЕИ ЕQUIРМЕИТ SCHEDULE ٥., MC 101.1366 **AMERICAN STANDARD** 3" SUPPLY WITH SLOAN TOUCH LESS FLUSH VALVE #111 ESS-1.28-0R-HW, BEMIS #19655SCT OPEN FRONT SEAT, PDI SIZE "A" HAMMER ARRESTER AND NECESSARY WALL Z-Z121-C ROOF DRAIN ВD FAUCET- K-16027-4 FAUCET -AMERICAN STANDARD ٦ SINGLE HOLE COUNTERTOP LAVATORY AND FAUCET ..7./L-L "2/1-r 1/5" YAOTAVAJ 21NK- K-5326 ٥., KITCHEN SINK DROP-IN INSTALLATION 3-HOLE 8" O.C., INSTALL CLEAN OUT ABOVE TRAP ARM. SINK -K-2567-3 **WODEL 25** WOODFORD NON-FREEZE HOSE BIBB G-TS JOATMA ١/٦.. EXPANSION TANK 2 GALLON TANK .9 GALLON ACCEPTANCE, 1 EACH WATER HEATER r-T3 FD1 FLOOR DRAIN LD SUPPLY WITH TRAP PRIMER CONNECTION. COMMENTS MODEL DESIGN MANUFACTURER ٨ W CM FIXTURE 138AJ PLUMBING FIXTURE SCHEDULE

COMMENTS MCA CONTROL ٨ Н **GST** CEW DRIVE WODEL MANUFACTURER LOCATION TABEL ELECTRICAL **BASIS OF DESIGN** HBY SCHEDULE 56.6 MAKE UP AIR UNIT TO BE ENERGIZED WHEN KEF-1 IS ENERGIZED. 9.6KW ELECTRIC COIL. 02.0 Z08V 0.5" W.C. MAU-1 STORAGE/WET ROOM | ELECTRO INDUSTRIES | EM-MD10-208-3-10 | DIRECT | 600 CFM

PROCESSOR CONTROL DAMPERS. A3 "T.0 ∀∃ 006 KEWOLE BYNEF MICKO BROCESSOK CONTROLLER SENSOKS, TIMED EXHAUST FROST CONTROL, OUTDOOR AND RETURN AIR LOW LEAKGEE HINGED ACCESS, MICKO PROCESSOR CONTROLLER, CONSTANT VOLUME, ON/OFF CONTROL, ELECTRIC HEATER ENABLE WITH OA RESET, 8.21 Λ80Ζ DIRECT ECV-10H-VG-P **CKEENHECK** MECH ŀ-VЯH

LAN COIL SCHEDULE 1-1/4" NPT A014 230V 45.0 50 53,200 BTU/HR SPACEPAK ODU-1, 2 AIR TO WATER PIPING CONNECTIONS REFRIGERANT TYPE MOP V MCA COOLING CAPACITY HEATING CAPACITY PH МАИИГАСТИВЕВ ELECTRICAL BASIS OF DESIGN OUTDOOR UNIT SCHEDULE

PUMP SCHEDULE 42,000 BTU/HR 860 CFM 0.50" W.C. 1 230V 3.8 7/8" NPT SUPPLY AND RETURN WATER CONNECTIONS MC2P-3642J SPACEPAK MAIN FLOOR EAST WING EC-5 820 CFM | 0.50" W.C. 1 7/8" NPT SUPPLY AND RETURN WATER CONNECTIONS 8.5 230Λ MC2P-3642J SPACEPAK CULTURAL EDUCATION FC-1 V Hq LABEL CEM ESP MANUFACTURER ELECTRICAL WOJJRIA **BASIS OF DESIGN**

ELECTRICAL BASIS OF DESIGN WATER HEATER SCHEDULE GRINDER STATION 13 GPM 15' WASTE 1 115V 1 - INTEGRAL FLOAT L60HI E ONE SP-1 BASEMENT SEWAGE EJECTOR COMMENTS FLUID HEAD FLOW MANUFACTURER ELECTRICAL BASIS OF DESIGN

Attachment A6 - Application Plans

COMMENTS

COMMENTS CONNECTIONS SAMA ٨ Hd FLUID WODEL MANUFACTURER 138A1 BASIS OF DESIGN ELECTRICAL ELECTRIC BOILER SCHEDULE WH-1, 2 DOMESTIC FULL BUILDING 1 208V 30 DUAL 4,500W NON-SIMULTANEOUS HEATING ELEMENTS FOR BACKUP 7∀£) G9 JA5 06 HYBRID 09-ST4H HTIMS OA 4OM V HY DNITAR RUCH TERRIT TYPE MANUFACTURER 138AJ

BUFFER TANK SCHEDULE INDUSTRIES 36KW ELECTRIC BOILER TqN "S 1-8 Λ80Ζ ABTAW %001 ELECTRO

INT 119-MAX 4 119MAX INSTALL AQUASTAT IN FACTORY THERMOWELL IBC BT-2 COOLING FULL BUILDING 119MAX INSTALL AQUASTAT IN FACTORY THERMOWELL XAM-611 TWI HEATING FULL BUILDING r-T8 Þ COMMENTS PORTS STORAGE MODEL MANUFACTURER SERVICE LABEL



June 2, 2023

Douglas Indian Association and Tribal Government Cultural Center Electrical Narrative

General

The electrical systems will comply with accepted codes, standards and recommended practices common to the electrical industry and as required by local and state authorities, including the following:

- National Electrical Code (NEC)
- International Fire Code (IFC)
- National Fire Protection Association (NFPA)
- Illuminating Engineering Society (IES)
- National Electrical Manufacturers Association (NEMA)
- National Electrical Contractors Association (NECA)

All equipment will be listed and labeled by a nationally recognized testing agency acceptable to the State of Alaska.

Utility Services and Distribution Equipment

The building will require a three-phase service for mechanical equipment loads and the elevator. An overhead utility extension is required from the 400-block on St. Anns Avenue to bring three-phase power to the site. Primary power will route from the nearest utility pole, underground to a pad mounted transformer located on the west side of the building. The transformer will feed a combination utility meter and 400 amp main circuit breaker located on the west exterior wall. A 400 amp, 120/208 volt three-phase main panelboard will be located in the Mechanical Room to serve the elevator, mechanical equipment, and Level 0 workstations, lighting and convenience receptacles. A sub-feed panelboard rated 225 amp, 120/208 volt, three-phase will be located in the Storage / Wet Room to supply Level 01 workstations, lighting, convenience receptacles and kitchen equipment. Both panelboards will be provided with surge protection devices to protect downstream equipment from transient voltages.

Indoor equipment will be NEMA 250, Type 1. Equipment buses and conductor connections will be tinplated aluminum. Panelboards will be surface mounted. Overcurrent protective devices will be molded case circuit breakers. All equipment will be commercial grade.

Communications Services and Distribution Equipment

Telephone and coax services will terminate on a 2-foot wide plywood backboard in the mechanical space. A data rack will be provided in the storage / computer lab space. The data rack will house patch panels, Owner provided network equipment, and head-end equipment for access control and camera surveillance systems. An uninterruptible power supply will be provided to supply back-up power to the communications head-end equipment and data rack.

Connecting blocks, cross-connects, and patch panels will be 110-style with insulation displacement connectors. Patch panels will be 48-port, minimum. The racks will be equipped with horizontal and vertical cable management and power strips.

Feeders and Branch Circuits

Feeders and branch circuits will be single conductors in conduit. All conductors will be copper with insulation Type THHN-THWN. Connectors and splices will be of size, ampacity rating, material, type, and class for application and service required. Feeders and branch circuits will be concealed, except in unfinished spaces.

Grounding and Bonding

Insulated copper equipment grounding conductors will be provided with all feeders and branch circuits.

Hangers and Supports

The project will comply with NECA for application of hangers and supports for electrical equipment and systems. Interior support devices will be steel; exterior will be hot-dip galvanized with stainless steel hardware.

Raceways and Boxes

Exposed, outdoor conduit and interior locations subject to damage will be galvanized rigid steel. Electrical metallic tubing will be utilized for interior raceways not subject to damage or concealed in finished surfaces. Connections to vibrating equipment shall be flexible metal conduit, except liquid-tight flexible metal conduit will be applied in damp or wet locations. Outlet and devices boxes will be sheet metal.

Identification for Electrical Systems

Branch circuit conductors will be identified with self-adhesive vinyl labels where conductors are accessible in panels, junction and pull boxes. All feeders and branch circuits will be color-coded for phase identification with factory applied color or half-lapped tape.

Equipment identification labels will be provided on each unit of equipment including disconnect switches and protection equipment, central or master units, control panels, control stations, and terminal cabinets. Systems include power, lighting, control, communication, signal, monitoring, and alarm.

Mechanical Equipment

The preliminary mechanical load is estimated to be approximately 90kVA. The major loads include an electric boiler, heat pumps, a heat recovery unit with an electric coil, and miscellaneous pumps. Branch circuits and connections for all mechanical equipment will be provided as required. Motors rated ½ HP and larger will be wired 208 volts, 3 phase. Motors less than ½ HP will be wired 120 volt, single phase. Disconnect switches will be heavy-duty type with fuses as required. Motor starter switches will be quick-make, quick-break toggle with on/off indication. Full voltage, across the line, magnetic controllers with bimetallic overload relays will be used for equipment requiring automatic control.

Lighting Systems

All light fixtures will utilize LED technology. Illumination levels shall comply with recommended practices outlined by IES.

Interior light fixtures will predominately be indirect / direct or volumetric type to provide uniform, low-glare illumination. Offices, reception, and the meeting room will be controlled by wall mounted dimmer switches with integral occupancy sensors. Restrooms, mechanical, and the storage rooms will be controlled by wall mounted occupancy sensors. The education classroom will be controlled by dimmers and will likely have multiple control groups. The lobby and corridor will be switched. Exit signs and emergency illumination will be provided as required along the means of egress.

Exterior lighting will be provided in the courtyard, on the balcony, around the building perimeter, and along the exterior stair. Wall mounted light fixtures will be dark sky compliant with cutoff optics to restrict light to the intended area of illumination. Light trespass to adjacent properties will be avoided by utilizing light fixtures with low lumen output. Exterior lighting will be controlled with a photocell and timer. The courtyard may be controlled with an occupancy sensor.

Wiring Devices

Receptacles will be provided for workstations and equipment. The design will provide sufficient devices to allow for flexibility. Convenience receptacles in the lobby and corridor will be located so that no point is more than 20-feet away from a receptacle. Four receptacles will be located in each enclosed office. The education classroom walls will be provided with devices spaced approximately 10-feet apart, with accommodations for a large wall mounted monitor with in-floor connectivity to stream digital content. Receptacles with special configurations will be provided as required by the Owner.

All devices will be specification grade, or better. Convenience receptacles will be 125V, 20A. Ground fault devices will be provided as required by the NEC, non-feed through type. Toggle switches will be 120/277V, 20A. Wall box dimmers will be modular, full-wave, solid-state units with integral, on-off switches. Smooth, high-impact thermoplastic wall plates will be used, except in unfinished spaces where galvanized steel will be allowed. Wet location device plates will be NEMA 250, Type 3R with lockable cover.

Low Voltage Devices and Wiring

All components of the data system will comply with Category 6 performance criteria. Two data outlets with two jacks per outlet will be provided in each enclosed office and workstation. Common work spaces will be provided with jacks as required for convenience and equipment. Network connections will be planned for wireless access points throughout the building. The data system configuration and outlet locations will be coordinated with the Owner's network equipment provider.

Cables shall be 100-ohm, four-pair unshielded twisted pair with thermoplastic jacket. Cables will terminate on a rack mounted patch panel in the storage / computer lab. Conduit for the data system will be 1" minimum. Conduit will be utilized in concealed and exposed conditions, except above accessible ceilings where unenclosed cabling methods may be used.

Camera Surveillance

A basic camera surveillance system will be provided to monitor the building exterior and entries. The system will utilize digital cameras that record on motion, only. Content will be stored on a network video recorder mounted in the data rack located in the storage / computer lab. A network-based software interface will be provided for control and playback.

Door Control

Power will be provided for electronic access control of exterior doors.

Fire Alarm

A basic control panel will be required to monitor the elevator landings for smoke and interface with the elevator controller for recall functions. The Type 1 hood in the kitchen is also required to be monitored for an alarm condition. The control panel will dial out to a constantly attended location for dispatch and sound a local audible and visual signal.