PURVIS FARM OUTLINE DEVELOPMENT PLAN

LOCATED IN THE SOUTH ONE-HALF OF SECTION 6, TOWNSHIP 4 NORTH, RANGE 67 WEST OF THE SIXTH PRINCIPAL MERIDIAN, COUNTY OF WELD, STATE OF COLORADO

444 Mountain Ave. | TEL 970.532.5891 Berthoud,CO 80513 | WEB TBGroup.us



PURVIS FARM OUTLINE **DEVELOPMENT** PLAN

JOHNSTOWN, CO

OWNER: 6037 **JOHNSTOWN**

144 North Mason Street Fort Collins CO 80524

COUNTY RD. 50 E Co Rd 14 PROJECT LOCATION

General Notes:

Vicinity Map:

- 1. ACCESS POINTS SHOWN ON THIS ODP ARE APPROXIMATE. EXACT LOCATIONS TO BE DETERMINED DURING THE PRELIMINARY AND FINAL PLATTING PROCESS BASED ON THE FINAL TRAFFIC IMPACT STUDY.
- 2. LOCAL AND COLLECTOR STREETS MAY CHANGE LOCATION, SIZE AND CONFIGURATION AT TIME OF PLATTING. LOCAL AND COLLECTOR
- STREETS SHALL CONFORM TO THE TOWN OF JOHNSTOWN STREET STANDARDS AT THE TIME OF PLATTING. 3. ALL DENSITIES AND UNIT COUNTS ARE PROJECTIONS, FINAL DENSITIES TO BE DETERMINED AT TIME OF PLATTING. DENSITY OF ANY
- GIVEN PHASE SHALL NOT EXCEED 9 DU/AC. ACTUAL NUMBER OF UNITS WILL BE DETERMINED AT TIME OF SUBDIVISION PLATTING. 4. AREAS OF DEVELOPMENT PARCELS SHOWN ARE APPROXIMATE AND MAY VARY. EXACT LOT SIZES WILL BE DETERMINED WITH EACH
- PRELIMINARY AND FINAL SUBDIVISION SUBMITTAL.. 5. FINAL CONFIGURATION OF PARCELS, OPEN SPACE AREAS AND STREETS MAY VARY FROM THAT SHOWN.
- 6. WHERE A PROPOSED USE IS NOT LISTED IN THE ODP, THE TOWN SHALL HAVE SOLE DISCRETION RELATING TO THE PROPOSED USE. 7. ALL DRAINAGE ELEMENTS ARE CONCEPTUAL IN NATURE AND FINAL DETERMINATIONS OF THE DRAINAGE SYSTEM, TO INCLUDE THE PLACEMENT OF DETENTION/RETENTION PONDS, CHANNELS, AND STORM SEWER, WILL BE MADE DURING THE PRELIMINARY AND FINAL DRAINAGE REPORTS AND DURING THE PRELIMINARY DEVELOPMENT PLAN PROCESS AS A PART OF THE FINAL SUBDIVISION PLATTING.
- 8. LANDSCAPING, SIGMA, ARCHITECTURE, NON-RESIDENTIAL PARKING, FENCING AND LIGHTING FOR DEVELOPMENT WITH THIS PUD SHALL EITHER FOLLOW THOSE APPLICABLE STANDARDS IN THE TOWN OF JOHNSTON MUNICIPAL CODE OR THE DEVELOPER MAY FORMULATE DESIGN STANDARDS REGULATING THE DESIGN, CHARACTER, LOCATION AND OTHER DETAILS OF THESE ELEMENTS PRIOR TO THEIR IMPLEMENTATION. THE DEVELOPER FORMULATED DESIGN STANDARDS MUST RECEIVE APPROVAL BY THE PLANNING AND DEVELOPMENT DIRECTOR PRIOR TO IMPLEMENTATION.

Development Phasing:

PHASING WILL OCCUR IN A LOGICAL AND COST EFFECTIVE MANNER BASED ON INFRASTRUCTURE DETENTION, AVAILABILITY OF UTILITY SERVICE, AND MARKET CONDITIONS. IT IS ANTICIPATED THE PROJECT WILL BE BUILT-OUT IN THREE PHASES. ALL PHASING IS SUBJECT TO TOWN OF JOHNSTOWN AND FRONT RANGE FIRE RESCUE AUTHORITY APPROVAL.

Legal Description:

A PORTION OF THE SOUTH ONE-HALF OF SECTION 6, TOWNSHIP 4 NORTH, RANGE 67 WEST OF THE SIXTH PRINCIPAL MERIDIAN, COUNTY OF WELD, STATE OF COLORADO.

Project Team:

Statement of Intent:

SINGLE-FAMILY LOTS (50' X 110') SINGLE-FAMILY LOTS (60' X 110') SINGLE FAMILY LOTS (15,000 SQ. FT.)

DUPLEX UNITS

OF USES, INCLUDING NEIGHBORHOOD COMMERCIAL.

CLOSER TO THE ARTERIAL STREET INTERSECTION.

THREE PRODUCT TYPES ARE ANTICIPATED AS FOLLOWS:

DEVELOPMENT IS STRONGLY ENCOURAGED IN THESE PARCELS.

THE INTENT OF THIS OUTLINE DEVELOPMENT PLAN (ODP) IS TO PROVIDE THE FRAMEWORK FOR THE

PURVIS FARM PROPERTY DEVELOPMENT. THIS ODP WILL CREATE A COMPATIBLE VARIETY OF LAND USES THAT ARE IN KEEPING WITH THE PROPERTY'S UNIQUE PHYSICAL ASPECTS AND TOPOGRAPHY.

THE RESIDENTIAL PLANNING AREAS ARE INTENDED TO PROVIDE FOR A VARIETY OF LOT TYPES AND SIZES AND THE MIXED USE PLANNING AREA IS INTENDED FOR THE DEVELOPMENT OF A WIDE VARIETY

FLEXIBILITY IN LOT SIZES AND HOUSING TYPES WILL ENCOURAGE INVENTIVE DESIGN TO FIT MARKET

THE HILL IN ODER TO OFFER VIEWS OF THE MOUNTAINS. THE MORE INTENSE USES ARE LOCATED

+/- 8 ACRES OF COMMERCIAL AND MIXED USE ARE PLANNED FOR THE SOUTHWEST CORNER OF THE

NEIGHBORHOOD SERVICES, OFFICE/FLEX OR SIMILAR USES. COMMERCIAL AND/OR MIXED-USE

PROPERTY, WHICH COULD INCLUDE A CONVENIENCE STORE WITH FUEL SALES, RETAIL, RESTAURANTS,

THIS DEVELOPMENT HAS ARTERIAL ROADS LOCATED ON THE SOUTH AND WEST BOUNDARIES OF THE PROPERTY. THE PROXIMITY TO AN ARTERIAL ROAD NETWORK WILL PROVIDE EXCELLENT ACCESS TO

DEMANDS. IN IN ADDITION, THIS ODP PROVIDES FOR A HIGHLY-AMENITIZED COMMUNITY, WITH MILES OF WALKING TRAILS AND SEVERAL POCKET PARKS LOCATED THROUGHOUT THE SUBDIVISION, ALLOWING FOR A PEREDSTRIAN-FRIENDLY COMMUNITY. THE PLAN TAKES ADVANTAGE OF THE NATURAL

TOPOGRAPHY OF THE SITE BY PROVIDING THE SINGLE FAMILY DETACHED RESIDENTIAL ON THE TOP OF

6037 JOHNSTOWN LLC 114 NORTH MASON STREET FORT COLLINS, CO 80524

OWNER'S REPRESENTATIVE

JEFF JENSEN JENSEN LAPLANTE DEVELOPMENT 1603 OAKRIDGE DRIVE, SUITE 101 FORT COLLINS CO 80525 970.227.0622 JEFF@JENSENLAPLANTE.COM

PLANNER:

CATHY MATHIS TB GROUP 444 MOUNTAIN AVENUE BERTHOUD, CO 80513 970.532.5891 CATHY@TBGROUP.US

CIVIL ENGINEER:

JOHN TUFTE PE SANDERSON STEWART ENGINEERING 425 EAST MULBERRY STREET FORT COLLINS, CO 80521 855.656.5255 JTUFTE@SANDERSONSTEWART.COM

Conditions of Approval:

- 1. PLANNING AREA A SHALL HAVE A MINIMUM OF 6,000 SQUARE FOOT LOTS.
- 2. PLANNING AREA A-1 SHALL HAVE A MINIMUM OF 15,000 SQUARE FOOT LOTS.
- 3. THE TOWN SUPPORTS A RIGHT-IN/RIGHT-OUT TO A 1/2-MOVEMENT ACCESS ON TO HIGHWAY 60.

December 30, 2020

Cover Sheet

___SHEET INFORMATION

Sheet Number:

Of: 5

Sheet Index:

COVER SHEET SHEET 1 OUTLINE DEVELOPMENT PLAN SHEET 2 CONCEPT PLAN

SHEET 3 MASTER UTILITY & ACCESS LOCATIONS PLAN SHEET 4 MASTER GRADING & DRAINAGE PLAN

THIS OUTLINE DEVELOPMENT PLAN, TO BE KNOWN AS PURVIS FARM ODP, IS APPROVED AND ACCEPTED BY THE TOWN OF JOHNSTOWN, BY ORDINANCE NUMBER 2021-200, PASSED AND ADOPTED ON FINAL READING AT THE REGULAR MEETING OF THE

TOWN COUNCIL OF THE TOWN OF JOHNSTOWN, COLORADO HELD ON THE 7TH DAY OF JULY, 2021.

ZONING:


PUD-MU

TOWN CLERK

Approvals:

TOWN COUNCIL

Existing Zoning:

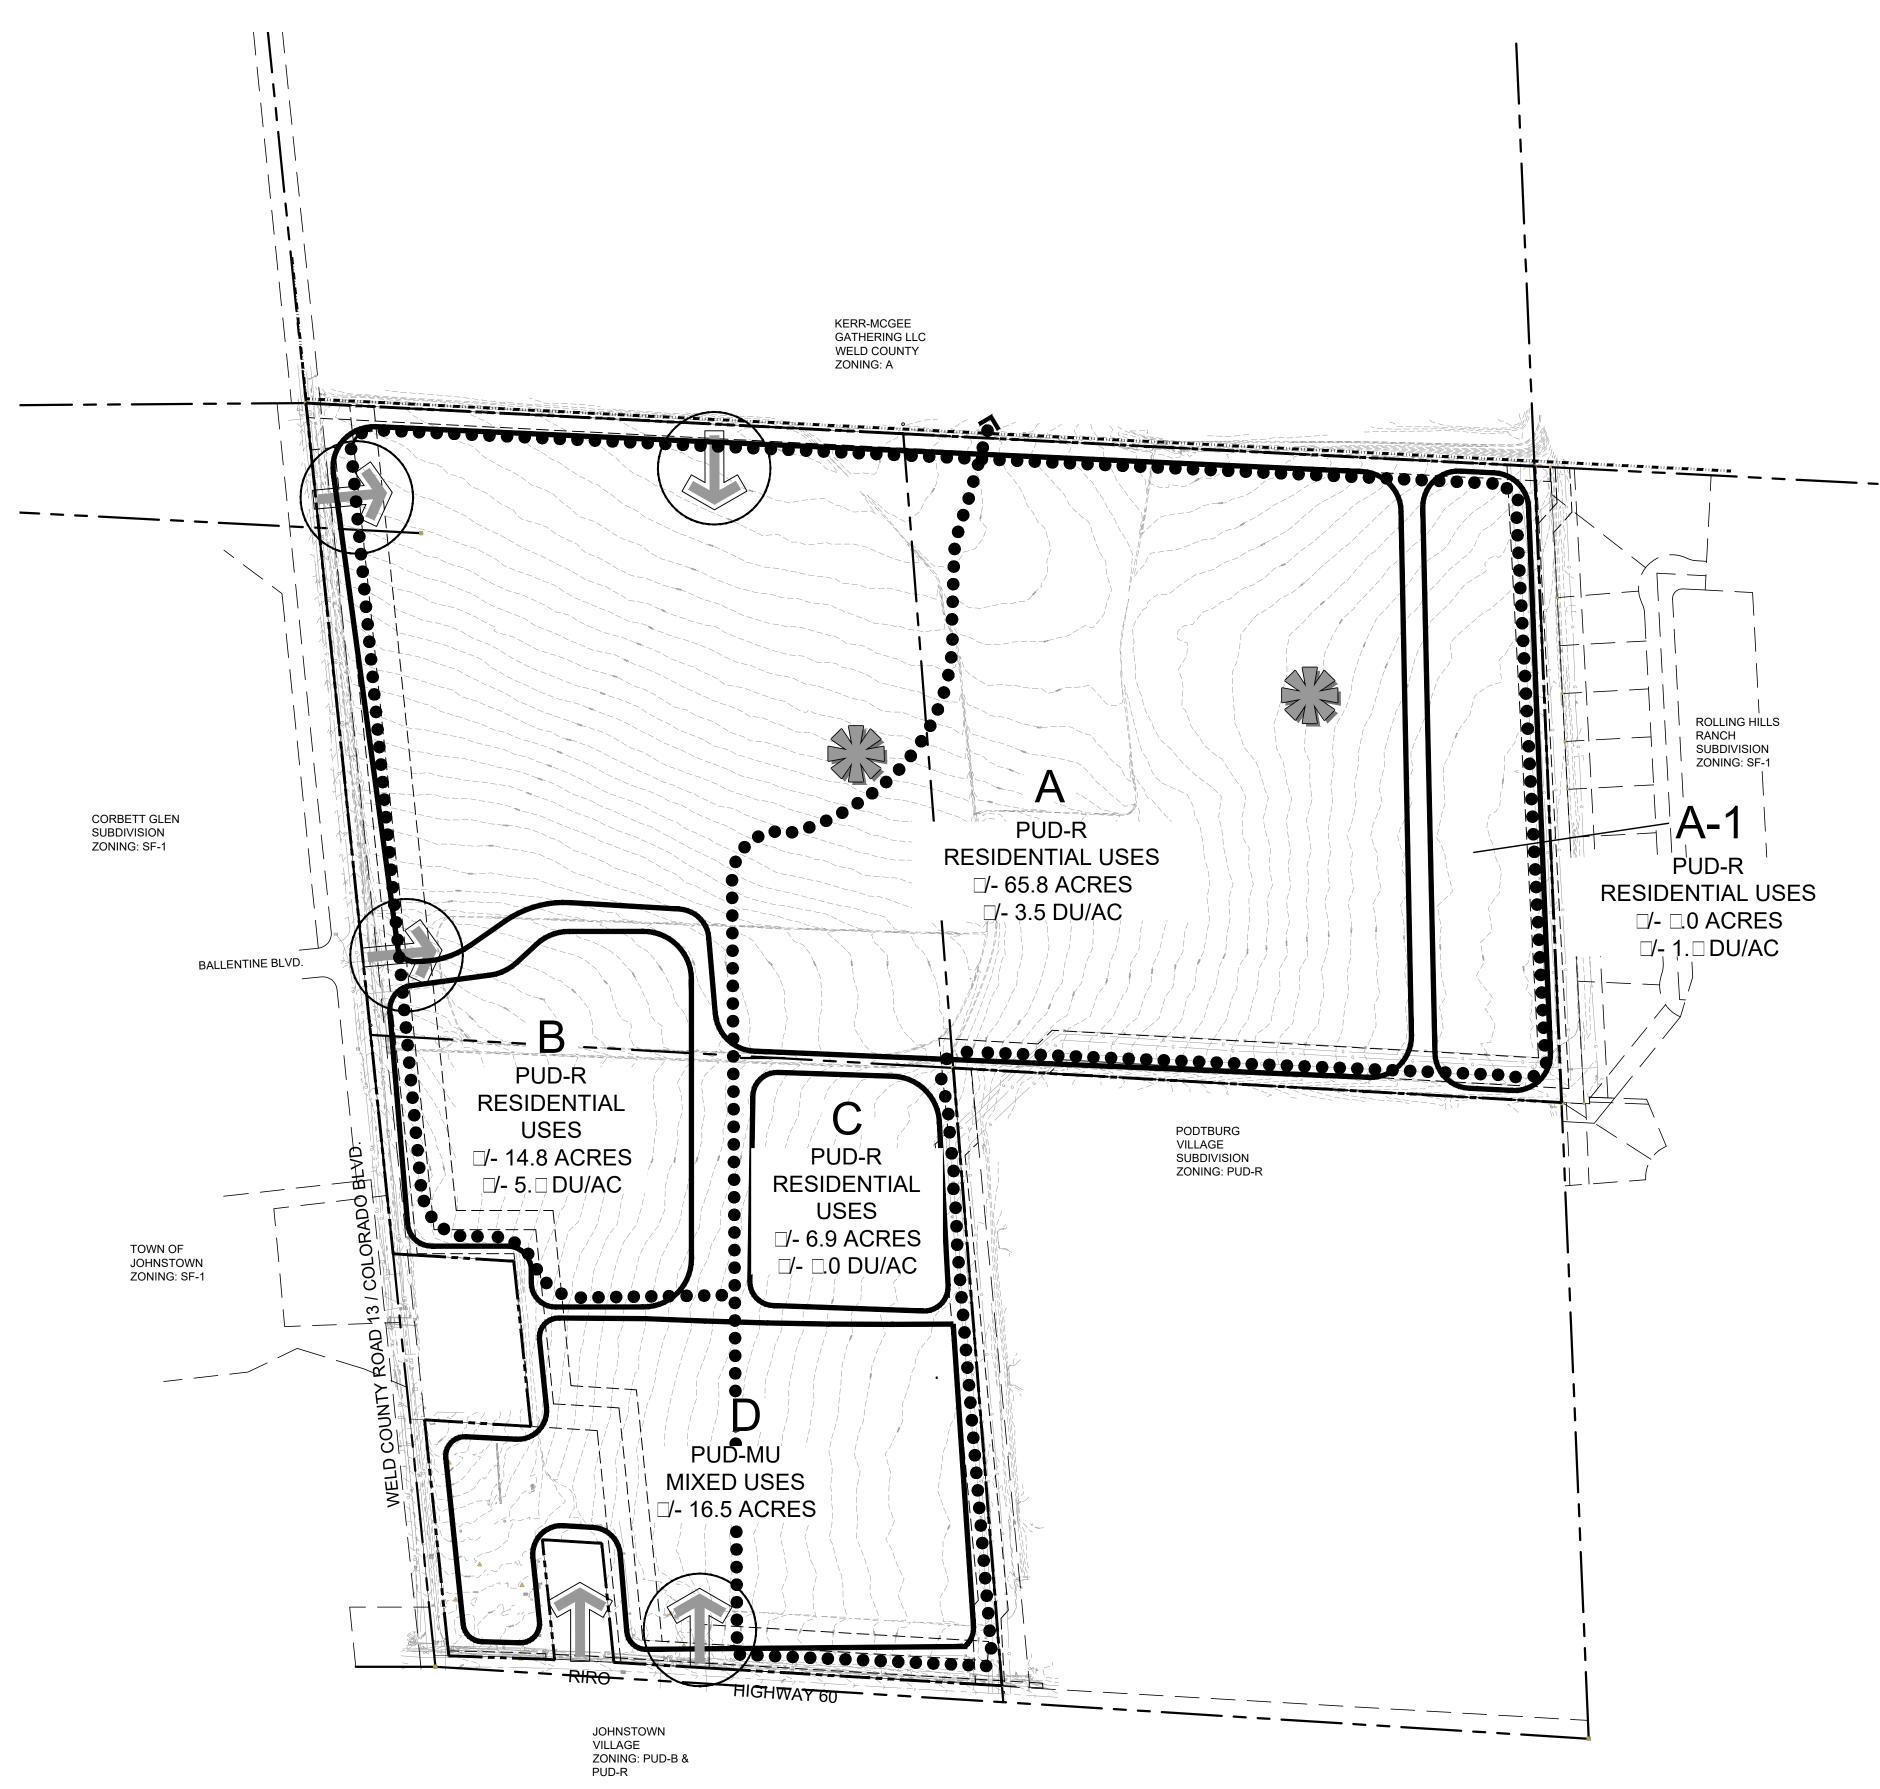

Densit□

ANTICIPATED RESIDENTIAL DENSITIES ARE SPECIFIED WITHIN EACH PARCEL. THE FINAL DENSITY SHALL BE DETERMINED AT THE TIME OF PLATTING.

PLANNING AREAS B AND C SHALL HAVE A MINIMUM DENSITY OF 5 D.U./ACRE AND A MAXIMUM DENSITY OF 10.0 D.U./ACRE.

PLANNING AREA A SHALL HAVE A MAXIMUM DENSITY OF 5.0 D.U./ACRE. PLANNING AREA D SHALL HAVE A MINIMUM DENSITY OF 10.0 D.U./ACRE WITH NO

Plannin ☐ Area Inde ☐

PLANNING AREA (PA)	APPROX. ACREAGE	ANTICIPATED USES
PA - A	+/- 65.8 AC	RESIDENTIAL USES
PA- A1	+/- 7.0 AC	RESIDENTIAL USES
PA - B	+/- 14.8 AC	RESIDENTIAL USES
PA - C	+/- 6.9 AC	RESIDENTIAL USES
PA - D	+/- 16.5 AC	MIXED USES

NGLE FAMILY DETACHED	
MINIMUM LOT SIZE	*6,000 SF
MAXIMUM HEIGHT	30'
FRONT SETBACK TO BUILDING HABITABLE SPACE	15'**
FRONT SETBACK TO GARAGE	20'
FRONT SETBACK TO SIDE LOADED GARAGE	10'
SIDE YARD SETBACK	5'
REAR YARD SETBACK (FRONT LOADED)	10'
REAR YARD SETBACK (ALLEY LOADED)	5'
SIDE (CORNER) SETBACK	10'

* EXCEPT FOR PLANNING AREA A-1, LOTS SHALL BE A MNIMUM OF 15,000 SQ. FT. ** 5' ENCROACHMENT ALLOWED FOR COVERED PORCHES.

NGLE FAMILY ATTACHED (DUPLEX LOTS)					
MINIMUM LOT SIZE	3,500 SF				
MAXIMUM HEIGHT	35'				
FRONT SETBACK TO BUILDING HABITABLE SPACE	20'*				
FRONT SETBACK TO GARAGE	20'				
FRONT SETBACK TO SIDE LOADED GARAGE	10'				
SIDE YARD SETBACK	0'				
REAR YARD SETBACK (FRONT LOADED)	10'				
REAR YARD SETBACK (ALLEY LOADED)	5'				
SIDE (CORNER) SETBACK	10'				
BUILDING SEPARATION	PER TOWN BUILDING CODE				

* 5' ENCROACHMENT ALLOWED FOR COVERED PORCHES.

SINGLE-FAMILY ATTACHED (TOWNHOME LOTS)

,	
MINIMUM LOT SIZE	1,950
MAXIMUM HEIGHT	35' (OR 50' WITH
	CONDITIONAL USE APPROVAL)
FRONT SETBACK TO BUILDING HABITABLE SPACE	15'*
MINIMUM FRONT SETBACK TO GARAGE	15'
FRONT SETBACK TO SIDE LOADED GARAGE	10'
REAR YARD SETBACK (FRONT LOADED)	10'
REAR YARD SETBACK (ALLEY LOADED)	5'
SIDE (CORNER) SETBACK	10'
BUILDING SEPARATION	PER TOWN BUILDING CODE
*5' ENCROACHMENT ALLOWED FOR COVERED POI	RCHES.

1. ZERO LOT LINES MAY BE UTILIZED WHEN A MAINTENANCE EASEMENT AND SIDE YARD EASEMENTS ARE EXECUTED.

2. IF THE TOWN OF JOHNSTOWN DEVELOPMENT STANDARDS ARE REVISED, THE MORE RESTRICTIVE STANDARDS SHALL APPLY. FOR ANY STANDARDS NOT ADDRESSED IN THIS ODP, TOWN CODES, GUIDELINES, AND STANDARDS WILL BE

4. PORCHES ARE CONSIDERED PART OF THE BUILDING FOR THE PURPOSE OF SETBACK RE□UIREMENTS.

5. GARAGES AND ACCESSORY BUILDINGS SHOULD BE AN INTEGRAL PART OF BOTH THE RESIDENCE AND THE OVERALL SITE. GARAGES AND GARAGE DOORS SHOULD BE DESIGNED SO THAT THEY ARE NOT THE DOMINANT ARCHITECTURAL FEATURES OF THE RESIDENCE. DESIGNS THAT CREATE OPEN- SPACE ENCLOSURES SUCH AS COURTYARDS, ENCLOSED PATIOS, AND PARKING COURTS ARE ENCOURAGED. GARAGES AND ACCESSORY BUILDINGS SHOULD BE CONNECTED TO THE MAIN RESIDENCE THROUGH THE USE OF BREEZEWAYS, PERGOLAS, AND COVERED WALKWAYS. THERE SHALL BE A MAXIMUM OF THREE CAR SPACES IN A GARAGE THAT IS ATTACHED AND FULLY ENCLOSED.

6. THE LANDSCAPE IN COMMON AREAS THROUGHOUT THE COMMUNITY SHOULD EMPHASIZE DROUGHT-TOLERANT AND NATIVE PLANT SPECIES. HOMEOWNERS AND BUILDERS ARE ENCOURAGED TO CONTINUE THIS STYLE OF DESIGN AND USE OF PLANT MATERIALS IN THE YARDS AROUND THE HOMES. LANDSCAPE IMPROVEMENTS ARE STRONGLY ENCOURAGED TO BE DESIGNED WITH WATER EFFICIENCY AS A MAJOR GOAL. THE FOLLOWING DESIGN TREATMENTS SHOULD BE KEPT IN MIND WHEN DESIGNING A WATER EFFICIENT LANDSCAPE:

APPROPRIATE TURF SELECTION USE OF MULCH TO MAINTAIN SOIL MOISTURE ZONING OF PLANT MATERIALS ACCORDING TO THEIR LIGHT AND WATER NEEDS IMPROVEMENT OF THE SOIL WITH ORGANIC MATTER EFFICIENT IRRIGATION SYSTEMS

PROPER MAINTENANCE AND IRRIGATION SCHEDULES RECIRCULATION OF WATER FOR DECORATIVE WATER FEATURES

NO RECREATIONAL VEHICLES, CAMPERS, BOATS, TRAILERS, MOTOR HOMES SHALL BE STORED OR PARKED IN SUCH A MANNER AS TO BE VISIBLE FROM ANY OTHER PROPERTY FOR LONGER THAN 12 HOURS IN A SEVEN 1110DAY PERIOD. SUCH VEHICLES SHALL BE KEPT ONLY WITHIN GARAGES OR ENCLOSED STRUCTURES.

PLANNING AREA D USES:

CONDITIONAL USES:

FAST FOOD RESTAURANT WITH OR WITHOUT DRIVE-THROUGH FACILITIES COFFEE SHOP

VEHICLE REPAIR

CHILD CARE CENTER LIMITED INDOOR RECREATION ESTABLISHMENT

GROCERY STORE E UIPMENT RENTAL ESTABLISHMENT

SMALL-SCALE RECEPTION CENTER ENTERTAINMENT FACILITY

RETAIL STORE WITH VEHICLE SERVICING VEHICLE MINOR REPAIR

CONVENIENCE RETAIL STORE WITH FUEL SALES

USES NOT ALLOWED:

OUTDOOR STORAGE **ENCLOSED MINI STORAGE** AGRICULTURAL OPERATIONS

ANIMAL AGRICULTURE PRISON OR DETENTION CENTER KENNEL, INCLUDING OUTDOOR ANIMAL USE AREAS

RECREATIONAL VEHICLE PARK

SHOOTING RANGE HEAVY MANUFACTURING

WORKSHOPS AND CUSTOM SMALL INDUSTRY USES

Land Use Summar ☐

LAND USE	ACRES
RESIDENTIAL DEVELOPMENT:	94.5 AC
MIXED-USE DEVELOPMENT:	16.5 AC
TOTAL	111.0 AC

Plannin ☐ Area Boundaries:

PLANNING AREA ACREAGES AND BOUNDARIES ARE PRELIMINARY AND SUBJECT TO CHANGE WITH DETAILED PLANNING. PLANNING ACREAGE MAY CHANGE UP TO 30 WITHOUT A MAJOR AMENDMENT TO THIS PUD DOCUMENT.

MAXIMUM HEIGHT	35' (OR 50' WITH CONDITIONAL USE APPROVAL)				
LOT COVERAGE	50% BUILDING				
LOT COVERAGE	20% LANDSCAPING				
SETBACK FROM ARTERIAL	15'				
PARKING SETBACK FROM ARTERIAL	50'				
NOTES:					
1. ADDITIONAL DESIGN REQUIREMENTS FOR COMMERCIAL DEVELOPMENT PER					

THE DESIGN GUIDELINES TO BE PRESENTED AT FINAL PLAT. 2. THE PLANNING DIRECTOR MAY APPROVE ADJUSTMENTS TO COMMERCIAL

SETBACKS THAT MAY BE NECESSARY DUE TO PARCEL SIZE, CONFIGURATION OR

O⊑en S⊑a⊑e, Par⊑s & Wal⊑s/Trails:

1. 30 OPEN SPACE WILL BE REQUIRED OVERALL DEVELOPMENTO 2. PUBLIC AND/OR PRIVATELY OWNED LAND WILL BE COUNTED TOWARDS OPEN SPACE RE UIREMENTS. 3. PORTIONS OF DETENTION PONDS WILL BE COUNTED TOWARDS OPEN SPACE REDUIREMENTS AND PARK SPACE CALCULATIONS. 4. PARK SPACE WILL BE COUNTED TOWARDS THE OPEN SPACE REUUIREMENTS. 5. OPEN SPACE MAY BE A LANDSCAPED AREA., A RECREATION AREA, SIDEWALKS AND/OR TRAILS, PLAZAS OR PLAYGROUNDS OR OTHER AREAS THAT ARE ACCESSIBLE TO THE RESIDENTS OF THE SUBDIVISION OR THE PUBLIC. OPEN SPACE AREAS LOCATED WITHIN A PRIVATE LOT WILL BE ACCESSIBLE TO THE RESIDENT OF THAT LOT ONLY.

1. 10 PARKS WILL BE REQUIRED BASED ON THE GROSS LAND AREA. 2. PARK LOCATIONS ARE CONCEPTUAL AND WILL BE FINALIZED AT THE TIME OF SUBDIVISION PLAT. 3. PARKS MAY BE PRIVATELY OR PUBLICLY OWNED, TO BE DETERMINED AT THE TIME OF FINAL PLAT. 4. ALL PARKS AND OPEN SPACES ARE ACCESSIBLE TO ALL INDIVIDUALS, REGARDLESS OF RESIDENCE WITHIN THE PURVIS FARM ODP.

PEDESTRIAN CONNECTIVITY: 1. CONCRETE WALKS WILL BE PROVIDED ALONG ALL STREETS. 2. ADDITIONAL WALKS AND/OR TRAILS TO BE DETERMINED AT THE TIME OF MORE DETAILED DESIGN AND/OR SUBDIVISION PLATTING. 3. DEVELOPMENT SHALL INCORPORATE ELEMENTS AND CONNECTIVITY FROM PARKS AND TRAILS MASTER PLAN AND THE JOHNSTOWN COMPREHENSIVE PLAN.

Par el Desi n Intent:

PARCELS A, B, AND C:

THE DESIGN INTENT FOR PLANNING AREAS A, B, AND C IS TO ALLOW FOR RESIDENTIAL DEVELOPMENT. RESIDENTIAL DEVELOPMENT COULD INCLUDE SINGLE FAMILY DETACHED, SINGLE FAMILY ATTACHED, TOWNHOMES OR MIXED-USE DEVELOPMENT. OTHER RESIDENTIAL USES NOT LISTED ABOVE WILL BE CONSIDERED/APPROVED BY THE PLANNING DIRECTOR.

PARCEL D:

THE DESIGN INTENT FOR PLANNING AREA D IS TO ALLOW FOR A WIDE RANGE OF DEVELOPMENT USES, INCLUDING NEIGHBORHOOD SCALE COMMERCIAL, WHICH COULD INCLUDE A CONVENIENCE STORE WITH FUEL SALES, RETAIL, RESTAURANTS, NEIGHBORHOOD SERVICES. OFFICE/FLEX OR SIMILAR USES. COMMERCIAL AND/OR MIXED-USE DEVELOPMENT IS STRONGLY ENCOURAGED IN THESE PARCELS.

Site Le □end:

—--- PROPERTY BOUNDARY DEVELOPMENT PARCEL BUBBLES FOR GRAPHICAL PURPOSES ONLY ——— RIGHT OF WAY

♦●●●● CONCRETE TRAIL




POTENTIAL ACCESS POINT - FULL MOVEMENT





JOHNSTOWN TOWN LIMITS

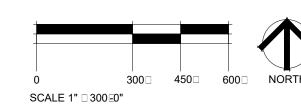



444 Mountain Ave. | TEL 970.532.5891 Berthoud, CO 80513 | WEB TBGroup.us




PURVIS FARM OUTLINE **DEVELOPMENT** PLAN

JOHNSTOWN, CO

OWNER: **JOHNSTOWN**

144 North Mason Street Fort Collins CO 80524

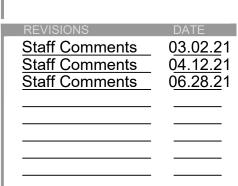


De ember 30, 2020

OUTLINE DEVELOPMENT PLAN

Sheet Number: 2

Of: **5**

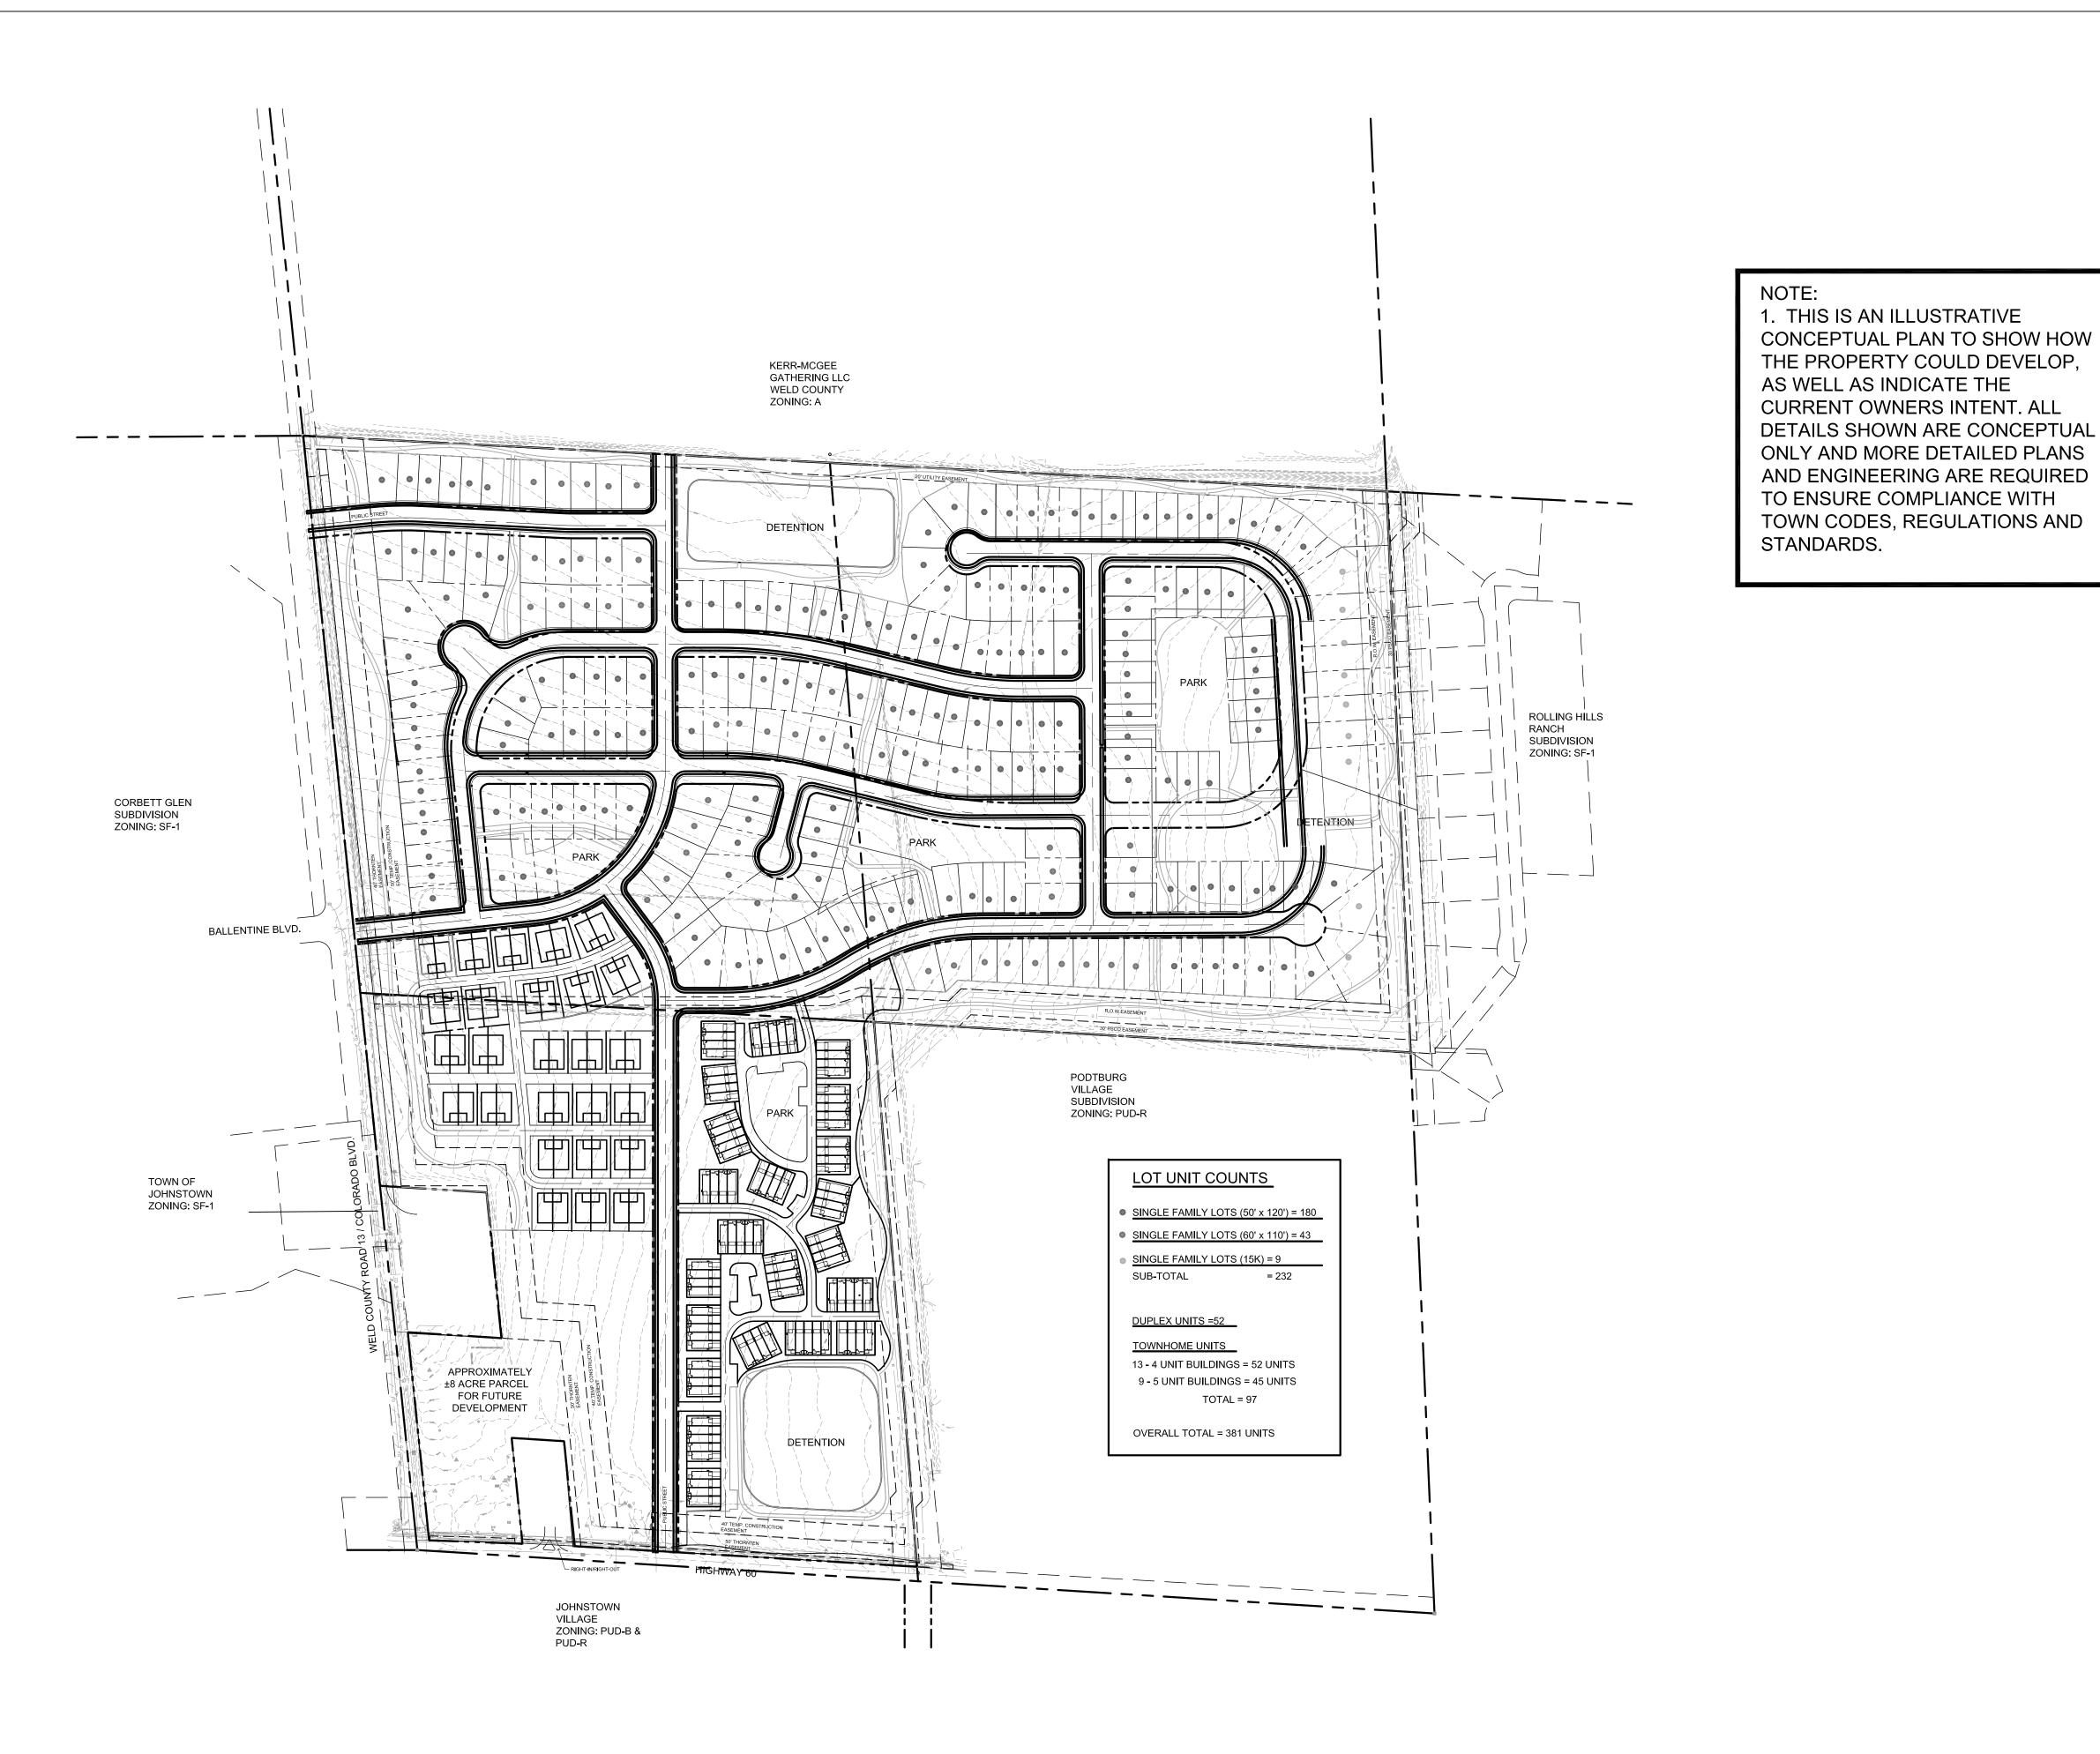



444 Mountain Ave. | те. 970.532.5891 Berthoud, CO 80513 | weв TBGroup.us

SANDERSON STEWART

PURVIS FARM OUTLINE DEVELOPMENT PLAN

JOHNSTOWN, CO

OWNER: 6037 JOHNSTOWN LLC

144 North Mason Street Fort Collins CO 80524

Staff Comments
Staff Comments
Od.12.21
Od.28.21
Od.28.21

December 30, 2020


CONCEPT PLAN

SHEET_TITLE

SHEET INFORMATION

Sheet Number: 3

Of 5

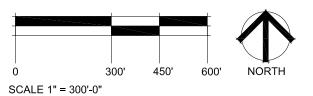



PLANNING AREA 1

8" WATERLINE

-PROPOSED

PLANNING AREA 3A

PLANNING AREA 3B

JOHNSTOWN VILLAGE

ZONING: PUD-B & PUD-R

APPROXIMATELY

±8 ACRE PARCEL FOR FUTURE

DEVELOPMENT

8" SANITARY SEWER

PROPOSED PUBLIC ROW

PROPOSED 8"-WATERLINE -PROPERTY LINE (TYP.)

DETENTION POND A

PROPOSED 8" SANITARY SEWER

PROPOSED 8"

SANITARY SEWER

PARK

POND C

STATE HIGHWAY 60

PROPOSED CONNECTION

(LOCATION APPROX.)

TO EXISTING 16" WATER MAIN

PROPOSED 8"-SANITARY SEWER

PLANNING AREA 2

PROPOSED -8" WATERLINE

PODTBURG VILLAGE

SUBDIVISION

EXISTING PROPOSED

60' R.O.W 30' PSCO 20' WIDE HOME
EASEMENT EASEMENT SUPPLY EXTENSION
(SEE NOTE 7) EASEMENT

PROPOSED -8" WATERLINE

SECTION LINE

PROPERTY LINE (TYP.)

SECTION LINE

EXISTING CORBET GLEN— LIFT STATION

(LOCATION APPROX.)

PROPOSED CONNECTION TO

AVAILABLE (SEE NOTE 5)
MANHOLE LOCATION TO BE

DETERMINED BY TOWN OF

PROPOSED CONNECTION
TO EXISTING 16" WATER MAIN

CORBETT GLEN

SUBDIVISION

EXISTING 40' THORNTON EASEMENT

BALLENTINE BLVD

PROPOSED CONNECTION
TO EXISTING 16" WATER MAIN

TOWN OF JOHNSTOWN

EXISTING SIGNALIZED — INTERSECTION

(LOCATION APPROX.)

(LOCATION APPROX.)

FUTURE SANITARY MANHOLE WHEN



	EXISTING	PROPOSED
SANITARY SEWER	ss	ss
POTABLE WATER	w	w
THORNTON RAW WATER	42"W	
PROPERTY BOUNDARY		
PRIVATE DRIVE		
RIGHT-OF-WAY		
EASEMENT LINE		
PLANNING AREA BOUNDARY		
POTENTIAL ACCESS POINT -FULL MOVEMENT		

POTENTIAL ACCESS POINT -RIGHT IN / RIGHT OUT



NOTES:

ROLLING HILLS SUBDIVISION

TO EXISTING SANITARY SEWER MANHOLE

PROPOSED CONNECTION

(LOCATION APPROX.)

-EXISTING SANITARY SEWER MANHOLE

(SEE NOTE 6)

TO ROLLING HILLS SUBDIVISION

- 1. PHASING WILL OCCUR IN A LOGICAL AND COST EFFECTIVE MANNER BASED ON INFRASTRUCTURE EXTENSION, AVAILABILITY OF UTILITY SERVICE, AND MARKET CONDITIONS. THE PROJECT WILL BE BUILT IN MULTIPLE PHASES AS THE AFOREMENTIONED CONDITIONS WILL DICTATE. ALL PHASING IS SUBJECT TO TOWN OF JOHNSTOWN AND FRONT RANGE FIRE RESCUE AUTHORITY APPROVAL.
- 2. EXISTING UNDERGROUND INSTALLATIONS & PRIVATE UTILITIES SHOWN ARE INDICATED ACCORDING TO THE BEST INFORMATION AVAILABLE TO THE ENGINEER. THE ENGINEER DOES NOT GUARANTEE THE ACCURACY OF SUCH INFORMATION. SERVICE LINES (WATER, POWER, GAS, STORM, SEWER, TELEPHONE & TELEVISION) MAY NOT BE STRAIGHT LINES OR AS INDICATED ON THE PLANS. STATE LAW REQUIRES CONTRACTOR TO CALL ALL UTILITY COMPANIES BEFORE EXCAVATION FOR EXACT LOCATIONS.
- 3. ALL WATER AND WASTEWATER ESTIMATED DEMAND CALCULATIONS WERE BASED ON THE TOWN OF JOHNSTOWN'S PUBLIC IMPROVEMENT DESIGN STANDARDS UNLESS OTHERWISE NOTED.
- 4. UTILITY MAINS AND SERVICES ARE SHOWN SCHEMATICALLY AND FINAL LOCATIONS WILL BE DETERMINED DURING FINAL PLAT AND CONSTRUCTION DOCUMENT PROCESS THROUGH THE TOWN OF JOHNSTOWN.
- 5. THE EXISTING LIFT STATION ON THE NORTHWEST CORNER OF THE PROPERTY, WEST OF COLORADO BLVD, IS ANTICIPATED TO BE ABANDONED AND REPLACED WITH A MANHOLE WITHIN THE COLORADO BLVD STREET SECTION BY THE TOWN OF JOHNSTOWN. A MANHOLE DEPTH OF 15-25 FT WOULD MAKE SERVING THE NORTHWEST PORTION OF THE PURVIS FARMS PROJECT SITE FEASIBLE. THE DEVELOPER SHALL COORDINATE THE DEPTH AND LOCATION OF THE FUTURE SANITARY SEWER MAIN WITHIN COLORADO BLVD.WITH THE TOWN OF JOHNSTOWN THROUGHOUT THE PRELIMINARY AND FINAL DESIGN.
- 6. AREAS SERVED BY THE ROLLING HILLS SANITARY SEWER IS DEPENDENT ON THE ADDITIONAL CAPACITY OF THE EXISTING SEWER SYSTEM. PROPOSED DEMANDS ON THE EXISTING SEWER WILL MEET THE TOWN OF JOHNSTOWN STANDARDS.
- 7. EXCLUSIVE 60' R.O.W EASEMENT CONTAINS THE FOLLOWING UTILITIES: ONE (1) WATER MAIN (KMG)

ONE (1) 12-INCH LIQUID PETROLEUM LINE (WES)

ONE (1) 24-INCH NATURAL GAS LINE (WES)
THE EXCLUSIVE 30' PSCO EASEMENT CONTAINS ONE (1) 16-INCH HIGH PRESSURE NATURAL GAS MAIN (XCEL)

- 8. ACCESS POINTS SHOWN ON THIS ODP ARE APPROXIMATE. EXACT LOCATIONS TO BE DETERMINED DURING THE PRELIMINARY AND FINAL PLATTING PROCESS BASED ON THE FINAL TRAFFIC IMPACT STUDY.
- 9. LOCAL AND COLLECTOR STREETS MAY CHANGE LOCATION, SIZE AND CONFIGURATION AT TIME OF PLATTING. LOCAL AND COLLECTOR STREETS SHALL CONFORM TO THE TOWN OF JOHNSTOWN STREET STANDARDS AT THE TIME OF PLATTING.
- 10. ALL DENSITIES AND UNIT COUNTS ARE PROJECTIONS, FINAL DENSITIES TO BE DETERMINED AT TIME OF PLATTING. DENSITY OF ANY GIVEN PHASE SHALL NOT EXCEED 9 DU/AC. ACTUAL NUMBER OF UNITS WILL BE DETERMINED AT TIME OF SUBDIVISION PLATTING.
- 11. AREAS OF DEVELOPMENT PARCELS SHOWN ARE APPROXIMATE AND MAY VARY. EXACT LOT SIZES WILL BE DETERMINED WITH EACH PRELIMINARY AND FINAL SUBDIVISION SUBMITTAL.
- 12. FINAL CONFIGURATION OF PARCELS, OPEN SPACE AREAS AND STREETS MAY VARY FROM THAT

2 HIGHWAY 60 EULL MOVEMENT

13. HIGHWAY 60 FULL MOVEMENT
THIS INTERSECTION IS NOTED AS A DESIRABLE FULL MOVEMENT. OUR TRAFFIC IMPACT STUDY
ANALYSIS DOES NOT SUPPORT THIS FULL MOVEMENT IN EXISTING CONDITIONS FROM A SAFETY AND
ACCESS PERSPECTIVE. THE TEAM ALSO REALIZES THE ACCESS PLAN CURRENTLY ONLY SHOWS A ¾
MOVEMENT BUT WOULD LIKE TO DISCUSS OPTIONS.

FROM A LAND DEVELOPMENT PERSPECTIVE, IT IS DESIRABLE TO ADD A FULL MOVEMENT TO HIGHWAY 60 LOCATED APPROXIMATELY 600 FEET EAST OF THE SIGNALIZED INTERSECTION OF COLORADO BOULEVARD. THE DESIGN TEAM WOULD LIKE TO WORK WITH CDOT TO REVIEW FULL MOVEMENT OPPORTUNITIES AND NECESSARY IMPROVEMENTS ALONG HWY 60 TO SUPPORT A FULL MOVEMENT.

	ESTIMATED WATER DEMAND						
Planning Area	Anticipated Uses	Units	Gross Area (ac)	SFE or Builidng Area (SF)	Average Day Demand (gpm)	Max Day Demand + Fire Flow	Peak Hour Demand (gpm)
1 & 2	Single-Family	238	N/A	238	74.4	1648.8	223.1
3A	Multi-Family	149	N/A	149	46.6	1593.1	139.7
3B	Commercial	50% Coverage	8.17	177943	24.9	1549.8	74.7
TOTALS					145.8	1791.7	437.5

PROPERTY LINE (TYP.)

STATE HIGHWAY 60-

FULL MOVEMENT

(SEE NOTE 13)

ESTIMATED WASTEWATER FLOW							
Planning Area	Anticipated Uses	Units	Gross Area (ac)	SFE or Builidng Area (SF)	Average Flow (gpm)	Peak Flow (gpm)	
1 & 2	Single-Family	238	N/A	238	36.4	141.4	
3A	Multi-Family	149	N/A	149	22.8	95.4	
3B	Commercial	50% Coverage	8.17	177943	24.7	102.2	
TOTALS			8.17		83.8	339.0	

WASTEWATER ASSUMPTIONS:
RESIDENTIAL AVERAGE FLOW (Qa)

PROPOSED CONNECTION

(LOCATION APPROX.)

TO EXISTING SANITARY SEWER

COMMERCIAL AVERAGE FLOW (Q_a) PEAKING FACTOR = 220 GPD/31 L = 200 GPD/1,000 SF BUILDING AREA (DENVER STANDARDS, MARCH 2008, ASSUMING OFFICE/SMALL BUSINESS/BIG BOX STORE USES) = $2.6 \times Q_a^{-0.16}$

WATER ASSUMPTIONS:

=150 GPCD (ASSUME 3 PEOPLE PER UNIT) = 201.6 GPD/1,000 SF OF BUILDING AREA (GREELEY STANDARDS,JUNE 2008, ASSUMING OFFICE/SMALL BUSINESS/BIG BOX STORE USES)


FIRE FLOW AVAILABILITY MAXIMUM DAY DEMAND (MDD) PEAKING HOUR DEMAND

RESIDENTIAL AVERAGE DAY DEMAND (ADD)

COMMERCIAL AVERAGE DAY DEMAND (ADD)

=1,500 GPM = 2 x ADD = 1.5 x MDD



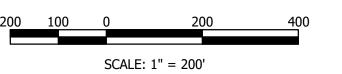



444 Mountain Ave. | TEL 970.532.5891 Berthoud,CO 80513 | WEB TBGroup.us



PURVIS FARM OUTLINE DEVELOPMENT PLAN

PROJECT TITLE

JOHNSTOWN, CO

OWNER:
JOHNSTOWN

144 North Mason Street Fort Collins CO 80524

REVISIONS DATE
STAFF COMMENTS 03/02/21

DECEMBER 30, 2020

DATE


MASTER UTILITY & ACCESS
LOCATIONS PLAN

SHEET INFORMATION

SHEET TITLE

Sheet Number: 4

Of: **5**

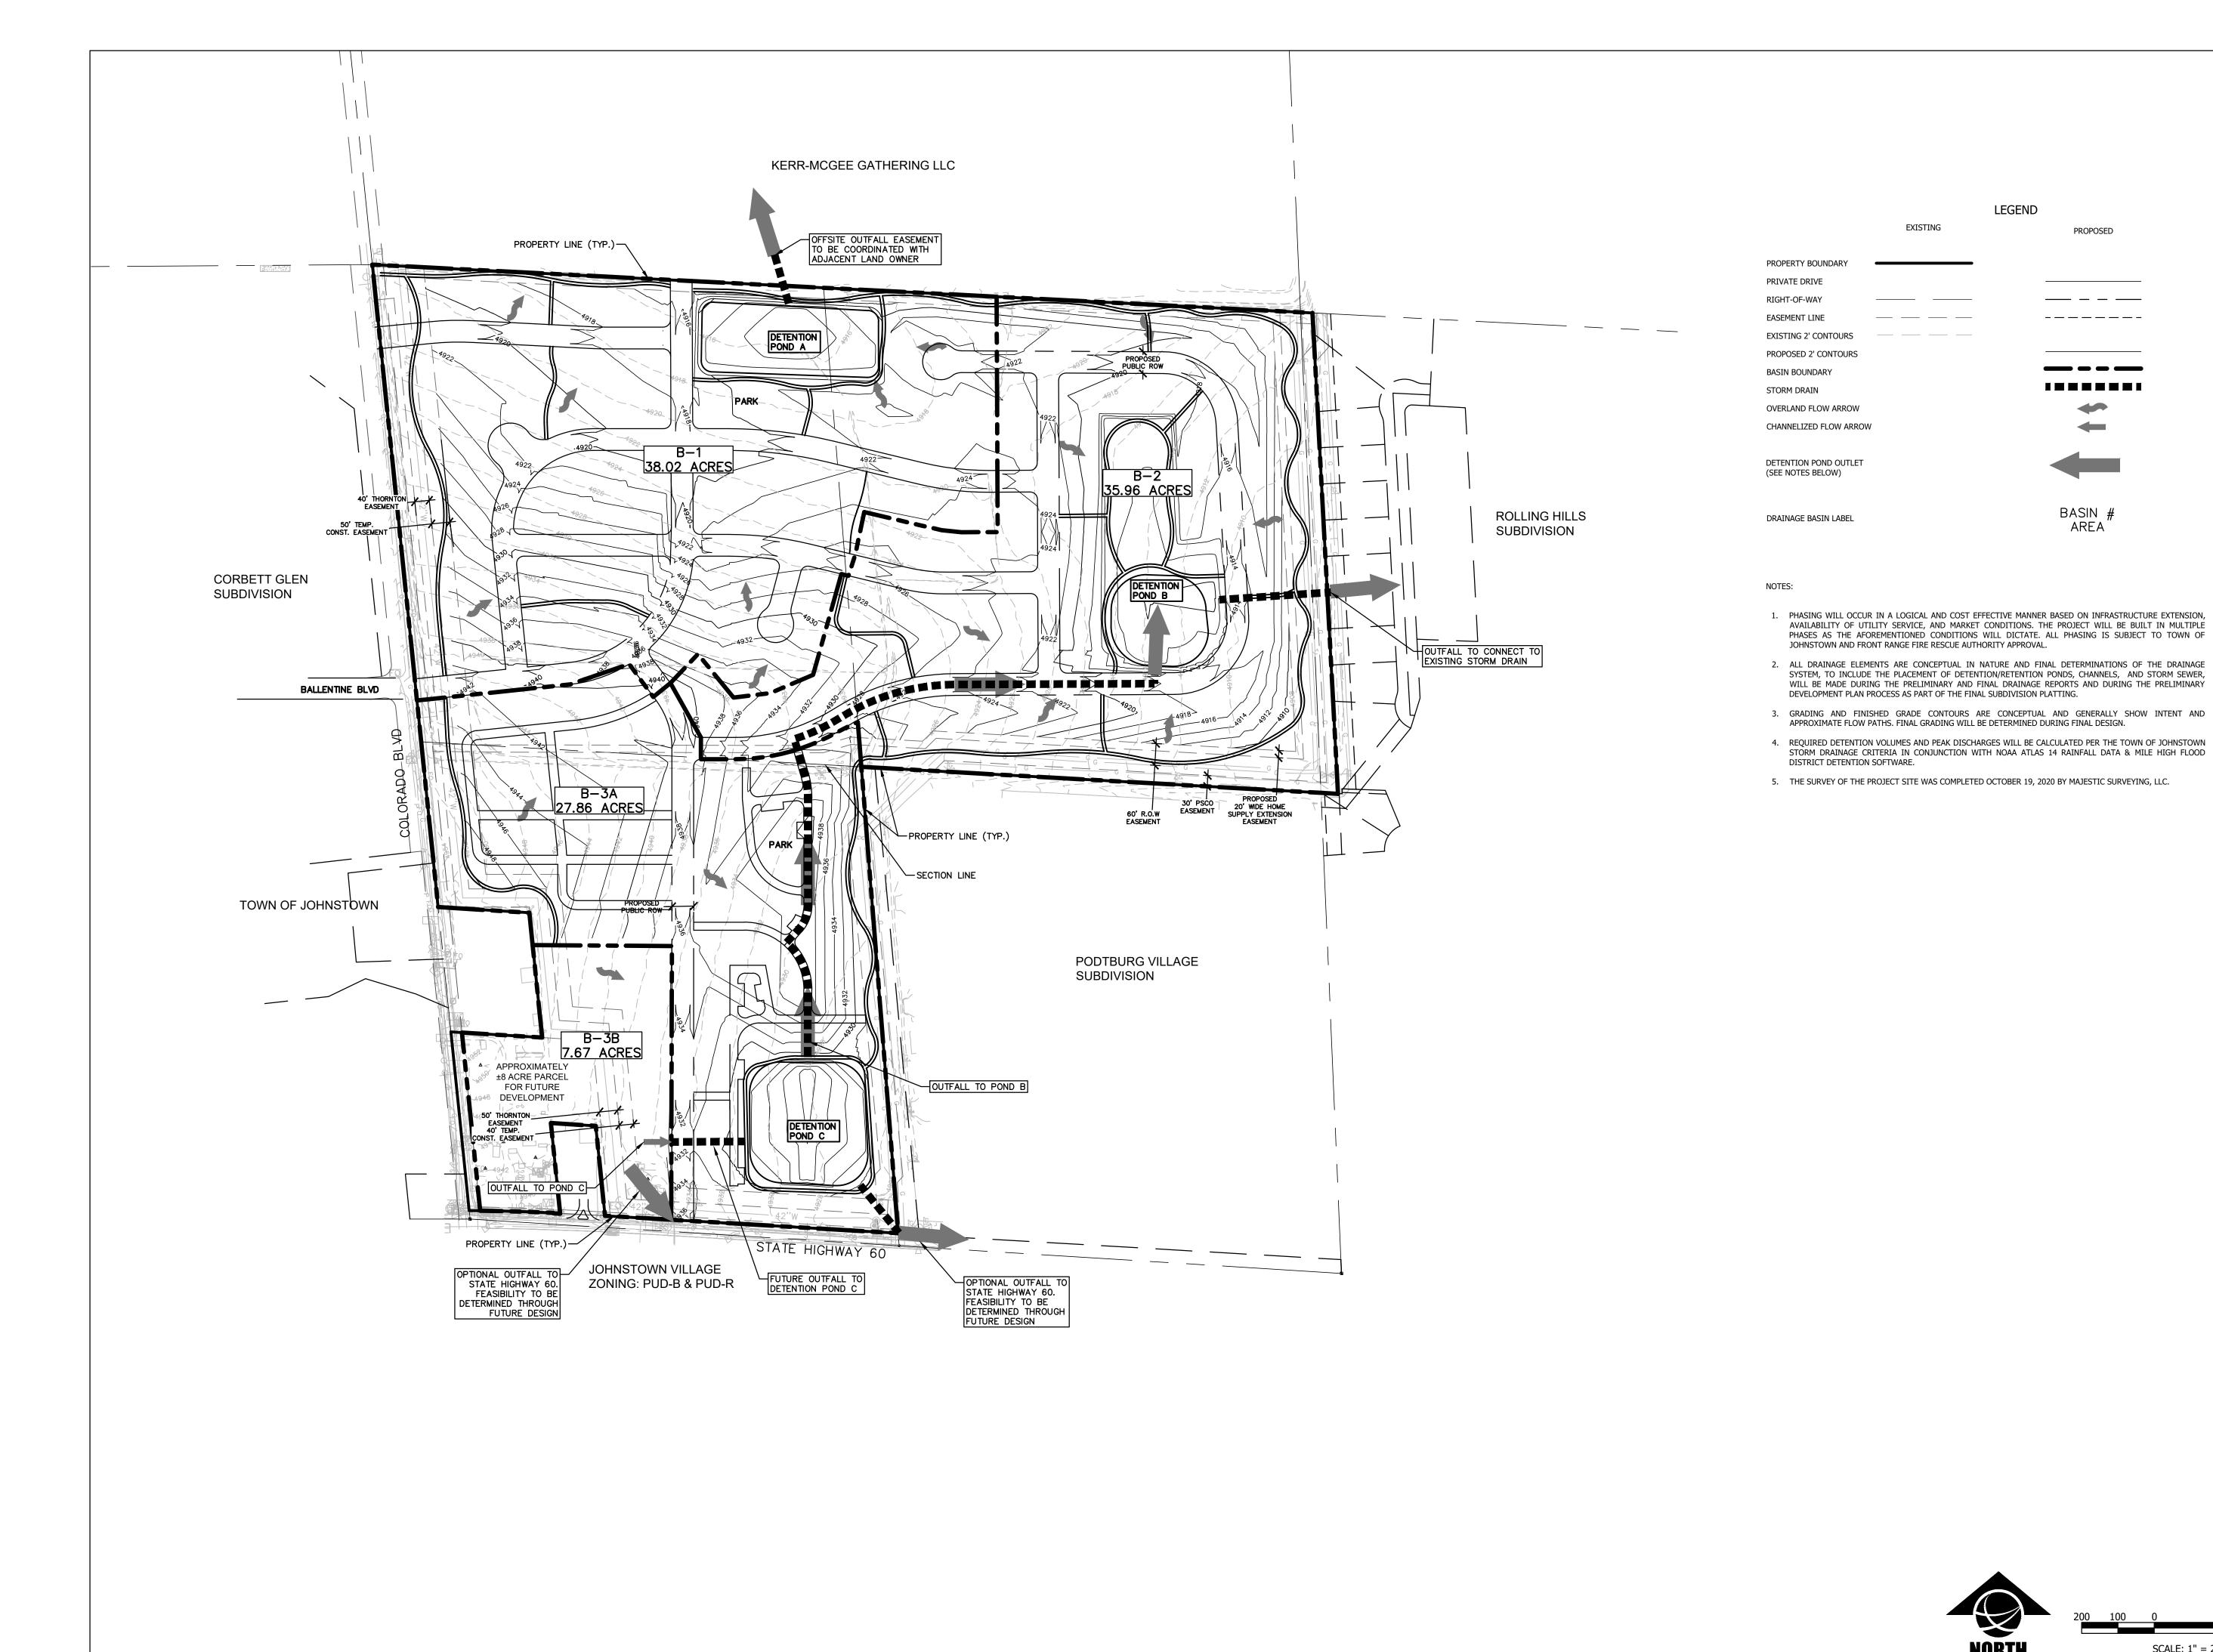



444 Mountain Ave. | тел 970.532.5891 Berthoud,CO 80513 | WEB TBGroup.us



PURVIS FARM OUTLINE DEVELOPMENT PLAN

PROJECT TITLE

JOHNSTOWN, CO

PREPARED FOR

OWNER: JOHNSTOWN

144 North Mason Street Fort Collins CO 80524

STAFF COMMENTS DATE

REVISIONS DATE

DECEMBER 30, 2020

MASTER GRADING & DRAINAGE PLAN

SHEET TITLE

SHEET INFORMATION

Sheet Number: 5

Of: **5**



SCALE: 1" = 200'

LEGEND

PROPOSED

_ _ _ _ _ _ _ _ _

BASIN #

AREA

EXISTING