Mountain View West Subdivision Third Replat FDP Submittal

Being a Replat of Tract A Block 3, 1st Replat of Block 1 Mountain View West Subdivision Replat, Lot 2 Block 2, Block 4 and Outlot C of Mountain View West Subdivision Replat Amendment No. 1, Situate in the Northwest Quarter of Section 9, Township 4 North, Range 67 West of the 6th P.M., Town of Johnstown, County of Weld, State of Colorado


Building Information				
Building Type	Number of Buildings	Number of Units		
5-plex	15	75		
4-plex	5	20		
3-plex	10	30		
Total	30	125		

	Land Use					
		Hardscape (sf)				
Right-of-Way	Private Drive	Private Sidewalk	Private Parking	Total Hardscape		
73,513	53,217	24,216	9,095	159,807		
	Landscape Area (sf)					
Irrigated Turf	Native Gras Area	Wood Mulch	Rock Mulch	Total Landscape		
30,141	145,227	49,591	136,338	280,465		
		Rooftop (sf)	•			
	117,186					
	Open Space					
Required (30% of site) = 3.8 Acres Provided = 6.4 Acres						

ROW Dedication				
Street	Area (ac)			
Public ROW	1.69			
Total ROW Dedication	1.69			

Parking Table				
Designation	Count			
Required Parking	250 (2 spaces per unit)			
Garage Parking	250 (2 per unit)			
Surface Parking (Including Handicap Parking)	17			
Handicap Parking Provided	3			
On-street parking (in ROW)	48			
Total Parking Provided	315			

1. This FDP is subject to Mountain View West PUD design guidelines as well as Town of Johnstown codes, guidelines, and standards 3. All private drives, common open spaces, and stormwater facilities will be owned and maintained by master HOA association

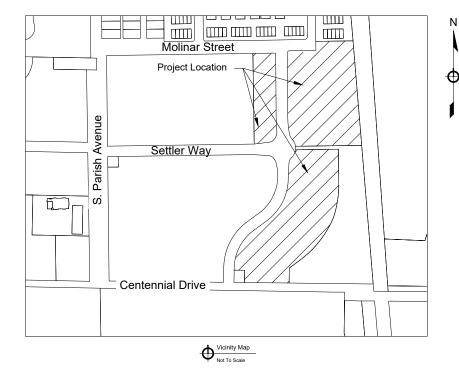

NOTE: LARGE FILE.
PLANNING STAFF REDUCED FILE SIZE --REMOVED DETAILED SITE PLAN SHEETS.

-REMOVED LIGHTING PLAN

-INCLUDED LANDSCAPE SHEETS 2, 3, & 8 AS GOOD EXEMPLARS OF THE LANDSCAPING PROPOSED ON-SITE.

	1	Rev	/ISI	ons	۱ ۱		
Page	Sheet Number	Sheet Title	Α	В	С	D	Е
1	C1.0	Coversheet	√	√	V		
2	C1.1	Overall Site Plan		✓	✓		
3	C1.2	Site Plan	✓	✓	✓		
4	C1.3	Site Plan	✓	✓	✓		
5	C1.4	Site Plan	✓	✓	✓		
6	C1.5	Site Plan	✓	✓	✓		
7-8	E1-2	Representative Elevations	✓	✓	√		
9	LT1	Lighting Plan			✓		П
10	L1	Overall Landscape	√	✓	V		П
11	L2	Landscape Plan	√	✓	V		П
12	L3	Landscape Plan	✓	✓	V		П
13	L4	Landscape Plan	√	✓	V		
14	L5	Landscape Plan	√	✓	✓		
15	L6	Landscape Plan	√	✓	✓		
16	L7	Landscape Plan	✓	✓	✓		
17	L8	Landscape Plan	✓	V	V		
18	L9	Landscape Plan			V		
19	L10	Landscape Details	✓	√	V		
20	L11	Landscape Details	✓	✓	✓		
21	L12	Water Use Plan	✓	✓	✓		
22	L13	Water Use Plan	✓	✓	√		

Sheet List Table Revisions

Legal Description

Being a Replat of Tract A Block 3, 1st Replat of Block 1 Mountain View West Subdivision Replat, Lot 2 Block 2, Block 4 and Outlot C of Mountain View West Subdivision Replat Amendment No. 1, Situate in the Northwest Quarter of Section 9, Township 4 North, Range 67 West of the 6th P.M., Town of Johnstown, County of Weld, State of Colorado

Project Contacts

Owner/Applicant
Mountain View Land Developers, LLC

Civil Engineer
LandOne Engineering, L
Daniel Hull, P.E.
Dan@landone.co
Civil Engineer
361 71st Avenue #100
Greeley, CO 80634
970-290-6190

Landscape Architect Ripley Design, Inc. 419 Canyon Avenue, Suite 200 Fort Collins, CO 80521 (970) 224-5828

Town of Johnstown 450 S Parish Ave, Johnstown, CO 80534 Phone: 970-587-4664

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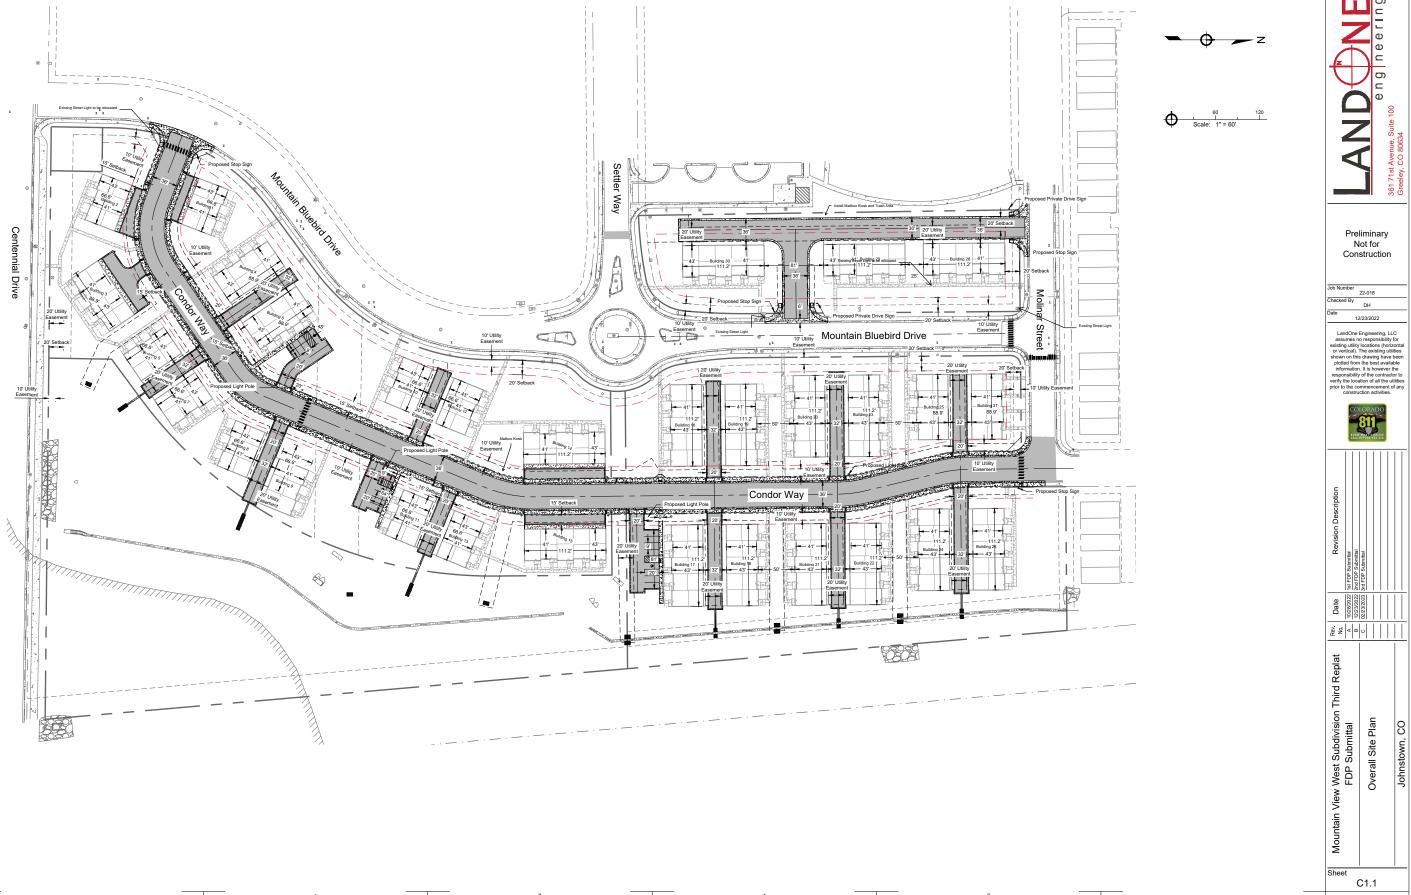
Preliminary Not for Construction


Checked By DH 22-018


This plat to be known as Mountain View West Subdivision 3rd Replat, is approved and accepted by the Town of Johnstown, by Resolution Number____ __, passed and adopted on final reading at a regular meeting of the Town Council of the Town of Johnstown, Colorado held on the _____day of


4. Final architectural elevations and model home plans will be reviewed prior to permitting.

Greeley, CO 80634 (970) 515-5294



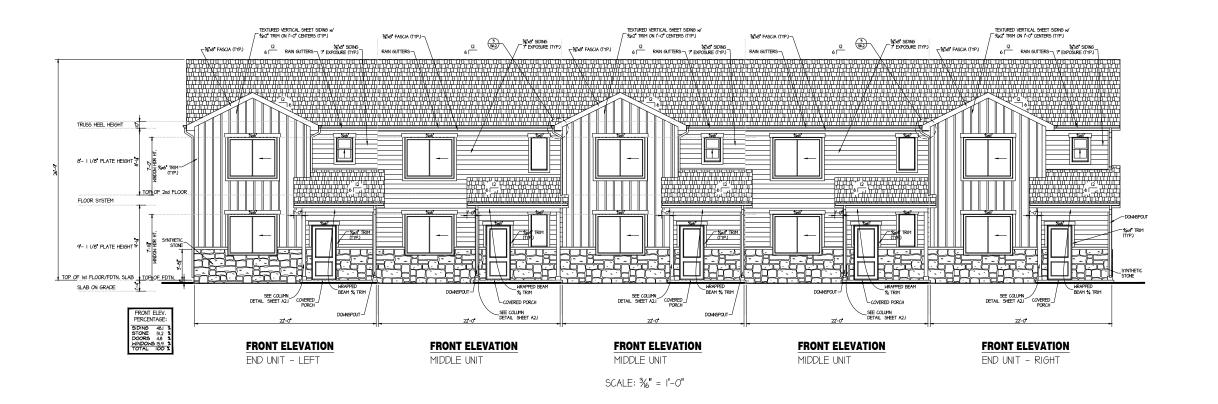

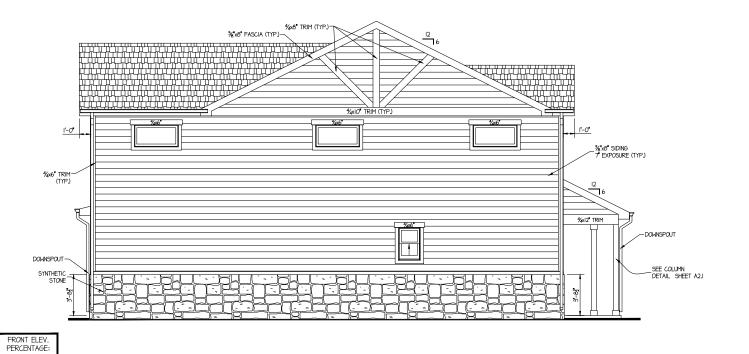

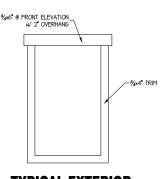

TYPICAL EXTERIOR WINDOW TRIM DETAIL

ELEVATION NOTES:

HEADERS: WINDOWS

- -- Ist FLOOR HT. = 7'-113''' -- 2nd FLOOR HT. = 7'-0"
- DOORS -- FRONT DOOR = 6'-8"

EXTERIOR:

- ALL VENTS THROUGH THE ROOF SHALL BE LOCATED ON THE SIDE OR THE REAR SLOPING ROOF SECTIONS. SOFFITS WILL EITHER BE VENTED MATERIAL OR HAVE ADEQUATE VENTING CUT IN DEPENDING ON AVAILABILITY OF MATERIAL.

SIDING 74.7 % STONE 22.6 % DOORS 0.0 % WINDOWS 2.7 % TOTAL 100 %

GUTTER & DOWNSPOUTS:

- ALL GUTTERS AND DOWNSPOUTS ARE LOCATED PER THE ELEVATIONS.
- ALL DOWNSPOUT LOCATIONS NEED 4' TIP OUTS ON



END UNIT SCALE: 1/4" = 1'-0"

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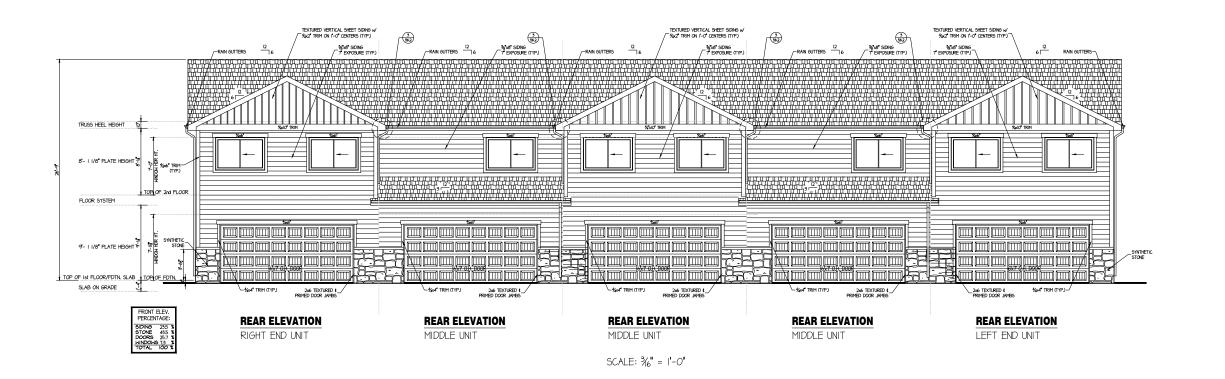
Greeley, Colorado 970-353-1492


FRONT - LEFT ELEVATIONS 5 - PLEX

JOHNSTOWN

00 <u>₩</u> 00 - Lot

2.24.23 SCALE AS NOTED
MODEL #
5-PLEX 5-PLE



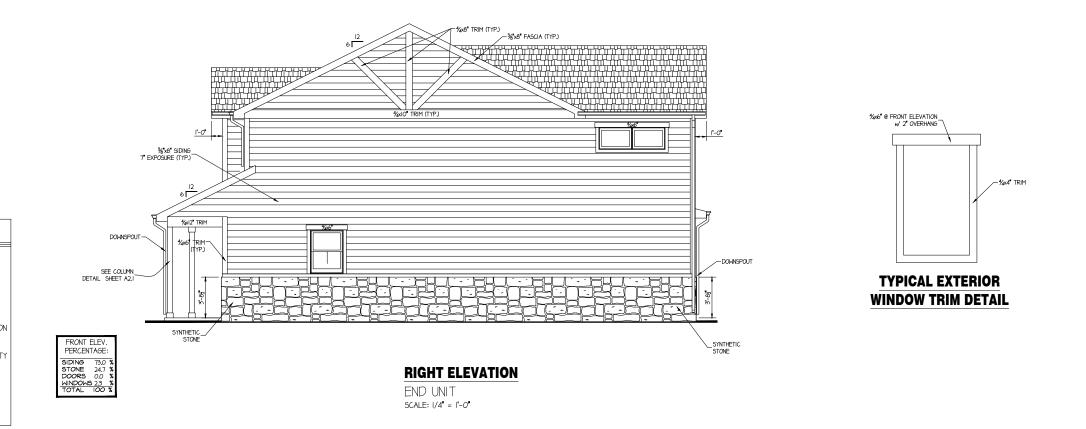

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Greeley, Colorado 970-353-1492

ELEVATIONS REAR · RIGHT | 5 · PLEX

JOHNSTOWN

0 $\stackrel{\cdot}{\mathbb{H}}$ Lot 00,

SCALE AS NOTED
MODEL #
5-PLEX

5-PLE

ELEVATION NOTES:

HEADERS: - WINDOWS

-- Ist FLOOR HT. = 7'-113/6" -- 2nd FLOOR HT. = 7'-0"

- DOORS -- FRONT DOOR = 6'-8"

EXTERIOR:


ALL VENTS THROUGH THE ROOF SHALL BE LOCATED ON THE SIDE OR THE REAR SLOPING ROOF SECTIONS.

SOFFITS WILL EITHER BE VENTED MATERIAL OR HAVE ADEQUATE VENTING CUT IN DEPENDING ON AVAILABILITY OF MATERIAL.

GUTTER & DOWNSPOUTS:

- ALL GUTTERS AND DOWNSPOUTS ARE LOCATED PER THE ELEVATIONS.

ALL DOWNSPOUT LOCATIONS NEED 4' TIP OUTS ON ENDS.

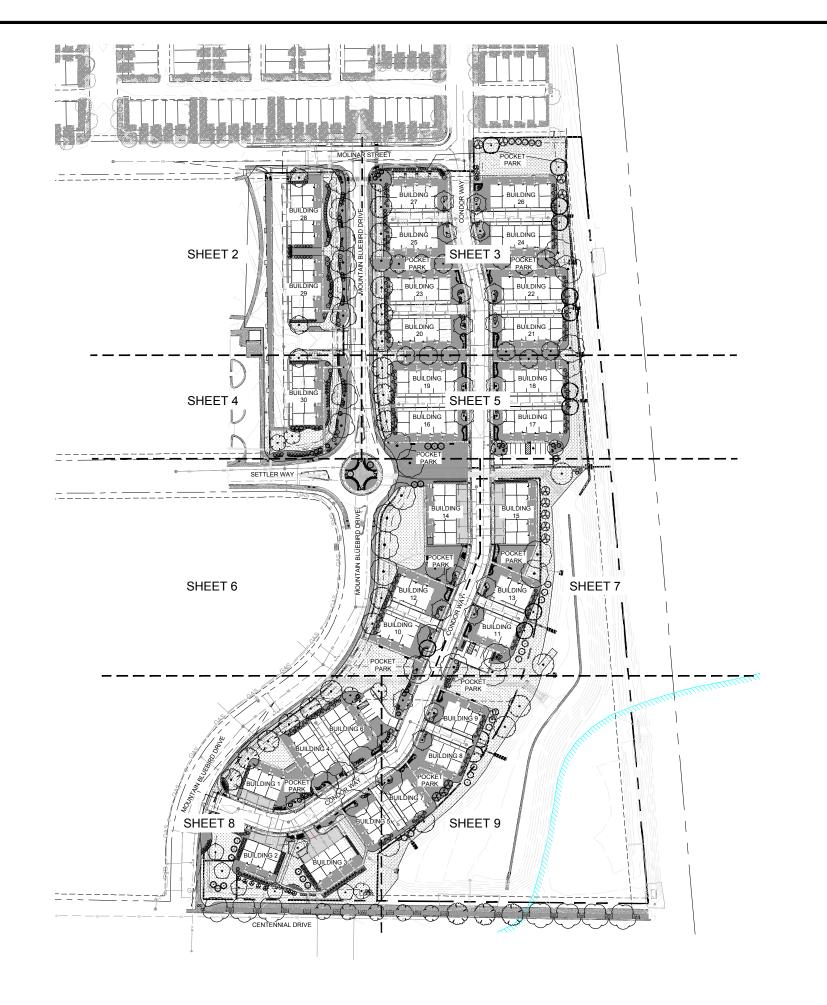

PLANT SCHEDULE

COMMON NAME
OHIO BUCKEYE
NORTHERN CATALPA
COMMON HACKBERRY
SHADEMASTER LOCUST
KENTUCKY COFFEETREE
CHINKAPIN OAK DECIDUOUS TREES AGL CSP COC GTI GDE QMU QRO TCG UAC CHINKAPIN OAK ENGLISH OAK GREENSPIRE LITTLELEAF LINDEN ACCOLADE ELM

EVERGREEN TREES PPB PPH

COMMON NAME BABY BLUE EYES SPRUCE HOOPSI SPRUCE

ORNAMENTAL TREES PCP SRJ

COMMON NAME 'CRIMSON POINTE FLOWERING PLUM JAPANESE TREE LILAC

COMMON NAME SUNISET HYSSOP FALSE INDIGO CONCORDE JAPANESE BARBERRY RED LEAF JAPANESE BARBERRY GREEN VELVET BOXWOOD DARK KNIGHT BLUEBEARD IVORY HALO® DOGWOOD ISANTI REDOSIER DOGWOOD WHITE SWAD CONNECT OWER

ISANTI REDOSIER DOGWOOD
WHITE SWAN CONEFLOWER
PURPLE BMPEROR CONEFLOWER
GOLD TIDE® FORSYTHIA
GOLDEN PRIVET
DIABLO NINEBARK
PRAMIE SNOW CINQUEFOIL
PAWNEE BUTTES SAND CHERRY
GRO-LOW FRAGRANT SUMAC
NEARLY WILD ROSE
MISS CANADA PRESTON LILAC
MOR-COLOURFUL™ WEIGELA

COMMON NAME BLONDE AMBITION GRASS KOREAN FEATHER REED GRASS FEATHER REED GRASS AVALANCHE FEATHER REED GRASS GRASSLAND SEDGE VARIEGATED EULALIA GRASS

LEGEND

ANA
BTC
BTA
BGV
CD2
CAB
CSI
EW
EP
FCO
LVG
POD
PFD
PSP
RGL
RAN
SPM
WI

02 LANDSCAPE MATERIAL DESCRIPTION SYMBOL

IRRIGATED TURF

NATIVE GRASS AREA

WOOD MULCH

= PROPERTY BOUNDARY
= MATCH LINE

____ = LOT LINE ---- = SETBACK

= RIGHT OF WAY = STORMWATER UTILITY

= WATER UTILITY = SANITARY SEWER UTILITY → PROPOSED PRIVACY FENCE

= PROPOSED GRADING = EXISTING SANITARY SEWER

= EXISTING GAS LINE = EXISTING ELECTRIC LINE = EXISTING WATER LINE

> = EXISTING STORMWATER UTILITY = EXISTING TOPOGRAPHY

• = LANDSCAPE BOULDERS = GAS METER

= FIRE HYDRANT = TRANSFORMER

MOUNTAIN VIEW WEST SUBDIVISION THRID PLAT

FDP SUBMITTAL

JOHNSTOWN, CO PREPARED BY:



419 Canyon Ave. Suite 200 Fort Collins, CO 80521 phone 970.224.5828 | fax 970.225.6657 | www.ripleydesigninc.com

OWNER

BAESSLER HOMES Mitch Nelson 33105 CR 33 Greeley, CO 80634 p. 970-373-8569

LANDSCAPE ARCHITECT

RIPLEY DESIGN INC. 419 Canyon Ave. Suite 200 Fort Collins, CO 80521

ENGINEER

LANDONE ENGINEERING, LLC Dan Hull, PE 361 71st Ave. Greeley, CO 80634 p. 970.632.2311




01 FDP ROUND 1
02 FDP ROUND 2
03 FDP ROUND 3

OVERALL LANDSCAPE PLAN



DRAWING NUMBER

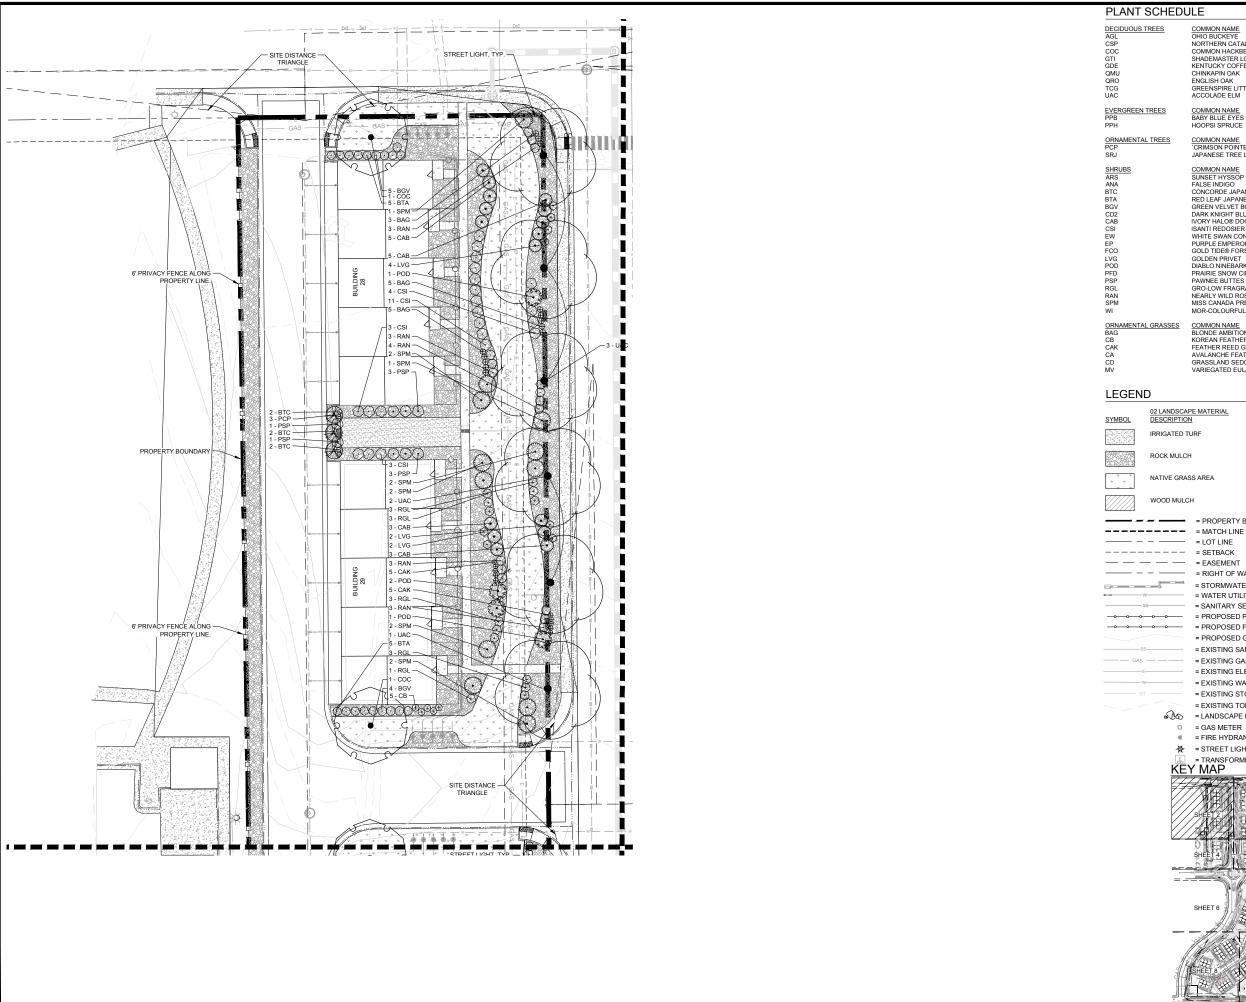

PLANT SCHEDULE

COMMON NAME
OHIO BUCKEYE
NORTHERN CATALPA
COMMON HACKBERRY
SHADEMASTER LOCUST
KENTUCKY COFFEETREE
CHINKAPIN OAK
ENGLISH OAK
GREENSPIRE LITTLELEAF LINDEN
ACCOLADE ELM DECIDUOUS TREES

EVERGREEN TREES COMMON NAME BABY BLUE EYES SPRUCE HOOPSI SPRUCE

COMMON NAME CRIMSON POINTE FLOWERING PLUM JAPANESE TREE LILAC

COMMON NAME
SUNSET HYSSOP
FALSE INDIGO
CONCORDE JAPANESE BARBERRY
RED LEAF JAPANESE BARBERRY
GREEN VELVET BOXWOOD
DARK KNIGHT BLUEBEARD
IVORY HALO® DOGWOOD
ISANTI REDOSIER DOGWOOD
WHITE SWAN CONNECT OWER WHITE SWAN CONEFLOWER
PURPLE EMPEROR CONEFLOWER
GOLD TIDE® FORSYTHIA GOLDEN PRIVET
DIABLO NINEBARK
PRAIRIE SNOW CINQUEFOIL
PAWNEE BUTTES SAND CHERRY GRO-LOW FRAGRANT SUMAC NEARLY WILD ROSE MISS CANADA PRESTON LILAC $\mathsf{MOR}\text{-}\mathsf{COLOURFUL}^{\intercal}\mathsf{WEIGELA}$

COMMON NAME BLONDE AMBITION GRASS KOREAN FEATHER REED GRASS FEATHER REED GRASS AVALANCHE FEATHER REED GRASS GRASSLAND SEDGE VARIEGATED EULALIA GRASS

02 LANDSCAPE MATERIAL DESCRIPTION

= PROPERTY BOUNDARY

- = LOT LINE ---- = SETBACK --- = EASEMENT = RIGHT OF WAY

> = STORMWATER UTILITY = WATER LITILITY

= SANITARY SEWER UTILITY → PROPOSED PRIVACY FENCE

→ PROPOSED FENCE = PROPOSED GRADING

= EXISTING SANITARY SEWER = EXISTING GAS LINE

= EXISTING ELECTRIC LINE = EXISTING WATER LINE

= EXISTING STORMWATER UTILITY = EXISTING TOPOGRAPHY ■ = LANDSCAPE BOULDERS

= GAS METER = FIRE HYDRANT

→ STREET LIGHT

KEY MAP



MOUNTAIN VIEW WEST SUBDIVISION THRID PLAT

FDP SUBMITTAL

IOHNSTOWN CO PREPARED BY:



419 Canyon Ave. Suite 200 Fort Collins, CO 80521 phone 970.224.5828 | fax 970.225.6657 | www.ripleydesigninc.com

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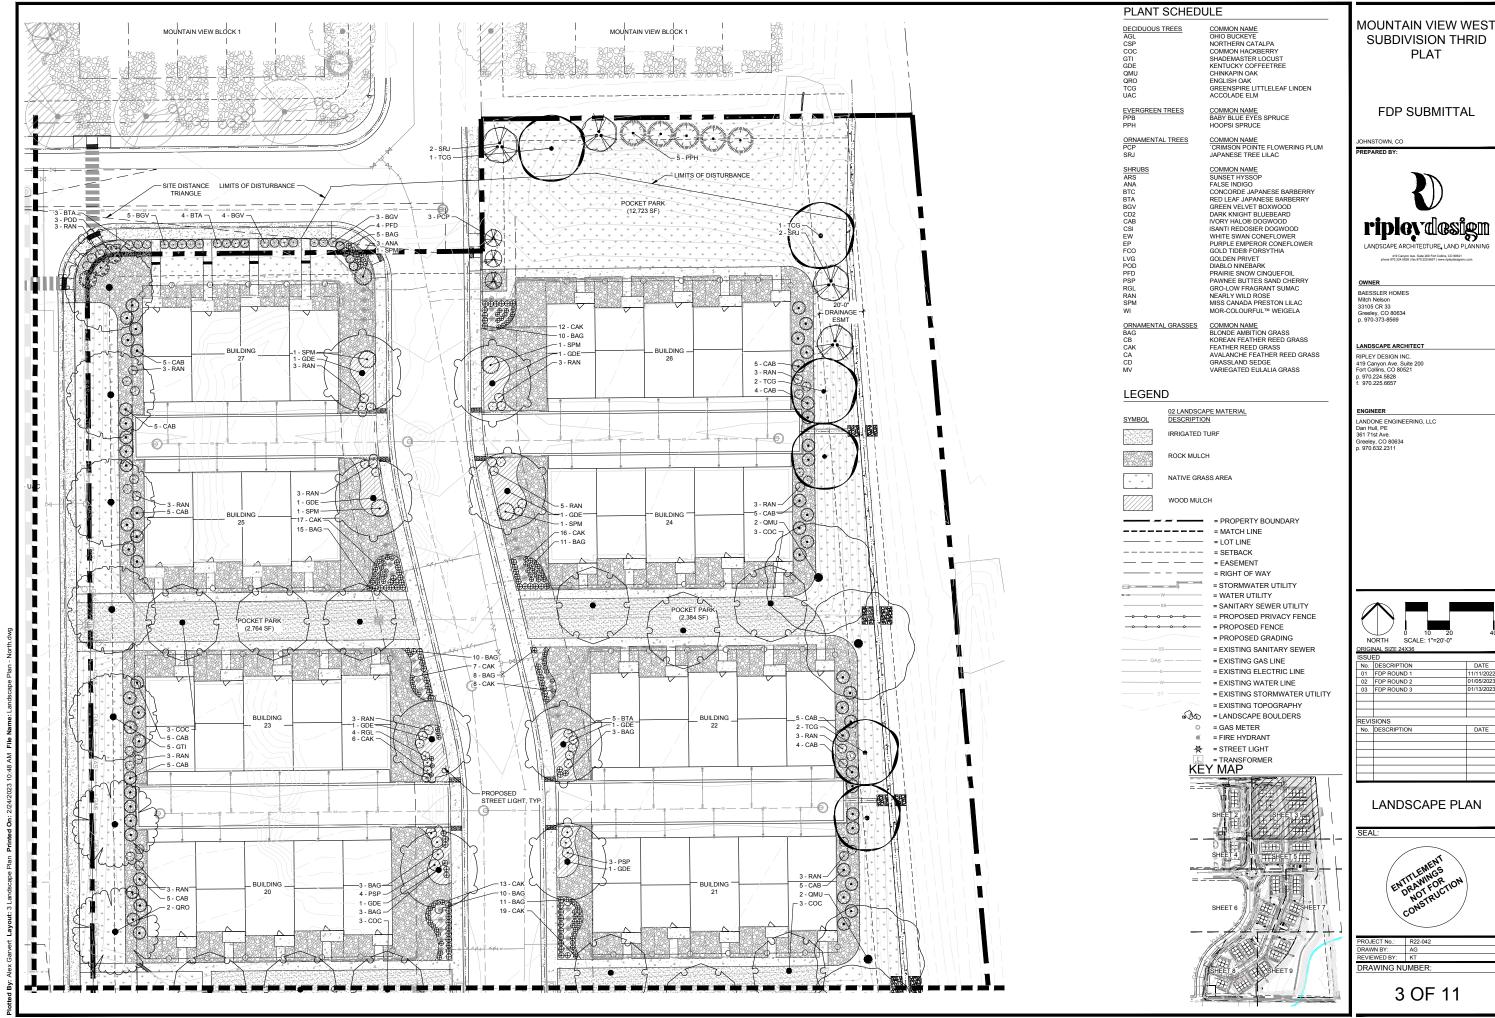
LANDONE ENGINEERING, LLC Dan Hull, PE 361 71st Ave. Greeley, CO 80634 p. 970.632.2311



01 FDP ROUND 1
02 FDP ROUND 2
03 FDP ROUND 3


LANDSCAPE PLAN

DRAWING NUMBER



SUBDIVISION THRID



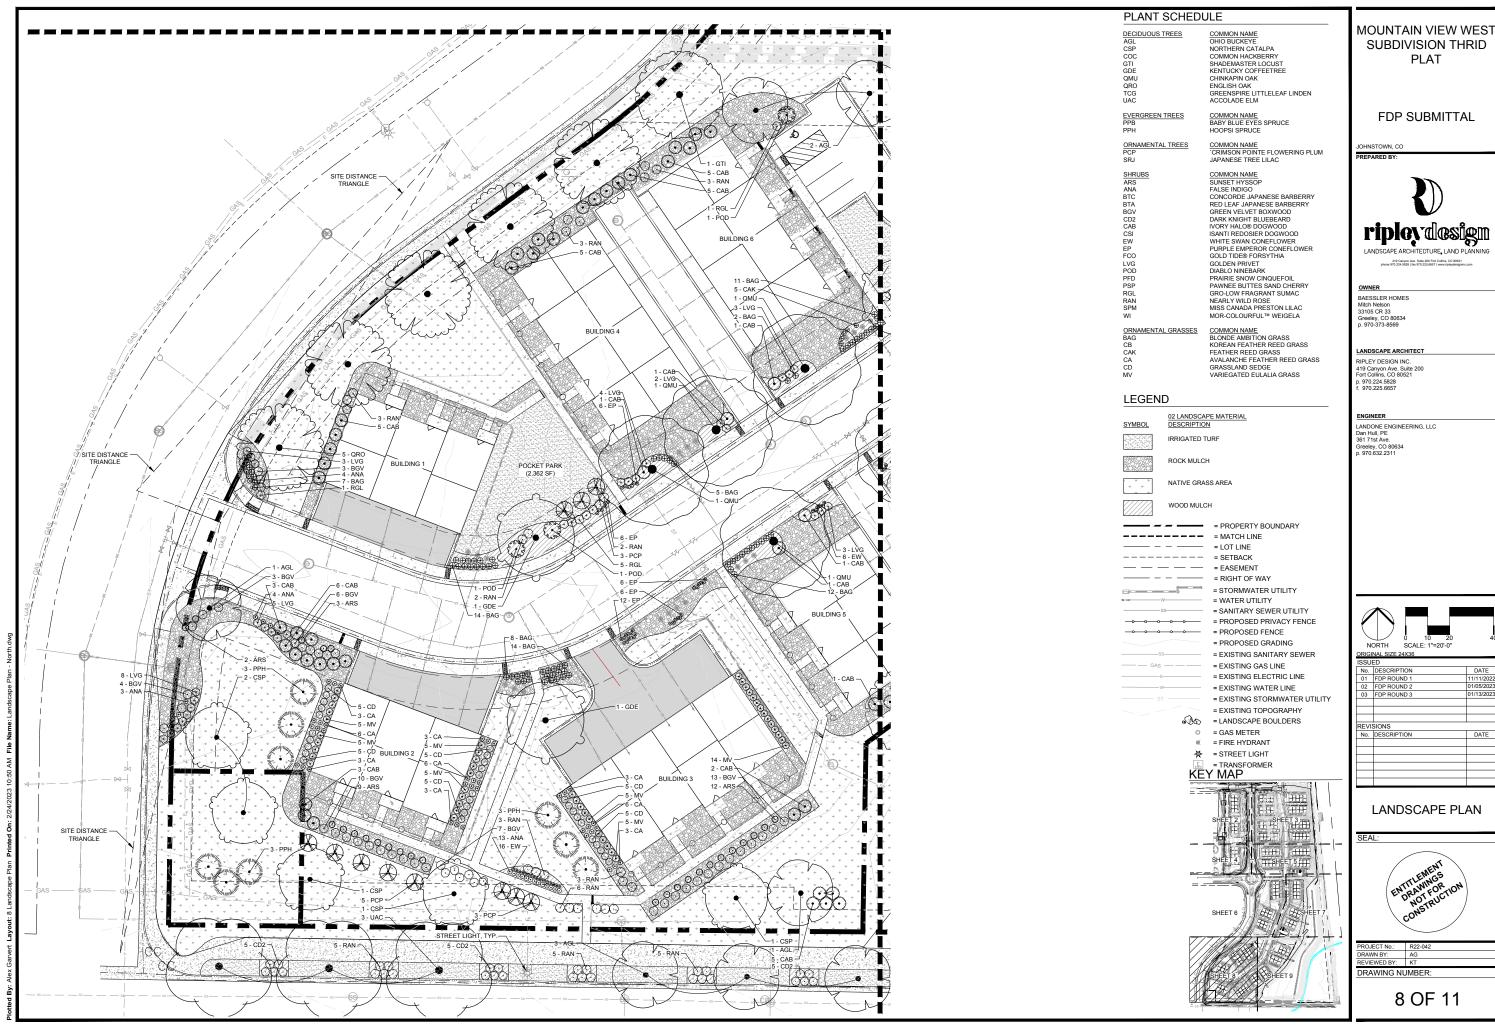


SUBDIVISION THRID





Ī	DESCRIPTION	DATE
	FDP ROUND 1	11/11/2022
Ī	FDP ROUND 2	01/05/2023
Ī	FDP ROUND 3	01/13/2023
Ī		
T	SIONS	
Ī	DESCRIPTION	DATE
ī		
Ī		
Ī		



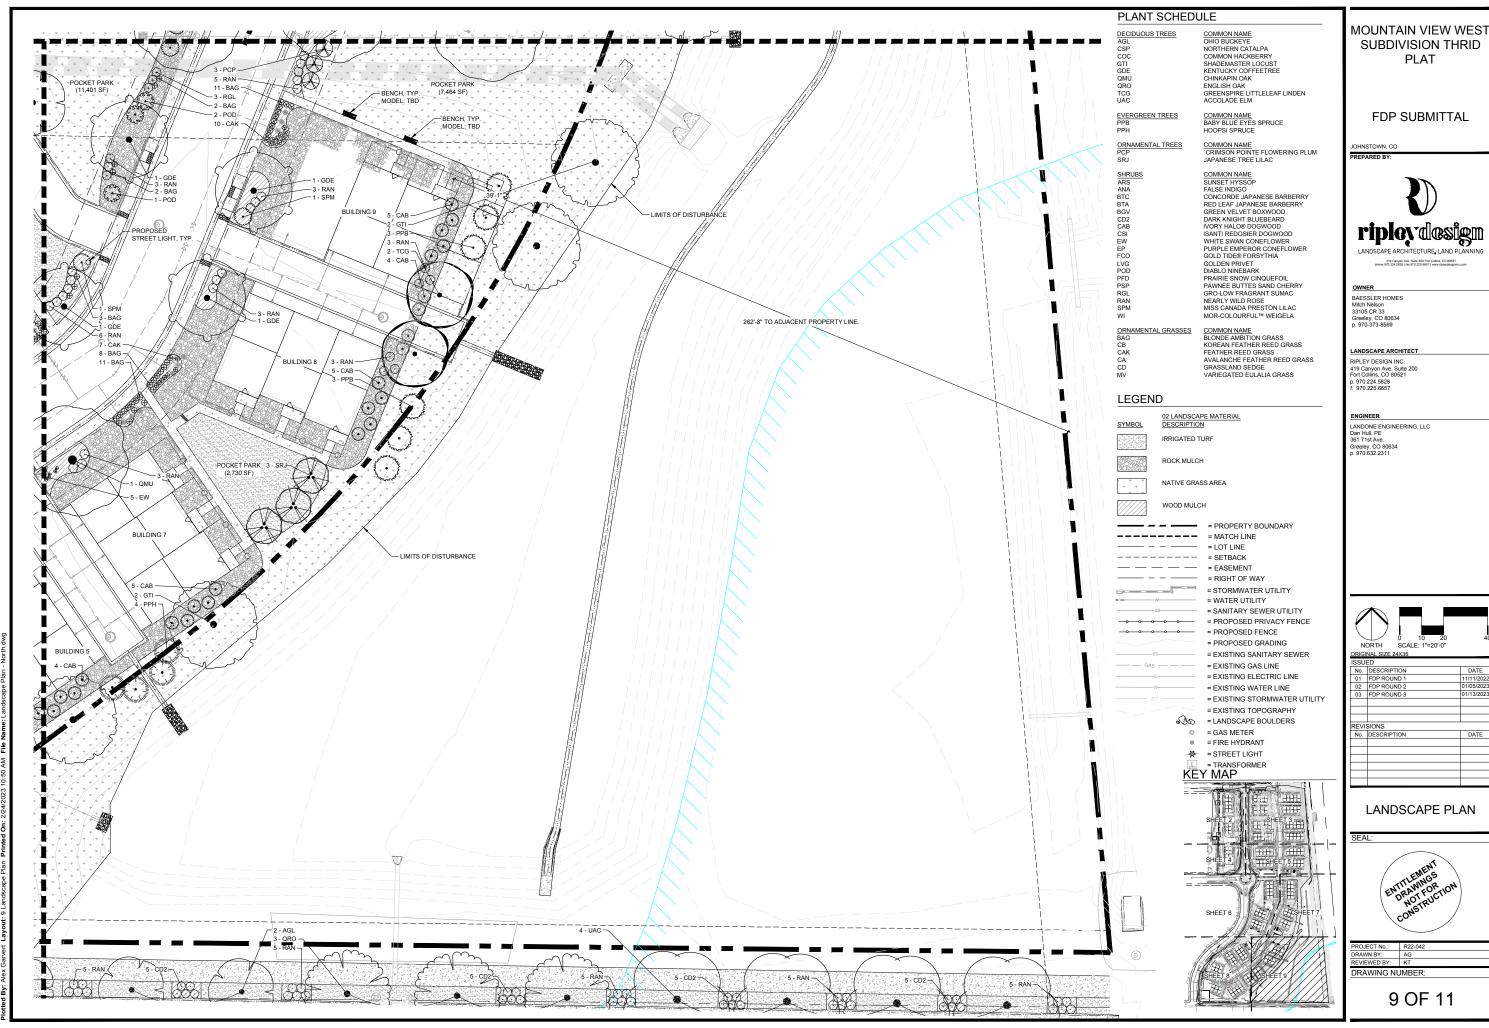

SUBDIVISION THRID



TREE PLANTING DETAIL - WOOD POSTS (1) SCALE: NTS

STAKING NOTES:
STAKE TREES PER FOLLOWING SCHEDULE, THEN REMOVE AT
END OF FIRST GROWING SEASON AS FOLLOWS:
1 1/2* CALIPER SIZE - MIN. 1 STAKE ON SIDE OF PREVAILING
WITH CALIPER SIZE - MIN. 2 STAKES - ONE ON N.W. SIDE,
ONE ON S.W. SIDE
3* CALIPER SIZE - MIN. AS TAKES - ONE ON N.W. SIDE,
ONE ON S.W. SIDE
3* CALIPER SIZE AND LAGGER - 3 STAKES PER DIAGRAM
WIRE OR CABLE SHALL BE MIN. 12 GAUGE. TIOHTEN ONLY
BROUGHT ONE PROM SUPPINO, ALLOW FOR SOME TRUMK
ACCOMMODATE 1 1/2* OF GROWTH AND BUFFER ALL BRANCHES

PRUNING NOTES:
DO NOT HEAVILY PRUNE THE TREE AT PLANTING, PRUNE
ONLY CROSSOVER LIMES, CO-DOMINANT LEADERS AND
BROKEN BRANCHES. SOME INTERIOR TIMES AND
LATERAL BRONCHES MAY GET PRUNCH ON HOVEYER, DO
NOT REMOVE THE TERMINAL BLUGS OF BRANCHES THAT
SATEND TO THE EDGE OF THE GROWN

2

MESH AND CONTAINERS FROM ENTIRE ROOT BALL AND TRUNK

 GUYING PLAN ROUND-TOPPED SOIL BERM 4" HIGH X 8" WIDE ABOVE ROOT BALL SURFACE SHALL BE CONSTRUCTED AROUND THE ROOT BALL BERM SHALL BEGIN AT ROOT BALL PERIPHERY. (OMIT IN TURF

OP-MO-04

CONIFER TREE PLANTING DETAIL - WOOD POSTS SCALE: NTS OP-MO-06

White Continues PLACEMENT NOTES:

SET SHRUB PLUMB. SPACE PLANTS, AND PLACE FOR REST EFFECT. SET TOP OF ROOTBALL 1-2" HIGHER THAN 4" HIGH WATER SAUCER

OP OF ROOT BALL

SCARIEY SIDES AND USE 1:1 SLOPE = SHRUB PLANTING DETAIL EMEMOVE CONTAINER (INCLUDING FIBER CONTAINERS), BASKETS, WIRE, ETC. FROM THE ROOT BALL BREAK UP ENDIGHLOR FOOTS WITH SHARP KNIFE OR SPADE. SPLIT BOTTOM OF ROOT BALL PLACE ON NUBSURBER SOIL TO PREVENT SETILEMENT. PRIOR TO MULCHING, LIGHTLY TAMP SOIL AROUND THE ROOT BALL IN 9 LIFTS TO BRACE SHRUB. DO NOT OWER COMPACT, WHEN THE PLANTING

(3) SCALE: NTS

NATIVE SEED MIX

NATIVE SEED WIX				
COMMON NAME	SEPCIES NAME	% OF MIX	# PLS/ACRE	HYDROZONE
ANNUAL RYE		20%	5.0	VL
SIDE OATS GRAMA	BOUTELOUA CURTIPENDULA	8%	2.0	VL
BLUE GRAMA	BOUTELOUA GRACILIS	12%	3.0	VL
SLENDER WHEATGRASS	ELYMUS TRACHUCAULUS	12%	3.0	VL
CANADA WILD RYE	ELYMUS CANADENSIS	12%	3.0	VL
WESTERN WHEATGRASS	PASCOPYRUM SMITHII	8%	2.0	VL
SWITCHGRASS	PANICUM VIRGATUM	6%	1.5	VL
LITTLE BLUESTEM	SCHIZACHYRIUM SCOPARIUM	6%	1.5	VL
BUFFALOGRASS	BOUTELOUA DACTYLOIDES	8%	2.0	VL
BIG BLUSTEM	ANDROPOGON GERARDII	8%	2.0	VL
		100 0000	25	

PLANT SCHEDULE

DECIDUOUS TREES	QTY	BOTANICAL / COMMON NAME	CONT
AGL	13	AESCULUS GLABRA / OHIO BUCKEYE	B & B
CSP	5	CATALPA SPECIOSA / NORTHERN CATALPA	B&B
COC	15	CELTIS OCCIDENTALIS / COMMON HACKBERRY	B & B
GTI	14	GLEDITSIA TRIACANTHOS INERMIS 'SHADEMASTER' TM / SHADEMASTER LOCUST	B&B
GDE	23	GYMNOCLADUS DIOICA `ESPRESSO` / KENTUCKY COFFEETREE	B&B
QMU	22	QUERCUS MUEHLENBERGII / CHINKAPIN OAK	B&B
QRO	13	QUERCUS ROBUR / ENGLISH OAK	B&B
TCG	13	TILIA CORDATA 'GREENSPIRE' / GREENSPIRE LITTLELEAF LINDEN	B&B
UAC	15	ULMUS X 'ACCOLADE' / ACCOLADE ELM	B&B
EVERGREEN TREES	QTY	BOTANICAL / COMMON NAME	CONT
PPB	19	PICEA PUNGENS 'BABY BLUE EYES' / BABY BLUE EYES SPRUCE	B & B
PPH	19	PICEA PUNGENS 'HOOPSII' / HOOPSI SPRUCE	B & B
ORNAMENTAL TREES	QTY	BOTANICAL / COMMON NAME	CONT
PCP PCP	20	PRUNUS CERASIFERA 'CRIMSON POINTE' / 'CRIMSON POINTE FLOWERING PLUM	B & B
SRJ	12	SYRINGA RETICULATA / JAPANESE TREE LILAC	B & B
SHRUBS	QTY	BOTANICAL / COMMON NAME	SIZE
ARS	26	AGASTACHE RUPESTRIS 'SUNSET' / SUNSET HYSSOP	5 GAL
ANA	27	AMORPHA NANA / FALSE INDIGO	3 GAL
BTC	9	BERBERIS THUNBERGII 'CONCORDE' / CONCORDE JAPANESE BARBERRY	5 GAL
BTA	34	BERBERIS THUNBERGII 'ATROPURPUREA' / RED LEAF JAPANESE BARBERRY	3 GAL
BGV	74	BUXUS X 'GREEN VELVET' / GREEN VELVET BOXWOOD	5 GAL
CD2	35	CARYOPTERIS X CLANDONENSIS 'DARK KNIGHT' / DARK KNIGHT BLUEBEARD	5 GAL
CAB	222	CORNUS ALBA 'BAILHALO' / IVORY HALO® DOGWOOD	5 GAL
CSI	21	CORNUS SERICEA 'ISANTI' / ISANTI REDOSIER DOGWOOD	3 GAI
EW	36	ECHINACEA PURPUREA 'WHITE SWAN' / WHITE SWAN CONEFLOWER	5 GAL
EP	48	ECHINACEA X 'PURPLE EMPEROR' / PURPLE EMPEROR CONEFLOWER	5 GAL
FCO	8	FORSYTHIA X 'COURTASOL' / GOLD TIDE® FORSYTHIA	5 GAL
LVG	57	LIGUSTRUM X VICARYI / GOLDEN PRIVET	5 GAL
POD	25	PHYSOCARPUS OPULIFOLIUS 'DIABLO' / DIABLO NINEBARK	5 GAL
PFD	4	POTENTILLA FRUTICOSA DAVURICA 'PRAIRIE SNOW' / PRAIRIE SNOW CINQUEFOIL	3 GAL
PSP	15	PRUNUS BESSEYI 'PAWNEE BUTTES' / PAWNEE BUTTES SAND CHERRY	3 GAL
RGL	71	RHUS AROMATICA 'GRO-LOW' / GRO-LOW FRAGRANT SUMAC	3 GAL
RAN	212	ROSA X 'NEARLY WILD' / NEARLY WILD ROSE	3 GAL
SPM	30	SYRINGA X PRESTONIAE 'MISS CANADA' / MISS CANADA PRESTON LILAC	5 GAL
WI	7	WEIGELA FLORIDA 'MORCOLZAM' / MOR-COLOURFUL™ WEIGELA	5 GAL
ORNAMENTAL GRASSES	QTY	BOTANICAL / COMMON NAME	SIZE
BAG	368	BOUTELOUA GRACILIS 'BLONDE AMBITION' / BLONDE AMBITION GRASS	1 GAI
CB	5	CALAMAGROSTIS BRACHYTRICHA / KORFAN FEATHER REED GRASS	1 GAI
CAK	338	CALAMAGROSTIS X ACUTIFLORA 'KARL FOERSTER' / FEATHER REED GRASS	1 GAL
CA	36	CALAMAGROSTIS X ACUTIFLORA 'AVALANCHE' / AVALANCHE FEATHER REED GRASS	1 GAL
CD	39	CAREX DIVULSA / GRASSLAND SEDGE	1 GAL
	39 84		
MV	84	MISCANTHUS SINENSIS 'VARIEGATUS' / VARIEGATED EULALIA GRASS	1 GAL

COMMON OPEN SPACE LANDSCAPE					
TOTAL PROPERTY AREA = 557,328 SF					
REQUIRED*	JIRED*: 167,198 SF PROPOSED: 280,465 SF				
TREES	63	TREES	188**		
SHUBS	312	SHRUBS	886**		

*COMMON OPEN SPACE LANDSCAPE REQUIREMENT CALCULATIONS ARE BASED ON TOWN OF JOHNSTOWN - LANDSCAPE STANDARDS AND SPECIFICATIONS SECTION E.1.b.i.c., EXCLUDES PRIVATE FRONT YARDS, POCKET PARKS AND RIGHT-OF-WAY.

-30 % OF SITE = 167,198 OR 3.8 ACRES - REQUIRED TREES (1 PER 4,500 SF) = 63 - REQUIRED SHRUBS (5 PER 4,500 SF) = 312

** ROW TREES AND SHRUBS, PRIVATE FRONT YARDS NOT INCLUDED IN COMMON OPEN SPACE

ARTERIAL RIGHT-OF-WAY LANDSCAPE						
CENTENNIAL DR. RIGHT	CENTENNIAL DR. RIGHT-OF-WAY AREA = +/- 14,874 SF					
REQL	REQUIRED* PROPOSED					
TREES	15	TREES	15			
SHUBS 75 SHRUBS 75						
*DEGUUDED *NDGG4.DE		•				

*REQUIRED LANDSCAPE MATERIAL -REQUIRED TREES (1 PER 1,000 SF) = 15 -REQUIRED SHRUBS (5 PER 1.000 SF) = 75

ARTERIAL BUFFER LANDSCAPE				
CENTENNIAL DR. BUFFER (30') = 24,390 SF (.056 ACRES)				
REQUIRED* PROPOSED				
TREES	13	TREES	14	
SHUBS	61	SHRUBS	70	

*REQUIRED LANDSCAPE MATERIAL
-REQUIRED TREES (1 PER 2,000 SF) = 13
-REQUIRED SHRUBS (5 PER 2,000 SF) = 61

POCKET PARK LANDSCAPE						
REQUIRED AREA (10% OF SITE) = 55,732 SF (1.28 ACRES)						
PROVIDED AREA = 56,346 SF (1.29 ACRES)						
REQUIRED* PROPOSED						
TREES	13	TREES	42			
SHUBS 65 SHRUBS 71						
*REQUIRED LANDSCAPE	MATERIAL					

-REQUIRED TREES (1 PER 4 500 SE) = 13

NOTE:
- ALL DETENTION LANDSCAPING REQUIREMENTS WERE SATISFIED AT THE TIME OF ANNEXATION
AND TOWN APPROVED PUD FOR MOUNTAIN VIEW WEST
- ALL OPEN SPACE AND PARK REQUIREMENTS WERE SATISFIED AT THE TIME OF ANNEXATION AND
TOWN APPROVED PUD FOR MOUNTAIN VIEW WEST.

LANDSCAPE NOTES

CAL 2"CAL 2"CAL 2"CAL 2"CAL 2"CAL

2"CAL 2"CAL

2"CAL 2"CAL

CAL

CAL 1.5"CAL

1.5"CAL

SIZE

- ALL PLANT MATERIAL SHALL MEET SPECIFICATIONS OF THE AMERICAN ASSOCIATION OF NURSERYMEN (AAN) FOR NUMBER ONE GRADE. ALL TREES SHALL BE BALLED AND BURLAPPED OR EQUIVALENT
- NO PLANT MATERIAL WITH MATURE GROWTH GREATER THAN THREE EEET (3') IN HEIGHT SHALL BE PLANTED WITHIN WATER AND SEWER EASEMENTS.
- NO SHRUBS SHALL BE PLANTED WITHIN FIVE FEET (5') RADIUS OR TREES WITHIN TEN FEET (10') OF WATER METERS, FIRE HYDRANTS, OR SANITARY SEWER MANHOLES.

 NOTE: PLANTINGS ADJACECT TO METERS WILL BE FIELD ADJUSTED TO AVOID CONFLICTS.
- DEVELOPER SHALL ENSURE THAT THE LANDSCAPE PLAN IS COORDINATED WITH THE PLANS DONE BY OTHER CONSULTANTS SO THAT THE PROPOSED GRADING, STORM DRAINAGE, OR OTHER CONSTRUCTION DOES NOT CONFLICT NOR PRECLUDE INSTALLATION AND MAINTENANCE OF LANDSCAPE ELEMENTS ON THIS PLAN.
- ALL LANDSCAPE AREAS WITHIN THE SITE SHALL BE IRRIGATED WITH AN AUTOMATIC CLOCK ACTIVATED UNDERGROUND IRRIGATION SYSTEM. AN IRRIGATION PLAN WILL BE REQUIRED PRIOR TO ISSUANCE OF A BUILDING PERMIT AND INSTALLED PRIOR TO C.O. ALL TURF AREAS TO BE IRRIGATED WITH AN AUTOMATIC ROP-UP IRRIGATION SYSTEM. ALL SHRUB BEDS AND TREES ARE TO BE IRRIGATED WITH AN AUTOMATIC IRRIGATION (TRICKLE) IRRIGATION SYSTEM, OR ACCEPTABLE ALTERNATIVE. THE IRRIGATION SYSTEM IS TO BE ADJUSTED TO MEET THE REQUIREMENTS OF THE INDIVIDUAL PLANT MATCHIAM. OF THE INDIVIDUAL PLANT MATERIAL.
- 6. ALL SHRUB BEDS TO BE MULCHED WITH COBBLE MULCH (3"DEPTH) OVER WEEDBARRIER FABRIC.
- 7. ALL PERENNIAL AREAS TO BE MULCHED WITH WOOD BARK MULCH (3"DEPTH), OMIT WEEDBARRIER FABRIC.
- 8. EDGING BETWEEN GRASS AND SHRUB BEDS SHALL BE $\frac{1}{6}$ " X 4" STEEL SET LEVEL WITH TOP OF SOD.
- TOPSOIL. TO THE MAXIMUM EXTENT FEASIBLE, TOPSOIL THAT IS REMOVED DURING CONSTRUCTION ACTIVITY SHALL
- 10. SOIL AMENDMENTS. PRIOR TO INSTALLATION OF PLANT MATERIALS, AREAS THAT HAVE BEEN COMPACTED OR DISTURBED BY CONSTRUCTION ACTIVITY, SHALL RECEIVE MINIMUM REQUIREMENTS FOR SOIL PREPARATION. MINIMUM SOIL PREPARATION SHALL INCLUDE THREE (3) CUBIC YARDS OF ORGANIC MATERIAL FOR 1,000 SQUARE FEET OF EXISTING SOIL TILLED TO A MINIMUM DEPTH OF SIX (6) INCHES. TREE AND SHRUB PITS SHALL BE BACKFILLED USING A MIXTURE OF ONETHIRD EXISTING SITE SOIL, ONE-THIRD TOPSOIL AND ONE-THIRD ORGANIC MATTER.
- 11. IT IS THE RESPONSIBILITY OF THE DEVELOPER AND THEIR CONTRACTORS TO BUILD THE PROJECT ACCORDING TO APPROVED PLANS AND DETAILS AND IN ACCORDANCE WITH CURRENT TOWN OF JOHNSTOWN LANDSCAPE GUIDELINES. FIELD CHANGES TO THESE PLANS ARE TO BE APPROVED BY THE TOWN OF JOHNSTOWN PRIOR TO ANY WORK. FIELD CONDITIONS THAT CONFLICT WITH OR JEOPARDIZE THE LONGEVITY OF THE PROPOSED IMPROVEMENTS SHALL BE BROUGHT TO THE ATTENTION OF THE TOWN OF JOHNSTOWN POR RESOLUTION, FAILURE TO BRING SUCH MATTERS TO THE ATTENTION OR TO OBTAIN APPROVAL OF REMEDIAL MEASURES WILL IN NO WAY RELIEVE THE CONTRACTOR OF THEIR OBLIGATION TO RESOLVE THE MATTER TO THE SATISFACTION OF THE TOWN OF JOHNSTOWN
- 12. THE IRRIGATION SYSTEM WILL BE DESIGNED TO MEET SECTION H.5 OF THE TOWN LANDSCAPE STANDARDS.
- 13. CONIFER TREES SHALL COMPRISE 25% OF ANY LANDSCAPE AREA WHERE SUITABLE. NO MORE THAN 15% OF ANY ONE

MOUNTAIN VIEW WEST SUBDIVISION THRID PLAT

FDP SUBMITTAL

IOHNSTOWN CO PREPARED BY:



419 Canyon Ave. Suite 200 Fort Collins, CO 80521

BAESSLER HOMES Mitch Nelson 33105 CR 33 Greeley, CO 80634 p. 970-373-8569

LANDSCAPE ARCHITECT

RIPLEY DESIGN INC 419 Canyon Ave. Suite 200 Fort Collins, CO 80521

ENGINEER


LANDONE ENGINEERING, LLC Dan Hull, PE 361 71st Ave. Greeley, CO 80634 p. 970.632.2311

No.	DESCRIPTION	DATE
01	FDP ROUND 1	11/11/2022
02	FDP ROUND 2	01/05/2023
03	FDP ROUND 3	01/13/2023
REVI	SIONS	
No.	DESCRIPTION	DATE

DETAILS AND NOTES



PROJECT No.:	R22-042	
DRAWN BY:	AG	
REVIEWED BY:	KT	
DRAWING NUMBER:		

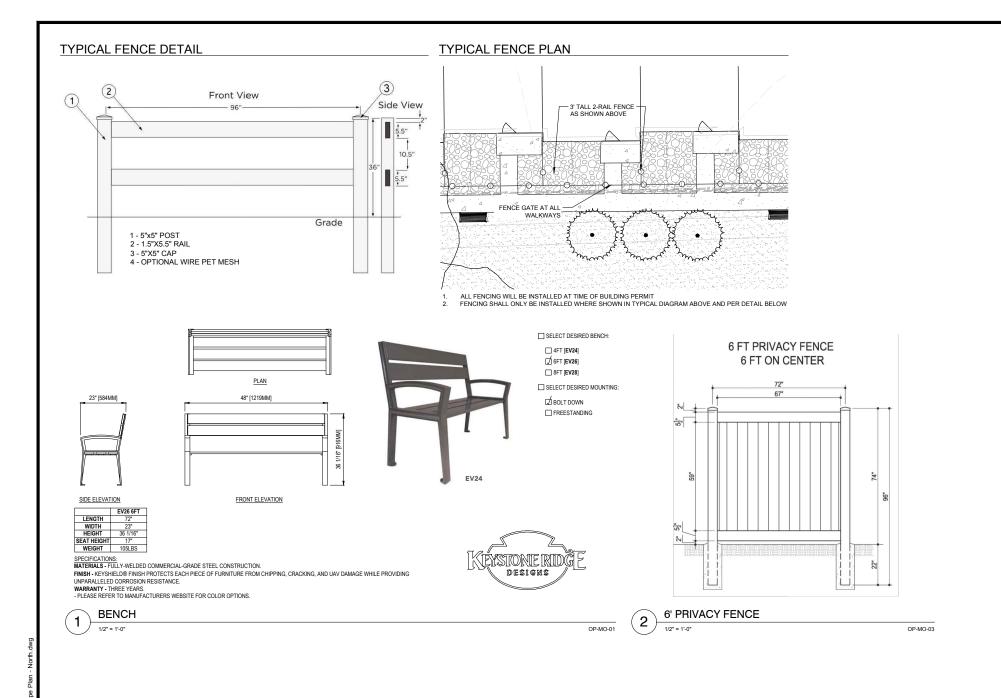

MOUNTAIN VIEW WEST SUBDIVISION THRID PLAT

FDP SUBMITTAL

JOHNSTOWN, CO PREPARED BY:



419 Canyon Ave. Suite 200 Fort Collins, CO 80521 phone 970.224.5828 | fax 970.225.8657 | www.ripleydesigninc.com

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LANDSCAPE ARCHITECT

RIPLEY DESIGN INC. 419 Canyon Ave. Suite 200 Fort Collins, CO 80521 p. 970.224.5828 f. 970.225.6657

ENGINEER

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No.	DESCRIPTION	DATE

DETAILS AND NOTES



DRAWING NUMBER:



NDSC	APE WATER USE TABLE
SYMBOL	DESCRIPTION

SYMBOL	DESCRIPTION	AREA (SF)	WATER NEEDED/ (GAL/ SF)	ANNUAL WATER USE (GALLONS)
	HIGH - IRRIGATED TURF	30,141	18	542,538
	MEDIUM - SHRUB BED	55,506	14	777,084
	VERY LOW - ROCK MULCH BEDS - NO LANDSCAPE PLANTING	45,446	3	136,338
	VERY LOW - NATIVE SEED MIX	145,227	3	435,681
	TOTAL:	276,320	6.85	1,891,641

NATIVE SEED MIX

COMMON NAME	SEPCIES NAME	% OF MIX	# PLS/ACRE	HYDROZONE
ANNUAL RYE		20%	5.0	VL
SIDE OATS GRAMA	BOUTELOUA CURTIPENDULA	8%	2.0	VL
BLUE GRAMA	BOUTELOUA GRACILIS	12%	3.0	VL
SLENDER WHEATGRASS	ELYMUS TRACHUCAULUS	12%	3.0	VL
CANADA WILD RYE	ELYMUS CANADENSIS	12%	3.0	VL
WESTERN WHEATGRASS	PASCOPYRUM SMITHII	8%	2.0	VL
SWITCHGRASS	PANICUM VIRGATUM	6%	1.5	VL
LITTLE BLUESTEM	SCHIZACHYRIUM SCOPARIUM	6%	1.5	VL
BUFFALOGRASS	BOUTELOUA DACTYLOIDES	8%	2.0	VL
BIG BLUSTEM	ANDROPOGON GERARDII	8%	2.0	VL
		100.0000	25	

MOUNTAIN VIEW WEST SUBDIVISION THRID PLAT

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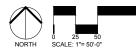
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LANDSCAPE ARCHITECT

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ENGINEER

LANDONE ENGINEERING, LLC Dan Hull, PE 361 71st Ave. Greeley, CO 80634 p. 970.632.2311



REVISIONS No. DESCRIPTION

WATER USE PLAN NORTH

KEY MAP



DRAWING NUMBER:

L12



542,538

777,084

136,338

435,681

1,891,641

55,506

45,446

145,227

6.85

TOTAL: 276,320

MEDIUM - SHRUB BED

VERY LOW - NATIVE SEED MIX

VERY LOW - ROCK MULCH BEDS - NO LANDSCAPE PLANTING

COMMON NAME	SEPCIES NAME	% OF MIX	# PLS/ACRE	HYDROZONE
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LANDSCAPE ARCHITECT RIPLEY DESIGN INC. 419 Canyon Ave. Suite 200 Fort Collins, CO 80521 p. 970.224.5828 f. 970.225.6657

ENGINEER

LANDONE ENGINEERING, LLC Dan Hull, PE 361 71st Ave. Greeley, CO 80634 p. 970.632.2311



RIGI	NAL SIZE 24X36	
SU	ED	
lo.	DESCRIPTION	DATE
)1	FDP ROUND 1	11/11/2022
)2	FDP ROUND 2	01/05/2023
)3	FDP ROUND 3	01/13/2023
EVI	SIONS	
lo.	DESCRIPTION	DATE

WATER USE PLAN SOUTH



DRAWING NUMBER:

L13

KEY MAP